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Architectural

- A0.0 Cover
- A0.1 Context Views
- A0.2 Context Views
- A0.3 Context Views
- A0.4 Height & Massing Analysis
- A0.6 Context Elevations
- A0.7 Skyline Analysis
- A0.8 Sun and Shade Study
- A1.0 Existing Site Survey
- A1.1 Site Plan
- A1.2 Average Grade Calculations
- A1.3 Level 1 Phasing Plan
- A1.4 P1 Phasing Plan
- A2.0 P2 Parking Plan
- A2.1 P1 Parking Plan
- A2.2 Level 1 Plan
- A2.3 Level 2 Plan
- A2.4 Level 3 Plan
- A2.5 Level 4 Plan
- A2.6 Level 5-13 Plan
- A2.7 Penthouse + Roof Plan
- A3.0 North Elevation
- A3.1 East Elevation
- A3.2 South Elevation
- A3.3 West Elevation
- A4.0 Building Sections
- A4.1 Building Sections
- A4.2 Building Section / Elevations

Landscape

- L0.00 Cover
- L0.01 General Information Sheet
- L0.02 Tree Survey Plan
- L0.03 Tree Management Plan
- L1.01 Landscape Materials - Ground
- L1.02 Landscape Materials - Roof
- L1.03 Stormwater Management & Grading
- L1.04 Landscape Precedents
- L1.05 Landscape Materials - Sections
- L1.06 Landscape Materials - Sections
- L1.07 Soil Volumes
- L3.01 Planting Plan
- L3.02 Planting Plan
- L4.01 Landscape Details

Civil

- C1.0 Conceptual Site Demolition
- C2.0 Conceptual Site Servicing Plant
- C3.0 Conceptual Site Surface Works

Electrical

- E100 Off-site Lighting Design & Details
- E101 Off-site Lighting Design & Details



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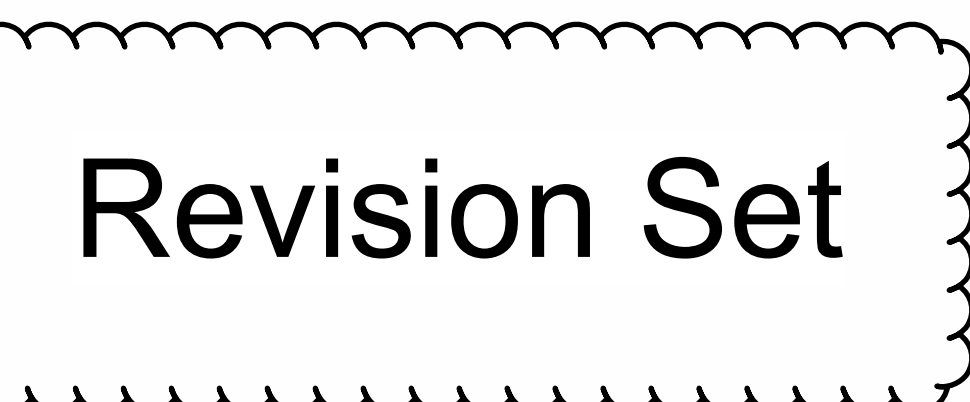


#21-18

Montreal and Quebec

205 Quebec Street
Victoria, BC

Rezoning/DP Resubmission



24.05.23




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1 Rendered Context View
NTS



2 Rendered Context View
NTS



1

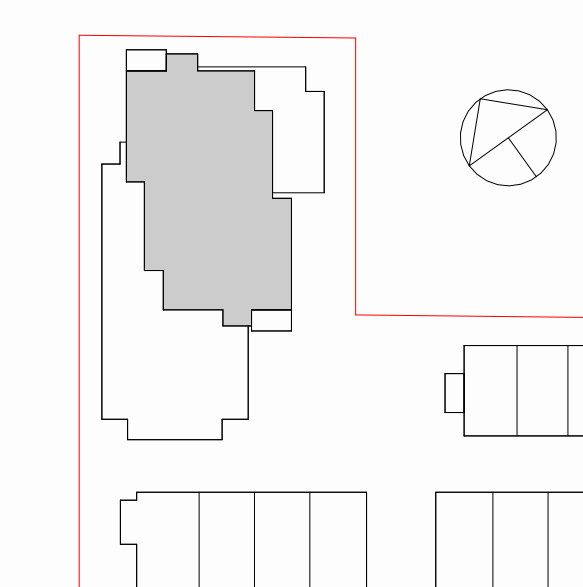2

6	Rezoning/DP Resubmission	23.12.22
5	Rezoning/DP Resubmission	22.12.06
4	Issued for ADP	22.08.02
2	Issued for Rezoning / DP	21.12.15
1	Issued for Dev. Tracker	21.10.19
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project name Montreal and Quebec 205 Quebec Street Victoria, BC		
sheet title Context Views		
project no.	#21-18	
scale	As indicated	
drawn by	CF	
date issued	sheet no.	
05/23/24	A0.1	

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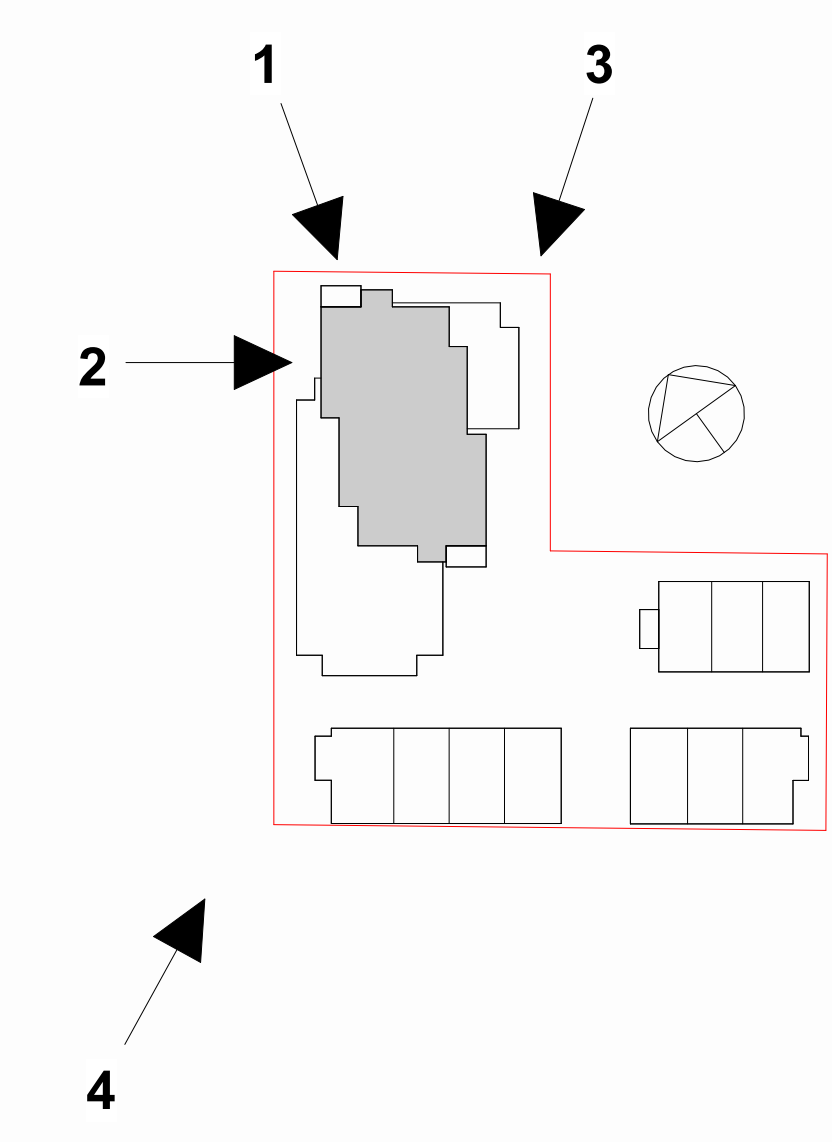
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1 Rendered Context View
NTS



2 Montreal Entry Render
NTS



3 Rendered Context View
1:1



4 Rendered Context View
1:1

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project name Montreal and Quebec 205 Quebec Street Victoria, BC		
sheet title Context Views		
project no.	#21-18	
scale	As indicated	
drawn by	CF	
date issued	05/23/24	sheet no. A0.2

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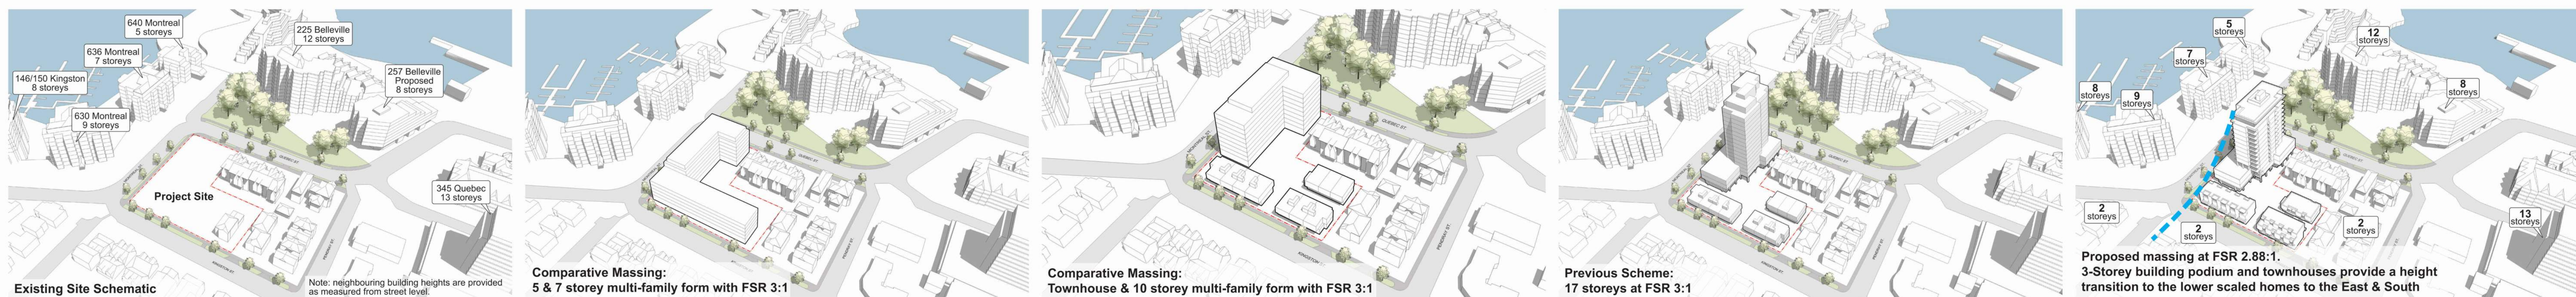
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URBAN HEIGHT DIAGRAM: Taller building forms wrap around the Downtown Core Area and bracket the marine entrance to the Inner Harbour.

- 10–18+ storeys
- 6–9 storeys



MASSING/HEIGHT RATIONALE

rev no	description	date
6	Rezoning/DP Resubmission 23.12.22	
5	Rezoning/DP Resubmission 22.12.08	
2	Issued for Rezoning / DP	21.12.15


project name
Montreal and Quebec
205 Quebec Street
Victoria, BC

sheet title
Height & Massing Analysis

project no.	#21-18
scale	NTS
drawn by	DZ
date issued	05/23/24
sheet no.	A0.4




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1. Harbour View from Bastion Square

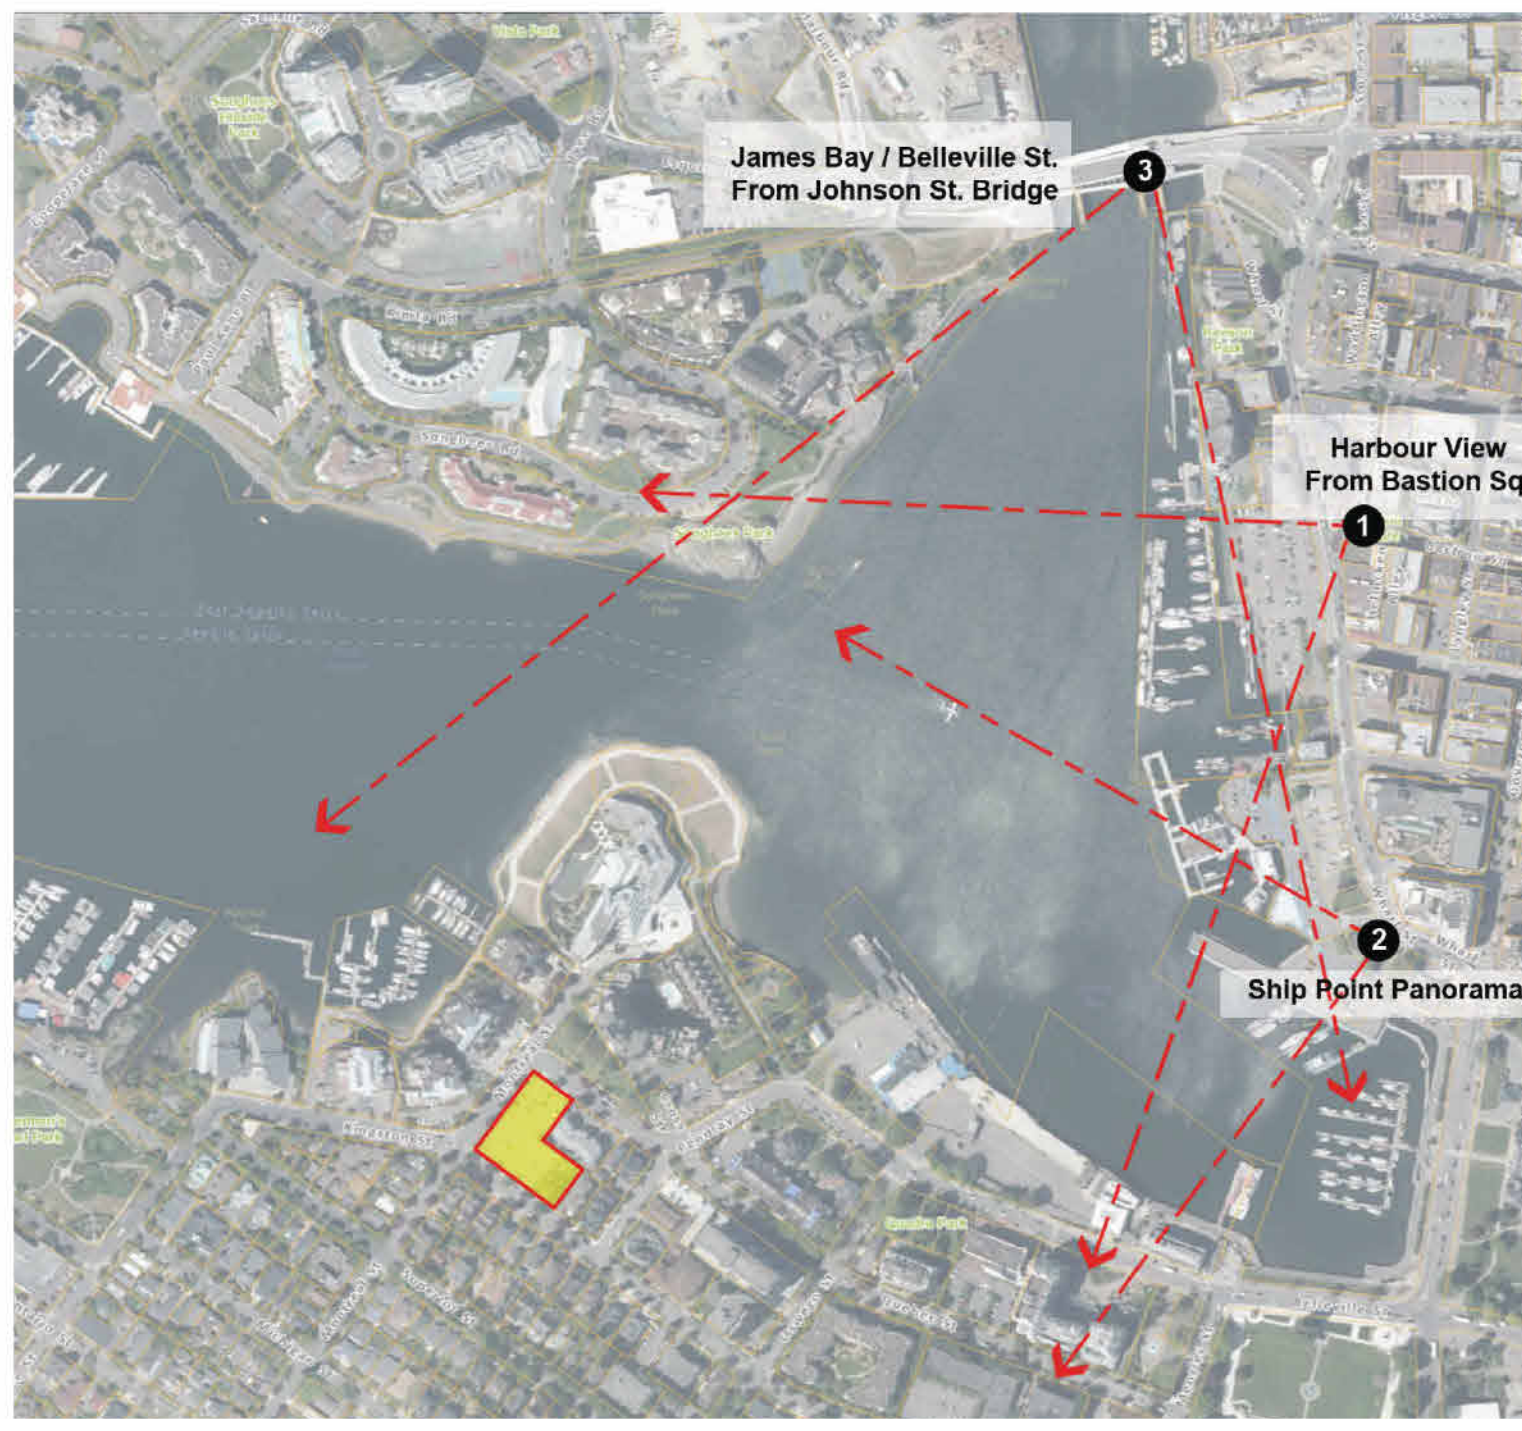

2. Ship Point Panorama



3. James Bay / Belleville Street from Johnson Street Bridge
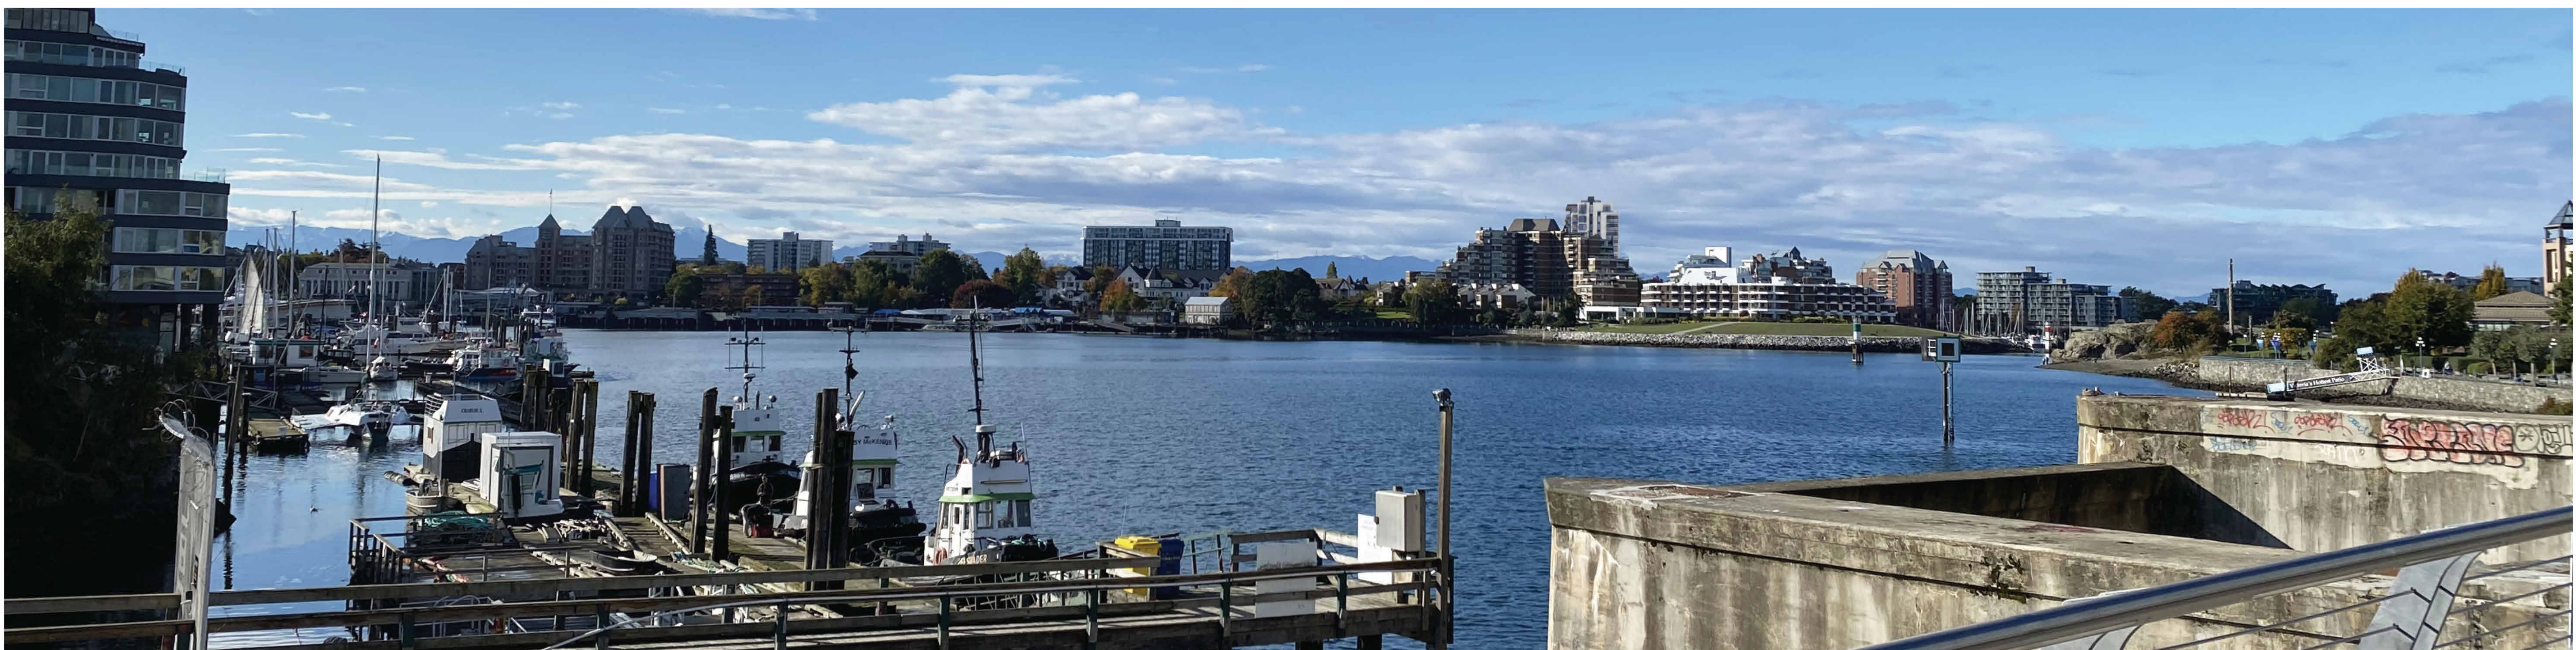
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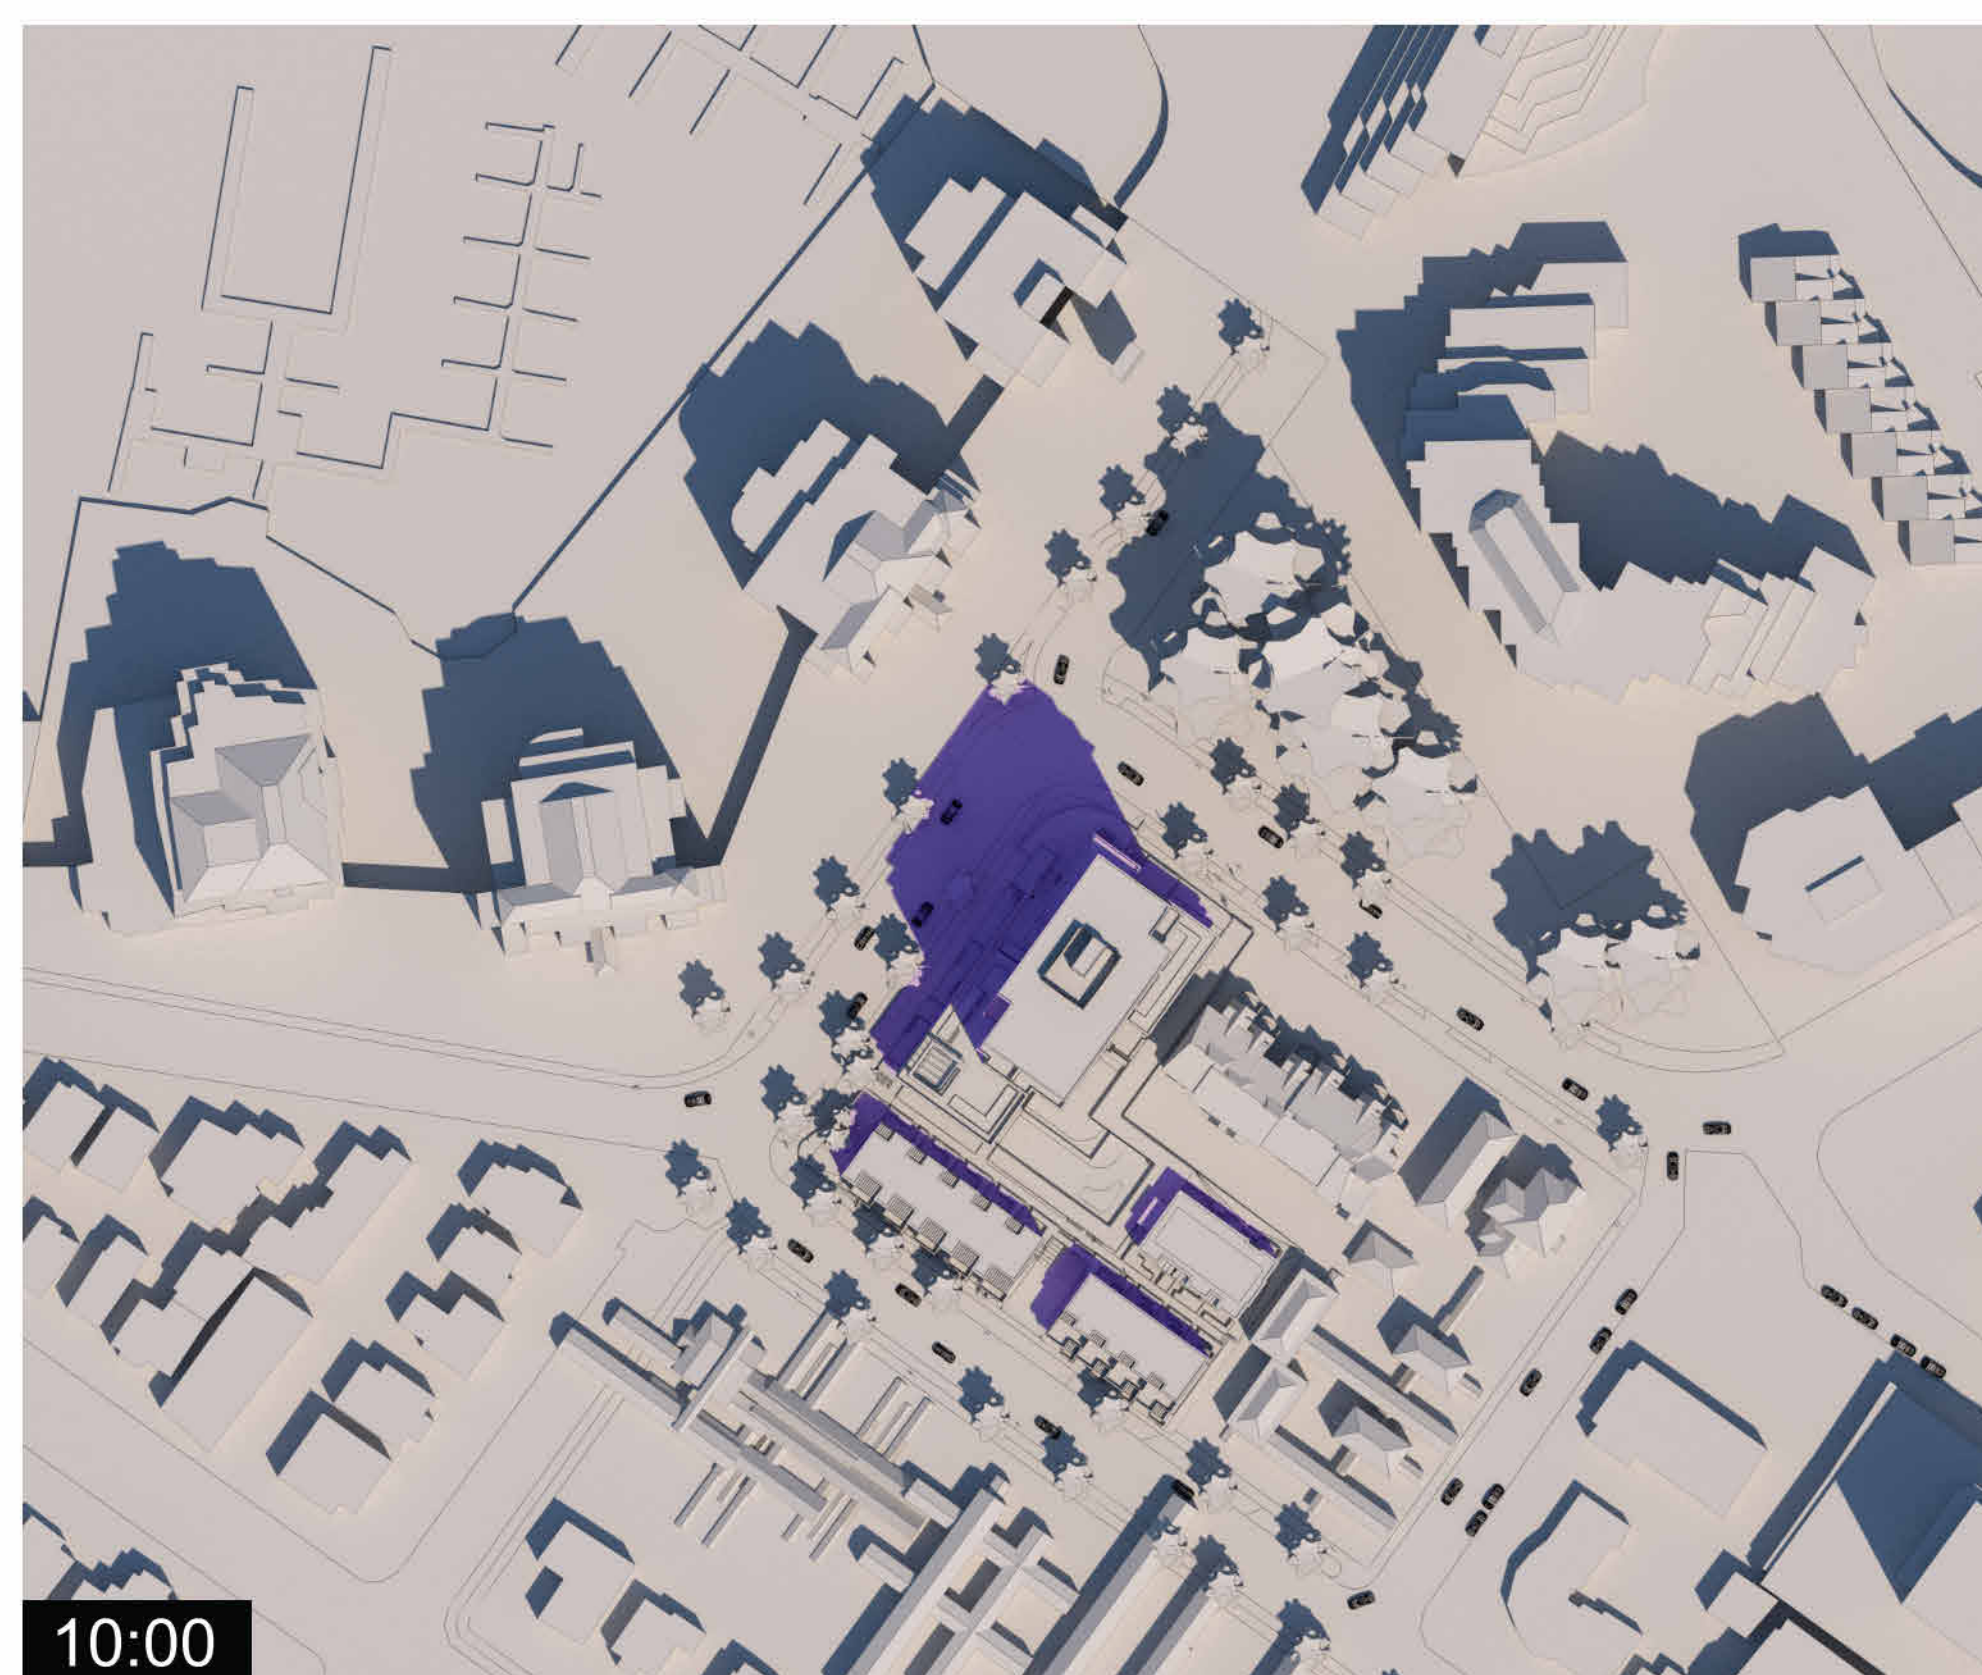
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project name
Montreal and Quebec
205 Quebec Street
Victoria, BC

sheet title
Skyline Analysis

project no.	#21-18
scale	NTS
drawn by	CF
date issued	05/23/24
sheet no.	A0.7


Spring / Fall Equinox



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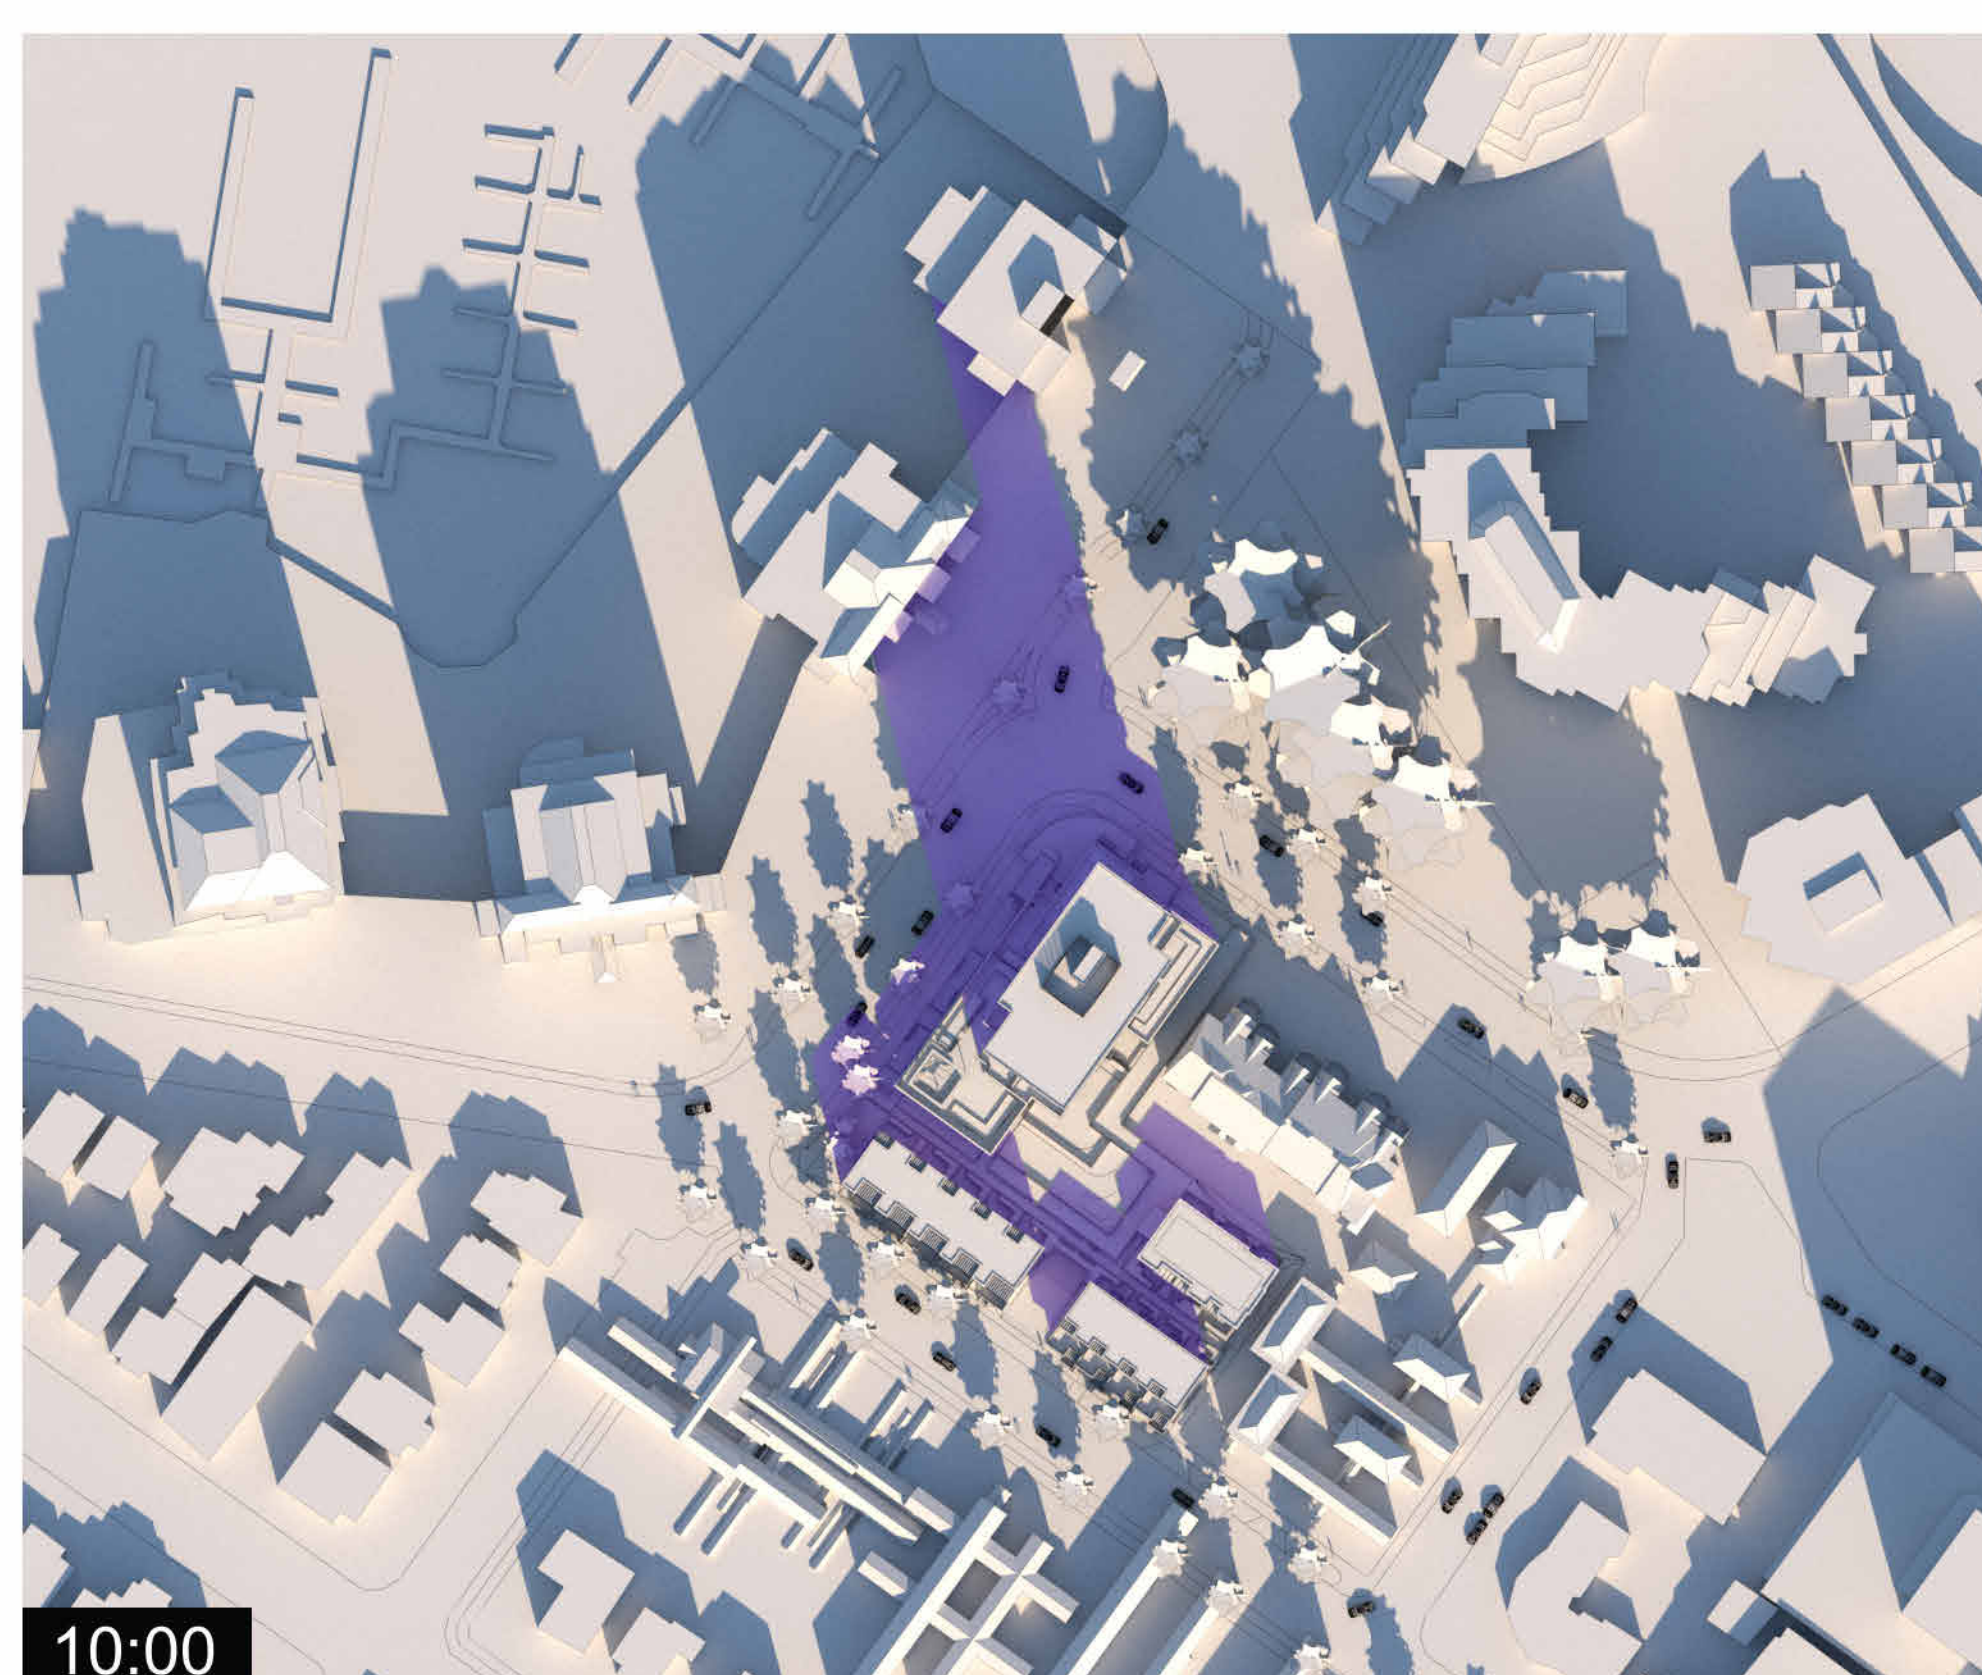


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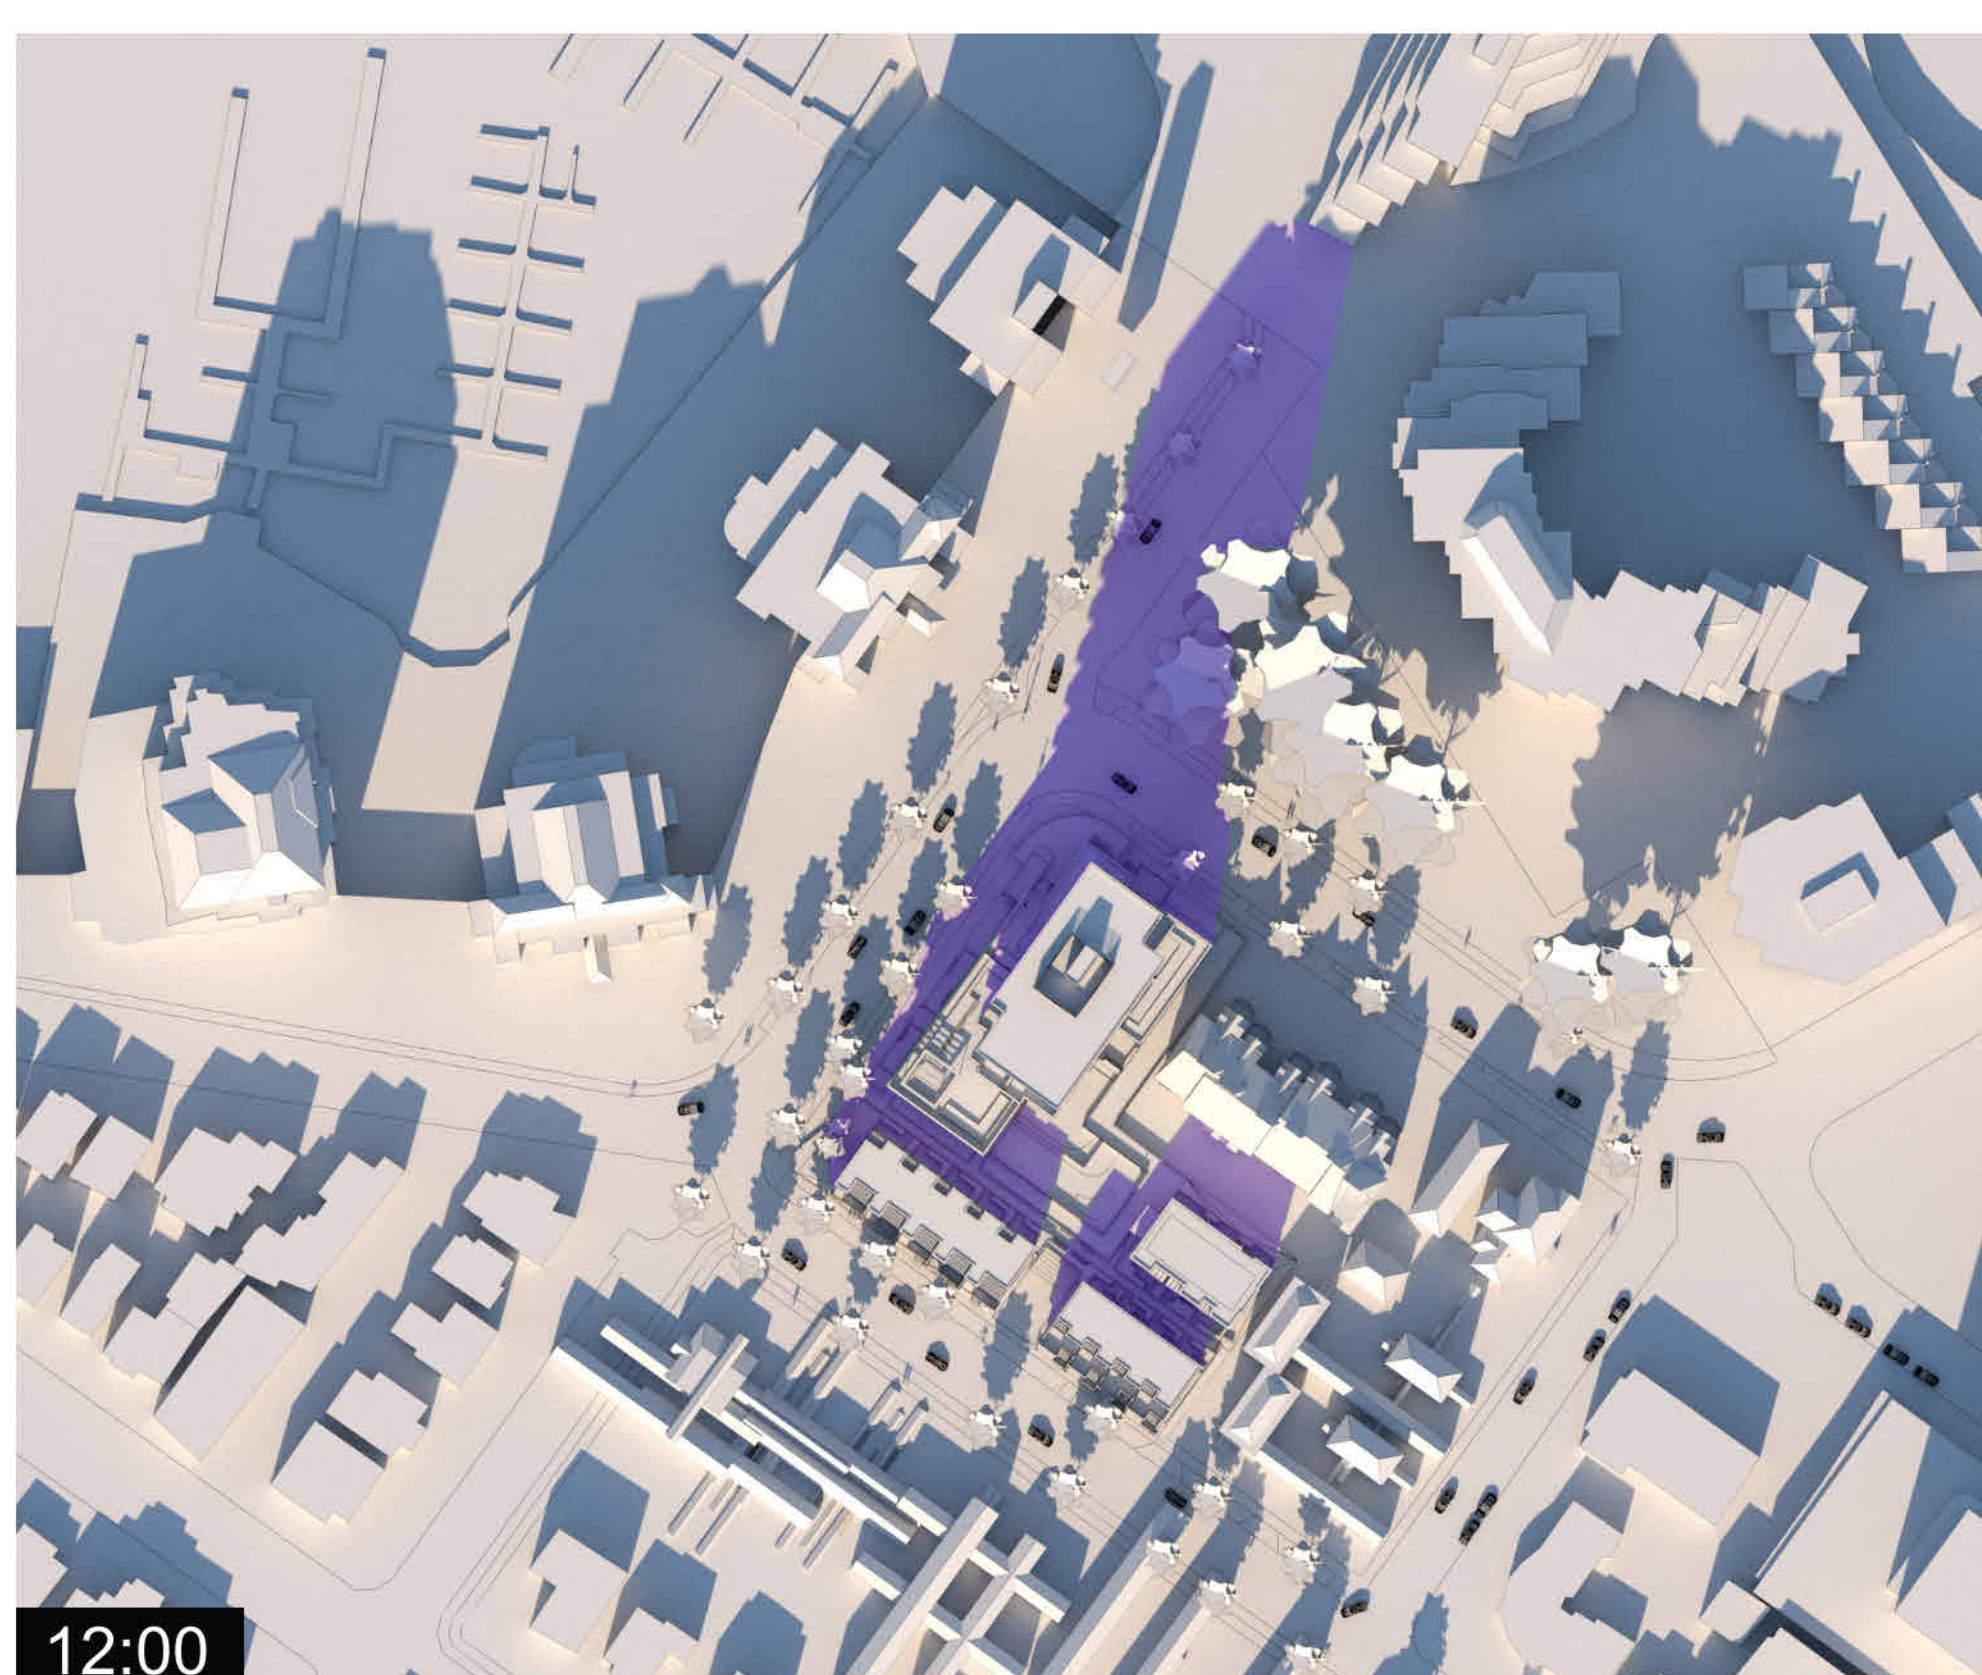


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Winter Solstice

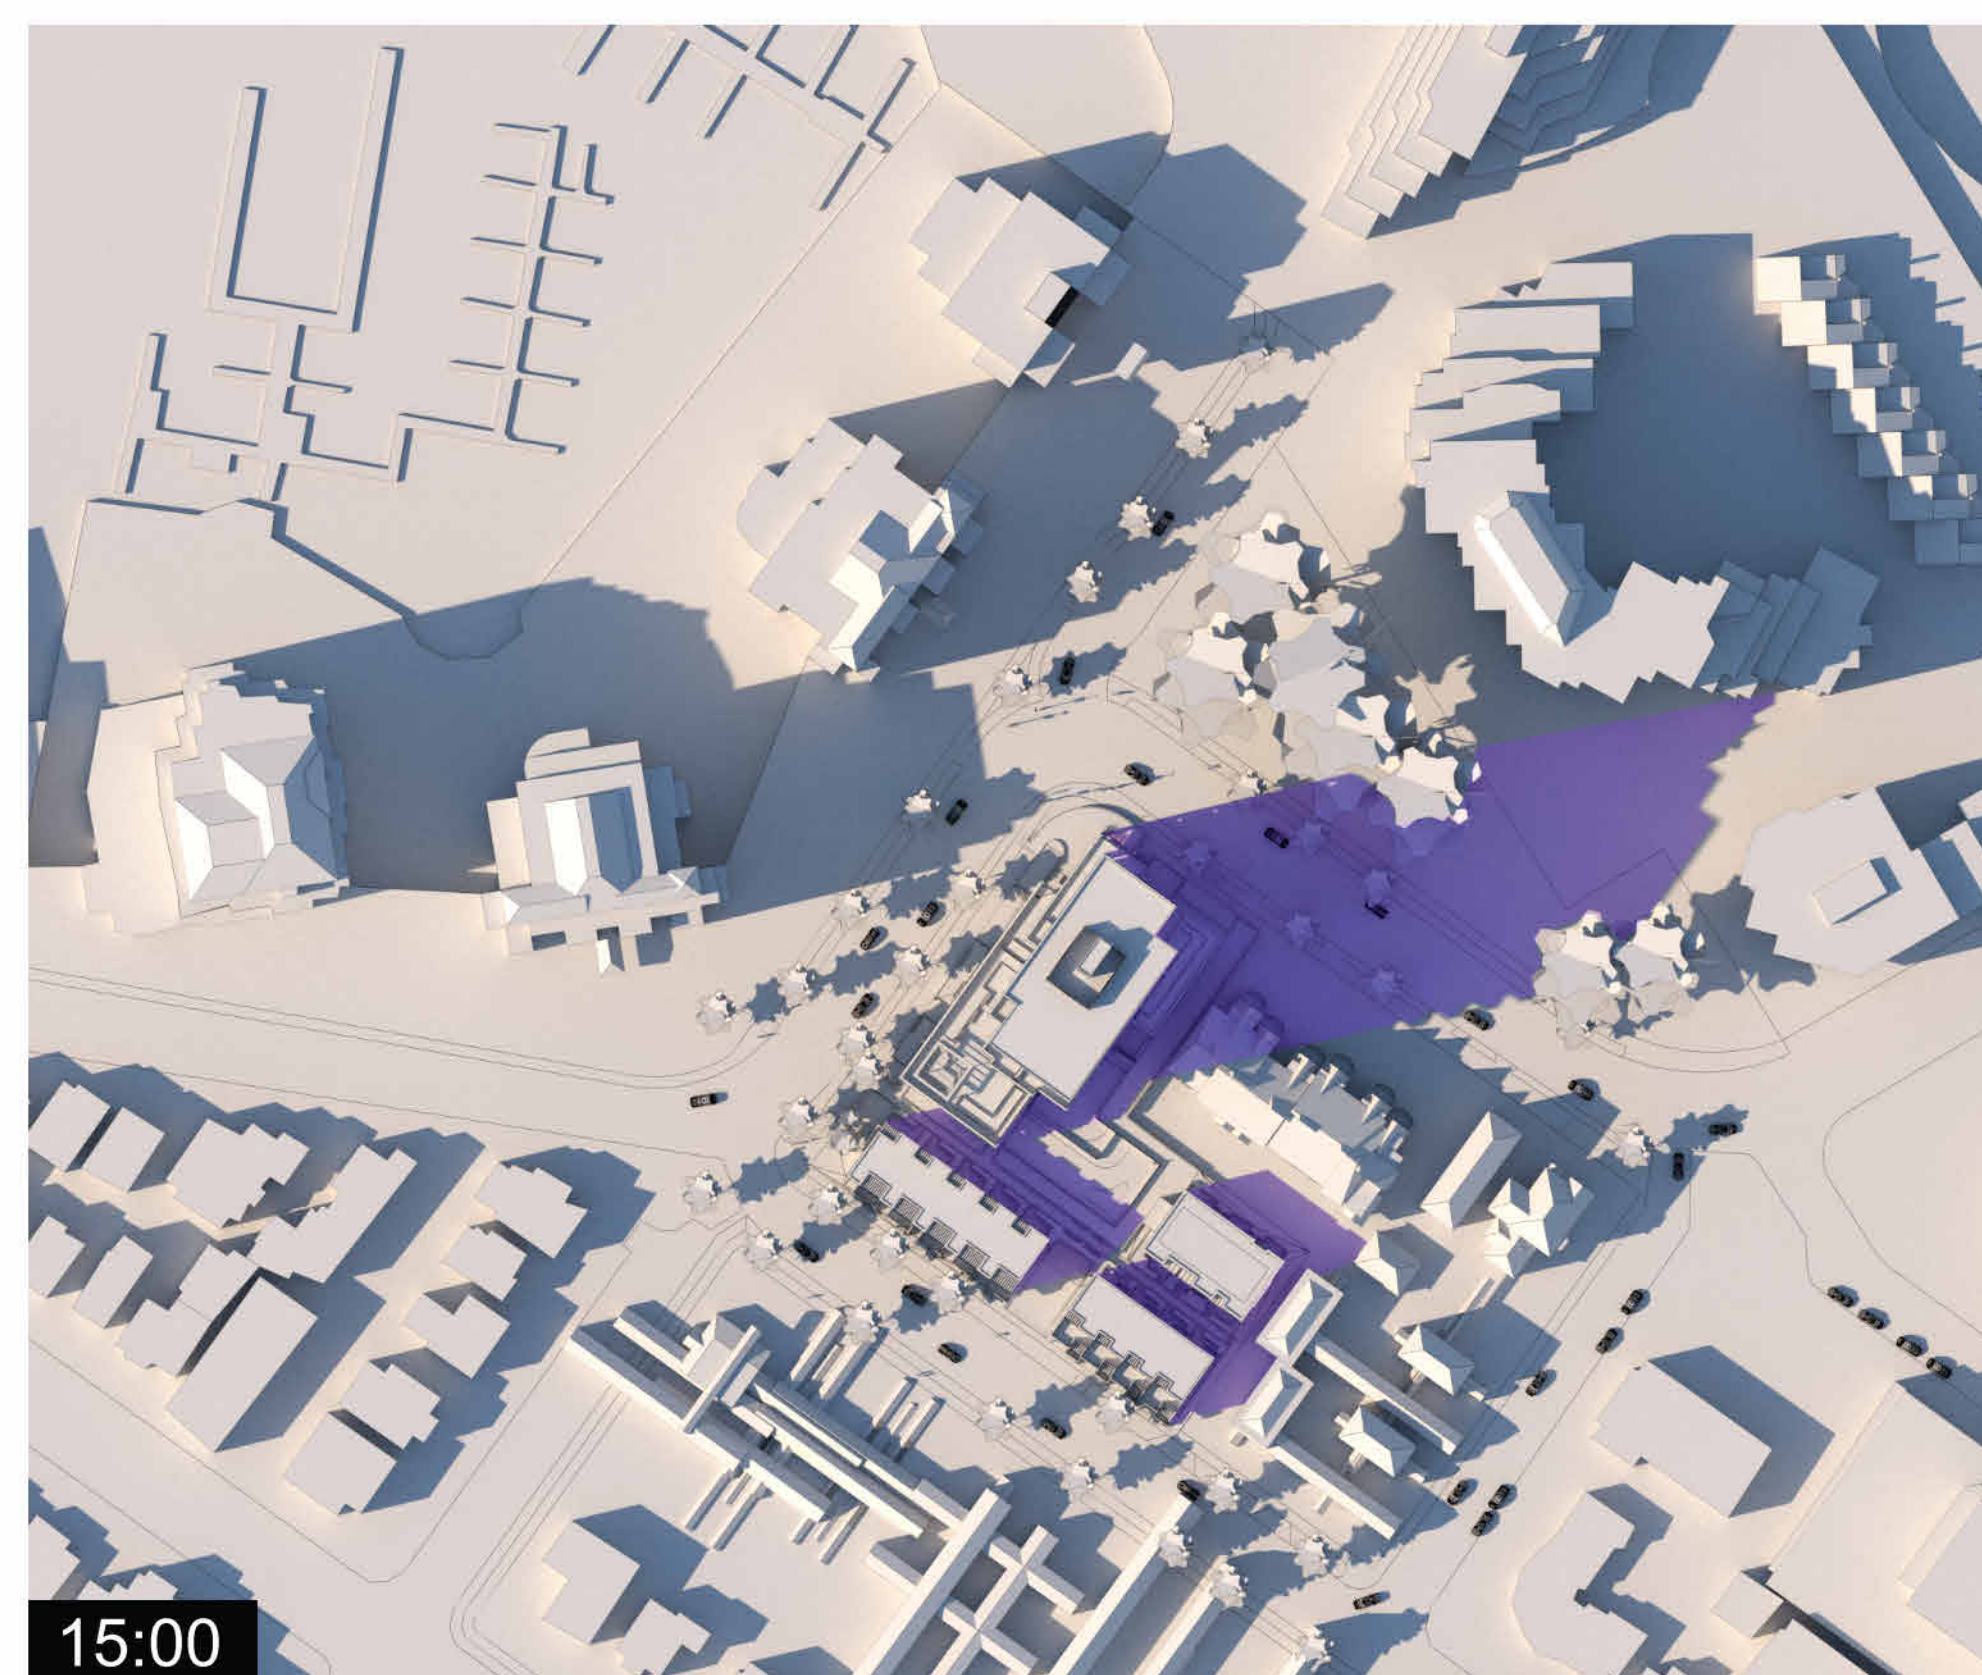

10:00




12:00



15:00

Summer Solstice

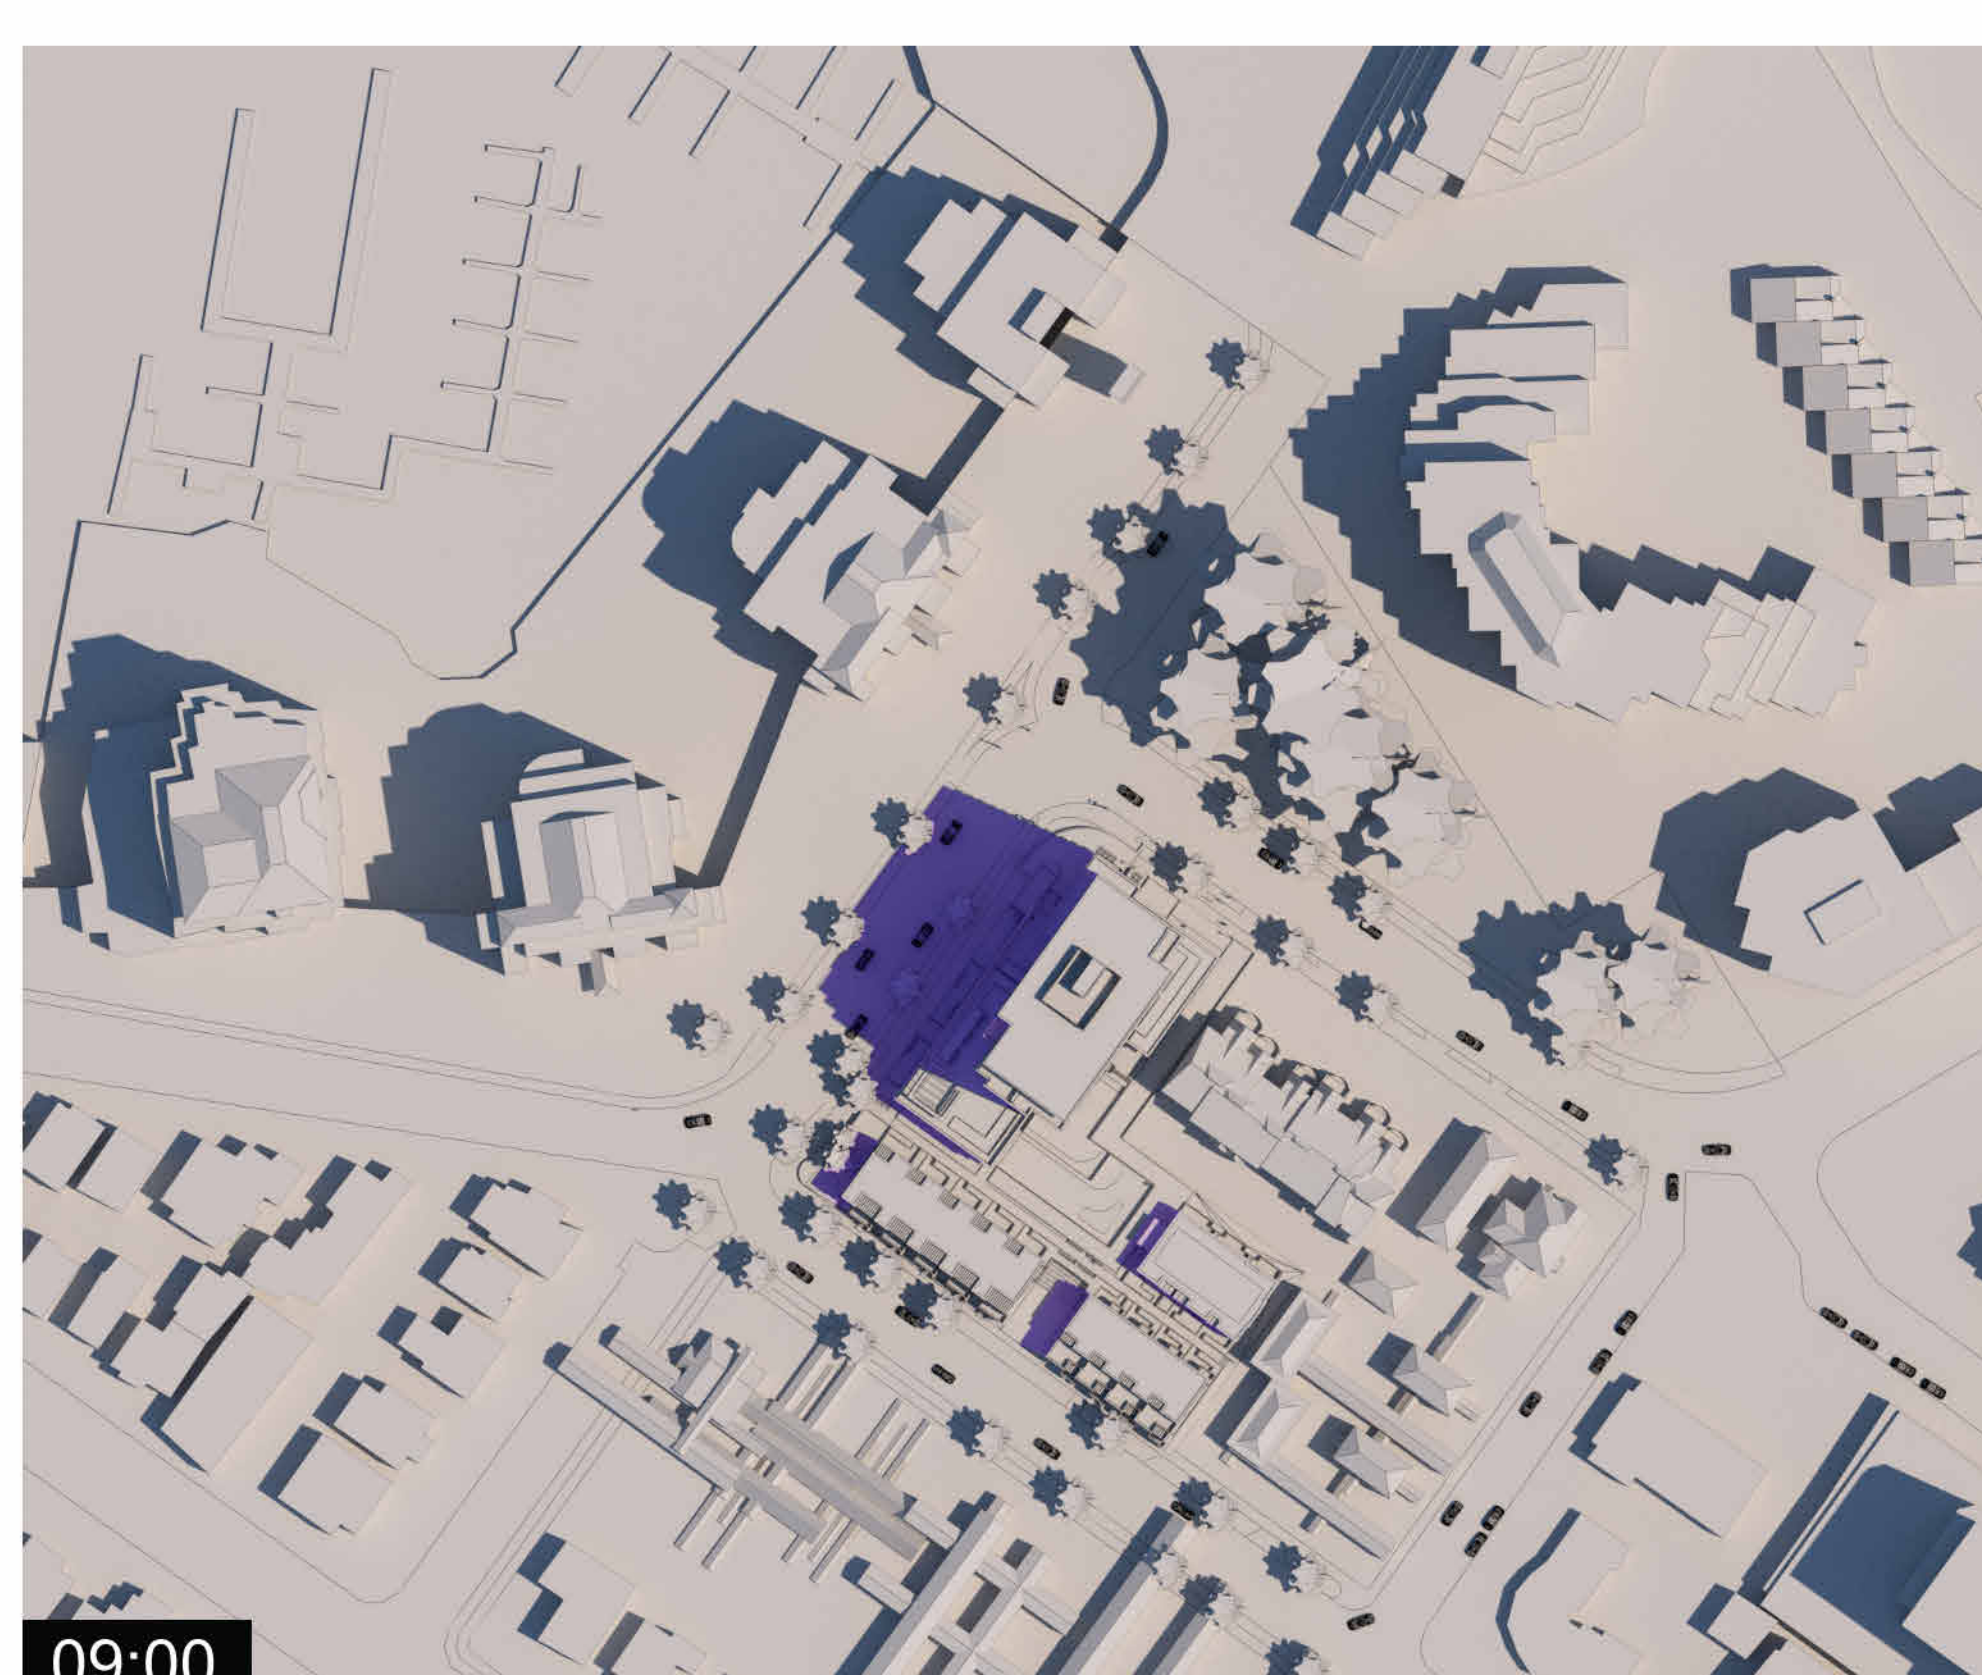


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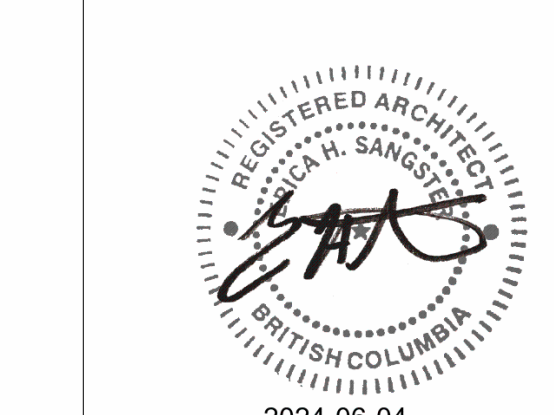


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Legend

- Shadows from Proposed Building
- Shadows from Existing Buildings



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Montreal and Quebec		
205 Quebec Street		
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sheet title		
Sun and Shade Study		
project no.	#21-18	
scale		
drawn by	DZ, GK	
date issued	05/23/24	sheet no.
		A0.8
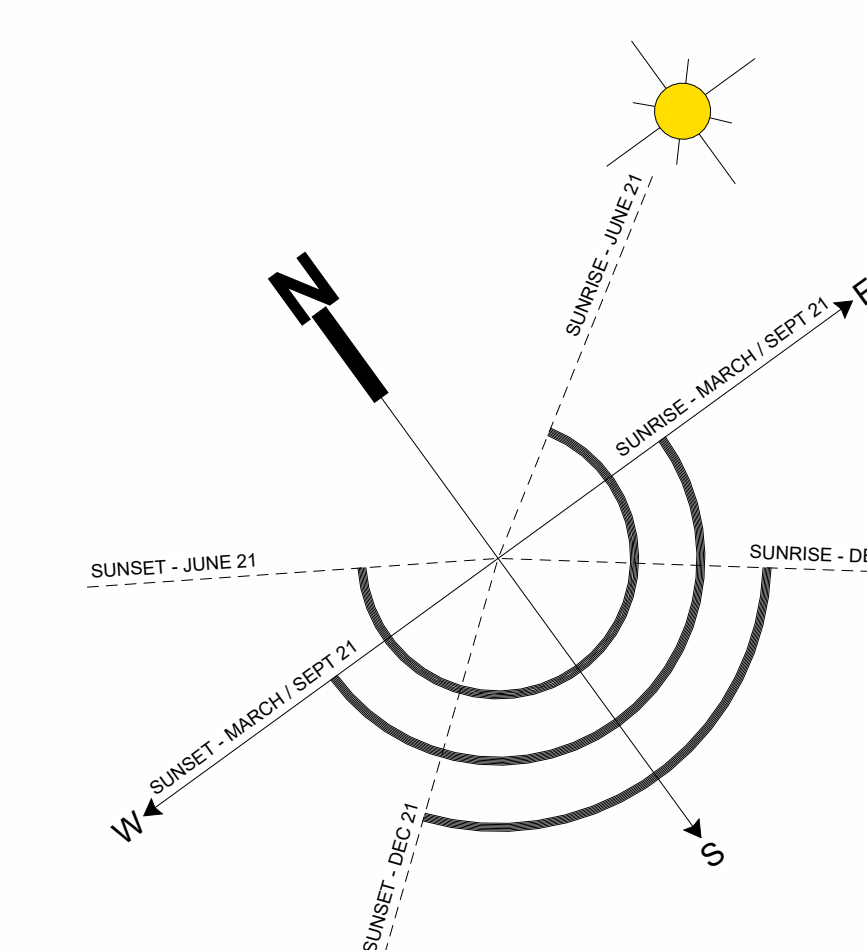
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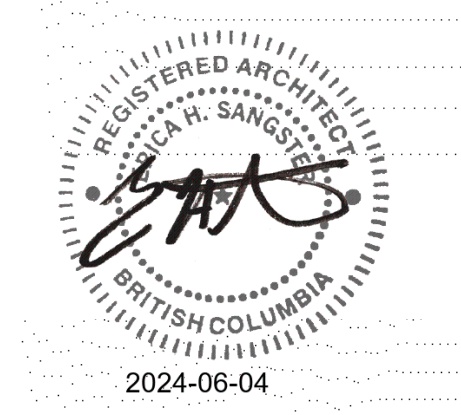
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205 Quebec Street
Victoria, BC

sheet title
Existing Site Survey

project no.	#21-18
scale	
drawn by	Author
date issued	05/23/24
sheet no.	A1.0

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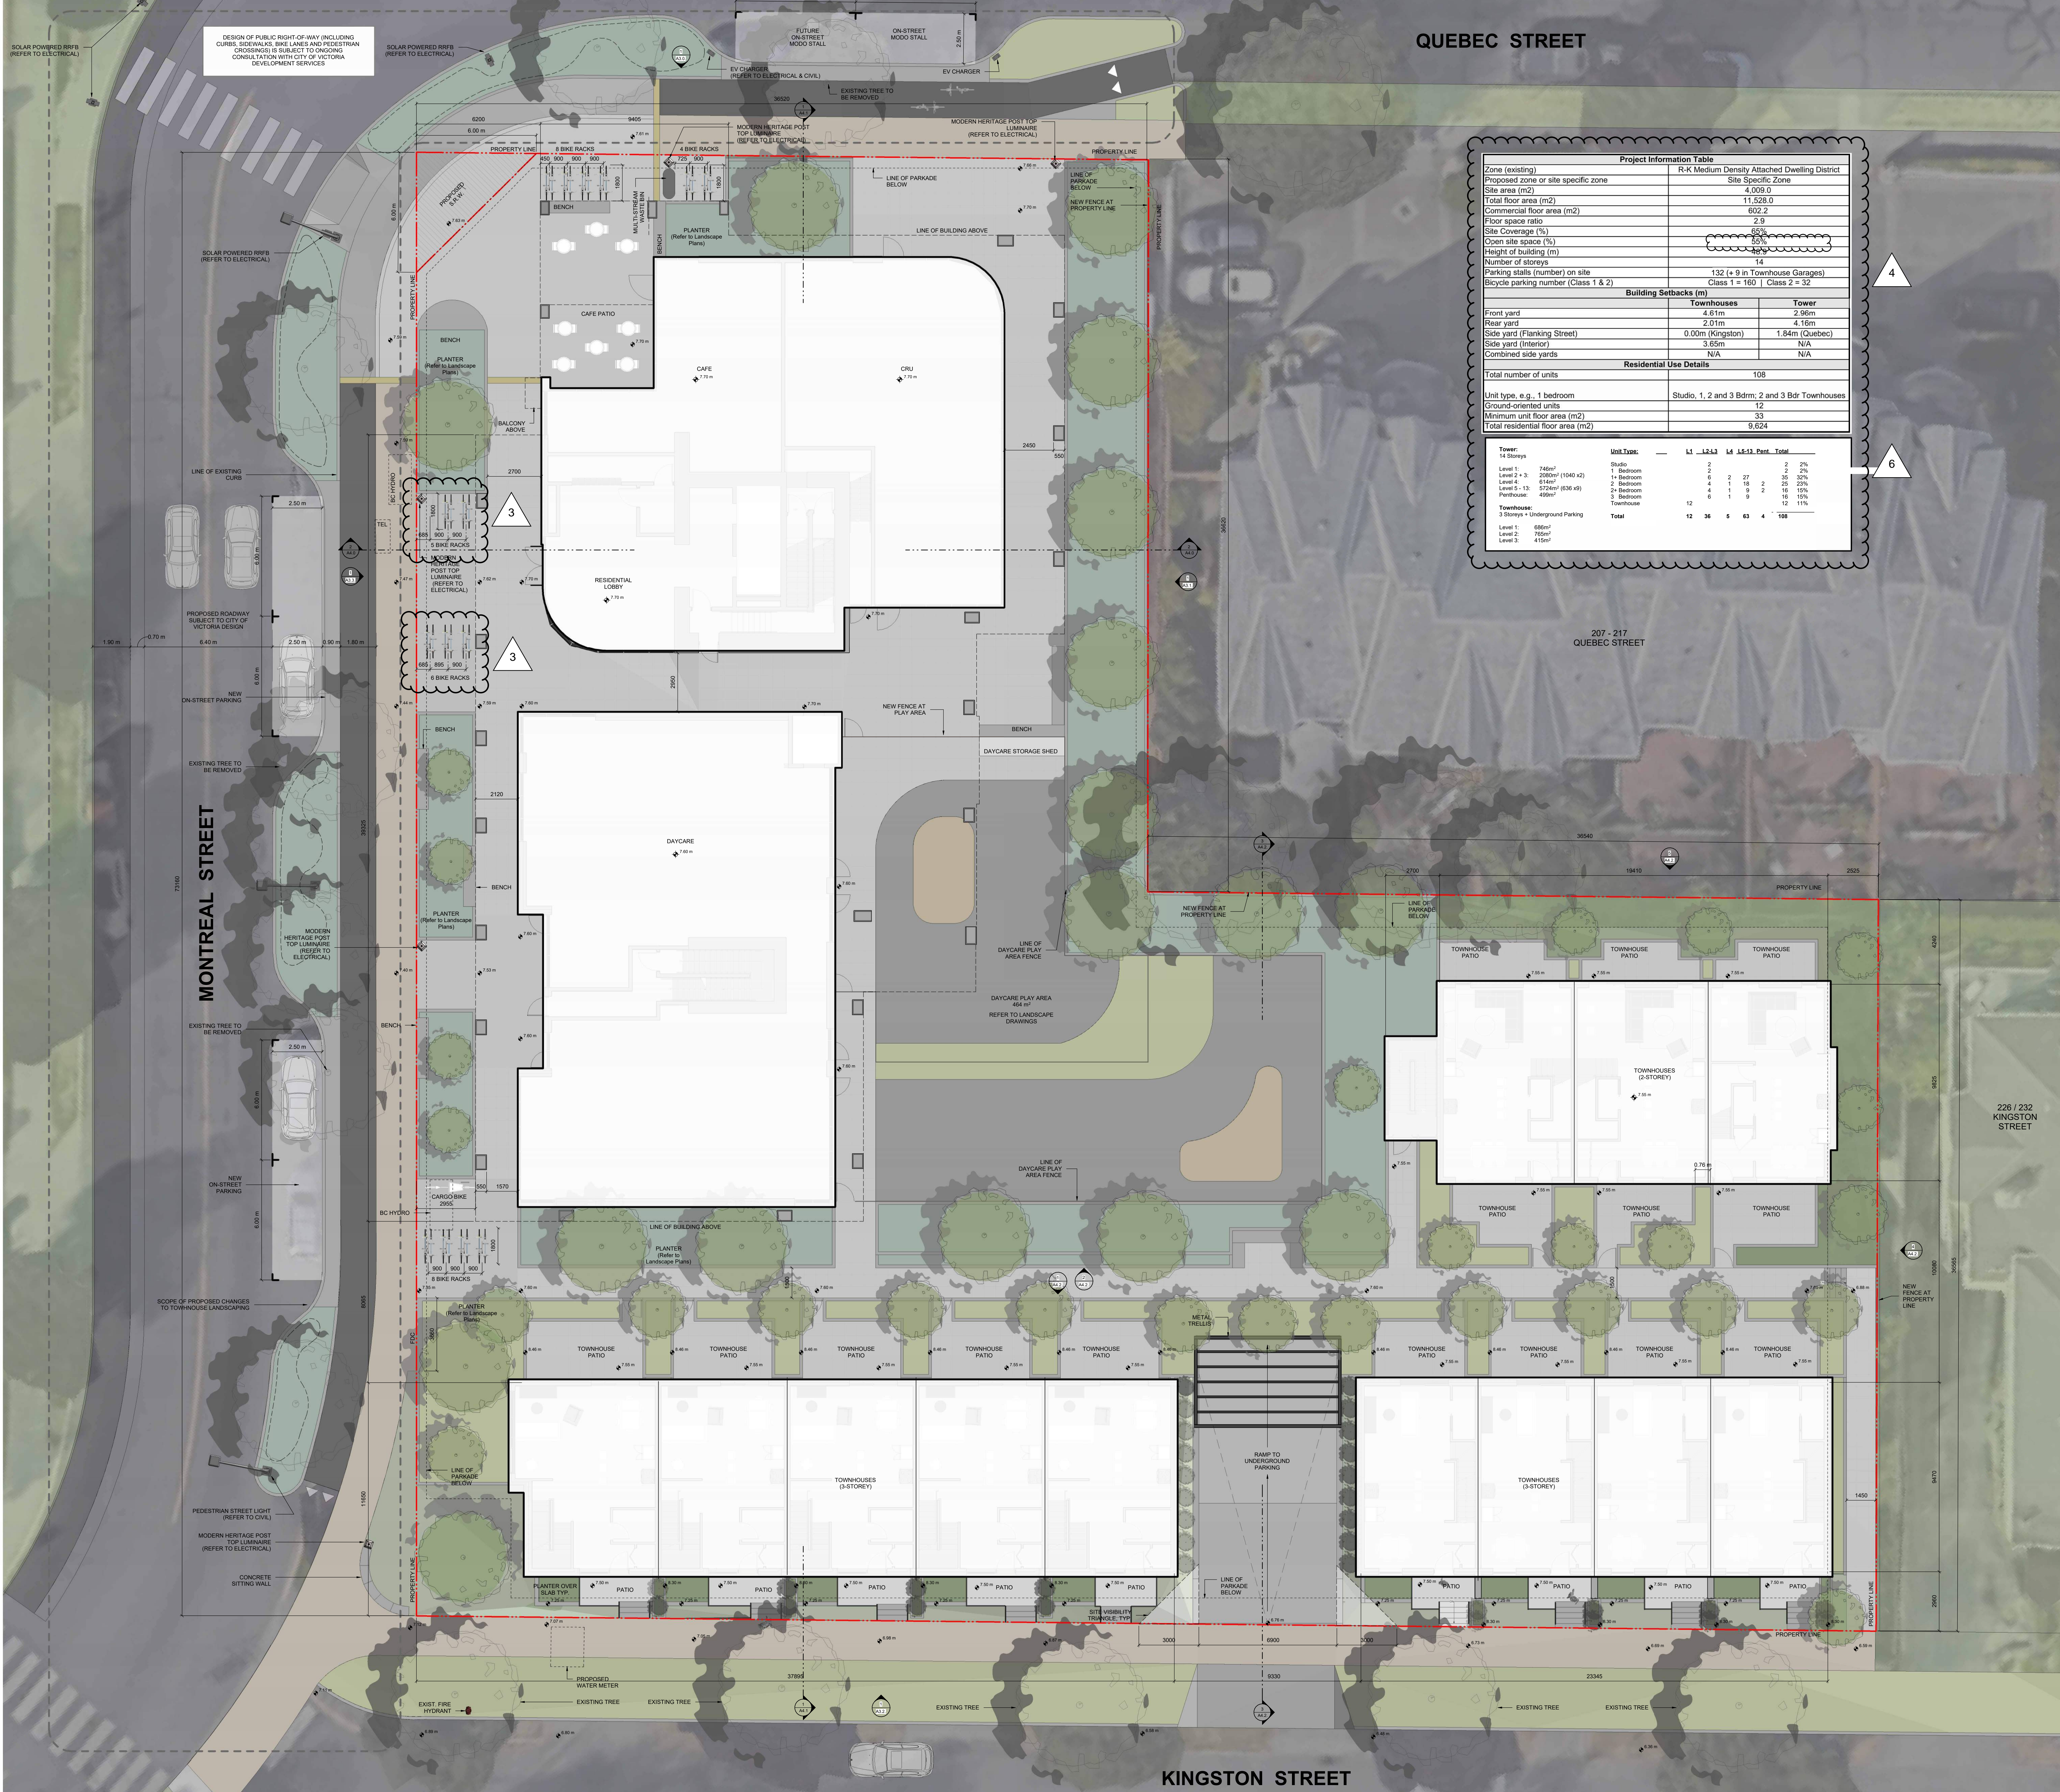
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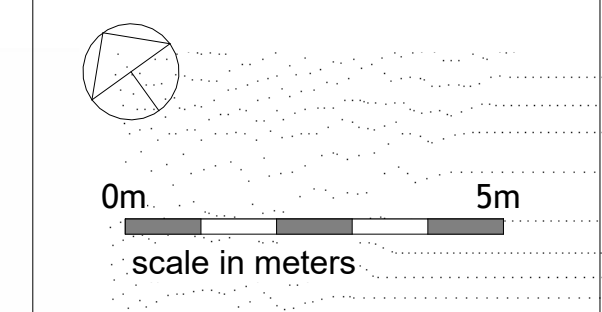
NOTES:
REFER TO LANDSCAPE PLANS FOR INFORMATION ON PAVING, ON PAVERS, FENCING, PLANTING AND TREES.

QUEBEC STREET

Project Information Table								
Zone (existing)	R-K Medium Density Attached Dwelling District							
Proposed zone or site specific zone	Site Specific Zone							
Site area (m ²)	4,009.0							
Total floor area (m ²)	11,528.0							
Commercial floor area (m ²)	602.2							
Floor space ratio	2.9							
Site Coverage (%)	85%							
Open site space (%)	15%							
Height of building (m)	14							
Number of storeys	14							
Parking stalls (number) on site	132 (+ 9 in Townhouse Garages)							
Bicycle parking number (Class 1 & 2)	Class 1 = 160 Class 2 = 32							
Building Setbacks (m)								
Townhouses	Tower							
Front yard	4.61m / 2.96m							
Rear yard	2.01m / 4.16m							
Side yard (Flanking Street)	0.00m (Kingston) / 1.84m (Quebec)							
Side yard (Interior)	3.65m / N/A							
Combined side yards	N/A / N/A							
Residential Use Details								
Total number of units	108							
Unit type, e.g., 1 bedroom	Studio, 1, 2 and 3 Bdrm; 2 and 3 Bdr Townhouse							
Ground-oriented units	12							
Minimum unit floor area (m ²)	33							
Total residential floor area (m ²)	9,624							
Tower: 14 Storeys								
Unit Type	L1	L2-L3	L4	L5-L13	Pent.	Total		
Level 1 - 3:	766m ²	1 Bedroom	2	2	2	2%		
Level 4 - 3:	2086m ² (1043 x2)	2 Bedroom	6	2	27	35	32%	
Level 4 - 13:	616m ²	1+ Bedroom	4	1	16	23	23%	
Penthouse:	496m ²	2+ Bedroom	4	1	6	16	15%	
		3 Bedroom	6	1	6	16	15%	
		Townhouse	12			12	11%	
Townhouse:	3 Storeys + Underground Parking	Total	12	36	6	63	4	108
Level 1:	686m ²							
Level 2:	785m ²							
Level 3:	419m ²							



Please refer to the accompanying resubmission memo for revision descriptions.



rev no	description	date
7	Rezonning DP Resubmission	24.05.23
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2	Issued for Dev. Tracker	21.10.19

project name
Montreal and Quebec
205 Quebec Street
Victoria, BC

sheet title
Site Plan


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drawn by	RP, GK, GB
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Grade Points (m Geodesic)	Existing	Proposed	Interval	Average Grade (m)	Distance (m)	Subtotal
A	7.67	7.35	A-B	7.35	9.41	69.13
B	7.70	7.35	B-C	7.35	1.71	12.57
C	7.68	7.35	C-D	7.35	16.80	123.48
D	7.73	7.35	D-E	7.35	16.89	122.83
E	7.71	7.35	E-F	7.35	3.08	22.60
F	7.67	7.35	F-G	7.35	2.34	17.16
G	7.67	7.35	G-H	7.35	1.33	9.74
H	7.66	7.35	H-I	7.30	15.47	112.93
I	7.68	7.25	I-J	7.25	5.66	41.00
J	7.72	7.25	J-K	7.17	14.82	106.15
K	7.08	7.25	K-L	7.09	9.01	63.88
L	7.10	7.25	L-M	7.10	11.10	78.81
M	7.10	7.25	M-N	7.18	6.64	47.61
N	7.27	7.25	N-O	7.25	5.16	37.41
O	7.40	7.25	O-P	7.18	2.72	19.52
P	7.39	7.10	P-Q	7.07	3.34	23.61
Q	7.45	7.04	Q-R	7.04	19.71	138.76
R	7.33	7.04	R-S	6.82	31.57	215.15
S	6.99	6.96	S-T	6.63	23.50	155.81
T	6.67	6.96	T-U	6.78	9.48	64.24
U	6.79	6.96	V-W	6.83	1.62	11.03
V	6.87	6.96	W-X	6.88	1.30	8.94
W	6.89	6.96	U-V	6.93	30.98	214.54
X	7.71	6.96	V-W	7.03	7.62	11.35
Y	7.09	7.09	W-X	7.09	7.30	9.22
Z	7.09	7.25	X-Y	7.11	5.87	41.67
Aa	7.12	7.25	Y-Z	7.11	9.08	64.52
Bb	7.10	7.35	Z-Aa	7.17	6.79	48.65
Cc	7.24	7.35	Aa-Bb	7.30	36.39	265.47
Dd	7.52	7.35	Bb-Cc	7.35	3.25	23.85
Ee	7.53	7.35	Cc-Aa	7.35	14.62	107.46
Total						322.29 2288.87
Geodesic Average Grade (m)						7.10



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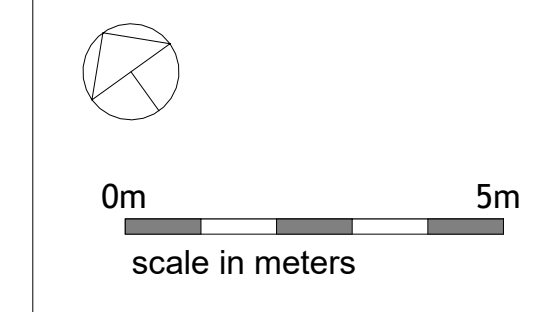
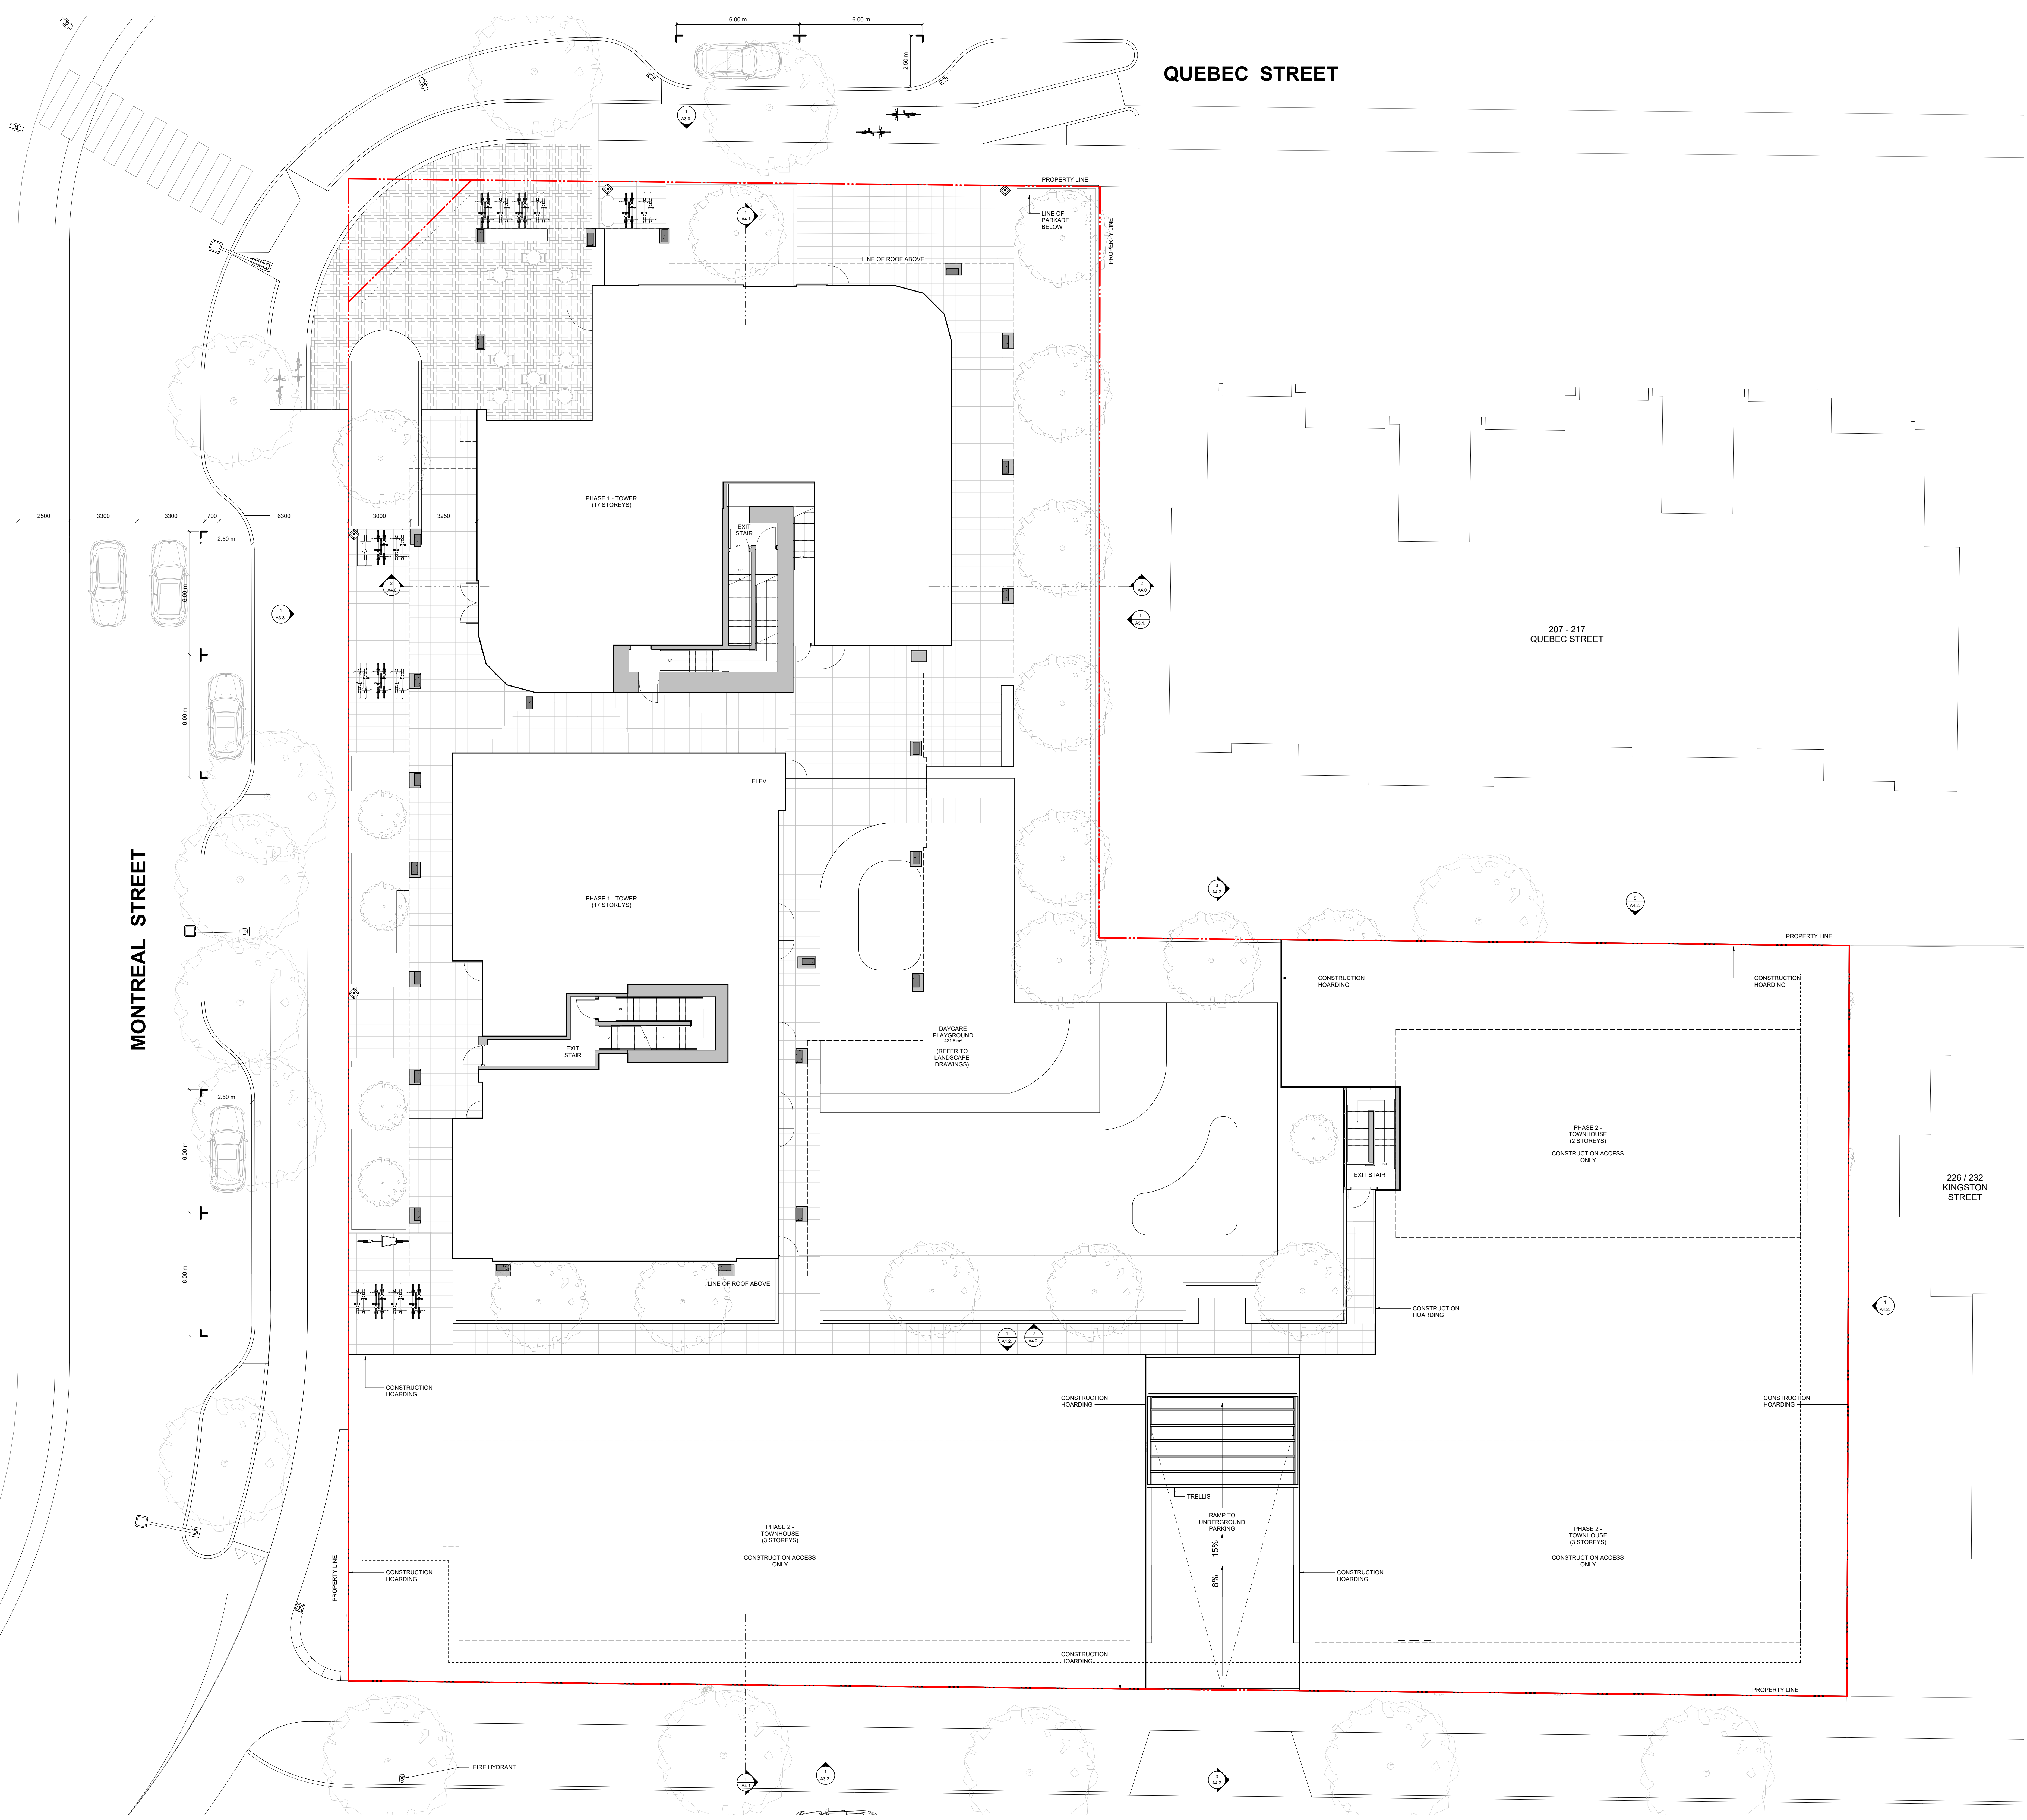
project name
Montreal and Quebec
205 Quebec Street
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sheet title
Average Grade Calculations

project no. #21-18
scale 1 : 100
drawn by RP, GK, GB
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sheet no. **A1.2**

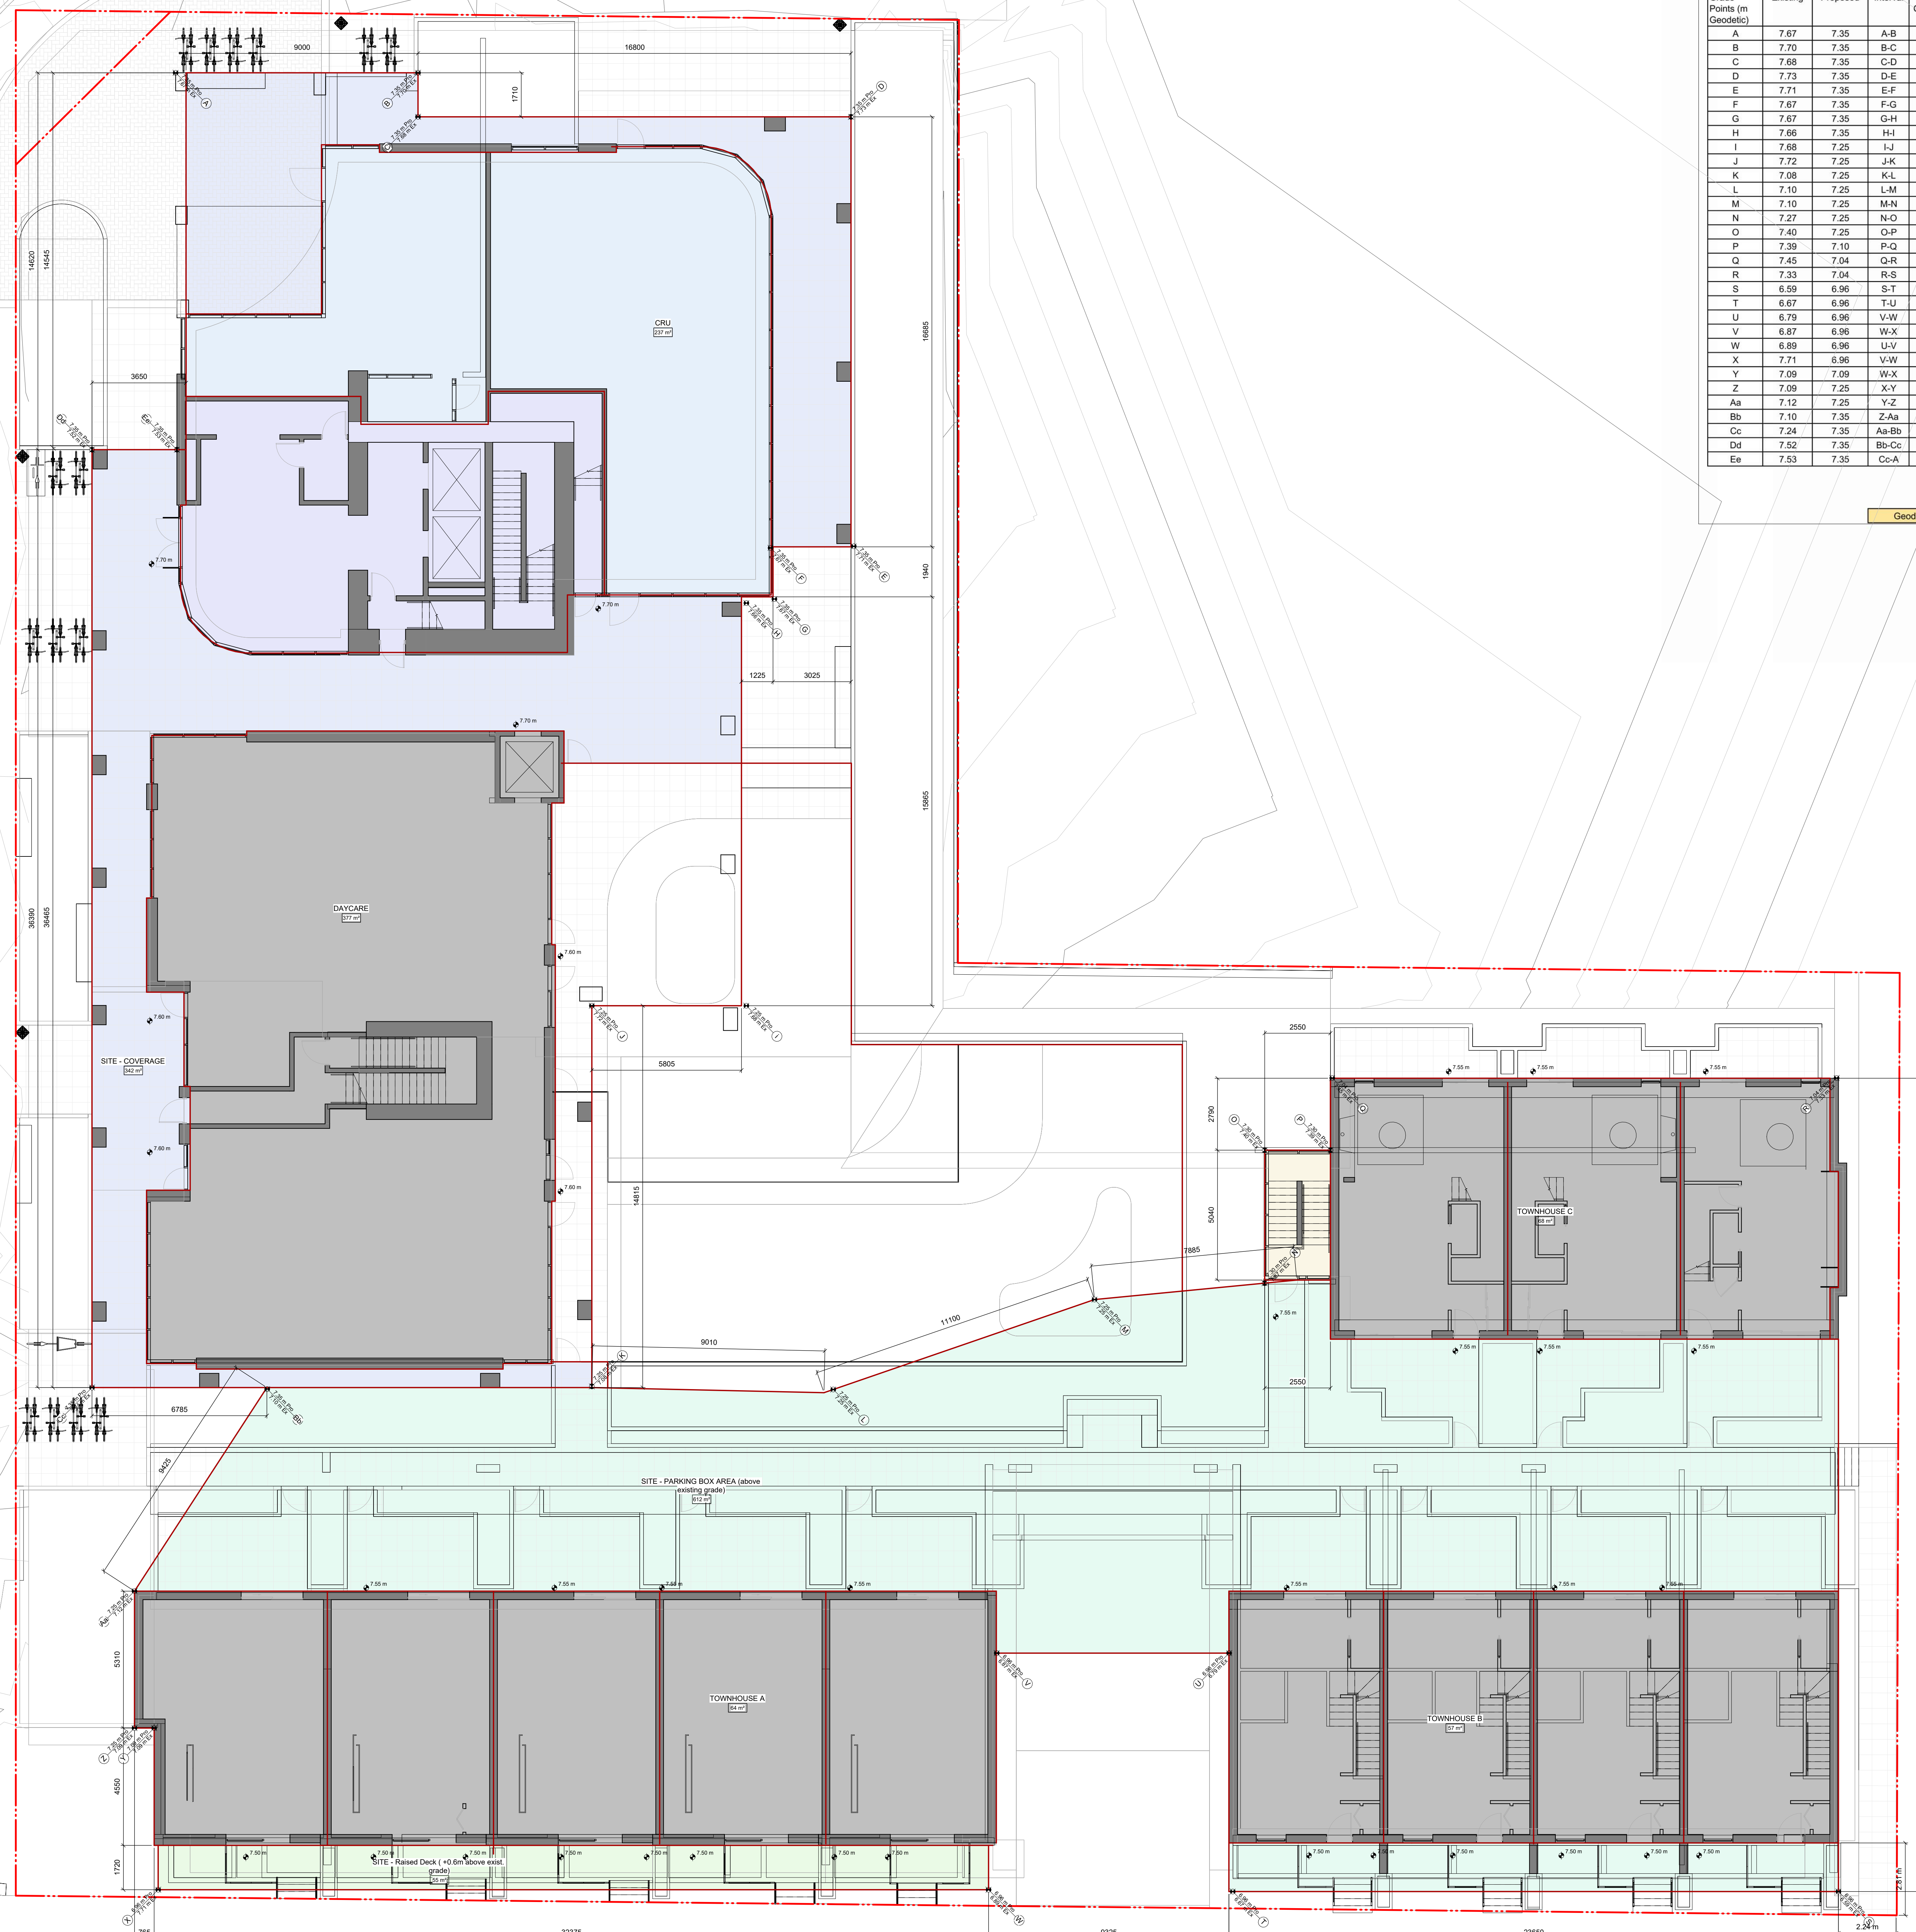

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project name
Montreal and Quebec
205 Quebec Street
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sheet title
Level 1 Phasing Plan


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drawn by	Author
date issued	05/23/24
sheet no.	A1.3

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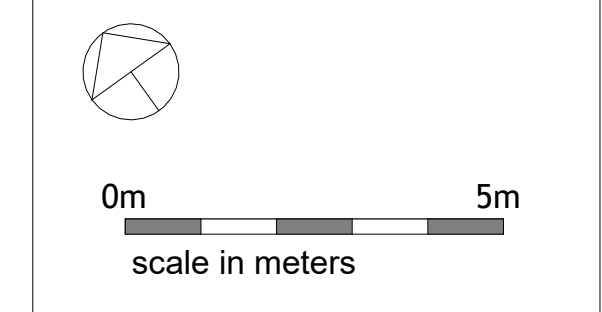


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205 Quebec Street
Victoria, BC


sheet title
P1 Phasing Plan

project no.	#21-18
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date issued	05/23/24
sheet no.	A1.4

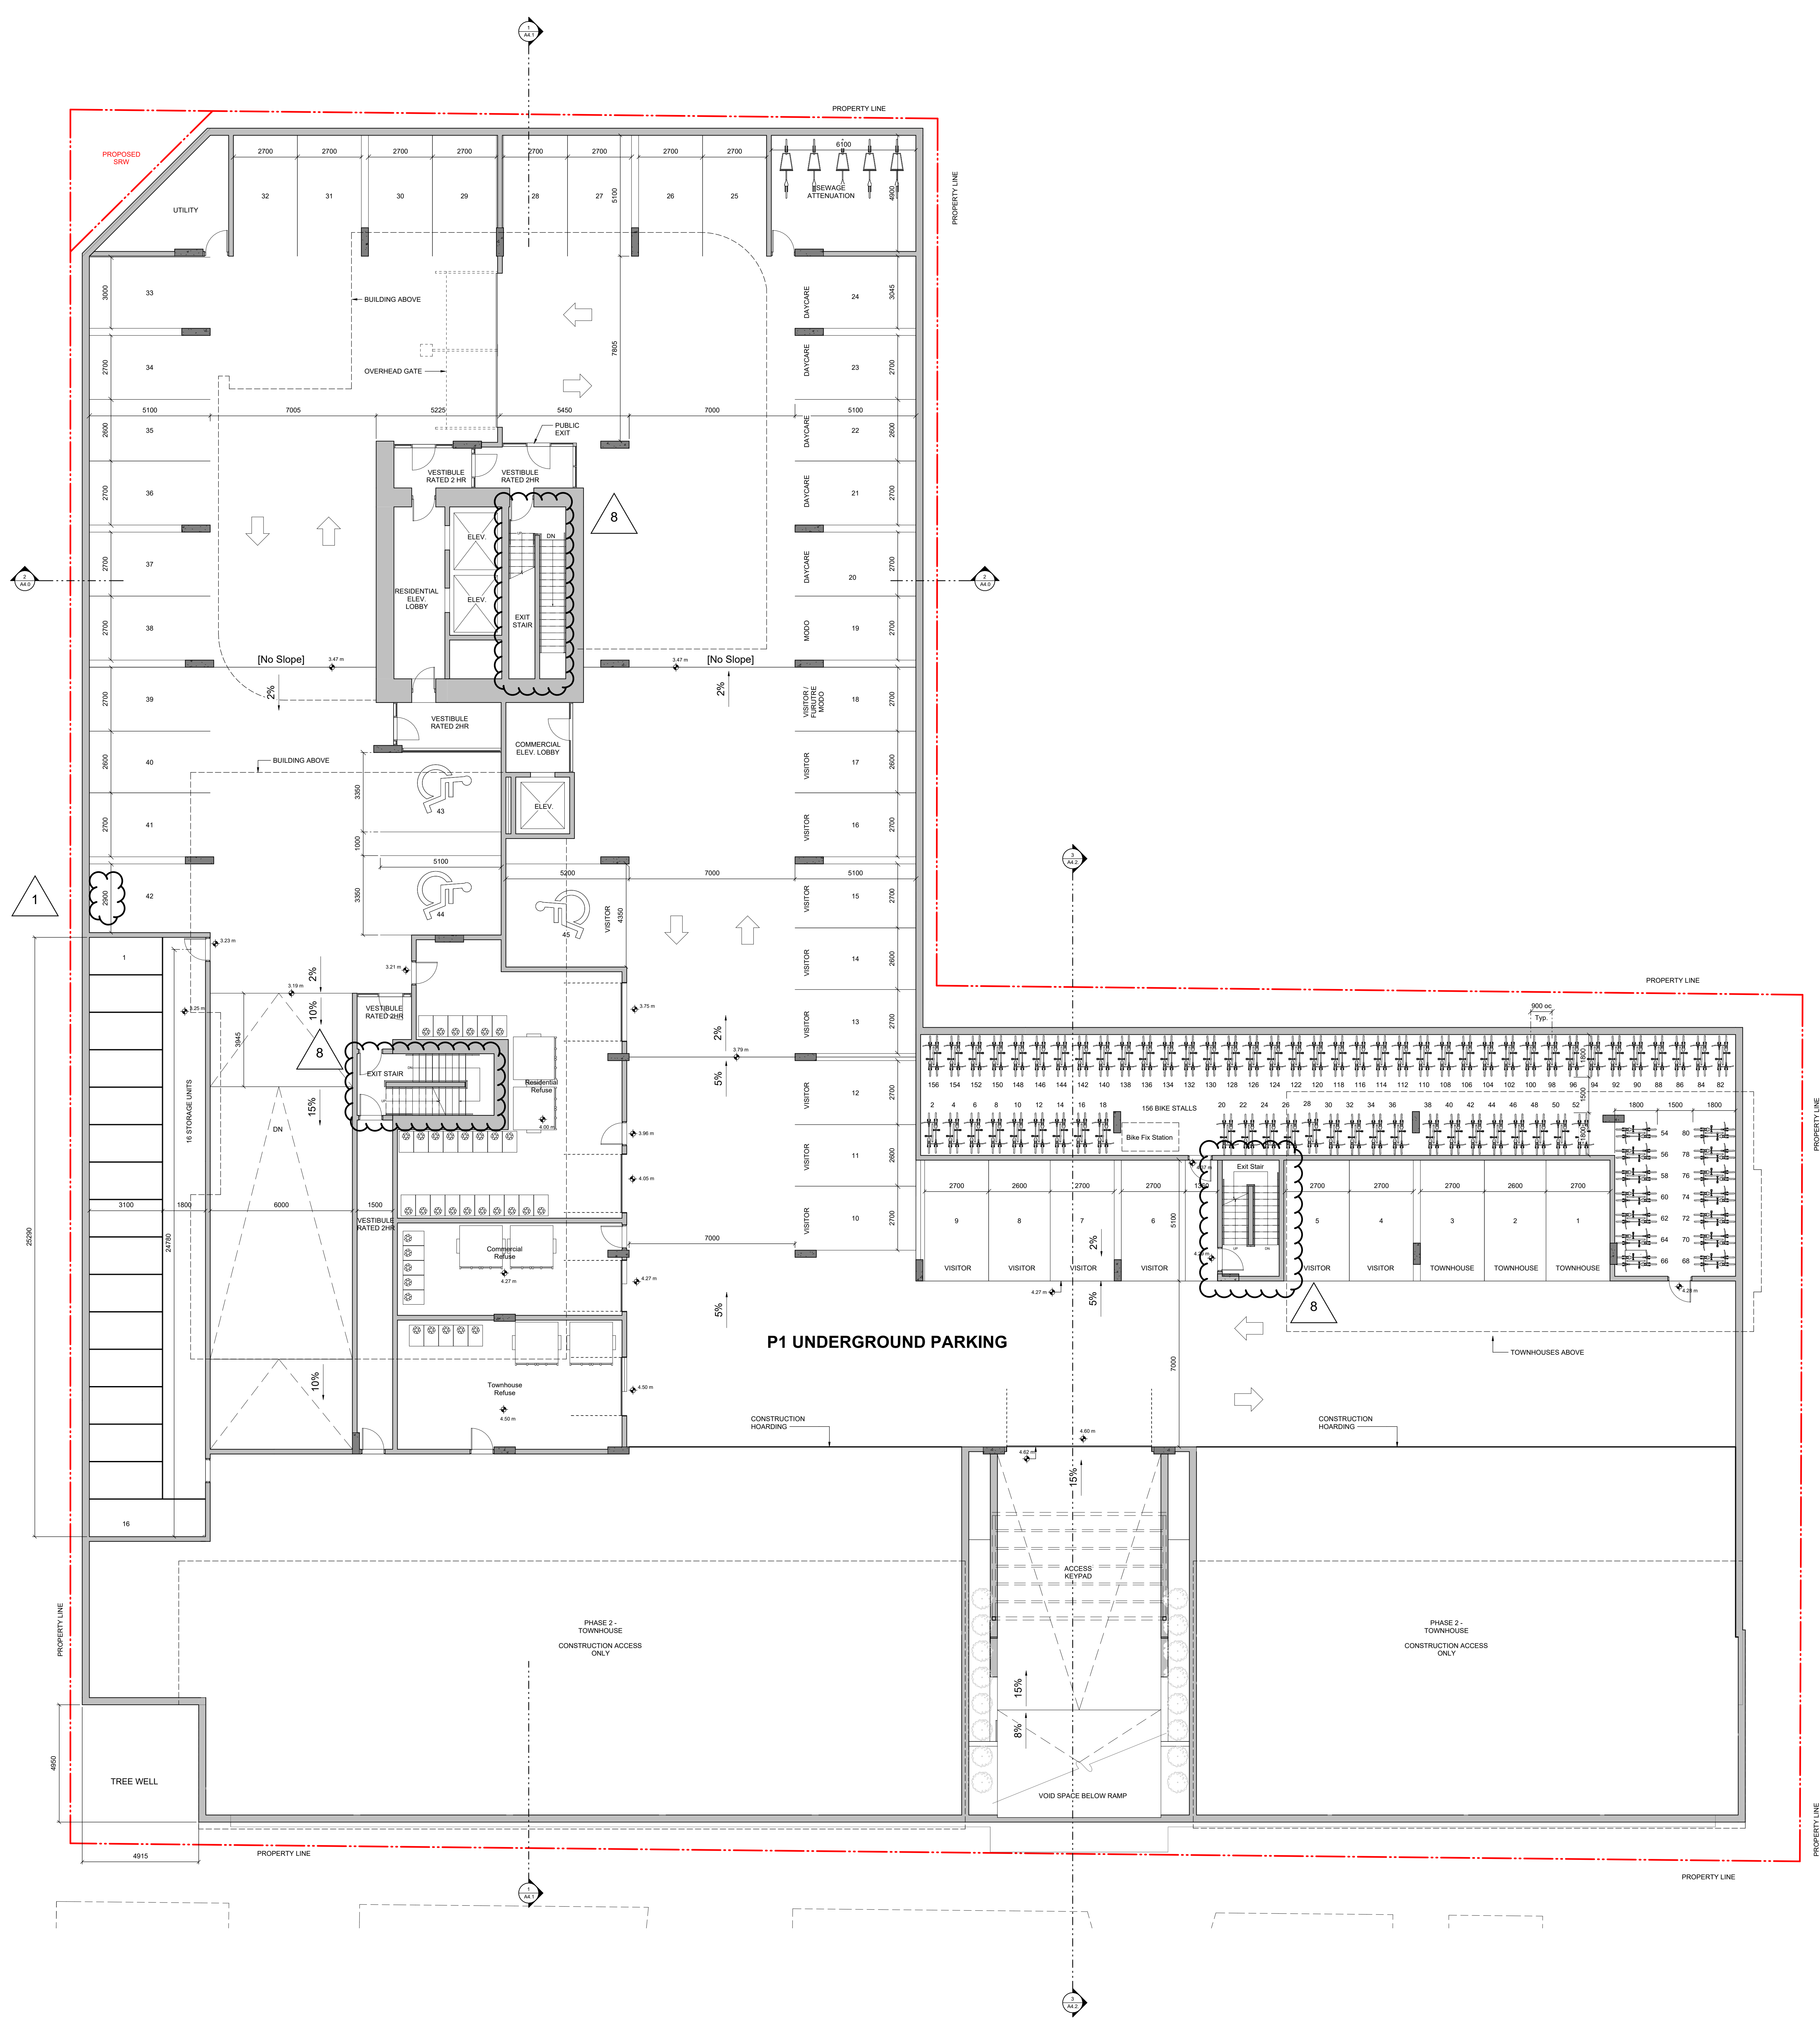
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Please refer to the accompanying resubmission memo for revision descriptions.



rev no	description	date
7	Re zoning DP Resubmission 24.05.23	
6	Re zoning DP Resubmission 23.12.22	
5	Re zoning DP Resubmission 22.12.06	
4	Issued for ADP	22.08.02
3	Issued for Re zoning / DP	21.12.15
2	Issued for Dev. Tracker	21.10.19
1	Issued for Dev. Tracker	21.10.19
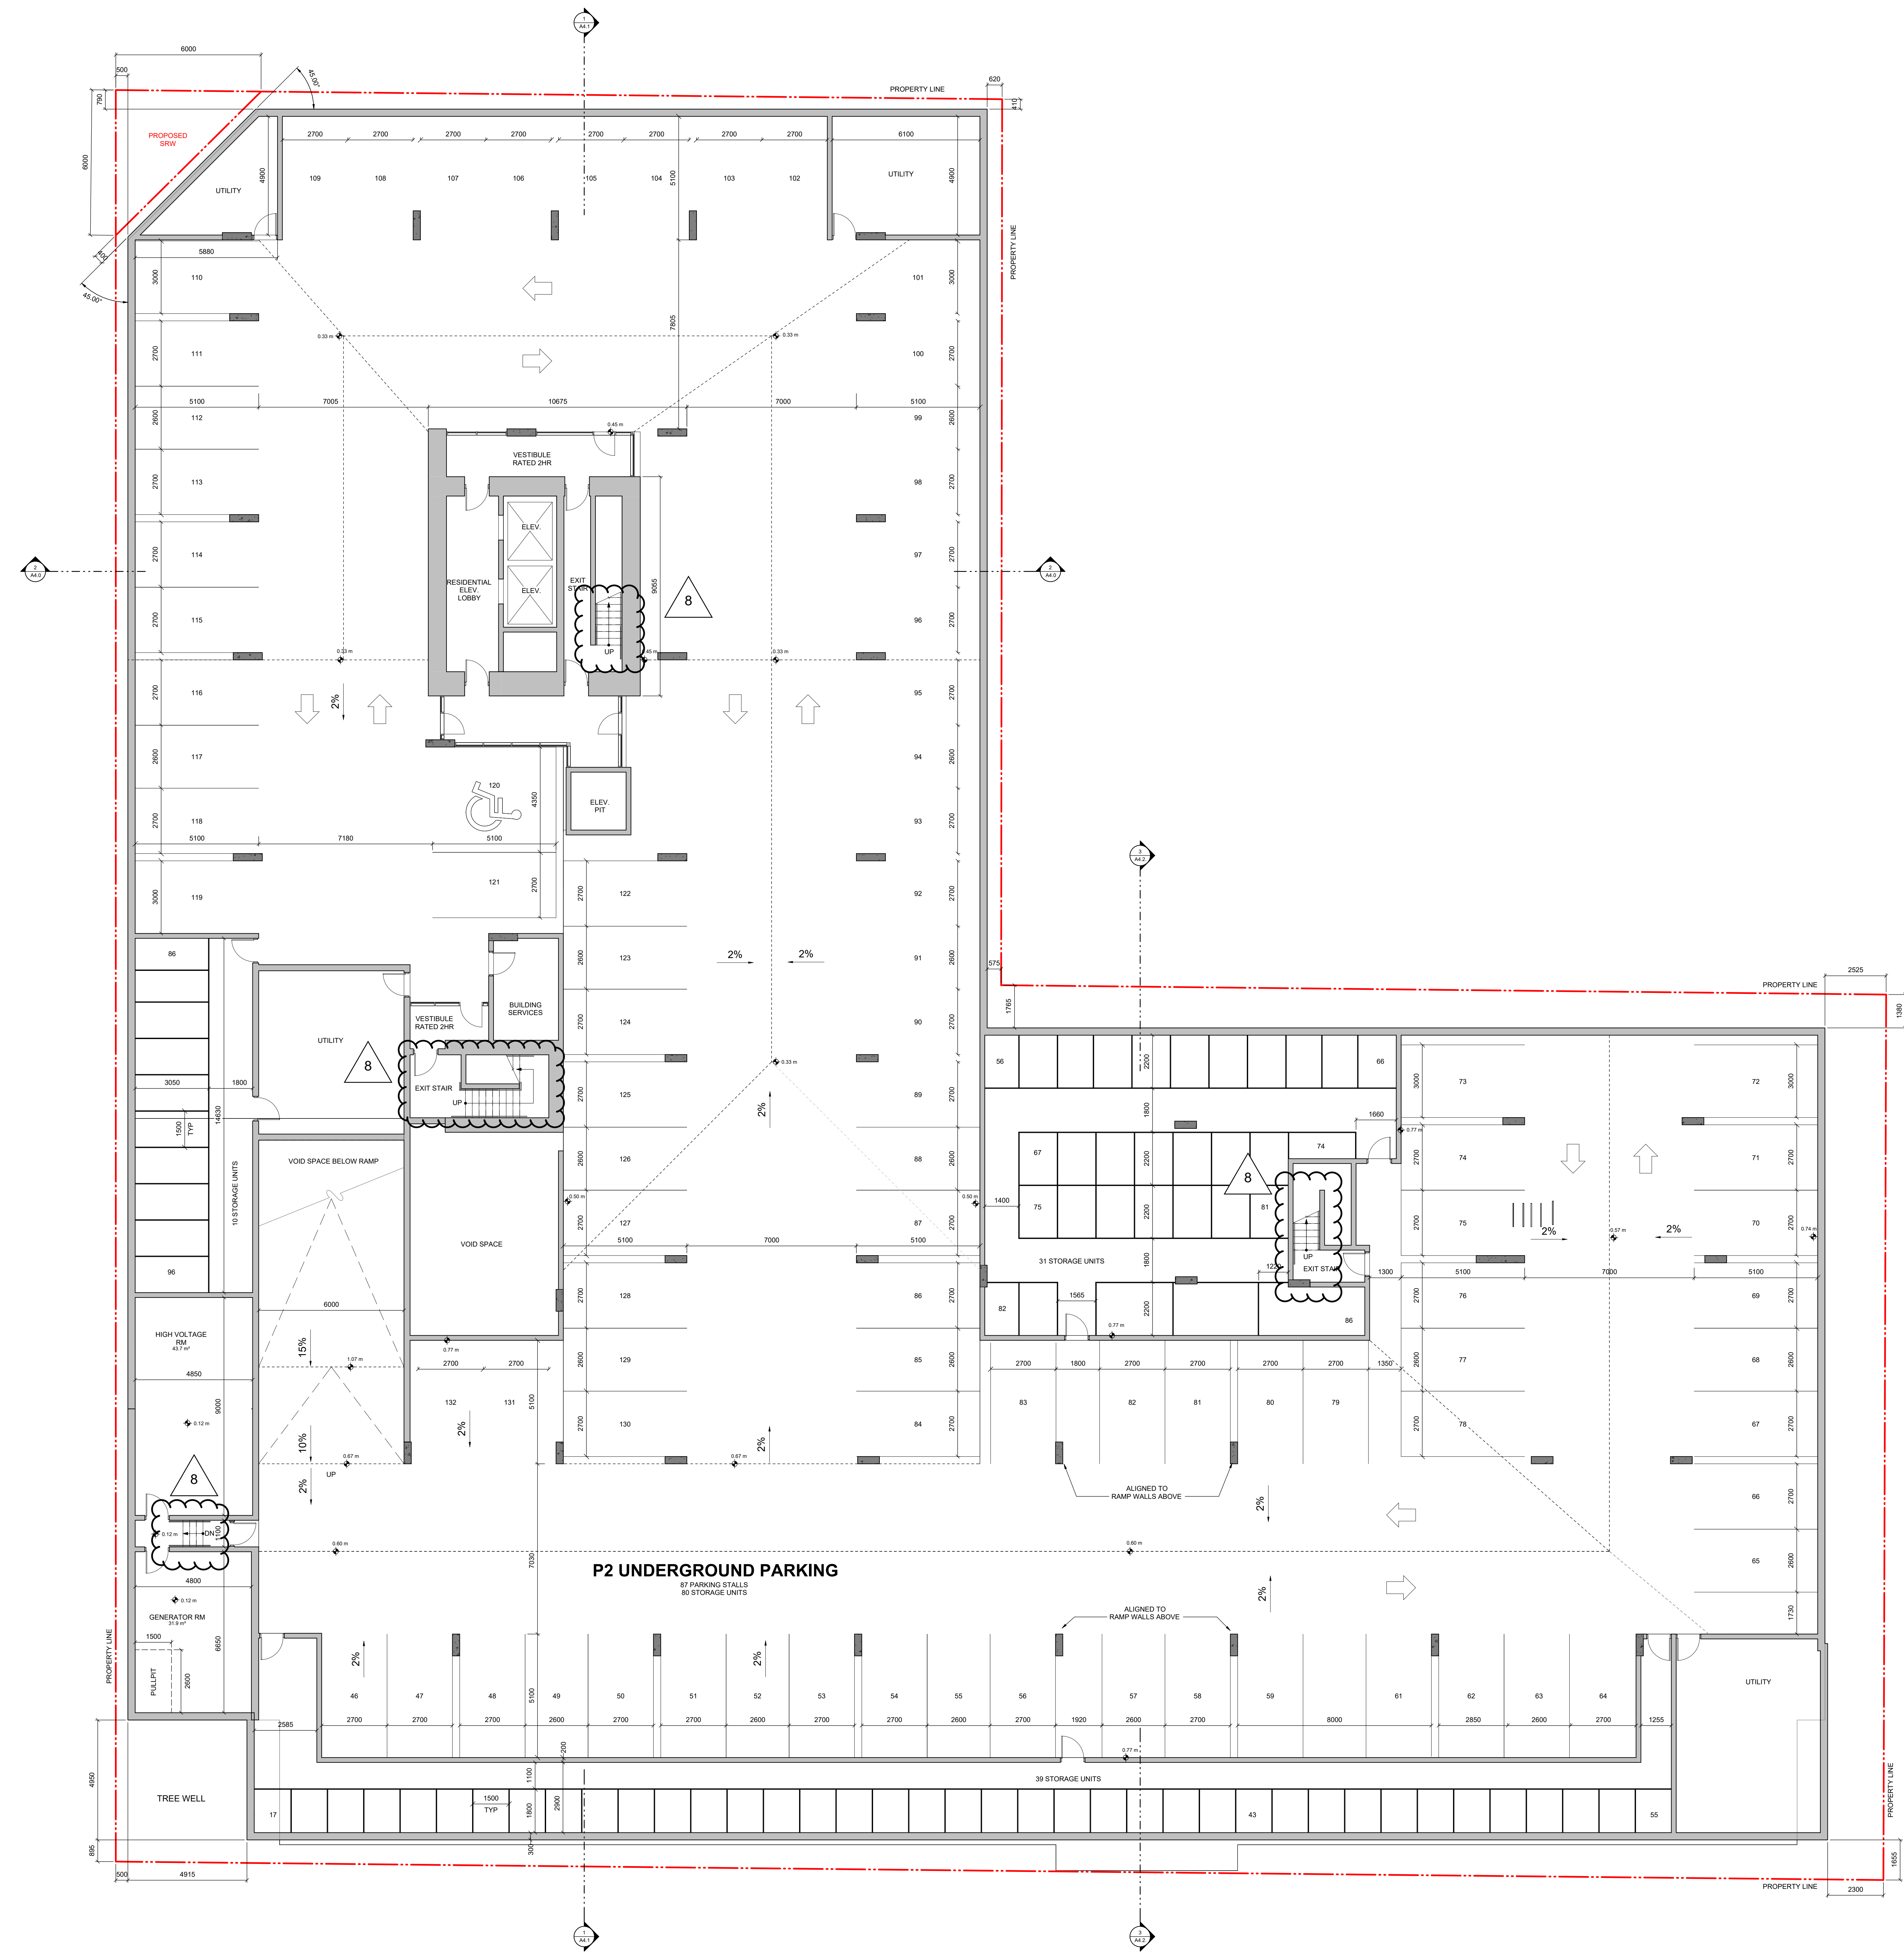
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project name
Montreal and Quebec
205 Quebec Street
Victoria, BC

sheet title
P2 Parking Plan

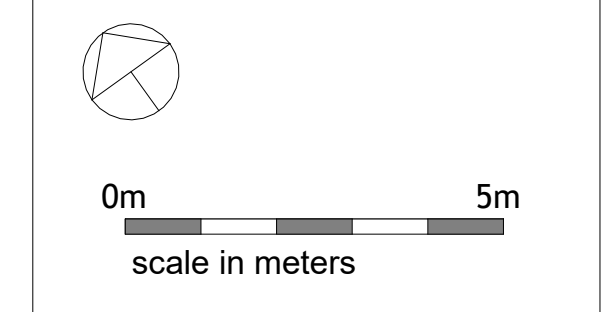
project no. #21-18
scale 1 : 100
drawn by RP / GK
date issued 05/23/24
sheet no. **A2.0**

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2024-06-04

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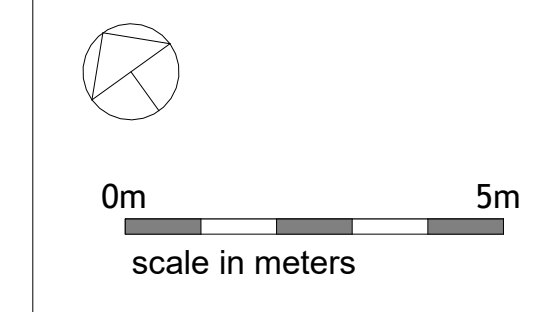


OFF-STREET VEHICLE PARKING		Schedule C 'Other Areas'		Expected Parking Demand (refer to Parking Study)	
Land Use Type		Parking Rate	Stalls	Parking Rate	Stalls
Residential:					
Multiple Dwelling	< 45	2	0.85	2	0.65
'Condominium'	45-70	36	1.00	36	0.80
	> 70	64	1.45	93	1.20
Townhouses	n/a	10	1.00	10	1.18
Visitors	n/a	112	0.10	11	0.10
Commercial:					
Commercial Retail Unit	152	n/a	1 per 37.5	4	1 per 80.00
Day Care (Care Facility)	312	n/a	1 per 80.0	4	1 per 21.00
Cafe / Restaurant	85	n/a	1 per 20.0	4	1 per 40.00
			Bylaw Standard:	164	Expected Demand:
					149
Requested Variance from Bylaw Requirements: -18					
Expected Parking Demand with shared parking strategy (refer to Parking Study): 139					
Total Proposed Off-Street Vehicle Parking: 146					

PARKING SUMMARY

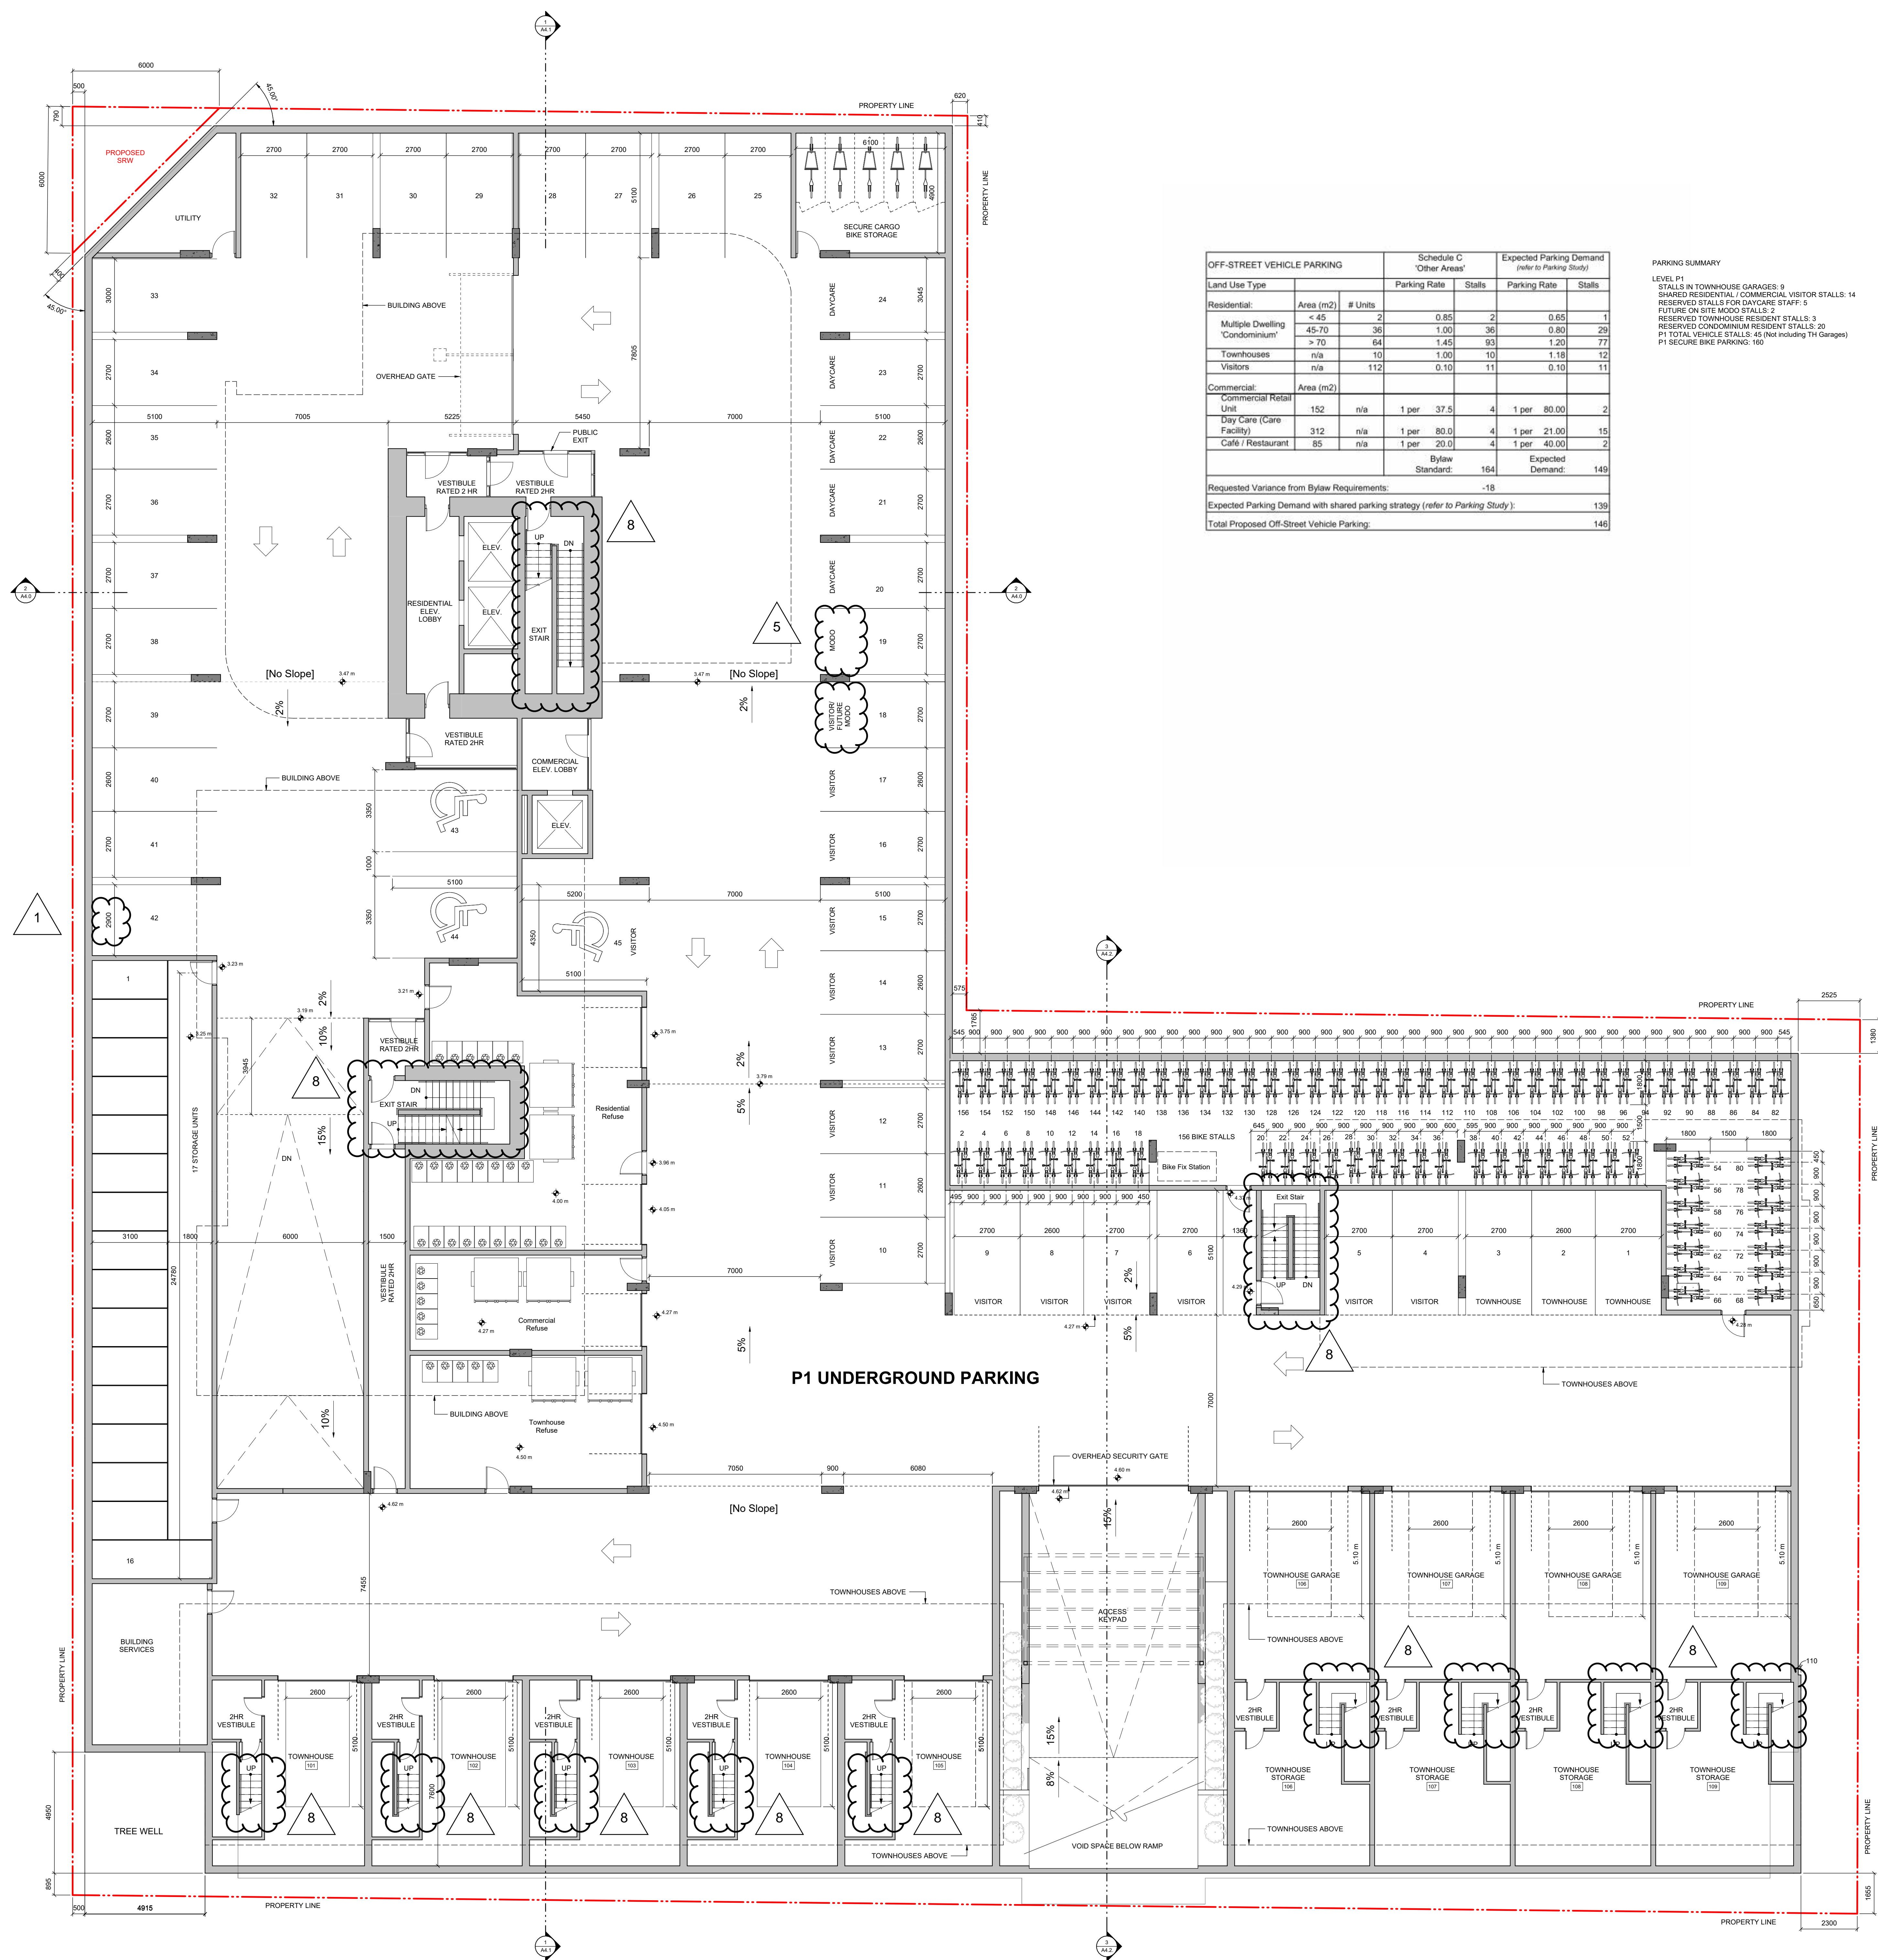LEVEL P1
 STALLS IN TOWNHOUSE GARAGES: 9
 SHARED RESIDENTIAL / COMMERCIAL VISITOR STALLS: 14
 RESERVED STALLS FOR DAYCARE STAFF: 5
 FUTURE ON-SITE BIKE STALLS: 3
 RESERVED TOWNHOUSE RESIDENT STALLS: 3
 RESERVED CONDOMINIUM RESIDENT STALLS: 20
 P1 TOTAL VEHICLE STALLS: 45 (Not including TH Garages)
 P1 SECURE BIKE PARKING: 160

Please refer to the accompanying resubmission memo for revision descriptions.



rev no	description	date
7	Rezonning DP Resubmission 24.05.23	
6	Rezonning DP Resubmission 23.12.22	
5	Rezonning DP Resubmission 22.12.06	
4	Issued for ADP	22.08.02
3	Issued for Rezonning DP	21.12.15
1	Issued for Dev. Tracker	21.10.19

project name
Montreal and Quebec
 205 Quebec Street
 Victoria, BC

sheet title
P1 Parking Plan


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drawn by	RP / GK
date issued	05/23/24
sheet no.	A2.1

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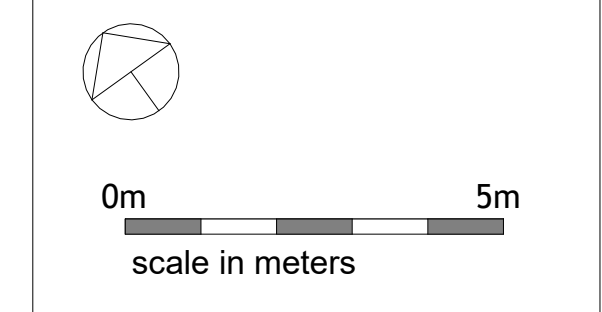


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NOTES:
1. REFER TO LANDSCAPE PLANS FOR INFORMATION ON PAVING, FENCING, PLANTINGS, AND TREES.



Please refer to the accompanying resubmission memo for revision descriptions.

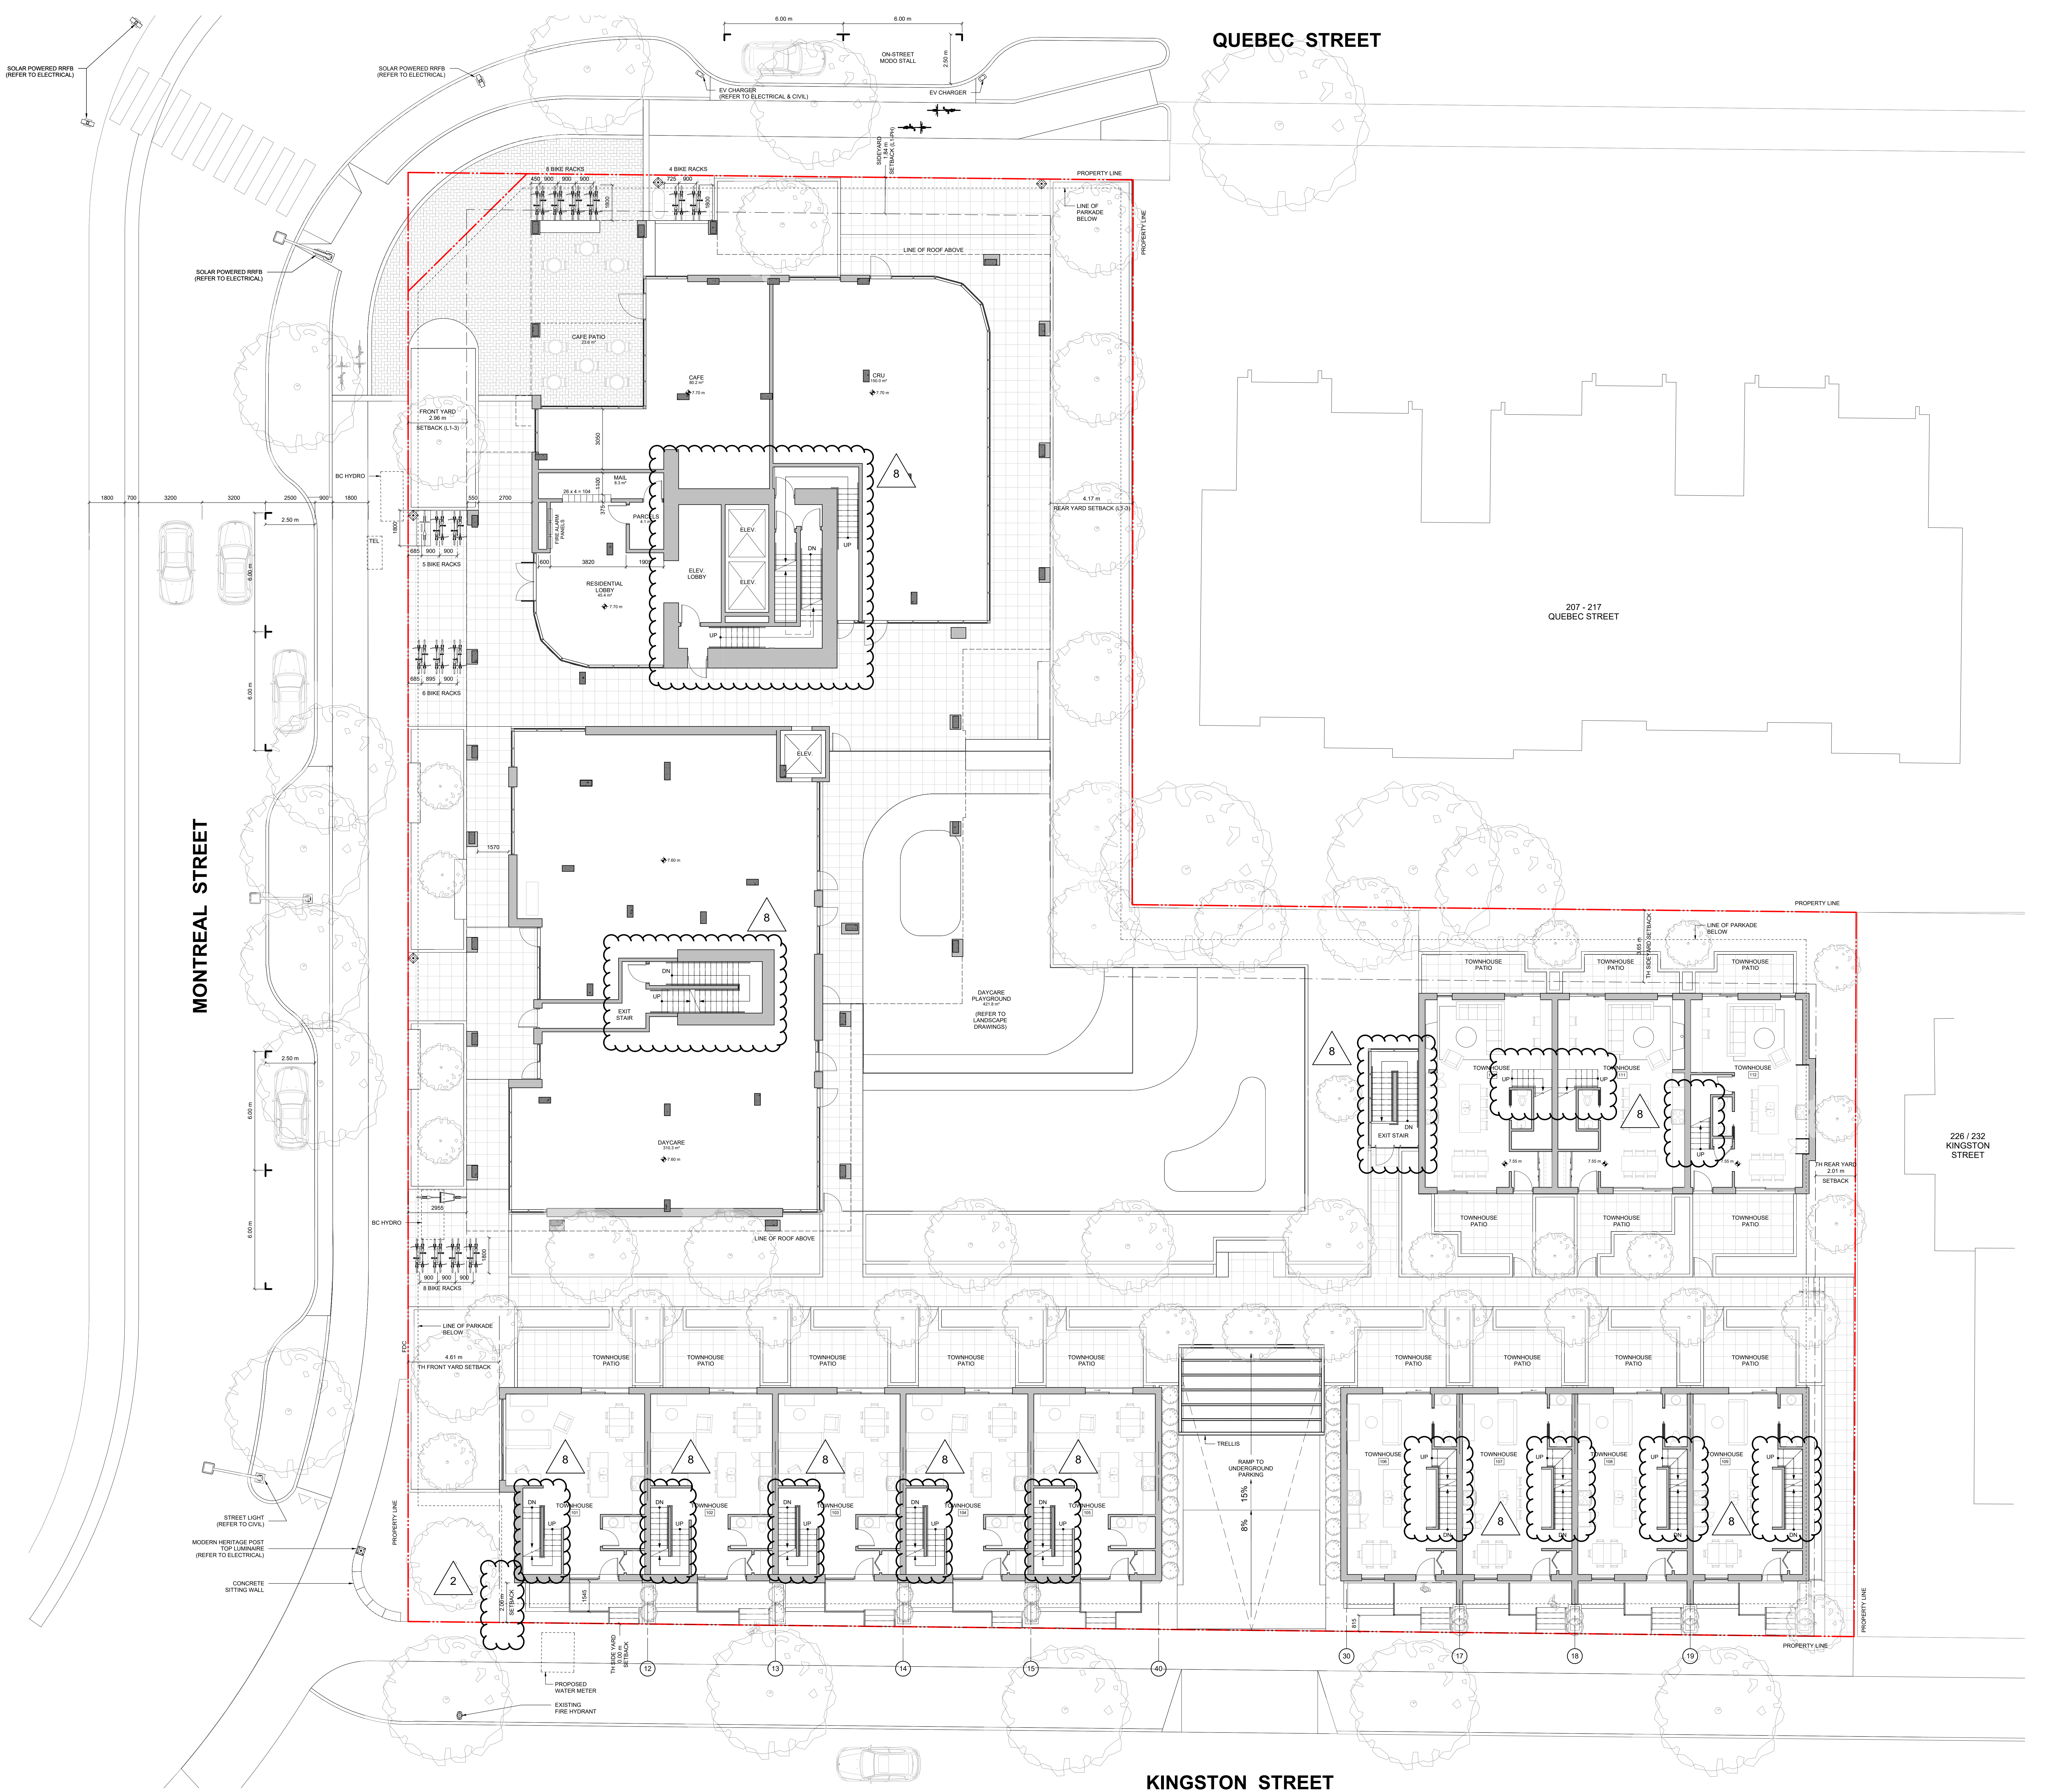

rev no	description	date
7	Rezonning DP Resubmission 24.05.23	
6	Rezonning DP Resubmission 23.12.22	
5	Rezonning DP Resubmission 22.12.06	
4	Issued for ADP	22.08.02
3	Issued for Rezonning DP	21.12.15
2	Issued for Dev. Tracker	21.10.19

project name
Montreal and Quebec
205 Quebec Street
Victoria, BC

sheet title
Level 1 Plan


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date issued	05/23/24
sheet no.	A2.2

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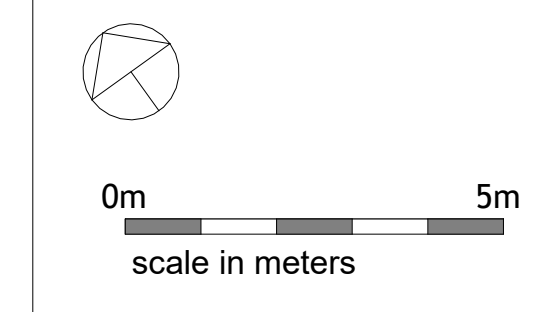


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rev no	description	date
7	Rezonning DP Resubmission 24.05.23	
6	Rezonning DP Resubmission 23.12.22	
5	Rezonning DP Resubmission 22.12.06	
4	Issued for ADP	22.08.02
3	Issued for Rezonning / DP	21.12.15
2	Issued for Dev. Tracker	21.10.19

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project name
Montreal and Quebec
205 Quebec Street
Victoria, BC

sheet title
Level 2 Plan

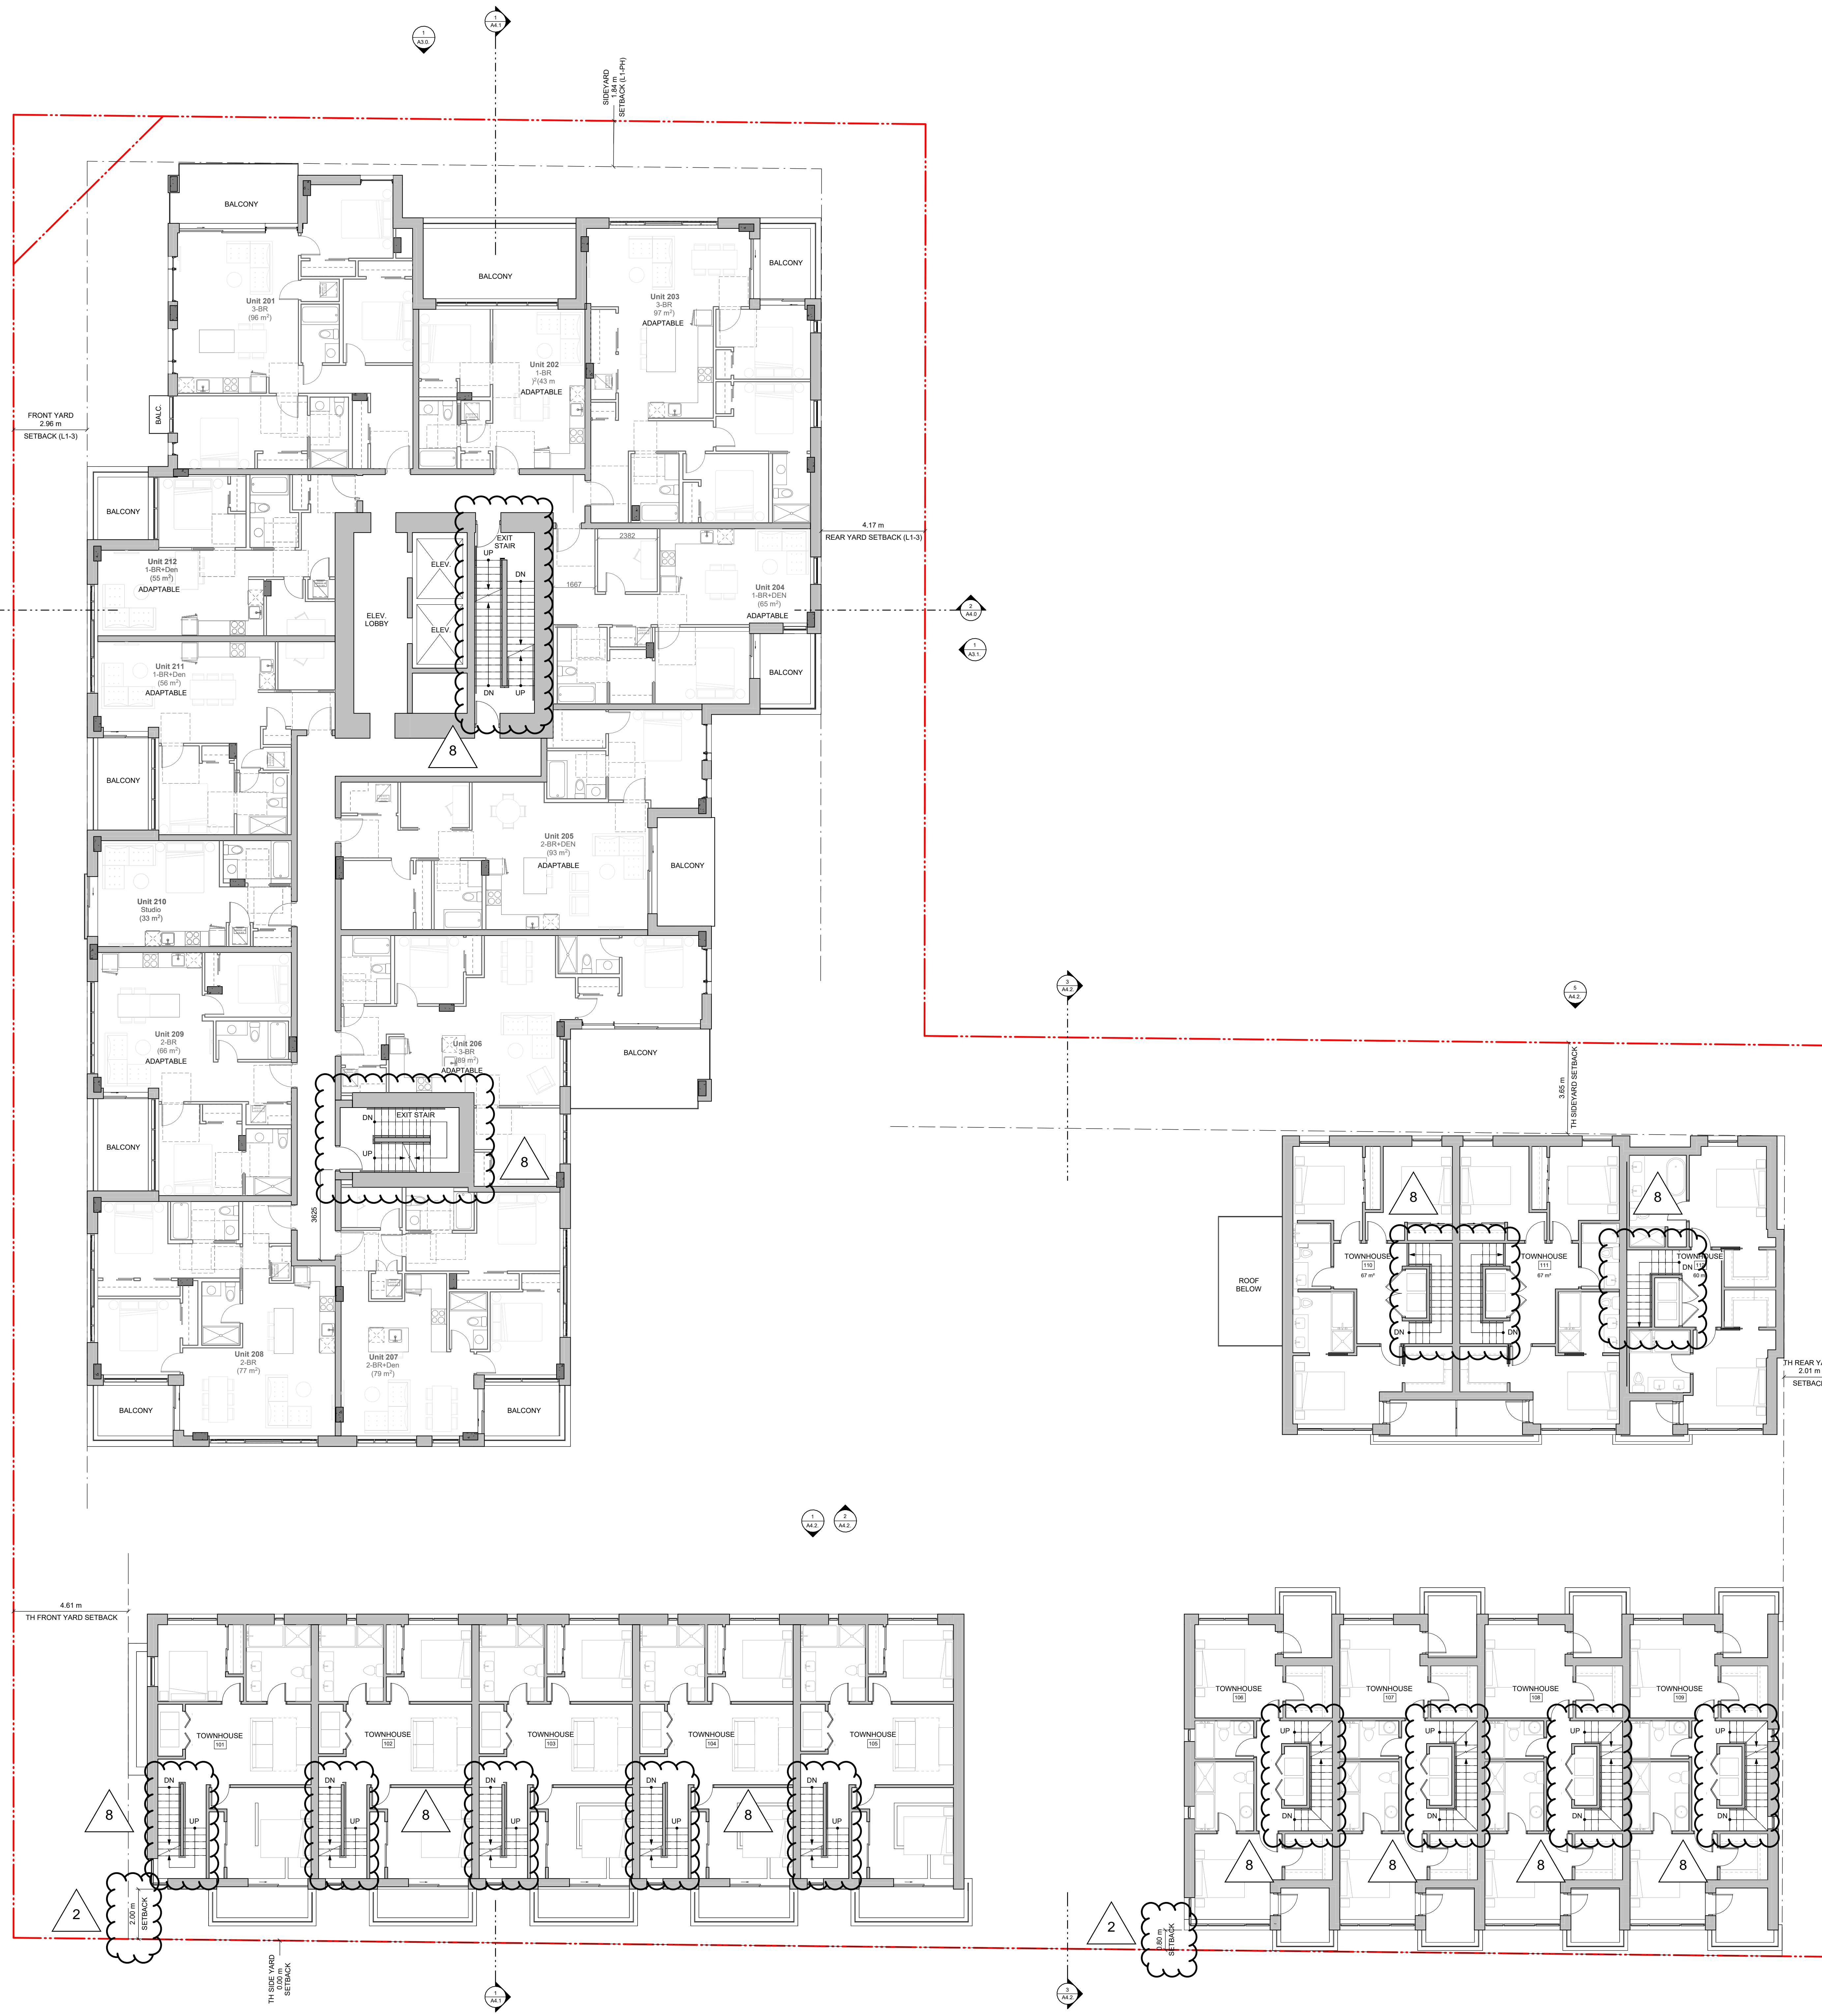project no.	#21-18
scale	1 : 100
drawn by	RP / GK / GB
date issued	05/23/24
sheet no.	A2.3


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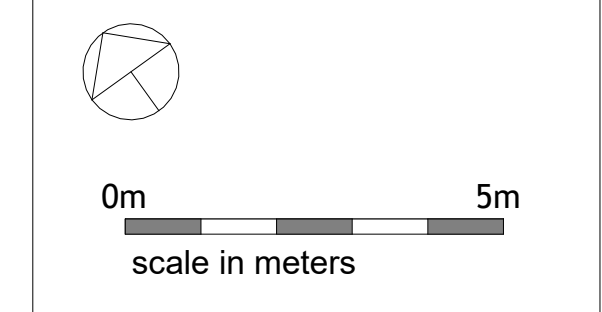
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NOTES:
1. REFER TO LANDSCAPE PLANS FOR INFORMATION ON PAVING, FENCING, PLANTINGS, AND TREES.



Please refer to the accompanying resubmission memo for revision descriptions.



rev no	description	date
7	Rezoning DP Resubmission	24.05.23
6	Rezoning DP Resubmission	23.12.22
5	Rezoning DP Resubmission	22.12.06
4	Issued for ADP	22.08.02
2	Issued for Rezoning / DP	21.12.15
1	Issued for Dev. Tracker	21.10.19
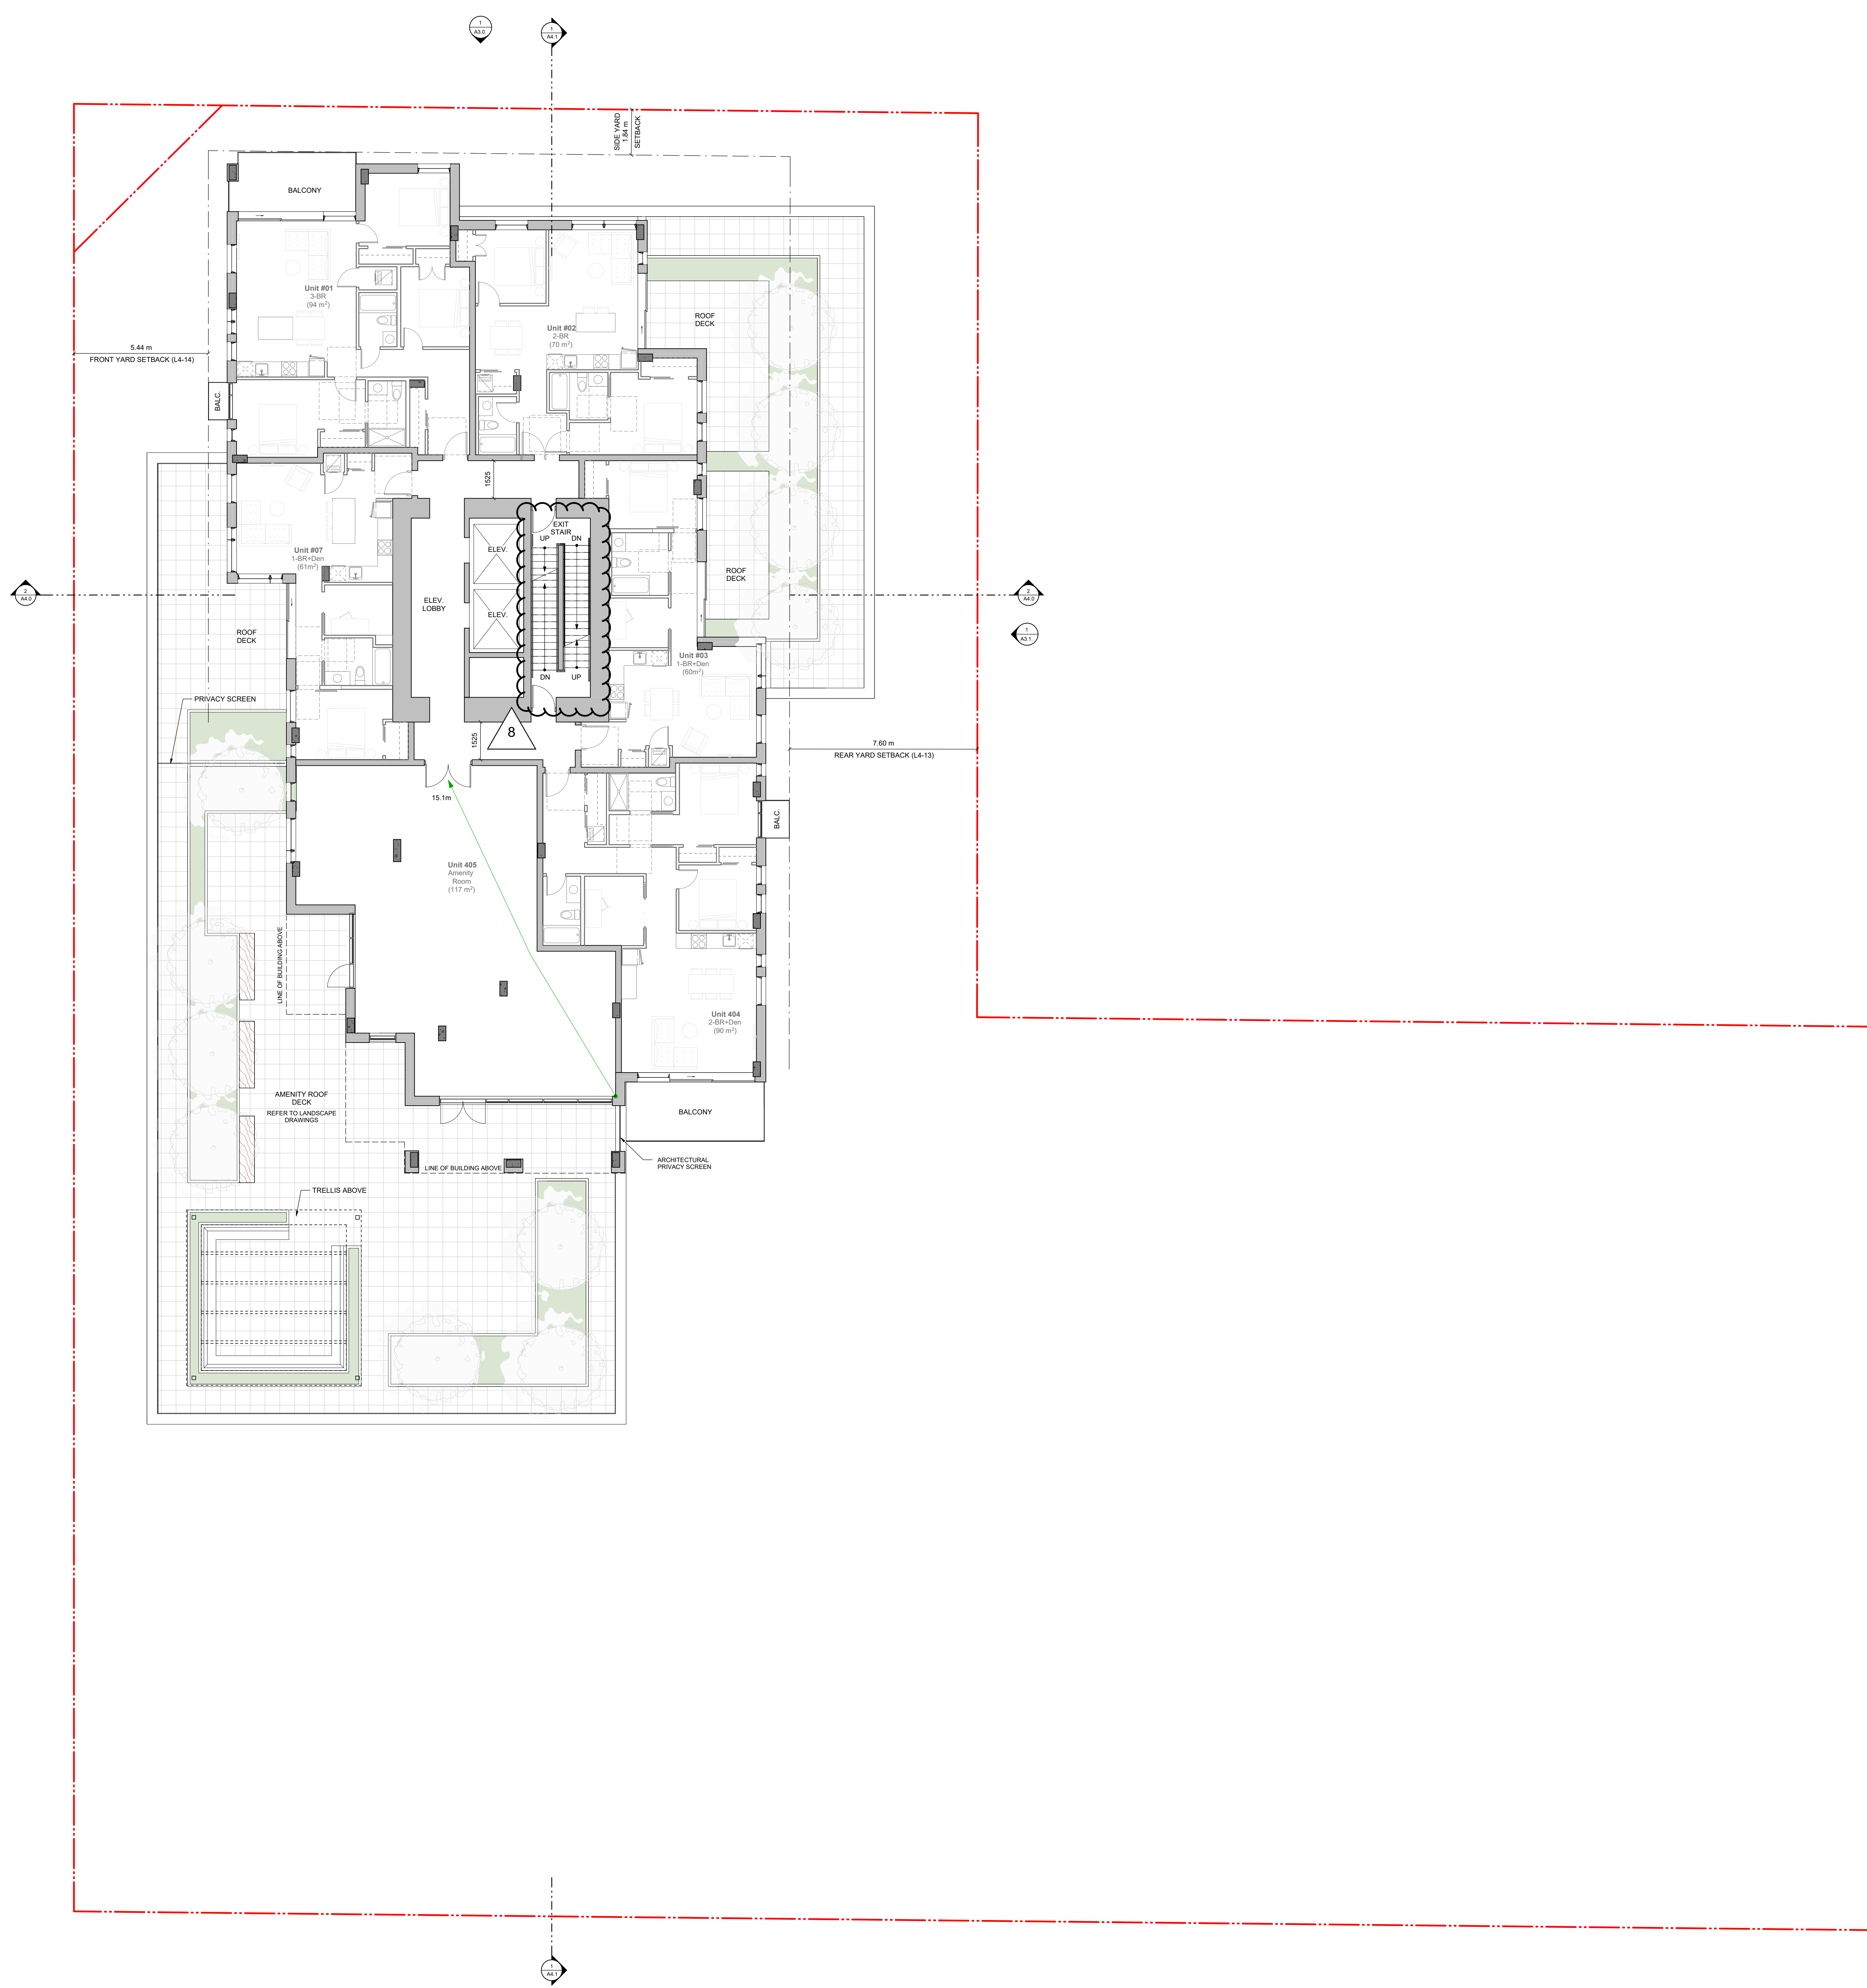
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project name
Montreal and Quebec
205 Quebec Street
Victoria, BC


sheet title
Level 4 Plan

project no. #21-18
scale 1 : 100
drawn by RP / GK / GB
date issued 05/23/24
sheet no. **A2.5**


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Please refer to the accompanying resubmission memo for revision descriptions.



rev no	description	date
7	Rezoning DP Resubmission	24.05.23
6	Rezoning DP Resubmission	23.12.22
5	Rezoning DP Resubmission	22.12.06
4	Issued for ADP	22.08.02
3	Issued for Rezoning / DP	21.12.15
2	Issued for Dev. Tracker	21.10.19
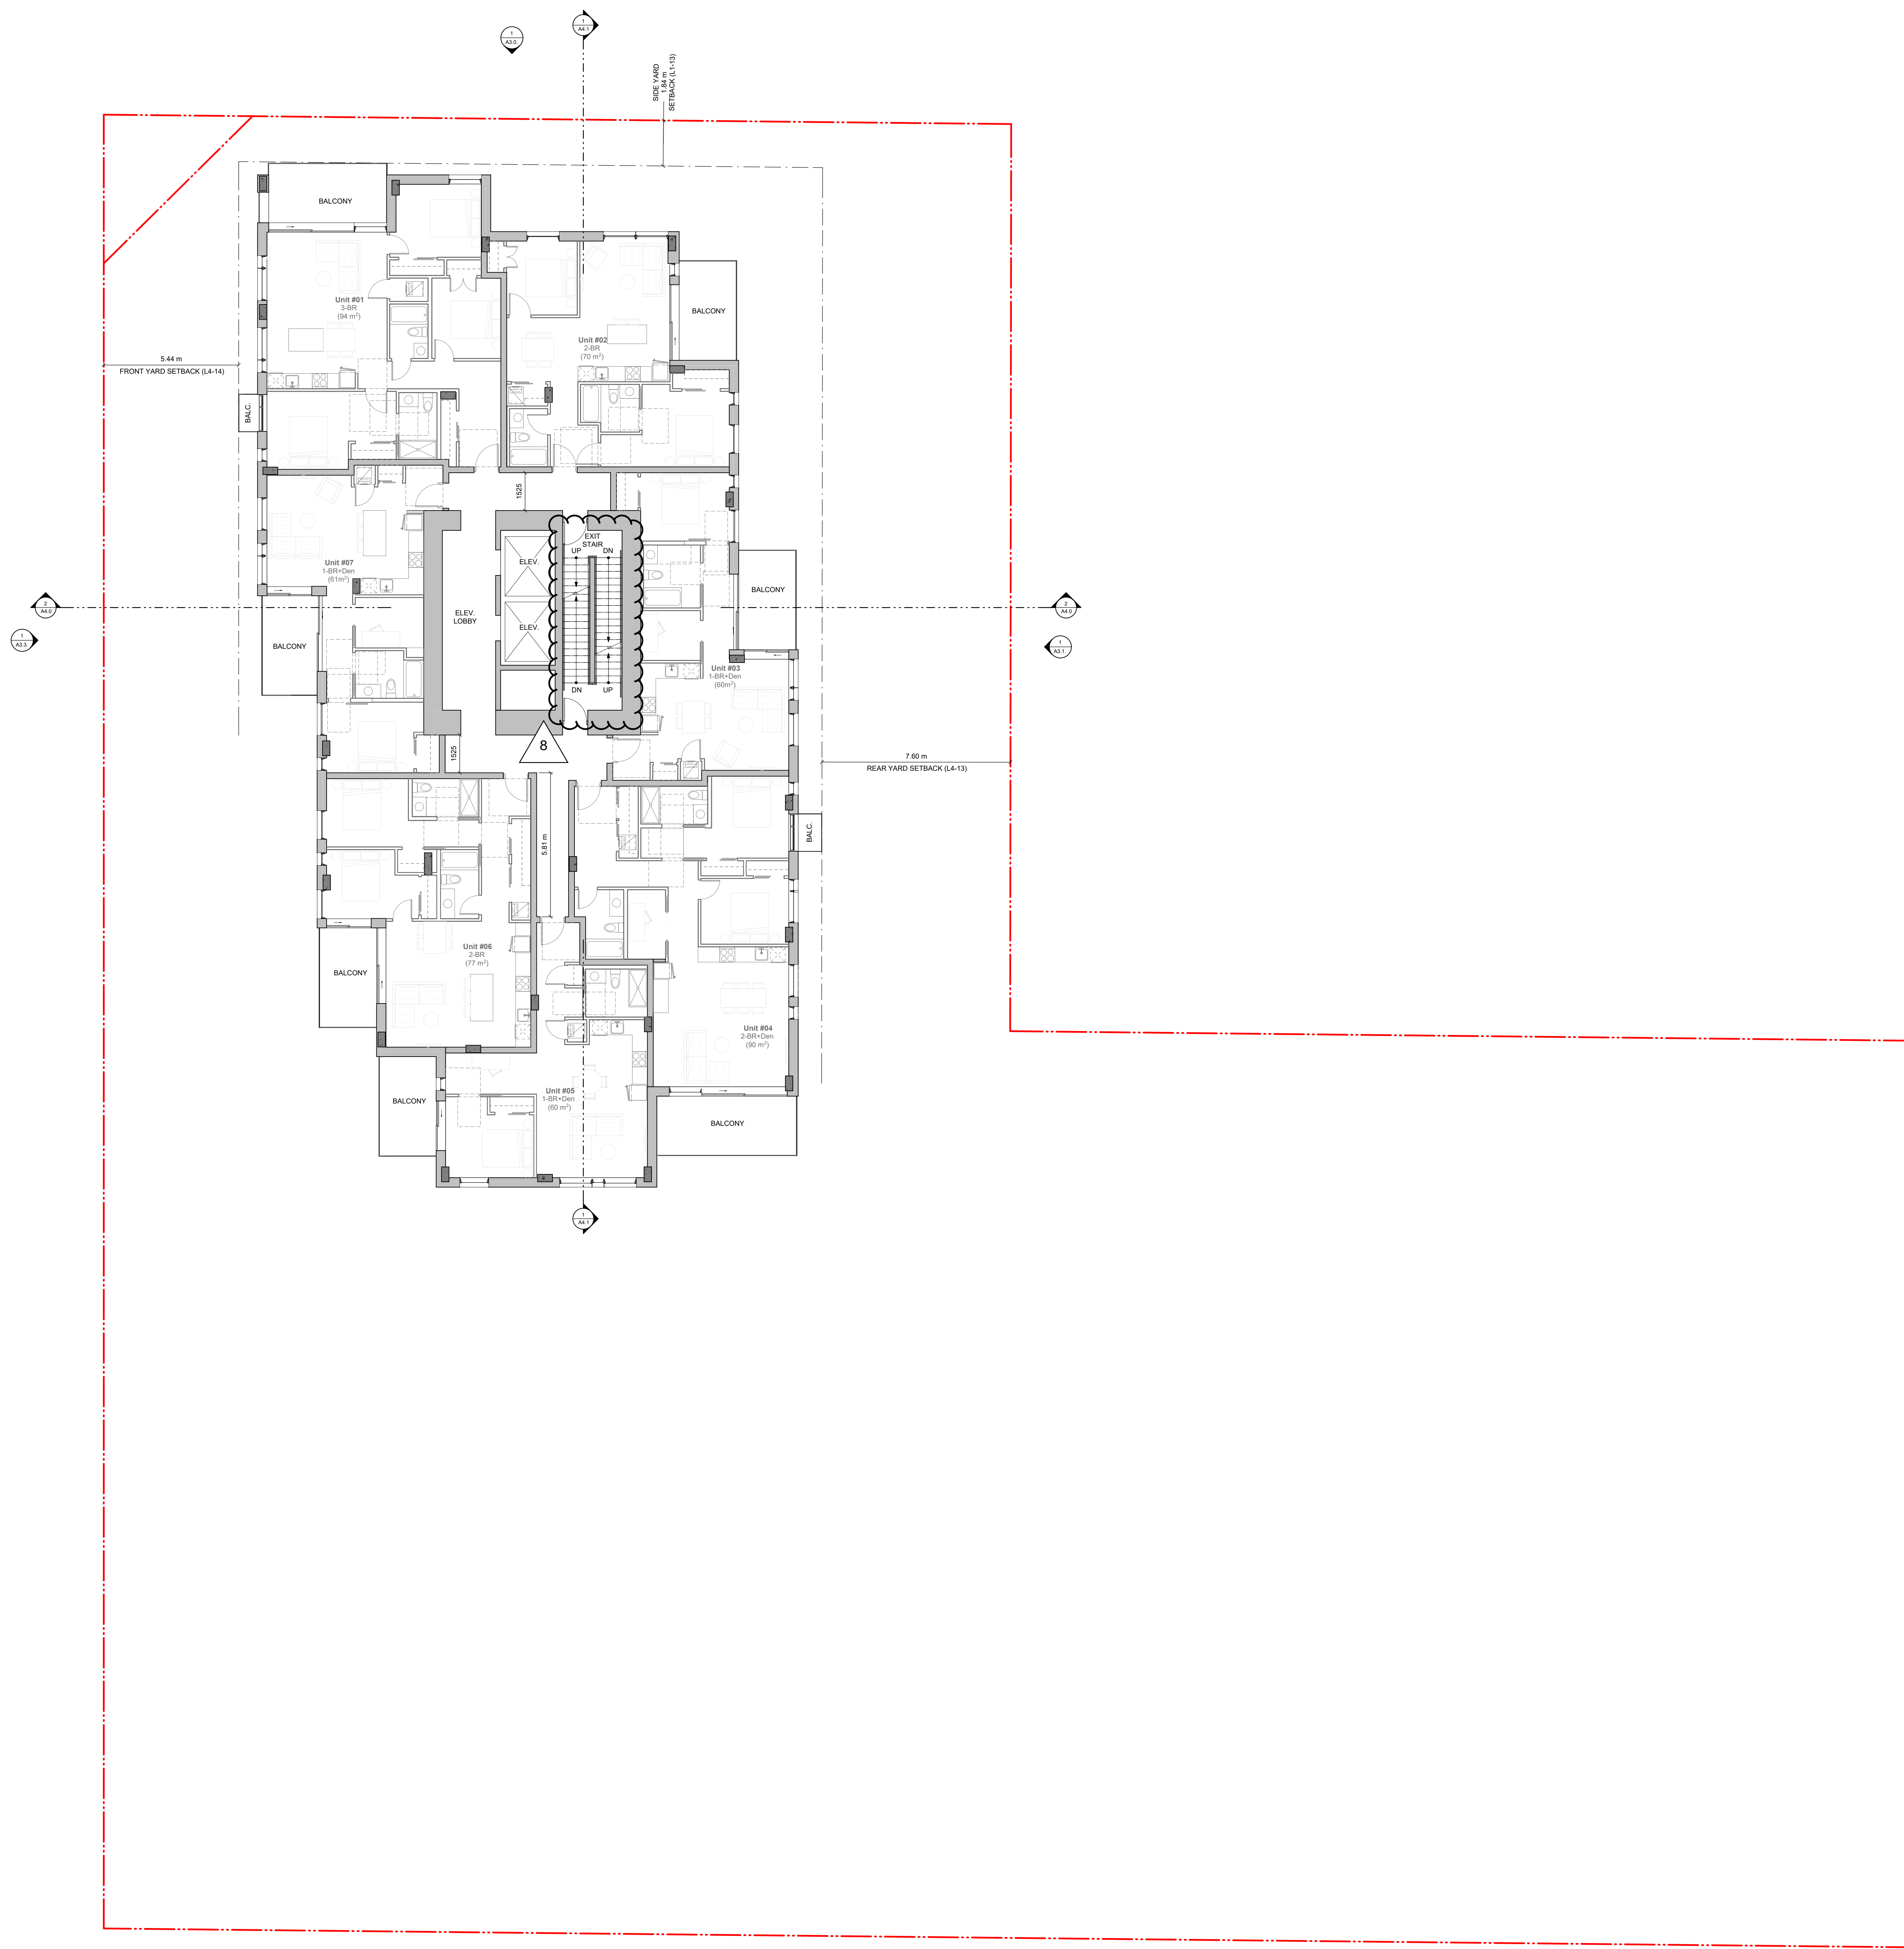
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project name
Montreal and Quebec
205 Quebec Street
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sheet title
Level 5-13 Plan

project no. #21-18
scale 1 : 100
drawn by RP / GK / GB
date issued 05/23/24
sheet no. **A2.6**

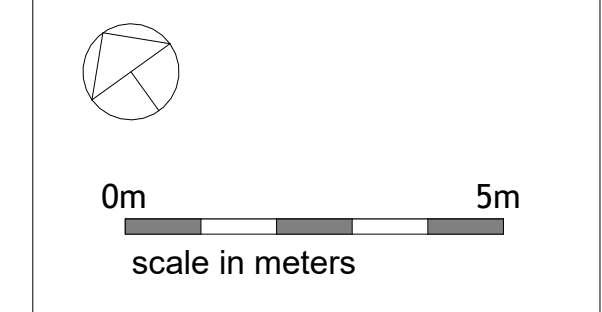

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ELEVATION MATERIALS KEY:

- 1 Cement Panel System
Colour: Sandstone
- 2 Raining Board Brick
Colour: Oatmeal
- 3 Fine Cement Panel
Colour: Dark Grey
- 4 Pre-finished Vertical Wood Siding
- 5 Soffit: T&G Wood
- 6 Glass Guards in Pre-finished Aluminum Frames
- 7 Glazed Canopies: Laminated Glazing on Painted Steel Structure
Colour: Iron / One
- 8 Prefinished Metal Parapet Flashing
Colour: Iron / One
- 9 Prefinished Metal Fascia
Colour: Iron / One
- 10 Perforated Metal Balcony Guard
Colour: Iron / One
- 11 Painted Metal Pergolas and Gates
Colour: Iron / One
- 12 Window and Doors: Clear Glazing in Dark Anodized Aluminum Frames
Colour: Iron / One
- 13 Glass Walls and Guards w/ Aluminum Frame
Colour: Iron / One
- 14 Exposed Architectural Concrete
- 15 Prefinished Metal Louvers
Colour: Iron / One
- 16 Prefinished Metal Panel
Colour: Iron / One



rev no	description	date
6	Rezoncing/DP Resubmission	23.12.22
5	Rezoncing/DP Resubmission	22.12.06
4	Issued for ADP	22.08.02
2	Issued for Rezoncing / DP	21.12.15
1	Issued for Dev. Tracker	21.10.19

project name
Montreal and Quebec
205 Quebec Street
Victoria, BC

sheet title
North Elevation

project no. #21-18
scale 1 : 100
drawn by CF / RP / GB
date issued 05/23/24
sheet no. **A3.0**



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- ELEVATION MATERIALS KEY:**
- ① Cement Panel System
Colour: Sandstone
 - ② Tumbling Brick Brick
Colour: Oatmeal
 - ③ Flute Cement Panel
Colour: Dark Grey
 - ④ Pre-finished Vertical Wood Siding
 - ⑤ Suffix: T&G Wood
 - ⑥ Glass Guards in Pre-finished Aluminum Frames
 - ⑦ Glazed Concrete Laminated Glazing on Panel Steel Structure
Colour: Iron / One
 - ⑧ Prefinished Metal Parapet Flashing
Colour: Iron / One
 - ⑨ Prefinished Metal Fascia
Colour: Iron / One
 - ⑩ Perforated Metal Balcony Guard
Colour: Iron / One
 - ⑪ Painted Metal Pergolas and Gates
Colour: Iron / One
 - ⑫ Anodized Aluminum Frames
Colour: Iron / One
 - ⑬ Glass Walls and Guards w/ Aluminum Frame
Colour: Iron / One
 - ⑭ Exposed Architectural Concrete
 - ⑮ Prefinished Metal Louvers
Colour: Iron / One
 - ⑯ Prefinished Metal Panel
Colour: Iron / One



rev no	description	date
6	Rezonning/DP Resubmission	23.12.22
5	Rezonning/DP Resubmission	22.12.06
4	Issued for ADP	22.08.02
2	Issued for Rezoning / DP	21.12.15
1	Issued for Dev. Tracker	21.10.19

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project name
Montreal and Quebec
205 Quebec Street
Victoria, BC

sheet title
East Elevation

project no. #21-18
scale 1 : 100

drawn by CF / RP / GB
date issued sheet no.

05/23/24 **A3.1**



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- ELEVATION MATERIALS KEY:**
- ① Cement Panel System
Colour: Sandstone
 - ② Tumbling Stone Brick
Colour: Oatmeal
 - ③ Fine Cement Panel
Colour: Dark Grey
 - ④ Pre-finished Vertical Wood Siding
 - ⑤ Soffits: T&G Wood
 - ⑥ Glass Guards in Pre-finished Aluminum Frames
 - ⑦ Glazed Canopies: Laminated Glazing on Painted Steel Structure
Colour: Iron / One
 - ⑧ Prefinished Metal Parapet Flashing
Colour: Iron / One
 - ⑨ Prefinished Metal Fascia
Colour: Iron / One
 - ⑩ Performed Metal Balcony Guard
Colour: Iron / One
 - ⑪ Painted Metal Pergolas and Gates
Colour: Iron / One
 - ⑫ Window and Doors: Clear Glazing in Dark Anodized Aluminum Frames
Colour: Iron / One
 - ⑬ Glass Walls and Guards w/ Aluminum Frame
Colour: Iron / One
 - ⑭ Exposed Architectural Concrete
 - ⑮ Prefinished Metal Louvers
Colour: Iron / One
 - ⑯ Prefinished Metal Panel
Colour: Iron / One



rev no	description	date
6	Rezoning/DP Resubmission	23.12.22
5	Rezoning/DP Resubmission	22.12.06
4	Issued for ADP	22.09.02
2	Issued for Rezoning / DP	21.12.15
1	Issued for Dev. Tracker	21.10.19

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project name
Montreal and Quebec
205 Quebec Street
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sheet title
South Elevation

project no. #21-18
scale 1 : 100
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sheet no. **A3.2**

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- ELEVATION MATERIALS KEY:**
- ① Cement Panel System
Colour: Sandstone
 - ② Flaming Stone Brick
Colour: Oakmead
 - ③ Fine Cement Panel
Colour: Dark Grey
 - ④ Pre-finished Vertical Wood Siding
 - ⑤ Soffits: T&G Wood
 - ⑥ Glass Guards in Pre-finished Aluminum Frames
 - ⑦ Glazed Canopies: Laminated Glazing on Painted Steel Structure
Colour: Iron / One
 - ⑧ Prefinished Metal Parapet Flashing
Colour: Iron / One
 - ⑨ Prefinished Metal Fascia
Colour: Iron / One
 - ⑩ Perforated Metal Balcony Guard
Colour: Iron / One
 - ⑪ Painted Metal Pergolas and Gates
Colour: Iron / One
 - ⑫ Window and Doors: Clear Glazing in Dark Anodized Aluminum Frames
Colour: Iron / One
 - ⑬ Glass Walls and Guards w/ Aluminum Frame
Colour: Iron / One
 - ⑭ Exposed Architectural Concrete
 - ⑮ Prefinished Metal Louvers
Colour: Iron / One
 - ⑯ Prefinished Metal Panel
Colour: Iron / One



rev no	description	date
6	Rezoning/DP Resubmission	23.12.22
5	Rezoning/DP Resubmission	22.12.06
4	Issued for ADP	22.09.02
2	Issued for Rezoning / DP	21.12.15
1	Issued for Dev. Tracker	21.10.19

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project name
Montreal and Quebec
205 Quebec Street
Victoria, BC

sheet title
West Elevation

project no. #21-18
scale 1 : 100
drawn by CF / RP / GB
date issued 05/23/24 sheet no. **A3.3**



2024-06-04

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7	Rezonning DP Resubmission 24.05.23
6	Rezonning DP Resubmission 23.12.22
5	Rezonning DP Resubmission 22.12.06
4	Issued for ADP 22.08.02
3	Rezonning DP Resubmission 20.04.14
2	Issued for Rezonning / DP 21.12.15

rev no	description	date
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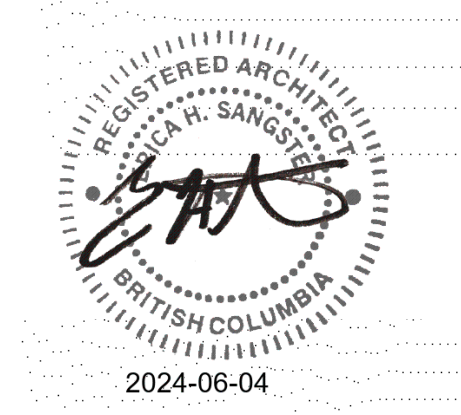
project name
Montreal and Quebec
205 Quebec Street
Victoria, BC

sheet title
Building Sections


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scale 1 : 100
drawn by RP
date issued 05/23/24

sheet no. **A4.0**

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rev no	description	date
7	Rezoning DP Resubmission 24.05.23	
6	Rezoning DP Resubmission 23.12.22	
5	Rezoning DP Resubmission 22.12.06	
4	Issued for ADP	22.08.02
3	Rezoning DP Resubmission 20.04.14	
2	Issued for Rezoning / DP	21.12.15

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project name
Montreal and Quebec
205 Quebec Street
Victoria, BC

sheet title
Building Sections

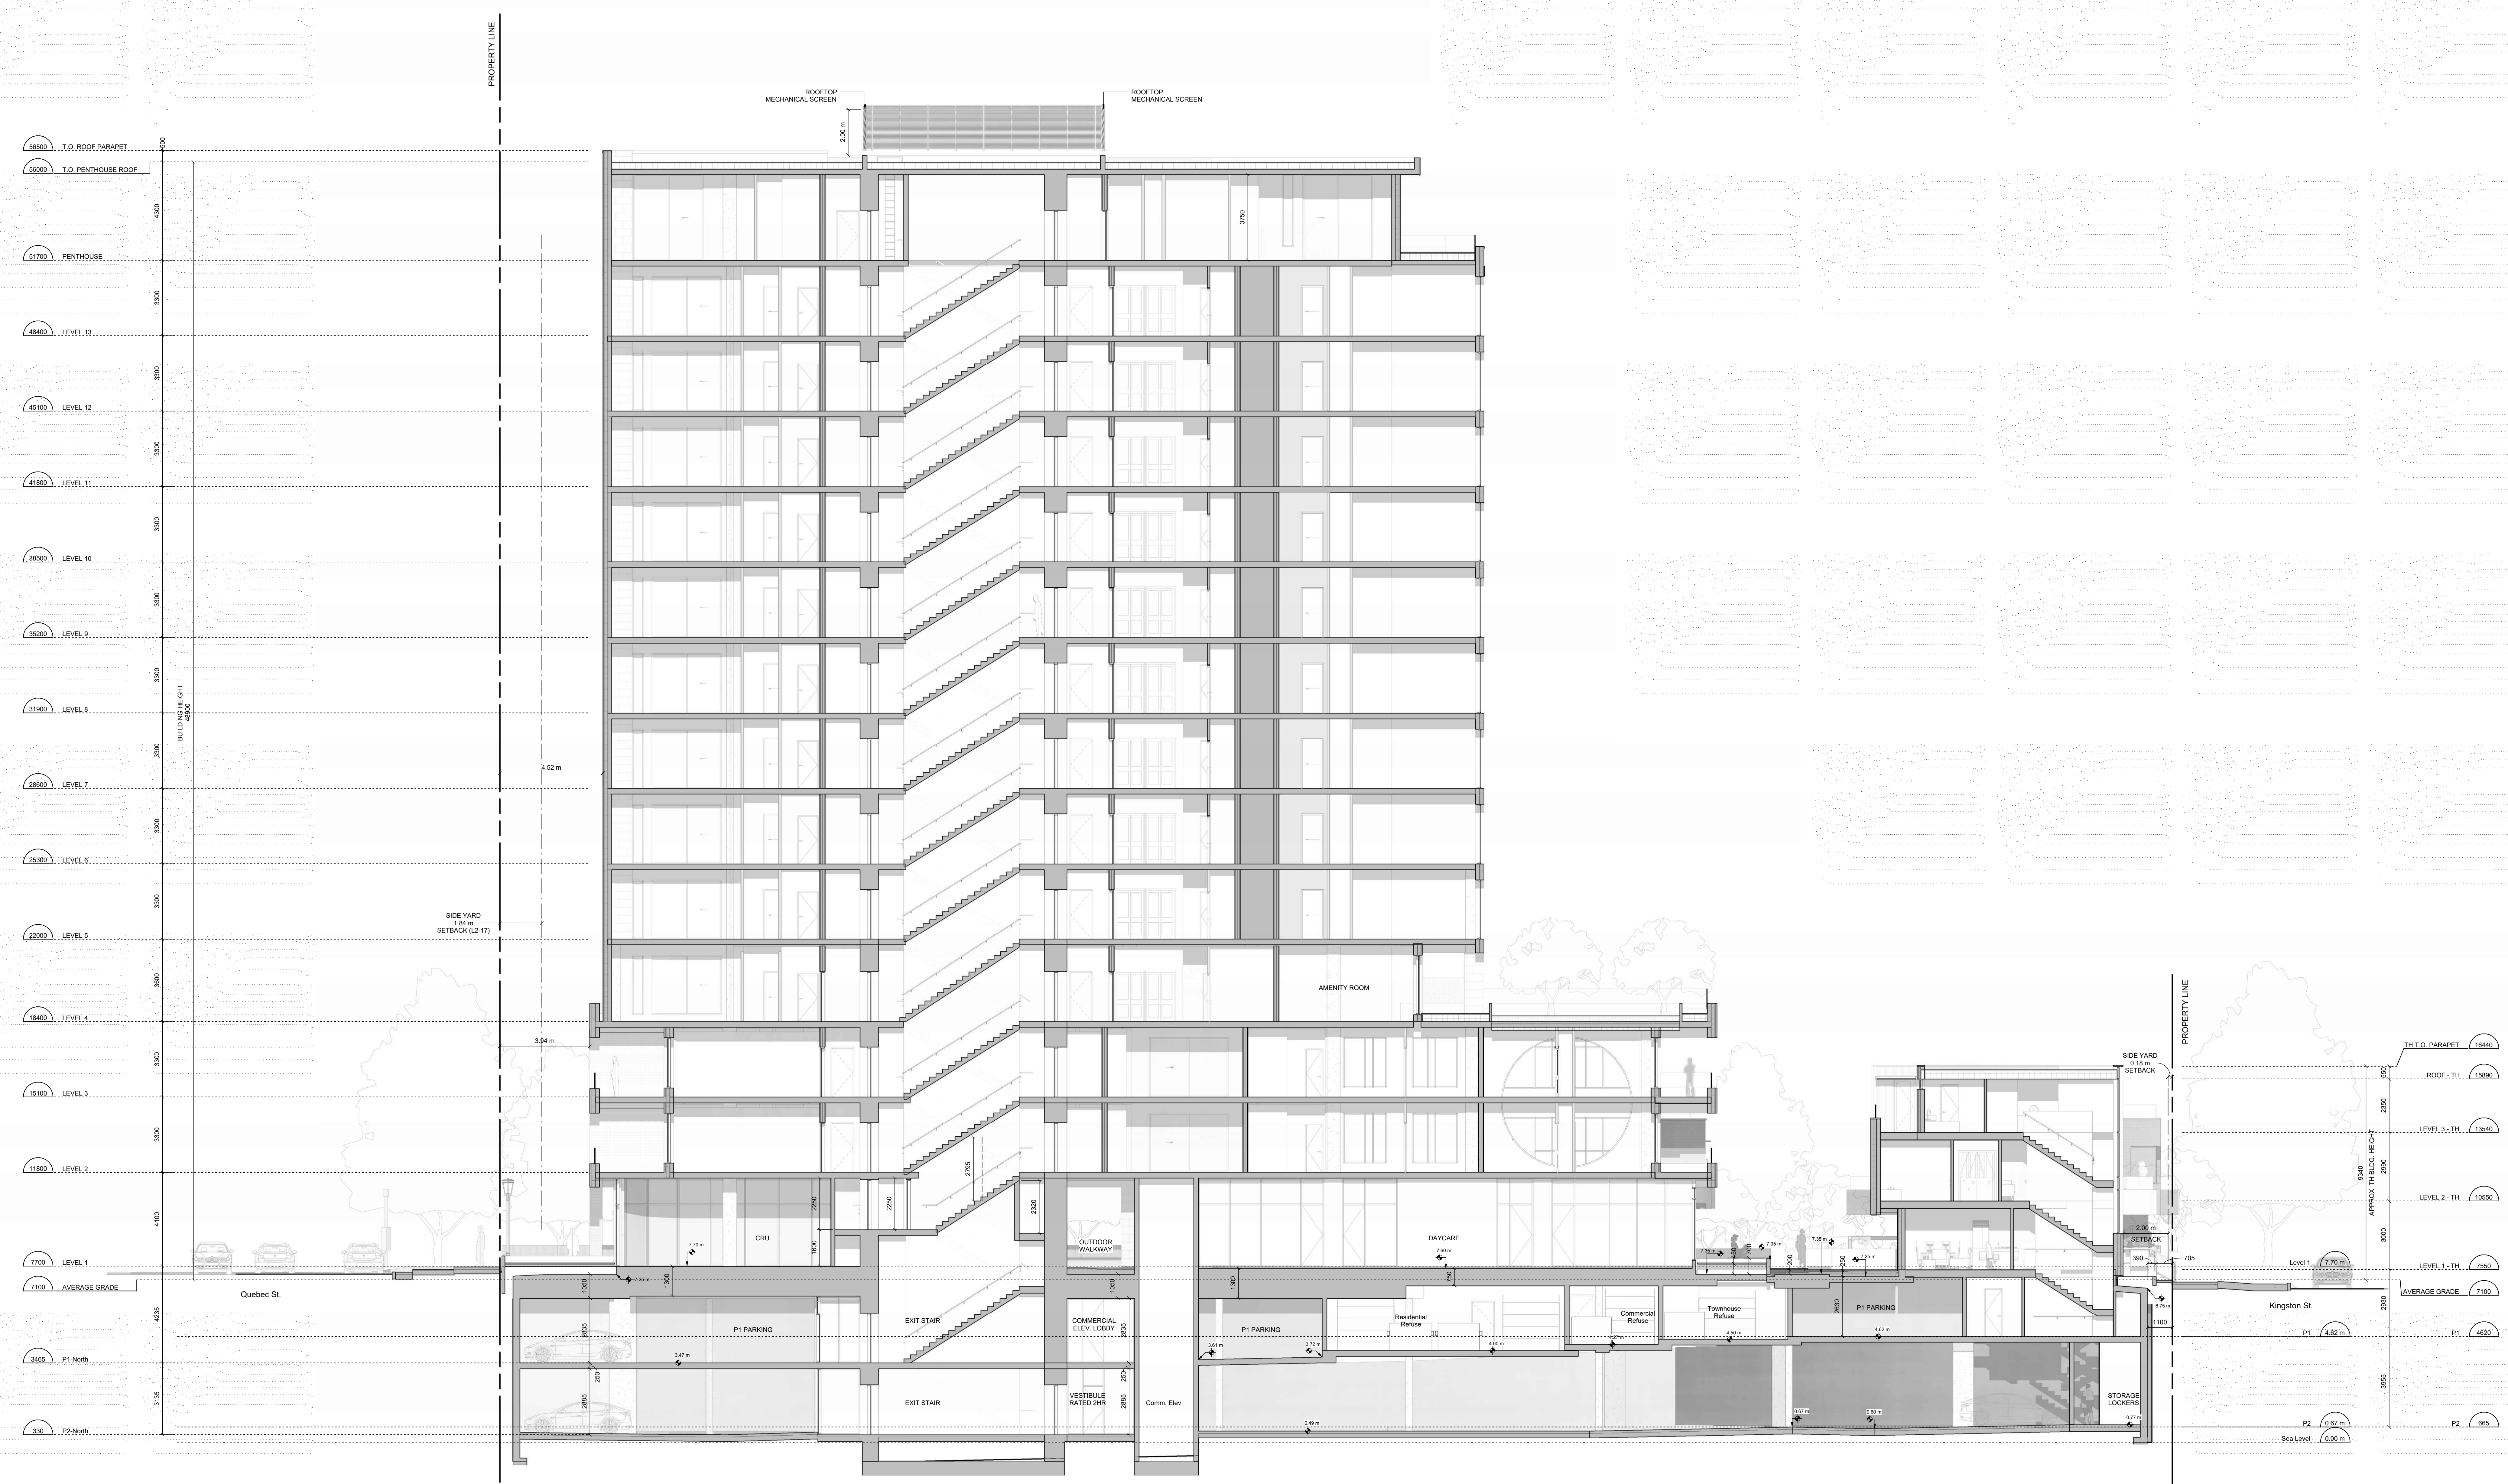project no.	#21-18
scale	1 : 100
drawn by	RP
date issued	05/23/24
sheet no.	A4.1

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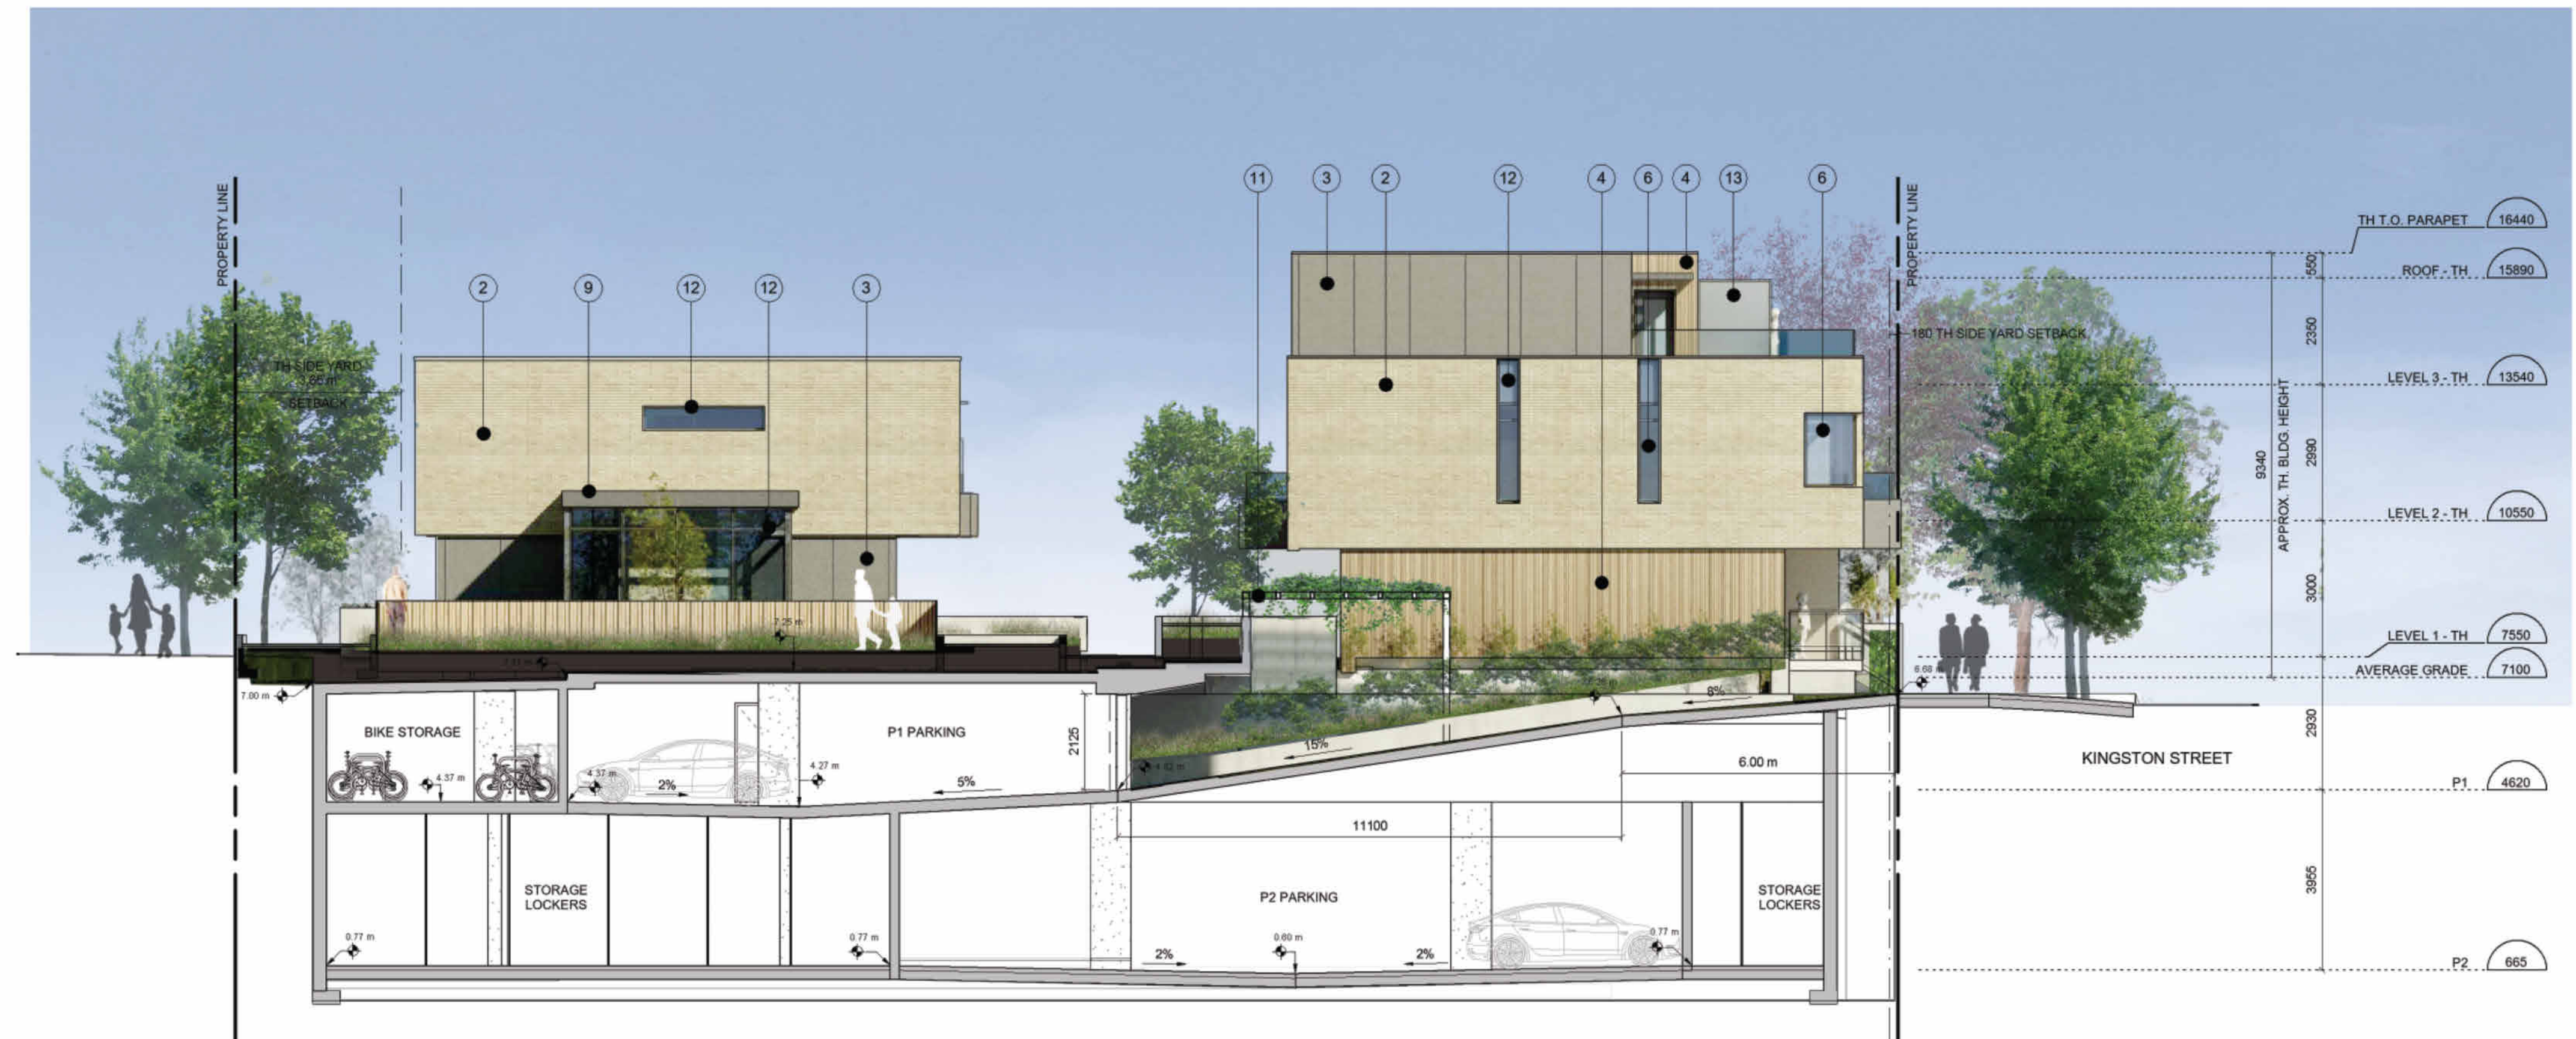
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 - 3 Fibre Cement Panel
Colour: Dark Grey
 - 4 Pre-finished Vertical Wood Siding
 - 5 Soffit: T&G Wood
 - 6 Glass Guards in Pre-finished Aluminum Frames
 - 7 Glazed Canopies, Laminated Glazing on Powder Coated Structure
Colour: Iron / Ole
 - 8 Pre-finished Metal Parapet Flashing
Colour: Iron / Ole
 - 9 Pre-finished Metal Fascia
Colour: Iron / Ole
 - 10 Perforated Metal Balcony Guard
Colour: Iron / Ole
 - 11 Painted Metal Pergolas and Gates
Colour: Iron / Ole
 - 12 Anodized Aluminum Frames
Colour: Iron / Ole
 - 13 Glass Walls and Guards w/ Aluminum Frame
Colour: Iron / Ole
 - 14 Exposed Architectural Concrete
 - 15 Pre-finished Metal Louvers
Colour: Iron / Ole
 - 16 Pre-finished Metal Panel
Colour: Iron / Ole



1 North Elevation - Townhouse
1:100



2 South Elevation - Townhouse
1:100



3 P1 Ramp @ Kingston St
1:100



4 East Elevation - Townhouse
1:100



5 North Elevation - Townhouse
1:100

rev no	description	date
6	Rezoning/DP Resubmission	23.12.22
5	Rezoning/DP Resubmission	22.12.06
4	Issued for ADP	22.08.02
3	Issued for Rezoning / DP	21.12.15

project name
Montreal and Quebec
205 Quebec Street
Victoria, BC

sheet title
Building Section / Elevations


project no. #21-18
scale 1:100
drawn by CF / RP / GK
date issued 05/23/24 sheet no. **A4.2**

Mike Geric Construction

Quebec & Montreal

Victoria, BC

KEY PLAN

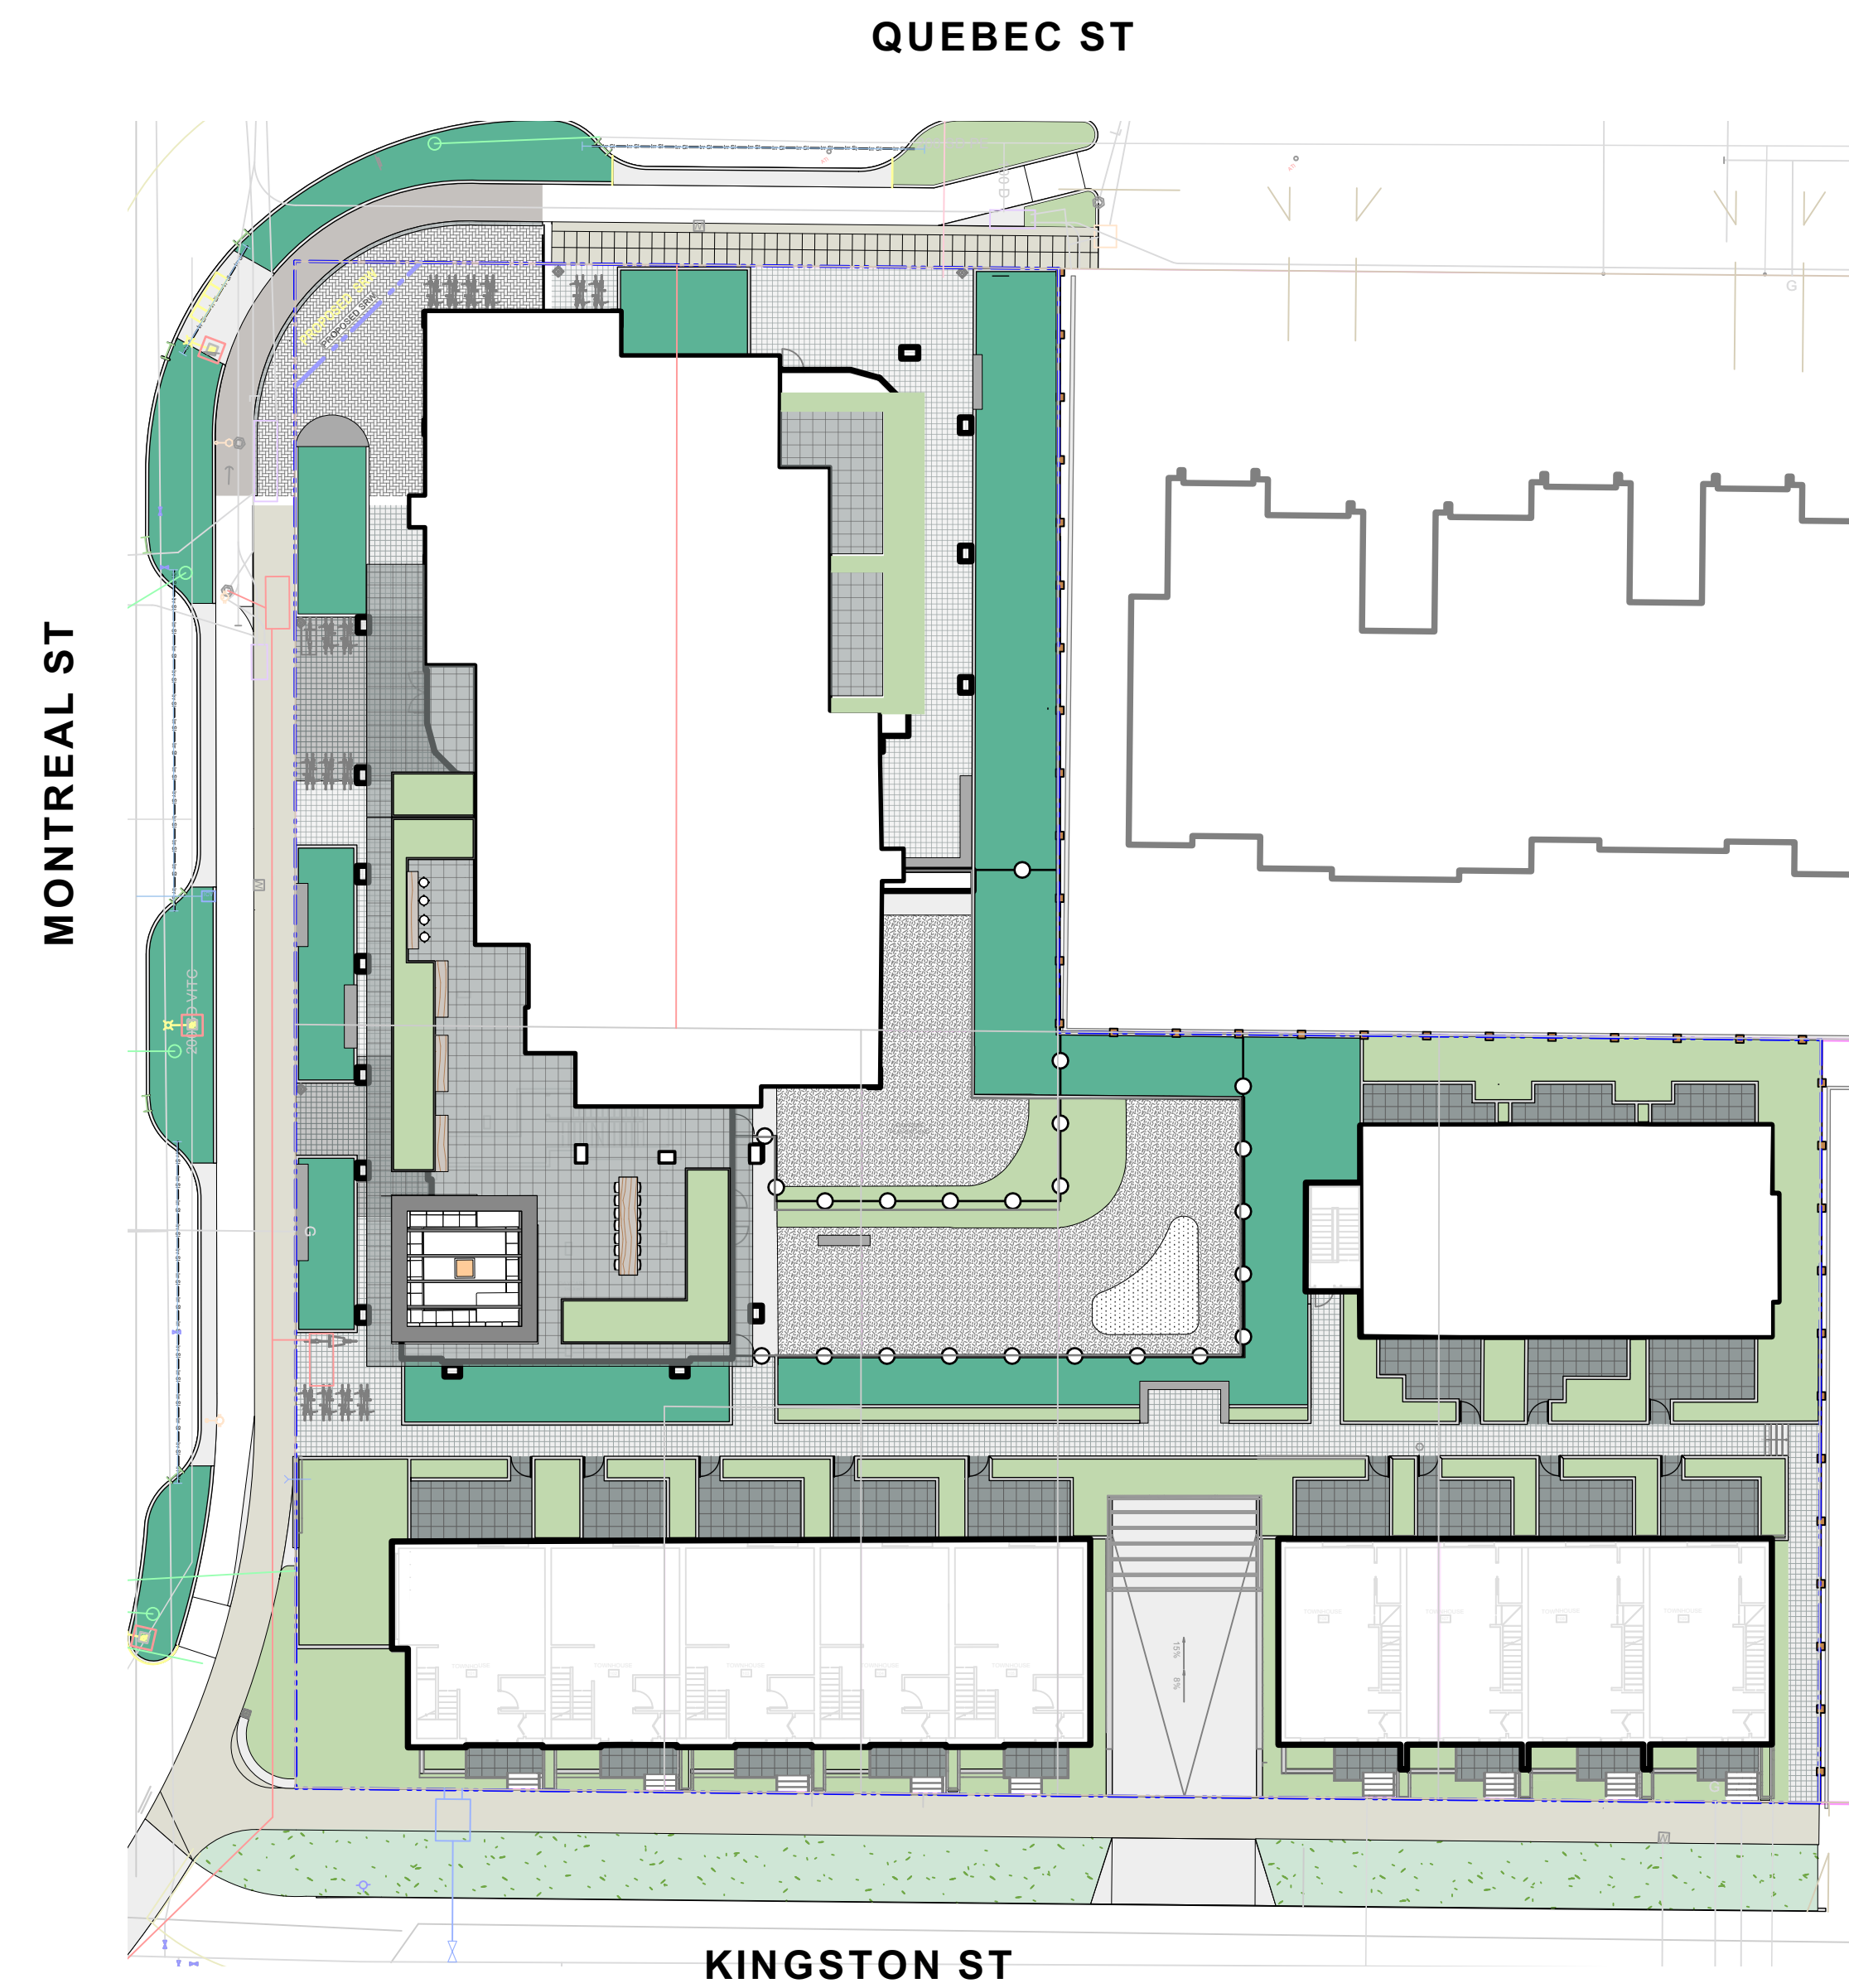

Landscape Sheets	
Sheet No.	Sheet Title
L0.00	Cover
L0.01	General Information Sheet
L0.02	Tree Survey Plan
L0.03	Tree Management Plan
L1.01	Landscape Materials - Ground Level
L1.02	Landscape Materials - Level 4
L1.03	Stormwater Management & Grading
L1.04	Landscape Precedents
L1.05	Landscape Materials - Sections
L1.06	Landscape Materials - Sections
L1.07	Replacement Tree Plan
L3.01	Planting Plan - Ground Level
L3.02	Planting Plan - Level 4
L4.01	Landscape Details

rev no	description	date
9	Rezoning/DP Resub.	2024-05-23
8	REV RZ/DP	2023-01-10
7	REV RZ/DP	2023-03-02
6	REV RZ/DP	2022-12-06
5	REV RZ/DP	2022-08-31
4	For Information	2022-06-27
3	REV RZ/DP	2022-04-14
2	DP	2021-12-16
1	Issued for Dev. Tracker	2021-10-19

MDI
Landscape Architects

3388A Terryson Ave. Phone: 250-412-2891
Victoria, BC V8Z 3P6 Fax: 250-412-2892

REGISTERED MEMBER
Scott Murdoch
341
LANDSCAPE ARCHITECTS
Scott Murdoch
2024-05-31
2024-05-31

client
Mike Geric Construction
4520 West Saanich Rd
Saanich, BC

project
QUEBEC & MONTREAL DEV.
501-502 MONTREAL ST.
VICTORIA, BC

sheet title
Cover

project no. 121.23
scale 1:### @ 24"x36"
drawn by MDI
checked by SM

revision no. sheet no.
9 L0.00

GENERAL NOTES

- Work performed shall comply with the following: a) These General Notes, and Construction Documents and Specifications; b) Canadian Landscape Standards, Current Edition (CLS-CE); and c) All applicable local, provincial, and federal codes, ordinances, and regulations.
- Contractor shall be responsible for verifying all existing site conditions including location of all property lines, existing structures, utilities, and buried infrastructure. Verify all field conditions prior to commencing work.
- Contractor is responsible for determining means and methods for construction. These drawings may indicate a limit of proposed improvements or limit of work for the delineation of expected extents of disturbance. Should limits of disturbance exceed boundaries defined in drawings, contractor shall contact Landscape Architect for resolution.
- Contractor is responsible for repairing all work disturbed by construction outside of limit lines defined on drawings or through their means and methods to a condition better than or equal to the existing conditions prior to commencement of construction at no additional cost to the owner.
- Contractor is responsible for maintaining a complete up-to-date set of drawings and specifications at the construction site and ensuring the documents are readily available for review by the Landscape Architect and governing agency.
- Contractor is responsible for coordination of all designs, drawings, specifications and other documents or publications upon which construction is based. Any discrepancies with the drawings and/or specifications and site conditions shall be brought to the attention of the Landscape Architect, prior to proceeding with construction.
- The drawings and specifications are complementary to one another and implied to correspond with one another. Any discrepancies should be brought to the attention of the Landscape Architect for resolution immediately.
- General Contractor and/or sub-contractors are responsible for all costs related to production and submission to consultant of all landscape as-built information including irrigation.

TREE RETENTION AND REMOVAL NOTES

- Tree protection fencing, for existing trees, to be installed prior to commencement of all site work. Refer to Arborist's plans for location of tree protection fencing, and protection fencing detail.
- Refer to arborist's report for detailed information for existing tree resources.

SITE GRADING AND DRAINAGE NOTES

- All elevations are in meters.
- Refer to Architectural plans, sections and elevations for top of slab elevations. Slab elevations indicated on Landscape drawings are for reference only. Report any discrepancies to consultant for review and response.
- All road, public walkway and vehicular drive aisles and parking area elevations indicated on the Landscape drawings are for reference only. Refer to Civil Engineering drawings. Report any discrepancies to consultant for review and response.
- Confirm all existing grades prior to construction. Report any discrepancies to consultant for review and response.
- Unless otherwise noted provide a minimum slope of 2% on all hard and soft Landscape areas to ensure positive drainage away from buildings, to rain gardens, or to drainage devices.
- All landscape areas shall not exceed a maximum slope of 3:1 in all instances.
- Upon discovery, contractor to refrain from blasting rock to meet landscape subgrades. Contractor to contact Landscape Architect on how to proceed in each instance.

IRRIGATION NOTES

- Contractor to provide irrigation system for all planters to current IAABC Standards and Contract Specifications.
- All specified work to meet the project specifications, and all standards or specifications established in the latest edition of the Canadian Landscape Standard and IAABC standards.
- Design/build drawings for detailed irrigation plan to be submitted to Contract Administrator in PDF and .dwg formats at least two weeks prior to commencement of irrigation installation
- Utilities - Contractor to verify location of all on-site utilities, prior to construction. Restoration of damaged utilities shall be made at the contractor's expense, to the satisfaction of the owner's representatives.
- Refer to electrical drawings for electrical service.
- Controller and backflow prevention device to be located in Mechanical Room, unless otherwise noted. Refer to Mechanical drawings for size and location of irrigation service.
- Contractor to verify pressure and flow prior to installation of irrigation and notify owner's representative in writing if such data adversely affects the operation of the system.
- Sleeves shall be installed at the necessary depths, prior to pavement construction. Sleeving shall extend 300 mm from edge of paving into planting area, and shall have ends marked above grade unless otherwise shown.
- Contractor to field fit irrigation system around existing trees, to limit disturbance to root systems.
- At various milestones during construction, inspection and testing of components will be required to ensure that the performance of irrigation system meets standards and specifications. Contractor to provide equipment and personnel necessary for performance of inspections and tests. Conduct all inspections and tests in the presence of the contract administrator. Keep work uncovered and accessible until successful completion of inspection or test.
- Over spray onto hardscape areas to be minimized. Use drip irrigation within small planting areas to avoid overspray.
- Trees within shrub or rain garden areas to be irrigated with spray heads.
- Trees in Plaza in hard pavement (soil cells below) to receive temporary irrigation system around root collar and permanent drip irrigation system
- Irrigation design shall be submitted for review and approval to City of Victoria Parks no less than 30 days prior to scheduled installation.
- Irrigation Inspections: required for all sleeving, open trench mainline and lateral lines, system operation, controller, backflow preventer (incl. inspection tag and testing report). Call CoV Parks 250-361-0600 min. 2 days in advance to arrange for irrigation inspections.

GROWING MEDIUM NOTES

- Refer to Landscape Specifications for growing medium properties by soil type.
- Advise Contract Administrator of sources of growing medium to be utilized 14 days in advance of starting work.
- Growing medium properties and handling shall meet CLS-CE (see Section 6 CLS-CE).
- Contractor is responsible for soil analysis and amendment requirements to supply suitable growing medium, as specified by testing agency. Soil analysis and amendment costs shall be included in the price for the work.
- Submit to the Landscape Architect a copy of the soil analysis report from Pacific Soil Analysis Inc. 5-11720 Voyageur Way, Richmond, BC, V6X 3G9, p. 604- 273-8226. The analysis shall be of tests done on the proposed growing medium from stratified samples taken from the supply source. Costs of the initial and all subsequent tests to ensure compliance with the specifications shall be borne by the Contractor.
- Contract Administrator will collect sample of growing medium in place and determine acceptance of material, depth of growing medium and finish grading. Approval of growing medium material subject to soil testing and analysis. Planting is not to occur until finished grades have been approved by Contract Administrator.

SITE LAYOUT NOTES

- Provide layout of all work for approval by Contract Administrator prior to proceeding with work. Requests for site review as required 48 hours in advance of performing any work, unless otherwise noted on this sheet.
- Layout and verify dimensions prior to construction. Bring discrepancies to the attention of the Contract Administrator.
- Written dimensions take precedence over scale. Do not scale drawings.
- All plan dimensions in metres and all detail dimensions in millimetres, unless otherwise noted.
- Where dimensions are called as 'equal' or 'eq', space referenced items equally, measured to centre line.

GENERAL PLANTING NOTES

- Plant quantities on Plans shall take precedence over plant list quantities.
- Provide layout of all work for approval by Contract Administrator prior to proceeding with work.
- Plant material, installation and maintenance to conform to the current edition of the Canadian Landscape Standard.
- Plant quantities and species may change between issuance of DP and Construction due to plant availability and design changes.
- Landscape installation to carry a 1 year warranty from date of acceptance. This warranty is based on adequate maintenance by the Owner after Acceptance. The Contractor will not be responsible for plant loss due to extreme climatic conditions such as abnormal freezing temperatures or hail which occur after Acceptance. The Contractor shall be responsible for plant loss due to inadequate acclimatization of plants for their planted location.

ON-SLAB TREE PLANTING NOTES

- For on-slab landscape, a root barrier will be installed to protect exposed water proof membranes. A dimple board (drain mat) will be installed over the root barrier.
- Parkade walls and foundation walls will be protected with a dimple board (drain mat) to convey water to the perimeter drain and protect wall from roots.
- A root barrier will be installed between the tree roots and perimeter drain, to minimize tree root interference with the drain, where the follow conditions exist in on-grade planting areas: a) where trees less than 8m tall are located closer than 2m from a parkade or foundation wall; b) where trees more than 8m tall are located closer than 3m from a parkade or foundation wall; and c) where perimeter drains are less than 2m deep.

BOULEVARD PLANTING NOTES

- Boulevard trees have been placed to avoid existing and proposed infrastructure. Trees planted within 1m of an existing underground municipal service will have a root barrier installed between the root ball and the existing infrastructure.
- Boulevard trees will be place a minimum of 1.5m from an above ground municipal service such as fire hydrant, streetlight or driveway.
- Boulevard tree species have been picked from the municipality's list of recommended boulevard trees or have been selected due their site-adapted qualities. Final selection of boulevard trees to be determined through consultation with municipal parks staff.
- Irrigation to be installed as per Municipal Specifications, for all boulevard planting areas (unless otherwise indicated).
- Design/build drawings for boulevard irrigation to be submitted to Contract Administrator in PDF and .dwg formats, at least two weeks prior to commencement of irrigation installation and will be reviewed by municipal staff.
- Refer to Civil drawings for location of boulevard irrigation point of connection. Separate water meter and timer/controller, to be provided at point of connection. Timer/controller for boulevard areas must be readily accessible to municipal staff.
- Boulevard irrigation to be inspected as per municipal specification by municipal staff. Boulevard tree irrigation system will be maintained and operated by municipality, after it is inspected and approved by municipal staff.
- Soil volume for boulevard trees to be as follows: 8 cu. m. for small trees, 12 cu. m. for medium trees, and 16 cu. m. for large trees.

OFF-SITE IRRIGATION

- Irrigation drawings must be submitted to Parks Division for review and approval 30 days prior to installation work.
- Irrigation Systems on City Property shall comply to City of Victoria Supplementary Specifications for Street Trees and Irrigation Schedule C, Bylaw 12-042, Subdivision Bylaw.
- The following irrigation and sleeving inspections by Parks Staff are required by Schedule C. Please contact Tom Sherbo, tsherbo@victoria.ca and copy treepermits@victoria.ca 48 hours prior to the required inspection time to schedule an inspection.
 - Irrigation sleeving prior to backfilling
 - Open trench main line and pressure test
 - Open trench lateral line
 - irrigation system, controller, coverage test, backflow preventer assembly test report required, backflow assembly is to have an inspection tag completed and attached.

OFF-SITE HORTICULTURE INSPECTIONS REQUIRED

- The following inspections are required for all off-site horticulture areas:
 - Excavated and scarified subgrade prior to placement of growing media.
 - Installed and prepared growing media prior to planting.
 - Plant material on-site prior to planting.
 - Planted landscape prior to much installation.
 - At time that planted and mulched landscape meets the conditions for Total Performance as required by MMCD.

LIST OF ABBREVIATIONS

APPROX	APPROXIMATE	M	METRE
ARCH	ARCHITECT	MAX	MAXIMUM
AVG	AVERAGE	MH	MANHOLE
B&B	BALLED AND BURLAPPED	MIN	MINIMUM
BC	BOTTOM OF CURB	MISC	MISCELLANEOUS
BLDG	BUILDING	MM	MILLIMETRE
BM	BENCHMARK	N	NORTH
BC	BOTTOM OF CURB	NIC	NOT IN CONTRACT
BR	BOTTOM OF RAMP	NO	NUMBER
BS	BOTTOM OF STEP	NOM	NOMINAL
BW	BOTTOM OF WALL	NTS	NOT TO SCALE
CAL	CALIPER	OC	ON CENTER
CB	CATCH BASIN	OD	OUTSIDE DIAMETER
CF	CUBIC FEET	PI	POINT OF CURVATURE
CIP	CAST IN PLACE	PE	POLYURETHANE
CL	CENTER LINE	PL	POINT OF INTERSECTION
CLR	CLEARANCE	PL	PROPERTY LINE
CM	CENTIMETER	PT	POINT, POINT OF TANGENCY
CO	CLEAN OUT	PVC	POLYVINYL CHLORIDE
CONT	CONTINUOUS	QTY	QUANTITY
CU M	CUBIC METRE	R	RADIUS
DEG	DEGREE	REF	REFERENCE
DEMO	DEMOLISH, DEMOLITION	REINF	REINFORCE(D)
DIA	DIAMETER	REQ'D	REQUIRE(D)
DIM	DIMENSION	REV	REVISION
DTL	DETAIL	ROW	RIGHT OF WAY
DWG	DRAWING	S	SOUTH
E	EAST	SAN	SANITARY
EA	EACH	SD	STORM DRAIN
EL	ELEVATION	SF	SQUARE FOOT (FEET)
ENG	ENGINEER	SHT	SHEET
EQ	EQUAL	SIM	SIMILAR
EST	ESTIMATE	SIM	SIMILAR
E.W.	EACH WAY	SPECS	SPECIFICATIONS
EXIST	EXISTING	SQ M	SQUARE METRE
EXP	EXPANSION, EXPOSED	ST	STORM SEWER
FFE	FINISHED FLOOR ELEVATION	STA	STATION
FG	FINISHED GRADE	STD	STANDARD
FL	FLOW LINE	SYM	SYMMETRICAL
FOC	FACE OF CURB	T&B	TOP AND BOTTOM
FT	FOOT (FEET)	TC	TOP OF CURB
FTG	FOOTING	TF	TOP OF FOOTING
GA	GAUGE	TH	THICK
GEN	GENERAL	TOPO	TOPOGRAPHY
GR	GRADE ELEVATION	TR	TOP OF RAMP
HORIZ	HORIZONTAL	TS	TOP OF STEP
HP	HIGH POINT	TW	TOP OF WALL
HT	HEIGHT	TYP	TYPICAL
ID	INSIDE DIAMETER	VAR	VARIABLES
INV	INVERT ELEVATION	VOL	VOLUME
IN	INCH(ES)	W	WIDTH
INCL	INCLUDE(D)	W/O	WITHOUT
JF	JOINT	WT	WEIGHT
LF	LINEAR FEET	WL	WATER LEVEL
LP	LOW POINT	WWF	WELDED WIRE FRAME
		YD	YARD
		@	AT

MATERIALS LEGEND

- 1.0 HARDSCAPE**
- 1.1 Asphalt. See Civil
 - 1.2 CIP Concrete
Light Broom Finish with Tooled Control Joints. Colour: Natural.
 - 1.3 CIP Concrete
Light Broom Finish with Radial Control Joints. Colour: Natural
 - 1.4 Standard Paver
8x8 tile pattern, colour Natural
 - 1.5 Standard Paver
8x8 tile pattern, colour Charcoal
 - 1.6 Patio
'Texada' Hydrapressed Slabs. 457 mm x 457 mm x40 mm. Charcoal colour. Square Grid. Supplier: Abbotsford Concrete. Nonpermeable.

1.0 HARDSCAPE: CITY STANDARDS

See 'Downtown Public Realm Plan & StreetScape Standards', Section 5.1.1 Inner Harbour, for details.

- 1.7 Trowel Joint Concrete.
See L4.01 For Pattern Details
- 1.8 Granite Pavers
@ 300mm x 100mm x 80mm. Mortar set. Paving field. Grey granite. Flamed Finish. Nonpermeable.
- 1.9 Grey Basalt Entry Band
Sandblasted Street name insert, 450mm width, Font Tisa Bro Bold - All caps, Finish Flamed

- 1.10 Granite Pavers
Solider Course Border 200mm Granite Pavers

2.0 DAYCARE

Design TBD by input from Daycare provider

- 2.1 Sand
- 2.2 Safety Surfacing

3.0 WALLS

- 3.1 Concrete Retaining Wall
- 3.2 Concrete Bench
- 3.3 Concrete Curb - See Civil.

4.0 FURNISHINGS

- 4.1 'Downtown Bicycle Rack' As specified in Victoria Downtown Public Plan & Streetscape Standard. No offsite Bike Racks.
- 4.2 Fire pit
- 4.3 Trash Bin
- 4.4 Trellis
- 4.5 Benches
- 4.6 Tables
- 4.7 Shed. See Architecture.

5.0 FENCES AND BARRIERS

- 5.1 1800mm Wood Fence
- 5.2 Picket Fence

6.0 LIGHTING See Arch and Electrical

7.0 PLANTING AREAS

- 7.1 Shrub Area
- 7.4 Rain Garden (See Dwg 1 L1.03 & 4.01)

LINE TYPE LEGEND

- Property line
- Extent of Parkade, below
- Pedestrian Sightline

UNDERGROUND UTILITIES

(Shown for reference only - refer to Civil Engineer's drawings).

- Civil Typical Inlet Drain

GRADING LEGEND


- Existing Landscape Grade
- Civil Grade, provided for reference only
- Architectural grade, provided for reference only
- Proposed Landscape Grade
 - TOW Top of Wall
 - BW Bottom of Wall
 - TOC Top of Curb
 - BC Bottom of Curb
 - TP Top of Pool
 - BP Bottom of Pool
 - TS Top of Stairs
 - BS Bottom of Stairs
 - HP High Point
 - LP Low Point

IRRIGATION LEGEND


- POC** Irrigation Point of Connection
Proposed Irrigation Point of Connection. Provide water service and electrical service from irrigation controller to valves.
- Irr SI** Irrigation Sleeve
Schedule 40 PVC, dia. shall be min 3x main line diameter, or 2x lateral line diameter. Install irrigation wiring in separate 2" electrical conduit. Extend sleeve 300 mm past edge of hard surface or walls.

LANDSCAPE DRAINAGE LEGEND


- Perforated Underdrain
- Sched 40 PVC
- C/O Clean out
- LA Rain Garden Overflow Drain
- L-AD 8" Square drain with ductile iron grate.
- Trench Drain
Aco K100 Trench Drain, Load Class 'A'.
- DRAINS BY OTHERS**
SD BL AD Mechanical Drains (For reference only)

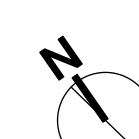

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rev no	description	date




3388A Terryson Ave. Phone: 250-412-2891
Victoria, BC V8C 2P6 Fax: 250-412-2892



2024-05-31

client	Mike Geric Construction 4520 West Saanich Rd Saanich, BC
project	QUEBEC & MONTREAL DEV. 501-502 MONTREAL ST. VICTORIA, BC
sheet title	General Information Sheet

project no.	121.23
scale	NA @ 24"x36"
drawn by	MDI
checked by	SM
revision no.	sheet no.
9	L0.01

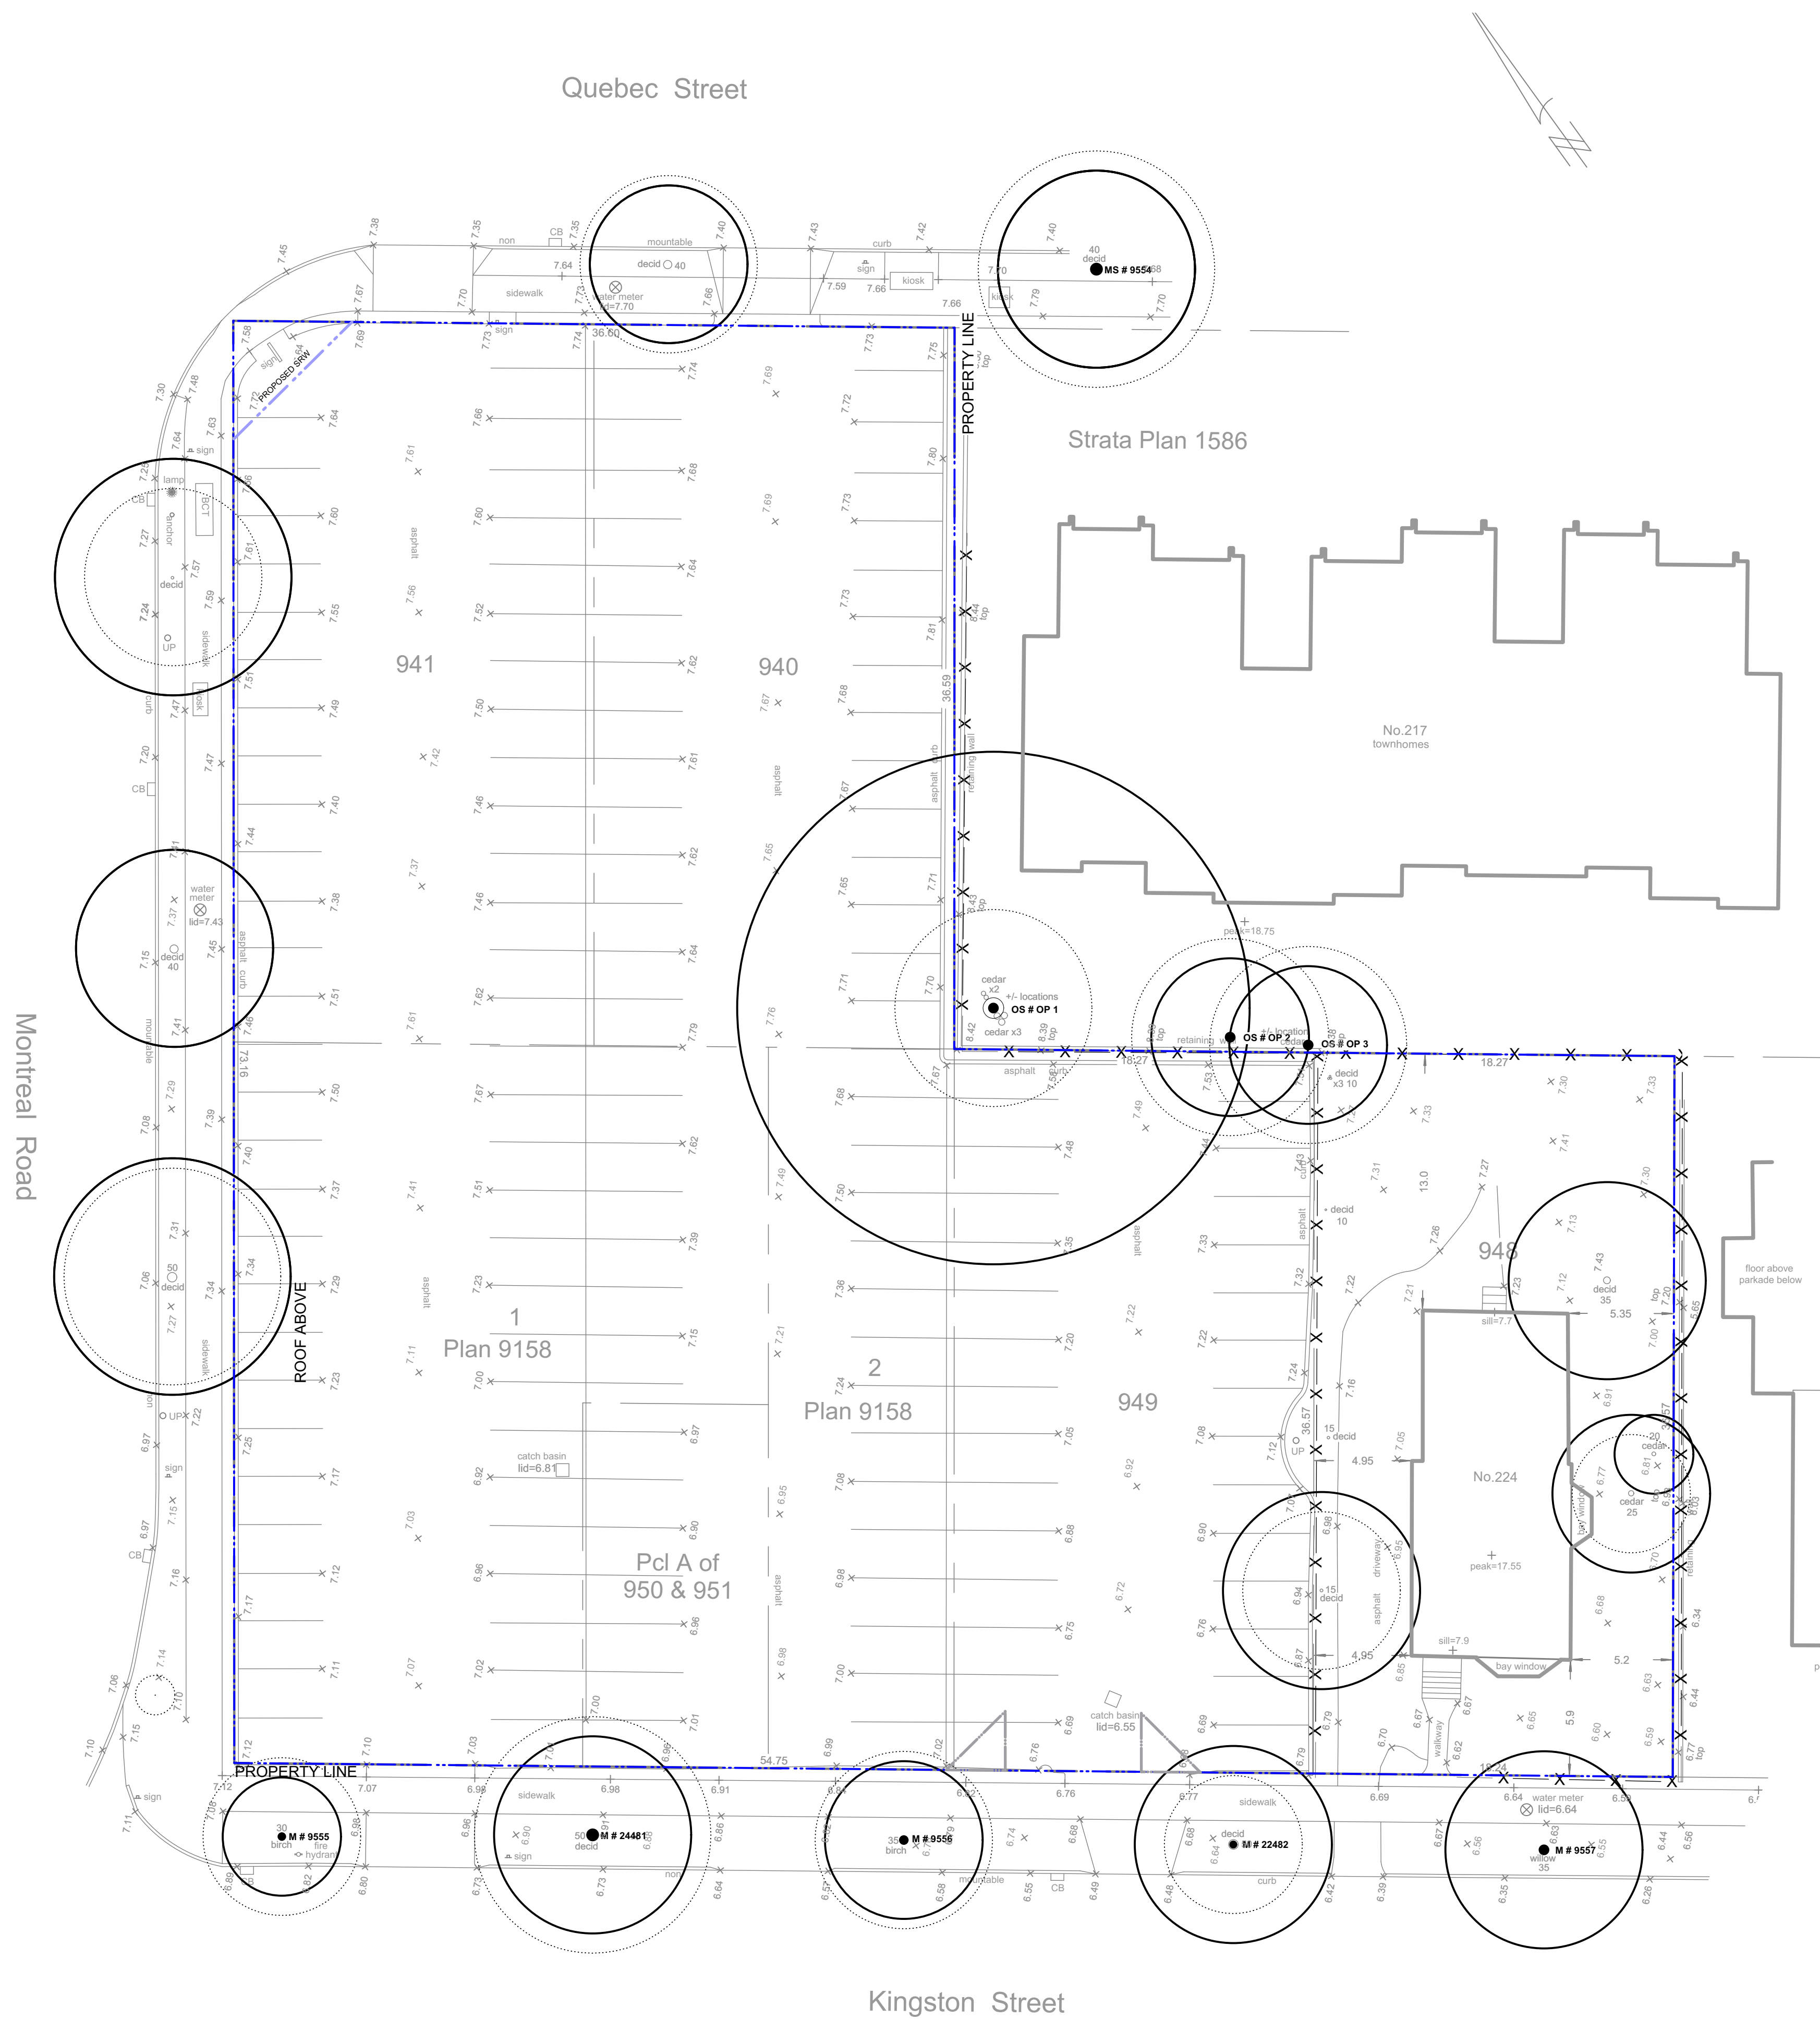

- LINE TYPE LEGEND**
- Property line
 - Right of Way
 - Extent of Roof, above
 - Extent of Parkade, below
 - Rain garden - TOP OF POOL
 - Rain garden - BOTTOM OF POOL



GRADING LEGEND

17.70 Existing Landscape Grade

UNDERGROUND UTILITIES
(Shown for reference only - refer to Civil Engineer's drawings).

- EXISTING**
- Storm drain
 - Sewer
 - Water
 - Electrical
 - Gas
 - Hydro Tel

EXISTING PLANT LEGEND
(Refer to Arborist Report and Tree Retention & Removal Plan for full details and management strategies).

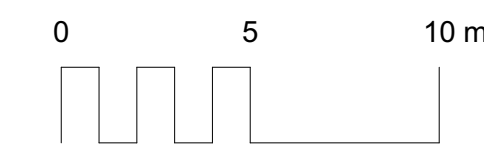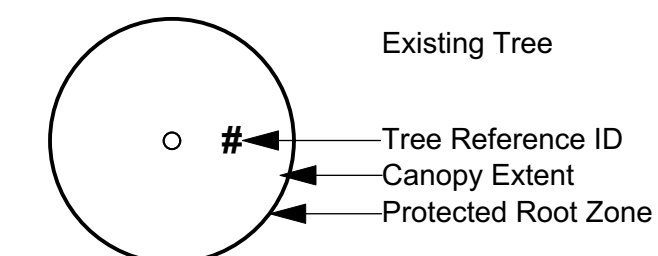

EXISTING TREE INVENTORY*

RETAINED TREES

TREE TAG #	DBH (cm)	CRZ	Species	Crown Spread (m)	Height (m)
9555	27	3	Betula papyrifera	8	9
24481	39	5	Prunus cerasifera	12	9
24482	38	5	Prunus cerasifera	7	9
9557	39	4	Betula pendula	10	11
9554	42	5	Aesculus carnea	12	9
Op1	105	12	Thuja plicata	10	14
Op2	35	4	Cedrus deodard	9	18
Op3	35	4	Sequoiadendron giganteum	9	10
2556	34	4	Betula papyrifera	9	10

TOTAL TREES TO BE RETAINED: 9

REMOVED TREES

TREE TAG #	DBH (cm)	Species	Crown Spread (m)	Height (m)
24460	35	Sorbus intermedia	9	0
24480	3	Prunus sargentii	1	3
24479	53	Prunus cerasifera	11	8
24478	44	Prunus cerasifera	10	8
24477	50	Prunus cerasifera	9	8
1	35	Thuja plicata smaragd	3	6
2	14	Thuja plicata smaragd	2	6
3	39	Pyrus sp.	5	4
4	44	Ilex aquifolium	4	6

TOTAL TREES TO BE REMOVED: 9

* Based on Arborist's Report received from Arborist, Dec 20, 2023. Refer to Arborist report and memo for details on tree conditions and Arborist recommendations.

D. Clark Arboriculture
2741 The Rise Victoria B.C. V8T-3T4
(250)474-1552 (250)208-1568
clarkarbor@gmail.com
www.dclarkarboriculture.com
Certified Arborist PN-6523A

rev no	description	date
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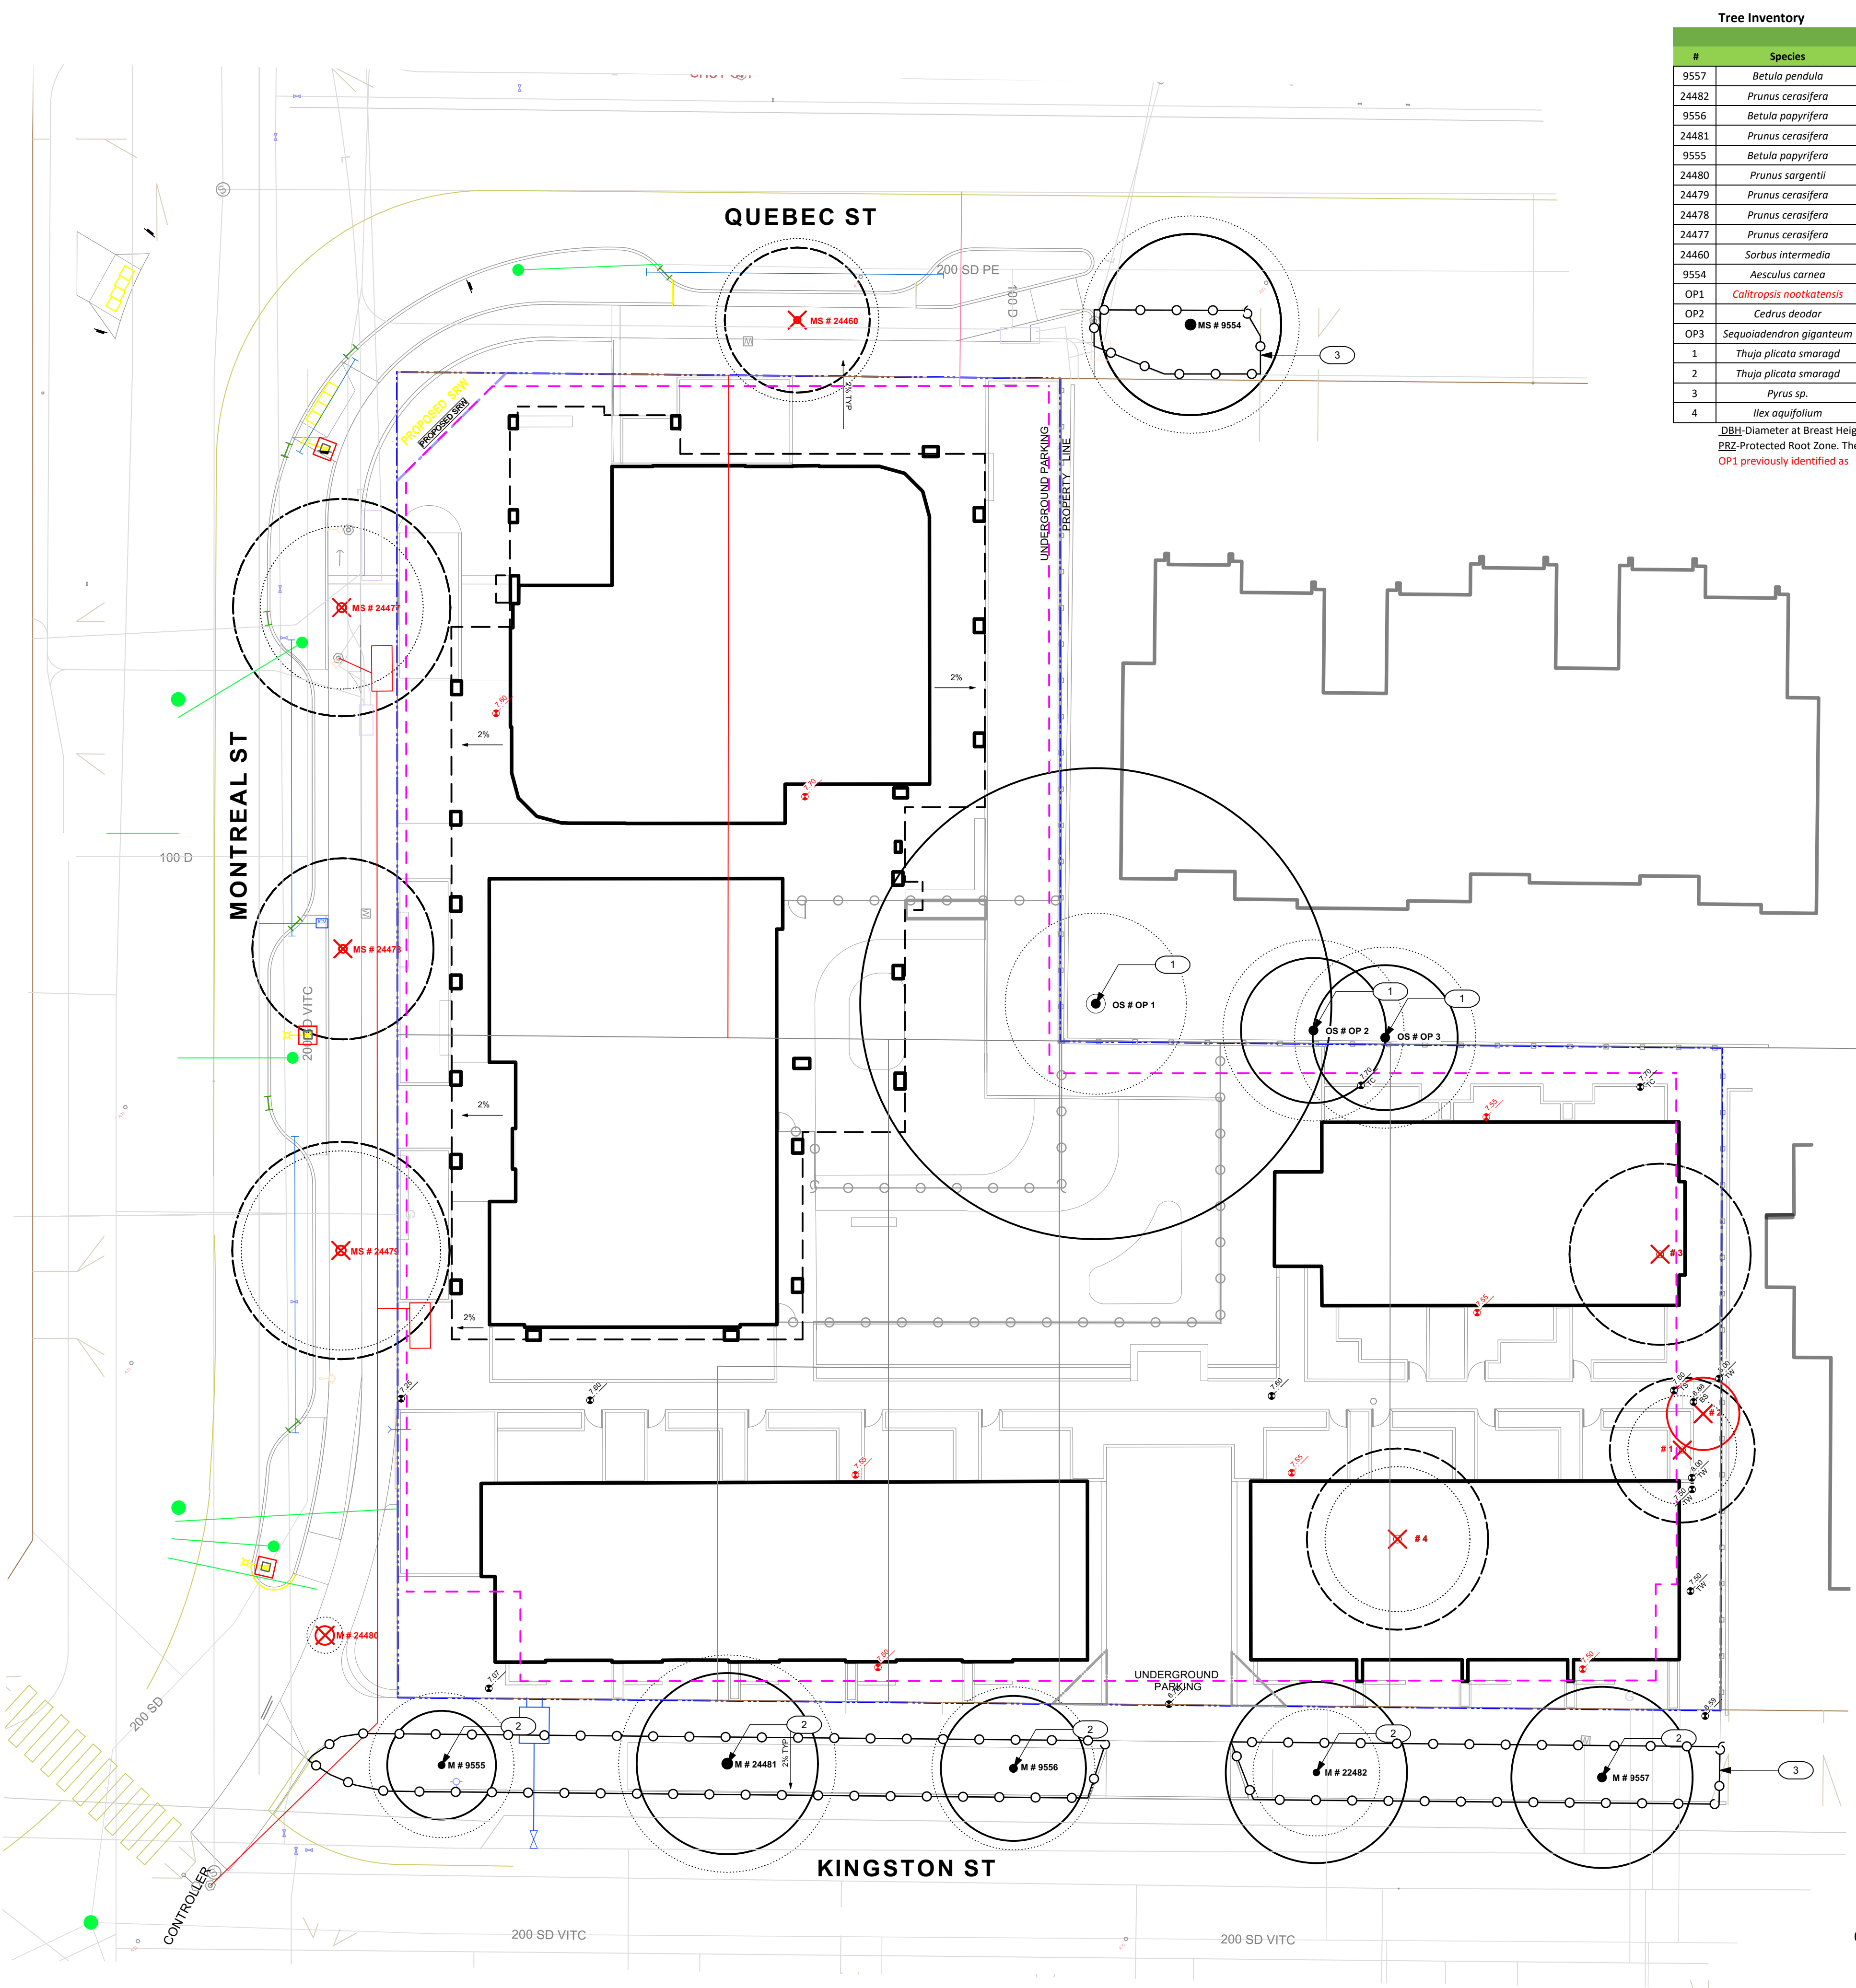


client
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4520 West Saanich Rd
Saanich, BC

project
QUEBEC & MONTREAL DEV.
501-502 MONTREAL ST.
VICTORIA, BC

sheet title
Tree Survey Plan

project no.	121.23
scale	1: 200 @ 24"x36"
drawn by	MDI
checked by	SM
revision no.	sheet no.



Tree Inventory

Kingston Residential Inventory of Trees												
#	Species	cm/DBH	Height/m	Spread	PRZ/m	Structure	Health	Bylaw protected	Retain/Remove	Reason for Removal	Additional Comments	Impact
9557	<i>Betula pendula</i>	39	11	10	5	Fair	Fair	Blvd	Retain		potentially impacted, requires supervision during excavations etc.	Unknown
24482	<i>Prunus cerasifera</i>	38	9	7	5	Fair	Fair	Blvd	Retain		potentially impacted by sidewalk upgrades and site servicing	Severe
9556	<i>Betula papyrifera</i>	34	10	9	4	Good	Fair	Blvd	Retain		potentially impacted by sidewalk upgrades and site servicing	Severe
24481	<i>Prunus cerasifera</i>	39	9	12	5	Fair	Fair	Blvd	Retain		potentially impacted by sidewalk upgrades and site servicing	Severe
9555	<i>Betula papyrifera</i>	27	9	8	3	Good	Fair	Blvd	Retain		potentially impacted by sidewalk upgrades and site servicing	Severe
24480	<i>Prunus sargentii</i>	3	3	1	0	Good	Good	Blvd	Remove	SW expansion and rehab	potentially impacted by sidewalk upgrades and site servicing	Severe
24479	<i>Prunus cerasifera</i>	53	8	11	6	Fair	Fair	Blvd	Remove	SW expansion and rehab	potentially impacted by sidewalk upgrades and site servicing	Severe
24478	<i>Prunus cerasifera</i>	44	8	10	5	Fair	Poor	Blvd	Remove	SW expansion and rehab	potentially impacted by sidewalk upgrades and site servicing	Severe
24477	<i>Prunus cerasifera</i>	50	8	9	6	Fair	Fair	Blvd	Remove	SW expansion and rehab	potentially impacted by sidewalk upgrades and site servicing	Severe
24460	<i>Sorbus intermedia</i>	35	9	9	4	Good	Good	Blvd	Remove	SW expansion and rehab	potentially impacted by sidewalk upgrades and site servicing	Severe
9554	<i>Aesculus carnea</i>	42	9	12	5	Good	Good	Blvd	Retain		potentially impacted by sidewalk upgrades and site servicing	Unknown
OP1	<i>Callitropsis nootkatensis</i>	105	14	10	13	Fair	Fair	yes	Retain		requires supervision during preconstruction exploratory excavation	Moderate
OP2	<i>Cedrus deodar</i>	35	18	10	4	Fair	Good	yes	Retain		requires supervision during excavations	Moderate
OP3	<i>Sequoiadendron giganteum</i>	35	10	9	4	Good	Fair	yes	Retain		requires supervision during excavations	Moderate
1	<i>Thuja plicata smaragd</i>	35	6	3	4	Fair	Fair	yes	Remove	within bldg footprint		Severe
2	<i>Thuja plicata smaragd</i>	14	6	2	2	Fair	Fair	yes	Remove	within bldg footprint		Severe
3	<i>Pyrus sp.</i>	39	4	5	5	Poor	Fair	yes	Remove	within bldg footprint		Severe
4	<i>Ilex aquifolium</i>	44	6	4	5	Poor	Good	yes	Remove	within bldg footprint		Severe

DBH: Diameter at Breast Height. Measured at 1.4m from the point of germination. Where the tree is multi-stemmed at 1.4m, the DBH shall be considered 100% of the stems rounded to the nearest cm.
 PRZ: Protected Root Zone. The PRZ shall be considered 12x the DBH radially, rounded to the nearest whole meter. TBD: To Be Determined. There is insufficient information to determine the suitability of retention.
 OP1 previously identified as *Thuja plicata*

- LINE TYPE LEGEND**
- Property line
 - Right of Way
 - Extent of Roof, above
 - Extent of Parkade, below
 - Rain garden - TOP OF POOL
 - Rain garden - BOTTOM OF POOL
- GRADING LEGEND**
- Existing Landscape Grade
- UNDERGROUND UTILITIES**
 (Shown for reference only - refer to Civil Engineer's drawings).
- | EXISTING | PROPOSED |
|-------------|----------|
| Storm drain | |
| Sewer | |
| Water | |
| Electrical | |
| Gas | |
| Hydro Tel | |

- EXISTING PLANT LEGEND**
 (Refer to Arborist Report and Tree Retention & Removal Plan for full details and management strategies).
- Retaining
 - Tree Reference ID
 - Canopy Extent
 - Protected Root Zone
 - Removal
 - Tree Reference ID
 - Canopy Extent

- REFERENCE NOTES**
- Requires onsite supervision of trees during excavation
 - Potentially impacted by site serving and grading
 - Tree Protection Fencing, refer to Arborist's report for further information.

N

D. Clark Arboriculture
 2741 The Rise Victoria B.C. V8T-3T4
 (250)474-1552 (250)208-1568
 clarkarbor@gmail.com
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 Certified Arborist PN-6523A

9	Rezoning/DP Resub.	2024-05-23
8	REV RZ/DP	2023-01-10
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6	REV RZ/DP	2022-12-06
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rev no	description	date

MDI
 Landscape Architects

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BRITISH COLUMBIA SOCIETY OF LANDSCAPE ARCHITECTS
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Scott Murdoch
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 4520 West Saanich Rd
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project
QUEBEC & MONTREAL DEV.
 501-502 MONTREAL ST.
 VICTORIA, BC

sheet title
Tree Management Plan

project no.	121.23
scale	1:200 @ 24"x36"
drawn by	MDI
checked by	SM
revision no.	sheet no.
9	L0.03



- 5.0 **FENCES AND BARRIERS**
 - 5.1 1800mm Wood Fence
 - 5.2 Picket Fence
- 6.0 **LIGHTING** See Arch and Electrical
- 7.0 **PLANTING AREAS**
 - 7.1 Shrub Area
 - 7.4 Rain Garden (See Dwg 1 L1.03 & 4.01)

- MATERIALS LEGEND**
- 1.0 **HARDSCAPE**
 - 1.1 Asphalt. See Civil
 - 1.2 CIP Concrete
Light Broom Finish with Tooled Control Joints. Colour: Natural.
 - 1.3 CIP Concrete
Light Broom Finish with Radial Control Joints. Colour: Natural
 - 1.4 Standard Paver
8x8 tile pattern, colour Natural
 - 1.5 Standard Paver
8x8 tile pattern, colour Charcoal
 - 1.6 Patio
'Texada' Hydrapressed Slabs. 457 mm x 457 mm x40 mm. Charcoal colour. Square Grid. Supplier: Abbotsford Concrete. Nonpermeable.

- 1.0 **HARDSCAPE: CITY STANDARDS**
See 'Downtown Public Realm Plan & StreetScape Standards', Section 5.1.1 Inner Harbour, for details.
- 1.7 Trowel Joint Concrete.
See L4.01 For Pattern Details
 - 1.8 Granite Pavers
@ 300mm x 100mm x 80mm. Mortar set. Paving field. Grey granite. Flamed Finish. Nonpermeable.
 - 1.9 Grey Basalt Entry Band
Sandblasted Street name insert, 450mm width, Font Tisa Bro Bold - All caps, Finish Flamed
 - 1.10 Granite Pavers
Solider Course Border 200mm Granite Pavers

- 2.0 **DAYCARE**
Design TBD by input from Daycare provider
- 2.1 Sand
 - 2.2 Safety Surfacing
- 3.0 **WALLS**
- 3.1 Concrete Retaining Wall
 - 3.2 Concrete Bench
 - 3.3 Concrete Curb - See Civil.

- 4.0 **FURNISHINGS**
- 4.1 'Downtown Bicycle Rack' As specified in Victoria Downtown Public Plan & Streetscape Standard. No offsite Bike Racks.
 - 4.2 Fire pit
 - 4.3 Trash Bin
 - 4.4 Trellis
 - 4.5 Benches
 - 4.6 Tables
 - 4.7 Shed. See Architecture.

- REFERENCE NOTES**
- 1 Plaza with built-in concrete benches with built in tables, covered patio seating and bike parking. Inner harbour paving materials.
 - 2 Pedestrian walkway through site.
 - 3 Day care spaces. Design to be confirmed / modified to meeting Island Health ECE Standards and input from daycare provider.
 - 4 Residential streetscape with walk-up patios. Retained street trees.
 - 5 Runoff from the condo and day care rooftops managed in rain gardens.
 - 6 Rain gardens integrated into streetscape to manage street runoff.

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2024-05-31

client	Mike Geric Construction 4520 West Saanich Rd Saanich, BC
project	QUEBEC & MONTREAL DEV. 501-502 MONTREAL ST. VICTORIA, BC
sheet title	Landscape Materials - Ground Level
project no.	121.23
scale	1:200 @ 24"x36"
drawn by	MDI
checked by	SM
revision no.	sheet no.
9	L1.01

QUEBEC ST

MONTREAL ST

KINGSTON ST

5.0 FENCES AND BARRIERS

- 5.1 1800mm Wood Fence
- 5.2 Picket Fence

6.0 LIGHTING See Arch and Electrical

7.0 PLANTING AREAS

- 7.1 Shrub Area
- 7.4 Rain Garden (See Dwg 1 L1.03 & 4.01)

REFERENCE NOTES

- 1 Fire pit nook with seating.
- 2 Dining area. with long harvest-style picnic tables.
- 3 Pergola.
- 4 High table with bar stools
- 5 Private patio spaces.

MATERIALS LEGEND

1.0 HARDSCAPE

- 1.1 Asphalt. See Civil
- 1.2 CIP Concrete Light Broom Finish with Tooled Control Joints. Colour: Natural.
- 1.3 CIP Concrete Light Broom Finish with Radial Control Joints. Colour: Natural
- 1.4 Standard Paver 8x8 tile pattern, colour Natural
- 1.5 Standard Paver 8x8 tile pattern, colour Charcoal
- 1.6 Patio 'Texada' Hydrapressed Slabs. 457 mm x 457 mm x40 mm. Charcoal colour. Square Grid. Supplier: Abbotsford Concrete. Nonpermeable.

1.0 HARDSCAPE: CITY STANDARDS

See 'Downtown Public Realm Plan & StreetScape Standards', Section 5.1.1 Inner Harbour, for details.

- 1.7 Trowel Joint Concrete. See L4.01 For Pattern Details
- 1.8 Granite Pavers @ 300mm x 100mm x 80mm. Mortar set. Paving field. Grey granite. Flamed Finish. Nonpermeable.
- 1.9 Grey Basalt Entry Band Sandblasted Street name insert, 450mm width, Font Tisa Bro Bold - All caps, Finish Flamed
- 1.10 Granite Pavers Solider Course Border 200mm Granite Pavers

2.0 DAYCARE

Design TBD by input from Daycare provider


- 2.1 Sand
- 2.2 Safety Surfacing

3.0 WALLS


- 3.1 Concrete Retaining Wall
- 3.2 Concrete Bench
- 3.3 Concrete Curb - See Civil.

4.0 FURNISHINGS


- 4.1 'Downtown Bicycle Rack' As specified in Victoria Downtown Public Plan & Streetscape Standard. No offsite Bike Racks.
- 4.2 Fire pit
- 4.3 Trash Bin
- 4.4 Trellis
- 4.5 Benches
- 4.6 Tables
- 4.7 Shed. See Architecture.

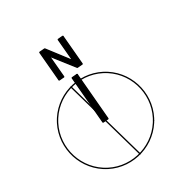

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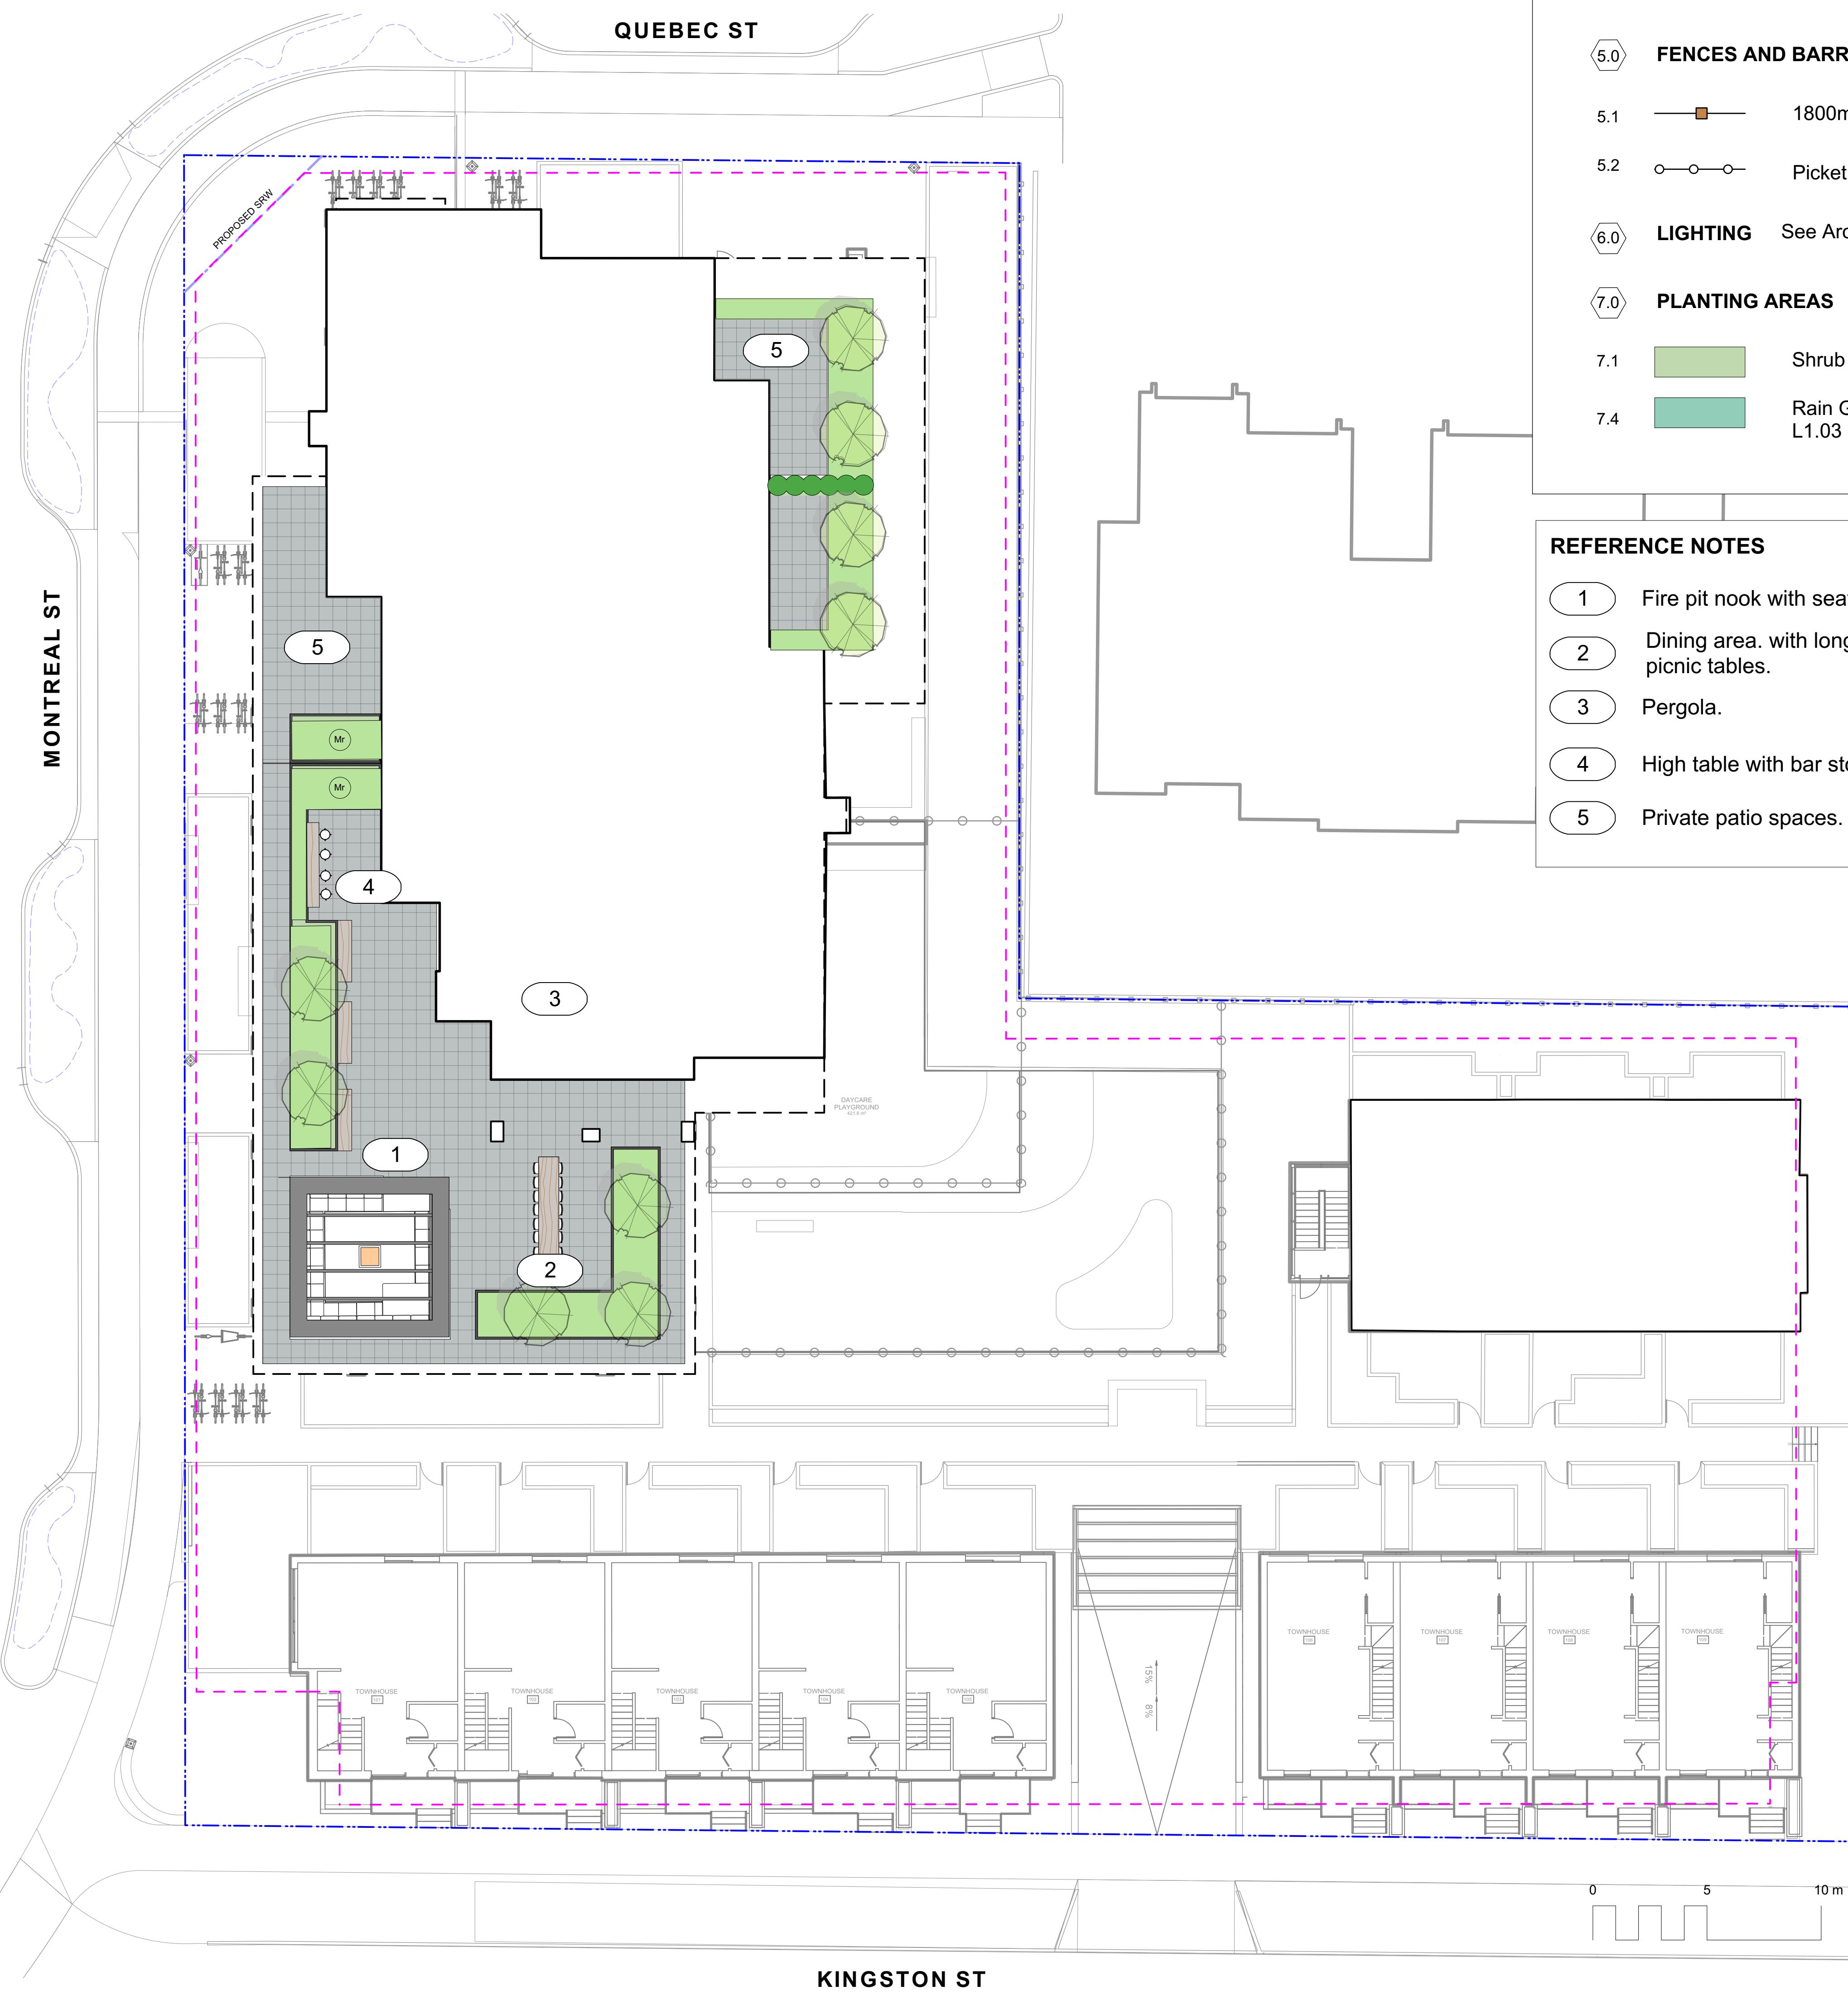


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Scott Murdoch
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LANDSCAPE ARCHITECT
2024-05-31

client	Mike Geric Construction 4520 West Saanich Rd Saanich, BC
project	QUEBEC & MONTREAL DEV. 501-502 MONTREAL ST. VICTORIA, BC
sheet title	Landscape Materials - Level 4
project no.	121.23
scale	1:150 @ 24"x36"
drawn by	MDI
checked by	SM
revision no.	sheet no.
9	L1.02





LEGEND

- PROPERTY LINE
 - - - - - EXTENT OF UNDERGROUND PARKING (INDICATIVE)
 - EXTENT OF ROOF / CANOPY LINE (INDICATIVE)
 - - - - - RAIN GARDEN - TOP OF POOL
 - - - - - RAIN GARDEN - BOTTOM OF POOL
 - 16.50 EXISTING GRADE (APPROXIMATE)
 - 16.45 PROPOSED ARCH GRADE
 - 16.35 PROPOSED LANDSCAPE GRADE
 - TP TOP OF POOL
 - BP BOTTOM OF POOL
 - DIRECTION OF FLOW
 - RAIN GARDEN ON GRADE
- IMPERVIOUS AREAS**
- ROOF DRAINS TO RAIN GARDEN
 - ROAD / HARDSCAPE DRAINS TO RAIN GARDEN

RAIN WATER MANAGEMENT NOTES


Water collected from road areas, building roofs, flow to the rain gardens located throughout the site.

Rain gardens are integrated building landscapes and landscape bulges within streetscape areas and are designed to capture, slow flows, and treat runoff from roadways.

Rain gardens will be designed with underdrains and a high-capacity overflow drain that will be connected to the onsite piped drainage system.

The rain gardens are sized such that the bottom of the rain garden is 5% of the impervious area to meet or exceed City of Victoria Green Stormwater Infrastructure Guidelines.

Boulevard rain gardens to be designed to City of Victoria Standards

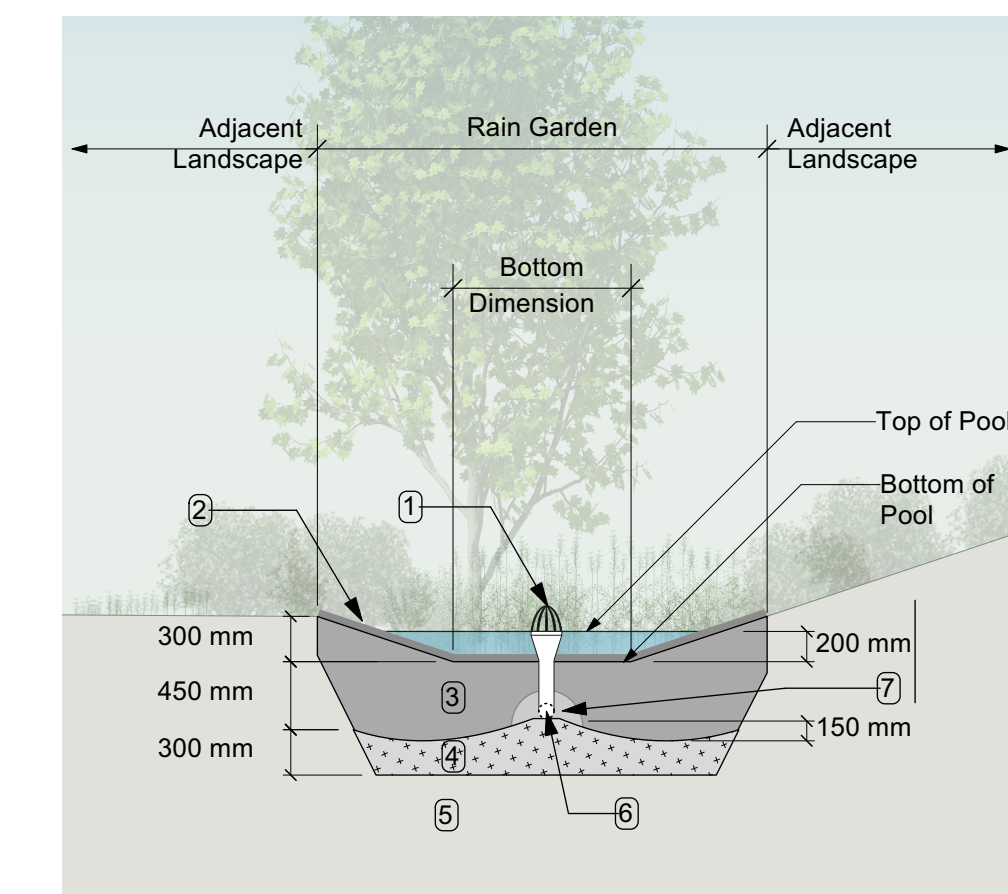


RAIN GARDEN MATERIALS

1. Overflow drain, 200 mm domed grate + adapter
2. Composted mulch, 50 -70 mm depth
3. Bio-retention growing medium, 450 mm depth
4. Scarified/tilled subgrade, 300 mm depth
5. Existing subgrade/native material
6. 100 mm diameter (min) perforated pipe
7. 25 mm diameter drain rock, 100 mm depth

1 Typical Rain Garden
Scale: 1:50

GRADING NOTES

1. All grades slope 2% from the building to back of curb.
2. Slab grade varies
3. All landscape walls are an average of 500mm height.
4. Kingston St Townhouses require 3-4 risers to meet grade.
5. Proposed curb grades to be determined by Civil (proposed grades will be similar to existing grades. See Civil for details)
6. All sidewalk slope 2% to back of curb.

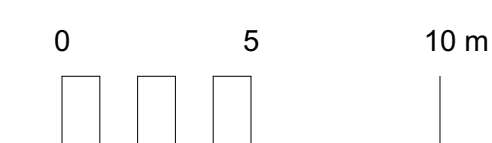


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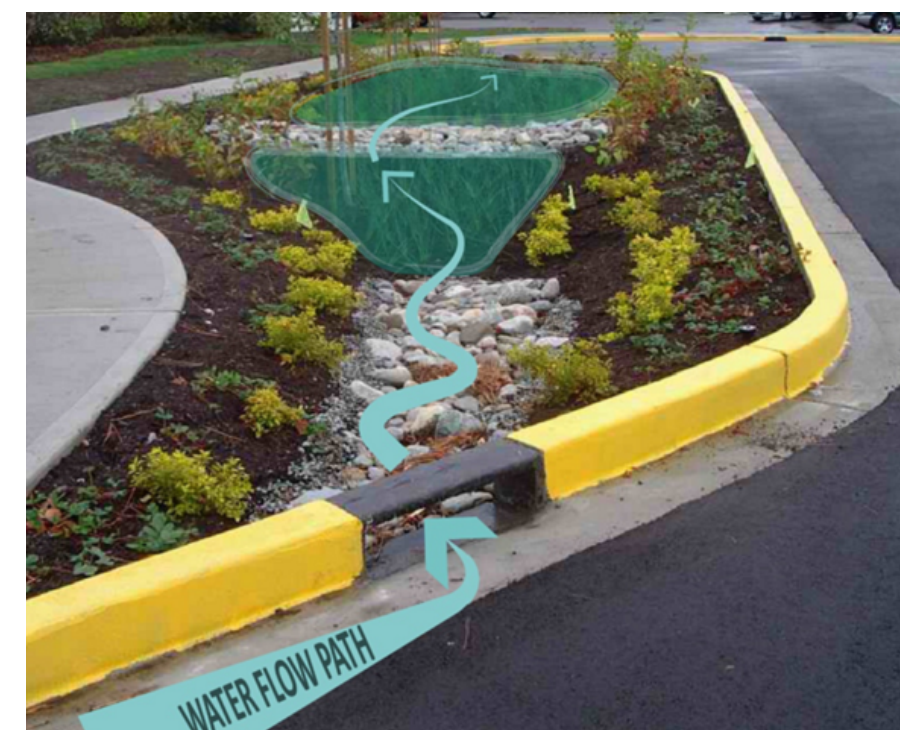
2024-05-31

client	Mike Geric Construction 4520 West Saanich Rd Saanich, BC
project	QUEBEC & MONTREAL DEV. 501-502 MONTREAL ST. VICTORIA, BC
sheet title	Stormwater Management & Grading
project no.	121.23
scale	1: 200 @ 24"x36"
drawn by	MDI
checked by	SM
revision no.	sheet no.
9	L1.03



ROOFTOP COMMON SPACE

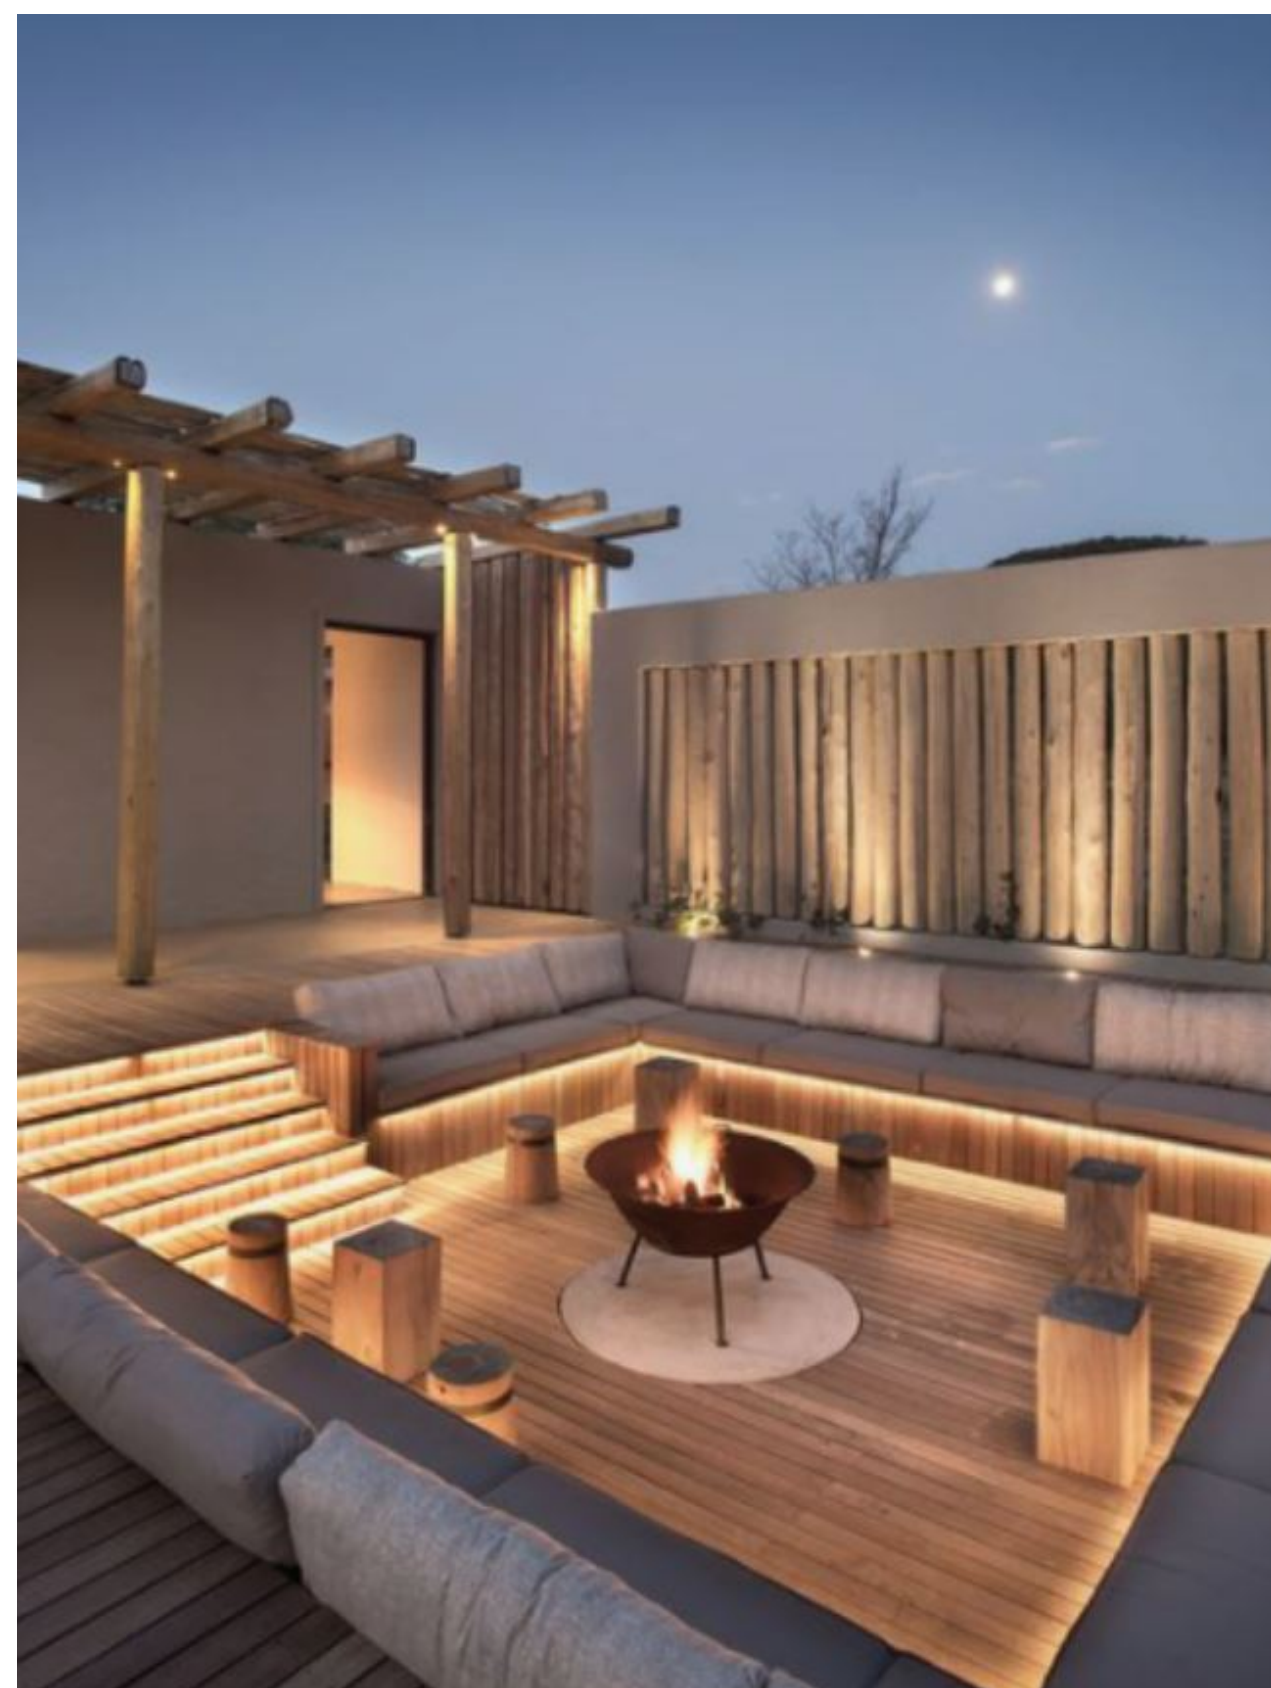DAYCARE - PLAY




STREETSCAPE MONTREAL & QUEBEC

STREETSCAPE KINGSTON



rev no	description	date
9	Rezoning/DP Resub.	2024-05-23
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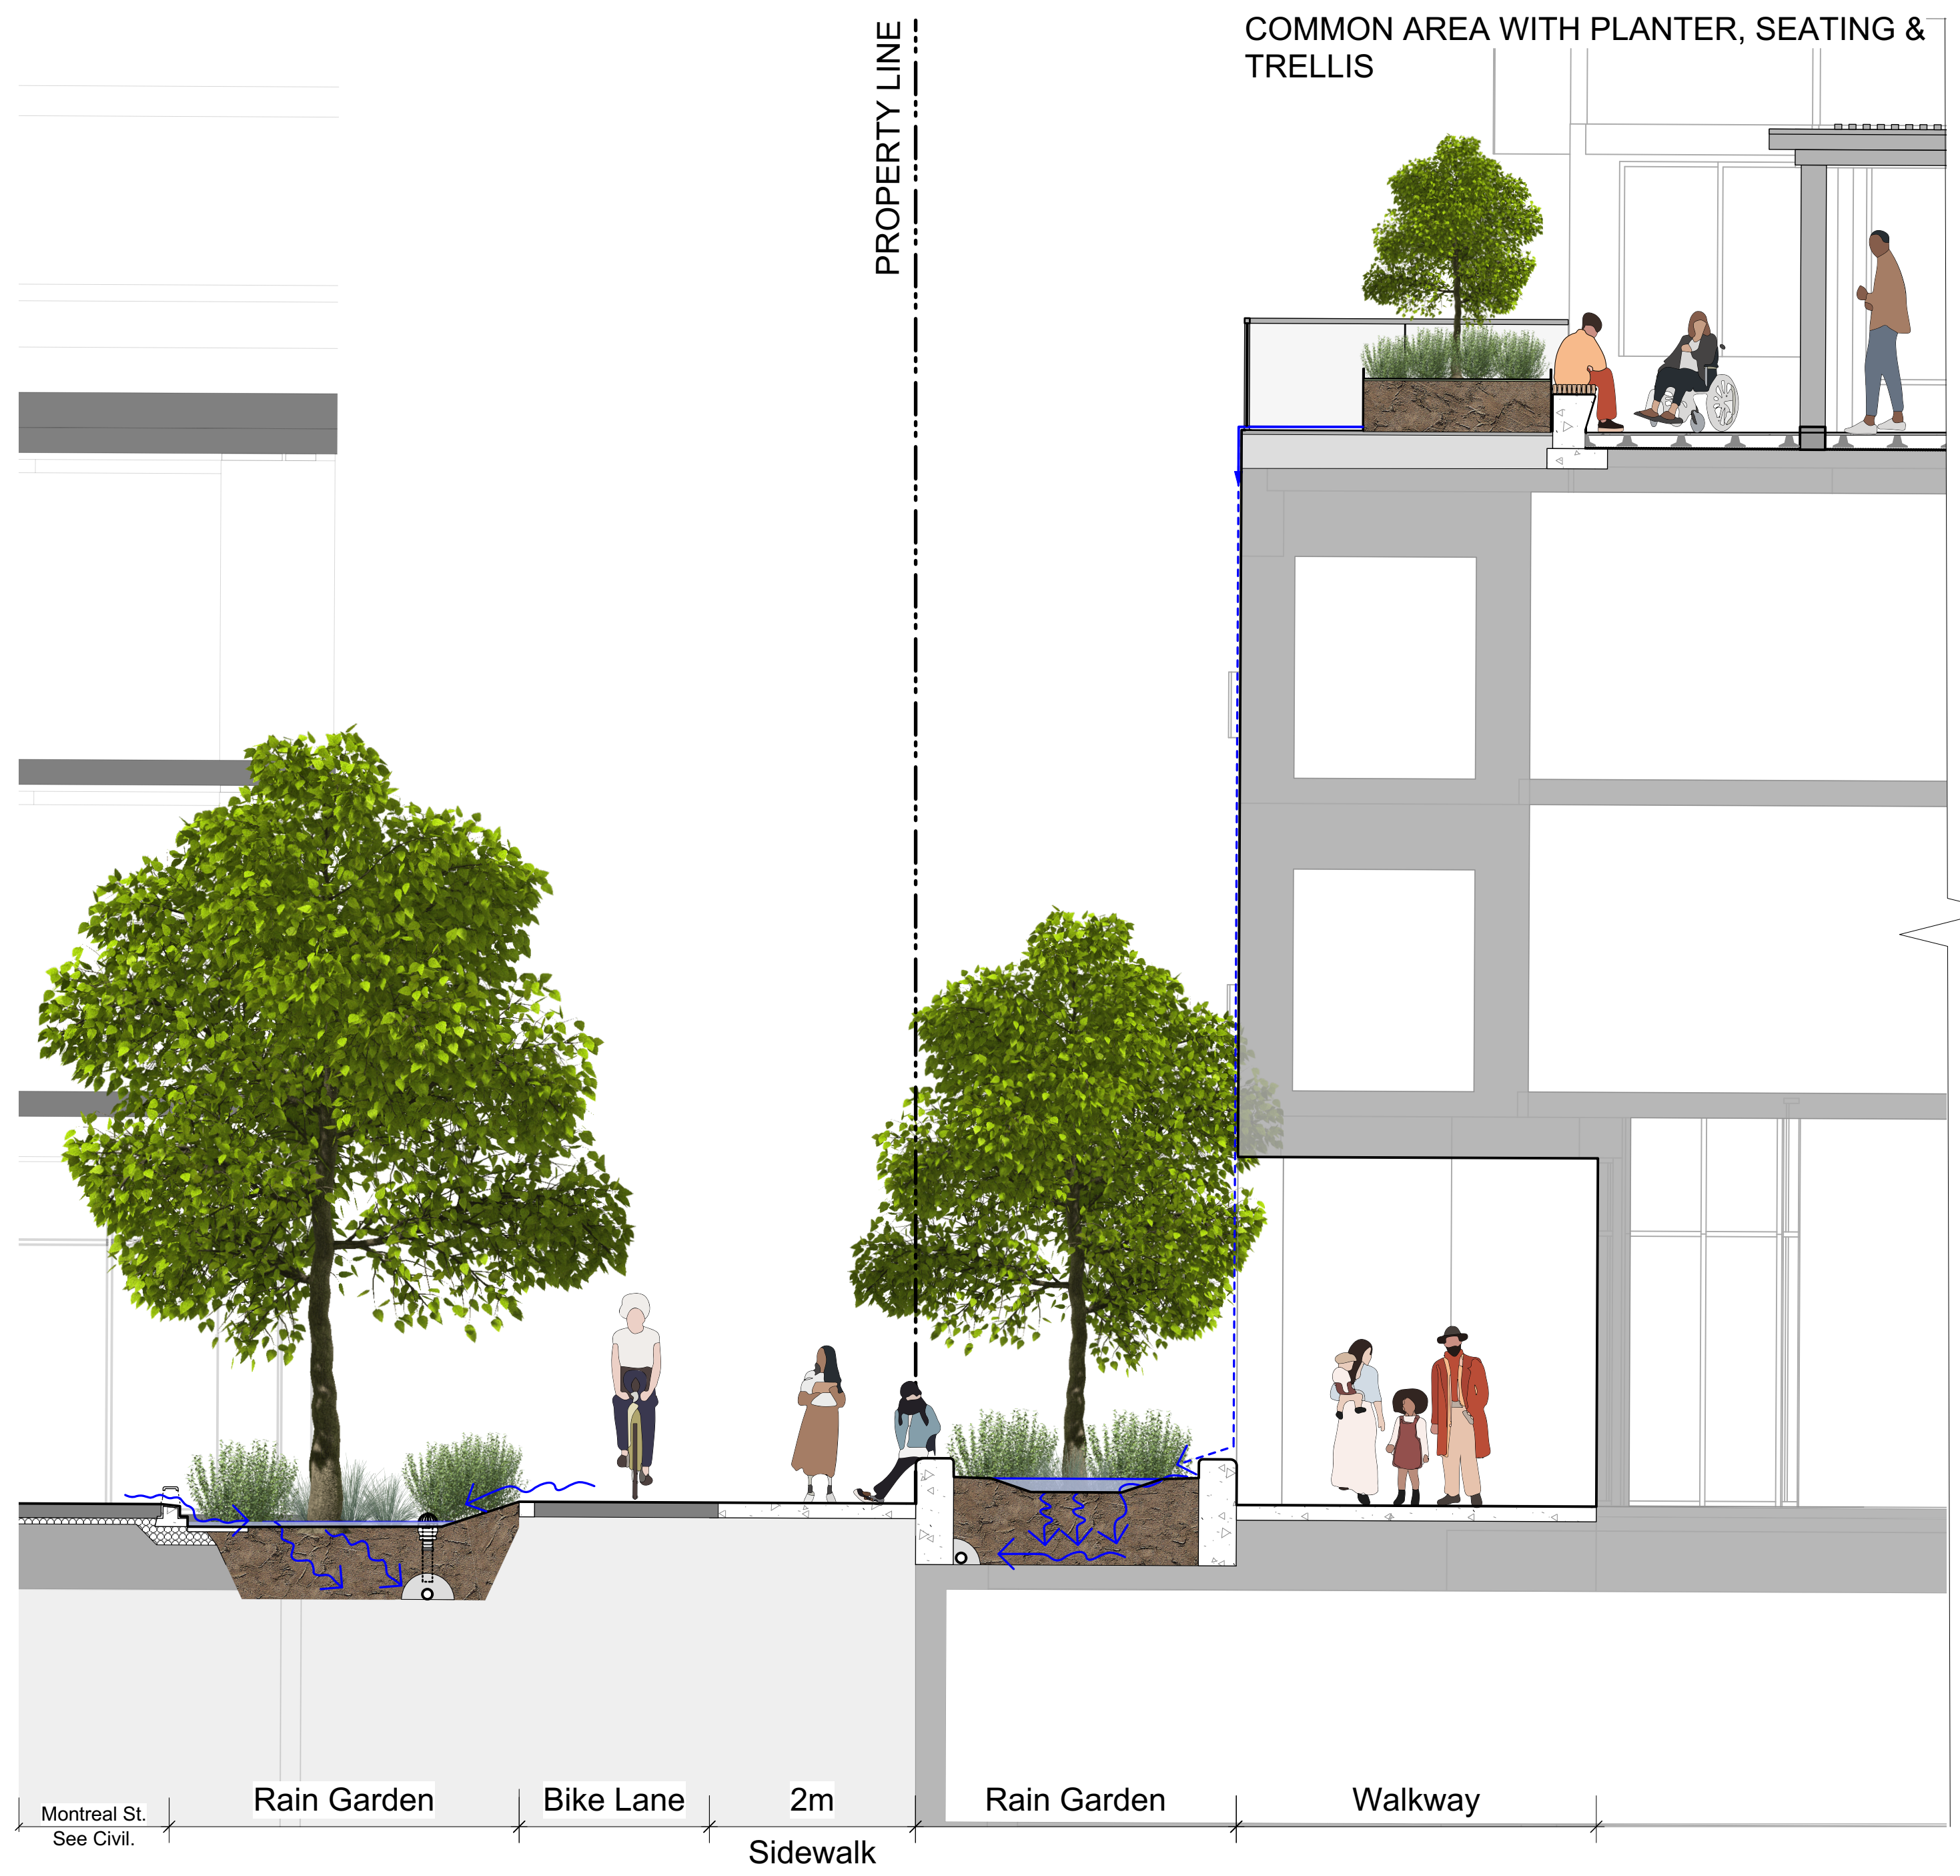
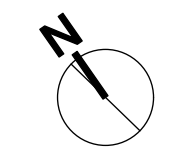
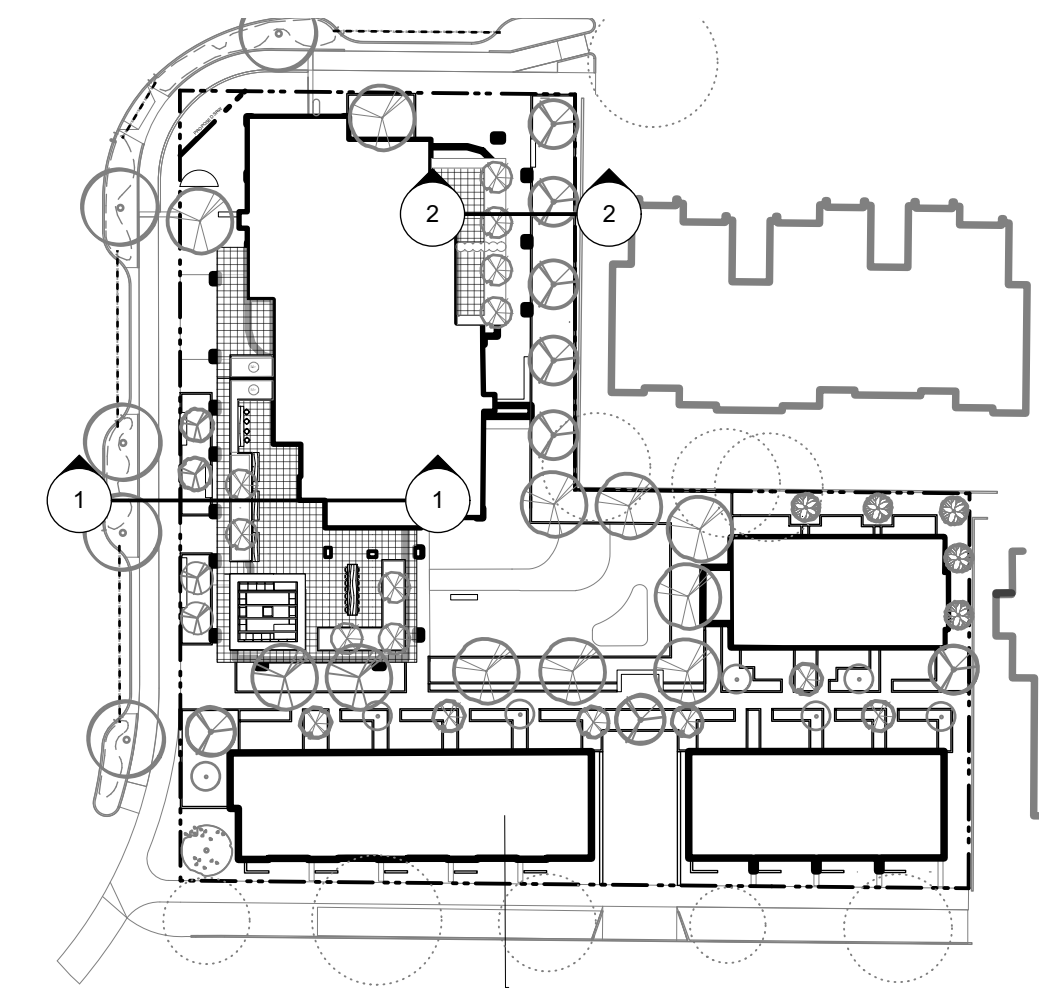

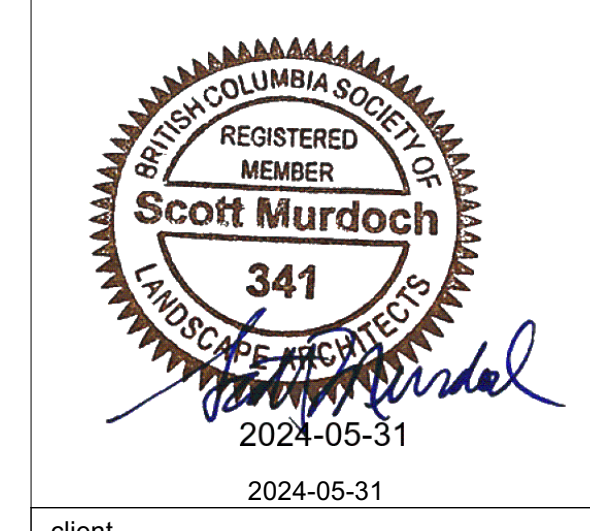
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project
QUEBEC & MONTREAL DEV.
 501-502 MONTREAL ST.
 VICTORIA, BC

sheet title
Landscape Precedents

project no.	121.23
scale	N/A @ 24"x36"
drawn by	MDI
checked by	SM
revision no.	sheet no.



1 Montreal Street Section



2 Section w. Neighbouring Townhomes

rev no	description	date
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project
QUEBEC & MONTREAL DEV.
 501-502 MONTREAL ST.
 VICTORIA, BC

sheet title
Landscape Materials - Sections

project no.	121.23
scale	1:50 @ 24"x36"
drawn by	MDI
checked by	SM
revision no.	sheet no.

9 **L1.05**





PRIVATE ROOF TOP PATIO

PROPERTY LINE

Kingston St
Retained Lawn & Tree
2m Sidewalk
Private Entry


1 Typical Kingston Street Section

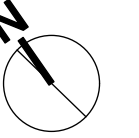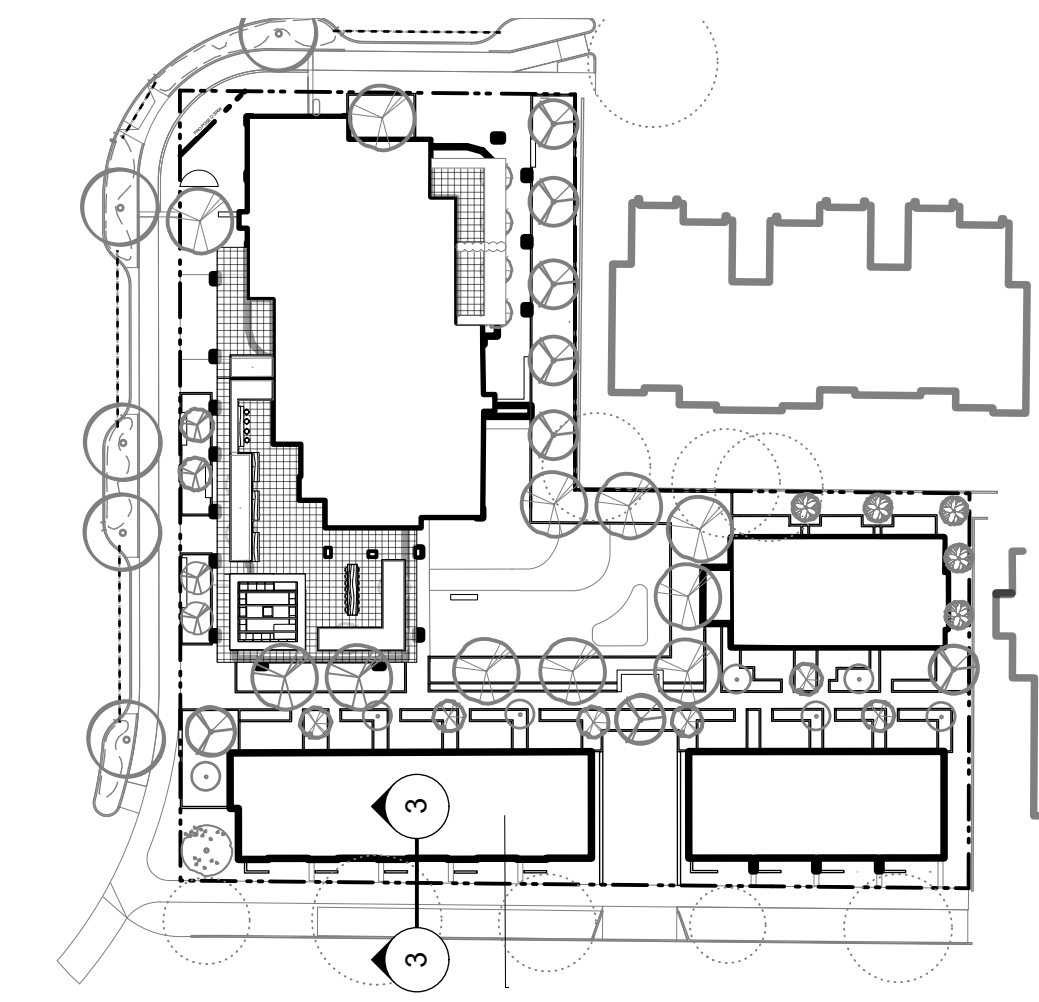

rev no	description	date
9	Rezoning/DP Resub.	2024-05-23
8	REV RZ/DP	2023-01-10
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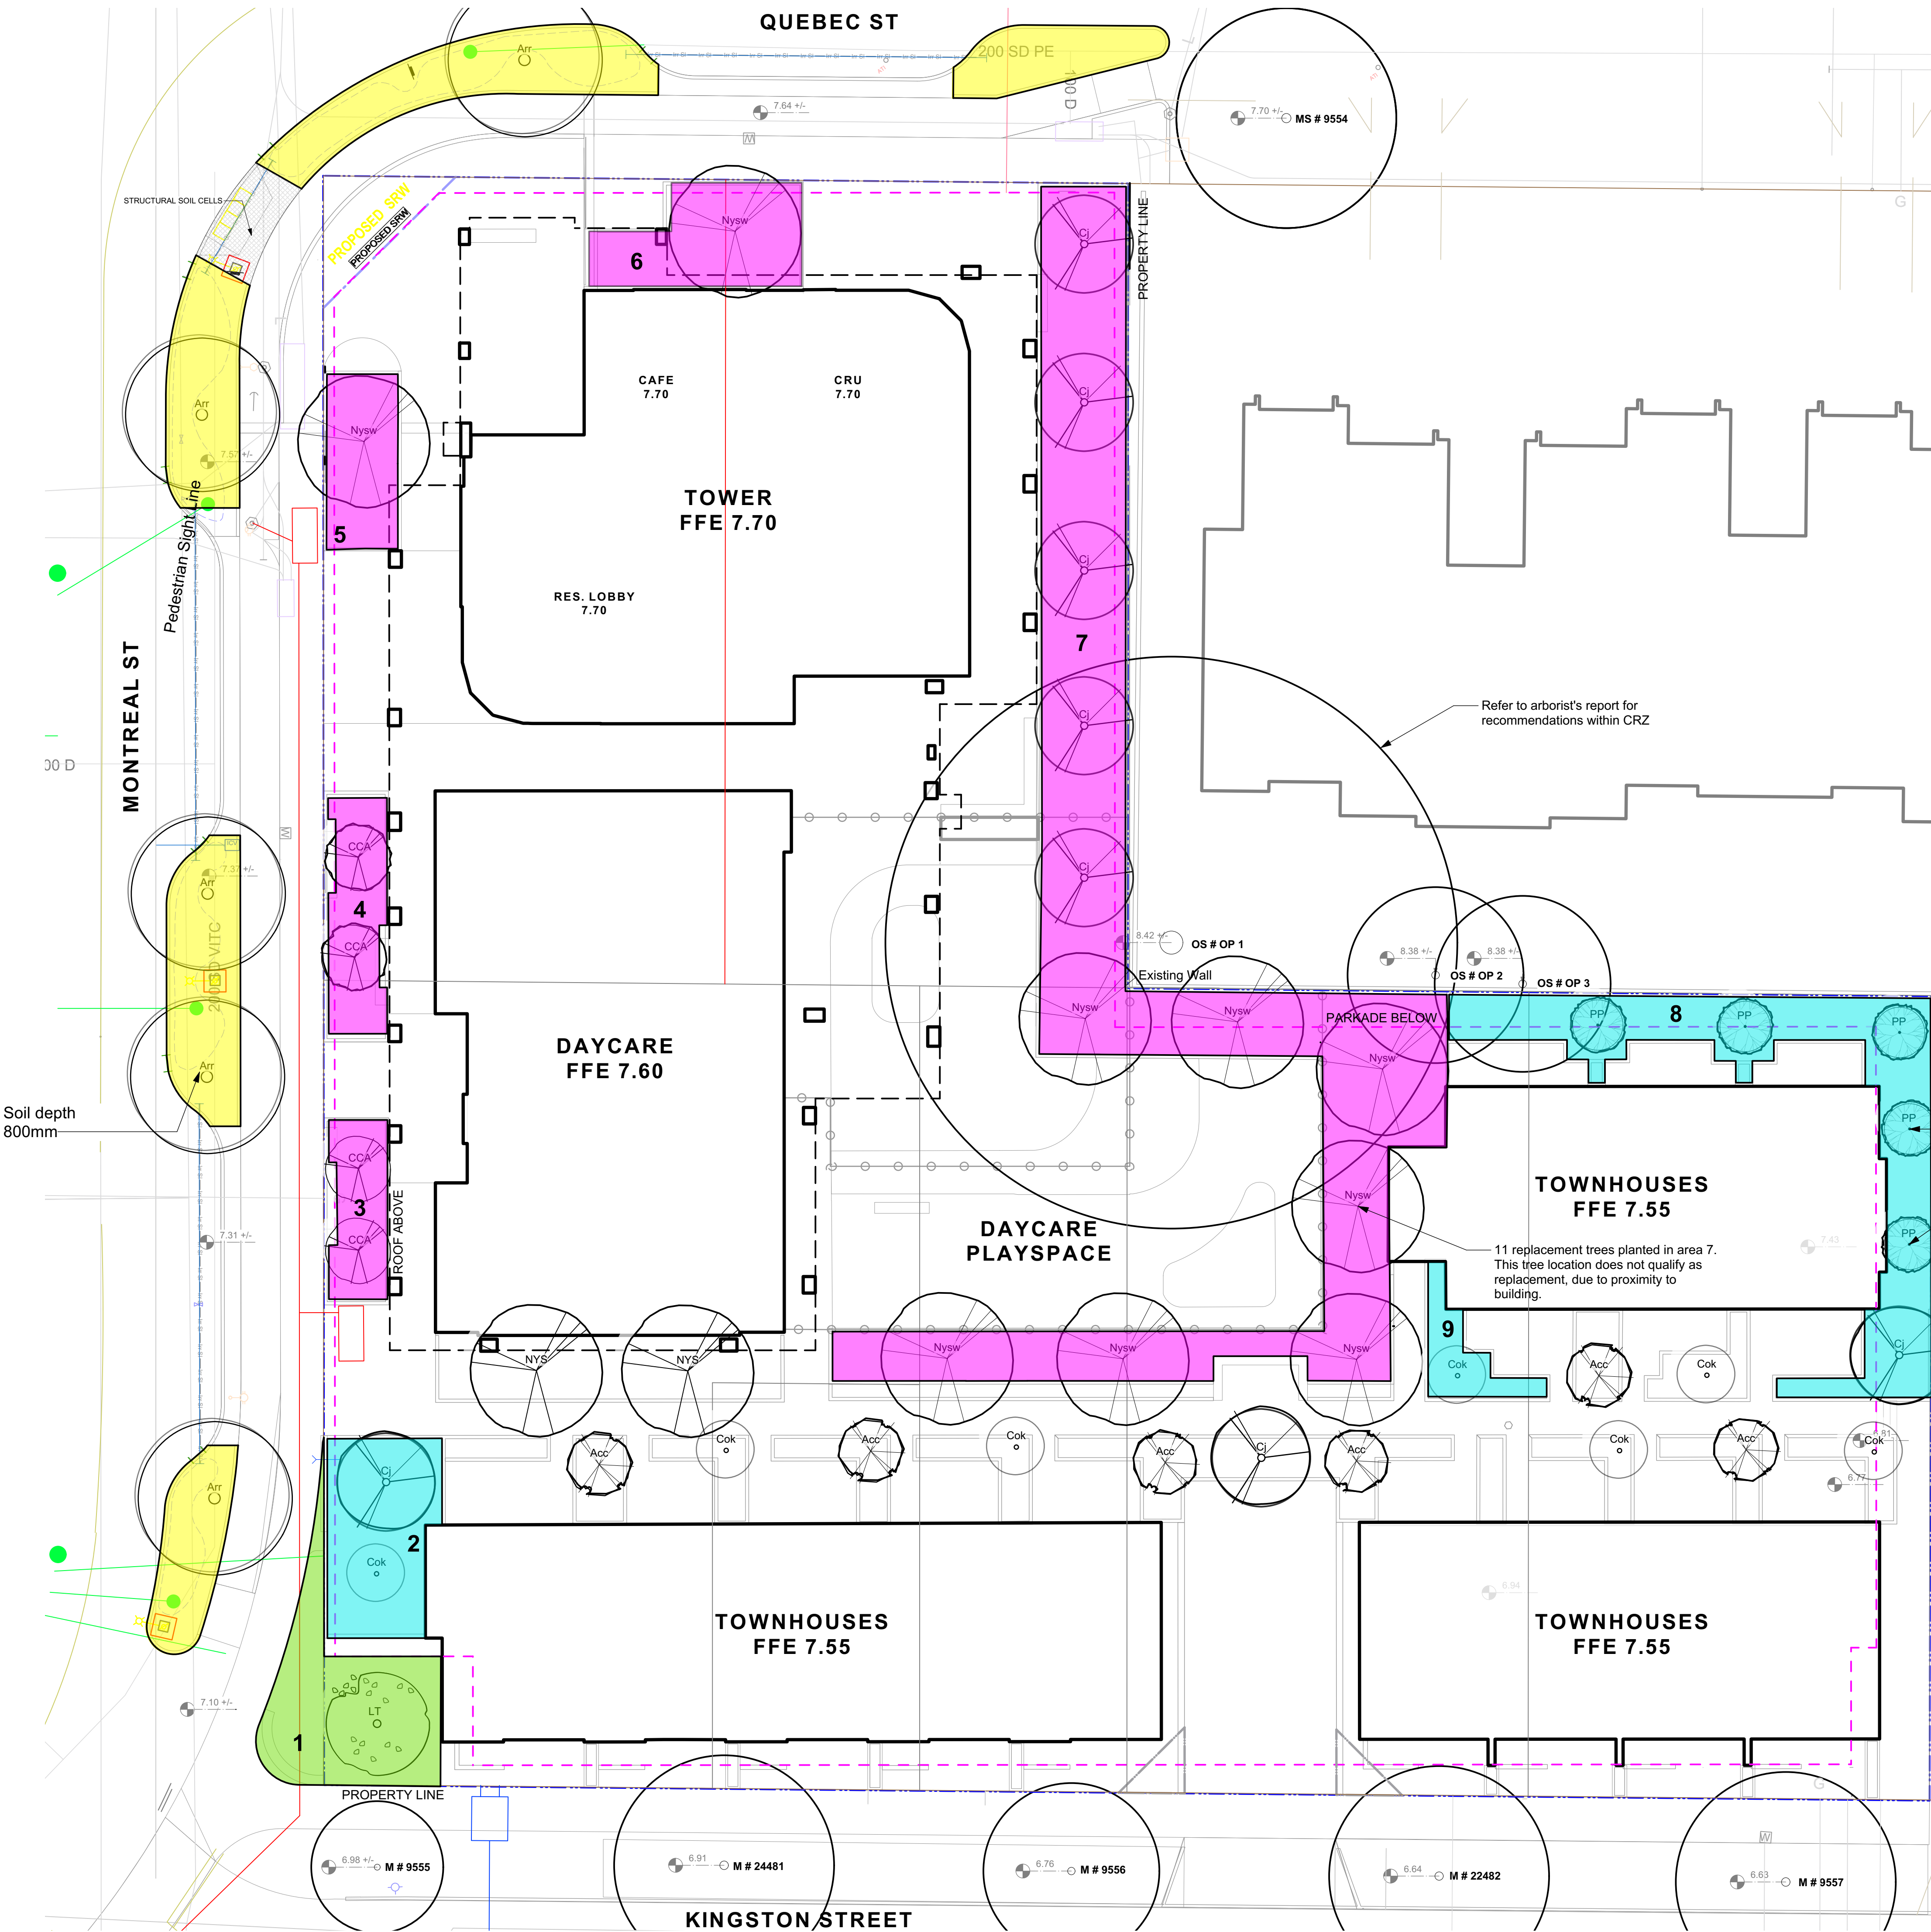
project
QUEBEC & MONTREAL DEV.
501-502 MONTREAL ST.
VICTORIA, BC

sheet title
**Landscape
Materials - Sections**

project no. 121.23
scale 1:50 @ 24"x36"
drawn by MDI
checked by SM

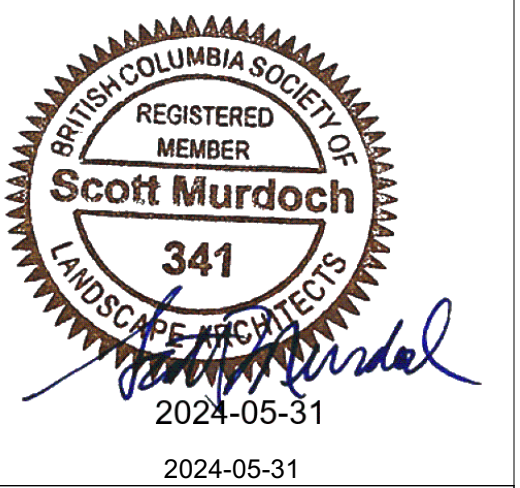revision no. sheet no.

9 **L1.06**



REPLACEMENT TREE SOIL VOLUME TABLE

Planting Area (* on slab)	Area (m2)	Soil Volume Multiplier	A. Estimated Soil Volume (m3)	TREES PROPOSED			SOIL VOLUME REQUIRED (m3)				
				B. Small	C. Medium	D. Large	E. Small	F. Medium	G. Large	Total	
ONSITE											
1	53.5	1	53.5			1	0	0	30	30	
2*	43.4	0.6	26.0	1	1		6	15	0	21	
3*	20.3	0.6	12.2	2			12	0	0	12	
4*	26.4	0.6	15.8	2			12	0	0	12	
5*	25.7	0.6	15.4		1		0	15	0	15	
6*	37.1	0.6	22.3		1		0	15	0	15	
7*	300.0	0.6	180.0		12		0	180	0	180	
8*	93.8	0.6	56.3	5	1		30	15	0	45	
9*	13.3	0.6	8.0	1			6	0	0	6	
Total				11	16	1					
Calculation Instructions							E	F	G	Total	
							If B=1, Bx8, If B>1, Bx6	If C=1, Cx20, If C>1, Cx15	If D=1, Dx35, If D>1, Dx30		E+F+G

PROPOSED TREE LIST

Sym	Qty	Botanical Name	Schd. Size	Common Name
Acc	6	Acer circinatum	2.4 m ht, 1.5 width	Vine Maple
Arr	5	Acer rubrum 'Red Sunset'	6.0cm cal, b&b	Red Sunset Red Maple
Cj	8	Cercidiphyllum japonicum	6.0cm cal, b&b	Katsura Tree
CCA	4	Cercis canadensis	5.0cm cal, b&b	Eastern Redbud
Cok	7	Cornus kousa 'Milky Way'	5.0cm cal, b&b	Milky Way Kousa Dogwood
LT	1	Liriodendron tulipifera	6.0cm cal, b&b	Tuliptree
NYS	2	Nyssa sylvatica 'Tupelo Tower'	6.0cm cal, b&b	Tupelo
Nysw	9	Nyssa sylvatica 'Wildfire'	6.0cm cal, b&b	Tupelo
PP	5	Parrotia persica	2.4 m ht, 1.5 width	Persian Ironwood

LEGEND


- Rain Garden over Slab 600mm
- Rain Garden on Grade w. Boulevard 600mm avg (or as specified on plan)
- Planter over Slab or Raised Planter - 600mm
- Tree soil on Grade - 600m

NOTES


1. Small Tree: min 6-8 cubic metres of soil
2. Medium Tree: min 15-20 cubic metres of soil
3. Large Tree: 30-35 cubic metres of soil

3 small and 1 medium replacement trees planted in area 8. These tree locations do not qualify as replacements, due to proximity to building.


11 replacement trees planted in area 7. This tree location does not qualify as replacement, due to proximity to building.

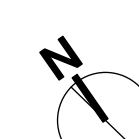

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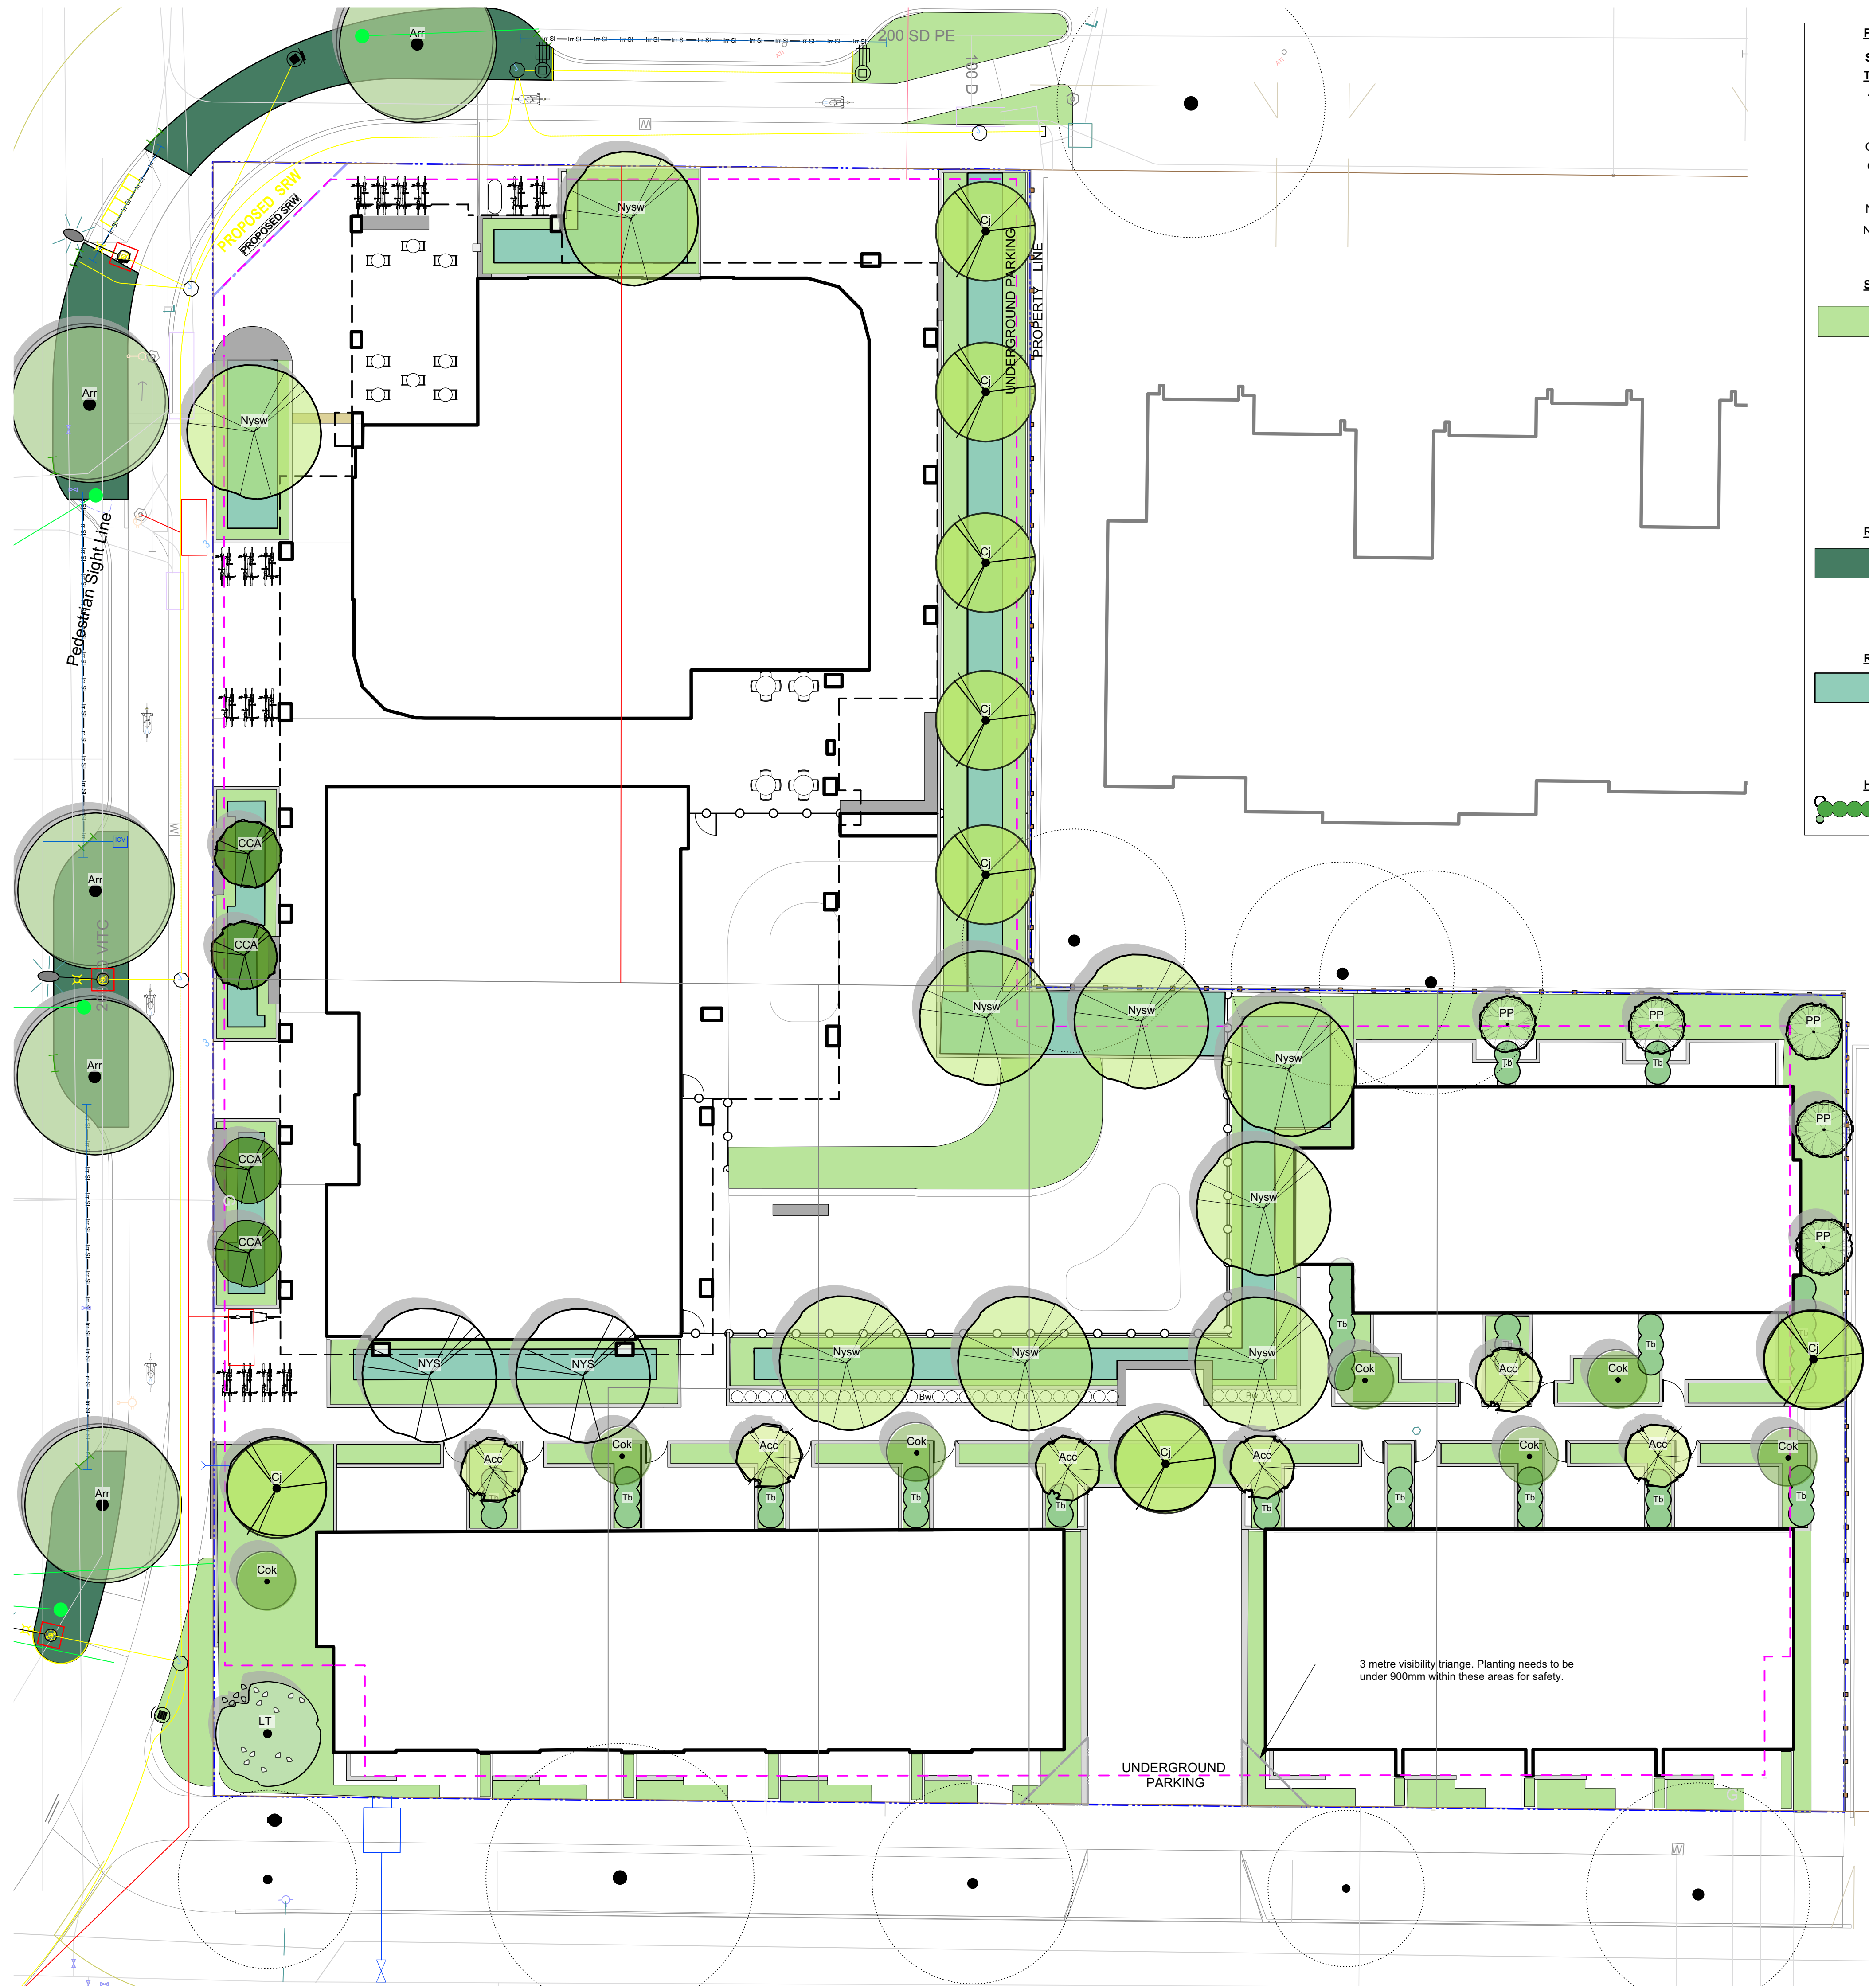


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REGISTERED MEMBER
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LANDSCAPE ARCHITECTS
2024-05-31

client	Mike Geric Construction 4520 West Saanich Rd Saanich, BC
project	QUEBEC & MONTREAL DEV. 501-502 MONTREAL ST. VICTORIA, BC
sheet title	Replacement Tree Plan
project no.	121.23
scale	1:150 @ 24"x36"
drawn by	MDI
checked by	SM
revision no.	sheet no.
9	L1.07



Sym	Qty	Botanical Name	Common Name	Schd. Size / Plant Spacing
TREES:				
Acc	6	Acer circinatum	Vine Maple	2.4 m ht, 1.5 width
Arr	5	Acer rubrum 'Red Sunset'	Red Sunset Red Maple	6.0cm cal, b&b
Cj	8	Cercidiphyllum japonicum	Katsura Tree	6.0cm cal, b&b
CCA	4	Cercis canadensis	Eastern Redbud	5.0cm cal, b&b
Cok	7	Cornus kousa 'Milky Way'	Milky Way Kousa Dogwood	5.0cm cal, b&b
LT	1	Liriodendron tulipifera	Tuliptree	6.0cm cal, b&b
NYS	2	Nyssa sylvatica 'Tupelo Tower'	Tupelo	6.0cm cal, b&b
Nysw	9	Nyssa sylvatica 'Wildfire'	Tupelo	6.0cm cal, b&b
PP	5	Parrotia persica	Persian Ironwood	2.4 m ht, 1.5 width
SHRUBS:				
178		Athyrium filix-femina var. cyclosorum	Northwestern Lady Fern	#1 pot
85		Chamaecyparis pisifera 'Sungold'	False Cypress 'Sungold'	#2 pot
43		Cornus sanguinea 'Midwinter Fire'	Midwinter Fire Dogwood	#1 pot
70		Eupatorium cannabinum	Hemp Agrimony	Sp3
419		Gaultheria shallon	Salal	#1 pot
503		Liriope muscari	Lily turf	#1 pot
262		Lonicera pileata	Privet Honeysuckle	#1 pot
70		Miscanthus sinensis 'Adagio'	Adagio Maiden Grass	#1 pot
57		Polystichum munitum	Sword Fern	#1 pot
178		Taxus baccata 'Repandens'	English Weeping Yew	#1 pot
130		Vaccinium ovatum 'Thunderbird'	Evergreen Huckleberry	#3 pot
70		Verben bonariensis	Purpletop Vervain	#1 pot
RAIN GARDEN PLANTERS STREET:				
356		Juncus 'Carmen's Grey'	Soft Common Rush	Sp3
356		Carex obnupta	Slough Sedge	#1 pot
71		Gaultheria shallon	Salal	Sp3
71		Mahonia nervosa	Oregon Grape Holly	#1 pot
43		Spiraea japonica 'Gold Mound'	Gold Mound Spiraea	#1 pot
RAIN GARDEN SITE:				
431		Carex obnupta	Slough Sedge	Sp3
34		Cornus sanguinea 'Midwinter Fire'	Midwinter Fire Dogwood	#1 pot
453		Juncus 'Carmen's Grey'	Soft Common Rush	Sp3
431		Liriope muscari	Lily turf	#1 pot
87		Schizostylis coccinea 'Oregon Sunset'	Crimson Flag	#1 pot
HEDGING/SCREENING:				
35		Buxus microphylla 'Winter Gem'	Littleleaf Boxwood	5
51		Taxus baccata	English Yew	#10 pot

REFERENCE NOTES

30%+ of planting scheme has been dedicated ecosystem services. Plants for pollinators are included, via the Pollinator and Allergy-Aware Gardening Guide. This site features native plants that are unique to the Southern Vancouver Island Bioregional zone. Food bearing plants are also added in addition to the guidelines. Additionally, rain garden plants provide stormwater management opportunities.

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2	DP	2021-12-16
1	Issued for Dev. Tracker	2021-10-19

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MDI
Landscape Architects

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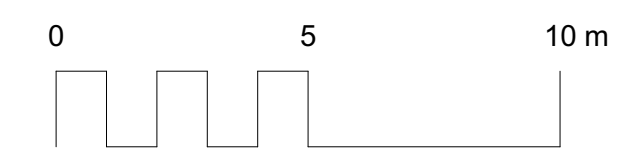
REGISTERED MEMBER
Scott Murdoch
341
LANDSCAPE ARCHITECTS
2024-05-31

client
Mike Geric Construction
4520 West Saanich Rd
Saanich, BC


project
QUEBEC & MONTREAL DEV.
501-502 MONTREAL ST.
VICTORIA, BC

sheet title
Planting Plan - Ground Level

project no.	121.23
scale	1: 150 @ 24"x36"
drawn by	MDI
checked by	SM
revision no.	sheet no.
9	L3.01



3 metre visibility triangle. Planting needs to be under 900mm within these areas for safety.

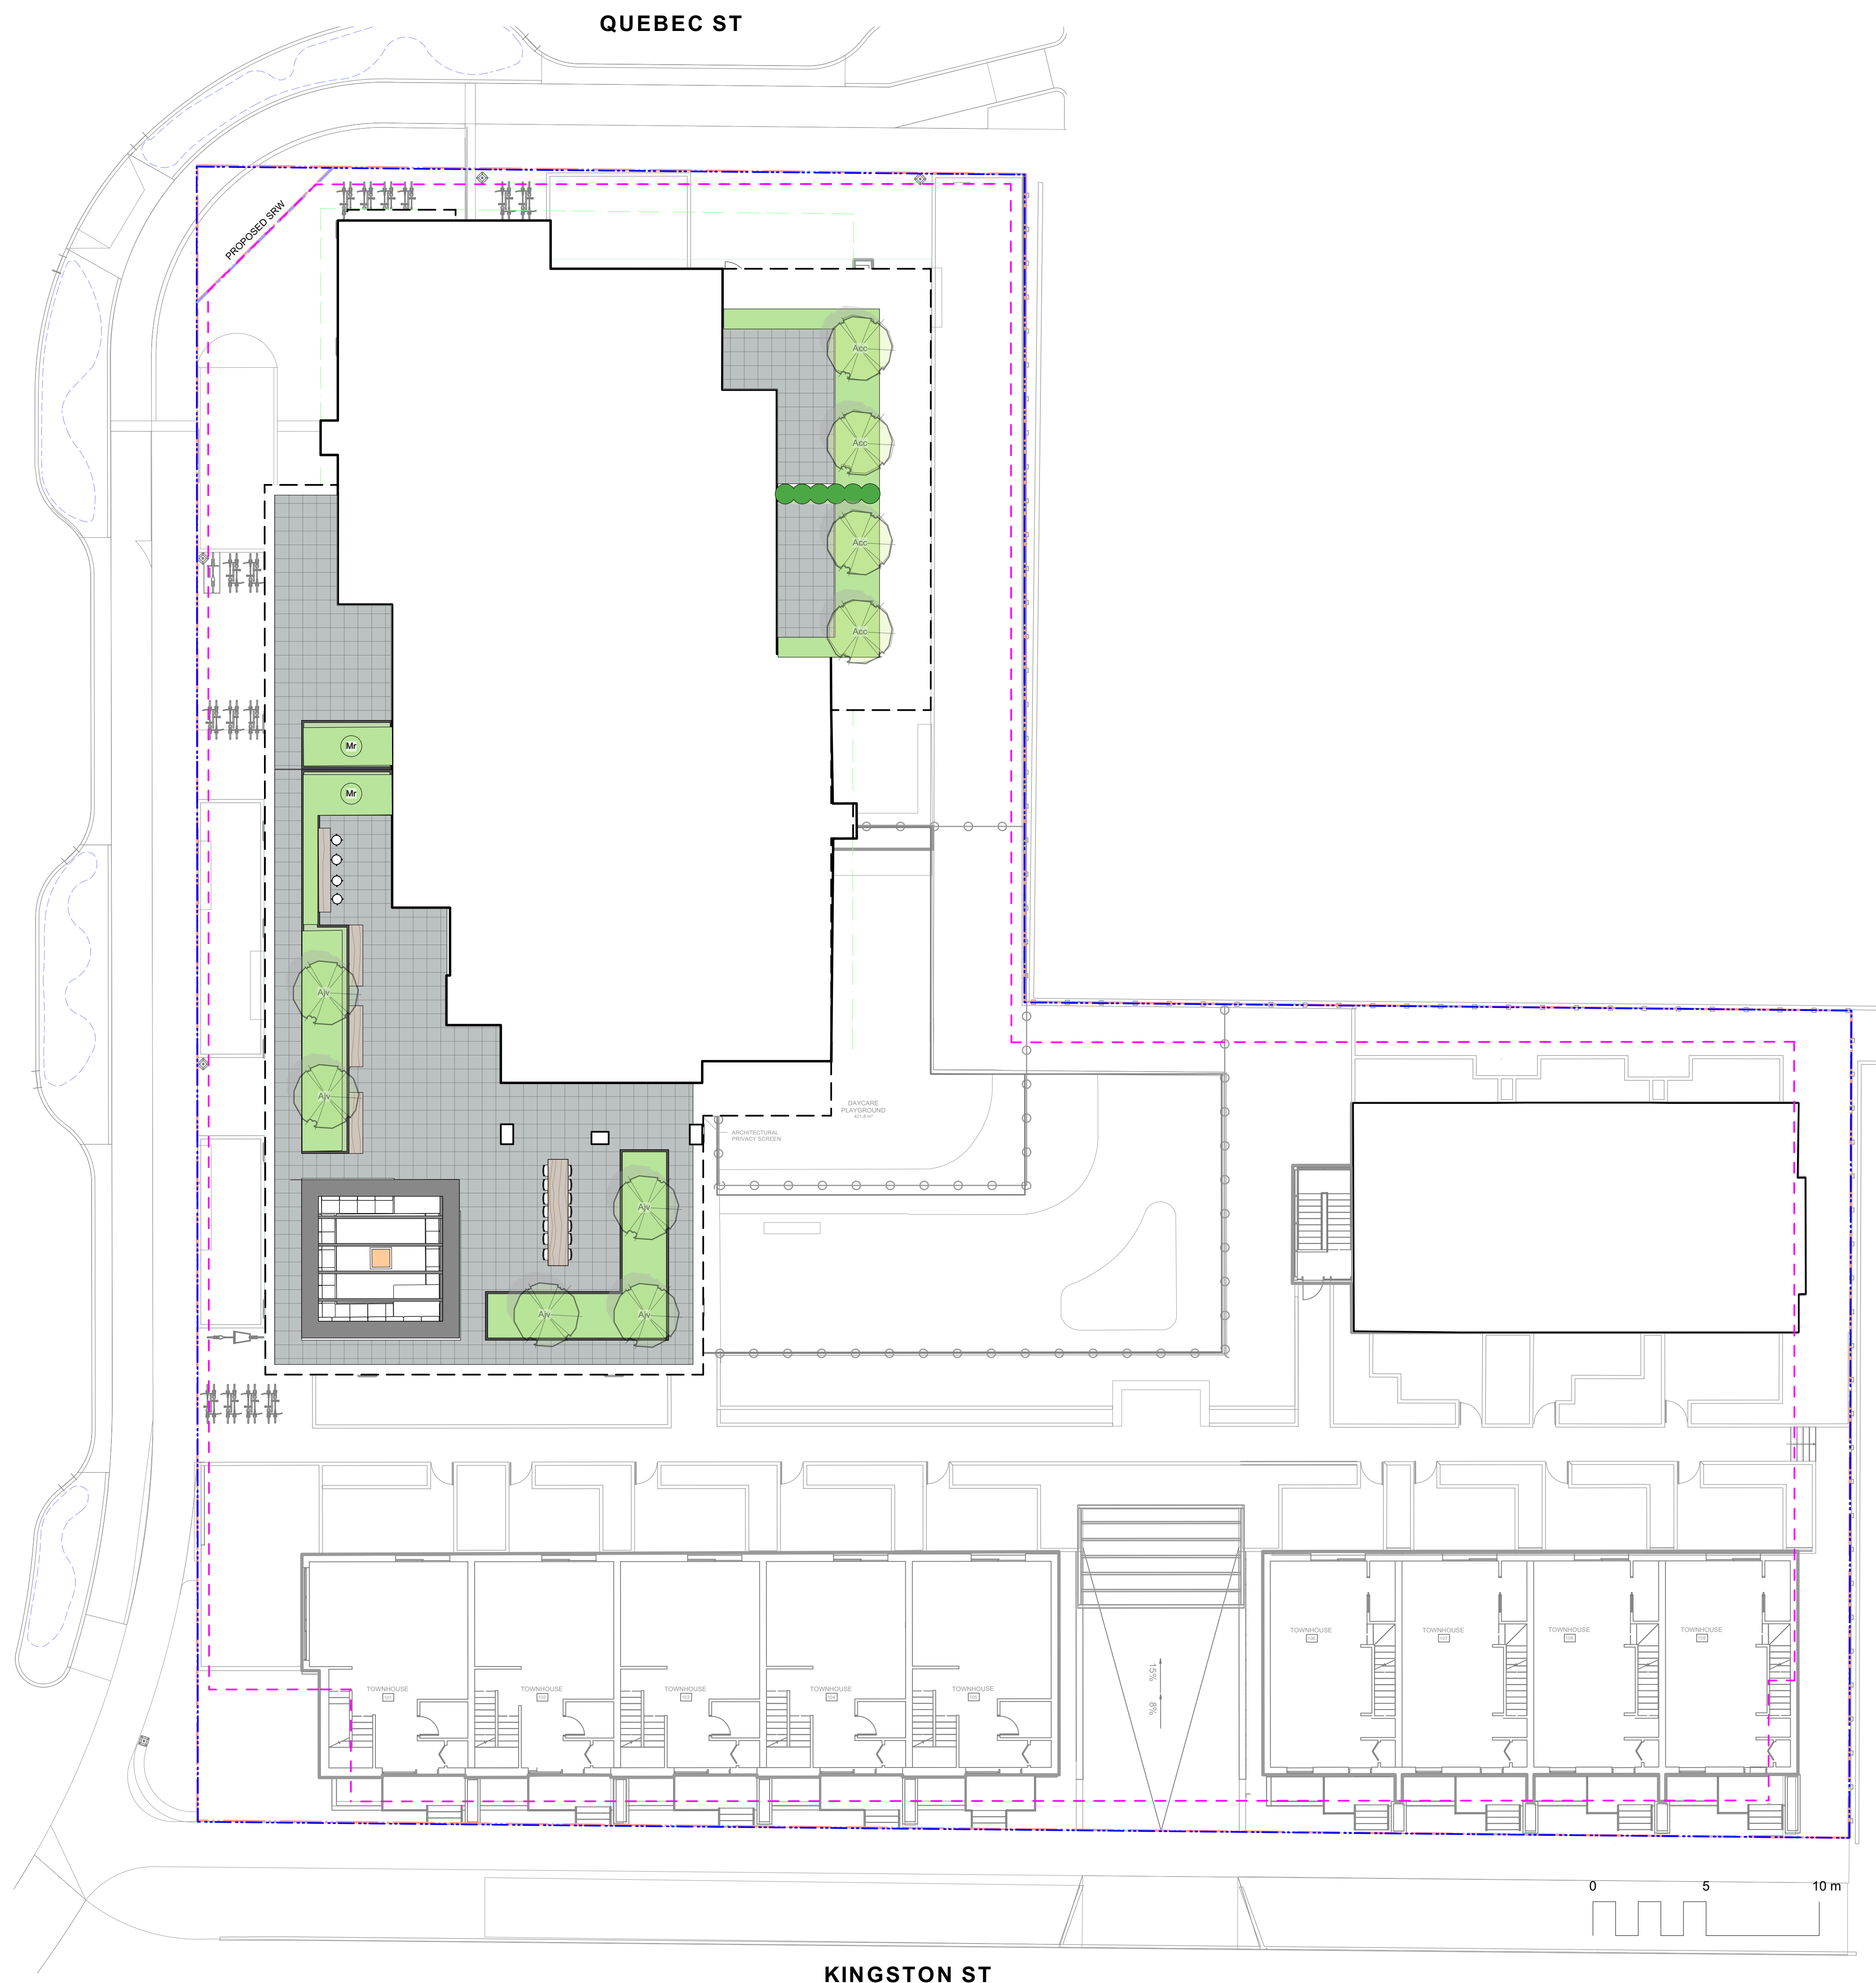

PLANT LIST				
Sym	Qty	Botanical Name	Common Name	Sched. Size / Plant Spacing
TREES:				
Acc	4	Acer circinatum	Vine Maple	2.4 m ht, 1.5 width
Ajv	5	Acer japonicum 'Vitifolium'	Japanese Maple	1.8 m height, specimen quality
Mr	2	Magnolia stellata 'Royal Star'	Royal Star Magnolia	1.2m b&b
SHRUBS & PERENNIALS				
■	24	Abelia x grandiflora 'Prostrata'	Prostrate White Abelia	#2 pot
■	32	Cistus x corbariensis	Rock Rose	#1 pot
■	35	Eriophyllum lanatum	Woolly Sunflower	#1 pot
■	107	Hebe topiaria	Topiariist's hebe	#1 pot
■	63	Lavandula angustifolia 'Hidcote'	Hidcote English Lavender	#1 pot
■	107	Mahonia repens	Prostrate Oregon Grape	#1 pot
■	16	Nepeta x faassenii	Catmint	Sp3
■	16	Rosmarinus officinalis	Rosemary	#2 pot
■	16	Salvia officinalis	Culinary Sage	#1 pot
■	24	Vaccinium ovatum 'Thunderbird'	Evergreen Huckleberry	#3 pot
■	0			
EVERGREEN HEDGE:				
●	6	Taxus baccata 'Repandens'	English Weeping Yew	#3 pot

REFERENCE NOTES

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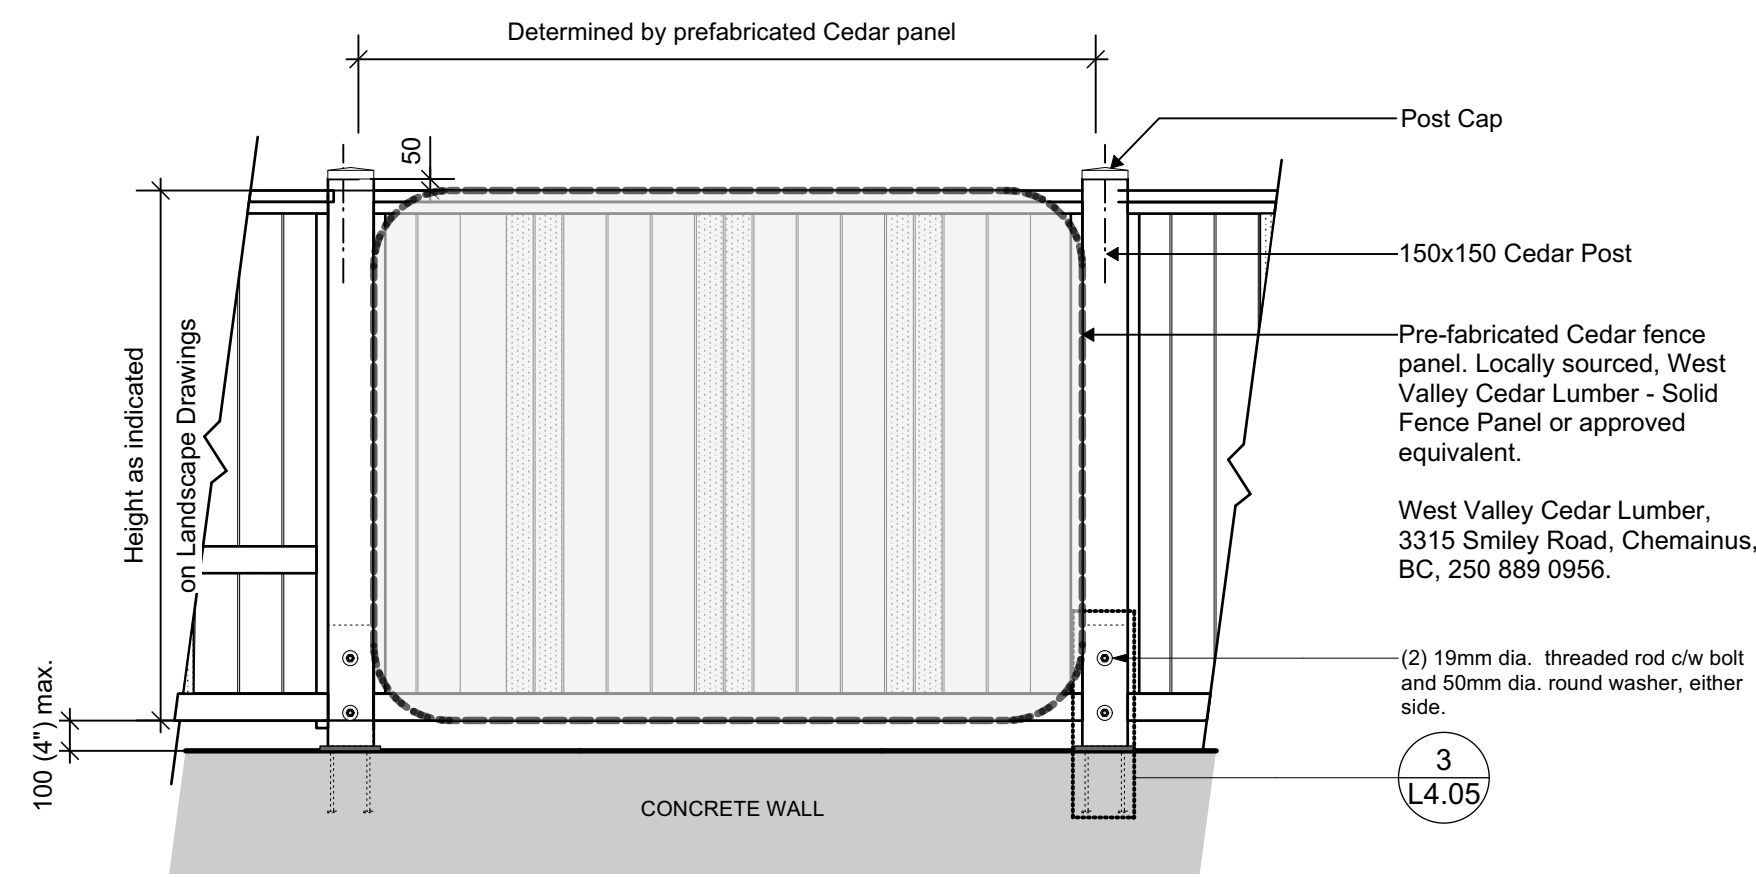
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client
Mike Geric Construction
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Saanich, BC

project
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501-502 MONTREAL ST.
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sheet title
Planting Plan - Level 4


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checked by	SM
revision no.	sheet no.
9	L3.02




GENERAL NOTES:

1. All fasteners to be galvanized only.
2. All lumber to be locally sourced Western Red Cedar (except Posts).
3. Coating system to be Sikkens - SRD. Colour to complement Architectural palette. Final selection to be confirmed by LA prior to application.

PLAN VIEW

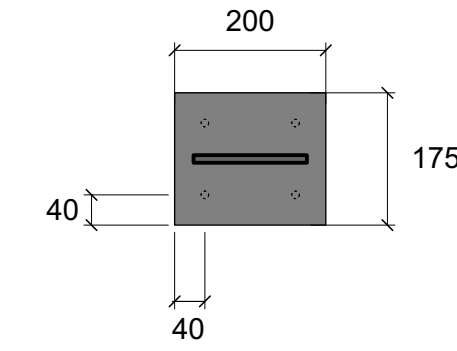


AXO VIEW

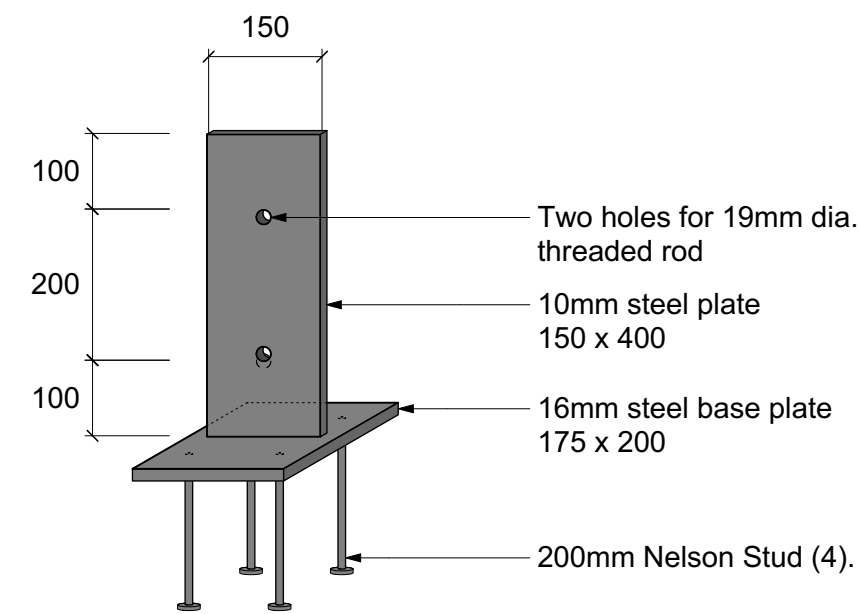

GENERAL NOTES:

1. All steel to be galvanized only.

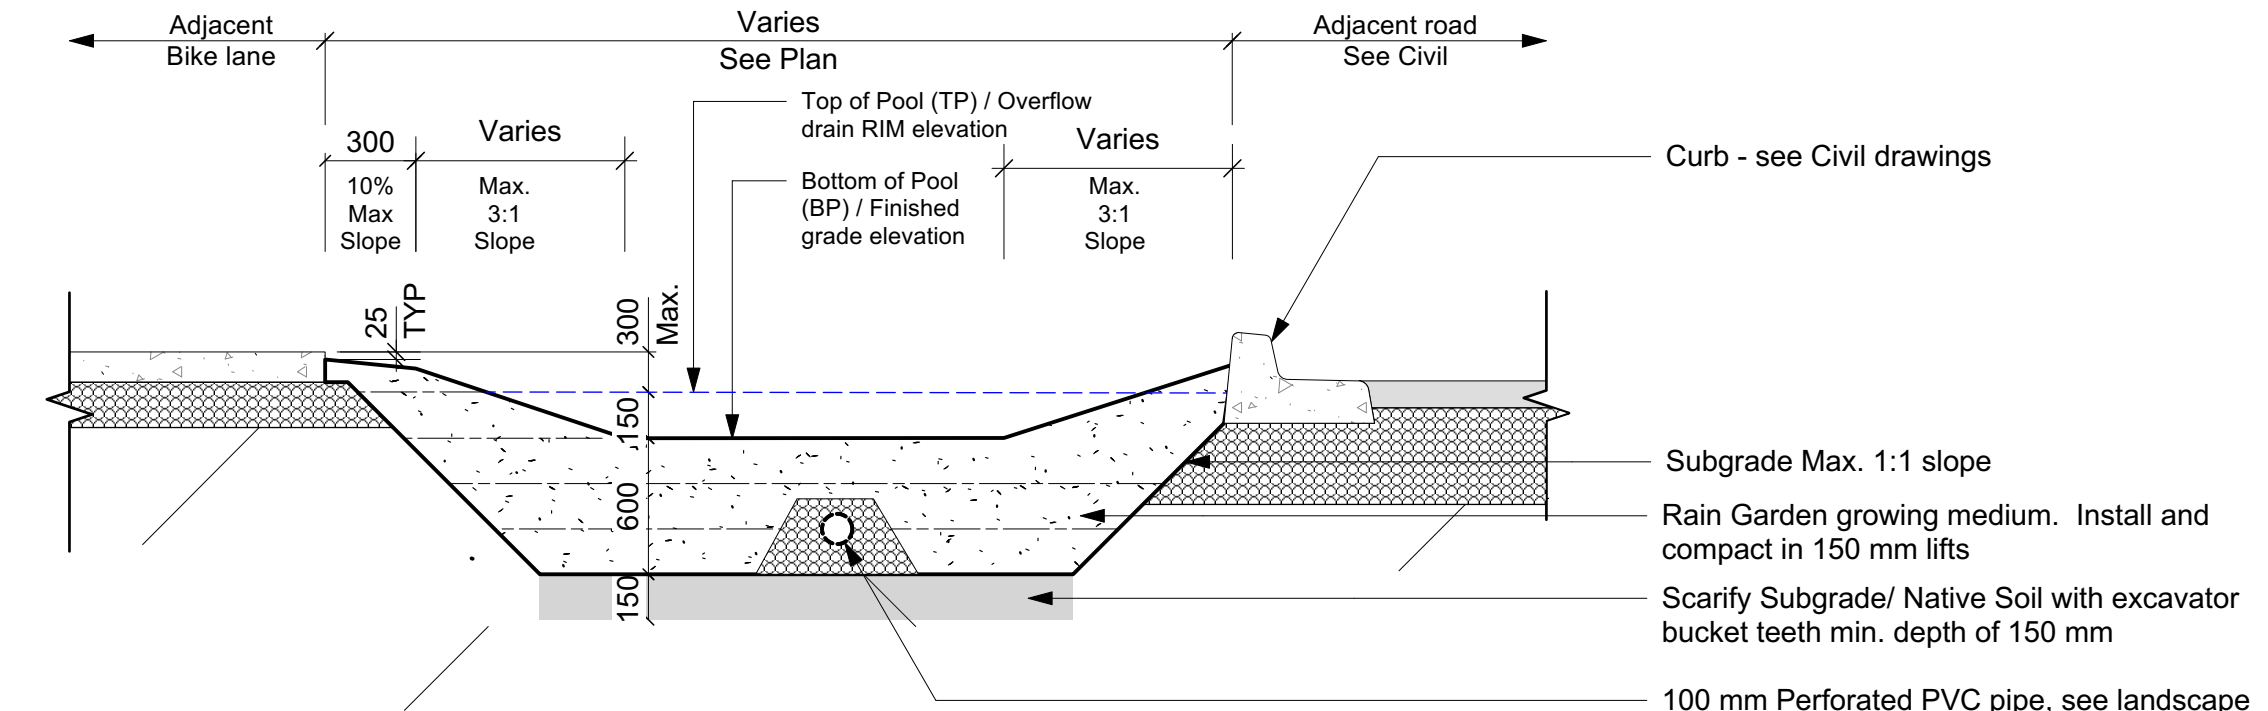


GENERAL NOTES:

1. Subgrade shall be sloped to drain with perforated pipe. Min. 0.5%.
2. Planting areas shall be mulched 50 mm depth.
3. Finish grade of mulch to be 25 mm below sidewalk.


1 Typical 6' Wood Fence On Concrete Wall
Scale: 1:25

2 Fence Post Knife Plate
Scale: 1:10

3 Boulevard Rain Garden - section
Scale: 1:25

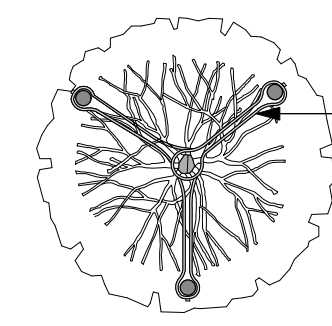


PLAN VIEW

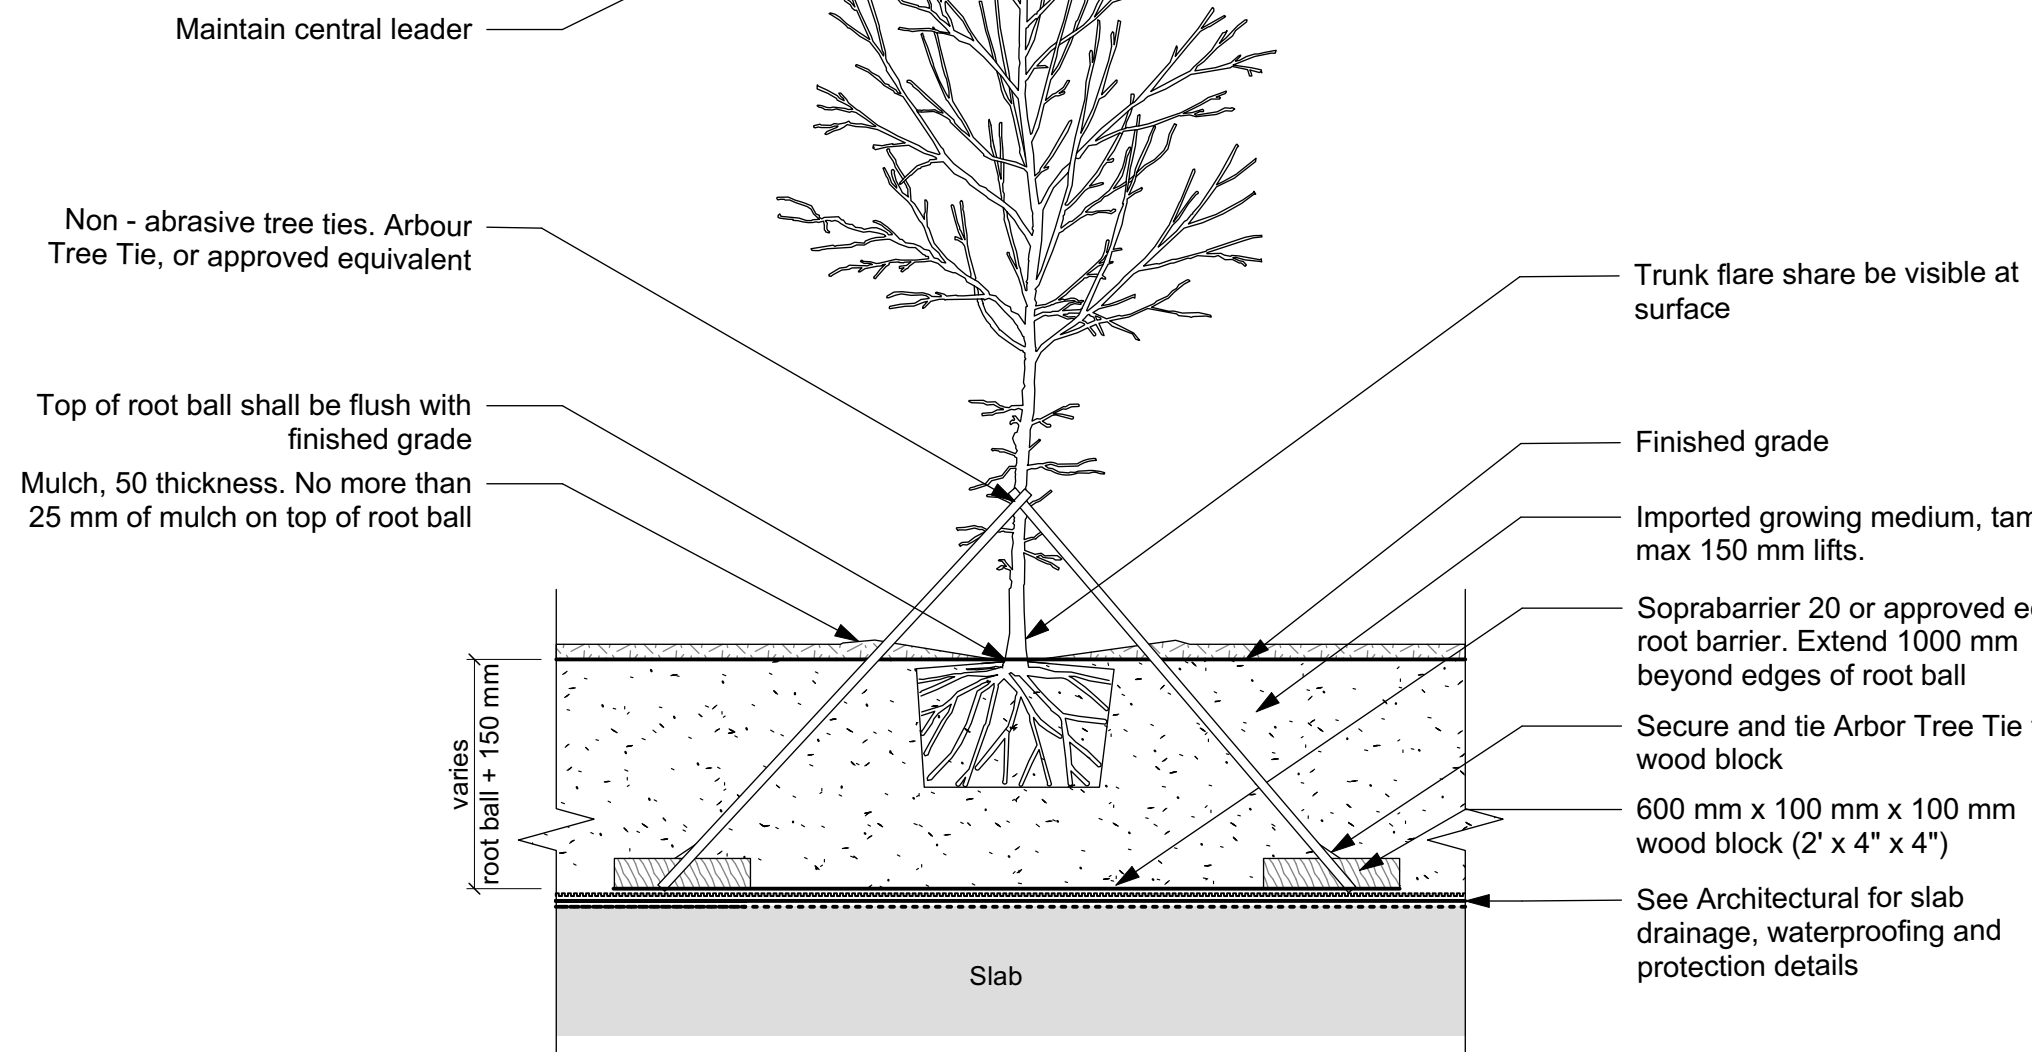


Notes:

1. Trees shall be of quality prescribed.
2. Trunk caliper shall meet Canadian Landscape Standard Current Edition for root ball size.
3. Max. depth of planting pit = rootball depth + 150 mm.
4. Place guy wires parallel to prevailing wind direction.
5. Follow supply nursery's instructions on removal of rope, burlap and wire baskets.

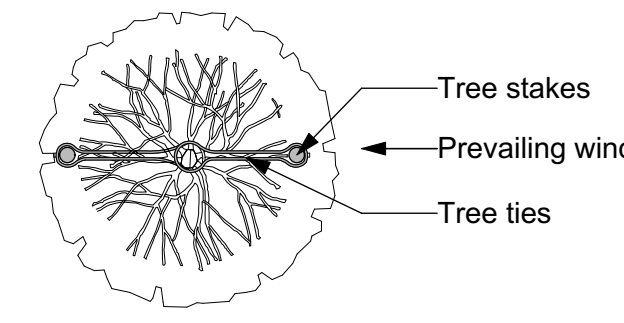

PLAN VIEW

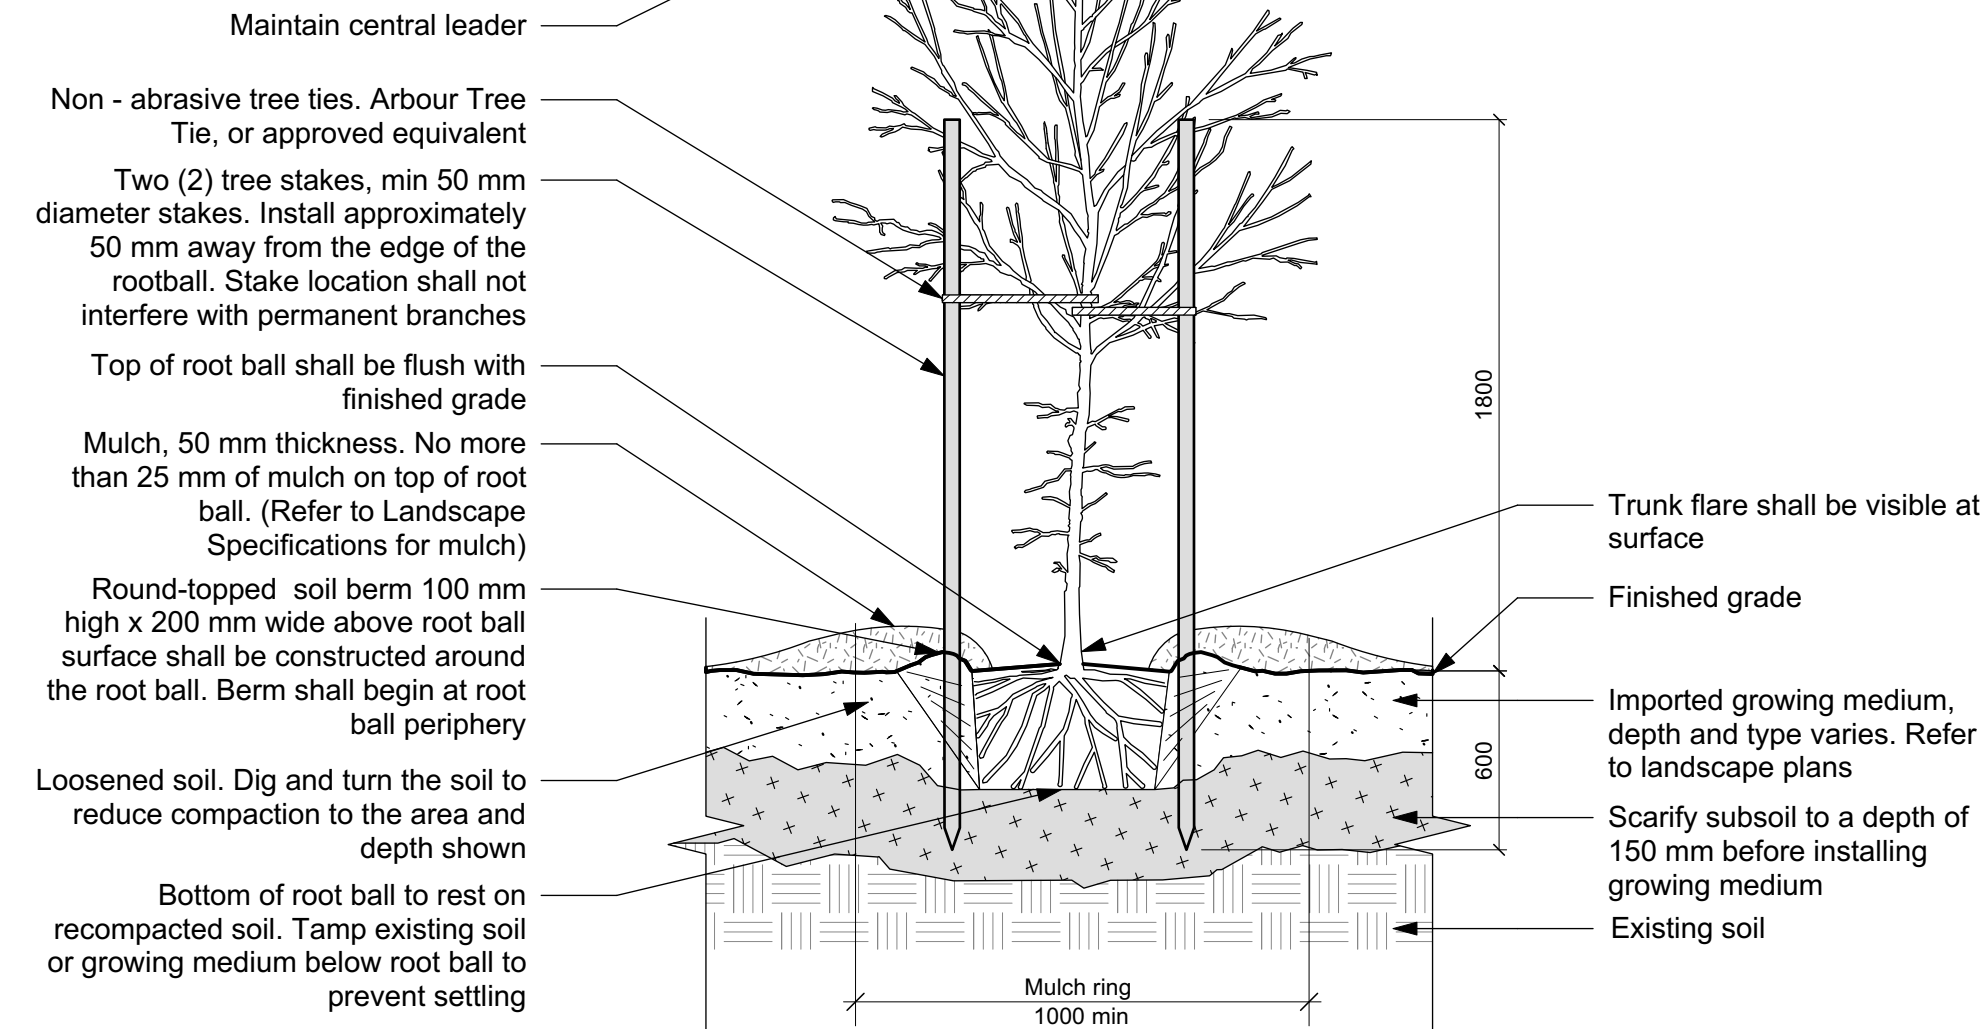


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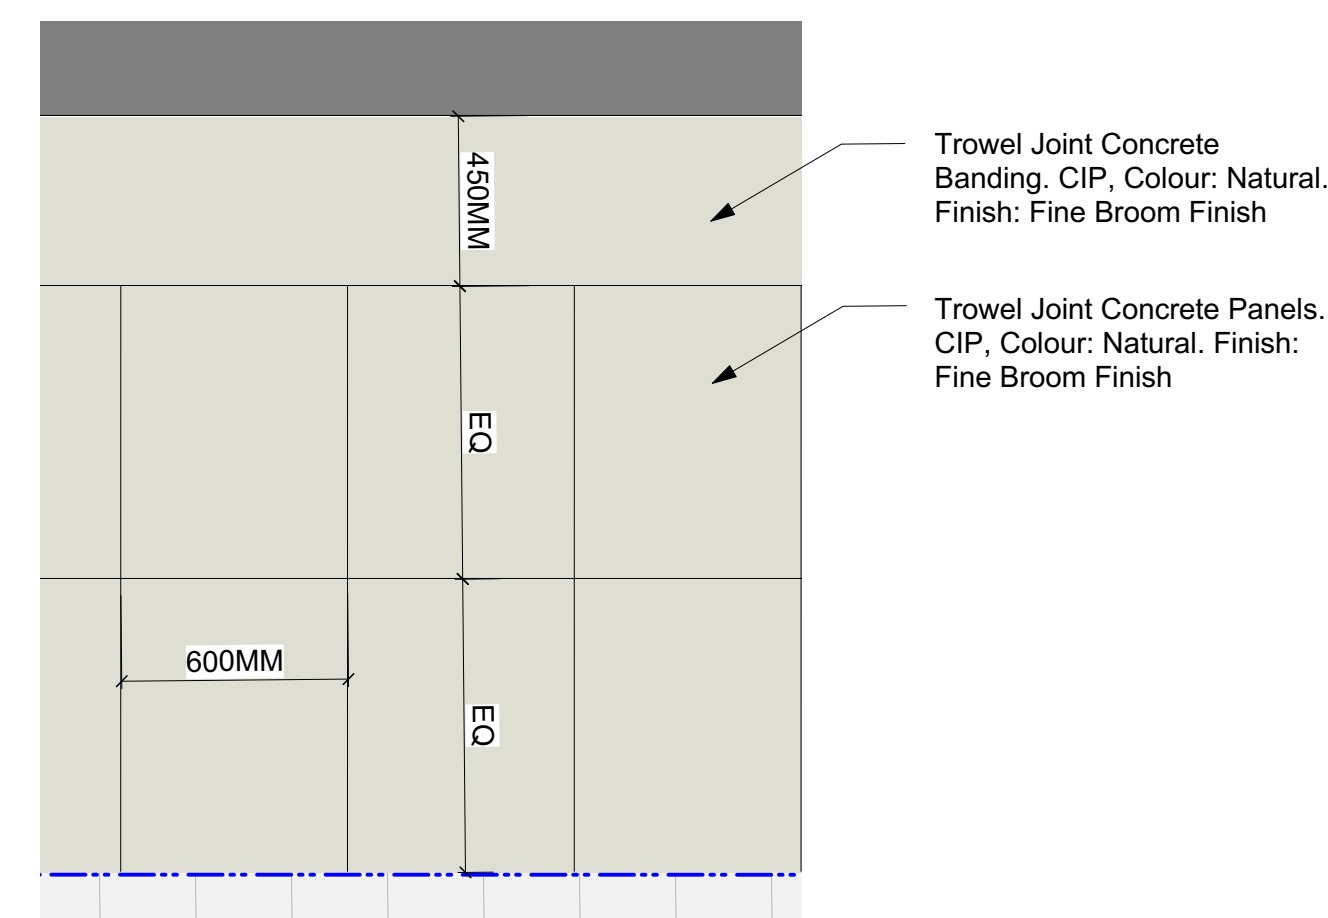
1. Trees shall be of quality prescribed
2. Trunk caliper shall meet Canadian Landscape Standard Current Edition for root ball size.
3. Max. depth of planting pit = rootball depth + 150 mm.
4. Place stakes parallel to prevailing wind direction.
5. Follow supply nursery's instructions on removal of rope, burlap, and wire baskets.

4 Tree Planting Detail on Slab
Scale: 1:25

5 Tree Planting Detail on Grade
Scale: 1:25

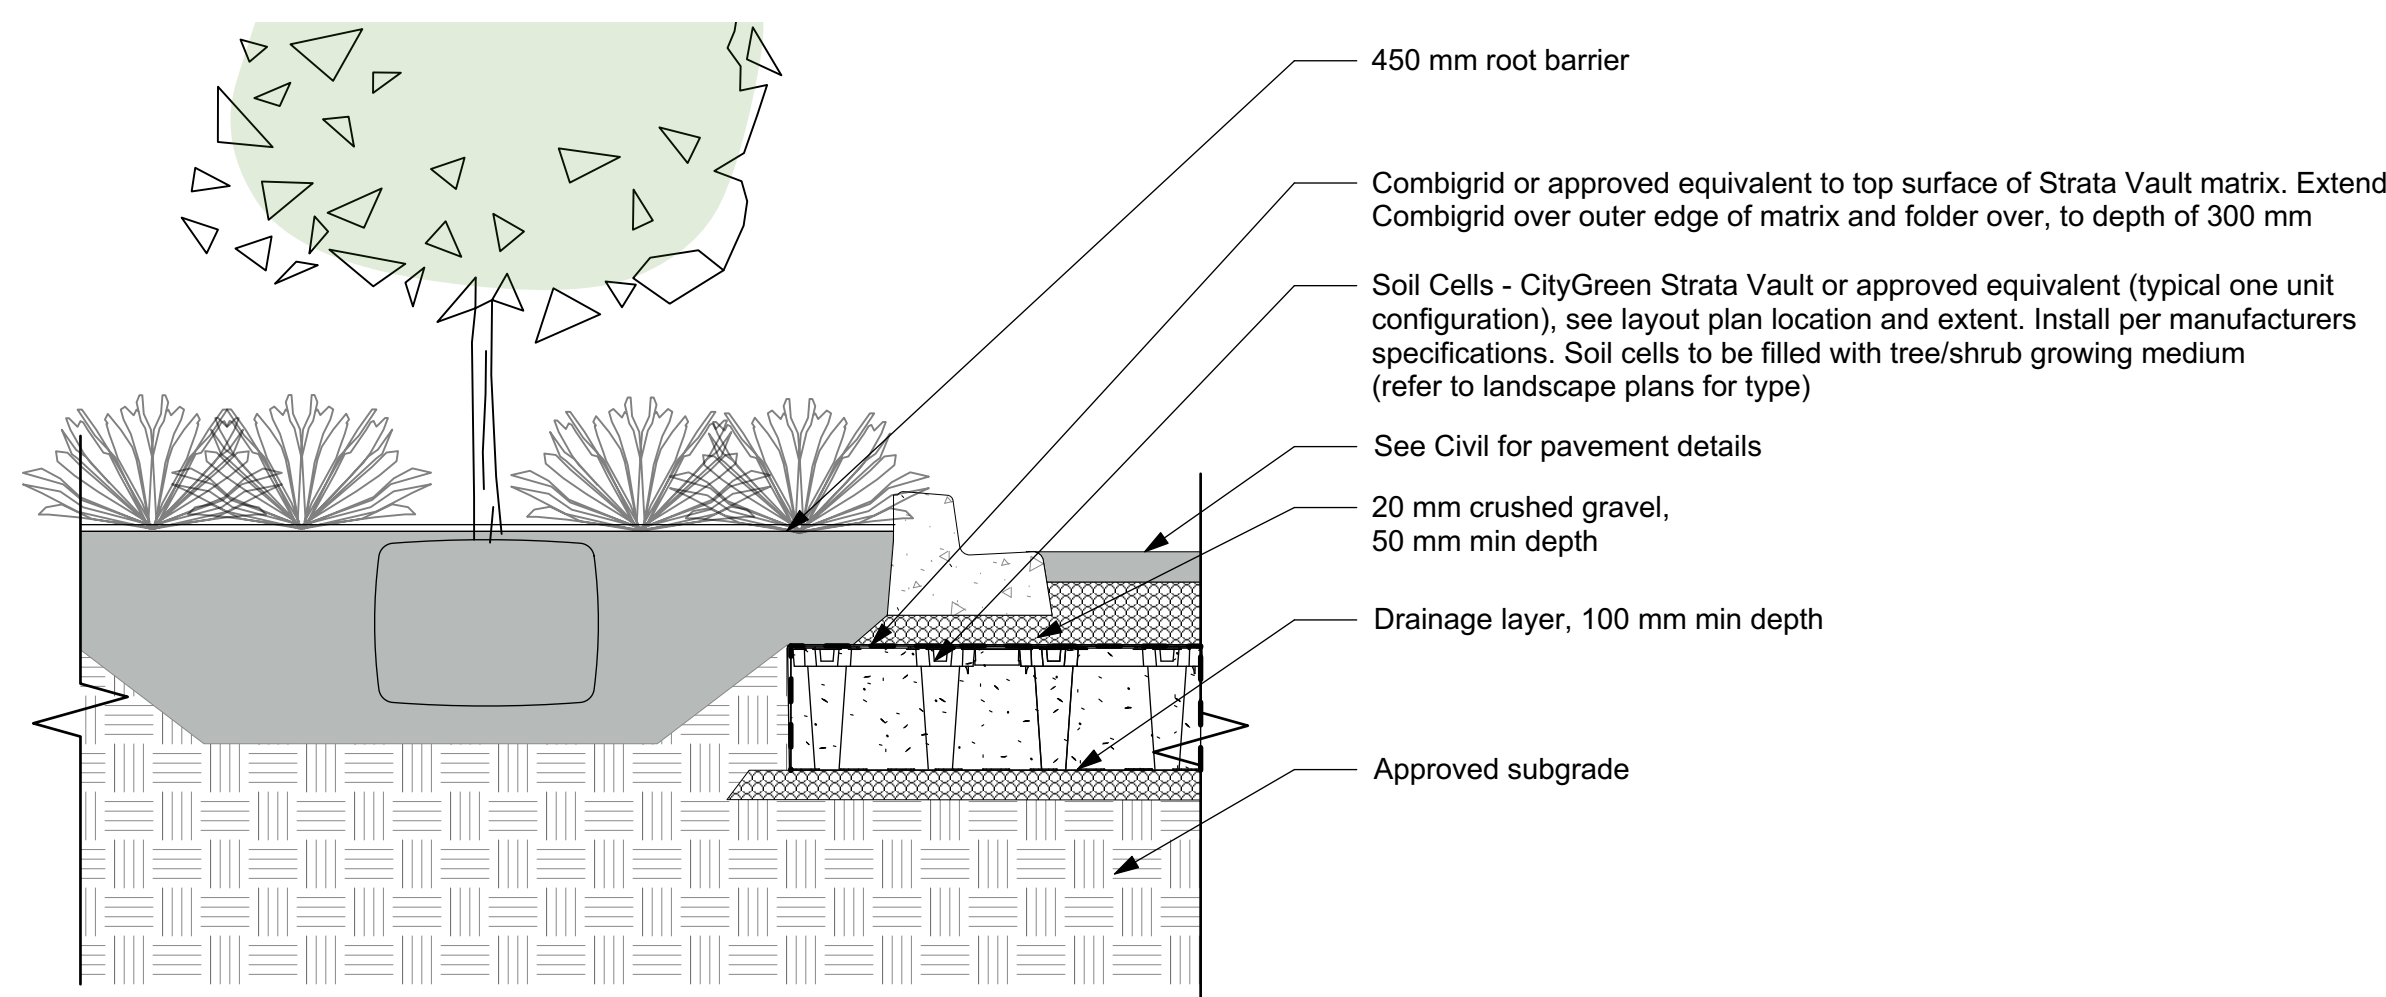

6 Structural Soil Cells
Scale: 1:25



7 City of Victoria Paving Detail
Scale: 1:20

ALL DRAWINGS TO BE READ IN ASSOCIATION WITH CONTRACT SPECIFICATIONS.

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