NOTE: For descriptive information pertaining to Landscape Architectural changes, please refer to the included letter prepared by Biophilia Design Collective Ltd.

Revision Number	Revision Title	Drawing	Description
1	Foul Bay Frontage	A1.0, A2.0, A2.1, A3.0, A4.0	In response to comments from Development Services, street-facing entries with canopies/awnings and patios with gated steps up the sidewalk have been added to all ground level units on Foul Bay (see item #7 for increase to Site Coverage). In response to comments from the Transportation Planner, a 1.75m paved sidewalk has been added to Foul Bay, stopping at the last unit entry path (future extension is shown dashed). The S.R.W. has also been reduced to exclude the existing heritage rock wall and gate post. Existing trees to be retained and removed have been updated and coordinated with Landscape and the Arborist's report.
2	Quamichan Street Frontage	A1.0, A2.1	In response to comments from the Transportation Planner, the number of openings through the existing stone wall has been reduced to one by combing the unit entry and through-site paths. To accommodate, the short-term bike parking has been moved east, and two spaces have beer relocated adjacent to the Redfern entry paths.
3	Redfern Frontage	A1.0, A2.1	In response to comments from the Transportation Planner, the number of unit entry paths has been reduced by one. Paths outside the property line have been changed to solid paving.
4	Electrical	A2.1, A4.0	An electrical room has been added, under the stairs to Unit C.
5	Distance Between Buildings	A1.0	In response to comments from the Plan Checker, a dimension from the East Building to the We Building (bay window) has been added. Note that the bay window does not overlap the East Building.
6	Tree Clarification	A1.0	Tree location and status updated and coordinated with Landscape and the Arborist's report.
7	Site Coverage	A1.0	Site Coverage has been adjusted to account for the new entry steps and patios along Foul Bay.
8	Redfern Tree	A3.2	Tree size reduced.
9	Play Area	A1.0, A2.1	Configuration of Play Area revised to accommodate new trees.
Leg {	end	Revision bubble Revision numbe	

List of Drawings

Architectural

D'Ambrosio architecture + urbanisr 2960 Jutland Road Victoria, BC

A0.0 Cover Sheet

A0.1 Site Survey + Location Plan

A0.2 Shadow Analysis

A0.3 3D Shadow Analysis

A1.0 Site Plan + Project Information

+ Grade Calculation
A2 0 Basement Plan

A2.1 First Storey Plan

A2.2 Second Storey Plan

A2.3 Third Storey Plan

A2.4 Roof Pla

A3.0 East Building Elevations

A3.1 West Building Elevations

A3.2 Street/Context Elevations
A3.3 Materials Palette

A4.0 Building Section

A4.1 Roof Sections

Landscape

Biophilia Design Collective Ltd. 1608 Camosun Street Victoria, BC

L0 Cover Page

L1 Landscape Site Plan

L2 Green Roof on Parking Facility

L3 Green Roof over Second Storey

L4 Existing Tree Removal and Retention Plan

L5 Arborist Report of Existing Trees

L6 Tree Planting Plan
L7 Shrub Planting Plan

L8 Planting Imagery

L9 Design Detail

Civil

J.E. Anderson 4212 Glanford Ave. Victoria, BC

C1 Site Servicing Plan

D'AMBROSIO architecture + urbanism

2960 Jutland Road
Victoria BC Canada V8T5K2
tel 250.384.2400
fax 250.384.7893
eml mail@fdarc.ca
web www.fdarc.ca



Bubbled Set


Changes made as a result of the Application Review and Plan Check

902 Foul Bay Road

Victoria B.C.




Revised Rezoning III July 29, 2021

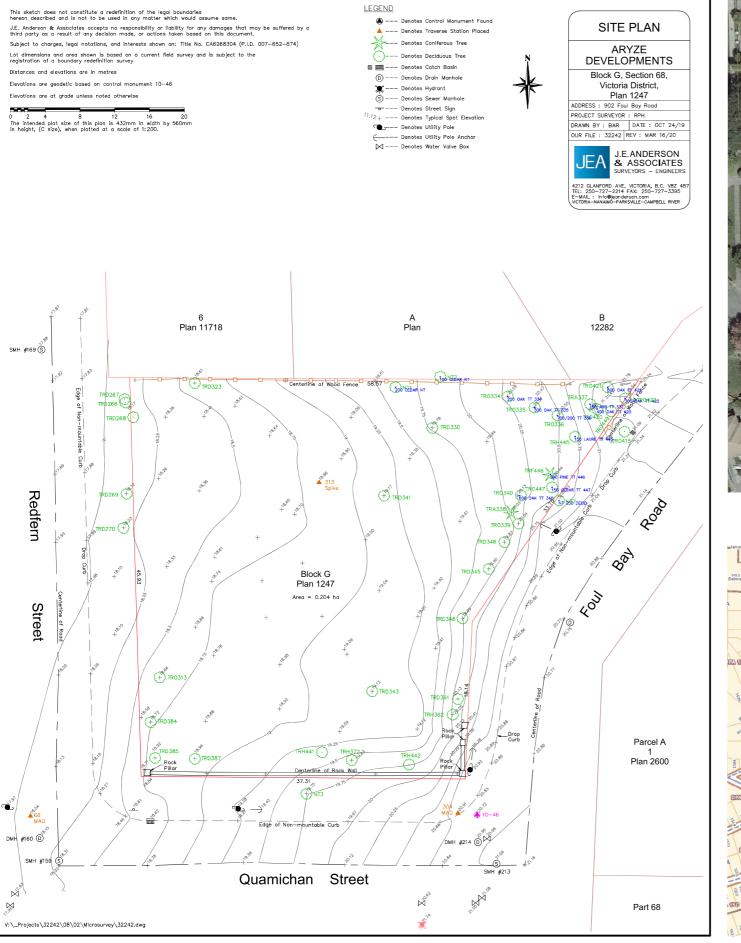

Site Survey
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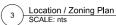
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Victoria, BC


Site Survey, Context, Location / Zoning Plan

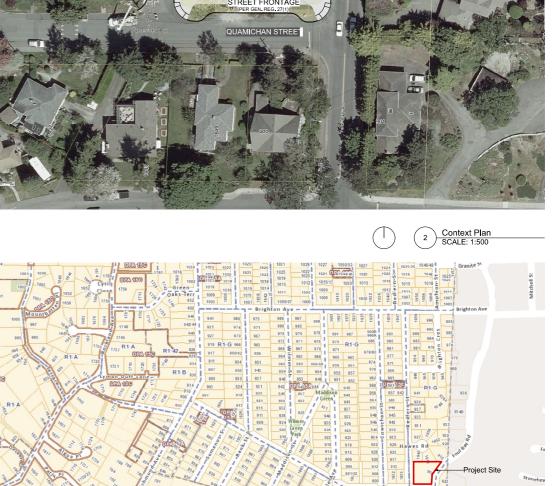revision no. sheet no. A0.1

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Quamichan Street



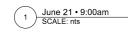

June 21 • 12:00pm SCALE: nts



June 21 • 5:00pm SCALE: nts



March 21 • 9:00am
SCALE: nts



5 March 21 • 12:00pm SCALE: nts



6 March 21 • 5:00pm SCALE: nts



7 December 21 • 10:00am



8 December 21 • 12:00pm SCALE: nts



9 December 21 • 3:00pm SCALE: nts





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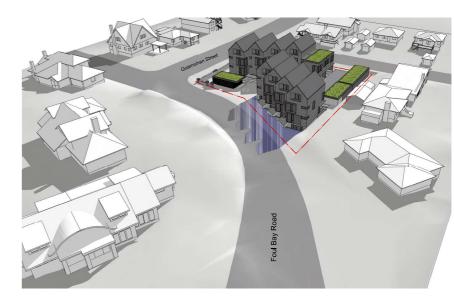
902 Foul Bay Road Victoria, BC

Shadow Studies

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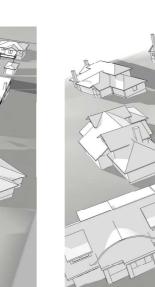




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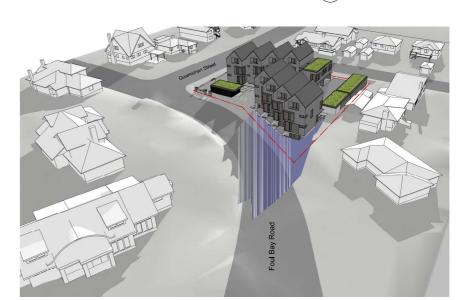
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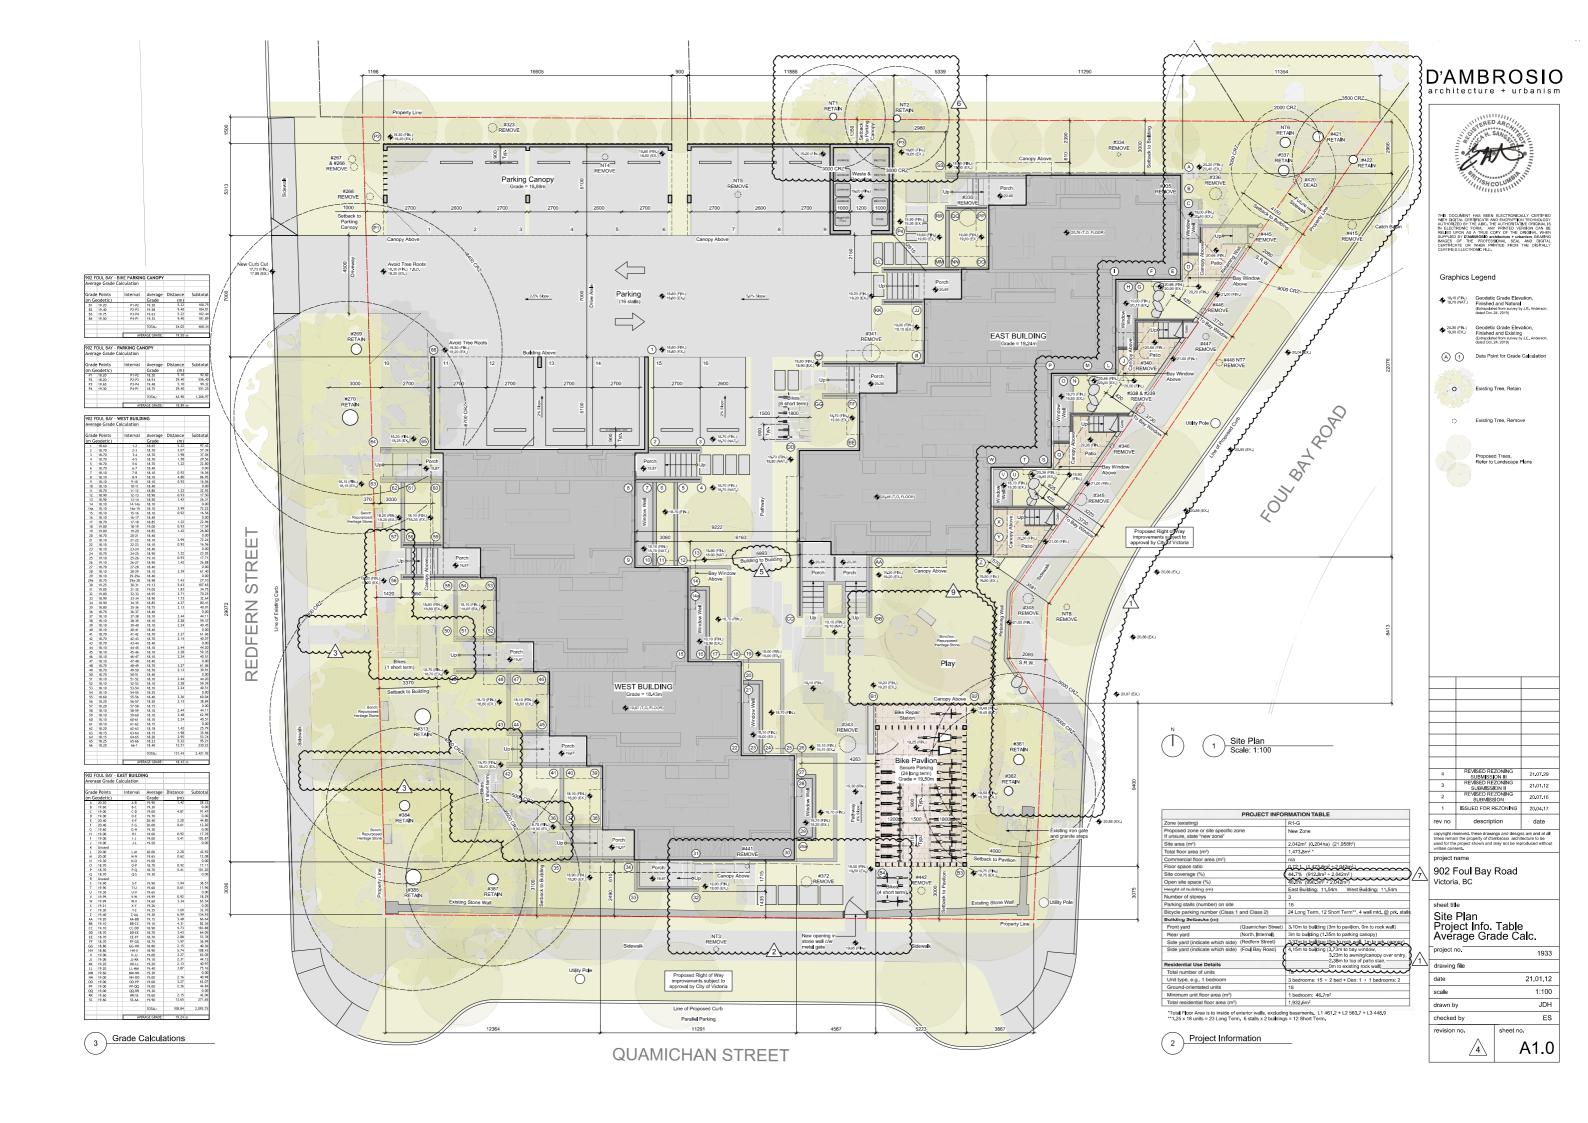
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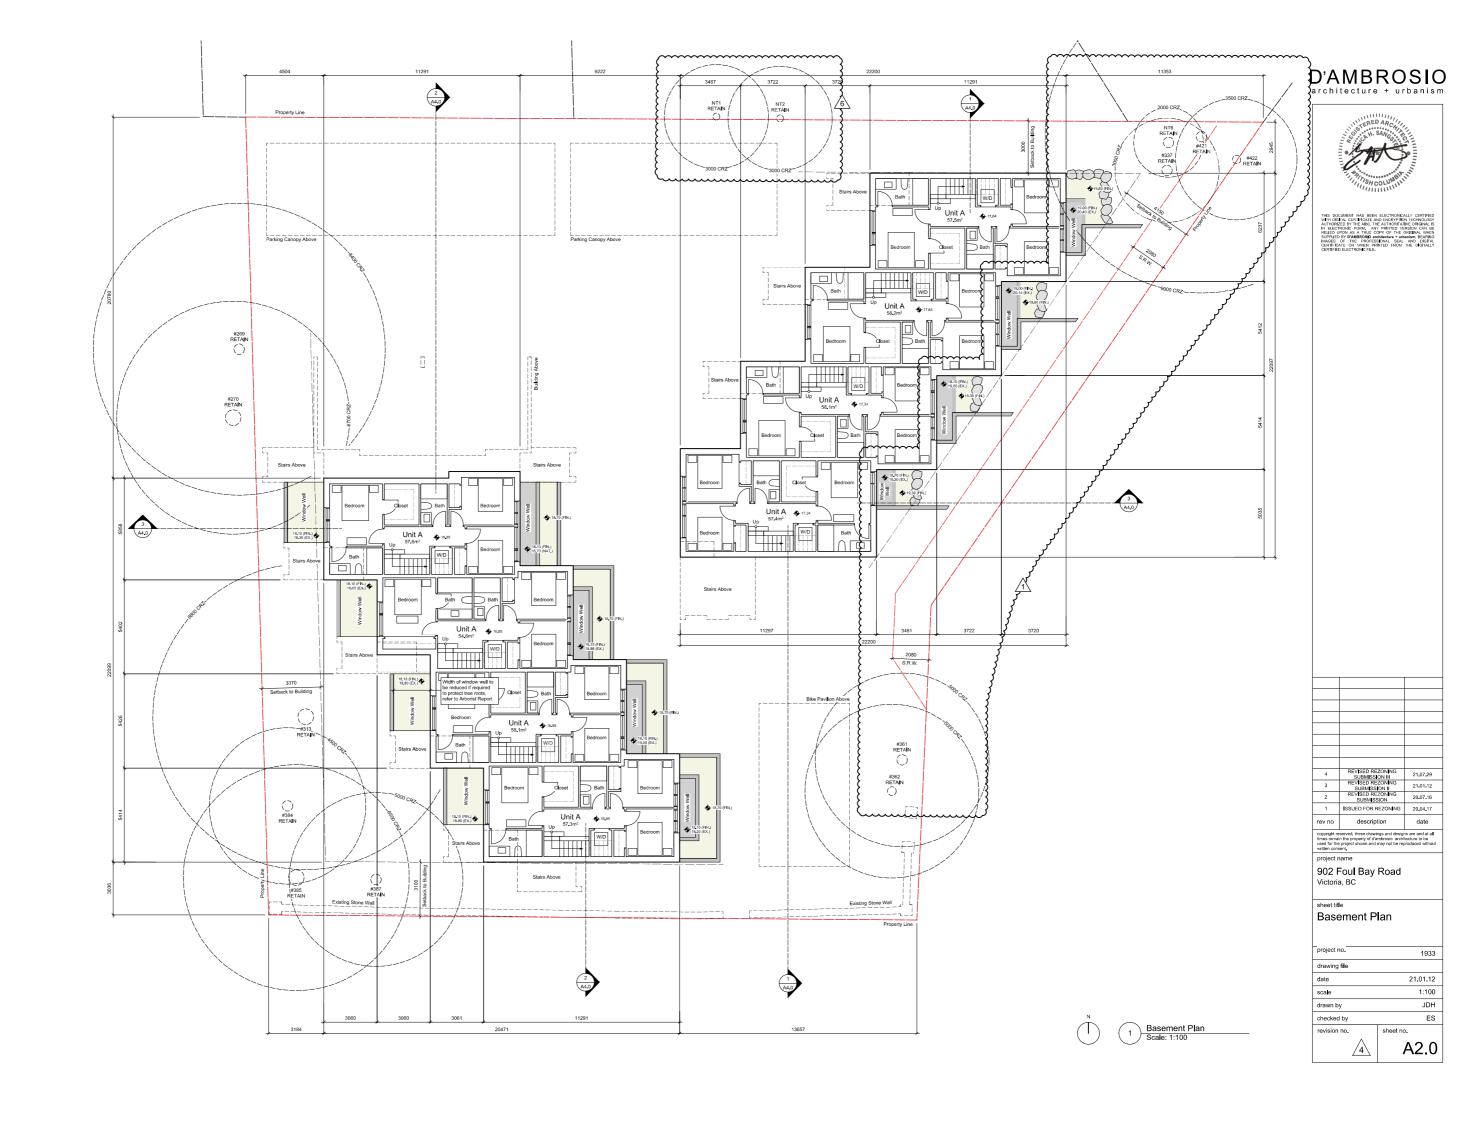



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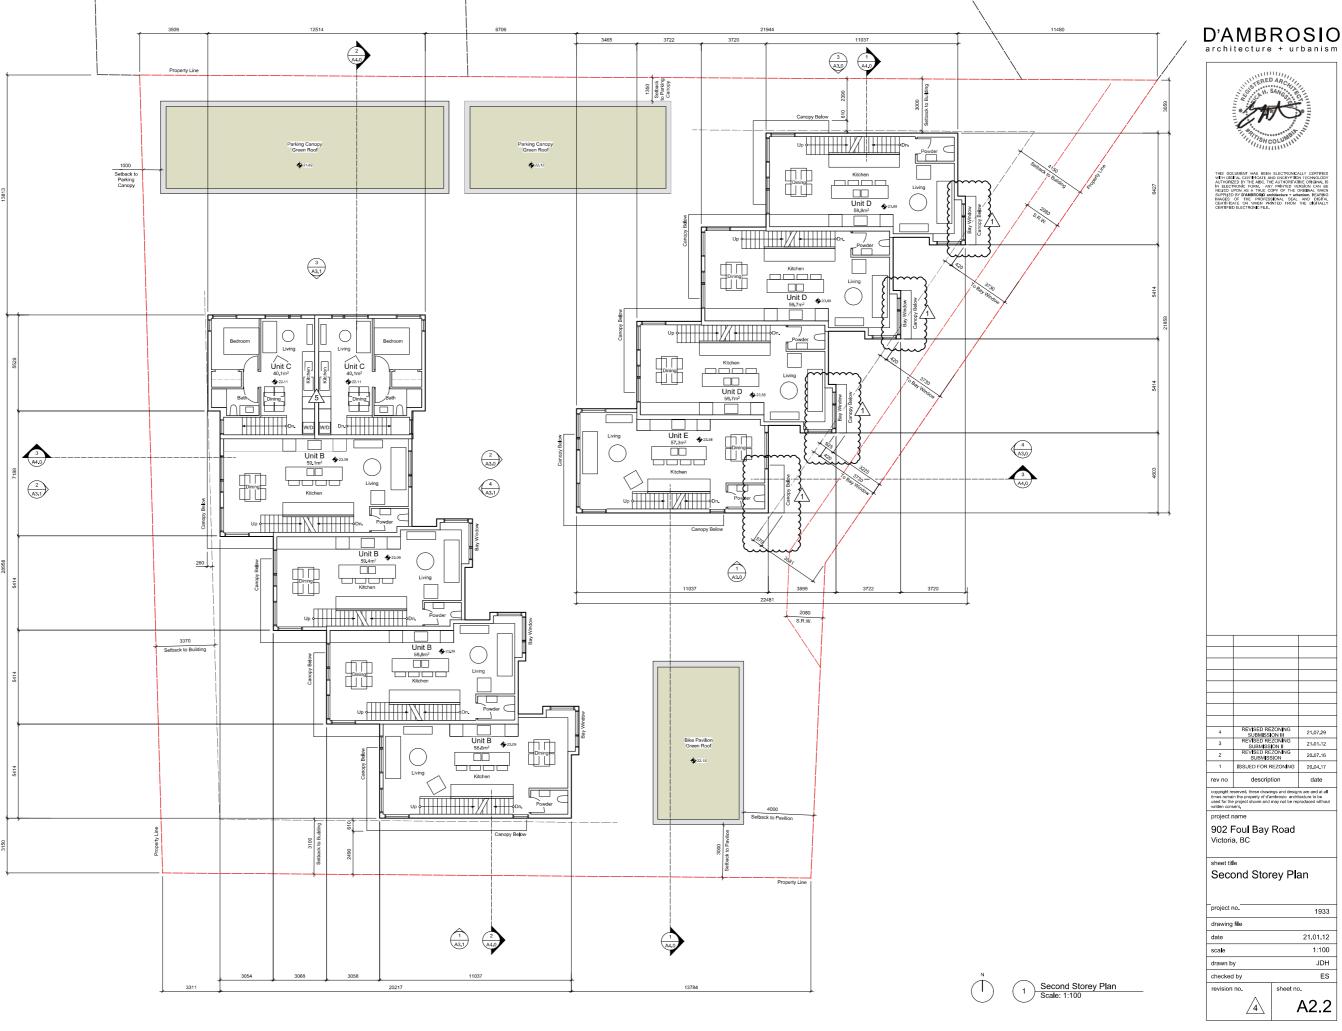
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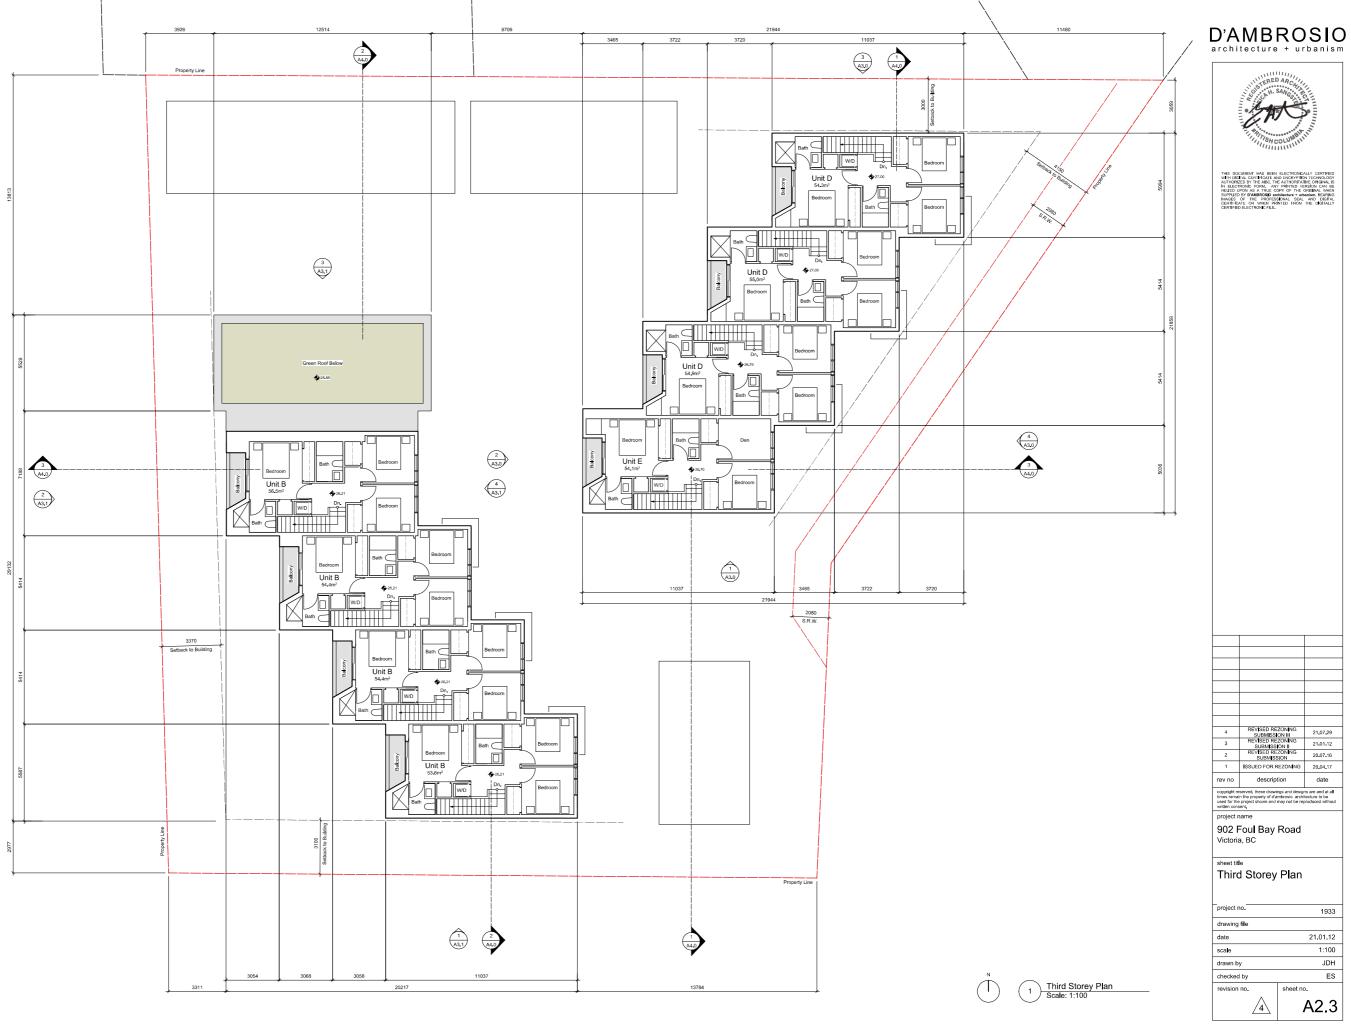








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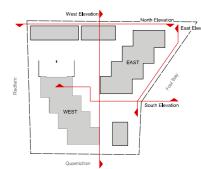


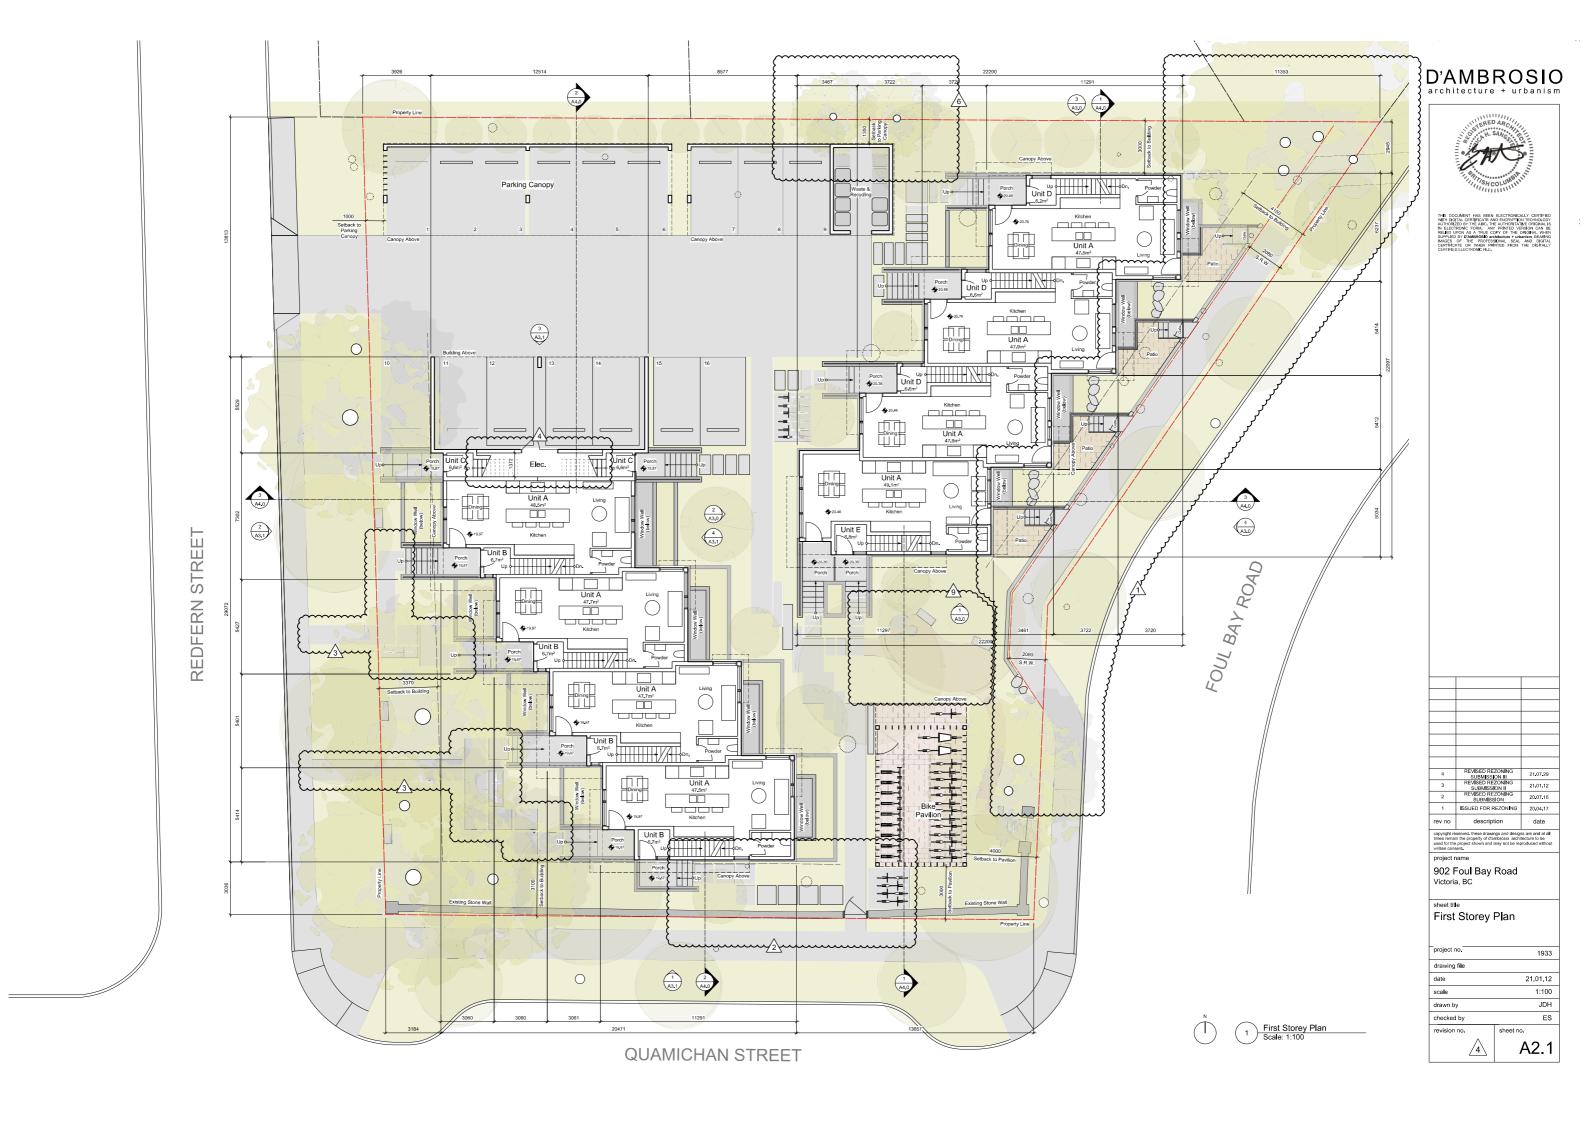

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902 Foul Bay Road Victoria, BC

East Building Elevations

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- Painted Metal Picket Guard Charcoal
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902 Foul Bay Road Victoria, BC

West Building Elevations

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D'AMBROSIO architecture + urbanism



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902 Foul Bay Road Victoria, BC

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Street/Context Elevations

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Materials Key

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Corner of Quamichan and Redfern SCALE: nts



2 Redfern Looking Southeast SCALE: nts



Materials Palette

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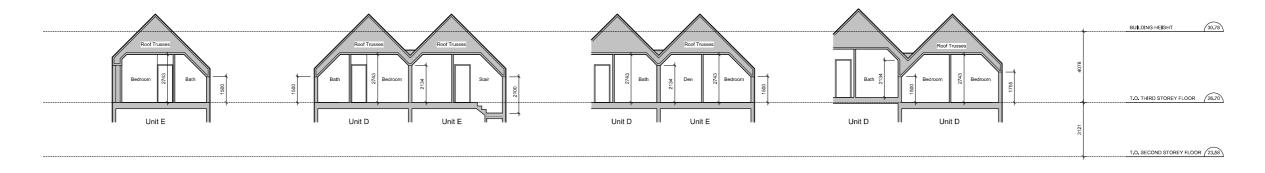


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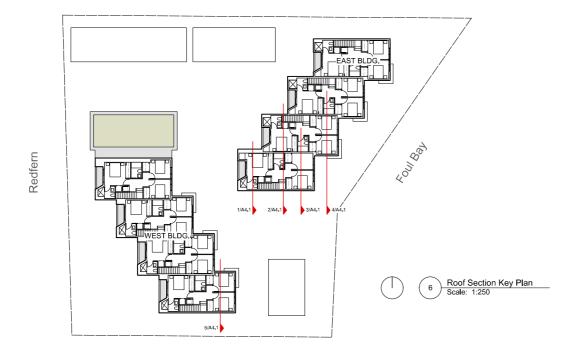
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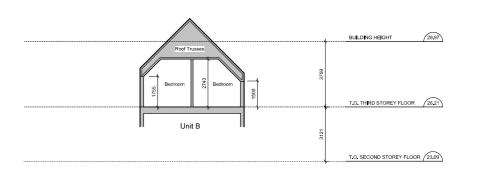
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Roof Section • East Building
Scale: 1:100



Quamichan



Roof Section • West Building
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902 Foul Bay Road Victoria, BC

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902 Foul Bay Rd Victoria, BC







STORM WATER MANAGEMENT - INDIGENOUS PLANTED GREEN ROOFS

NATURAL PLAY AREA

POLLINATOR





GARRY OAK MEADOW

GRANITE STONE WALL PRESERVATION


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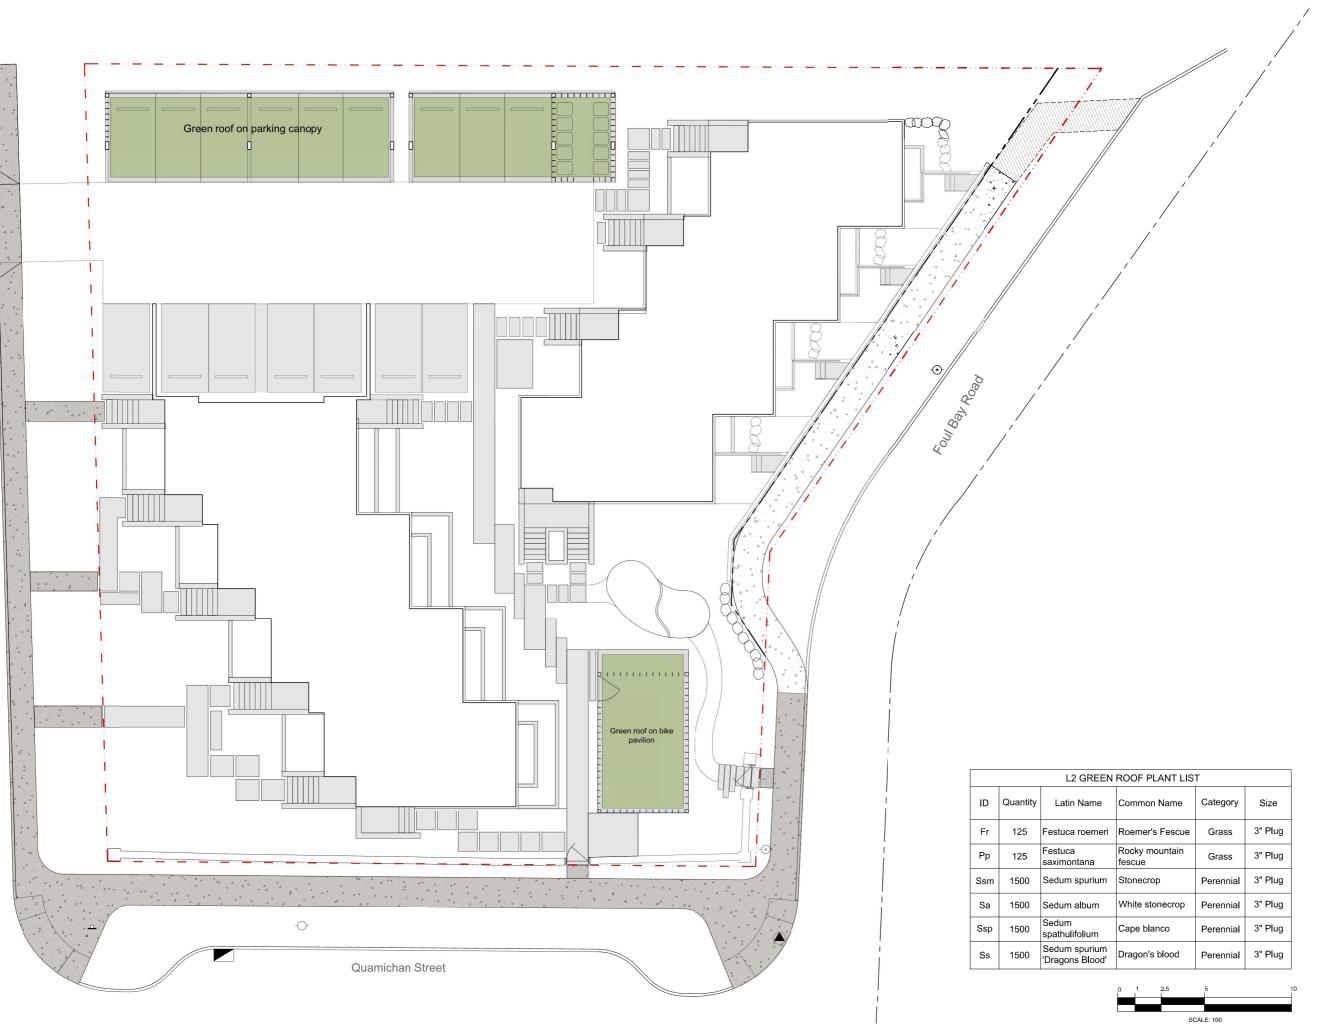




Landscape Revision List

Revision Number	Revision Title	Drawing	Description
1	Foul Bay Frontage	L1	 Street facing entries and patios revised as per architectural Sidewalk revised to 1.75 m width as per architectural / civil Concrete retaining wall moved on to private property as per civil Boulder retaining wall on private property added adjacent to existing trees to reduce impacts to existing trees – in coordination with civil and arborist Municipal sidewalk revised to terminate at northerly unit entry; proposed sidewalk extension dashed – as per architectural / civil Alignment of sidewalk adjusted to provide additional space between the sidewalk and existing trees – in coordination with civil and arborist 2.08 m Statutory Right of Way (SRW) added terminating at end of boulder retaining wall and excluding the heritage wall – as per civil SRW dimensioned and highlighted on landscape plans Updated civil plans incorporated into landscape plans showing all existing and proposed utilities and power poles Civil adjusted location of proposed water service to accommodate an (1) additional boulevard tree
2	Quamichan Street Frontage	L1	Sidewalks (2) crossing municipal frontage combined; entry to unit revised, bike parking shifted to other side of sidewalk and reduced from 6 to 4 bike parking spaces – additional bike parking (2) provided adjacent to units on Redfern Street Walkways to units adjusted toward buildings to provide additional undisturbed area adjacent to existing trees
3	Redfern Frontage	L1	Sidewalks (2) crossing municipal frontage combined Bike parking (2) added at shared entry walkways
4	Park / Playground	L1	Shape of park / playground revised to provide additional offset for proposed trees from bike parking pavilion
5	Municipal Sidewalks	L1	All walkways on municipal property revised to standard broom finish concrete sidewalks
6	Existing Trees	L1, L4	 Existing trees on landscape drawing updated to match legal survey locations Existing trees to remain / remove updated as per arborist Existing trees on adjacent property to remain
7	Tree Planting	L1, L4	Additional street tree added to Foul Bay frontage Tree planting in general revised in response to site plan changes Replacement trees revised as per City comments Summary of trees to be removed and replacement trees required updated
8	Tree Protection Fencing	L4	See arborist report for tree protection fencing specifications, location and phasing instructions
9	Shrub Planting	L1, L8	 Shrub planting in general revised in response to site plan changes Proposed shrubs removed from underneath existing trees to minimize disturbance to tree roots as per City comments Shrubs removed from within 0.45 m from property line as per City comments (assume groundcovers and perennials are acceptable) Shrub designations updated as per City comments Methodology for percentage analysis noted as per City comments
10	Arborist Report	L5	Arborist tree retention and removal spreadsheet updated
11	Soil Volume	L7	Drawing indicating available soil volume per tree added



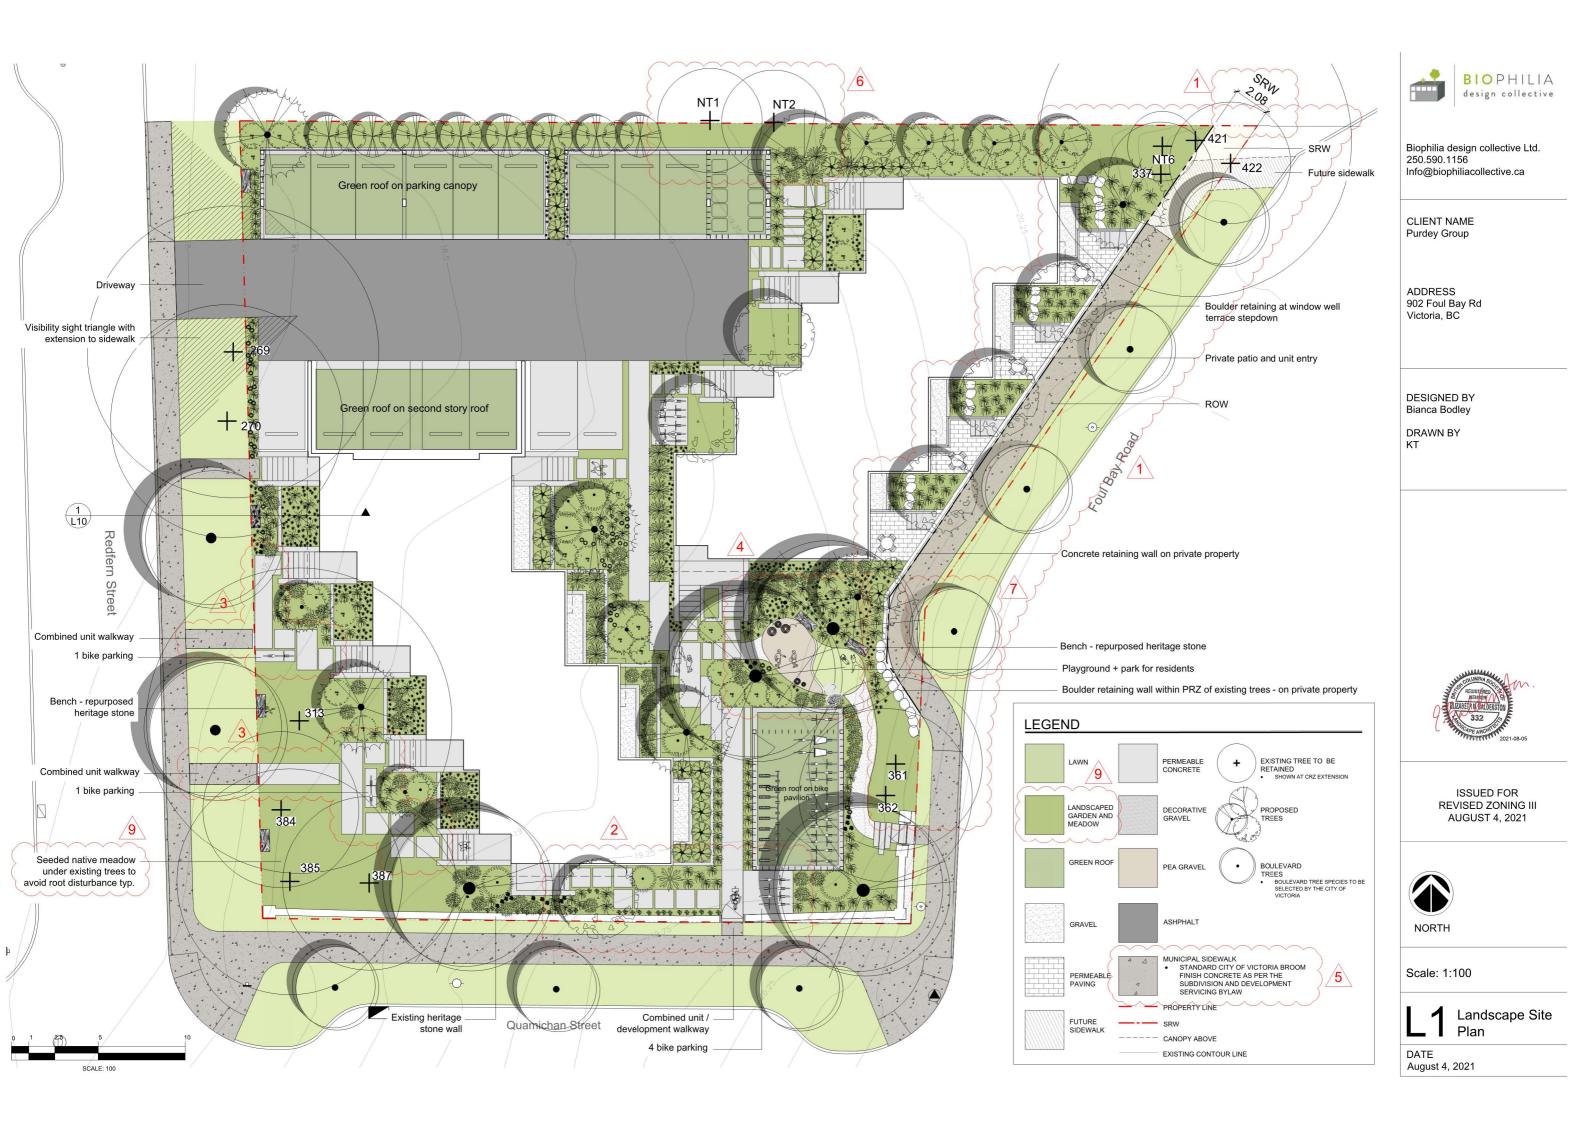



CLIENT NAME Purdey Group

ADDRESS 902 Foul Bay Rd Victoria, BC

DESIGNED BY Bianca Bodley

DRAWN BY




ISSUED FOR REVISED ZONING III AUGUST 4, 2021



Scale: 1:100

_____ Green Roof on Parking Facility

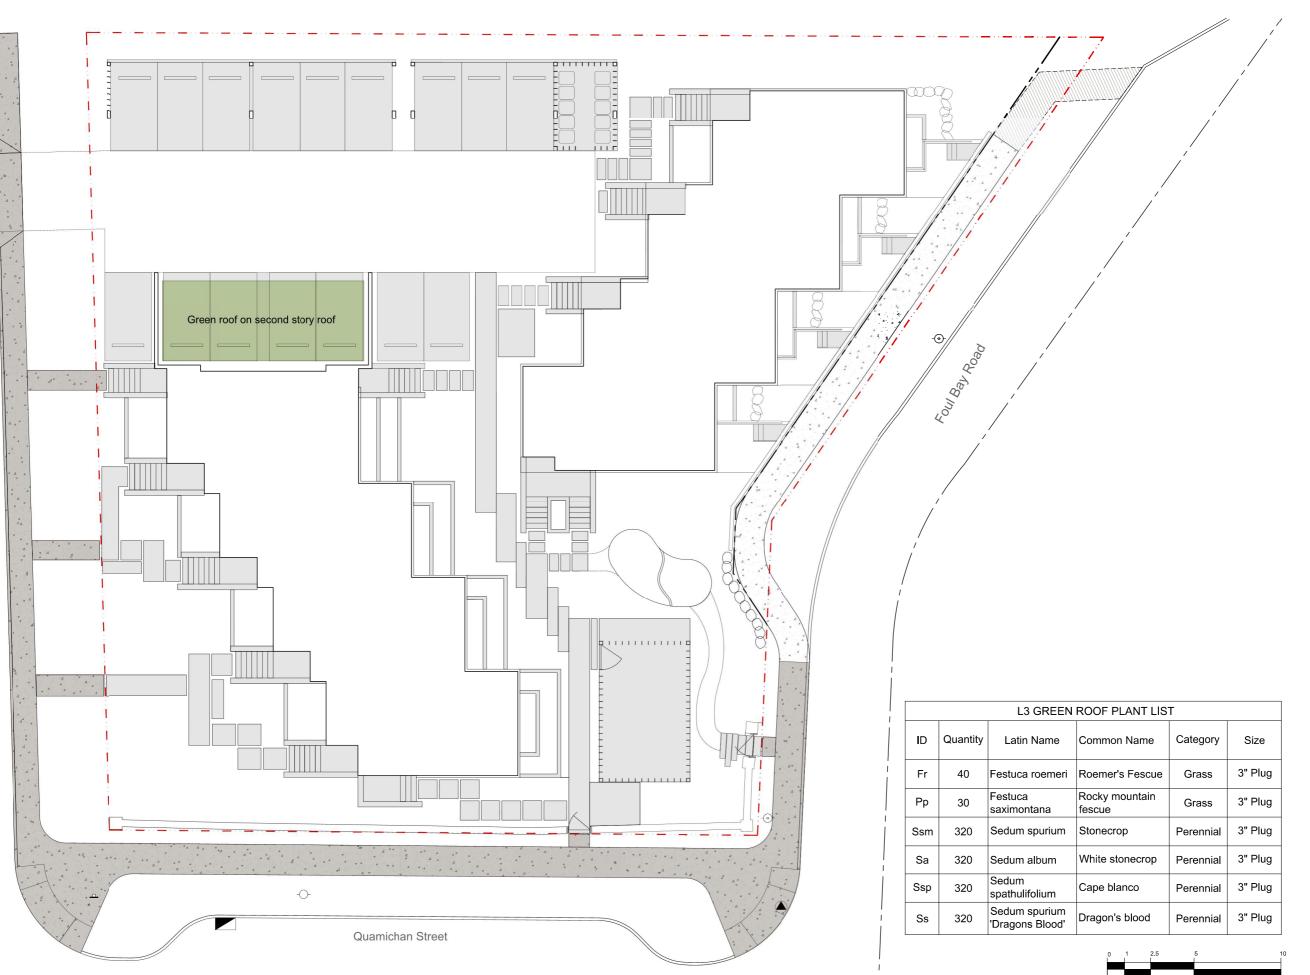



CLIENT NAME Purdey Group

ADDRESS 902 Foul Bay Rd Victoria, BC

DESIGNED BY Bianca Bodley

DRAWN BY



ISSUED FOR REVISED ZONING III AUGUST 4, 2021




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Green Roof over Second Storey

DATE August 4, 2021

SCALE: 100



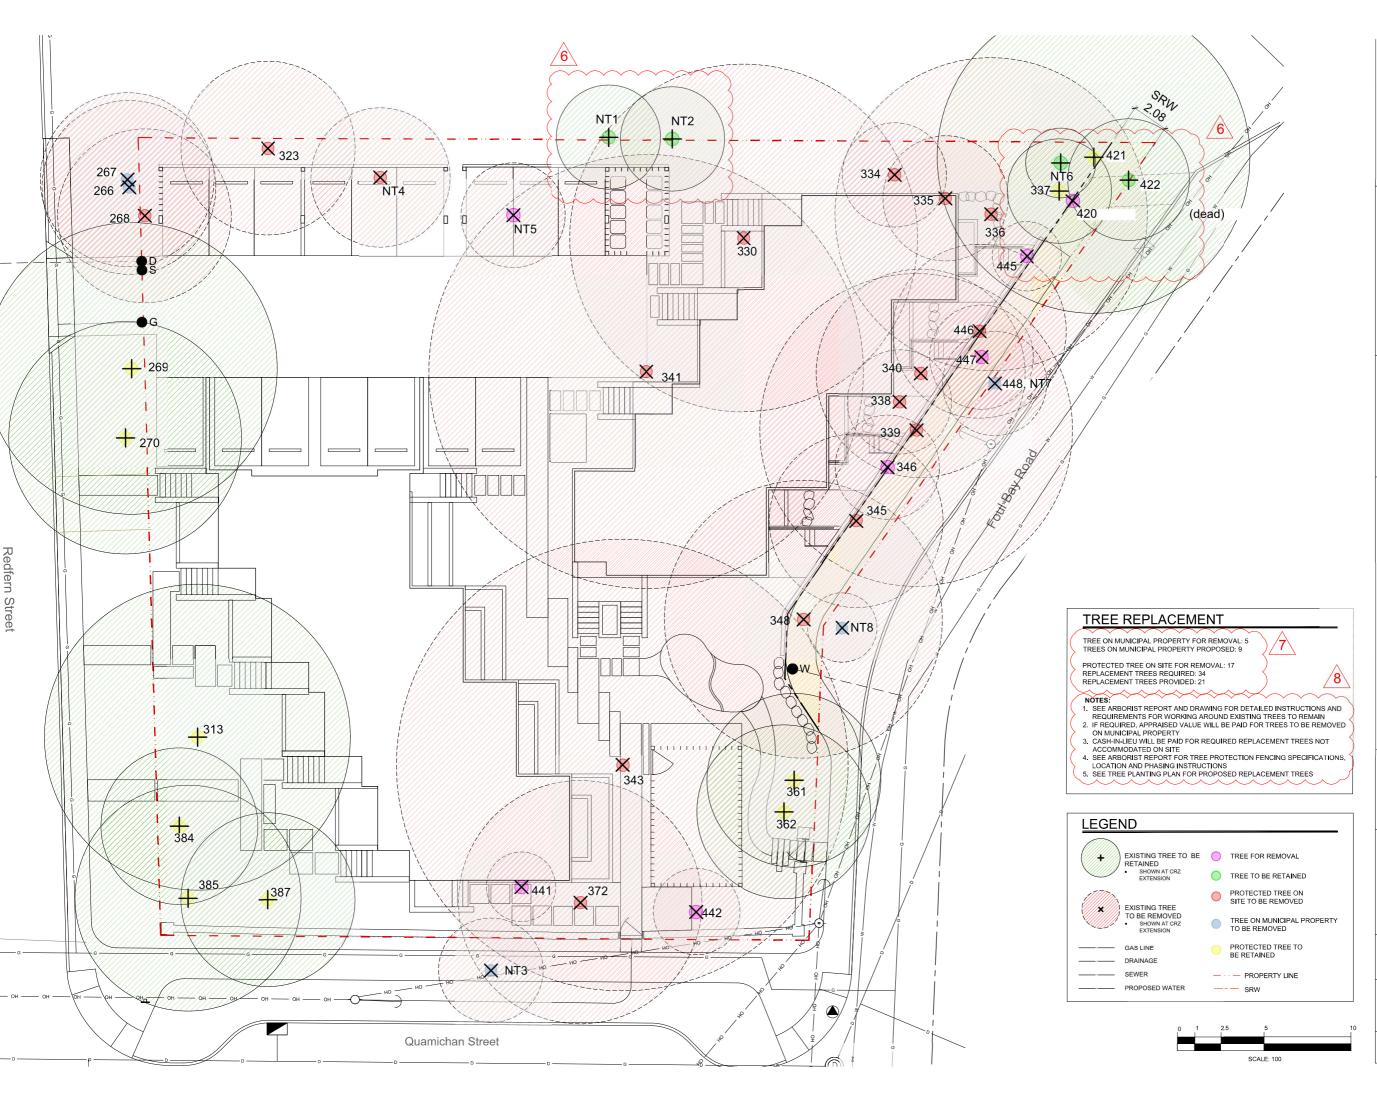

CLIENT NAME Purdey Group

ADDRESS 902 Foul Bay Rd Victoria, BC

DESIGNED BY Bianca Bodley

DRAWN BY



ISSUED FOR REVISED ZONING III AUGUST 4, 2021



Scale: 1:100



Tree Removal and Retention Plan

amended 07.27.21

Tree Resource Spreadsheet 902 Foul Bay Road

Source Spreadsheet

. 🗆					Crown								
Tre	e ID	Comnon Name	Latin Name	DBH (cm) ~ approximate	Spread (m)	CRZ (m)	Relative Tolerance	Health	Structure		Bylaw protected	Retention Status	Reason for removal
26		Trembling aspen	Populus tremuloides	26,37	8.0	5.0	Moderate	Fair	Fair	Co-dominant, smaller stem dead, large deadwood, ivy on trunk	Municipal	х	Impacts from parking and changes in drainage.
26		Trembling aspen	Populus tremuloiáes	41.0	7.0	5.0	Moderate	Fair	Fair	Large deadwood, ivy on main trunk, broken limb in canopy	Municipal	X	Impacts from parking and changes in drainage.
26		Trembling aspen	Populus tremuloiáes	46.0	9.0	5.0	Moderate	Fair	Fair	Large deadwood, ivy on trunk, canker	Yes	х	Impacts from parking and changes in drainage.
26	69	Horse chestnut	Aesculus hippocastanum	33,34,35,45	8.0	8.4	Good	Fair	Fair/poor	Multi stem at 1 meter, included bark in stem unions.	Municipal	Retain	
27	70	Horse chestnut	Aesculus hippocastanum	84.0	14.0	6.7	Good	Fair	Fair/poor	Multi-stem at 3 meters. Internal crack in limb on south side	Municipal	Retain	
31	13	Garryoak	Quercus garryana	88.0	18.0	8.8	Good	Fair	Fair	Large deadwood, some epicormic growth	Yes	Retain	
32	23	Horse chestnut	Aesculus hippocastanum	51.0	9.0	5.0	Good	Fair	Fair	Ivy on main trunk, insect damage, canker, possible root disturbance from previous structure removal.	Yes	х	Parking and structure.
33	30	Garry oak	Quercus garryana	106.0	9.0	10.0	Good	Poor	Poor	Cambium dieback and decay in main trunk. Previously reduced, cavities in trunk.	Yes	х	In building
33	34	Garryoak	Quercus garryana	26.0	8.0	3.0	Good	Good	Fair	Asymmetric crown, canker on trunk	Yes	Х	Too close to excavation for building
33	35	Garry oak	Quercus garryana	36.0	12.0	3.6	Good	Good	Fair	Some end weighted limbs, suppressed by adjacent tree	Yes	Х	In building
33	36	Garry oak	Quercus garryana	67, 26	18.0	8.0	Good	Fair	Fair	May have originally been two trees, large deadwood	Yes	X	In building
33	37	Arbutus	Arbutus menziesii	12.0	5.0	3.0	Poor	Fair	Fair	Canker on lower trunk	Yes	Retain	
33	38	Arbutus	Arbutus menziesii	18.0	4.0	3.0	Poor	Good	Good		Yes	Х	Too close to excavation for building
33	39	Garryoak	Quercus garryana	52,62	13.0	9.0	Good	Fair	Fair	co-dominant at 1.3 meters, ivy on trunk, asymmetric crown.	Yes	х	Too close to excavation for building
34	40	Garryoak	Quercus garryana	62.0	9.0	6.0	Good	Fair	Fair	Some large deadwood	Yes	x	In building
Ì		Garryoak Common Name		62.0 DBH (cm) ~ approximate	9.0 Crown Spread (m)	6.0 CRZ (m)	Good Relative Tolerance	Fair Health	Fair Structure	Some large deadwood Remarks and Recommendations	Yes Bylaw protected	X Retention Status	In building Reason for removal
Tre	e ID	Common	garryana	DBH (cm)	Crown Spread	CRZ	Relative				Bylaw	Retention	
Tre	ee ID	Common Name European	garryana Latin Name	DBH (cm) ~ approximate	Crown Spread (m)	CRZ (m)	Relative Tolerance	Health	Structure	Remarks and Recommendations Stunted growth at top, some epicormic growth, possible	Bylaw protected	Retention Status	Reason for removal
34	41 43	Common Name European Beech European	garryana Latin Name Fagus sylvatica	DBH (cm) ~ approximate 85.0	Crown Spread (m)	CRZ (m)	Relative Tolerance	Health Fair	Structure Fair	Remarks and Recommendations Stunted growth at top, some epicormic growth, possible minor root injury from old house removal. Armillaria fruiting bodies around base and on buttress	Bylaw protected Yes	Retention Status X	Reason for removal In building Too close to excavation for
34 34 34 34 34 34 34 34 34 34 34 34 34 3	41 43 45	Common Name European Beech European Beech	garryana Latin Name Fagus sylvatica Fagus sylvatica Aesculus	DBH (cm) ~ approximate 85.0	Crown Spread (m) 17.0	CRZ (m) 12.5	Relative Tolerance Poor	Health Fair Fair	Structure Fair Fair	Remarks and Recommendations Stunted growth at top, some epicormic growth, possible minor root injury from old house removal. Armillaria fruiting bodies around base and on buttress roots. Recommend closer examination if retained. Co-dominant at 3meters ivy on trunk, cavities in old	Bylaw protected Yes	Retention Status X	Reason for removal In building Too close to excavation for building Too close to excavation for
34 34 34 34 34 34 34 34 34 34 34 34 34 3	41 43 45 46	Common Name European Beeck European Beeck Horse chestnut	garryana Latin Name Fagus sylvatica Fagus sylvatica Aesculus hippocastanum	DBH (cm) - approximate 85.0 89.0 64.0	Crown Spread (m) 17.0 15.0	CRZ (m) 12.5 13.0 5.0	Relative Tolerance Poor Poor Good	Health Fair Fair Fair	Structure Fair Fair Fair	Remarks and Recommendations Stunted growth at top, some epicormic growth, possible minor root injury from old house removal. Armillaria fruiting bodies around base and on buttress roots. Recommend closer examination if retained. Co-dominant at 3meters ivy on trunk, cavities in old	Bylaw protected Yes Yes	Retention Status X X	Reason for removal In building Too close to excavation for building Too close to excavation for building Too close to excavation for building
3-3-3-3-3-3-3-3-3-3-3-3-3-3-3-3-3-3-3-	41 43 445 446 448	Common Name European Beeck European Beeck Horse chestnut	garryana Latin Name Fagus sylvatica Fagus sylvatica Aesculus hippocastanum Ilex aquifolium	DBH (cm) ~ approximate 85.0 89.0 64.0 28.0	Crown Spread (m) 17.0 15.0 10.0	12.5 13.0 5.0	Poor Poor Good Good	Health Fair Fair Good	Structure Fair Fair Fair Fair	Remarks and Recommendations Stunted growth at top, some epicormic growth, possible minor root injury from old house removal. Armillaria fruiting bodies around base and on buttress roots. Recommend closer examination if retained. Co-dominant at 3meters ivy on trunk, cavities in old pruning wounds	Bylaw protected Yes Yes	X X X X	Reason for removal In building Too close to excavation for building
3.3 3.3 3.3 3.3 3.3 3.3 3.3 3.3 3.3 3.3	441 43 445 446 48 61	Comnon Name European Beeck European Beeck Horse chestnut Holly European Birch	garryana Latin Name Fagus sylvatica Fagus sylvatica Aesculus hippocastamum Ilex aquifolium Betula pendula Aesculus	DBH (cm) approximate 85.0 89.0 64.0 28.0	17.0 15.0 10.0 4.0	12.5 13.0 5.0 3.0	Relative Tolerance Poor Poor Good Good Poor	Health Fair Fair Good Fair	Structure Fair Fair Fair Fair	Remarks and Recommendations Stunted growth at top, some epicormic growth, possible minor root injury from old house removal. Armillaria fruiting bodies around base and on buttress roots. Recommend closer examination if retained. Co-dominant at 3meters ivy on trunk, cavities in old pruning wounds Some tip dieback, possibly insect related	Bylaw protected Yes Yes Yes No Yes	Retention Status X X X X	Reason for removal In building Too close to excavation for building
3-3-3-3-3-3-3-3-3-3-3-3-3-3-3-3-3-3-3-	41 43 45 46 48 61 62	Common Name European Beeck European Beeck Horse chestnut Holly European Birch Horse chestnut	garryana Latin Name Fagus sylvatica Fagus sylvatica Aesculus hippocastanum Betula pendula Aesculus hippocastanum	DBH (cm) - approximate 85.0 89.0 64.0 28.0 65.0	17.0 15.0 10.0 4.0 9.0	CRZ (m) 12.5 13.0 5.0 8.0 5.0	Relative Tolerance Poor Poor Good Good Poor Good	Health Fair Fair Good Fair	Structure Fair Fair Fair Fair Fair	Remarks and Recommendations Stunted growth at top, some epicormic growth, possible minor root injury from old house removal. Armillaria fruiting bodies around base and on buttress roots. Recommend closer examination if retained. Co-dominant at 3meters ivy on trunk, cavities in old pruning wounds Some tip dieback, possibly insect related	Bylaw protected Yes Yes Yes No Yes	X X X X X Retain	Reason for removal In building Too close to excavation for building
3-3-3-3-3-3-3-3-3-3-3-3-3-3-3-3-3-3-3-	41 43 45 46 48 61 62 72	Common Name European Beeck European Beeck Horse chestnut Holly European Birch Horse chestnut	garryana Latin Name Fagus sylvatica Fagus sylvatica Aesculus hippocastanum Ilex aquifolium Betula pendula Aesculus hippocastanum Ilex aquifolium	DBH (cm) - approximate 85.0 89.0 64.0 28.0 65.0 62.0	17.0 15.0 10.0 4.0 9.0 8.0	CRZ (m) 12.5 13.0 5.0 8.0 5.0 5.0	Relative Tolerance Poor Poor Good Good Good Good Good	Health Fair Fair Good Fair Good	Structure Fair Fair Fair Fair Fair Fair Fair	Remarks and Recommendations Stunted growth at top, some epicormic growth, possible minor root injury from old house removal. Armillaria fruiting bodies around base and on buttress roots. Recommend closer examination if retained. Co-dominant at 3meters ivy on trunk, cavities in old pruning wounds Some tip dieback, possibly insect related Pruned for utilities Possible cavity in lower trunk. Closer examination	Bylaw protected Yes Yes Yes No Yes Yes Yes	X X X X X Retain	Reason for removal In building Too close to excavation for building, services.
3-3-3-3-3-3-3-3-3-3-3-3-3-3-3-3-3-3-3-	41 43 45 46 48 61 62 72 84	Common Name European Beeck European Beeck Horse chestnut Holly European Birch Hotse chestnut	garryana Latin Name Fagus sylvatica Fagus sylvatica Aesculus hippocastanum Ilex aquifolium Betula pendula Aesculus hippocastanum Ilex aquifolium Betula pendula Aesculus Aesculus Aesculus Aesculus	DBH (cm) approximate 85.0 89.0 64.0 28.0 65.0 52.0	17.0 15.0 10.0 4.0 9.0 9.0 11.0	12.5 13.0 5.0 3.0 8.0 5.0	Relative Tolerance Poor Poor Good Good Poor Good Poor	Health Fair Fair Good Fair Good Fair	Structure Fair Fair Fair Fair Fair Fair Fair Fair	Remarks and Recommendations Stunted growth at top, some epicormic growth, possible minor root injury from old house removal. Armillaria fruiting bodies around base and on buttress roots. Recommend closer examination if retained. Co-dominant at 3meters ivy on trunk, cavities in old pruning wounds Some tip dieback_possibly insect related Pruned for utilities Possible cavity in lower trunk. Closer examination recommended if retained	Bylaw protected Yes Yes No Yes Yes Yes Yes Yes	X X X X X Retain Retain	Reason for removal In building Too close to excavation for building, services.
Tre	41 43 45 46 48 61 62 72 84 85	Common Name European Beeck European Beeck Horse chestnut Holly European Birch Horse chestnut Holly Horse chestnut	garryana Latin Name Fagus sylvatica Fagus sylvatica Aesculus hippocastanum Betula pendula Aesculus hippocastanum Betula pendula Aesculus hippocastanum Betula pendula Aesculus hippocastanum Aesculus hippocastanum Aesculus	DBH (cm) approximate 85.0 89.0 64.0 28.0 65.0 52.0 59.0	17.0 15.0 10.0 4.0 9.0 9.0 11.0 8.0	12.5 13.0 5.0 8.0 5.0 7.0 4.5	Relative Tolerance Poor Poor Good Good Poor Good Good Good Good	Health Fair Fair Good Fair Good Fair Fair	Structure Fair Fair Fair Fair Fair Fair Fair Fair	Remarks and Recommendations Stunted growth at top, some epicormic growth, possible minor root injury from old house removal. Armillaria fruiting bodies around base and on buttress roots. Recommend closer examination if retained. Co-dominant at 3meters ivy on trunk, cavities in old pruning wounds Some tip dieback, possibly insect related Pruned for utilities Possible cavity in lower trunk. Closer examination recommended if retained. Multi stem at 2.5 meters	Bylaw protected Yes Yes No Yes Yes Yes Yes Yes Yes	X X X X X X Retain Retain	Reason for removal In building Too close to excavation for building, services.
3 3 3 3 3 3 3 3 3 3 3 3 3 3 3 3 3 3 3	41 43 45 46 48 61 62 72 84 85 87	Common Name European Beeck European Beeck Horse chestnut Holly European Birch Holly European Birch Horse chestnut Holly Horse chestnut	garryana Latin Name Fagus sylvatica Fagus sylvatica Aesculus hippocastanum Ilex aquifolium Betula pendula Aesculus hippocastanum Ilex aquifolium Betula pendula Aesculus hippocastanum Aesculus hippocastanum Aesculus hippocastanum Aesculus hippocastanum Aesculus hippocastanum Aesculus	DBH (cm)approximate 85.0 89.0 64.0 28.0 65.0 52.0 59.0 54.0 80.0	17.0 15.0 10.0 4.0 9.0 9.0 11.0 8.0 12.0	CRZ (m) 12.5 13.0 5.0 8.0 5.0 7.0 4.5	Relative Tolerance Poor Poor Good Good Poor Good Good Good Good Good Good Good Good	Health Fair Fair Good Fair Good Fair Fair	Structure Fair Fair Fair Fair Fair Fair Fair Fair	Remarks and Recommendations Stunted growth at top, some epicormic growth, possible minor root injury from old house removal. Armillaria fruiting bodies around base and on buttress roots. Recommend closer examination if retained. Co-dominant at 3meters ivy on trunk, cavities in old pruning wounds Some tip dieback, possibly insect related Pruned for utilities Possible cavity in lower trunk. Closer examination recommended if retained Multi stem at 2.5 meters Multi stem, ivy on trunks	Bylaw protected Yes Yes Yes No Yes Yes Yes Yes Yes Yes	X X X X X X Retain Retain Retain	Reason for removal In building Too close to excavation for building, services.
3-3-3-3-3-3-3-3-3-3-3-3-3-3-3-3-3-3-3-	41 43 45 46 48 61 62 72 84 85 87 20	Common Name European Beeck European Beeck Horse chestnut Holly European Birch Horse chestnut Holly Horse chestnut Holly Horse chestnut	garryana Latin Name Fagus sylvatica Fagus sylvatica Aesculus hippocastamum Betula pendula Aesculus hippocastamum Ilex aquifolium Betula pendula Aesculus hippocastamum Aesculus	DBH (cm)approximate 85.0 89.0 64.0 28.0 65.0 52.0 59.0 54.0 80.0	17.0 15.0 10.0 4.0 9.0 9.0 11.0 8.0 12.0	CRZ (m) 12.5 13.0 5.0 8.0 5.0 7.0 4.5	Relative Tolerance Poor Poor Good Good Poor Good Good Good Good Good Good Good G	Health Fair Fair Good Fair Good Fair Fair Fair Fair	Structure Fair Fair Fair Fair Fair Fair Fair Fair	Remarks and Recommendations Stunted growth at top, some epicormic growth, possible minor root injury from old house removal. Armillaria fruiting bodies around base and on buttress roots. Recommend closer examination if retained. Co-dominant at 3meters ivy on trunk, cavities in old pruning wounds Some tip dieback, possibly insect related Pruned for utilities Possible cavity in lower trunk. Closer examination recommended if retained Multi stem at 2.5 meters Multi stem, ivy on trunks Large stubbed off limbs	Bylaw protected Yes Yes Yes No Yes Yes Yes Yes Yes Yes Yes	X X X X X Retain Retain Retain Retain Retain	Reason for removal In building Too close to excavation for building, services.

	Common		DBH (cm)	Crown Spread	CRZ	Relative				Bylaw	Retention	
Tree ID		Latin Name	~ approximate	(m)	(m)	Tolerance	Health	Structure	Remarks and Recommendations	protected	Status	Reason for removal
												Too close to excavation for
441	Holly	Ilex aquifolium	10.0	4.0	2.0	Good	Fair/poor	Fair/poor		No	X	building
												Landscaping choice, replace with a healthy young tree of a
442	Holly	Ilex aquifolium	17,17	5.0	2.5	Good	Fair/poor	Fair/poor		No	X	better species.
445	Holly	Ilex aquifolium	13.0	4.0	2.0	Good	Good	Good		No	x	Too close to excavation for building
446	Douglas fir	Pseudotsuga menziesii	30.0	8.0	5.0	Poor	Fair	Good	Young tree, some thinning foliage	Yes	x	Too close to excavation for building
		menareon .	5010	010		1001	1411	0000	Today area, bonie animag romge	100		
	Western Red cedar	Thuja plicata	19.0	6.0	3.0	Moderate	Good	Good	Young tree	No	x	Too close to excavation for building
448		Laburnum										Remove as requested by city
(N.t.7)	Laburnum	anagyroides	17,15,11	4.0	3.0	Moderate	Poor	Poor	Decay on 17 cm stem	Municipal	X	staff.
N.t. 1	Chamaecyparis	Chamaecyparis sp.	22.0	5.0	3.0	Poor	Fair/poor	Fair	Sparse foliage, neighbours tree, within a meter of property line.	Neighbours	Retain	
14.6.1	Спапассуранз	<i>sp.</i>	22.0	3.0	3.0	1001	Гангроог	Tan	III.	reignoours	Retain	
		Laburnum										
N.t. 2	Laburnum	anagyroides	20, 10, 10	5.0	3.0	Moderate	Fair	Fair	Multi stem, neighbours tree, within a meter of property line	. Neighbours	Retain	
	English	Crataegus										
	hawthorn	laevigata	28.0	6.0	3.0	Good	Fair	Fair	Ivy on trunk, municipal tree, suckering at base.	Municipal	х	Municipal sidewalk conflict
N.t. 4	Holly	Ilex aquifolium	30,15	6.0	4.0	Good	Good	Fair		Yes	х	in parking
		Prunus										
N.t. 5	Laurel hedge	laurocerasus	Multi	18.0	3.0	Good	Good	Fair	Largest stem 20cm	No	X	in parking
N + 6	Hally	Have a assistations	12.0	4.0	2.0	Good	Good	Fair		No	Retain	
N.t.6	Holly	Ilex aquifolium	12,8	4.0	2.0	Good	Good	rair		No	Keum	
N.t.8	Holly	Ilex aquifolium	14.0	3.0	2.0	Good	Fair	Good		Municipal	x	Remove as requested by city staff.

Prepared by: Talbot Mackenzie & Associates ISA Certified and Consulting Arborists Phone: (250) 479-8733 Fax: (250) 479-7050 email: tmtreehelp@gmail.com



Biophilia design collective Ltd. 250.590.1156 Info@biophiliacollective.ca

CLIENT NAME Purdey Group

ADDRESS 902 Foul Bay Rd Victoria, BC

DESIGNED BY Bianca Bodley

DRAWN BY KT




ISSUED FOR REVISED ZONING III AUGUST 4, 2021

Scale: NTS

L5 Arborist Report of Existing Trees



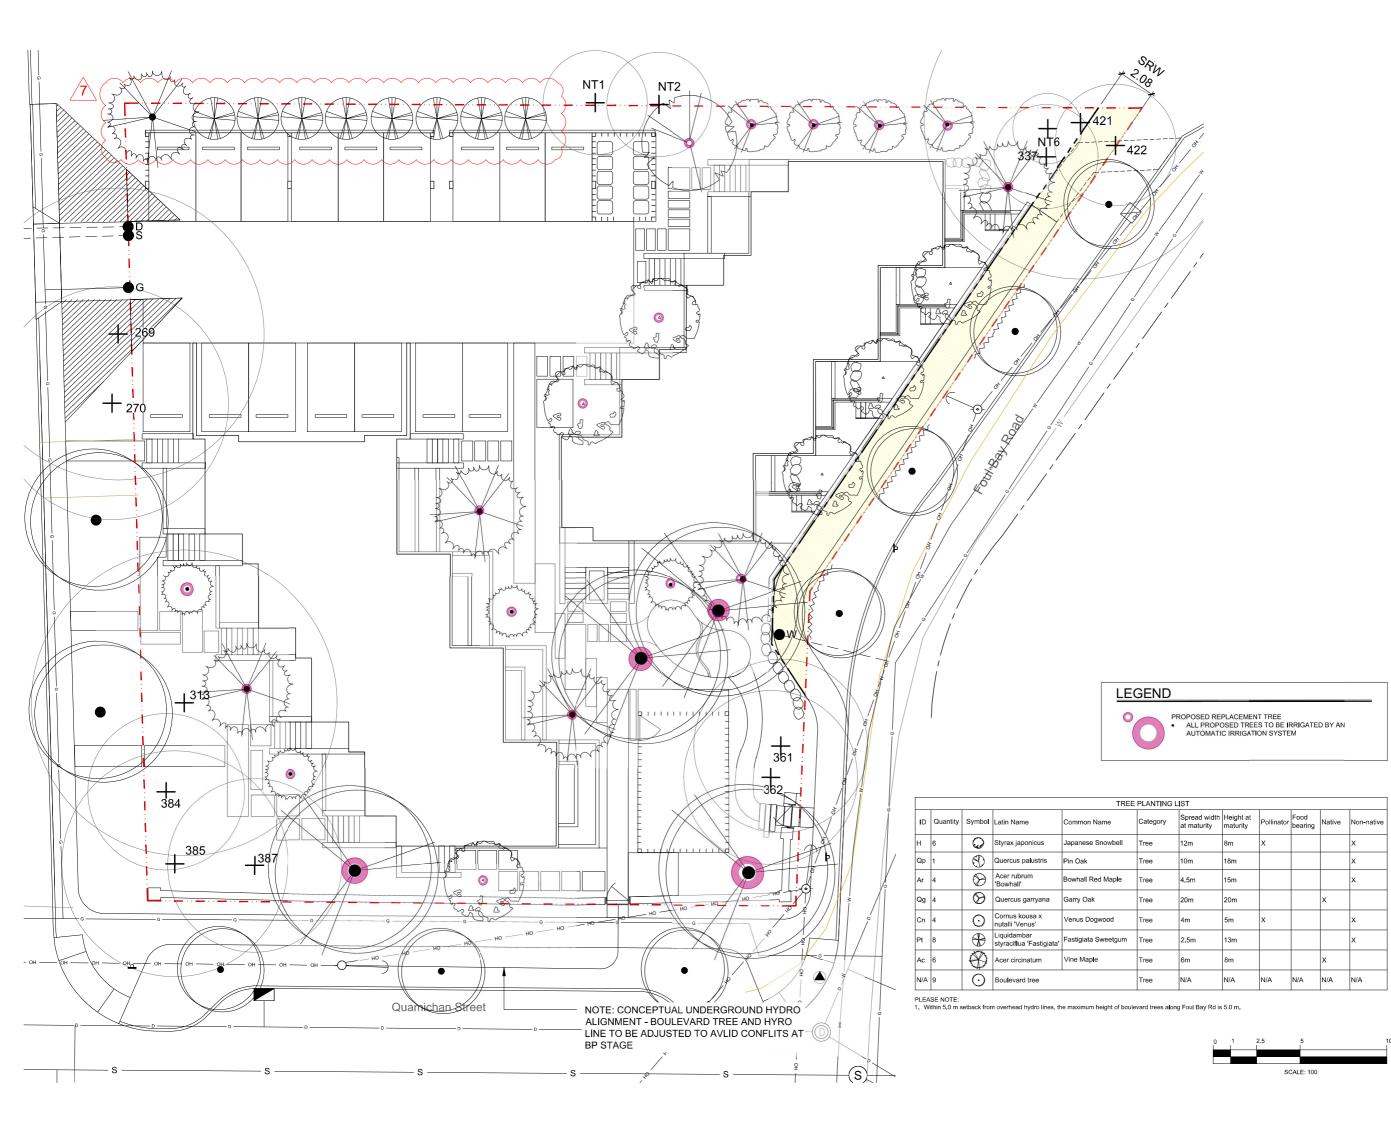



CLIENT NAME Purdey Group

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DRAWN BY





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Scale: 1:100

6 Tree Planting Plan





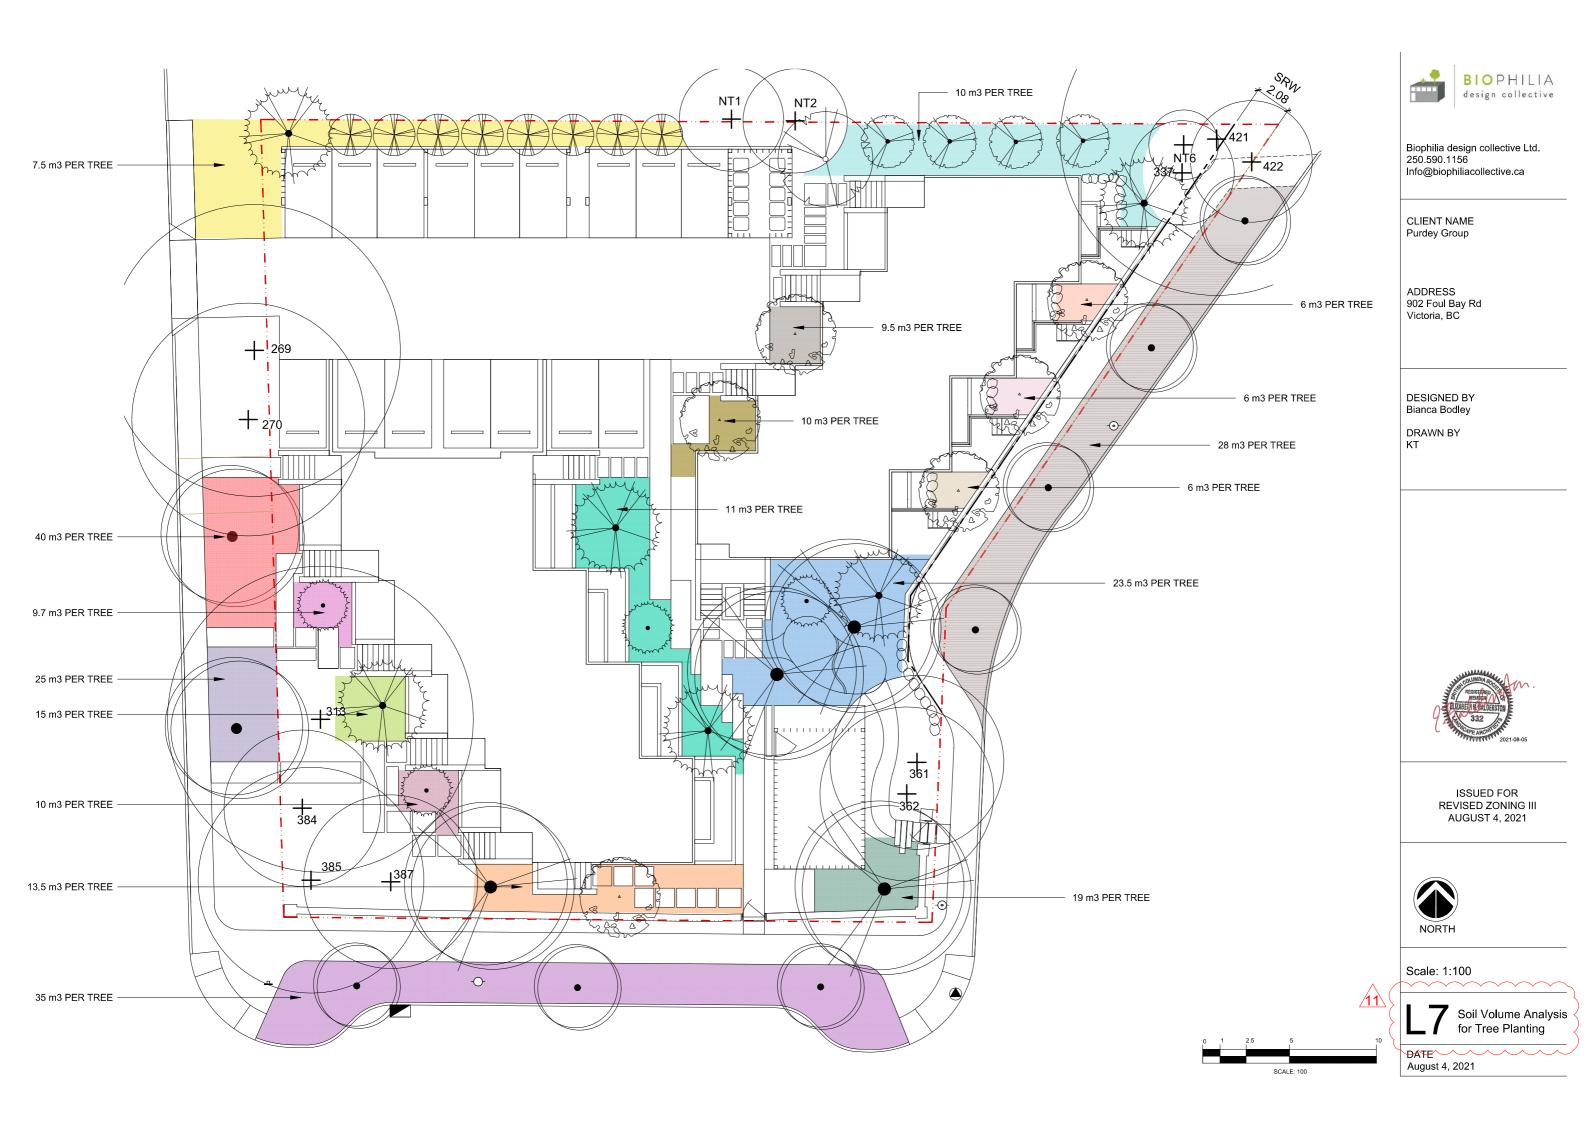
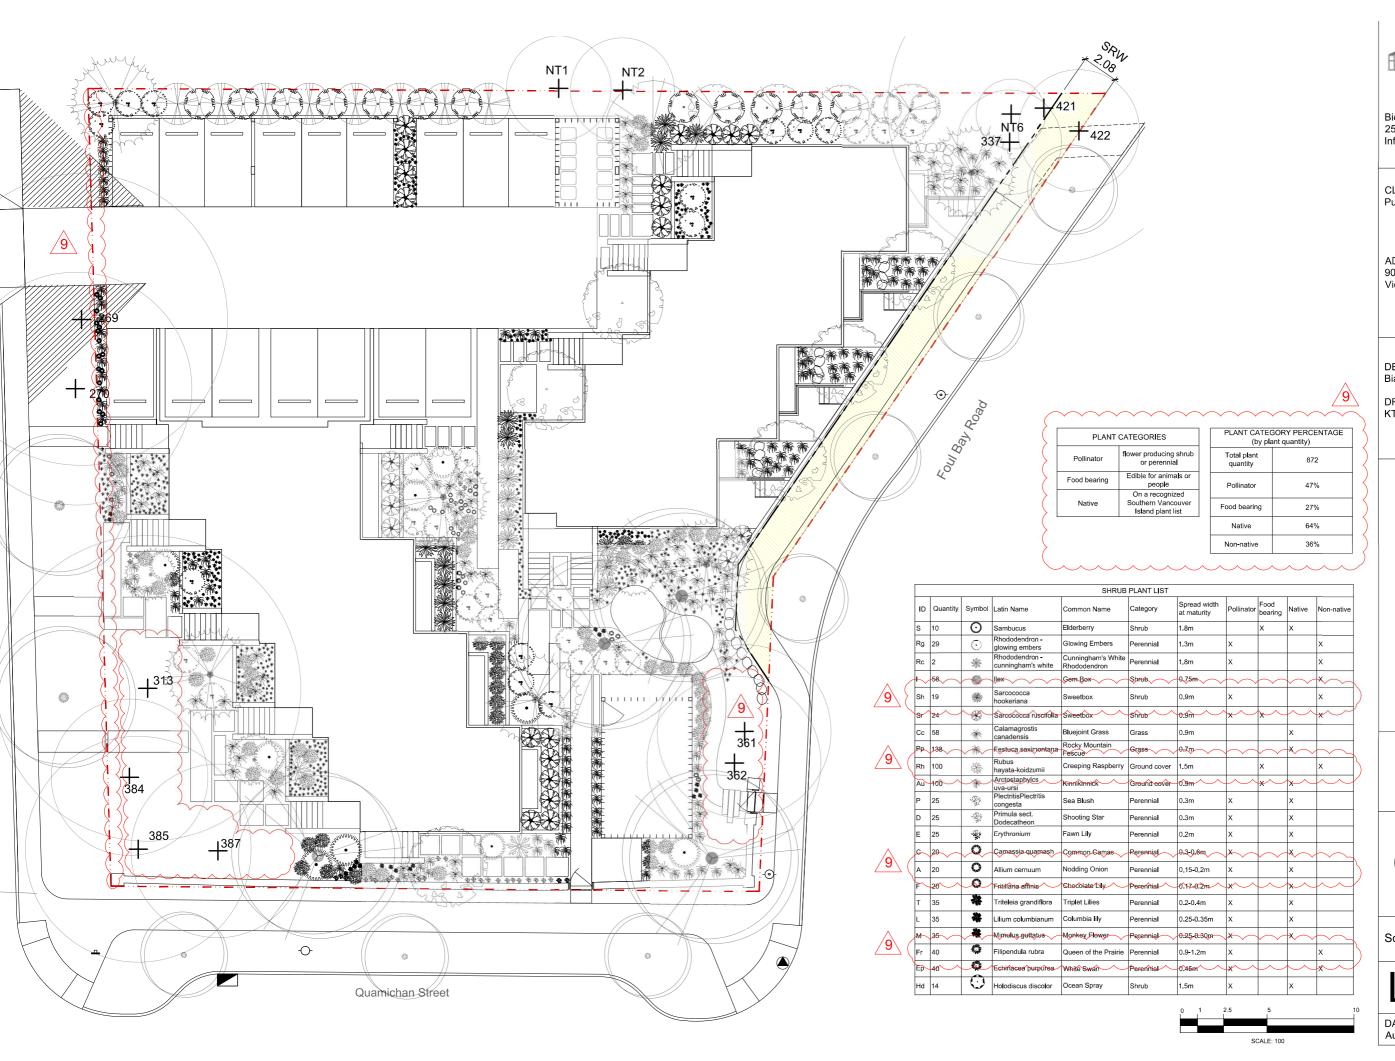
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Scale: 1:100

L8 Shrub Planting Plan

spring blooming bulbs





Erythronium, Fawn lily





Mimulus, Monkey flower







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Planting Imagery

DATE August 4, 2021



Camassia, Camas



Grass



Lilium, Lily





sun + shade plant palette

Triteleia, Triplet lilies





summer blooming bulbs





Echinacea purpurea, White swan Filipendula rubra, Queen of the prairie



Festuca saximontana, Rocky Mountain grass









Rubus hayata-koidzumii, Creeping raspberry



llex, Gem box





Arbutus unedo 'Compacta', Dwarf Strawberry



Sedum spurium, Dragon's blood





Sedum spathulifolium, Cape blanco




Sedum album, White stonecrop







Acer pseudosie Korean maple

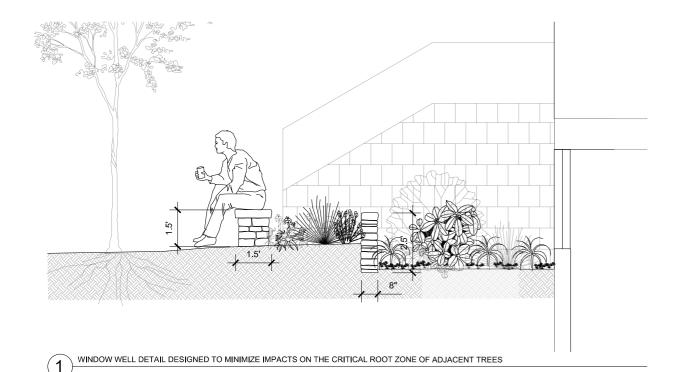



MORTARED HERITAGE STONE ROCK WALL FOR WINDOW WELL RETENTION



BENCH WITH REPURPOSED HERITAGE STONE



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L10 DESIGN DETAIL