DRAWING LIST

ARCHITECTURAL

EXISTING SITE PLAN & CONTEXT A0.1 LEGAL SURVEY A0.2 SITE PLAN A0.3 PERSPECTIVES A1.1 A1.2 PERSPECTIVES A1.3 PERSPECTIVES A2.0 FLOOR PLAN - P0 & P1 A2.1 FLOOR PLAN - LEVEL 1 A2.2 FLOOR PLAN - LEVEL 2 A2.3 FLOOR PLAN - LEVEL 3 A2.4 FLOOR PLAN - LEVEL 4 A2.5 FLOOR PLAN - LEVEL 5 A2.6 FLOOR PLAN - LEVEL 6

A2.7 **ROOF PLAN**

A4.0 **BUILDING ELEVATIONS BUILDING ELEVATIONS** A4.1 **BUILDING ELEVATIONS** A4.2 STREET ELEVATIONS A4.3 **BUILDING SECTIONS**

A4.5 SUN STUDY

A4.6 MATERIALS BOARD

A5.1 AVERAGE GRADE CALCULATIONS A5.2 **BUILDING CODE ANALYSIS**

LANDSCAPE

L0.00 GENERAL SHEET INFORMATION L0.01 L0.02 TREE REPLACEMENT L0.03 STORMWATER MANAGEMENT L1.01 LANDSCAPE MATERIALS L1.02 LANDSCAPE LIGHTING CONCEPT L1.03 LANDSCAPE SECTIONS LANDSCAPE GRADING - OVERALL L3.01 PLANTING PLAN

LANDSCAPE DETAILS - PLANTING

<u>CIVIL</u>

L3.02

22-148-CSP PRELIMINARY CIVIL PLAN



CAPITAL REGION HOUSING CORPORATION - VILLAGE ON THE GREEN

1132 & 1138 JOHNSON STREET, VICTORIA BC

Revisions

ISSUED FOR: DELEGATED DEVELOPMENT PERMIT RESUBMISSION

NOVEMBER 25, 2024



Capital Region Housing Corporation

300 - 1590 CEDAR HILL CROSS ROAD VICTORIA BC V8P 2P5

TEL 250 472 8013

LHRA.CA

ARCHITECT

OWNER/CLIENT

t. 250.360.5965

RICO APILAN

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MCELHANNEY CONSULTING SERVICES LTD. 500 - 3960 Quadra Street Victoria, BC, V8X 4A3 t. 250.370.9221

NATHAN DUNLOP ndunlop@mcelhanney.com

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TALBOT MACKENZIE & ASSOCIATES / TALMACK 3575 Douglas Street BOX #48153 Victoria, BC, V8Z 7H6 t. 250.479.8733

NOAH TALBOT noah@talmack.ca


SURVEYOR

SURVEYING LTD. 500 - 3960 Quadra Street Victoria, BC, V8X 4A3 t. 250.370.9221


ROB LEIPER rleiper@mcelhanney.com



MCELHANNEY ASSOCIATES LAND

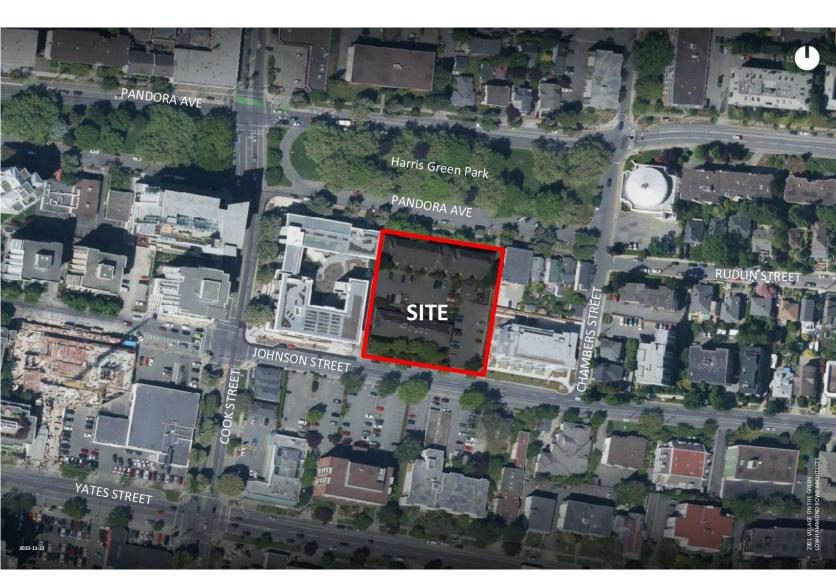

EXISTING SITE CONTEXT

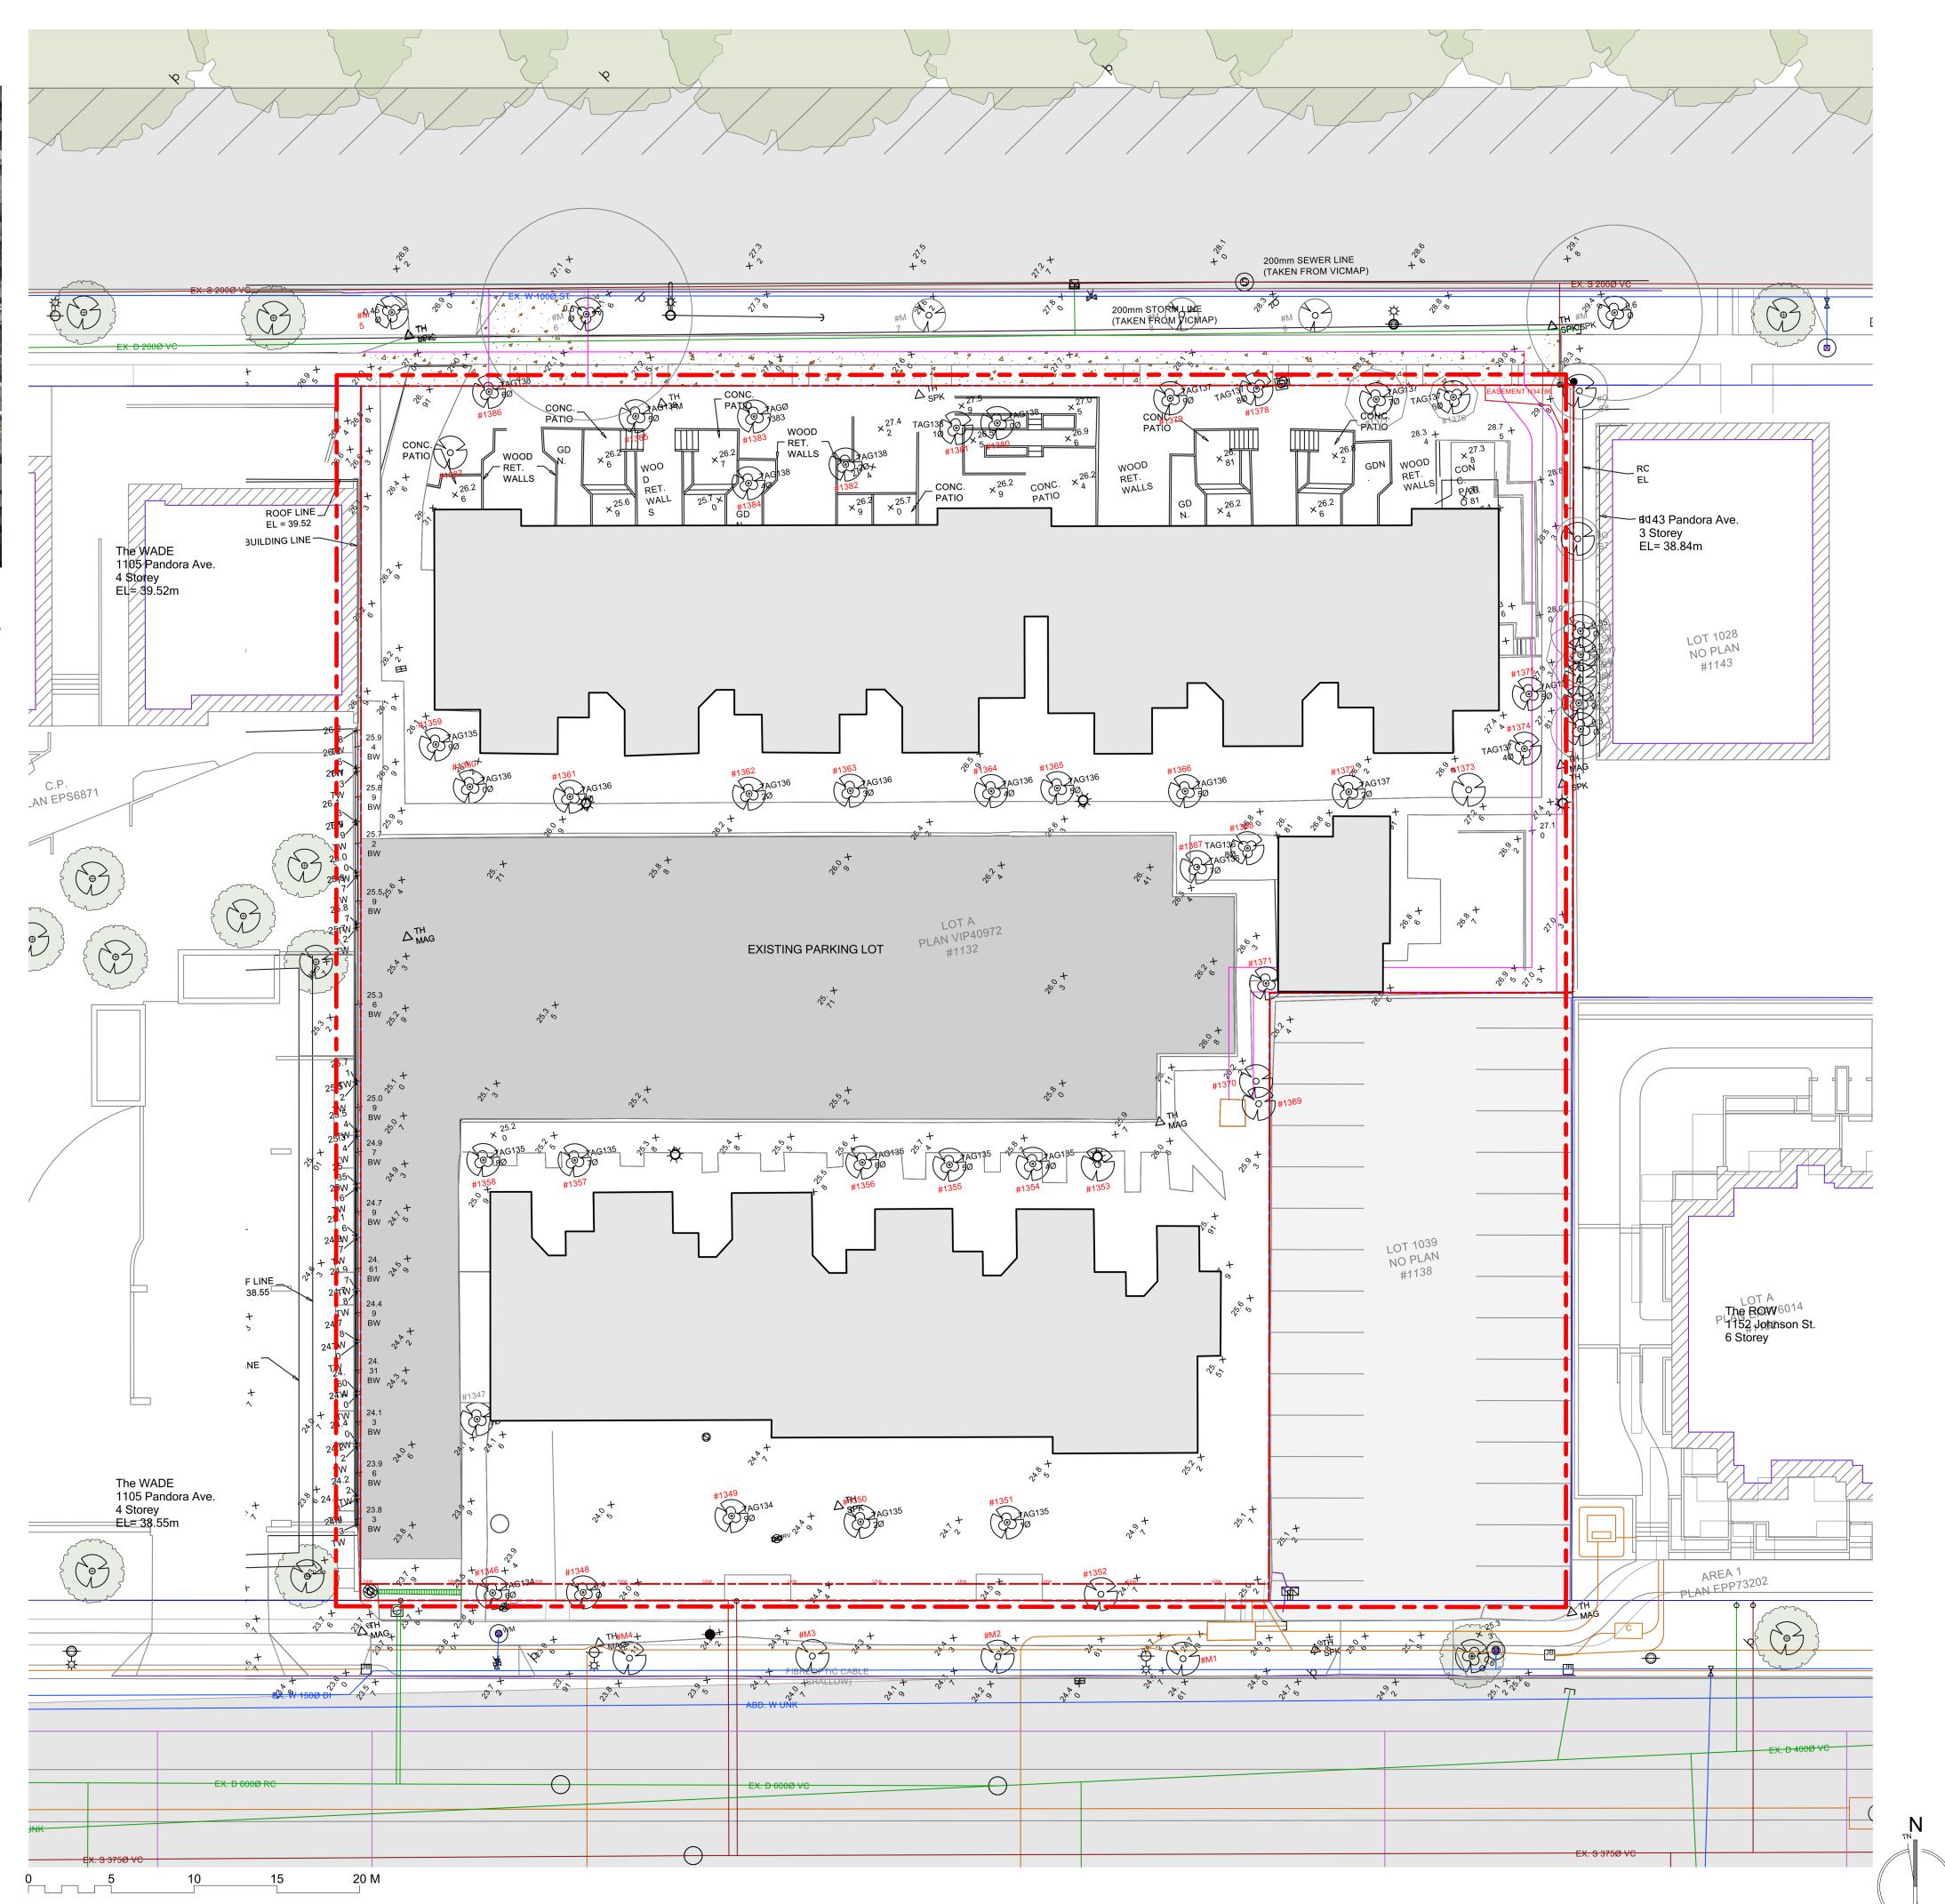

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EXISTING SITE PLAN & CONTEXT

2301

A0.1

Plot date 2024 11 25

EXISTING SITE PLAN

File name 2301_CRHC Johnson St_CENTRAL.RVT



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2301

Sheet title

LEGAL SURVEY

SITE PLAN OF

VILLAGE ON THE GREEN

1132 and 1138 Johnson Street, Victoria, BC

McElhanney Associates Land Surveying Ltd.

500 - 3960 Quadra Street,

Victoria BC V8X 4A3

Tel. 250 370 9221

SCALE 1:250


UNLESS OTHERWISE NOTED

Original Drawing Size: (864mm x 560mm)

PLAN ID.: 22330123600-V-SITE-001

A0.2

File name 2301_CRHC Johnson St_CENTRAL.RVT Plot date 2024 11 25

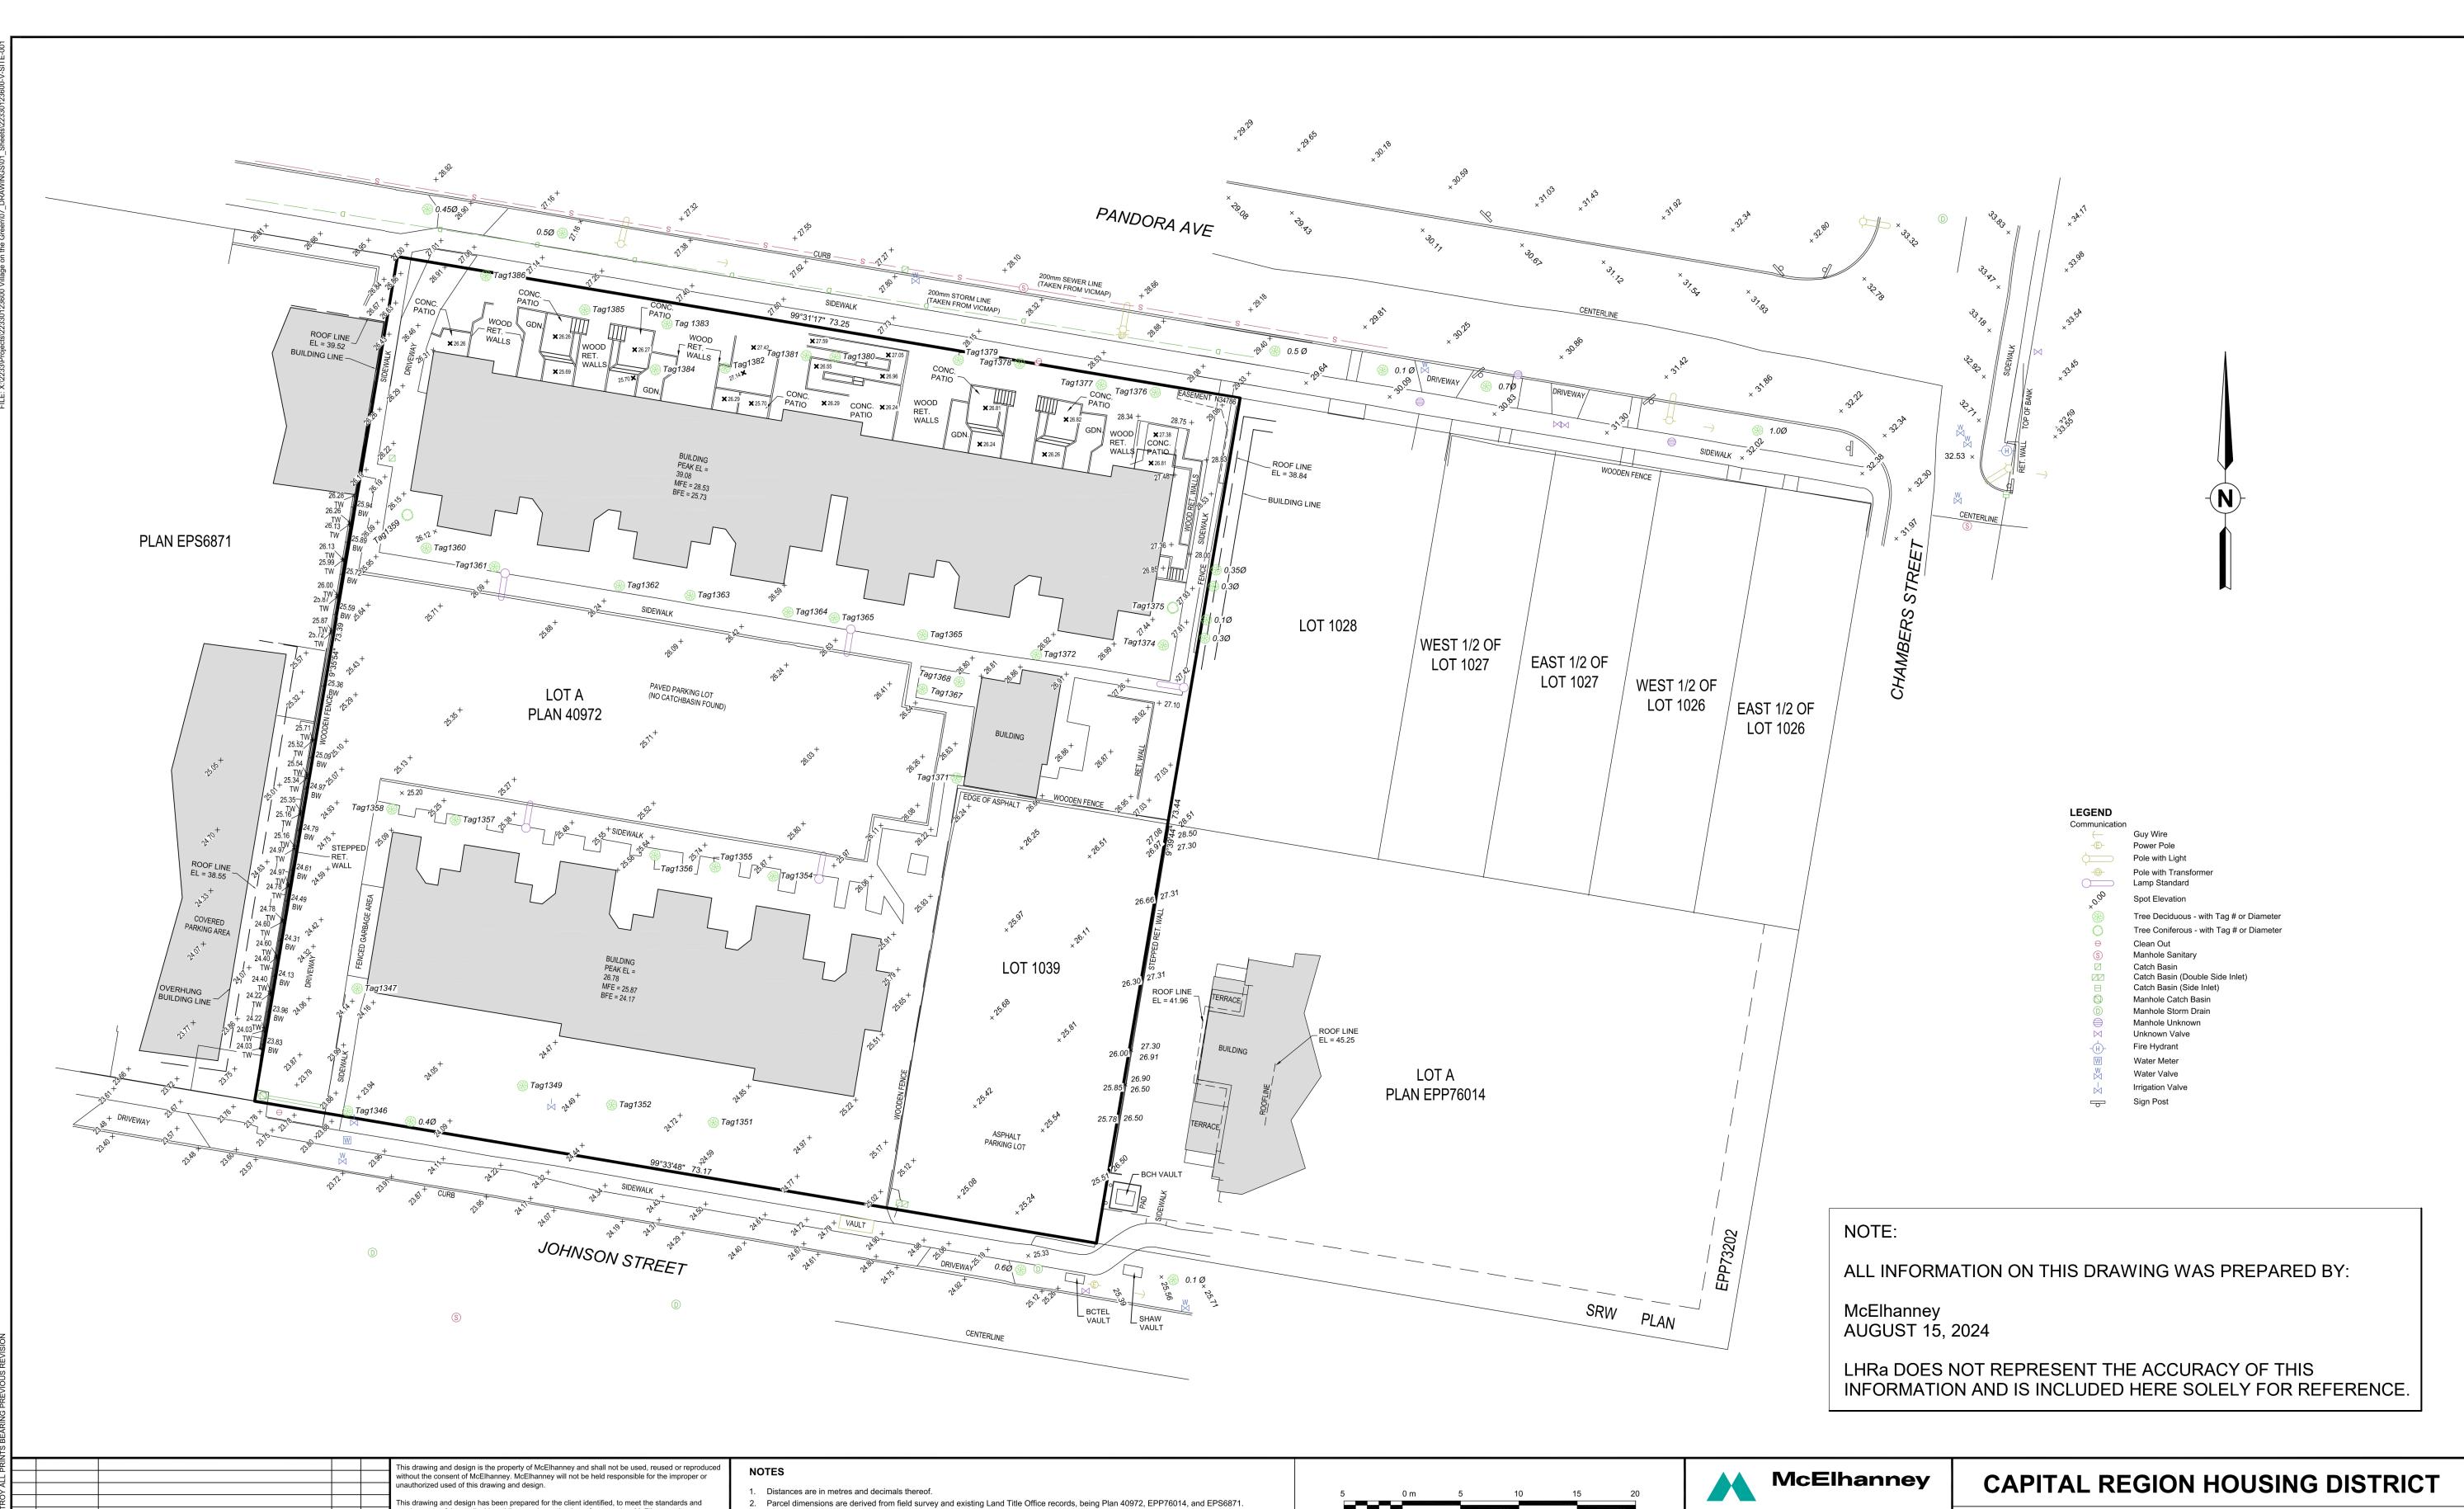

requirements of the applicable public agencies at the time of preparation. McElhanney, its

Additional Survey Added

Additional Survey Added

DESCRIPTION

REVISIONS

4/28/2023

9/1/2021

REV DATE

ployees, subconsultants and agents will not be liable for any losses or other consequences

esulting from the use or reliance upon, or any changes made to, this drawing, by any third party,

including contractors, suppliers, consultants and stakeholders, or their employees or agents, withou

ormation on existing underground facilities may not be complete or accurate. McElhanney, it's

ipes, cables or other facilities whether shown or omitted from this plan. Prior to construction,

contractor shall expose locations of all existing facilities by hand digging or hydrovac and advise the

3. This plan represents field surveys conducted on 2021-06-22, 2023-03-14, 2023-07-19, and 2024-07-25

multiply by the combined scale factor of 0.999607472 around a reference point at N 5363738.155m, E 473968.429m


Coordinates are local ground. To convert to UTM zone 10 NAD83 (CSRS)

6. Elevations are referenced to GCM 379800 (16-95), having an elevation of 26.151m.

Elevations are in meters and referred to Geodetic Datum CVD28BC.

8. This document shall not be used to define property lines or property corners.

7. Property Title Subject to: Easement N34786.

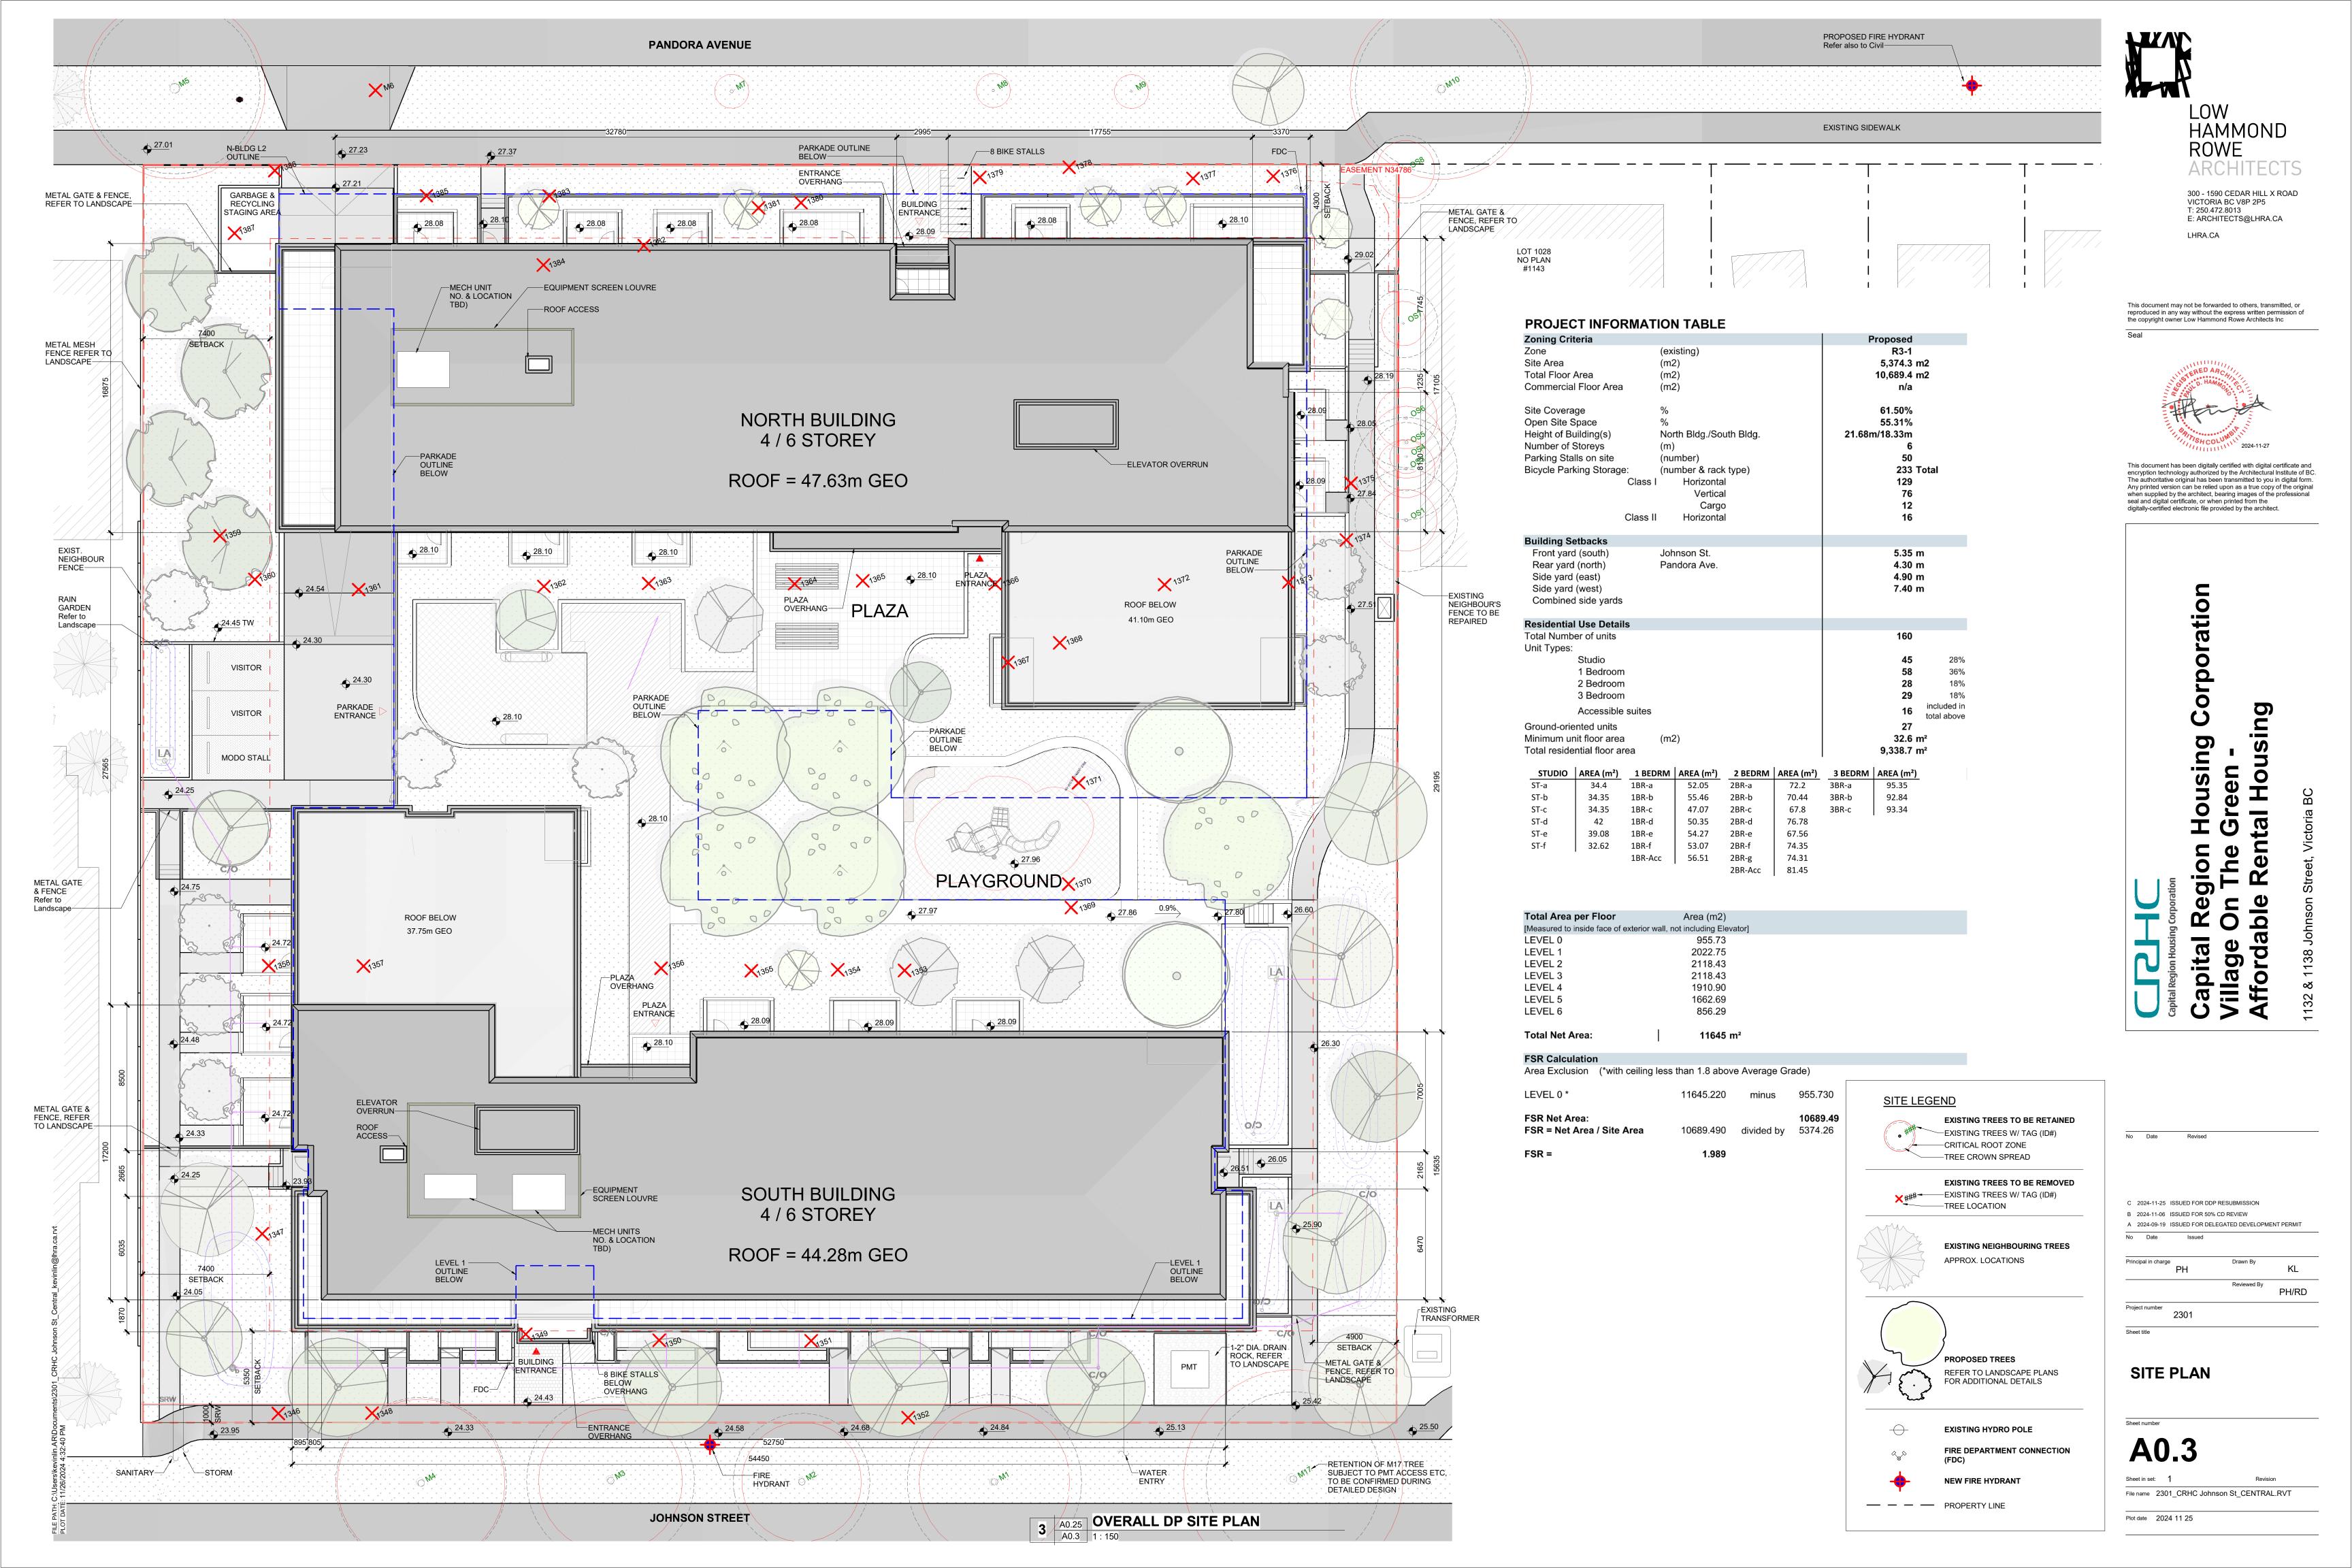

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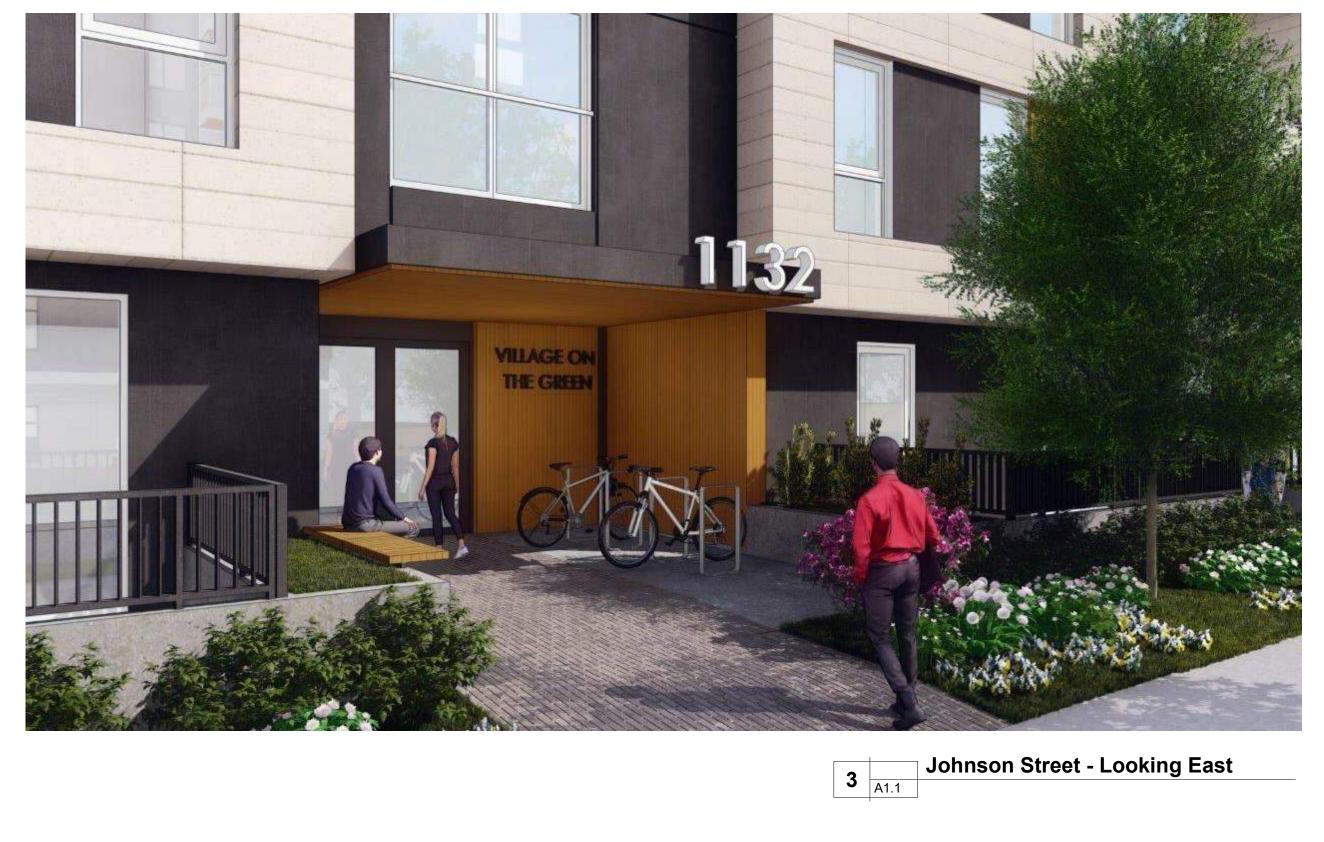
PERSPECTIVES

Plot date 2024 11 25

A1.1 File name 2301_CRHC Johnson St_CENTRAL.RVT









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Project number 2301

PERSPECTIVES

Plot date 2024 11 25


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PERSPECTIVES

A1.3

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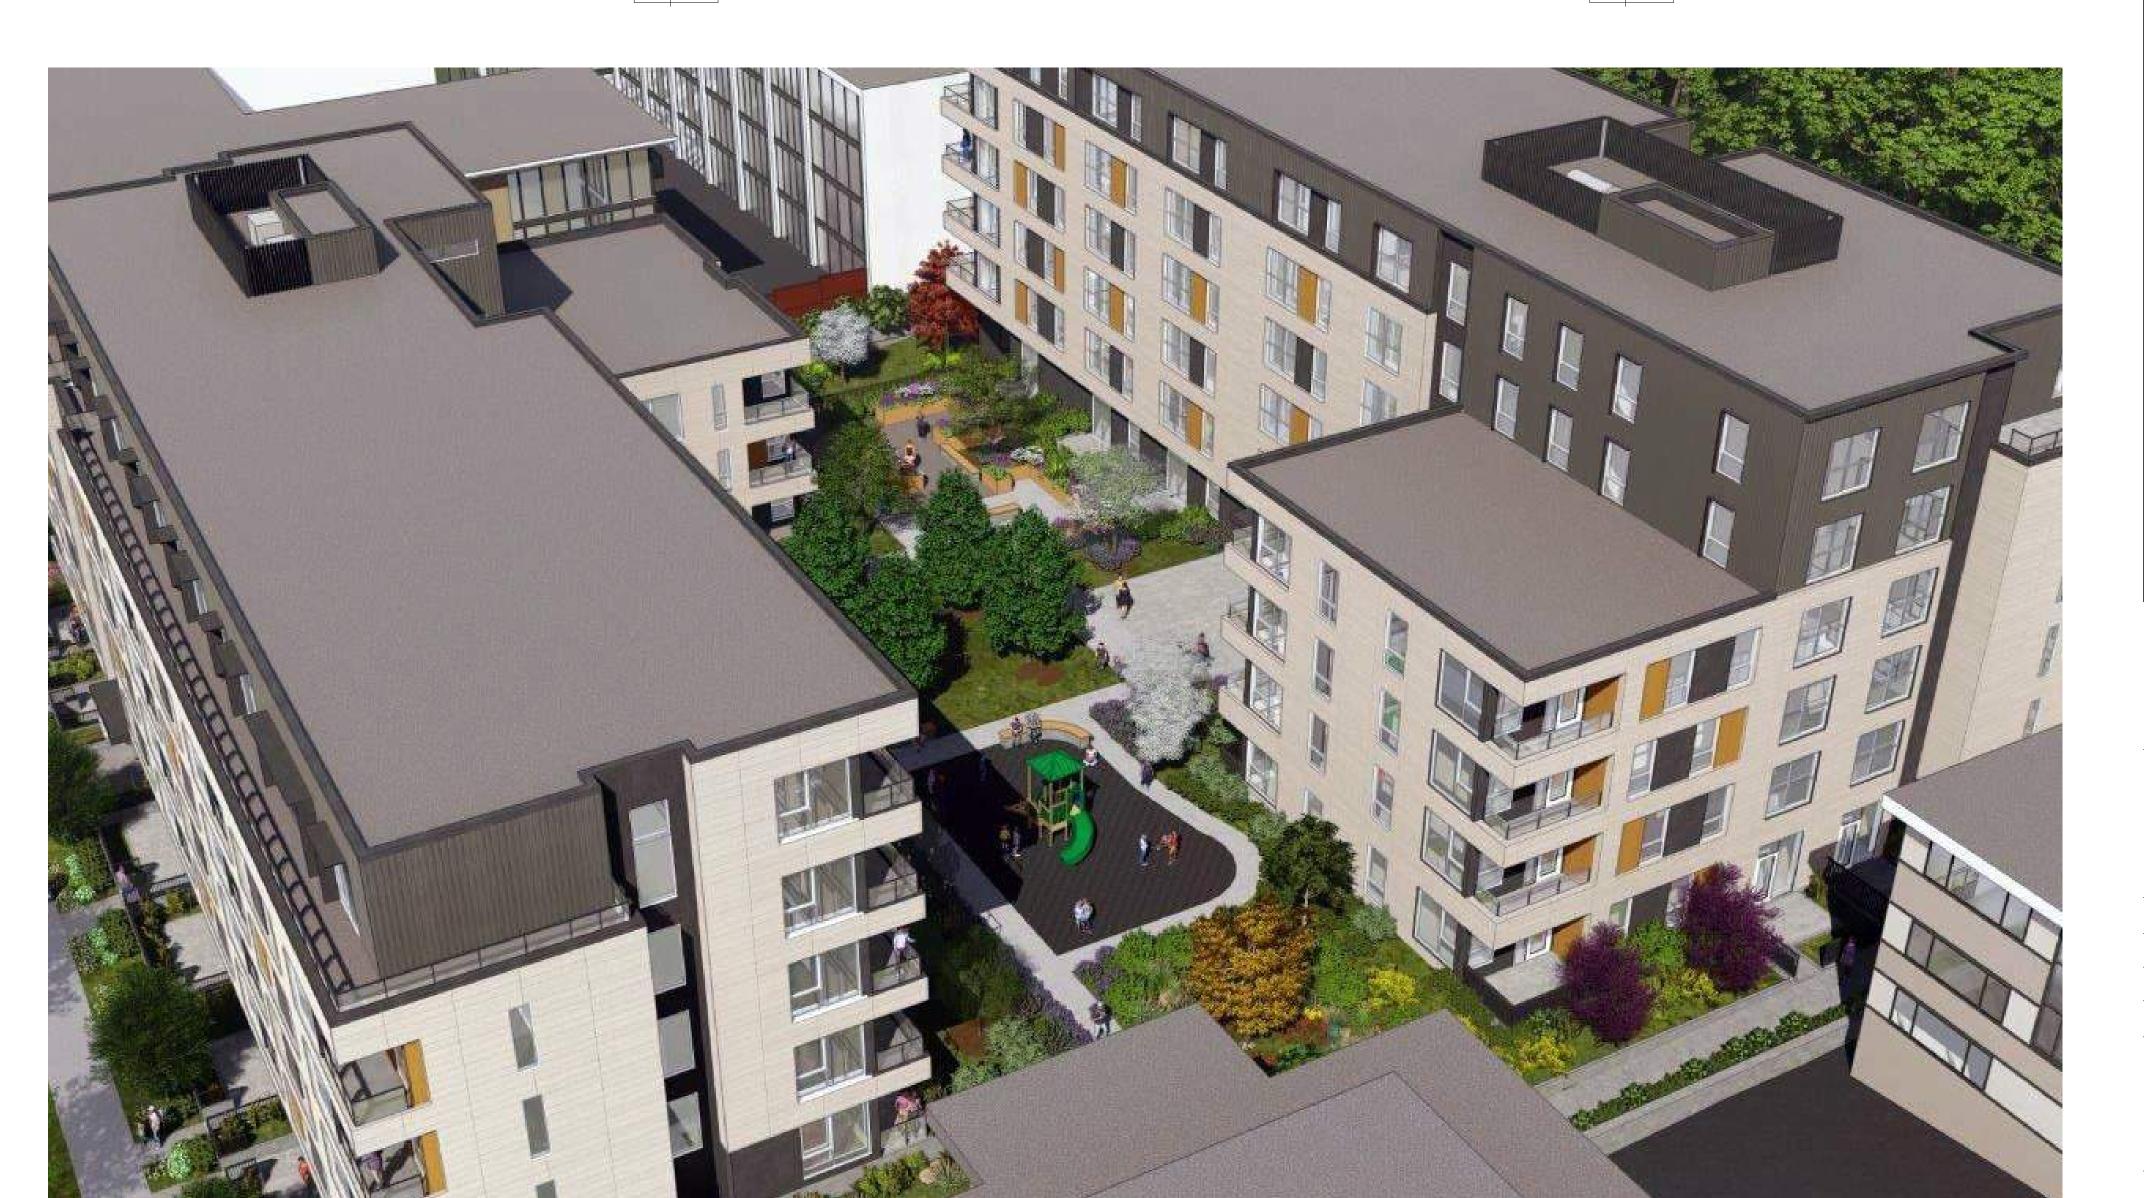





Courtyard View - Facing South-East

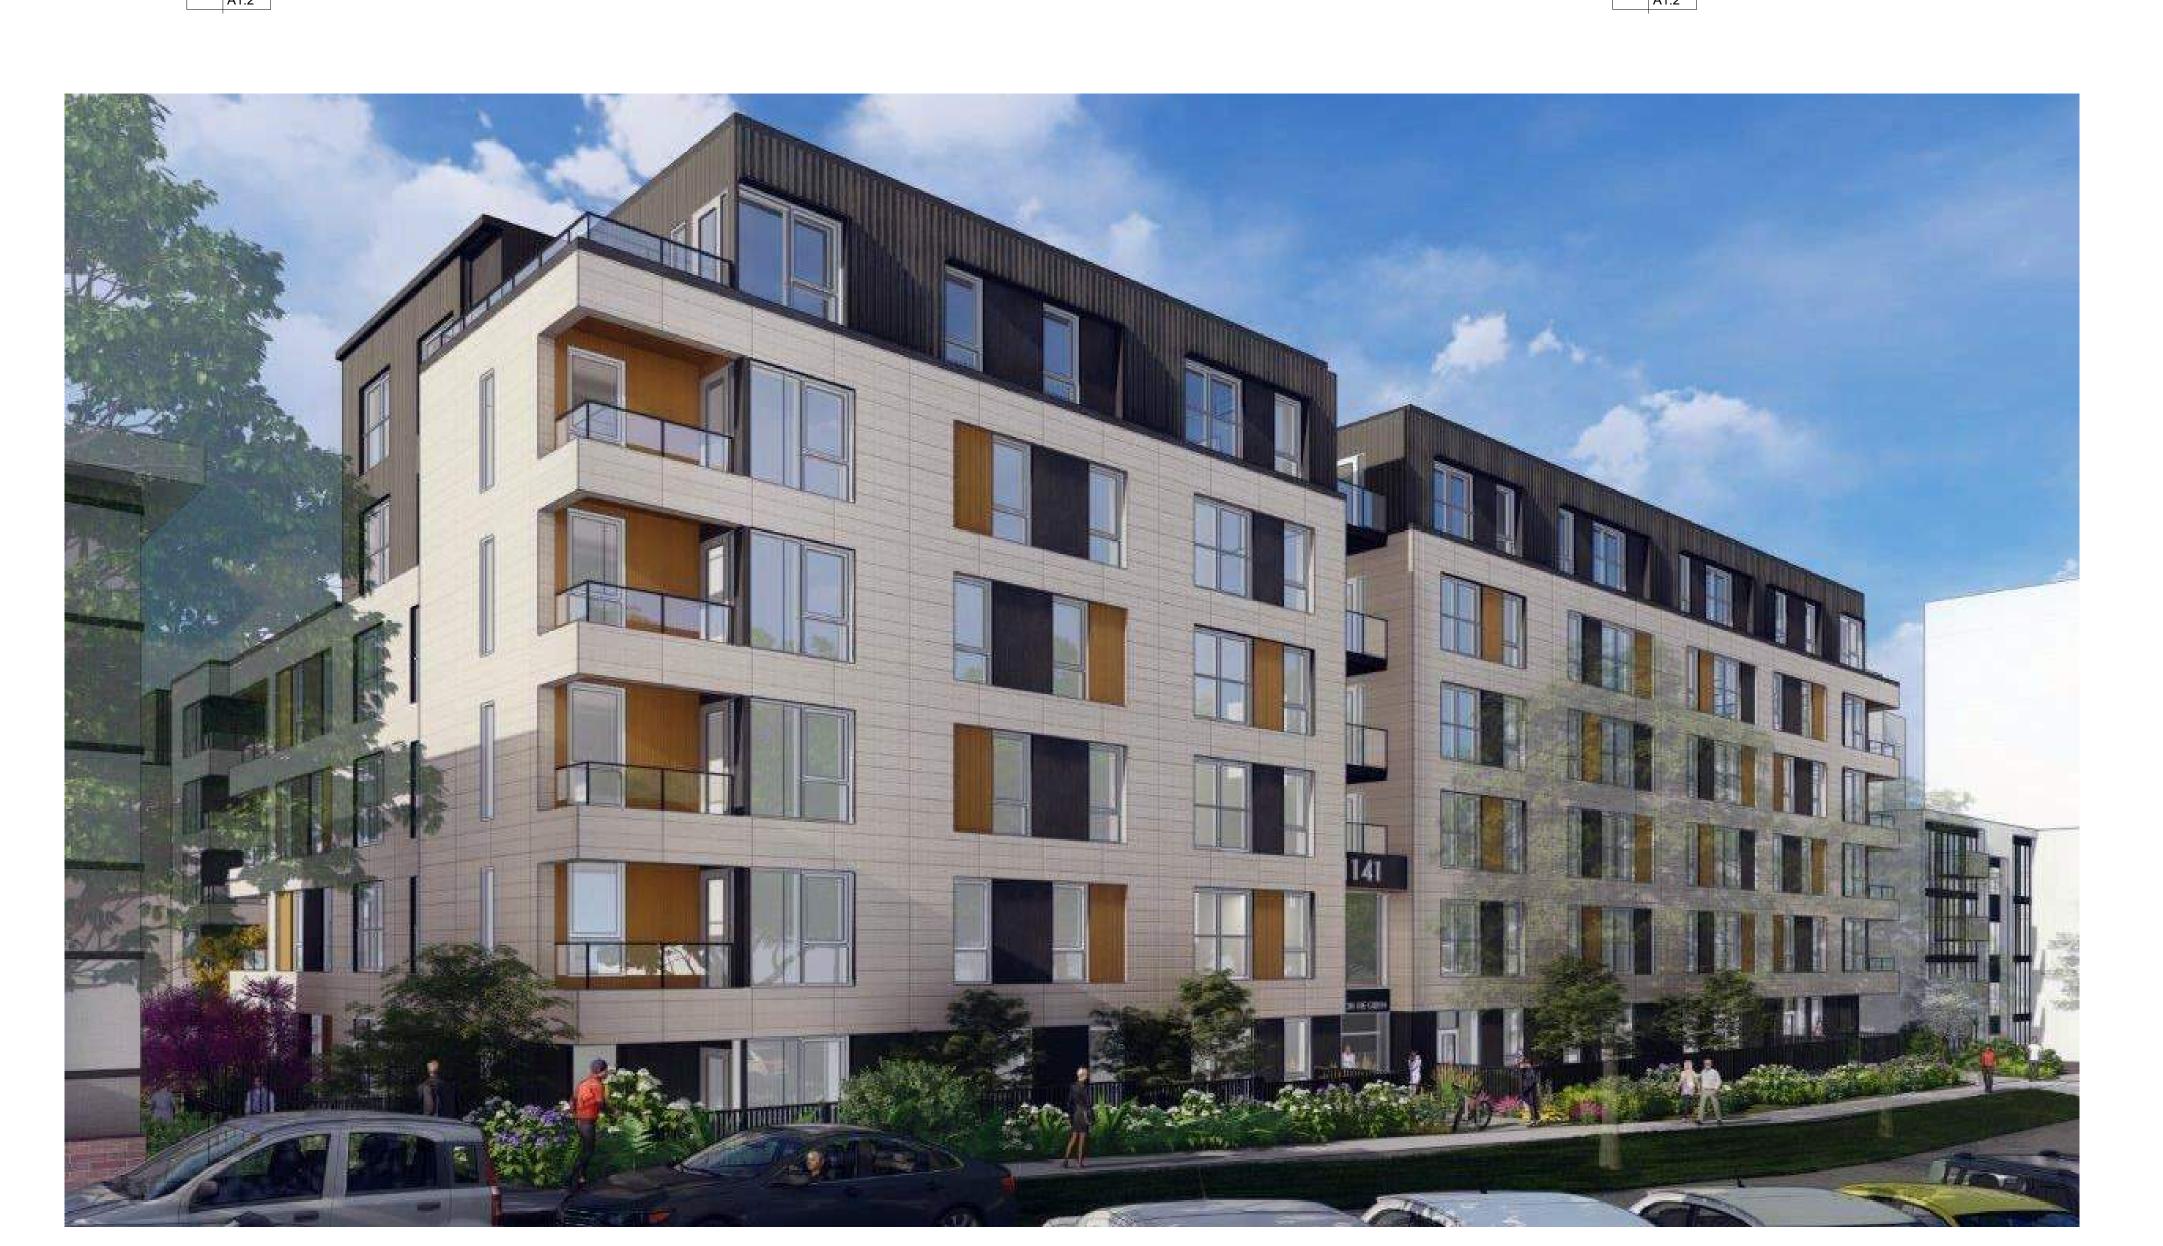

Courtyard View - Facing West



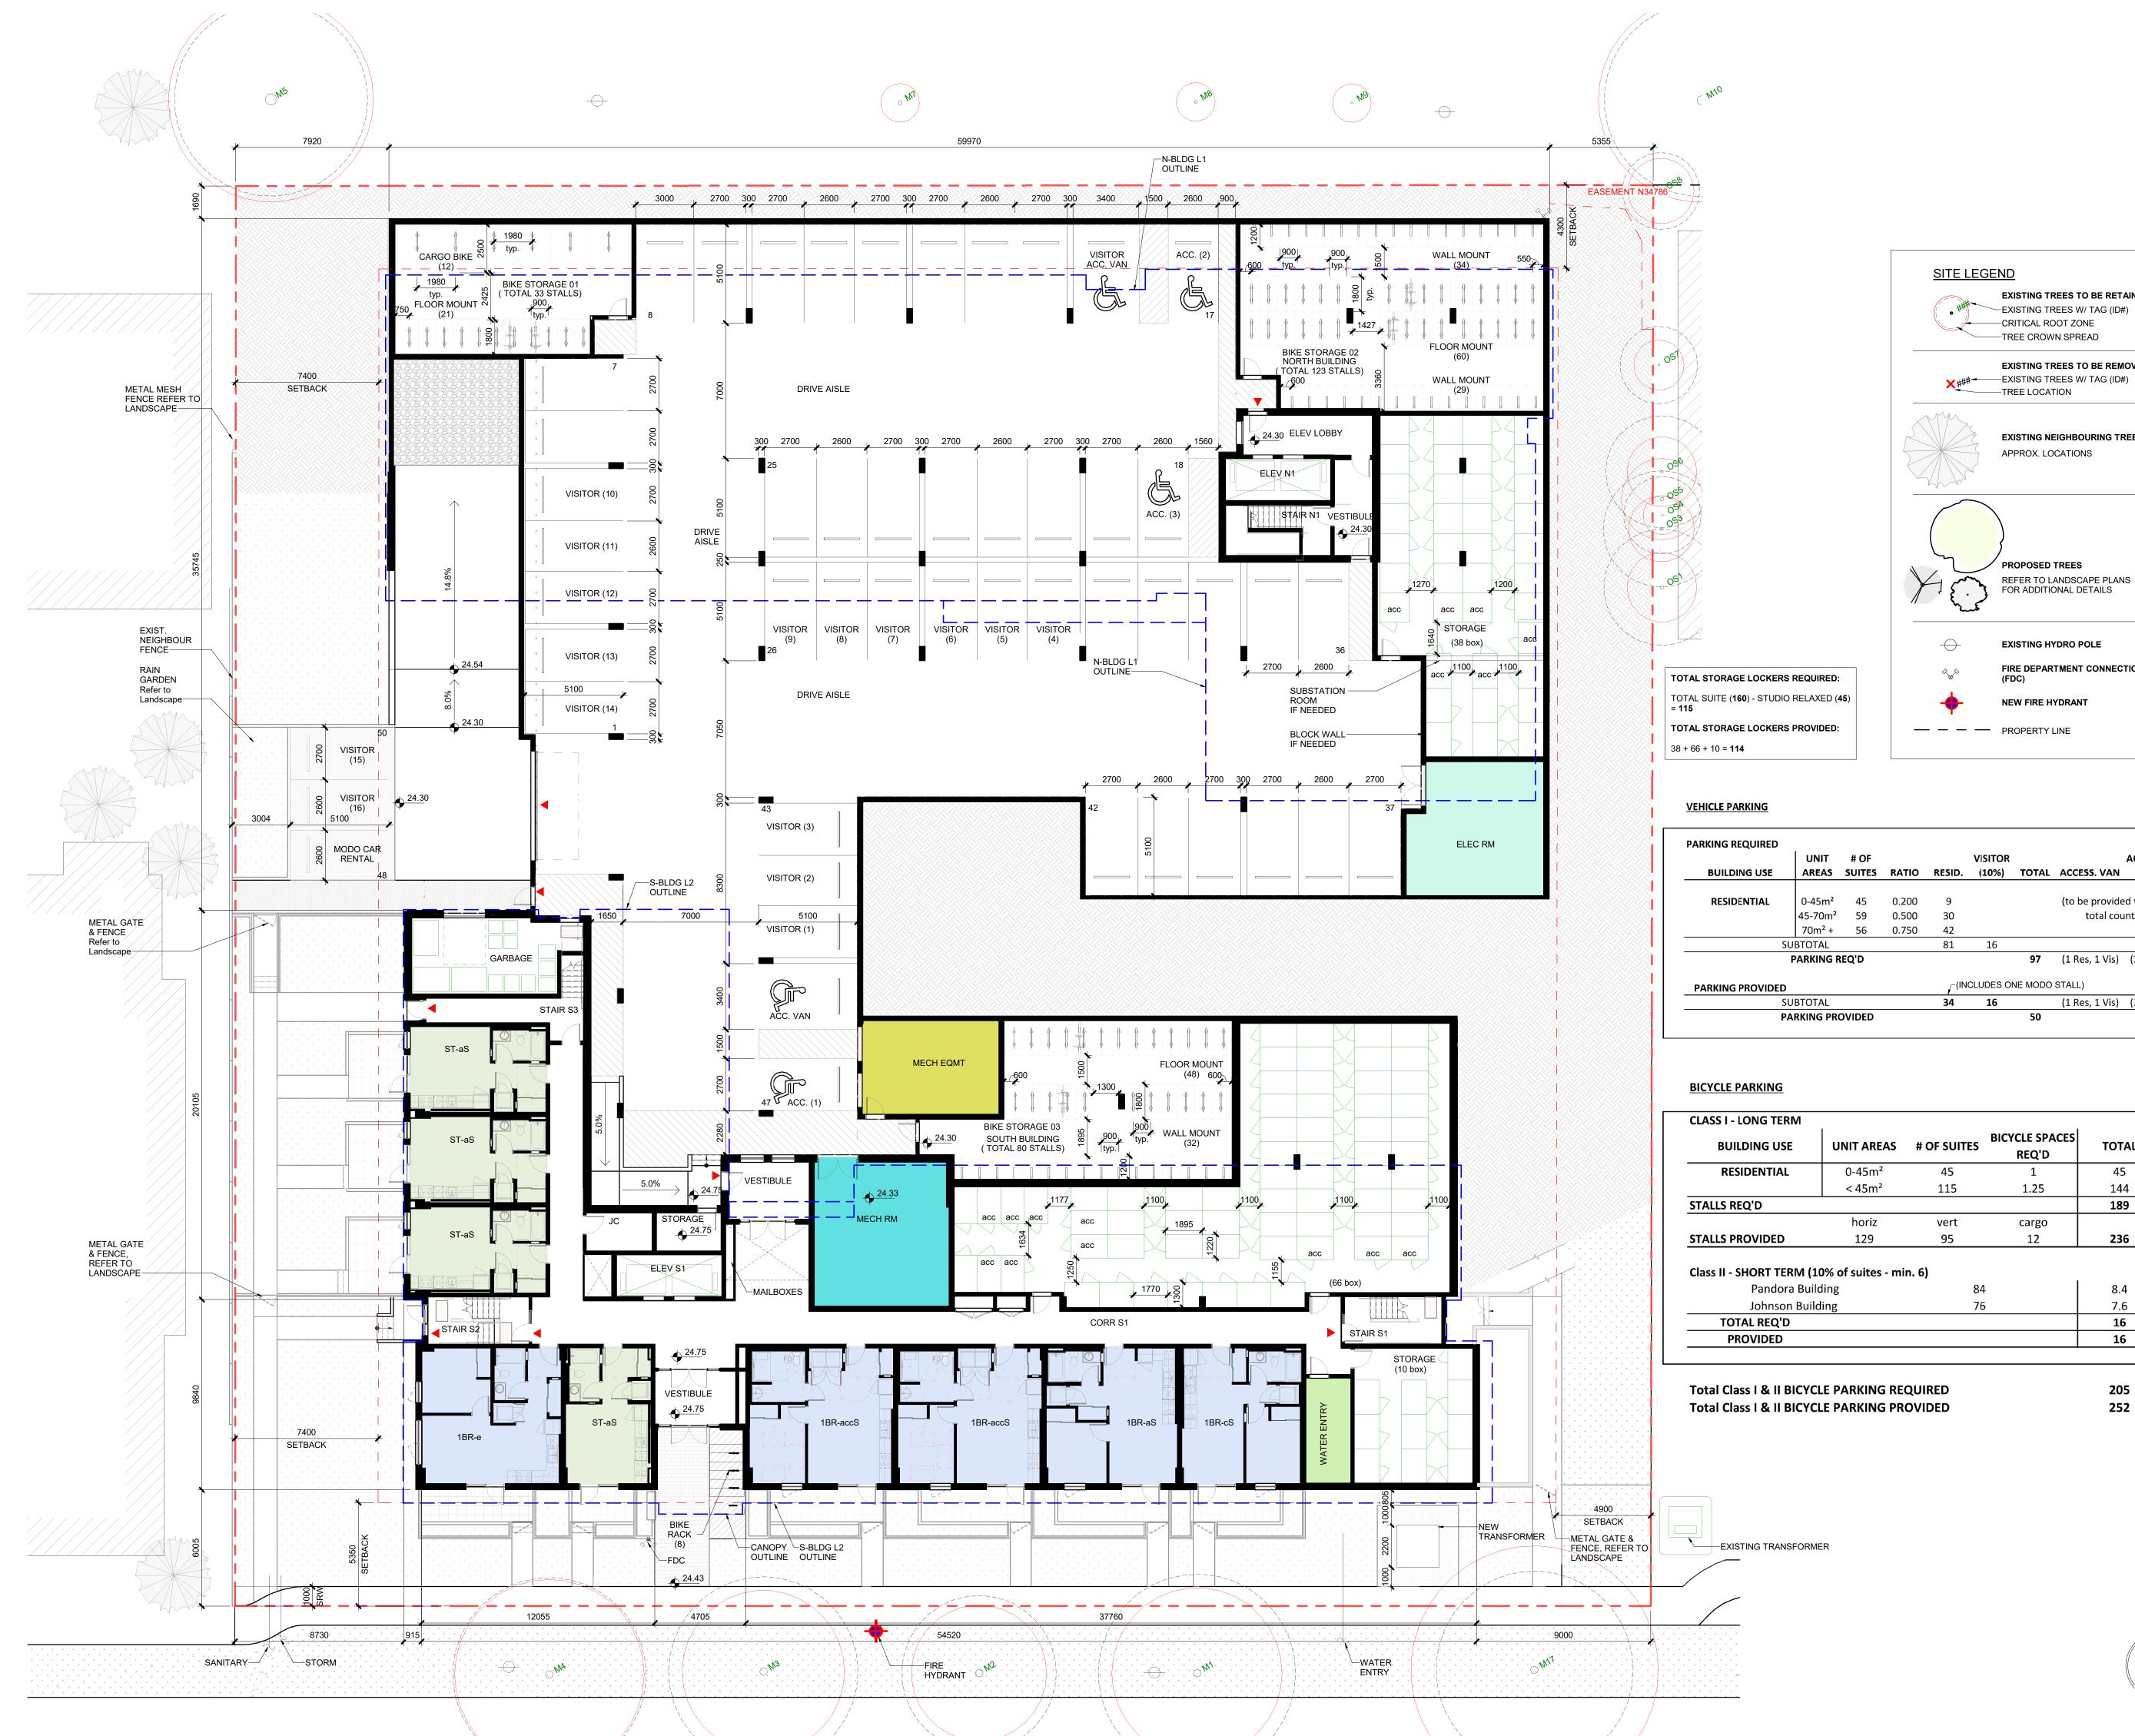

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Capital Region Ho Village On The Gra Affordable Rental

FOR ADDITIONAL DETAILS **EXISTING HYDRO POLE** FIRE DEPARTMENT CONNECTION

EXISTING TREES TO BE RETAINED

EXISTING TREES TO BE REMOVED

EXISTING NEIGHBOURING TREES

REFER TO LANDSCAPE PLANS

(1 Res, 1 Vis) (3 Res)

CRITICAL ROOT ZONE

TREE LOCATION

TREE CROWN SPREAD

APPROX. LOCATIONS

NEW FIRE HYDRANT — — — PROPERTY LINE

PARKING REQUIRED								
	UNIT	# OF			VISITOR			ACCESS.
BUILDING USE	AREAS	SUITES	RATIO	RESID.	(10%)	TOTAL	ACCESS. VAN	CAR
RESIDENTIAL	0-45m ²	45	0.200	9			(to be provide	ed within
	45-70m ²	59	0.500	30			total cou	ınt)
	70m² +	56	0.750	42				
SI	JBTOTAL			81	16			
	PARKING R	REQ'D				97	(1 Res, 1 Vis)	(3 Res)
PARKING PROVIDED				(IN	CLUDES Of	NE MODO	STALL)	

CLASS I - LONG TERM				
BUILDING USE	UNIT AREAS	# OF SUITES	BICYCLE SPACES REQ'D	TOTAL
RESIDENTIAL	0-45m²	45	1	45
	< 45m²	115	1.25	144
STALLS REQ'D				189
	horiz	vert	cargo	
STALLS PROVIDED	129	95	12	236
Class II - SHORT TERM (•	ı	
Pandora Bu	ilding	84		8.4
Johnson Bui	lding	76	7.6	
TOTAL REQ'D				16
				16


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Sheet title

No Date

Principal in charge Project number

FLOOR PLAN - P0 & P1

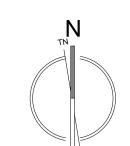

205

252

Sheet in set: 1

File name 2301_CRHC Johnson St_CENTRAL.RVT Plot date 2024 11 25



2720

2720

3075

60375

17750

3375

32780

3475

3075

10135

4295



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FLOOR PLAN - LEVEL 2


Project number 2301

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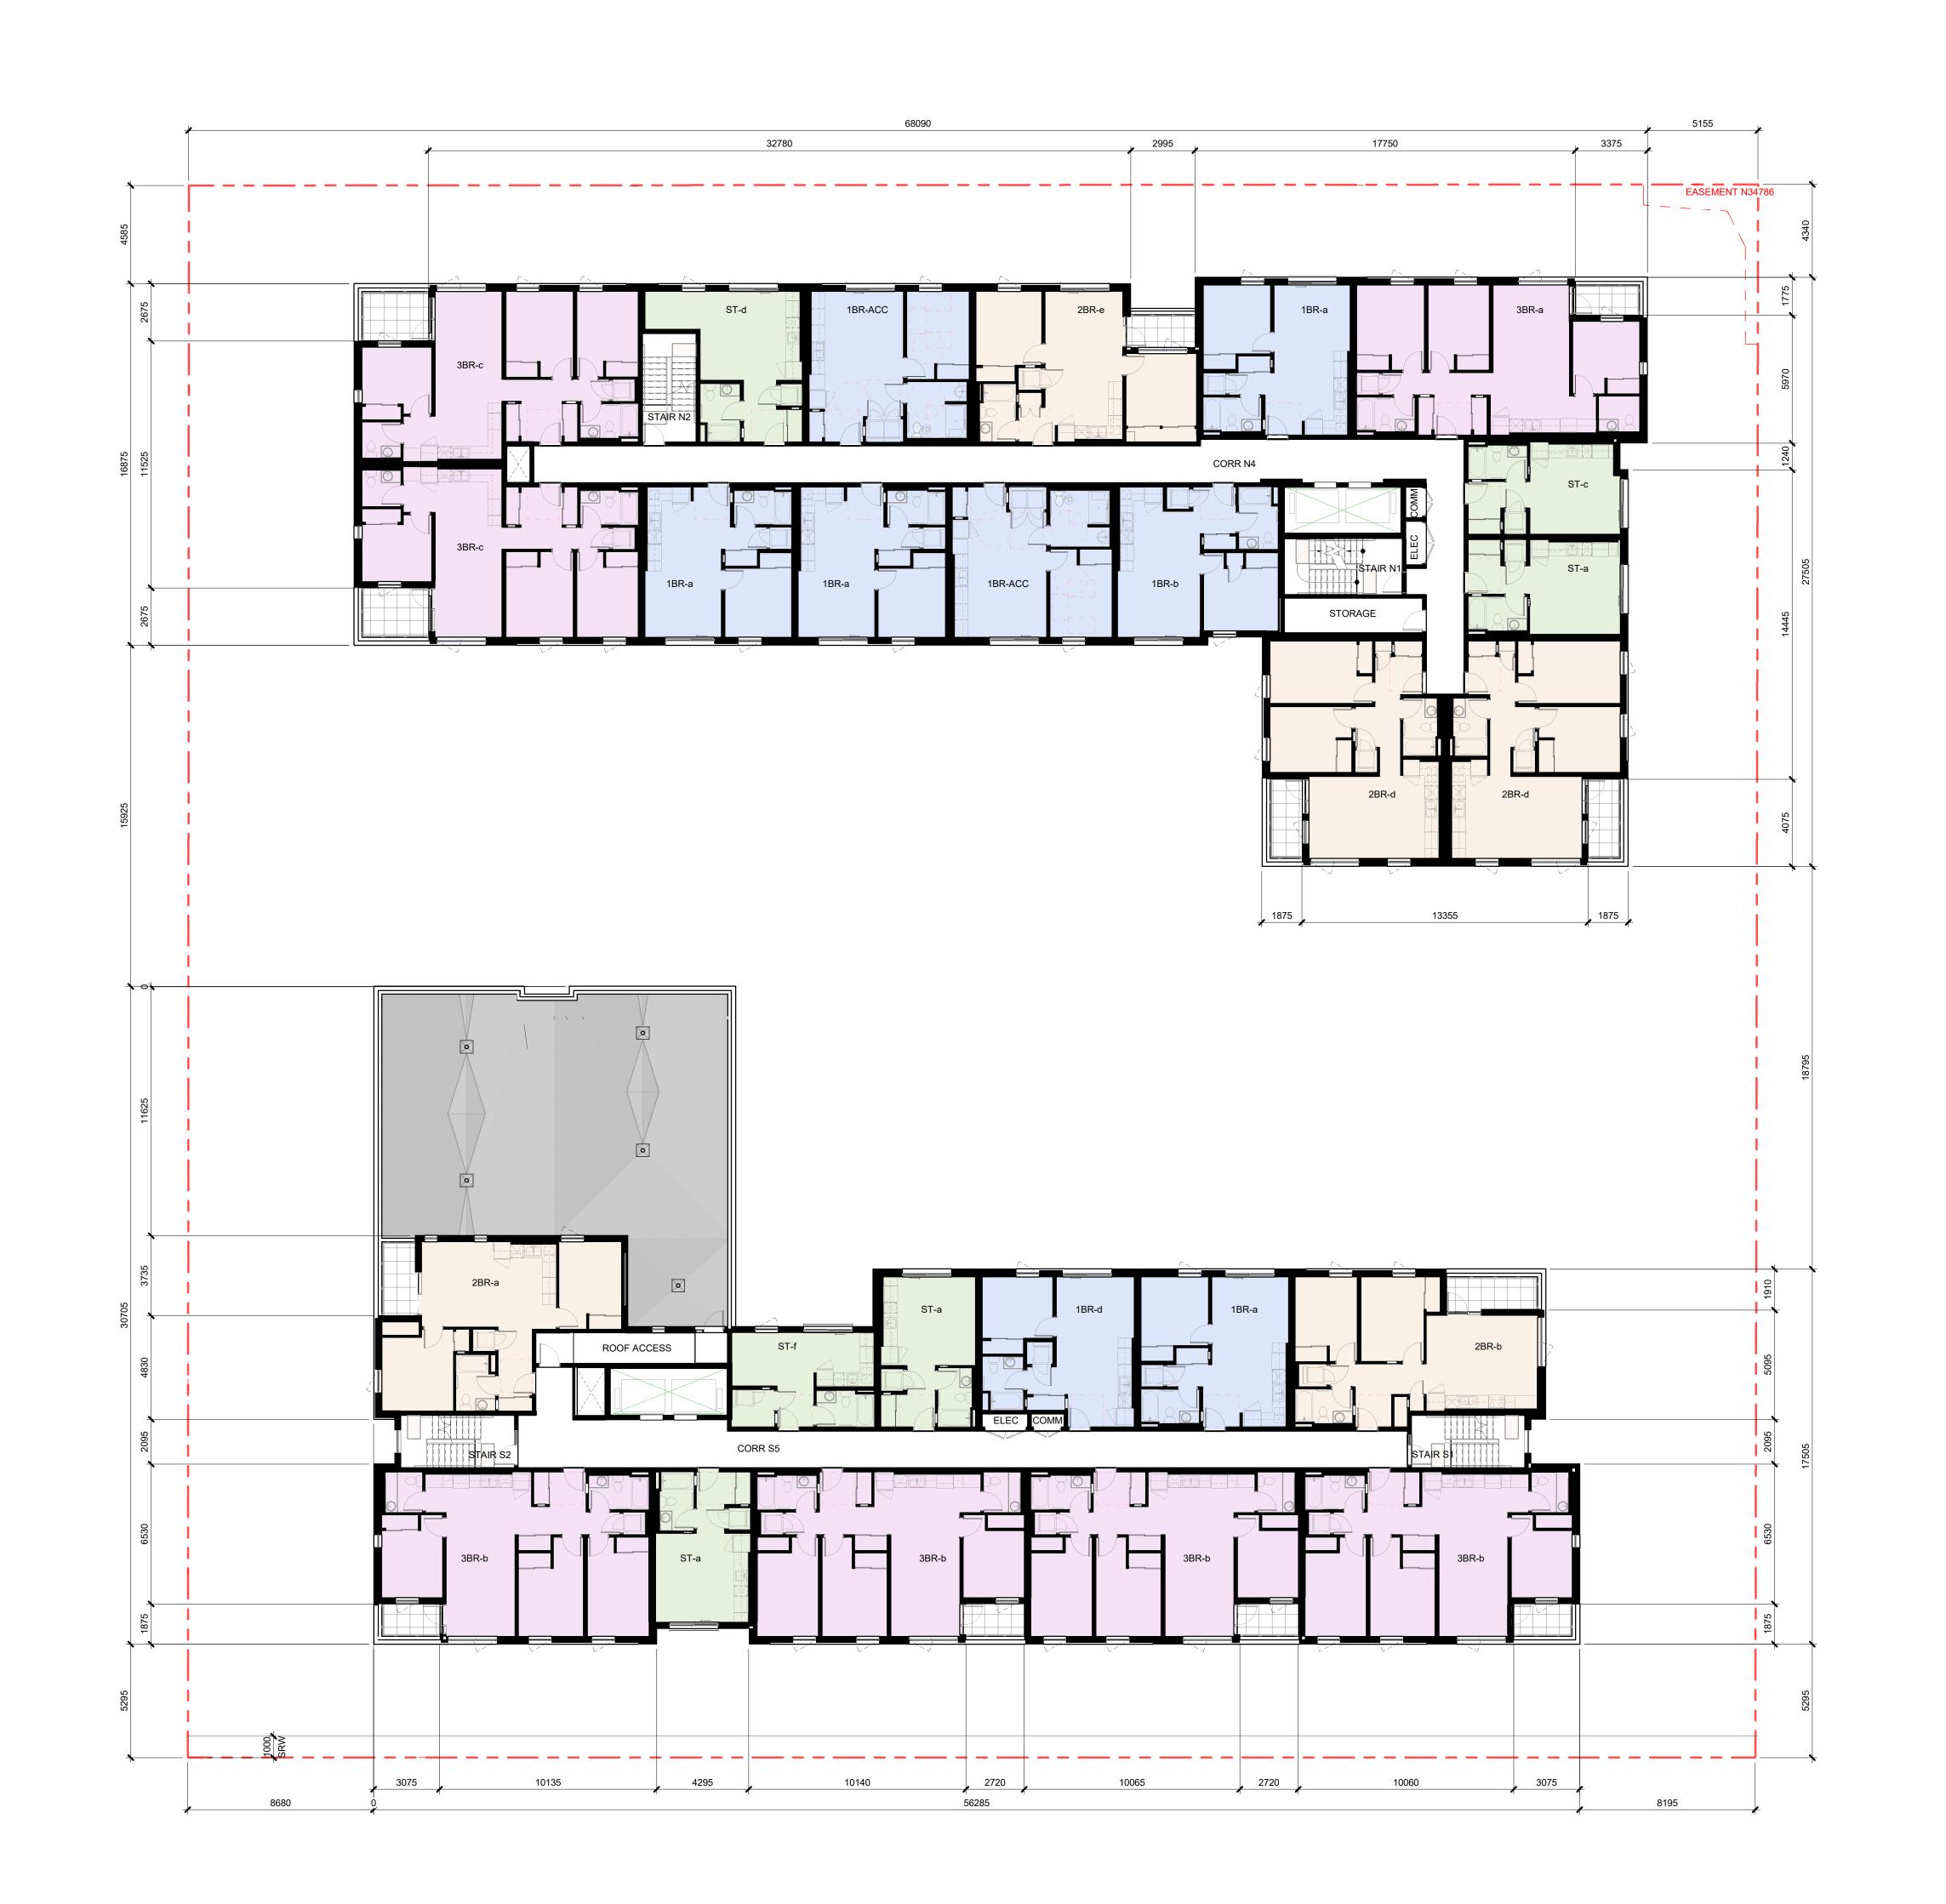
1 11.2024 Revision 1 No Date Revised

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Project number 2301

FLOOR PLAN - LEVEL 3

File name 2301_CRHC Johnson St_CENTRAL.RVT

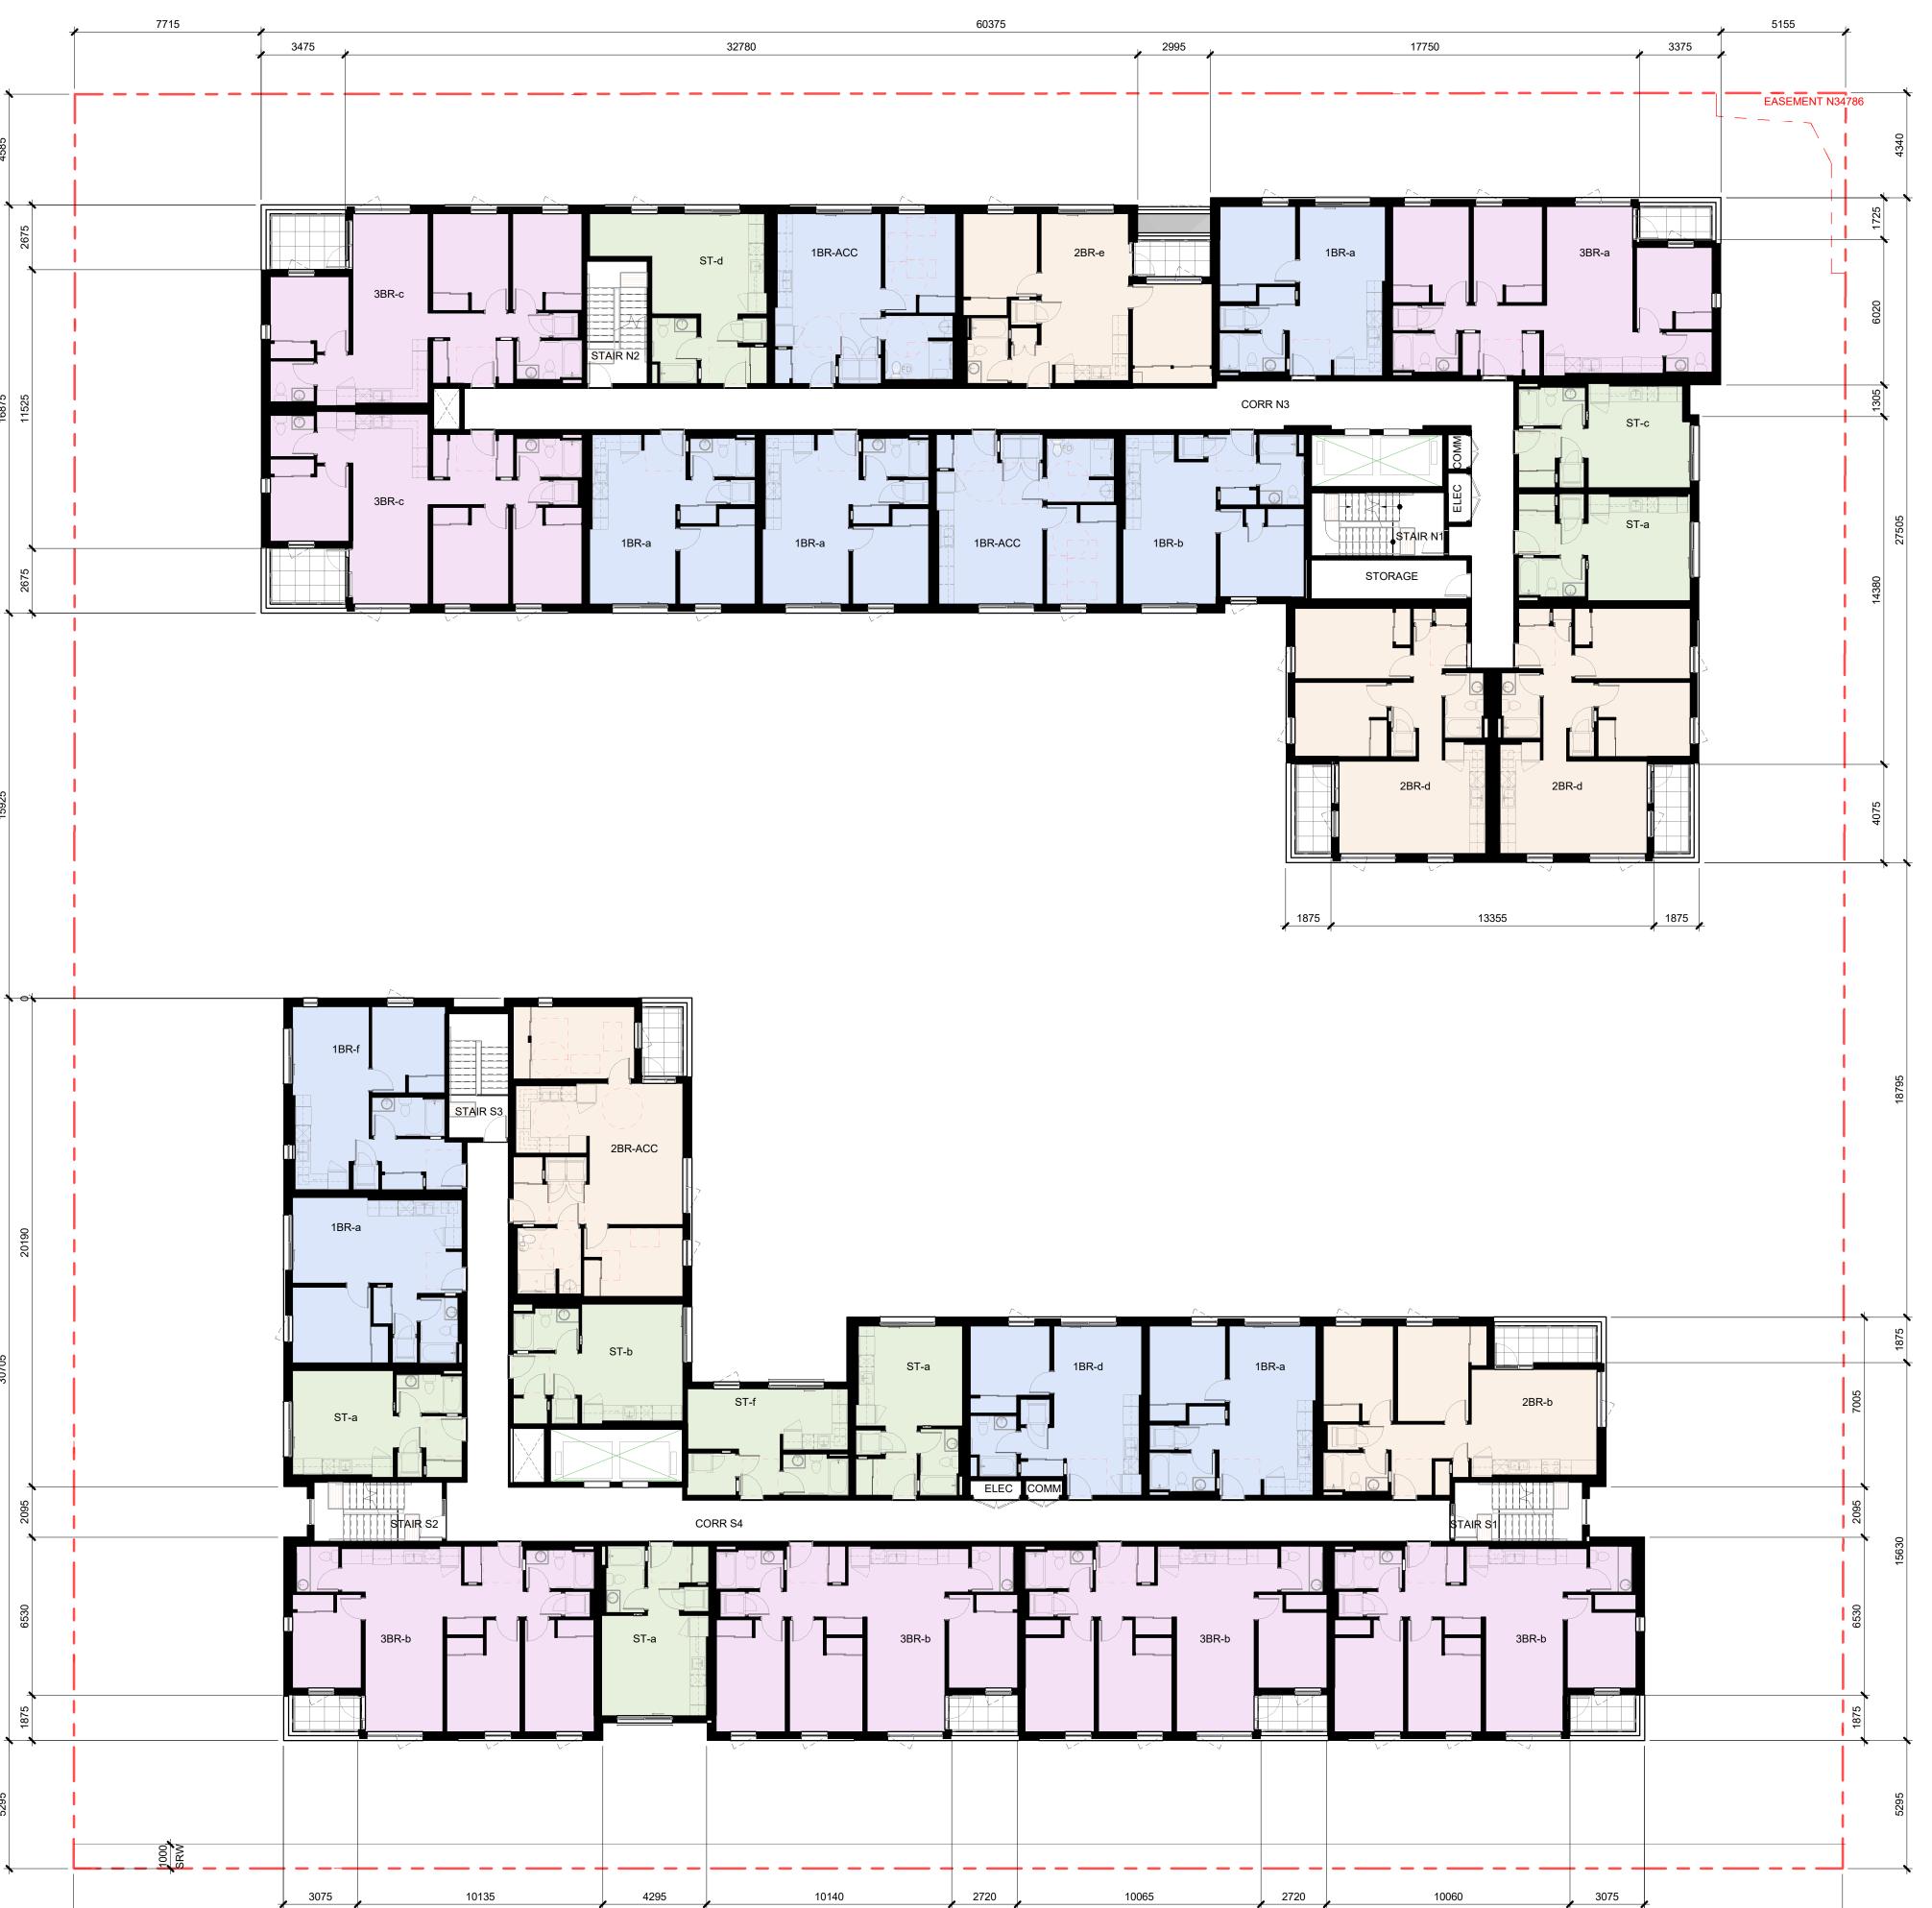



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Project number 2301 **FLOOR PLAN - LEVEL 4**


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Plot date 2024 11 25

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Sheet number

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Plot date 2024 11 25

Project number 2301

1 11.2024 Revision 1
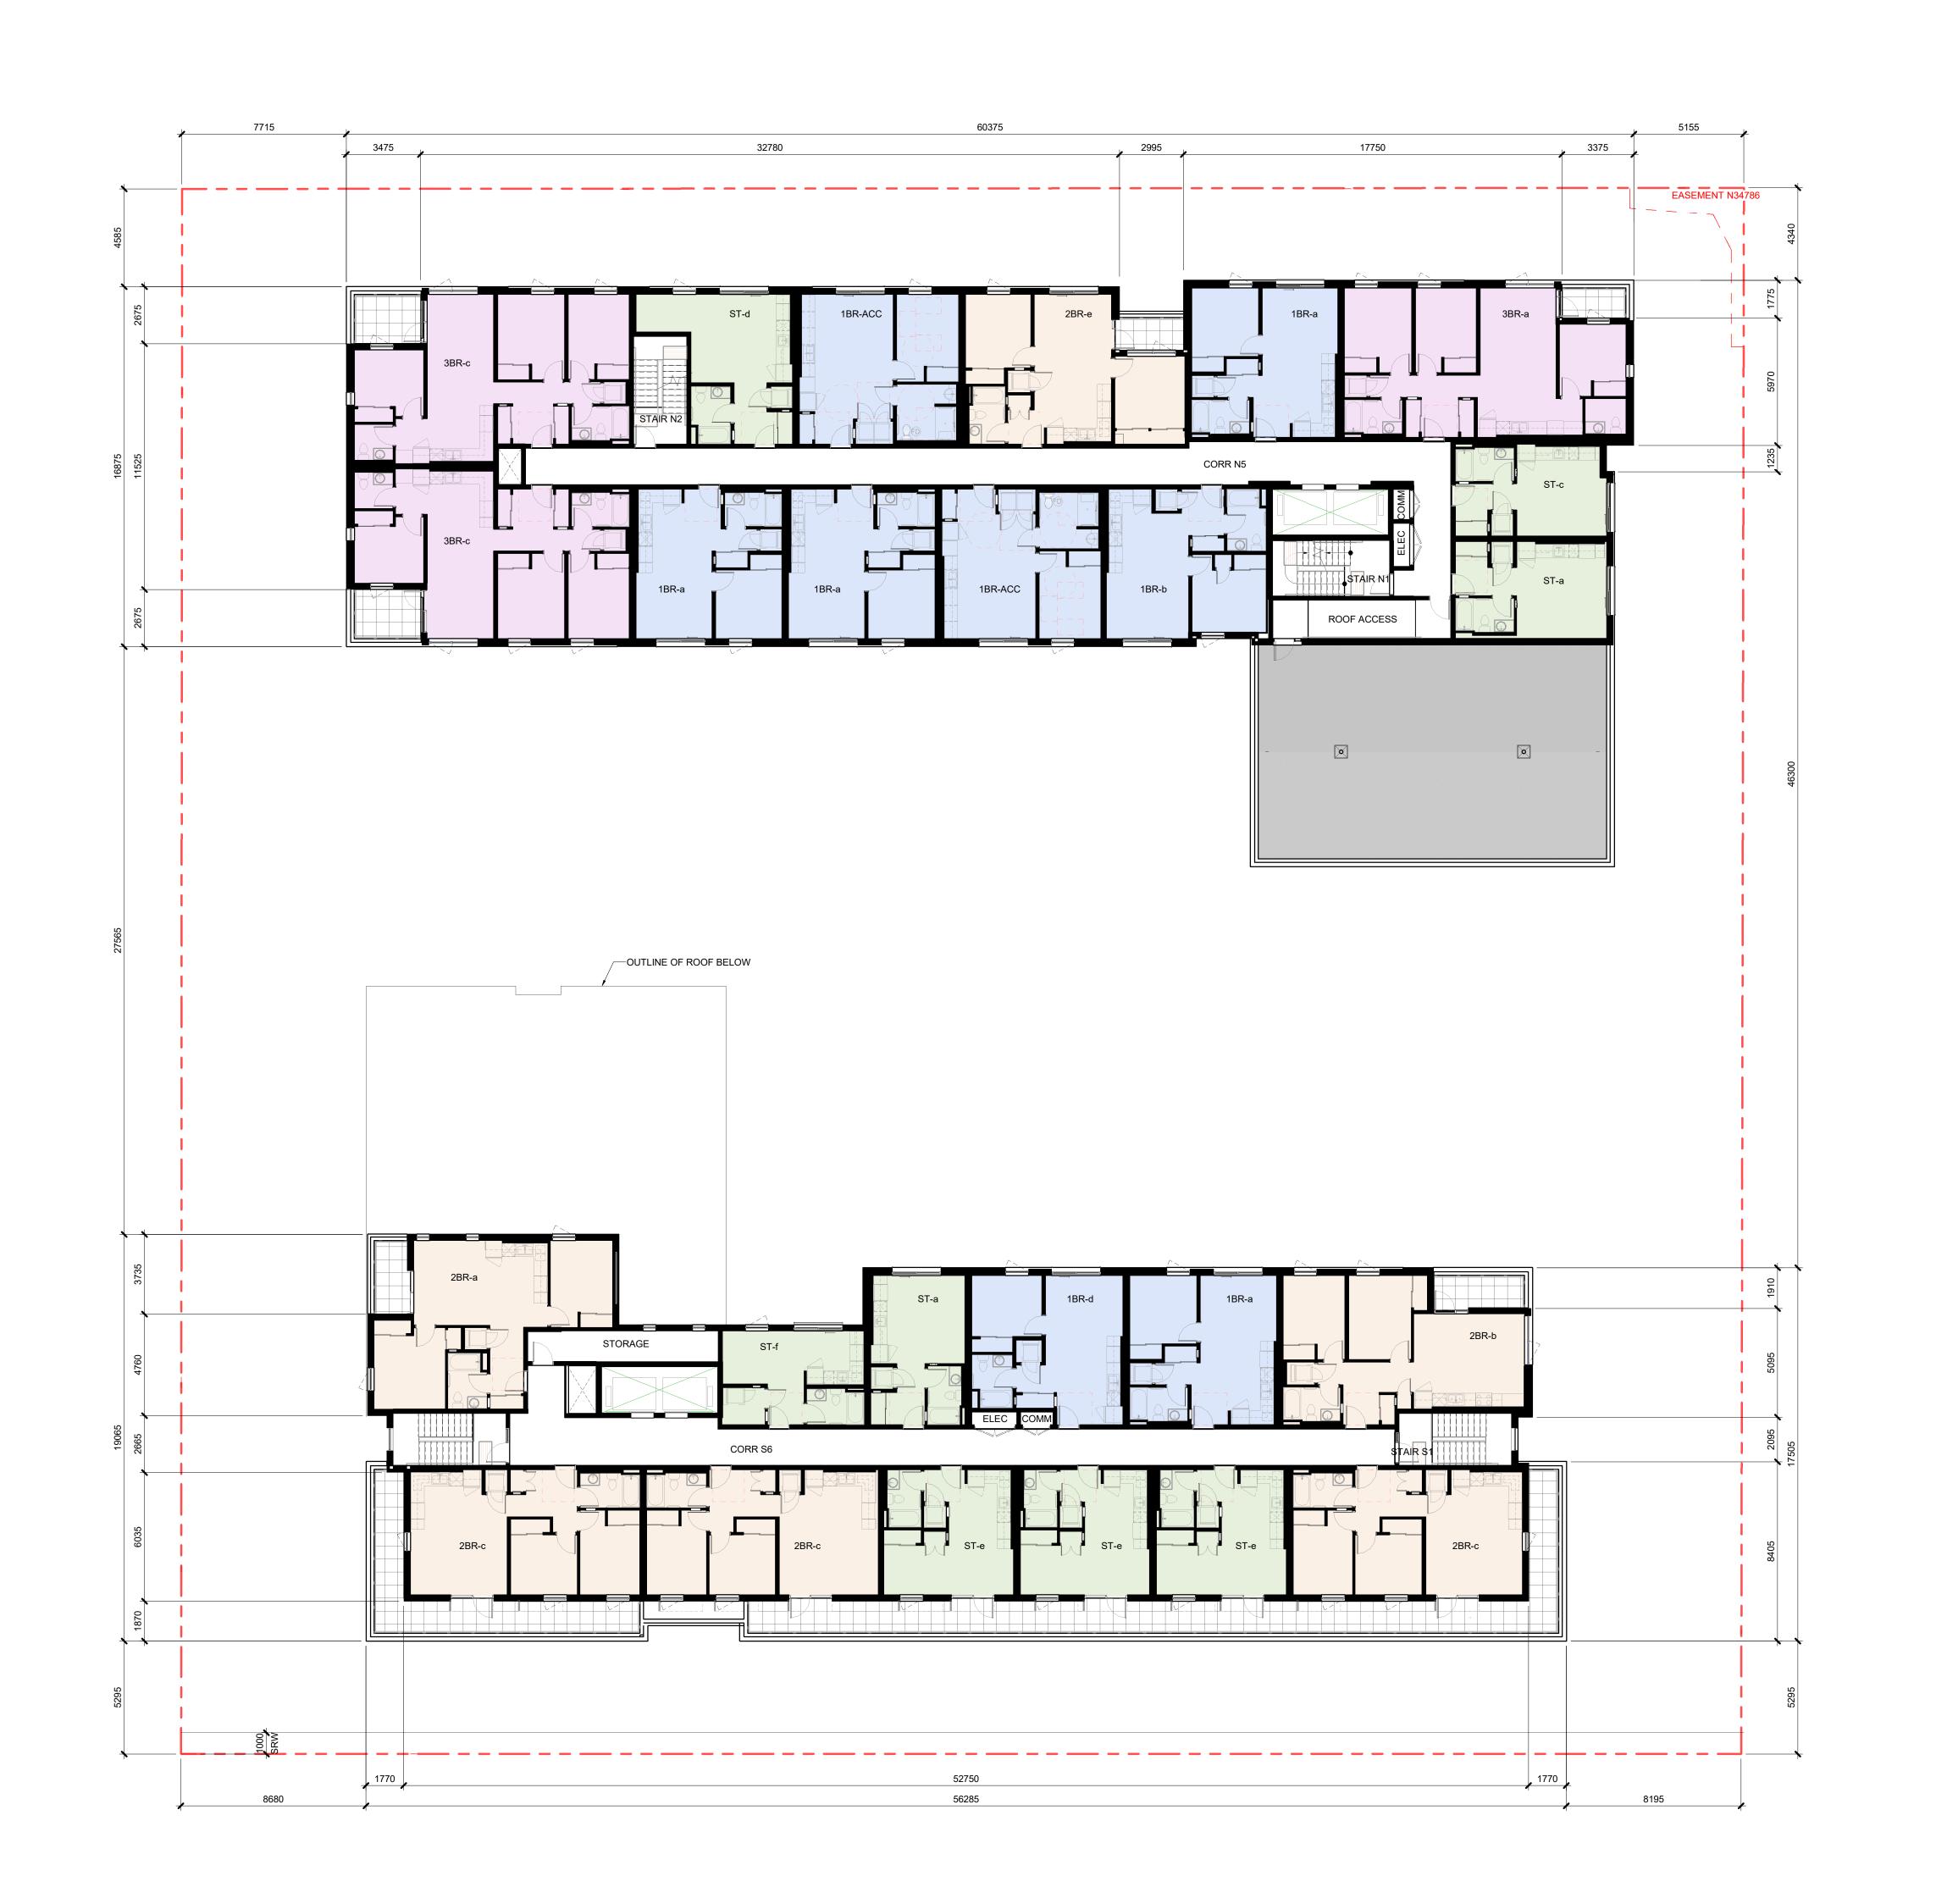
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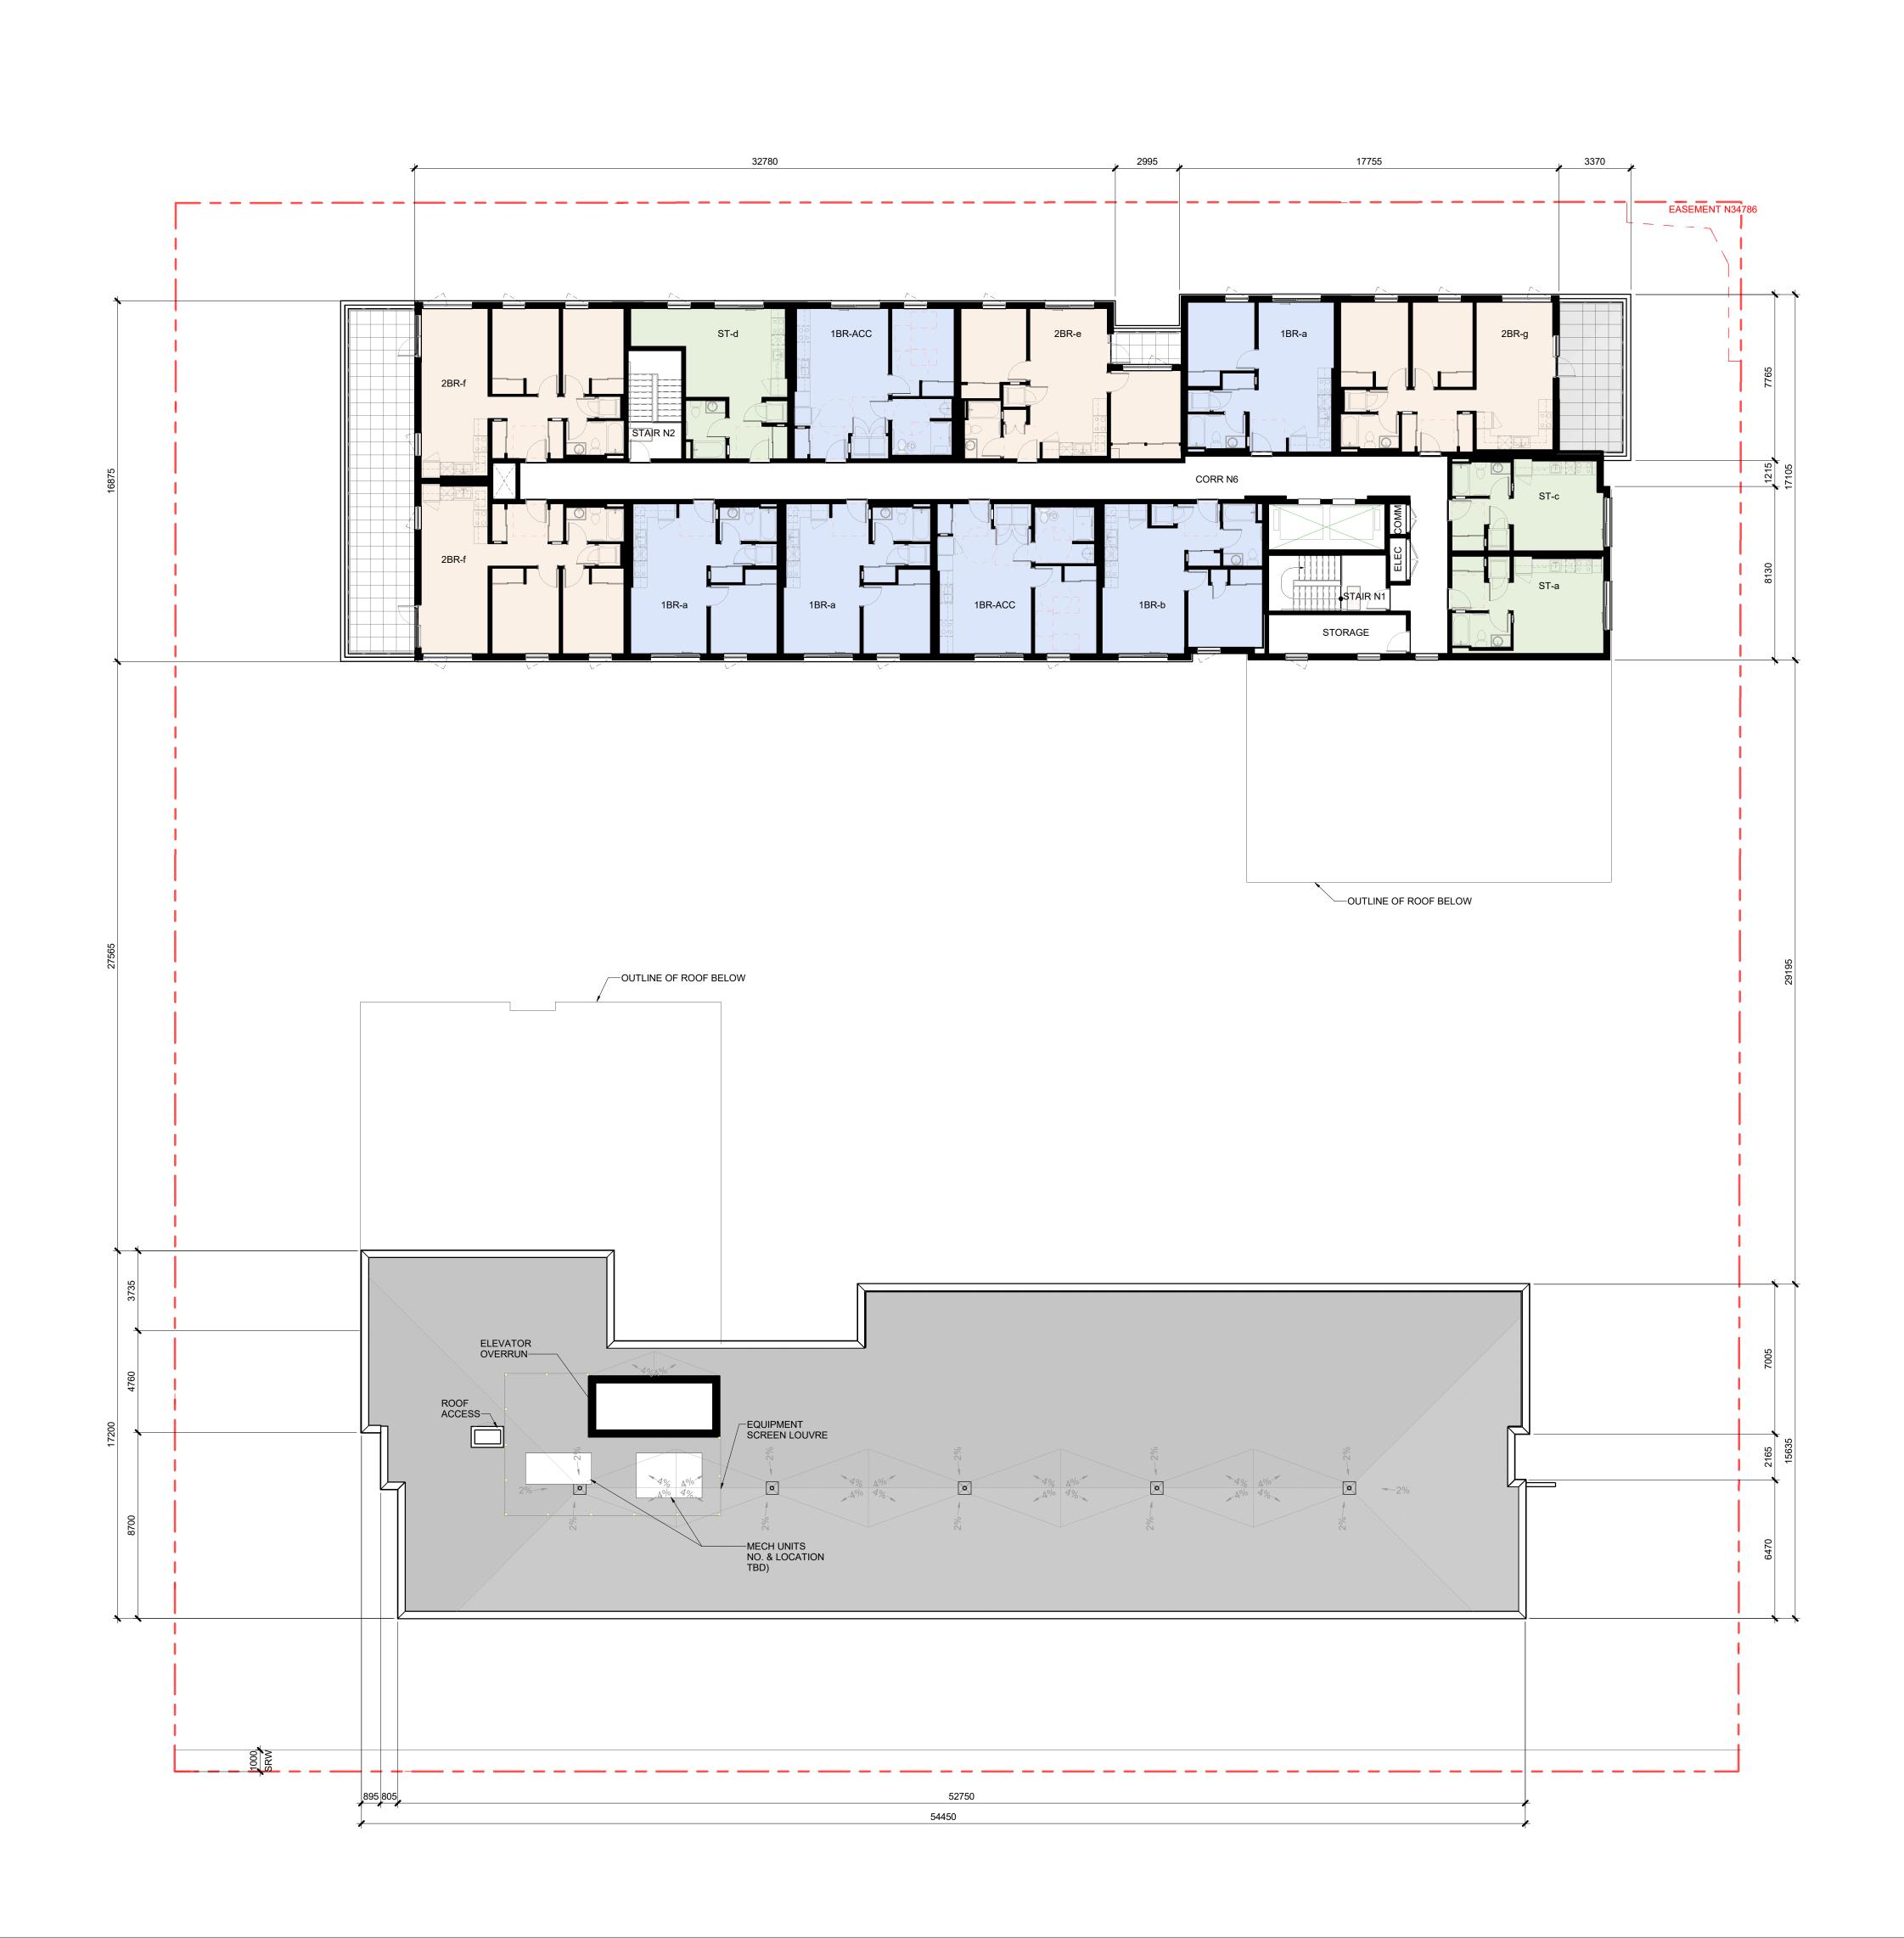
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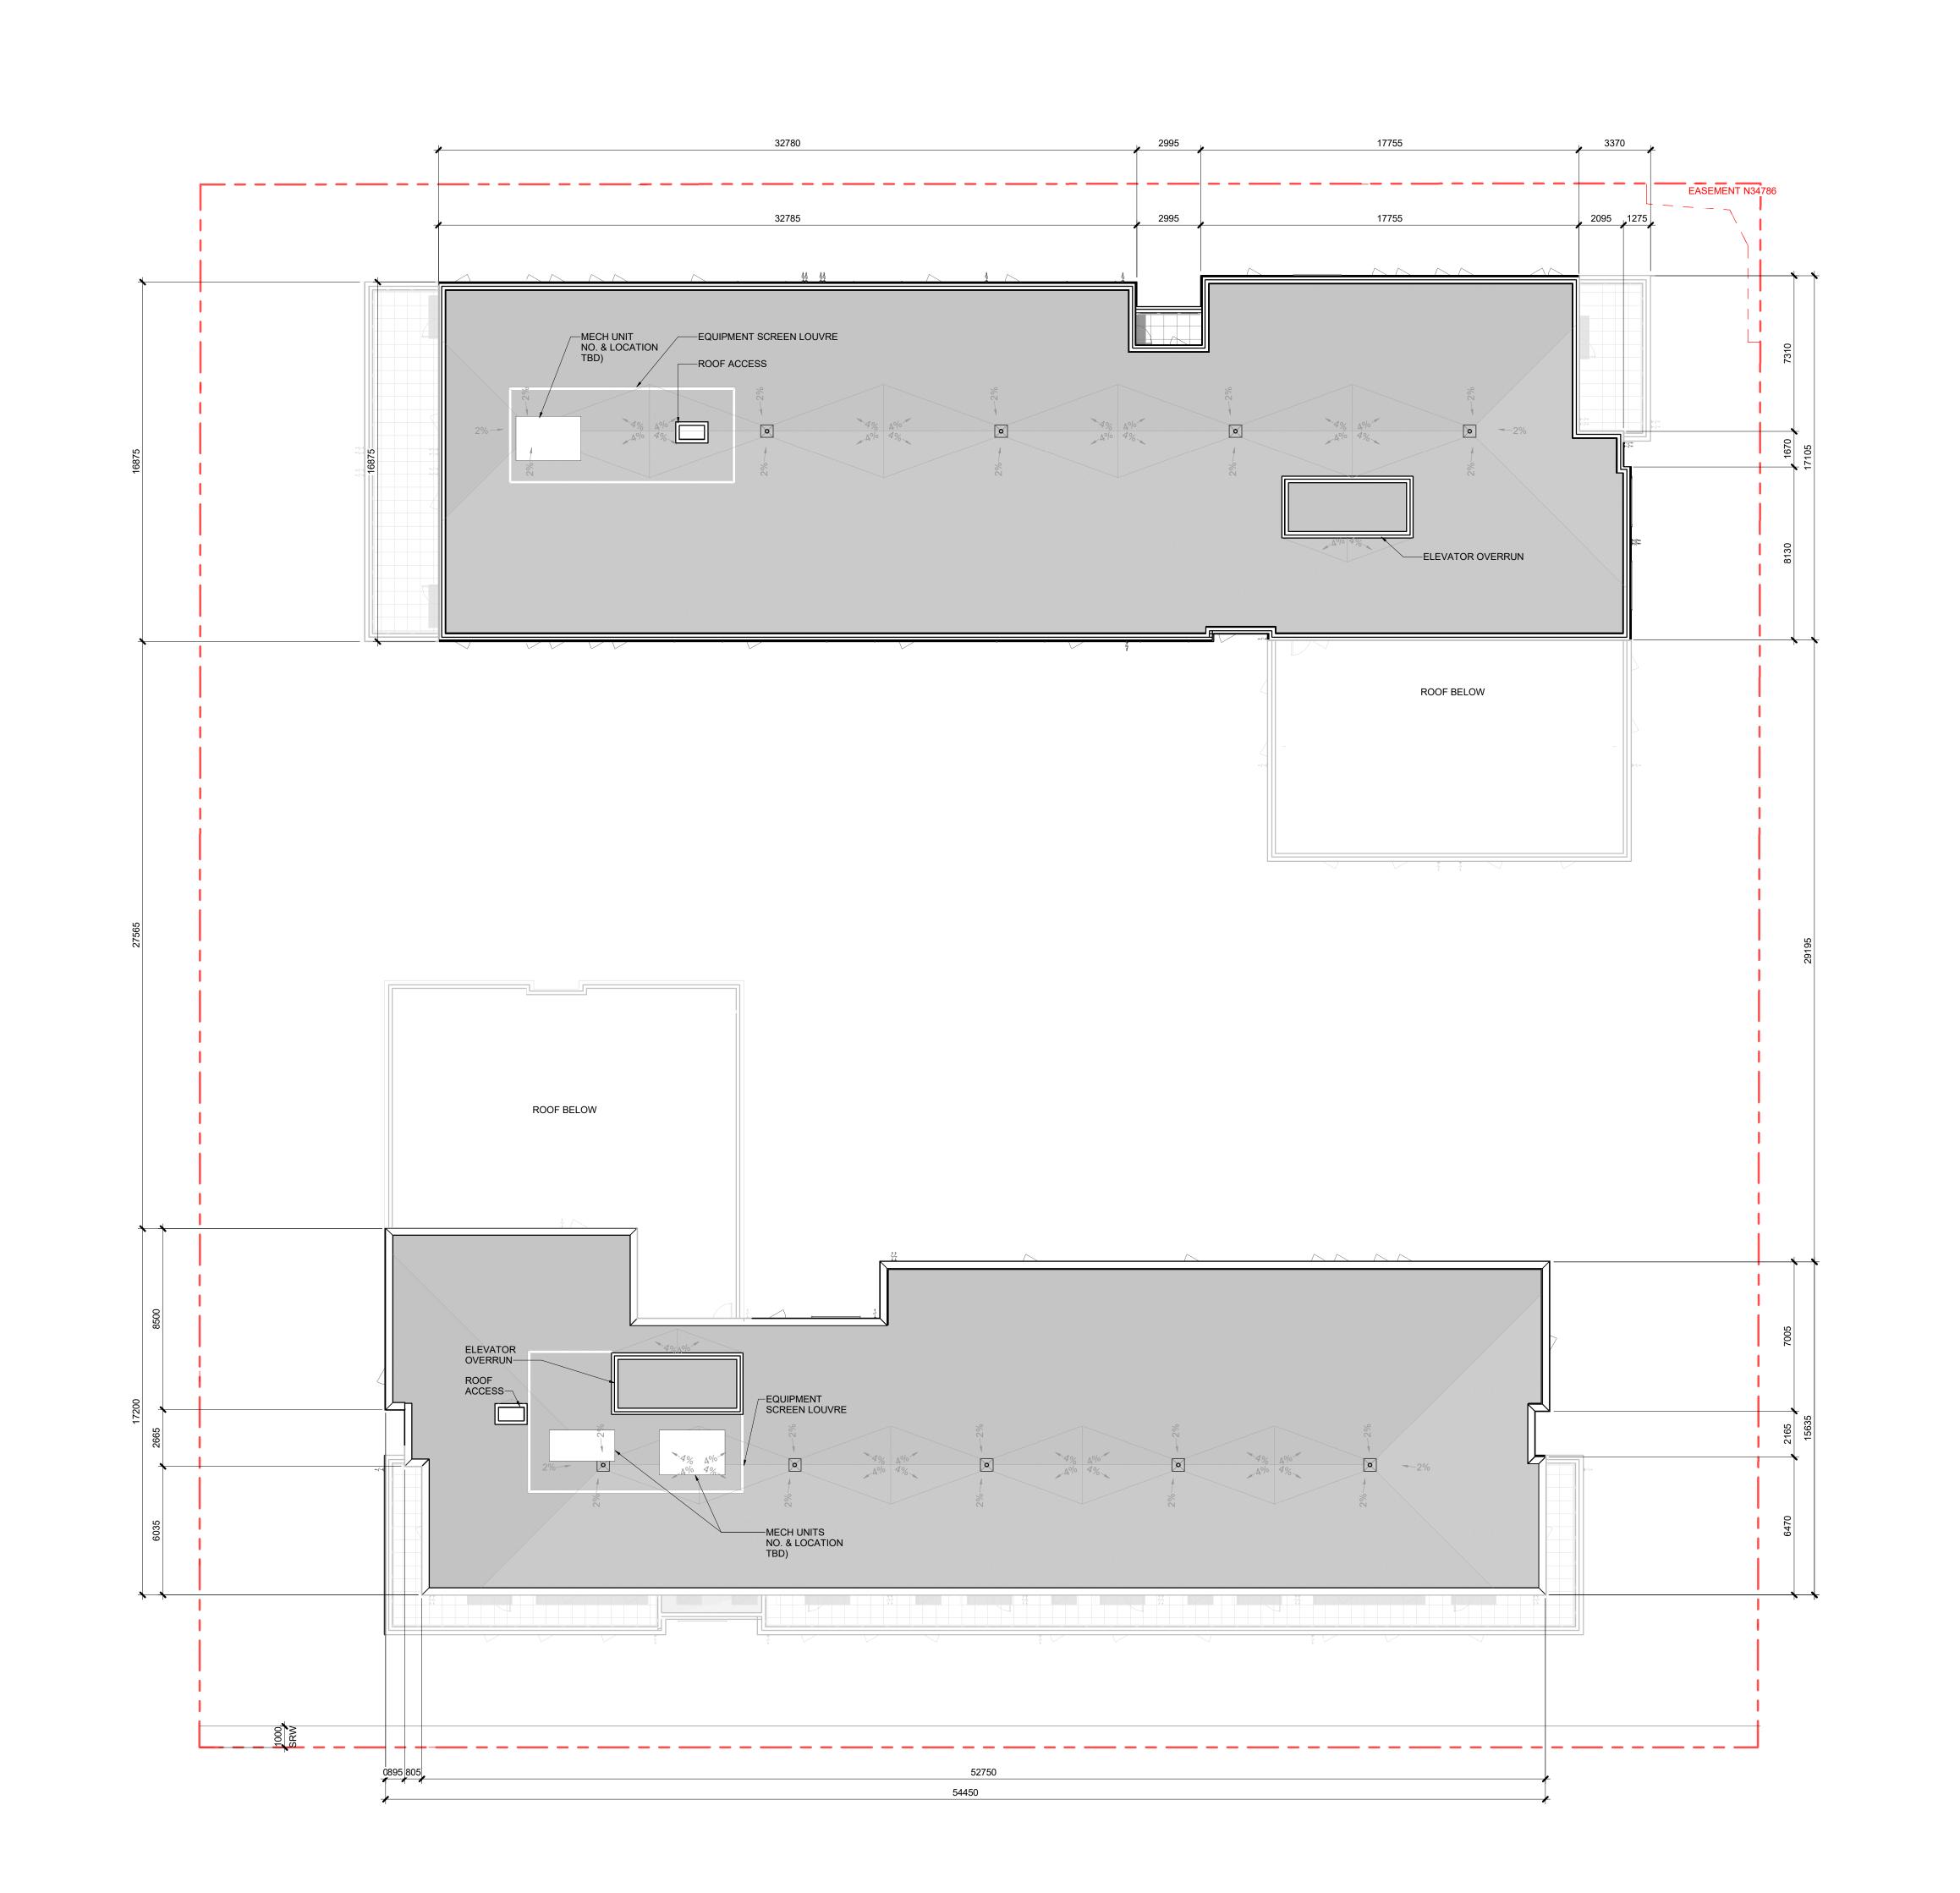
FLOOR PLAN - LEVEL 6

A2.6

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 Revision
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 2301_CRHC Johnson St_CENTRAL.RVT
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Project number 2301

ROOF PLAN

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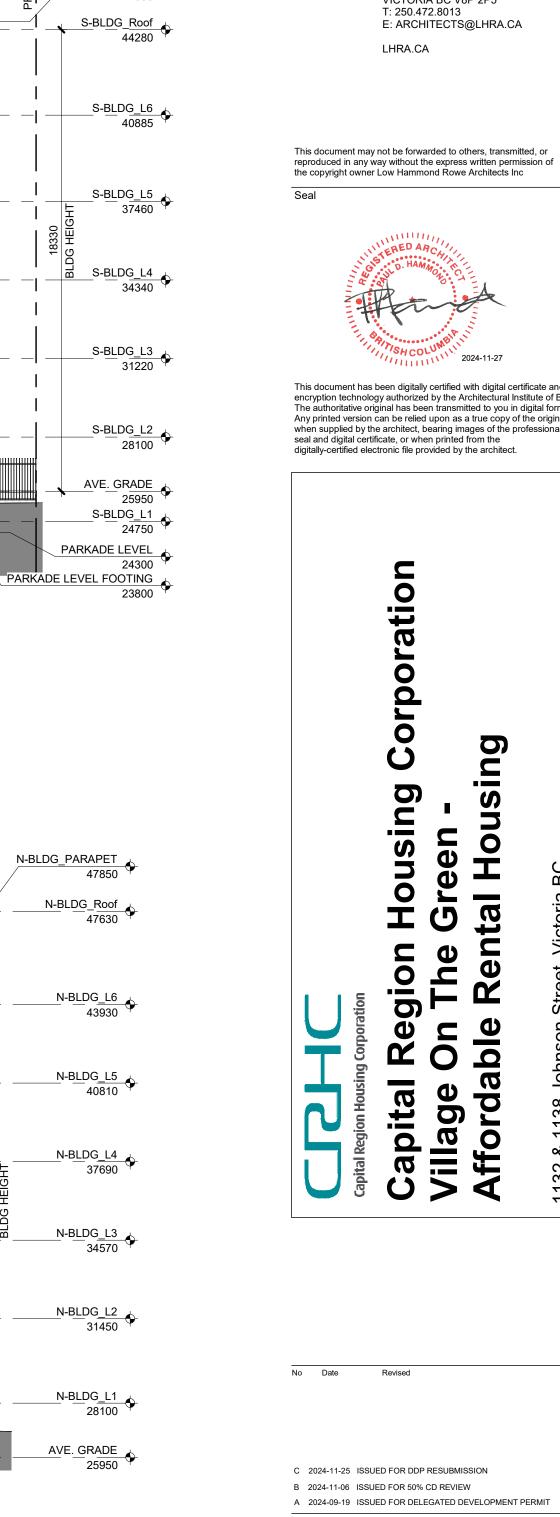
Capital Region Ho Village On The Gr Affordable Rental

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BUILDING ELEVATIONS

Plot date 2024 11 25

A4.0 File name 2301_CRHC Johnson St_CENTRAL.RVT



S-BLDG_PARAPET 44600

-EQUIPMENT SCREEN **ELEVATOR** OVERRUN -LOUVRE 5 3 5 7 **4** N-BLDG_PARAPET 47850 N-BLDG_L6 43930 N-BLDG_L5 40810 N-BLDG_L4 37690 N-BLDG_L3 34570 N-BLDG_L2 31450 N-BLDG_L1 28100 FDC---

2 JOHI A4.0 1:150

JOHNSON ST ELEVATION - SOUTH



—EQUIPMENT SCREEN


ELEVATOR OVERRUN -

FDC—

6



Charcoal

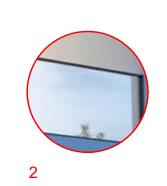


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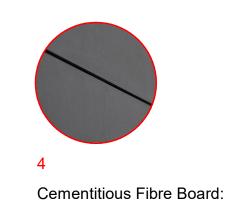





Warm Colour

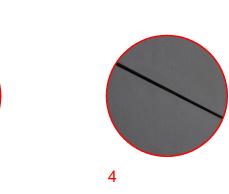


Charcoal



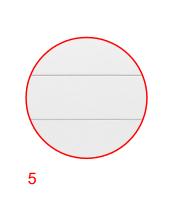

Cementitious Fibre Board:

Light Warm-Grey Colour

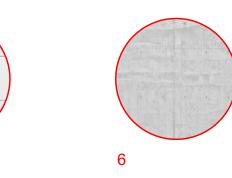

Architectural Concrete



White Vinyl Window

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BUILDING ELEVATIONS

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Principal in charge

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Project number 2301

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BUILDING ELEVATIONS

A4.2

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2301

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LOW

A4.4

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Corporation

lousing Capital Region Ho Village On The Gra Affordable Rental

C 2024-11-25 ISSUED FOR DDP RESUBMISSION B 2024-11-06 ISSUED FOR 50% CD REVIEW

Project number 2301

BUILDING SECTIONS

A4.4

Plot date 2024 11 25

File name 2301_CRHC Johnson St_CENTRAL.RVT






1 A4.4 BUILDING SECTION 1 - VIEW EAST
A4.4 1: 150



WINTER SOLSTICE 12NOON

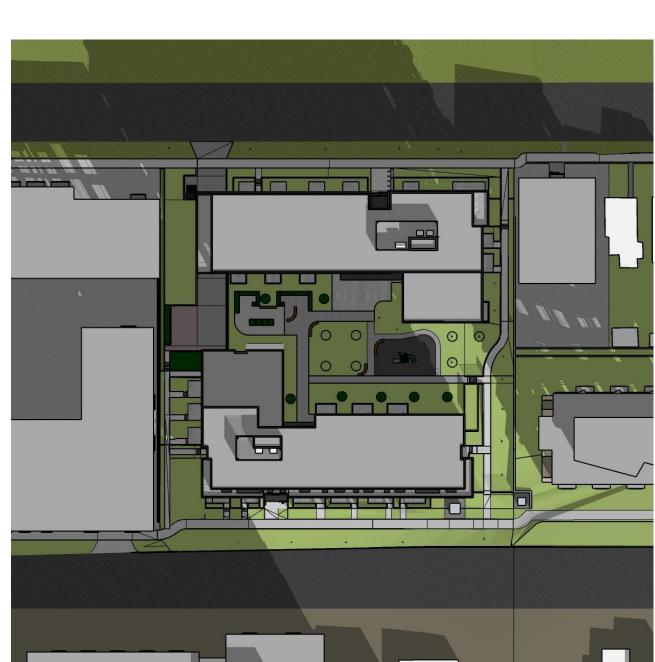



FALL EQUINOX 3PM



FALL EQUINOX 12NOON






SUMMER SOLSTICE 3PM



SUMMER SOLSTICE 12NOON



SUMMER SOLSTICE 9AM

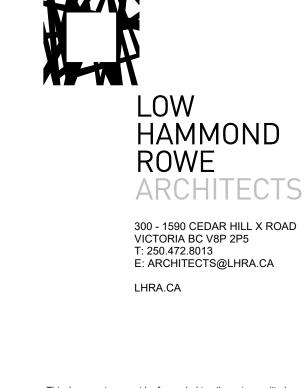

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Sheet title

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A4.5

File name 2301_CRHC Johnson St_CENTRAL.RVT

Plot date 2024 11 25

WINTER SOLSTICE 9AM FALL EQUINOX 9AM

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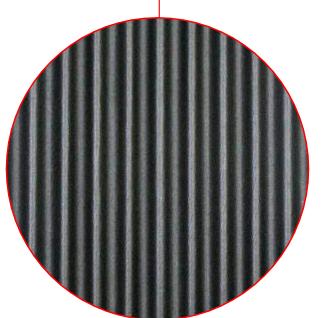
C 2024-11-25 ISSUED FOR DDP RESUBMISSION B 2024-11-06 ISSUED FOR 50% CD REVIEW A 2024-09-19 ISSUED FOR DELEGATED DEVELOPMENT PERMIT

MATERIALS BOARD


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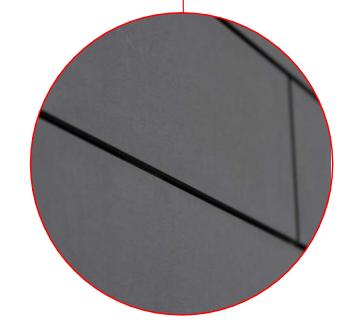
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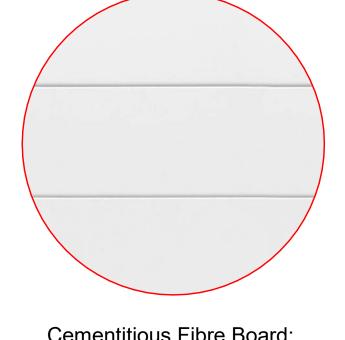











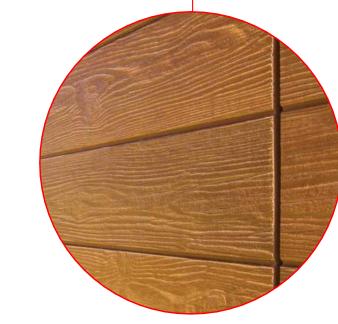

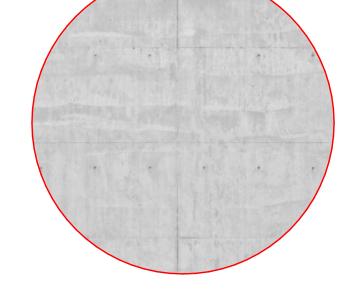



Architectural Concrete

Cementitious Fibre Board: Warm Colour Corrugated Metal: Charcoal Railing Glazing

Cementitious Fibre Board: Charcoal

Cementitious Fibre Board: Light Warm-Grey Colour

White Vinyl Window

A 26.92 ×

6791

EE 26.24

FF 26.23

CC 25.38

BB 25.25 a 24.75 b 24.15

AA 24.50 Z 24.52 a 24.25 b 24.75

Y1 23.38 24.00 Y2 23.39 24.00

W 24.42 24.75

X 24.32 24.65

4521

36032

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Capital Region Ho Village On The Gra Affordable Rental

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Project number 2301

AVERAGE GRADE CALCULATIONS

Plot date 2024 11 25

A5.1 File name 2301_CRHC Johnson St_CENTRAL.RVT

2301_CRHC VOG - 1132 JOHNSON STREET

19-Sep-24

G 28.22

Q 25.69 P 25.69 26.51 1610 S 25.64 26.51

25.10 25.20 25.30

28.20 28.30

L 26.25

27.85

28950

N 25.62 27.90

27.95 m **PANDORA ST** 24.75 m JOHNSON ST 27.5 m PARKADE ROOF 24.3 m UG PARKADE

Graue	Points(m G Existing	,			۸۷	orago	Hoight		Distance	Calculation
	EXISTILIS	Proposed				erage +	Height b	/2 =	Distance	d x avg height
Α	26.92	27.15	А ТО В	,	a 26.92	+	27.64) /2 = 27.28	36.032	982.95
A B	27.64	28.10	ВТОС	`	27.64	+	28.78) /2 = 27.28	3.659	103.22
C	27.04	28.10	C TO D	`	27.48	+	28.78) /2 = 27.79	3.039	89.43
D	27.48	28.10	D TO E	`	27.48	+	27.70) /2 = 27.79	1.035	28.66
E	27.70	28.10	E TO F	`	27.70	+	28.10) /2 = 27.90	17.602	491.10
F	28.33	28.10	F TO G	`	28.10	+	28.10) /2 = 27.30	1.785	50.16
G	28.22	28.10	G TO H	``	28.10	+	28.10) /2 = 28.10	3.209	90.17
Н	28.40	28.10	НТОЛ	``	28.10	+	26.77) /2 = 27.44	30.791	844.75
 I	26.77	27.70	J TO K	``	26.77	+	26.01) /2 = 26.39	24.245	639.83
K	26.01	27.75	K TO L	``	26.01	+	26.25) /2 = 26.13	5.300	138.49
i.	26.25	27.90	L TO M	\	26.25	+	26.02) /2 = 26.14	11.525	301.21
M	26.02	27.90	M TO N	``	26.02	+	25.62) /2 = 25.82	11.300	291.77
N	25.62	27.90	N TO O	\	25.62	+	26.21) /2 = 25.92	31.000	803.37
0	26.21	27.80	O TO P	\	26.21	+	25.69) /2 = 25.95	14.500	376.28
P	25.69	26.51	P TO Q	Ι ,	25.69	+	25.69) /2 = 25.69	0.610	15.67
Q	25.69	26.51	Q TO R	l ὶ	25.69	+	25.62) /2 = 25.66	2.468	63.32
R.	25.62	26.51	R TO S	l ``	25.62	+	25.64) /2 = 25.63	1.610	41.26
S	25.64	26.51	S to T	l ;	25.64	+	25.41) /2 = 25.53	7.463	190.49
T	25.41	25.41	T to T1a	l ;	25.41	+	25.20) /2 = 25.31	6.889	174.33
T1a	25.22	25.20	T1a to T1b	l ;	25.20	+	24.85) /2 = 25.03	0.000	0.00
T1b	25.22	24.85	T1b to T2a	lì	24.85	+	24.47) /2 = 24.66	28.950	713.91
U	24.47	24.65	U to V	lì	24.47	+	24.60) /2 = 24.54	3.076	75.47
V	24.60	24.75	V to W	lì	24.60	+	24.42) /2 = 24.51	4.521	110.81
w	24.42	24.75	W to X	`	24.42	+	24.32) /2 = 24.37	3.076	74.96
X	24.32	24.65	X to Y	lί	24.32	+	24.03) /2 = 24.18	12.400	299.77
Υ	24.03	24.55	Y to Z	lι	24.03	+	24.00) /2 = 24.02	7.522	180.64
Y1	24.03	24.00	Y to Z	lί	24.00	+	24.00) /2 = 24.00	0.290	6.96
Y2	24.03	24.00	Y to Z	lί	24.00	+	24.00) /2 = 24.00	2.318	55.63
Z	24.52	24.00	Z to Aaa	lί	24.00	+	24.25) /2 = 24.13	1.700	41.01
AAa	24.50	24.25	AAa to AAb	Ιì	24.25	+	24.50) /2 = 24.38	0.000	0.00
AAb	24.50	24.75	AAb to BBa	Ιì	24.50	+	24.75) /2 = 24.63	16.049	395.21
BBa	25.25	24.75	BBa to BBb	Ιì	24.75	+	24.15) /2 = 24.45	0.000	0.00
BBb	25.25	24.15	BBb to CC		24.15	+	24.75) /2 = 24.45	3.932	96.14
CC	25.38	24.75	CC to DD		24.75	+	24.30) /2 = 24.53	5.871	143.99
DD	25.44	24.30	DD to EE		24.30	+	25.30) /2 = 24.80	18.863	467.80
EE	26.24	25.30	EE to FF		25.30	+	25.30) /2 = 25.30	6.791	171.81
FF	26.23	25.30	FF to A	lί	25.30	+	26.92) /2 = 26.11	16.946	442.46

25.30 | FF to A | (25.30 + 346.546 8993.01 8993.01 / 346.55 **25.95** m **Average Grade:**

T 00.00

00.00

EXISTING AVERAGE GRADE PROPOSED AVERAGE GRADE

LEGEND:

EXPOSED BUILDING FACE SETBACK DISTANCE: +/- 8.7 m UNPROTECTED AREA ALLOWED 8m+: 94.6% PERCENT UNPROTECTED OPENINGS: 26%

WEST FACE

NORTH FACE

153.38 m²

29.89 m²

685.78 m²

204.37 m²

EXPOSED BUILDING FACE

UNPROTECTED OPENINGS

NORTH FACE RECESSED EXPOSED BUILDING FACE

UNPROTECTED OPENINGS

EXPOSED BUILDING FACE

UNPROTECTED OPENINGS

SETBACK DISTANCE: +/- 8.2 m

UNPROTECTED AREA ALLOWED 8.2m: 85.6%

PERCENT UNPROTECTED OPENINGS: 20%

286.22 m²

SOUTH FACE

1055.37 m²

EXPOSED BUILDING FACE

UNPROTECTED OPENINGS

SETBACK DISTANCE: +/- 16.7 m

UNPROTECTED AREA ALLOWED 9m+: 100%

PERCENT UNPROTECTED OPENINGS: 30%

SETBACK DISTANCE: +/- 14.67 m

SETBACK DISTANCE: +/- 8 m UNPROTECTED AREA ALLOWED 8m: 82%

PERCENT UNPROTECTED OPENINGS: 19%

UNPROTECTED AREA ALLOWED 9m+: 100% PERCENT UNPROTECTED OPENINGS: 30%

S-BLDG_WEST FACE ELEVATION - CODE 8 A5.2 1:400

S-BLDG_NORTH FACE ELEVATION - CODE 7 A5.2 1:400



S-BLDG_EAST FACE ELEVATION - CODE 6 A5.2 1:400




S-BLDG_SOUTH FACE ELEVATION - CODE 5 A5.2 1:400



N-BLDG_WEST FACE ELEVATION - CODE **4** A5.2 1 : 400



N-BLDG_NORTH FACE ELEVATION - CODE **3** A5.2 1:400

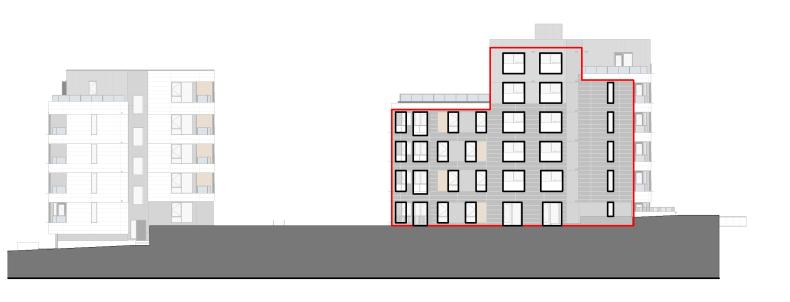

N-BLDG_EAST FACE ELEVATION - CODE 2 A5.2 1:400



N-BLDG_SOUTH FACE ELEVATION - CODE **1** A5.2 1:400



NORTH FACE EXPOSED BUILDING FACE 1106.61 m² UNPROTECTED OPENINGS 353.27 m² SETBACK DISTANCE: +/- 16.6 m UNPROTECTED AREA ALLOWED 9m+: 100% PERCENT UNPROTECTED OPENINGS: 32%

EXPOSED BUILDING FACE

UNPROTECTED OPENINGS

SETBACK DISTANCE: +/- 7.7 m UNPROTECTED AREA ALLOWED 7.7m: 77.2%

PERCENT UNPROTECTED OPENINGS: 25%

256.69 m²

EAST FACE EXPOSED BUILDING FACE **UNPROTECTED OPENINGS** SETBACK DISTANCE: +/- 5.2 m UNPROTECTED AREA ALLOWED 5.2m: 42.4% PERCENT UNPROTECTED OPENINGS: 28%

SOUTH FACE EXPOSED BUILDING FACE 209.87 m² **UNPROTECTED OPENINGS** SETBACK DISTANCE: +/- 9.5 m **UNPROTECTED AREA ALLOWED 9m+: 100%** PERCENT UNPROTECTED OPENINGS: 28% SOUTH RECESSED PART 1

EXPOSED BUILDING FACE 512.5 m² UNPROTECTED OPENINGS SETBACK DISTANCE: +/- 14.67 m UNPROTECTED AREA ALLOWED 9m+: 100% PERCENT UNPROTECTED OPENINGS: 31%

SOUTH RECESSED PART 2

EXPOSED BUILDING FACE 311.63 m² UNPROTECTED OPENINGS SETBACK DISTANCE: +/- 8.2 m UNPROTECTED AREA ALLOWED 8.2: 85.6% PERCENT UNPROTECTED OPENINGS: 33%

LOW HAMMOND 300 - 1590 CEDAR HILL X ROAD

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Corporation

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C 2024-11-25 ISSUED FOR DDP RESUBMISSION B 2024-11-06 ISSUED FOR 50% CD REVIEW A 2024-09-19 ISSUED FOR DELEGATED DEVELOPMENT PERMIT

No Date Issued Project number 2301

Sheet title **BUILDING CODE ANALYSIS**


Sheet number

A5.2 File name 2301_CRHC Johnson St_CENTRAL.RVT Plot date 2024 11 25

Capital Region Housing Corporation


Village on the Green

Affordable Rental Housing Victoria, BC

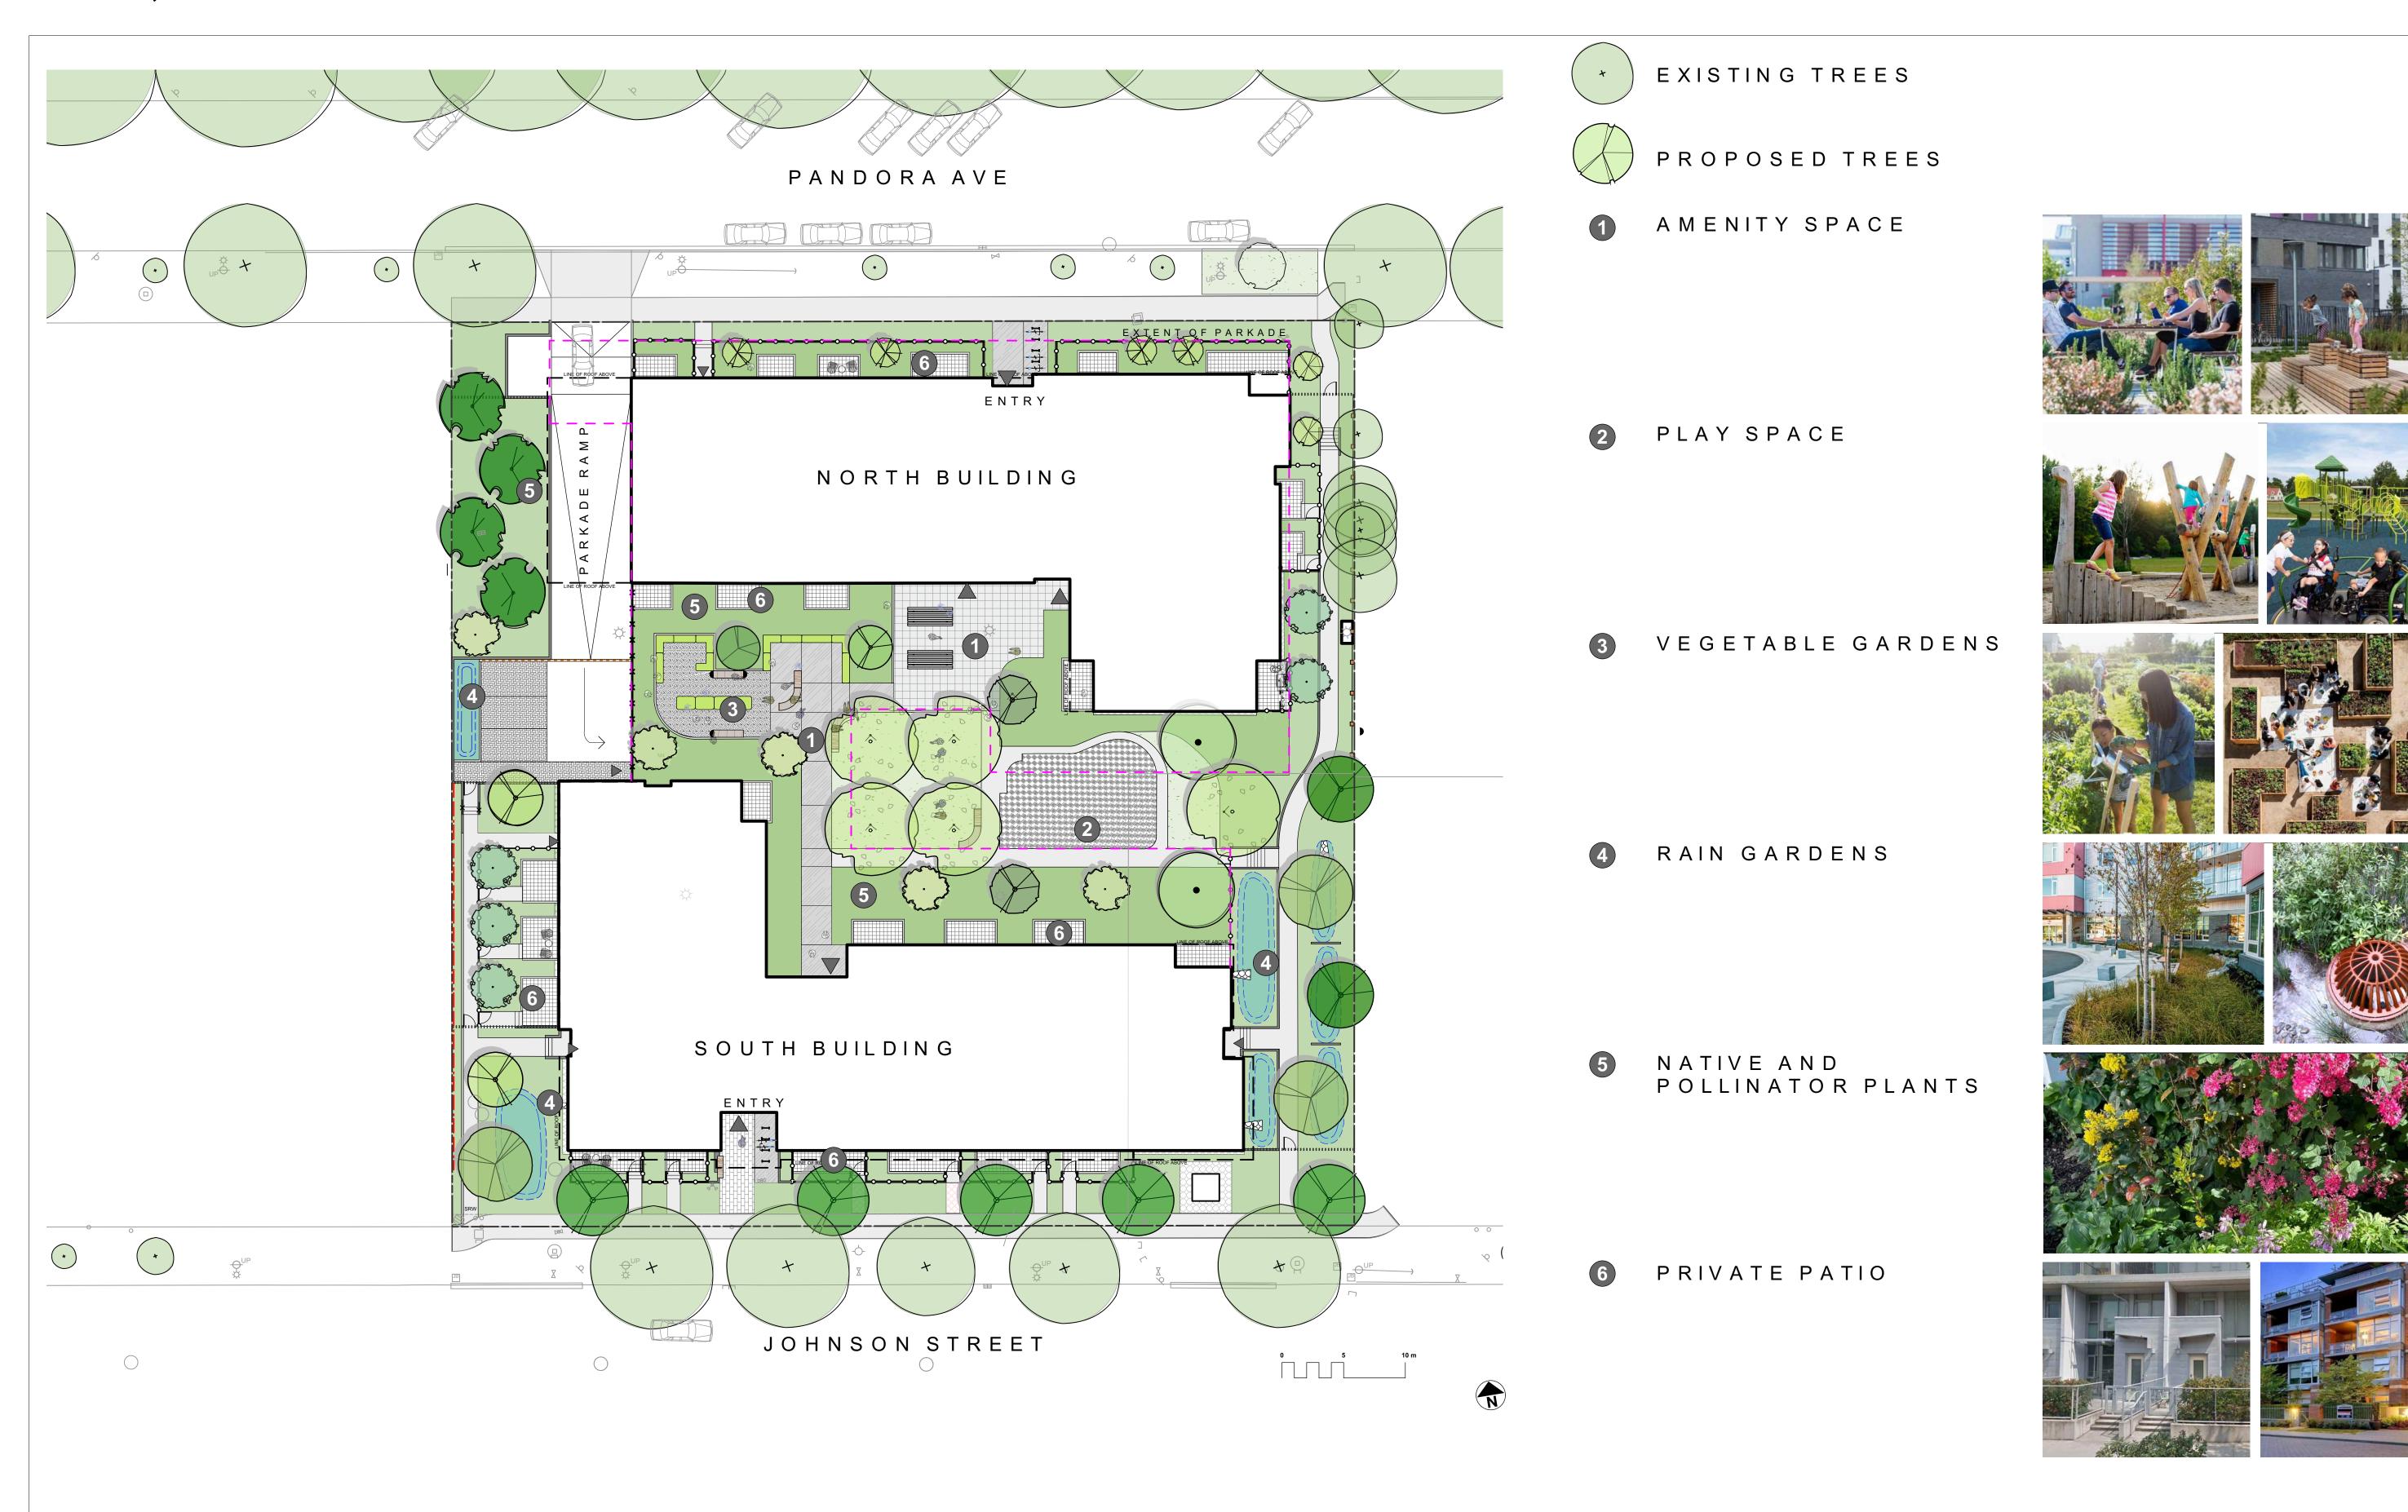



2	DDP Rev.	2024-11-25
1	Delegated DP	2024-09-19
No.	Issued For	Issue Date

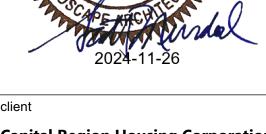

Capital Region Housing Corporation

project

VILLAGE ON THE GREEN 1132 & 1138 Johnson St Victoria, BC

sheet title

Cover

project no. 123.05
scale 1:250 @ 24"x36"
drawn by MDI

checked by

L0.00

GENERAL NOTES

- 1. Work performed shall comply with the following: a) These General Notes, and Construction Documents and Specifications; b) Canadian Landscape Standards, Current Edition (CLS-CE); and c) All applicable local, provincial, and federal codes, ordinances, and regulations.
- 2. Contractor shall be responsible for verifying all existing site conditions including location of all property lines, existing structures, utilities, and buried infrastructure. Verify all field conditions prior to commencing work.
- 3. Contractor is responsible for determining means and methods for construction. These drawings may indicate a limit of proposed improvements or limit of work for the delineation of expected extents of disturbance. Should limits of disturbance exceed boundaries defined in drawings, contractor shall
- contact Landscape Architect for resolution. 4. Contractor is responsible for repairing all work disturbed by construction outside of limit lines defined on drawings or through their means and methods to a condition better than or equal to the existing conditions prior to commencement of construction at no additional cost to the owner.
- 5. Contractor is responsible for maintaining a complete up-to-date set of drawings and specifications at the construction site and ensuring the documents are readily available for review by the Landscape Architect and governing agency.
- 6. Contractor is responsible for coordination of all designs, drawings, specifications and other documents or publications upon which construction is based. Any discrepencies with the drawings and/or specifications and site conditions shall be brought to the attention of the Landscape Architect, prior to proceeding with construction.
- 7. The drawings and specifications are complementary to one another and implied to correspond with one another. Any discrepencies should be brought to the attention of the Landscape Architect for resolution immediately.
- 8. General Contractor and/or sub-contractors are responsible for all costs related to production and submission to consultant of all landscape as-built information including irrigation.

TREE RETENTION AND REMOVAL NOTES

- 1. Tree protection fencing, for existing trees, to be installed prior to commencement of all site work. Refer
- to Arborist's plans for location of tree protection fencing, and protection fencing detail. 2. Refer to arborist's report for detailed information for existing tree resources.

SITE GRADING AND DRAINAGE NOTES

- 1. All elevations are in meters.
- 2. Refer to Architectural plans, sections and elevations for top of slab elevations. Slab elevations indicated on Landscape drawings are for reference only. Report any discrepancies to consultant for
- 3. All road, public walkway and vehicular drive aisles and parking area elevations indicated on the Landscape drawings are for reference only. Refer to Civil Engineering drawings. Report any discrepancies to consultant for review and response.
- 4. Confirm all existing grades prior to contruction. Report any discrepancies to consultant for review and response.
- 5. Unless otherwise noted provide a minimum slope of 2% on all hard and soft Landscape areas to
- ensure positive drainage away from buildings, to rain gardens, or to drainage devices.
- 6. All landscape areas shall not exceed a maximum slope of 3:1 in all instances.
- 7. Upon discovery, contractor to refrain from blasting rock to meet landscape subgrades. Contractor to contact Landscape Architect on how to proceed in each instance.

IRRIGATION NOTES

- 1. Contractor to provide irrigation system for all planters to current IIABC Standards and Contract
- 2. All specified work to meet the project specifications, and all standards or specifications established in the lastest edition of the Canadian Landscape Standard and IIABC standards.
- 3. Design/build drawings for detailed irrigation plan to be submitted to Contract Administrator in PDF and .dwg formats at least two weeks prior to commencement of irrigation installation
- 4. Utilties Contractor to verify location of all on-site utilities, prior to construction. Restoration of damaged utilities shall be made at the contractor's expense, to the satisfaction of the owner's representatives.
- Refer to electrical drawings for electrical service.
- Controller and backflow prevention device to be located in Mechanical Room, unless otherwise noted. Refer to Mechanical drawings for size and location of irrigation service.
- 7. Contractor to verify pressure and flow prior to installation of irrigation and notify owner's representative
- in writing if such data adversely affects the operation of the system Sleeves shall be installed at the necessary depths, prior to pavement construction. Sleeving shall extend 300 mm from edge of paving into planting area, and shall have ends marked above grade
- . Contractor to field fit irrigation system around existing trees, to limit disturbance to root systems. 10. At various milestones during construction, inspection and testing of components will be required to ensure that the performance of irrigation system meets standards and specifications. Contractor to provide equipment and personnel necessary for performance of inspections and tests. Conduct all inspections and tests in the presence of the contract administrator. Keep work uncovered and accessible until successful completeition of inspection or test.
- 11. Over spray onto hardscape areas to be minimized. Use drip irrigation within small planting areas to avoid overspray.
- 12. Trees within shrub or rain garden areas to be irrigated with spray heads.
- 13. Trees in Plaza in hard pavement (soil cells below) to recieve temporary irrigation system around root collar and permanent drip irrigation system

GROWING MEDIUM NOTES

- 1. Refer to Landscape Specifications for growing medium properties by soil type.
- 2. Advise Contract Administrator of sources of growing medium to be utilized 14 days in advance of
- Growing medium properties and handling shall meet CLS-CE (see Section 6 CLS-CE).
- Contractor is responsible for soil analysis and amendment requirements to supply suitable growing medium, as specified by testing agency. Soil analysis and amendment costs shall be included in the price for the work.
- 5. Submit to the Landscape Architect a copy of the soil analysis report from Pacific Soil Analysis Inc. 5-11720 Voyageur Way, Richmond, BC, V6X 3G9. p. 604- 273-8226. The analysis shall be of tests done on the proposed growing medium from stratified samples taken from the supply source. Costs of the initial and all subsequent tests to ensure compliance with the specifications shall be borne by
- Contract Administrator will collect sample of growing medium in place and determine acceptance of material, depth of growing medium and finish grading. Approval of growing medium material subject to soil testing and analysis. Planting is not to occur until finished grades have been approved by Contract Administrator.

SITE LAYOUT NOTES

- 1. Provide layout of all work for approval by Contract Administrator prior to proceeding with work. Requests for site review as required 48 hours in advance of performing any work, unless otherwise
- 2. Layout and verify dimensions prior to construction. Bring discrepancies to the attention of the Contract
- Administrator. 3. Written dimensions take precedence over scale. Do not scale drawings.
- 4. All plan dimensions in metres and all detail dimensions in millimetres, unless otherwise noted.
- 5. Where dimensions are called as 'equal' or 'eq', space referenced items equally, measured to centre

PAVING NOTES

- 1. Final concrete control joint layout to be confirmed by Landscape Architect prior to installation. Control joints to logically align with edges, corners, and intersections of Landscape and Architectural elements and/or as indicated on plan. Contractor to obtain layout approval by Landscape Architect prior to installation. Contractor to pour concrete pavement in alternating panels as required to achieve control joint design and to prevent cracking.
- 2. Cast in place concrete areas that are subject to vechicular loading shall be structurally reinforced for applicable vehicular loading requirements. See Structural Engineering drawings

GENERAL PLANTING NOTES

Landscape Standard.

- 1. Plant quantities on Plans shall take precedence over plant list quantities.
- Provide layout of all work for approval by Contract Administrator prior to proceeding with work. 3. Plant material, installation and maintenance to conform to the current edition of the Canadian
- 4. Plant quantities and species may change between issuance of DP and Construction due to plant availability and design changes. Substitutions to be approved by Landscape Architect.

ON-SLAB TREE PLANTING NOTES

- 1. For on-slab landscape, a root barrier will be installed to protect exposed water proof membranes. A dimple board (drain mat) will be installed over the root barrier.
- 2. Parkade walls and foundation walls will be protected with a dimple board (drain mat) to convey water to the perimeter drain and protect wall from roots.
- 3. A root barrier will be installed between the tree roots and perimeter drain, to minimize tree root interference with the drain, where the follow conditions exist in on-grade planting areas: a)where trees less than 8m tall are located closer than 2m from a parkade or foundation wall; b) where trees more than 8m tall are located closer than 3m from a parkade or foundation wall; and c) where perimeter drains are less than 2m deep.

OFF SITE IRRIGATION NOTES

- 1. All boulevard irrigation work, including required inspections, shall comply to "City of Victoria" Supplementary Specifications for Street Trees and Irrigation Schedule C, Bylaw 12-042, Subdivision
- 2. The irrigation system and sleeving inspection requirements can be found in Schedule C of the Victoria Subdivision and Development Servicing Bylaw No. 12-042. Irrigation Inspections required for all sleeving, open trench mainline and lateral lines, system operation, controller, backflow preventer (incl. inspection tag and testing report). Call CoV Parks 250-361-0600 min. 2 days in advance to arrange for irrigation inspections.
- 3. Design/build drawings for boulevard Irrigation drawings must be submitted to Parks Division and Landscape Architect for review and approval minimum 30 days prior to installation work
- 4. Boulevard irrigation point of connection to be 25 mm service from existing water connection on, refer to Civil drawings for location. Separate water meter and timer/controller, to be provided at point of connection. Timer/controller for boulevard areas must be readily accessible to municipal staff.
- 5. Boulevard irrigation to be inspected as per municipal specification by municipal staff. Boulevard tree irrigation system will be maintained and operated by municipality, after it is inspected and approved by municipal staff.
- 6. Boulevard Irrigation electric zone valves to be RainBird PGA, except tree drip valves: Rainbird Low Flow Control Zone Kit w/ PR Filter; XCZLF-100-PRF 1.
- 7. 100mm diameter PVC Sleeving is required for all irrigation piping installed under hard surfaces. Extend sleeve 300mm beyond edge of hard surface into soft landscape areas.

OFF-SITE IRRIGATION INSPECTIONS REQUIRED

- 1. The following irrigation and sleeving inspections by Parks Staff are required by Schedule C. Please contact Tom Sherbo, tsherbo@victoria.ca and copy treepermits@victoria.ca 48 hours prior to the required inspection time to schedule an inspection.
 - (1) Irrigation sleeving prior to backfilling
 - (2) Open trench main line and pressure test
- (3) Open trench lateral line
- (4) irrigation system, controller, coverage test, backflow preventer assembly test report required, backflow assembly is to have an inspection tag completed and attached.

BOULEVARD PLANTING NOTES

- 1. The Victoria Subdivision and Development Servicing Bylaw No. 12-042 and the associated Schedules can be found on the City of Victoria Bylaws webpage.
- 2. The finished grade for boulevards must be firm against footprints, loose textured, free of all stones, roots, and branches. Parks inspection is required to turf installation. Please contact Tom Sherbo, tsherbo@victoria.ca and copy treepermits@victoria.ca 48 hours prior to the required inspection time to schedule an inspection.
- 3. Final inspection of turf shall be conducted once the turf has knit, mowed at least twice to a height of 2.5 inches and no surface soil is visible.
- Required Parks inspections for seed and sod boulevard: Inspection of excavated and scarified subgrade prior to backfill.
- 2. Inspection of installed, rolled and prepared growing media prior to sodding. 3. Inspection when the installed turfgrass meets the conditions for total performance
- as required in the Current Edition of the Canadian Landscape Standard.
- A soil test for the growing media, for each landscape application on City Property must be submitted to the City Parks treepermits@victoria.ca for review at least one week prior to soil placement. Growing media must meet the standards for each specific landscape application as required in the current edition of the Canadian Landscape Standard.

OFF-SITE HORTICULTURE INSPECTIONS REQUIRED

- 1. The following inspections are required for all off-site horticulture areas:
 - (1) Excavated and scarified subgrade prior to placement of growing media.
 - (2) Installed and prepared growing media prior to planting.
 - (3) Plant material on-site prior to planting.
 - (4) Planted landscape prior to mulch installation. (5) At time that planted and mulched landscape meets the conditions for Total Performance as
 - required by MMCD.

WARRANTY AND MAINTENANCE NOTES

- 1. Contractor is responsible for Maintenance from installation to Acceptance of the work by the Contract Administrator.
- 2. Refer to Landscape Specifications for Maintenance Period following Acceptance.
- 3. Landscape installation to carry a 1-year warranty from date of acceptance. This warranty is based on adequate maintenance by the Owner after Acceptance, as determined by the Landscape Architect. The Contractor will not be responsible for plant loss or damage to other products by causes out of the
- Contractor's control, such as vandalism, "acts of God", "excessive wear and tear", or abuse. 4. Contractor is responsible for plant damage, failure and death due to poor delivery, storage and
- handling, and all other installation related aspects up until the End of Warranty period.
- 5. Plant material, installation and maintenance to conform with the current edition of the Canadian Landscape Standards, and the Contract Specifications

HARDSCAPE SURFACES Concrete - Type 1 Light broom finish, sawcut control joints Light exposed finish with sawcut control joints Concrete - Type 2 Concrete Unit Paving 'Texada' Hydrapressed Slabs. 457 mm x 457 mm x - On Slab 40 mm. Charcoal colour. Pattern: Stacked Bond. Supplier: Belgard Canada. Aggregate Pathway Pathways screenings. Concrete Unit Paving Standard 225 mm x 112.5 mm x 60 mm thick. Natural colour. Pattern: Running Bond. Supplier: Belgard Canada. Safety Surfacing Poured in Place Rubber or approved equivalent Concrete Unit Paving Standard 225 mm x 112.5 mm x 80 mm thick. Parking Area Shadow colour. Pattern: 90 herringbone. Supplier: Belgard Canada. Double Standard 225 mm x 225 mm x 60 mm thick. Concrete Unit Paving On Grade Natural colour. Pattern: Running Bond Supplier: Belgard Canada. STEPS Comes with hand rails as per BCBC. Steps Type 1 WALLS / CURBS Cast in Place 25 MPa concrete wall, smooth-rubbed expoces Concrete Wall Cast in Place Concrete Curb SITE FURNISHINGS Bicycle Rack 2 bicycle capacity. mmcite Bikeblocq or Maglin Iconic 2300 series Dry Storage Bench with wood seat Bench Type 1 96"l x 23"w x 18" h, Green Theory Pill or approved equivalent Two sided wood bench Bench Type 2 mmcite Landscape Compact series LPC02 and LPC13 assembly or Maglin Ogden series Convex wood bench Bench Type 3 mmcite Landscape Compact series 2 x LPC11-e assemly or Maglin Ogden series Wood picnic table Picnic Table model TBD 17"h x 24" w modular metal vegetable planter, Raised Vegetable Planter 1 Sproutedbox Garden, or approved equivalent 32"h x 60"w x 60" I modular metal vegetable Raised Vegetable Planter 2 Sproutedbox Garden, or approved equivalent (Accessible) Provide voiding to meet structural requirements 20"w modular metal planter Raised Planter Green Theory Rectangle or approved equivalent Provide voiding to meet structural requirements RAILINGS, BARRIERS, FENCING 1800 mm high Metal Picket Fence -1100 mm high Metal Railing Refer to Architect's drawings Wood privacy fence _____ To match existing wood fence, adjacent property SOFTSCAPE Shrub and Tree 2P growing medium, 450 mm depth Planting Area - On Shrub and Tree 1P growing medium, depth varies 600 mm for all Planting Area - On tree locations. Lawn Area (Sod) 1H growing medium, 150 mm depth Rain Garden Area -Rain Garden growing medium, 450 mm depth On Grade Soil Cell Bridge 1X Silva Cell, or approved equivalent Grass Grid

LINE TYPE LEGEND

Property line Extent of Roof, above Extent of Parkade, below Rain garden - TOP OF POOL Rain garden - BOTTOM OF POOL




UNDERGROUND UTILITIES


(Shown for reference only - refer to Civil Engineer's drawings). **EXISTING PROPOSED**

Storm drain - _ _ _ _ . Water Electrical

EXISTING PLANT LEGEND (Refer to Arborist Report and Tree Management Plan for full details

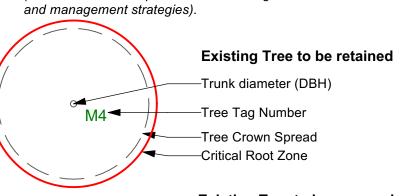

Existing Tree to be removed

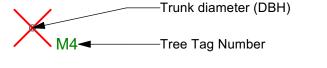

GRADING LEGEND

Existing Landscape Grade Civil Grade, provided for reference only

Arch

Proposed Landscape Grade TOW Top of Wall BP Bottom of Pool BW Bottom of Wall TS Top of Stairs TOC Top of Curb BS Bottom of Stairs BC Bottom of Curb HP High Point LP Low Point TP Top of Pool

LIST OF ABBREVIATIONS

HEIGHT

INCH(ES)

INCLUDE(D)

LOW POINT

LINEAR FEET

INSIDE DIAMETER

INVERT ELEVATION

METRE **APPROX APPROXIMATE** MAXIMUM MAX ARCH ARCHITECT MFR MANUFACTURER AVG **AVERAGE** MH MANHOLE B&B BALLED AND BURLAPPED MIN MINIMUM вс BOTTOM OF CURB MISC MISCELLANEOUS BLDG BUILDING MM MILLIMETRE **BENCHMARK** NORTH **BOTTOM OF CURB** NOT IN CONTRACT NIC BOTTOM OF RAMP NUMBER **BOTTOM OF STEP** NOM NOMINAL **BOTTOM OF WALL** NTS NOT TO SCALE CAL CB CALIPER OC ON CENTER CATCH BASIN OUTSIDE DIAMETER CUBIC FEET POINT OF CURVATURE **CAST IN PLACE** POLYURETHANE CENTER LINE POINT OF INTERSECTION CLR CLEARANCE PROPERTY LINE CM CENTIMETER POINT, POINT OF TANGENCY CO CONT CLEAN OUT PVC POLYVINYL CHLORIDE CONTINUOUS QUANTITY CUBIC METRE RADIUS DEG DEGREE REF REFERENCE DEMO DEMOLISH, DEMOLITION REINF REINFORCE(D) DIA DIM DTL DIAMETER REQ'D REQUIRE(D) DIMENSION REV REVISION DETAIL ROW RIGHT OF WAY DWG DRAWING SOUTH SAN SANITARY EACH SD STORM DRAIN **ELEVATION** EL ENG SQUARE FOOT (FEET) SF FNGINFFR SHT EQ EST EQUAL SIM SIMII AR **ESTIMATE** SPECS **SPECIFICATIONS** E.W. EACH WAY SQ M SQUARE METRE **EXIST EXISTING** STORM SEWER EXPANSION, EXPOSED STA STATION FFE FINISHED FLOOR ELEVATION STD STANDARD FINISHED GRADE SYM T&B SYMMETRICAL FLOW LINE FL FOC TOP AND BOTTOM FACE OF CURB TOP OF CURB FT FTG FOOT (FEET) TOP OF FOOTING FOOTING GAUGE TOPO **TOPOGRAPHY** GEN GENERAL TOP OF RAMP GRADE ELEVATION TS TOP OF STEP HORIZ HORIZONTAL TW TOP OF WALL HIGH POINT TYP

DDP Rev. 2024-11-25 2 2024-09-19 Delegated DP No. Issued For Issue Date REGISTERED MEMBER Scott Murdoch

Capital Region Housing Corporation

VILLAGE ON THE GREEN 1132 & 1138 Johnson St Victoria, BC

sheet title

General Information Sheet

123.05 project no N/A @ 24"x36" scale MDI drawn by SM checked by sheet no.

L0.01

ALL DRAWINGS TO BE READ IN ASSOCIATION WITH CONTRACT SPECIFICATIONS.

VAR

VOL

W/O

WWF

ΥD

TYPICAL

VARIES

VOLUME

WITHOUT


WEIGHT

YARD ΑT


WATER LEVEL

WELDED WIRE FRAME

WITH

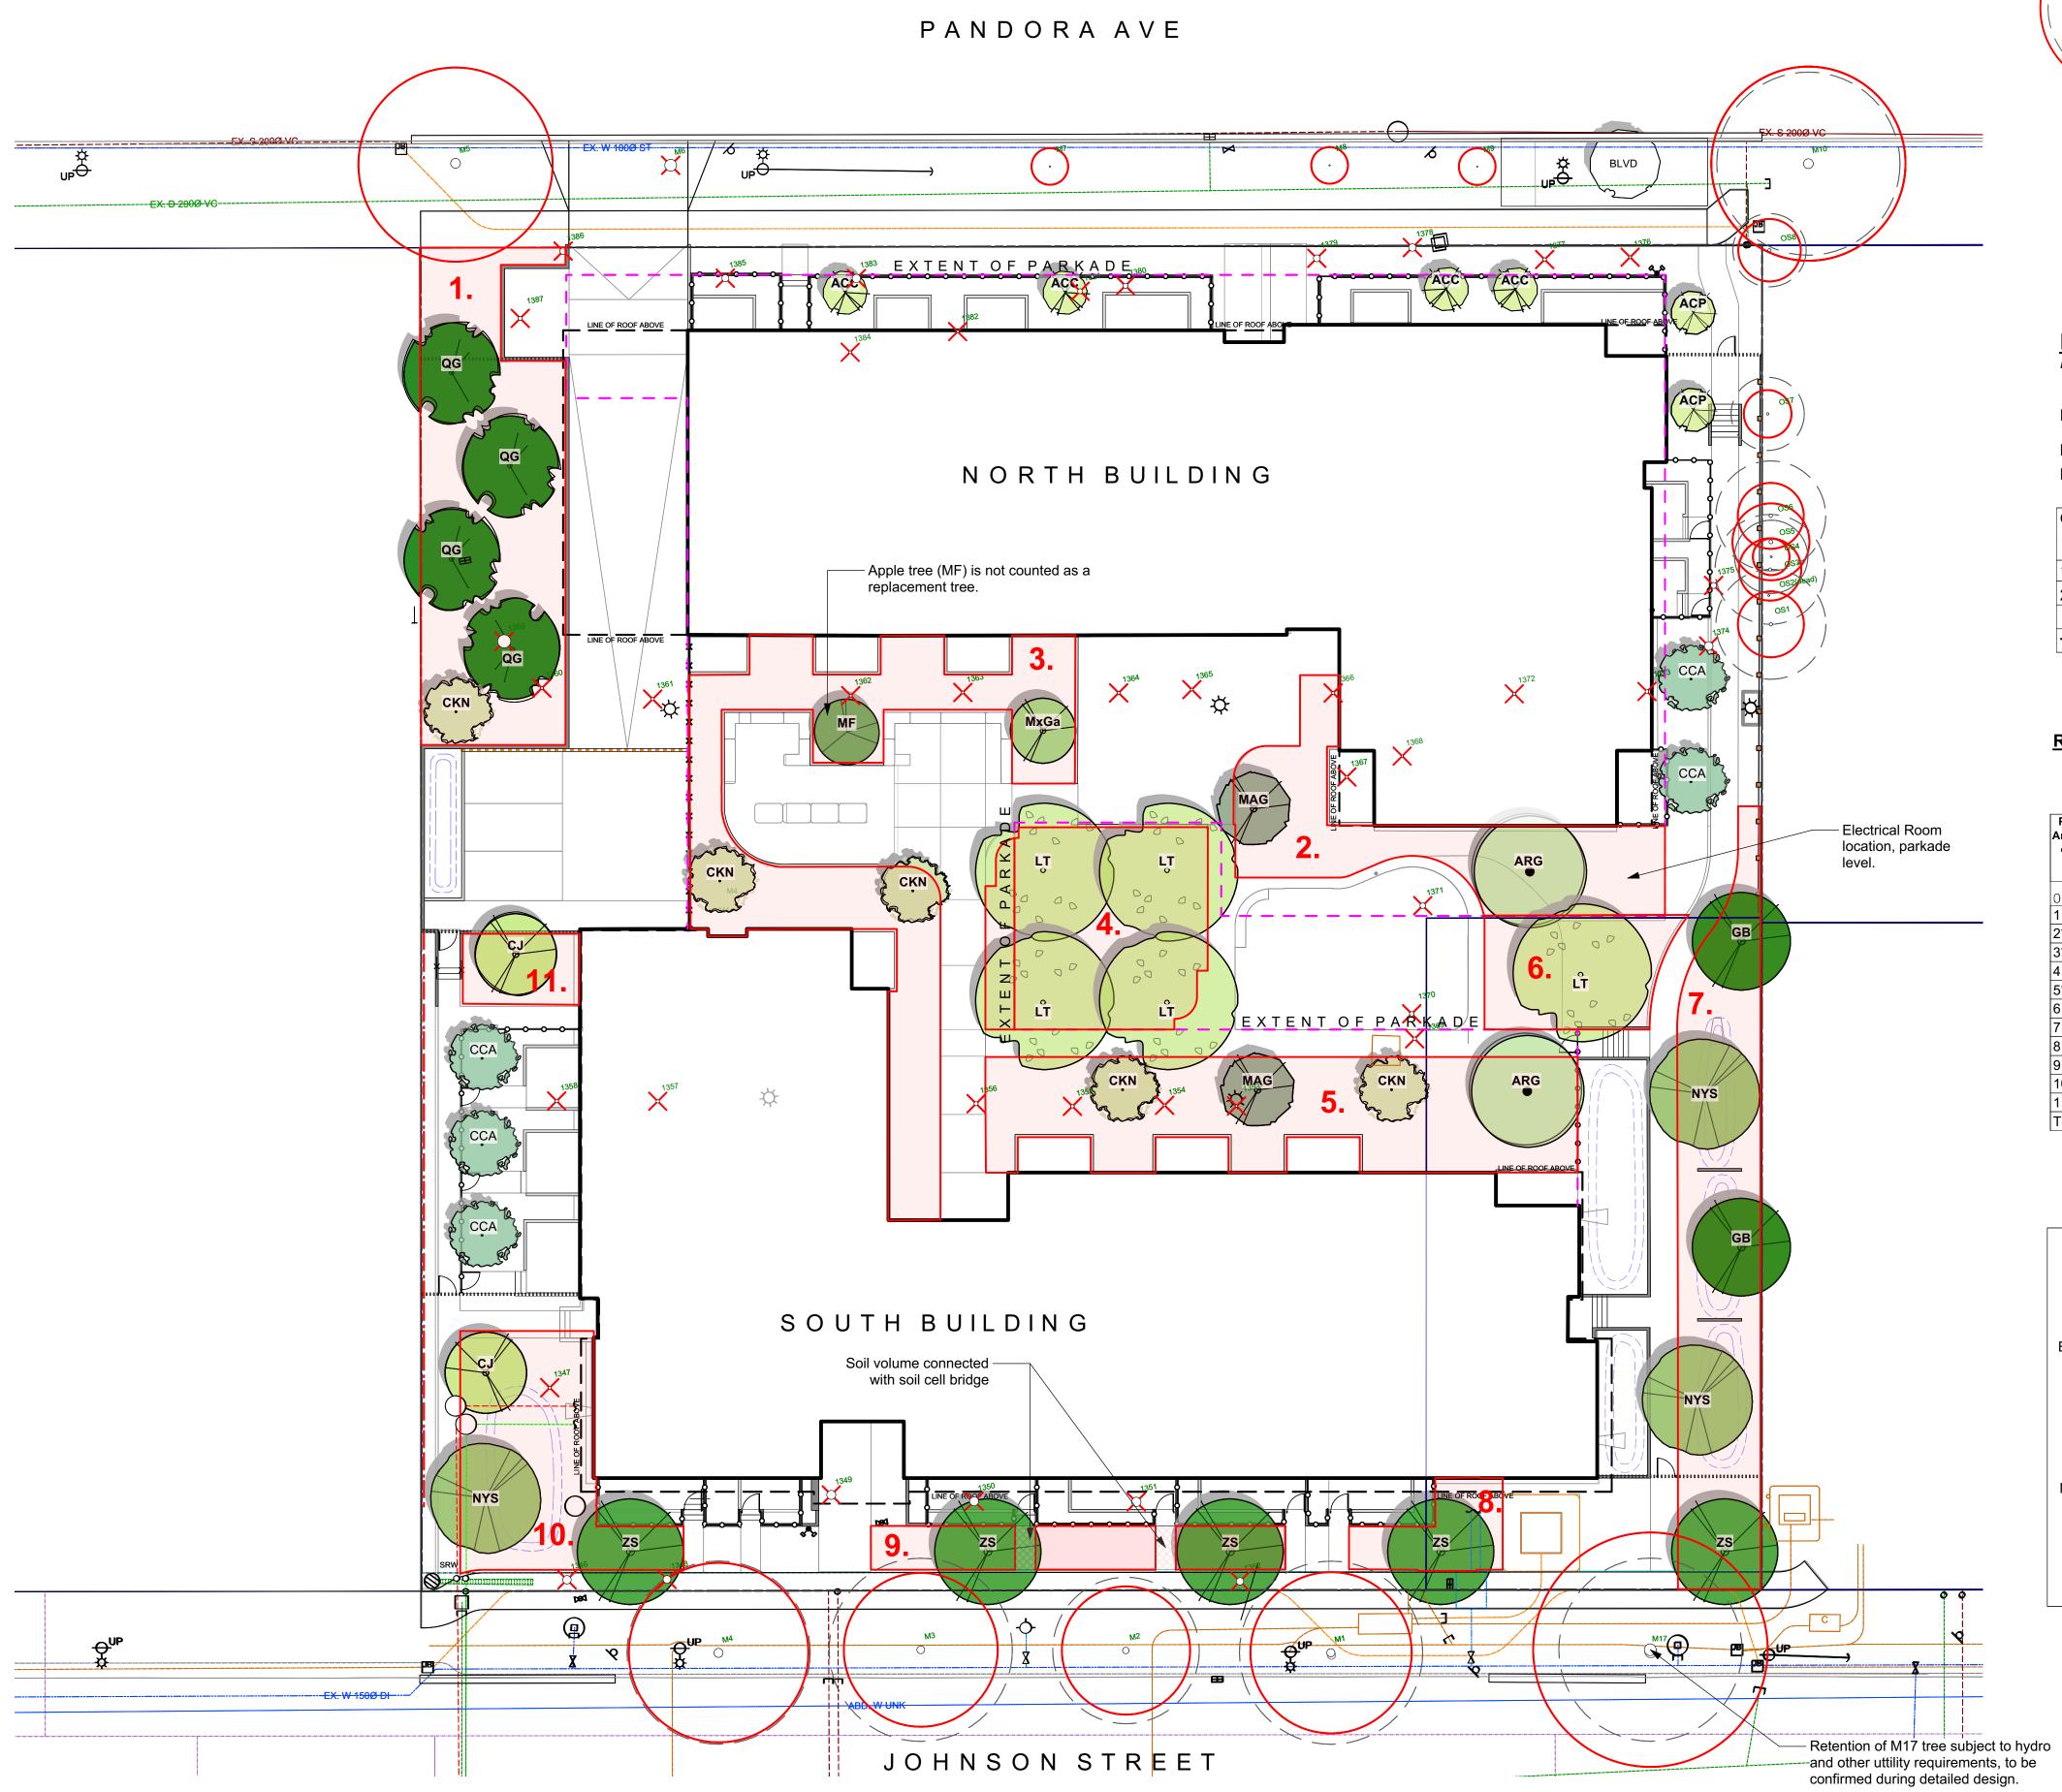



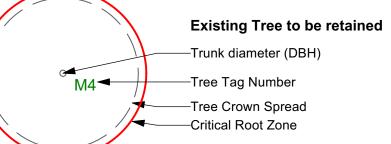

Existing Tree to be removed

Trunk diameter (DBH)

M4

— Tree Tag Number

REPLACEMENT TREE SUMMARY

Refer to Arborist's Report for further details.

REQUIRED (as per Tree Protection Bylaw)

Lot Area: 5370 sq m
Minimum # of Trees for Lot Area: 27

	Count	Multiplier	Total
1:1 Replacement Trees - Schedule E Part 1	24	1	24
2:1 Replacement Trees - Schedule E Part 2	6	0.5	3

REPLACEMENT TREE SOIL VOLUME TABLE

				REPLACEMENT TREES PROPOSED			SOIL VOLUME REQUIRED (m3)			
Planting Area ID (*= on slab)	Area (m2)	Soil Volume Multiplier	A. Estimated Soil Volume (m3)	B. Small	C. Medium	D. Large	E. Small	F. Medium	G. Large	Total
ONSITE										
1	200.0	1	200.0	1		4	6	0	120	126
2*	113.0	0.6	67.8		2		0	30	0	30
3*	191.6	0.6	115.0	4			24	0	0	24
4	128.2	1 & 0.6	122.0			4	0	0	120	120
5*	180.9	0.6	108.5	3	1		18	15	0	33
6	59.0	1	59.0			1	0	0	30	30
7	167.7	1	167.7		4	1	0	60	30	90
8	29.8	1	29.8		1		0	20	0	20
9	48.0	1	48.0		2		0	30	0	30
10	104.5	1	104.5		3		0	45	0	45
11	24.0	1	24.0		1		0	20	0	20
Total				8	14	10				

<u> </u>	PROPO	SED TREE LIST		
Sym	Qty	Botanical Name	Schd. Size	Common Name
ACC	4	Acer circinatum	2.4 m ht, 1.5 width	Vine Maple
ACP	2	Acer circinatum 'Pacific Fire'	2.4 m ht, 1.5 width	Pacific Fire Vine Maple
ARG	2	Acer rubrum 'Autumn Glory'	6.0cm cal, b&b	Autumn Glory Red Maple
BLVD	1	Boulevard Tree as per COV Parks	6.0 cm cal, b+b	Boulevard Tree as per COV Pa
CJ	2	Cercidiphyllum japonicum	5.0cm cal, b&b	Katsura Tree
CCA	5	Cercis canadensis	5.0cm cal, b&b	Eastern Redbud
CKN	7	Cornus x 'Venus'	5.0cm cal, b&b	White Flowering Dogwood
GB	2	Ginkgo biloba	7.0cm cal, b&b	Maidenhair Tree
LT	5	Liriodendron tulipifera	6.0cm cal, b&b	Tuliptree
MAG	2	Magnolia kobus	4.0cm cal, b&b	Kobus Magnolia
MxGa	1	Magnolia x 'Galaxy'	4.0cm cal, b&b	Galaxy Magnolia
MF	1	Malus domestica Fuji	#10 pot, Min 1.2m ht	Fuji Apple
NYS	3	Nyssa sylvatica	6.0cm cal, b&b	Tupelo
QG	4	Quercus garryana	4.0cm cal, b&b	Garry Oak
ZS	5	Zelkova serrata 'Green Vase'	6.0cm cal, b&b	Green Vase Zelkova
	0			





2	DDP Rev.	2024-11-25
	Delegated DP	2024-09-19
0.	Issued For	Issue Date



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VILLAGE ON THE GREEN 1132 & 1138 Johnson St Victoria, BC

sheet title


Tree Replacement

project no.		123.05
scale	1:200	@ 24"x36"
drawn by		MDI
checked by		SM
sheet no.		

L0.02

PANDORA AVE _____FX_S 200Ø VC_____ ---EX:-D-200Ø-∀C--EXTENT OF PARKAD, 5 EXTENT OF PARKADE NORTH BUILDI<mark>NG</mark> EXTENT OF PARKADE _____ SOUTH BUILDING M17 JOHNSON STREET



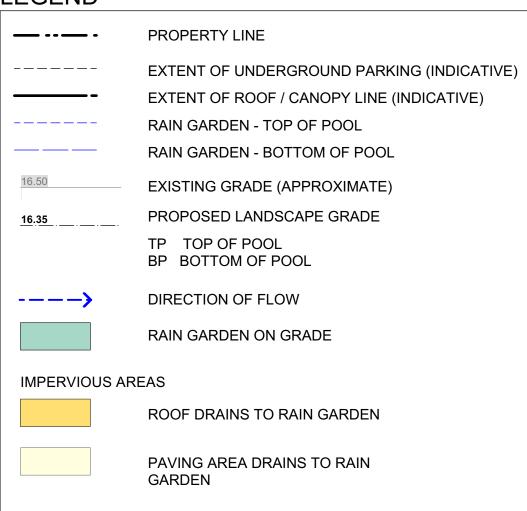


RAIN WATER MANAGEMENT NOTES

Water collected from building roofs flow to the rain gardens located throughout the site.

Rain gardens are integrated building landscapes and are designed to capture, slow flows, and treat runoff from roadways.

Rain gardens will be designed with underdrains and a high-capacity overflow drain that will be connected to the onsite piped drainage system.

The rain gardens are sized such that the bottom of the rain garden is 5% of the impervious area, to meet or exceed City of Victoria Green Stormwater Infrastructure Guidelines.

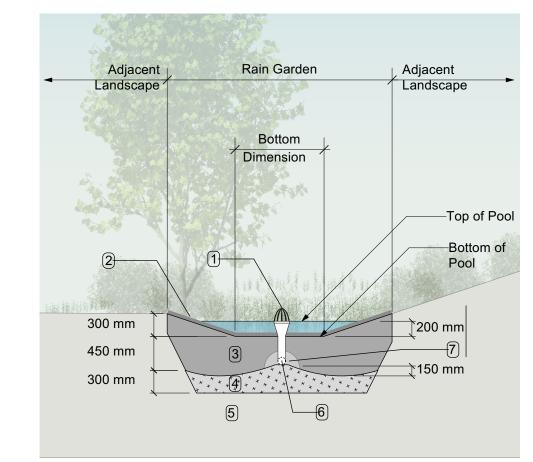

RAIN GARDEN MATERIALS


- Overflow drain, 200 mm domed grate + adapter
 Composted mulch, 50 -70 mm depth
- 3. Bio-retention growing medium, 450 mm depth 4. Scarified/tilled subgrade, 300 mm depth
- 5. Existing subgrade/native material
- 6. 100 mm diameter (min) perforated pipe 7. 25 mm diameter drain rock, 100 mm depth

Typical Rain Garden
Scale: 1:50

0 5 10 m



2	DDP Rev.	2024-11-25
1	Delegated DP	2024-09-19
No.	Issued For	Issue Date

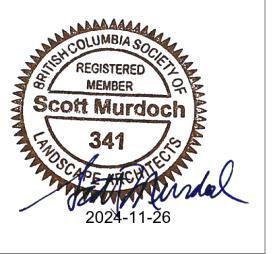

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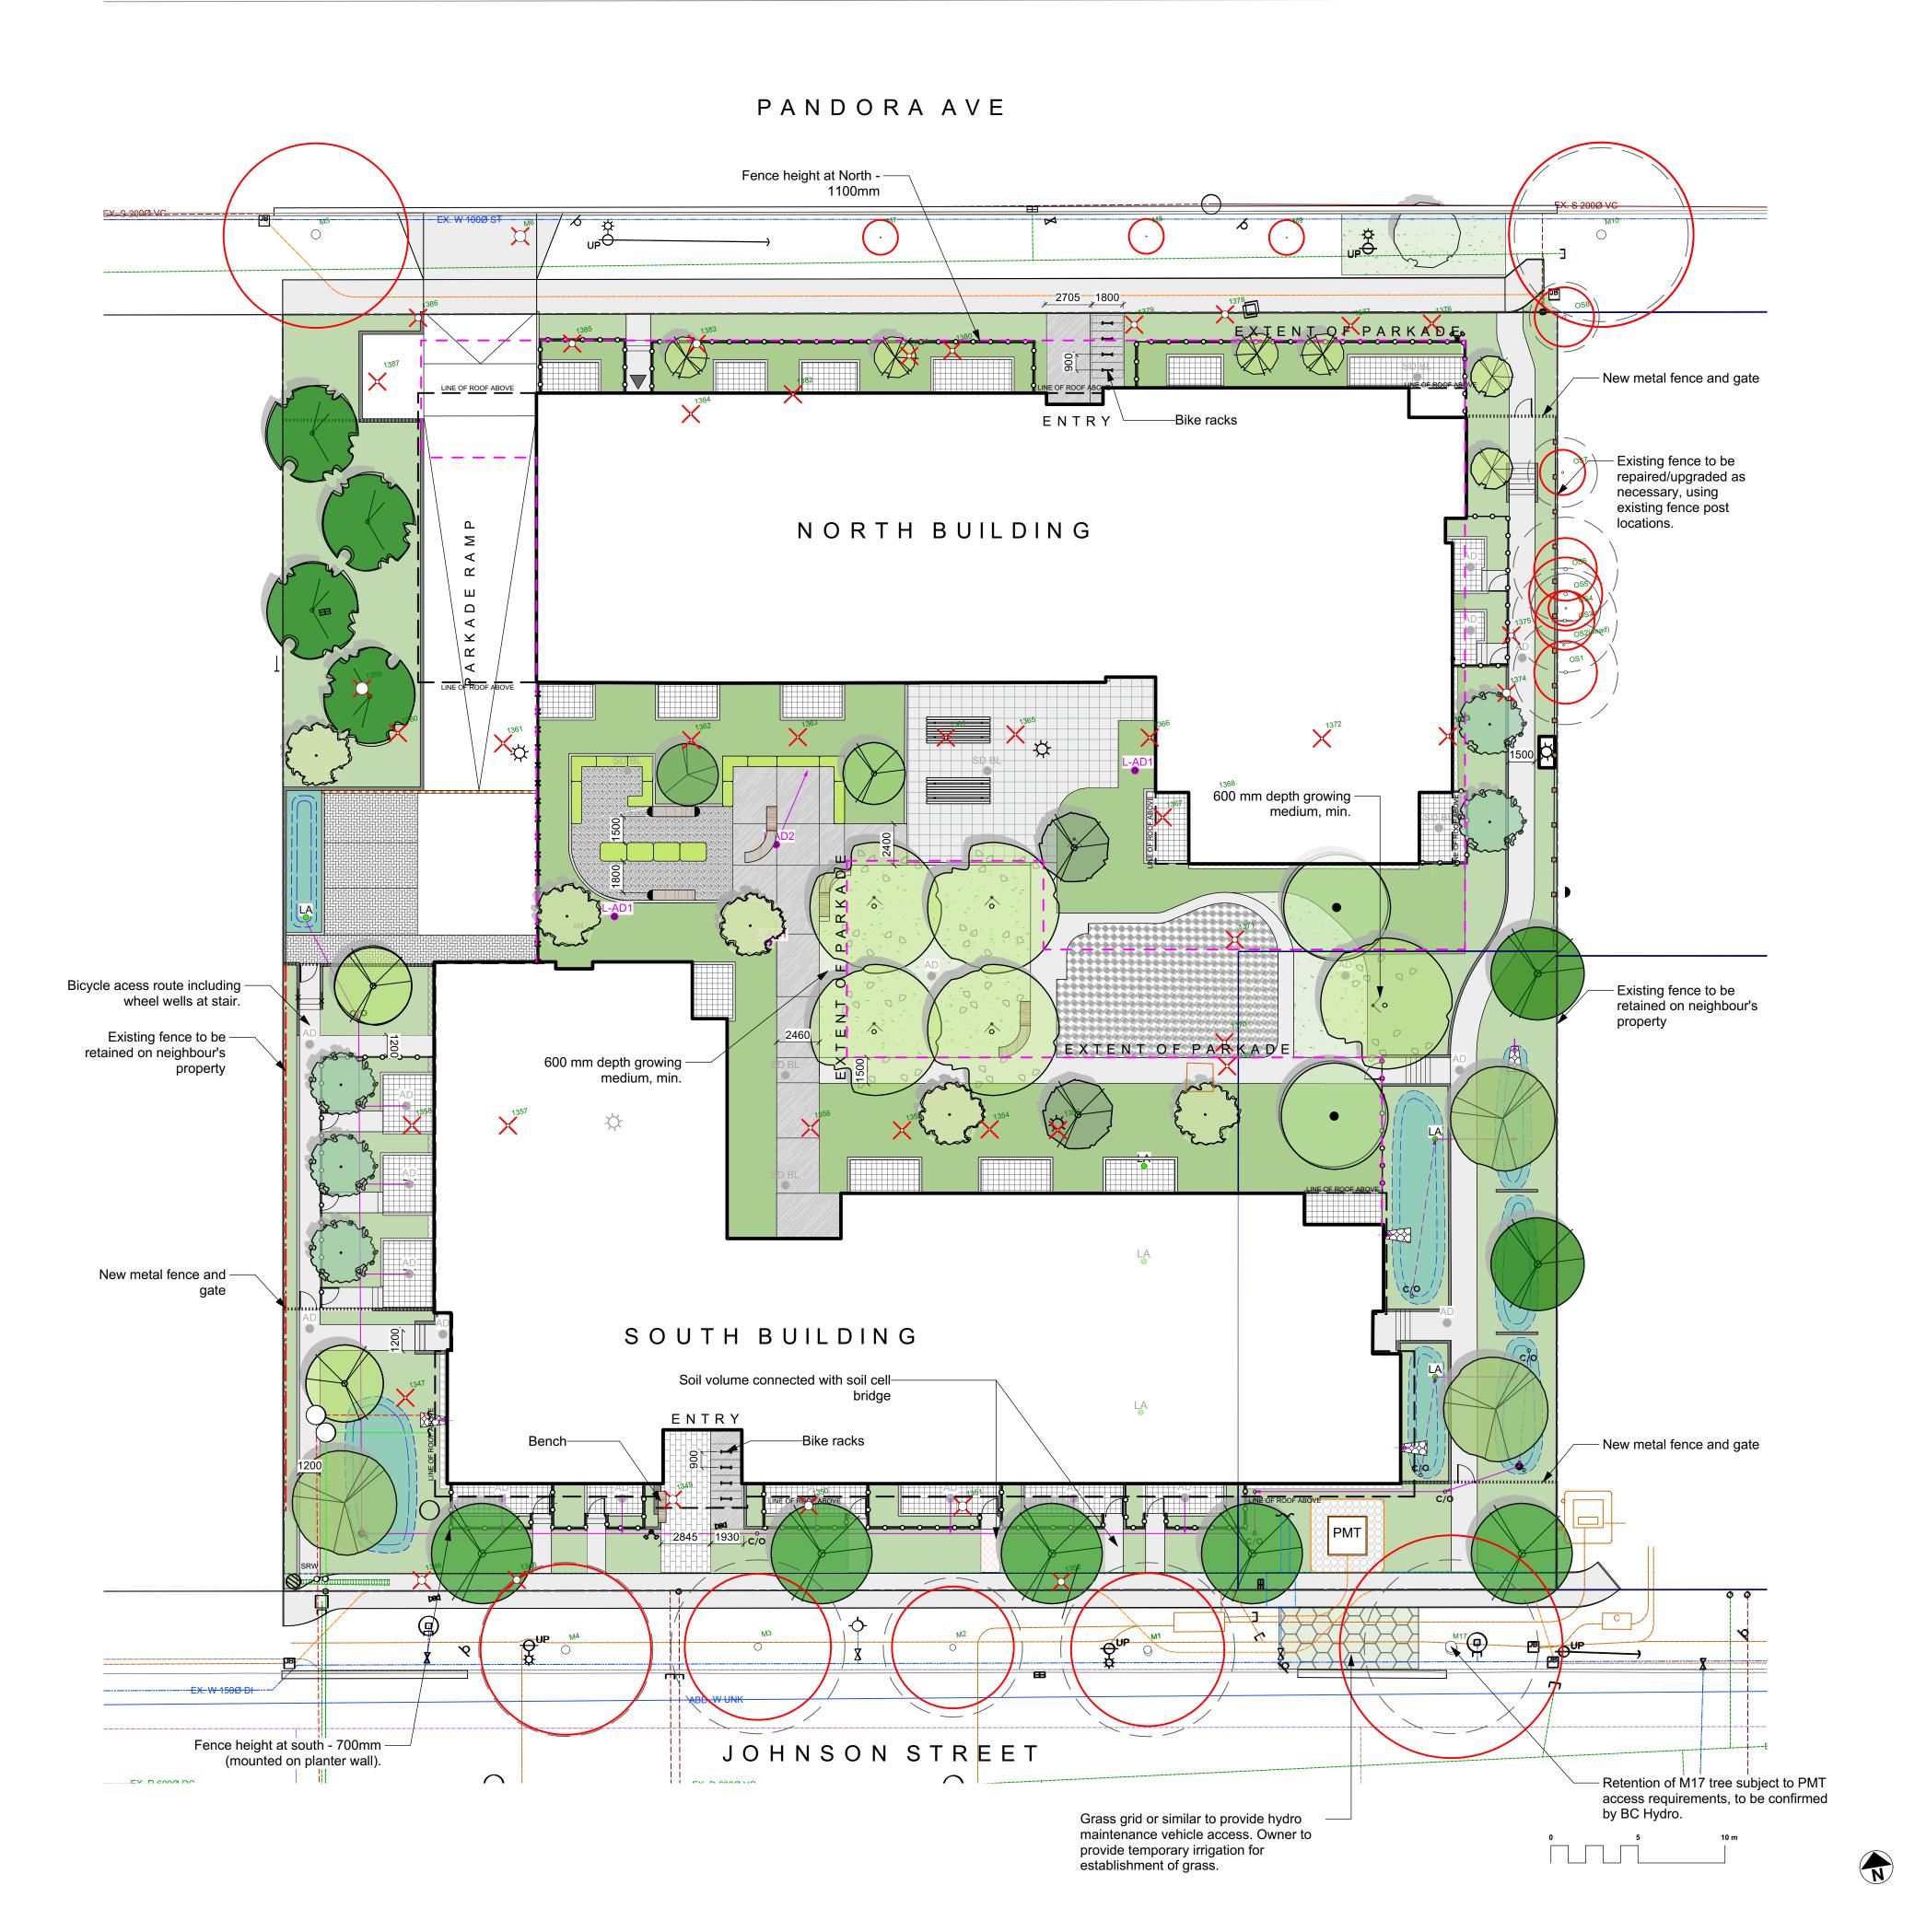
VILLAGE ON THE GREEN 1132 & 1138 Johnson St Victoria, BC


sheet title

Stormwater Management

project no.		123.05
scale	1:200	@ 24"x36'
drawn by		MDI
checked by		SM
sheet no.		

L0.03



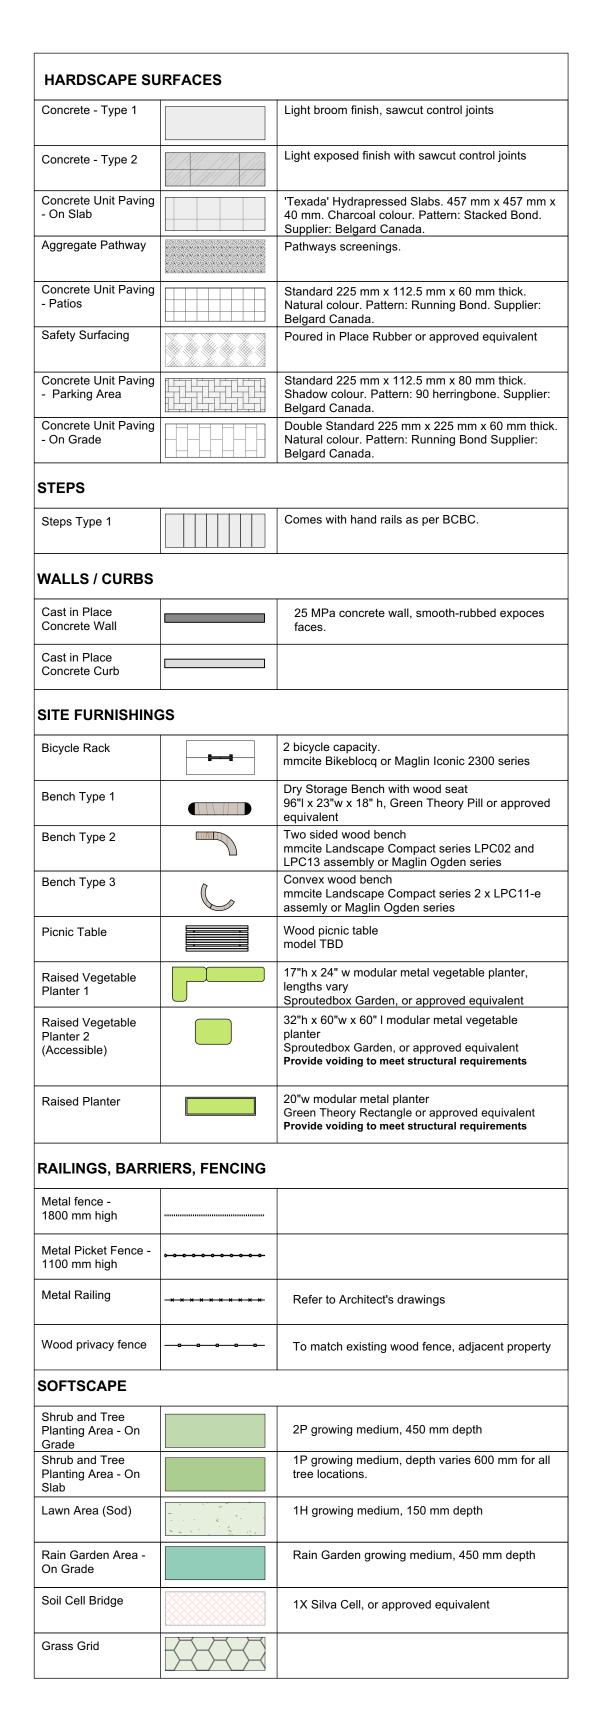

LINE TYPE LEGEND

Property line

Extent of Roof, above

Extent of Parkade, below

Rain garden - TOP OF POOL

Rain garden - BOTTOM OF POOL





DDP Rev.

Delegated DP

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REGISTERED

2024-09-19

Issue Date

2

No.

Capital Region Housing Corporation

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VILLAGE ON THE GREEN 1132 & 1138 Johnson St Victoria, BC


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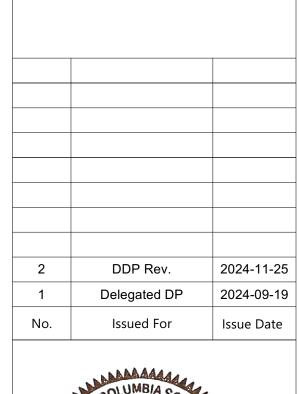
Landscape Materials

project no.		123.05
scale	1:200	@ 24"x36
drawn by		MDI
checked by		SM
sheet no.		
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L1.01

SITE LIGHTING Inset Wall Light Landscape Bollard / Post mounted light Landscape Tree



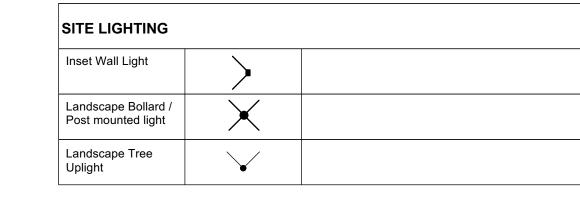

3388A Tennyson Ave P: 250.412-2891 Victoria, BC V8Z 3P6 E: admin@mdidesign.ca



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VILLAGE ON THE GREEN 1132 & 1138 Johnson St Victoria, BC


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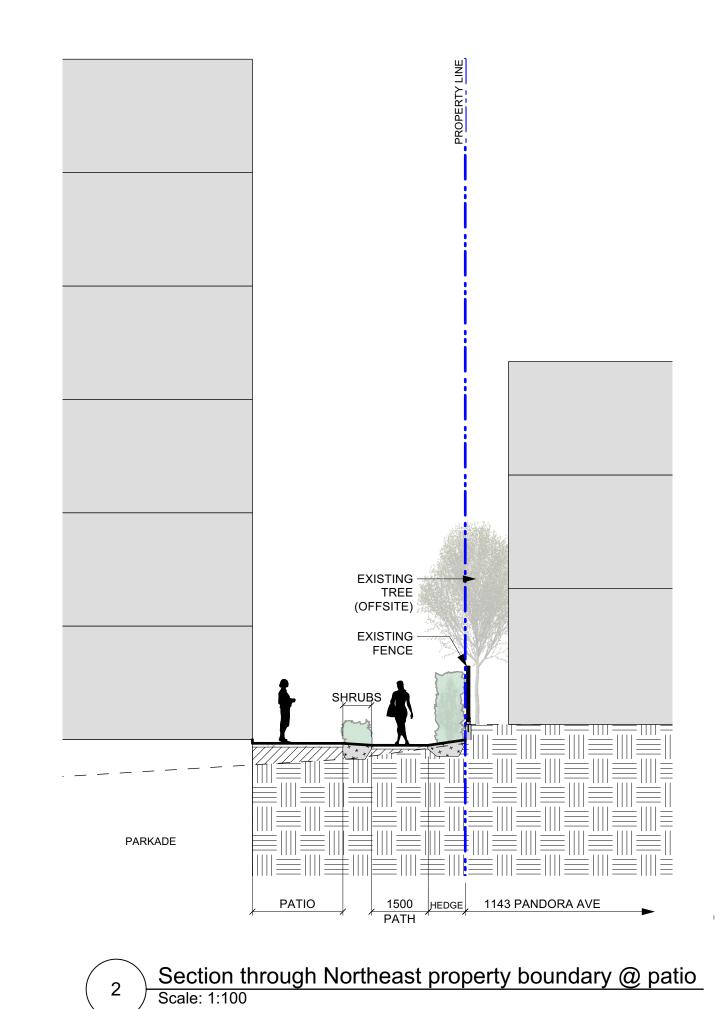
Landscape Lighting Concept


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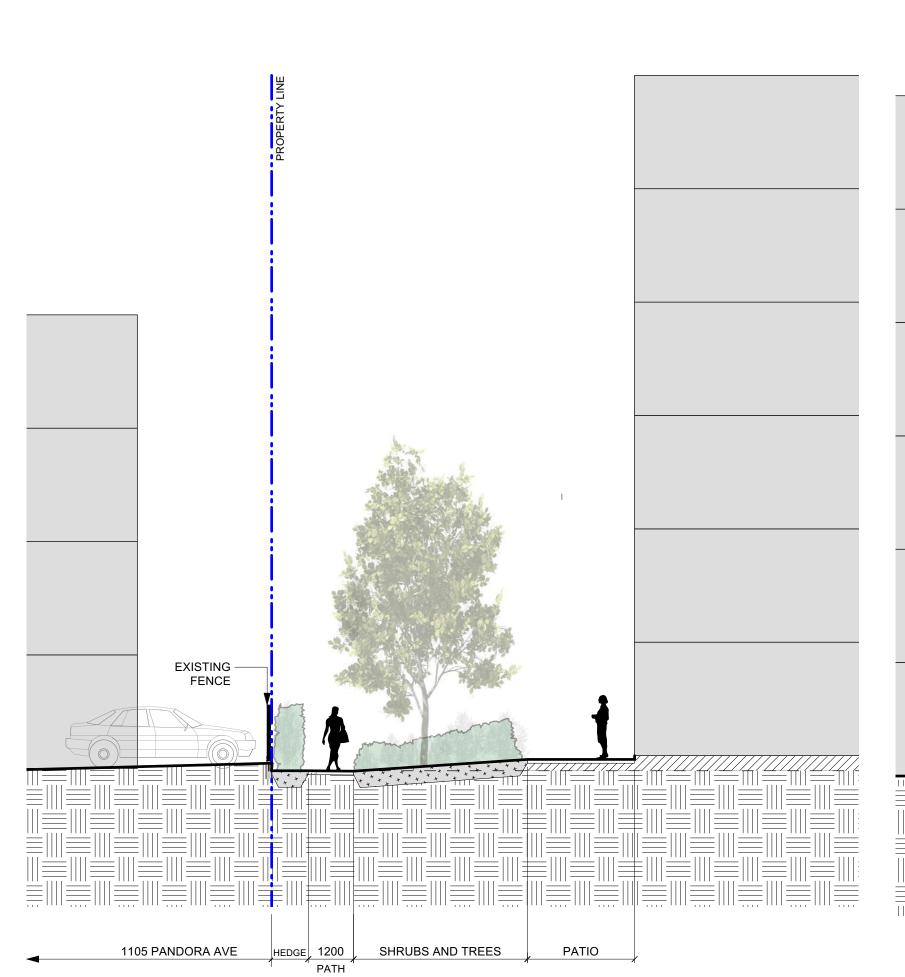
0 5 10 m

	PANDORA AVE
	EX. \$ 200Ø VC
UP EX. D 200Ø VC	THE DECEMBER AND D
EX: D-200Ø-VG	386 1378 1
	1387 1387 1388 EXTENTOF PARKADZ
	LINE OF ROOF ABOVE
	NORTH BUILDING
	(375) (32(dequi)) (35) (375)
	1360 LINE O FROOF ABOVE 1361 1362 1363 1365 1365
	Nogry Jook Jacob March 1367
	MA 1371
	AD 1358 1357 1354 1354 1354
	LINE OF ROOF ABOVE
	SOUTH BUILDING
	ENTRY
	1200
	LINE OF ROOF ABOVE PMT
	1346 1348 135P 135P
——————————————————————————————————————	T V V V V V V V V V V V V V V V V V V V
EX. W 150Ø DI	MBD WUNK
EV D 6000 DC	JOHNSON STREET







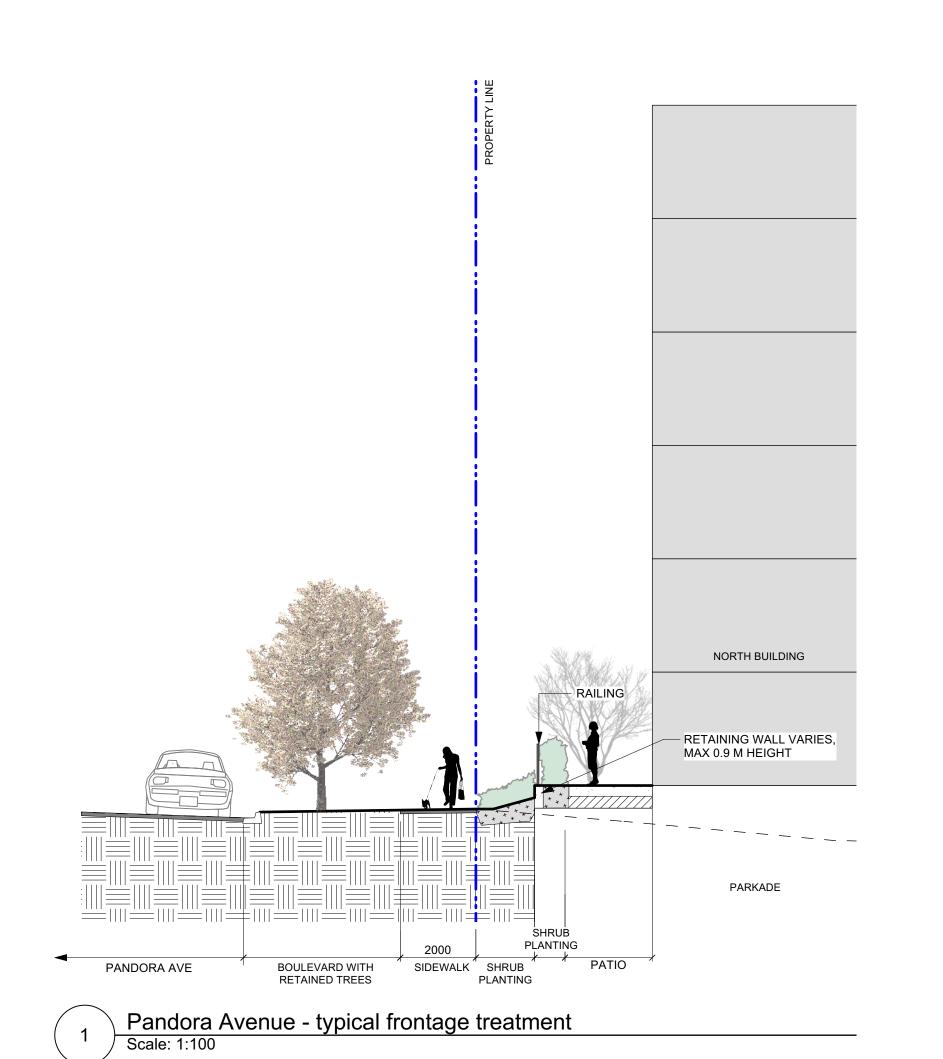

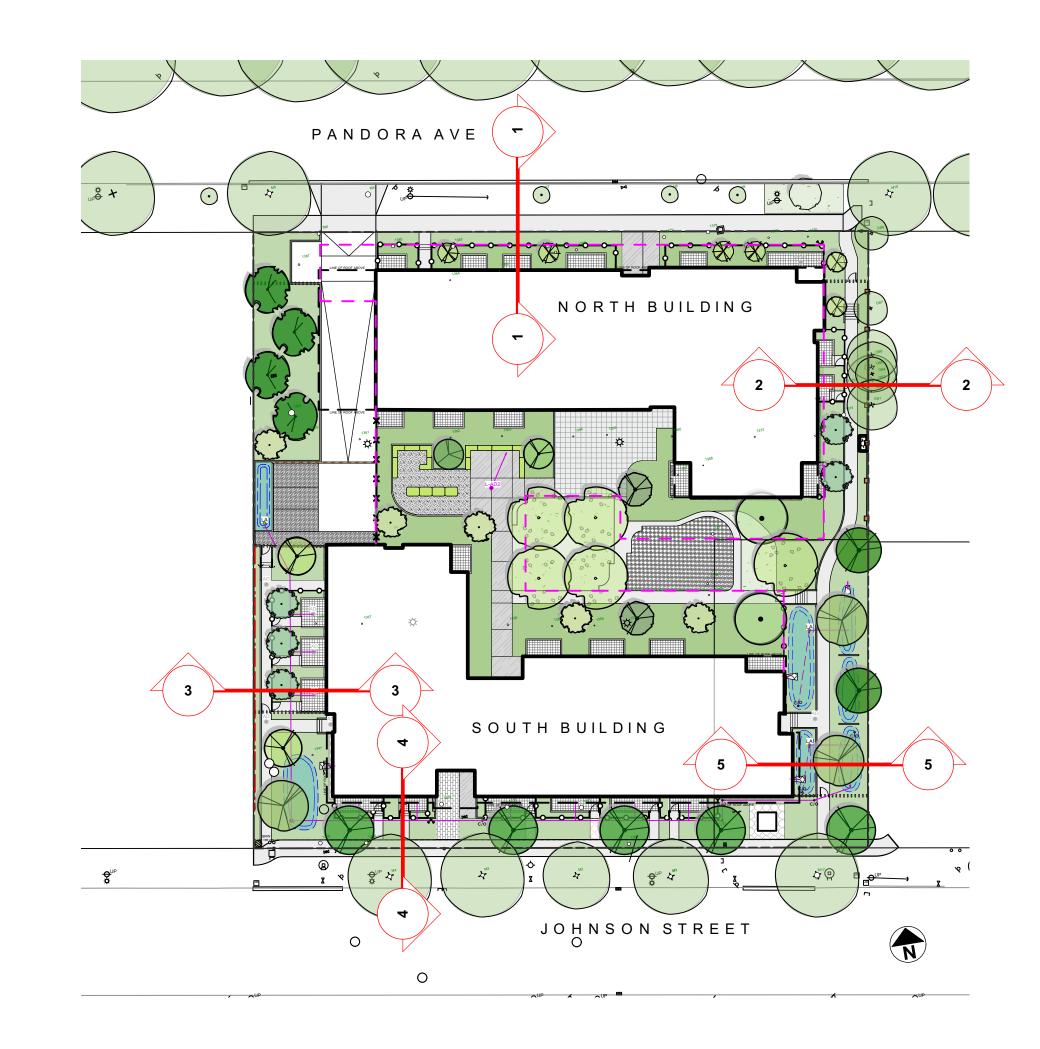

Section through Southwest property boundary @ patio
Scale: 1:100

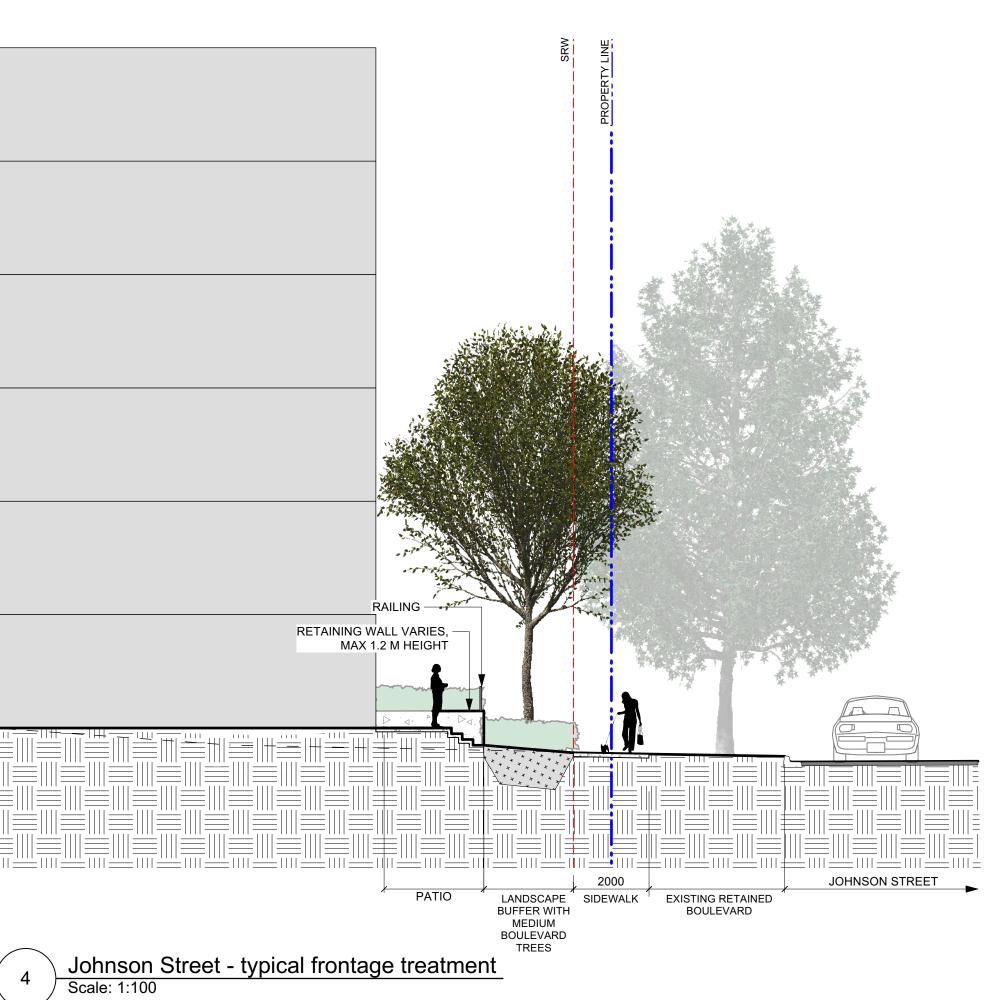

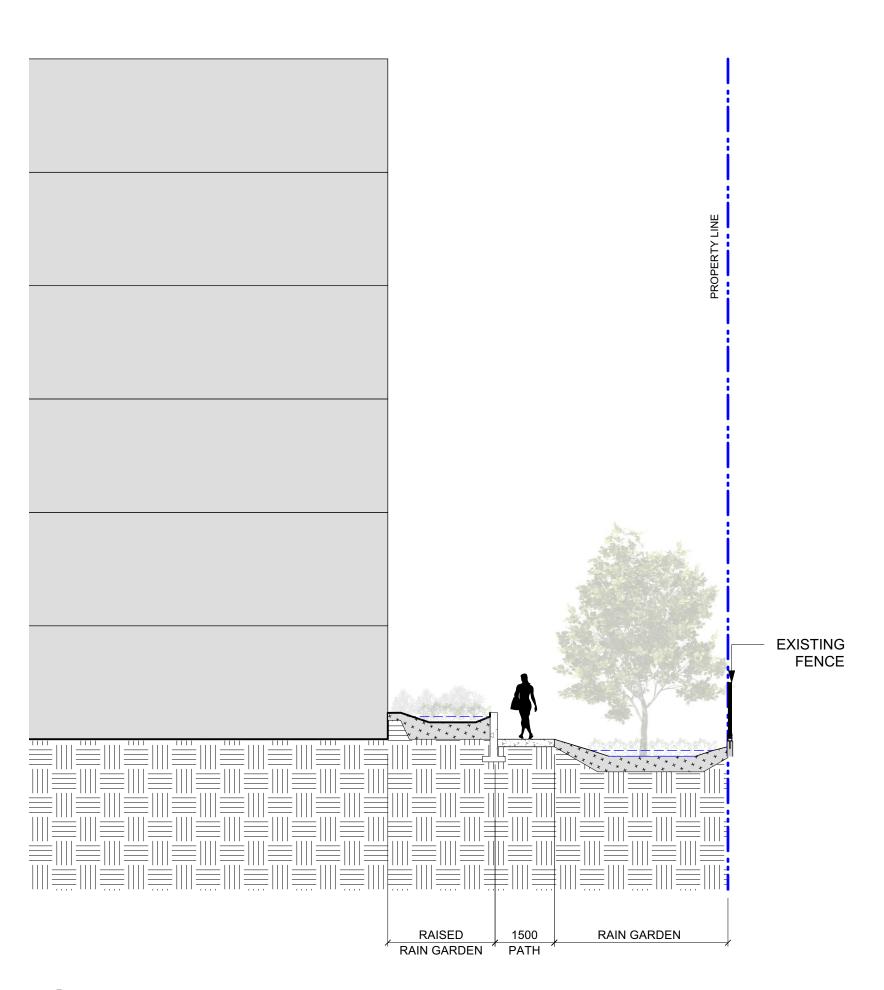

Section through Southeast property boundary @ Rain Garden

Scale: 1:100



2	DDP Rev.	2024-11-2
1	Delegated DP	2024-09-1
No.	Issued For	Issue Date



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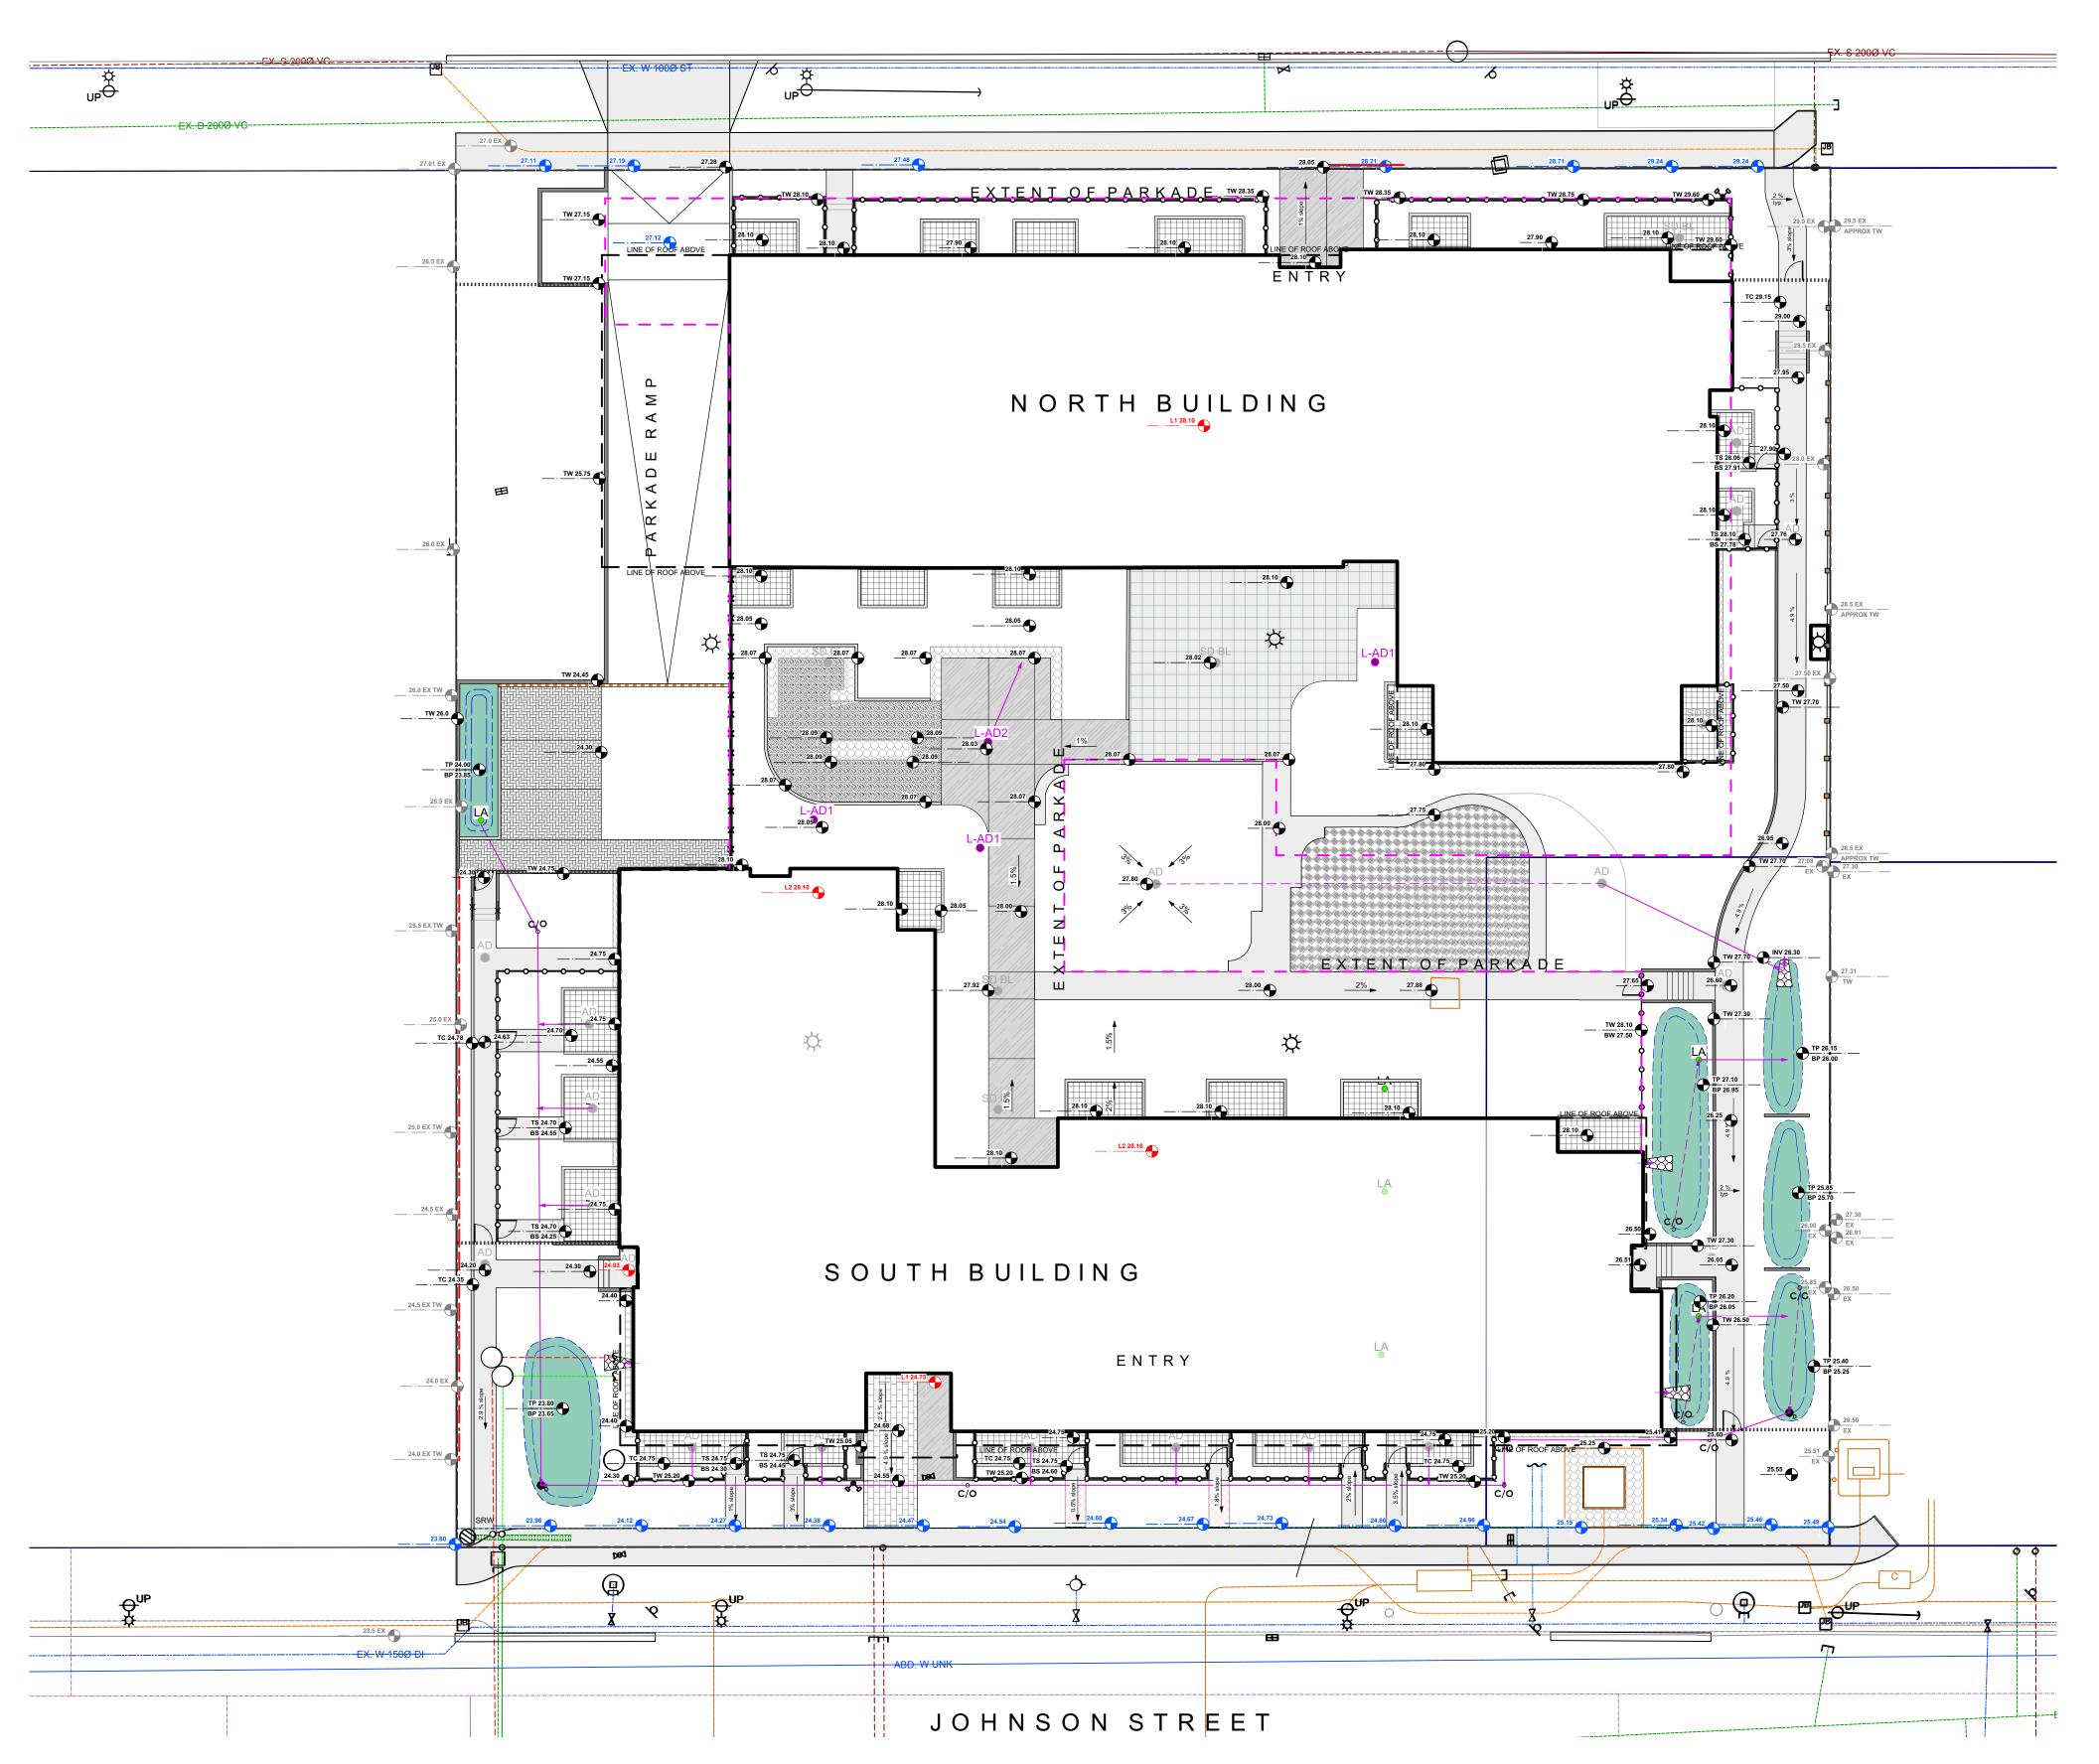
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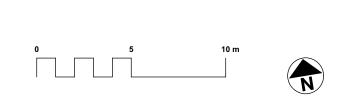
Landscape Sections

project no.		123.05
scale	AS NOTED	@ 24"x36
drawn by		MDI
checked by		SM
sheet no.		

L1.03

PANDORA AVE





GRADING LEGEND

Existing Landscape Grade



Architectural grade, provided for reference

Civil Grade, provided for reference only



BW Bottom of Wall TS Top of Stairs
TOC Top of Curb BS Bottom of Stairs
BC Bottom of Curb HP High Point
TP Top of Pool LP Low Point

	Perforated Underdrain
	Sched 40 PVC
-	Gravel flow dissipator
c/o	Clean out
LA	Rain Garden Overflow Drain. 8 DIA
L-AD2	Hardscape Bilevel connection
D	Rain Garden Overflow Drain with Catch Basin. 24" DIA
L-AD1	Inspection Chamber in softscape @ slab drain
AD	Area Drain
	Trench Drain
DRAINS BY OTH	
SD BL	Mechanical Drains - bilevel (For Reference Only)



DDP Rev. Delegated DP



Capital Region Housing Corporation


VILLAGE ON THE GREEN 1132 & 1138 Johnson St Victoria, BC

sheet title

Landscape Grading - Overall

project no.		123.05
scale	1:200	@ 24"x36"
drawn by		MDI
checked by		SM
sheet no.		

L2.00

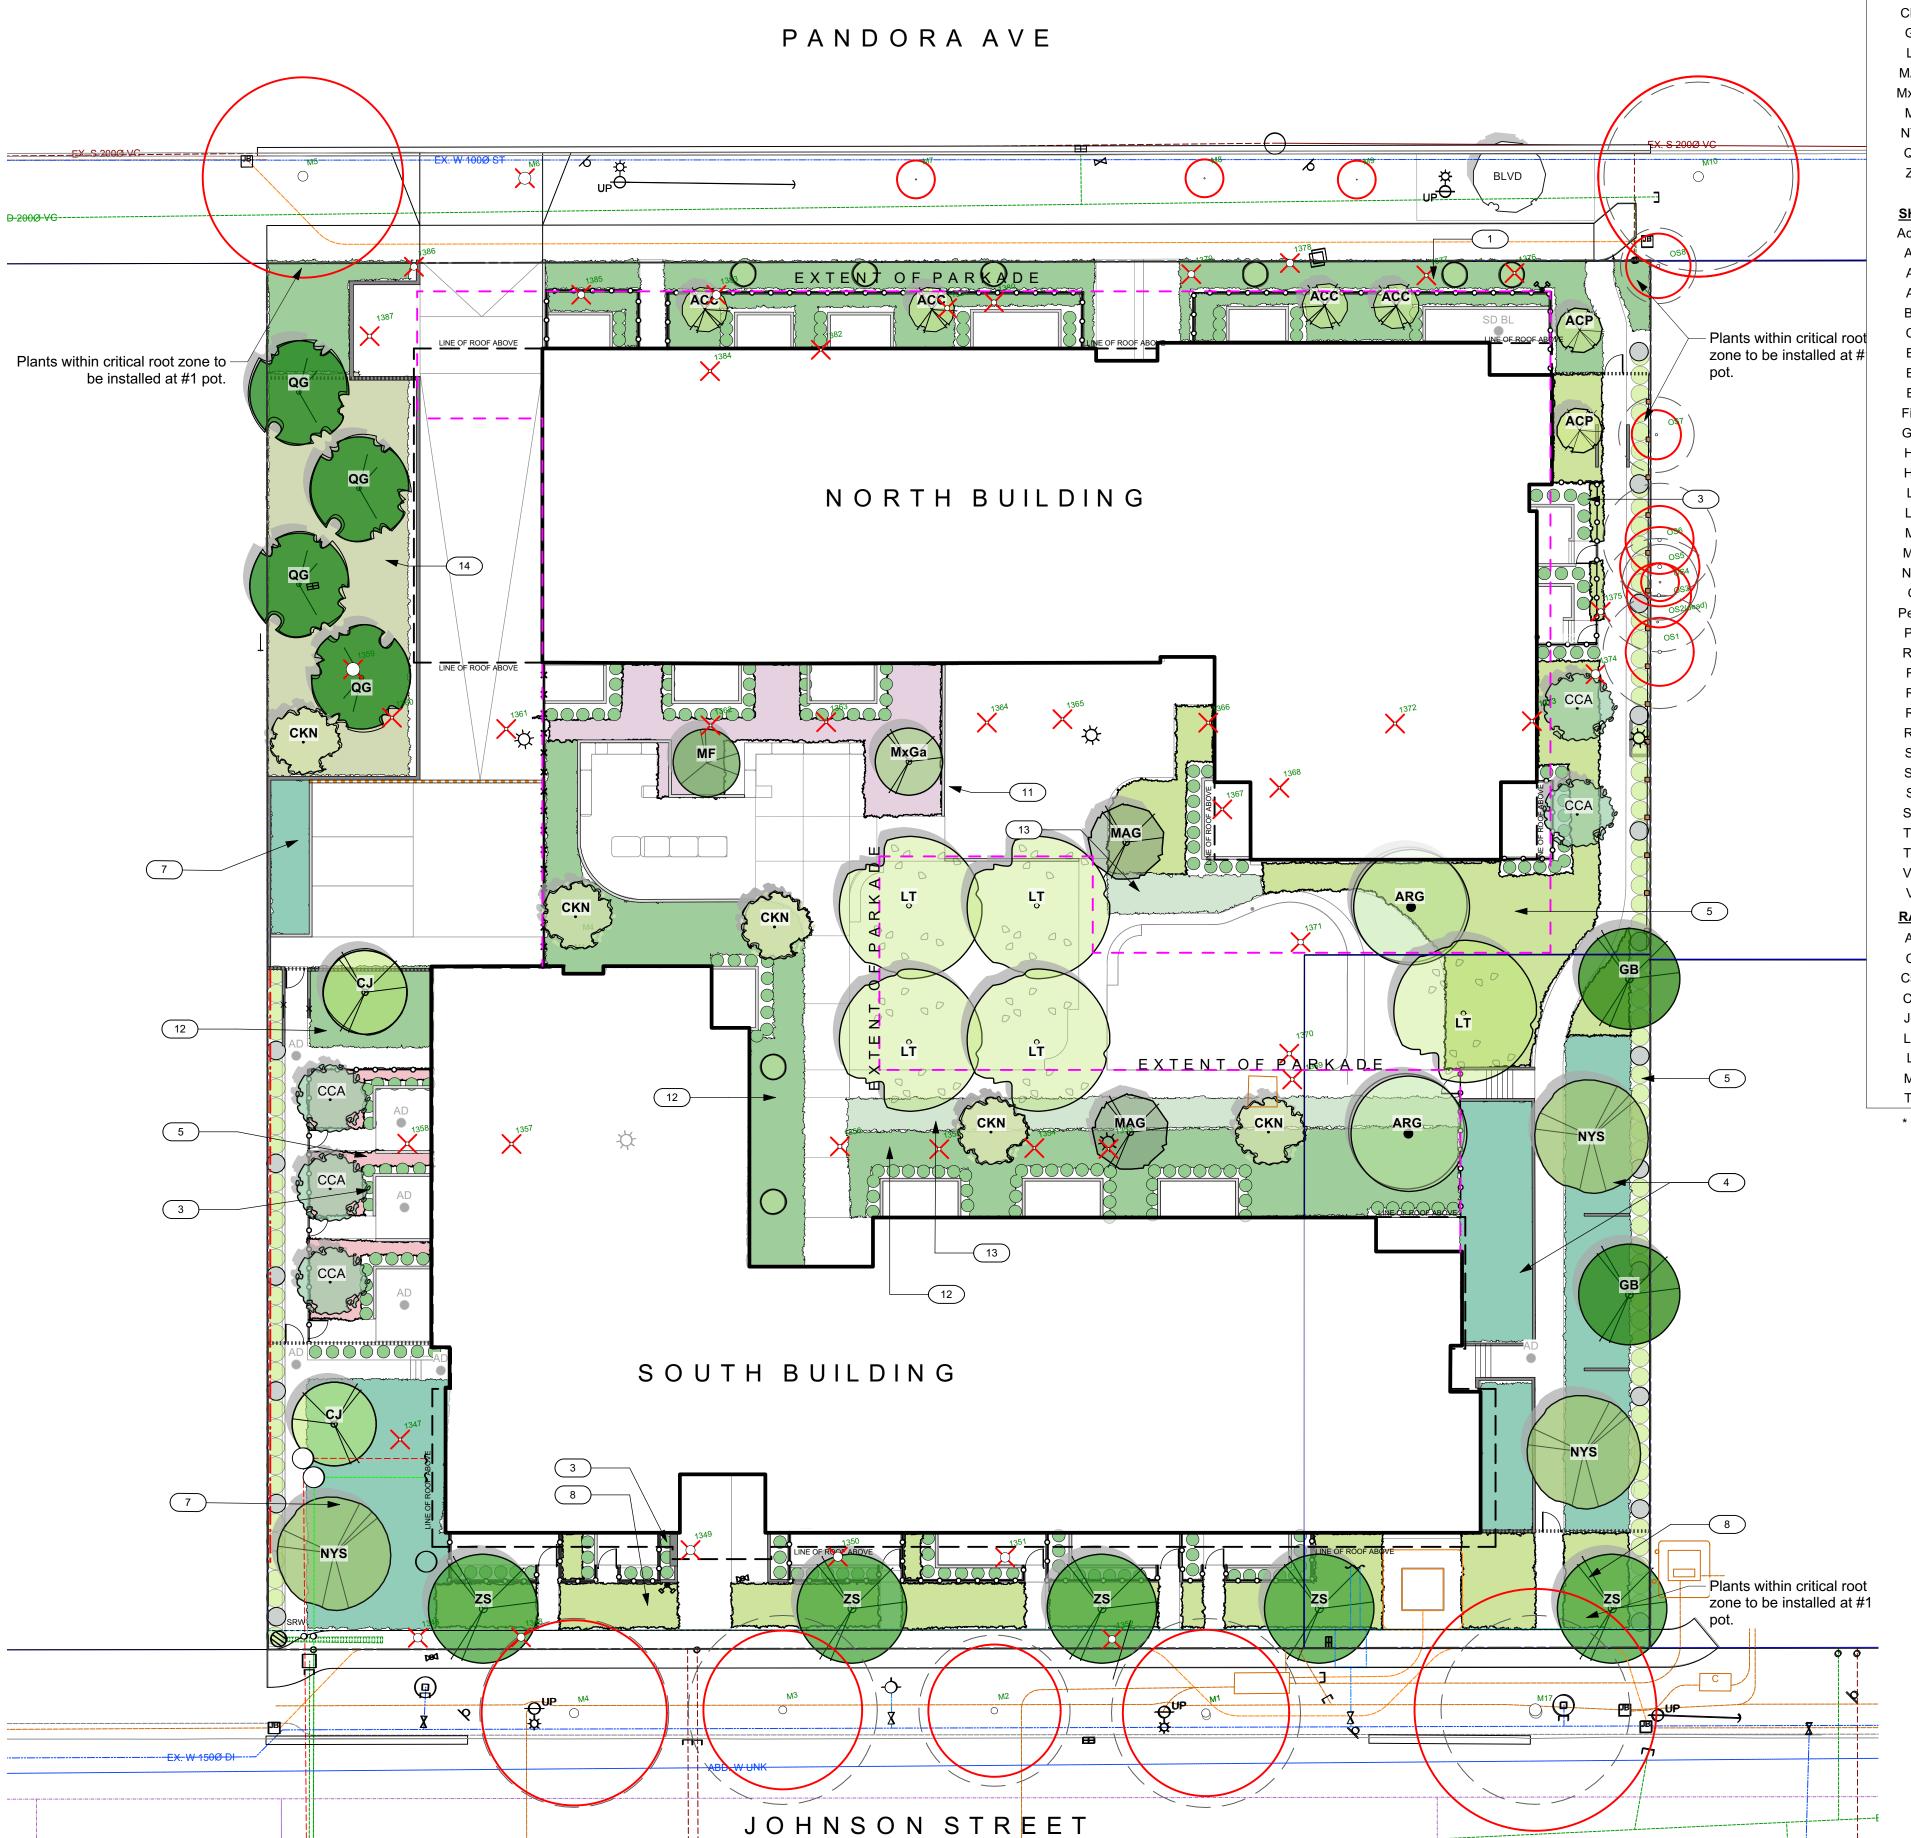

8

8



* DENOTES NATIVE/ POLLINATOR/ EDIBLE PLANTS

Taxus baccata 'Repandens'

PLANTING PALLETTE NOTES

Pandora frontage planting: Rhododendrons, Sword and Lady Fern, Evergreen Huckleberry, Fothergilla,


#1 pot

English Weeping Yew

- Native and adaptive plantings, part shade. Includes Oregon Grape Holly, Salal, Wooly Sunflower, Red Flowering Currant.
- Hedging around private patios. Yew species.
- Tiered rain garden plantings. Soft Common Rush, Slough Sedge, Dwarf Red Twig Dogwood, Creeping Yew, Lily Turf.
- Mixed Native hedging. Oregon Grape, Red Flowering Currant.
- Perennial pollinators. Russian Sage, Catmint, Echinacea, Aster.
- Sunny rain garden. Soft Common Rush, Dwarf Maiden Grass, Midwinter Fire Dogwood, Lily Turf.
- Johnson Street frontage. Brachyglottis, Catmint, Dwarf Mediterranean Spurge, Point Reyes Creeper, Hebe.
- 9 Drought tolerant low hedge. Warty Barberry.
- Raised planters, planted by residents.
- Native and adaptive plantings shade. Sword, Maidenhair, and Lady Ferns; Prostrate Oregon Grape, Solomon's Seal, Barrenwort, Sorrel.
- Berry plantings. Evergreen Huckleberry, blueberry. Garry Oak understory along parkade ramp. Snowberry and Nootka Rose.

Herb and pollinator plantings. Rosemary, Sage, Lavender, Oregano, Thyme.



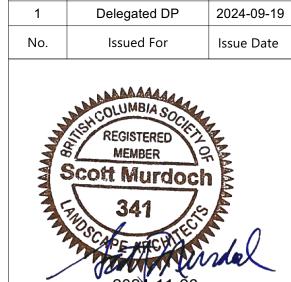

DDP Rev.

2

Capital Region Housing Corporation

VILLAGE ON THE GREEN 1132 & 1138 Johnson St


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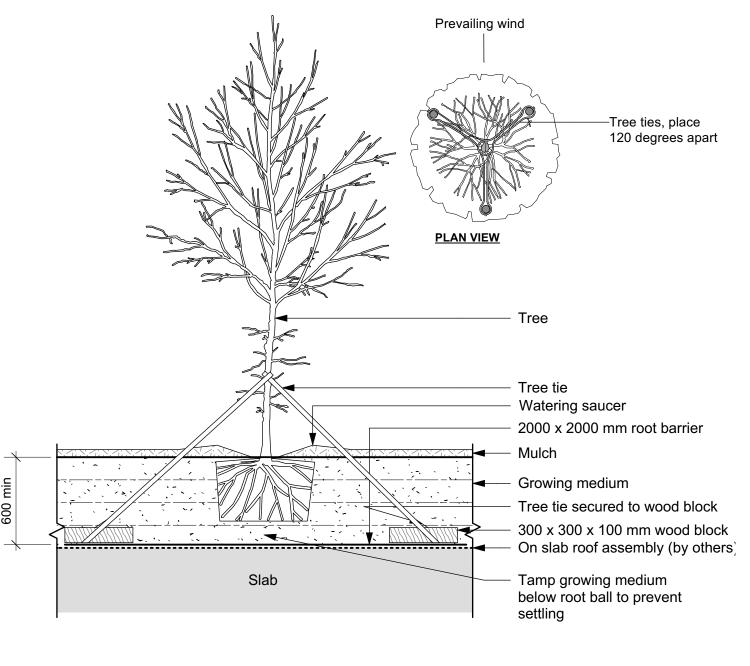
Victoria, BC


Planting Plan


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L3.01






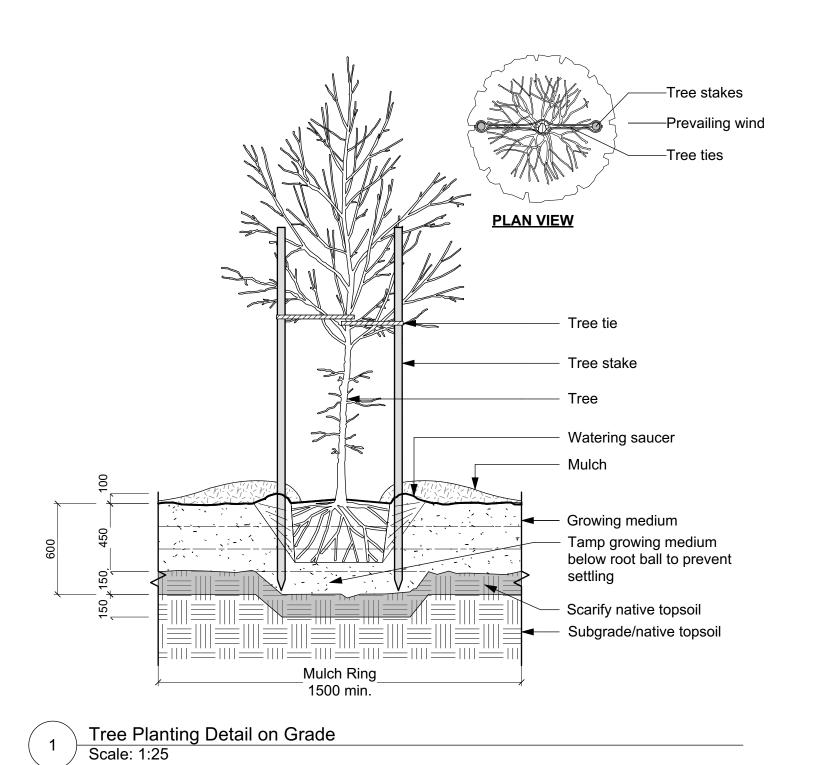


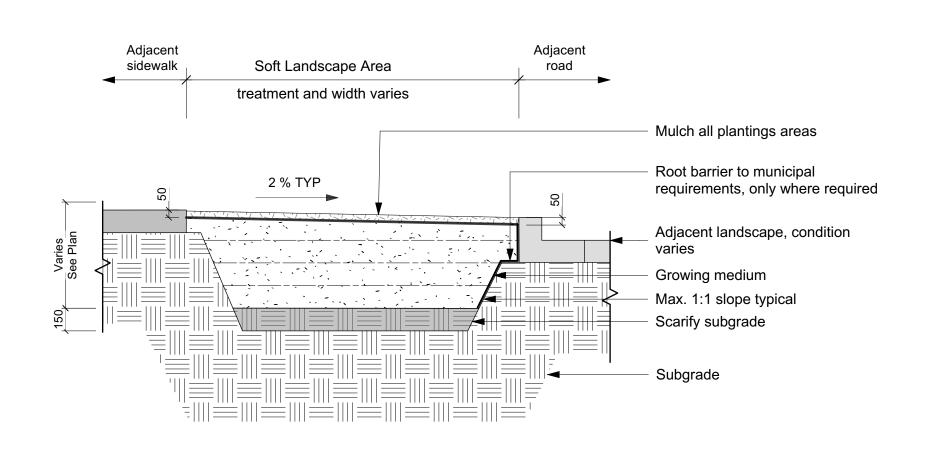

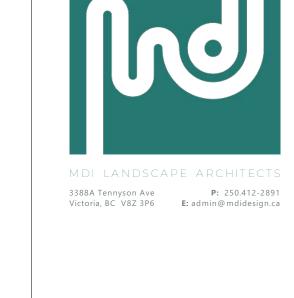
Tree Planting Detail on Slab
Scale: 1:25 Typical Boulevard Treatment
Scale: 1:25

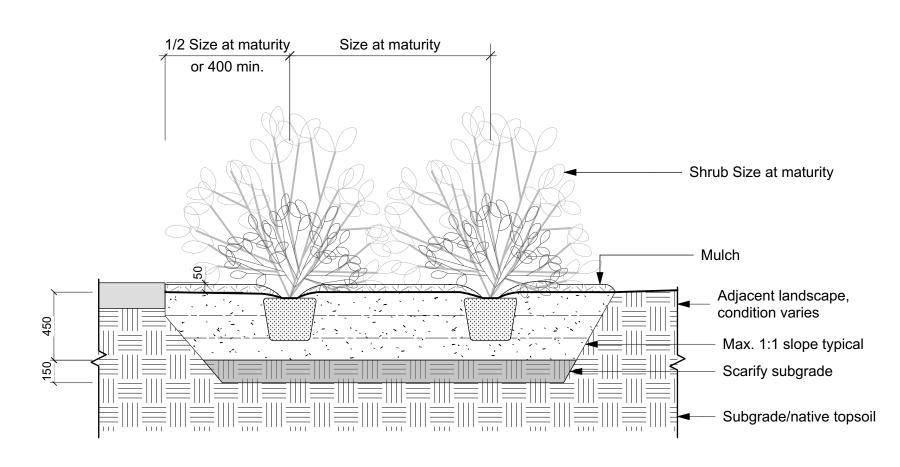



Shrub Planting Area Scale: 1:25

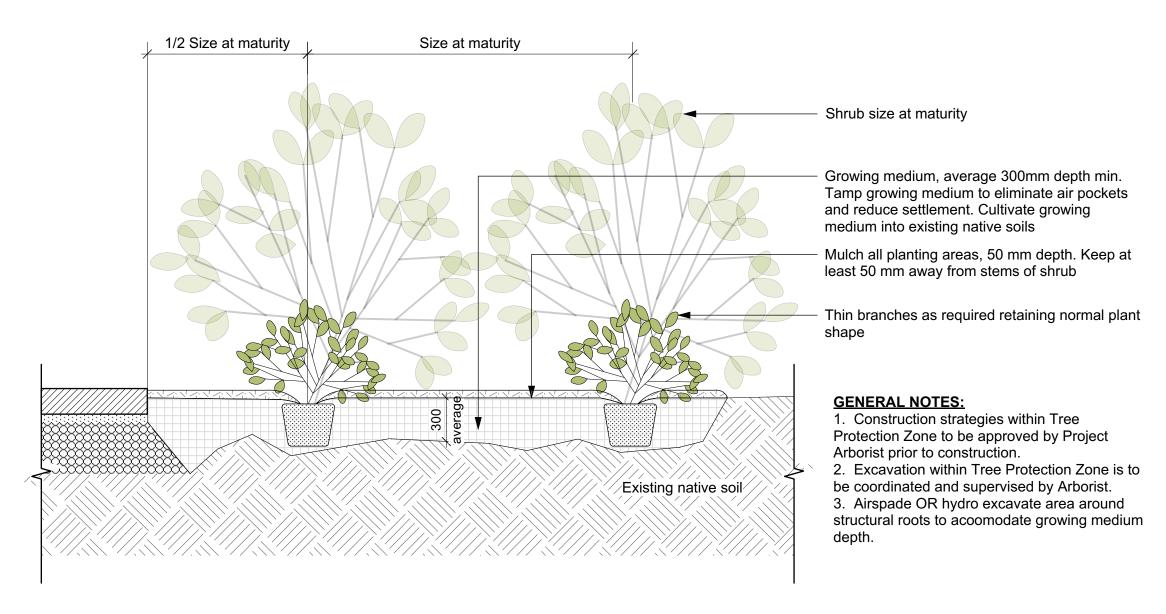


Shrub Planting Area in Tree Protection Zone Scale: 1:25

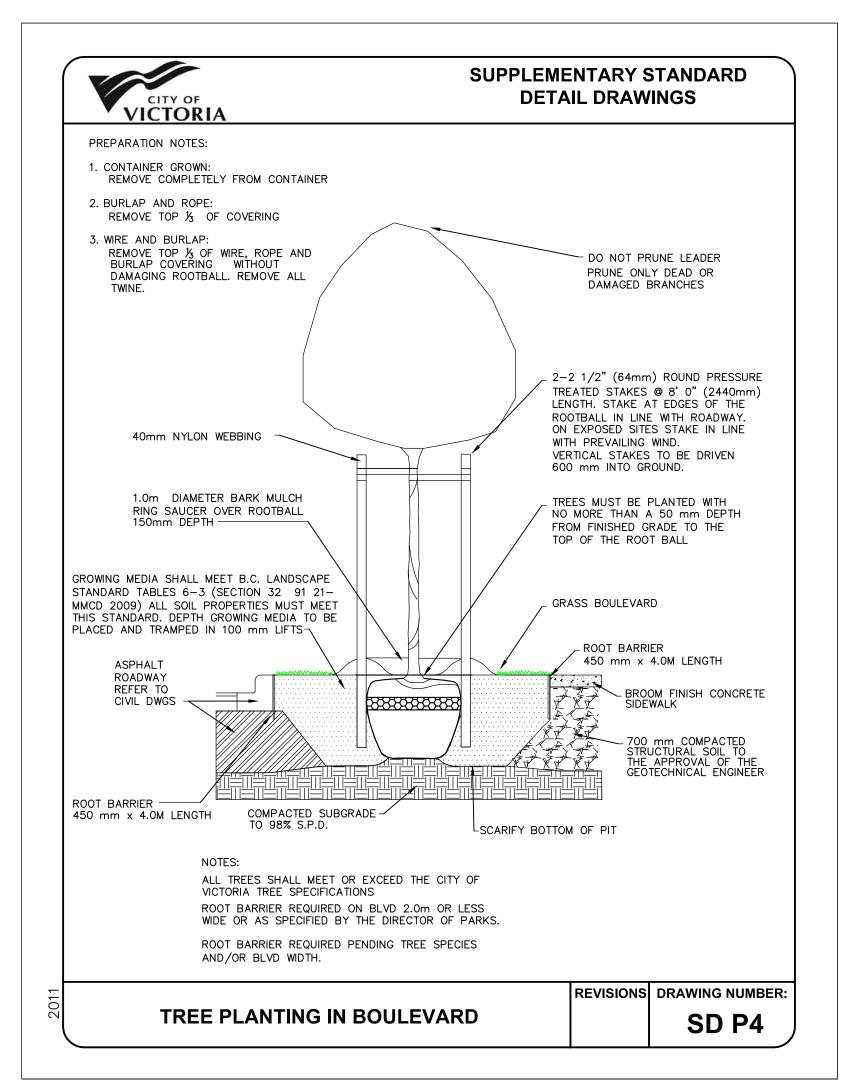

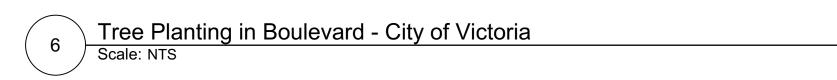

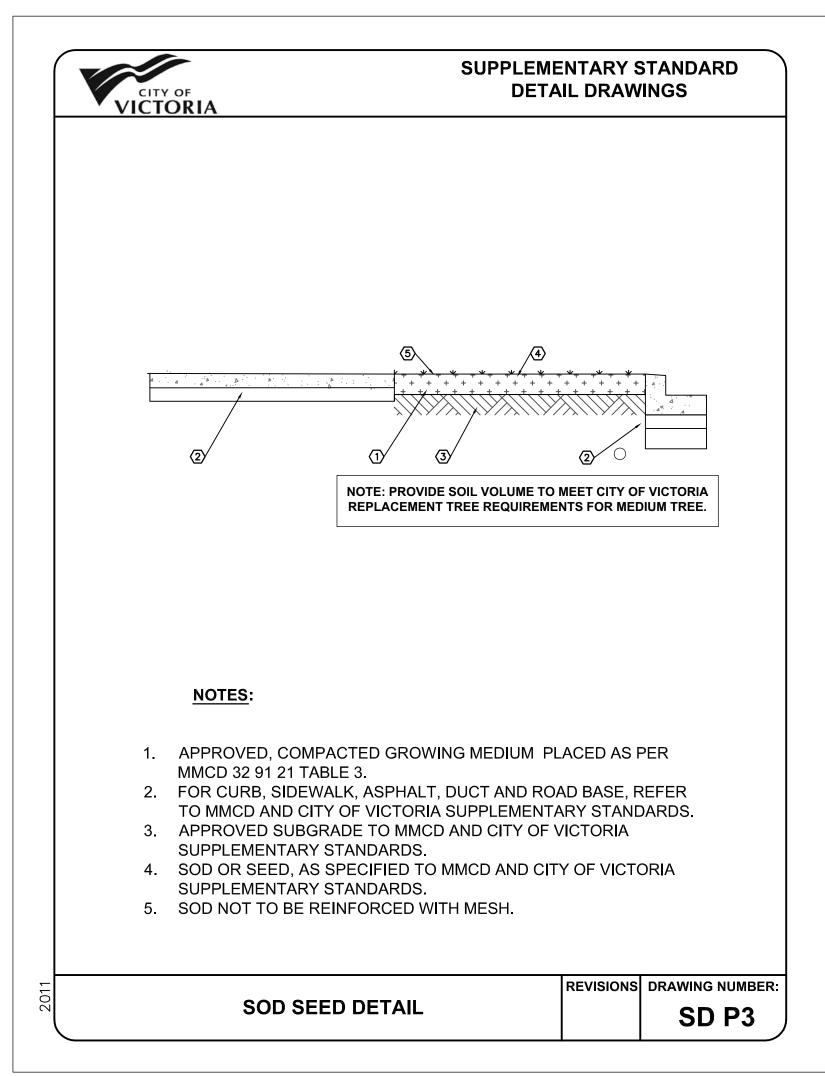

Lawn Area in Boulevard - City of Victoria Scale: Scale: NTS

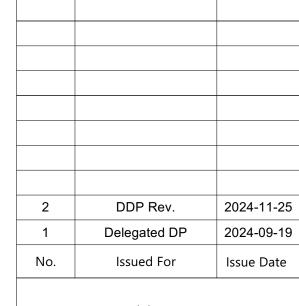



Capital Region Housing Corporation

VILLAGE ON THE GREEN 1132 & 1138 Johnson St Victoria, BC

sheet title

Landscape Details: Planting

project no.		123.05
scale	AS NOTED	@ 24"x36"
drawn by		MDI
checked by		SM
sheet no.		
	L3	3.02

