






PROJECT LOCATION PLAN (NTS)

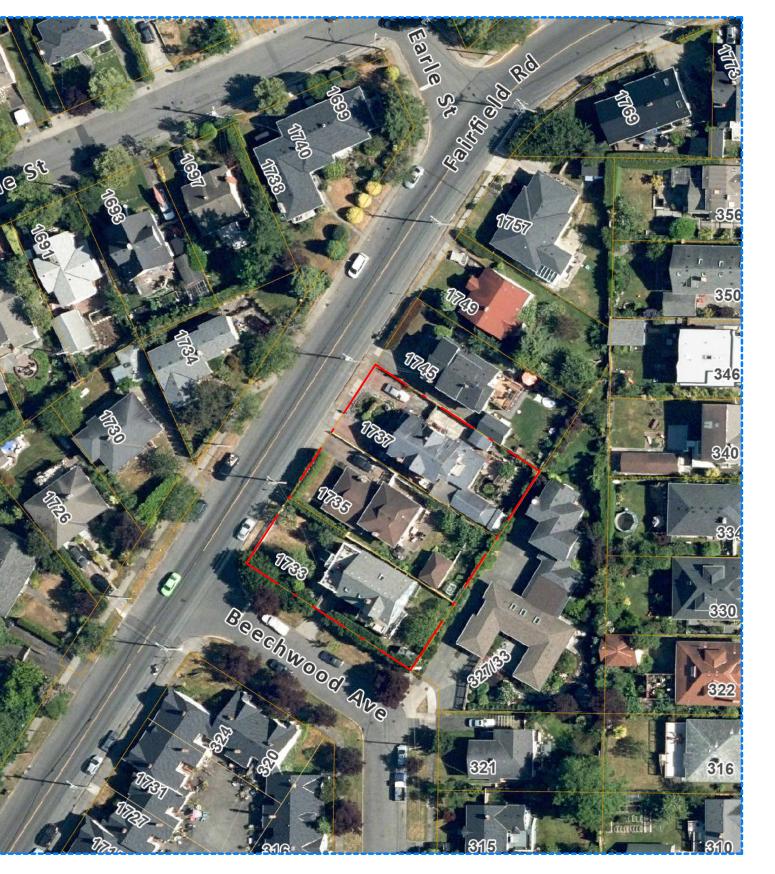

PROJECT SITE (NTS)

CONTACTS

OWNER

Aryze Developments Inc. 1839 Fairfield Road Victoria, BC V85 1G9

Juan Crespi juan@aryze.ca 250.661.4493

ARCHITECT

Cascadia Architects 101 - 804 Broughton Street Victoria, BC V8W 1E4 Gregory Damant, Architect AIBC greg@cascadiaarchitects.ca 250.590.3223

LANDSCAPE DESIGNER


Biophilia 1608 Camosun Street Victoria, BC V8T 3E6

Bianca Bodley bianca@biophiliacollective.ca 250.590.1156

CIVIL ENGINEER

McElhanney 500 - 3960 Quadra Street Victoria, BC V8X 4A3

Nathan Dunlop ndunlop@mcelhanney.com 778.746.7417

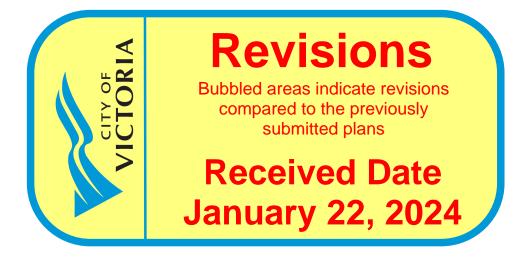

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SHADOW STUDIES

SITE PLAN & PROJECT DATA

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TREE PLANTING PLAN SOIL VOLUME ANALYSIS

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UPPER LEVELS PLANTING PLAN

DETAILS



1 BEECHWOOD ELEVATION PERSPECTIVE
SCALE = 1:100





13	DP/RZ Rev4	Jan 18, 2024
4	DP/RZ Rev2	Jan 26, 2023
3	DP/RZ Rev1	July 20, 2022
2	DP/RZ Submission	April 29, 2022
1	Development Tracker Application	March 7, 2022
NO.	DESCRIPTION	DATE



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1733-1737 Fairfield Rd

PERSPECTIVES

1:100 Revis

Revision

Jan 18, 2024


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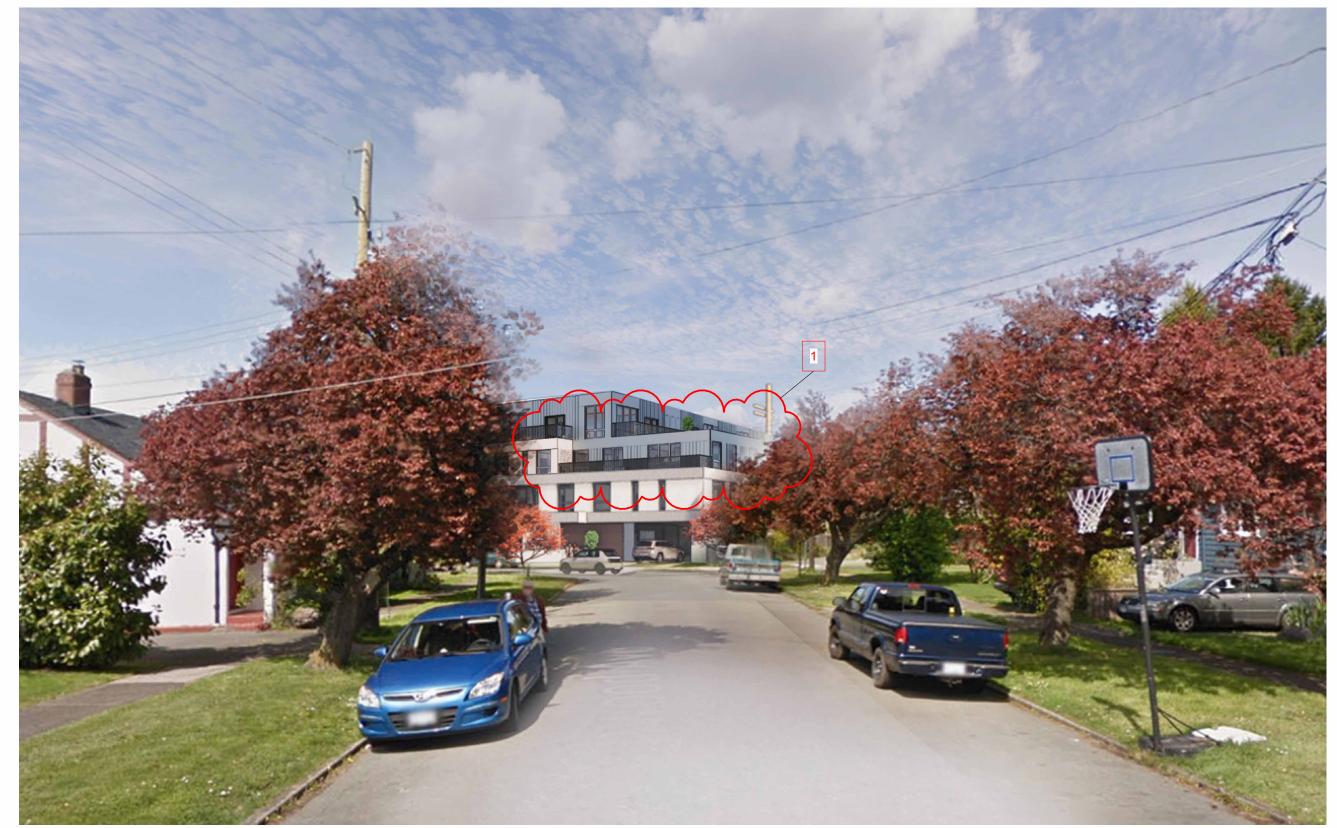







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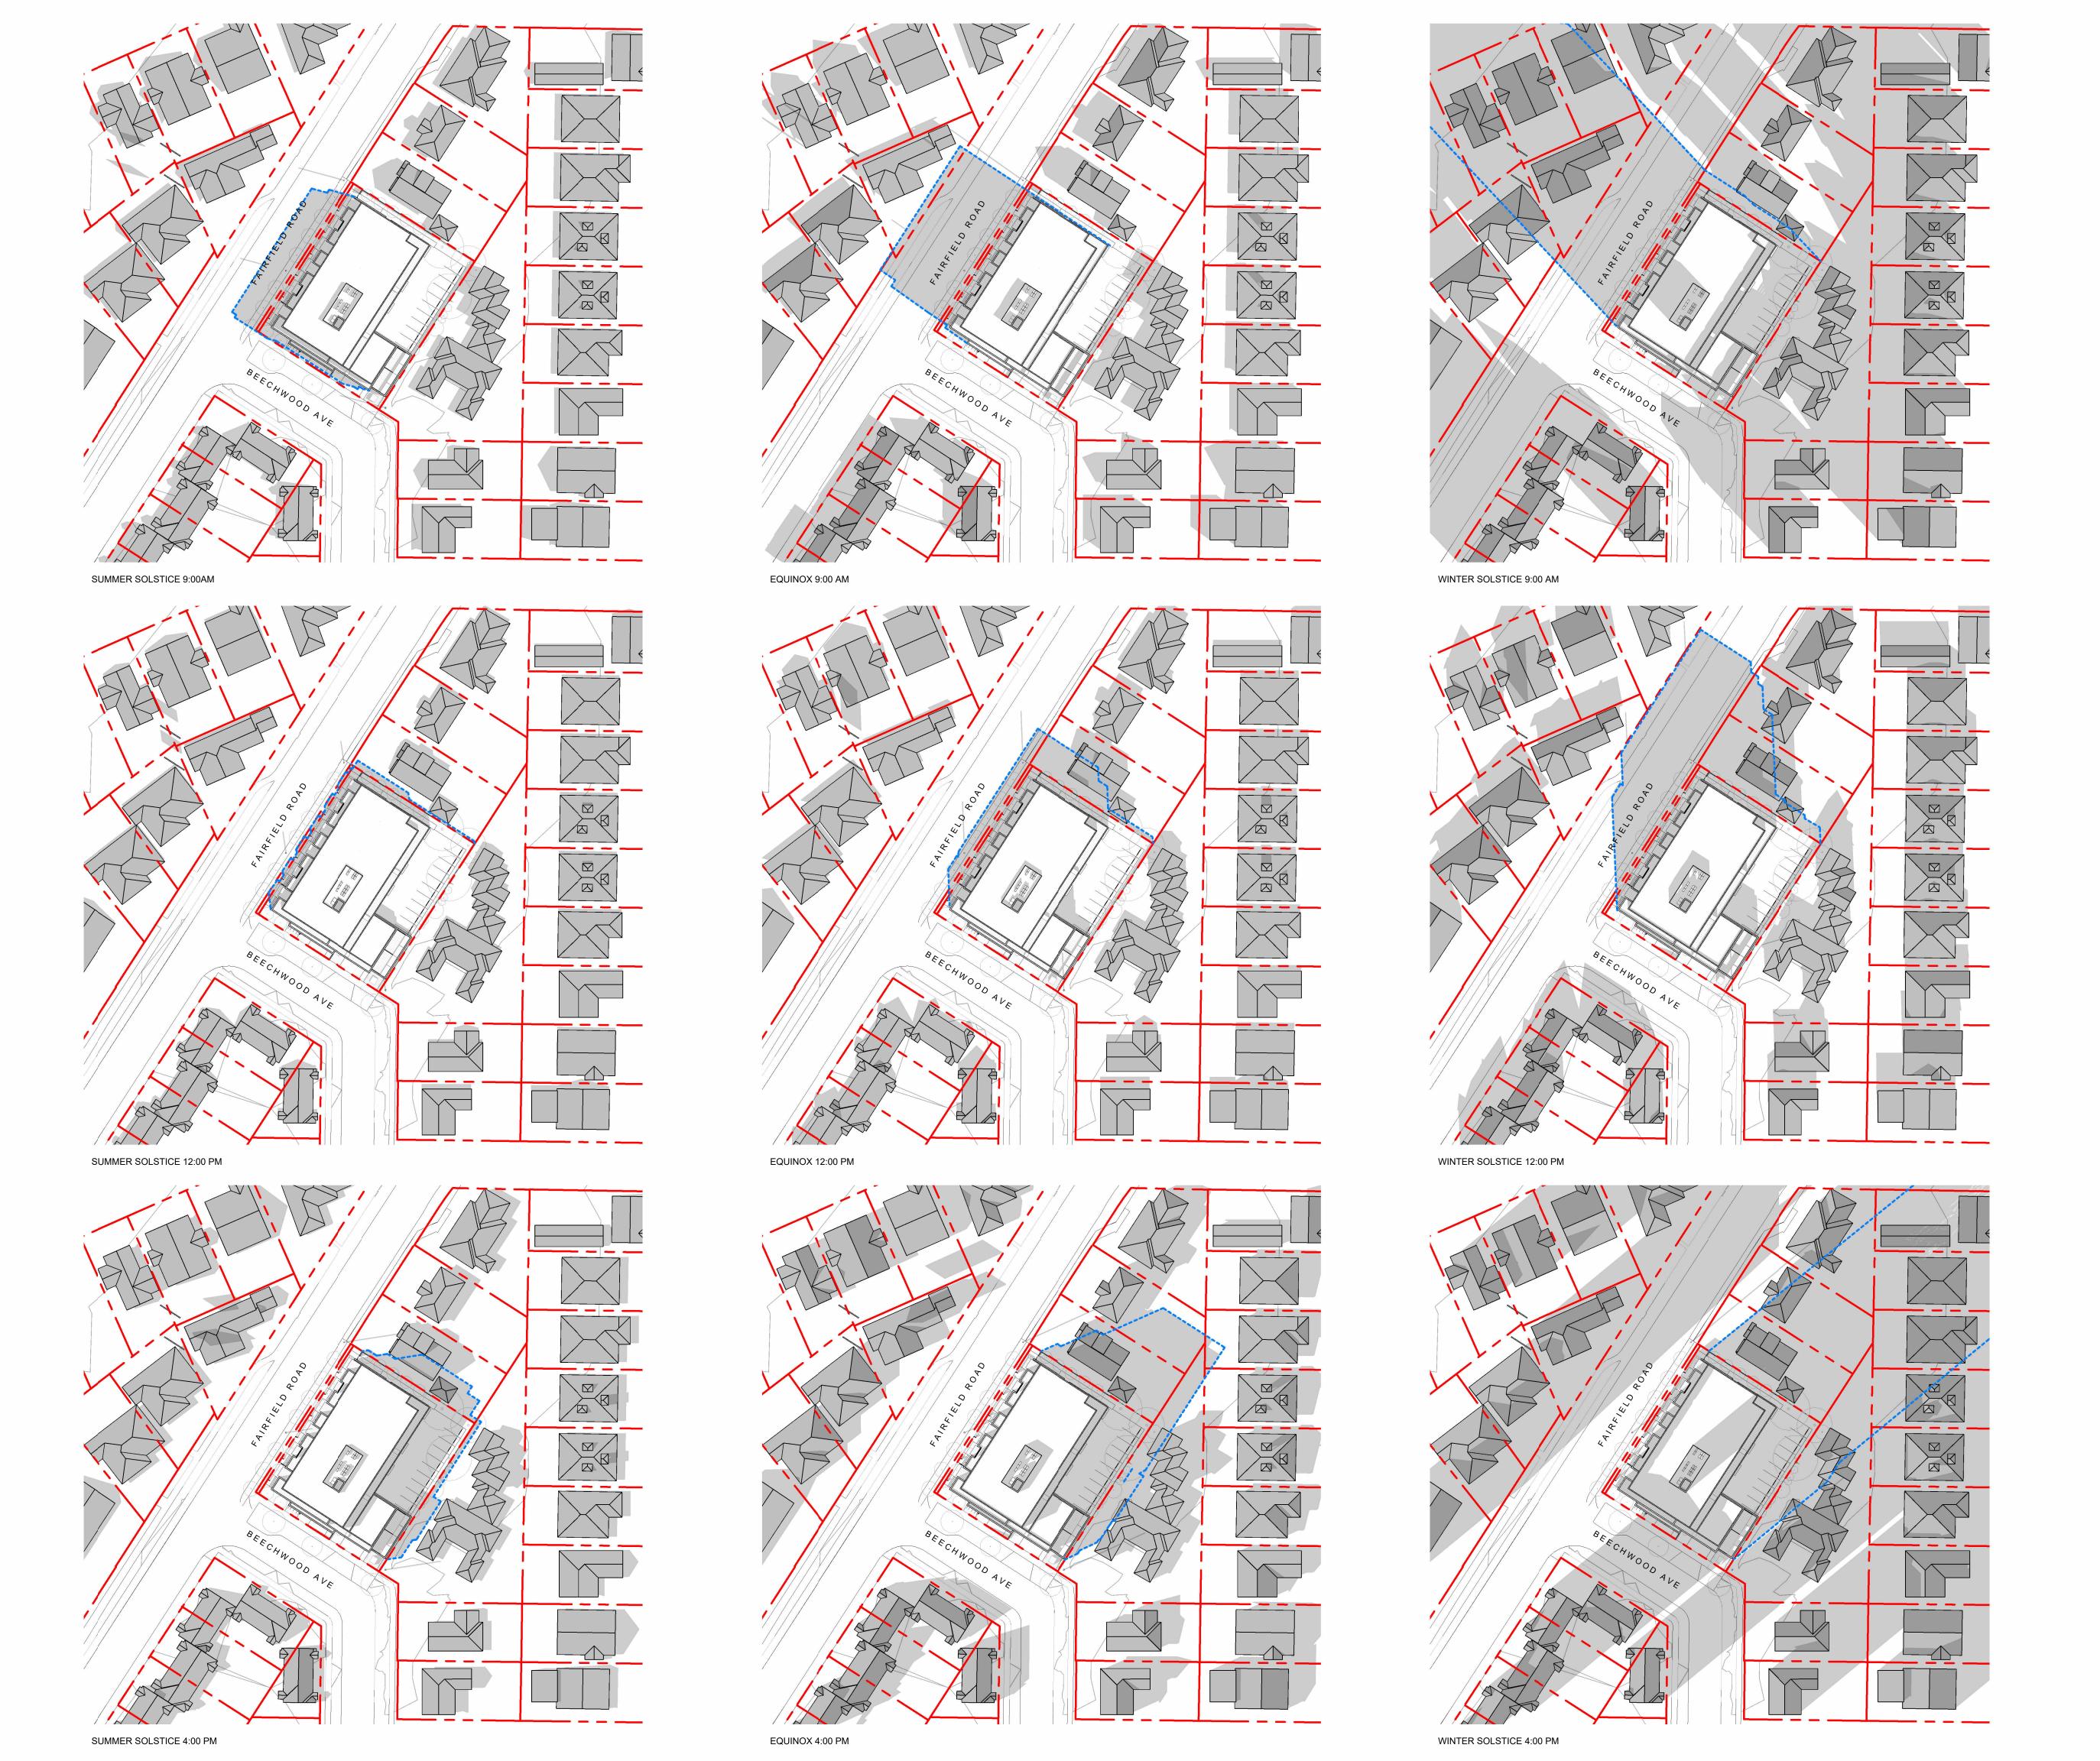


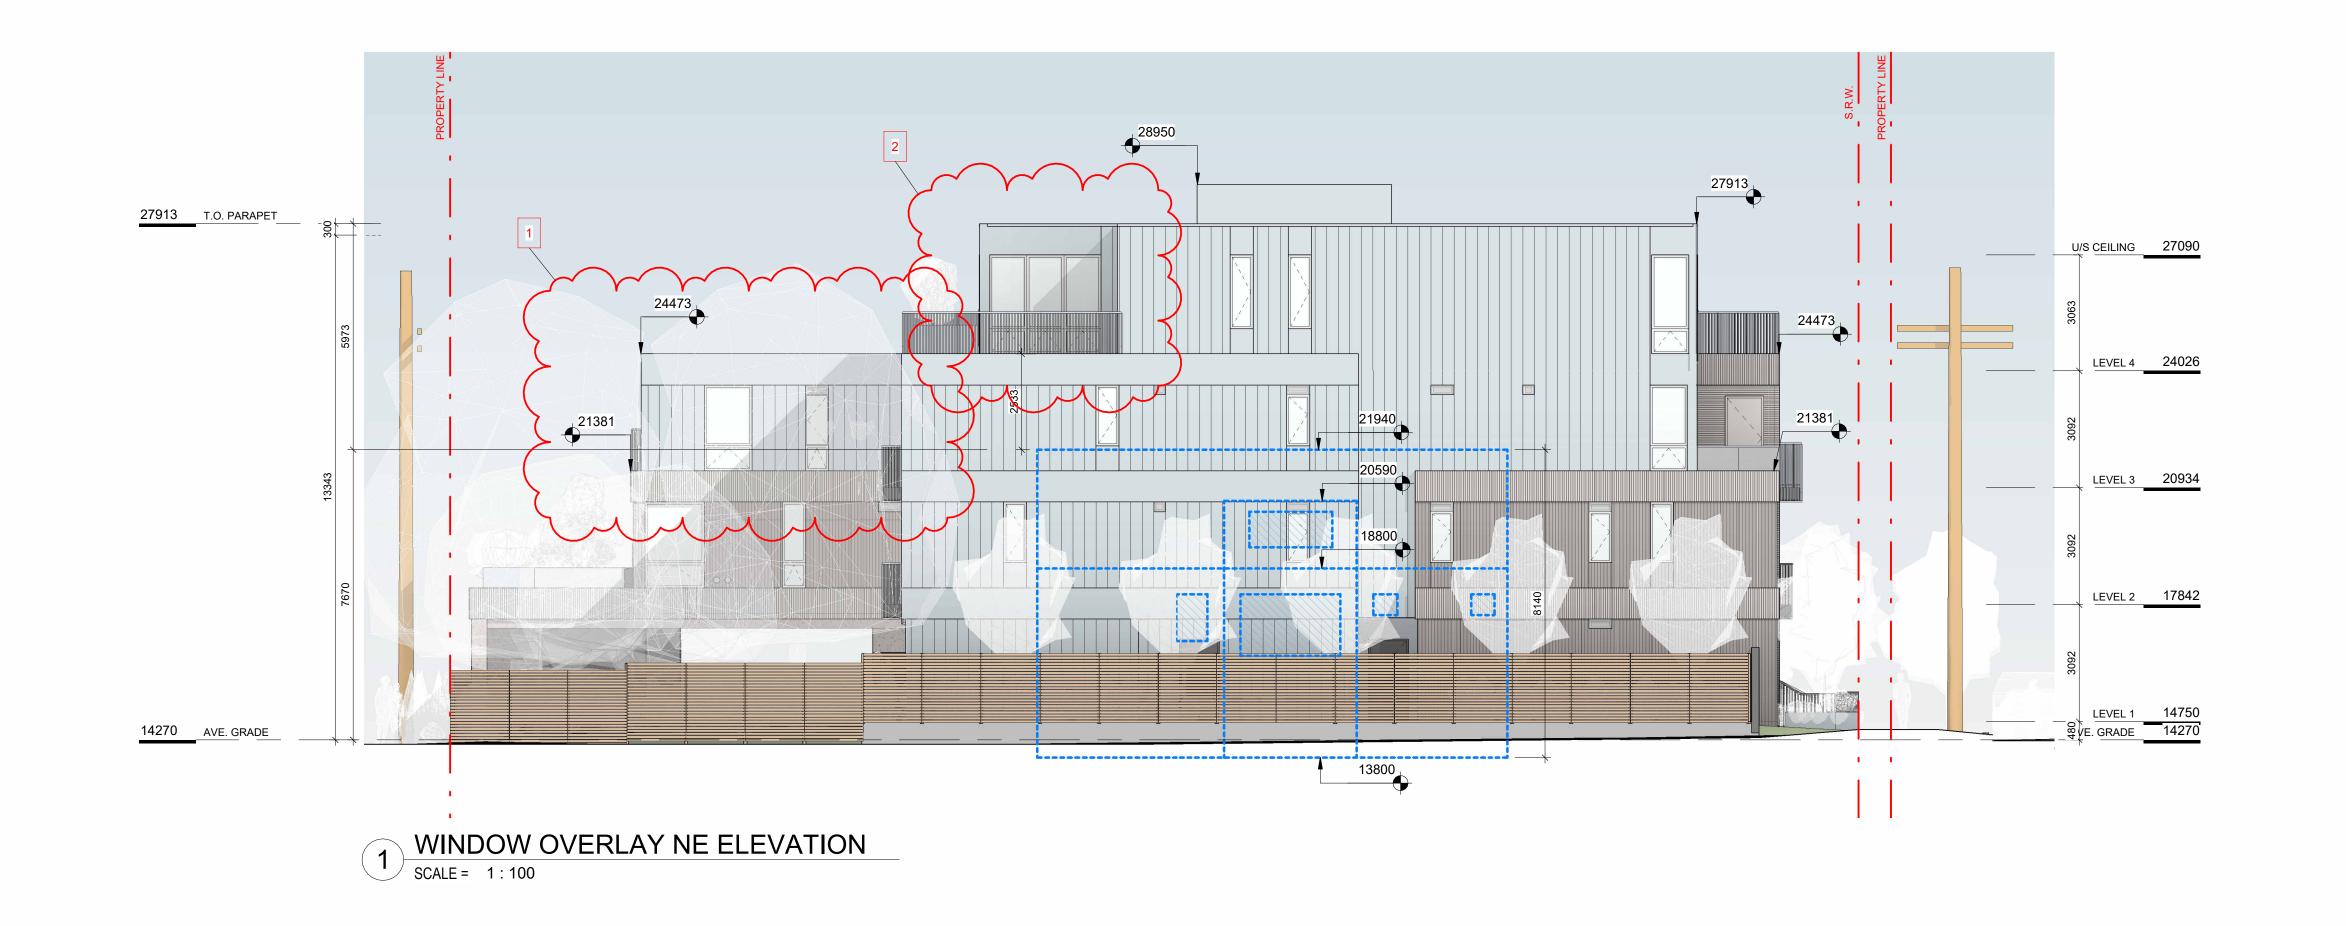


1 CONTEXT PERSPECTIVE FAIRFIELD ROAD
SCALE = 1:100


2 CONTEXT PERSPECTIVE BEECHWOOD AVE SCALE = 1:100



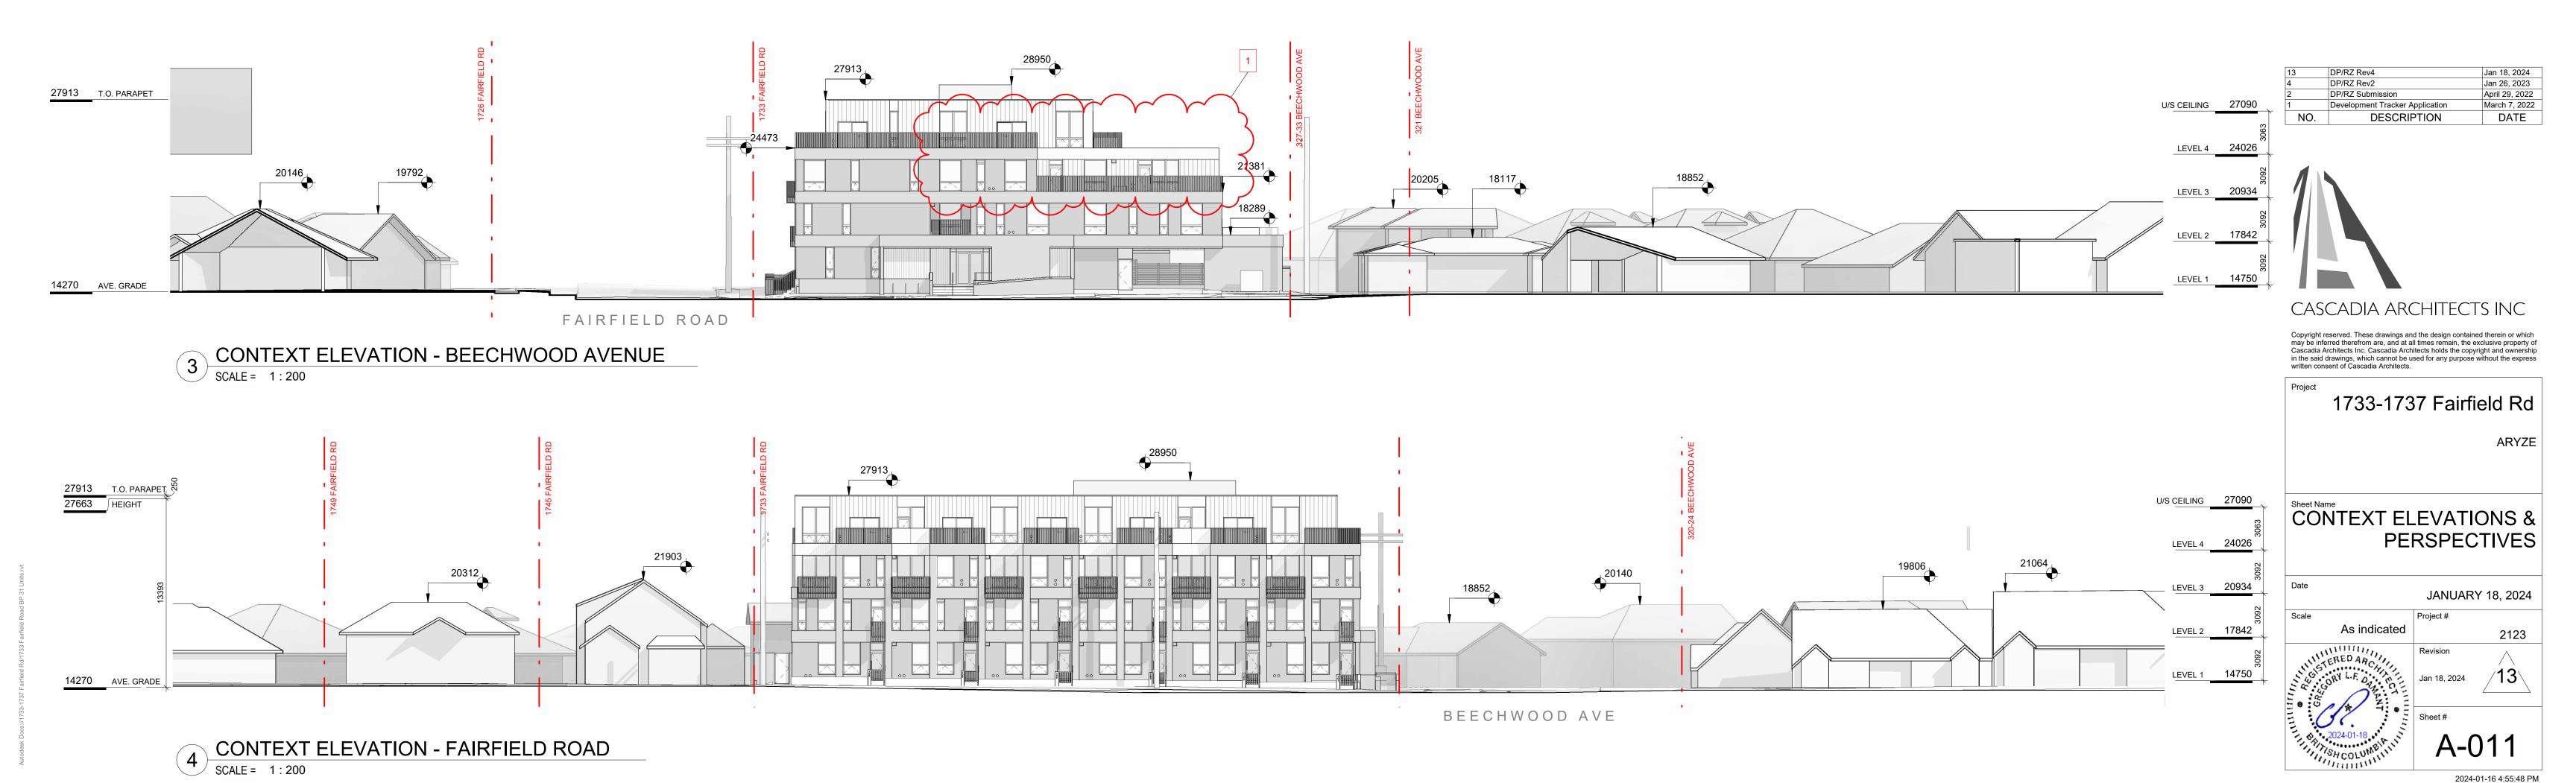

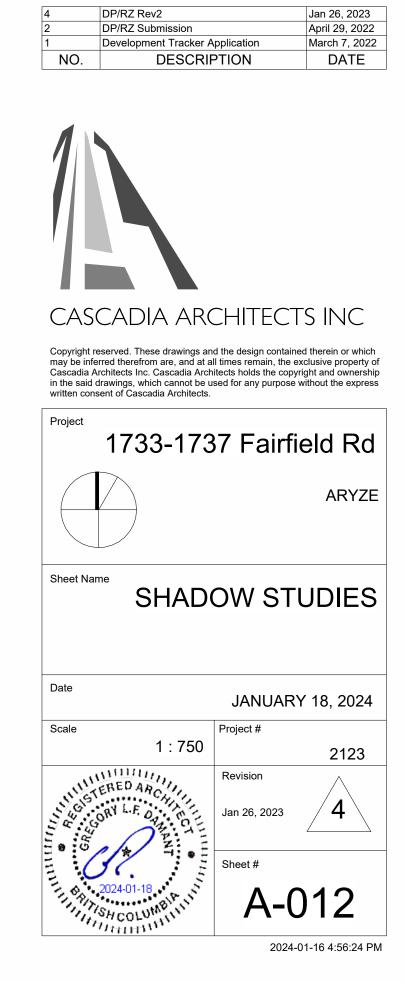

Autodesk Docs://1733-1737 Fairfield Rd/1733 Fairfield Road B

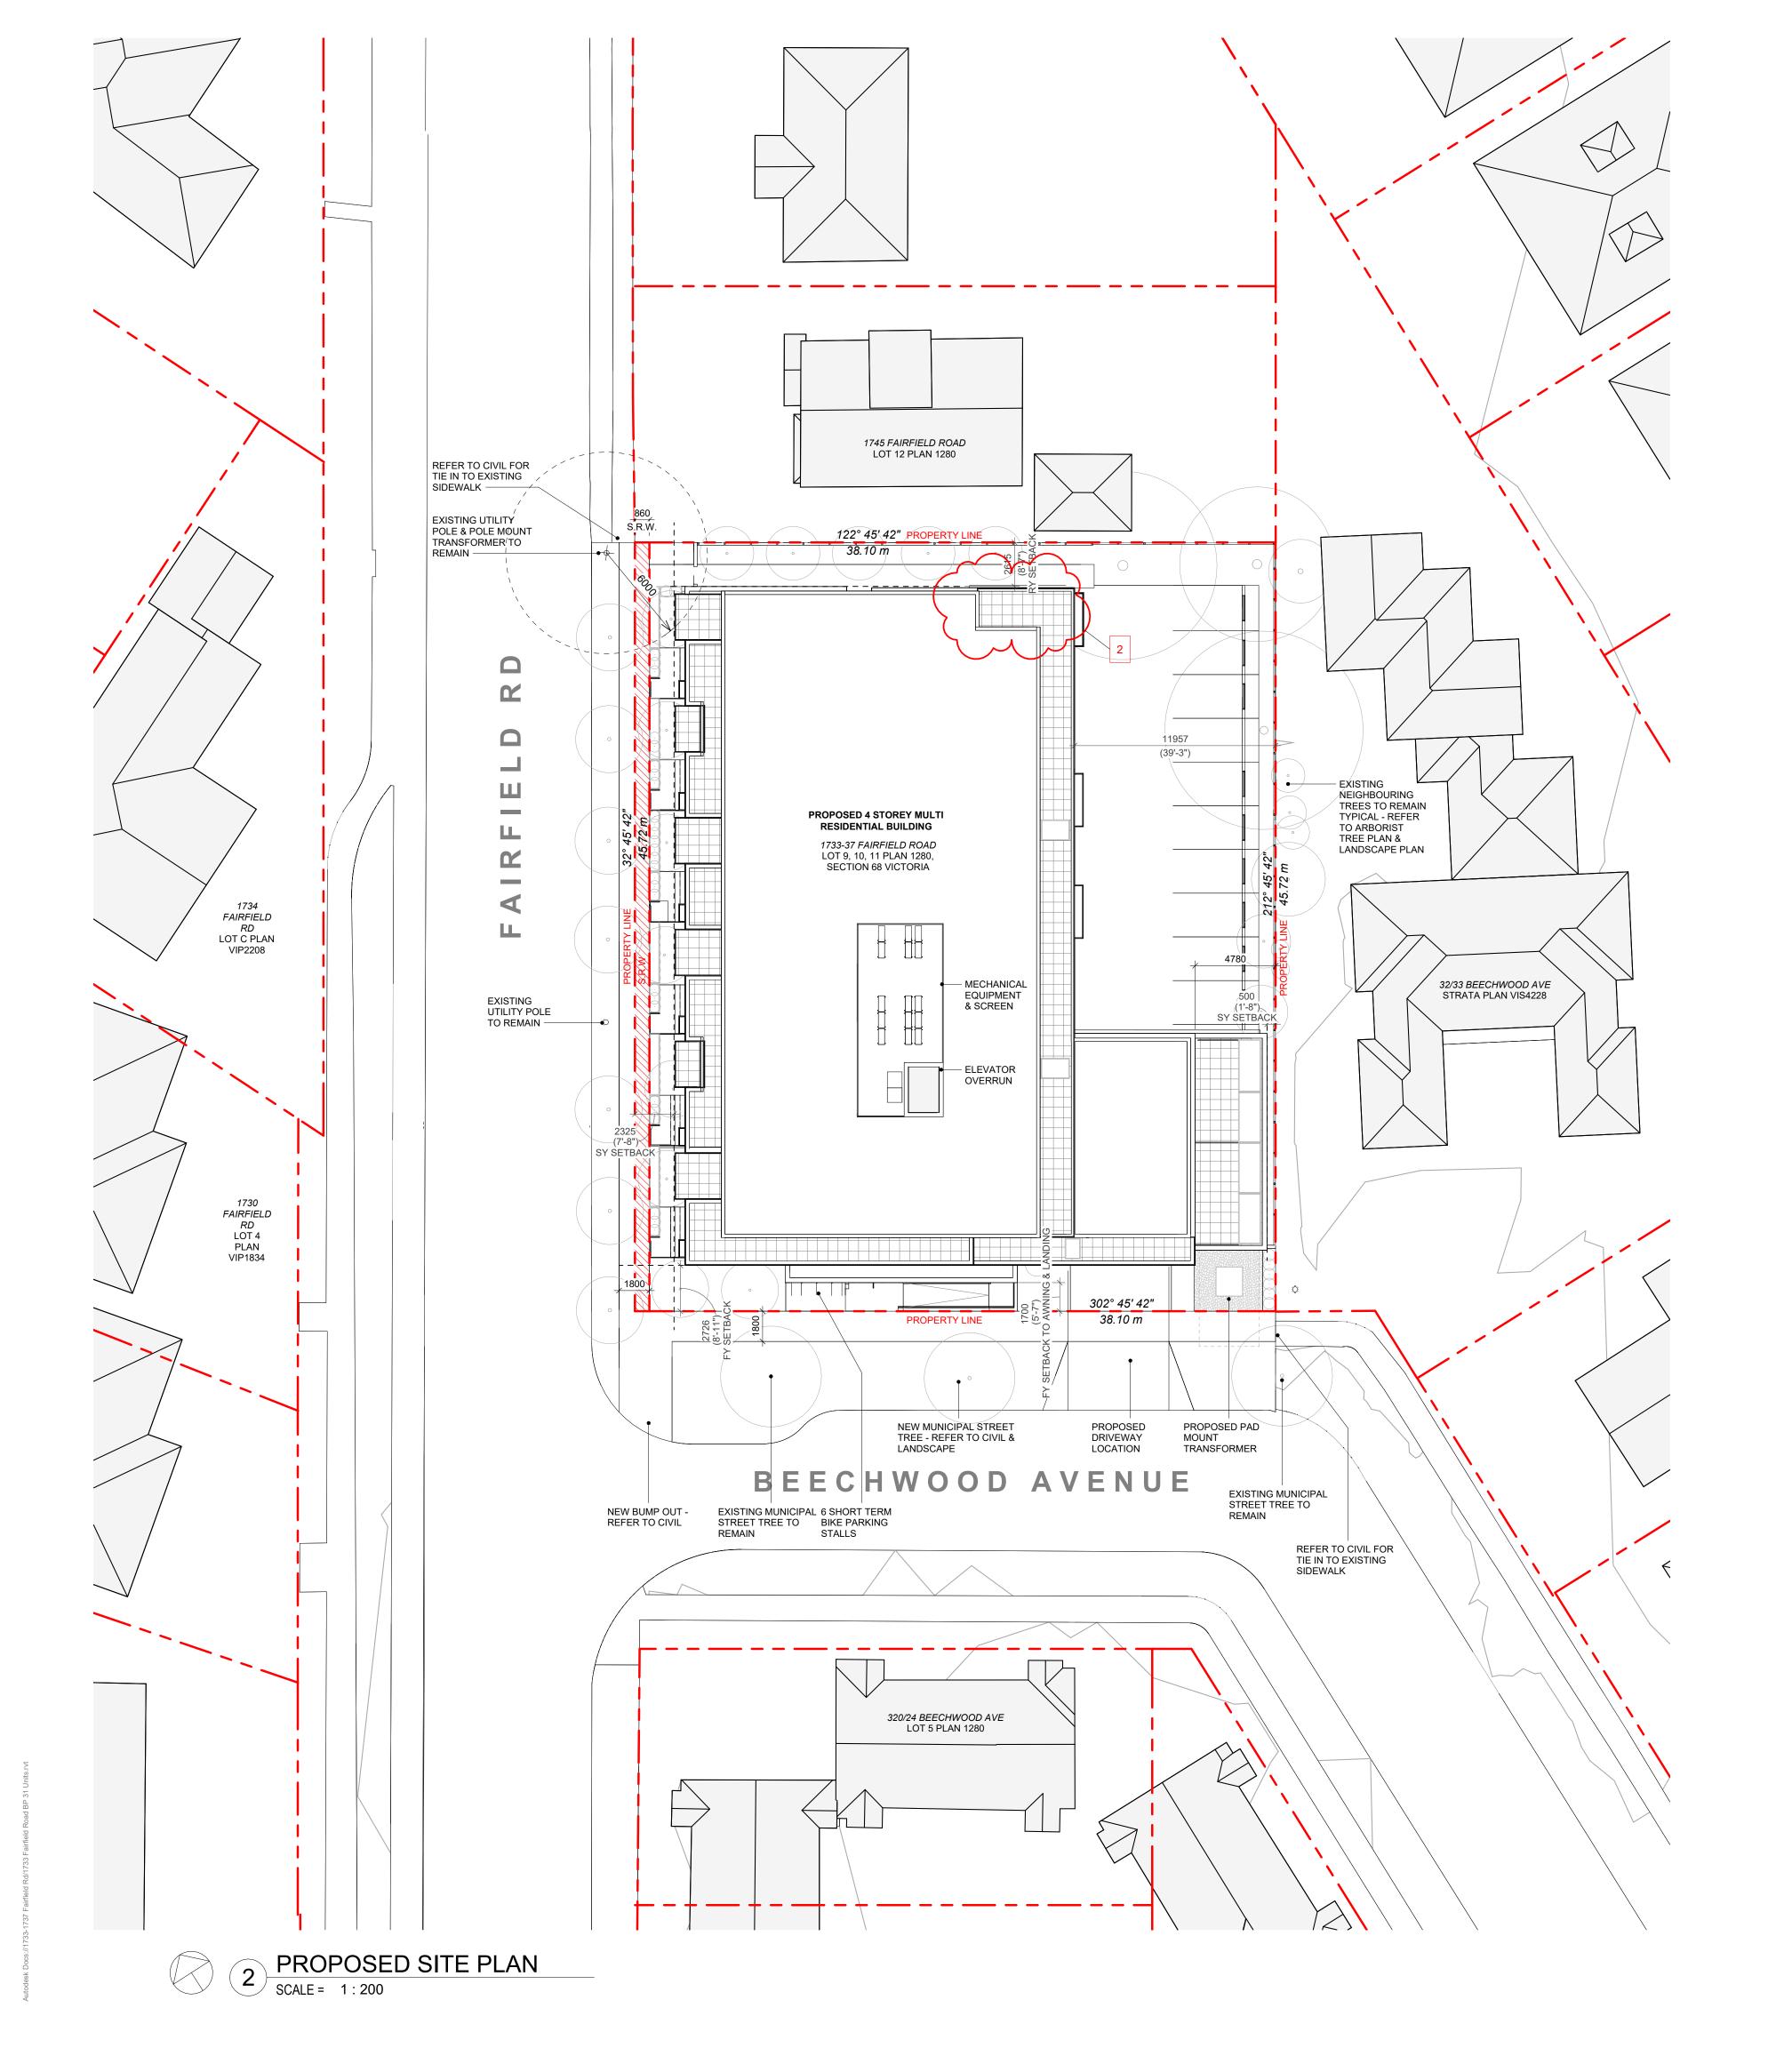

DATA

MUNICIPALITY	CITY OF VICTORIA	
MUNICIPAL ADDRESS	1733-37 FAIRFIELD ROAD, VICTORIA BC	
LEGAL DESCRIPTION	LOT 9, 10, 11, PLAN 1280, SECTION 68 VICTORIA	
PROJECT DESCRIPTION	4 STOREY MULTI UNIT RESIDENTIAL BUILDING	

PROJECT INFORMATION

ZONE (EXISTING)	R1-G
PROPOSED ZONE	UNKNOWN
SITE AREA (m²)	1,7 4 1:93m²
TOTAL FLOOR AREA (m²)	3118.36m²
COMMERCIAL FLOOR AREA (m²)	0
FLOOR SPACE RATIO	1.79:1
SITE COVERAGE (%)	1057
OPEN SITE SPACE (%)	23%
HEIGHT (m)	13.39m
NUMBER OF STOREYS	4
	REQUIRED PROVIDED
PARKING STALLS (#) TOTAL ON SITE	23 (+1sml)
PARKING STALLS - VISITOR (#) ON SITE	3 2
BICYCLE PARKING (#) SHORT TERM	6
BICYCLE PARKING (#) LONG TERM	37 51
	\

BUILDING SETBACKS (m)		7_	
	PROPOSED]
FRONT YARD (BEECHWOOD AVE)	2.73m		
FRONT YARD (TO AWNING/LANDING)	1.70m		
INTERNAL SIDE YARD (TO BALCONY)	0.50m		
INTERNAL SIDE YARD (TO BUILDING FACE)	4.78m		
SIDE YARD (FAIRFIELD RD)	2.33m		
REAR YARD	2.62m		
COMBINED SIDE YARDS	2.83m		

RESIDENTIAL USE DETAILS	
TOTAL NUMBER OF UNITS	29
UNIT TYPE	TOWNHOMES (6), 1 BEDS (10),2 BEDS (13),
GROUND-ORIENTATED UNITS	
MINIMUM UNIT FLOOR AREA (m²)	51m ²

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1733-1737 Fairfield Rd

755-1757 1 4111

SITE PLAN & PROJECT DATA

Scale JANUARY 18, 2024

Scale Project #


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Jan 18, 2024 /13

Sheet #

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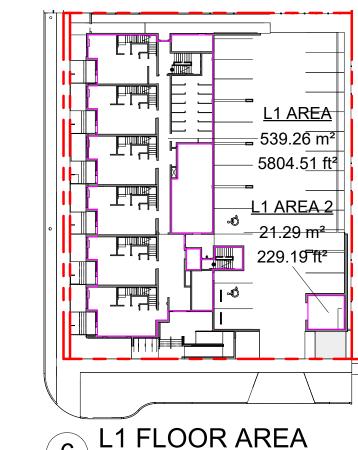
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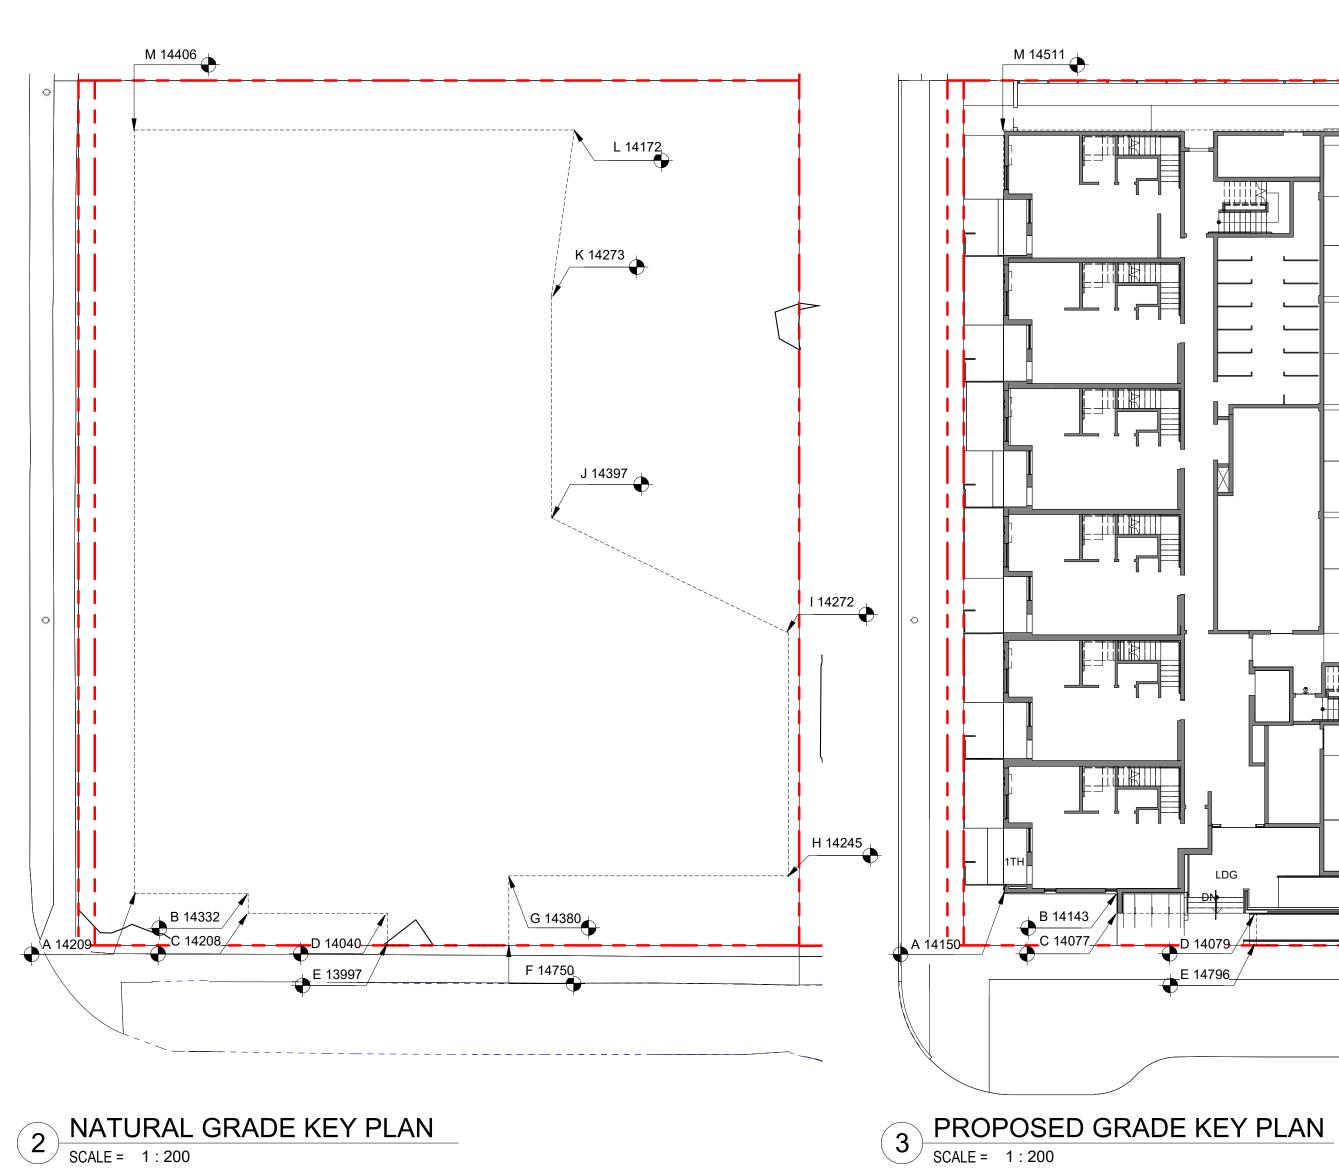
1 DISTANCE BTWN POINTS KEY PLAN SCALE = 1:200

POINT NAME	NATURAL	PROPOSED	DISTANCE BI	etween points	AVE. OF POINTS
Α	14.209	14.42	Point A & B	6.008	85.20
В	14.332	14.15	Point B & C	1.026	14.50
С	14.208	14.12	Point C & D	7.381	103.92
D	14.04	14.11	Point D & E	1.7	23.83
Ε	13.997	14.10	Point E & F	6.4	89.96
F	14.75	14.11	Point F & G	3.63	51.72
G	14.38	14.44	Point G & H	13.35	191.33
Н	14.346	14.28	Point H & I	12.88	183.90
1	14.273	14.41	Point I & J	12.663	181.52
J	14.397	14.69	Point J & K	11.7	167.72
K	14.273	14.64	Point K & L	8.887	126.40
L	14.172	14.62	Point L & M	23.256	332.30
M	14.406	14.64	Point M & N	40.38	577.74


2130.03 **Total** 149.26 **Average Grade** 14.27 *NOTE: Lowest grade point governs per Schedule A definition

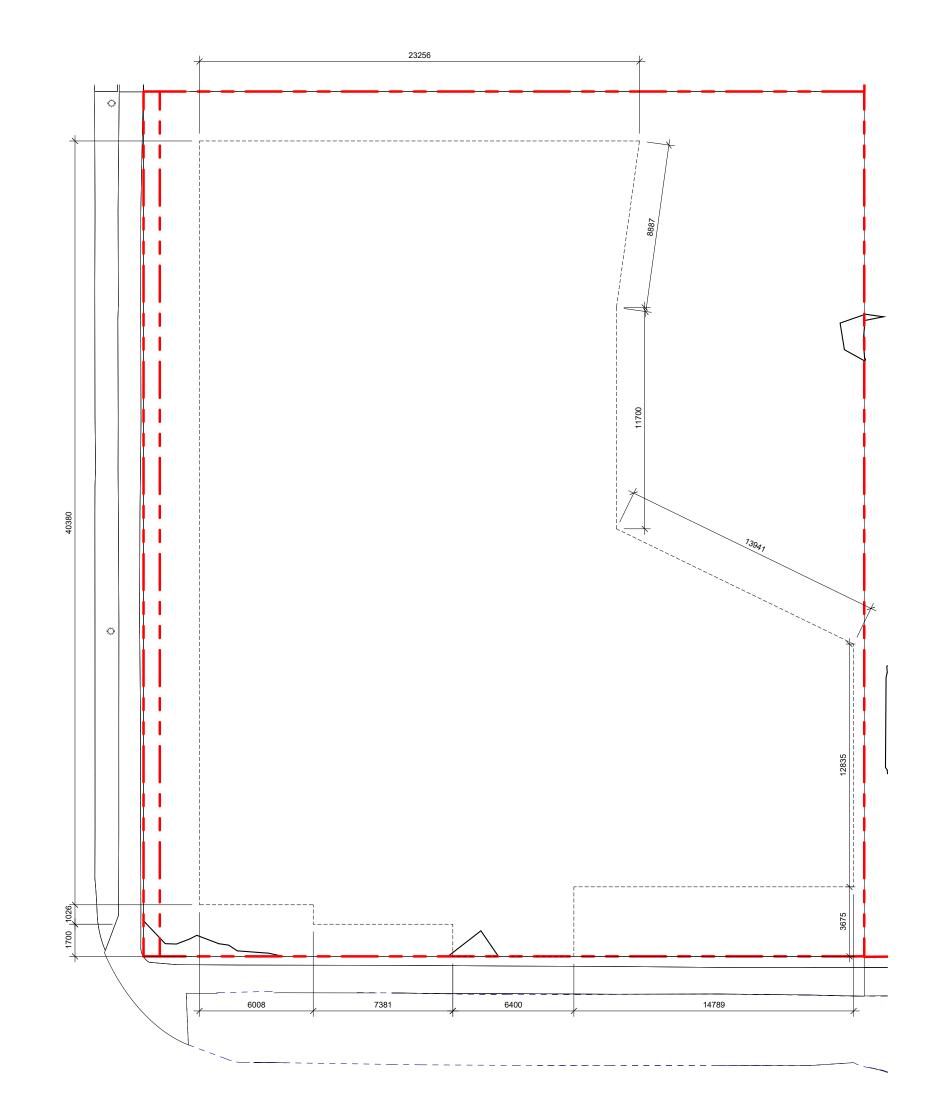


6 L1 FLOOR AREA SCALE = 1:500




2 NATURAL GRADE KEY PLAN
SCALE = 1:200

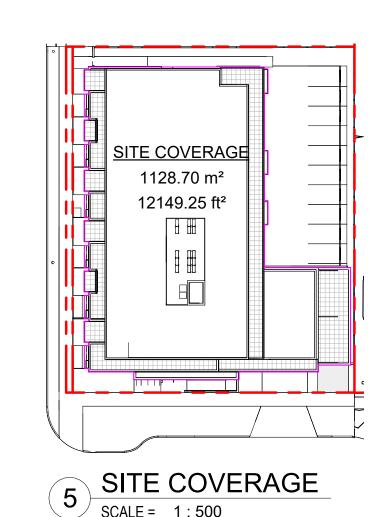


OPEN SITE SPACE SCALE = 1:500

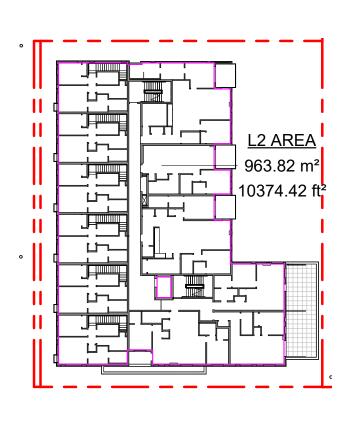


7 L2 FLOOR AREA SCALE = 1:500

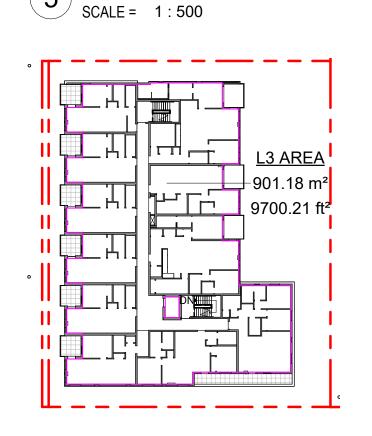

8 L3 FLOOR AREA SCALE = 1:500

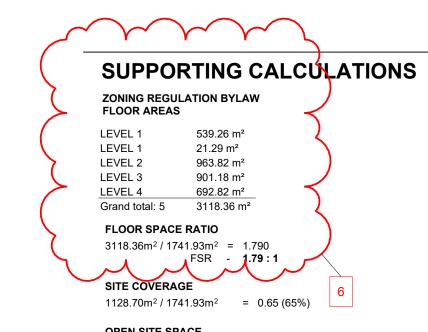

 $395.01m^2 / 1741.93m^2 = 0.23 (23\%)$

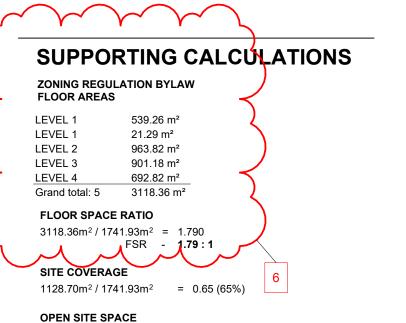

HEIGHT OF PATIOS, STAIRS, & RAMP TO

1TH PATIO (WORST CASE GRADING ALONG FAIRFIELD RD - THEREFORE ALL <600mm)

14750 - 14200*(PROPOSED)* = 550mm 14750 - 14171*(EXISTING)* = 579mm

LDG (LANDING AT PRIMARY ENTRANCE)

14750 - 14114*(PROPOSED)* = 636mm 14750 - 14040 *(EXISTING)* = 710mm

RMP (INTERMEDIARY RAMP LANDING)

14507 - 14114*(PROPOSED)* = 393mm 14507 - 14280 *(EXISTING)* = 227mm

EXISTING & PROPOSED GRADE REFER TO GRADE KEY PLANS

-692.82 m² 7457.42 ft²

9 L4 FLOOR AREA

F-	3 2	DP/RZ Rev1 DP/RZ Submission	July 20, 2022 April 29, 2022
-	1	Development Tracker Application	March 7, 2022
	NO.	DESCRIPTION	DATE

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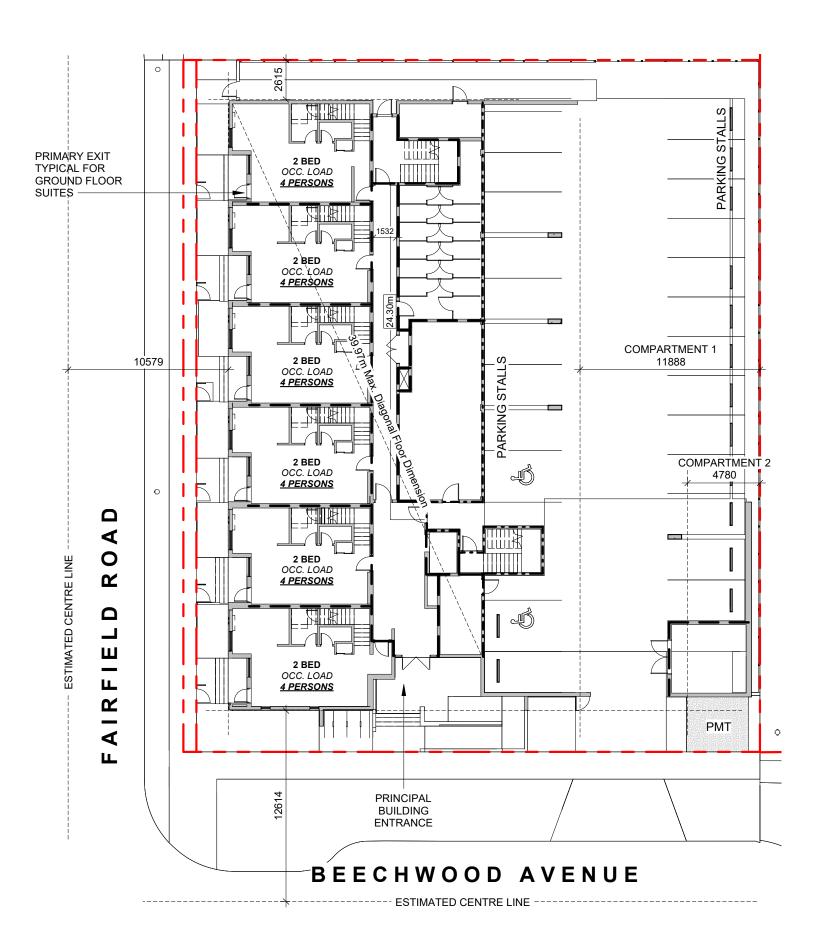
written consent of Cascadia Architects. 1733-1737 Fairfield Rd

ZONING CALCULATIONS

JANUARY 18, 2024 As indicated 2123 Jan 18, 2024

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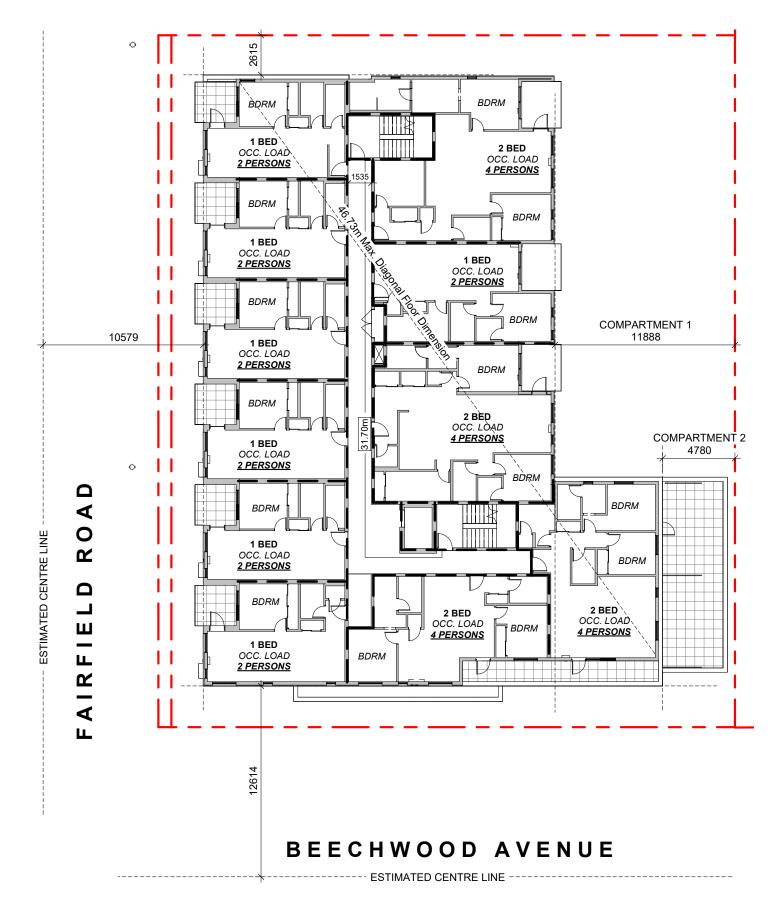
OCCUPANT LOAD: Occupancy: Group C
12 Bedrooms x 2 persons/bedroom

= 24 persons

MINIMUM EXIT WIDTH:

Ramps, Corridors, Passageways
the greater of 6.1mm x 24 = 146.4mm
or 1100mm (minimum 1500mm for or 1100mm accessible path of travel)

1 L1 CODE REVIEW KEY PLAN
SCALE = 1:250




OCCUPANT LOAD: Occupancy: Group C 15 Bedrooms x 2 persons/bedroom = 30 persons

MINIMUM EXIT WIDTH:

Ramps, Corridors, Passageways
the greater of 6.1mm x 30 = 183mm
the greater of 8mm x 30 = 240mm or 1100mm (minimum 1500mm for or 1100mm accessible path of travel)

3 L3 CODE REVIEW KEY PLAN
SCALE = 1:250

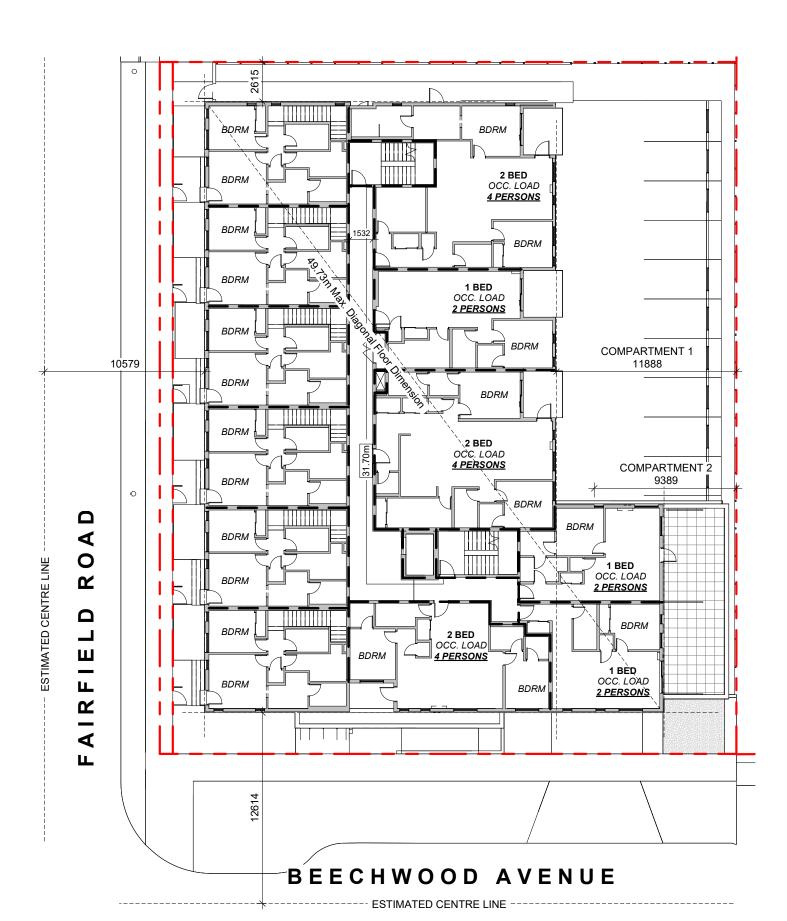

OCCUPANT LOAD: Occupancy: Group C 9 Bedrooms x 2 persons/bedroom


= 18 persons

MINIMUM EXIT WIDTH:

accessible path of travel)

Ramps, Corridors, Passageways
the greater of 6.1mm x 18 = 109.8mm
the greater of 8mm x 18 = 144.0mm or 1100mm (minimum 1500mm for or 1100mm

L2 CODE REVIEW KEY PLAN

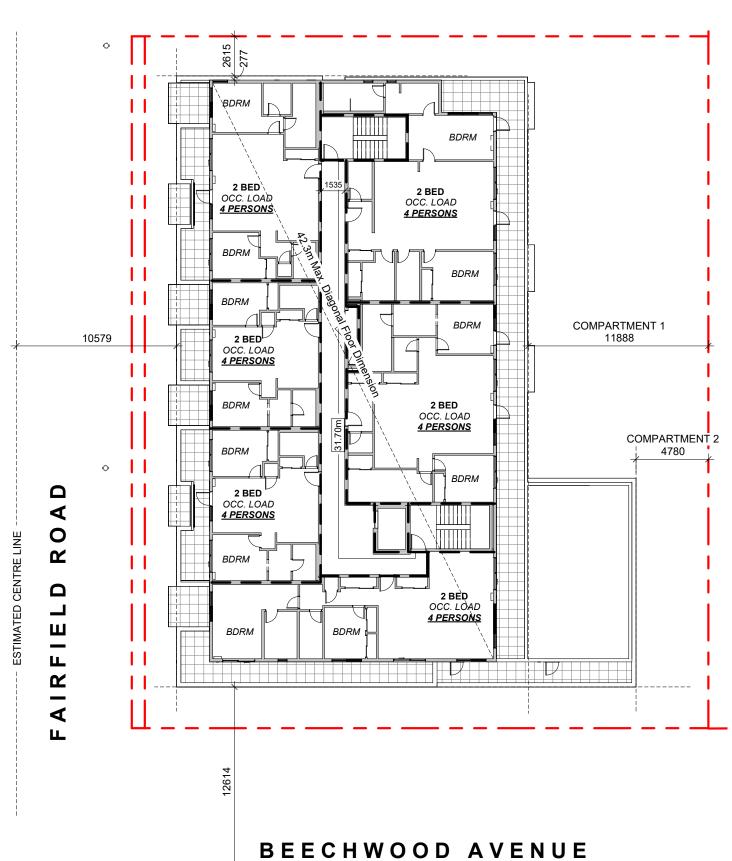

- ESTIMATED CENTRE LINE -

OCCUPANT LOAD: MINIMUM EXIT WIDTH: Occupancy: Group C 12 Bedrooms x 2 persons/bedroom

Ramps, Corridors, Passageways
the greater of 6.1mm x 24 = 146.4mm
the greater of 8mm x 24 = 184mm or 1100mm (minimum 1500mm for accessible path of travel)

L4 CODE REVIEW KEY PLAN SCALE = 1:250

BUILDING CODE ANALYSIS

PROJECT TYPE	NEW CONSTRUCTION RENOVATION ADDITION	N
GOVERNING BUILDING CODE	2018 BC BUILDING CODE	
MAJOR OCCUPANCY	A1 A2 A3 A4 B1 B2 B3 C D E F1 F2 F3	3.1.2.1
BUILDING AREA	1116 m² (approx)	1.4.1.2
GRADE	18.75 m geodetic	1.4.1.2
BUILDING HEIGHT (STOREYS)	4 STOREYS ABOVE GRADE 0 STOREYS BELOW GRADE	1.4.1.2

BUILDING FIRE SAFETY & CONSTRUCTION CLASSIFICATION

CLASSIFICATION	GROUP C, UP TO 4 STOREYS, SPRINKLERED	3.2.2.51
MAXIMUM BUILDING AREA	1800 m ²	3.2.2.51
No. OF STREETS FACING	1 (BEECHWOOD AVE UNDER 9M MINIMUM STREET WIDTH)	3.2.2.10
CONSTRUCTION TYPES PERMITTED	✓ COMBUSTIBLE NON-COMBUSTIBLE	3.2.2.51
FIRE ALARM SYSTEM	YES NO	3.2.4.1
STANDPIPE SYSTEM	YES NO	3.2.5.8
HIGH BUILDING	YES NO	3.2.6.1
INTERCONNECTED FLOOR SPACE	YES NO EXCEPT WITHIN AT GRADE RESIDENTIAL UNITS	3.2.8


FIRE RESISTANCE RATINGS

HORIZONTAL SEPARATIONS	1 hr FLOORS 1 hr MEZZANINE Unrated ROOF	3.2.2.51
LOADBEARING WALLS, COLUMNS & ARCHES	1 hr (NOT LESS THAN THAT REQUIRED FOR SUPPORTED STRUCTURE)	3.2.2.51
EXITS	1 hr	3.4.4.1


EXITS FROM FLOOR AREAS

NUMBER OF EXITS REQUIRED	2	3.4.2.1
SEPARATION OF EXITS (MIN.)	1/2 MAX. DIAGONAL FLOOR AREA, BUT NEED NOT BE > 9 m	3.4.2.3
MAX. TRAVEL DISTANCE ALLOWED	m, GROUP C	3.4.2.5
MEZZANINE	YES NO	3.2.8

FIRE RESISTANCE RATING - KEY - - - - - - UNRATED FIRE SEPERATIONS 1.5 HOUR _----2 HOUR

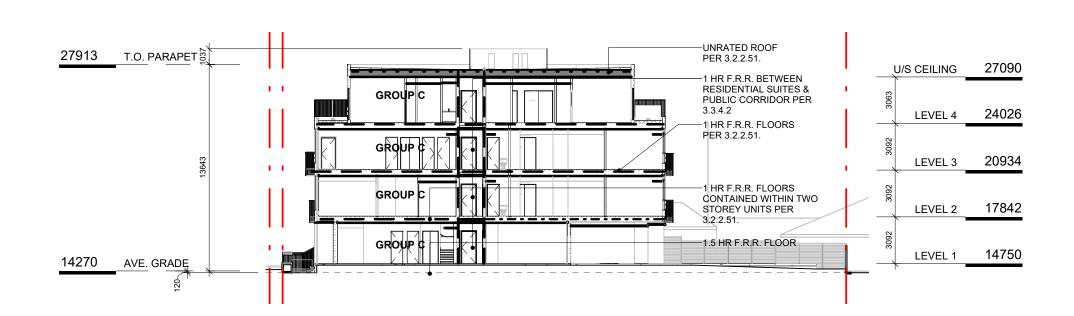

5 CODE REVIEW KEY SECTION
SCALE = 1:250

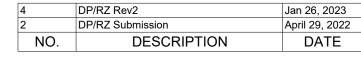



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CODE REVIEW

JANUARY 18, 2024

As indicated


2123 Jan 26, 2023

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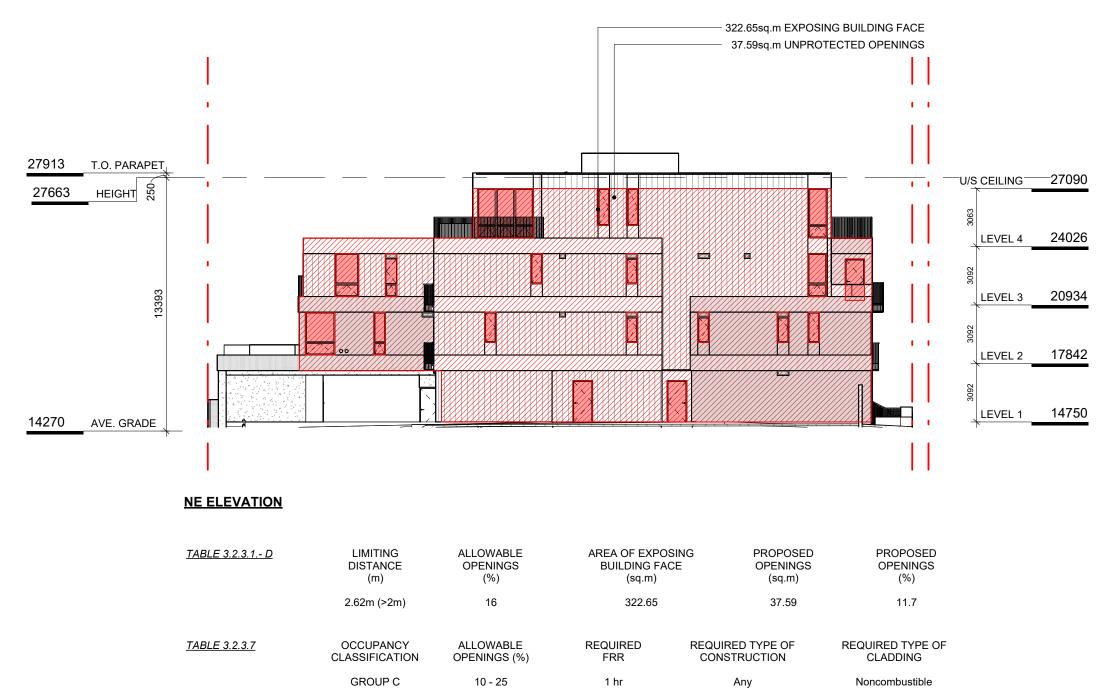


NW ELEVATION - LD KEY SCALE = 1:200




SE ELEVATION - LD KEY SCALE = 1:200

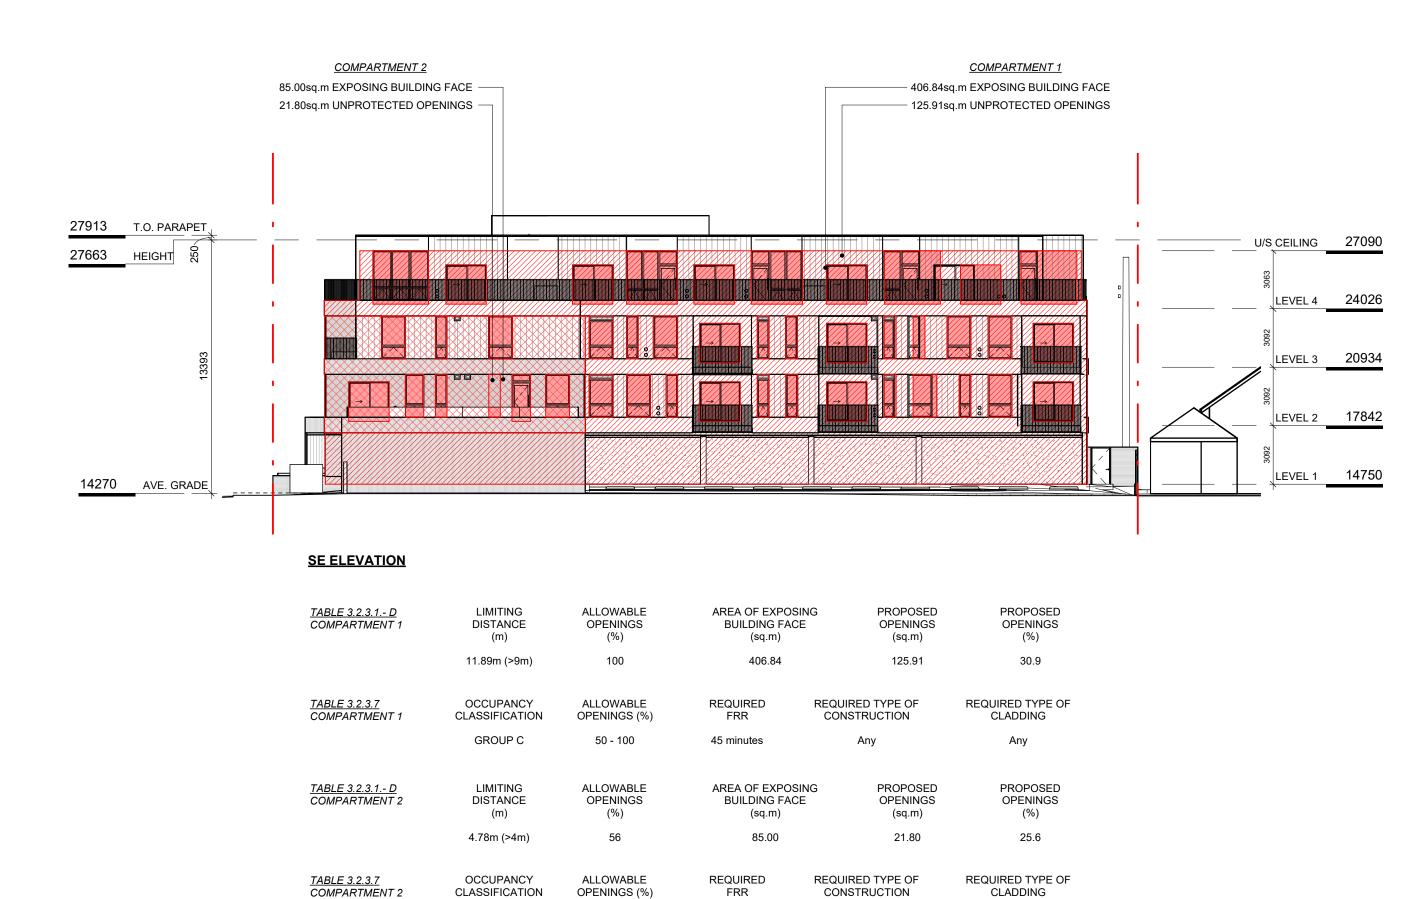GROUP C



2 NE ELEVATION - LD KEY SCALE = 1:200

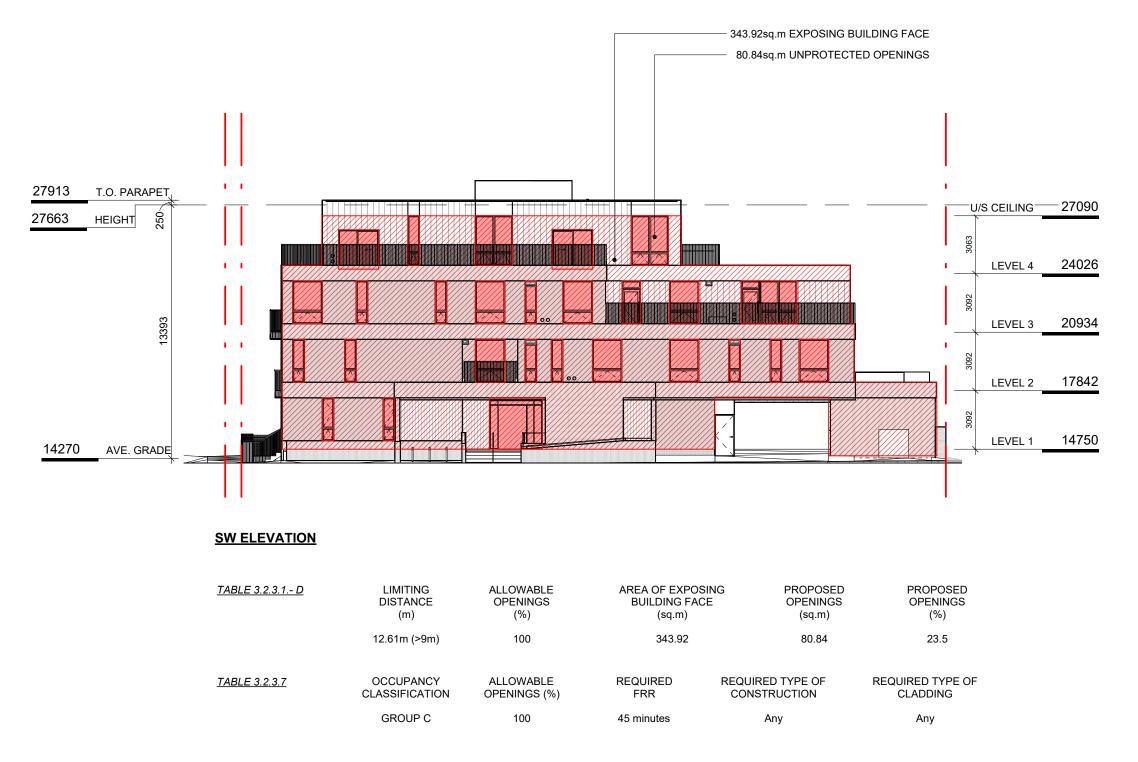

3 SW ELEVATION - LD KEY



DP/RZ Rev2 DP/RZ Rev1


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DP/RZ Submission

DESCRIPTION

Aug 10, 2023 Jan 26, 2023 July 20, 2022 April 29, 2022 DATE





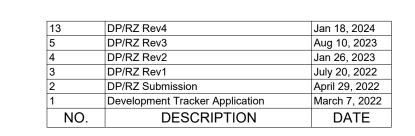

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LEVEL 1 PROPOSED PLAN

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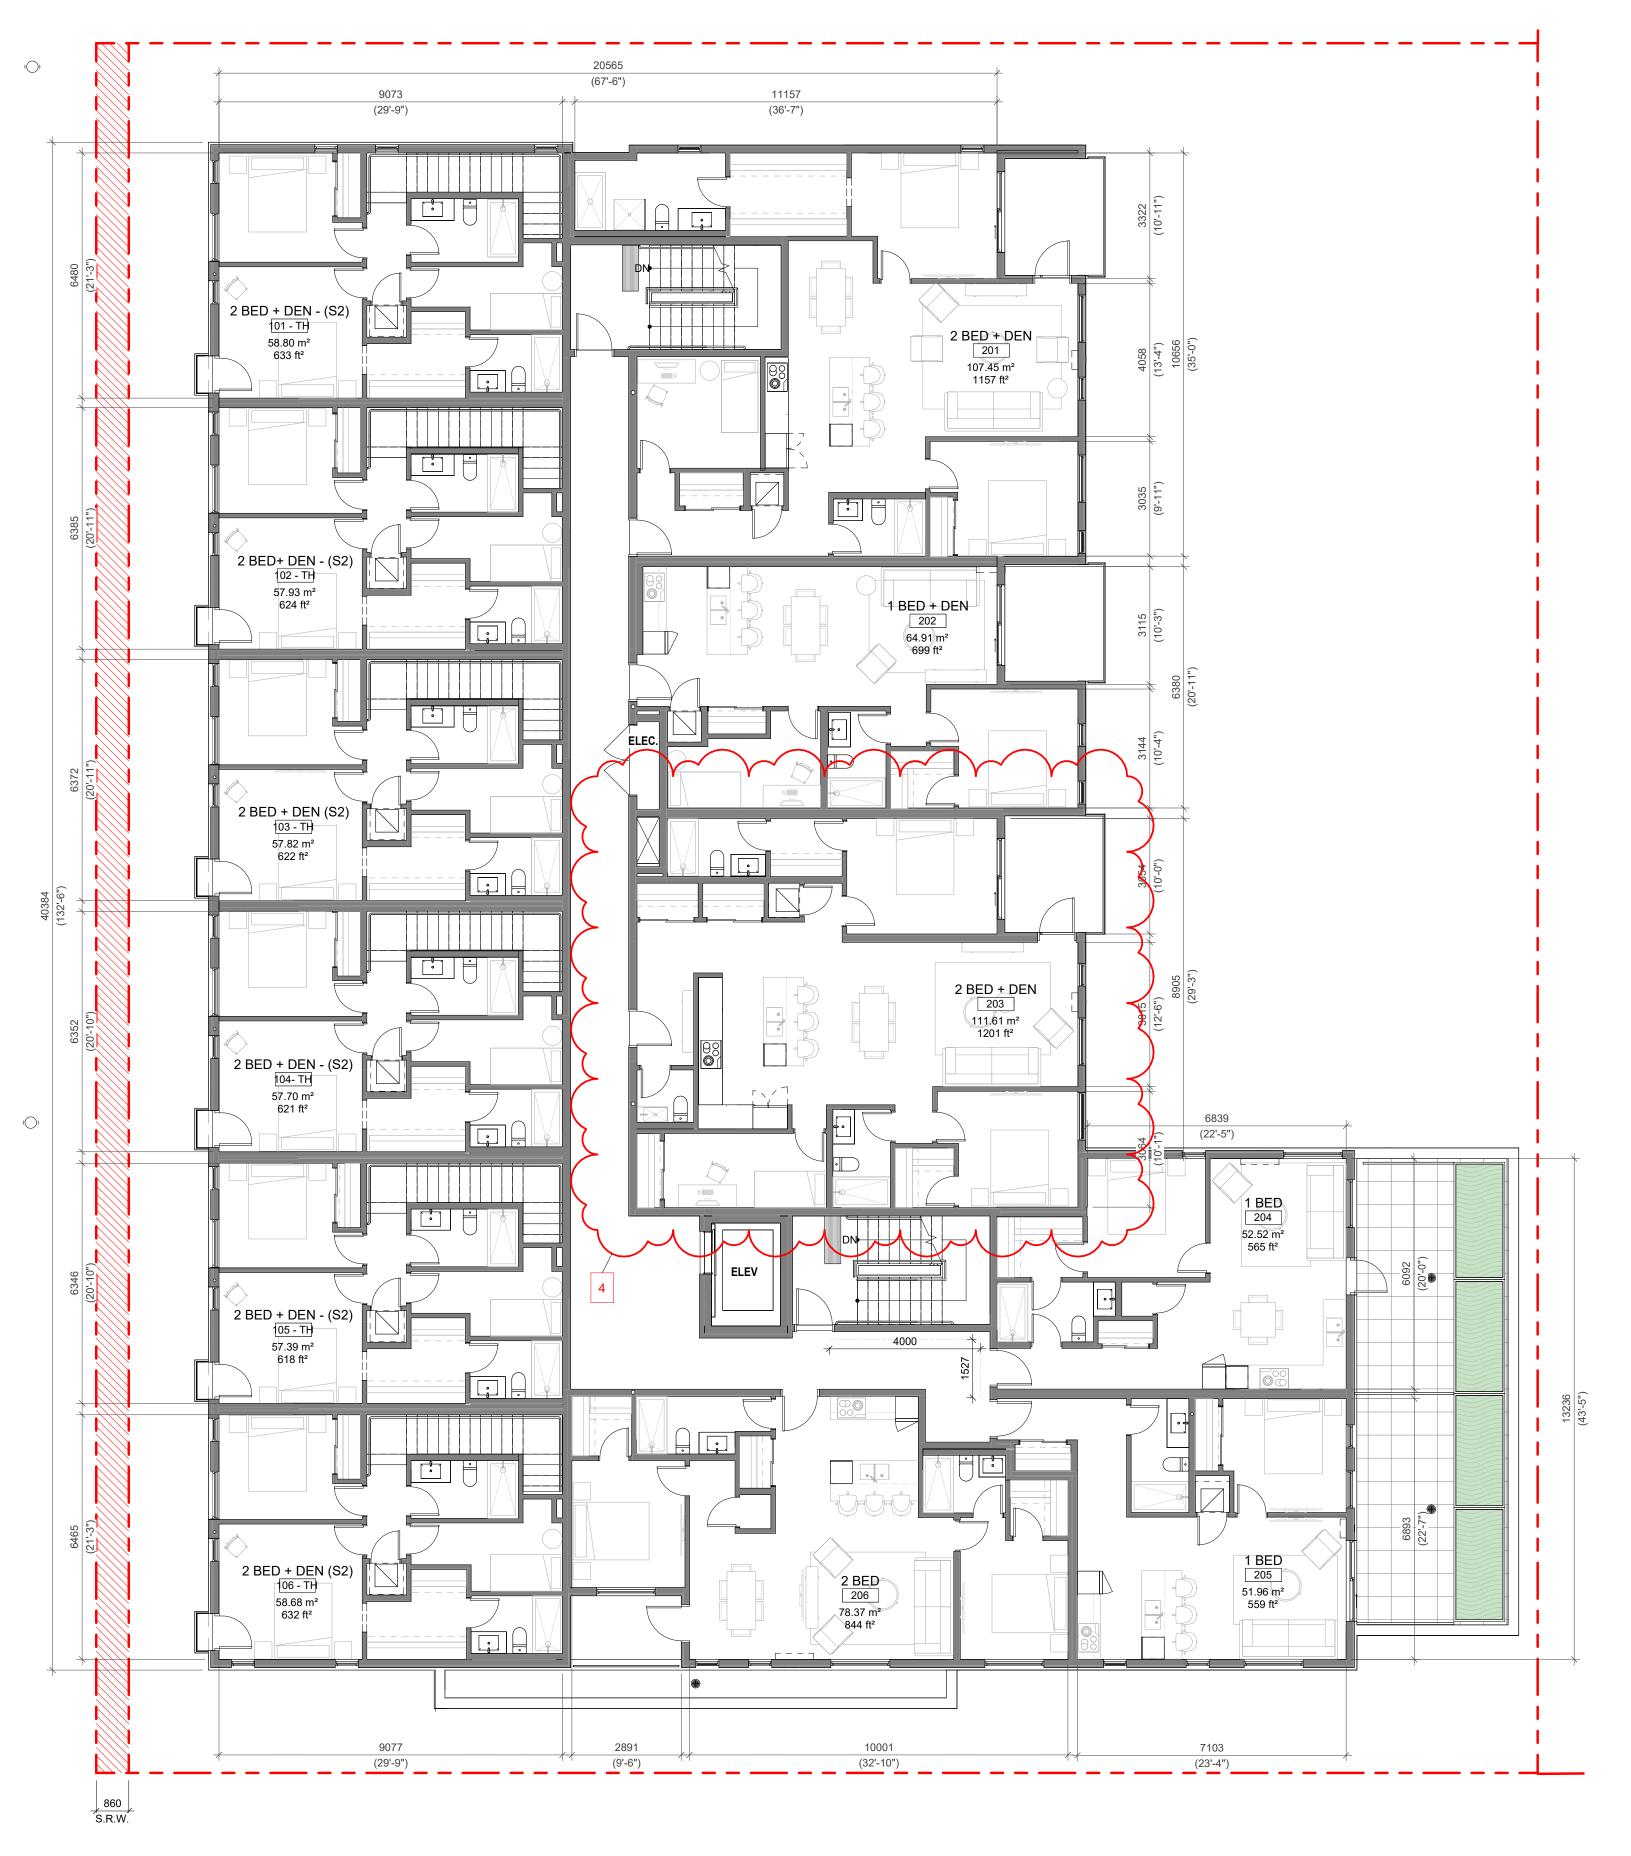
Revision

Jan 18, 2024

13

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1 L2 PROPOSED PLAN
SCALE = 1:100



NO.	DESCRIPTION	DATE
1	Development Tracker Application	March 7, 2022
2	DP/RZ Submission	April 29, 2022
3	DP/RZ Rev1	July 20, 2022
4	DP/RZ Rev2	Jan 26, 2023
5	DP/RZ Rev3	Aug 10, 2023
13	DP/RZ Rev4	Jan 18, 2024



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1733-1737 Fairfield Rd

LEVEL 2 PROPOSED PLAN

JANUARY 18, 2024

1:100 Pro

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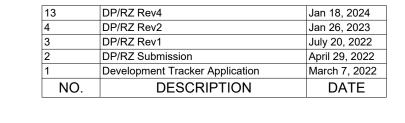
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LEVEL 3 PROPOSED PLAN

JANUARY 18, 2024

1:100



Jan 18, 2024

1 L3 PROPOSED PLAN
SCALE = 1:100

2123







NO.	DESCRIPTION	DATE
1	Development Tracker Application	March 7, 2022
2	DP/RZ Submission	April 29, 2022
3	DP/RZ Rev1	July 20, 2022
4	DP/RZ Rev2	Jan 26, 2023
13	DP/RZ Rev4	Jan 18, 2024



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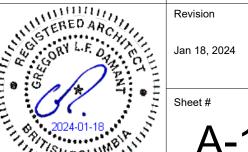
1733-1737 Fairfield Rd

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LEVEL 4 PROPOSED PLAN

JANUARY 18, 2024

Scale 1:100



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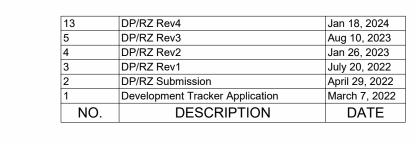
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2 SW ELEVATION SCALE = 1:100





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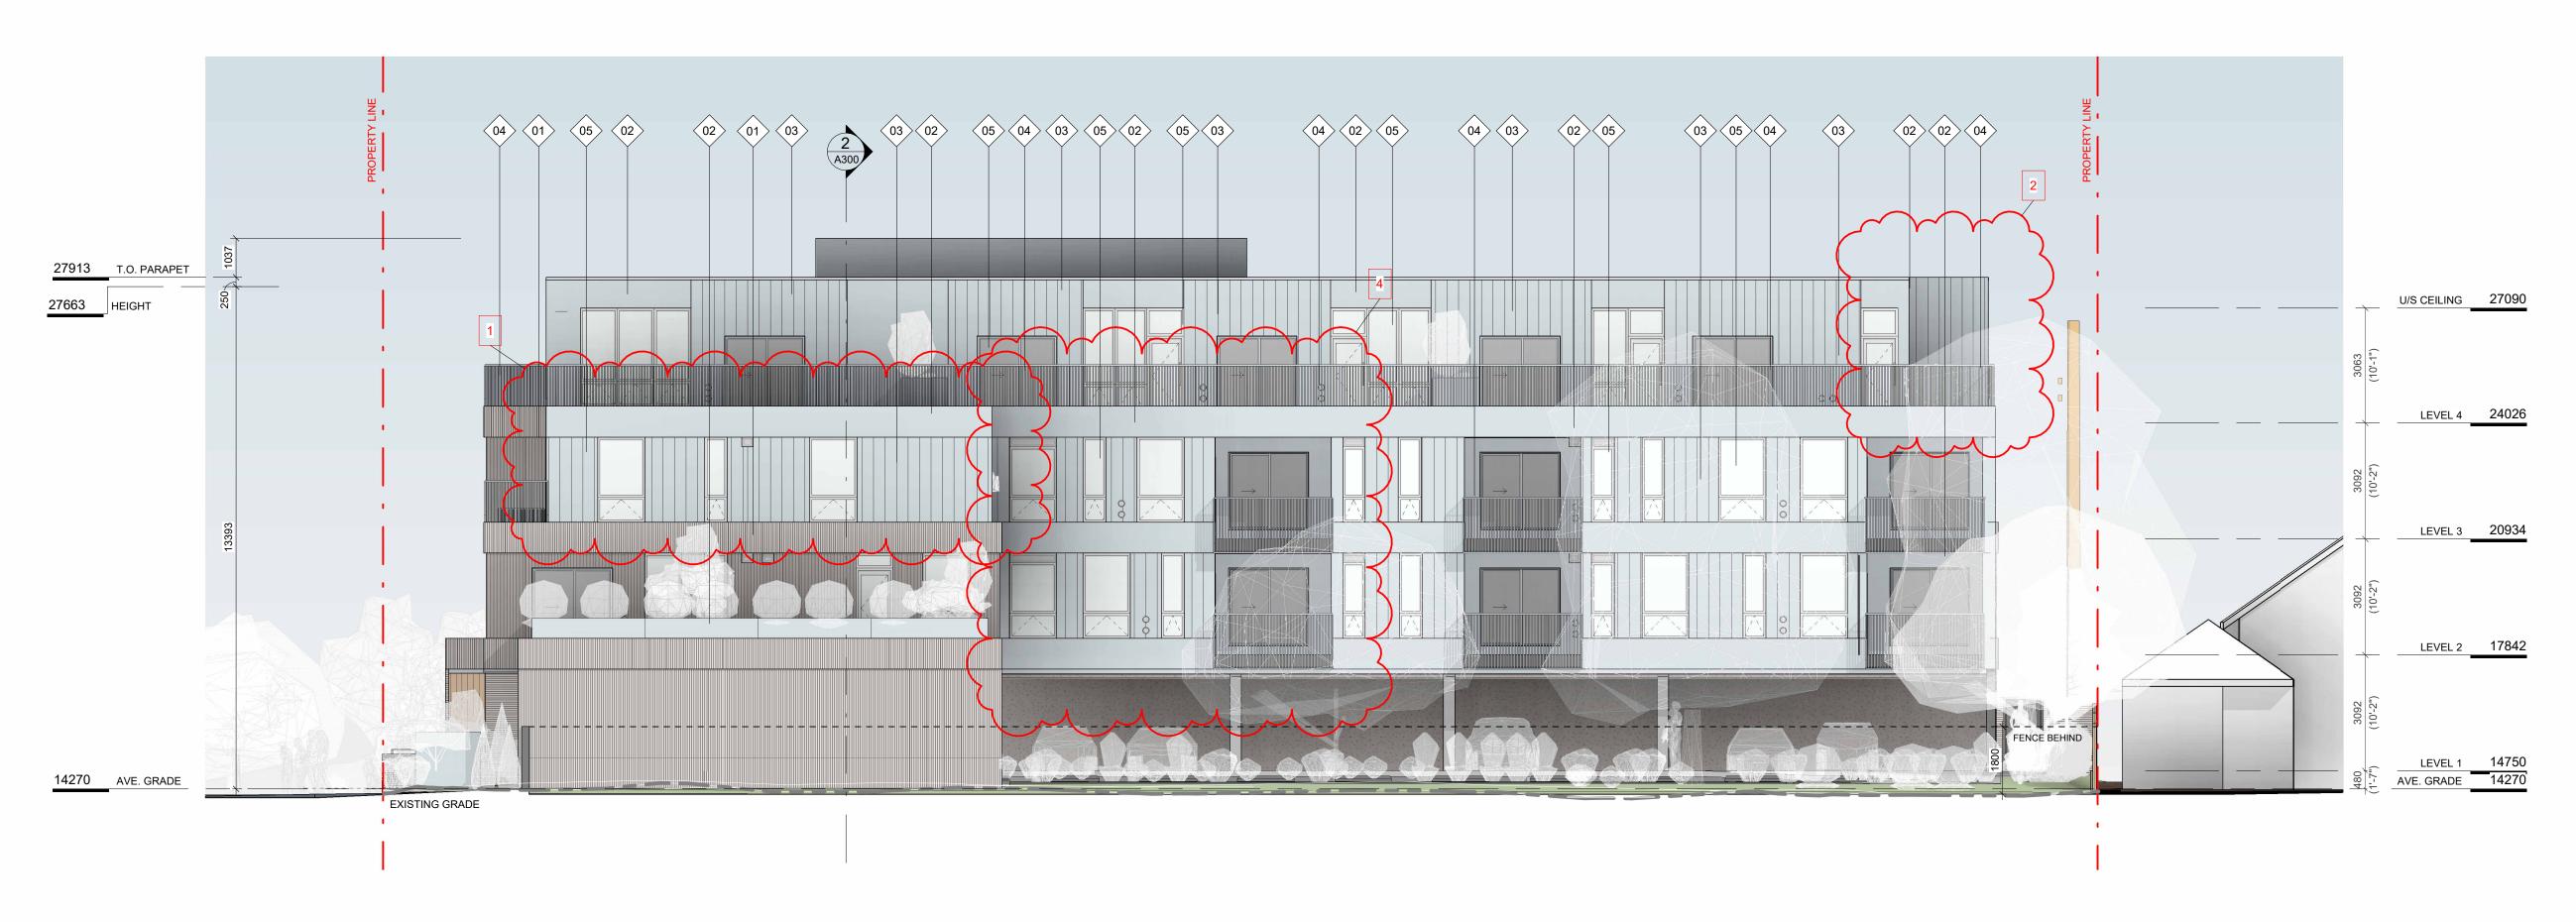
EXTERIOR ELEVATIONS

As indicated


JANUARY 18, 2024 2123

Jan 18, 2024


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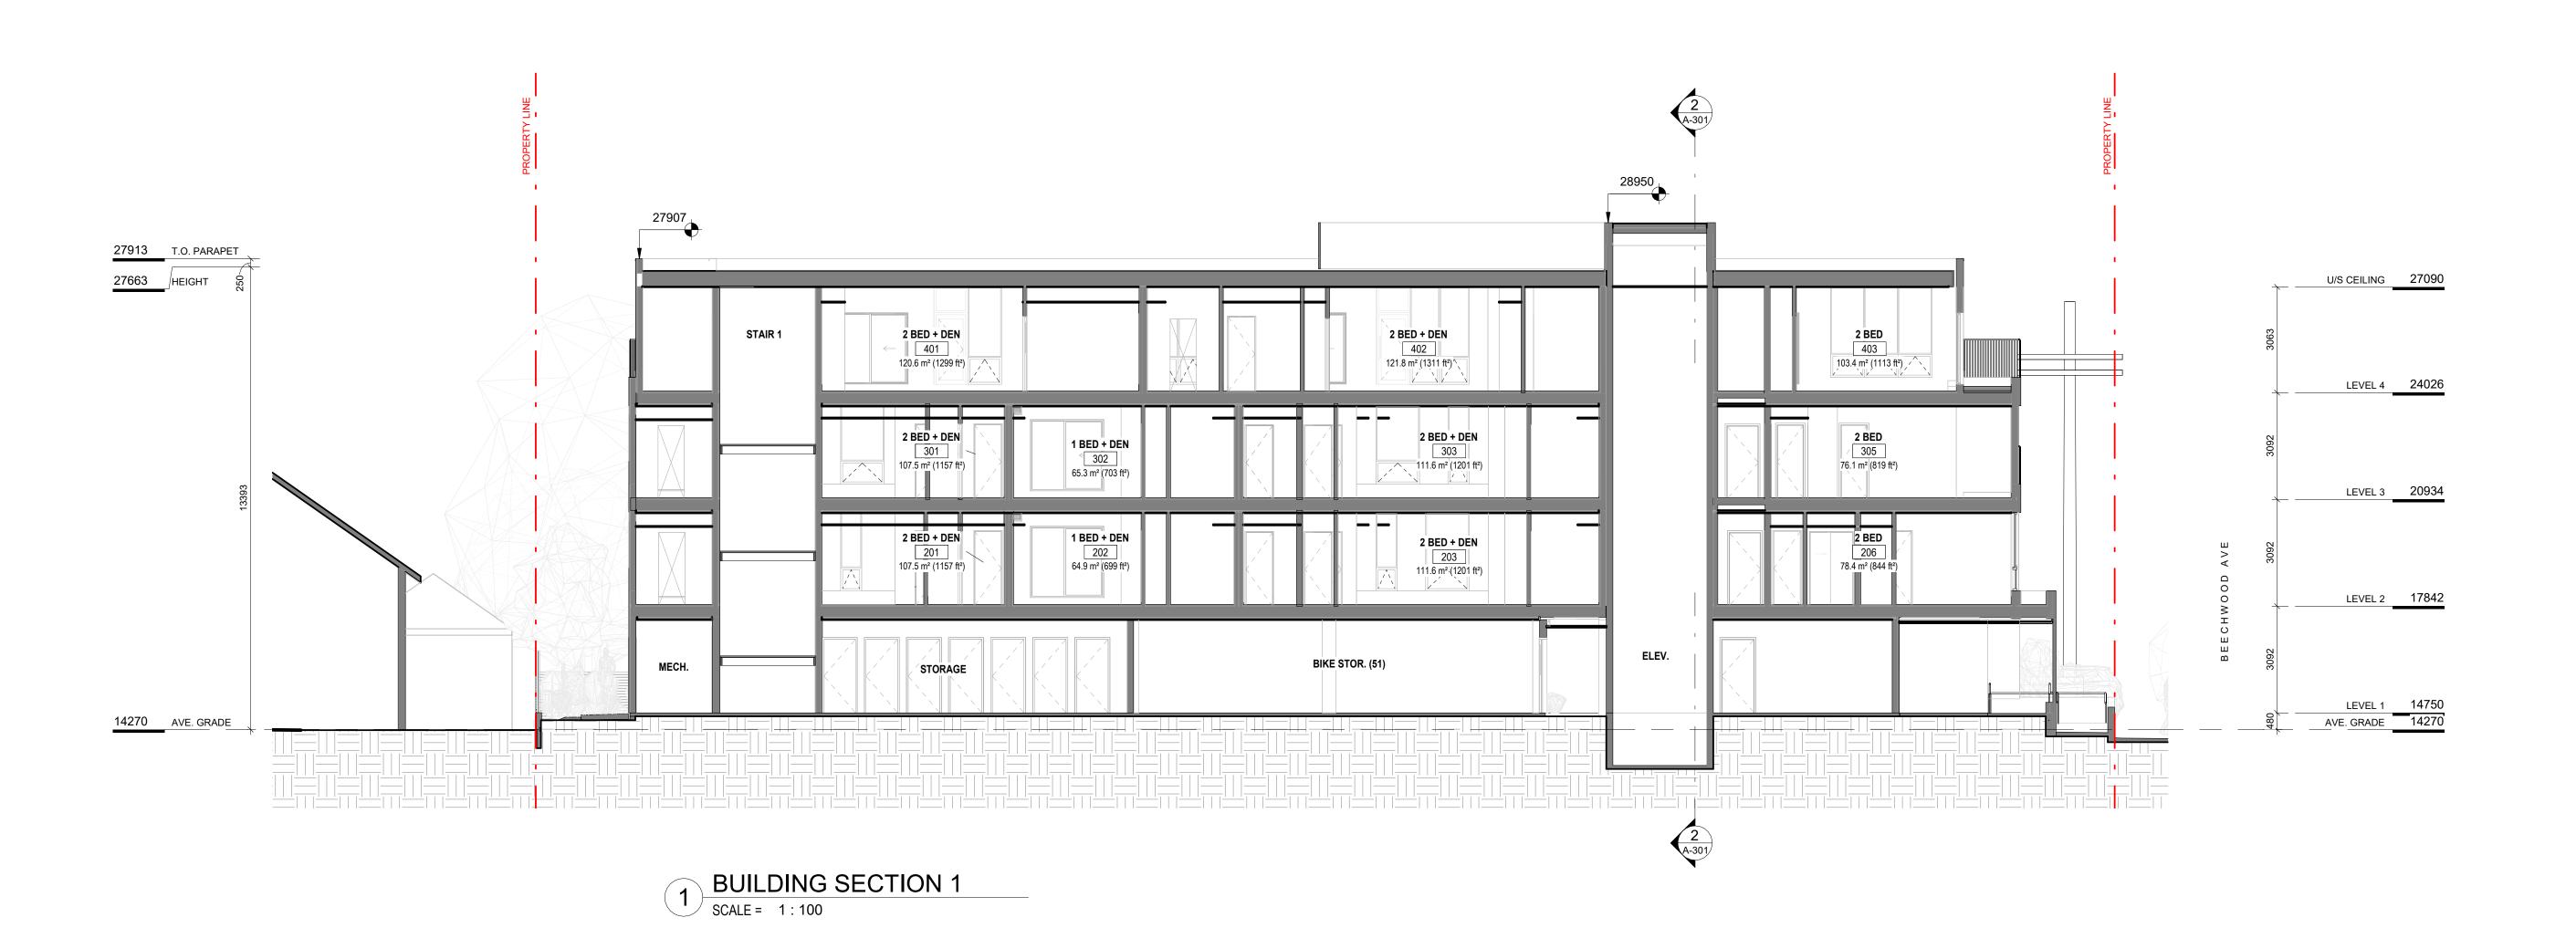
EXTERIOR ELEVATIONS


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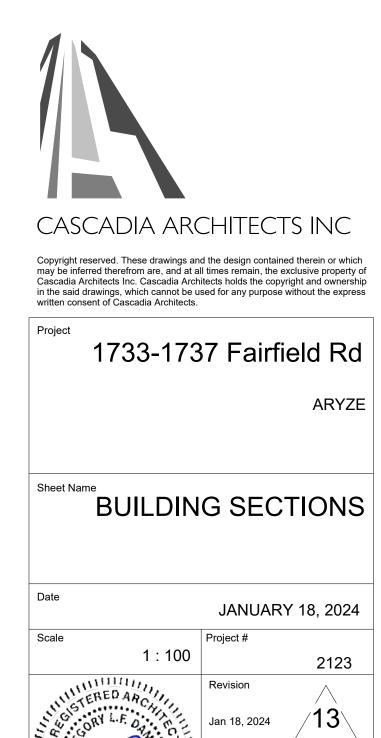
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2123



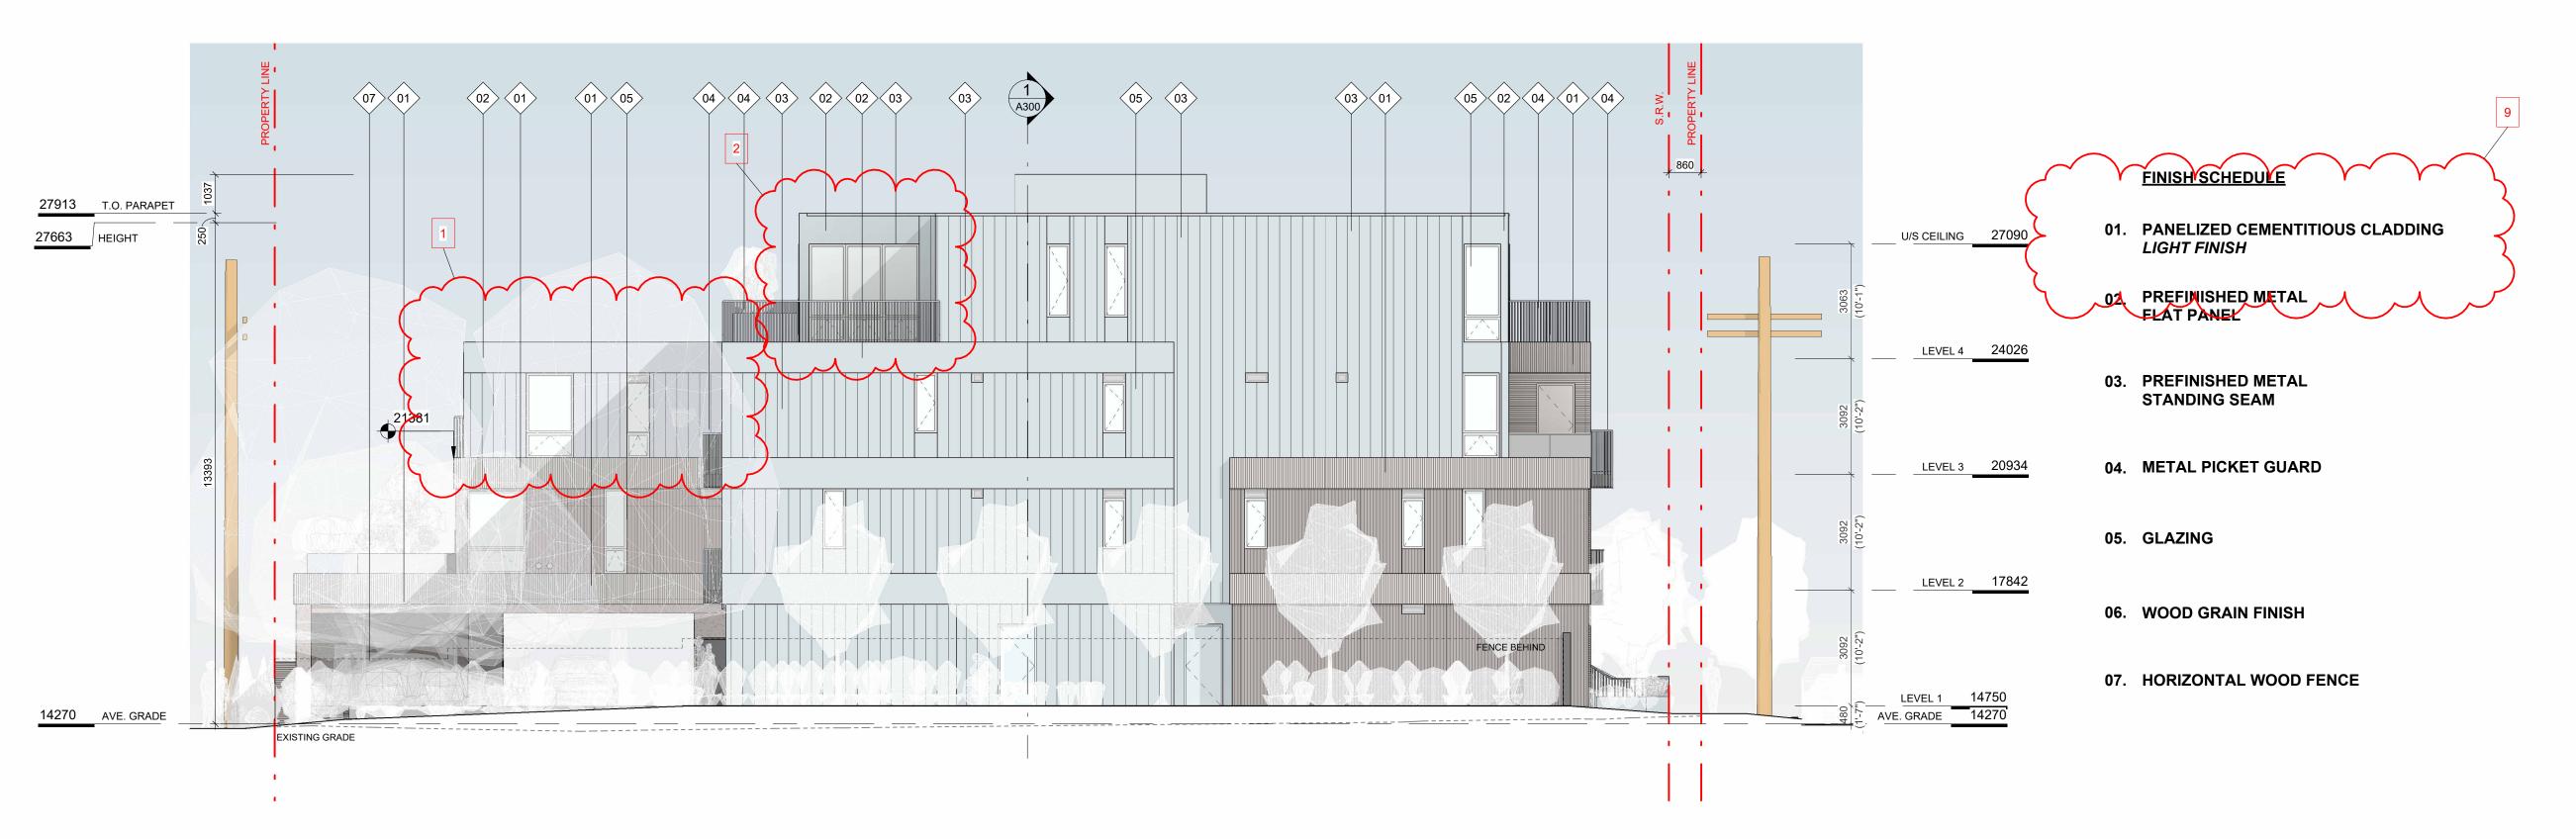

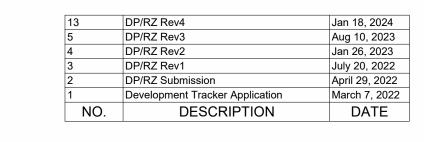

DP/RZ Rev2
DP/RZ Rev1
DP/RZ Submission

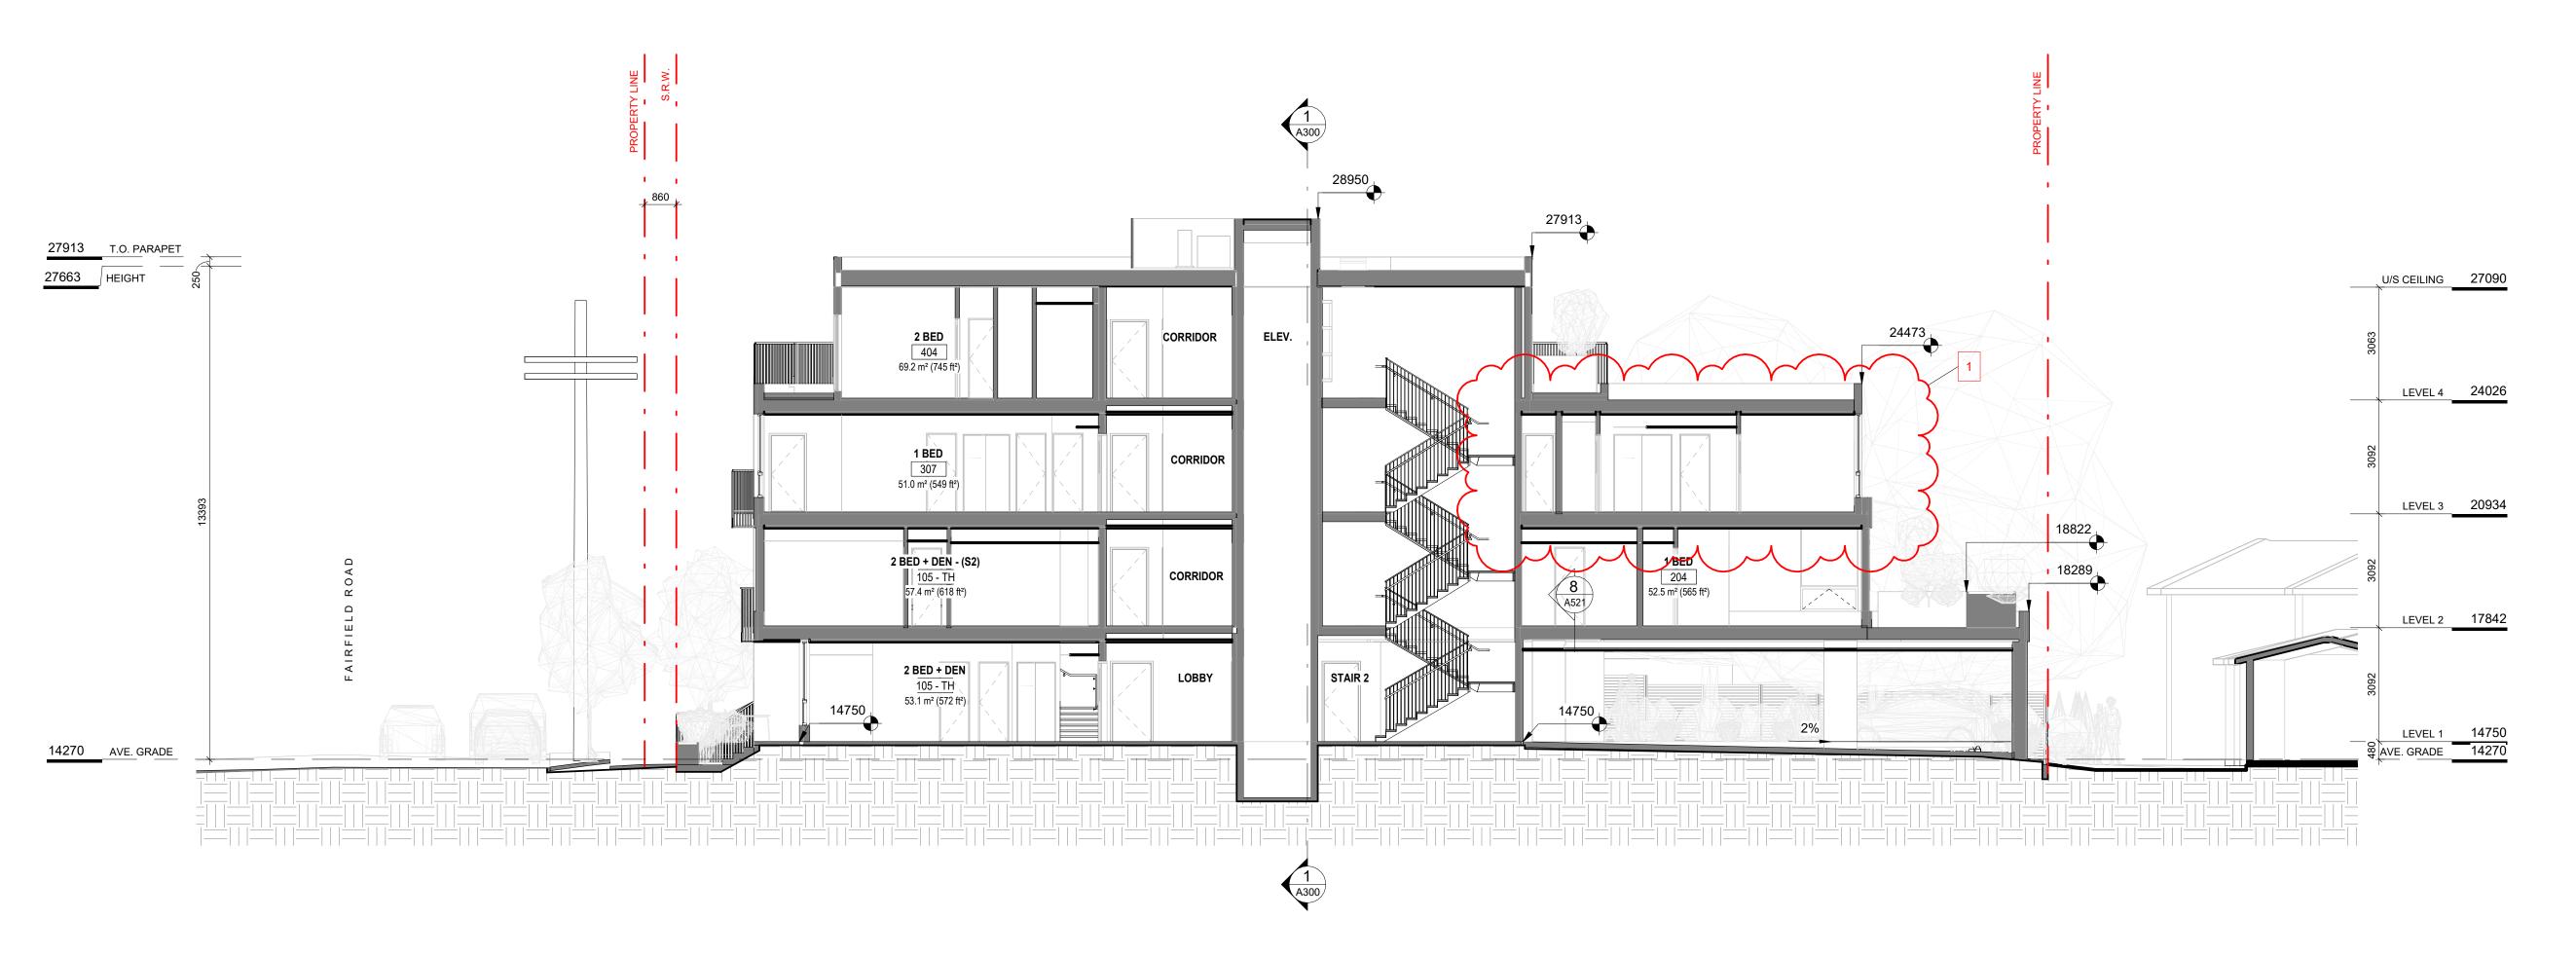NO.


Development Tracker Application

DESCRIPTION

Jan 18, 2024 Jan 26, 2023 July 20, 2022 April 29, 2022 March 7, 2022 DATE

2024-01-16 4:59:50 PM

2 BUILDING SECTION 2
SCALE = 1:100

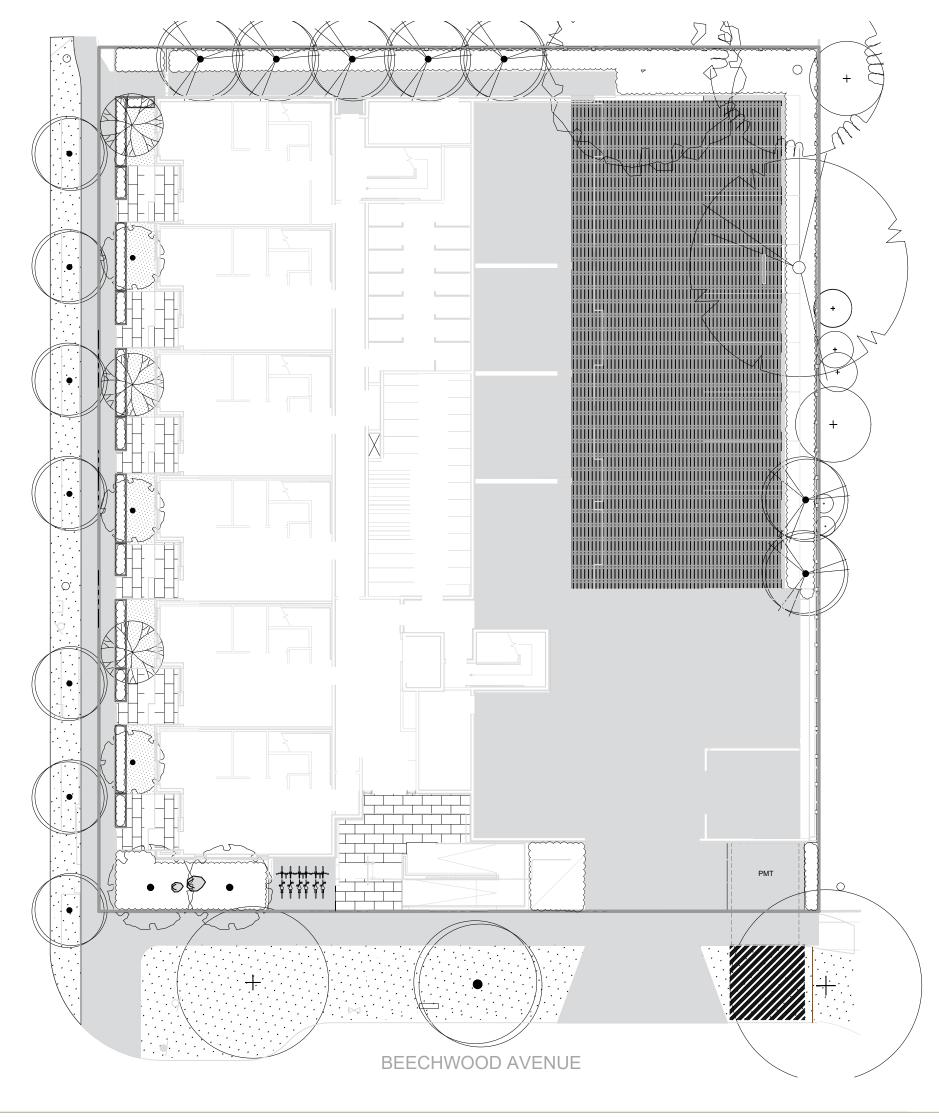

MATERIAL SPECIFICATIONS

- GROWING MEDIUM TESTING. MIXING. HANDLING AND PLACEMENT TO CLS SECTION 6.
- 2. ON SITE GROWING MEDIUM TYPE TO BE: AS PER DRAWING LEGEND. 3. PLANTER GROWING MEDIUM TO BE:
 - 50% BY VOLUME 1H HIGH TRAFFIC LAWN GROWING MEDIUM 50% BY VOLUME Pro-Mix HP Mychorrizae OR APPROVED EQUAL

- OFF-SITE GROWING MEDIUM: BOULEVARD GROWING MEDIUM TO BE:
 - MMCD Planting Areas Growing Medium to City of Victoria Supplementary Specifications Schedule 'B', Table 2. AS PER MUNICIPAL STANDARD.
 - IF NO MUNICIPAL STANDARD, GROWING MEDIUM TO CLS SECTION 6 2L LOW TRAFFIC LAWN AREAS.

1. MULCH IN ALL OTHER AREAS TO BE: Mitchell Excavating Ltd. Fine Bark Mulch - fir/hemlock OR APPROVED EQUAL.

2. HANDLING AND PLACEMENT TO CLS Section 10 - Mulching/Mulch

- 1. MUNICIPAL SOD TO BE: No. 1 Premium Grade Nursery Turfgrass.
- 2. HANDLING AND PLACEMENT TO BCLS Section 8 Turfgrass Sod. 3. SHALL BE SUITED TO THE LOCALITY, SITE CONDITIONS AND INTENDED FUNCTION OF THE PROJECT AREA.

1. ROOT BARRIER TO BE: Deeproot 18" Universal Guide OR APPROVED EQUAL.

1. FILTER FABRIC TO BE: Soprema Soprafiltre non-woven geotextile OR APPROVED EQUAL. 2. INSTALL AS PER MANUFACTURER'S SPECIFICATIONS AND LANDSCAPE DETAILS.

AGGREGATE:

- 1. PLANTER DRAIN ROCK TO BE: 19 mm MINUS GRANULAR BASE (TO MMCD SPECIFICATION) 2. GREEN ROOF DRAIN ROCK TO BE: 6 mm WASHED DRAIN ROCK
 - SUBMITTALS

- ALL PRODUCTS AND WORKMANSHIP, INCLUDING: PLANT MATERIAL, TRANSPORTATION, HANDLING AND PROTECTION. SCHEDULING AND STORAGE, WATERING AND IRRIGATION, TIME OF PLANTING, PLANTING, CONDITIONS FOR ACCEPTANCE AND INSECTS PESTS AND DISEASE CONTROL, TO BCLS SECTION 9 - PLANTS AND PLANTING, WRITTEN SPECIFICATIONS AND
- 2. CONDITIONS FOR TOTAL PERFORMANCE TO MMCD SECTION PLANTING OF TREES, SHRUBS AND GROUNDCOVERS. 3. IN THE EVENT OF A DISCREPANCY BETWEEN QUANTITIES LISTED ON THE PLANTING PLAN AND IN THE PLANT LIST. THE PLANTING PLAN QUANTITIES TO TAKE PRECEDENCE.

CAST IN PLACE CONCRETE:

1. ALL CAST IN PLACE CONCRETE AND ASSOCIATED WORK AND MATERIALS TO CONFORM TO MMCD SPECIFICATIONS; ASSOCIATED WORK INCLUDES GRADING, SUBGRADE COMPACTION, GRANULAR BASE MATERIALS AND COMPACTION.

IRRIGATION - DESIGN BUILD

IRRIGATION:

- 1. IT IS THE INTENTION OF THE PROJECT THAT THE LANDSCAPE CONTRACTOR FURNISH A FUNCTIONAL AUTOMATIC IRRIGATION SYSTEM TO ALL ON-SITE AND OFF SITE LANDSCAPE AREAS AS DESCRIBED ON THE LANDSCAPE DRAWINGS AND IN THIS SECTION.
- 2. THE SCOPE OF WORK INCLUDES SUPPLY AND INSTALLATION OF BACKFLOW PREVENTER, CONTROLLER, ALL IRRIGATION COMPONENTS, IRRIGATION SLEEVES YEAR MAINTENANCE/WARRANTY (SEE WRITTEN SPECIFICATIONS AND REQUIREMENTS BELOW) AND AN OPERATION MANUAL.
- 3. THE IRRIGATION CONTRACTOR SHALL COORDINATE WITH THE GENERAL CONTRACTOR AND ELECTRICAL CONTRACTOR FOR THE INSTALLATION OF IRRIGATION SLEEVES.

MAINTENANCE

- 4. UPON COMPLETION OF IRRIGATION INSTALLATION, CONTRACTOR TO SUBMIT AS-CONSTRUCTED DRAWINGS, OPERATION AND MAINTENANCE MANUAL, TOOLS PROVIDED BY THE MANUFACTURER AND BASE IRRIGATION SCHEDULE TO IIABC STANDARDS (SECTION 5 OF BCLS).
- 5. INSPECT AND CALIBRATE IRRIGATION SYSTEM AS PER SEASONAL REQUIREMENTS.
- INSPECT GROWING MEDIUM FREQUENTLYMINIMUM MONTHLY AND WEEKLY DURING PERIODS OF DROUGHT AND HIGH HEAT) FOR MOISTURE CONTENT AND ADJUST IRRIGATION SCHEDULE AS OFTEN AS REQUIRED TO MAINTAIN THE HEALTH OF THE PLANT MATERIAL DUE TO: RAPID DRAINAGE IN THE GROWING MEDIUM, ABSENCE OF A WATER TABLE, FINITE AMOUNT OF GROWING MEDIUM, AND EXPOSURE TO CLIMATIC CONDITIONS.
- 7. CONTRACTOR TO COORDINATE WITH THE OWNER'S MAINTENANCE REPRESENTATIVE AND TOGETHER PERFORM ONE WINTERIZATION AND ONE SPRING START-UP DURING THE ONE YEAR WARRANTY PERIOD.

SUBMITTALS					
SPECIFICATION SECTION	TITLE	SHOP DRAWINGS	MOCK-UP	SUBMITTALS	FOR APPROVAL
MMCD 03 30 20	CONCRETE WALKS, CURBS AND GUTTERS				
MMCD 03 30 53	CAST IN PLACE CONCRETE				
MMCD 31 02 17	AGGREGATES AND GRANULAR MATERIALS				
MMCD 31 22 01	SITE GRADING				
MMCD 31 24 13	ROADWAY EXCAVATION, EMBANKMENT AND COMPACTION				
MMCD 32 11 23	GRANULAR BASE				
MMCD 32 14 01	UNIT PAVING		yes	yes	product cut sheets, mockup 3.0m paved area on site
CLS 4	GRADING AND DRAINAGE				
CLS 5	IRRIGATION	yes			irrigation design for approval
CLS 6	GROWING MEDIUM			yes	supplier name, growing medium test results
CLS 7	LAWNS AND GRASS (HYDRAULIC SEEDING)			yes	supplier name, product information
CLS 8	TURFGRASS SOD			yes	supplier name, product information
CLS 9	PLANTS AND PLANTING		yes	yes	nursery name, tree and shrub layout on site prior to planting
CLS 10	MULCHING			yes	
CLS 11	LANDSCAPE OVER STRUCTURES - GREEN ROOFS				
CLS 12	CONTAINER GROWN PLANTS				



1733 FAIRFIELD

1733 FAIRFIELD ROAD, VICTORIA, BC

SHEET LIST

L0.1 TREE MANAGEMENT & REMOVAL PLAN

L1.1 MATERIALS PLAN - LEVEL 1

L1.2 MATERIALS PLAN - UPPER LEVELS

L2.1 LAYOUT PLAN

L3.1 GRADING PLAN

L4.1 SOIL VOLUME PLAN

L4.2 TREE PLANTING PLAN

L4.3 PLANTING PLAN - LEVEL 1

L4.4 PLANTING PLAN - UPPER LEVELS

L5.1 LIGHTING PLAN

L6.1 IRRIGATION PLAN - LEVEL 1

L6.2 IRRIGATION PLAN - UPPER LEVELS

L7.1 PAVING DETAILS

L7.2 SITE FURNISHINGS DETAILS

L7.3 PLANTING DETAILS

GENERAL LANDSCAPE NOTES

GENERAL

- 1. DO NOT PROCEED IN UNCERTAINTY. DO NOT SCALE DRAWINGS.
 - DRAWINGS AND SPECIFICATIONS ARE TO BE READ IN CONJUNCTION WITH ALL OTHER DRAWINGS/SPECIFICATIONS IN THIS PROJECT SET. ANY DISCREPANCIES AMONG DRAWINGS,
- SPECIFICATIONS AND INDUSTRY BEST PRACTICES TO BE REPORTED TO THE PROJECT / CONSTRUCTION MANAGER AND THE LANDSCAPE CONSULTANT FOR DIRECTION.
- ALL LANDSCAPE SPECIFICATION SECTIONS AND DRAWINGS ARE AFFECTED BY REQUIREMENTS OF DIVISION 01 SECTIONS (PROVIDED IN THE PROJECT MANUAL). CONTRACTOR TO FAMILIARIZE THEMSELVES WITH ALL SITE CONDITIONS, INCLUDING THE LIMITS OF WORK AND EXISTING FEATURES TO BE PROTECTED, PRIOR TO SUBMITTING
- CONTRACTOR TO CONFIRM LOCATION AND ELEVATION OF ALL UNDERGROUND UTILITIES/FEATURES PRIOR TO COMMENCING WORK.
- CONTRACTOR TO TAKE NECESSARY PRECAUTIONS TO PROTECT SITE FEATURES / CONDITIONS, WITHIN AND BEYOND THE LIMITS OF WORK EXISTING AT THE TIME OF CONSTRUCTION. ALL DISTURBED SURFACES, AREAS, STRUCTURES, VEGETATION, HABITAT ETC. ON PUBLIC / PRIVATE PROPERTY TO PROMPTLY BE RESTORED TO EQUAL OR BETTER CONDITION THAN EXISTING
- AND TO THE SATISFACTION OF THE MUNICIPALITY HAVING JURISDICTION / PROPERTY OWNER. CONTRACTOR TO MAINTAIN THE SITE IN A SAFE AND TIDY CONDITION AT ALL TIMES. DO NOT OBSTRUCT PEDESTRIAN OR VEHICULAR CIRCULATION. DO NOT LEAVE UNPROTECTED HOLES / PITS / OPENINGS OVERNIGHT. ALL EXCESS MATERIALS AND REFUSE TO BE REMOVED FROM THE SITE DAILY UNLESS OTHERWISE DIRECTED BY THE CONSTRUCTION MANAGER.

- ALL WORK ON MUNICIPAL PROPERTY TO CONFORM TO THE CITY OF VICTORIBEVELOPMENT STANDARDS (AUTHORITY HAVING JURISDICTIONINCLUDING BUT NOT LIMITED TO:
- 1.1. CITY OF VICTORIA SUPPLEMENTARY SPECIFICATIONS SCHEDULE 'B' TO THE SUBDIVISION AND DEVELOPMENT SERVICING BYLAW NO. 12-042
- 1.2. CITY OF VICTORIA SUPPLEMENTAL DRAWINGS 2. CITY OF VICTORIA SUPPLEMENTARY SPECIFICATIONS FOR STREET TREES AND IRRIGATION, SCHEDULE C.ALL LANDSCAPE WORK ON THE DEVELOPMENT SITE TO CONFORM TO THE
- CURRENT EDITION OF THECanadian Landscape Standard (CLS), UNLESS SPECIFICALLY STATED OTHERWISE IN WRITTEN SPECIFICATIONS AND ON DRAWINGS. ALL HARD SURFACE (INCLUDING BUT NOT LIMITED TO PAVING, CONCRETE RETAINING WALLS AND CONCRETE PLANTERS) TO CONFORM TO TWASter Municipal Construction Documents Association PLATINUM EDITION (MMCD) AND MMCD SUPPLEMENTAL DRAWINGS AND SPECIFICATIONS. UNLESS SPECIFICALLY STATED OTHERWISE IN WRITTEN SPECIFICATIONS AND ON
- 4. IN CASES OF CONFLICT BETWEEN THE CLS AND THE MMCD, THE MORE STRINGENT REQUIREMENT WILL TAKE PRECEDENCE.
- LANDSCAPE CONTRACTOR TO BE FAMILIAR WITH MUNICIPAL DEVELOPMENT STANDARDS AND BE IN POSSESSION OF THE CLS AND MMCD MANUALS AND SUPPLEMENTAL DRAWINGS AND
- 6. GROWING MEDIUM AND GROWING MEDIUM TESTING TO CLS Section 6. 7. IRRIGATION DESIGN AND INSTALLATION TO IIABC STANDARDS AND CLS Section 5.

1. CONTRACTOR TO COORDINATE INSTALLATION OF IRRIGATION AND ELECTRICAL SLEEVES WITH ARCHITECTURAL, MECHANICAL, ELECTRICAL AND CIVIL WORKS.

SUBMITTALS:

1. CONTRACTOR TO PROVIDE SAMPLES, TEST RESULTS AND SHOP DRAWINGS TO LANDSCAPE CONSULTANT FOR REVIEW AND APPROVAL 45 DAYS PRIOR TO INSTALLATION. 2. SEE ALSO SUBMITTALS TABLE BELOW FOR ADDITIONAL INFORMATION.

GROWING MEDIUM TESTING:

1. GROWING MEDIUM TEST RESULTS ARE MANDATORY. TEST RESULTS TO INCLUDE ANALYSIS OF ALL GROWING MEDIUM NUTRIENTS NOTED IN CLS 6.2.7 AND ARE TO BE REPORTED IN THE SAME UNITS AS NOTED IN THAT SECTION.

- TEST RESULTS TO INCLUDE ANALYSIS OF SOIL TEXTURE, ORGANIC CONTENT AND ACIDITY AS PER CLS 6.3.5 AND BE REPORTED IN THE SAME UNITS AS NOTED IN THAT SECTION. TEST RESULTS TO INCLUDE RECOMMENDATIONS FOR AMENDMENTS TO MEET THE REQUIREMENTS FOR EACH GROWING MEDIUM TYPE.
- RECOMMENDED GROWING MEDIUM TESTING FACILITY: Pacific Soil Analysis Inc. 11720 Voyageur Way, Richmond, BC V6X 3G9.

1. COMPACTION TESTS FOR HARD SURFACE SUBGRADE, GRANULAR SUB-BASE, AND GRANULAR BASE ARE MANDATORY.

1. CONTRACTOR TO ALERT THE LANDSCAPE CONSULTANT A MINIMUM OF 3 WORKING DAYS PRIOR TO REQUIRED LANDSCAPE INSPECTIONS.

1. REQUESTS FOR SUBSTITUTIONS TO CONFORM TO THE DIVISION 01 SECTION AND BE SUBMITTED TO THE LANDSCAPE CONSULTANT, THROUGH THE PROJECT ADMINISTRATOR, A MINIMUM OF 45 DAYS PRIOR TO SCHEDULED WORK. 2. PLEASE NOTE THAT SOME SUBSTITUTIONS MAY REQUIRE MUNICIPAL APPROVAL.

WARRANTY:

1. CONTRACTOR SHALL WARRANTY ALL WORKMANSHIP AND MATERIALS FOR 1 FULL YEAR FOLLOWING THE DATE OF TOTAL PERFORMANCE AS PER MMCD UNLESS SPECIFICALLY NOTED

OTHERWISE. FAULTY MATERIALS AND WORKMANSHIP SHALL BE PROMPTLY REPAIRED / REPLACED TO THE SATISFACTION OF THE LANDSCAPE CONSULTANT.

ENVIRONMENTAL PROTECTION:

1. CONTRACTOR TO INSTALL AND MAINTAIN SEDIMENTATION FILTRATION MEASURES AS REQUIRED FOR LANDSCAPE WORKS TO PREVENT MATERIALS FROM LEAVING THE SITE AND / OR ENTERING STORM DRAINS; STOCKPILED LANDSCAPE MATERIALS ARE TO BE KEPT TARPED.

ELECTRICAL - DESIGN BUILD

9. THE USE OF GEL FILLED WIRE NUTS IS REQUIRED.

LANDSCAPE LIGHTING:

1. IT IS THE INTENTION OF THE PROJECT THAT THE LANDSCAPE CONTRACTOR FURNISH A FUNCTIONAL LIGHTING SYSTEM AS DESCRIBED ON THE DRAWINGS AND IN THIS SECTION.

THE SCOPE OF WORK INCLUDES SUPPLY AND INSTALLATION OF LOW VOLTAGE LIGHTING PRODUCTS, CABLING, TRANSFORMER(S) / POWER SUPPLIES / DRIVERS AND ELECTRICAL SLEEVES. 3. ELECTRICAL CONTRACTOR IS TO INCLUDE POWER (CONDUIT AND CONDUCTORS) TO LOW VOLTAGE TRANSFORMERS/DRIVERS IN SUPPORT OF THE LANDSCAPE LIGHTING PLAN. THE NUMBER OF CONNECTION POINTS IS NOT DETERMINED - THIS DEPENDS ON HOW THE LANDSCAPE CONTRACTOR LAYS OUT THE SYSTEM, BUT WILL NOT EXCEED 5. REFER TO THE LANDSCAPE LIGHTING PLAN FOR GENERAL INFORMATION.

4. 15A 1P CIRCUIT FROM HOUSE PANEL, SWITCHED BY A PROGRAMMABLE TIMER INSTALLED IN THE ELECTRICAL ROOM.

TRANSFORMER TO BE ADEQUATELY SIZED FOR THE LOAD PLUS 40% RESERVE CAPACITY. TRANSFORMERS TO BE ARRANGED SUCH THAT NO LOAD REQUIRES WIRING IN EXCESS OF 75'.

TIMER FUNCTION ON TRANSFORMER TO BE DISABLED IF PROVIDED. TRANSFORMERS, DRIVERS AND POWER SUPPLIES ARE TO BE INSTALLED IN GROUND JUNCTION BOXES, SUPPLIED AND INSTALLED BY THIS DIVISION.

8. THE LANDSCAPE CONTRACTOR SHALL COORDINATE WITH THE ELECTRICAL CONTRACTOR FOR AC CIRCUIT TO EACH JUNCTION BOX LOCATION AND WITH THE GENERAL CONTRACTOR FOR THE INSTALLATION OF ELECTRICAL SLEEVES.

IRRIGATION COORDINATION:

1. ELECTRICAL CONTRACTOR TO COORDINATE WITH CONSTRUCTION MANAGER AND IRRIGATION DESIGNER/INSTALLER TO PROVIDE ELECTRICAL FOR THE OPERATION OF AN AUTOMATIC IRRIGATION SYSTEM AND CONTROLLER.

Table 1. Tree Inventory Multiple stems form at 3m above grade - included bark at main stem Project arborist to union with active response growth, supervise all excavation cherry plum cerasifera 47 10 5.9 5 Good Fair/good M1 Yes City City critical root zone. Retain Moderate associated surface decay. installation of the Recently planted - still staked, 'Pacific sunset' 5 6 0.6 Moderate included bark at stem unions. *Possible for transplant. Remove grade - no major weaknesses Project arborist to Purple leaf Prunus pruning wounds with associated required within the Moderate surface decay.

Codomimant stems form at .3m cherry plum cerasifera 26 6 3.3 4 Good Fair/good critical root zone. Retain above grade - included bark - not Located within the active, historic pruning wounds footprint of the Unsuitable Moderate existing building.

Multiple stems form at 1m above proposed building. grade - narrow angles of Located within the ittachment, stems topped and Fair/poor Unsuitable Moderate decayed with sloughing bark. proposed building. grade for overhead utilities Laburnum sp. 21, 28 7 6.3 4 Fair Poor Unsuitable Poor proposed building. Remove sloughing bark. opped historically at 5m above grade - multiple regrowth leaders footprint of the form at topping locations. proposed building. Will be heavily impacted by excavation required foundation of the form at 2m above grade - narrow proposed building. Also angles of attachment, main stem topped historically at 4m above footprint of the Prunus sp. 55 5 6.9 4 Fair Fair/poor Unsuitable Moderate grade - large topping wound. Will be heavily impacted to construct the Flowering cherry, codominant proposed building. Will .5m above grade, large heading excavation for the 19, 25 5 4.6 proposed parking stall. Remove Will be heavily impacted by excavation required yew trees spaced less than 1m foundation of the English yew Taxus baccata 8, 6 5 2.5 1 Fair Fair/poor Unsuitable Moderate apart. Will be heavily impacted by excavation required Growing within a hedge row of 5 to construct the yew trees spaced less than 1m English yew Taxus baccata 5, 5, 5 5 1.4 1 proposed building. Will be heavily impacted by excavation required Growing within a hedge row of 5 English yew Taxus baccata 9 5 2.5 1 Fair Fair/poor Unsuitable Moderate yew trees spaced less than 1m foundation of the Will be heavily impacted by excavation required Growing within a hedge row of 5 to construct the yew trees spaced less than 1m proposed building. Will be heavily impacted by excavation required yew trees spaced less than 1m foundation of the English yew Taxus baccata 9, 4 5 2.6 1 Fair Fair/poor Unsuitable Moderate Will be heavily impacted by excavation required Growing within a hedge row of 13 to construct the yew trees spaced less than 1m English yew Taxus baccata 11,16 5 2.8 proposed building. by excavation required yew trees spaced less than 1m foundation of the English yew Taxus baccata 18 5 2.3 1 Fair Fair/poor Unsuitable Moderate Will be heavily impacted Growing within a hedge row of 13 to construct the yew trees spaced less than 1m Taxus baccata 12, 8 5 2.1 proposed building. by excavation required Growing within a hedge row of 13 to construct the yew trees spaced less than 1m foundation of the English yew Taxus baccata 8, 8 5 2.6 1 Fair Fair/poor Unsuitable Moderate Will be heavily impacted Growing within a hedge row of 13 to construct the yew trees spaced less than 1m Taxus baccata 14, 8 5 2.4 proposed building. by excavation required Growing within a hedge row of 13 to construct the yew trees spaced less than 1m foundation of the English yew Taxus baccata 12, 5 5 1.9 1 Fair Fair/poor Unsuitable Moderate Will be heavily impacted Growing within a hedge row of 13 to construct the yew trees spaced less than 1m Fair Fair/poor Unsuitable Moderate apart. proposed building. by excavation required Growing within a hedge row of 13 to construct the yew trees spaced less than 1m foundation of the English yew Taxus baccata 5, 4 5 2 1 Fair Fair/poor Unsuitable Moderate Will be heavily impacted by excavation required Growing within a hedge row of 13 to construct the yew trees spaced less than 1m English yew Taxus baccata , 4 5 1.8 proposed building. Will be heavily impacted by excavation required yew trees spaced less than 1m foundation of the English yew Taxus baccata 5, 4 5 2.2 1 Fair Fair/poor Unsuitable Moderate apart. proposed building. Will be heavily impacted by excavation required Growing within a hedge row of 13 to construct the yew trees spaced less than 1m proposed building. Will be heavily impacted by excavation required Growing within a hedge row of 13 to construct the yew trees spaced less than 1m foundation of the English yew Taxus baccata 16 5 2 1 Fair Fair/poor Unsuitable Moderate apart. Will be heavily impacted by excavation required Growing within a hedge row of 13 to construct the yew trees spaced less than 1m English yew Taxus baccata 5, 5, 5 5 2.4 proposed building. Will be heavily impacted by excavation required Growing within a hedge row of 7 yew trees spaced less than 1.25m foundation of the English yew Taxus baccata 5, 5 5 2.3 1 Fair Fair/poor Unsuitable Moderate proposed building. Remove Will be heavily impacted by excavation required Growing within a hedge row of 7 to construct the yew trees spaced less than 1.25m foundation of the English yew Taxus baccata 8, 4 5 1.3 proposed building. by excavation required Growing within a hedge row of 7 yew trees spaced less than 1.25m foundation of the English yew Taxus baccata 4, 4, 4, 5 1.3 1 Fair Fair/poor Unsuitable Moderate Will be heavily impacted by excavation required Growing within a hedge row of 7 to construct the yew trees spaced less than 1.25m Fair Fair/poor Unsuitable Moderate proposed building. by excavation required Growing within a hedge row of 7 yew trees spaced less than 1.25m foundation of the English yew Taxus baccata 8, 8, 8 5 2.2 1 Fair Fair/poor Unsuitable Moderate proposed building.
Will be heavily impacted Growing within a hedge row of 7 to construct the yew trees spaced less than 1.25m foundation of the English yew Taxus baccata 12, 5 5 1.9 proposed building. Will be heavily impacted by excavation required Growing within a hedge row of 7 to construct the yew trees spaced less than 1.25m foundation of the proposed building.
Will be heavily impacted English yew Taxus baccata 5, 5, 5 5 2.6 1 Fair Fair/poor Unsuitable Moderate apart. Growing within a hedge row of 5 yew trees spaced less than 1m to construct the apart. *1 Bylaw size stem within foundation of the proposed building. Will be heavily impacted Growing within a hedge row of 5 by excavation required yew trees spaced less than 1m apart. *1 Bylaw size stem within to construct the foundation of the proposed building.
Will be heavily impacted English yew Taxus baccata 22 5 2.8 1 Fair Fair/poor Unsuitable Moderate Growing within a hedge row of 5 yew trees spaced less than 1m by excavation required to construct the apart. *1 Bylaw size stem within foundation of the proposed building. Growing within a hedge row of 5 by excavation required yew trees spaced less than 1m apart. *1 Bylaw size stem within to construct the foundation of the foundation of the proposed building. Remove
Will be heavily impacted English yew Taxus baccata 13 5 1.6 1 Fair Fair/poor Unsuitable Moderate hedge. Growing within a hedge row of 5 yew trees spaced less than 1m by excavation required to construct the apart. *1 Bylaw size stem within foundation of the proposed building. Will be heavily impacted by excavation required Hedge row consisting of approximately 30 individual stems - foundation of the proposed building. Codominant stems form at .3m above grade - no major Located within the weaknesses visible at stem union, footprint of the Moderate ivy covered trunk. proposed parking stall. Remove opped historically at 5m above grade - multiple regrowth leaders footprint of the *Parking stall proposed arborist to supervise all

Moderate narrow planting strip.

within the crz.

WINDMILL PALM REQUESTED TO BE-TRANSPLANTED / REMOVED BY LANDSCAPE TO ALLOW FOR PLANTING OF LARGE CANOPY




BOULEVARD TREE M2 TO BE REMOVED AND RELOCATED BY CITY OF VICTORIA FOR INSTALLATION OF PROPOSED WATER CONNECTION (SEE CIVIL). REMOVAL TO BE PAID FOR BY DEVELOPER.


			Location		Name				Critical		Conditio	n	Retention				
revious tag #	Tag or ID#	Surveyed ? (Yes / No)	(On, Off, Shared, City)	Bylaw protected ? (Yes / No / City)	Common	Botanical	dbh (cm)	Ht (m)	root zone radius (m)	Dripline radius (m)	Health	Structural	Suitability (onsite trees)	Relative tolerance	General field observations/remarks	Tree retention comments	Retentior status
	OS2	Yes	Off	No	Emerald cedar	Thuja occidentalis 'smaragd'	10~	4	1.3	0.5	Fair	Fair		Moderate	Juvenile hedge tree growing within narrow planting strip.	*Parking stall proposed within the crz. Project arborist to supervise all excavation required within the crz.	Retain*
	OS3	Yes	Off	No	Honey locust	Gleditsia triacanthos	10~	8	1.3	2	Good	Good		Moderate	Juvenile hedge tree growing within narrow planting strip.	Project arborist to supervise all excavation required within the crz.	Retain
	OS4	Yes	Off	No	Emerald cedar	Thuja occidentalis 'smaragd'	5, 5, 5, 5~	5	1.4	1	Good	Fair		Moderate	Multiple stems hedge tree growing within narrow planting strip.	Project arborist to supervise all excavation required within the crz.	Retain
	OS5	Yes	Off	No	Emerald cedar	Thuja occidentalis 'smaragd'	8, 8, 10, 4~	5	2.5	1	Good	Fair		Moderate	Multiple stems hedge tree growing within narrow planting strip.	*Parking stall proposed within the crz. Project arborist to supervise all excavation required within the crz.	Retain*
	OS6	Yes	Off	No	Cherry	Prunus sp.	8, 6, 6~	5	1.9	1	Good	Fair		Moderate	Flowering cherry, growing within narrow planting strip.	*Parking stall proposed within the crz. Project arborist to supervise all excavation required within the crz.	Retain*
	Hedge 2	Yes	On	No	Emerald cedar	Thuja occidentalis 'smaragd'	5 - 10cm	5	0.5	0.5	Good	Fair		Moderate	Hedge row consisting of 14 individual stems. No bylaw stems.	Will be heavily impacted by excavation required to construct the proposed parking stalls	
	OS7	Yes	Off	No	Japanese maple	Acer palmatum	5, 5, 5, 4, 4	5	1.4	2	Good	Fair		Moderate	Multiple stems form at .5m above grade.	Project arborist to supervise all excavation required within the crz.	Retain
	3422	No	On	No	Windmill palm	Trachycarpus fortunei	29	4	3.0	2	Good	Fair	Unsuitable	Good	Crown raised approx. 50%	*Parking stall proposed within the crz. Possible for retention or transplanted elsewhere. Project arborist to supervise all excavation required within the crz.	Retain*

BEECHWOOD AVENUE

NOTE: SEE ORIGINAL TREE INVENTORY AND TABLES IN REPORT PREPARED BY TALBOT & MACKENZIE



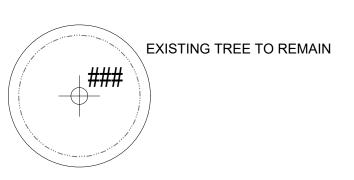

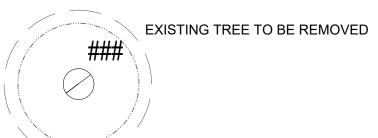

TREE PROTECTION FENCING TO OUTSIDE OF DRIPLINE WHERE POSSIBLE (AS SHOWN)

> TO BE MAINTAINED UNTIL COMPLETION OF CONSTRUCTION TO MUNICIPAL STANDARD

PROTECTED TREE AND SHRUB FOR REMOVAL

MUNICIPAL TREE FOR REMOVAL



1608 Camosun Street, Victoria BC V8T 3E6 Info@biophiliacollective.ca 250 590 1156

OWNER/CLIENT:

ARYZE DEVELOPMENTS

PROJECT ADDRESS:

1733 FAIRFIELD, VICTORIA, BC

DESIGNED BY:BIANCA BODLEY DRAWN BY: TYLER YESTAL

NO.	ISSUE	YY\MM\DD
1	ISSUED FOR DEVELOPMENT TRACKER	22\03\04
2	ISSUED FOR RZ/DP	22\05\02
3	ISSUED FOR COORDINATION	22\07\18
4	ISSUED FOR RZ/ DP	22\07\20
5	ISSUED FOR RZ/ DP RESUBMISSION	23\01\24
6	ISSUED FOR RZ/ DP RESUBMISSION	2023\08\18
7	25% BUILDING PERMIT	2023\10\10
8	ISSUED FOR BP COORDINATION	2023/11/24
9	DP/RZ REV 4	2024/01/12


SEAL

NORTH ARROW

DRAWING TITLE:

TREE REMOVAL & PROTECTION PLAN

DWG NO:

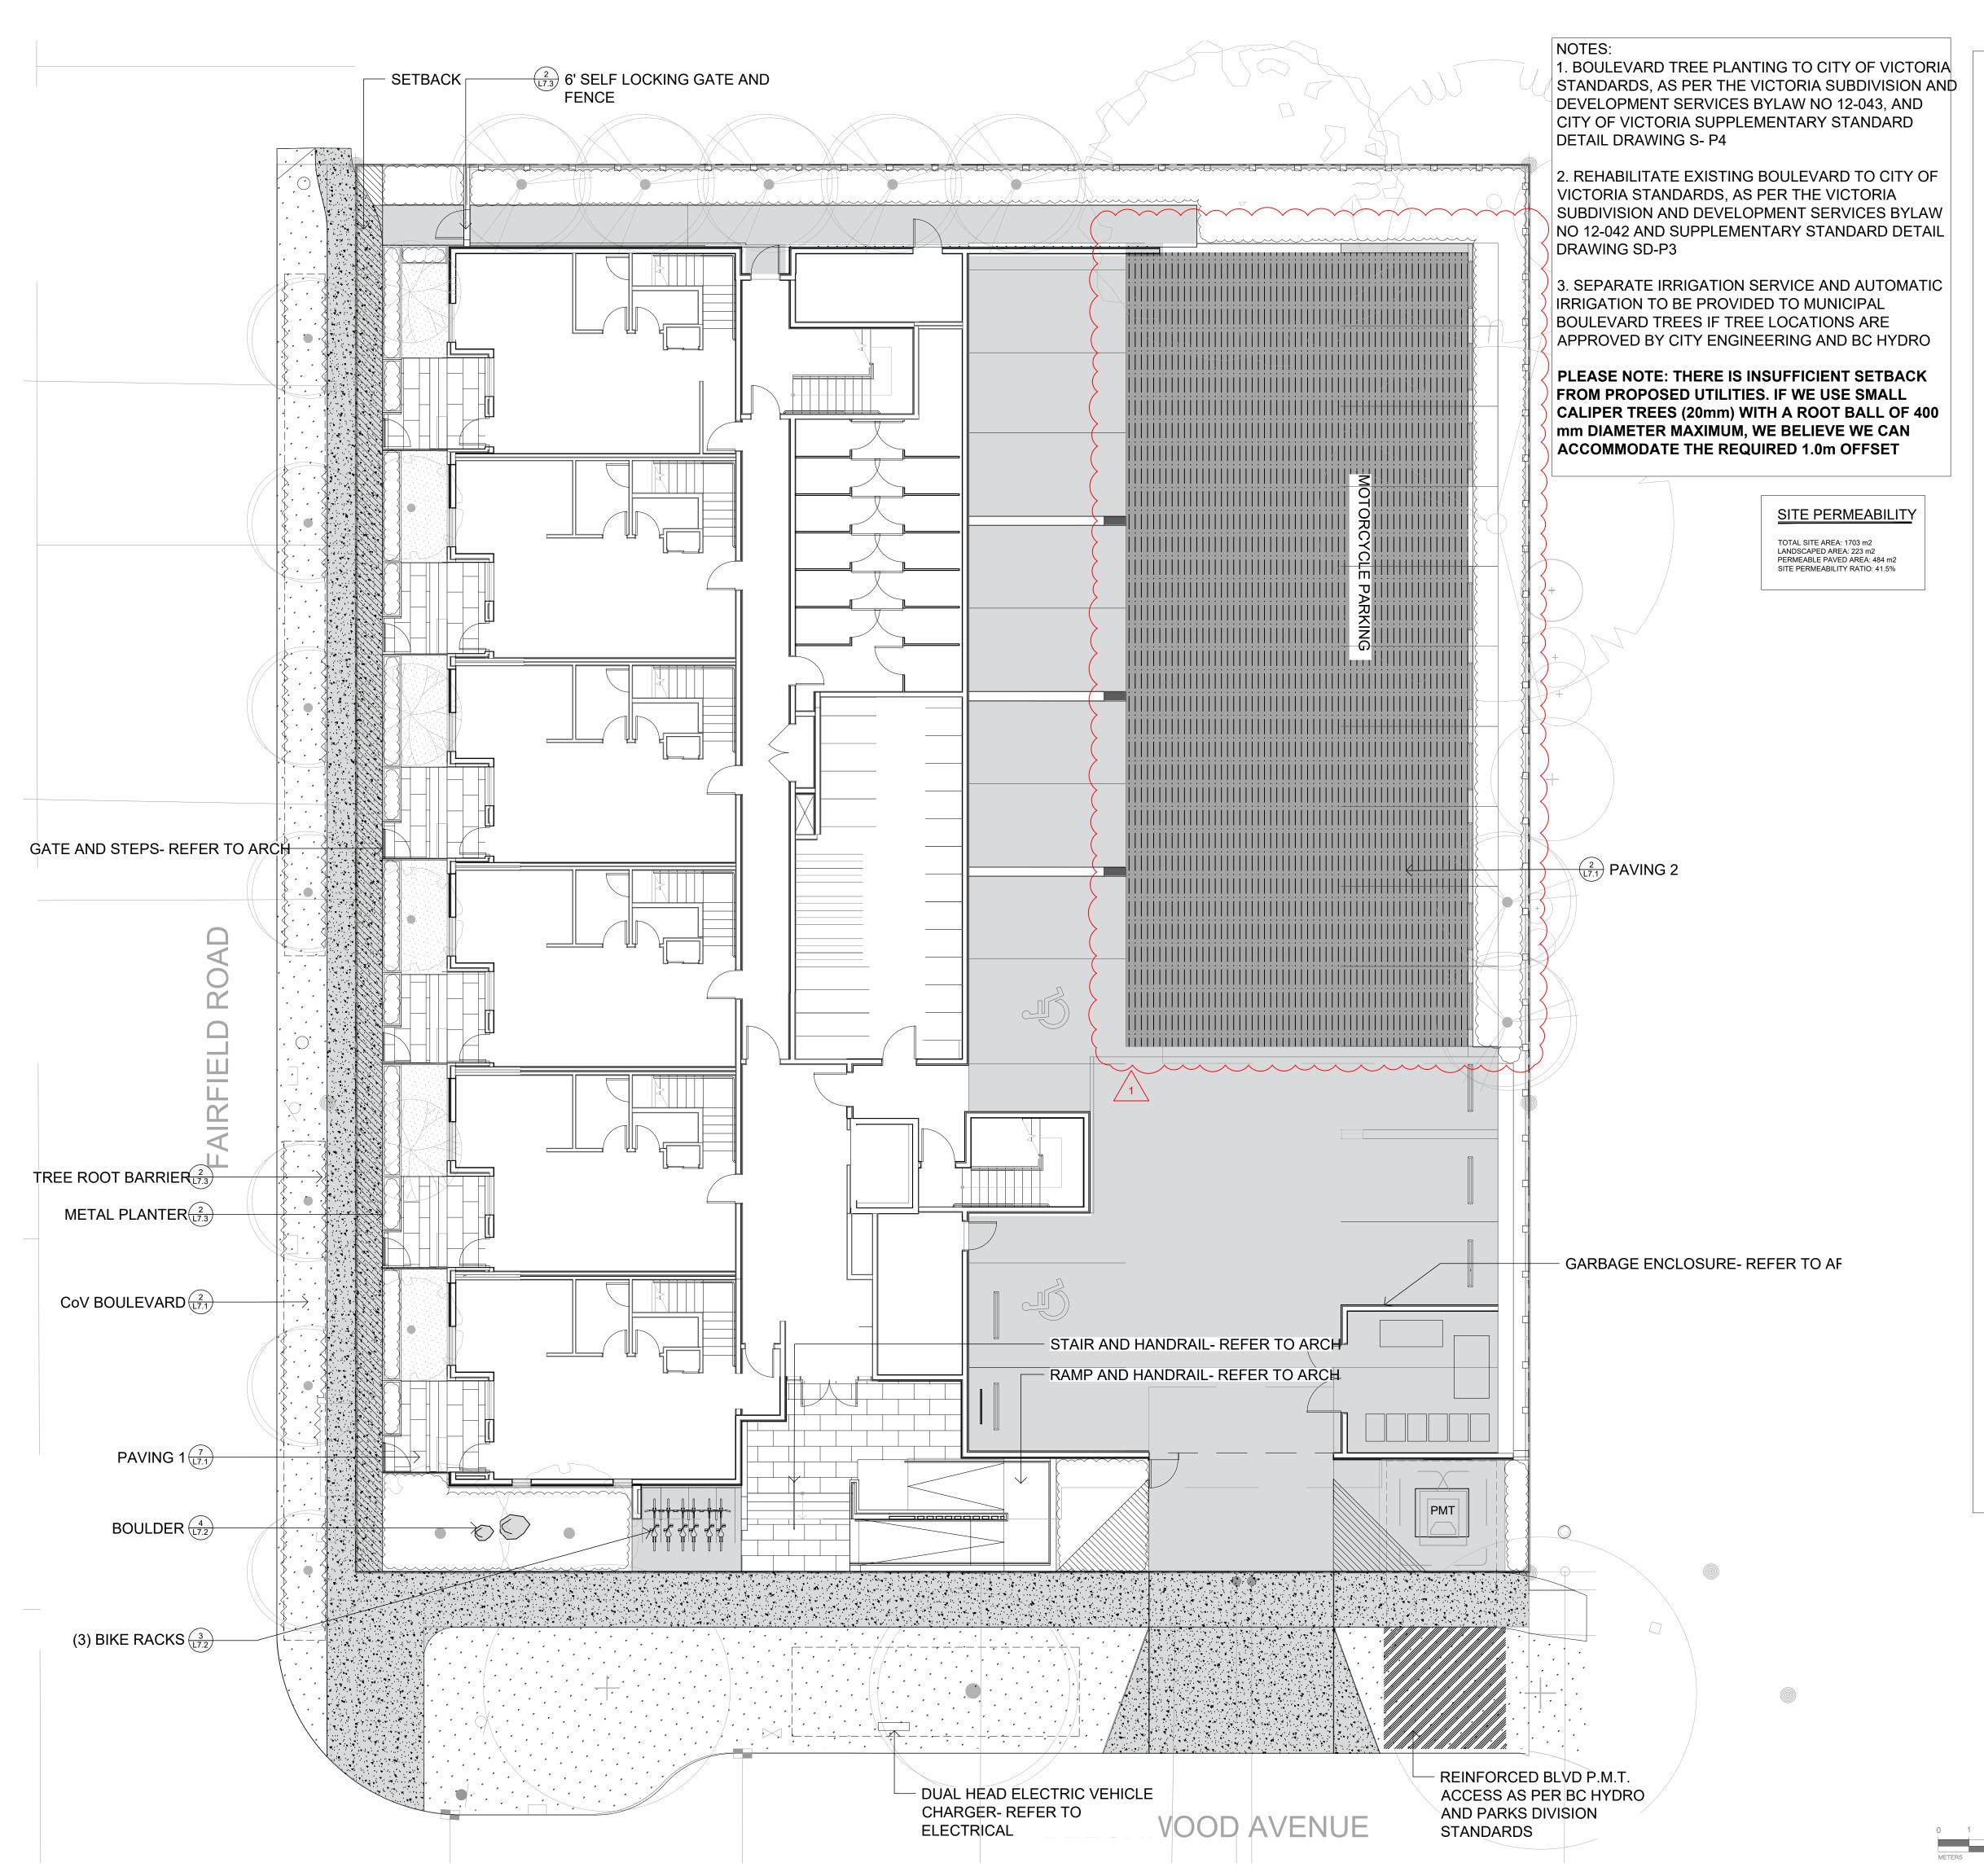



_____ _____

PROPERTY LINE



ROOF OVERHANG



 1000 mm DEPTH GROWING MEDIUM 50 mm DEPTH MULCH



RAISED PLANTER

 450 mm DEPTH PLANTER GROWING MEDIUM • 50 mm DEPTH MULCH



PARKING STALL PAVER NEWSTONE DORADO DRAIN PAVERS

PATIO AND BALCONY PAVER ARISTOKRAT™ SERIES COLOR: CASCADE GRANITE

 SIZE: 24" X 48" ON PEDESTALS

COLOR: CHARCOAL

SOD MUNICIPAL BOULEVARD AREA

 150 mm DEPTH HIGH TRAFFIC LAWN GROWING MEDIUM SOD

SOD MUNICIPAL BOULEVARD AREA

 150mm DEPTH HIGH TRAFFIC LAWN GROWING MEDIUM 850 mm DEPTH GROWING MEDIUM FOR TREE PIT

SOD

 1000 mm DEPTH PLANTING AREAS GROWING MEDIUM (MMCD) FOR LAWN AREA WITH TREES + SOD

 150 mm DEPTH HIGH TRAFFIC LAWN GROWING MEDIUM (MMCD) FOR AREA WITHOUT TREES + SOD

MUNICIPAL SIDEWALK

 CIP CONCRETE WITH BROOM FINISH TO CITY OF VICTORIA MUNICIPAL STANDARDS

CONCRETE PATH AND DRIVEWAY



TREE PIT WITH 1000mm DEPTH GROWING MEDIUM FOR BOULEVARD TREES



SURFACE MOUNT ON CONCRETE PAD



LANDSCAPE BOULDER VANCOUVER ISLAND GRANITE OR




FENCE


• 6' HT SOLID CEDAR WOOD FENCE STAIN: HEMLOCK GREY




EXISTING BOULEVARD TREE TO BE RETAINED

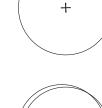


PROPOSED BOULEVARD TREE TO BE SPECIFIED BY CITY OF VICTORIA PARKS

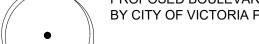



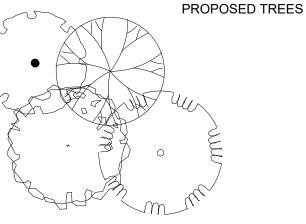

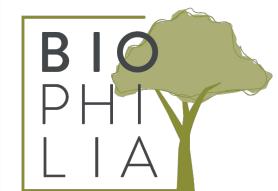

1608 Camosun Street, Victoria BC V8T 3E6 Info@biophiliacollective.ca 250 590 1156

OWNER/CLIENT:

ARYZE DEVELOPMENTS

PROJECT ADDRESS:

1733 FAIRFIELD, VICTORIA, BC

DESIGNED BY:BIANCA BODLEY

DRAWN BY: TYLER YESTAL

NO.	ISSUE	YY\MM\DD
1	ISSUED FOR DEVELOPMENT TRACKER	22\03\04
2	ISSUED FOR RZ/DP	22\05\02
3	ISSUED FOR COORDINATION	22\07\18
4	ISSUED FOR RZ/ DP	22\07\20
5	ISSUED FOR RZ/ DP RESUBMISSION	23\01\24
6	ISSUED FOR RZ/ DP RESUBMISSION	2023\08\18
7	25% BUILDING PERMIT	2023\10\10
8	ISSUED FOR BP COORDINATION	2023/11/24
9	DP/RZ REV 4	2024/01/12


SEAL

NORTH ARROW

DRAWING TITLE:

LANDSCAPE SITE PLAN LEVEL 1

DWG NO:

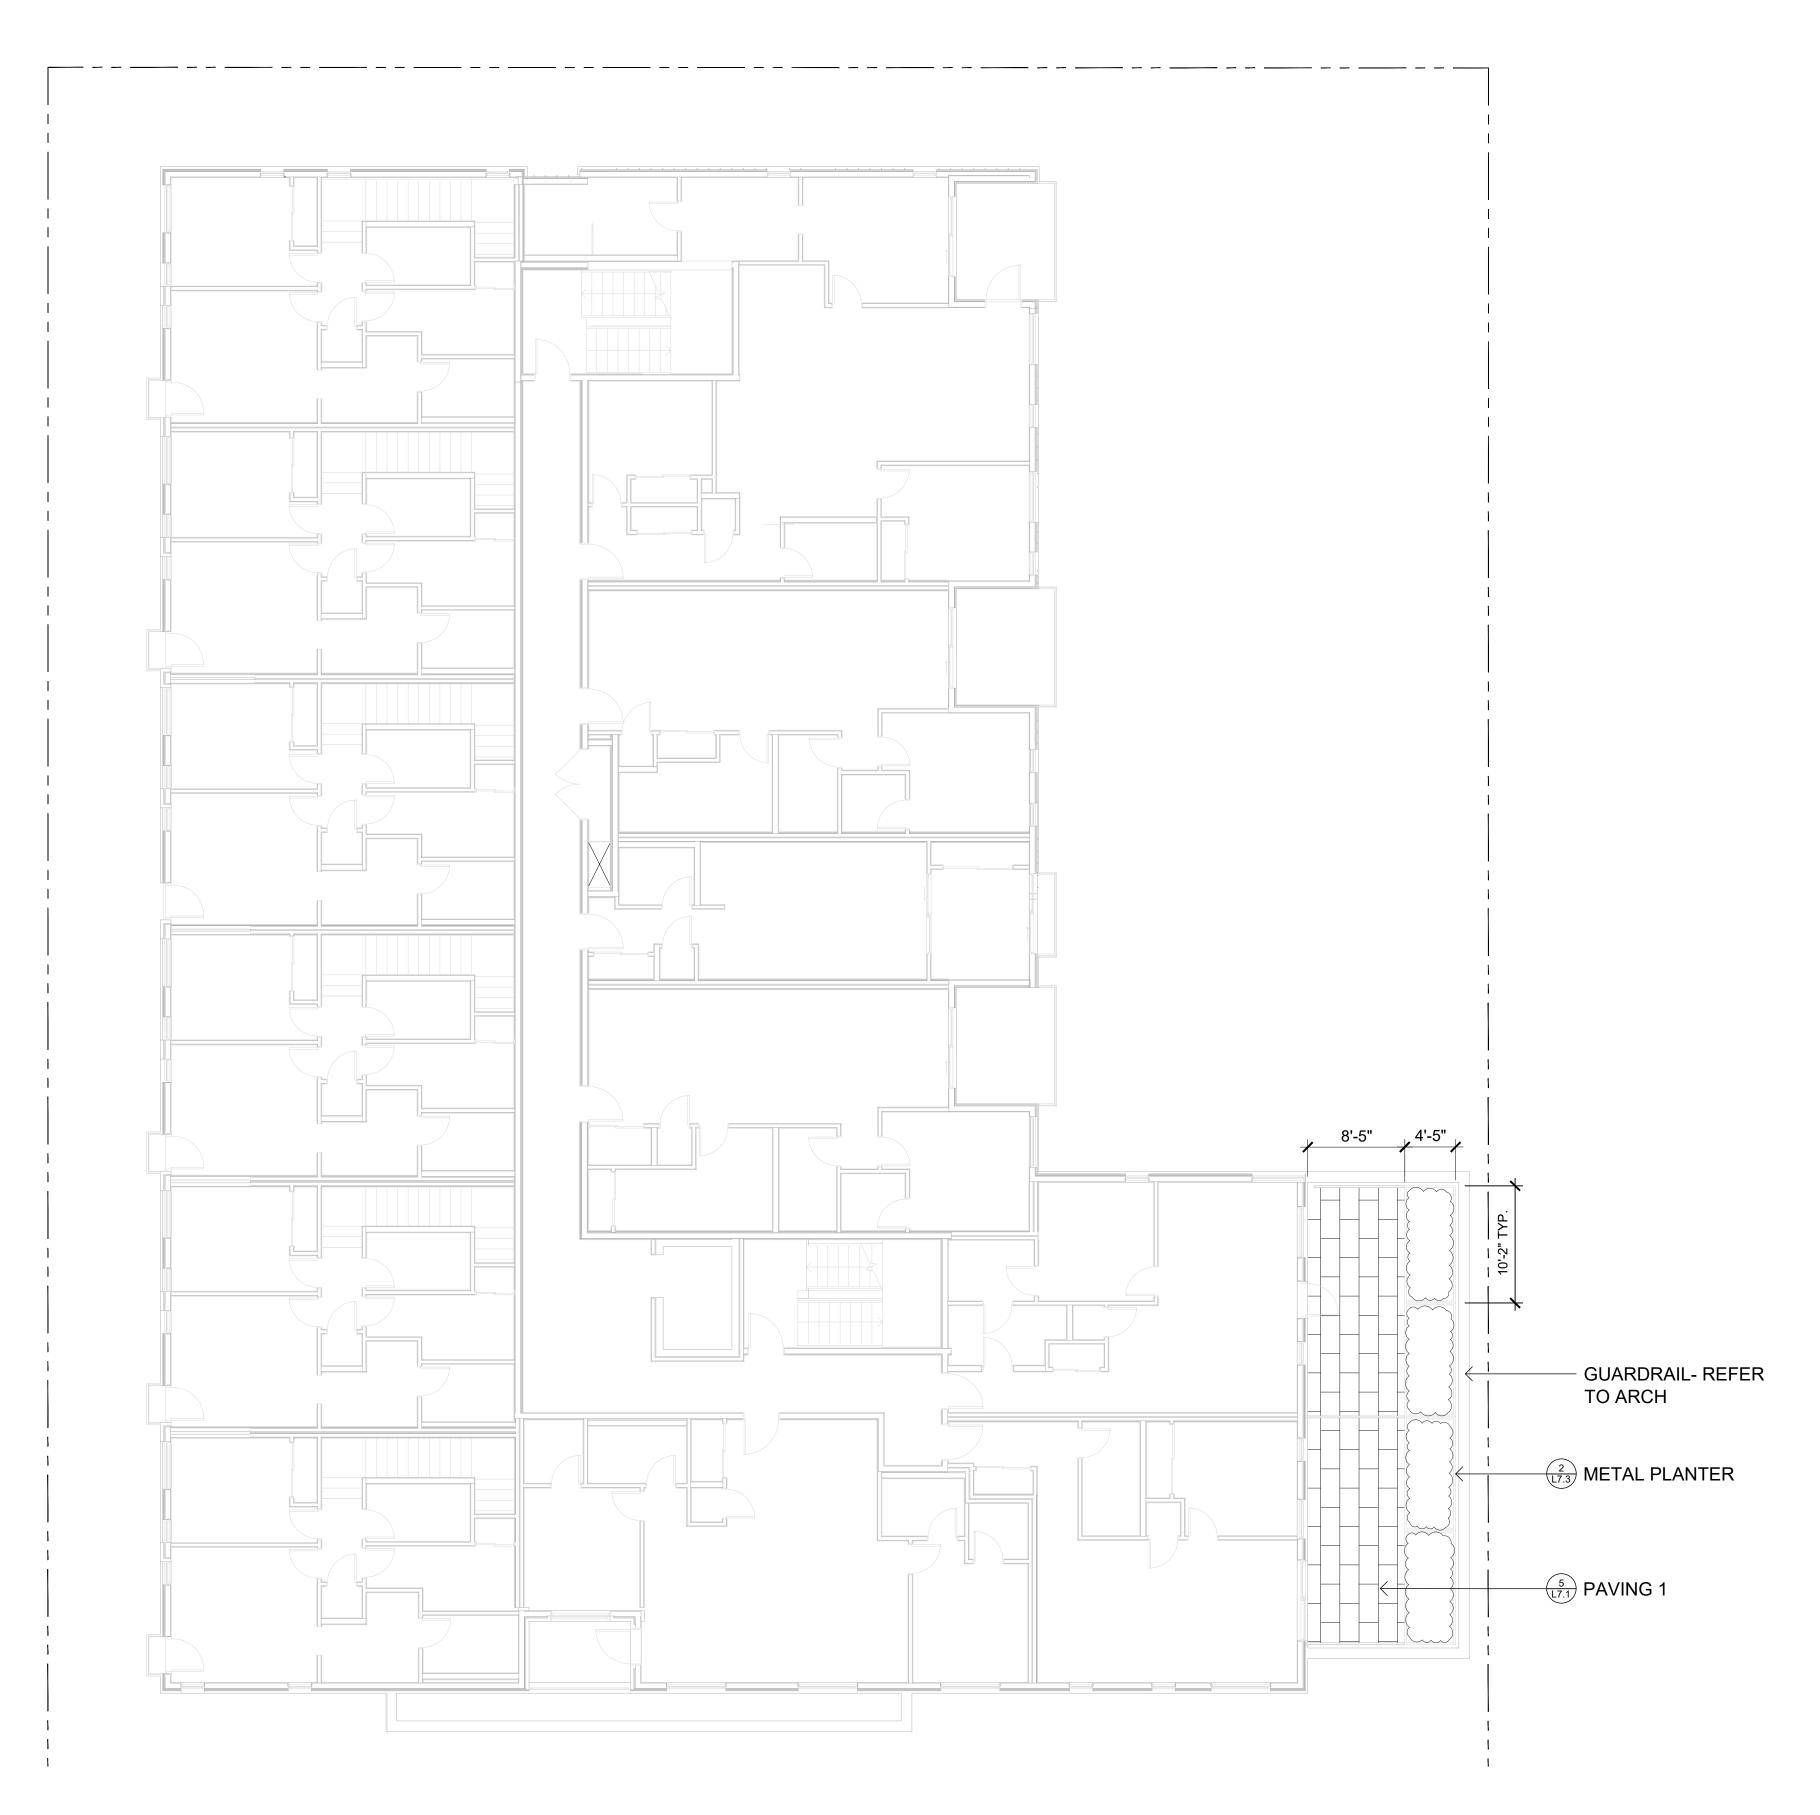





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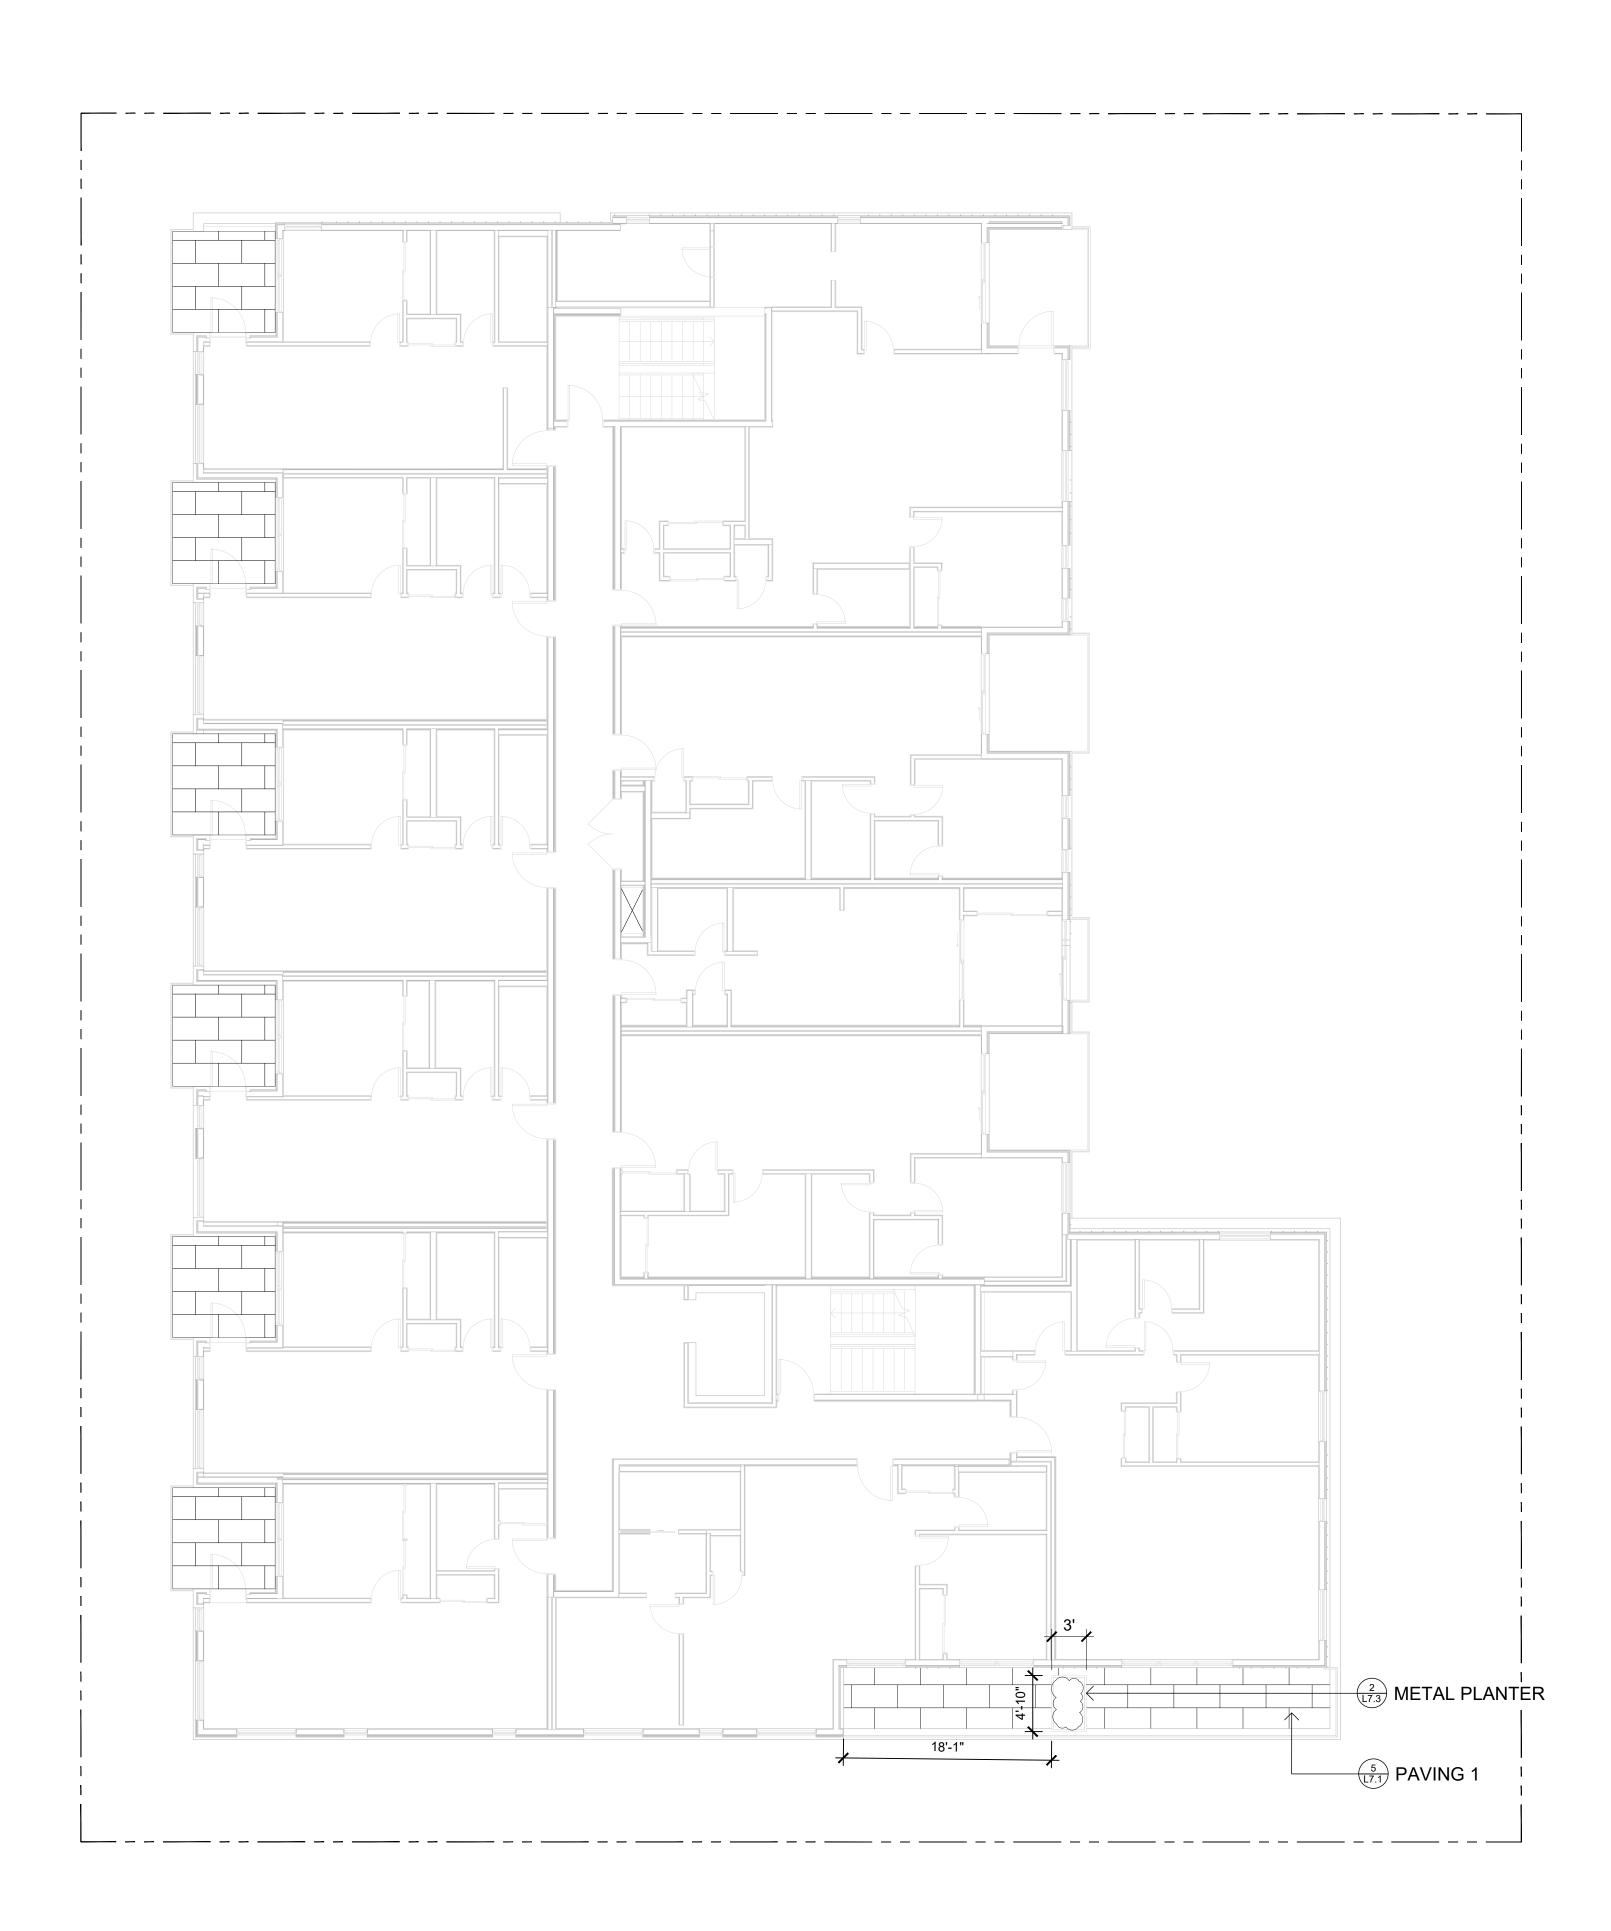
SEAL

NORTH ARROW


LANDSCAPE MATERIALS AND LAYOUT PLAN LEVELS 2, 3, & 4

DWG NO:

SCALE: AS NOTED





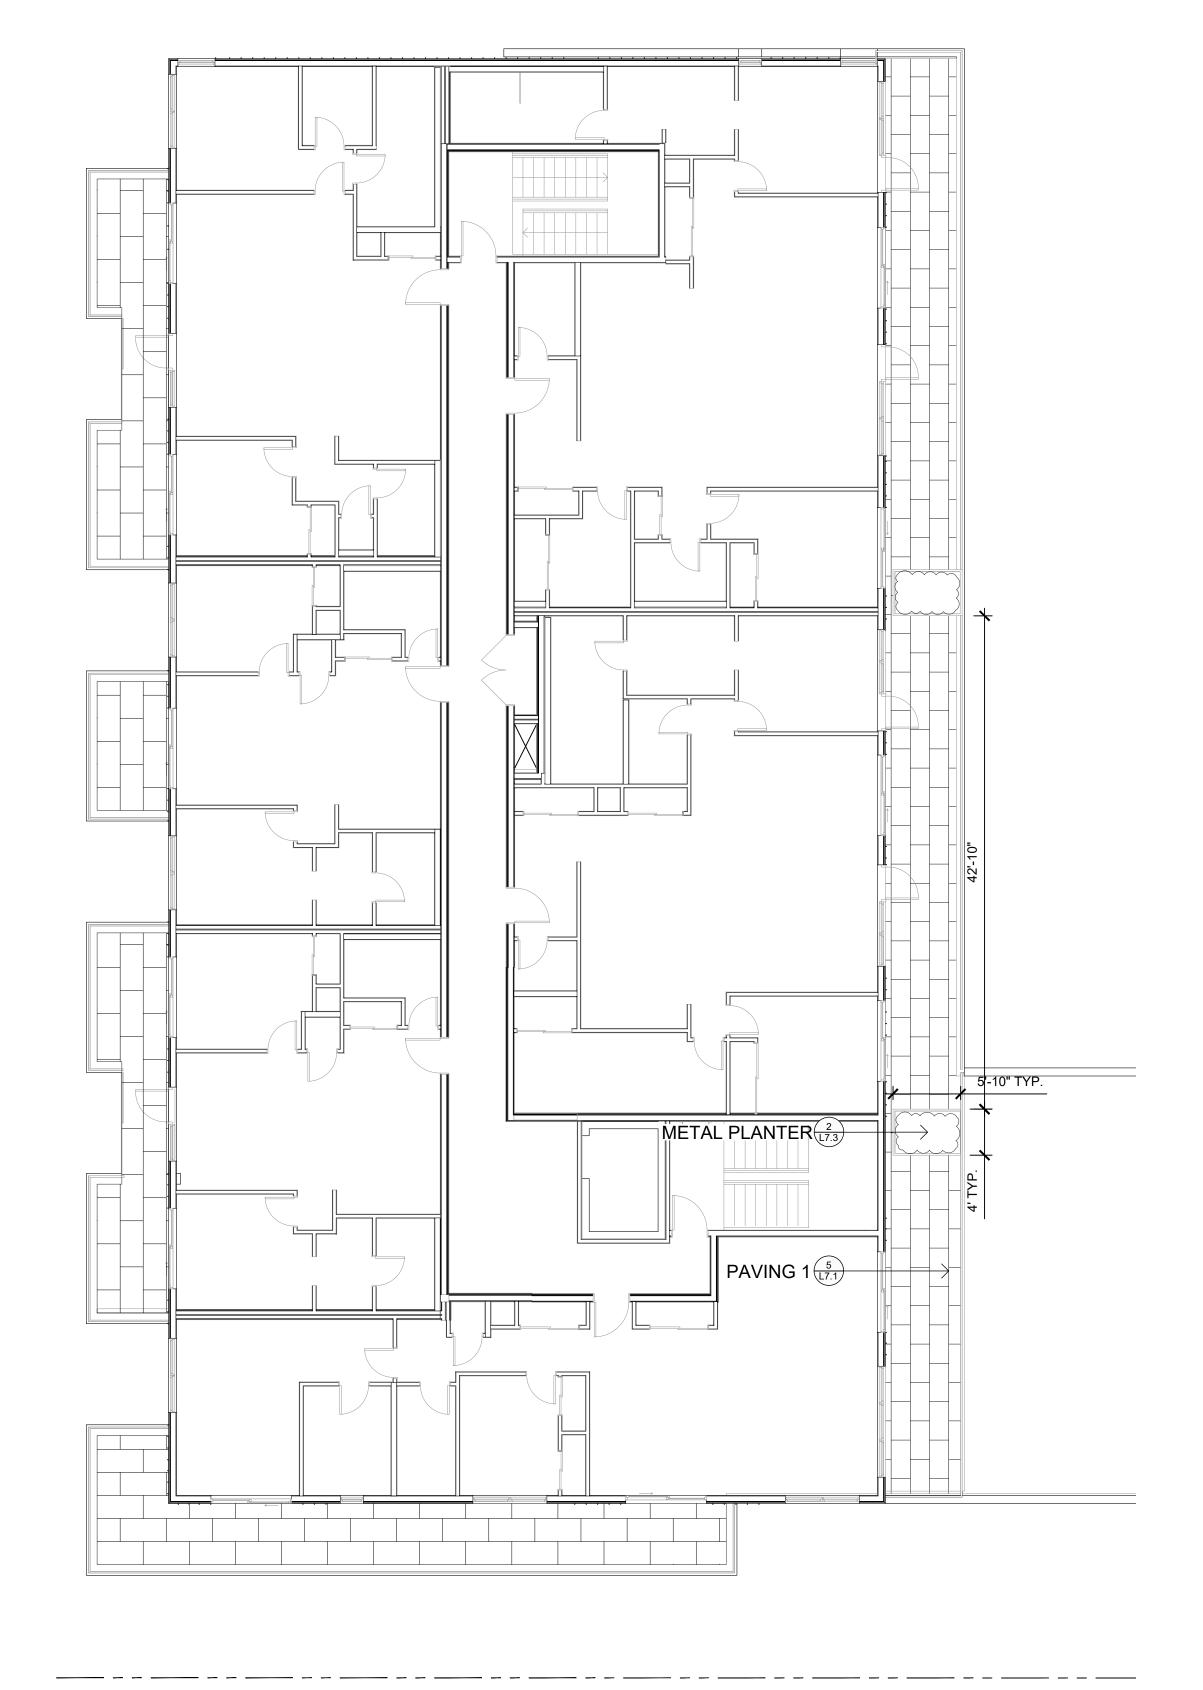

2 LEVEL 4 BALCONY & PLANTER L1.3 1:100





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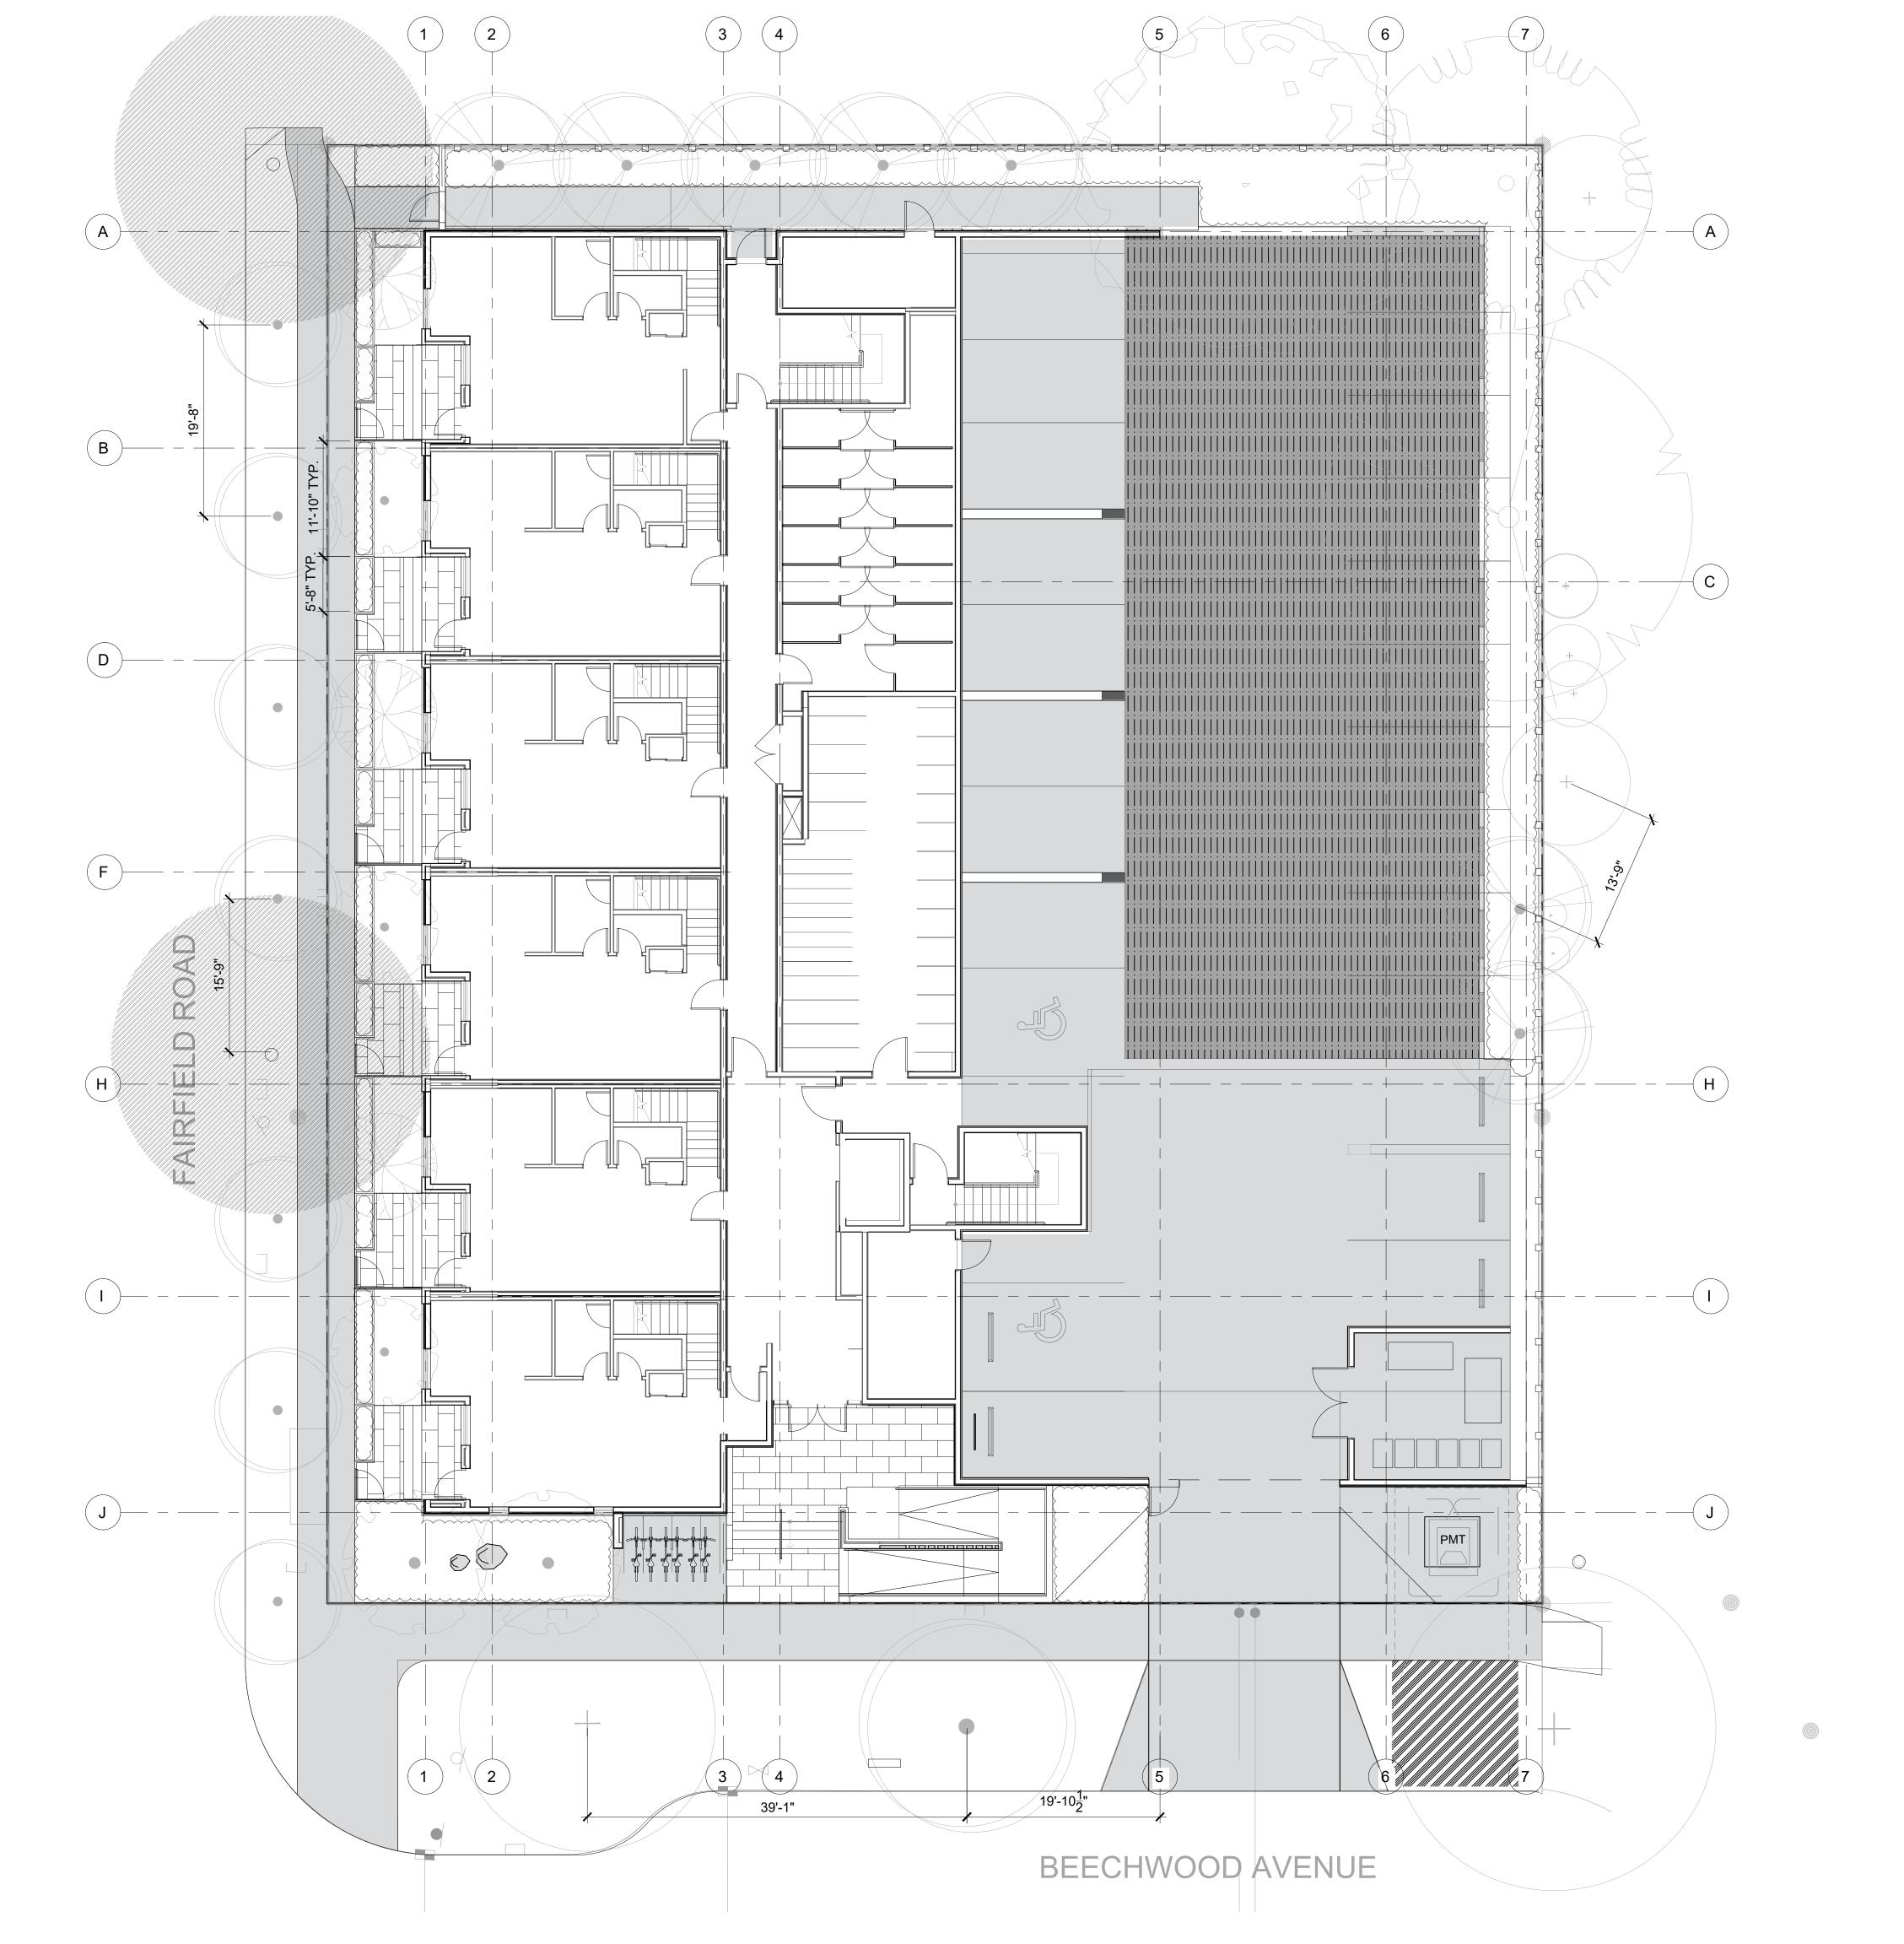
SEAL

NORTH ARRO

LANDSCAPE MATERIALS
AND LAYOUT PLAN
LEVELS 2, 3, & 4

DWG NO:

SCALE: AS NOTED





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2024/01/12

9 DP/RZ REV 4

SEAL

LAYOUT PLAN NOTES

ALL DIMENSIONS ARE NOMINAL
 REFER TO GRADING PLAN FOR ELEVATIONS

3. ALL SITE FURNISHINGS TO BE CONFIRMED WITH LANDSCAPE ARCHITECT PRIOR TO INSTALLATION


NORTH ARROW

DRAWING TITLE:

LAYOUT PLAN

DWG NO:

L2.1

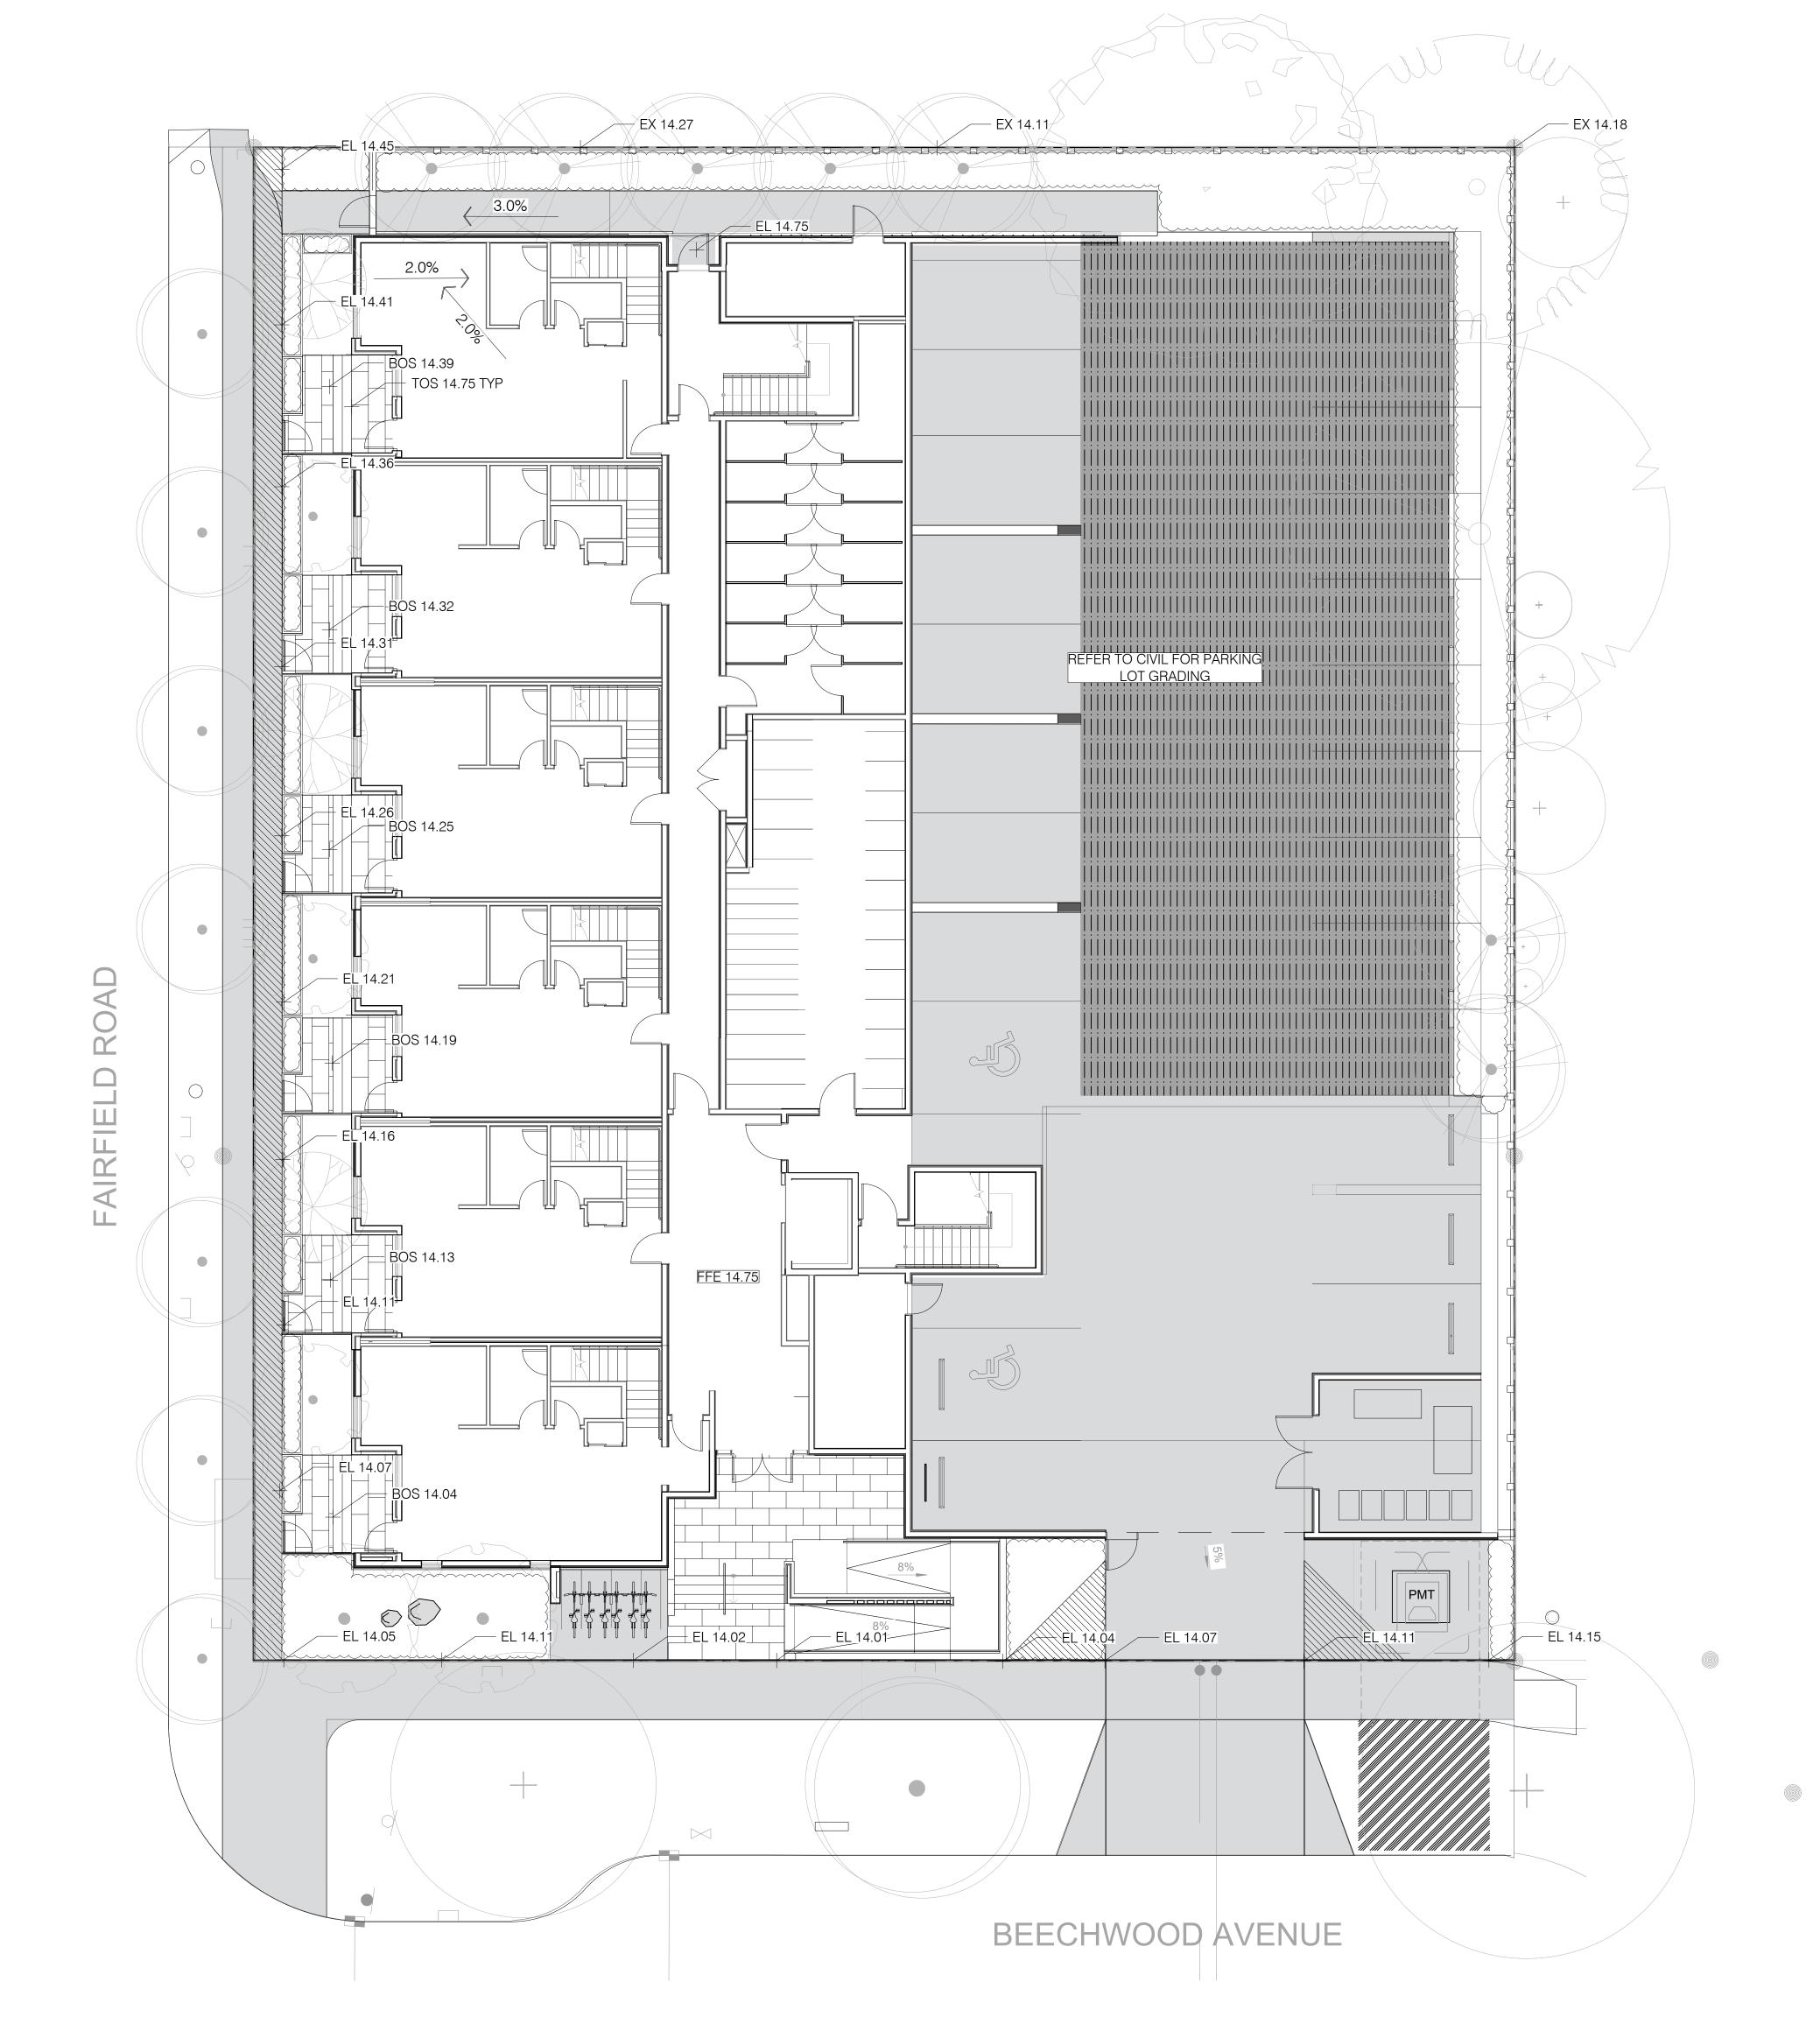



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SEAL

GRADING PLAN NOTES

 ALL ELEVATIONS ARE NOMINAL. CONTRACTOR TO VERIFY SPOT ELEVATION PRIOR THE START OF CONSTRUCTION.
 ALL ELEVATIONS ARE TO TOP OF FINISHED GRADE UNLESS

REFER TO CIVIL FOR ALL OFFISITE AND PARKING LOT GRADING.
 REFER TO ARCH FOR ONSITE PATIO GRADING.


NORTH ARROW

DRAWING TITLE:

GRADING PLAN

DWG NO:

SCALE: 1:100

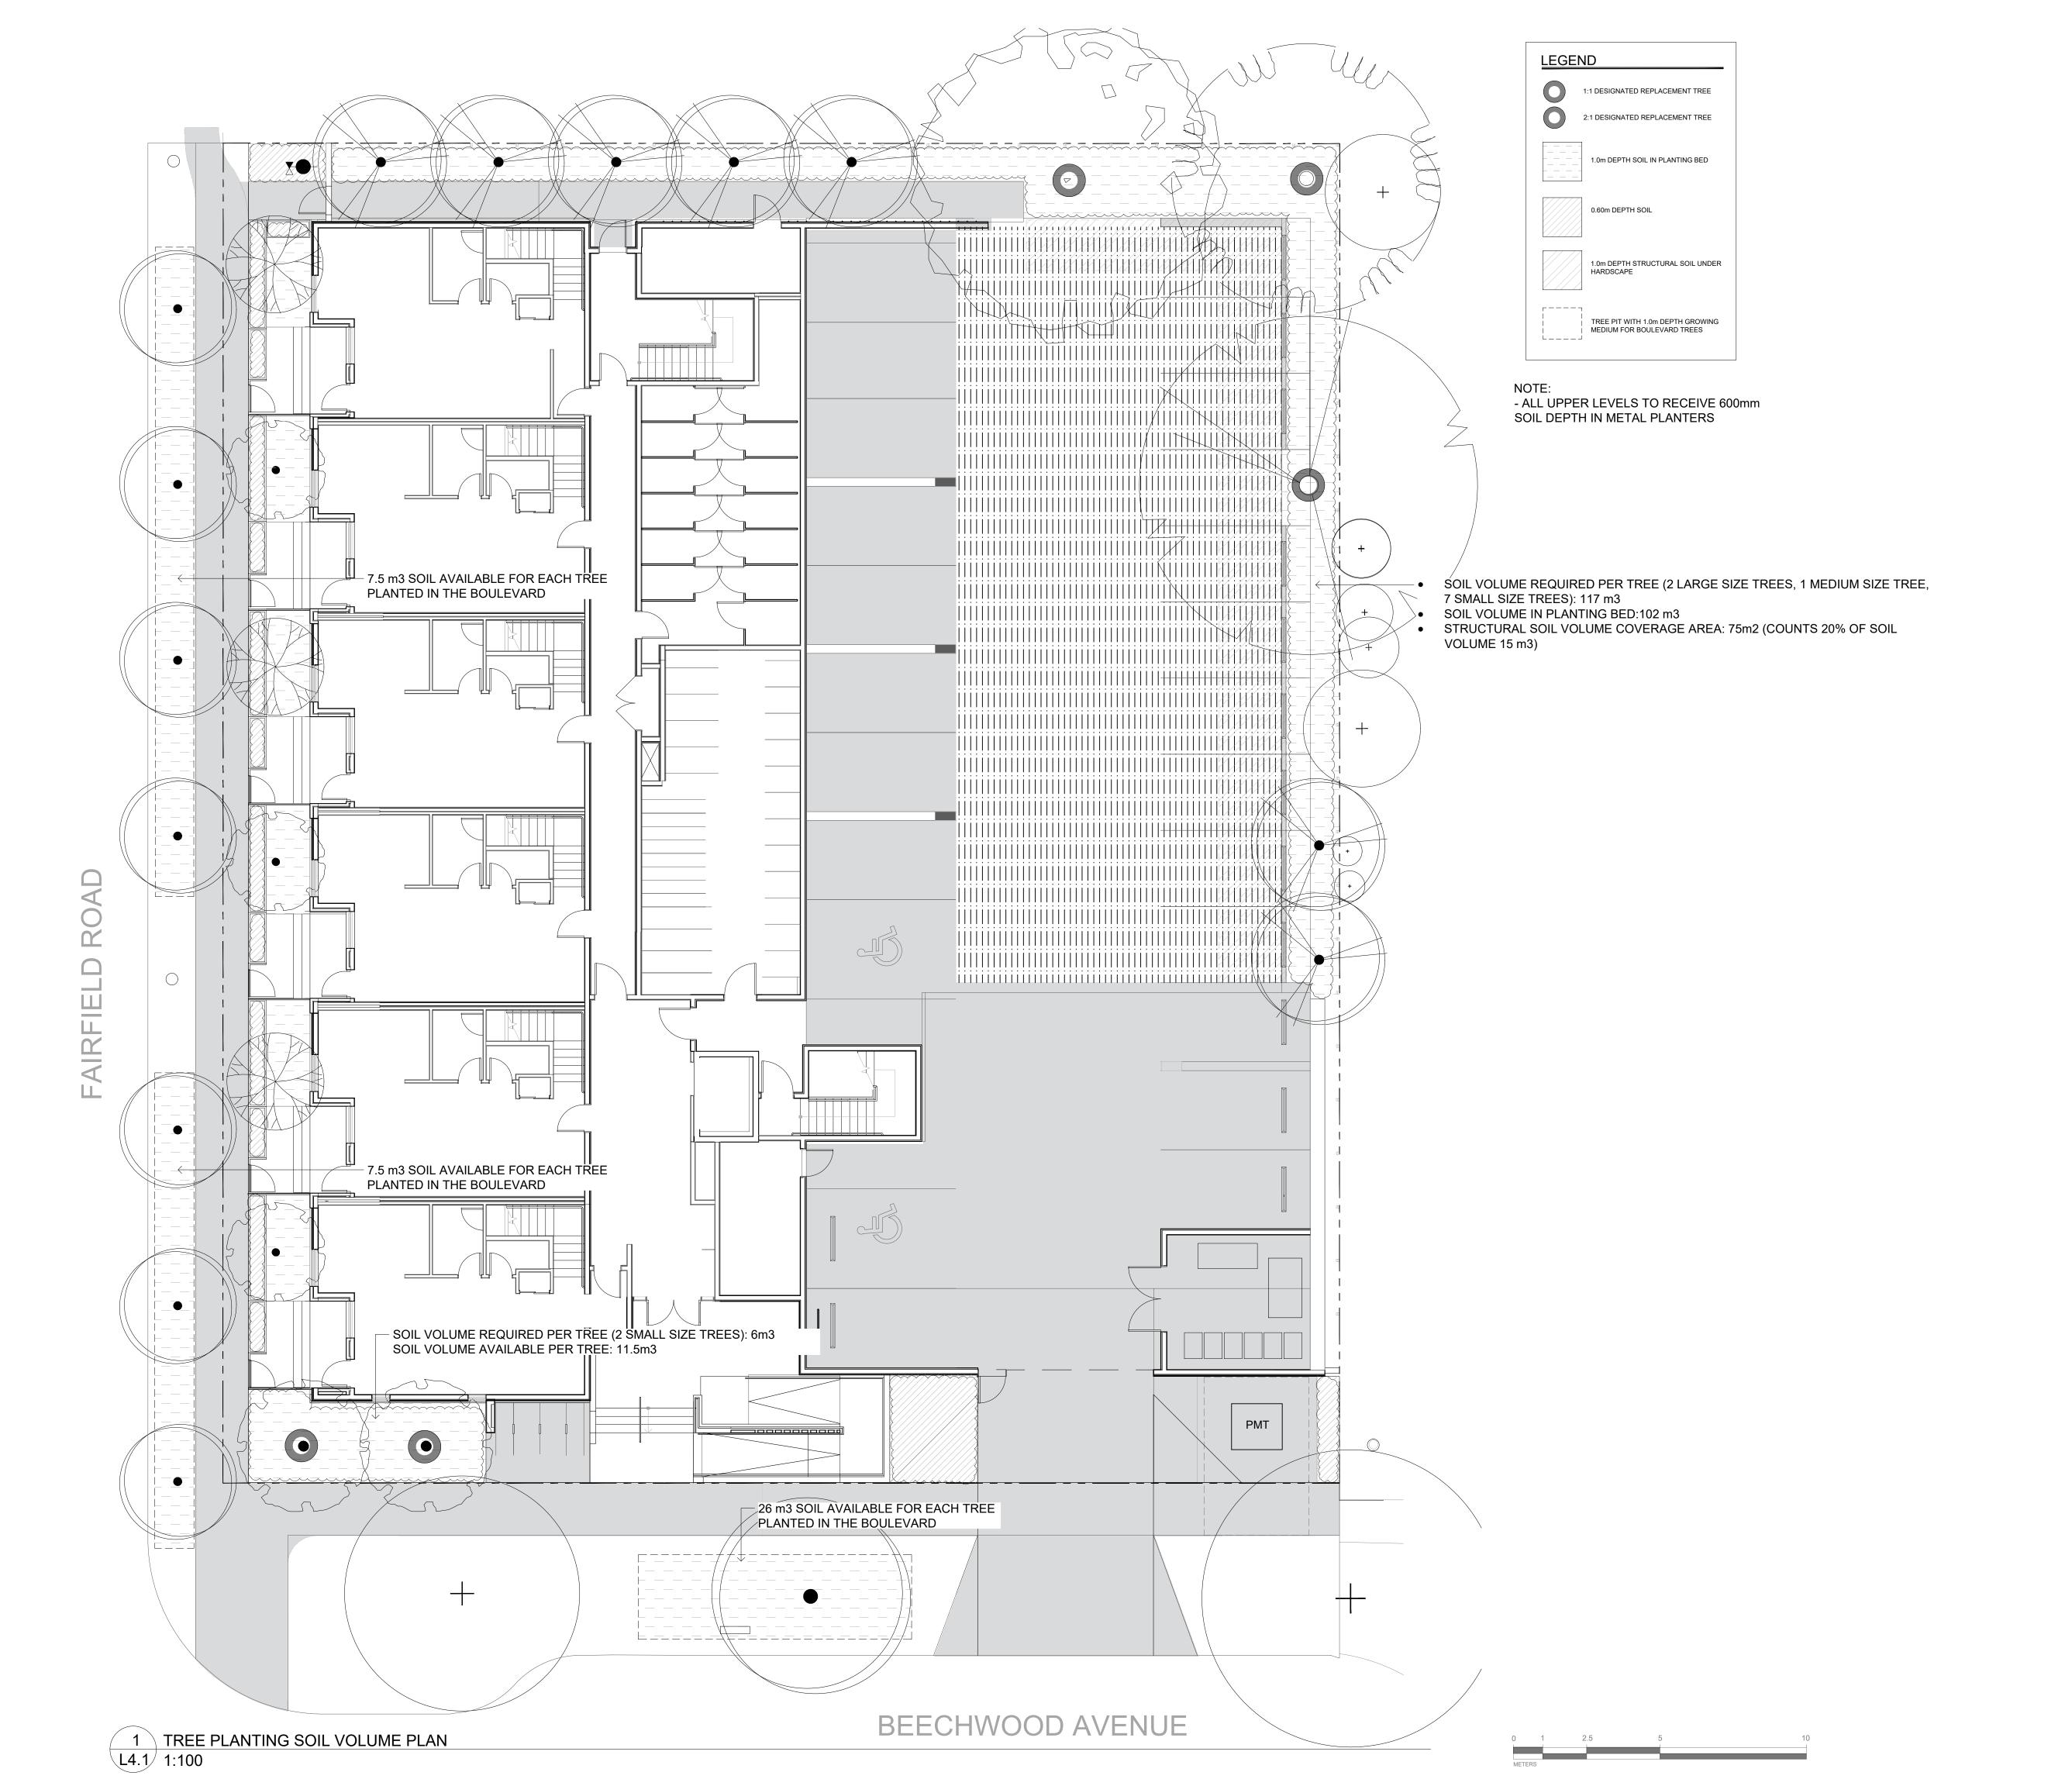



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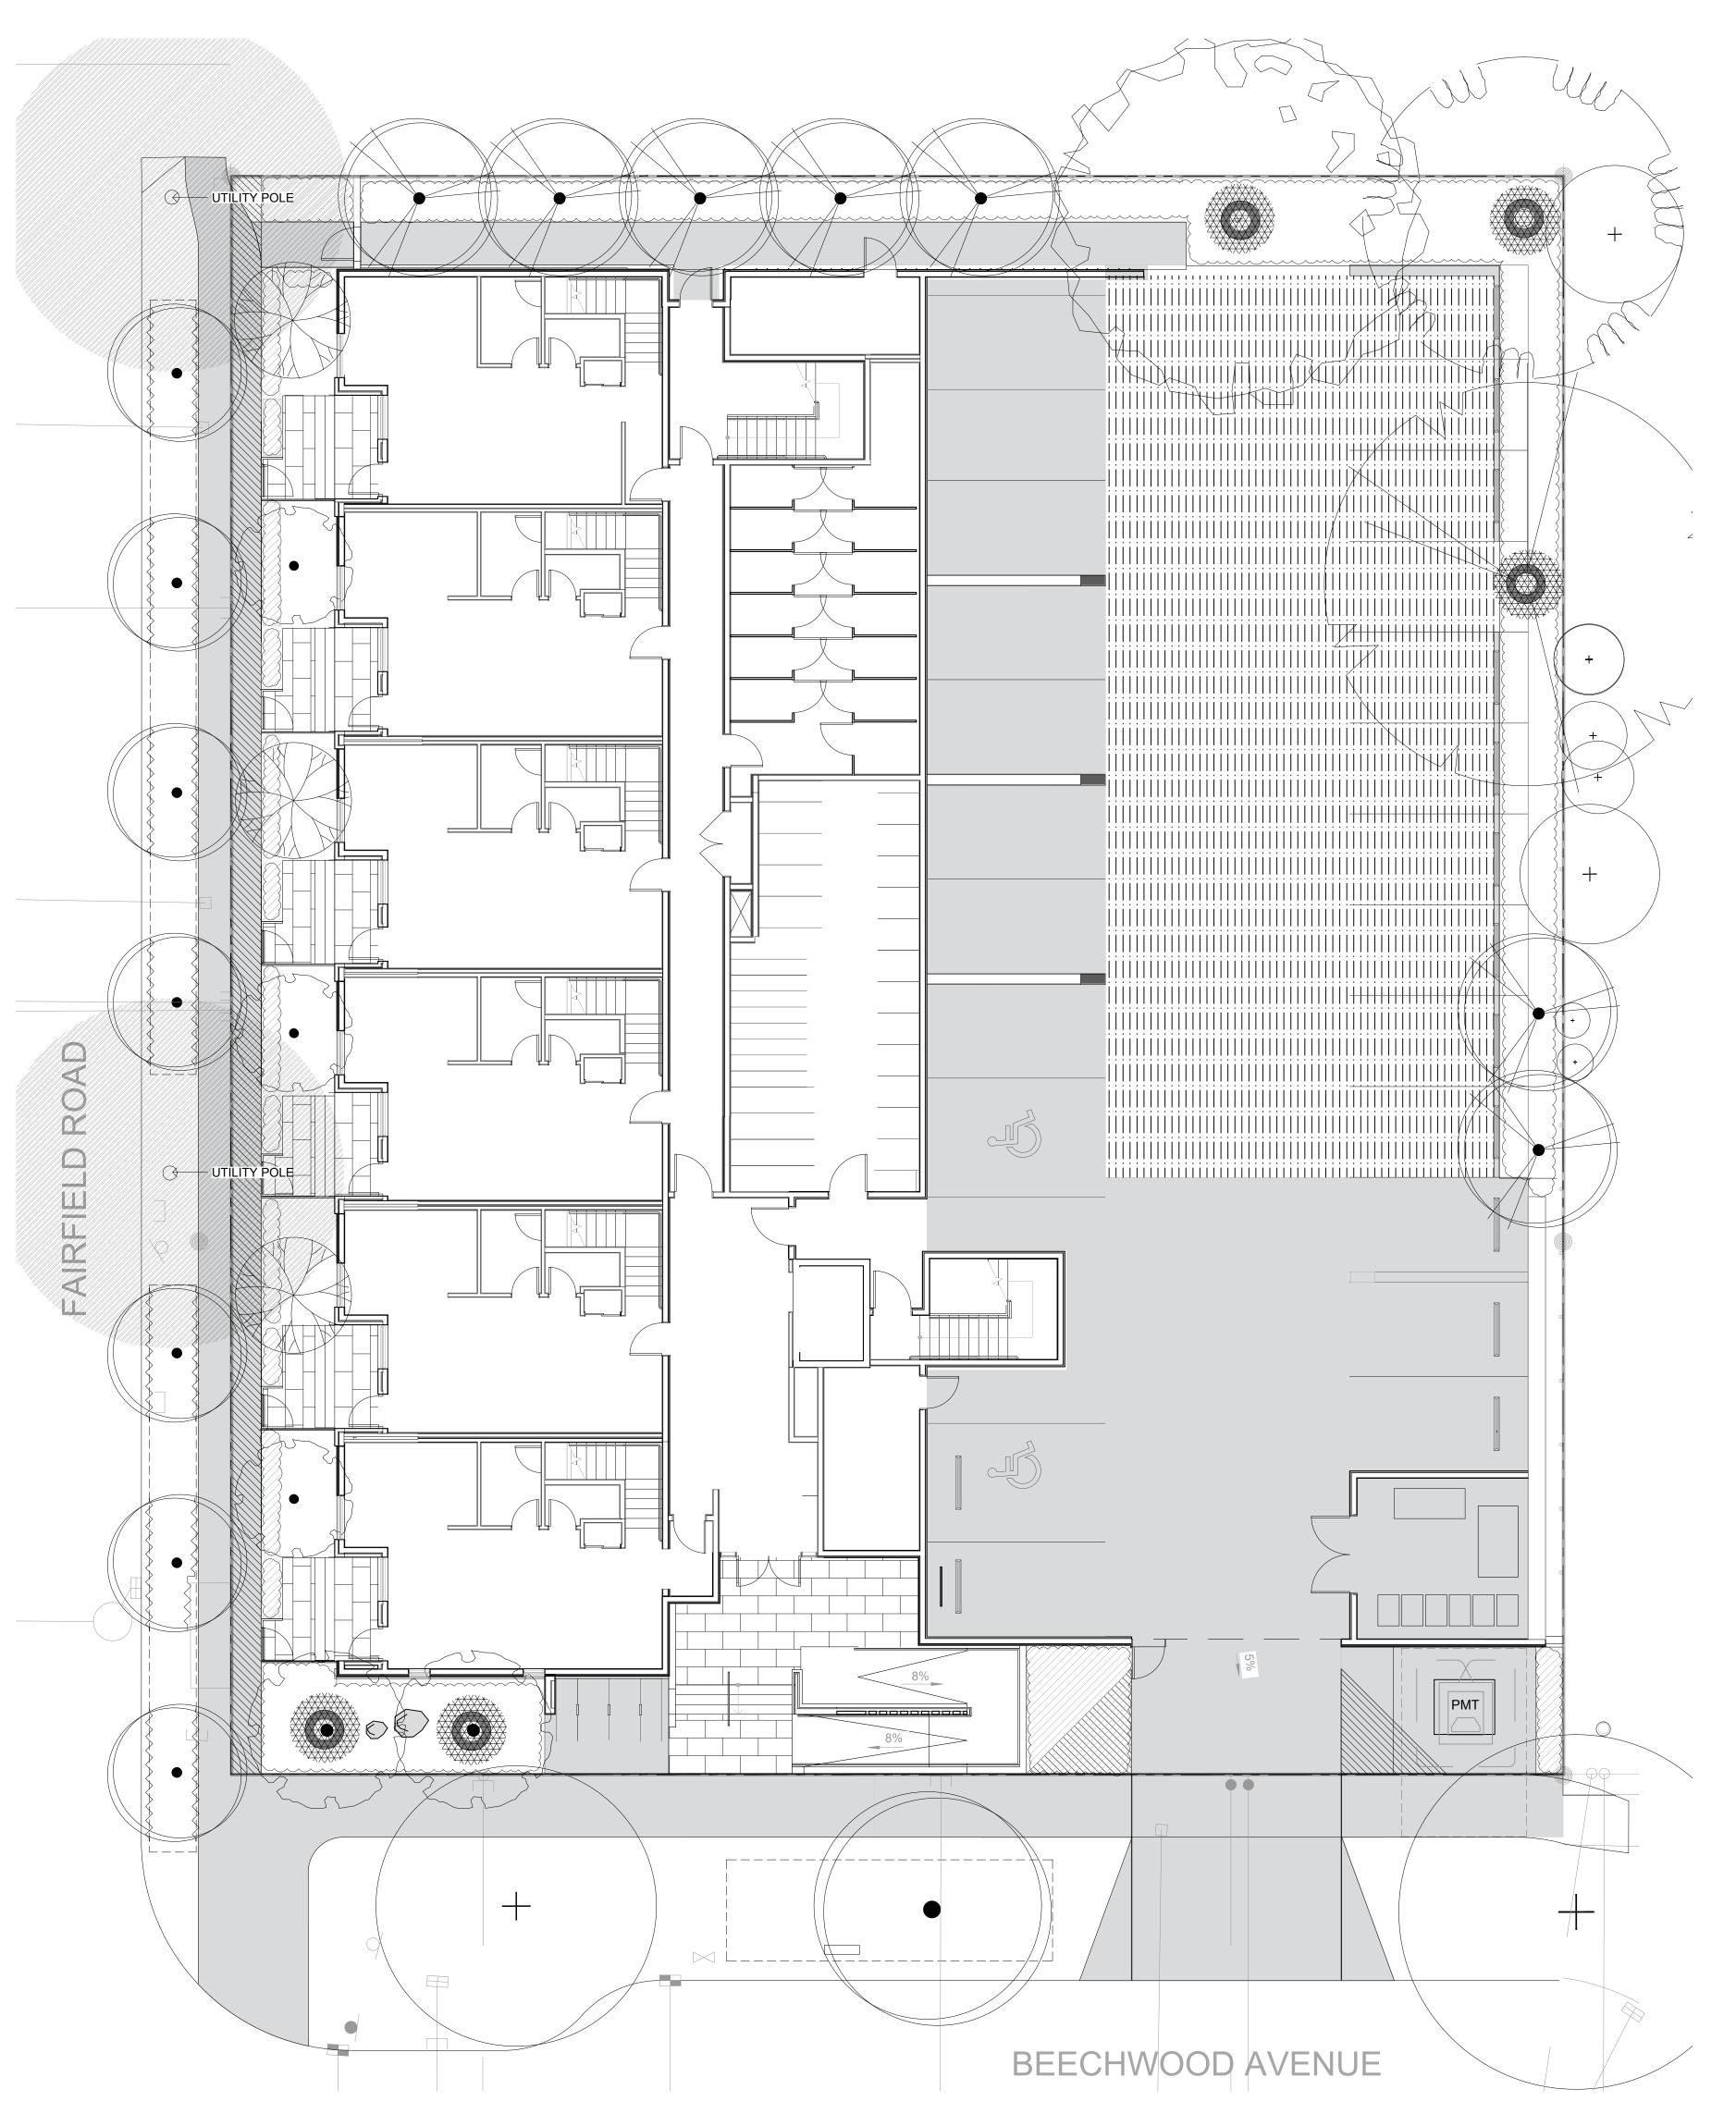
NORTH ARROW


DRAWING TITLE:

SOIL VOLUME PLAN

DWG NO:

AS NOTED 4



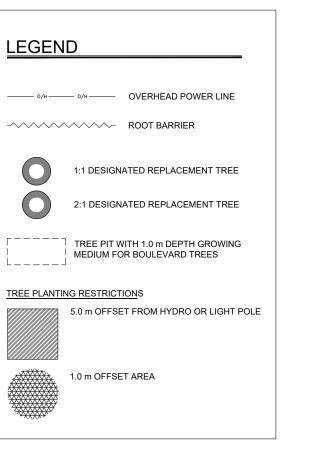

Quantity	Symbol	Latin Name	Common Name	Container	Caliper	Size	Native
5		Acer griseum	Paperbark Maple	B&B	6 cm	>2 m	
1	The same of the sa	Fraxinus americana 'Autumn Applause'	Autumn Applause white ash	B&B	6 cm	>2 m	
1	Z T	Liriodendron tulipifera	Tulip tree	B&B	6 cm	>2 m	
7		Parrotia persica 'Ruby Vase'	Ruby Vase Parrotia	B&B	6 cm	>2 m	
3		Styrax japonicus	Japanese snowbell	B&B	6 cm	>2 m	
1	To De la Contraction de la Con	Quercus palustris	Pin Oak	B&B	6 cm	>2 m	
8	•	BOULEVARD TREE TO BE DETERMINED BY PARKS AT BP		B&B	TBD		

TREE STATUS	TOTAL	TO BE RETAINED	TO BE REMOVED	REPLACEMENTS REQUIRED	MINIMUM REQUIRED FOR LOT SIZE	PROPOSED
ON-SITE TREES AND SHRUBS BYLAW PROTECTED	7	0	7	7	9	4
MUNICIPAL TREES	3	2	1	1		8
NEIGHBORING TREES, BYLAW PROTECTED	0	0	0	0		0

REPLACEMENT TREES TO BE PLANTED ON SITE	4	
REPLACEMENT TREE SHORTFALL	3	
TOTAL PROPOSED TREES ON SITE (REPLACEMENT (ACTUAL) + OTHER)	18	

NOTES:

- IRRIGATION SYSTEM ON CITY PROPERTY SHALL COMPLY TO CITY OF VICTORIA SUPPLEMENTARY SPECIFICATIONS FOR STREET TREES AND IRRIGATION SCHEDULE C, BYLAW 12-042, SUBDIVISION BYLAW. IRRIGATION DRAWINGS MUST BE SUBMITTED TO PARKS DIVISION FOR REVIEW AND APPROVAL 30 DAYS PRIOR TO INSTALLATION WORK. THE FOLLOWING IRRIGATION AND SLEEVING INSPECTIONS BY PARKS STAFF ARE REQUIRED BY SCHEDULE C.
- IRRIGATION INSPECTION REQUIREMENTS:
- a. THE IRRIGATION SYSTEM AND SLEEVING INSPECTION REQUIREMENTS CAN BE FOUND IN SCHEDULE C OF THE VICTORIA SUBDIVISION AND DEVELOPMENT SERVICING BYLAW NO. 12-042.
- b. IRRIGATION SLEEVING PRIOR TO BACKFILLING*
- c. OPEN TRENCH MAIN LINE AND PRESSURE TEST
- d. OPEN TRENCH LATERAL LINE
- e. IRRIGATION SYSTEM, CONTROLLER, COVERAGE TEST, BACKFLOW PREVENTER ASSEMBLY TEST REPORT
- REQUIRED, BACKFLOW ASSEMBLY IS TO HAVE AN INSPECTION TAG COMPLETED AND ATTACHED. • 100MM SDR 28 PIPE WILL BE USED FOR IRRIGATION SLEEVING UNDER HARD SURFACES. INSTALLATIONS WHERE
- A 90-DEGREE BEND IS REQUIRED SHOULD BE INSTALLED USING 100MM SDR 28 GSX (22.5 DEGREE) LONG SWEEPS. INSTALL WILL BE AT 400MM DEPTH.



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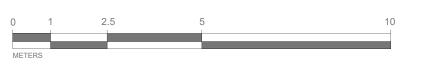
SEAL


ACTUAL NUMBER : 5 2 x LARGE TREE (1:1) 1 x MEDIUM TREE (1:1) 2 x SMALL TREE (2:1)

NORTH ARROW

DRAWING TITLE:

TREE PLANTING PLAN



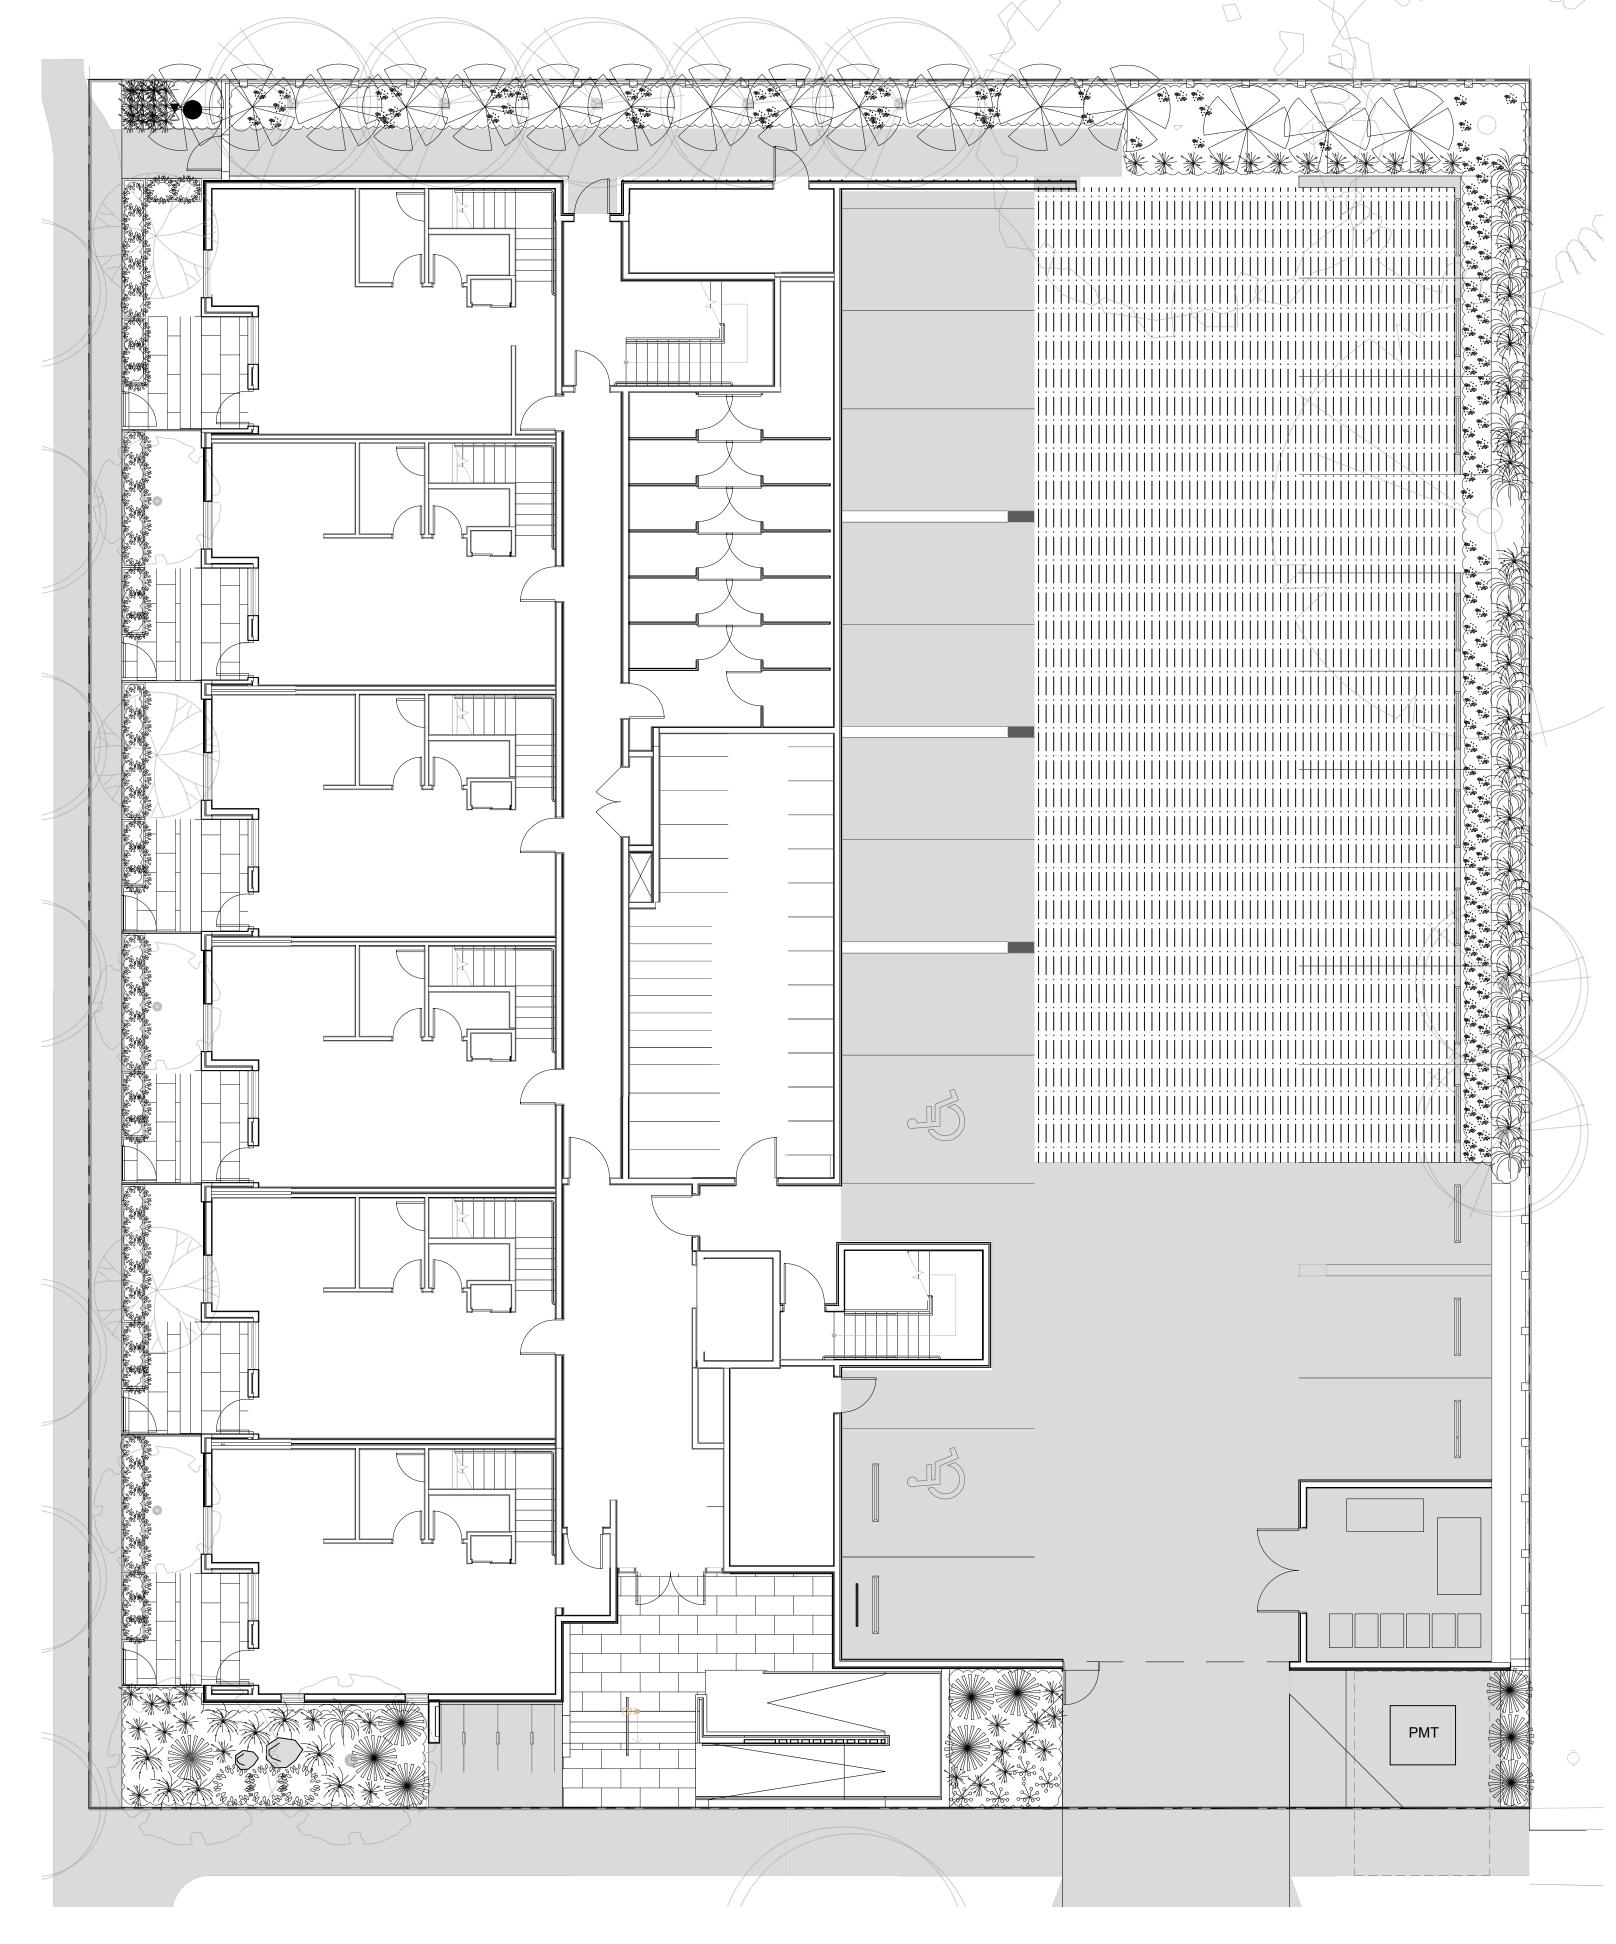

Quantity	Symbol	Latin Name	Common Name	Container	Native	Pollinator
12	<i></i>	Armeria maritima 'Alba'	White-flowered Thrift	10cm		у
60	≈:. ∴@	Arctostaphylos Uva-Ursi 'Massachusetts'	Kinnikinnick	10cm	у	у
30	*	Carex testacea 'Prairie Fire'	New Zealand hair sedge	#1		
10		Cephalotaxus harringtonia 'Prostrata'	Spreading Japanese plum yew	#2		
16		Choisya ternata	Mexican mock orange	#3		у
50	\$ \$ \$ \$ \$ \$ \$ \$ \$ \$ \$ \$ \$ \$ \$ \$ \$ \$ \$	Hebe pinguifolia 'Sutherlandii'	Hebe Sutherlandii	#1		
30		Miscanthus sinensis 'Huron Light'	Huron Light maiden grass	#1		
25		Miscanthus sinensis 'Morning Light'	Chinese silver grass Morning Light	#1		
	9.0	Verbena honariensis				

Dwarf purpletop

'Lollipop'

PLANTS FROM THE BC LANDSCAPE STANDARD, CURRENT EDITION.

1. PLANTS IN PLANT LISTS ARE SPECIFIED ACCORDING TO THE CANADIAN NURSERY LANDSCAPE ASSOCIATION CANADIAN STANDARDS FOR NURSERY STOCK AND SECTION 12, CONTAINER GROWN

PLANTING PLAN NOTES

- ALL PLANT MATERIAL TO BCSLA STANDARDS.
- 2. THE SEARCH ARE FOR PLANT MATERIAL IS THE PACIFIC NORTHWEST INCLUDING WASHINGTON,
- OREGON AND BRITISH COLUMBIA.

 3. CONFIRM PLANTING LAYOUT WITH LANDSCAPE ARCHITECT ON SITE.
- 4. ALL SOIL VOLUMES TO MEET THE STANDARDS OF THE CITY OF VICTORIA. REFER TO SOIL DEPTH PLANS FOR SOIL DEPTH REQUIREMENTS.
- 5. ALL GROWING MEDIUM PROVISION AND INSTALLATION TO BE IN LINE WITH CANADIAN LANDSCAPE
- 6. REFER TO CIVIL AND MECHANICAL FOR DRAINS.
- 7. ALL ONSITE AND OFF-SITE LANDSCAPE AREAS TO BE IRRIGATED BY AN UNDERGROUND AUTOMATIC IRRIGATION SYSTEM. IRRIGATION TO BE SUPPLIED BY CONTRACTOR
- 8. PLANTING AROUND EXISTING CRITICAL TREE ROOT ZONES TO BE INSTALLED UNDER THE SUPERVISION OF A CERTIFIED ARBORIST.
- 0 1 25 5 10

1 GROUND FLOOR PLANTING PLAN

L3 1:100

BIO PHT LIA

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SEAL

NORTH ARROW


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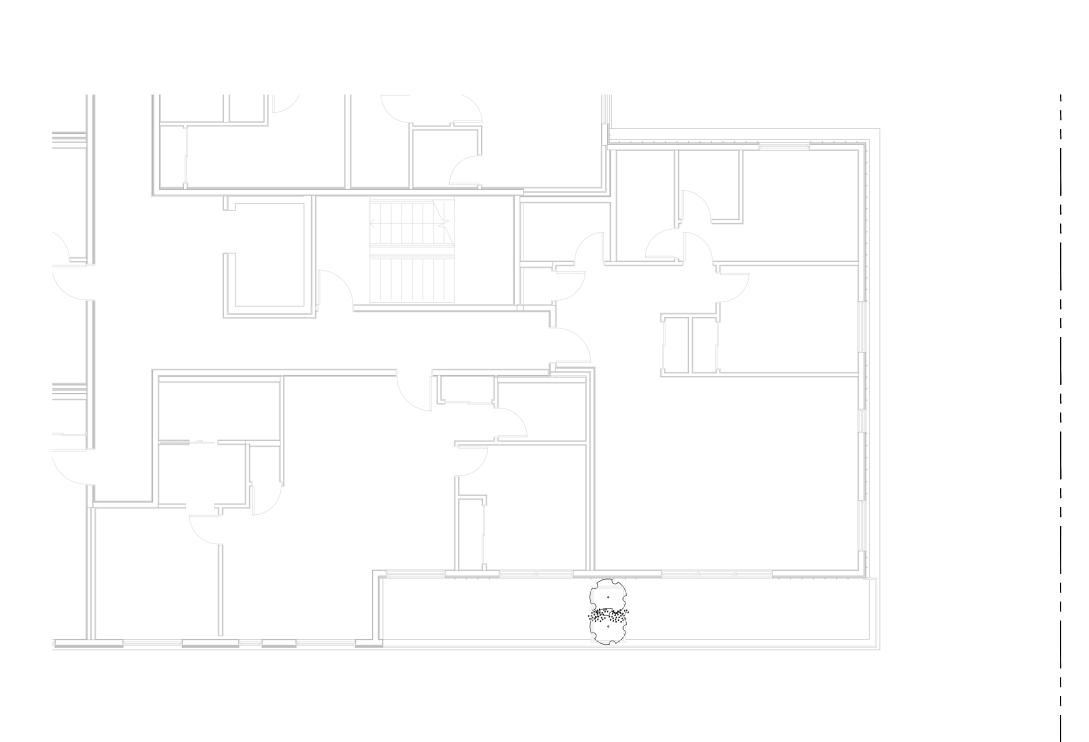
SHRUB PLANTING PLAN
LEVEL 1

DWG NO:


. **L4**.

CALE: **1:100**



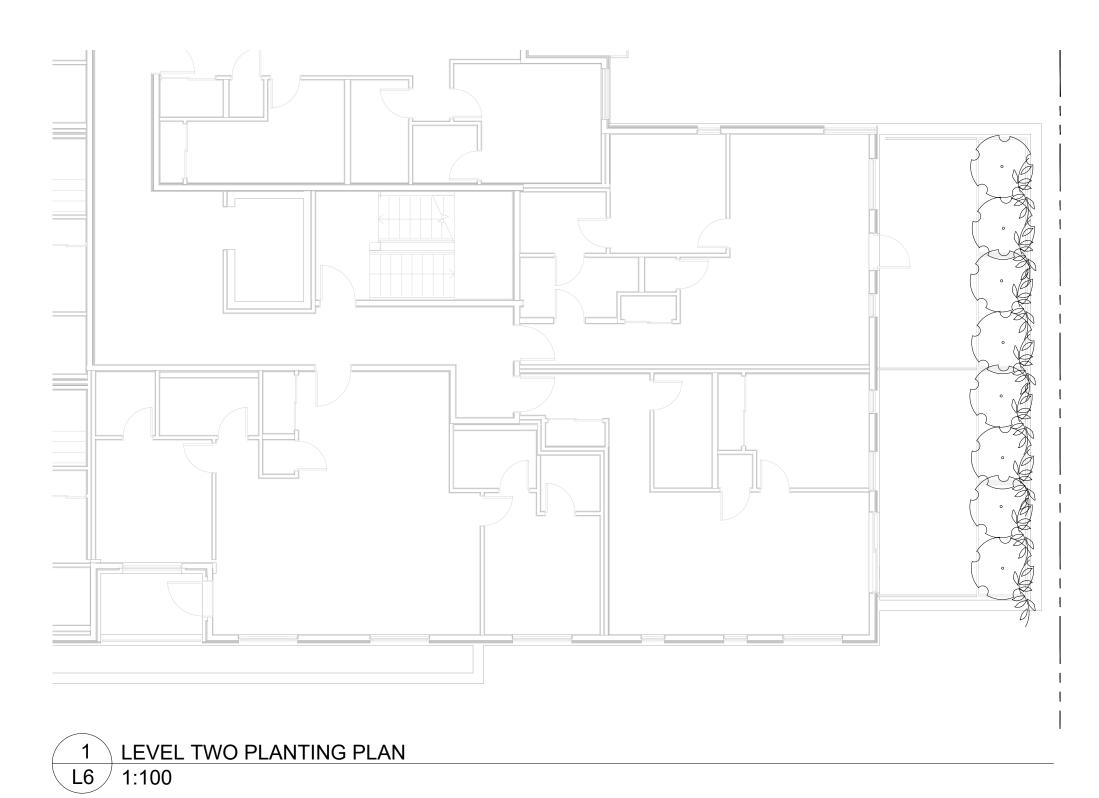



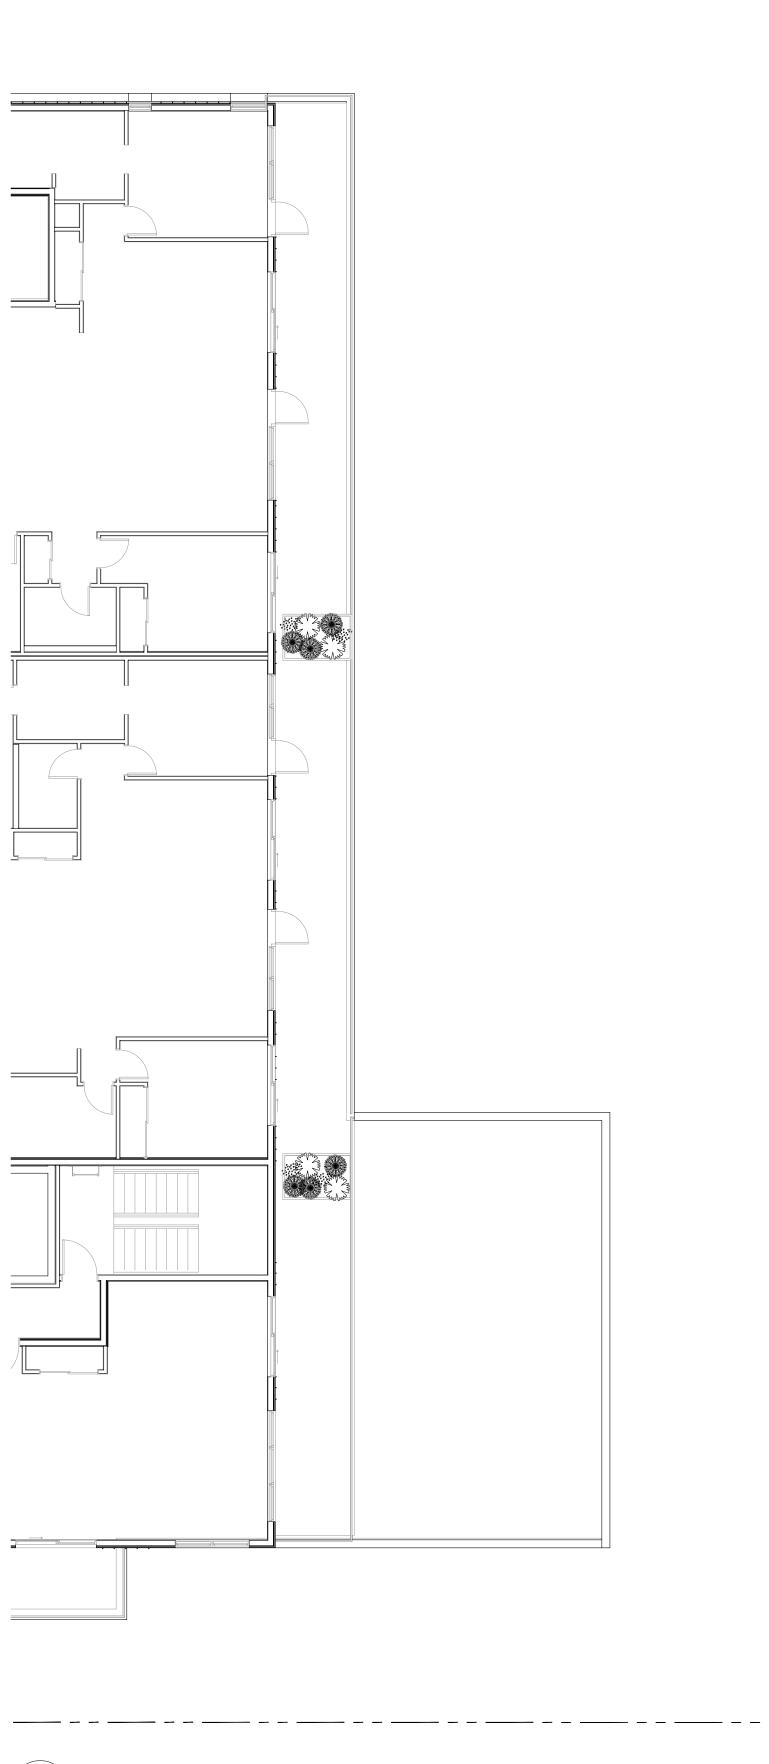

3 LEVEL FOUR PLANTING PLAN L6 1:100

PLANT S	SCHEDULE			T		Ι
Quantity	Symbol	Latin Name	Common Name	Container	Native	Pollinato
6		Armeria maritima 'Alba'	White-flowered Thrift	10cm		у
10		Choisya ternata	Mexican Orange Blossom	#3		у
6		Pinus strobus 'Horsford Dwarf'	Horsford Dwarf Eastern white pine	#2		
	an/m		Place A Thore White			

Reblooming Azalea

Virginia Creeper

#2

1. PLANTS IN PLANT LISTS ARE SPECIFIED ACCORDING TO THE CANADIAN NURSERY LANDSCAPE ASSOCIATION CANADIAN STANDARDS FOR NURSERY STOCK AND SECTION 12, CONTAINER GROWN PLANTS FROM THE BC LANDSCAPE STANDARD, CURRENT EDITION.

Parthenocussus

quinquefolia

PLANTING PLAN NOTES

ALL PLANT MATERIAL TO BCSLA STANDARDS.
 THE SEARCH ARE FOR PLANT MATERIAL IS THE PACIFIC NORTHWEST INCLUDING WASHINGTON,

OREGON AND BRITISH COLUMBIA.

CONFIRM PLANTING LAYOUT WITH LANDSCAPE ARCHITECT ON SITE.
 ALL SOIL VOLUMES TO MEET THE STANDARDS OF THE CITY OF VICTORIA. REFER TO SOIL DEPTH

PLANS FOR SOIL DEPTH REQUIREMENTS.

STANDARDS

6. REFER TO CIVIL AND MECHANICAL FOR DRAINS.
7. ALL ONSITE AND OFF-SITE LANDSCAPE AREAS TO BE IRRIGATED BY AN UNDERGROUND AUTOMATIC

5. ALL GROWING MEDIUM PROVISION AND INSTALLATION TO BE IN LINE WITH CANADIAN LANDSCAPE

IRRIGATION SYSTEM. IRRIGATION TO BE SUPPLIED BY CONTRACTOR

8. PLANTING AROUND EXISTING CRITICAL TREE ROOT ZONES TO BE INSTALLED UNDER THE SUPERVISION OF A CERTIFIED ARBORIST.



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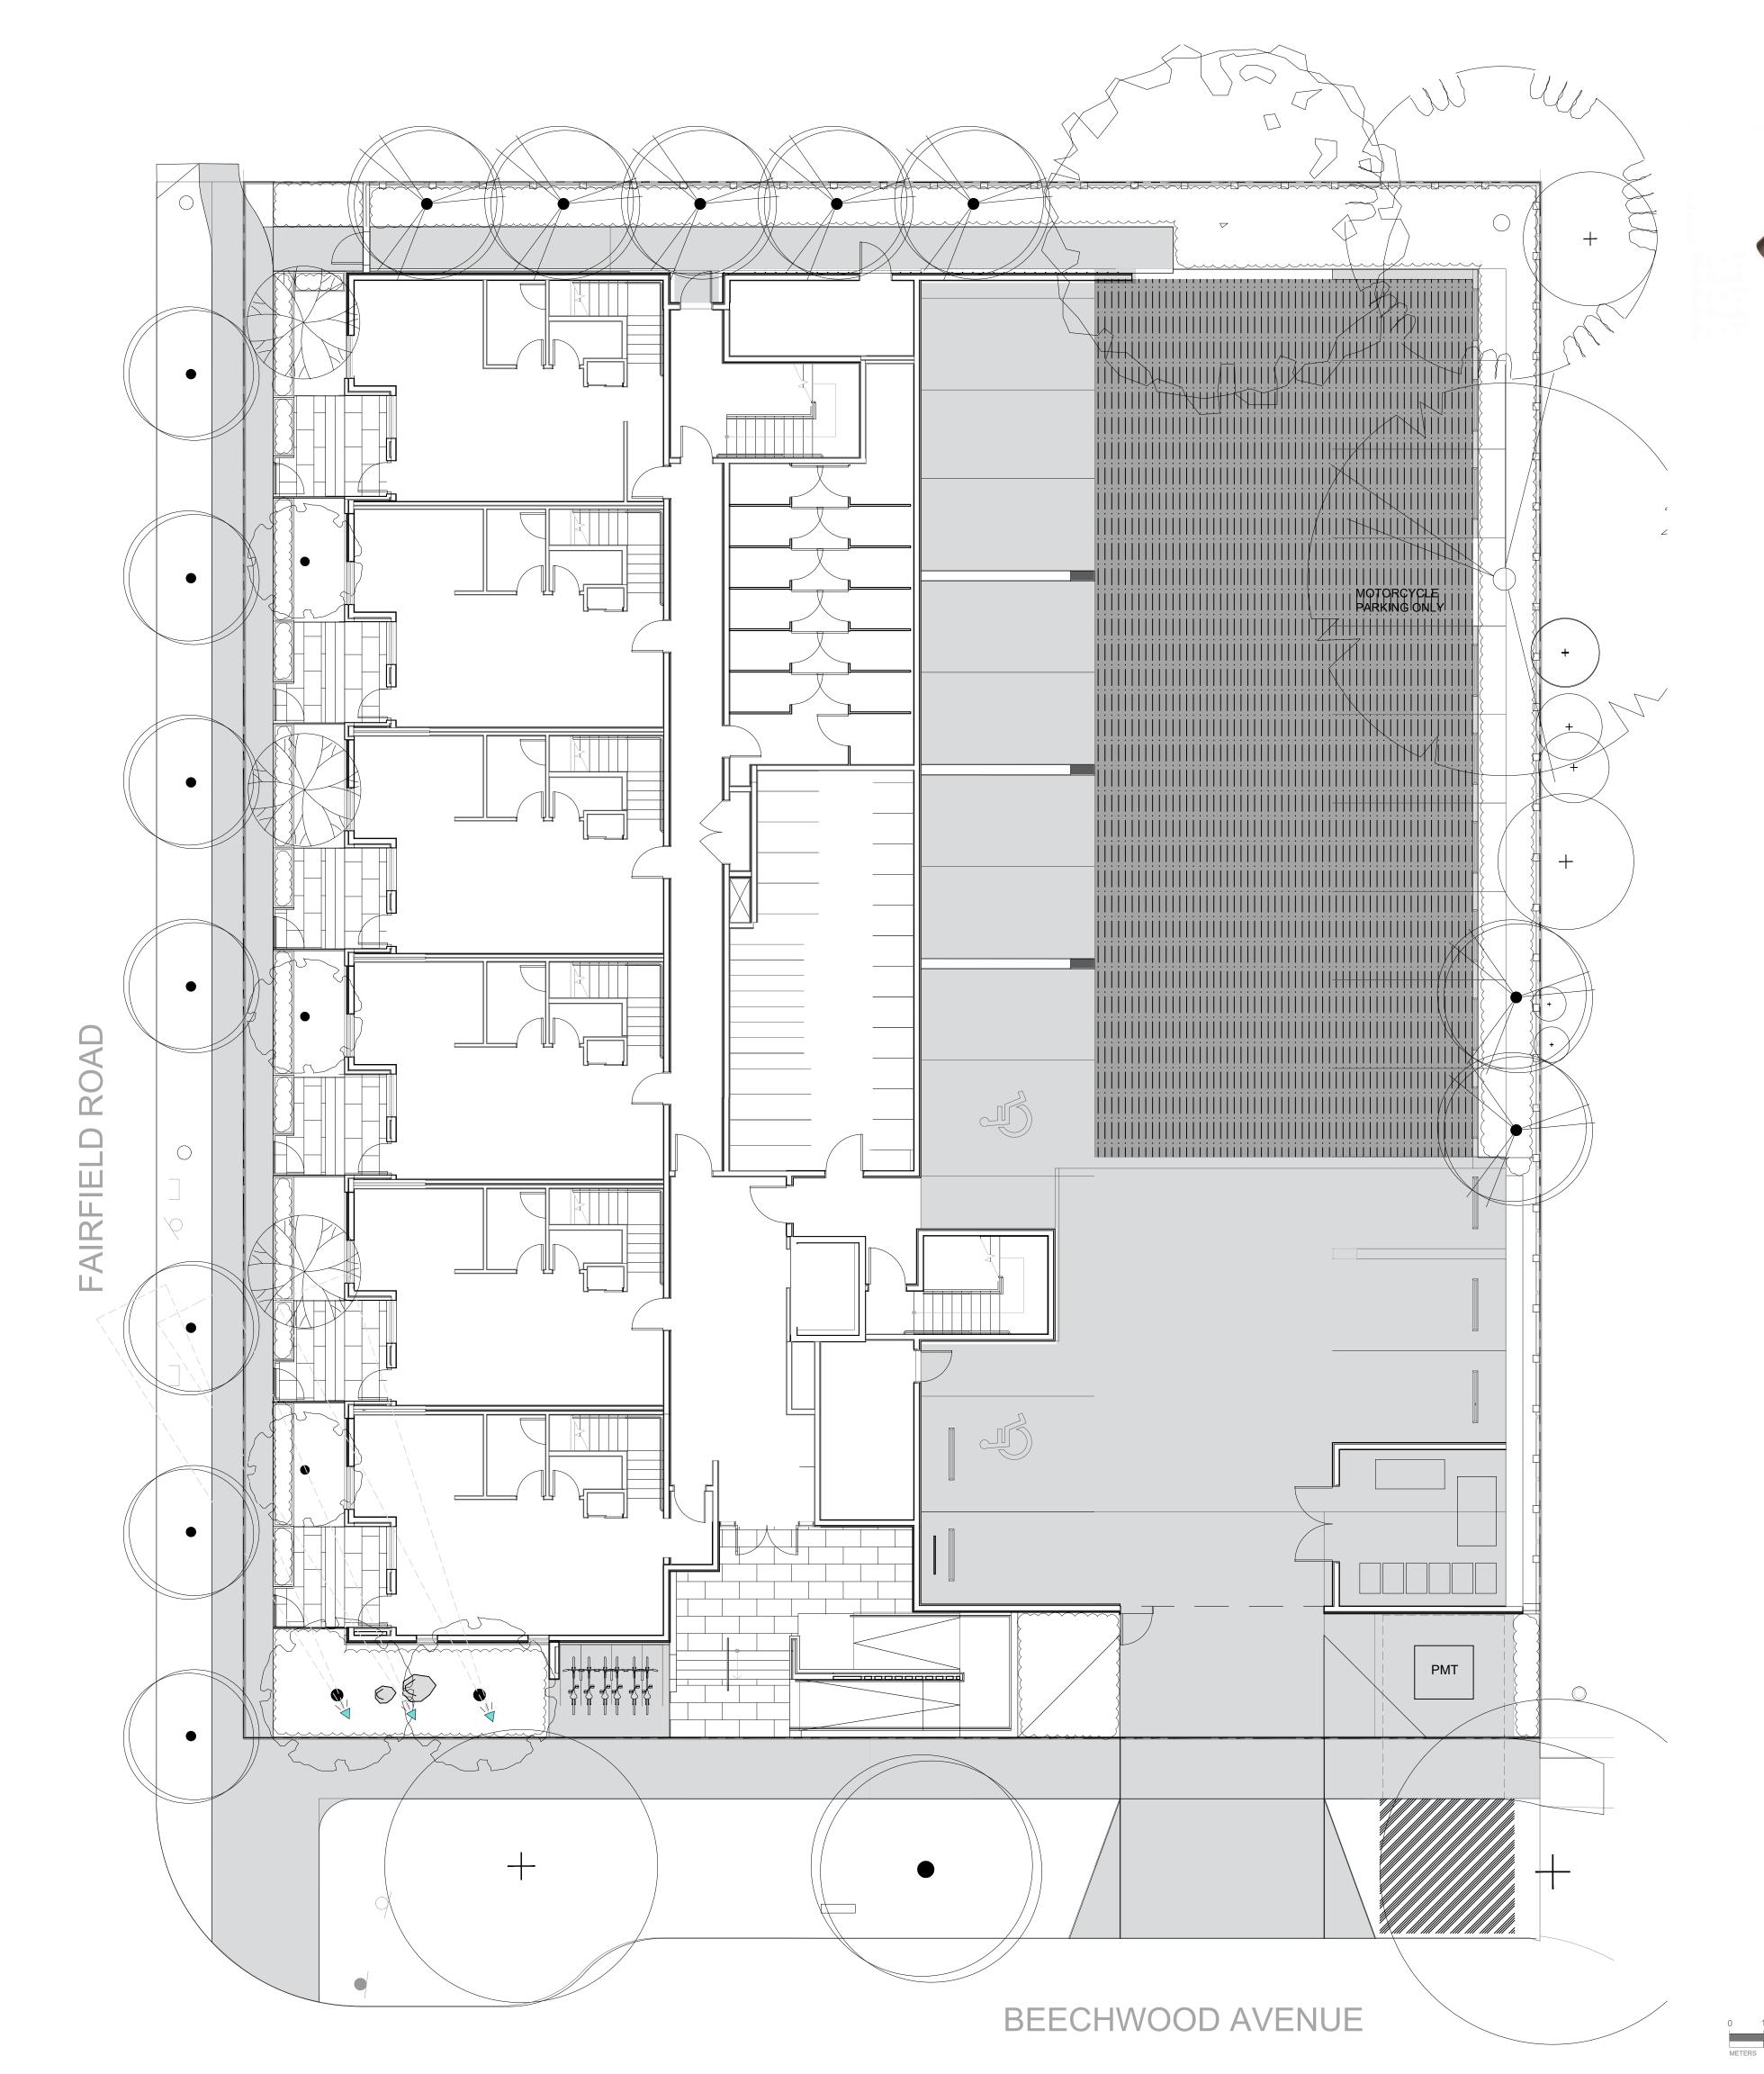
SEAL

NORTH ARROW

DRAWING TITLE:

SHRUB PLANTING PLAN LEVELS 2, 3, & 4





LIGHTING SCHEDULE

<u>SYMBOL</u> MANUFACTURER/MODEL/DESCRIPTION

WAC Landscape Lighting 5111

LED Accent Mini Landscape Spotlight Order code: 5111, Aluminum Alloy, (BK) Black on Aluminum, Mounting

Lamp: 5111 Integrated LED, 18W|23VA, 2700K, Beamspread: Narrow Accessories: Additional Mounting Stake

<u>QTY</u>

<u>DETAIL</u>



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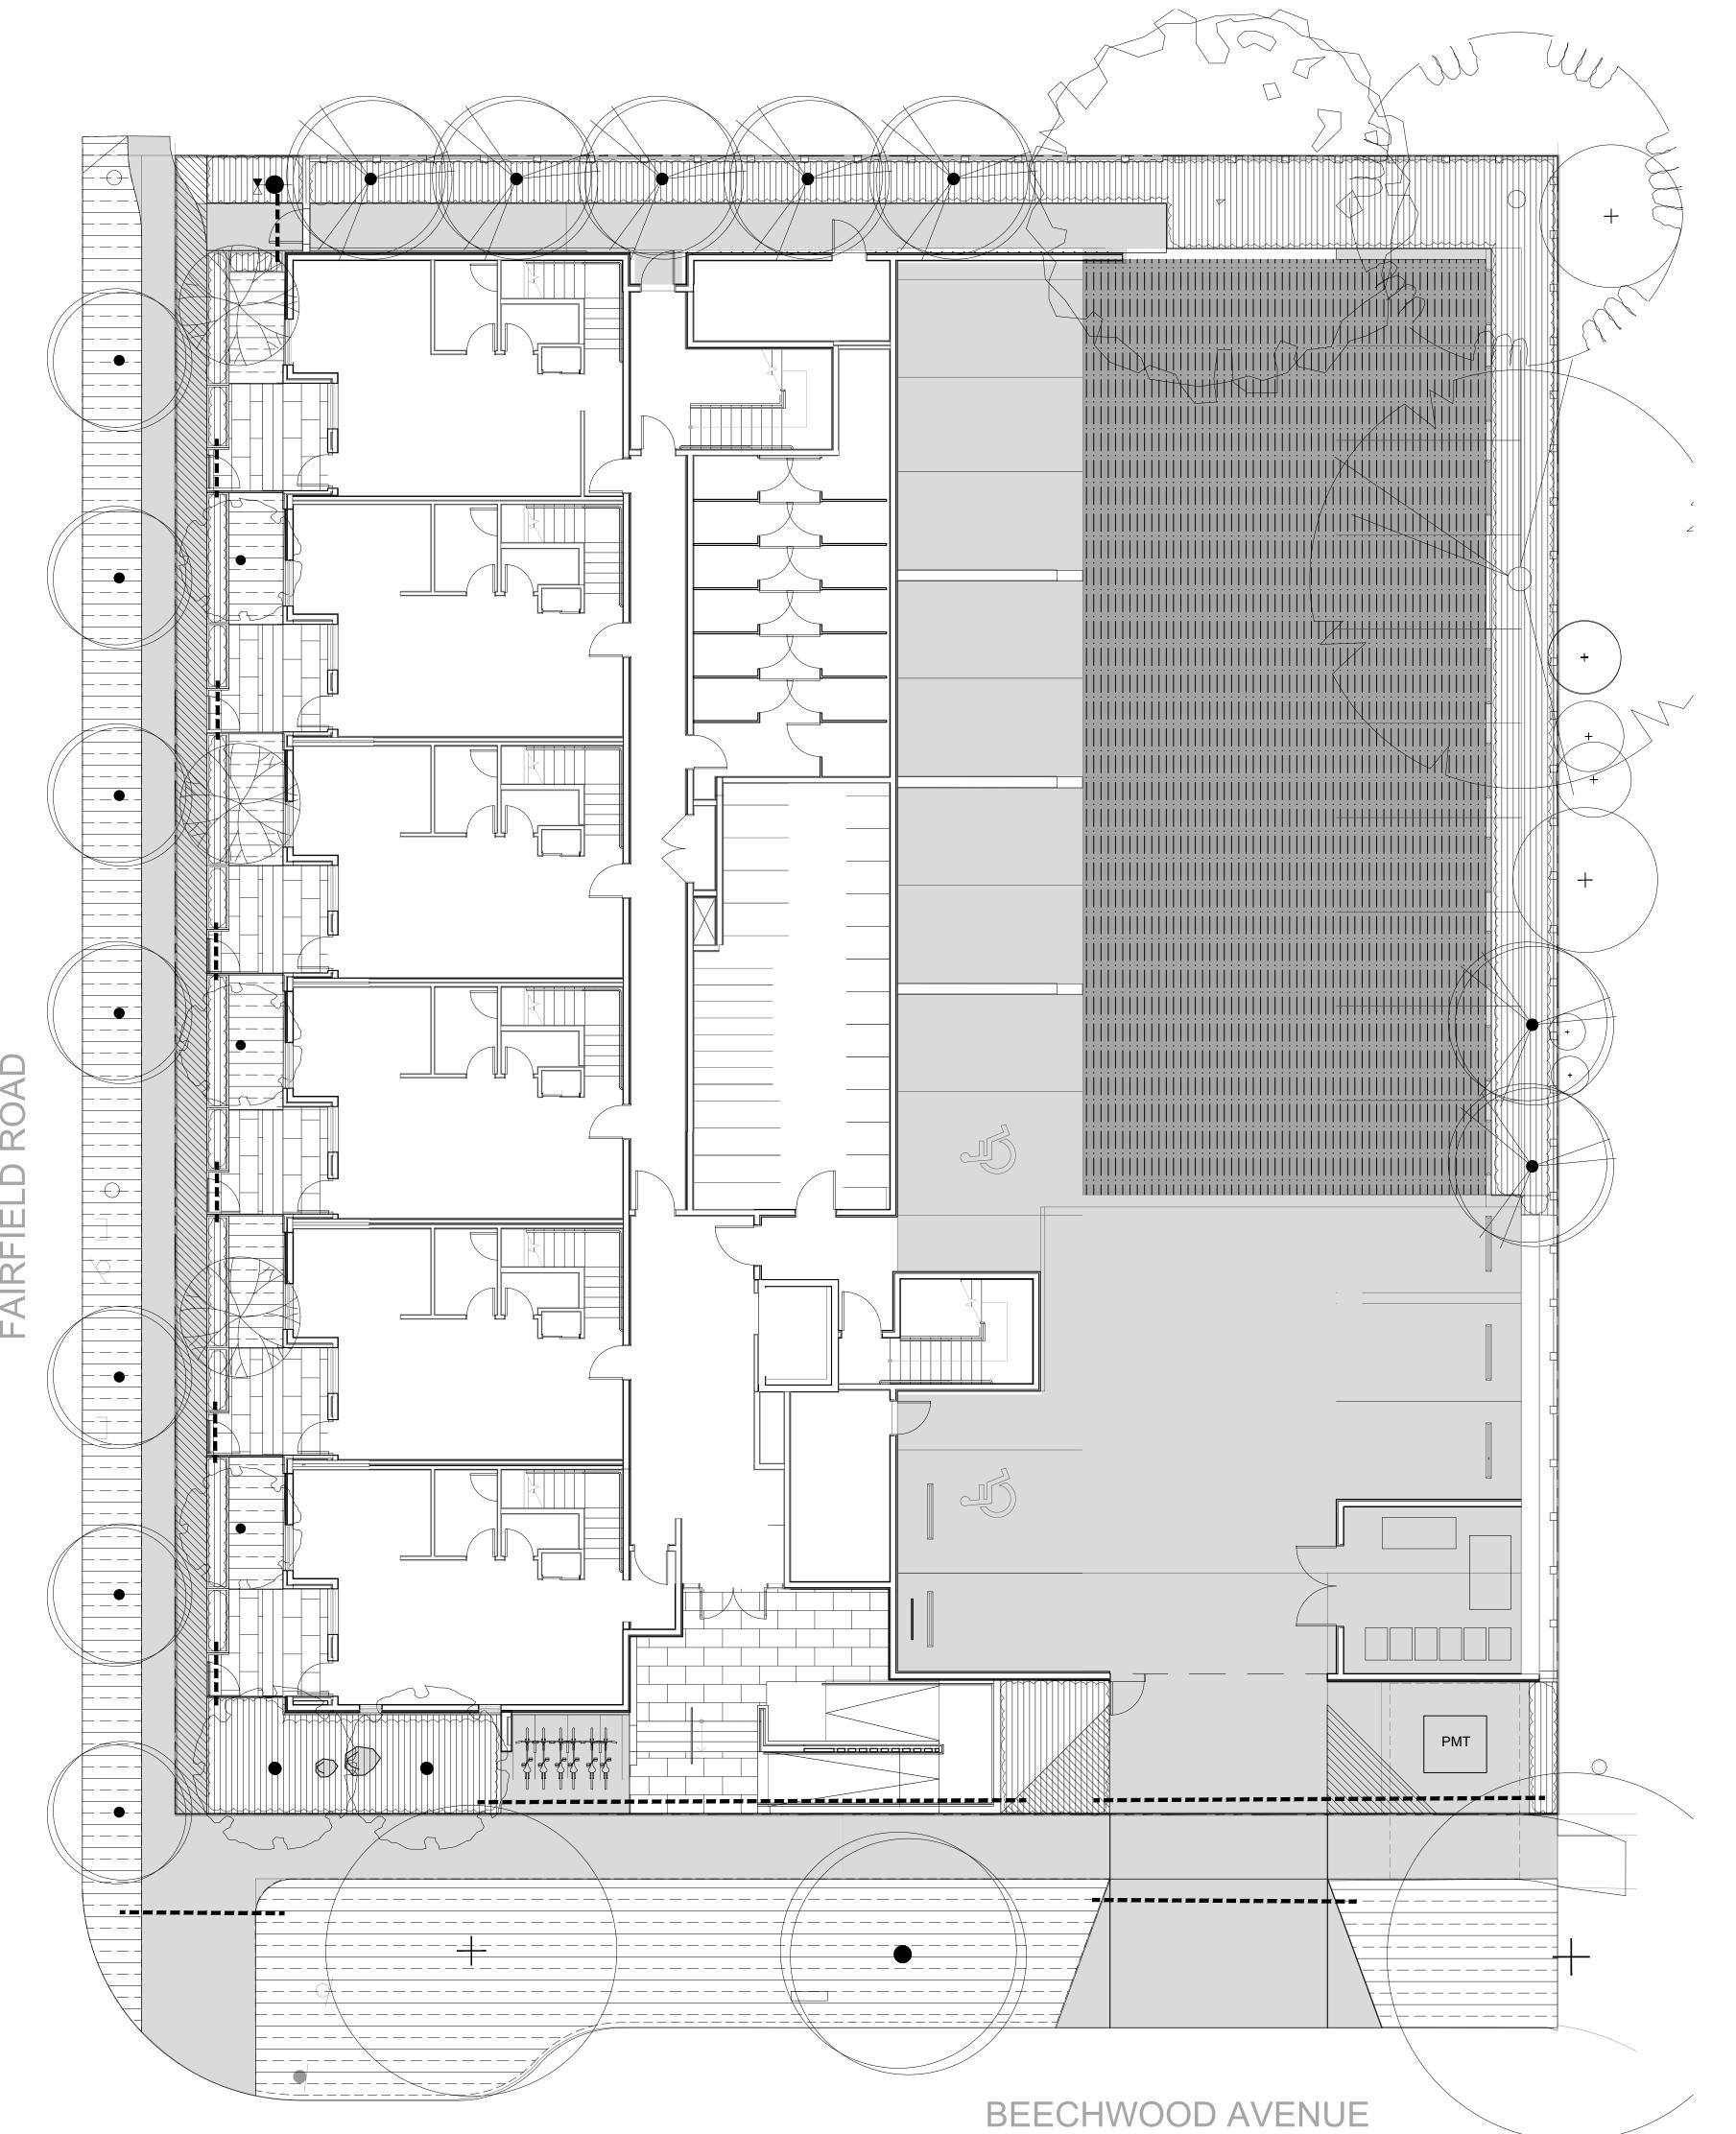
SEAL

NORTH ARROW

DRAWING TITLE:

LANDSCAPE LIGHTING PLAN LEVEL 1

DWG NO:



LEGEND

THE SIZE OF THE INTERIOR PIPE OF MIN. 50MM DIA.

H HOSE BIB

SHUT OFF VALVE

2" PVC POINT OF CONNECTION

AREA TO RECEIVE DRIPLINE- RAIN BIRD XFS-CV-09-12 SUB-SURFACE LANDSCAPE DRIPLINE WITH A HEAVY-DUTY .3 BAR CHECK VALVE. 3.41 LPH EMITTERS AT 30CM O.C. DRIPLINE LATERALS SPACED AT 30CM APART, WITH EMITTERS OFFSET FOR TRIANGULAR PATTERMN. SPECIFY XF INSERT FITTINGS

т

TREES IN THIS AREA TO RECEIVE IRRIGATION

NOTES

- IRRIGATION PLANS TO BE SUBMITTED A
BUILDING PERMIT SUBMISSION.
- OFFSITE TREES TO BE IRRIGATED BY
SEPARATE IRRIGATION SYSTEM.
- ALL OFFSITE IRRIGATION TO FOLLOW
THE CITY OF VICTORIA STANDARDS
- IRRIGATION DRIPLINE TO BE INSTALLED
SUB-SURFACE AND SLEEVED UNDER
METAL PLANTERS
REFER TO MECHANICAL FOR HOSEBIB
LOCATIONS



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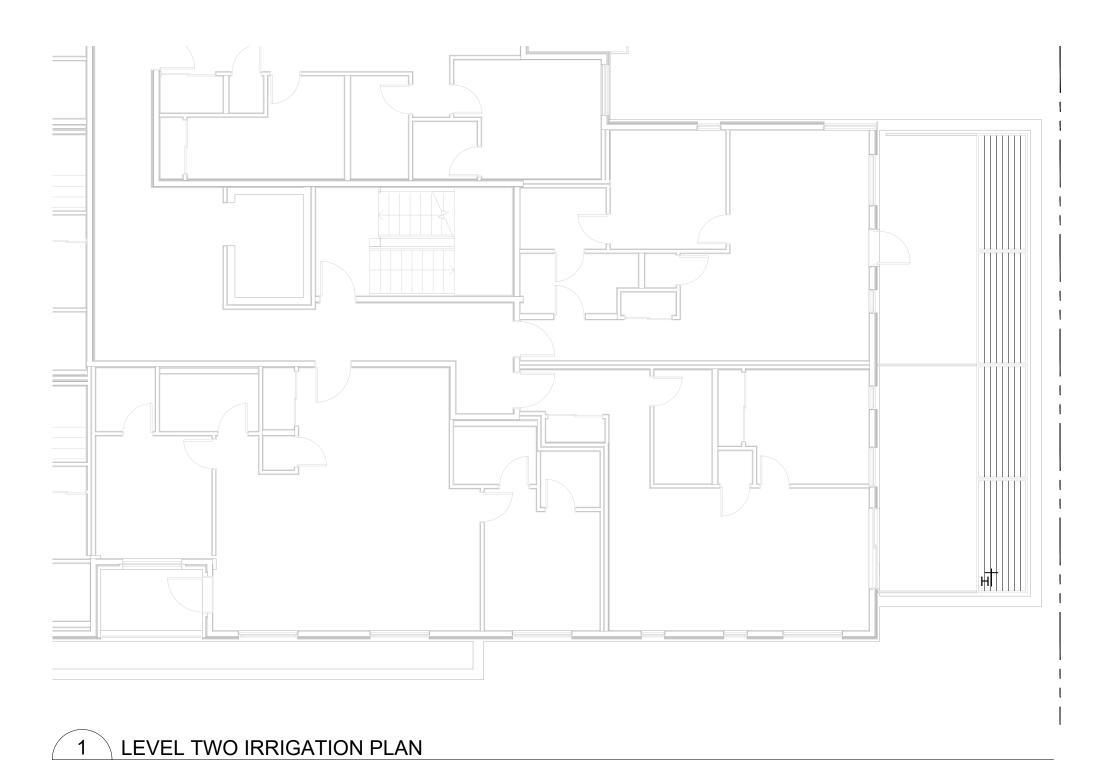
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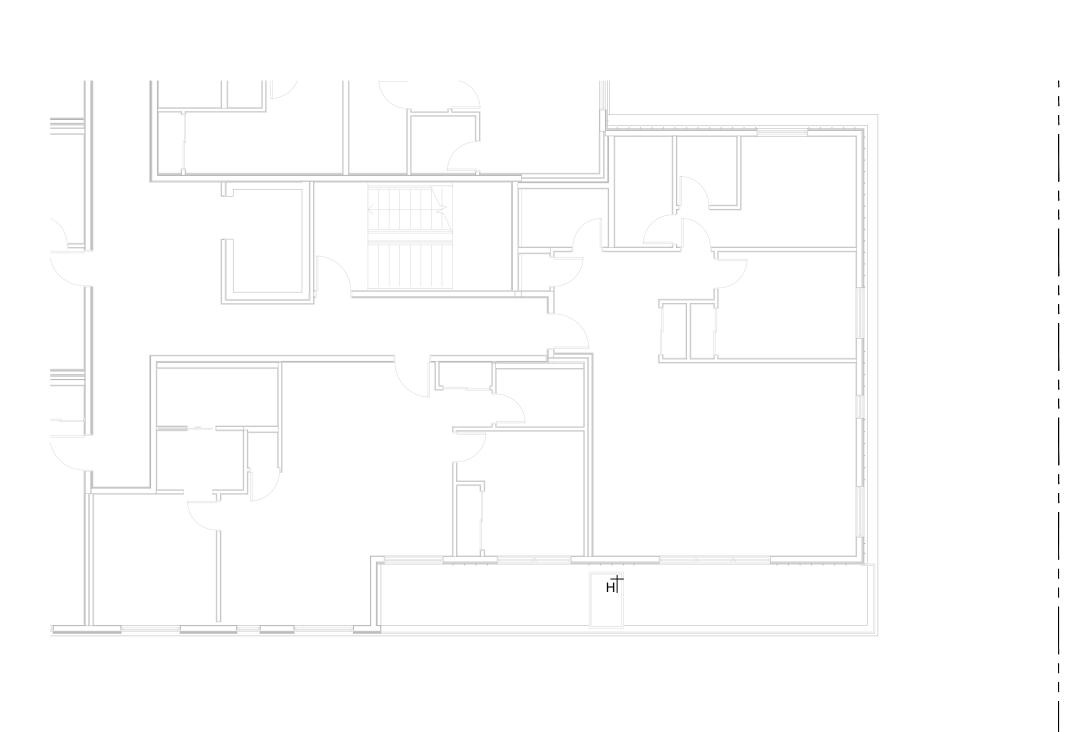
IRRIGATED AREAS PLAN LEVEL 1

DWG NO:

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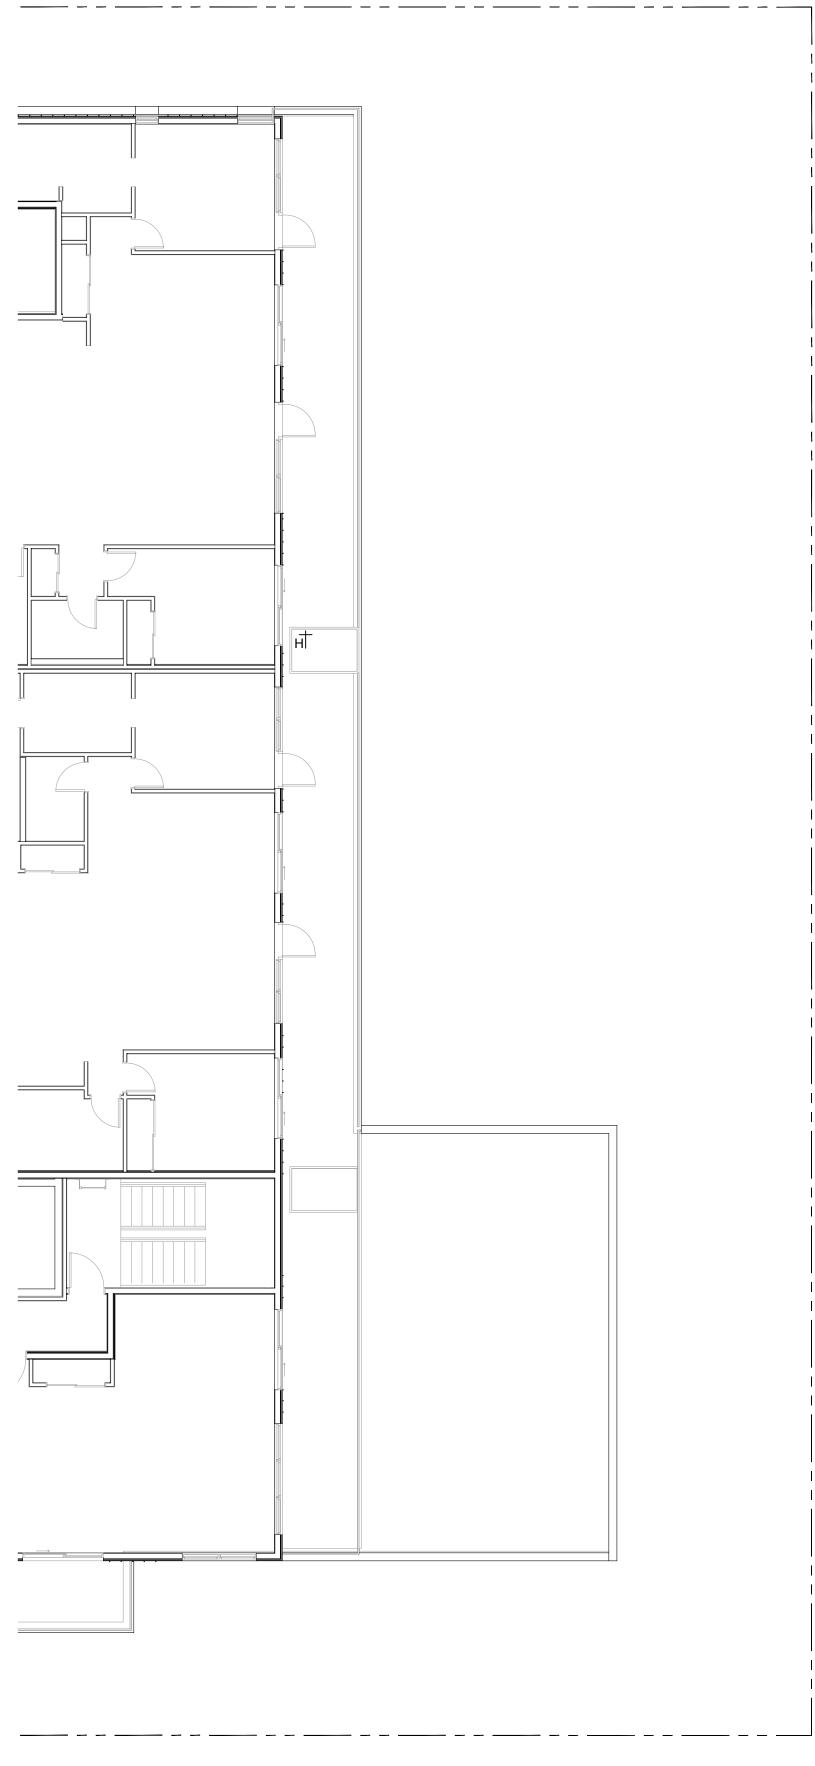
0 1 2.5 5





2 LEVEL THREE IRRIGATION PLAN 1:100

L6.2 1:100



3 LEVEL FOUR IRRIGATION PLAN L6.2 1:100

LEGEND

---- PIPE SLEEVE: PVC SCHEDULE 40 TWICE THE SIZE OF THE INTERIOR PIPE OF MIN. 50MM DIA.

2" PVC POINT OF CONNECTION

HOSE BIB

SHUT OFF VALVE

AREA TO RECEIVE DRIPLINE- RAIN BIRD XFS-CV-09-12 SUB-SURFACE LANDSCAPE DRIPLINE WITH A HEAVY-DUTY .3 BAR CHECK VALVE. 3.41 LPH EMITTERS AT 30CM O.C. DRIPLINE LATERALS SPACED AT 30CM APART, WITH EMITTERS OFFSET FOR TRIANGULAR PATTERMN. SPECIFY XF INSERT **FITTINGS**

TREES IN THIS AREA TO RECEIVE IRRIGATION

NOTES

- IRRIGATION PLANS TO BE SUBMITTED AT BUILDING PERMIT SUBMISSION. - OFFSITE TREES TO BE IRRIGATED BY SEPARATE IRRIGATION SYSTEM. - ALL OFFSITE IRRIGATION TO FOLLOW THE CITY OF VICTORIA STANDARDS - IRRIGATION DRIPLINE TO BE INSTALLED SUB-SURFACE AND SLEEVED UNDER METAL PLANTERS REFER TO MECHANICAL FOR HOSEBIB

LOCATIONS

OWNER/CLIENT: ARYZE DEVELOPMENTS

1608 Camosun Street, Victoria BC V8T 3E6

Info@biophiliacollective.ca 250 590 1156

PROJECT ADDRESS:

1733 FAIRFIELD, VICTORIA, BC

DESIGNED BY:BIANCA BODLEY DRAWN BY: TYLER YESTAL


NO. ISSUE YY\MM\DD 1 ISSUED FOR DEVELOPMENT TRACKER 22\03\04 2 ISSUED FOR RZ/DP 22\05\02 3 ISSUED FOR COORDINATION 22\07\18 4 ISSUED FOR RZ/ DP 22\07\20 5 ISSUED FOR RZ/ DP RESUBMISSION 23\01\24 6 ISSUED FOR RZ/ DP RESUBMISSION 2023\08\18 7 25% BUILDING PERMIT 2023\10\10 8 ISSUED FOR BP COORDINATION 2023/11/24 9 DP/RZ REV 4 2024/01/12

NORTH ARROW


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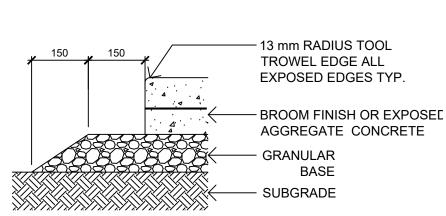
IRRIGATED AREAS PLAN LEVELS 2, 3, & 4



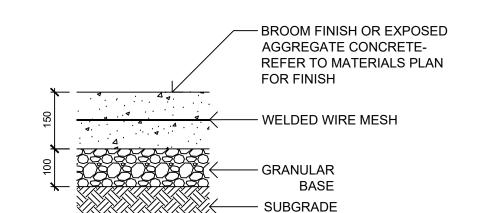


- SUBGRADE AND GRANULAR BASE TO BE
- COMPACTED TO MIN. 95% MPD. CONCRETE SIDEWALK TO MMCD/MUNICIPAL
- SPECIFICATIONS • WELDED WIRE REINFORCEMENT MESH TO BE 6 X 6 X W2.9 X W2.9 (152 x 152 MW18.7/18.7) AND TO BE INSTALLED PER NRC NBC AND CAC
- STANDARDS. MIN 50 mm COVER ABOVE AND BELOW MESH.



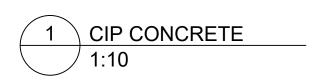

 EXTEND GRANULAR BASE 300 mm PAST EDGE OF SIDEWALK




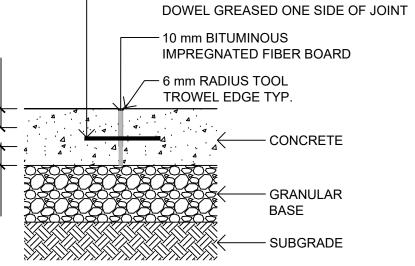

10 mm DIA X 200 mm LONG SMOOTH BAR

- BAR DOWELS @ 450 mm O.C. AND STARTING 300 mm FROM OUTSIDE EDGE OF CONCRETE - CENTER IN CONCRETE SLAB (MIN. 50 mm COVER)
- ISOLATION JOINT MAXIMUM SPACING 9.0 m JOINTING AS PER LAYOUT PLAN AND AT ALL ABUTTING CONCRETE STRUCTURES



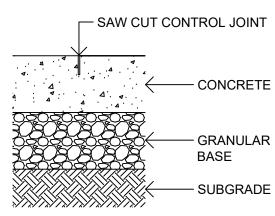


JOINT DEPTH 1/3 SLAB THICKNESS

REFER TO PAVER MANUFACTURER FOR

INSTALLATION

 CONTROL JOINT MAXIMUM SPACING 3.0 m JOINTING PATTERN AS PER LAYOUT PLAN



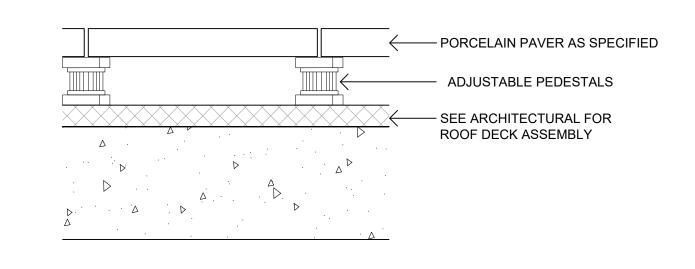


- PRIOR TO INSTALLATION, CONTRACTOR TO CONFIRM WITH ARCHITECTURAL / MEMBRANE CONSULTANT IF PROTECTION BOARD IS REQUIRED FOR PAVER PEDESTAL INSTALLATION; IF PROTECTION BOARD IS REQUIRED AND HAS NOT BEEN INSTALLED BY ARCHITECTURAL, CONTRACTOR TO NOTIFY GENERAL CONTRACTOR.
- ADJUSTABLE PEDESTALS TO BE BlackJack OneStep or BlackJack ScrewJack PEDESTALS AS REQUIRED OR APPROVED EQUAL.
- INSTALLATION TO MANUFACTURER'S SPECIFICATIONS.

Available At

View Gallery



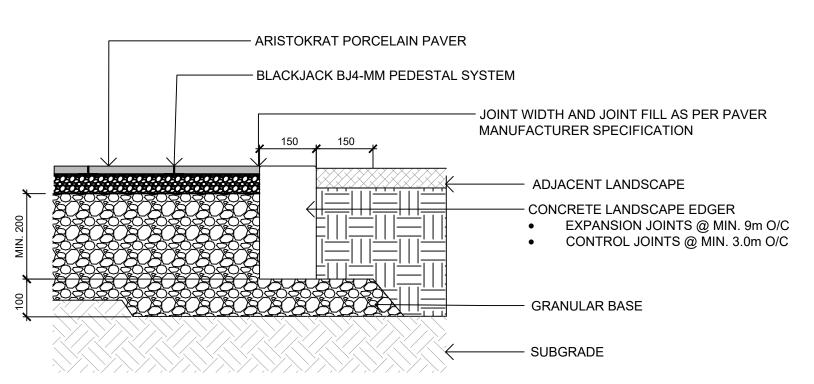

- JOINT WIDTH AND JOINT FILL AS PER

SIZE: 228 X 304 X 80MM

ADJACENT LANDSCAPE - 40-50mm BEDDING COURSE

ASTM NO8 AGGREGATE

MIN. 95% MOD. PROCTOR.

- GEOTEXTILE

COLOUR: CHARCOAL

PAVER MANUFACTURER SPECIFICATION

- NEWSTONE- DORADO DRAIN PAVER

- BASE MATERIALS (19mm MINUS WELL

EXTENTS. GEOTECH TO REVIEW

GRADED CRUSHED ROCK) COMPACTED TO

- SUBGRADE AND GRANULAR BASE TO BE COMPACTED TO MIN.
- 95% MPD. CONCRETE TO MMCD SPECIFICATION UNLESS NOTED OTHERWISE.




SUBGRADE AND GRANULAR BASE TO BE COMPACTED TO MIN. 95% MPD.

PAVER AND PAVER INSTALLATION TO MMCD AND MANUFACTURER'S

GRANULAR BASE TO BE COMPACED IN MAX. 100mm LIFTS.


SPECIFICATION UNLESS NOTED OTHERWISE.

GEOTECH TO REVIEW PRIOR TO INSTALLATION.

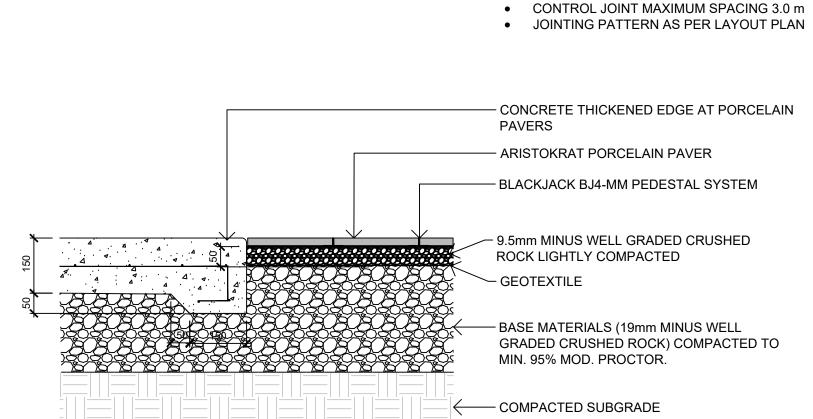



Aristokrat® Series

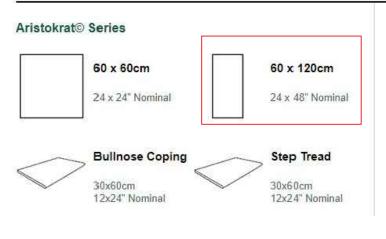












■ 7393 HOPCOTT ROAD, DELTA, BC V4G 187 | 604-332-4030

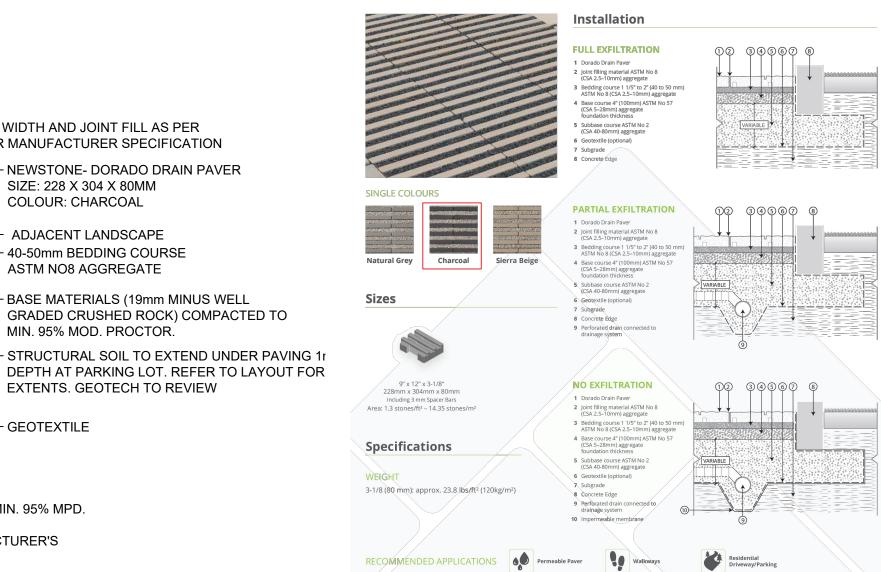

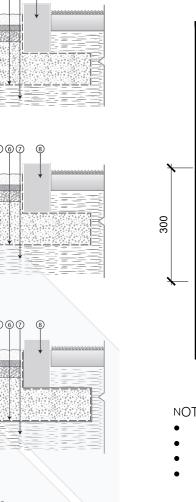

NEWSTONEGROUP.CA

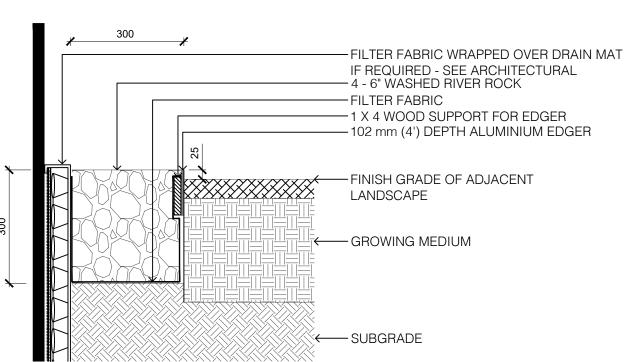

- LANDSCAPE EDGER TO BE: PERMALOC CleanLine Commercial Grade Landscape Edging OR APPROVED EQUAL 4.8mm (3/16") THICKNESS; 102mm (4") HEIGHT; 4.8m (16') LENGTH; NATURAL MILL FINISH; 305mm (12") STAKE.
- INSTALL EDGER AS PER MANUFACTURER'S INSTRUCTIONS
- 1 X 4 WOOD SUPPORT TO BE STAKED IN PLACE AND USED TO ENSURE EDGER IS INSTALLED IN A STRAIGHT LINE AND MAINTAINS A STRAIGHT ALIGNMENT DURING THE INSTALLATION OF GROWING MEDIUM AND RIVER ROCK. MAY BE SCRAP WOOD AS LONG AS IT IS STRAIGHT.
- FILTER FABRIC TO BE POLYPROPYLENE FIBRE NONWOVEN GEOTEXTILE, SUCH AS NILEX 4551 OR APPROVED EQUAL





1608 Camosun Street, Victoria BC V8T 3E6 Info@biophiliacollective.ca 250 590 1156

OWNER/CLIENT:

ARYZE DEVELOPMENTS

PROJECT ADDRESS:

1733 FAIRFIELD VICTORIA, BC

DESIGNED BY: BIANCA BODLEY

DRAWN BY: TYLER YESTAL

NO.	ISSUE	YY\MM\DD
1	ISSUED FOR DEVELOPMENT TRACKER	22\03\04
2	ISSUED FOR RZ/DP	22\05\02
3	ISSUED FOR COORDINATION	22\07\18
4	ISSUED FOR RZ/ DP	22\07\20
5	ISSUED FOR RZ/ DP RESUBMISSION	23\01\24
6	ISSUED FOR RZ/ DP RESUBMISSION	2023\08\18
7	25% BUILDING PERMIT	2023\10\10


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DRAWING TITLE:

PAVING DETAILS



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SEAL


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SITE FURNISHINGS DETAILS

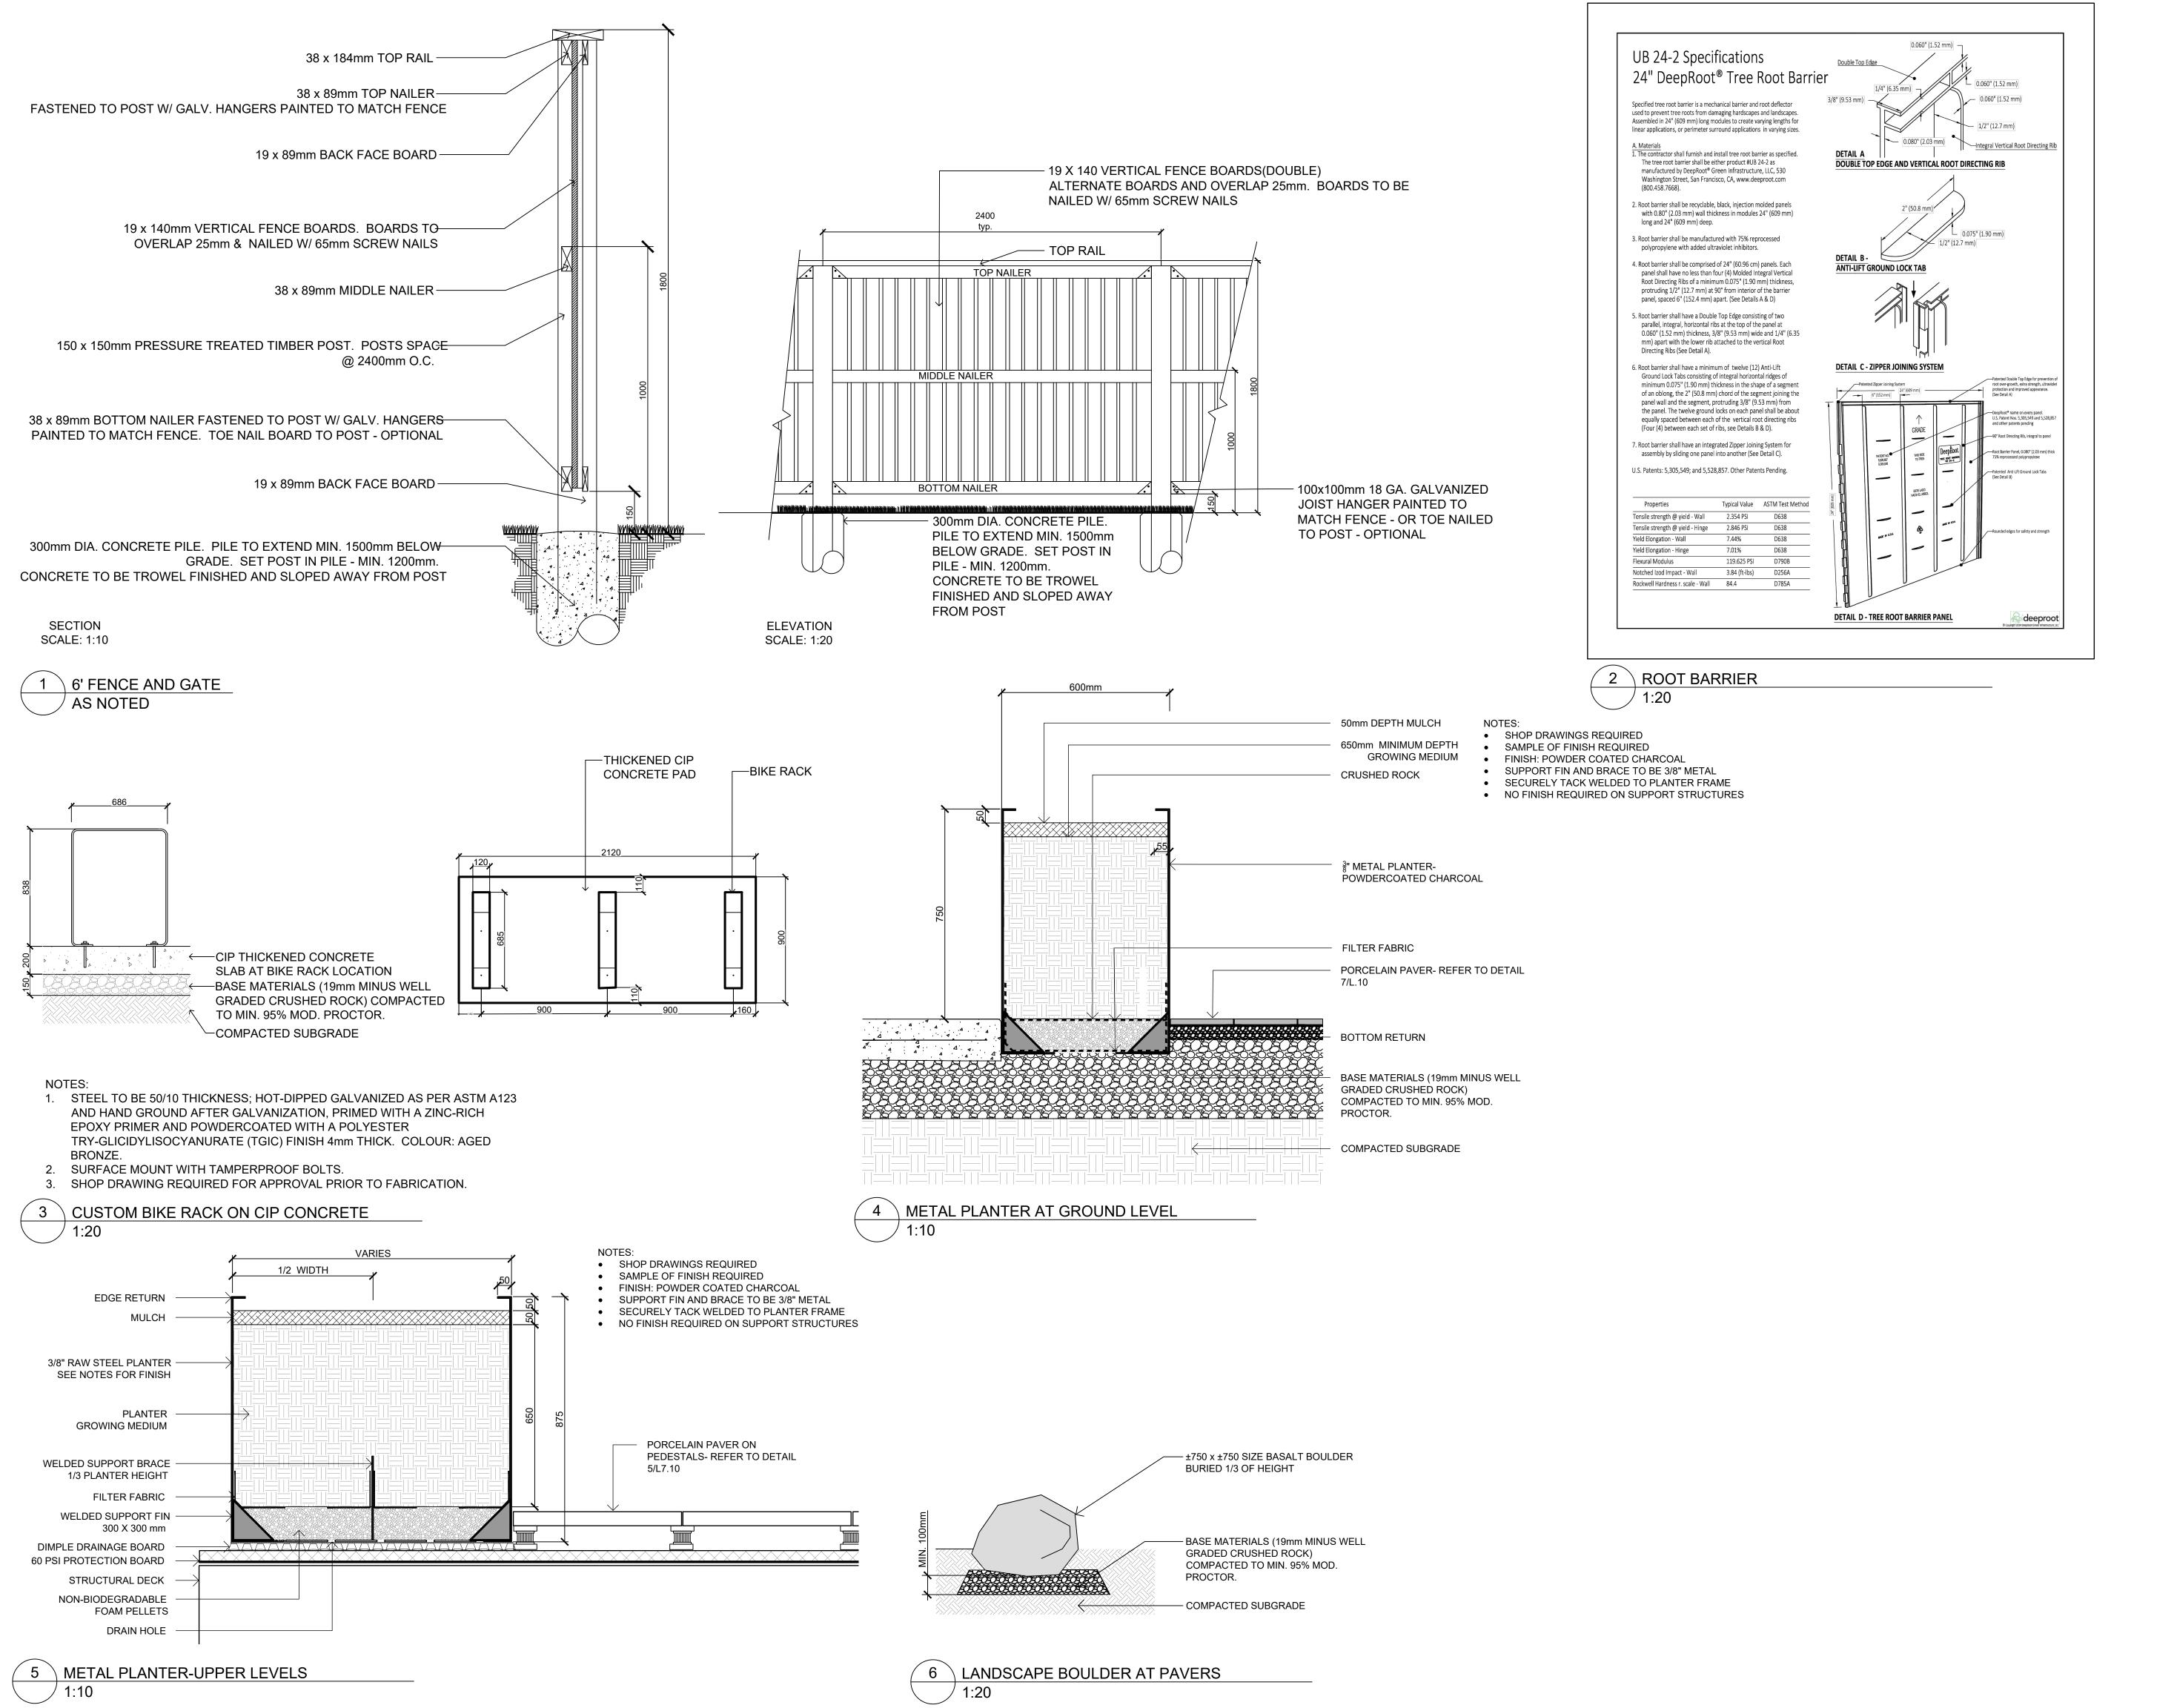DWG NO:


L7.2




NOTES

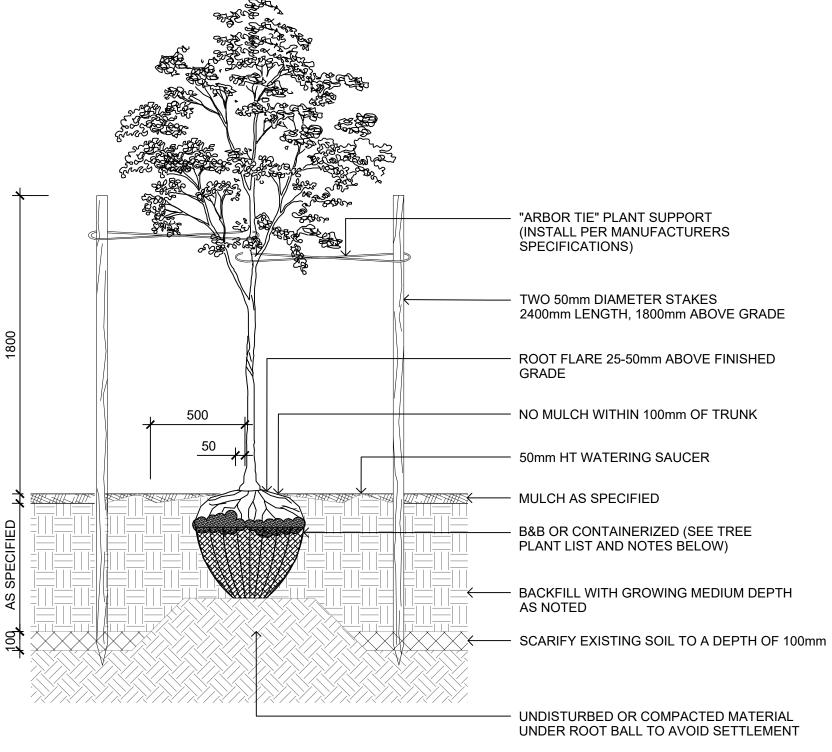- CONTRACTOR SHALL INSURE PERCOLATION OF ALL PLANTING PITS PRIOR TO INSTALLATION
- 2. FOR B&B: REMOVE TOP 1/3 OF BURLAP AND CAGE PRIOR TO BACKFILLING WITH GROWING MEDIUM
- FOR CONTAINERS: LOOSEN ROOT STRUCTURE AND ENSURE NO CIRCLING ROOTS BY LIGHT ROOT PRUNING
 INSTALL TREE TIE AT APPROX. 50% OF TREE HT. FOR CONIFERS LESS THAN 3m HT. AND 100mm BELOW LOWEST BRANCH
- FOR DECIDUOUS LESS THAN 100mm CAL. DO NOT REMOVE OR CONSTRAIN ANY BRANCHES.
- 5. STANDARD TREE PLANTING DETAILS TO BE APPLIED ACCORDINGLY TO TREES PLANTED IN PLANTERS
- 6. TREE PLANTING ON MUNICIPAL PROPERTY TO MUNICIPAL STANDARD DETAIL



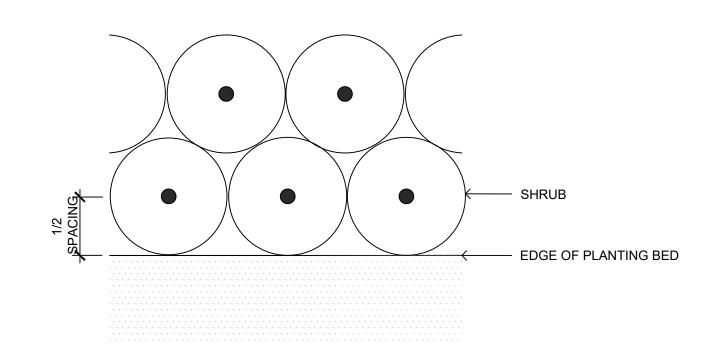




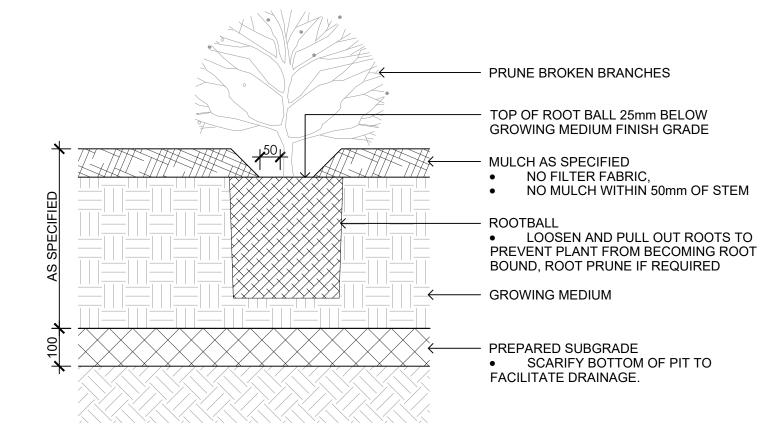


NOTES:
1. SHRUB PLANTING AS PER WRITTEN SPECIFICATIONS
2. GROWING MEDIUM AND MULCH AS PER WRITTEN SPECIFICATIONS



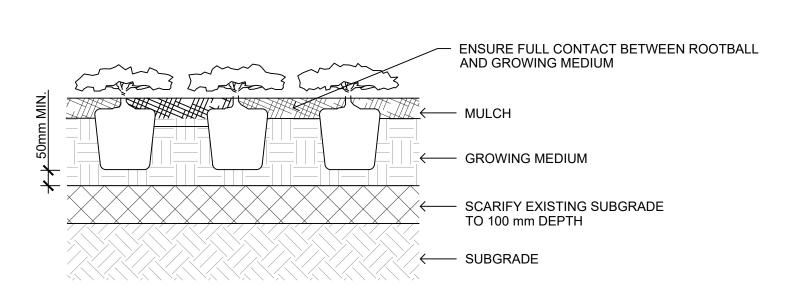

NOTES:

- PLACE AND COMPACT SUBGRADE AS PER WRITTEN SPECIFICATIONS
- SUBGRADE TO BE COMPACTED TO A CONSISTENT 80% M.P.D
 GROWING MEDIUM AND MULCH AS PER WRITTEN SPECIFICATIONS
- 3 GROUNDCOVER PLANTING

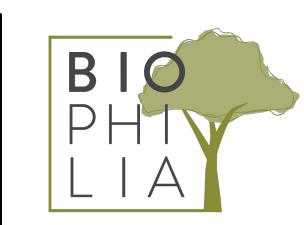

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22\07\20

4 ISSUED FOR RZ/ DP

7 25% BUILDING PERMIT

SEAL

NORTH ARROW

DRAWING TITLE:

PLANTING DETAILS

VG NO:

L7.3

