



Clarity Cannabis Victoria, BC BC Ltd. (1400 Quadra Street)

A000

Clarity Cannabis BC Ltd. Victoria, BC, 1400 Quadra Street



Proposed Location

Drawing Index

Legends & Schedules

Symbol Legend 101 Door Tag SIM A101 Section Callout

W1>

Name Elevation

1 A101 SIM

1 / A101

? A101

(A101) Interior Elevation Tag

CW-1 Curtain Wall Tag BL-1 Borrowed Light Tag

W1 SF-1

GB-1 Glass Block Tag



Sheet Number -View Number -Referencing Sheet Number 1/8" = 1'-0"

Ceiling Legend



2'x4' Recessed Light Fixture

1'x4' Recessed Light Fixture

2'x2' Recessed Light Fixture

1'x4'/2'x4' Surface Mount Light Fixture

Supply Air Diffuser Return Air Grill

Supply Air Diffuse

) Supply Air Grill Recessed Light

0

Pendant Light

0 - PC

	ELECTRICAL LEGEND
0	DUPLEX RECEPTACLE
o	SPLIT RECEPTACLE
0	RECEPTACLE - COUNTER HEIGHT 42" A.F.F.
₫ 240V	220V DUPLEX RECEPTACLE
Ö GFI	GROUND FAULT INTERRUPTER
Ø ^{WP-GFI}	WEATHER PROOF RECEPTACLE w/ GFI
\$	SINGLE POLE SWITCH
\$ 3	THREE WAY SWITCH
\$□	DIMMER SWITCH
\$°°	OCCUPANCY SENSOR SWITCH
ф	INCADESCENT FIXTURE - CEILING MOUNT
어	INCADESCENT FIXTURE - WALL MOUNT
8	EXIT LIGHT
P.E.C.	PHOTO ELECTRIC CELL - CONFIRM MOUNTING LOCATION
46	REMOTE MTD. EM. HEAD
1	BATTERY PACK c/w INTEGRAL HEADS
▼	BLUE DATA & WHITE DATA
•	BLUE DATA OUTLET
4	FLOOD LIGHT
(S)	SMOKE DETECTOR
N.L.	NIGHT LIGHT
T	THERMOSTAT (REFER TO MECH. DRAWINGS)

Washroom Accessories


Bradley 6563 Surface Mount Soap Dispense Bradley 5234 Tollet Tissue Dispenser Bradley 780-2436 24"x36" Mirror Bradley 9114 Robe Hook (Install on Door) Free Standing Waste Bin by Owner Towel Rod by Owner

Notes:


CONFIRM ALL DIMENSIONS ON SITE. NOTIFY UCG OF ANY DISCREPANCIES.
 SEE SPECIFICATION PACKAGE PROVIDED BY DESIGNER'S FOR
THE FOLLOWING:
 PLUMBING FIXTURES
 LICHT FIXTURES
 INTERIOR FINSHES
 DISPLAYS
 FURNITURE & DECOR

	Door Schedule												
				Door	Data				Frame Data	1			
				Door	Dime	nsions			Jamb	Wall	Frame	1	
Mark	From Room: Name	To Room: Name	Door Type	Finish	Width	Height	Hardware	Frame Type	Width	Thickeness	Finish	Fire Rating	Comments
	Retail Area	Exterior			3' - 0"	8' - 8 1/2"							
102	IT Closet	Retail Area			3' - 0"	7' - 0"			0' - 5 3/4"	0' - 4 7/8"			
103	Retail Area	Storage Rm			3' - 0"	7' - 0"			0' - 5 3/4"	0' - 4 7/8"			
104	Retail Area	Office			3' - 0"	7' - 0"			0' - 5 3/4"	0' - 4 7/8"			
106		Exterior			3' - 0"	7' - 0"			0' - 5 3/4"	0' - 4"			
107					18' - 0"	16' - 0"							
108	Retail Area	Wshrm			3' - 0"	7' - 0"			0' - 5 3/4"	0' - 4 7/8"			
110		Exterior			3' - 0"	7' - 0"			0' - 8 1/4"	0' - 10"			

Door Type Schedule

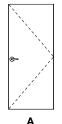



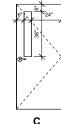

С

Door Hardware Schedule

- a PRIVACY SET DORMA C500 SERIES LR LEVER 626 FINISH BUTTON WALL STOP CLOSER LCN 4040 BB HINGES (1 1/2 PAIR) SILENCERS
- b KEYED LOCKSET DORMA C500 SERIES LR LEVER 626 FINISH BUTTON WALL STOP BB HINGES (1 1/2 PAIR) SILENCERS
- d EXISTING TO REMAIN CONFIRM CONDITION REPLACE AS REQ'D SEE NOTES RE-KEY AS REQUIRED

- PROVIDE ULC RATED/LABELLED HARDWARE TO ALL RATED DOORS AS PER DOOR SCHEDULE

- PROVIDE WALL STOPS FOR DOORS AS REQ'D

- ALL PERIMETER ENTRY POINTS MUST BE SECURED WITH A LOCKING DEVICE THAT PENETRATES THE DOOR FRAME A MINIMUM OF 1.25cm

- CONFIRM ALL HARDWARE REQUIREMENTS WITH PHYSICAL SECURITY SCHEDULE. SEE SECURITY PLAN

Physical Security

CAM - Network Camera
M - Motion PIR and Dual Tech Detector
GB - Glass Break Detector
DC - Door Contact
Key - Alarm Key Pad
Panic - Panic/Hold-up Button
Siren - Alarm Siren
SD - Smoke/Heat Detector

Security Headend Note: Physical Security Design meets and exceeds Security Requirements and Compliance

SCOPE OF WORK: INTERIOR LEASEHOLD IMPROVEMENT 1400 QUADRA STREET, VICTORIA, BC. BUILDING CLASSIFICATION: NUMBER OF STORIES NUMBER OF STREETS/ACCESS ROUTES SPRINKLER SYSTEM REQUIRED SPRINKLER SYSTEM REQUIRED SPRINKLER SYSTEM REQUIRED FIRE ALARM SYSTEM REQUIRED BUILDING CLASSIFICATION TYPE OF CONSTRUCTION HIGH BUILDING HAZARDOUS SUBSTANCES BARRIER FREE ACCESSIBLE EXISTING CONCRETE & STEEL SUITE AREAS: TOTAL SUITE AREA 84.54m2 [910ft2] FIRE RESISTANCE RATING: LOAD BEARING COMPONENTS: DEMISING WALL: SPACIAL SEPARATION: ALL EXISTING EXPOSING BUILDING FACES TO REMAIN UNCHANGED WITH RESPECT TO LIMITING DISTANCE AND SPATIAL SEPARATION OCCUPANT LOAD: 3.70m2/PERSON NUMBER OF STAFF EXIT CAPACITY: REQUIRED WIDTH WIDTH PROVIDED ENTRANCES PROVIDED EXITS PROVIDED BARRIER FREE ENTRANCES REQUIRED BARRIER FREE ENTRANCES PROVIDED TRAVEL DISTANCE: TRAVEL DISTANCE: EXITS PROVIDED 15M SITE REQUIRED WASHROOM REQUIRED FOR EACH SEX: PROVIDED: 1 1 UNIVERSAL

BUILDING CODE ANALYSIS

Wall Schedule

INTERIOR WALLS



INTERIOR WALL - SOUND CONTROL

WALL FINISH
5/8" GYPSUM BOARD
3 5/8" STEEL STUDS @ 16"o.c.
(TO u/s DECK)
ROXUL AFB INSULATION
5/8" GYPSUM BOARD
WALL FINISH



P2 INTERIOR WALL - DEMISING - 1HR FRR

WALL FINISH
58" TYPE "X" GYPSUM BOARD
6" STEEL STUDS @ 16" o.c.
ROXUL AFB INSULATION
2- LAYERS 58" TYPE "X" GYPSUM BOARD
WALL FINISH

EXTERIOR WALLS




EXTERIOR WALL - Existing WALL EXTERIOR FINISH EXISTING STRUCTURE WALL INTERIOR FINISH


UCG Revision Schedule Revision Revision Revision Date Number Description Schedules Street) Victoria, BC (1400 Quadra \$ ∞ర Legends Cannabis Clarity (BC Ltd. SCALE: As indicated DATE: 11/09/2018 DRAWN: EER


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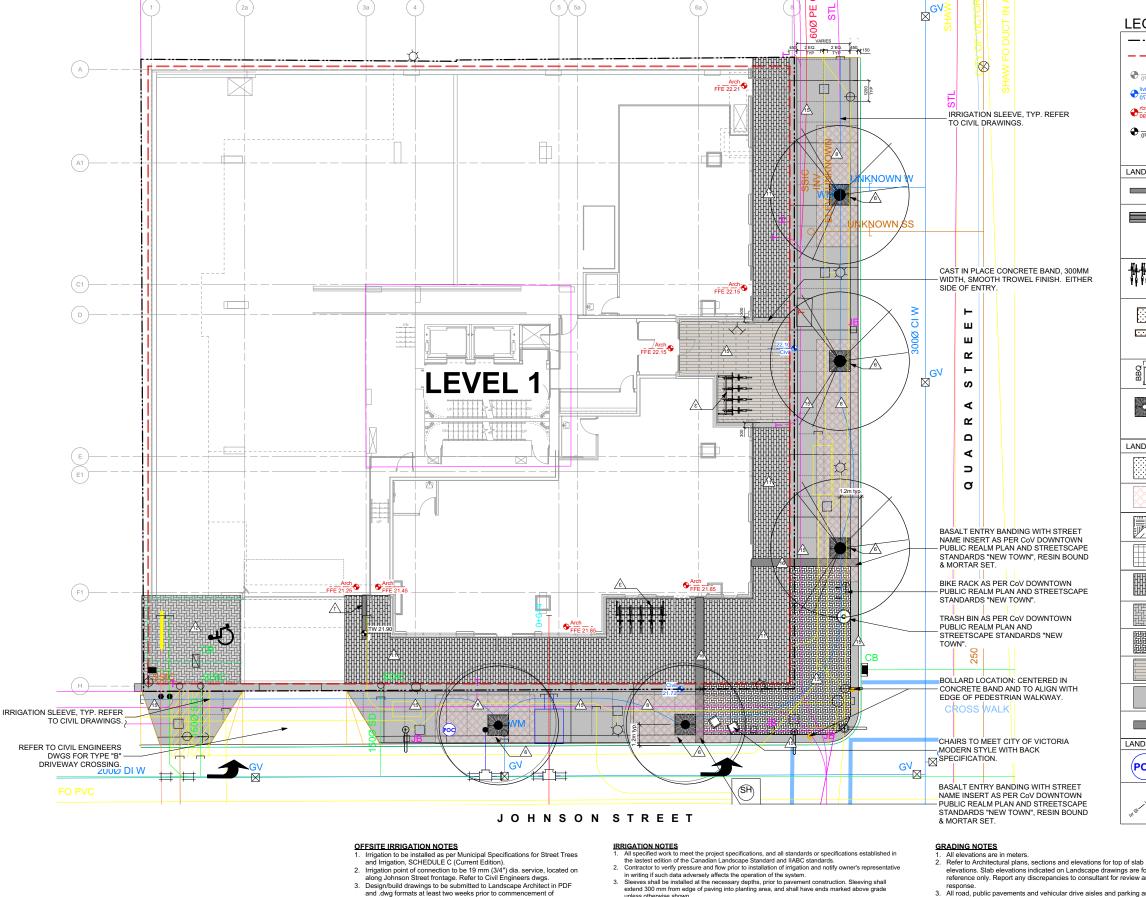
PROJECT INFORMATION TABLE					
ZONE (EXISTING)	CBD-2				
SITE AREA (m2)	1,374.84				
UNIT FLOOR AREA (m2)	84.54				
PARKING STALLS (NUMBER) ON SITE	1 EXTERIOR, 107 INTERIOR				
BICYCLE PARKING NUMBER (CLASS 1 AND CLA	ASS 2) 47 LONG TERM (INCL. 2 COMMERCIAL), 13 SHORT TERM				



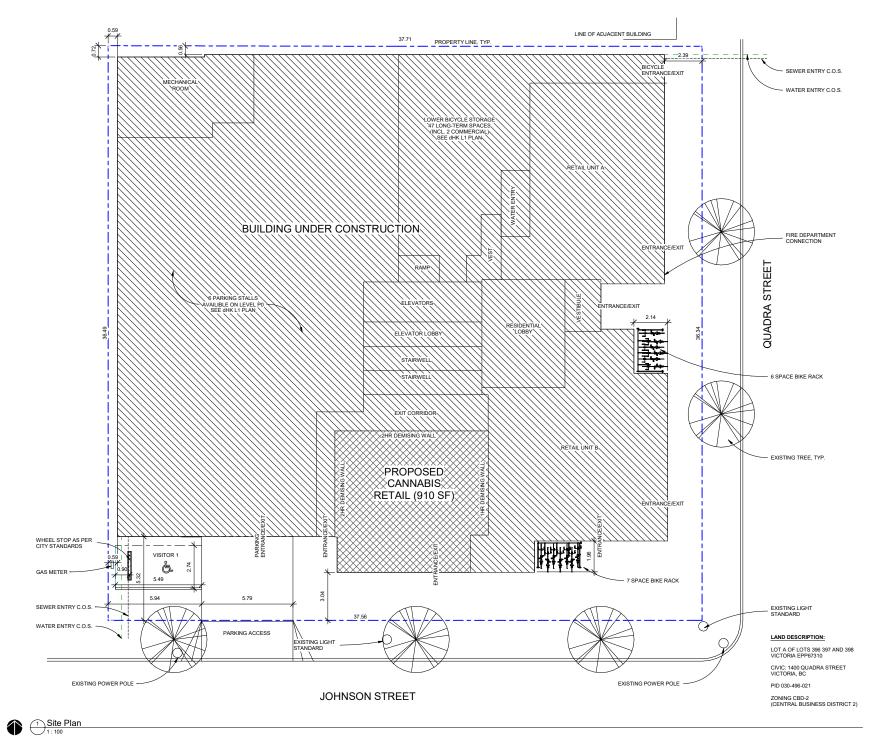

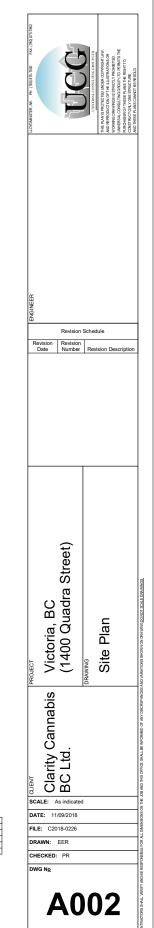

Revision Schedule Revision Revision Revision Date Number Description	Oria, BC O Quadra Street) No Quadra Street) Number Description	toria, BC 00 Quadra Street) 00 Quadra Street) in Floor Plan
	orii 00 n F	PROJECT Clarity Cannabis Victoria Clarity Cannabis Victoria (1400 - 1700
	orii 00 n F	PROLECT (1400 or DEWINNE STORE) Main F

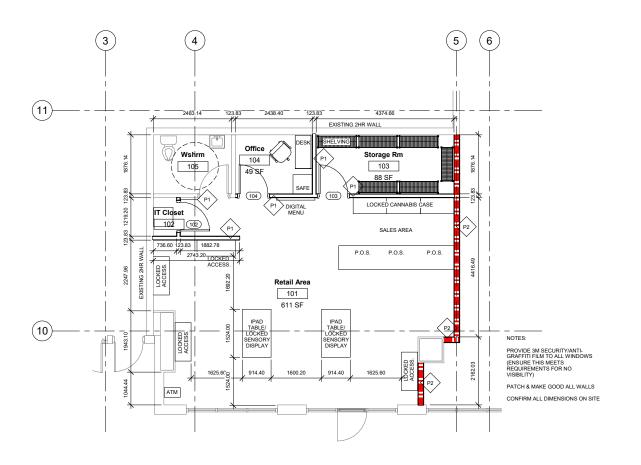

and .dwg formats at least two weeks prior to commencement of

- extend 300 mm from edge of paving into planting area, and shall have ends marked above grade unless otherwise shown.

 4. Utilities Contractor to verify location of all on-site utilities, prior to construction. Resoration of damaged utilities shall be made at the contractor's expense, to the satisfaction of the owner's representatives.

 5. Refer to mechanical drawings for irrigation point of connection.

 6. Contractor to field fit irrigation system around existing trees, to limit disturbance to root systems.

 7. At various milestones during construction, inspection and testing of components will be required to ensure that the performance of irrigation system meets standards and specifications. Contractor to provide equipment and personnel necessary for performance of inspections and tests in the presence of the contract administrator. Keep work uncovered and accessible until successful completeition of inspection or test.

 8. Over spray onto hardscape areas to be minimized. Use drip irrigation within small planting areas to avoid overspray.
- elevations. Slab elevations indicated on Landscape drawings are for reference only. Report any discrepancies to consultant for review and
- 3. All road, public pavements and vehicular drive aisles and parking area elevations indicated on the Landscape drawings are for reference only. Refer to Civil Engineering drawings. Report any discrepancies to consultant for review and response.
- Confirm all existing grades prior to contruction. Report any
- discrepancies to consultant for review and response.

 5. Unless otherwise noted provide a minimum slope of 2% on all hard
- onless one was noted provide a minimum slope of 2% of an hard and soft Landscape areas to ensure positive drainage away from buildings, or to drainage devices.
 All landscape areas shall not exceed a maximum slope of 3:1 in all
- instances.

DRAWING NOTES

- DO NOT SCALE DRAWING: Verify all property lines and existing
- Structures/vegetation to remain, prior to commencing work.

 All plan dimensions in metres and all detail dimensions in millimetres

 Plant quantities on Plans shall take precedence over plant list
- Contractor to confirm location and elevation of all existing services and
- utilities prior to start of construction.

 Provide layout of all work for approval by Landscape Architect prior to proceeding with work.

 Contractor to provide irrigation system for all planters to current IIABC
- Standards and Contract Specifications.
- Landscape installation to carry a 1 year warranty from date of
- Acceptance.
 Plant material, installation and maintenance to conform to the current edition of the Canadian Landscape Standard.
- General Contractor and/or sub-contractors are responsible for all costs related to production and submission to consultant of all landscape
- as-built information including irrigation.

 10. Tree protection fencing, for existing trees, to be installed prior to commencement of all site work



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1	RZ / DP Resubmission	17 SEPT 2018
/ no	description	date



DEVELOPMENTS LTD.

210-737 YATES STREET VICTORIA, BC

project

1400 QUADRA STREET, VICTORIA, BC

Landscape Materials & Layout Plan - Level 1

project no.		117.11
scale	1:100	@ 24"x36
drawn by		ML/JD/TB
checked by		SM/PdG
revison no.	sheet no.	
<u></u>	L	1.01

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LEGEND

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LANDSCAPE MATERIALS

_____ Property line

Extent of Parkade, below (indicative only)

Existing Landscape Grade

TW Top of Wall BW Bottom of Wall TS Top of Stairs BS Bottom of Stair

LANDSCAPE STRUCTURES/ FURNISHINGS CIP Concrete Wall

(1) @ 5' length. (1) @ 10' length.

 $\sqrt{2}$

Civil Grade, provided for reference only

Architectural grade, provided for reference

Bench - Type 1 Model: Hutch Park Bench (#: HB-5) or approved equiv. frame colour: Pewter, slat Colour: Walnut. Supplier:

Planters

Model: Planters Perfect™ (or approved equiv.), aluminum, powder coat finish, colour: Pewter. Allow for drainage and irrigation. Supplier: Green Theory Distributors

BBQ Free-standing, stainless steel. Contractor to liaise with

owner for additional information

© Tree Grate and Guard
Standard, as per City of Victoria specifications.
Supplier: Dobney Foundry.

Shrub / Tree Planting Area - In Planter
450mm depth, Type 2L growing medium, refer to
Landscape Specifications.

Extensive Green Roof

100mm depth, Type 1P growing medium, refer to Landscape Specifications.

Structural Soil (under pavement)
750mm depth, refer to Landscape Sp

Unit Paving - Type 1

Unit Paving - Type 2

Unit Paving - Type 3

Unit Paving - Type 4

Unit Paving - Type 5

Cast-in-Place Concrete

LANDSCAPE INFRASTRUCTURE

POC

Basalt Paver Entry Banding w/ Street Name

Proposed Irrigation Point of Connection

Irrigation Sleeve Schedule 40 PVC, dia. shall be min 3x main line

Irrigation Point of Connection

L4.01

NA

8 L4.01

NA


7 L4.01

6 L4.01

See L4.01

N/A

Bicycle Rack
Model: Campus Rack, (1) @ #S5 and (1) @ S4 or
approved equiv., galv., powder coat, colour: black.
Surface mounted into sub-surface concrete footing.
Supplier: Dero.

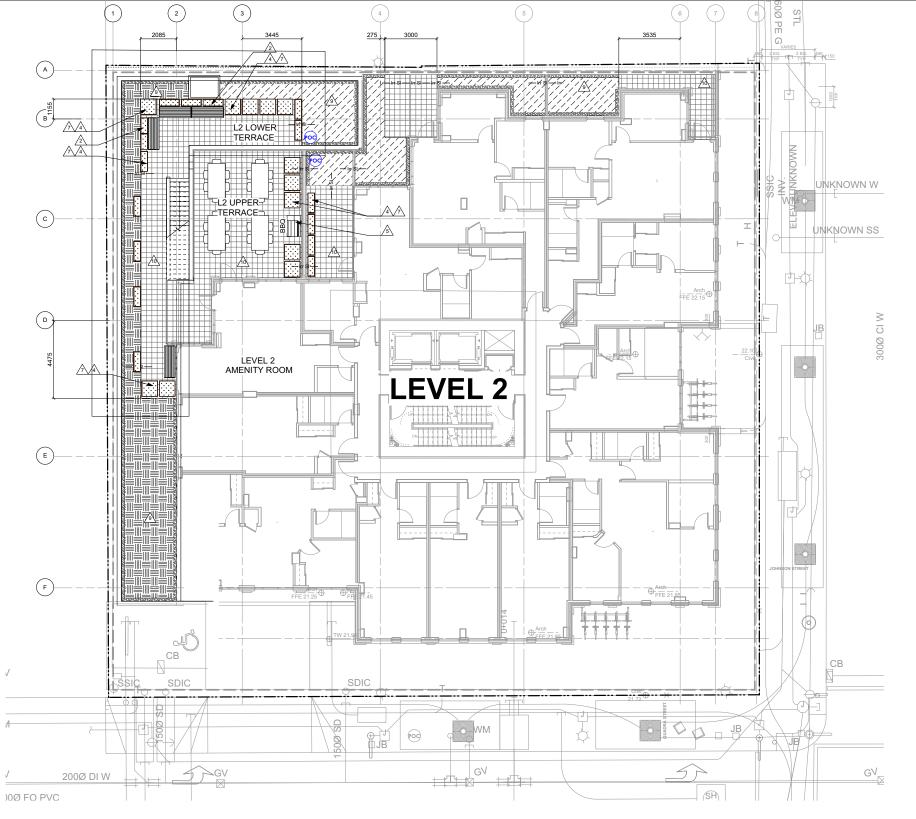


JOHNSON STREET

LEGEND

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- Plant quantities and species may change between issuance of DP and Construction due
- 1. Plant quantities and species may change between issuance of by and consistent to plant availability and design changes.
 2. All planters to be filled with voiding foam or other suitable voiding material to limit maximum soil depth. Structural engineer to confirm maximum soil depth (assumed
- All planters to be installed on pedestals to sit max. 50mm proud of adjacent finished
- A. An planters to be installed on pedestals to six max. Softling product adjacent initiating grade of pavers.
 Each patio to recieve independent irrigation system for planters. Allow for hose bib connection c/w residential grade backflow device, battery controller and suitable dripline and/or micro sprays. Conceal irrigation equipment below pavers within void space. Provide conduit sleeving through base of aluminum planters for irrigation lines.

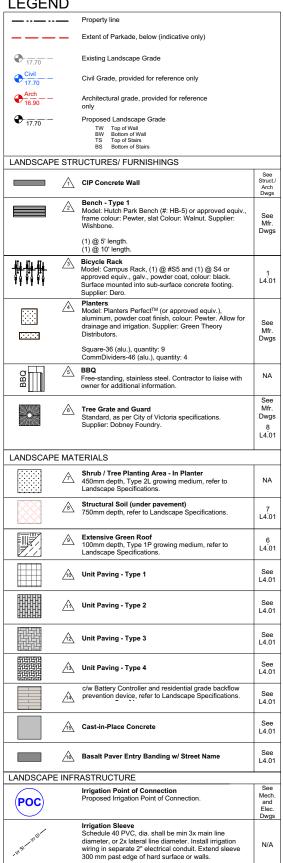

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Murdoch de Greeff INC

Landscape Planning & Design 200 - 524 Culduthel Road Phone: 250.412.2891 Victoria, BC V8Z 1G1 Fax: 250.412.2892


DEVELOPMENTS LTD. 210-737 YATES STREET VICTORIA, BC

project


1400 QUADRA STREET, VICTORIA, BC

Landscape Materials & Layout Plan - Level 2

project no.	117.11
scale	1:100 @ 24"x36
drawn by	ML/JD/TB
checked by	SM/PdG
revison no.	sheet no.
	L1.02

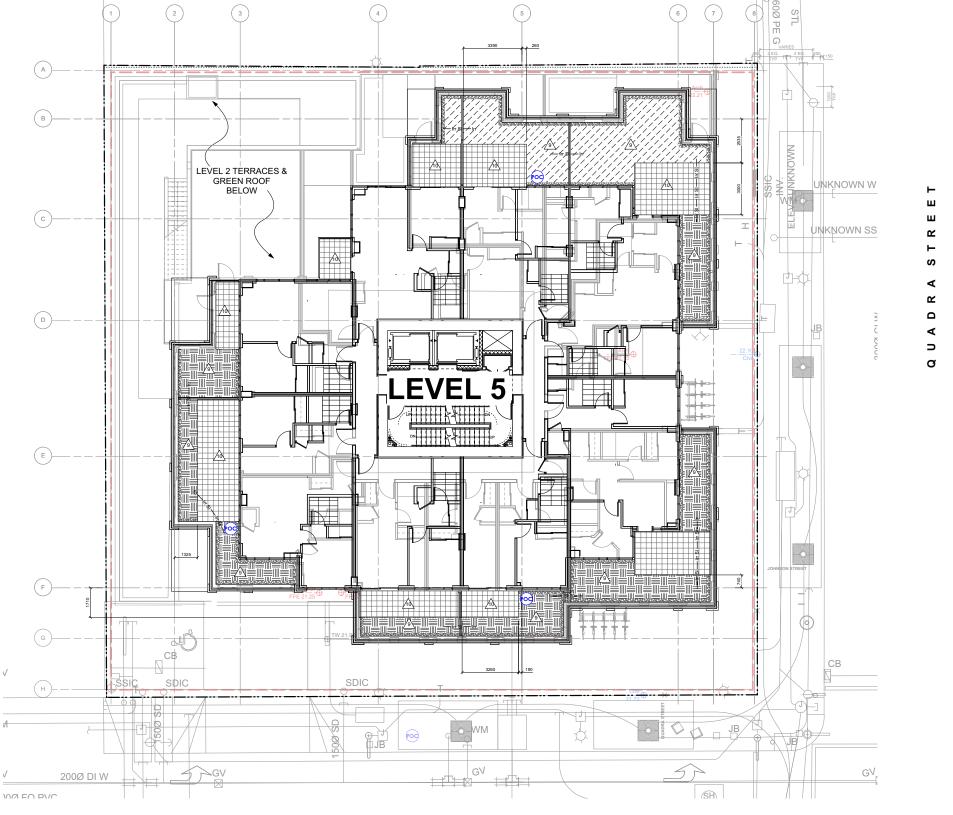

JOHNSON STREET

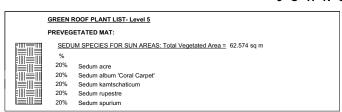


NOTES FOR PRE-VEGETATED MAT:

- PLANT SPECIES TO BE PRE-GROWN ON MATS OR TILES WITH SPECIES PROPORTIONS AS INDICATED CHANGES TO SPECIES AND/OR COMPOSITION SHALL REQUIRE APPROVAL BY LANDSCAPE ARCHITECT AND CLIENT.
- PRE-VEGETATED MATS SHALL ACHIEVE 80% PLANT COVERAGE AT TIME OF SUPPLY AND 90% COVERAGE AT 12 MONTHS POST ACCEPTANCE.
- 1 YEAR MAINTENANCE, AS PER THE SUPPLIERS SPECIFICATION.

	GREEN	ROOF PLANT LIST- Level 5		
	PLANT S	SPECIES FOR SHADE AREAS:		
$\overline{7}$	SHADE	AREAS:		
1/1	Qty	Botanical Name	Common Name	Schd. Size / Plant Spacing
//	87	Aquilegia formosa	Red Columbine	Sp3, 30cm o.c.
21	87	Cornus canadensis	Bunchberry	Sp3, 30cm o.c.
1	87	Dicentra formosa	Western Bleeding Heart	Sp3, 30cm o.c.
4	87	Gaultheria shallon	Salal	Sp3, 30cm o.c.
:4	87	Oxalis oregana	Redwood Sorrel	Sp3, 30cm o.c.
4	87	Polypodium glycyrrhiza	Licorice Fern	Sp3. 30cm o.c.

LEGEND

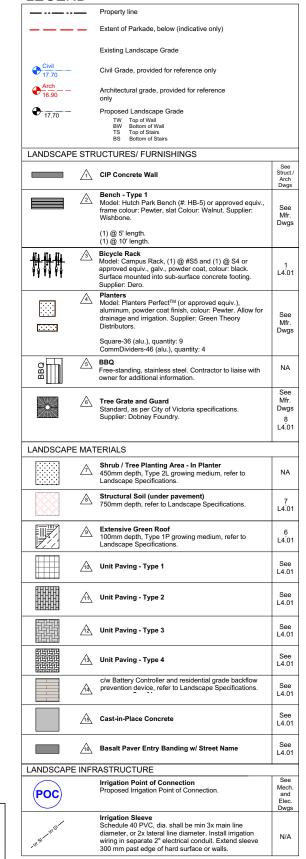

- 1. Plant quantities and species may change between issuance of DP and Construction due
- to plant availability and design changes.

 All planters to be filled with voiding foam or other suitable voiding material to limit maximum soil depth. Structural engineer to confirm maximum soil depth (assumed 450mm).
- All planters to be installed on pedestals to sit max. 50mm proud of adjacent finished
- grade of pavers.

 4. Each patio to recieve independent irrigation system for planters. Allow for hose bib connection c/w residential grade backflow device, battery controller and suitable dripline and/or micro sprays. Conceal irrigation equipment below pavers within void space. Provide conduit sleeving through base of aluminum planters for irrigation lines.



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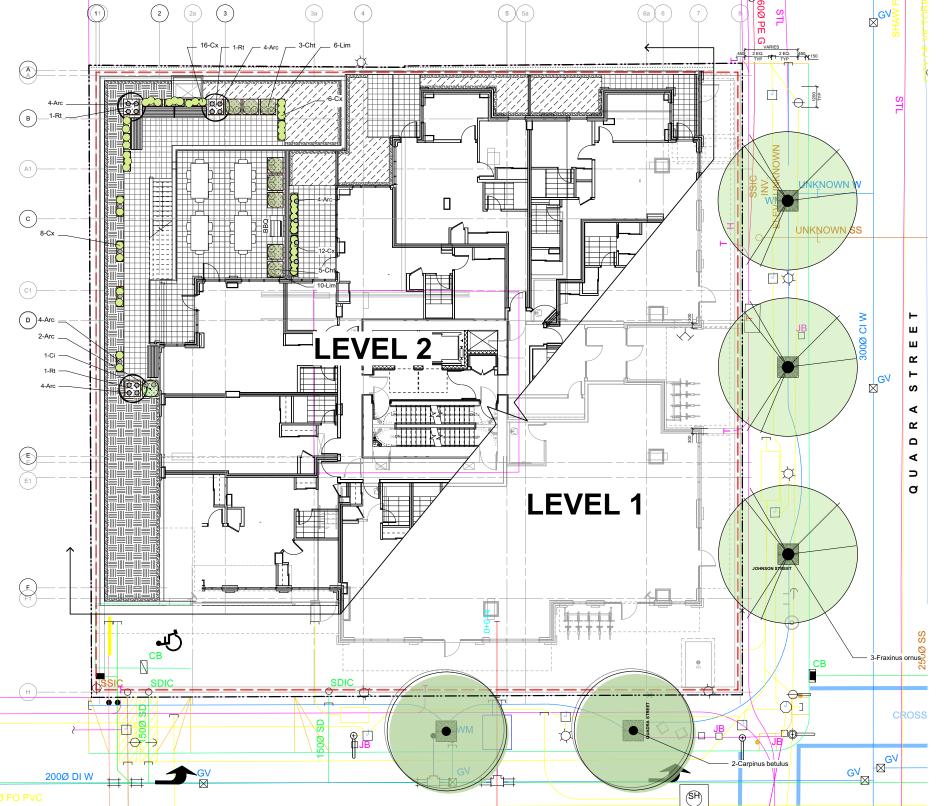
ALPHA PROJECT DEVELOPMENTS LTD. 210-737 YATES STREET

VICTORIA, BC

1400 QUADRA STREET,

Landscape Materials & Layout Plan - Level 5


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revison no.	sheet no.	
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JOHNSON STREET

0 5 10 m

Sym	Qty	Botanical Name	Common Name	Schd. Size / Plant Spacing
TREES	<u>s:</u>			
	2	Carpinus betulus	European Hornbeam	6.0cm cal, b&b
	3	Fraxinus ornus	Flowering Ash	6.0cm cal, b&b
PLAN	LIST -	LEVEL 2		
TREES	<u>}:</u>			
	3	Rhus typhina	Staghorn Sumac	#5 pot
euniii	BS/FER	NS/GRASSES/SEDGES/GROUNDCOVERS:		
SHKU		Arctostaphylos uva-ursi	Kinnikinnick	#1 pot
Arc	22	Arctostaphylos dva-drsi		
	22 42	Calamagrostis x acutiflora 'Karl Foerster'	Feather Reed Grass	#1 pot
Arc			Feather Reed Grass Mexican Orange	,
Arc Cx	42	Calamagrostis x acutiflora 'Karl Foerster'		#1 pot



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ALPHA PROJECT DEVELOPMENTS LTD.

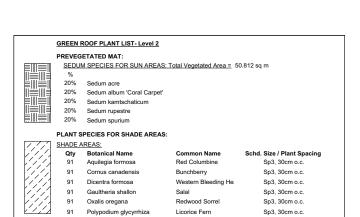210-737 YATES STREET VICTORIA, BC

1400 QUADRA STREET, VICTORIA, BC

sheet title

Planting Plan -

- PLANTING NOTES

 1. Plant quantities and species may change between issuance of DP and Construction due to plant availability and design changes.

 2. Green roof to be proprietary sedum mat system for sun areas and planted with shade tolerant species for shade areas. Refer to plant list.

 3. Final selection of boulevard trees to be determined through
- consultation with City of Victoria Parks staff.

 4. All raised alumininum planters to be irrigated

9

scale


drawn by

SM/PdG revison no. L3.01

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117.11 @ 24"x36"

ML/JD/TB

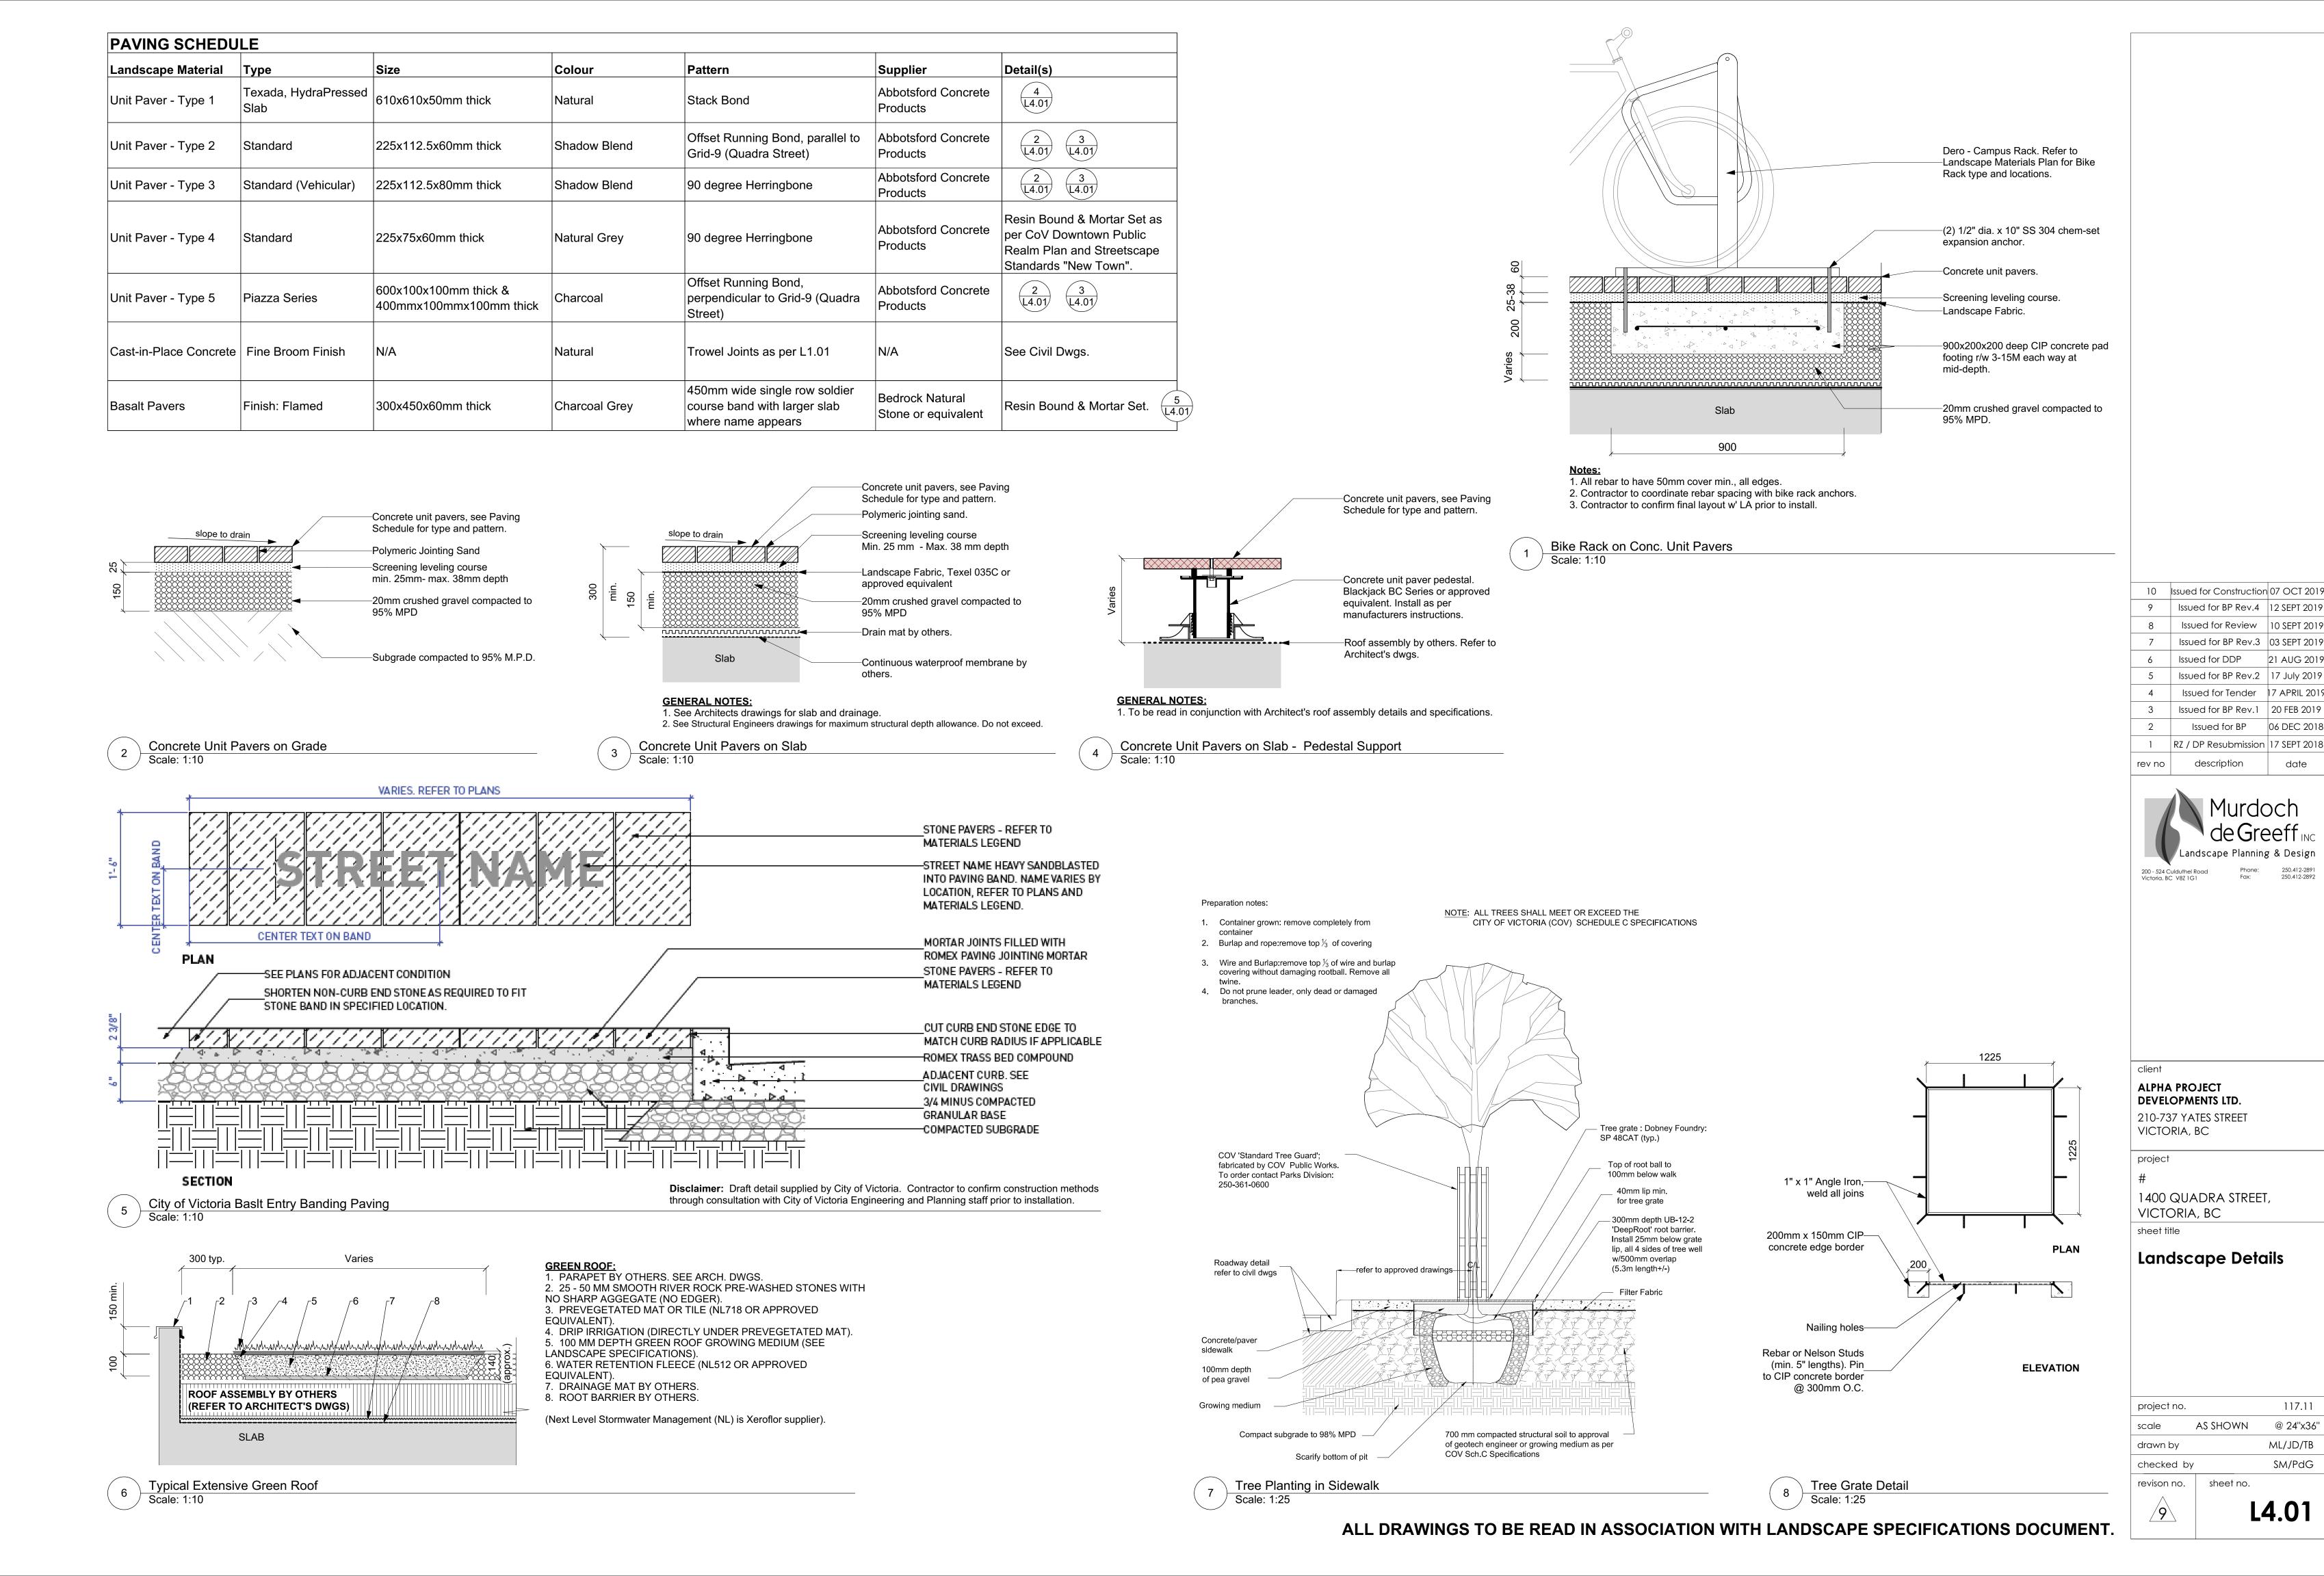

date

117.11