
# 937 VIEW STREET



Project Rendering - Main Entry Streetscape at View Street



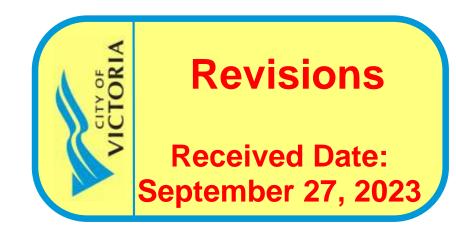

# ■ LIST OF DRAWINGS

## ARCHITECTURAL Project Data A100 Survey A101 Site Plan Existing Site Plan Proposed Setback Plans Site Context - Shadow Analysis Site Context - Street Views Site Context - Street Elevations Site Context - Materials Site Context - Rendered Views Livability - Rendered Interior Views A118 Livability - Rendered Interior Views Level 2 Plan Levels 3-5 Plan Levels 6 Plan Levels 7-22 Plan Level 23 Plan Roof Plan **Building Elevations Building Elevations**

# LANDSCAPE

A402 Building Sections
A911 Area Plans

L1.01	Landscape Plan L1
L1.02	Landscape Plans Upper Level
L1.03	Stormwater Mangement
L3.01	Planting Plan L1
L3.02	Planting Plan Upper Levels

Adjacent Buildings Analysis Building Sections

# CIVIL

- 1		
	C100	General Notes
	C200	Site Servicing Plan
	C300	Grading Plan
	C400	BC Hydro Information Plan

23-08-15 Issued for DP Revisions
23-05-09 Issued for DP Revisions
21-12-20 Issued for DP Revisions
21-05-04 Issued for DP Revisions
20-08-12 Issued for DP Revisions
19-10-02 Issued for DP Revisions
Issued for DP Revisions

Plot Date 23-05-09 Drawing File

Drawn By RCI Checked By

Scale 1:1 Project Number

View St. Residential

937 View Street

Cover



dHKarchitects Victoria 977 Fort Street

**′ictoria** 77 Fort Street V8V 3K3 **T** 1•250•658•336 **Ianaimo** 02-5190 Dublin Way V9T 0H2 **T** 1•250•585•58<sup>,</sup>

# 937 VIEW STREET






**LIST OF ABBREVIATIONS** 

Gypsum Wallboard

Hollow Core Hollow Core Wood

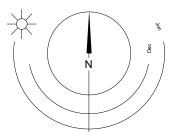

**BUILDING CODE SUMMARY** 

MAJOR OCCUPANCY CLASSIFICATION:

GROUP C - RESIDENTIAL

NUMBER OF STREETS FACING:

ACCESSIBLE ENTRANCE

CONSTRUCTION REQUIREMENTS:

ACCESSIBLE FACILITIES

**BUILDING AREA:** 

1087 m<sup>2</sup> (11 700 s.f.)

BUILDING HEIGHT:

23 STOREYS

Ref. 3.2.6.1 (1)(d)

BRITISH COLUMBIA BUILDING CODE 2018 - PART 3

3.2.2.47 GROUP C, ANY HEIGHT, ANY AREA, SPRINKLERED

ADDITIONAL REQUIREMENTS FOR HIGH BUILDINGS

NON-COMBUSTIBLE CONSTRUCTION WITH 2 HR MIN. FIRE

RESISTANCE RATING TO FLOORS AND LOADBEARING

CANADIAN STANDARDS ASSOCIATION B651-18

	ing abbreviations are used on door, window	, and finish schedule	es as well as on			
architectur	ral drawings and details.					The fo
ACST	Acrylic Stucco	H/C	Handicap	SPC	Solid Particleboard Core	BEDR
ACT	Acoustical Tile	HM	Hollow Metal	ST	Structure	
AFF	Above Finished Floor	HP	High Point	STL	Steel	20
AL	Aluminum	HSS	Hollow Steel Section	STN	Stain(ed)	
AO	Auto-Opener	H/W	Hardware	STNT	Stone Tile	(10
AP	Annunciator Panel	INSUL	Insulated	SS	Stainless Steel	
BG	Building Grade	LAM	Laminated Glass	SVF	Sheet Vinyl Flooring	
CEM	Cementitious Backing Board	LP	Low Point	TB	Towel Bar	
Conc	Concrete	MDFB	Medium Density Fibreboard Base	T/D	Tempered / Double Glazed	W-
CBK	Concrete Block	MR	Mirror	TLAM	Tempered Laminated Glass	VV-
CII	Contorlino	MD	Motal Panal	TCI	Tompored Class	

Wood

Waterproof Membrane

Water Repellant Coating

AL AO AP BG CEM Conc CBK C/L CPT CT Metal Panel Tempered Glass TLGL TOC TOD TOI TOP TOS TOW Carpet Tile O/H OW PF Overhead Translucent Glass Operable Window Top of Concrete Ceramic Tile C/W DD Complete With Prefinished Top of Drain PLAM Deck Drain Plastic Laminate Top of Insulation PLS PSF PT PTD PTD/W PTW RA Electric Bike Storage Top of Parapet Plaster EL EPC EV EXP AGG EXT FD FEC FFE Pressed Steel Frame Top of Slab Elevation Top of Wall Epoxy Polymer Coating Paper Towel Dispenser Electric Vehicle Parking Toilet Paper Exposed Aggregate Paper Towel Dispenser / Waste Unfinished (for GWB means taped and filled by not sanded to minimum ULC requirements where applicable) Paper Towel Waste UNO Floor Drain Roof Anchor Unless Noted Otherwise RB RES Fire Extinguisher Cabinet Rubber Base Underside of... Finished Floor Elevation Resilient Flooring Vinyl Composition Tile Finished Grade Roof Drain Vision Glass RD-P Roof Drain - Planter Vinyl Impact Sheet GBL GL RWL SAFI SCW Glass Block Rain Water Leader Spray Applied Fibrous Insulation Vinyl Wall Covering Georgian Wire Glass Solid Core Wood Water Closet

Soap Dispenser

Spandrel Glass

|--|

following annotations are used on hitectural drawings and details: DROOM ROOM NAME & ROOM NUMBER DOOR NUMBER See Door Schedule

> WINDOW NUMBER See Window Schedule

W1 WALL TYPE
See Assemblies Schedule

2.0 hr RATED WALL DESIGNATION 00.00 ELEVATION DATUM

CEILING HEIGHT

KEYNOTE SYMBOL

AREA OF DROP CEILING

MATERIAL TAG

INTERIOR ELEVATION REFERENCE

W1 C1 F1 B1 ROOM FINISHES

# PROJECT DESCRIPTION

937 VIEW STREET, VICTORIA, BC.

LEGAL DESCRIPTION: LOT A, OF LOTS 785, 786, and 787, VICTORIA CITY, PLAN 36505

# **ZONING BYLAW SUMMARY**

## **BUILDING DESCRIPTION:** 23 STOREY RESIDENTIAL BUILDING

RESIDENTIAL RENTAL R-48 HARRIS GREEN DEVELOPMENT PERMIT AREA: DPA 713 (HC) SITE AREA: 1 572.3 m<sup>2</sup> (16 924 s.f.)

FLOOR AREA: 707 m<sup>2</sup> (7 610 s.f.) Level 1: 735 m² (7 911 s.f.) Level 2: 801 m<sup>2</sup> (8 622 s.f.) x 3 = 2 403 m<sup>2</sup> Level 3-5: 477.5 m<sup>2</sup> (5 140 s.f.) x 17 = 8 118 m<sup>2</sup> Level 6-22: 327 m<sup>2</sup> (6 168 s.f.) Level 23:

TOTAL PROPOSED: 12 356 m<sup>2</sup> (132 999 s.f.) FLOOR SPACE RATIO: SITE COVERAGE: OPEN SITE SPACE:

**GREEN STORMWATER INFRASTRUCTURE:** 

\*Minimum 30% of paving area, refer to Landscape drawing L1.01 17.7 m (GEODETIC AVG GRADE) GRADE OF BUILDING:

See Site Plan for Grade Calculations HEIGHT OF BUILDING: SETBACKS:

FRONT (View Street): REAR (S): SIDE (È): SIDE (W): NUMBER OF STOREYS: 23 STOREYS

SUITE COMPOSITION Studio < 30m<sup>2</sup>: 1 Bed / 1 Bath <45m<sup>2</sup>: 2 Bed / 1 Bath <45m<sup>2</sup>: 3 Bed / 1 Bath > 45m<sup>2</sup>: 3 Bed / 2 Bath > 45m<sup>2</sup>: 8 Suites

TOTAL: 269 SUITES RESIDENTIAL PARKING: COMMERCIAL PARKING:

Required Long Term: Provided Long Term: 310 (25% EB) Required Short Term: Provided Short Term:

# **PROJECT DIRECTORY**

# Nelson Investments Inc.

595 Howe Street, 10th Floor Chris Nelson tel: 604.318.6877 Vancouver, BC chris@nelsoninvestmentsinc.com V6C 2T5

**ARCHITECT** dHKarchitects Charles Kierulf 977 Fort Street tel: 250.658.3367 Victoria, B.C. fax: 250.658.3397 crk@dhk.ca

STRUCTURAL 3600 Uptown Blvd

Chris Jagues Building 15, Suite 301 tel: 778.834.2331 Victoria, BC V8Z 0B9 Chris.Jaques@wsp.com

MECHANICAL Avalon Mechanical Consultants Ltd. 1245 Esquimalt Rd #300,

Jamie Clarke tel: 250.384.4128 Victoria, BC V9A 3P2 jclarke@avalonmechanical.com

**ELECTRICAL CONSULTANT** Nemetz & Ass Ltd

2009 W 4th Ave Bijan Valagohar Vancouver, BC tel: 604.736.6562 V6J 1N3 bijan@nemetz.com


LANDSCAPE CONSULTANT Murdoch de Greeff Inc. Scott Murdoch 200-524 Culduthel Rd. tel: 250.412.2819 fax: 250.412.2892 Victoria, BC V8Z 1G1 scott@mdidesign.ca

**GEOTECHNICAL** Shane Moore Ryzuk Geotechnical 28 Crease Avenue tel: 250.475.3131 Victoria, BC fax: 250.475.3611 shane@ryzuk.com

**CIVIL CONSULTANT** Sarah Campden tel: 250.590.4875 Herold Engineering 1051 Vancouver Street Victoria, BC fax: 250.590.4392 V8V 4T6 SCampden@heroldengineering.com


**ENVELOPE CONSULTAN** Morrison Hershfield 536 Broughton Street, 2nd Floor tel: 250.361.1215 x1142201 Victoria, BC fax: 250.361.1235 V8W 1C6 craudoy@morrisonhershfield.com

Outline Main Floor

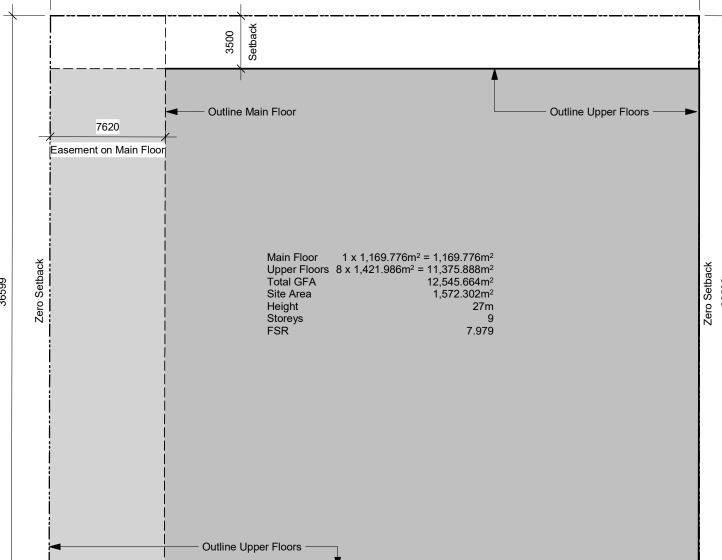


42945

2 Base FSR Calculation A001 SCALE: 1 : 250

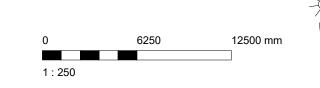

Zero Setback 42988

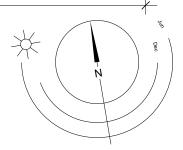

23-05-09 Drawing File NOTE: All dimensions are shown in millimeters

23-08-15

23-05-09

21-05-04

20-08-12

20-01-08

19-10-02

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Issued for DP Revisions 5

Issued for DP Revisions 3

Issued for DP Revisions 2

Issued for DP

Issued for DP Revisions 1

View St. Residential


937 View Street

Project Data



dHKarchitects Victoria

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 lot Date
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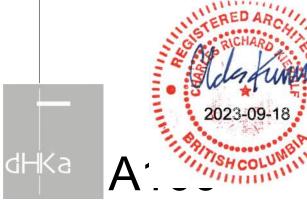
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 ADM
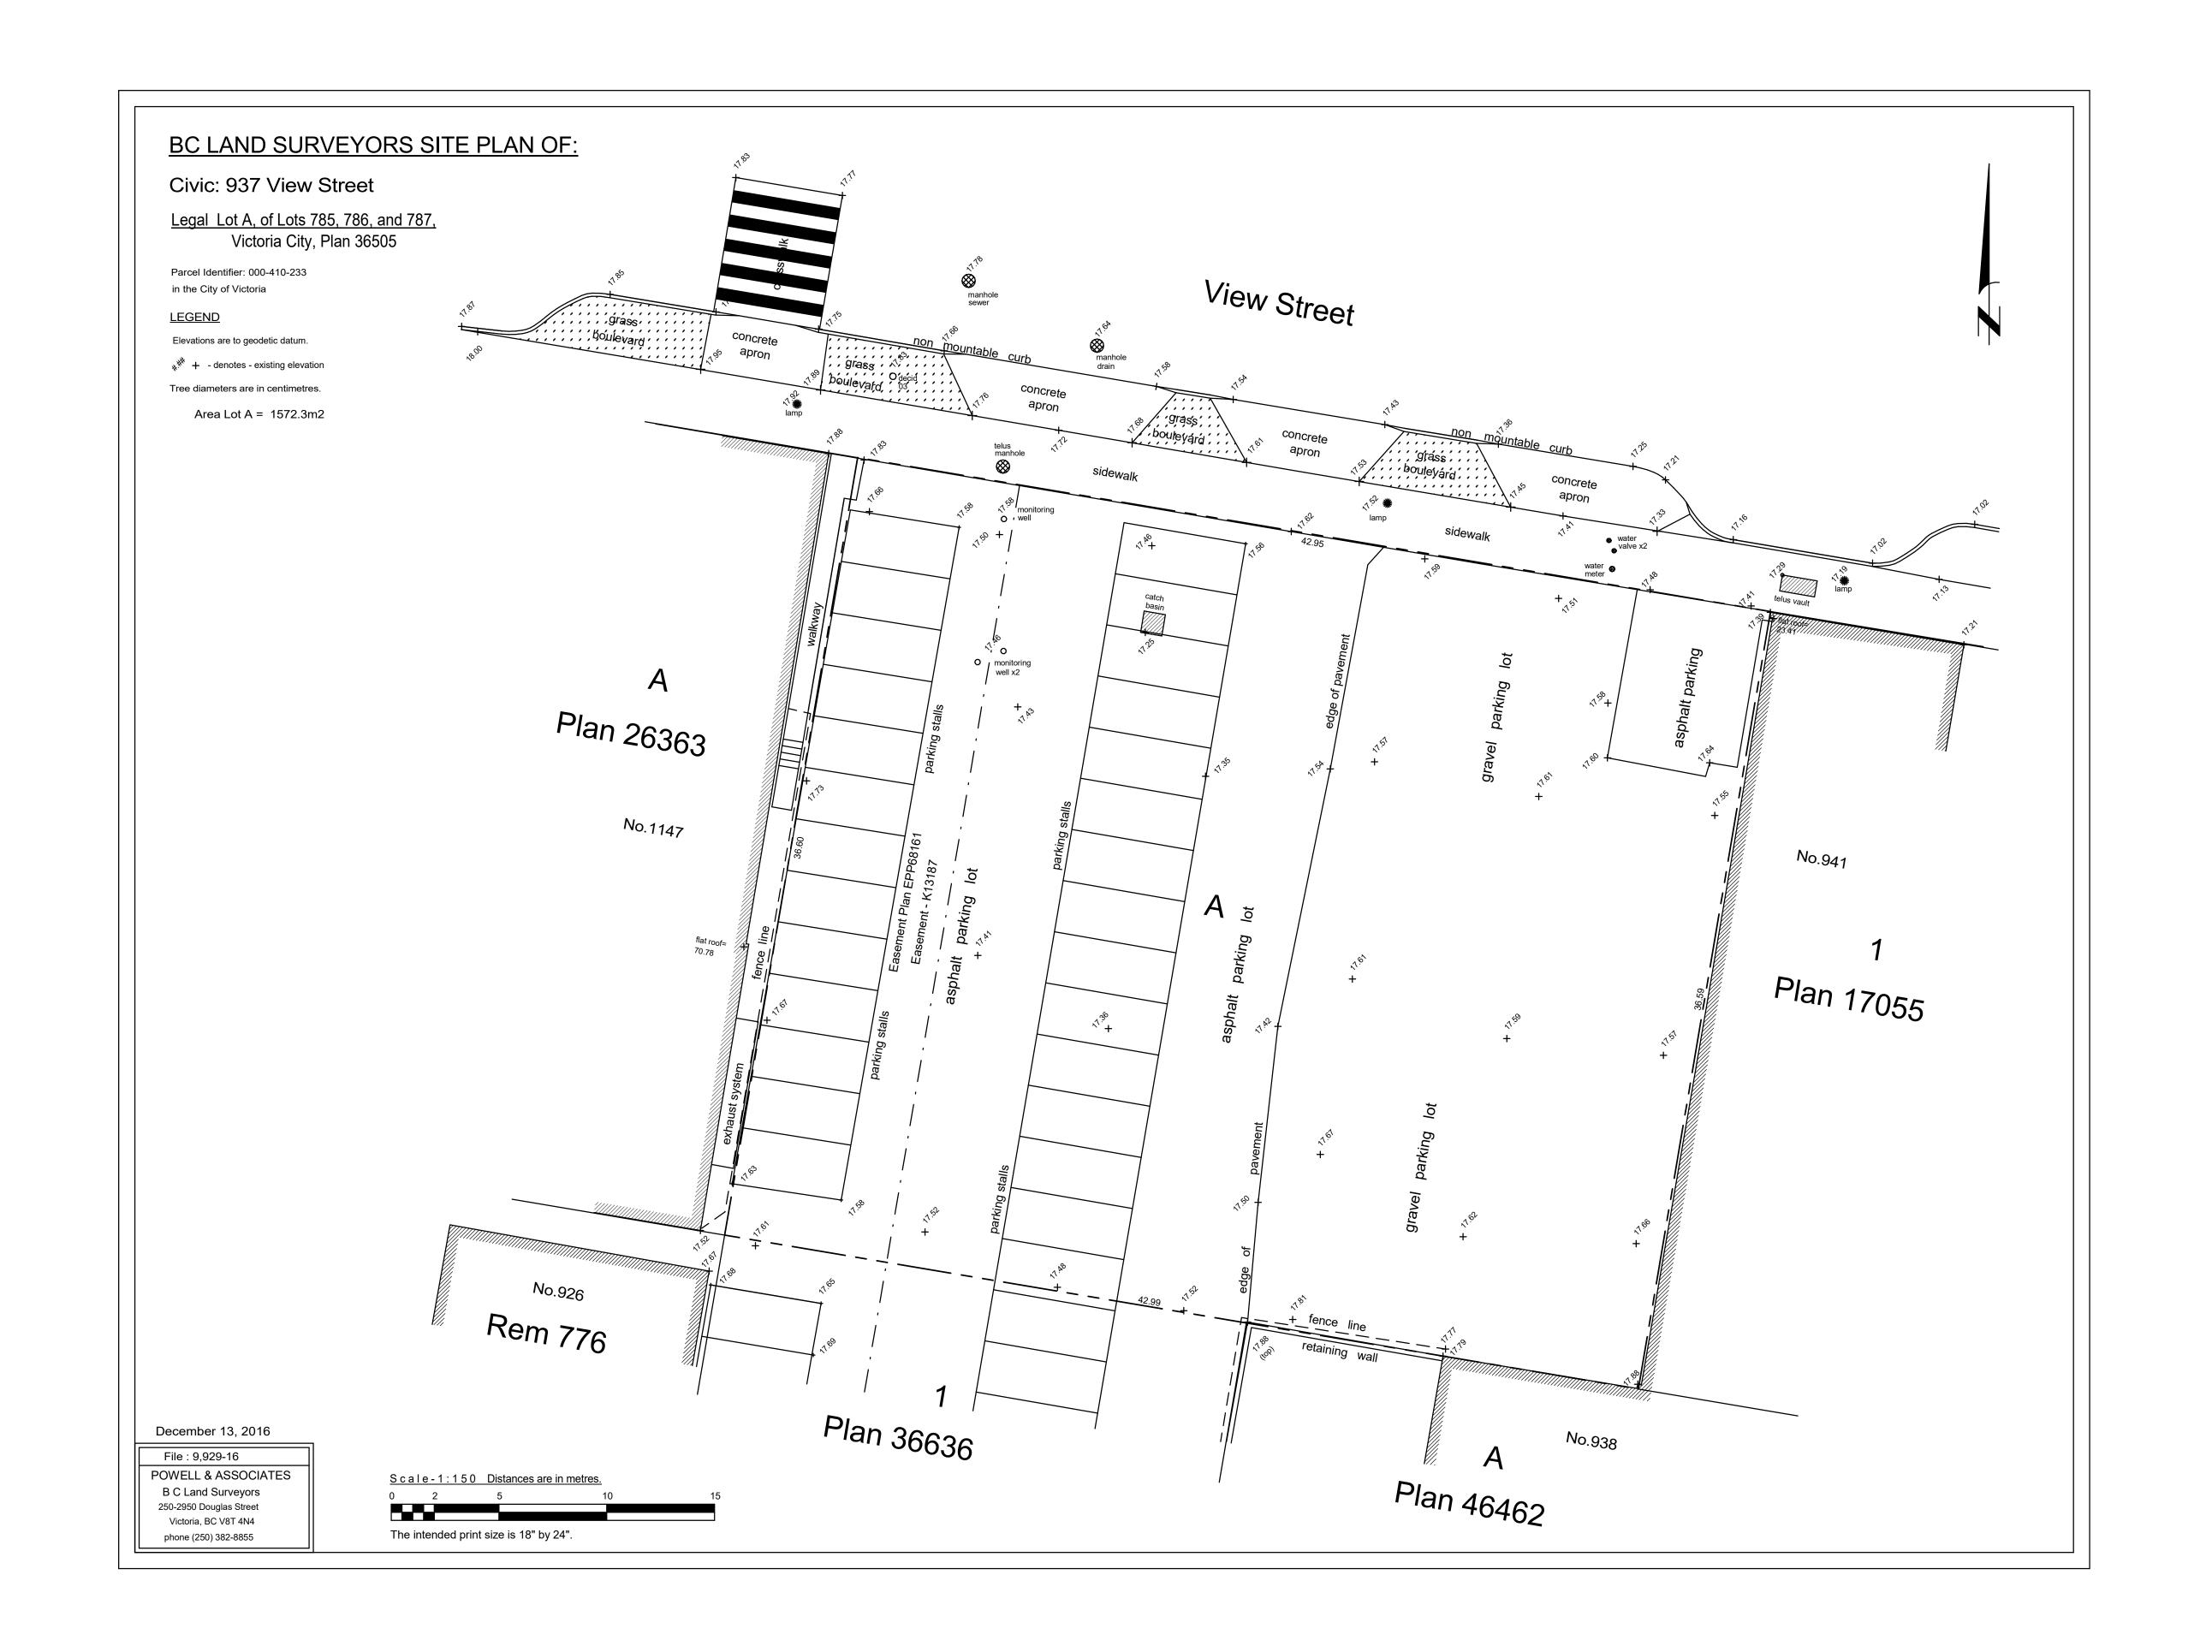
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 Project Number
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View St. Residential

937 View Street

Survey





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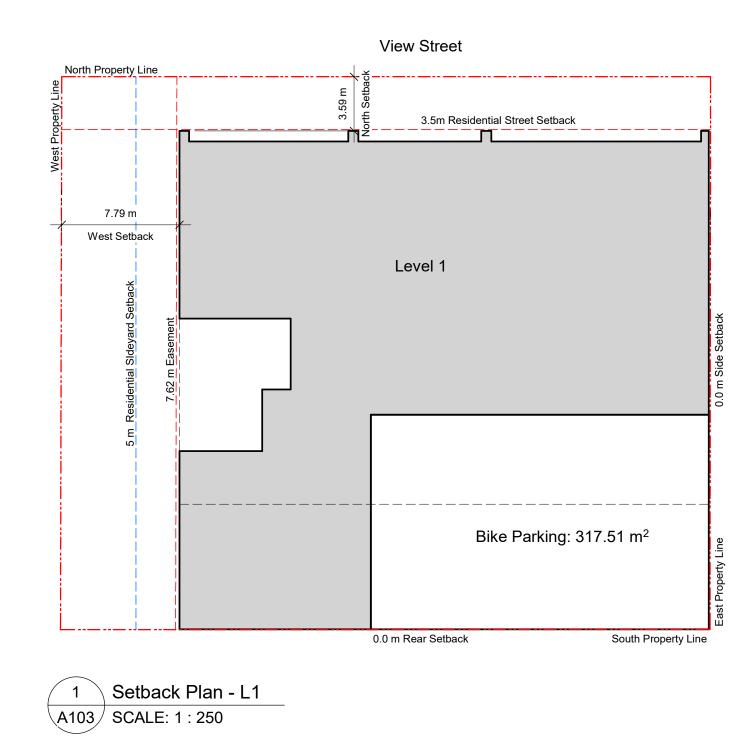
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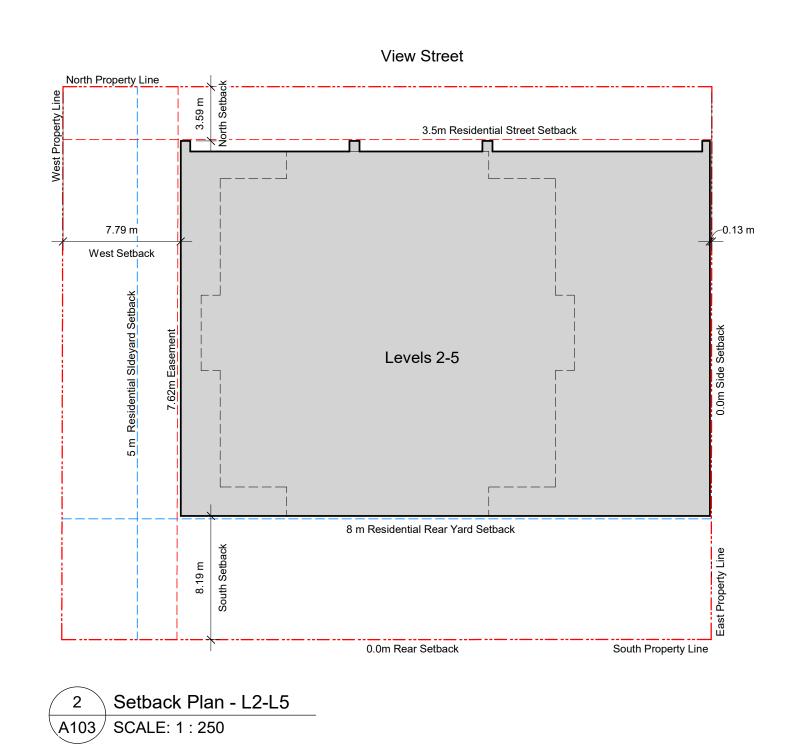
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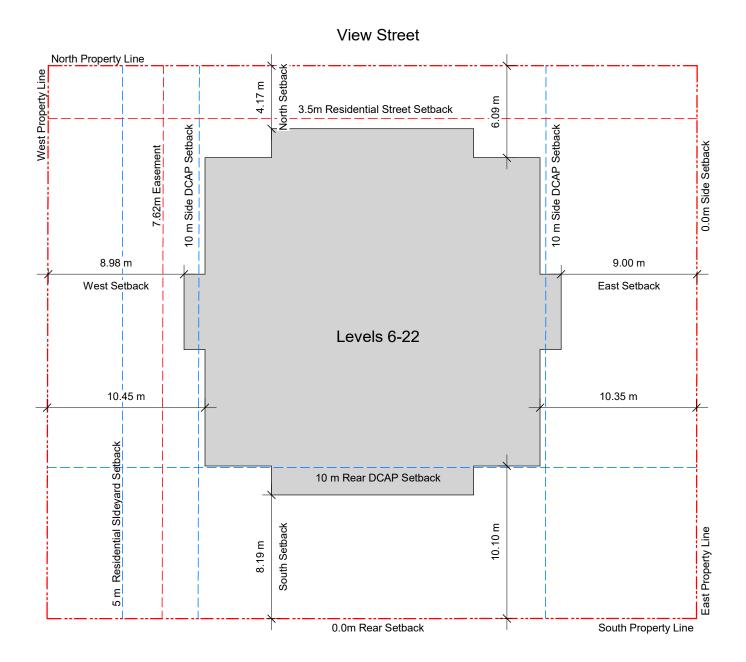
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3 Setback Plan - L6-L22 A103 SCALE: 1 : 250

23-05-09 Issued for DP Revisions 5
21-05-04 Issued for DP Revisions 3
20-08-12 Issued for DP Revisions 2

Plot Date 23-05-09 Drawing File

Drawn By RCI Checked By

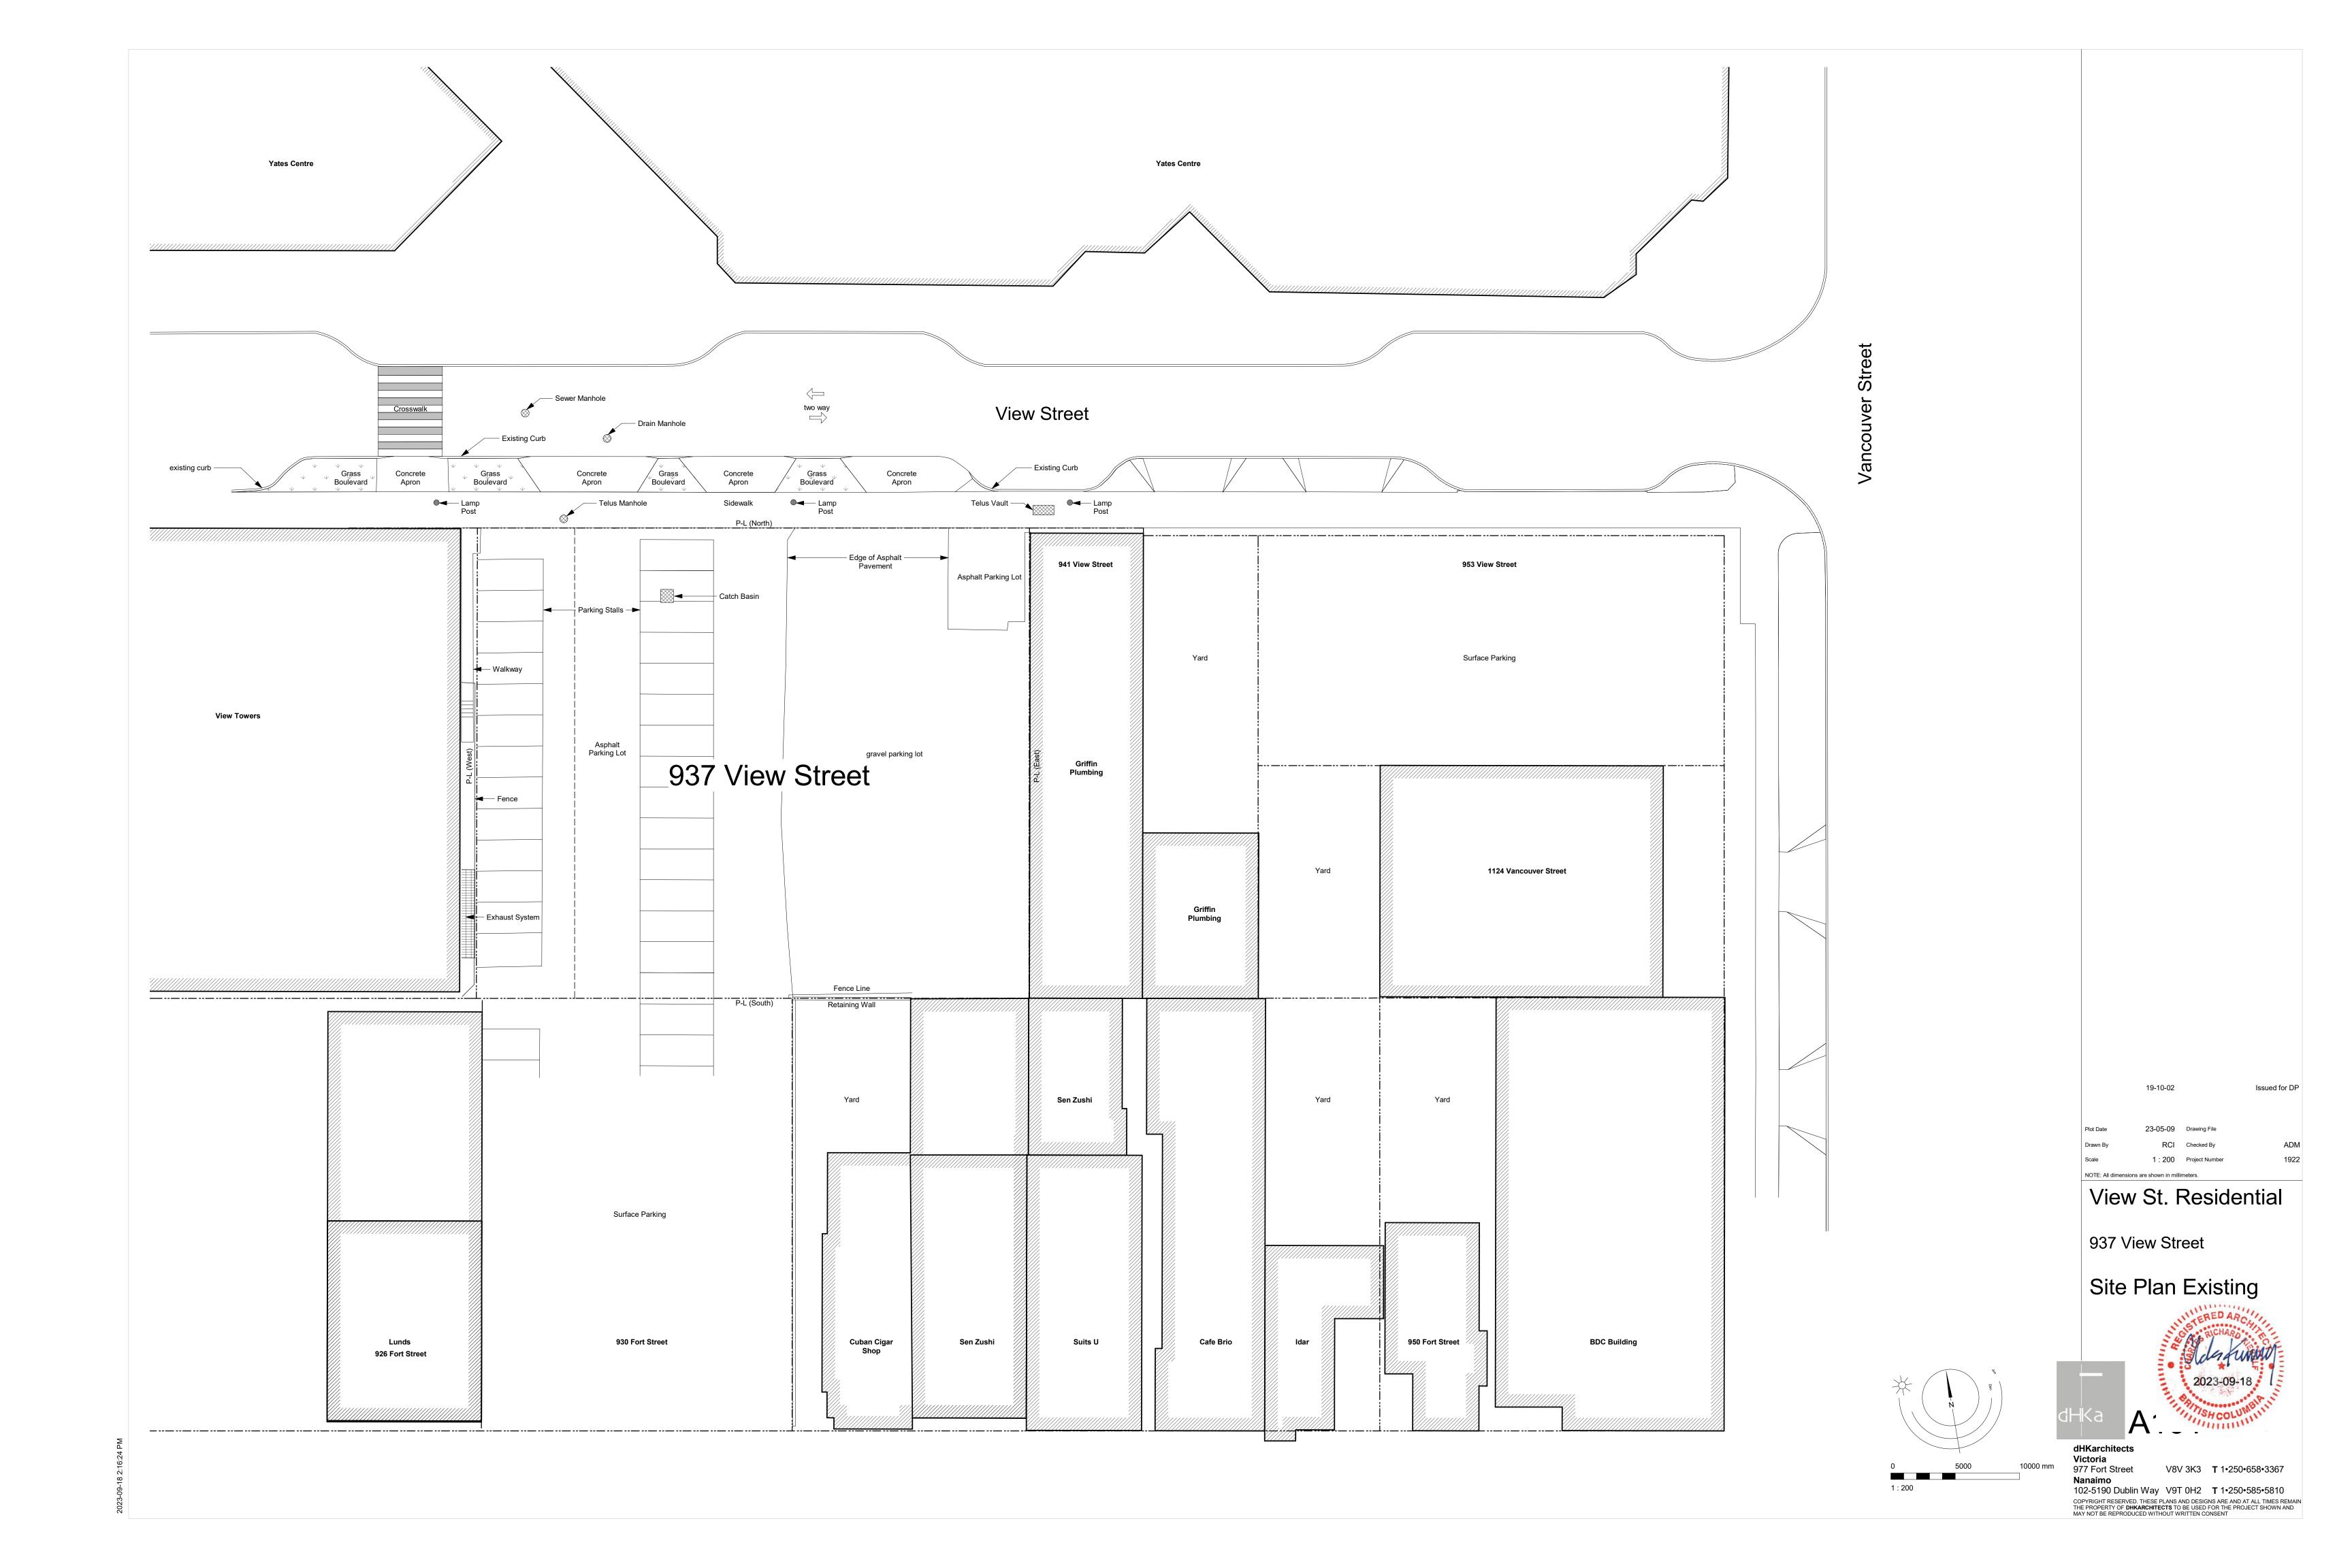Scale 1:250 Project Number
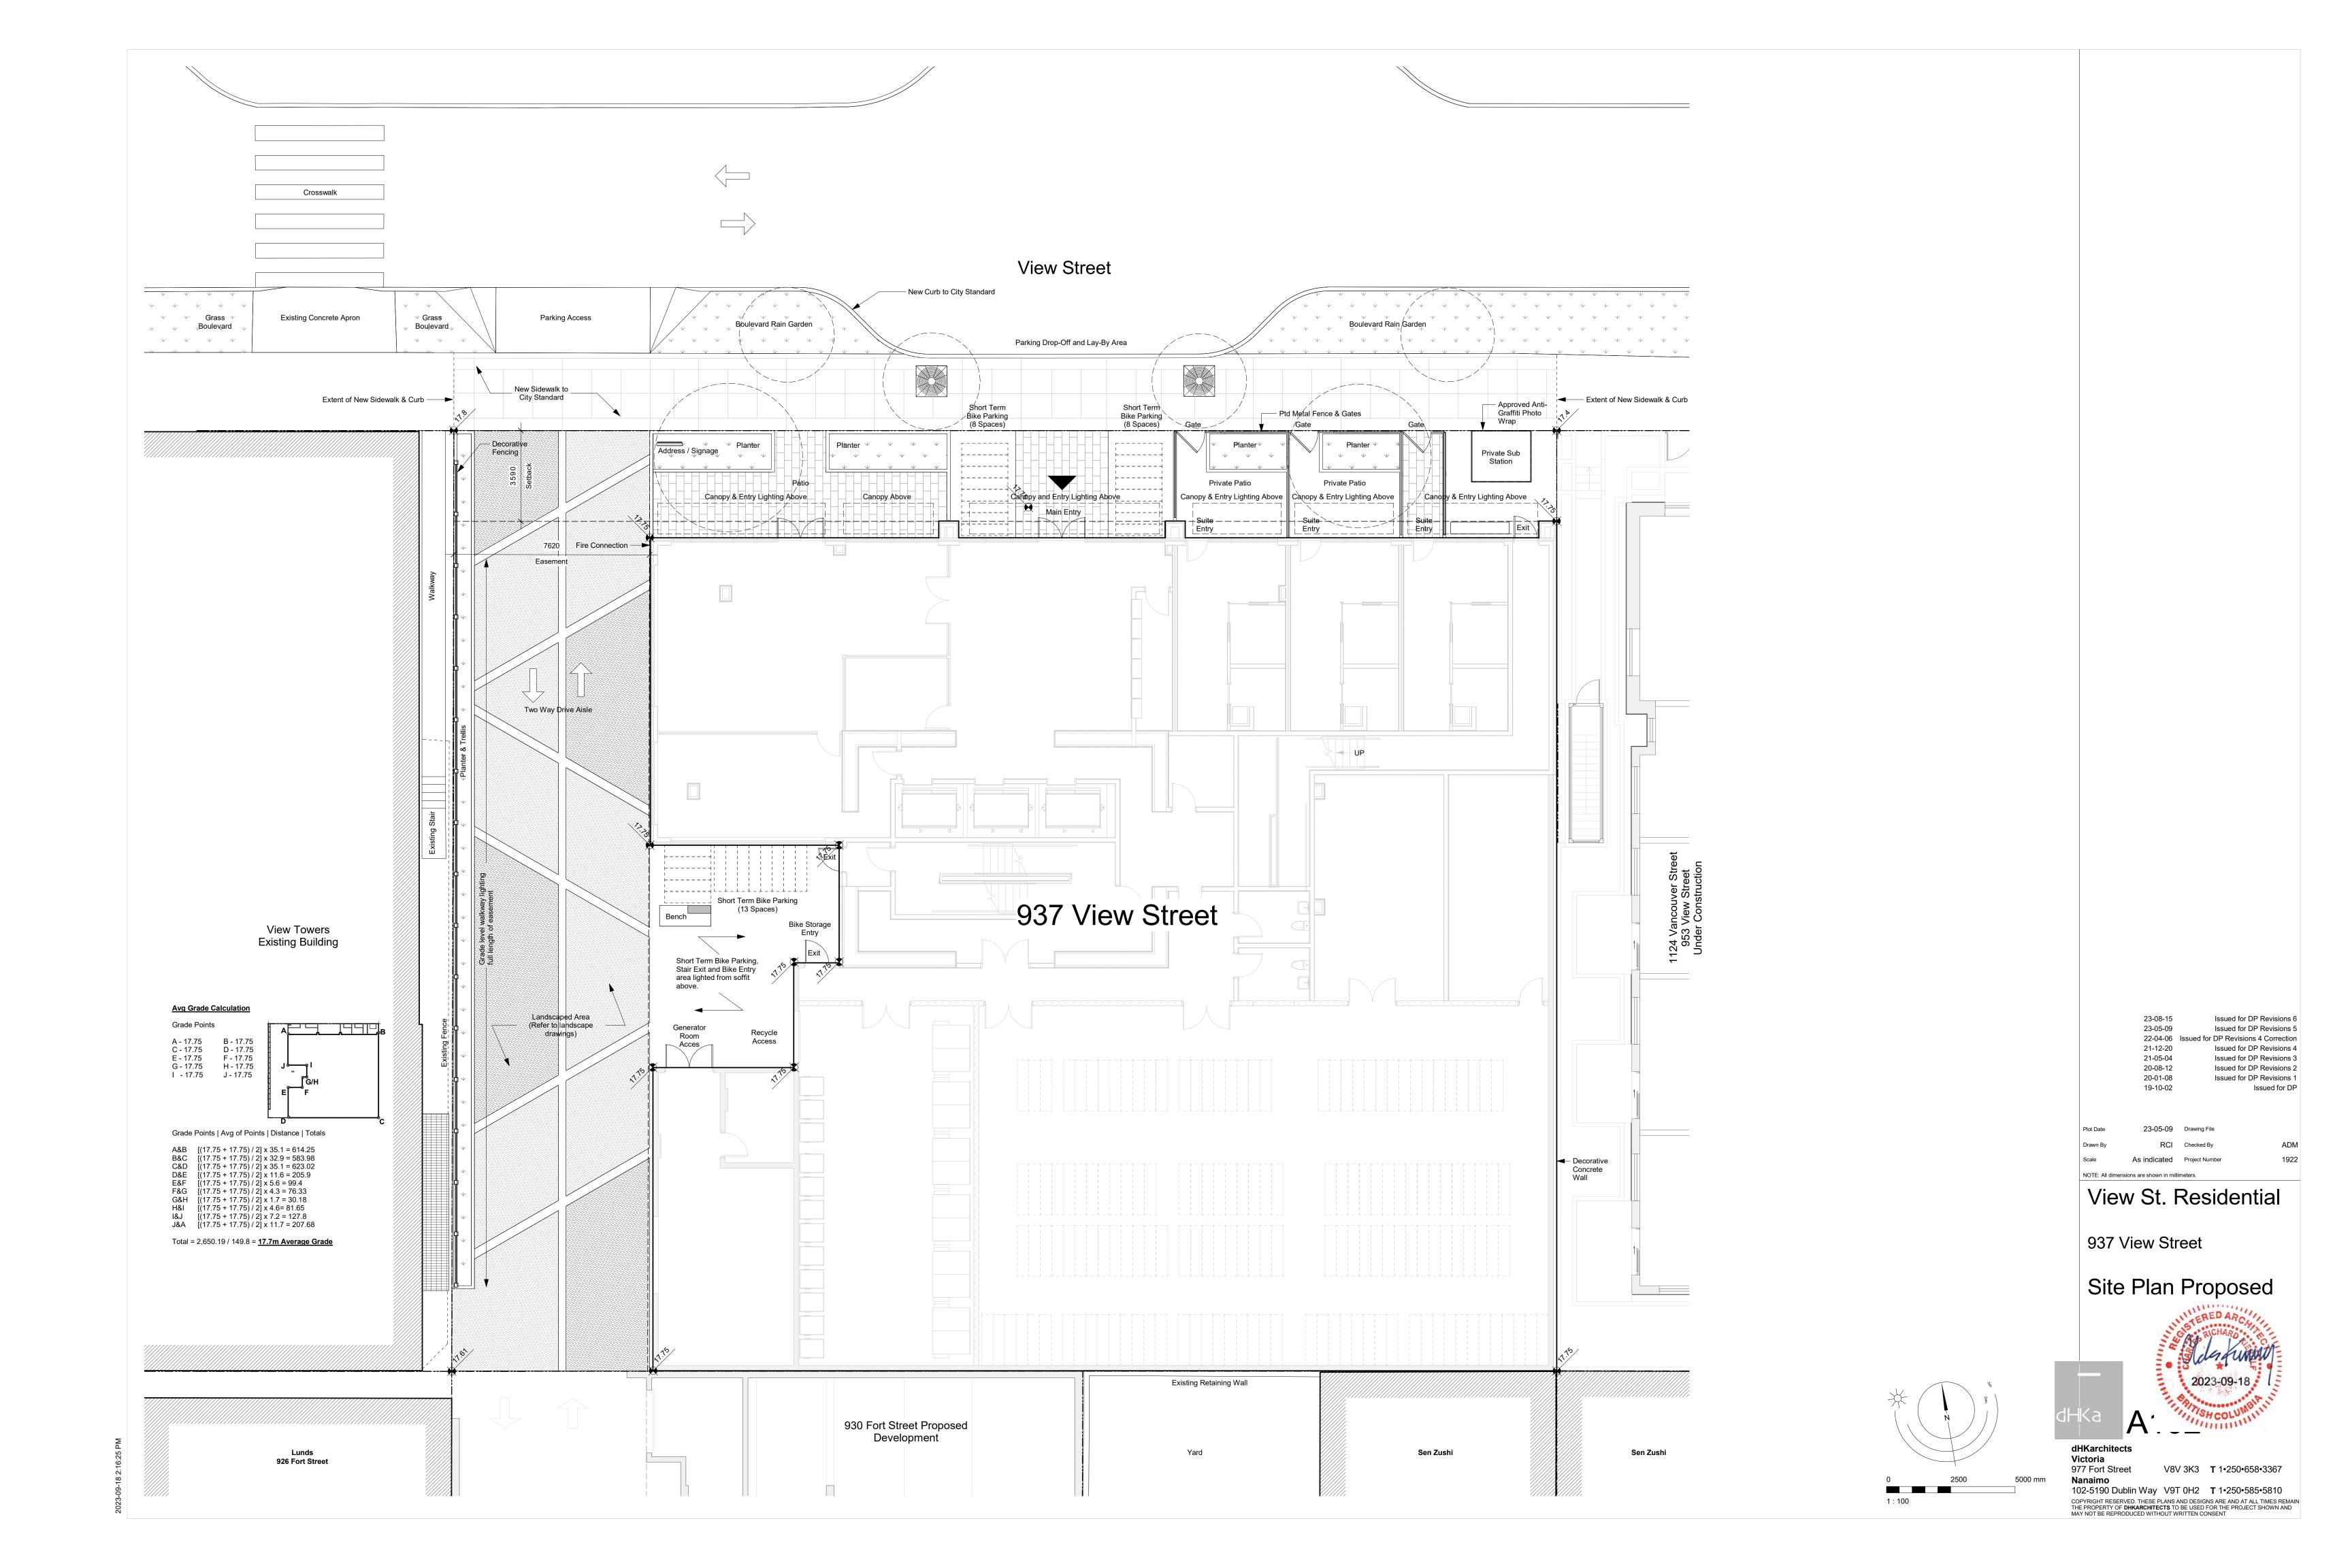
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View St. Residential


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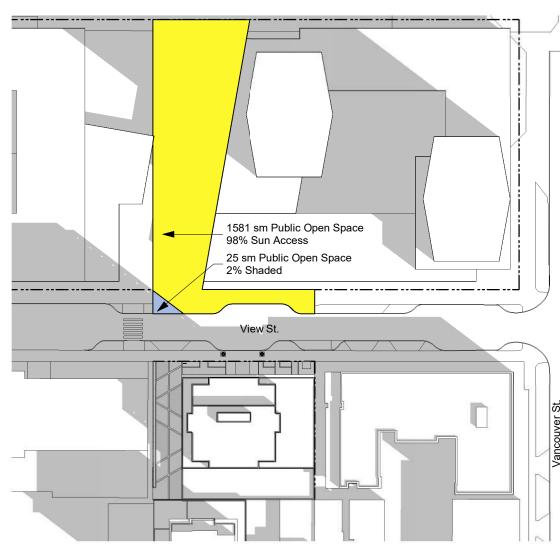
Setback Plans




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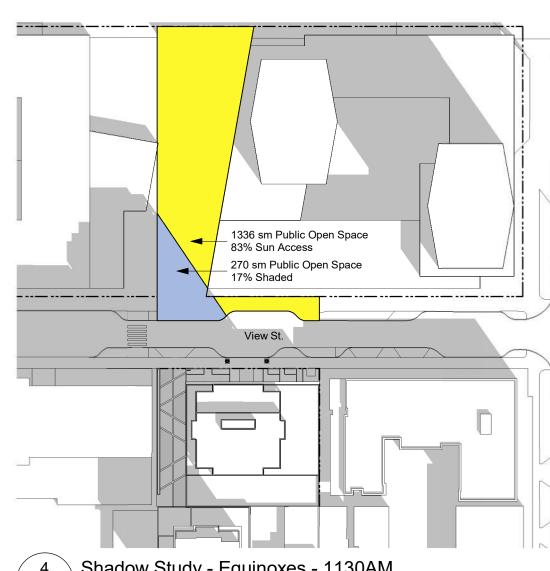





2 Shadow Study - Equinoxes - 1030AM A105 SCALE: 1:1000

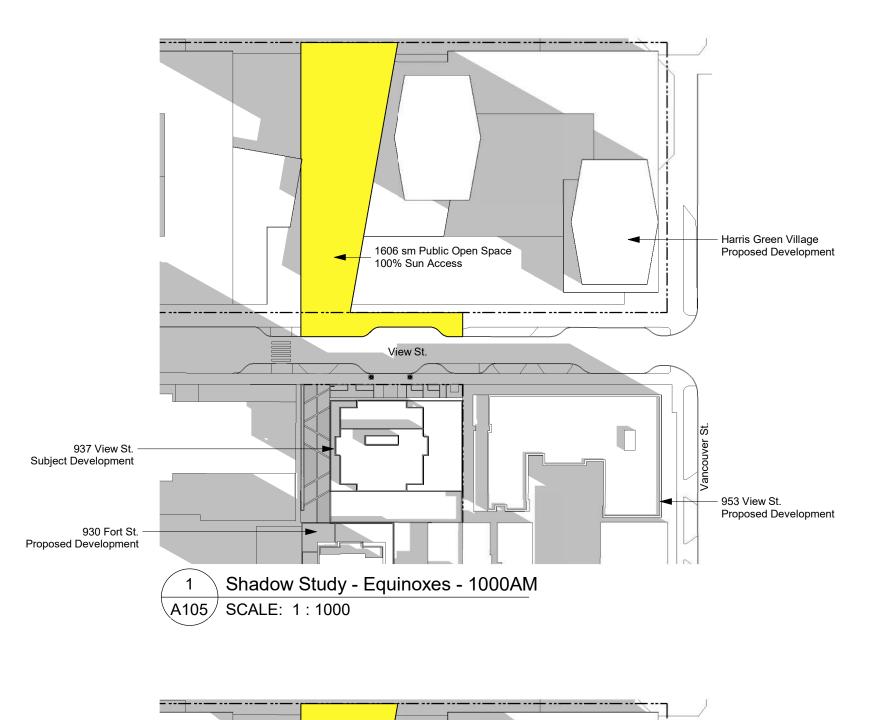


3 Shadow Study - Equinoxes - 1100AM A105 SCALE: 1:1000

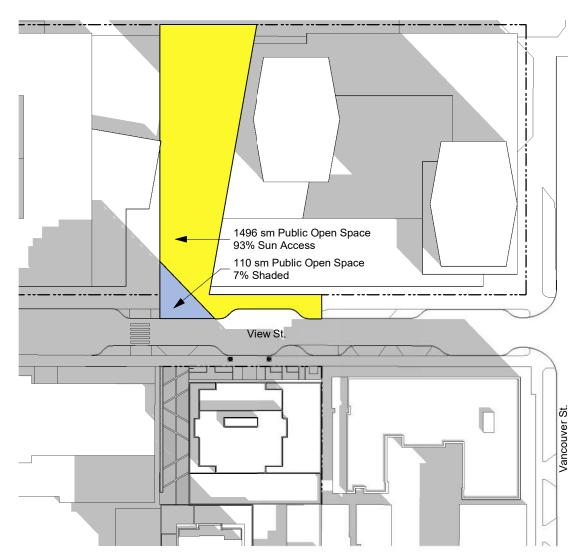

4 Shadow Study - Equinoxes - 1130AM A105 SCALE: 1:1000

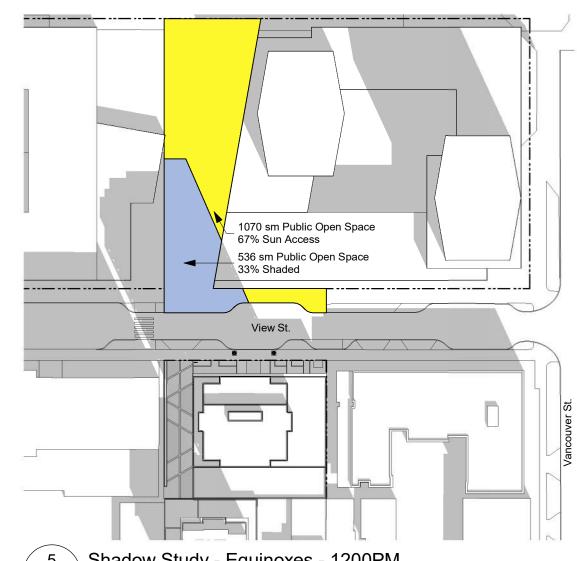


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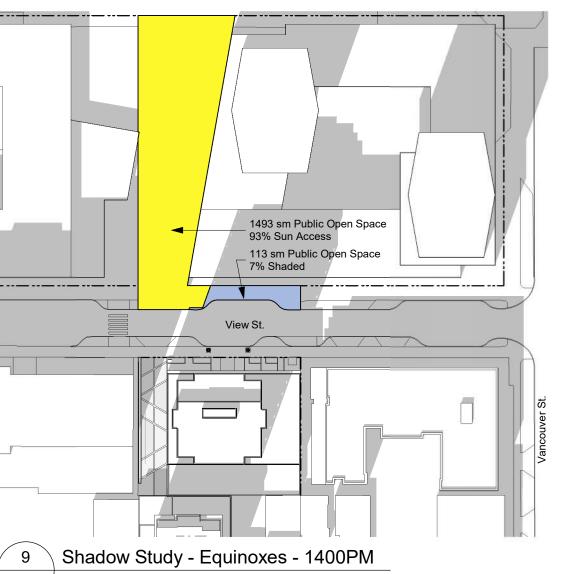


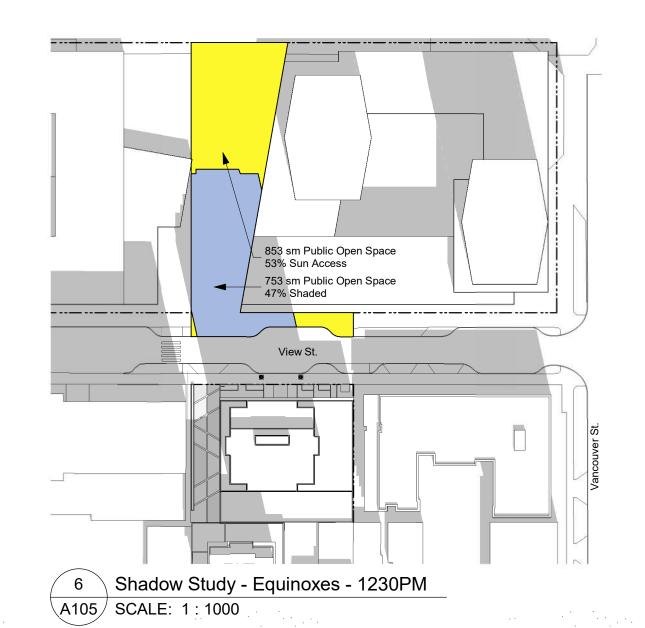1140 sm Public Open Space 71% Sun Access 466 sm Public Open Space \_\_ 29% Shaded View St. 7 Shadow Study - Equinoxes - 1300PM


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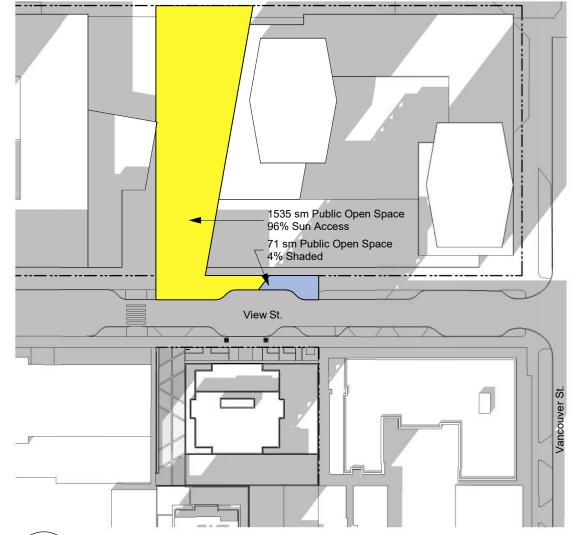
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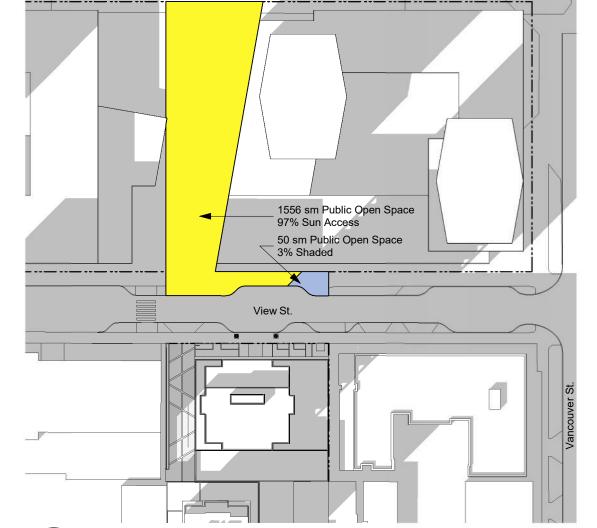
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10 Shadow Study - Equinoxes - 1430PM A105 SCALE: 1:1000

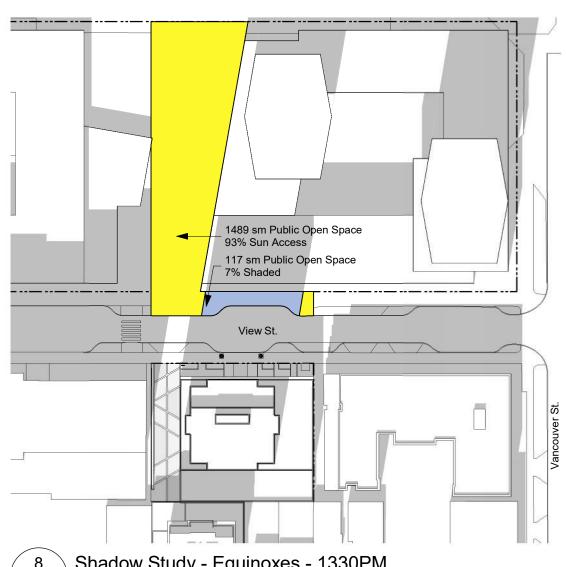


Shadow Study - Equinoxes - 1500PM A105 SCALE: 1:1000



Shadow Study - Equinoxes - 1530PM

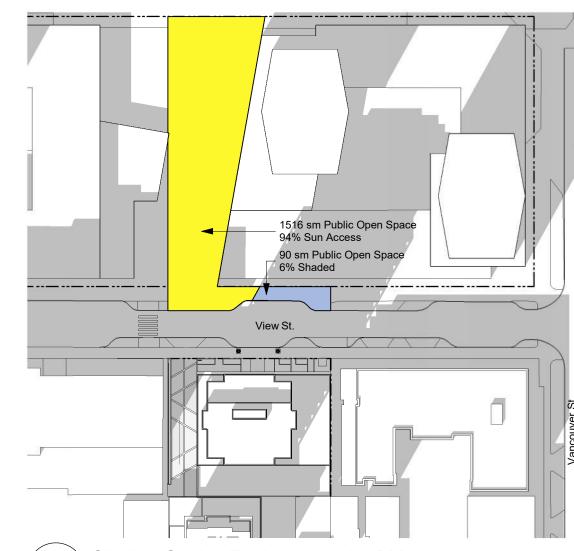A105 SCALE: 1:1000

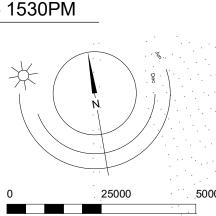

1:1000

23-05-09 Drawing File NOTE: All dimensions are shown in millimeters.

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23-05-09

21-05-04 20-08-12

20-01-08

19-10-02

View St. Residential


937 View Street


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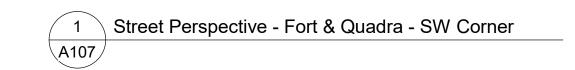
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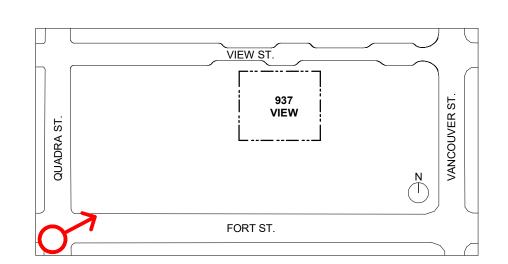
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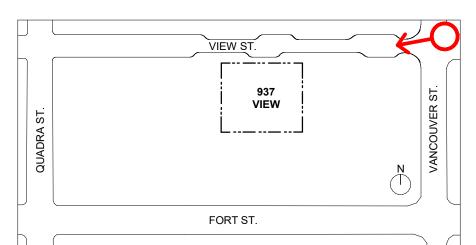



937 View St. Subject Development (23 Storeys) 953 View St. Proposed Development Harris Green Village — Proposed Development (28-32 Storeys) View Towers (20 Storeys)




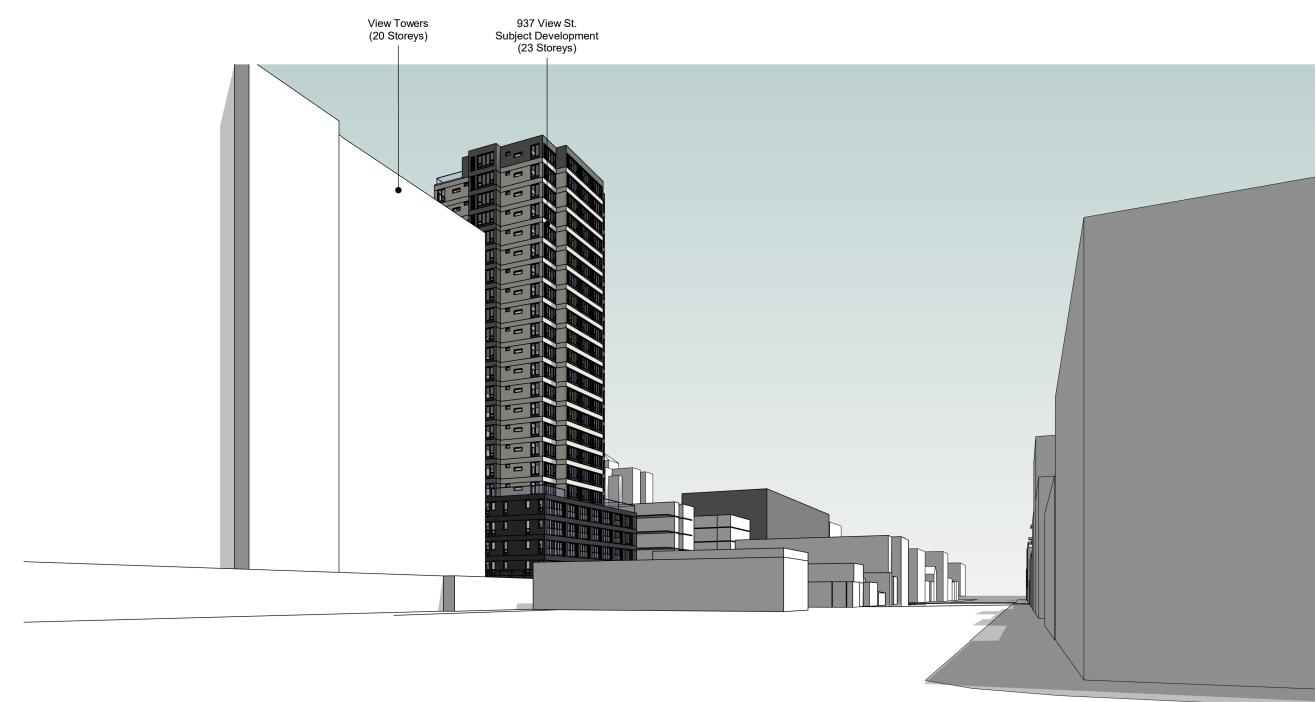



2 Street Perspective - View & Vancouver - NE Corner

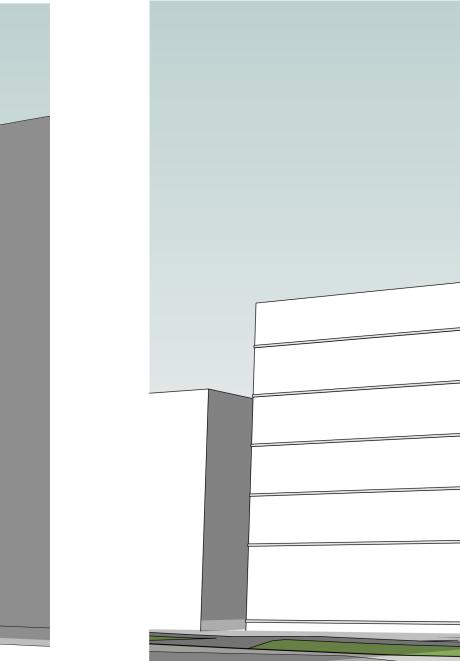

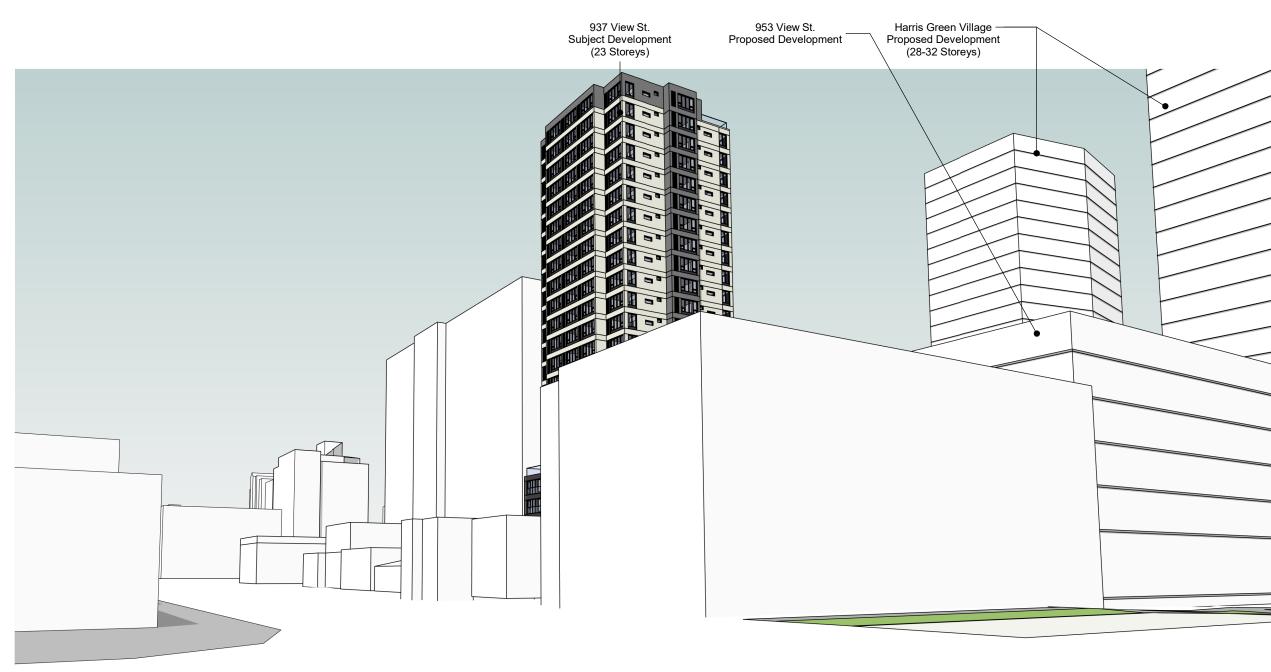


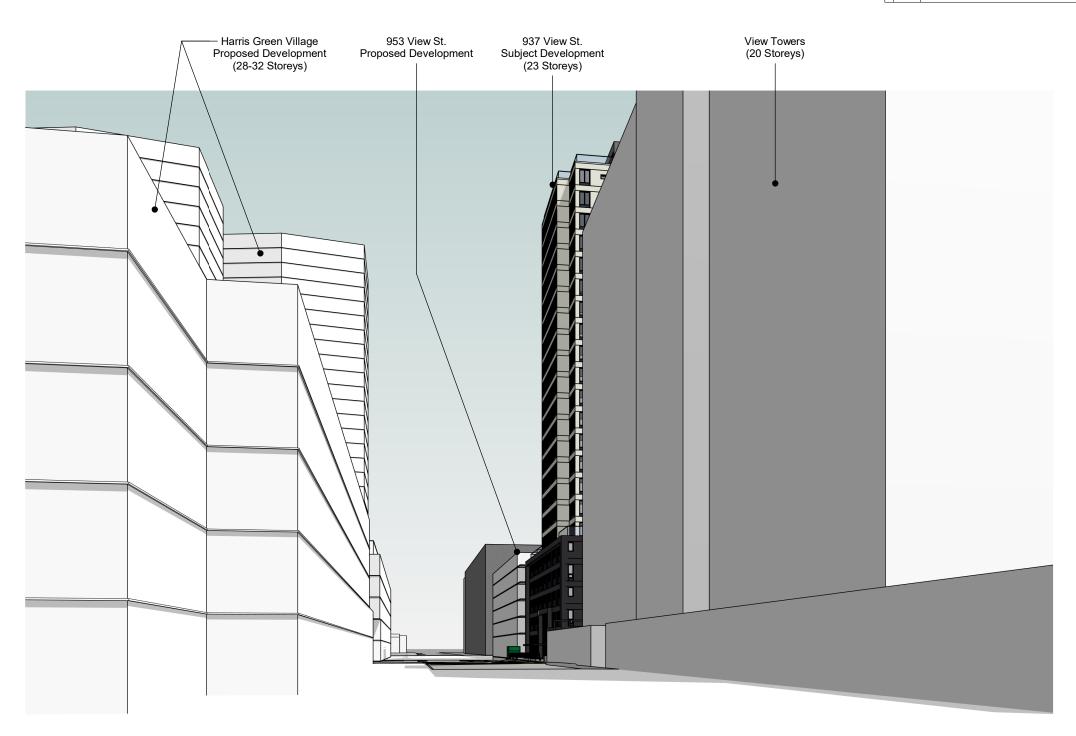

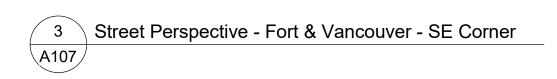

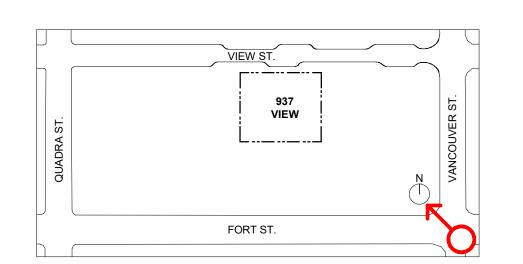

4 Street Perspective - View & Quadra - NW Corner

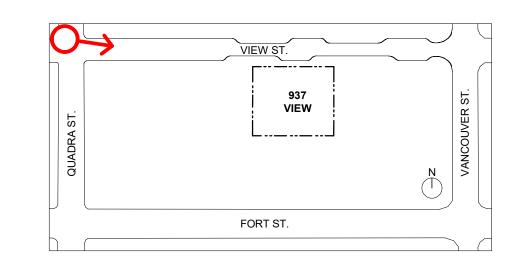

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View St. Residential


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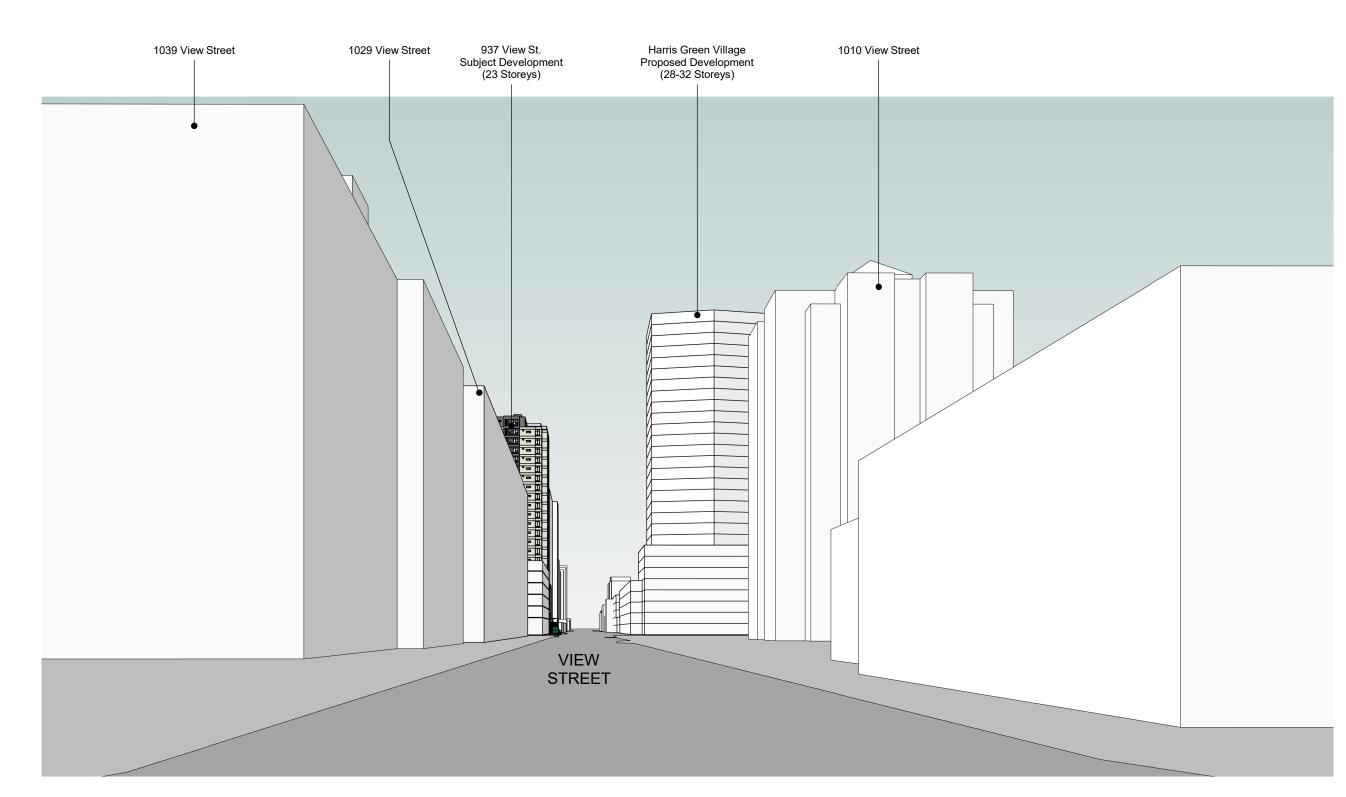
Site Context - Street Views




A107

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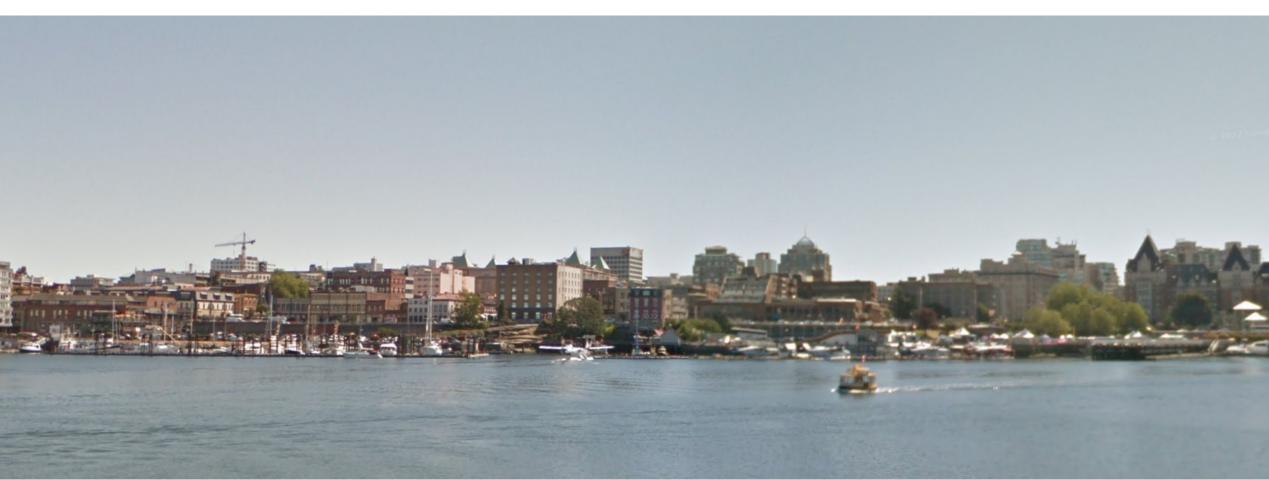


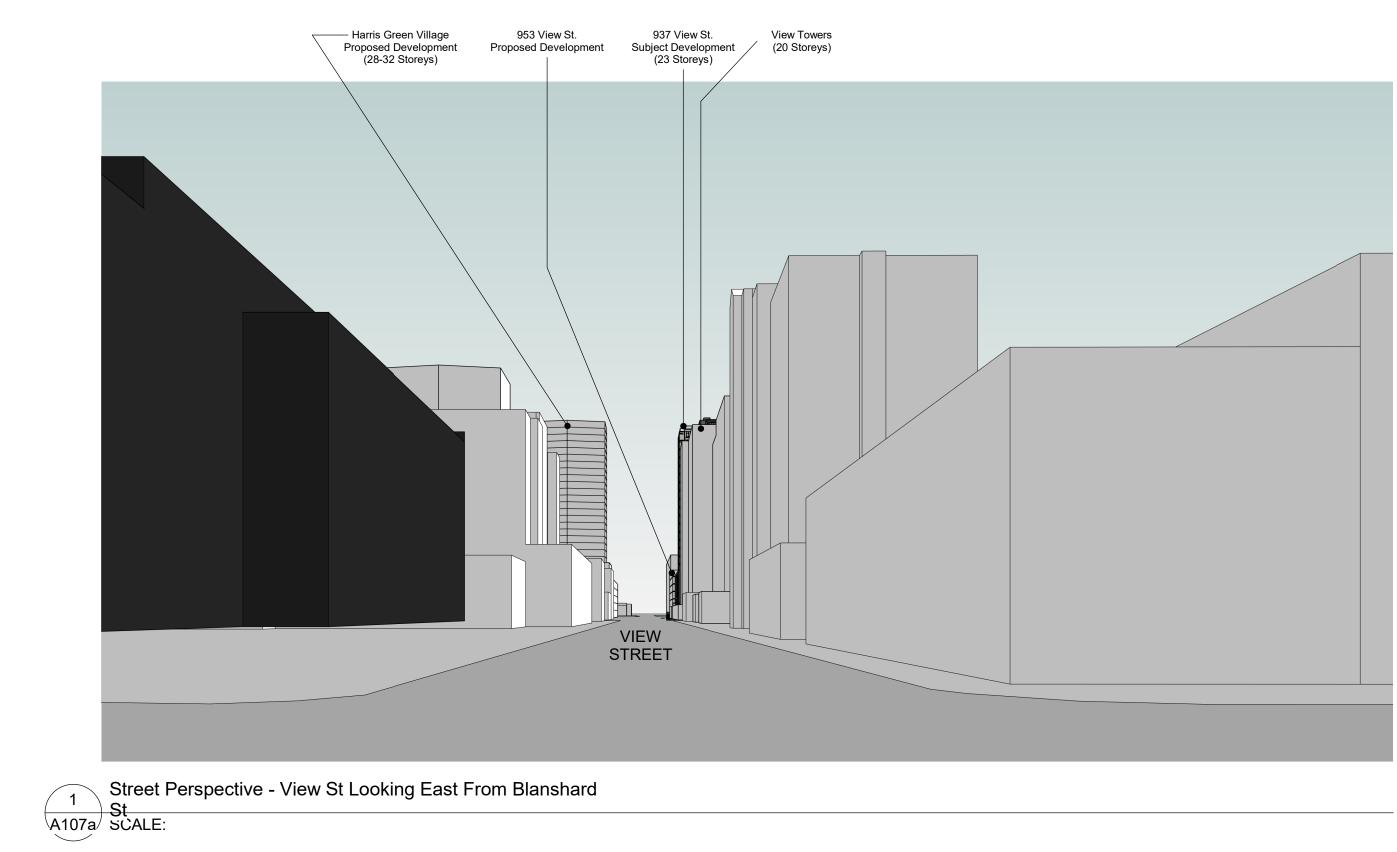


3 Street Perspective - View St Looking West From Cook St A107a SCALE:

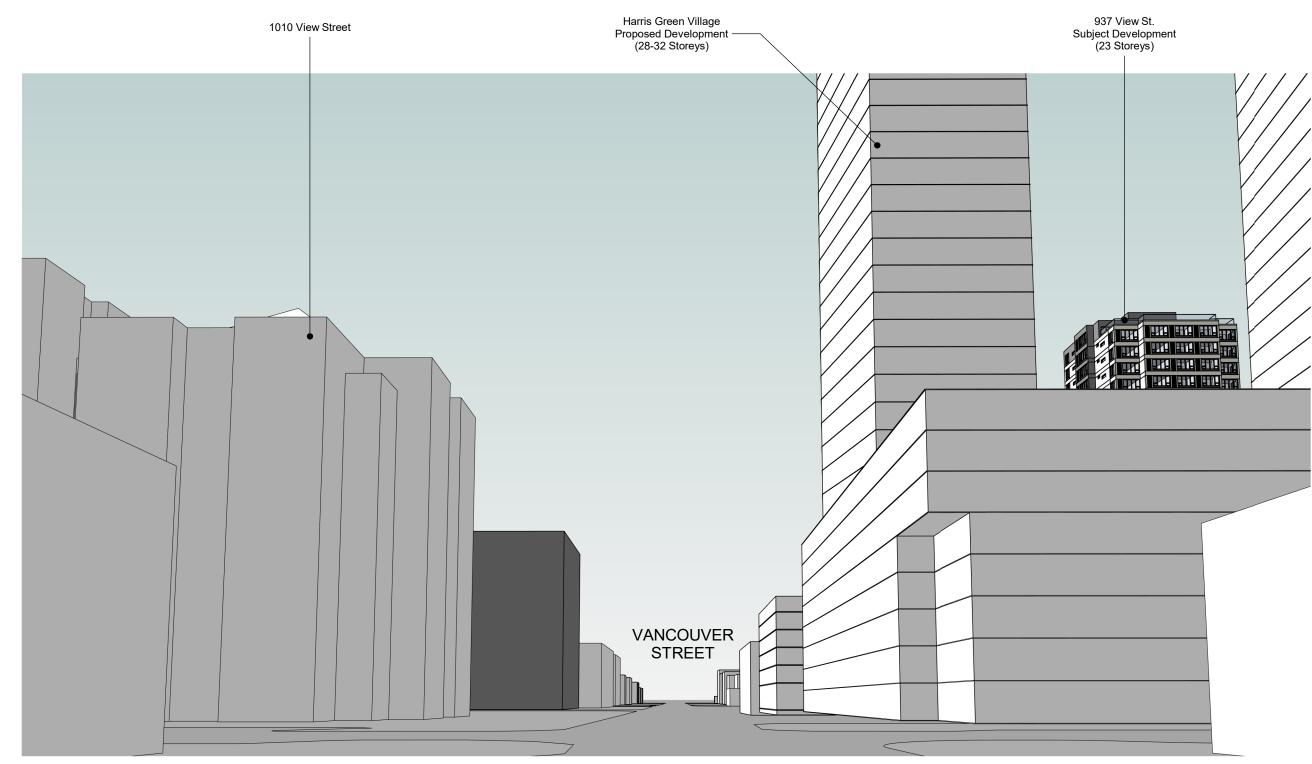

Street Perspective - Vancouver St Looking South From Yates St SCALE:




Existing View of Downtown From Laurel Pt.

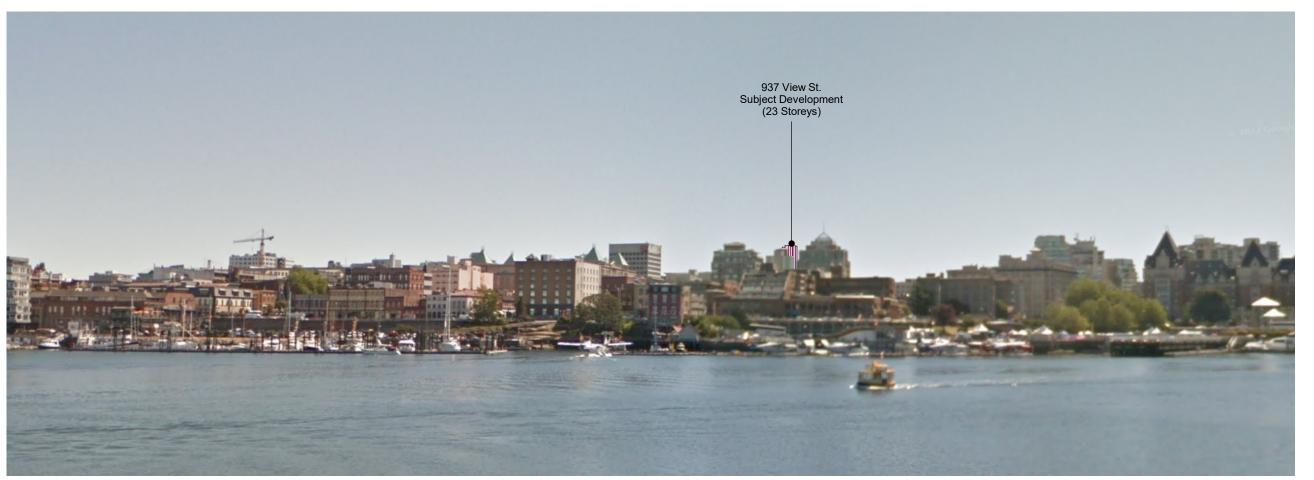

Modeled View of Downtown From Laurel Pt. With Proposed Development

4 DCAP View Cone From Laurel Pt

A107a SCALE: 1:100

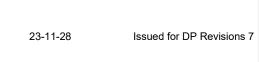

View St. Residential

937 View Street

Site Context



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1 Street Elevation - North

A108 | SCALE: 1 : 300

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21-12-20 Issued for DP Revisions 4
21-05-04 Issued for DP Revisions 3
20-08-12 Issued for DP Revisions 2
20-01-08 Issued for DP Revisions 1
19-10-02 Issued for DP

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tale 1:300 Project Number

View St. Residentia

937 View Street


Site Context - Street
Elevati




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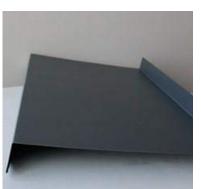
Rainscreen Panel System - Gray



Rainscreen Panel System - White

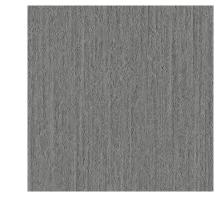

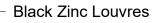
— Black Zinc Flashing



Low E Insulated windows



Rainscreen Panel
 System - Dark Gray
 Textured

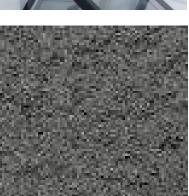

937 View Street

JOT VIEW Officer

21-05-04 20-08-12

20-01-08

19-10-02

View St. Residential



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Painted Metal — Gates, Trellis, Guards & Fencing

Tempered and Laminated

Structural Glass Guardrail w/

Aluminum Cap Rail

Anodized

Three

Signage

Dimensional Backlit Address


Window Wall -System w/ Low E


Insulated Glass & LED Coloured


Backlit Feature

Architectural Exposed
Concrete
Benches/Planters




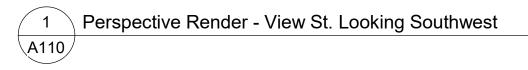

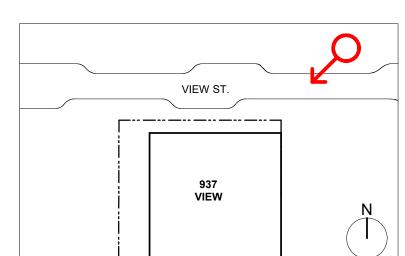

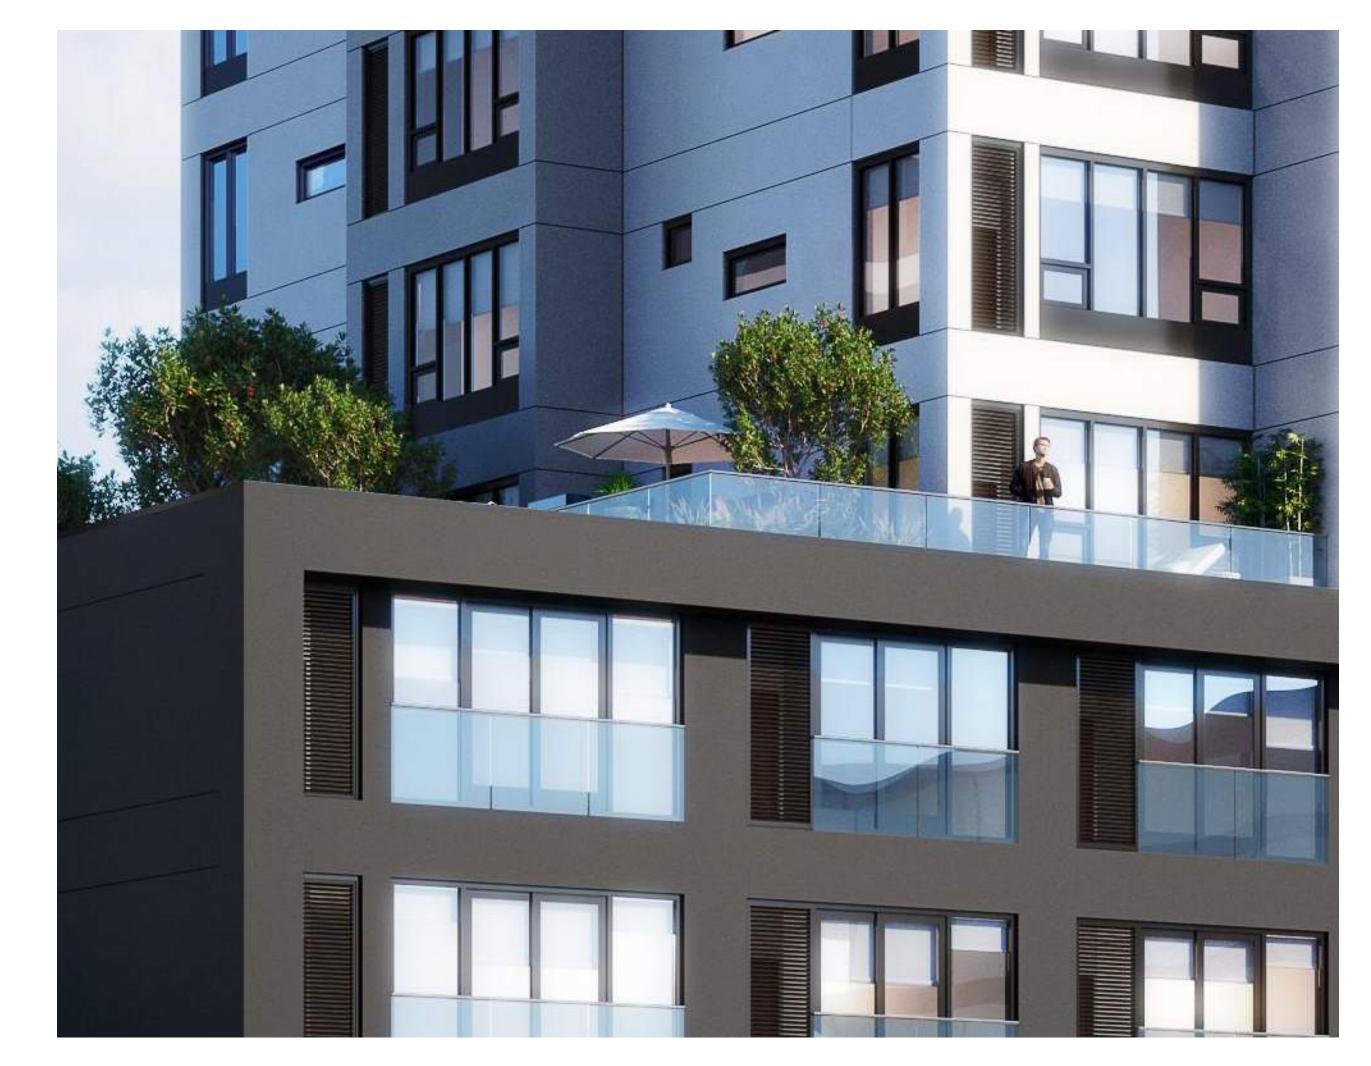

Perspective Rendering - L6 Terraces Overlooking View St
A110

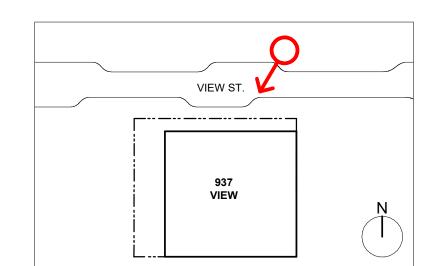

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Issued for DP Revisions 1 20-08-12 20-01-08

View St. Residential

937 View Street


Site Context -Rende



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1 Perspective Rendering - Main Entry Interface at View St
A111



Issued for DP Revisions 5 Issued for DP Revisions 3 20-08-12 Issued for DP Revisions 2 20-01-08 Issued for DP Revisions 1 View St. Residential

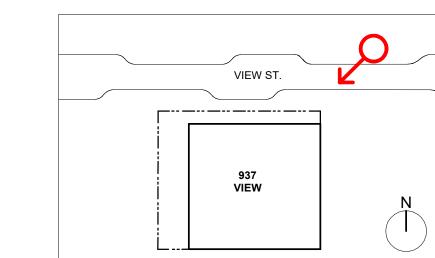937 View Street

Site Context -Rende


**Victoria** 977 Fort Street


102-5190 Dublin Way V9T 0H2 **T** 1•250•585•5810 COPYRIGHT RESERVED. THESE PLANS AND DESIGNS ARE AND AT ALL TIMES REMAIN THE PROPERTY OF **DHKARCHITECTS** TO BE USED FOR THE PROJECT SHOWN AND MAY NOT BE REPRODUCED WITHOUT WRITTEN CONSENT



Perspective Rendering - Easement Looking at Bike Entry

A112 SCALE: 1:1

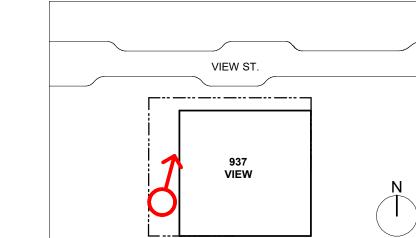


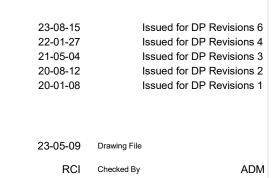

View St. Residential

937 View Street

Site Context -

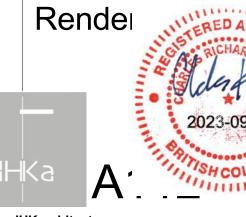


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1 Perspective Rendering - L6 Amenity Terrace
A113 SCALE: 1:1




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View St. Residential

937 View Street

Site Context -

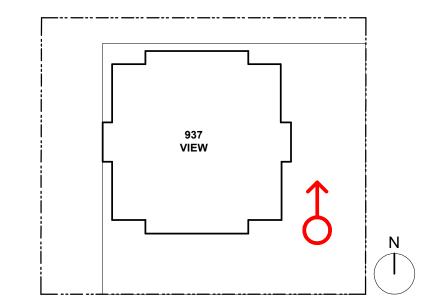
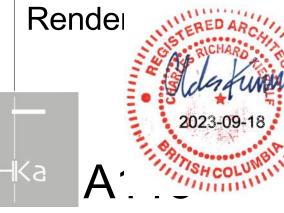
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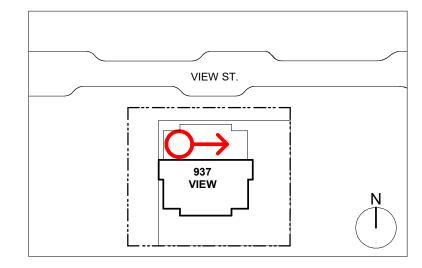
V8V 3K3 **T** 1•250•658•3367 Nanaimo

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Perspective Rendering - L23 Amenity Terrace
A114



23-08-15 20-08-12 20-01-08 Issued for DP Revisions 6 Issued for DP Revisions 2 Issued for DP Revisions 1


View St. Residential

937 View Street

Site Context -Rende

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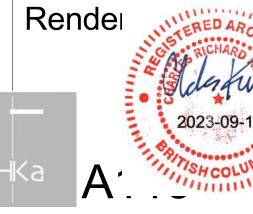


Issued for DP Revisions 4 Issued for DP Revisions 3 Issued for DP Revisions 2 20-01-08 Issued for DP Revisions 1

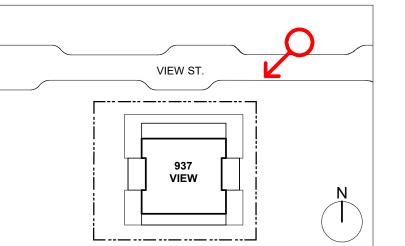View St. Residential

937 View Street

Site Context -




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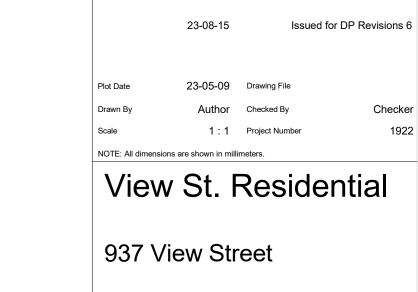


Rendered View of Main Lobby Area - East Elevation


1 Perspective Rendering - Main Lobby Area A117 SCALE: 1:1

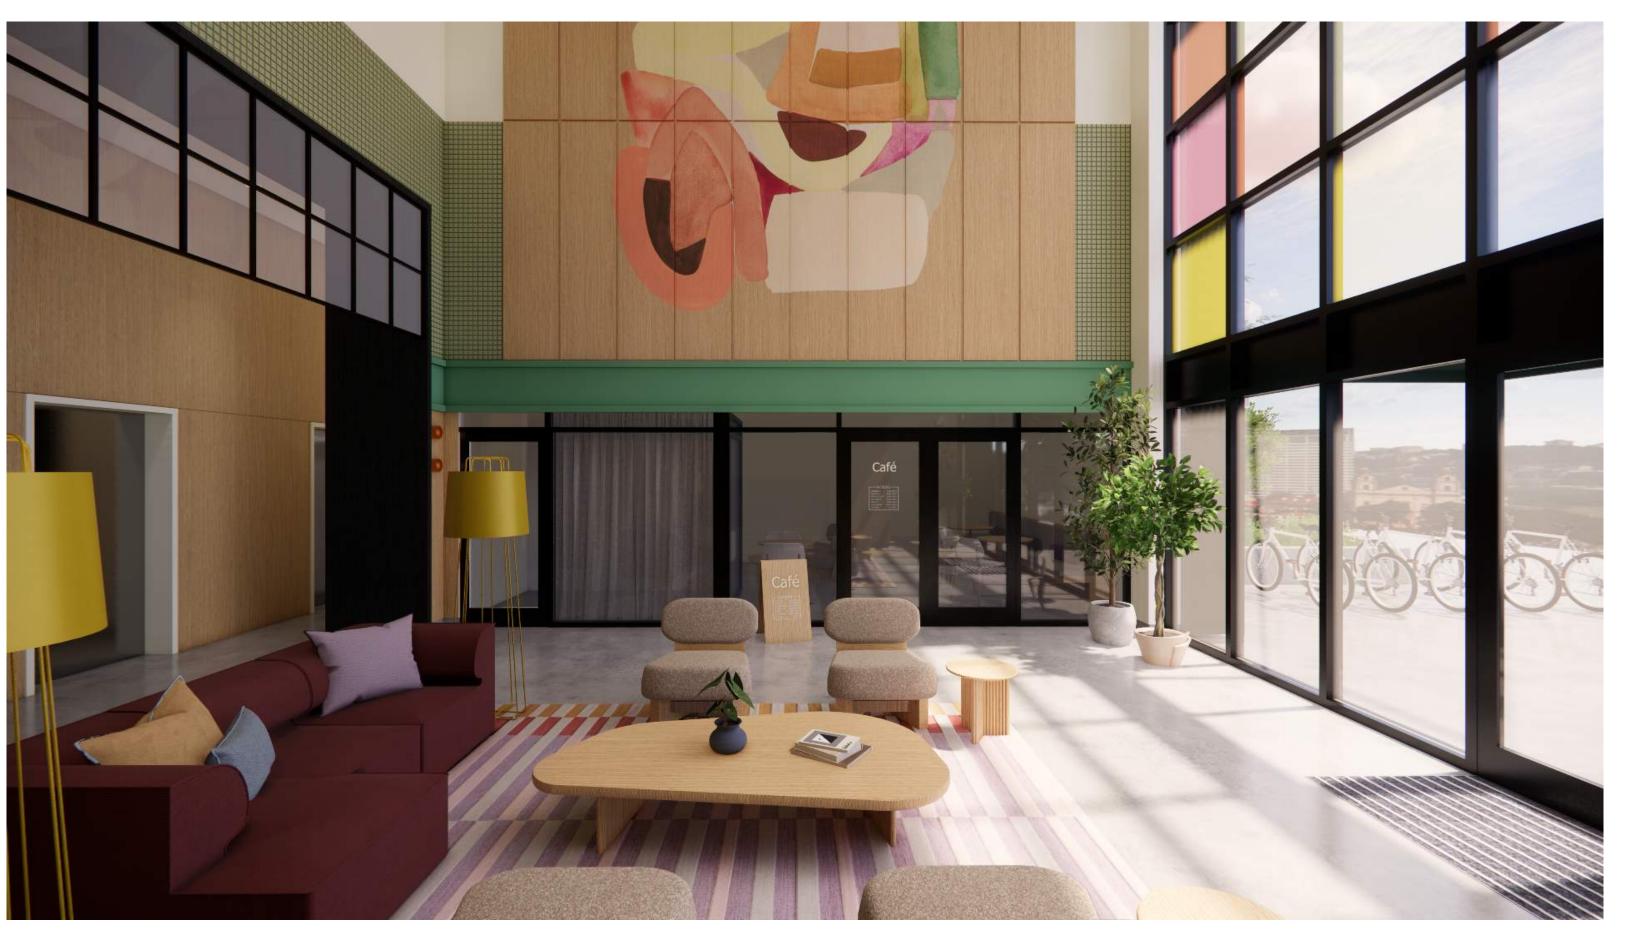

Rendered View of Main Lobby Area - West Elevation



Livability - Rendered Interior

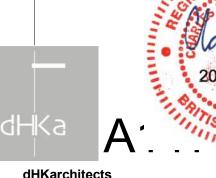


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# 1 3 6 5

Rendered Plan View of Unit Type C (NTS)



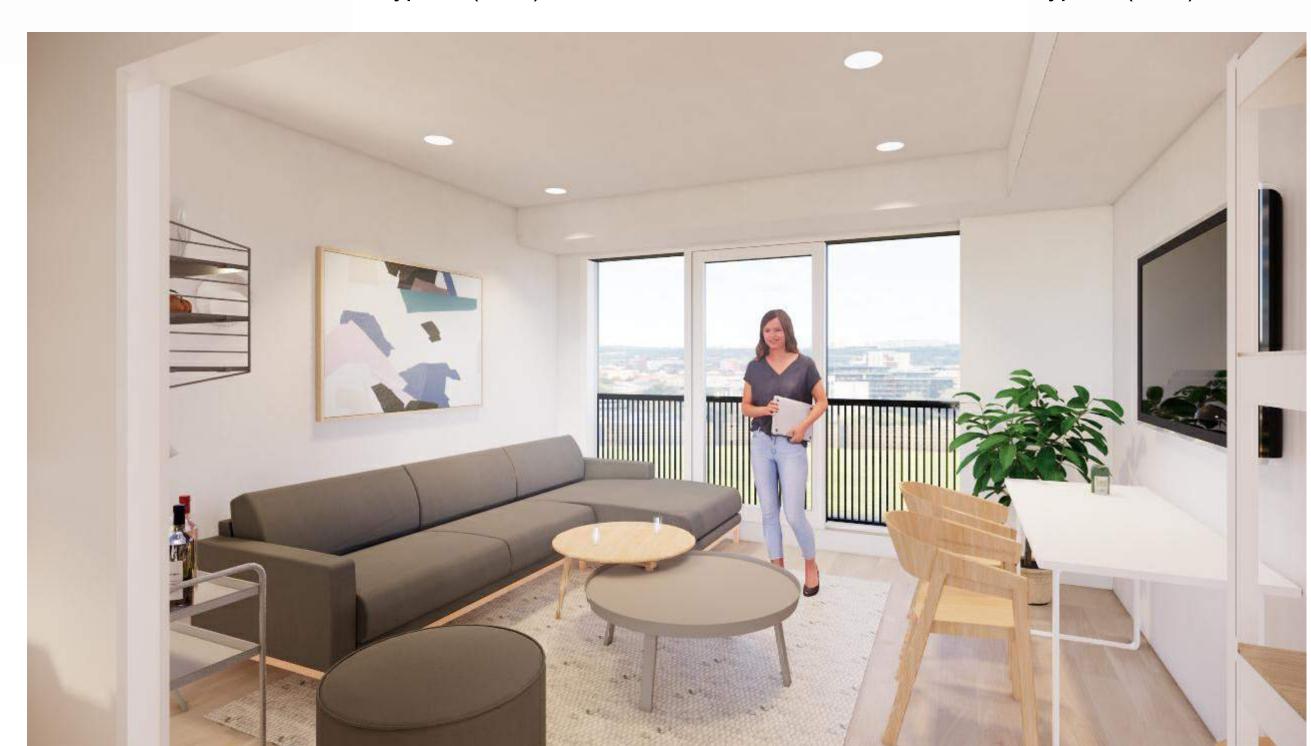


Rendered View of Living Area


# TYPICAL UNIT TYPE C

# **LIVABILITY NOTES**


- 33 m sq average size (min 32.16 max 33.09 m sq)
   Juliette Balcony and full height windows on primary elevation for light and air access.
   Built in storage and bedroom furniture.
- 4. W/D in every unit.
- 5. Three piece bathrooms with built in linen storage and medicine cabinets.
  6. Full featured galley style kitchen and cabinets including tub style stailess steel sink, microwave, electric induction range and electric oven.
  7. Living area sized for flexibility with prewired for high speed data / cable.
  8. High ceilings with high performance LED lighting.

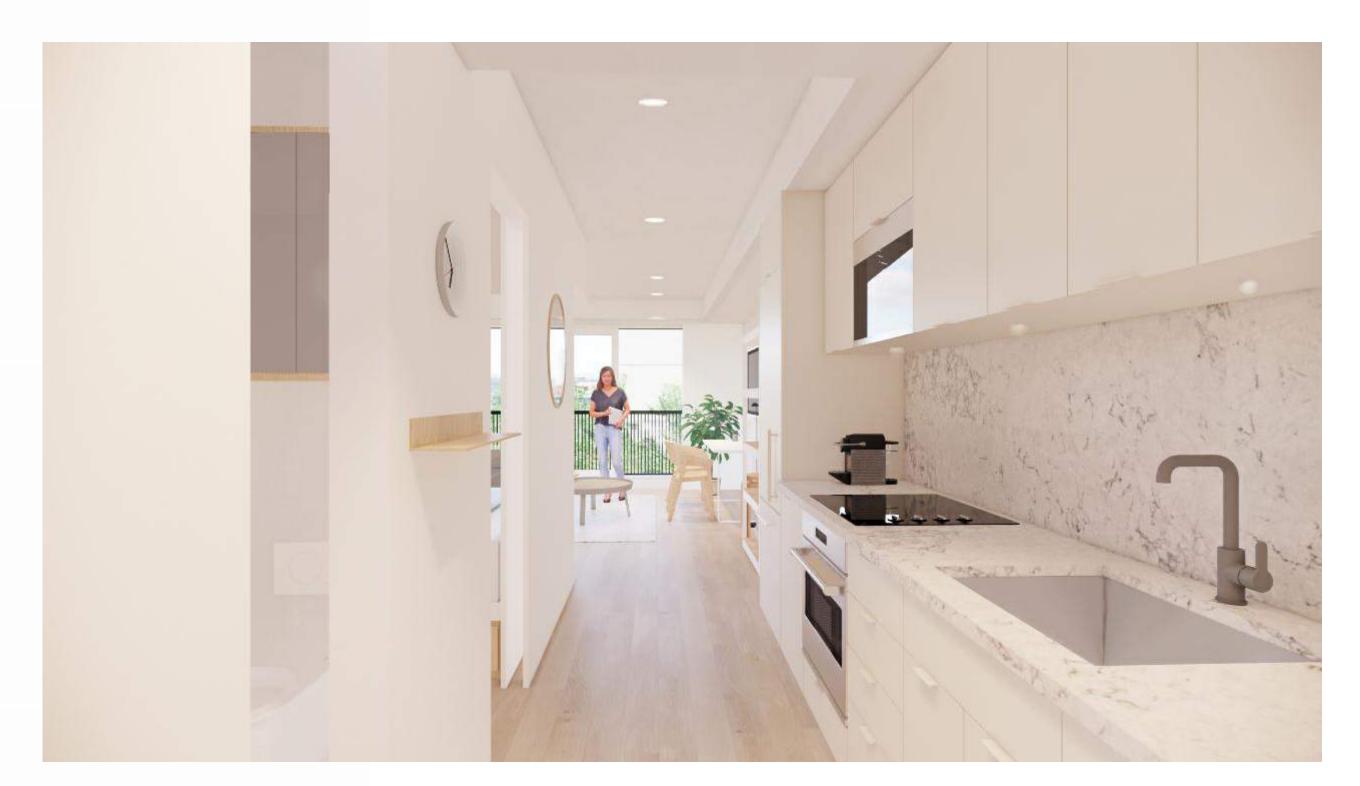

Rendered View of Kitchen Area

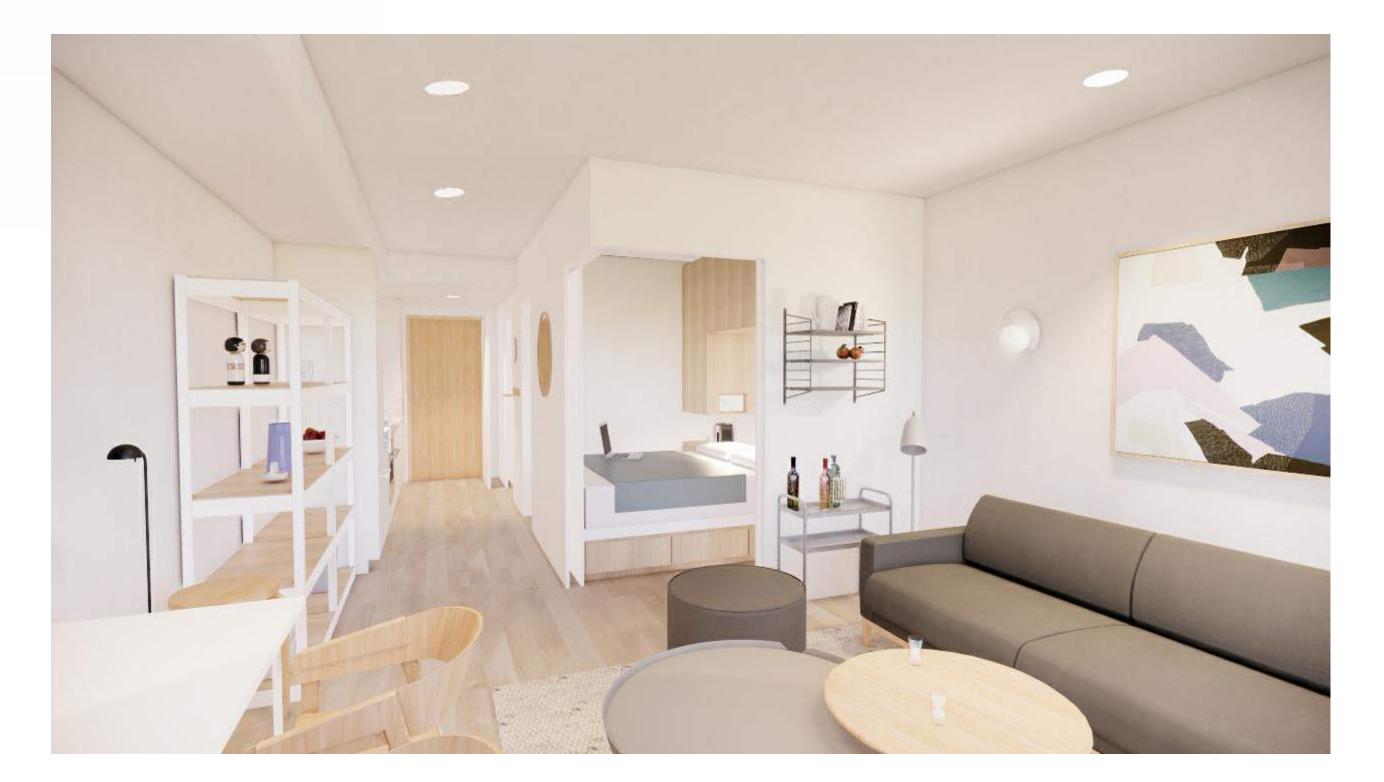

Rendered View of Living and Bedroom Area

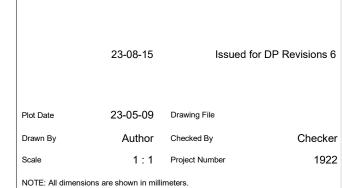


View St. Residential

937 View Street


Livability - Rendered Interior



Victoria 977 Fort Street

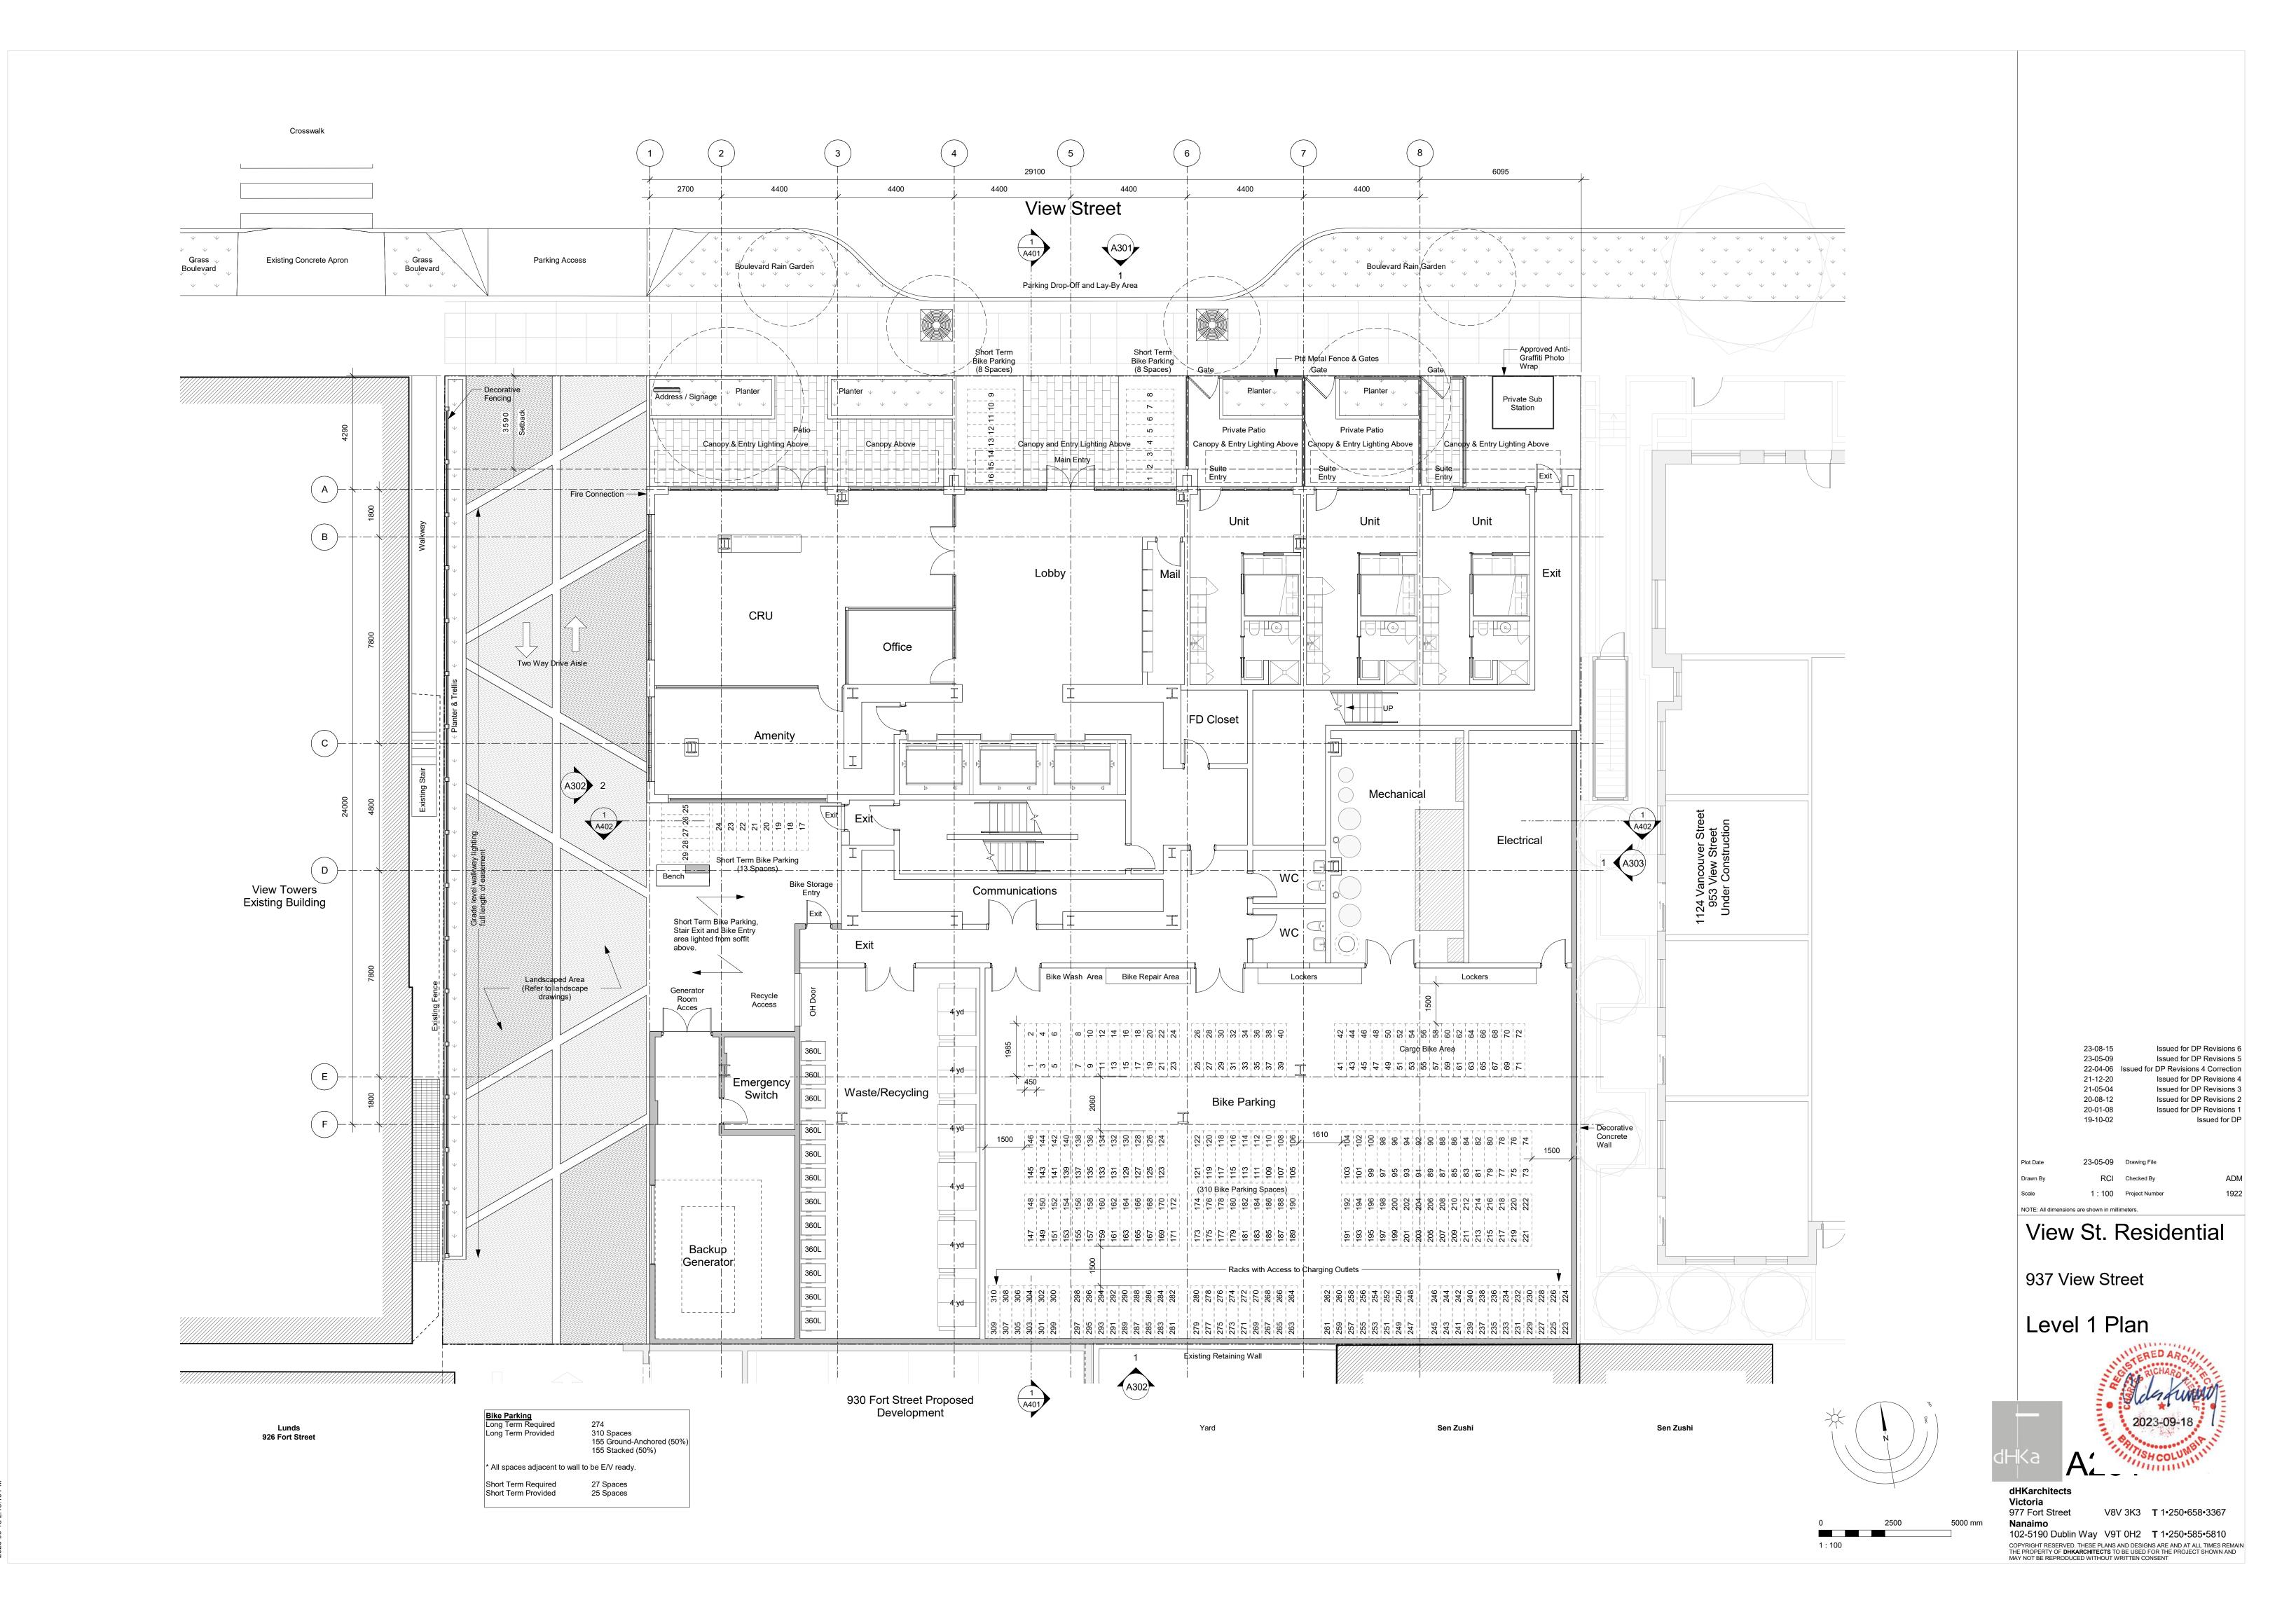

00 18 0.18 10 DM

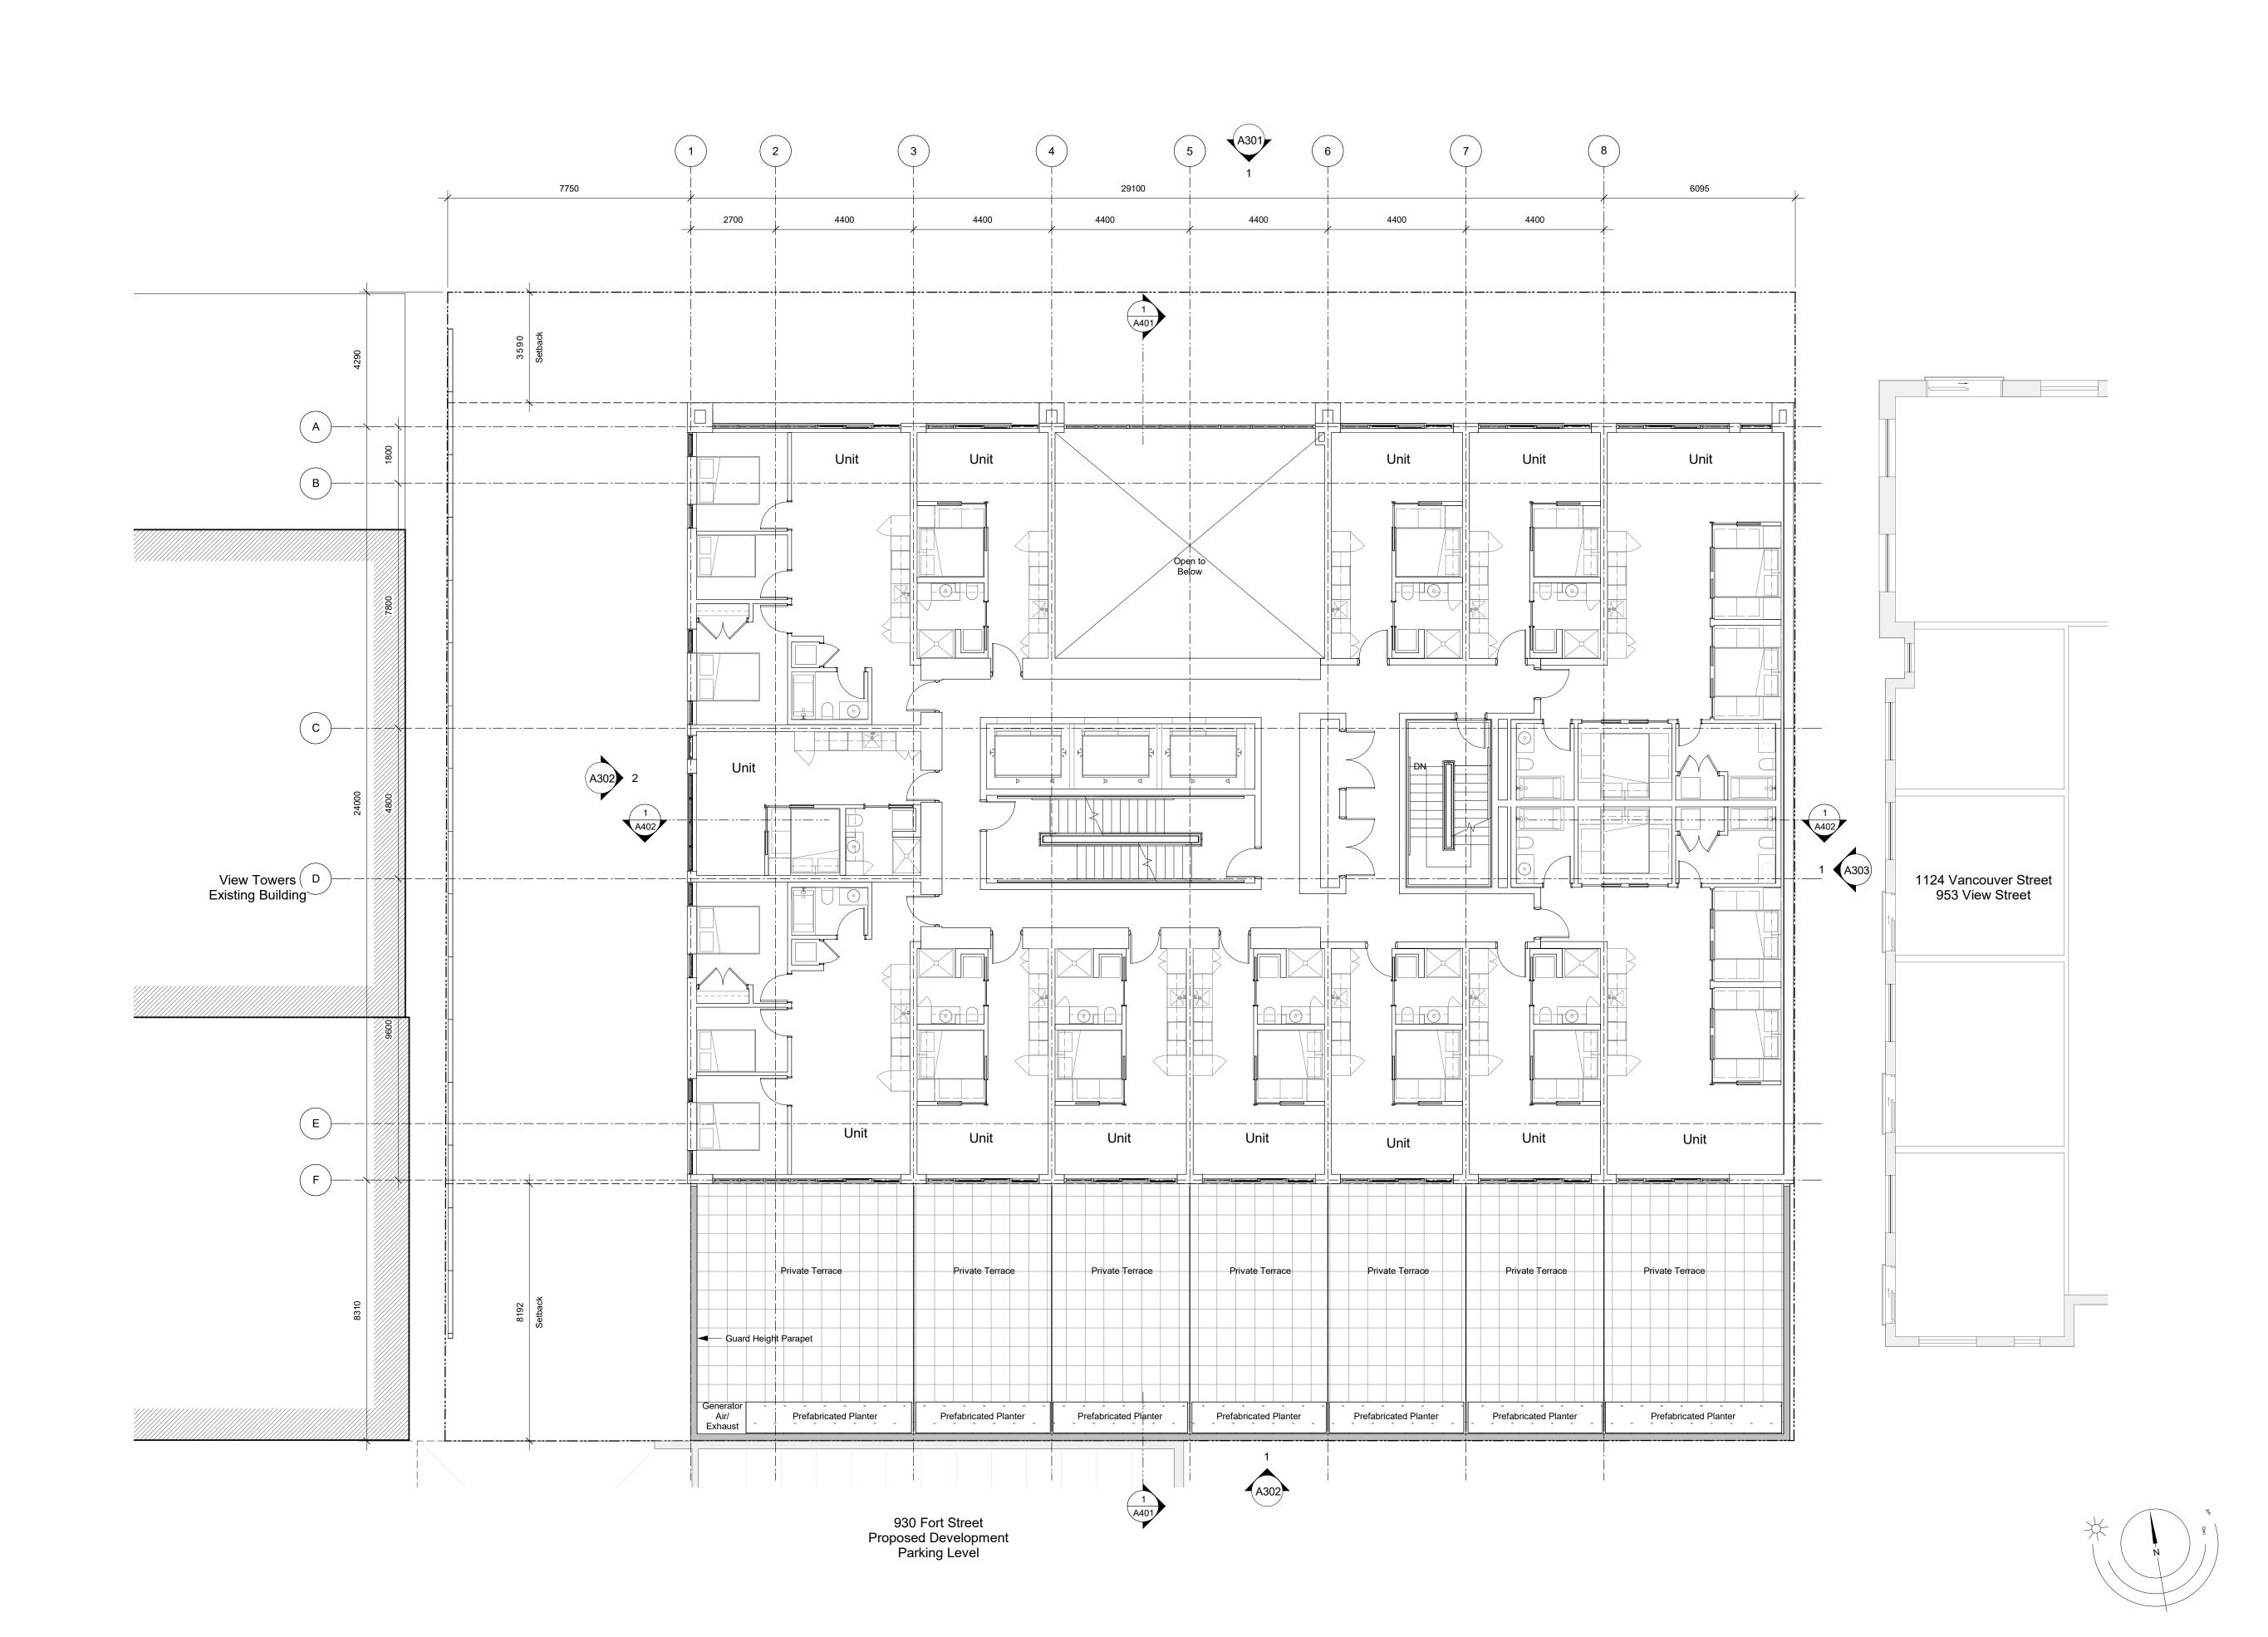

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21-05-04 Issued for DP Revisions 3
20-08-12 Issued for DP Revisions 2
20-01-08 Issued for DP Revisions 1
19-10-02 Issued for DP

awn By RCI Checked By
ale 1:100 Project Number

View St. Residential

937 View Street


NOTE: All dimensions are shown in millimeters.

Level 2 Plan



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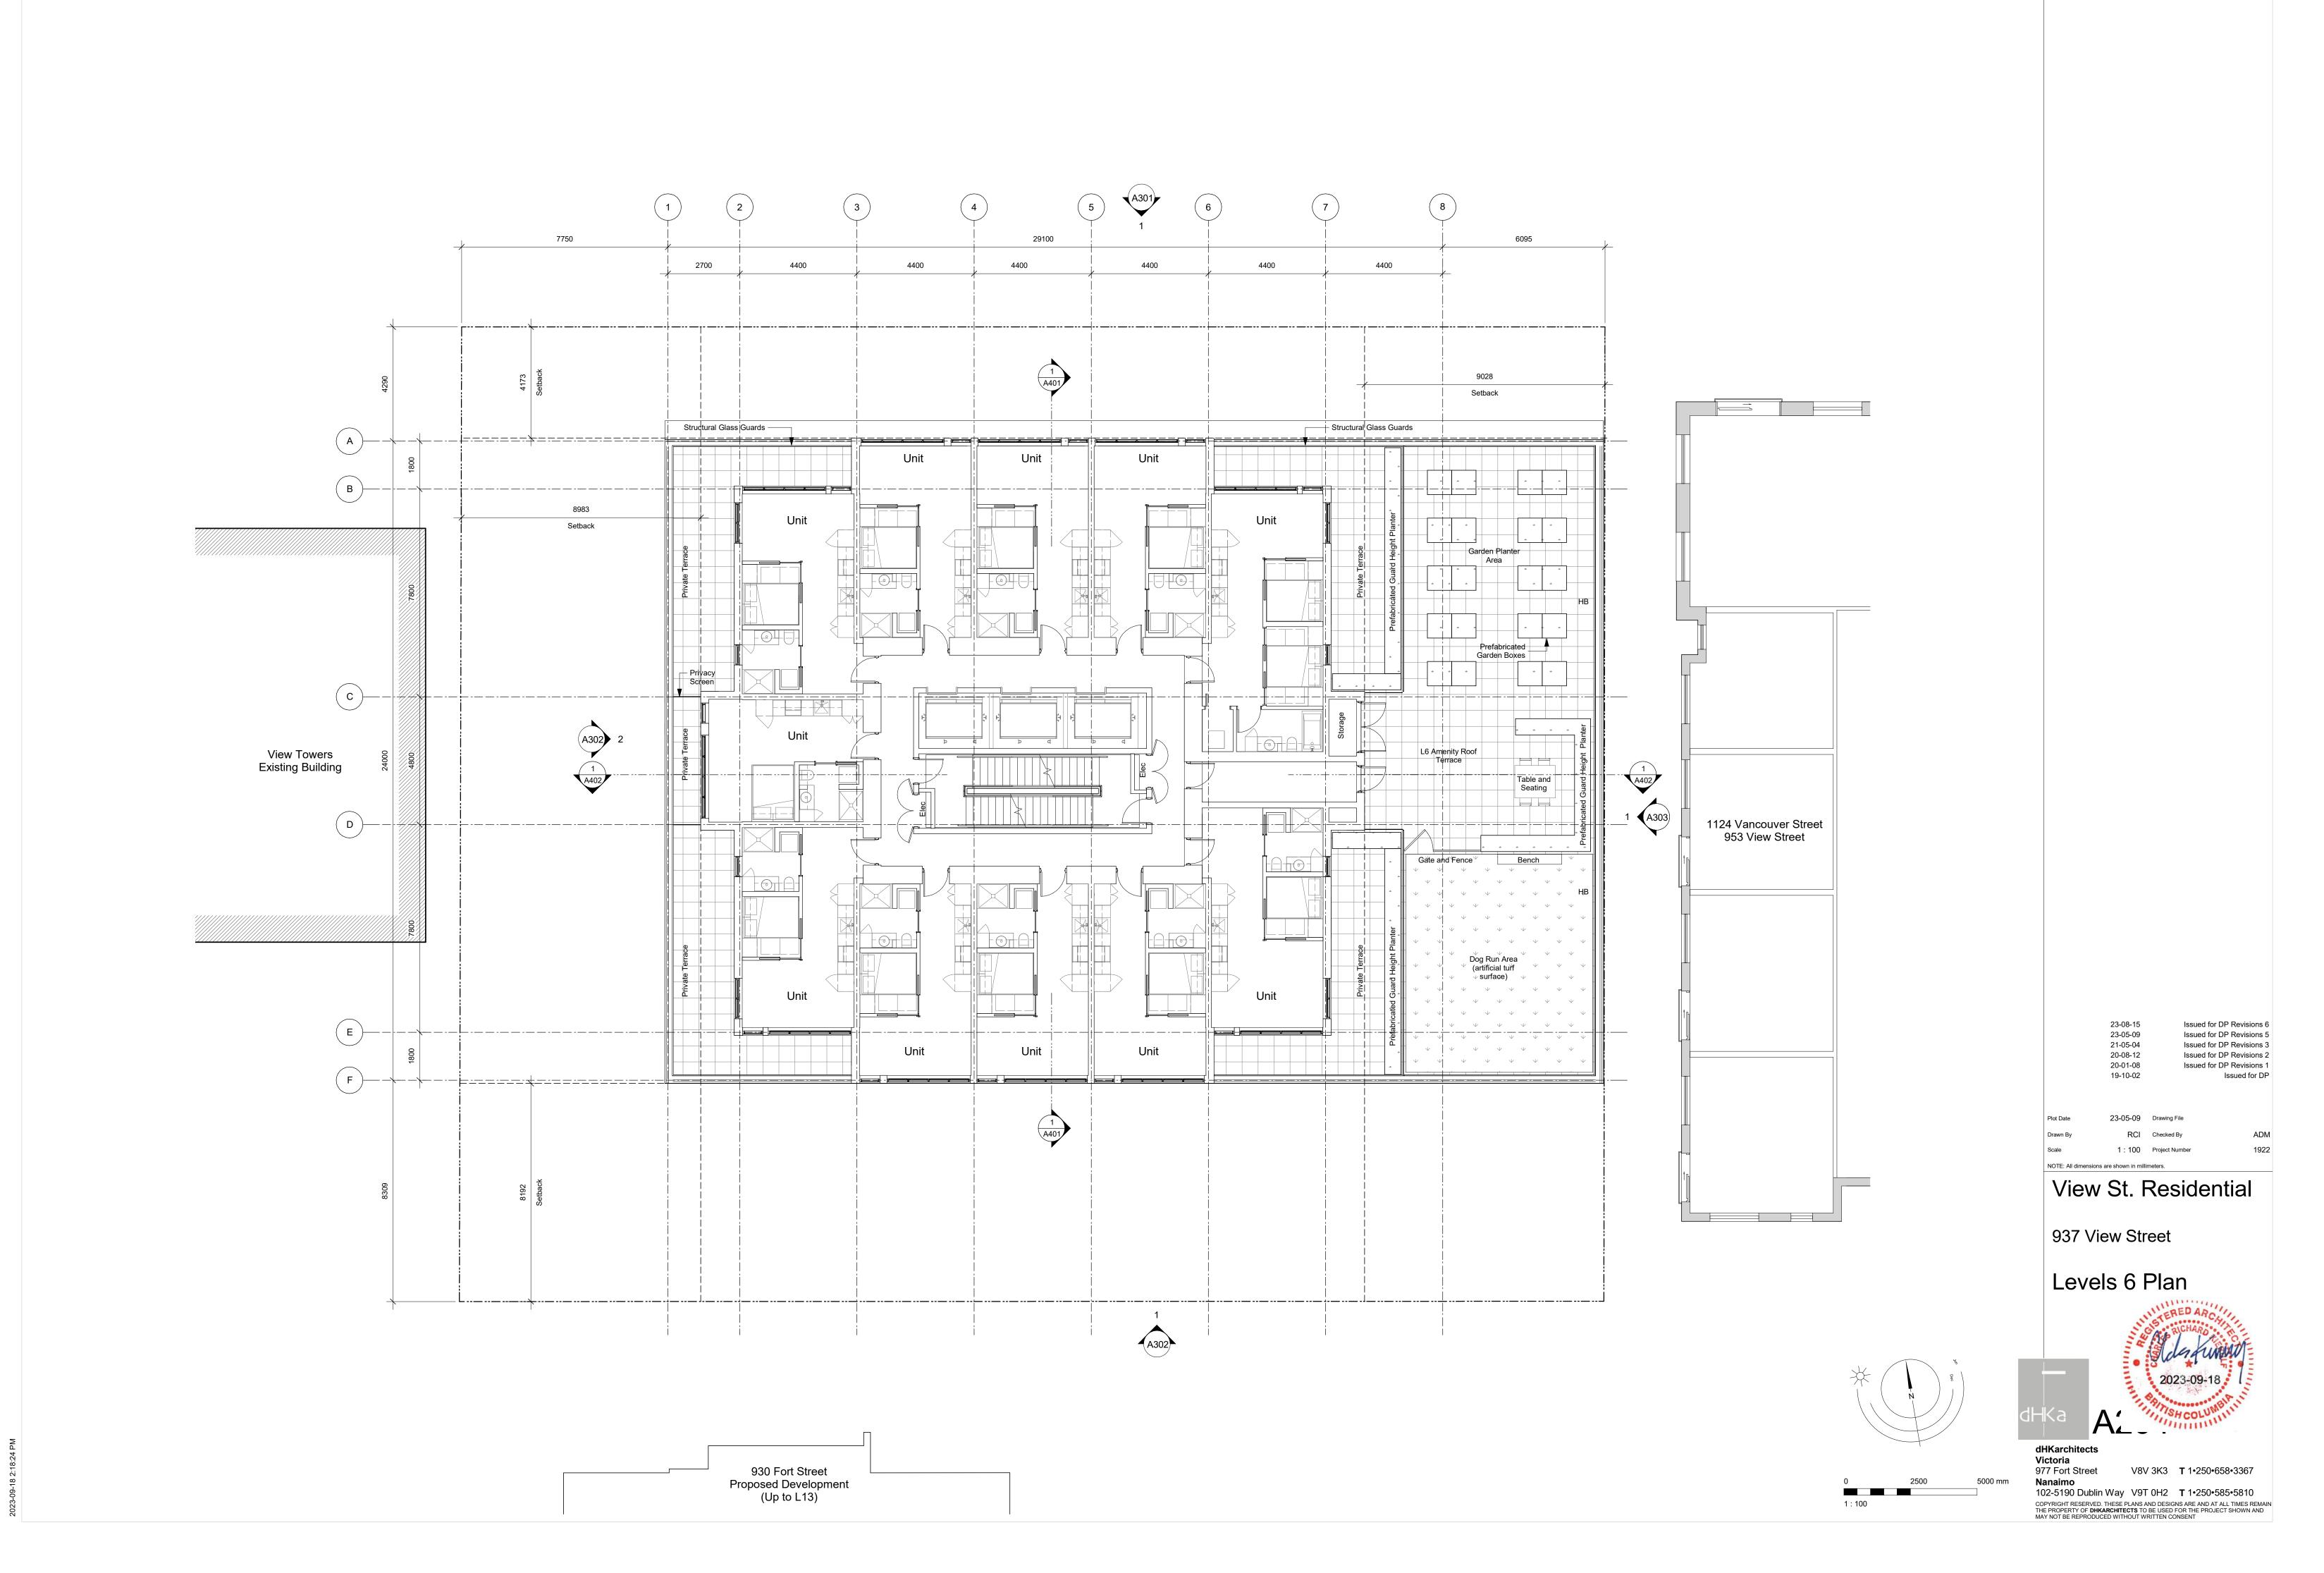
937 View Street


Levels 3-5 Plan

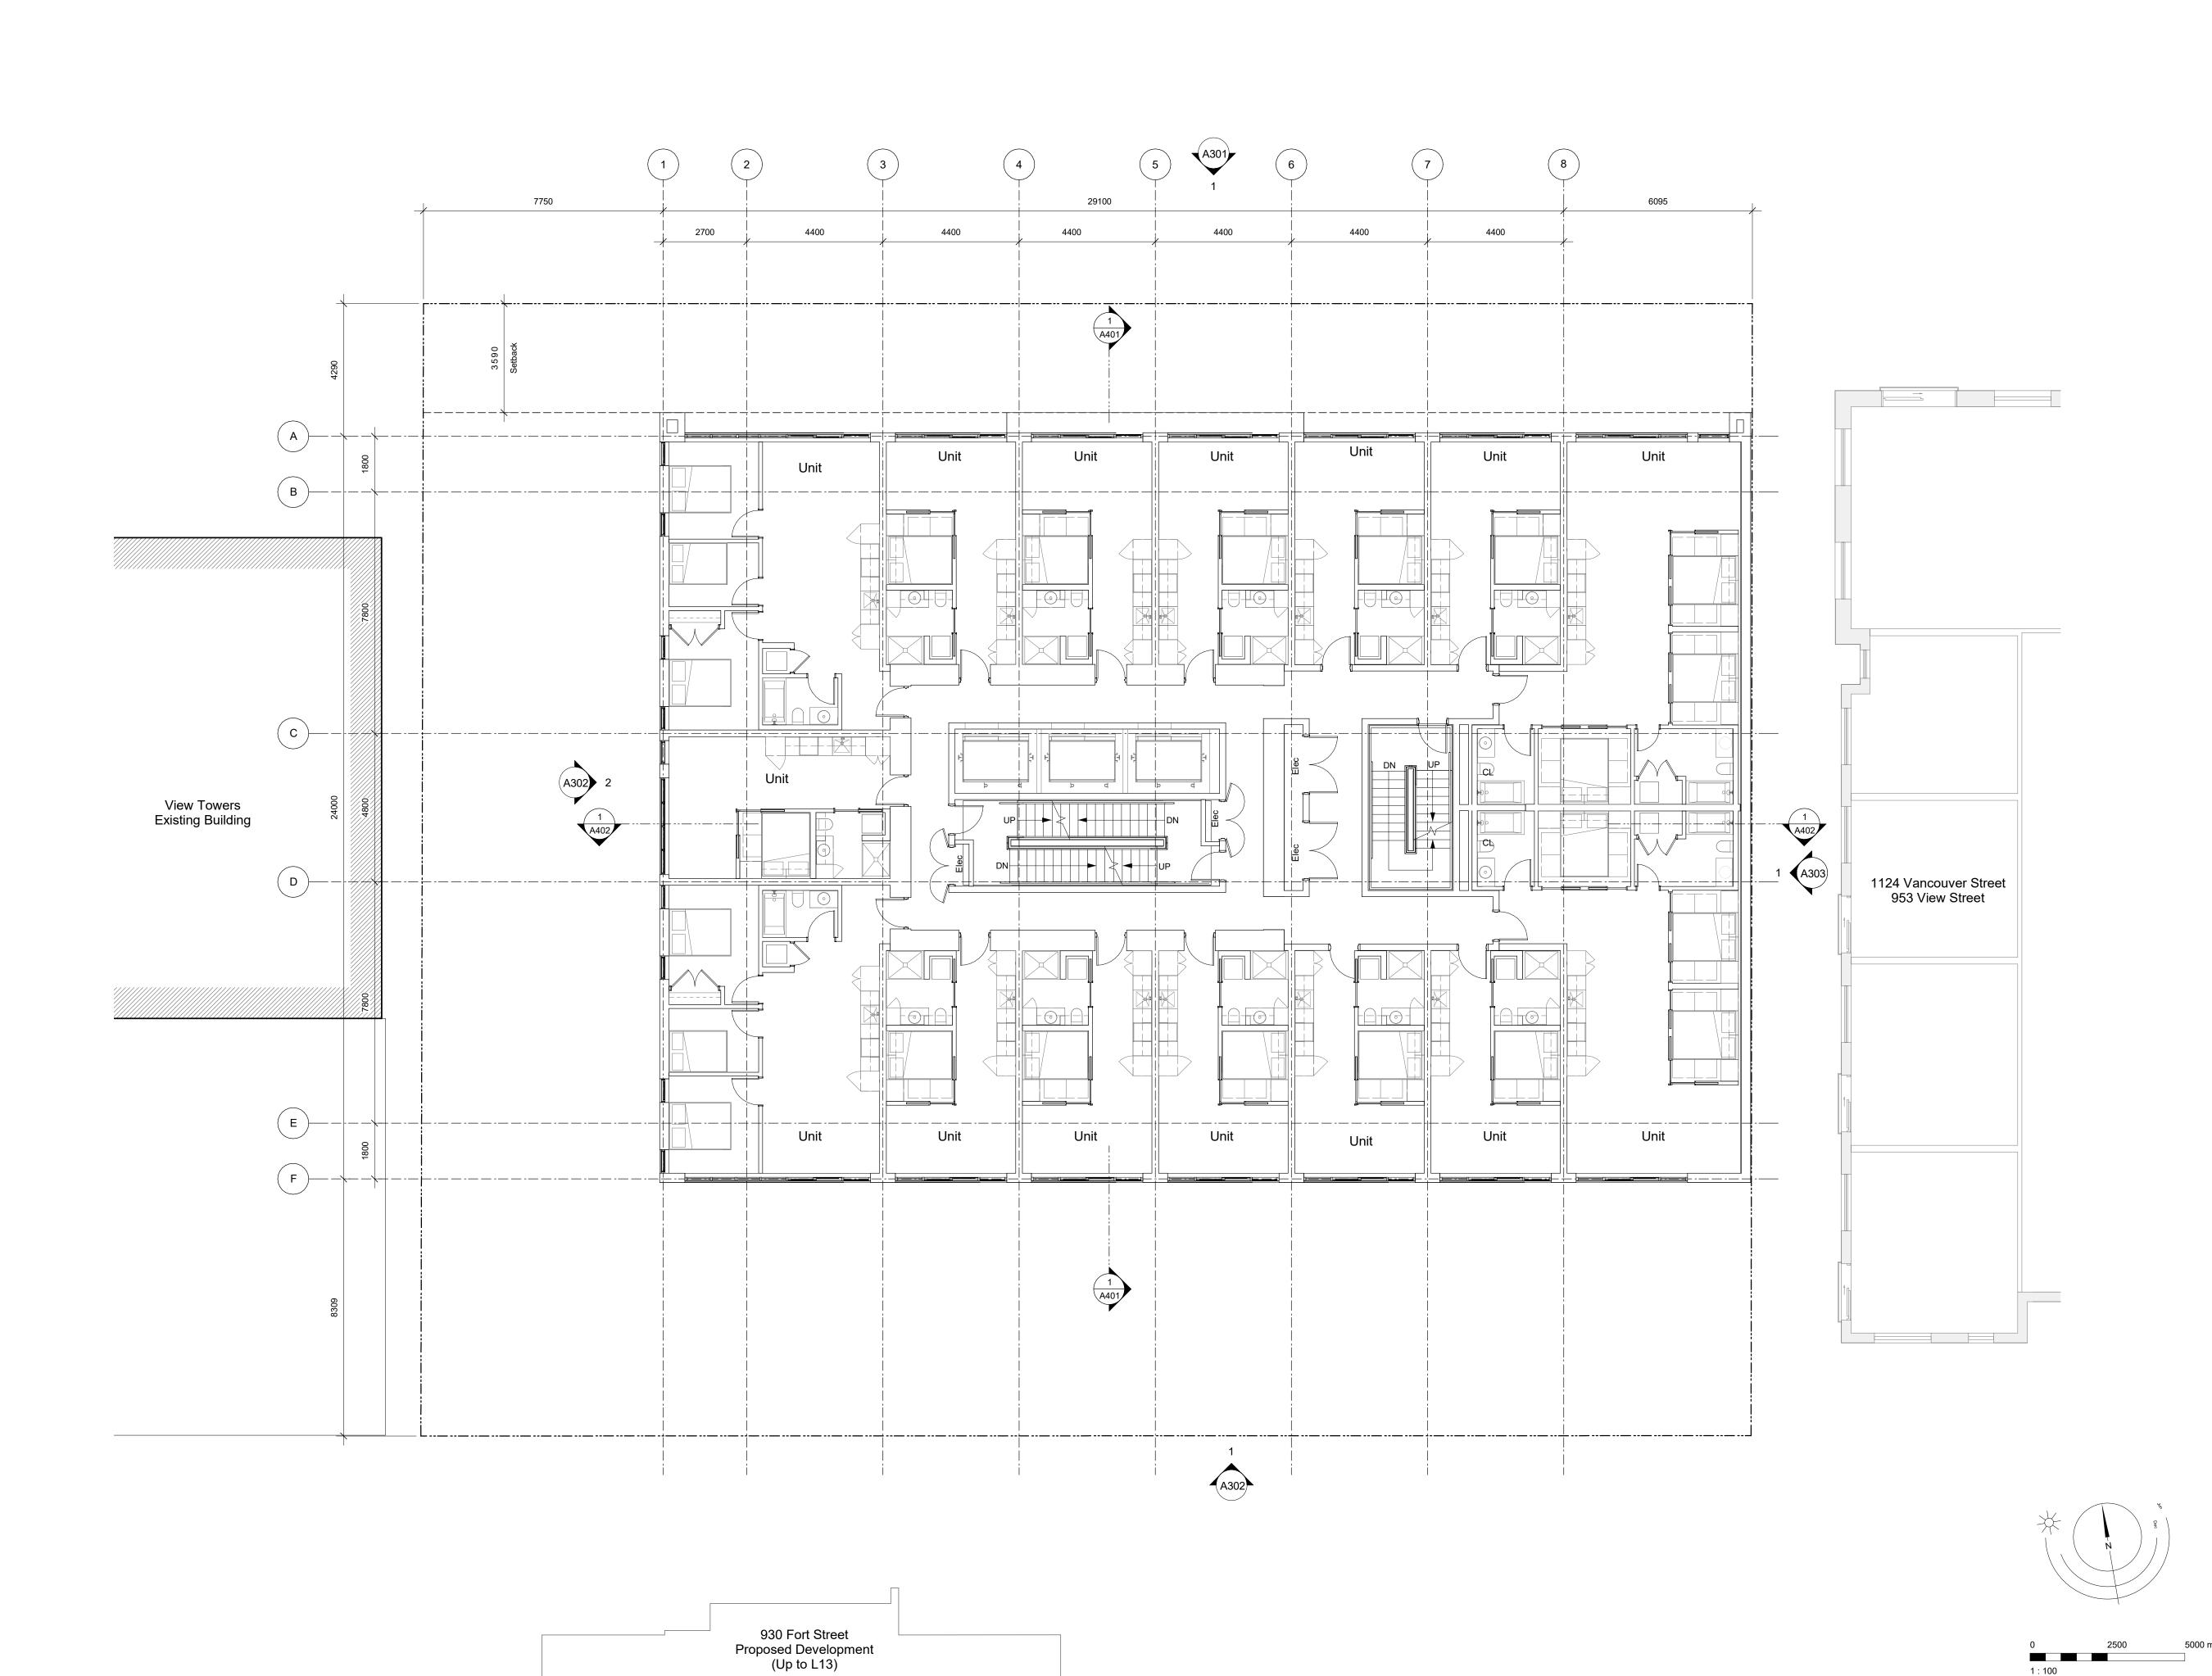

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930 Fort Street Proposed Development (Up to L13)

21-05-04 20-08-12 20-01-08 19-10-02

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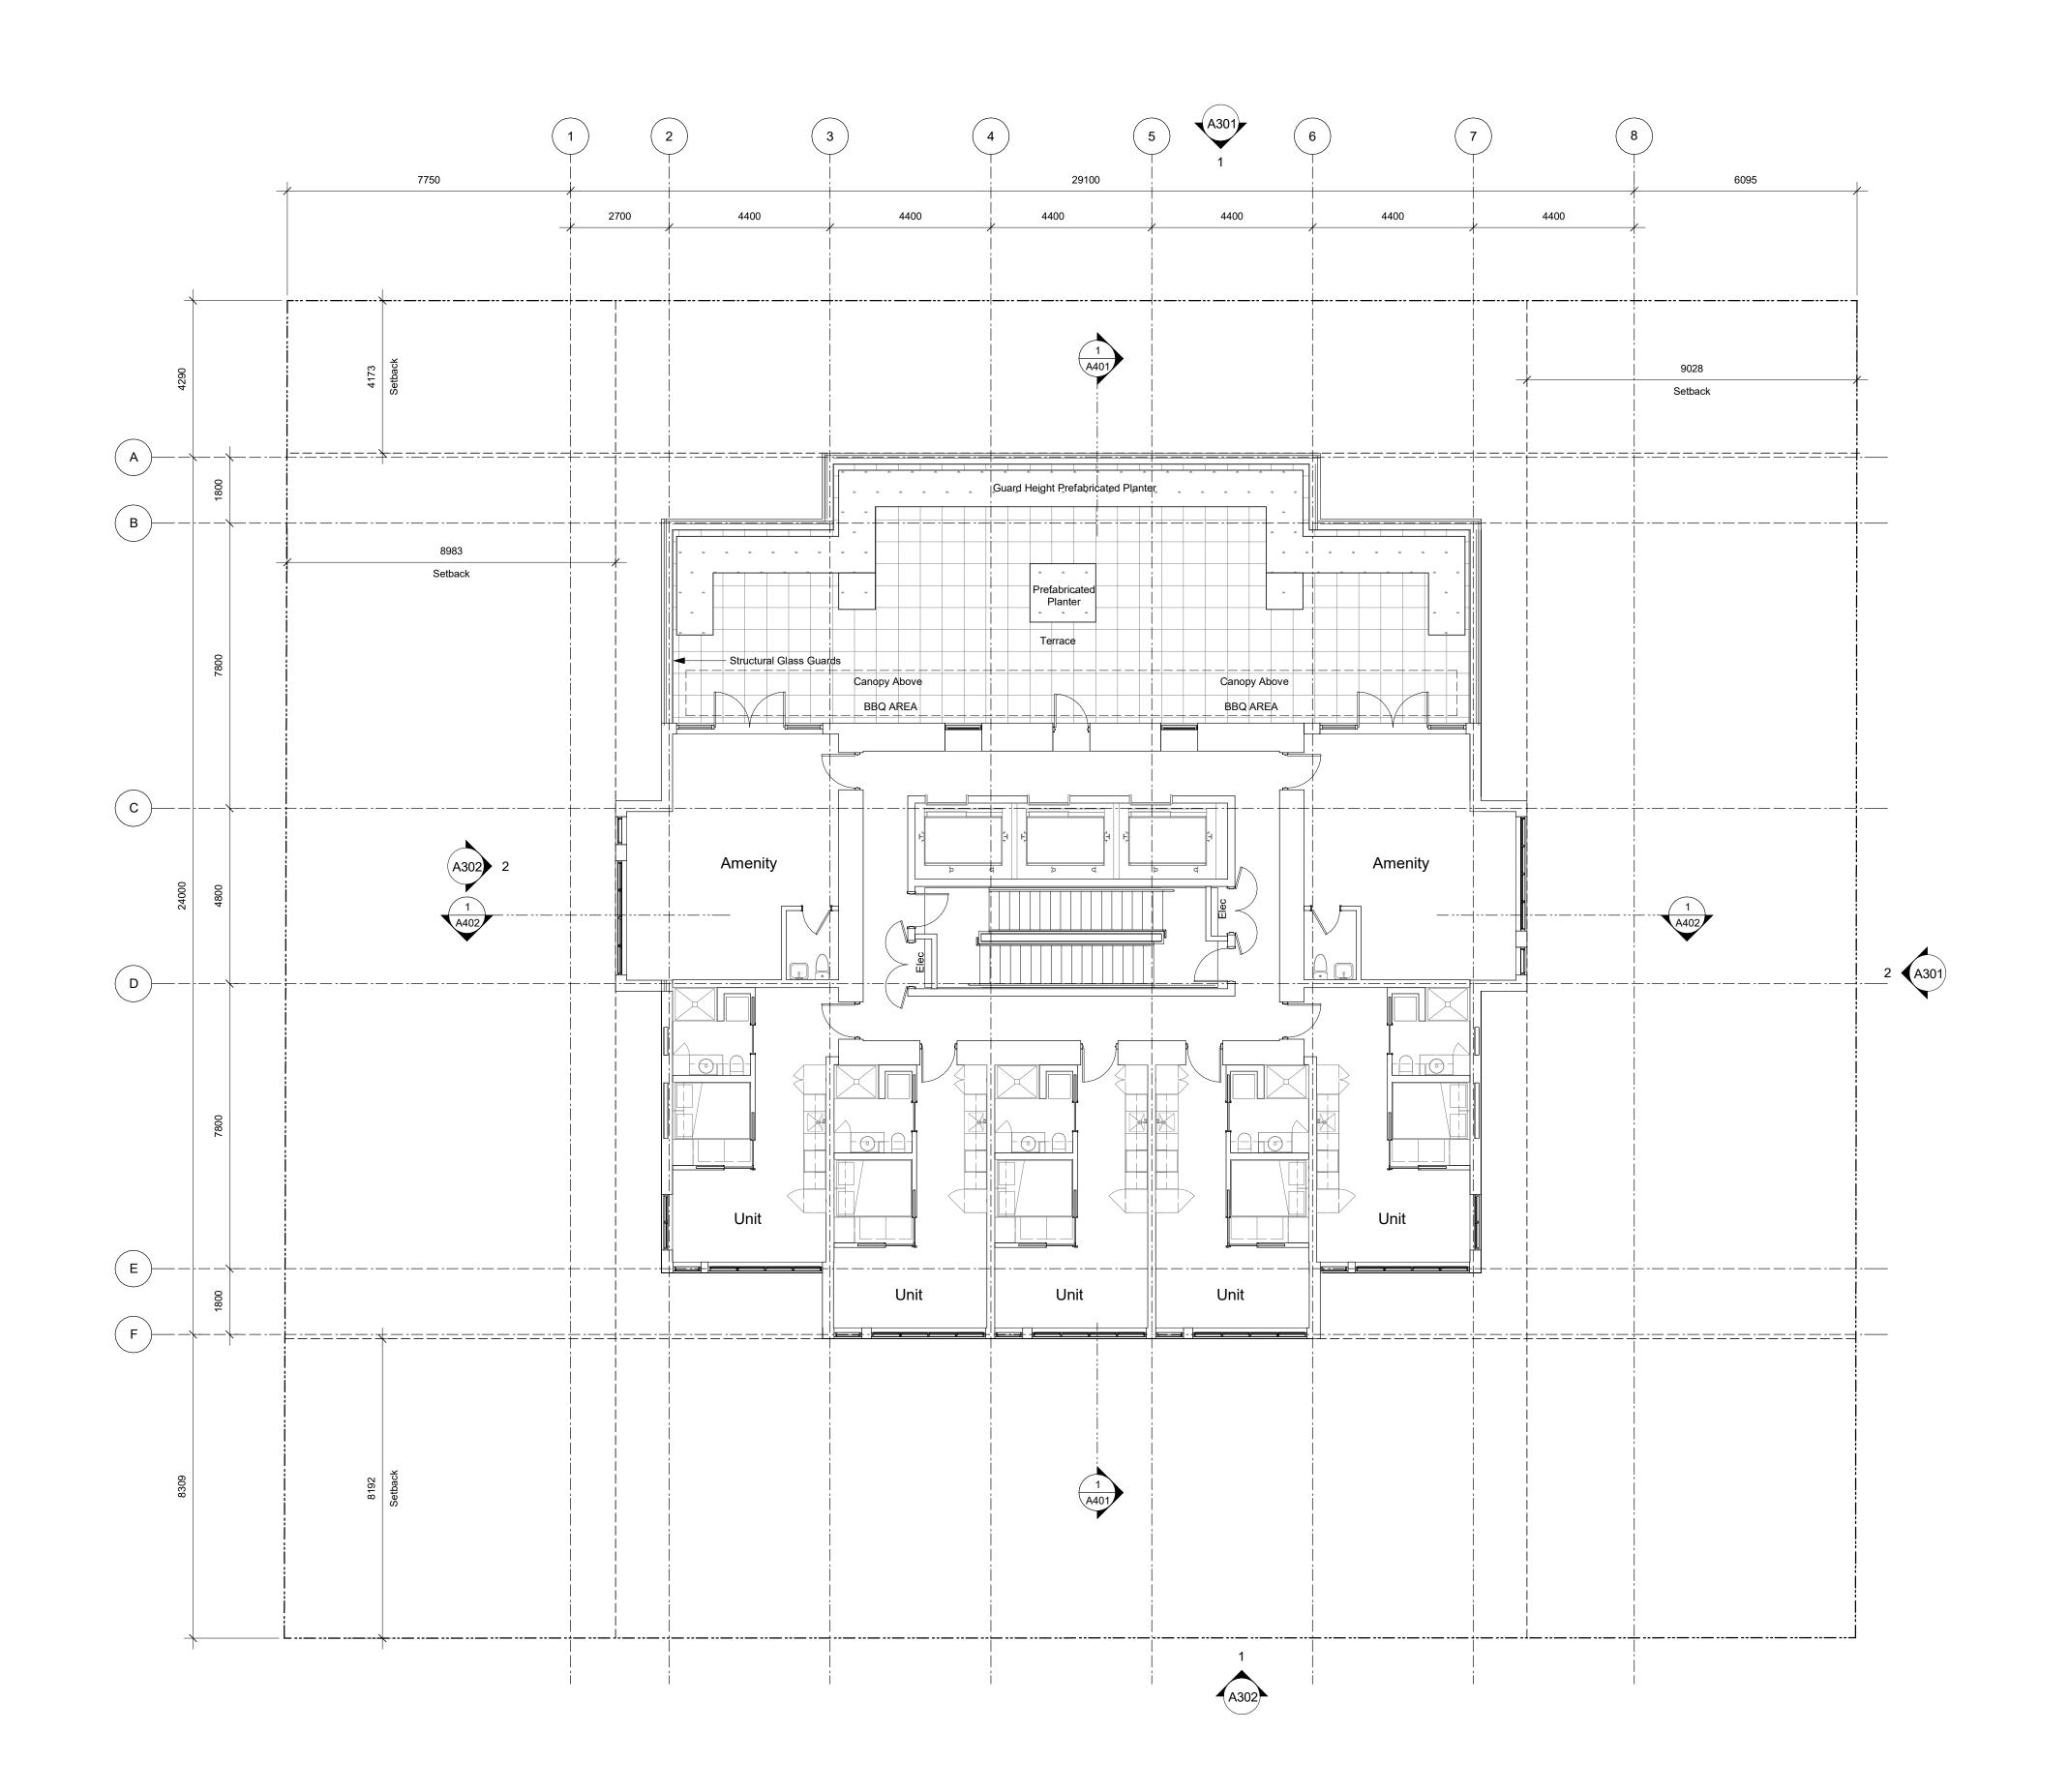
View St. Residential

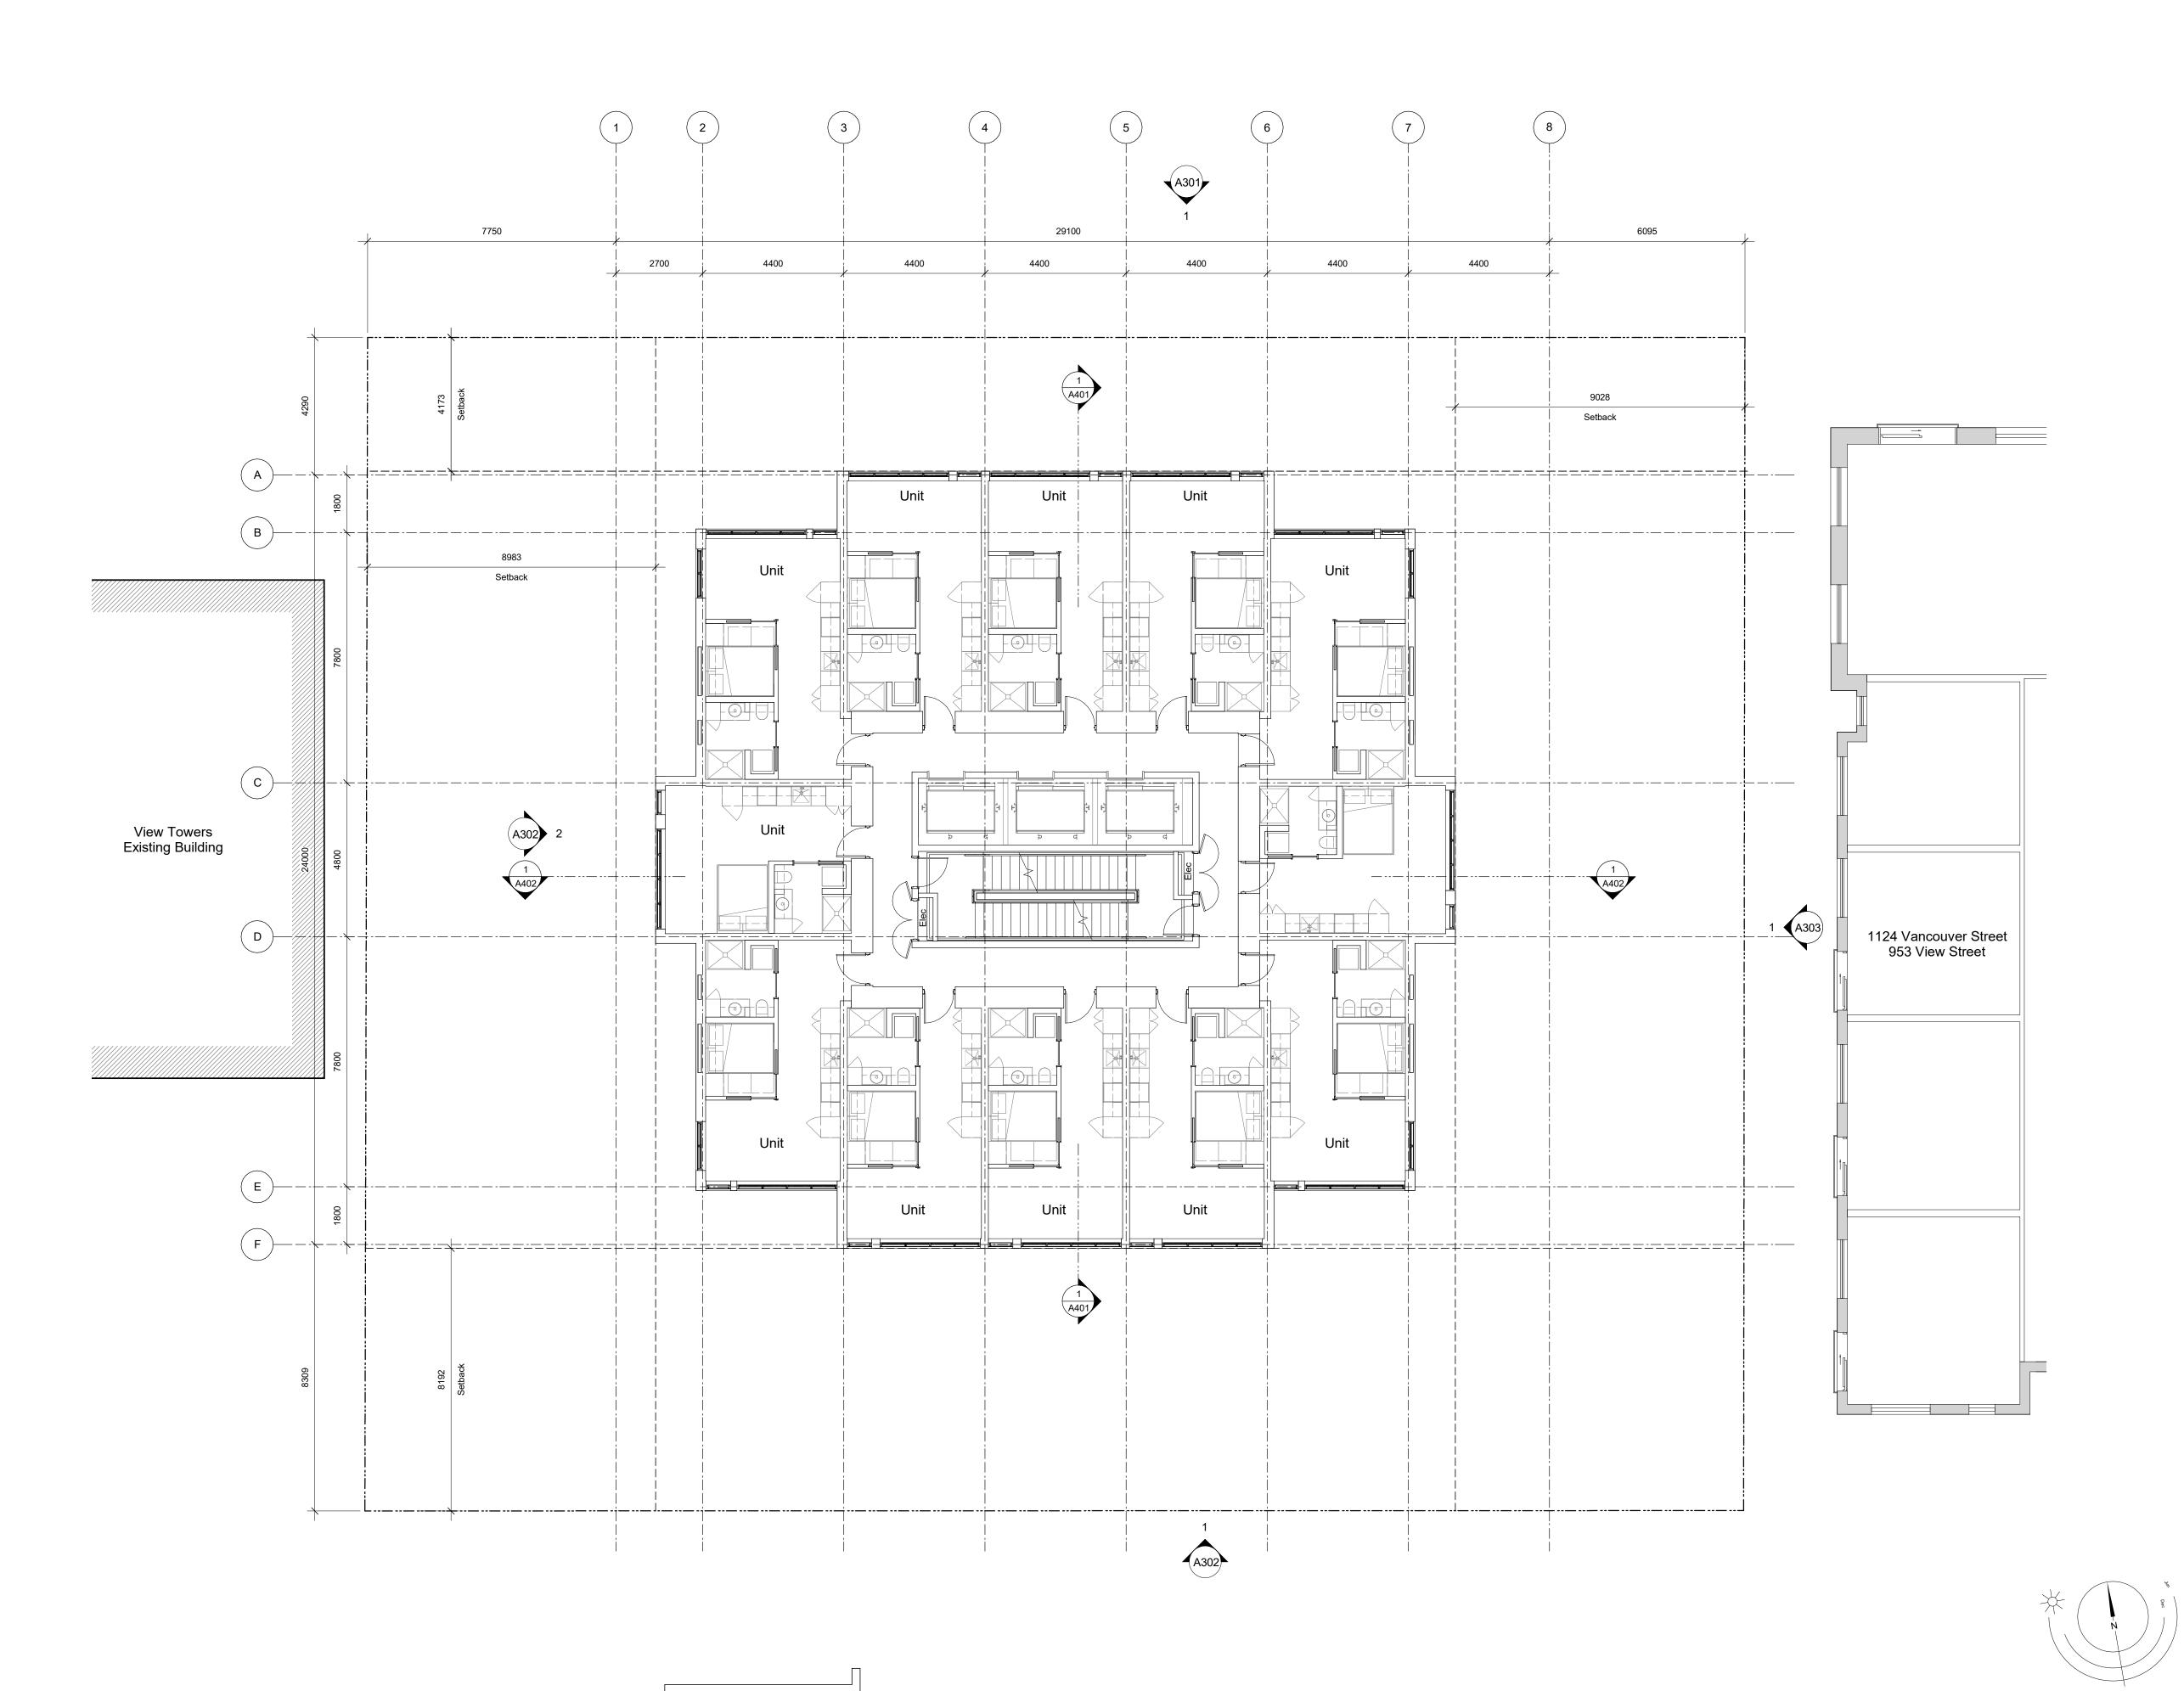937 View Street

Levels 7-22 Plan



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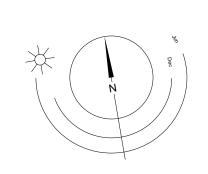
20-08-12 20-01-08 19-10-02


Issued for DP Revisions 3 Issued for DP Revisions 2 Issued for DP Revisions 1

View St. Residential

937 View Street


Level 23 Plan



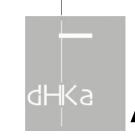

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20-08-12 20-01-08 19-10-02

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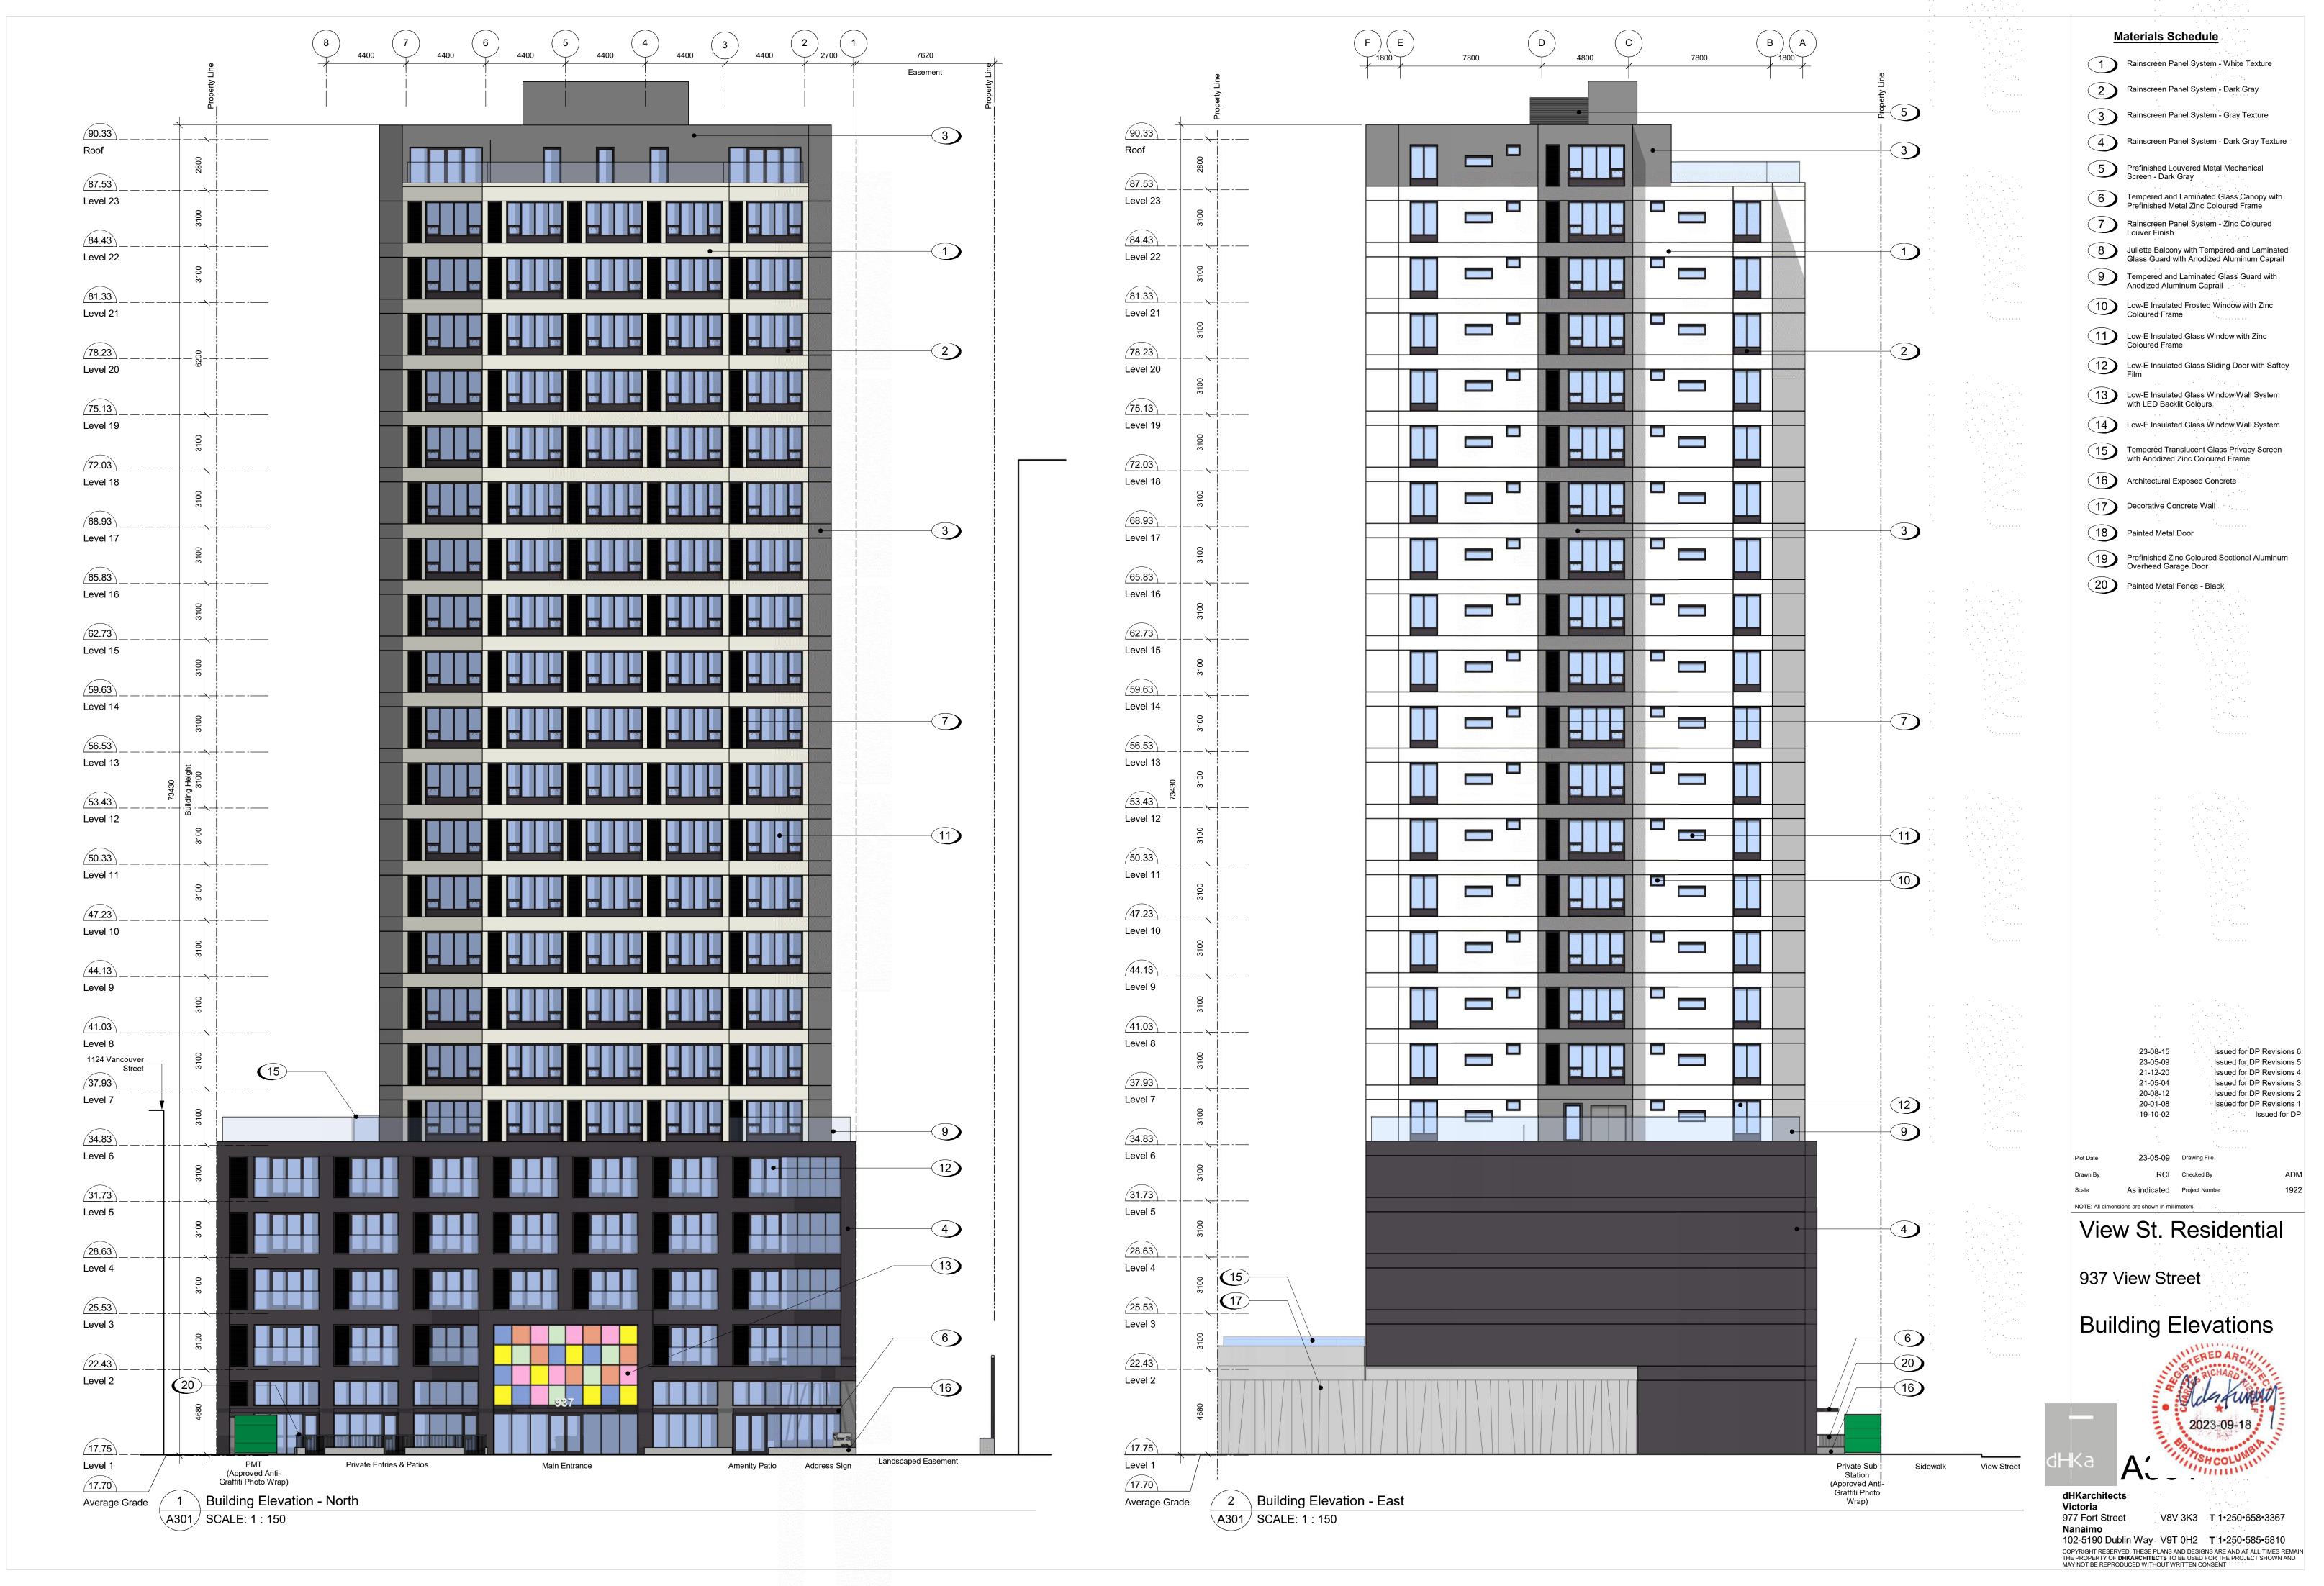
937 View Street

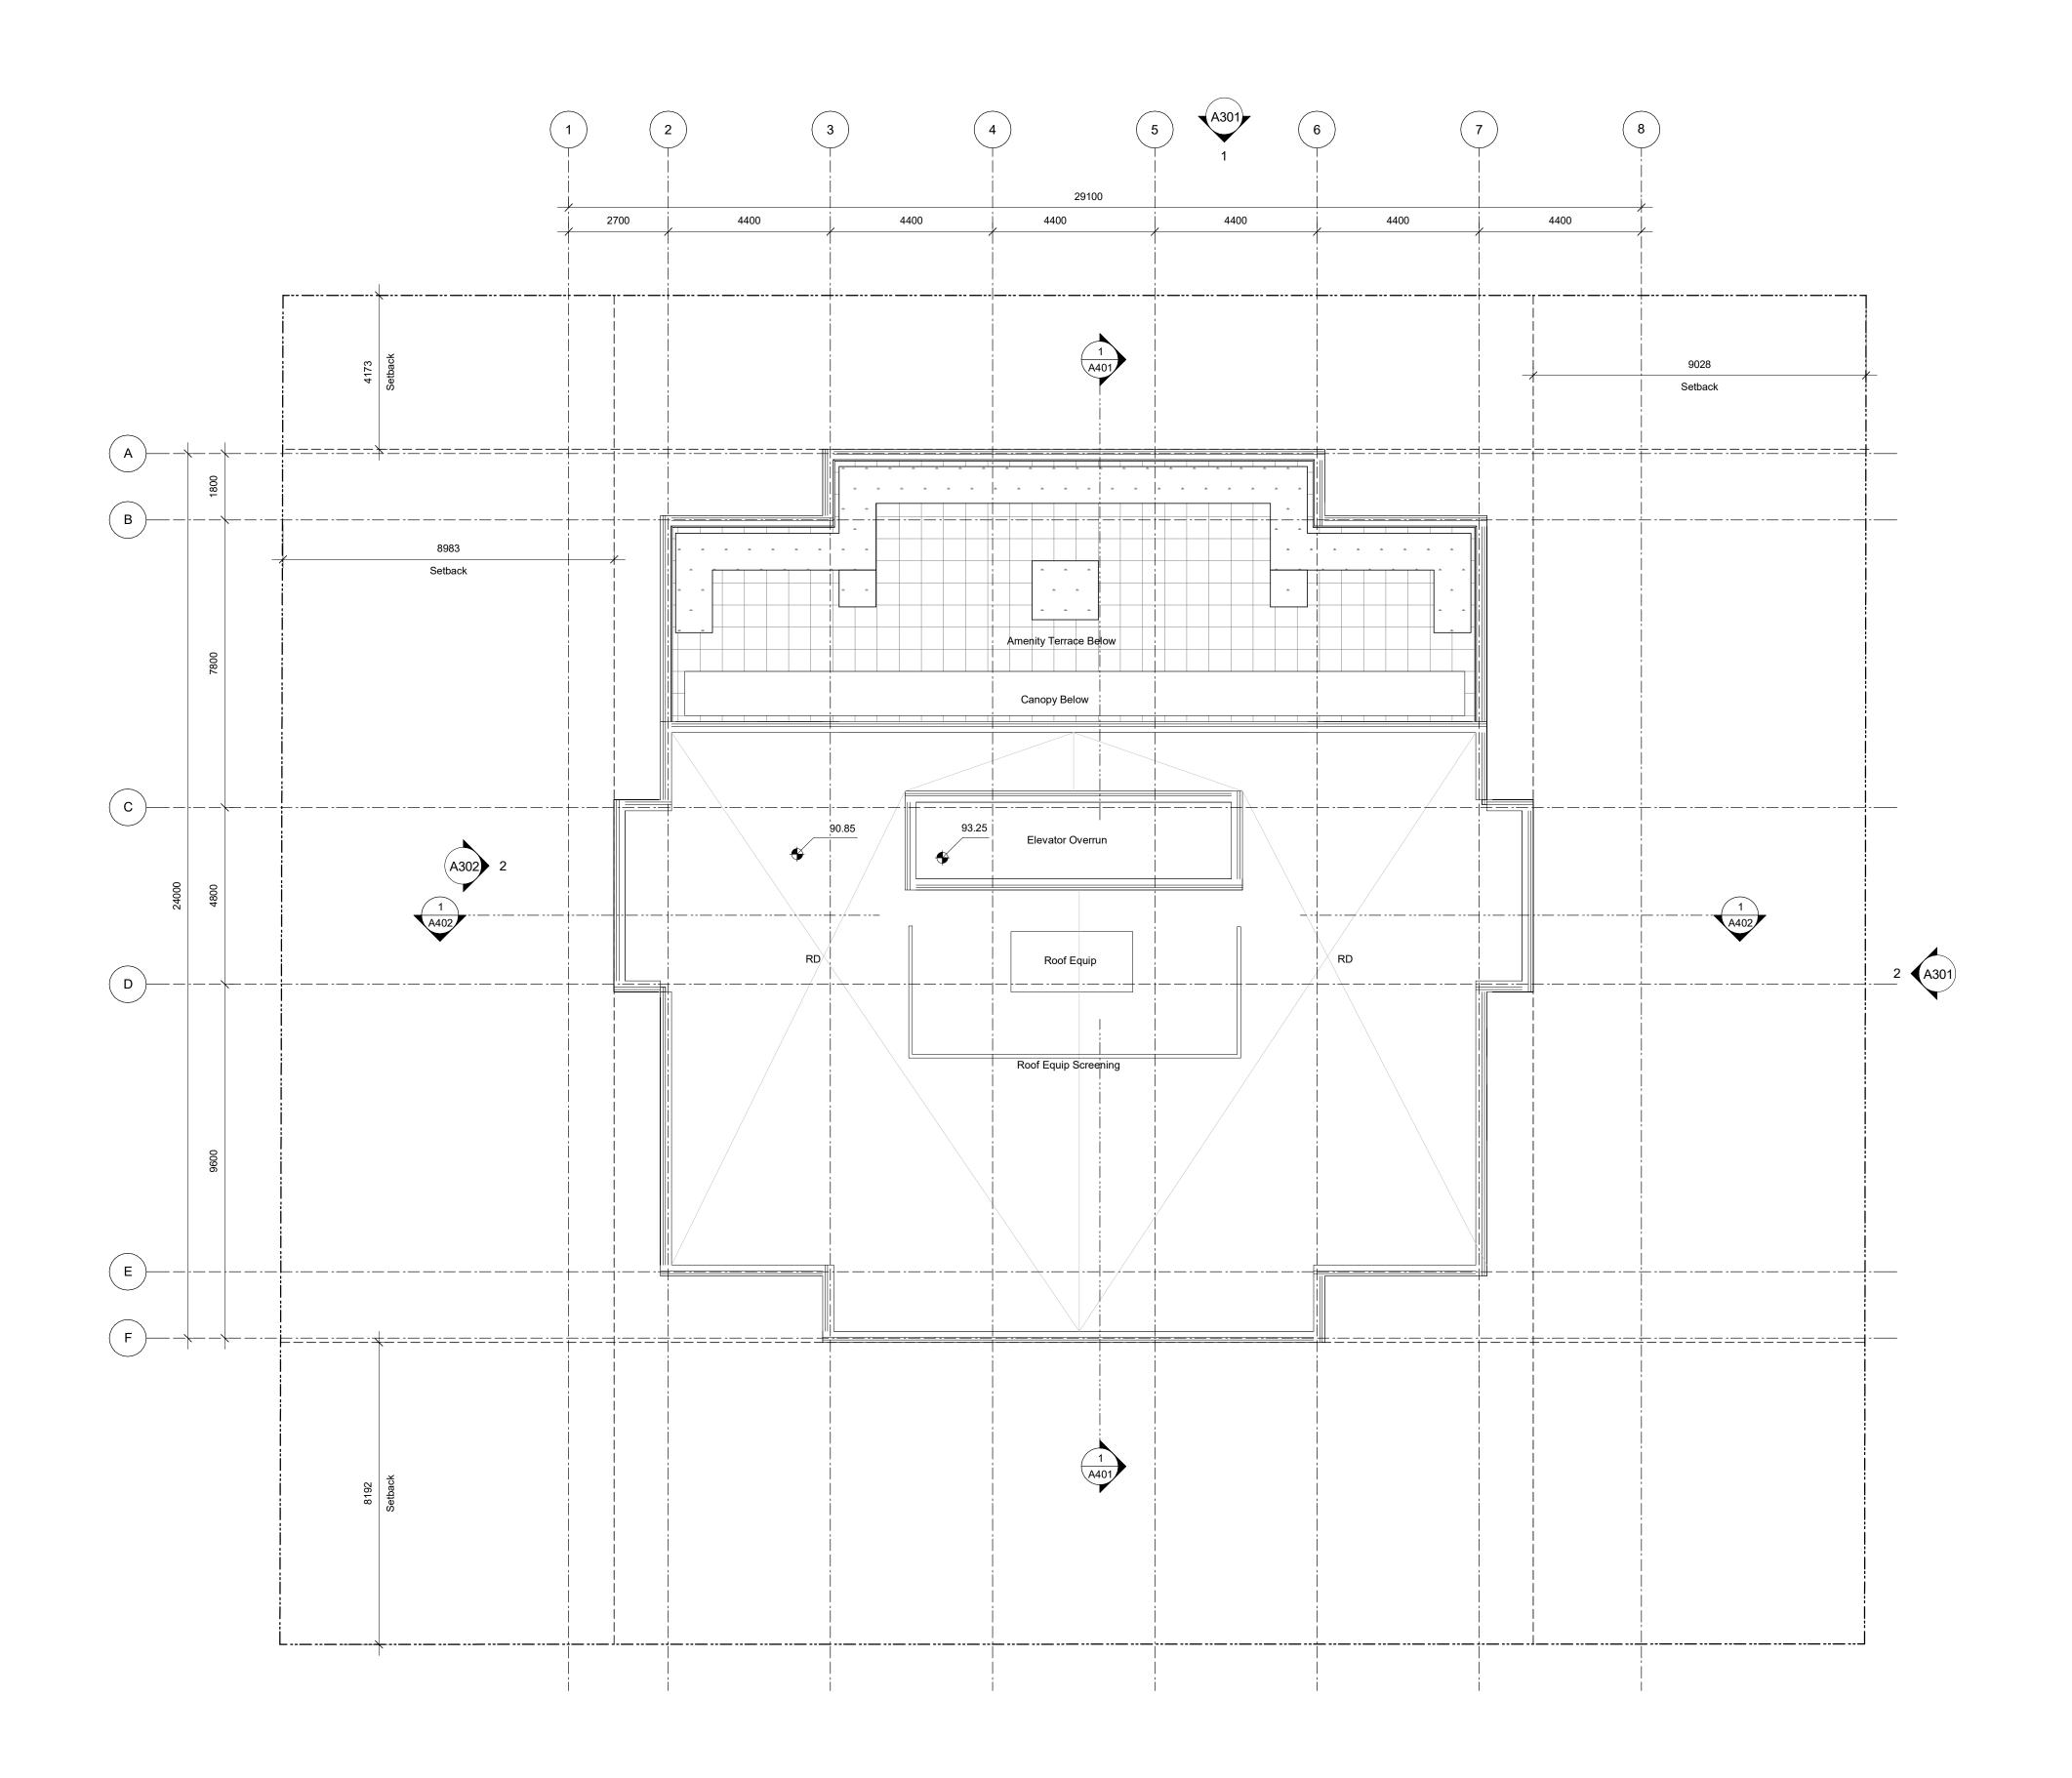Roof Plan



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1 Roof - Overall A209 SCALE: 1:100





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1 Building Elevation - East - Adjacent Window Overlay
A303 SCALE: 1:100







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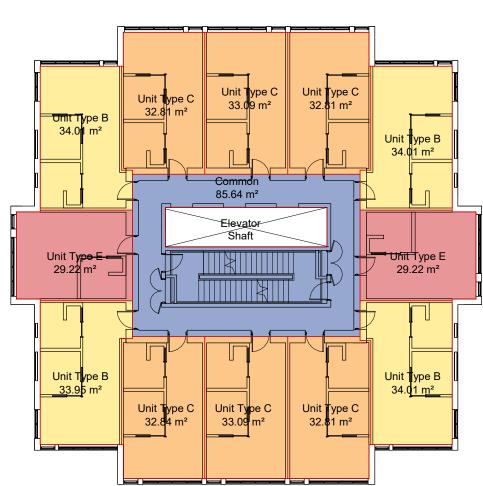


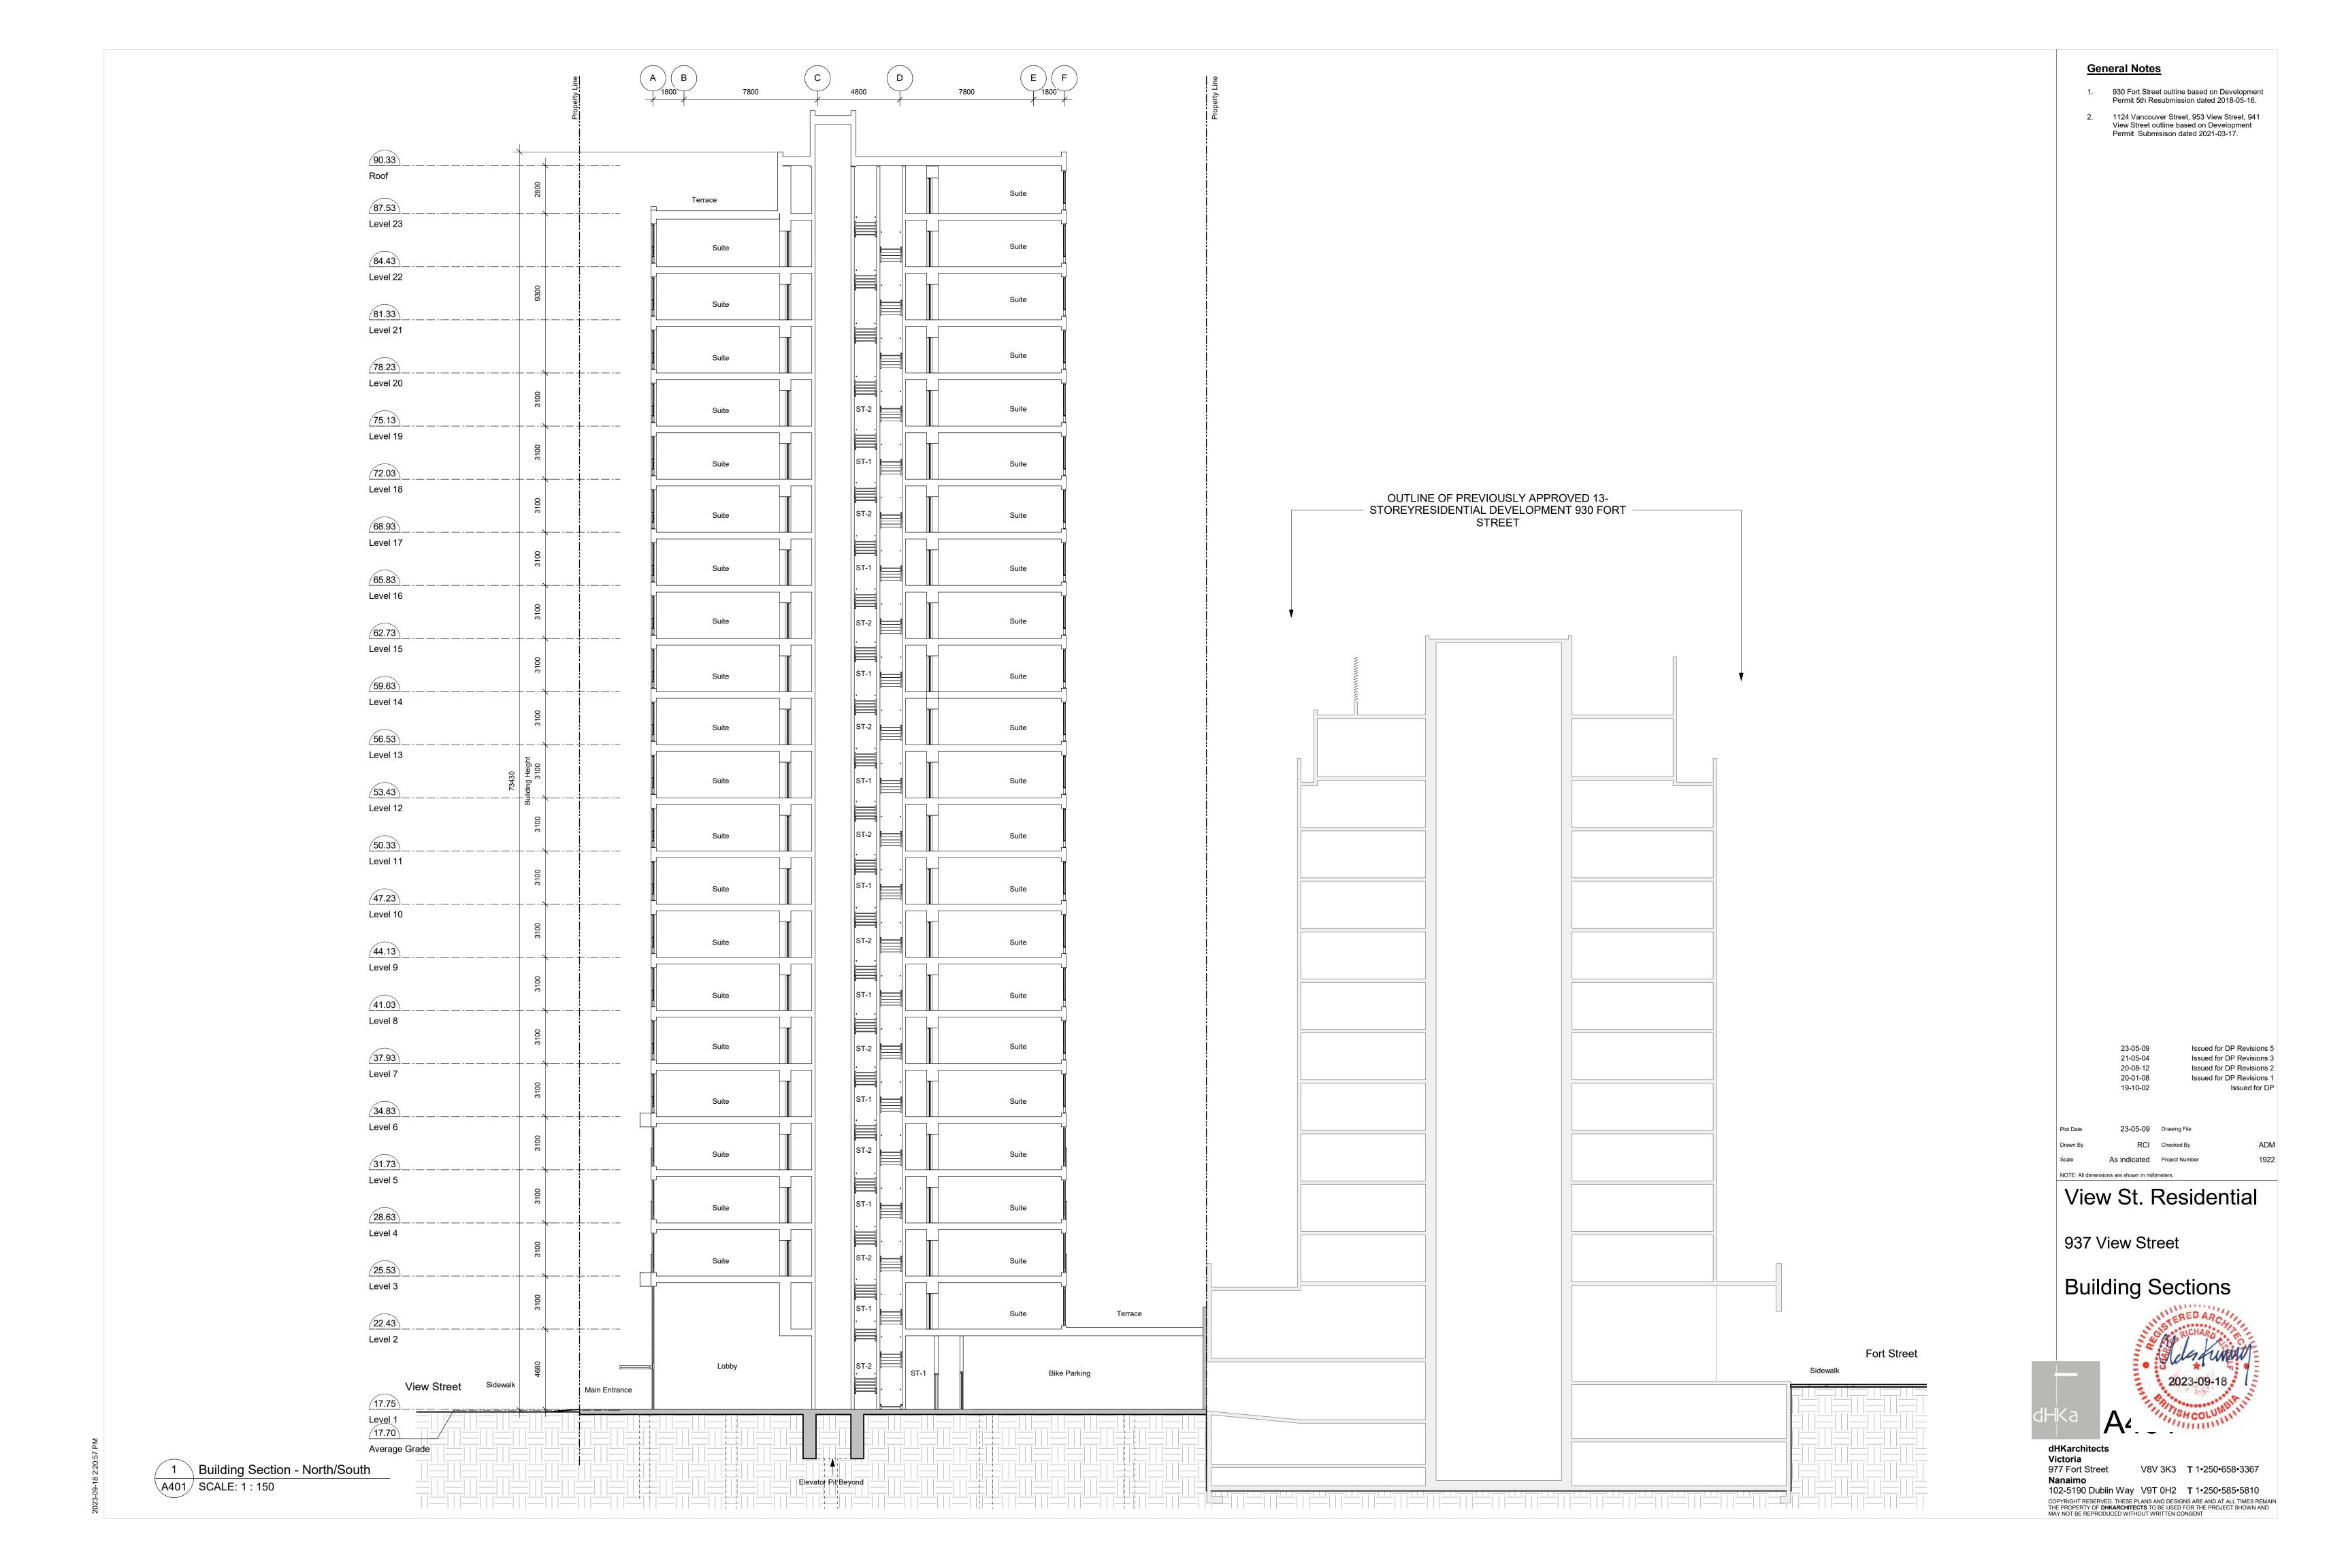

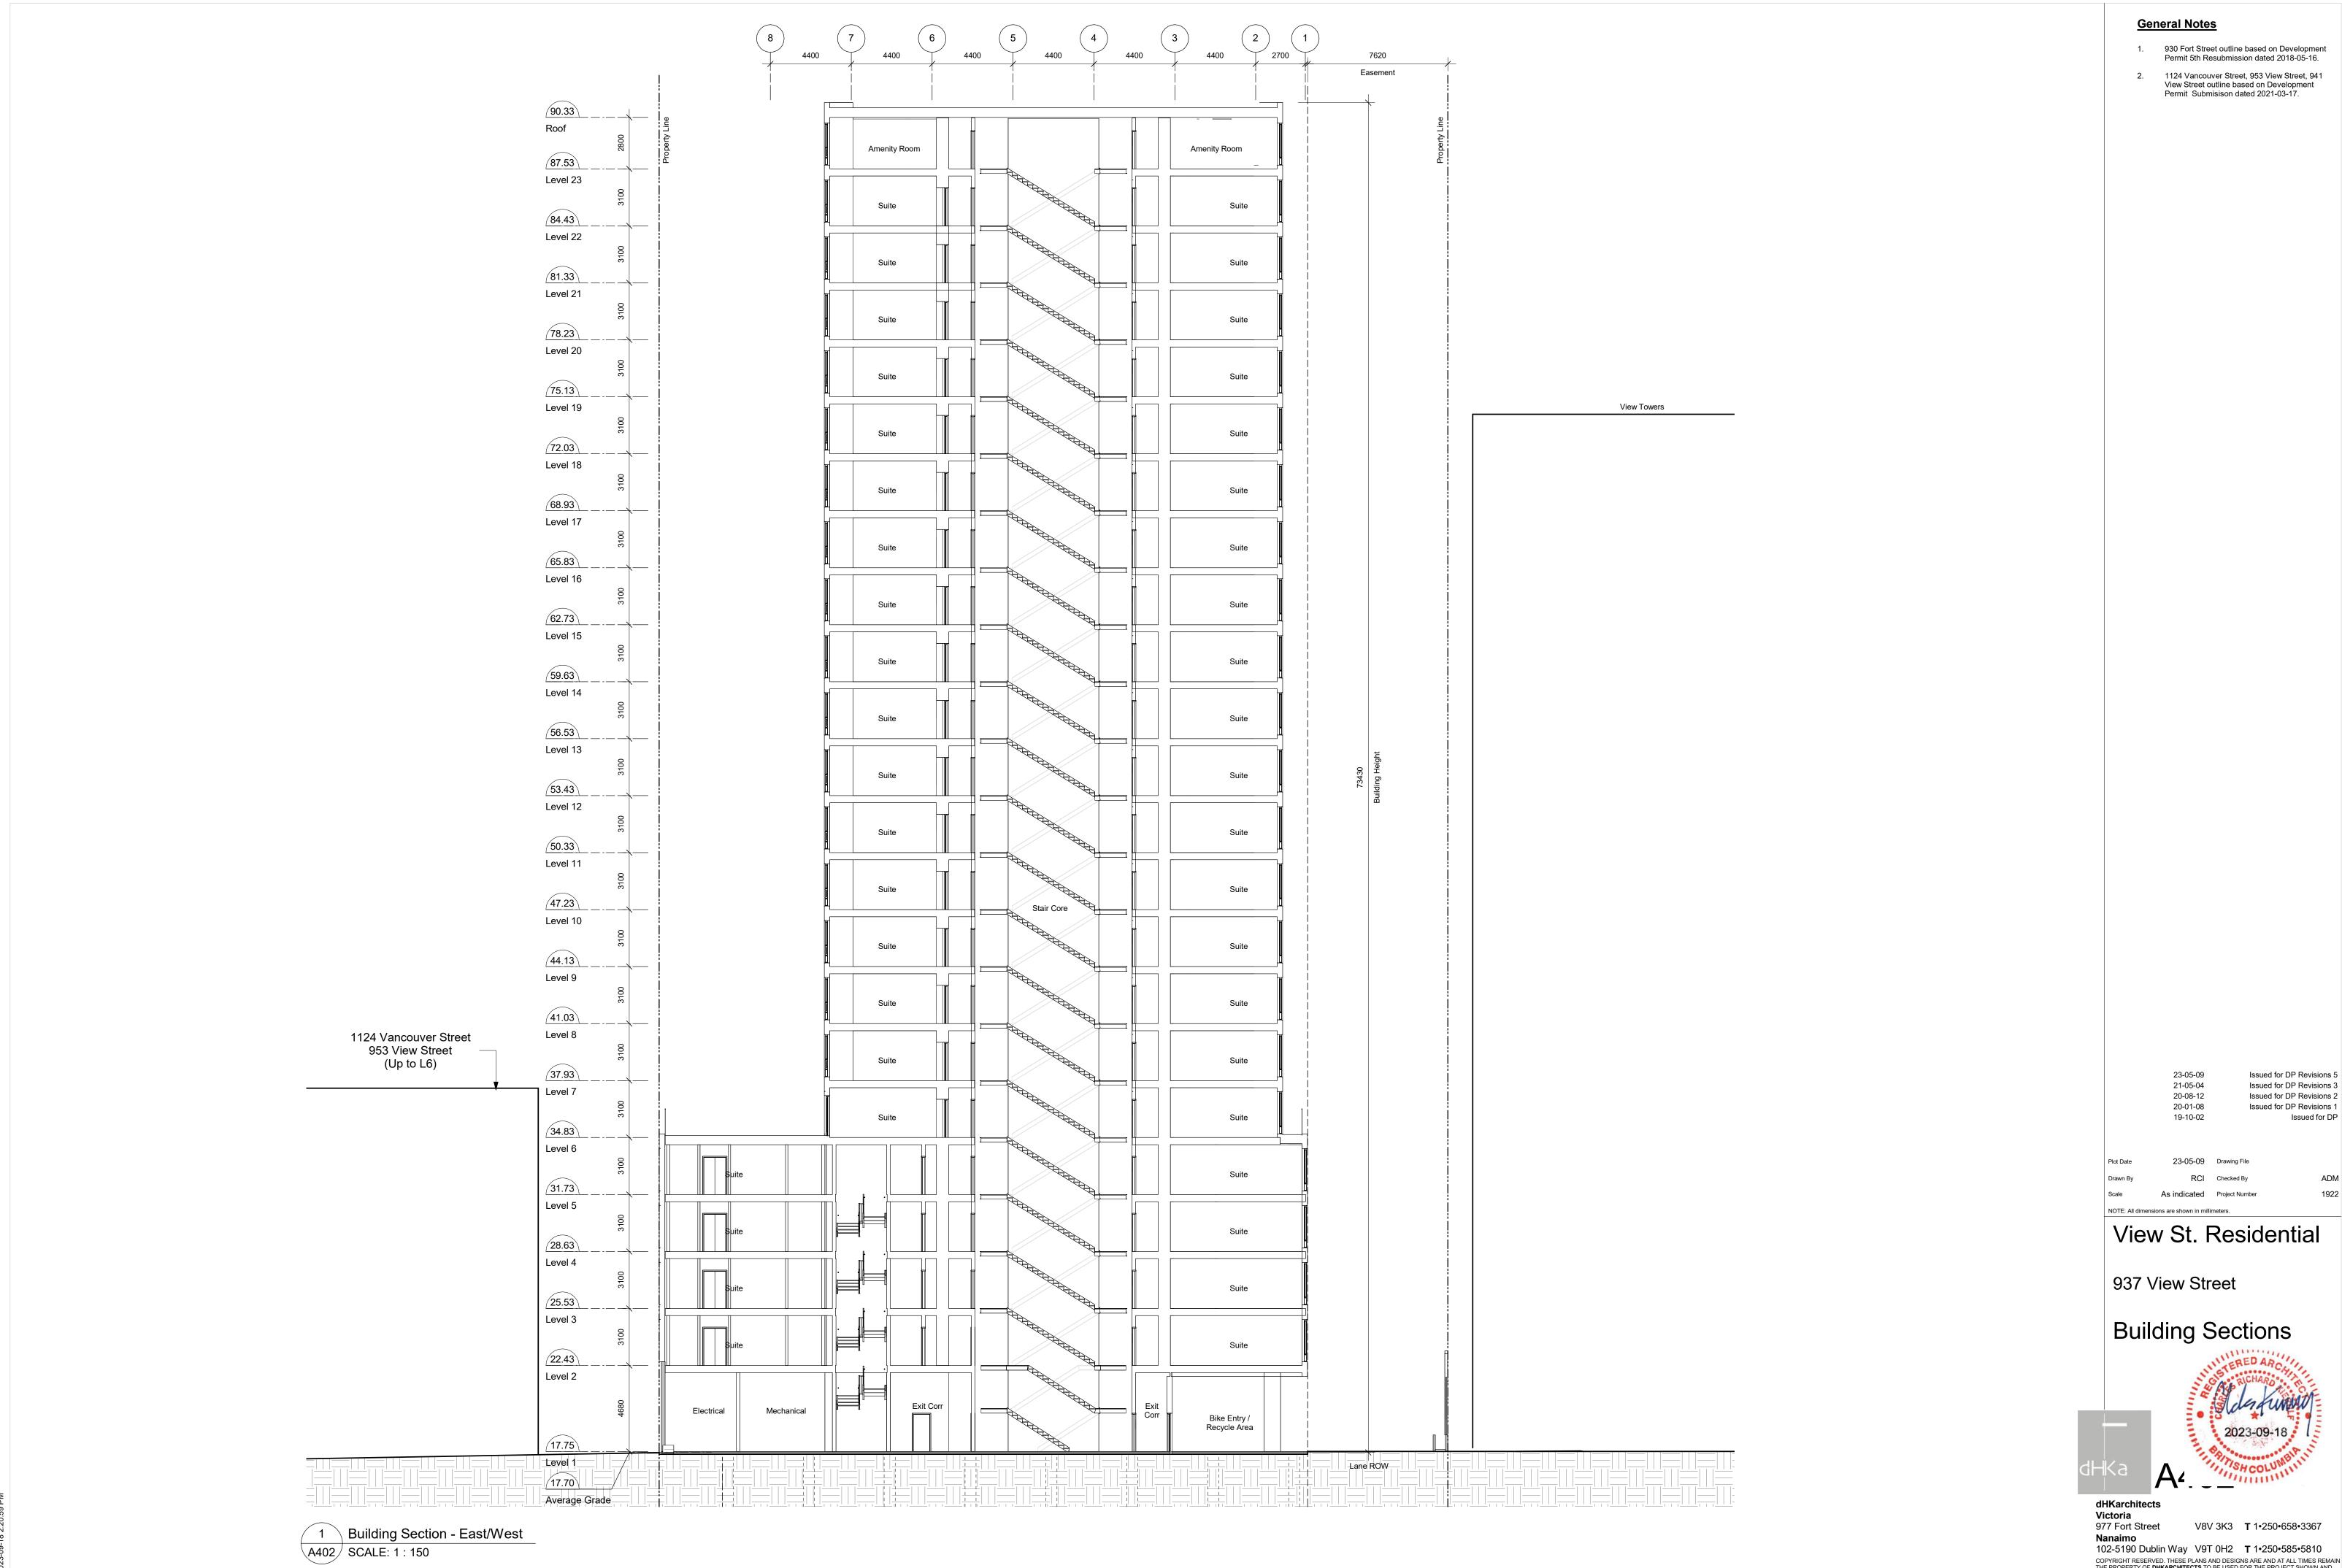
5 Level L6 Area Plan A911 | SCALE: 1:200

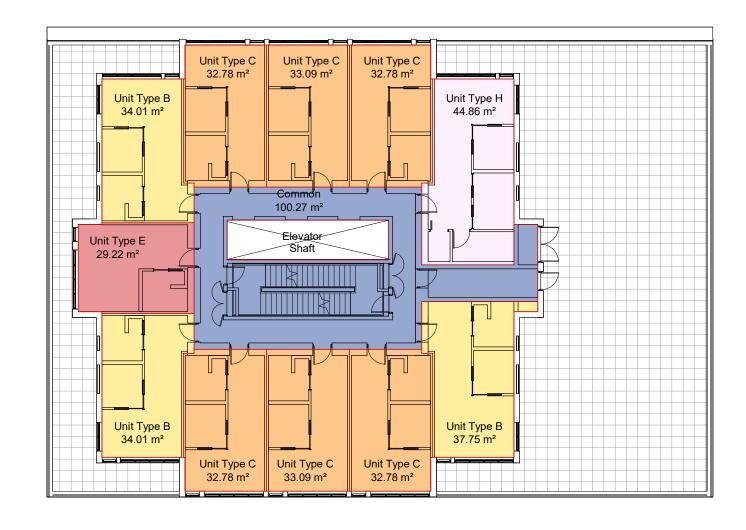

2 Level L2 Area Plan A911 SCALE: 1:200

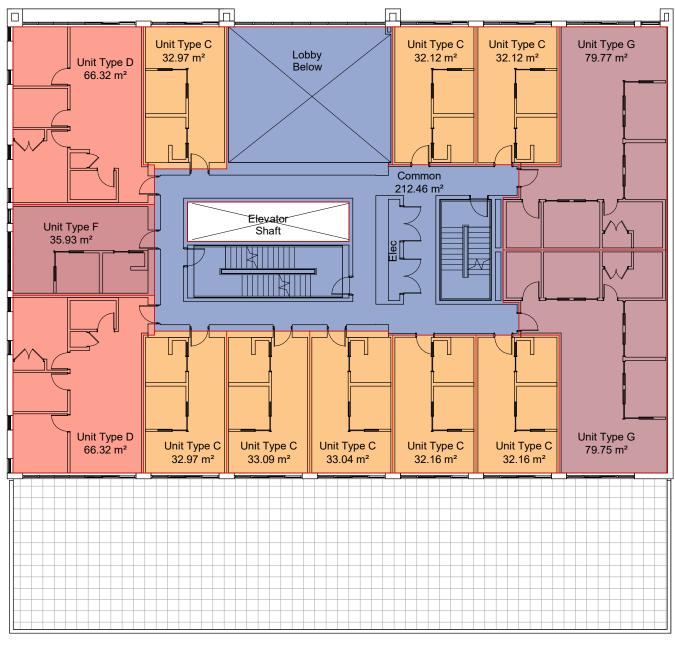

6 Levels L7-L22 Area Plan

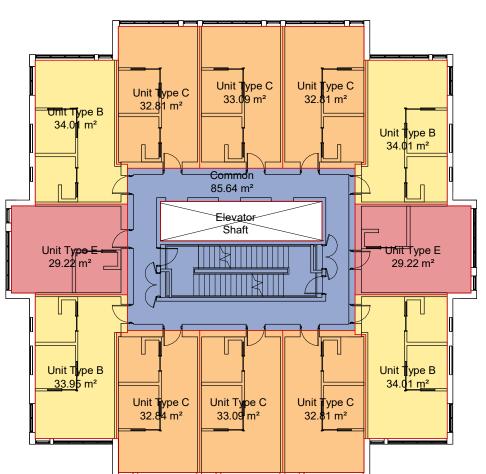


# A911 | SCALE: 1:200


# Floor Areas

Level	Area
Not Placed	0 m²
Level 1	707 m <sup>2</sup>
Level 2	801 m <sup>2</sup>
Level 3	801 m <sup>2</sup>
Level 4	801 m <sup>2</sup>
Level 5	801 m <sup>2</sup>
Level 6	477 m²
Level 7	478 m²
Level 8	477 m²
Level 9	478 m²
Level 10	478 m²
Level 11	478 m²
Level 12	478 m²
Level 13	478 m²
Level 14	477 m²
Level 15	478 m²
Level 16	478 m²
Level 17	478 m²
Level 18	478 m²
Level 19	478 m²
Level 20	478 m²
Level 21	478 m²
Level 22	478 m²
Level 23	327 m²

<b>Area Summary</b>		Unit Type and Count Su	<u>mmary</u>
Site Area	1,572 sm	Studio (Types E)	33
Total FAR Areas	12,356 sm	1BR (Types A, B, C, F)	219
		2BR (Type H)	1
FAR	7.86	3BR (Types D, G)	16
		Total Units	269

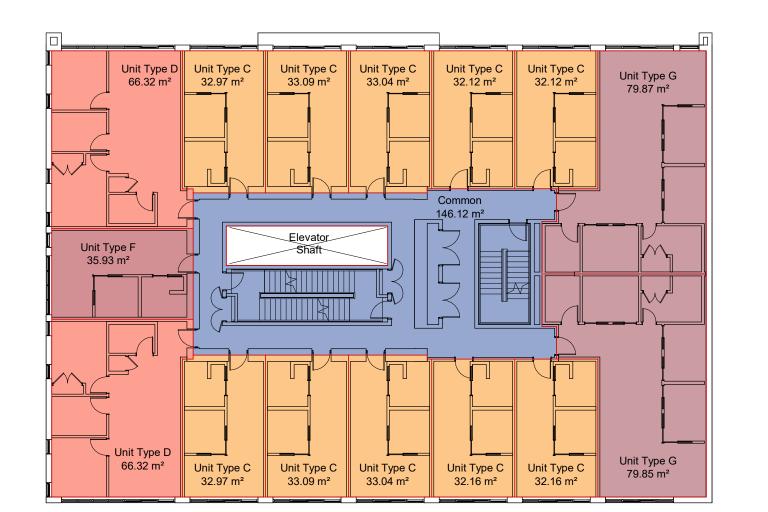


3 Levels L3-L5 Area Plan A911 SCALE: 1:200

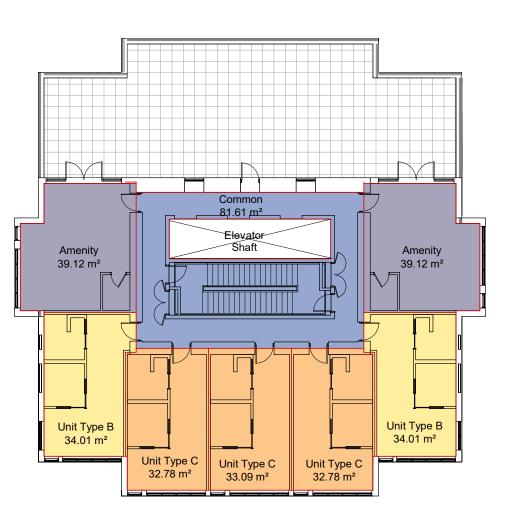

4 Level L23 Area Plan A911 | SCALE: 1:200

**General Notes** 

- 1. Plans and Area Schedule show areas measured to inside face of exterior walls, and centre of demising walls.
- 2. See A001 for required bike counts.
- Unit Schedule areas measured to inside face of wall finish on all sides.

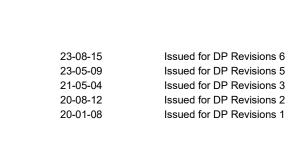

View St. Residential

23-05-09 Drawing File


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Area Plans



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LEGEND

— · · — Property line — ·· — ·· – Extent Of Underground Parking (indicative) **---** Extent Of Roof / Canopy Line (indicative) ---- Rain garden - TOP OF POOL Rain garden - **BOTTOM OF POOL** •17.75 Architectural grade, provided for reference only • 17.62 Civil grade, provided for reference only • 17.75 Proposed landscape grade TW Top of Wall BW Bottom of Wall TC Top of Curb BC Bottom of Curb TP Top of Pool BP Bottom of Pool TS Top of Stairs BS Bottom of Stairs

UNDERGROUND UTILITIES

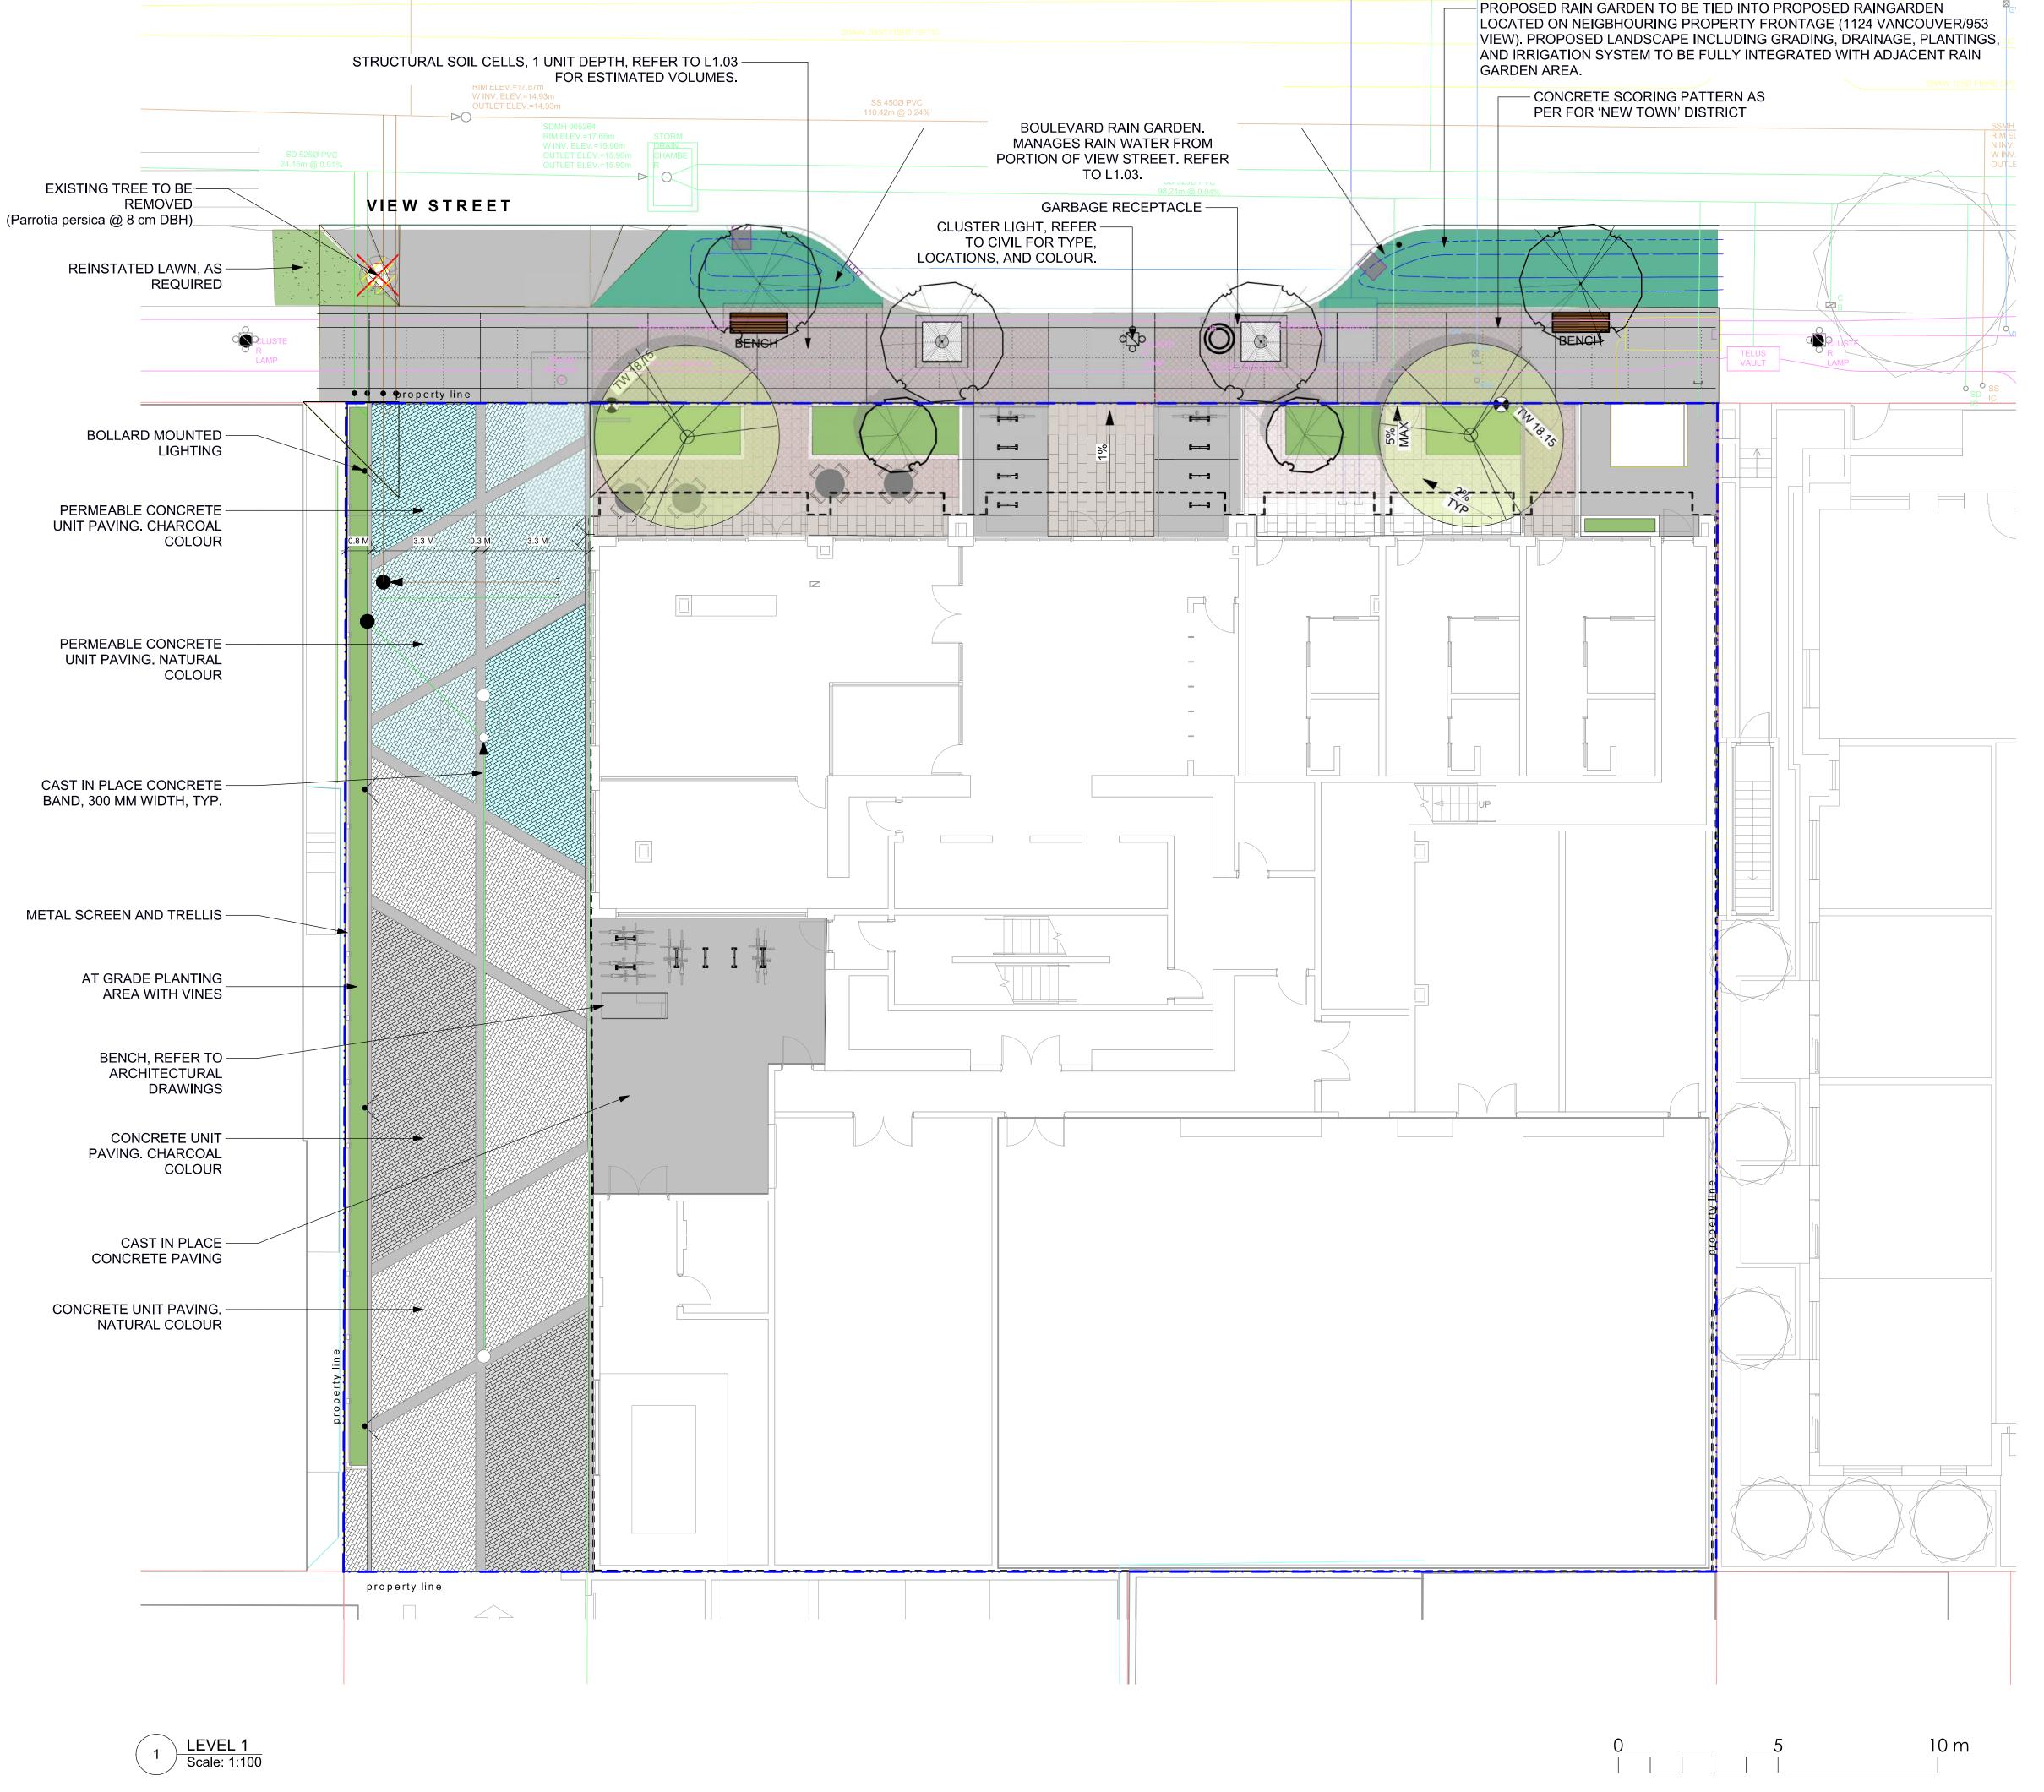LANDSCAPE MATERIALS

Main Entry Paving
Concrete Unit Paving

Patio Paving
Concrete Unit Paving

Permeable Paving
Permeable Concrete Unit Paving

Driveway Paving

**Driveway Paving** 

Vehicular Concrete Unit Paving, natural/light colour

Vehicular Concrete Unit Paving, charcoal/dark colour

Cast in place concrete paving
Fine broom finish

Rain Garden Area on Grade
450 mm depth growing medium

Raised Planting Area
Growing medium depth varies, minimum 450 mm

Structural Soil Cells
1 soil cell depth

LANDSCAPE FURNISHINGS

Wood Bench with Backrest
2 total @ 1765mm Length x 610mm Depth

Maglin MBE-0870-00025

Type A: Modern Metal Bin

Bicycle Rack
14 total

GENERAL NOTES

1. Work performed shall comply with the following: a) These General Notes, and Construction Documents and Specifications; b) Canadian Landscape Standards, Current Edition (CLS-CE); and c) All applicable local, provincial, and federal codes, ordinances,

 Contractor shall be responsible for verifying all existing site conditions including location of all property lines, existing structures, utilities, and buried infrastructure. Verify all field conditions prior to commencing work.

Contractor is responsible for determining means and methods for construction. These drawings may indicate a limit of proposed improvements or limit of work for the delineation of expected extents of disturbance. Should limits of disturbance exceed boundaries defined in drawings, contractor shall contact Landscape Architect for resolution.


4. Contractor is responsible for repairing all work disturbed by construction outside of limit lines defined on drawings or through their means and methods to a condition better than or equal to the existing conditions prior to commencement of construction at no additional cost to the owner.

Contractor is responsible for maintaining a complete up-to-date set of drawings and specifications at the construction site and ensuring the documents are readily available for review by the Landscape Architect and governing agency.

6. Contractor is responsible for coordination of all designs, drawings, specifications and other documents or publications upon which construction is based. Any discrepencies with the drawings and/or specifications and site conditions shall be brought to the attention of the Landscape Architect, prior to proceeding with construction.
7. The drawings and specifications are complementary to one another and implied to

Landscape Architect for resolution immediately.8. General Contractor and/or sub-contractors are responsible for all costs related to production and submission to consultant of all landscape as-built information including irrigation.

correspond with one another. Any discrepencies should be brought to the attention of the

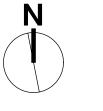

DP REV	23.09.1
DP REV	23.05.10
DP REV	21.04.30
Dev Permit Revisions	20.08.11
Issued for DP revisions	20.01.08
DP REV	19.10.17
DEV PERMIT	17.07.07
description	date



duthel Road Phone: 250.412 /8Z 1G1 Fax: 250.412



2023-09-15

NELSON INVESTMENTS, INC.


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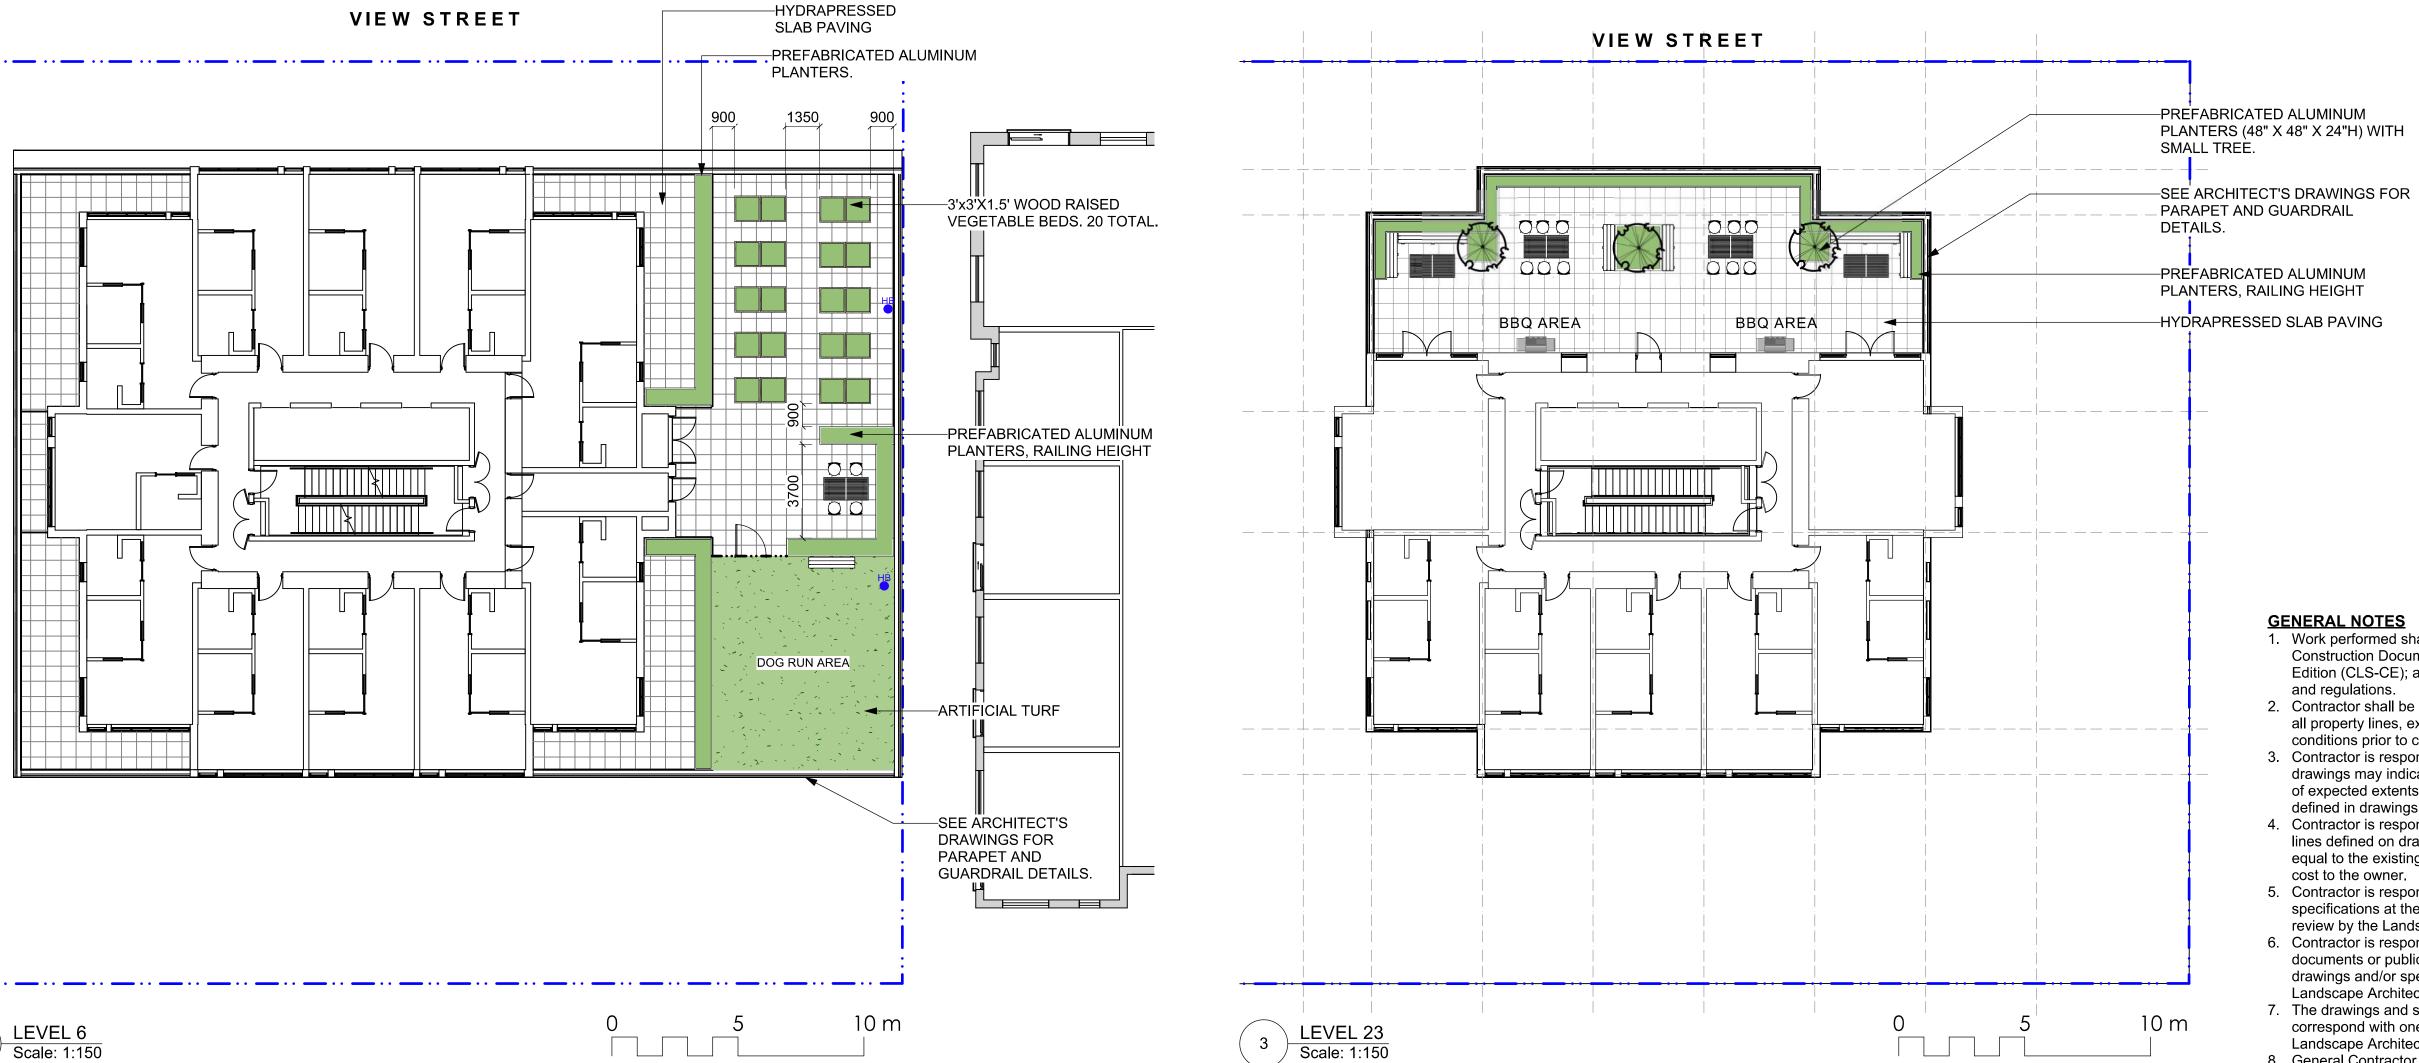
VIEW STREET RESIDENTIAL 937 VIEW STREET VICTORIA, BC


sheet title

Landscape Materials: Ground Level

project no.		119.24
scale	AS NOTED	@ 24"x36"
drawn by		ML
checked by		SM/PdG
revison no.	sheet no.	
<u>7</u>	L	1.01



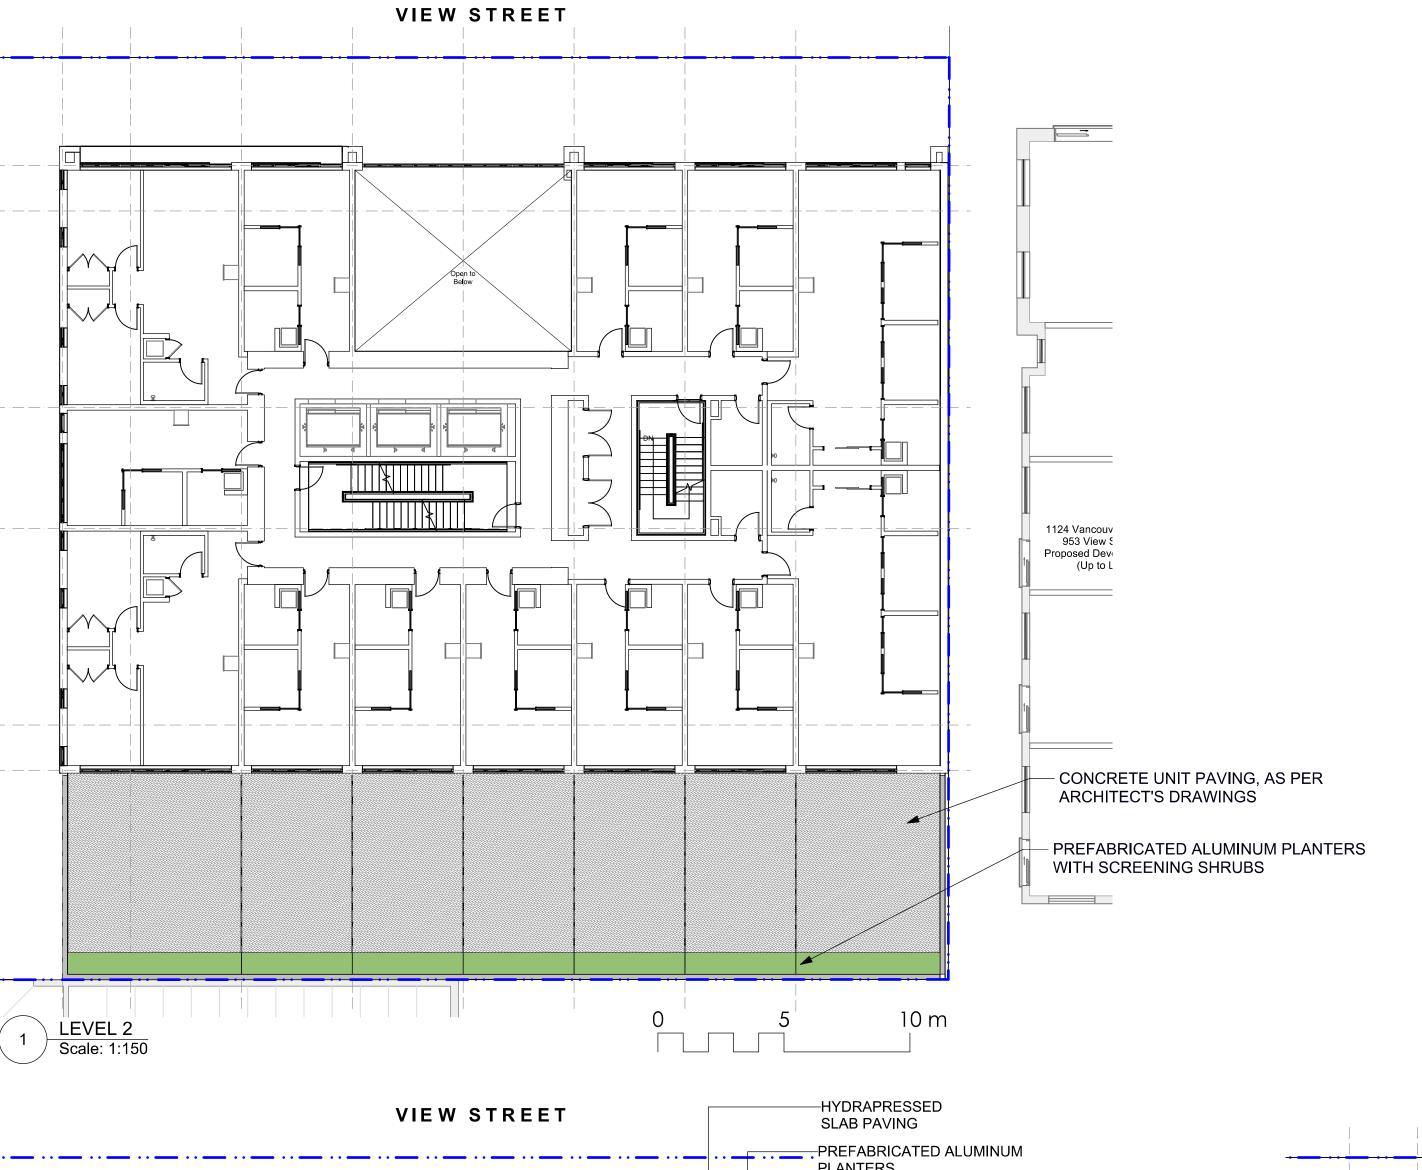

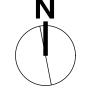

7	DP REV	23.09.1
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2	DP REV	19.10.17
1	DEV PERMIT	17.07.07
ev no	description	date





2023-09-15

NELSON INVESTMENTS, INC.

VIEW STREET RESIDENTIAL 937 VIEW STREET VICTORIA, BC

sheet title

Landscape **Materials: Upper** Levels

project no.		119.24
scale	AS NOTED	@ 24"x36"
drawn by		ML
checked by		SM/PdG
revison no.	sheet no.	
7	L	1.02

**GENERAL NOTES** 


irrigation.

- 1. Work performed shall comply with the following: a) These General Notes, and Construction Documents and Specifications; b) Canadian Landscape Standards, Current Edition (CLS-CE); and c) All applicable local, provincial, and federal codes, ordinances,
- 2. Contractor shall be responsible for verifying all existing site conditions including location of all property lines, existing structures, utilities, and buried infrastructure. Verify all field
- conditions prior to commencing work.


  3. Contractor is responsible for determining means and methods for construction. These drawings may indicate a limit of proposed improvements or limit of work for the delineation of expected extents of disturbance. Should limits of disturbance exceed boundaries
- defined in drawings, contractor shall contact Landscape Architect for resolution. 4. Contractor is responsible for repairing all work disturbed by construction outside of limit lines defined on drawings or through their means and methods to a condition better than or equal to the existing conditions prior to commencement of construction at no additional
- cost to the owner. 5. Contractor is responsible for maintaining a complete up-to-date set of drawings and specifications at the construction site and ensuring the documents are readily available for
- review by the Landscape Architect and governing agency.


  6. Contractor is responsible for coordination of all designs, drawings, specifications and other documents or publications upon which construction is based. Any discrepencies with the drawings and/or specifications and site conditions shall be brought to the attention of the Landscape Architect, prior to proceeding with construction.
- correspond with one another. Any discrepencies should be brought to the attention of the Landscape Architect for resolution immediately. 8. General Contractor and/or sub-contractors are responsible for all costs related to production and submission to consultant of all landscape as-built information including

7. The drawings and specifications are complementary to one another and implied to

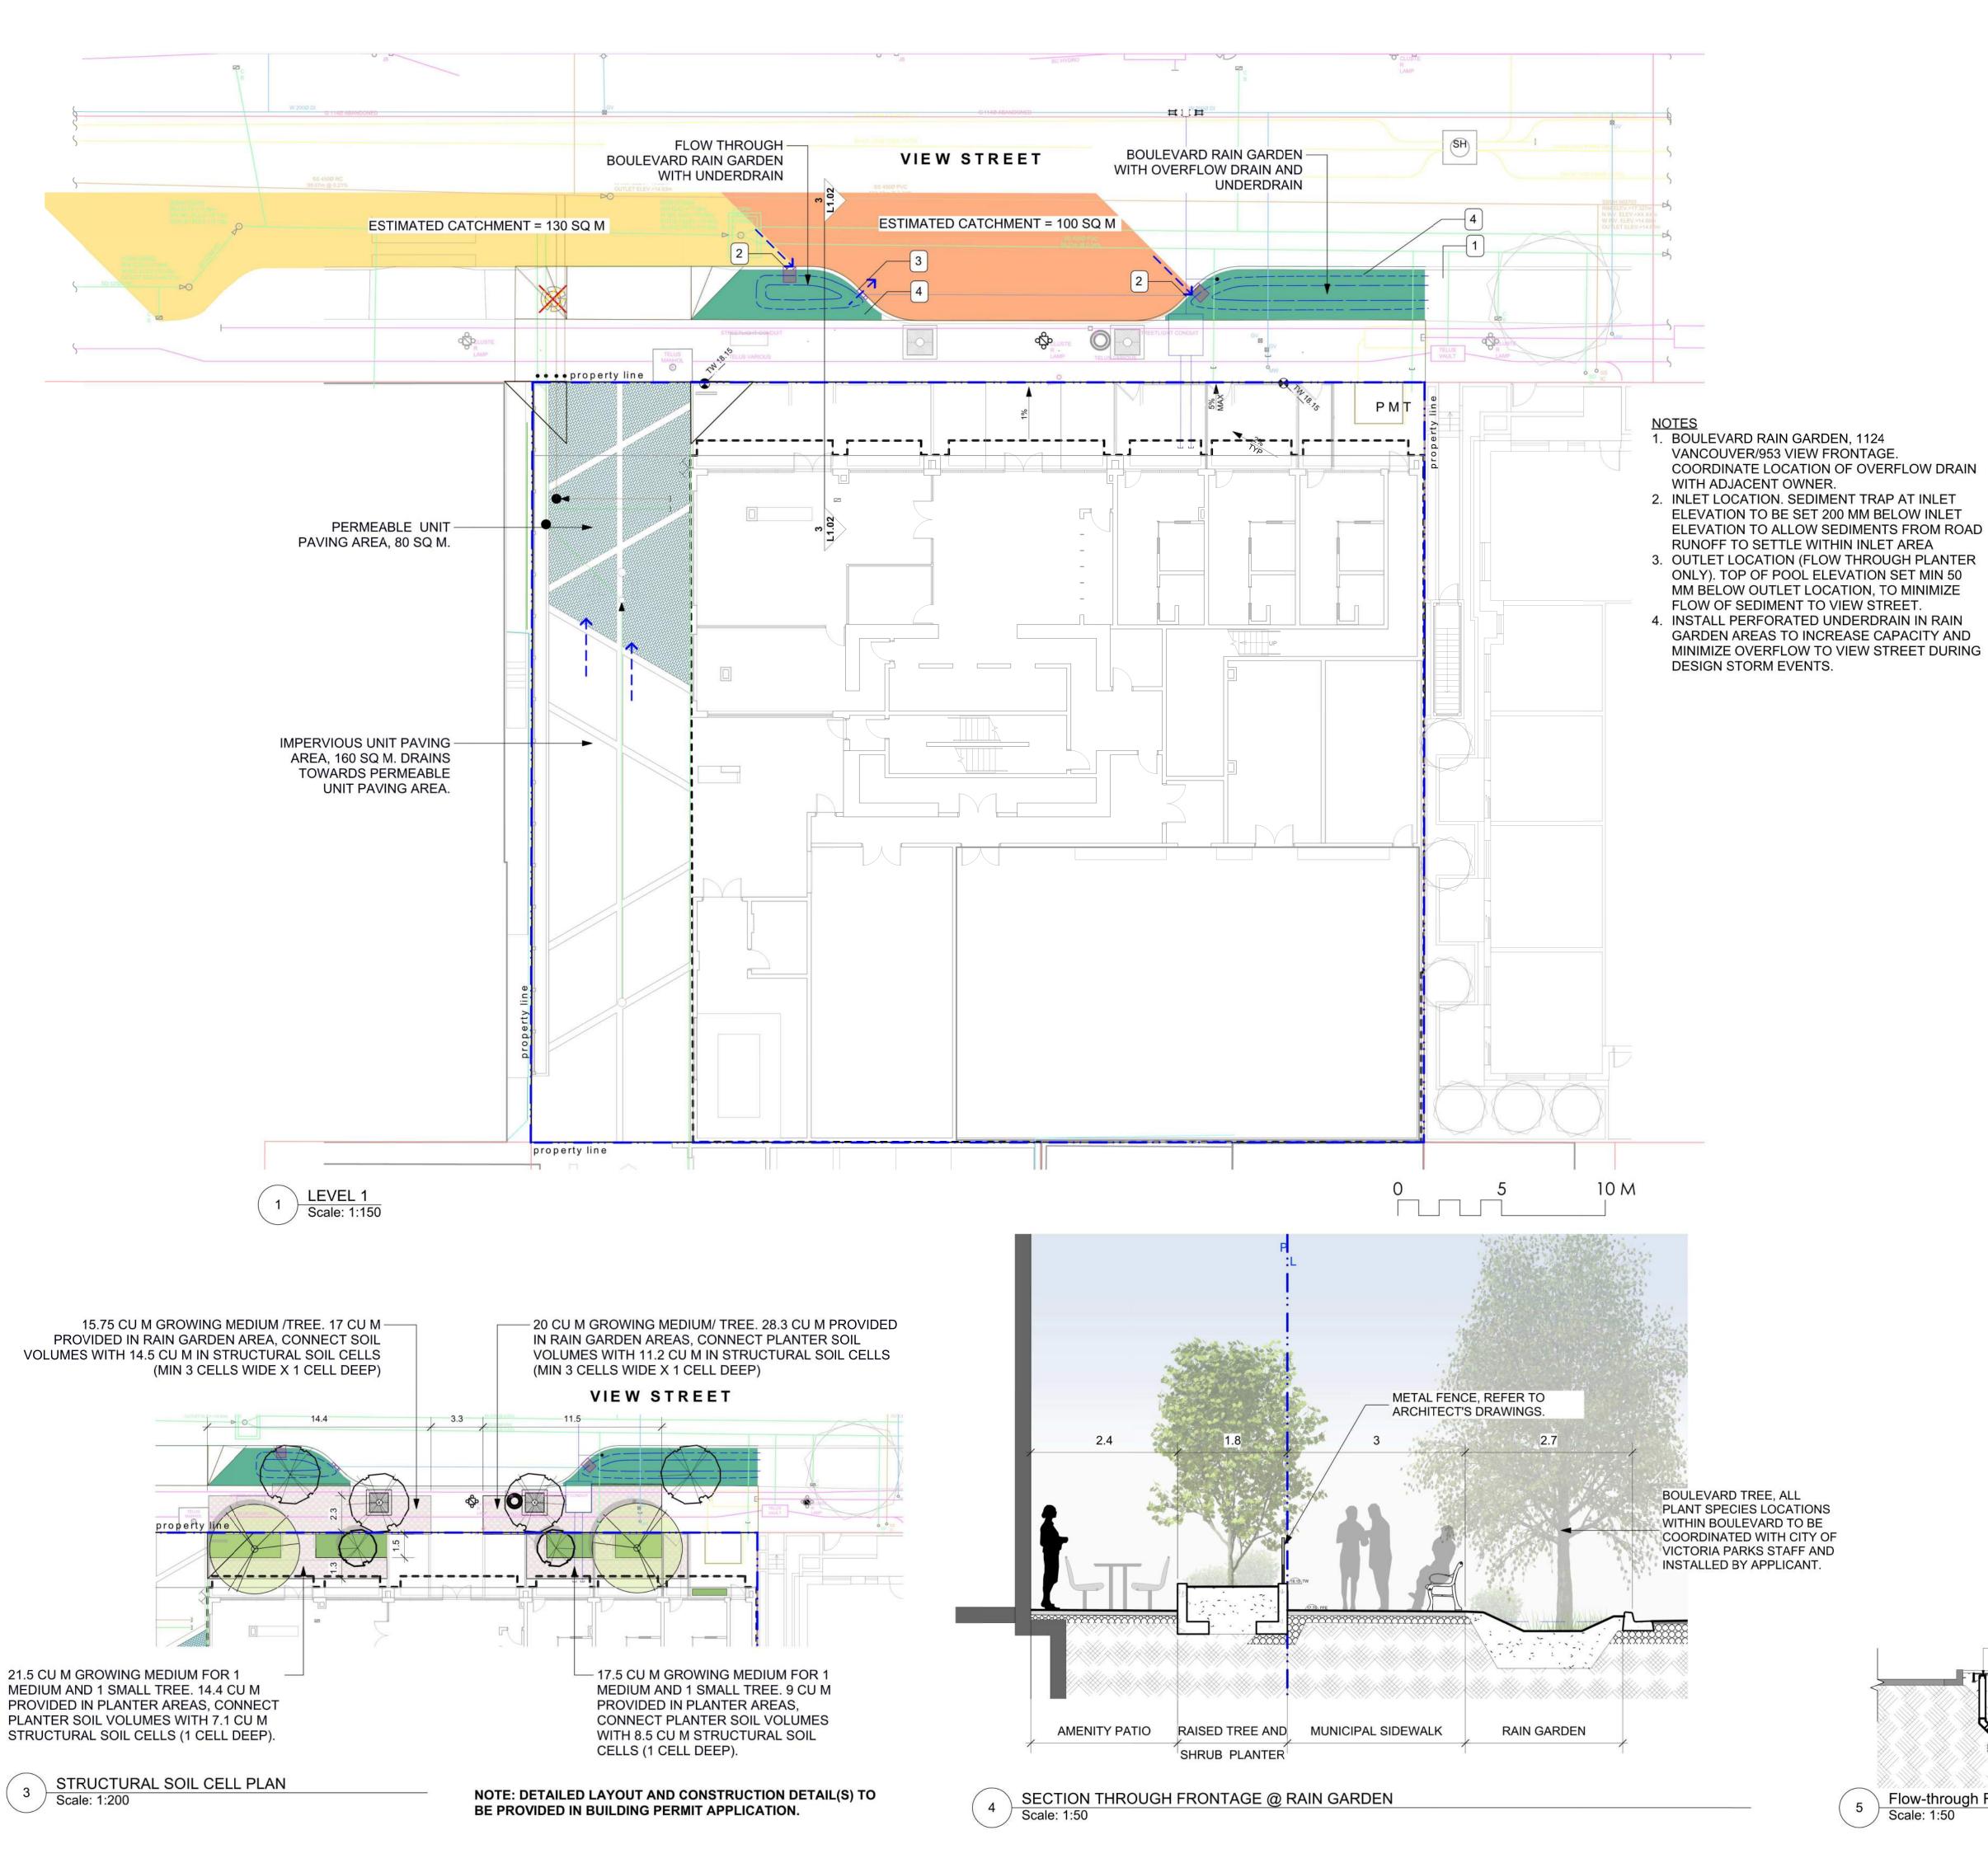



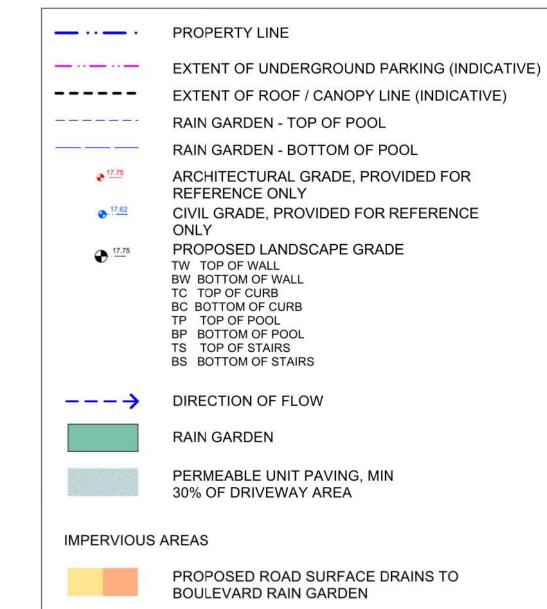

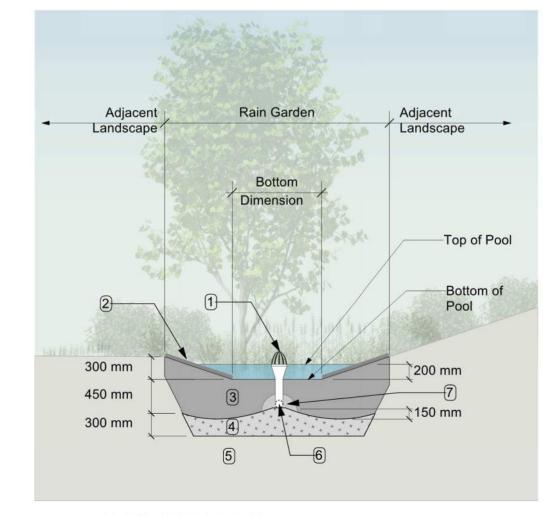

RAIN GARDEN MATERIALS

- 1. Overflow drain, 200 mm domed grate + adapter
- 2. Composted mulch, 50 -70 mm depth. Sides of rain garden only. 3. Bio-retention growing medium, 450 mm depth
- 4. Scarified/tilled subgrade, 300 mm depth
- 5. Existing subgrade/native material
- 6. 100 mm diameter (min) perforated pipe
- 7. 25 mm diameter drain rock. 100 mm depth

# TYPICAL RAIN GARDEN


# RAIN WATER MANAGEMENT NOTES


Rain gardens are integrated landscape bulges within streetscape areas and are designed to capture, slow flows, and treat runoff from roadways.

The west rain garden is appproximately 2% of the contributing impervious area, and will be designed as flow through planter.

The east rain garden will be designed with underdrains and a high-capacity overflow drain that will be connected to the municipal stormdrain system. The 937 View portion of east rain garden is approximately 20% of the contributing impervious area. Grading, drainage, and planting for the east rain garden will be fully integrated with the adjacent rain garden area, fronting the current development on 1124 Vancouver/953 View Street.

Permeable unit paving will be installed along the north portion of the driveway, as is sized at 30% of driveway area. Impervious areas of driveway will drain towards permeable unit paving area. Refer to Civil Engineers for permeable paving details.

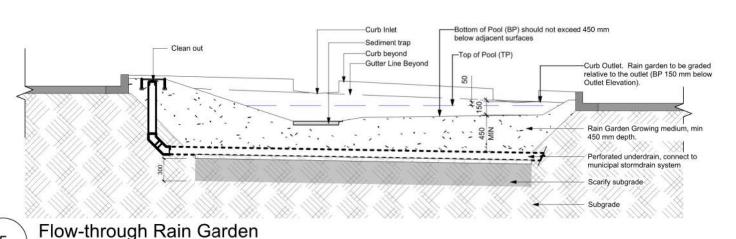

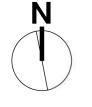

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2023-09-15


**NELSON INVESTMENTS, INC.** 

VIEW STREET RESIDENTIAL 937 VIEW STREET VICTORIA, BC

sheet title

# Stormwater Management

project no.		119.24
scale	AS NOTED	@ 24"x36"
drawn by		ML
checked by		SM/PdG
revison no.	sheet no.	
$\triangle$		1.03

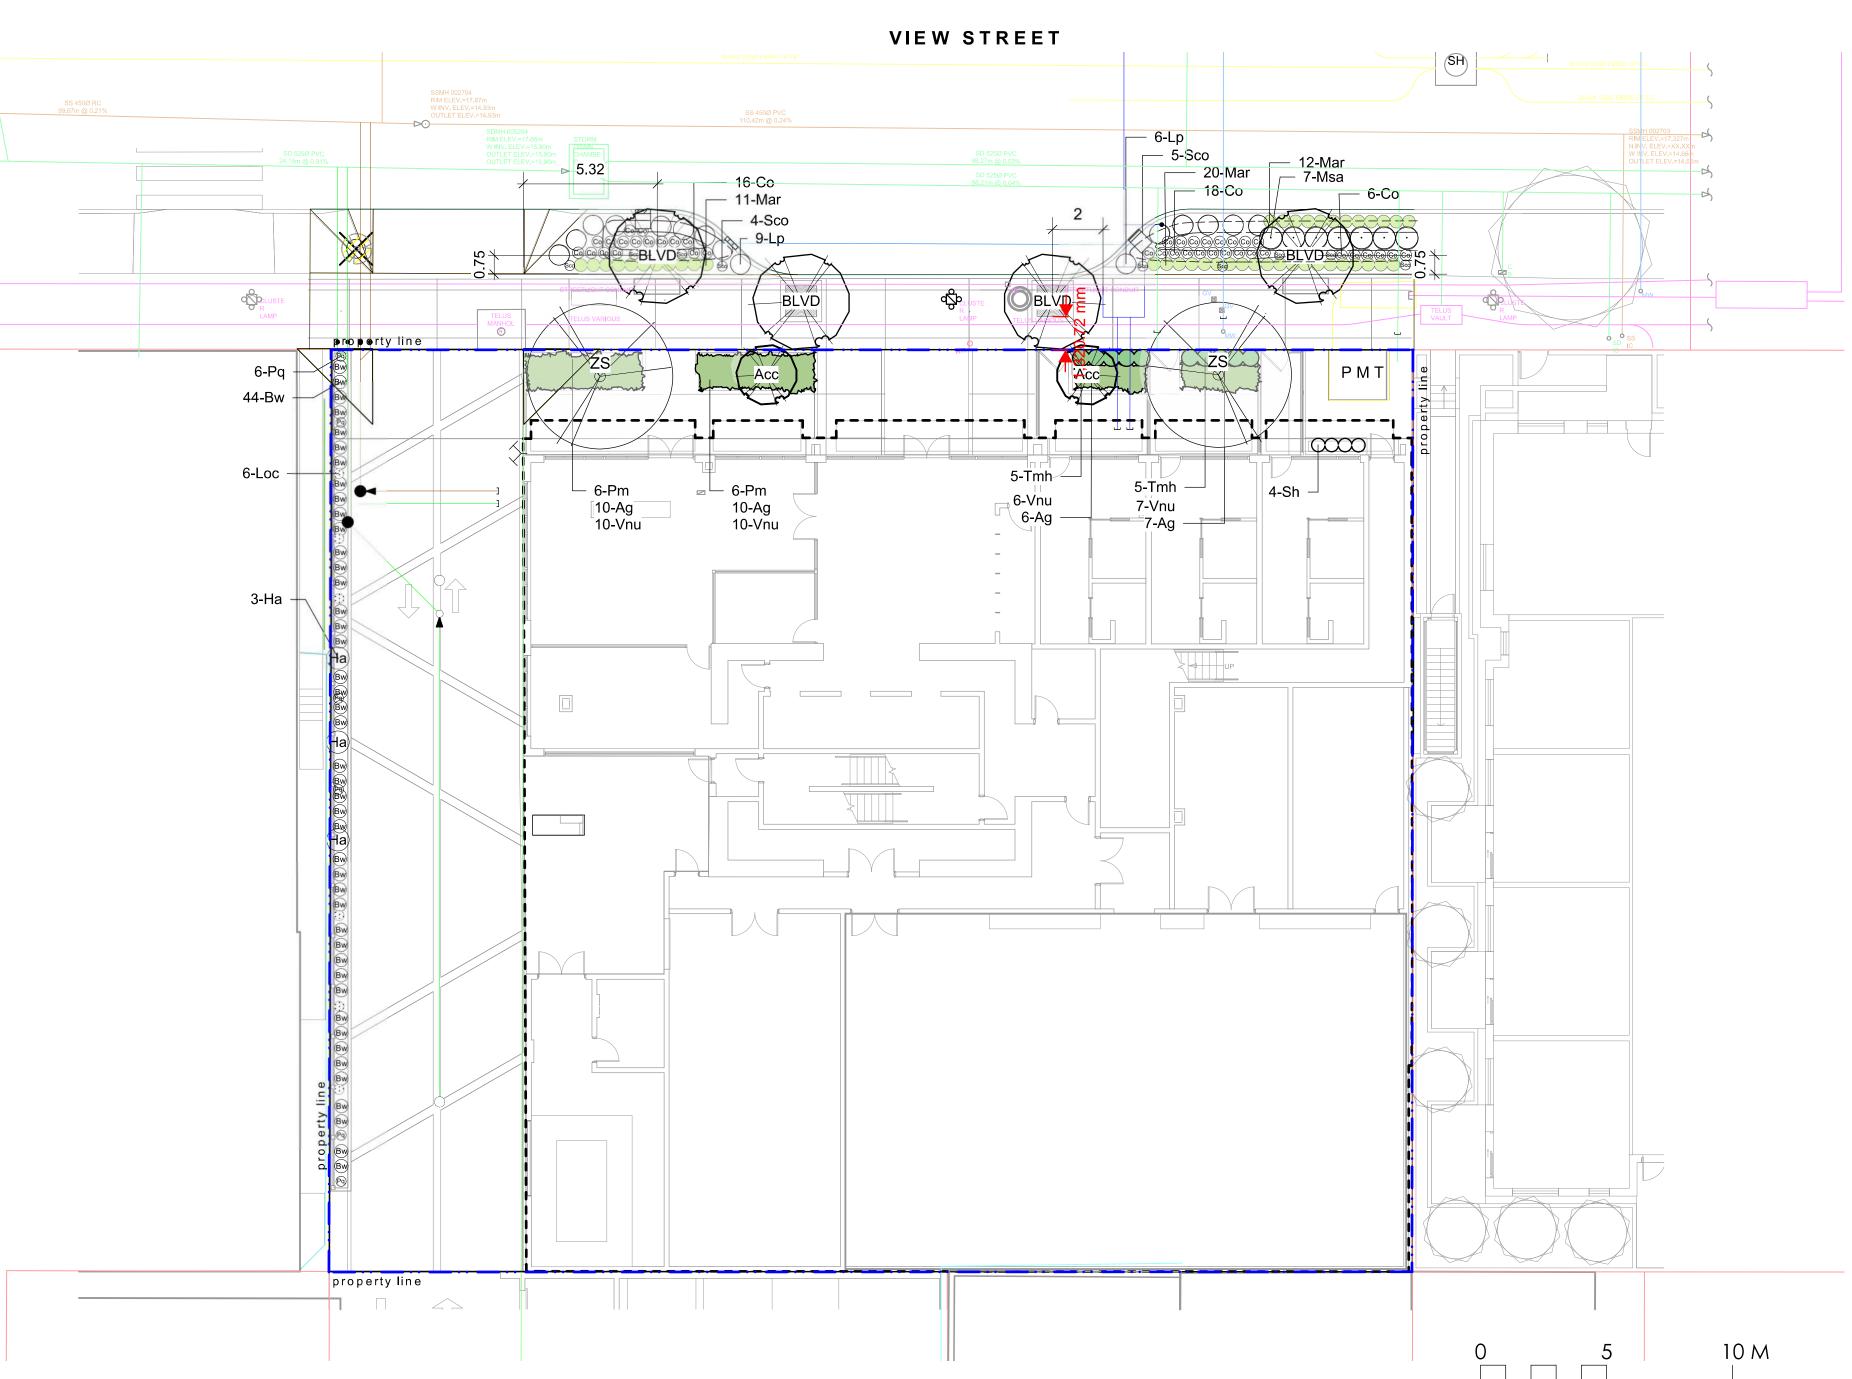



Sym	Qty	Botanical Name	Common Name	Schd. Size / Plant Spacing
		TREES:		
Acc	2	Acer circinatum	Vine Maple	1.8 m height, specimen qualit
BLVD	4	Boulevard Tree as per COV Parks	Boulevard Tree as per COV Parks	6 cm cal, b+b
ZS	2	Zelkova serrata	Japanese Zelkova	6.0cm cal, b&b
		SHRUBS:		
Ag	33	Azalea japonica 'Glacier'	Glacier Azalea	#1 pot
Bw	44	Buxus microphylla 'Winter Gem'	Littleleaf Boxwood	#1 pot
Co	40	Carex obnupta	Slough Sedge	#1 pot
На	3	Hydrangea anomala subsp petiolaris	Climbing Hydrangea	#1 pot
Loc	6	Lonicera ciliosa	Western Trumpet Honeysuckle	#1 pot
Lp	15	Lonicera pileata	Privet Honeysuckle	#2 pot
Mar	43	Mahonia repens	Prostrate Oregon Grape	#1 pot
Msa	7	Miscanthus sinensis 'Adagio'	Adagio Maiden Grass	#1 pot
Pq	6	Parthenocissus quinquefolia	Virginia Creeper	#1 pot
Pm	12	Polystichum munitum	Sword Fern	#1 pot
Sh	4	Sarcococca hookeriana var humilis	Himilayan Sweet Box	#1 pot
Sco	9	Schizostylis coccinea 'Oregon Sunset'	Crimson Flag	#1 pot
Tmh	10	Taxus x media 'Hilii'	Hilii Yew	#3 pot, 0.6 m ht. male only
Vnu	33	Vaccinium nummularia	Coin Whortleberry	#1 pot

# **GENERAL PLANTING NOTES**

- 1. Plant quantities on Plans shall take precedence over plant list quantities.
- 2. Provide layout of all work for approval by Contract Administrator prior to proceeding with work.
- 3. Plant material, installation and maintenance to conform to the current edition of the Canadian Landscape Standard.
- 4. Plant quantities and species may change between issuance of DP and Construction due to plant availability and design changes. Substitutions to be approved by Landscape Architect.

# **BOULEVARD & GREENWAY PLANTING NOTES**

- 1. Final selection and placement of boulevard trees to be determined through consultation with
- 2. Boulevard trees have been placed to avoid existing and proposed infrastructure. Trees planted within 1m of an existing underground municipal service will have a root barrier installed between the root ball and the existing infrastructure
- 3. Boulevard trees will be place a minimum of 1.5 m from an above ground municipal service such as fire hydrant, streetlight or driveway.
- 4. Proposed Street Trees must comply to City of Victoria Supplementary Specifications for Street Trees and Irrigation Schedule C, Bylaw 12-042, Subdivision Bylaw and the current version of the Canadian Landscape Standard. Planting details can be found in Schedule B3-4 or on the approved landscape plan. The following tree inspections by Parks Staff are required by Schedule C. To schedule an inspection please contact Rob Hughes, rhughes@victoria.ca and
- also copy treepermits@victoria.ca 48 hours prior to the required inspection time. 5. Trees must have one dominant central leader or single straight trunk, 5-8 cm diameter, caliper measured 15 cm above ground, well balanced crown with branching starting at 1.8 m-2.5 m above ground, as per the City of Victoria Supplemental Drawings SD P4 and must comply with the current version of the Canadian Landscape Standard
- 6. Parks will require [3] inspections for tree planting: 1) Inspection of excavated tree pits, soil cells, root barriers. 2) Inspection of trees prior to planting. (Parks staff can inspect trees prior to shipping at local nurseries. Photos can be provided from up-island and mainland nurseries. Tree must meet the spec upon delivery.) 3) Inspection of installed tree with mulch and staking. Contact treepermits@victoria.ca to arrange for inspections, allow for 48 hrs notice.
- 7. The finished grade for boulevards must be firm against footprints, loose textured, free of all stones, roots, and branches. Parks inspection is required to turf installation. Email gstaniforth@victoria.ca to arrange for inspections, allow 48 hrs notice.
- 8. Final inspection of turf shall be conducted once the turf has knit, mowed at least twice to a height of 2.5 inches and no surface soil is visible.
- 9. Plant material and installation must meet or exceed the current edition of the Canadian
- Landscape Standard and specifications for planted landscapes as required in the MMCD.
- 10. Planted Landscape Inspections: 1) Excavated and scarified subgrade prior placement of the growing media 2) Installed and prepared Growing media prior to planting 3) Plant material onsite prior to planting (Parks staff can inspect plants prior to shipping at local nurseries. Photos can be provided from up-island and mainland nurseries.) 4) Planted landscape prior to the installation of mulch. 5) Inspection when the planted and mulched

an inspection please contact Tom Sherbo, tsherbo@victoria.ca

and also copy treepermits@victoria.ca 48 hours prior to the required inspection time. 11. The applicant will be required to pay the appraised value of the small boulevard tree proposed for removal. When the tree fee has been paid, the City will post the tree for [10] working days, after which it can be removed at the expense of the applicant.

landscaping meets the conditions for total performance as required in the MMCD.To schedule

# **IRRIGATION NOTES**

- 1. Contractor to provide irrigation system for all planting areas to current IIABC Standards and Contract Specifications.
- 2. All specified work to meet the project specifications, and all standards or specifications established in the lastest edition of the Canadian Landscape Standard and IIABC standards Design/build drawings for detailed irrigation plan to be submitted to Contract
- Administrator in PDF and .dwg formats at least two weeks prior to commencement of irrigation installation
- 4. Utilties Contractor to verify location of all on-site utilities, prior to construction. Restoration of damaged utilities shall be made at the contractor's expense, to the satisfaction of the owner's representatives.


7. Contractor to verify pressure and flow prior to installation of irrigation and notify

- 5. Refer to electrical drawings for electrical service. 6. Controller and backflow prevention device to be located in Mechanical Room, unless otherwise noted. Refer to Mechanical drawings for size and location of irrigation
- owner's representative in writing if such data adversely affects the operation of the 8. Sleeves shall be installed at the necessary depths, prior to pavement construction.
- Sleeving shall extend 300 mm from edge of paving into planting area, and shall have ends marked above grade unless otherwise shown.
- 9. Contractor to field fit irrigation system around existing trees, to limit disturbance to
- 10. At various milestones during construction, inspection and testing of components will be required to ensure that the performance of irrigation system meets standards and specifications. Contractor to provide equipment and personnel necessary for performance of inspections and tests. Conduct all inspections and tests in the presence of the contract administrator. Keep work uncovered and accessible until successful completeition of inspection or test.
- 11. Over spray onto hardscape areas to be minimized. Use drip irrigation within small planting areas to avoid overspray.
- 12. Trees within shrub or rain garden areas to be irrigated with spray heads. 13. Trees in Plaza in hard pavement (soil cells below) to recieve temporary irrigation system around root collar and permanent drip irrigation system
- 14. Irrigation Systems on City property shall comply to City of Victoria Supplementary Specifications for Street Trees and Irrigation Schedule C, Bylaw 12-042, SubdivisionBylaw. Irrigation drawings must be submitted to Parks Division for review and approval 30 days prior to installation work. The following irrigation and sleeving inspections by Parks Staff are required by Schedule C. To schedule an inspection please contac Tom Sherbo, tsherbo@victoria.ca and also copy treepermits@victoria.ca 48 hours prior to the required inspection time.

-Tree stakes -Prevailing wind Tree tie Tree stake Tree Watering saucer Growing medium Bottom of root ball rests on recompacted soil. Tamp growing medium below root ball to prevent settling. Scarify native topsoil Subgrade/native topsoil Mulch Ring



1500 min.

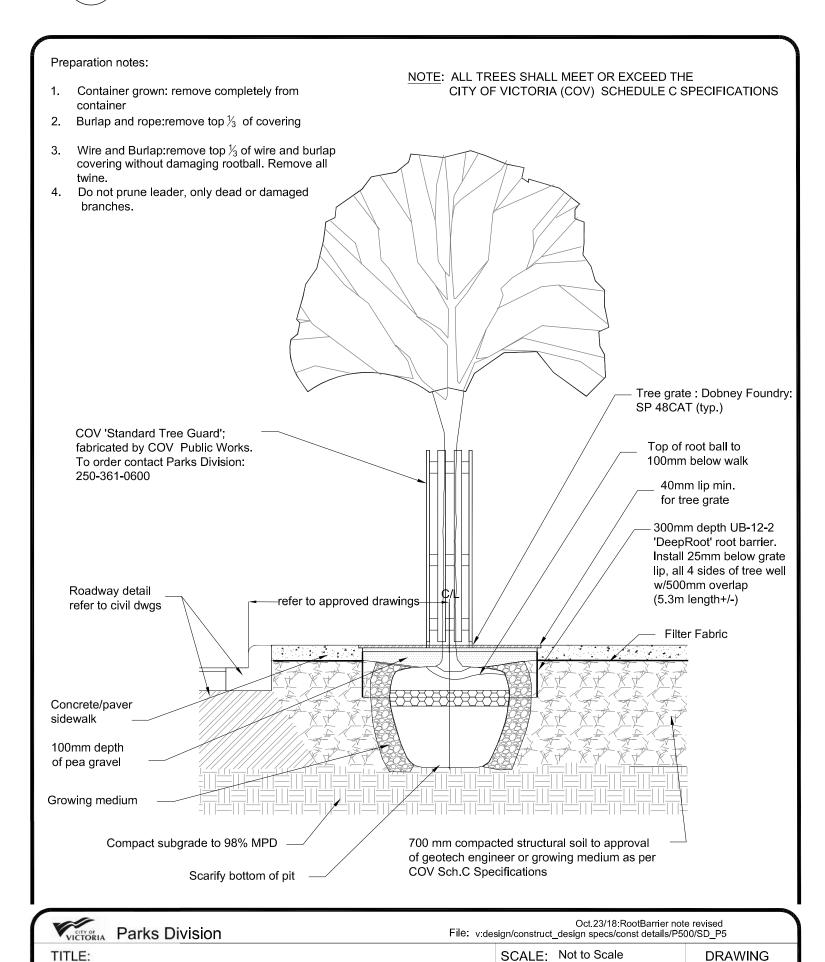

1. Work performed shall comply with the following: a) These General Notes, and Construction Documents and Specifications; b) Canadian Landscape Standards, Current Edition (CLS-CE); and c) All applicable local, provincial, and federal codes, ordinances, and regulations.

Tree Planting in Sidewalk with Tree Guard


DATE: Feb.27, 2018

DWN.:

APP'D.:

SD-P5

- . Contractor shall be responsible for verifying all existing site conditions including location of all property lines, existing structures, utilities, and buried infrastructure. Verify all field conditions prior to commencing work.
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- construction at no additional cost to the owner. 5. Contractor is responsible for maintaining a complete up-to-date set of drawings and specifications at the construction site and ensuring the documents are readily available for review by the Landscape Architect and governing agency.
- 6. Contractor is responsible for coordination of all designs, drawings, specifications and other documents or publications upon which construction is based. Any discrepencies with the drawings and/or specifications and site conditions shall be brought to the attention of the Landscape Architect, prior to proceeding with construction.
- 7. The drawings and specifications are complementary to one another and implied to correspond with one another. Any discrepencies should be brought to the attention of the Landscape Architect for resolution immediately.
- 8. General Contractor and/or sub-contractors are responsible for all costs related to production and submission to consultant of all landscape as-built information including irrigation.

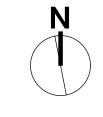

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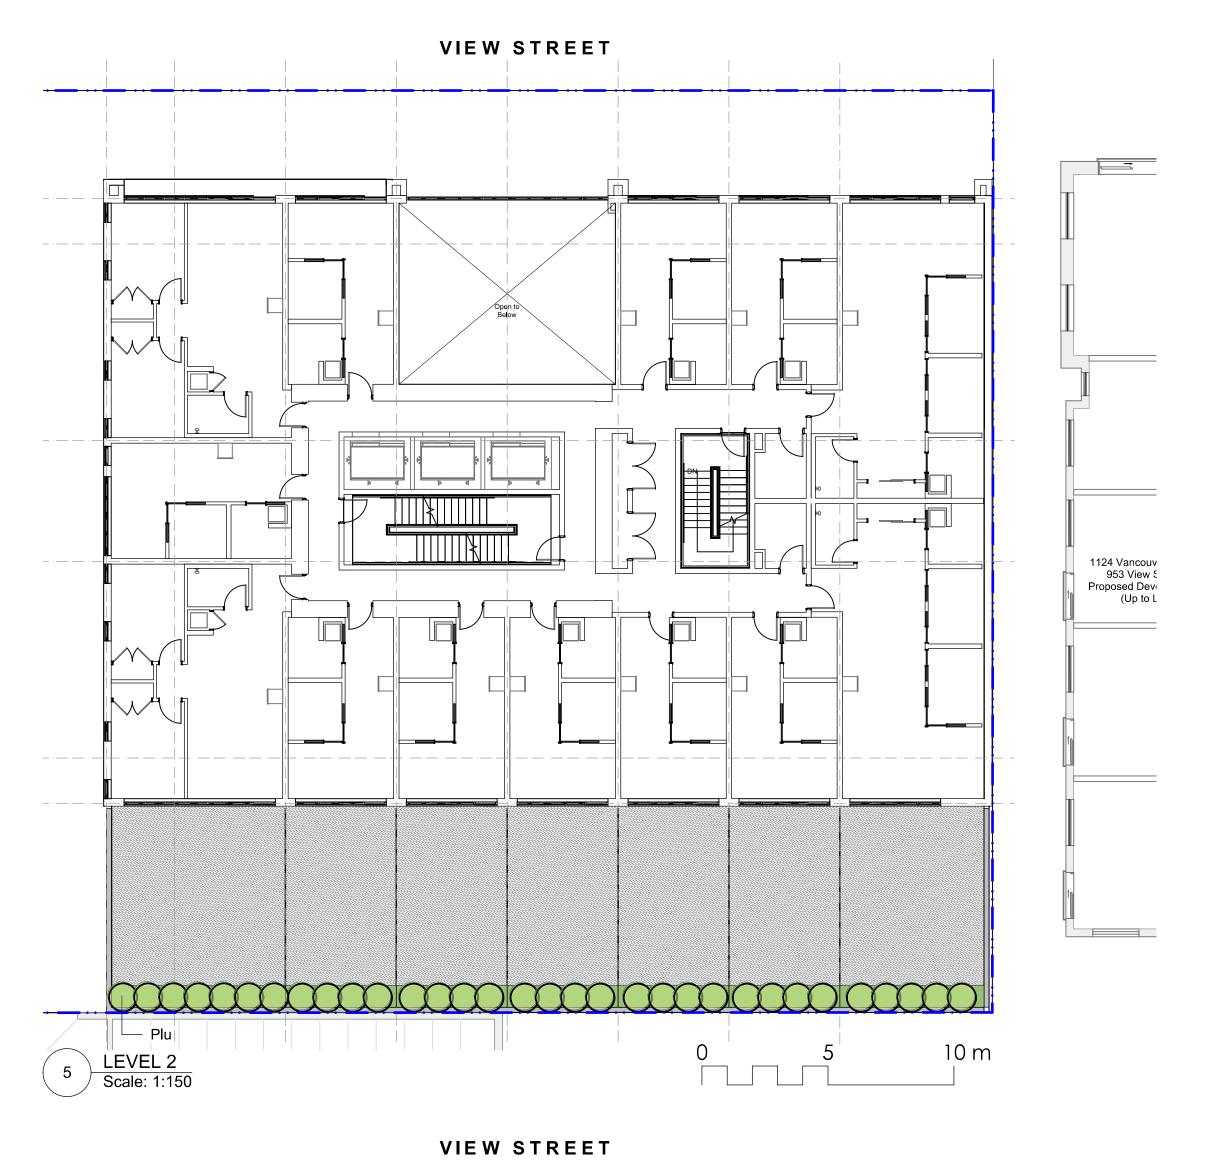
**NELSON INVESTMENTS, INC.** 

VIEW STREET RESIDENTIAL 937 VIEW STREET VICTORIA, BC


sheet title

**Planting Plan: Ground Level** 

project no.		119.24
scale	AS NOTED	@ 24"x36"
drawn by		ML
checked by		SM/PdG
revison no.	sheet no.	




PLANT	LIST			
Sym	Qty	Botanical Name	Common Name	Schd. Size / Plant Spacing
LEVEL	<u>. 2</u>			
Plu	32	Prunus Iusitanica	Portugal Laurel	#3 pot
<u>LEVEL</u>	<u>. 6</u>			
TREES	<u>}:</u>			
SHRUE	3S/PER	ENNIALS:		
Ag	13	Azalea japonica 'Glacier'	Glacier Azalea	
Ptn	54	Pittosporum tobira 'Nana'	Dwarf Pittosporum	
Vo	13	Vaccinium ovatum	Evergreen Huckleberry	
	0			
<u>LEVEL</u>	<u>. 23</u>			
TREES	<u>8:</u>			
Psw	3	Pinus sylvestris 'Waterii'	Bonsai Pine	specimen, cloud pruned min 2 m height,
SHRUE	3S/PER	ENNIALS:		
Cvsk	24	Calluna vulgaris 'Silver Knight'	Silver Knight Scotch Heather	#1 pot
Pvi	29	Pennisetum villosum	Feathertop Grass	#1 pot
St	44	Stipa tenuissima	Mexican Feathergrass	#1 pot

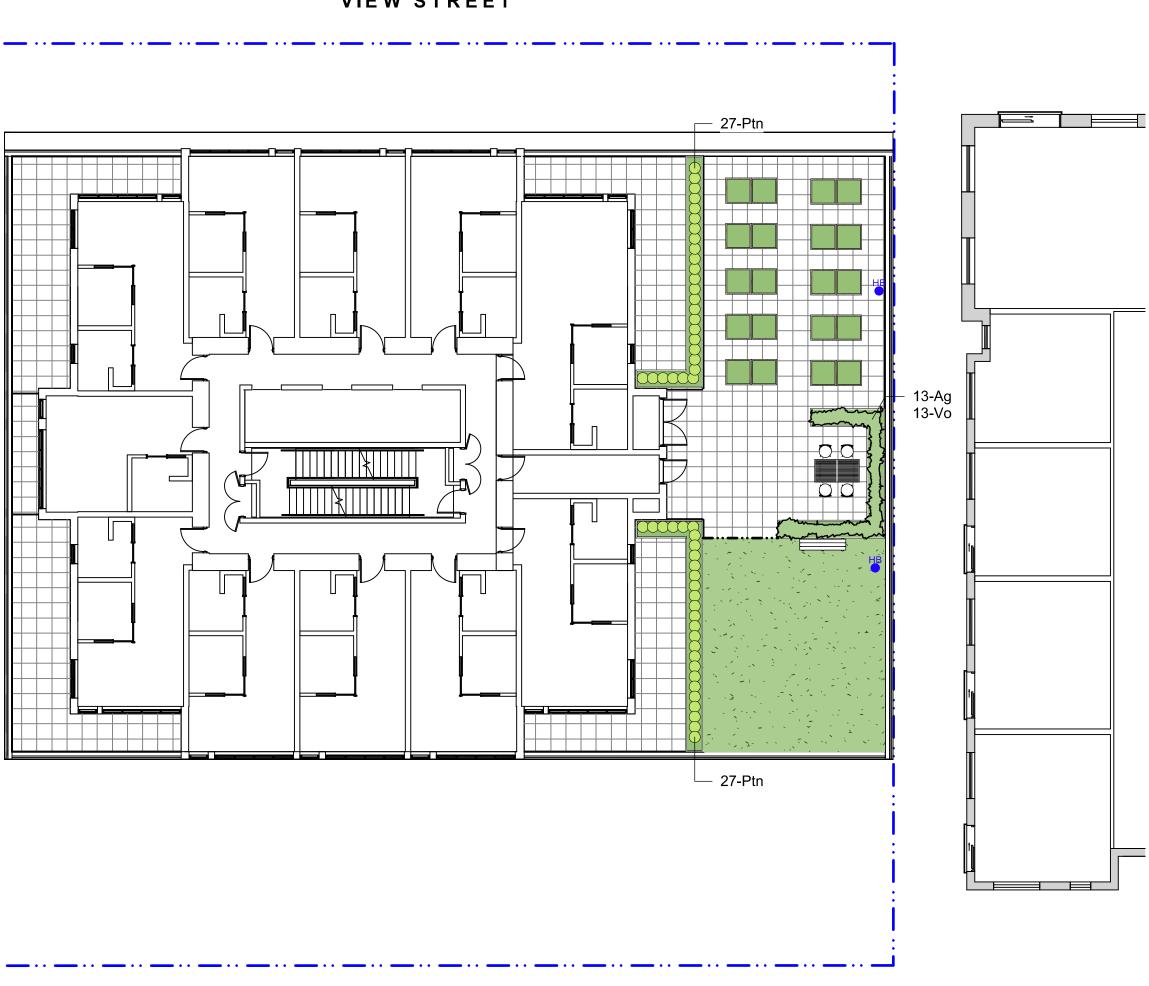

LEVEL 6
Scale: 1:150

0 5 10 m

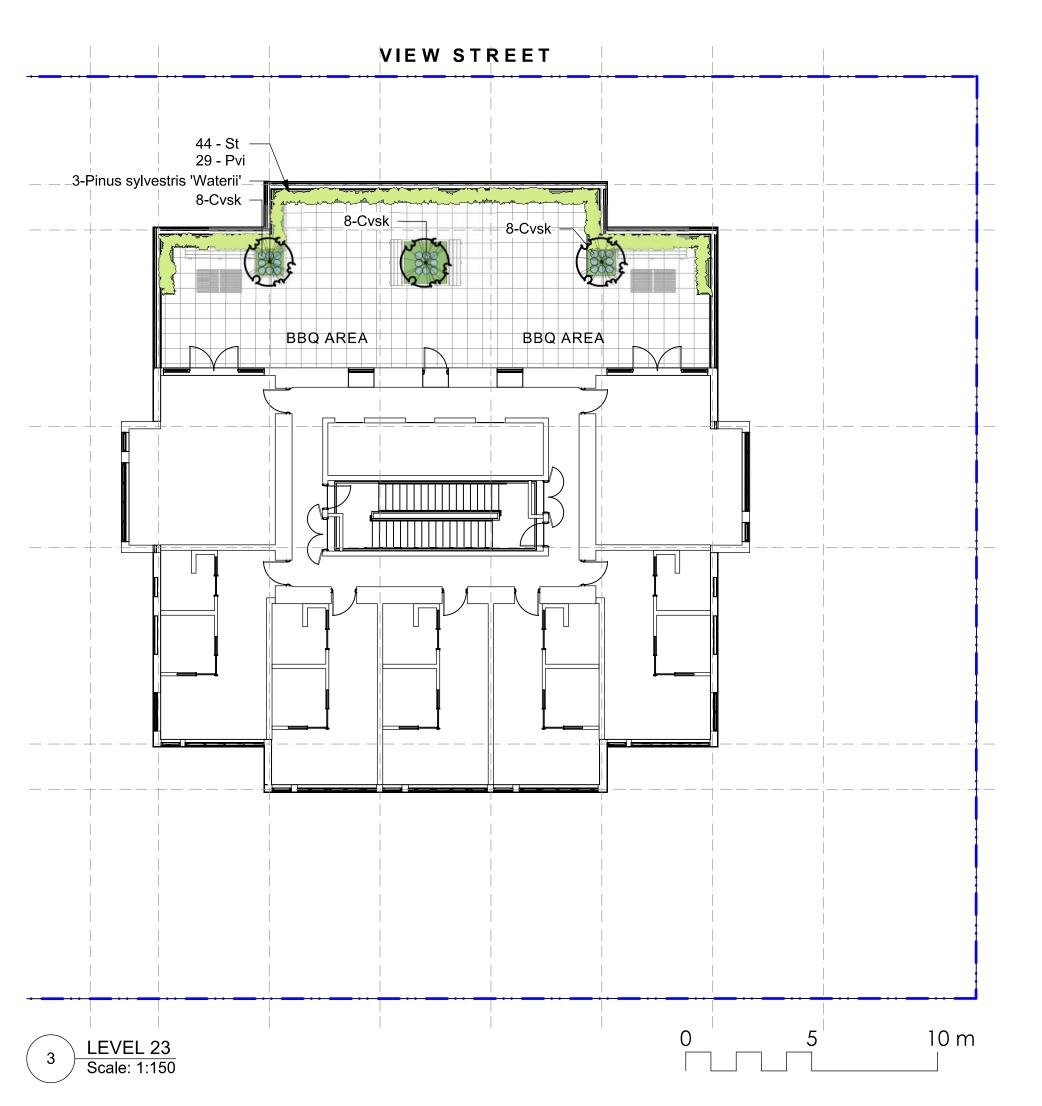

# GENERAL NOTES

irrigation.

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- Contractor shall be responsible for verifying all existing site conditions including location of all property lines, existing structures, utilities, and buried infrastructure. Verify all field conditions prior to commencing work
- conditions prior to commencing work.

  3. Contractor is responsible for determining means and methods for construction. These drawings may indicate a limit of proposed improvements or limit of work for the delineation of expected extents of disturbance. Should limits of disturbance exceed boundaries defined in drawings, contractor shall contact Landscape Architect for resolution.
- 4. Contractor is responsible for repairing all work disturbed by construction outside of limit lines defined on drawings or through their means and methods to a condition better than or equal to the existing conditions prior to commencement of construction at no additional cost to the owner.
- 5. Contractor is responsible for maintaining a complete up-to-date set of drawings and specifications at the construction site and ensuring the documents are readily available for review by the Landscape Architect and governing agency.
  6. Contractor is responsible for coordination of all designs, drawings, specifications and other
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- Landscape Architect, prior to proceeding with construction.

  7. The drawings and specifications are complementary to one another and implied to correspond with one another. Any discrepencies should be brought to the attention of the Landscape Architect for resolution immediately.

production and submission to consultant of all landscape as-built information including

8. General Contractor and/or sub-contractors are responsible for all costs related to

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24 Culduthel Road Phone: 250.41 a, BC V8Z 1G1 Fax: 250.41



2023-09-15

NELSON INVESTMENTS, INC.

oject

VIEW STREET RESIDENTIAL 937 VIEW STREET VICTORIA, BC

sheet title

Planting Plan: Upper Levels

project no.		119.24
scale	AS NOTED	@ 24"x36"
drawn by		ML
checked by		SM/PdG
revison no.	sheet no.	
<b>7</b>	L	3.02

# LECEND

EXISTING	PROPOSED	DESCRIPTION	EXISTING	PROPOSED	DESCRIPTION
///		EDGE OF PAVEMENT			REDUCER
CURB		CURB AND GUTTER		<del>-x x x x</del>	FENCE
		EDGE OF GRAVEL	~ ~ ~ ~	<b>→ →</b>	DITCH/SWALE
TB/BB		TOP/BOTTOM OF BANK		w	WATERMAIN (SIZE AND MATERIAL NOTED)
СВ		CATCH BASIN		s	SANITARY SEWER (SIZE AND MATERIAL NOTE
WV WV	<del></del>	WATER VALVE	D	D	STORM DRAIN (SIZE AND MATERIAL NOTED)
- <del>-</del>	<b>+</b>	FIRE HYDRANT	Т——Т	Т	UNDERGROUND TELEPHONE
=======================================	<del></del> 1	CAPPED END	Н	——н——	UNDERGROUND HYDRO
$\ominus$		UTILITY POLE AND STREET LIGHT (LABELED PP,TP,PP/LS ETC.)	· ·		MONUMENT
· MH	-	MANHOLE			PROPERTY LINE
——⊗ CO		CLEANOUT		5+100 5+110	CENTERLINE AND STATIONING
oSSIC/SDIC	SSIC/SDIC	SANITARY/STORM INSPECTION CHAMBER (200# RISER)	· · · · · · · · · · · · · · · · · · ·		SANITARY SEWER SERVICE CONNECTION AT M
JB		JUNCTION BOX	+32.75	43.170)+	ELEVATIONS
——————————————————————————————————————		AIR VALVE			PAVEMENT REMOVAL
WM	wM	WATER METER			ASPHALT MILL AND OVERLAY








DWG NO. DESCRIPTION	DWG No.	<b>DESCRIPTION</b>
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C100 GENERAL NOTES, LOCATION PLAN, KEY PLAN, DRAWINGS LIST & LEGEND

C200 C300 C400 SITE SERVICING PLAN GRADING PLAN BC HYDRO INFORMATION PLAN

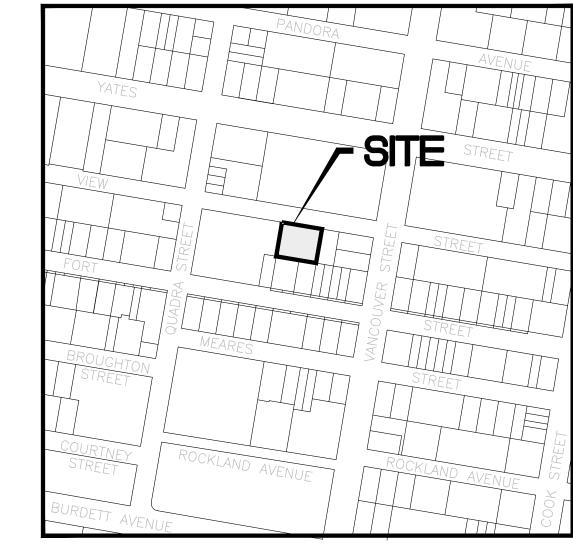

# **LOCATION PLAN**

937 VIEW STREET LOT A, OF LOTS 785, 786 AND 787, VICTORIA CITY, PLAN 36505. R-48, HARRIS GREEN RESIDENTIAL

LAND USE: 253 UNIT 15 STOREY RESIDENTIAL BUILDING PROPOSED: 1572m²

SITE AREA: DWELLING FOOTPRINT AREA: 725m<sup>2</sup> MAIN FLOOR ELEVATION: 17.60m

PLAN TO ACCOMPANY DEVELOPMENT PERMIT APPLICATION

# **GENERAL NOTES:**

CIVIC ADDRESS:

LEGAL:

ZONING:

- 1. ALL WORK AND MATERIALS ARE TO BE IN ACCORDANCE WITH THE CITY OF VICTORIA (CoV) SPECIFICATIONS, ITS SUPPLEMENTARY MASTER MUNICIPAL SPECIFICATIONS, STANDARD DETAIL DRAWINGS AND MMCD UNLESS OTHERWISE NOTED. IF A CONFLICT BETWEEN SPECIFICATIONS ARISES, THE MOST STRINGENT SHALL APPLY.
- 2. THE ENGINEER SHALL BE NOTIFIED 48 HOURS PRIOR TO COMMENCEMENT OF WORK.
- SIGNATURE BLOCK FOR SHALLOW UTILITIES TO BE SIGNED AND DATED PRIOR TO CONSTRUCTION. 4. PERMITS TO CONSTRUCT WORKS ON THE CoV RIGHT OF WAY MUST BE OBTAINED FROM THE CoV ENGINEERING DEPARTMENT PRIOR TO COMMENCING WORK. PERMITS MUST BE ON SITE FOR REVIEW AS
- 5. CONFIRM LOCATION AND ELEVATION OF ALL EXISTING UTILITIES AT ALL CROSSINGS AND CONNECTIONS AND REPORT ANY DISCREPANCIES TO THE ENGINEER PRIOR TO CONSTRUCTION.
- 6. CONFIRM THAT ELEVATION, LOCATION AND GRADIENT OF ASPHALT MATCH EXISTING PRIOR TO PLACEMENT
- OF ASPHALT OR CONCRETE. 7. ALL TREES NOT BEING REMOVED IN THE CONSTRUCTION AREA SHALL BE PROTECTED. CARE TO BE
- TAKEN TO RETAIN AS MANY TREES AS POSSIBLE. 8. ADJUST ALL MANHOLES, WATER VALVES, HYDRO VAULTS, ETC. TO MATCH NEW CONSTRUCTION.
- 9. ALL LOCATIONS AND ELEVATIONS OF EXISTING UTILITIES SHOWN ARE APPROXIMATE ONLY AND SHOULD BE CONFIRMED BY USE OF A PIPE LOCATOR AND MANUAL DIGGING. ALL OR ANY STRUCTURES NOT NECESSARILY SHOWN.
- 5. ALL EXCAVATED TRENCH AND SUBEXCAVATION MATERIALS TO BE DISPOSED OF OFFSITE.
- 6. ALL ELEVATIONS ARE TO GEODETIC DATUM.
- 7. DATA SOURCES: -TOPOGRAPHIC SURVEY COMPLETED BY POWELL & ASSOCIATES BC LAND SURVEYORS, DECEMBER 2016. -DIGITAL GIS PROVIDED BY CoV. -BC 1 CALL DATA FOR SHALLOW UTILITIES.

# **ROAD NOTES:**

- 1. CONSTRUCT ALL SIDEWALK AND DRIVEWAY CROSSINGS IN ACCORDANCE WITH CoV AND MMCD STANDARDS AS NOTED ON DRAWINGS.
- 2. MAINTAIN VEHICULAR AND PEDESTRIAN ACCESS ALONG VIEW STREET DURING CONSTRUCTION. ROAD RESTORATION FOR VIEW STREET TO COV SUPPLEMENTAL DWG. No. SD G5a AND G5b.
- 4. THE PROVISION OF APPROVED SIGNS AND CERTIFIED TRAFFIC CONTROL PERSONNEL IS THE
- CONTRACTOR'S SOLE RESPONSIBILITY. 5. ALL PAVEMENT EXCAVATIONS TO BE SAWCUT.
- 6. PROJECT FRONTAGE TO BE RESTORED AS NOTED ON CIVIL, LANDSCAPE AND ARCHITECTURAL DRAWINGS AS PER CoV "NEW TOWN" SPECIFICATIONS.
- 7. PEDESTRIAN WALKING AREA TO BE DELINEATED DURING THE CONSTRUCTION OF THE WORKS AND MUST BE EASILY RECOGNIZABLE BY THE PUBLIC AND CONTAIN NO OBSTRUCTIONS TO MOBILITY SCOOTERS OR WHEELCHAIRS AND NO HAZARDOUS CONDITIONS. THE PUBLIC USING THESE AREAS MUST BE ADEQUATELY PROTECTED FROM TRAFFIC.

# **WATER NOTES:**


- WATER SERVICE CONNECTION TO BE PER CoV STD. DWG. No. W2d SS.
- 2. CONTRACTOR TO CONFIRM THAT EXISTING WATER SERVICES HAVE BEEN CAPPED BY CONTRACTOR/DEVELOPER AND INSPECTED BY CoV PLUMBING DEPARTMENT AT DEVELOPER'S EXPENSE.

# STORM DRAIN AND SANITARY SEWER NOTES:

- 1. CONTRACTOR TO CONFIRM THAT EXISTING SANITARY AND STORM DRAIN SERVICES HAVE BEEN CAPPED BY CONTACTOR/DEVELOPER AND INSPECTED BY CoV PLUMBING DEPARTMENT AT DEVELOPER'S EXPENSE.
- 2. STORM DRAIN AND SANITARY SEWER CONNECTIONS TO BE AS PER CoV STD. DWG. No. S7 SS. 3. STORM DRAIN CONNECTION TO BE 2000 PVC SDR28 AT A MINIMUM GRADE OF 2.00% UNLESS OTHERWISE NOTED.
- 4. SANITARY SEWER CONNECTION TO BE 2500 PVC SDR28 AT A MINIMUM GRADE OF 2.00% UNLESS
- 5. UNDERGROUND SERVICES TO BE LOCATED, EXPOSED AND ELEVATIONS CONFIRMED AT CROSSINGS PRIOR TO INSTALLATION OF CONNECTIONS.

# SHALLOW UTILITY AND STREET LIGHT NOTES:

- 1. EXISTING BC HYDRO, TELUS, SHAW CABLE AND FORTIS BC INFRASTRUCTURE INFORMATION SHOWN ON DRAWINGS IS SCHEMATIC AND FOR INFORMATION ONLY.
- 2. REFER TO UTILITY COMPANY DESIGN DRAWINGS FOR CONSTRUCTION DETAILS. CONSTRUCT UNDERGROUND UTILITIES AS SPECIFIED AND IN ACCORDANCE WITH BC HYDRO, TELUS, SHAW CABLE SPECIFICATIONS AND DRAWINGS.
- 3. CONFIRM AND COORDINATE WITH CoV FORCES REINSTATEMENT OF LAMP STANDARDS AS PER CoV SUPPLEMENTARY STANDARD DETAIL DRAWINGS, INCLUDING BASES, CONDUIT AND JUNCTION BOX.
- . CONTACT BC 1 CALL AT 1-800-474-6886 A MINIMUM OF 48 HOURS PRIOR TO CONSTRICTION. 5. CONTACT BC HYDRO, TELUS, SHAW CABLE AND FORTIS BC 48 HOURS PRIOR TO THE START OF ANY
- 6. BC HYDRO TO COORDINATE AND PROVIDE LIAISON WITH COV PRIOR TO AND DURING CONSTRUCTION.

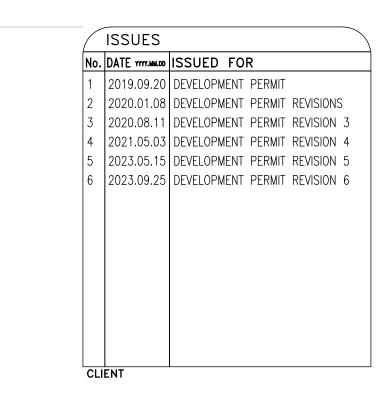

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GENERAL NOTES, LOCATION PLAN, KEY PLAN, DRAWINGS LIST & LEGEND

DESIGNED ENGINEER'S SEAL DESIGN REVIEW DRAFTED DRAFTING REVIEW PROJECT No. CLIENT DRAWING No. 5094-001 H: AS NOTED

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HEL DRAWING No.

