#### **PROJECT INFORMATION CIVIC ADDRESS** 1230 GRANT STREET 1209,1218,1219,1220, and 1226 NORTH PARK STREET R-2 1219 VINING STREET 1235 CALEDONIA AVENUE USE 1211 GLADESTONE AVENUE **LEGAL DESCRIPTION** LOT 4 VIP205 SECTION SR VICTORIA LOT 5 VIP205 SECTION SR VICTORIA **LOT 6 VIP205 SECTION SR VICTORIA** LOT 7 VIP205 SECTION SR VICTORIA N 56' OF LOT 8 VIP205 SECTION SR VICTORIA REM LOT 8 VIP205 SECTION SR VICTORIA LOT 9 VIP205 SECTION SR VICTORIA 3544/8681.1 = 41% LOT 18 VIP205 SECTION SR VICTORIA LOT A SECTION 53, SPRING RIDGE, VIP55528 SITE AREA 8681.1 SM PROJECT DESCRIPTION THE PROJECT INVOLVES THE DEVELOPMENT OF 158 AFFORDABLE HOUSING RESIDENTIAL UNITS AND SUPPORT FACILITIES IN 2 APARTMENT AND 3 TOWNHOUSE BUILDINGS OVER ONE BASEMENT LEVEL OF PARKADE. **BUILDING HEIGHTS ZONING APARTMENT 1** 4 STOREYS 4 STOREYS, 12.0 M 5 STOREYS 5 STOREYS, 14.78 M **APARTMENT 2** TOWNHOUSE 3 STOREYS 4 STOREYS, 11.25 M( 3 STOREYS 3 STOREYS, 10.65 M **TOWNHOUSE 2 TOWNHOUSE 3** 3 STOREYS 3 STOREYS, 9.8 M BCBC BUILDING AREAS APARTMENT 1 872 SM **APARTMENT 2** 875 SM TOWNHOUSE 653 SM **TOWNHOUSE 2** 652 SM TOWNHOUSE 3 260 SM GROSS BUILDING AREAS ZONING 275 SM\* \* AREA OF PARKADE EXCLUDING EXTERIOR WALLS, VEHICL ► AND BICYCLE PARKING AND CIRCULATION. **APARTMENT 1** PROVIDED 776 SM 800 SM LEVEL 1 LEVEL 2 872 SM 850 SM LEVEL 3 872 SM 850 SM LEVEL 4 723 SM 704 SM 3267 SM 3180 SM **TOTAL APARTMENT 2** 789 SM 765 SM LEVEL 1 LEVEL 2 656 SM 637 SM LEVEL 3 831 SM 809 SM LEVEL 4 831 SM 809 SM LEVEL 5 690 SM **TOTAL** 3797 SM 3692 SM TOWNHOUSE 1 LEVEL 0 601 SM 566 SM LEVEL 1 603 SM 581 SM 608 SM 592 SM LEVEL 2 LEVEL 3 645 SM TOTAL 2457 SM 2372 SM **TOWNHOUSE 2** LEVEL 0 645 SM 0 SM 607 SM 590 SM LEVEL 1 LEVEL 2 607 SM 590 SM LEVEL 3 645 SM 632 SM TOTAL 2504 SM 1812 SM **TOWNHOUSE 3** LEVEL 1 231 SM 222 SM LEVEL 2 243 SM 235 SM LEVEL 3 253 SM TOTAL 727 SM 703 SM **RESIDENTIAL UNIT SUMMARY** APARTMENTS 1 & 2 14 STUDIO @ 34 SM 38 ONE BED @ 47 - 49 SM 7 ACCESSIBLE ONE BED @ 53 SM 14 TWO BED @ 61 - 76 SM 5 ACCESSIBLE TWO BED @ 71 SM 12 THREE BED @ 78 - 88 SM 1 ACCESSIBLE THREE BED @ 98 SM 6 FOUR BED @ 98 - 118 SM 97 TOTAL TOWNHOUSES 1 -3 81 - 90 SM 55 TWO BED @ 2 ACCESSIBLE TWO BED @ 104 SM 2 THREE BED @ 118 SM 4 FOUR BED @ 130 SM 61 TOTAL

**VEHICLE PARKING** PARKADE 112

**BICYCLE PARKING** 

SURFACE 0

LONG TERM SHORT TERM

TOTAL 112

#### **VICTORIA ZONING BYLAW SUMMARY**

ZONING

RESIDENTIAL

FLOOR SPACE RATIO

GROSS BUILDING FLOOR AREA (ZONING) / SITE AREA 11759/8681.1 = 1.35

SITE COVERAGE

AREA OF LOT OCCUPIED BY ANY STRUCTURE/ SITE AREA

**OPEN SITE SPACE** 

SITE AREA - (BUILDING AREA + SURFACE PARKING AREA) 8681.1 - 3460 = 5221.1

 $\sim\sim\sim\sim$ 

OPEN SITE SPACE/ SITE AREA 5221.1/ 8681.1 = 49%

**AVERAGE GRADE (GEODETIC)** 

(SEE SITE PLAN FOR GRADE CALCULATION). **APARTMENT 1** 33.5 M APARTMENT 2 33.4 M TOWNHOUSE ' 33.0 M 32.6 M TOWNHOUSE 2 TOWNHOUSE 3 32.8 M

HEIGHT OF BUILDINGS

(AS MEASURED FROM AVERAGE GRADE). APARTMENT 1 12.000 M **APARTMENT 2** 14.780 M 11.250 M TOWNHOUSE TOWNHOUSE 2 10.650 M 9.800 M TOWNHOUSE 3

VÉHICLE PARKING

< 45 SM .2 X 14 = 2.8.5 X 58 = 29 45 - 70 SM > 70 SM  $.75 \times 86 = 64.5$ **SUBTOTAL** 96.3 (96) 1 X 158 = 15.8 (16) **VISITOR** TOTAL REQUIRED 112

117

**BICYCLE PARKING** 

LONG TERM < 45 SM 14 X 11 = 14 1.25 X 144 = 180 TOTAL LONG TERM REQUIRED TOTAL PROVIDED

SHORT TERM

RESIDENTIAL (THE GREATER OF) .1 X 158 OR 6 X 5 TOTAL SHORT TERM REQUIRED TOTAL PROVIDED

**CODE ANALYSIS** 

REFERENCE DOCUMENT BCBC 2018

**PARKADE** OCCUPANCY CLASSIFICATIONS (TABLE 3.1.2.1) **BELOW GRADE PARKADE -**

GROUP F. DIVISION 3 - LOW HAZARD INDUSTRIAL

OCCUPANCY SEPARATIONS (TABLE 3.1.3.1) BELOW GRADE PARKADE CONSIDERED AS A SEPARATE BUILDING AND SEPARATED FROM THE FLOORS OF ALL BUILDINGS ABOVE BY A 2 HOUR FIRE SEPARATION IN ACCORDANCE WITH 3.2.1.2.

**BUILDING SIZE AND CONSTRUCTION RELATIVE TO OCCUPANCY** 

3.2.2.78 - GROUP F, DIVISION 3 - ANY HEIGHT, ANY AREA, SPRINKLERED FIRE SUPPRESSION - FULL SPRINKLERED ALLOWABLE HEIGHT - ANY HEIGHT ALLOWABLE AREA - ANY AREA **CONSTRUCTION - NON COMBUSTIBLE** FLOOR ASSEMBLIES - 2 HOUR SUPPORTING WALLS AND STRUCTURE - 2 HOUR

ACTUAL SIZE AND CONSTRUCTION

FIRE SUPPRESSION - FULL SPRINKLERED **HEIGHT - 1 STOREY** AREA - 3905 SM CONSTRUCTION - NON COMBUSTIBLE FLOOR ASSEMBLY - 2 HOUR SUPPORTING WALLS AND STRUCTURE - 2 HOUR

**APARTMENT 1** 

**OCCUPANCY CLASSIFICATIONS** (TABLE 3.1.2.1) **GROUP C - RESIDENTIAL** 

OCCUPANCY SEPARATIONS (TABLE 3.1.3.1)

BUILDING SIZE AND CONSTRUCTION RELATIVE TO OCCUPANCY 3.2.2.51 - GROUP C, UP TO 4 STOREYS, SPRINKLERED

FIRE SUPPRESSION - FULLY SPRINKLERED ALLOWABLE HEIGHT - 4 STOREYS ALLOWABLE AREA - 1800 SM (BASED ON FOUR STOREYS) CONSTRUCTION - COMBUSTIBLE OR NON COMBUSTIBLE FLOOR ASSEMBLIES - 1 HOUR SUPPORTING WALLS AND STRUCTURE - 1 HOUR

**ACTUAL SIZE AND CONSTRUCTION** 

**ROOF ASSEMBLY - NONE** 

FIRE SUPPRESSION - FULLY SPRINKLERED HEIGHT - 4 STOREYS AREA - 872 SM CONSTRUCTION - COMBUSTIBLE FLOOR ASSEMBLY - 1 HOUR SUPPORTING WALLS AND STRUCTURE - 1 HOUR ROOF ASSEMBLY - NONE

<u>APARTMENT 2</u>

OCCUPANCY CLASSIFICATIONS (TABLE 3.1.2.1) **GROUP C - RESIDENTIAL** 

OCCUPANCY SEPARATIONS (TABLE 3.1.3.1)

**BUILDING SIZE AND CONSTRUCTION RELATIVE TO OCCUPANCY** 3.2.2.50 - GROUP C. UP TO 6 STOREYS. SPRINKLERED

FIRE SUPPRESSION - FULLY SPRINKLERED ALLOWABLE HEIGHT - 6 STOREYS & 18 M ALLOWABLE AREA - 1800 SM (BASED ON FIVE STOREYS) CONSTRUCTION - COMBUSTIBLE OR NON COMBUSTIBLE FLOOR ASSEMBLIES - 1 HOUR SUPPORTING WALLS AND STRUCTURE - 1 HOUR ROOF ASSEMBLY - 1 HOUR

**ACTUAL SIZE AND CONSTRUCTION** 

FIRE SUPPRESSION - FULLY SPRINKLERED HEIGHT - 5 STOREYS, 14.96 M AREA - 875 SM **CONSTRUCTION - COMBUSTIBLE** FLOOR ASSEMBLY - 1 HOUR SUPPORTING WALLS AND STRUCTURE - 1 HOUR ROOF ASSEMBLY - 1 HOUR

#### **CODE ANALYSIS CONTINUED**

**TOWNHOUSE 1 OCCUPANCY CLASSIFICATIONS** (TABLE 3.1.2.1) GROUP C - RESIDENTIAL

**OCCUPANCY SEPARATIONS** (TABLE 3.1.3.1)

BUILDING SIZE AND CONSTRUCTION RELATIVE TO OCCUPANCY 3.2.2.54 - GROUP C. UP TO 3 STOREYS. SPRINKLERED

FIRE SUPPRESSION - FULLY SPRINKLERED ALLOWABLE HEIGHT - 3 STOREYS ALLOWABLE AREA - 1800 SM (BASED ON THREE STOREYS) CONSTRUCTION - COMBUSTIBLE OR NON COMBUSTIBLE FLOOR ASSEMBLIES - 45 MIN. SUPPORTING WALLS AND STRUCTURE - 45 MIN. ROOF - NONE

**ACTUAL SIZE AND CONSTRUCTION** 

FIRE SUPPRESSION - FULLY SPRINKLERED **HEIGHT - 3 STOREYS WITH BASEMENT** AREA - 653 SM CONSTRUCTION - COMBUSTIBLE FLOOR ASSEMBLY - 45 MIN. SUPPORTING WALLS AND STRUCTURE - 45 MIN. ROOF ASSEMBLY - NONE

**TOWNHOUSE 2** 

**OCCUPANCY CLASSIFICATIONS** (TABLE 3.1.2.1) GROUP C - RESIDENTIAL

**OCCUPANCY SEPARATIONS** (TABLE 3.1.3.1)

**BUILDING SIZE AND CONSTRUCTION RELATIVE TO OCCUPANCY** 3.2.2.54 - GROUP C, UP TO 3 STOREYS, SPRINKLERED

FIRE SUPPRESSION - FULLY SPRINKLERED ALLOWABLE HEIGHT - 3 STOREYS ALLOWABLE AREA - 1800 SM (BASED ON THREE STOREYS) CONSTRUCTION - COMBUSTIBLE OR NON COMBUSTIBLE FLOOR ASSEMBLIES - 45 MIN. SUPPORTING WALLS AND STRUCTURE - 45 MIN. ROOF - NONE

**ACTUAL SIZE AND CONSTRUCTION** 

FIRE SUPPRESSION - FULLY SPRINKLERED HEIGHT - 3 STOREYS WITH BASEMENT AREA - 652 SM CONSTRUCTION - COMBUSTIBLE FLOOR ASSEMBLY - 45 MIN. SUPPORTING WALLS AND STRUCTURE - 45 MIN. **ROOF ASSEMBLY - NONE** 

**OCCUPANCY CLASSIFICATIONS** (TABLE 9.10.2.1) GROUP C - RESIDENTIAL

FIRE-RESISTANCE RATINGS (TABLE 9.10.8.1)

USE - RESIDENTIAL (GROUP C) MAXIMUM HEIGHT - 3 STOREYS MAXIMUM AREA - 600 SM CONSTRUCTION - COMBUSTIBLE OR NON COMBUSTIBLE FLOOR ASSEMBLIES - 45 MIN. SUPPORTING WALLS AND STRUCTURE - 45 MIN. ROOF ASSEMBLY - NONE

**ACTUAL SIZE AND CONSTRUCTION** 

FIRE SUPPRESSION - FULLY SPRINKLERED **HEIGHT - 3 STOREYS WITH BASEMENT** AREA - 392 SM **CONSTRUCTION - COMBUSTIBLE** FLOOR ASSEMBLY - 45 MIN. SUPPORTING WALLS AND STRUCTURE - 45 MIN. **ROOF ASSEMBLY - NONE** 

**ARCHITECTURAL** A001 PROJECT INFORMATION A002 SURVEY

A101 PARKADE PLAN

**DRAWING INDEX** 

A201 ARCHITECTURAL SITE PLAN A202 AVERAGE GRADE CALCULATIONS

A203 L1 PLAN A204 L2 PLAN **A205 L3 PLAN** 

A206 L4 PLAN A207 L5 PLAN A208 ROOF PLAN

A301 ELEVATIONS - APARTMENT A302 ELEVATIONS - APARTMENT 2 A303 ELEVATIONS - APARTMENT 2

A304 ELEVATIONS - TOWNHOUSE A305 ELEVATIONS - TOWNHOUSE 2

A306 ELEVATIONS - TOWNHOUSE 3 A307 SHADOW STUDIES

A308 VIEW ANALYSIS A309 VIEW ANALYSIS A310 VIEW ANALYSIS

A311 PERSPECTIVE STUDIES A312 PERSPECTIVE STUDIES A313 SKYLINE ANALYSIS

A401 BUILDING SECTIONS

A402 BUILDING SECTIONS

A403 BUILDING SECTIONS

A404 BUILDING SECTIONS

A601 L1 PLAN - APARTMENTS

A602 L2 PLAN - APARTMENTS A603 L3 PLAN - APARTMENTS A604 L4 PLAN - APARTMENTS

A605 L5 PLAN - APARTMENTS A606 TOWNHOUSE 1 A607 TOWNHOUSE A608 TOWNHOUSE 2

A609 TOWNHOUSE 2 A610 TOWNHOUSE 3

A701 APARTMENT UNIT PLANS A702 APARTMENT UNIT PLANS A703 TOWNHOUSE S 1 & 2 UNIT PLANS

A704 TOWNHOUSE 3 UNIT PLANS A705 AMENITY ROOM

CONCEPTUAL SERVICING 19-028-REZONING

20/01/15

FWP che

ISSUED FOR DP

SEE DRAWING project number

SEPTEMBER 2019

LANDSCAPE

L1.01 LANDSCAPE OVERVIEW PLAN L1.02 LANDSCAPE MATERIALS SOUTH

L1.03 LANDSCAPE MATERIALS NORTH L1.04 STORMWATER MANAGEMENT

L1.05 TREE RETENTION & REMOVAL PLAN L3.01 PLANTING PLAN SOUTH


L3.02 PLANTING PLAN NORTH L5.01 LANDSCAPE SECTIONS

ISSUED FOR COTW


ISSUED FOR ADF


RESPONSE TO PLANNING REVIEW

1907 PROJECT INFORMATION

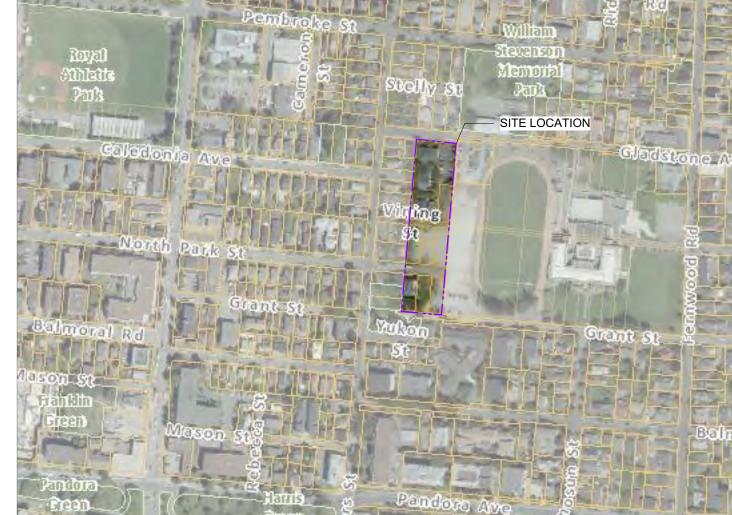



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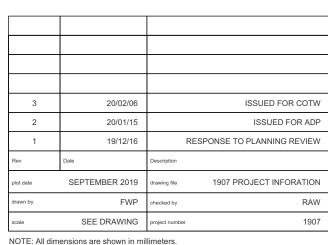


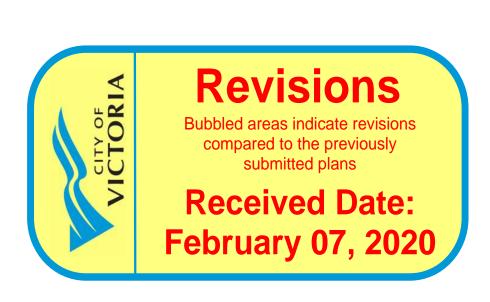

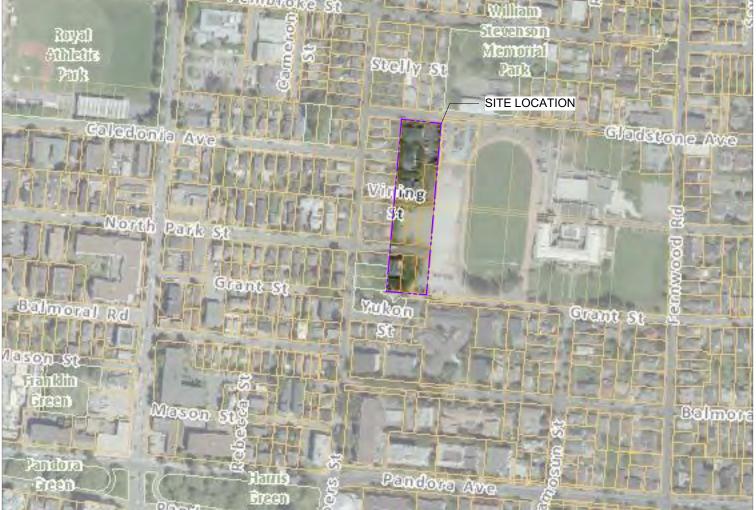





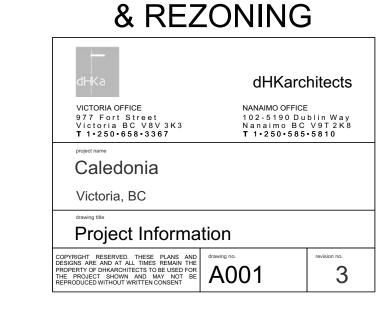

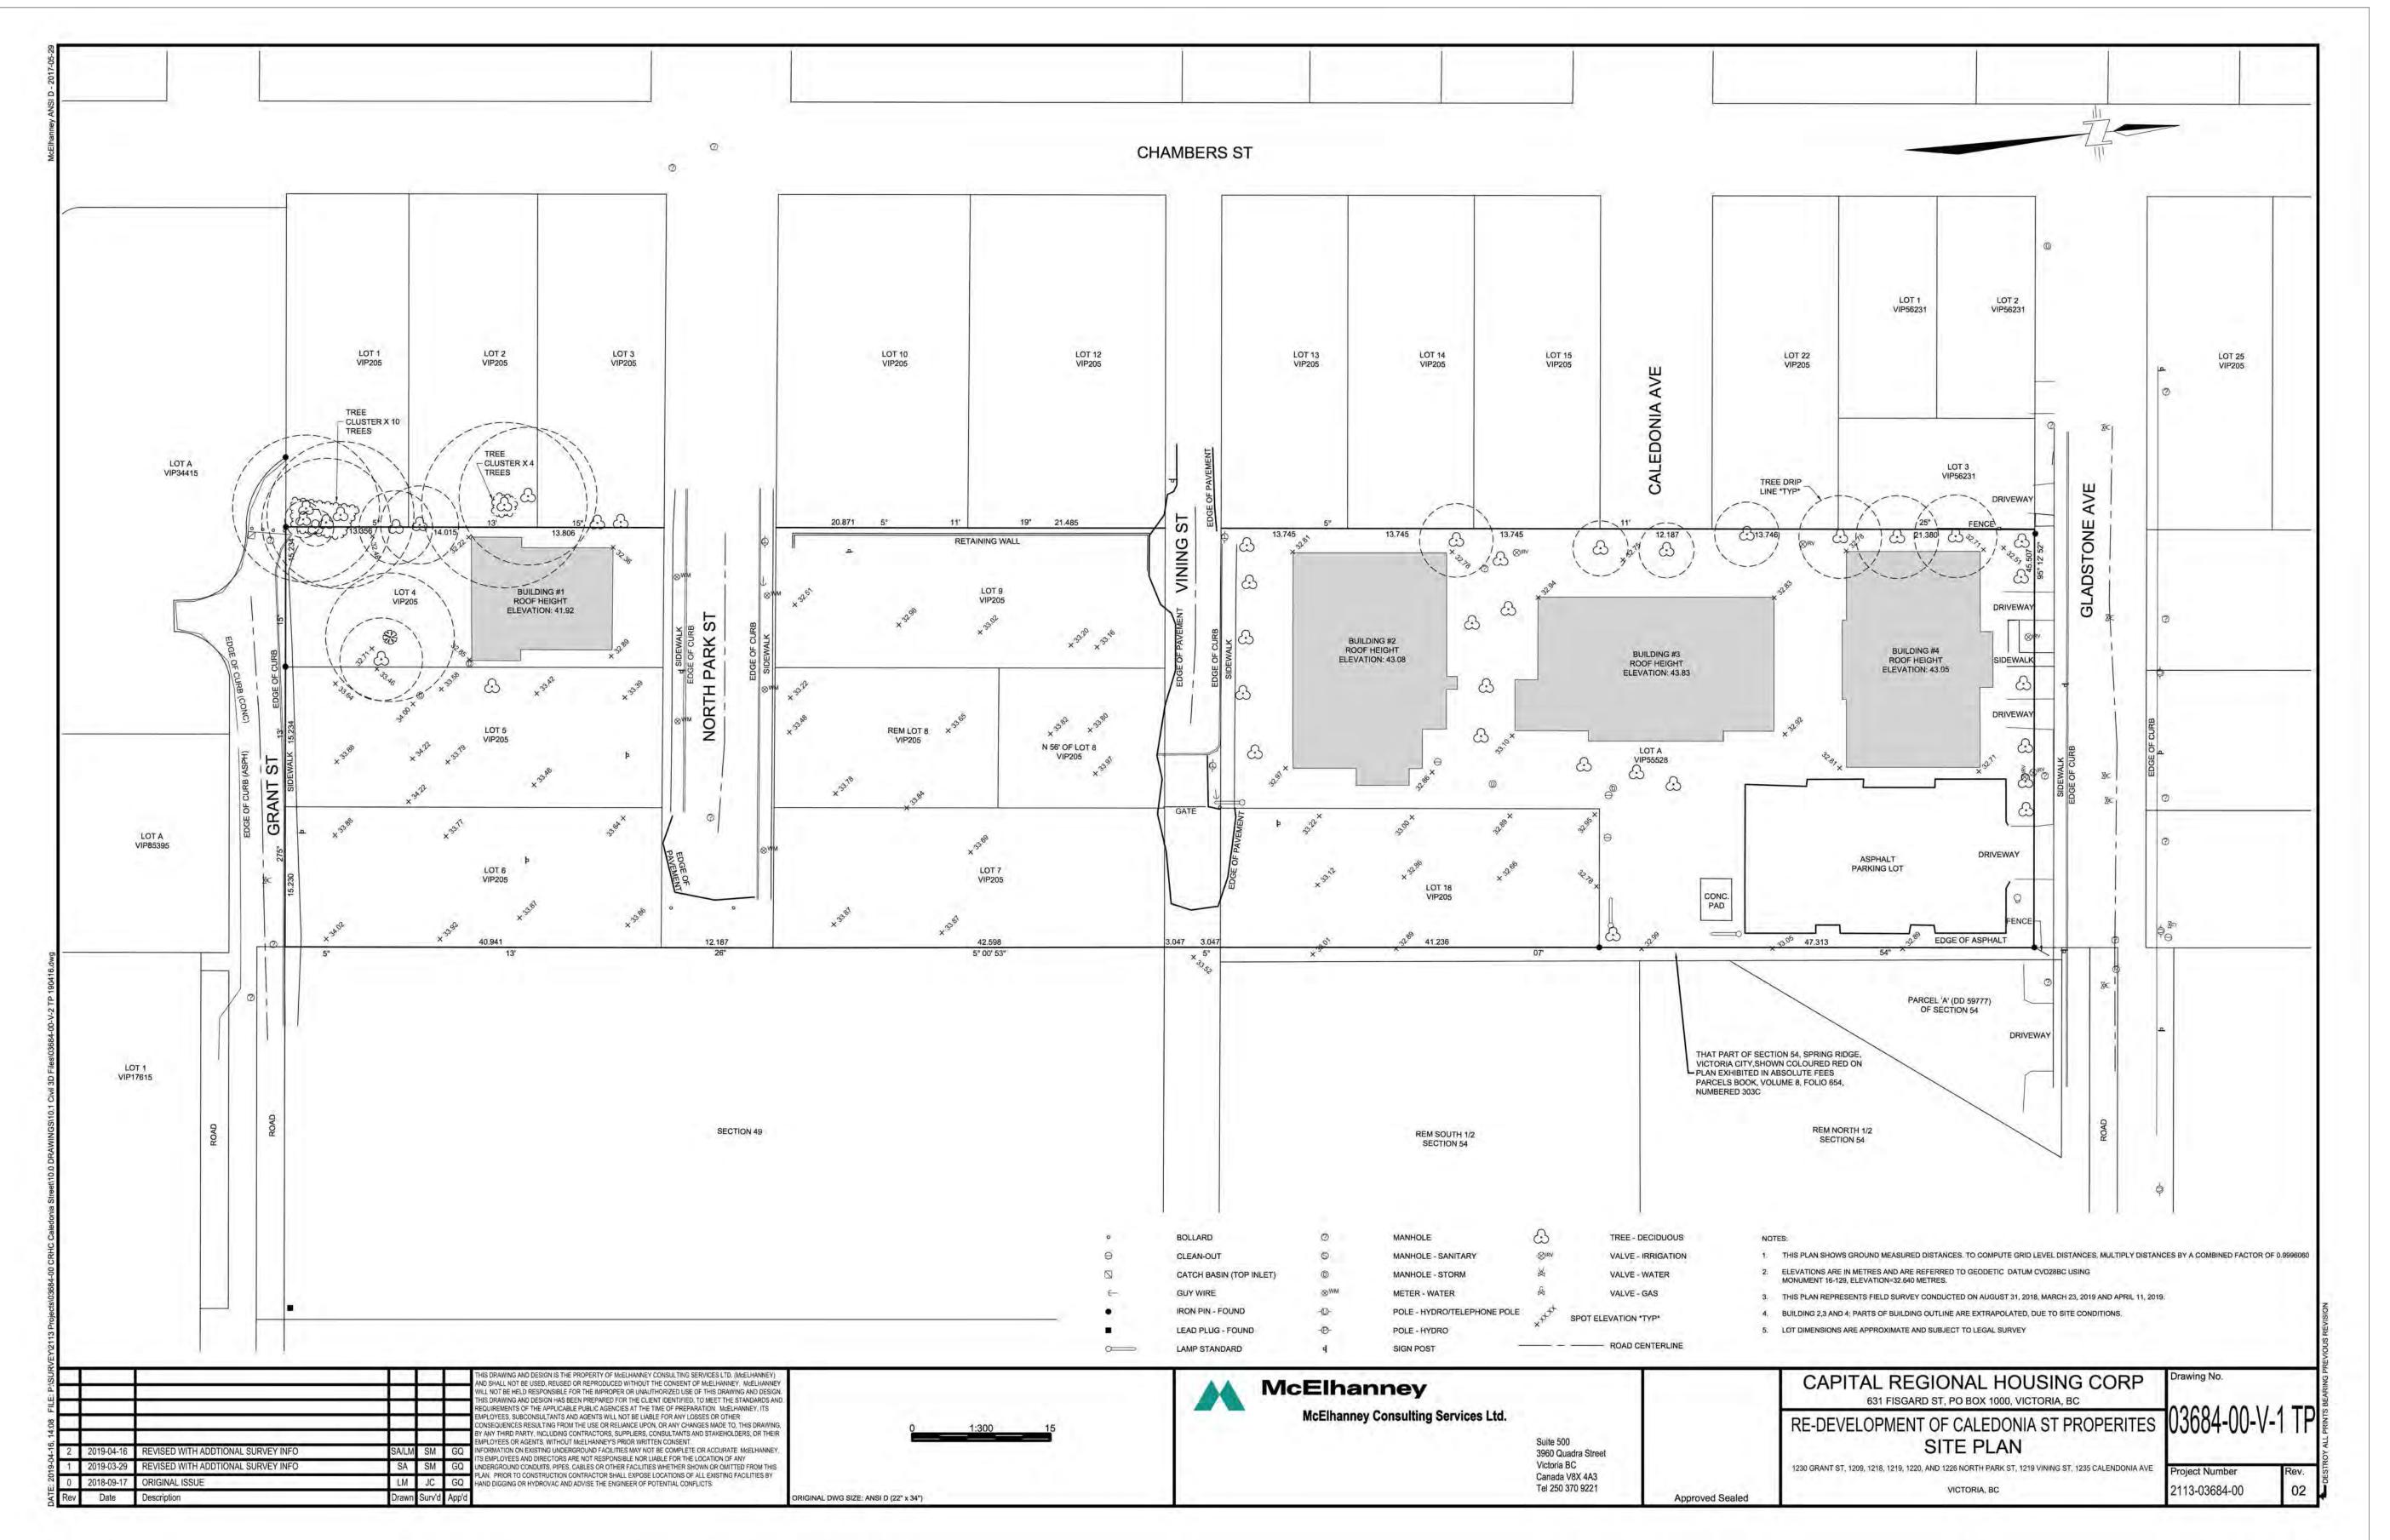

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drawing no.	revision no.
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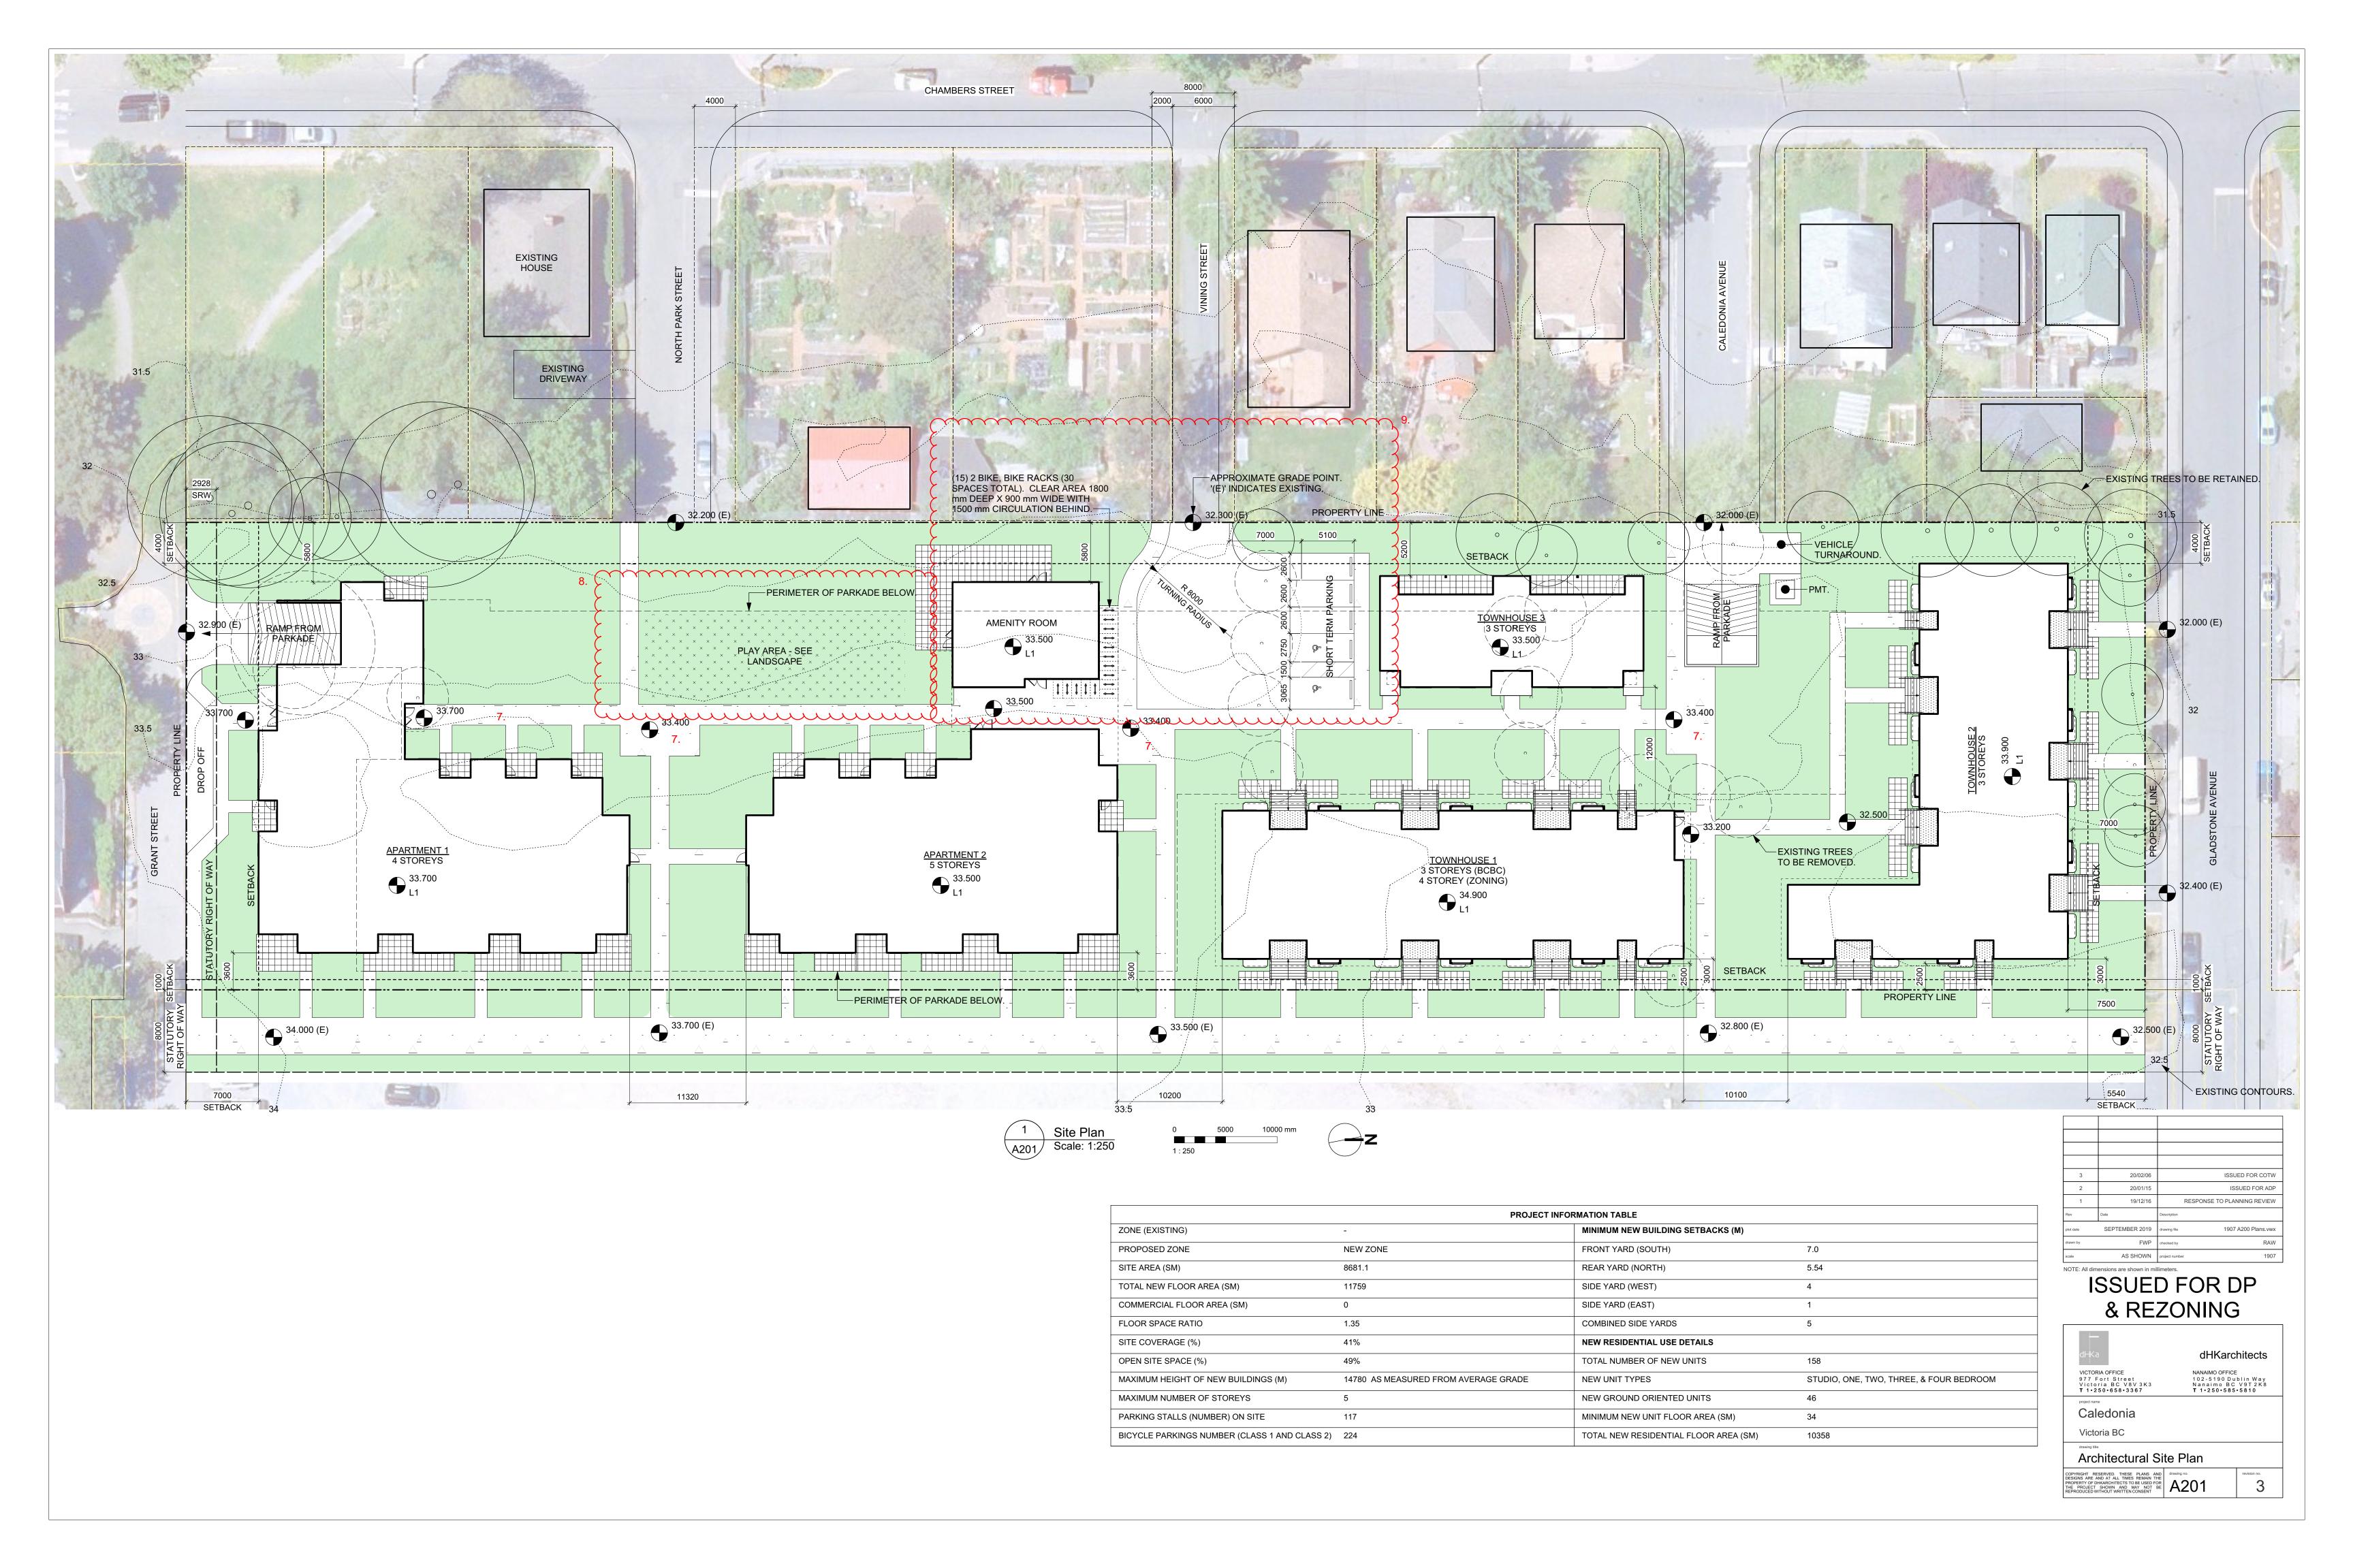


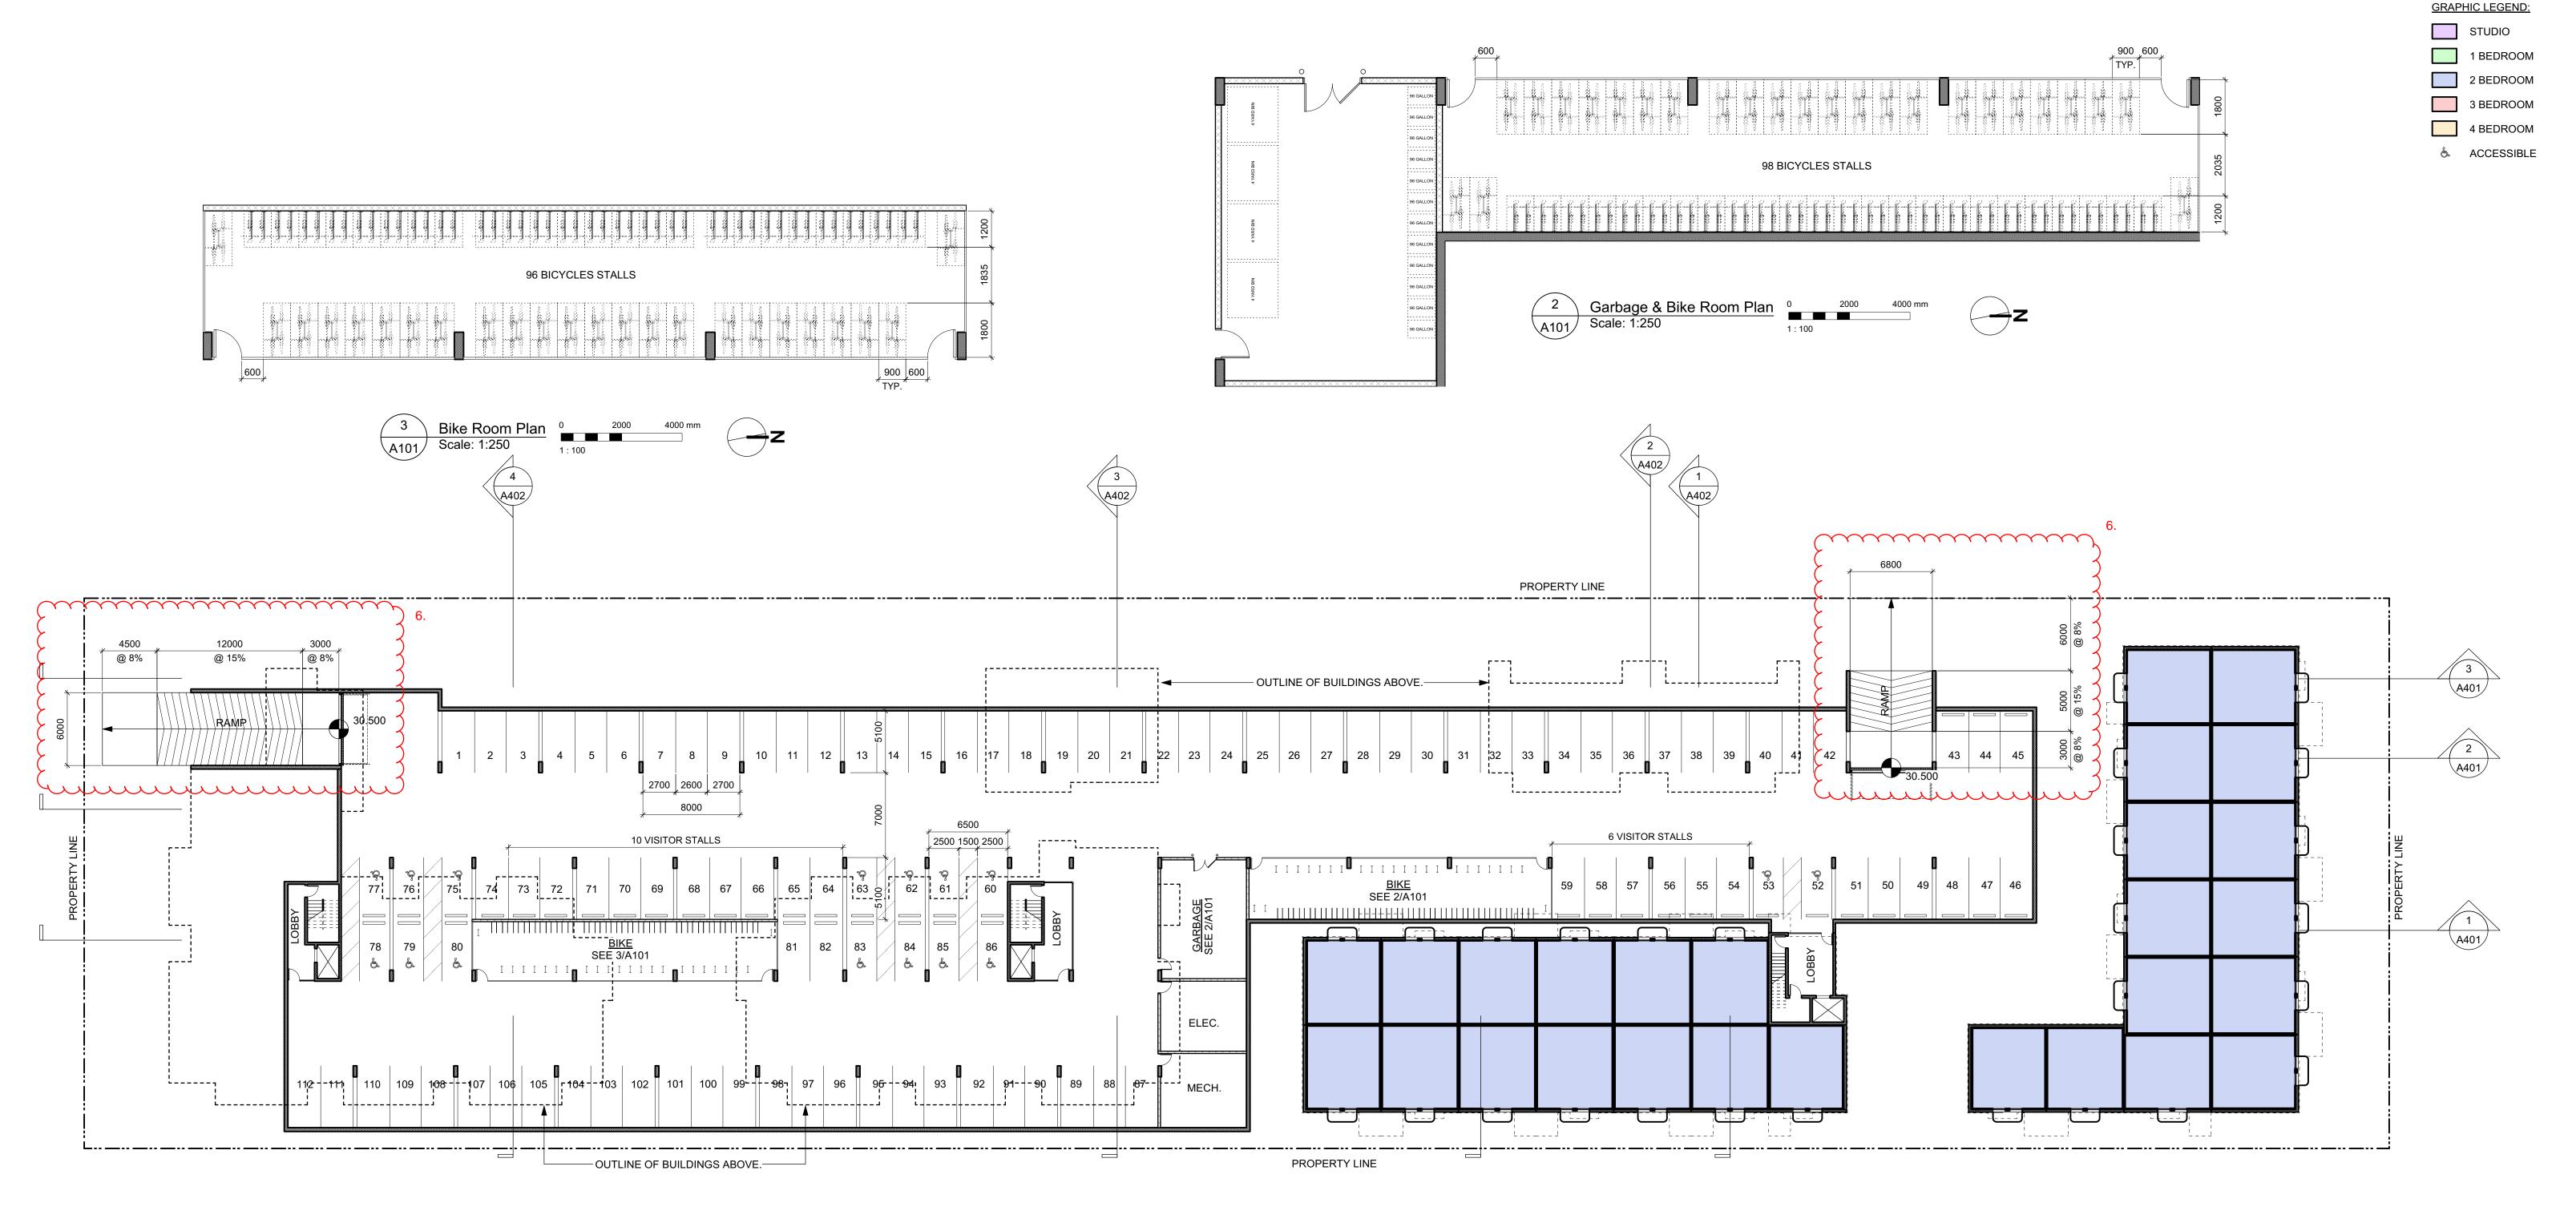
VEHICLE PARKING (	CALCULATION
UNITS < 45 SM UNITS 45-70 SM UNITS >70 SM SUBTOTAL VISITOR	14 X .2 = 2.8 58 X .5 = 29 86 X .75 = 64.5 96.3 (96) 158 X .1 = 15.8 (16)
TOTAL REQUIRED PROVIDED	112 117 (5 SURFACE) ARKING CALCULATION
UNITS < 45 SM UNITS > 45 SM TOTAL REQUIRED PROVIDED	14 X 1 = 14 144 X 1.25 = 180

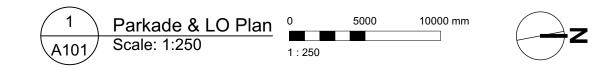3	20/02/06	ISSUED F	OR COTV
2	20/01/15	ISSUED	FOR ADI
1	19/12/16	RESPONSE TO PLANNING	3 REVIEV
Rev	Date	Description	
plot date	SEPTEMBER 2019	drawing file 1907 A200	Plans.vw
drawn by	FWP	checked by	RAV
scale	AS SHOWN	project number	190

ISSUED FOR DP
& REZONING

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project name		
Caledonia		
Victoria BC		
drawing title		
Parkade & LO I	Plan	
		revision no.
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APARTM	ENT 1	NT 1					
side	corner grade point	+ corner grade point	/ 2	average grade per side	X length of side	TOTAL	
A&B	32.5	32.6	2	32.6	1.8	58.6	
B&C	32.6	32.6	2	32.6	3.8	123.9	
C&D	32.6	33.3	2	33.0	10.0	329.5	
D&E	33.3	33.3	2	33.3	1.8	59.9	
E&F	33.3	33.8	2	33.6	5.4	181.2	
F&G	33.8	33.7	2	33.8	3.4	114.8	
G&H	33.7	33.5	2	33.6	1.8	60.5	
H&I	33.5	38.4	2	36.0	3.0	107.9	
I&J	38.4	33.5	2	36.0	1.8	64.7	
J&K	33.5	33.5	2	33.5	3.4	113.9	
K&L	33.5	33.4	2	33.5	1.8	60.2	
L&M	33.4	33.4	2	33.4	3.0	100.2	
M&N	33.4	33.5	2	33.5	1.8	60.2	
N&O	33.5	33.4	2	33.5	3.4	113.7	
O&P	33.4	33.3	2	33.4	1.8	60.0	
P&Q	33.3	33.3	2	33.3	3.0	99.9	
Q&R	33.3	33.5	2	33.4	3.6	121.4	
R&S	33.5	33.5	2	33.5	2.6	88.4	
S&T	33.5	33.7	2	33.6	4.9	163.6	
T&U	33.7	33.8	2	33.8	6.7	226.0	
U&V	33.8	33.8	2	33.8	3.0	101.4	
V&W	33.8	33.8	2	33.8	1.8	60.8	
W&X	33.8		2	33.8			
		33.8			7.4	250.1	
X&Y Y&Z	33.8	33.8	2	33.8	1.8	60.8	
	33.8	33.9	2	33.9	3.0	101.6	
Z&AA	33.9	33.9		33.9	1.8	61.0	
AA&BB	33.9	33.9	2	33.9	7.4	250.9	
BB&CC	33.9	33.9	2	33.9	1.8	61.0	
CCⅅ	33.9	33.9	2	33.9	3.4	115.3	
DD&EE	33.9	33.9	2	33.9	1.8	61.0	
EE&FF	33.9	33.9	2	33.9	7.8	264.4	
FF&GG	33.9	33.9	2	33.9	1.8	61.0	
GG&HH	33.9	33.9	2	33.9	3.8	128.8	
HH&II	33.9	34.0	2	34.0	10.0	339.5	
II&JJ	34.0	34.0	2	34.0	1.9	62.9	
JJ&KK	34.0	34.0	2	34.0	3.0	100.3	
KK&LL	34.0	34.0	2	34.0	1.8	61.2	
LL&MM	34.0	34.0	2	34.0	6.8	231.2	
MM&NN	34.0	34.0	2	34.0	1.8	61.2	
NN&OO	34.0	33.0	2	33.5	6.3	211.6	
OO&PP	33.0	32.9	2	33.0	6.2	204.3	
QQ&RR	31.2	31.2	2	31.2	6.2	191.9	
SS&TT	32.6	32.5	2	32.6	1.9	61.8	
TT&A	32.5	32.5	2	32.5	6.3	205.2	
							GRADE = TOTAL/Perimete
				Perimeter	167.5	5617.8	33.5

GRADE (	CALCULATION						
APARTM							
side	corner grade point	+ corner grade point	/ 2	average grade per side	X length of side	TOTAL	
A 0 D	20.7	20.0		20.0	44.0	405.4	
A&B	32.7	32.8	2	32.8	14.2	465.1	
B&C	32.8	33.3	2	33.1	9.4	310.7	
C&D	33.3	33.5	2	33.4	5.0	167.0	
D&E	33.5	33.5	2	33.5	3.4	113.9	
E&F	33.5	33.5	2	33.5	1.8	60.3	
F&G	33.5	33.5	2	33.5	3.4	113.9	
G&H	33.5	33.5	2	33.5	1.8	60.3	
H&I	33.5	33.5	2	33.5	3.0	100.5	
I&J	33.5	33.5	2	33.5	1.8	60.3	
J&K	33.5	33.5	2	33.5	10.0	335.0	
K&L	33.5	33.6	2	33.5	3.8	127.4	
L&M	33.6	33.6	2	33.6	1.8	60.5	
M&N	33.6	33.6	2	33.6	7.8	262.1	
N&O	33.6	33.6	2	33.6	1.8	60.5	
O&P	33.6	33.6	2	33.6	3.4	114.2	
P&Q	33.6	33.6	2	33.6	1.8	60.5	
Q&R	33.6	33.7	2	33.7	7.4	249.0	
R&S	33.7	33.7	2	33.7	1.8	60.7	
S&T	33.7	33.7	2	33.7	3.0	101.1	
T&U	33.7	33.7	2	33.7	1.8	60.7	
U&V	33.7	33.7	2	33.7	7.4	249.4	
V&W	33.7	33.7	2	33.7	1.8	60.7	
W&X	33.7	33.7	2	33.7	3.0	101.1	
X&Y	33.7	33.6	2	33.7	6.7	225.3	
Y&Z	33.6	33.6	2	33.6	4.9	163.6	
Z&AA	33.6	33.6	2	33.6	2.6	88.7	
AA&BB	33.6	33.5	2	33.6	3.6	122.0	
BB&CC	33.5	33.5	2	33.5	3.0	100.5	
CCⅅ	33.5	33.5	2	33.5	1.8	60.3	
DD&EE	33.5	33.6	2	33.6	3.4	114.1	
EE&FF	33.5	33.5	2	33.5	1.8	60.3	
FF&GG	33.5	33.5	2	33.5	3.0	100.5	
GG&HH	33.5	33.5	2	33.5	1.8	60.3	
HH&II	33.5	33.5	2	33.5	3.4	113.9	
II&JJ	33.5	33.5	2	33.5	1.8	60.3	
JJ&KK	33.5	33.5	2	33.5	3.0	100.5	
KK&LL	33.5	33.5	2	33.5	1.8	60.3	
LL&MM	33.5	33.5	2	33.5	3.4	113.9	
MM&NN	33.5	33.5	2	33.5	2.8	93.8	
NN&OO	33.5	33.3	2	33.5	4.6	153.1	
00&A	33.3	32.7	2	33.0	10.2	336.6	
							GRADE =
							TOTAL/Perimete
				Perimeter	164.0	5482.6	33.4

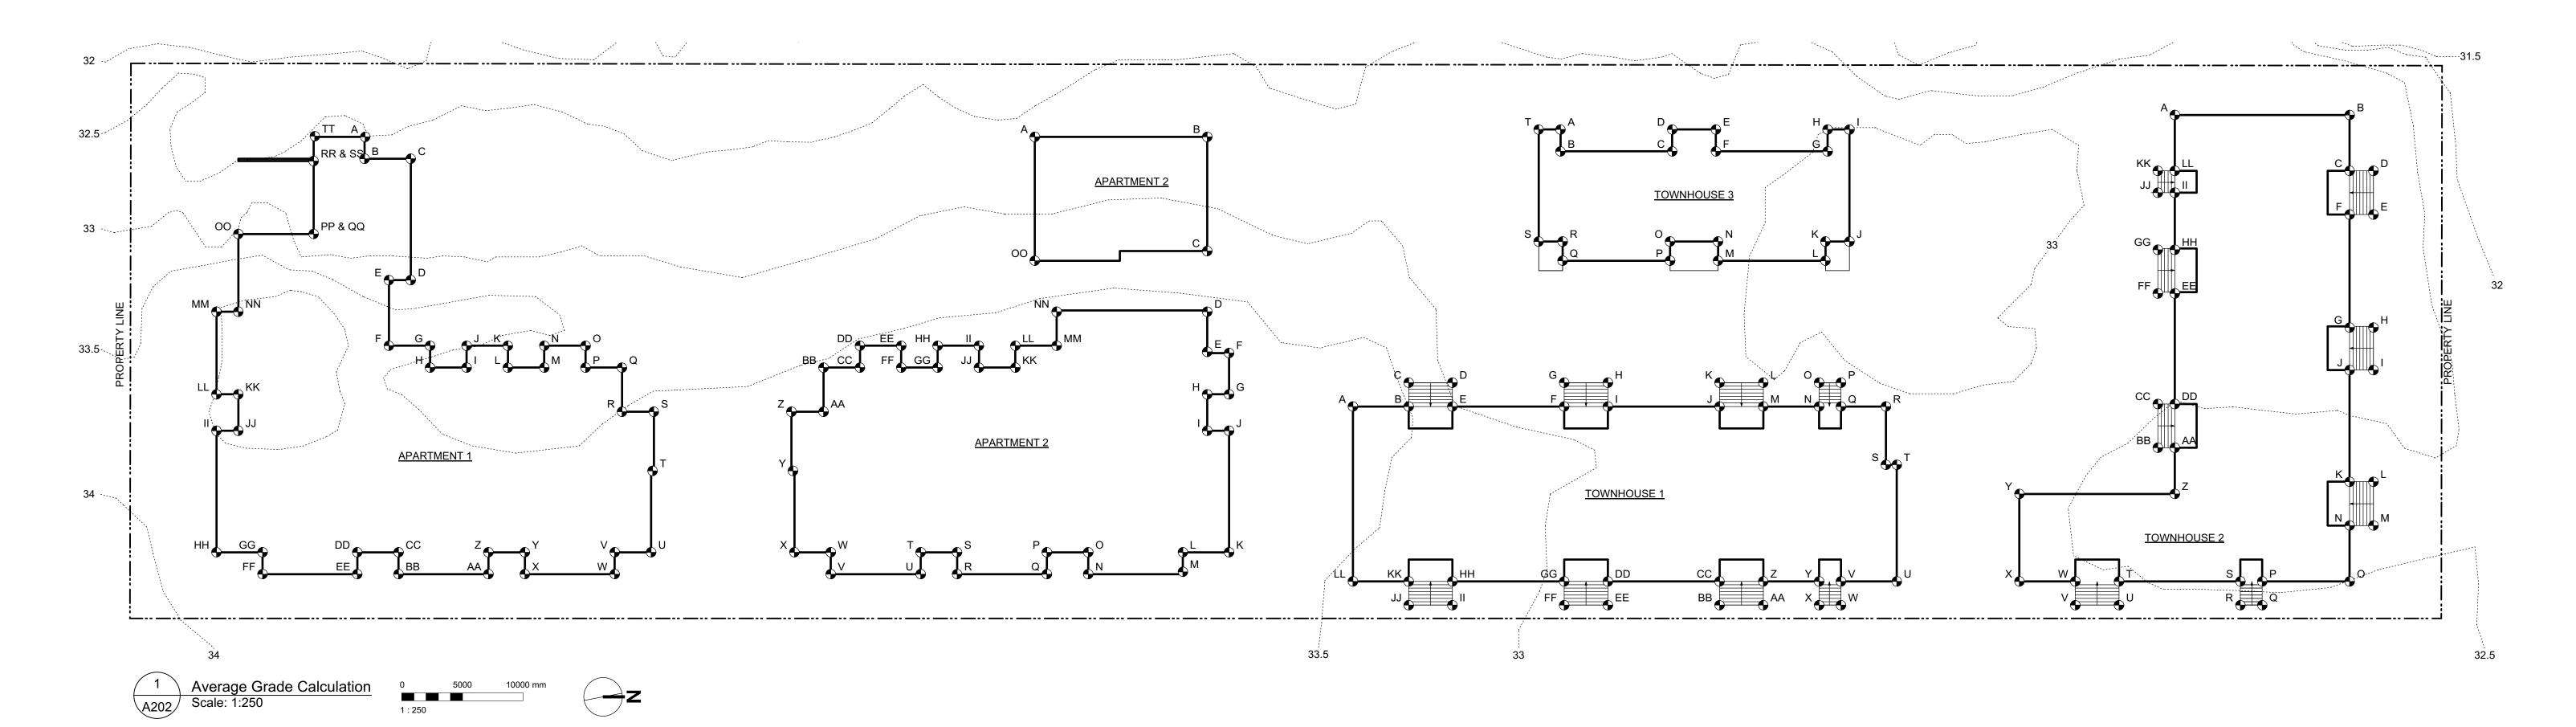TOWNHO	CALCULATION OUSE 1						
side	corner grade point	+ corner grade point	/ 2	average grade per side	X length of side	TOTAL	
A&B	33.6	33.5	2	33.6	4.6	153.2	
B&C	33.5	33.4	2	33.5	2.0	65.6	
C&D	33.4	33.0	2	33.2	3.6	119.5	
D&E	33.0	33.0	2	33.0	2.0	64.7	
E&F	33.0	32.9	2	33.0	9.2	303.1	
F&G	32.9	32.9	2	32.9	2.0	64.5	
G&H	32.9	32.9	2	32.9	3.6	118.4	
H&I	32.9	32.9	2	32.9	2.0	64.5	
I&J	32.9	32.8	2	32.9	9.2	302.2	
J&K	32.8	32.9	2	32.9	2.0	64.4	
K&L	32.9	33.0	2	33.0	3.6	118.6	
L&M	33.0	32.8	2	32.9	2.0	64.5	
M&N	32.8	32.7	2	32.8	4.6	150.7	
N&O	32.7	32.8	2	32.8	2.0	64.2	
O&P	32.8	32.9	2	32.9	1.8	59.1	
P&Q	32.9	32.7	2	32.8	2.0	64.3	
Q&R	32.7	32.9	2	32.8	3.7	121.4	
R&S	32.9	32.7	2	32.8	4.8	157.4	
S&T	32.7	32.7	2	32.7	0.9	29.4	
T&U	32.7	32.7	2	32.7	9.6	313.9	
U&V	32.7	32.7	2	32.7	4.6	150.4	
V&W	32.7	32.7	2	32.7	2.0	64.1	
W&X	32.7	32.8	2	32.8	1.8	59.0	
X&Y	32.8	32.8	2	32.8	2.0	64.3	
Y&Z	32.8	32.8	2	32.8	4.6	150.9	
Z&AA	32.8	32.8	2	32.8	2.0	64.3	
AA&BB	32.8	32.9	2	32.9	3.6	118.3	
BB&CC	32.9	32.9	2	32.9	2.0	64.5	
CCⅅ	32.9	32.9	2	32.9	9.2	302.7	
DD&EE	32.9	32.9	2	32.9	2.0	64.5	
EE&FF	32.9	33.0	2	33.0	3.6	118.6	
FF&GG	33.0	33.0	2	33.0	2.0	64.7	
GG&HH	33.0	33.2	2	33.1	9.2	304.5	
HH&II	33.2	33.2	2	33.2	2.0	65.1	
II&JJ	33.2	33.3	2	33.3	3.6	119.7	
JJ&KK	33.3	33.3	2	33.3	2.0	65.3	
KK&LL	33.3	33.4	2	33.4	4.6	153.4	
LL&A	33.4	33.6	2	33.5	14.5	484.1	
							GRADE = TOTAL/Perimeter
				Perimeter	149.8	4941.8	33.0

TOWNHO				_			
side	corner grade point	+ corner grade point	/ 2	average grade per side	X length of side	TOTAL	
A&B	32.7	32.6	2	32.7	14.4	471.6	
B&C	32.6	32.6	2	32.6	4.6	150.0	
C&D	32.6	32.6	2	32.6	2.0	63.9	
D&E	32.6	32.6	2	32.6	3.6	117.4	
E&F	32.6	32.6	2	32.6	2.0	63.9	
F&G	32.6	32.6	2	32.6	9.2	299.9	
G&H	32.6	32.6	2	32.6	2.0	63.9	
H&I	32.6	32.6	2	32.6	3.6	117.4	
I&J	32.6	32.6	2	32.6	2.0	63.9	
J&K	32.6	32.5	2	32.6	9.2	299.5	
K&L	32.5	32.5	2	32.5	2.0	63.7	
L&M	32.5	32.5	2	32.5	3.6	117.0	
M&N	32.5	32.5	2	32.5	2.0	63.7	
N&O	32.5	32.5	2	32.5	4.6	149.5	
O&P	32.5	32.5	2	32.5	7.2	234.0	
P&Q	32.5	32.5	2	32.5	2.0	63.7	
Q&R	32.5	32.5	2	32.5	1.8	58.5	
R&S	32.5	32.5	2	32.5	2.0	63.7	
S&T	32.5	32.5	2	32.5	10.0	325.0	
T&U	32.5	32.5	2	32.5	2.0	63.7	
U&V	32.5	32.6	2	32.6	3.6	117.2	
V&W	32.6	32.6	2	32.6	2.0	63.9	
W&X	32.6	32.6	2	32.6	4.6	150.0	
X&Y	32.6	32.6	2	32.6	7.2	234.7	
Y&Z	32.6	32.6	2	32.5	12.8	416.0	
Z&AA	32.4		2	32.5			
		32.5			3.8	123.3	
AA&BB	32.5	32.5	2	32.5	1.4	45.5	
BB&CC	32.5	32.5	2	32.5	3.6	117.0	
CCⅅ	32.5	32.5	2	32.5	1.4	45.5	
DD&EE	32.5	32.8	2	32.7	9.2	300.4	-
EE&FF	32.8	32.8	2	32.8	1.4	45.9	-
FF&GG	32.8	32.8	2	32.8	3.6	118.1	
GG&HH	32.8	32.8	2	32.8	1.4	45.9	
HH&II	32.8	32.8	2	32.8	4.6	150.9	
II&JJ	32.8	32.9	2	32.9	1.4	46.0	
JJ&KK	32.9	32.9	2	32.9	1.8	59.2	
KK&LL	32.9	32.8	2	32.9	1.4	46.0	
LL&A	32.8	32.7	2	32.8	4.6	150.7	
							GRADE
							TOTAL/Peri
				Perimeter	159.2	5189.9	32.6


TOWNH	IOUSE 3						
side	corner grade point	+ corner grade point	/ 2	average grade per side	X length of side	TOTAL	
A&B	32.6	32.6	2	32.6	1.8	58.7	
B&C	32.6	32.6	2	32.6	9.2	299.9	
C&D	32.6	32.6	2	32.6	1.8	58.7	
D&E	32.6	32.7	2	32.7	3.6	117.5	
E&F	32.7	32.8	2	32.8	1.8	59.0	
F&G	32.8	33.0	2	32.9	9.2	302.7	
G&H	33.0	33.0	2	33.0	1.8	59.4	
H&I	33.0	33.0	2	33.0	1.8	59.4	
I&J	33.0	33.0	2	33.0	9.3	305.7	
J&K	33.0	33.0	2	33.0	2.0	65.2	
K&L	33.0	33.0	2	33.0	1.6	52.3	
L&M	33.0	32.9	2	33.0	8.9	291.6	
M&N	32.9	32.9	2	32.9	1.6	52.1	
N&O	32.9	32.9	2	32.9	4.0	130.0	
O&P	32.9	32.9	2	32.9	1.6	52.1	
P&Q	32.9	32.8	2	32.9	8.9	290.7	
Q&R	32.8	32.8	2	32.8	1.6	52.0	
R&S	32.8	32.8	2	32.8	2.0	64.8	
S&T	32.8	32.6	2	32.7	9.3	303.6	
T&A	32.6	32.6	2	32.6	1.8	58.7	
							GRADE =
							TOTAL/Perimete
				Perimeter	83.3	2734.1	32.8

#### 10. NEW SHEET.

3	20/02/06	ISSUED FOR COTW
2	20/01/15	ISSUED FOR ADP
1	19/12/16	RESPONSE TO PLANNING REVIEW
Rev	Date	Description
plot date	SEPTEMBER 2019	drawing file 1907 A200 Plans.vwx
drawn by	FWP	checked by RAW
scale	AS SHOWN	project number 1907

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<del></del> dHKa	dHKarc	hitects
VICTORIA OFFICE 977 Fort Street Victoria BC V8V 3K3 T 1 • 250 • 658 • 3367	NANAIMO OFFICE 102-5190 Du Nanaimo BC <b>T</b> 1•250•585	blin Way V9T 2K8
Caledonia		
Victoria BC	Calculations	
Average Grade	drawing no.	revision no
DESIGNS ARE AND AT ALL TIMES REMAIN THE PROPERTY OF DHKARCHITECTS TO BE USED FOR THE PROJECT SHOWN AND MAY NOT BE REPRODUCED WITHOUT WRITTEN CONSENT	A202	3



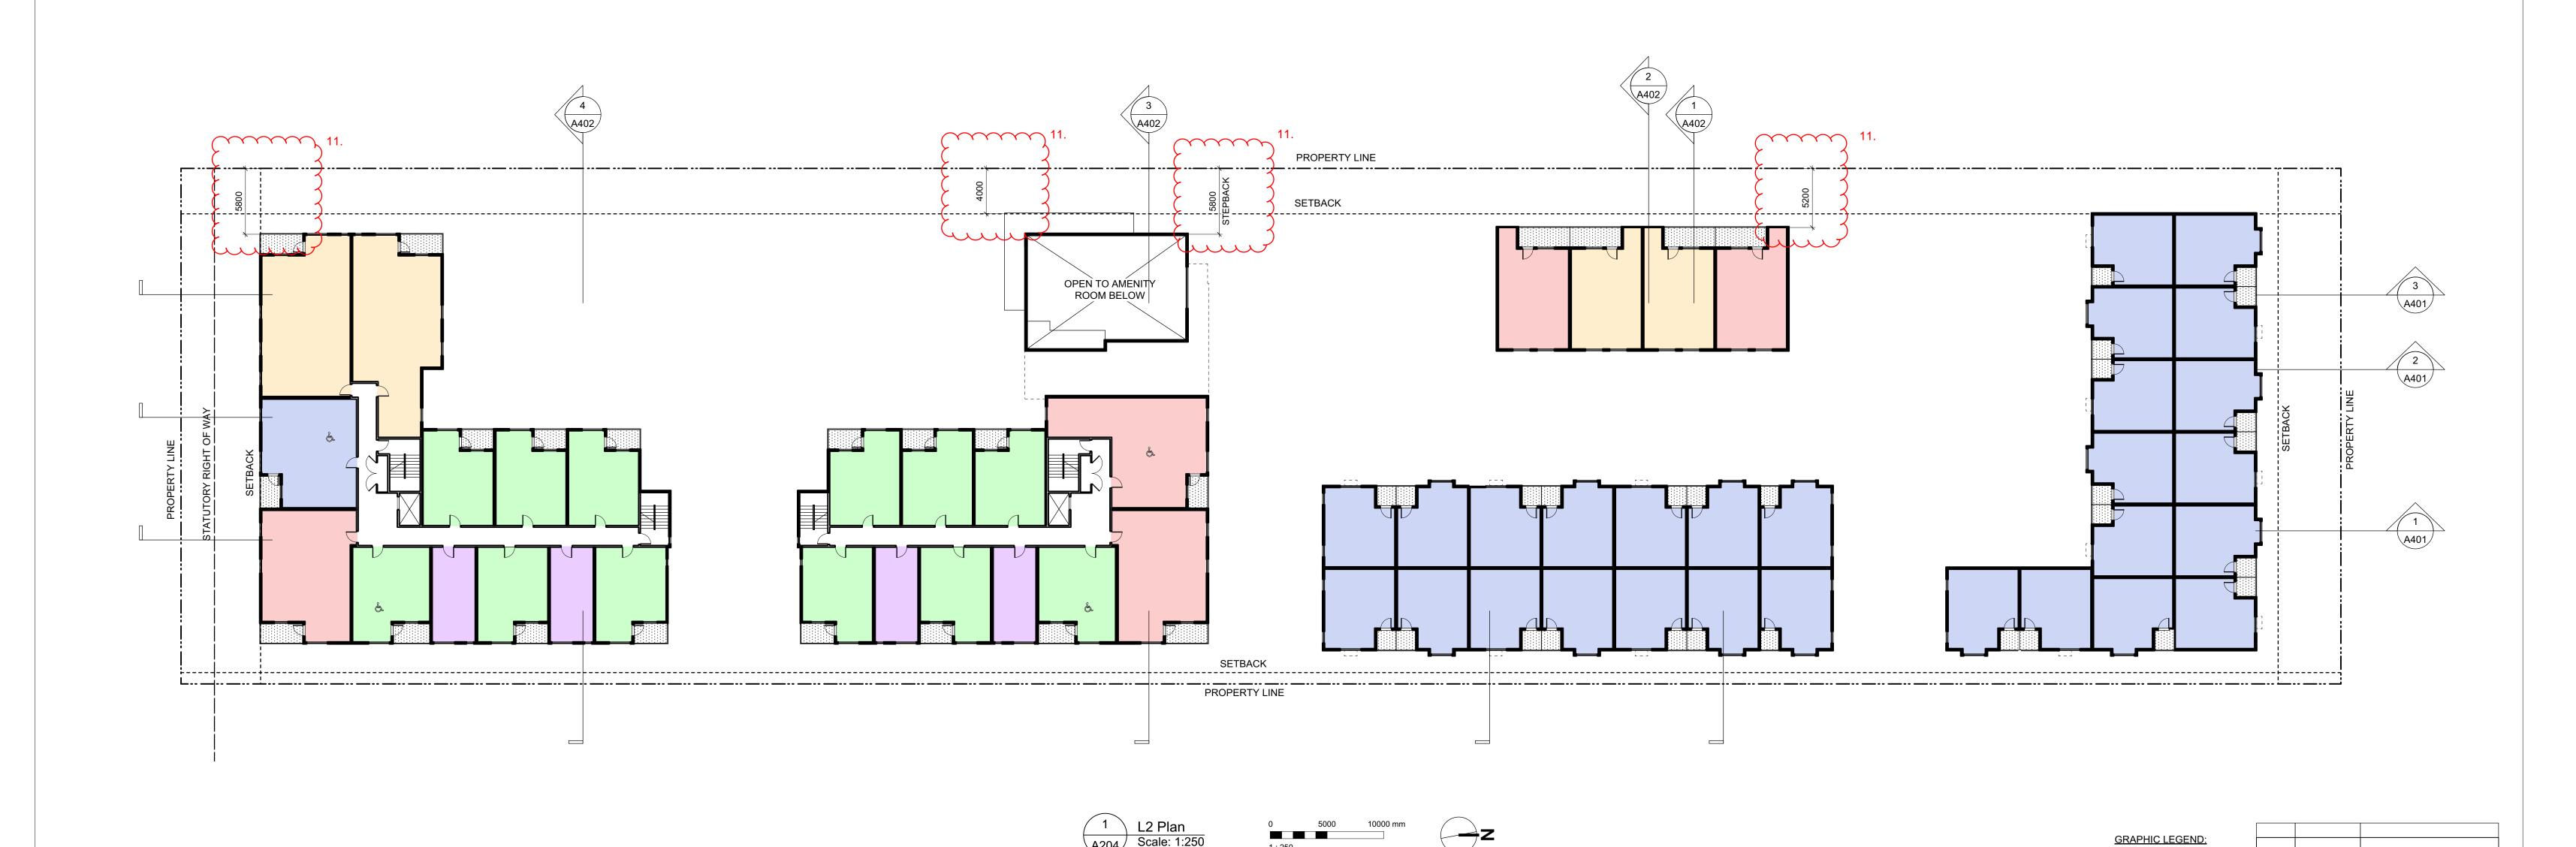

STUDIO

1 BEDROOM

2 BEDROOM

3 BEDROOM

4 BEDROOM

& ACCESSIBLE

ISSUED FOR COTW

1907 A200 Plans.vwx

RAW

3

RESPONSE TO PLANNING REVIEW

dHKarchitects

NANAIMO OFFICE 102-5190 Dublin Way Nanaimo BC V9T2K8 **T** 1•250•585•5810

ISSUED FOR ADP

20/01/15

19/12/16

SEPTEMBER 2019 drawing file

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Victoria BC V8V 3K3
T 1-250-658-3367

Caledonia

Victoria BC

L2 Plan

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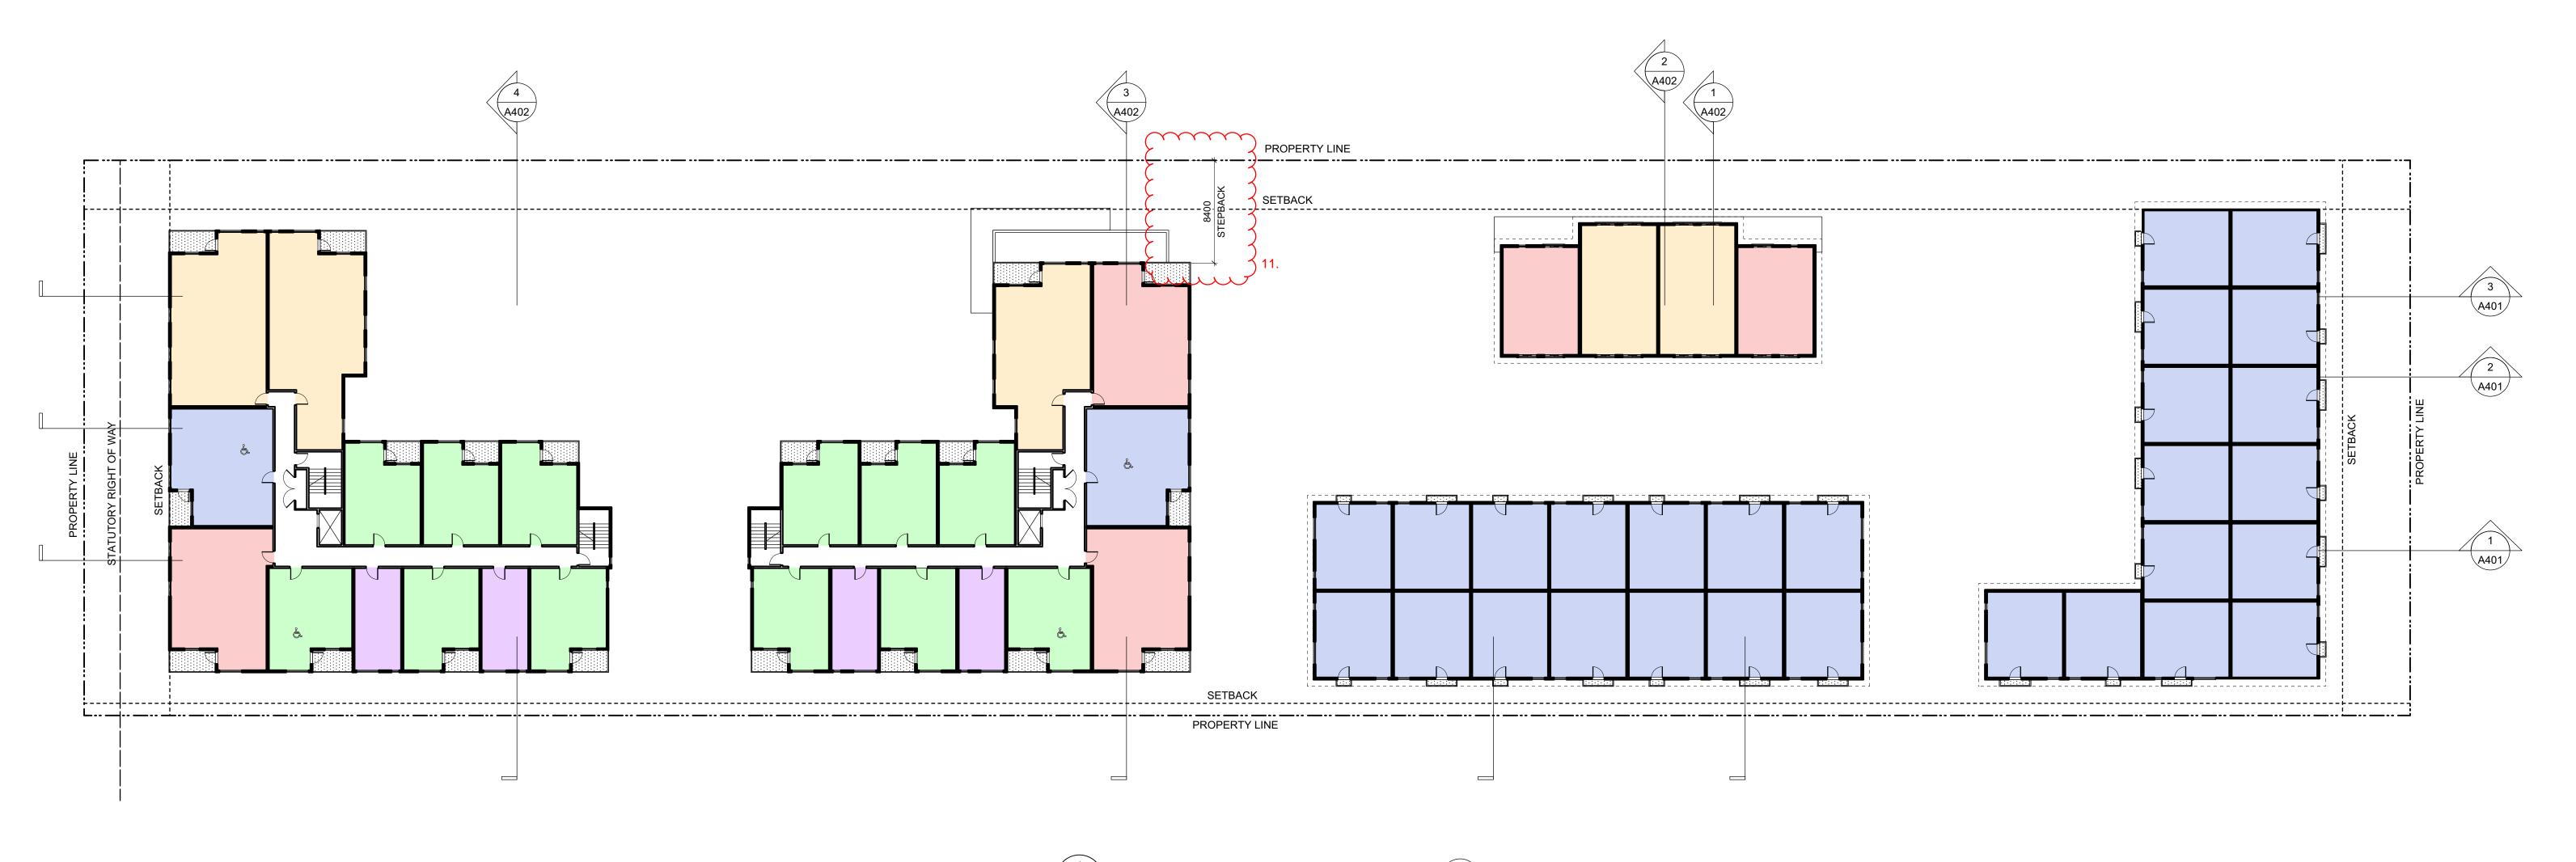
FWP checked by

NOTE: All dimensions are shown in millimeters.

ISSUED FOR DP

& REZONING


AS SHOWN project number






3	20/02/06	ISSUED FOR COTW
2	20/01/15	ISSUED FOR ADP
1	19/12/16	RESPONSE TO PLANNING REVIEW
Rev	Date	Description
plot date	SEPTEMBER 2019	drawing file 1907 A200 Plans.vwx
drawn by	FWP	checked by RAW
scale	AS SHOWN	project number 1907

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VICTORIA OFFICE 977 Fort Street Victoria BC V8V3K3 T 1.250.658.3367	NANAIMO OFFICE 102-5190 Du Nanaimo BC <b>T</b> 1•250•585	blin Way V9T2K8
Caledonia		
Victoria BC		
L3 Plan		
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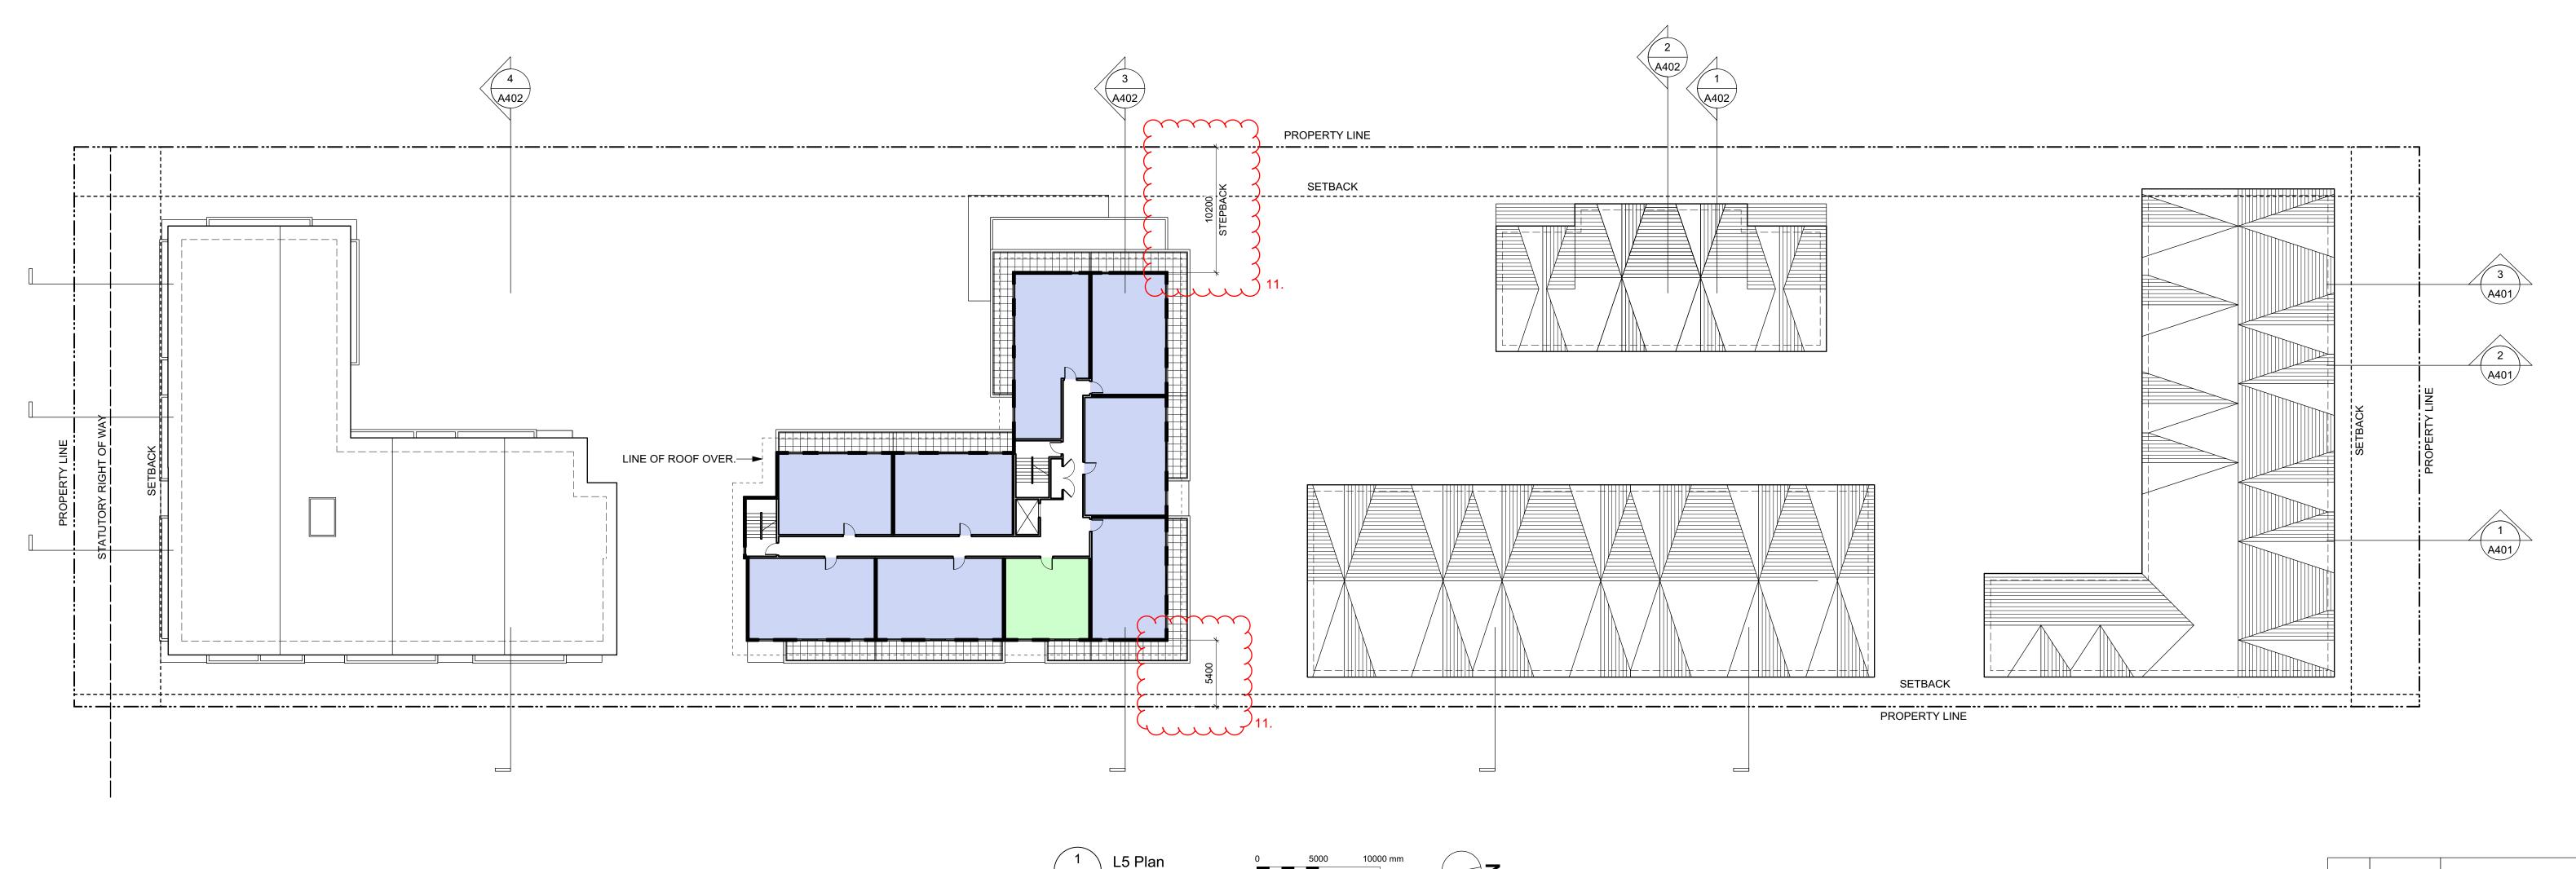


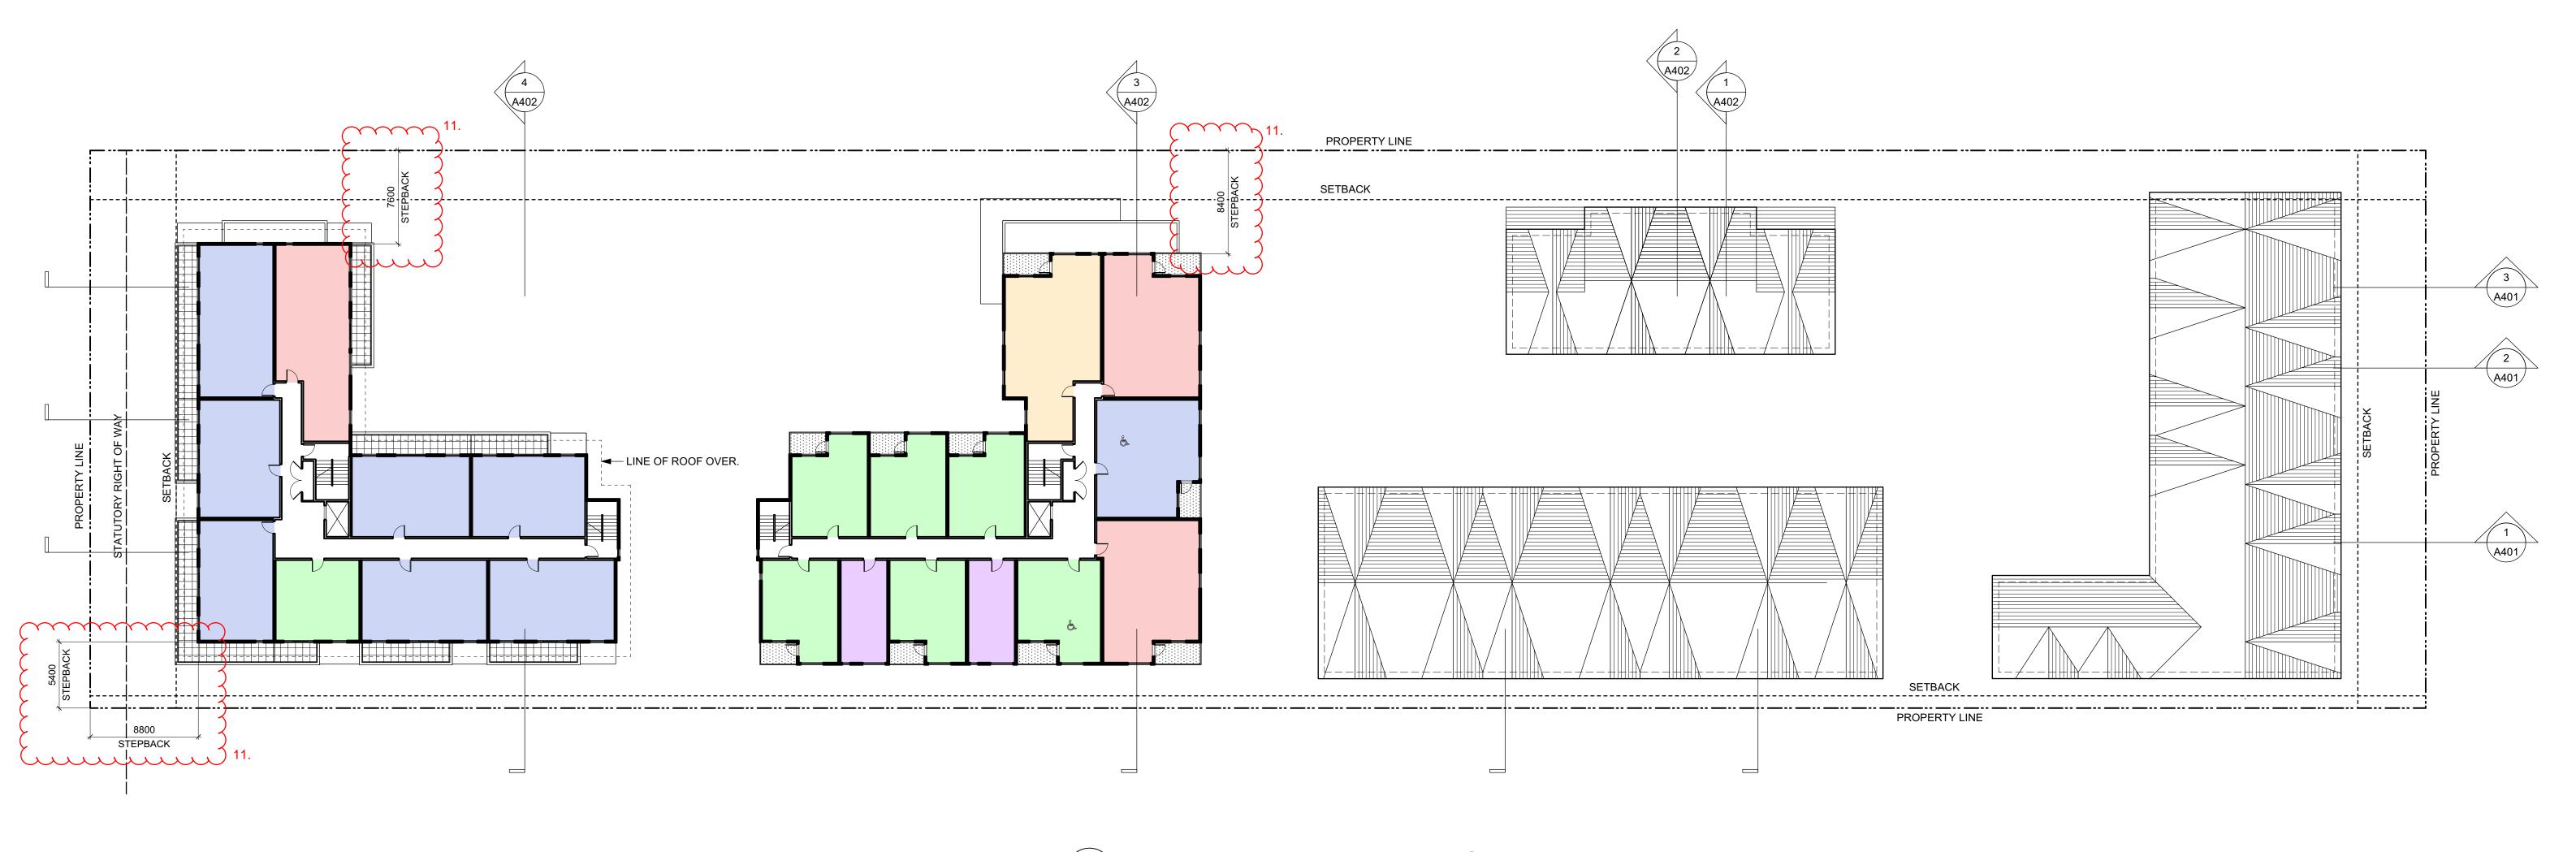

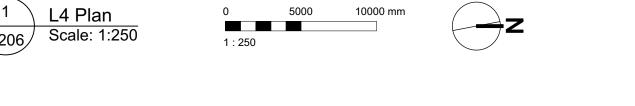GRAPHIC LEGEND:		
	STUDIO	
	1 BEDROOM	
	2 BEDROOM	
	3 BEDROOM	
4 BEDROOM		
Ġ.	ACCESSIBLE	

3	20/02/06	ISSUED FOR COTW
2	20/01/15	ISSUED FOR ADF
1	19/12/16	RESPONSE TO PLANNING REVIEW
Rev	Date	Description
plot date	SEPTEMBER 2019	drawing file 1907 A200 Plans.vwx
drawn by	FWP	checked by RAW
scale	AS SHOWN	project number 1907

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<del>-</del> dHKa	dHKarc	hitects
VICTORIA OFFICE 977 Fort Street Victoria BC V8V 3K3 T 1.250.658.3367	NANAIMO OFFICE 102-5190 Du Nanaimo BC <b>T</b> 1•250•585	blin Way V9T 2K8
Caledonia		
Victoria BC  drawing title  L4 Plan		
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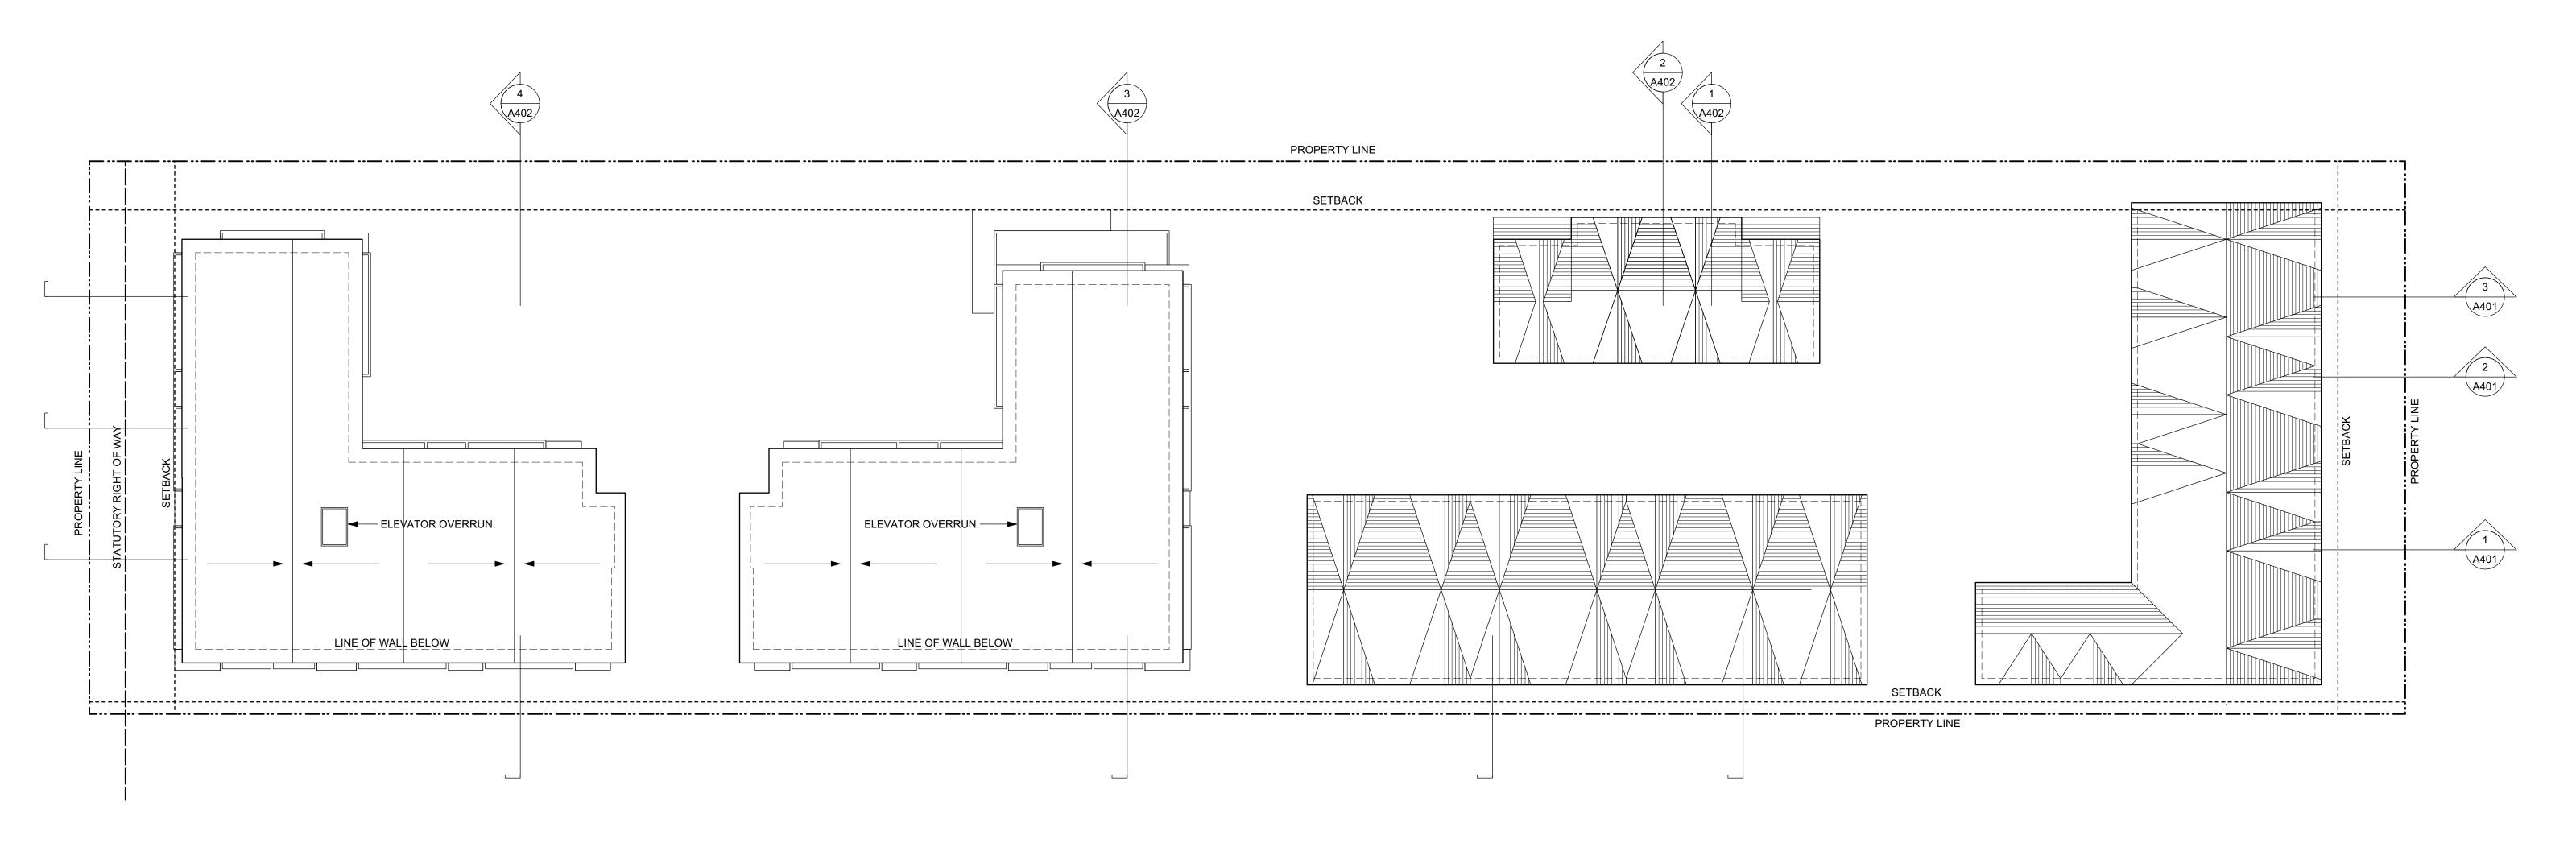






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2	20/01/15	ISSUED FOR ADF
1	19/12/16	RESPONSE TO PLANNING REVIEW
Rev	Date	Description
plot date	SEPTEMBER 2019	drawing file 1907 A200 Plans.vwx
drawn by	FWP	checked by RAW
scale	AS SHOWN	project number 1907

## NOTE: All dimensions are shown in millimeters. ISSUED FOR DP & REZONING

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VICTORIA OFFICE 977 Fort Street Victoria BC V8V 3K3 T 1•250•658•3367	NANAIMO OFFICE 102-5190 Dublin Wa Nanaimo BC V9T21 <b>T</b> 1•250•585•5810
project name	
Caledonia	
Victoria BC	
drawing title	
L5 Plan	



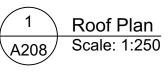

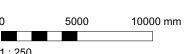


3	20/02/06	ISSUED FOR COT
2	20/01/15	ISSUED FOR AD
1	19/12/16	RESPONSE TO PLANNING REVIE
Rev	Date	Description
plot date	SEPTEMBER 2019	drawing file 1907 A200 Plans.vw
drawn by	FWP	checked by RA
scale	AS SHOWN	project number 190

dHKa	dHKarchitects
VICTORIA OFFICE 977 Fort Street Victoria BC V8V 3K3 T 1•250•658•3367	NANAIMO OFFICE 102-5190 Dublin Way Nanaimo BC V9T2K8 <b>T</b> 1•250•585•5810
project name	
Caledonia	
Victoria BC	
drawing title	
Roof Plan	







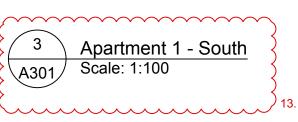



Apartment 1 - West
Scale: 1:100

#### **COLOUR & MATERIALS LEGEND**

- BRICK VENEER Red Apartment 1 Only
- 2 FIBRE CEMENT PANEL Teal
- 3 VINYL WINDOWS & DOORS Teal
- DEFENSIONED ALLIMINIUM CHARD EDAME ( DIOVETO TAX
- PREFINISHED ALUMINUM GUARD, FRAME & PICKETS Teal
- 5 METAL FLASHING Teal
- 6 ACCENT PAINT COLOUR Rust
- 7 FIBRE CEMENT LAP SIDING Soft Brown
- 8 FIBRE CEMENT PANEL Warm Grey Apartment 2 Only
- FIBRE CEMENT PANEL Walli Gley Apartil
- 9 SOFFIT Warm Grey Apartment 2 Only
- 10 PAINTED CONCRETE Warm Grey
- 11 FIBRE CEMENT PANEL Warm White
- SOFFIT Warm White
- 13 FIBRE CEMENT LAP SIDING Medium Blue-Grey

- 14 FIBRE CEMENT LAP SIDING White
- 15 VINYL WINDOWS & DOORS Dark Grey
- 16 PREFINISHED ALUMINUM GUARD & FRAME Dark Grey
- 17 METAL FLASHING Dark Grey
- 18 ASPHALT SHINGLES Warm Grey
- FIBRE CEMENT SHINGLES Warm Grey
- VINYL WINDOWS & DOORS White
- METAL DOWNSPOUT & FLASHING Light Warm Grey
- FIBRE CEMENT PANEL Dark Grey
- FIBRE CEMENT PANEL Light Grey
- ACCENT PAINT COLOUR Bright Orange
- 25 ACCENT PAINT COLOUR Bright Blue
- 26 ACCENT PAINT COLOUR Chartreuse

3	20/02/06	ISSUED FOR COTW
2	20/01/15	ISSUED FOR ADP
1	19/12/16	RESPONSE TO PLANNING REVIEW
Rev	Date	Description
plot date	SEPTEMBER 2019	drawing file 1907 A300 Elevations.vwx
drawn by	NLC	checked by RAW
scale	1:100	project number 1907
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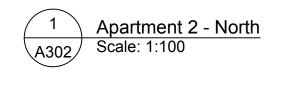
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9 V	VICTORIA OFFICE 77 Fort Street Victoria BC V8V3K3 1-250•658•3367	NANAIMO OFFICE 102-5190 Dublin Way Nanaimo BC V9T 2K8 <b>T</b> 1•250•585•5810
	oject name Caledonia	
\	/ictoria BC	

Elevations - Apartment 1

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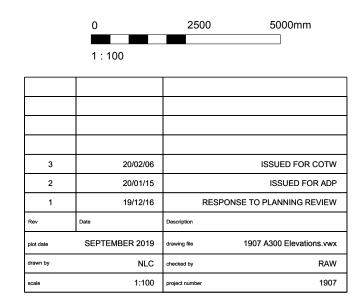


Apartment 2 - South
Scale: 1:100 

#### **COLOUR & MATERIALS LEGEND**

- 1 BRICK VENEER Red Apartment 1 Only
- 2 FIBRE CEMENT PANEL Teal
- 3 VINYL WINDOWS & DOORS Teal
- PREFINISHED ALUMINUM GUARD, FRAME & PICKETS Teal
- 5 METAL FLASHING Teal
- 6 ACCENT PAINT COLOUR Rust
- 7 FIBRE CEMENT LAP SIDING Soft Brown
- 8 FIBRE CEMENT PANEL Warm Grey Apartment 2 Only
- 9 SOFFIT Warm Grey Apartment 2 Only
- 10 PAINTED CONCRETE Warm Grey
- 11 FIBRE CEMENT PANEL Warm White
- SOFFIT Warm White
- 13 FIBRE CEMENT LAP SIDING Medium Blue-Grey

- 14 FIBRE CEMENT LAP SIDING White
- 15 VINYL WINDOWS & DOORS Dark Grey
- PREFINISHED ALUMINUM GUARD & FRAME Dark Grey
- 17 METAL FLASHING Dark Grey
- 18 ASPHALT SHINGLES Warm Grey
- 19 FIBRE CEMENT SHINGLES Warm Grey
- VINYL WINDOWS & DOORS White
- 21 METAL DOWNSPOUT & FLASHING Light Warm Grey
- FIBRE CEMENT PANEL Dark Grey
- FIBRE CEMENT PANEL Light Grey
- ACCENT PAINT COLOUR Bright Orange
- 25 ACCENT PAINT COLOUR Bright Blue
- 26 ACCENT PAINT COLOUR Chartreuse



<del></del>	dHKarc	hitects
VICTORIA OFFICE 977 Fort Street Victoria BC V8V 3K3 T 1•250•658•3367	NANAIMO OFFICE 102-5190 Du Nanaimo BC <b>T</b> 1•250•585	blin Way V9T 2K8
Caledonia Victoria BC		
Elevations - Apartment 2		
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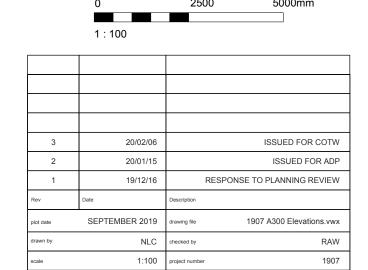


Apartment 2 - West
Scale: 1:100

#### **COLOUR & MATERIALS LEGEND**

- 1 BRICK VENEER Red Apartment 1 Only
- 2 FIBRE CEMENT PANEL Teal
- 3 VINYL WINDOWS & DOORS Teal
- PREFINISHED ALUMINUM GUARD, FRAME & PICKETS Teal
- 5 METAL FLASHING Teal
- 6 ACCENT PAINT COLOUR Rust
- 7 FIBRE CEMENT LAP SIDING Soft Brown
- 8 FIBRE CEMENT PANEL Warm Grey Apartment 2 Only
- 9 SOFFIT Warm Grey Apartment 2 Only
- 10 PAINTED CONCRETE Warm Grey
- 11 FIBRE CEMENT PANEL Warm White
- SOFFIT Warm White
- 13 FIBRE CEMENT LAP SIDING Medium Blue-Grey

- 14 FIBRE CEMENT LAP SIDING White
- 15 VINYL WINDOWS & DOORS Dark Grey
- PREFINISHED ALUMINUM GUARD & FRAME Dark Grey
- 17 METAL FLASHING Dark Grey
- 18 ASPHALT SHINGLES Warm Grey
- 19 FIBRE CEMENT SHINGLES Warm Grey
- 20 VINYL WINDOWS & DOORS White
- 21 METAL DOWNSPOUT & FLASHING Light Warm Grey
- FIBRE CEMENT PANEL Dark Grey
- FIBRE CEMENT PANEL Light Grey
- 24 ACCENT PAINT COLOUR Bright Orange
- 25 ACCENT PAINT COLOUR Bright Blue
- 26 ACCENT PAINT COLOUR Chartreuse




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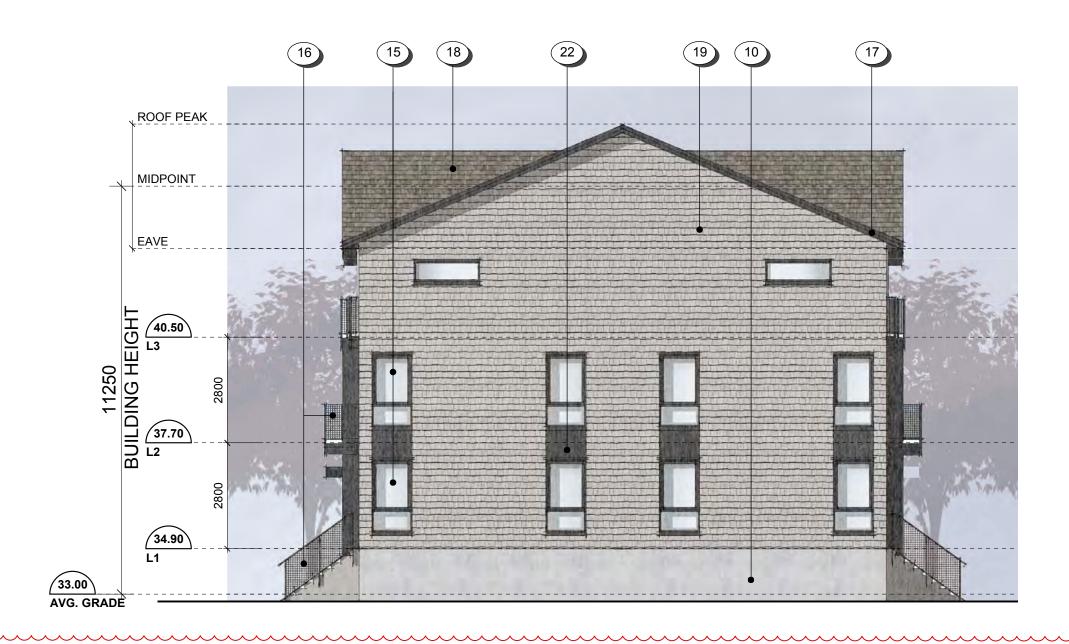
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VICTORIA OFFICE 977 Fort Street Victoria BC V8V 3K3 T 1•250•658•3367	NANAIMO OFFICE 102-5190 Dublin Way Nanaimo BC V9T 2K8 <b>T</b> 1•250•585•5810
Caledonia	
Victoria BC	

Elevations - Apartment 2

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Townhouse 1 - South Scale: 1:100



Townhouse 1 - East
A304 Scale: 1:100

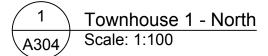

4 Townhouse 1 - West
A304 Scale: 1:100

#### **COLOUR & MATERIALS LEGEND**

- BRICK VENEER Red Apartment 1 Only
- 2 FIBRE CEMENT PANEL Teal
- 3 VINYL WINDOWS & DOORS Teal
- PREFINISHED ALUMINUM GUARD, FRAME & PICKETS Teal
- 5 METAL FLASHING Teal
- 6 ACCENT PAINT COLOUR Rust
- 7 FIBRE CEMENT LAP SIDING Soft Brown
- 8 FIBRE CEMENT PANEL Warm Grey Apartment 2 Only
- 9 SOFFIT Warm Grey Apartment 2 Only
- 10 PAINTED CONCRETE Warm Grey
- 11 FIBRE CEMENT PANEL Warm White
- SOFFIT Warm White
- 13 FIBRE CEMENT LAP SIDING Medium Blue-Grey

- 14 FIBRE CEMENT LAP SIDING White
- 15 VINYL WINDOWS & DOORS Dark Grey
- 16 PREFINISHED ALUMINUM GUARD & FRAME Dark Grey
- 17 METAL FLASHING Dark Grey
- 18 ASPHALT SHINGLES Warm Grey
- FIBRE CEMENT SHINGLES Warm Grey
- VINYL WINDOWS & DOORS White
- METAL DOWNSPOUT & FLASHING Light Warm Grey
- FIBRE CEMENT PANEL Dark Grey
- FIBRE CEMENT PANEL Light Grey
- ACCENT PAINT COLOUR Bright Orange

- ACCENT PAINT COLOUR Bright Blue 26 ACCENT PAINT COLOUR - Chartreuse

	1 : 100	
3	20/02/06	ISSUED FOR COTW
2	20/01/15	ISSUED FOR ADP
1	19/12/16	RESPONSE TO PLANNING REVIEW
Rev	Date	Description
plot date	SEPTEMBER 2019	drawing file 1907 A300 Elevations.vwx
drawn by	NLC	checked by RAW
scale	1:100	project number 1907
		•

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977 Fort Street
Victoria BC V8V 3K3
T 1.250.658.3367 NANAIMO OFFICE 102-5190 Dublin Way Nanaimo BC V9T2K8 **T** 1•250•585•5810

Caledonia Victoria BC

Elevations - Townhouse 1

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2 Townhouse 2 - East A305 Scale: 1:100





Townhouse 2 - South
Scale: 1:100

Townhouse 2 - West
A305 Scale: 1:100

#### **COLOUR & MATERIALS LEGEND**

- BRICK VENEER Red Apartment 1 Only
- 2 FIBRE CEMENT PANEL Teal
- 3 VINYL WINDOWS & DOORS Teal
- PREFINISHED ALUMINUM GUARD, FRAME & PICKETS Teal
- 5 METAL FLASHING Teal
- 6 ACCENT PAINT COLOUR Rust
- 7 FIBRE CEMENT LAP SIDING Soft Brown
- 8 FIBRE CEMENT PANEL Warm Grey Apartment 2 Only
- 9 SOFFIT Warm Grey Apartment 2 Only
- 10 PAINTED CONCRETE Warm Grey
- 11 FIBRE CEMENT PANEL Warm White
- SOFFIT Warm White
- 13 FIBRE CEMENT LAP SIDING Medium Blue-Grey

- 14 FIBRE CEMENT LAP SIDING White
- 15 VINYL WINDOWS & DOORS Dark Grey
- 16 PREFINISHED ALUMINUM GUARD & FRAME Dark Grey
- 17 METAL FLASHING Dark Grey
- 18 ASPHALT SHINGLES Warm Grey
- FIBRE CEMENT SHINGLES Warm Grey
- VINYL WINDOWS & DOORS White
- METAL DOWNSPOUT & FLASHING Light Warm Grey
- FIBRE CEMENT PANEL Dark Grey
- FIBRE CEMENT PANEL Light Grey
- ACCENT PAINT COLOUR Bright Orange
- ACCENT PAINT COLOUR Bright Blue 26 ACCENT PAINT COLOUR - Chartreuse


	1 : 100	
3	20/02/06	ISSUED FOR COTW
2	20/01/15	ISSUED FOR ADP
1	19/12/16	RESPONSE TO PLANNING REVIEW
Rev	Date	Description
plot date	SEPTEMBER 2019	drawing file 1907 A300 Elevations.vwx
drawn by	NLC	checked by RAW
scale	1:100	project number 1907
NOTE: All a		W:


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VICTORIA OFFICE 977 Fort Street Victoria BC V8V 3K3 T 1.250.658.3367	NANAIMO OFFICE 102-5190 Dublin Way Nanaimo BC V9T2K8 T 1•250•585•5810
Caledonia	
Viotoria PC	

Victoria BC

Elevations - Townhouse 2 COPYRIGHT RESERVED. THESE PLANS AND DESIGNS ARE AND AT ALL TIMES REMAIN THE PROPERTY OF DIKKARCHITECTS TO BE USED FOR THE PROJECT SHOWN AND MAY NOT BE REPRODUCED WITHOUT WRITTEN CONSENT



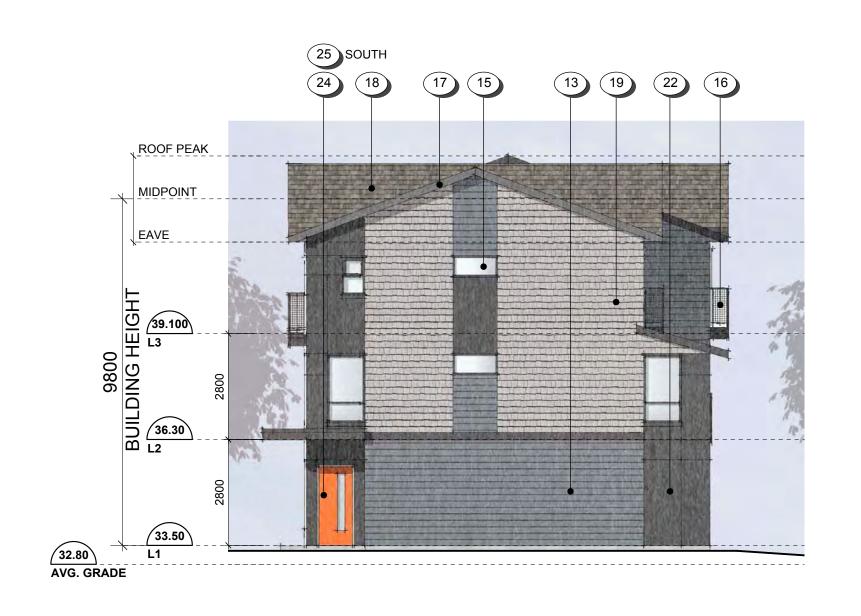

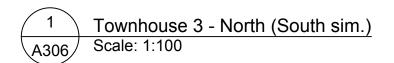

Townhouse 3 - East A306 Scale: 1:100



Townhouse 3 - West
A306 Scale: 1:100

#### **COLOUR & MATERIALS LEGEND**

- 1 BRICK VENEER Red Apartment 1 Only
- 2 FIBRE CEMENT PANEL Teal
- 3 VINYL WINDOWS & DOORS Teal
- PREFINISHED ALUMINUM GUARD, FRAME & PICKETS Teal
- 5 METAL FLASHING Teal
- 6 ACCENT PAINT COLOUR Rust
- 7 FIBRE CEMENT LAP SIDING Soft Brown
- 8 FIBRE CEMENT PANEL Warm Grey Apartment 2 Only
- 9 SOFFIT Warm Grey Apartment 2 Only
- 10 PAINTED CONCRETE Warm Grey
- 11 FIBRE CEMENT PANEL Warm White
- SOFFIT Warm White
- 13 FIBRE CEMENT LAP SIDING Medium Blue-Grey

- 14 FIBRE CEMENT LAP SIDING White
- 15 VINYL WINDOWS & DOORS Dark Grey
- PREFINISHED ALUMINUM GUARD & FRAME Dark Grey
- 17 METAL FLASHING Dark Grey
- ASPHALT SHINGLES Warm Grey
- 19 FIBRE CEMENT SHINGLES Warm Grey
- VINYL WINDOWS & DOORS White
- 21 METAL DOWNSPOUT & FLASHING Light Warm Grey
- FIBRE CEMENT PANEL Dark Grey
- FIBRE CEMENT PANEL Light Grey
- 24 ACCENT PAINT COLOUR Bright Orange
- ACCENT PAINT COLOUR Bright Blue
- 26 ACCENT PAINT COLOUR Chartreuse

	1.100	
3	20/02/06	ISSUED FOR COTW
2	20/01/15	ISSUED FOR ADP
1	19/12/16	RESPONSE TO PLANNING REVIEW
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ISSUED FOR DP
& REZONING

1907 A300 Elevations.vwx

SEPTEMBER 2019 drawing file

NLC checked by


1:100 project number

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VICTORIA OFFICE 977 Fort Street Victoria BC V8V 3K3 T 1•250•658•3367	NANAIMO OFFICE 102-5190 Dublin Way Nanaimo BC V9T2K8 <b>T</b> 1•250•585•5810
project name	
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Victoria BC	

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	Elevations - Townhouse 3


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### **EXISTING**

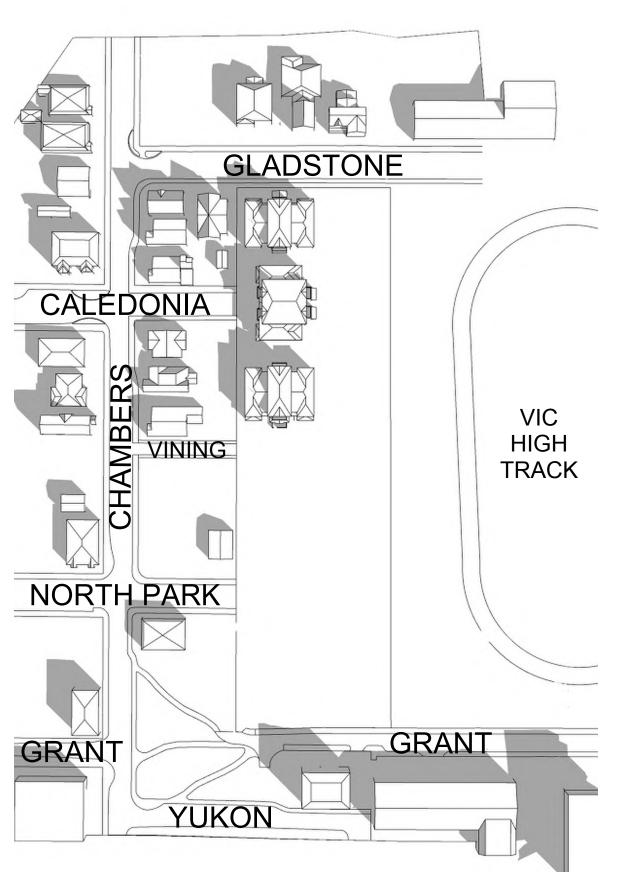


9:00AM - SEPTEMBER 21ST

#### **EXISTING**

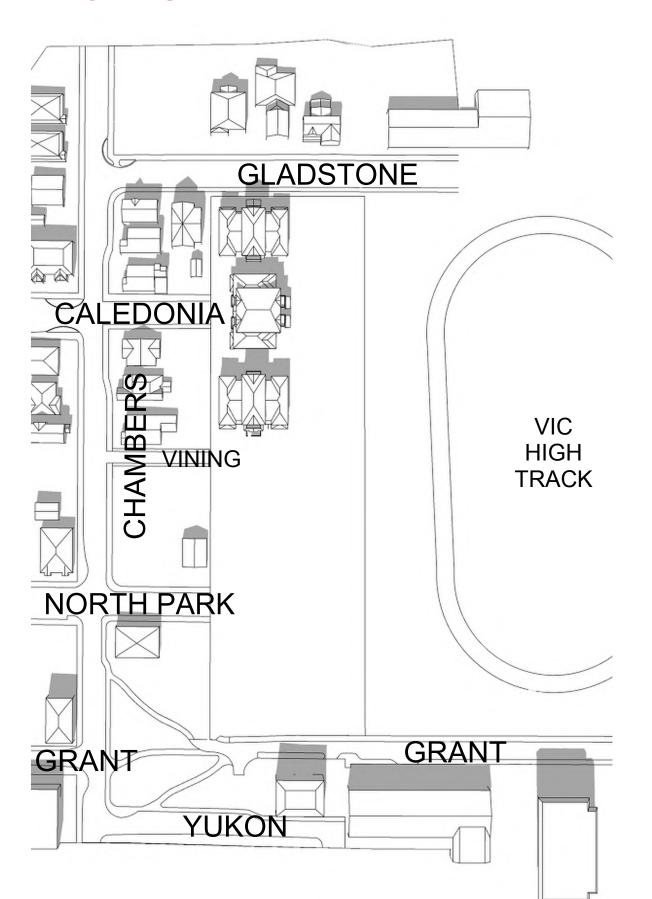


**12:00PM - SEPTEMBER 21ST** 

#### **EXISTING**

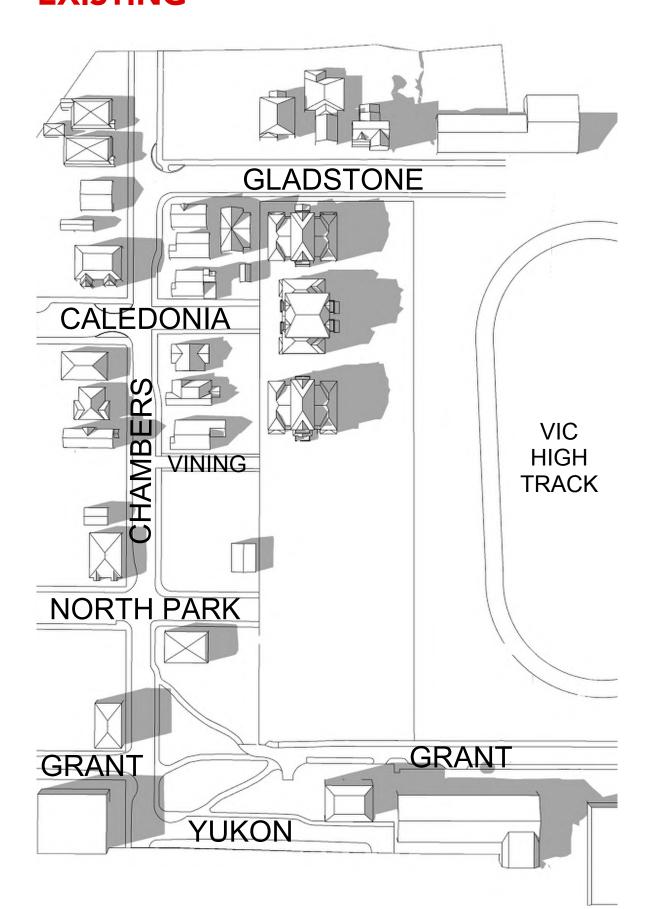


4:00PM - SEPTEMBER 21ST

#### **PROPOSED**

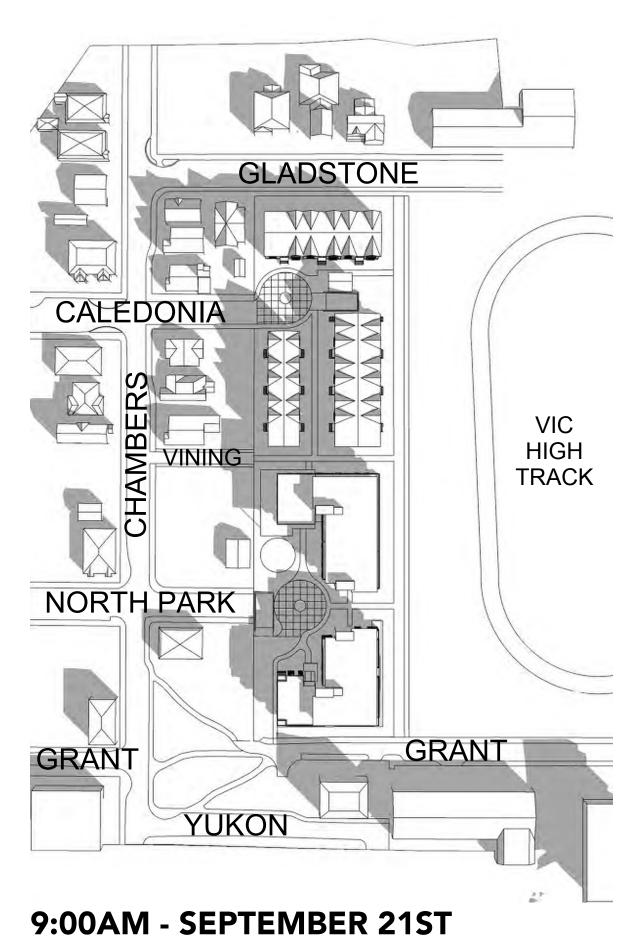


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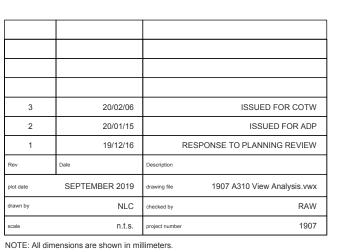


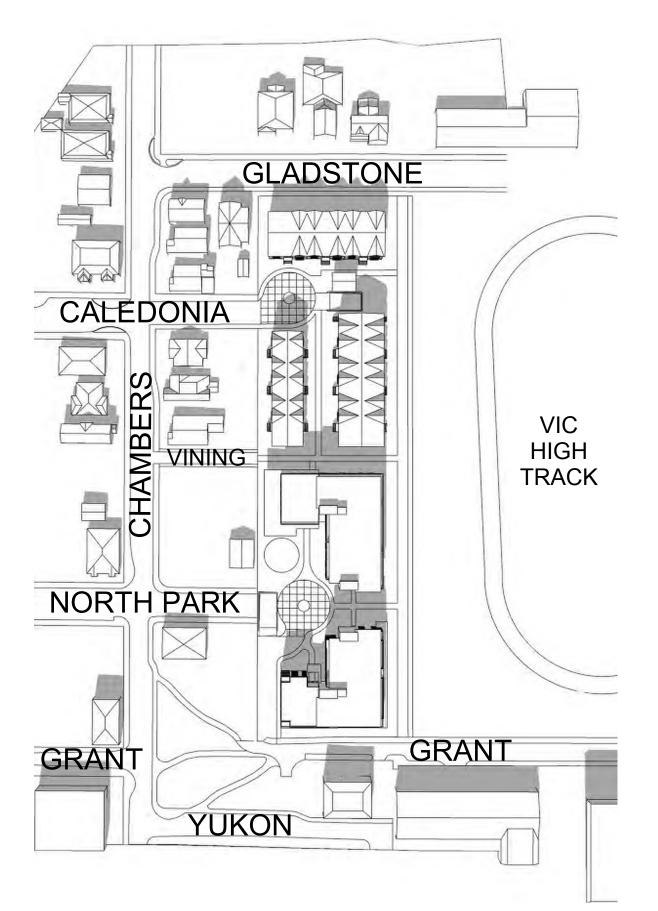**12:00PM - SEPTEMBER 21ST** 


#### **PROPOSED**

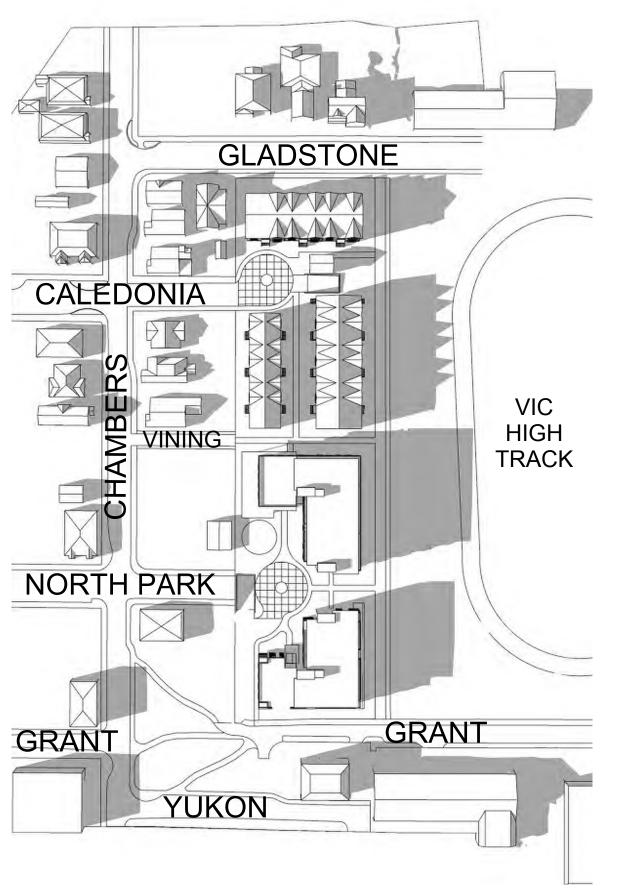

4:00PM - SEPTEMBER 21ST



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& REZONING

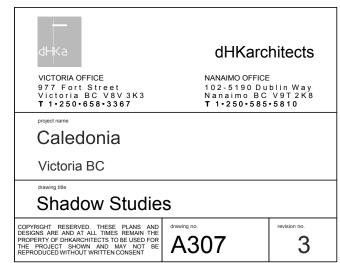



**BEFORE - LOOKING WEST - FROM VIC HIGH** 



**AFTER - LOOKING WEST - FROM VIC HIGH** 

3	20/02/06	ISSUED FOR COTW
2	20/01/15	ISSUED FOR ADP
1	19/12/16	RESPONSE TO PLANNING REVIEW
Rev	Date	Description
plot date	SEPTEMBER 2019	drawing file 1907 A310 View Analysis.vwx
drawn by	NLC	checked by RAW
scale	n.t.s.	project number 1907
NOTE: All dim	ensions are shown in mil	limeters.

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VICTORIA OFFICE 977 Fort Street Victoria BC V8V 3K3 T 1.250.658.3367	NANAIMO OFFICE 102-5190 Du Nanaimo BC <b>T</b> 1•250•585	blin Way V9T2K8
caledonia		
Caledonia		
Victoria BC		
View Analysis		
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**BEFORE LOOKING WEST - FROM GRANT STREET** 



BEFORE - LOOKING WEST - FROM GLADSTONE AVENUE




**AFTER LOOKING WEST - FROM GRANT STREET** 




AFTER LOOKING WEST - FROM GLADSTONE AVENUE

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2	20/01/15	ISSUED FOR ADF	
1	19/12/16	RESPONSE TO PLANNING REVIEW	
Rev	Date	Description	
plot date	SEPTEMBER 2019	drawing file 1907 A310 View Analysis.vwx	
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Caledonia		
Victoria BC		
View Analysis		
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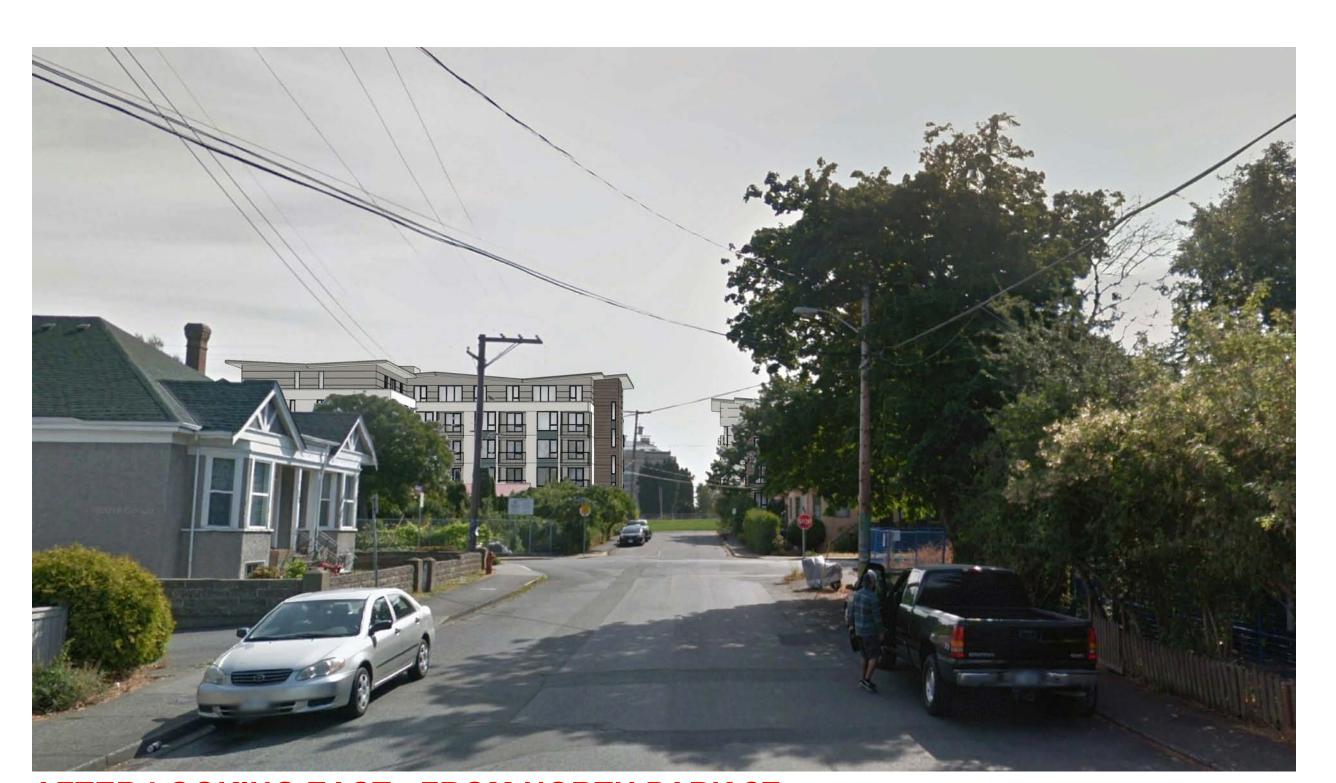
BEFORE LOOKING EAST - FROM CALEDONIA AVE.

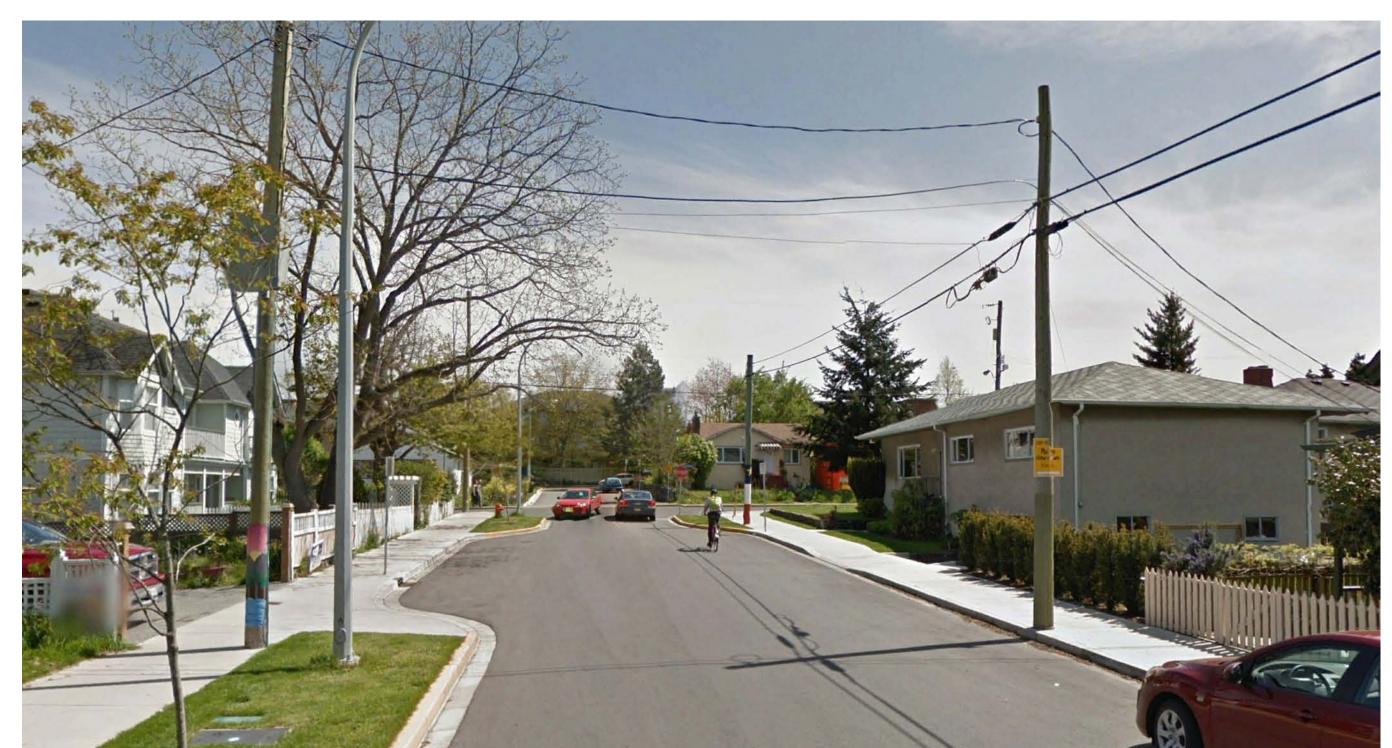

AFTER LOOKING EAST - FROM CALEDONIA AVE.

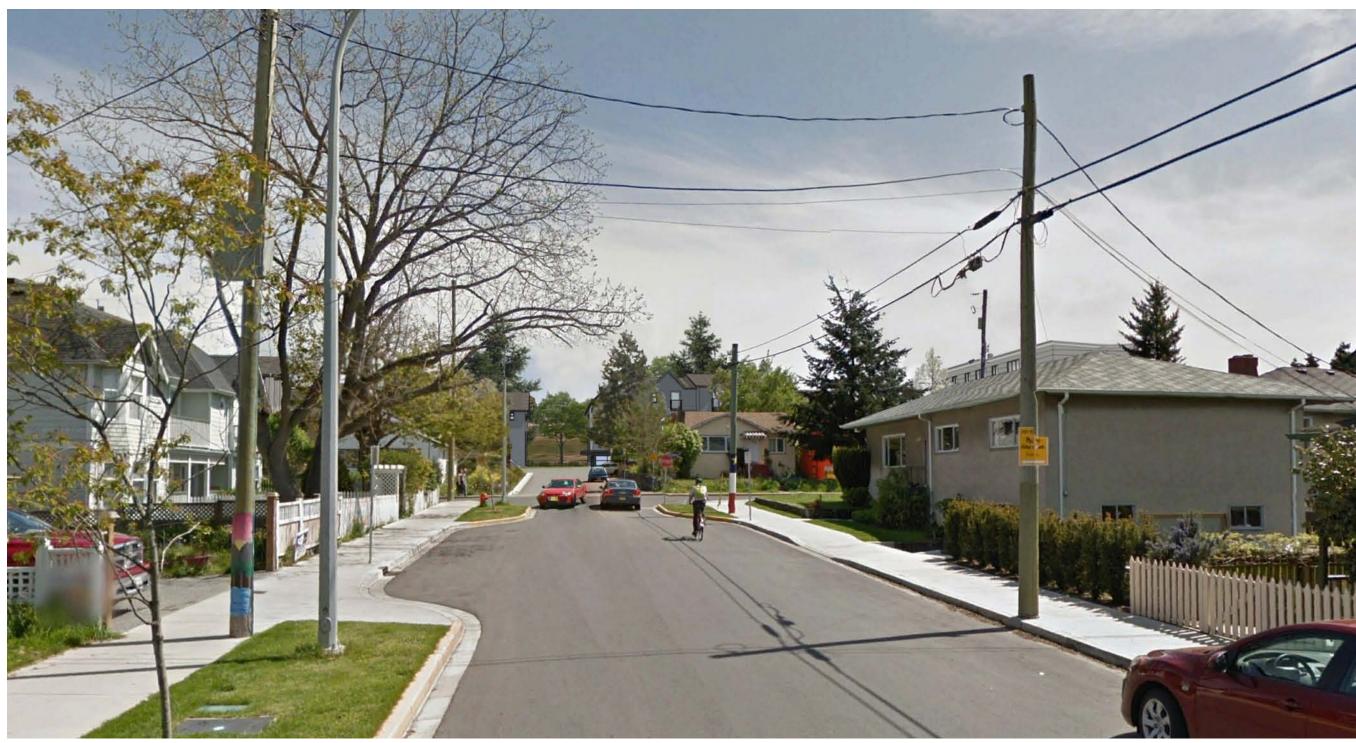

BEFORE LOOKING EAST - FROM NORTH PARK ST.



AFTER LOOKING EAST - FROM NORTH PARK ST.

3	20/02/06	ISSUED FOR COTW
2	20/01/15	ISSUED FOR ADP
1	19/12/16	RESPONSE TO PLANNING REVIEW
Rev	Date	Description
plot date	SEPTEMBER 2019	drawing file 1907 A310 View Analysis.vwx
drawn by	NLC	checked by RAW
scale	n.t.s.	project number 1907
NOTE: All di	mensions are shown in mi	llimeters

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& REZONING

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NANAIMO OFFICE 102-5190 Dublin Way Nanaimo BC V9T2K8 <b>T</b> 1•250•585•5810	
A310	revision no.
	NANAIMO OFFICE 102-5190 Du Nanaimo BC T 1-250-585



**LOOKING SOUTH - GLADSTONE AVENUE** 



**LOOKING EAST - NORTH PARK STREET** 



3	20/02/06	ISSUED FOR COTW
2	20/01/15	ISSUED FOR ADP
1	19/12/16	RESPONSE TO PLANNING REVIEW
Rev	Date	Description
plot date	SEPTEMBER 2019	drawing file 1907 A310 View Analysis.vwx
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scale	n.t.s.	project number 1907
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Caledonia	
Victoria BC	
Perspective Stu	udies
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**LOOKING EAST - VINING STREET** 



**TOWNHOUSES - AT GLADSTONE AVENUE** 



**APARTMENT - AT GRANT STREET** 



**INTERIOR COURTYARD - LOOKING NORTH** 



PLAYGROUND & AMENITY AREA - LOOKING NORTH

3	20/02/06	ISSUED FOR COTW
2	20/01/15	ISSUED FOR ADP
1	19/12/16	RESPONSE TO PLANNING REVIEW
Rev	Date	Description
plot date	SEPTEMBER 2019	drawing file 1907 A310 View Analysis.vwx
drawn by	NLC	checked by RAW
scale	n.t.s.	project number 1907


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<del></del> dHKa	dHKarc	hitects
VICTORIA OFFICE 977 Fort Street Victoria BC V8V3K3 T 1•250•658•3367	NANAIMO OFFICE 102-5190 Du Nanaimo BC <b>T</b> 1•250•585	blin Way V9T 2K8
Caledonia		
Victoria BC		
Perspective Stu	udies	
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GLADSTONE AVENUE



3	20/02/06	ISSUED FOR COTW
1	19/12/16	RESPONSE TO PLANNING REVIEW
Rev	Date	Description
plot date	19/12/16	drawing file 1907 A308 Streetscape Elevations.vwx
drawn by	FWP/NLC	checked by RAW
scale	AS SHOWN	project number 1907
NOTE: All dime	ensions are shown in mil	limeters.


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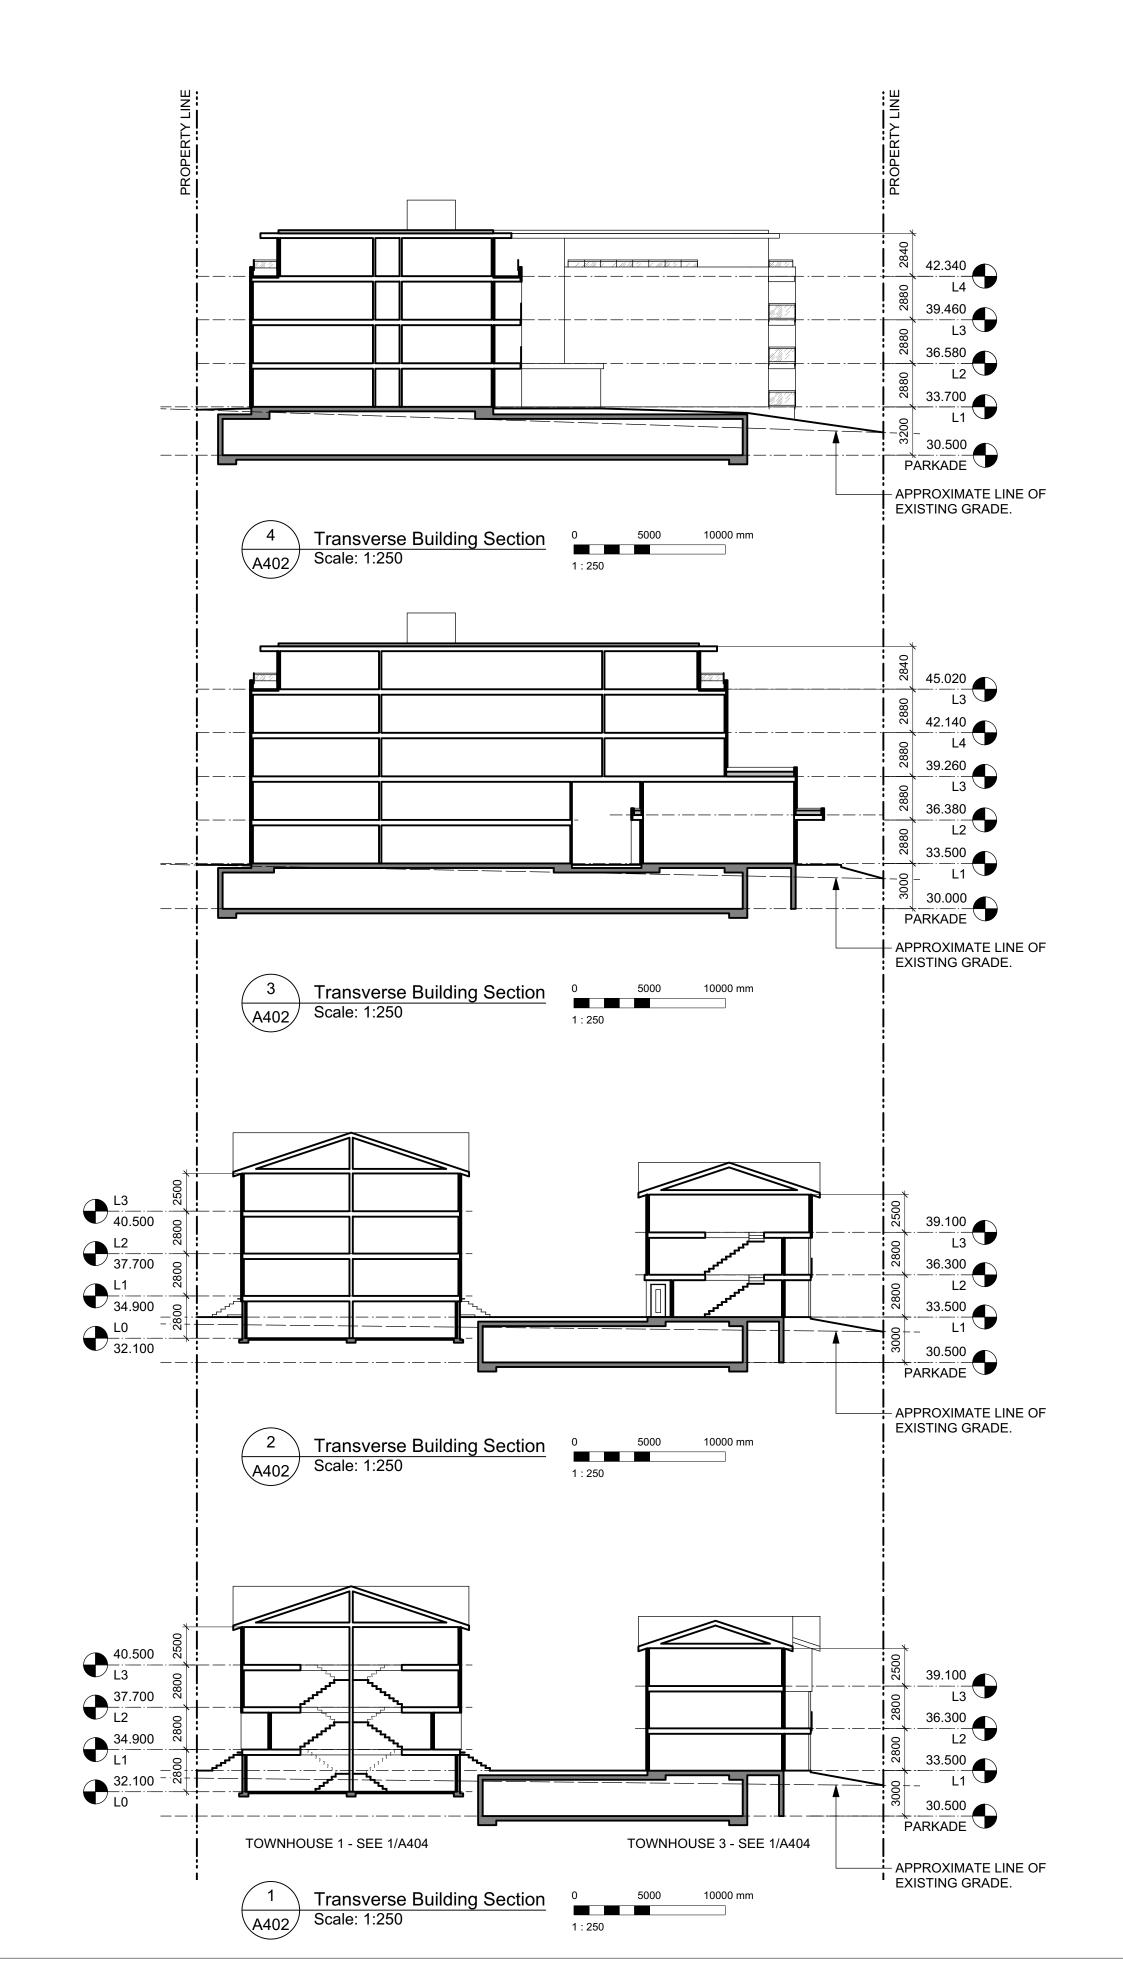
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NANAIMO OFFICE
102-5190 Dublin V Nanaimo BC V9T : <b>T 1·250·585·58</b> 10


Caledonia Victoria BC

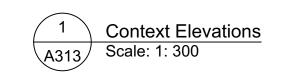Streetscape Elevations


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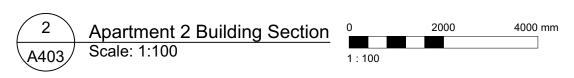





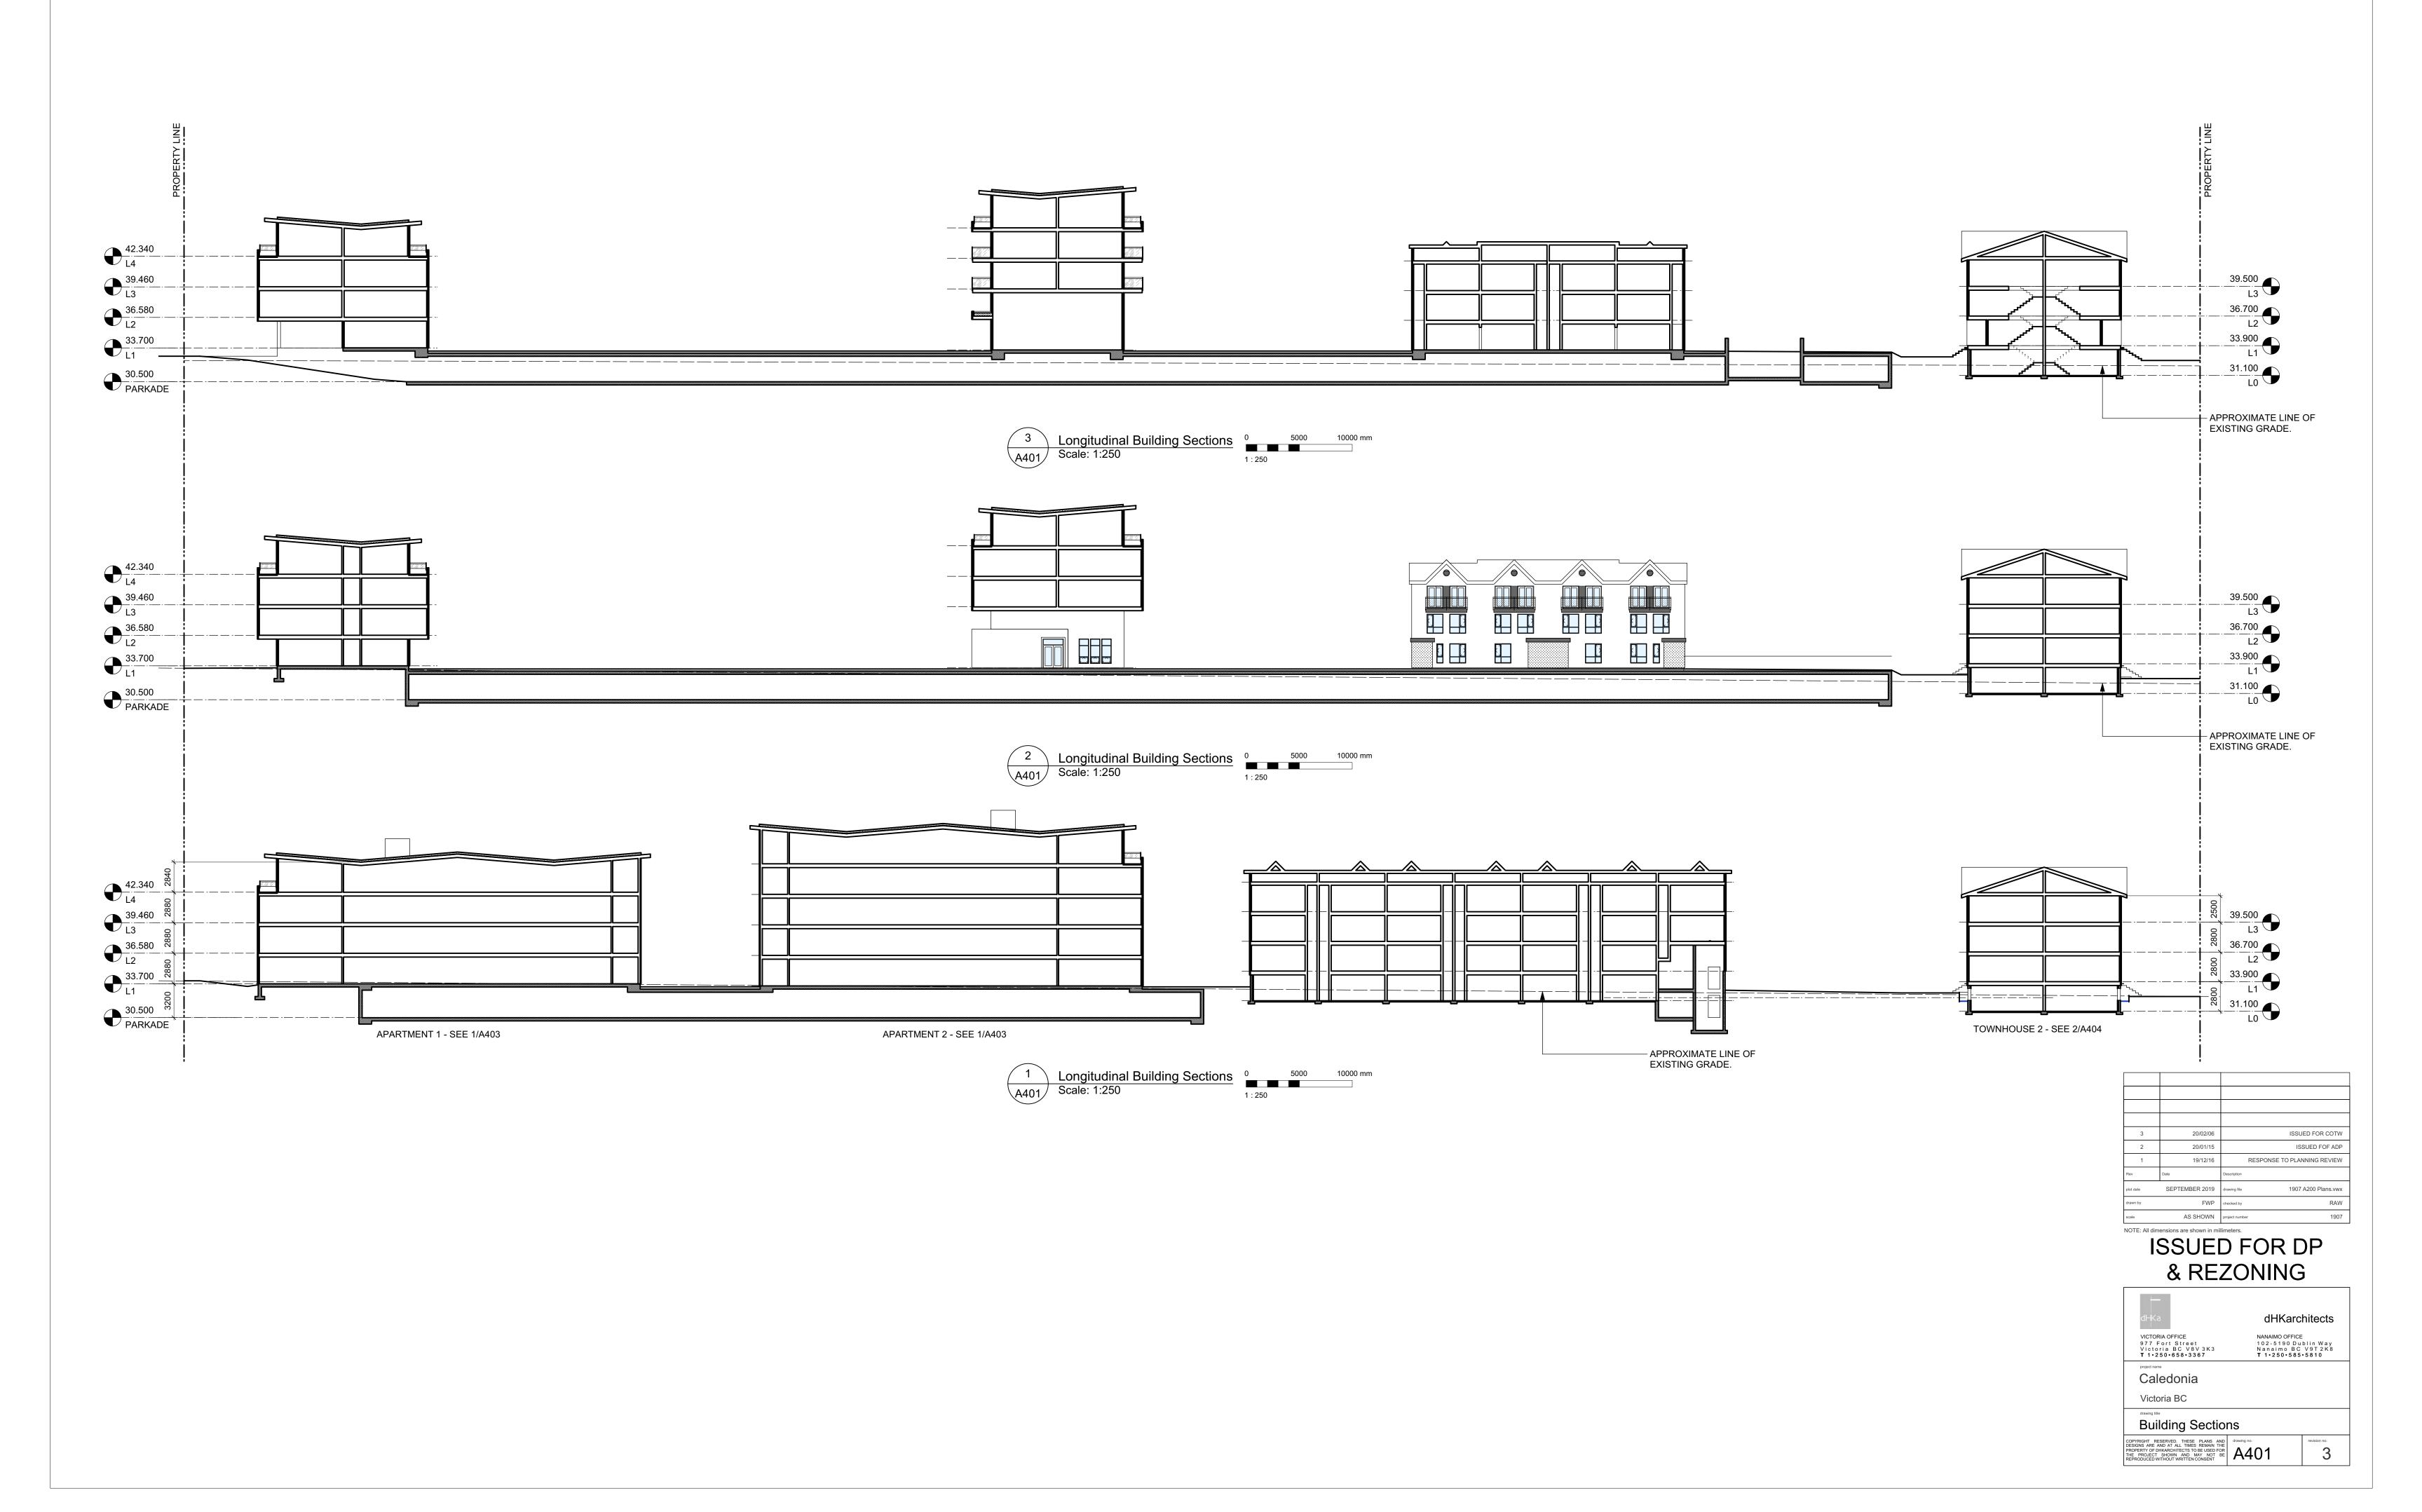
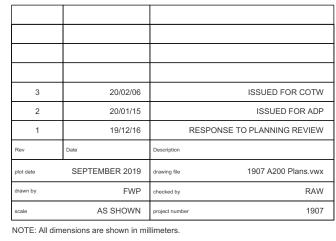
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Building Section	ns	
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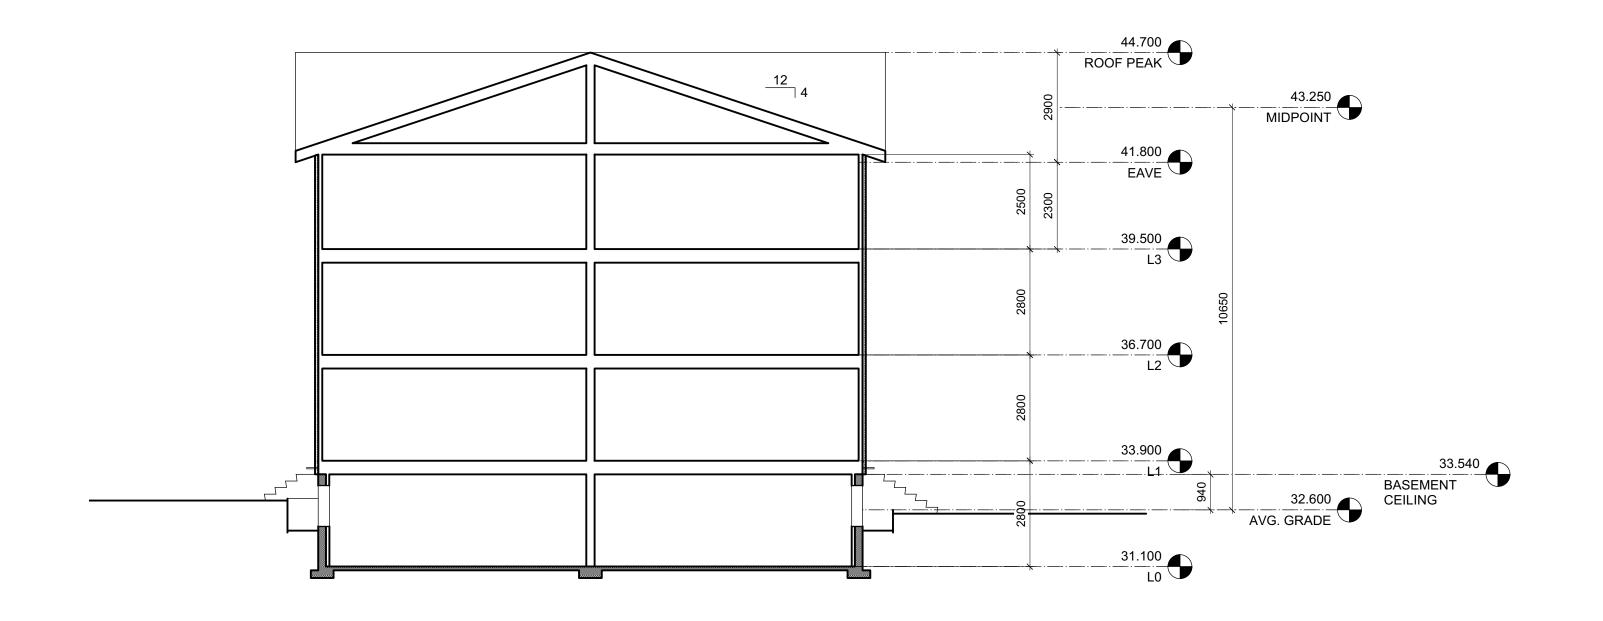


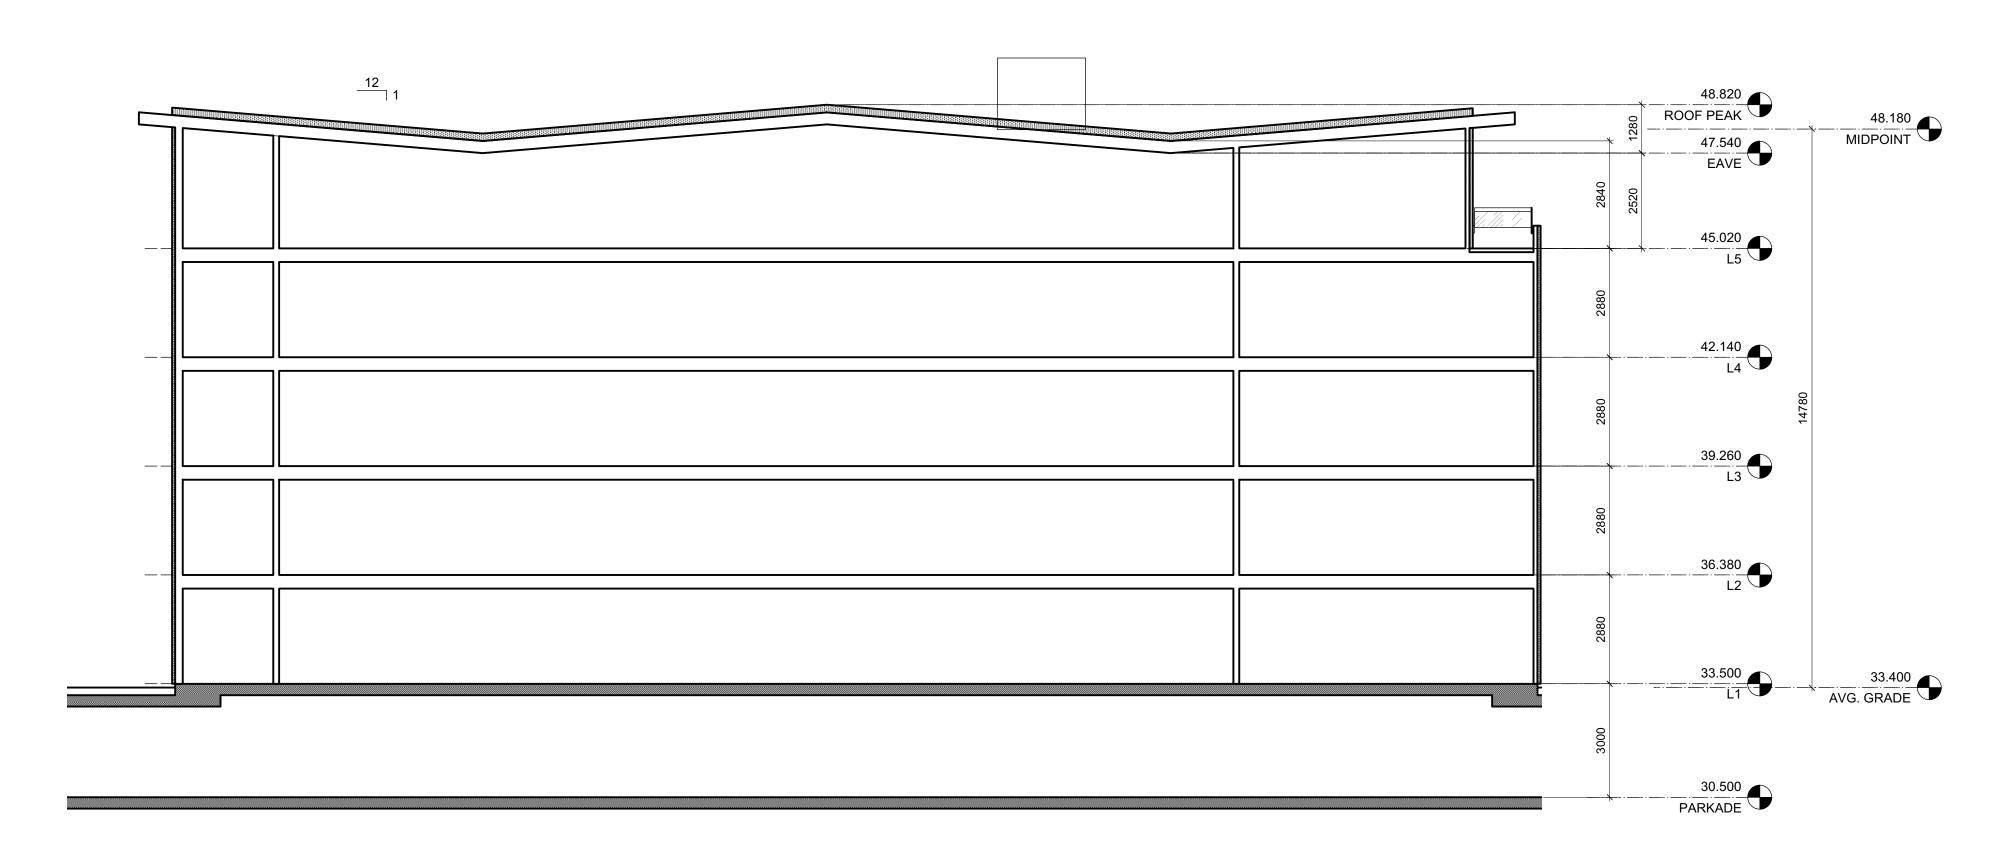


#### 16. NEW SHEET.

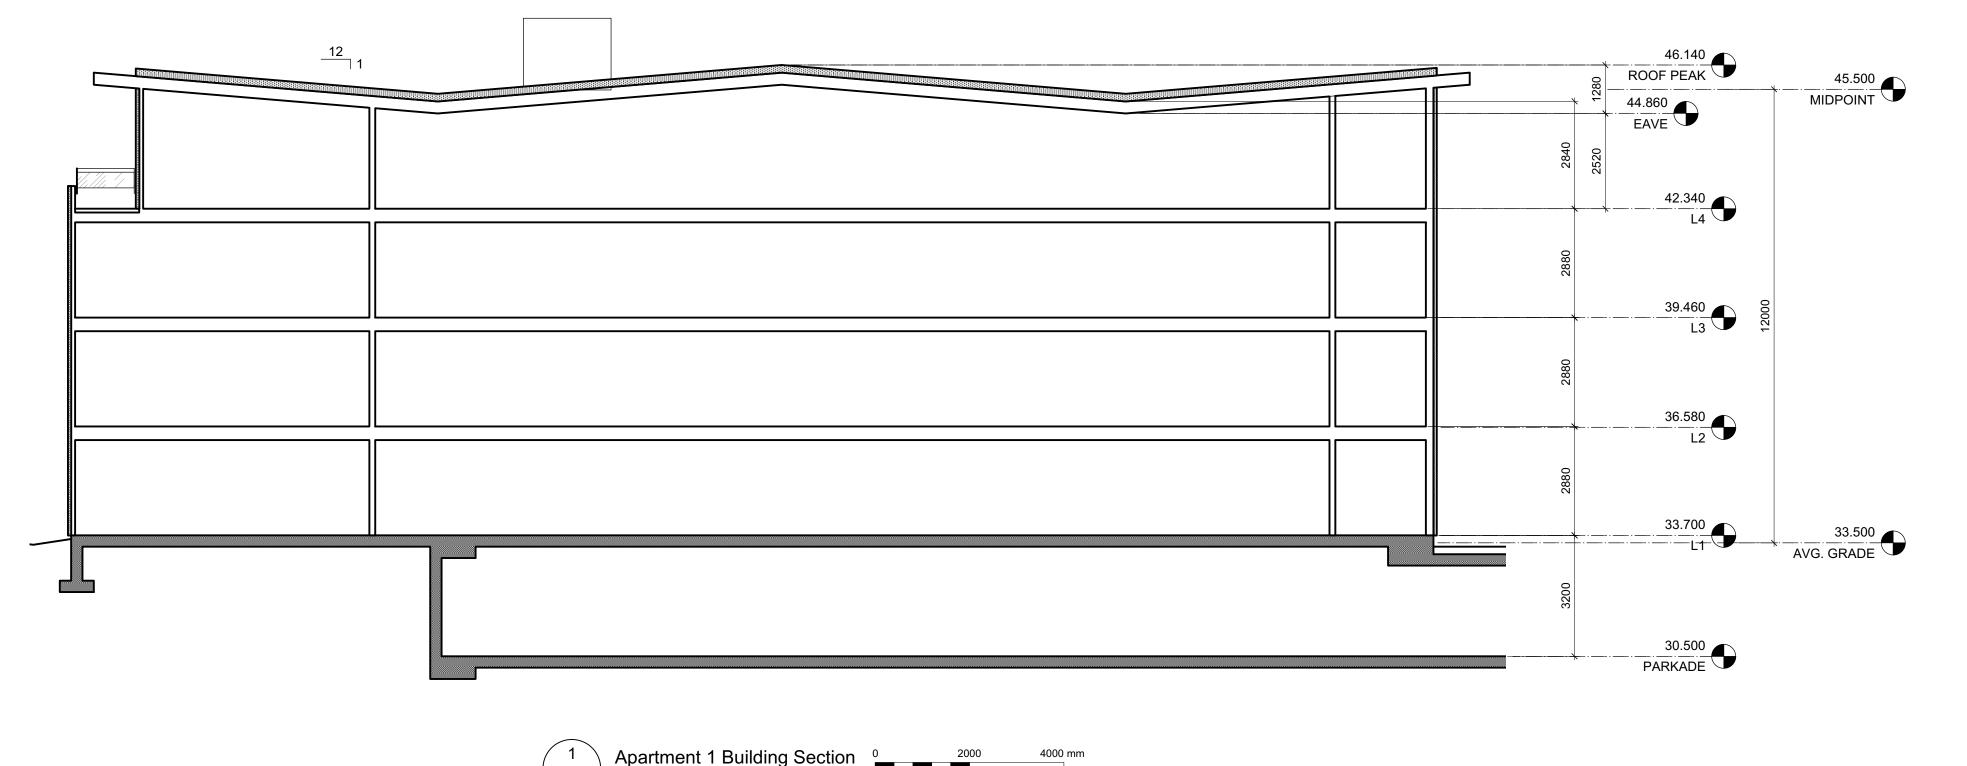
3	20/02/06	ISSUED FOR CO
2	20/01/15	ISSUED FOR A
1	19/12/16	RESPONSE TO PLANNING REVIE
Rev	Date	Description
plot date	SEPTEMBER 2019	drawing file 1907 A200 Plans.v
drawn by	FWP	checked by RA
scale	AS SHOWN	project number 19

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VICTORIA OFFICE 977 Fort Street Victoria BC V8V3K3 T 1•250•658•3367	NANAIMO OFFICE 102-5190 Du Nanaimo BC <b>T</b> 1•250•585	blin Way V9T 2K8
Caledonia		
Victoria BC		
Building Section	ns	
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Townhouses 1 & 3 Building Section
Scale: 1:100

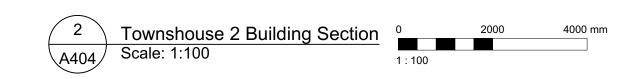

#### 16. NEW SHEET.

3	20/02/06	ISSUED FOR COT
2	20/01/15	ISSUED FOR AL
1	19/12/16	RESPONSE TO PLANNING REVIE
Rev	Date	Description
plot date	SEPTEMBER 2019	drawing file 1907 A200 Plans.vv
drawn by	FWP	checked by RA
scale	AS SHOWN	project number 19

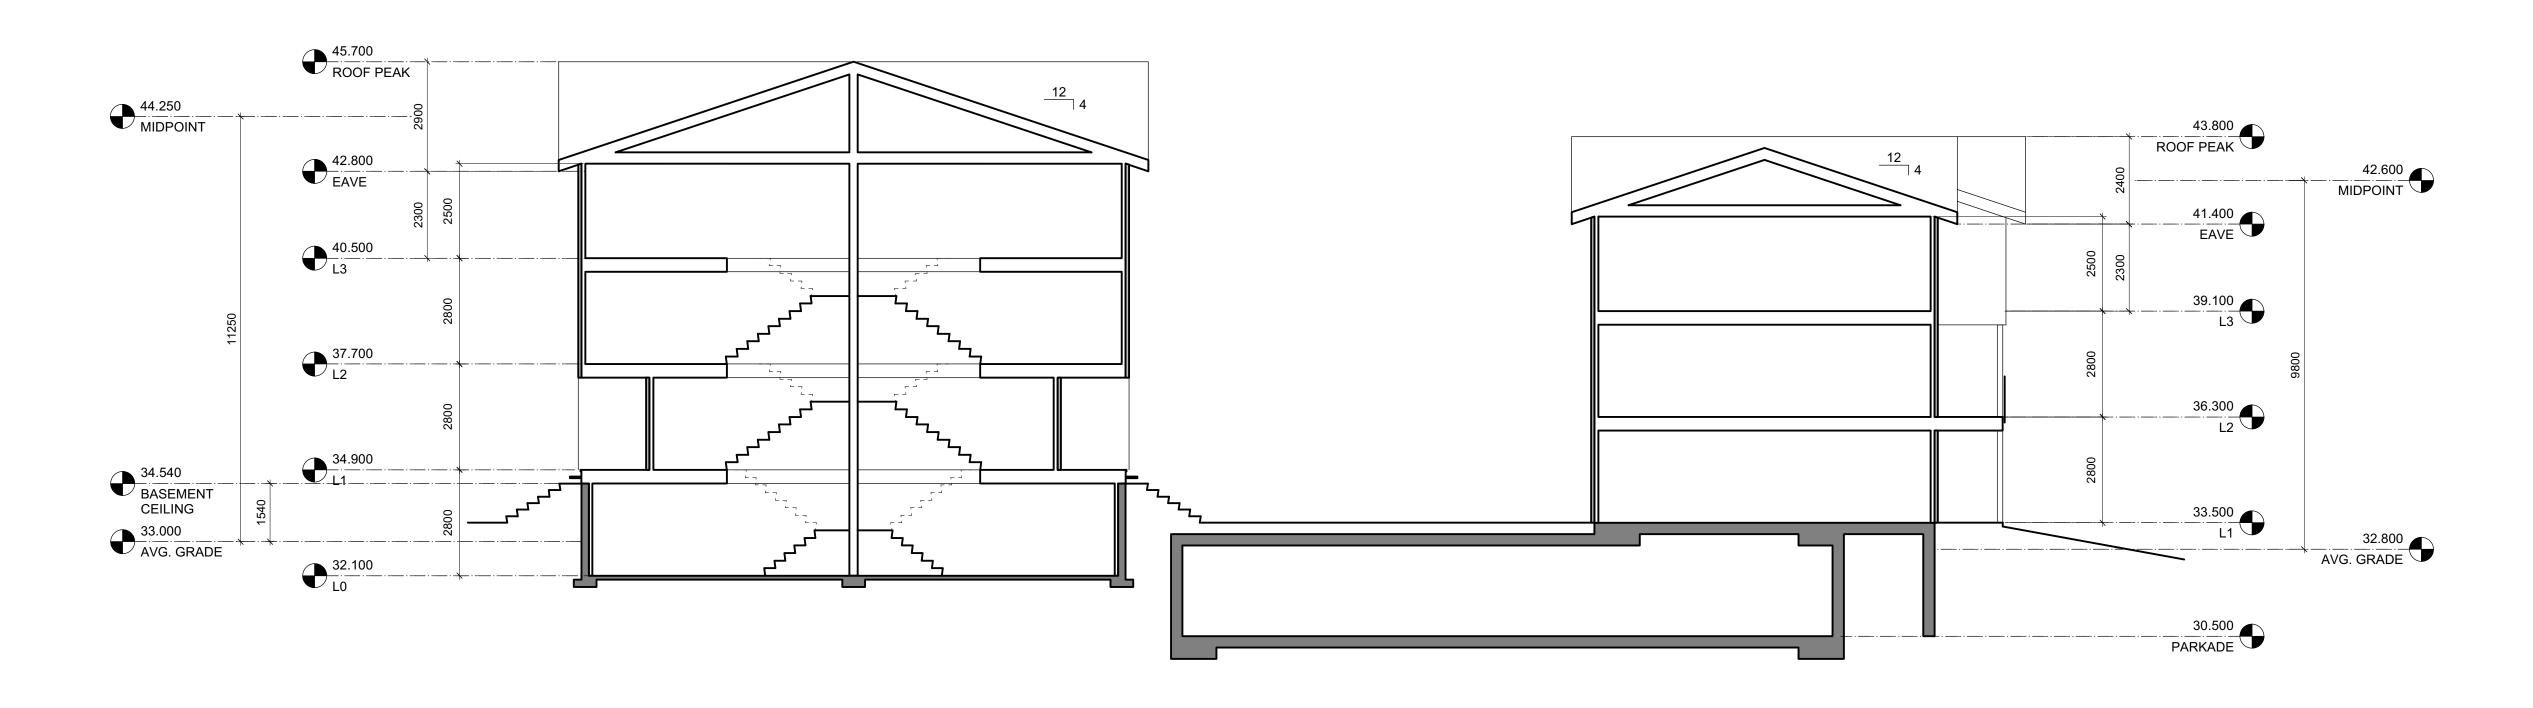
## NOTE: All dimensions are shown in millimeters. ISSUED FOR DP & REZONING


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<del>−</del> dHKa	dHKarc	hitects
VICTORIA OFFICE 977 Fort Street Victoria BC V8V 3K3 T 1.250.658.3367	NANAIMO OFFICE 102-5190 Du Nanaimo BC <b>T</b> 1•250•585	blin Way V9T2K8
caledonia		
Victoria BC		
Building Section	ns	
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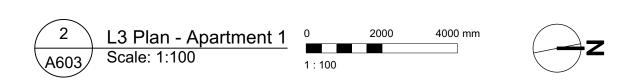
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2	20/01/15	ISSUED FOR ADD
1	19/12/16	RESPONSE TO PLANNING REVIEW
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olot date	SEPTEMBER 2019	drawing file 1907 A200 Plans.vw
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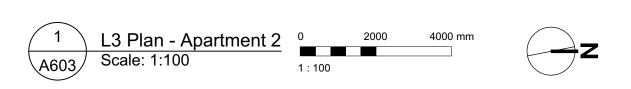
ŀΡΙ	HIC LEGEND:	
	STUDIO	
	1 BEDROOM	
	2 BEDROOM	
	3 BEDROOM	
	4 BEDROOM	
	ACCESSIBLE	

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<del>–</del> dHKa	dHKarc	hitects	
VICTORIA OFFICE 977 Fort Street Victoria BC V8V 3K3 T 1•250•658•3367	NANAIMO OFFICE 102-5190 Du Nanaimo BC <b>T</b> 1•250•585	blin Way V9T2K8	
caledonia			
Victoria BC			
L2 Plan - Apart	ments		
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3	20/02/06		ISSUED FOR COTW
2	20/01/15		ISSUED FOR ADP
1	19/12/16	RESPONS	SE TO PLANNING REVIEW
Rev	Date	Description	
plot date	SEPTEMBER 2019	drawing file	1907 A200 Plans.vwx
drawn by	FWP	checked by	RAW
scale	AS SHOWN	project number	1907

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NANAIMO OFFICE 102-5190 Dublin Way Nanaimo BC V9T2K8 **T** 1•250•585•5810

revision no.

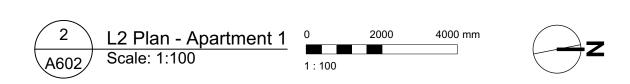GRAPHIC LEGEND:	-	
STUDIO	dHKa	dHKa
1 BEDROOM	VICTORIA OFFICE 977 Fort Street Victoria BC V8V3K3 T 1.250.658.3367	NANAIMO O 102-519 Nanaimo <b>T 1•250•</b>
2 BEDROOM	project name	
3 BEDROOM	Caledonia	
4 BEDROOM	Victoria BC	
& ACCESSIBLE	L3 Plan - Apartı	ments
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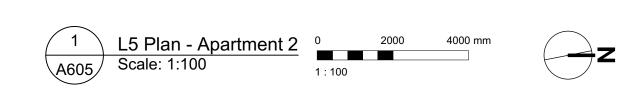


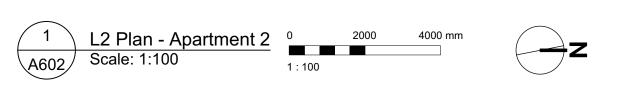

3	20/02/06	ISSUED FOR COTW
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1	19/12/16	RESPONSE TO PLANNING REVIEW
Rev	Date	Description
plot date	SEPTEMBER 2019	drawing file 1907 A200 Plans.vwx
drawn by	FWP	checked by RAW
scale	AS SHOWN	project number 1907

GRAPHIC LEGEND:	-	
STUDIO	dHKa	dHKarchitects
1 BEDROOM	VICTORIA OFFICE 977 Fort Street Victoria BC V8V3K3	NANAIMO OFFICE 102-5190 Dublin Way Nanaimo BC V9T2K8
2 BEDROOM	T 1 • 2 5 0 • 6 5 8 • 3 3 6 7  project name	T 1.250.585.5810
3 BEDROOM	Caledonia Victoria BC	
4 BEDROOM	drawing title	_
& ACCESSIBLE	L4 Plan - Apartme	ents
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3	20/02/06	ISSUED FOR COTW
2	20/01/15	ISSUED FOR ADP
1	19/12/16	RESPONSE TO PLANNING REVIEW
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plot date	SEPTEMBER 2019	drawing file 1907 A200 Plans.vwx
drawn by	FWP	checked by RAW
scale	AS SHOWN	project number 1907

**GRAPHIC LEGEND:** 

1 BEDROOM

2 BEDROOM

3 BEDROOM


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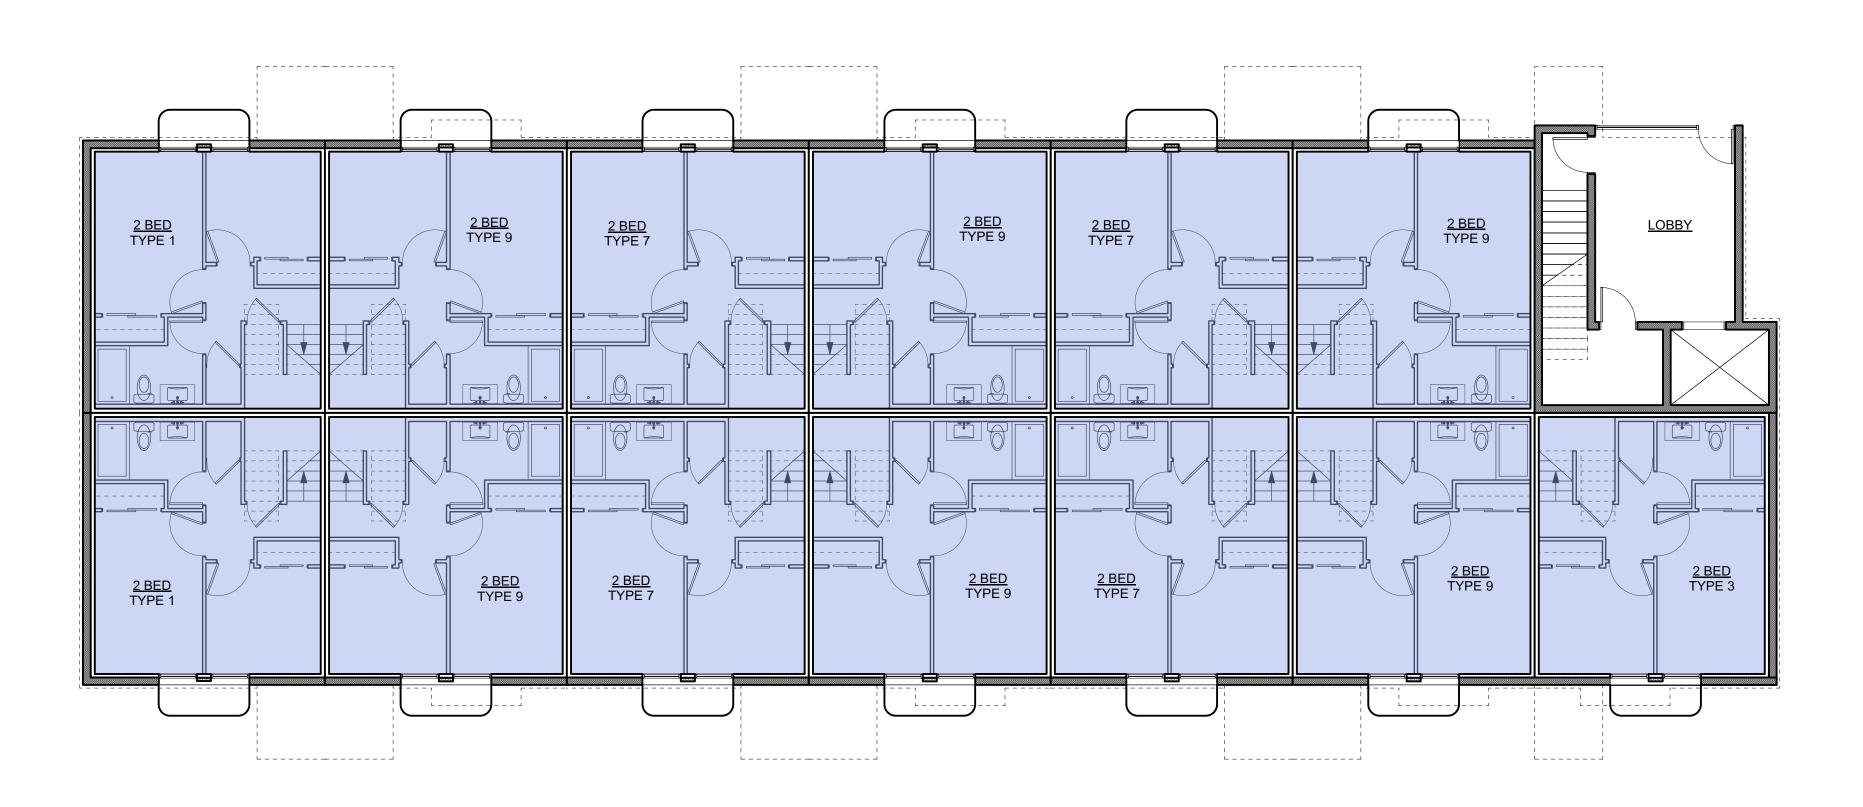
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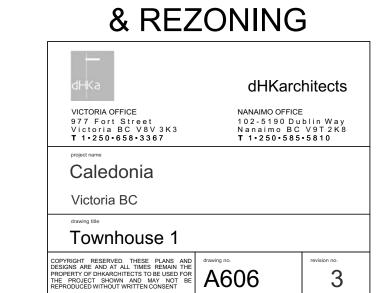
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Victoria BC		
drawing title		
L5 Plan - Apart	ments	
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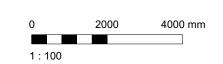
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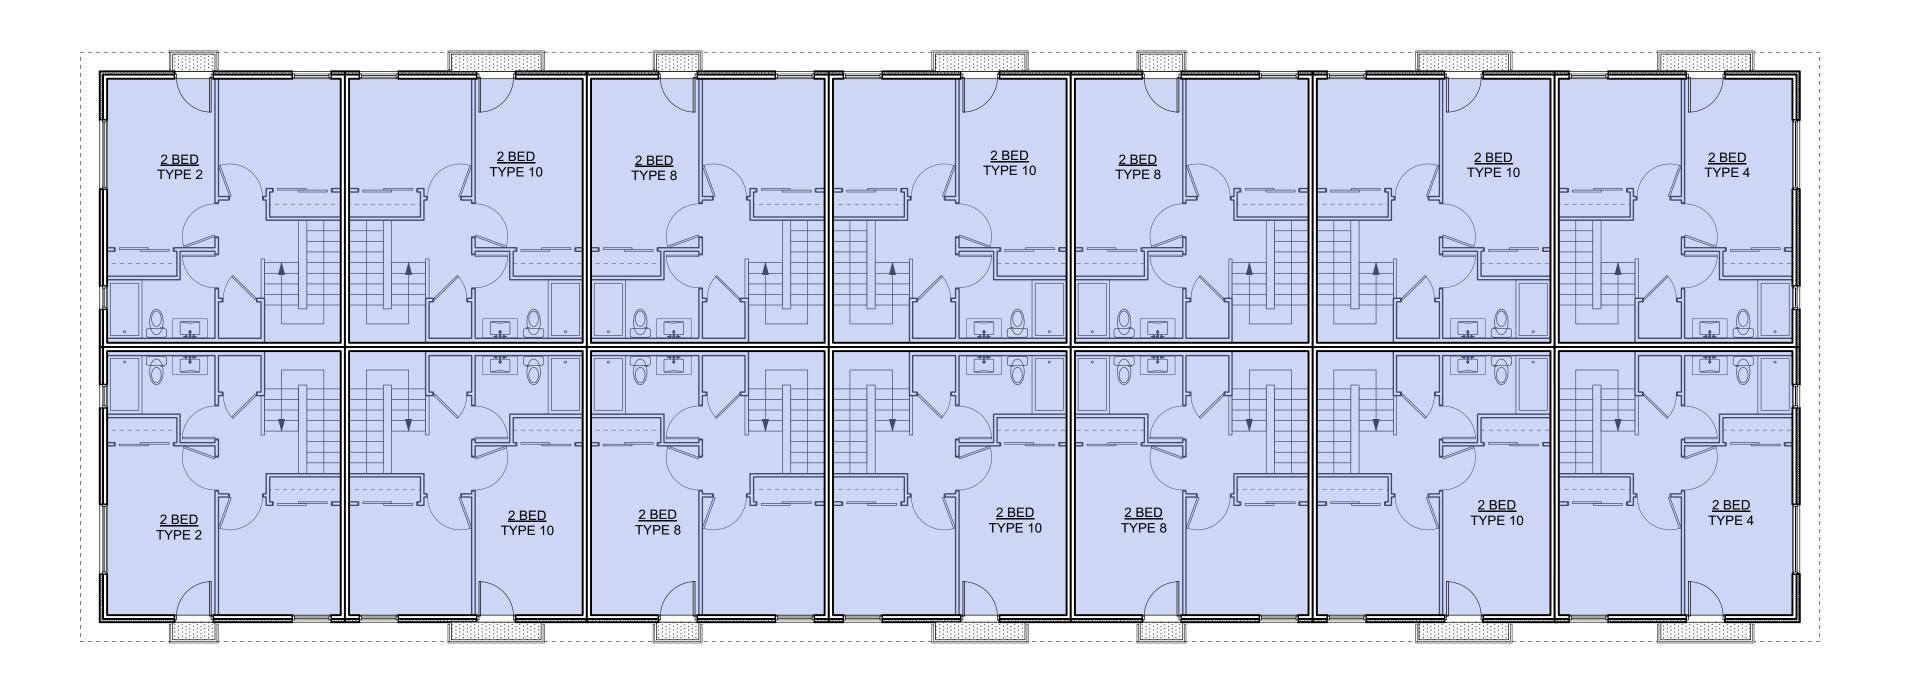
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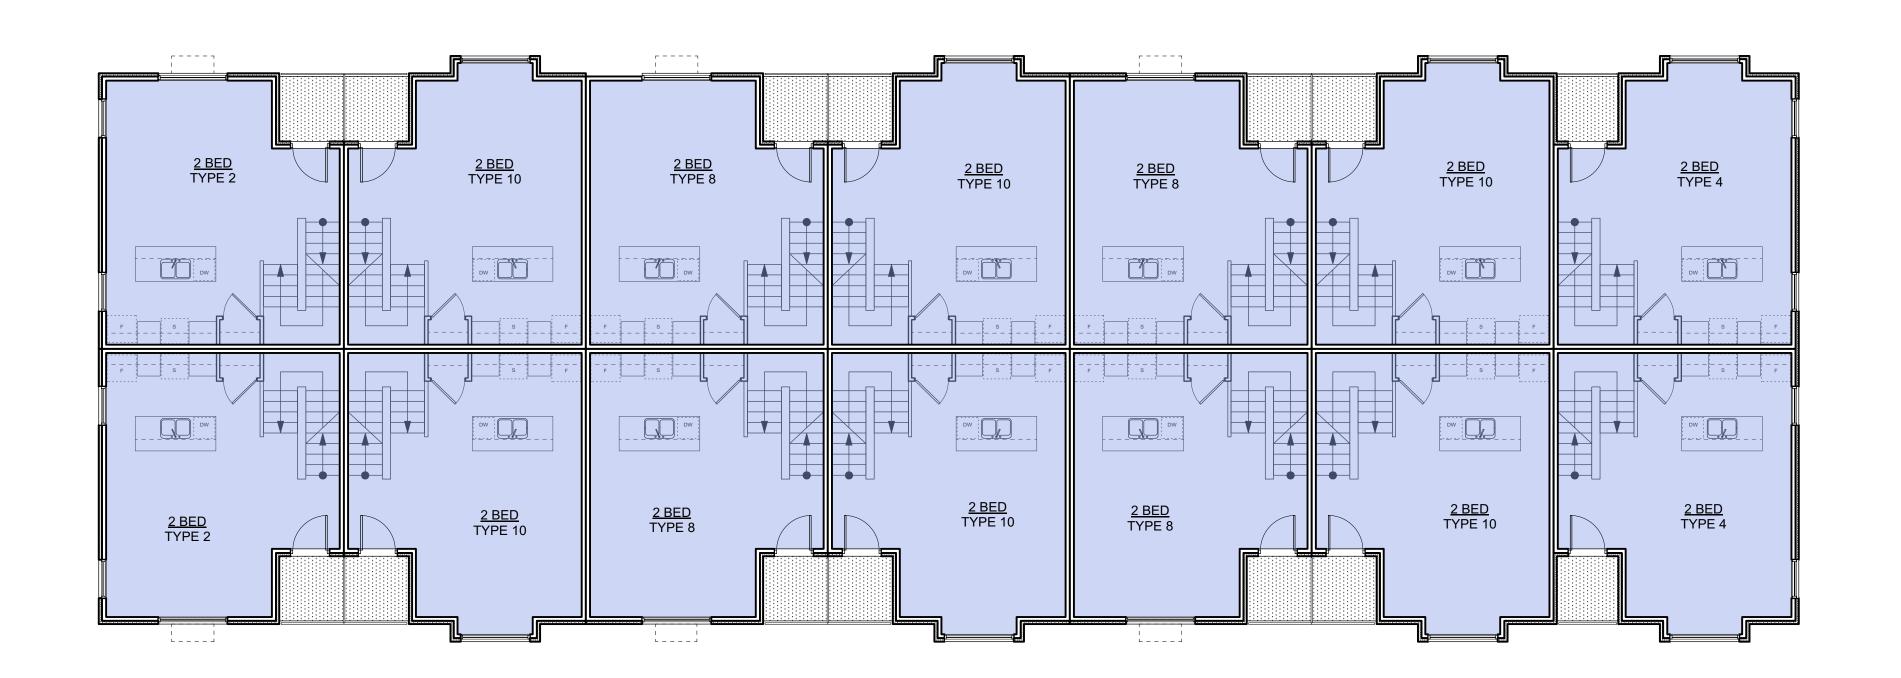












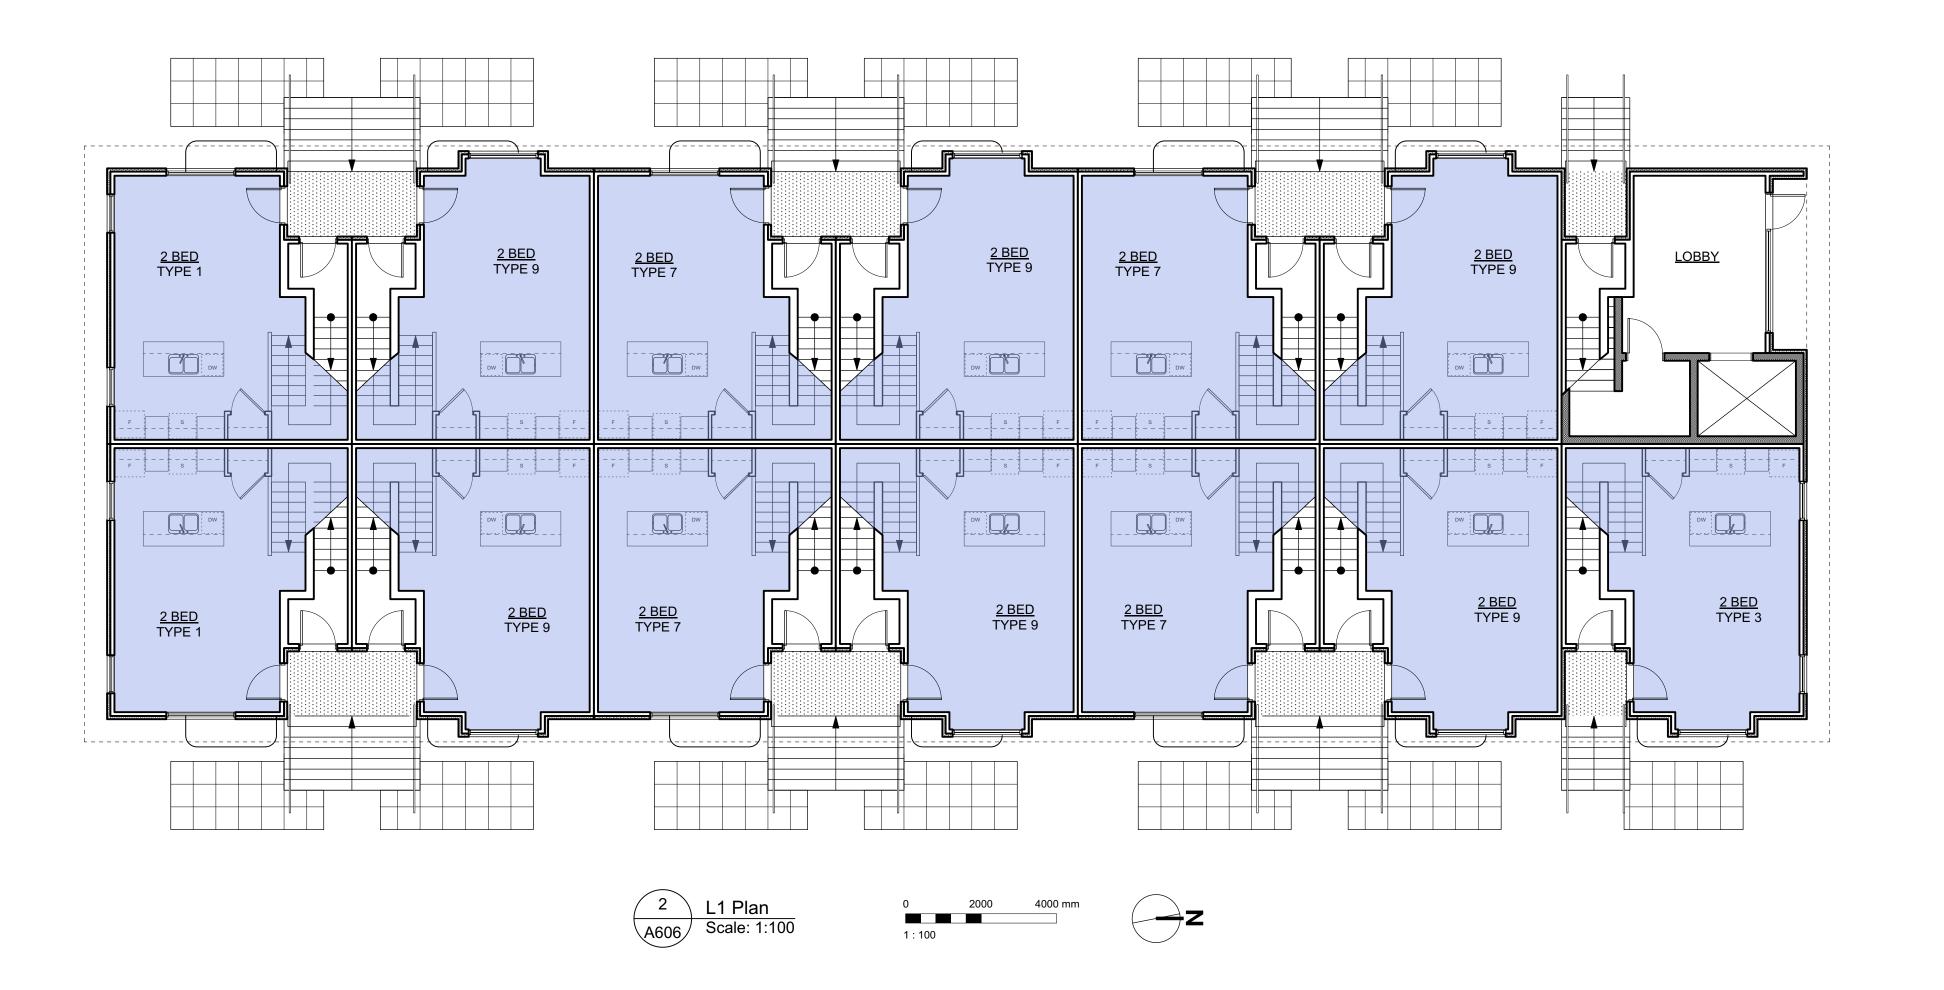

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Rev	Date	Description
plot date	SEPTEMBER 2019	drawing file 1907 A200 Plans
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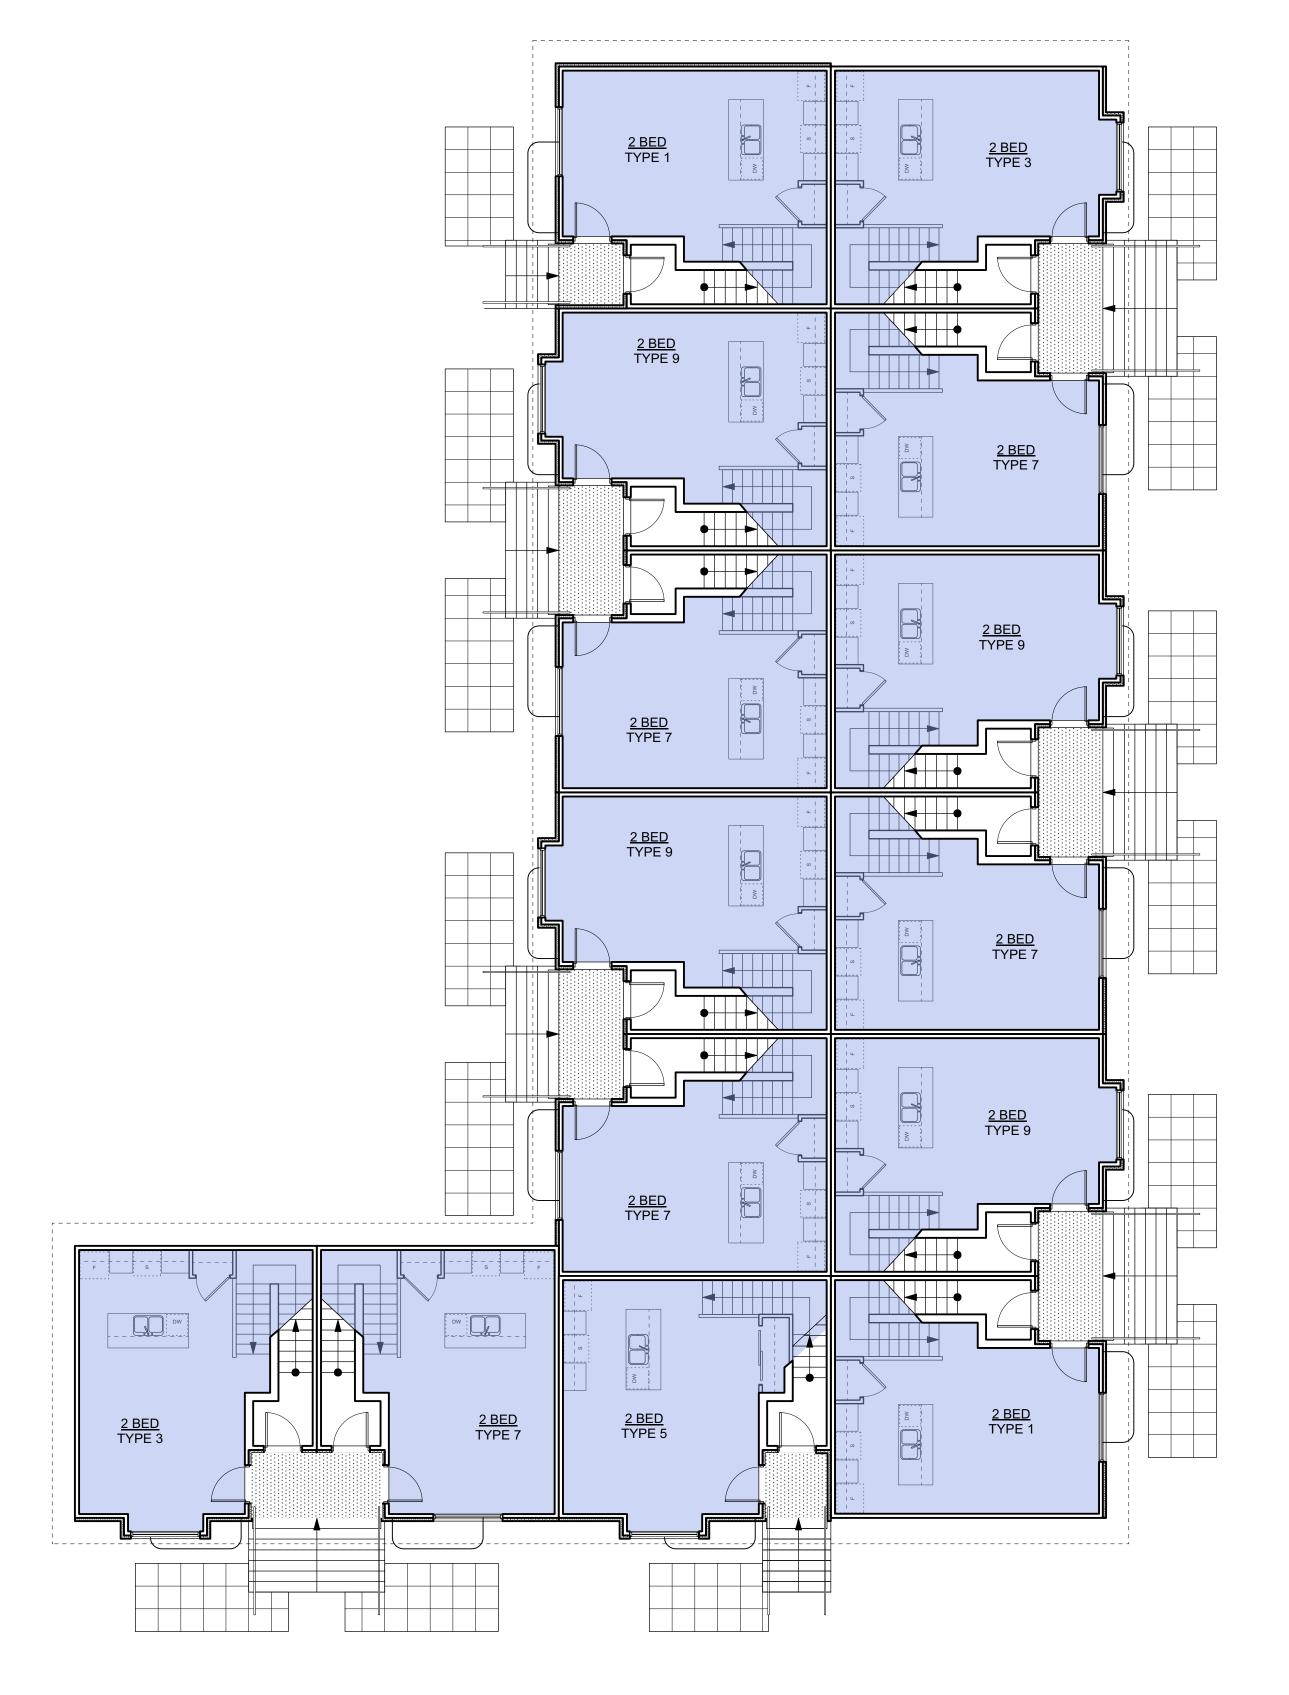


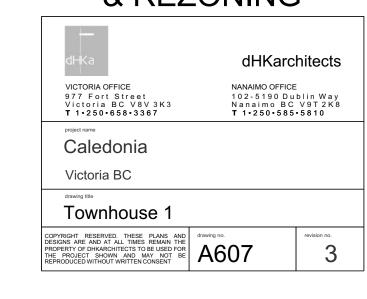





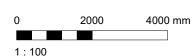







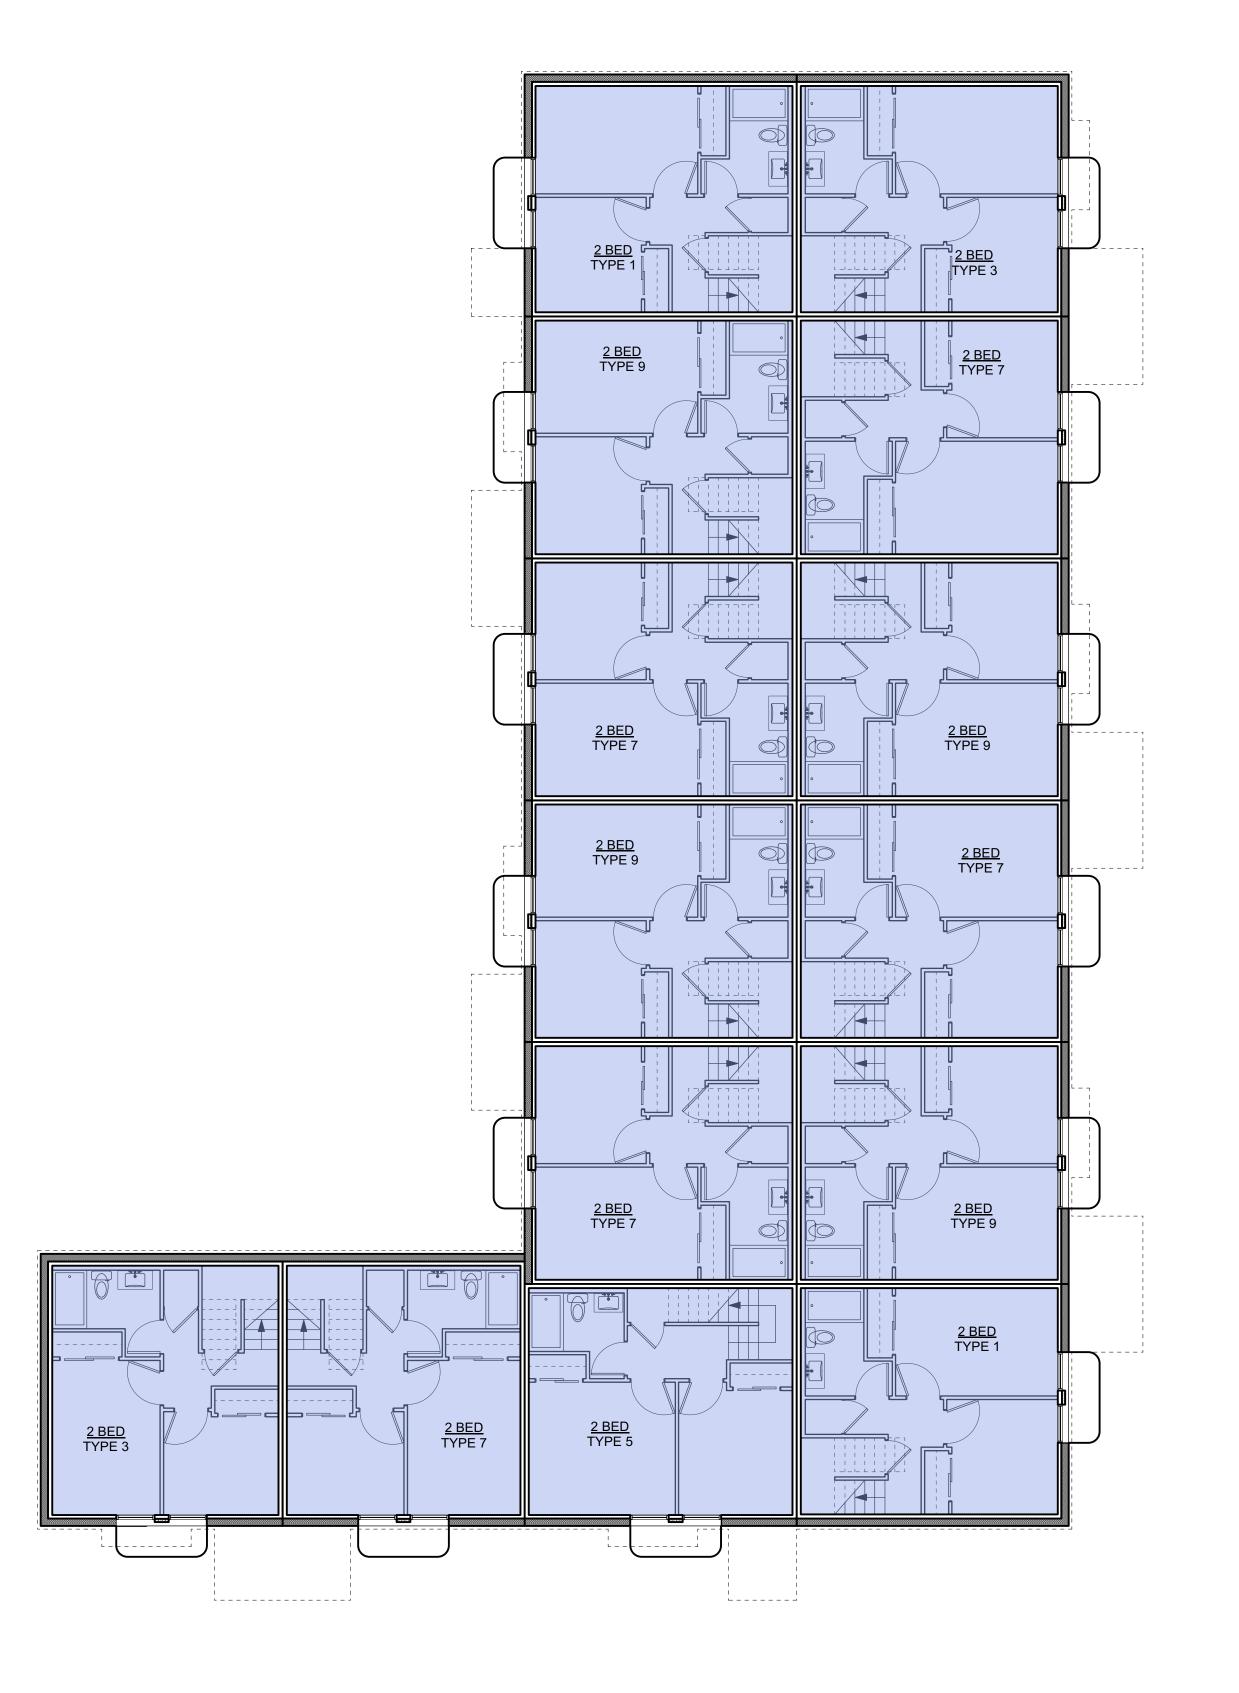


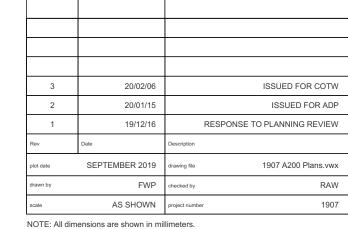



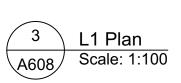


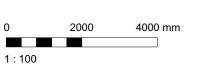


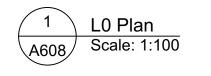






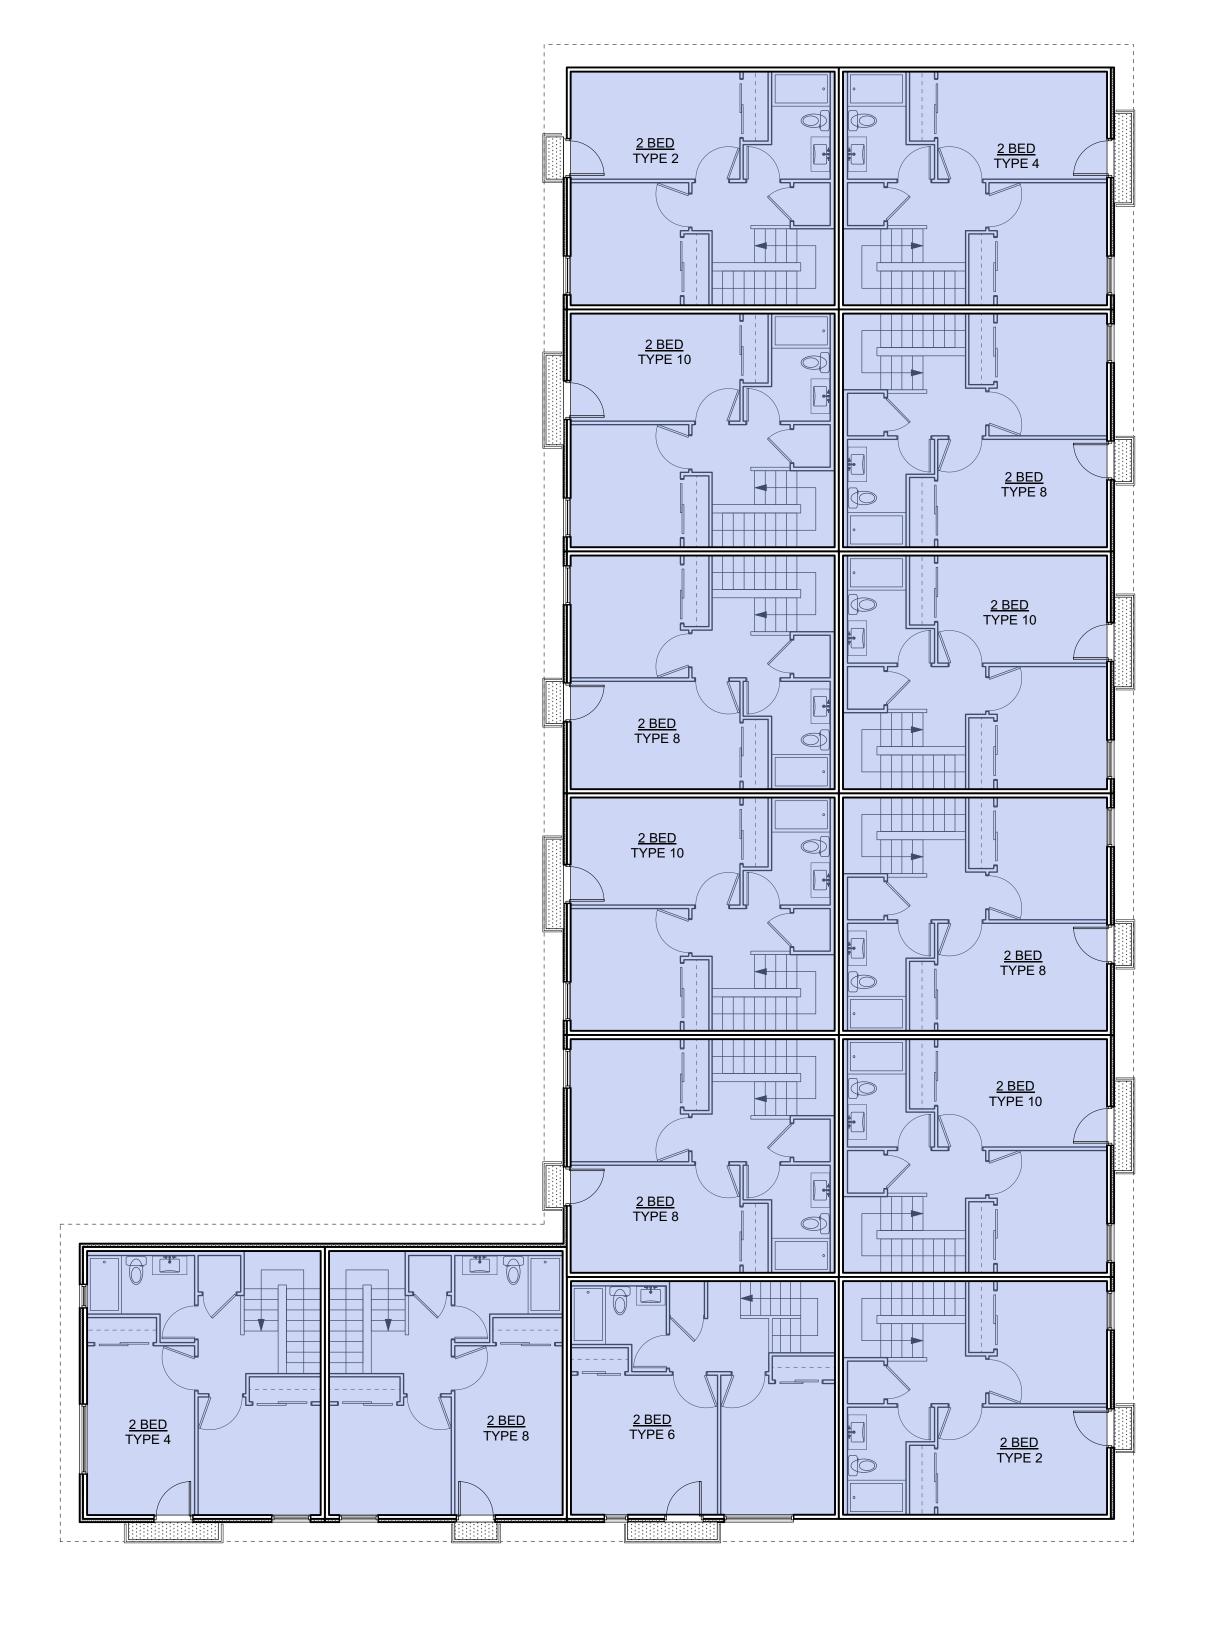


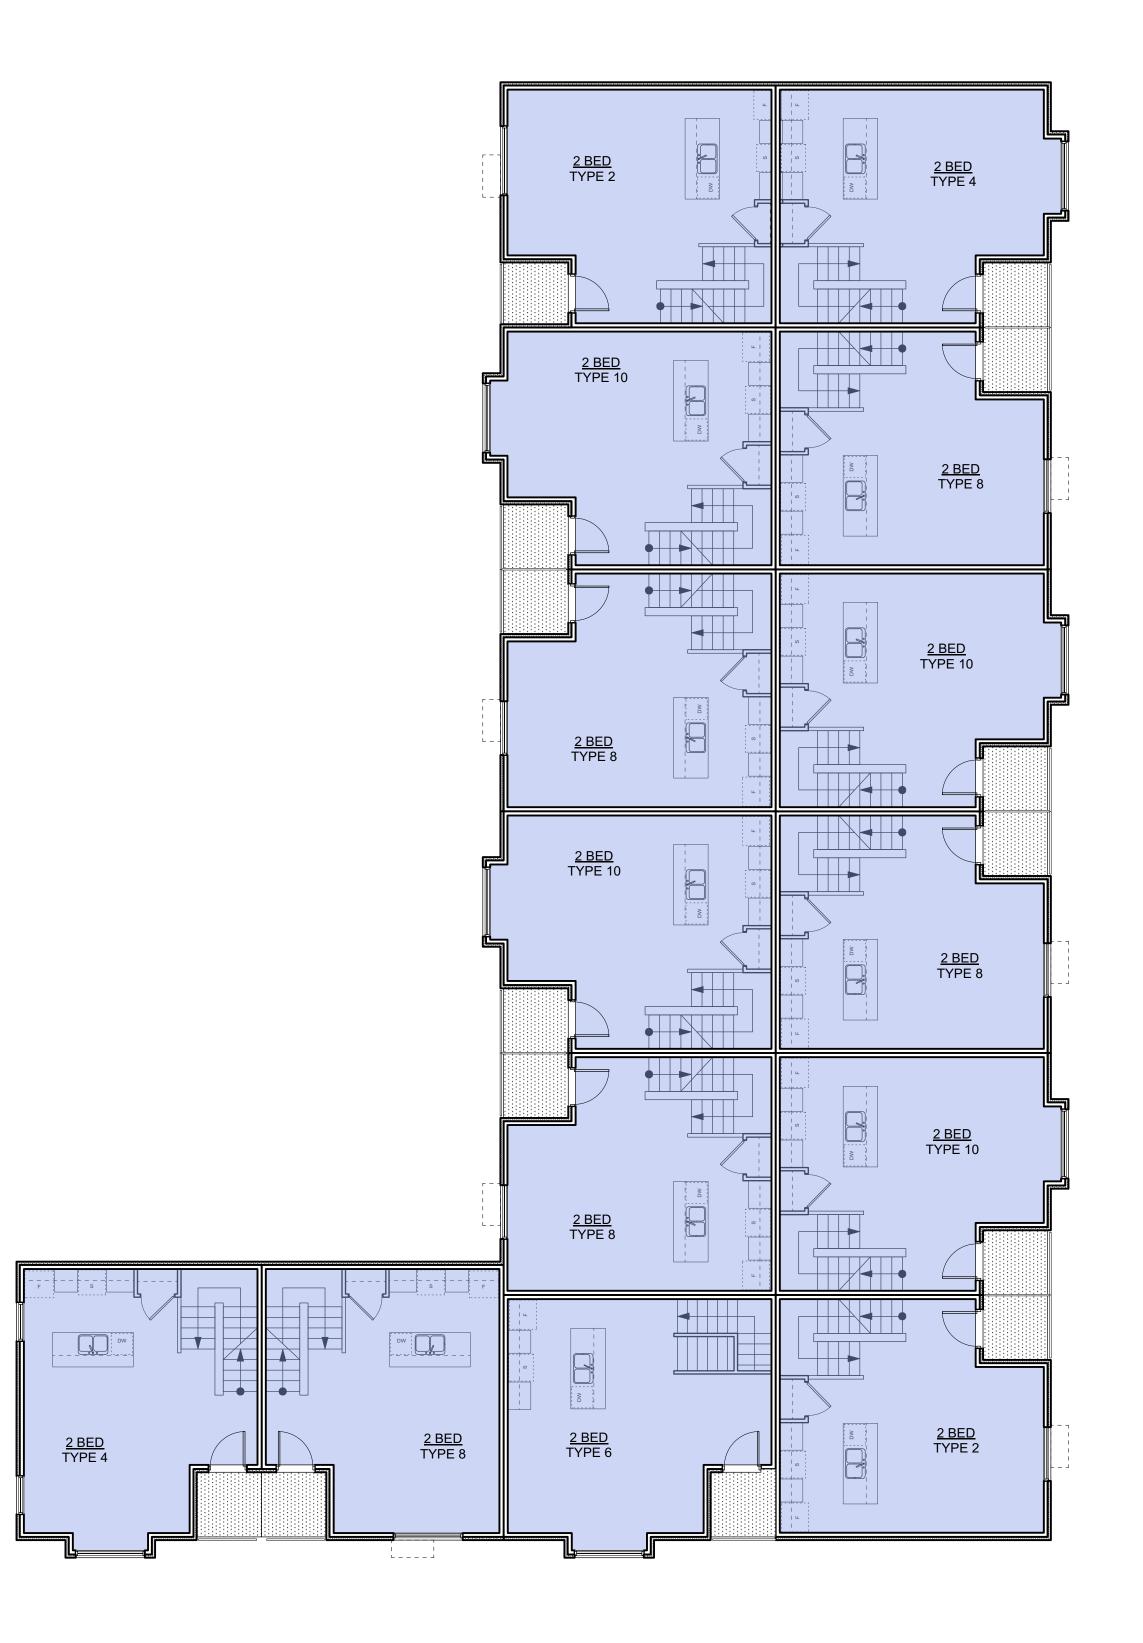

3	20/02/06		ISSUED FOR COTV
2	20/01/15		ISSUED FOR ADE
1	19/12/16	RESPONS	E TO PLANNING REVIEW
Rev	Date	Description	
plot date	SEPTEMBER 2019	drawing file	1907 A200 Plans.vwx
drawn by	FWP	checked by	RAV
scale	AS SHOWN	project number	1907



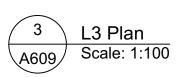


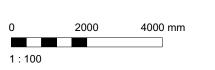









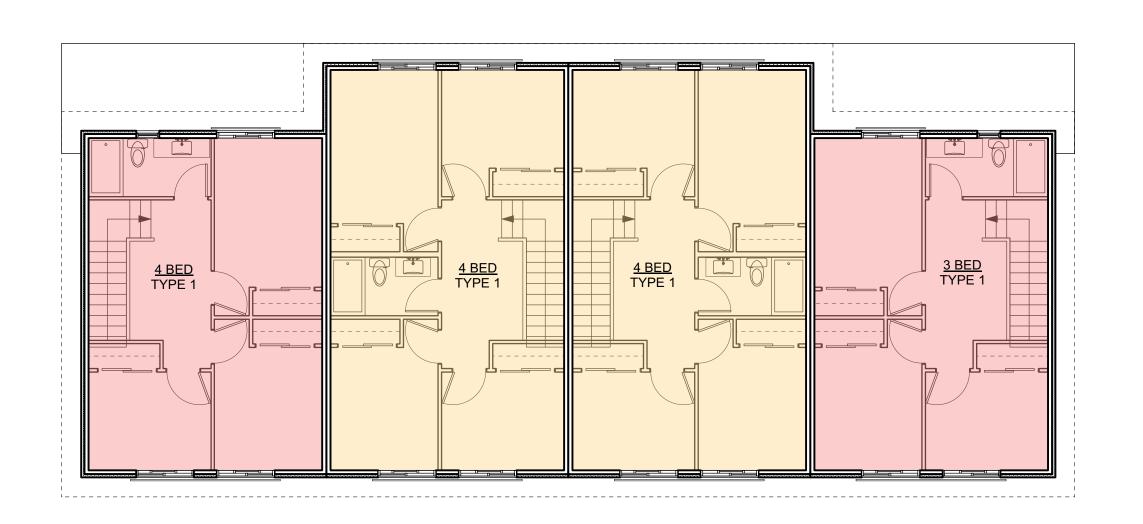



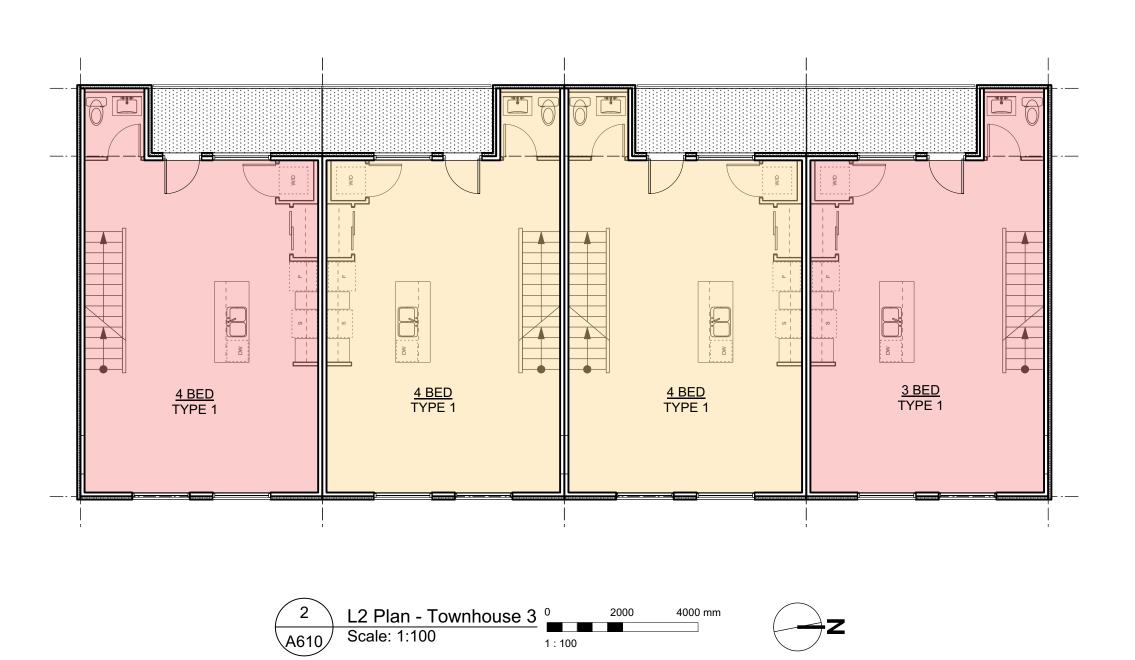

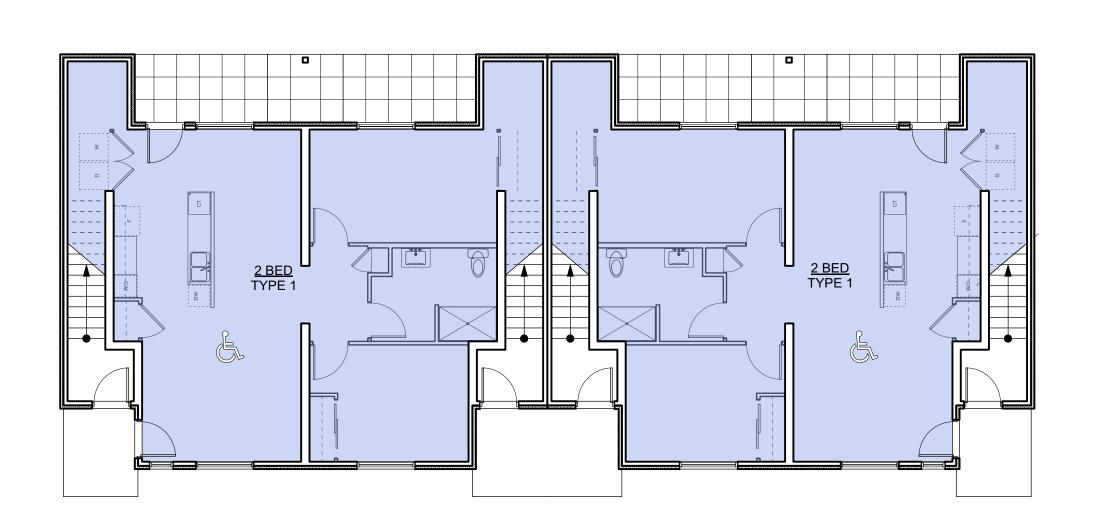



3	20/02/06	ISSUED FOR CO
2	20/01/15	ISSUED FOR
1	19/12/16	RESPONSE TO PLANNING REV
Rev	Date	Description
plot date	SEPTEMBER 2019	drawing file 1907 A200 Plans.
drawn by	FWP	checked by
scale	AS SHOWN	project number

**GRAPHIC LEGEND:** 

1 BEDROOM

2 BEDROOM

3 BEDROOM


4 BEDROOM

& ACCESSIBLE


STUDIO


G I L L		& INLZONINO			
<del></del> dHKa	dHKarc	hitects			
VICTORIA OFFICE 977 Fort Street Victoria BC V8V 3K3 T 1.250.658.3367	NANAIMO OFFICE 102-5190 Du Nanaimo BC <b>T</b> 1•250•585	blin Way V9T2K8			
Caledonia Caledonia					
Victoria BC					
Townhouse 3					
COPYRIGHT RESERVED. THESE PLANS AND DESIGNS ARE AND AT ALL TIMES REMAIN THE PROPERTY OF DHIKARCHITECTS TO BE USED FOR THE PROJECT SHOWN AND MAY NOT BE REPRODUCED WITHOUT WRITTEN CONSENT	A610	revision no.			




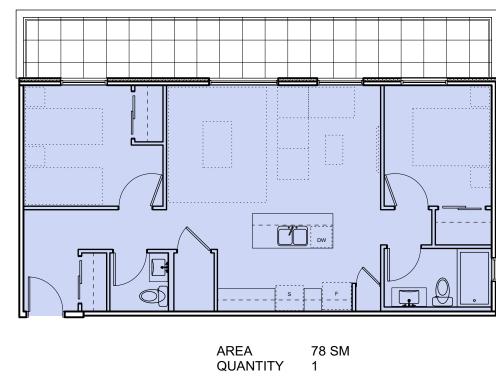



14 2 Bed Type 7 A701 Scale: 1:100

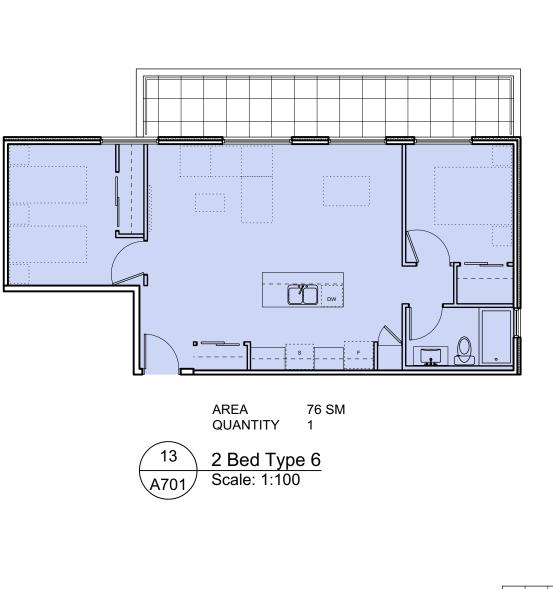

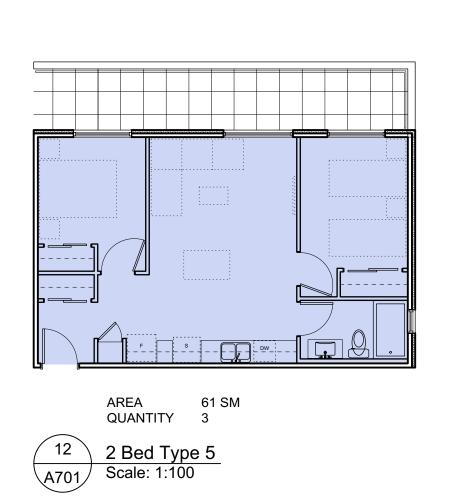

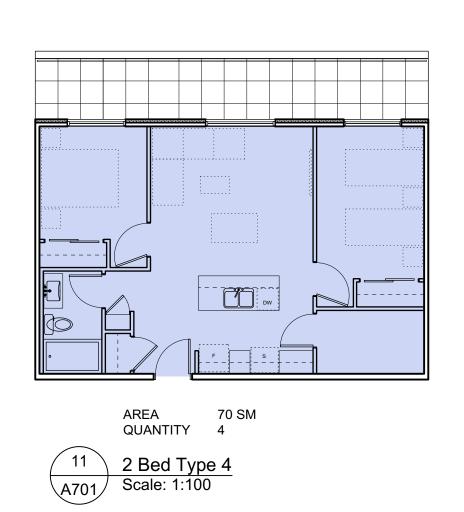


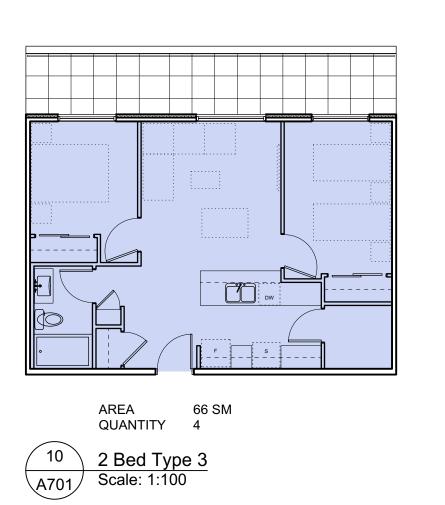

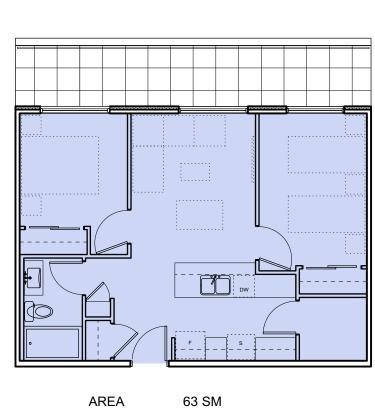







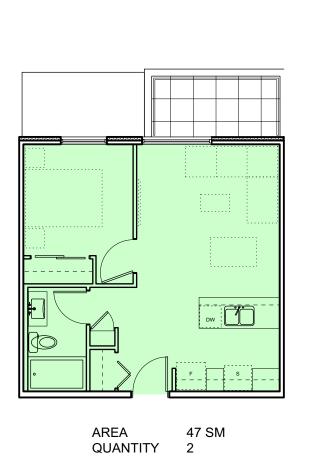



7 1 Bed Type 3 A701 Scale: 1:100

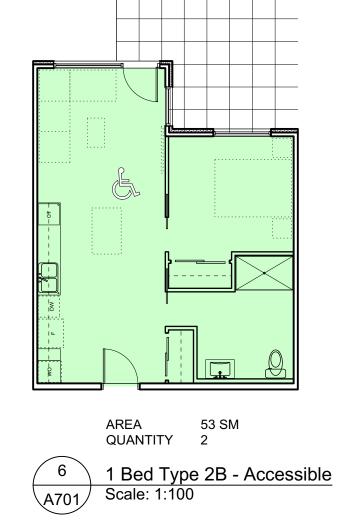




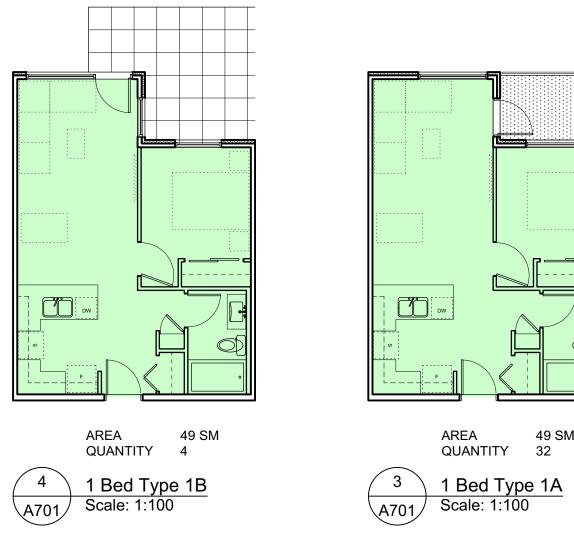

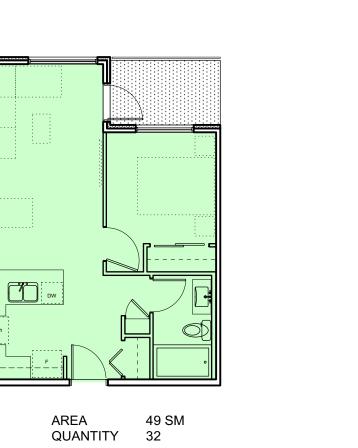

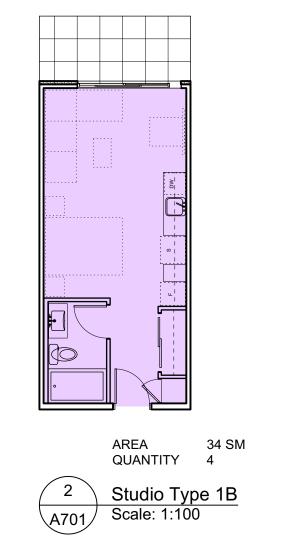

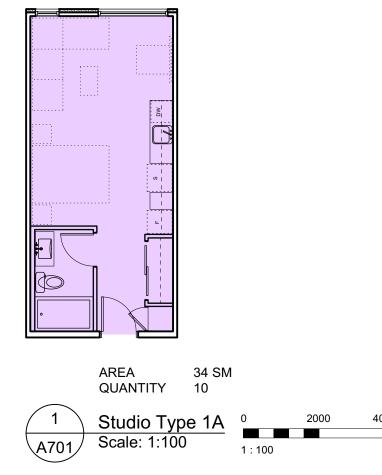

plot date	SEPTEMBER 2019	drawing file 1907 A200 Plans.vw
drawn by	FWP	checked by RAV
scale	AS SHOWN	project number 190
NOTE: All d	dimensions are shown in mi	Ilimeters.
		D FOR DP ZONING
dH. VICT	ORIA OFFICE	dHKarchitects
Vict	Fort Street toria BC V8V 3K3	102-5190 Dublin Way Nanaimo BC V9T 2K8

20/02/06 20/01/15

19/12/16


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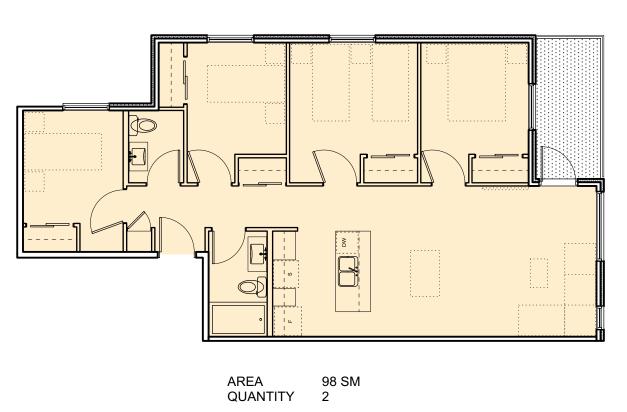
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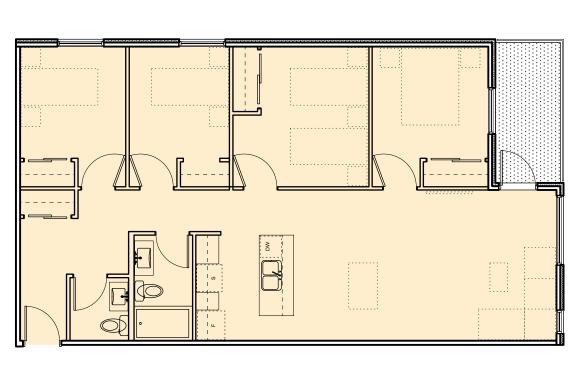
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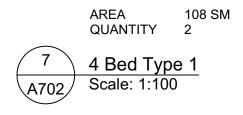
dHKa	dHKarc	hitects
VICTORIA OFFICE 977 Fort Street Victoria BC V8V 3K3 T 1.250.658.3367	NANAIMO OFFICE 102-5190 Du Nanaimo BC <b>T</b> 1•250•585	blin Way V9T2K8
project name		
Caledonia		
Victoria BC		
drawing title	<b>D</b> .	
Apartment Unit	Plans	
OPYRIGHT RESERVED. THESE PLANS AND	drawing no.	revision no.











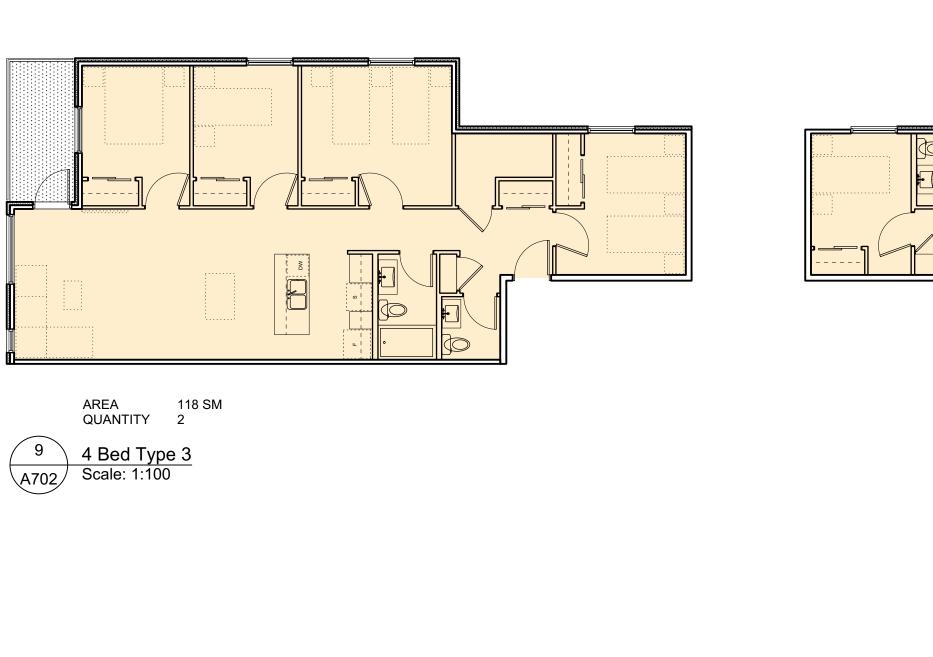


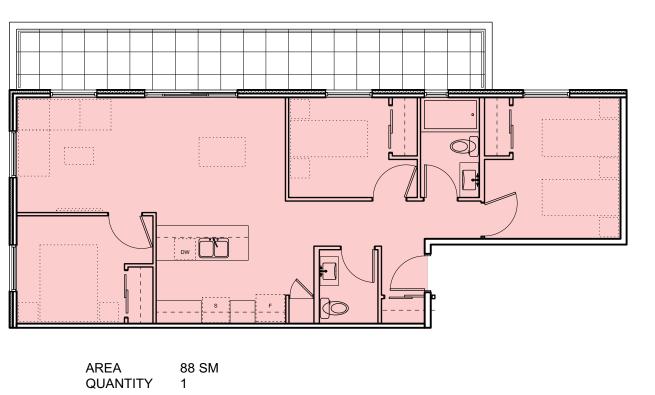



6 3 Bed Type 5 A702 Scale: 1:100


8 4 Bed Type 2 A702 Scale: 1:100

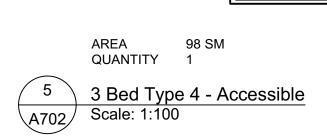

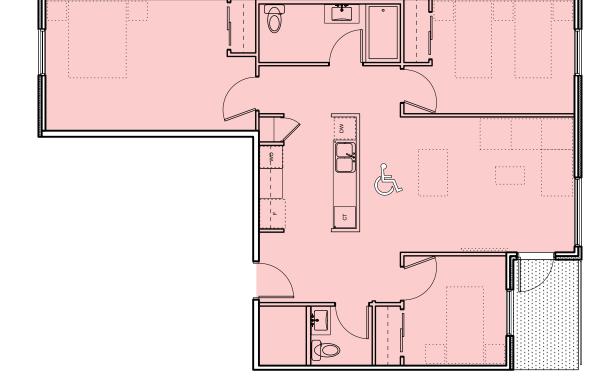

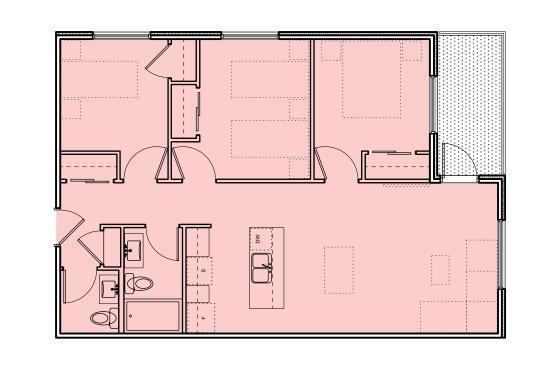


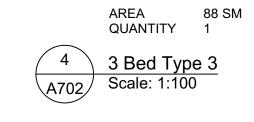

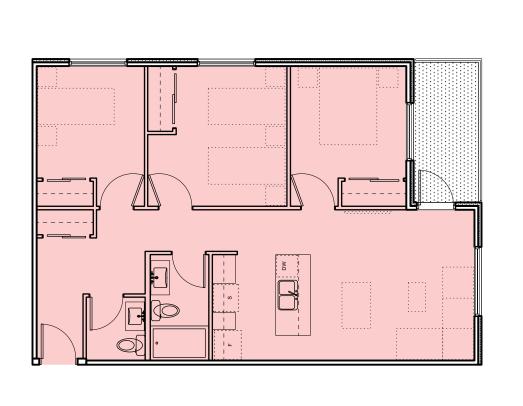


AREA 88 SM QUANTITY 2

3 Bed Type 2
A702 Scale: 1:100

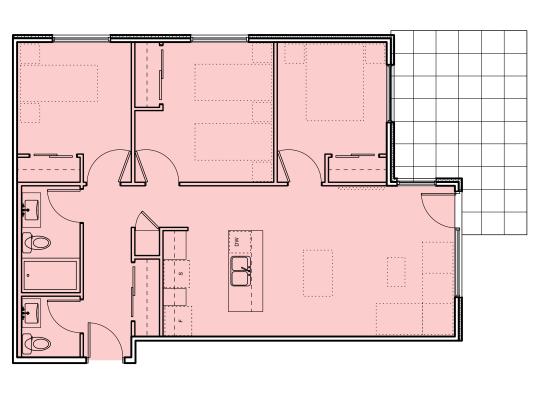

	AREA QUANTITY	88 SM 2
2	3 Bed Type	e 1B
A702	Scale: 1:100	1

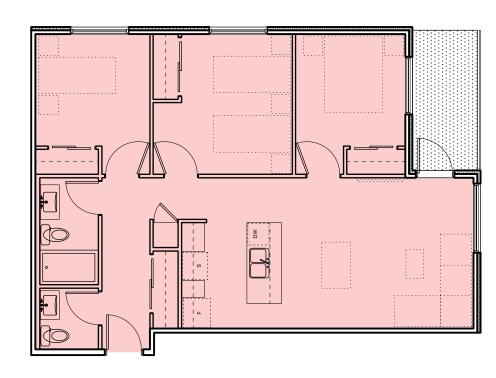

	AREA QUANTITY	88 SM 5	1		
1 A702	3 Bed Type Scale: 1:100		1:100	2000	4000 mm

3	20/02/06	ISSUED FOR COTW
2	20/01/15	ISSUED FOR ADP
1	19/12/16	RESPONSE TO PLANNING REVIEW
Rev	Date	Description
plot date	SEPTEMBER 2019	drawing file 1907 A200 Plans.vwx
drawn by	FWP	checked by RAW
scale	AS SHOWN	project number 1907
		•


NOTE: All dimensions are shown in millimeters.

ISSUED FOR DP

& REZONING

<del></del> dHKa	dHKarc	hitects		
VICTORIA OFFICE 977 Fort Street Victoria BC V8V 3K3 T 1.250.658.3367	NANAIMO OFFICE 102-5190 Du Nanaimo BC <b>T</b> 1•250•585	blin Way V9T2K8		
Caledonia				
Victoria BC				
drawing title				
Apartment Unit Plans				
COPYRIGHT RESERVED. THESE PLANS AND DESIGNS ARE AND AT ALL TIMES REMAIN THE PROPERTY OF DHARACHITECTS TO BE USED FOR THE PROJECT SHOWN AND MAY NOT BE REPRODUCED WITHOUT WRITTEN CONSENT	A702	revision no.		



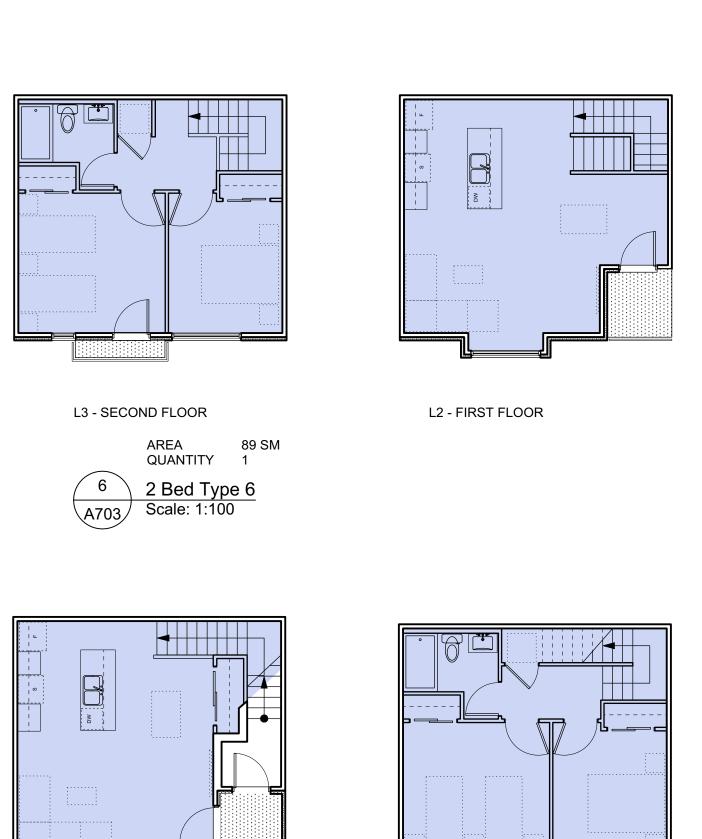


L0 - FIRST FLOOR

L1 - SECOND FLOOR

AREA QUANTITY

3 2 Bed Type 5 A703 Scale: 1:100

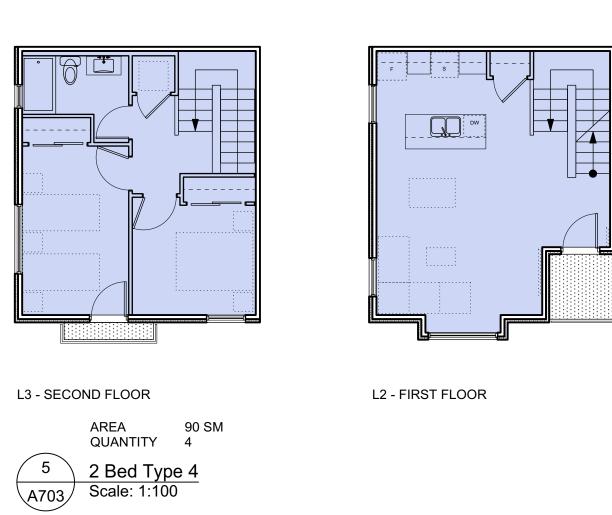


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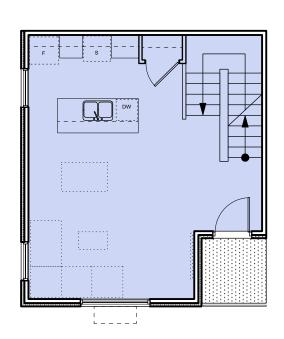
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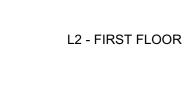
AREA 82 S QUANTITY 3


2 Bed Type 3 Scale: 1:100

82 SM






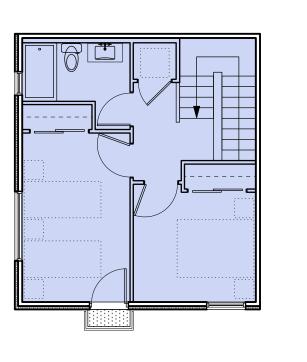

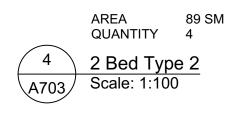

2 Bed Type 1 Scale: 1:100

L3 - SECOND FLOOR

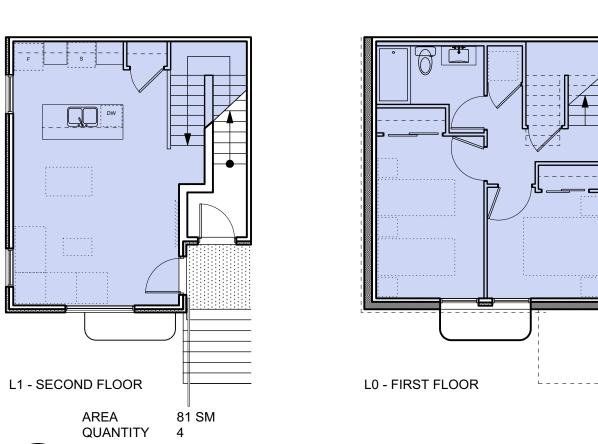

JL			
	3	20/02/06	ISSUED FOR COTV
	2	20/01/15	ISSUED FOR ADA
	1	19/12/16	RESPONSE TO PLANNING REVIEV
Rev		Date	Description
plot da	ate	SEPTEMBER 2019	drawing file 1907 A200 Plans.vw.
drawn	by	FWP	checked by RAV
scale		AS SHOWN	project number 190

**GRAPHIC LEGEND:** 

STUDIO

1 BEDROOM

2 BEDROOM


3 BEDROOM

4 BEDROOM


& ACCESSIBLE






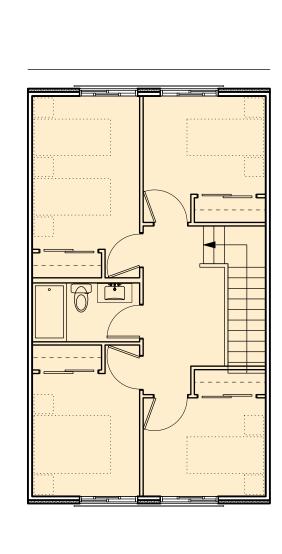





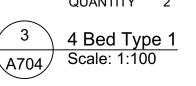

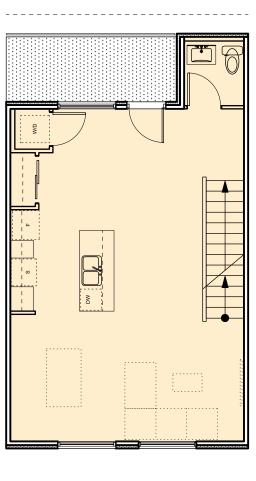


L0 - FIRST FLOOR

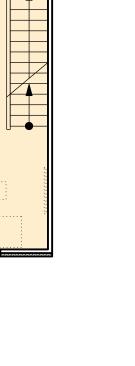

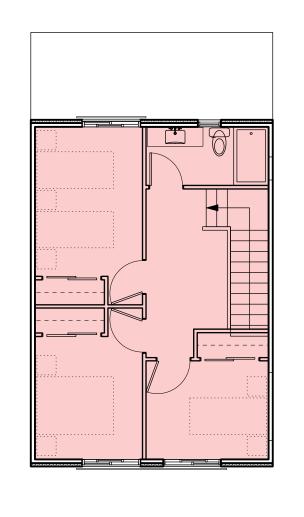


L1 - SECOND FLOOR

AREA 118 SM
QUANTITY 2

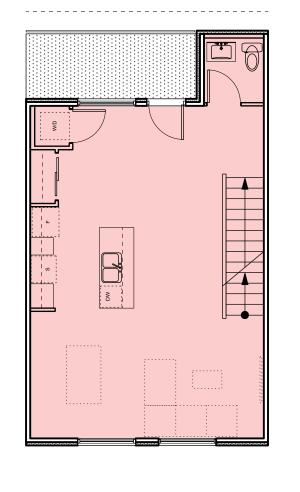

L0 - FIRST FLOOR



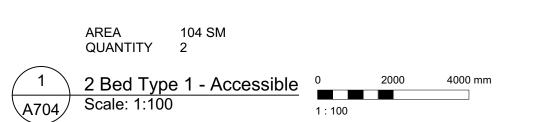


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2	20/01/15	ISSUED FOR AD
1	19/12/16	RESPONSE TO PLANNING REVIEV
Rev	Date	Description
plot date	SEPTEMBER 2019	drawing file 1907 A200 Plans.vw
drawn by	FWP	checked by RAV
scale	AS SHOWN	project number 190


NOTE: All dimensions are shown in millimeters.


ISSUED FOR DP

& REZONING

& NEZUNING			
<del></del> dHKa	dHKarc	hitects	
VICTORIA OFFICE 977 Fort Street Victoria BC V8V3K3 T 1.250.658.3367	NANAIMO OFFICE 102-5190 Du Nanaimo BC <b>T</b> 1•250•585	blin Way V9T 2K8	
Caledonia			
Victoria BC  drawing title  Townhouse 3 U	Init Plans		
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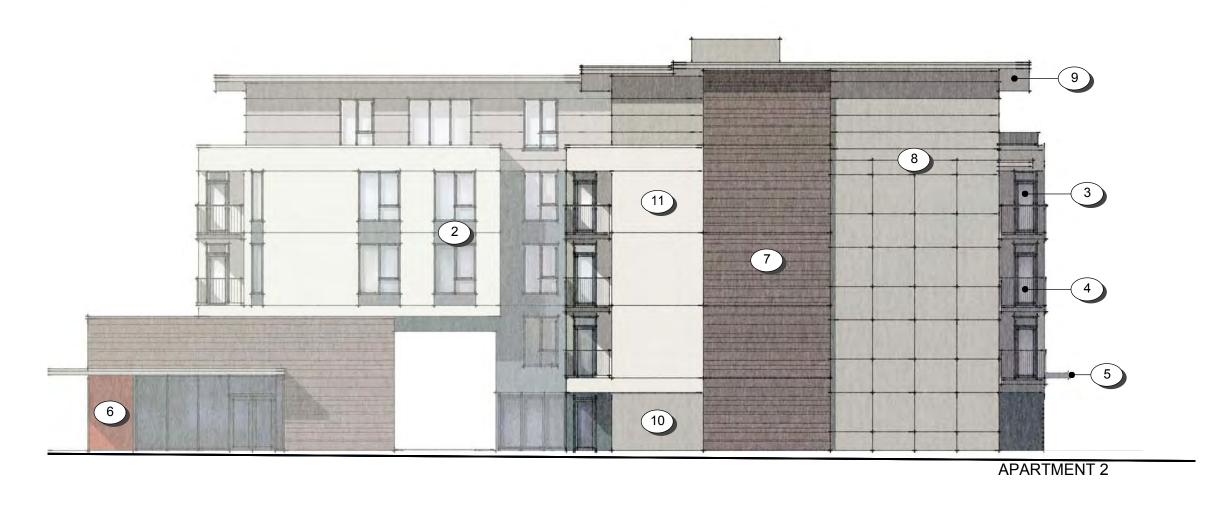


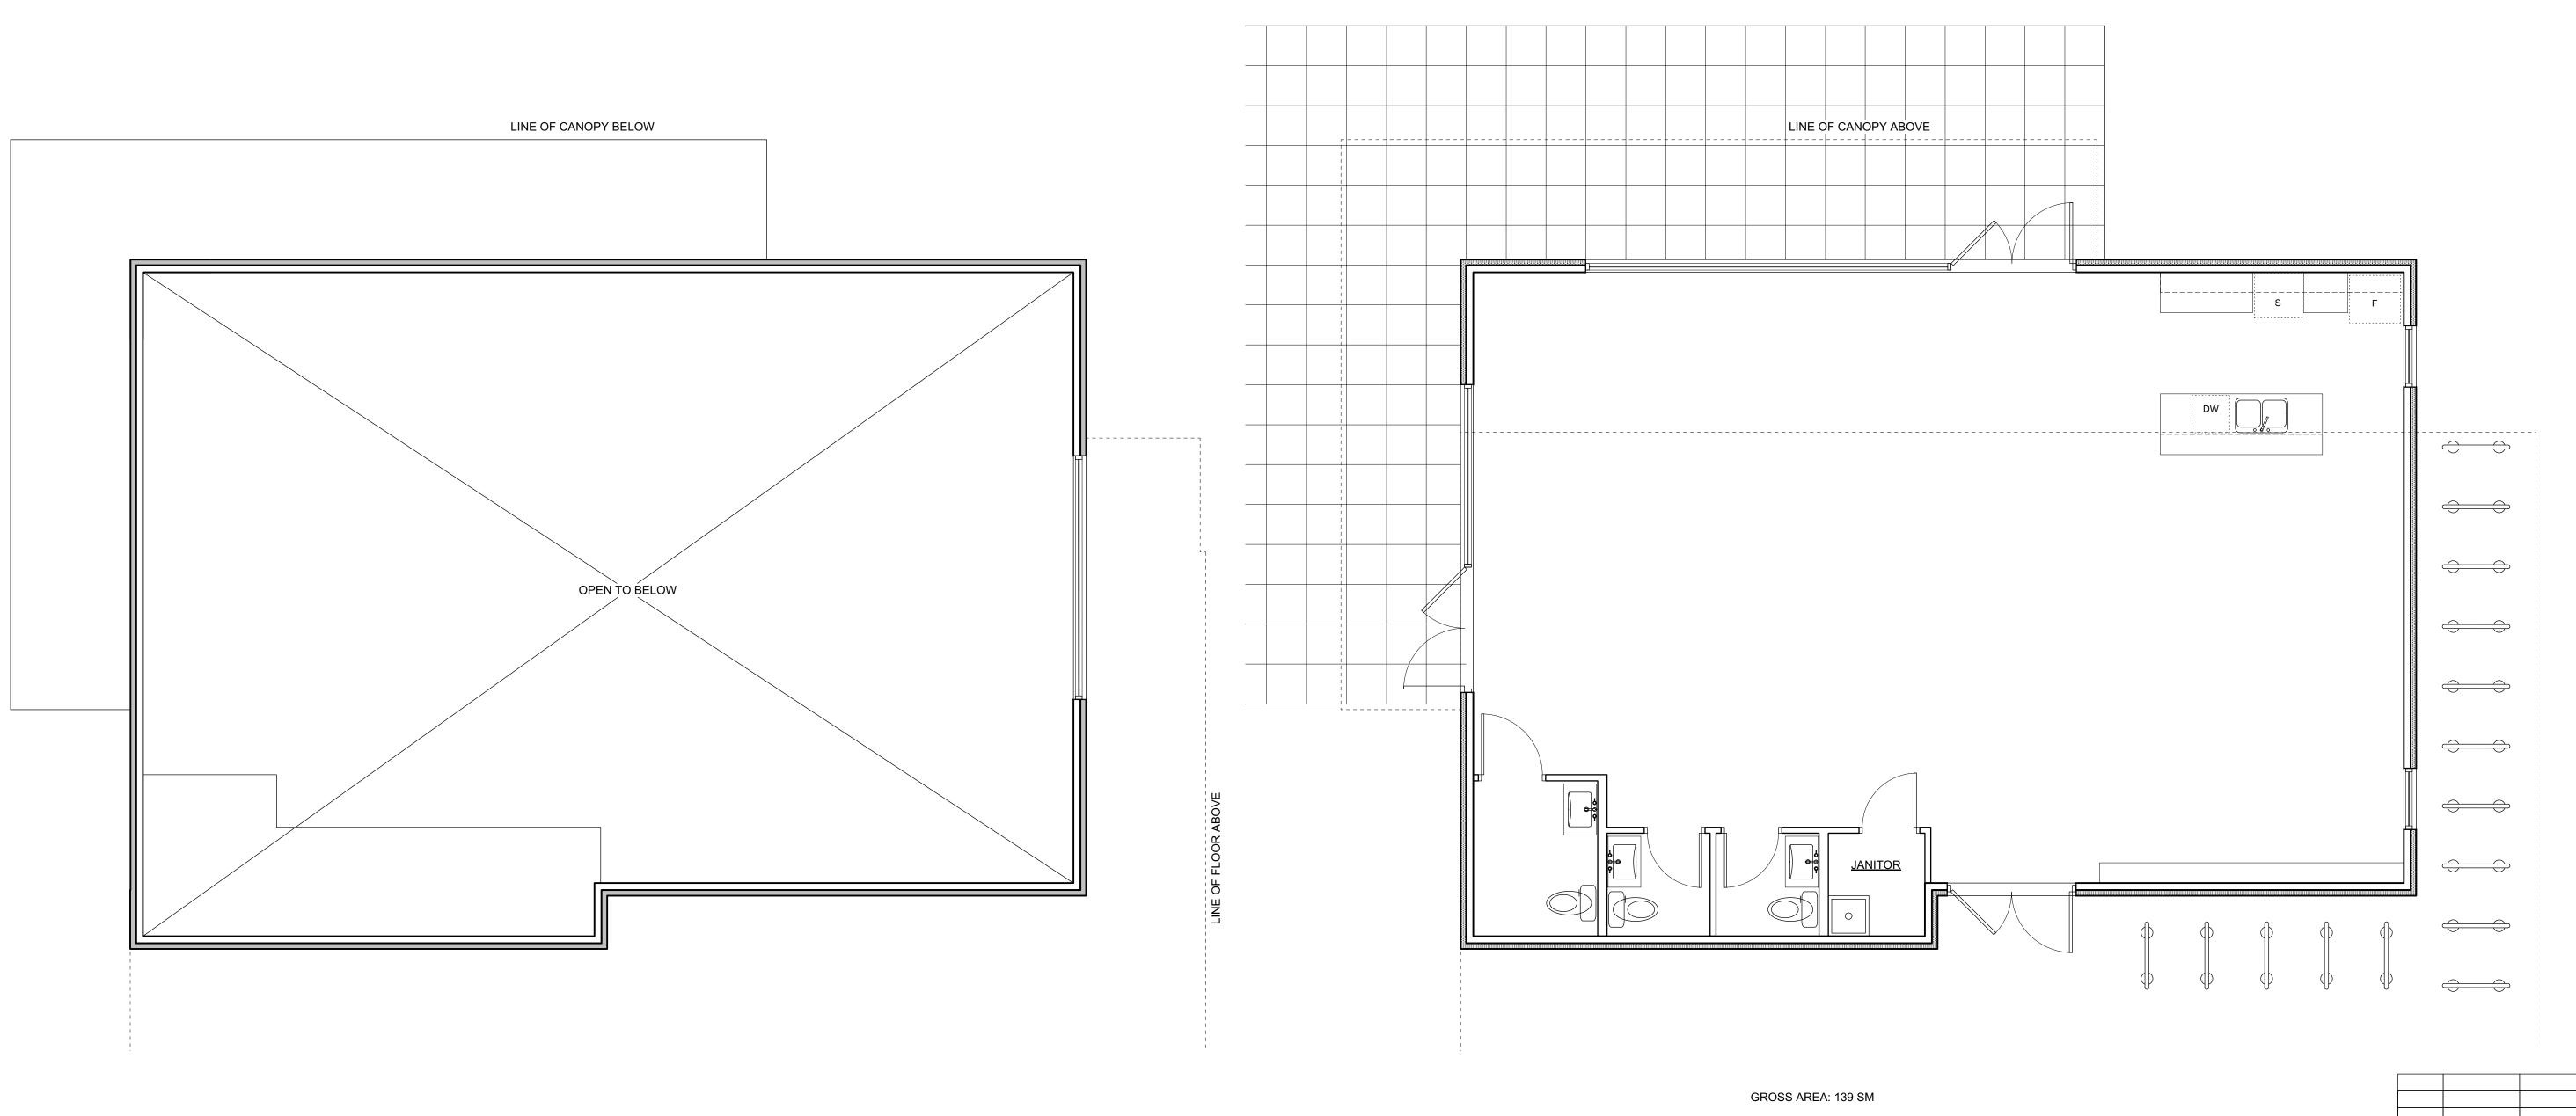
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2	20/01/15	ISSUED FOR AD
1	19/12/16	RESPONSE TO PLANNING REVIE
Rev	Date	Description
plot date	SEPTEMBER 2019	drawing file 1907 A200 Plans.vw
drawn by	FWP	checked by RA
scale	AS SHOWN	project number 190

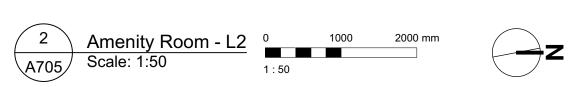
dHKa	dHKarc	hitects
VICTORIA OFFICE 977 Fort Street Victoria BC V8V3K3 T 1.250.658.3367	NANAIMO OFFICE 102-5190 Du Nanaimo BC T 1-250-585	blin Way V9T 2K8
Caledonia		
Victoria BC		
Amenity Room		
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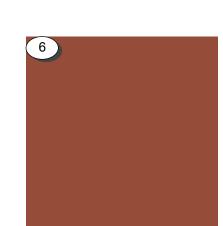
## **APARTMENTS 1 & 2**

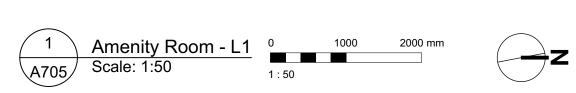








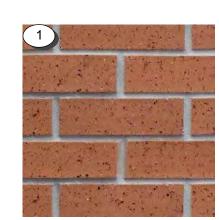

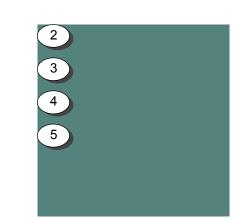


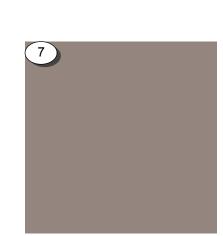

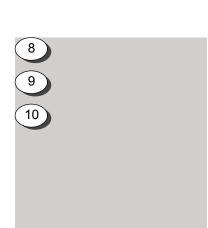

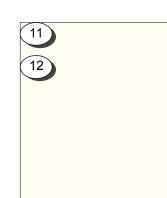

## TOWNHOUSES 1, 2 & 3

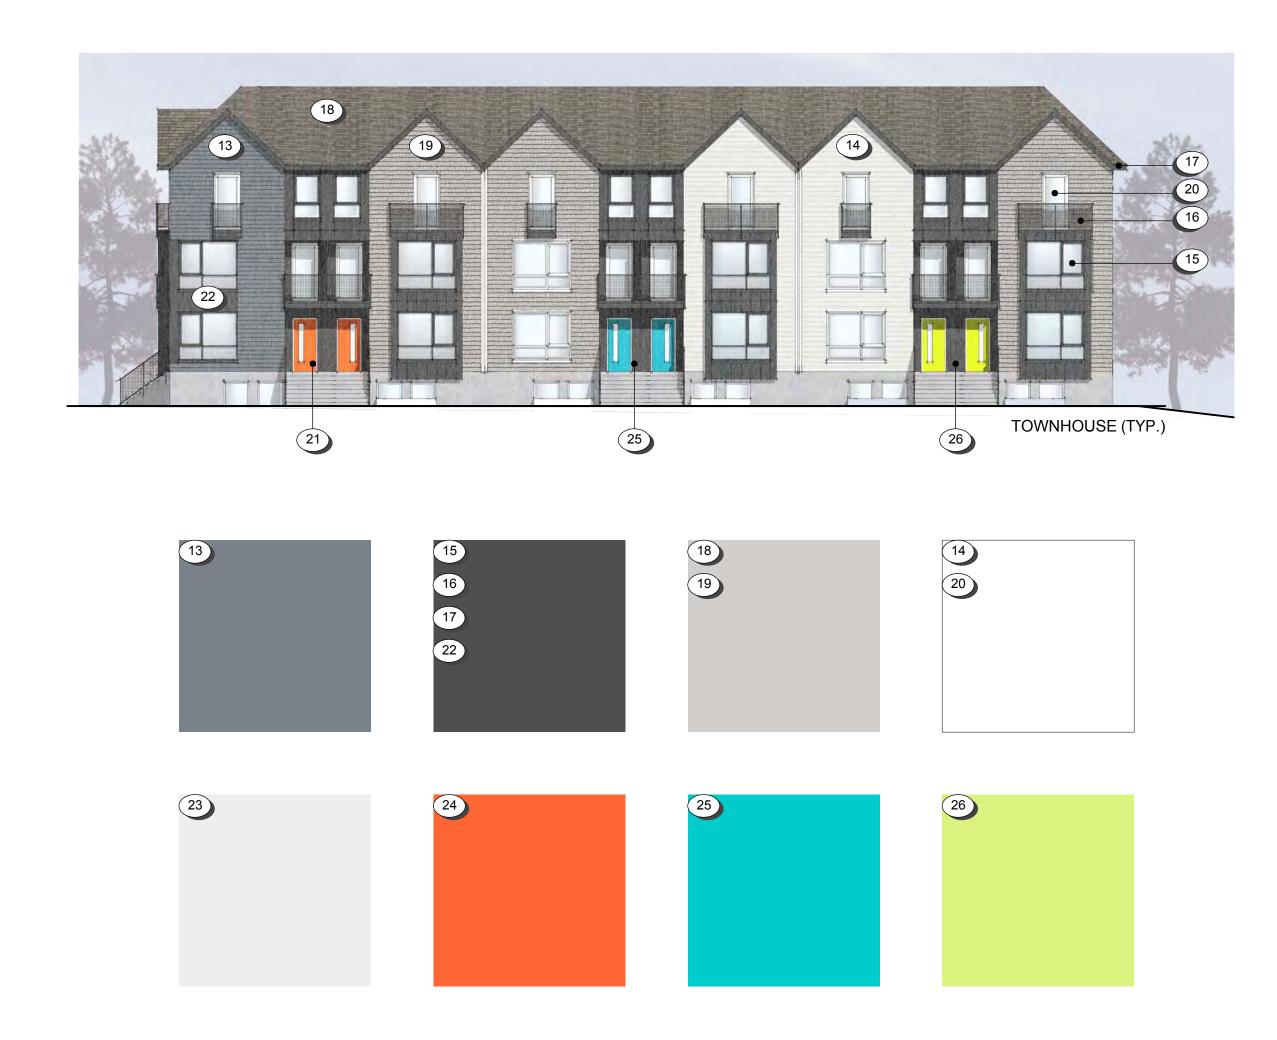

# **COLOUR & MATERIAL LEGEND**


- BRICK VENEER Red Apartment 1 Only
- <sup>2</sup> FIBRE CEMENT PANEL Teal
- VINYL WINDOWS & DOORS Teal
- 4 PREFINISHED ALUMINUM GUARD, FRAME & PICKETS Teal
- METAL FLASHING Teal
- ACCENT PAINT COLOUR Rust
- → FIBRE CEMENT LAP SIDING Soft Brown
- SOFFIT Warm Grey Apartment 2 Only
- 10 PAINTED CONCRETE Warm Grey
- 11 FIBRE CEMENT PANEL Warm White
- <sup>12</sup> SOFFIT Warm White
- <sup>13</sup> FIBRE CEMENT LAP SIDING Medium Blue-Grey

- 14) FIBRE CEMENT LAP SIDING White
- UNYL WINDOWS & DOORS Dark Grey
- PREFINISHED ALUMINUM GUARD & FRAME Dark Grey
- METAL FLASHING Dark Grey
- <sup>®</sup> ASPHALT SHINGLES Warm Grey
- <sup>19</sup> FIBRE CEMENT SHINGLES Warm Grey
- <sup>20</sup> VINYL WINDOWS & DOORS White
- <sup>21</sup> METAL DOWNSPOUT & FLASHING Light Warm Grey
- <sup>22</sup> FIBRE CEMENT PANEL Dark Grey
- <sup>23</sup> FIBRE CEMENT PANEL Light Grey
- <sup>24</sup> ACCENT PAINT COLOUR Bright Orange
- 25 ACCENT PAINT COLOUR Bright Blue
- <sup>26</sup> ACCENT PAINT COLOUR Chartreuse

3	20/02/06	ISSUED FOR COTW
2	20/01/15	ISSUED FOR ADP
1	19/12/16	RESPONSE TO PLANNING REVIEW
Rev	Date	Description
plot date	SEPTEMBER 2019	drawing file 1907 A300 Elevations.vwx
drawn by	NLC	checked by RAW
scale	1:150	project number 1907

ISSUED FOR DP & REZONING

<b>3.</b> . <b>12</b>	0111110
d <b>H</b> Ka	dHKarchitects
VICTORIA OFFICE 977 Fort Street Victoria BC V8V 3K3 T 1-250-658-3367	NANAIMO OFFICE 102-5190 Dublin Way Nanaimo BC V9T2K8 T 1•250•585•5810
caledonia	
Victoria BC	
Colours & Materi	als
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PLAY PLACES that foster fun and creativity.

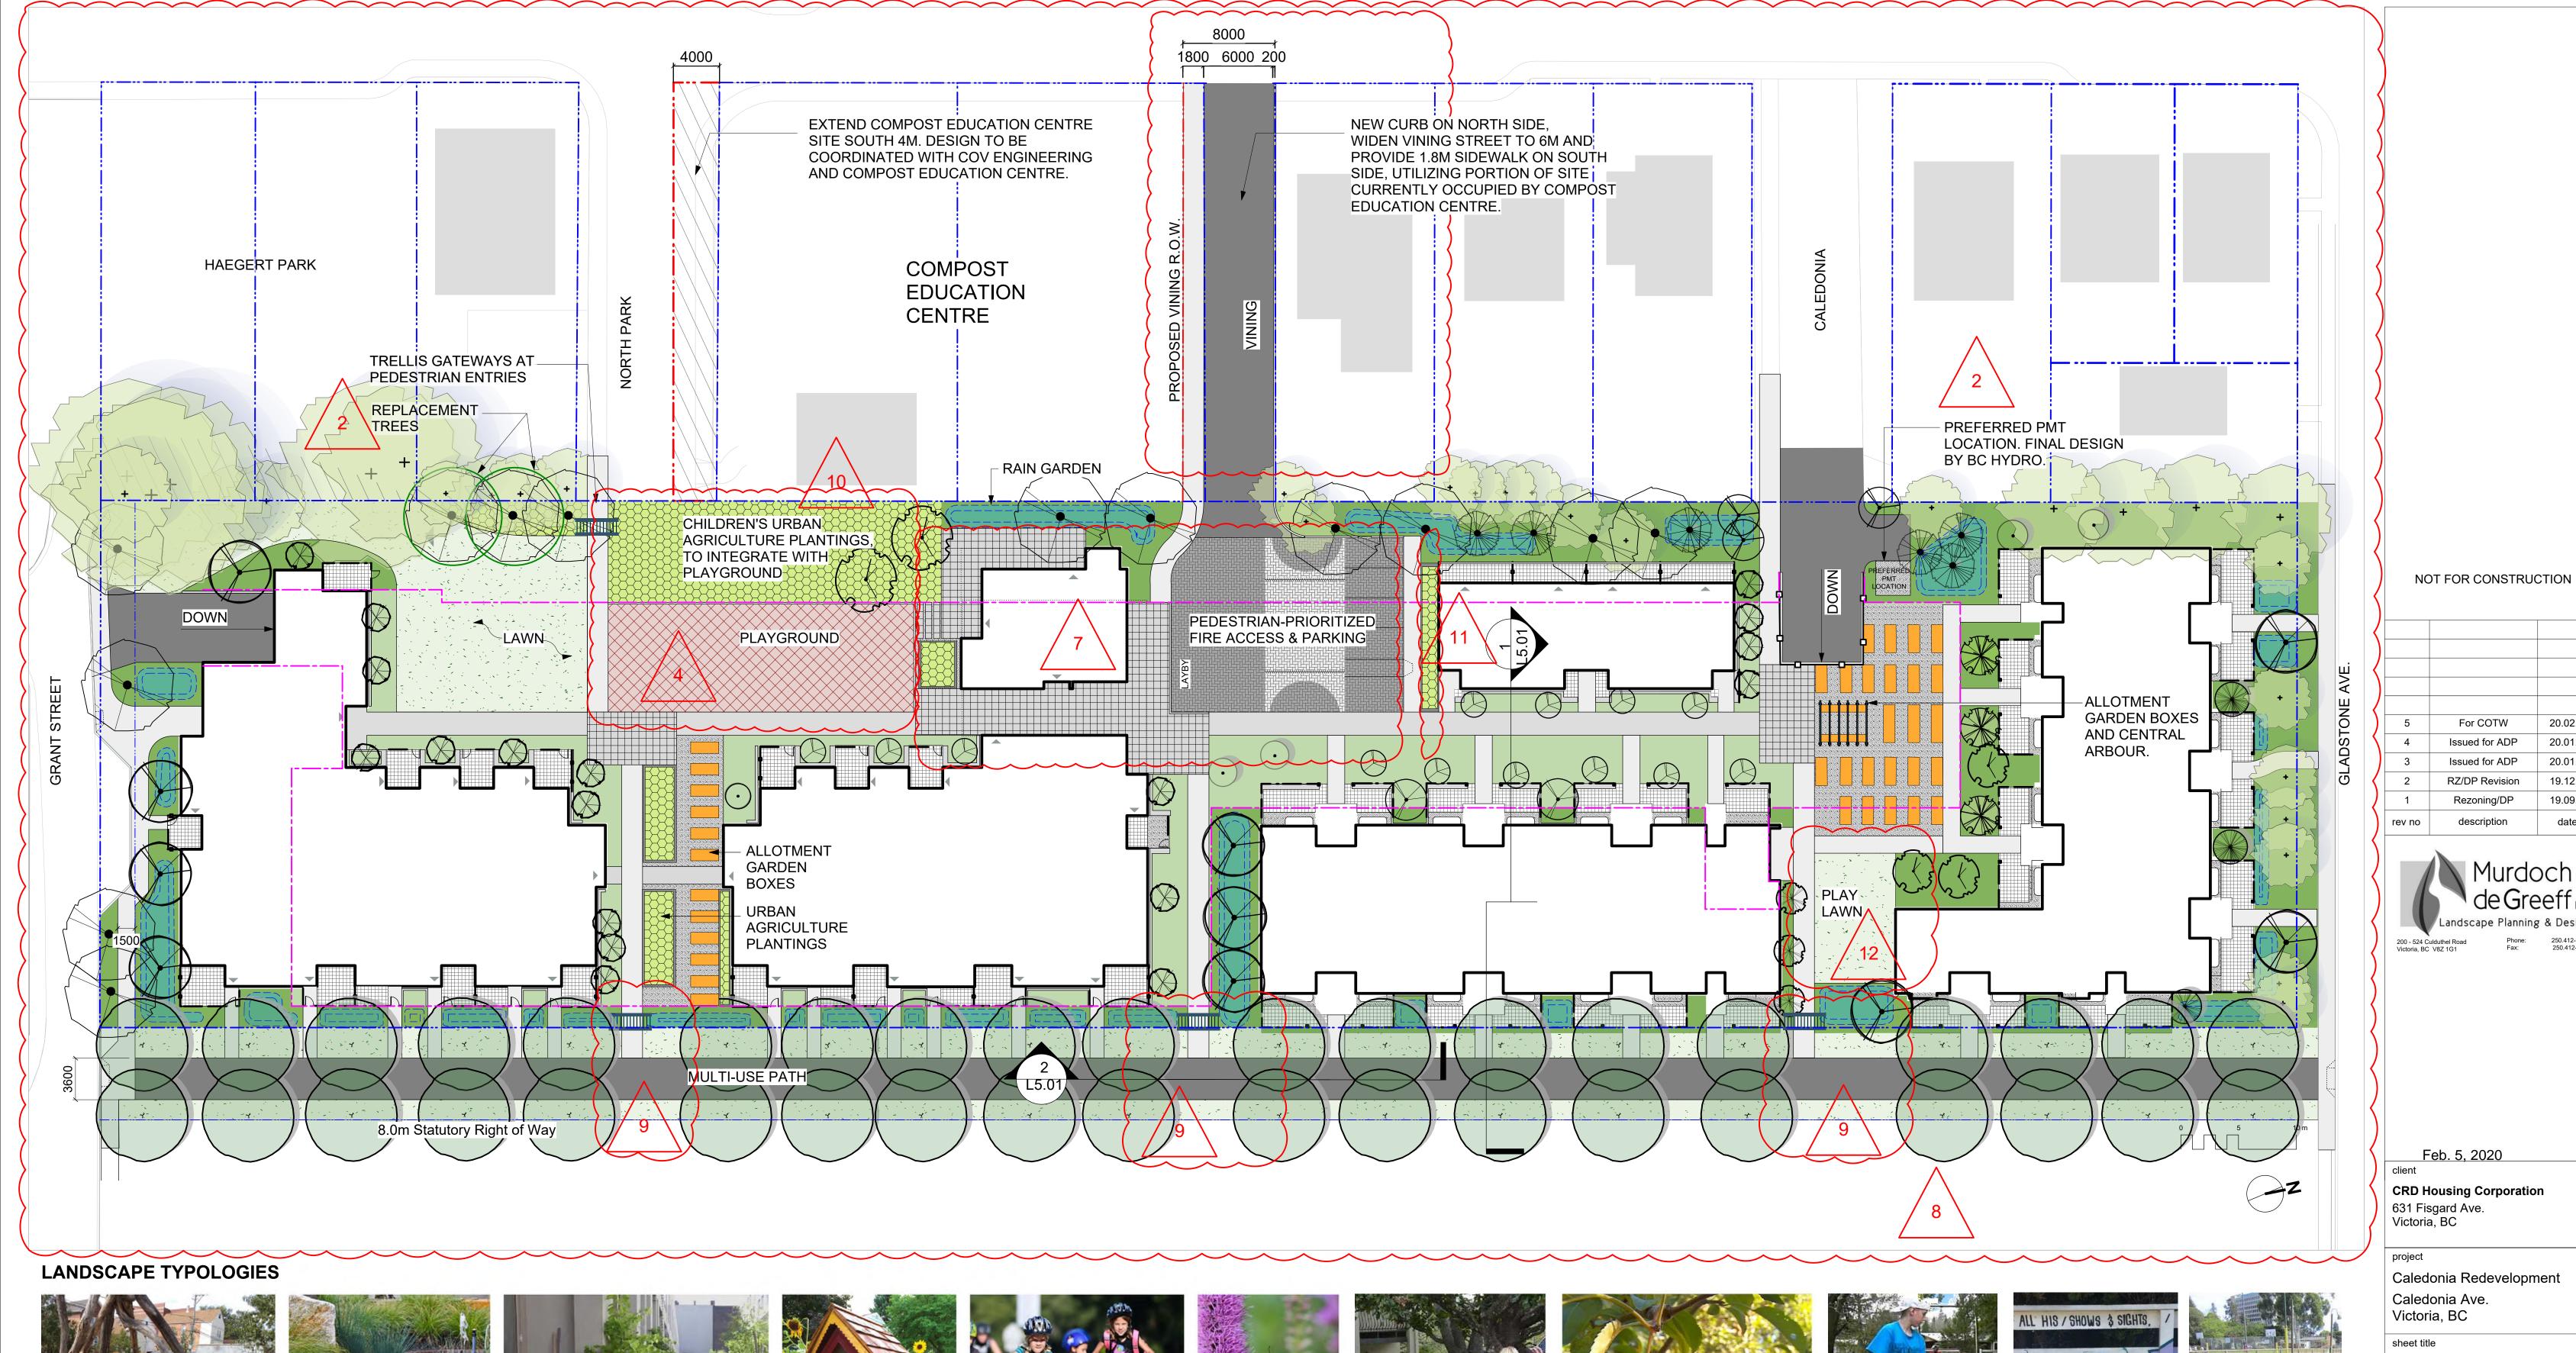

RAIN GARDENS that slow & cleanse rainwater.



PERSONAL OUTDOOR AREAS that can be modified, beautified and funkified.



**GATHERING PLACES** that help neighbours get to know each other and support each other.



BICYCLE FACILITIES that make it easy for people of all ages to hop on their bikes.



PLANTINGS that provide food for birds, bees and butterflies.



OUTDOOR SOCIAL SPACES for gethering and sharing food.



PLANTINGS that provide beauty and food for people.



ACTIVE PLAY SPACES that support community sports.



PUBLIC ART that celebrates Fernwood's artistic spirit.



COMMUNITY GARDEN PLOTS that boost local food security.

5	For COTW	20.02.04
4	Issued for ADP	20.01.15
3	Issued for ADP	20.01.15
2	RZ/DP Revision	19.12.16
1	Rezoning/DP	19.09.26
no	description	date



# Feb. 5, 2020


CRD Housing Corporation 631 Fisgard Ave. Victoria, BC

Caledonia Redevelopment Caledonia Ave.

sheet title Landscape

**Overview Plan** 

2	L	1.01
revison no.	sheet no.	
checked by		PdG
drawn by		ТВ
scale	1: 250	@ 24"x36
project no.		119.18

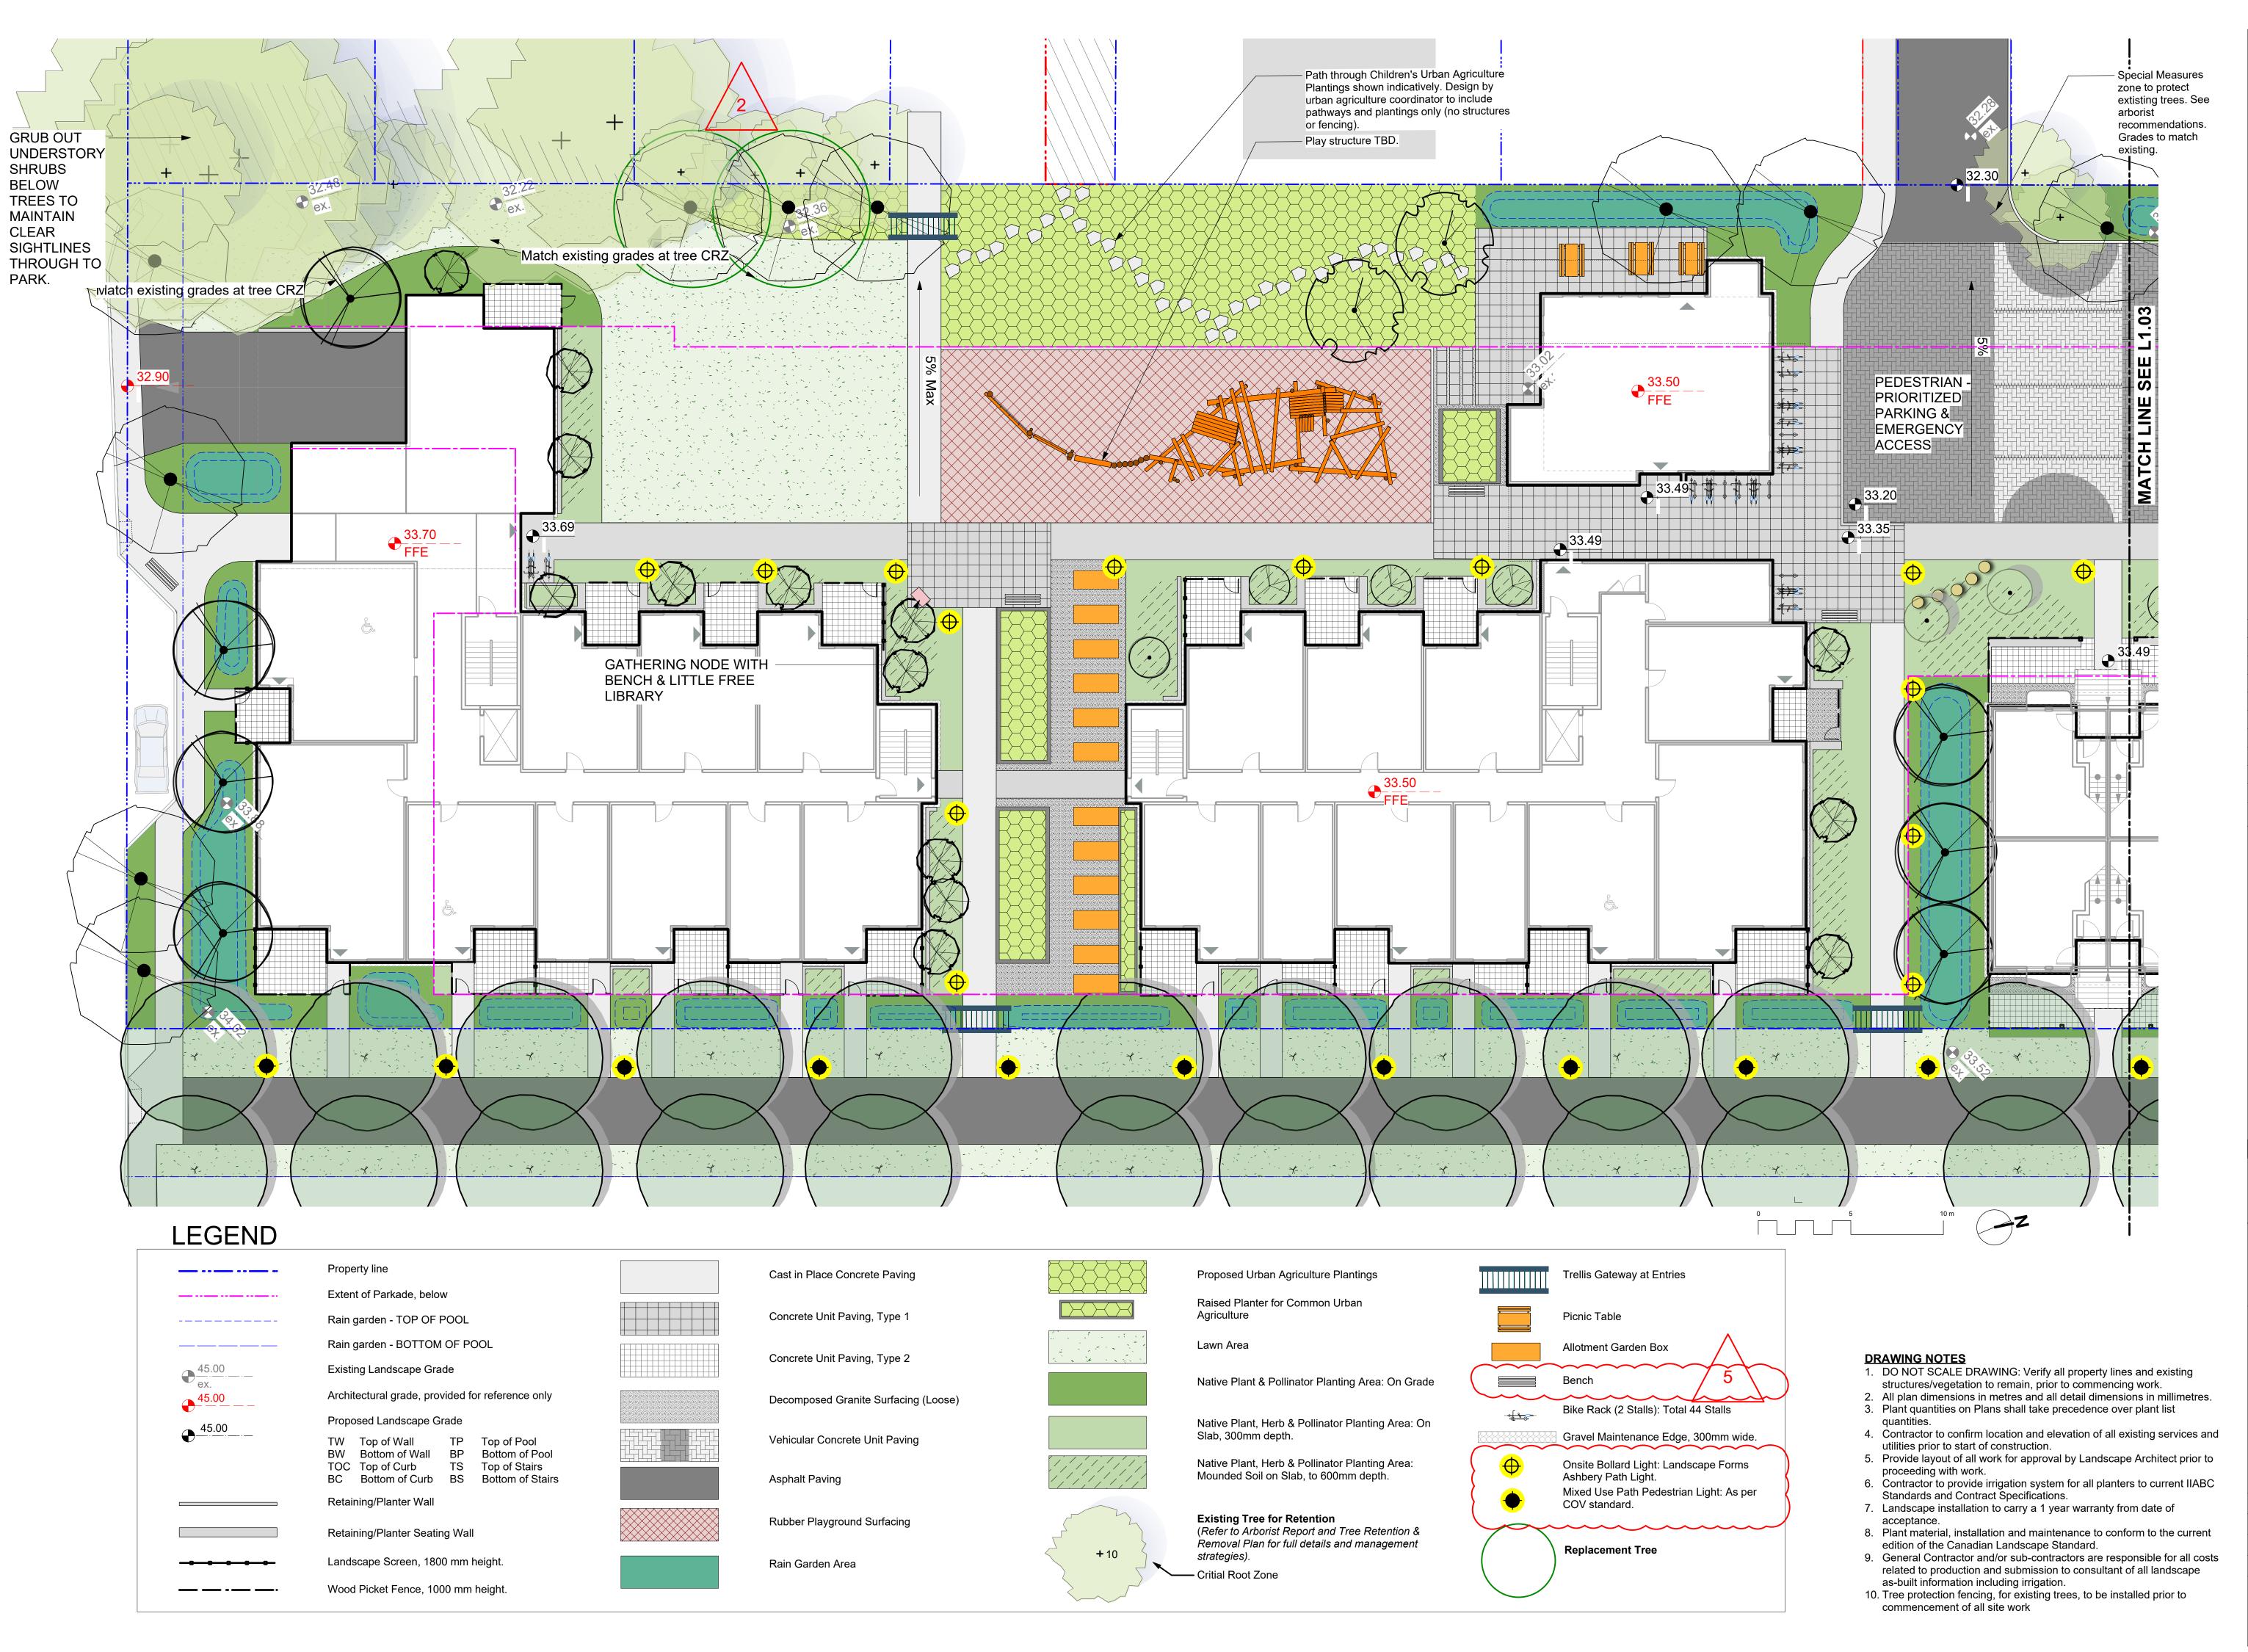

NOT FOR CONSTRUCTION

5 For COTW 20.02.04
4 Issued for ADP 20.01.15
2 RZ/DP Revision 19.12.16
1 Rezoning/DP 19.09.26
rev no description date



Feb. 5, 2020

CRD Housing Corporation
631 Fisgard Ave.
Victoria, BC

project


Caledonia Redevelopm

Caledonia Redevelopment Caledonia Ave. Victoria, BC

sheet title

### Landscape Materials South

project no.		119.18
scale	1: 150	@ 24"x36"
drawn by		ТВ
checked by		PdG
revison no.	sheet no.	
2	L	1.02

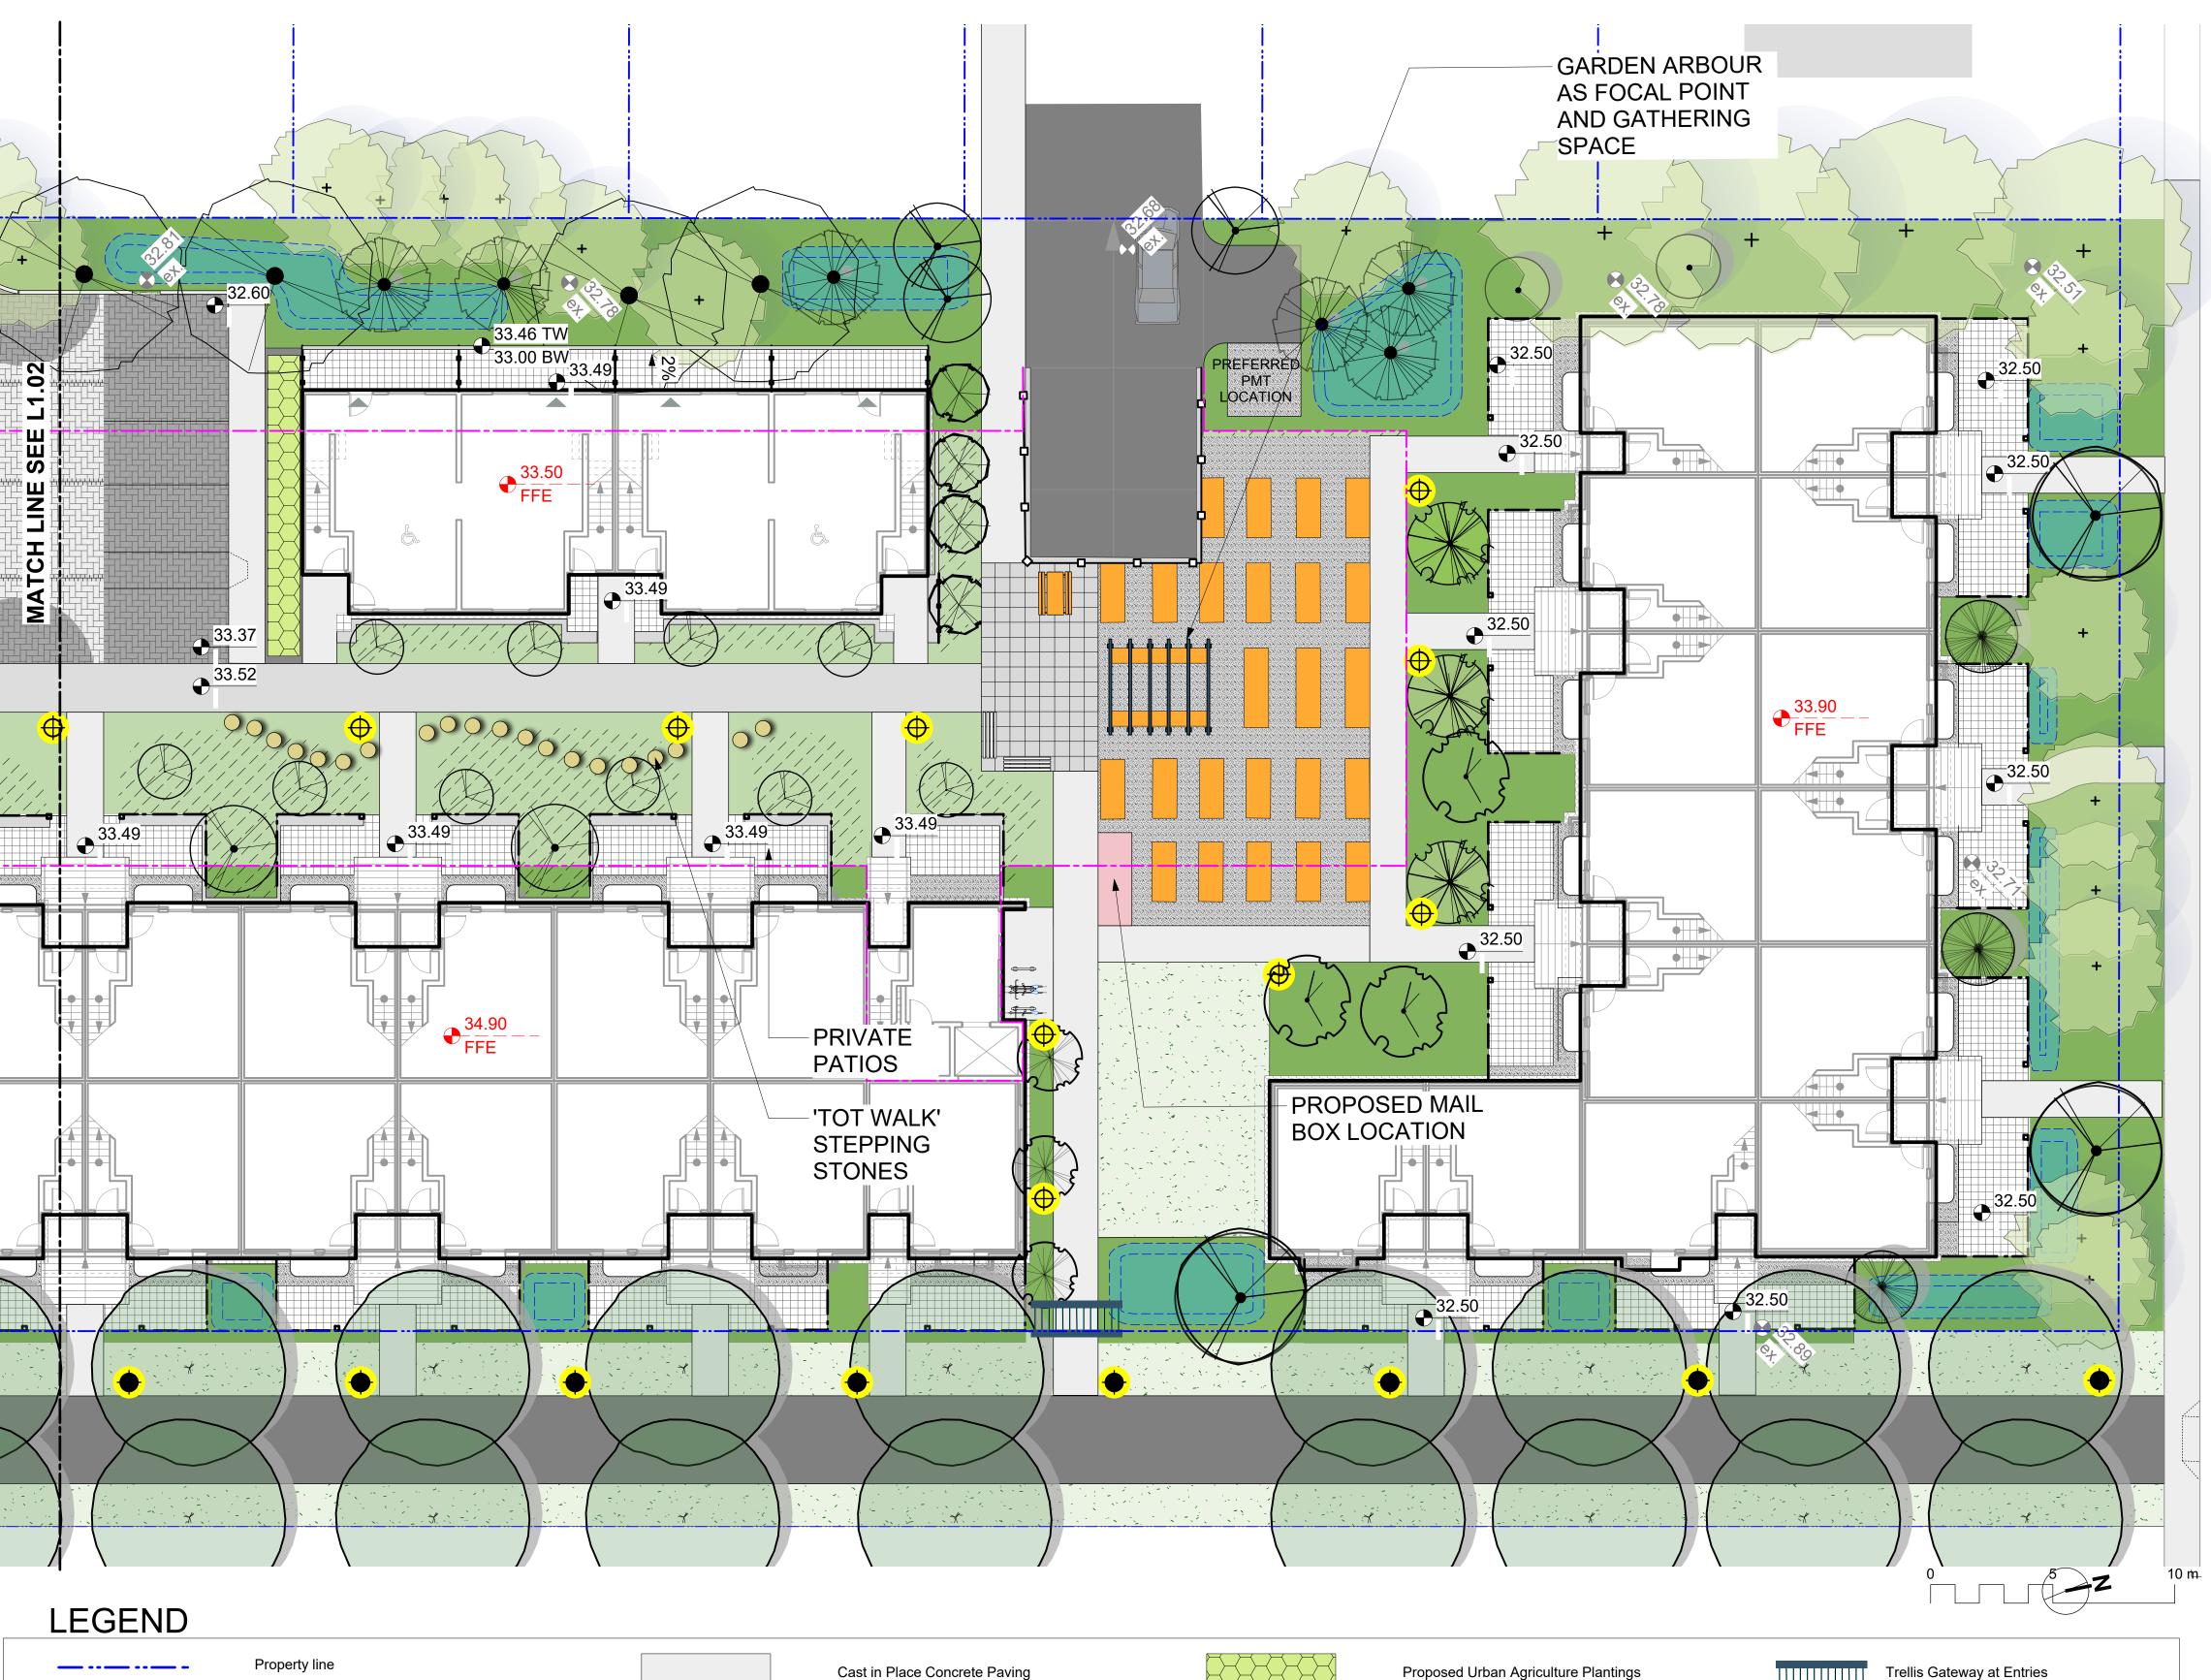

Concrete Unit Paving, Type 1

Concrete Unit Paving, Type 2

Vehicular Concrete Unit Paving

Rubber Playground Surfacing

Asphalt Paving

Rain Garden Area

Decomposed Granite Surfacing (Loose)

Raised Planter for Common Urban

Native Plant & Pollinator Planting Area: On Grade

Native Plant, Herb & Pollinator Planting Area: On

Native Plant, Herb & Pollinator Planting Area:

(Refer to Arborist Report and Tree Retention &

Removal Plan for full details and management

Mounded Soil on Slab, to 600mm depth.

**Existing Tree for Retention** 

Picnic Table

Allotment Garden Box

Ashbery Path Light.

Replacement Tree

COV standard.

Bike Rack (2 Stalls): Total 44 Stalls

Gravel Maintenance Edge, 300mm wide.

Onsite Bollard Light: Landscape Forms

Mixed Use Path Pedestrian Light: As per

Agriculture

Lawn Area

strategies).

— Critial Root Zone

Slab, 300mm depth.

**+** 10

Extent of Parkade, below

-----

45.00

45.00

Rain garden - TOP OF POOL

Existing Landscape Grade

Proposed Landscape Grade

TW Top of Wall

Retaining/Planter Wall

Retaining/Planter Seating Wall

Landscape Screen, 1800 mm height.

Wood Picket Fence, 1000 mm height.

Rain garden - BOTTOM OF POOL


Architectural grade, provided for reference only

BW Bottom of Wall BP Bottom of Pool

BC Bottom of Curb BS Bottom of Stairs

TOC Top of Curb TS Top of Stairs

TP Top of Pool

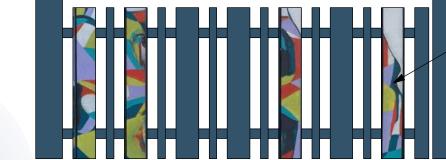

Repurposed
Fence Board
every 2-6



Proposed Picket Fence Detail

#### NOT FOR CONSTRUCTION

5	For COTW	20.02.04
4	Issued for ADP	20.01.15
2	RZ/DP Revision	19.12.16
1	Rezoning/DP	19.09.26
rev no	description	date



Feb. 5, 2020

**CRD Housing Corporation** 

Caledonia Redevelopment Caledonia Ave. Victoria, BC

sheet title


631 Fisgard Ave. Victoria, BC

### Landscape **Materials North**

revison no.	sheet no.	PaG
drawn by		TB PdG
scale	1: 150	@ 24"x36"
project no.		119.18

#### **DRAWING NOTES**

- 1. DO NOT SCALE DRAWING: Verify all property lines and existing
- structures/vegetation to remain, prior to commencing work. 2. All plan dimensions in metres and all detail dimensions in millimetres. 3. Plant quantities on Plans shall take precedence over plant list
- 4. Contractor to confirm location and elevation of all existing services and
- utilities prior to start of construction.
- 5. Provide layout of all work for approval by Landscape Architect prior to
- proceeding with work. 6. Contractor to provide irrigation system for all planters to current IIABC
- Standards and Contract Specifications. 7. Landscape installation to carry a 1 year warranty from date of
- acceptance. 8. Plant material, installation and maintenance to conform to the current
- edition of the Canadian Landscape Standard. 9. General Contractor and/or sub-contractors are responsible for all costs related to production and submission to consultant of all landscape
- as-built information including irrigation. 10. Tree protection fencing, for existing trees, to be installed prior to commencement of all site work

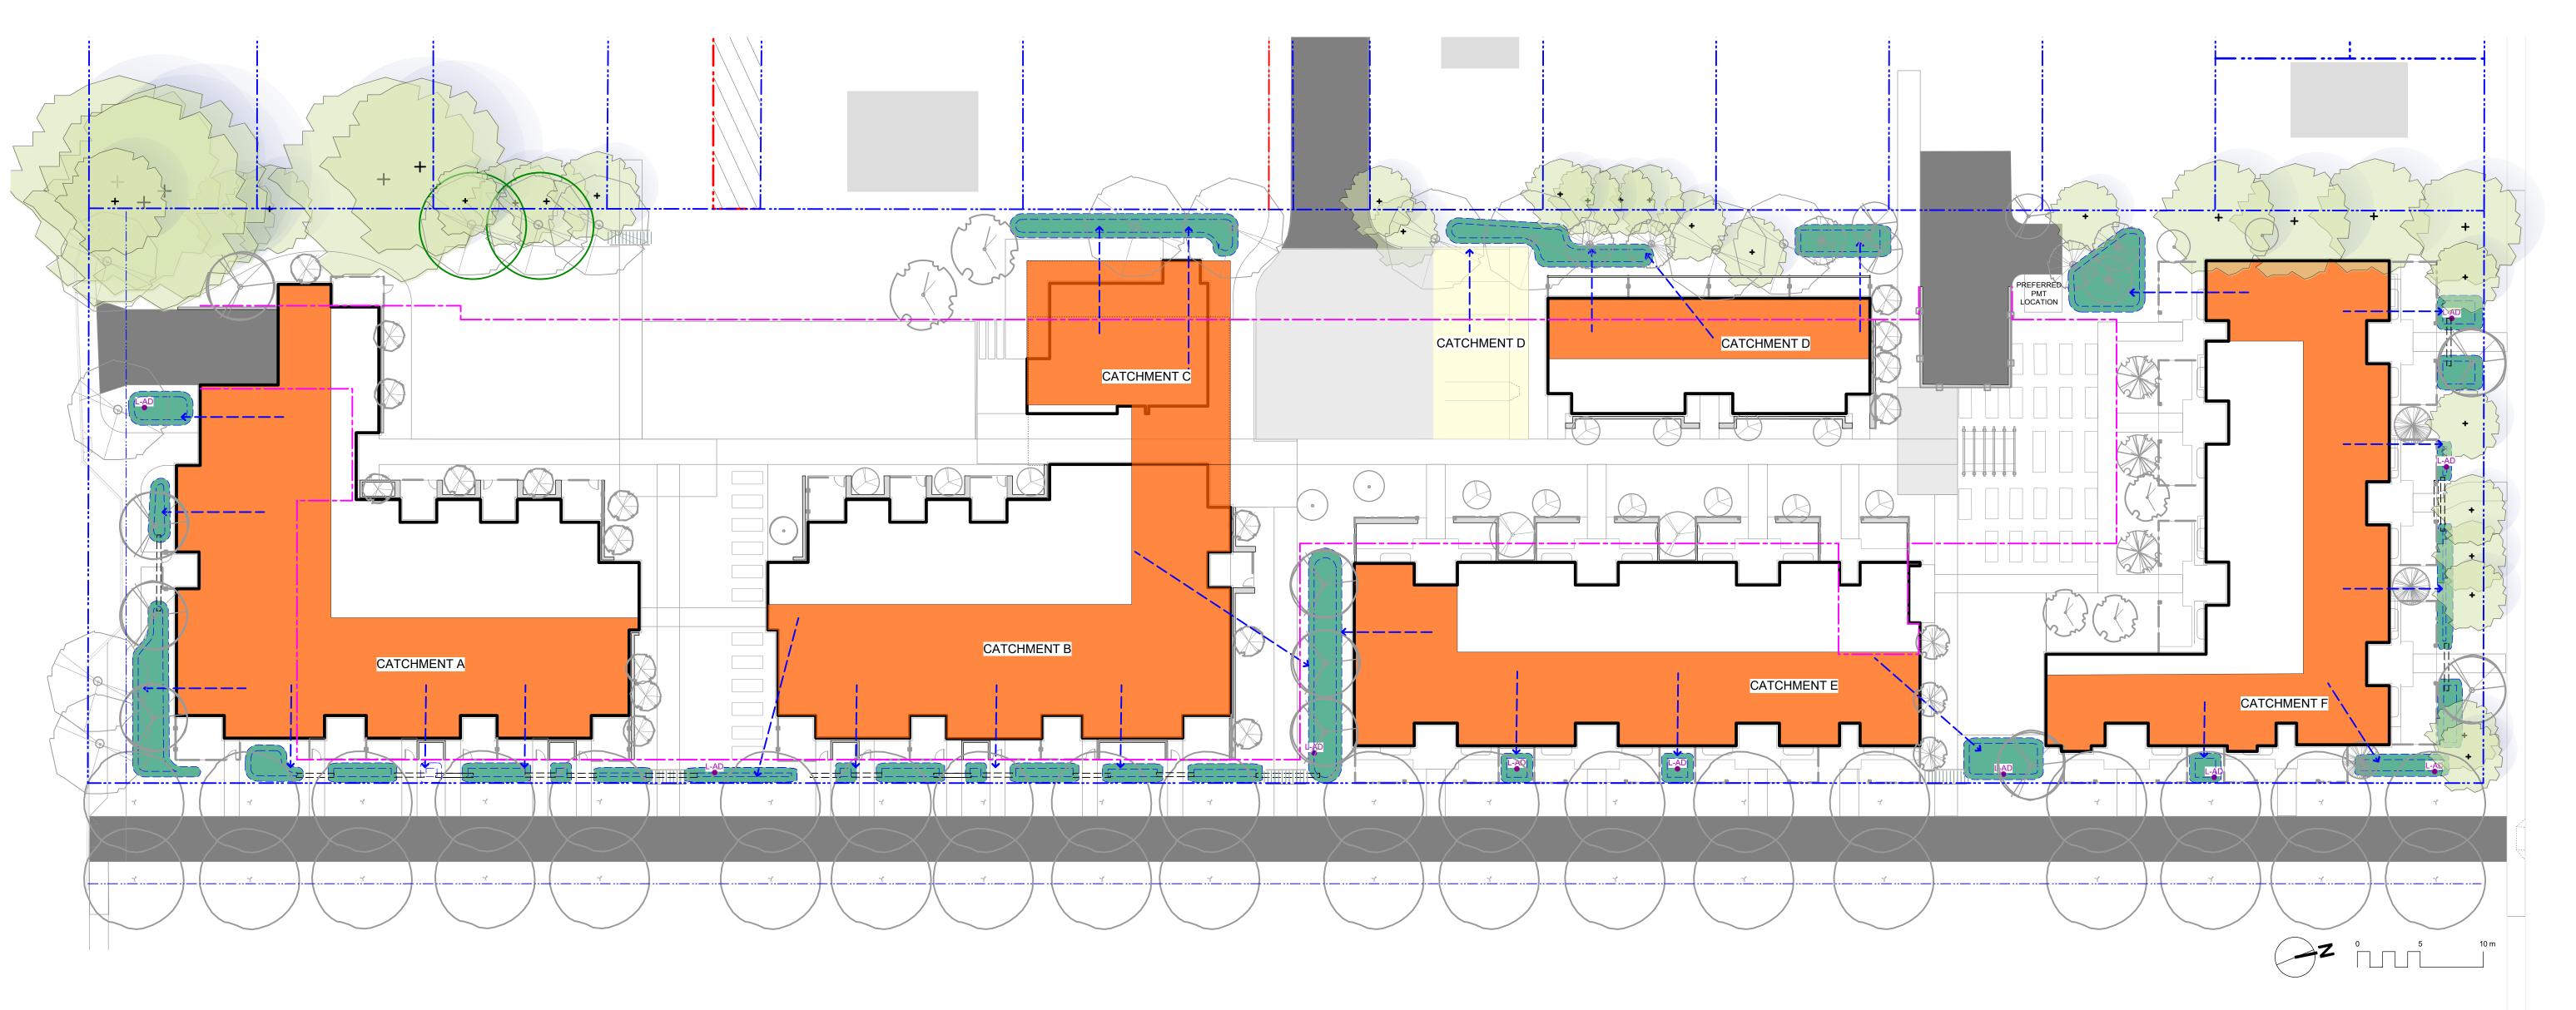

Rain Garden Capacity Calculations								
Catchment Area	Contributing Impervious Area	Design Storm Runoff Volume Contributing to Rain Garden	Planter Growing Medium Depth	Stormwater Treatment Capacity per sq. m. of Rain Garden	Rain Garden Area	Rain Garden Capacity	Excess (+) or Deficient (-) Capacity	Soil Volume
	(sq. m.)	(cu. m./day)	( m.)	(cu. m./day)	(sq. m.)	(cu. m./day)	(cu.m./day)	(cu.m.)
Catchment A	560.0	28.0	0.60	0.8	40.0	30.0	2.0	24.0
Catchment B	420.0	21.0	0.60	0.8	25.0	18.8	-2.3	15.0
Catchment C	220.0	11.0	0.60	0.8	34.0	25.5	14.5	20.4
Catchment D	230.0	11.5	0.60	0.8	30.0	22.5	11.0	18.0
Catchment E	365.0	18.3	0.60	0.8	33.0	18.5	0.3	19.8
Catchment F	400.0	20.0	0.60	0.8	50.0	37.5	17.5	30.0
total	2195.0	109.8			212.0	152.8	43.0	127.2

#### Assumptions

- Design storm is a 2 year storm event which equals 5 cm of water, in a 24 hr period.
- Rain Garden design based on 150 mm live ponding plus 20% of the sand/ compost growing medium volume (assuming growing medium has 20% void space) with a minimum infiltration rate of 2 cm/hour (or 48 cm per day), via perforated underdrain.


#### RAIN WATER MANAGEMENT NOTES

Water collected from portions of the building roofs flow to the rain gardens located throughout the site. Rain gardens have been situated

Rain gardens are designed to capture, slow flows, and treat runoff. Rain gardens will be designed with underdrains and a high □capacity overflow drain that will be connected to the onsite piped drainage system. The rain gardens are sized such that the bottom of the rain garden is 5% of the impervious area, which is the area required to manage Victoria's 2 year storm event.

Walkways will be sloped to drain to adjacent absorbant landscape. Larger paved areas such as driveways and turnarounds will be drained directly to the storm system.

Portions of the roof which cannot be easily connected to rain gardens will be drained directly to the storm system. The roof catchments are shown schematically and will be refined during detailed design.

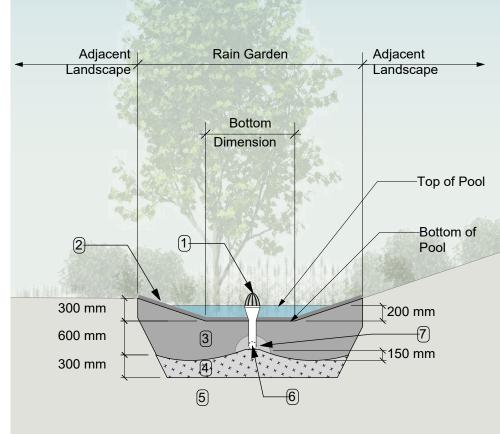


#### RAIN GARDEN MATERIALS

- 2. Composted mulch, 50 -70 mm depth
- 4. Scarified/tilled subgrade, 300 mm depth
- Existing subgrade/native material
- Typical Rain Garden



- 1. Overflow drain, 200 mm domed grate + adapter
- 3. Bio-retention growing medium, 600 mm depth
- 6. 100 mm diameter (min) perforated pipe 7. 25 mm diameter drain rock, 100 mm depth
- Scale: 1:50

# LEGEND

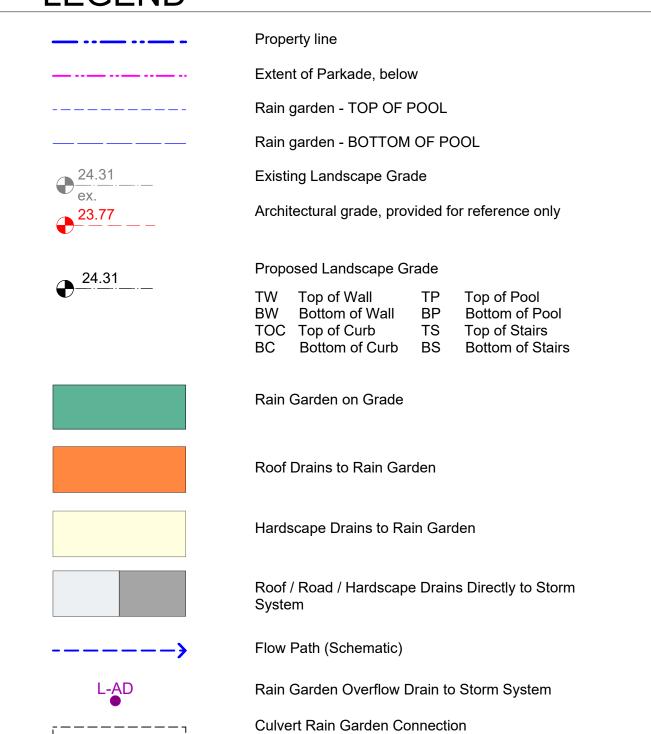

#### NOT FOR CONSTRUCTION

5	For COTW	20.02.0
4	Issued for ADP	20.01.
2	RZ/DP Revision	19.12.1
1	Rezoning/DP	19.09.2
rev no	description	date
	1	1



Feb. 5, 2020

CRD Housing Corporation 631 Fisgard Ave. Victoria, BC


Caledonia Redevelopment

Caledonia Ave. Victoria, BC

sheet title

Stormwater Management

project no.		119.18
scale	1: ###	@ 24"x36"
drawn by		ТВ
checked by		PdG
revison no.	sheet no.	
2	L	1.04

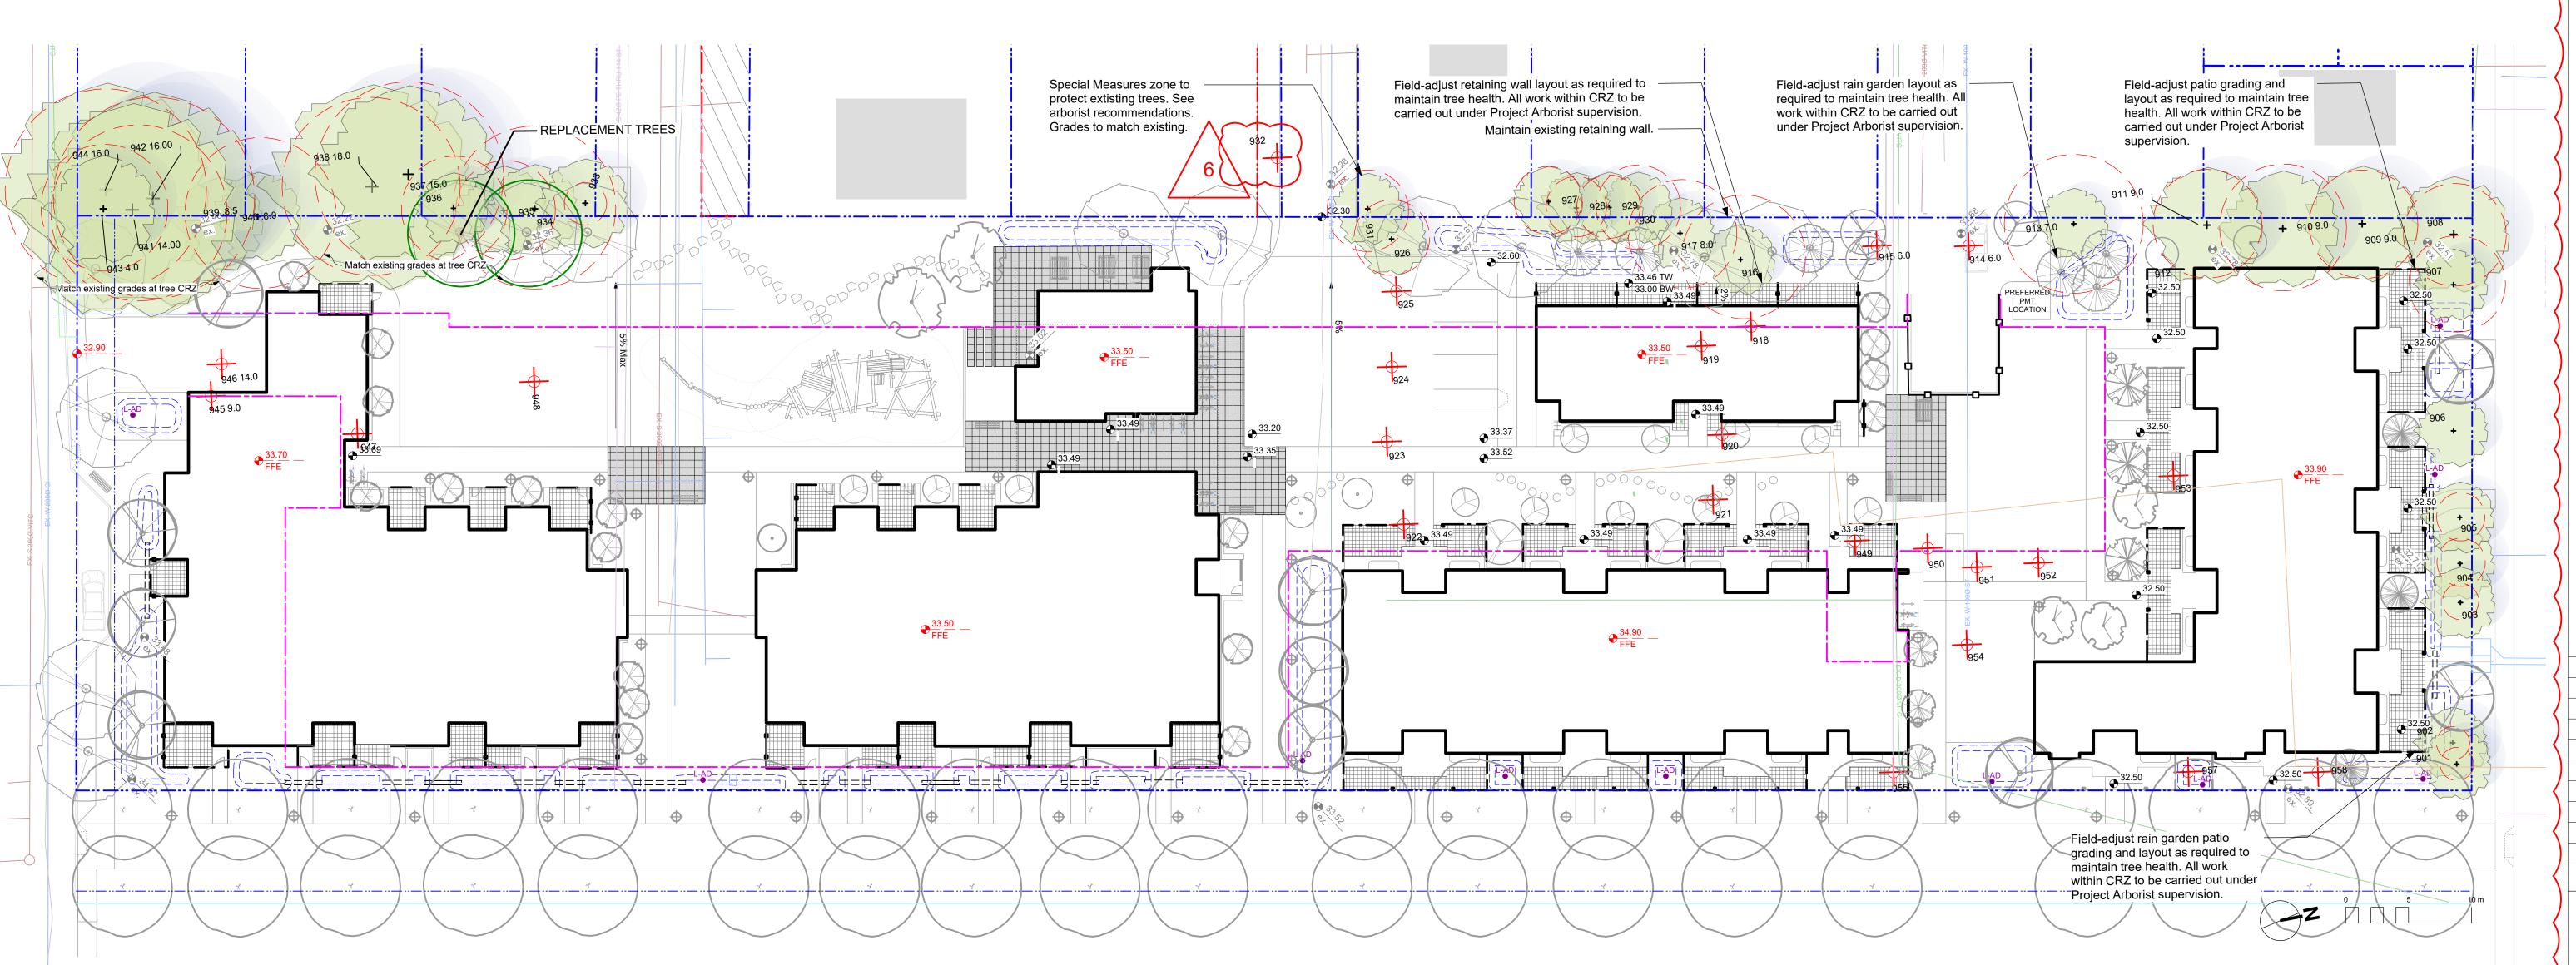

REMOVED TREE SUMMARY\*

#### **DRAWING NOTES**

- DO NOT SCALE DRAWING: Verify all property lines and existing structures/vegetation to remain, prior to commencing work.
- 2. All plan dimensions in metres and all detail dimensions in millimetres.3. Plant quantities on Plans shall take precedence over plant list
- quantities.

  4. Contractor to confirm location and elevation of all existing services and
- utilities prior to start of construction.

  5. Provide layout of all work for approval by Landscape Architect prior to
- proceeding with work.
- 6. Contractor to provide irrigation system for all planters to current IIABC Standards and Contract Specifications.
- 7. Landscape installation to carry a 1 year warranty from date of
- acceptance.Plant material, installation and maintenance to conform to the current
- edition of the Canadian Landscape Standard.
- 9. General Contractor and/or sub-contractors are responsible for all costs related to production and submission to consultant of all landscape as-built information including irrigation.
- 10. Tree protection fencing, for existing trees, to be installed prior to commencement of all site work

TREE TAG #	DBH (cm)	Species	Bylaw Protected
901	11	Tulip Tree	no
902	11	Tulip Tree	no
903	12	Tulip Tree	no
904	16	Tulip Tree	no
905	16	Tulip Tree	no
906	25	Tulip Tree	no
907	32	Tulip Tree	no
908	34	Tulip Tree	no
909	36	English oak	no
910	42	English oak	no
911	36	English oak	no
912	46	Sycamore maple	no
913	46	Red oak	no
916	41	Red oak	no
917	36	Red oak	no
926	25	Red maple	no
927	23	Zebra cedar	no
928	20	Zebra cedar	no
929	21	Zebra cedar	no
930	28	Zebra cedar	no
931	27	Douglas fir	no
933	14	Eastern white cedar	no
934	54	Edible chestnut	no
935	33	Edible chestnut	no
936	35	Western redcedar	no
937	58	Scotch elm	no
938	42,56,49,59	Scotch elm	yes
939	33	Scotch elm	no
940	33	Scotch elm	no
941	25,39,38,28,29	Scotch elm	yes
942	27,33,23,34,22	Scotch elm	yes
944	35,25,40,41	Scotch elm	yes


\* Based on Arborist's Report recieved from Dogwood Tree Services, 09/25/2019. Refer to Arborist report for details on tree conditions and

**RETAINED TREE SUMMARY\*** 

TOTAL TREES TO BE RETAINED:

Arborist recommendations.

REE TAG #	DBH (cm)	Species	Bylaw Protected?
914	45	Norway maple	no
915	43	Red oak	no
918	34	Red oak	no
919	30	Tulip Tree	no
920	20	Tulip Tree	no
921	33	Tulip Tree	no
922	24	Red maple	no
923	30	Tulip Tree	no
924	20	Tulip Tree	no
925	41	Tulip Tree	no
932	74	Bluegum	no
943	42	Pear	no
945	36	Oregon ash	no
946	68	Douglas fir	yes
947	37	Pear	no
948	30	Ellwood juniper	no
949	25	Red maple	no
950	22	Tulip tree	no
951	19	Red maple	no
952	18	Red maple	no
953	32	Red maple	no
954	13	Tulip tree	no
955	35	Red maple	no
956	10	Eastern white cedar	no
957	24	Red oak	no
958	23	Red oak	no
OTAL TREES	S TO BE REMO	OVED:	26

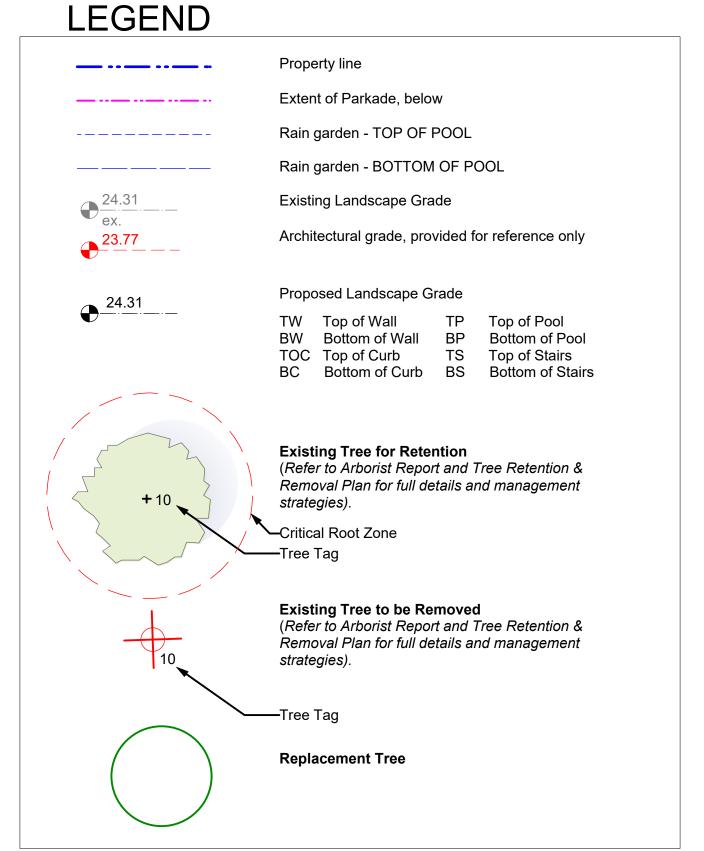



5	For COTW	20.02.04
4	Issued for ADP	20.01.15
2	RZ/DP Revision	19.12.16
1	Rezoning/DP	19.09.26
rev no	description	date
		•



Feb. 5, 2020

CRD Housing Corporation
631 Fisgard Ave.

project
Caledonia Redevelopment

Caledonia Ave.
Victoria, BC


sheet title

Victoria, BC

Tree Retention & Removal Plan

oroject no.		119.18
scale	1: 250	@ 24"x36"
drawn by		ТВ
checked by		PdG
evison no.	sheet no.	
2		1.05

1

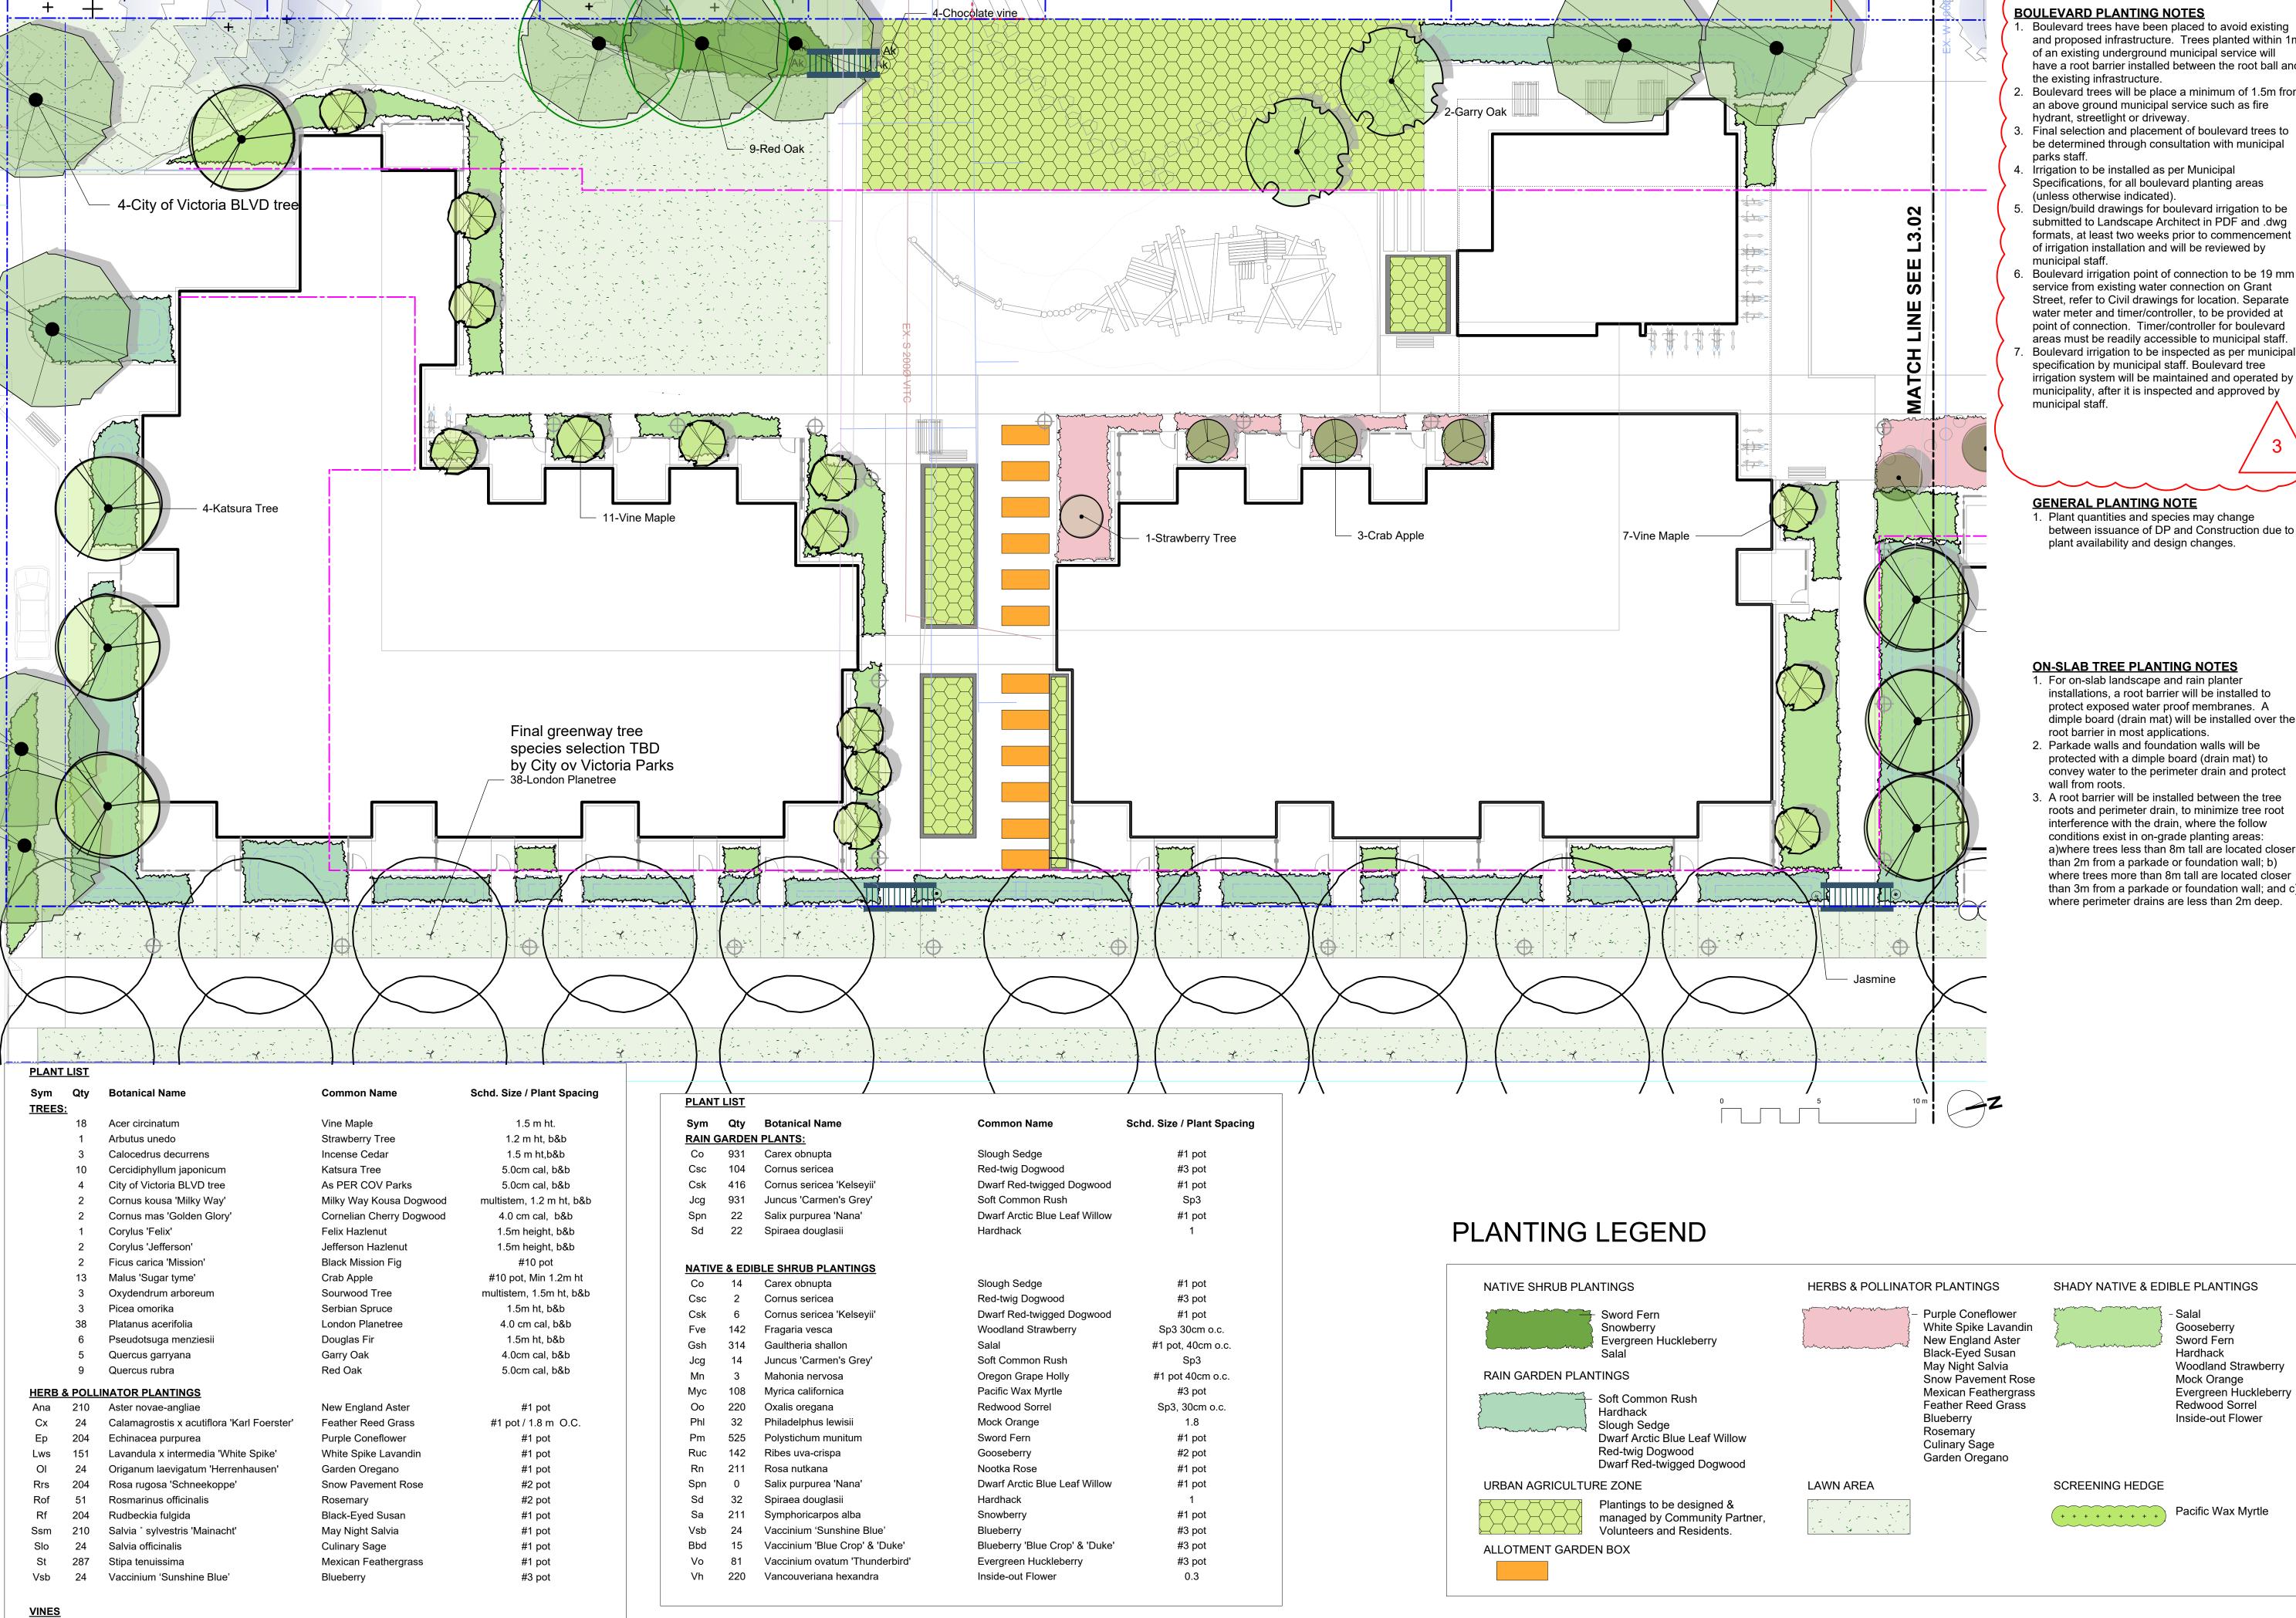

Passiflora caerulea

Akebia quinata

4 Actinidia arguta

Jasminum nudiflorum

Blue Passionflower

Jasmine

Chocolate vine

Hardy Kiwi

#1 pot

#1 pot

#2 pot

#2 pot

Boulevard trees have been placed to avoid existing and proposed infrastructure. Trees planted within 1m of an existing underground municipal service will have a root barrier installed between the root ball and

Boulevard trees will be place a minimum of 1.5m from an above ground municipal service such as fire

3. Final selection and placement of boulevard trees to be determined through consultation with municipal

4. Irrigation to be installed as per Municipal Specifications, for all boulevard planting areas

5. Design/build drawings for boulevard irrigation to be submitted to Landscape Architect in PDF and .dwg formats, at least two weeks prior to commencement of irrigation installation and will be reviewed by

6. Boulevard irrigation point of connection to be 19 mm service from existing water connection on Grant Street, refer to Civil drawings for location. Separate water meter and timer/controller, to be provided at point of connection. Timer/controller for boulevard areas must be readily accessible to municipal staff. Boulevard irrigation to be inspected as per municipal specification by municipal staff. Boulevard tree irrigation system will be maintained and operated by municipality, after it is inspected and approved by

1. Plant quantities and species may change between issuance of DP and Construction due to plant availability and design changes.

**ON-SLAB TREE PLANTING NOTES** 1. For on-slab landscape and rain planter installations, a root barrier will be installed to protect exposed water proof membranes. A dimple board (drain mat) will be installed over the

2. Parkade walls and foundation walls will be protected with a dimple board (drain mat) to convey water to the perimeter drain and protect

3. A root barrier will be installed between the tree roots and perimeter drain, to minimize tree root interference with the drain, where the follow conditions exist in on-grade planting areas: a)where trees less than 8m tall are located closer than 2m from a parkade or foundation wall; b) where trees more than 8m tall are located closer than 3m from a parkade or foundation wall; and c) where perimeter drains are less than 2m deep.

NOT FOR CONSTRUCTION

5	For COTW	20.02.04
4	Issued for ADP	20.01.15
2	RZ/DP Revision	19.12.16
1	Rezoning/DP	19.09.26
rev no	description	date
		1



Feb. 5, 2020

**CRD Housing Corporation** 631 Fisgard Ave. Victoria, BC


project Caledonia Redevelopment

Caledonia Ave. Victoria, BC

sheet title

**Planting Plan South** 

project no.		119.18
scale	1: 150	@ 24"x36"
drawn by		ТВ
checked by		PdG
revison no.	sheet no.	
2	L	3.01

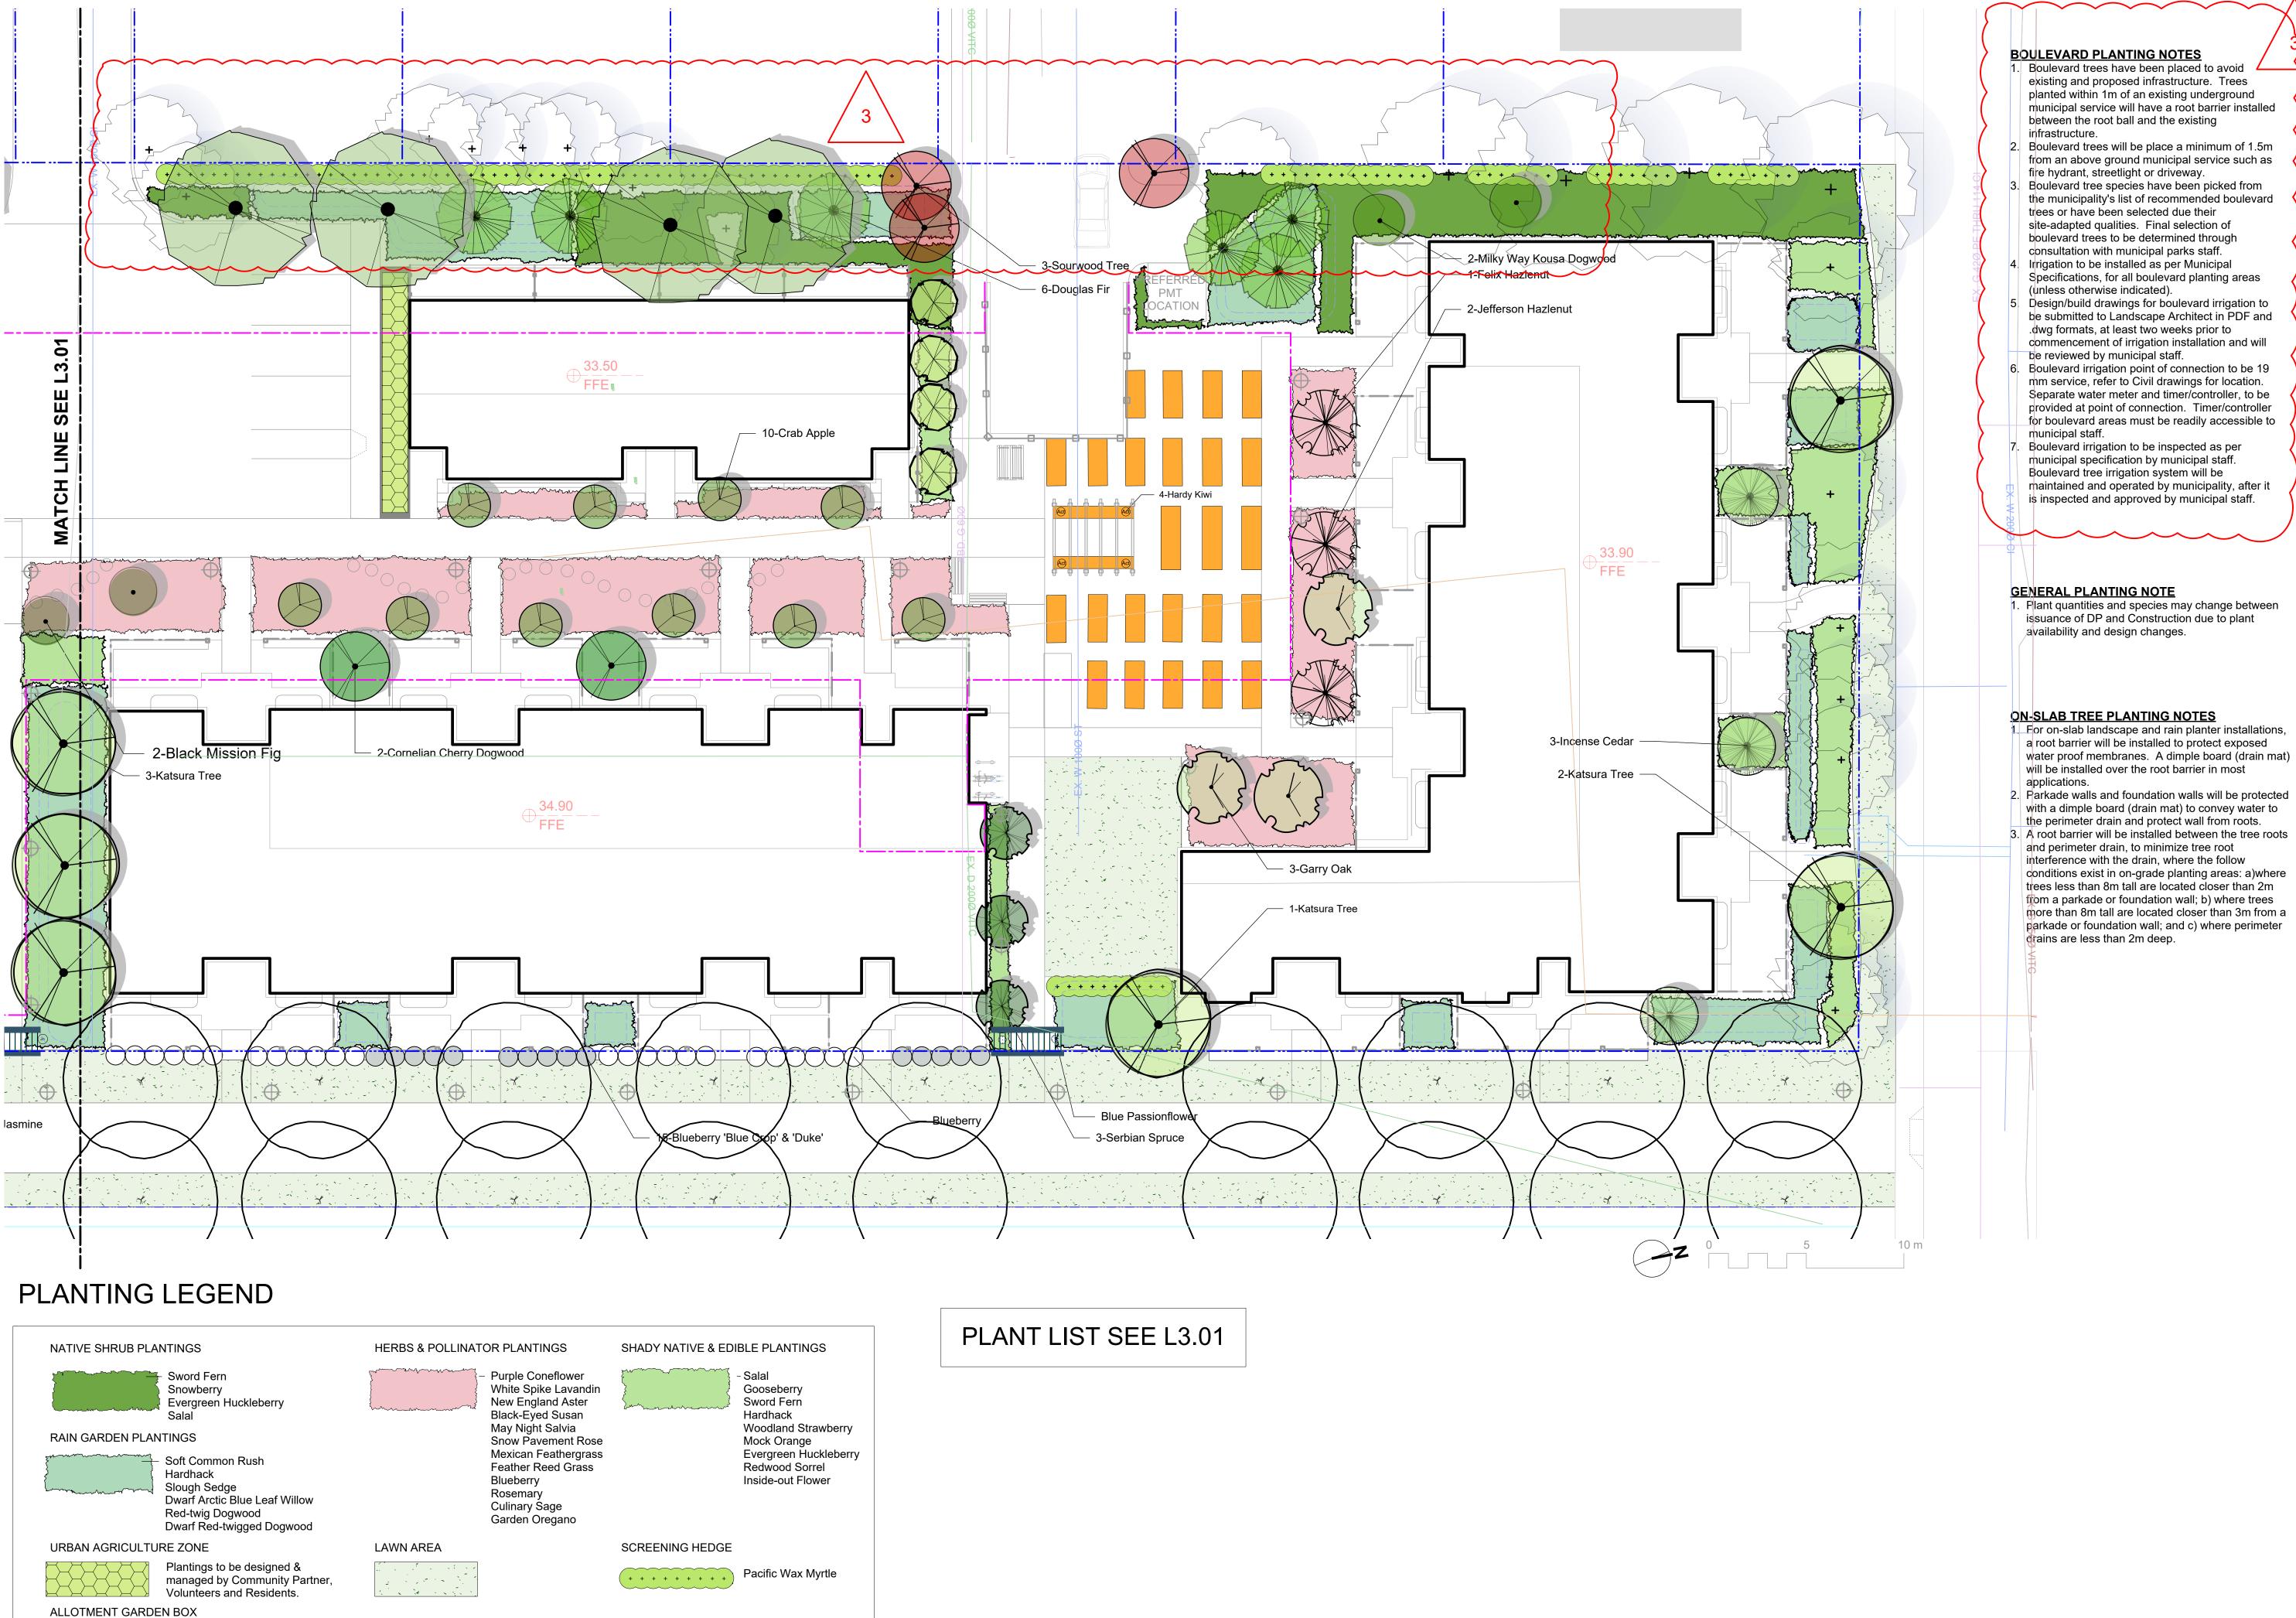

- existing and proposed infrastructure. Trees planted within 1m of an existing underground municipal service will have a root barrier installed
- 2. Boulevard trees will be place a minimum of 1.5m from an above ground municipal service such as
- Boulevard tree species have been picked from the municipality's list of recommended boulevard
- Specifications, for all boulevard planting areas
- be submitted to Landscape Architect in PDF and commencement of irrigation installation and will
- mm service, refer to Civil drawings for location. Separate water meter and timer/controller, to be provided at point of connection. Timer/controller for boulevard areas must be readily accessible to
- maintained and operated by municipality, after it is inspected and approved by municipal staff.

issuance of DP and Construction due to plant

### 1 For on-slab landscape and rain planter installations, a root barrier will be installed to protect exposed water proof membranes. A dimple board (drain mat)

- 2. Parkade walls and foundation walls will be protected with a dimple board (drain mat) to convey water to the perimeter drain and protect wall from roots.
- interference with the drain, where the follow conditions exist in on-grade planting areas: a)where trees less than 8m tall are located closer than 2m from a parkade or foundation wall; b) where trees more than 8m tall are located closer than 3m from a parkade or foundation wall; and c) where perimeter

#### NOT FOR CONSTRUCTION

5	For COTW	20.02.04
4	Issued for ADP	20.01.15
2	RZ/DP Revision	19.12.16
1	Rezoning/DP	19.09.26
rev no	description	date



Feb. 5, 2020

**CRD Housing Corporation** 631 Fisgard Ave. Victoria, BC

Caledonia Redevelopment Caledonia Ave. Victoria, BC

sheet title

#### **Planting Plan North**

project no.		119.18
scale	1: 150	@ 24"x36"
drawn by		ТВ
checked by		PdG
revison no.	sheet no.	
2		3.02



Section at Pedestrian Allee and Townhouses
Scale: 1:50



2 Section at Pedestrian Walkway
Scale: 1:50

#### NOT FOR CONSTRUCTION

5	For COTW	20.02.0
4	Issued for ADP	20.01.
2	RZ/DP Revision	19.12.
1	Rezoning/DP	19.09.2
rev no	description	date



Feb. 5, 2020

CRD Housing Corporation 631 Fisgard Ave. Victoria, BC

Caledonia Redevelopment

Caledonia Ave. Victoria, BC

sheet title

## **Landscape Sections**

project no.		119.18
scale	1: 250	@ 24"x36"
drawn by		ТВ
checked by		PdG
revison no.	sheet no.	
2	L	.5.01