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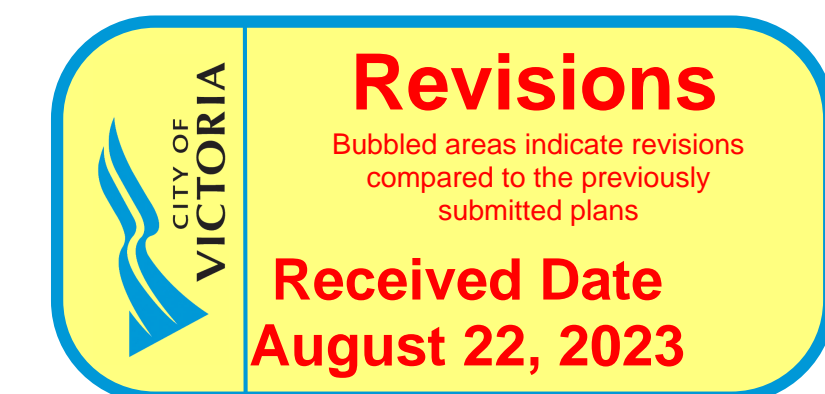
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## LIST OF DRAWINGS

## ARCHITECTURAL

- A-000 COVER
- A-009 PERSPECTIVES
- A-010 PERSPECTIVE & WINDOW OVERLAY
- A-011 CONTEXT ELEVATIONS & PERSPECTIVES
- A-012 SHADOW STUDIES
- A-050 SITE PLAN & PROJECT DATA
- A-051 ZONING CALCULATIONS
- A-052 CODE REVIEW
- A-053 SPATIAL SEPARATION
- A-101 LEVEL 1 PROPOSED PLAN
- A-102 LEVEL 2 PROPOSED PLAN
- A-103 LEVEL 3 PROPOSED PLAN
- A-104 LEVEL 4 PROPOSED PLAN
- A-200 EXTERIOR ELEVATIONS
- A-201 EXTERIOR ELEVATIONS
- A-301 BUILDING SECTIONS

**CIVIL**

- C-1 PRELIMINARY CIVIL PLAN

## LANDSCAPE

- L-1 LANDSCAPE SITE PLAN
- L-1.1 PAVEMENT SPECIFICATIONS
- L-2 UPPER LEVEL LANDSCAPE PLAN
- L-3 TREE REMOVAL PLAN
- L-4 TREE PLANTING PLAN
- L-4.1 SOIL VOLUME ANALYSIS
- L-5 GROUND FLOOR PLANTING PLAN
- L-6 UPPER LEVELS PLANTING PLAN
- L-7 DETAILS



PROJECT LOCATION PLAN (NTS)



PROJECT SITE (NTS)

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ARYZE

1733-1737 Fairfield Rd

AUGUST 21, 2023

Project #	2123	Date	AUGUST 21, 2023
Sheet #	A-000	Revision	<div> <div>5</div> <div>Aug 18, 2023</div> </div>

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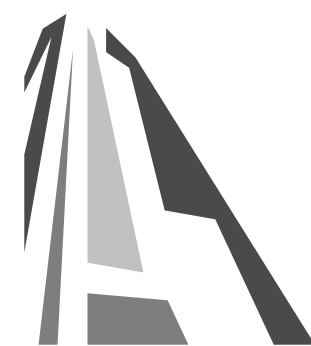


1 BEECHWOOD ELEVATION PERSPECTIVE  
SCALE = 1 : 100



2 FAIRFIELD PEDESTRIAN VIEW  
SCALE = 1 : 100


4	DPIRZ Rev2	Jan 26, 2023
3	DPIRZ Rev1	July 20, 2022
2	DPIRZ Submission	April 29, 2022
1	Development Tracker Application	March 7, 2022
NO.	DESCRIPTION	DATE




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Project		1733-1737 Fairfield Rd	
		ARYZE	
Sheet Name		PERSPECTIVES	
Date		AUGUST 21, 2023	
Scale	1 : 100	Project #	2123
		Revision	4
		Jan 26, 2023	
		Sheet #	A-009





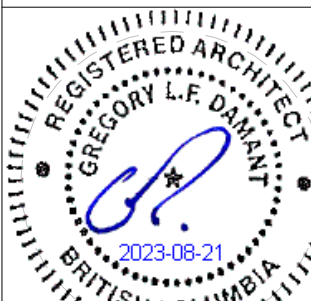


1 WINDOW OVERLAY NE ELEVATION  
SCALE = 1 : 100

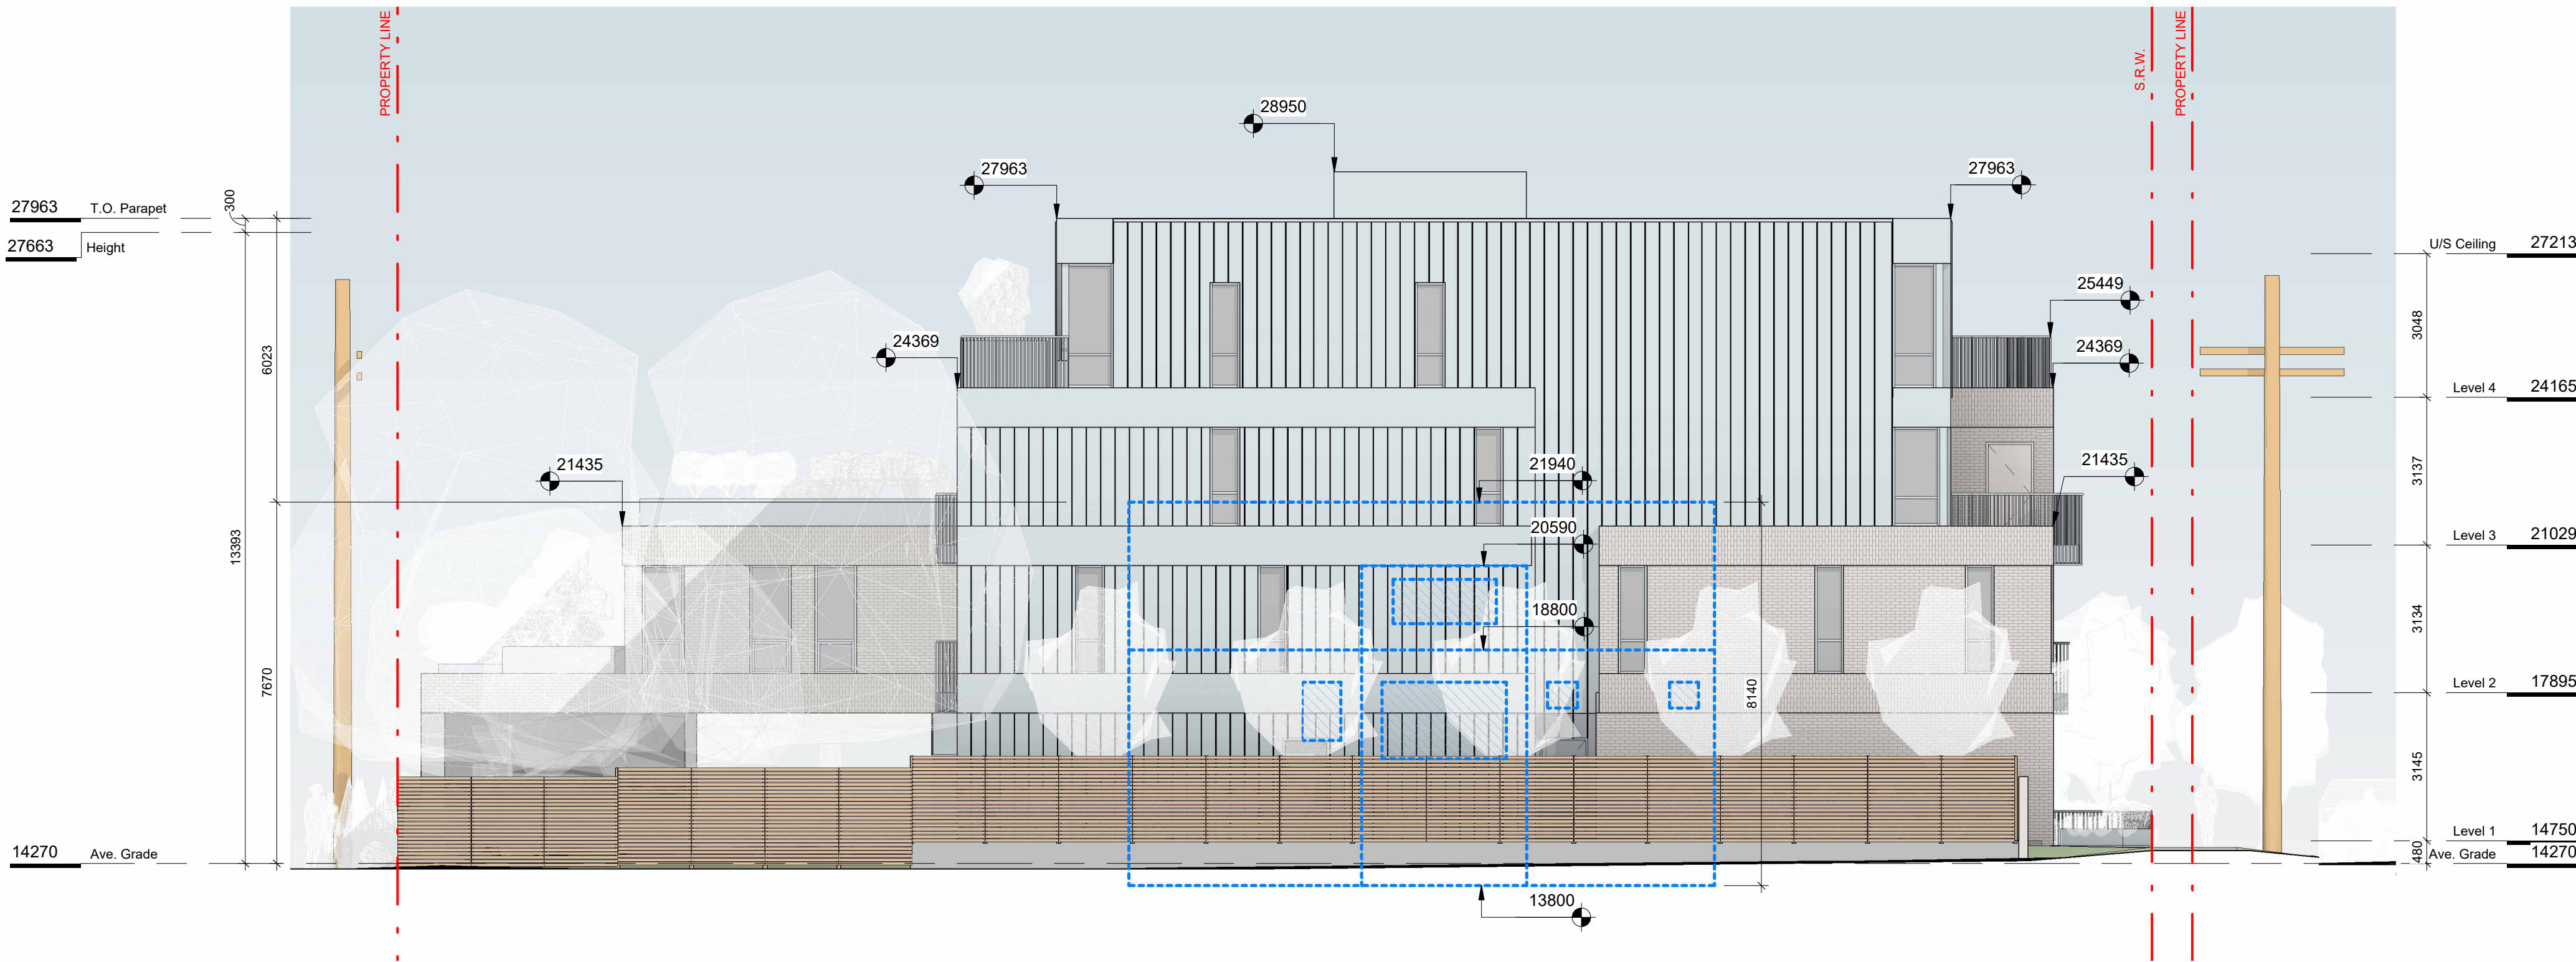

2 FAIRFIELD NORTH PERSPECTIVE  
SCALE = 1 : 100

4	DPIRZ Rev2	Jan 26, 2023
3	DPIRZ Rev1	July 20, 2022
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Sheet Name	PERSPECTIVE & WINDOW OVERLAY	
Date	AUGUST 21, 2023	
Scale	1 : 100	Project # 2123
Revision	Jan 26, 2023	4
Sheet #	A-010	
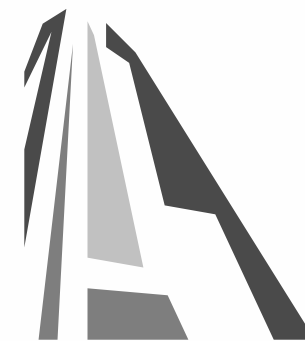
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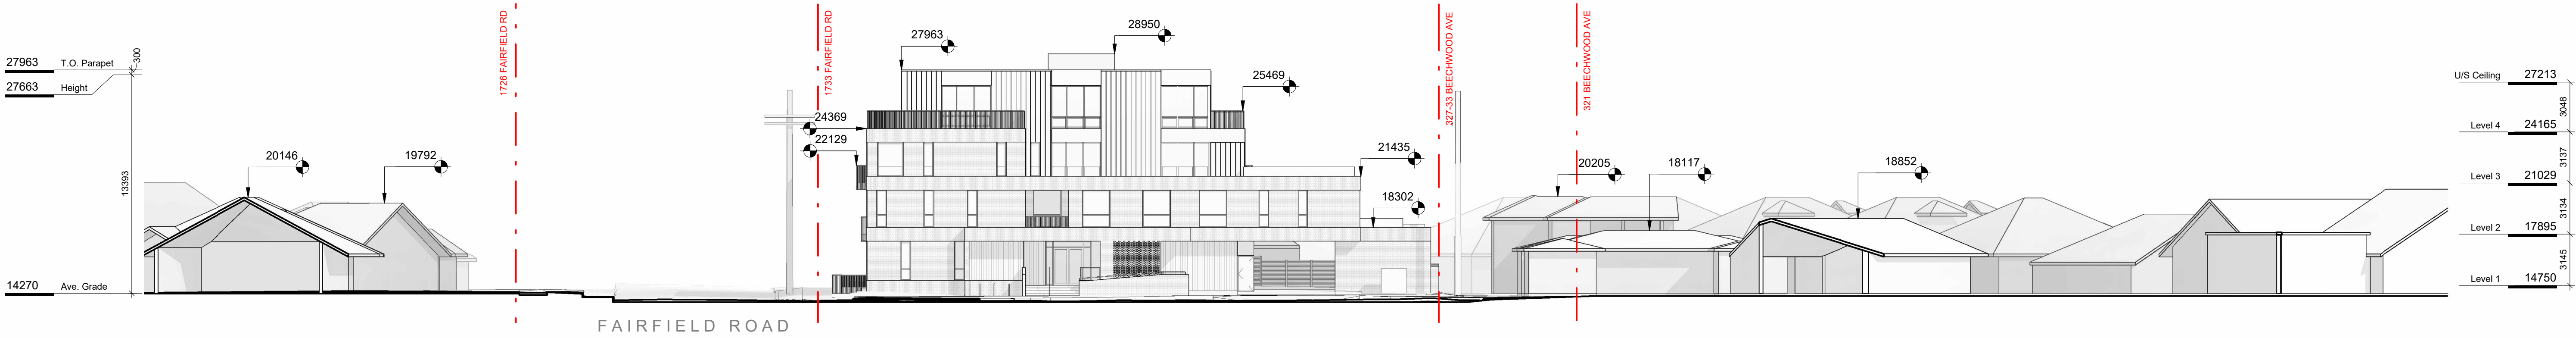






1 CONTEXT PERSPECTIVE FAIRFIELD ROAD  
SCALE = 1 : 100

2 CONTEXT PERSPECTIVE BEECHWOOD AVE  
SCALE = 1 : 100




3 CONTEXT ELEVATION - BEECHWOOD AVENUE  
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4 CONTEXT ELEVATION - FAIRFIELD ROAD  
SCALE = 1 : 200

4	DPIRZ Rev2	Jan 26, 2023
2	DPIRZ Submission	April 29, 2022
1	Development Tracker Application	March 7, 2022
NO.	DESCRIPTION	DATE




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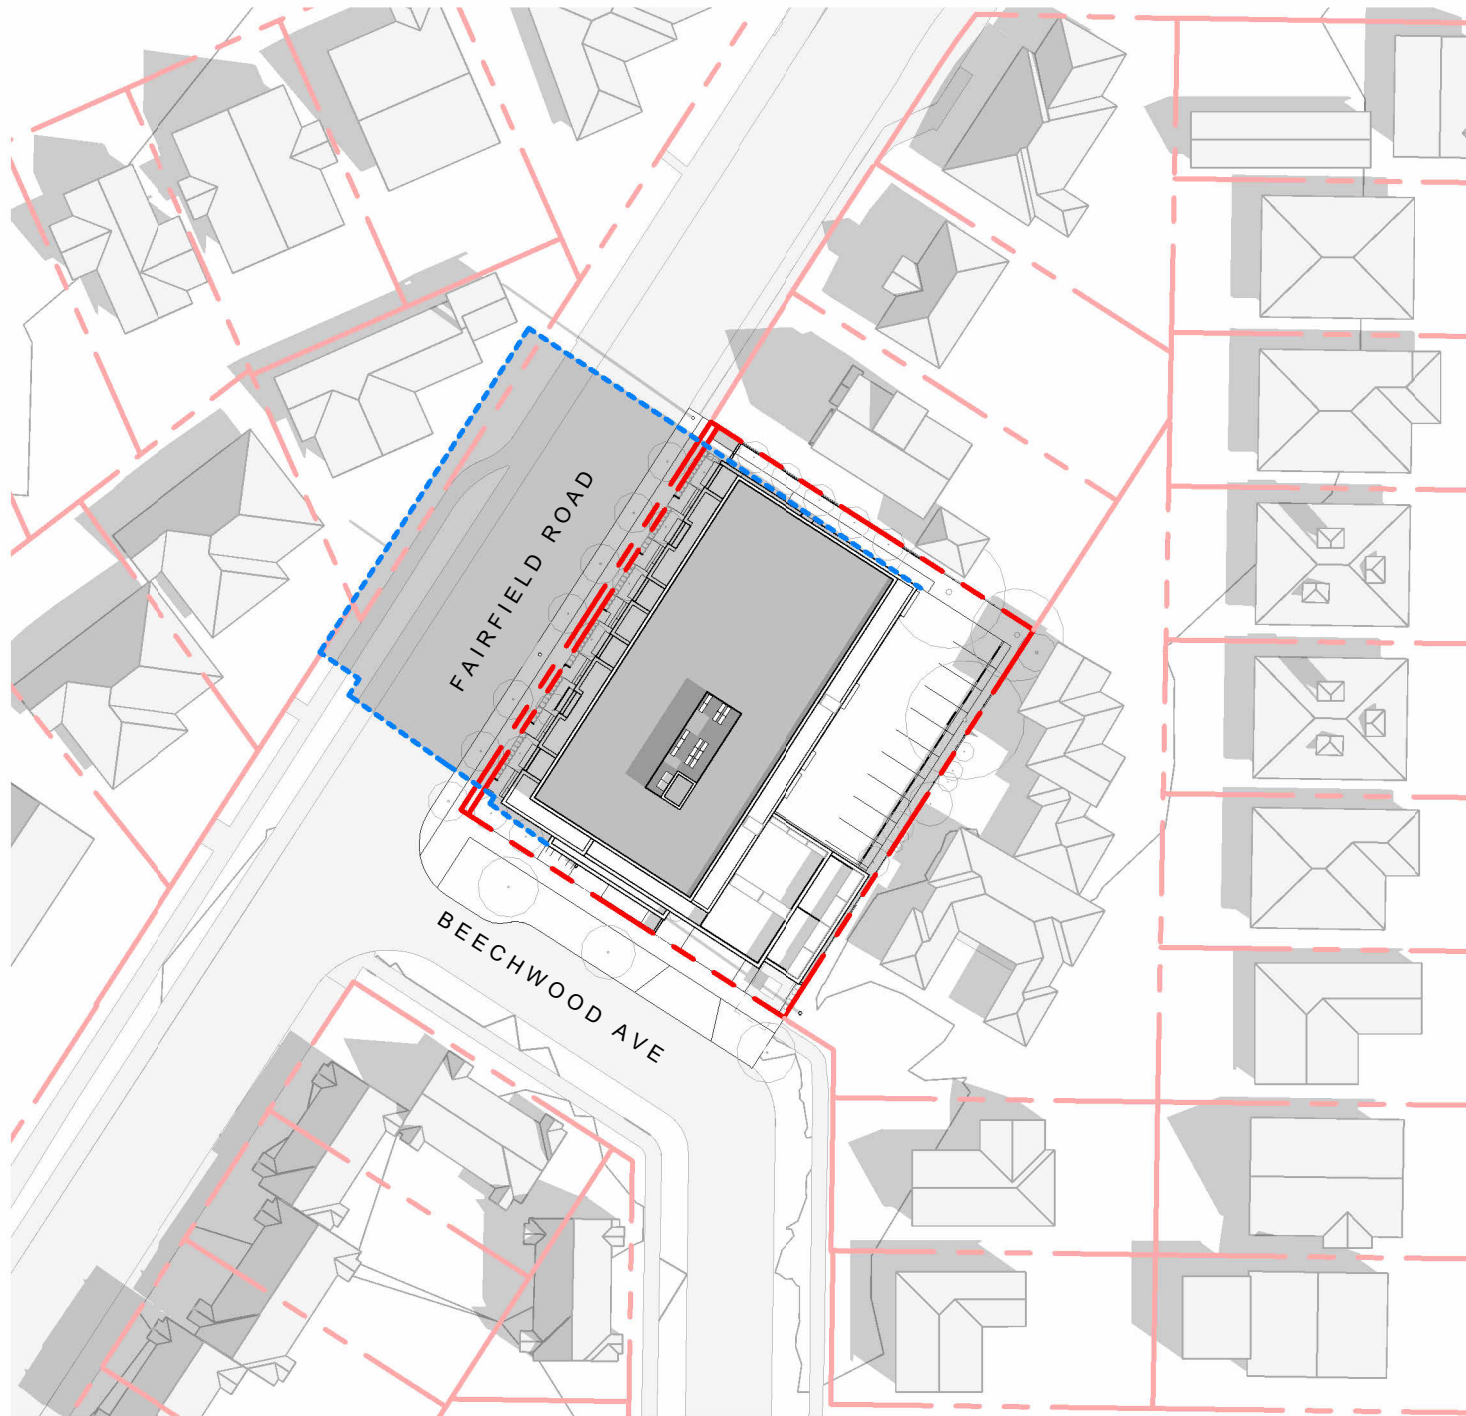
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Sheet Name CONTEXT ELEVATIONS & PERSPECTIVES		
Date AUGUST 21, 2023		
Scale As indicated	Project # 2123	Revision Jan 26, 2023
Sheet # A-011		4

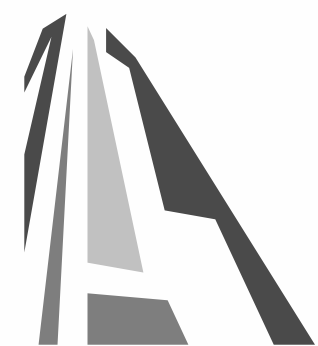






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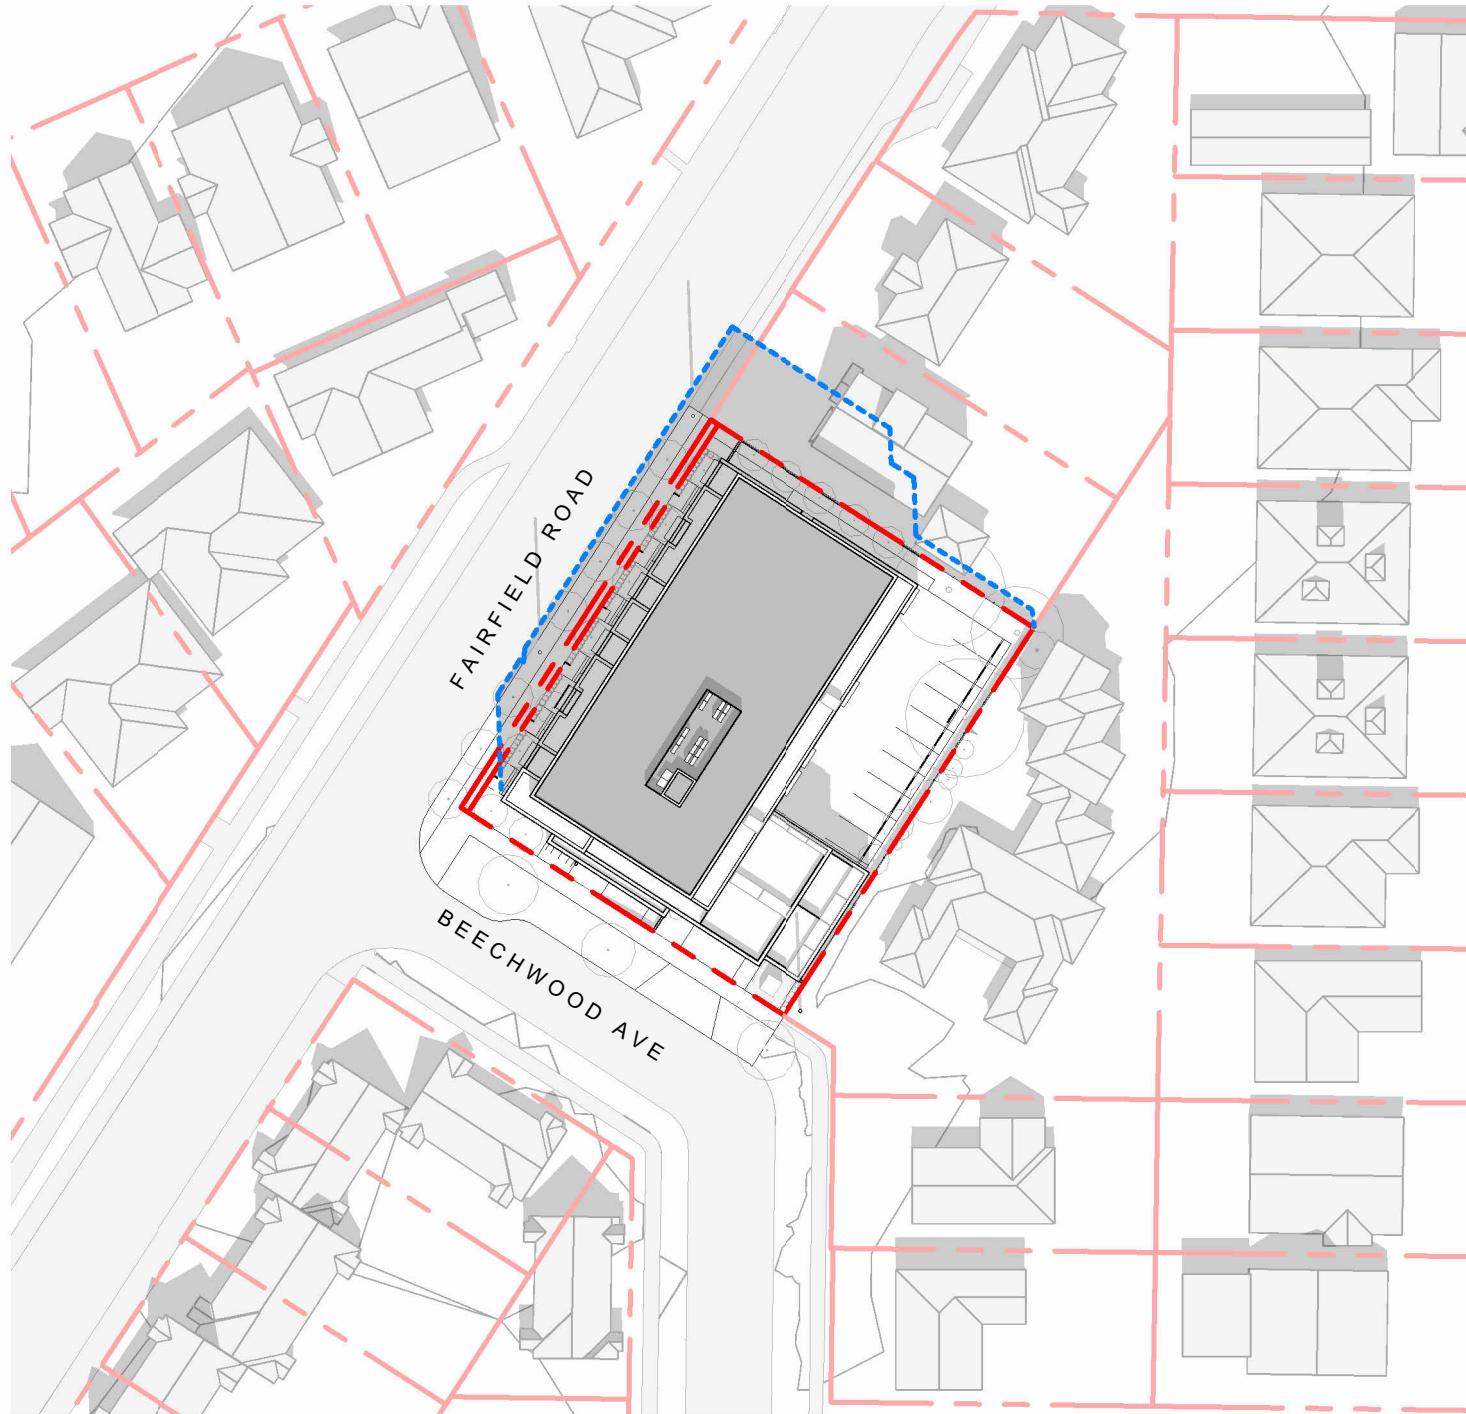
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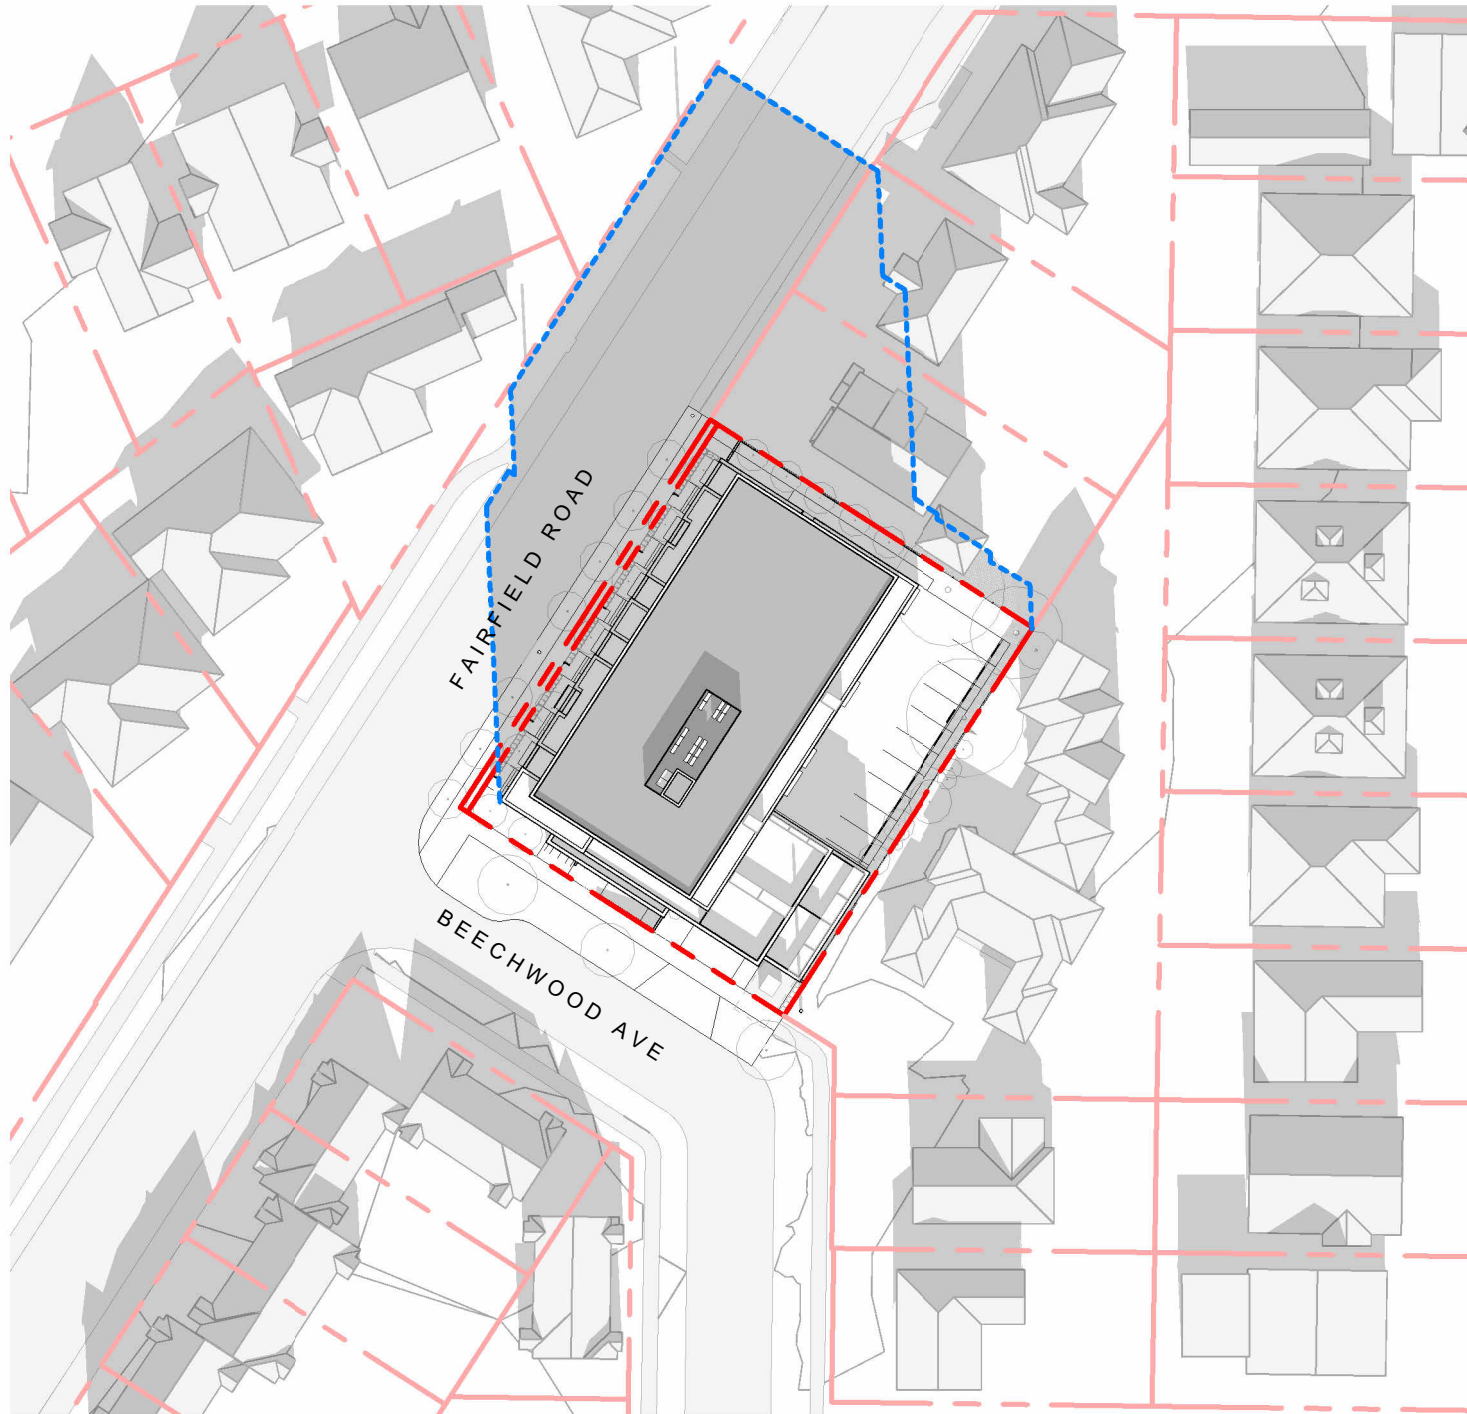
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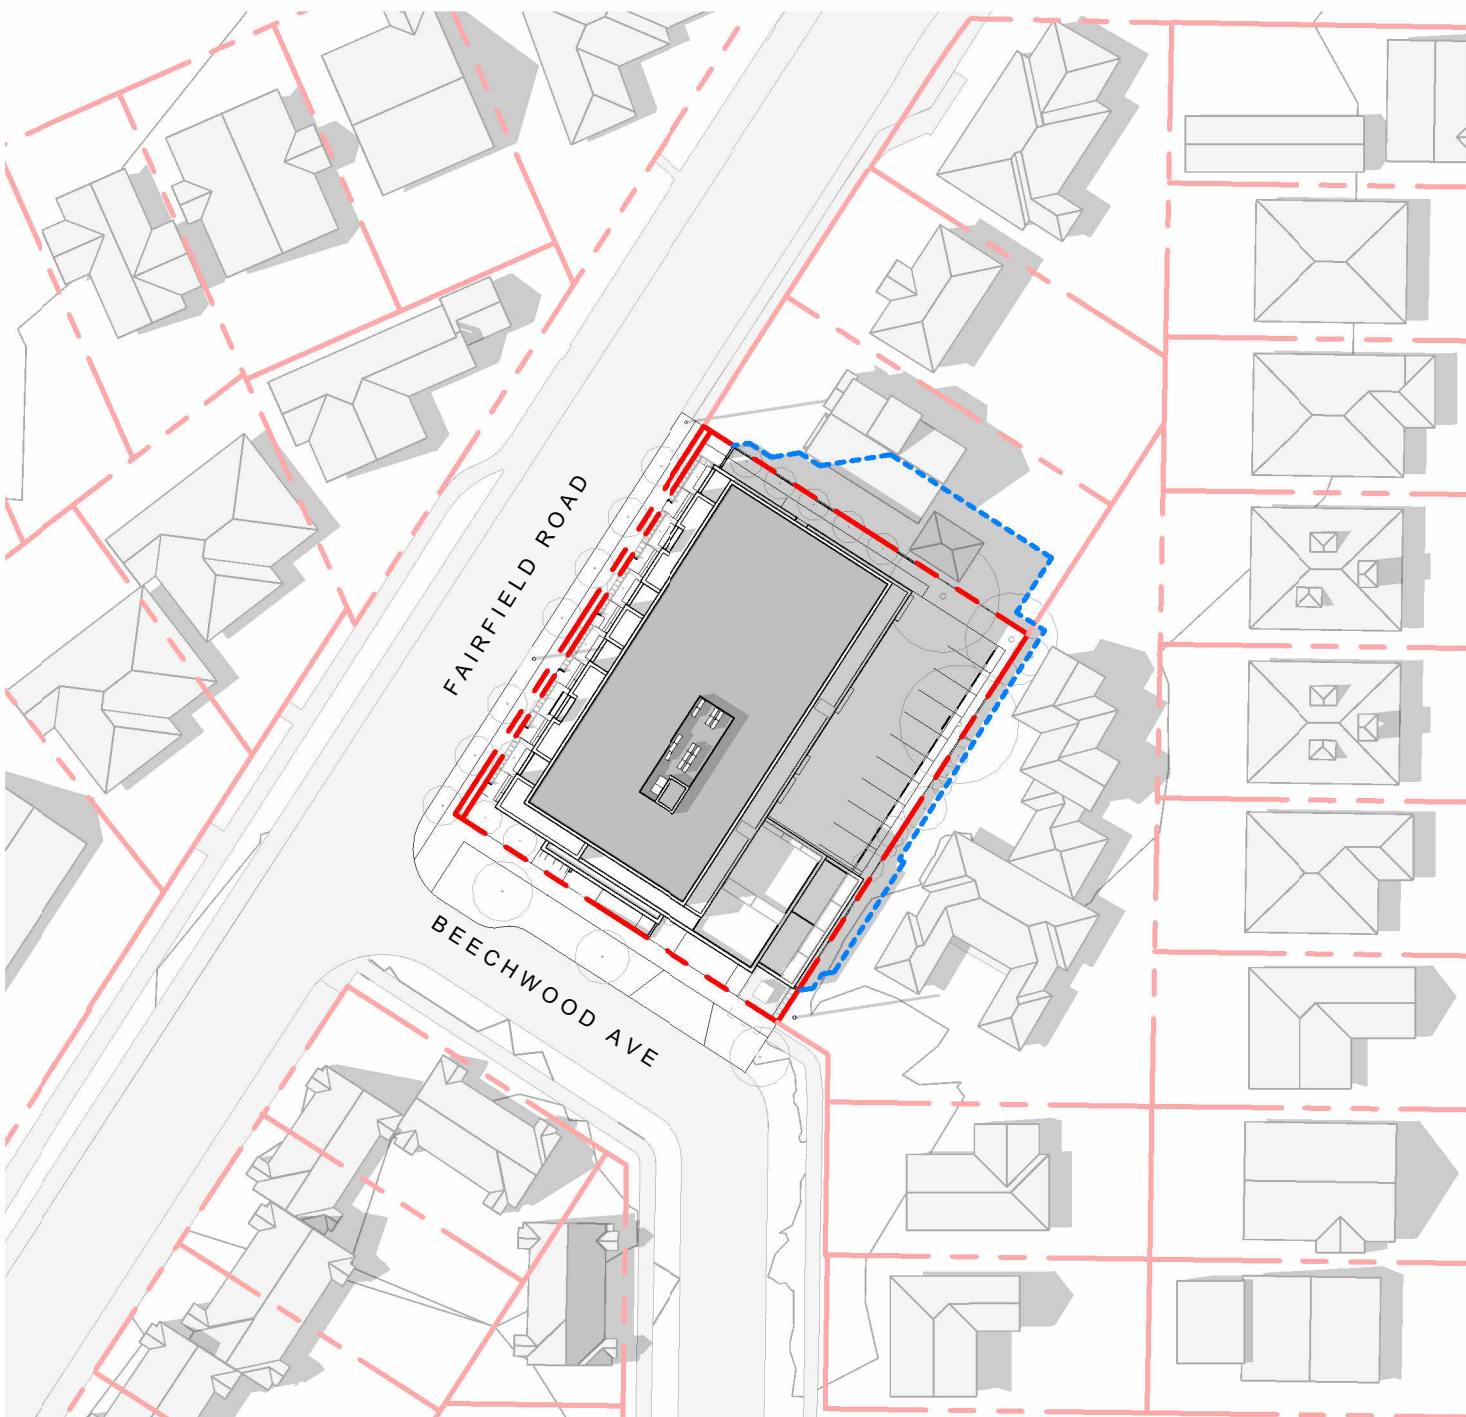
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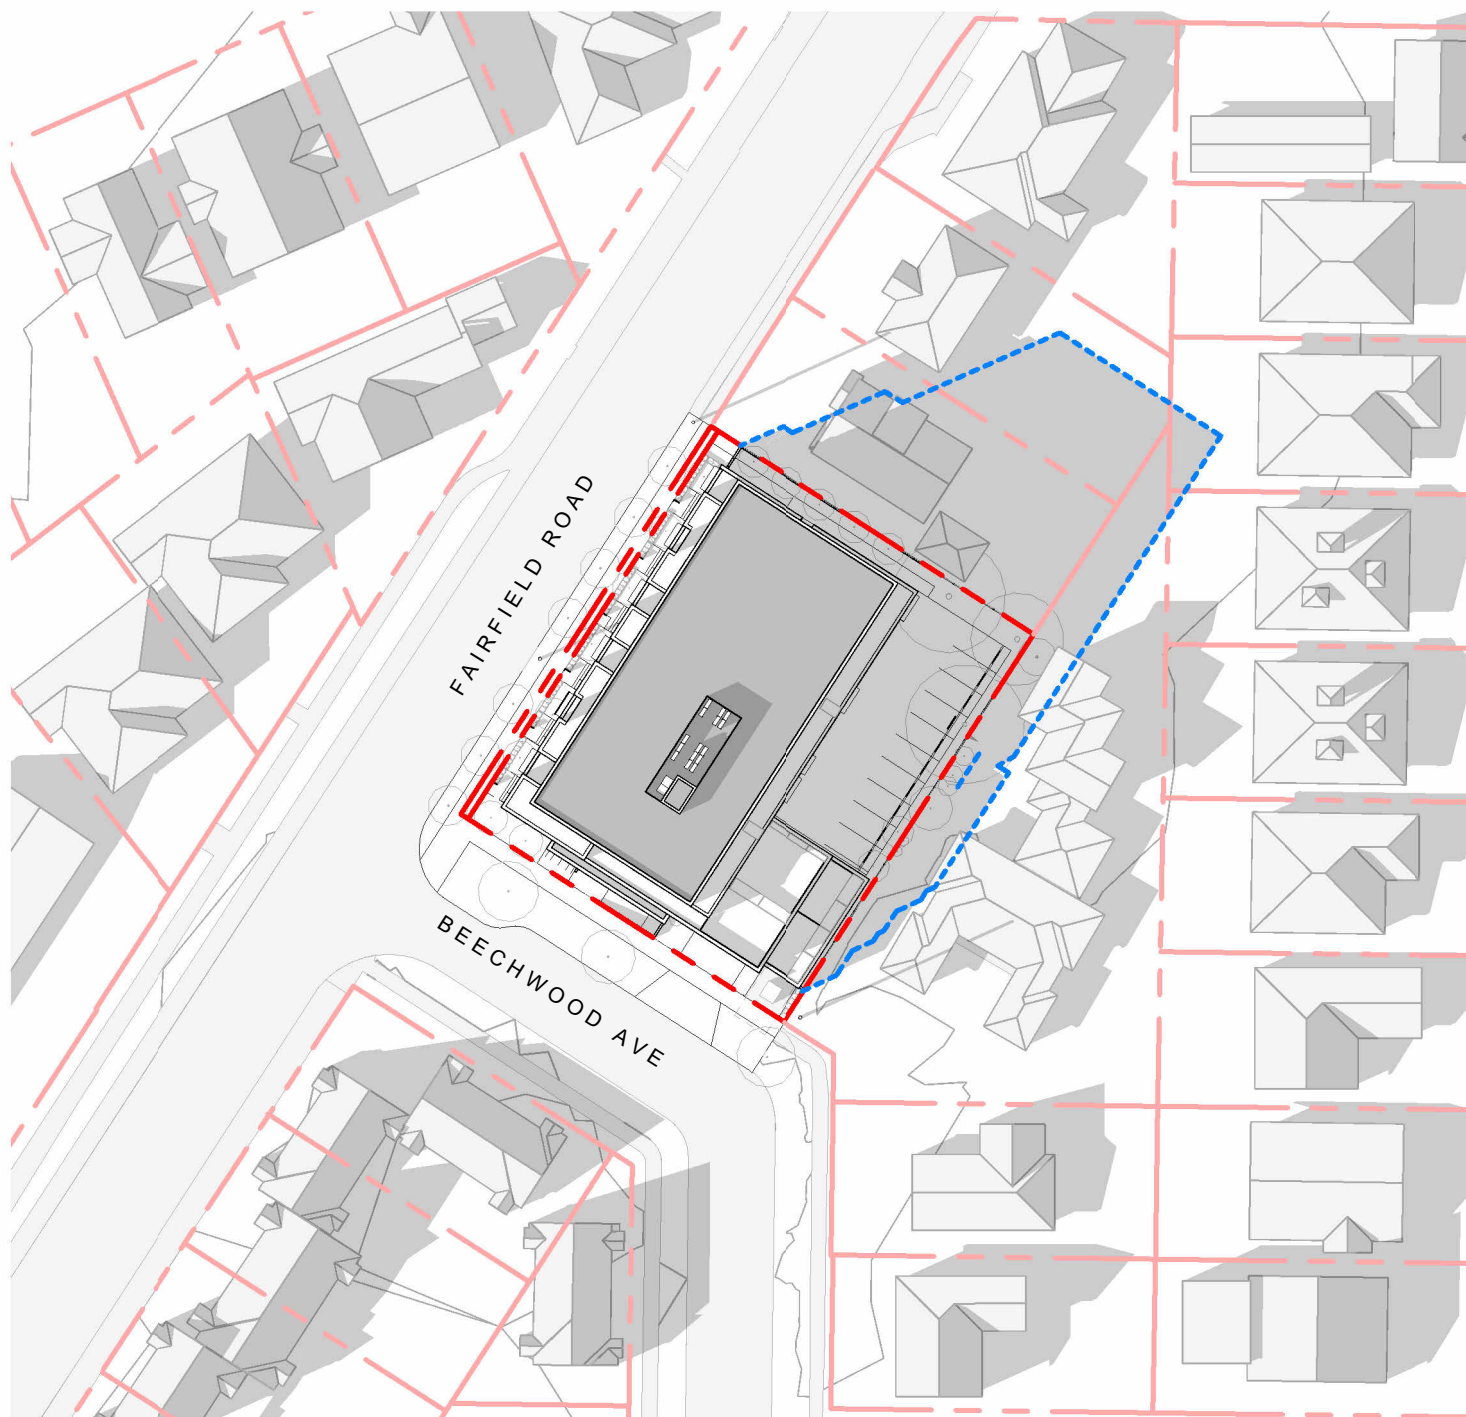
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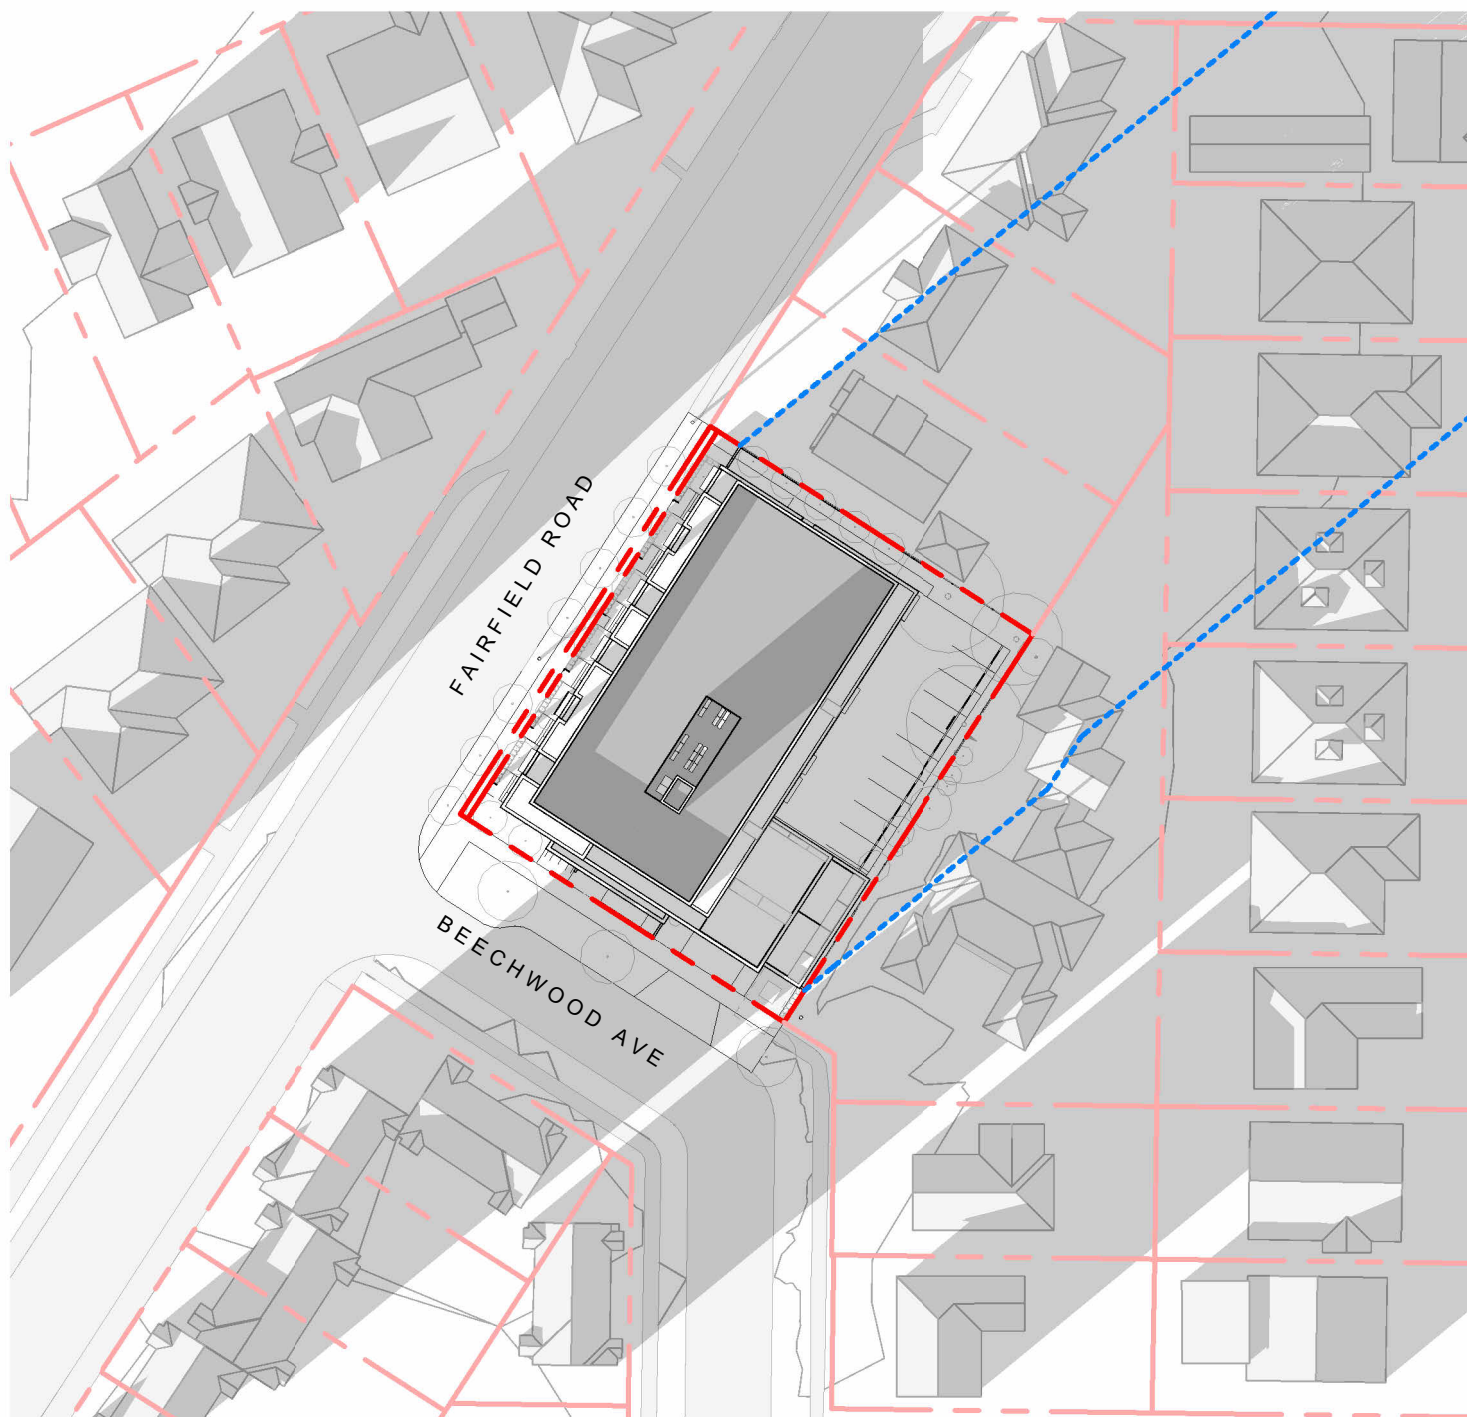
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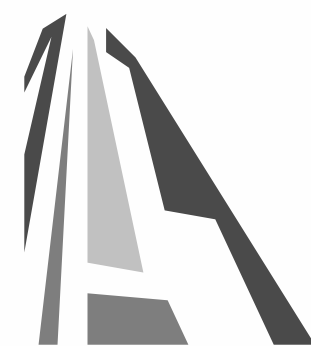

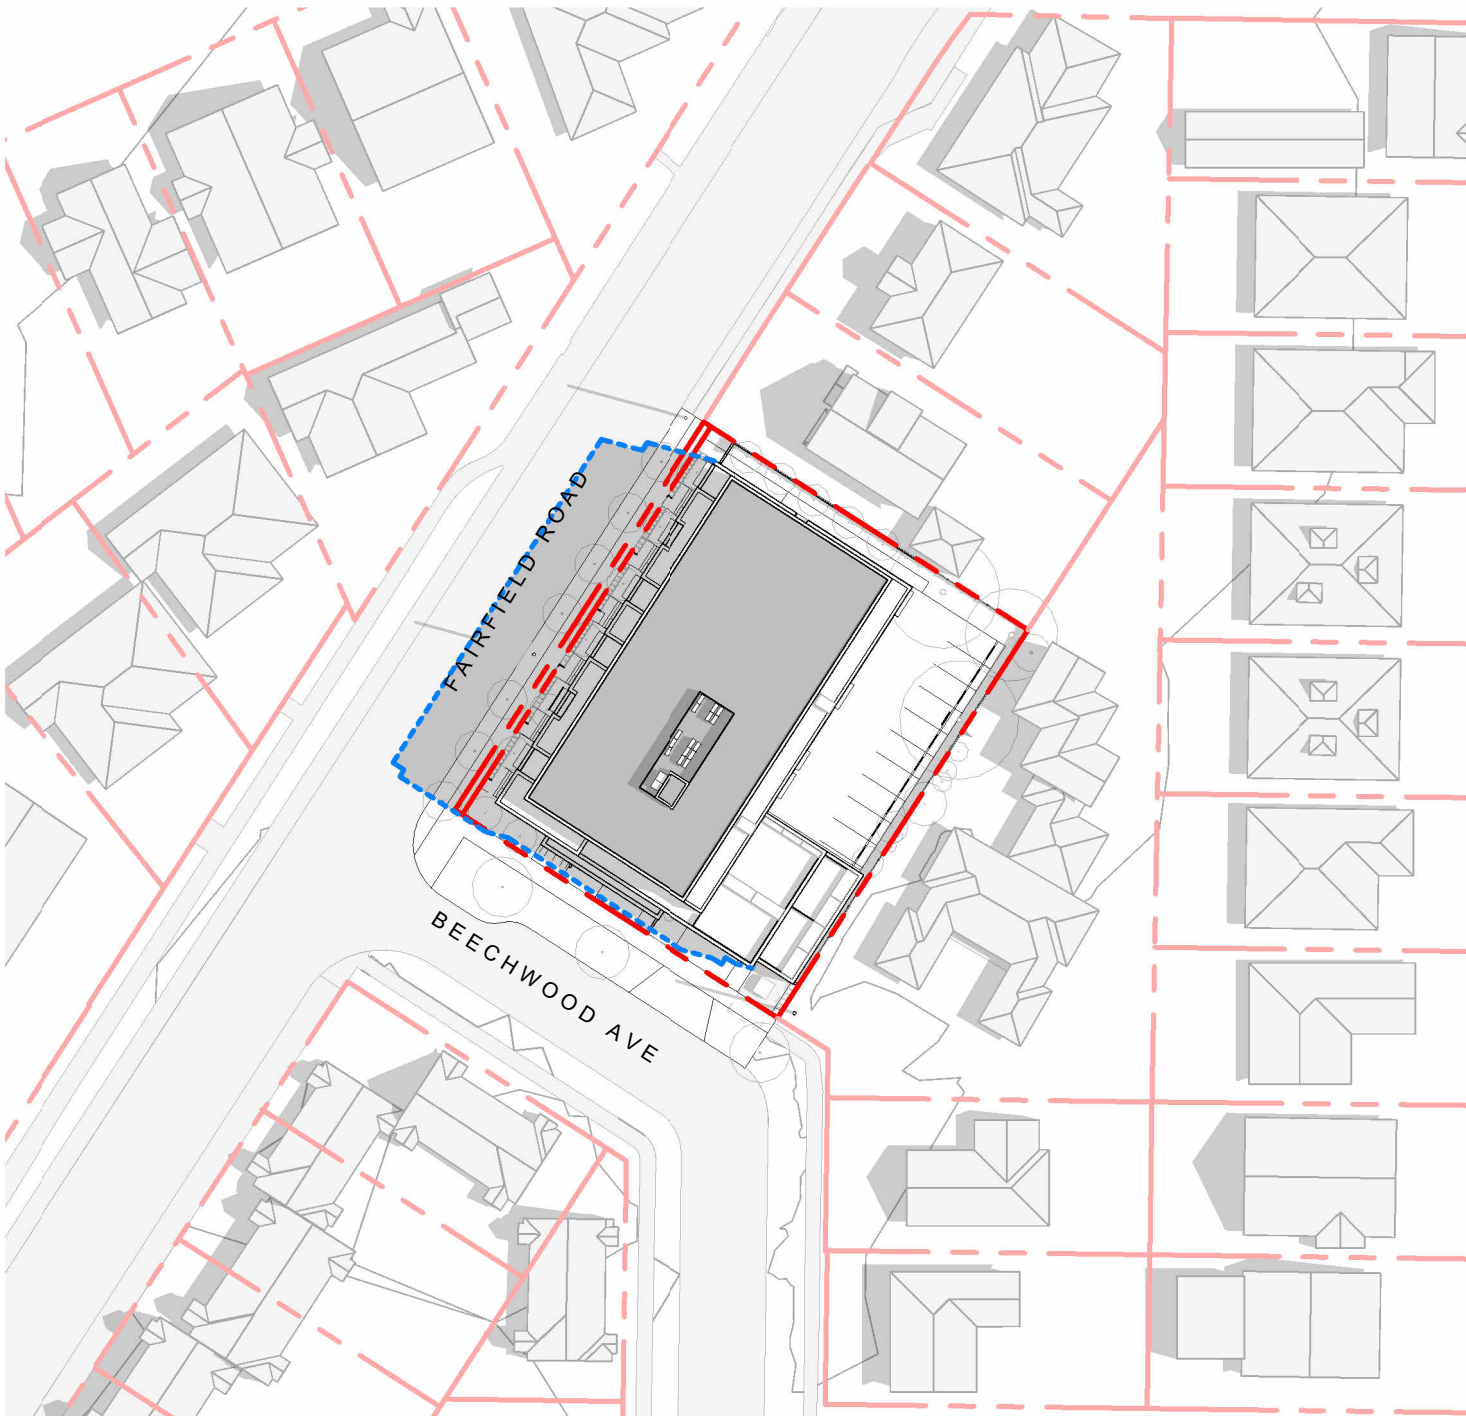
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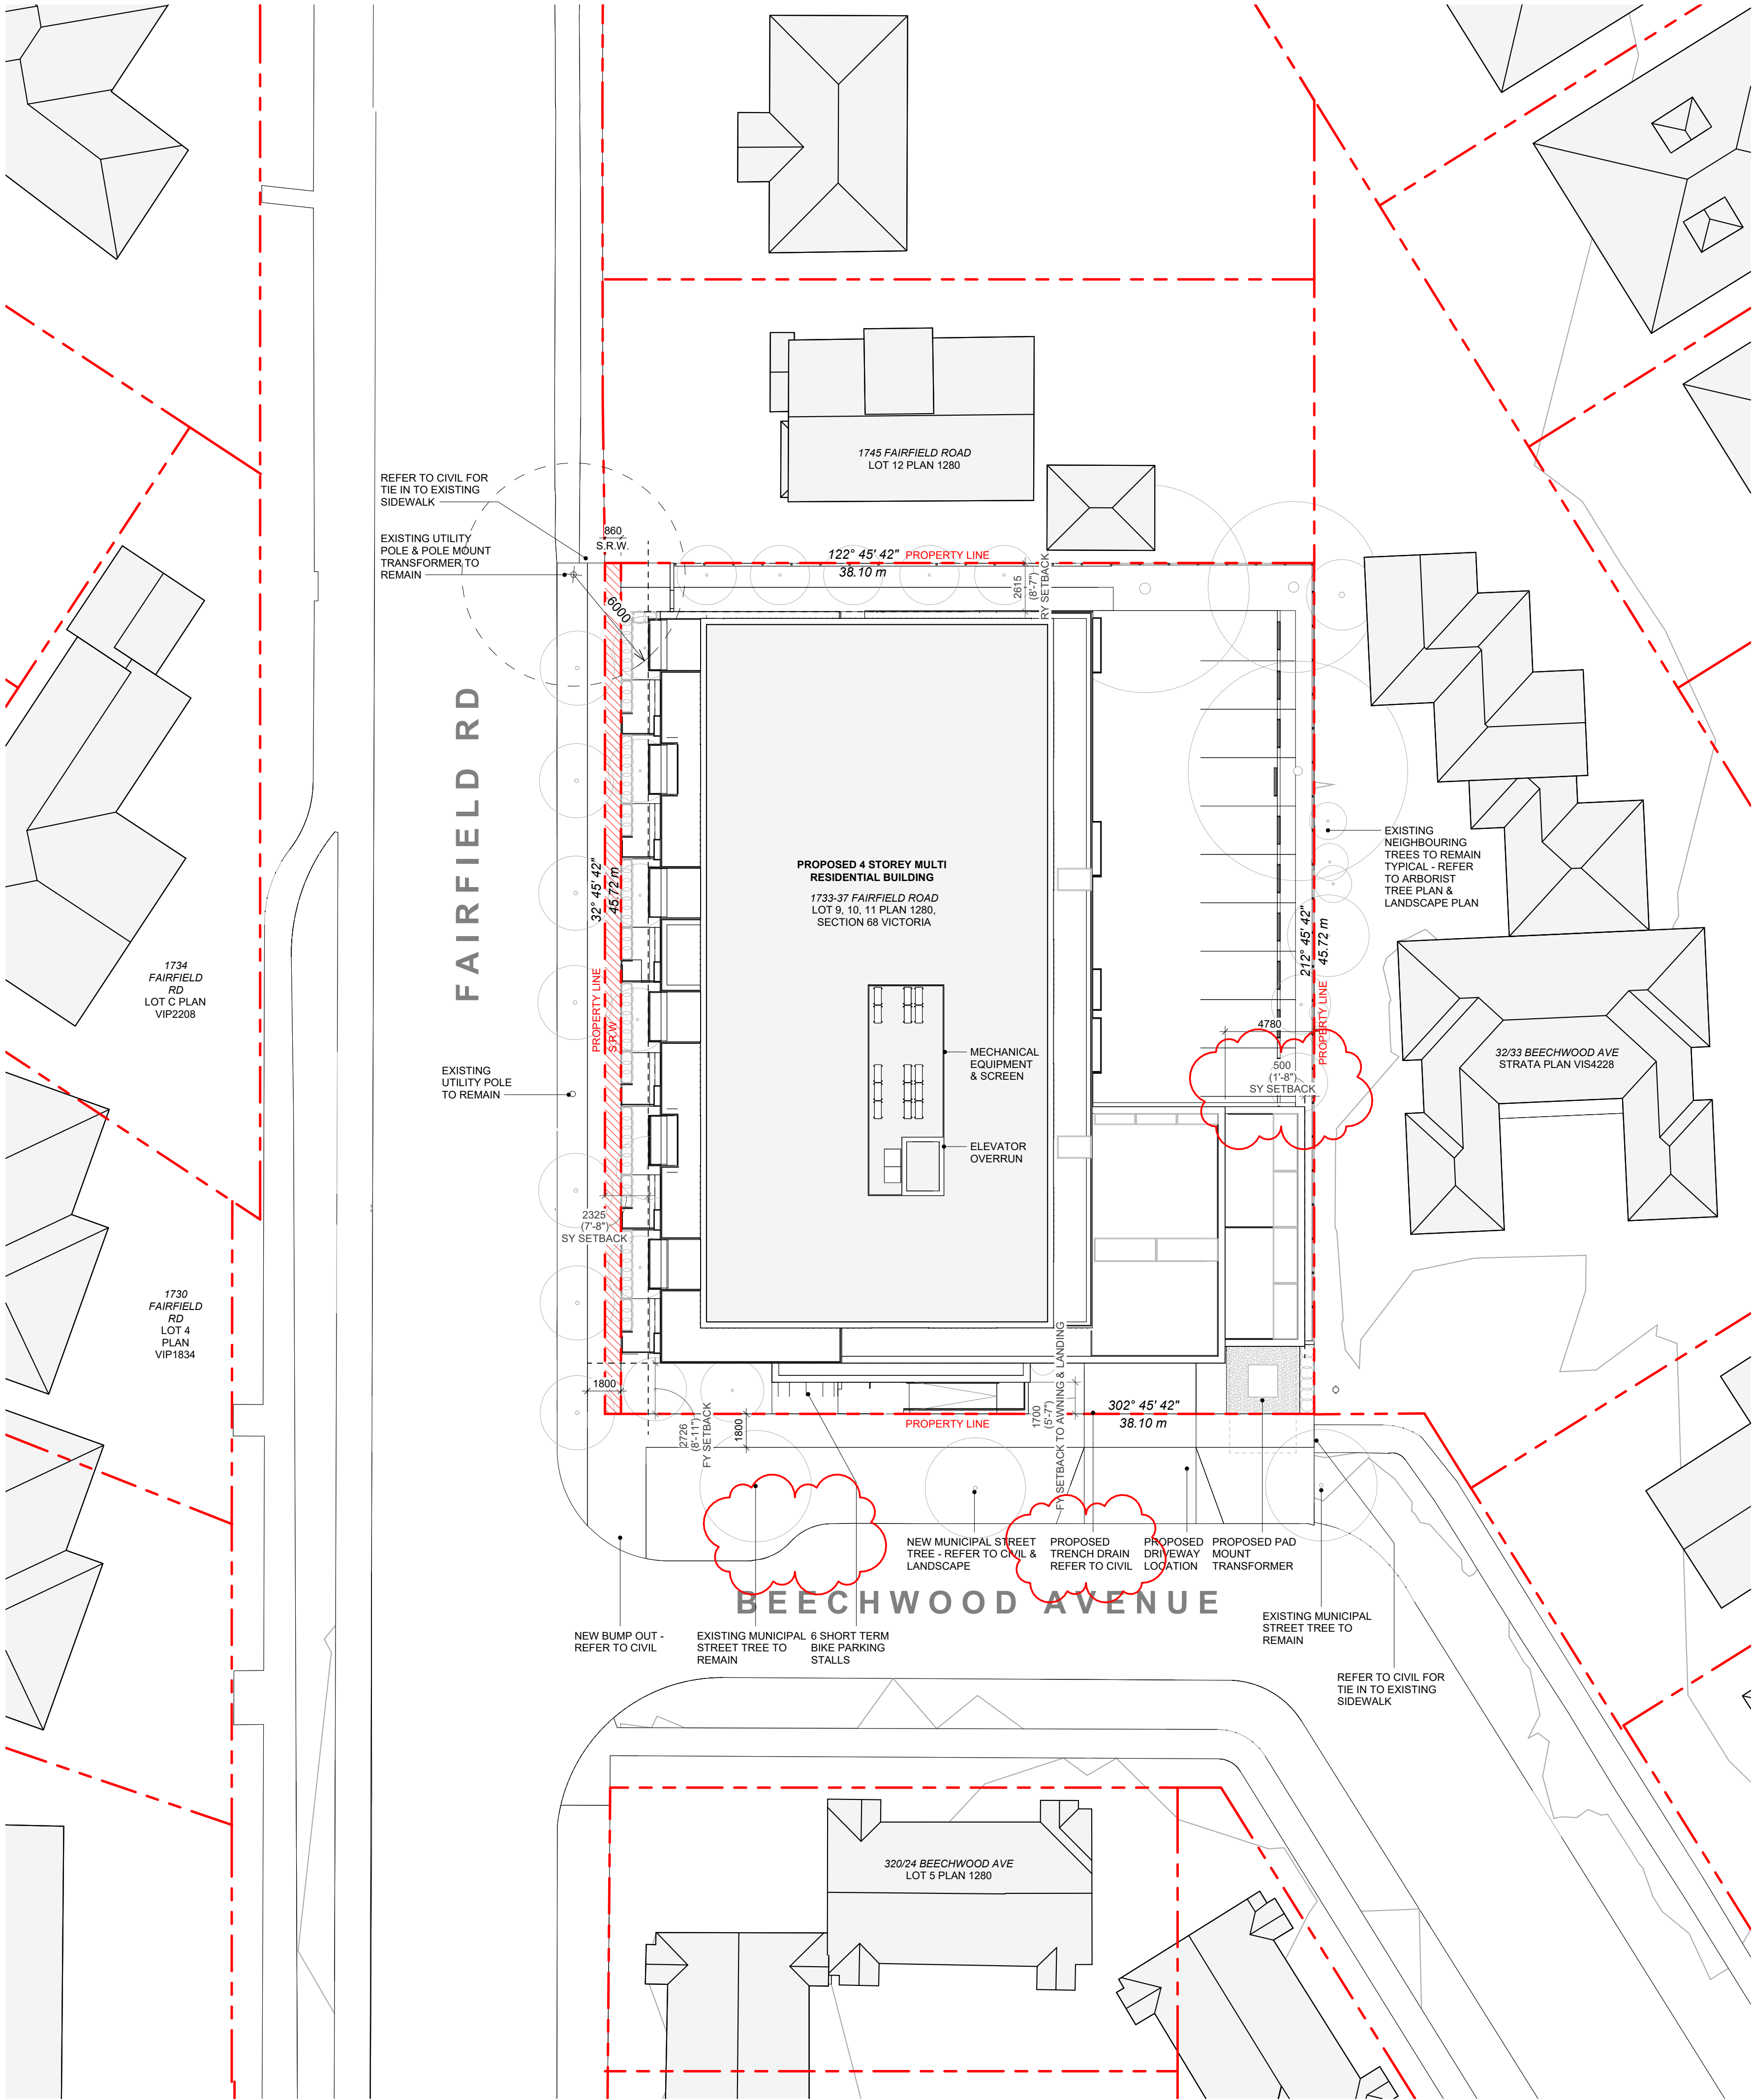
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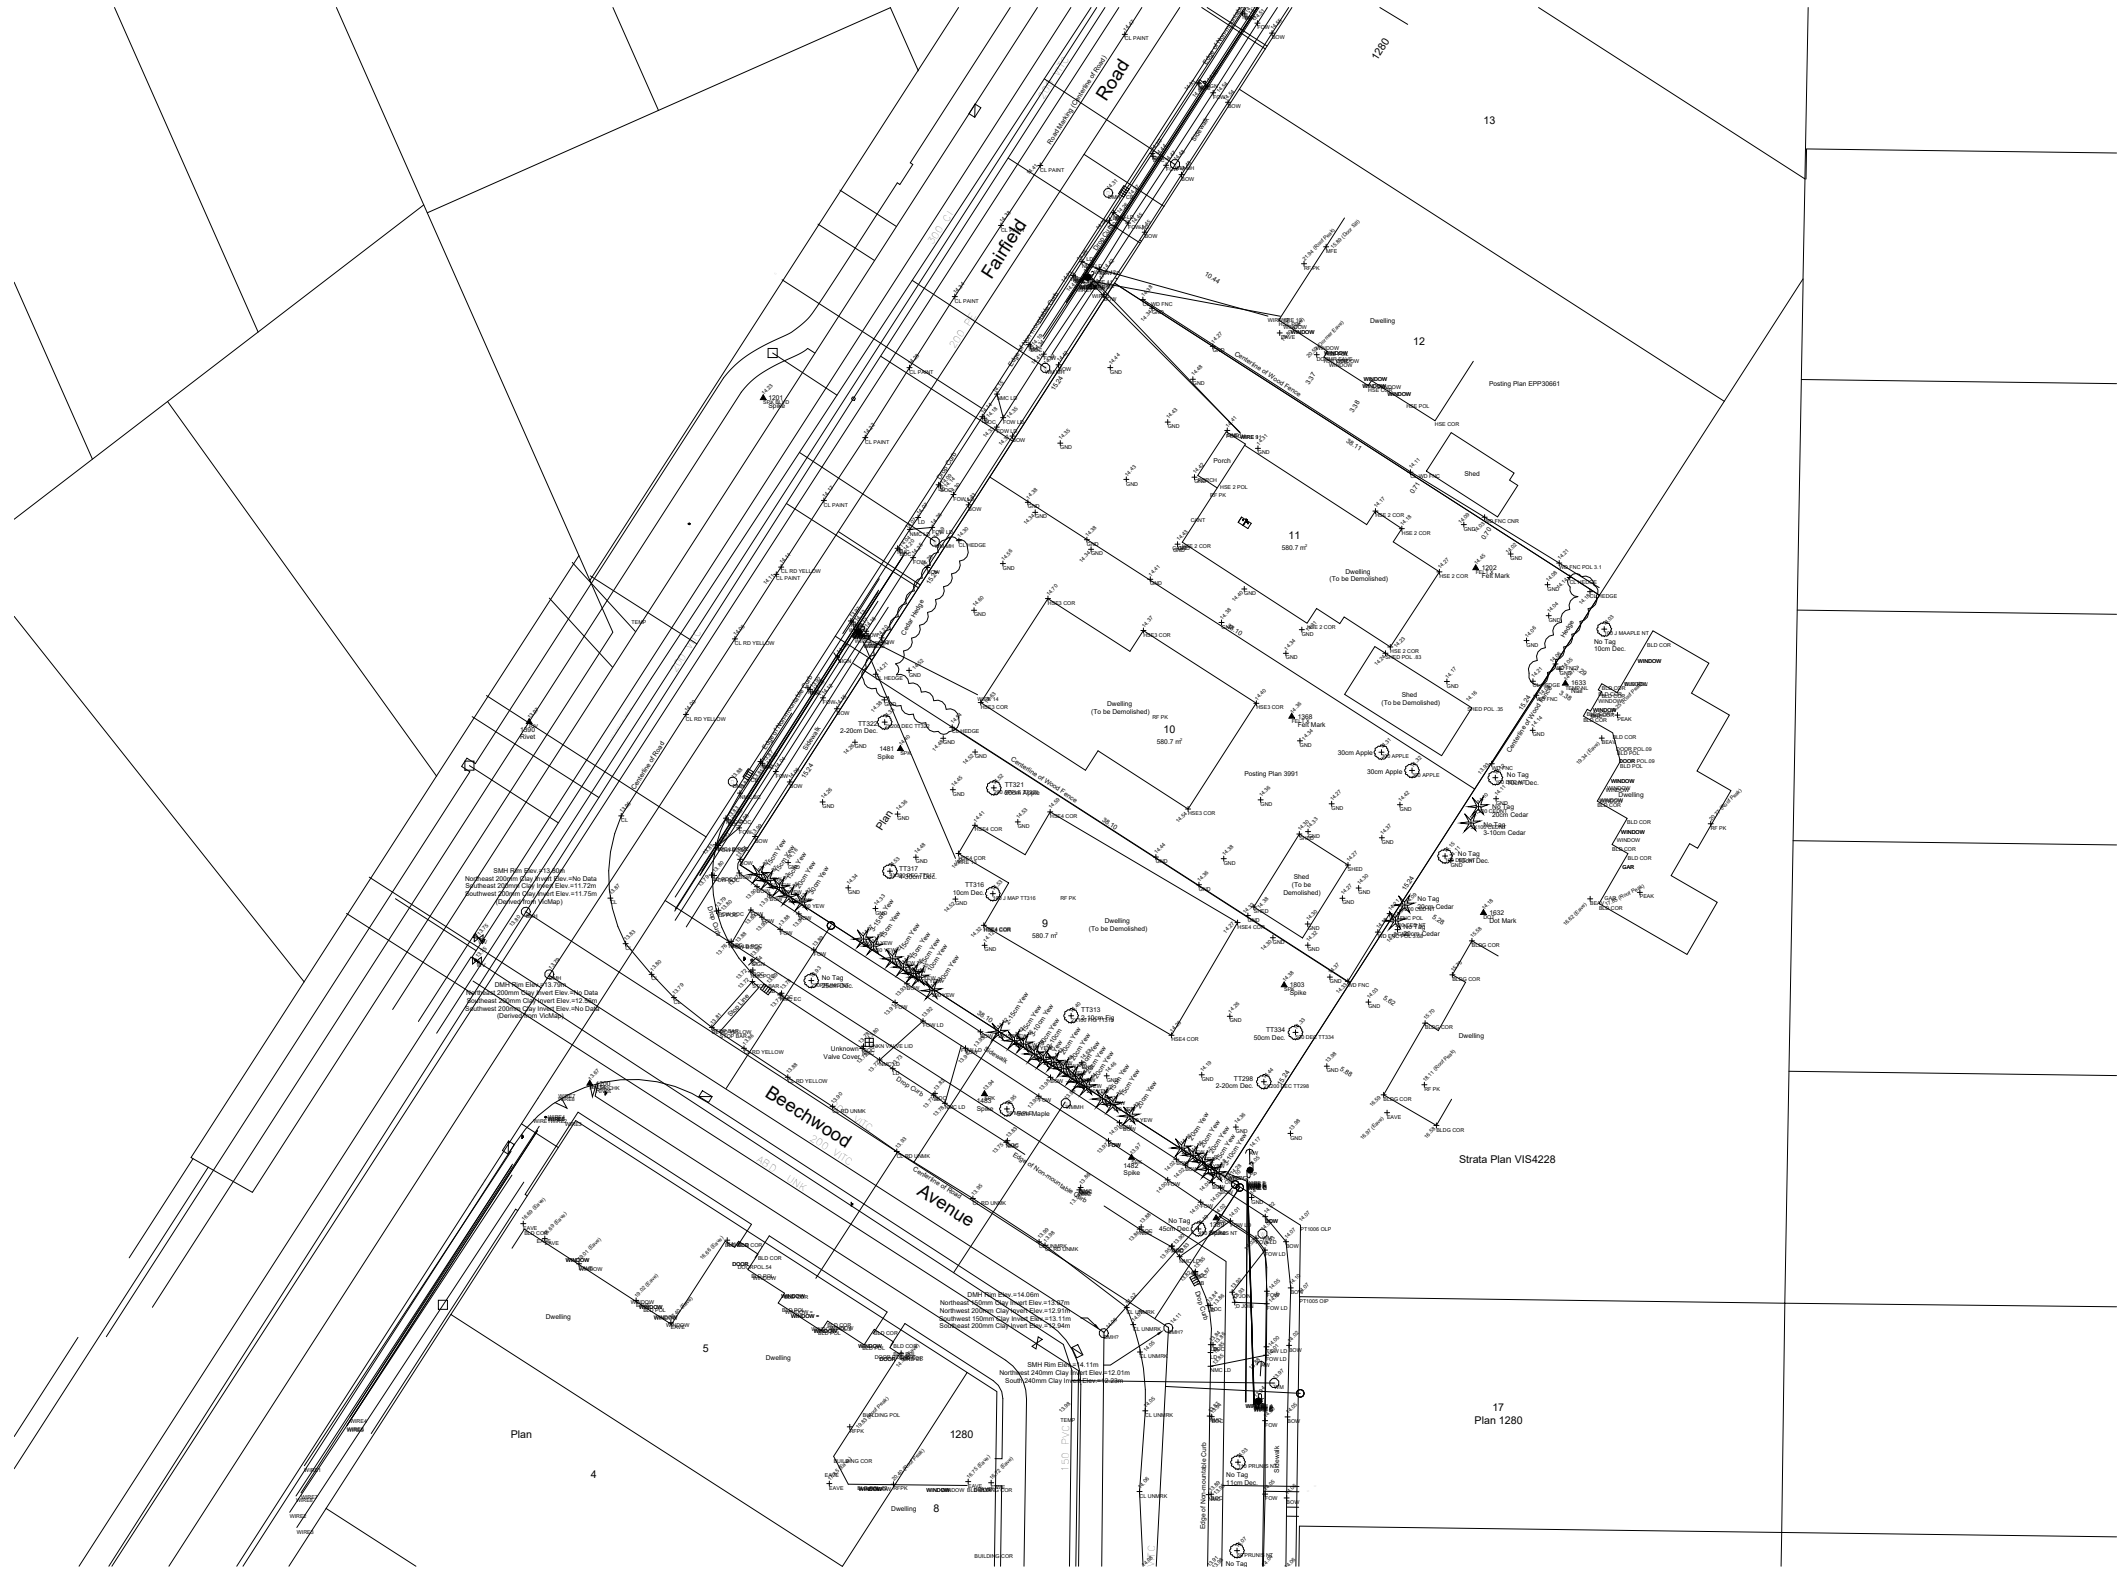
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	ARYZE	
Sheet Name	SHADOW STUDIES	
Date	AUGUST 21, 2023	
Scale	1 : 750	Project # 2123
	Revision	4
	Jan 26, 2023	
	Sheet #	A-012
2023-08-21		
REGISTERED ARCHITECT		
GREGORY L.F. DAWY		
BRITISH COLUMBIA		

2023-08-21 9:24:20 AM



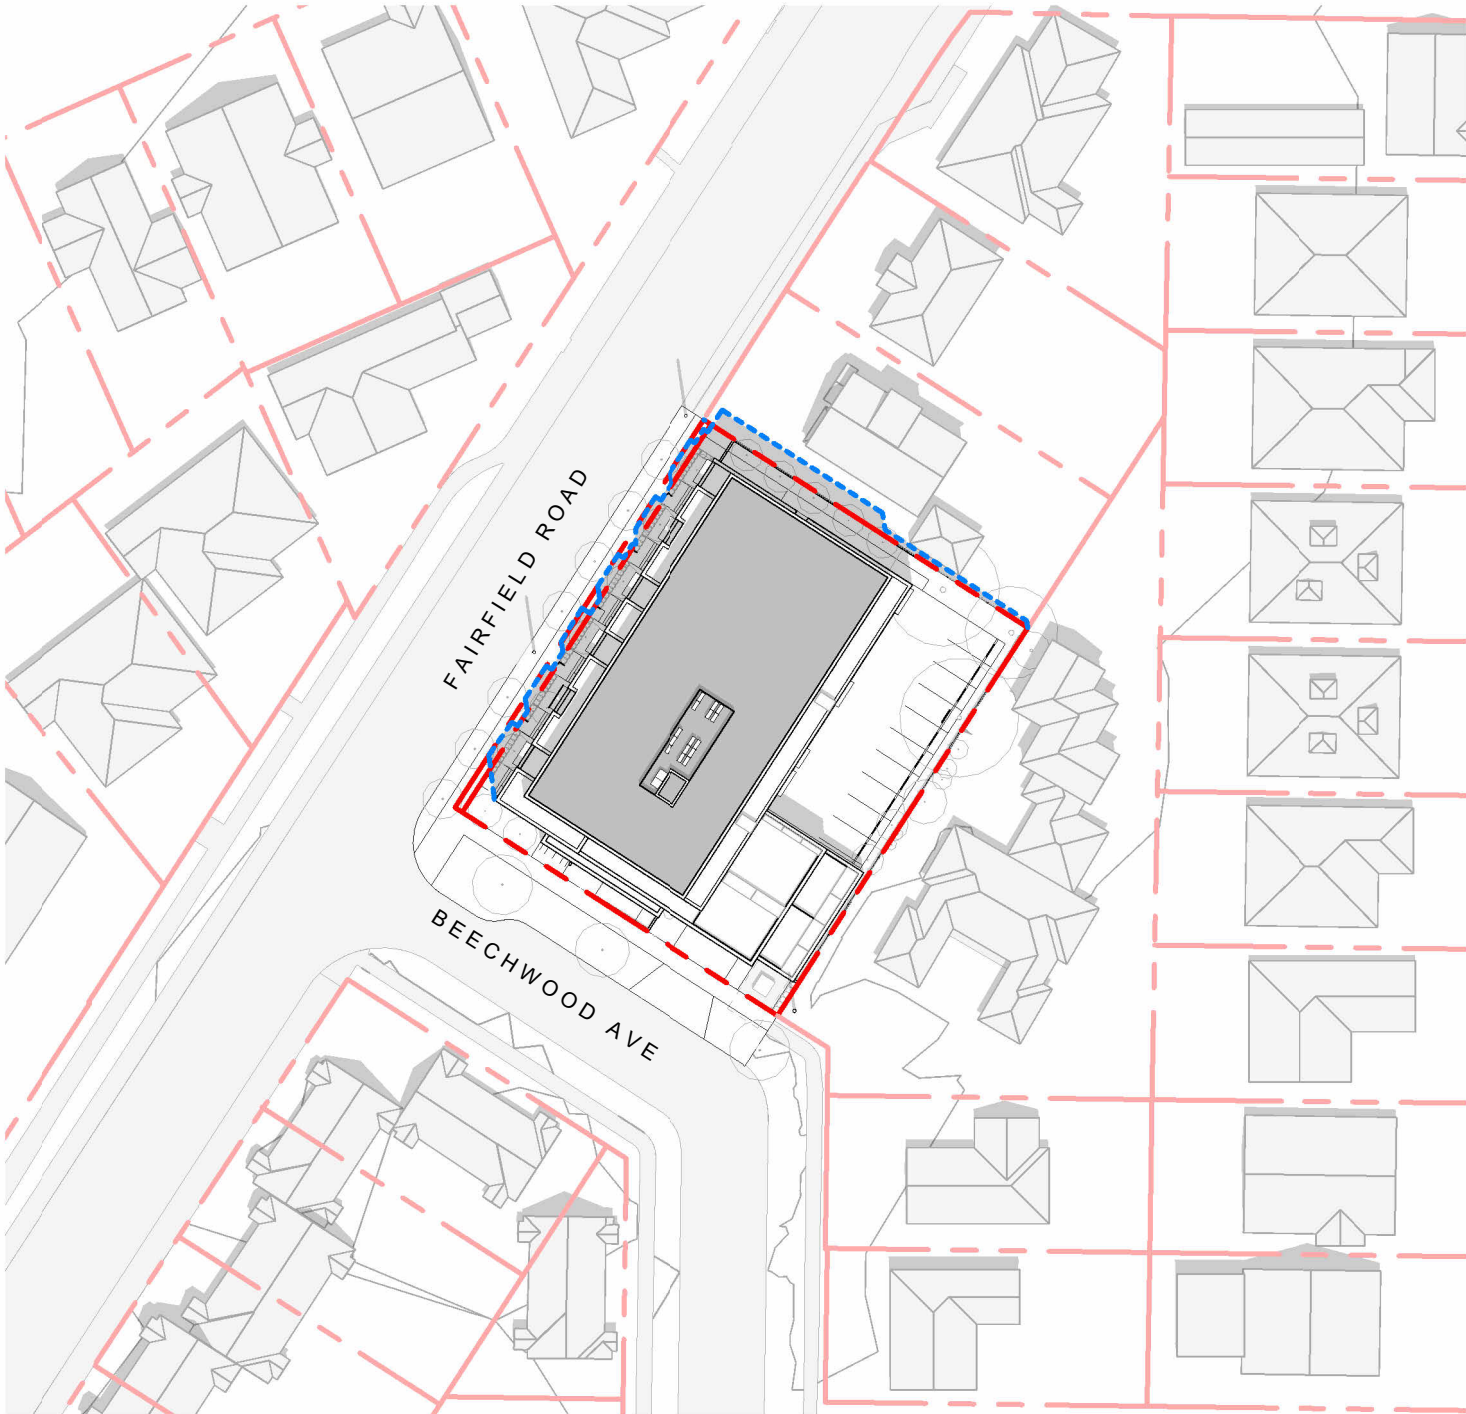

2 PROPOSED SITE PLAN  
SCALE = 1 : 200



1 EXISTING SURVEY  
SCALE = 1 : 500

#### DATA

MUNICIPALITY	CITY OF VICTORIA
MUNICIPAL ADDRESS	1733-37 FAIRFIELD ROAD, VICTORIA BC
LEGAL DESCRIPTION	LOT 9, 10, 11, PLAN 1280, SECTION 88 VICTORIA
PROJECT DESCRIPTION	4 STOREY MULTI UNIT RESIDENTIAL BUILDING

#### PROJECT INFORMATION

ZONE (EXISTING)	R1-G
PROPOSED ZONE	UNKNOWN
SITE AREA (m <sup>2</sup> )	1,741.93m <sup>2</sup>
TOTAL FLOOR AREA (m <sup>2</sup> )	2985.20m <sup>2</sup>
COMMERCIAL FLOOR AREA (m <sup>2</sup> )	0
FLOOR SPACE RATIO	1.71:1
SITE COVERAGE (%)	65%
OPEN SITE SPACE (%)	23%
HEIGHT (m)	13.39m
NUMBER OF STOREYS	4
	REQUIRED PROVIDED
PARKING STALLS (#) ON SITE	23
PARKING STALLS - VISITOR (#) ON SITE	3
BICYCLE PARKING (#) SHORT TERM	6
BICYCLE PARKING (#) LONG TERM	54

#### BUILDING SETBACKS (m)

	PROPOSED
FRONT YARD (BEECHWOOD AVE)	2.73m
FRONT YARD (TO AWNING/LANDING)	4.70m
INTERNAL SIDE YARD (TO BALCONY)	0.50m
INTERNAL SIDE YARD (TO BUILDING FACE)	4.78m
SIDE YARD (FAIRFIELD RD)	2.33m
REAR YARD	2.82m
COMBINED SIDE YARDS	2.83m

#### RESIDENTIAL USE DETAILS

TOTAL NUMBER OF UNITS	30
UNIT TYPE	TOWNHOMES (6), STUDIO (2), 1 BEDS (13), 2 BEDS (7), 3 BEDS (2)
GROUND-ORIENTATED UNITS	6
MINIMUM UNIT FLOOR AREA (m <sup>2</sup> )	41m <sup>2</sup>
TOTAL RESIDENTIAL FLOOR AREA (m <sup>2</sup> )	1975m <sup>2</sup>

5	DPIRZ Rev3	Aug 18, 2023
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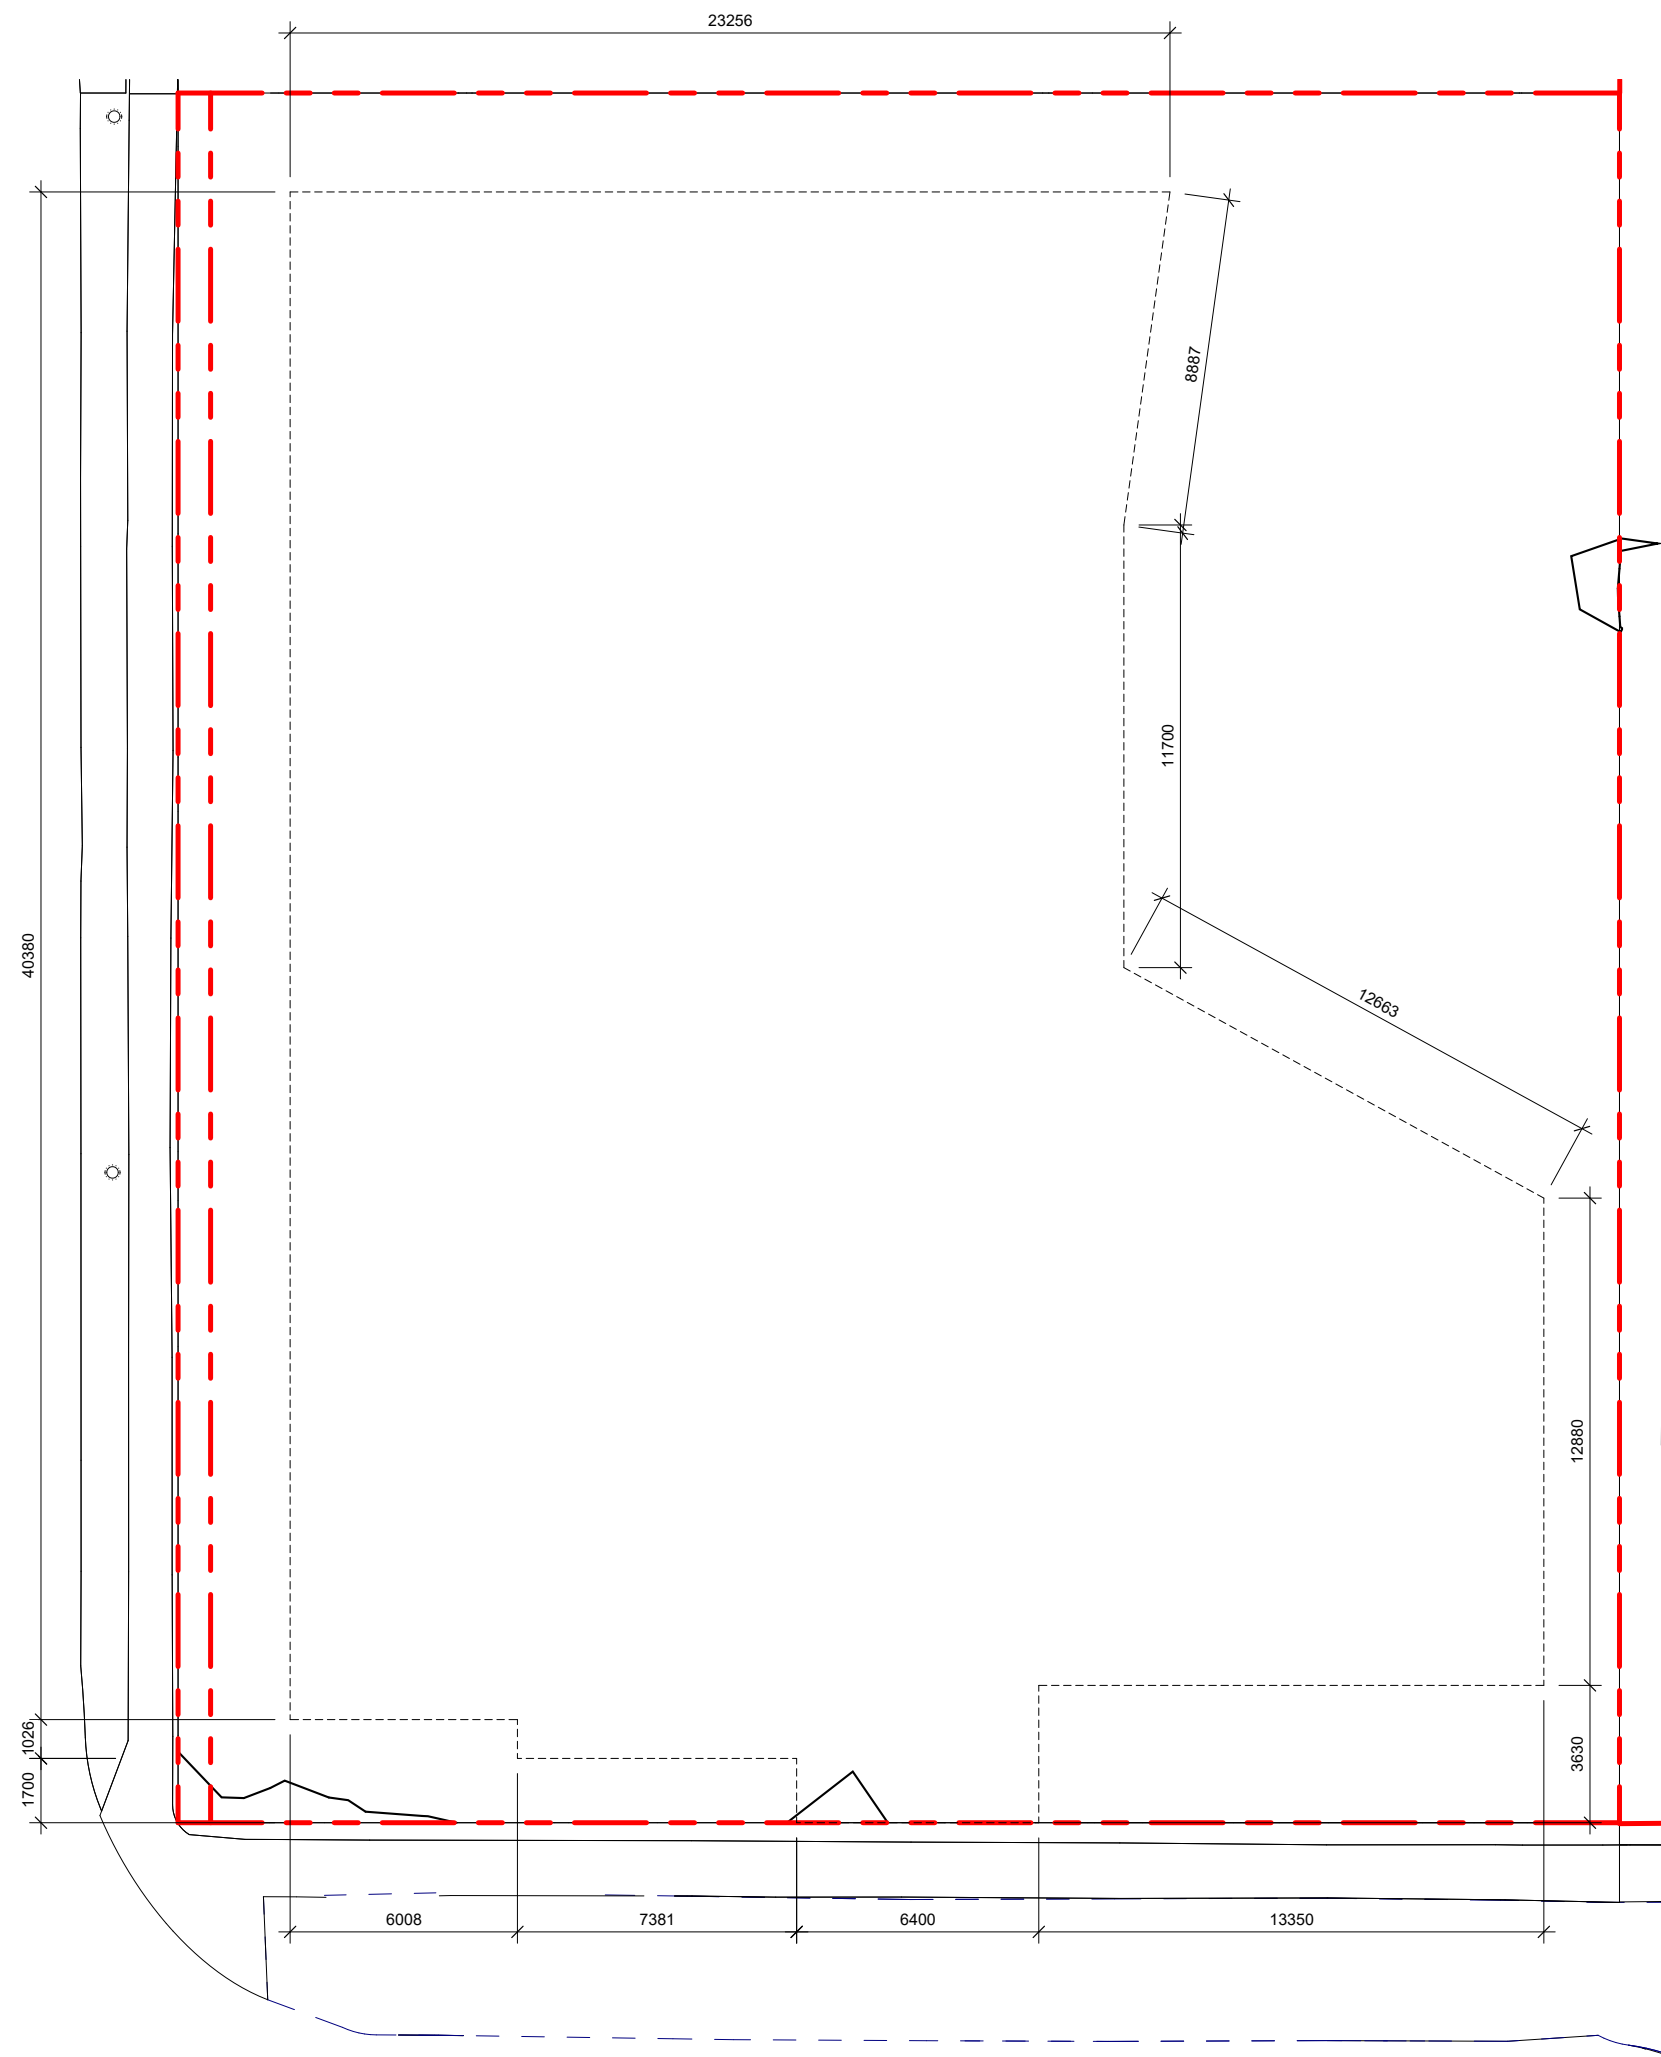
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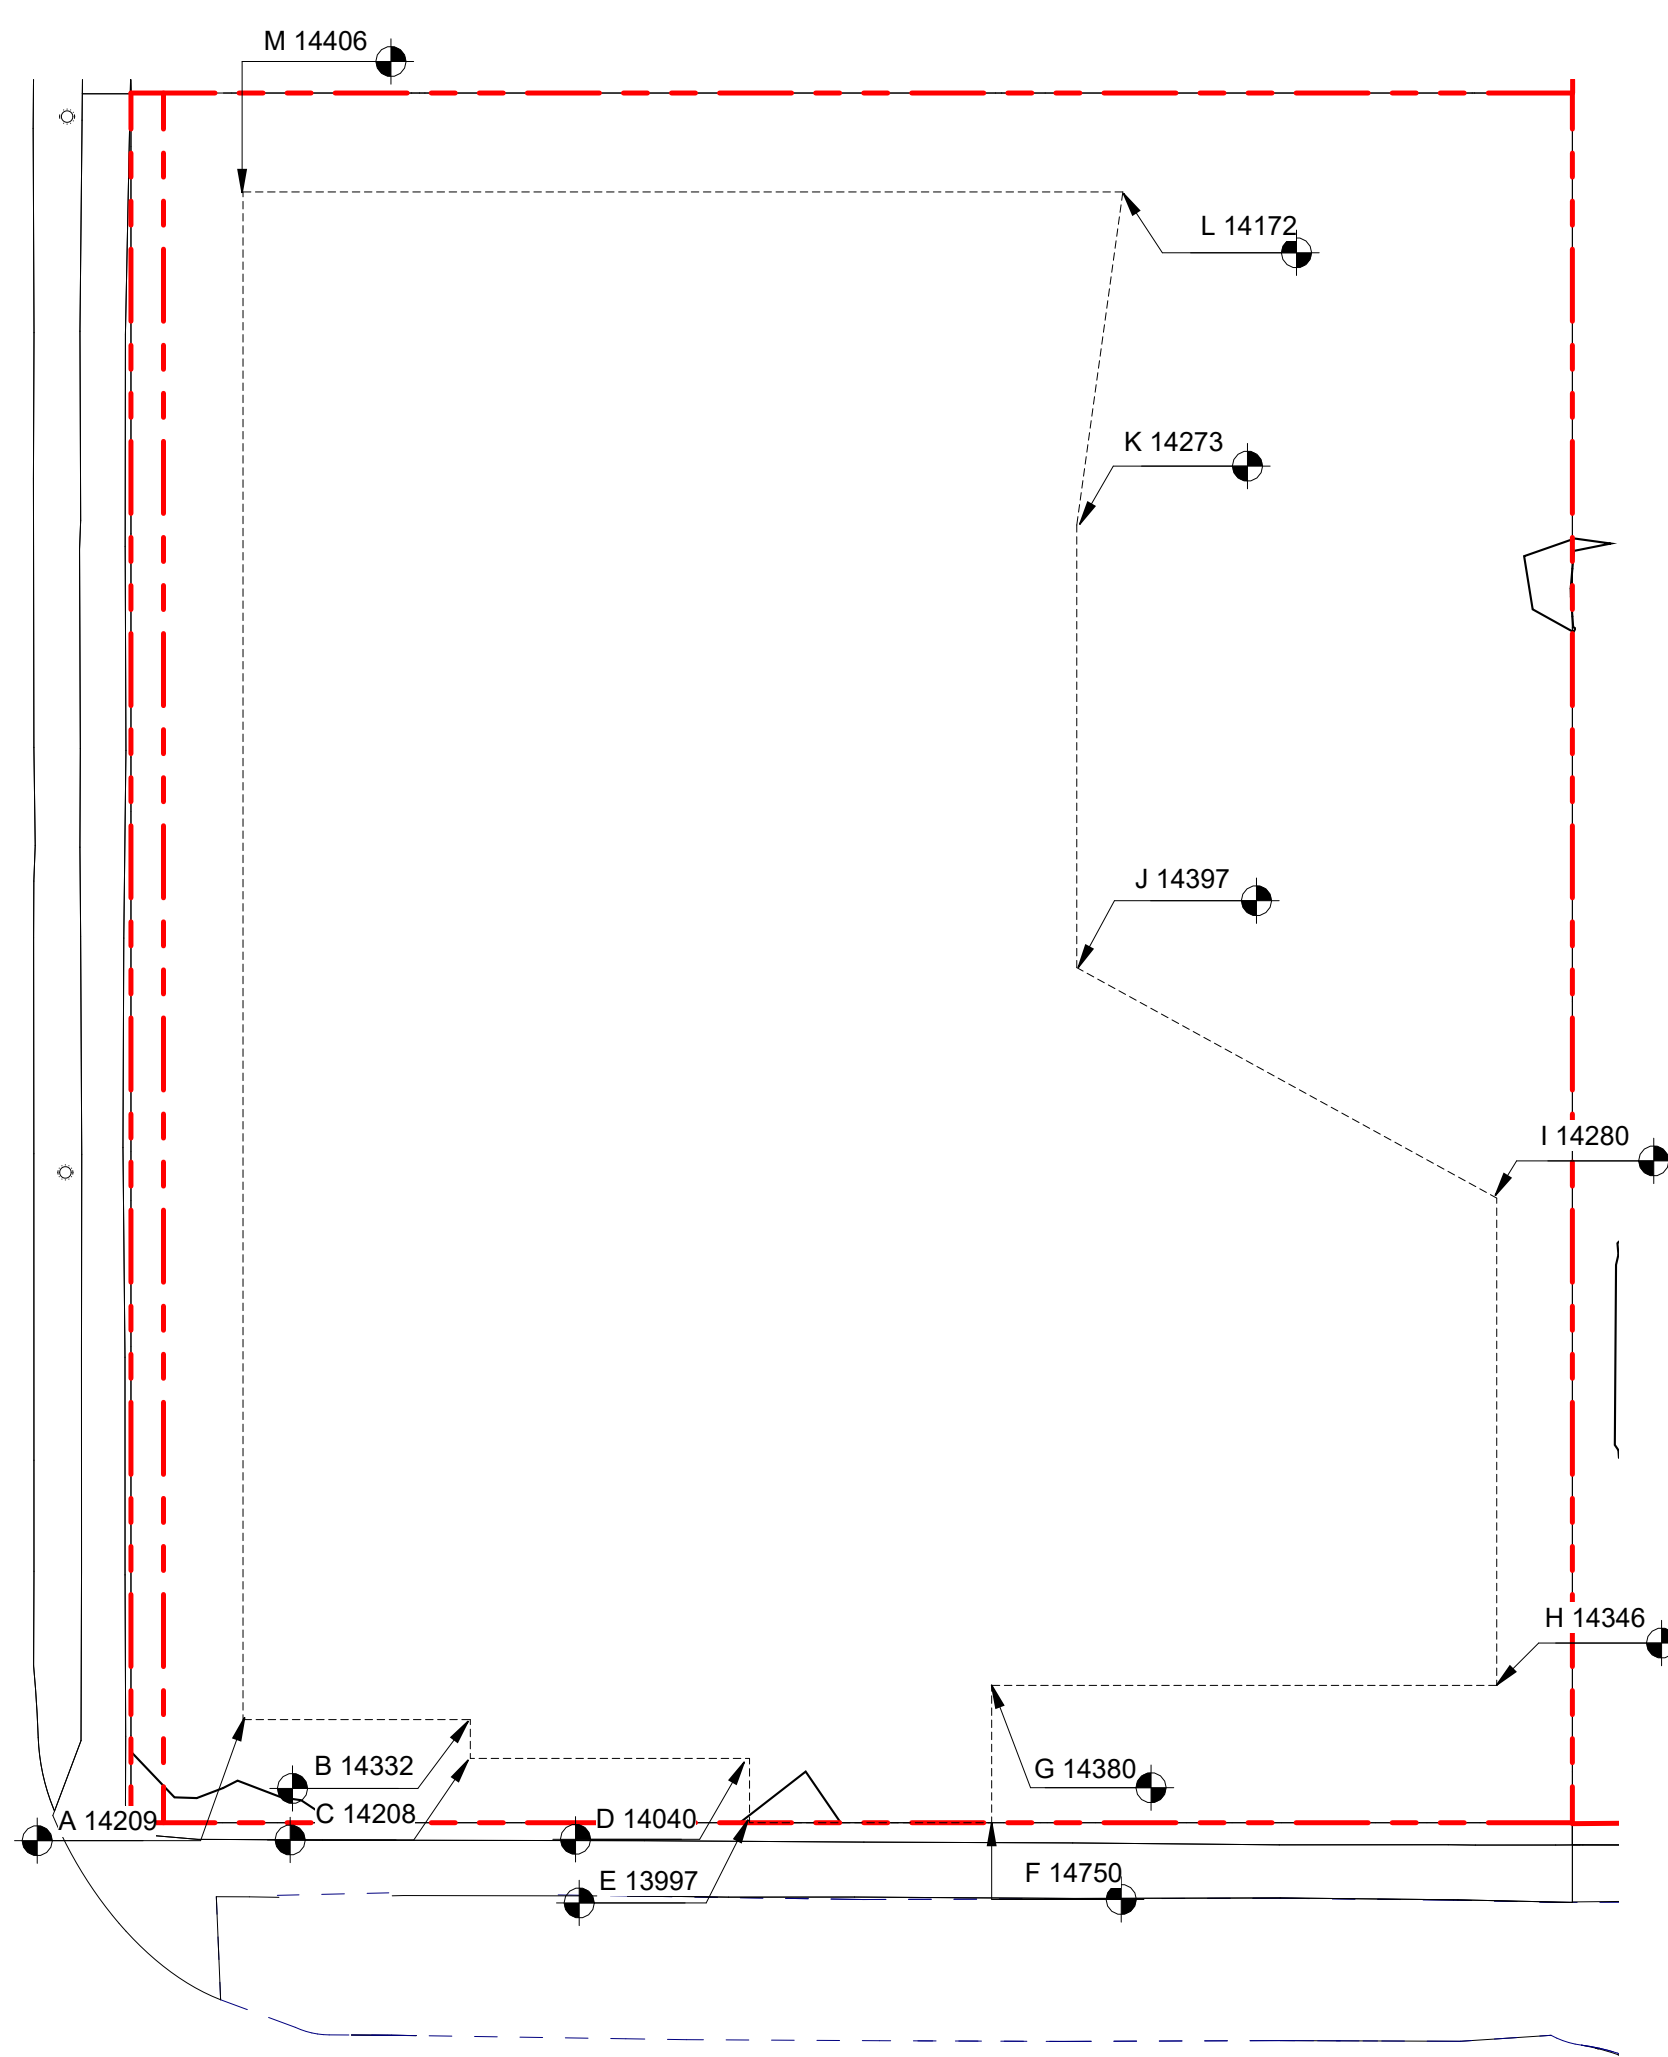
Project	1733-1737 Fairfield Rd	ARYZE
Sheet Name	SITE PLAN & PROJECT DATA	
Date	AUGUST 21, 2023	
Scale	As indicated	Project # 2123
		Revision 5
		Sheet # A-050








1 DISTANCE BTWN POINTS KEY PLAN  
SCALE = 1 : 200



2 NATURAL GRADE KEY PLAN  
SCALE = 1 : 200

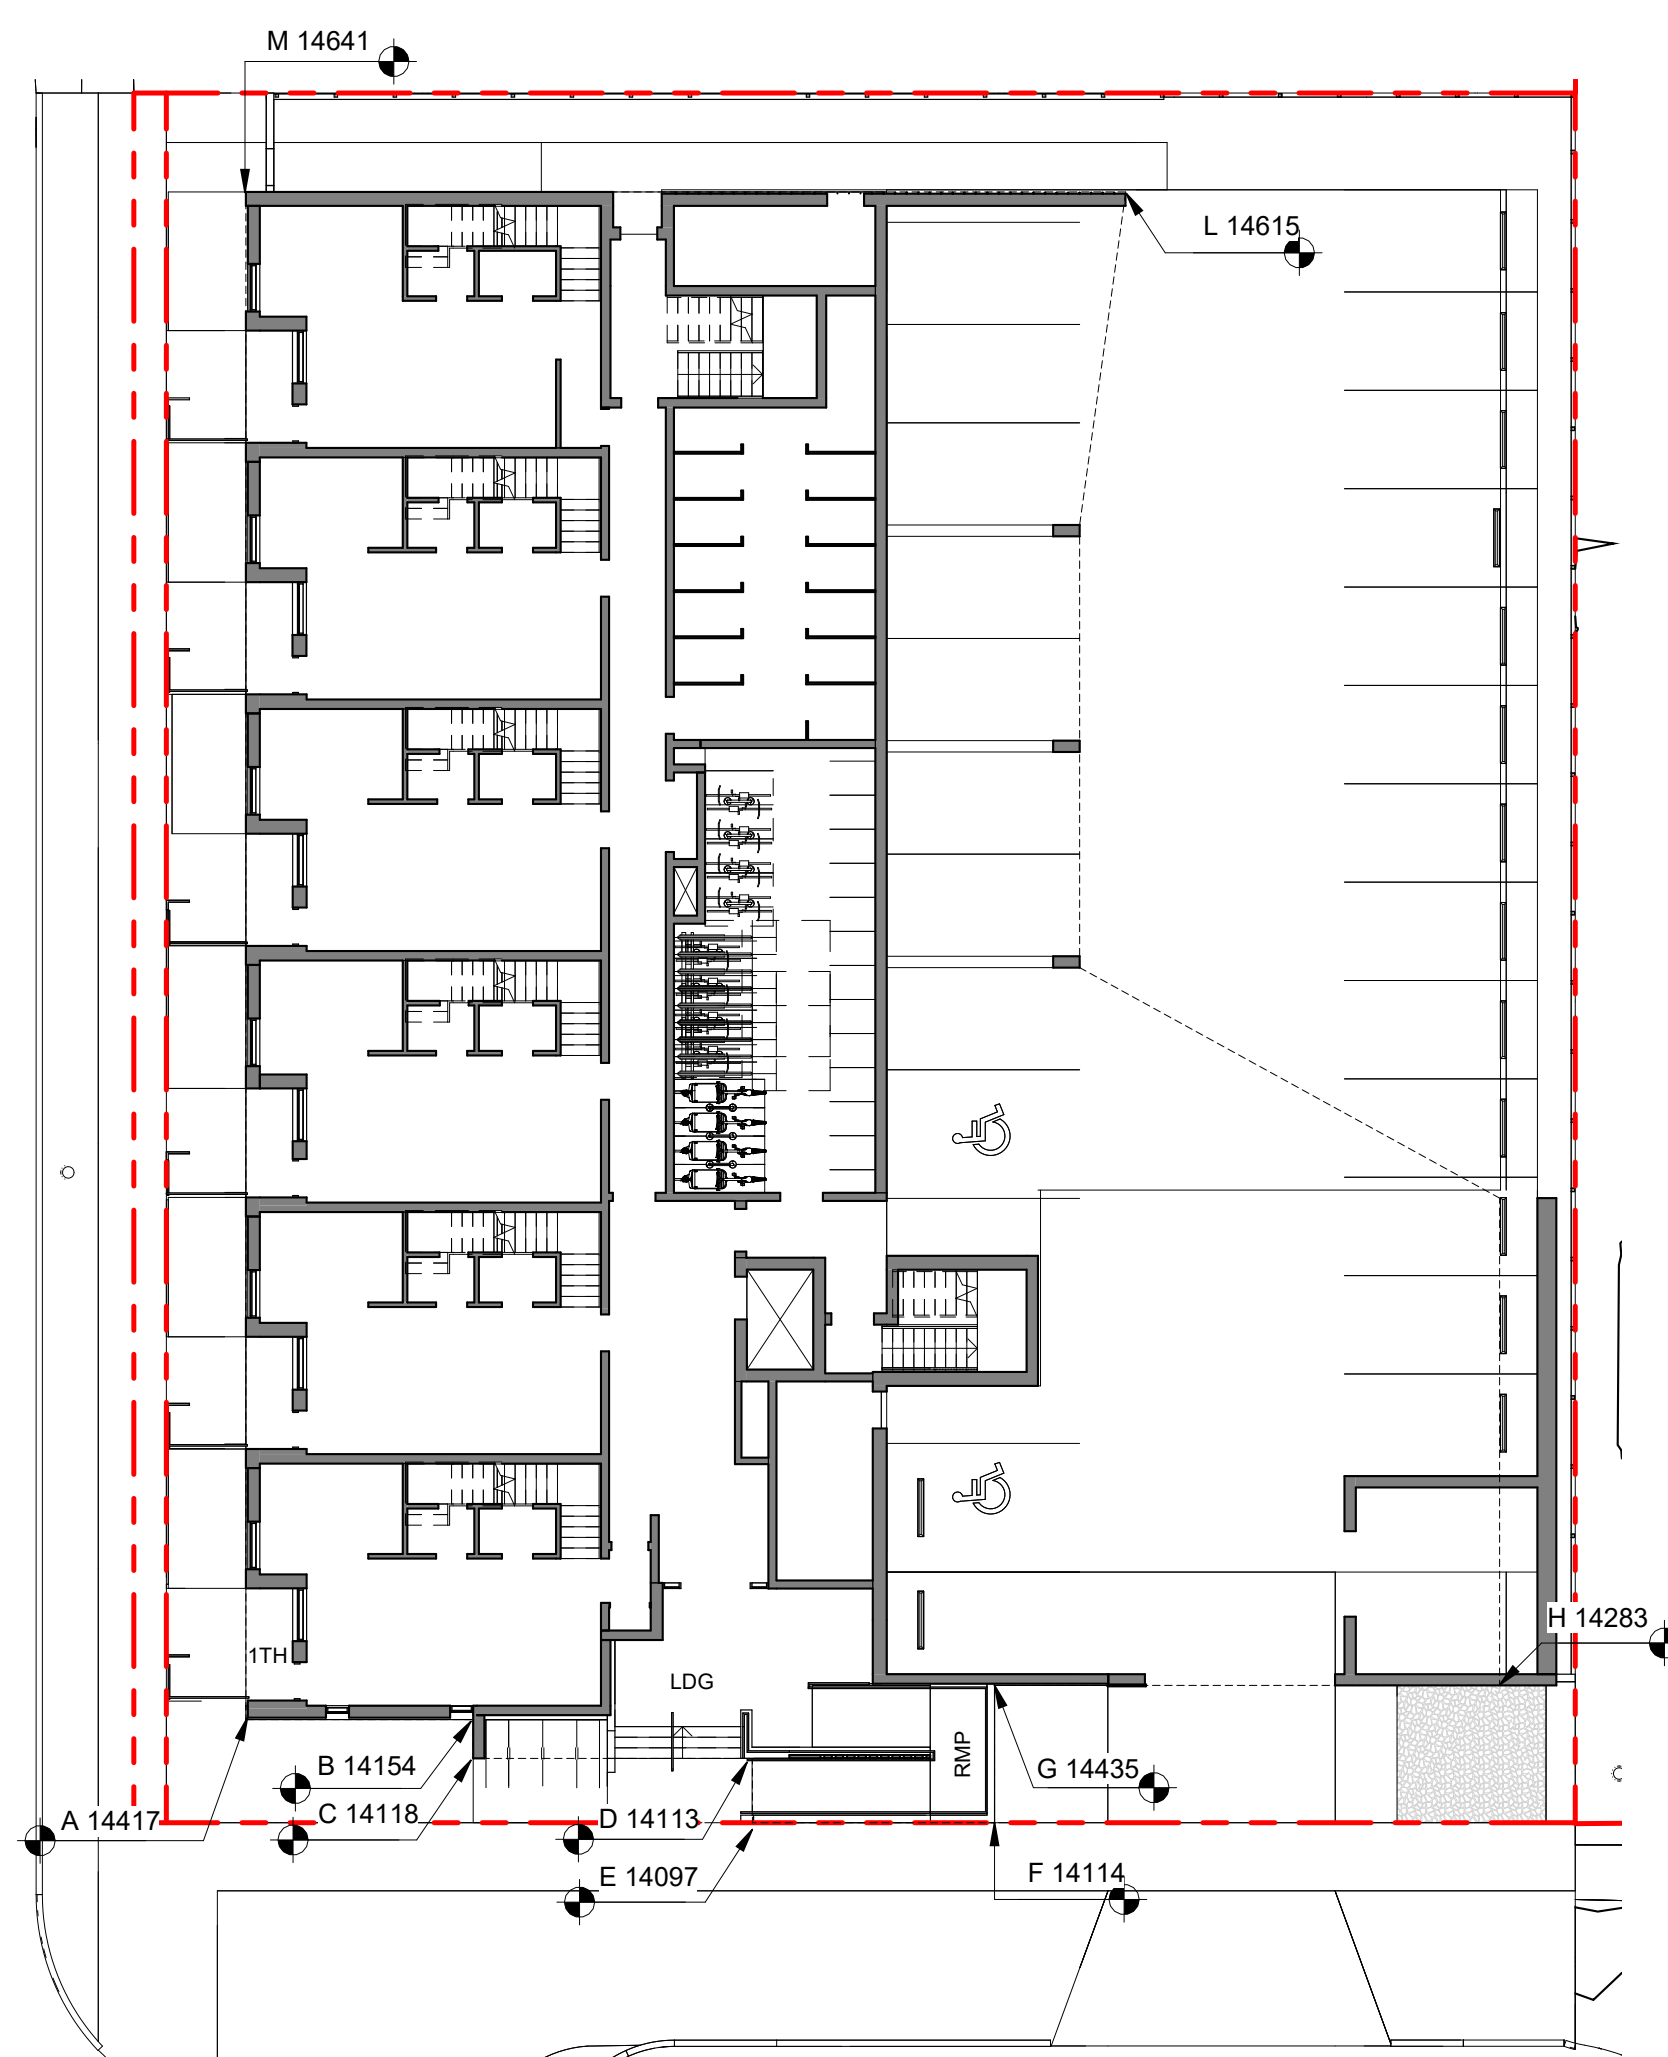


3 PROPOSED GRADE KEY PLAN  
SCALE = 1 : 200


POINT NAME	NATURAL	PROPOSED	DISTANCE BETWEEN POINTS		AVE. OF POINTS
A	14.209	14.42	Point A & B	6.008	85.20
B	14.332	14.15	Point B & C	1.026	14.50
C	14.208	14.12	Point C & D	7.381	103.92
D	14.04	14.11	Point D & E	1.7	23.83
E	13.997	14.10	Point E & F	6.4	89.96
F	14.75	14.11	Point F & G	3.63	51.72
G	14.38	14.44	Point G & H	13.35	191.33
H	14.346	14.28	Point H & I	12.88	183.90
I	14.273	14.41	Point I & J	12.663	181.52
J	14.397	14.69	Point J & K	11.7	167.72
K	14.273	14.64	Point K & L	8.887	126.40
L	14.172	14.62	Point L & M	23.256	332.30
M	14.406	14.64	Point M & N	40.38	577.74

Total	149.26	2130.03
Average Grade	14.27	

\*NOTE: Lowest grade point governs per Schedule A definition

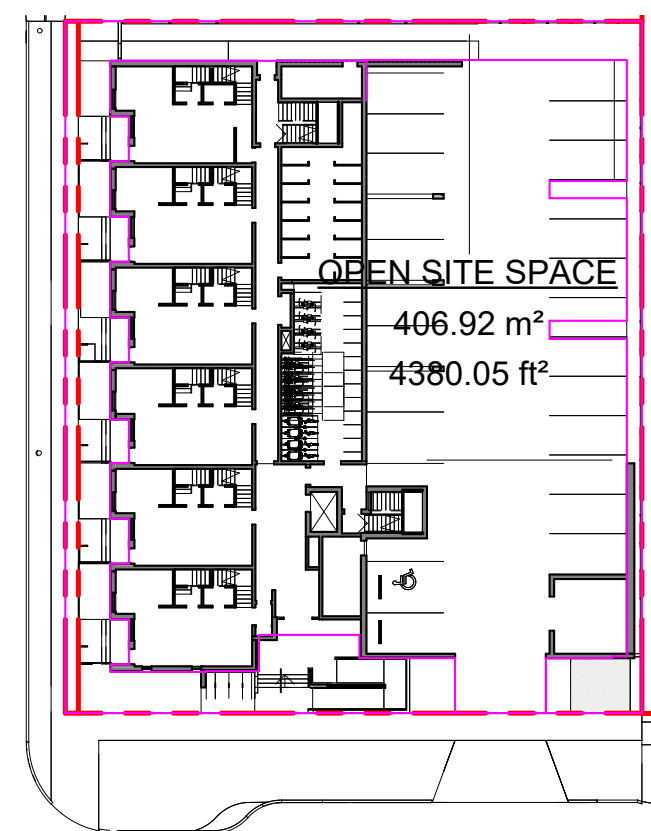

4 OPEN SITE SPACE  
SCALE = 1 : 500

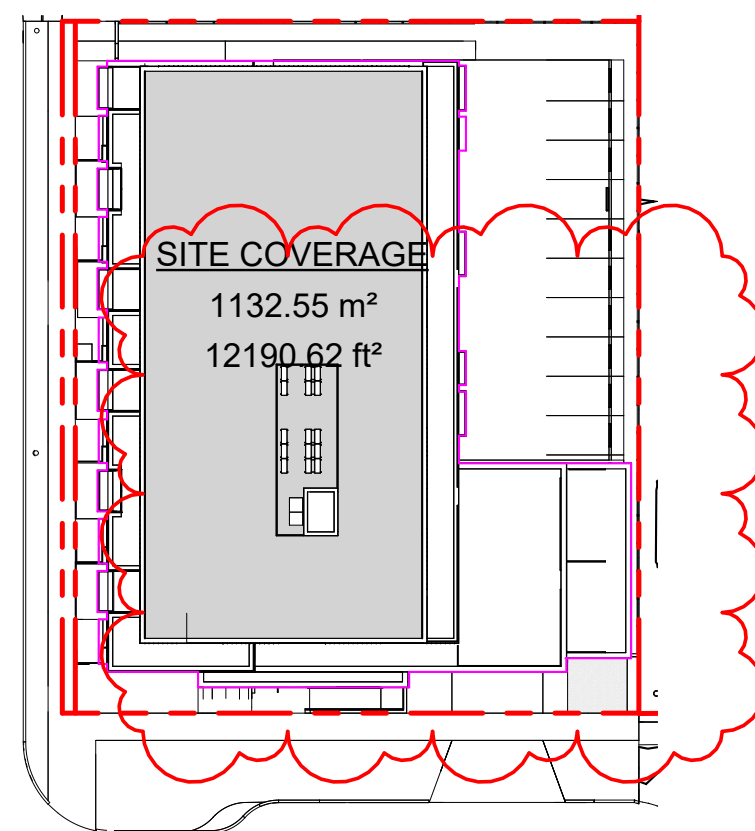

5 SITE COVERAGE  
SCALE = 1 : 500

### SUPPORTING CALCULATIONS

#### ZONING REGULATION BYLAW FLOOR AREAS

Level 1	542.56 m <sup>2</sup>
Level 2	951.08 m <sup>2</sup>
Level 3	785.79 m <sup>2</sup>
Level 4	682.07 m <sup>2</sup>
Grand total: 5	2965.20 m <sup>2</sup>

#### FLOOR SPACE RATIO

2965.20m<sup>2</sup> / 1741.93m<sup>2</sup> = 1.714

FSR - 1.71 : 1

#### SITE COVERAGE

1132.55m<sup>2</sup> / 1741.93m<sup>2</sup> = 0.65 (65%)

#### OPEN SITE SPACE

406.92m<sup>2</sup> / 1741.93m<sup>2</sup> = 0.23 (23%)

#### HEIGHT OF PATIOS, STAIRS, & RAMP TO EXISTING & PROPOSED GRADE REFER TO GRADE KEY PLANS

**1TH PATIO**  
(WORST CASE GRADING ALONG FAIRFIELD RD - THEREFORE ALL <600mm)  
14750 - 14200(PROPOSED) = 550mm  
14750 - 14171(EXISTING) = 579mm

**LDG (LANDING AT PRIMARY ENTRANCE)**  
14750 - 14114(PROPOSED) = 636mm  
14750 - 14040 (EXISTING) = 710mm

**RMP (INTERMEDIARY RAMP LANDING)**  
14507 - 14114(PROPOSED) = 393mm  
14507 - 14280 (EXISTING) = 227mm


5	DPIRZ Rev3	Aug 18, 2023
4	DPIRZ Rev2	Jan 26, 2023
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Project		1733-1737 Fairfield Rd	
		ARYZE	
Sheet Name		ZONING CALCULATIONS	
Date		AUGUST 21, 2023	
Scale	As indicated	Project #	2123
Revision		Aug 18, 2023	
Sheet #		A-051	










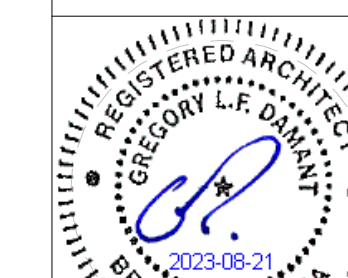

NW ELEVATION

TABLE 3.2.3.1.-D	LIMITING DISTANCE (m)	ALLOWABLE OPENINGS (%)	AREA OF EXPOSING BUILDING FACE (sq.m)	PROPOSED OPENINGS (sq.m)	PROPOSED OPENINGS (%)
	10.60m (>9m)	100	496.26	213.77	43
TABLE 3.2.3.7	LIMITING DISTANCE (m)	ALLOWABLE OPENINGS (%)	REQUIRED FRR	REQUIRED TYPE OF CONSTRUCTION	REQUIRED TYPE OF CLADDING
	10.12m (>9m)	100	45 minutes	Any	Any

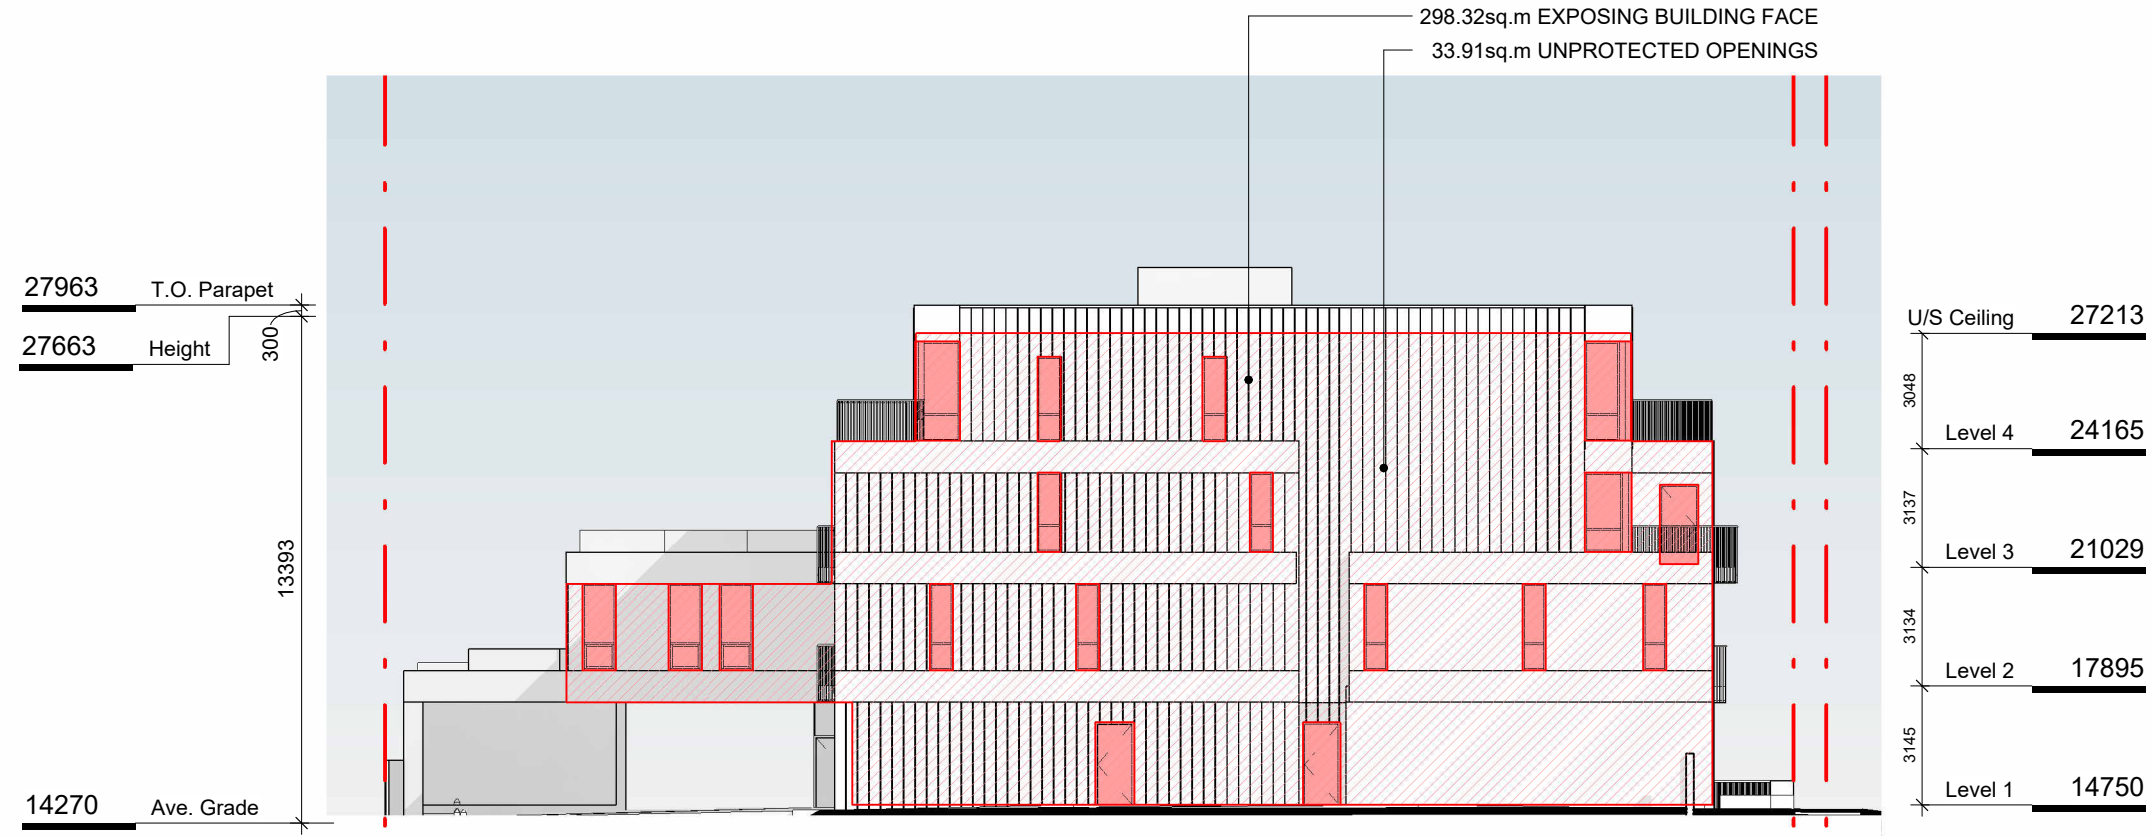

NE ELEVATION

TABLE 3.2.3.1.-D	LIMITING DISTANCE (m)	ALLOWABLE OPENINGS (%)	AREA OF EXPOSING BUILDING FACE (sq.m)	PROPOSED OPENINGS (sq.m)	PROPOSED OPENINGS (%)
	2.62m (>2m)	16	298.32	33.91	11.4
TABLE 3.2.3.7	OCCUPANCY CLASSIFICATION	ALLOWABLE OPENINGS (%)	REQUIRED FRR	REQUIRED TYPE OF CONSTRUCTION	REQUIRED TYPE OF CLADDING
	GROUP C	10 - 25	1 hr	Any	Noncombustible

1 NW ELEVATION - LD KEY  
SCALE = 1 : 200

2 NE ELEVATION - LD KEY  
SCALE = 1 : 200



SE ELEVATION

TABLE 3.2.3.1.-D COMPARTMENT 1	LIMITING DISTANCE (m)	ALLOWABLE OPENINGS (%)	AREA OF EXPOSING BUILDING FACE (sq.m)	PROPOSED OPENINGS (sq.m)	PROPOSED OPENINGS (%)
	11.89m (>9m)	100	453.14	141.26	31.2
TABLE 3.2.3.7 COMPARTMENT 1	OCCUPANCY CLASSIFICATION	ALLOWABLE OPENINGS (%)	REQUIRED FRR	REQUIRED TYPE OF CONSTRUCTION	REQUIRED TYPE OF CLADDING
	GROUP C	50 - 100	45 minutes	Any	Any
TABLE 3.2.3.1.-D COMPARTMENT 2	LIMITING DISTANCE (m)	ALLOWABLE OPENINGS (%)	AREA OF EXPOSING BUILDING FACE (sq.m)	PROPOSED OPENINGS (sq.m)	PROPOSED OPENINGS (%)
	4.78m (>4m)	56	43.20	17.70	41.0
TABLE 3.2.3.7 COMPARTMENT 2	OCCUPANCY CLASSIFICATION	ALLOWABLE OPENINGS (%)	REQUIRED FRR	REQUIRED TYPE OF CONSTRUCTION	REQUIRED TYPE OF CLADDING
	GROUP C	50 - 100	45 minutes	Any	Any

4 SE ELEVATION - LD KEY  
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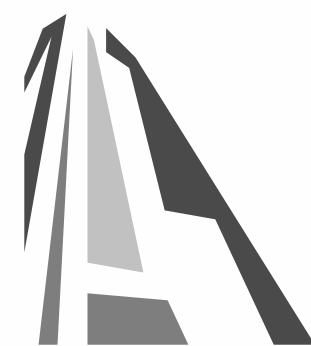


SW ELEVATION

TABLE 3.2.3.1.-D	LIMITING DISTANCE (m)	ALLOWABLE OPENINGS (%)	AREA OF EXPOSING BUILDING FACE (sq.m)	PROPOSED OPENINGS (sq.m)	PROPOSED OPENINGS (%)
	12.61m (>9m)	100	315.54	84.24	26.7
TABLE 3.2.3.7	OCCUPANCY CLASSIFICATION	ALLOWABLE OPENINGS (%)	REQUIRED FRR	REQUIRED TYPE OF CONSTRUCTION	REQUIRED TYPE OF CLADDING
	GROUP C	100	45 minutes	Any	Any

3 SW ELEVATION - LD KEY  
SCALE = 1 : 200

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Project	1733-1737 Fairfield Rd	
	ARYZE	
Sheet Name	SPATIAL SEPARATION	
Date	AUGUST 21, 2023	
Scale	1 : 200	Project # 2123
Revision	Aug 18, 2023	5
Sheet #	A-053	








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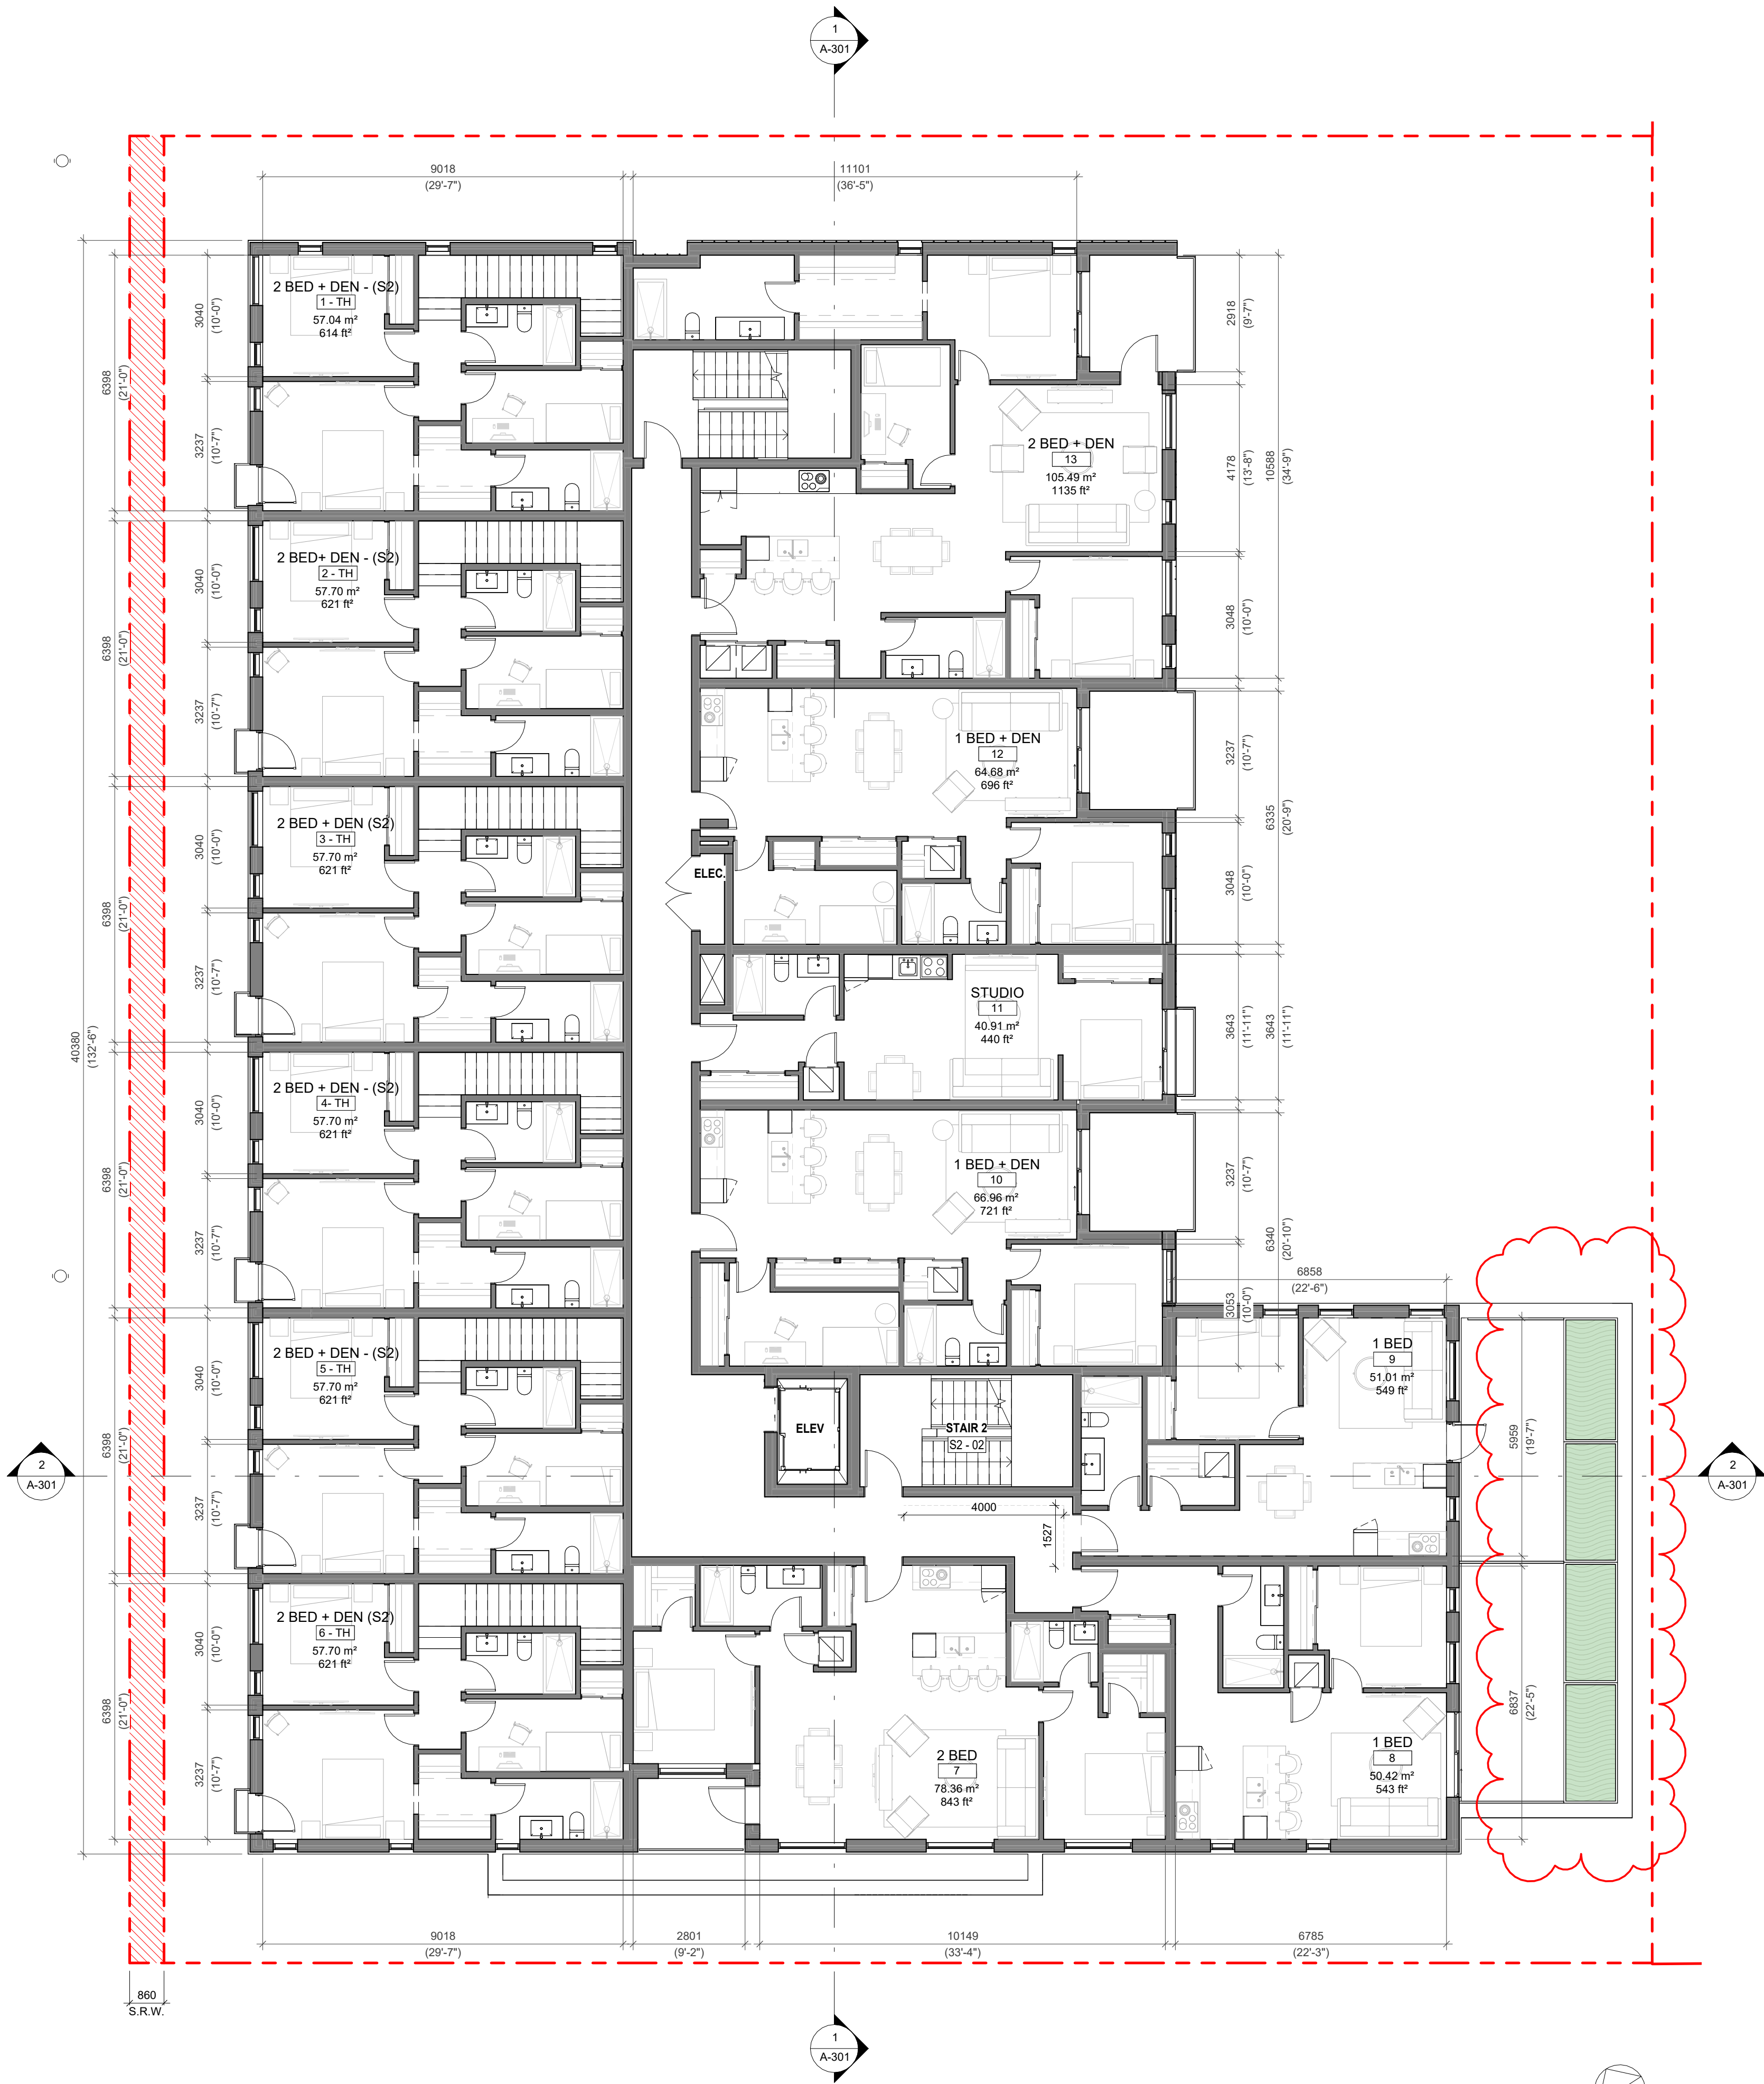
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Project	1733-1737 Fairfield Rd	
	ARYZE	
Sheet Name	LEVEL 1 PROPOSED PLAN	
Date	AUGUST 21, 2023	
Scale	1 : 100	Project # 2123
	Revision	Aug 18, 2023 5
	Sheet #	A-101








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Project		1733-1737 Fairfield Rd	
		ARYZE	
Sheet Name			
LEVEL 2 PROPOSED PLAN			
Date			
AUGUST 21, 2023			
Scale		Project #	2123
1 : 100		Revision	5
		Aug 18, 2023	
		Sheet #	A-102

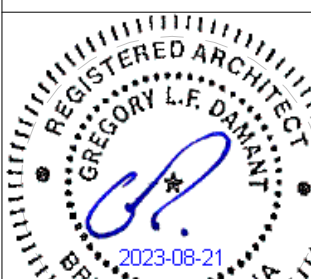



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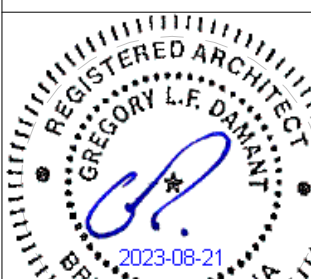
4	DPIRZ Rev2	Jan 26, 2023
3	DPIRZ Rev1	July 20, 2022
2	DPIRZ Submission	April 29, 2022
1	Development Tracker Application	March 7, 2022
NO.	DESCRIPTION	DATE

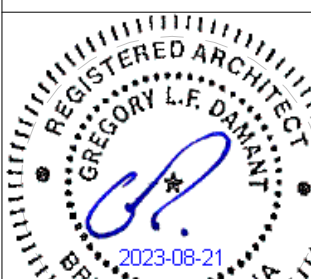

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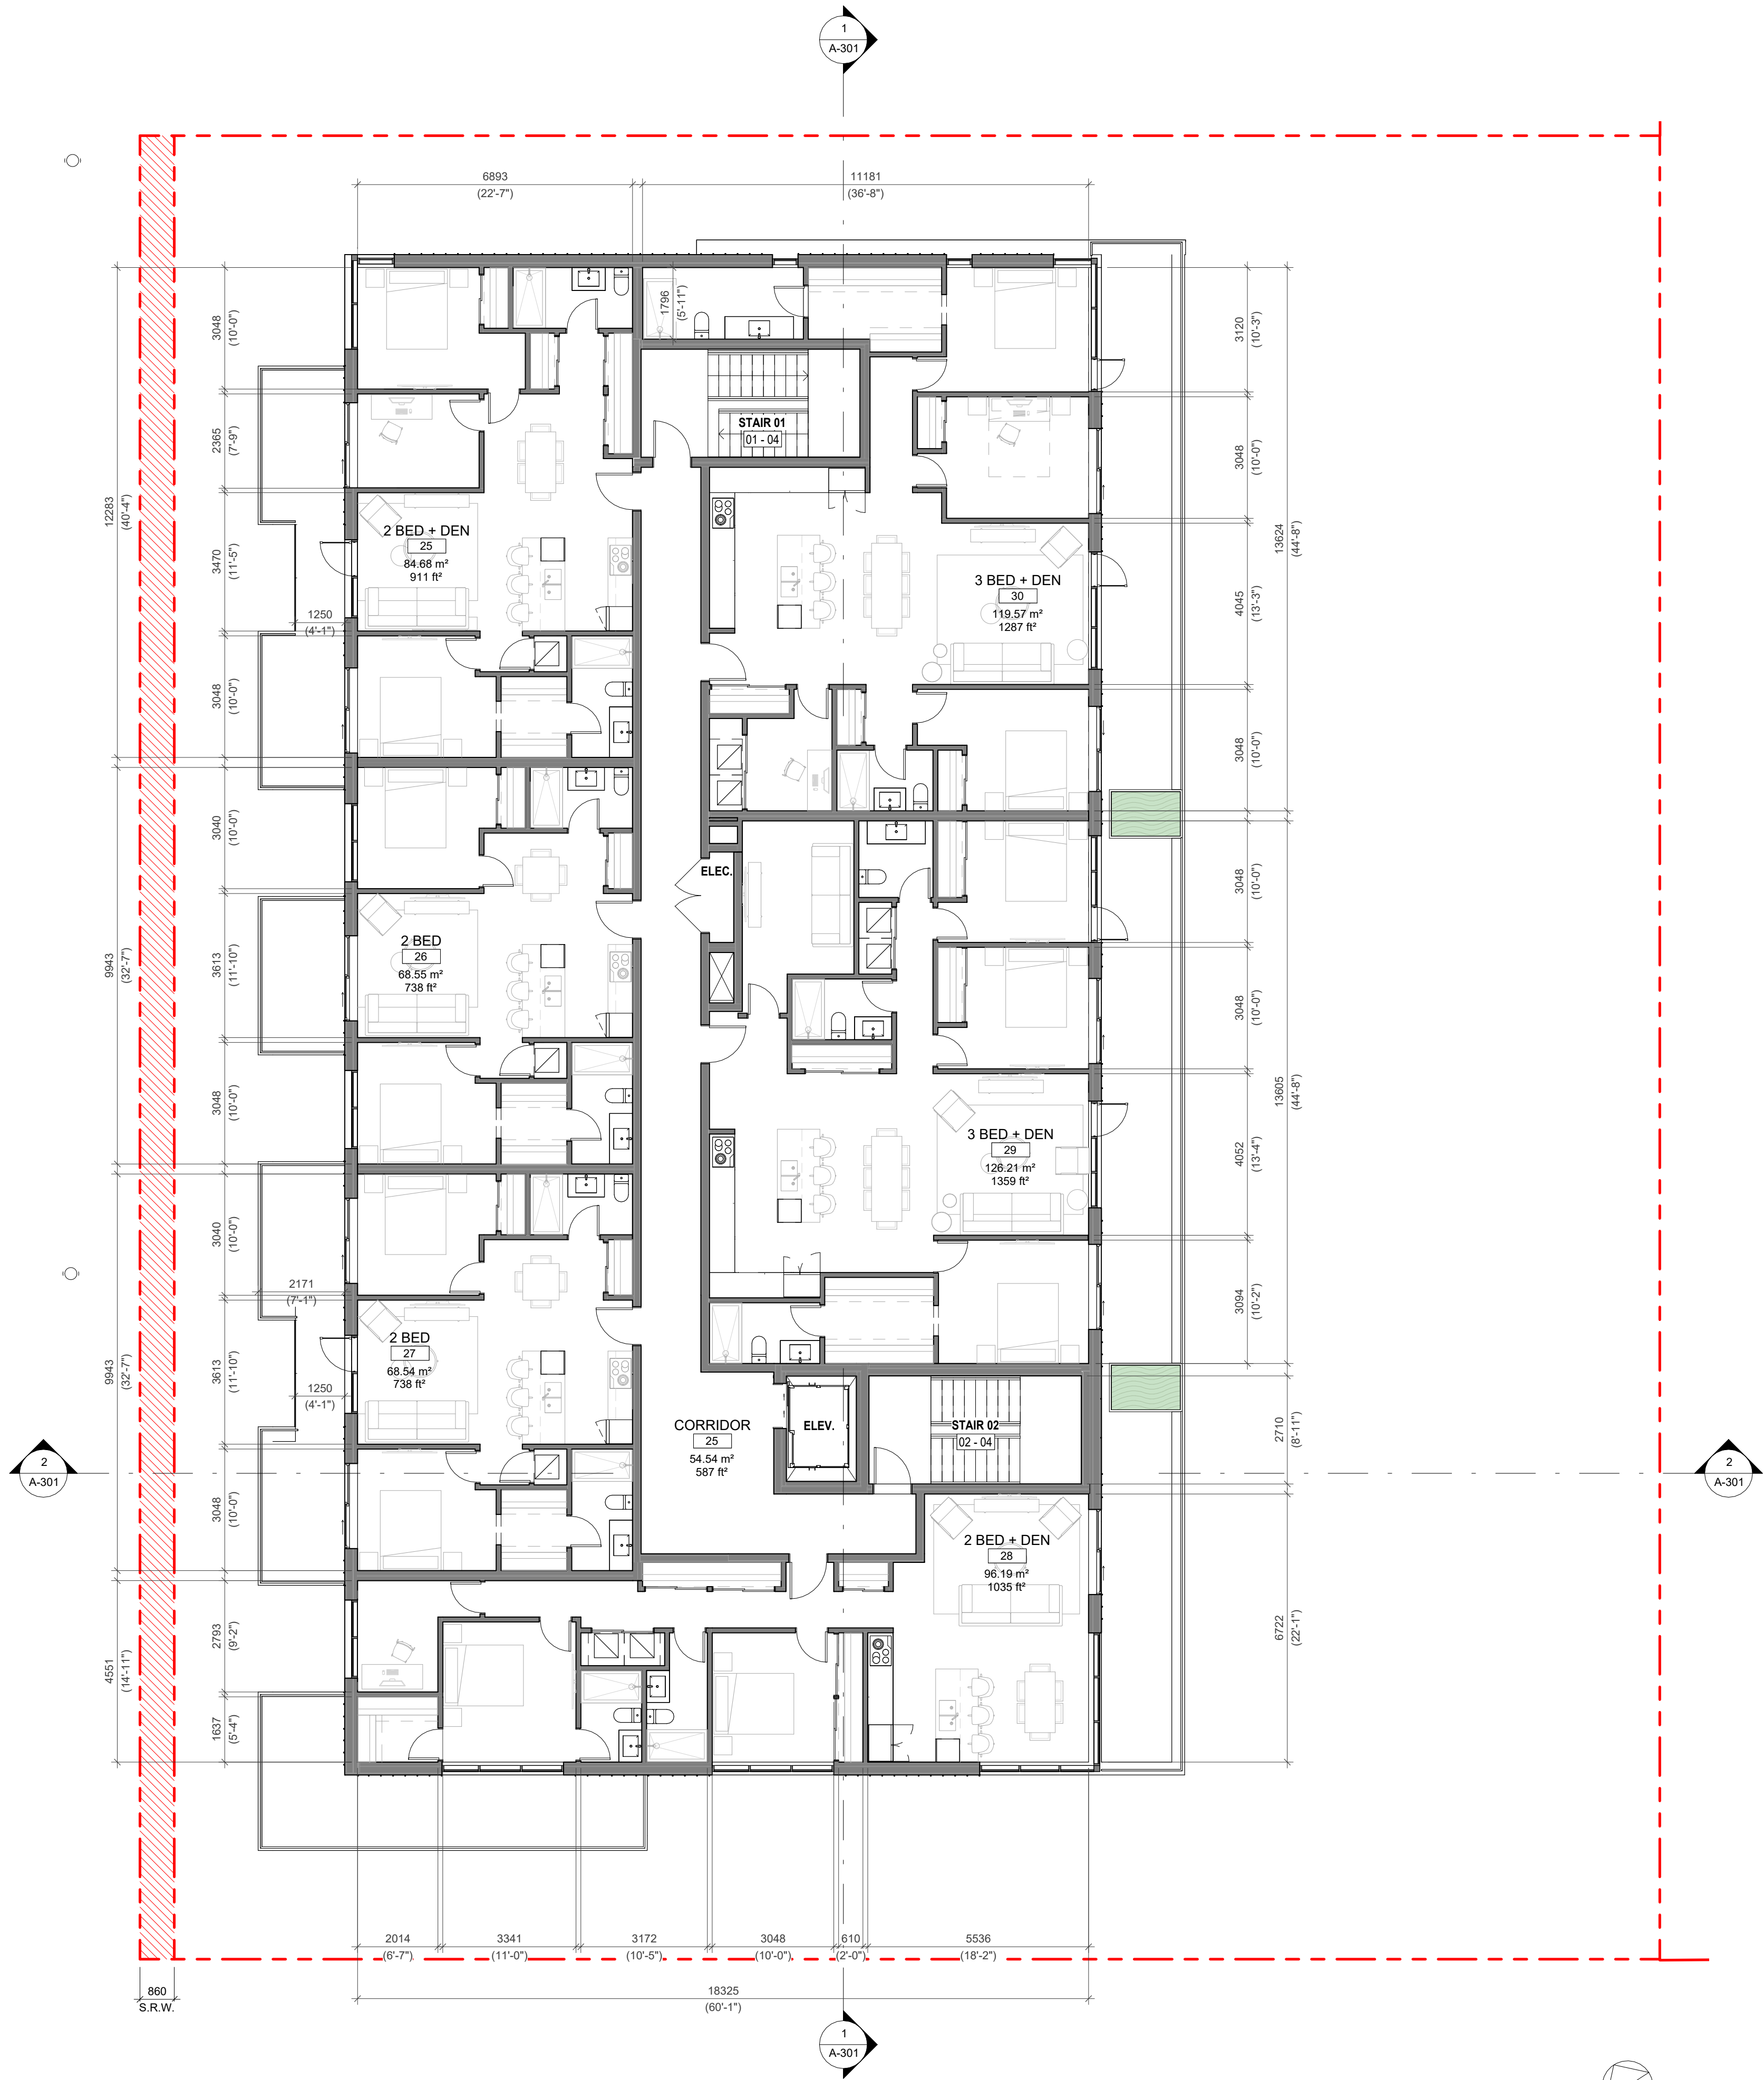
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Project		1733-1737 Fairfield Rd	
		ARYZE	
Sheet Name			
LEVEL 3 PROPOSED PLAN			
Date			
AUGUST 21, 2023			
Scale		Project #	2123
1 : 100		Revision	4
		Jan 26, 2023	
		Sheet #	A-103





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4	DPIRZ Rev2	Jan 26, 2023
3	DPIRZ Rev1	July 20, 2022
2	DPIRZ Submission	April 29, 2022
1	Development Tracker Application	March 7, 2022
NO.	DESCRIPTION	DATE



CASCADIA ARCHITECTS INC


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Project		1733-1737 Fairfield Rd	
		ARYZE	
Sheet Name			
LEVEL 4 PROPOSED PLAN			
Date		AUGUST 21, 2023	
Scale		Project #	2123
1 : 100		Revision	4
		Jan 26, 2023	
		Sheet #	A-104






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1 NW ELEVATION  
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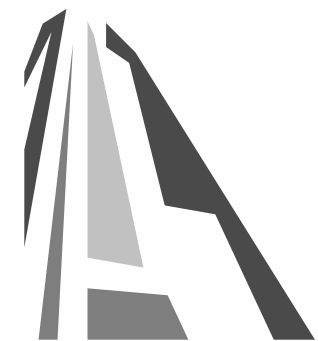


2 SW ELEVATION  
SCALE = 1 : 100
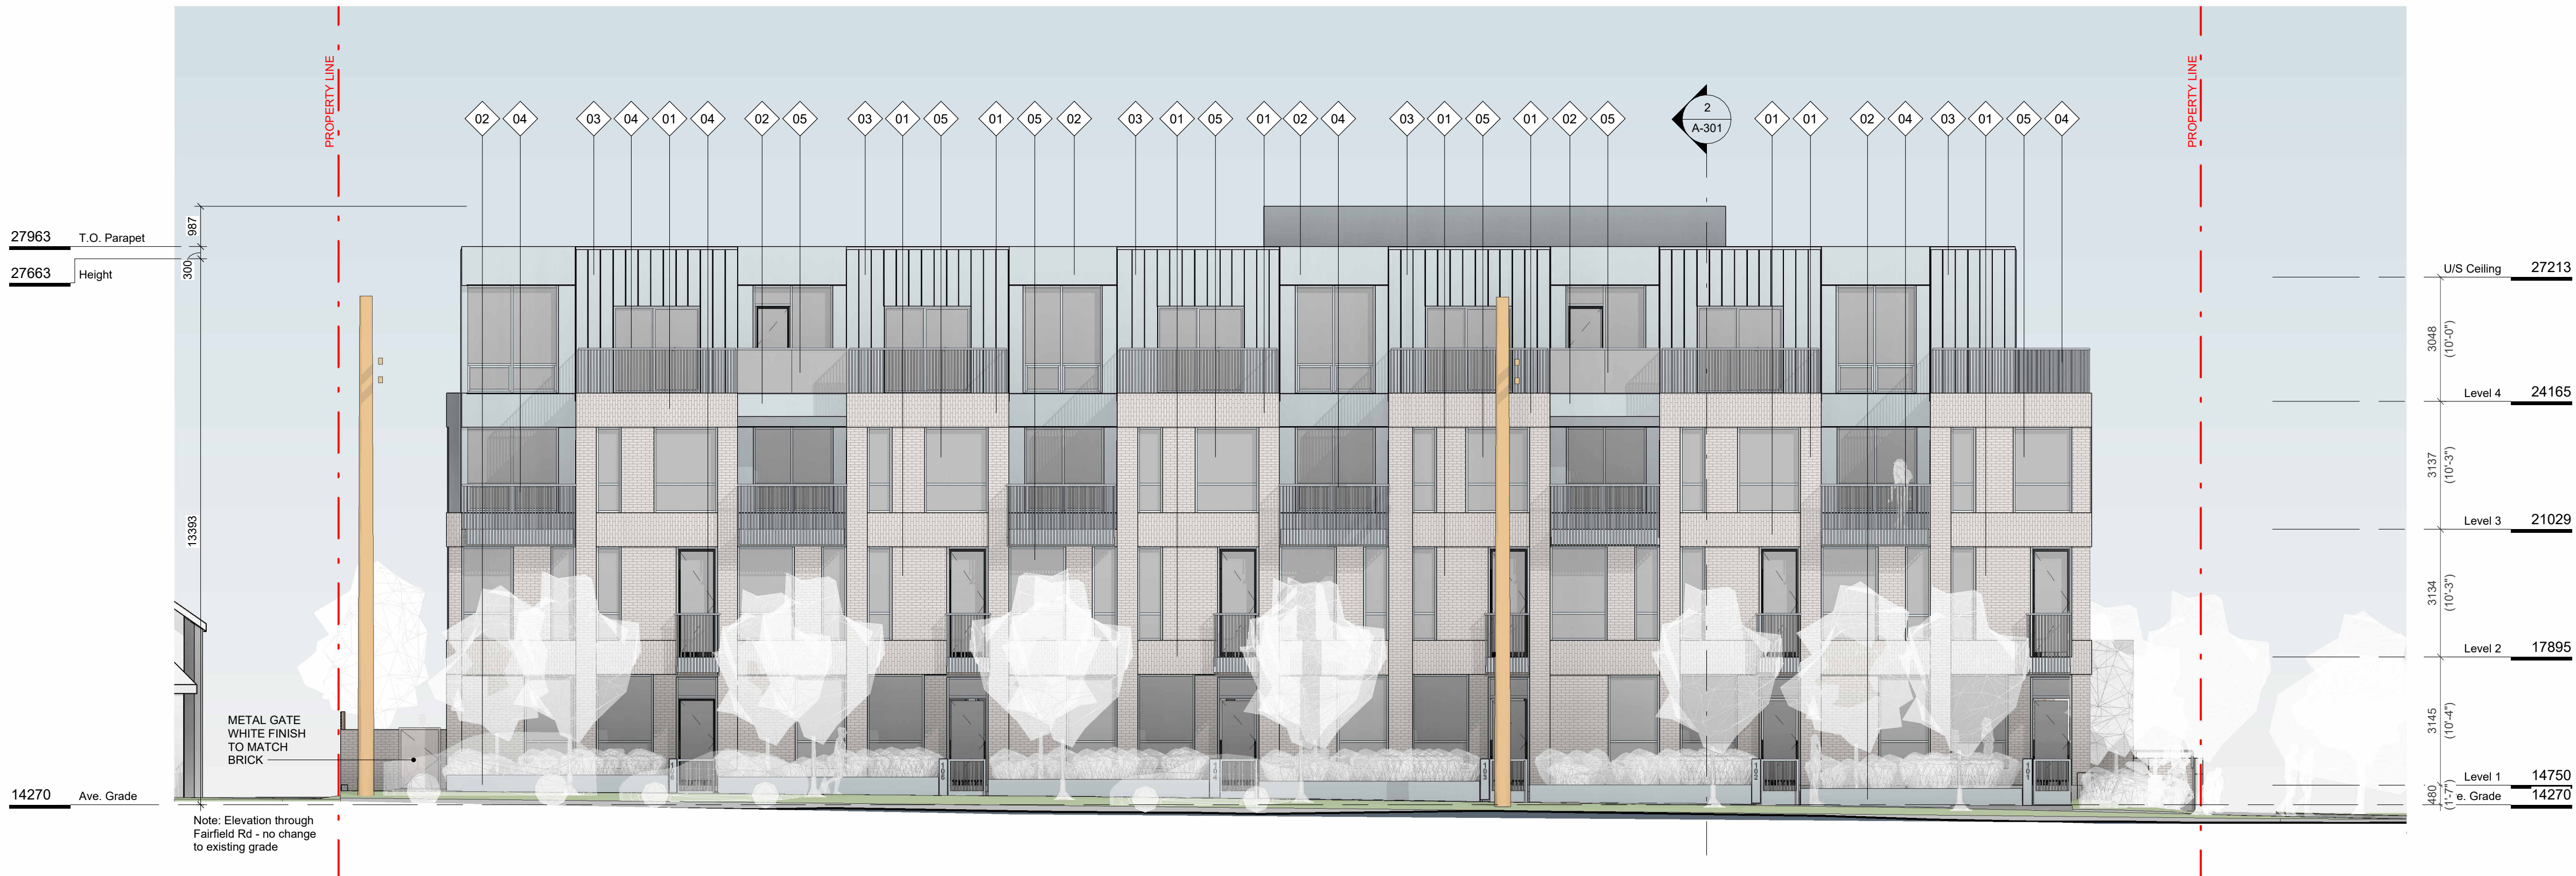
#### FINISH SCHEDULE

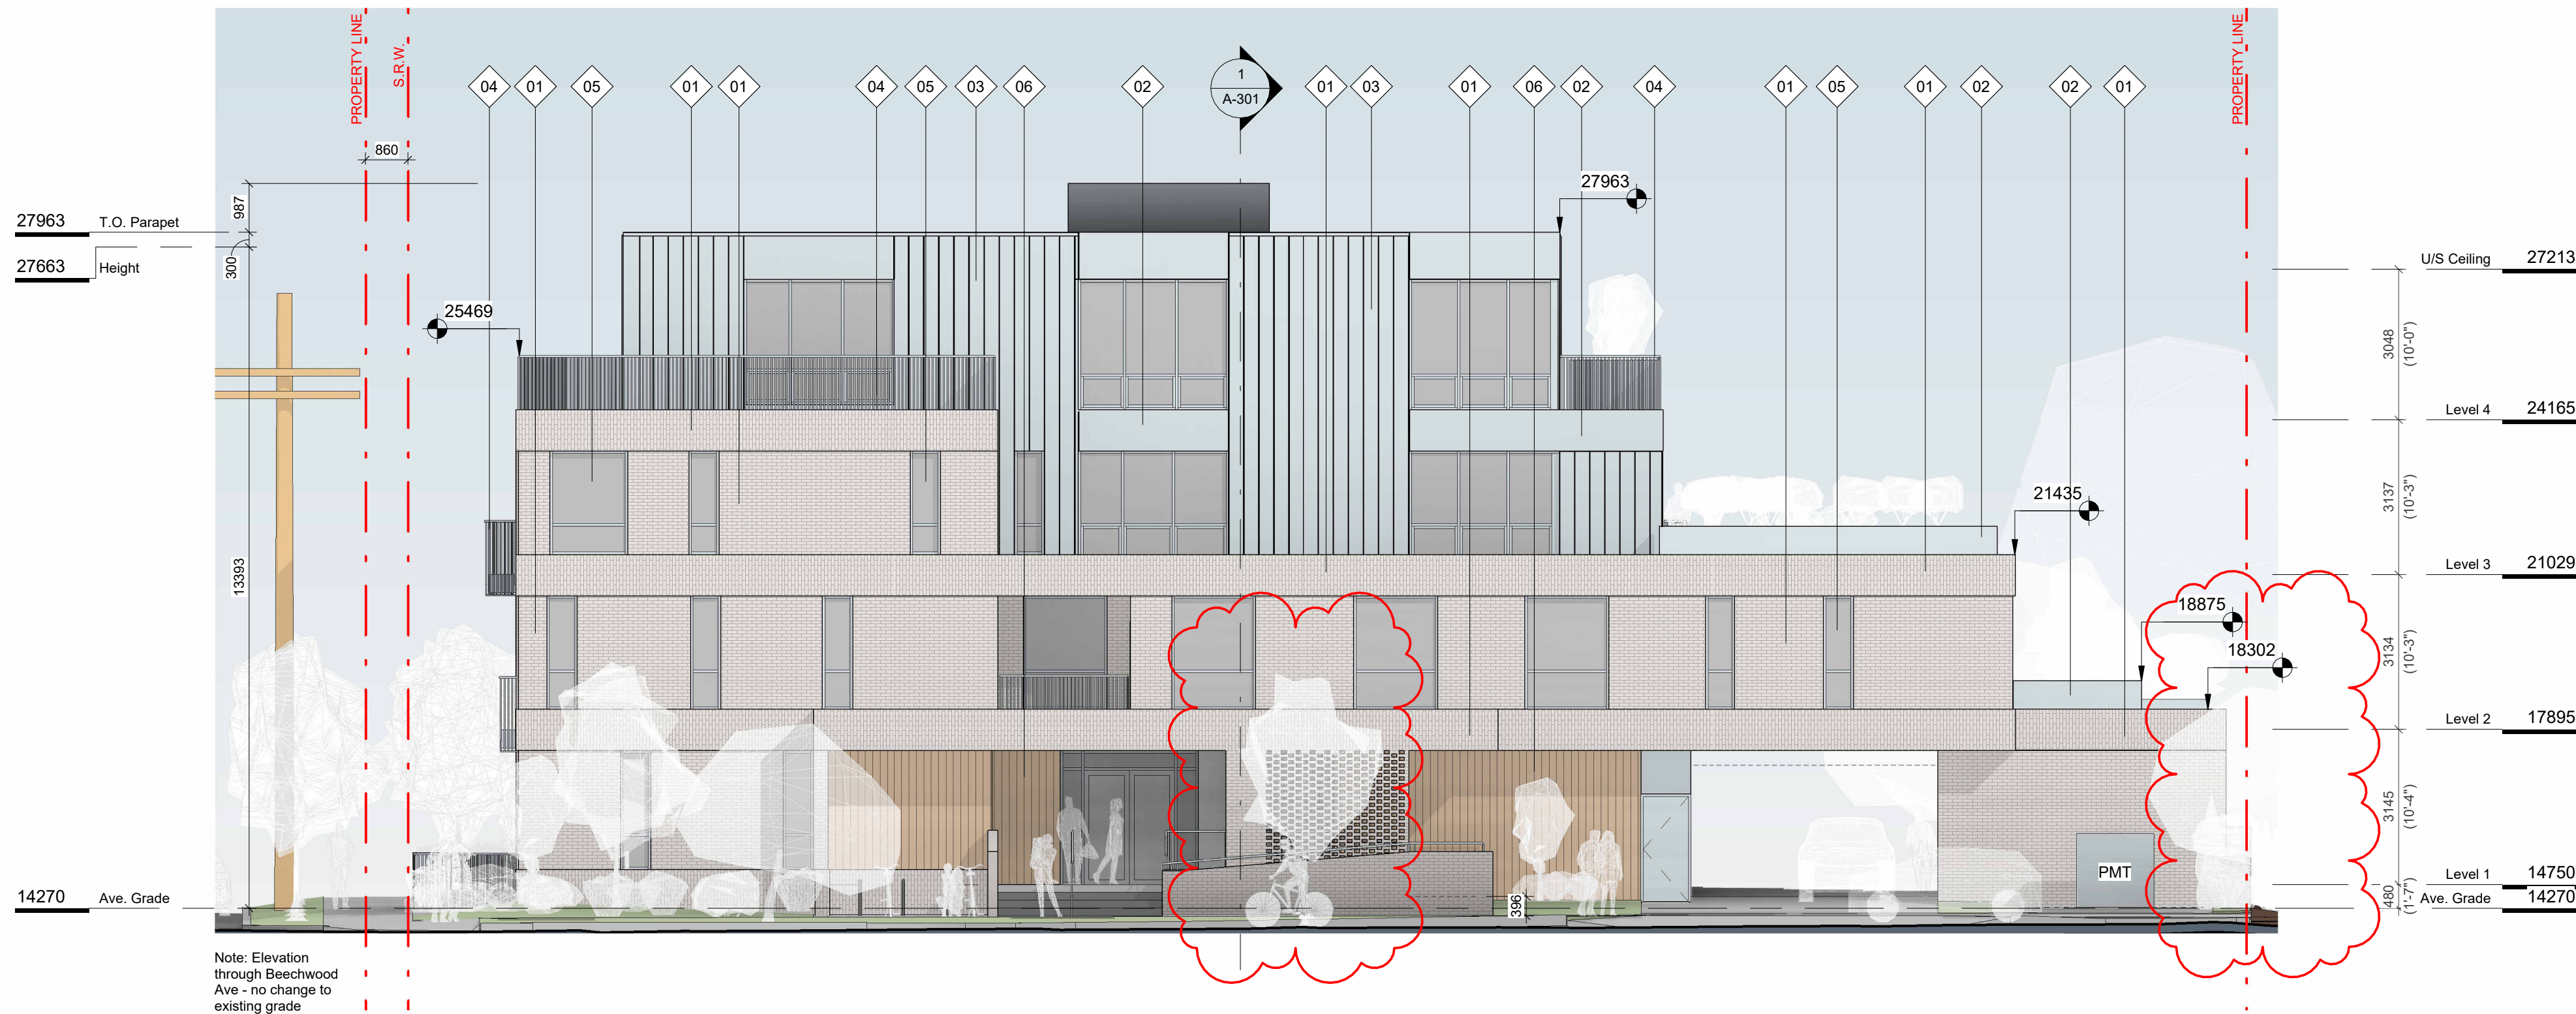01. BRICK  
LIGHT FINISH
02. PREFINISHED METAL  
FLAT PANEL
03. PREFINISHED METAL  
STANDING SEAM
04. METAL PICKET GUARD
05. GLAZING
06. WOOD GRAIN FINISH
07. HORIZONTAL WOOD FENCE

5	DPIRZ Rev3	Aug 18, 2023
4	DPIRZ Rev2	Jan 26, 2023
3	DPIRZ Rev1	July 20, 2022
2	DPIRZ Submission	April 29, 2022
1	Development Tracker Application	March 7, 2022
NO.	DESCRIPTION	DATE



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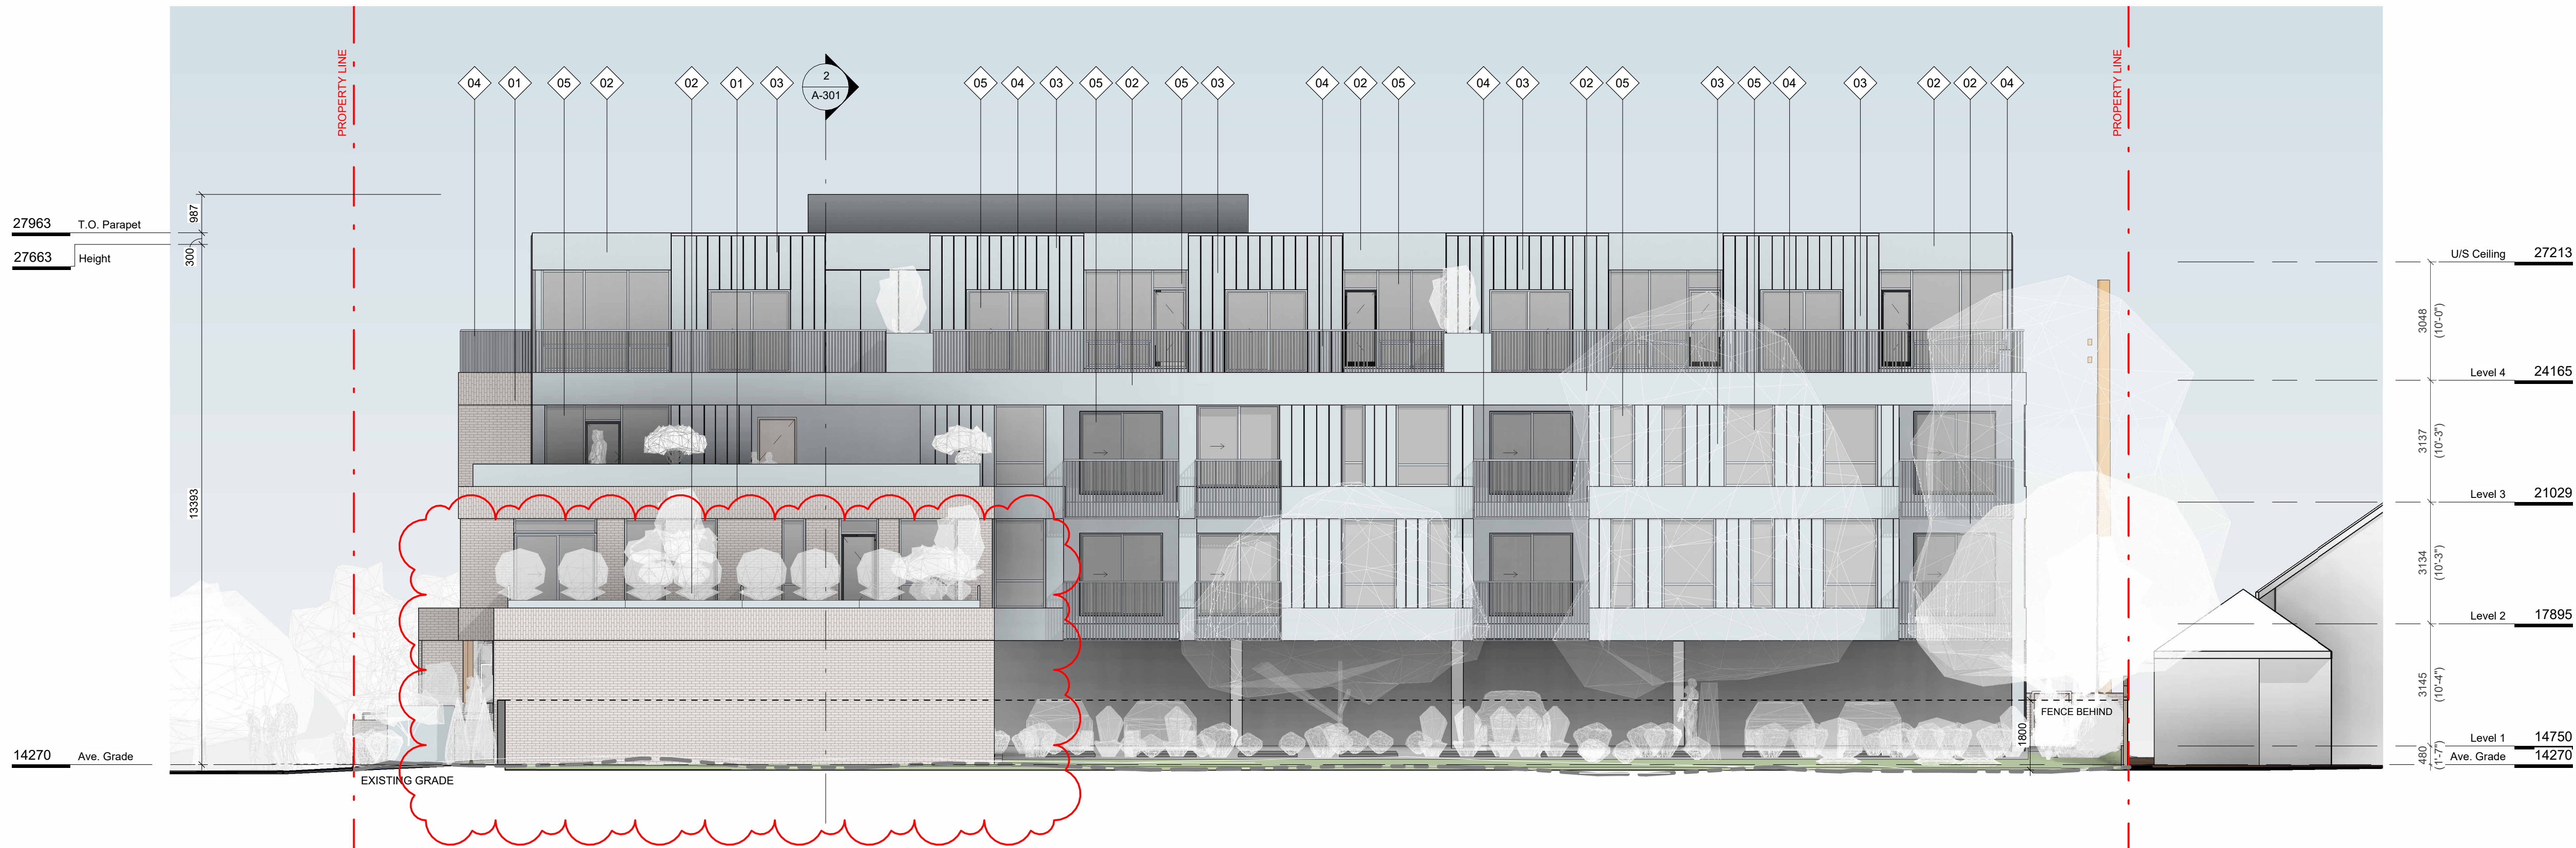
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Project 1733-1737 Fairfield Rd ARYZE		
Sheet Name EXTERIOR ELEVATIONS		
Date AUGUST 21, 2023		
Scale As indicated	Project # 2123	Revision Aug 18, 2023 5
Sheet # A-200		


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1 SE ELEVATION  
SCALE = 1 : 100




2 NE ELEVATION  
SCALE = 1 : 100

#### FINISH SCHEDULE

01. BRICK  
LIGHT FINISH
02. PREFINISHED METAL  
FLAT PANEL
03. PREFINISHED METAL  
STANDING SEAM
04. METAL PICKET GUARD
05. GLAZING
06. WOOD GRAIN FINISH
07. HORIZONTAL WOOD FENCE

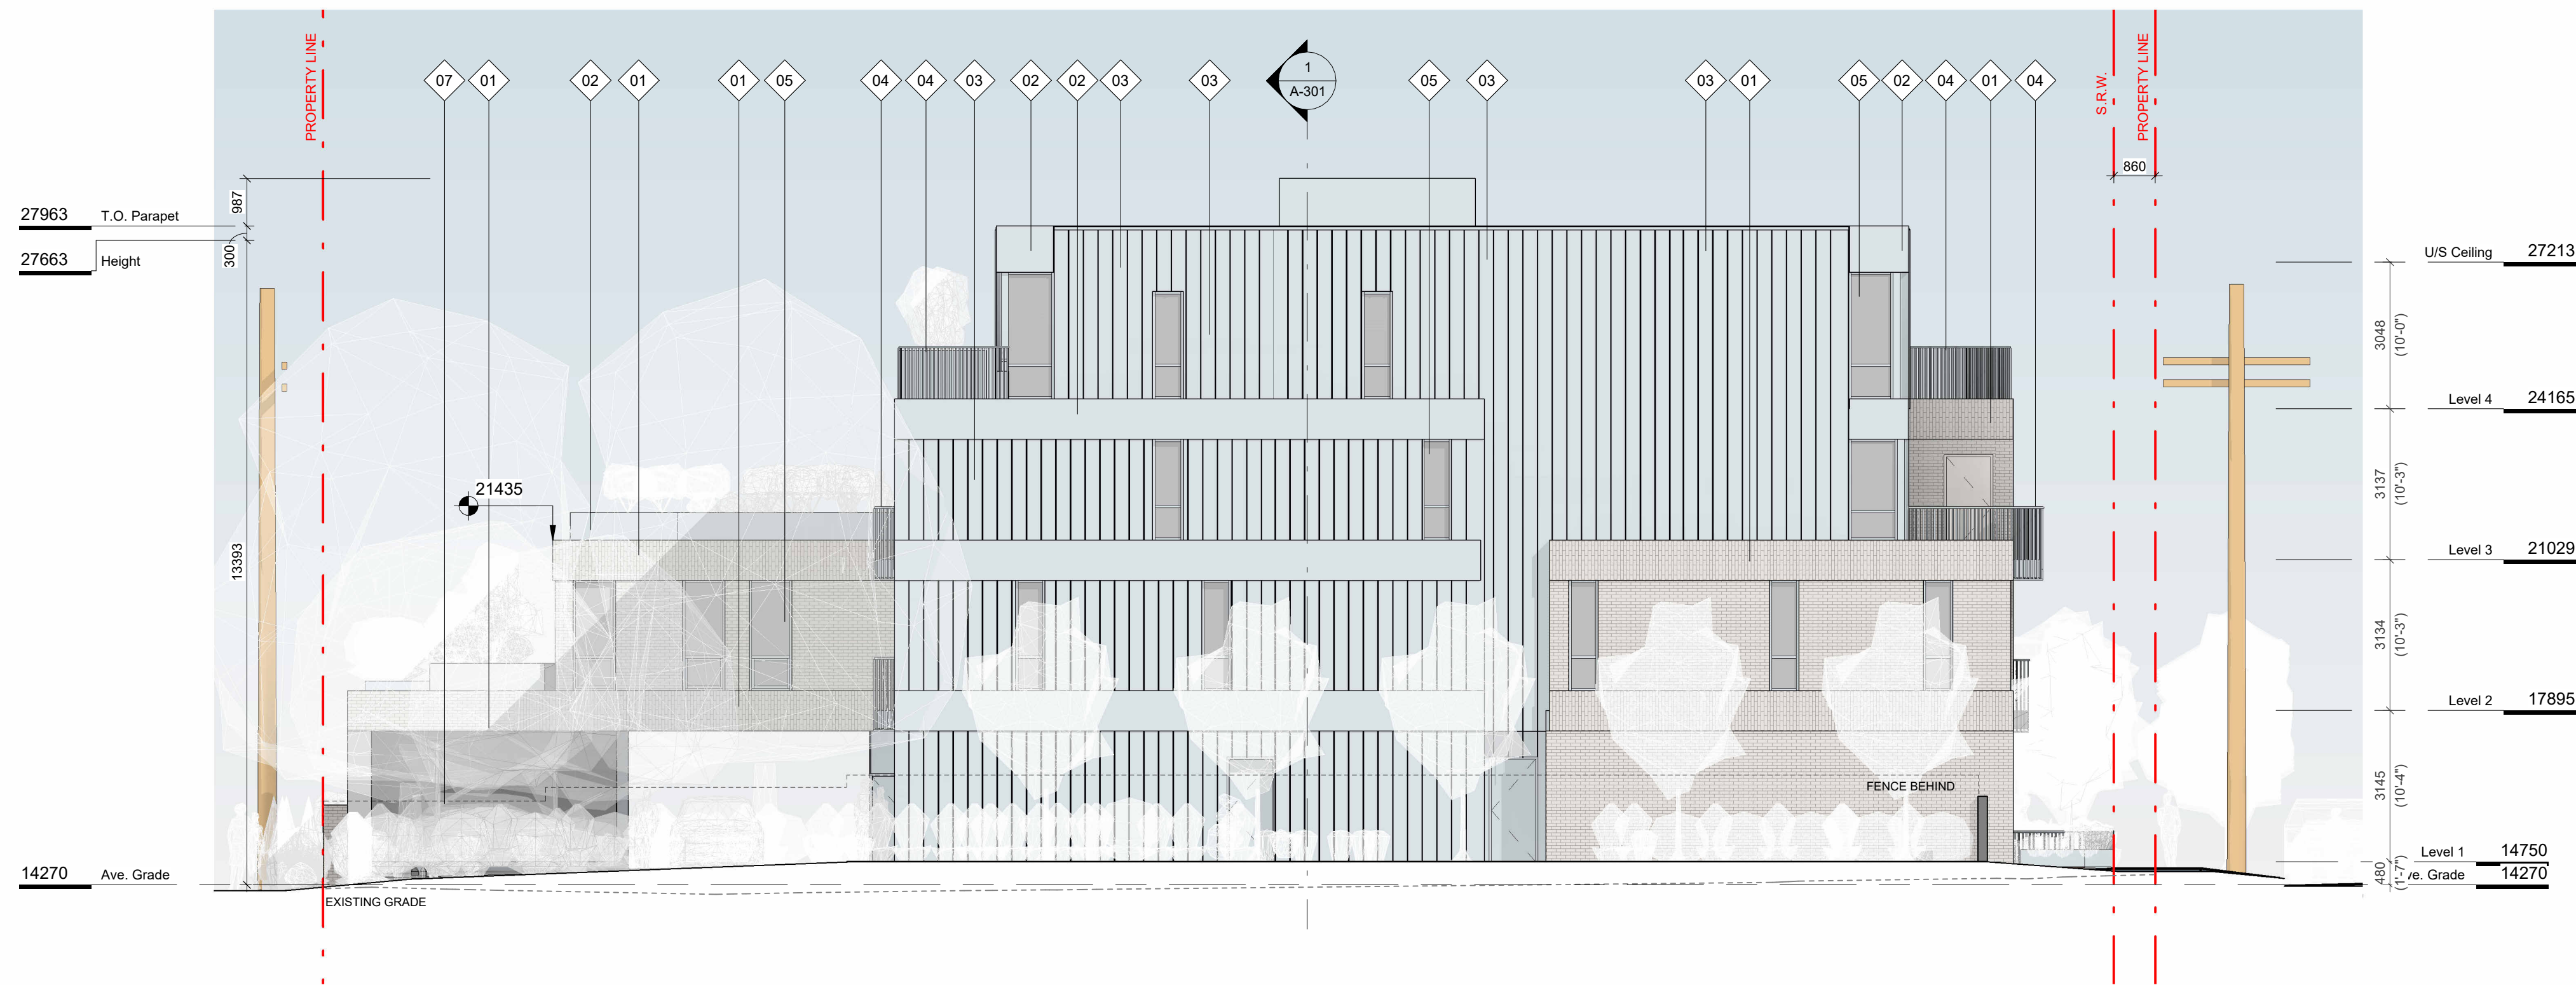5	DPIRZ Rev3	Aug 18, 2023
4	DPIRZ Rev2	Jan 26, 2023
3	DPIRZ Rev1	July 20, 2022
2	DPIRZ Submission	April 29, 2022
1	Development Tracker Application	March 7, 2022
NO.	DESCRIPTION	DATE

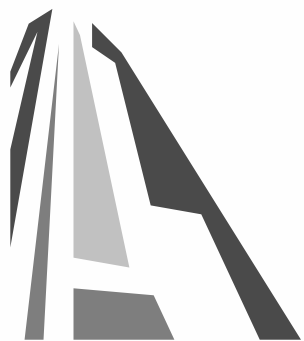

CASCADIA ARCHITECTS INC


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Project 1733-1737 Fairfield Rd ARYZE		
Sheet Name EXTERIOR ELEVATIONS		
Date	AUGUST 21, 2023	
Scale	As indicated	Project # 2123
	Revision	Aug 18, 2023 5
	Sheet #	A-201


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1 BUILDING SECTION 1  
SCALE = 1 : 100



2 BUILDING SECTION 2  
SCALE = 1 : 100

4	DPIRZ Rev2	Jan 26, 2023
3	DPIRZ Rev1	July 20, 2022
2	DPIRZ Submission	April 29, 2022
1	Development Tracker Application	March 7, 2022
NO.	DESCRIPTION	DATE

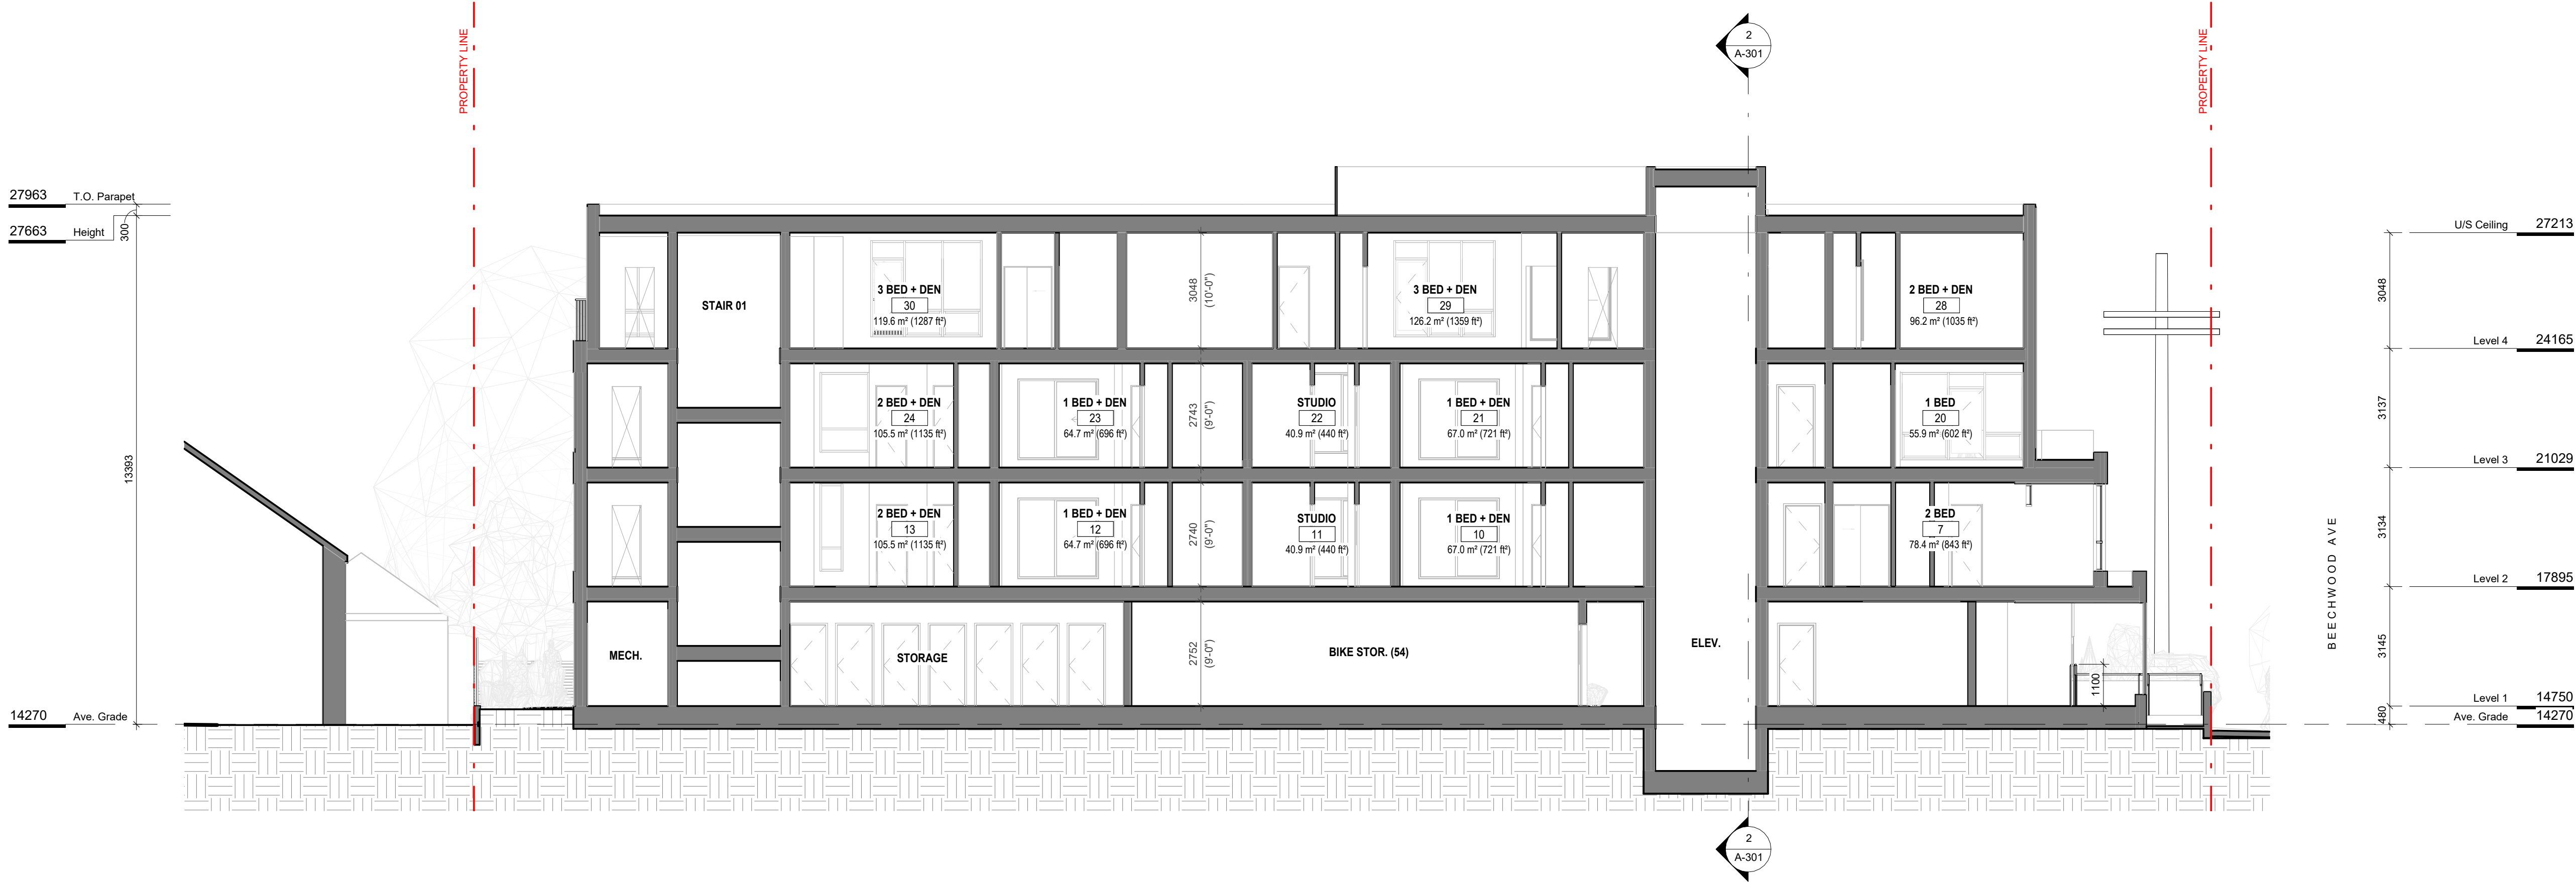
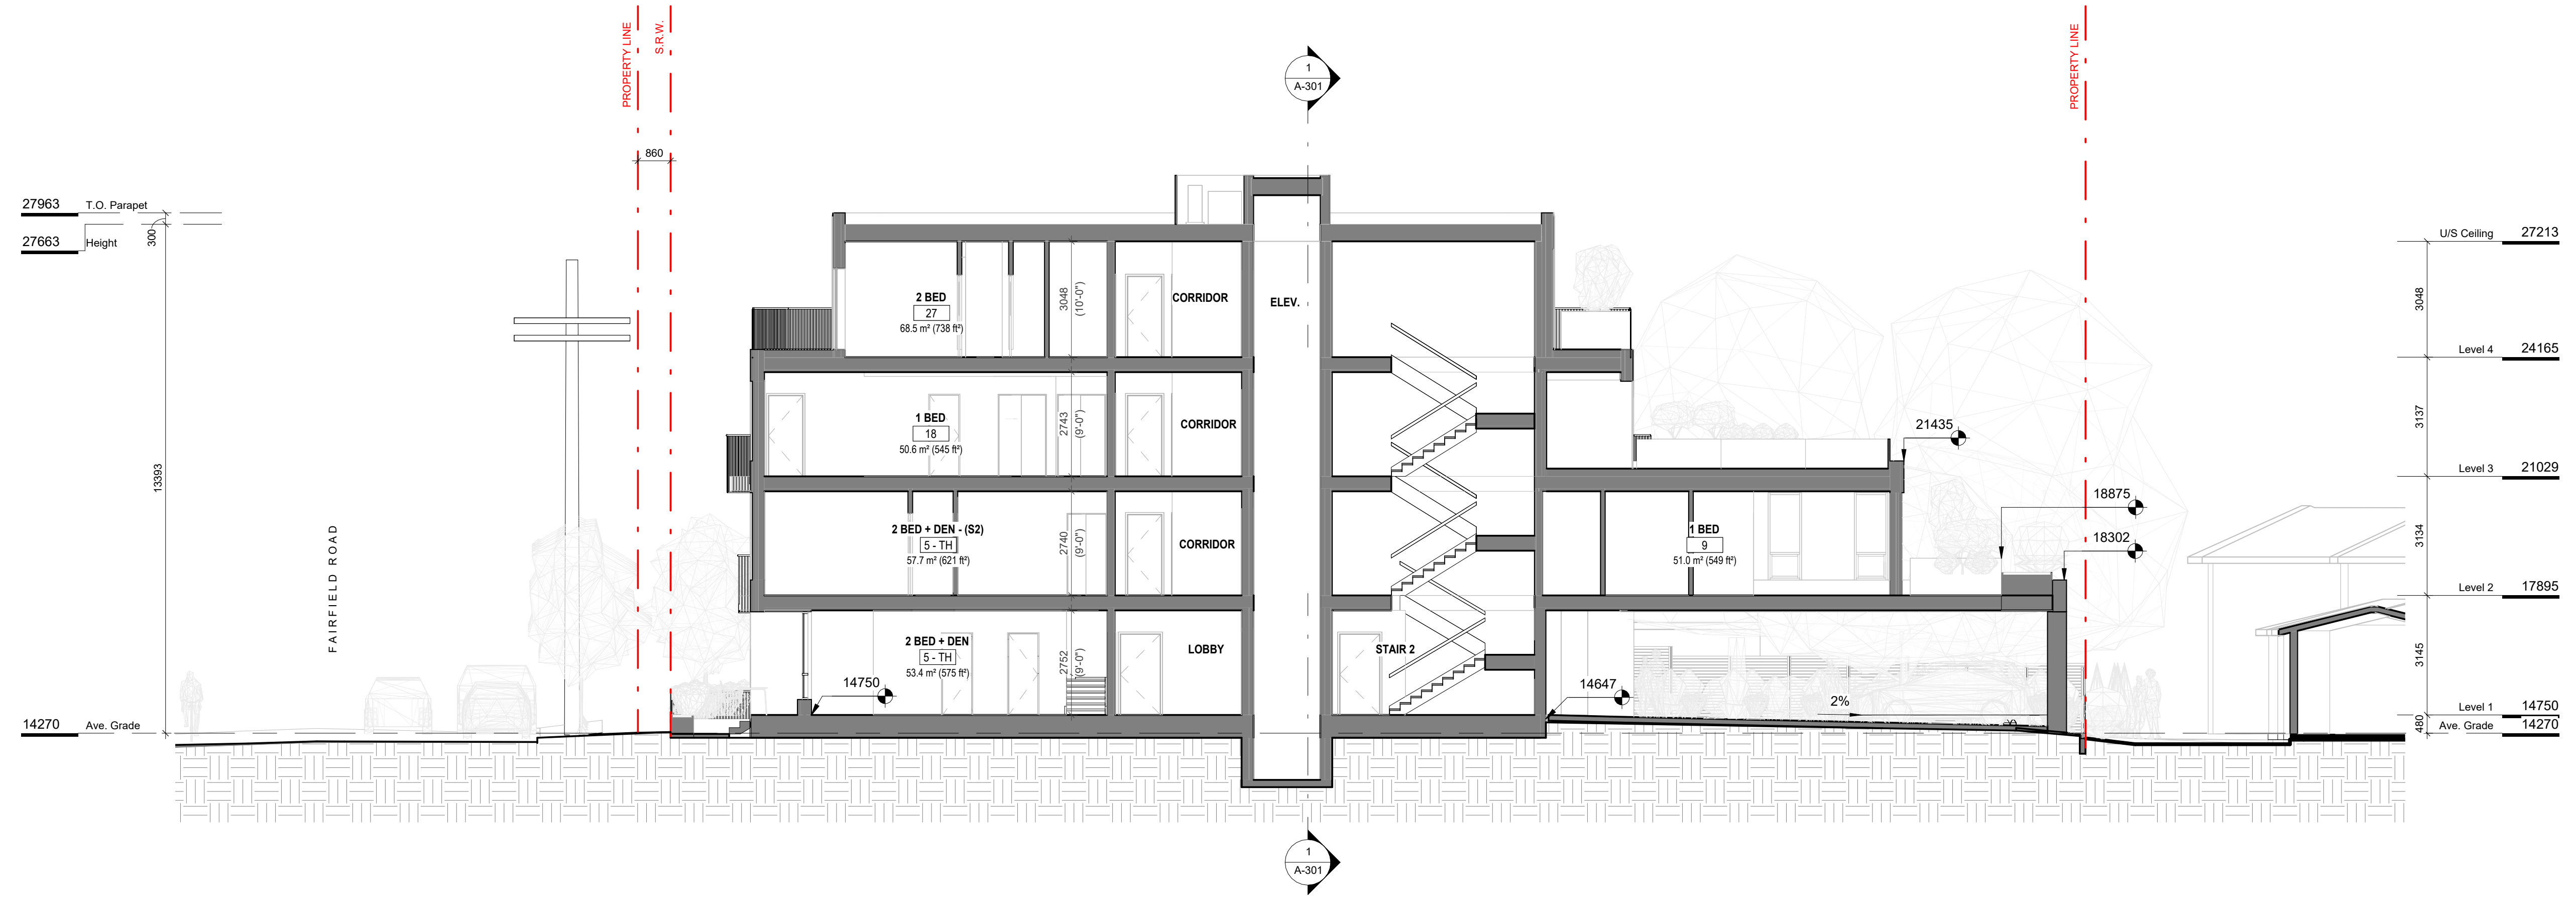
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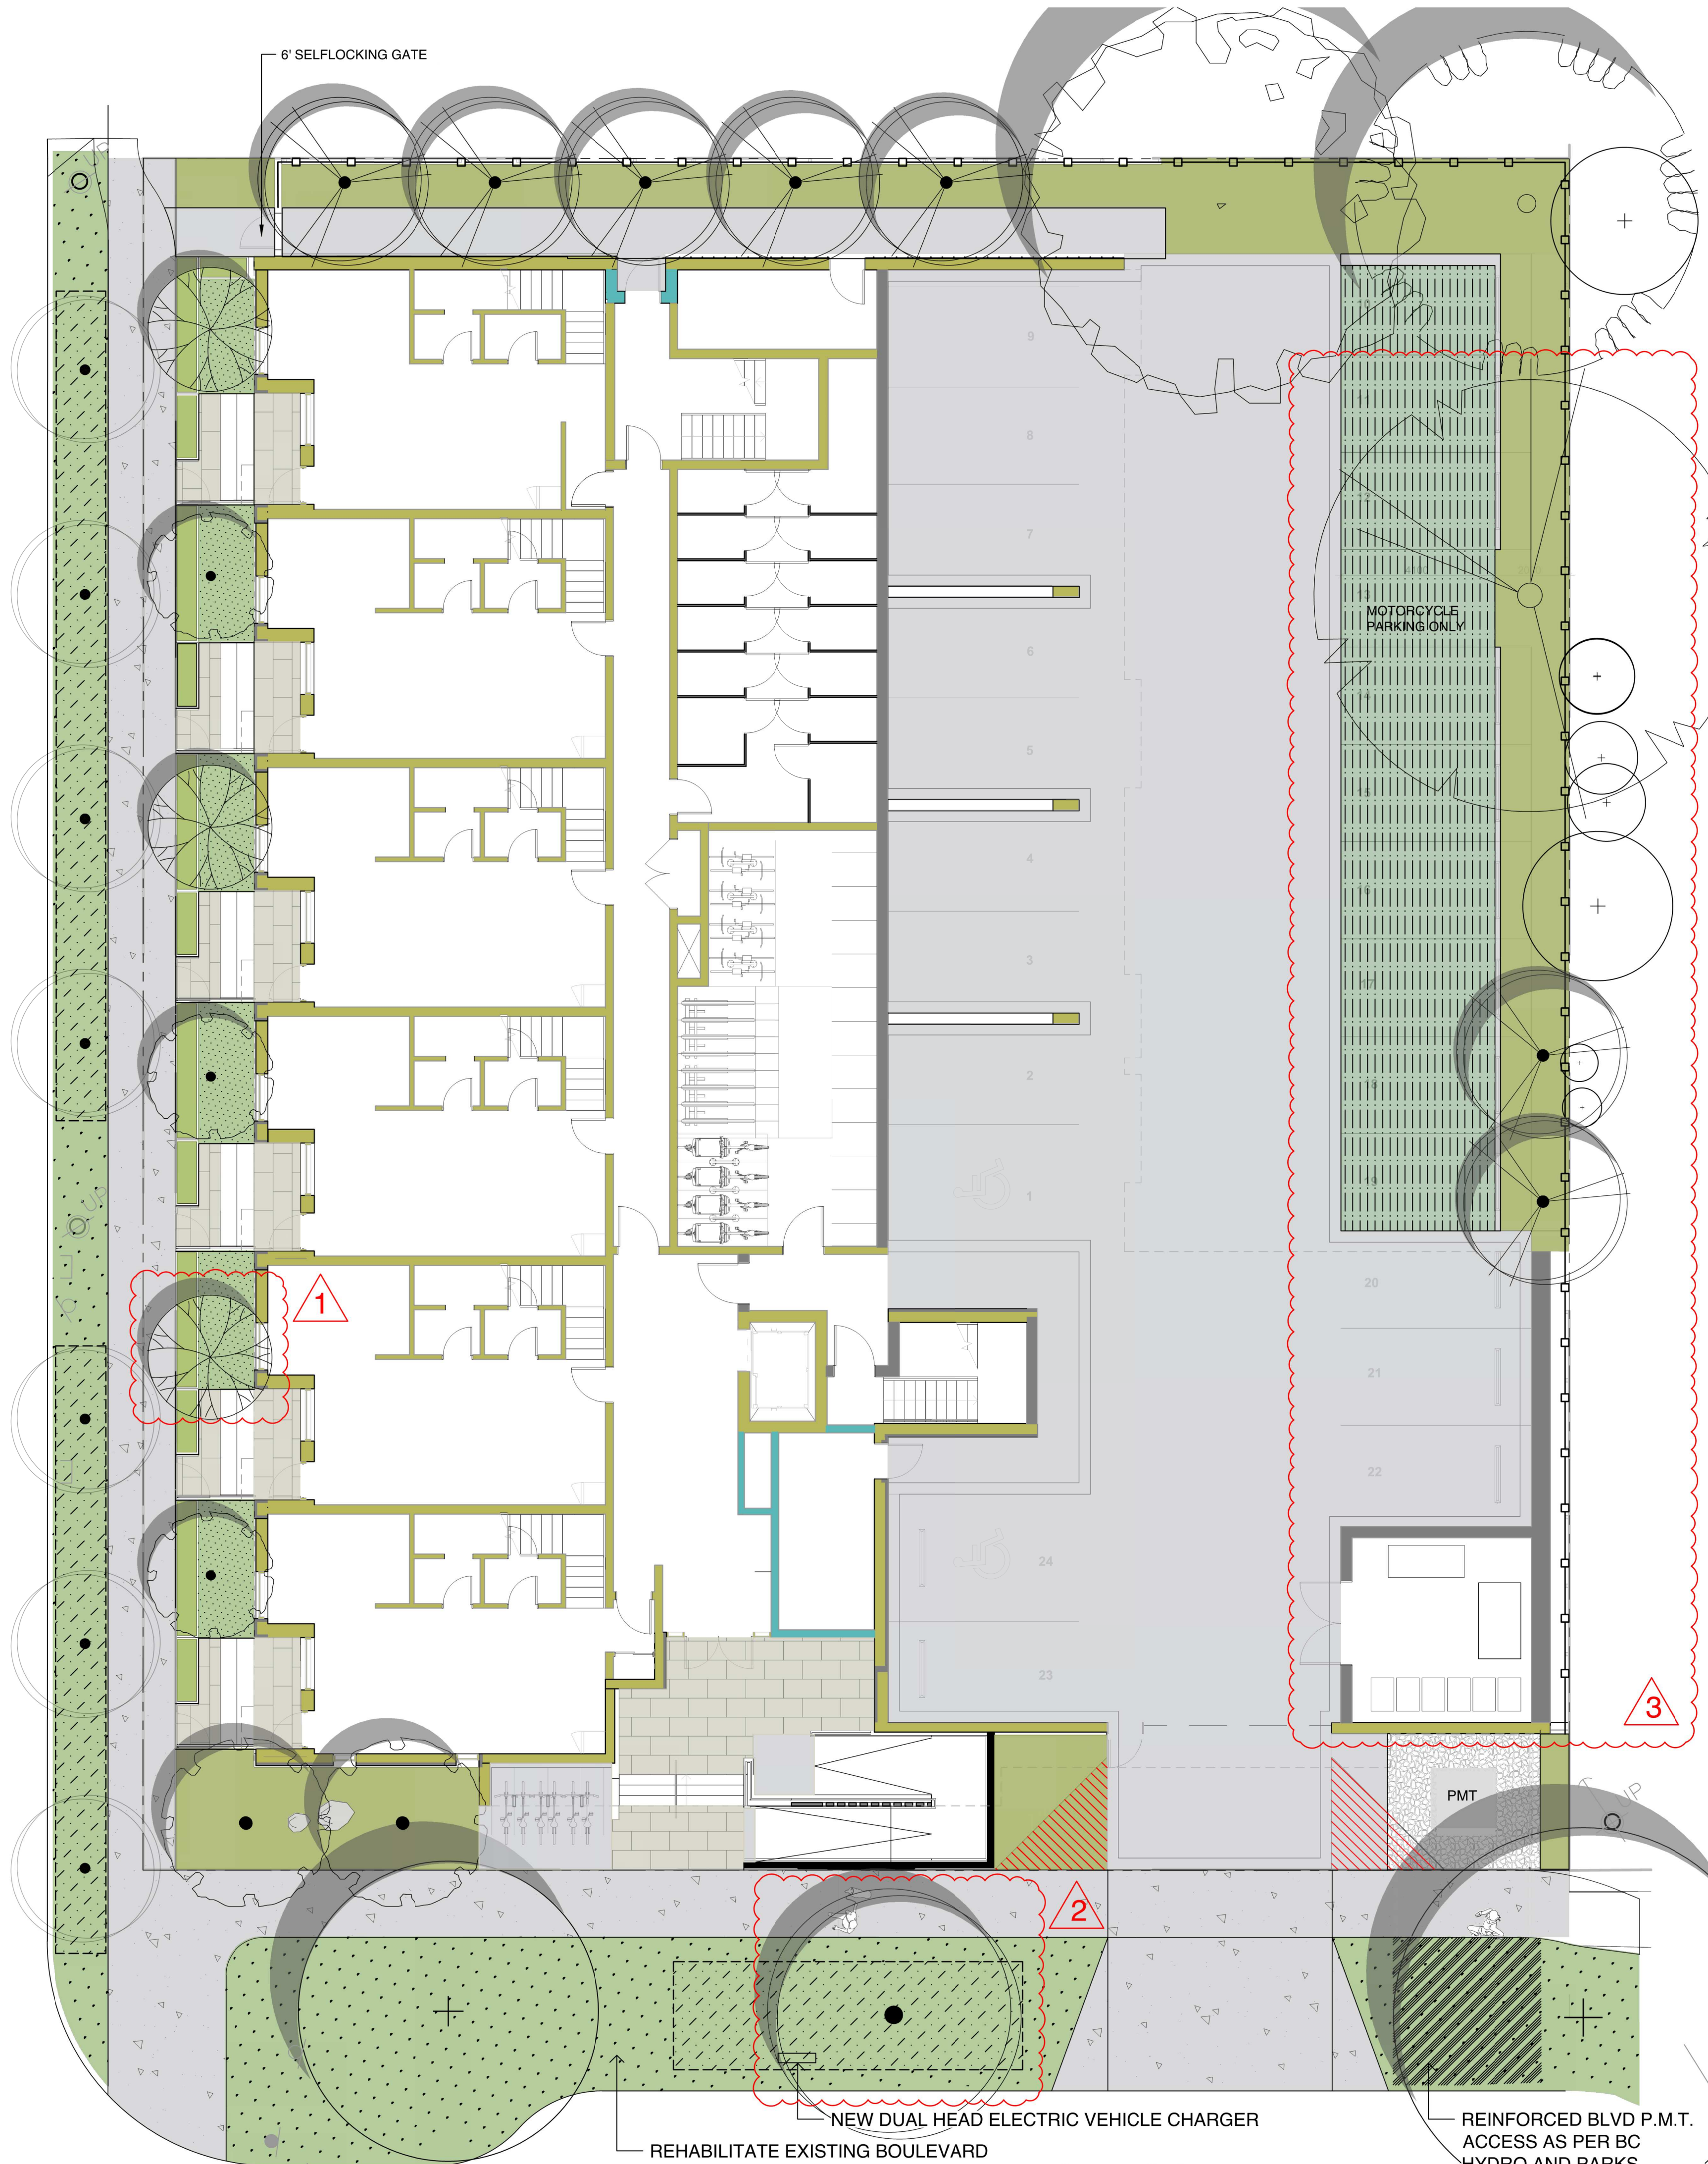
Project 1733-1737 Fairfield Rd ARYZE		
Sheet Name BUILDING SECTIONS		
Date AUGUST 21, 2023		
Scale 1 : 100	Project # 2123	
	Revision Jan 26, 2023	4
	Sheet # A-301	

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FAIRFIELD ROAD

BEECHWOOD AVENUE




LEGEND

- PROPERTY LINE  
ROOF OVERHANG
- ON-SITE LANDSCAPE AREA
- 1000 mm DEPTH PLANTING AREAS GROWING MEDIUM (MMCD)
  - 50 mm DEPTH MULCH
- RAISED PLANTER
- 450 mm DEPTH PLANTER GROWING MEDIUM
  - 50 mm DEPTH MULCH
- PARKING STALL PAVER
- NEWSTONE DORADO DRAIN PAVERS
  - COLOR: CHARCOAL
- GROUND FLOOR PATIO AND UPPER LEVEL BALCONY PAVER
- ARISTOKRAT™ SERIES
  - COLOR: CASCADE GRANITE
  - SIZE: 24" X 48"
- SOD MUNICIPAL BOULEVARD AREA
- 150 mm DEPTH HIGH TRAFFIC LAWN GROWING MEDIUM (MMCD)
  - SOD
- SOD MUNICIPAL BOULEVARD AREA
- 1000 mm DEPTH LOW TRAFFIC LAWN GROWING MEDIUM (MMCD)
  - SOD
- SOD ON SITE
- 1000 mm DEPTH PLANTING AREAS GROWING MEDIUM (MMCD) FOR LAWN AREA WITH TREES + SOD
  - 150 mm DEPTH HIGH TRAFFIC LAWN GROWING MEDIUM (MMCD) FOR AREA WITHOUT TREES + SOD
- MUNICIPAL SIDEWALK
- CIP CONCRETE WITH BROOM FINISH TO CITY OF VICTORIA MUNICIPAL STANDARDS
- CONCRETE PATH AND DRIVEWAY
- TREE PIT WITH 1000mm DEPTH GROWING MEDIUM FOR BOULEVARD TREES
- BIKE RACK
- SURFACE MOUNT ON CONCRETE PAD
- LANDSCAPE BOULDER
- VANCOUVER ISLAND GRANITE OR BASALT
- FENCE
- 6' HT SOLID CEDAR WOOD FENCE
  - STAIN: HEMLOCK GREY
- EXISTING BOULEVARD TREE TO BE RETAINED
- PROPOSED BOULEVARD TREE TO BE SPECIFIED BY CITY OF VICTORIA PARKS
- PROPOSED TREES

SITE PERMEABILITY

TOTAL SITE AREA 1703 m<sup>2</sup>  
LANDSCAPED AREA 223 m<sup>2</sup>  
PERMEABLE PAVED AREA 484 m<sup>2</sup>  
SITE PERMEABILITY RATIO: 41.6%

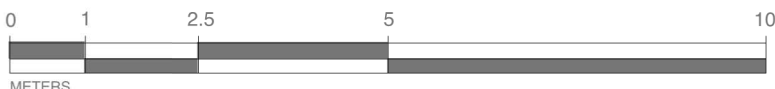


SITE PAVER SELECTION

FRONT PATIOS ON FAIRFIELD



ARISTOKRAT™ SERIES  
CASCADE GRANITE

PARKING STALLS

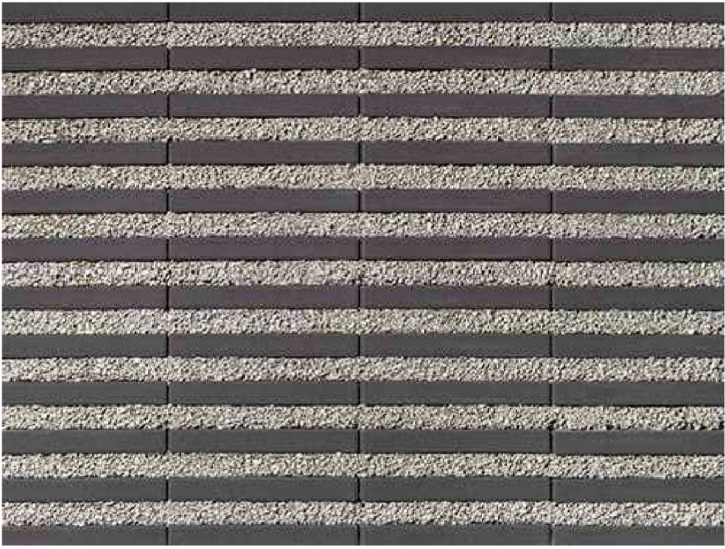

NEWSTONE DORADO DRAIN  
CHARCOAL

NOTES:

- BOULEVARD TREE PLANTING TO CITY OF VICTORIA STANDARDS, AS PER THE VICTORIA SUBDIVISION AND DEVELOPMENT SERVICES BYLAW NO 12-043, AND CITY OF VICTORIA SUPPLEMENTARY STANDARD DETAIL DRAWING S- P4
- REHABILITATE EXISTING BOULEVARD TO CITY OF VICTORIA STANDARDS, AS PER THE VICTORIA SUBDIVISION AND DEVELOPMENT SERVICES BYLAW NO 12-042 AND SUPPLEMENTARY STANDARD DETAIL DRAWING SD-P3
- SEPARATE IRRIGATION SERVICE AND AUTOMATIC IRRIGATION TO BE PROVIDED TO MUNICIPAL BOULEVARD TREES IF TREE LOCATIONS ARE APPROVED BY CITY ENGINEERING AND BC HYDRO

**PLEASE NOTE: THERE IS INSUFFICIENT SETBACK FROM PROPOSED UTILITIES. IF WE USE SMALL CALIPER TREES (20mm) WITH A ROOT BALL OF 400 mm DIAMETER MAXIMUM, WE BELIEVE WE CAN ACCOMMODATE THE REQUIRED 1.0m OFFSET FROM THE ROOT BALL TO THE BC HYDRO UTILITY BUT NOT THE REQUIRED OFFSET TO THE PROPOSED STREET LIGHT CONDUIT.**



1608 Camosun Street, Victoria BC V8T 3E6  
Info@biophilialcollective.ca 250 590 1156

OWNER/CLIENT:

ARYZE DEVELOPMENTS

PROJECT ADDRESS:

1733 FAIRFIELD,  
VICTORIA, BC

DESIGNED BY: BIANCA BODLEY  
DRAWN BY: KIM TANG

NO.	ISSUE	YYMM/DD
1	ISSUED FOR DEVELOPMENT TRACKER	22/03/04
2	ISSUED FOR RZ/DP	22/05/02
3	ISSUED FOR COORDINATION	22/07/18
4	ISSUED FOR RZ/DP	22/07/20
5	ISSUED FOR RZ/DP RESUBMISSION	23/01/24
6	ISSUED FOR RZ/DP RESUBMISSION	2023/08/18

SEAL



NORTH ARROW



DRAWING TITLE:

LANDSCAPE SITE PLAN


DWG NO:

SCALE: 1:100

L1




Dorado Drain Paver

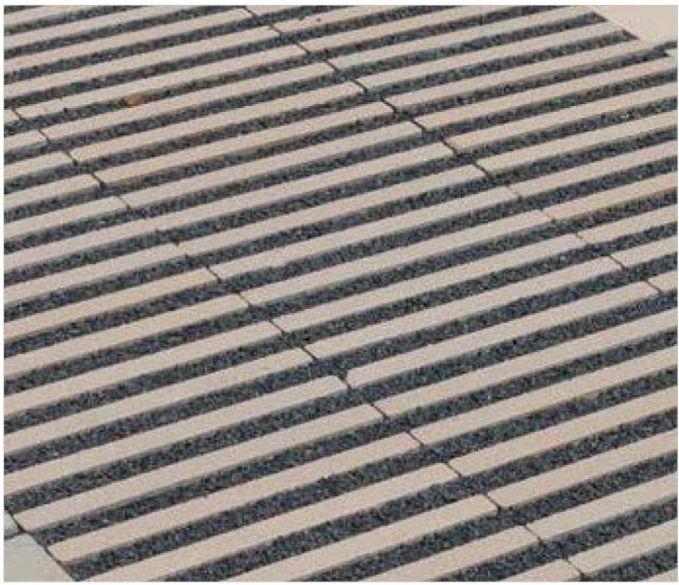

Installation

FULL EXFILTRATION

- 1 Dorado Drain Paver
- 2 Joint filling material ASTM No 8 (CSA 2.5-10mm) aggregate
- 3 Bedding course 1 1/5" to 2" (40 to 50 mm) ASTM No 8 (CSA 2.5-10mm) aggregate
- 4 Base course 4" (100mm) ASTM No 57 (CSA 5-28mm) aggregate foundation thickness
- 5 Subbase course ASTM No 2 (CSA 40-80mm) aggregate
- 6 Geotextile (optional)
- 7 Subgrade
- 8 Concrete Edge

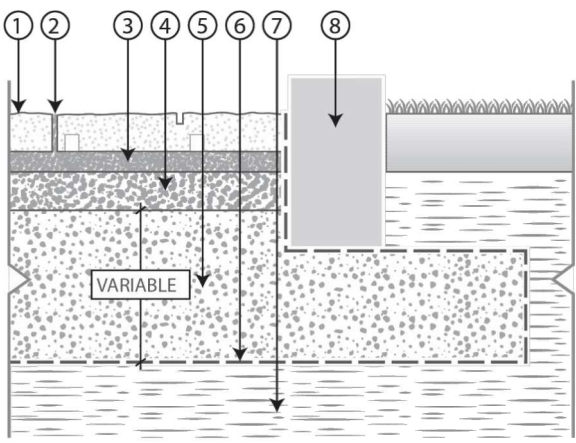


SINGLE COLOURS



PARTIAL EXFILTRATION

- 1 Dorado Drain Paver
- 2 Joint filling material ASTM No 8 (CSA 2.5-10mm) aggregate
- 3 Bedding course 1 1/5" to 2" (40 to 50 mm) ASTM No 8 (CSA 2.5-10mm) aggregate
- 4 Base course 4" (100mm) ASTM No 57 (CSA 5-28mm) aggregate foundation thickness
- 5 Subbase course ASTM No 2 (CSA 40-80mm) aggregate
- 6 Geotextile (optional)
- 7 Subgrade
- 8 Concrete Edge
- 9 Perforated drain connected to drainage system

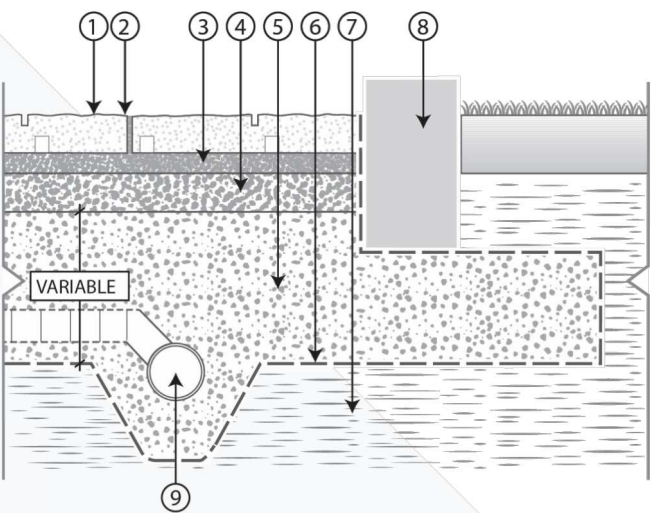

Sizes




Specifications

**WEIGHT**  
3-1/8 (80 mm); approx. 23.8 lbs/ft<sup>2</sup> (120kg/m<sup>2</sup>)

NO EXFILTRATION

- 1 Dorado Drain Paver
- 2 Joint filling material ASTM No 8 (CSA 2.5-10mm) aggregate
- 3 Bedding course 1 1/5" to 2" (40 to 50 mm) ASTM No 8 (CSA 2.5-10mm) aggregate
- 4 Base course 4" (100mm) ASTM No 57 (CSA 5-28mm) aggregate foundation thickness
- 5 Subbase course ASTM No 2 (CSA 40-80mm) aggregate
- 6 Geotextile (optional)
- 7 Subgrade
- 8 Concrete Edge
- 9 Perforated drain connected to drainage system
- 10 Impermeable membrane

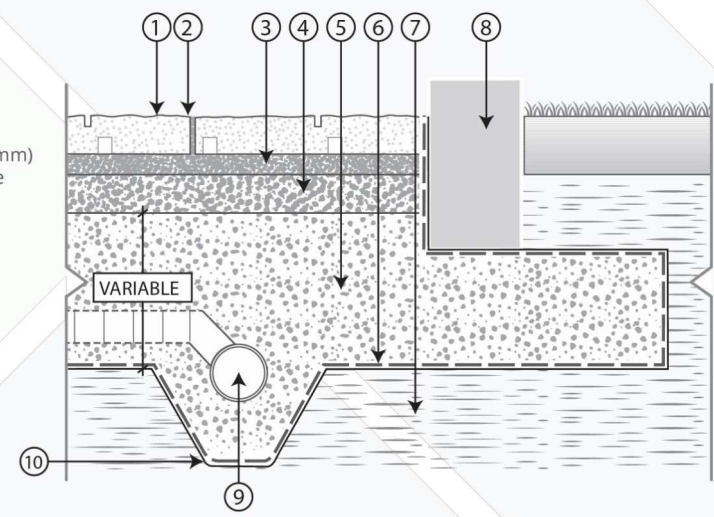

RECOMMENDED APPLICATIONS



7393 HOPCOTT ROAD, DELTA, BC V4G 1B7 | 604-332-4030

NEWSTONEGROUP.CA

Colours in photographs are not exact representations, but are given to provide close reference. Measurements and product dimension are nominal.

Aristokrat® Series

The Aristokrat® Series is perfect for terraces, roof decks, patios, court yards, swimming pools, water features or any traditional hardscape areas. Porcelain slabs deliver performance, style, versatility and are resistant to staining, fading, marking, chemicals and extreme weather. It is the ideal choice for residential or commercial outdoor applications but can also be used indoors for aesthetic continuity.



Aristokrat® Series



Available At



COLORS



1608 Camosun Street, Victoria BC V8T 3E6  
Info@biophiliacollective.ca 250 590 1156

OWNER/CLIENT:

ARYZE DEVELOPMENTS

PROJECT ADDRESS:

1733 FAIRFIELD,  
VICTORIA, BC


DESIGNED BY: BIANCA BODLEY  
DRAWN BY: KIM TANG

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5	ISSUED FOR RZ/ DP RESUBMISSION	23/01/24
6	ISSUED FOR RZ/ DP RESUBMISSION	2023/08/18

SEAL



NORTH ARROW

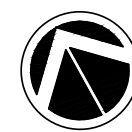

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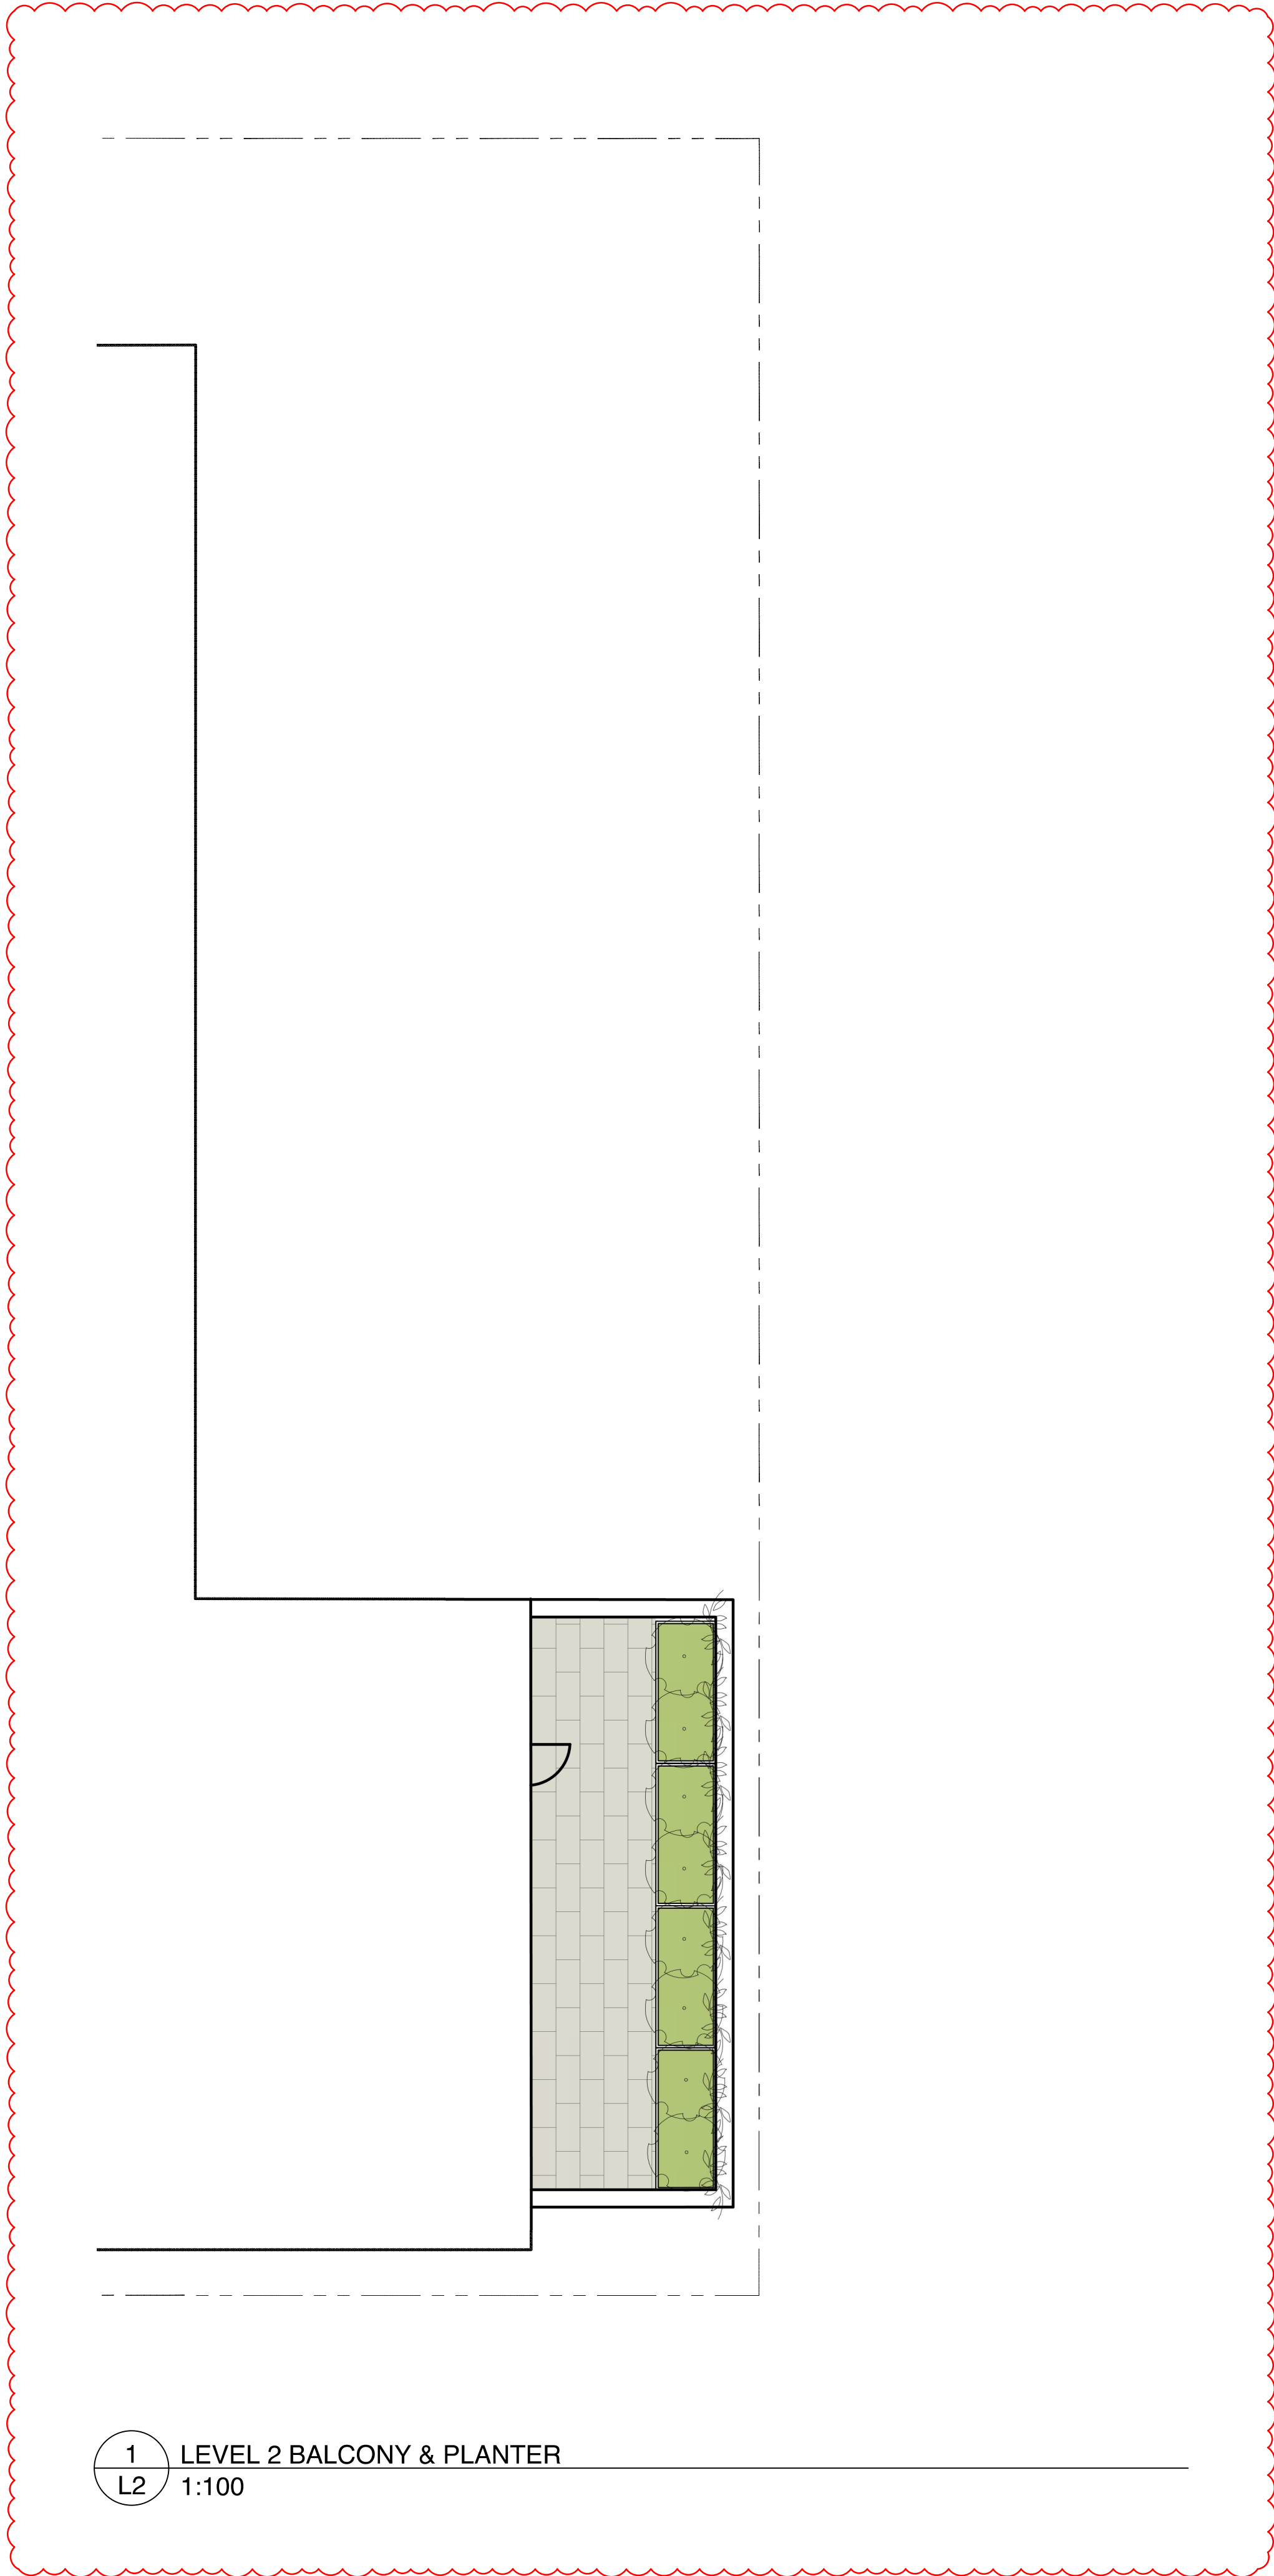
PAVEMENT  
SPECIFICATIONS

DWG NO:

SCALE: NTS


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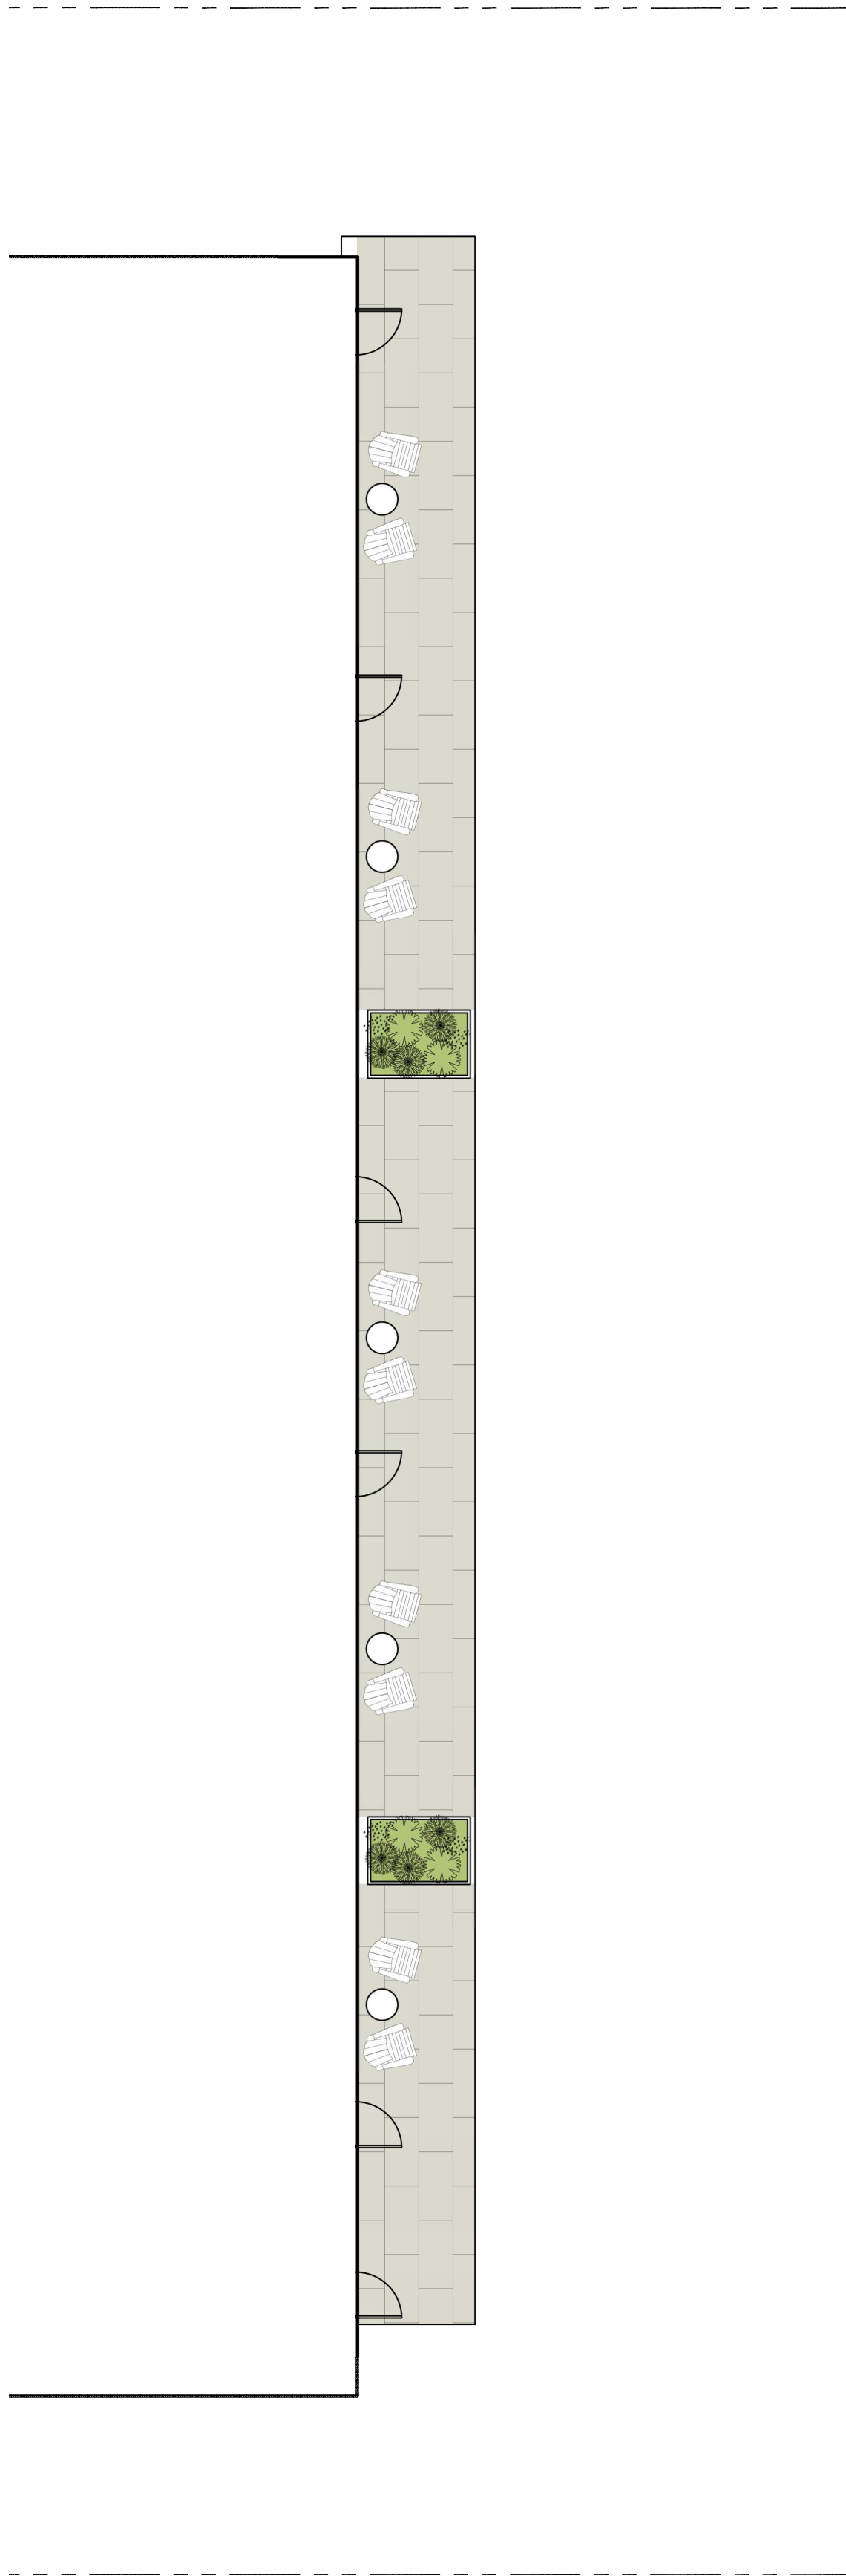


1  
L2  
LEVEL 2 BALCONY & PLANTER  
1:100


4



2  
L2  
LEVEL 3 BALCONY & PLANTER  
1:100

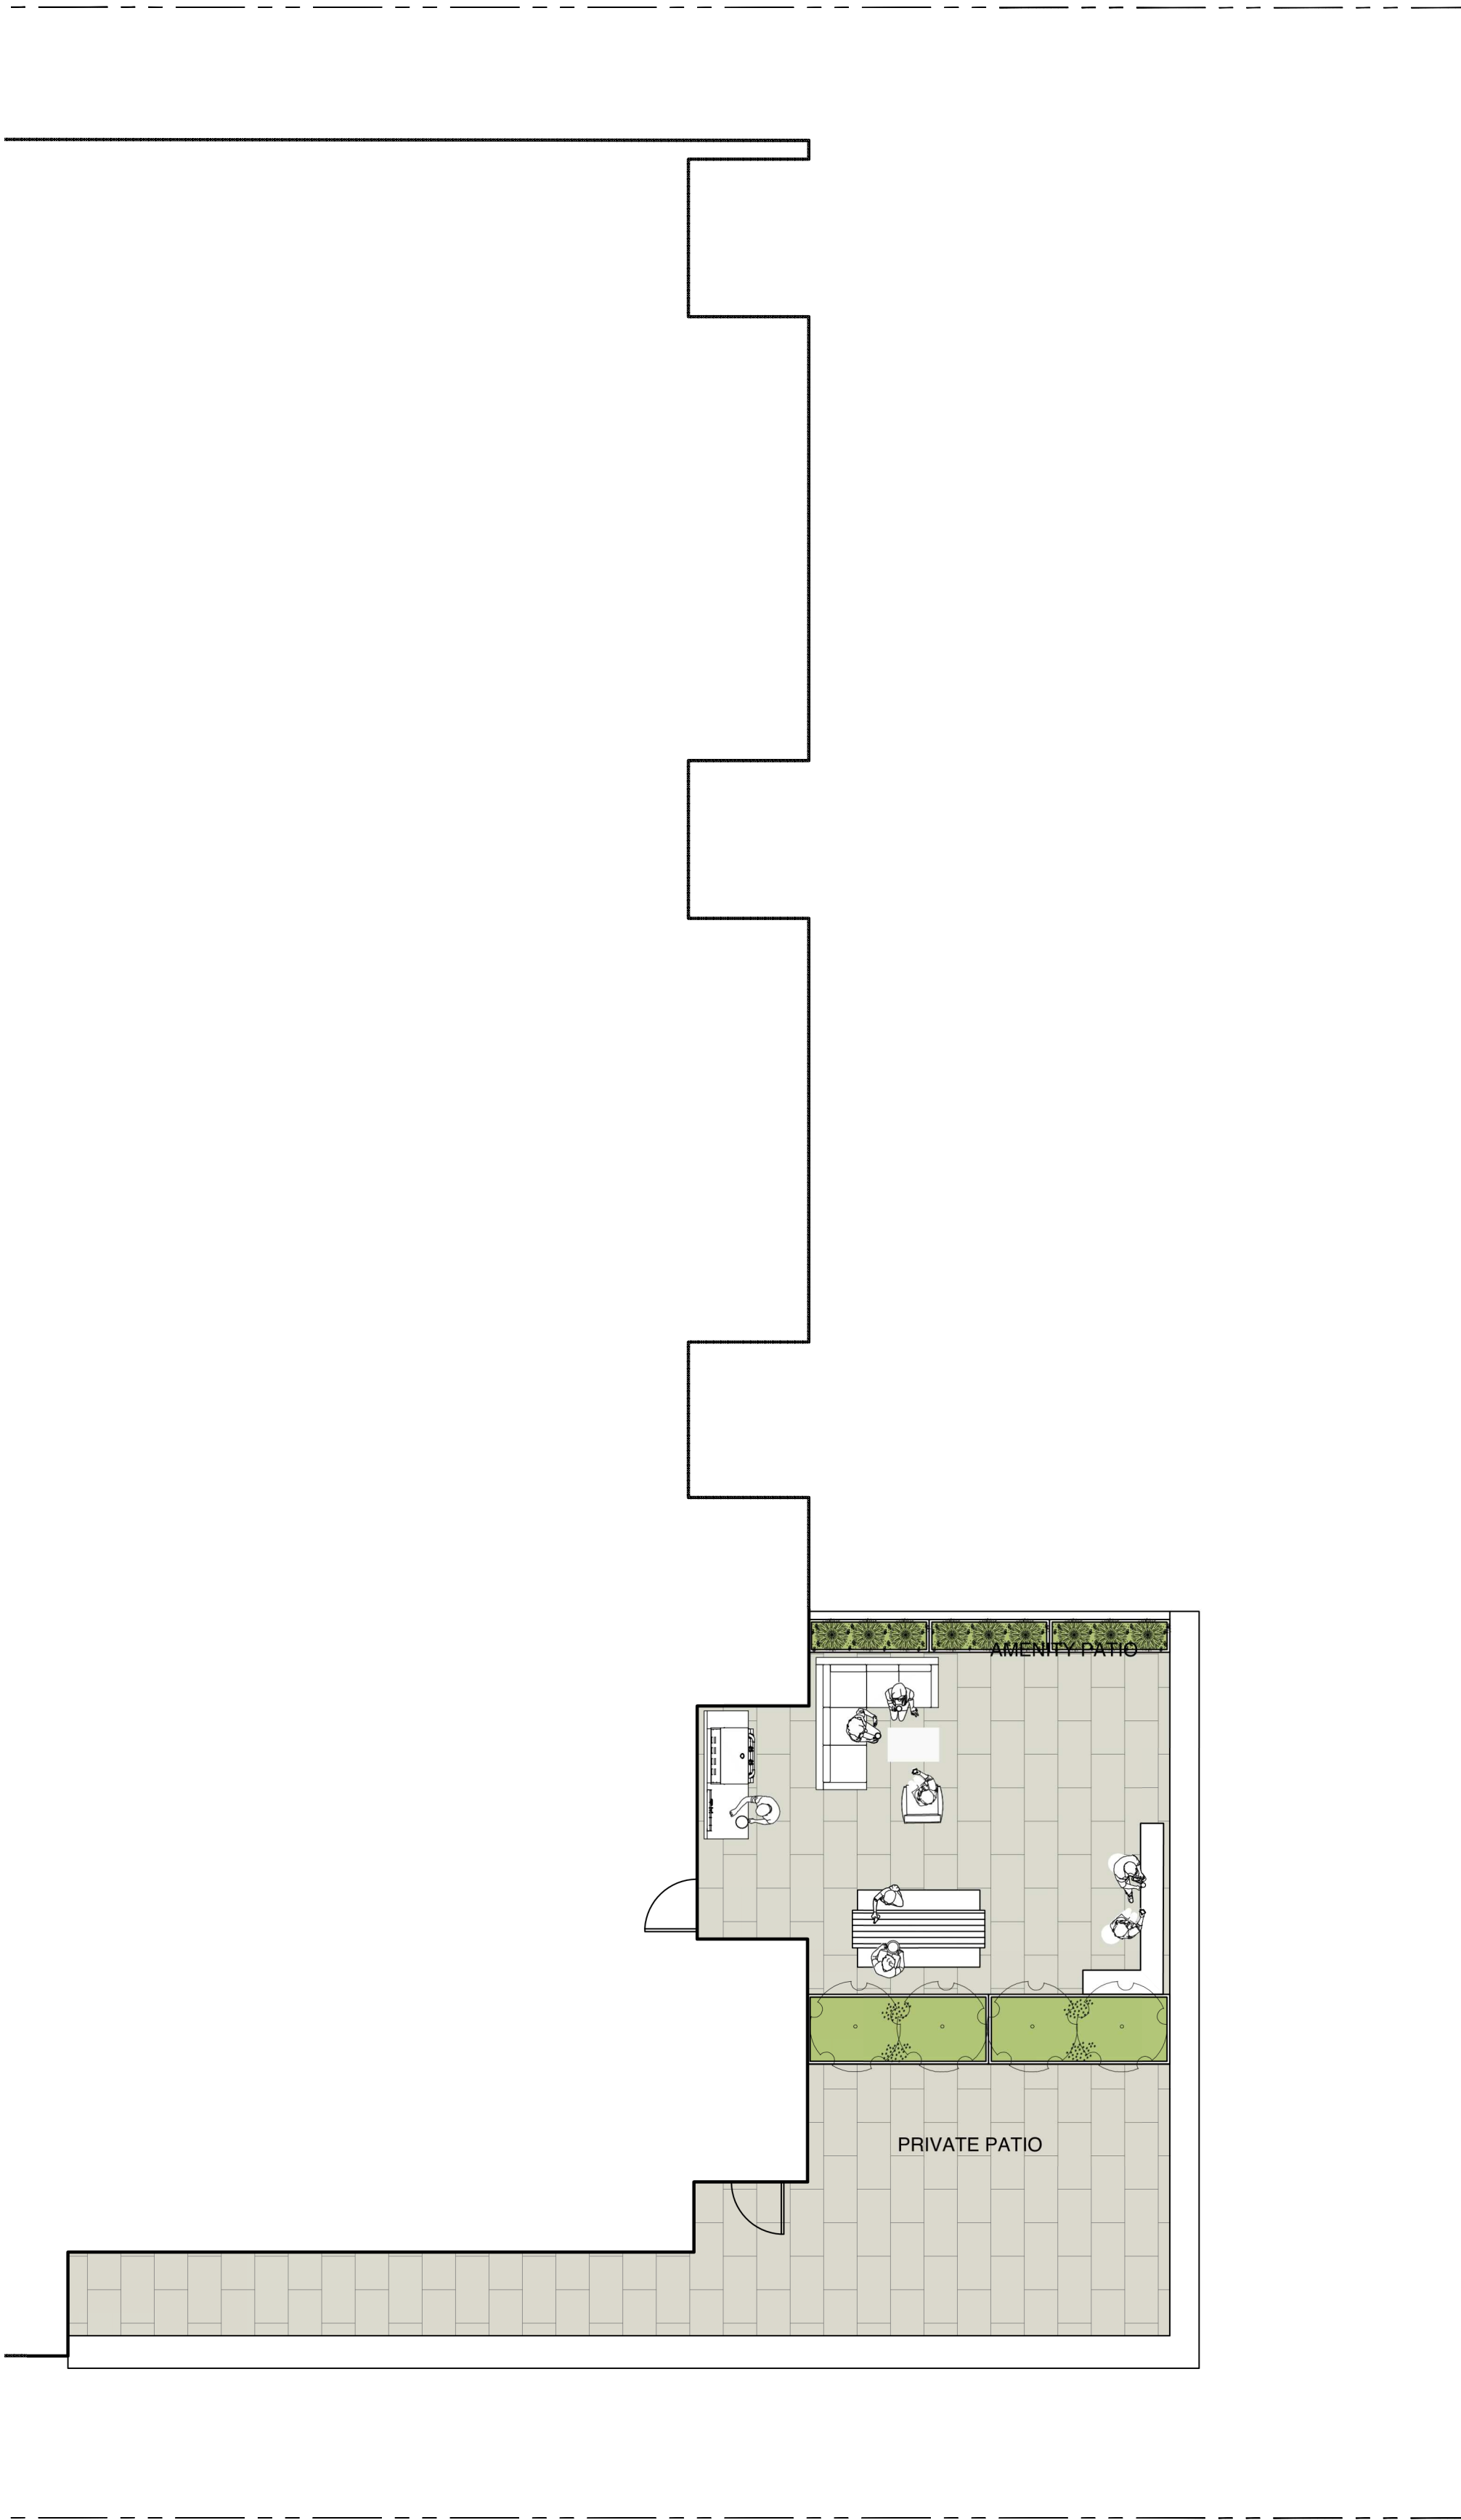

3  
L2  
LEVEL 4 BALCONY & PLANTER  
1:100

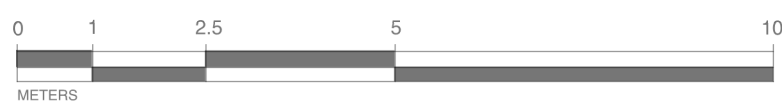

1608 Camosun Street, Victoria BC V8T 3E6  
Info@biophilialcollective.ca 250 590 1156

OWNER/CLIENT:  
**ARYZE DEVELOPMENTS**

PROJECT ADDRESS:  
**1733 FAIRFIELD,  
VICTORIA, BC**

DESIGNED BY: **BIANCA BODLEY**  
DRAWN BY: **KIM TANG**

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5	ISSUED FOR RZ/ DP RESUBMISSION	23/01/24
6	ISSUED FOR RZ/ DP RESUBMISSION	2023/08/18

SEAL



NORTH ARROW



DRAWING TITLE:  
**UPPER LEVEL  
LANDSCAPE PLANS**

DWG NO:

SCALE: **AS NOTED**

**L2**



Previous tag #	Tag ID #	Surveyed ? (Yes / No)	Location (On, Off, Shared, City)	Name		Critical root zone		Condition		Retention Suitability (on-site trees)	Relative tolerance	General field observations/remarks	Tree retention comments	Retention status				
				Bytech protected ? (Yes / No / City)	Common	Botanical	dbh (cm)	Ht (m)	Radius (m)						Drip-line radius (m)	Health	Structural	
M1	Yes	City	City	Purple leaf cherry plum	<i>Prunus cerasifera</i>	47	10	5.9	5	Good	Fair/good	Moderate	Multiple stems form at 2m above grade - included bark at main stem union with active response growth. Historic pruning wounds with associated surface decay.	Project arborist to supervise all excavation required within the critical root zone. Will be heavily impacted by the installation of the proposed water line. *Possible for transplant.	Retain			
M2	Yes	City	City	Pacific sunset maple	<i>Acer truncatum</i> <i>Pacific sunset</i>	5	6	0.6	1	Good	Good	Moderate	Recently planted - still staked, included bark at stem unions. Multiple stems form at 4m above grade - no major weaknesses visible at stem unions. Historic pruning wounds with associated surface decay.	Project arborist to supervise all excavation required within the critical root zone.	Remove*			
M3	Yes	City	City	Purple leaf cherry plum	<i>Prunus cerasifera</i>	26	6	3.3	4	Good	Fair/good	Moderate	Codominant stems form at 3m above grade - included bark - not active. Historic pruning wounds with associated decay.	Located within the footprint of the proposed building.	Retain			
313	3383	Yes	On	No	Fig	<i>Ficus sp.</i>	11.8	6	5	2	2	Good	Fair	Unsuitable	Good	Growing within close proximity to existing building. Multiple stems form at 1m above grade - narrow angles of attachment, stems topped and decayed with southing bark. Topped historically at 7m above grade for overhead utilities clearance. Stem decay with southing bark.	Located within the footprint of the proposed building.	Remove
316	3384	Yes	On	No	Japanese maple	<i>Acer palmatum</i>	3, 3	6	5	1.2	1.5	Good	Fair	Unsuitable	Moderate	Topped historically at 5m above grade - multiple regrowth leaders form at topping locations.	Located within the footprint of the proposed building.	Remove
317	3385	Yes	On	Yes	Pacific dogwood	<i>Cornut nuttallii</i>	28, 23, 34	32	8	8.8	4	Fair	Fair/poor	Unsuitable	Moderate	Flowering cherry, multiple stems firm at 2m above grade - narrow angles of attachment, main stem topped historically at 4m above grade - large topping wound.	Located within the footprint of the proposed building. Will be heavily impacted by excavation required to construct the foundation of the proposed building. Will also be impacted by excavation required to construct the proposed parking stall.	Remove
322	3386	Yes	On	Yes	Golden chain tree	<i>Laburnum sp.</i>	21, 28	7	6.3	4	Fair	Poor	Unsuitable	Poor	Flowering cherry, codominant stems form at base - crossing at 5m above grade, large heading cuts.	Will be heavily impacted by excavation required to construct the foundation of the proposed building. Will be heavily impacted by excavation required to construct the foundation of the proposed building.	Remove	
321	3387	Yes	On	Yes	Apple	<i>Malus sp.</i>	14, 23	10	3.9	3	Fair	Poor	Unsuitable	Moderate	Growing within a hedge row of 5 yew trees spaced less than 1m apart.	Will be heavily impacted by excavation required to construct the foundation of the proposed building. Will be heavily impacted by excavation required to construct the foundation of the proposed building.	Remove	
334	3388	Yes	On	Yes	Cherry	<i>Prunus sp.</i>	55	5	6.9	4	Fair	Fair/poor	Unsuitable	Moderate	Growing within a hedge row of 5 yew trees spaced less than 1m apart.	Will be heavily impacted by excavation required to construct the foundation of the proposed building. Will be heavily impacted by excavation required to construct the foundation of the proposed building.	Remove	
298	3389	Yes	On	Yes	Cherry	<i>Prunus sp.</i>	19, 25	5	4.6	4	Fair	Fair/poor	Unsuitable	Moderate	Growing within a hedge row of 13 yew trees spaced less than 1m apart.	Will be heavily impacted by excavation required to construct the foundation of the proposed building. Will be heavily impacted by excavation required to construct the foundation of the proposed building.	Remove	
3390	Yes	On	No	English yew	<i>Taxus baccata</i>	10.8, 8.6	5	2.5	1	Fair	Fair/poor	Unsuitable	Moderate	Growing within a hedge row of 5 yew trees spaced less than 1m apart.	Will be heavily impacted by excavation required to construct the foundation of the proposed building. Will be heavily impacted by excavation required to construct the foundation of the proposed building.	Remove		
3391	Yes	On	No	English yew	<i>Taxus baccata</i>	5, 5.5	5	1.4	1	Fair	Fair/poor	Unsuitable	Moderate	Growing within a hedge row of 5 yew trees spaced less than 1m apart.	Will be heavily impacted by excavation required to construct the foundation of the proposed building. Will be heavily impacted by excavation required to construct the foundation of the proposed building.	Remove		
3392	Yes	On	No	English yew	<i>Taxus baccata</i>	10, 9.8	5	2.5	1	Fair	Fair/poor	Unsuitable	Moderate	Growing within a hedge row of 5 yew trees spaced less than 1m apart.	Will be heavily impacted by excavation required to construct the foundation of the proposed building. Will be heavily impacted by excavation required to construct the foundation of the proposed building.	Remove		
3393	Yes	On	No	English yew	<i>Taxus baccata</i>	8.8, 4.3	5	1.9	1	Fair	Fair/poor	Unsuitable	Moderate	Growing within a hedge row of 5 yew trees spaced less than 1m apart.	Will be heavily impacted by excavation required to construct the foundation of the proposed building. Will be heavily impacted by excavation required to construct the foundation of the proposed building.	Remove		
3394	Yes	On	No	English yew	<i>Taxus baccata</i>	10, 9.9, 9.4	5	2.6	1	Fair	Fair/poor	Unsuitable	Moderate	Growing within a hedge row of 13 yew trees spaced less than 1m apart.	Will be heavily impacted by excavation required to construct the foundation of the proposed building. Will be heavily impacted by excavation required to construct the foundation of the proposed building.	Remove		
3395	Yes	On	No	English yew	<i>Taxus baccata</i>	11, 16	5	2.8	1	Fair	Fair/poor	Unsuitable	Moderate	Growing within a hedge row of 13 yew trees spaced less than 1m apart.	Will be heavily impacted by excavation required to construct the foundation of the proposed building. Will be heavily impacted by excavation required to construct the foundation of the proposed building.	Remove		
3396	Yes	On	No	English yew	<i>Taxus baccata</i>	18	5	2.3	1	Fair	Fair/poor	Unsuitable	Moderate	Growing within a hedge row of 13 yew trees spaced less than 1m apart.	Will be heavily impacted by excavation required to construct the foundation of the proposed building. Will be heavily impacted by excavation required to construct the foundation of the proposed building.	Remove		
3397	Yes	On	No	English yew	<i>Taxus baccata</i>	12, 8	5	2.1	1	Fair	Fair/poor	Unsuitable	Moderate	Growing within a hedge row of 13 yew trees spaced less than 1m apart.	Will be heavily impacted by excavation required to construct the foundation of the proposed building. Will be heavily impacted by excavation required to construct the foundation of the proposed building.	Remove		
3398	Yes	On	No	English yew	<i>Taxus baccata</i>	10, 10.8, 8.6	5	2.6	1	Fair	Fair/poor	Unsuitable	Moderate	Growing within a hedge row of 13 yew trees spaced less than 1m apart.	Will be heavily impacted by excavation required to construct the foundation of the proposed building. Will be heavily impacted by excavation required to construct the foundation of the proposed building.	Remove		
3399	Yes	On	No	English yew	<i>Taxus baccata</i>	14, 8	5	2.4	1	Fair	Fair/poor	Unsuitable	Moderate	Growing within a hedge row of 13 yew trees spaced less than 1m apart.	Will be heavily impacted by excavation required to construct the foundation of the proposed building. Will be heavily impacted by excavation required to construct the foundation of the proposed building.	Remove		
3400	Yes	On	No	English yew	<i>Taxus baccata</i>	12, 5	5	1.9	1	Fair	Fair/poor	Unsuitable	Moderate	Growing within a hedge row of 13 yew trees spaced less than 1m apart.	Will be heavily impacted by excavation required to construct the foundation of the proposed building. Will be heavily impacted by excavation required to construct the foundation of the proposed building.	Remove		
3401	Yes	On	No	English yew	<i>Taxus baccata</i>	8.8, 5.5	5	2	1	Fair	Fair/poor							

FAIRFIELD ROAD

1660 1ST

EX: G-420-DP-THRU: 1660 1ST

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Previous tag #	Tag or ID #	Surveyed? (Yes / No)	Location (On, Off, Shaded, City)	Bylaw protected? (Yes / No / City)	Name		Critical root zone dimensions			Condition		Retention Suitability (conifers, trees)	Relative tolerance	General field observations/remarks	Tree retention comments	Retention status
					Common	Botanical	dbh (cm)	Ht (m)	Radius (m)	Drip-line radius (m)	Health					
	OS2	Yes	Off	No	Emerald cedar	<i>Thuja occidentalis</i> 'smaragd'	10-	4	1.3	0.5	Fair	Fair	Moderate	Juvenile hedge tree growing within narrow planting strip.	"Parking stall proposed within the crz. Project arborist to supervise all excavation required within the crz."	Retain*
	OS3	Yes	Off	No	Honey locust	<i>Gleditsia triacanthos</i>	10-	8	1.3	2	Good	Good	Moderate	Juvenile hedge tree growing within narrow planting strip.	"Project arborist to supervise all excavation required within the crz. Project arborist to supervise all excavation required within the crz."	Retain
	OS4	Yes	Off	No	Emerald cedar	<i>Thuja occidentalis</i> 'smaragd'	5.5, 5.5-	5	1.4	1	Good	Fair	Moderate	Multiple stems hedge tree growing within narrow planting strip.	"Parking stall proposed within the crz. Project arborist to supervise all excavation required within the crz."	Retain
	OS5	Yes	Off	No	Emerald cedar	<i>Thuja occidentalis</i> 'smaragd'	8, 8, 10, 4-	5	2.5	1	Good	Fair	Moderate	Multiple stems hedge tree growing within narrow planting strip.	"Parking stall proposed within the crz. Project arborist to supervise all excavation required within the crz. Project arborist to supervise all excavation required within the crz."	Retain*
	OS6	Yes	Off	No	Cherry	<i>Prunus</i> sp.	8, 6, 6-	5	1.9	1	Good	Fair	Moderate	Flowering cherry, growing within narrow planting strip.	"Will be heavily impacted by excavation required to construct the proposed parking stalls. Project arborist to supervise all excavation required within the crz."	Retain*
	Hedge 2	Yes	On	No	Emerald cedar	<i>Thuja occidentalis</i> 'smaragd'	5, 10cm	5	0.5	0.5	Good	Fair	Moderate	Hedge row consisting of 14 individual stems. No bylaw stems.	"Project arborist to supervise all excavation required within the crz."	Remove
	OS7	Yes	Off	No	Japanese maple	<i>Acer palmatum</i>	5.5, 5, 4.4	5	1.4	2	Good	Fair	Moderate	Multiple stems form an S, 5m above grade.	"Parking stall proposed within the crz. Possible for retention or transplanted elsewhere. Project arborist to supervise all excavation required within the crz."	Retain
	3422	No	On	No	Windmill palm	<i>Trachycarpus fortunei</i>	29	4	3.0	2	Good	Fair	Unsuitable	Crown raised approx. 50%.	"Project arborist to supervise all excavation required within the crz."	Retain*


MUNICIPAL TREE FOR REMOVAL

DESIGNED BY: BIANCA BODLEY  
DRAWN BY: KIM TANG

SCALE: 1:150


# L3



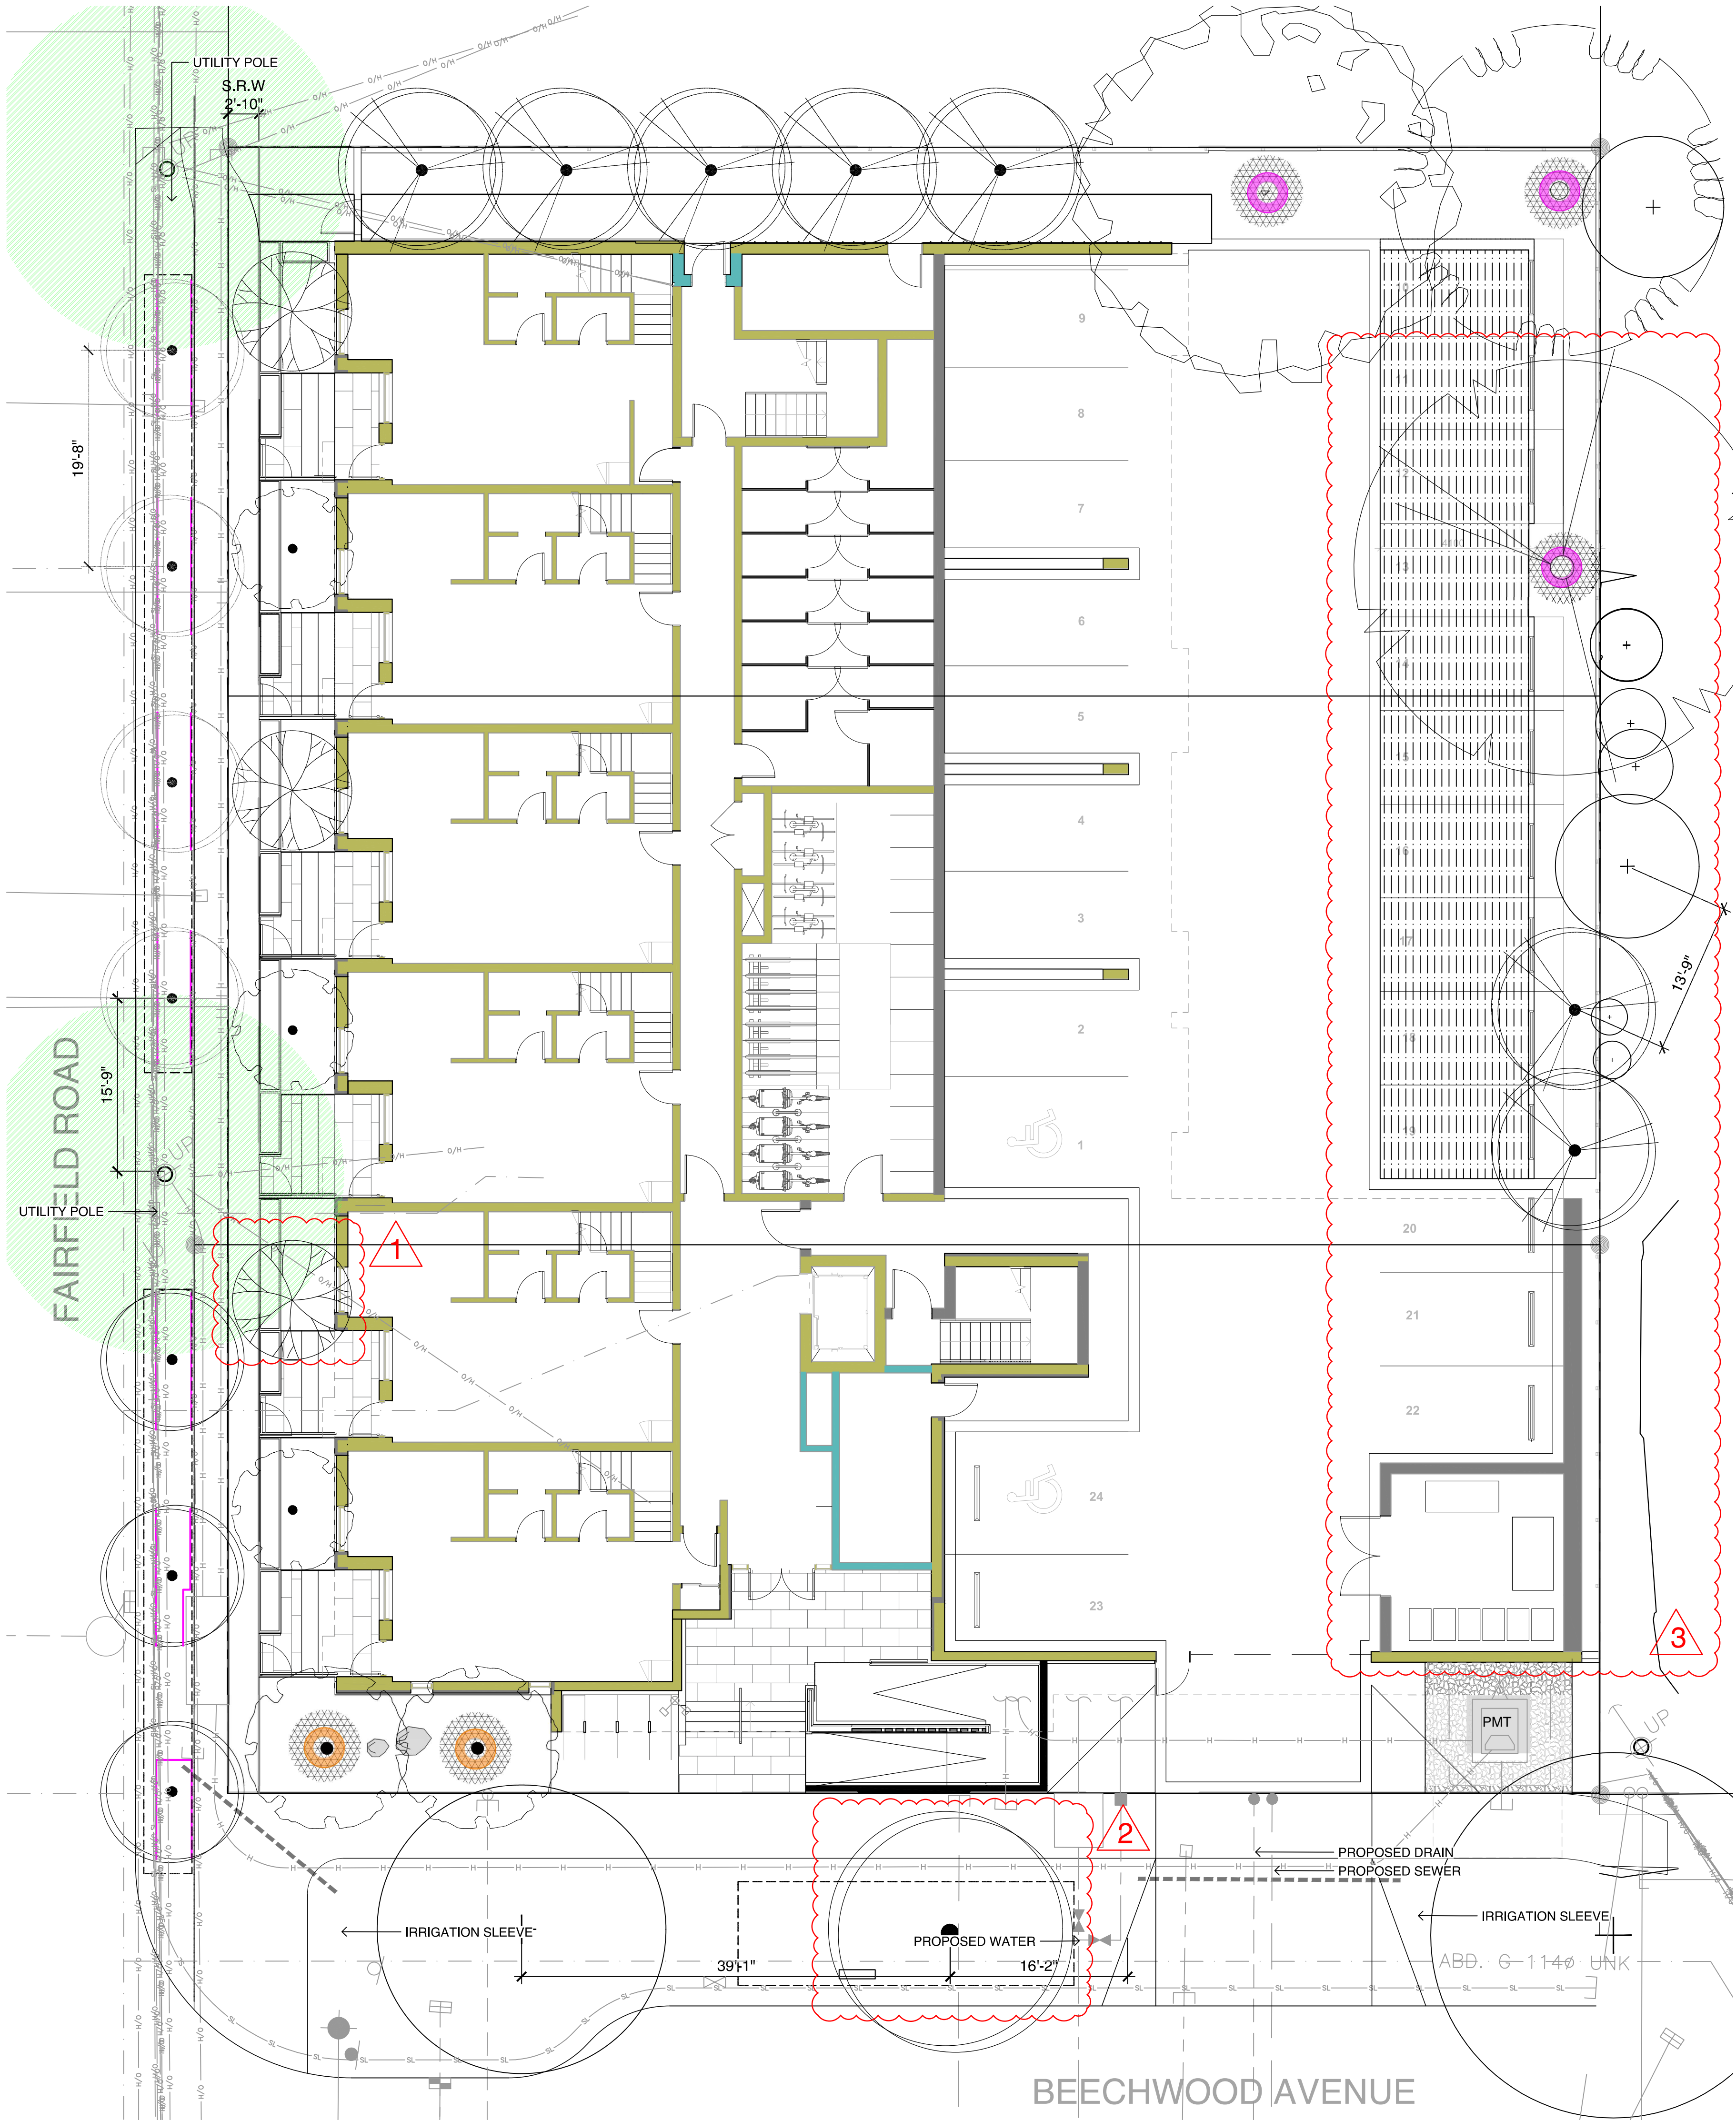

**LEGEND**

- OVERHEAD POWER LINE
- ROOT BARRIER
- 1:1 DESIGNATED REPLACEMENT TREE
- 2:1 DESIGNATED REPLACEMENT TREE
- TREE PIT WITH 1.0 m DEPTH GROWING MEDIUM FOR BOULEVARD TREES
- TREE PLANTING RESTRICTIONS
  - 5.0 m OFFSET FROM HYDRO OR LIGHT POLE
  - 1.0 m OFFSET AREA

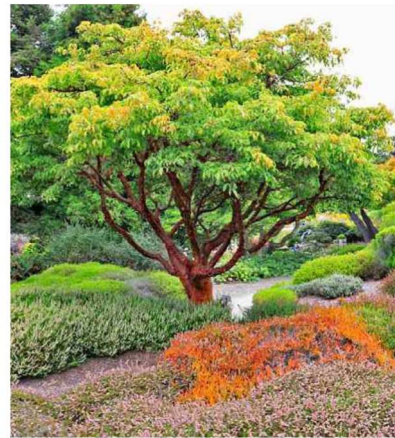

PAPERBARK MAPLE



AUTUMN APPLAUSE  
WHITE ASH



PERSIAN PARROTIA  
'VERONICA'



JAPANESE SNOWBELL



PIN OAK

TREE SCHEDULE										
Quantity	Symbol	Latin Name	Common Name	Container	Caliper	Size	Native	Remarks	Height at Maturity (m)	Spread at Maturity (m)
5		Acer griseum	Paperbark Maple	B&B	6 cm	>2 m		full/part sun	6-9	5-7
1		Fraxinus americana 'Autumn Applause'	Autumn Applause white ash	B&B	6 cm	>2 m		Medium	12-15	7-9
1		Liriodendron tulipifera	Tulip tree	B&B	6 cm	>2 m		full sun	18-24	9-12
7		Parrotia persica 'Ruby Vase'	Ruby Vase Parrotia	B&B	6 cm	>2 m		full sun	7-9	4-6
3		Styrax japonicus	Japanese snowbell	B&B	6 cm	>2 m		full sun - part shade	7.0	7.0
1		Quercus palustris	Pin Oak	B&B	6 cm	>2 m		full sun	10	10
8		BOULEVARD TREE TO BE DETERMINED BY PARKS AT BP		B&B	TBD					


NOTES:  
1. PLANTS IN PLANT LISTS ARE SPECIFIED ACCORDING TO THE CANADIAN NURSERY LANDSCAPE ASSOCIATION CANADIAN STANDARDS FOR NURSERY STOCK AND SECTION 12: CONTAINER GROWN PLANTS FROM THE SC LANDSCAPE STANDARDS, CURRENT EDITION.

TREE IMPACT SUMMARY TABLE						
TREE STATUS	TOTAL	TO BE RETAINED	TO BE REMOVED	REPLACEMENTS REQUIRED	MINIMUM REQUIRED FOR LOT SIZE	PROPOSED
ON-SITE TREES AND SHRUBS BYLAW PROTECTED	7	0	7	7	9	4
MUNICIPAL TREES	3	2	1	1		8
NEIGHBORING TREES, BYLAW PROTECTED	0	0	0	0		0

REPLACEMENT TREES TO BE PLANTED ON SITE	4
REPLACEMENT TREE SHORTFALL	3
TOTAL PROPOSED TREES ON SITE (REPLACEMENT (ACTUAL) + OTHER)	18

ACTUAL NUMBER : 5  
2 x LARGE TREE (1:1)  
1 x MEDIUM TREE (1:1)  
2 x SMALL TREE (2:1)

- NOTES:
- IRRIGATION SYSTEM ON CITY PROPERTY SHALL COMPLY TO CITY OF VICTORIA SUPPLEMENTARY SPECIFICATIONS FOR STREET TREES AND IRRIGATION SCHEDULE C, BYLAW 12-042, SUBDIVISION BYLAW. IRRIGATION DRAWINGS MUST BE SUBMITTED TO PARKS DIVISION FOR REVIEW AND APPROVAL 30 DAYS PRIOR TO INSTALLATION WORK. THE FOLLOWING IRRIGATION AND SLEEVING INSPECTIONS BY PARKS STAFF ARE REQUIRED BY SCHEDULE C.
  - IRRIGATION INSPECTION REQUIREMENTS:
    - a. THE IRRIGATION SYSTEM AND SLEEVING INSPECTION REQUIREMENTS CAN BE FOUND IN SCHEDULE C OF THE VICTORIA SUBDIVISION AND DEVELOPMENT SERVICING BYLAW NO. 12-042.
    - b. IRRIGATION SLEEVING PRIOR TO BACKFILLING\*
    - c. OPEN TRENCH MAIN LINE AND PRESSURE TEST
    - d. OPEN TRENCH LATERAL LINE
    - e. IRRIGATION SYSTEM, CONTROLLER, COVERAGE TEST, BACKFLOW PREVENTER ASSEMBLY TEST REPORT REQUIRED, BACKFLOW ASSEMBLY IS TO HAVE AN INSPECTION TAG COMPLETED AND ATTACHED.
  - 100MM SDR 28 PIPE WILL BE USED FOR IRRIGATION SLEEVING UNDER HARD SURFACES. INSTALLATIONS WHERE A 90-DEGREE BEND IS REQUIRED SHOULD BE INSTALLED USING 100MM SDR 28 GSX (22.5 DEGREE) LONG SWEEPS. INSTALL WILL BE AT 400MM DEPTH.

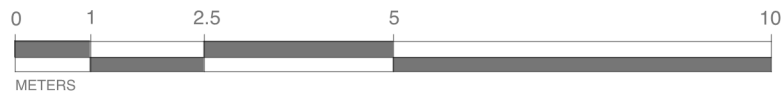

1608 Camosun Street, Victoria BC V8T 3E6  
Info@biophilicollective.ca 250 590 1156

OWNER/CLIENT:  
**ARYZE DEVELOPMENTS**

PROJECT ADDRESS:  
**1733 FAIRFIELD,  
VICTORIA, BC**

DESIGNED BY: BIANCA BODLEY  
DRAWN BY: KIM TANG

NO.	ISSUE	YYMM/DD
1	ISSUED FOR DEVELOPMENT TRACKER	22/03/04
2	ISSUED FOR RZ/DP	22/05/02
3	ISSUED FOR COORDINATION	22/07/18
4	ISSUED FOR RZ/DP	22/07/20
5	ISSUED FOR RZ/DP RESUBMISSION	23/01/24
6	ISSUED FOR RZ/DP RESUBMISSION	2023/08/18

SEAL



NORTH ARROW




DRAWING TITLE:  
**TREE PLANTING PLAN**

DWG NO:

**L4**

SCALE: 1:100



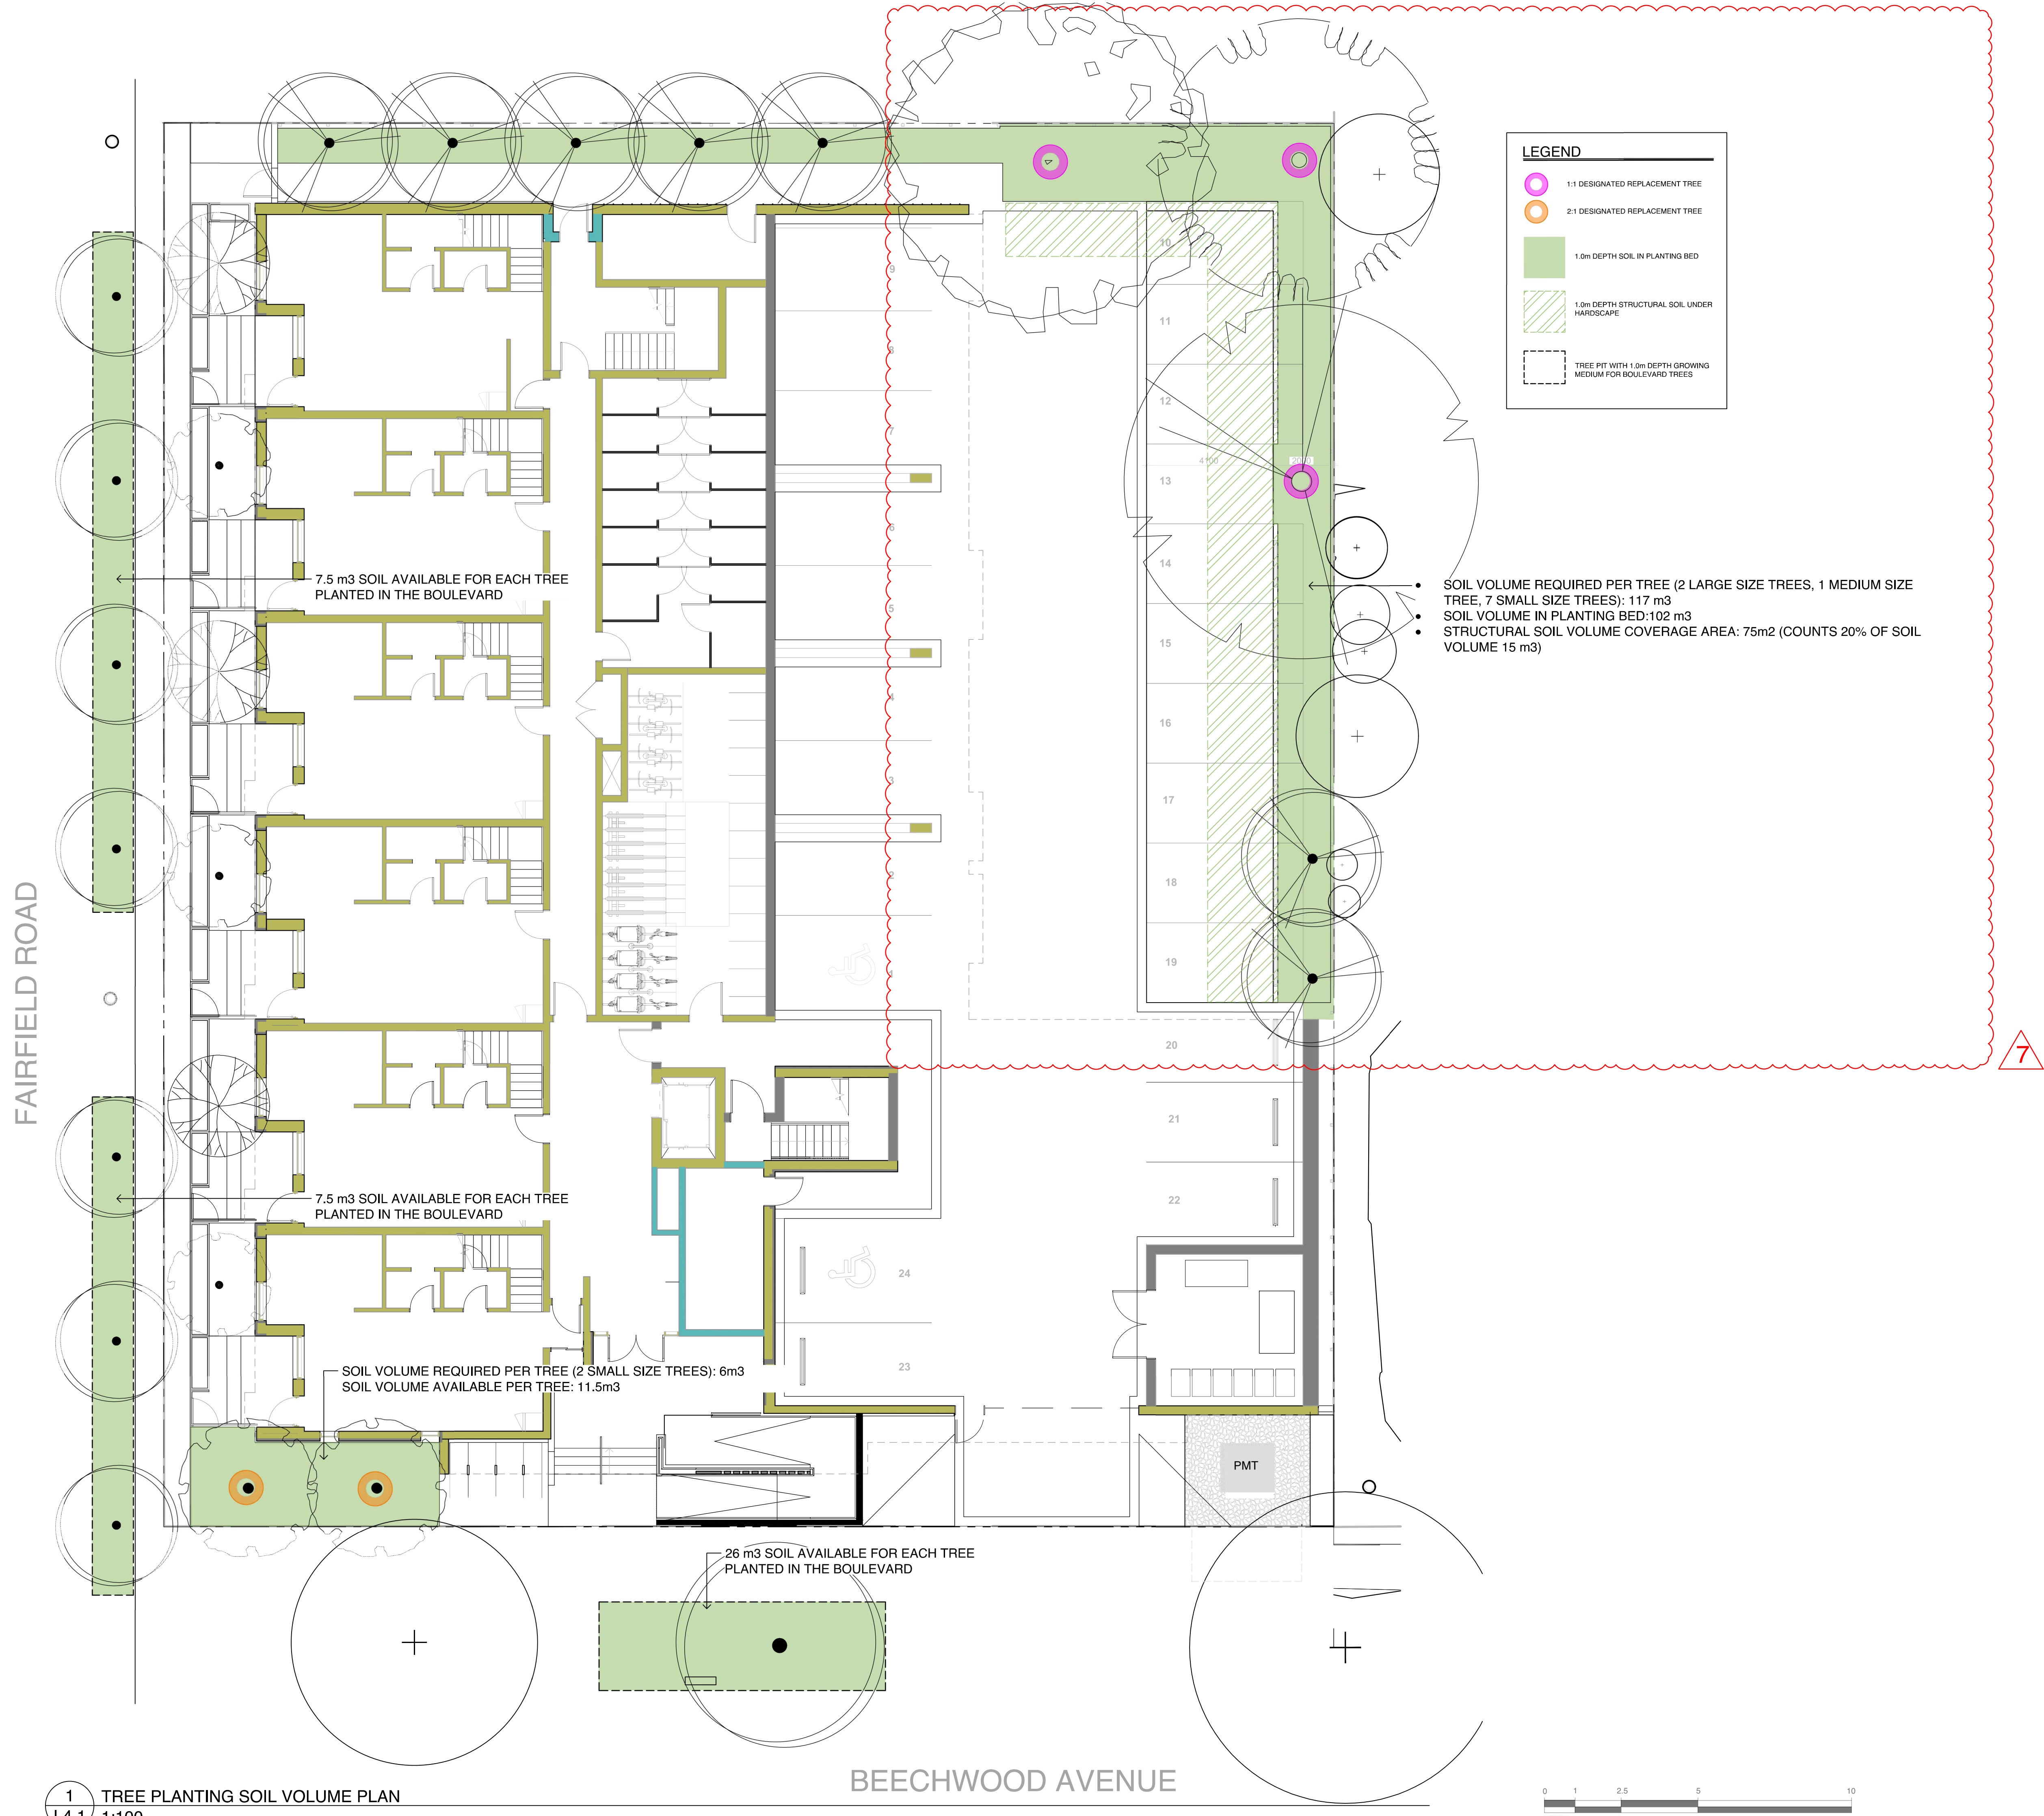

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Info@biophilialcollective.ca 250 590 1156

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DRAWN BY: KIM TANG

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5	ISSUED FOR RZ/DP RESUBMISSION	23/01/24
6	ISSUED FOR RZ/DP RESUBMISSION	2023/08/18

SEAL



NORTH ARROW



DRAWING TITLE:  
**SOIL VOLUME ANALYSIS**

DWG NO:

SCALE: AS NOTED

**L4.1**






PLANT SCHEDULE						
Quantity	Symbol	Latin Name	Common Name	Container	Native	Pollinator
12		Armeria maritima 'Alba'	White-flowered Thrift	10cm		y
60		Arctostaphylos Uva-Ursi 'Massachusetts'	Kinnikinnick	10cm	y	y
30		Carex testacea 'Prairie Fire'	New Zealand hair sedge	#1		
10		Cephalotaxus harringtonia 'Prostrata'	Spreading Japanese plum yew	#2		
16		Choisya ternata	Mexican mock orange	#3		y
50		Hebe pinguiifolia 'Sutherlandii'	Hebe Sutherlandii	#1		
30		Miscanthus sinensis 'Huron Light'	Huron Light maiden grass	#1		
25		Miscanthus sinensis 'Morning Light'	Chinese silver grass Morning Light	#1		
5		Verbena bonariensis 'Lollipop'	Dwarf purpletop	#1		Y
NOTES: 1. PLANTS IN PLANT LISTS ARE SPECIFIED ACCORDING TO THE CANADIAN NURSERY LANDSCAPE ASSOCIATION CANADIAN STANDARDS FOR NURSERY STOCK AND SECTION 12, CONTAINER GROWN PLANTS FROM THE BC LANDSCAPE STANDARD, CURRENT EDITION.						



WHITE FLOWERED THRIFT   KINNIKINNICK   NEW ZEALAND HAIR SEDGE   SPREADING PLUM YEW



MEXICAN ORANGE BLOSSOM   HEBE SUTHERLANDII   CHINESE SILVER GRASS   HURON LIGHT MAIDEN GRASS   DWARF PURPLETOP

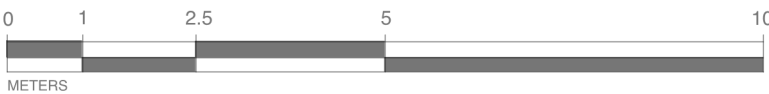

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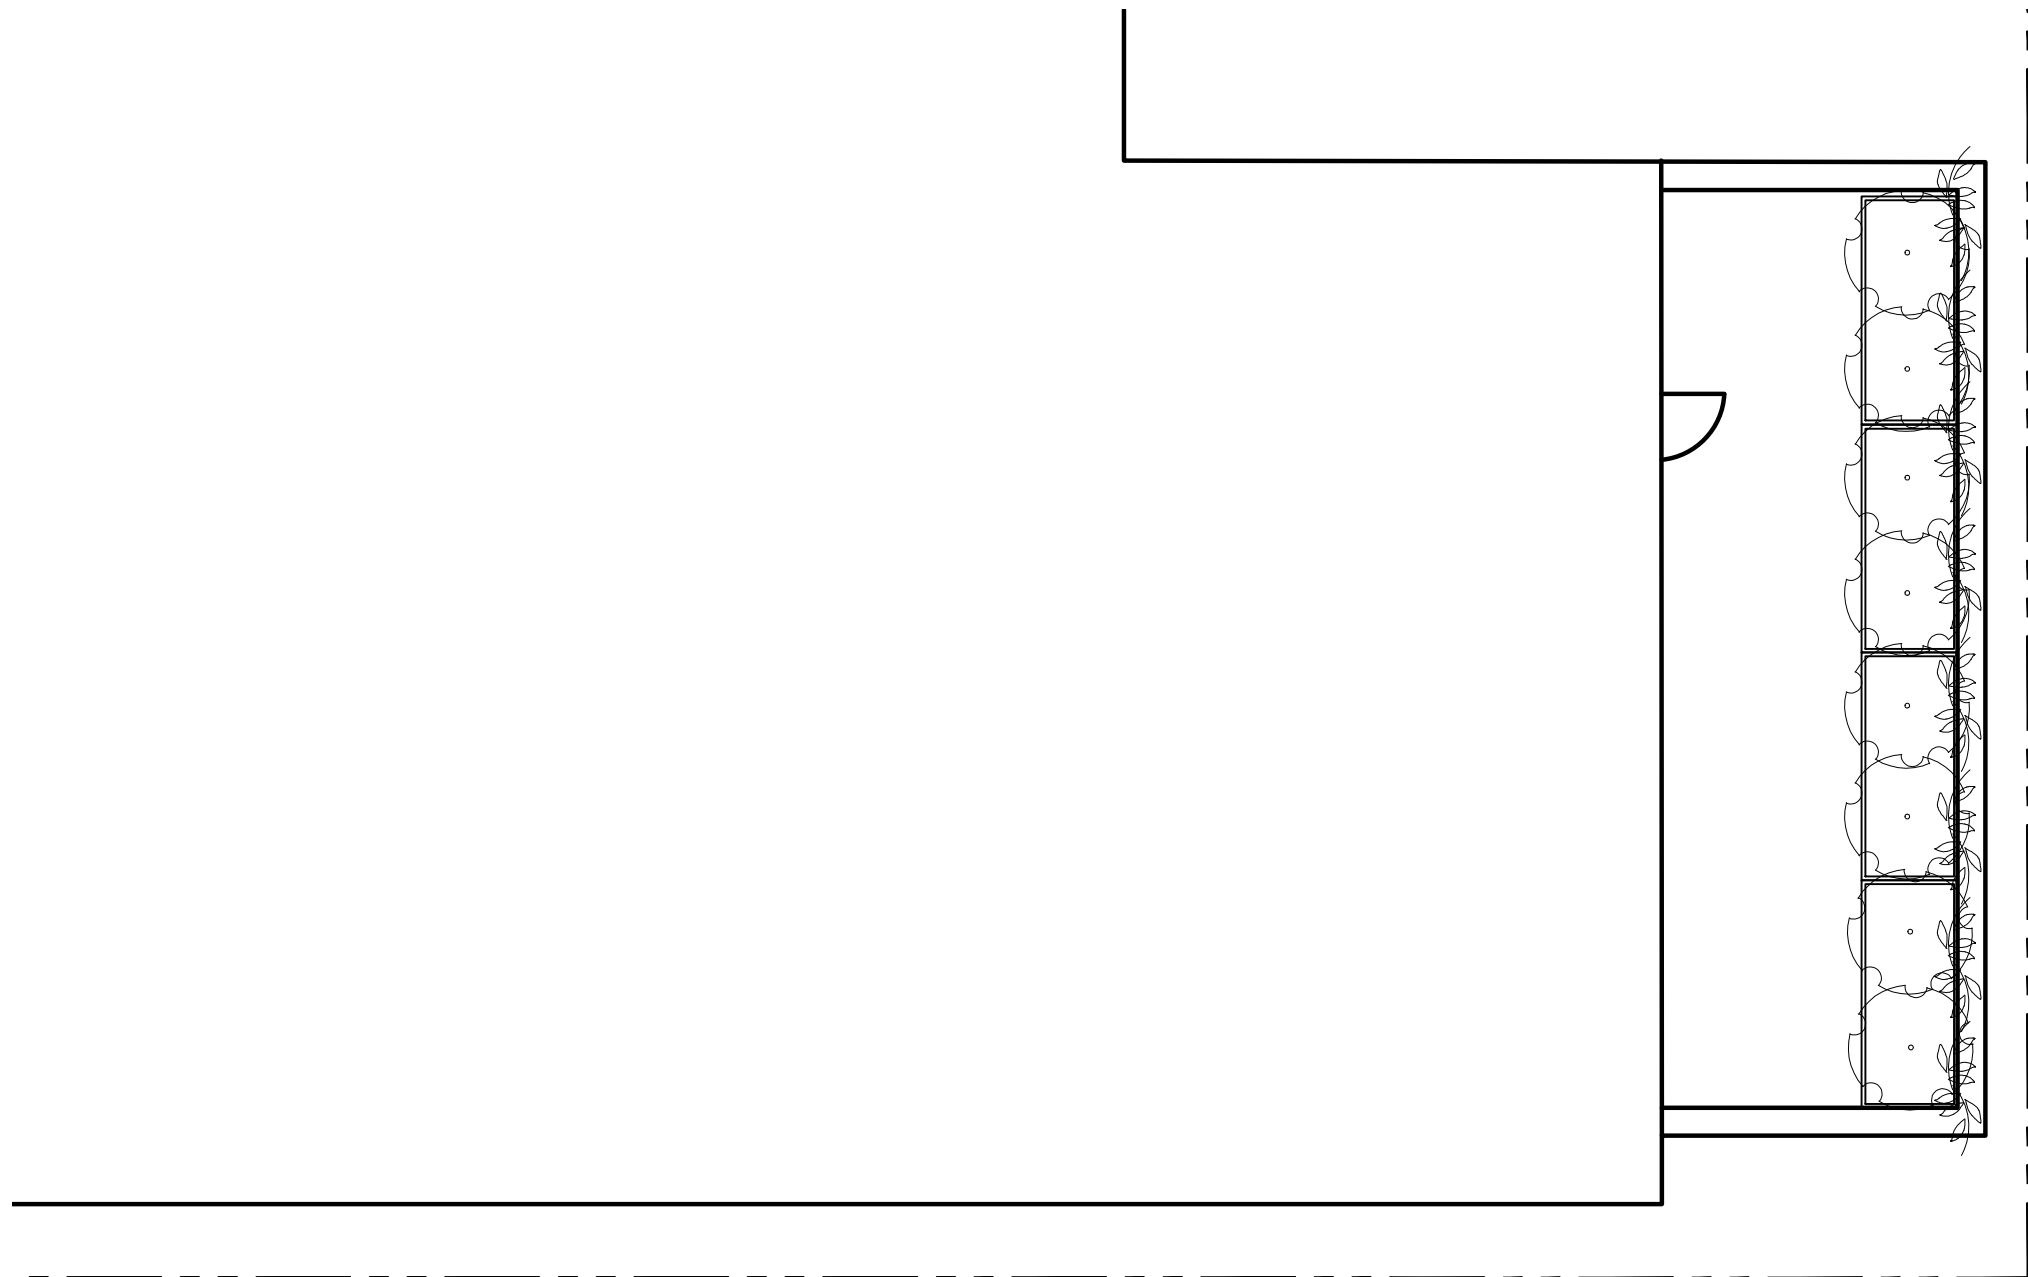
SEAL




NORTH ARROW








1 LEVEL TWO PLANTING PLAN  
L6 1:100

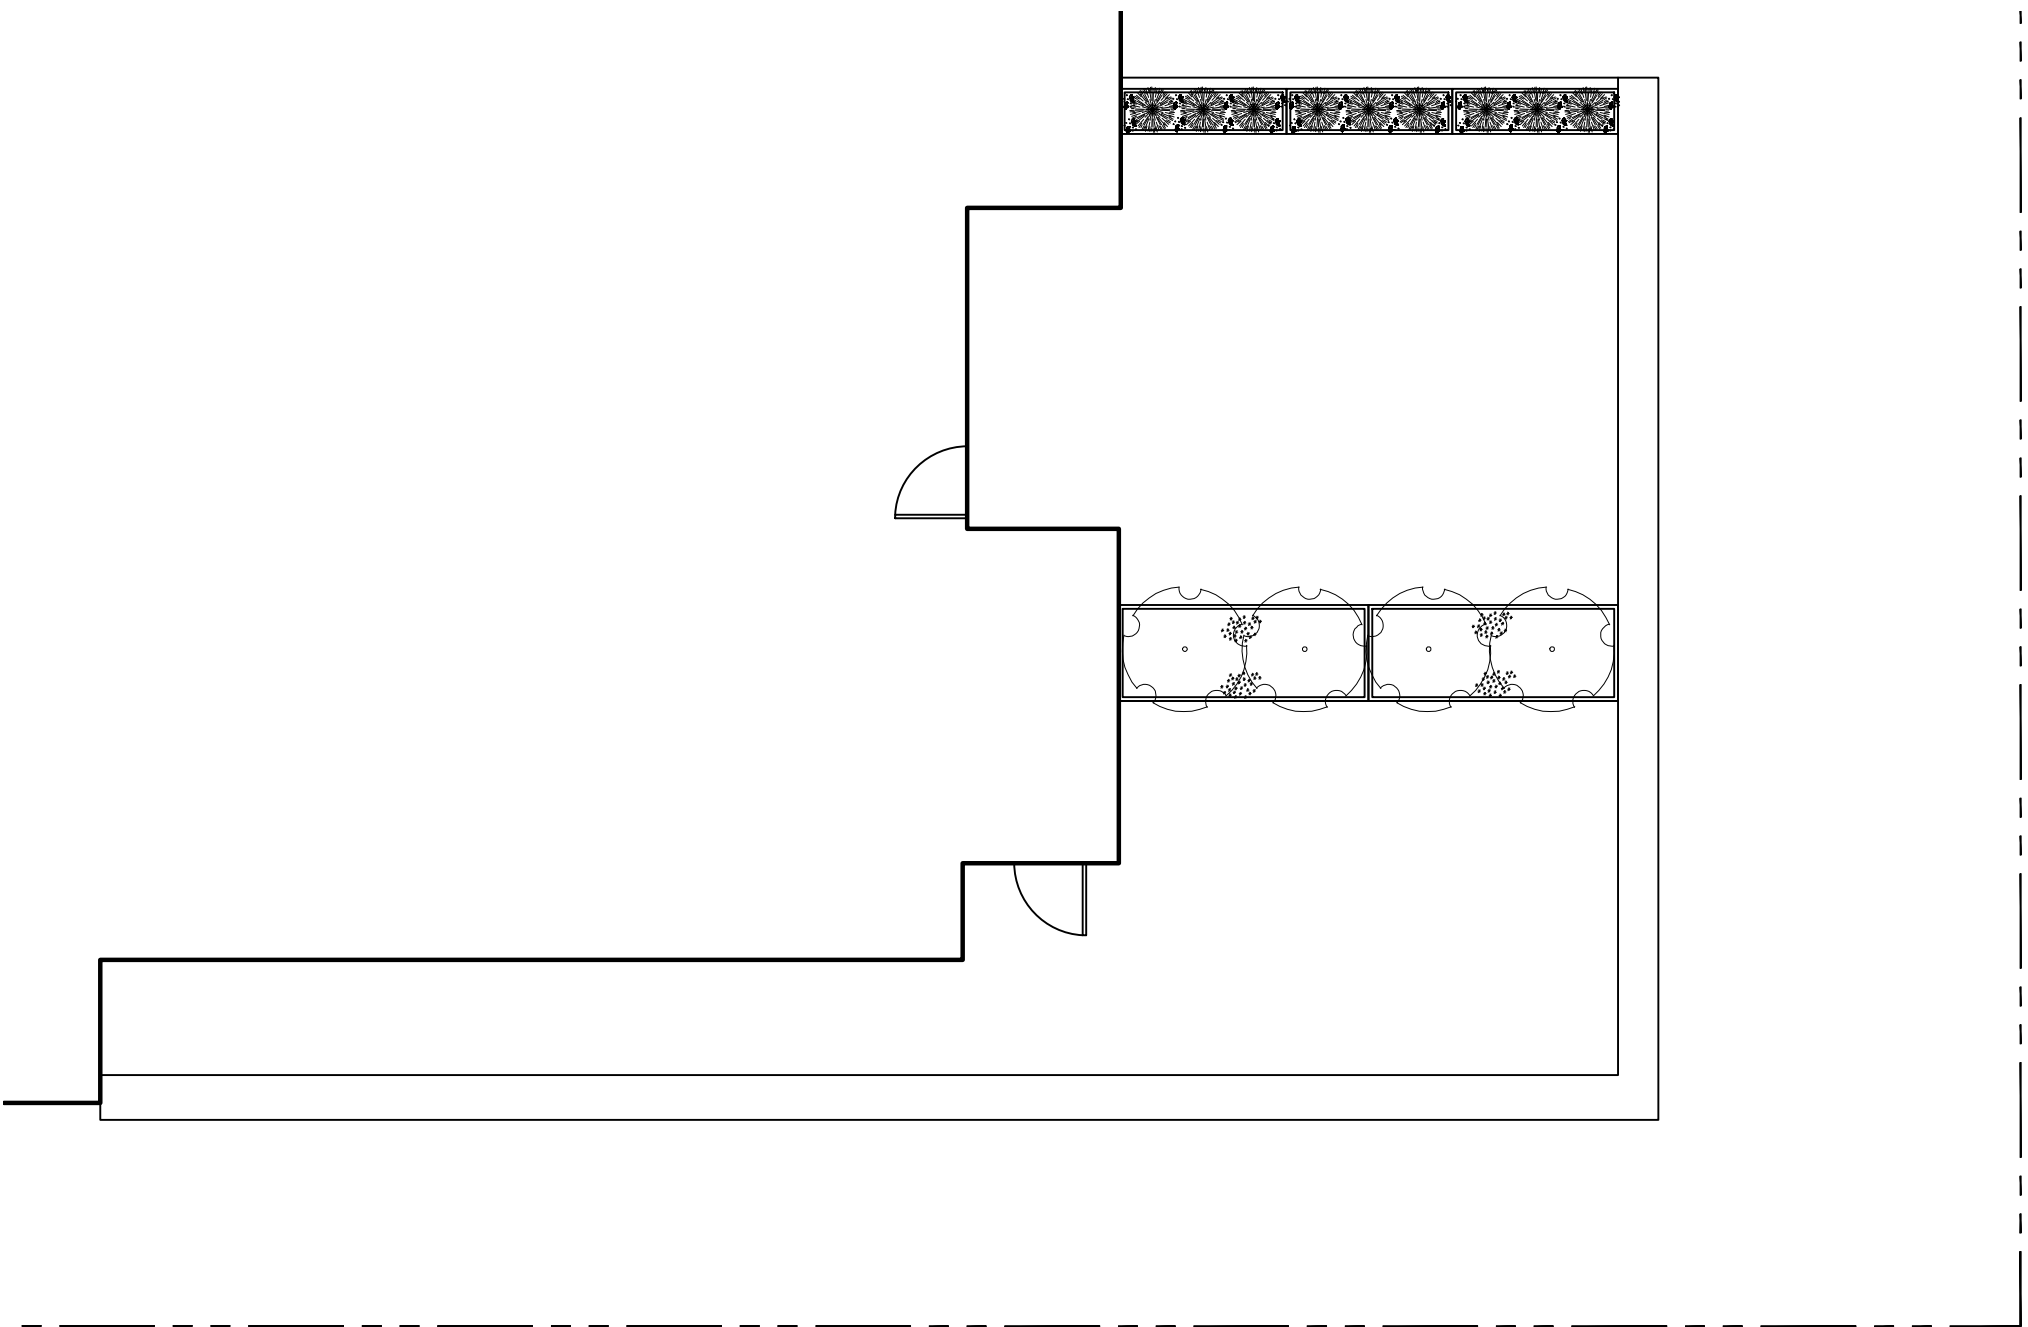


2 LEVEL THREE PLANTING PLAN  
L6 1:100

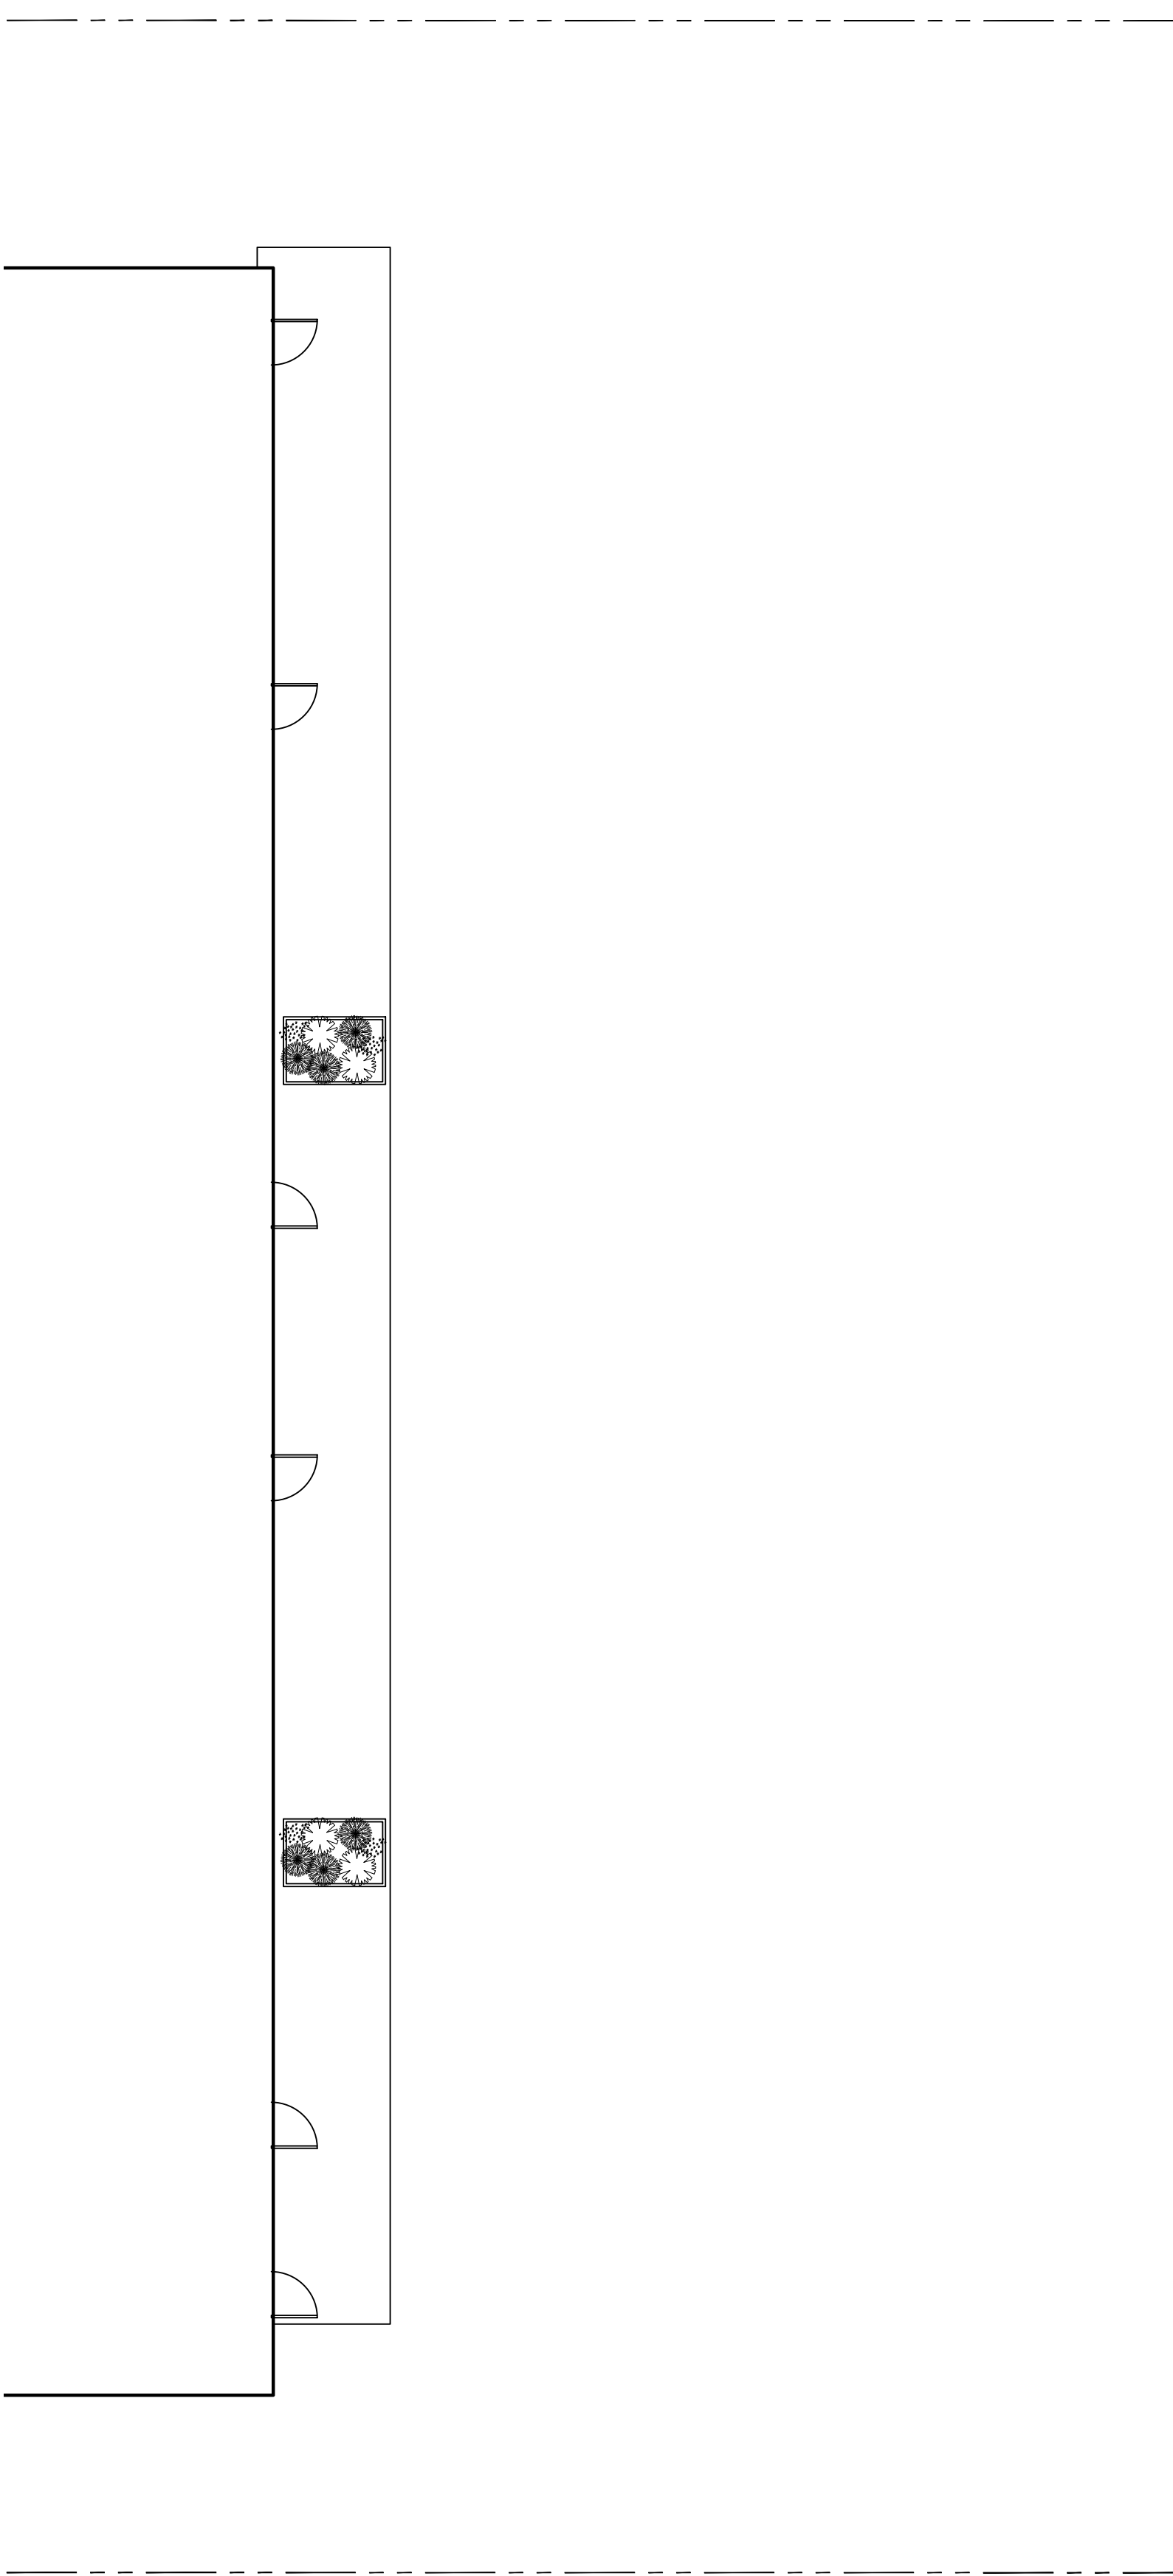

3 LEVEL FOUR PLAN  
L6 1:100

PLANT SCHEDULE						
Quantity	Symbol	Latin Name	Common Name	Container	Native	Pollinator
6		Armeria maritima 'Alba'	White-flowered Thrift	10cm		y
10		Arctostaphylos Uva-Ursi 'Massachusetts'	Kinnikinnick	10cm	y	y
12		Choisya ternata	Mexican Orange Blossom	#3		y
15		Pinus strobus 'Horsford Dwarf'	Horsford Dwarf Eastern white pine	#2		
4		Rhododendron x Bloom-A-Thon® White Reblooming Azalea		#1		y
8		Parthenocussus quinquefolia	Virginia Creeper	#2		
NOTES: 1. PLANTS IN PLANT LISTS ARE SPECIFIED ACCORDING TO THE CANADIAN NURSERY LANDSCAPE ASSOCIATION CANADIAN STANDARDS FOR NURSERY STOCK AND SECTION 12, CONTAINER GROWN PLANTS FROM THE BC LANDSCAPE STANDARD, CURRENT EDITION.						

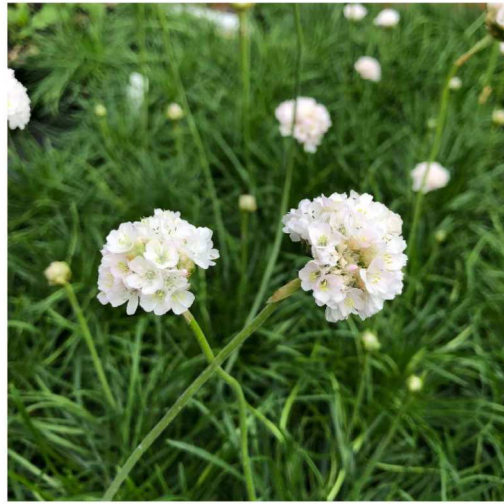

WHITE FLOWERED THRIFT



KINNIKINNICK




MEXICAN ORANGE BLOSSOM



HORSFORD DWARF EASTERN WHITE PINE



WHITE REBLOOMING AZALEA

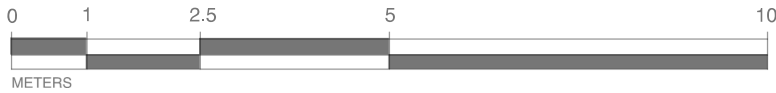

1608 Camosun Street, Victoria BC V8T 3E6  
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ARYZE DEVELOPMENTS

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DRAWN BY: KIM TANG

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6	ISSUED FOR RZ/ DP RESUBMISSION	2023/08/18

SEAL



NORTH ARROW



DRAWING TITLE:  
UPPER LEVEL  
PLANTING PLANS

DWG NO:

SCALE: AS NOTED

L6





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Info@biophiliacollective.ca 250 590 1156

OWNER/CLIENT:  
ARYZE DEVELOPMENTS

PROJECT ADDRESS:  
1733 FAIRFIELD,  
VICTORIA, BC

DESIGNED BY: BIANCA BODLEY  
DRAWN BY: KIM TANG

NO.	ISSUE	YYMM/DD
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5	ISSUED FOR R2/ DP RESUBMISSION	23/01/24
6	ISSUED FOR R2/ DP RESUBMISSION	2023/08/18

SEAL



NORTH ARROW




DRAWING TITLE:  
DETAILS


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SCALE: AS NOTED


L7

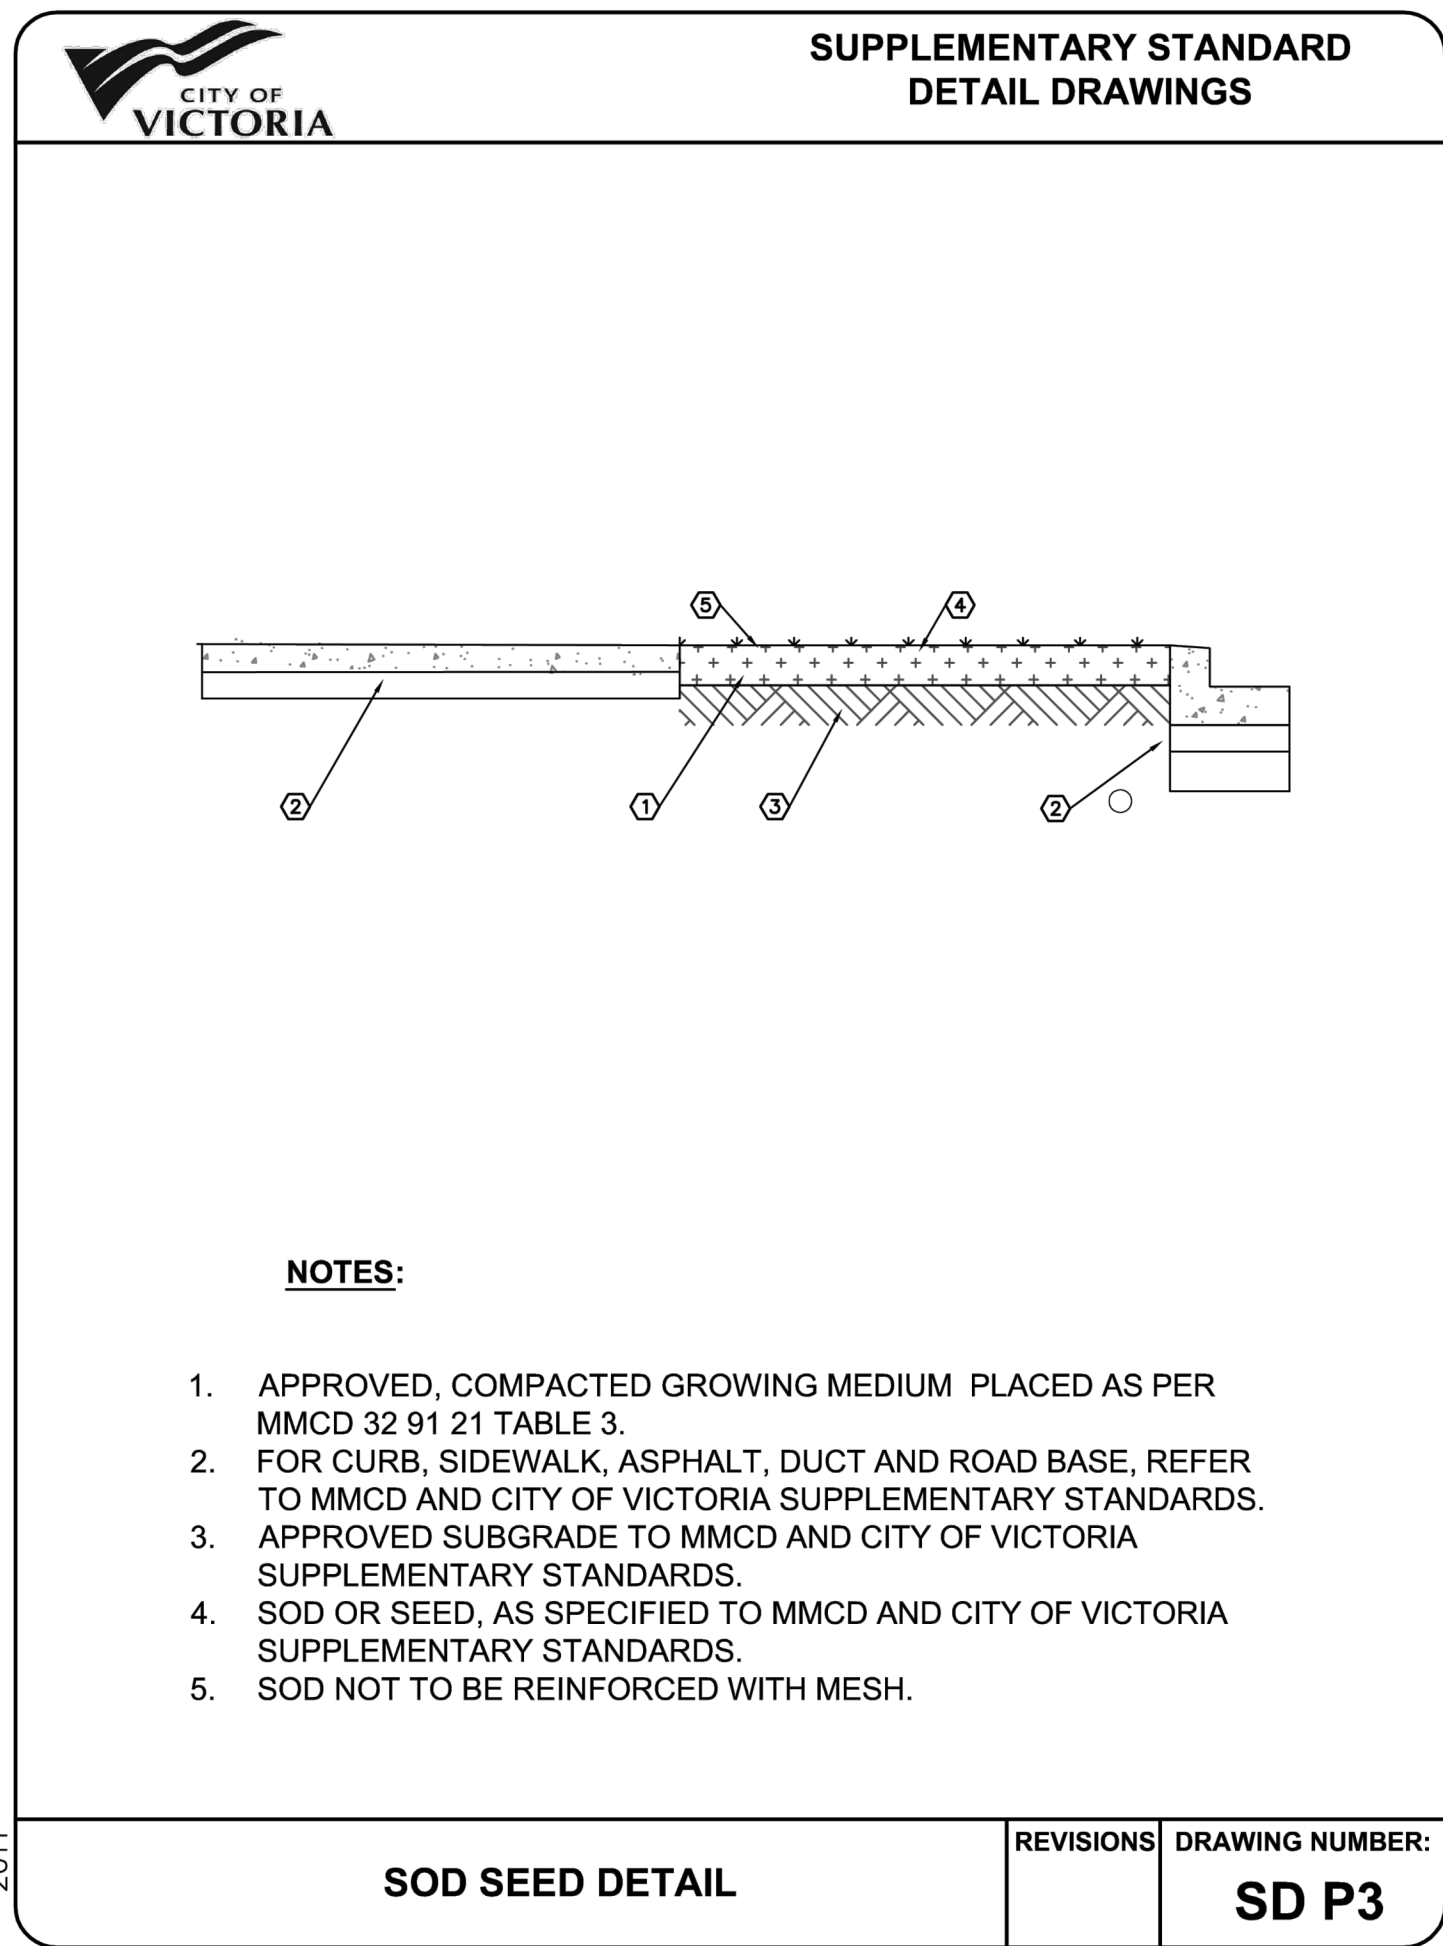

1  
L5 SOD SEED DETAIL  
NTS

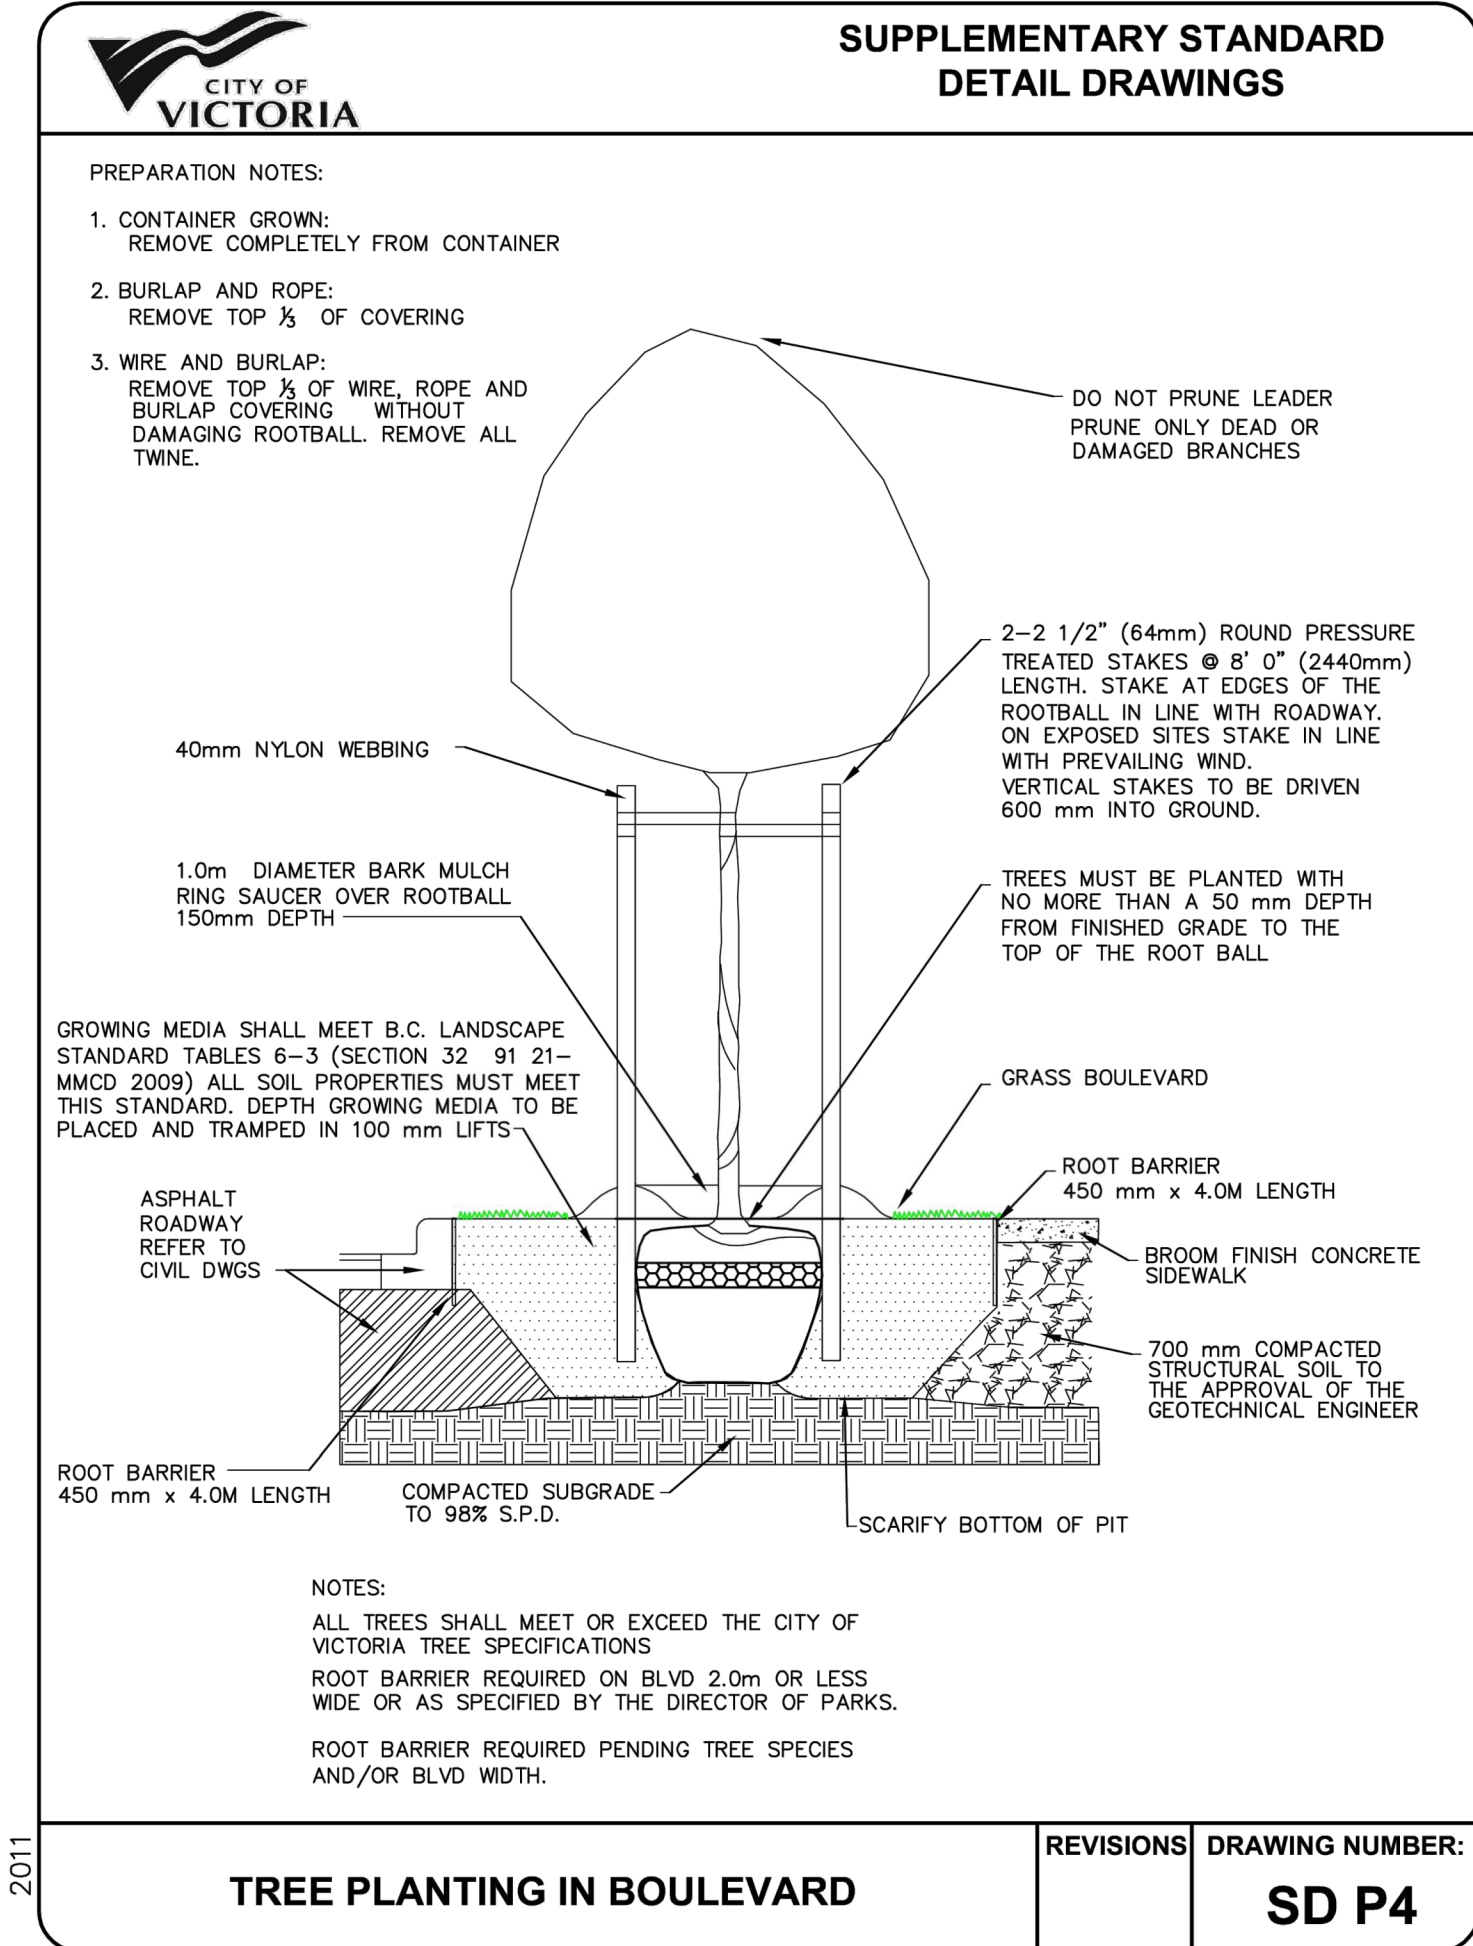


2  
L5 TREE PLANTING IN BOULEVARD  
NTS

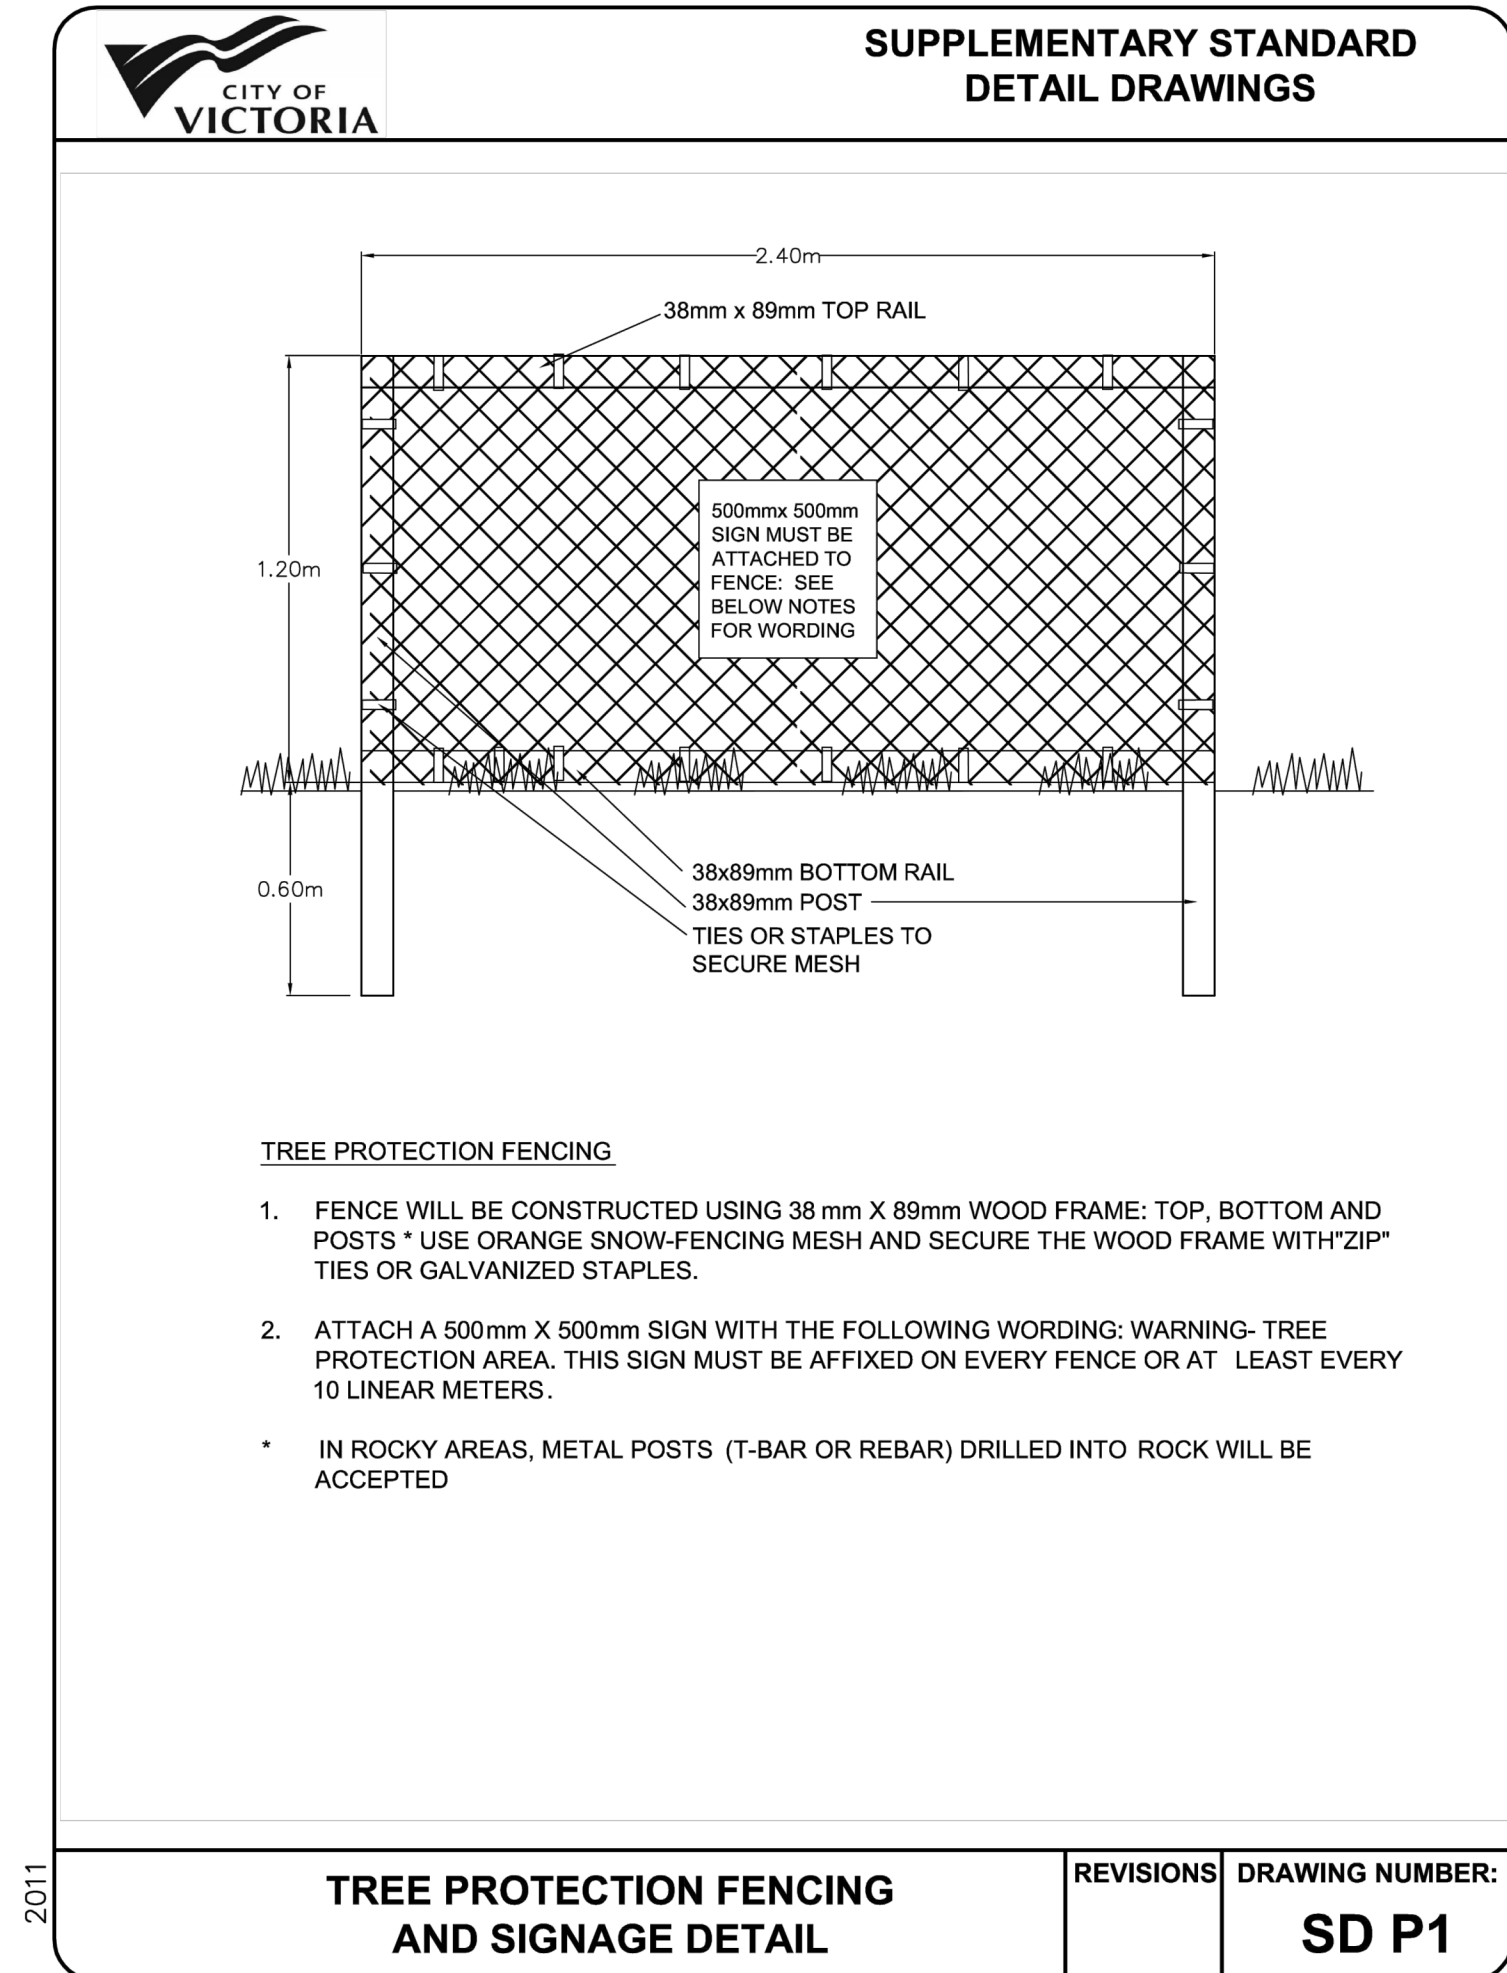



3  
L5 TREE PROTECTION FENCING AND SIGNAGE DETAIL  
NTS

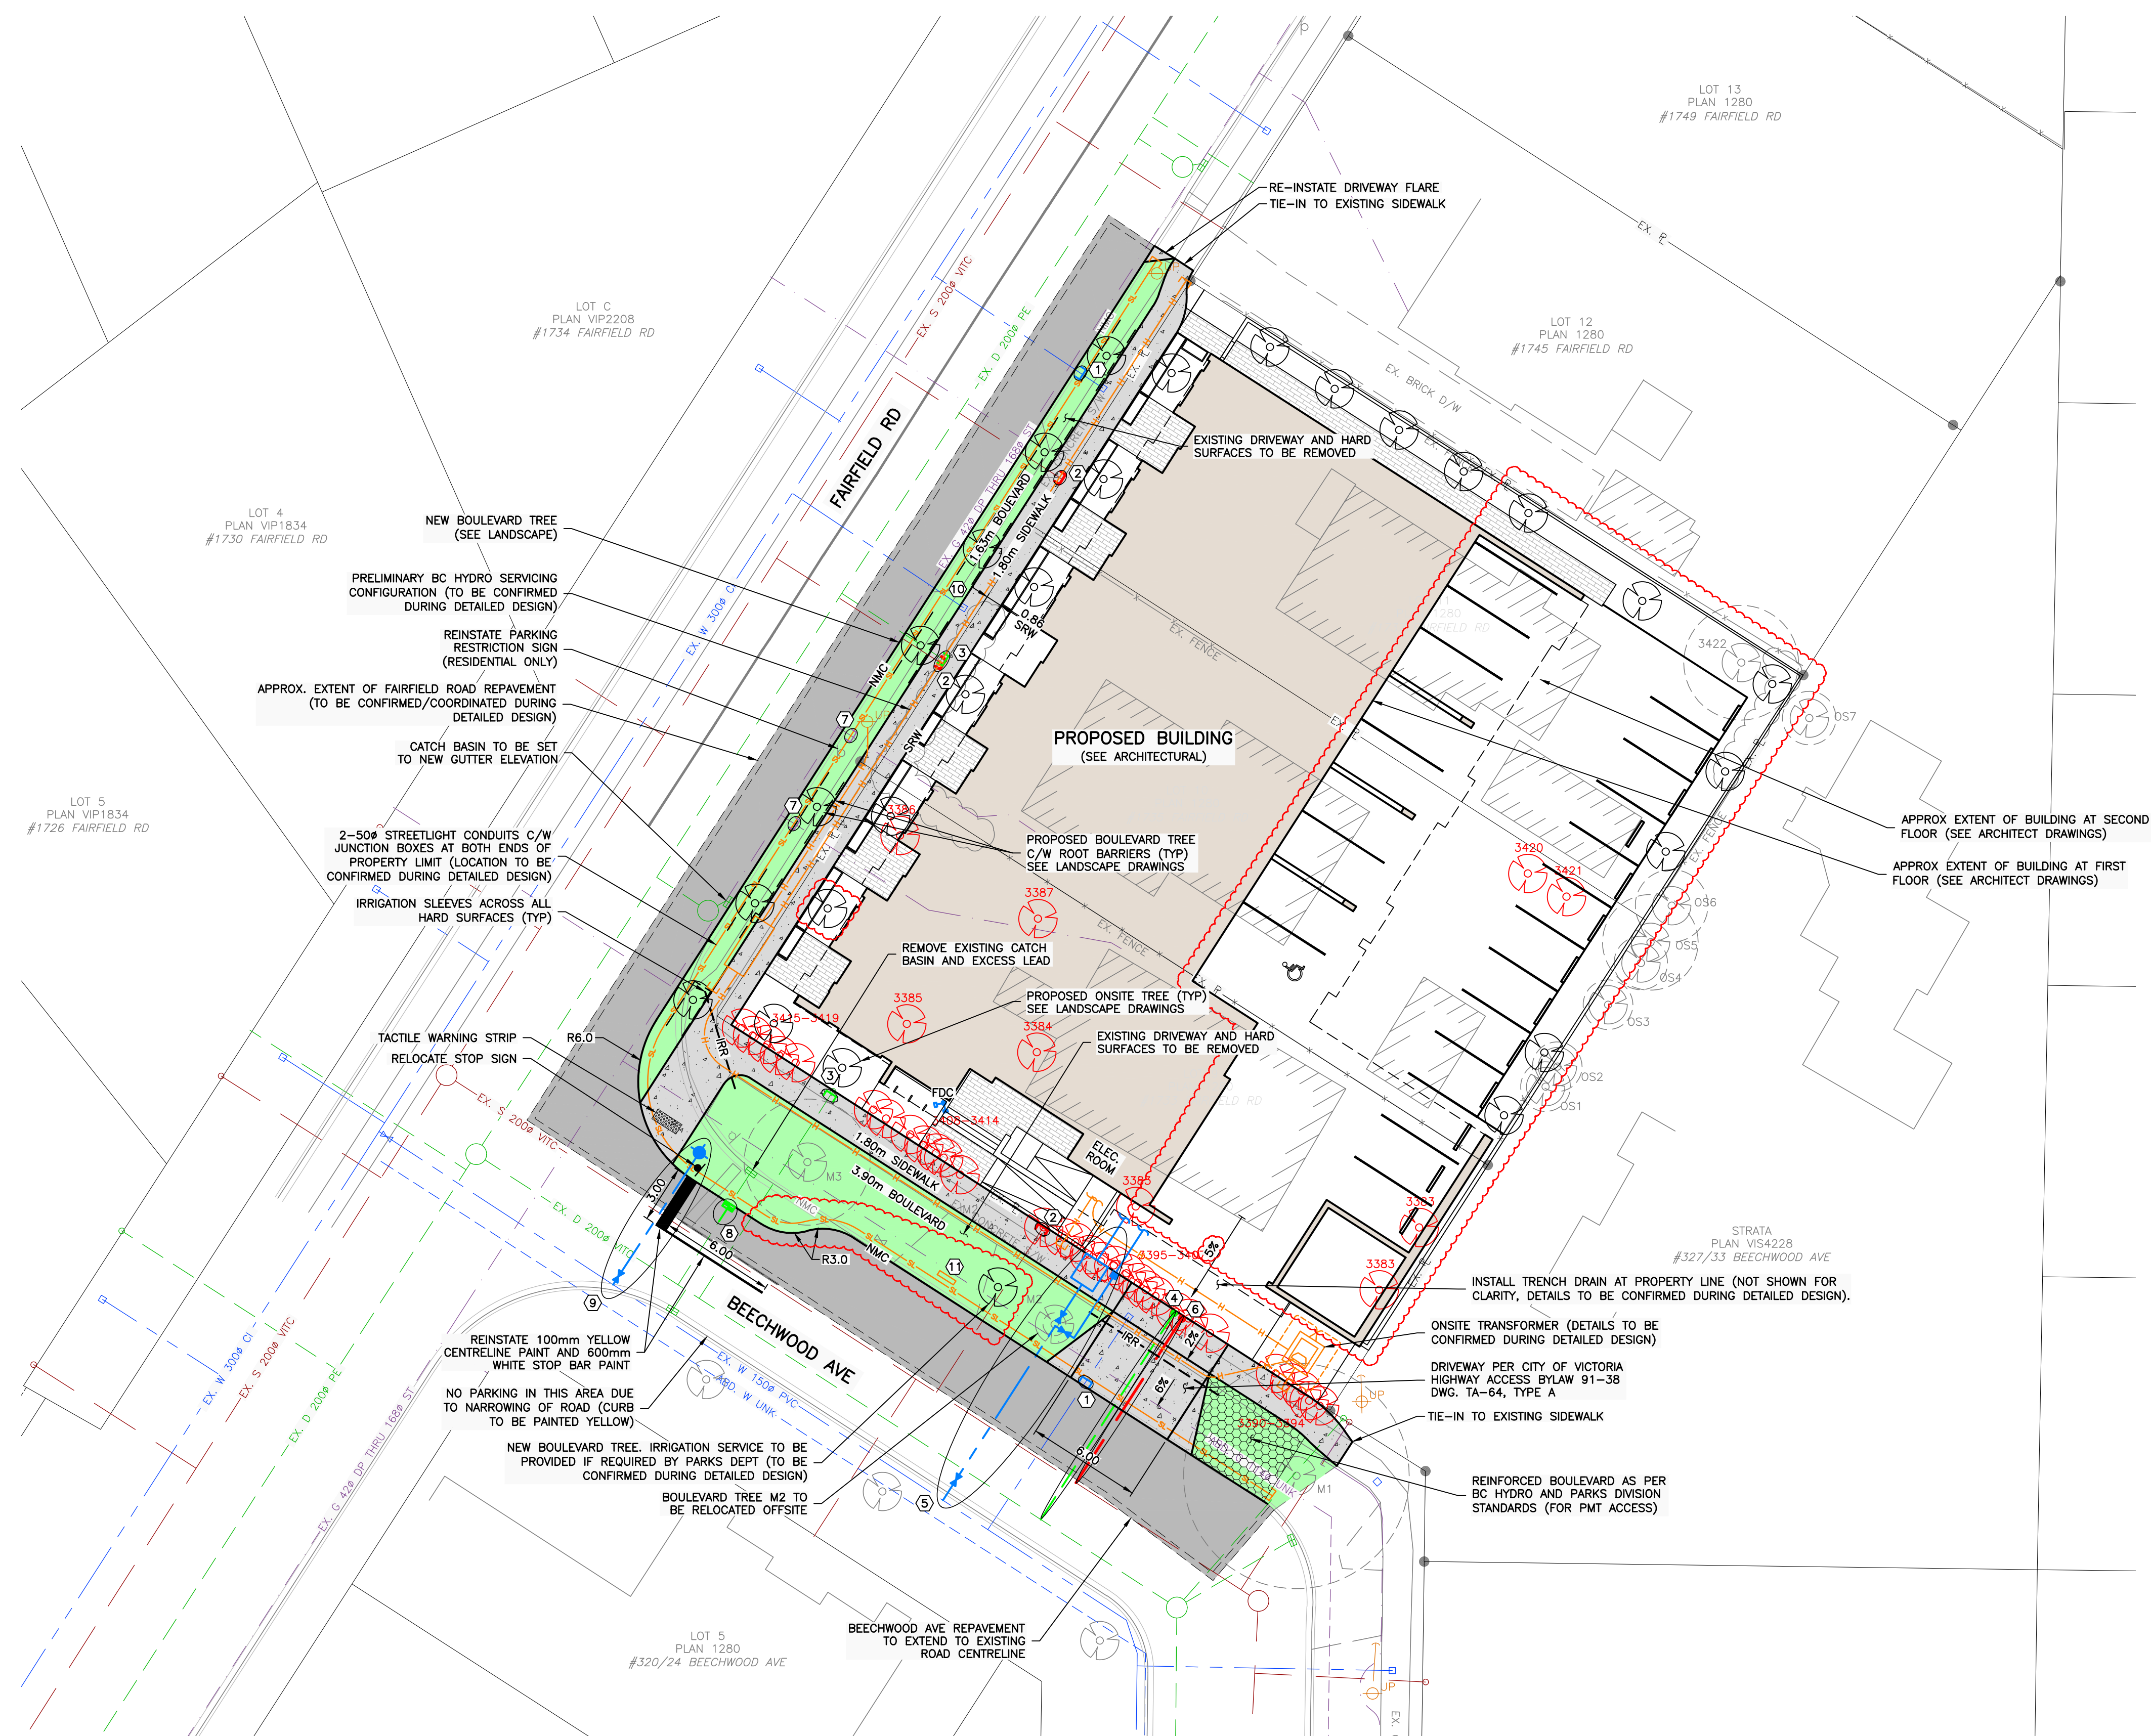



SHEET NOTES	
No.	DESCRIPTION
1	EXISTING HYDRO SERVICE TO BE CAPPED AND ABANDONED BY CoV FORCES AT DEVELOPER'S EXPENSE. HYDRO POLE TO BE SUPPORTED DURING CONSTRUCTION.
2	EXISTING SANITARY SEWER SERVICE TO BE CAPPED AND ABANDONED AT PROPERTY LINE.
3	EXISTING STORM SEWER SERVICE TO BE CAPPED AND ABANDONED AT PROPERTY LINE.
4	NEW 150mm STORM SERVICE CONNECTION c/w INSPECTION CHAMBER TO PROPERTY LINE BY CoV FORCES AT DEVELOPER'S EXPENSE.
5	NEW 150mm FIRE SERVICE c/w METER CHAMBER AS PER CoV STD. DWG. SD W2G AND 50mm DOMESTIC WATER SERVICE BY CoV FORCES AT DEVELOPER'S EXPENSE.
6	NEW 150mm SANITARY SERVICE c/w INSPECTION CHAMBER TO PROPERTY LINE BY CoV FORCES AT DEVELOPER'S EXPENSE.
7	EXISTING GAS SERVICE TO BE CAPPED AND ABANDONED BY FORTISBC FORCES.
8	NEW CATCH BASIN PER CoV STD. DWG. SD S110 BY DEVELOPER'S CONTRACTOR. ENSURE OUTLET ELEVATION IS SET TO ACHIEVE MIN. 2% GRADE TO MAIN. 150mm PVC CATCH BASIN LEAD ADJUSTMENT AND CONNECTION BY CoV FORCES AT DEVELOPER'S EXPENSE.
9	NEW FIRE HYDRANT BY CoV FORCES AT DEVELOPER'S EXPENSE. LOCATION TO BE CONFIRMED DURING DETAILED DESIGN.
10	EXISTING WATER SERVICE TO BE RE-USED FOR IRRIGATION. BACKFLOW PREVENTOR TO BE INSTALLED.
11	NEW DUAL HEAD ELECTRIC VEHICLE CHARGER (LOCATION TO BE CONFIRMED DURING DETAILED DESIGN).

 EXISTING TREE TO BE REMOVED.

 EXISTING TREE TO REMAIN.

**NOTES:**


- FOR BUILDING INFORMATION, SEE DRAWINGS BY CASCADIA ARCHITECTS INC.
- FOR LANDSCAPING, SEE DRAWINGS BY BIOPHILIA DESIGN COLLECTIVE.
- FOR LEGAL INFORMATION, SEE DRAWINGS BY J.E. ANDERSON & ASSOCIATES.
- UTILITY SIZES AND LOCATIONS TO BE CONFIRMED DURING DETAILED DESIGN.
- ALL EXISTING ON-SITE BUILDINGS, DRIVEWAYS, FENCES, HEDGES, RETAINING WALLS, ETC. TO BE REMOVED AND DISPOSED OFF-SITE (NOT SHOWN FOR CLARITY).
- BASE INFORMATION SHOWN IS PRODUCED FROM A COMBINATION OF FIELD SURVEY AND GIS INFORMATION PROVIDED BY THE CITY OF VICTORIA (VICTORIA). ALL INFORMATION TO BE CONFIRMED IN THE FIELD PRIOR TO CONSTRUCTION (INCLUDING COMPLETING A BOONECALL).
- ONSITE BIKE PARKING, ETC. NOT SHOWN FOR CLARITY (SEE ARCHITECT AND LANDSCAPE DRAWINGS).

PERMIT TO PRACTICE  
McElhanney Ltd.  
PERMIT NUMBER: 1003299  
Engineers and Geoscientists of BC

SEE ARCHITECTURAL AND LANDSCAPE  
DRAWINGS FOR ADDITIONAL INFORMATION

LEGAL PLAN & TOPOGRAPHIC  
SURVEY PROVIDED BY J.E.  
ANDERSON & ASSOCIATES

AUGUST 21, 2023  
**ISSUED FOR  
REZONING**

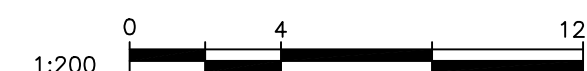


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NO.	DATE	BY	ISSUED	NO.	DATE	BY	REVISIONS
3	2023-08-21	ND	ISSUED FOR REZONING				
2	2023-01-25	ND	ISSUED FOR REZONING				
1	2022-04-27	ND	ISSUED FOR DEVELOPMENT PERMIT				

**McElhanney**

500 - 3960 QUADRA STREET  
VICTORIA, BC V8X 4A3

PH (250) 370-9221

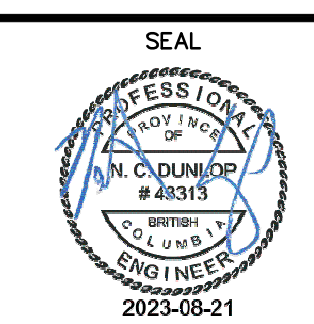

PROJECT:	1733 FAIRFIELD ROAD, VICTORIA, BC	SCALE	HORIZ: 1:200	VERT:
TITLE:	PRELIMINARY CIVIL PLAN	PROJECT NO.	21-187	ISSUED/REVISION
		APPROVING AUTHORITY FILE NO.		
		DRAWING NO.	21-187-CSP	