

ZONING INFORMATION - LOT 469	ZONING INFORMATION
CIVIC ADDRESS: 506 Herald Street, Victoria, BC	CIVIC ADDRESS: 506 Herald Street,
ZONE (EXISTING): OTD-1	ZONE (EXISTING): OTD-1
PROPOSED ZONE: No change to zone. No change of use .	PROPOSED ZONE: No change to zone. No change of use
SITE AREA (m ²): Lot 469: 685 m ²	SITE AREA (m²): Lot 470: 687 m ²
FLOOR AREA (m ²): L1: 171 m ² (no change) Mezzanine: 67 m ² (proposed)	FLOOR AREA (m ²): L1: 76 m ² (no chang Mezzanine: 16 m ² (proposed
TOTAL: 237 m ² (proposed)	TOTAL: 92 m ² (proposed
COMMERCIAL FLOOR AREA (m ²): 237 m ²	COMMERCIAL FLOOR AREA (m ²): 92 m ²
FLOOR SPACE RATIO: .35: 1	FLOOR SPACE RATIO: .13: 1
SITE COVERAGE (%): 28%	SITE COVERAGE (%): 12%
HEIGHT OF BUILDING (m): 8.6 m	HEIGHT OF BUILDING (m): 8.6 m
NUMBER OF STOREYS: 2 (one storey plus mezzanine, and rooftop patio)	NUMBER OF STOREYS: 2 (one
PARKING STALLS ON SITE: 8 (existing, no change)	PARKING STALLS ON SITE: 4 (exist
PARKING STALLS REQUIRED: none	PARKING STALLS REQUIRED: none
BICYCLE PARKING NUMBER (CLASS 1 & CLASS 2): none (4 provided)	BICYCLE PARKING NUMBER (CLA
BUILDING SETBACKS (m) OTD-1 Zone, therefore, no setbacks required.	BUILDING SETBACKS (m) OTD-1 Zone, therefore, no setbacks re

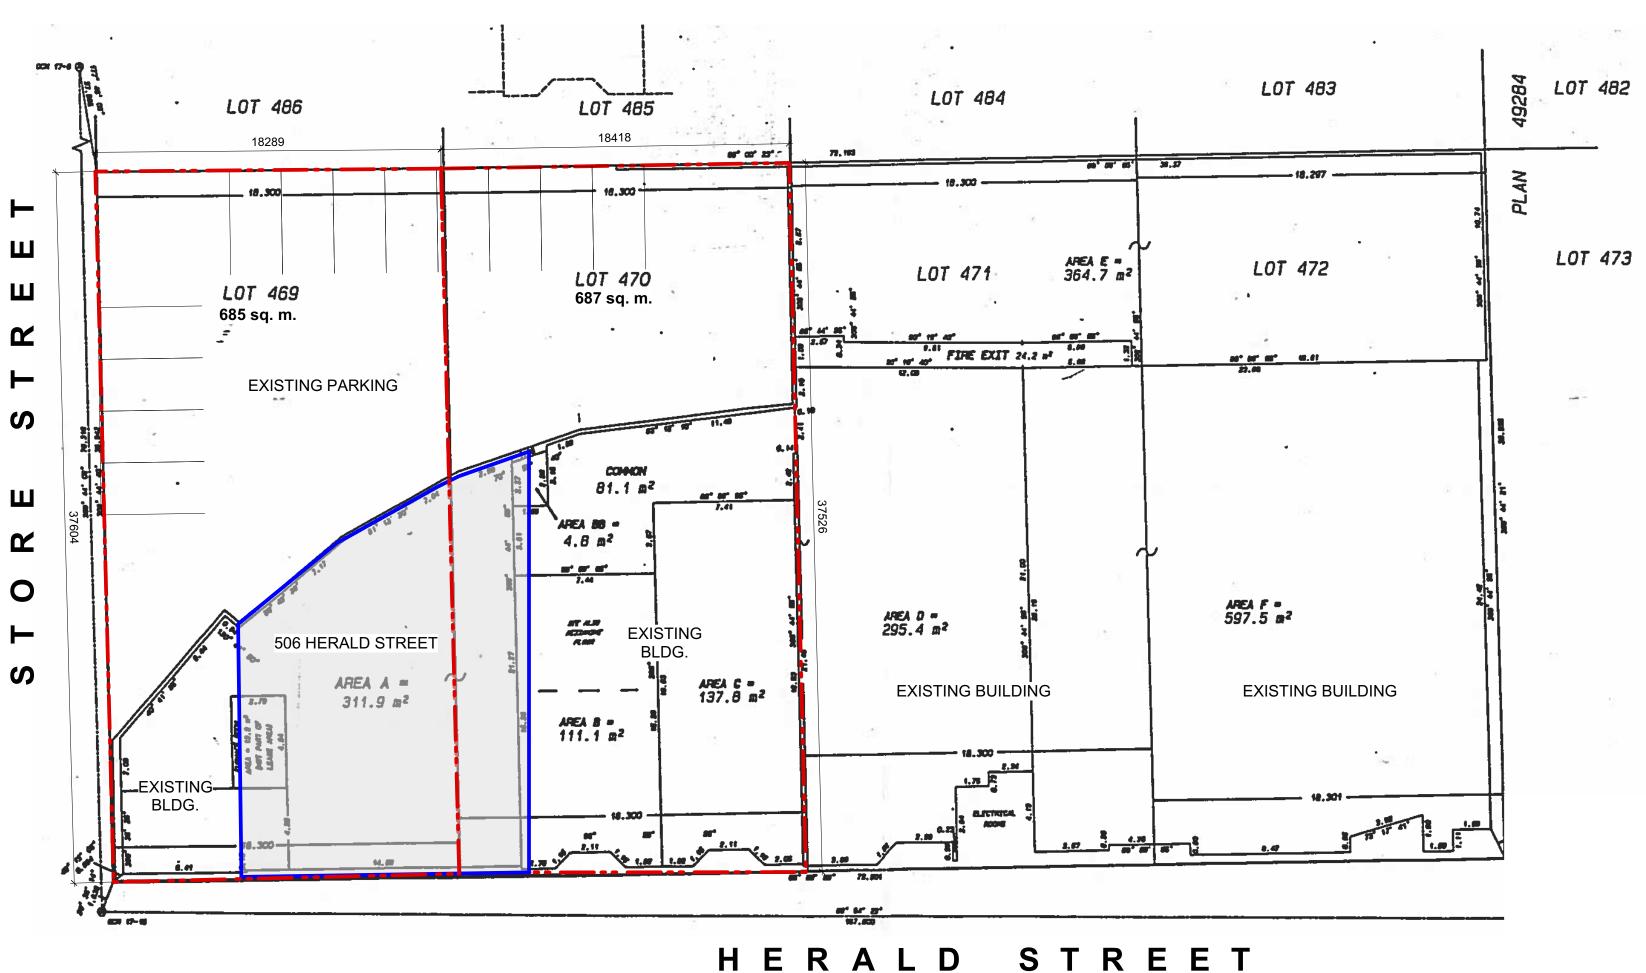

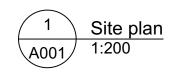

N - LOT 470

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ne storey plus mezzanine, and rooftop patio)

isting, no change)

ASS 1 & CLASS 2): none

s required.



REGISTERED OWNER

Mike & Lee Spence 5067 Cordova Bay Road Victoria, BC V8Y 2K1

ARCHITECT

dHKiarchitects 977 Fort Street Victoria, BC V8V 3K3

STRUCTURAL CONSULTANT

Sorensen TRILOGY Engineering Ltd. 215 - 737 Goldstream Avenue Brian Lang Victoria, BC tel: 250.880.2117 V9B 2X4 brianl@sorensenTRILOGY.ca

MECHANICAL CONSULTANT Avalon Mechanical Consultants Ltd.

300 - 1245 Esquimalt Road

Victoria, BC

V9A 3P2

Mirek Demidow tel: 250.384.4128 fax: 250.384.4134

tel: 250.818.5465

Charles Kierulf

crk@dhk.ca

tel: 250.658.3367

lee.spence.112@gmail.com

ELECTRICAL CONSULTANT

Williams Engineering Michael Phillips 202-31 Bastion Square tel: 778.406.0023 ext.6001 Victoria, BC MPhillips@williamsengineering.com V8W 1J1

ZONE 1 Arterial Commercial 1:1 Ratio Permitted (maximum total area: 9 m²)

SIGN TYPE Combination Sign: Business name painted on facade (mural style). SIGN AREA AS SHOWN 8.9 sq m

Note: Final sign design to be done by others in compliance to current sign bylaws.

BUILDING CODE SUMMARY - 506 Herald Street, Victoria, BC

REFERENCED DOCUMENT: BRITISH COLUMBIA BUILDING CODE 2018 - PART 3

BUILDING AREA [Building Footprint]: 1900 m2 overall, 260 m² for A-2 506 Herald Street .

BUILDING HEIGHT:	Two (2) store
NUMBER OF STREETS FACING:	One (1)
SPRINKLERED:	Yes

MAJOR OCCUPANCY CLASSIFICATIONS: Group E (3.2.2.67) and A2 (3.2.2.27). 3.2.2.67 is more restrictive.

SEPARATION OF MAJOR OCCUPANCIES: (3.1.3.1) • Minimum fire-resistance rating of fire separation, Group E to A-2: 2 hours., Group A-2 to A-2 - none.

CONSTRUCTION TYPE (3.1.4): Combustible Heavy Timber Construction

OCCUPANT LOAD (3.1.17):

1.2 m²/person for dining and beverage. 4.6 m² /person for process rooms.

Ground Floor.

Gross Floor Area 260 m ² (served by 2 exits f	ront and rear) T
Ground Floor Restaurant Area:	124 m ²
Ground Floor Process Area:	73 m ²
Cooler:	19 m ²

Mezzanine: Gross Floor Area 83 m² (served by 1 stair down to Ground Floor) Total Load: 67 people Mezzanine Restaurant Area: $56 \text{ m}^2 = 67 \text{ people}$

Rooftop:

Gross Area 167 m² (served by 2 exits front and rear) Total Load: 200 people (seasonal). Rooftop Restaurant Area: $167 \text{ m}^2 = 200 \text{ people}$

Total Calculated Occupant Load: 390; Occupant load limited and posted per 3.1.17.1.2) to 277 people.

CONSTRUCTION REQUIREMENTS (3.2.2.67):

• Group E, up to 3 storeys, Sprinklered • 1) A building classified as Group E is permitted to conform to Sentence(2) provided a) except as permitted by Sentences 3.2.2.7.(1) and 3.2.2.18.(2), the building is sprinklered throughout, b) it is not more than 3 storeys in building height, and

- c) it has abuilding area not more than
- i) 7 200 m2 if 1 storey in building height, 2) The building referred to in Sentence (1) is permitted to be of combustible construction or noncombustible
- construction used singly or in combination, and a) floor assemblies shall be fire separations with a fire - resistance rating not less than 45min,
- b) mezzanines shall have, if of combustible construction, a fire-resistance rating not less than 45 min, c) loadbearing walls, columns and arches supporting an assembly required to have a fire-resistance rating shall i) have a fire-resistance rating not less than 45 min, or
- ii) be of noncombustible construction, and
- required for the fire separation.

FIRE ALARM AND DETECTION SYSTEMS (3.2.4):

- Signal to Fire Department required, 2 stage. Will notify that an alert signal has been initiated (3.2.4.8.3)
 Building is one storey and less than 2000 m², and therefore can be one fire zone. An annunciator is not required if there is only one zone (3.2.4.9(2,3))
- Visual and audible trouble signal to be provided at main entrance (3.2.4.4)
- Electrical supervision of fire alarm system required (3.2.4.10) • Smoke detectors not required (3.2.4.12)
- Fire alarm system monitoring required (3.2.4.16)
- Manual pull stations required at exits (3.2.4.17)

EXITS AND EGRESS:

Travel Distance to an exit is 45 m maximum (3.4.2.5); 8.5 m (Ground Floor), 13 m (Mezzanine), 29 m (Roof) actual. Minimum Width of Exits (3.4.3.2): Exit corridor / passageway: 1100 mm 900 mm Stair: 800 mm Doorways:

WASHROOMS:

• Building occupancy is limited to 178 people as per approved liquor licence, with an additional 99 people on the roof (unlicensed) for a total of 277 people. Total Number of water closets provided (3.7.2.2.A) is 9. All water closet stalls are private and unisex. Sign with occupant limit to be posted on site. • Accessible washroom provided is ground floor universal washroom (3.7.2.10).

SIGNAGE BYLAW SUMMARY

REFERENCED DOCUMENT: CITY OF VICTORIA SIGNAGE BYLAW 14-097

DRAWING LIST


Architectural

A001	Project Data & Site Plan
A201	Level 1 & Mezzanine Floor Plar
A202	Roof Top Plan
A203	Seating Plan
A401	Elevations
A501	Sections
A601	Materials Board

rey


Total Load: 123 people $n^2 = 103$ people $m^2 = 16$ people $m^2 = 4 people$

d) loadbearing walls, columns and arches supporting a fire separation shall have a fire-resistance rating not less than that

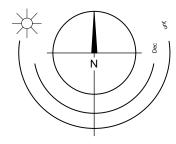


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2		21 JAN 2020		Re-Issued for Development Permit
1		12 NOV 2019		Re-Issued for Development Permit
Rev	Date	31 DEC 2018	Description	Issued for Development Permit
plot date		31 MAR 2020	drawing file	
drawn by		nlc	checked by	crk
scale		As Noted	project number	1748

dHKa de Hoog	& Kierulf arc	hitects
VICTORIA OFFICE 977 Fort Street Victoria BC V8V3K3 T 1•250•658•3367	NANAIMO OFFICE 102-5190 Du Nanaimo BC T 1•250•585	blin Way V9T2K8
^{project name} Herald Brew Pt 506 Herald Street Victoria, BC	ub	
Project Data &	Floor Plan	
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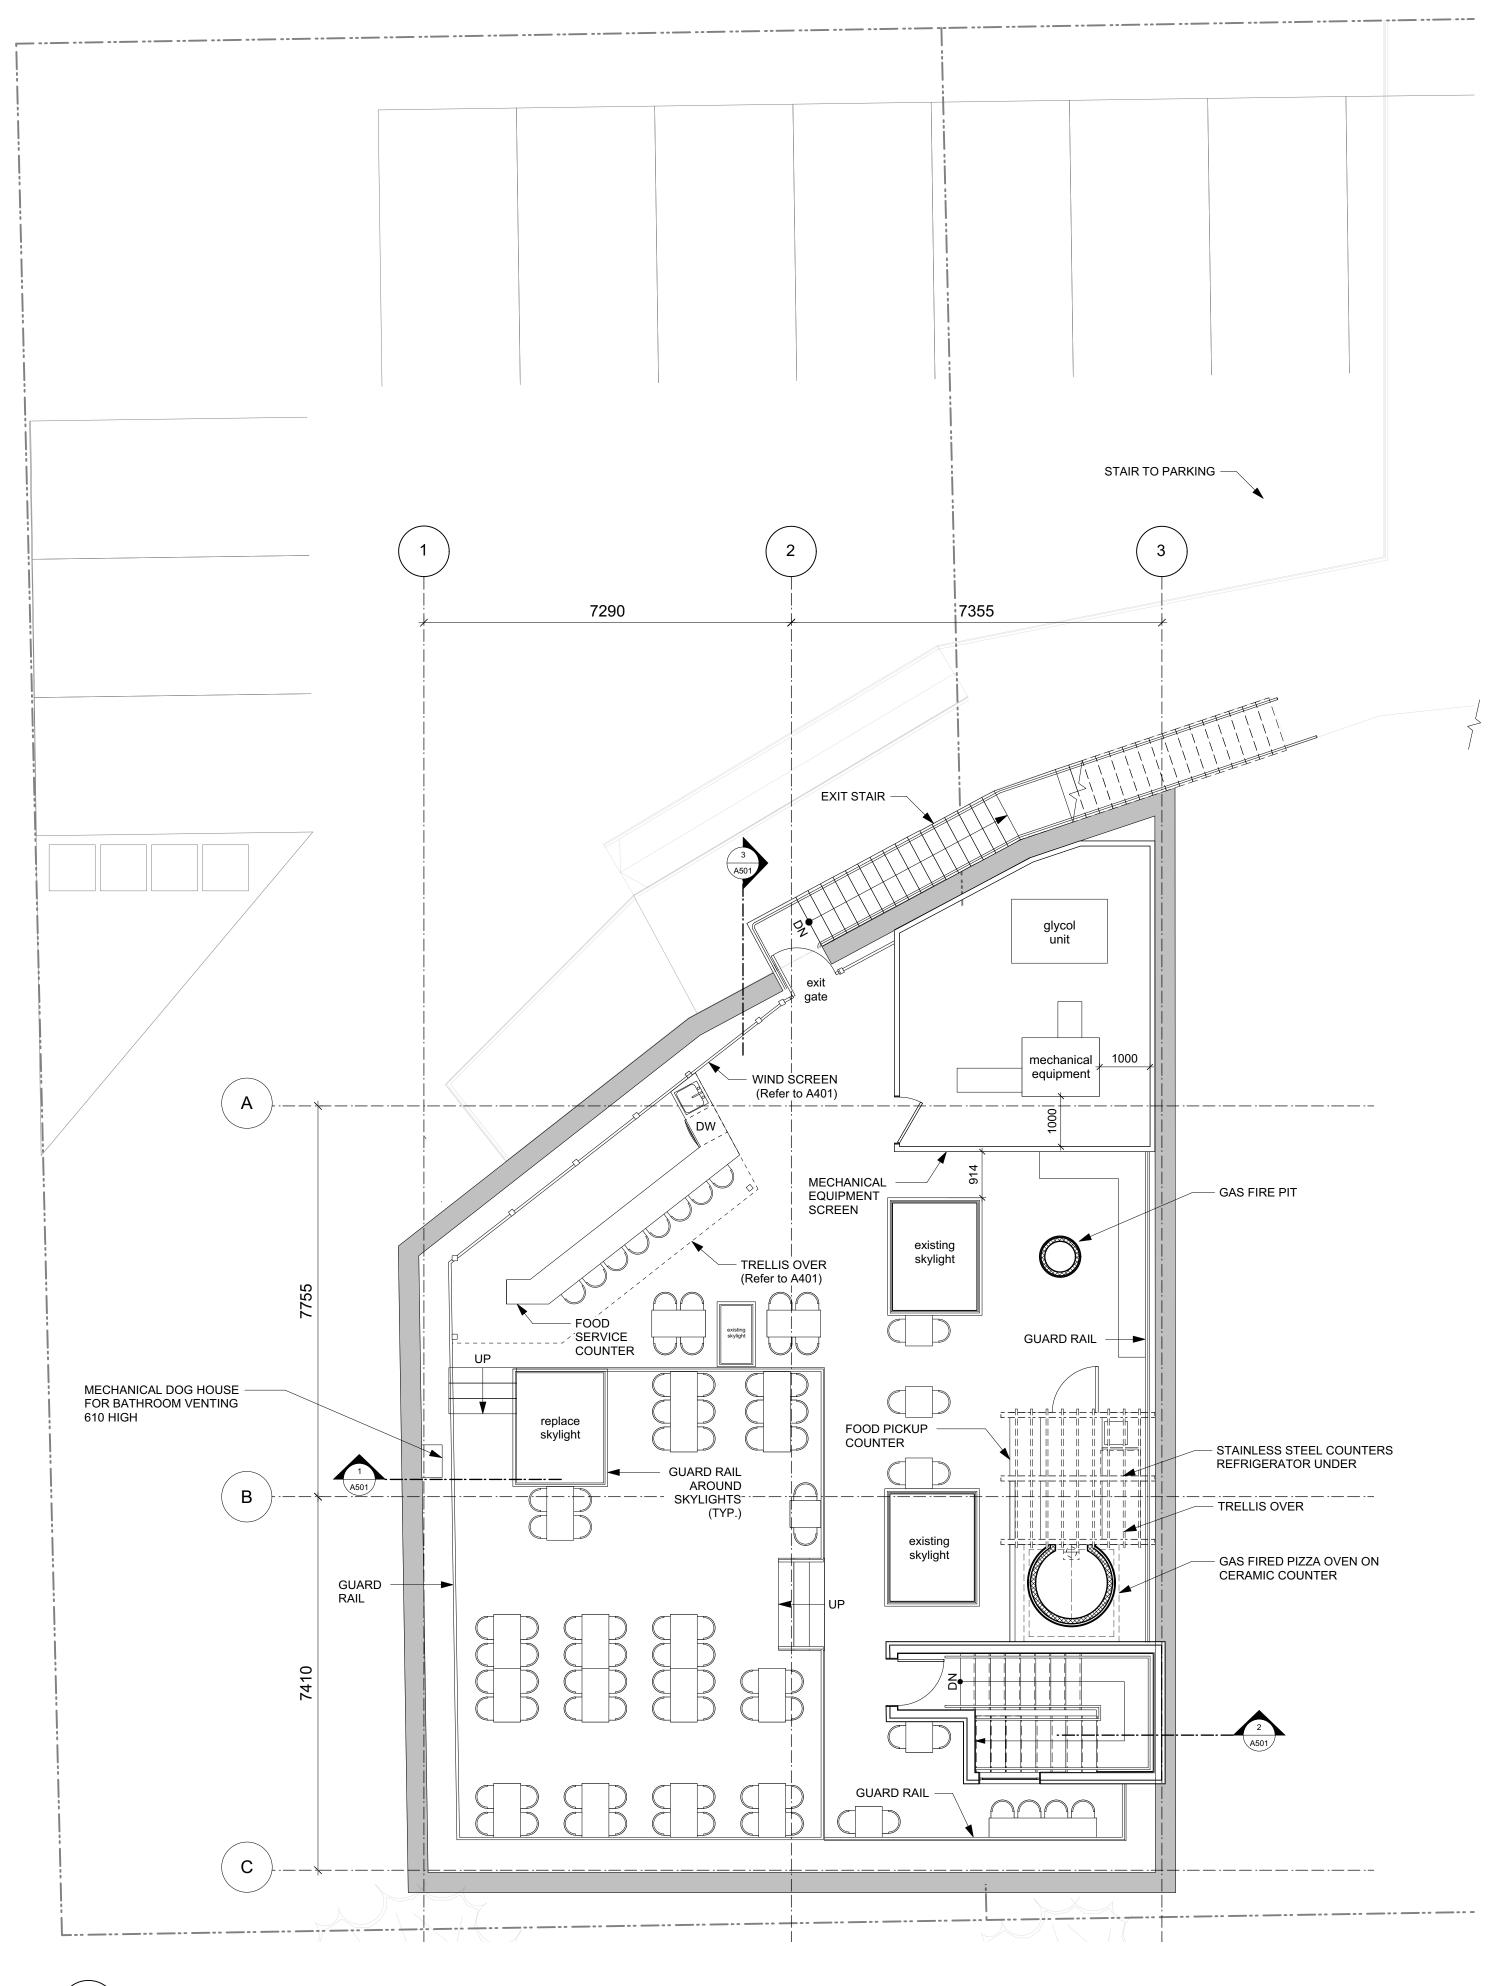


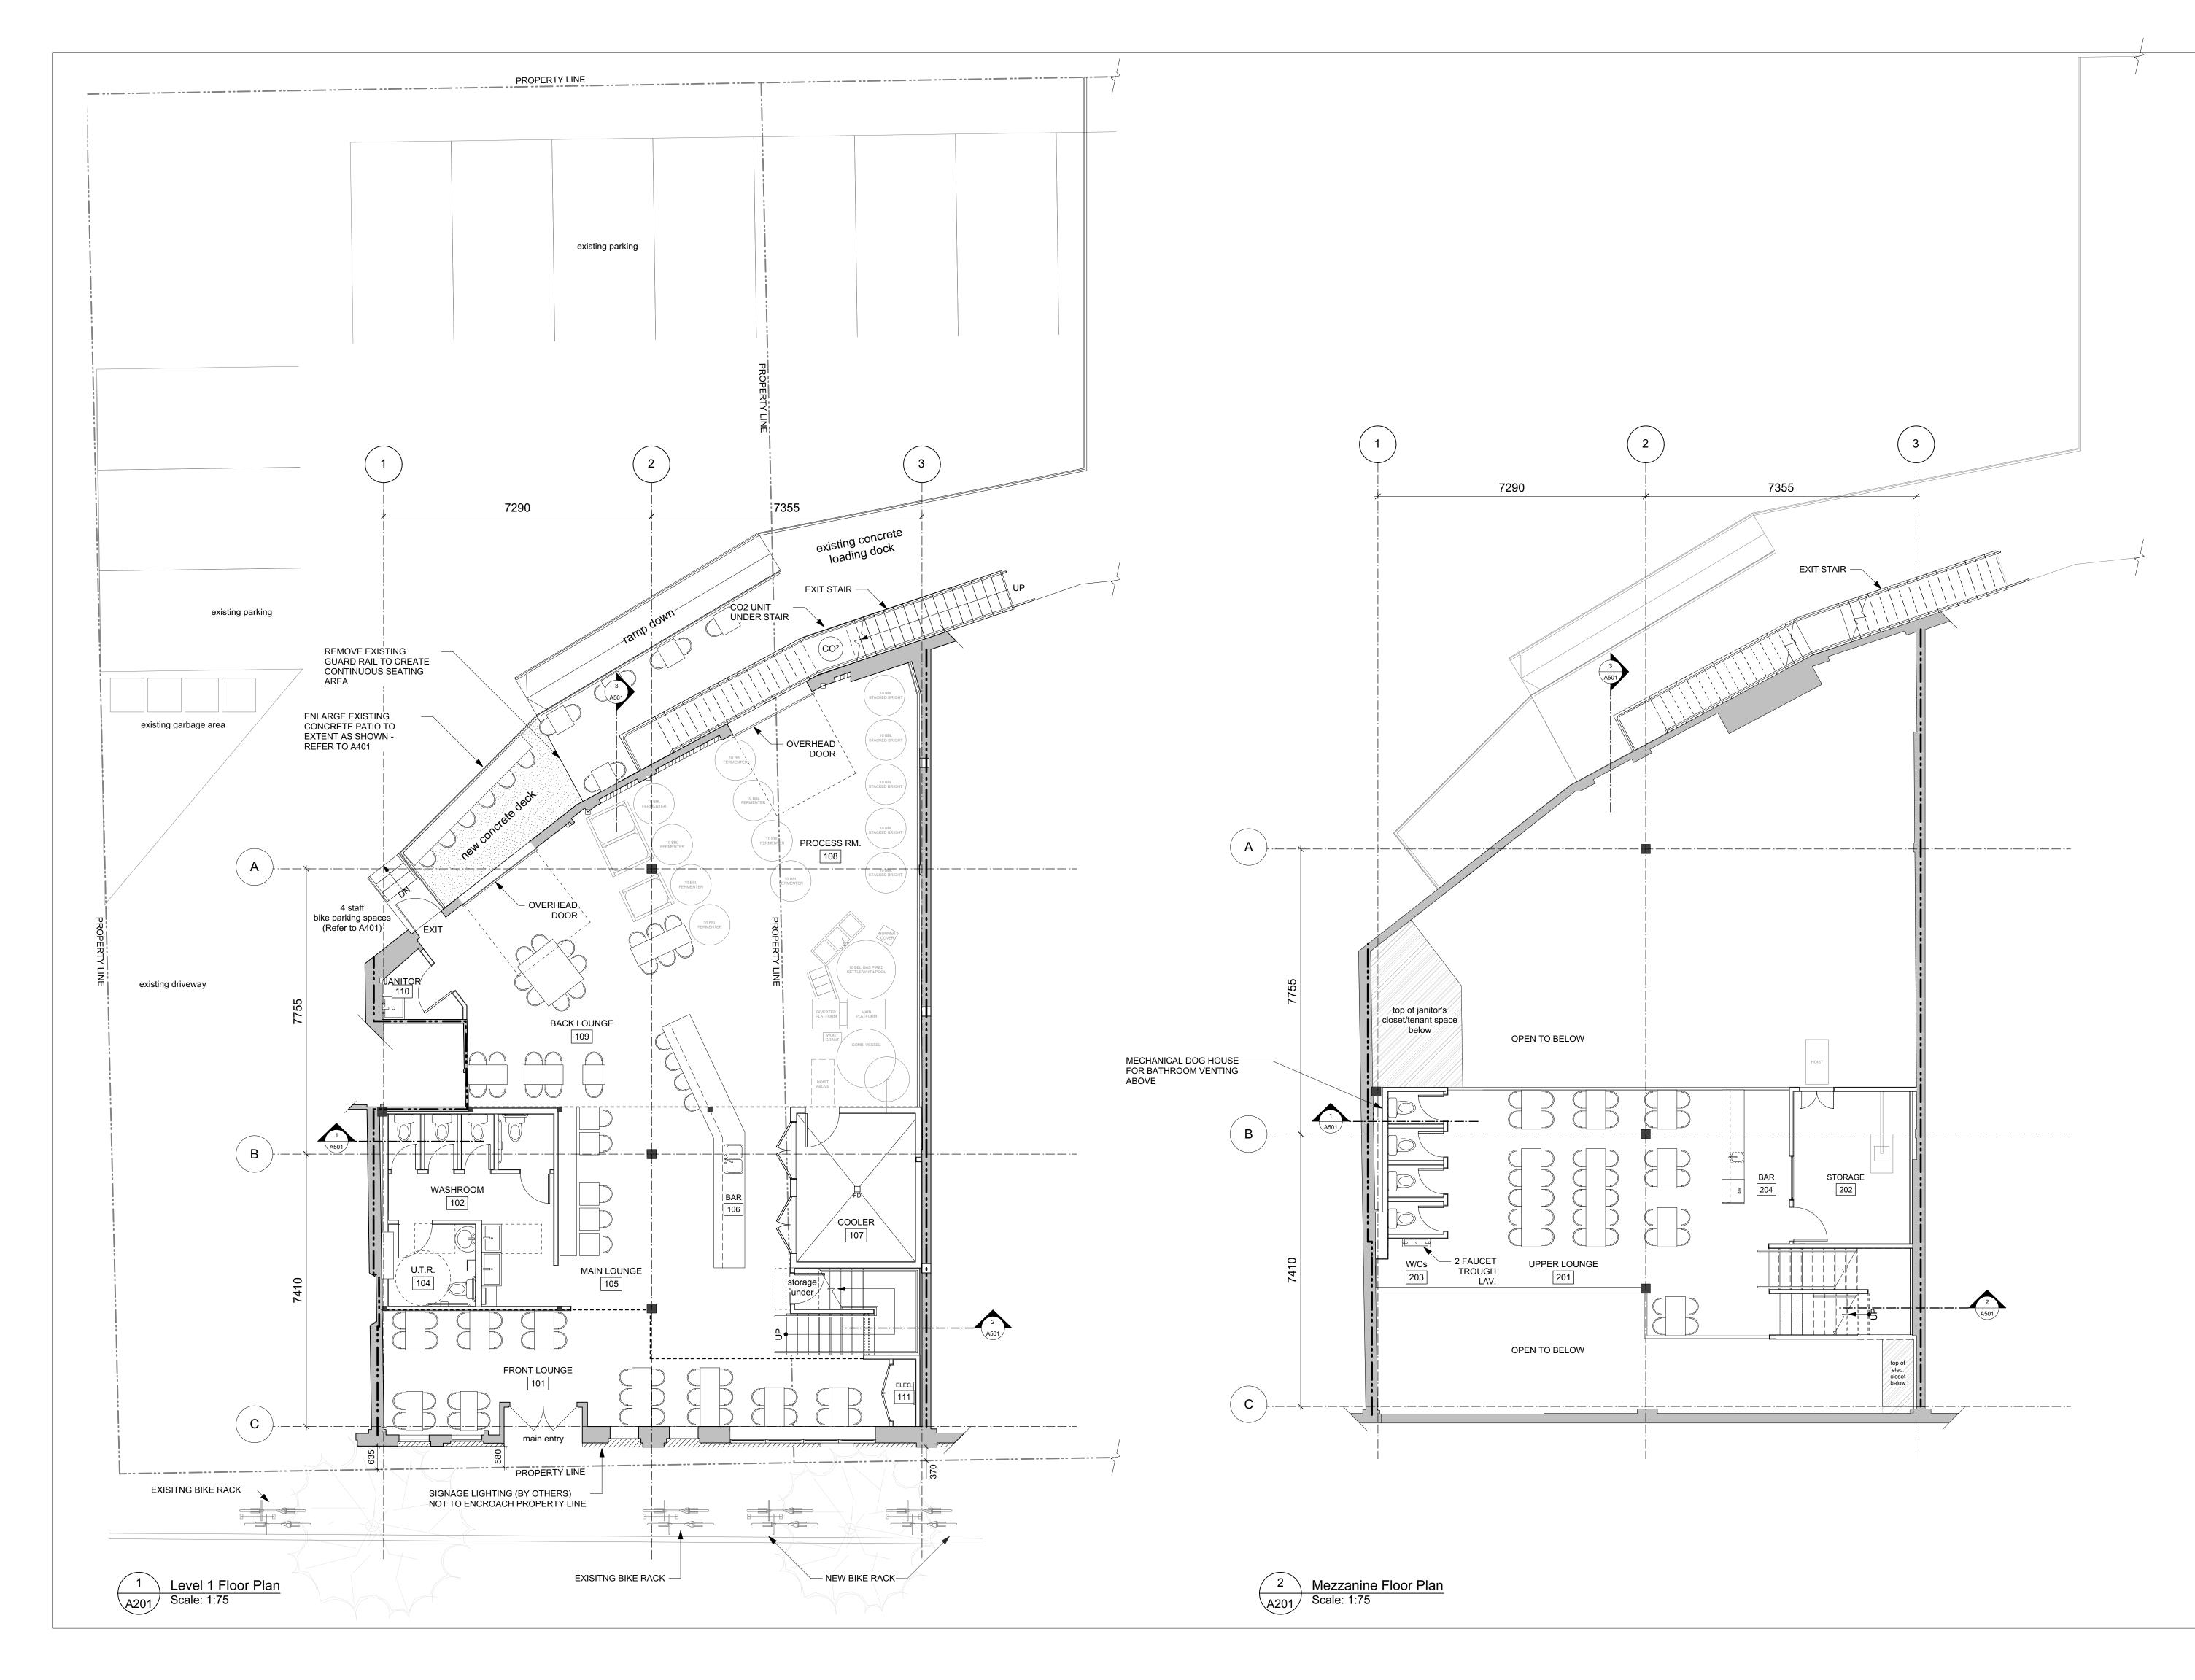General Notes

- Contractor to verify all dimensions and confirm same on site. Architect to be notified in case of any discrepancies.
- 2. Shaded walls are existing.
- All gridlines are to centreline of existing columns, centre of studs, and face of existing interior brickwork unless noted otherwise. Plans to be read in conjunction with details to confirm.



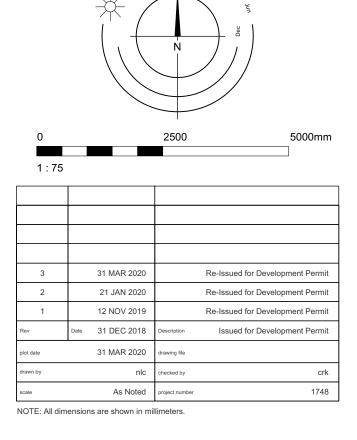



Rooftop Plan Scale: 1:75 (1) (A202)


- GAS FIRED PIZZA OVEN ON CERAMIC COUNTER 2 A501 _____

- STAINLESS STEEL COUNTERS REFRIGERATOR UNDER - TRELLIS OVER

— GAS FIRE PIT

General Notes


- Contractor to verify all dimensions and confirm same on site. Architect to be notified in case of any discrepancies.
- 2. Shaded walls are existing.
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plot date		31 MAR 2020	drawing file	
drawn by		nlc	checked by	crk
scale		As Noted	project number	1748

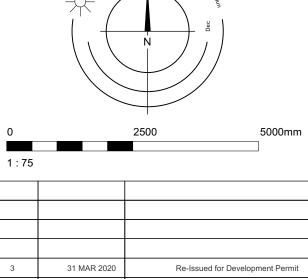NOTE: All dimensions are shown in millimeters.

dHKa de Hoog	& Kierulf are	chitects
VICTORIA OFFICE 977 Fort Street Victoria BC V8V3K3 T 1•250•658•3367	NANAIMO OFFIC 102-5190 D Nanaimo B T 1•250•58	ublin Way C V9T 2K8
^{project name} Herald Brew Pu 506 Herald Street Victoria, BC	Jb	
Roof Top Floor	Plan	
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	Zen Retreat - 0535
\mathbf{O}	Retain existing brick
$\mathbf{)}$	Prefinished aluminum Climb-proof mesh ins
$\mathbf{)}$	Prefinished aluminum Fir posts - Clear Stair
$\mathbf{)}$	Paint new concrete ir
\mathbf{O}	Anodized metal.
\mathbf{O}	1828 mm high windb glass and prefinished Fir posts and trellis -
	Prefinished aluminum


8 Prefinished aluminum guardrail frame - Dark Grey Translucent tempered glass inset.


10 New lighting to co-ordinate with existing (by others).

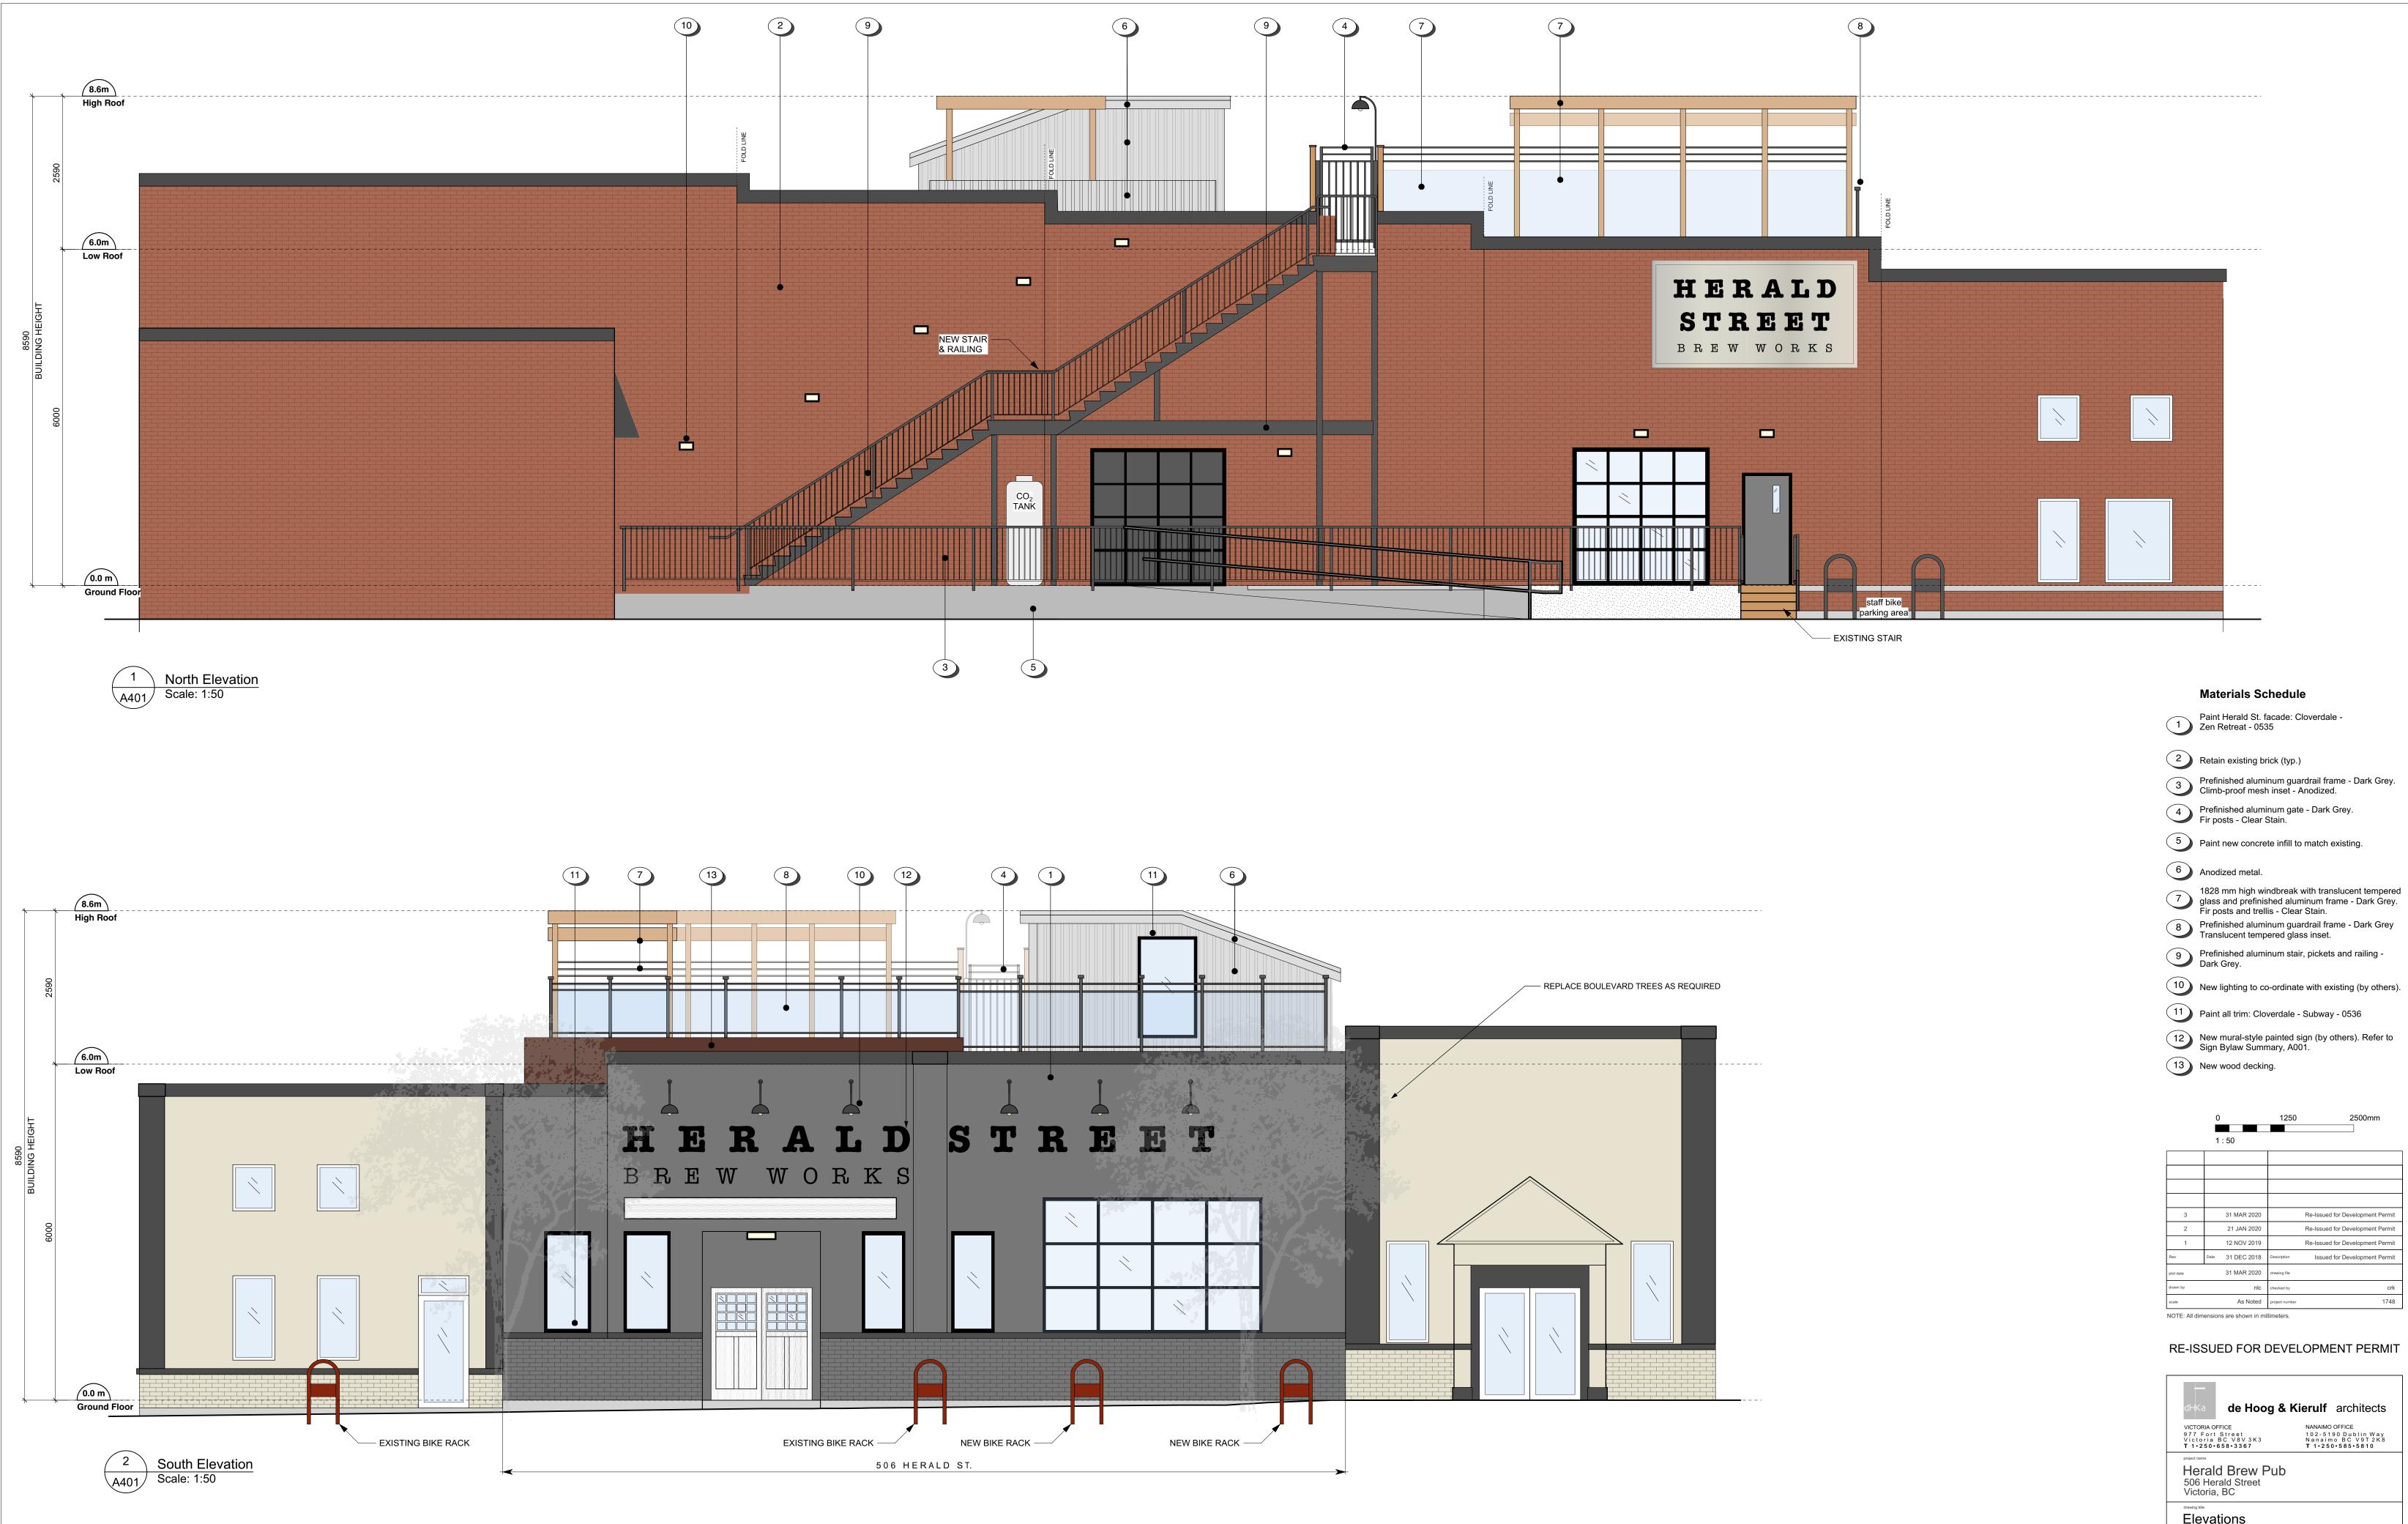
12 New mural-style painted sign (by others). Refer to Sign Bylaw Summary, A001.

	0 1	: 50	1250	2500mm
3		31 MAR 2020		Re-Issued for Development Permit
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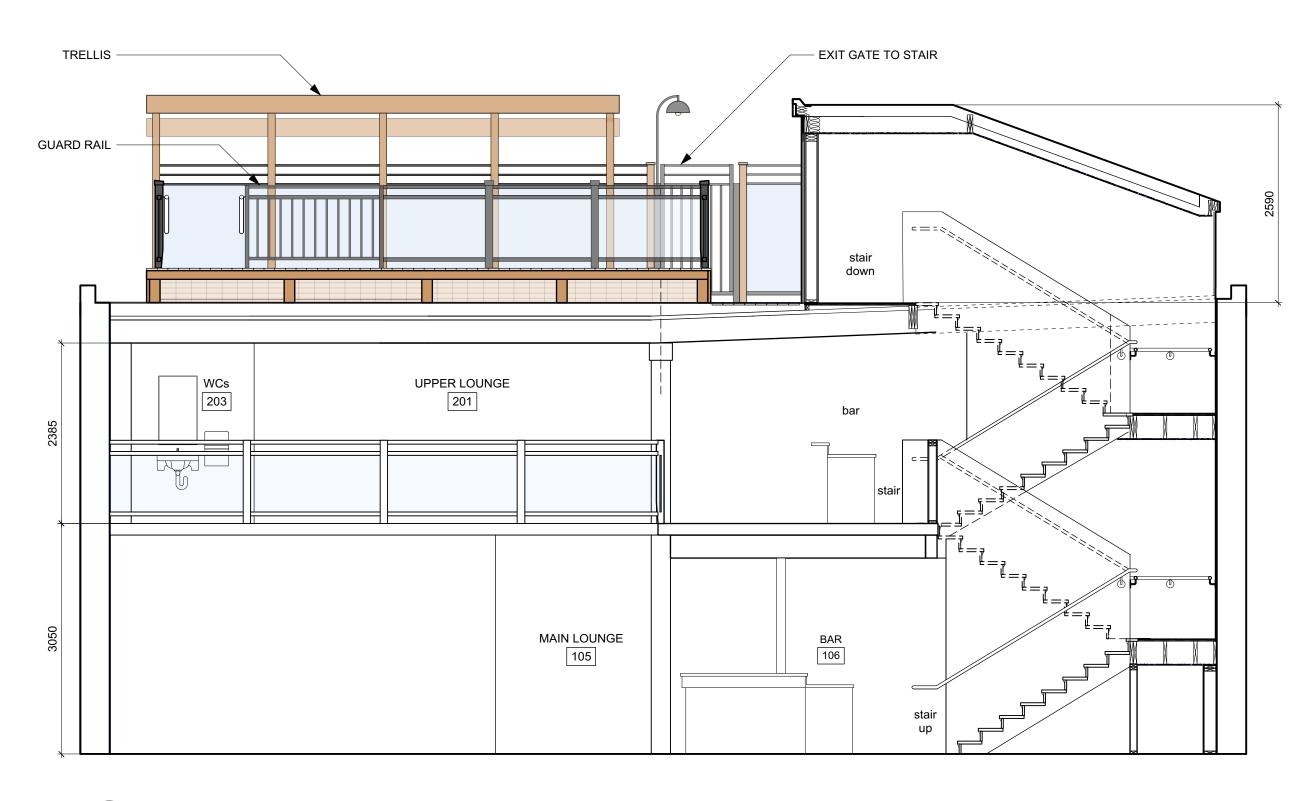
dHKa de Hoog	& Kierulf ar	chitects
VICTORIA OFFICE 977 Fort Street Victoria BC V8V3K3 T 1・250・658・336 7	NANAIMO OFFI 102-5190 E Nanaimo B T 1•250•5 8	Dublin Way C V9T 2K8
^{project name} Herald Brew Pu 506 Herald Street Victoria, BC	ıb	
Elevations		
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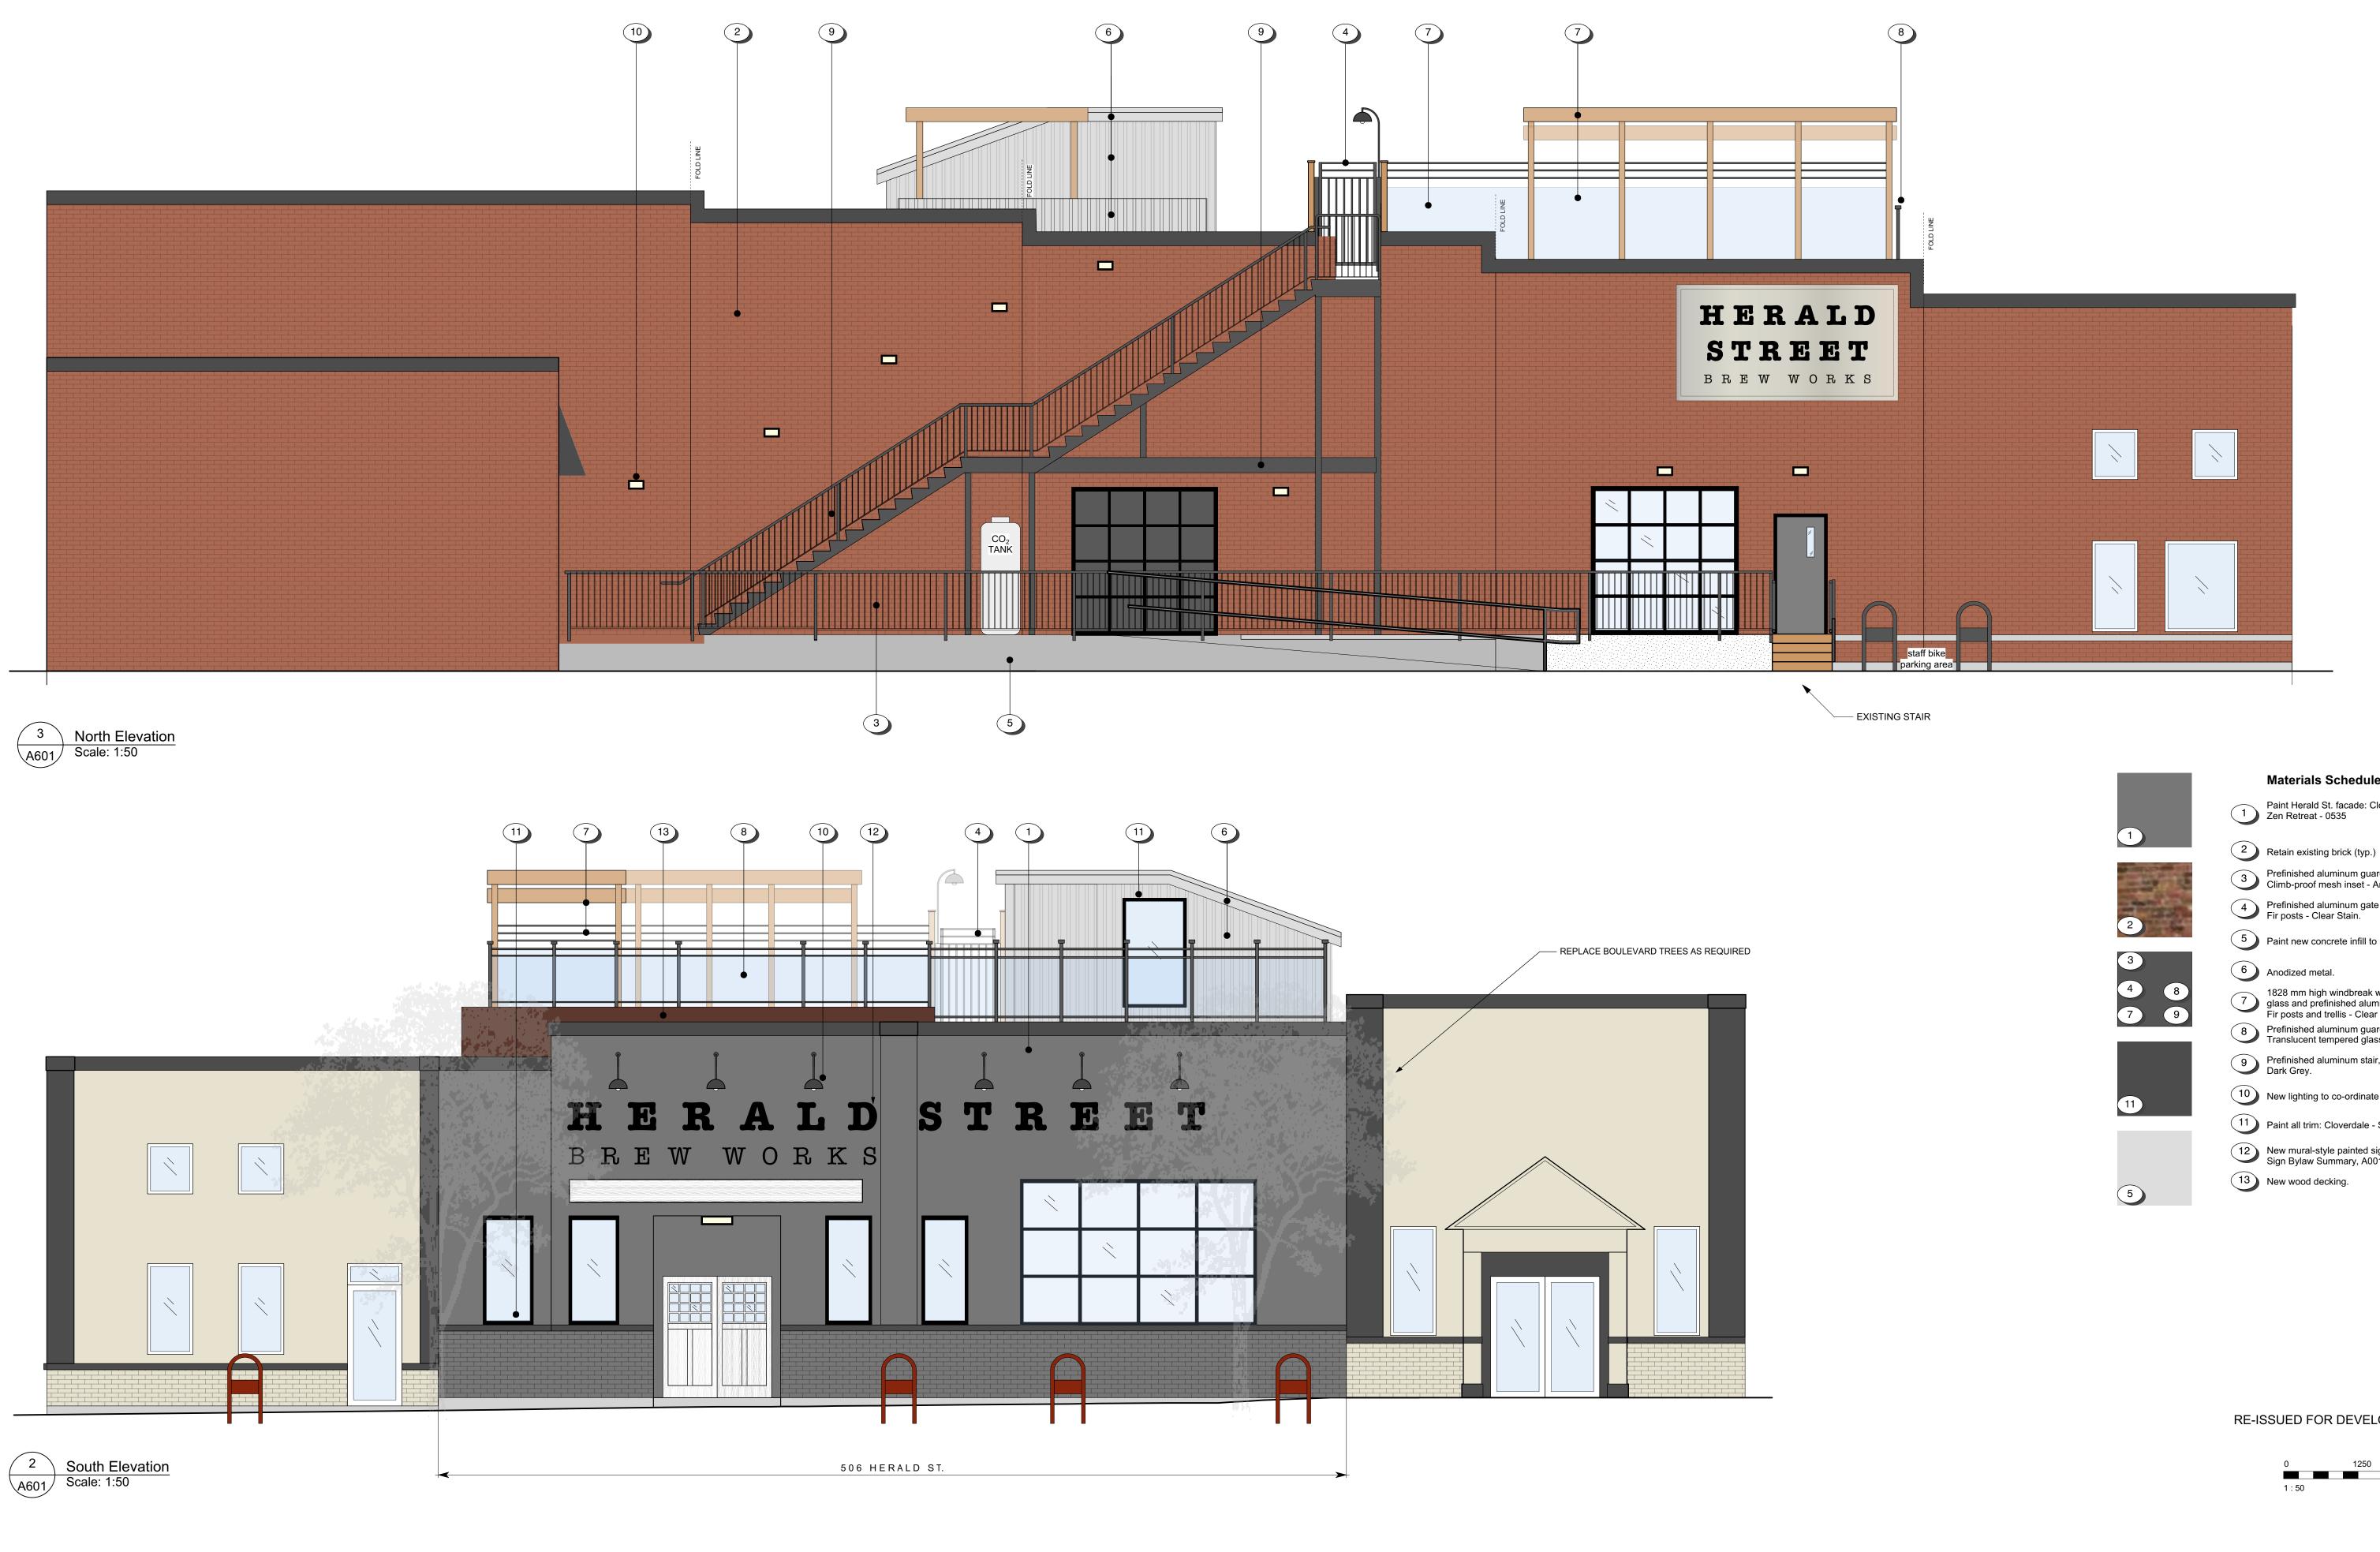
1Building SectionA501Scale: 1:50



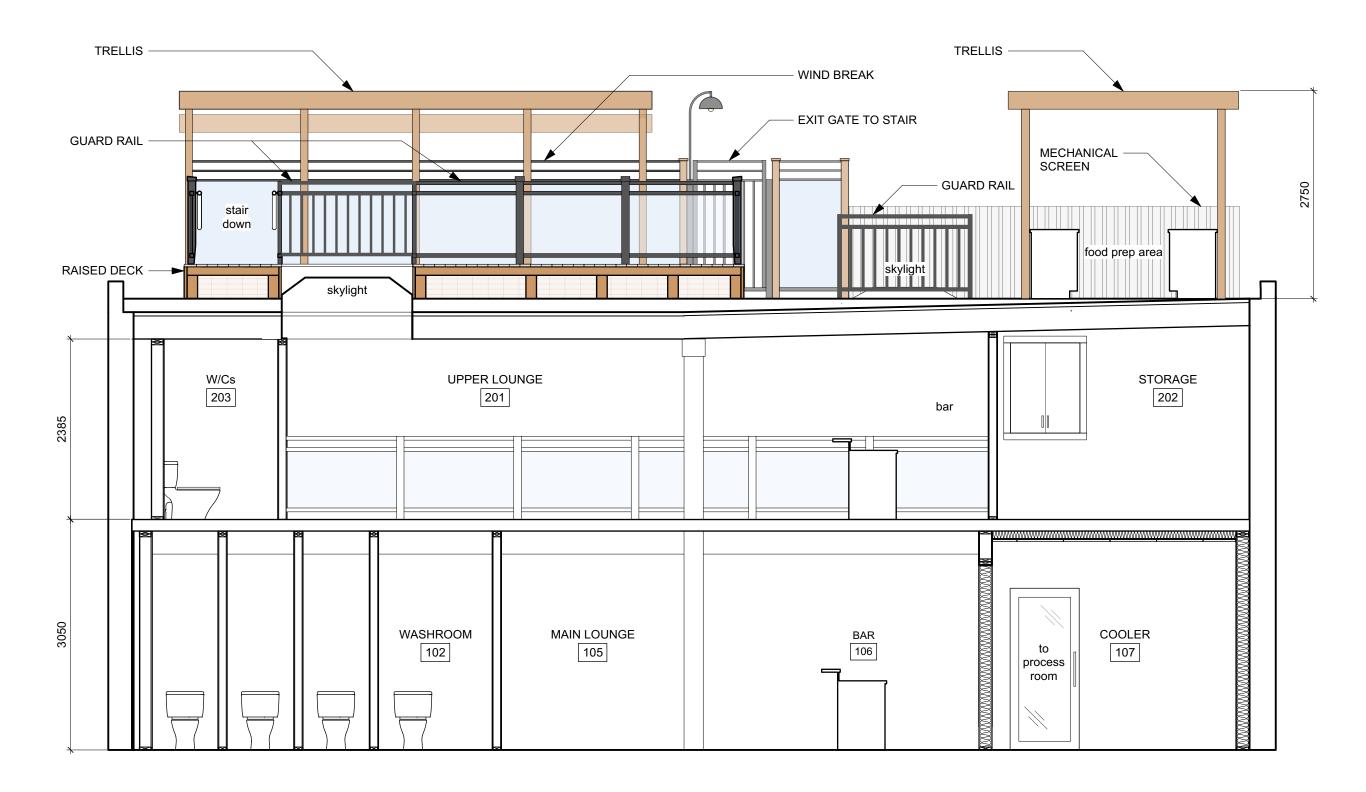
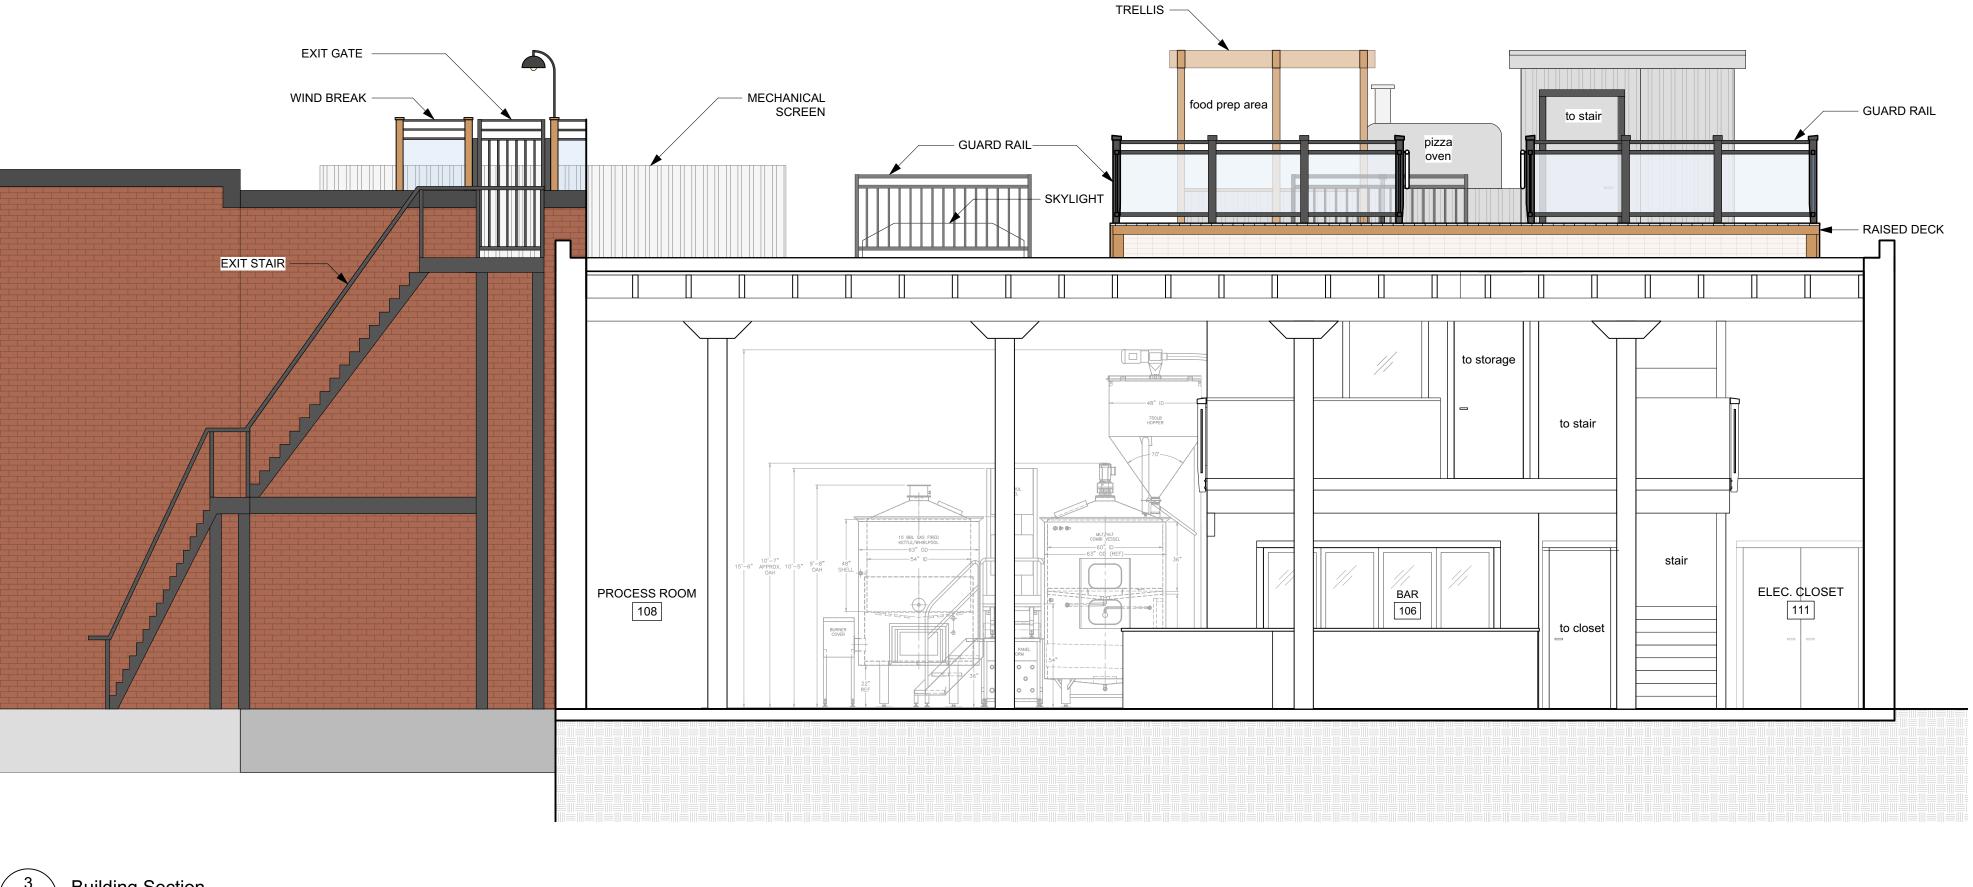
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3		31 MAR 2020		Re-Issued for Development Permit
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1		12 NOV 2019		Re-Issued for Development Permit
Rev	Date	31 DEC 2018	Description	Issued for Development Permit
plot date		31 MAR 2020	drawing file	
drawn by		nlc	checked by	crk
scale		As Noted	project number	1748

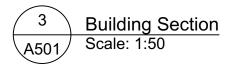dHKa de Hoog & Kierulf architects		
VICTORIA OFFICE NANAIMO OFFICE 977 Fort Street 102-5190 Dublin Way Victoria BC V8V 3K3 Nanaimo BC V9T 2K8 T 1・250・658・3367 T 1・250・585・5810		
Project name Herald Brew Pub 506 Herald Street Victoria, BC		
Sections		
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Mike & Lee Spence Victoria, BC 31 MAR 2020

Herald Brew Pub



Materials Schedule

Paint Herald St. facade: Cloverdale -Zen Retreat - 0535

- Prefinished aluminum guardrail frame Dark Grey.
 Climb-proof mesh inset Anodized. Prefinished aluminum gate - Dark Grey. Fir posts - Clear Stain.
- 5 Paint new concrete infill to match existing.

1828 mm high windbreak with translucent tempered glass and prefinished aluminum frame - Dark Grey.
 Fir posts and trellis - Clear Stain.

8 Prefinished aluminum guardrail frame - Dark Grey Translucent tempered glass inset.

Prefinished aluminum stair, pickets and railing -Dark Grey.

10 New lighting to co-ordinate with existing (by others).

11 Paint all trim: Cloverdale - Subway - 0536

12 New mural-style painted sign (by others). Refer to Sign Bylaw Summary, A001.

RE-ISSUED FOR DEVELOPMENT PERMIT

1250 2500mm





de Hoog & Kierulf architects dHKa