Parking Count

Standard stalls 79
Accesible stalls 3


Total stalls 82

HDR ARCHITECTURE ASSOCIATES 203-655 TYEE ROAD VICTORIA, B.C. V9A 6X5 PH. 1.250.388.5588

Greater VICTORIA School District

SCHOOL DISTRICT 61 VIC HIGH SCHOOL

1260 GRANT STREET VICTORIA, BC V8T 1C2

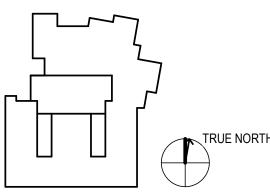

Project Manager
Project Designer
Project Architect
Landscape Architect
Civil Engineer

DIANA STUDER

JIM MANN
LADR LANDSCAPE ARCHITECTS
WESTBROOK ENGINEERING

Structural Engineer
Mechanical Engineer
Electrical Engineer
Plumbing Engineer
Interior Designer
Engineer
HEROLD ENGINEERING
M3 ENGINEERING
M3 ENGINEERING
M3 ENGINEERING
HDR ARCHITECTURE
HDR ARCHITECTURE

Sheet Reviewer Author

DATE
AUGUST 11, 2020
NOV. 20, 2020

DESCRIPTION
ISSUED FOR VARIANCE PE
ISSUED FOR VARIANCE PE

HDR ARCHITECTURE

NOV. 20, 2020 ISSUED FOR VARIANCE PERMIT REVISIONS

Project Number 10199559


Original Issue 07/09/20

Variance Submission for City - Site Plan - Existing

Scale 1 : 500

AC1.1

Project Status

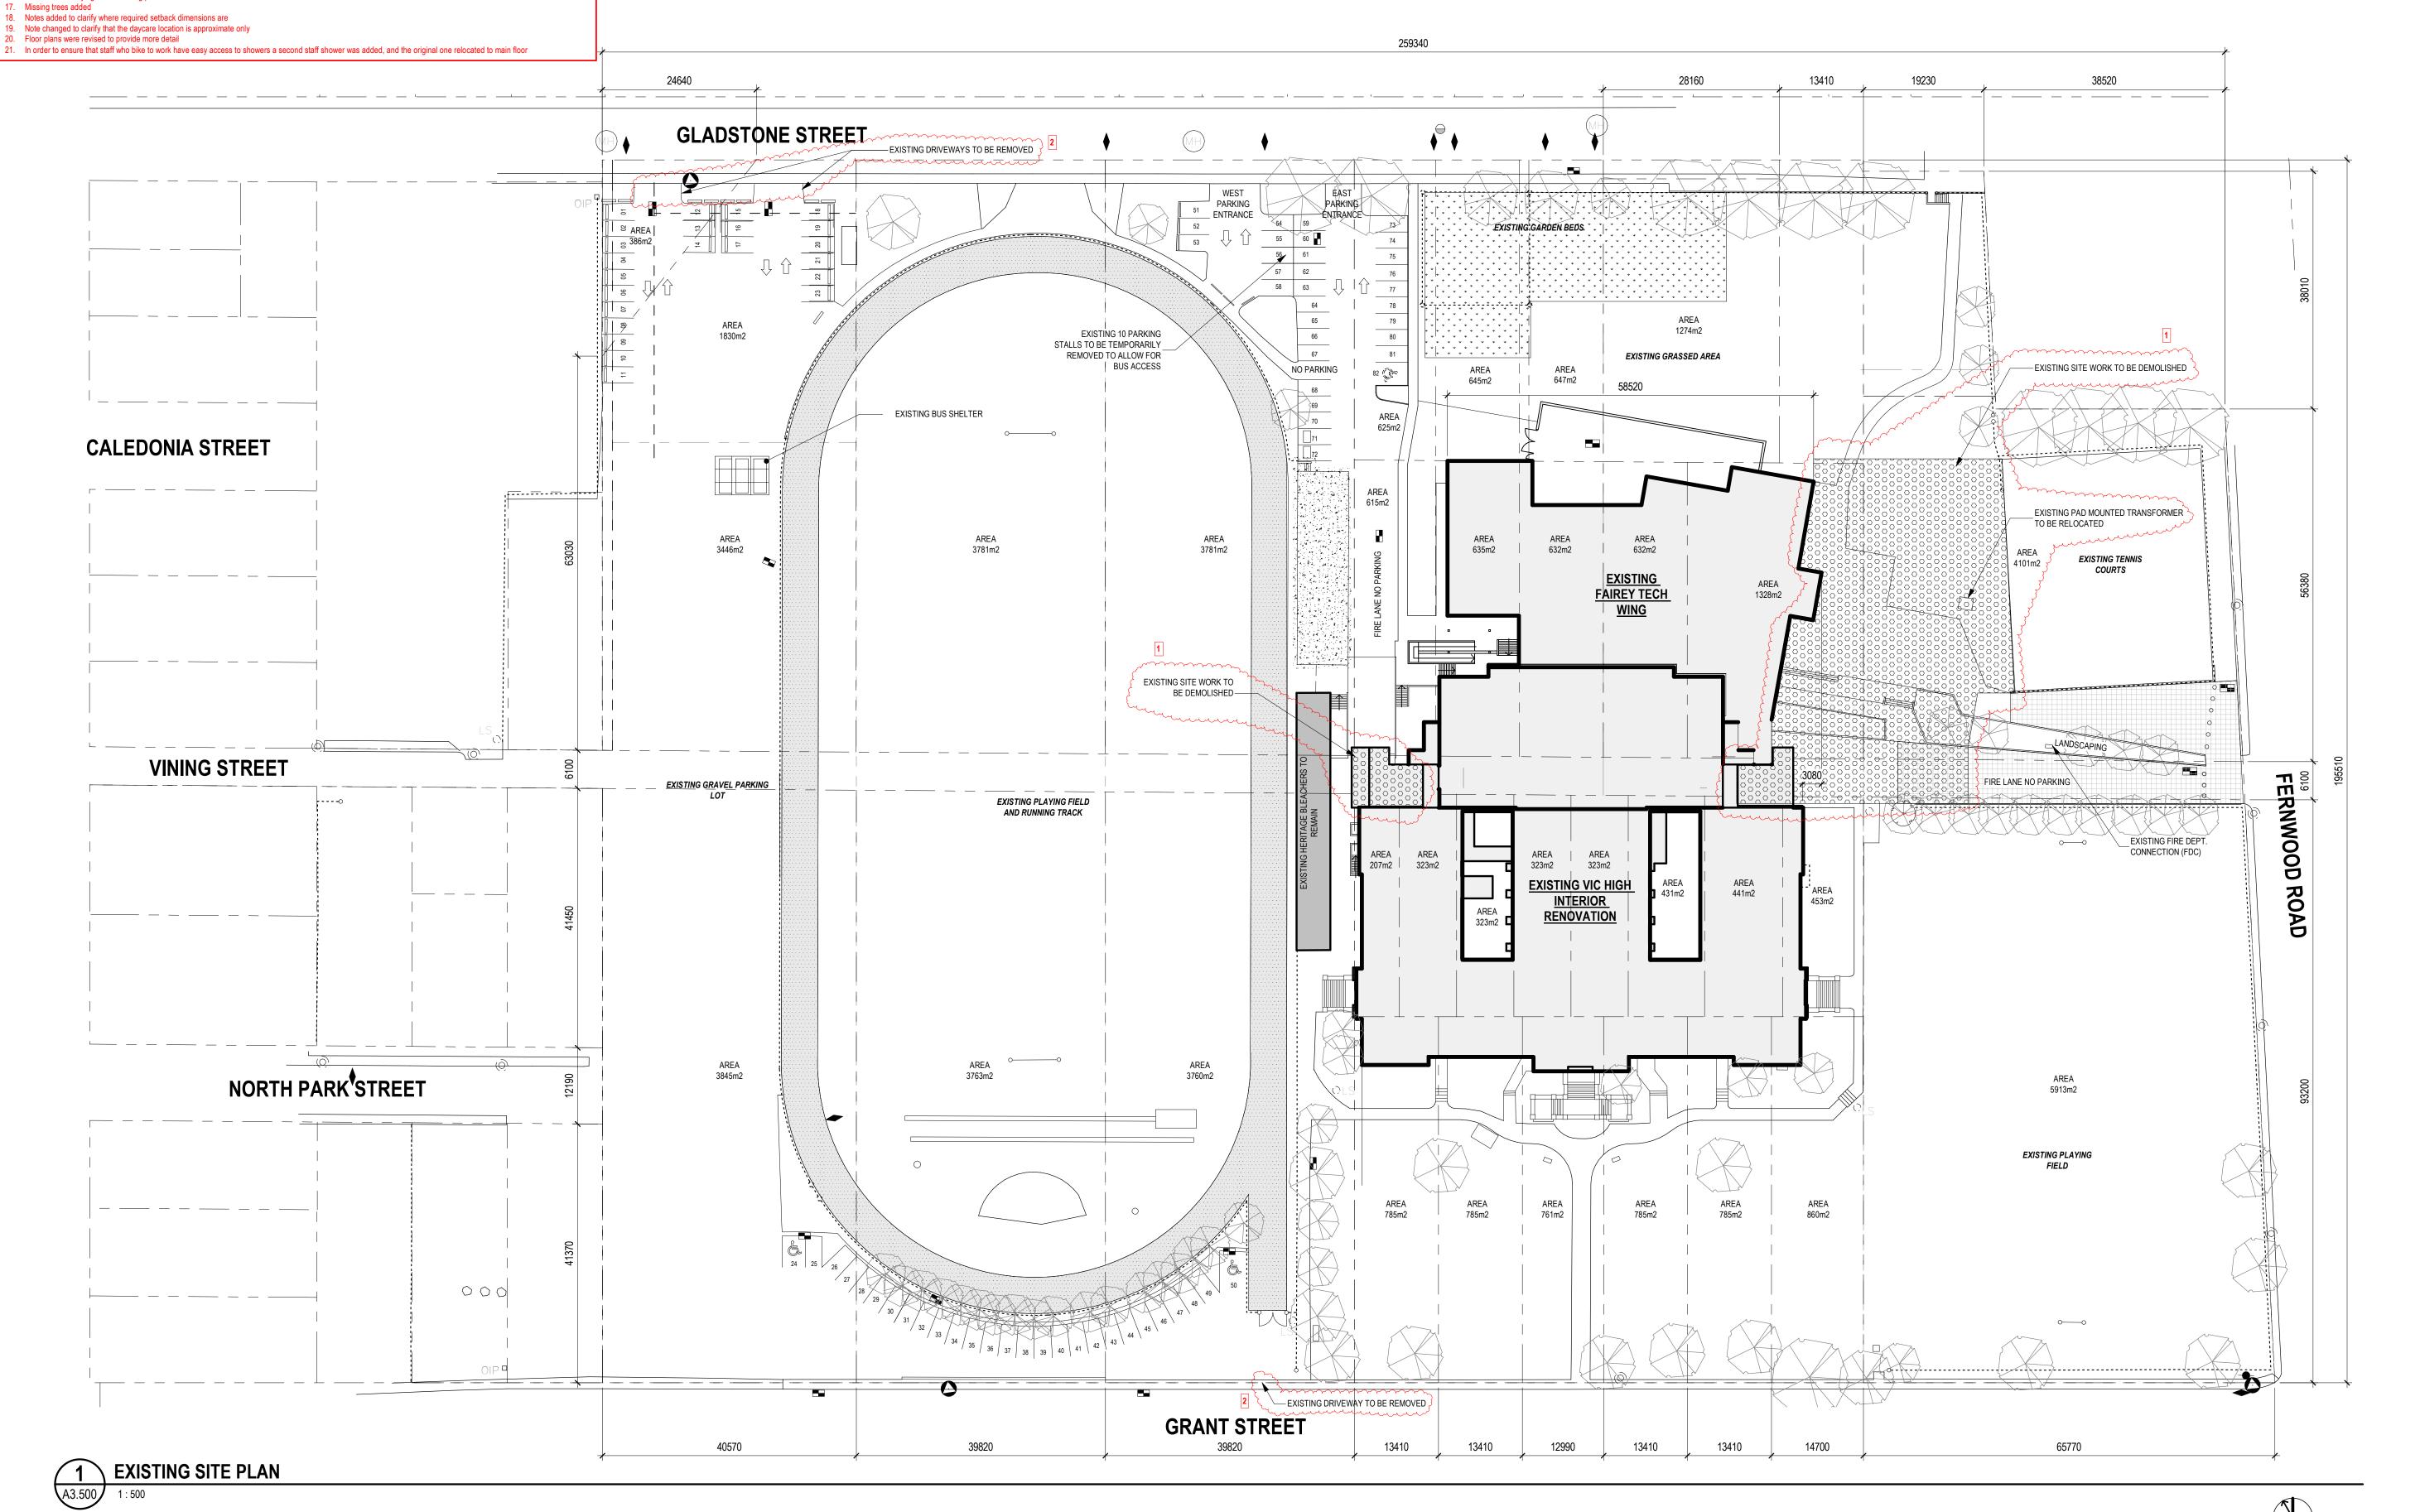


					REQUIRED	PROPO
CIVIC ADDRESS:	1260 GRANT STREET, VIC	TORIA, BC, CANADA			~~~~~	
LEGAL DESCRIPTION:	LOT B, SECTION 59, SPRIN SECTION 57, SPRING RIDO		PLAN 25139, LOT A-F,	PARKING (VEHICLE):	283 3	14
PROJECT DESCRIPTION:	RENOVATION AND ADDITI	ON TO EXISTING SCHO	OOL		 	
FLOOR AREA:				PARKING (BICYCLE):	{	
EXISTING FLOOR AREA NEW FLOOR AREA ADDED TOTAL FLOOR AREA	19,275 m² (207,474 ft²) 1,628 m² (17,524 ft²) 20,904 m² (225,008 ft²)			LONG TERM SHORT TERM	13 168	18
······································		~~~~~~~~~~~~~~~~~~~~~~~~~~~~~~~~~~~~~~	3	TOTAL	181	20
	EXISTING	REQUIRED	PROPOSED			
SITE AREA:	49,791 m² (535946 ft²)	555m2 (5973ft²)	49,791 m² (535946ft²)			
	12%	MAX. 40%	14%			
SITE COVERAGE:			ζ			
	80%	MIN. 30%	78%			
	80% 0.39 to 1	MIN. 30% MAX5 to 1	78% 0.42 to 1			
OPEN SITE SPACE:			}			

REVISION NUMBER LEGEND

- Existing site work to be demolished and pad mounted transformer to be relocated
- Existing driveways to be removed Project data sheet edits: required number of parking stalls corrected, average grade added, open site space and site coverage added, number of storys added, height added 4. Number of bike parking stalls on drawing revised to match the project data sheet, landscaping layout revised, pad mounted transformer relocated
- 5. Note added to confirm maximum slope of parking areas
- Note added to confirm material used for parking surfaces Notes added to clarify continuous sidewalk locations and general coordination with adjacent project
- Annotations added to clarify setbacks to existing building on Gladstone, Fernwood, and interior lot line 9. Point elevations added
- 10. Cross walks and sight line clearances added on driveway crossings
- 11. Hatching added to denote areas with restricted vehicle access 12. Accessible parking stalls reconfigured
- 13. Note added to clarify that 2 new standard stalls are being added to the existing South parking lot 14. Existing vehicle access lane for shop added
- Building entrance markers added 16. Note added clarifying which existing paths and stairs are to be removed
- 17. Missing trees added 18. Notes added to clarify where required setback dimensions are
- 19. Note changed to clarify that the daycare location is approximate only
- 20. Floor plans were revised to provide more detail 21. In order to ensure that staff who bike to work have easy access to showers a second staff shower was added, and the original one relocated to main floor

LOCATION PLAN

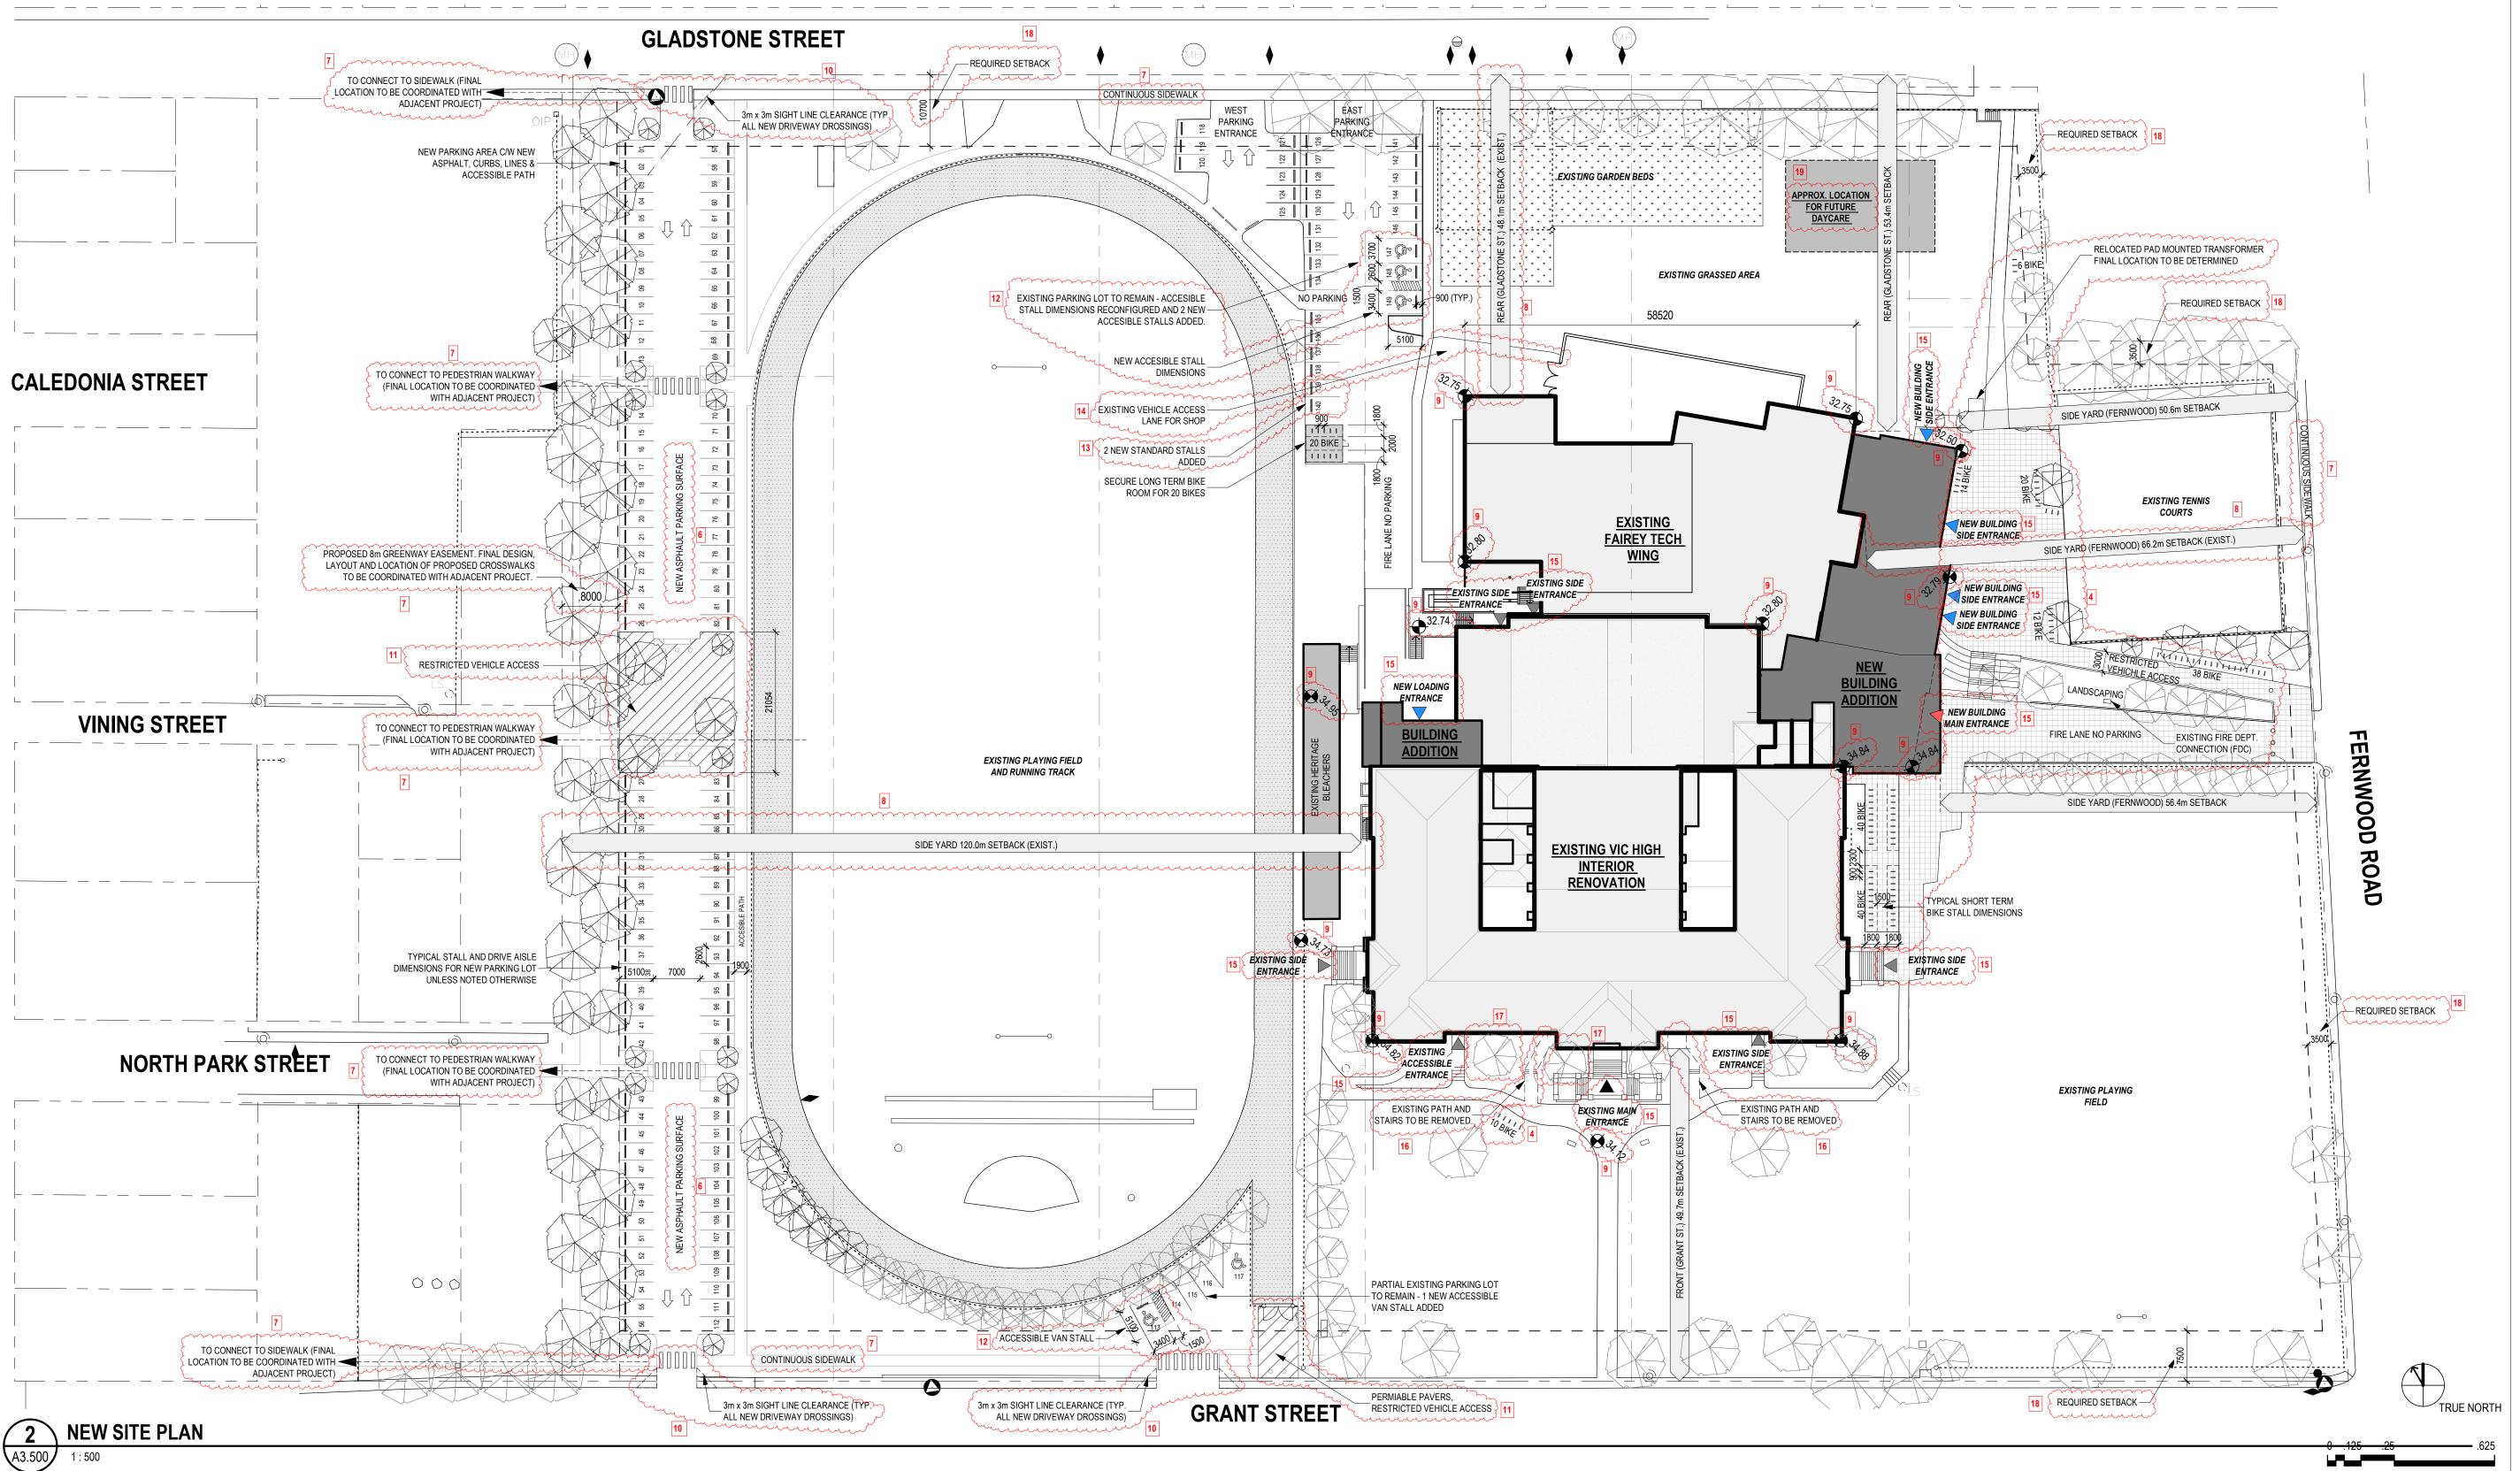




HDR ARCHITECTURE ASSOCIATES 203-655 TYEE ROAD VICTORIA, B.C. V9A 6X5 PH. 1.250.388.5588



SCHOOL DISTRICT 61 VIC HIGH SCHOOL

1260 GRANT STREET VICTORIA, BC V8T 1C2

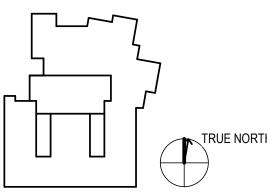

DIANA STUDER Project Manager Landscape Architect | LADR LANDSCAPE ARCHITECTS WESTBROOK ENGINEERING

HDR ARCHITECTURE

Sheet Reviewer JIM MANN

AUGUST 11, 2020 ISSUED FOR VARIANCE PERMIT

NOV. 20, 2020 ISSUED FOR VARIANCE PERMIT REVISIONS

Project Number

Original Issue 07/09/20

Variance Submission - Site Plan - New


As indicated





SCHOOL DISTRICT 61 VIC HIGH SCHOOL

1260 GRANT STREET VICTORIA, BC V8T 1C2

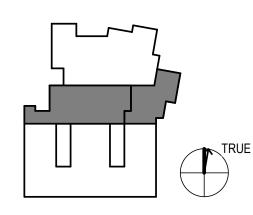

Project Manager

HDR ARCHITECTURE

Sheet Reviewer Author


NOV. 20, 2020 ISSUED FOR VARIANCE PERMIT

Project Number Original Issue 08/11/20

Variance Submission **Basement Floorplan**

Sheet Number


AC1.3

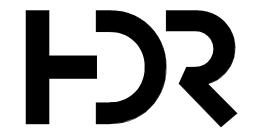



SCHOOL DISTRICT 61 VIC HIGH SCHOOL

1260 GRANT STREET VICTORIA, BC V8T 1C2

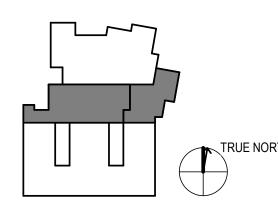

Project Manager

WESTBROOK ENGINEERING

HDR ARCHITECTURE

Sheet Reviewer Author

NO. DATE DESCRIPTION
AUGUST 11, 2020 ISSUED FOR VARIANCE PERMIT 2 NOV. 20, 2020 ISSUED FOR VARIANCE PERMIT REVISIONS

Project Number 10199559

Original Issue 08/12/20

Variance Submission Level 1 Floorplan

Sheet Number

AC1.4


Project Status

0 .125 .25



SCHOOL DISTRICT 61 VIC HIGH SCHOOL

1260 GRANT STREET VICTORIA, BC V8T 1C2

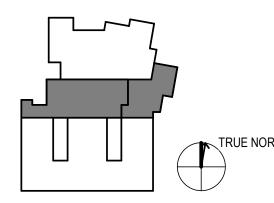

Project Manager
Project Designer
Project Architect
Landscape Architect
Civil Engineer
DIANA STUDER

DIANA STUDER

LADR LANDSCAPE ARCHITECT
WESTBROOK ENGINEERING

tural Engineer hanical Engineer rical Engineer bing Engineer bor Designer hanical Engineer hanical Engineer

Sheet Reviewer Author

NO. DAT

DATE
NOV. 20, 2020
ISSUED FOR VARIANCE PERMIT REVISIONS

HDR ARCHITECTURE

Project Number

Original Issue 08/12/20

Ob and Name

Variance Submission Level 2 Floorplan


Sheet Number

AC1.5

Project Status
Project Status

1 VARIANCE SUBMISSION - LEVEL 2


0 .125 .25 .625

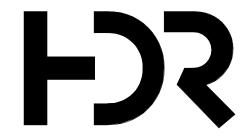



SCHOOL DISTRICT 61 VIC HIGH SCHOOL

1260 GRANT STREET VICTORIA, BC V8T 1C2

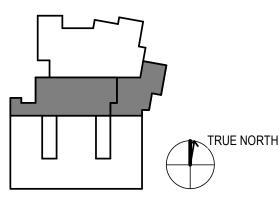

Project Manager DIANA STUDER Landscape Architect | LADR LANDSCAPE ARCHITECTS

WESTBROOK ENGINEERING

HDR ARCHITECTURE

Sheet Reviewer Author

NOV. 20, 2020 ISSUED FOR VARIANCE PERMIT

Project Number Original Issue 08/12/20

Variance Submission Level 3 Floorplan

Sheet Number

AC1.6

Project Status

0 .125 .25

1 VARIANCE SUBMISSION - LEVEL 3
A3.500 1:200

. Existing site work to be demolished and pad mounted transformer to be relocated

Existing driveways to be removed Project data sheet edits: required number of parking stalls corrected, average grade added, open site space and site coverage added, number of storys added, height added Number of bike parking stalls on drawing revised to match the project data sheet, landscaping layout revised, pad mounted transformer relocated

Note added to confirm maximum slope of parking areas

Note added to confirm maximum slope of parking areas
 Note added to confirm material used for parking surfaces
 Notes added to clarify continuous sidewalk locations and general coordination with adjacent project
 Annotations added to clarify setbacks to existing building on Gladstone, Fernwood, and interior lot line

9. Point elevations added 10. Cross walks and sight line clearances added on driveway crossings

11. Hatching added to denote areas with restricted vehicle access 12. Accessible parking stalls reconfigured

13. Note added to clarify that 2 new standard stalls are being added to the existing South parking lot 14. Existing vehicle access lane for shop added


15. Building entrance markers added

16. Note added clarifying which existing paths and stairs are to be removed 17. Missing trees added

18. Notes added to clarify where required setback dimensions are

19. Note changed to clarify that the daycare location is approximate only

20. Floor plans were revised to provide more detail 21. In order to ensure that staff who bike to work have easy access to showers a second staff shower was added, and the original one relocated to main floor

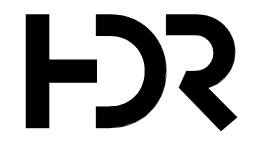


HDR ARCHITECTURE ASSOCIATES 203-655 TYEE ROAD VICTORIA, B.C. V9A 6X5 PH. 1.250.388.5588



SCHOOL DISTRICT 61 VIC HIGH SCHOOL

1260 GRANT STREET VICTORIA, BC V8T 1C2

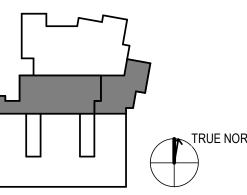

Project Manager DIANA STUDER Project Designer Project Architect Landscape Architect | LADR LANDSCAPE ARCHITECTS

WESTBROOK ENGINEERING Civil Engineer Structural Engineer HEROLD ENGINEERING Mechanical Engineer M3 ENGINEERING Electrical Engineer RB ENGINEERING Plumbing Engineer HDR ARCHITECTURE Interior Designer

HDR ARCHITECTURE

Equipment Planner HDR ARCHITECTURE

Sheet Reviewer Author


Wayfinding

Project Number

Original Issue 08/12/20

Variance Submission Level 4 Floorplan

AC1.7

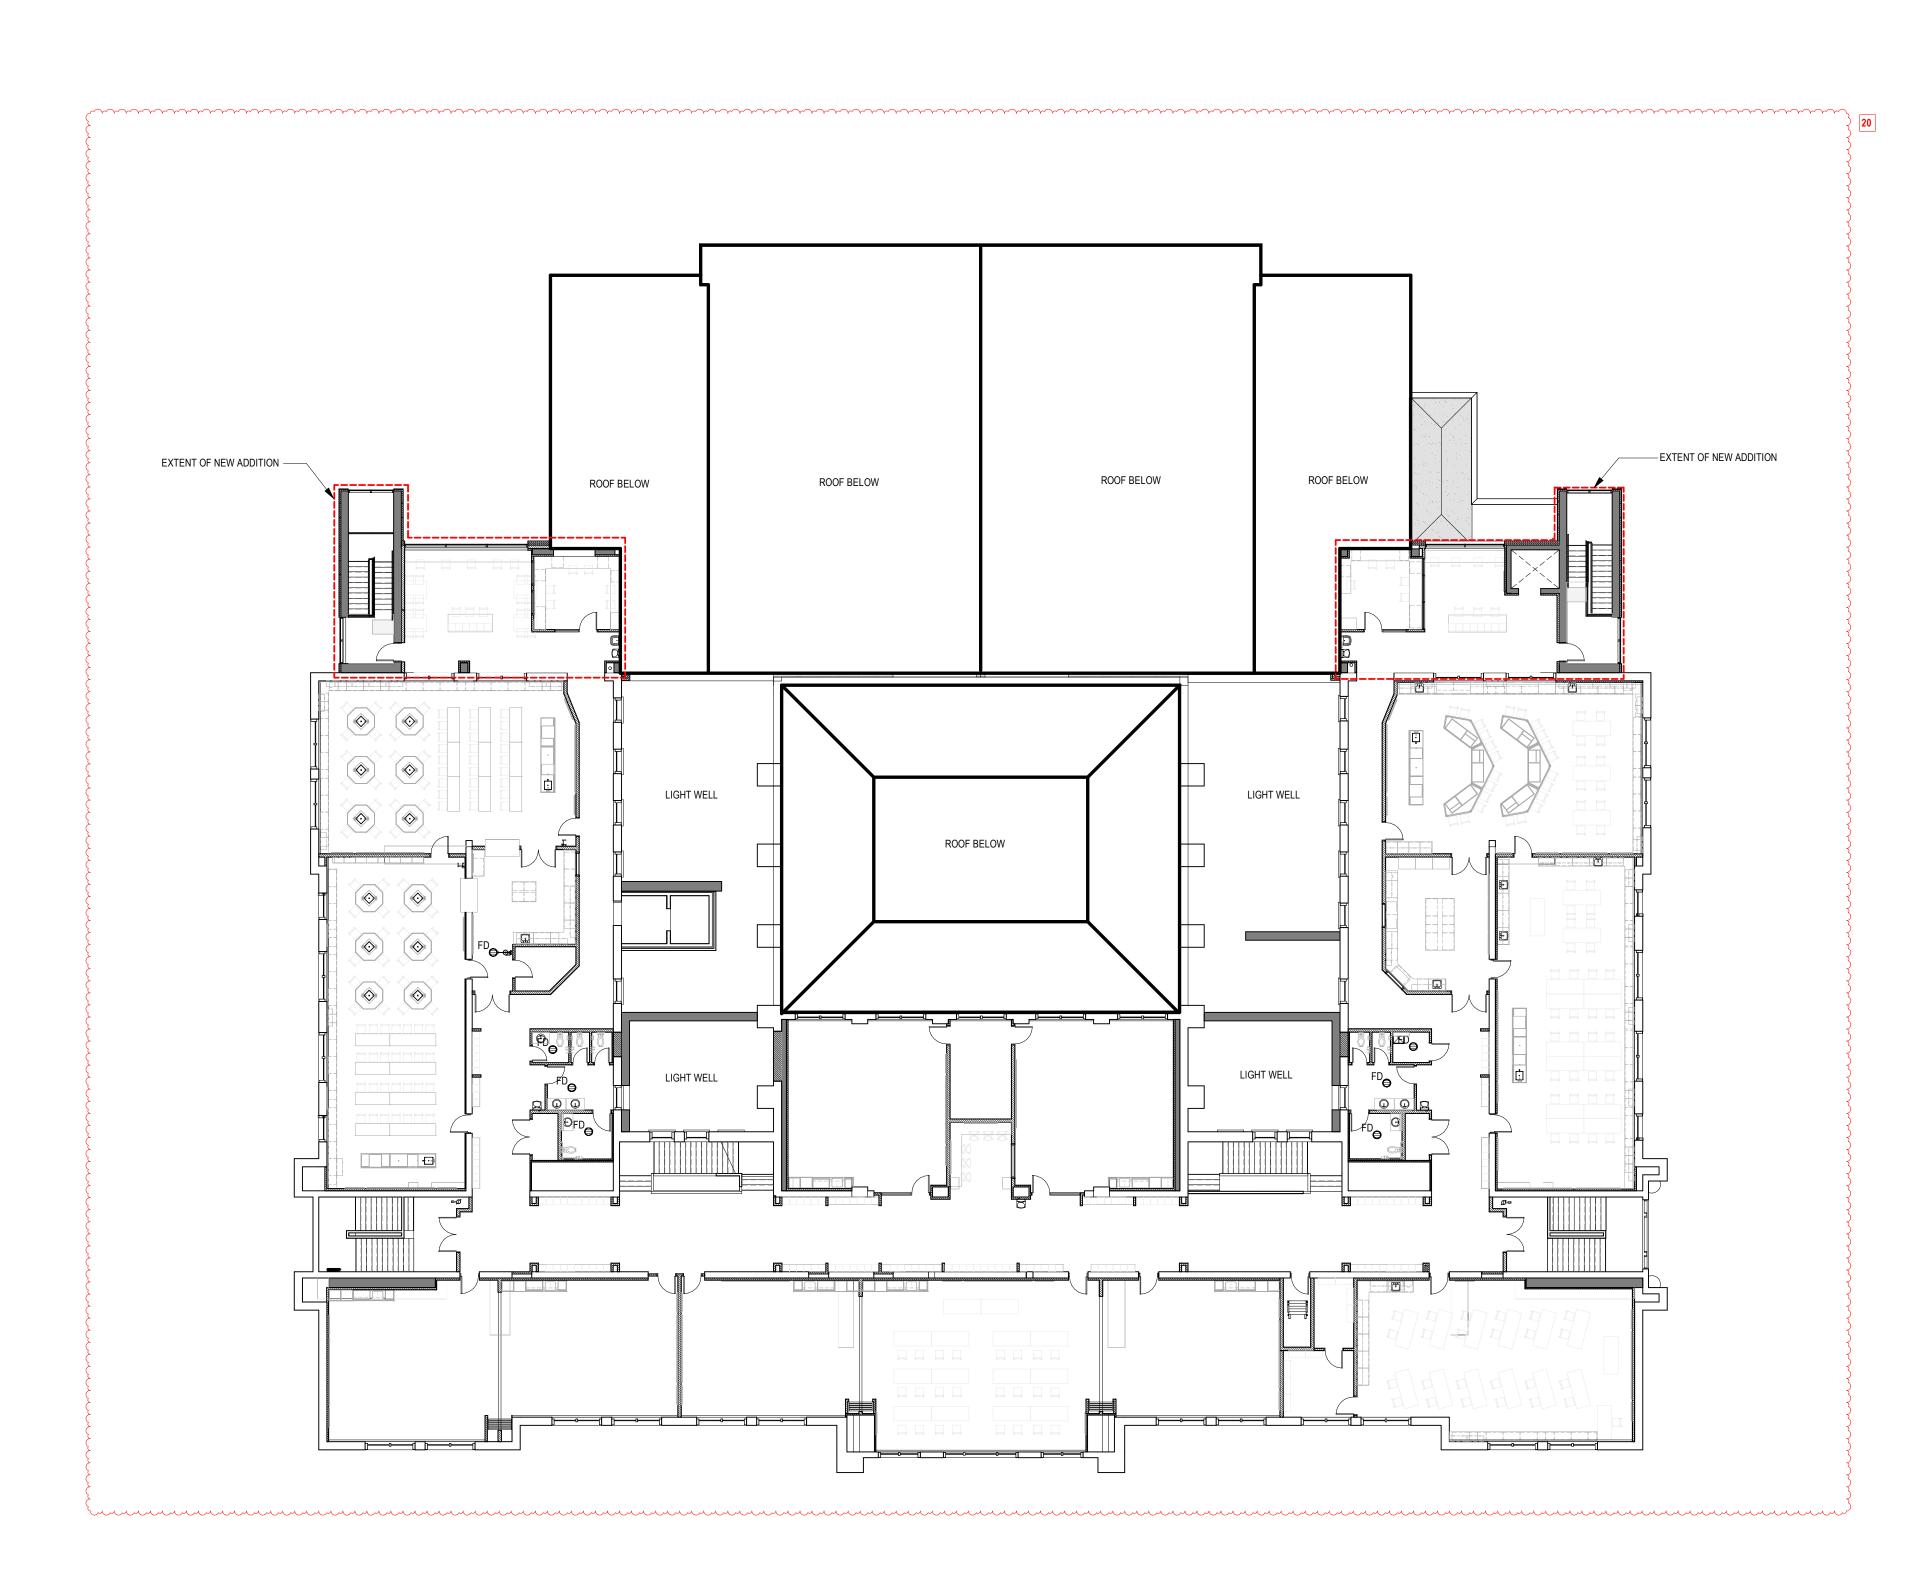



EXTERIOR ELEVATIONS LEGEND



SCHOOL DISTRICT 61 VIC HIGH SCHOOL

1260 GRANT STREET VICTORIA, BC V8T 1C2

DIANA STUDER Project Manager WESTBROOK ENGINEERING

HDR ARCHITECTURE

Sheet Reviewer Author

OCT. 27, 2020 ISSUED FOR CONCRETE TENDER NOV. 02, 2020 ISSUED FOR BUILDING PERMIT
ISSUED FOR CONCRETE TENDER
ADDENDUM 2 NOV. 16, 2020

10199559

NOV. 20, 2020 ISSUED FOR VARIANCE PERMIT REVISIONS

Original Issue 05/04/20

Project Number


EXTERIOR ELEVATIONS

As indicated

Sheet Number

A3.500


Project Status

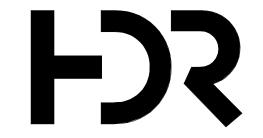



SCHOOL DISTRICT 61 VIC HIGH SCHOOL

1260 GRANT STREET VICTORIA, BC V8T 1C2

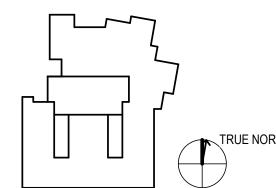

Project Manager
Project Designer
Project Architect
Landscape Architect
Civil Engineer
Structural Engineer
Mechanical Engineer

DIANA STUDER

JIM MANN
LADR LANDSCAPE ARCHITECTS
WESTBROOK ENGINEERING
HEROLD ENGINEERING
M3 ENGINEERING
DE FAIGNEERING
DIANA STUDER

mical Engineer
cal Engineer
ing Engineer
r Designer
ment Planner
inding

M3 ENGINEERING
RB ENGINEERING
M4 ENGINEERING
HDR ARCHITECTURE
HDR ARCHITECTURE

Sheet Reviewer Author

DATE
AUG. 11, 2020 ISSUED FOR 50% REVIEW / COSTING
OCT. 27, 2020 ISSUED FOR PROGRESS REVIEW
NOV. 02, 2020 ISSUED FOR CONCRETE TENDER
NOV. 16, 2020 ISSUED FOR BUILDING PERMIT
NOV. 17, 2020 ISSUED FOR CONCRETE TENDER
ADDENDUM 2

NOV. 17, 2020 ISSUED FOR CONCRETE TENDER
ADDENDUM 2

NOV. 20, 2020 ISSUED FOR VARIANCE PERMIT
REVISIONS

Project Number 1

Original Issue 06/22/20

...

EXTERIOR ELEVATIONS

As indicated

A3.501


Project Status
Project Status



VIC HIGH - WEST PARKING | LANDSCAPE CONCEPT



TREE LEGEND

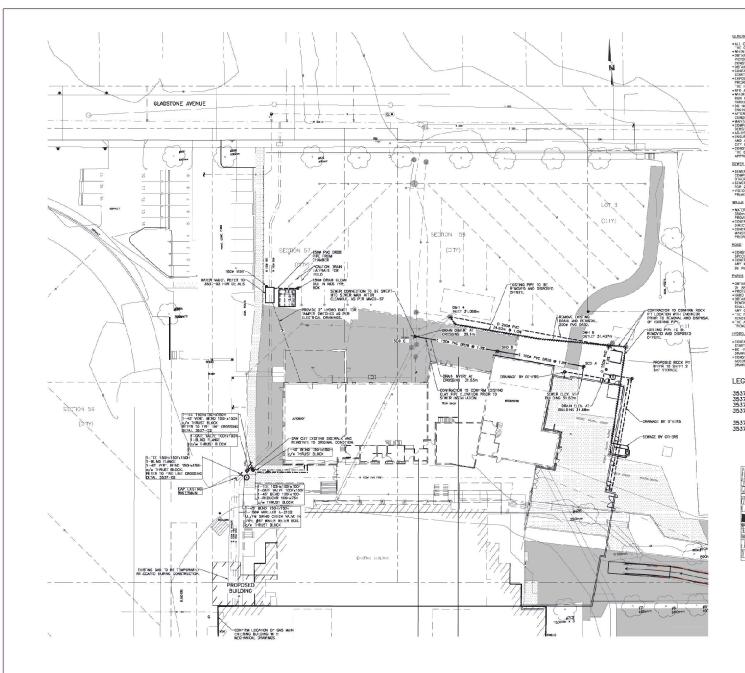



GENSOL NOTES:

4. THE CITY OF MOTORS AND REPORT TO BE IT ACCORDANCE WIT WICE, PATTERN 62 TOW, AND ACCOUNTED THE REVIEW IN 15 TOWN OF MOTORS AND ACCOUNTED THE REVIEW IN 15 TOWN OF MOTORS AREAS, THE WITE THROUGH THE THROUGH

SEWER AND DRAIN AND AND AND SERVICE CONSCITONS O BE 1000 MY BREE FT MANAGE 690.5 OF 2.0.

**STEP AND THE PROPERTY OF THE THE PROPERTY OF THE THE PROPERTY OF T

THE THE ARE THE TO BE THE GREAT WINN STANDING CODE THE ALL WITTE WARS FROM TO BE THE STANDING THE ATTEMPT AND THE ATTEMPT AND

PARKS

CHORD AND PARKET FOR THE OTHOUGH PARKS DEPARTMENT PRIOR TO THE STATE OF ANY DESIGNATION. OF CHORDER PARKS DEPARTMENT PRIOR TO THE STATE OF THE STATE

HYDRO, TELEPHONE, CABLE, STREET LIGHTING AND GAS

LEGEND

3537-01 - GENERA. NO'ES & PLAN
3537-02 - DETAL;
3537-04 - BUS TURN NG
3537-04 - CONCEPT (NO'T INCLUDED)
7537-05 - PARKING LOT SRUDNOS STATION 0+90-2+40
7537-06 - PARKING LOT SRUDNOS STATION 0+90-2+40
7537-06 - PARKING LOT SRUDNOS STATION 12-20-3-110



LOCATION PLAN



HDR ARCHITECTURE ASSOCIATES, INC. VICTORIA HIGH SEISNIC UPGRADES 1290 SKYNT STREET, VICTORIA, BC V8T 102



Eletrical Engineer Short Reviewer



NO. DATE

ISSUED FOR BUILDING PERMIT AND TRADER MAY 15, 2022 ISSUED FOR CONSTRUCTION - JULY 28, 2020

GENERAL NOTES & PLAN

0.als 1:250

C1.01




001 N NOS TYPE

150# PVC ER28-

0.E


PLAN

- MOSHEL GOWN ON UNDIVISION AND ALL SUPER C-CAMBRIC COMPACITOR R CUSISTY IN ALRES NOT O EDUCED 150mm.
 ITTIMO MALERIAIS SHALL BE RATED TO MINIMUM 150PS.
 S EMPIRON THE GAT C MALERIA (MICLUMA) SOTI BATE VALVES) 3 MALL BE PROR TO MIRINAL DIX STIL.
 ANY SACRET OPERATION UNIL THE WORKS HAVE BEEN INSPECTED BY

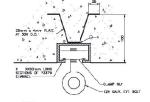


NOTE: CHANNEL SECTION TO BE CAST INTO CELLING OF CHAMBER OVER THE MAINLINE AND BYPASS LINE.

LIFTING BRACKET DETAIL

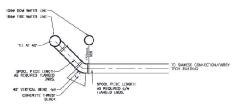


FIRE LINE WATER CROSSING


TEM	QUANT.	DESCRIPTION	
0	1	PRECAST CONCRETE CHAMBER, LANGLEY MODEL 3/52 OR APPROVED EQUINALENT.	
②	Z	150mm# TRANSTION COUPLING, ROBAR 1506 COUPLING (EPOXY CONTED WITH STAINLESS STEEL FASTENERS).	
3	2	100mms TRANSTION COUPLING ROBAR 1806 COUPLING (EFOXY CONTED WITH STAINLESS STEEL "ASTENERS).	
•	T	150mm/# ZURN 350A DOUBLE CHECK VALVE BACKFLOW PREVENTER ASSEMBLY. RELCCATE EXSTING /ROM MECHANICAL ROOM	
③	2	150mm/ MUFITER 2361 UI/FM RESILENT WEDGE GATE VALVE 150Fx150F c/w TAMPER SWITCHES	
0	1	100mm# WATTS SER'ES LITTO DOUBLE CHECK WAME ASSEMBLY. RELOCATE EXISTING ASSEMBLY FROM MECHANICAL ROOM	
①	2	100mm/# GA : VALVE 100Fx100F RELOCATE EXSTING VALVE FROM MECHANICAL ROOM	
(8	T-RUST RNG PLATE (710mm X 710mm X 9.5mm THCK)	
(1)	1	150-mm/ DISMANTLING JOINT C/W D CLASS FLANGE, ROMAC DI400 OR APPROVED COURALIST.	
10	1	100mm/ DISMANTLING JOINT C/W D CLASS FLANCE. ROMAC DJ400 OR APPROVED EDUMALENT.	
111	1	150# PVC SUR28 SUMP DRAIN C/W IRAP.	
12	4	GRINNELL PIPE SUPPORTS OR APPROVED ALTERNATE (2 PER ASSOMBLY)	
13)	1	150mm# PIPF VENT C/W HC BIRD SCREEN. FUSION BONDED FPCKY-COAFED STONEHENG	
①	5	PENETRATION BELT SEALS, "LINK SEAL" OR APPROVED EQUIVALENT.	
13)	2	150mmm FLG. X FLUSH END STEEL SPOOL PIECE MINIMUM LENG'H 1.4rr, C/W TYPE 'P' SS RESTRANER HARNESS AS SHOWN ON VAULT DETAIL.	
(13)	2	100mms FLG. X FLUSH END STEEL SPOOL PIECE. MINIMUM LENGTH 1.4m, C/W TYPE 'P'	

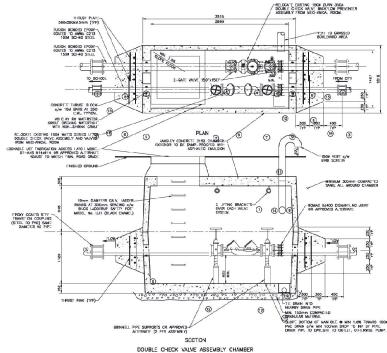



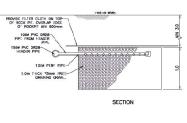



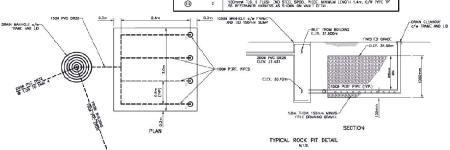



HDR ARCHITECTURE ASSOCIATES, INC. VICTORIA HIGH SEISNIC UPGRADES

1290 SKKNI STREET, VICTORIA, BOVST 102




Electrical Engineer Short Reviewer NC. DATE




ISSUED FOR BUILDING PERMIT AND TRIDER MAY 15, 10/2 ISSUED FOR CONSTRUCTION - JULY 28, 2020 ADDED BUILDING AND EMPLOYING - MOVEMBER (7, 2021


DETAILS

C1.02

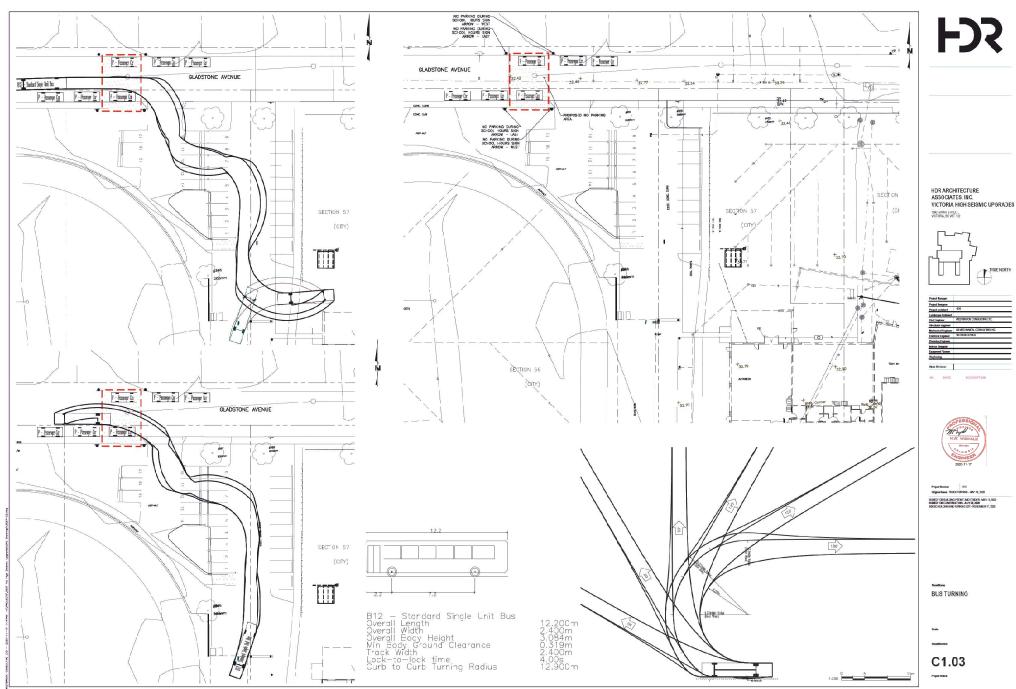

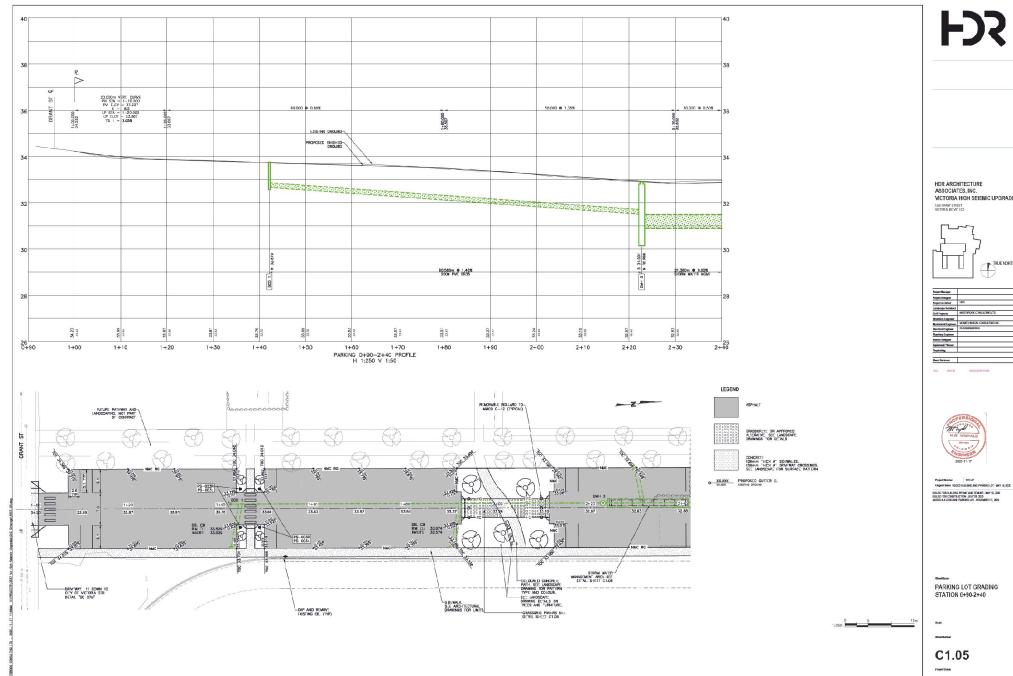

VICTORIA HIGH SEISMIC UPGRADES

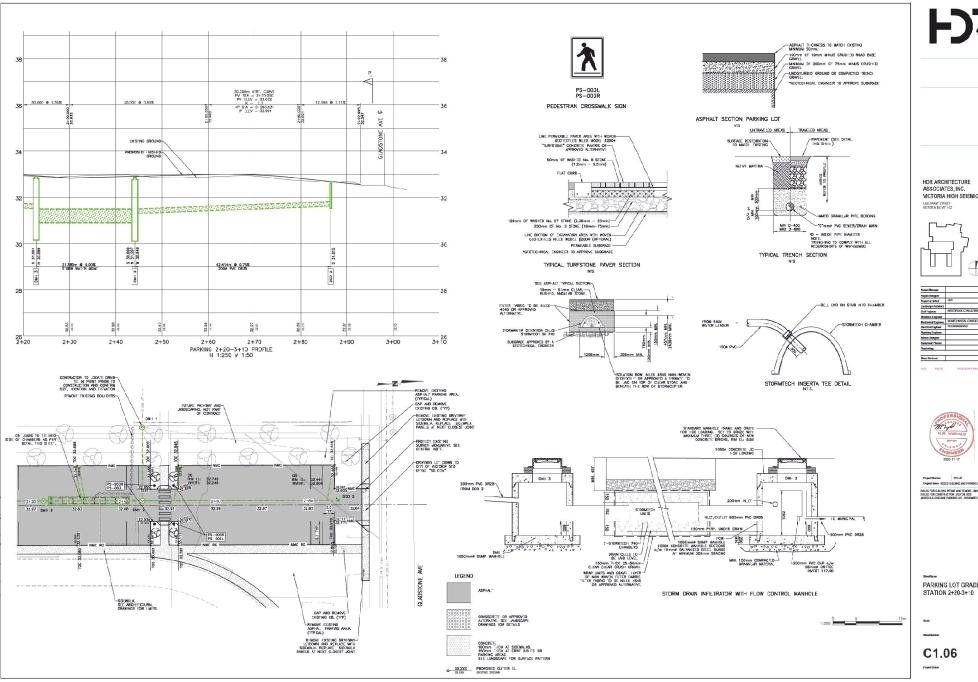



VICTORIA HIGH SEISMIC UPGRADES



Project Manager	
Project Designer	
Project Architect	HDR
Landscapo Audutoct	
Civil Feginner	WESTHROOK CONSULTINGLITE
Mustury Engineer	
Hectorical Engineer	MOMECHANICAL CONSULTING NO.
Decifical Engineer	RE-ENGINEERING
Plumbing Engineer	
Interfor Designer	
Equipment Planner	
Nayiralay	



Organi teme ADDED EUR. SING AND PARKING LOT - MKY 15, 1020

PARKING LOT GRADING