

Landscape



#### Contacts + Drawing List

# Architectural Anchitectural AD.0 Cover AD.1 Context Views AD.2 Context Views AD.3 Context Views AD.3 Context Views AD.3 Context Views AD.4 Height & Massing Analysis AD.6 Context Elevations AD.7 Skylne Analysis AD.8 Sun and Shade Study A1.1 Site Plan A1.2 Average Grade Calculations A1.3 Level 1 Phasing Plan A1.2 Average Grade Calculations A1.3 Level 1 Phasing Plan A2.1 PP Parking Plan A2.1 PP Parking Plan A2.2 Level 3 Plan A2.2 Level 3 Plan A2.3 Level 2 Plan A2.4 Level 3 Plan A2.5 Level 5-13 Plan A2.6 Level 5-13 Plan A2.7 Penthouse + Roof Plan A3.0 North Elevation A3.1 East Elevation A3.1 Seast Elevation A3.2 South Elevation A3.3 West Elevation A3.3 West Elevation A3.3 Building Sections A4.1 Building Sections A4.1 Building Sections Architect Landscape Architect

# Electrical



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250.384.2400 mail@daustudio.ca www.daustudio.ca

Rezoning/DP Resubmission

25.02.13

### Civil Consultant

#### **Electrical Consultant**

#### Transportation Consultant

#21-18 Montreal and Quebec 205 Quebec Street Victoria, BC






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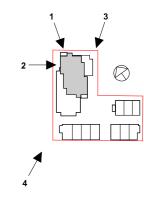
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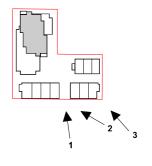






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URBAN HEIGHT DIAGRAM: Taller building forms wrap around the Downtown Core Area and bracket the marine entrance to the Inner Harbour.

10–18+ storeys 6–9 storeys

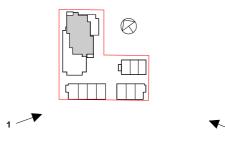









MASSING/HEIGHT RATIONALE

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Montreal and Quebec
205 Quebec Street
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1. Harbour View from Bastion Square



2. Ship Point Panoroma




3. James Bay / Belleville Street from Johnson Street Bridge


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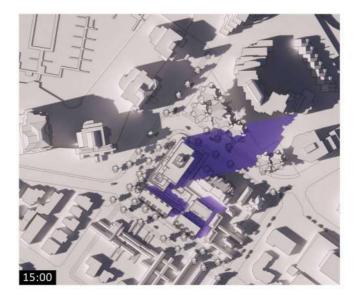
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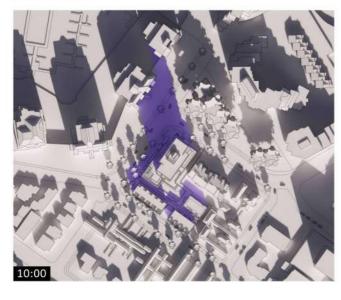
### Spring / Fall Equinox






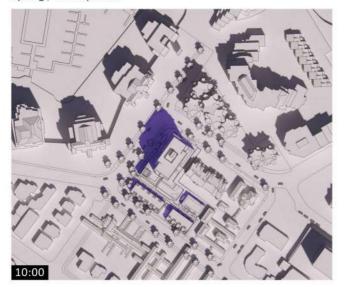

#### Winter Solstice

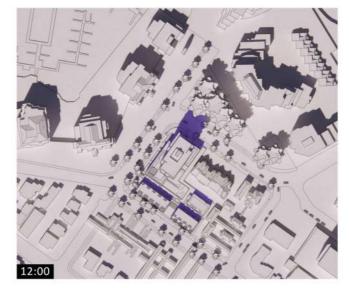

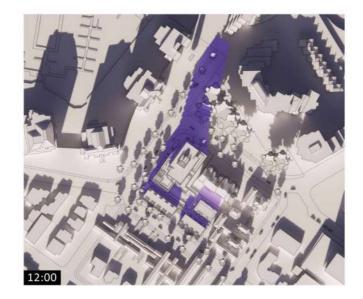





#### Summer Solstice





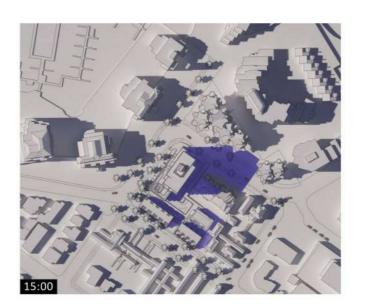

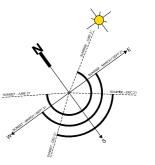

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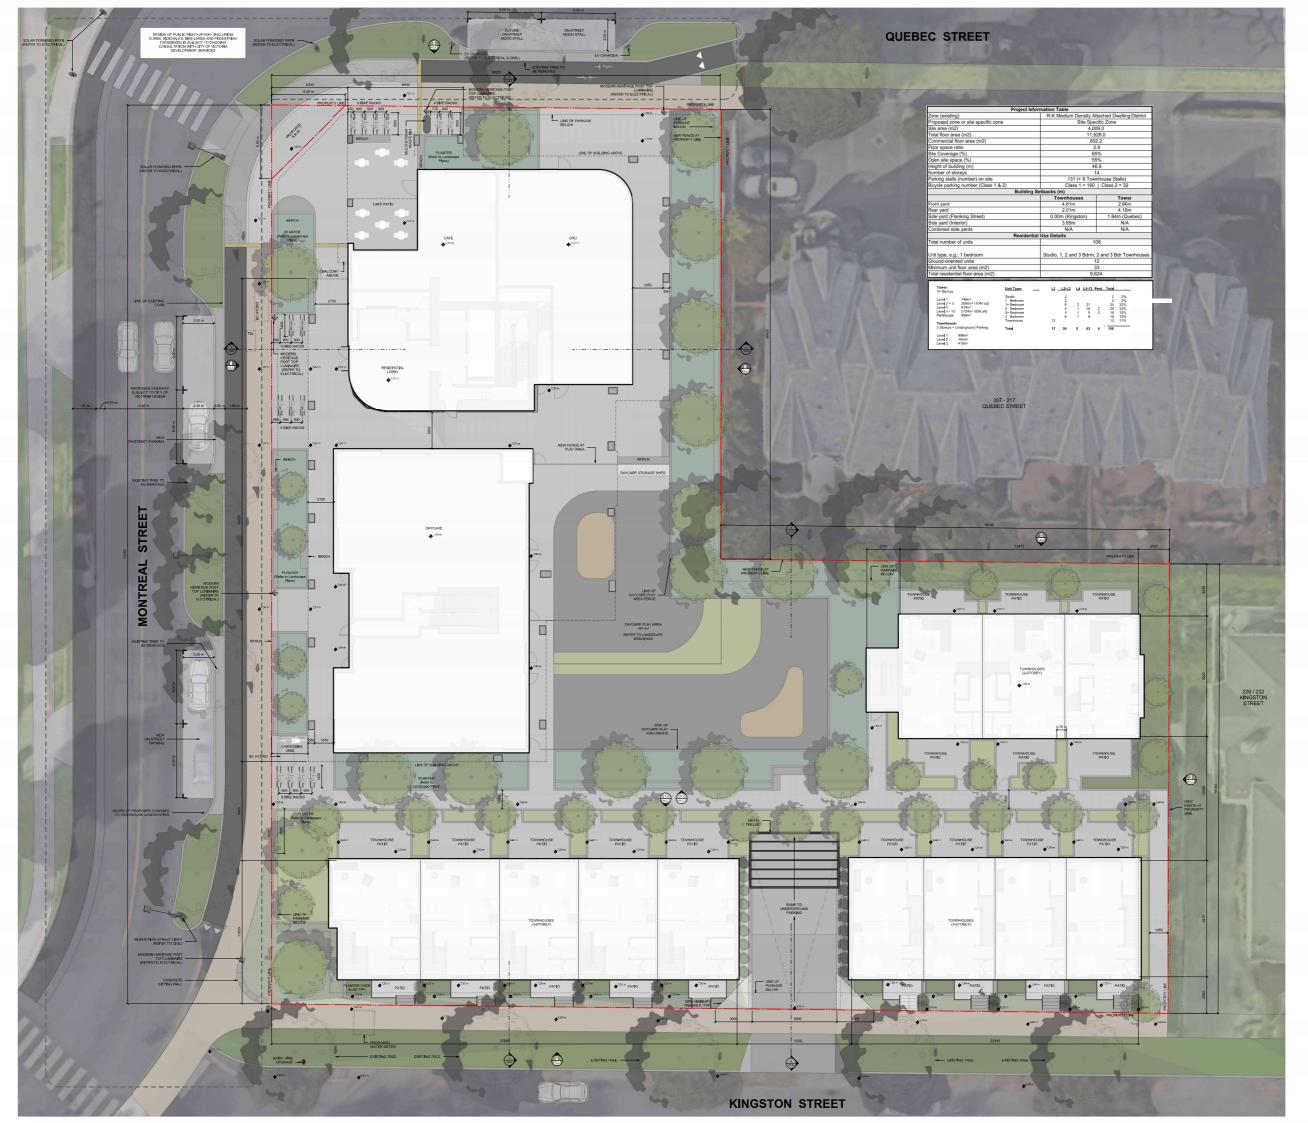


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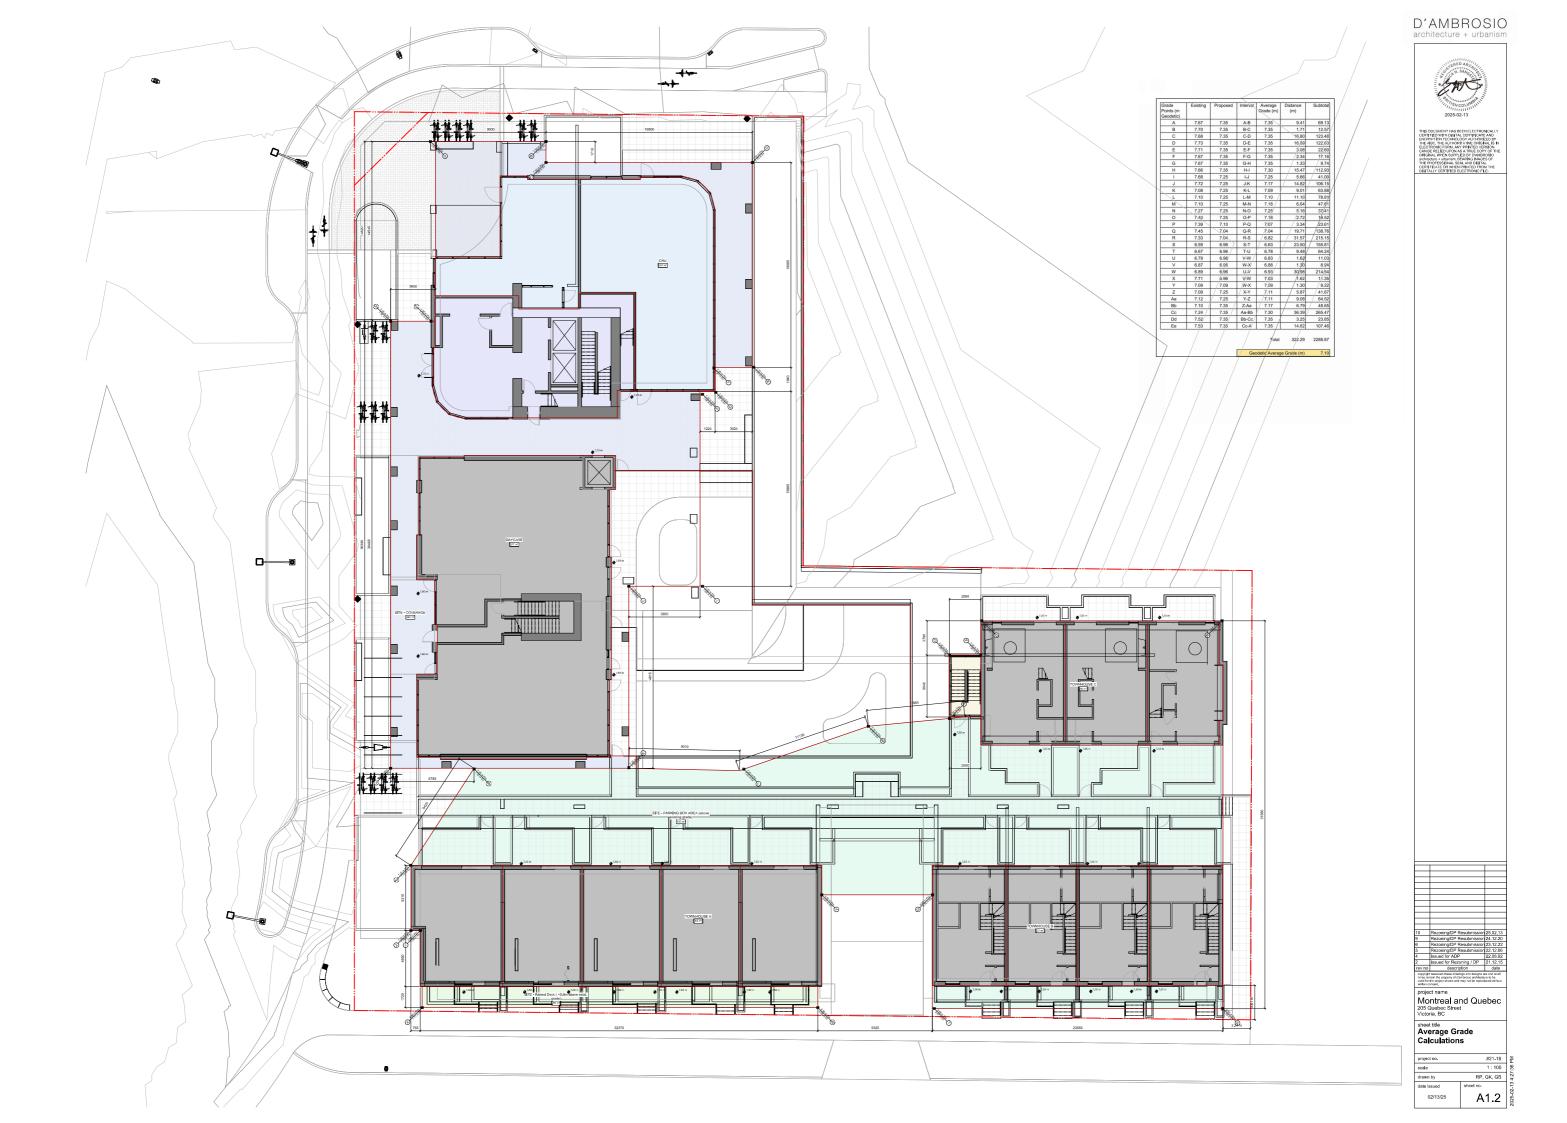
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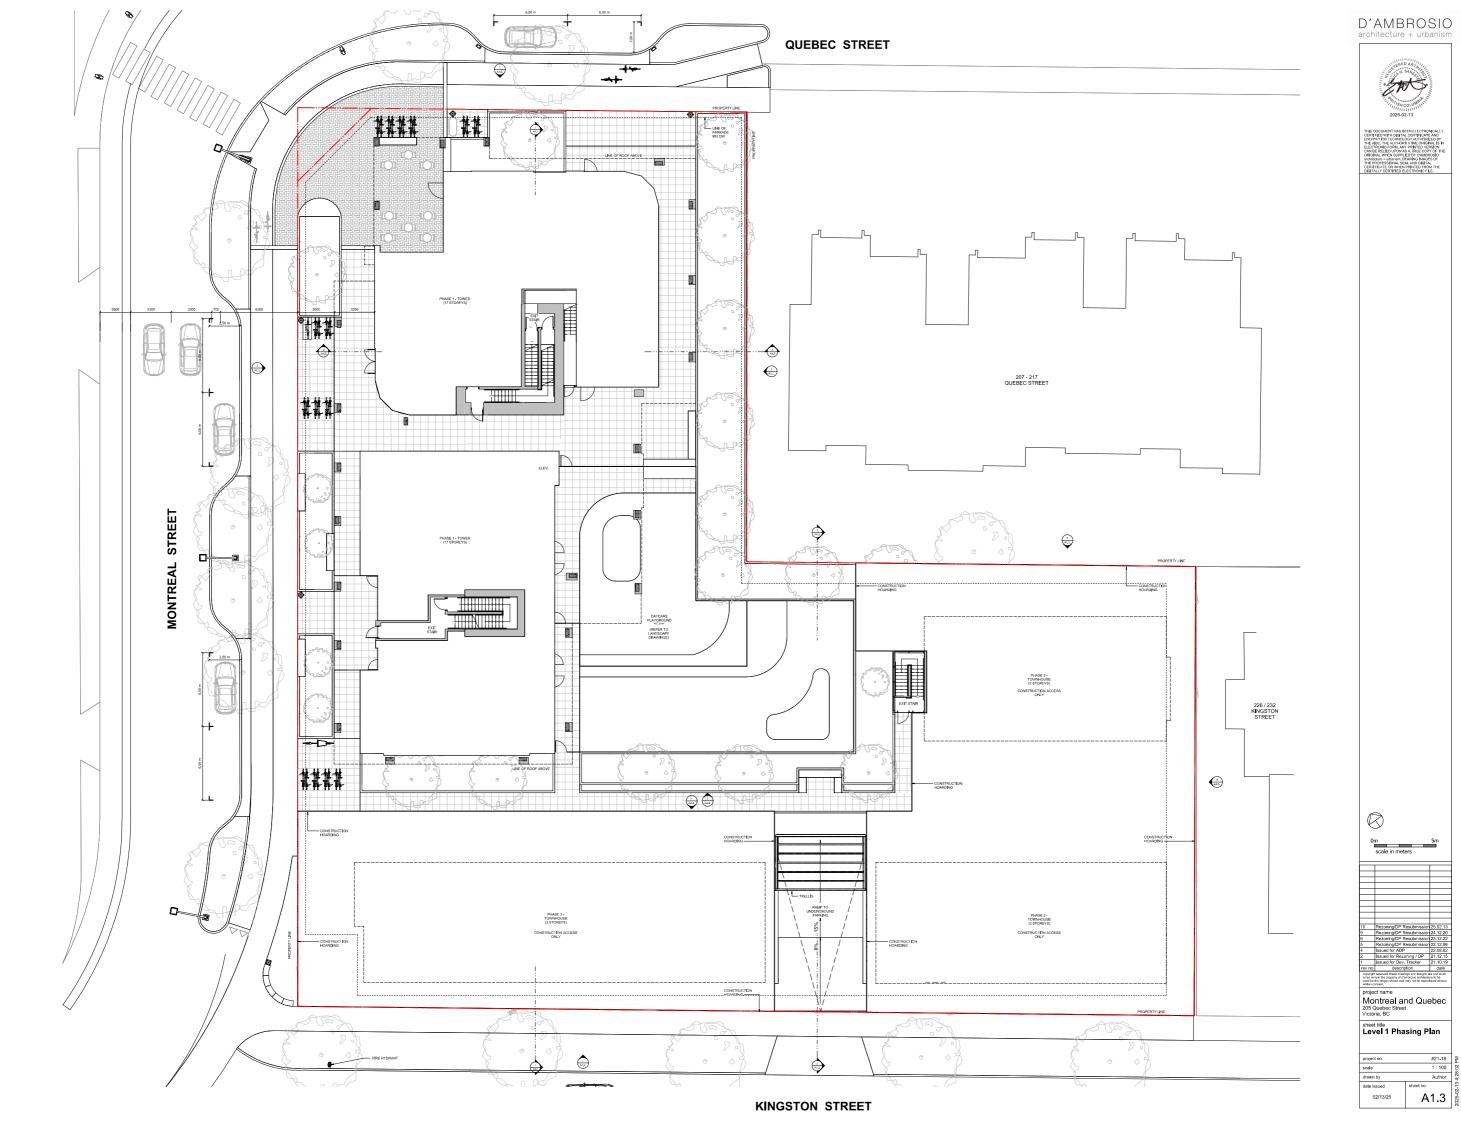
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Montreal and Quebec
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Victoria, BC

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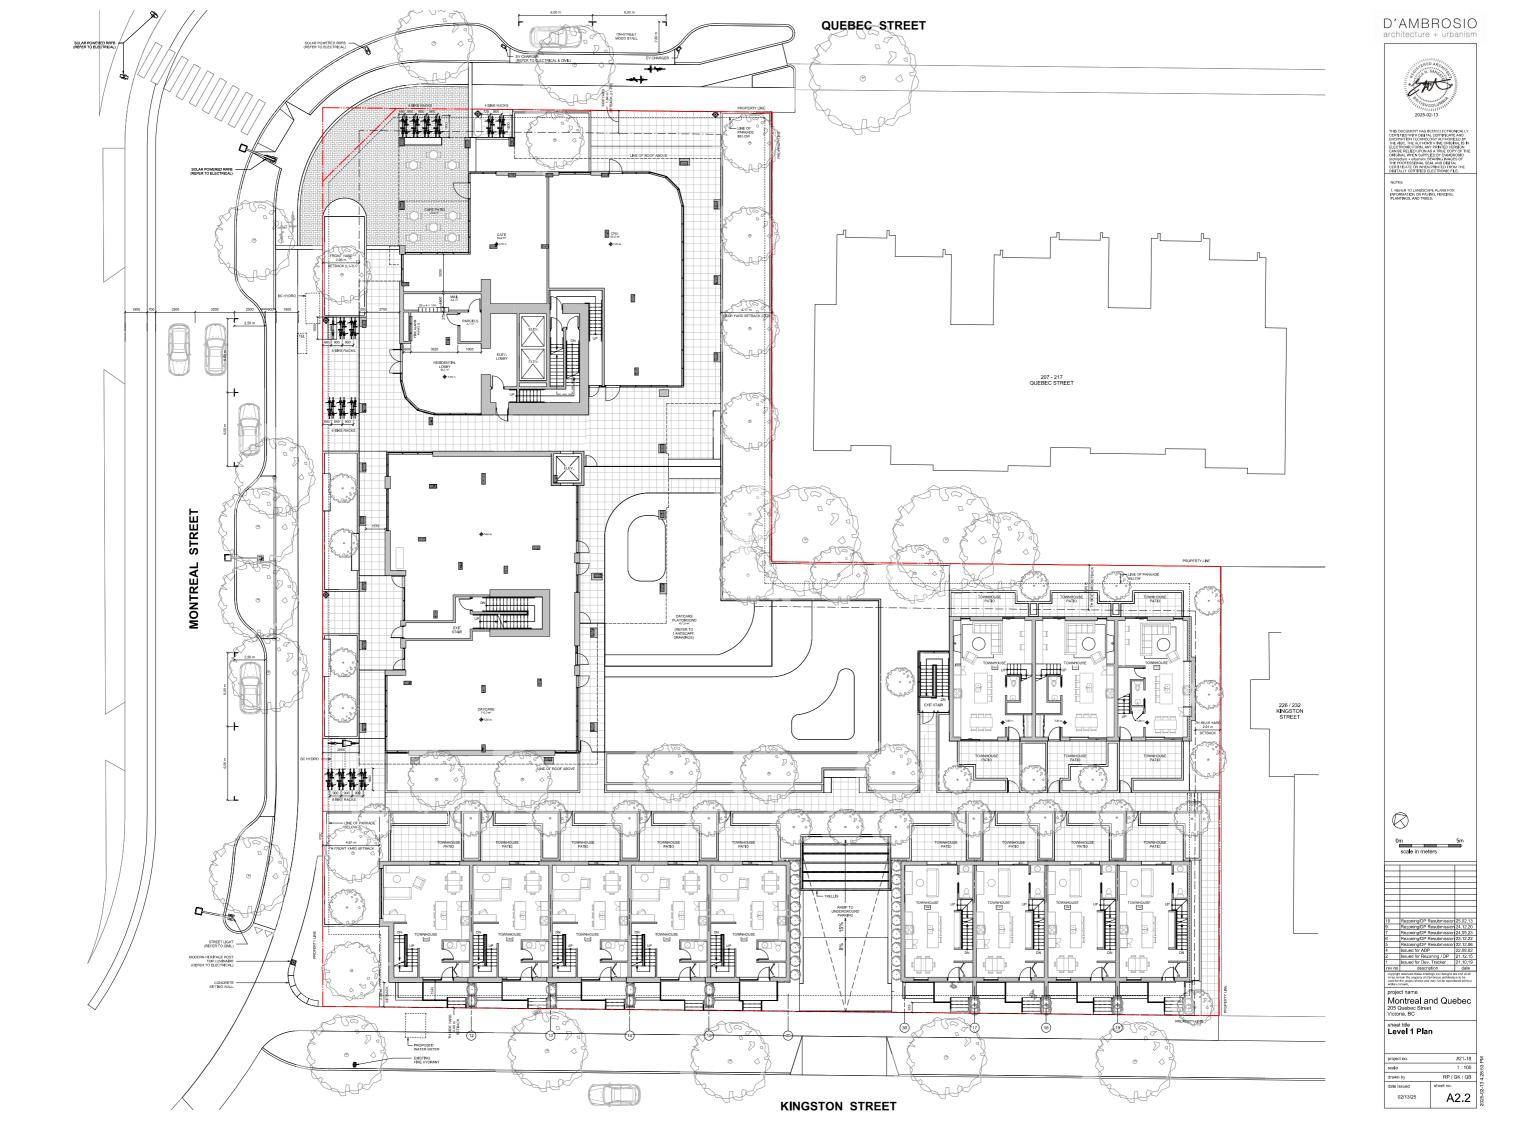
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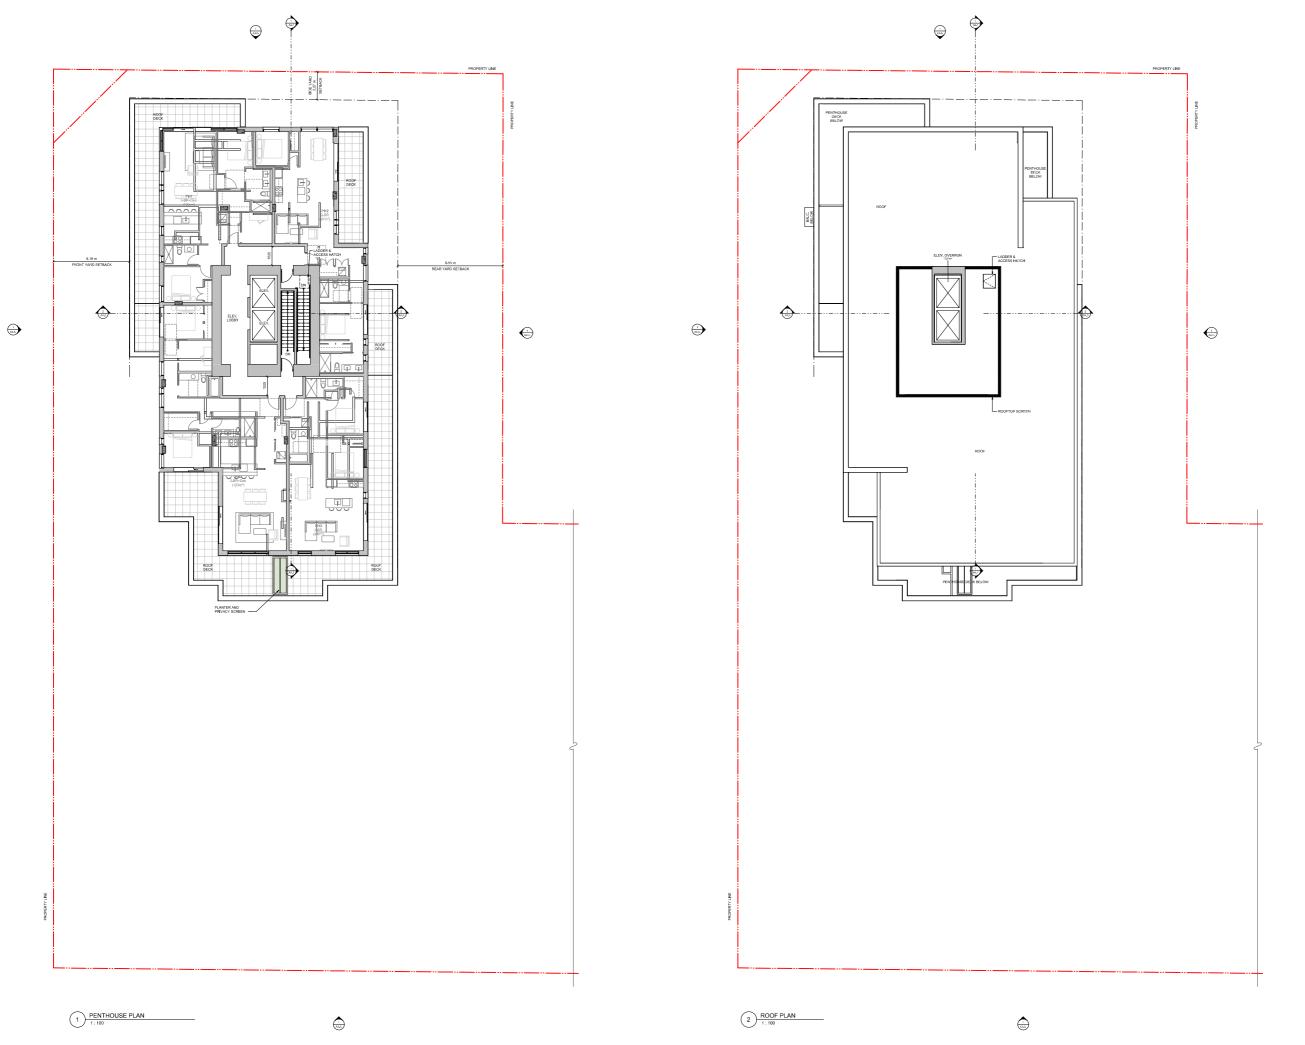
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Victoria, BC

Penthouse + Roof PI

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Cement Panel System
 Colour: Sandstone
 Running Bond Brick
 Colour: Ostmeal

15 Prefinished Metal Louvers Colour: Iron / Ore

16 Prefinished Metal Panel Colour: Iron / Ore

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Montreal and Quebec
205 Quebec Street
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Fibre Cement Panel
 Colour: Dark Grey
 Pre-finished Vertical Wood
 Soffits: T&G Wood

The Mindow and Doors: Clear Glazir
Anodized Aluminum Frames
Colour: Iron / Ore
The Glass Walls and Guards w/ Alum
Colour: Iron / Ore
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(15) Prefinished Metal Louvers Colour: Iron / Ore

(6) Prefinished Metal Panel Colour: Iron / Ore

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Montreal and Quebec
205 Quebec Street
Victoria, BC

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# Cement Panel System Colour: Sandstone Running Bond Brick Colour: Ostmeal

- Window and Doors: Clear Glas
   Anodrzed Alaminum Frames
   Colour: Iron / Ore
   Glass Walls and Guards w/ Air
   Colour: Iron / Ore
- 15 Prefinished Metal Louvers Colour: Iron / Ore
- 16 Prefinished Metal Panel Colour: Iron / Ore



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# Cement Panel System Colour: Sandstone Running Bond Brick Colour: Ostmeal

- 3 Fibre Cement Panel
  Colour: Dark Grey
  Pre-finished Vertical Wo
  S Soffits: T&G Wood

- (2) Window and Doors: Clear Claz Anodized Aluminum Frames Colour: Iron / Ore (3) Glass Walls and Guards w/ Alu Colour: Iron / Ore
- 15 Prefinished Metal Louvers Colour: Iron / One
- 16 Prefinished Metal Panel Colour: Iron / Ore



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Montreal and Quebec
205 Quebec Street
Victoria, BC

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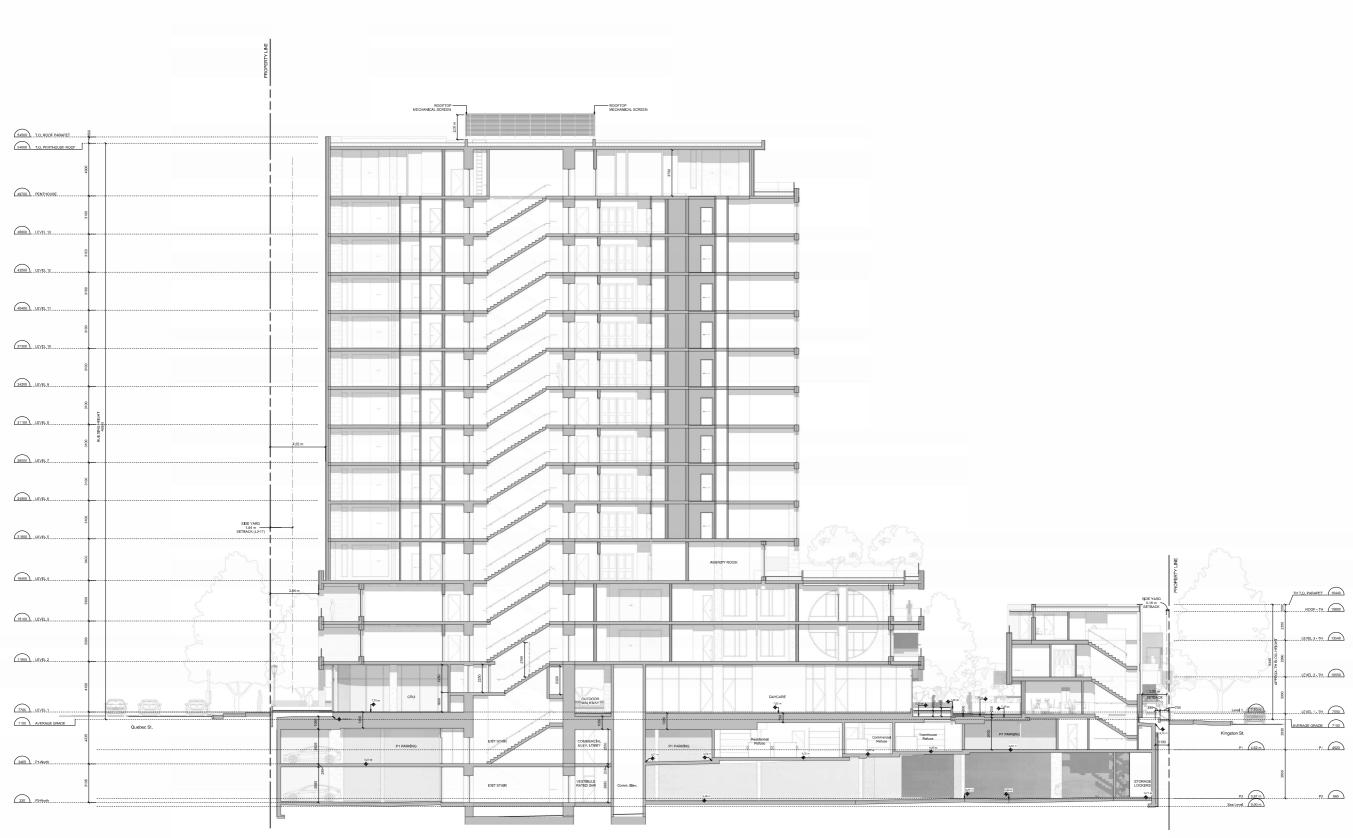
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North Elevation - Townhouse



South Elevation - Townhouse



3 P1 Ramp @ Kingston St





North Elevation - Townhouse

## D'AMBROSIO



Centrol Panel System
Centrol Sendotre
Running Band Brick
Colour Colmail
Fibre Coment Panel
Colour Dark Grey
Pre-Inished Vertical Wo
Seffet: T&G Wood

Glass Guards in Pre-diright
 Glass Guards in Pre-diright
 Glass Guard Canoples: Lamined
 Glader Canoples: Lamined
 Calour: Iron / Ore
 Prefinished Metal Parapet
 Calour: Iron / Ore
 Prefinished Metal Fascia
 Calour: Iron / Ore

Perforated Metal Balcony Colour: Iron / Ore

Painted Metal Pergoles and Gate Colour: Iron / One

Colour Iron Fore
 Amodized Aluminum Frames
 Colour: Iron / Ore
 Glass Walls and Guards wi Alum
 Colour: Iron / Ore

15 Profinished Metal Louvers Colour: Iron / Ore 16 Prefinished Metal Panel Colour: Iron / Ore

Montreal and Quebec
205 Quebec Street
Victoria, BC


sheet title Building Section / Elevations

A4.2

Mike Geric Construction

# **Quebec & Montreal**

Victoria, BC

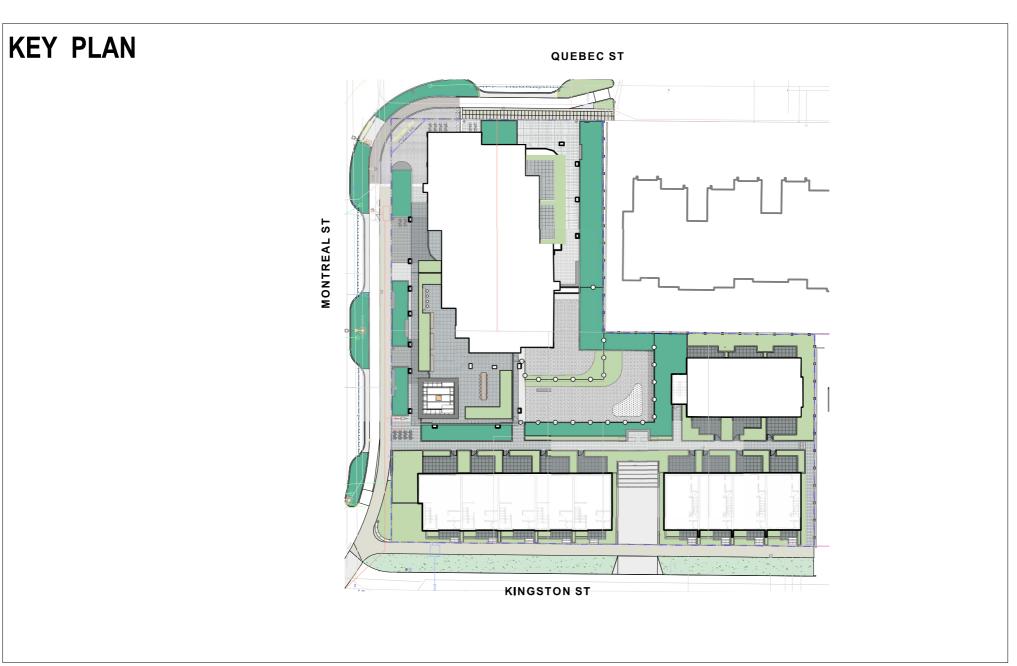

_andscape Sheets		
Sheet No.	Sheet Title	
L0.00	Cover	
L0.01	General Information Sheet	
L0.02	Tree Survey Plan	
L0.03	Tree Management Plan	
L1.01	Landscape Materials - Ground Level	
L1.02	Landscape Materials - Level 4	
L1.03	Stormwater Management & Grading	
L1.04	Landscape Precedents	
L1.05	Landscape Materials - Sections	
L1.06	Landscape Materials - Sections	
L1.07	Replacement Tree Plan	
L3.01	Planting Plan - Ground Level	
L3.02	Planting Plan - Level 4	
L4.01	Landscape Details	









Mike Geric Construction 4520 West Saanich Rd Saanich, BC

QUEBEC & MONTREAL DEV. 501-502 MONTREAL ST. VICTORIA, BC

Cover

	121.23
1: ###	@ 24"x36"
	MDI
	SM
sheet no.	

L0.00

#### GENERAL NOTES

- Work performed shall compty with the following: a) These General Notes, and Construction Documents and Specifications; b) Canadian Landscape Standards, Current Edition (CLS-CE); and c) All applicable local, provincial, and federal codes, ordinances, and regulations. Contractor shall be responsible for verifying all existing site conditions including location of all property lines, existing structures, utilities, and buried infrastructure. Verify all field conditions prior to commencing work.
- indicate a limit of proposed improvements or limit of work for the delineation of expected extents of disturbance. Should limits of disturbance exceed boundaries defined in drawings, contractor shall contact Landscape Architect for resolution.
- Contractor is responsible for repairing all work disturbed by construction outside of limit lines defined on drawings or through their means and methods to a condition better than or equal to the existing conditions prior to commencement of construction at no additional cost to the owner. S Contractor is responsible for maintaining a complete up-to-date set of drawings and specifications at the construction site and ensuring the documents are readily available for review by the Landscape
- Architect and governing agency.

  Contractor is responsible for coordination of all designs, drawings, specifications and other documents or publications upon which construction is based. Any discrepencies with the drawings and/or specifications and site conditions shall be brought to the attention of the Landscape Architect, prior to consequence with construction.
- proceeding with construction.

  The drawings and specifications are complementary to one another and implied to correspond with one another, Any discrepencies should be brought to the attention of the Landscape Architect for
- General Contractor and/or sub-contractors are responsible for all costs related to production and submission to consultant of all landscape as-built information including irrigation

- TREE RETENTION AND REMOVAL NOTES

  1. Tree protection fencing, for existing trees, to be installed prior to commencement of all site work. Refer to Arborist's plans for location of tree protection fencing, and protection fencing detail.

  2. Refer to arborist's report for detailed information for existing tree resources.

#### SITE GRADING AND DRAINAGE NOTES

- All elevations are in meters.
   Refer to Architectural plans, sections and elevations for top of slab elevations. Slab elevations indicated on Landscape drawings are for reference only. Report any discrepancies to consultant for
- 3. All road, public walkway and vehicular drive aisles and parking area elevations indicated on the Landscape drawings are for reference only. Refer to Civil Engineering drawings. Report any discrepancies to consultant for review and response.

  4. Confirm all existing grades prior to contruction. Report any discrepancies to consultant for review and
- response.

  5. Unless otherwise noted provide a minimum slope of 2% on all hard and soft Landscape areas to ensure positive drainage away from buildings, to rain gardens, or to drainage devices.

  6. All landscape areas shall not exceed a maximum slope of 3:1 in all instances.

  7. Upon discovery, contractor to refrain from blasting rock to meet landscape subgrades, Contractor to contact Landscape Architect on how to proceed in each instance.

- Contractor to provide irrigation system for all planters to current IIABC Standards and Contract Specifications.
- All specified work to meet the project specifications, and all standards or specifications established in
- All specified work to meet the project specifications, and all standards or specifications established in
  the lastest edition of the Canadian Landscape Standard and IIABC standards.
   Design/build drawings for detailed irrigation plan to be submitted to Contract Administrator in PDF and
  .dwg formats at least two weeks prior to commencement of irrigation installation
   Utilities Contractor to verify location of all on-site utilities, prior to construction. Restoration of
  damaged utilities shall be made at the contractor's expense, to the satisfaction of the owner's
  consequentiation.

- representatives.

  5. Refer to electrical drawings for electrical service.

  6. Controller and backflow prevention device to be located in Mechanical Room, unless otherwise noted. Refer to Mechanical drawings for size and location of irrigation service.

  7. Contractor to verify pressure and flow prior to installation of irrigation and notify owner's representative in writing if such data adversely affects the operation of the system.

  8. Sleeves shall be installed at the necessary depths, prior to pavement construction. Sleeving shall extend 300 mm from edge of paving into planting area, and shall have ends marked above grade unless otherwise shown.
- 9. Contractor to field fit irrigation system around existing trees, to limit disturbance to root systems 9. Contractor to field fit irrigation system around existing trees, to limit disturbance to root systems.
  10. At various milestones during construction, inspection and testing of components will be required to ensure that the performance of irrigation system meets standards and specifications. Contractor to provide equipment and personnel necessary for performance of inspections and tests. Conduct all inspections and tests in the presence of the contract administrator. Keep work uncovered and accessible until successful completeition of inspection or test.
  11. Over spray onto hardscape areas to be minimized. Use drip irrigation within small planting areas to avoid oversorav.

- avoid overspray.

  12. Trees within shrub or rain garden areas to be irrigated with spray heads.

  13. Trees in Plaza in hard pavement (soil cells below) to recieve temporary irrigation system around root collar and permanent drip irrigation system

  14. Irrigation design shall be submitted for review and approval to City of Victoria Parks no less than 30 days prior to scheduled installation.

  15. Irrigation Inspections: required for all sleeving, open trench maintine and lateral lines, system
- operation, controller, backflow preventer (incl. inspection tag and testing report). Call CoV Parks 250-361-0600 min. 2 days in advance to arrange for irrigation inspections.

#### GROWING MEDIUM NOTES

- Refer to Landscape Specifications for growing medium properties by soil type.
   Advise Contract Administrator of sources of growing medium to be utilized 14 days in advance of

- stating work.

  Growing medium properties and handling shall meet CLS-CE (see Section 6 CLS-CE).

  Contractor is responsible for soil analysis and amendment requirements to supply suitable grow medium, as specified by testing agency. Soil analysis and amendment costs shall be included
- price for the work.

  Submit to the Landscape Architect a copy of the soil analysis report from Pacific Soil Analysis Inc.
  5-11720 Voyageur Way, Richmond, BC, V6X 3G9, p. 604- 273-8226. The analysis shall be of tests done on the proposed growing medium from stratified samples taken from the supply source. Costs of the initial and all subsequent tests to ensure compliance with the specifications shall be borne by
- 6. Contract Administrator will collect sample of growing medium in place and determine acceptance of material, depth of growing medium and finish grading. Approval of growing medium material subject to soil testing and analysis. Planting is not to occur until finished grades have been approved by

#### SITE LAYOUT NOTES

- t of all work for approval by Contract Administrator prior to proceeding with work. Requests for site review as required 48 hours in advance of performing any work, unless otherwise
- Layout and verify dimensions prior to construction. Bring discrepancies to the attention of the Contract Administrator.
- Witten dimensions take precedence over scale. Do not scale drawings.

  All plan dimensions in metres and all detail dimensions in millimetres, unless otherwise noted.

  Where dimensions are called as 'equal' or 'eq', space referenced items equally, measured to centre

- GENERAL PLANTING NOTES

  1. Plant quantities on Plans shall take precedence over plant list quantities.
  2. Provide layout of all work for approval by Contract Administrator prior to proceeding with work.
  3. Plant material, installation and maintenance to conform to the current edition of the Canadian
- Landscape Standard. Plant quantities and species may change between issuance of DP and Construction due to plant
- availability and design changes.

  5. Landscape installation to carry a 1 year warranty from date of acceptance. This warranty is based on andequate maintenance by the Owner after Acceptance. The Contractor will not be responsible for plant loss due to extreme climatic conditions such as abnormal freezing temperatures or hail which occur after Acceptance. The Contractor shall be responsible for plant loss due to inadequate acclimatization of plants for their planted location.

#### ON-SLAB TREE PLANTING NOTES

- IN-SLAB I REE PLANTING MOTES.

  For on-slab landscape, a root barrier will be installed to protect exposed water proof membranes. A dimple board (drain mat) will be installed over the root barrier.

  Parkade walls and foundation walls will be protected with a dimple board (drain mat) to convey water to the perimeter drain and protect wall from roots.

  A root barrier will be installed between the tree roots and perimeter drain, to minimize tree root interference with the drain, where the follow conditions exist in on-grade planting areas: a)where trees less than 8m tall are located closer than 2m from a parkade or foundation wall; b) where remineter than 8m tall are located closer than 9m from a parkade or foundation wall; on where perimeter than 8m tall are located closer than 3m from a parkade or foundation wall; and c) where perimete

- Boulevard trees have been placed to avoid existing and proposed infrastructure. Trees planted within 1m of an existing underground municipal service will have a root barrier installed between the root ball
- Boulevard trees will be place a minimum of 1.5m from an above ground municipal service such as fire ydrant, streetlight or driveway.
- Boulevard tree species have been picked from the municipality's list of recommended boulevard trees or have been selected due their site-adapted qualities. Final selection of boulevard trees to be determined through consultation with municipal parks staff.

  Irrigation to be installed as per Municipal Specifications, for all boulevard planting areas (unless
- Design/build drawings for boulevard irrigation to be submitted to Contract Administrator in PDF and dwg formats, at least two weeks prior to commencement of irrigation installation and will be reviewed
- .dwg formats, at least two weeks prior to commencement of irrigation installation and will be reviewed by municipal staff.

  6. Refer to Civil drawings for location of boulevard irrigation point of connection. Separate water meter and timer/controller, to be provided at point of connection. Timer/controller for boulevard areas must be readily accessible to municipal staff.

  7. Boulevard irrigation to be inspected as per municipal specification by municipal staff. Boulevard tree irrigation system will be maintained and operated by municipality, after it is inspected and approved by municipal staff.
- Soil volume for boulevard trees to be as follows: 8 cu. m. for small trees, 12 cu. m. for medium trees, and 16 cu. m. for large trees.

#### OFF-SITE IRRIGATION

- ings must be submitted to Parks Division for review and approval 30 days prior to allation work.
- Installation work.

  I Irrigation Systems on City Property shall comply to City of Victoria Supplementary Specifications for Street Trees and Irrigation Schedule C, Bylaw 12-042, Subdivision Bylaw.

  The following irrigation and sleeving inspections by Parks Staff are required by Schedule C. Please contact Tom Sherbo, tsherbo@victoria.ca and copy treepermits@victoria.ca 48 hours prior to the required inspection time to schedule an inspection.
  - (1) Irrigation sleeving prior to backfilling (2) Open trench main line and pressure test

  - (3) Onen trench lateral line
  - (3) Open deficie nation and a second property of the proper

#### OFF-SITE HORTICULTURE INSPECTIONS REQUIRED

- e following inspections are required for all off-site horticulture areas:

  (1) Excavated and scarified subgrade prior to placement of growing media.
- (2) Installed and prepared growing media prior to planting.(3) Plant material on-site prior to planting.
- (4) Planted landscape prior to mulch installation.
- (5) At time that planted and mulched landscape meets the conditions for Total Performance as required by MMCD.

MAXIMUM MANHOLE

#### LIST OF ABBREVIATIONS

1000	ADOLUTEOT	MH	MANHOLE
ARCH	ARCHITECT	MIN	MINIMUM
AVG	AVERAGE	MISC	MISCELLANEOUS
B&B	BALLED AND BURLAPPED	MM	MILLIMETRE
BC	BOTTOM OF CURB	N	NORTH
BLDG	BUILDING	NIC	NOT IN CONTRACT
BM	BENCHMARK	NO	NUMBER
BC	BOTTOM OF CURB	NOM	NOMINAL
BR	BOTTOM OF RAMP	NTS	NOT TO SCALE
BS	BOTTOM OF STEP	OC	ON CENTER
BW	BOTTOM OF WALL	OD	OUTSIDE DIAMETER
CAL	CALIPER	PC	POINT OF CURVATURE
CB	CATCH BASIN	PE	POLYURETHANE
CF	CUBIC FEET	PI	POINT OF INTERSECTION
CIP	CAST IN PLACE	PI	
CL	CENTER LINE		PROPERTY LINE
CLR	CLEARANCE	PT	POINT, POINT OF TANGEN
CM	CENTIMETER	PVC	POLYVINYL CHLORIDE
CO	CLEAN OUT	QTY	QUANTITY
CONT	CONTINUOUS	R	RADIUS
CUM	CUBIC METRE	REF	REFERENCE
DEG	DEGREE	REINF	REINFORCE(D)
DEMO	DEMOLISH, DEMOLITION	REQ'D	REQUIRE(D)
DIA	DIAMETER	REV	REVISION
		ROW	RIGHT OF WAY
DIM	DIMENSION	S	SOUTH
DTL	DETAIL	SAN	SANITARY
DWG	DRAWING	SD	STORM DRAIN
E	EAST	SF	SQUARE FOOT (FEET)
EA	EACH	SHT	SHEET
EL	ELEVATION	SIM	SIMILAR
ENG	ENGINEER	SPECS	SPECIFICATIONS
EQ	EQUAL	SQ M	SQUARE METRE
EST	ESTIMATE	ST	STORM SEWER
E.W.	EACH WAY	STA	STATION
EXIST	EXISTING	STD	STANDARD
EXP	EXPANSION, EXPOSED	SYM	SYMMETRICAL.
FFE	FINISHED FLOOR ELEVATION	T&B	TOP AND BOTTOM
FG	FINISHED GRADE	TC	TOP OF CURB
FL	FLOW LINE	TF	TOP OF CORB
FOC	FACE OF CURB	TH	THICK
FT	FOOT (FEET)	TOPO	
FTG	FOOTING		TOPOGRAPHY
GA	GAUGE	TR	TOP OF RAMP
GEN	GENERAL	TS	TOP OF STEP
GR	GRADE ELEVATION	TW	TOP OF WALL
HORIZ	HORIZONTAL	TYP	TYPICAL
HP	HIGH POINT	VAR	VARIES
HT	HEIGHT	VOL	VOLUME
ID	INSIDE DIAMETER	W	WITH
INV	INVERT ELEVATION	W/O	WITHOUT
IN	INCH(ES)	WT	WEIGHT
INCL		WL	WATER LEVEL
	INCLUDE(D)	WWF	WELDED WIRE FRAME
JT	JOINT		

#### **MATERIALS LEGEND**


#### HARDSCAPE

#### Asphalt, See Civil 1.1

1.2

1.3

14

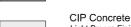

Light Broom Finish with Tooled Control Joints. Colour: Natural

CIP Concrete Light Broom Finish with Radial Control Joints. Colour: Natural

Standard Paver

8x8 tile pattern, colour Natural Standard Paver 1.5 8x8 tile pattern, colour Charcoal

Patio 16

'Texada' Hydrapressed Slabs. 457 mm x 457 mm x40 mm. Charcoal colour. Square Grid. Supplier: Abbotsford Concrete. Nonpermeable.

#### HARDSCAPE: CITY STANDARDS

See 'Downtown Public Realm Plan & StreetScape

Trowel Joint Concrete. See I 4 01 For Pattern Details

> Granite Pavers @ 300mm x 100mm x 80mm, Mortar set. Paving field. Grey granite. Flamed Finish. Nonpermeable.

1.9 Grey Basalt Entry Band Sandblasted Street name insert 450mm width, Font Tisa Bro Bold -

All caps. Finish Flamed

1.10 Granite Pavers Solider Course Border 200mm

Granite Pavers DAYCARE Design TBD by imput from Daycare provider

2.1 Sand Safety Surfacing 2.2

(3.0) WALLS

3.1

4.1

4.3

3.3

Concrete Retaining Wall

3.2 Concrete Bench

 $\langle 4.0 \rangle$ FURNISHINGS

> 'Downtown Bicycle Rack' As specified in Victoria Downtown Public Plan & Streetscape Standard. No offsite Bike Racks.

Concrete Curb - See Civil.

42

Fire pit

Trash Bin

Trellis

Benches

4.7 Shed. See Architecture.

#### FENCES AND BARRIERS

1800mm Wood Fence 5 1

 $\circ$ Picket Fence

LIGHTING See Arch and Electrical  $\langle 6.0 \rangle$ 

 $\langle 7.0 \rangle$ PLANTING AREAS

7.1 Shrub Area

Rain Garden (See Dwg 1 L1.03 & 4.01)

#### LINE TYPE LEGEND

**—** · · · **—** · · · -Property line ----Extent of Parkade, below Pedestrian Sightline

#### **UNDERGROUND UTILITIES**

(Shown for reference only - refer to Civil Engineer's drawings).

#### **GRADING LEGEND**

Existing Landscape Grade Civil Grade, provided for reference only Architectural grade, provided for reference

Proposed Landscape Grade

#### IRRIGATION LEGEND




Irrigation Point of Connection Proposed Irrigation Point of Connection. Provide water service and electrical service from irrigation controller to valves.

- Irr SI -- Irr SI --

Irrigation Sleeve
Schedule 40 PVC, dia, shall be min 3x main line
diameter, or 2x lateral line diameter. Install irrigation
wiring in separate 2" electrical conduit. Extend
sleeve 300 mm past edge of hard surface or walls.

#### LANDSCAPE DRAINAGE LEGEND

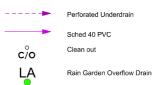

L-AD 8" Square drain with ductile iron grate. Trench Drain Aco K100 Trench Drain, Load Class 'A'.

DRAINS BY OTHERS SD BL AD



8	REV RZ/DP	2023-12-2
7	REV RZ/DP	2023-03-0
6	REV RZ/DP	2022-12-0
5	REV RZ/DP	2022-08-3
4	For Information	2022-06-2
3	REV RZ/DP	2022-04-1
2	DP	2021-12-1
1	Issued for Dev. Tracker	2021-10-1
rev no	description	date





2023-12-22

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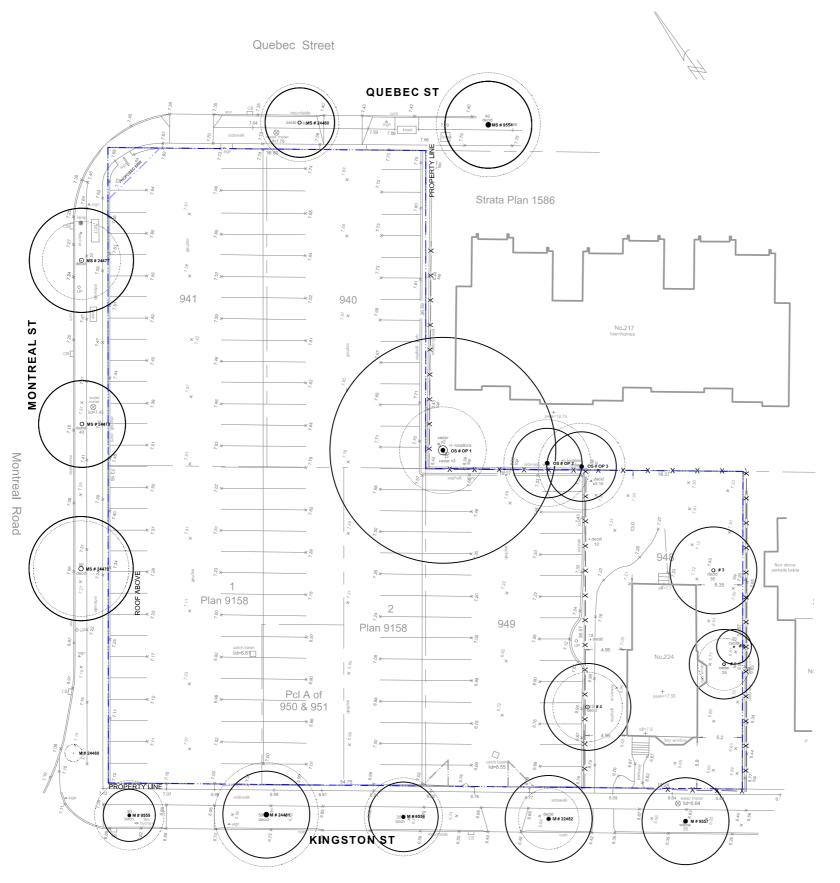
QUEBEC & MONTREAL DEV 501-502 MONTREAL ST.

VICTORIA. BC

#### **General Information** Sheet

project no.		121.23
scale	NA	@ 24"x36"
drawn by		MDI
checked by		SM

L0.01



Kingston Street

#### LINE TYPE LEGEND

Property line
Right of Way
Extent of Roof, above

 - - - Extent of Parkade, below

 - - - - Rain garden - TOP OF POOL

 Rain garden - BOTTOM OF POOL
 Rain garden - BOTTOM OF POOL

#### GRADING LEGEND

17.70 Existing Landscape Gra

#### UNDERGROUND UTILITIES

Shown for reference only - refer to Civil Engineer's drawings).

Storm drain

EXISTING

Sewer
Water
Electrical

Gas Hydro Tel

#### EXISTING PLANT LEGEND

details and management strategies).



0 5 10 m

#### **EXISTING TREE INVENTORY\***

#### TOTAL TREES TO BE RETAINED: 9


REMOVED TREES

TREE TAG #	DBH (cm)	Species	Spread (m)	(m)
24460	35	Sorbus intermedia	9	0
24480	3	Prunus sargentii	1	3
24479	53	Prunus cerasifera	11	8
24478	44	Prunus cerasifera	10	8
24477	50	Prunus cerasifera	9	8
1	35	Thuja plicata smaragd	3	6
2	14	Thuja plicata smaragd	2	6
3	39	Pyrus sp.	5	4
4	44	llex aquifolium	4	6

#### TOTAL TREES TO BE REMOVED: 9

\* Based on Arborist's Report recieved from Arborist, 09/28/2021. Refer to Arborist report for details on tree conditions and Arborist recommendations.



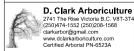

8	REV RZ/DP	2023-12-22
7	REV RZ/DP	2023-03-02
6	REV RZ/DP	2022-12-06
5	REV RZ/DP	2022-08-3
4	For Information	2022-06-27
3	REV RZ/DP	2022-04-14
2	DP	2021-12-16
1	Issued for Dev. Tracker	2021-10-19
rev no	description	date



Victoria, BC V8Z 3P6



2023-12-22


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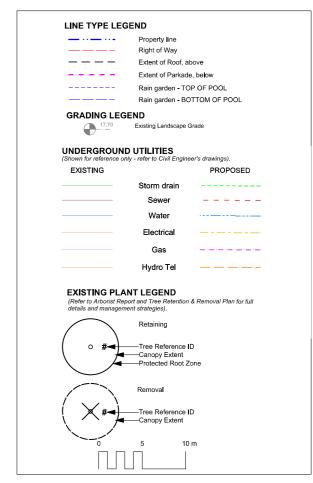
QUEBEC & MONTREAL DEV. 501-502 MONTREAL ST. VICTORIA, BC

about title

#### Tree Survey Plan

revison no.	sheet no.	SIVI
drawn by		MDI SM
scale	1: 200	@ 24"x36"
project no.		121,23



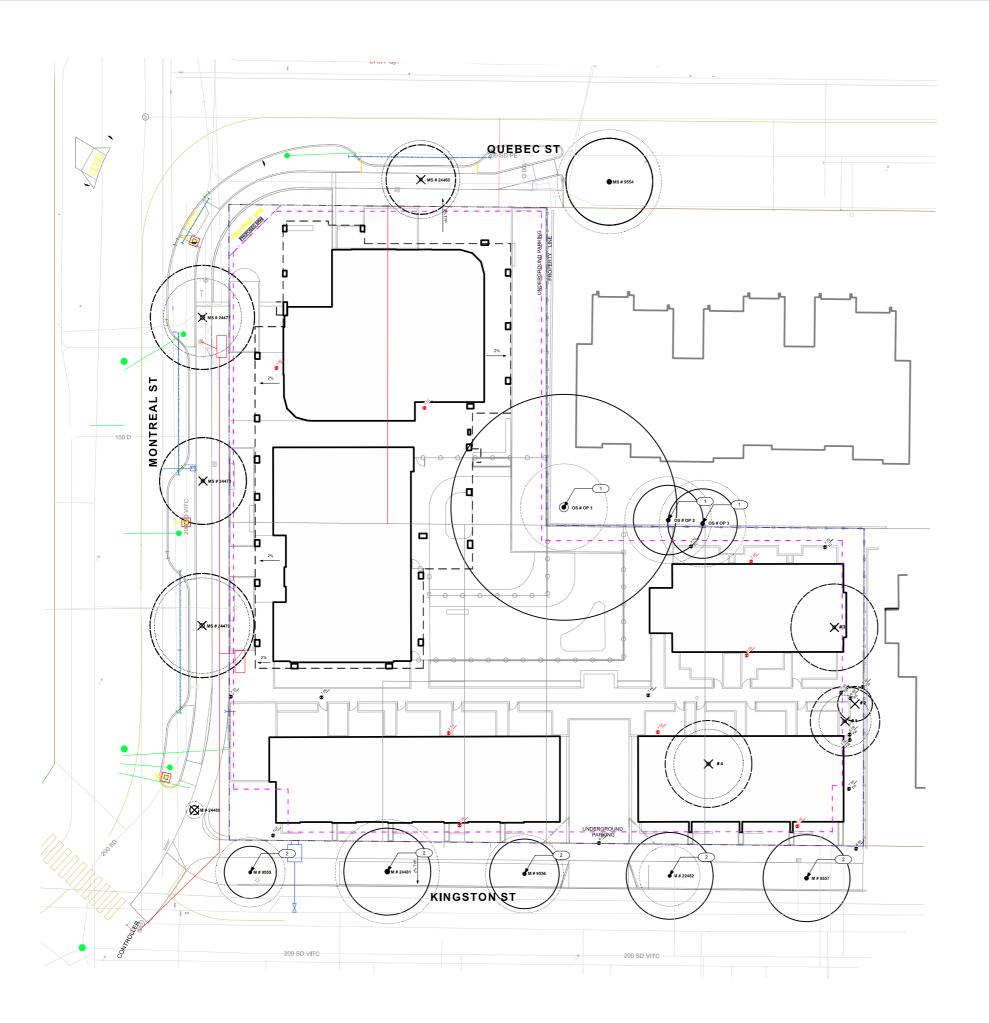

EXISTING 1	REE INVE	NTO	RY*		
RETAINED TR		007	Superior	Crown	Heigh
	DBH (cm)	CRZ	•	Spread (m)	(m)
9555	27	3	Betula papyrifera	8	9
24481	39	5	Prunus cerasifera	12	9
24482	38	5	Prunus cerasifera	7	9
9557	39	4	Betula pendula	10	11
9554	42	5	Aesculus carnea	12	9
Op1	105	12	Thuja plicata	10	14
Op2	35	4	Cedrus dreadar	9	18
Op3	35	4	Sequoiadendron giganteum	9	10
2556	34	4	Betula papyrifera	9	10

## TOTAL TREES TO BE RETAINED: 9

REMOVED TREES

TREE TAG #	DBH (cm)	Species	Crown Spread (m)	Height (m)
24460	35	Sorbus intermedia	9	0
24480	3	Prunus sargentii	1	3
24479	53	Prunus cerasifera	11	8
24478	44	Prunus cerasifera	10	8
24477	50	Prunus cerasifera	9	8
1	35	Thuja plicata smaragd	3	6
2	14	Thuja plicata smaragd	2	6
3	39	Pyrus sp.	5	4
4	44	llex aquifolium	4	6

#### TOTAL TREES TO BE REMOVED: 9

\* Based on Arborist's Report recieved from Arborist, 09/28/2021. Refer to Arborist report for details on tree conditions and Arborist recommendations.

#### REFERENCE NOTES

Requires onsite supervision of trees during excavation

2 Potentially impacted by site serving and grading





8	REV RZ/DP	2023-12-22
7	REV RZ/DP	2023-03-02
6	REV RZ/DP	2022-12-06
5	REV RZ/DP	2022-08-31
4	For Information	2022-06-27
3	REV RZ/DP	2022-04-14
2	DP	2021-12-16
1	Issued for Dev. Tracker	2021-10-19
rev no	description	date






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QUEBEC & MONTREAL DEV. 501-502 MONTREAL ST. VICTORIA, BC

#### **Tree Management** Plan

8	L	0.03
revison no.	sheet no.	
checked by		SM
drawn by		MDI
scale	1: 200	@ 24"x36"
project no.		121.23



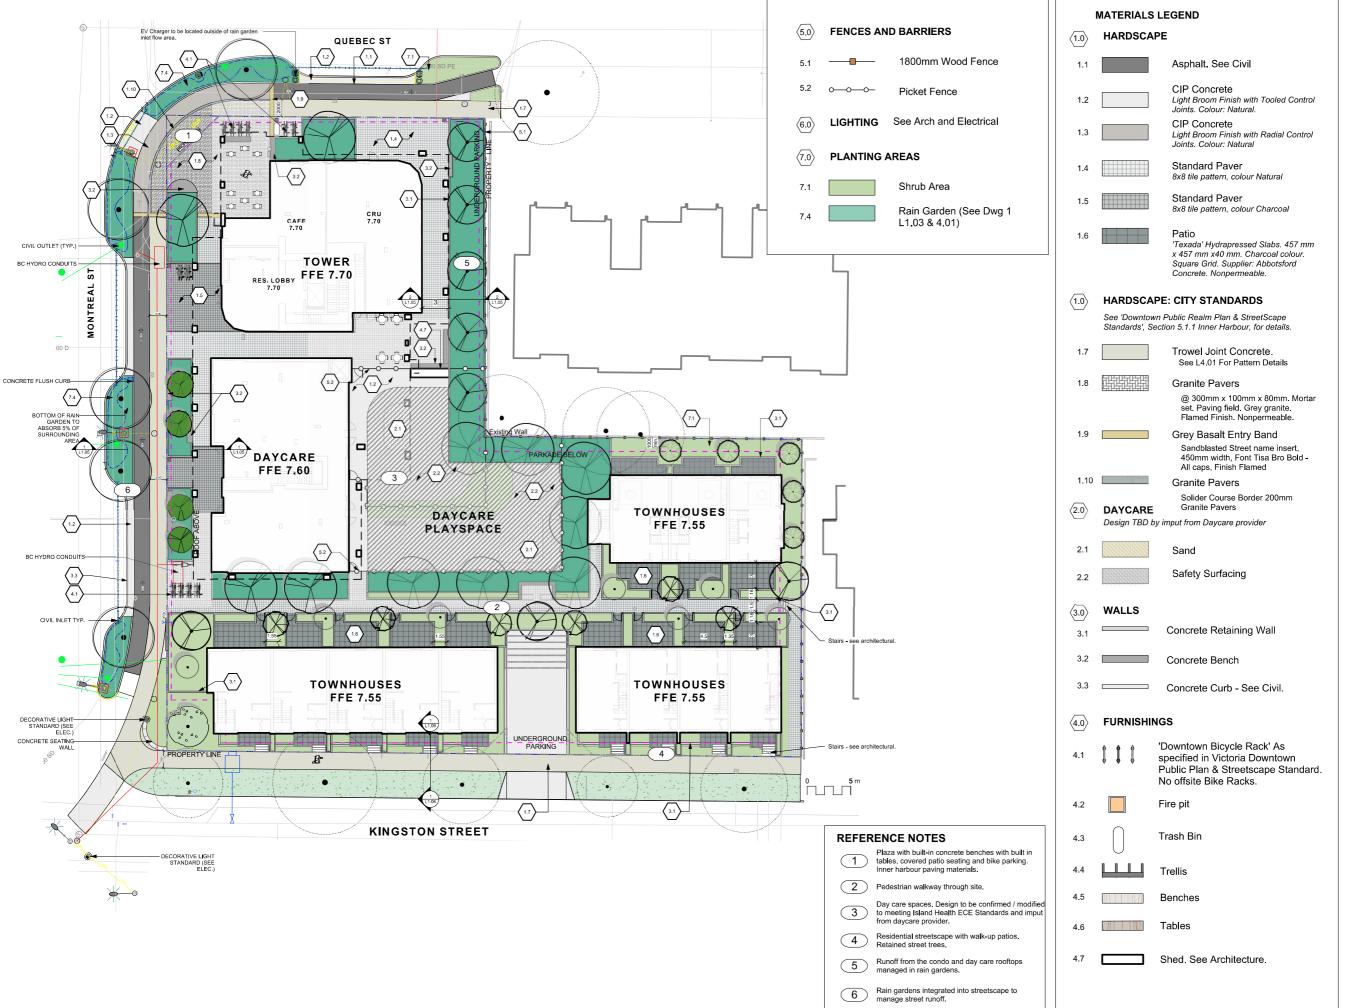

8	REV RZ/DP	2023-12-22
7	REV RZ/DP	2023-03-02
6	REV RZ/DP	2022-12-06
5	REV RZ/DP	2022-08-31
4	For Information	2022-06-27
3	REV RZ/DP	2022-04-14
2	DP	2021-12-16
1	Issued for Dev. Tracker	2021-10-19
no no	description	date



BA Tennyson Ave. oria, BC V8Z 3P6



2023-12-2

Mike Geric Construction 4520 West Saanich Rd

Saanich, BC

QUEBEC & MONTREAL DEV. 501-502 MONTREAL ST. VICTORIA, BC

sheet title

Landscape Materials - Ground Level

project no.		121.23
scale	1:200	@ 24"x36"
drawn by		MDI
checked by		SM
revison no.	sheet no.	
8	L	1.01



#### MATERIALS LEGEND

HARDSCAPE  $\langle 1.0 \rangle$ 

1.2

1.4

1.6

Asphalt. See Civil

CIP Concrete Light Broom Finish with Tooled Control Joints. Colour: Natural. CIP Concrete

Standard Paver

Light Broom Finish with Radial Control Joints. Colour: Natural

8x8 tile pattern, colour Natural Standard Paver

1.5 8x8 tile pattern, colour Charcoal Patio

'Texada' Hydrapressed Slabs. 457 mm x 457 mm x40 mm Charcoal colour Square Grid. Supplier: Abbotsford Concrete. Nonpermeable

#### HARDSCAPE: CITY STANDARDS

See 'Downtown Public Realm Plan & StreetScape Standards', Section 5.1.1 Inner Harbour, for details.

1.7 Trowel Joint Concrete. See L4.01 For Pattern Details

**Granite Pavers** @ 300mm x 100mm x 80mm. Mortar

set. Paving field. Grey granite. Flamed Finish. Nonpermeable.

Solider Course Border 200mm

Grey Basalt Entry Band Sandblasted Street name insert, 450mm width, Font Tisa Bro Bold -All caps, Finish Flamed

1.10 **Granite Pavers** 

Granite Pavers DAYCARE Design TBD by imput from Daycare provider

2.1 Sand

Safety Surfacing 2.2

 $\langle 3.0 \rangle$ WALLS

1.9

Concrete Retaining Wall 3.1

3.2 Concrete Bench

3.3 Concrete Curb - See Civil.

#### 4.0 FURNISHINGS

'Downtown Bicycle Rack' As 4.1 specified in Victoria Downtown Public Plan & Streetscape Standard. No offsite Bike Racks.

Fire pit

4.2

Trash Bin 4.3

4.4 Trellis

4.5 Benches

4.6

4.7 Shed. See Architecture.



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4	For Information	2022-06-27
3	REV RZ/DP	2022-04-14
2	DP	2021-12-16
1	Issued for Dev. Tracker	2021-10-19
v no	description	date





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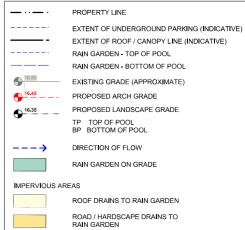
QUEBEC & MONTREAL DEV. 501-502 MONTREAL ST. VICTORIA, BC

Landscape Materials - Level 4

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#### RAIN WATER MANAGEMENT NOTES


Water collected from road areas, building roofs, flow to the rain gardens located throughout the site.

Rain gardens are integrated building landscapes and landscape bulges within streetscape areas and are designed to capture, slow flows, and treat runoff from roadways.

Rain gardens will be designed with underdrains and a high-capacity overflow drain that will be connected to the onsite piped drainage system.

The rain gardens are sized such that the bottom of the rain garden is 5% of the impervious area to meet or exceed City of Victoria Green Stormwater Infrastructure Guidelines.

Boulevard rain gardens to be designed to City of Victoria Standards

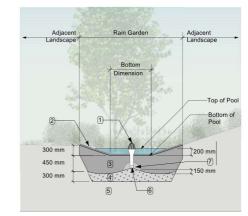

- RAIN GARDEN MATERIALS

  1. Overflow drain, 200 mm domed grate + adapter

  2. Composted mulch, 50 -70 mm depth

  3. Bio-retention growing medium, 450 mm depth

  4. Scarified/tilled subgrade, 300 mm depth

  5. Existing subgrade/native material

  6. 100 mm diameter (min) perforated pipe

  7. 25 mm diameter drain rock, 100 mm depth



#### **GRADING NOTES**

- 1. All grades slope 2% from the building to back of curb.
- 2. Slab grade varies
- 3. All landscape walls are an average of 500mm height.
- 4. Kingston St Townhouses require 3-4 risers to meet grade.
- 5. Proposed curb grades to be determined by Civil (proposed grades will be similar to existing grades. See Civil for details) 6. All sidewalk slope 2% to back of curb.



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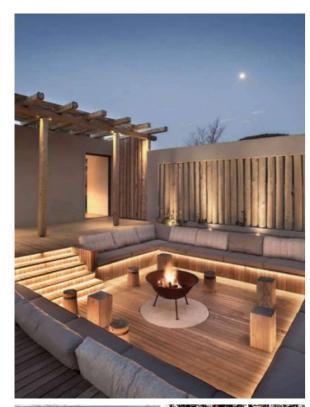
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#### Stormwater Management & Grading

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DAYCARE - PLAY















STREETSCAPE KINGSTON

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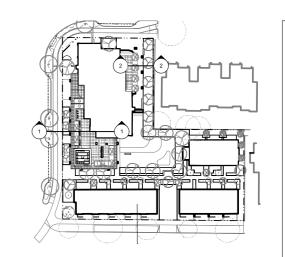
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Landscape Precedents

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Rain Garden Bike Lane 2m Rain Garden Walkway Walkway Rain Garden	PROPERTY LINE	COMMON AREA WITH PLANTER, SEATING & TRELLIS	PRIVATE BALCONY W. PLANTER	PROPERTY LINE	
See Civil.  Sidewalk	Montreal St.   Rain Garden   Bike Lane   2m   Rain Garden   Sidewalk	Walkway	Walkway	Rain Garden	

Montreal Street Section

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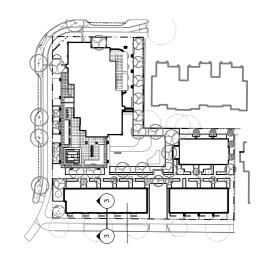
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Section w. Neighbouring Townhomes



1 Typical Kingston Street Section





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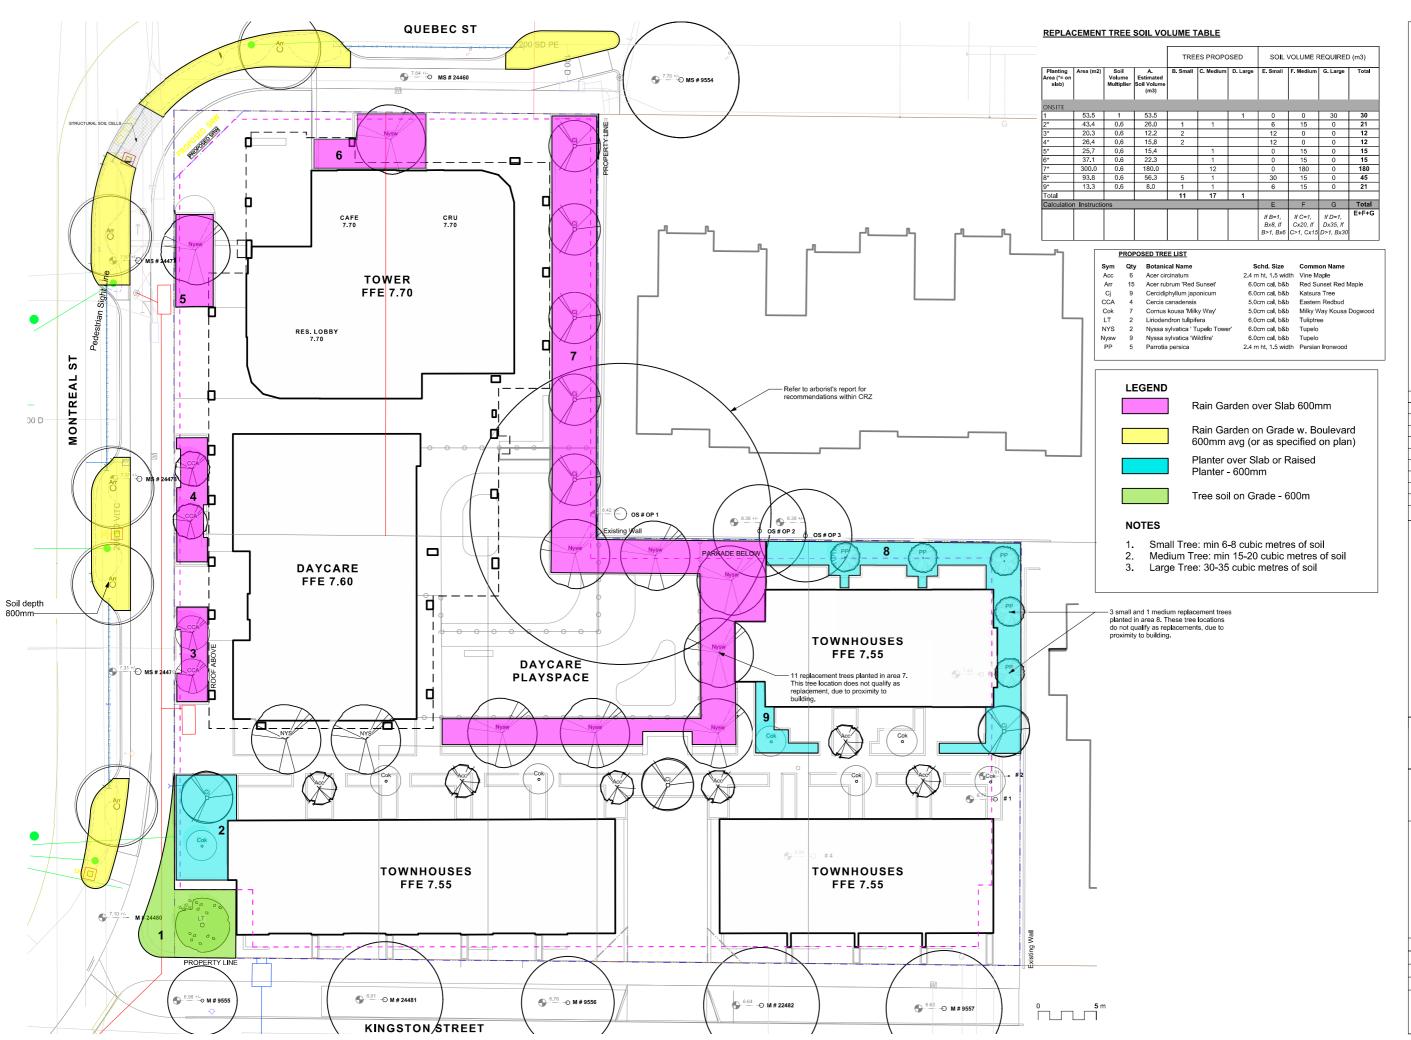


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Landscape Materials - Sections

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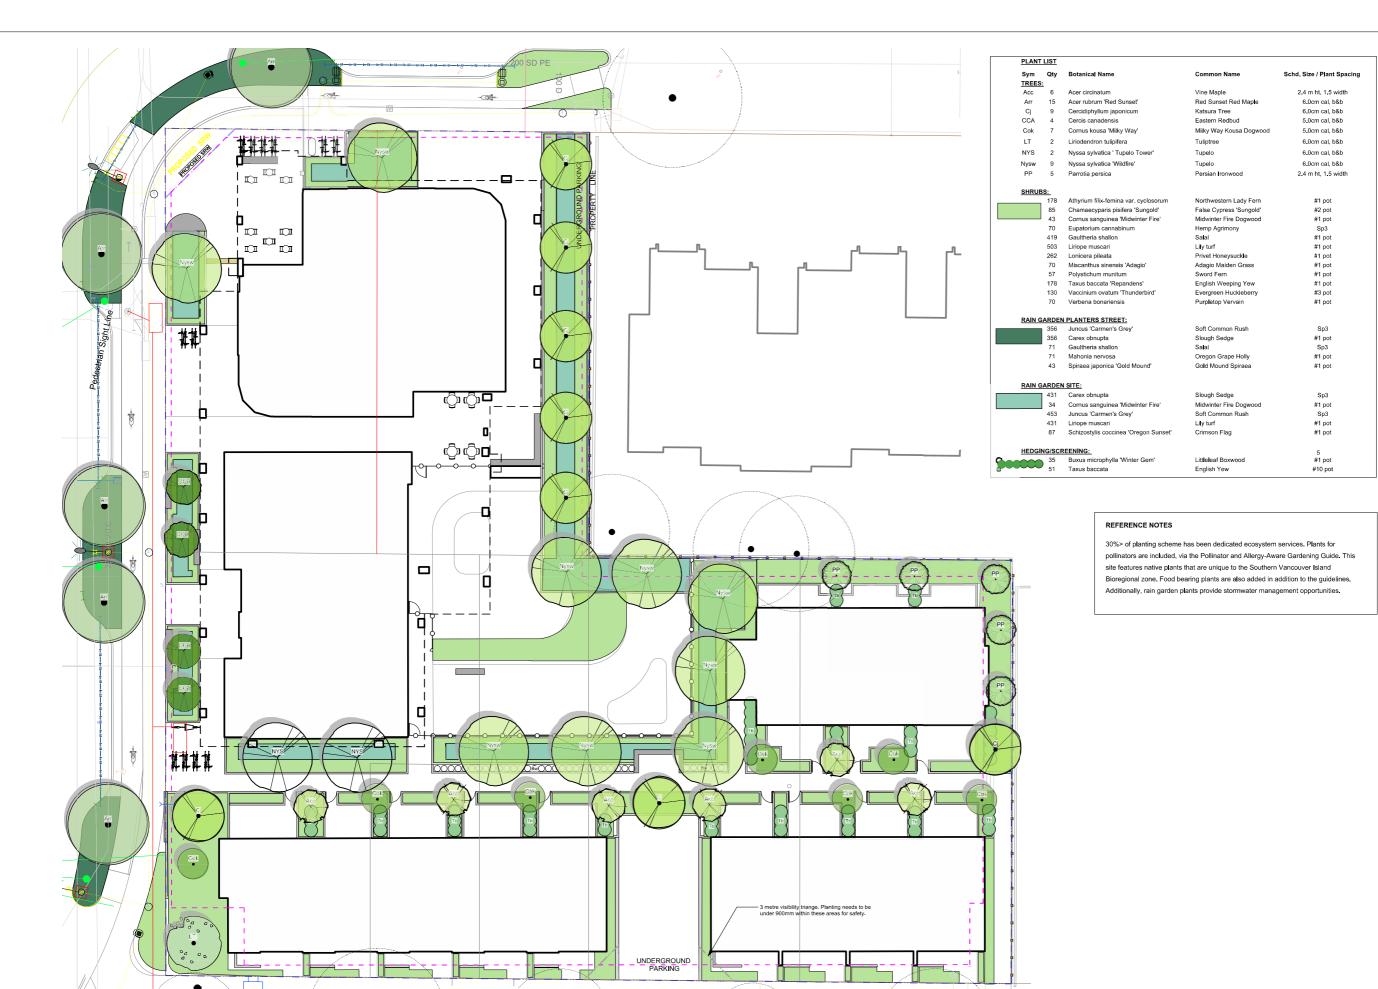
Scott Murdoch 341

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Replacement Tree Plan

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Planting Plan - Ground Level

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Sym	Qty	Botanical Name	Common Name	Schd. Size / Plant Spacing
Acc	<u>i:</u> 4	Acer circinatum	Vine Maple	2.4 m ht. 1.5 width
Ajv	5	Acer japonicum 'Vitifolium'	Japanese Maple	1.8 m height, specimen qualit
Mr	2	Magnolia stellata 'Royal Star'	Royal Star Magnolia	1.2m b&b
SHRUE	3S & PE	RENNIALS		
	24	Abelia x grandiflora 'Prostrata'	Prostrate White Abelia	#2 pot
	32	Cistus x corbariensis	Rock Rose	#1 pot
	35	Eriophyllum lanatum	Wooly Sunflower	#1 pot
	107	Hebe topiaria	Topiarist's hebe	#1 pot
	63	Lavandula angustifolia 'Hidcote'	Hidcote English Lavender	#1 pot
	107	Mahonia repens	Prostrate Oregon Grape	#1 pot
	16	Nepeta x faassenii	Catmint	Sp3
	16	Rosmarinus officinalis	Rosemary	#2 pot
	16	Salvia officinalis	Culinary Sage	#1 pot
	24	Vaccinium ovatum 'Thunderbird'	Evergreen Huckleberry	#3 pot
	0			

#### REFERENCE NOTES

30%> of planting scheme has been dedicated ecosystem services. Plants for pollinators are included, via the Pollinator and Allergy-Aware Gardening Guide. This site features native plants that are unique to the Southern Vancouver Island Bioregional zone. Food bearing plants are also added in addition to the guidelines. Additionally, rain garden plants provide stormwater management opportunities.



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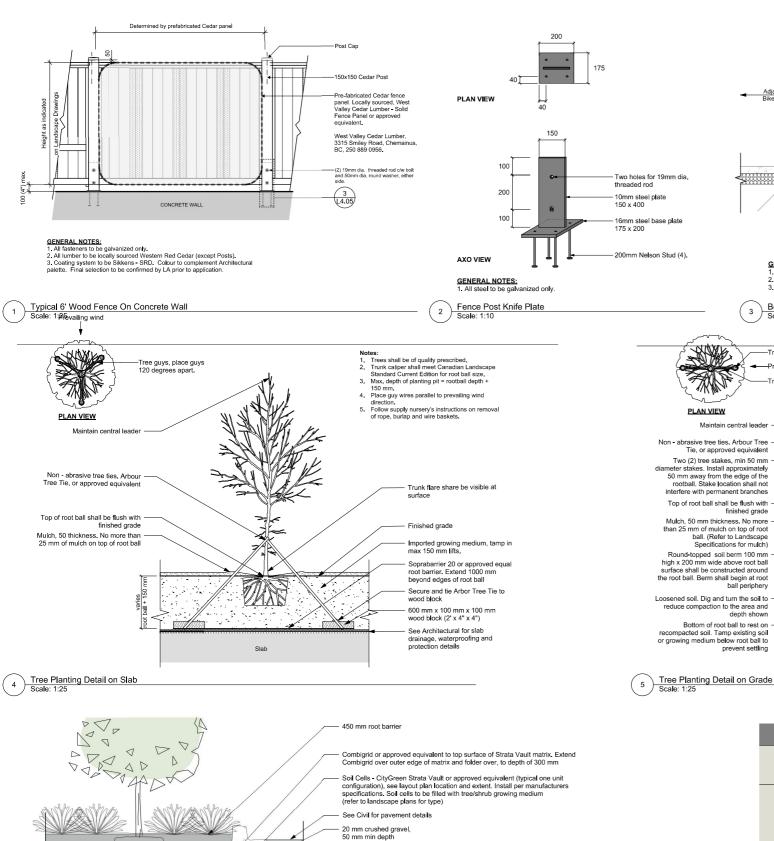
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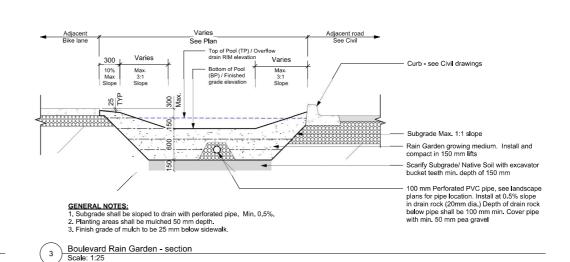
Planting Plan - Level

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Drainage layer, 100 mm min depth


Approved subgrade



Notes:

1. Trees shall be of quality prescribed Trunk caliper shall meet Canadian Landscape
 Standard Current Edition for root ball size.
 Max. depth of planting pit = rootball depth + direction

Follow supply nursery's instructions on re of rope, burlap, and wire baskets. PLAN VIEW Maintain central leader Non - abrasive tree ties. Arbour Tree Tie, or approved equivalent Two (2) tree stakes, min 50 mm ameter stakes. Install approximately 50 mm away from the edge of the rootball. Stake location shall not interfere with permanent branches Top of root ball shall be flush with finished grade Mulch, 50 mm thickness. No more than 25 mm of mulch on top of root ball. (Refer to Landscape Specifications for mulch) Trunk flare shall be visible at surface Round-topped soil berm 100 mm high x 200 mm wide above root ball surface shall be constructed around the root ball. Berm shall begin at root ball periphery Finished grade Imported growing medium, depth and type varies. Refer to landscape plans Loosened soil. Dig and turn the soil to reduce compaction to the area and depth shown Scarify subsoil to a depth of 150 mm before installing growing medium Bottom of root ball to rest on recompacted soil. Tamp existing soil or growing medium below root ball to prevent settling Existing soil

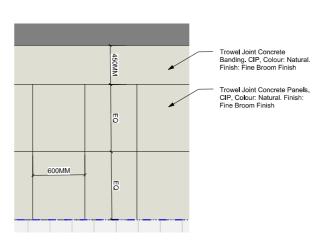

7 City of Victoria Paving Detail
Scale: 1:20



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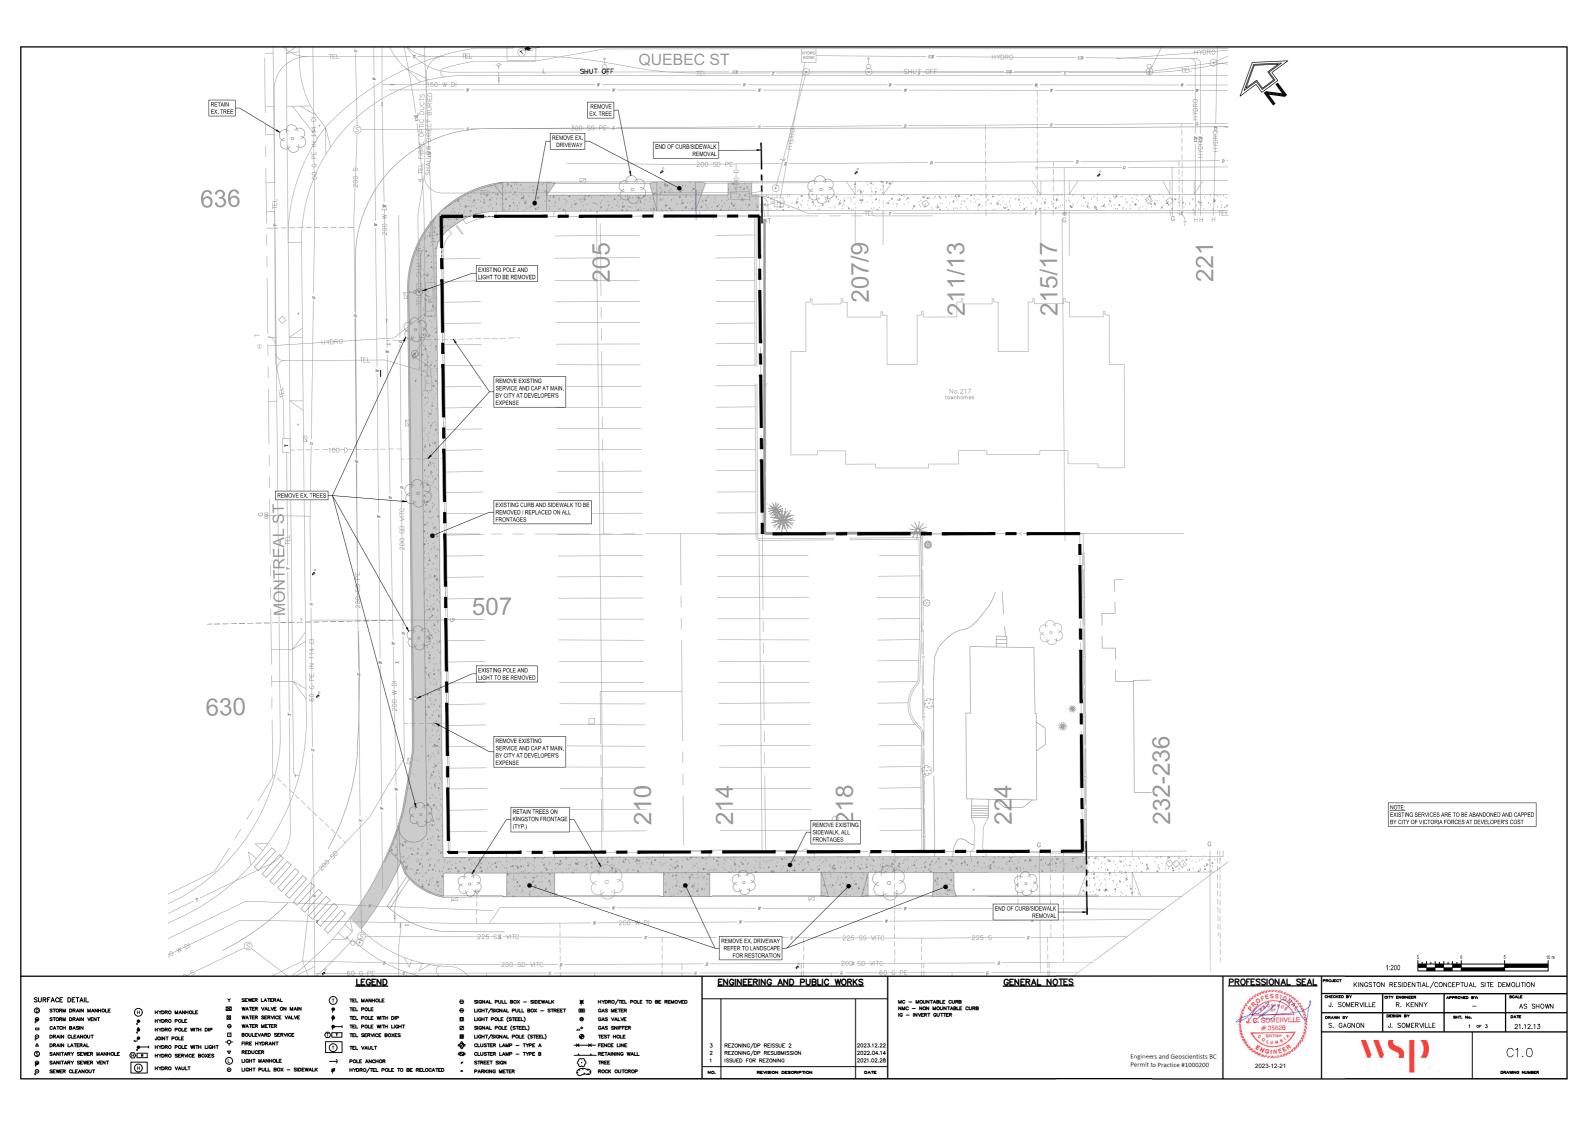
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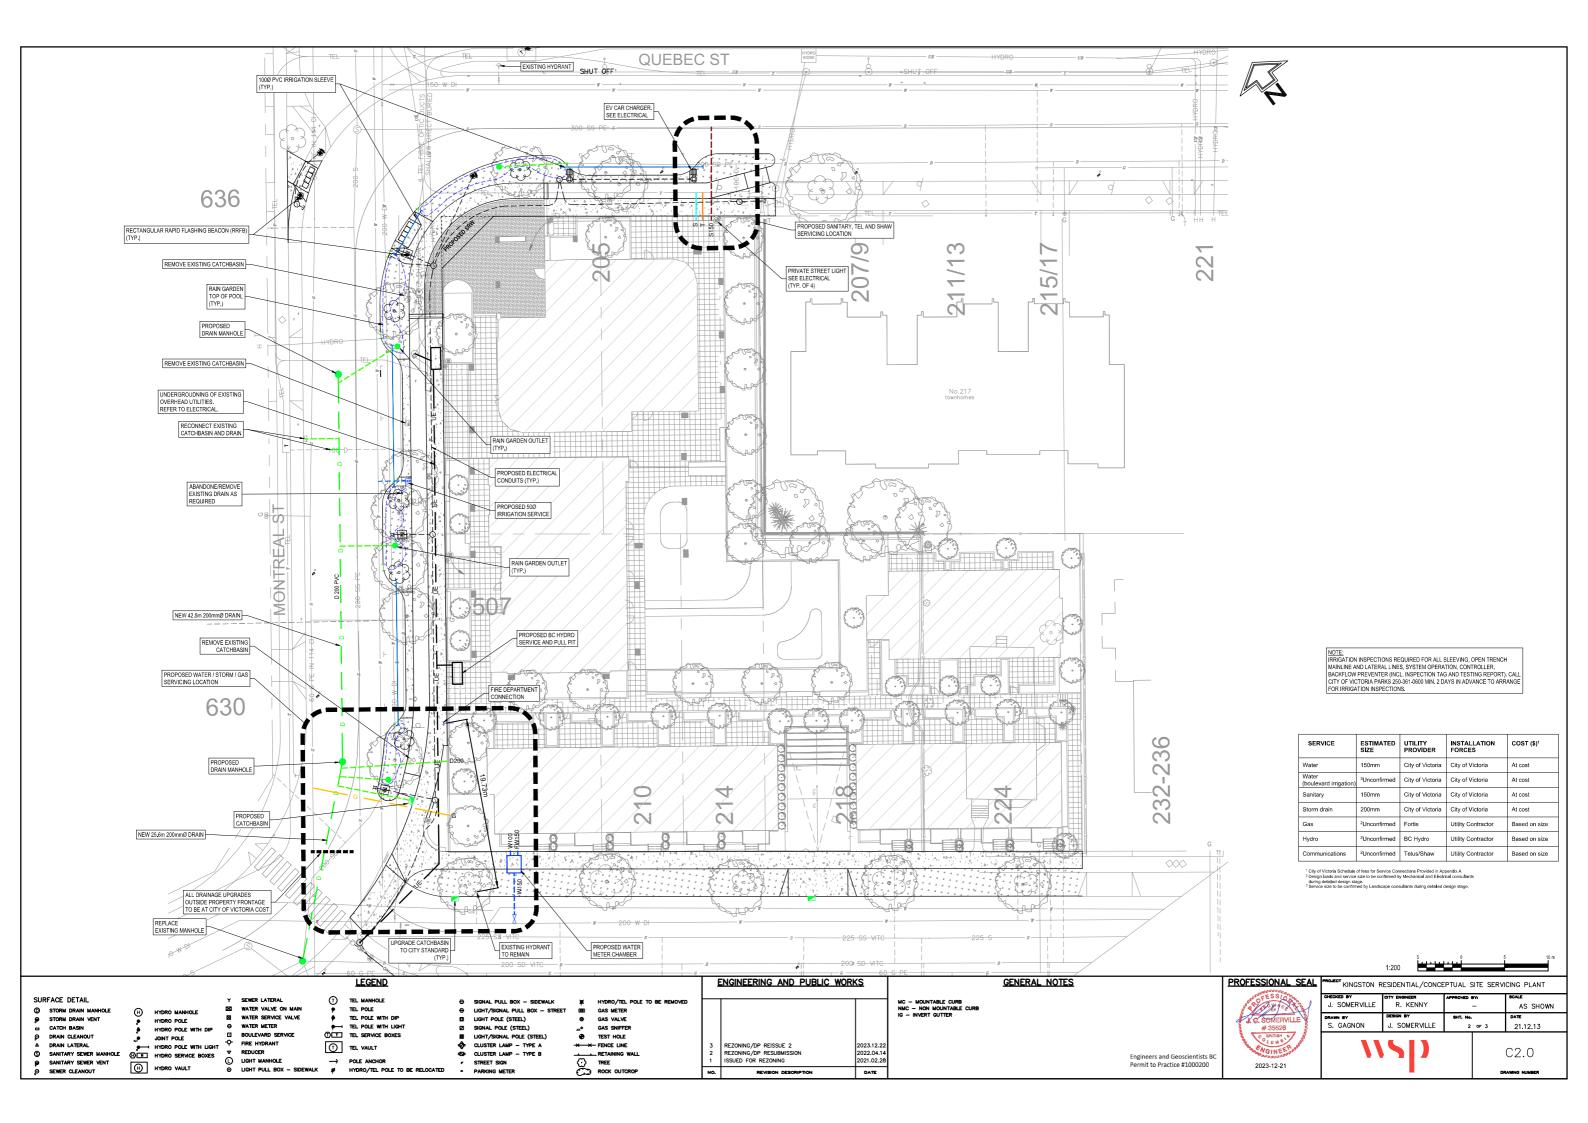
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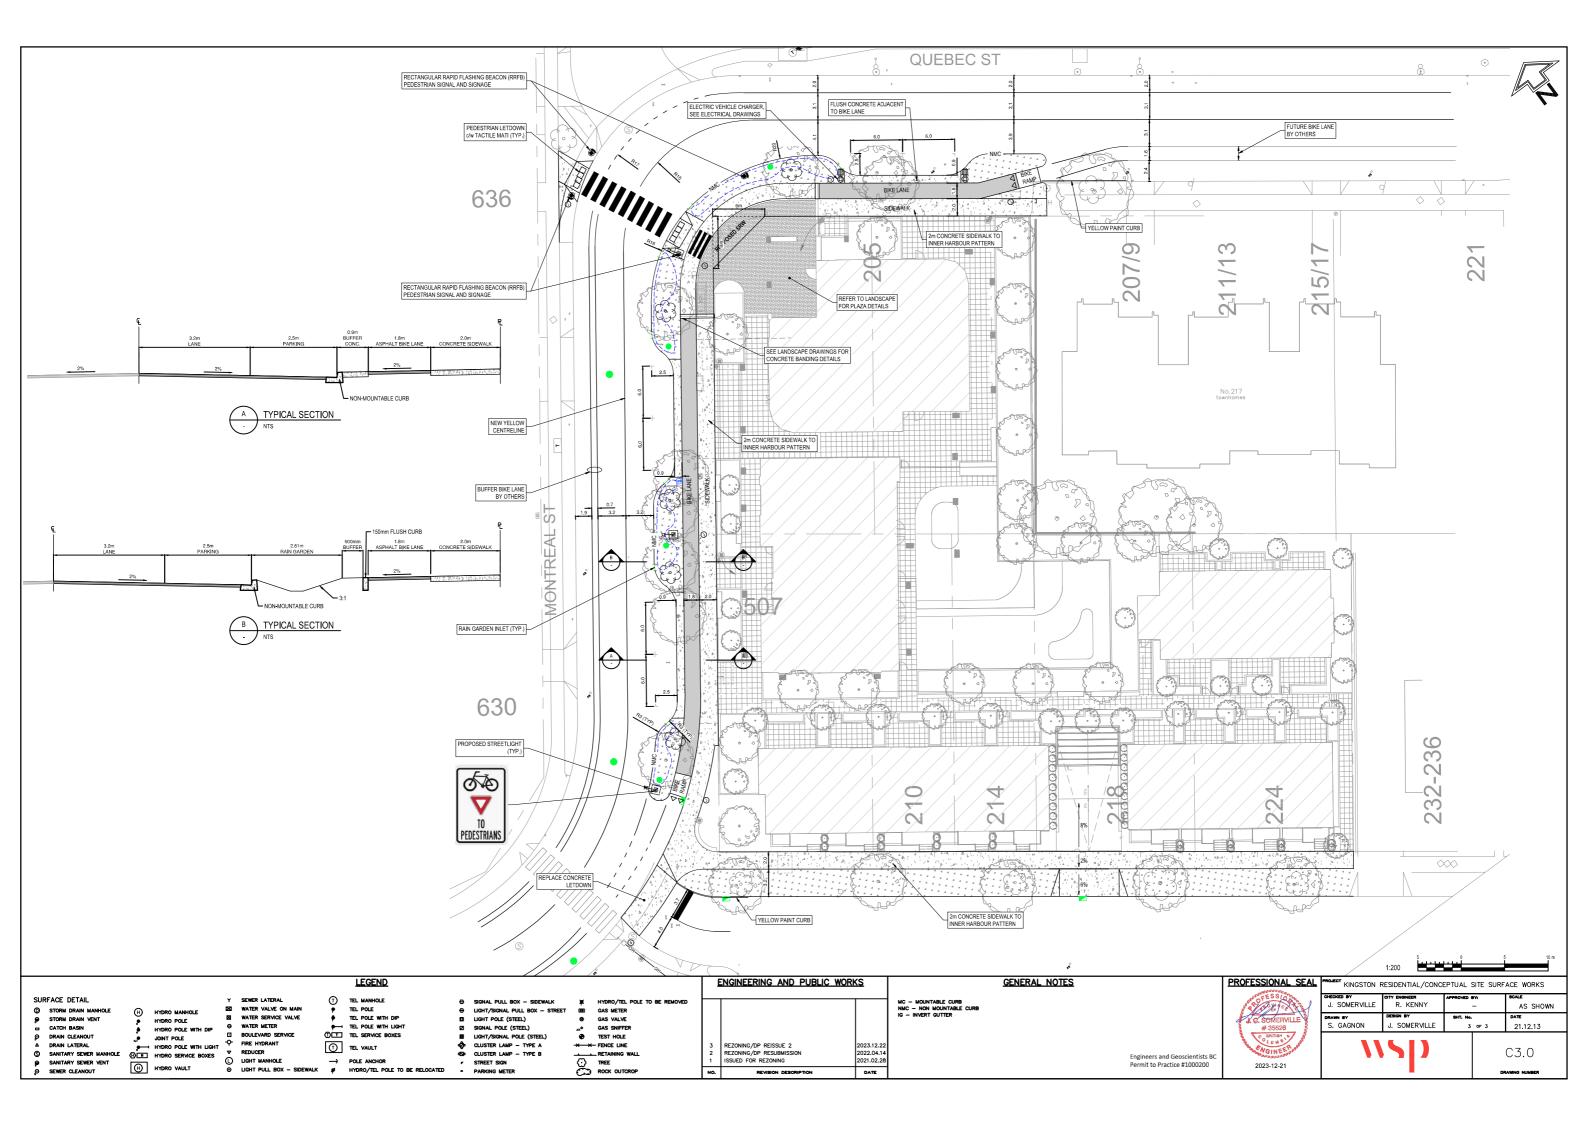
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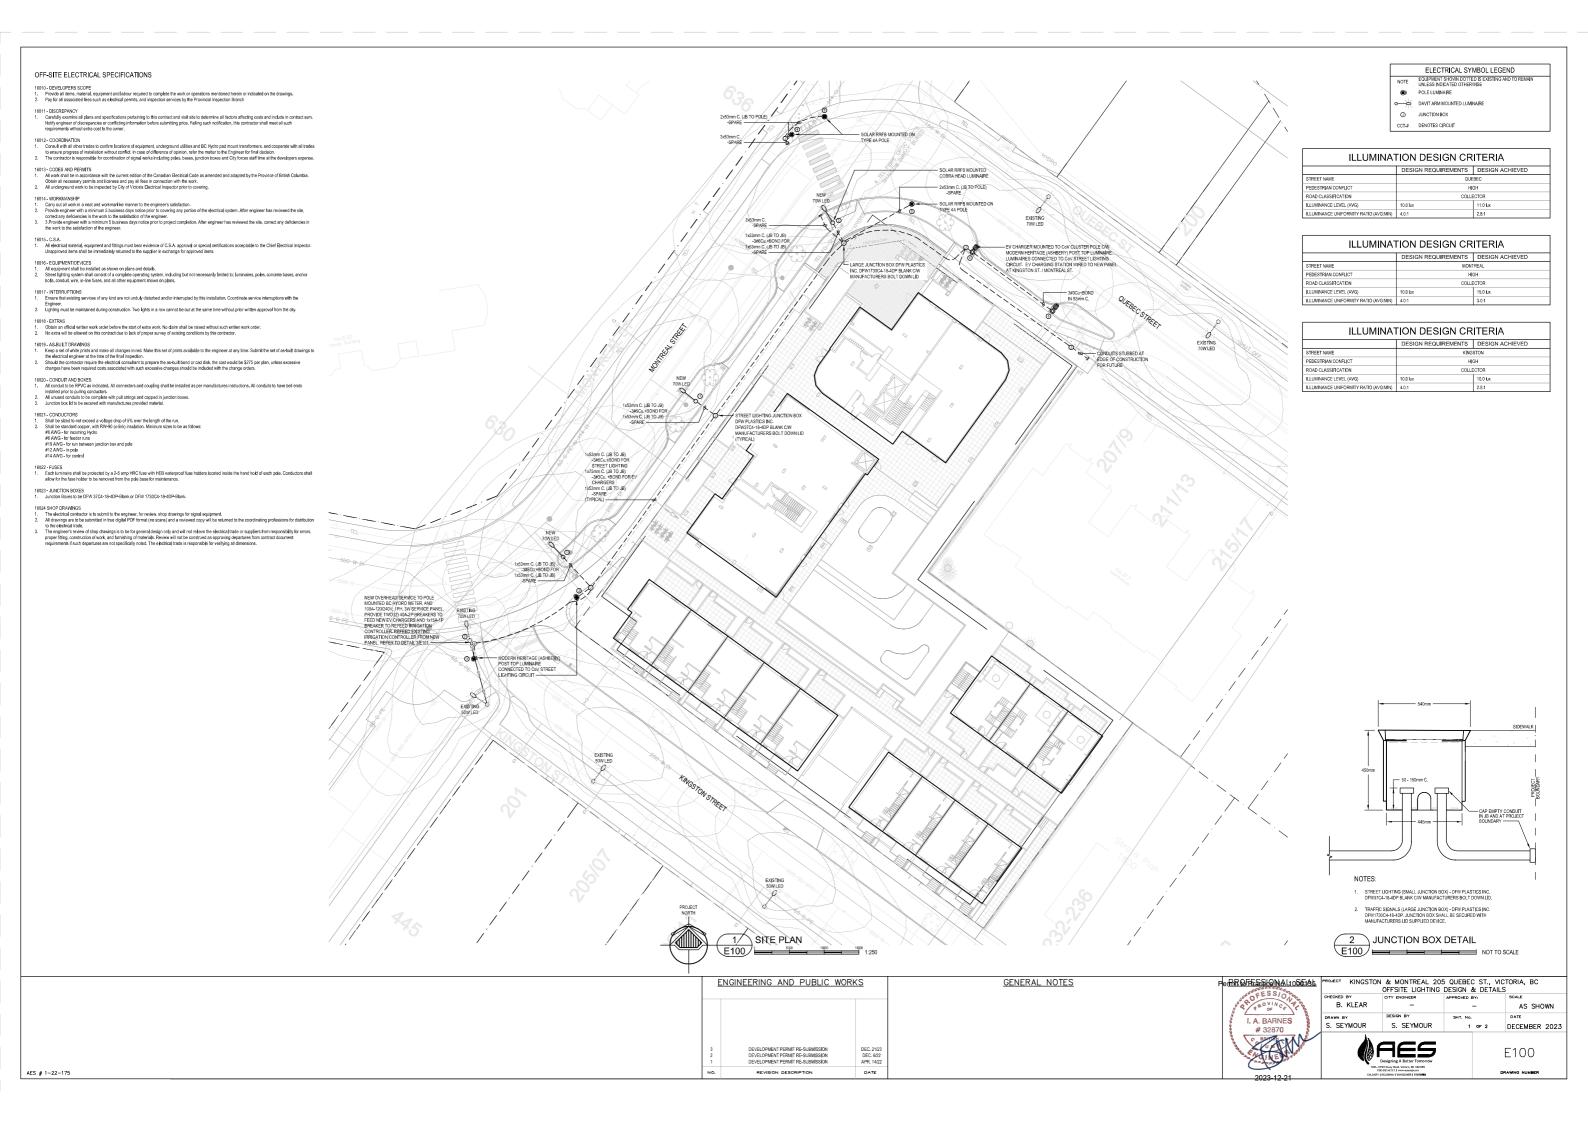
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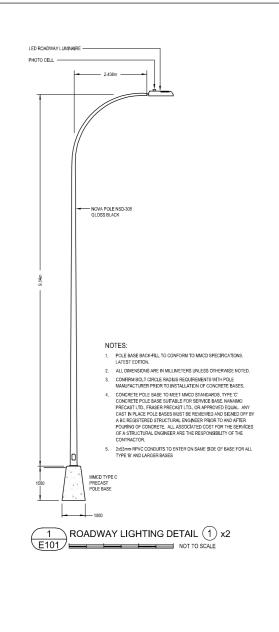
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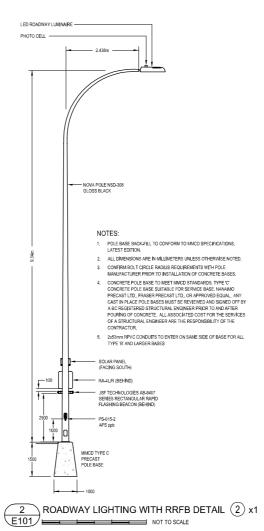

















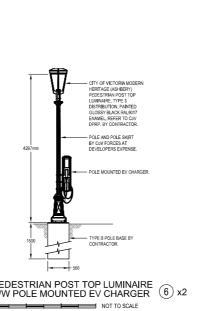


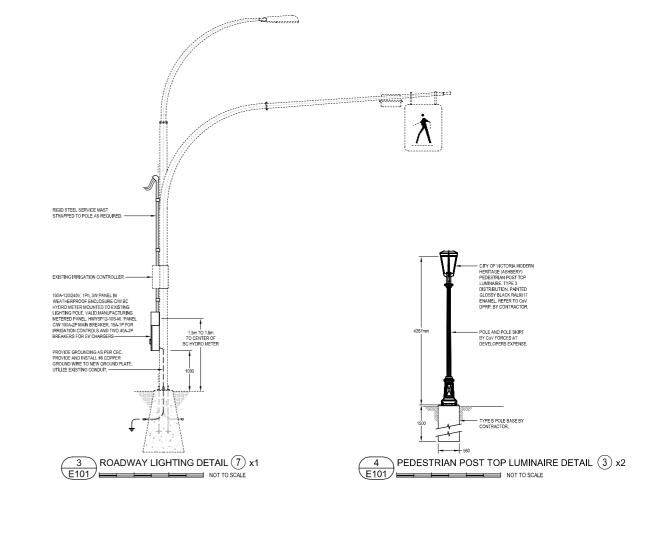

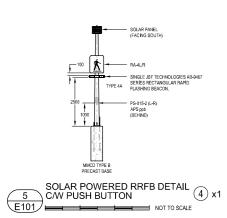


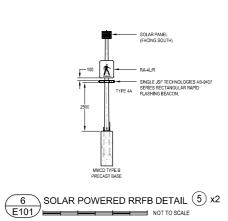

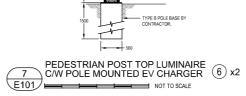

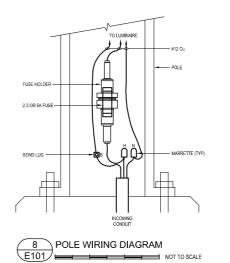

GENERAL NOTES

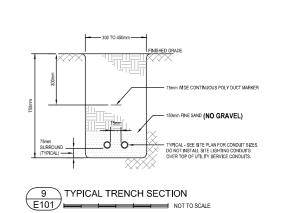

NO	PEVISION DESCRIPTION	DATE
1	DEVELOPMENT PERMIT RE-SUBMISSION	APR. 14/22
2	DEVELOPMENT PERMIT RE-SUBMISSION	DEC. 6/22
3	DEVELOPMENT PERMIT RE-SUBMISSION	DEC, 21/23
1	ENGINEERING AND PUBLIC WO	<u>ORKS</u>



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10000	S. SEYMOUR	S. SEYMOUR	SHT. No.	OF 2	DECEMBER 2023
	B. KLEAR	-		_	AS SHOWN
	CHECKED BY	CITY ENGINEER	APPROVED E	3Y:	SCALE
<u> 186</u>		& MONTREAL 205 OFFSITE LIGHTING			
-AE	PROJECT KINGSTON	& MONTRFAL 205	OUERE	ST VIC	TORIA BC

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