

OWNER

CONTACTS

1030 Fort Street Holdings Ltd. Care of Jawl Properties Ltd. 1515 Douglas St Suite 200 Victoria, BC V8W 2G4

ARCHITECT

Cascadia Architects 101 - 804 Broughton Street Victoria, BC V8W 1E4

LANDSCAPE DESIGNER

Murdoch de Greeff 200 - 524 Culduthel Road Victoria, BC V8Z 1G1

CIVIL ENGINEER

WSP 301-3600 Uptown Blvd. Victoria, BC V8Z 089

Robert Jawl rkj@jawlproperties.com 250.475.0338

Gregory Damant, Architect AIBC greg@cascadiaarchitects.ca 250.590.3223

Scott Murdoch, Landscape Architect, R.P. Bio. scott@mdidesign.ca 250.412.2891

> Ben Harms, P. Eng. Ben.Harms@wsp.com 250.384.5510

LIST OF DRAWINGS

ARCHITECTURAL

A000	Cover
A010	Perspectives
A01 1	Material Specification
A050	Spatial Separation
A051	Code Analysis
A 100	Site Plan and Project

Site Plan and Project Data Proposed Floor Plans L1 & L2 Proposed L3-6 & Roof Plan

Building Elevations S-W Building Elevations N-E Building Sections

Context & Shadow Study **Context Perspectives**

L1.01 Landscape Materials

LANDSCAPE

CIVIL

Conceptual Site Servicing Plan Conceptual Surface Works & Site Grading



VIEW OF NORTH FACING FACADE





VIEW FROM FORT STREET EAST

6	RZ/DP Response to TRG Comment - Rev4	JUNE 29, 2022
5	RZ/DP Response to ADP Comment - Rev3	APRIL 21, 2022
4	RZ/DP Content for ADP - Rev2	FEB 09, 2022
3	RZ/DP Response to TRG Comment - Rev1	NOV 30, 2021
2	RZ/DP	SEPT 15, 2021
1	Issued for Development Tracker	AUG 03, 2021
NO.	DESCRIPTION	DATE



CASCADIA ARCHITECTS

reserved. These drawings and the design contained therein or which may be inferred therefrom are, and at all times remain, the exclusive property of Cascadia Architects Inc. Cascadia Architects holds the copyright and ownership in the said drawings, which cannot be used for any purpose without the express written consent of Cascadia Architects.

1030 FORT STREET

JAWL PROPERTIES

1030 Fort Street, Victoria BC

Perspectives

JUNE 29, 2022

1 : 200

Revision
JUNE 29, 2022

JUNE 29, 2022 6
Sheet #


A010

2022-06-28 10:04:45 AM





Terra cotta precedent: 10 Bond Street, NYC

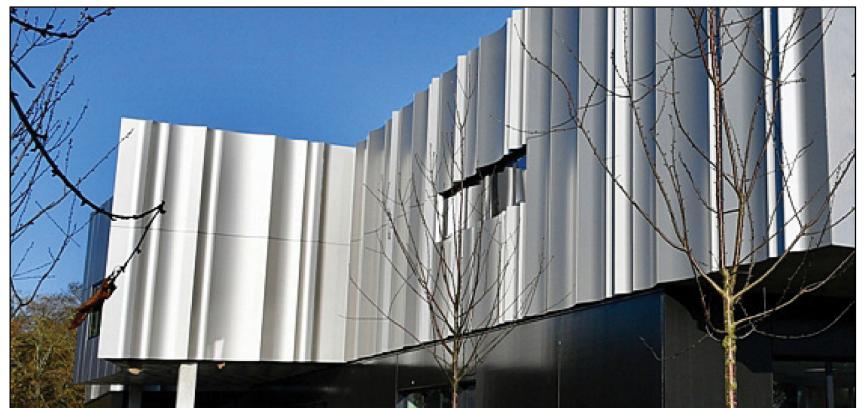

Pre-finished metal precedent: École Ducasse, 64 Rue du Ranelagh, Paris

PALETTE



Glazed ceramic tile in warm red brown color with scalloped

PRE-FINISHED METAL

Red brown color with scalloped

FRITTED GLASS

Vertical opaque frits of the 3 chosen red brown hues

CEDAR SOFFIT

Vertical grain, clear finish

CEMENTITIOUS PANEL


> Board and batten type finish with 2 selected red brown colors

ARCHITECTURAL CONCRETE

CONCRETE

MATERIAL



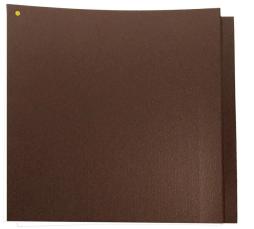

PHYSICAL

SAMPLING





RZ/DP Response to ADP Comment - Rev3 APRIL 21, 2022 DESCRIPTION



which reserved. These drawings and the design contained therein or which may be inferred therefrom are, and at all times remain, the exclusive property of Cascadia Architects Inc. Cascadia Architects holds the copyright and ownership in the said drawings, which cannot be used for any purpose without the express written consent of Cascadia Architects.

1030 FORT STREET

JAWL PROPERTIES 1030 Fort Street, Victoria BC

Material Specifications




JUNE 29, 2022 $/\,6\,$


A011 2022-06-28 10:04:50 AM


JUNE 29, 2022



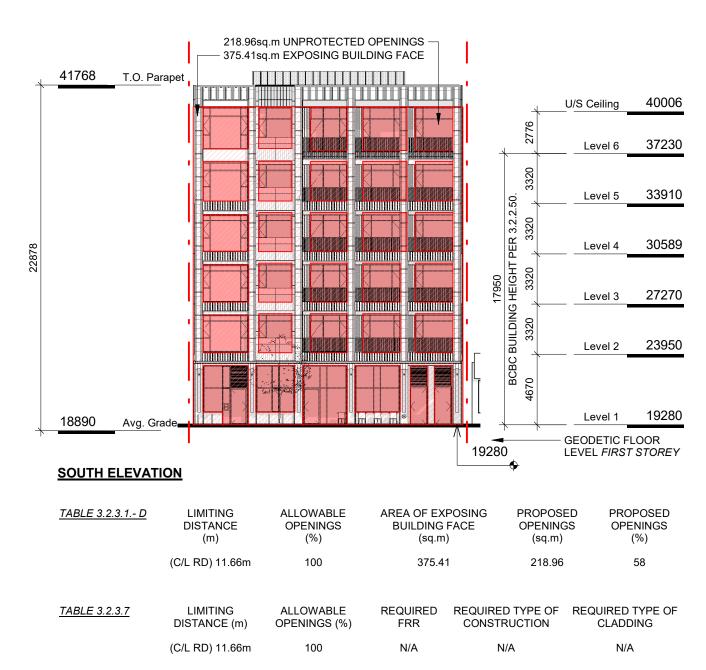


Scale = 1:250

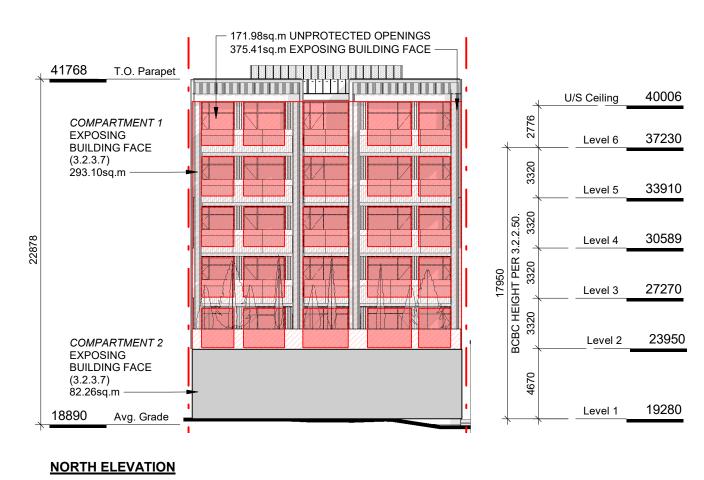

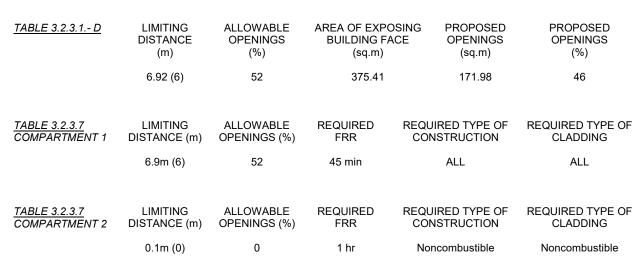


North Elevation - LD Key


SCALE = 1:250

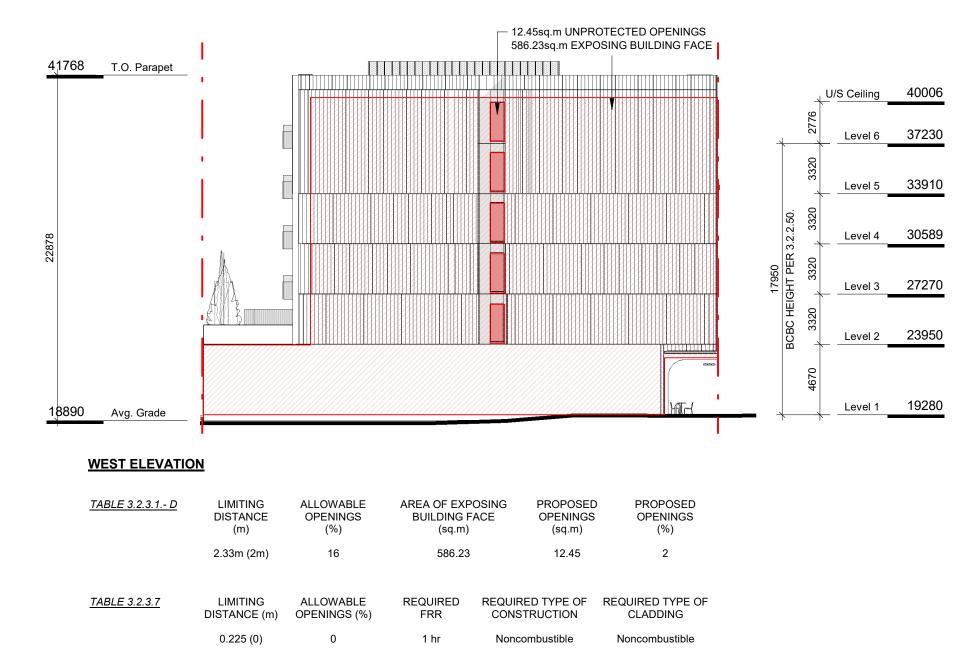




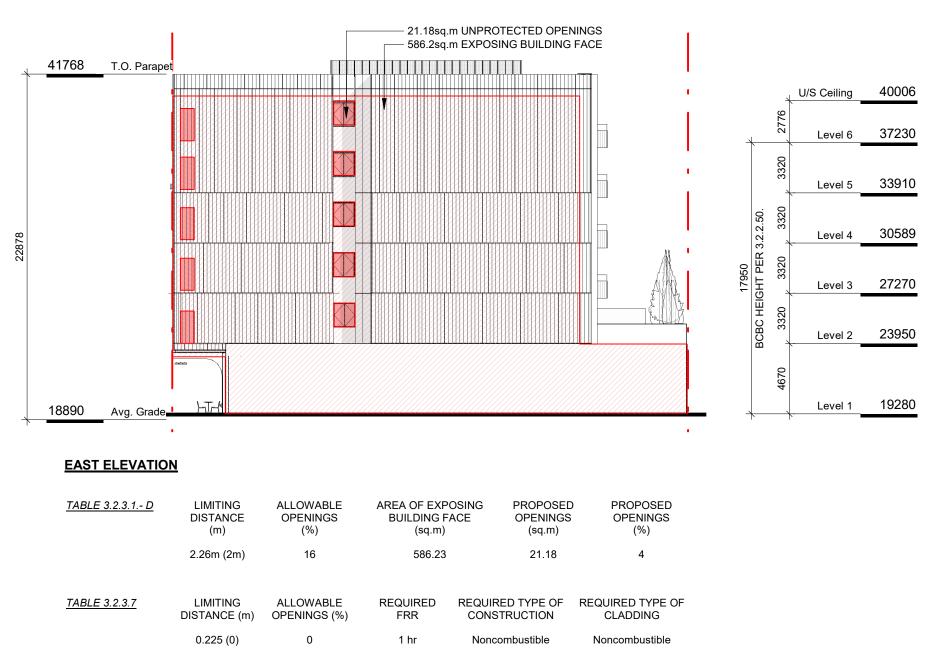



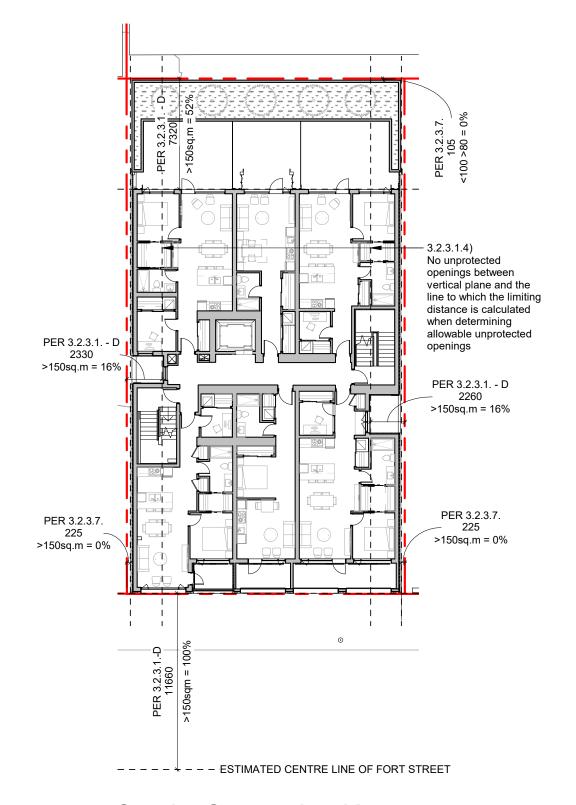

Spatial Separation Keyplan

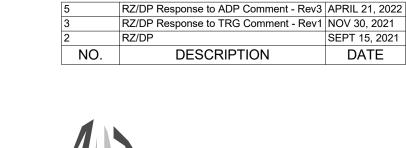



CASCADIA ARCHITECTS


reserved. These drawings and the design contained therein or which may be inferred therefrom are, and at all times remain, the exclusive property of Cascadia Architects Inc. Cascadia Architects holds the copyright and ownership in the said drawings, which cannot be used for any purpose without the express written consent of Cascadia Architects.

1030 FORT STREET

JAWL PROPERTIES 1030 Fort Street, Victoria BC

Spatial Separation

JUNE 29, 2022 Project #

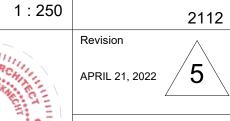


Sheet #

2022-06-28


2022-06-28 10:05:06 AM

A050

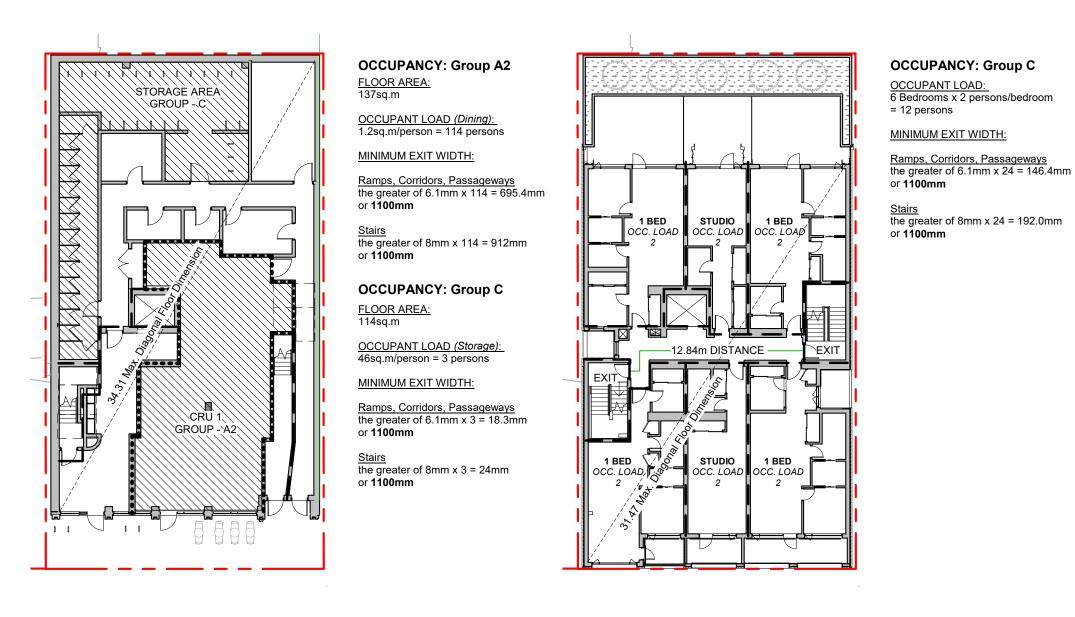

1 Level 1 Code Plan
SCALE = 1:250

2 Level 2-6 Typ. Code Plan
SCALE = 1:250

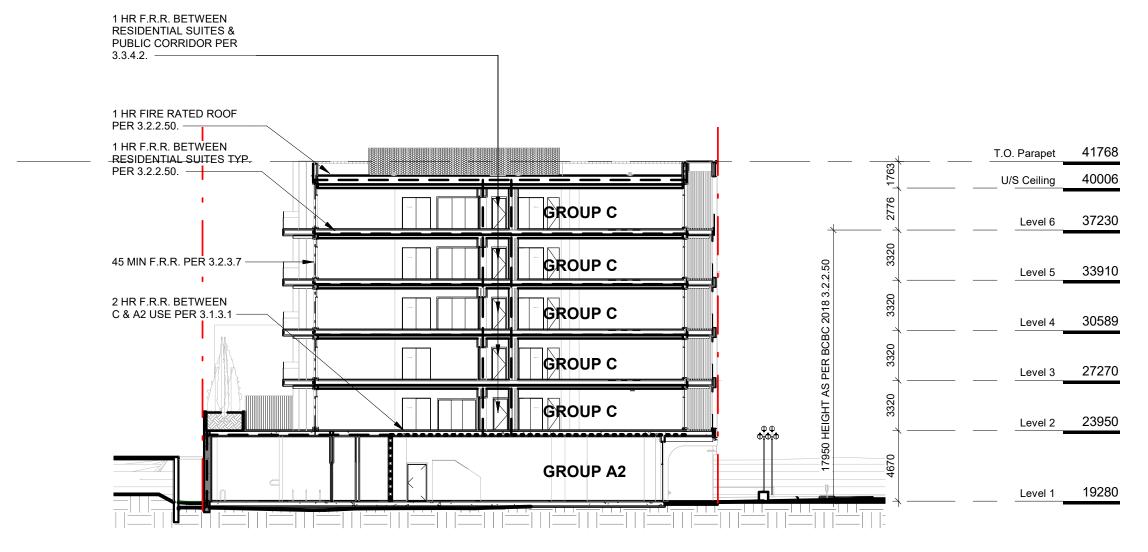

3 F.R.R. Separations - Key Section SCALE = 1:250

BUILDING CODE ANALYSIS

PROJECT TYPE	NEW CONSTRUCTION RENOVATION ADDITION	N
GOVERNING BUILDING CODE	2018 BC BUILDING CODE	
MAJOR OCCUPANCY	A1 A2 A3 A4 B1 B2 B3 C D E F1 F2 F3	3.1.2.1
SUPERIMPOSED OCCUPANCY	A1 A2 A3 A4 B1 B2 B3 C D E F1 F2 F3	3.2.2.7
BUILDING AREA	576 m ²	1.4.1.2
GRADE	18.75 m geodetic	1.4.1.2
BUILDING HEIGHT (STOREYS, m)	6 STOREYS ABOVE GRADE <18 m, LEVEL 1 TO LEVEL 6 0 STOREYS BELOW GRADE	1.4.1.2, 3.2.2.50

FIRE RESISTANCE R	ATING - KEY
	UNRATED FIRE SEPERATIONS 45 MIN 1 HOUR 1.5 HOUR 2 HOUR

BUILDING FIRE SAFETY & CONSTRUCTION CLASSIFICATION

CLASSIFICATION	GROUP C, UP TO 6 STOREYS, SPRINKLERED	3.2.2.50
No. OF STREETS FACING	1	3.2.2.10
CONSTRUCTION TYPES PERMITTED	✓ COMBUSTIBLE NON-COMBUSTIBLE	3.2.2.50
FIRE ALARM SYSTEM	YES NO	3.2.4.1
STANDPIPE SYSTEM	YES NO	3.2.5.8
HIGH BUILDING	YES NO	3.2.6.1
INTERCONNECTED FLOOR SPACE	YES NO	3.2.8

FIRE RESISTANCE RATINGS

HORIZONTAL SEPARATIONS	1 hr FLOORS 1 hr MEZZANINE 1 hr ROOF	3.2.2.50
LOADBEARING WALLS, COLUMNS & ARCHES	1 hr (NOT LESS THAN THAT REQUIRED FOR SUPPORTED STRUCTURE)	3.2.2.50
EXITS	1 hr	3.4.4.1
MAJOR OCCUPANCY SEPARATION	2 hr C to A2	3.1.3.1

EXITS	FROM	FLOOR	AREAS

NUMBER OF EXITS REQUIRED	2	3.4.2.1
SEPARATION OF EXITS (MIN.)	1/2 MAX. DIAGONAL FLOOR AREA, BUT NEED NOT BE > 9 m	3.4.2.3
MAX. TRAVEL DISTANCE ALLOWED	45 m, GROUP C 45 m, GROUP A2	3.4.2.5
MEZZANINE	YES NO	3.2.8

OCCUPIED FLOOR AREAS & OCCUPANT LOAD

LEVEL 1	137	sq.m, A2 (Dining)	114	sq.m, C (Storage)	0 bds	C (Residential)	1.4.1.2, 3.1.17.1
LEVEL 2 - 6	0	sq.m, A2 (Dining)	0	sq.m, C (Storage)	6 bds	C (Residential)	1.4.1.2, 3.1.17.1
TOTAL	137	sq.m, A2 (Dining)	114	sq.m, C (Storage)	30 bds	C (Residential)	1.4.1.2, 3.1.17.1
OCCUPANT LOAD	114	1.2sq.m./person	3	46sq.m./person	60	2 persons*bdrm	3.1.17.1

WATER CLOSETS	OCCUPANT LOAD	REQUIRED	PROVIDED	
LEVEL 1(A2)	114 PERSONS	2 M 3 F	T.B.D. AT T.I.	3.7.2.2- A

ACCESSIBILITY		
UNIVERSAL WASHROOM	REQUIRED AT LEVEL 1	3.8.2.8.3

3		RZ/DP Response to TRG Comment - Rev1	NOV 30, 2021
2		RZ/DP	SEPT 15, 202
	NO.	DESCRIPTION	DATE



CASCADIA ARCHITECTS

which may be inferred therefrom are, and at all times remain, the exclusive property of Cascadia Architects Inc. Cascadia Architects holds the copyright and ownership in the said drawings, which cannot be used for any purpose without the express written consent of Cascadia Architects.

roject

1030 FORT STREET

JAWL PROPERTIES

1030 Fort Street, Victoria BC

Sheet Name Code Analysis

•

JUNE 29, 2022

As indicated


2022-06-28




A051

2022-06-28 10:05:11 AM

2112

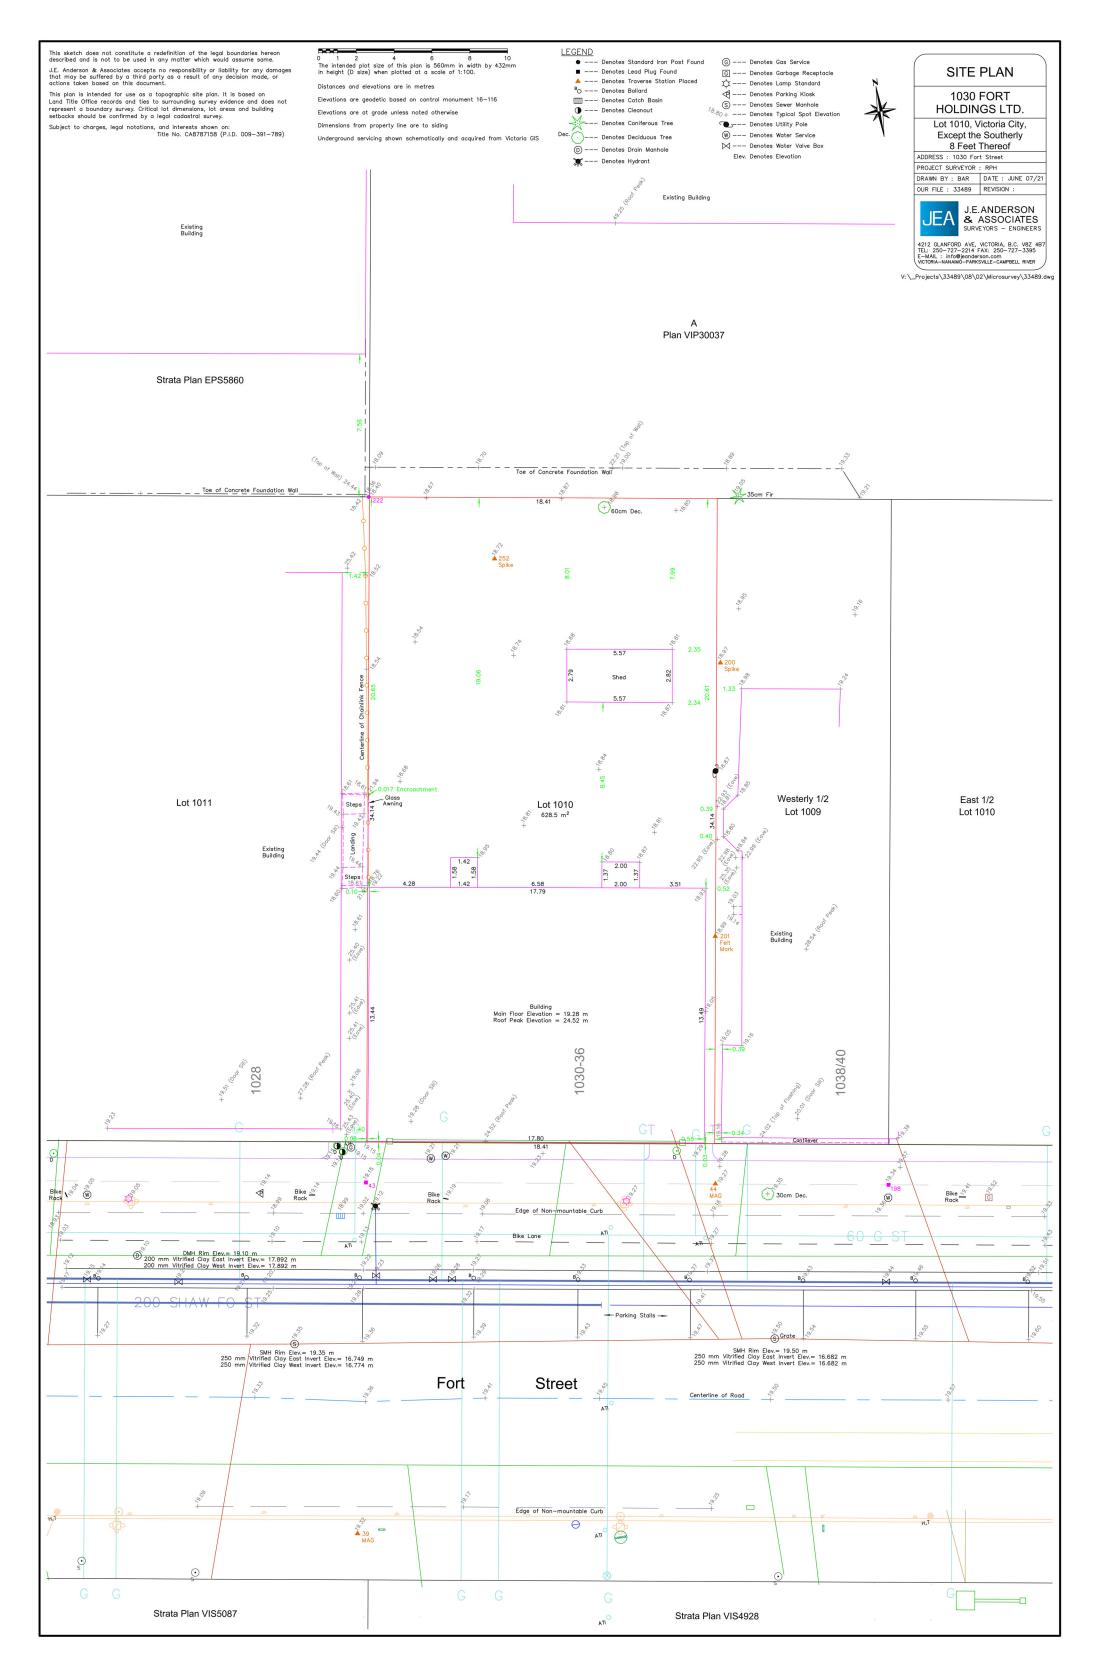

EXISTING SITE SURVEY SCALE = 1:200

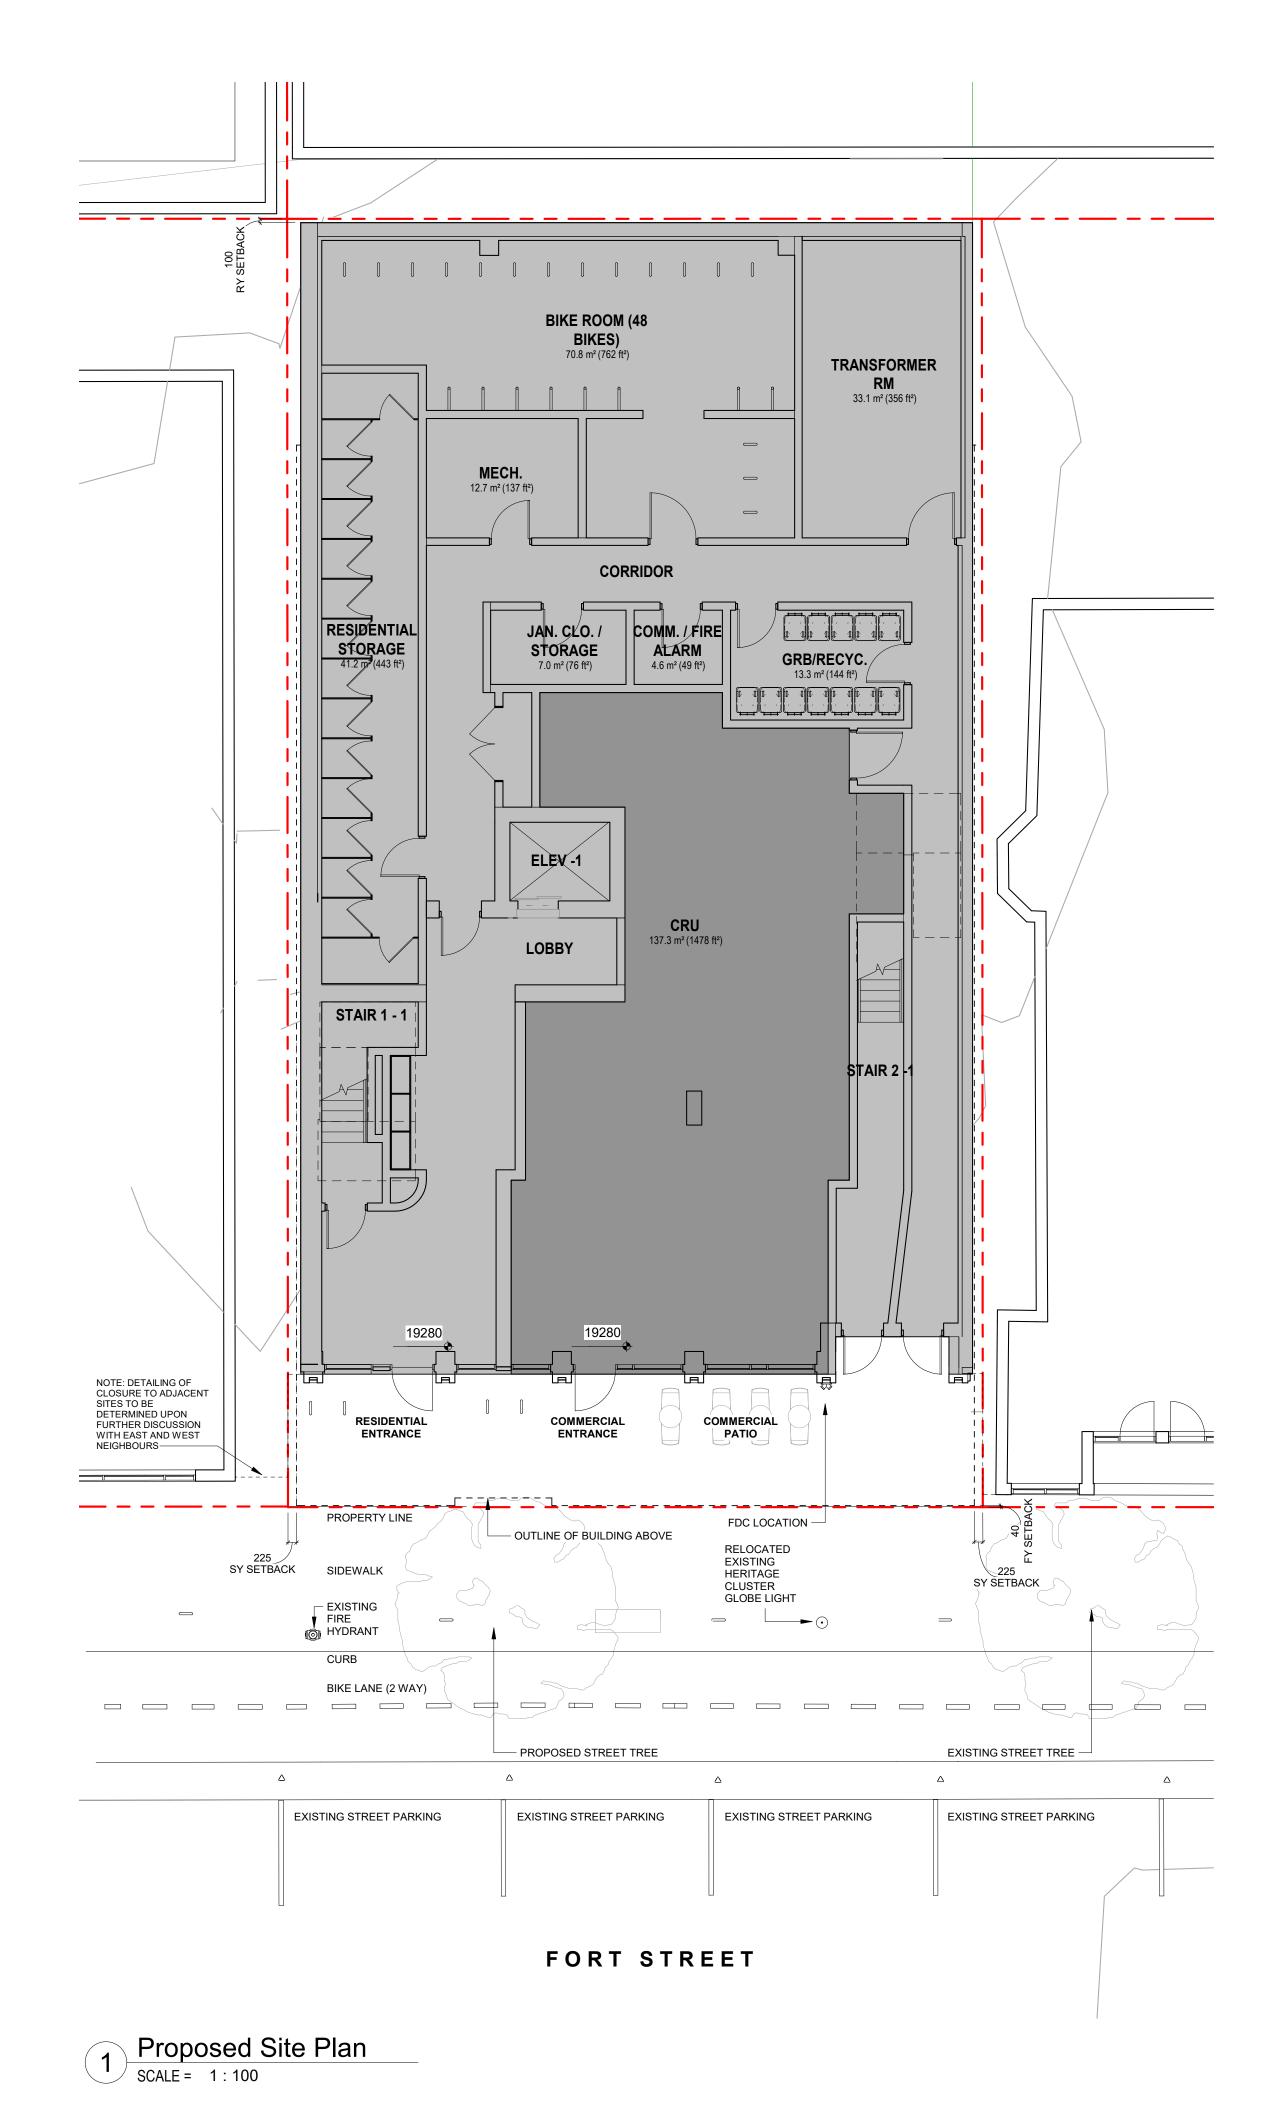

DATA

MUNICIPALITY	CITY OF VICTORIA
MUNICIPAL ADDRESS	1030 FORT STREET, VICTORIA BC
LEGAL DESCRIPTION	LOT 1010, VICTORIA CITY, EXCEPT THE SOUTHERLY 8 FEET THEREOF
PROJECT DESCRIPTION	6 STOREY BUILDING 5 STOREYS RESIDENTIAL OVER 1 STOREY COMMERCIAL

PROJECT INFORMATION

ZONE (EXISTING)	CA-42	
PROPOSED ZONE	UNKNOWN	
SITE AREA (m²)	628.5m ²	
TOTAL FLOOR AREA (m²)	2,460m²	
COMMERCIAL FLOOR AREA (m²)	137m²	
FLOOR SPACE RATIO	4:1	
SITE COVERAGE (%)	97.5%	
OPEN SITE SPACE (%)	14%	
ROOF STRUCTURE (%)	26%	
HEIGHT (m)	22.28m	
NUMBER OF STOREYS	6	
	REQUIRED	PROVIDED
PARKING STALLS (#) ON SITE	24	0
BICYCLE PARKING (#) SHORT TERM	8	8
BICYCLE PARKING (#) LONG TERM	36	48

BUILDING SETBACKS (m)	
FRONT YARD	0.04m
REAR YARD (LEVEL 1)	0.10m
REAR YARD (TO BUILDING FACE LEVEL 2-6)	7.35m
SIDE YARD (W)	0.23m
SIDE YARD (E)	0.23m
COMBINED SIDE YARDS	0.46m

RESIDENTIAL USE DETAILS	
TOTAL NUMBER OF UNITS	30
UNIT TYPE	1 BD+ DEN (20), STUDIO (10)
GROUND-ORIENTATED UNITS	0
MINIMUM UNIT FLOOR AREA (m²)	36.7m ²
TOTAL RESIDENTIAL FLOOR AREA (m²)	1,651m ²

SUPPORTING CALCULATIONS

ZONING REGULATION BYLAW FLOOR AREAS		ZONING BYLA FLOOR AREAS	
Level 1	444.74 m²	Level 1	450.87 m
Level 2	403.03 m ²	Level 2	408.60 m
Level 3	403.08 m ²	Level 3	408.60 m
Level 4	403.08 m ²	Level 4	408.60 m
Level 5	403.08 m ²	Level 5	408.60 m
Level 6	403.08 m ²	Level 6	408.60 m
Grand total: 6	2460.09 m²	Grand total: 6	2493.84 r

Grand total: 6 2460.09 m² FLOOR SPACE RATIO FLOOR SPACE RATIO $2460m^2 / 628.5m^2 = 3.9 : 1$ $2515m^2 / 628.5m^2 = 4:1$ rounded - 4:1 SITE COVERAGE ROOFTOP STRUCTURE

% COVERAGE $608.5 \text{m}^2 / 628.5 \text{m}^2 = 0.97 (97\%)$ $129.6m^2 / 491.0m^2 = 0.264 (26\%)$ OPEN SITE SPACE $85.6m^2 / 628.5m^2 = 0.14 (14\%)$

AVERAGE GRADE GRADE POINTS: GRADE POINTS: (PROPOSED) (NATURAL) 18.450 18.450 18.960 **19.090 19.070** 18.960 19.200


NATURAL GRADE POINTS (EXISTING)

GRADE POINTS:

19.200

((18.450 + 18.960)/2) x 17.8 = 332.95 ((18.960 + 19.090)/2) x 30.5 = 580.26 ((19.090 + 19.070)/2) x 17.8 = 339.62 ((19.070 + 18.450)/2) x 30.5 = 572.18 1,825.01

AVERAGE GRADE = 1825.01/96.6 = **18.89**

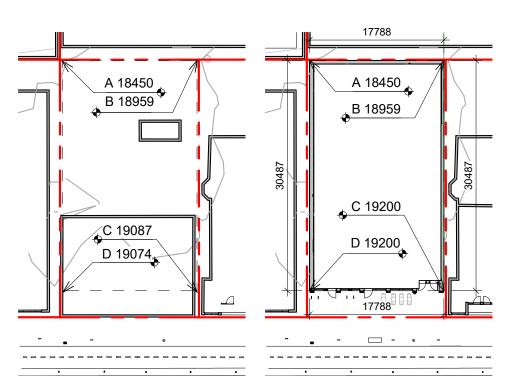


GRADE POINTS (PROPOSED)

3	RZ/DP Response to TRG Comment - Rev1	NOV 30, 202
2	RZ/DP	SEPT 15, 202
1	Issued for Development Tracker	AUG 03, 202
NO.	DESCRIPTION	DATE



CASCADIA ARCHITECTS

which may be inferred therefrom are, and at all times remain, the exclusive property of Cascadia Architects Inc. Cascadia Architects holds the copyright and ownership in the said drawings, which cannot be used for any purpose without the express written consent of Cascadia Architects.

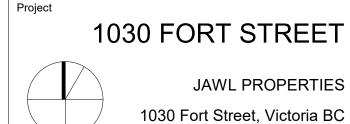


Sheet Nata Project Data

JUNE 29, 2022 As indicated 2112 Revision NOV 30, 2021 Sheet #

A100 2022-06-28


2022-06-28 10:05:24 AM

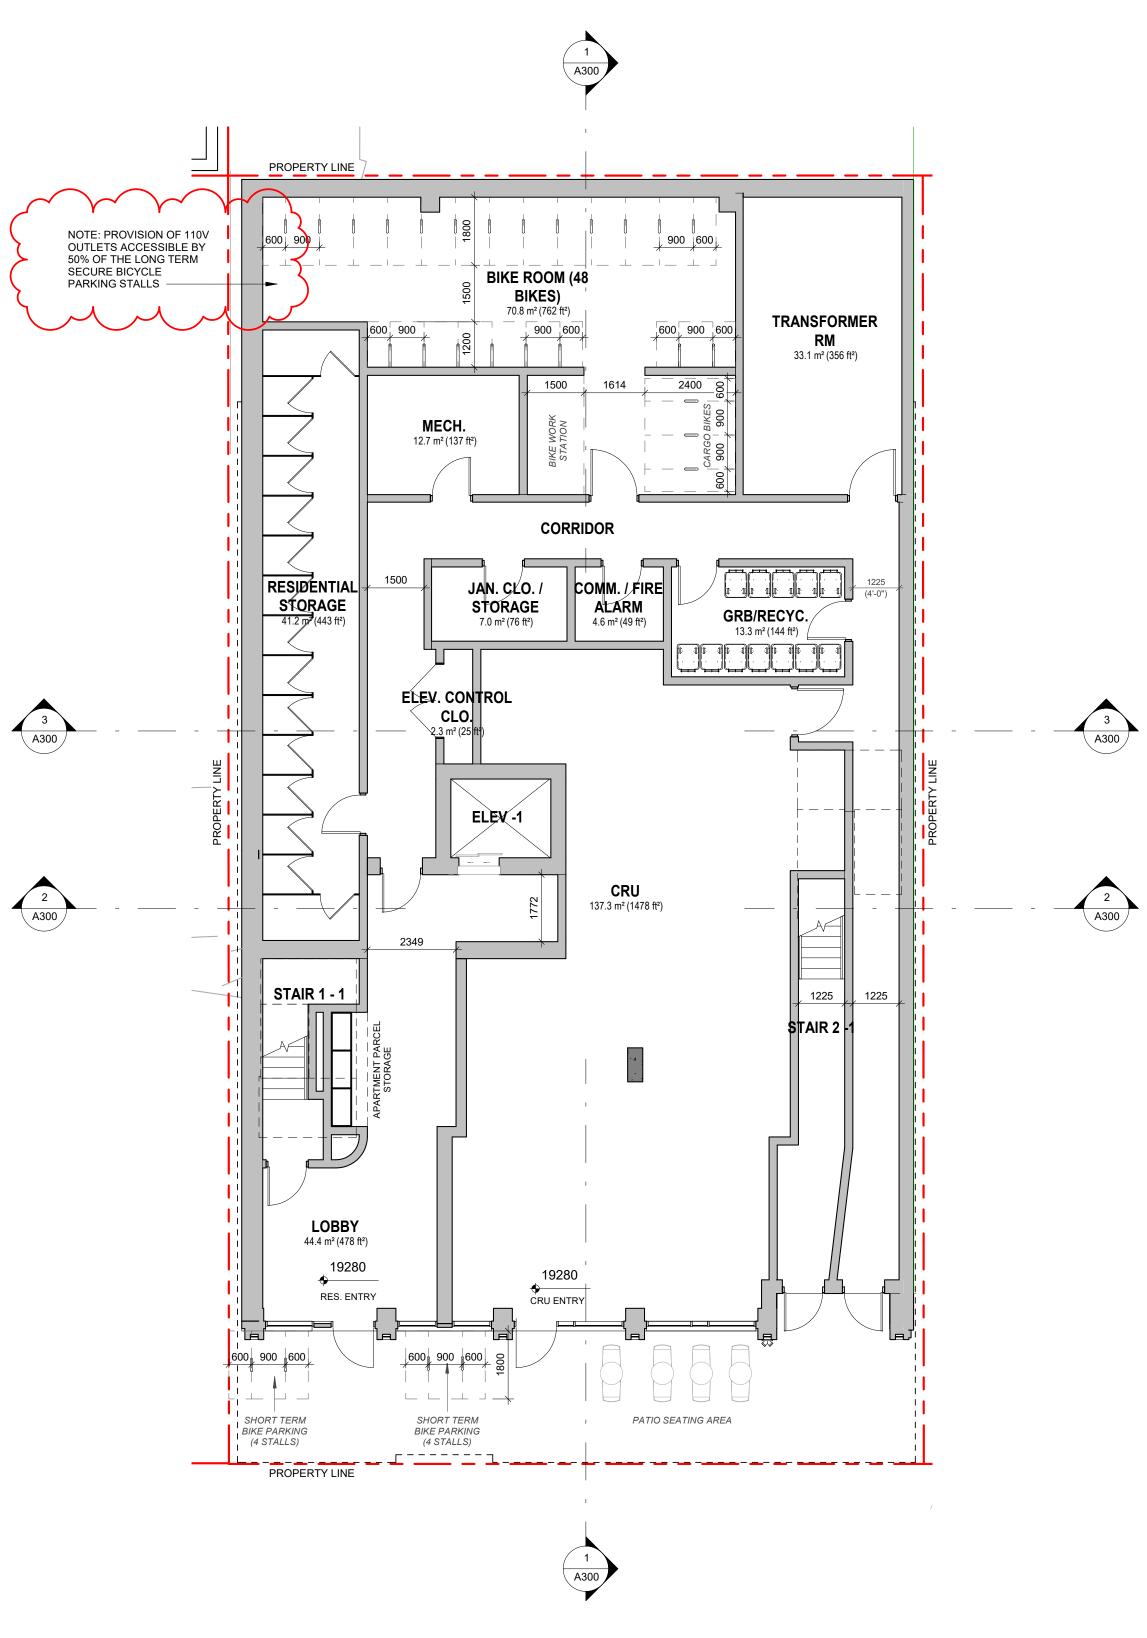

LEVEL 1 - ZONING REGULATION BYLAW - FLOOR AREA: 445sq.m (measured to inside face of exterior wall, excluding elevator shaft & required bike parking)

LEVEL 1 - ZONING BYLAW 2018 - FLOOR AREA: 451sq.m (measured to inside face of exterior wall, excluding required bike parking)


1 Level 1 Proposed Plan
SCALE = 1:100

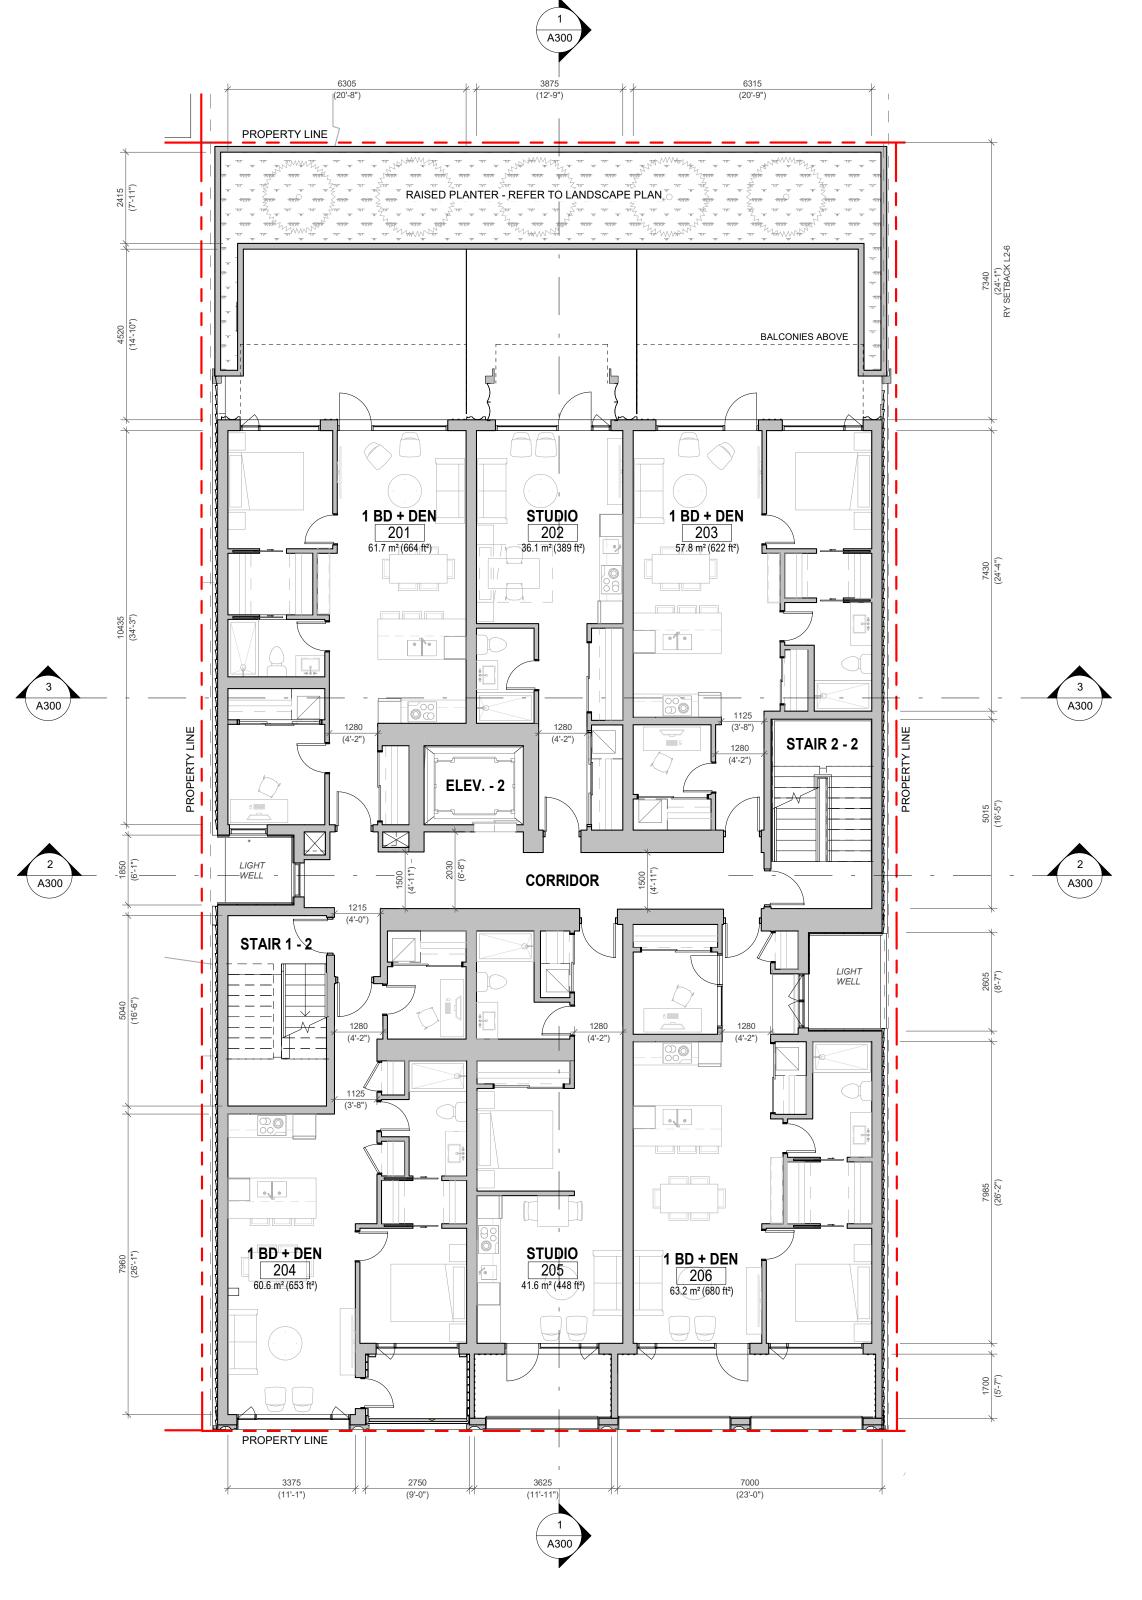

LEVEL 2-6 - ZONING REGULATION BYLAW - FLOOR AREA: 403sq.m (measured to inside face of exterior wall, excluding elevator shaft & required bike parking)

LEVEL 2-6 - ZONING BYLAW 2018 - FLOOR AREA: 409sq.m (measured to inside face of exterior wall)


2 Levels 2 Proposed Plan
SCALE = 1:100

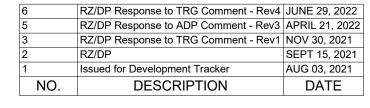




CASCADIA ARCHITECTS


which reserved. These drawings and the design contained therein or which may be inferred therefrom are, and at all times remain, the exclusive property of Cascadia Architects Inc. Cascadia Architects holds the copyright and ownership in the said drawings, which cannot be used for any purpose without the express written consent of Cascadia Architects.

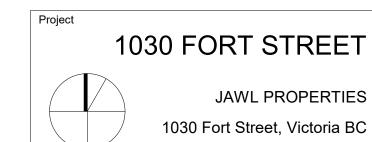



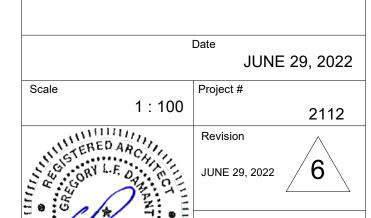


2022-07-11 7:52:08 AM

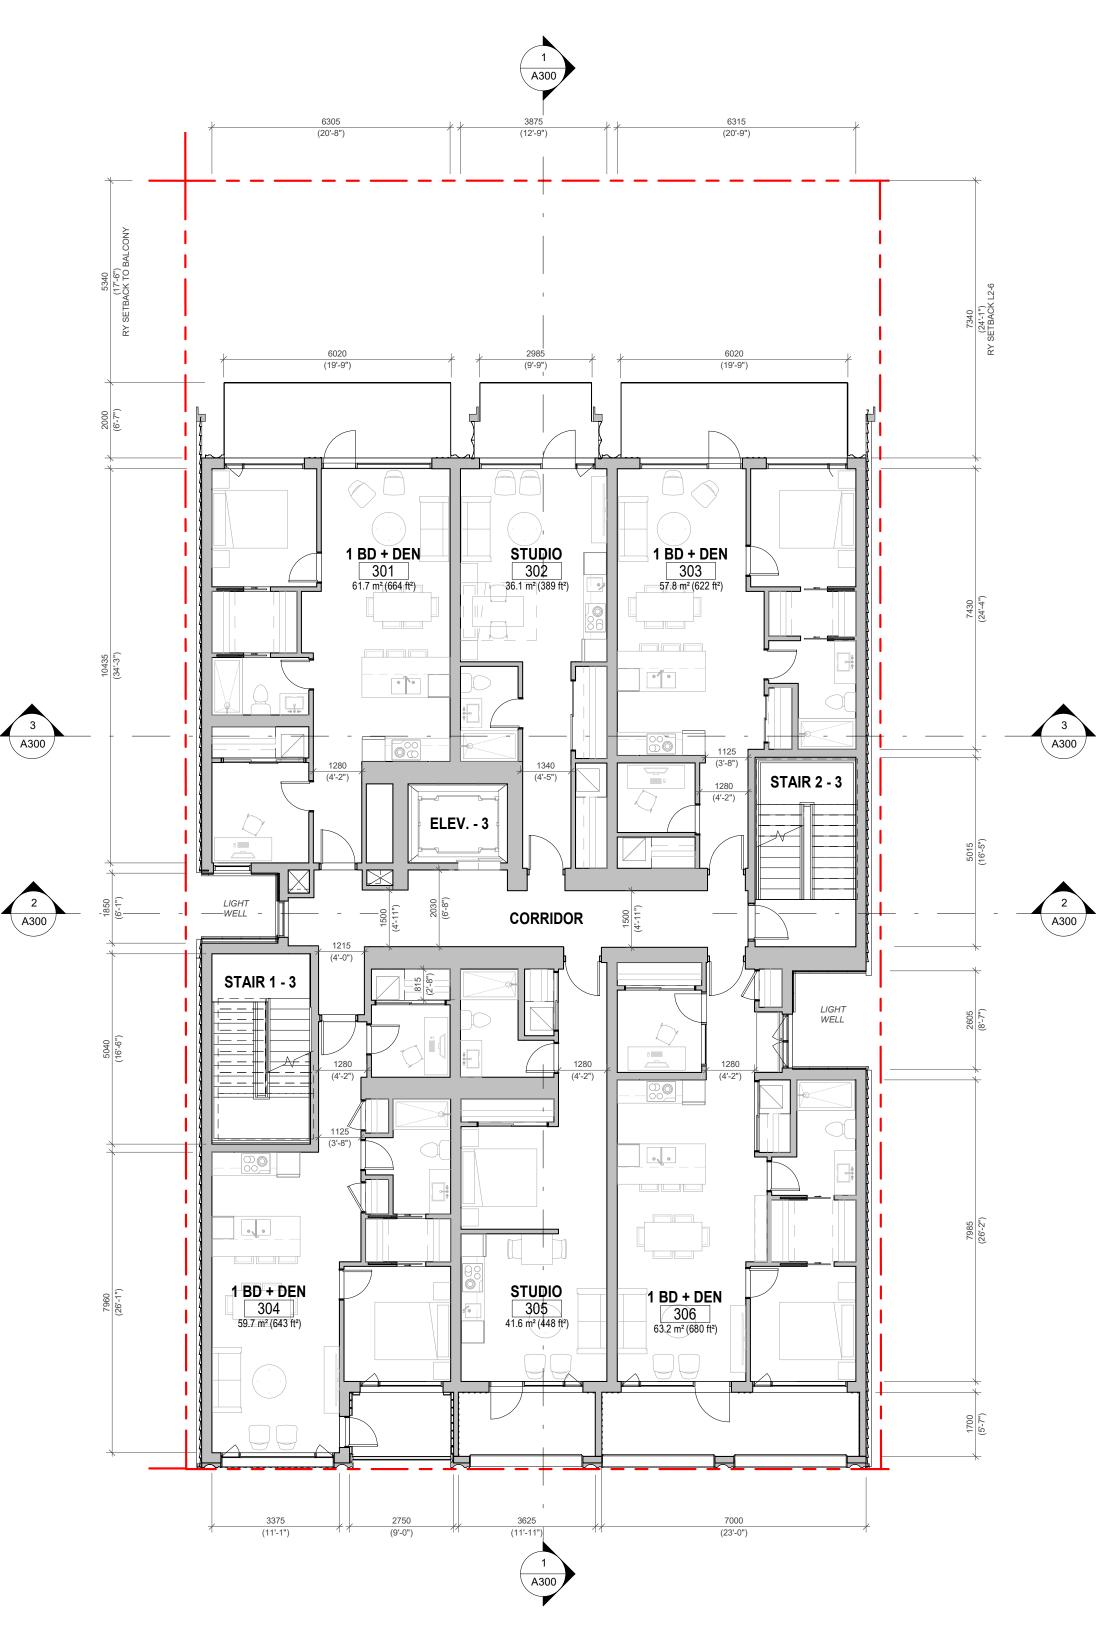


LEVEL 2-6 - ZONING REGULATION BYLAW - FLOOR AREA: 403sq.m (measured to inside face of exterior wall, excluding elevator shaft & required bike parking) LEVEL 2-6 - ZONING BYLAW 2018 - FLOOR AREA: 409sq.m (measured to inside face of exterior wall)

2 Level 3-6 Typical Proposed Plan
SCALE = 1:100

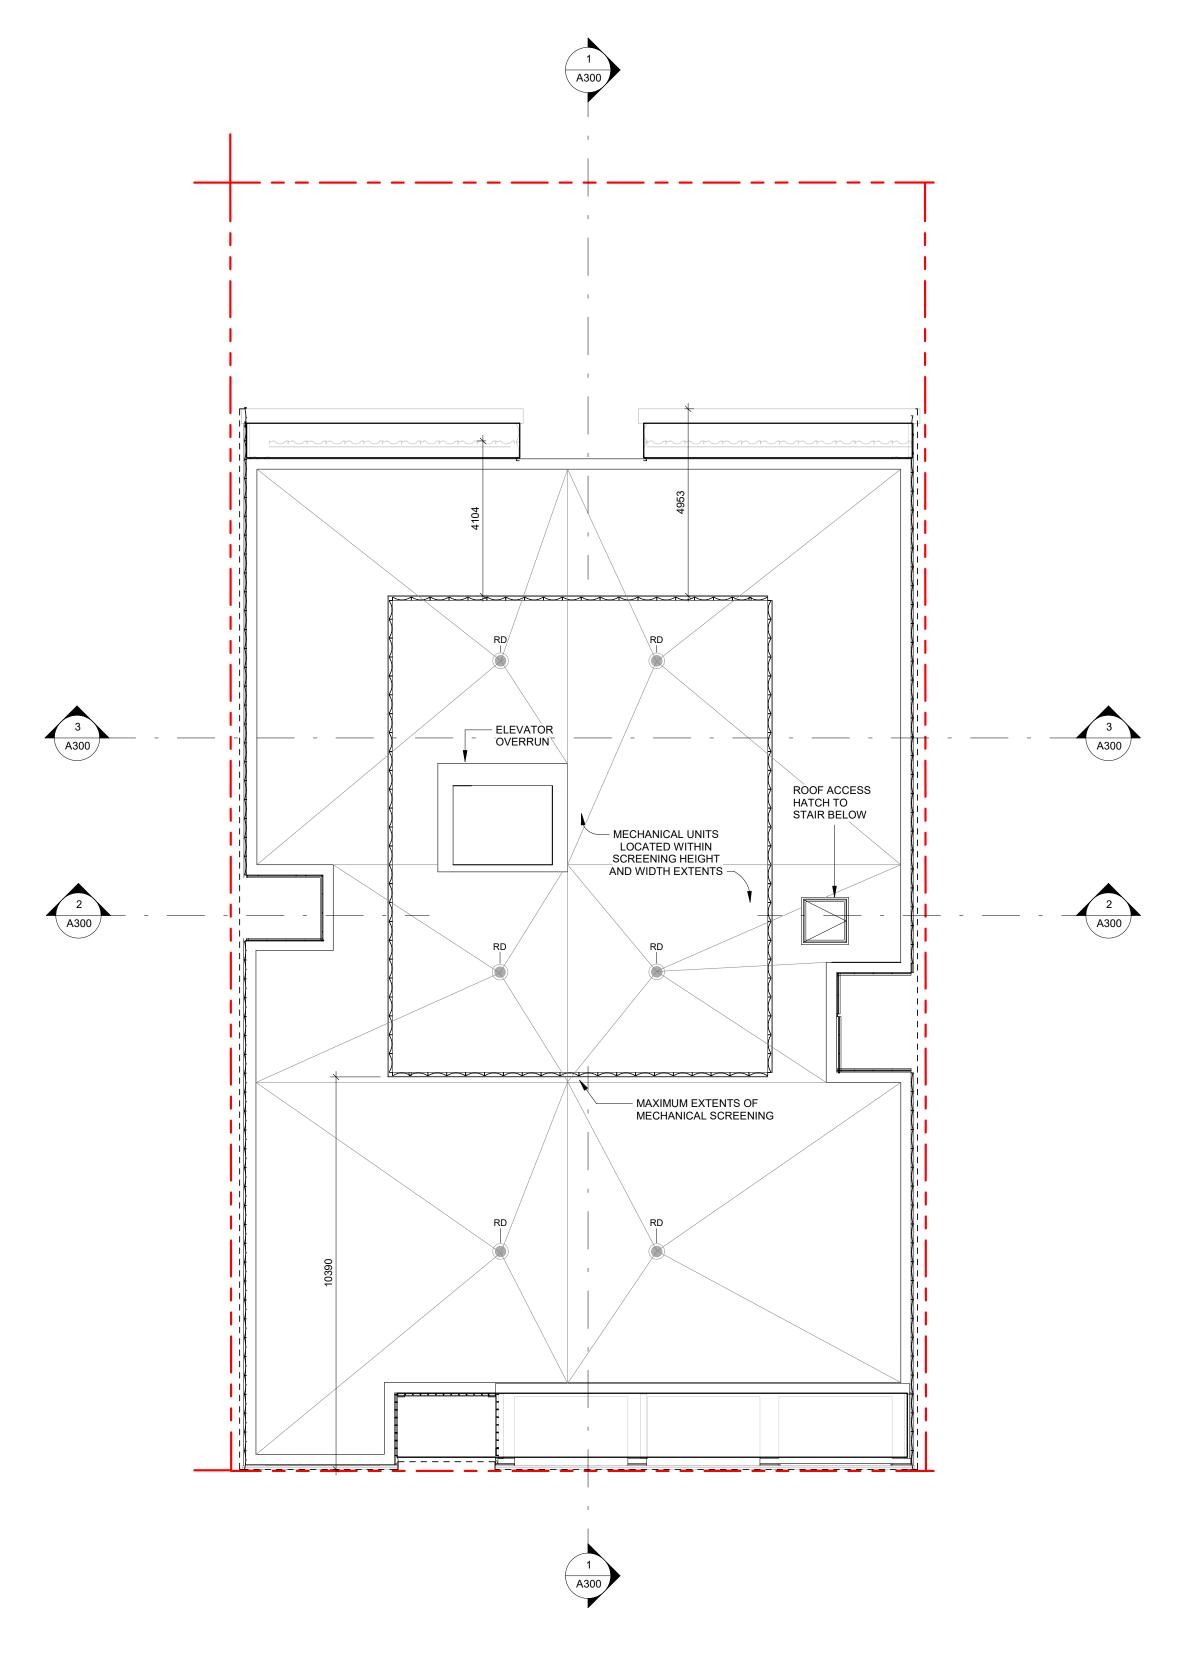

ZONING BYLAW 2018 - ROOF AREA: 491sq.m ZONING BYLAW 2018 - ROOFTOP STRUCTURE EXTENTS: 130sq.m

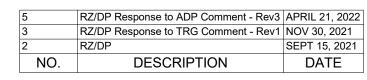



CASCADIA ARCHITECTS


which may be inferred therefrom are, and at all times remain, the exclusive property of Cascadia Architects Inc. Cascadia Architects holds the copyright and ownership in the said drawings, which cannot be used for any purpose without the express written consent of Cascadia Architects.



JAWL PROPERTIES 1030 Fort Street, Victoria BC

Proposed L3-6 & Roof Plan

JUNE 29, 2022 1:100

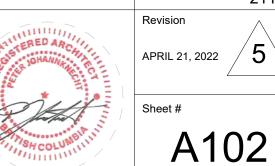


A102

2022-06-28 10:05:29 AM



South Elevation

SCALE = 1:100

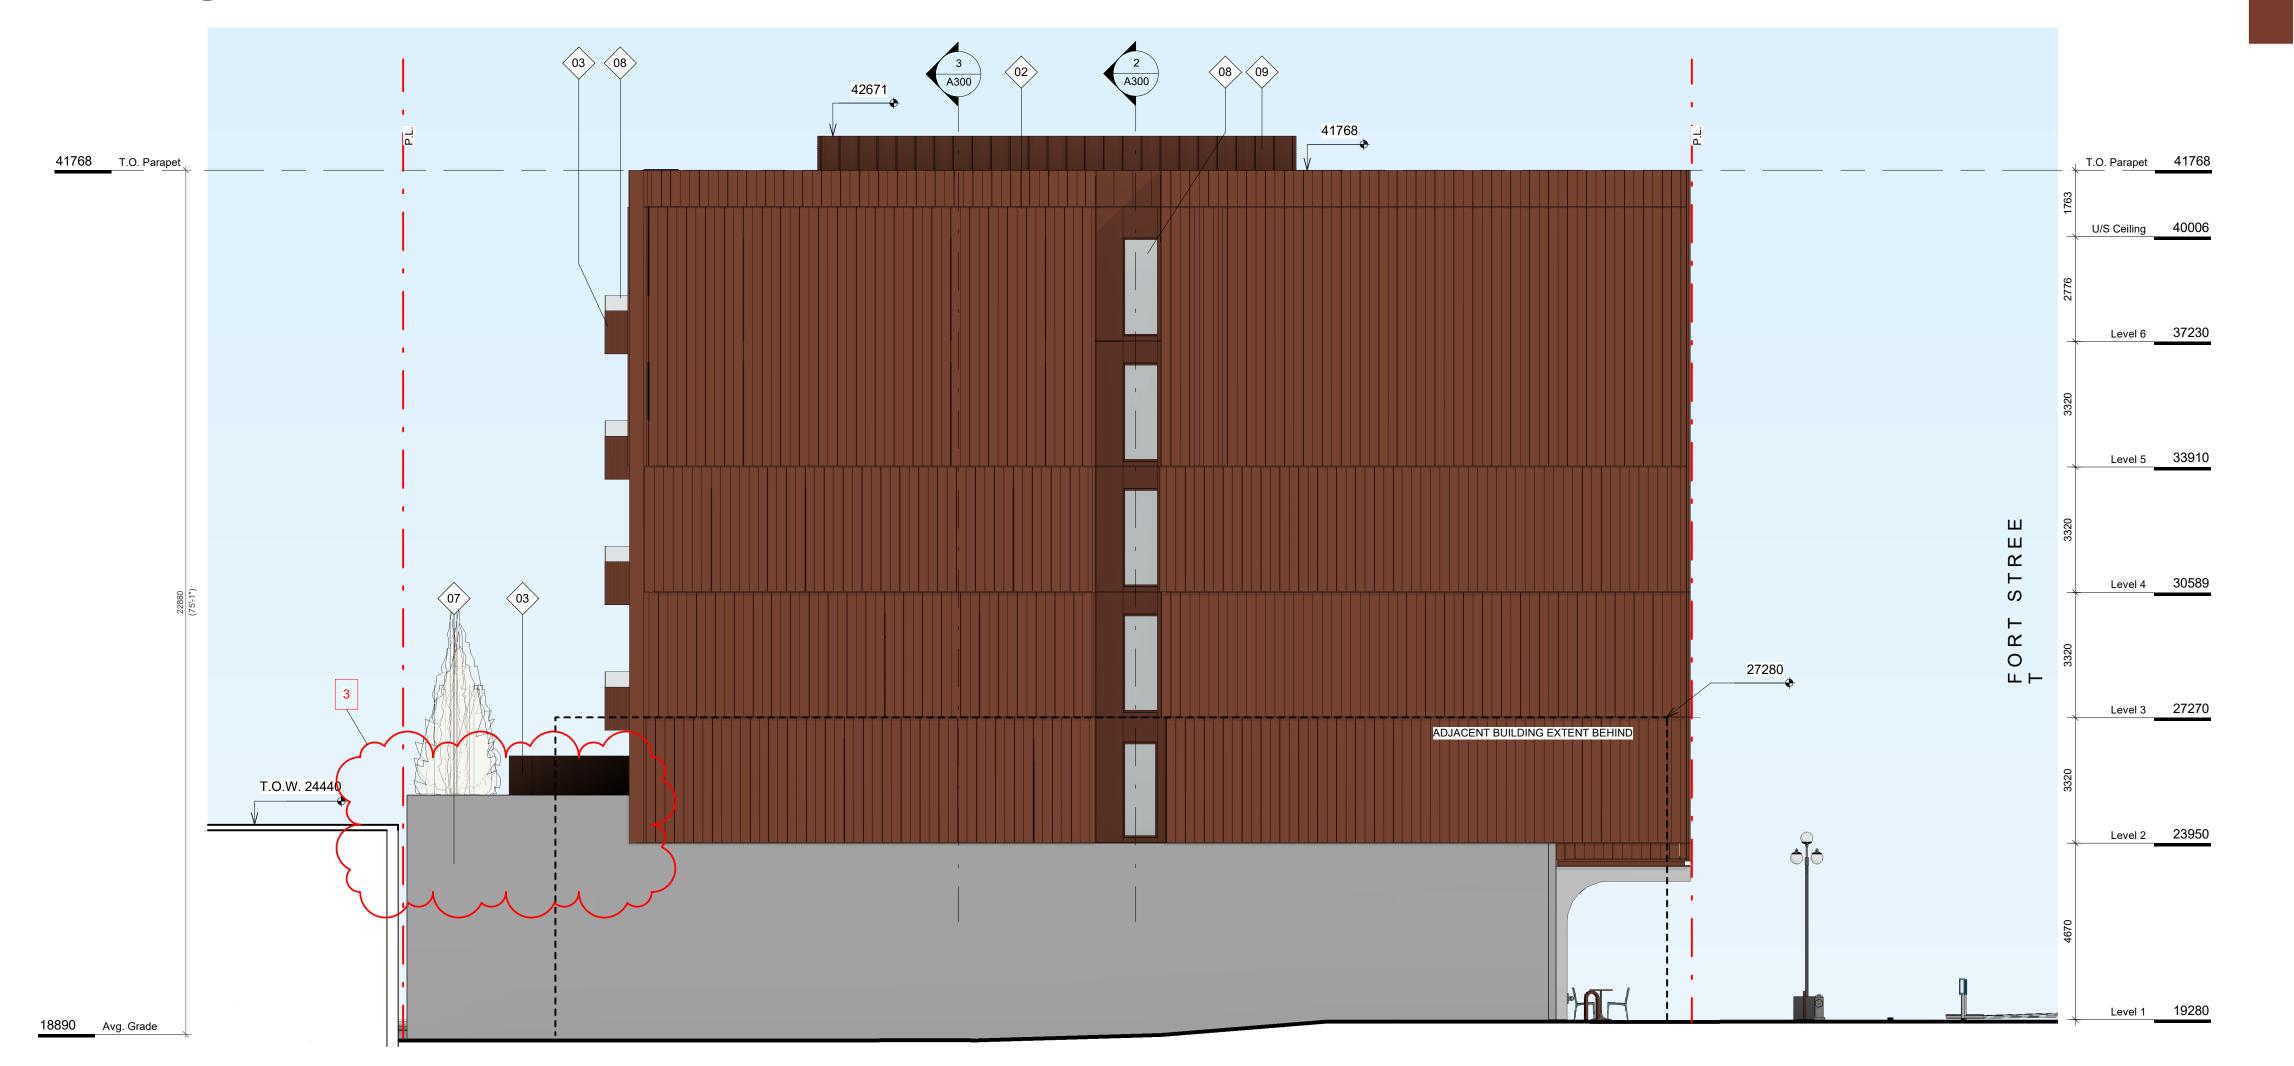

01. TERRA COTTA

FINISH MATERIALS

02. PRE-FINISHED METAL

03. FRITTED GLASS

04. CEDAR SOFFIT

05. CEMENTITIOUS PANEL

06. ARCHITECTURAL CONCRETE

07. CONCRETE

08. TRANSPARENT

GLASS

09. PRE-FINISHED PERFORATED METAL

NO.	DESCRIPTION	DATE
1	Issued for Development Tracker	AUG 03, 2021
2	RZ/DP	SEPT 15, 2021
3	RZ/DP Response to TRG Comment - Rev1	NOV 30, 2021
4	RZ/DP Content for ADP - Rev2	FEB 09, 2022
5	RZ/DP Response to ADP Comment - Rev3	APRIL 21, 2022
6	RZ/DP Response to TRG Comment - Rev4	JUNE 29, 2022



CASCADIA ARCHITECTS

which reserved. These drawings and the design contained therein or which may be inferred therefrom are, and at all times remain, the exclusive property of Cascadia Architects Inc. Cascadia Architects holds the copyright and ownership in the said drawings, which cannot be used for any purpose without the express written consent of Cascadia Architects.

1030 FORT STREET

JAWL PROPERTIES

1030 Fort Street, Victoria BC

Sheet Name Building Elevations S-W

Date JUNE 29, 2022

As indicated

2112

Revision

JUNE 29, 2022

Sheet #


2022-06-28 10:06:05 AM


A200

2022-06-28

West Elevation

SCALE = 1:100

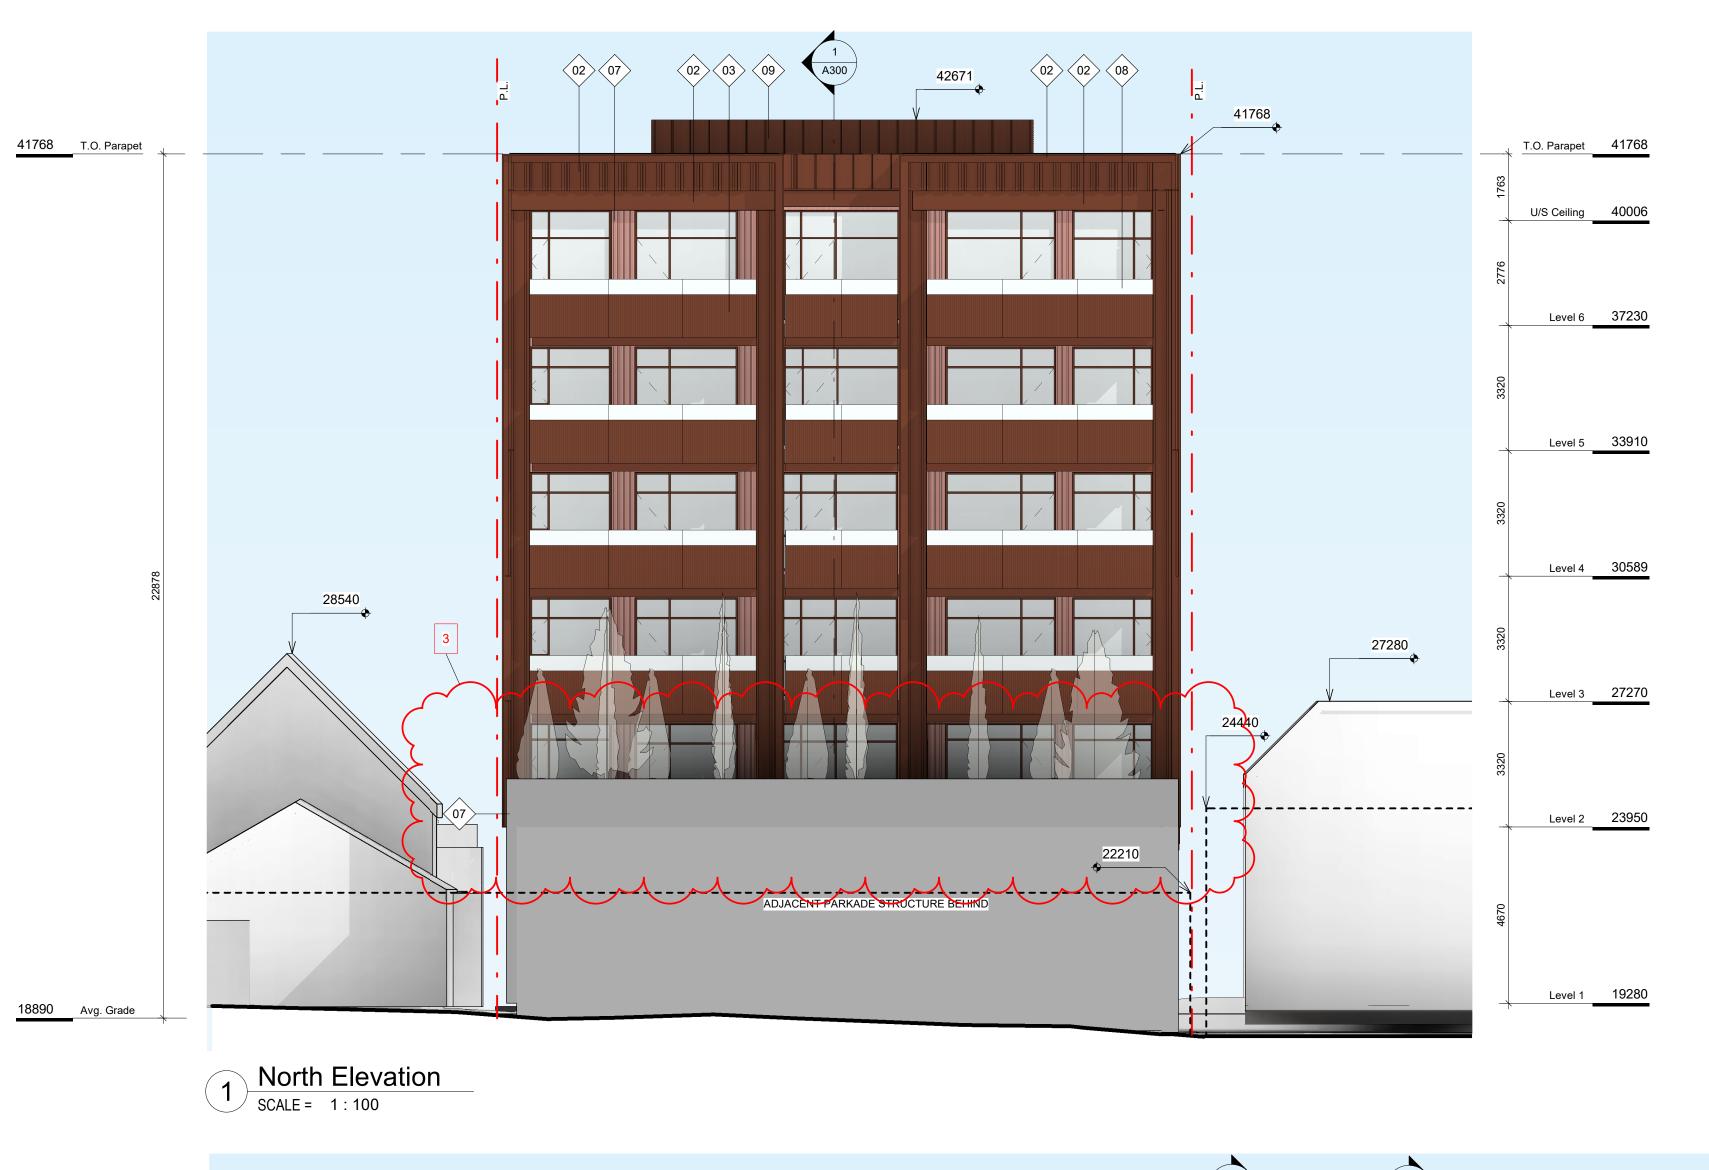

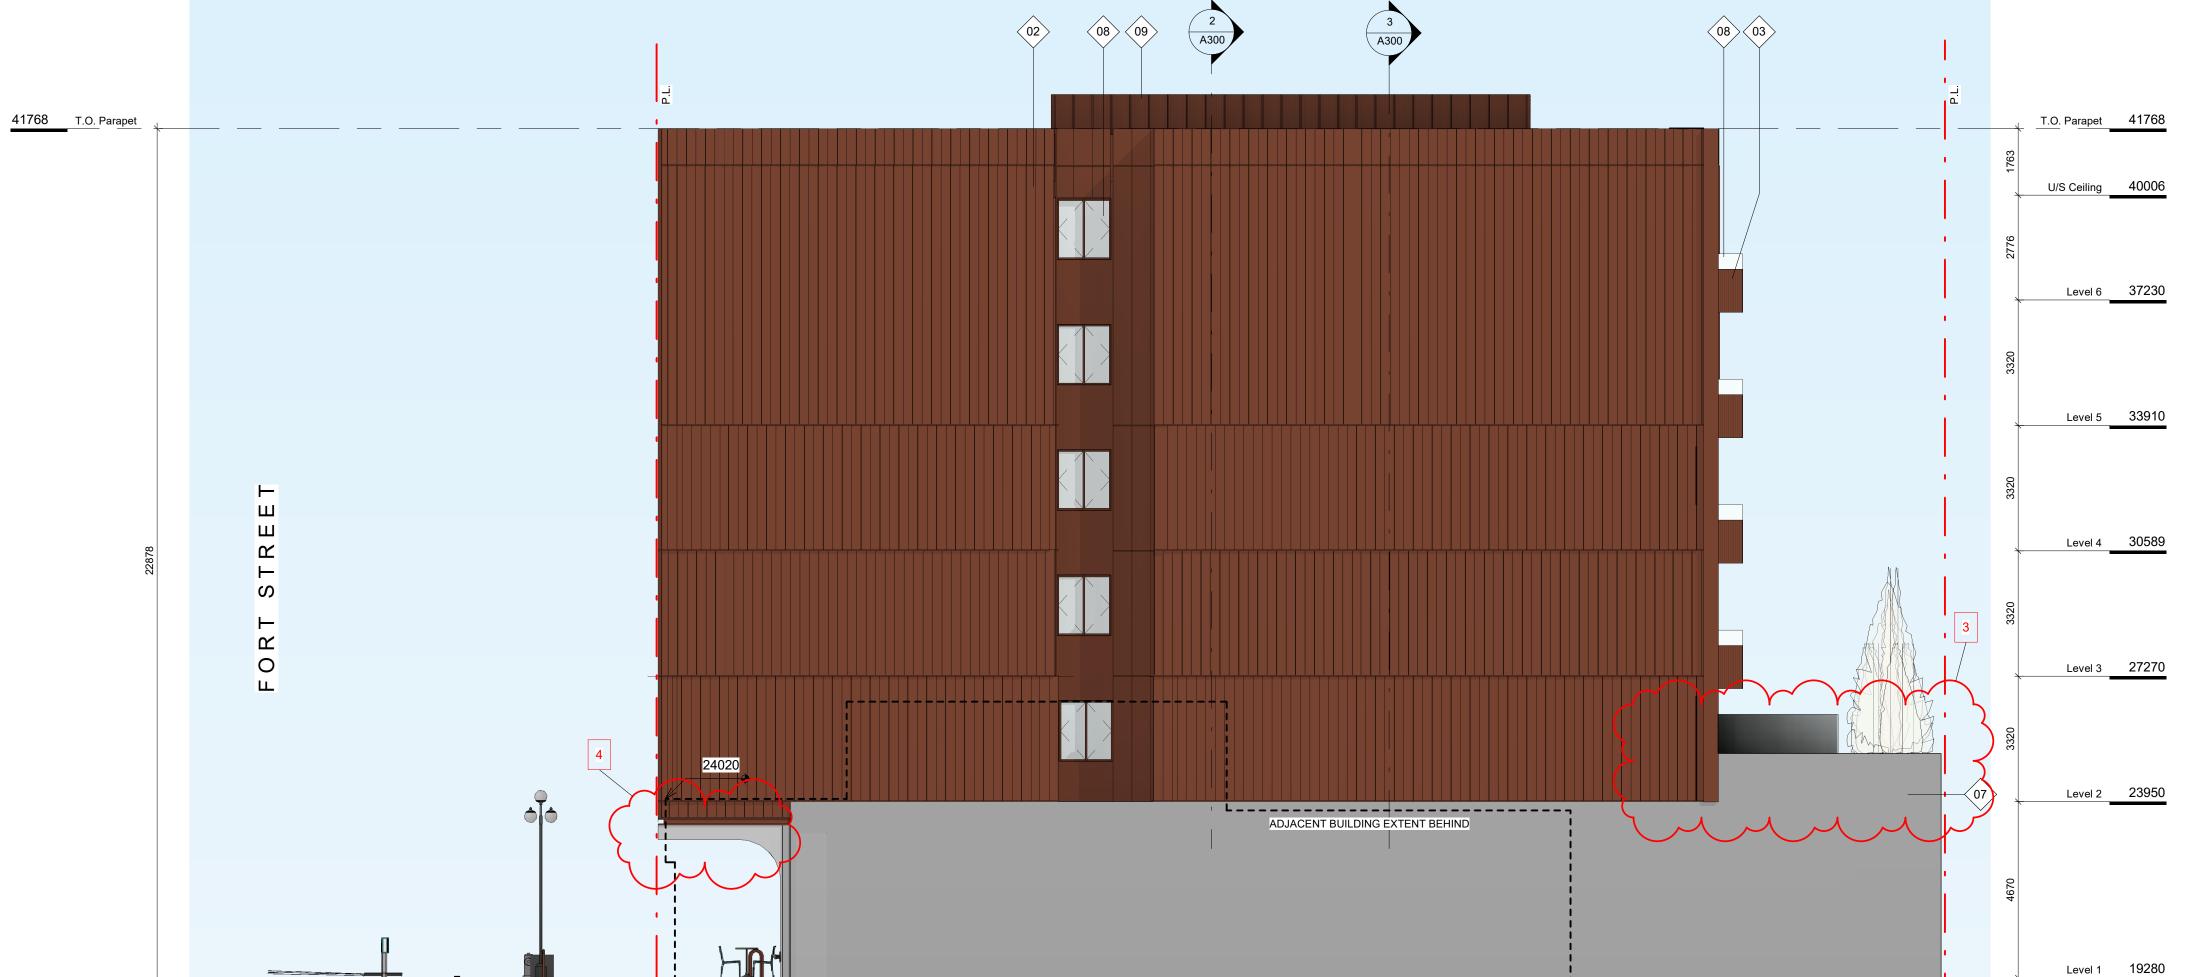



01. TERRA COTTA

02. PRE-FINISHED METAL

03. FRITTED GLASS

04. CEDAR SOFFIT

05. CEMENTITIOUS **PANEL**

06. ARCHITECTURAL CONCRETE

07. CONCRETE

08. TRANSPARENT

GLASS

09. PRE-FINISHED PERFORATED METAL

6	RZ/DP Response to TRG Comment - Rev4	JUNE 29, 2022
5	RZ/DP Response to ADP Comment - Rev3	APRIL 21, 2022
4	RZ/DP Content for ADP - Rev2	FEB 09, 2022
3	RZ/DP Response to TRG Comment - Rev1	NOV 30, 2021
2	RZ/DP	SEPT 15, 2021
1	Issued for Development Tracker	AUG 03, 2021
NO.	DESCRIPTION	DATE



CASCADIA ARCHITECTS

which may be inferred therefrom are, and at all times remain, the exclusive property of Cascadia Architects Inc. Cascadia Architects holds the copyright and ownership in the said drawings, which cannot be used for any purpose without the express written consent of Cascadia Architects.

1030 FORT STREET

JAWL PROPERTIES 1030 Fort Street, Victoria BC

Sheet Name Building Elevations N-E

JUNE 29, 2022

As indicated


JUNE 29, 2022 / 6


A201

2112

2022-06-28 2022-06-28 10:06:38 AM

2 East Elevation
SCALE = 1:100

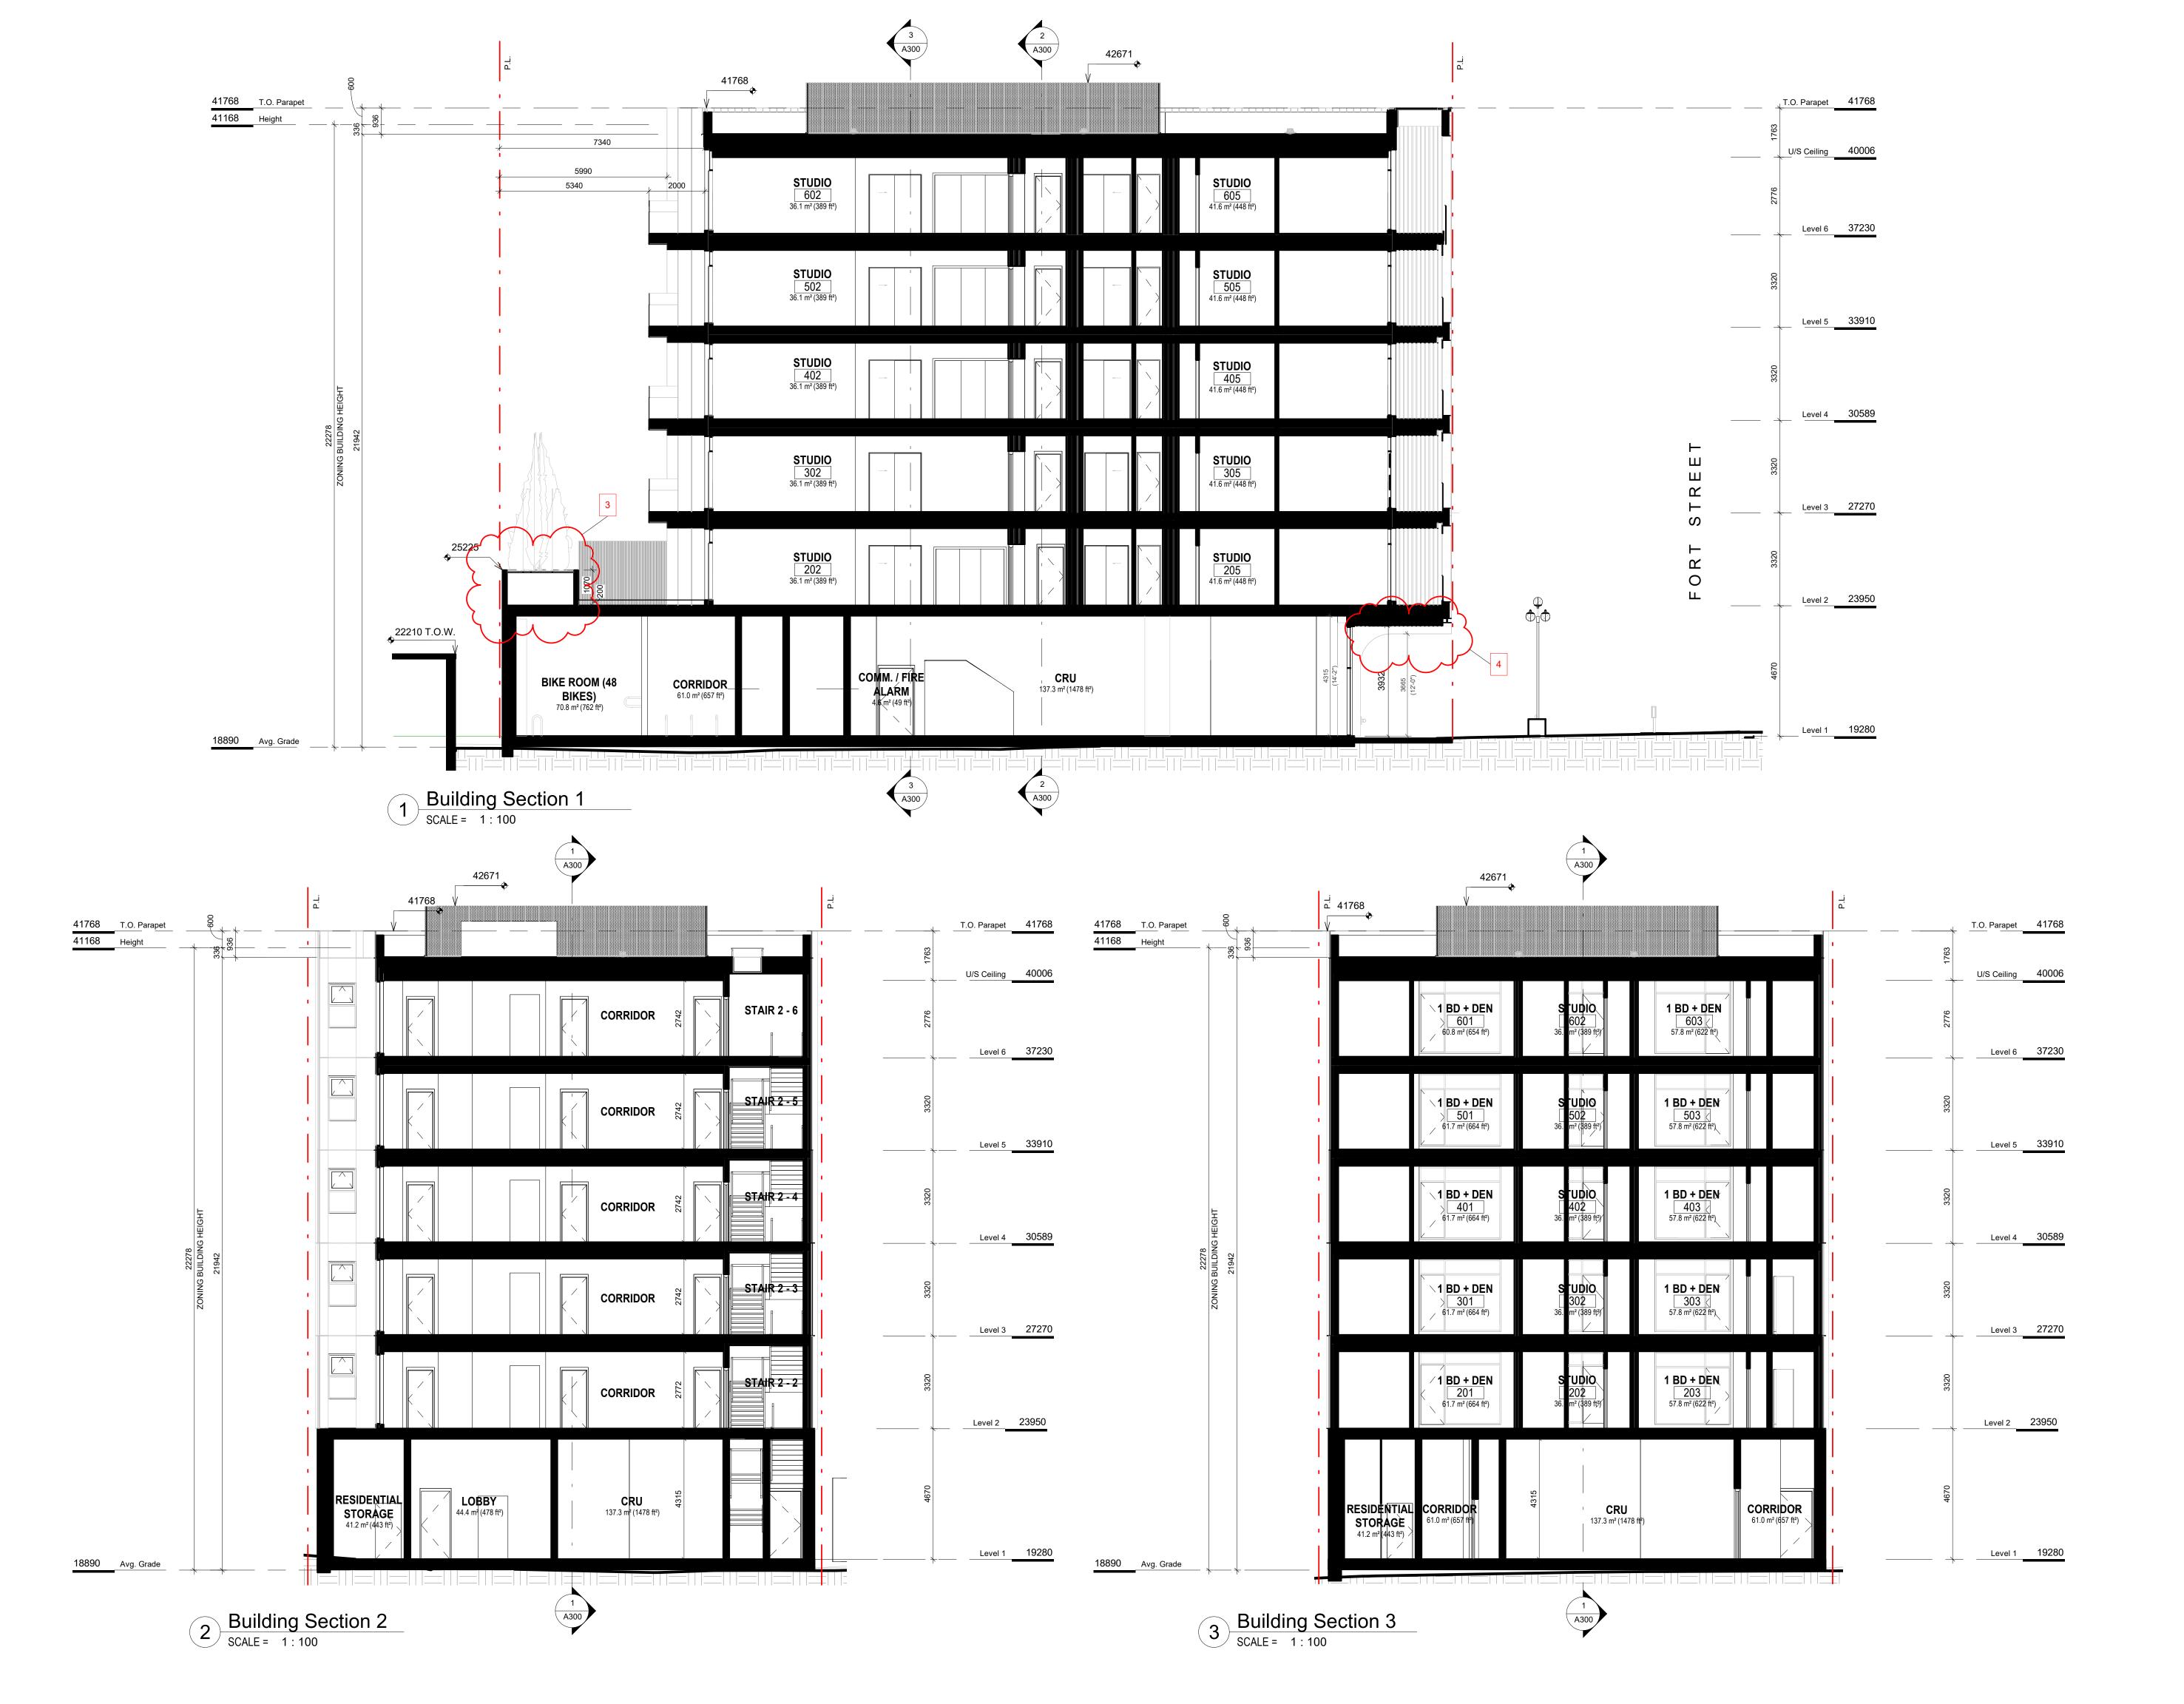

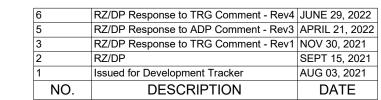



CASCADIA ARCHITECTS


which may be inferred therefrom are, and at all times remain, the exclusive property of Cascadia Architects Inc. Cascadia Architects holds the copyright and ownership in the said drawings, which cannot be used for any purpose without the express written consent of Cascadia Architects.

1030 FORT STREET

JAWL PROPERTIES 1030 Fort Street, Victoria BC

Building Sections

JUNE 29, 2022 Project #

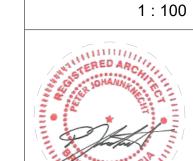


Revision JUNE 29, 2022 / 6 Sheet #

2112

2022-06-28 10:06:53 AM

A300 2022-06-28

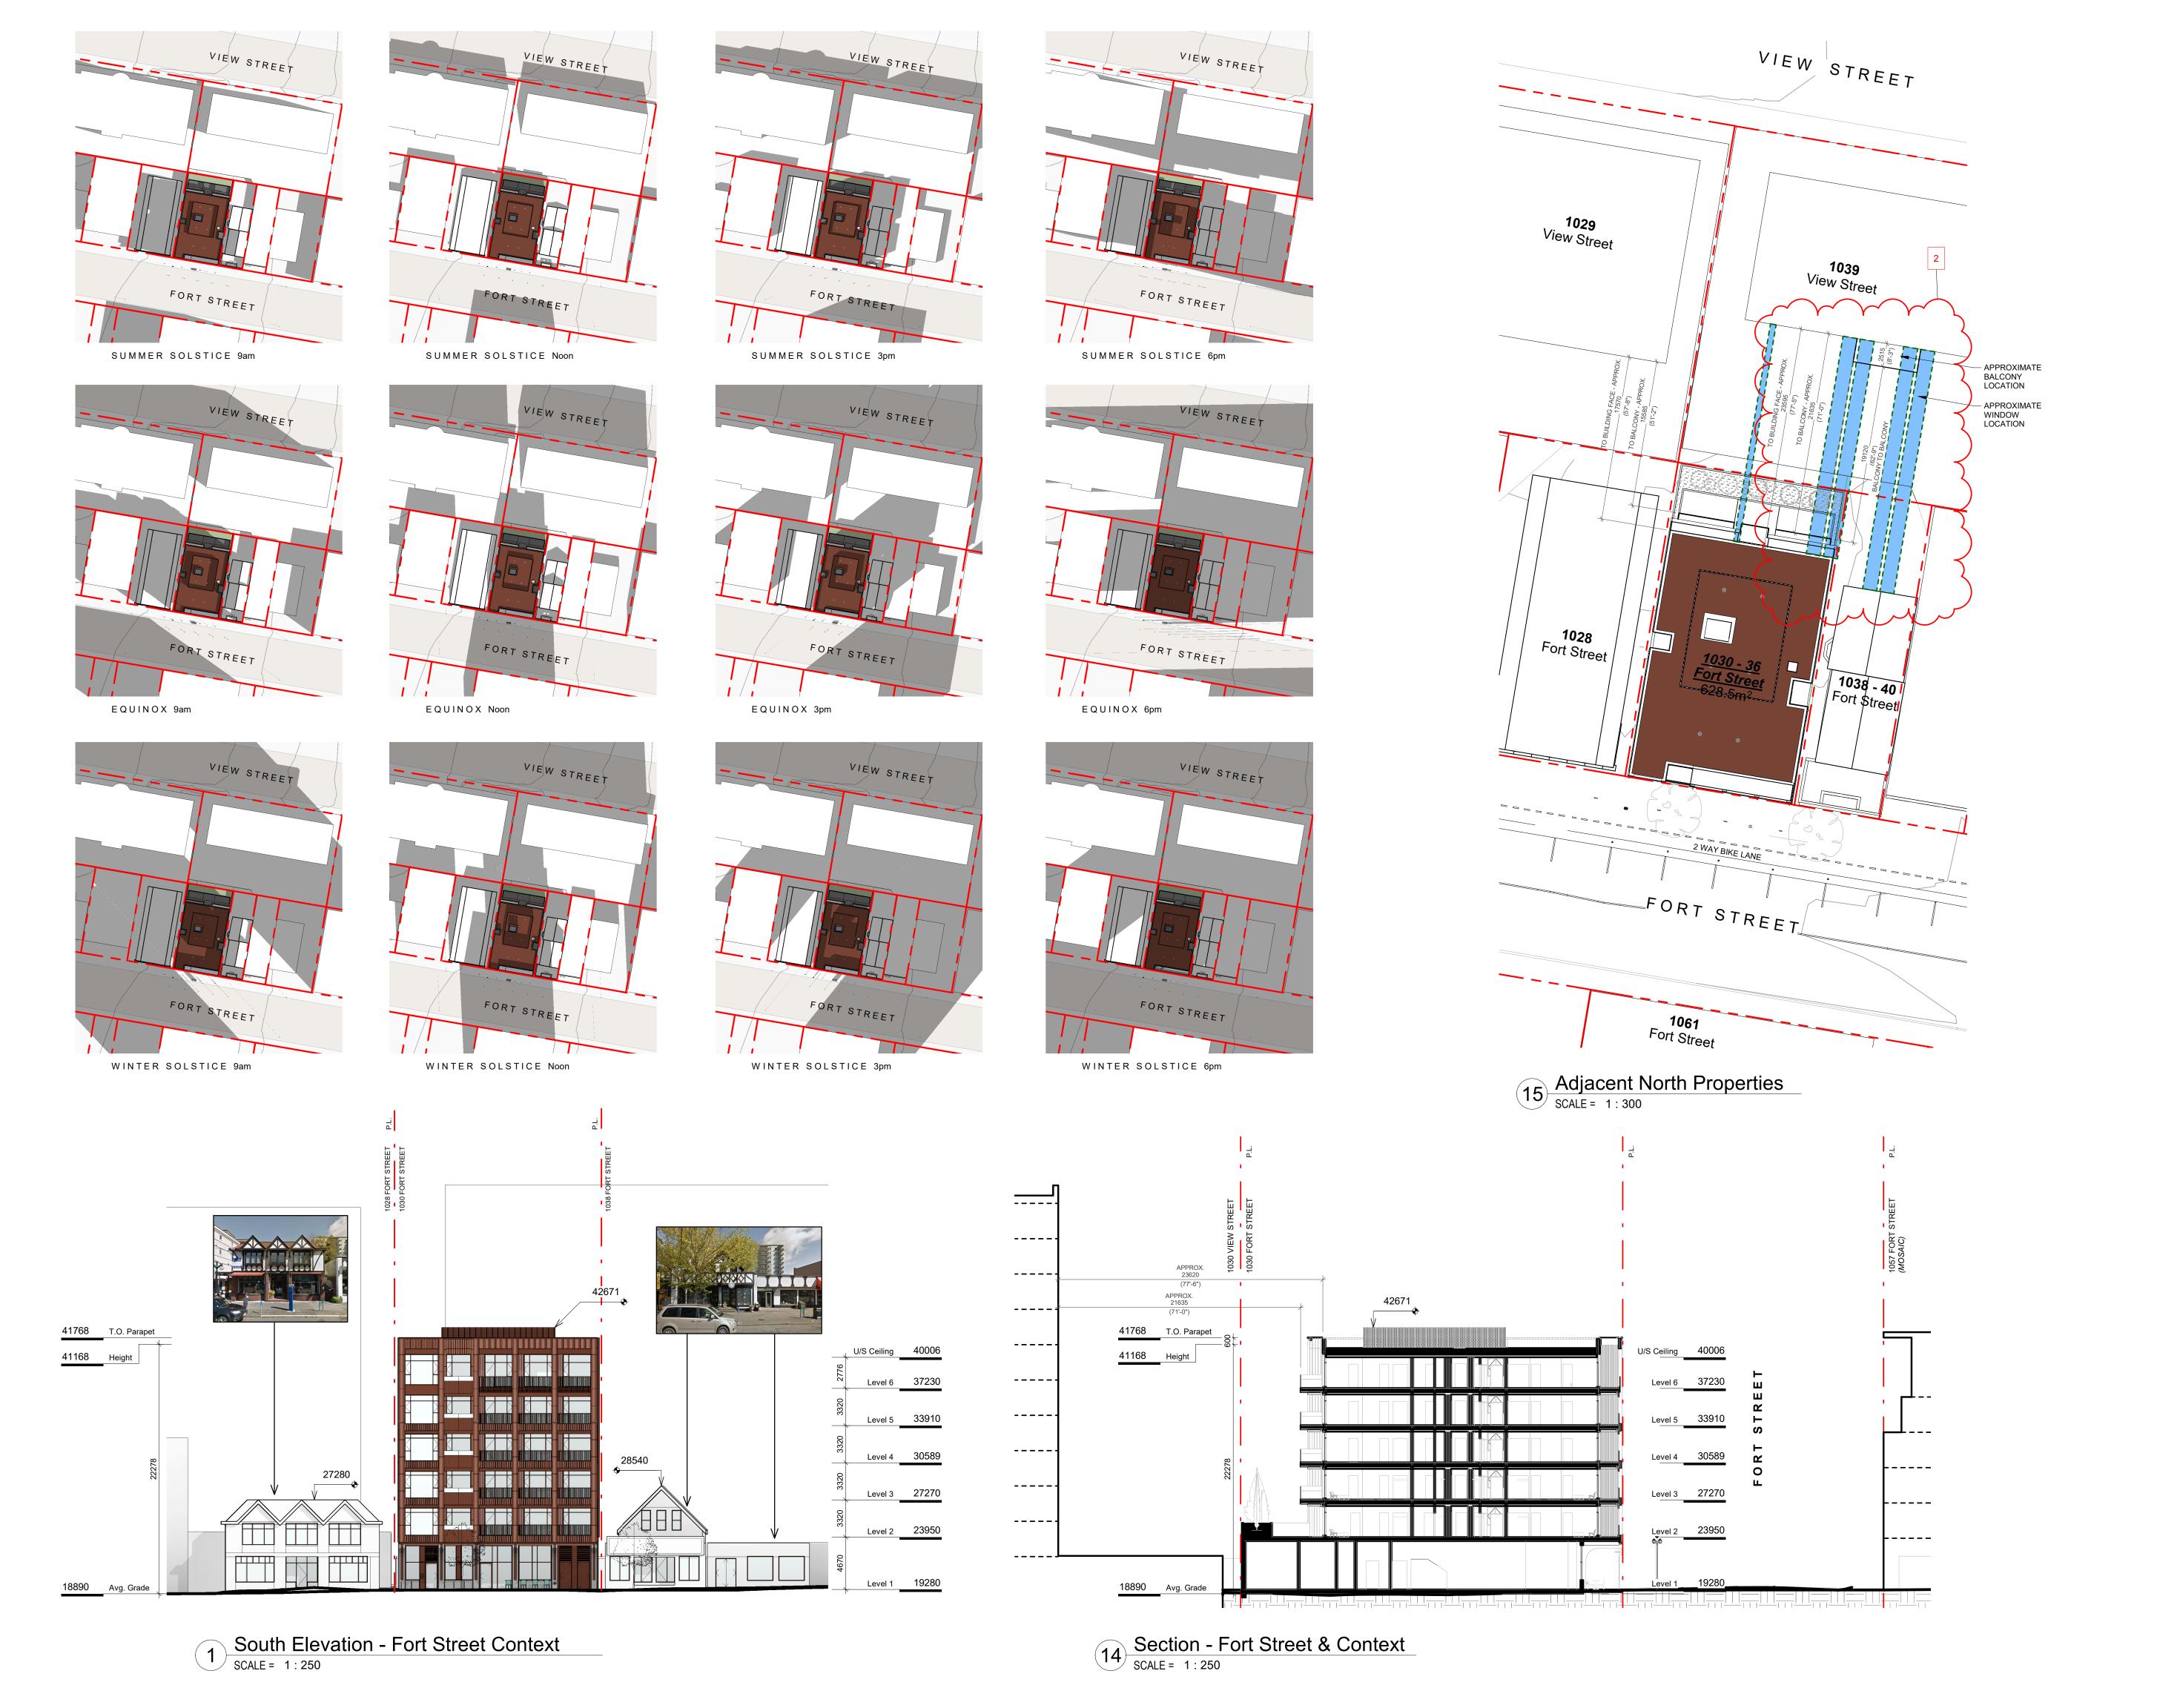

JAWL PROPERTIES
1030 Fort Street, Victoria BC

Sheet Name Context & Shadow Study

Date

JUNE 29, 2022

Scale

As indicated

Project #

Revision

JUNE 29, 2022

Sheet #

A500

Sheet #

A500

2022-06-28

2022-06-28 10:07:26 AM

RZ/DP Response to TRG Comment - Rev4 JUNE 29, 2022
RZ/DP Response to ADP Comment - Rev3 APRIL 21, 2022
RZ/DP Response to TRG Comment - Rev1 NOV 30, 2021

DESCRIPTION

CASCADIA ARCHITECTS

which reserved. These drawings and the design contained therein or which may be inferred therefrom are, and at all times remain, the exclusive property of Cascadia Architects Inc. Cascadia Architects holds the copyright and ownership in the said drawings, which cannot be used for any purpose without the express written consent of Cascadia Architects.

NO.


AUG 03, 2021 DATE







CONTEXT VIEW FROM FORT STREET EAST

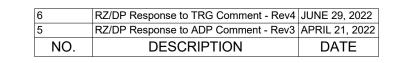



CASCADIA ARCHITECTS

reserved. These drawings and the design contained therein or which may be inferred therefrom are, and at all times remain, the exclusive property of Cascadia Architects Inc. Cascadia Architects holds the copyright and ownership in the said drawings, which cannot be used for any purpose without the express written consent of Cascadia Architects.

1030

1030 FORT STREET

JAWL PROPERTIES

1030 Fort Street, Victoria BC

Context Perspectives

JUNE 29, 2022

e Project

Scale 1:200

Revision


JUNE 29, 2022

6

Sheet #

A501

6-28 2022-06-28 10:07:28 AM

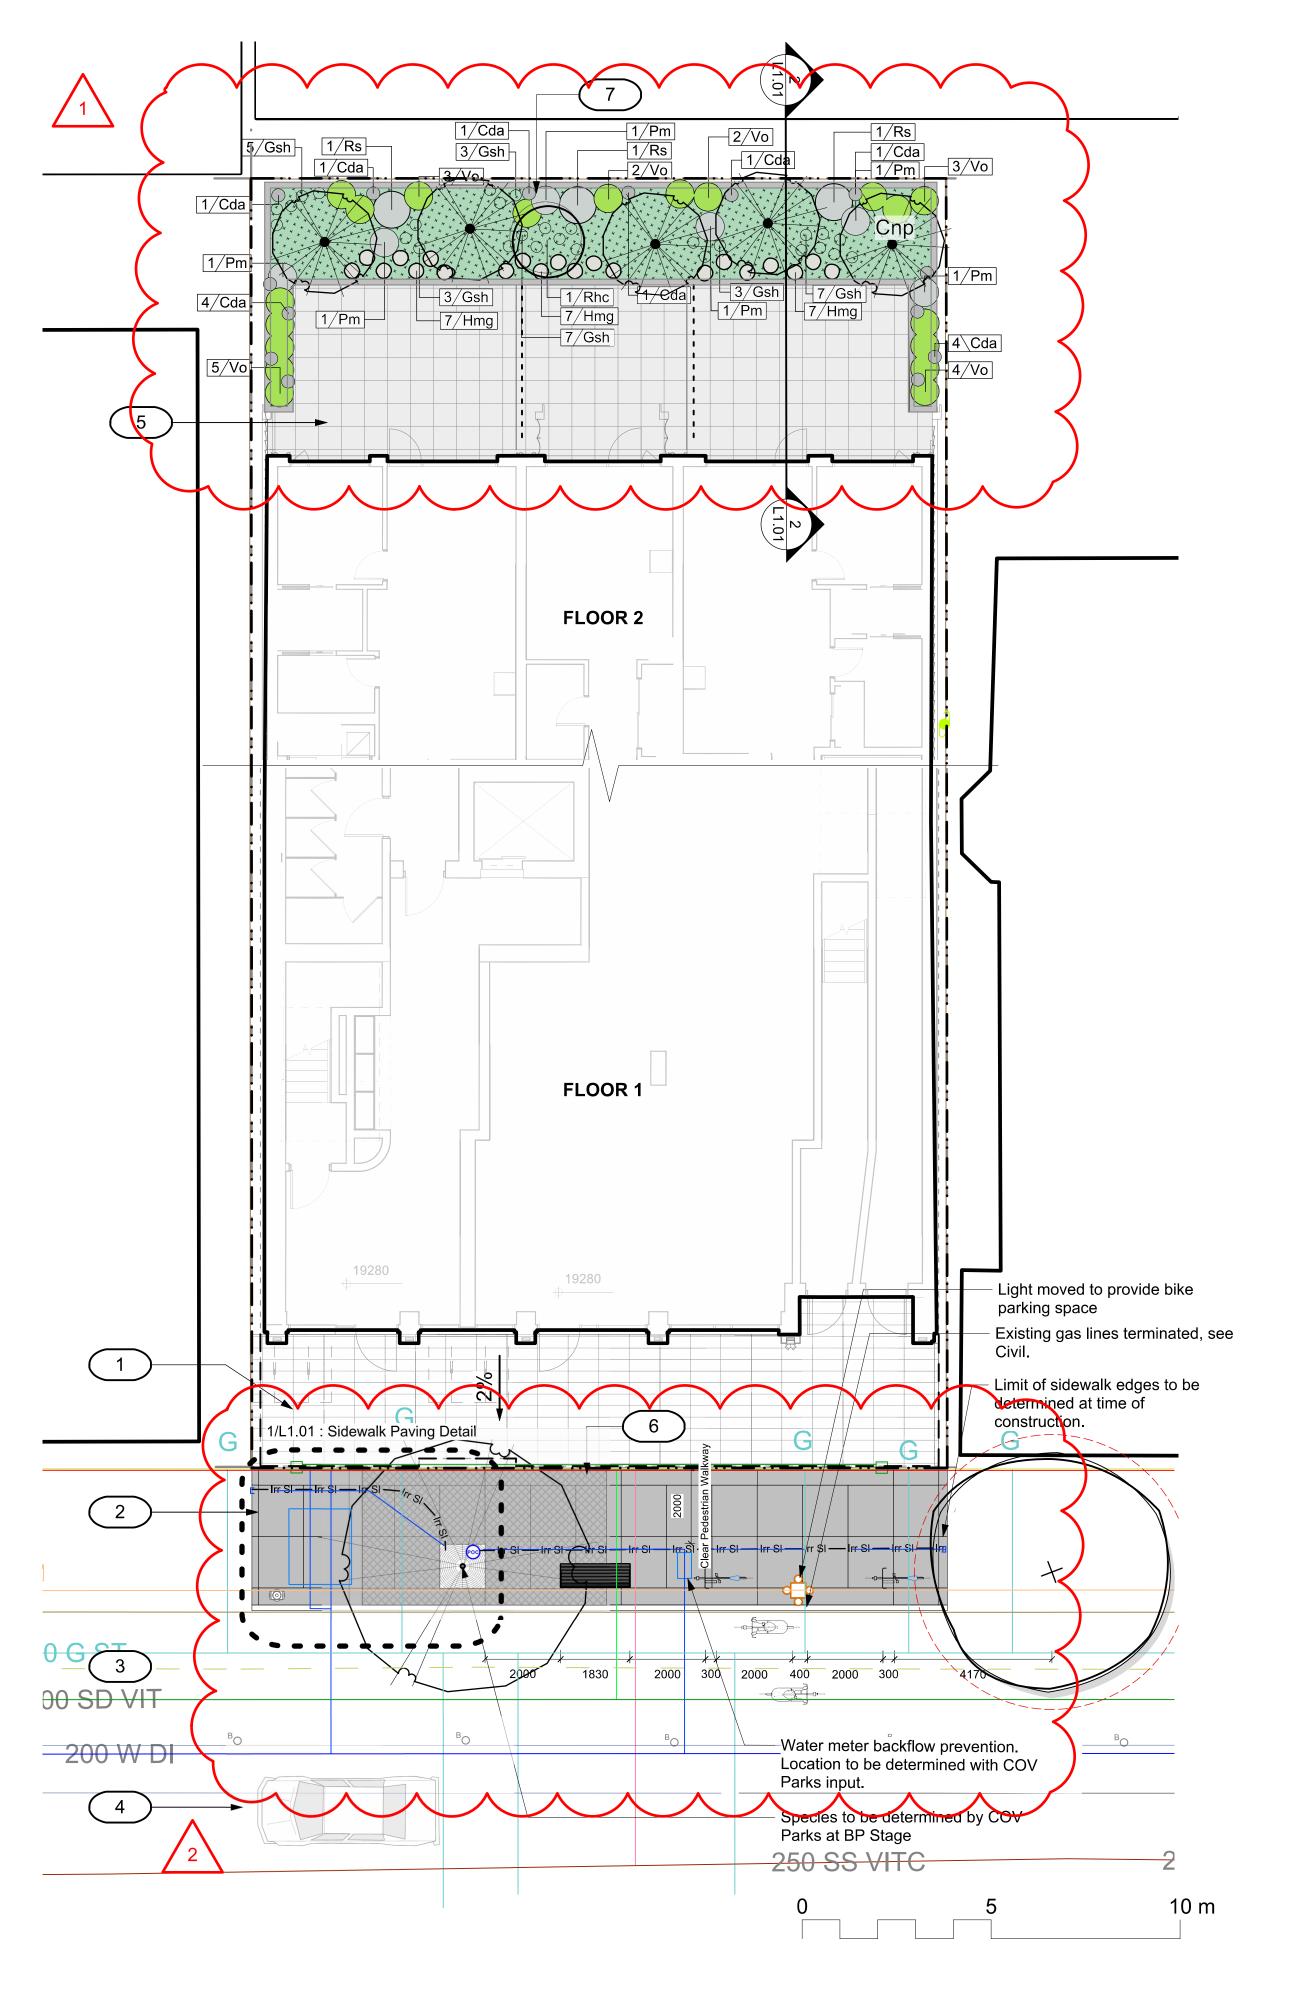


REFERENCE NOTES

- 1. Entrance Plaza Pedestrian Sidewalk
- Bike Lane
- 4. Parking
- 5. Level 2 Patio with planters and tree screening. 6. 20 cu m growing medium for medium sized boulevard tree. 150 structural soil cells (50 cells x 3 cells deep)
- 7. Landscape Planter. 1200 Depth x 42.5 sq. m. Volume 51 cu m.

REVISIONS:

- 1. Planter height increased to 1.7m. Guard rail removed. Soil volume increased to 51 cu m. Plant selection updated for
- increased height and quantity. 2. Location of irrigation connection revised.

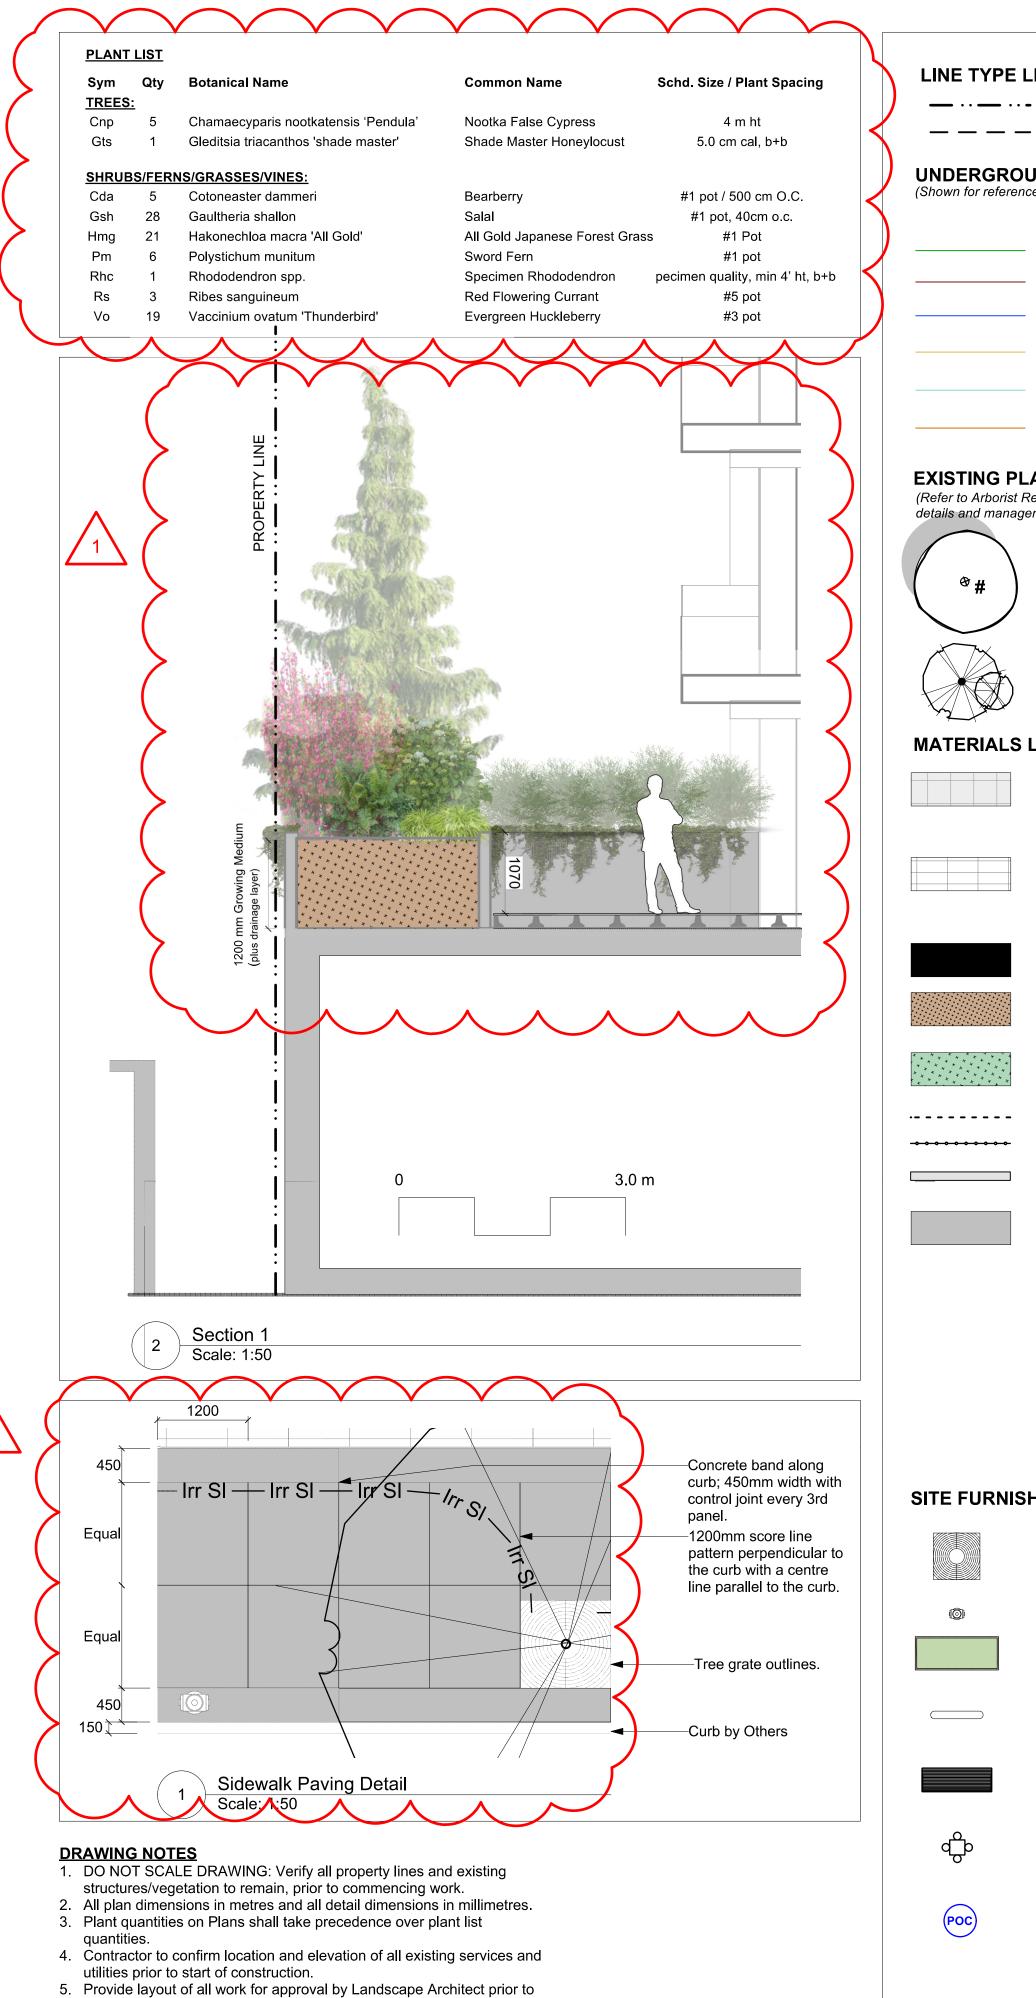

- proceeding with work. 6. Contractor to provide irrigation system for all planters to current IIABC Standards and Contract Specifications. Boulevard irrigation system to meet City of Victoria Supplementary Specification for Street Trees and
- Irrigation Bylaw. 7. Landscape installation to carry a 1 year warranty from date of acceptance.
- 8. Plant material, installation and maintenance to conform to the current edition of the Canadian Landscape Standard.
- 9. General Contractor and/or sub-contractors are responsible for all costs related to production and submission to consultant of all landscape as-built information including irrigation.
- 10. Tree protection fencing, for existing trees, to be installed prior to commencement of all site work

LINE TYPE LEGEND

— ··- Property line — — — Extent of Roof, above

UNDERGROUND UTILITIES

(Shown for reference only - refer to Civil Engineer's drawings).

Storm drain Sewer


Water

Electrical


Hydro Tel

EXISTING PLANT LEGEND

(Refer to Arborist Report and Tree Retention & Removal Plan for full details and management strategies).

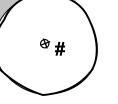



Existing Tree to be retained

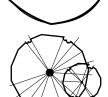

Proposed Trees

MATERIALS LEGEND

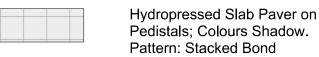

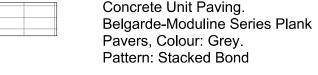



Structural Soil - City Green Strata Vault or approved equivalent.

Growing Medium

Planting Area 900mm Depth

-----Privacy Screening Guard Rail

-Concrete Retaining Wall - On Grade

New Town- City of Victoria Standard Trowel Joint Concrete; Cast in Place, Side Walk Fill & Frame Natural Colour,

Fine Broom Finish 1200mm Scoreline pattern perpendicular to curb (Pattern to be adjusted to fit with tree grate layout)

450mm concrete band along curb and back side of sidewalk (Property line) Control joints every 3rd planel of 450mm bands

SITE FURNISHINGS LEGEND



Tree Grate



Planters

Fire Hydrant



Downtown Bike Racks



Pedestrian Lighting - New Town - Heritage Cluster Light Type A Circular

New Town - Type F: Metal modern bench



Irrigation Point of Connection - City supply for boulevard tree. Provide water servuce and electrical service from irrigation controller to valves.

Irrigation Sleeve (100mm Dia.) — Irr SI — Irr SI ·

MATERIAL PALETTE




PAVING







Rev 3. 2022-06-29 2022-04-21 Rev 2. Rev 1. 2021-11-30 DP 03/Aug/2021 description rev no

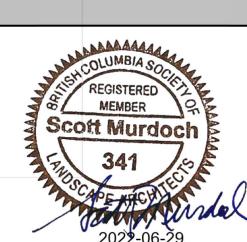

Murdoch

_andscape Planning & Design

2022-06-29

Jawl Properties Ltd, 1515 Douglas St Suite 200, Victoria, BC

project 1030 Fort Street 1030 Fort Street,

sheet title Landscape

Victoria, B.C.

Materials

project no.		121.29
scale	1: 100	@ 24"x36"
drawn by		KH
checked by		SM
revison no.	sheet no.	
\wedge	•	4 04

L1.01 <u>/4\</u>

ENGINEERING NOTES:

- 1. ALL CONSTRUCTION AND MATERIALS TO BE IN ACCORDANCE WITH THE LATEST VERSION OF THE CITY OF VICTORIA SPECIFICATIONS, MASTER MUNICIPAL CONSTRUCTION DOCUMENT (MMCD) PLATINUM EDITION, AND THESE DRAWINGS.
- 2. ALL CONSTRUCTION SURVEY LAYOUT TO BE PROVIDED BY THE CONTRACTOR.
- 3. PERMIT TO CONSTRUCT WORKS ON CITY RIGHT-OF-WAY MUST BE OBTAINED FROM THE CITY ENGINEERING DEPARTMENT BEFORE WORKS COMMENCE. NOTIFY CITY OF VICTORIA 48 HOURS PRIOR TO CONSTRUCTION.
- 4. ALL SERVICE LOCATIONS AND CROSSINGS ARE NOT GUARANTEED AS TO THEIR ACCURACY. LOCATIONS OF ALL EXISTING SERVICES, FEATURES AND APPURTENANCES SHOWN ON THE DRAWINGS ARE TO BE CONSIDERED APPROXIMATE ONLY. VERIFY ALL LOCATIONS IN THE FIELD PRIOR TO CONSTRUCTION.
- 5. CONTACT BC-1 (1-800-474-6886), BC HYDRO, TELUS, SHAW CABLE, AND FORTIS BC FOR UNDERGROUND UTILITY LOCATIONS 72 HOURS PRIOR TO CONSTRUCTION.
- 6. CONTRACTOR TO VIDEO INSPECT EXISTING 200mm STORM DRAIN BETWEEN EAST AND WEST PROPERTY LINES ALONG PROJECT FRONTAGE PRE AND POST CONSTRUCTION TO CONFIRM PIPE CONDITION.
- EXISTING SERVICES MUST BE EXPOSED AT CROSSING POINTS PRIOR TO CONSTRUCTION.
 ANY CONFLICT BETWEEN EXISTING INFRASTRUCTURE AND THE DESIGN TO BE RELAYED
- TO ENGINEER AND CITY TECHNICIAN IMMEDIATELY.

 9. ADJUST ALL PROPOSED AND EXISTING APPURTENANCES TO MEET FINAL DESIGN GRADES.


 10. CITY CREWS TO INSTALL ALL SEWER AND DRAIN CONNECTIONS AND SERVICES UP TO THE
- PROPERTY LINE, AT THE DEVELOPER'S EXPENSE.


 11. WATER SERVICE CONNECTIONS ARE TO BE INSTALLED TO NEW METER AT THE PROPERTY LINE BY THE CITY OF VICTORIA MUNICIPAL CREW, AT THE DEVELOPER'S EXPENSE. THE
- CONTRACTOR SHALL NOT OPERATE ANY WATERMAIN OR SERVICE VALVES.

 12. CONTRACTOR IS RESPONSIBLE FOR COORDINATION WITH ALL PARTIES REQUIRED FOR SERVICING TO PROPERTY LINE, INCLUDING ABANDONMENT OF EXISTING SERVICES. CAP
- ABANDONED HYDRO/TEL/SHAW CONDUIT 300mm OUTSIDE PROPERTY LINE.

 13. UNDERGROUND WIRING TO BE CONSTRUCTED IN ACCORDANCE WITH BC ELECTRICAL
- CODE, BC HYDRO/TEL DRAWINGS AND SPECIFICATIONS.
- 14. OVERHEAD WIRING IS NOT SHOWN ON CONTRACT DRAWINGS.15. STREETS SHALL BE SWEPT CLEAN ON A REGULAR BASIS TO REMOVE ANY CONSTRUCTION
- 16. ALL CONSTRUCTION TO BE IN ACCORDANCE WITH CITY OF VICTORIA STORMWATER BYLAW.
- 17. DISPOSE OF ALL UNSUITABLE EXCAVATED MATERIAL AS PER SPECIFICATIONS, IN
- ACCORDANCE WITH ALL APPLICABLE REGULATIONS.

 18. ALL TRAFFIC CONTROL TO CONFORM TO THE MOST CURRENT WORKSAFE BC, MMCD AND MINISTRY OF TRANSPORTATION SPECIFICATIONS (TRAFFIC CONTROL MANUAL FOR WORK ON BOADWAYS)
- 19. PROVIDE TRAFFIC CONTROL, SIGNAGE, BARRICADES, ILLUMINATION, AND DETOUR ROUTING AS REQUIRED TO MAINTAIN TRAFFIC FLOW AND EMERGENCY VEHICLE ACCESS. OUTBOUND ARTERIAL ROAD TRAVEL LANES TO BE OPEN AFTER 3:00 PM.
- 20. THE CONTRACTOR WILL BE HELD RESPONSIBLE FOR THE REPAIR OF ANY DAMAGE CAUSED TO EXISTING STREETS OR SERVICES BY CONSTRUCTION EQUIPMENT AND/OR TRUCKS HAULING MATERIALS TO THE SITE. THIS WILL INCLUDE DAILY CLEANING OR SWEEPING ALL EXISTING ROADS OF DIRT AND DEBRIS CAUSED BY CONSTRUCTION ACTIVITY
- 21. ALL ASPHALT AND CONCRETE CUTS TO BE SQUARE CUT WITH SAW.
- 22. COORDINATE CONSTRUCTION OF ALL WORKS WITHIN ROADWAYS WITH CITY OF VICTORIA WORKS CREWS.
- 23. REFER TO ELECTRICAL AND MECHANICAL DRAWINGS FOR BC HYDRO, TELUS, SHAW CABLE AND FORTIS BC UTILITY CONSTRUCTION DETAILS.
- 24. FIELD SURVEY COMPLETED BY GEOVERRA 2020/2021.
- 25. CONTRACTOR IS TO PROVIDE AS-CONSTRUCTED DRAWING MARKUPS TO ENGINEER UPON CONSTRUCTION COMPLETION.

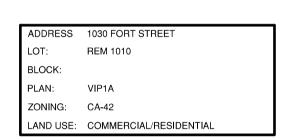


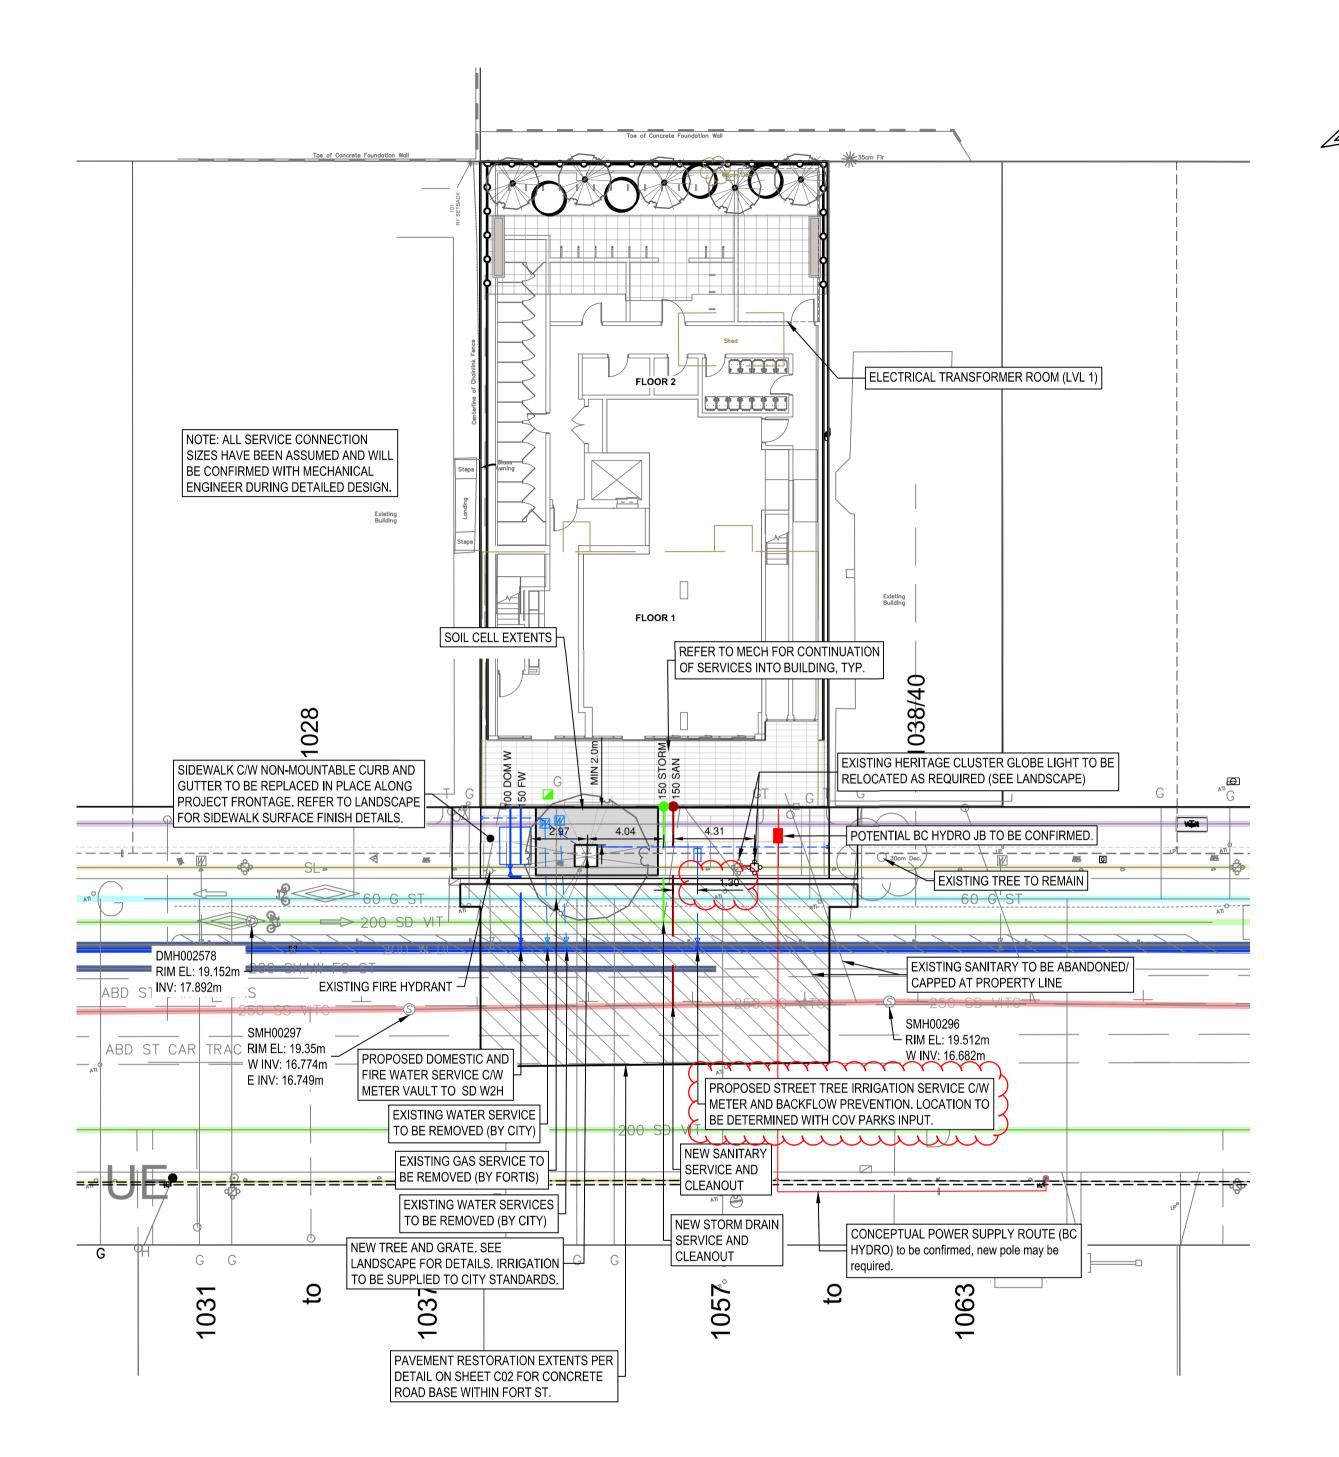

SERVICE	ESTIMATED SIZE	UTILITY PROVIDER	INSTALLATION FORCES	COST(\$) ¹
WATER	150mm	City of Victoria	City of Victoria	At Cost
SANITARY	150mm	City of Victoria	City of Victoria	At Cost
STORM DRAIN	150mm	City of Victoria	City of Victoria	At Cost
GAS	² Unconfirmed	Fortis	Utility Contractor	Based on Size
HYDRO	² Unconfirmed	BC Hydro	Utility Contractor	Based on Size
COMMUNICATIONS	² Unconfirmed	Telus/Shaw	Utility Contractor	Based on Size

City of Victoria Schedule of fees for Service Connections Provided in Appendix A
 Design loads and service size to be confirmed by mechanical and Electrical consultants during detailed design stage.

	WORKS AND SERVICES CHECK TABLE			
	PLAN CHECKER	AUTHORIZED REPRESENTATIVE		DATE
	PLAN CHECKER	NAME	SIGNATURE	DATE
	BC HYDRO			
<u> </u>	TELUS			
UTILITY	FORTIS BC			
	SHAW			
AL.	UNDERGROUND UTILITIES			
MUNICIPAL	TRANSPORTATION DESIGN & INFRASTRUCTURE			
M	LAND DEVELOPMENT			

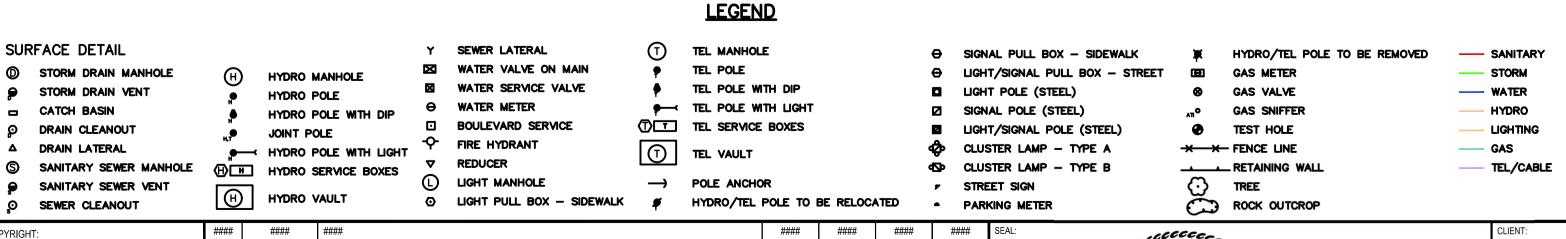

COPYRIGHT:


THIS DRAWING AND DESIGN IS COPYRIGHT
PROTECTED WHICH SHALL NOT BE USED,
REPRODUCED OR REVISED WITHOUT
WRITTEN PERMISSION BY WSP CANADA INC.

DISCLAIMER:

DISCLAIMER:

THE CONTRACTOR SHALL CHECK AND VERIFY ALL DIMENSIONS AND UTILITY LOCATIONS AND REPORT ALL ERRORS AND OMISSIONS PRIOR TO COMMENCING WORK.

THIS DRAWING IS NOT TO BE SCALED.

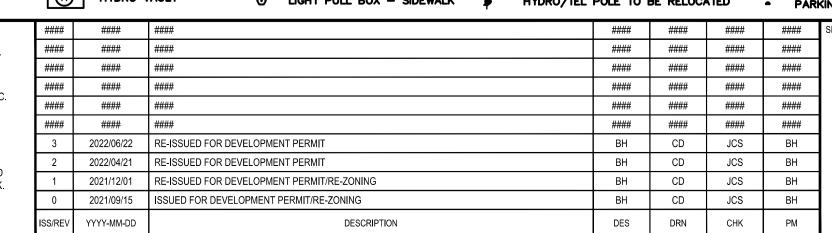



JAWL PROPERTIES LTD. 1515 Douglas St Suite 200, Victoria, BC

CLIENT REF. NO:



301-3600 Uptown Blvd Victoria BC, Canada V8Z 0B9 T+ 1 250-384-5510 F+ 1 250-386-2844 wsp.com

PROJECT:	TITLE:	
1030 FORT STREET MIXED-USE DEVELOPMENT	CONCEPTUAL CIVIL PLAN	
	DRAWING NO:	
	C01	
PROJECT NO: 211-06978-00	SHEET NO: 1 OF 2	
SCALE:	ISSUE:	ISS/REV:
1:200	RE-ISSUED FOR DEVELOPMENT PERMIT	9
DISCIPLINE: CIVIL	2022/06/22	3

