PROJECT IMAGE



DRAWING INDEX

SET LIST - ARCH DP

Sheet Number Sheet Name

COVER SHEET EXISTING SITE PLAN/SURVEY

SITE PLAN

STREETSCAPE

MAIN FLOOR PLAN A2.2 SECOND FLOOR PLAN

THIRD FLOOR PLAN **ROOF PLAN**

ELEVATIONS ELEVATIONS

BUILDING SECTIONS

BUILDING SECTIONS & AVERAGE GRADE

3D STREET VIEWS

SHADOW STUDY - WINTER SOLTICE

SHADOW STUDY - EQUINOX

SHADOW STUDY - SUMMER SOLTICE

SET LIST CIVIL - DP


Sheet Number Sheet Name

PRELIMINARY CIVIL PLAN

SET LISTLANDSCAPE - DP

Sheet Number Sheet Name

SKL.01 LANDSCAPE LAYOUT

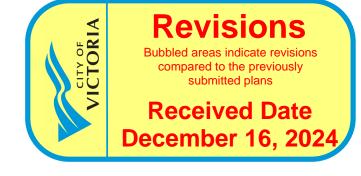

LOCATION PLAN

JOB No.: 2422



t: 250.589.5156

ARCHITECTURAL: Six Mile Furniture Continuum Architecture 519 Pandora Avenue 1652 Island Hwy, Victoria, BC V9B 1H8

Victoria, BC V8W 1N5 t: 250.388.4261 f: 250.388.9771

201 - 1515 Douglas Street Victoria, BC V8W 2G4

Nathan Dunlop

LANDSCAPE: Duane Ensing Landscape Design


t: 778.746.7417

Duan Ensing
e: duane@landscapesolutions.ca





NOT FOR CONSTRUCTION

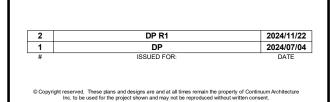


STANDARD FURNITURE DOUGLAS


COVER SHEET



2900 DOUGLAS ST, VICTORIA, BC V8T 4N4

SCALE: As indicated

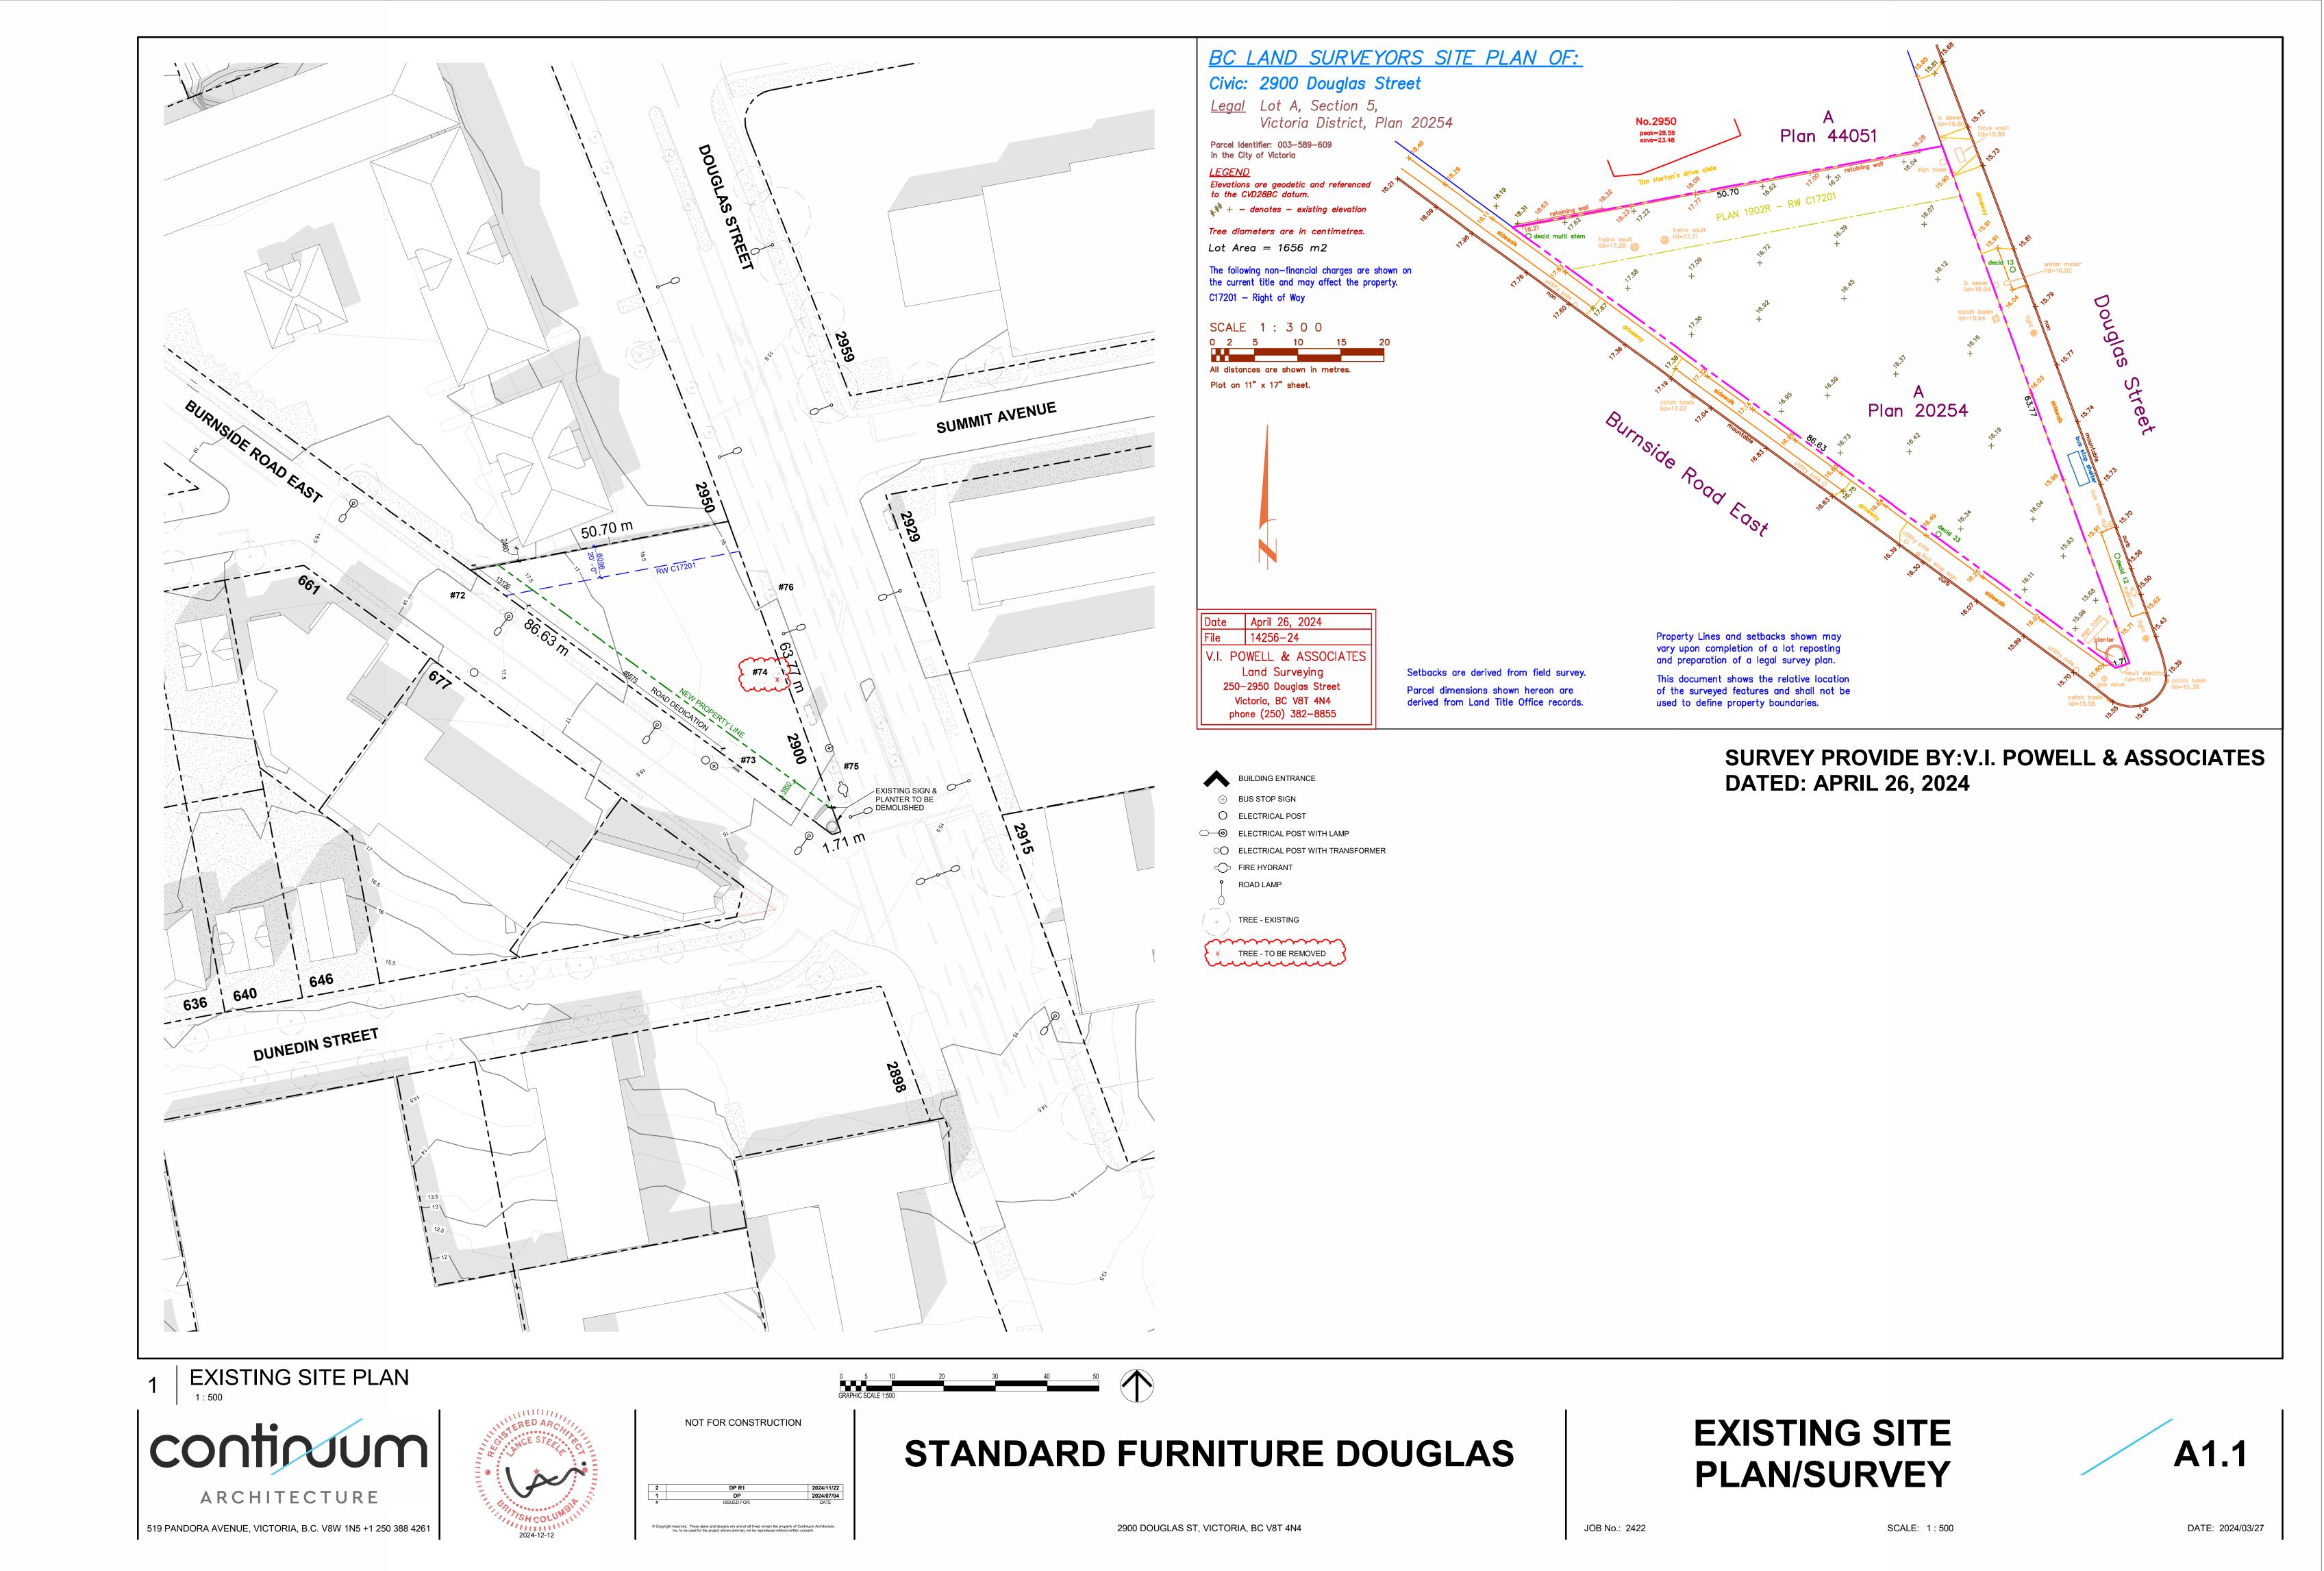

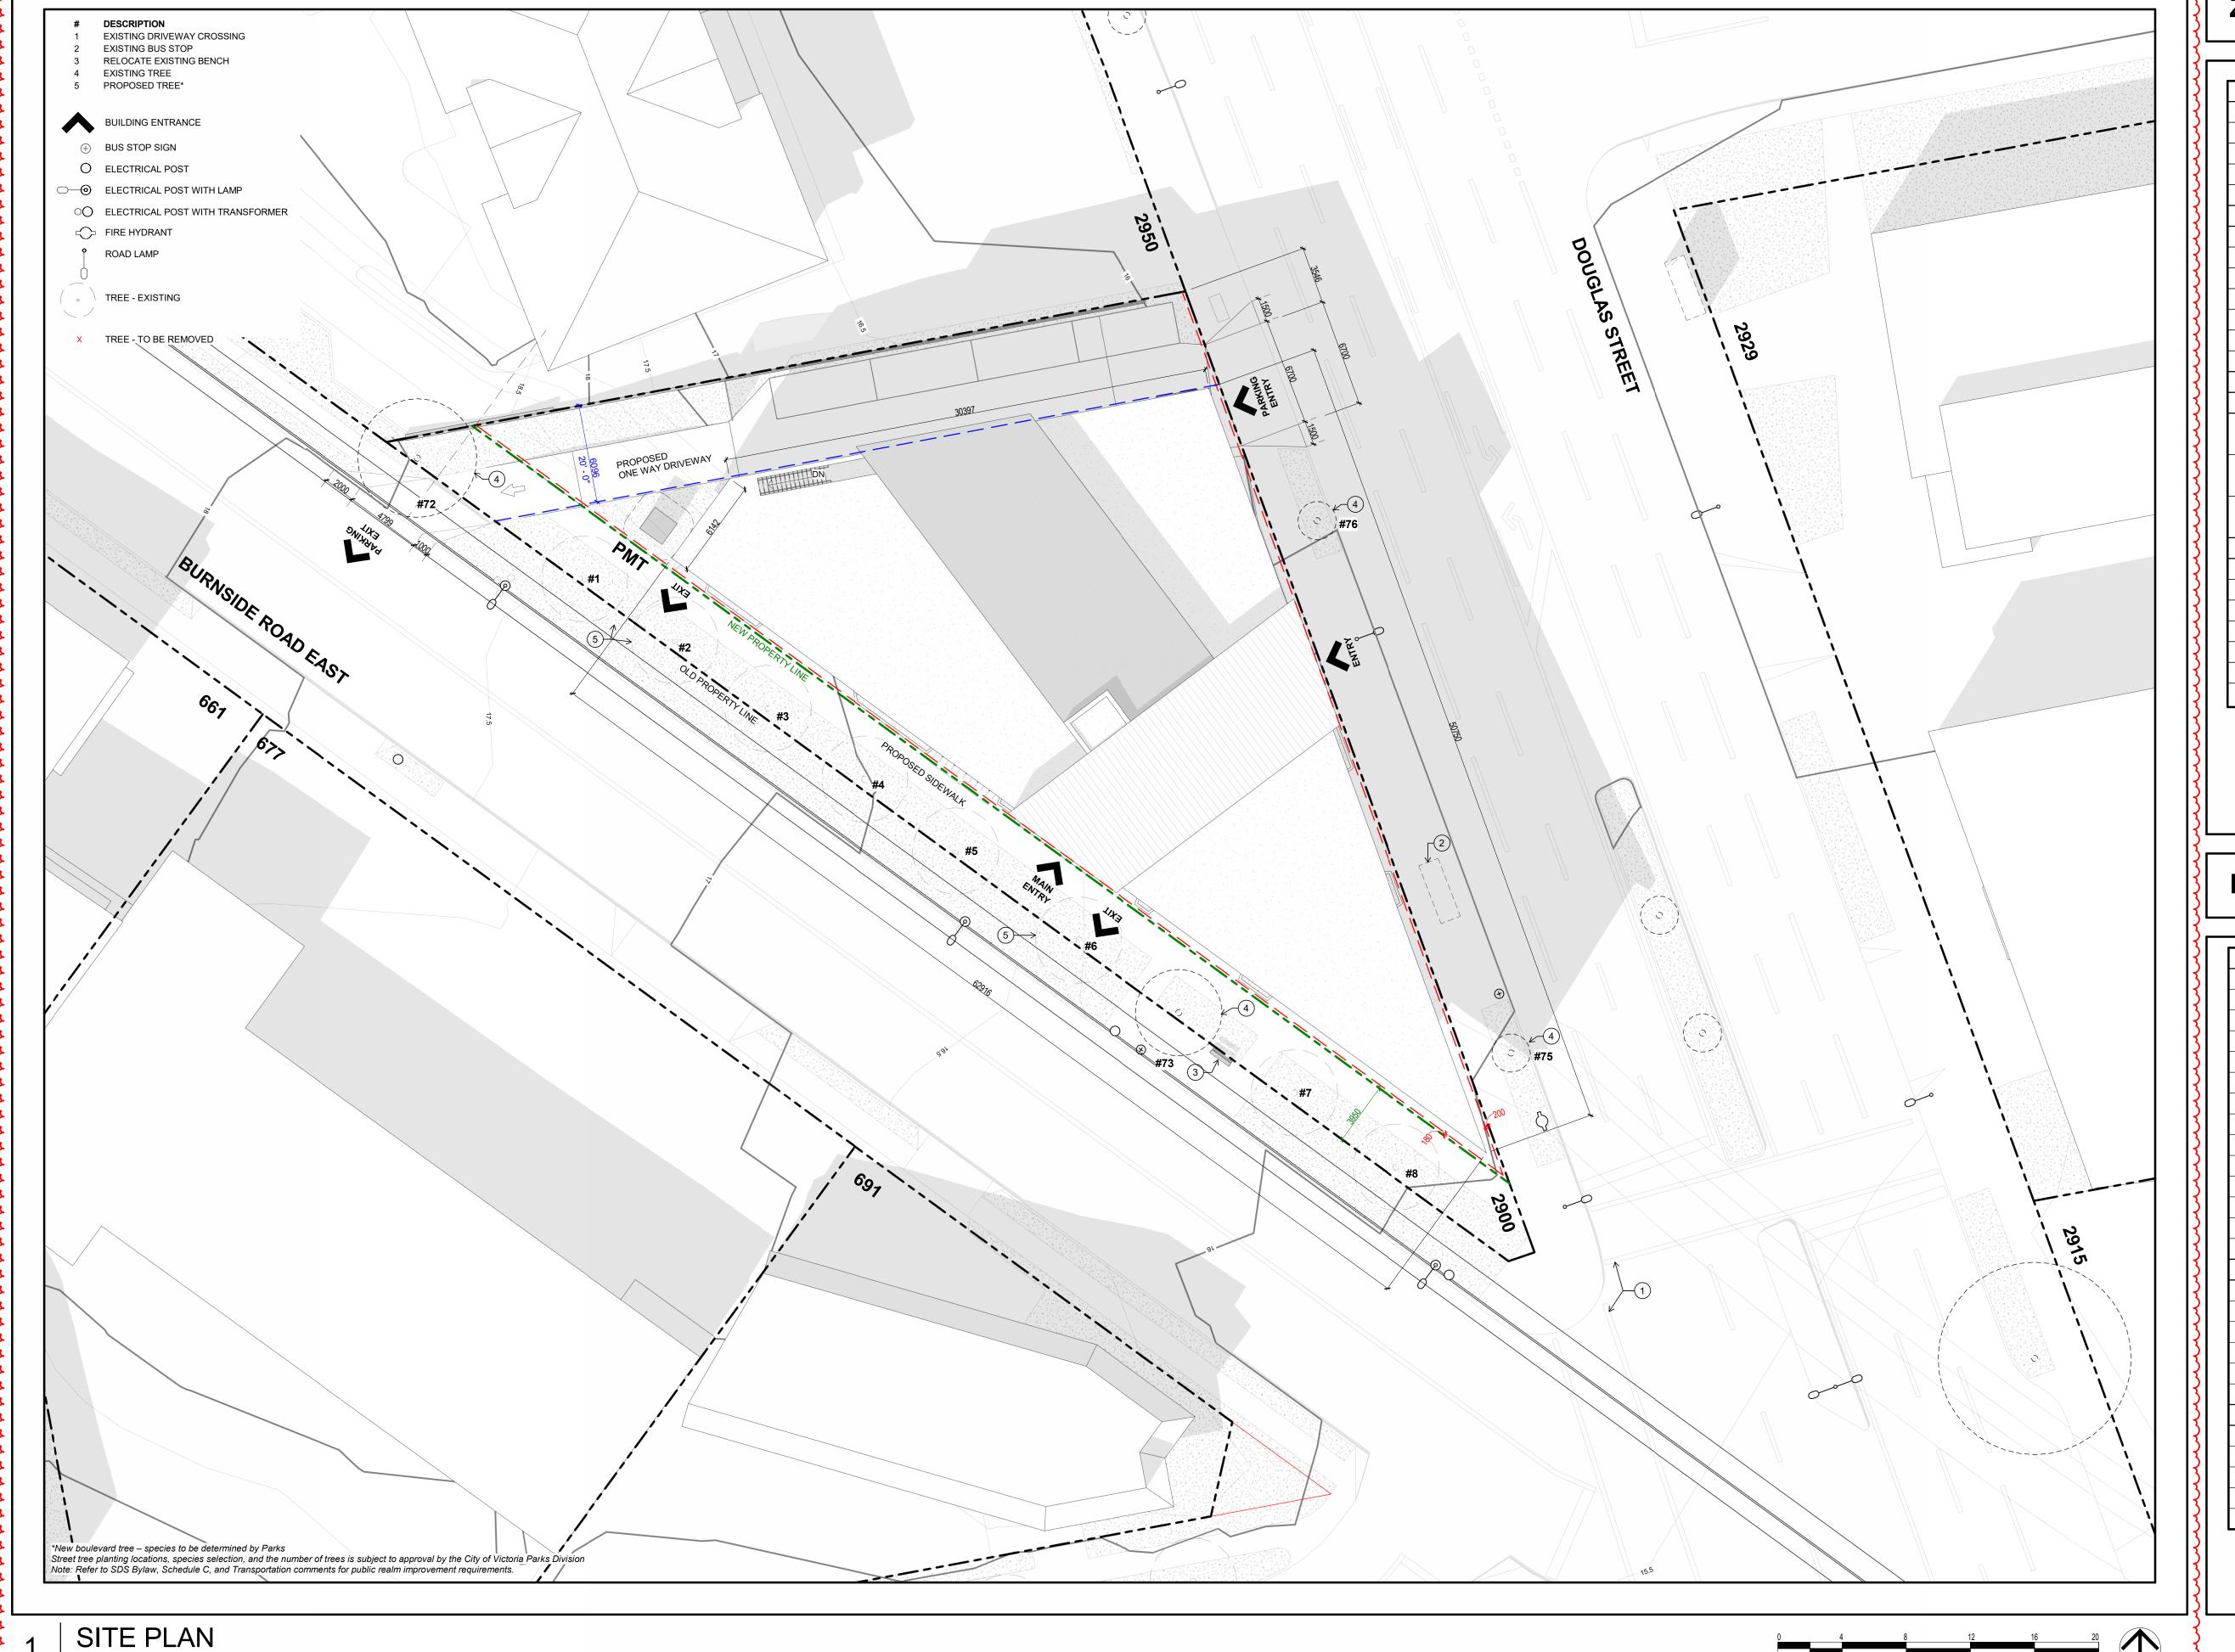

ZONING DATA

MUNICIPAL ADDRESS:	2900 DOUGLAS ST, VICTORIA, BC V8T 4N4	
LEGAL DESCRIPTION:	LOT A, SECTION 5, VICTORIA DISTRICT, PLAN VIP202	
PID:	003-589-609	
SITE AREA:	1 654m² PRE DEDICATION 1 323m² POST DEDICAT	
ZONING DATA		
CLASSIFICATION:	C-1 ZONE - LIMITED COMMERCIAL DISTRICT	
AVERAGE GRADE:	16.60 m	
	ALLOWABLE	PROPOSED
FLOOR SPACE RATIO:	1.40 / 1	1.29 / 1
TOTAL FLOOR AREA*:	1 852 m²	1 712 m ²
BUILDING HEIGHT: PRIMARY	12 m	11.97 m
SECONDARY	12 m	} 14.27 m }
		~~~
SETBACKS	REQUIRED	PROVIDED
STREET LINE (DOUGLAS ST):	6 m	0.2 m
STREET LINE (BURNSIDE RD EAST):	6 m	0.18 m
INTERNAL LOT LINE (ABUT ON NON RES):	0 m	0 m
PARKING	REQUIRED	PROVIDED
TOTAL PARKING:	46 (1 / 37.5 m²)	£ 13
STANDARD PARKING:	48	11 }
ACCES. PARKING:	1	1
VAN ACCES. PARKING:	1	1
BICYCLE PARKING (LONG TERM):	9 (1 / 200 m²)	10
BICYCLE PARKING (SHORT TERM):	9 (1 / 200 m²)	9

* DEFINITION CITY OF VICTORIA:

AREA: MEANS THE ENTIRE AREA WHICH IN PLAN IS ENCLOSED BY THE INTERIOR FACE OF THE EXTERIOR WALLS OF THE
STOREY AT FLOOR LEVEL PLUS THE AREA ENCLOSED BY ANY CANTILEVERED ELEMENT THAT IS WITHIN THAT
STOREY AND THAT IS ABOVE FLOOR LEVEL, BUT DOES NOT INCLUDE OF THE FOLLOWING AREAS:


A) THE AREA USED OR INTENDED TO BE USED FOR REQUIRED PARKING OR MOVEMENT OF MOTOR VEHICLES, AS A) THE AREA USED OR INTENDED TO BE USED FOR REQUIRED PARKING OR MOVEMENT OF MOTOR VEHICLES, AS SET OUT IN THIS BYLAW, WHICH IS CALCULATED STARTING FROM THE LOWEST LEVEL OF THE BUILDING;
B) THE AREA USED OR INTENDED TO BE USED FOR REQUIRED BICYCLE PARKING, LONG-TERM, AS SET OUT IN THIS BYLAW, WHICH IS CALCULATED STARTING FROM THE LOWEST LEVEL OF THE BUILDING;
C) THE AREA OR AREAS OF BALCONIES, EXPOSED DECKS, PATIOS OR ROOFS; AND
D) THE AREA OF ELEVATOR SHAFTS.

### **BUILDING CODE DATA**

Total Floor Area:	1 677 m ²	
Building Type:	MERCANTILE OCCUPANCIES	
Group:	GROUP E	
Occupancy Classification:	3.2.2.69 - 3 Storeys	
Max Building Area:	2 400 m²	
Floor & Supporting Structure Rating:	45 min	
Construction Type:	Noncombustible	
Occupancy Separations:	N/A	
Sprinklered:	Yes	
Building Area*:	1 991 m²	
Floor Area*:	1 710 m²	
Max Travel Distance:	45 m (3.4.2.5c)	
BCBC Part:	3	
Occupant load:		
Mercantile uses - First storeys (3.70)	86 people	
Mercantile uses - Other storeys (5.60)	216 people	
Business - Offices (9.30)	7 people	
Other Uses - Storage (46)	2 people	
Total Occupant Load	311 people	
WC required:		
Mercantile (3.7.2.2.11) :	REQUIRED	PROVIDED
Male (1 WC / 300 Males):	1	1
Female (1 WC / 150 Females):	2	2
Office (3.7.2.2.2) :		
Occupant load < 10 (1 Mix):	1	1

BUILDING AREA: MEANS THE GREATEST HORIZONTAL AREA OF A BUILDING ABOVE GRADE WITHIN THE OUTSIDE SURFACE OF EXTERIOR WALLS AND THE CENTRE LINE OF

FLOOR AREA: MEANS THE SPACE ON ANY STOREY OF A BUILDING BETWEEN EXTERIOR WALLS AND REQUIRED FIREWALLS, INCLUDING THE SPACE OCCUPIED BY INTERIOR WALLS AND PARTITIONS, BUT NOT INCLUDING

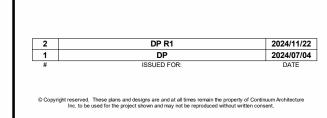

STANDARD FURNITURE DOUGLAS


SITE PLAN

SCALE: As indicated



ARCHITECTURE

### **STREETSCAPES**

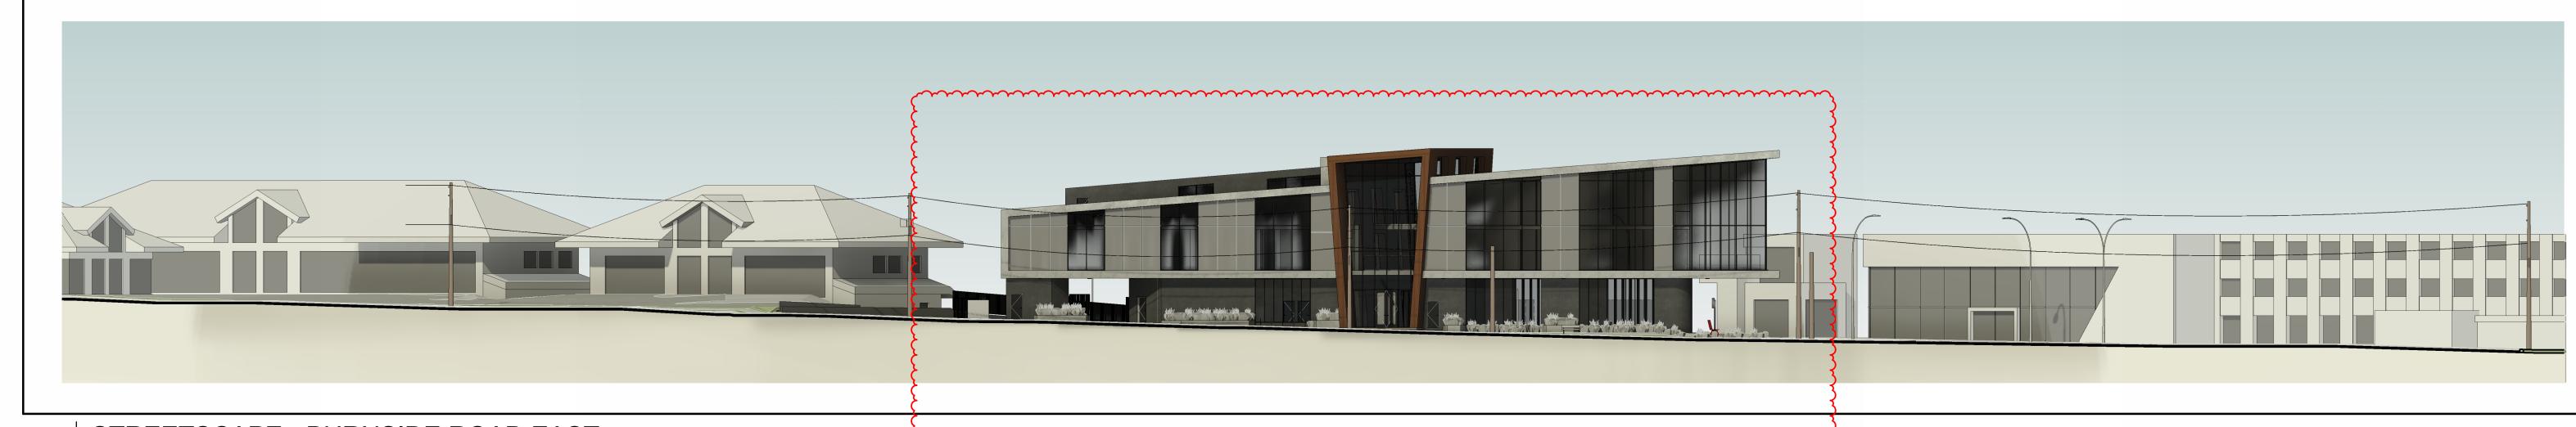


1 STREETSCAPE - BURNSIDE ROAD EAST



2 STREETSCAPE - DOUGLAS STREET


#### **NEIGHBOURING BUILDINGS PHOTOGRAPHS**

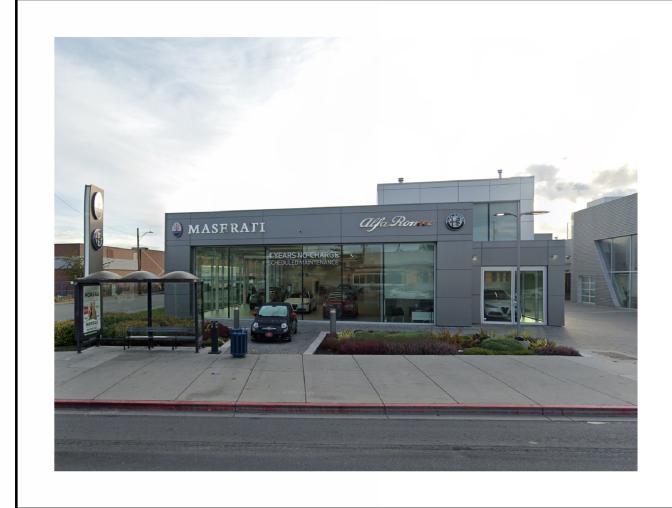







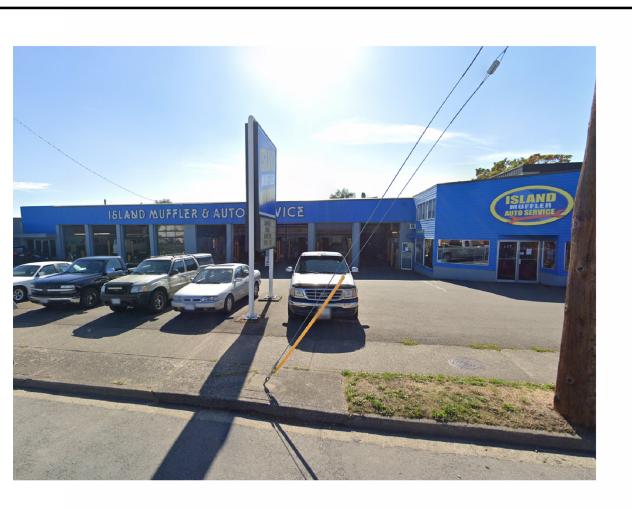

2929 DOUGLAS STREET

2929 DOUGLAS STREET

2950 DOUGLAS STREET

677 BURNSIDE ROAD EAST


691 BURNSIDE ROAD EAST

CONTINUM

ARCHITECTURE

519 PANDORA AVENUE, VICTORIA, B.C. V8W 1N5 +1 250 388 4261



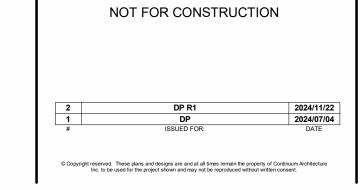

STANDARD FURNITURE DOUGLAS


**STREETSCAPE** 

A1.3

2900 DOUGLAS ST, VICTORIA, BC V8T 4N4

JOB No.: 2422

SCALE: 1:250 DATE: 2024/03/27

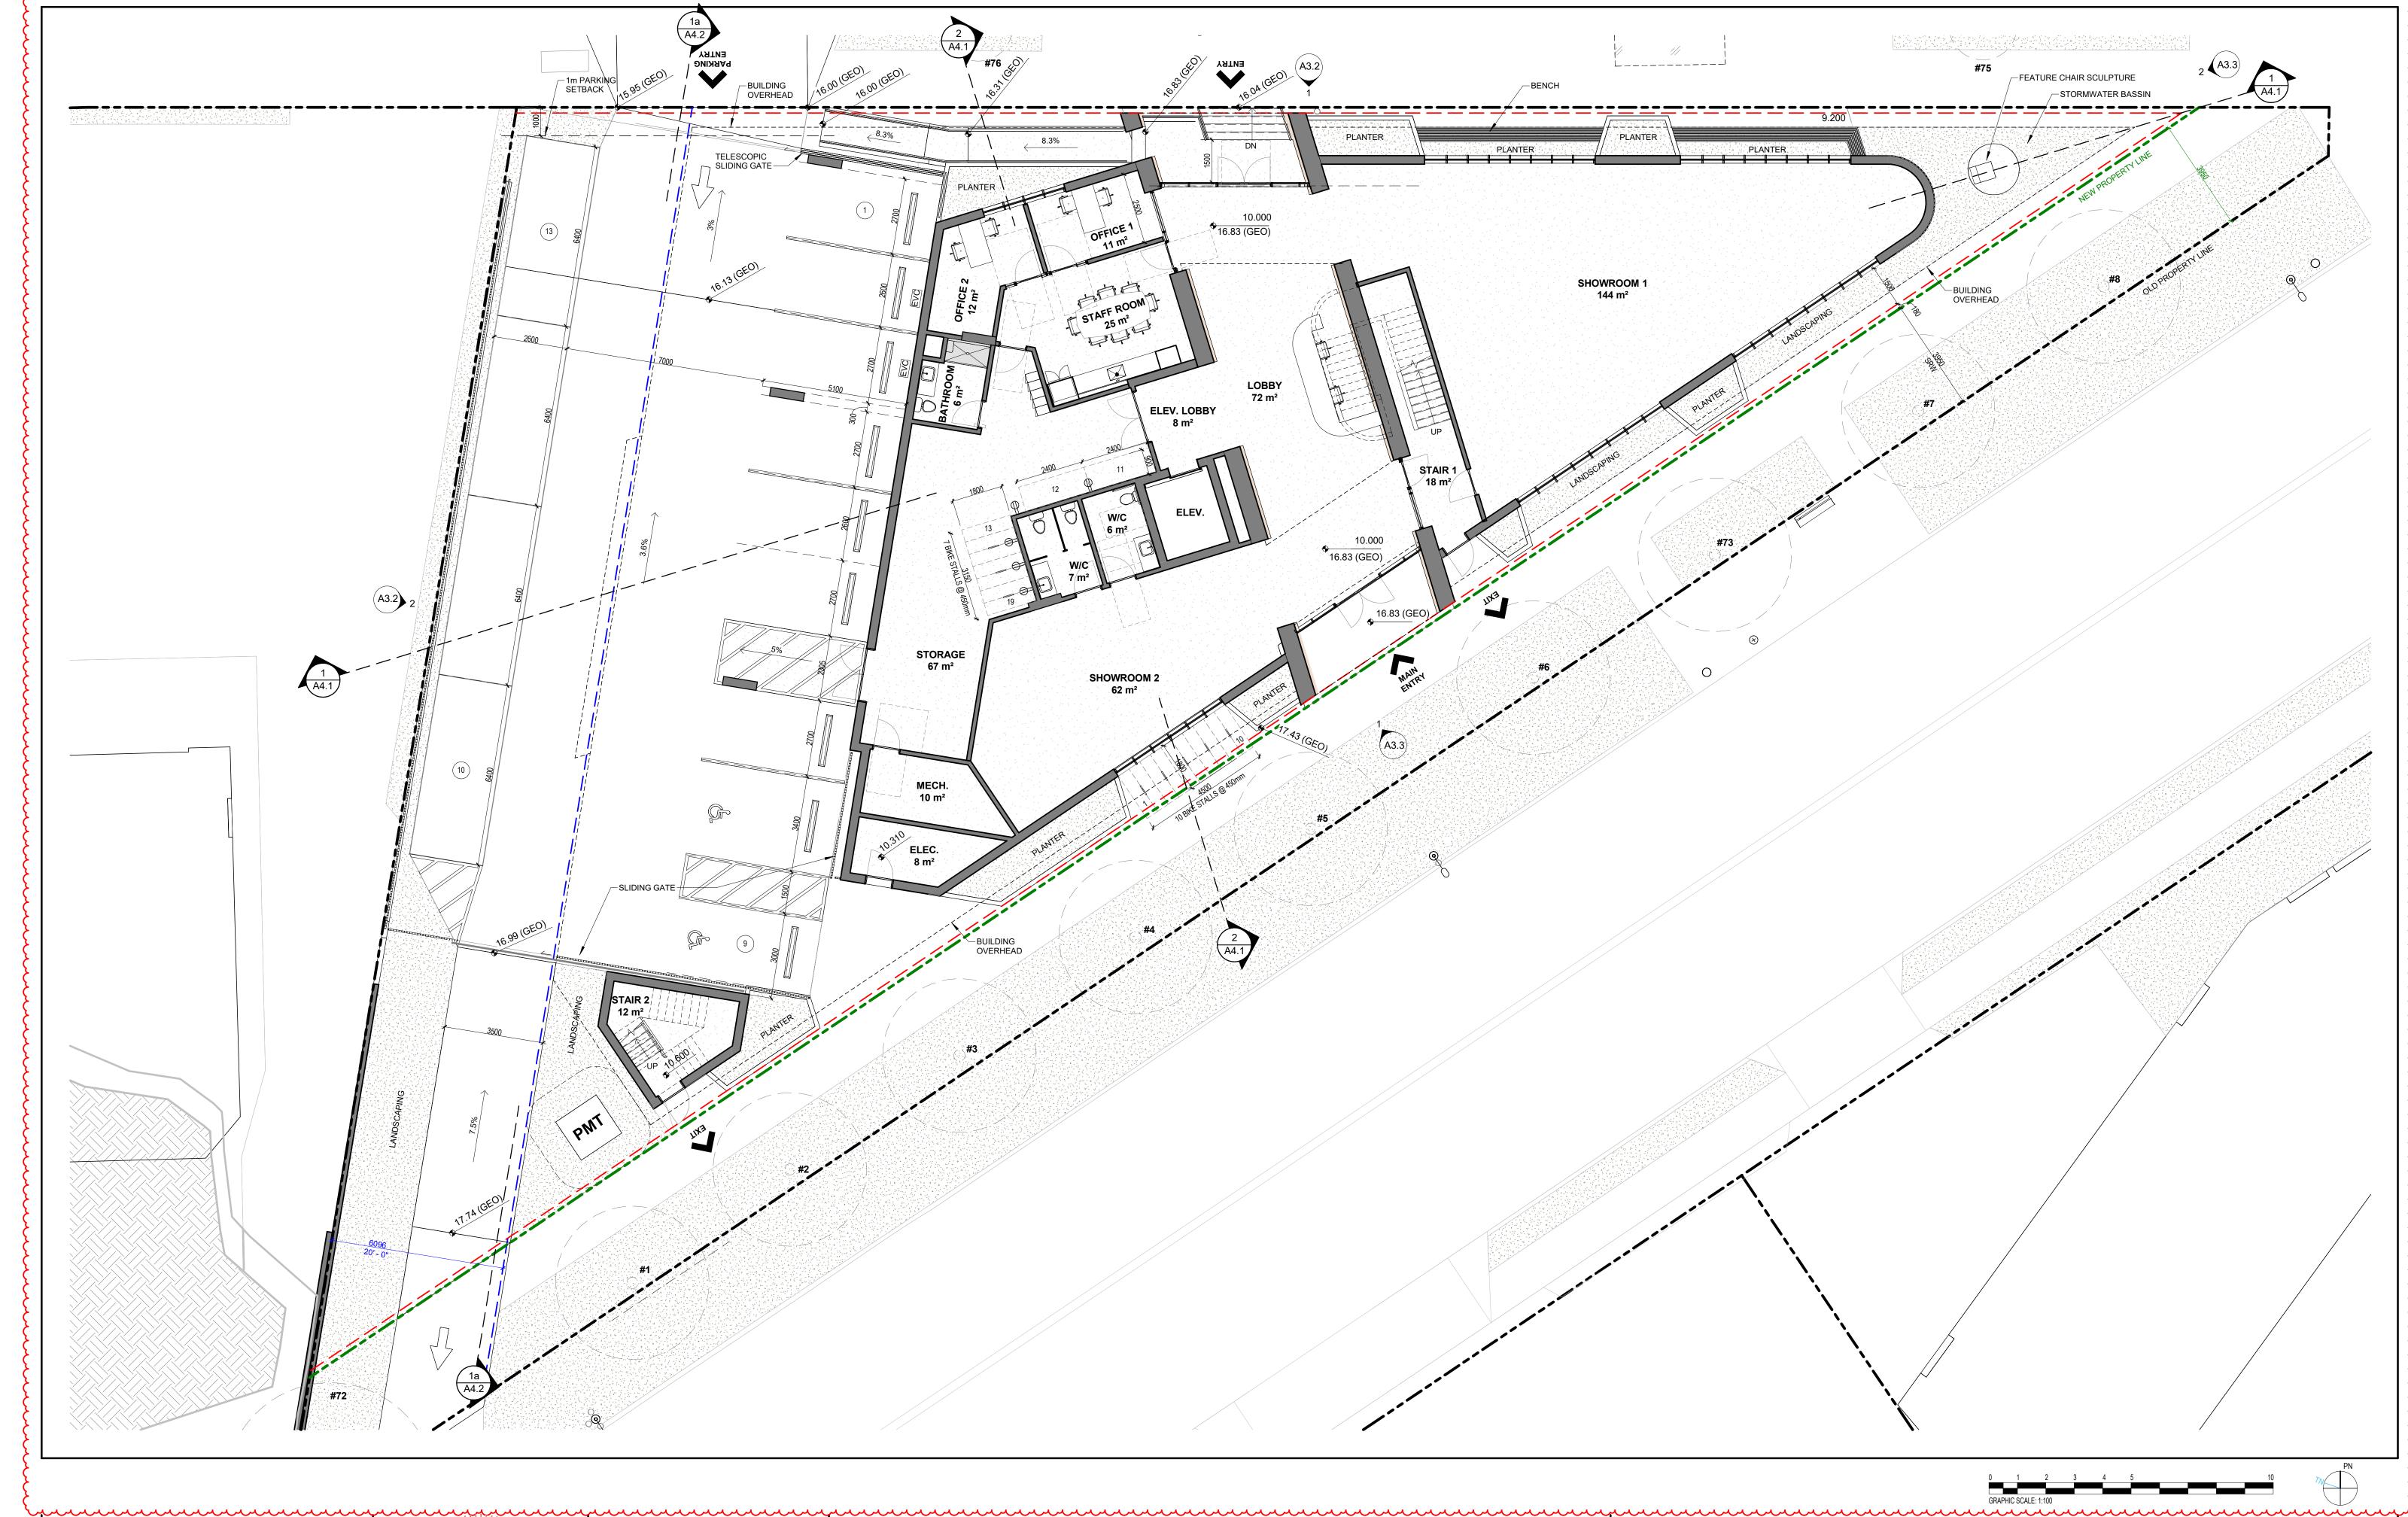

 $egree^{-1}
egree^{-1}
egree^{-$ 





NOT FOR CONSTRUCTION


STANDARD FURNITURE DOUGLAS

MAIN FLOOR PLAN

**A2.1** 

2900 DOUGLAS ST, VICTORIA, BC V8T 4N4

JOB No.: 2422

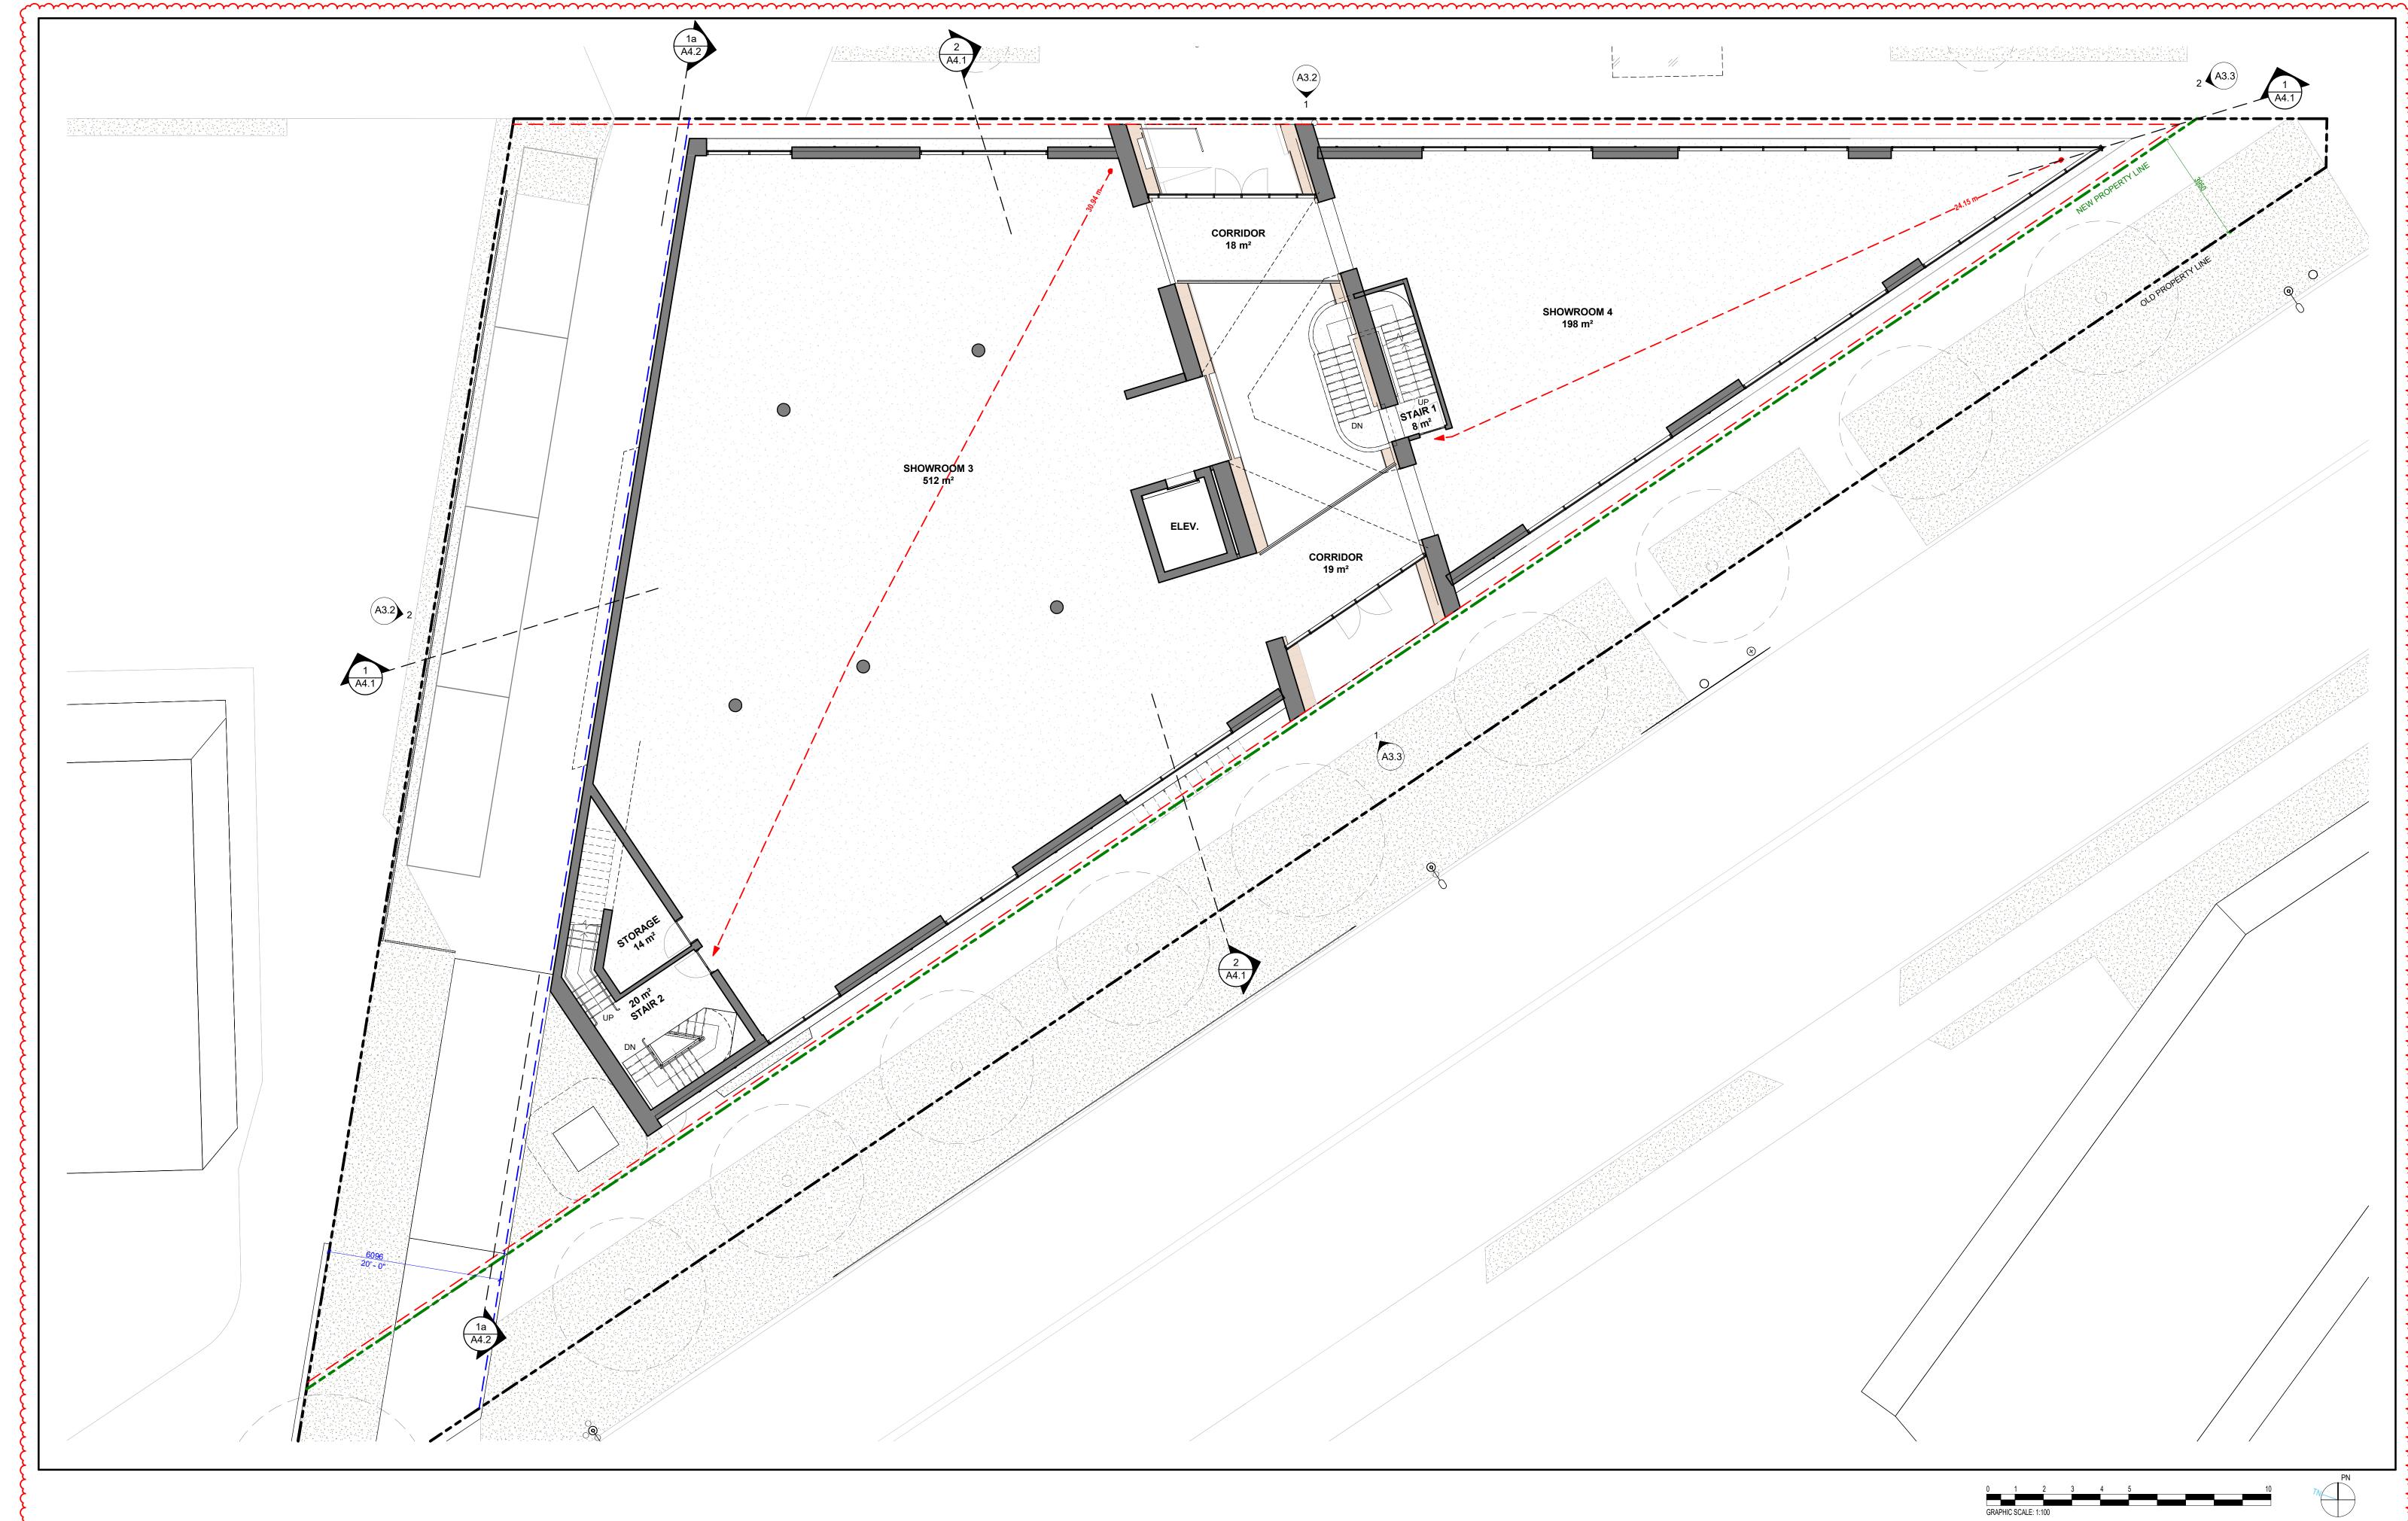





NOT FOR CONSTRU


STANDARD FURNITURE DOUGLAS

SECOND FLOOR PLAN

A2.2

2900 DOUGLAS ST, VICTORIA, BC V8T 4N4

422

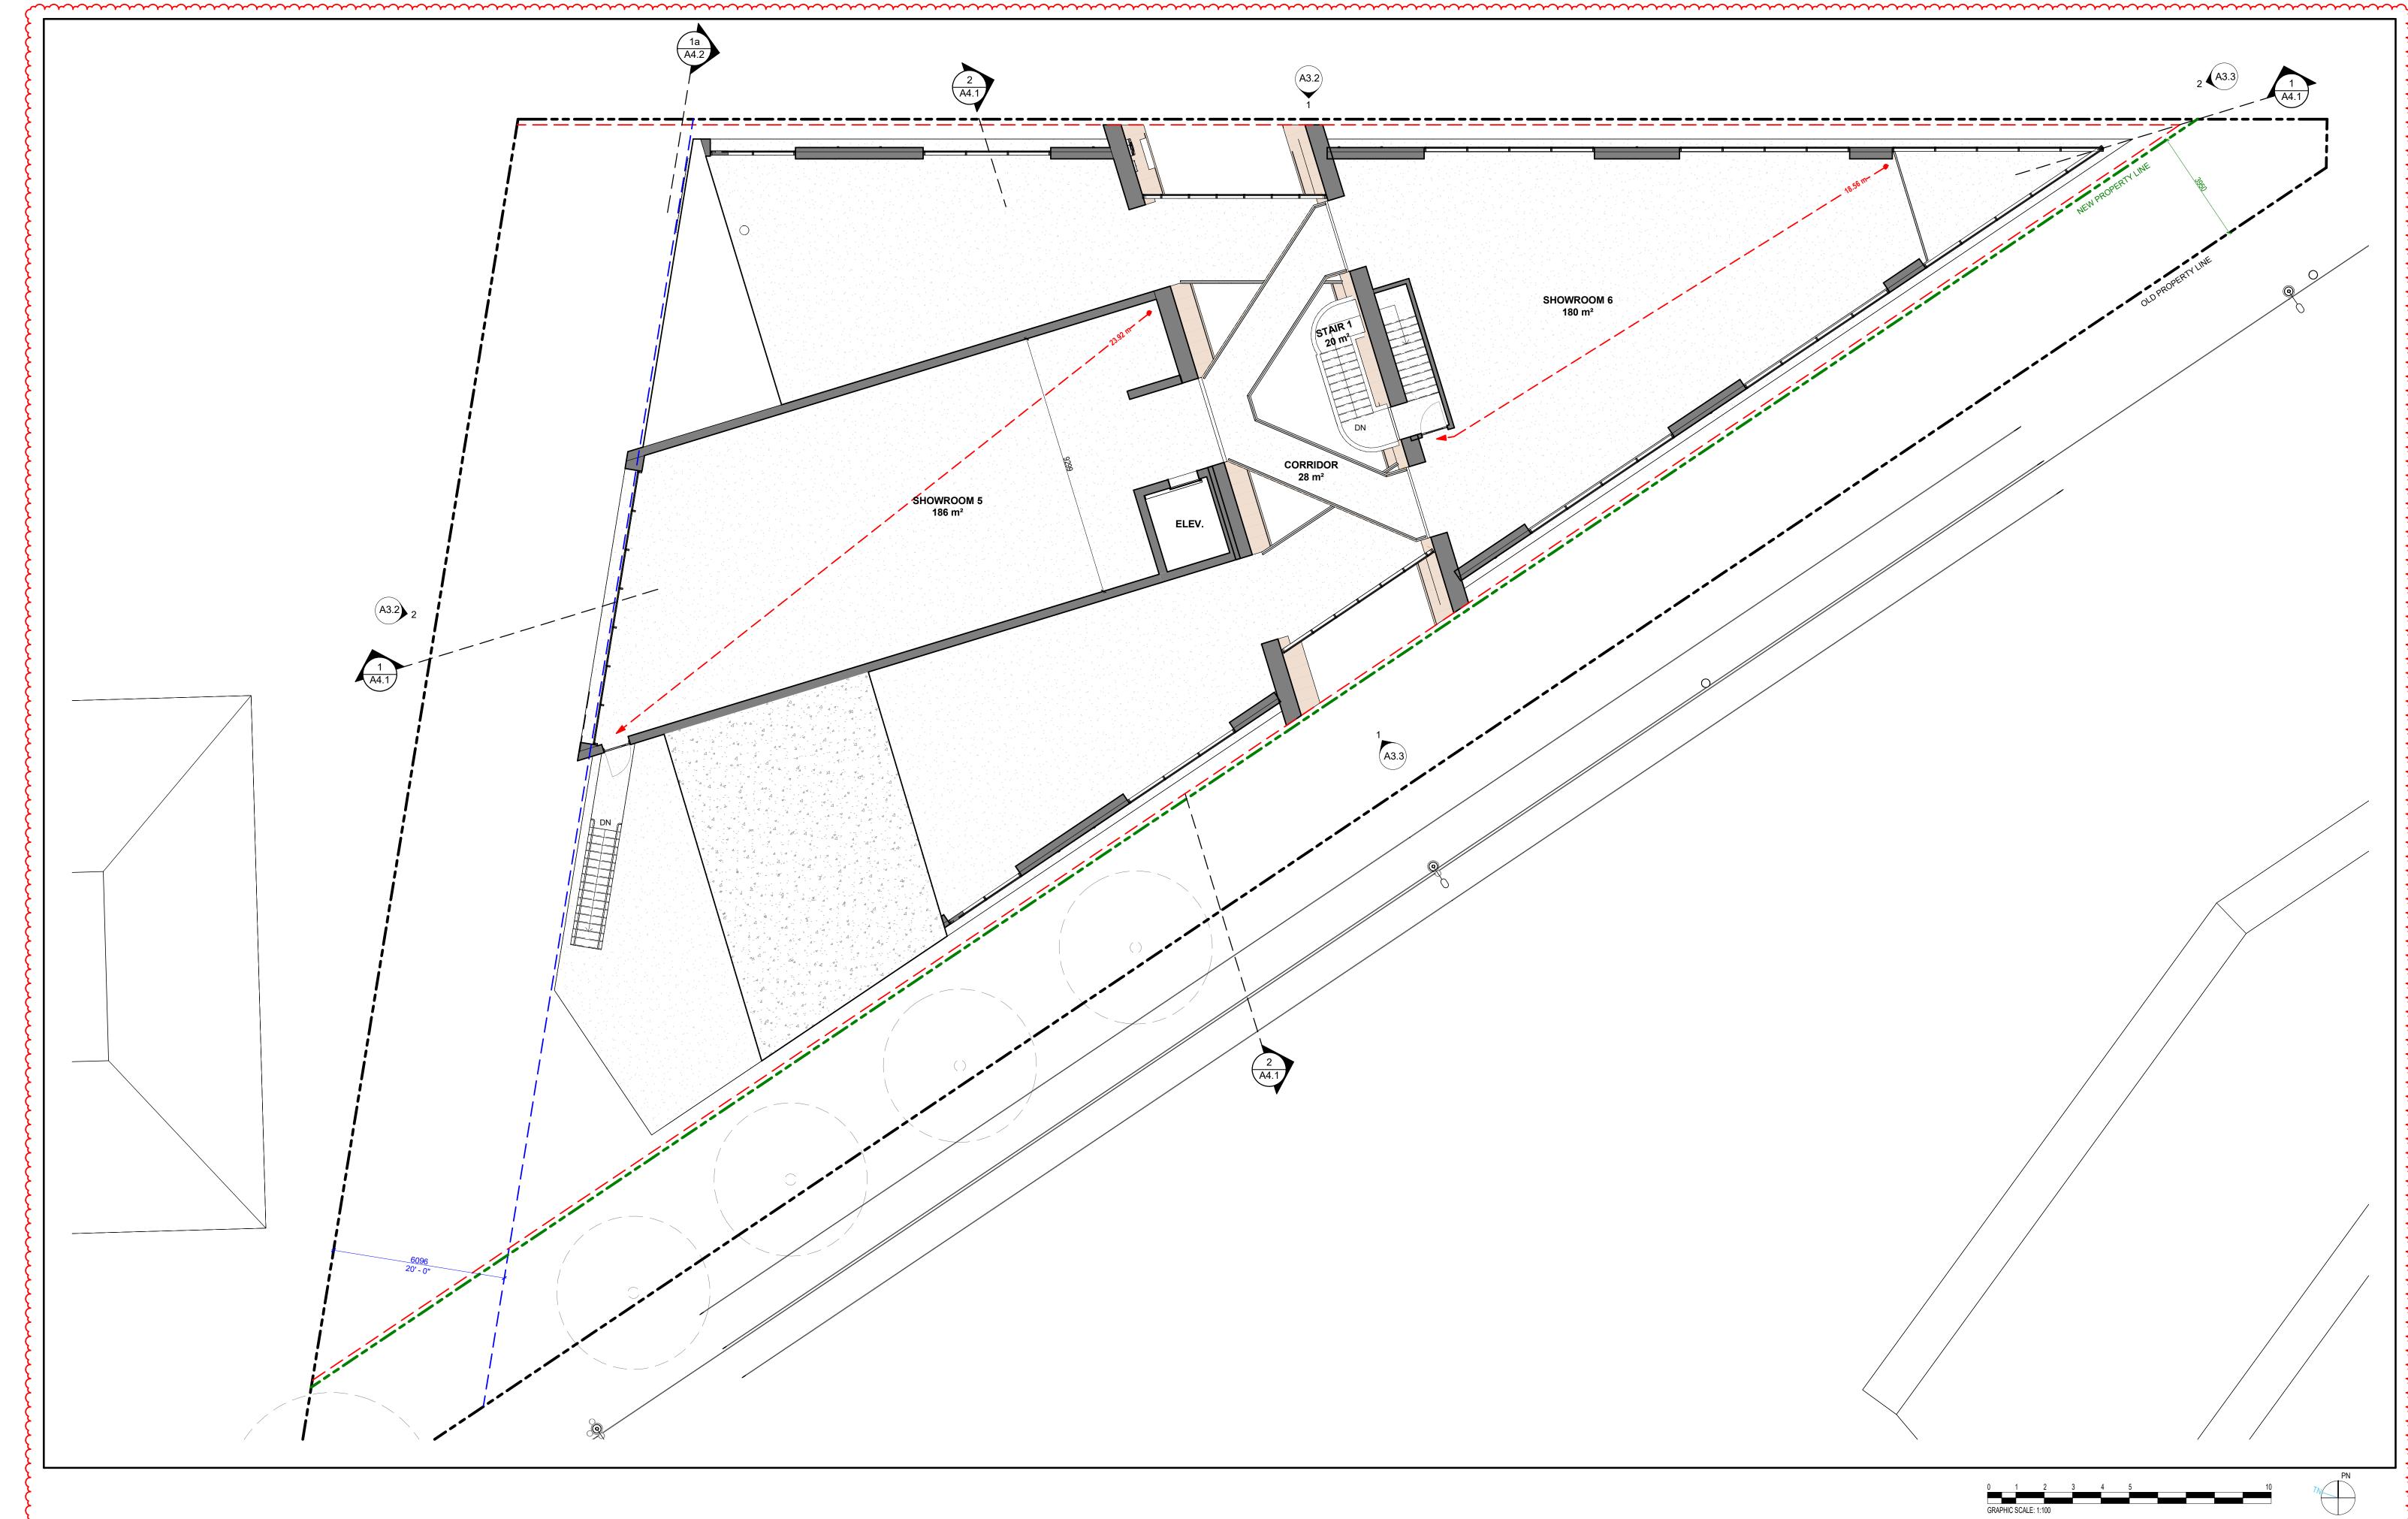






# STANDARD FURNITURE DOUGLAS

THIRD FLOOR PLAN

**A2.3** 

2900 DOUGLAS ST, VICTORIA, BC V8T 4N4

JOB No.: 2422

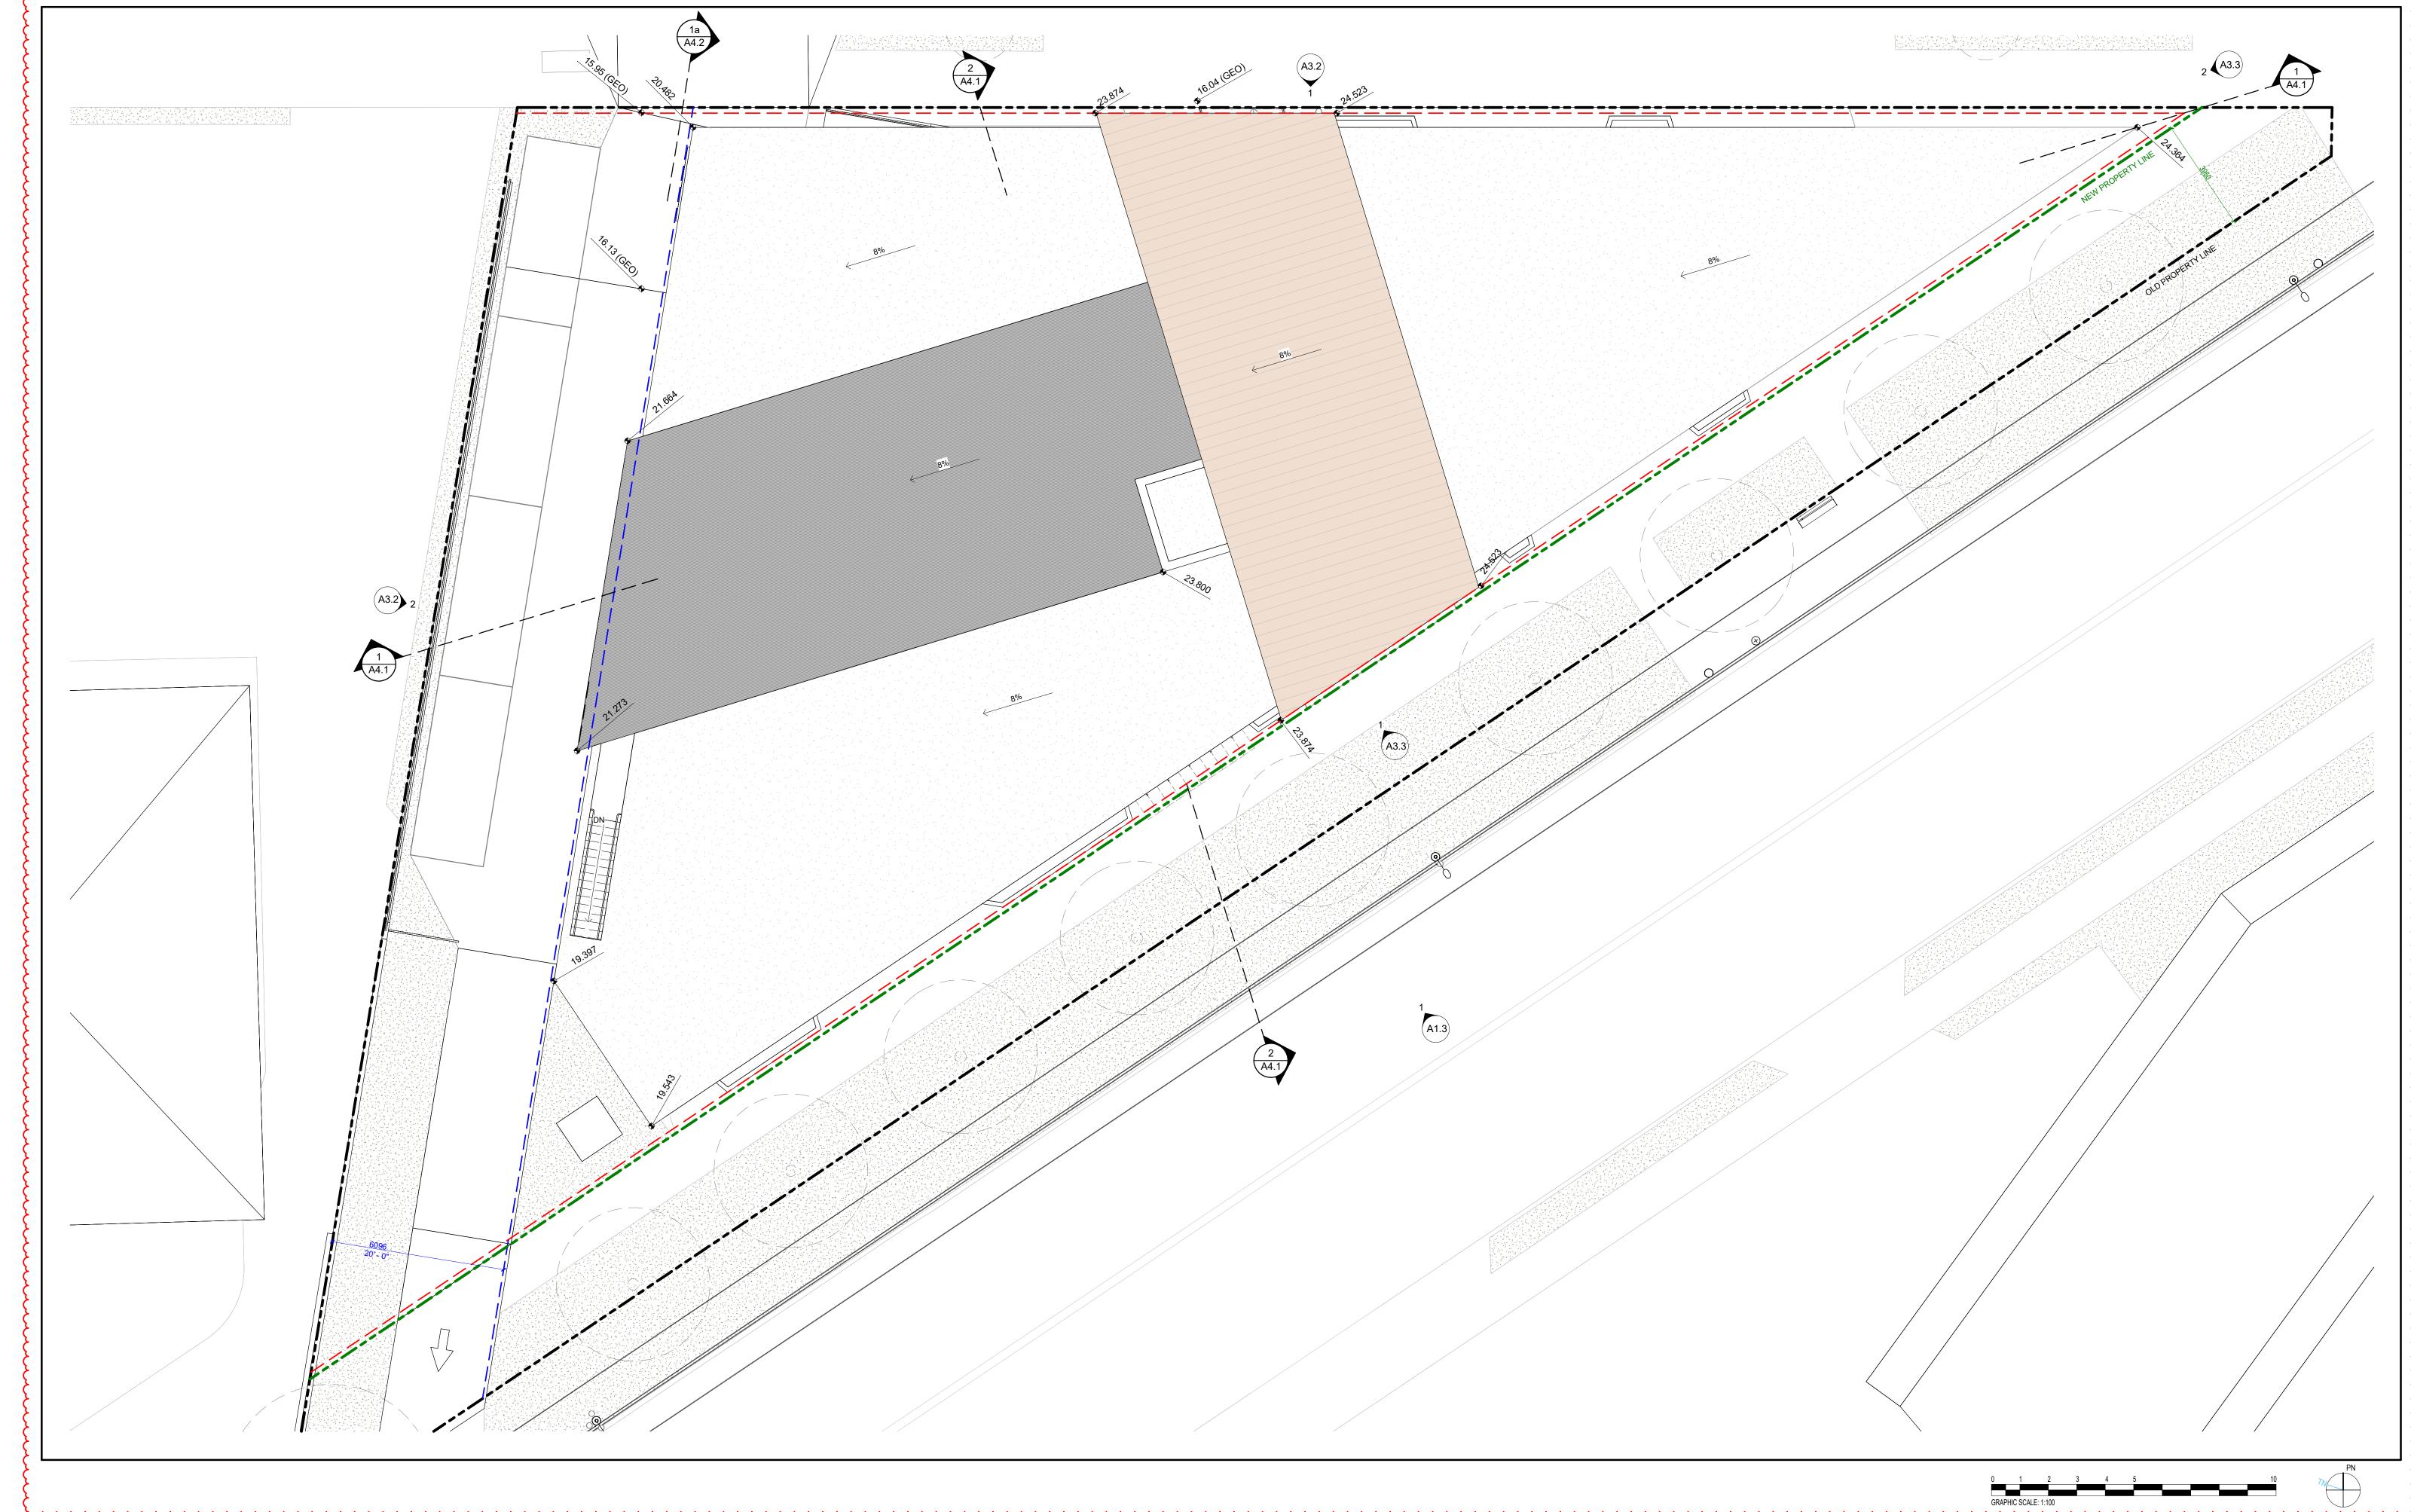





NOT FOR CONSTRUC


STANDARD FURNITURE DOUGLAS

**ROOF PLAN** 


**A2.4** 

2900 DOUGLAS ST, VICTORIA, BC V8T 4N4

JOB No.: 2422

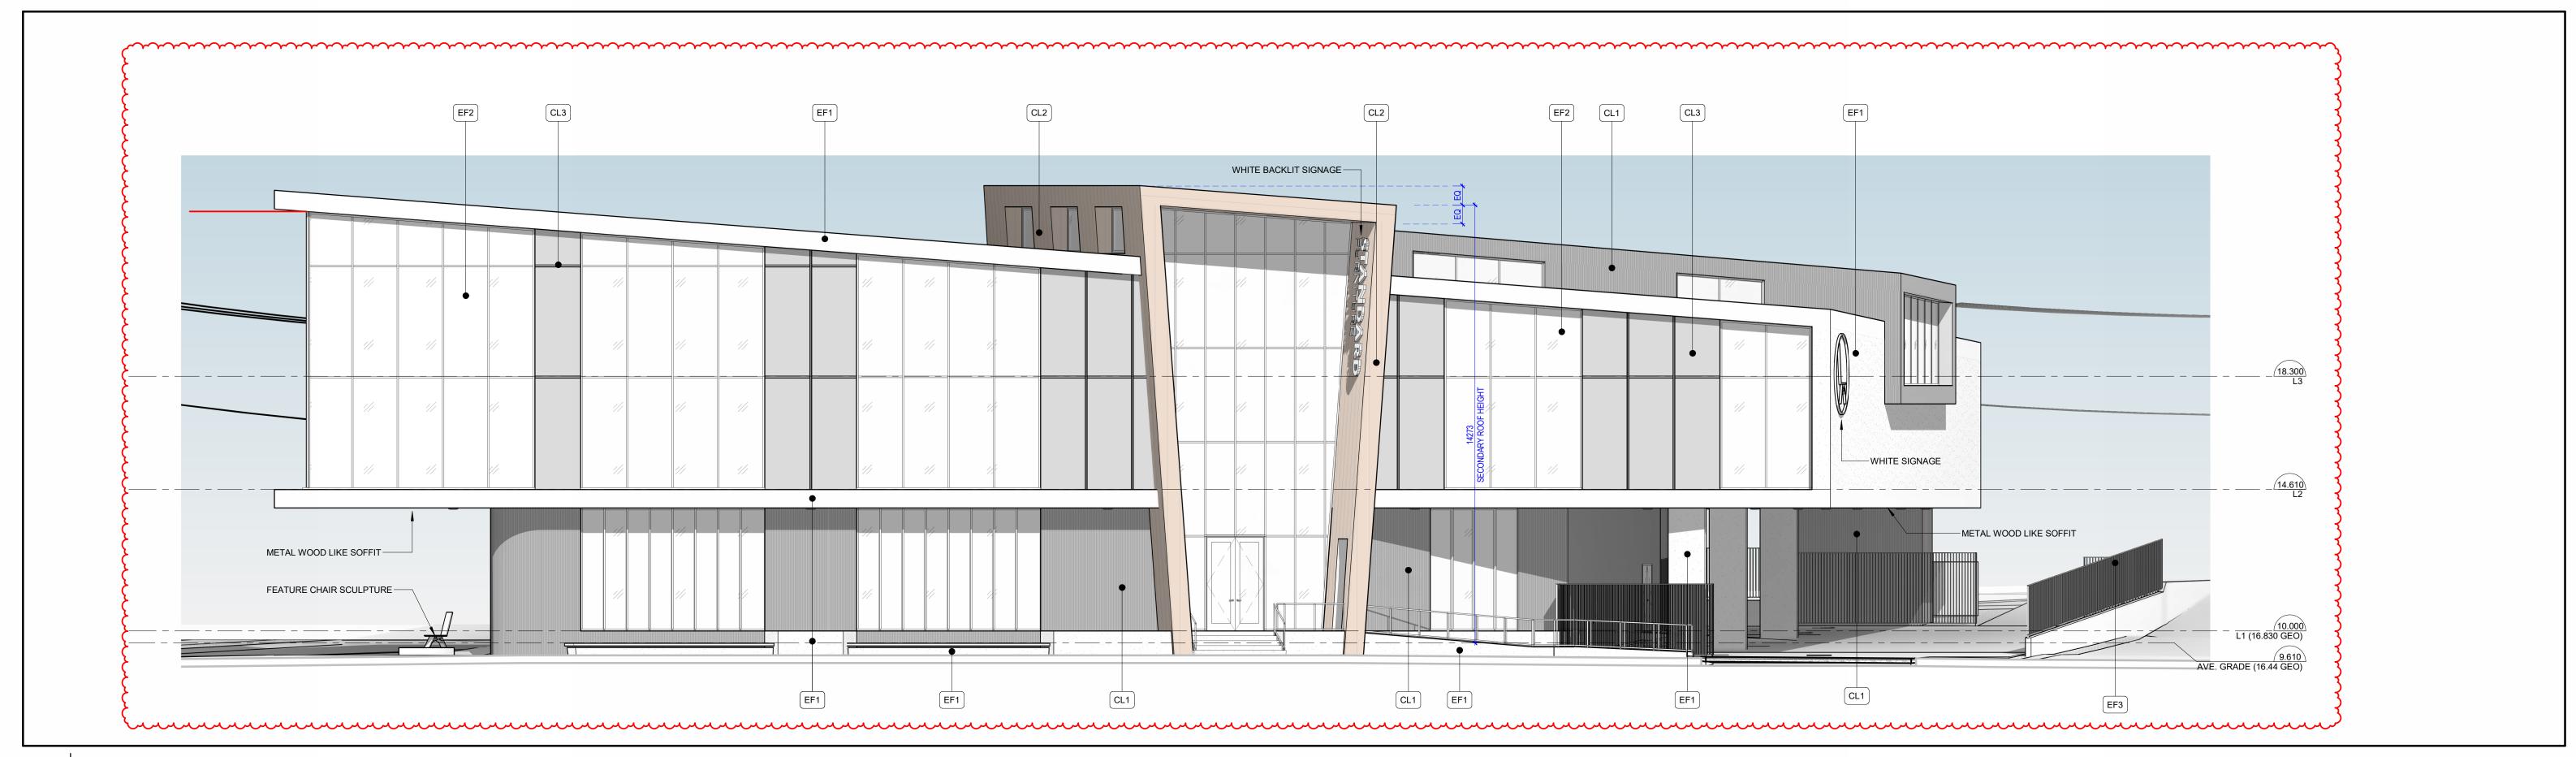

1 EXTERIOR ELEVATION - TRUE EAST

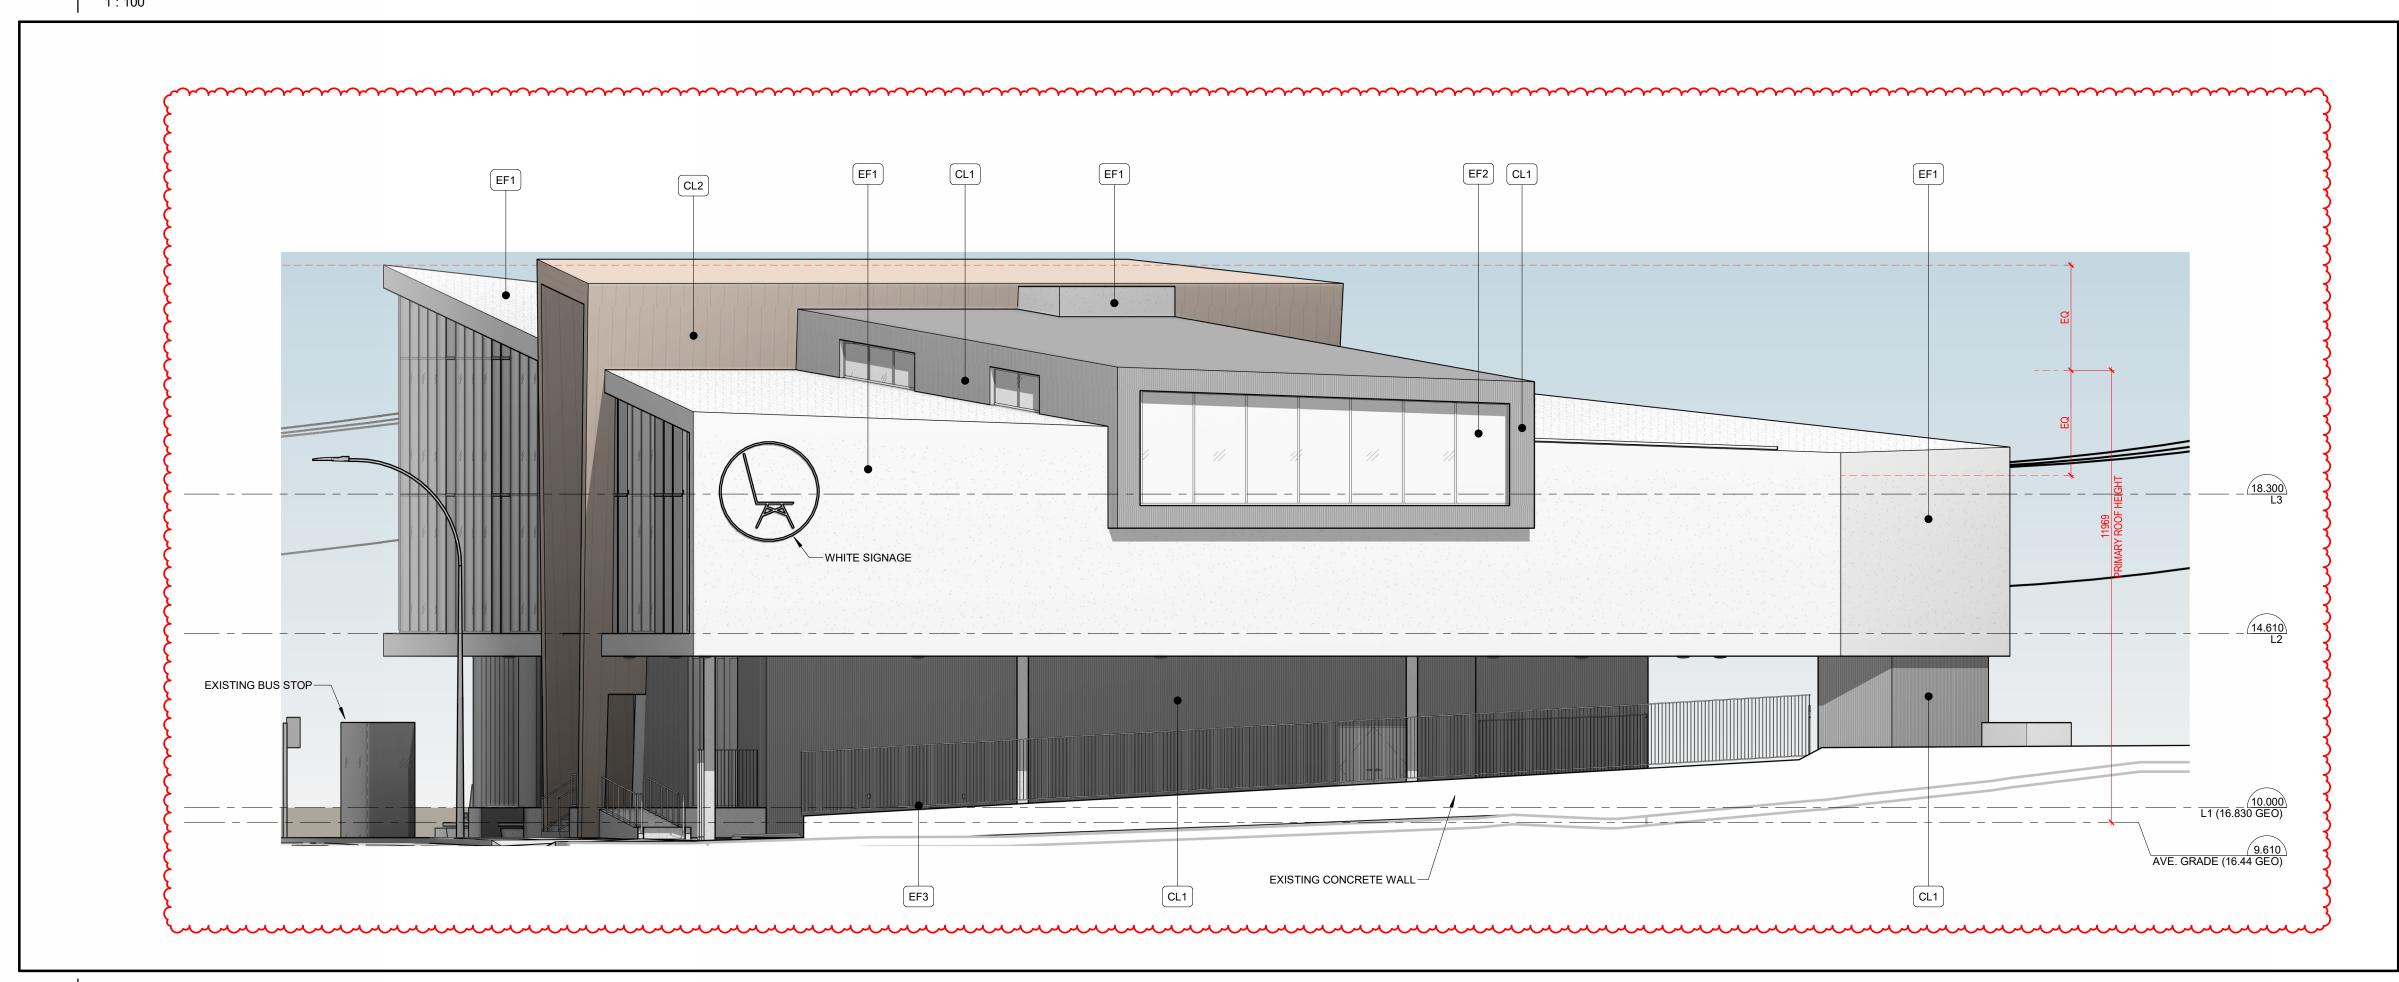



### **ELEVATION KEY NOTES**



2 EXTERIOR ELEVATION - TRUE NORTH



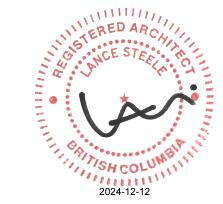

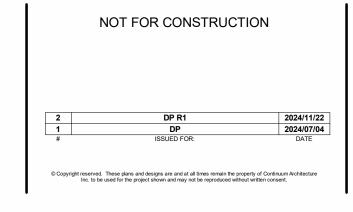

STANDARD FURNITURE DOUGLAS


**ELEVATIONS** 

A3.2


2900 DOUGLAS ST, VICTORIA, BC V8T 4N4

JOB No.: 2422

SCALE: As indicated

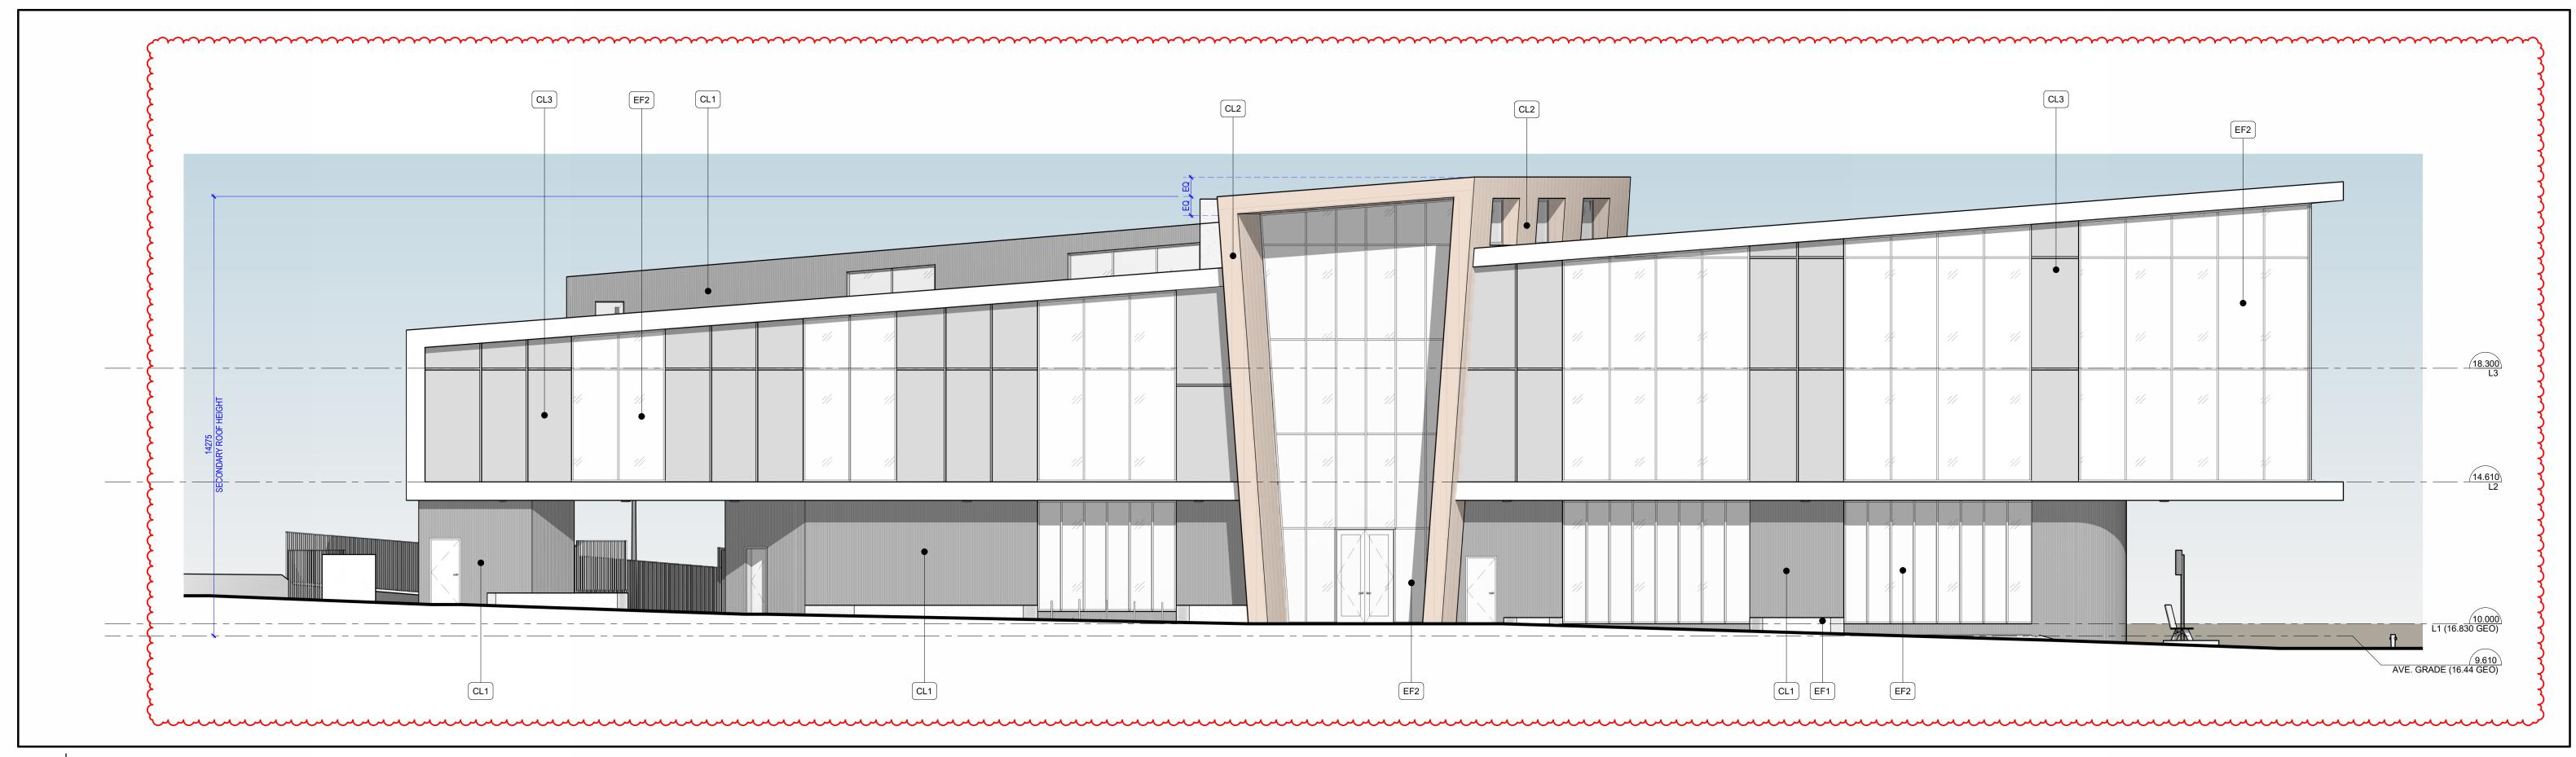



## 1 EXTERIOR ELEVATION - TRUE WEST

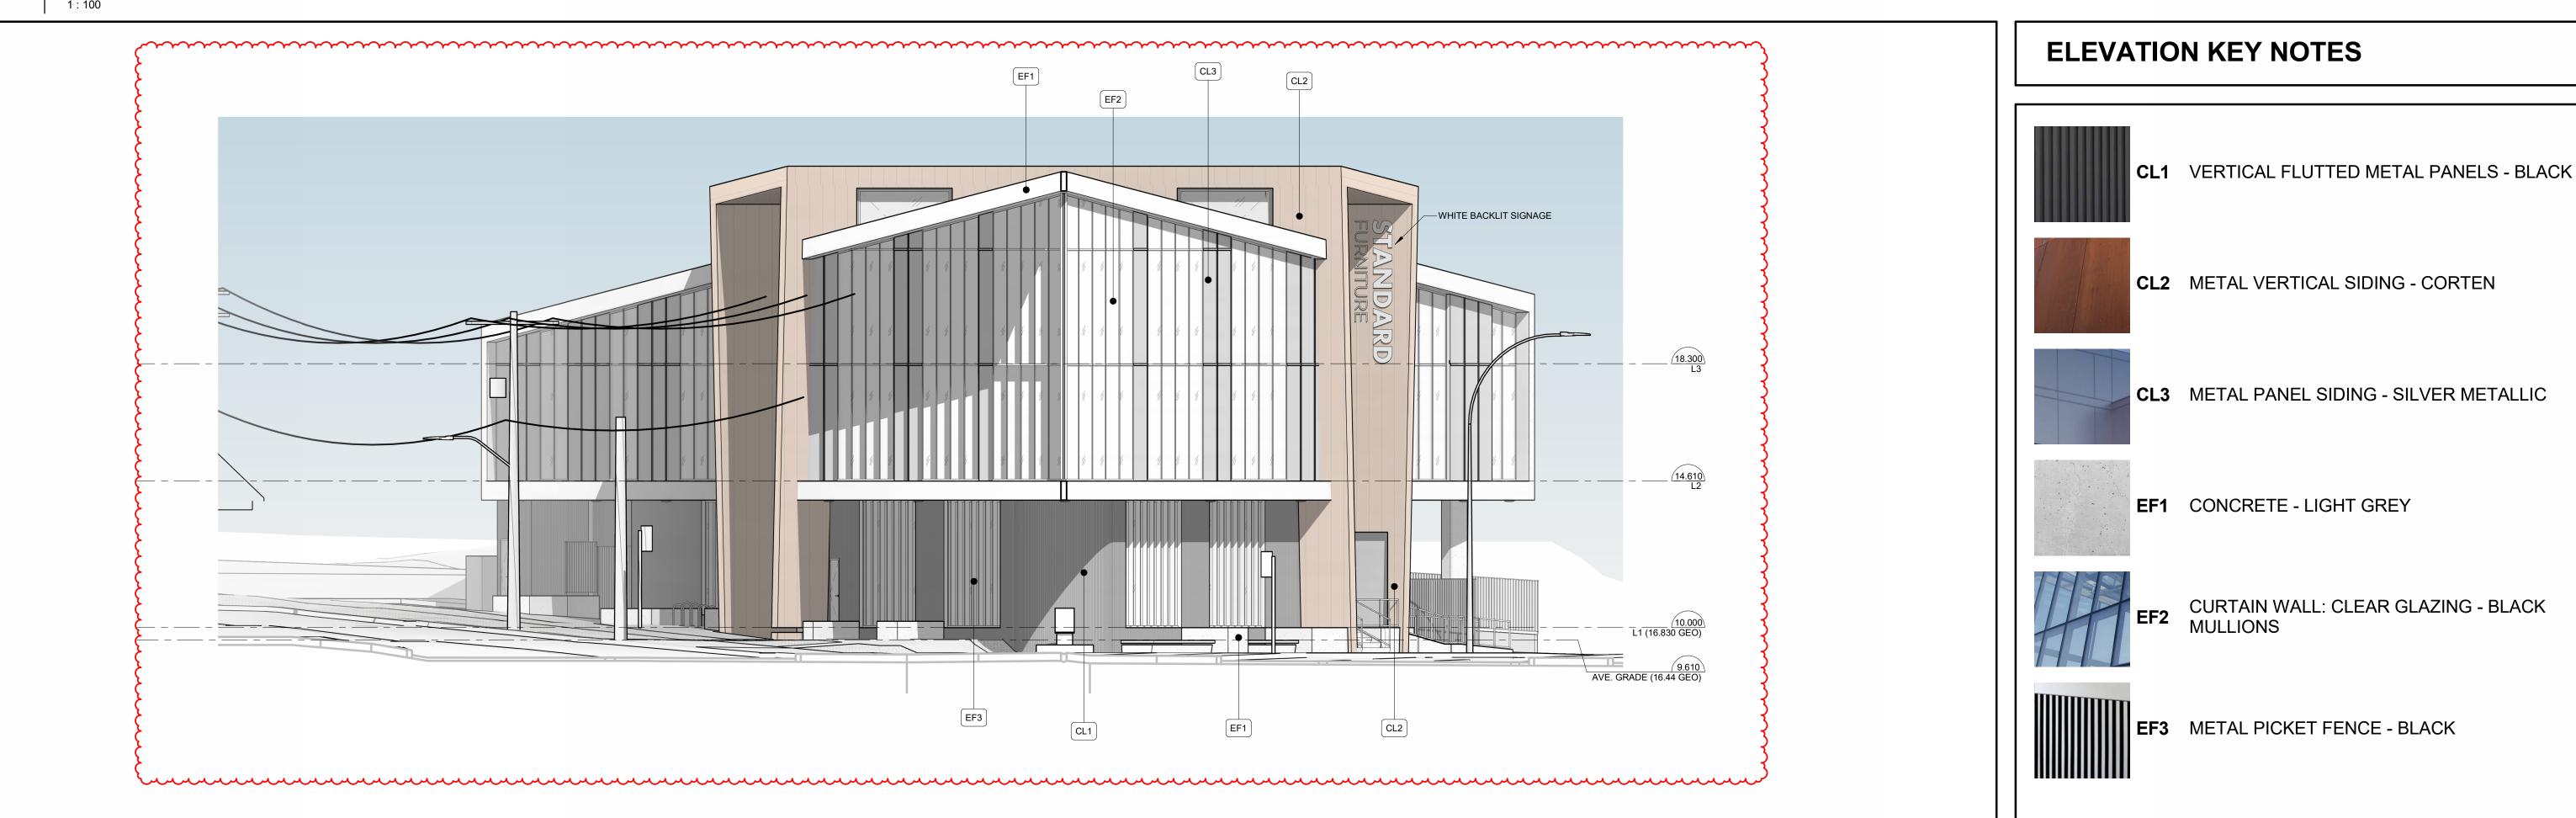

# 2 EXTERIOR ELEVATION - TRUE SOUTH



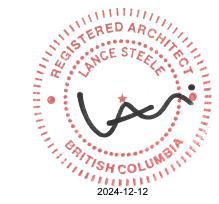

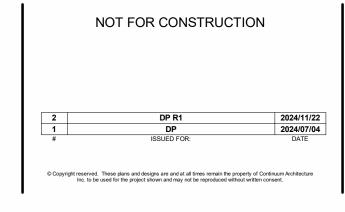

# STANDARD FURNITURE DOUGLAS


**ELEVATIONS** 




2900 DOUGLAS ST, VICTORIA, BC V8T 4N4

JOB No.: 2422

SCALE: As indicated

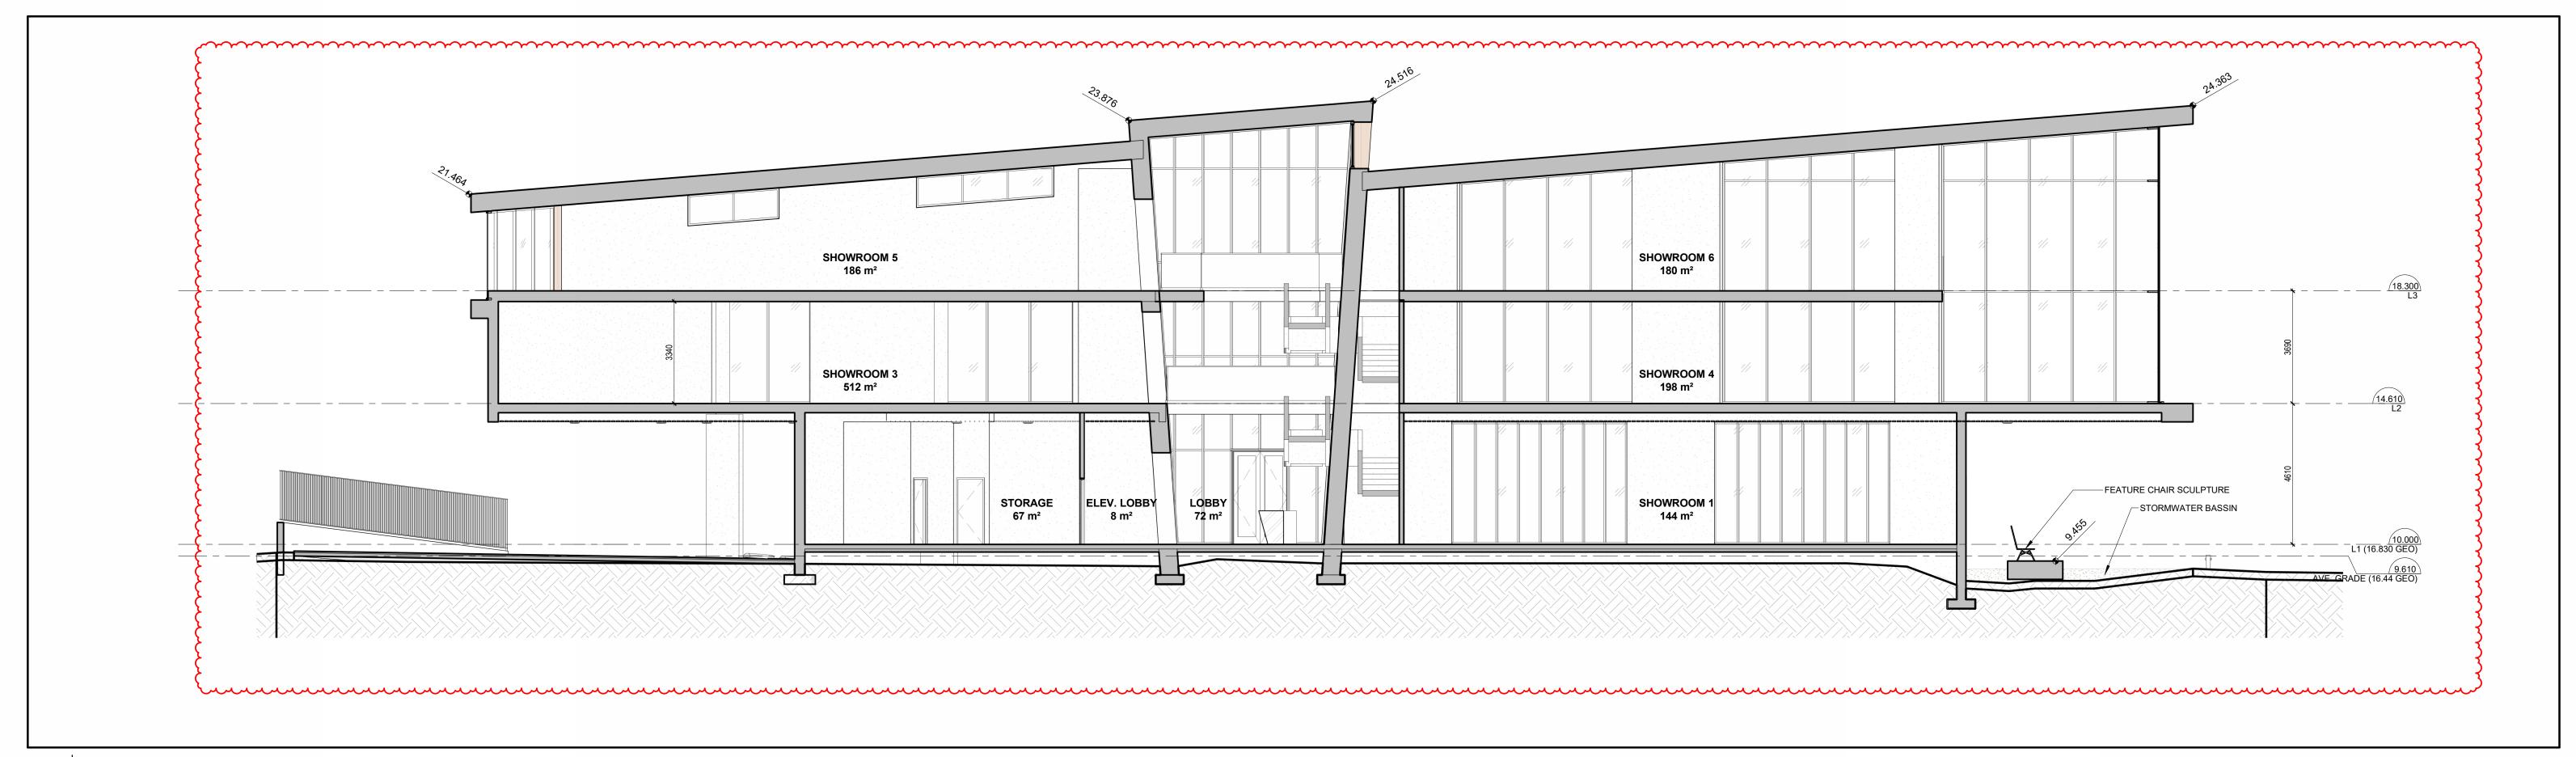



1 BUILDING SECTION - LONGITUDINAL1

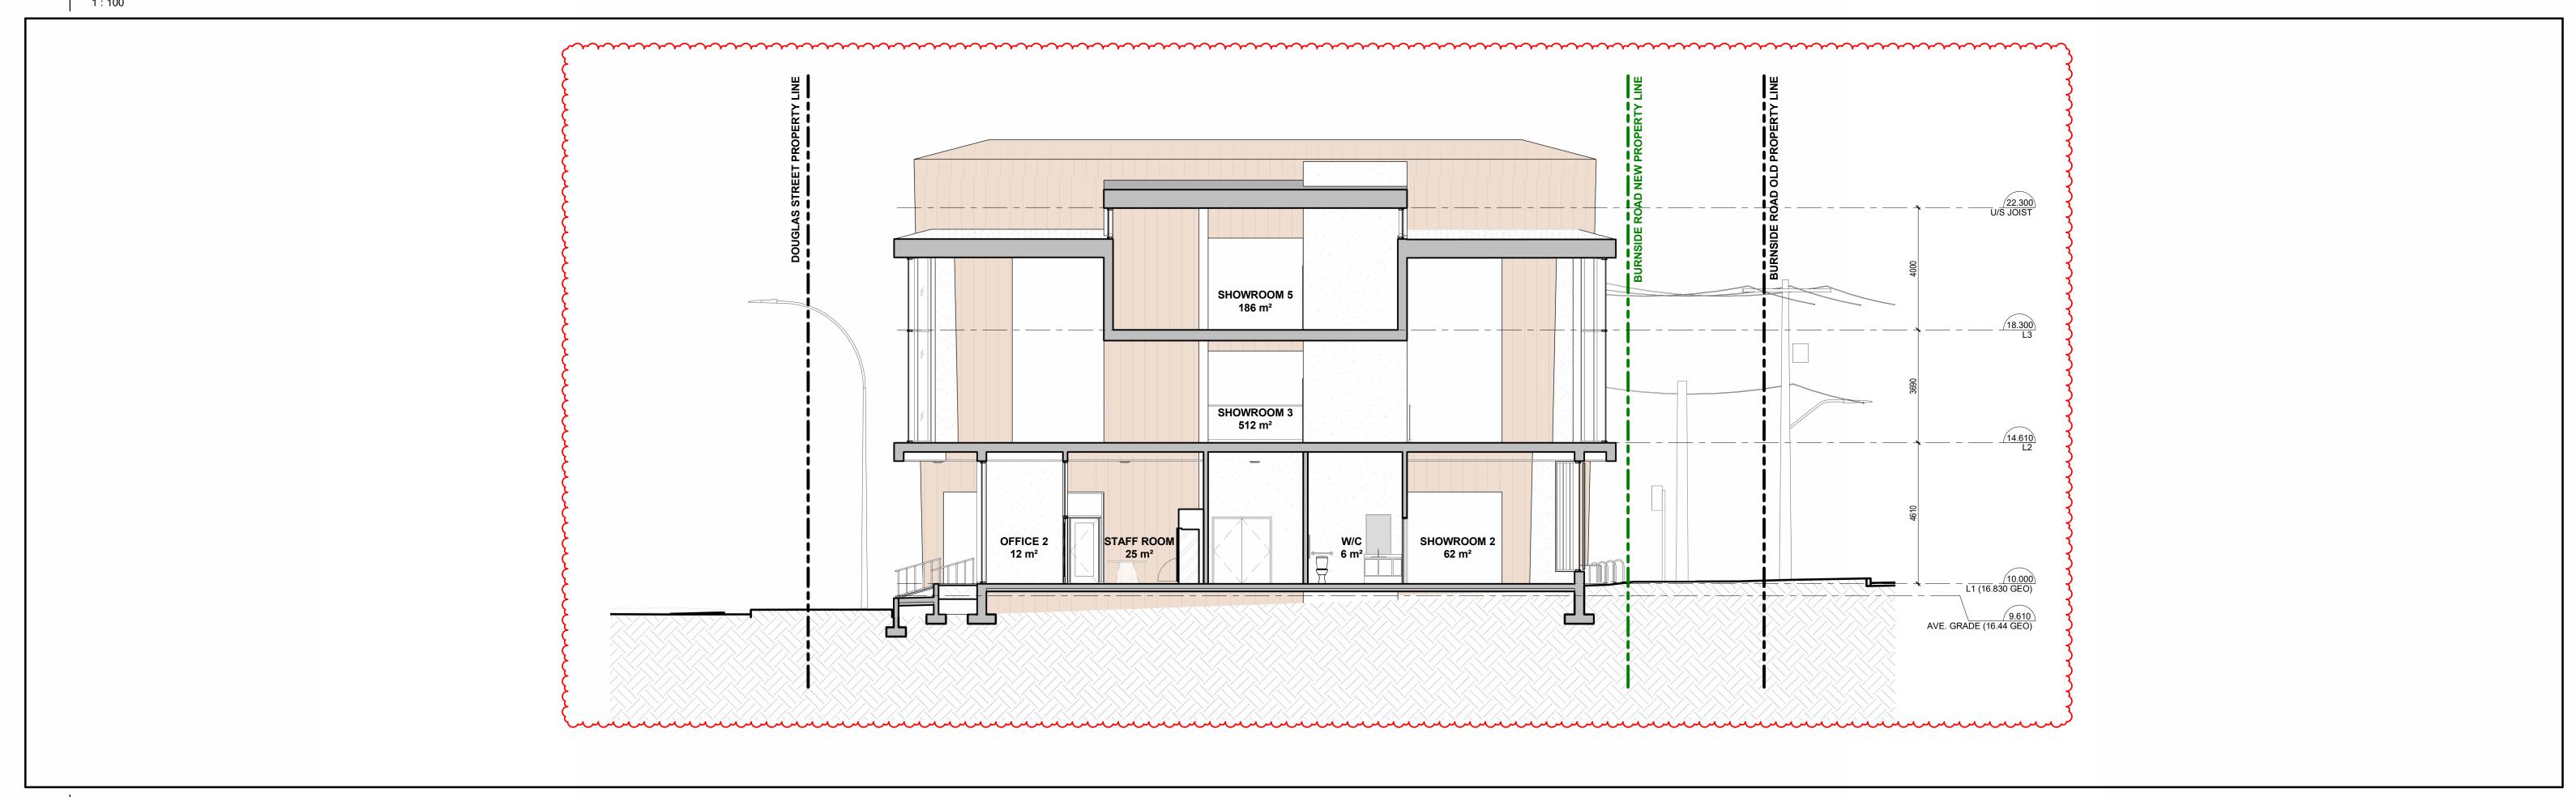

2 BUILDING SECTION - TRAVERSAL



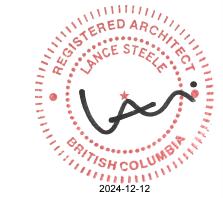

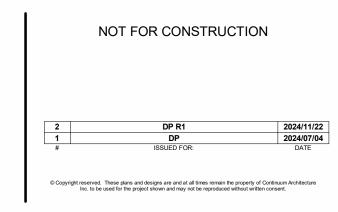


# STANDARD FURNITURE DOUGLAS

**BUILDING SECTIONS** 


SCALE: 1:100



2900 DOUGLAS ST, VICTORIA, BC V8T 4N4

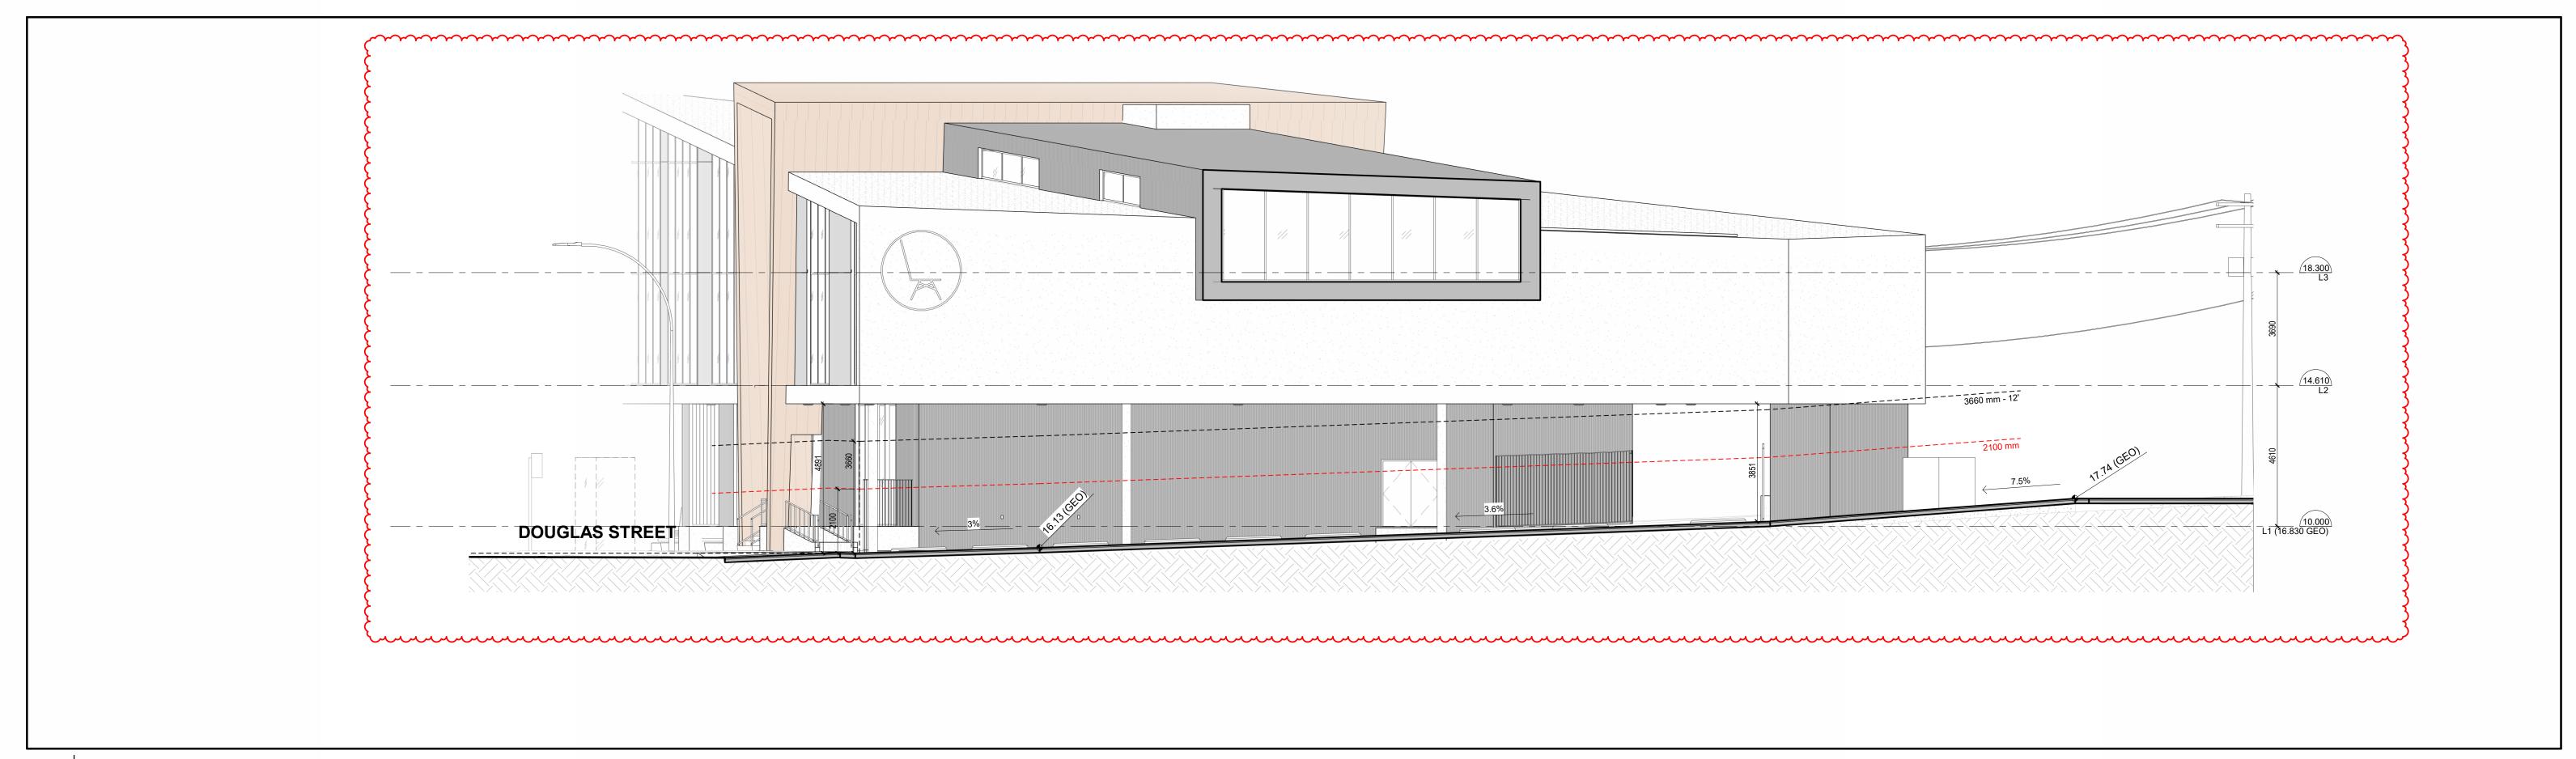

## 1a BUILDING SECTION - TRAVERSAL PARKADE

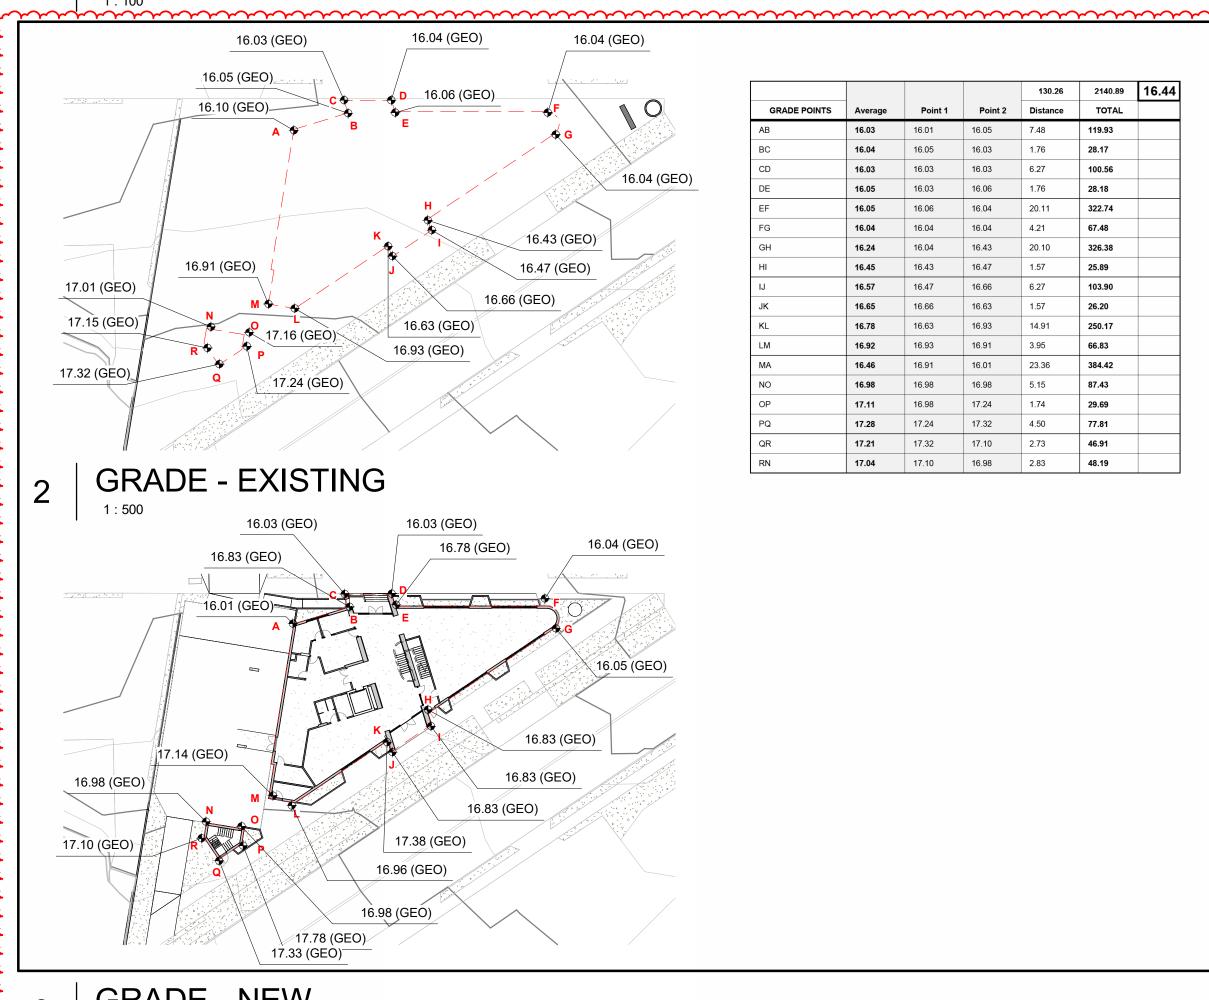

**GRADE - NEW** 

ARCHITECTURE



STANDARD FURNITURE DOUGLAS

**BUILDING SECTIONS & AVERAGE GRADE** 

**A4.2** 

JOB No.: 2422



RENDER - DOUGLAS & BURNSIDE INTERSECTION



RENDER - DOUGLAS TRUE NORTH ELEVATION




RENDER - DOUGLAS ENTRY



RENDER - BURNSIDE NW VIEW



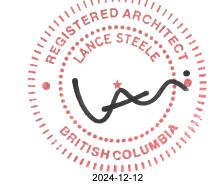


STANDARD FURNITURE DOUGLAS

**3D STREET VIEWS** 

**A5.1** 

2900 DOUGLAS ST, VICTORIA, BC V8T 4N4 JOB No.: 2422 SCALE:

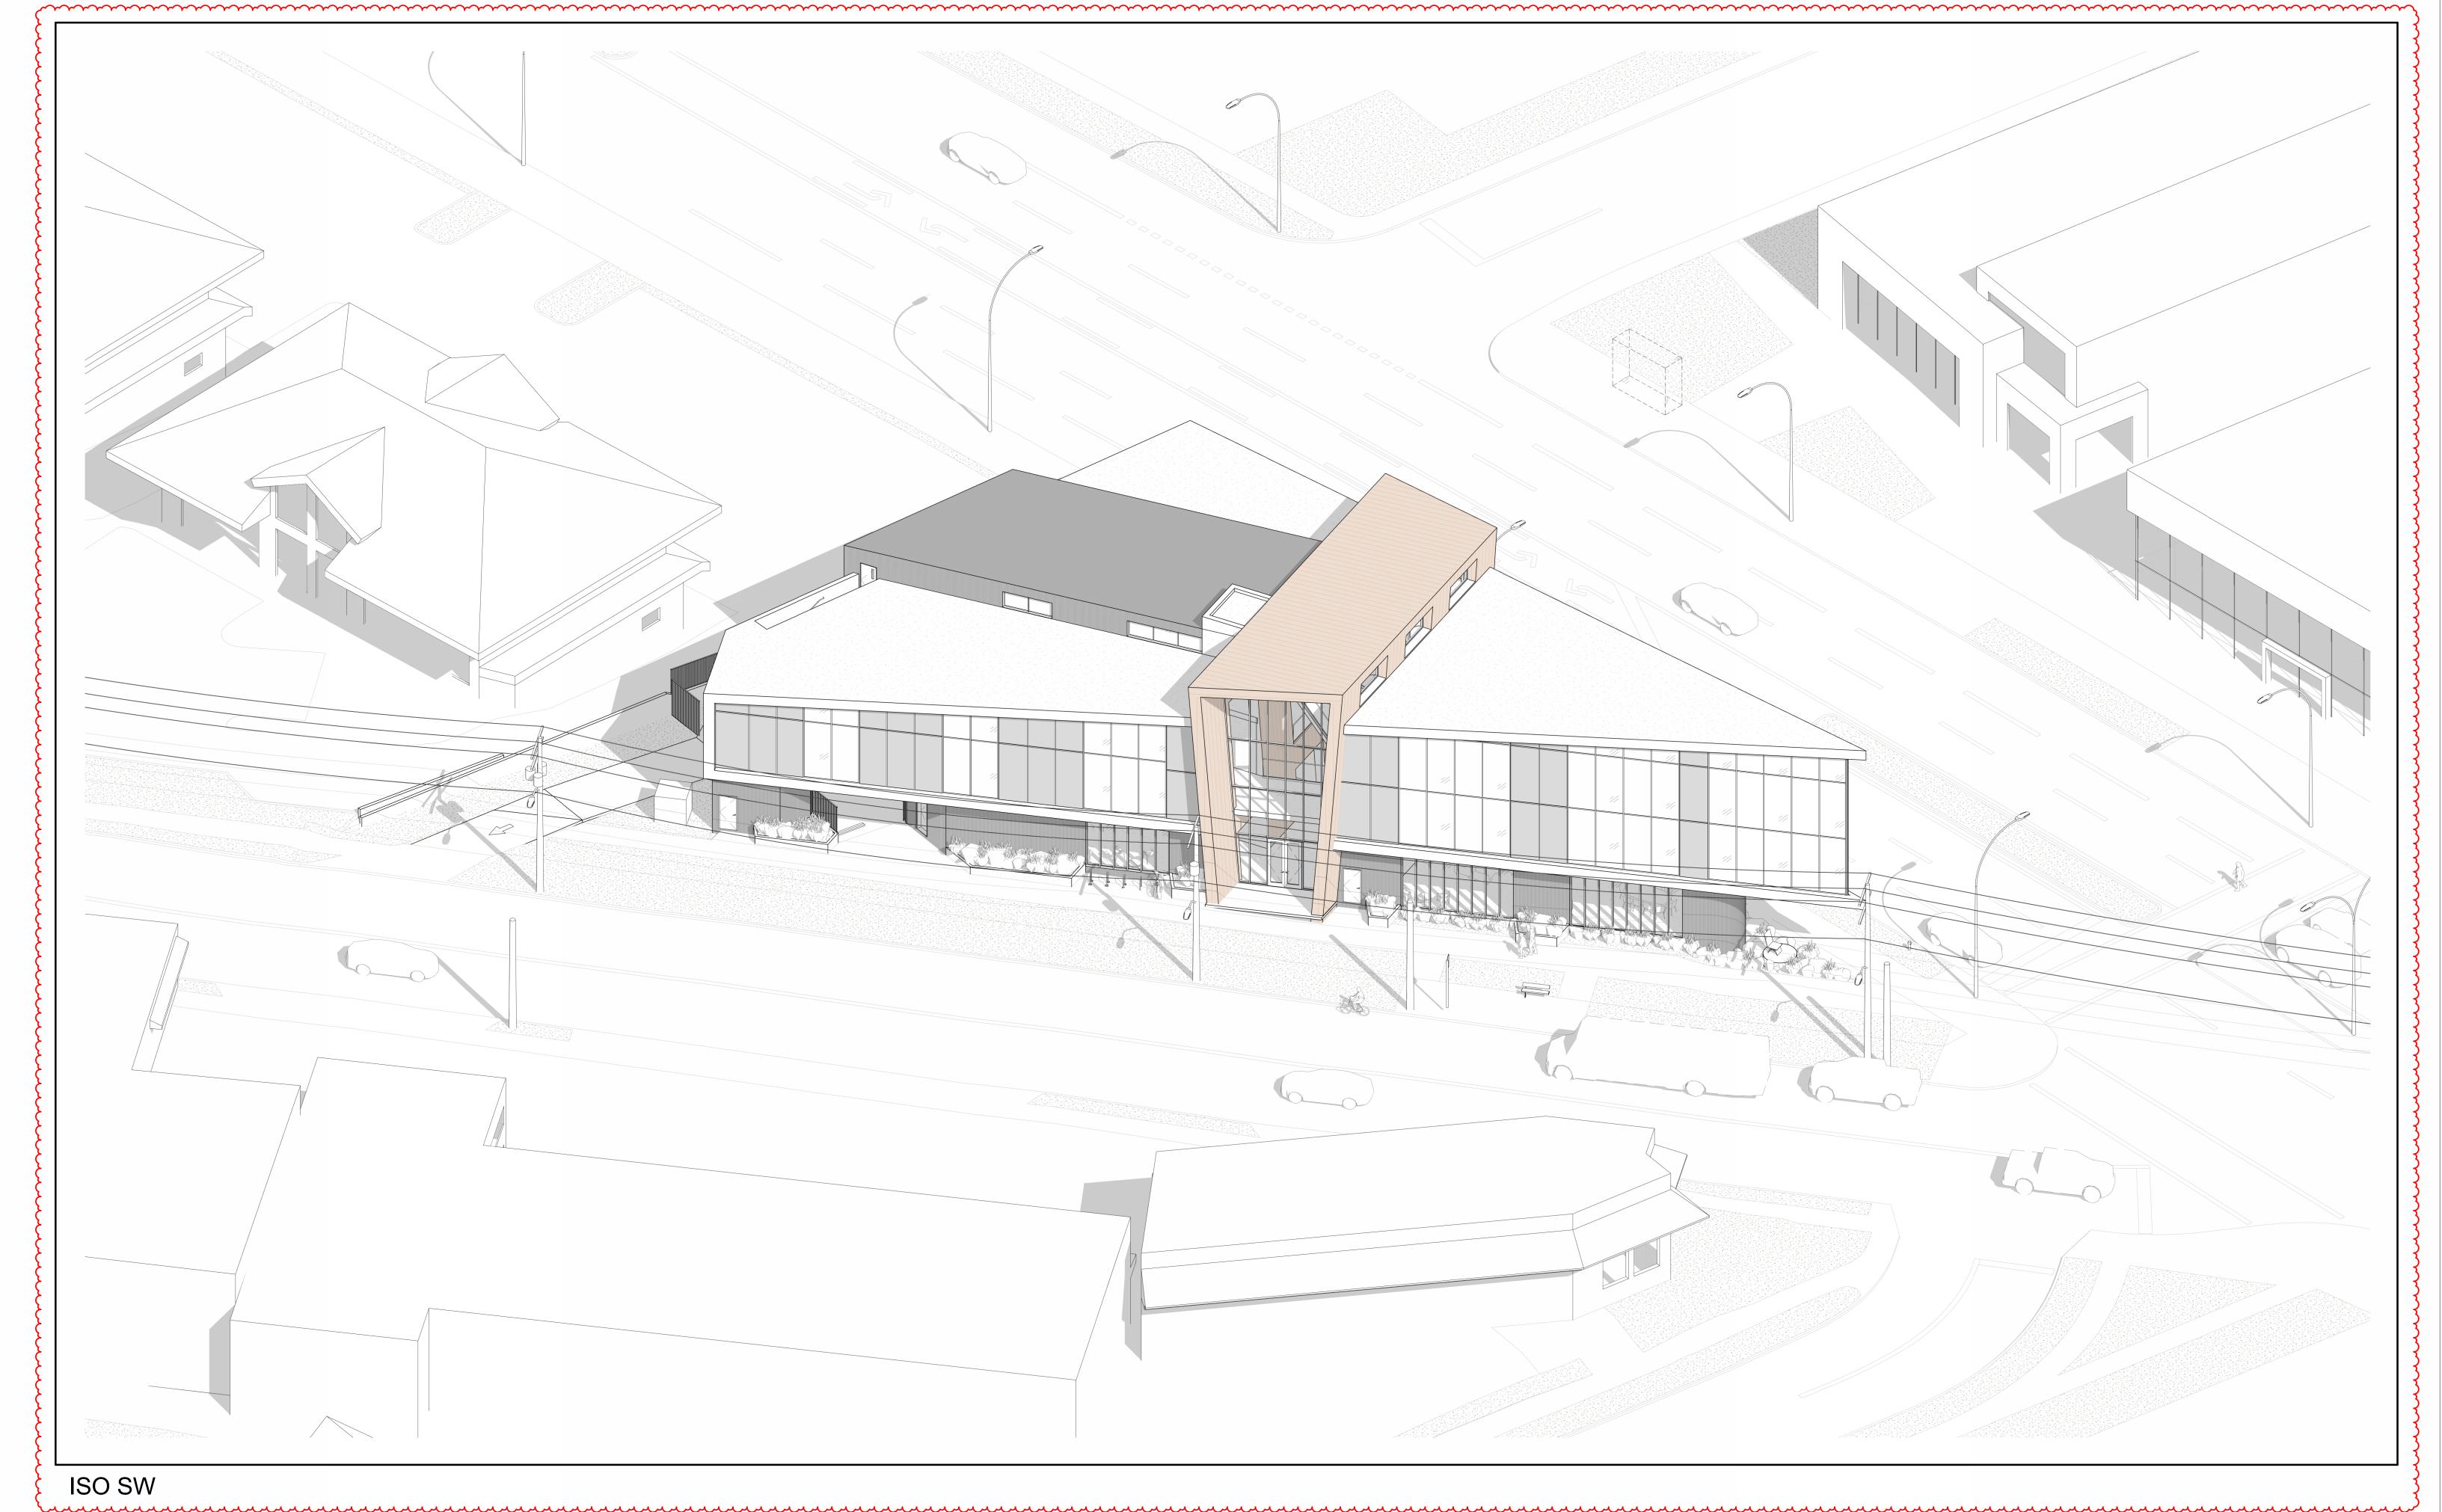





NOT FOR CONSTRUCTION

2 DP R1 2024/11/22
1 DP 2024/07/04
# ISSUED FOR: DATE

© Copyright reserved. These plans and designs are and at all times remain the property of Continuum Architecture line, to be used for the project shown and may not be reproduced without written consent.


STANDARD FURNITURE DOUGLAS

**AERIAL VIEW** 

**A5.2** 


2900 DOUGLAS ST, VICTORIA, BC V8T 4N4

JOB No.: 2422

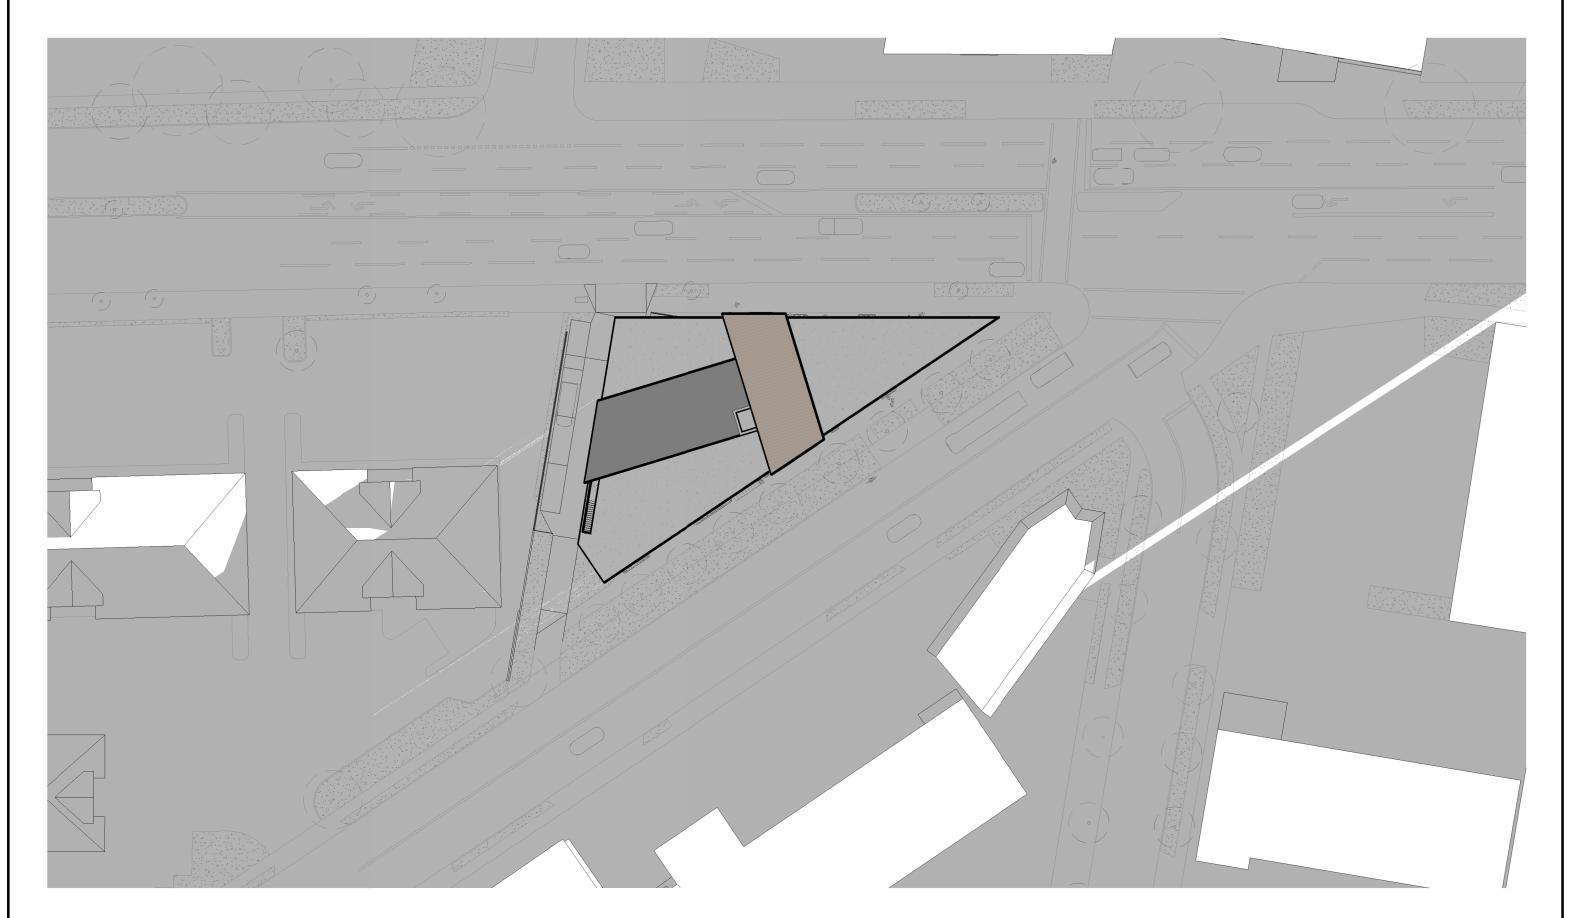

1 SHADOW STUDY - WINTER SOLTICE - 8am

2 SHADOW STUDY - WINTER SOLTICE - NOON

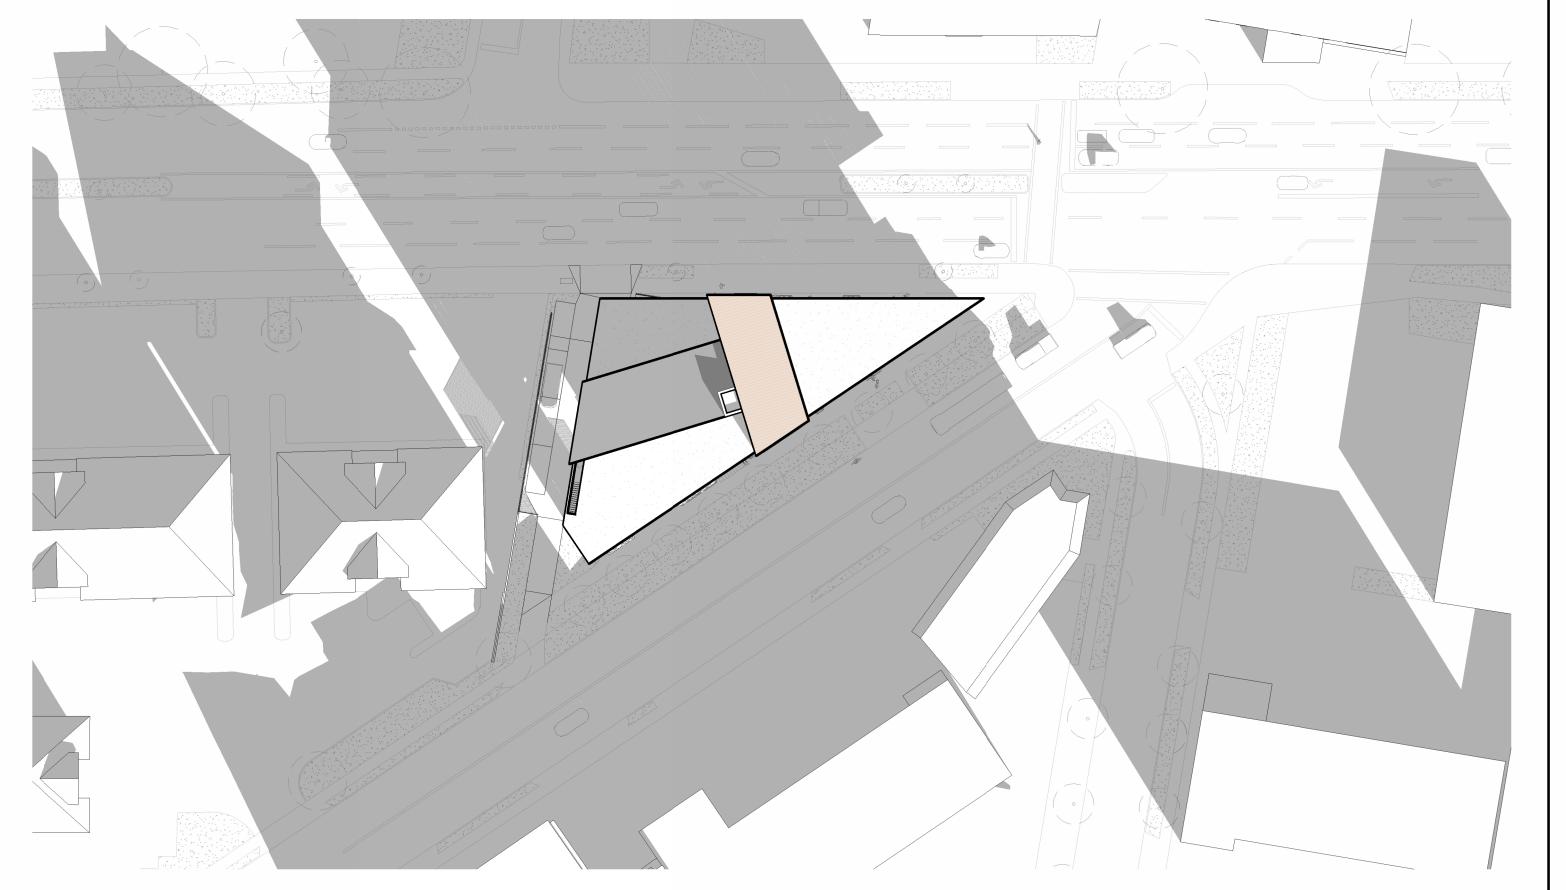

3 SHADOW STUDY - WINTER SOLTICE - 4pm

4 SHADOW STUDY - WINTER SOLTICE - EXISTING - 4pm





| 2 | DP R1 | 202 | 1 | DP | 202 | # | ISSUED FOR:


# STANDARD FURNITURE DOUGLAS

SHADOW STUDY - WINTER SOLTICE


A6.1

2900 DOUGLAS ST, VICTORIA, BC V8T 4N4


JOB No.: 2422 SCALE: 1:500

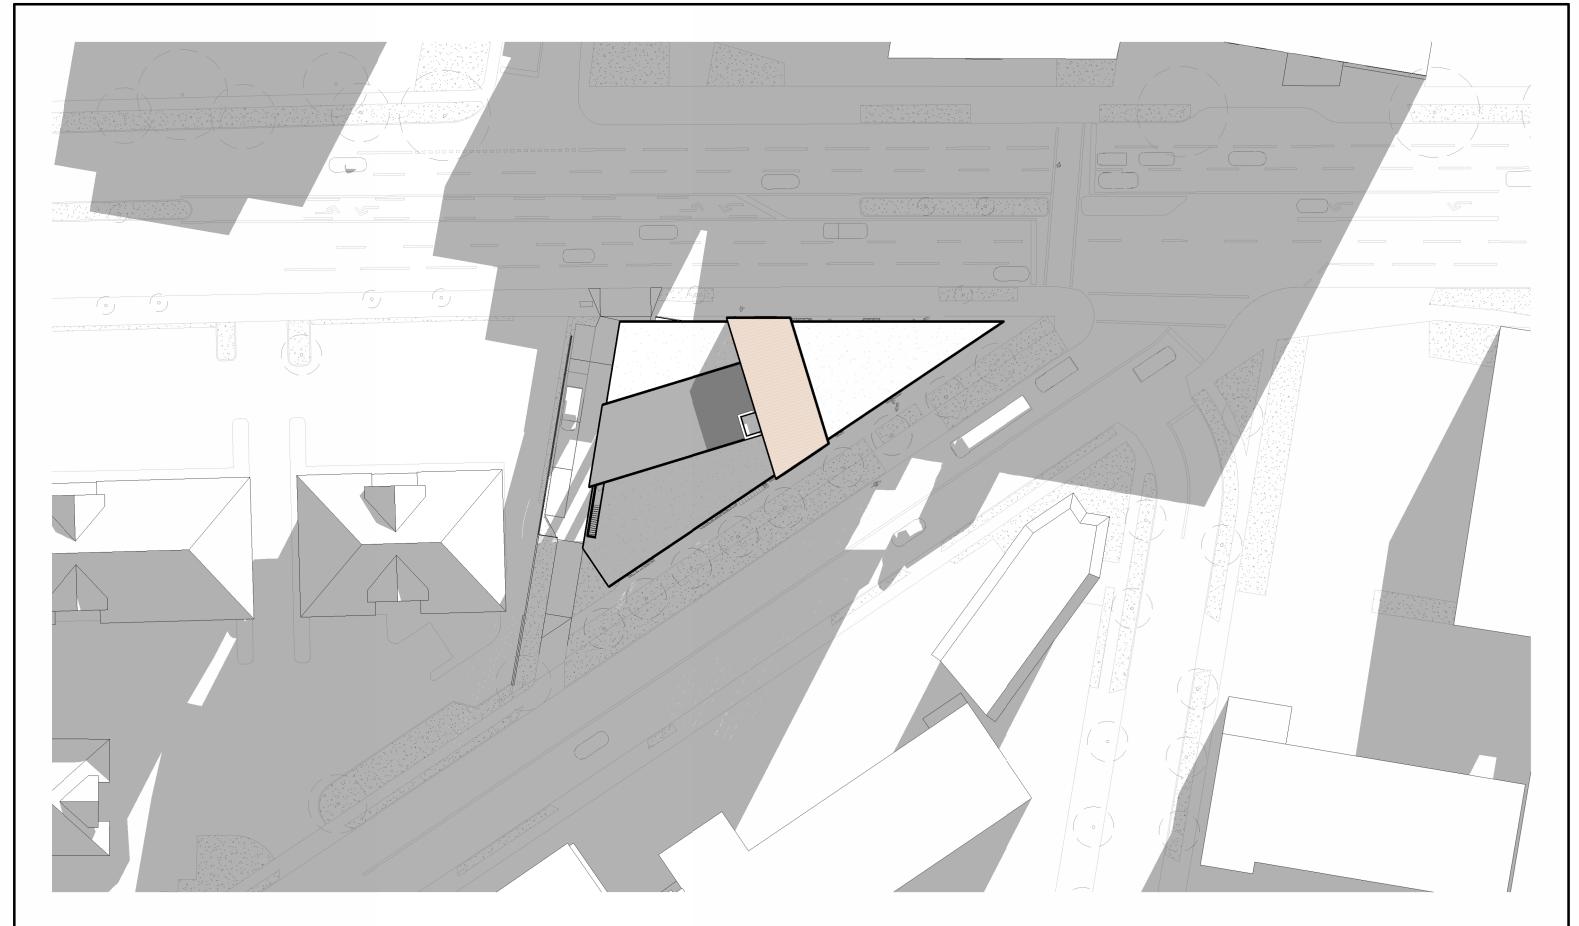




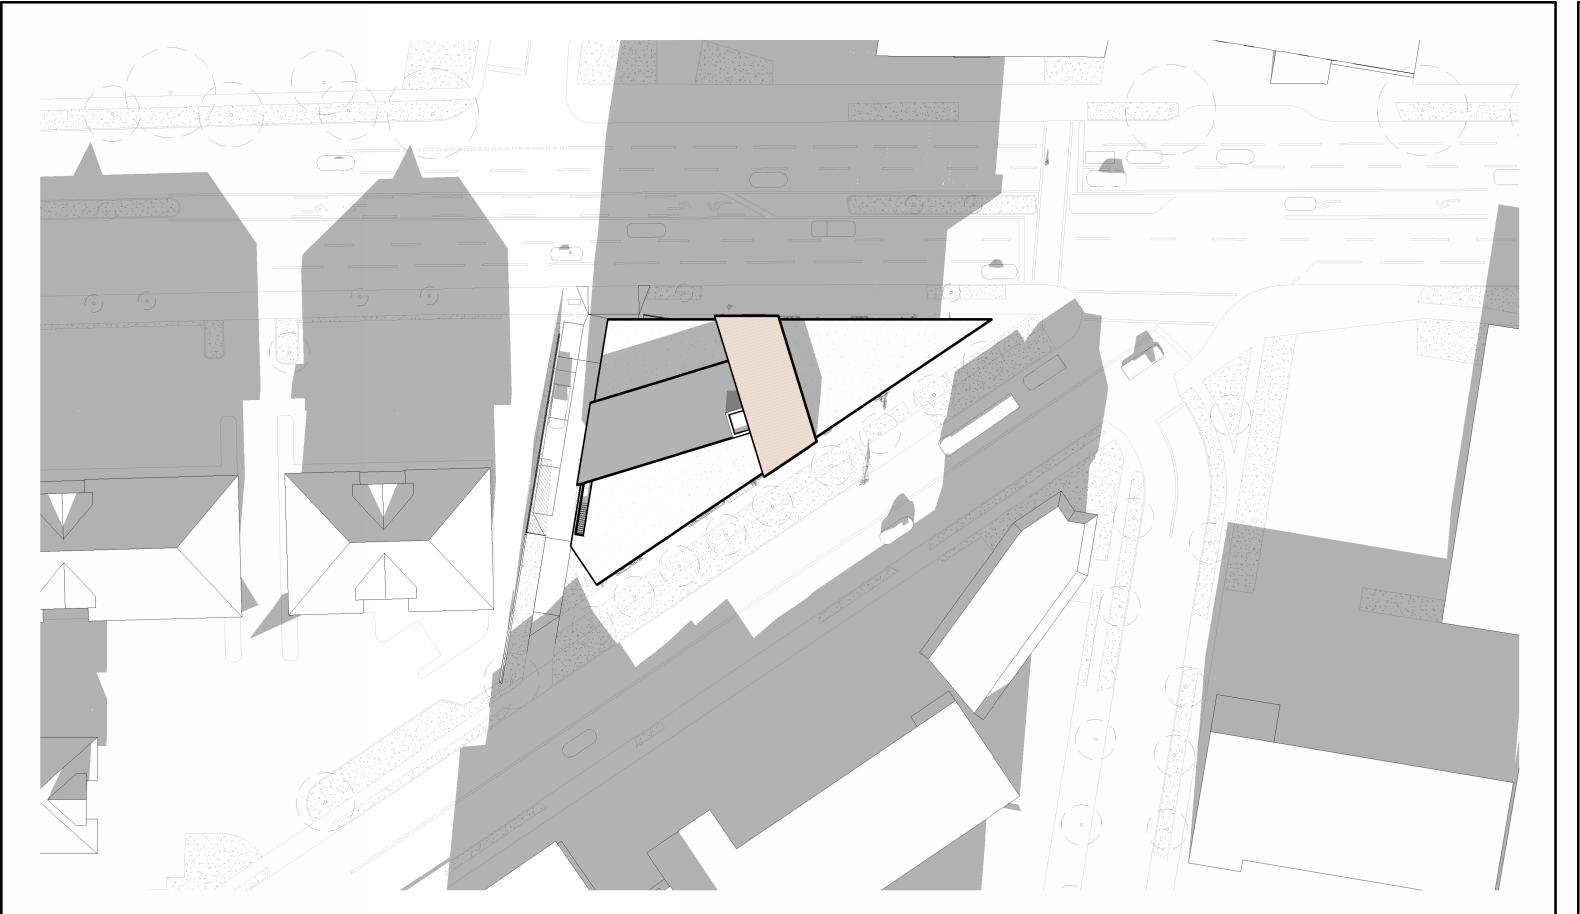

3 SHADOW STUDY - SPRING/AUTUMN EQUINOX - 6pm

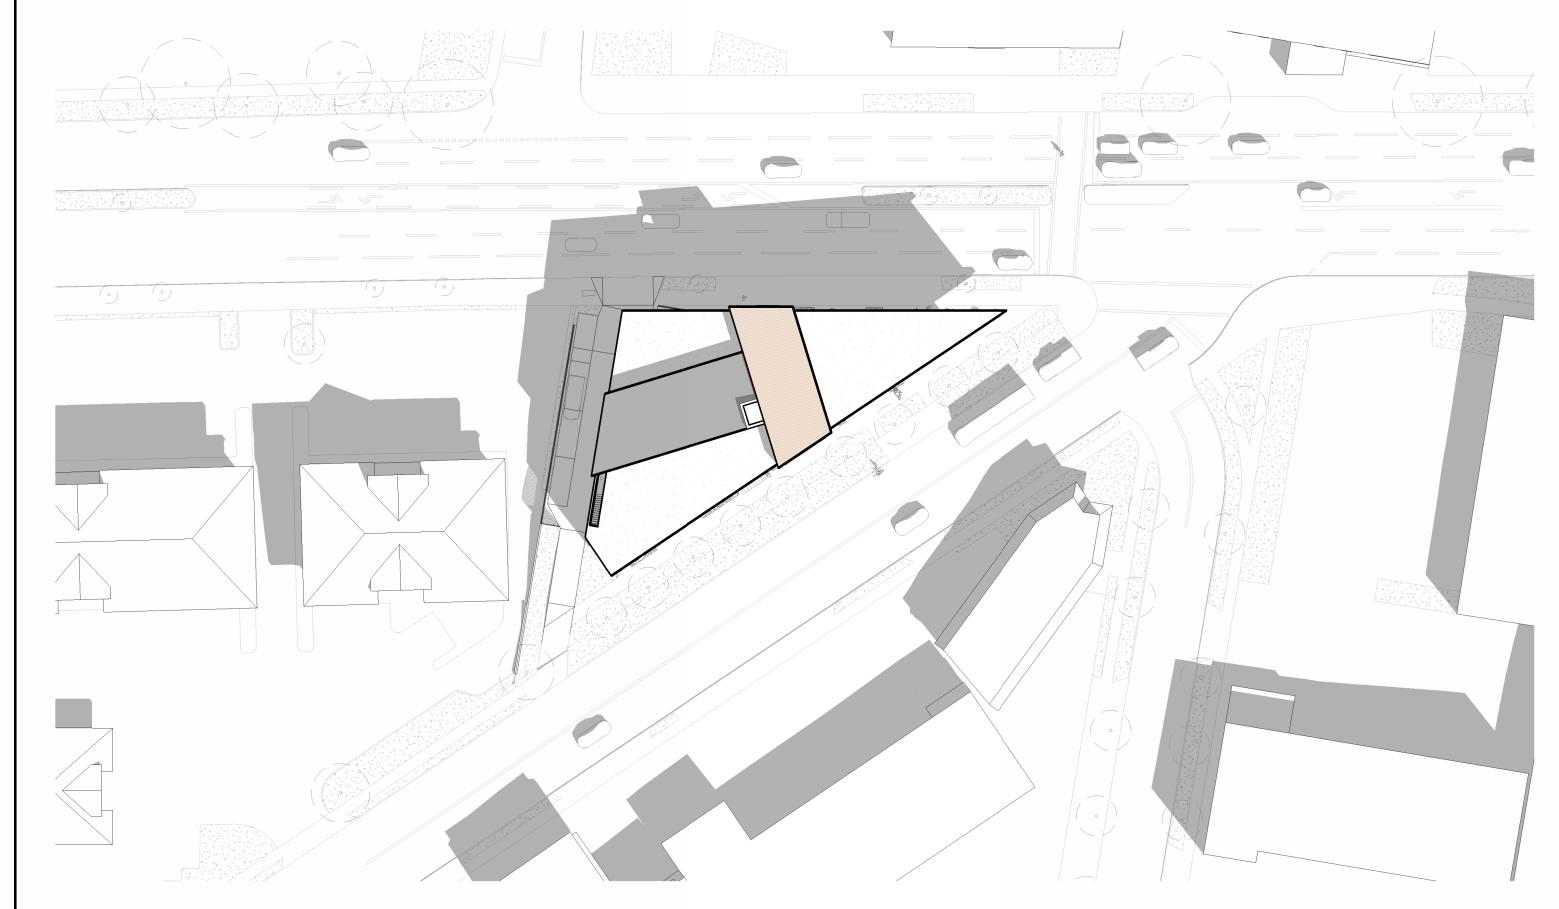

2 SHADOW STUDY - SPRING/AUTUMN EQUINOX - NOON

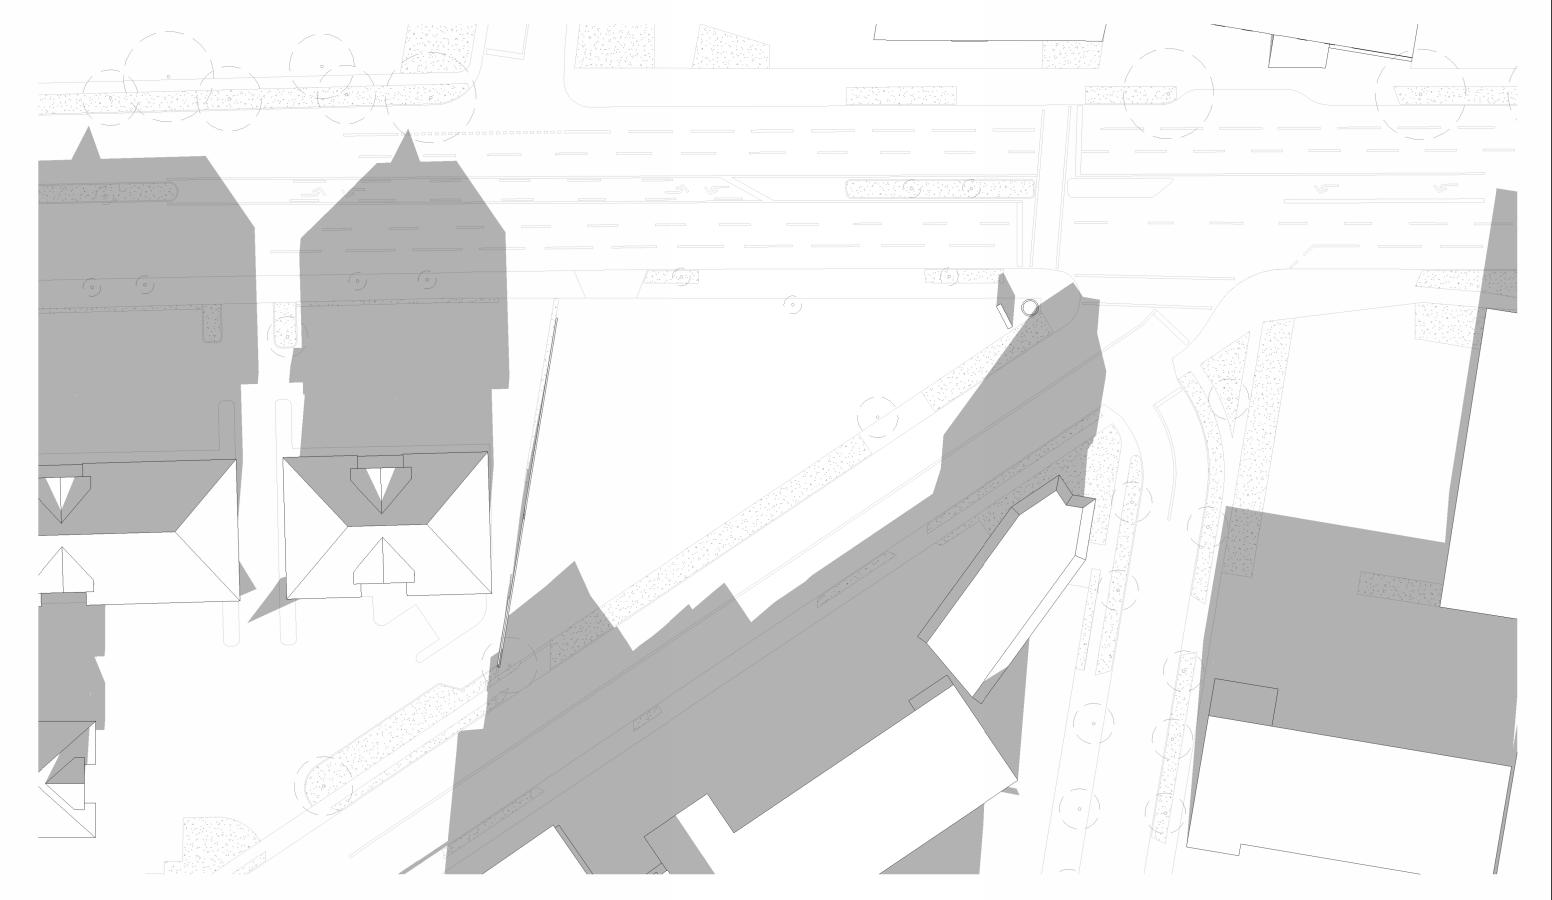

4 SHADOW STUDY - EQUINOX - EXISTING - 6pm






STANDARD FURNITURE DOUGLAS


SHADOW STUDY - EQUINOX

A6.2


2900 DOUGLAS ST, VICTORIA, BC V8T 4N4

JOB No.: 2422 SCALE

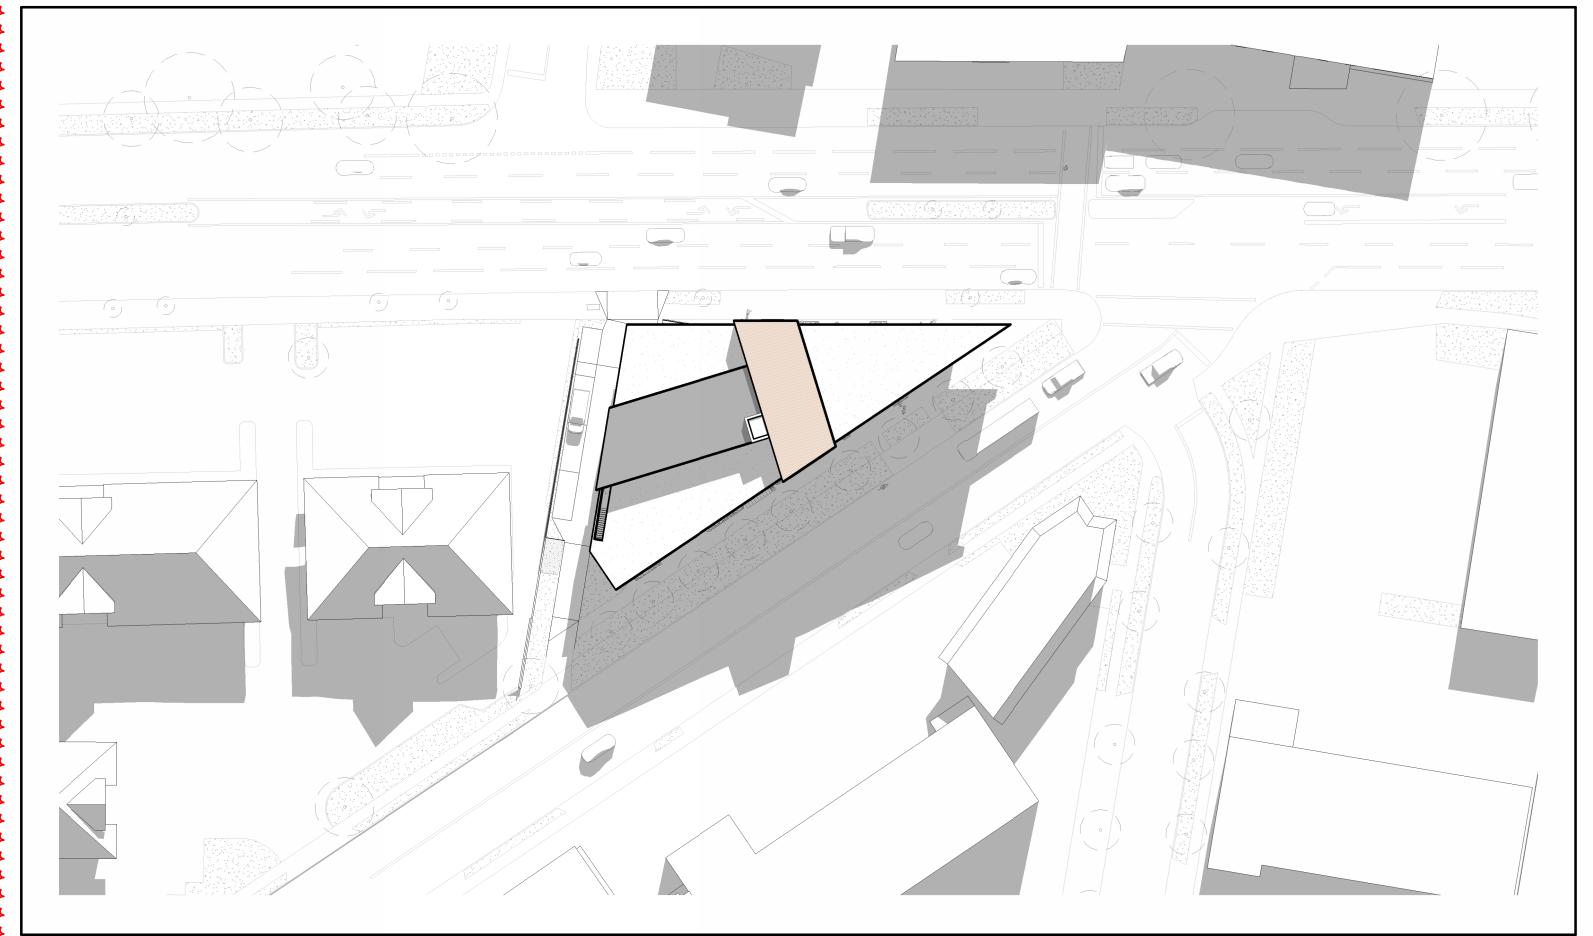


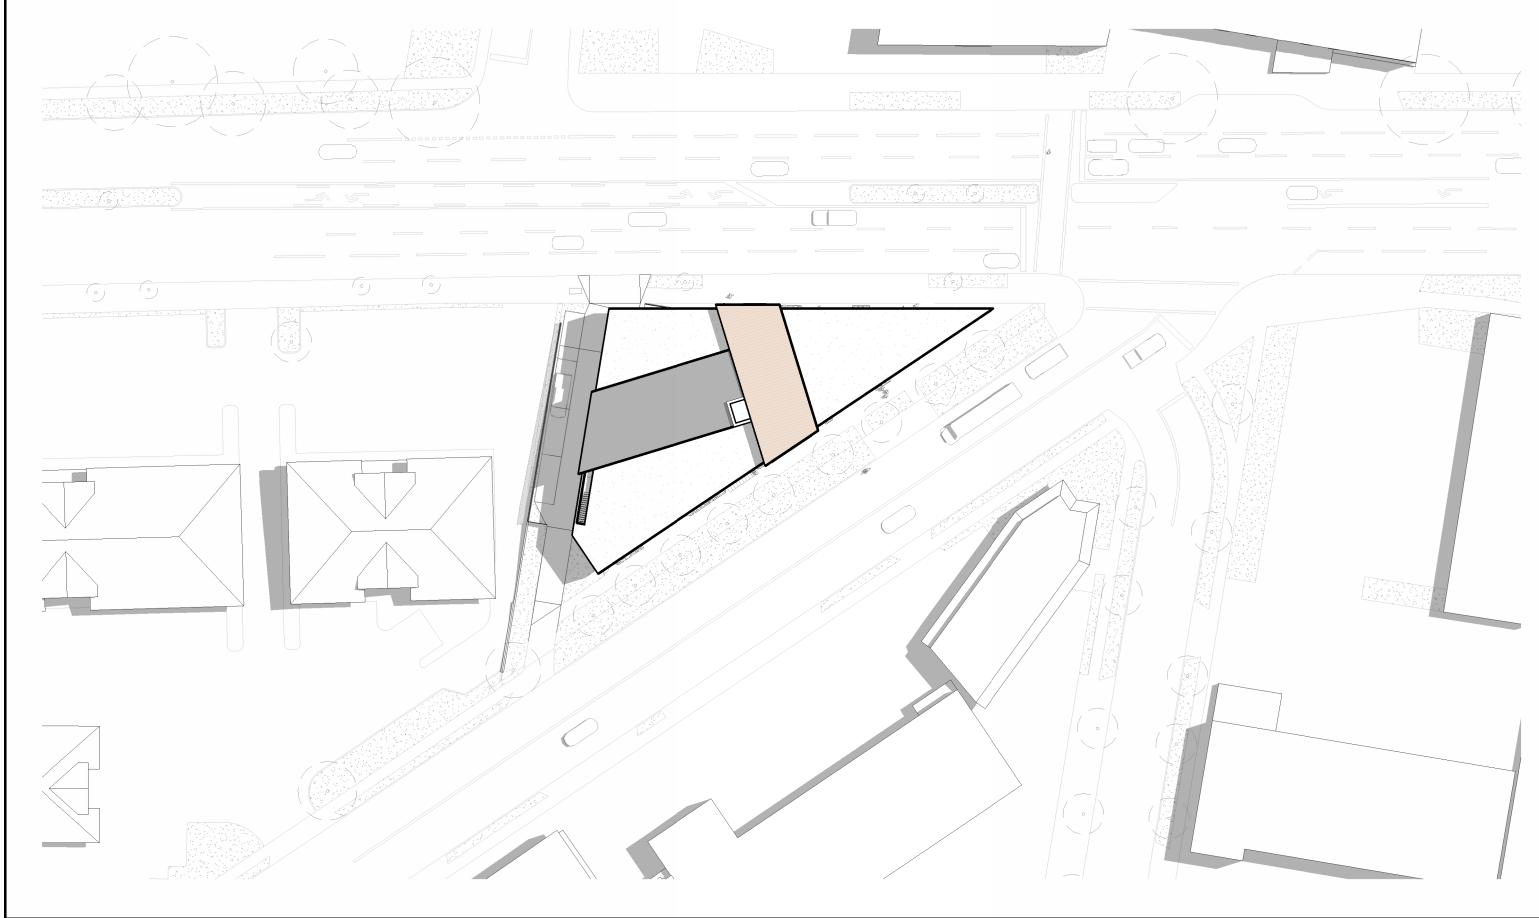

1 SHADOW STUDY - SUMMER SOLTICE - 8am

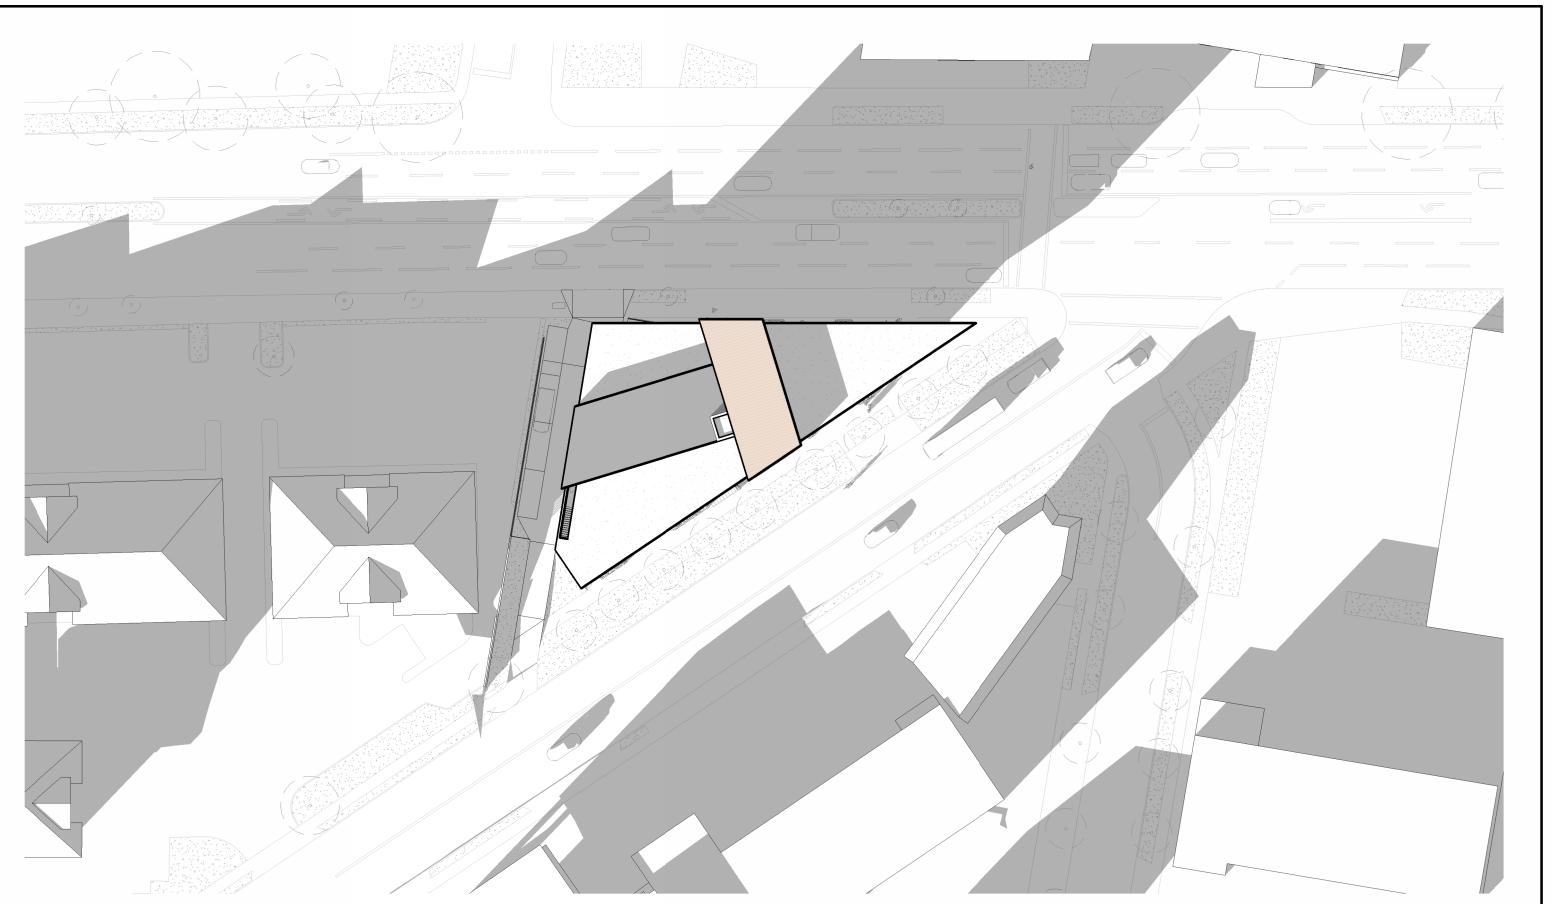

2 SHADOW STUDY - SUMMER SOLTICE - NOON

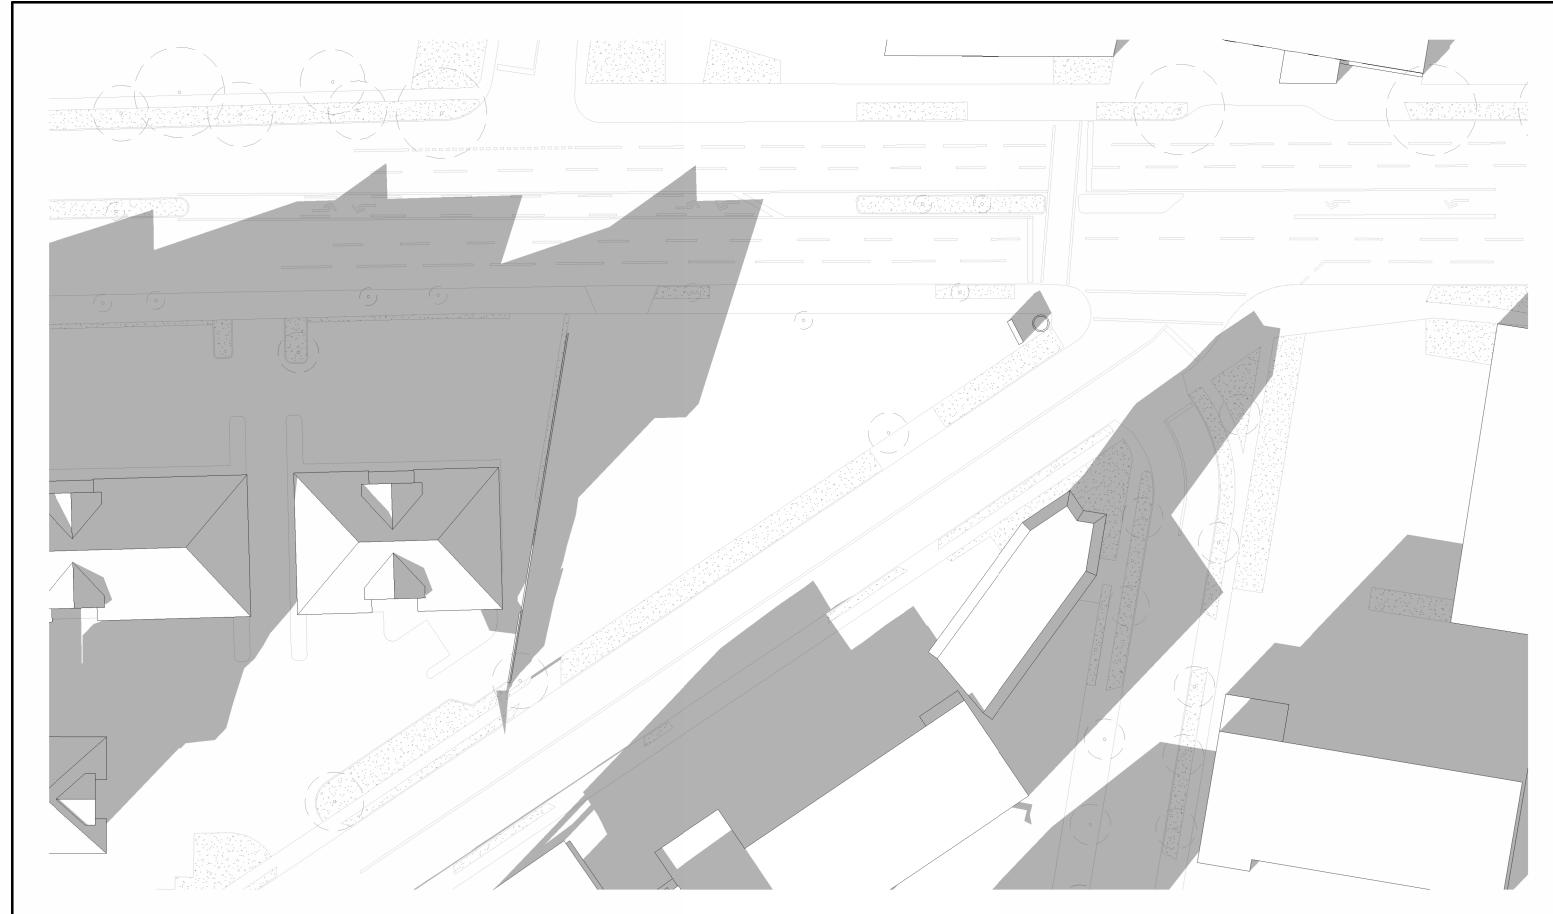

SHADOW STUDY - SUMMER SOLTICE - 8pm

4 SHADOW STUDY - SUMMER SOLTICE - EXISTING - 8pm





STANDARD FURNITURE DOUGLAS


2900 DOUGLAS ST, VICTORIA, BC V8T 4N4

SHADOW STUDY - SUMMER SOLTICE

A6.3

JOB No.: 2422

22 SCALE: 1:500

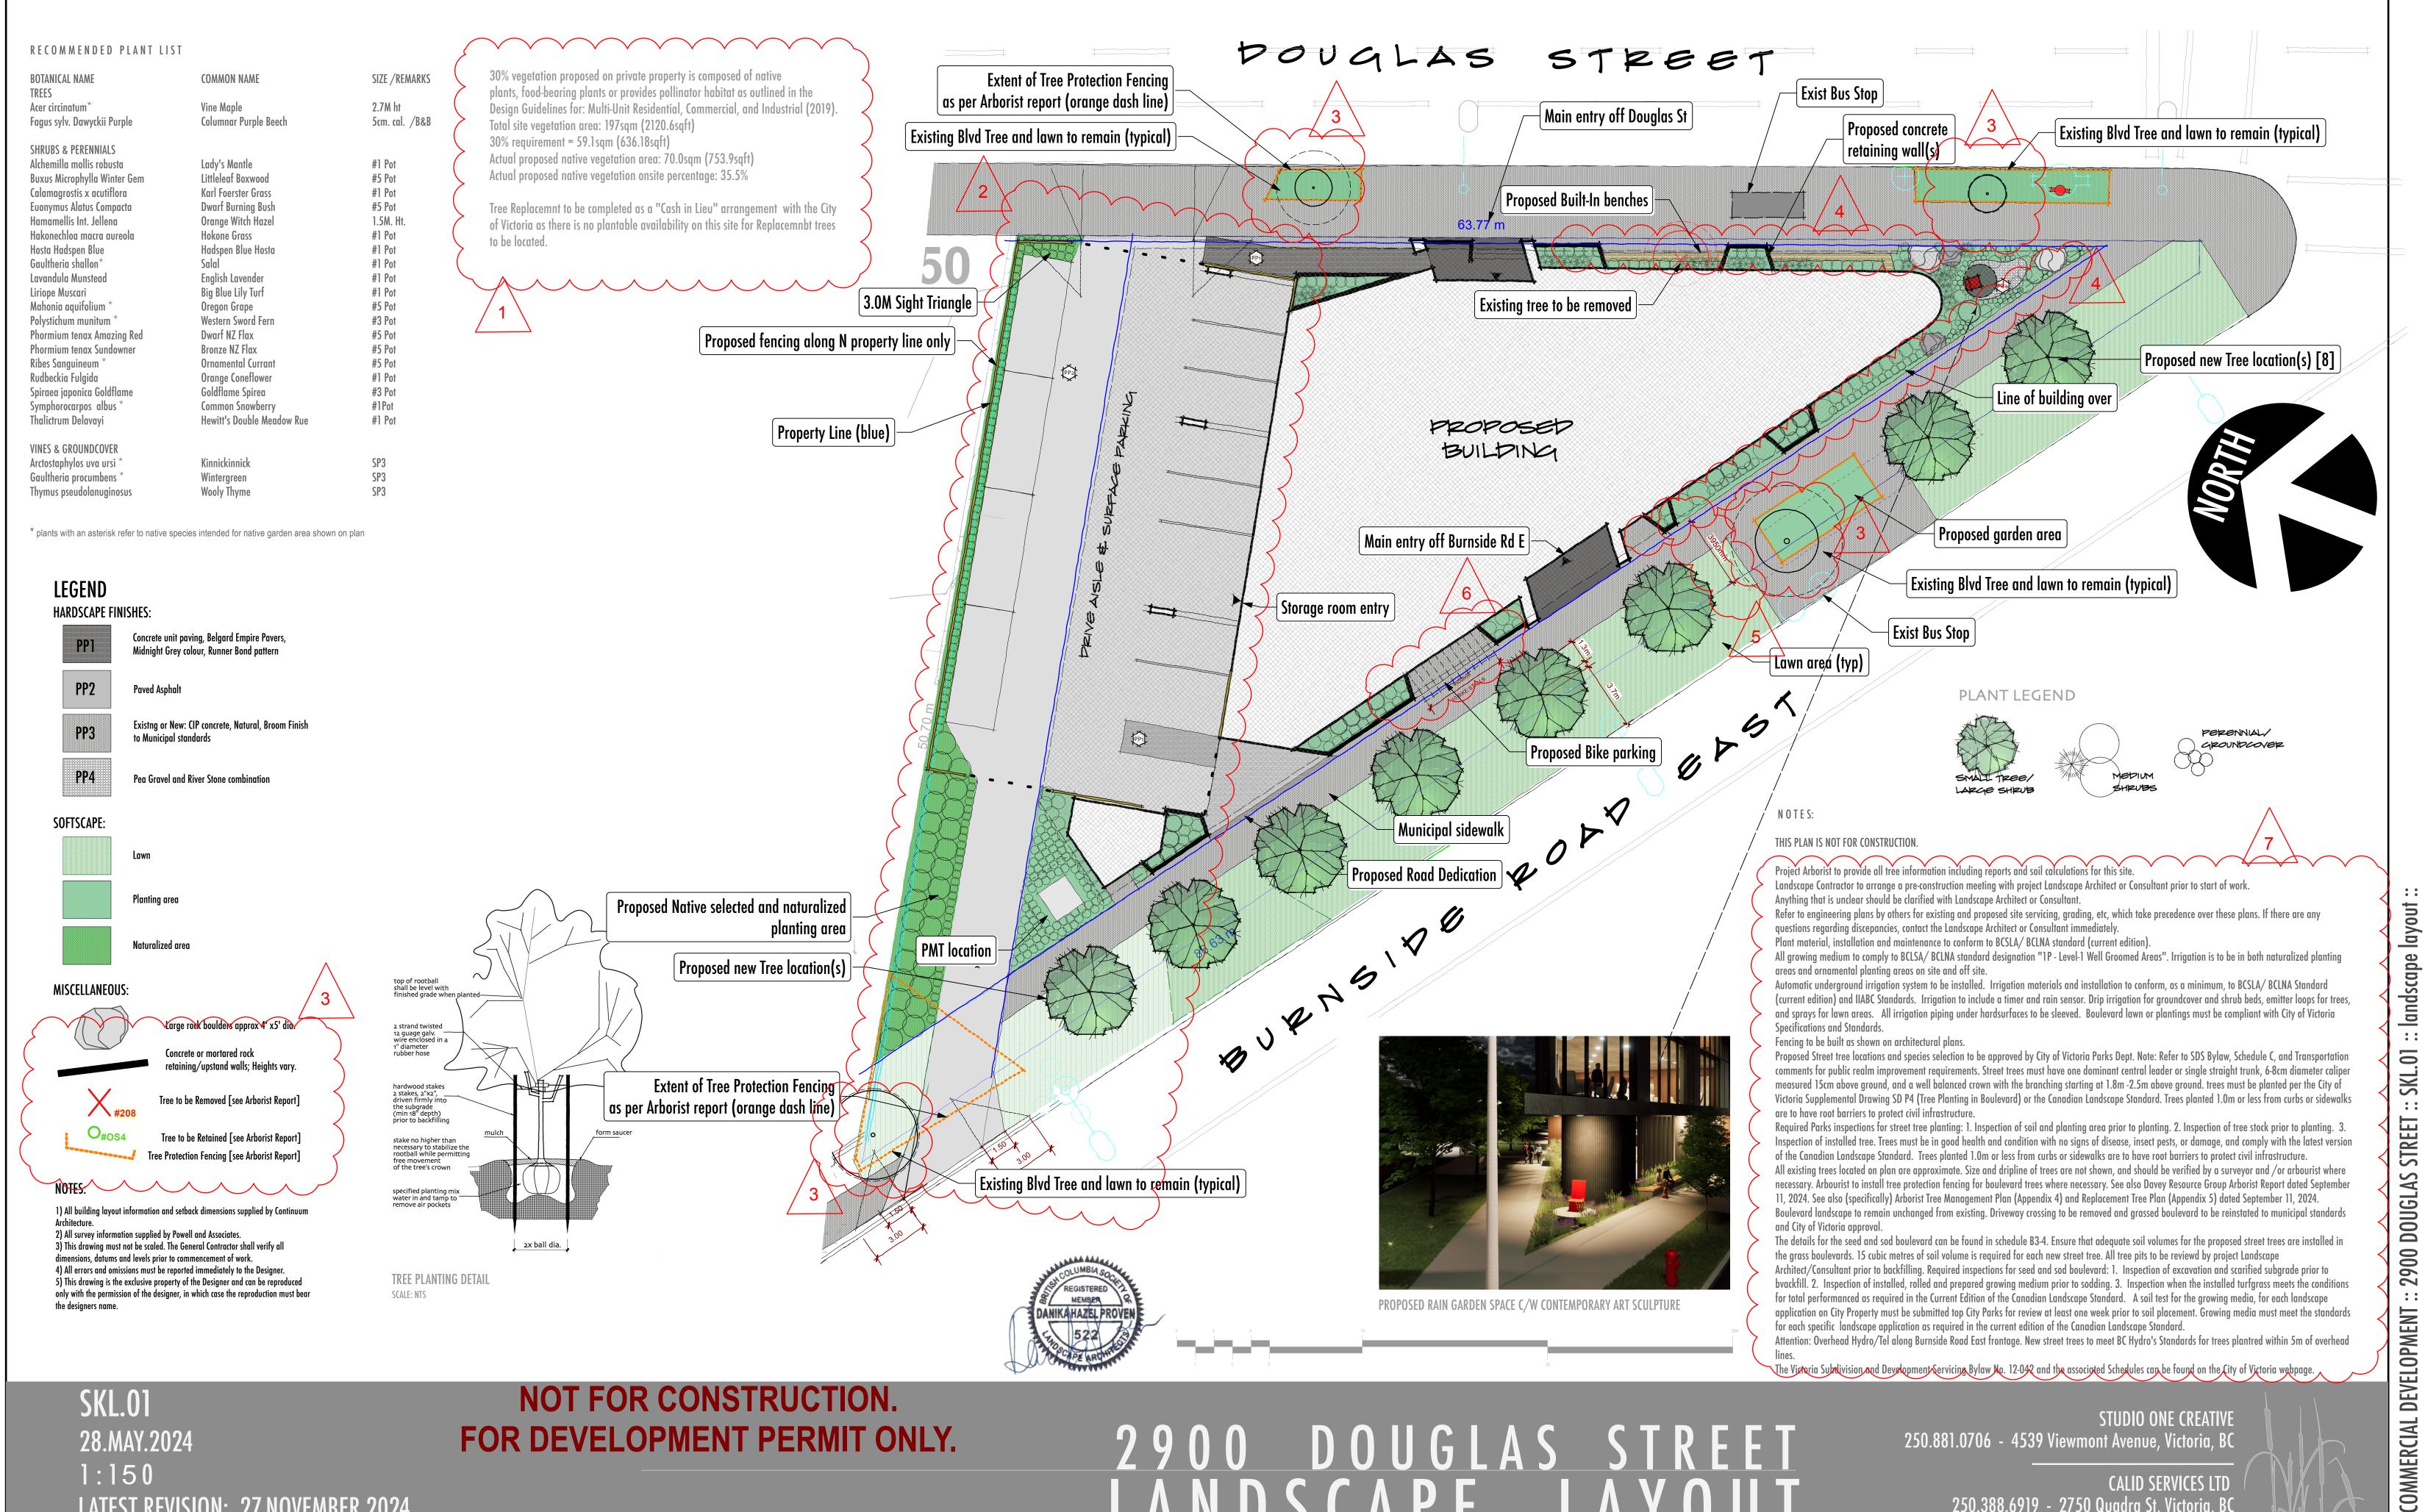

250.388.6919 - 2750 Quadra St, Victoria, BC

