

1055 Alston Street

PROJECT DIRECTORY

REGISTERED OWNER Reyes Holdings Corp 1055 Alston Street Victoria, BC

ARCHITECT dHKarchitects 977 Fort Street Victoria, BC

V9A 3S6

V8V 3K3
Charles Kierulf

V8V 3K3

crk@dhk.ca 250.658.3367 STRUCTURAL CONSULTANT Skyline Engineering 380 - 4243 Glanford Avenue Victoria. BC

Cord MacLean cmaclean@seng.ca 250.590.4133

MECHANICAL CONSULTANT Avalon 1245 Esquimalt Road Victoria, BC V9A 3P2

Mirek Demidow mirek@avalonmechanical.com 250.384.4128

ELECTRICAL CONSULTANT
Conclusive Edge Engineering
101-57158 Symington Road 20E
Springfield, MB
R2.I 4I 6

Amir Tavakoli atavakoli@ceengineering.ca 250.216.2138

LANDSCAPE CONSULTANT
Forsite Landscape Architecture
975 Alston Street
Victoria, BC

Brad Forth forsiteland@hotmail.com 250.590.5302

V9A 3S5

CIVIL CONSULTANT
Westbrook Consulting Ltd.
866 Goldstream Ave #115
Victoria, BC
V9B 0J3

Bruce Crawshaw bcrawshaw@wbrook.ca 250.391.8592

GEOTECHNICAL

#6-40 Cadillac Avenue Victoria, BC V8Z 1T2 Shane Moore

shane@ryzuk.com

Victoria, BC

V8T 4N4

250.475.3131

SURVEYOR

Powel & Associates
250-2950 Douglas Street

James Worton james@powellsurveys.com 250.382.8855

ENVELOPE CONSULTANT Evoke Suite 102 - 814 Broughton St Victoria, BC V8W 1E4

Chris Raudoy craudoy@evokebuildings.com 250.415.8141

PROJECT DESCRIPTION

CIVIC ADDRESS: 1055 Alston Street Victoria, BC V9A 3S6

LEGAL DESCRIPTION LOT 105, DISTRICT LOT 119, ESQUIMALT DISTRICT, PLAN 3237 INCLUDED IN PLAN 4010

ZONING BYLAW SUMMARY

BUILDING DESCRIPTION:

Basement: Industrial Use (F-2 and 3)
1st Storey: Storage Garage (Group F-2 and 3)
2nd - 5th Storeys: Residential Dwelling Units (Group C)

EXISTING ZONE: M2-S, Songhees Light Industrial District

11%

Industrial and Residentail

PROPOSED ZONE: TBC

SITE AREA: 1406 m² (15,134 s.f.) **SITE COVERAGE:** 80%

OPEN SITE SPACE: FLOOR AREAS

TOTAL PROPOSED: 3381 m²

FLOOR SPACE RATIO: 2.4 FSR

GRADE OF BUILDING: 16.35 m (GEODETIC)
See Site Plan for Grade Calculation

HEIGHT OF BUILDING: 21.1 m

NUMBER OF STOREYS: 5

RESIDENTIAL PARKING: 19 stalls (incl. 2 accessible, 2 visitor)

COMMERCIAL PARKING: 2 stalls (incl. 1 accessible)

TOTAL CAR PARKING 21

BICYCLE PARKING: 65 Class 1 + 6 short term (rack)

 SETBACKS:

 FRONT (West):
 4.15 m

 REAR (East):
 2.77 m

 SIDE (North):
 0 m

 SIDE (South):
 0.3 m

 COMBINED SIDE:
 0.3 m

SUITE COMPOSITION:

 Studio:
 28

 1 Bed:
 24

 2 Bed:
 4

 TOTAL:
 56 SUITES

Minimum Unit Floor Area 34 m²

Building Code Summary

Referenced Document: BCBC 2024 - Part 3

Major Occupancy Classification - Group C Residential - Basement Storey (allowable): Assembly (A-2), Business and Personal Services (D) Mercantile (E), and/or Industrial Use (F-2 and 3)

3)- 1st Storey (proposed): Storage Garage (Group F-3, associated with residential use above). Open-air storage garage.- 2nd - 5th Storeys (proposed): Residential Dwelling Units (Group C)

Building Area: 1141m2

Building Height: 5 Storeys

Number of Streets Facing: 2 Accessible Facilities: Accessible Entrance / Accessible Stalls

Construction Requirments:
3.2.2.48 Group C, up to 6 Storeys, Sprinklered, Noncombustible Construction
2) the building shall be of noncombustible construction, and
a) floor assemblies shall be fire separations with a fire-resistance rating not less than 1 h,


b) mezzanines shall have a fire-resistance rating not less than 1 h

Noncombustible cladding throughout the building.

2 h concrete fire separation between the residential storage garage and the first storey.

Site Anaylsis



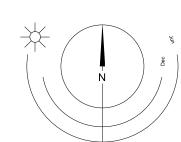

Drawning List

A001	Project Data
A002	Survey
A004	Street View
A007	Shadow Studies
A101	Site Plan Overall
A102	Site Plan - Circulation
A103	Site Plan - Grading
A201	Lower Commercial / Industrial - Tyee Rd
A202	Mezzanine
A203	Parkade - Alston Street
A204	Level 1
A205	Level 2
A206	Level 3
A207	Level 4
A208	Roof
A208a	Roof Amenity Space
A208b	Roof Drainage
A301	Building Elevation
A302	Building Elevation
A303	Building Elevation
A304	Building Elevation
A401	Building Section - Looking North

List of Abbreviations

The following abbreviations are used on door, window, and finish schedules as well as on architectural drawings and details.

ACST	Acrylic Stucco	HP	High Point	ST	Structure
ACT	Acoustical Tile	HSS	Hollow Steel Section	STL	Steel
AFF	Above Finished Floor	H/W	Hardware	STN	Stain(ed)
AL	Aluminum	INSUL	Insulated	STNT	Stone Tile
BG	Building Grade	LAM	Laminated Glass	SS	Stainless Steel
CEM	Cementitious Backing Board	LP	Low Point	SVF	Sheet Vinyl Flooring
Conc	Concrete	MDFB	Medium Density Fibreboard Base	TB	Towel Bar
CBK	Concrete Block	MR	Mirror	T/D	Tempered / Double Glazed
C/L	Centerline	MP	Metal Panel	TLAM	Tempered Laminated Glass
CPT	Carpet Tile	O/H	Overhead	TGL	Tempered Glass
CT	Ceramic Tile	OW	Operable Window	TLGL	Translucent Glass
C/W	Complete With	PF	Prefinished	TOC	Top of Concrete
DD	Deck Drain	PLAM	Plastic Laminate	TOD	Top of Drain
EL	Elevation	PLS	Plaster	TOI	Top of Insulation
EPC	Epoxy Polymer Coating	PSF	Pressed Steel Frame	TOP	Top of Parapet
EXP AGG	Exposed Aggregate	PT	Paint	TOS	Top of Slab
EXT	Exterior	PTD	Paper Towel Dispenser	TOW	Top of Wall
FD	Floor Drain	PTD/W	Paper Towel Dispenser / Waste	TP	Toilet Paper
FEC	Fire Extinguisher Cabinet	PTW	Paper Towel Waste	UNF	Unfinished (for GWB means taped and filled by not sanded to
FFE	Finished Floor Elevation	RA	Roof Anchor		minimum ULC requirements where applicable)
FG	Finished Grade	RB	Rubber Base	UNO	Unless Noted Otherwise
GB	Grab Bar	RES	Resilient Flooring	U/S	Underside of
GBL	Glass Block	RD	Roof Drain	VCT	Vinyl Composition Tile
GL	Glass	RD-P	Roof Drain - Planter	VI	Vision Glass
GWG	Georgian Wire Glass	RWL	Rain Water Leader	VIS	Vinyl Impact Sheet
GWB	Gypsum Wallboard	SAFI	Spray Applied Fibrous Insulation	VT	Vinyl Tile
HC	Hollow Core	SCW	Solid Core Wood	VWC	Vinyl Wall Covering
HCW	Hollow Core Wood	SD	Soap Dispenser	WC	Water Closet
H/C	Handicap	SL	Sealer	WD	Wood
HM	Hollow Metal	SP	Spandrel Glass	WPM	Waterproof Membrane
		SPC	Solid Particleboard Core	WRC	Water Repellant Coating

Annotations Legend

The following annotations are used on architectural drawings and details:

BEDROOM ROOM NAME & ROOM NUMBER

101a DOOR NUMBER See Door Schedule

See Window Schedule

WALL TYPE
See Assemblies Schedule

W-10 WINDOW NUMBER

2.0 hr RATED WALL DESIGNATION

00.00 ELEVATION DATUM

2440 CEILING HEIGHT

AREA OF DROP CEILING

1 KEYNOTE SYMBOL

12 MATERIAL TAG



W1 C1 F1 B1 ROOM FINISHES

dHKarchitects
Victoria

dHKarchitects
Victoria
977 Fort Street V8V 3K3 T 1•250•658•3367
Nanaimo
102-5190 Dublin Way V9T 0H2 T 1•250•585•5810
COPYRIGHT RESERVED. THESE PLANS AND DESIGNS ARE AND AT ALL TIMES REMAIN THE PROPERTY OF DHKARCHITECTS TO BE USED FOR THE PROJECT SHOWN AND MAY NOT BE REPRODUCED WITHOUT WRITTEN CONSENT

DDP Revisions

DP / Rezoning

CALUC

DDP Revisions

DP / Rezoning Rev. 6

DP / Rezoning Rev. 3

DP / Rezoning Rev. 2

DP / Rezoning Rev. 1

10 25-05-02

8 24-06-27

5 23-10-26

4 23-07-25

3 23-06-15

2 23-03-30

1 23-03-25

NOTE: All dimensions are shown in millimeters.

Project Data


Alston

V9A 3S6

As indicated Project Number

1055 Alston St, Victoria, BC

:025-05-06 12:09:27 PM

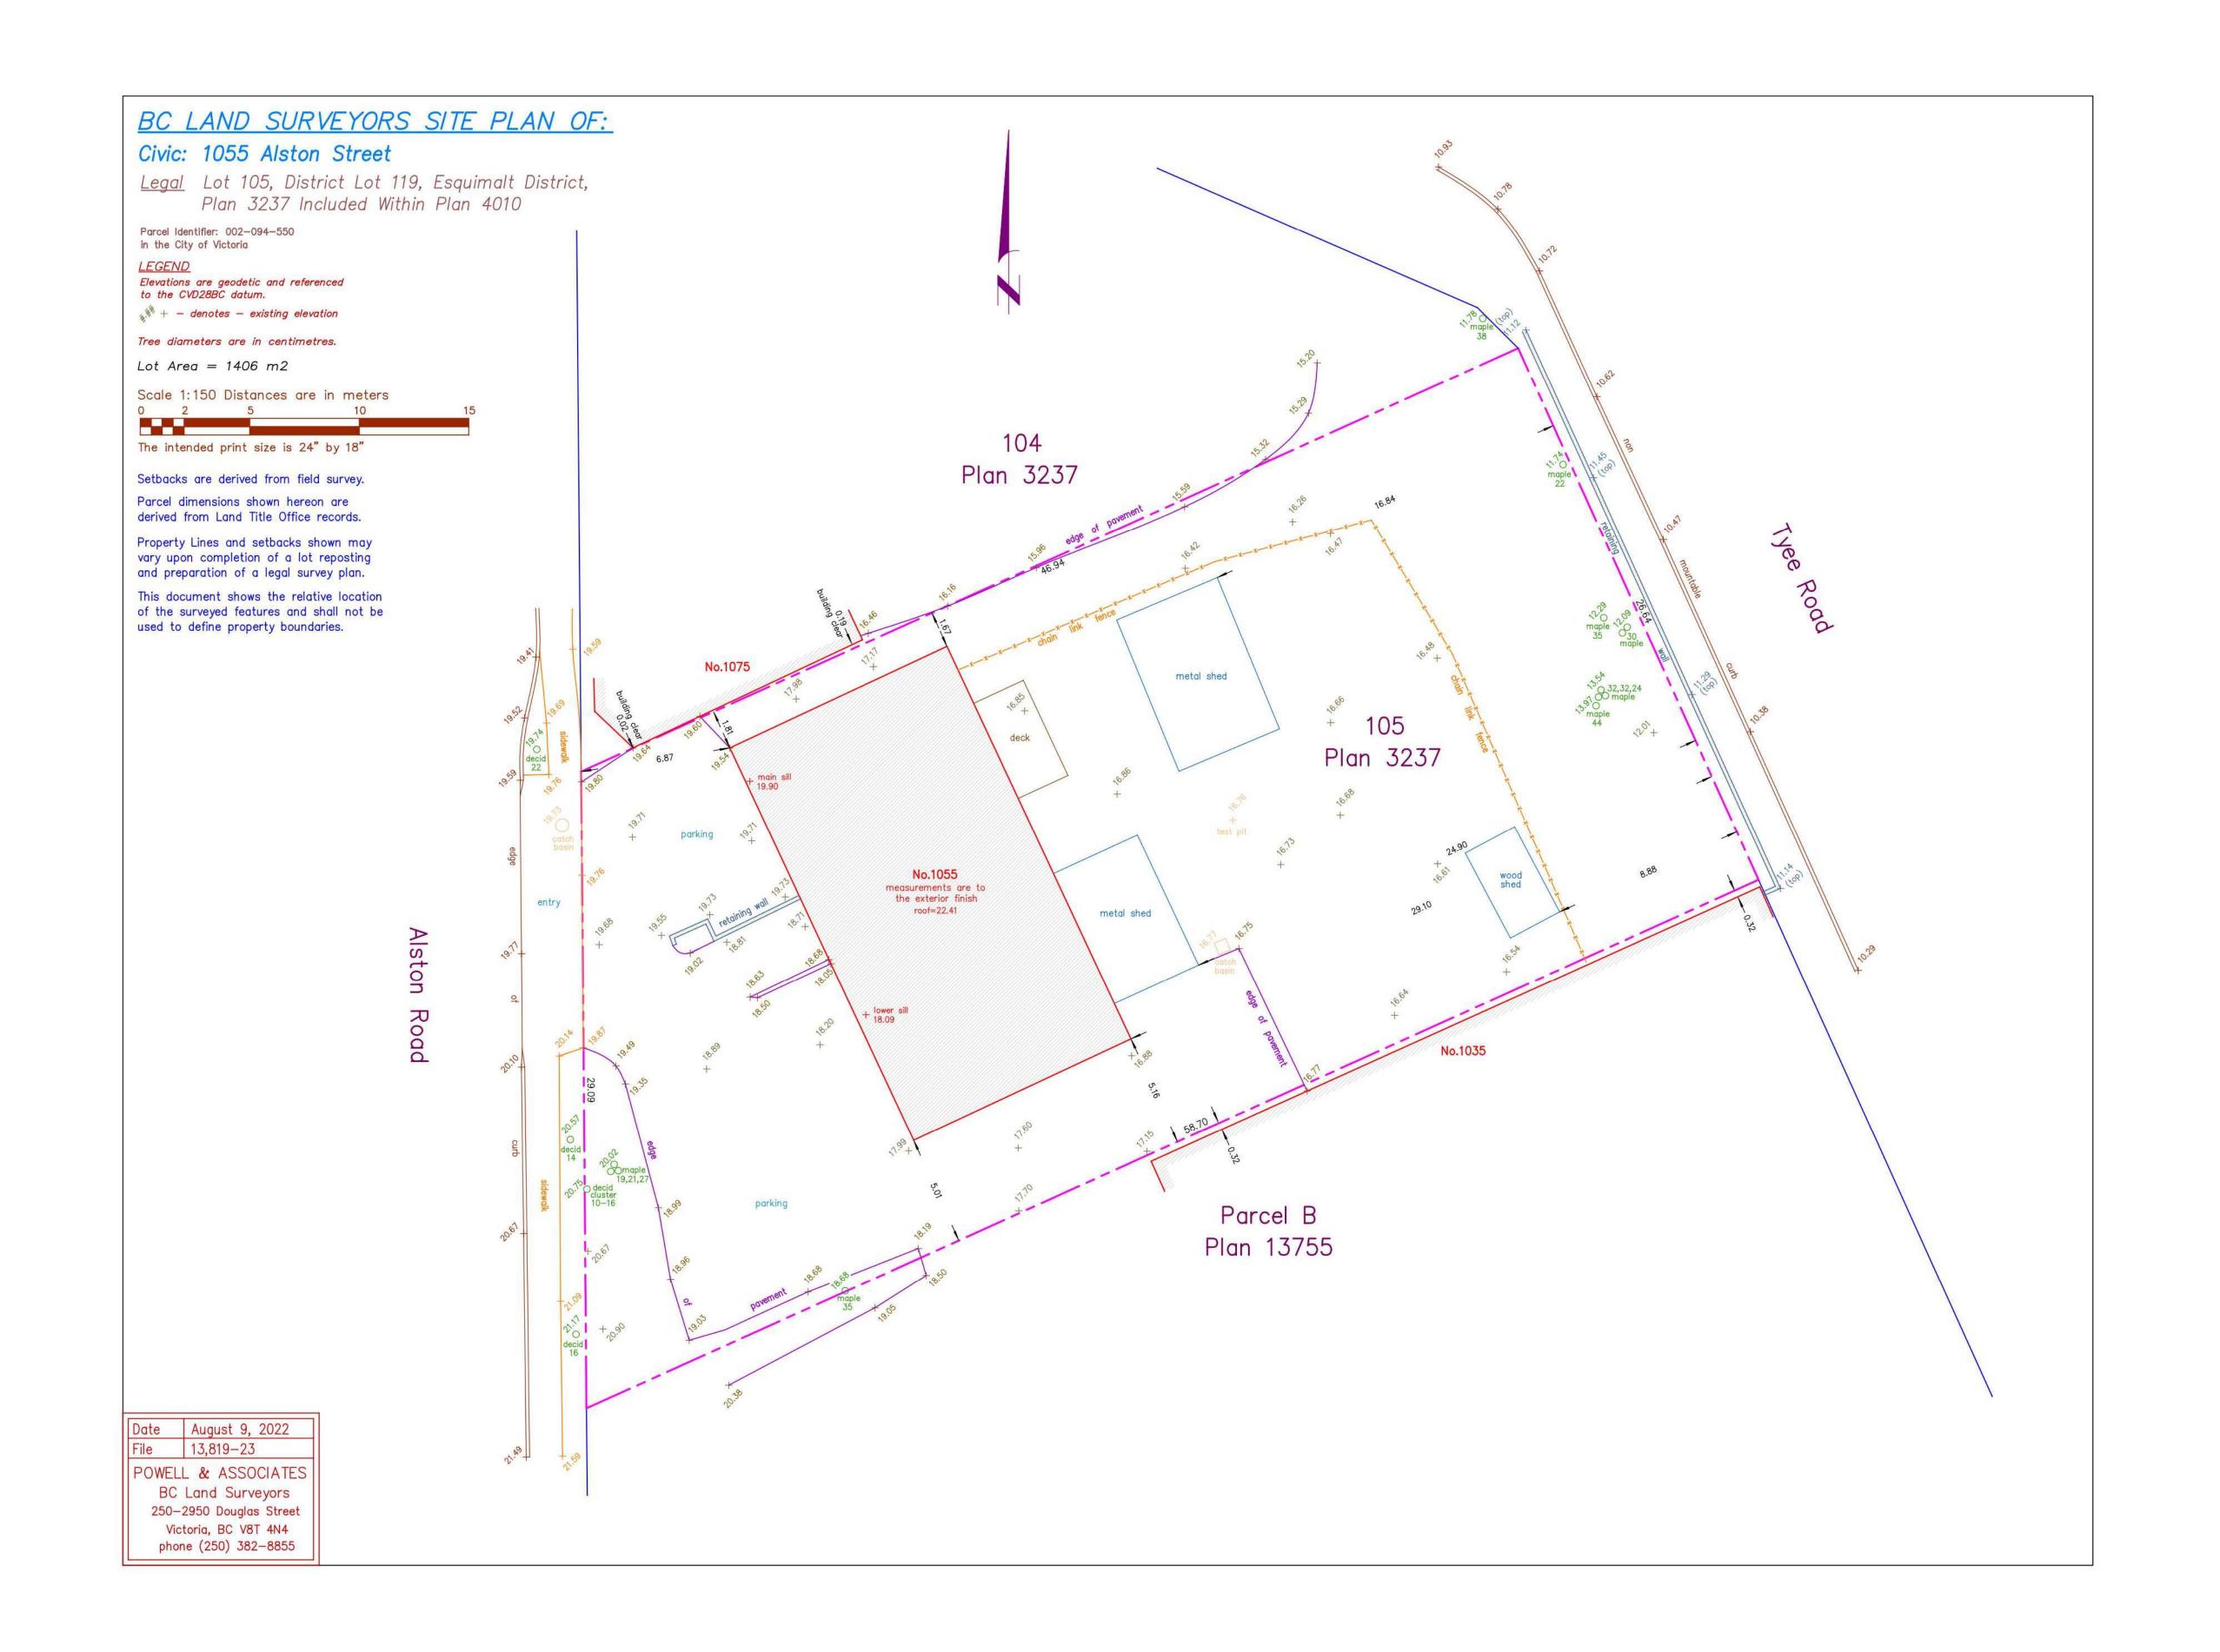




Alston

1055 Alston St, Victoria, BC V9A 3S6

Survey

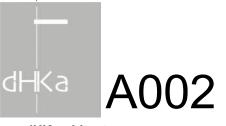

dHKarchitects

Victoria
977 Fort Street V8V 3K3 T 1•250•658•3367
Nanaimo
102-5190 Dublin Way V9T 0H2 T 1•250•585•5810
COPYRIGHT RESERVED. THESE PLANS AND DESIGNS ARE AND AT ALL TIMES REMAIN THE PROPERTY OF DHKARCHITECTS TO BE USED FOR THE PROJECT SHOWN AND MAY NOT BE REPRODUCED WITHOUT WRITTEN CONSENT



Alston Street View

736 Tyee Road 740 Tyee Road 790 Tyee Road

Tyee Street View

10 25-05-02 3 23-06-15 2 23-03-30 1 23-03-25 DDP Revisions DP / Rezoning Rev. 1 DP / Rezoning CALUC NOTE: All dimensions are shown in millimeters.

Alston

1055 Alston St, Victoria, BC V9A 3S6

Street View





dHKarchitects Victoria 977 Fort Street


102-5190 Dublin Way V9T 0H2 T 1•250•585•5810


COPYRIGHT RESERVED. THESE PLANS AND DESIGNS ARE AND AT ALL TIMES REMAIN
THE PROPERTY OF **DHKARCHITECTS** TO BE USED FOR THE PROJECT SHOWN AND
MAY NOT BE REPRODUCED WITHOUT WRITTEN CONSENT

Summer Solstice

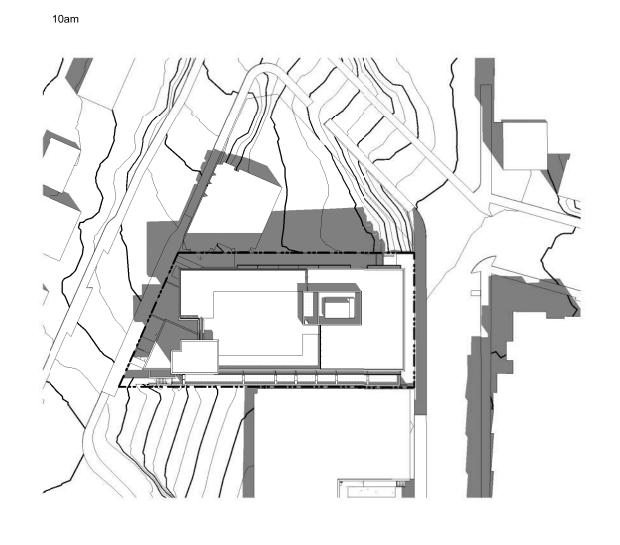


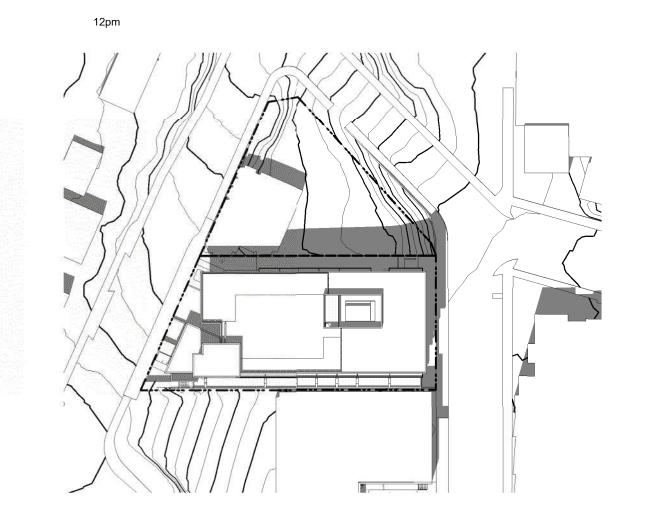


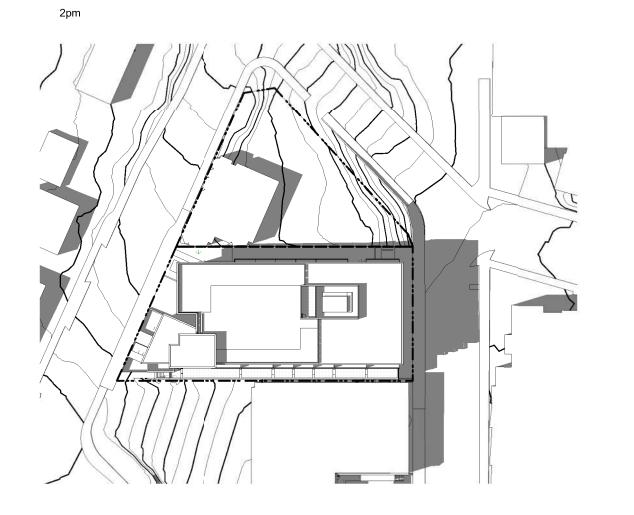


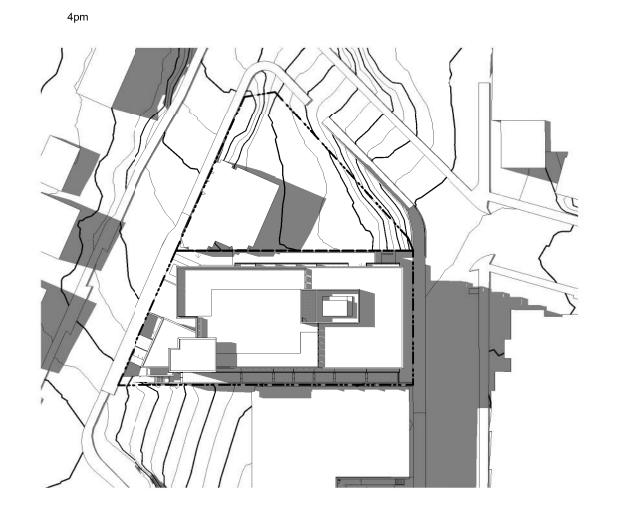


Equinox

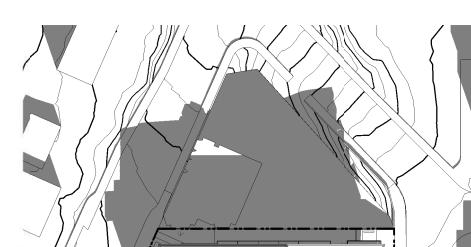

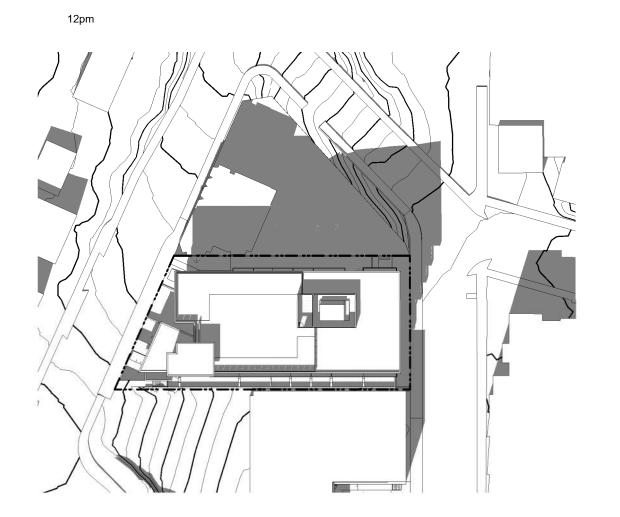


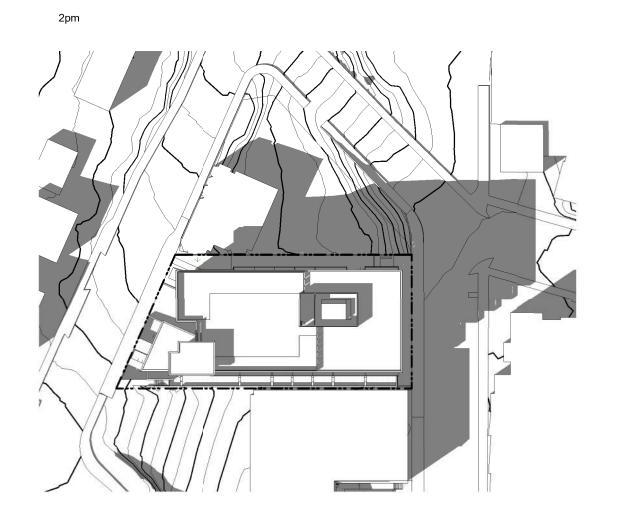


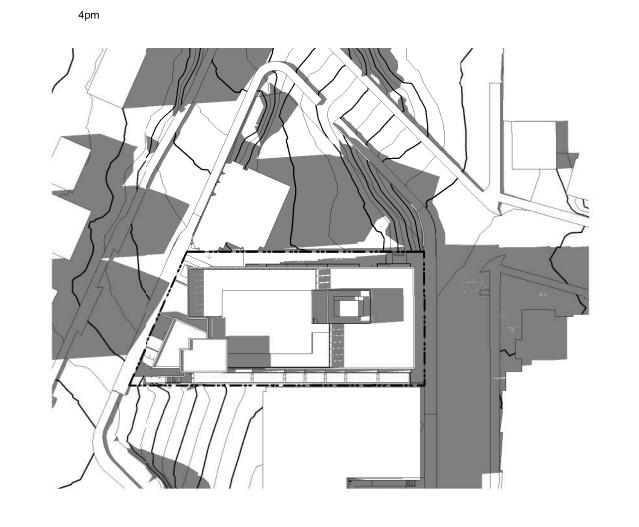


Winter Solstice

10am

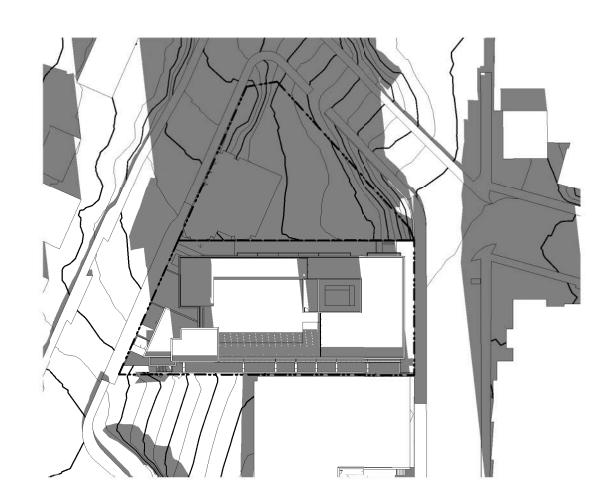

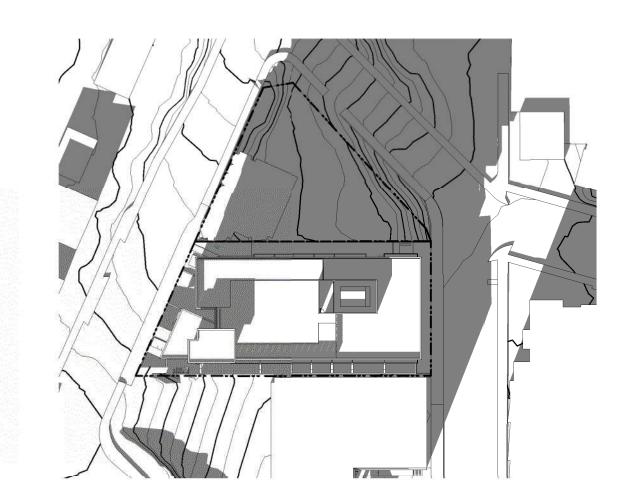

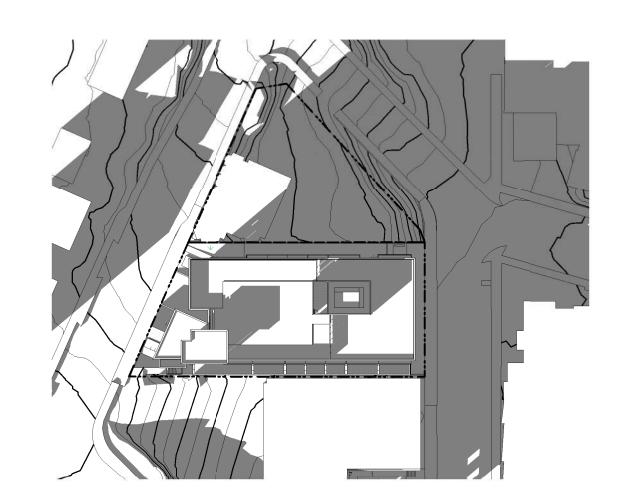




	10 2	25-05-02 23-03-30		DDP Revisions DP / Rezoning
Rev	10	25-05-02	Description	DDP Revisions
Plot Date		06/15/23	Project Status	DP / Rezoning
Drawn By		Author	Checked By	Checker
Scale		1 : 750	Project Number	2304
NOTE: All	dimensions	are shown in milli	meters.	


Alston

1055 Alston St, Victoria, BC V9A 3S6

Shadow Studies

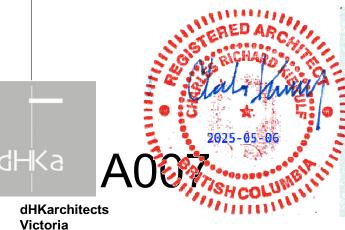

dHKarchitects
Victoria
977 Fort Street V8V 3K3 T 1•250•658•3367
Nanaimo
102-5190 Dublin Way V9T 0H2 T 1•250•585•5810
COPYRIGHT RESERVED. THESE PLANS AND DESIGNS ARE AND AT ALL TIMES REMAIN THE PROPERTY OF DHKARCHITECTS TO BE USED FOR THE PROJECT SHOWN AND MAY NOT BE REPRODUCED WITHOUT WRITTEN CONSENT

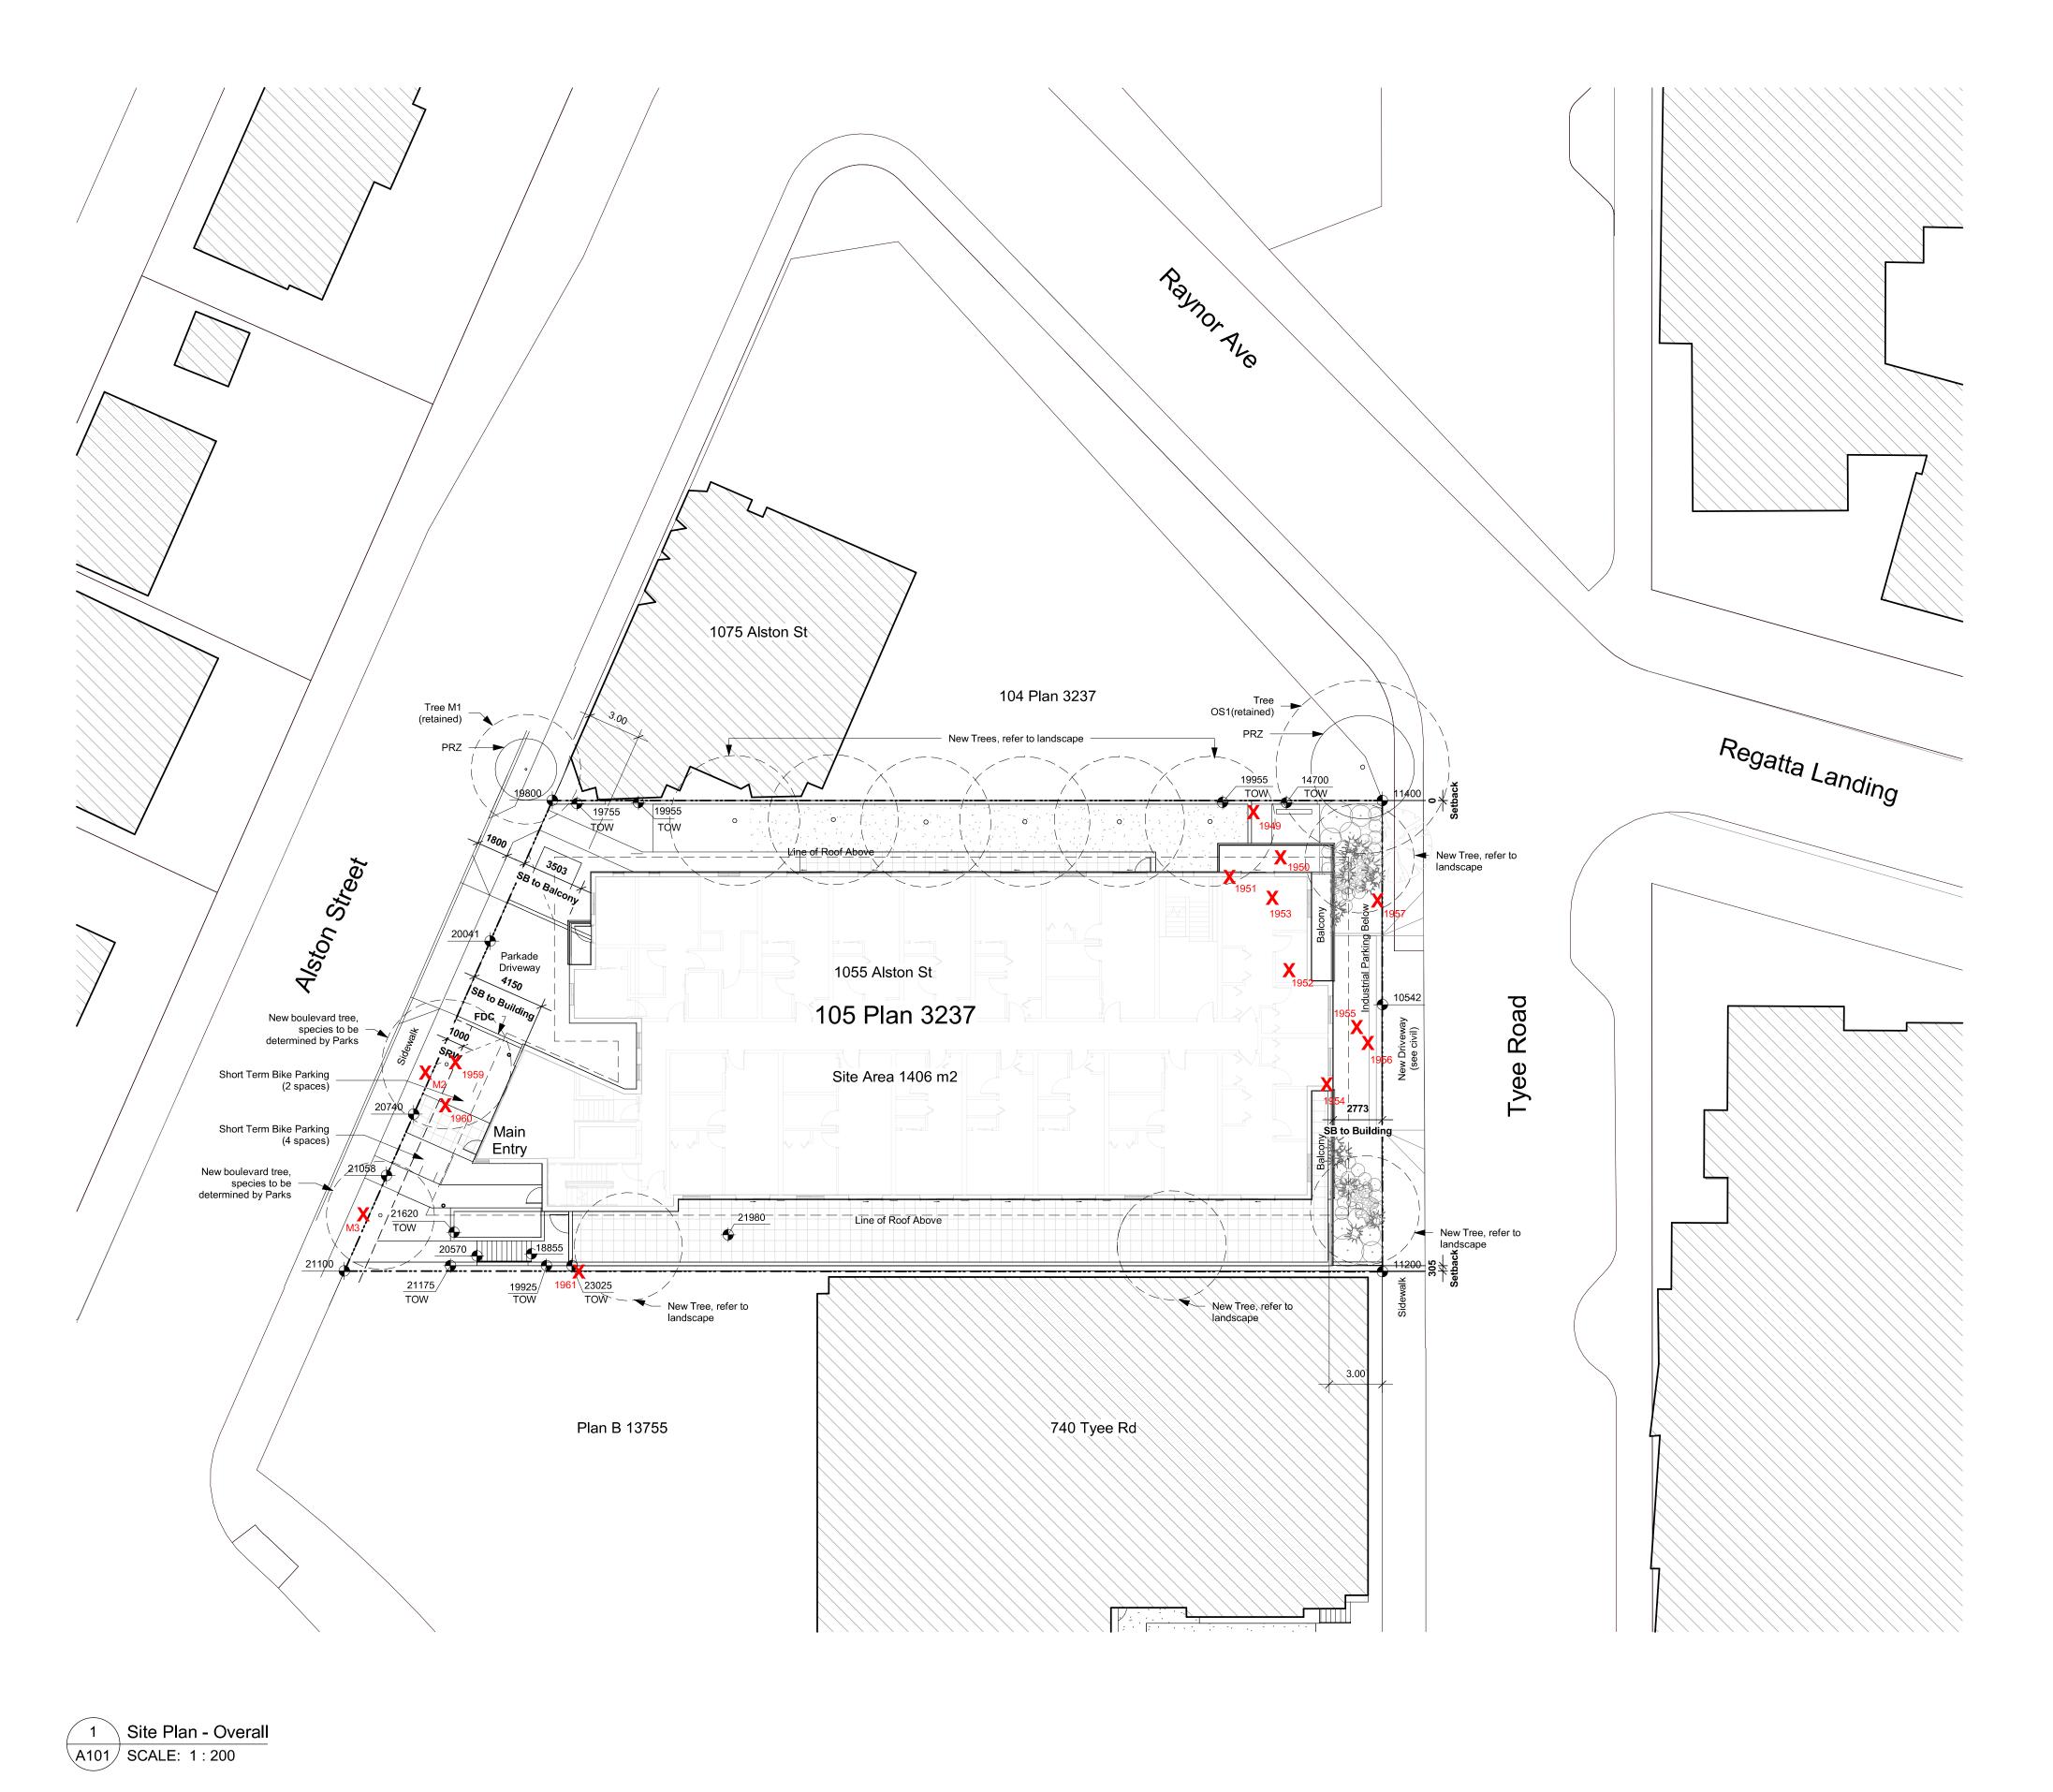

General Notes: Refer to Civil drawings for all roadways, driveways, curbs, and grading.

Refer to Landscape drawings for all hard and soft landscaping on site.

9 24-07-22 8 24-06-27 DP / Rezoning Rev. 6 DP / Rezoning Rev. 5 7 24-04-11 6 24-02-14 DP / Rezoning Rev. 4 5 23-10-26 DP / Rezoning Rev. 3 4 23-07-25 DP / Rezoning Rev. 2 2 23-03-30 DP / Rezoning 1 23-03-25 CALUC


DP / Rezoning Rev. 7


Alston

NOTE: All dimensions are shown in millimeters.


1055 Alston St, Victoria, BC V9A 3S6

Site Plan Overall

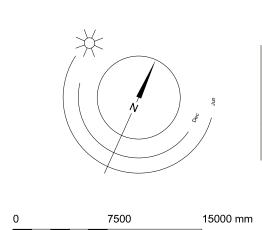

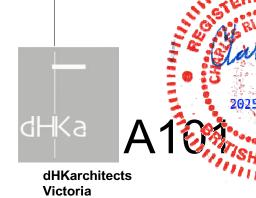


Victoria 977 Fort Street V8V 3K3 **T** 1•250•658•3367 102-5190 Dublin Way V9T 0H2 **T** 1•250•585•5810 COPYRIGHT RESERVED. THESE PLANS AND DESIGNS ARE AND AT ALL TIMES REMAIN THE PROPERTY OF **DHKARCHITECTS** TO BE USED FOR THE PROJECT SHOWN AND MAY NOT BE REPRODUCED WITHOUT WRITTEN CONSENT

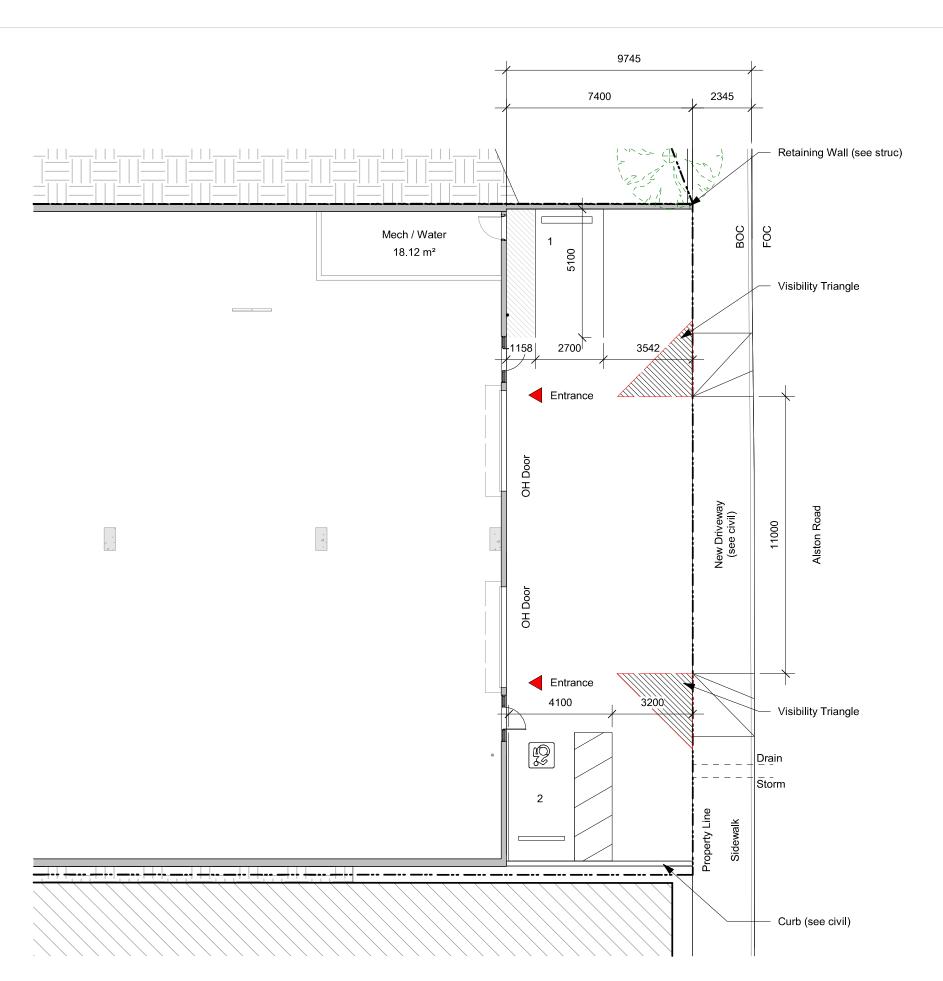

1 Site - Tyee Rd - Circulation A102 SCALE: 1:150

Note:
- Civil to Confirm Sidewalk Elevation
- PMT Conc Pad to Match Sidewalk Elevation

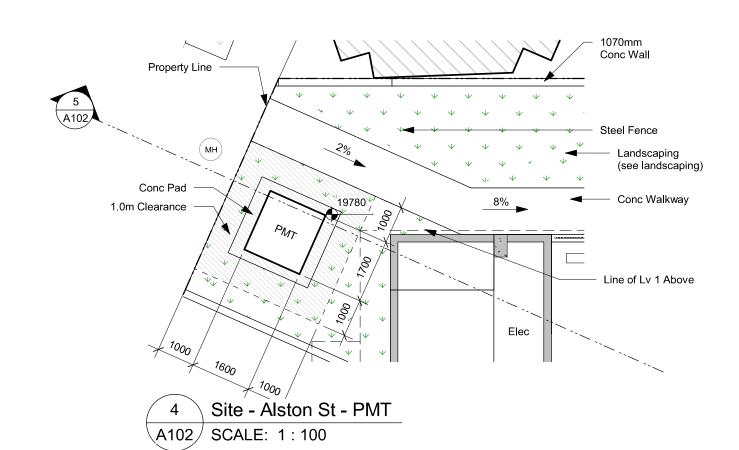

3600 B1
76.70 m²
1000 1600 1000


21.955


Level 1

PMT

Parkade - Alston St

5 Section 3 A102 SCALE: 1:100

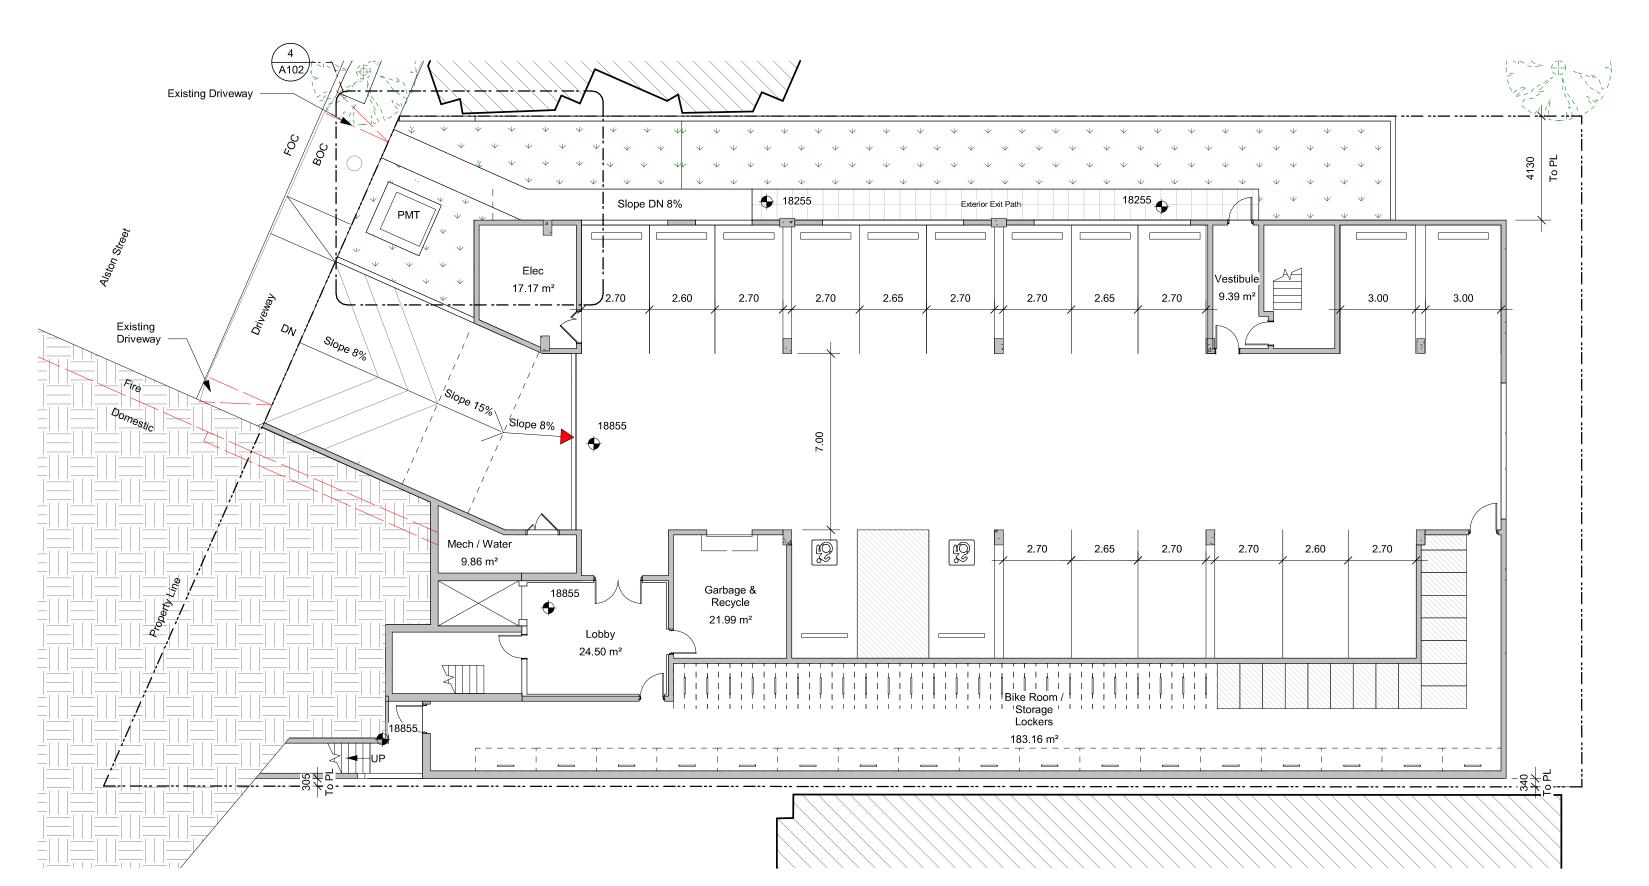

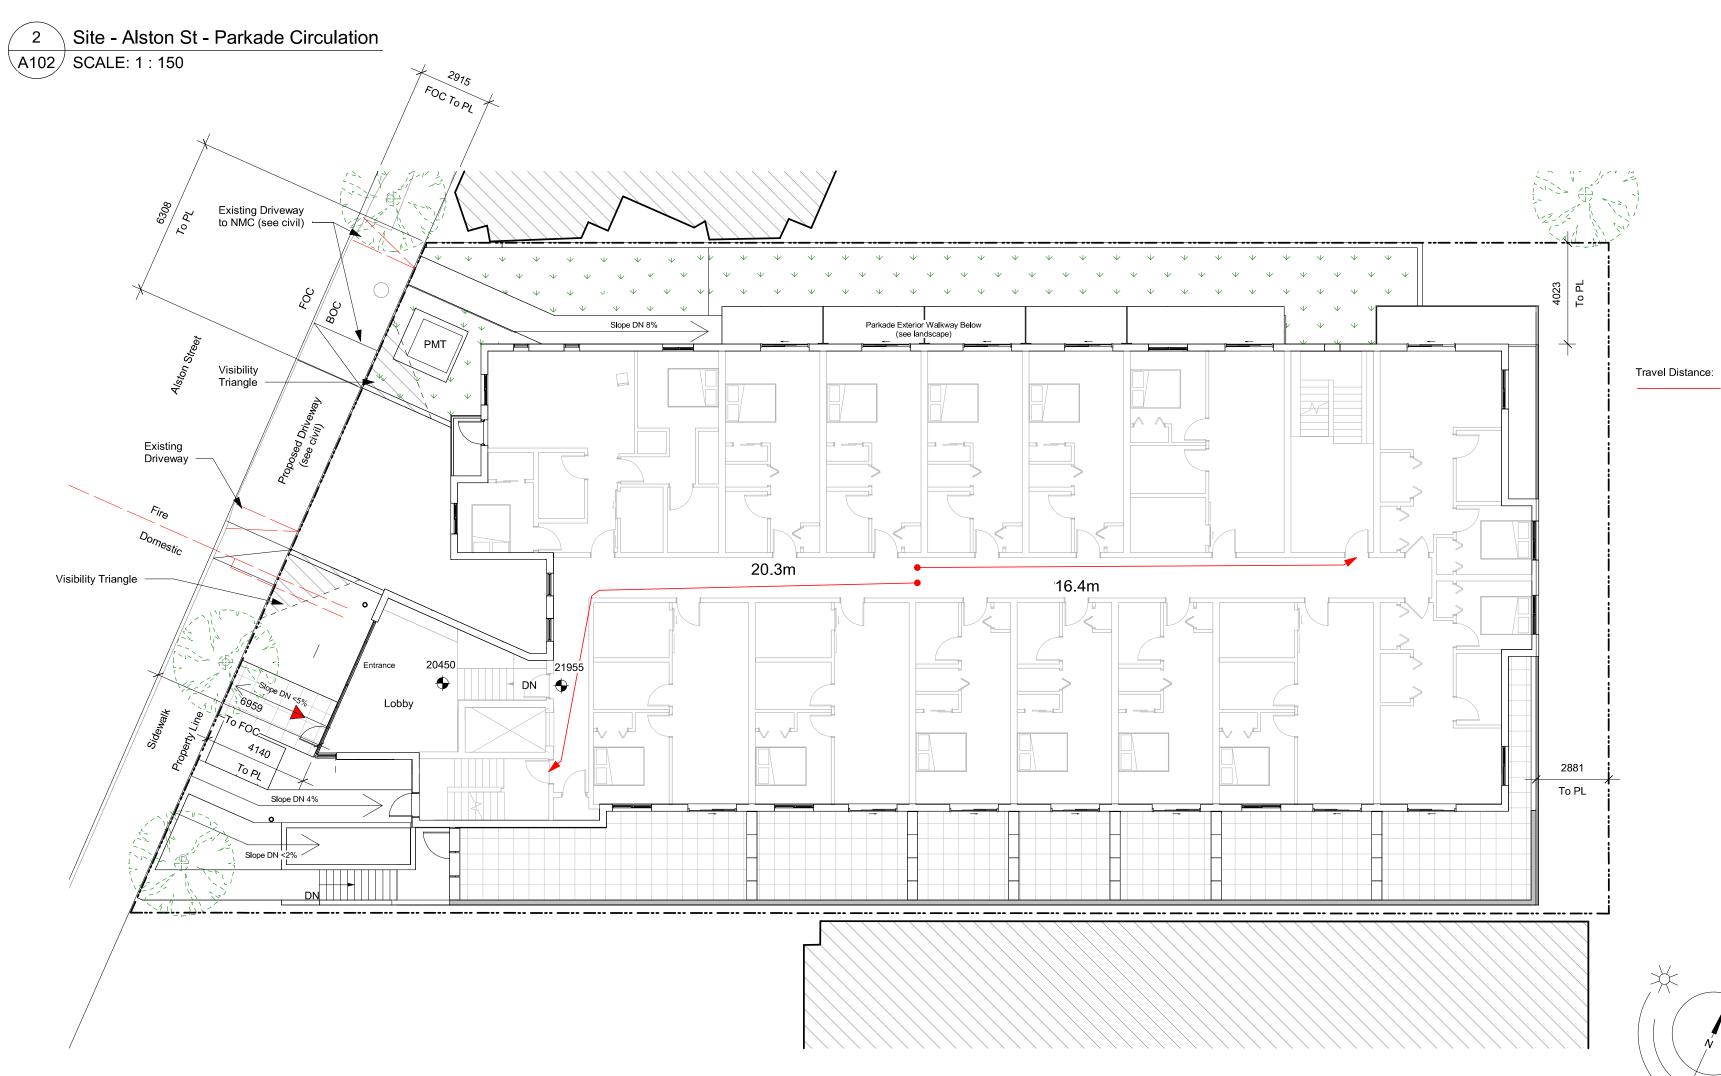

dHKa

dHKarchitects
Victoria
977 Fort Street
Nanaimo

General Notes:

1. Refer to Civil drawings for all roadways, driveways, curbs,

Refer to Landscape drawings for all hard and soft landscaping on site.

Victoria
977 Fort Street V8V 3K3 T 1•250•658•3367
Nanaimo
102-5190 Dublin Way V9T 0H2 T 1•250•585•5810
COPYRIGHT RESERVED. THESE PLANS AND DESIGNS ARE AND AT ALL TIMES REMAIN THE PROPERTY OF DHKARCHITECTS TO BE USED FOR THE PROJECT SHOWN AND MAY NOT BE REPRODUCED WITHOUT WRITTEN CONSENT

1055 Alston St, Victoria, BC V9A 3S6

Circulation,

10 25-05-02

5 23-10-26

4 23-07-25

3 23-06-15

2 23-03-30

NOTE: All dimensions are shown in millimeters.

Site Plan -


Alston

DDP Revisions


DP / Rezoning Rev. 3

DP / Rezoning Rev. 2 DP / Rezoning Rev. 1 DP / Rezoning

3 Site - Alston St - Level 1 Circulation A102 SCALE: 1:150

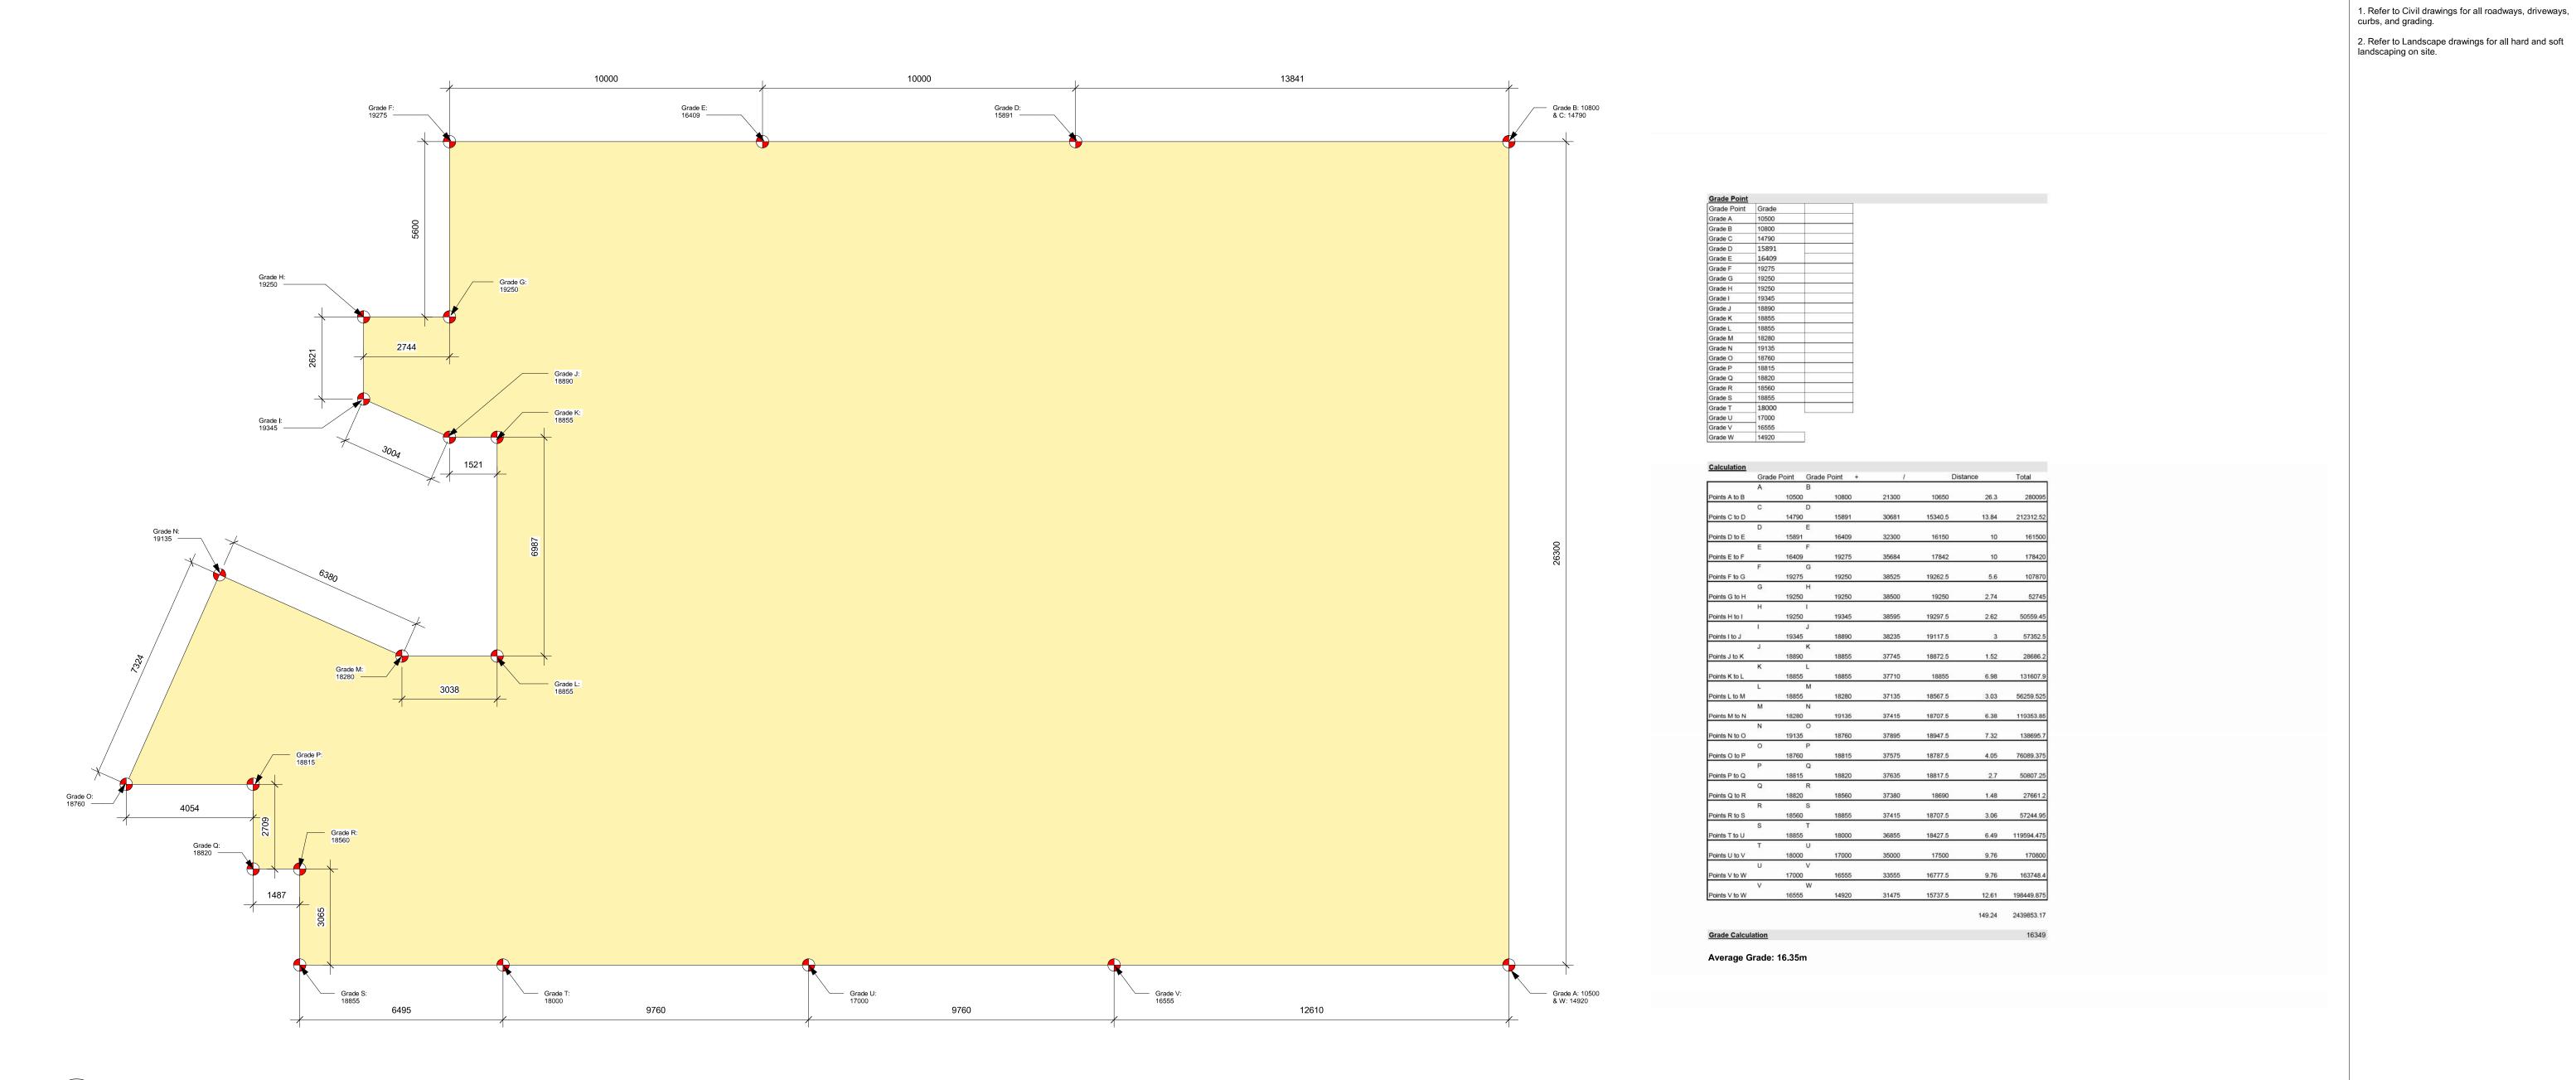

1 Grading A103 SCALE: 1:100

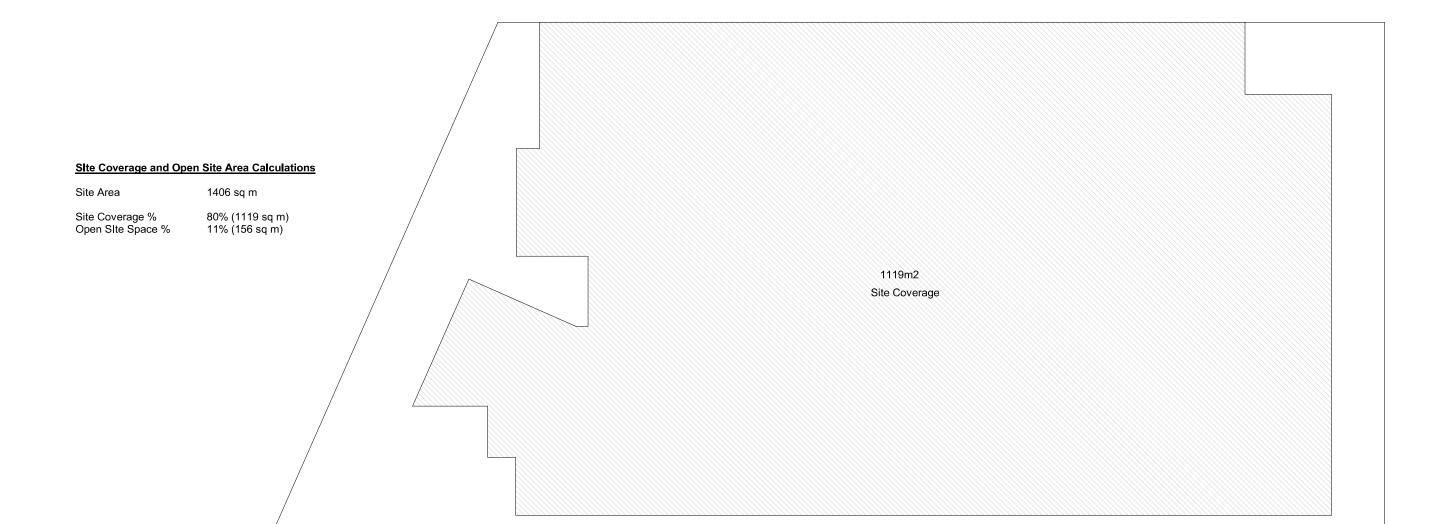



5 23-10-26 DP / Rezoning Rev. 3
4 23-07-25 DP / Rezoning Rev. 2
2 23-03-30 DP / Rezoning

ev 5 23-10-26 Description DP / Rezoning Rev. 3

ot Date 06/15/23 Project Status DP / Rezoning

rawn By SWS Checked By CRK

Alston

NOTE: All dimensions are shown in millimeters.

General Notes:


1055 Alston St, Victoria, BC V9A 3S6

Site Plan - Grading




2 Site Coverage A103 SCALE: 1:200

Victoria
977 Fort Street V8V 3K3 T 1•250•658•3367
Nanaimo
102-5190 Dublin Way V9T 0H2 T 1•250•585•5810
COPYRIGHT RESERVED. THESE PLANS AND DESIGNS ARE AND AT ALL TIMES REMAIN THE PROPERTY OF DHKARCHITECTS TO BE USED FOR THE PROJECT SHOWN AND MAY NOT BE REPRODUCED WITHOUT WRITTEN CONSENT

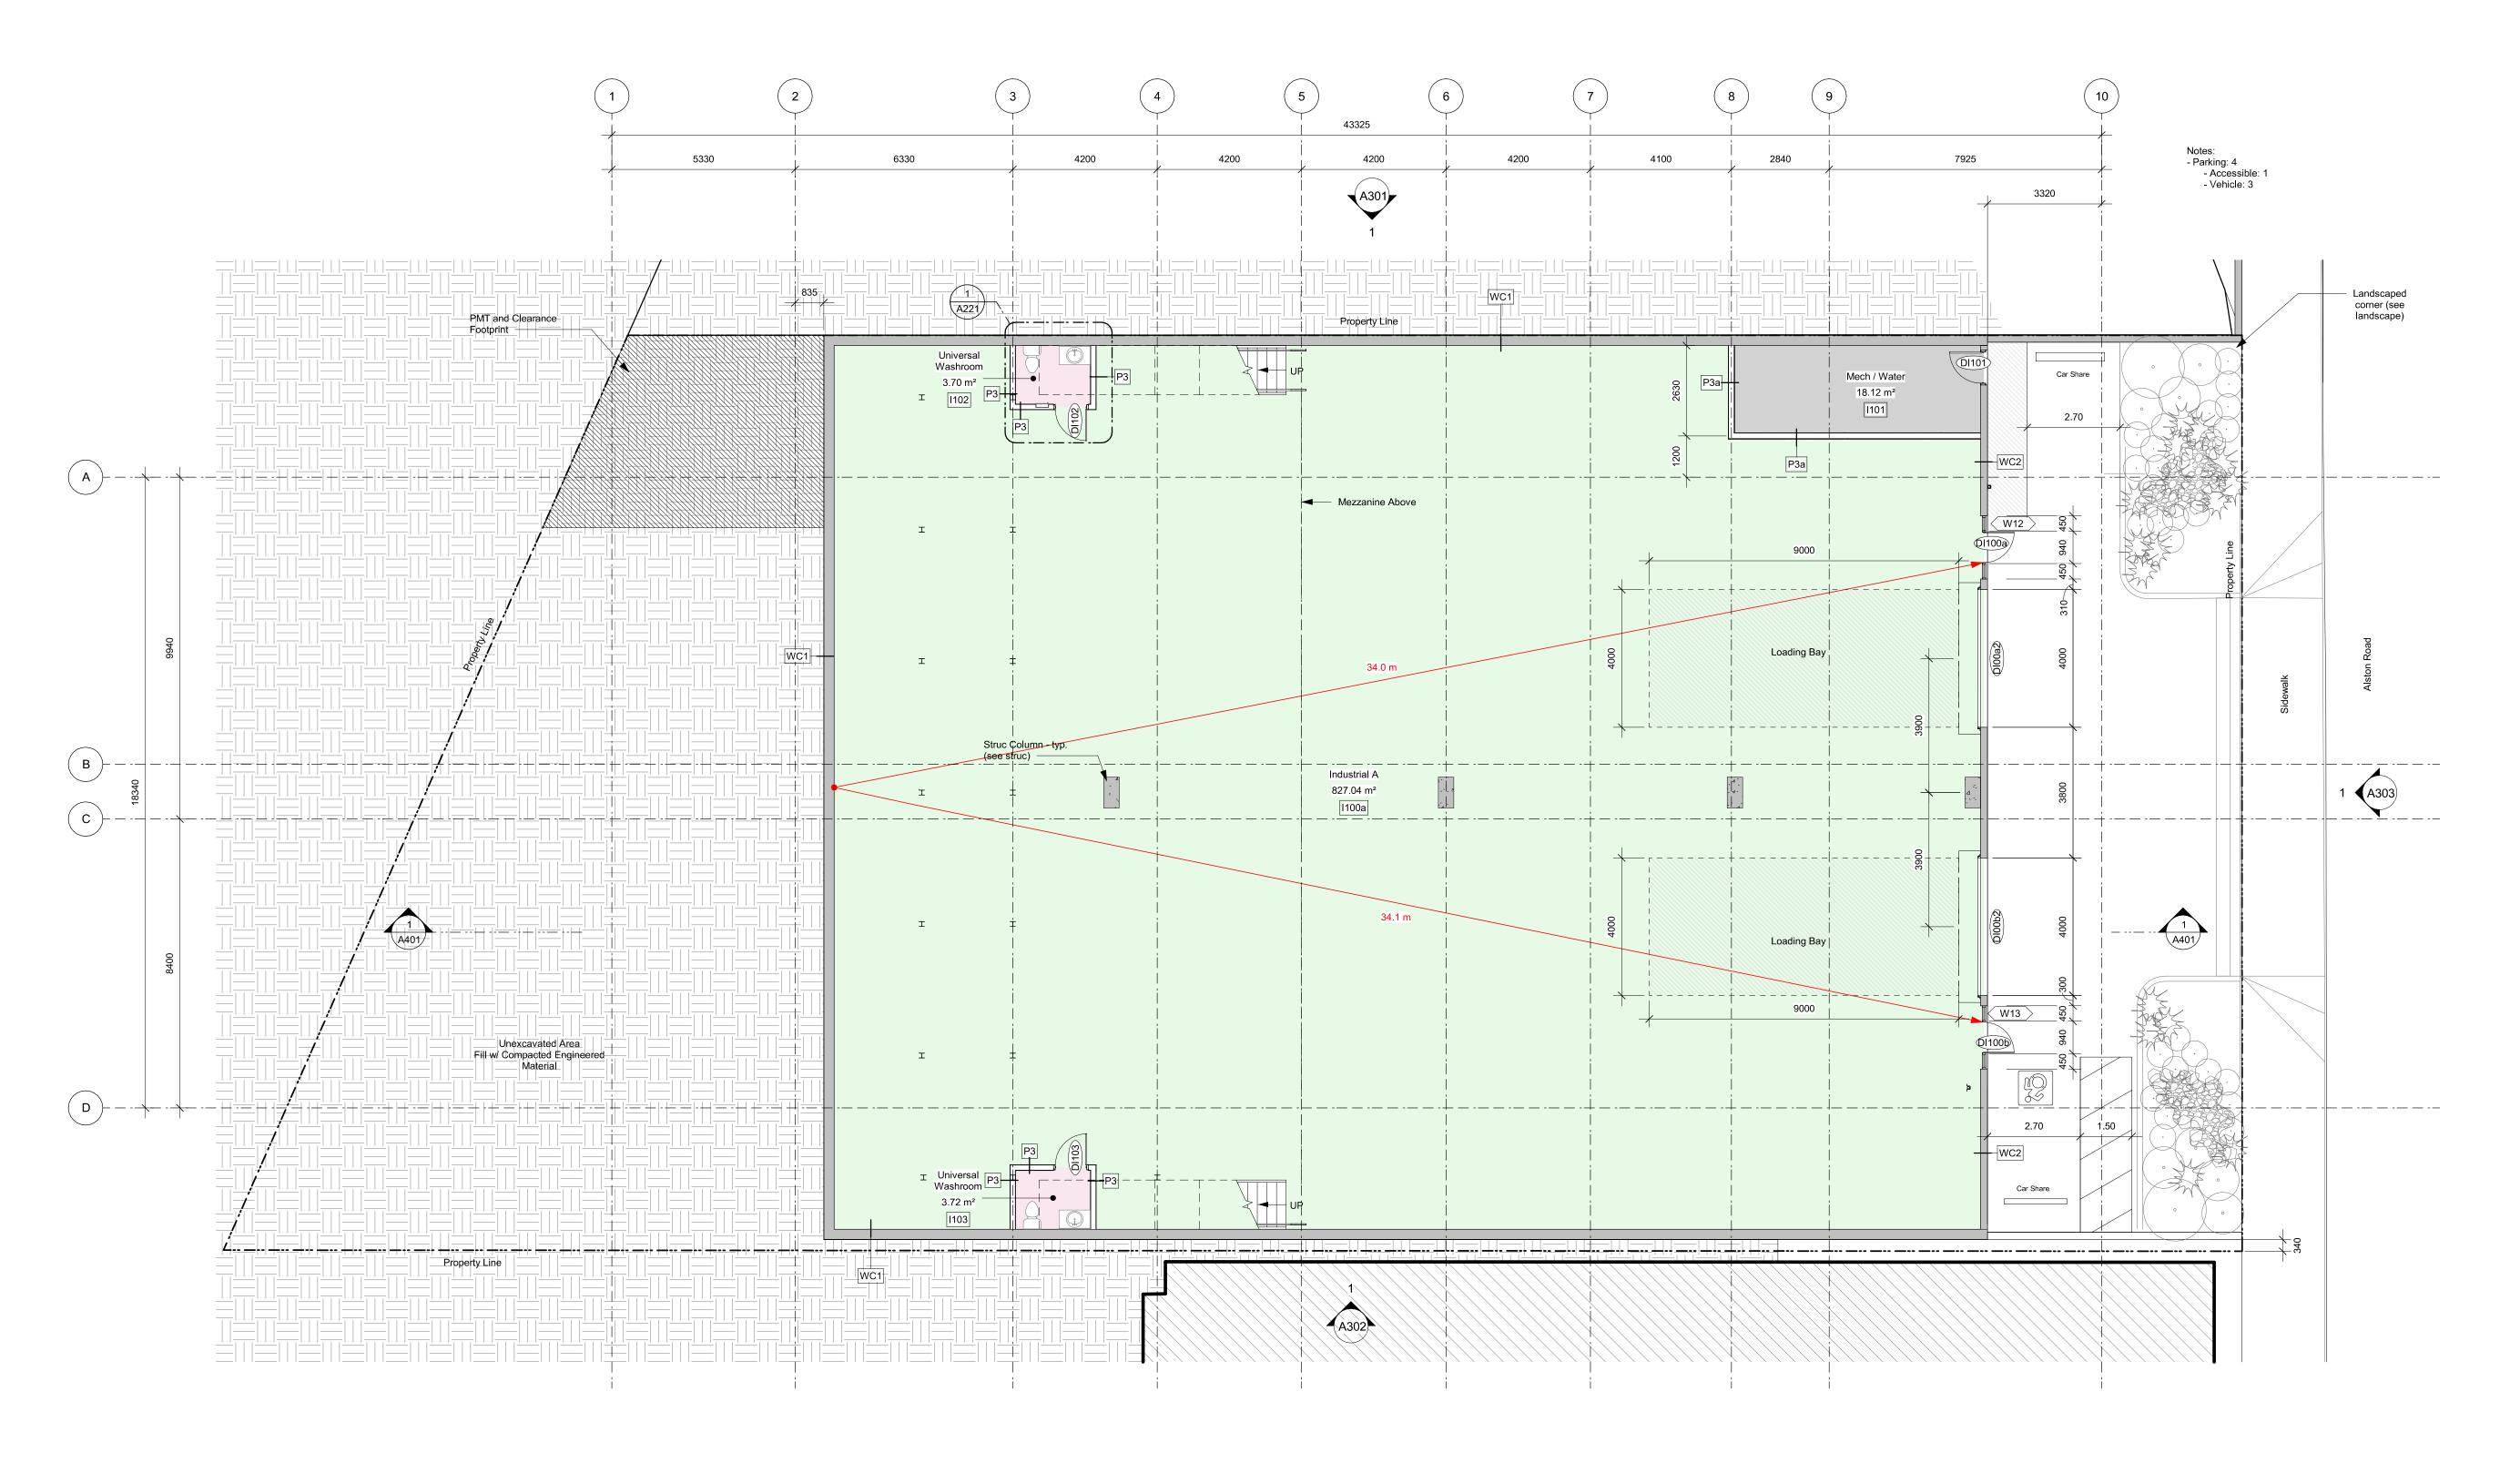


1 Industrial - Tyee Rd A201 SCALE: 1:100

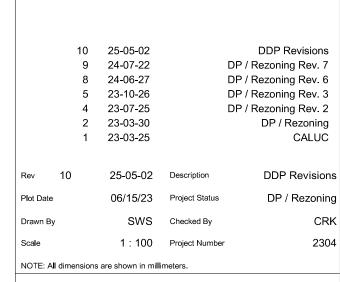

Alston

1055 Alston St, Victoria, BC V9A 3S6


Lower Commercial / Industrial - Tyee Rd

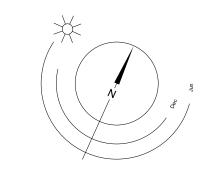

dHKarchitects
Victoria
977 Fort Street
Nanaimo

Victoria
977 Fort Street V8V 3K3 T 1•250•658•3367
Nanaimo
102-5190 Dublin Way V9T 0H2 T 1•250•585•5810
COPYRIGHT RESERVED. THESE PLANS AND DESIGNS ARE AND AT ALL TIMES REMAIN THE PROPERTY OF DHKARCHITECTS TO BE USED FOR THE PROJECT SHOWN AND MAY NOT BE REPRODUCED WITHOUT WRITTEN CONSENT

25-05-06 12:09:44 PM

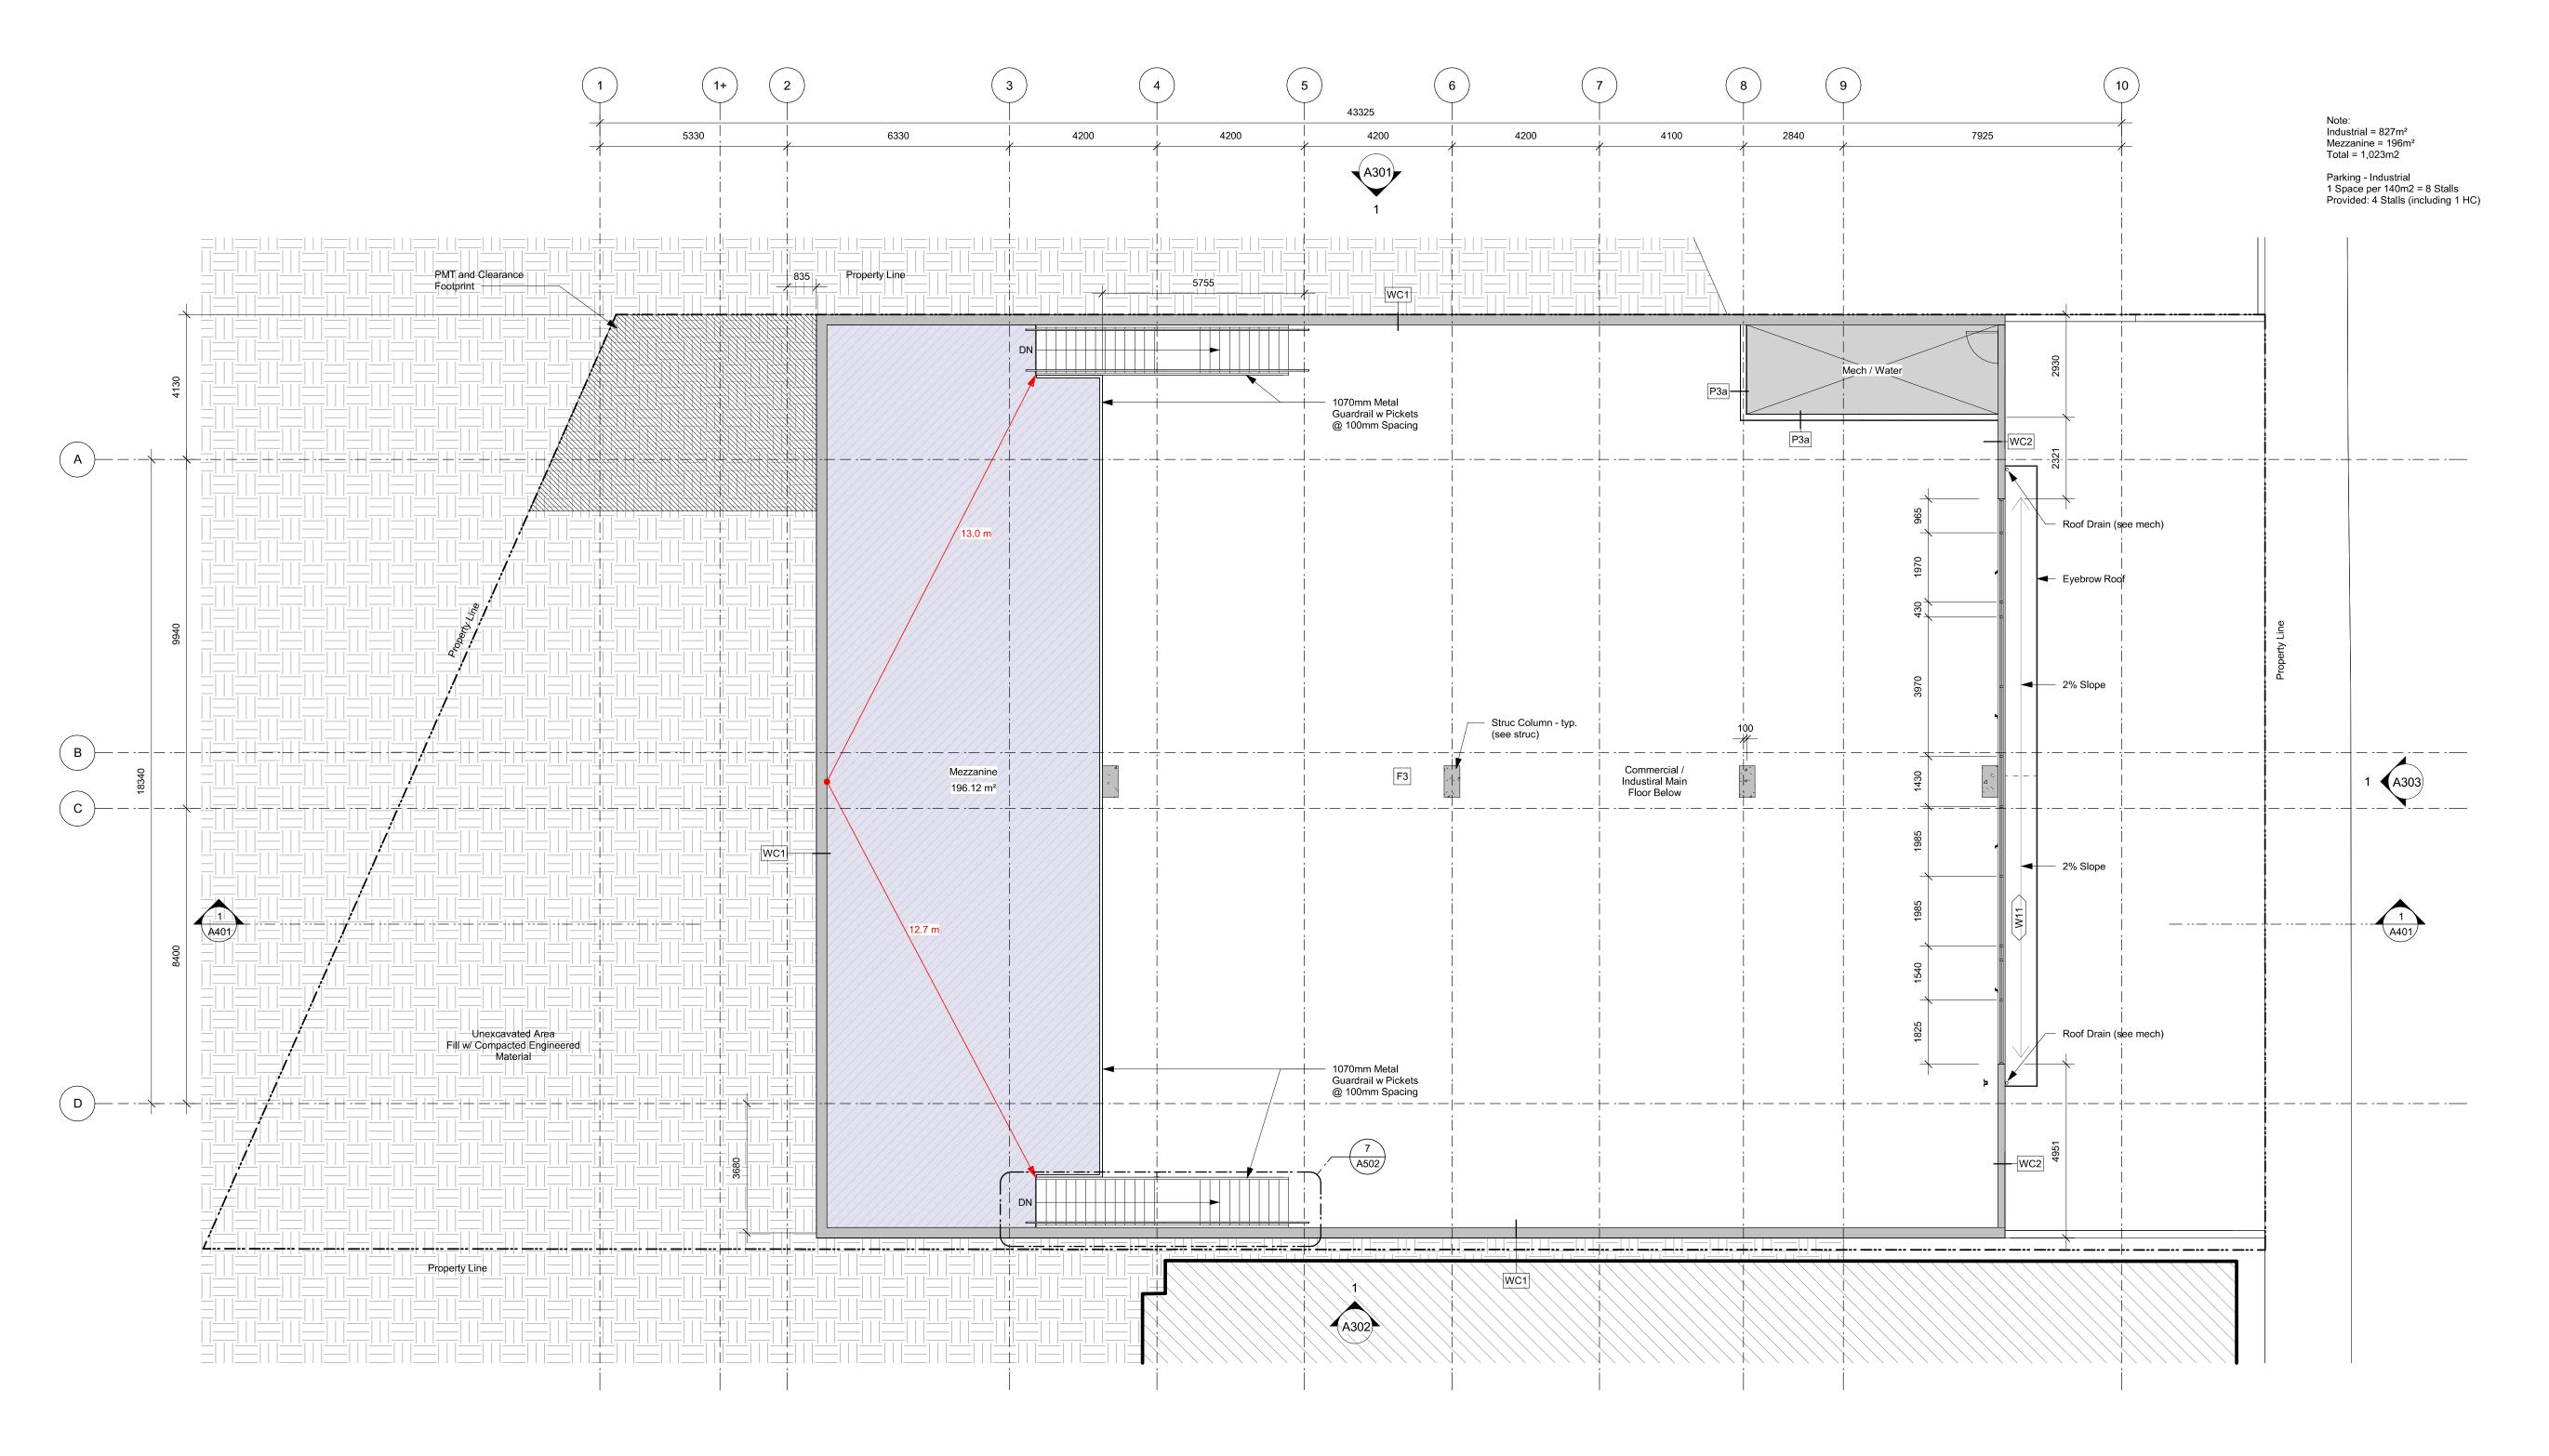

1 Industrial - Mezzanine A202 SCALE: 1:100 5 23-10-26 DP / Rezoning Rev. 3
2 23-03-30 DP / Rezoning
1 23-03-25 CALUC


Rev 5 23-10-26 Description DP / Rezoning Rev. 3
Plot Date 25/04/16 Project Status DP / Rezoning

Drawn By SWS Checked By
Scale 1:100 Project Number
NOTE: All dimensions are shown in millimeters.

Alston


1055 Alston St, Victoria, BC V9A 3S6

Mezzanine

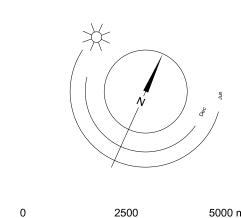

dHKarchitects
Victoria
977 Fort Street

Victoria
977 Fort Street V8V 3K3 T 1•250•658•3367
Nanaimo
102-5190 Dublin Way V9T 0H2 T 1•250•585•5810
COPYRIGHT RESERVED. THESE PLANS AND DESIGNS ARE AND AT ALL TIMES REMAIN THE PROPERTY OF DHKARCHITECTS TO BE USED FOR THE PROJECT SHOWN AND MAY NOT BE REPRODUCED WITHOUT WRITTEN CONSENT

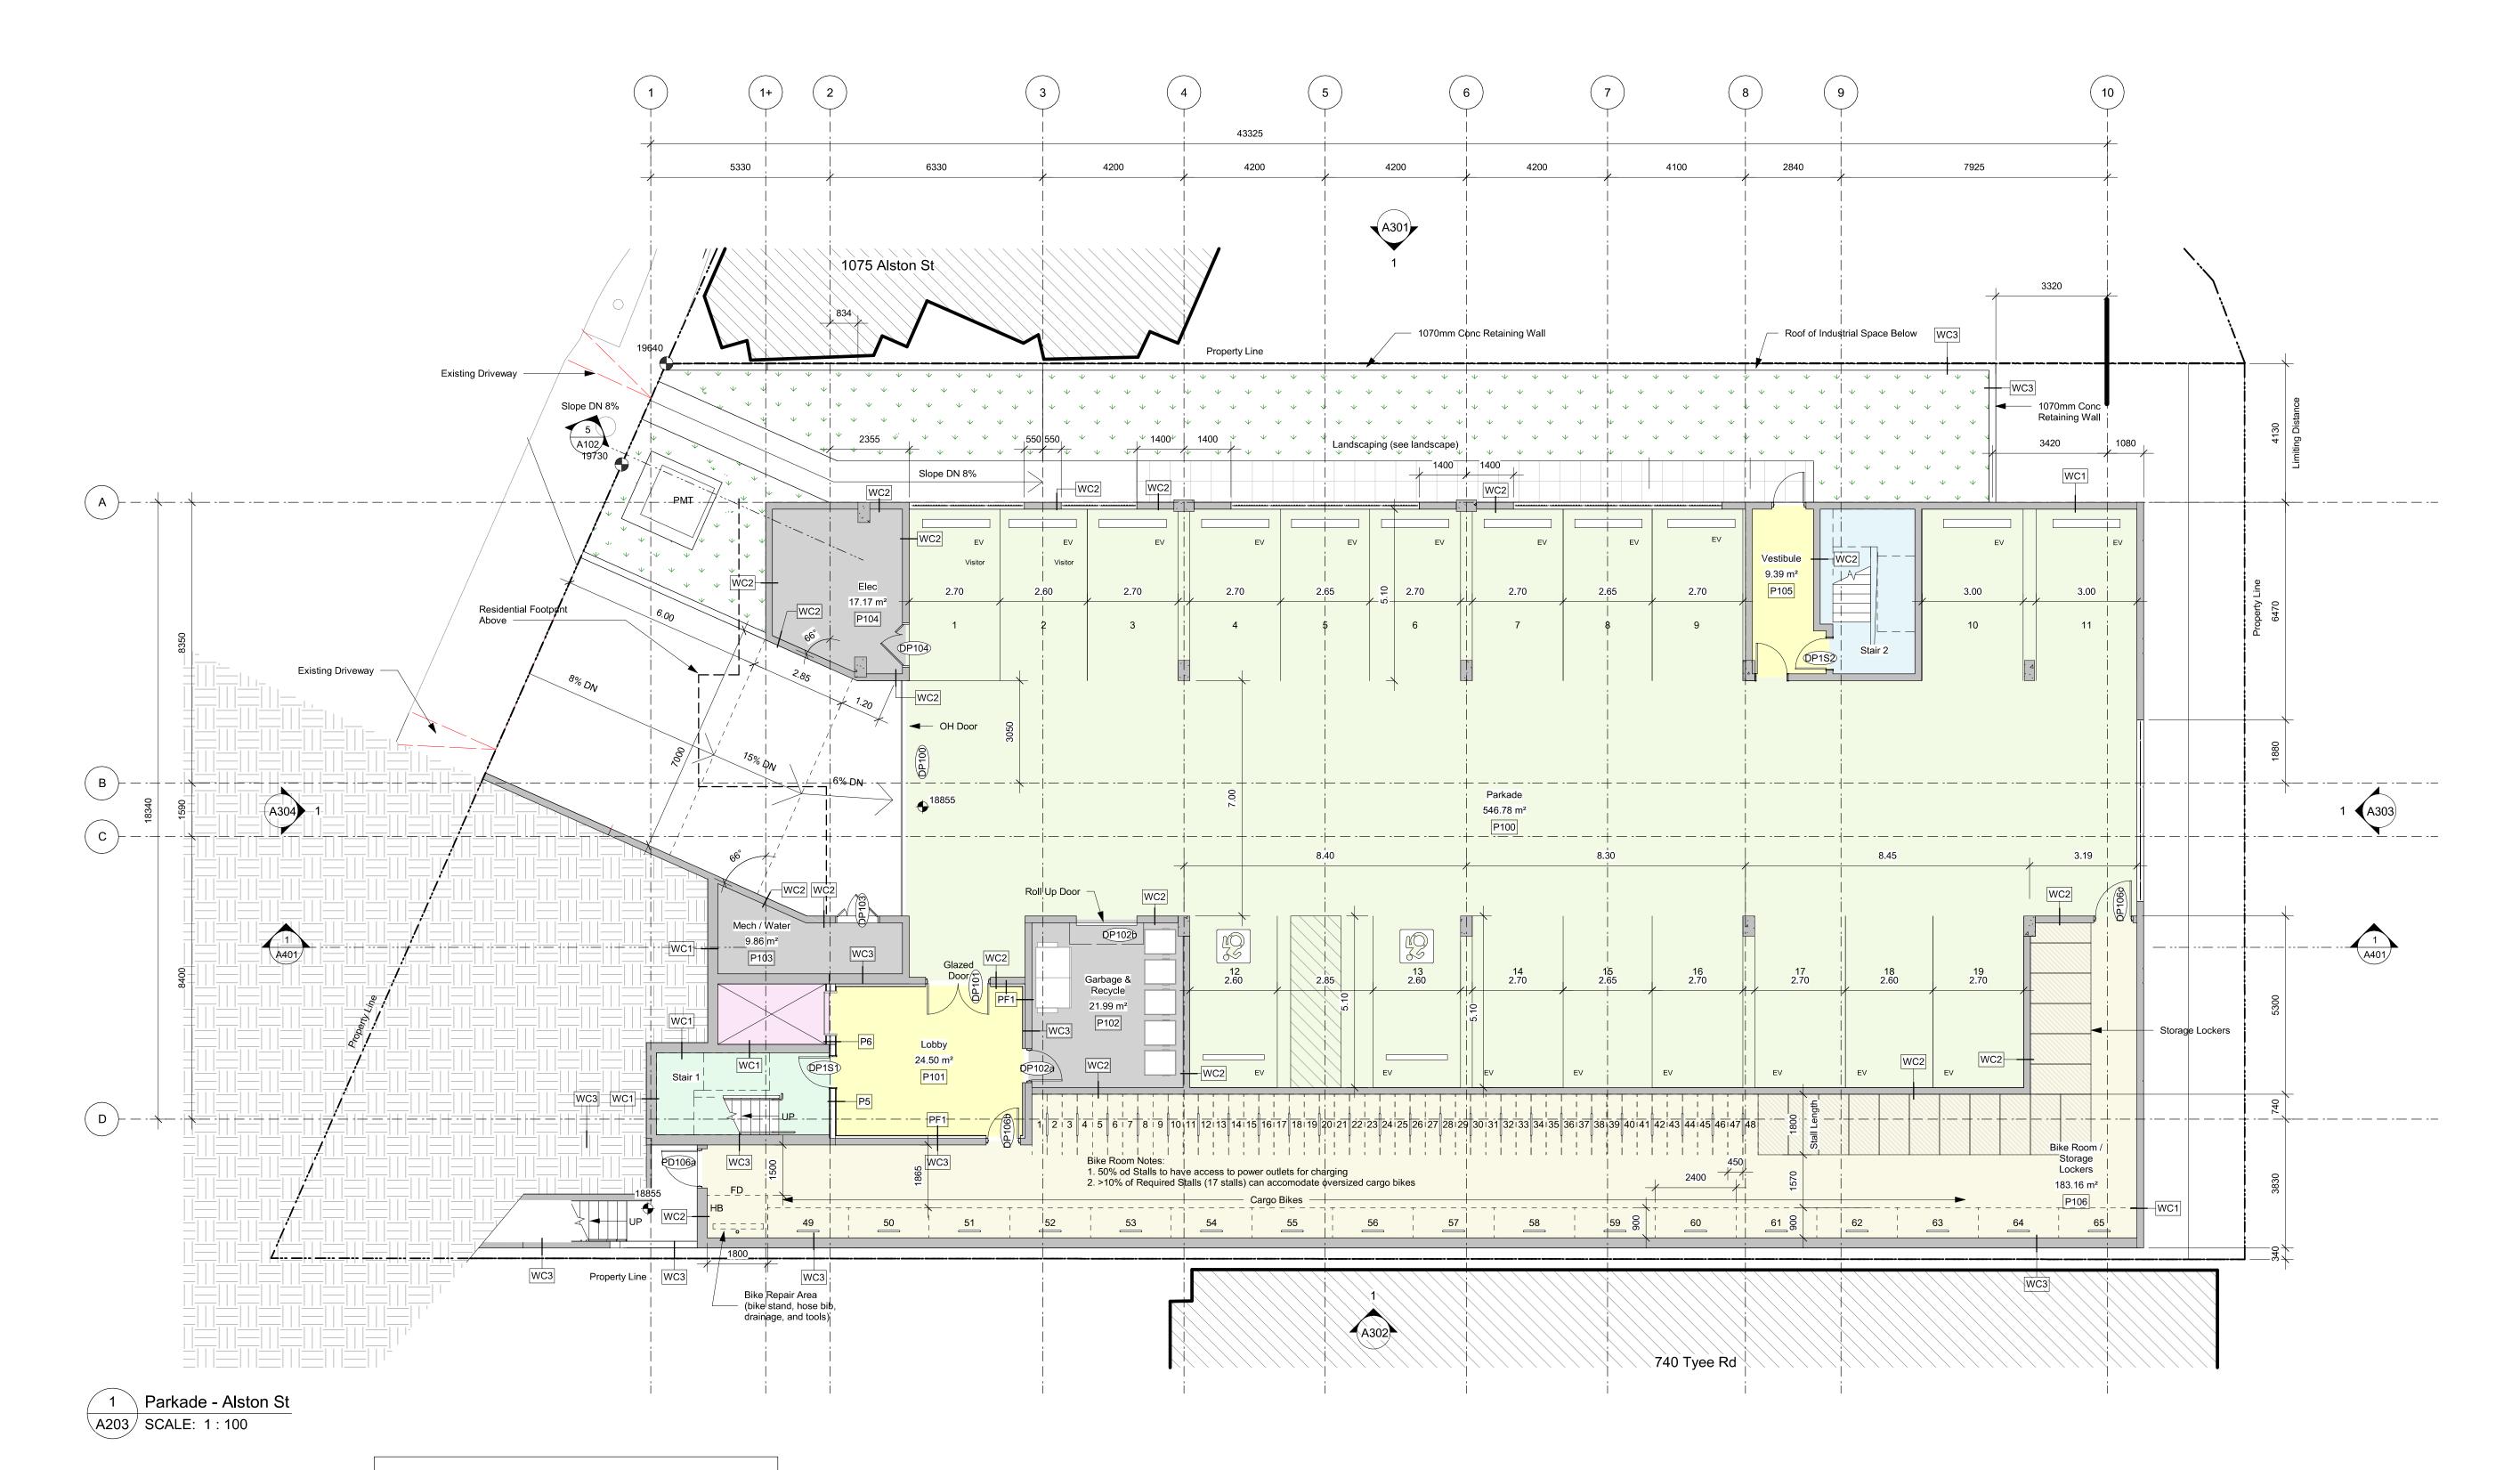

PARKING NOTES

Bike Parking P1: Total 65 Class 1 groud mounted (48 std size, 17 oversized)

Car Parking P1: Total 19 (2 Accessible, Each Stall to have EV Charging)

DDP Revisions 10 25-05-02 24-07-22 DP / Rezoning Rev. 7 DP / Rezoning Rev. 5 7 24-04-11 6 24-02-14 DP / Rezoning Rev. 4 5 23-10-26 DP / Rezoning Rev. 3 4 23-07-25 DP / Rezoning Rev. 2 3 23-06-15 DP / Rezoning Rev. 1 2 23-03-30 DP / Rezoning 1 23-03-25 CALUC


Alston

NOTE: All dimensions are shown in millimeters.

1055 Alston St, Victoria, BC V9A 3S6


Parkade - Alston

Street

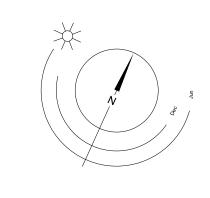

dHKarchitects
Victoria
977 Fort Street
Nanaimo
102-5190 Dublin

dHKarchitects
Victoria
977 Fort Street V8V 3K3 T 1•250•658•3367
Nanaimo
102-5190 Dublin Way V9T 0H2 T 1•250•585•5810
COPYRIGHT RESERVED. THESE PLANS AND DESIGNS ARE AND AT ALL TIMES REMAIN THE PROPERTY OF DHKARCHITECTS TO BE USED FOR THE PROJECT SHOWN AND MAY NOT BE REPRODUCED WITHOUT WRITTEN CONSENT

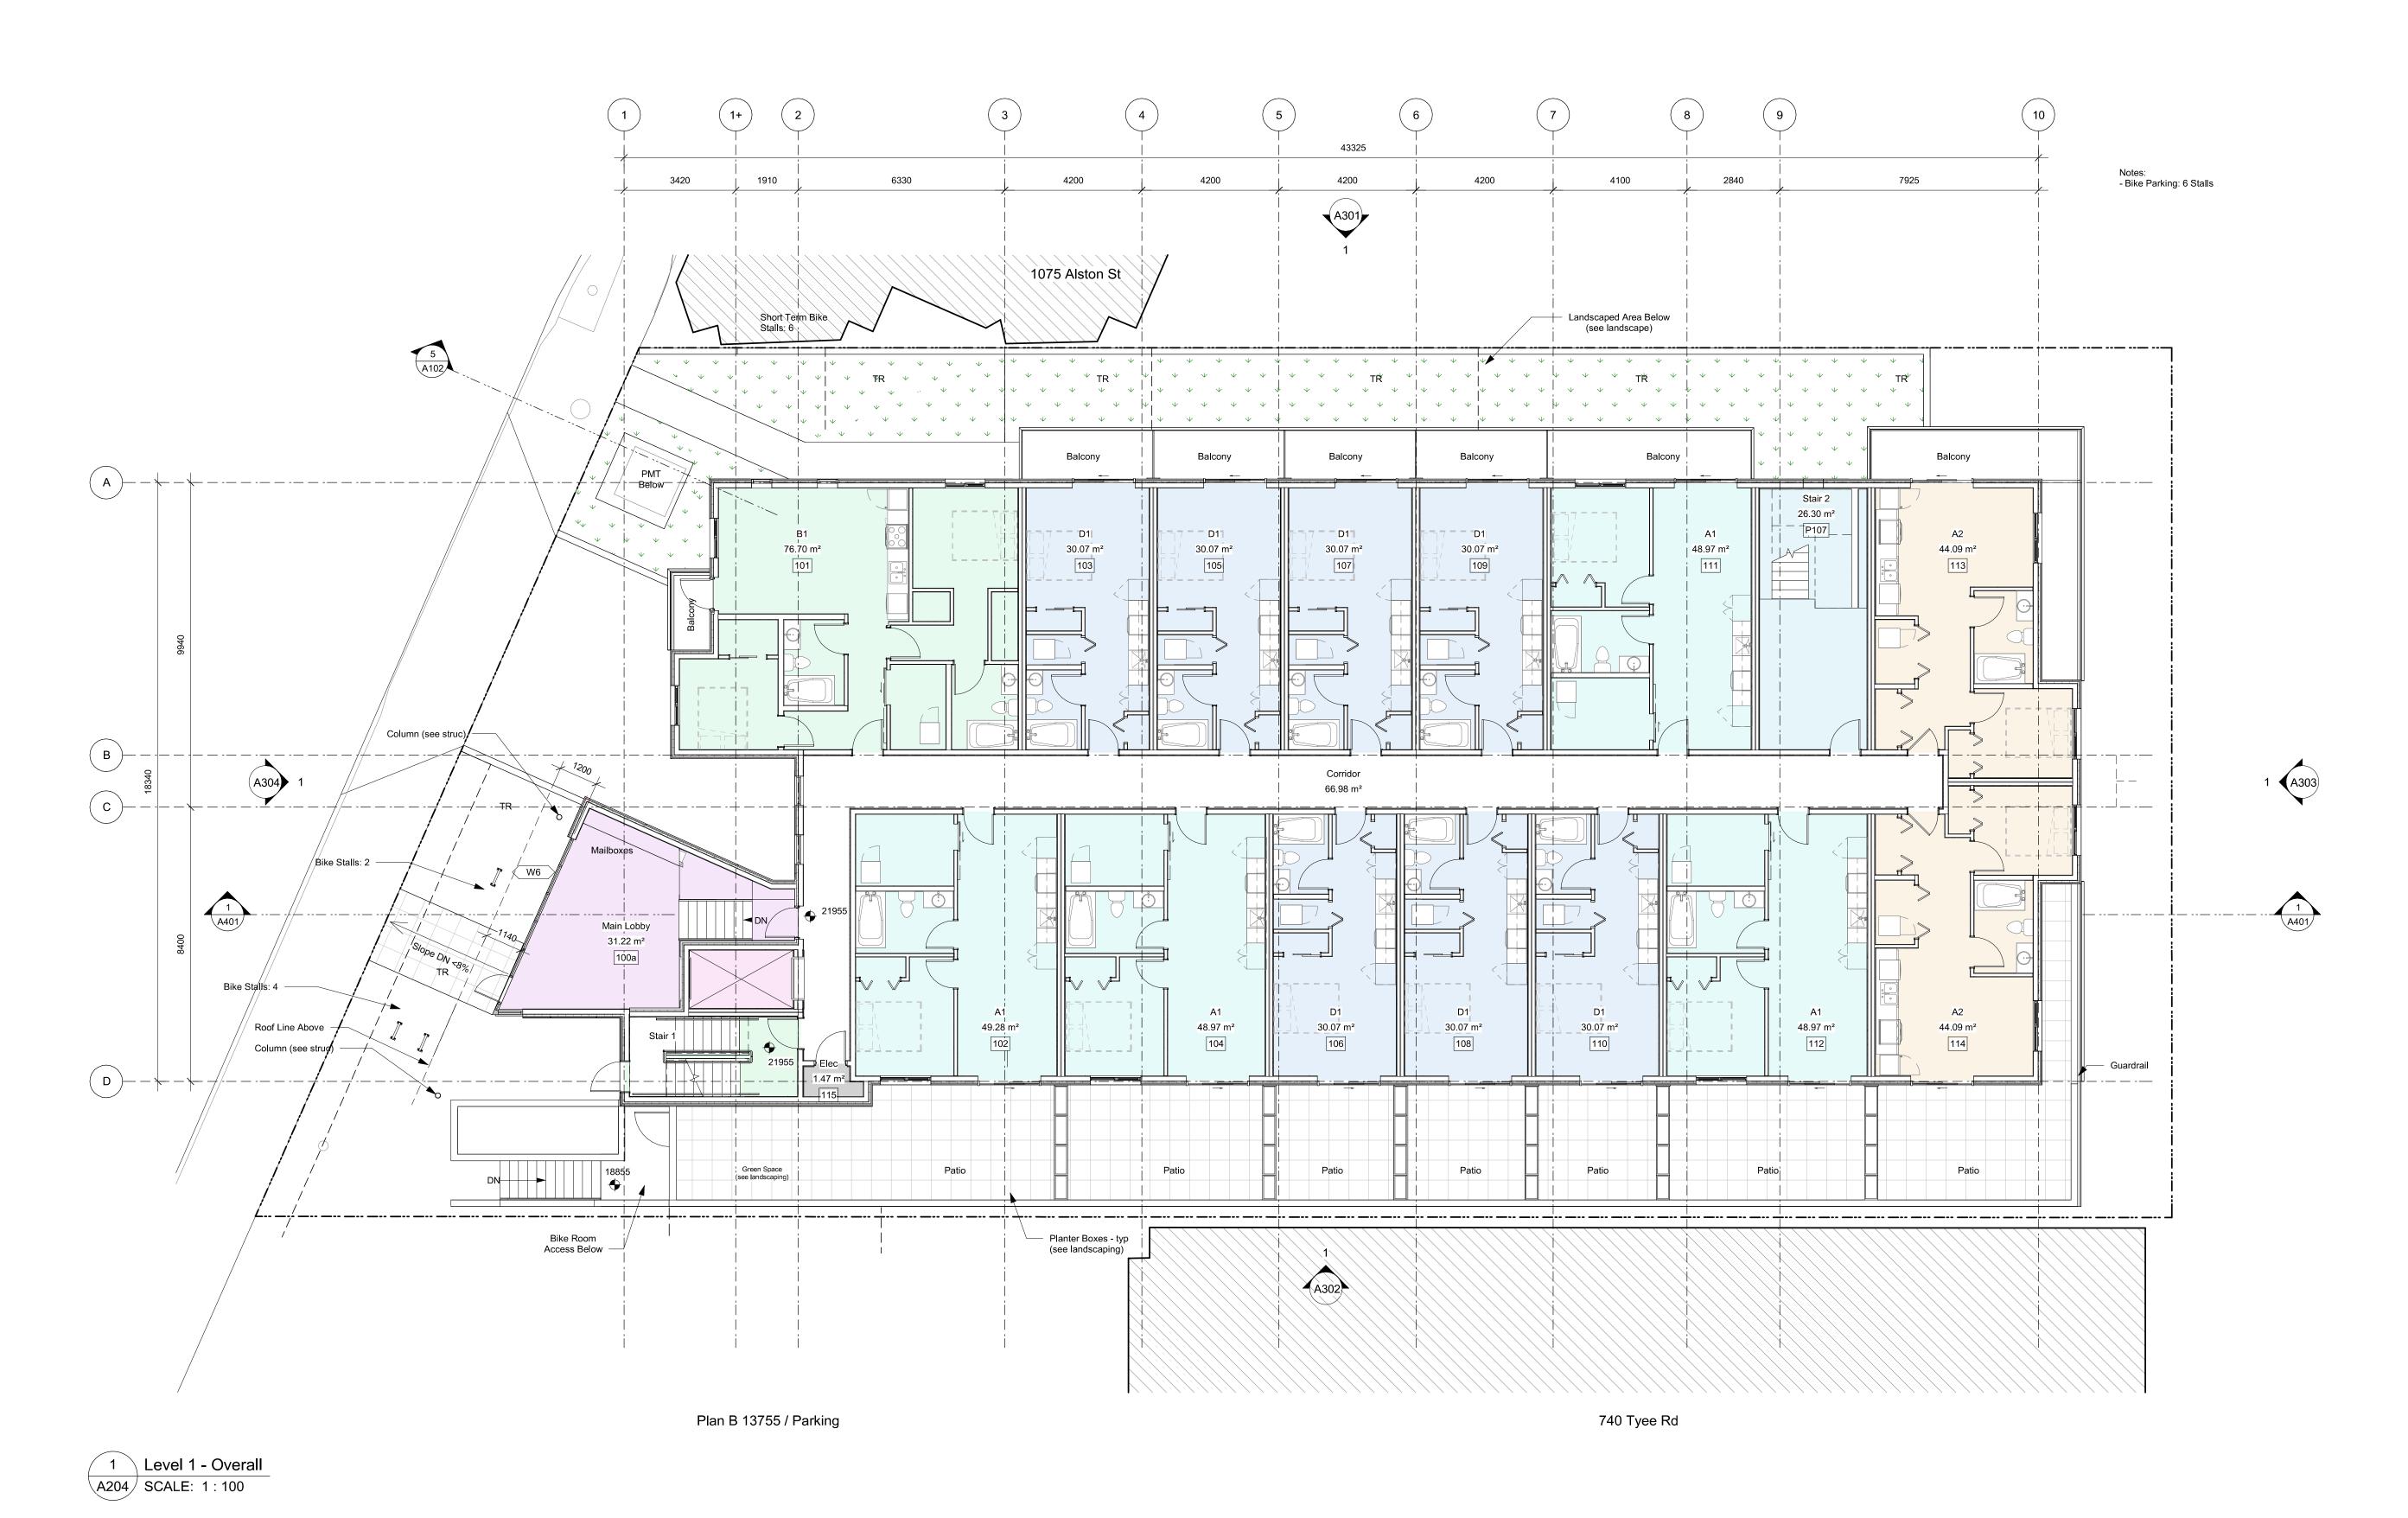

 10
 25-05-02
 DDP Revisions

 5
 23-10-26
 DP / Rezoning Rev. 3

 4
 23-07-25
 DP / Rezoning Rev. 2

 3
 23-06-15
 DP / Rezoning Rev. 1

 2
 23-03-30
 DP / Rezoning

 1
 23-03-25
 CALUC

 Rev
 10
 25-05-02
 Description
 DDP Revisions

 Plot Date
 06/15/23
 Project Status
 DP / Rezoning

 Drawn By
 SWS
 Checked By
 CRK


 Scale
 1 : 100
 Project Number
 2304

Alston

NOTE: All dimensions are shown in millimeters.

1055 Alston St, Victoria, BC V9A 3S6

Level 1

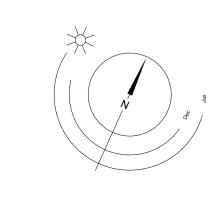

dHKarchited Victoria 977 Fort Street 2500 5000 mm Nanaimo

dHKarchitects
Victoria
977 Fort Street V8V 3K3 T 1•250•658•3367
Nanaimo
102-5190 Dublin Way V9T 0H2 T 1•250•585•5810
COPYRIGHT RESERVED. THESE PLANS AND DESIGNS ARE AND AT ALL TIMES REMAIN THE PROPERTY OF DHKARCHITECTS TO BE USED FOR THE PROJECT SHOWN AND MAY NOT BE REPRODUCED WITHOUT WRITTEN CONSENT

25-05-06 12:09:48 PM



1 Level 2 - Overall A205 SCALE: 1:100


		10 2 1	25-05-02 23-03-30 23-03-25		DDP Revisions DP / Rezoning CALUC
Rev	10		25-05-02	Description	DDP Revisions
Plot Date			06/15/23	Project Status	DP / Rezoning
Drawn By	y		sws	Checked By	CRK
Scale			1 : 100	Project Number	2304
NOTE: A	ll dim	ensions	are shown in mi	Ilimeters.	

Alston

1055 Alston St, Victoria, BC V9A 3S6

COPYRIGHT RESERVED. THESE PLANS AND DESIGNS ARE AND AT ALL TIMES REMAIN THE PROPERTY OF **DHKARCHITECTS** TO BE USED FOR THE PROJECT SHOWN AND MAY NOT BE REPRODUCED WITHOUT WRITTEN CONSENT

Level 2

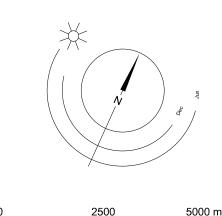

dHKarchitects

Victoria

977 Fort Street

Nanaimo

102-5190 Dublin Way

V9T 0H2

T 1-250-585-5810

25_05_06 12:09:50 PM



1 Level 3 - Overall A206 SCALE: 1:100

 10
 25-05-02
 DDP Revisions

 2
 23-03-30
 DP / Rezoning

 1
 23-03-25
 CALUC

 Rev
 10
 25-05-02
 Description
 DDP Revisions

 Plot Date
 06/15/23
 Project Status
 DP / Rezoning

 Drawn By
 SWS
 Checked By
 CRK


 Scale
 1 : 100
 Project Number
 2304

 NOTE: All dimensions are shown in millimeters.

Alston

1055 Alston St, Victoria, BC V9A 3S6

Level 3

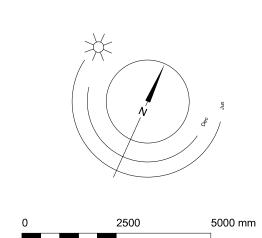

dHKarchitects
Victoria
977 Fort Street

V8V 3K3

dHKarchitects
Victoria
977 Fort Street V8V 3K3 T 1•250•658•3367
Nanaimo
102-5190 Dublin Way V9T 0H2 T 1•250•585•5810
COPYRIGHT RESERVED. THESE PLANS AND DESIGNS ARE AND AT ALL TIMES REMAIN THE PROPERTY OF DHKARCHITECTS TO BE USED FOR THE PROJECT SHOWN AND MAY NOT BE REPRODUCED WITHOUT WRITTEN CONSENT






	0 25-05-02 2 23-03-30 1 23-03-25		DDP Revisions DP / Rezoning CALUC
Rev 10	25-05-02	Description	DDP Revisions
Plot Date	06/15/23	Project Status	DP / Rezoning
Drawn By	sws	Checked By	CRK
Scale	1 : 100	Project Number	2304
NOTE: All dimens	ions are shown in mil	llimeters.	

Alston

1055 Alston St, Victoria, BC V9A 3S6


Level 4

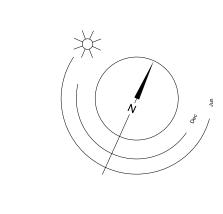

dHKarchitects Victoria 977 Fort Street V8V 3K3 **T** 1•250•658•3367

5000 mm 102-5190 Dublin Way V9T 0H2 **T** 1•250•585•5810 COPYRIGHT RESERVED. THESE PLANS AND DESIGNS ARE AND AT ALL TIMES REMAIN THE PROPERTY OF **DHKARCHITECTS** TO BE USED FOR THE PROJECT SHOWN AND MAY NOT BE REPRODUCED WITHOUT WRITTEN CONSENT

1 Level 4 - Overall A207 SCALE: 1:100

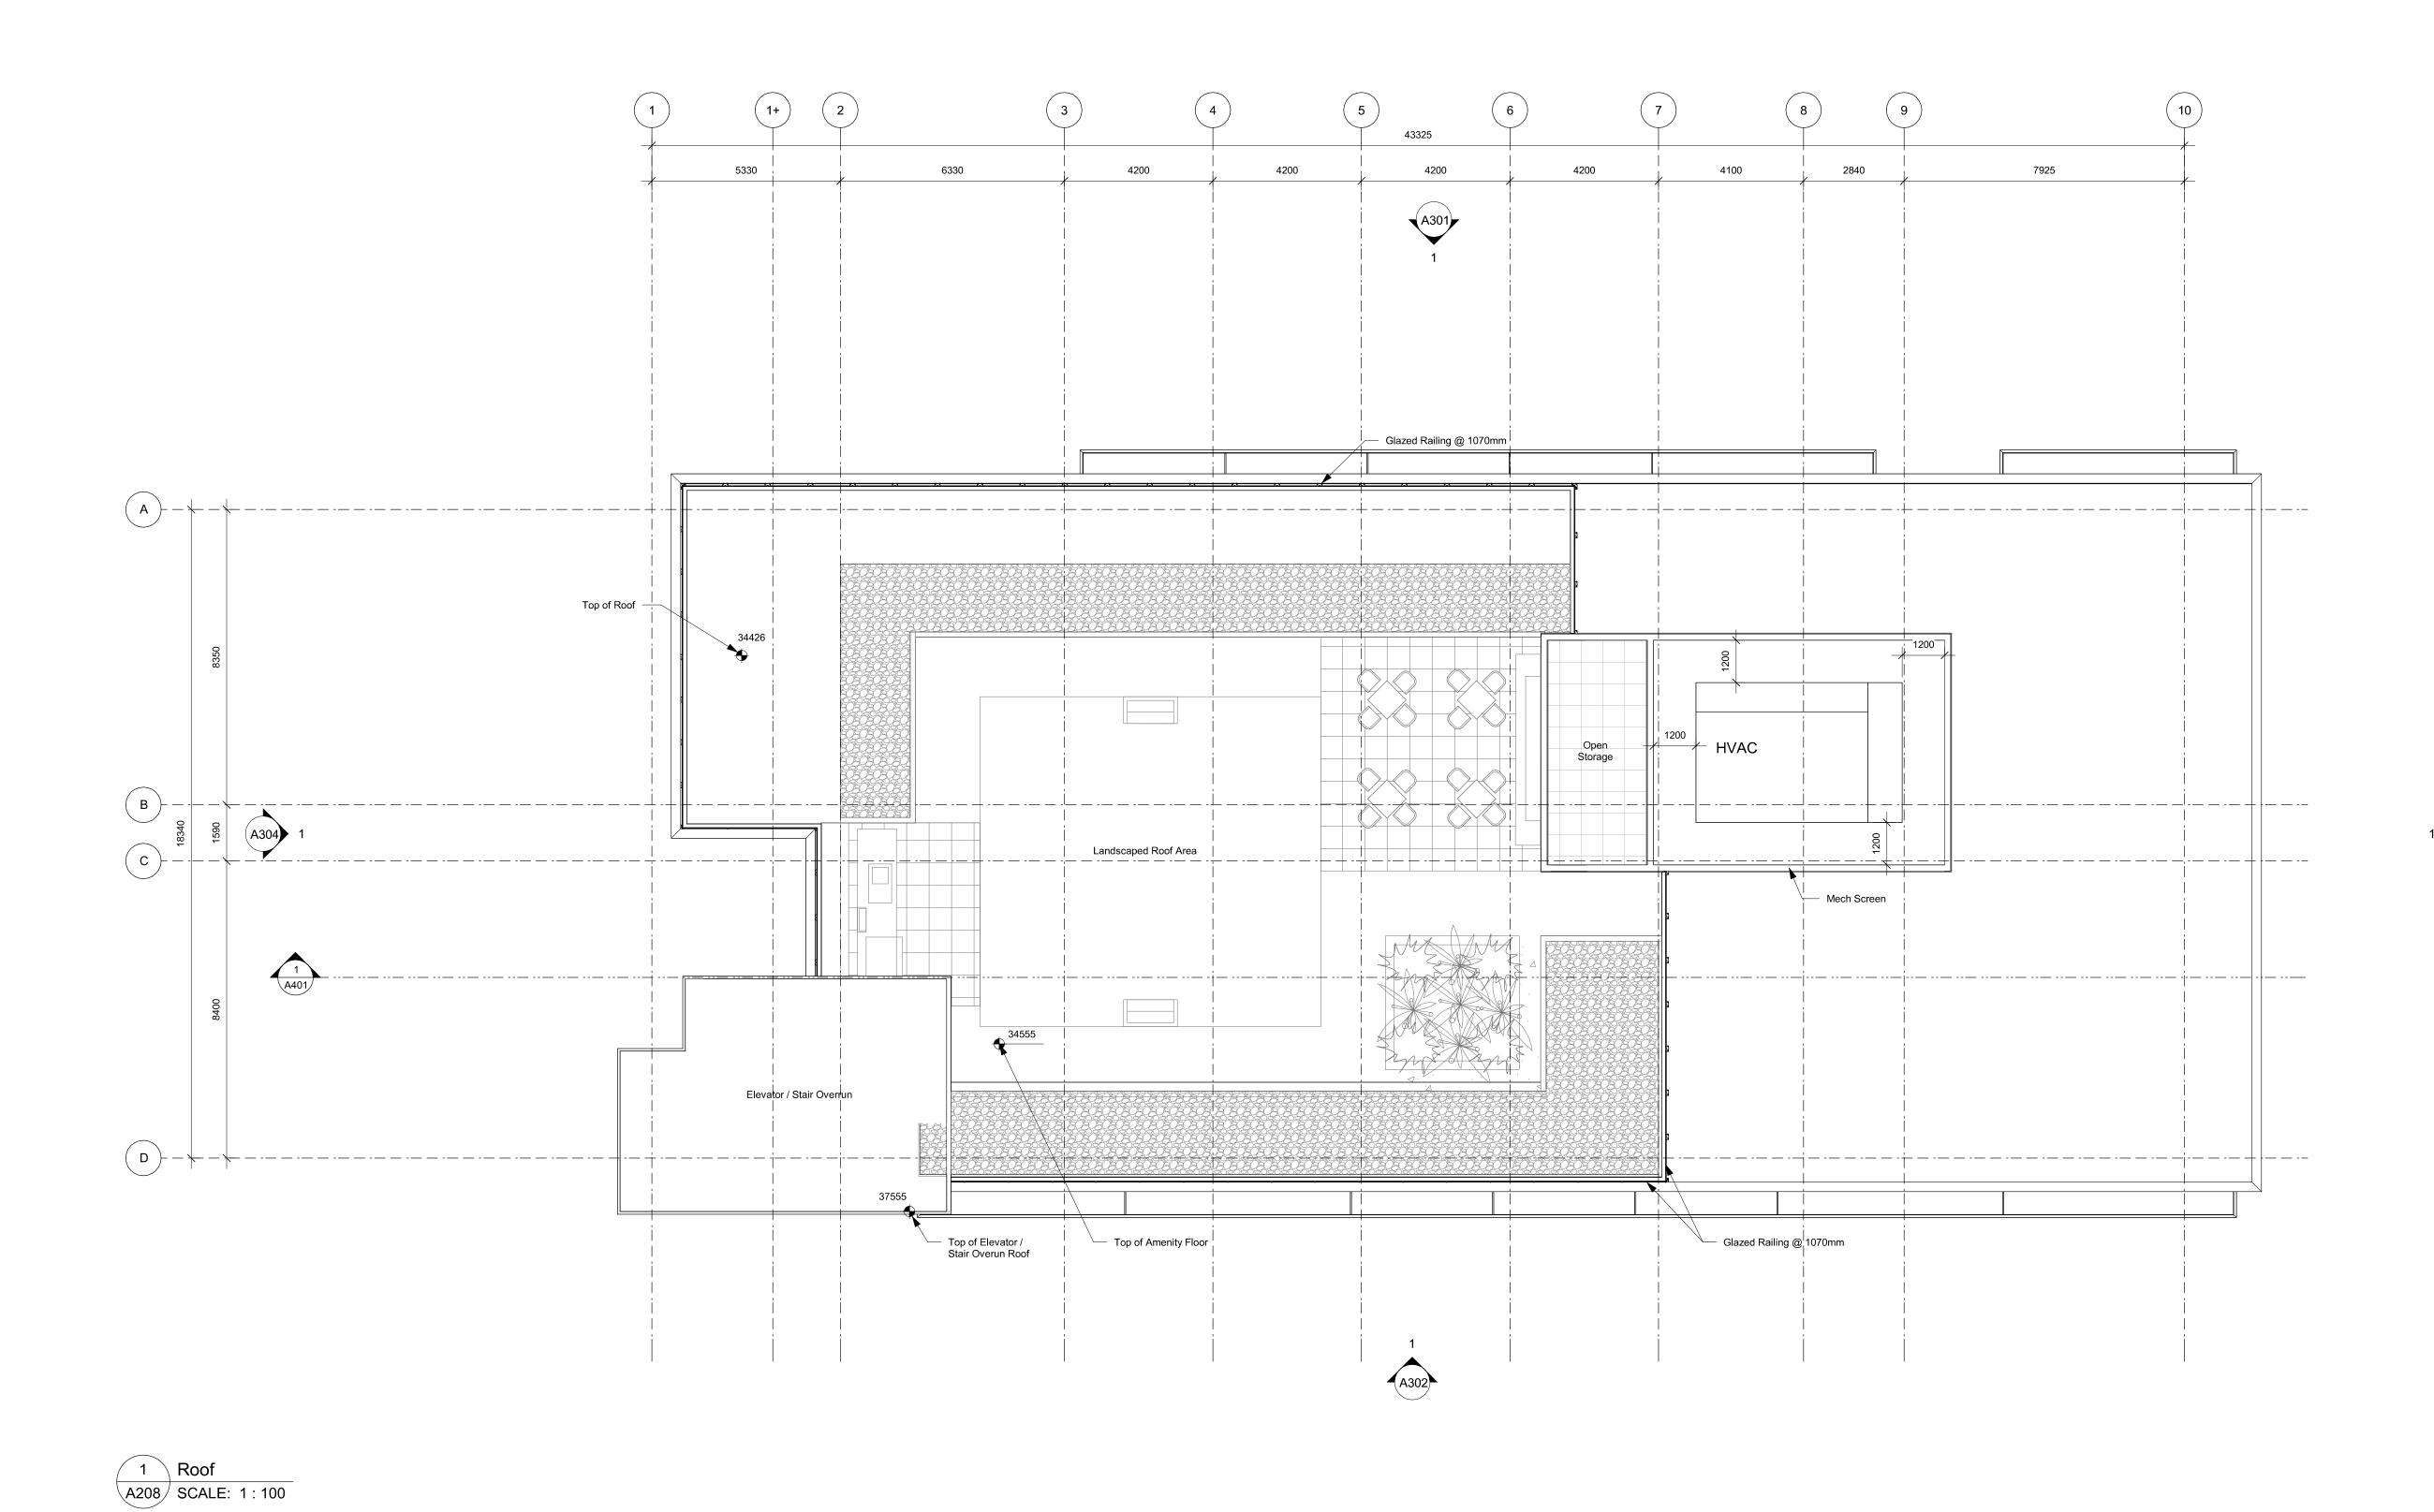


10 25-05-02 DDP Revisions 4 23-07-25 DP / Rezoning Rev. 2 3 23-06-15 DP / Rezoning Rev. 1 2 23-03-30 DP / Rezoning 1 23-03-25 CALUC


Alston

NOTE: All dimensions are shown in millimeters.

1055 Alston St, Victoria, BC V9A 3S6


Roof

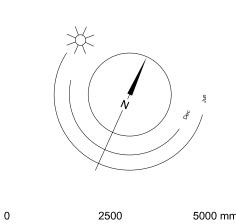

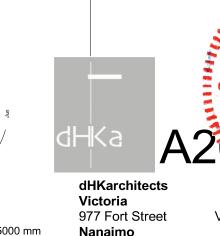

5000 mm

V8V 3K3 **T** 1•250•658•3367 102-5190 Dublin Way V9T 0H2 **T** 1•250•585•5810 COPYRIGHT RESERVED. THESE PLANS AND DESIGNS ARE AND AT ALL TIMES REMAIN THE PROPERTY OF **DHKARCHITECTS** TO BE USED FOR THE PROJECT SHOWN AND MAY NOT BE REPRODUCED WITHOUT WRITTEN CONSENT

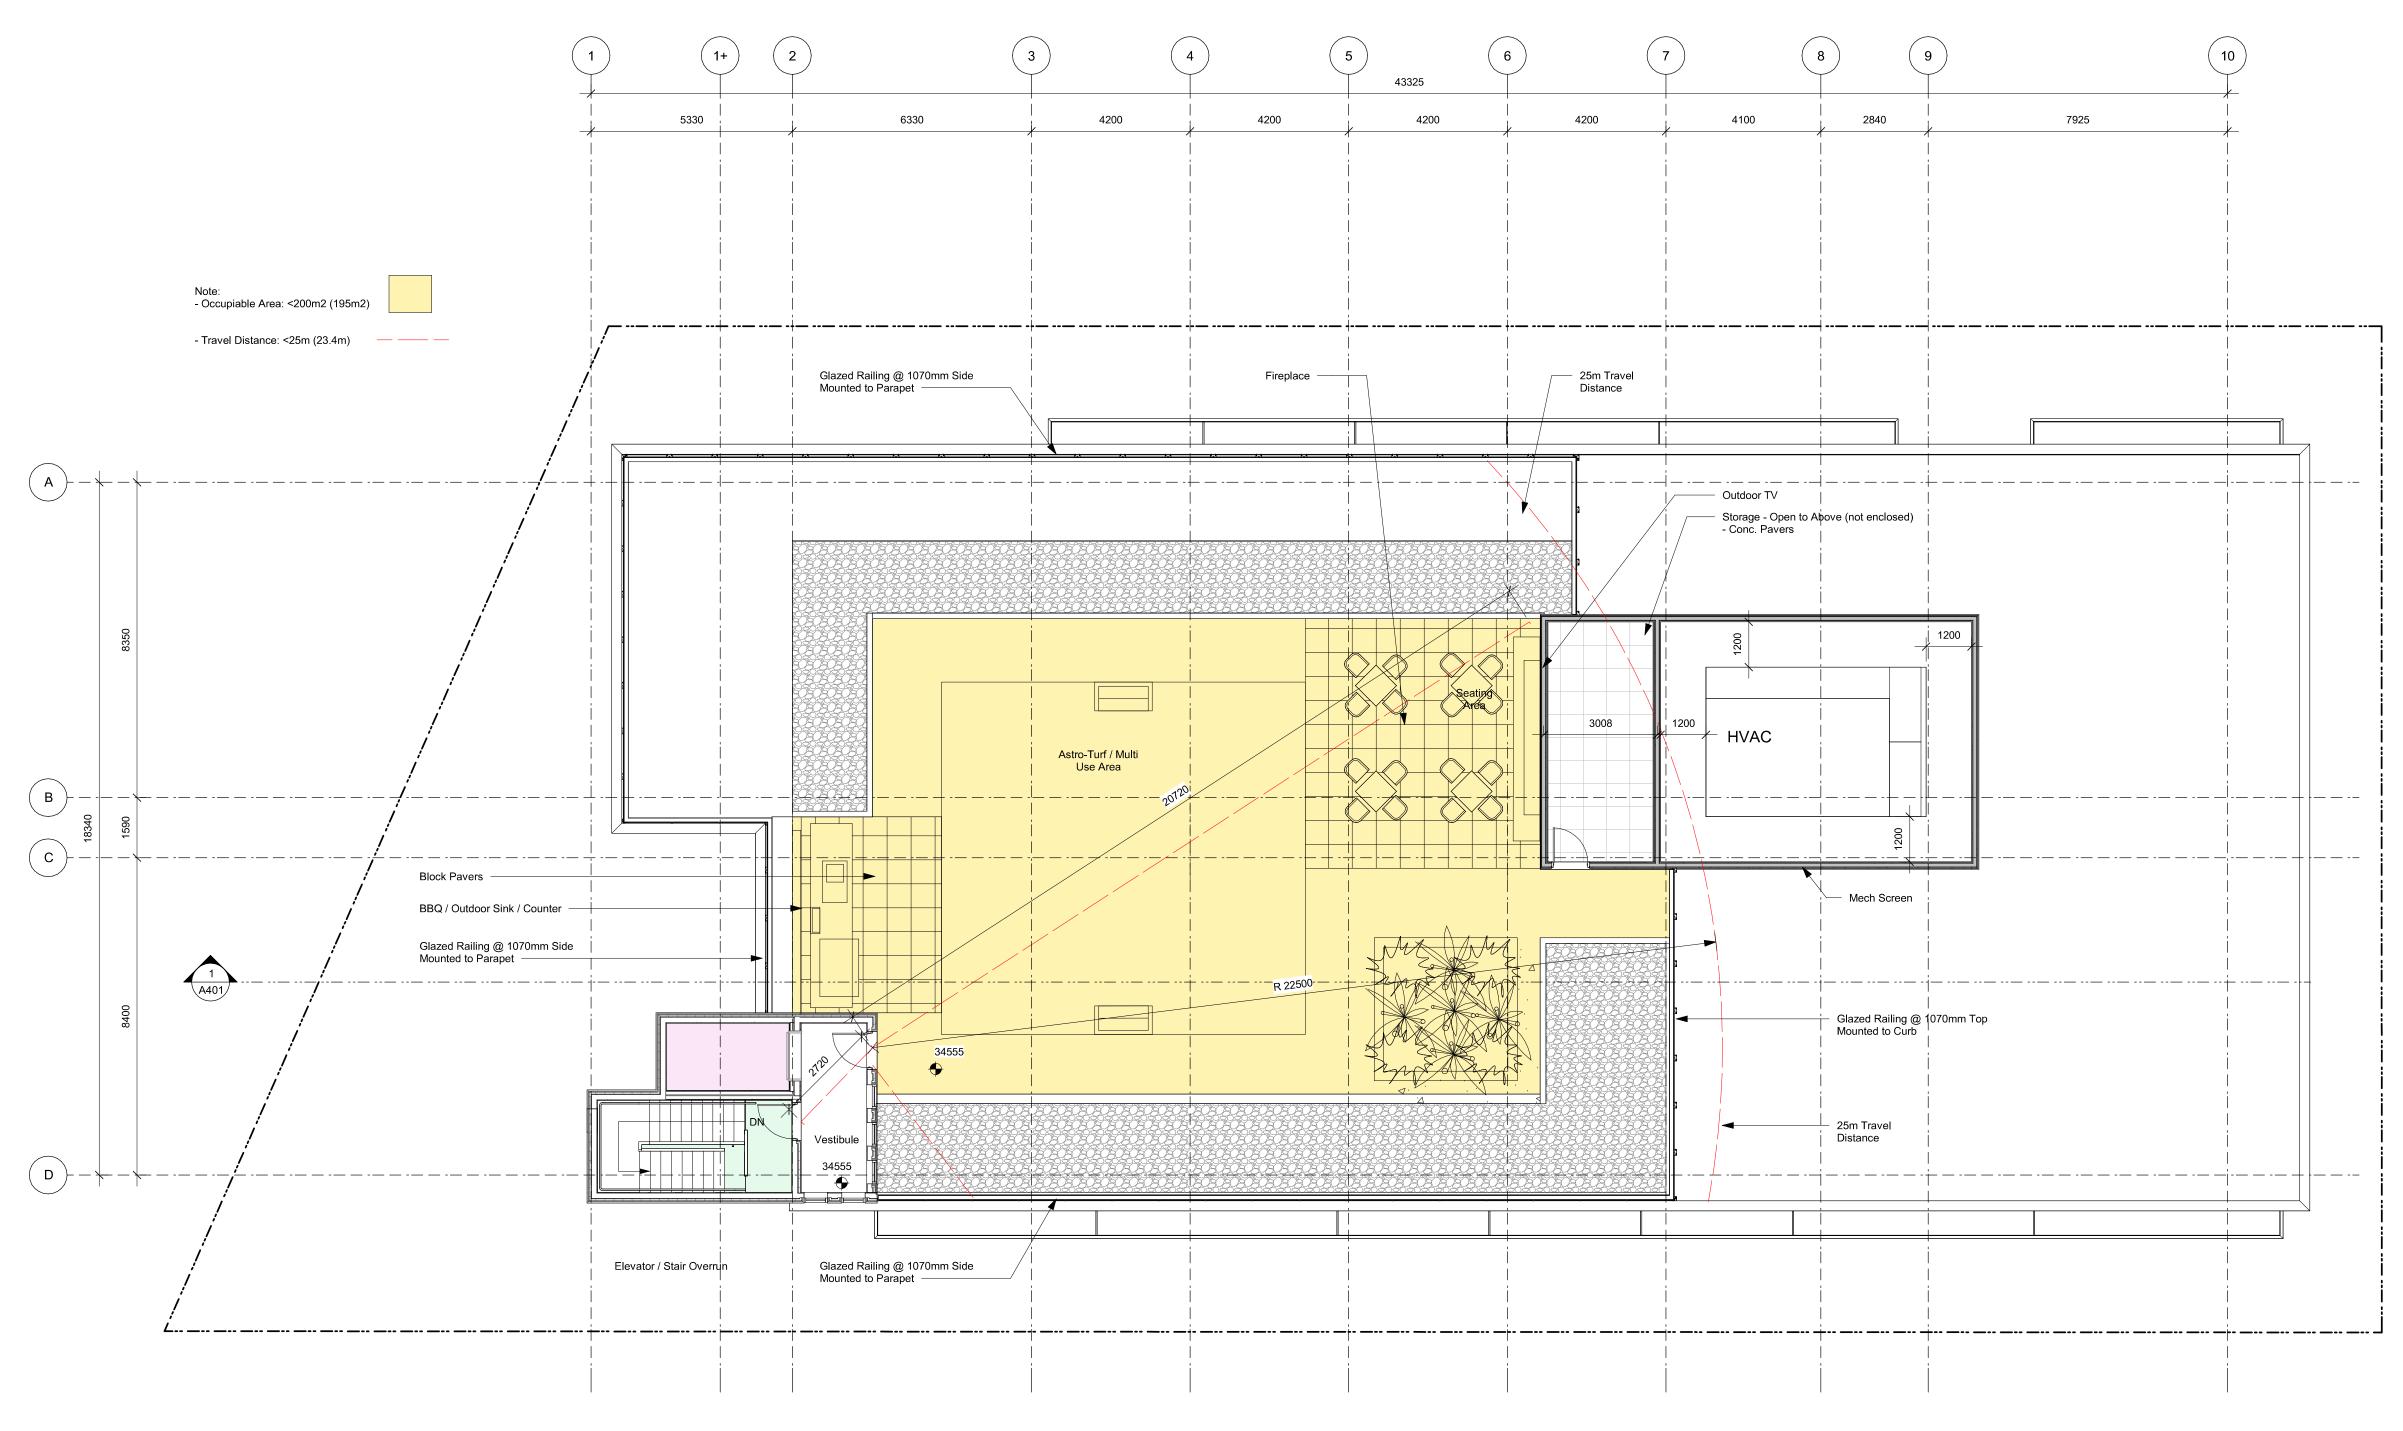

1 Roof Amenity Space A208a SCALE: 1:100

Recessed Lighting - typ.

	,	-	5-05-02 3-06-15		DDP Revisions DP / Rezoning Rev. 1
Rev	10	2	25-05-02	Description	DDP Revisions
Plot Date		C	06/15/23	Project Status	DP / Rezoning
Drawn By			sws	Checked By	CRK
Scale			1 : 100	Project Number	2304
NOTE: All	l dimen	sions are	shown in mi	Ilimeters.	

Alston


1055 Alston St, Victoria, BC V9A 3S6

Roof Amenity Space



Victoria 977 Fort Street Nanaimo

102-5190 Dublin Way V9T 0H2 **T** 1•250•585•5810 COPYRIGHT RESERVED. THESE PLANS AND DESIGNS ARE AND AT ALL TIMES REMAIN THE PROPERTY OF **DHKARCHITECTS** TO BE USED FOR THE PROJECT SHOWN AND MAY NOT BE REPRODUCED WITHOUT WRITTEN CONSENT

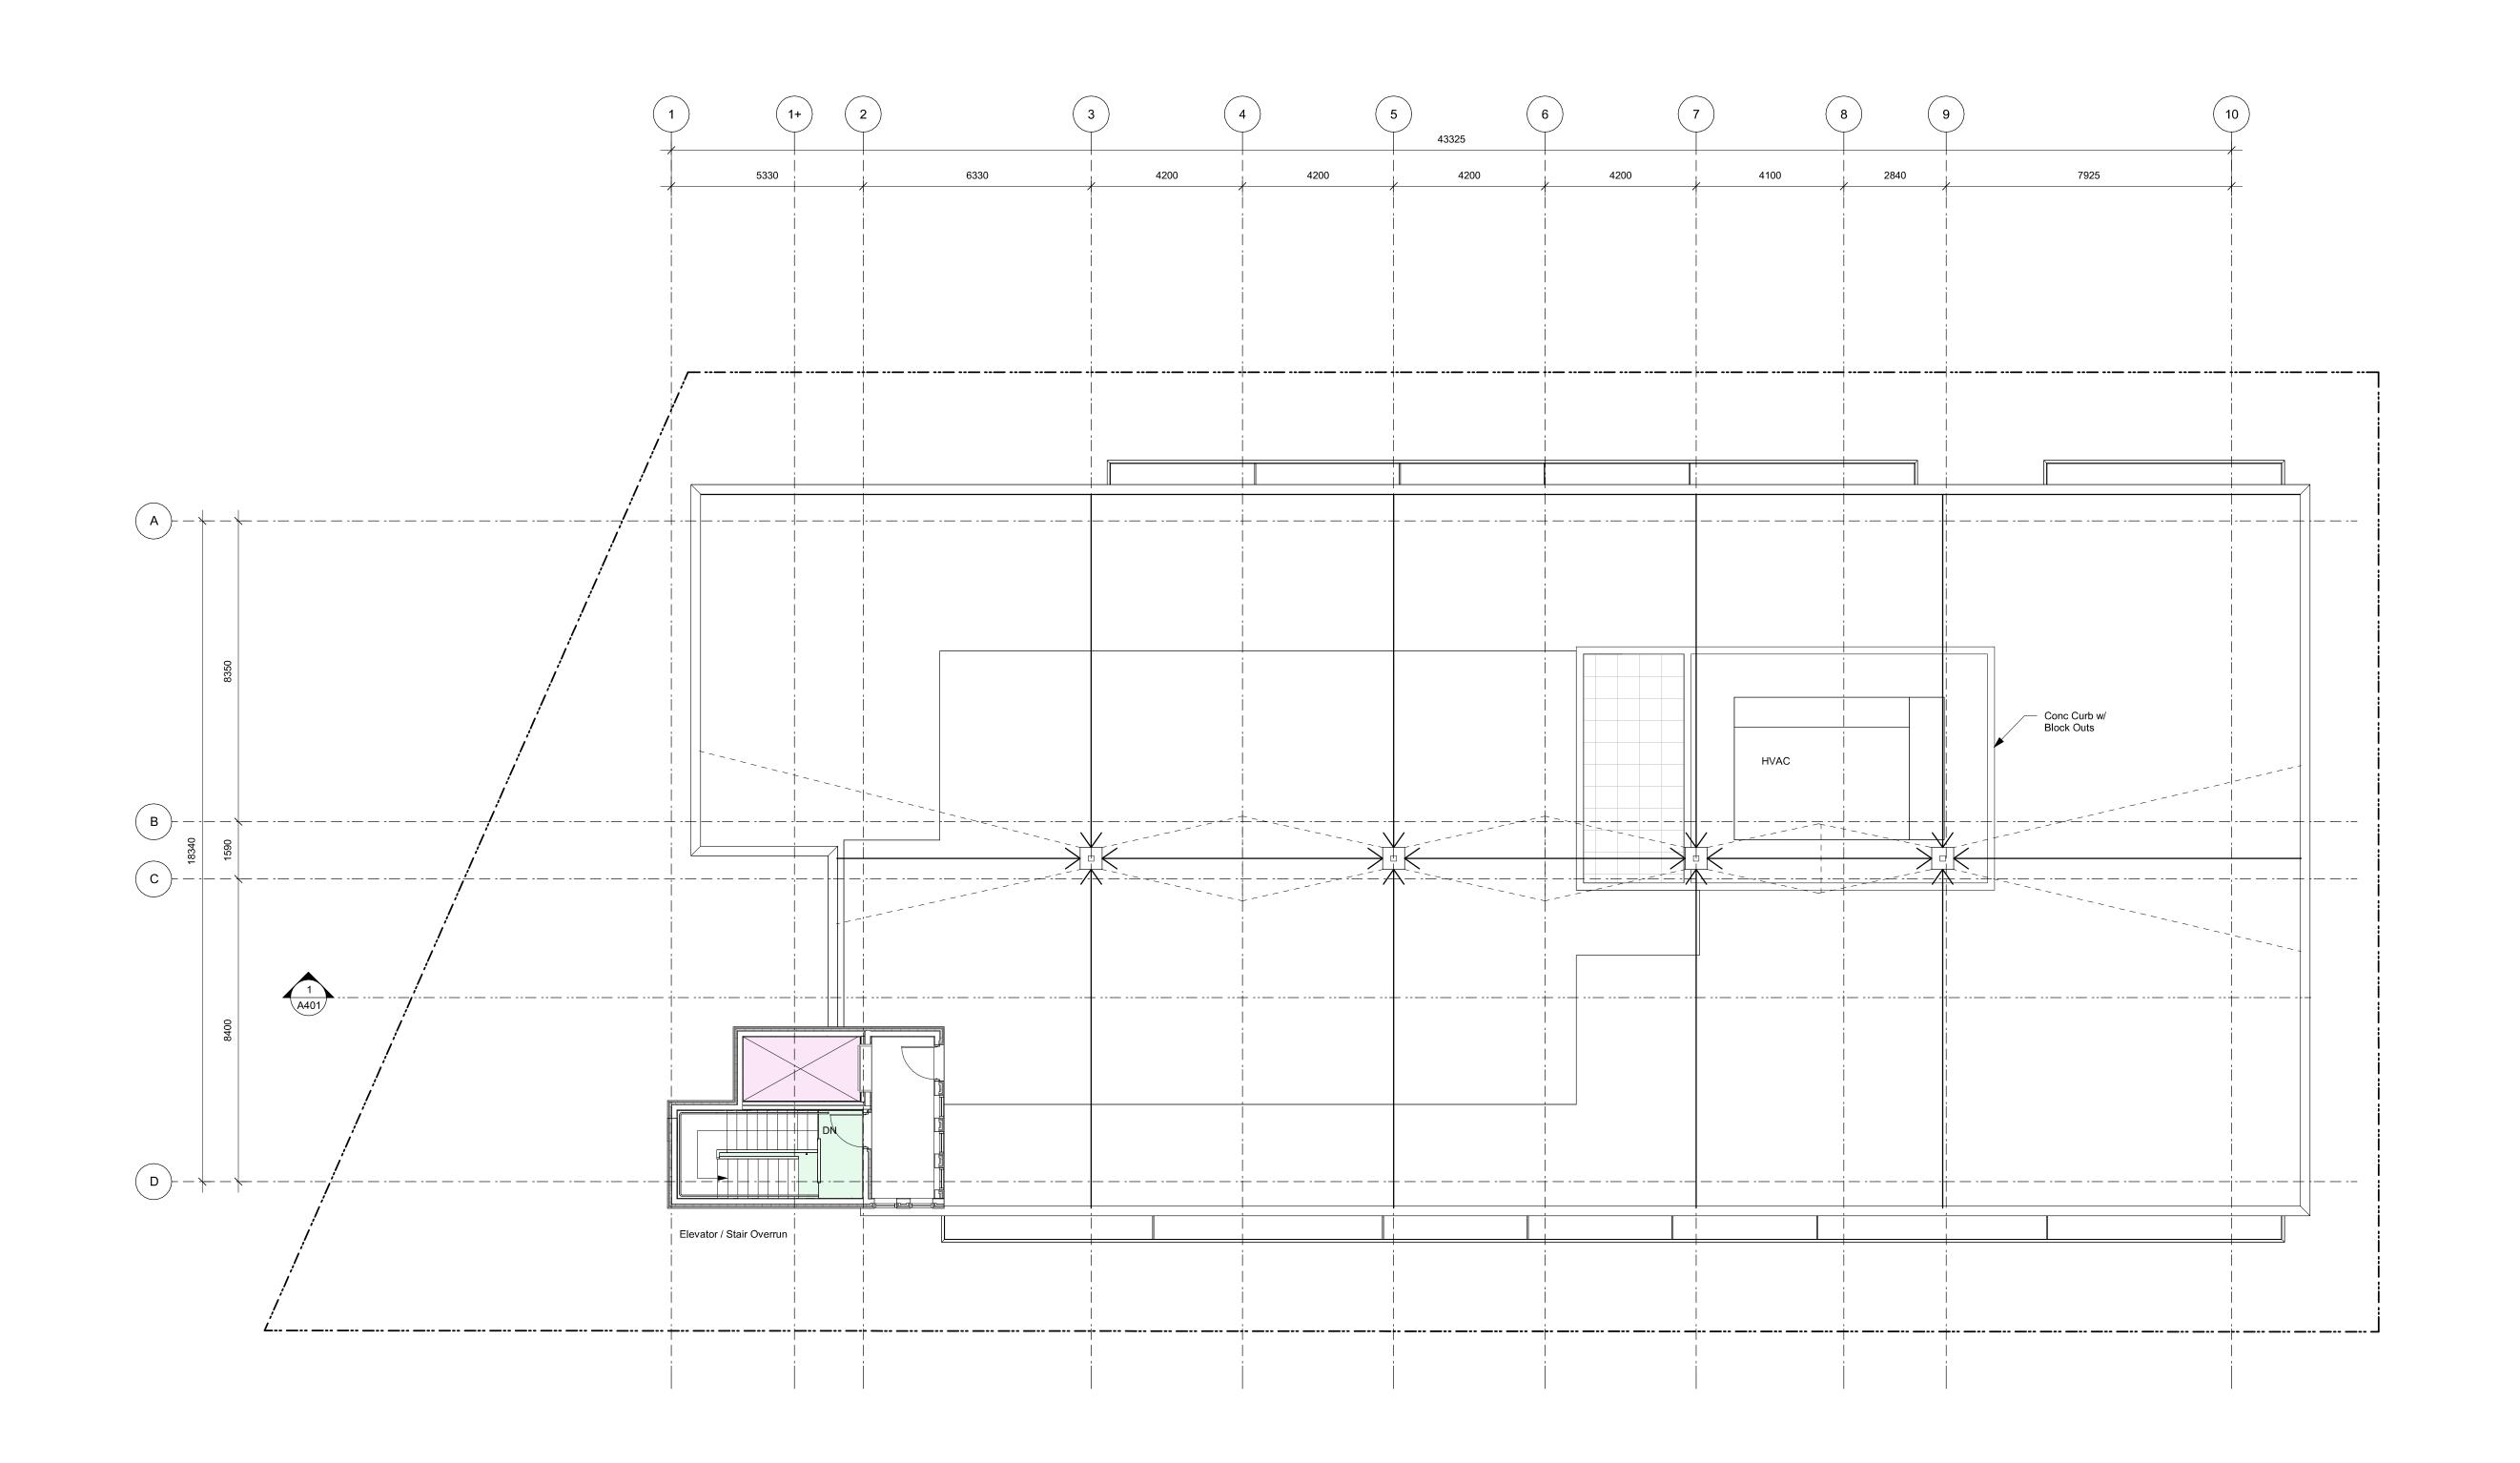

1 Roof Drainage A208b SCALE: 1:100

		3	23-06-15		DP / Rezoning Rev. 1		
Rev	3		23-06-15	Description	DP / Rezoning Rev. 1		
Plot Date			06/15/23	Project Status	DP / Rezoning		
Drawn By			sws	Checked By	CRK		
Scale			1 : 100	Project Number	2304		
NOTE: All	NOTE: All dimensions are shown in millimeters.						

Alston

1055 Alston St, Victoria, BC V9A 3S6

Roof Drainage



25-05-06 12:09:55 PM

Victoria
977 Fort Street V8V 3K3 T 1•250•658•3367
Nanaimo
102-5190 Dublin Way V9T 0H2 T 1•250•585•5810
COPYRIGHT RESERVED. THESE PLANS AND DESIGNS ARE AND AT ALL TIMES REMAIN THE PROPERTY OF DHKARCHITECTS TO BE USED FOR THE PROJECT SHOWN AND MAY NOT BE REPRODUCED WITHOUT WRITTEN CONSENT



Material Board Aluminum Flashing Material # Material Colour 4 7/8" Corrugated Metal Panel 5 Architectural Concrete 20 Light Pewter 2897 (24ga) 9822 (28ga) Metal Composite Panel 2 13 18 Nissan Grey 19 Brushed Carbon

Materials Legend

- Pre-finished Aluminum Flashing Grey
- Parapet Metal Composite Panel Grey
- Guardrail Tempered Glass w/ Aluminum Rails Black
- Corrugated Metal Panel Vertical Orrientation Grey and Black
- Corrugated Metal Panel Horizontal Orrientation Grey and Black
- Balcony / Patio Sliding Door -Black
- 7 Vinyl Frame Window -Black
- 8 Planter (see landscaping)
- 9 1070mm Guard Concrete
- Parkade Wall Architectural Concrete
- 11 Perforated Metal Screen
- Retaining Wall Concrete
- Metal Composite Panel -Grey and Red
- Metal Door -Black
- Anodized Aluminum Storefront Glazing w/ Doors Black
- Overhead Door -Black
- Canopy Structural Column (see structural) Black
- Lobby Canopy / Roof Metal Composite Panel Grey
- Eyebrow Roof Metal Composite Panel Red
- 20 Archiectural Concrete
- 21 RWL Guard
- 22 Signage

Note: see A103 for grades

DDP Revisions 10 25-05-02 5 23-10-26 DP / Rezoning Rev. 3 4 23-07-25 DP / Rezoning Rev. 2 3 23-06-15 DP / Rezoning Rev. 1 2 23-03-30 DP / Rezoning 1 23-03-25 CALUC DDP Revisions

Alston


NOTE: All dimensions are shown in millimeters.


1055 Alston St, Victoria, BC V9A 3S6


Building Elevation



dHKarchitects Victoria 977 Fort Street V8V 3K3 **T** 1•250•658•3367 Nanaimo 102-5190 Dublin Way V9T 0H2 **T** 1•250•585•5810 COPYRIGHT RESERVED. THESE PLANS AND DESIGNS ARE AND AT ALL TIMES REMAIN THE PROPERTY OF **DHKARCHITECTS** TO BE USED FOR THE PROJECT SHOWN AND MAY NOT BE REPRODUCED WITHOUT WRITTEN CONSENT

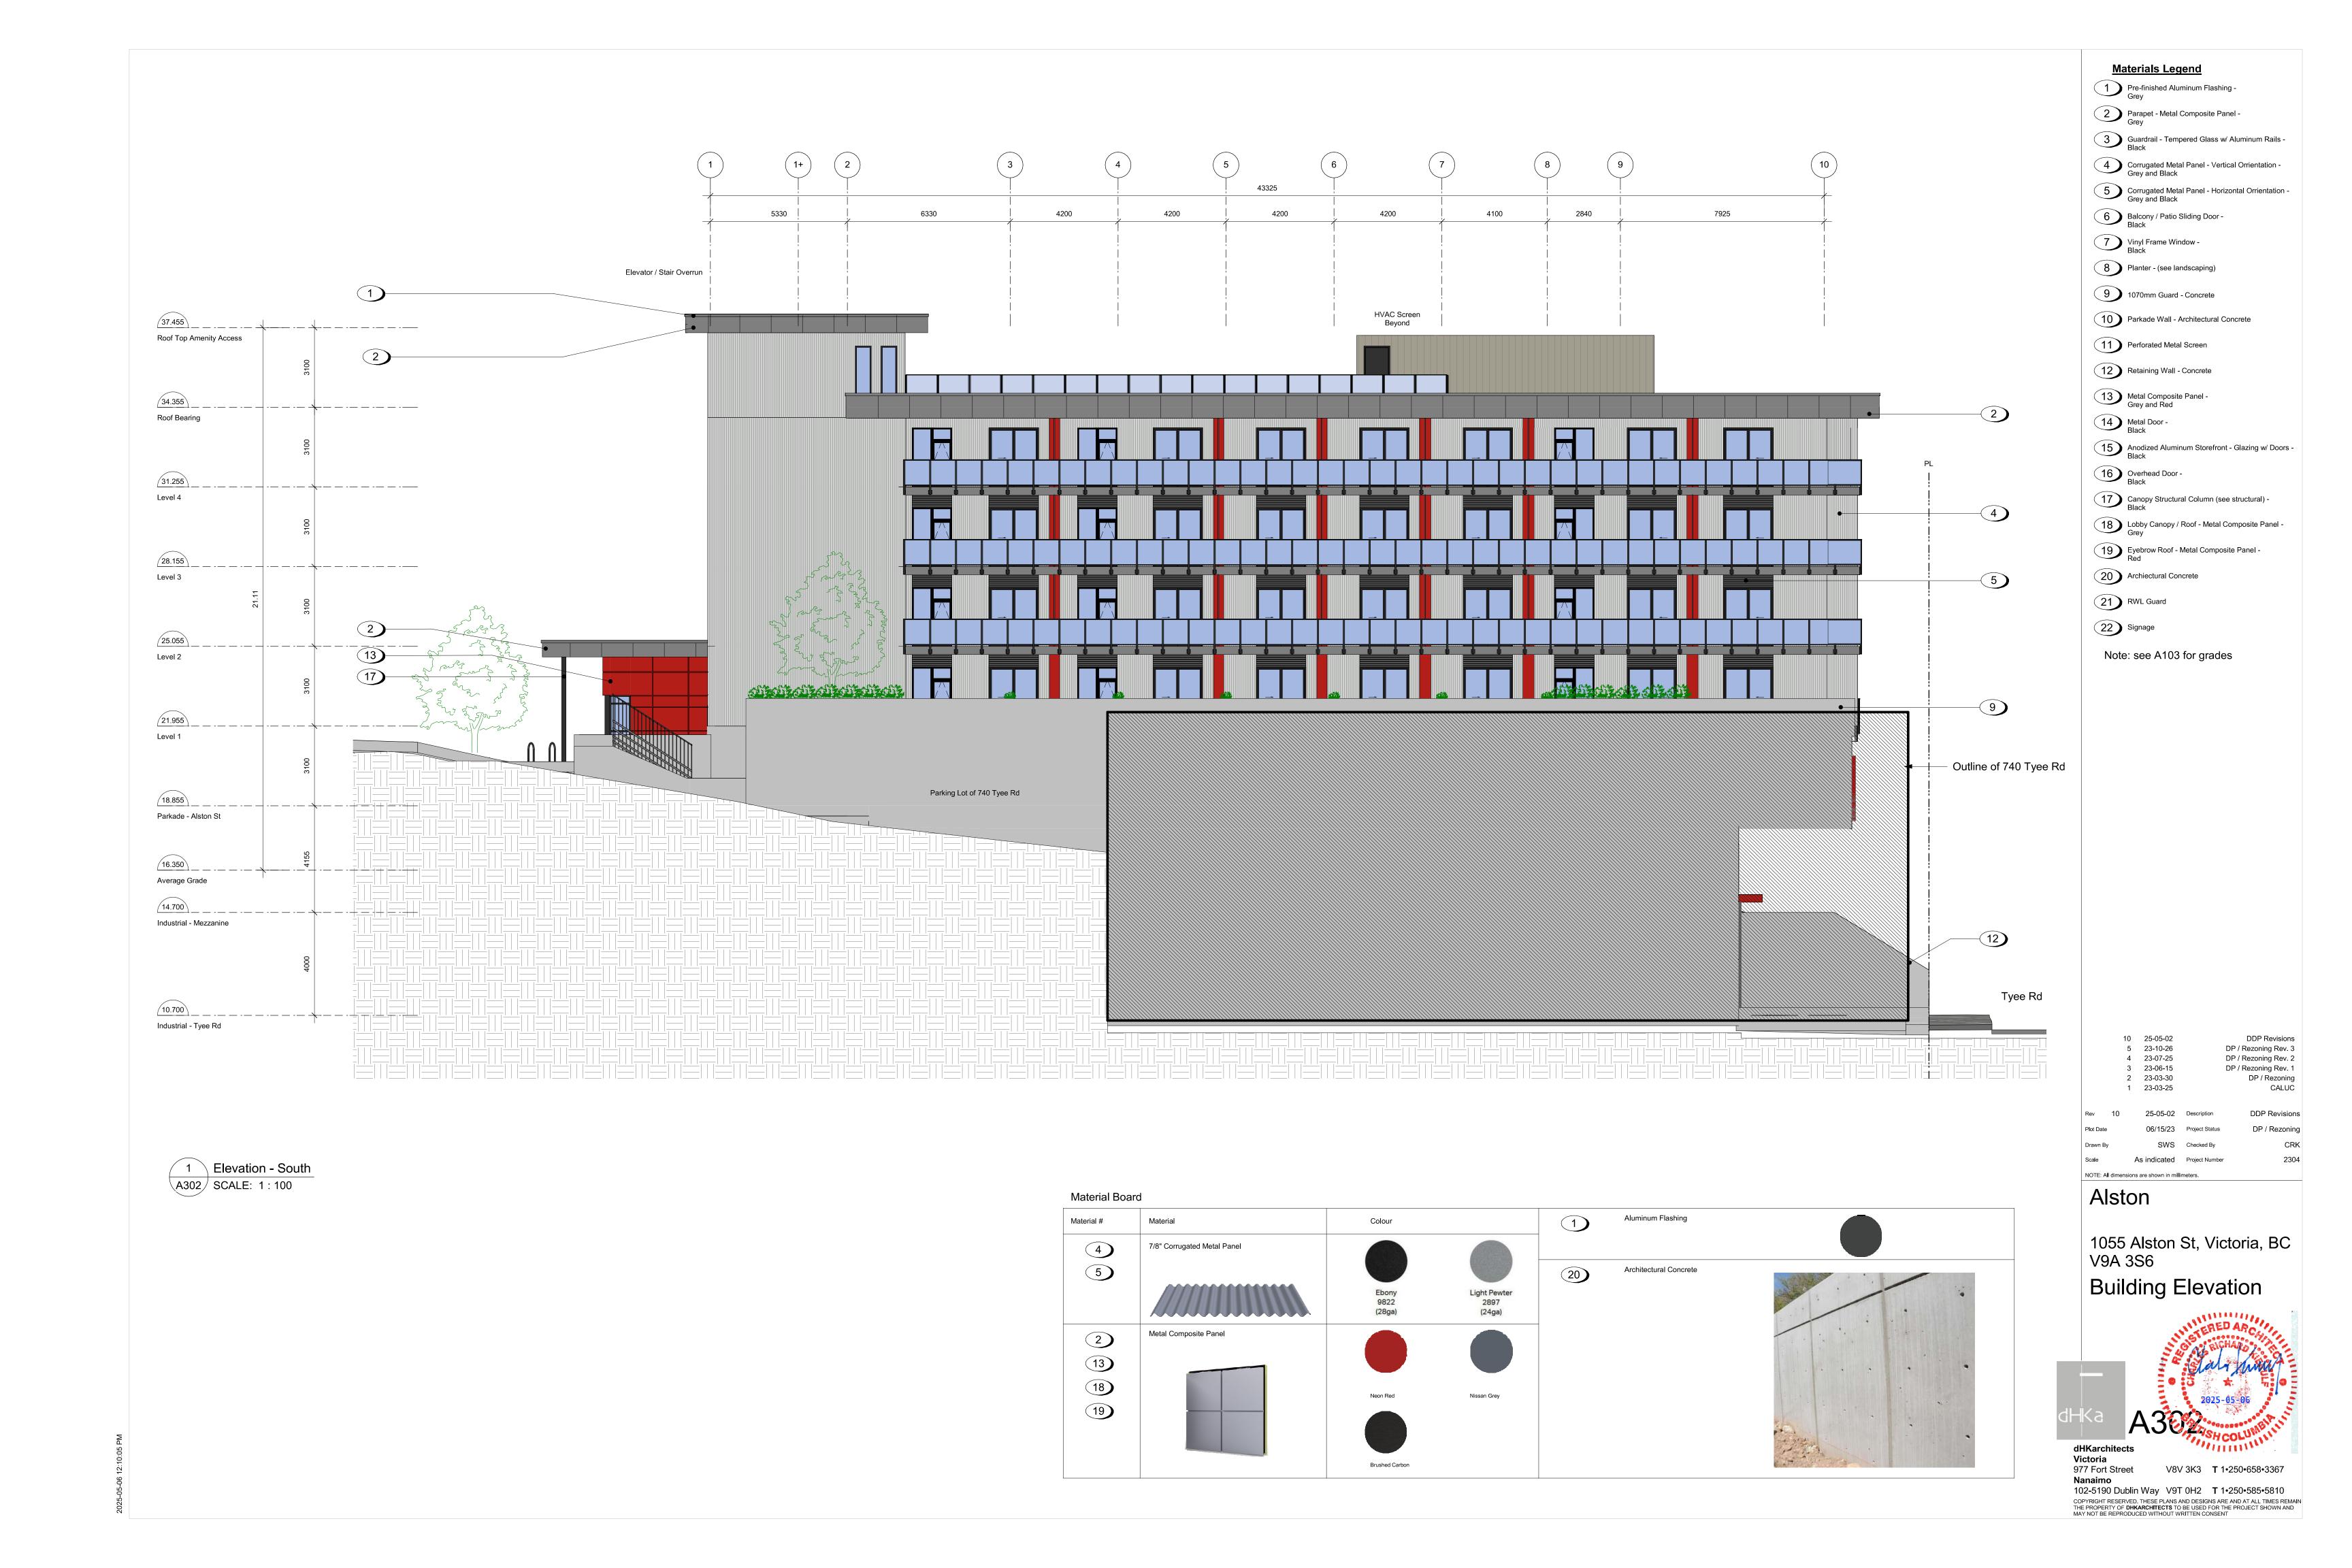

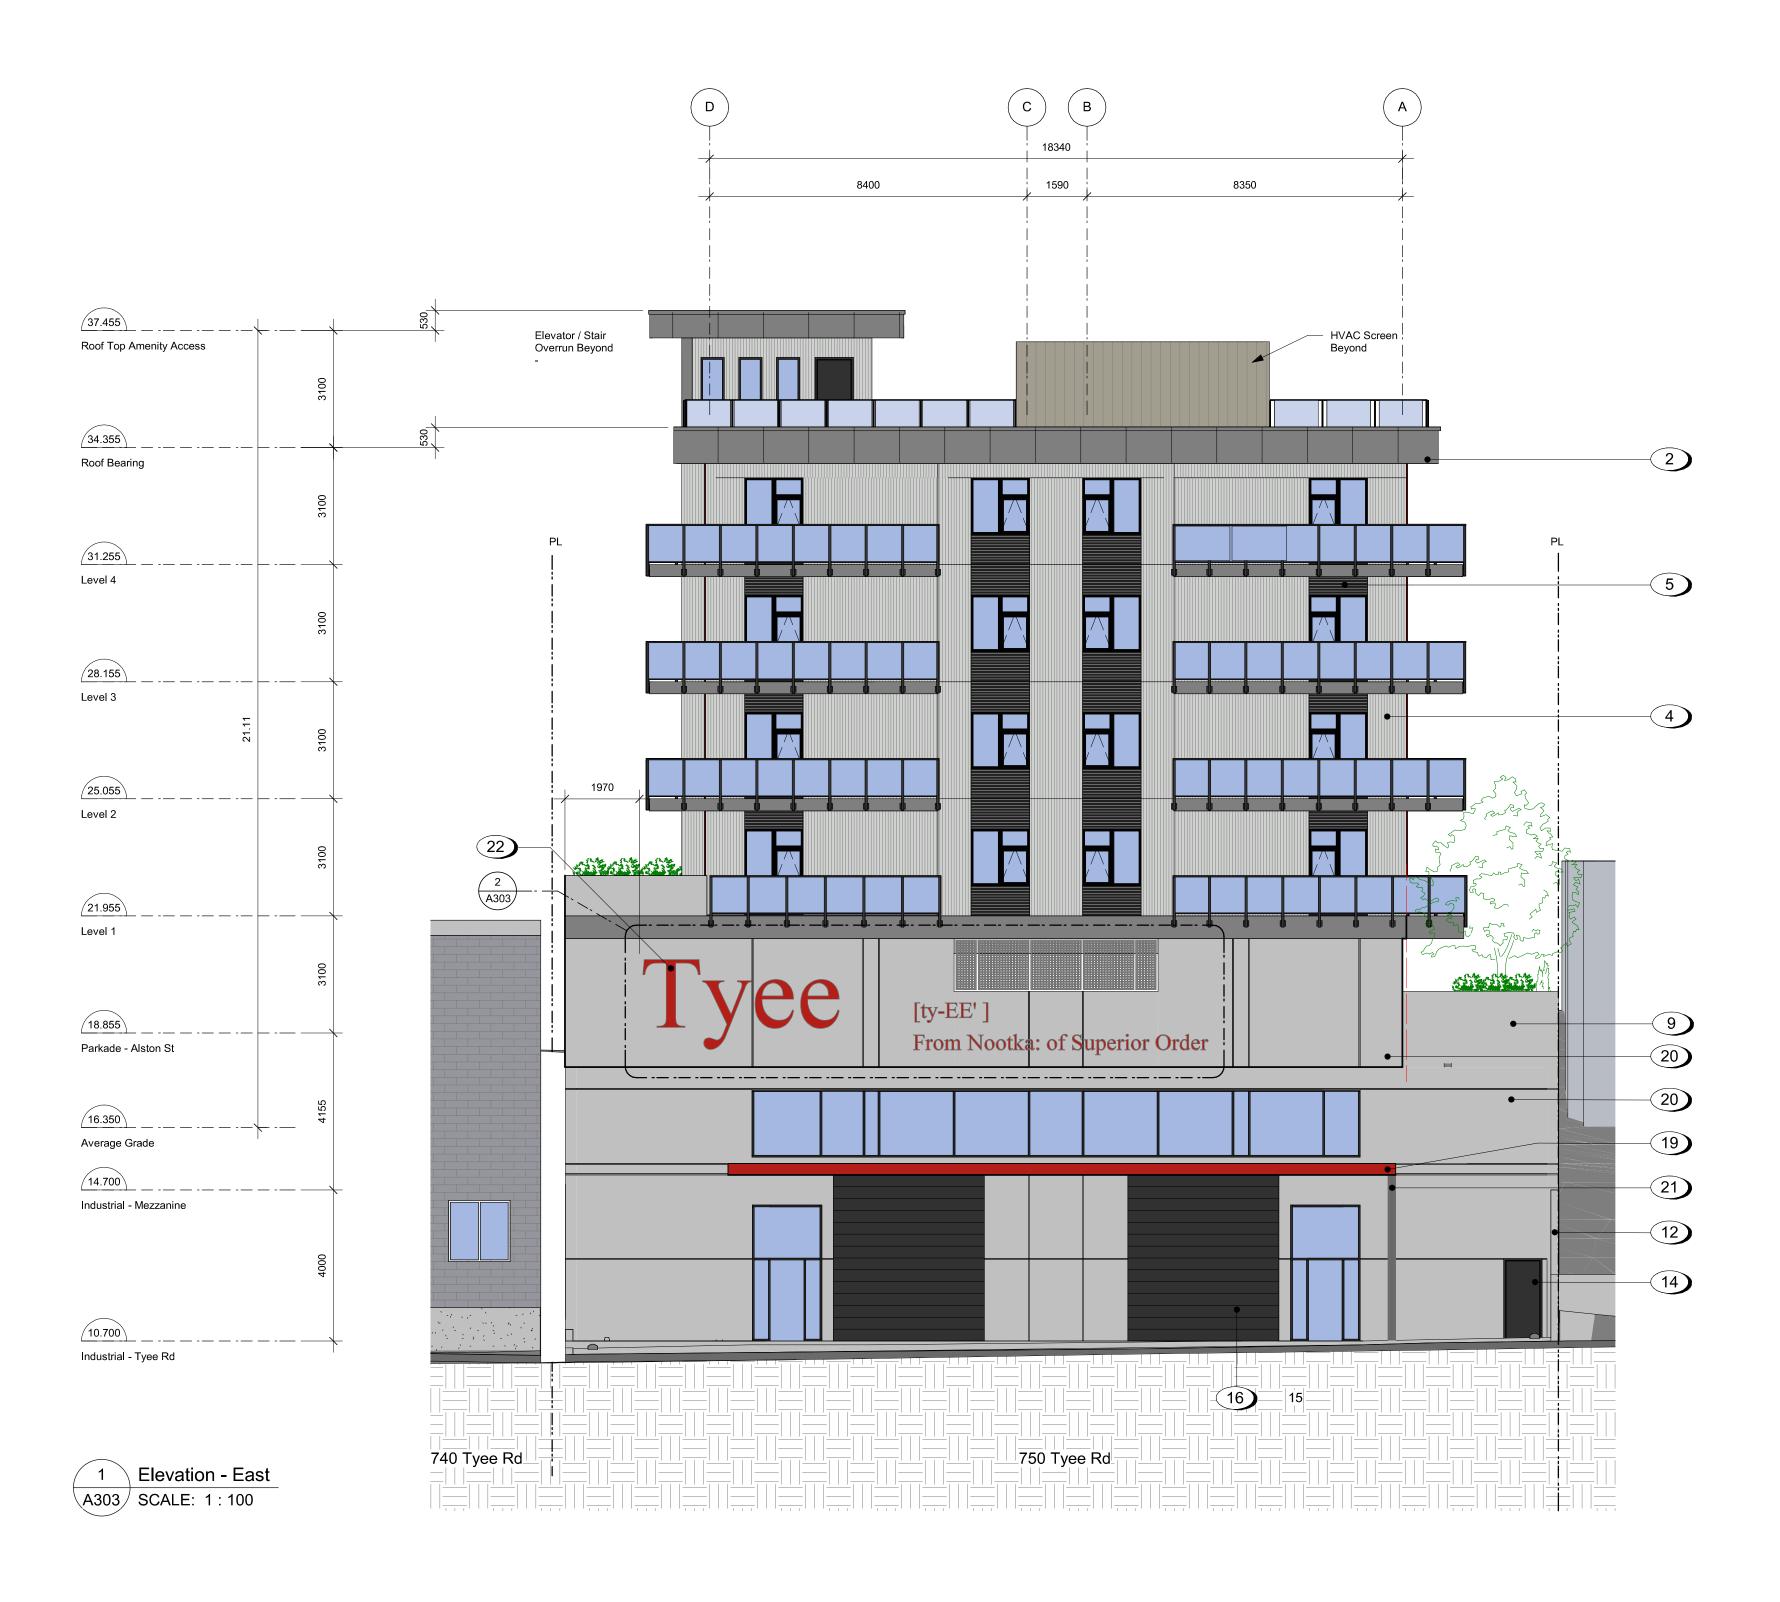

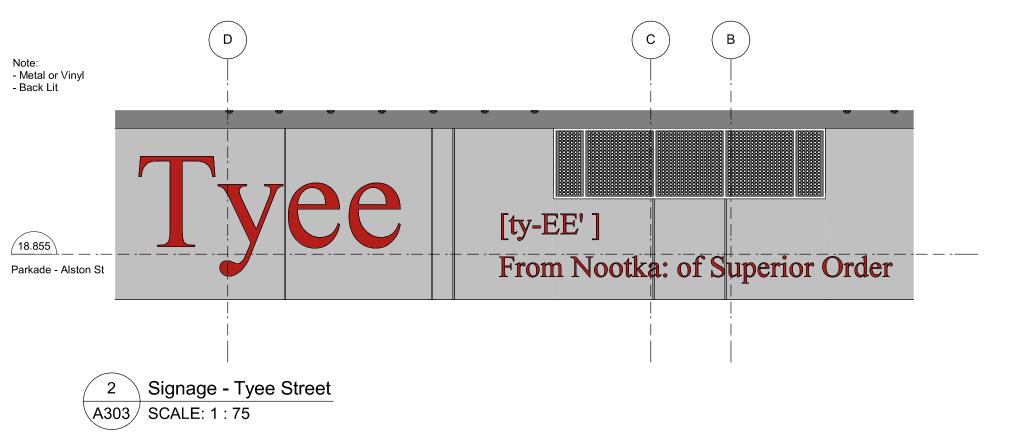

Material Boa	rd	T				
Material #	Material	Colour		1	Aluminum Flashing	
4	7/8" Corrugated Metal Panel					
5				20)	Architectural Concrete	
	///////	Ebony 9822	Light Pewter 2897			
		(28ga)	(24ga)			
2	Metal Composite Panel					
13)						
18)		Neon Red	Nissan Grey			
19)						
		Brushed Carbon				

Materials Legend

- Pre-finished Aluminum Flashing Grey
- Parapet Metal Composite Panel Grey
- Guardrail Tempered Glass w/ Aluminum Rails Black
- Corrugated Metal Panel Vertical Orrientation Grey and Black
- Corrugated Metal Panel Horizontal Orrientation Grey and Black
- Balcony / Patio Sliding Door -Black
- 7 Vinyl Frame Window Black
- 8 Planter (see landscaping)
- 9 1070mm Guard Concrete
- Parkade Wall Architectural Concrete
- Perforated Metal Screen
- Retaining Wall Concrete
- Metal Composite Panel -Grey and Red
- Metal Door -Black
- Anodized Aluminum Storefront Glazing w/ Doors Black
- Overhead Door -Black
- Canopy Structural Column (see structural) Black
- Lobby Canopy / Roof Metal Composite Panel Grey
- Eyebrow Roof Metal Composite Panel Red
- 20 Archiectural Concrete
- 21 RWL Guard

22 Signage

Note: see A103 for grades

10	25-05-02		DDP Revision
5	23-10-26		DP / Rezoning Rev.
4	23-07-25		DP / Rezoning Rev.
3	23-06-15		DP / Rezoning Rev.
2	23-03-30		DP / Rezonii
1	23-03-25		CALL
10	25.05.02	Description	DDD Povisi

NOTE: All dimensions are shown in millimeters.

Alston

1055 Alston St, Victoria, BC V9A 3S6

Building Elevation




Victoria 977 Fort Street Nanaimo 102-5190 Dublin Way V9T 0H2 **T** 1•250•585•5810 COPYRIGHT RESERVED. THESE PLANS AND DESIGNS ARE AND AT ALL TIMES REMAIN THE PROPERTY OF **DHKARCHITECTS** TO BE USED FOR THE PROJECT SHOWN AND MAY NOT BE REPRODUCED WITHOUT WRITTEN CONSENT



1 Elevation - West



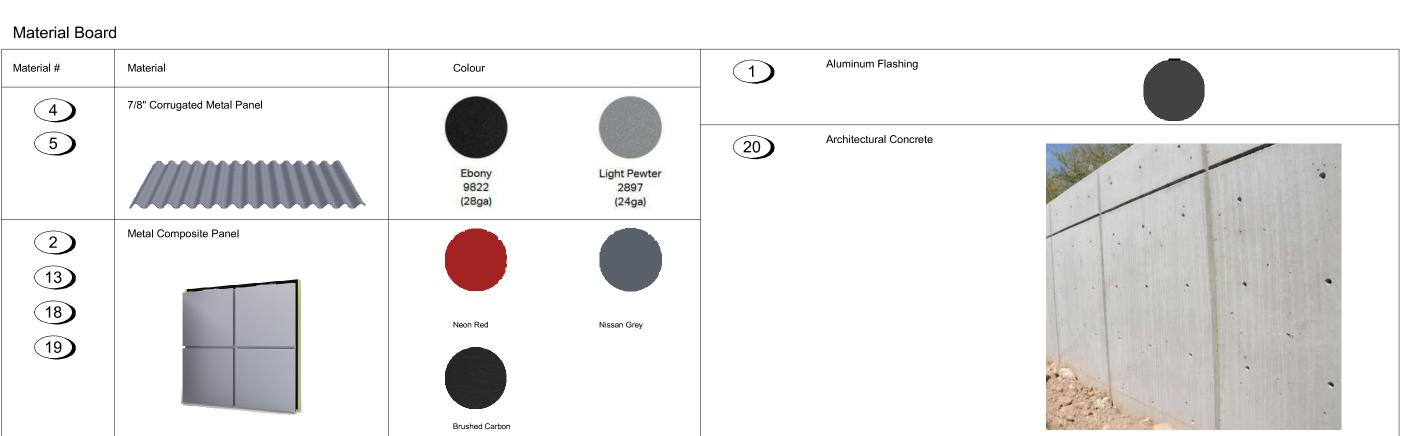

2 Signage - Alston Street A304 SCALE: 1:75

Materials Legend

- Pre-finished Aluminum Flashing Grey
- Parapet Metal Composite Panel Grey
- Guardrail Tempered Glass w/ Aluminum Rails Black
- Corrugated Metal Panel Vertical Orrientation Grey and Black
- Corrugated Metal Panel Horizontal Orrientation Grey and Black
- Balcony / Patio Sliding Door -Black
- 7 Vinyl Frame Window Black
- 8 Planter (see landscaping)
- 9 1070mm Guard Concrete
- Parkade Wall Architectural Concrete
- 11 Perforated Metal Screen
- Retaining Wall Concrete
- Metal Composite Panel -Grey and Red
- Metal Door -Black
- Anodized Aluminum Storefront Glazing w/ Doors Black
- Overhead Door -Black
- Canopy Structural Column (see structural) Black
- Lobby Canopy / Roof Metal Composite Panel Grey
- Eyebrow Roof Metal Composite Panel Red
- 20 Archiectural Concrete
- 21 RWL Guard
- 22 Signage

Note: see A103 for grades

10 25-05-02 DDP Revisions 4 23-07-25 DP / Rezoning Rev. 2 DP / Rezoning Rev. 1 3 23-06-15 2 23-03-30 DP / Rezoning 1 23-03-25 CALUC DDP Revisions NOTE: All dimensions are shown in millimeters.


Alston

1055 Alston St, Victoria, BC V9A 3S6

Building Elevation



dHKarchitects Victoria 977 Fort Street V8V 3K3 **T** 1•250•658•3367 Nanaimo 102-5190 Dublin Way V9T 0H2 **T** 1•250•585•5810 COPYRIGHT RESERVED. THESE PLANS AND DESIGNS ARE AND AT ALL TIMES REMAIN THE PROPERTY OF **DHKARCHITECTS** TO BE USED FOR THE PROJECT SHOWN AND MAY NOT BE REPRODUCED WITHOUT WRITTEN CONSENT

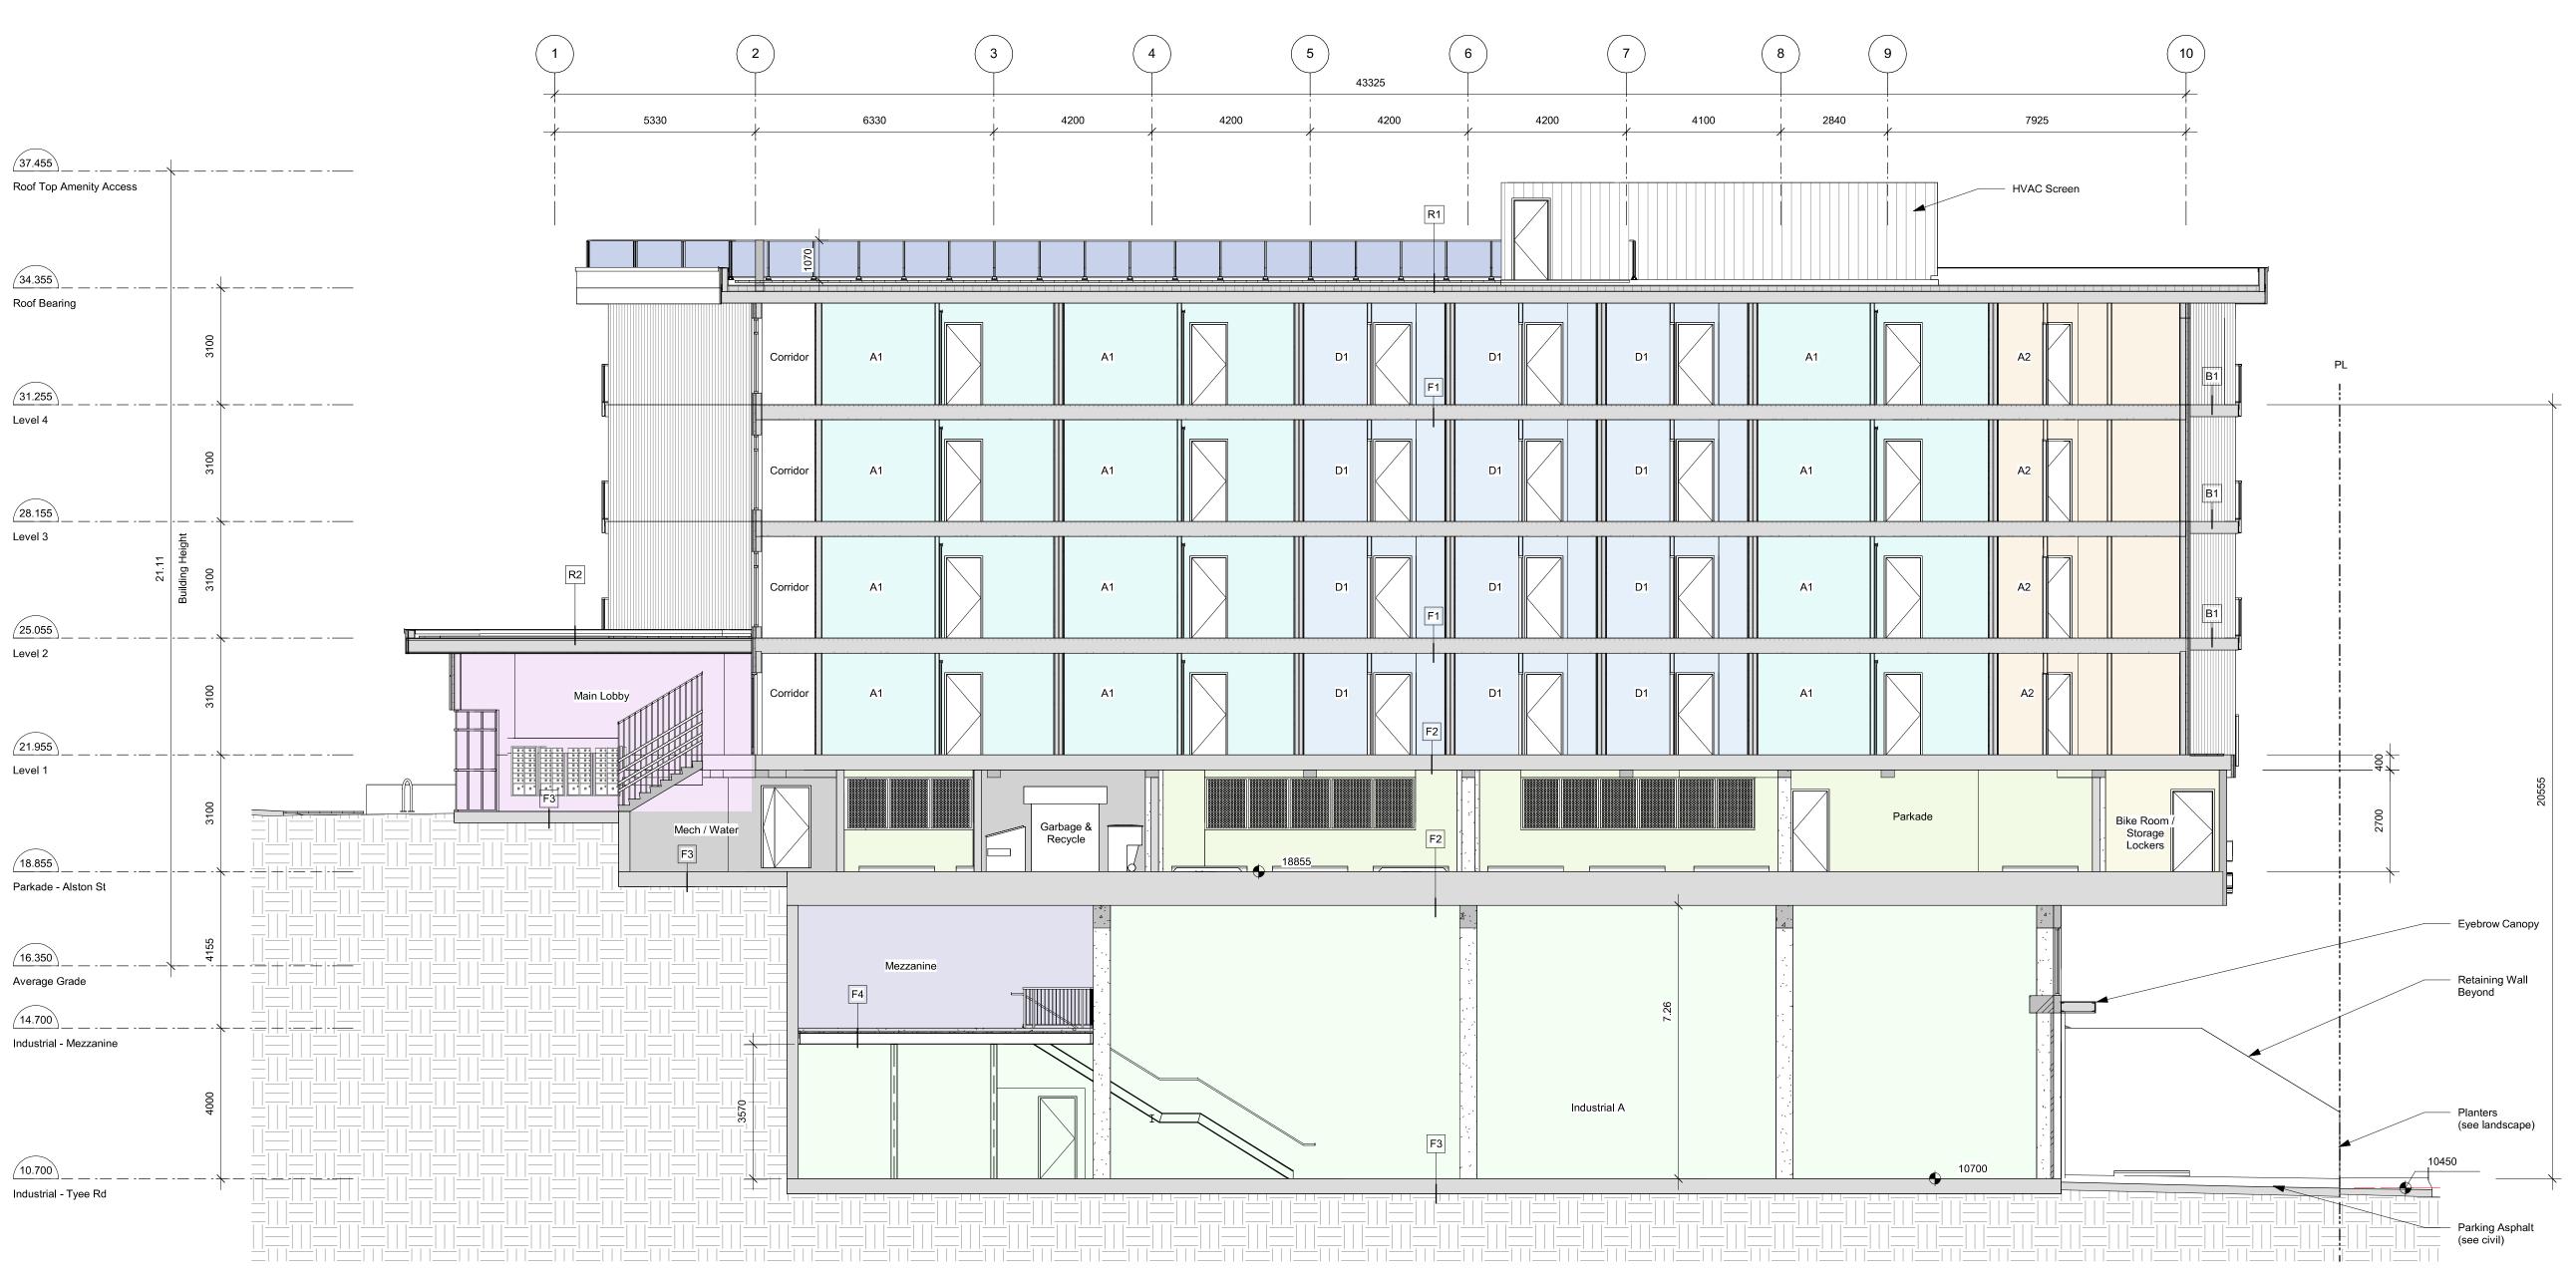

1 Building Section - Looking North - Lobby
A401 SCALE: 1:100

 10
 25-05-02
 DDP Revisions

 5
 23-10-26
 DP / Rezoning Rev. 3

 4
 23-07-25
 DP / Rezoning Rev. 2

 3
 23-06-15
 DP / Rezoning Rev. 1

 Rev
 10
 25-05-02
 Description
 DDP Revisions

 Plot Date
 06/15/23
 Project Status
 DP / Rezoning

 Drawn By
 SWS
 Checked By
 CRK

 Scale
 As indicated
 Project Number
 2304


 NOTE: All dimensions are shown in millimeters.

Fire Separation Legend


Alston


1055 Alston St, Victoria, BC V9A 3S6

Building Section - Looking North

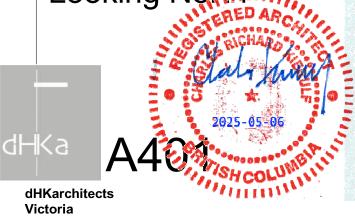


dHKarchitects
Victoria
977 Fort Street V8V 3K3 T 1•250•658•3367
Nanaimo
102-5190 Dublin Way V9T 0H2 T 1•250•585•5810
COPYRIGHT RESERVED. THESE PLANS AND DESIGNS ARE AND AT ALL TIMES REMAIN THE PROPERTY OF DHKARCHITECTS TO BE USED FOR THE PROJECT SHOWN AND MAY NOT BE REPRODUCED WITHOUT WRITTEN CONSENT

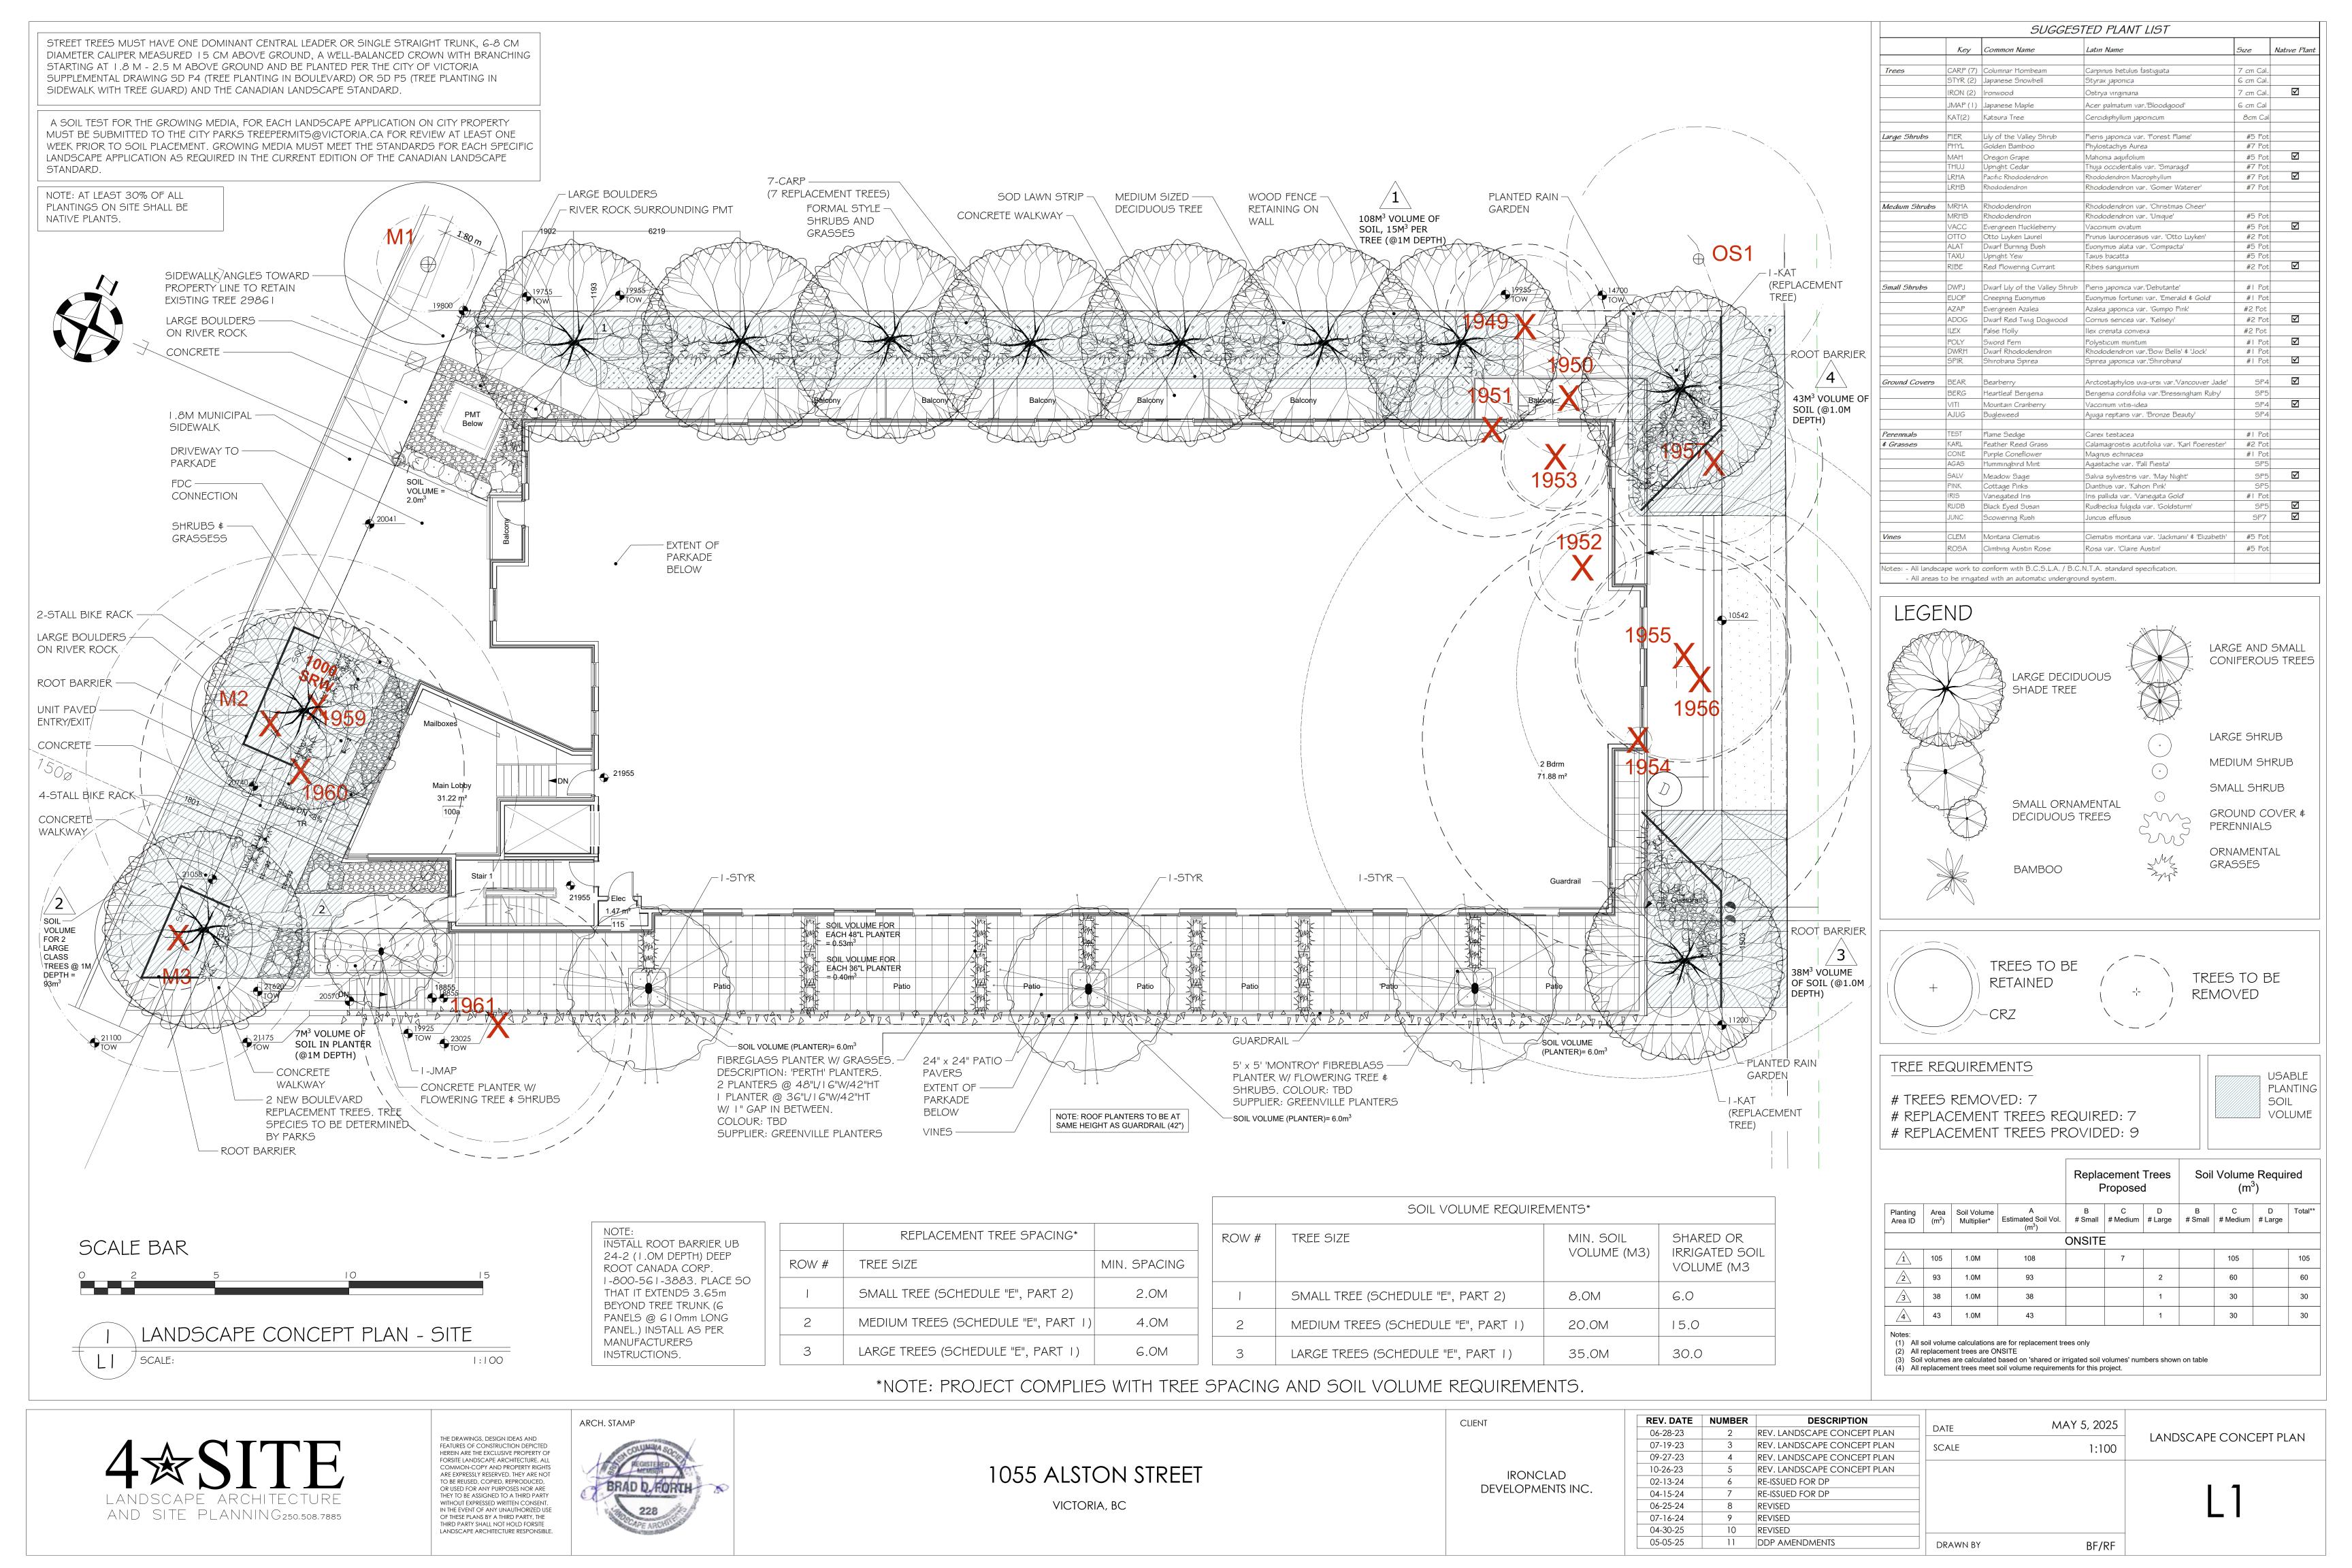


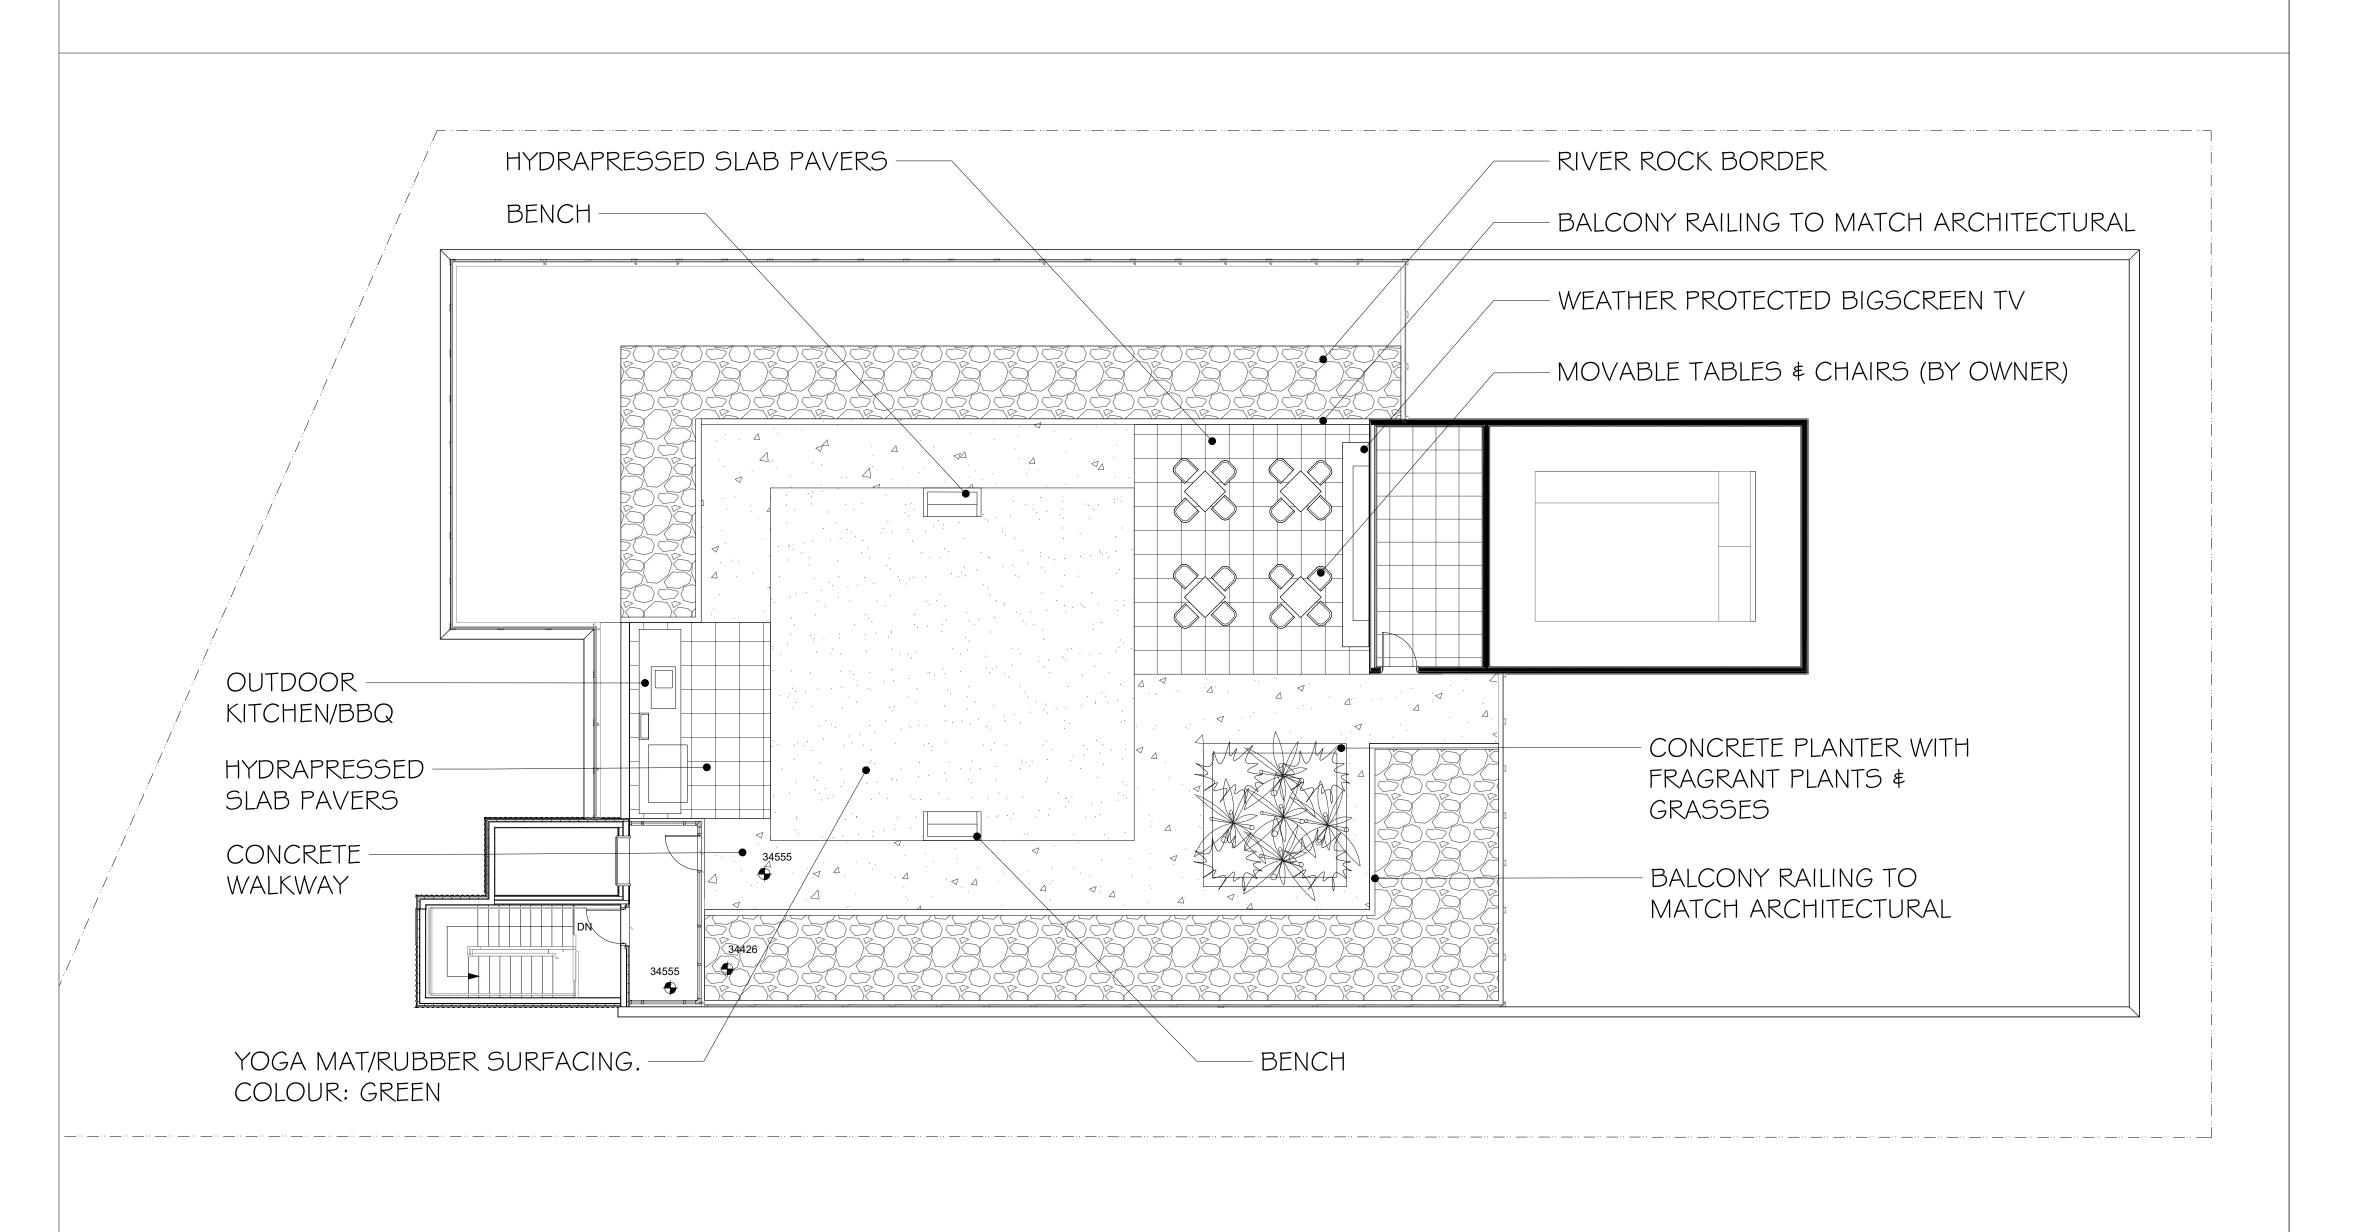



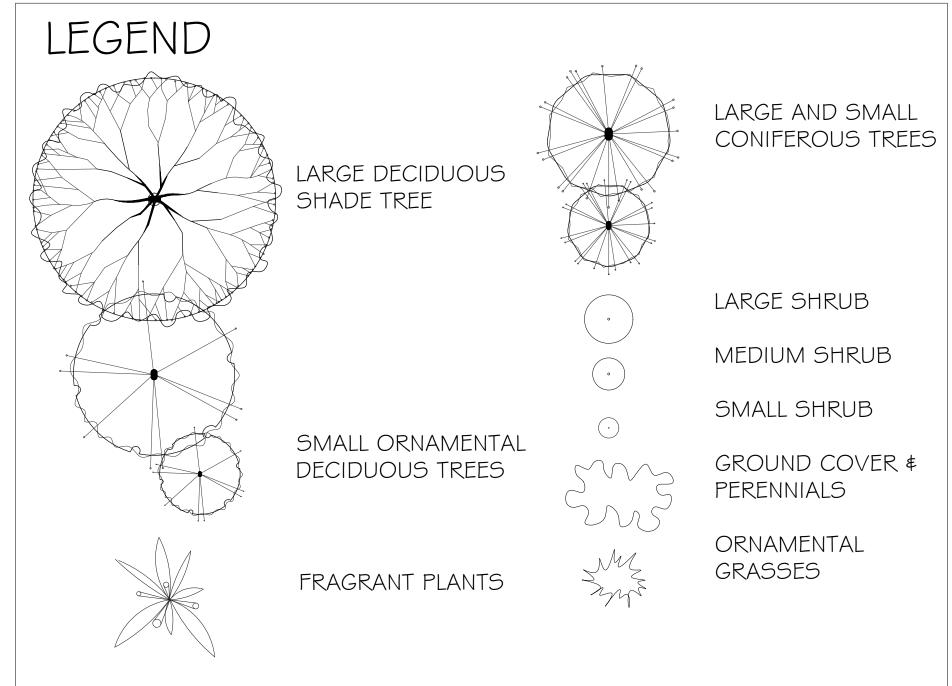



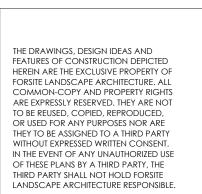



1055 ALSTON STREET

CLIENT

IRONCLAD DEVELOPMENTS INC.

REV. DATE	NUMBER	DESCRIPTION
03-15-23	1	PRELIM. LANDSCAPE CONCEPT PLAN
06-15-23	2	REV. LANDSCAPE CONCEPT PLAN
10-26-23	3	REV. LANDSCAPE CONCEPT PLAN
06-25-24	4	RE-ISSUED FOR DP
07-16-24	5	REVISED
04-08-25	6	REVISED - FOR REVIEW
04-24-25	7	REVISED - FOR REVIEW
05-05-25	8	DDP AMENDMENTS

DATE	MAY 5, 2025	
SCALE	1:100	

BF/RF

DRAWN BY

LANDSCAPE CONCEPT PLAN (ROOF AMENITY)

