

REAR YARD W/ ACCESSORY BUILDING & COVERED PATIO

1721 ADANAC ST, VICTORIA BC NORTH JUBILEE HOUSEPLEX

MULTI-SUITE RESIDENTIAL, NEW CONSTRUCTION

New houseplex development including six strata residential units as well as an accessory building at the rear of the site for bicycle storage. Unit mix includes 4 one bedroom suites and 2 three bedroom

LANDSCAPE

Greenspace Designs Erin Renwick

erin@greenspacedesigns.com

The proposed project adheres to the regulations for a houseplex (Schedule P, 3.0), with variances, within the Missing Middle Housing Initiative.

PROJECT DIRECTORY

Cascara Construction Rob Duncan rob@cascaraconstruction.com

ARCHITECTURAL

Fold Architecture Inc. Mark Ashby mashby@foldarchitects.com

PROJECT INFORMATION				
Zone	R1-B			
OCP Land Use	SINGLE FAMILY DWELLING DISTRICT			
Address	1721 Adanac St, Victoria BC			
Legal Description	THE EASTERLY 30 FEET OF LOT 33, AND REM LOT 34, SECTION 25, VICTORIA DISTRICT, PLAN 339			
PID	032-292-821			
Description (Change of Use)	NEW CONSTRUCTION - MULTI -FAMILY DWELLING			
Code Ref and Part	BCBC 2024, PART 9			
Occupancy	RESIDENTIAL			
Building Area m2	388m2			
Building Height (m)	11.67m			
Number of Storeys	3 (+ Basement)			
Number of Facing Streets	1			
Sprinklered	Yes			
Fire Department Response Time	<10min			
Energy Compliance Path	Step Code 5			
Survey ID	VIP14195 - Dec 18,2023			

SHEET LIST

DOOR & WINDOW SCHEDULE SITE PLAN + ZONING COMPLIANCE

AVERAGE GRADE

LIMITING DISTANCE

SHADOW STUDIES

EGRESS PLANS

FLOOR PLANS

FLOOR PLANS **ELEVATIONS N+E**

ELEVATION S+W

SECTION N-S ACCESSORY BUILDING

Revisions **Received Date: September 16, 2024**



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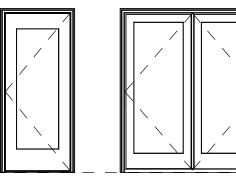
No.	Description	Date
2	Issued for MMHI Development Permit	24.04.22
3	Issued for MMHI DP Rev.	24.06.26
4	Issued for MMHI DP Rev. 2	24.09.03

CASCARA CONSTRUCTION
NORTH JUBILEE HOUSEPLEX COVER


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Date	2024.09.10
Project number	1
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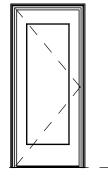
DOOR SCHEDULE DESCRIPTION AREA (sm) TYPE D1 Glazed Suite Entry Door 914 2134 1.95 m² D2 Glazed Double Patio Door 1845 2134 3.94 m² D3 Glazed Single Patio Door 914 2134 1.95 m² 1829 2134 3.90 m² D4A Solid Double Door D4B Solid Double Door 1524 2134 3.25 m² D5 Entry Gate 914 1136 1.04 m² D5 Entry Gate 914 1136 1.04 m² DS1 Interior Suite Single Door 762 2134 1.63 m² DS2 Interior Suite Sliding Closet Door 1000 2134 2.13 m² DS2 Interior Suite Sliding Closet Door 1200 2134 2.56 m² DS2 Interior Suite Sliding Closet Door 1525 2134 3.25 m² DS2 Interior Suite Sliding Closet Door 1800 2134 3.84 m² DS3 Interior Suite Single Bifold Door 762 2134 1.63 m² DS3 Interior Suite Single Bifold Door 813 2134 1.73 m² DS3 Interior Suite Single Bifold Door 914 2134 1.95 m²




D1





D2

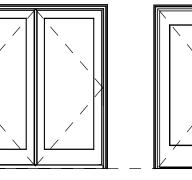


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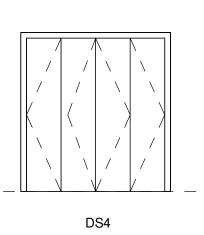


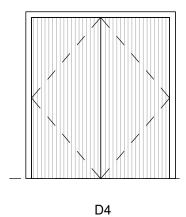

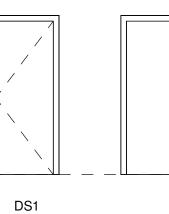
DS2

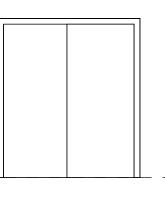

DS3

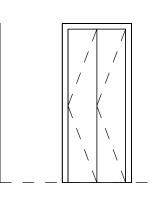

	WINDOW SCHEDULE						
Mark	TYPE	DESCRIPTION	DIMENSIONS SILL HEIGHT	HEIGHT	WIDTH	AREA	COMMENTS
E1.1	G6 Tilt &	Turn	1615	532	1499	0.8 m ²	
E1.2		Turn	1615	532	1499	0.8 m ²	
E1.3		Turn	903	1499	532	0.8 m ²	
E1.4		Turn	903	1499	532	0.8 m ²	
E2.1	G5 Tilt &	Turn	633	1499	532	0.8 m ²	
E2.2	G5 Tilt &	Turn	634	1499	532	0.8 m ²	
E2.3	G5 Tilt &	Turn	634	1499	532	0.8 m ²	
E2.4	G5 Tilt &	Turn	-374	1499	532	0.8 m ²	
E3.1	G5 Tilt &	Turn	634	1499	532	0.8 m ²	
E3.2	G5 Tilt &	Turn	634	1499	532	0.8 m ²	
E3.3	G5 Tilt &	Turn	634	1499	532	0.8 m ²	
E3.4	G5 Tilt &	Turn	-374	1499	532	0.8 m ²	
N1.1	G1 Tilt &	Turn	450	1684	756	1.3 m²	
N1.2	G1 Tilt &	Turn	450	1684	756	1.3 m ²	
N2.1	G2 Tilt &	Turn	450	1684	1512	2.5 m ²	
N2.1	G2 Tilt &	Turn	450	1684	1512	2.5 m ²	
N2.2	G1 Tilt &	Turn	450	1684	756	1.3 m ²	
N2.3	G1 Tilt &	Turn	450	1684	756	1.3 m ²	
N2.4	G1 Tilt &	Turn	450	1684	756	1.3 m ²	
N3.1	G2 Tilt &	Turn	450	1684	1512	2.5 m ²	
N3.1	G2 Tilt &	Turn	450	1684	1512	2.5 m ²	
N3.2	G1 Tilt &	Turn	450	1684	756	1.3 m ²	
N3.3	G1 Tilt &	Turn	450	1684	756	1.3 m ²	
N3.4	G1 Tilt &	Turn	450	1684	756	1.3 m ²	
N4.1	G1 Tilt &	Turn	450	1684	756	1.3 m ²	
N4.2	G1 Tilt &	Turn	450	1684	756	1.3 m ²	
N4.3	G4 Tilt &	Turn	152	1981	1511	3.0 m ²	
N4.3	G4 Tilt &	Turn	152	1981	1511	3.0 m ²	
R1	G8 Fixed	d Curb Mounted Skylight					570mm x 1790mm
R2	G8 Fixed	d Curb Mounted Skylight					570mm x 1790mm
S1.1		Turn	450	1684	756	1.3 m ²	
S1.2		Turn	450	1684	756	1.3 m²	
S2.1	G2 Tilt &	Turn	450	1684	1512	2.5 m ²	
S2.2		Turn	450	1684	756	1.3 m ²	
S2.3		Turn	450	1684	756	1.3 m ²	
S2.4		Turn	450	1684	756	1.3 m²	
S3.1		Turn	450	1684	756	1.3 m²	
S3.2		Turn	450	1684	756	1.3 m²	
S3.3		Turn	450	1684	756	1.3 m²	
S4.1		Turn	152	1981	756	1.5 m ²	
S4.2		Turn	152	1981	756	1.5 m ²	
W1.1		Turn	1615	532	1499	0.8 m ²	
W1.2		Turn	1616	756	827	0.6 m ²	
W1.3		Turn	1615	756	827	0.6 m ²	
W1.4		Turn	1839	532	1499	0.8 m ²	
W2.1		Turn	634	1499	532	0.8 m ²	
W2.2		Turn	634	1499	532	0.8 m ²	
W2.3		Turn	634	1499	532	0.8 m ²	
W2.4		Turn	634	1499	532	0.8 m ²	
W2.5		Turn	2522	1499	532	0.8 m ²	
W3.1		Turn	634	1499	532	0.8 m ²	
W3.2		Turn	634	1499	532	0.8 m ²	
W3.3		Turn	634	1499	532	0.8 m ²	
W3.4	G5 Tilt &	Turn	2522	1499	532	0.8 m ²	

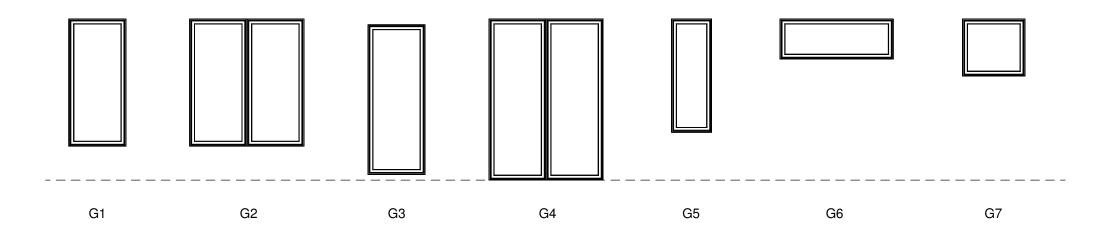

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No.	Description	Date
1	Costing Class C	24.03.22
3	Issued for MMHI DP Rev.	24.06.26
4	Issued for MMHI DP Rev. 2	24.09.03

CASCARA CONSTRUCTION
NORTH JUBILEE
HOUSEPLEX
DOOR & WINDOW
SCHEDULE

Project number	1
Date	2024.09.10
Drawn by	MW
Checked by	MA

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 Scale
 1:50

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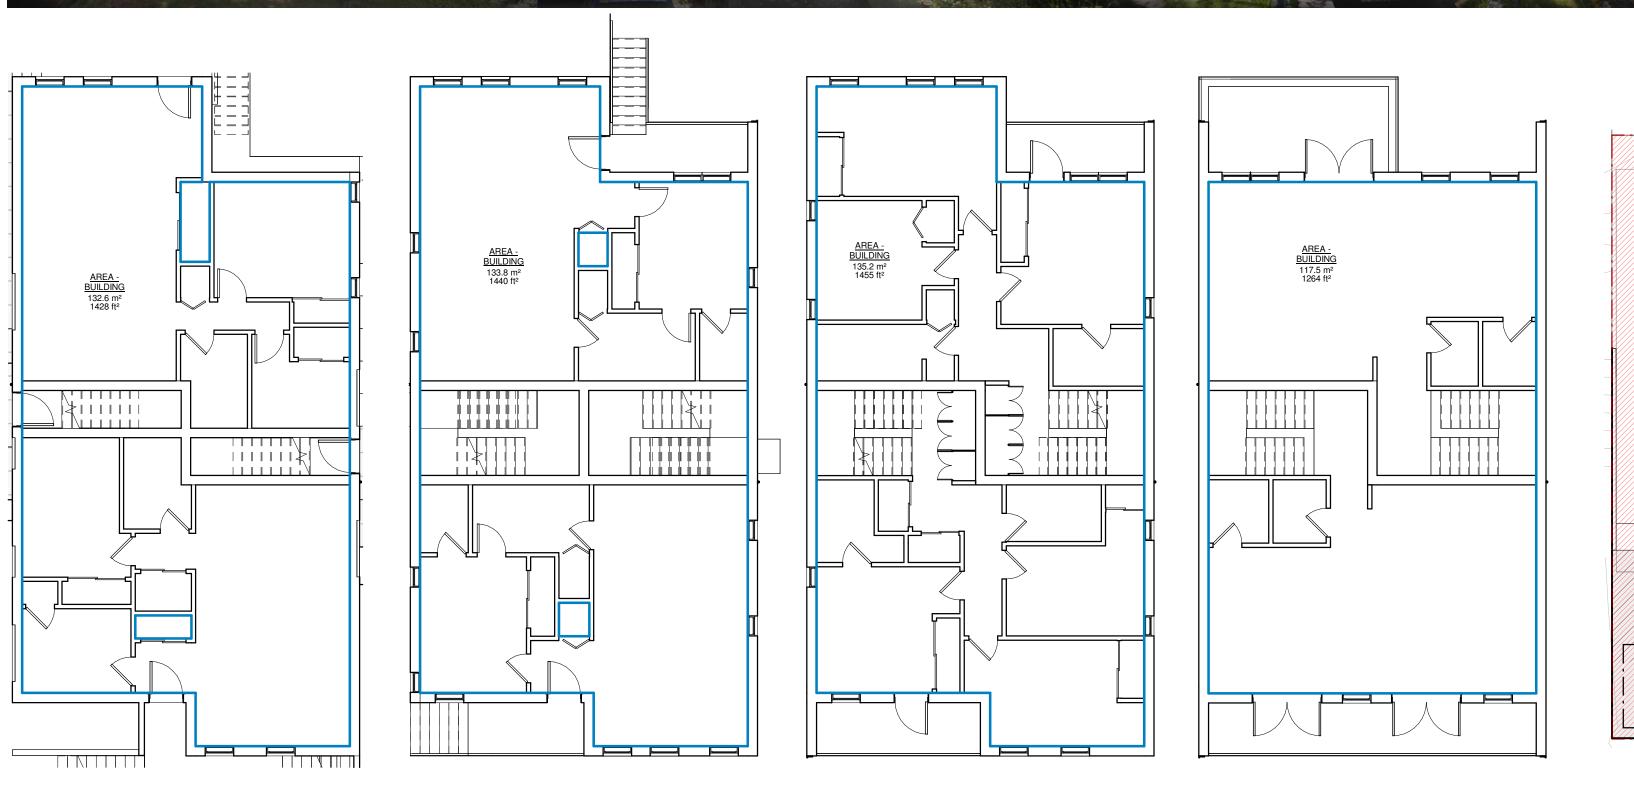
CONTEXT PLAN - NOT TO SCALE




	ZONING COMPLIANCE				
Clause	Desicription	Permitted	Proposed	Comments	
_	Permitted Use	Residential	Residential	Complies	
2.4.e	Floor Area	390m2	386.5m2	Excludes Bike/Storage,133.8+135.2+117.5	
2.4.e	Floor Space Ratio	1.0:1	1.0:1	386.5m2/390m2 = 0.99	
3.1c	Distance from Street to Building	Max. 30m	8.49m	Complies	
3.1c 3.2.b	Height	12.0m	11.67m	·	
	<u>_</u>			Complies	
3.2.c	Finished Ceiling Height - Lowest Level (Min.)	1.1m	1.75m	Complies	
3.3.a	Front Setback	4.0m	4.0m	Complies	
3.3.c	Side Setback (West)	1.50m	1.50m	Complies	
3.3.c	Side Setback (East)	1.50m	1.50m	Complies	
3.3.d	Rear Setback	10.0m	10.0m	Complies	
3.3.e	Roof projections in setbacks	0.75m	0.6m Max.	Complies, Includes Entry Door Canopies	
3.3.f	Building Separation (Min.)	5.0m	5.0m	Complies	
3.4	Rear Yard Coverage	25%	25%	30.4m2/121.7m2	
3.4.a	Coverage	40%	50%	Variance Requested	
3.4.a	Coverage Area	156m2	193m2	-	
3.4.a	Lot Area	390m2	-	-	
3.4.b	Open Site Space	45%	45%	173.8m2/390m2	
3.4.c	Minimum Landscape Area	35m2	35m2	Variance Requested - Minimum Dimension	
6.1	Required Parking	3.7	1	Variance Requested	
6.2.b	Long Term Bicycle Parking Stalls	12	12	Complies	
6.2.c	Long Term Oversized Bicycle Stalls (15%)	1.8	3	Complies	
C-1.2.2	Short Term Bicycle Parking Stalls	6	6	Complies	
C-3.2.b	Long Term Ground Anchored Stalls (50%)	6	9	Complies	
F-4.a	Accessory Building - Rear Setback	0.6m	0.6m	Complies	
F-4.b	Accessory Building - Side Setback (West)	0.6m	1.5m	Complies	
F-4.b	Accessory Building - Side Setback (Fast)	0.6m	0.6m	Complies	

STREETSCAPE ELEVATION - NOT TO SCALE





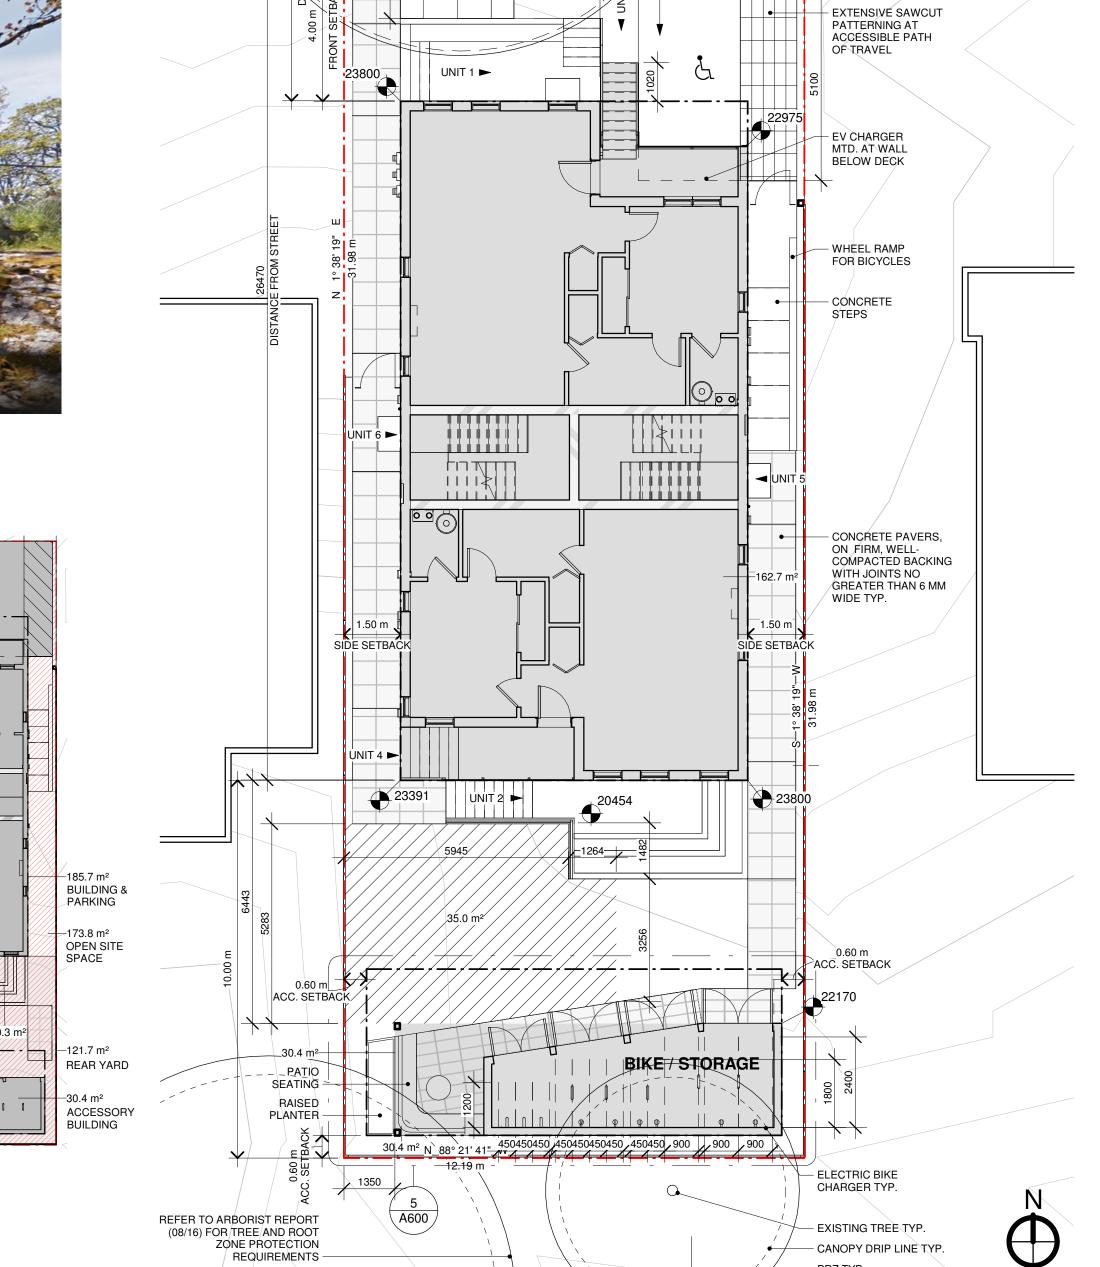

REFER TO ARBORIST REPORT (08/16) FOR TREE AND ROOT ZONE PROTECTION REQUIREMENTS

SEPARATED SIDEWALK CURB & GUTTER PER CITY STANDARD SD-C15"

3 BASEMENT - AREA 1:100 1:100

5 <u>L2 - AREA</u> 1:100

7 OPEN SITE SPACE 1:200

1 SITE PLAN 1:100

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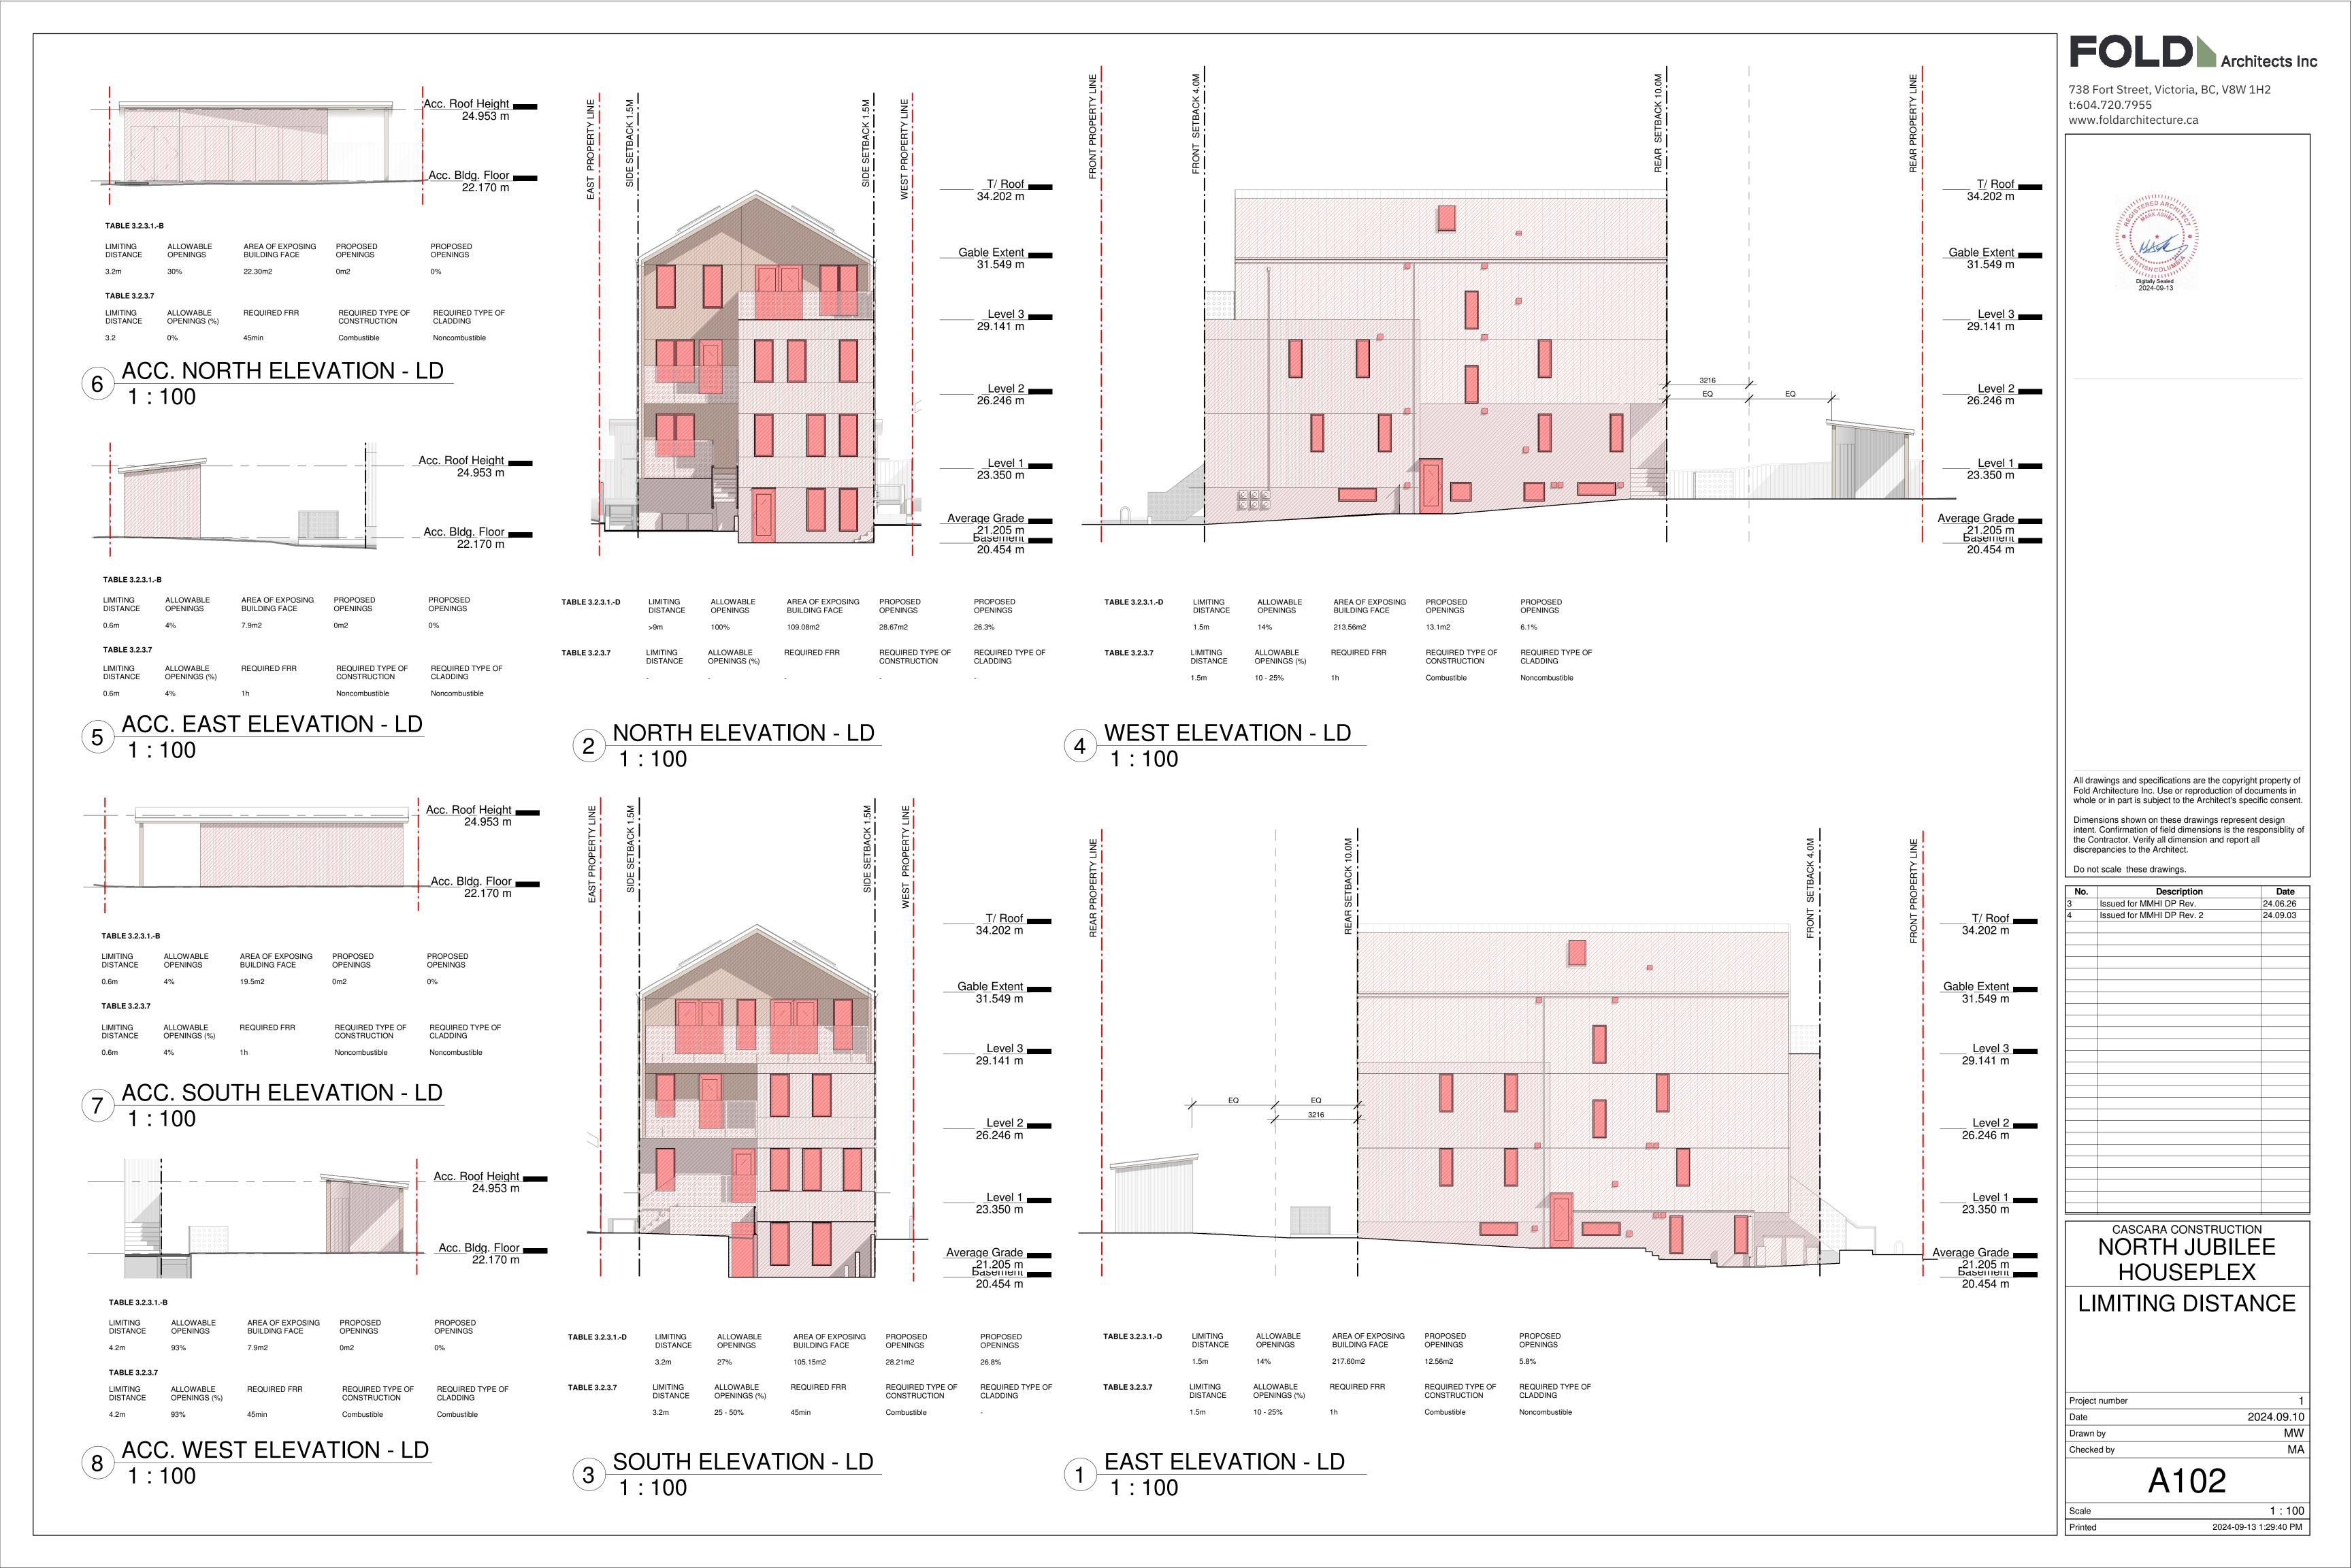
CASCARA CONSTRUCTION
NORTH JUBILEE HOUSEPLEX SITE PLAN + ZONING COMPLIANCE


Project number 2024.09.10 Drawn by Checked by


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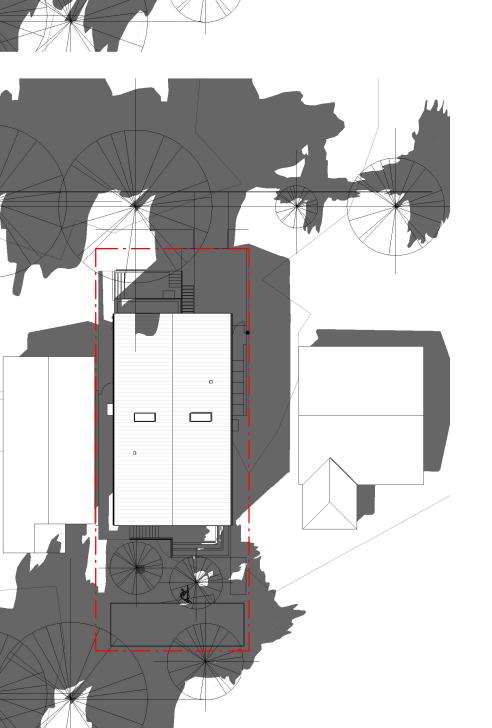
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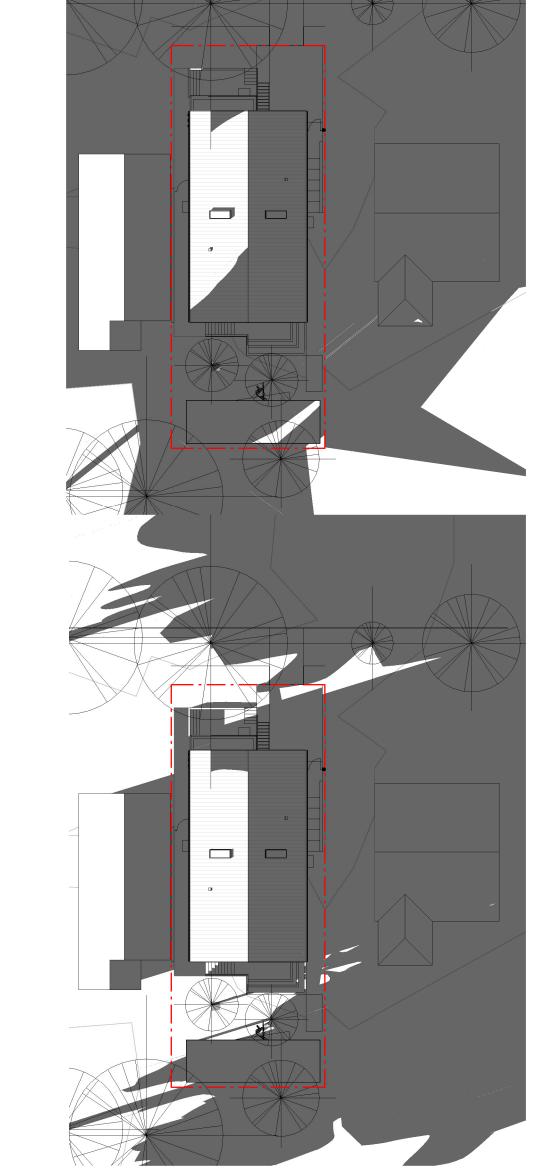









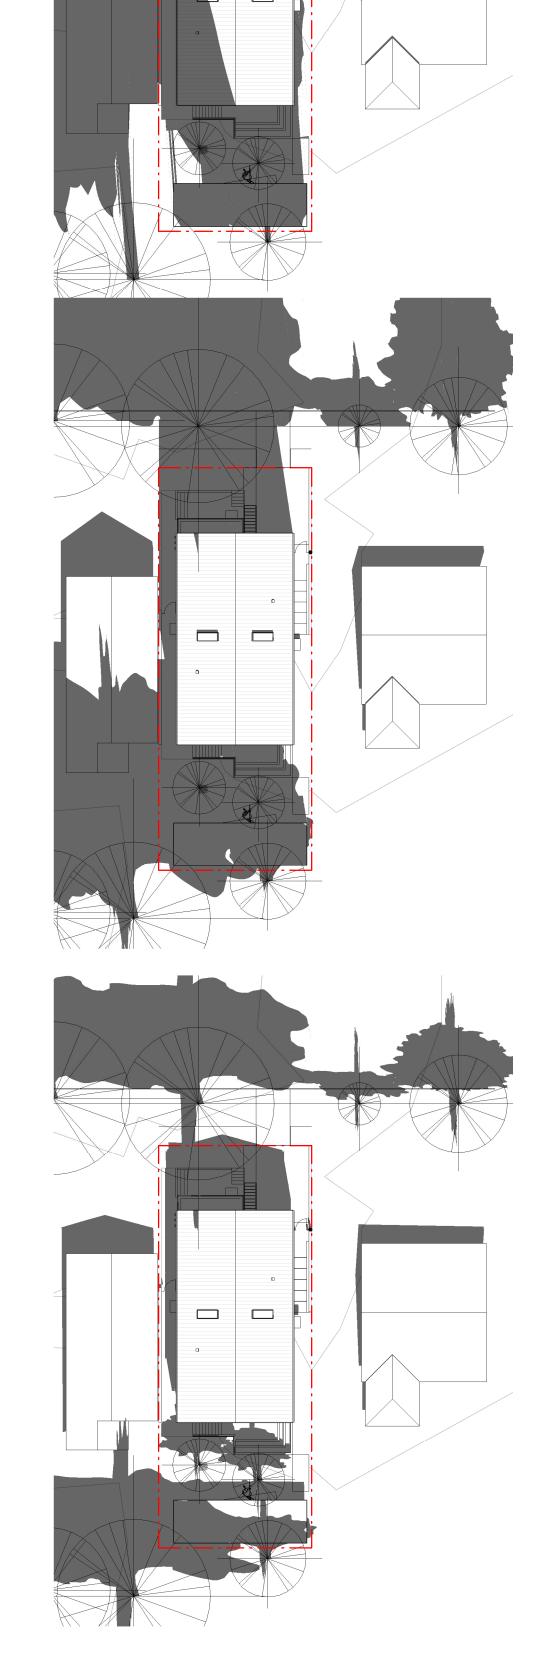

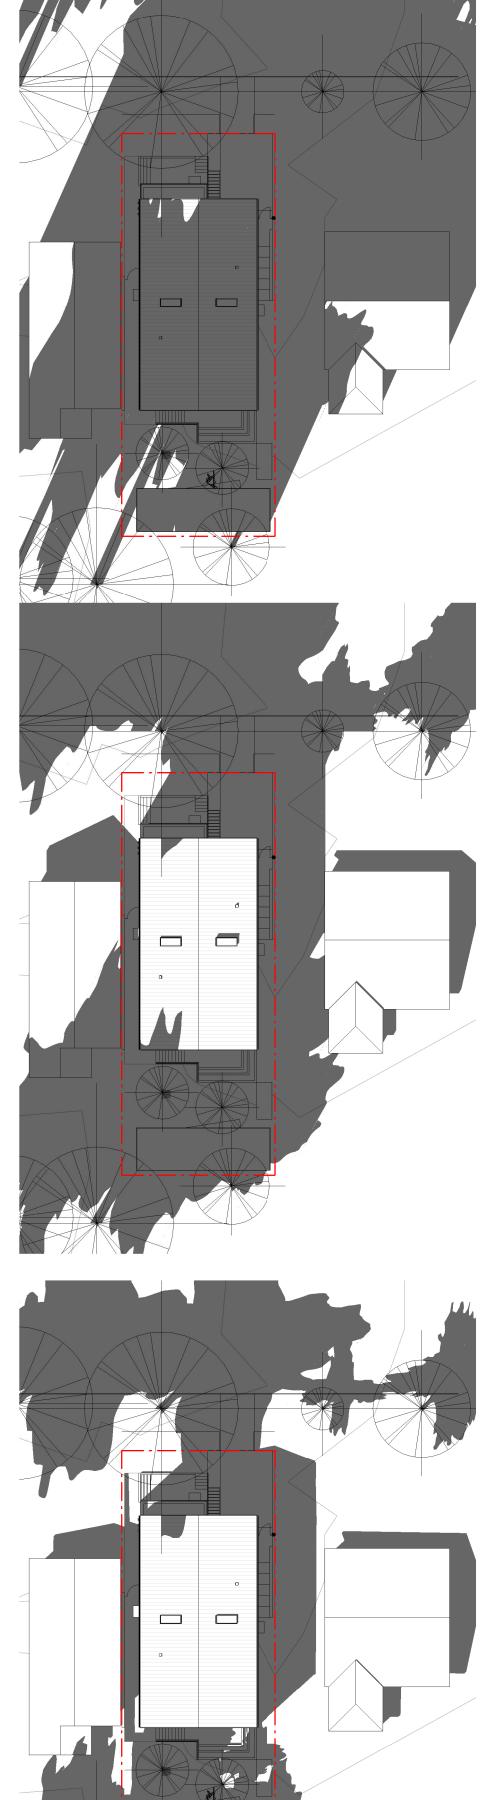

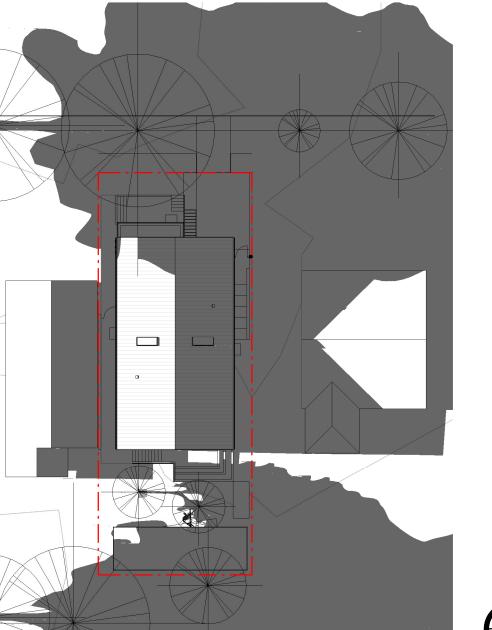





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CASCARA CONSTRUCTION NORTH JUBILEE HOUSEPLEX SHADOW STUDIES

Project number		1
Date		2024.09.10
Drawn by		MW
Checked by		MA
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A103

1:300 2024-09-13 1:29:45 PM WINTER LIGHT CONDITIONS - 1721 ADANAC ST. FRONT YARD PHOTO TAKEN DECEMBER 2023

SUMMER LIGHT CONDITIONS - 1721 ADANAC ST. REAR YARD PHOTO TAKEN JUNE 2024




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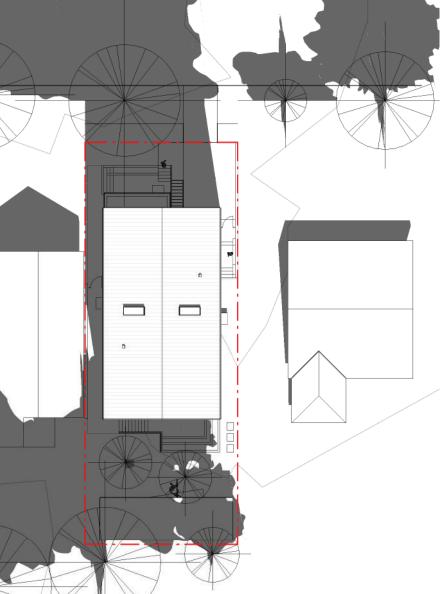



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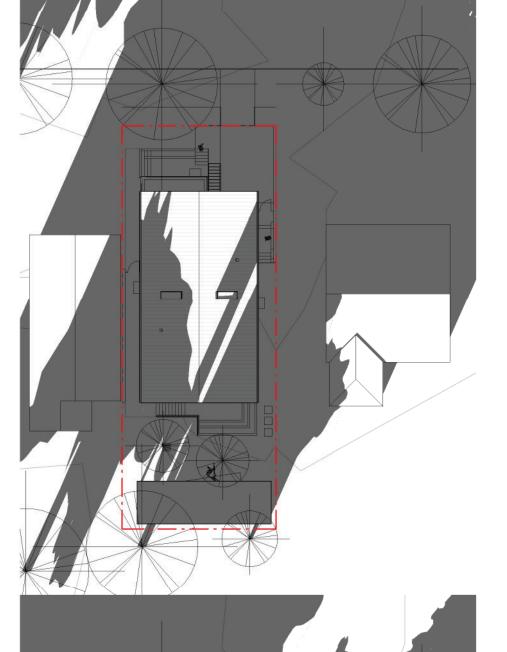
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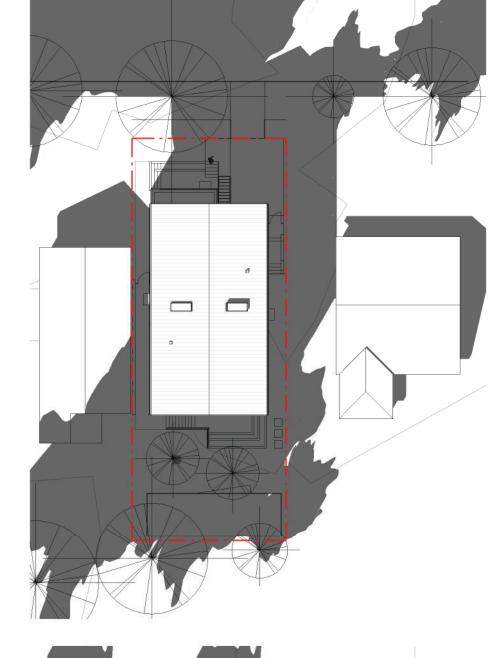








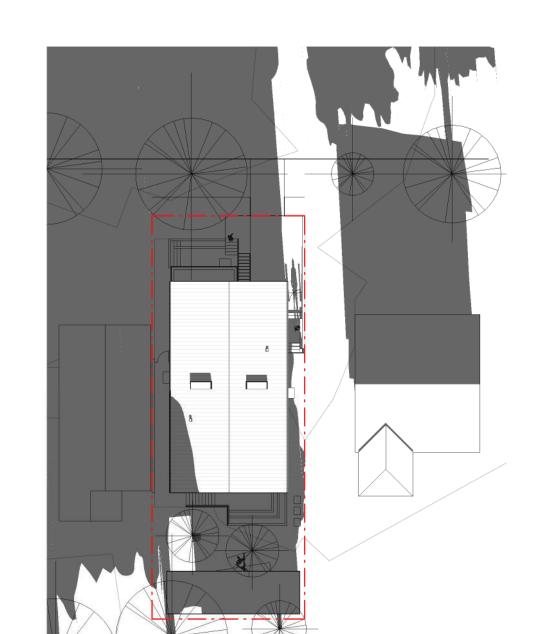


2PM

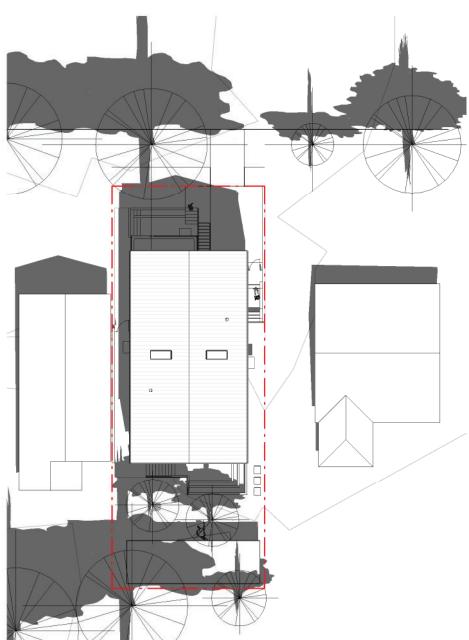

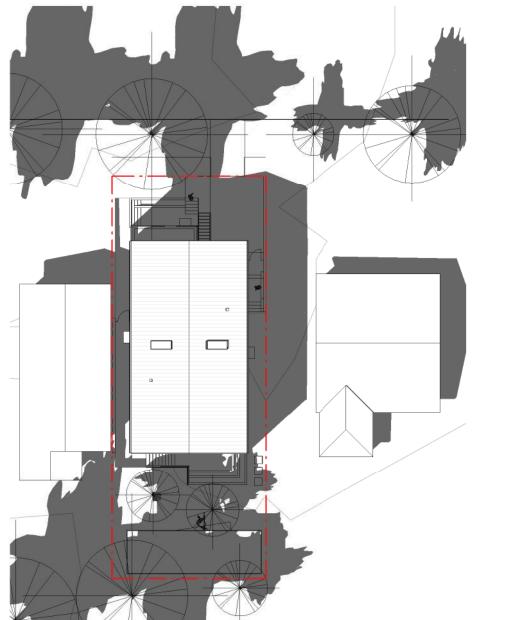

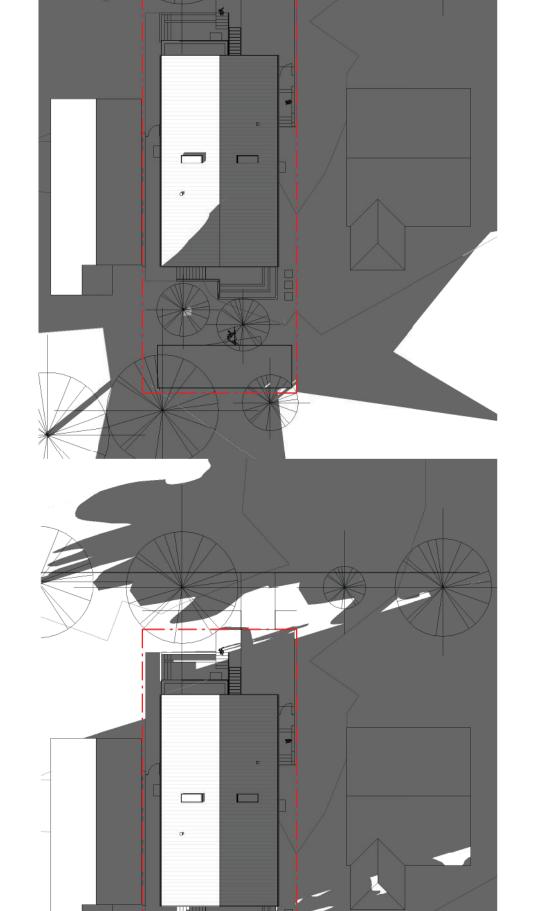

5PM

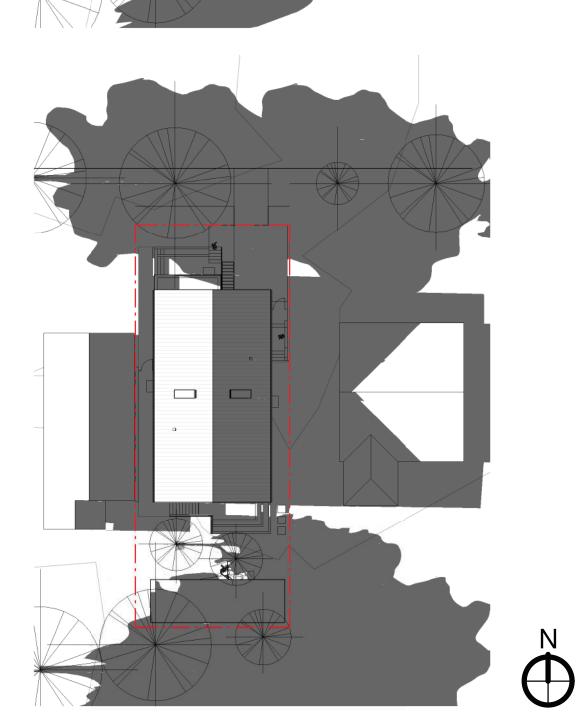

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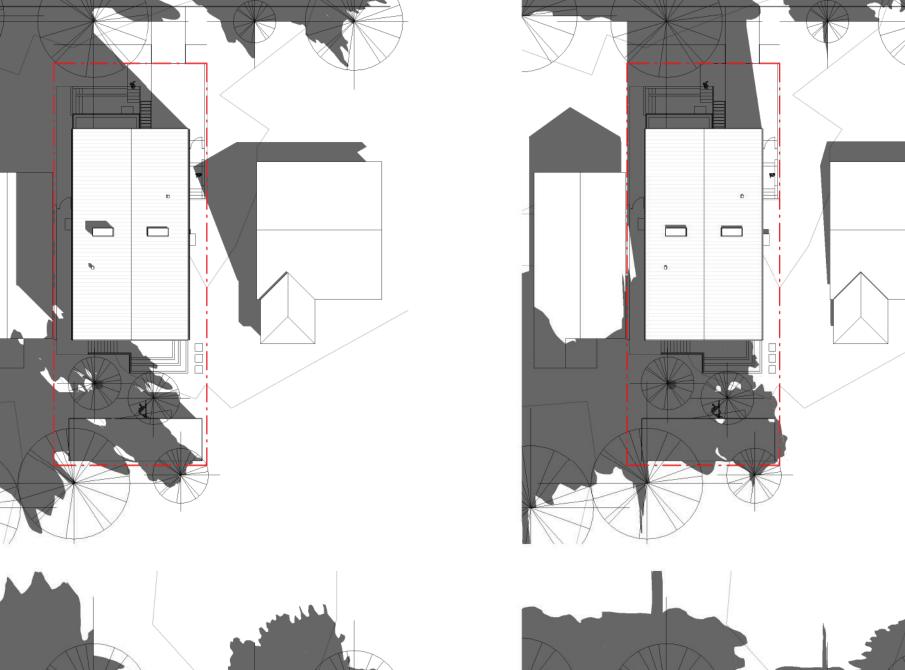
CASCARA CONSTRUCTION
NORTH JUBILEE HOUSEPLEX SHADOW STUDIES


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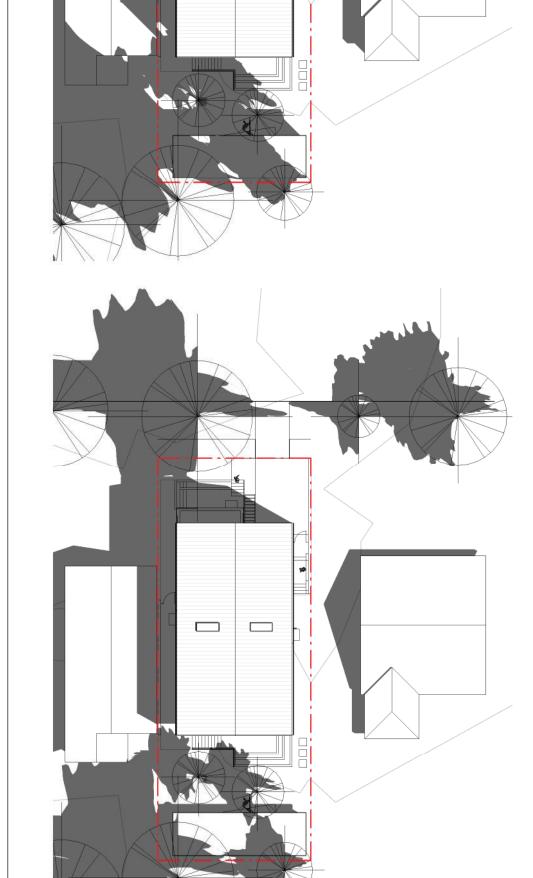
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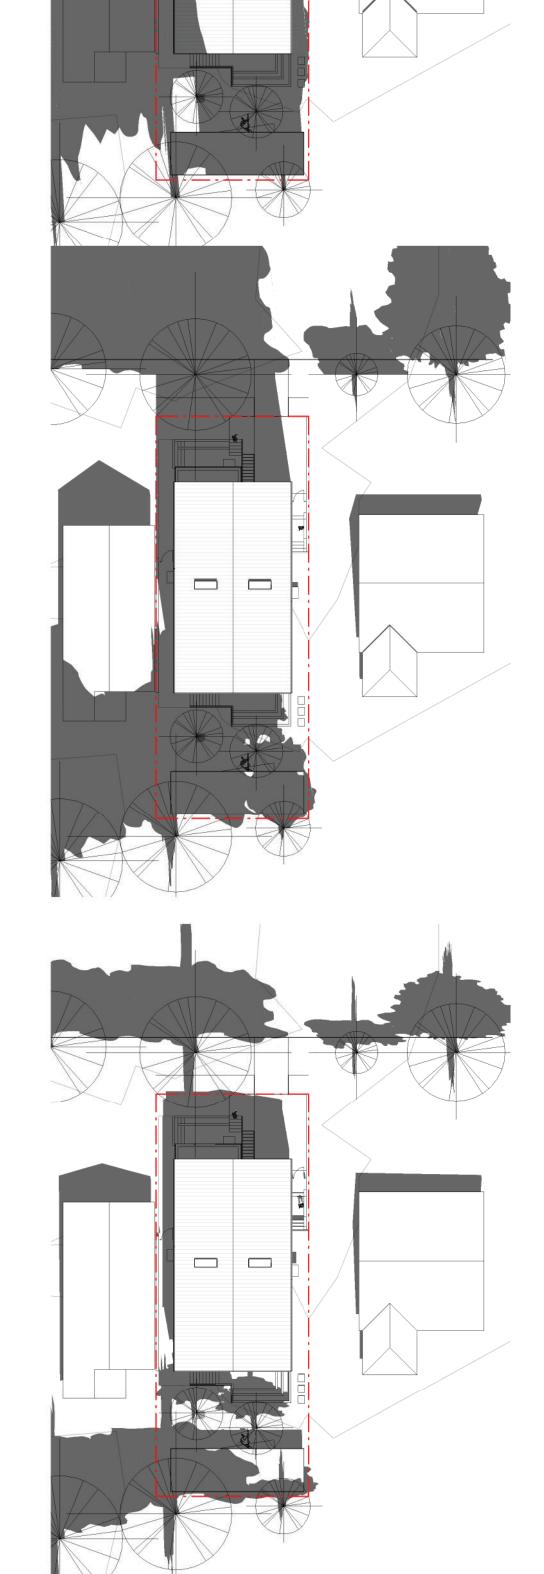






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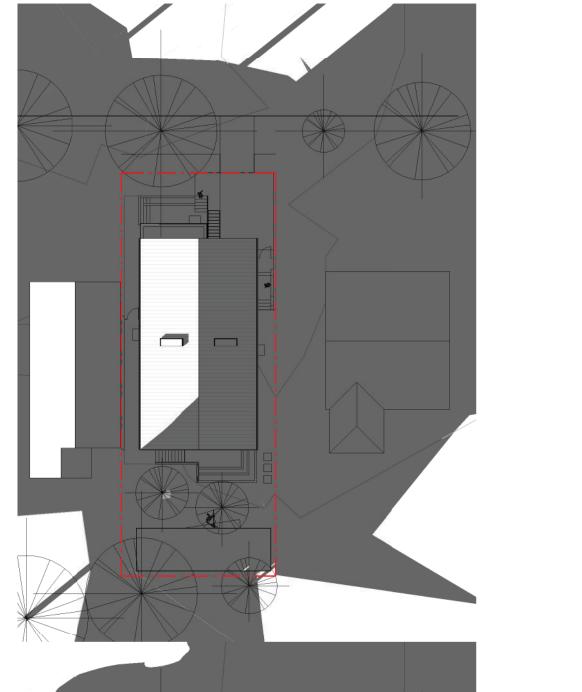







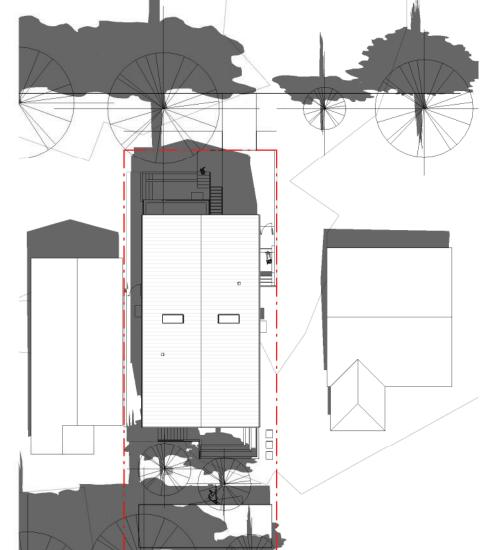

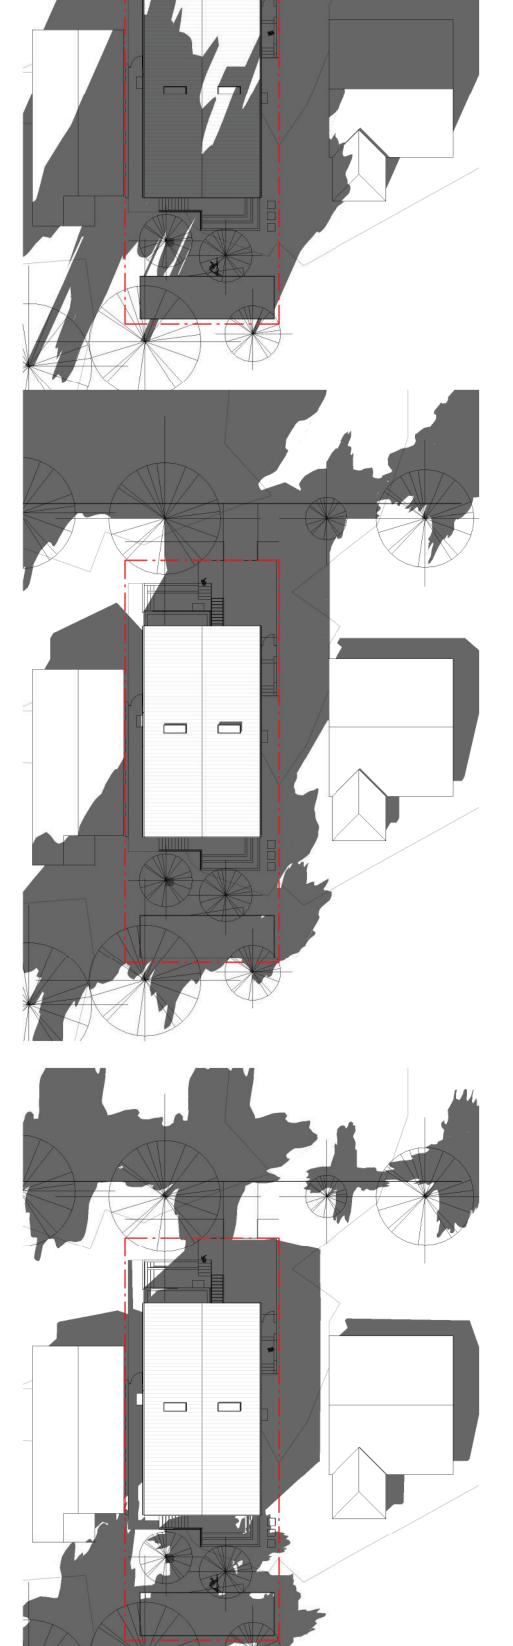

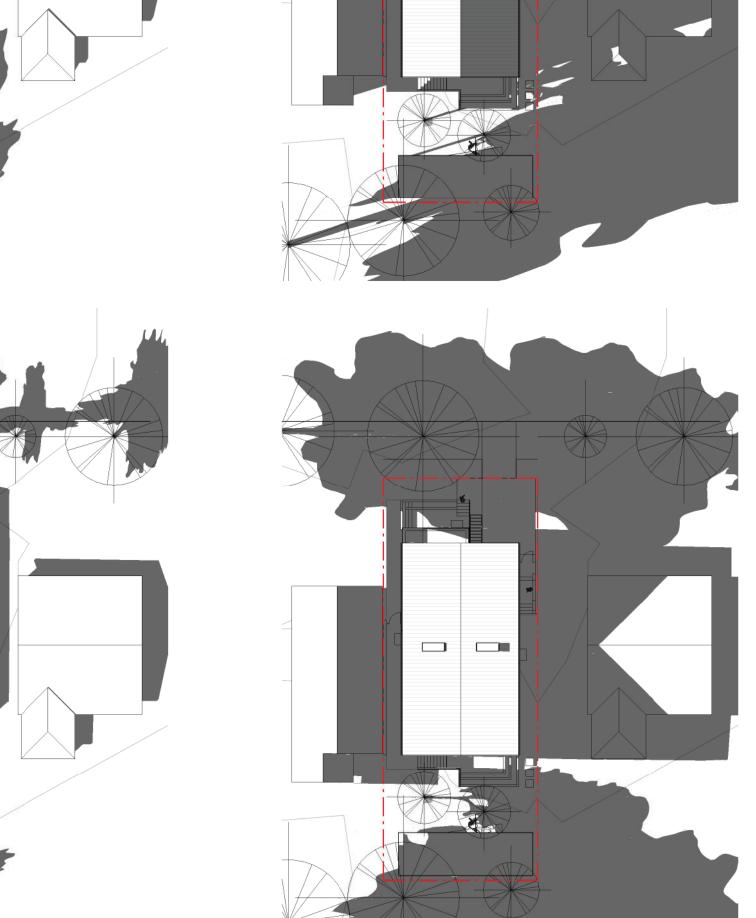

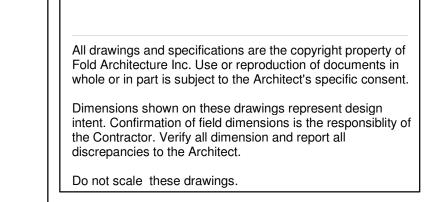

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CASCARA CONSTRUCTION NORTH JUBILEE HOUSEPLEX SHADOW STUDIES

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	2024.06.26


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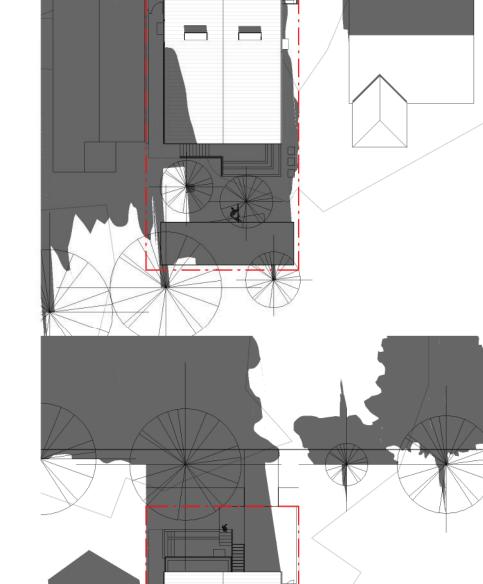
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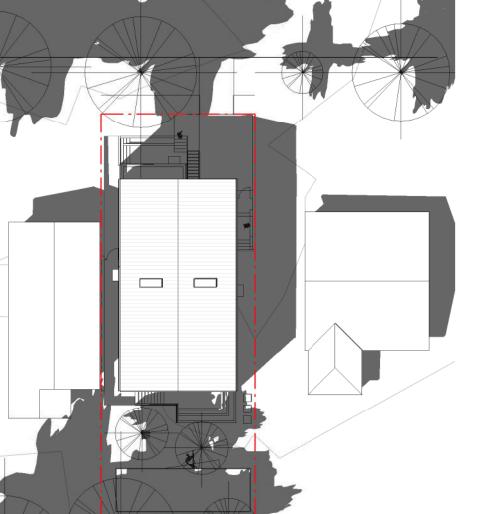
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ALTERNATE DESIGN: 20 DEGREE ROOF PITCH











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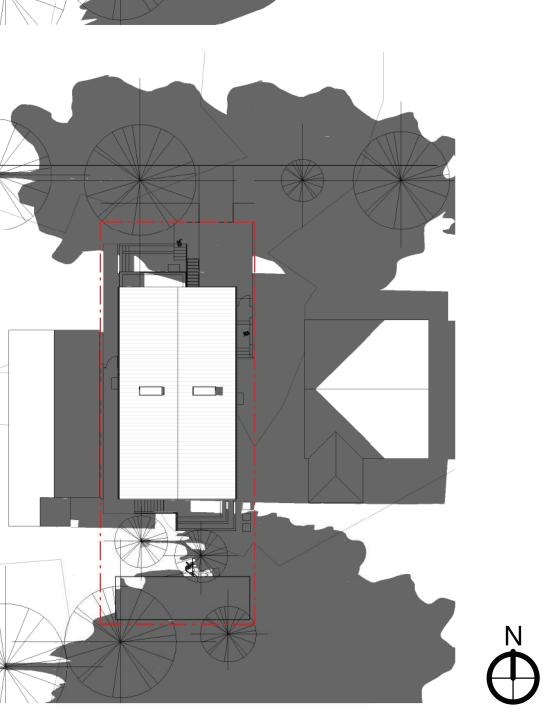


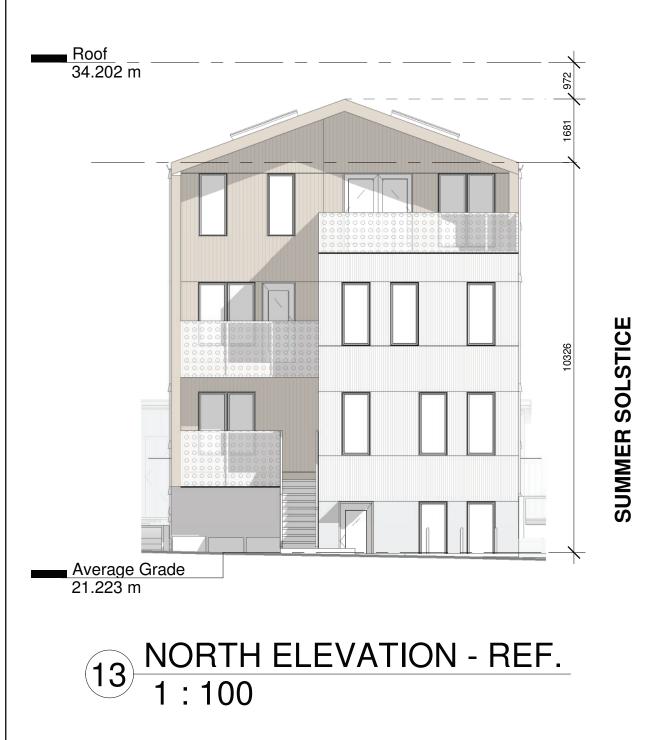

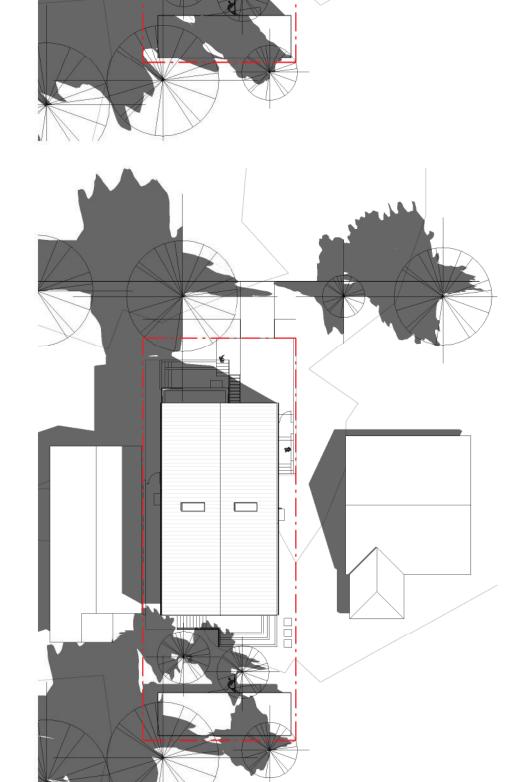

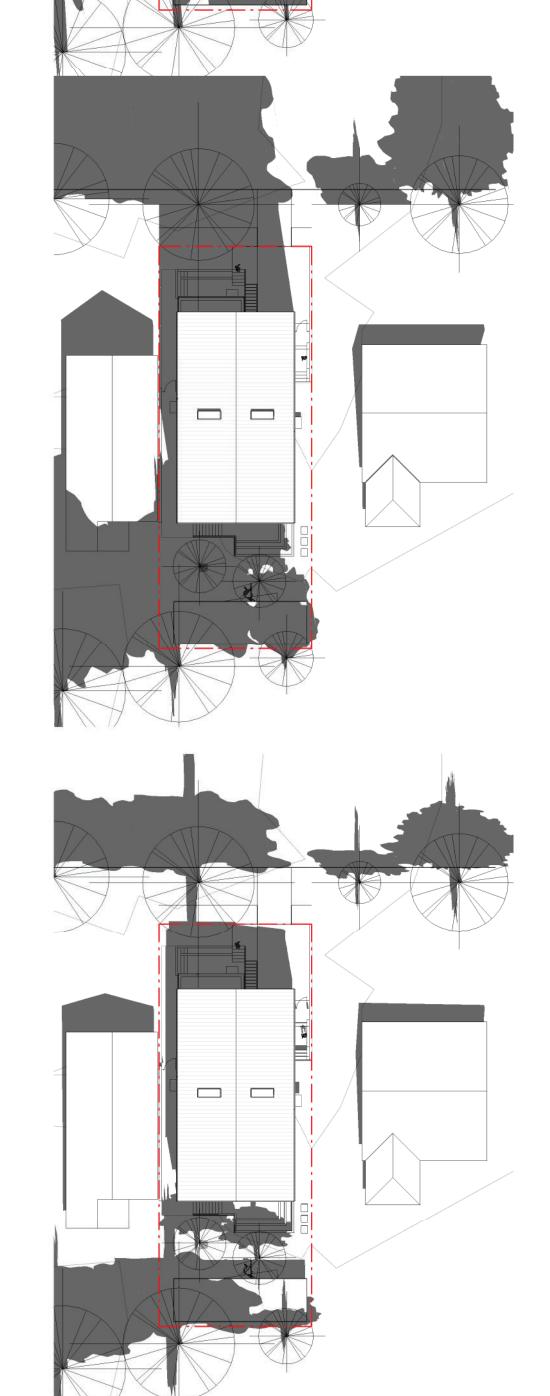

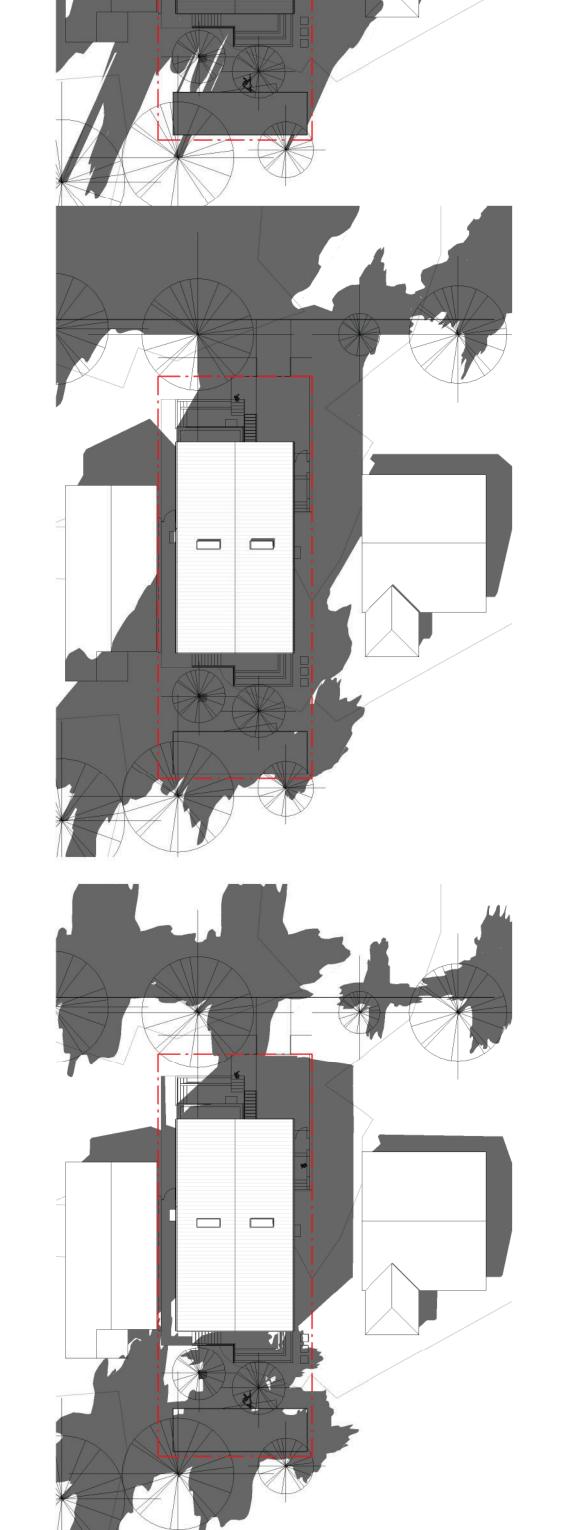

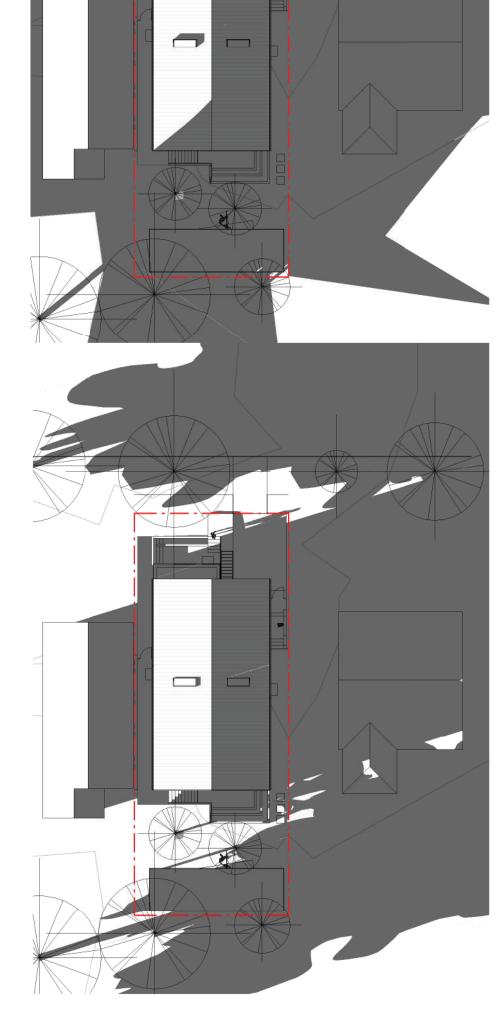

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FOLD Architects Inc

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t:604.720.7955

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Do not scale these drawings.

NO.	Description	Date
3	Issued for MMHI DP Rev.	24.06.26

CASCARA CONSTRUCTION
NORTH JUBILEE HOUSEPLEX


SHADOW STUDIES


Project Number 2024.06.26 Drawn by Checked by


A103


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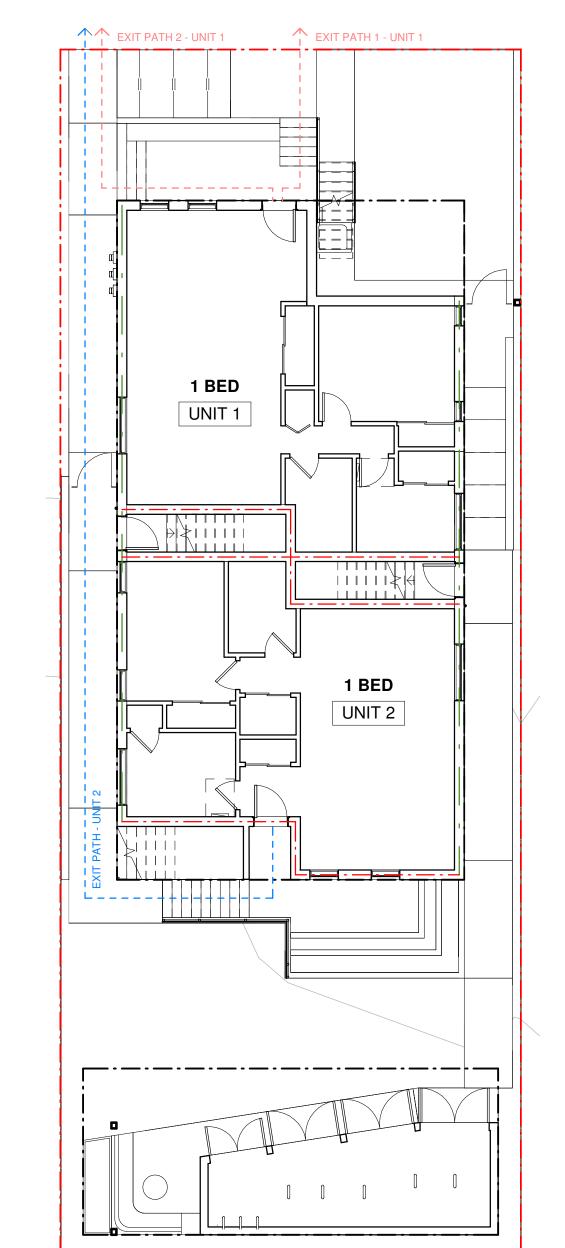


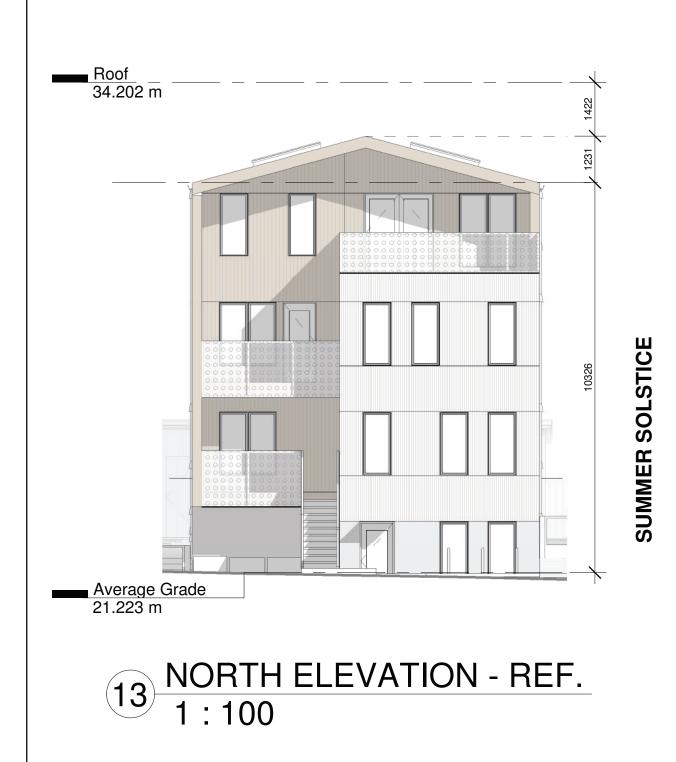


3 EGRESS - L1 SUITES 1:100

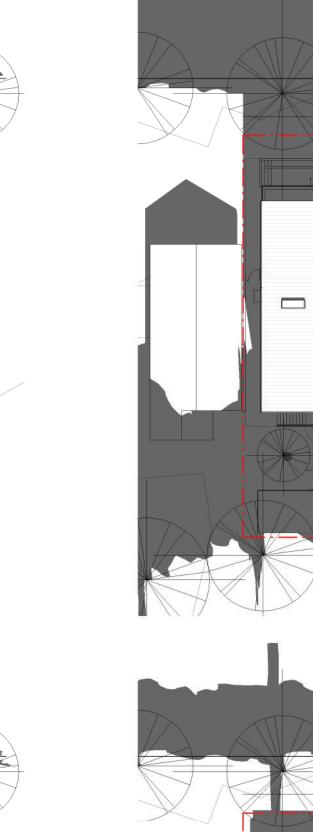2 EGRESS - UPPER LVL SUITES 1:100

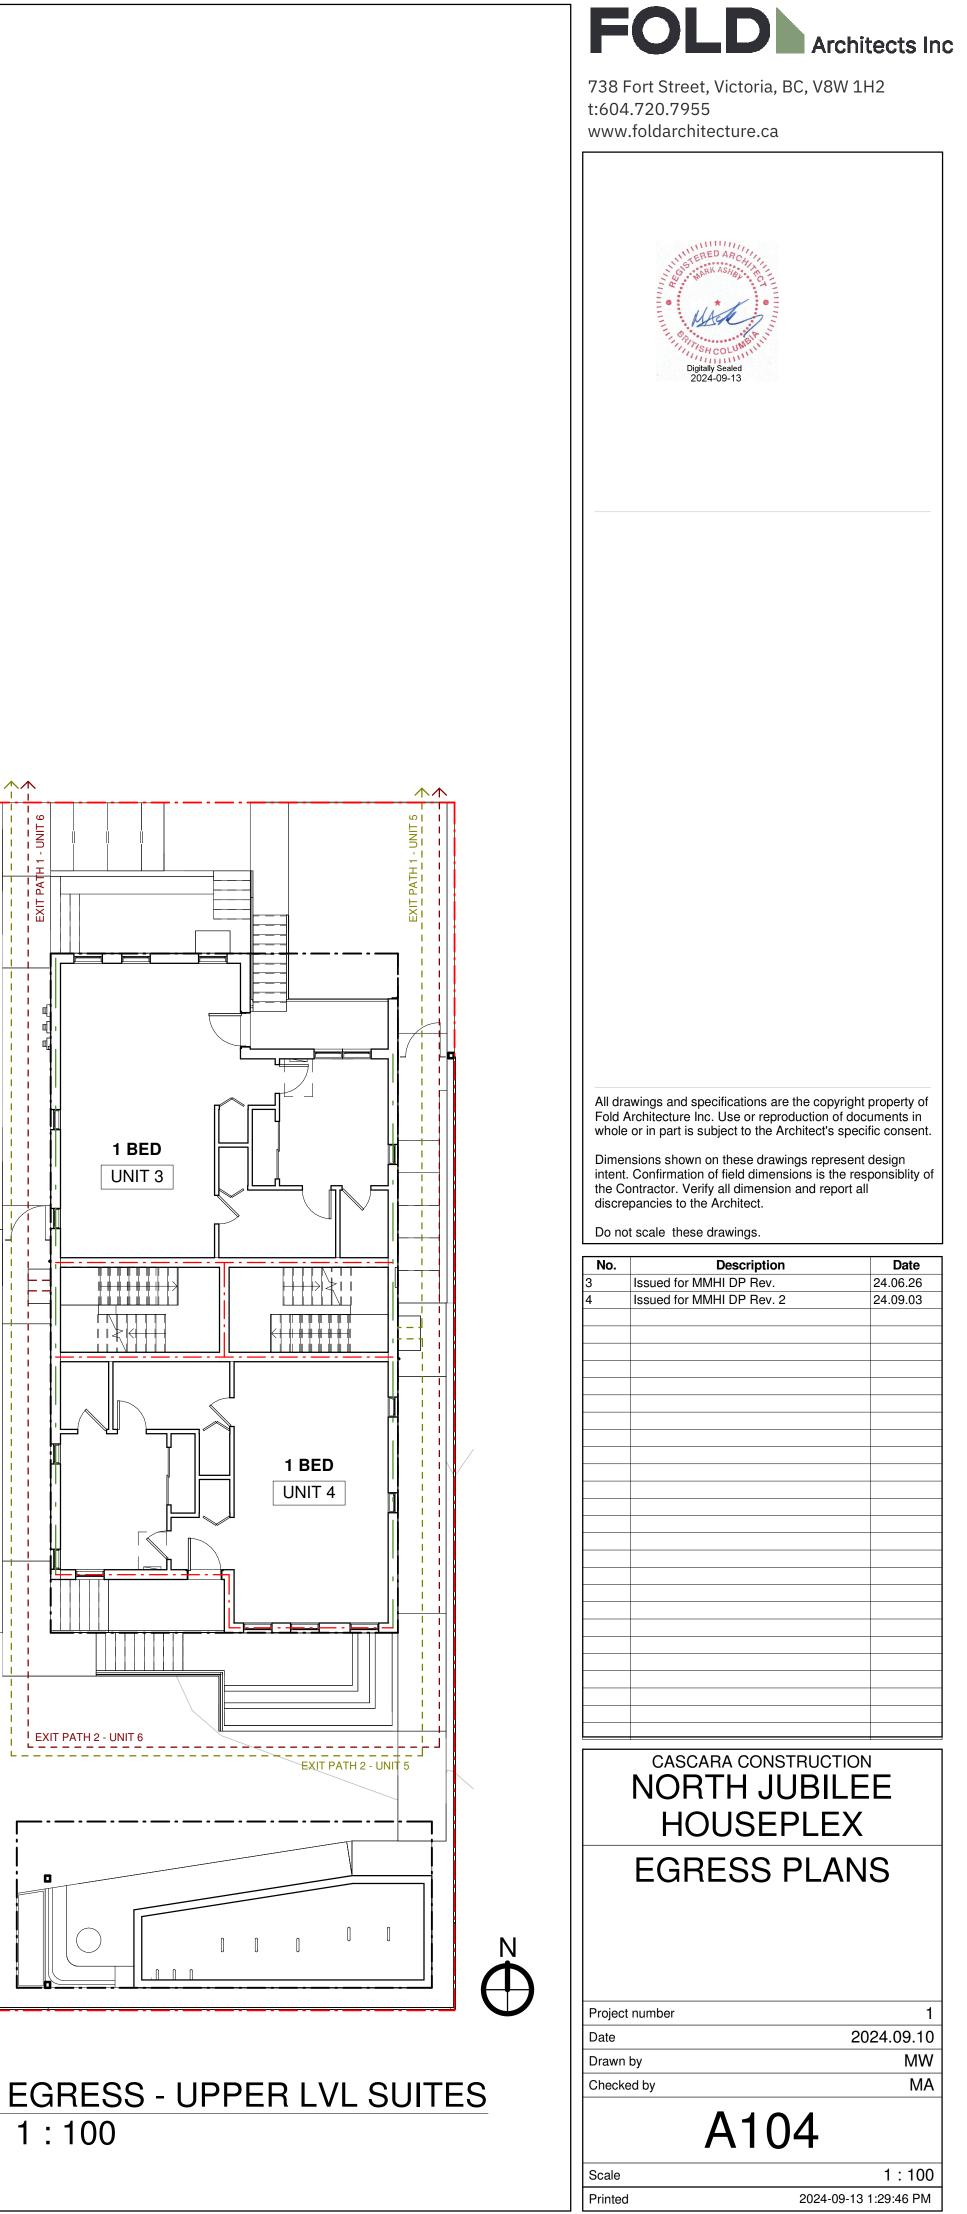UNIT 3

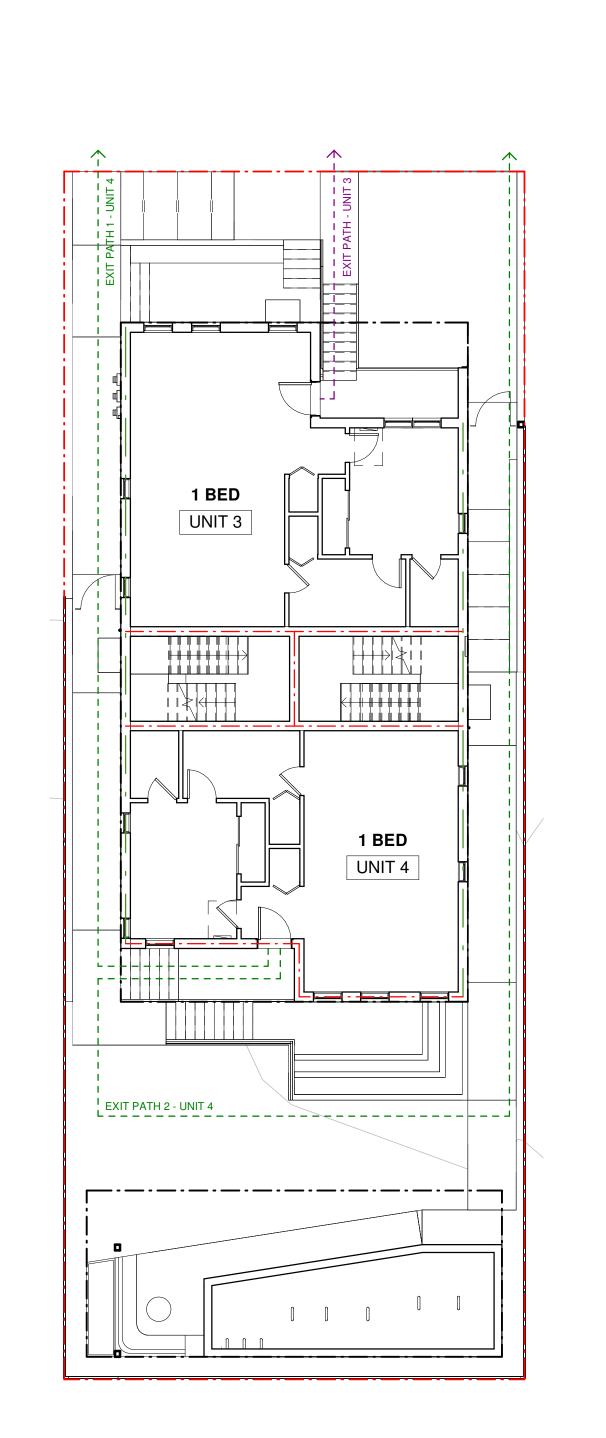



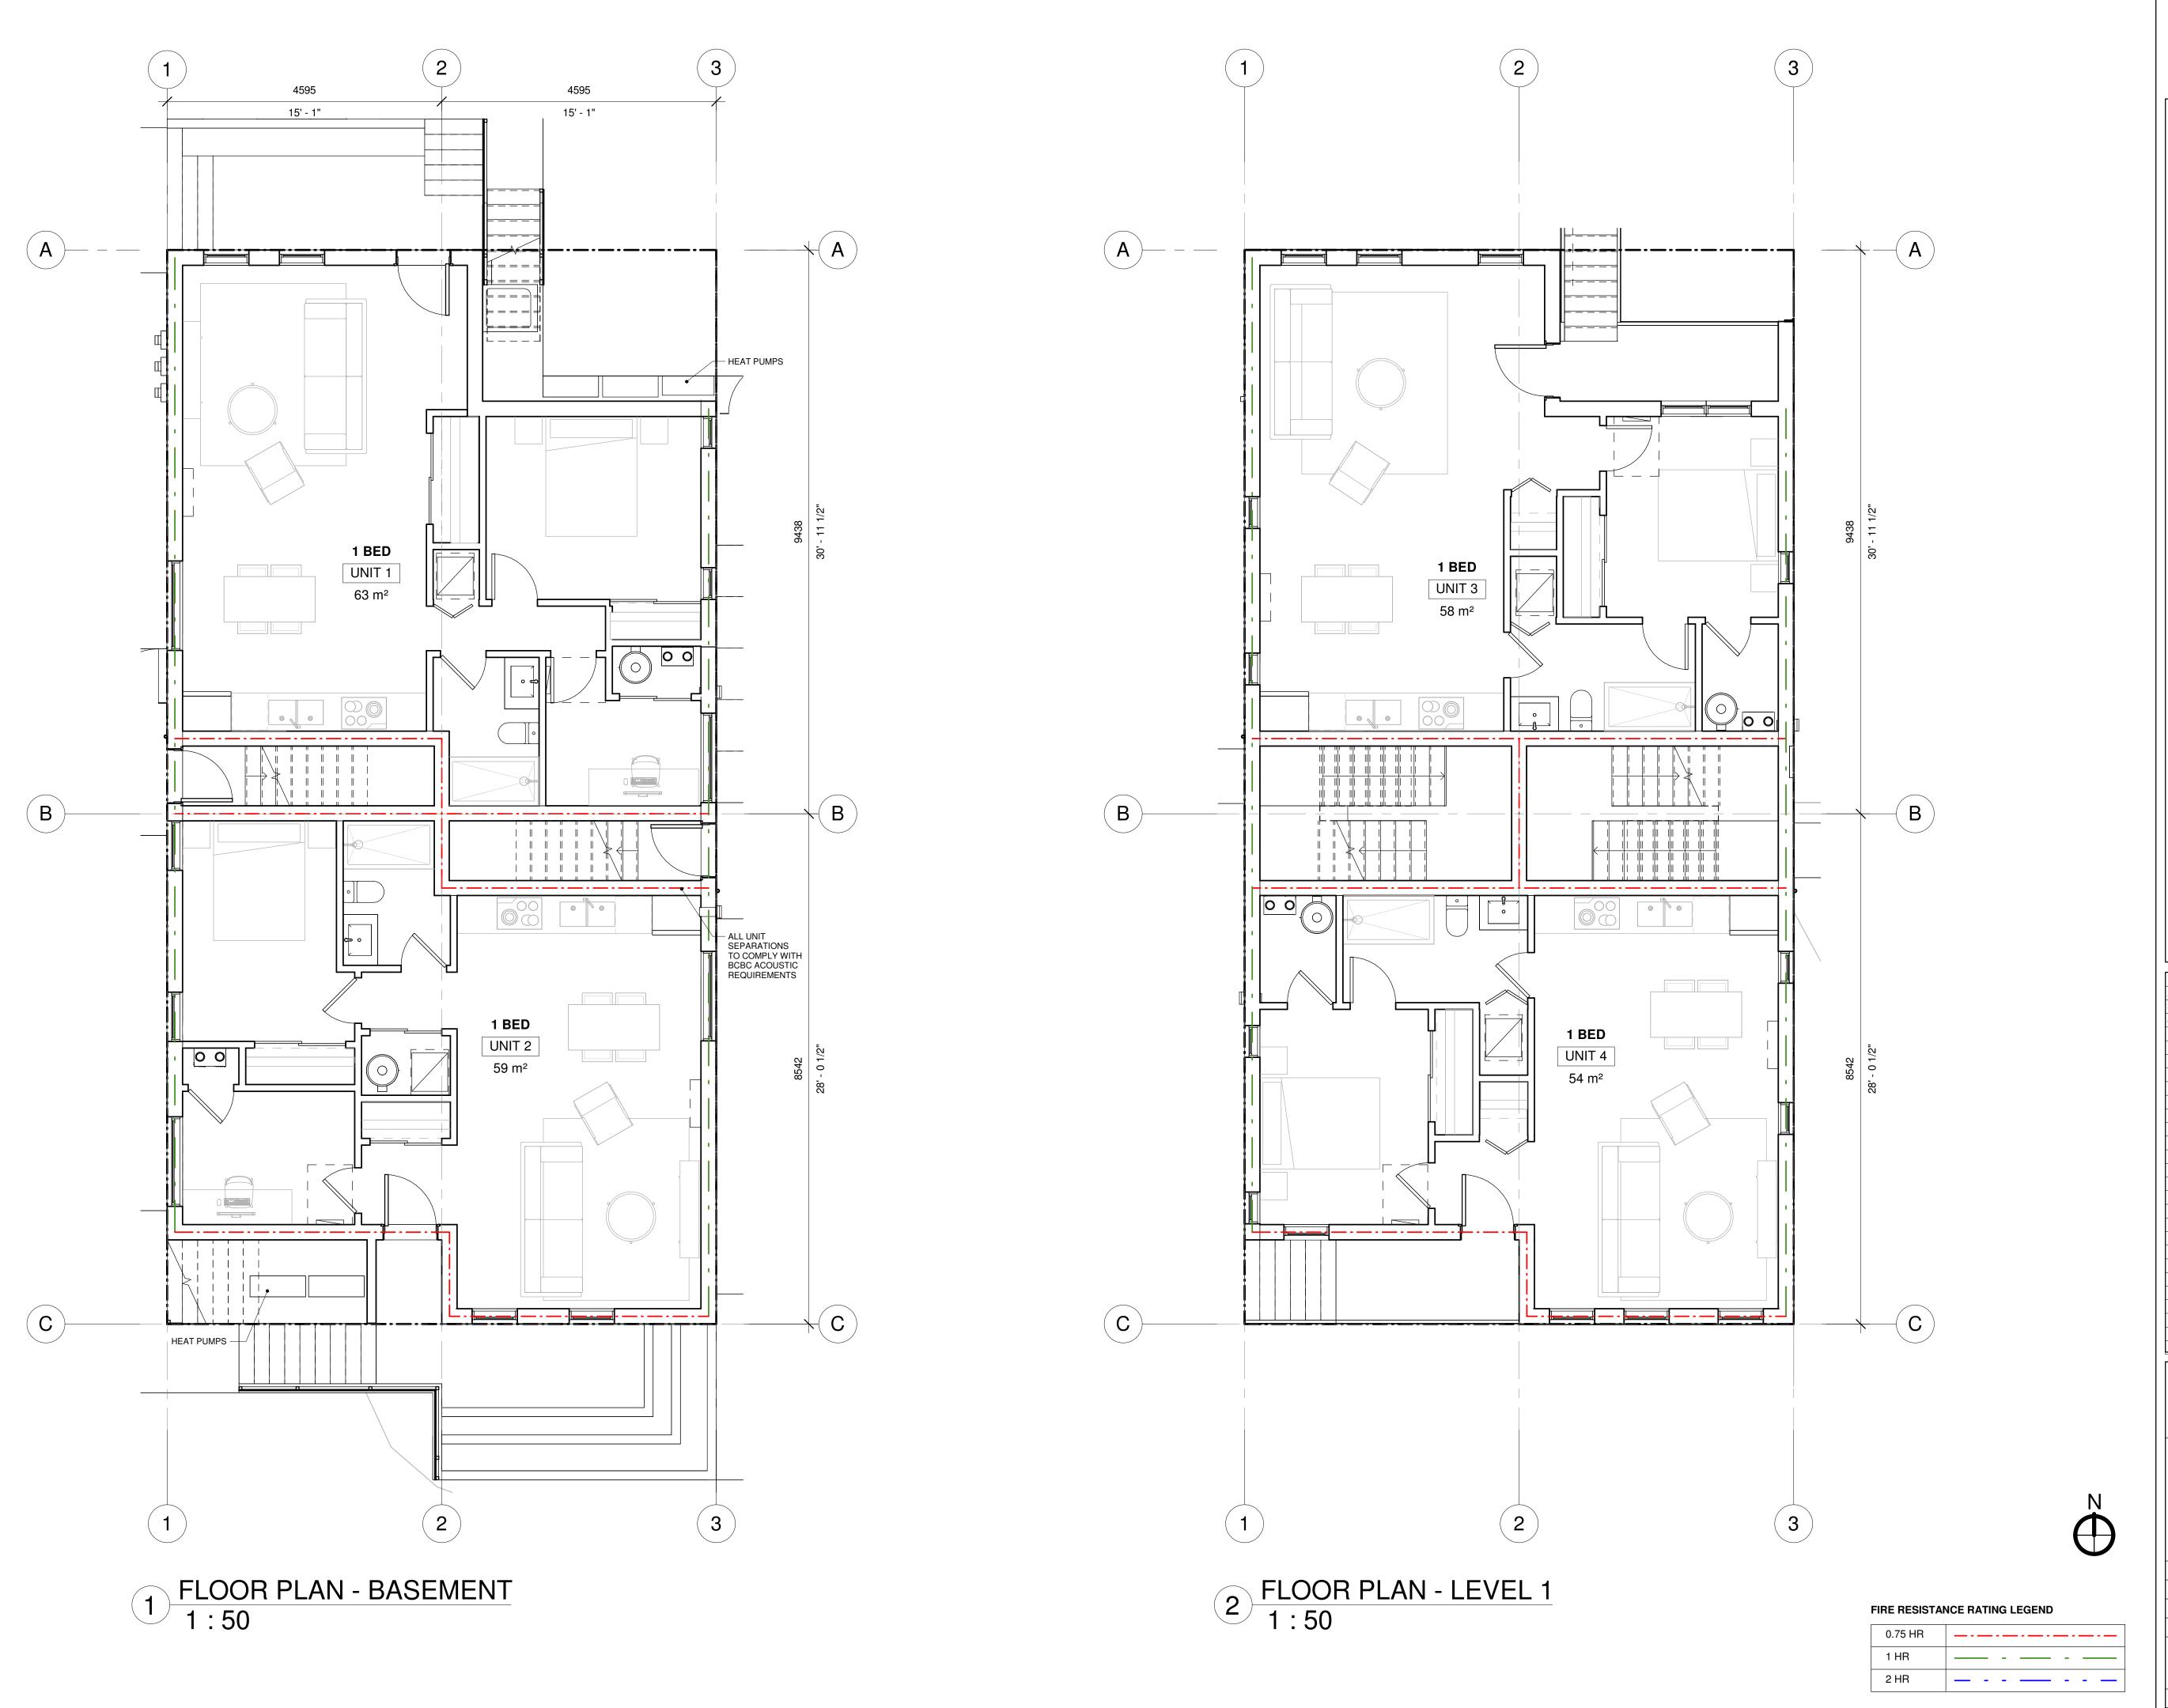



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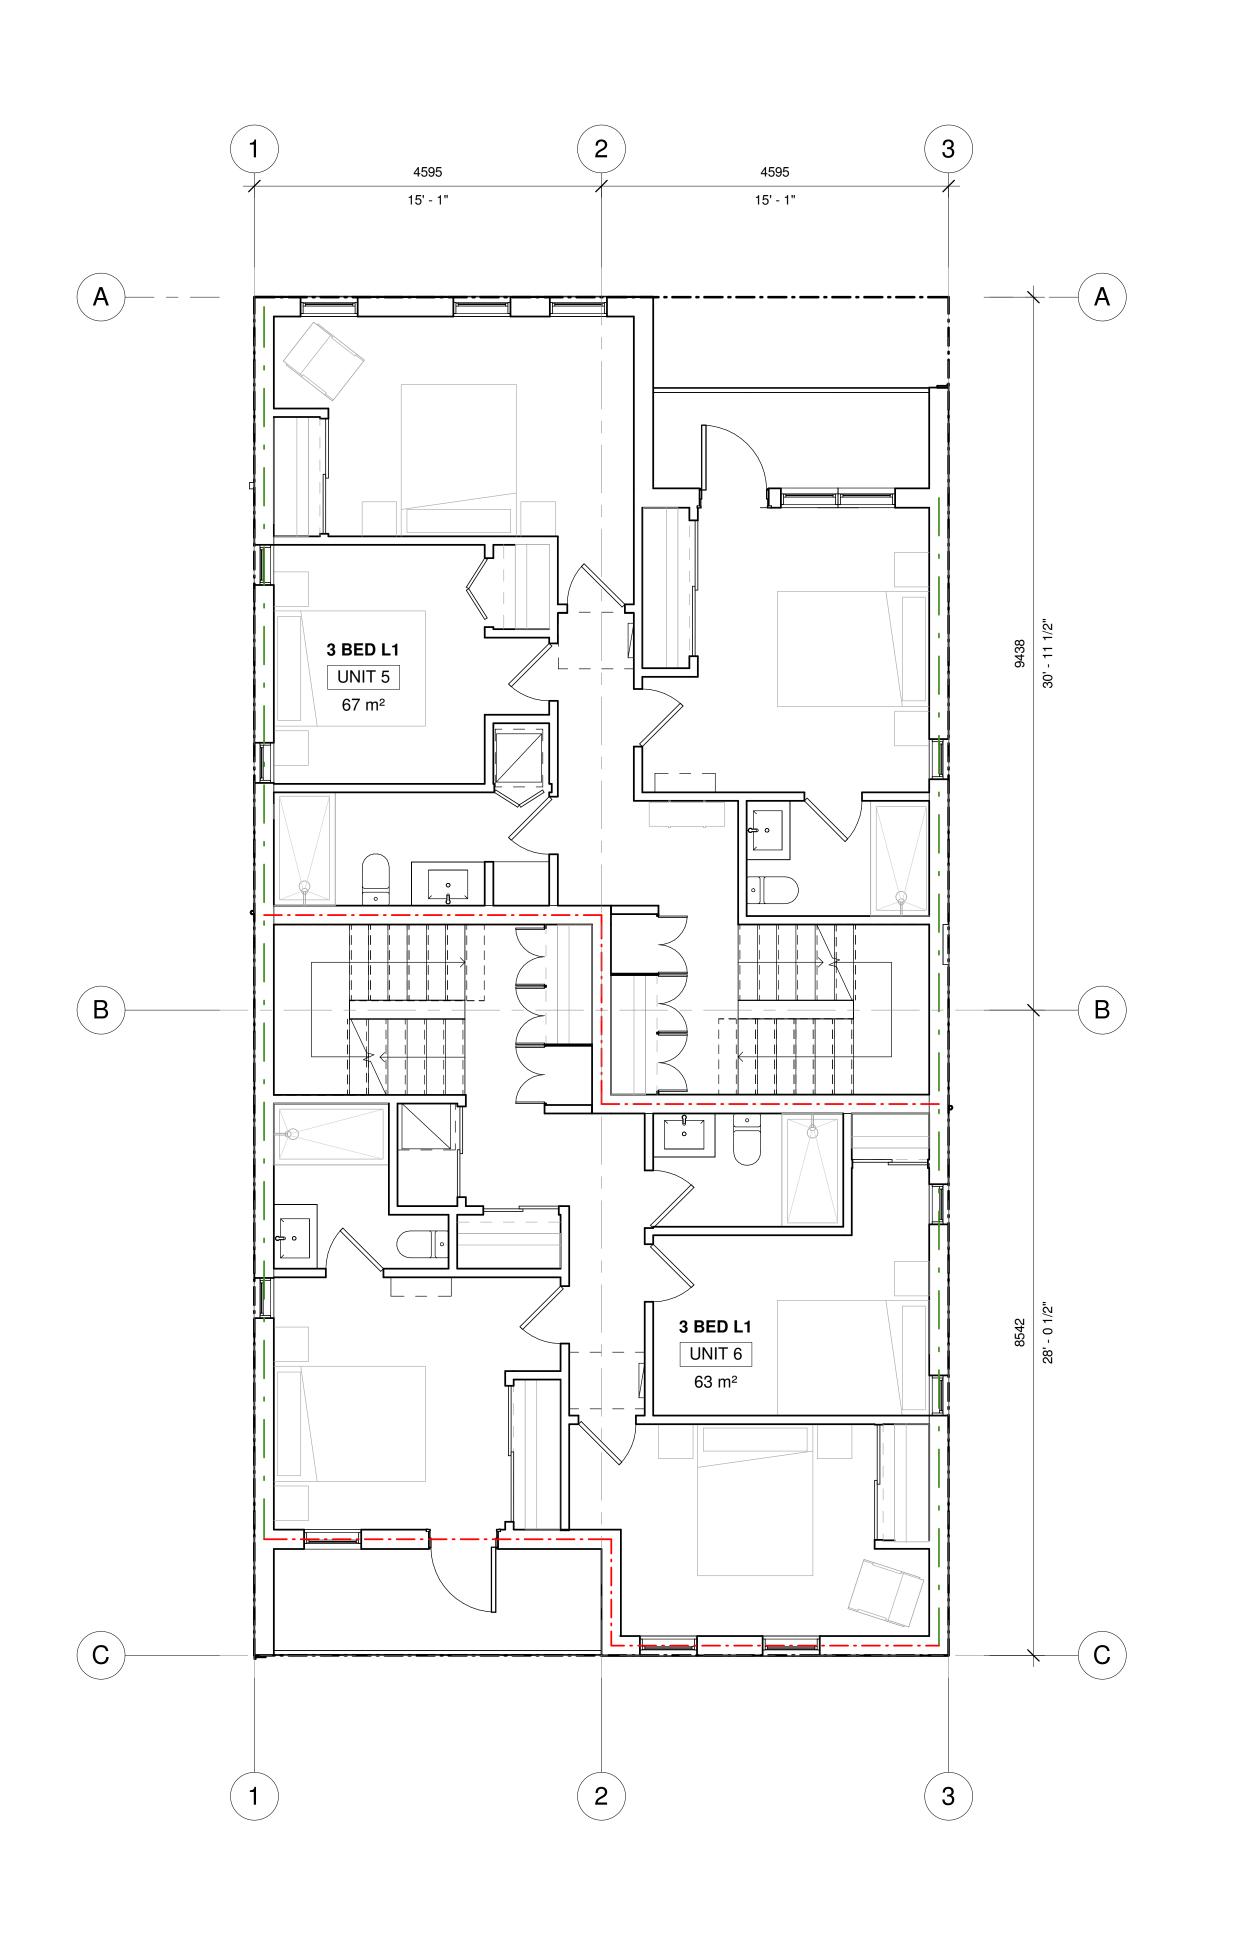
No.	Description	Date
2	Issued for MMHI Development Permit	24.04.22
3	Issued for MMHI DP Rev.	24.06.26
4	Issued for MMHI DP Rev. 2	24.09.03
	+	


CASCARA CONSTRUCTION
NORTH JUBILEE
HOUSEPLEX
FLOOR PLANS

Project number	1
Date	2024.09.10
Drawn by	MW
Checked by	MA

A200

As indicated 2024-09-13 1:29:46 PM



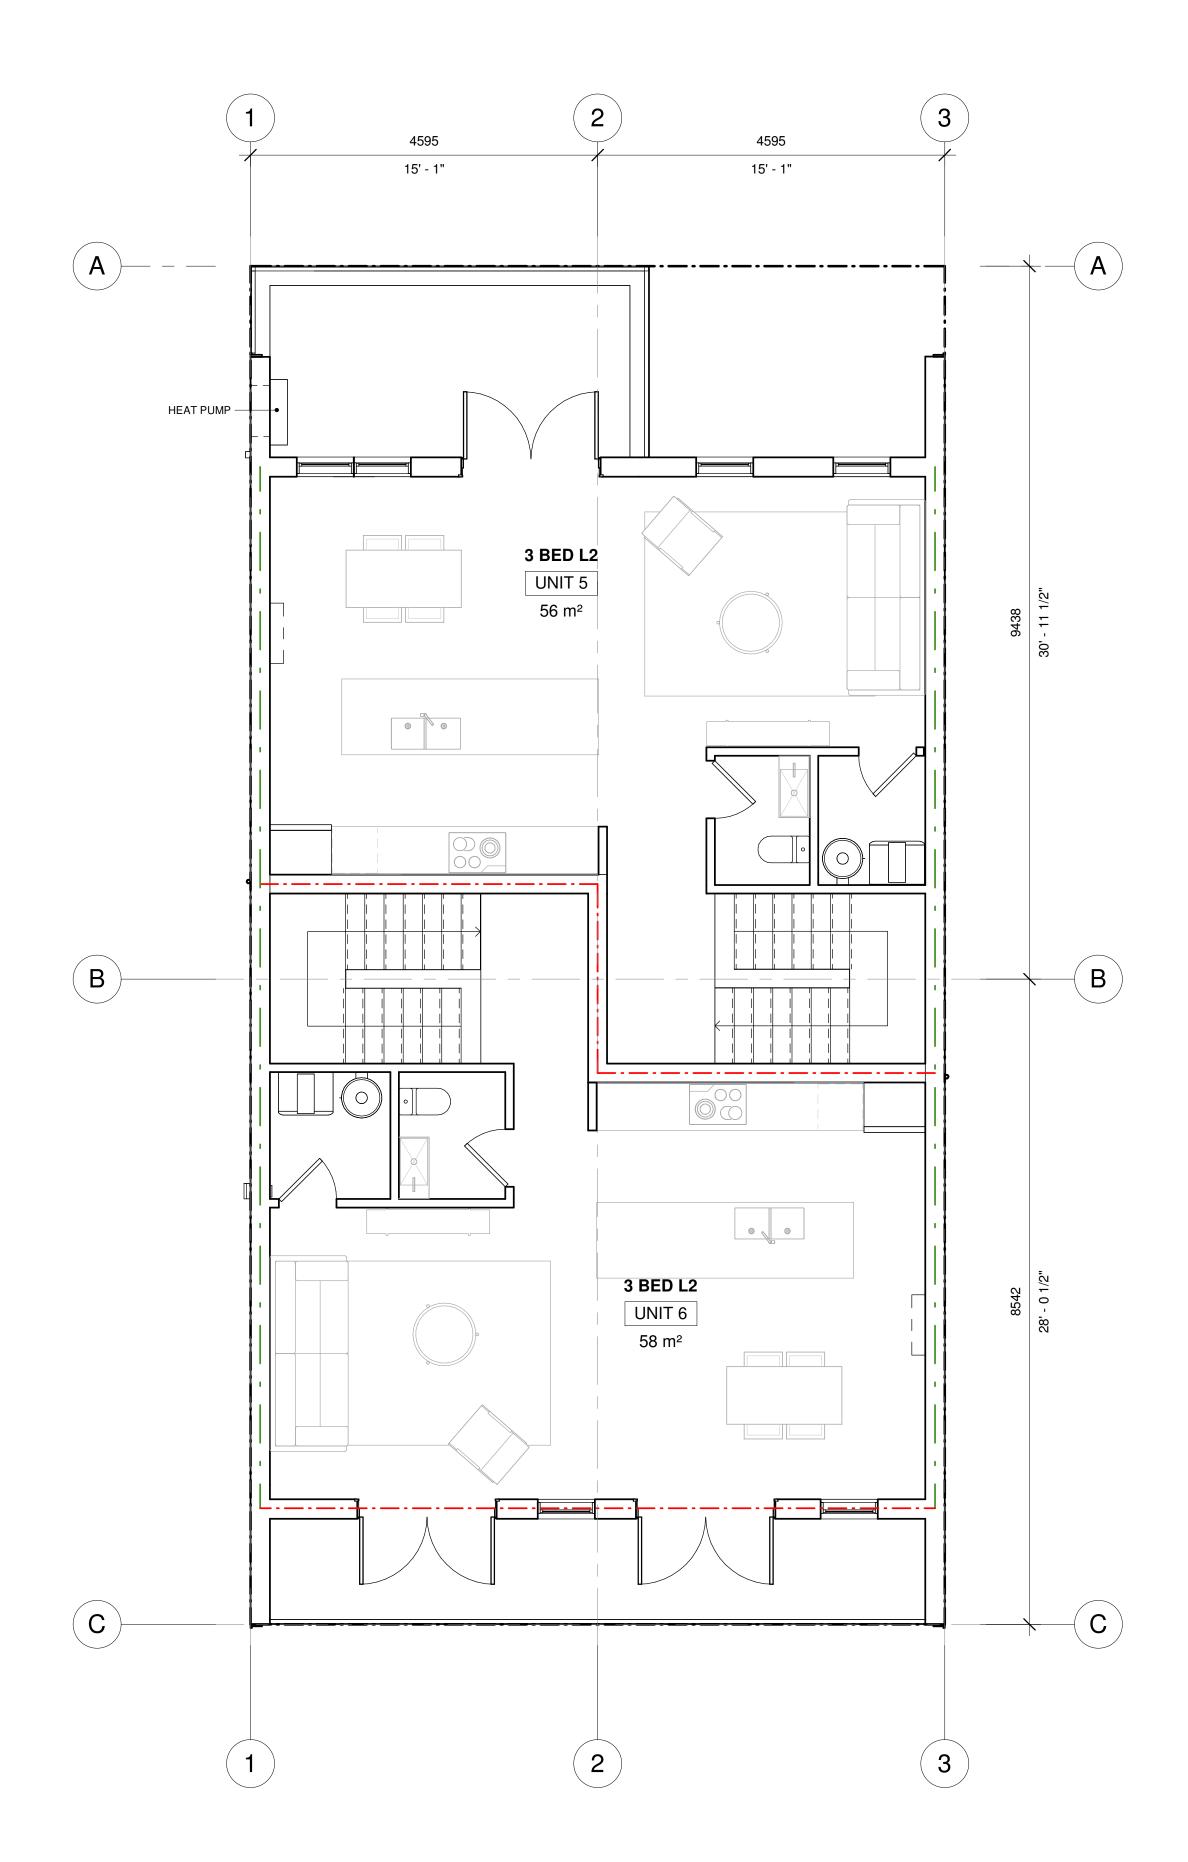

1 FLOOR PLAN - LEVEL 2 1:50 2 FLOOR PLAN - LEVEL 3 1:50

FIRE RESISTANCE RATING LEGEND

0.75 HR	
1 HR	
2 HR	



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	No. December Det.		
No.	Description	Date	
2	Issued for MMHI Development Permit	24.04.22	
3	Issued for MMHI DP Rev.	24.06.26	
4	Issued for MMHI DP Rev. 2	24.09.03	

CASCARA CONSTRUCTION
NORTH JUBILEE
HOUSEPLEX
FLOOR PLANS

Project number	1
Date	2024.09.10
Drawn by	MW
Checked by	MA

A201

As indicated 2024-09-13 1:29:47 PM





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No.	Description	Date
2	Issued for MMHI Development Permit	24.04.22
3	Issued for MMHI DP Rev.	24.06.26
4	Issued for MMHI DP Rev. 2	24.09.03
	+	

CASCARA CONSTRUCTION NORTH JUBILEE HOUSEPLEX **ELEVATIONS N+E**

Project number	
Date	2024.09.1
Drawn by	MV
Checked by	M

A400


1:50 2024-09-13 1:29:51 PM



2 SOUTH ELEVATION 1:50

3 WEST ELEVATION
1 · 50

MATERIAL FINISHES

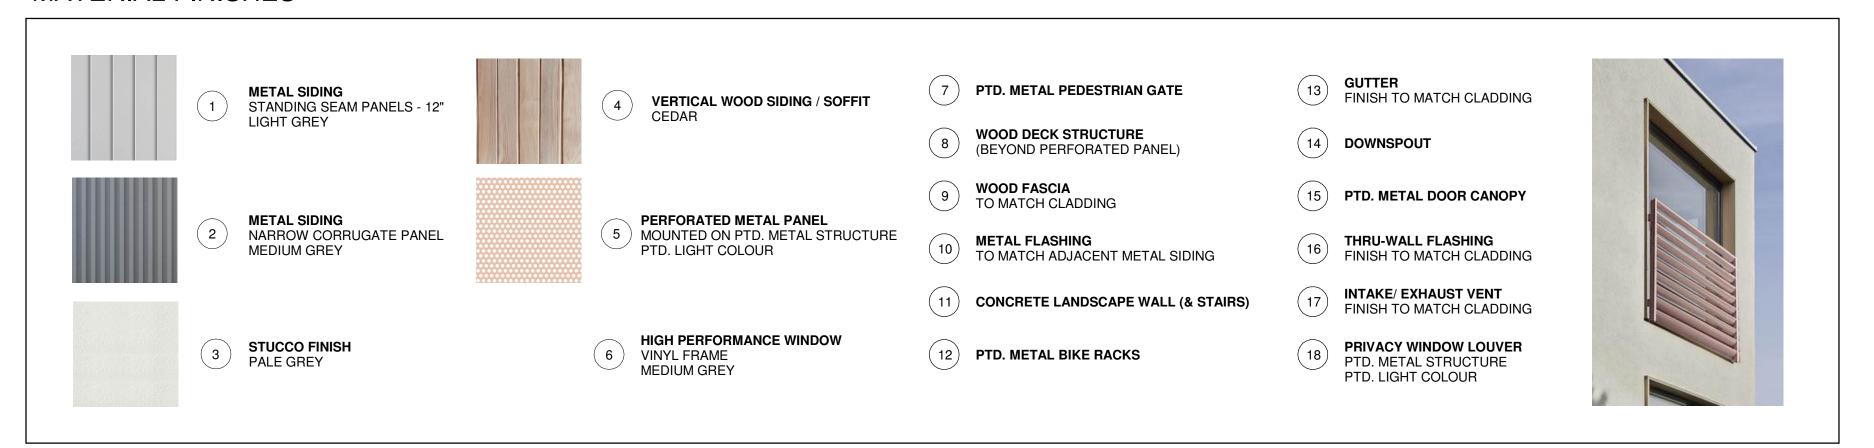

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Do not scale these drawings.

No.	Description	Date
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3	Issued for MMHI DP Rev.	24.06.2
4	Issued for MMHI DP Rev. 2	24.09.0


CASCARA CONSTRUCTION NORTH JUBILEE HOUSEPLEX **ELEVATION S+W**


Project number	1
Date	2024.09.10
Drawn by	MW
Checked by	MA

A401

Printed

1:50 2024-09-13 1:29:55 PM

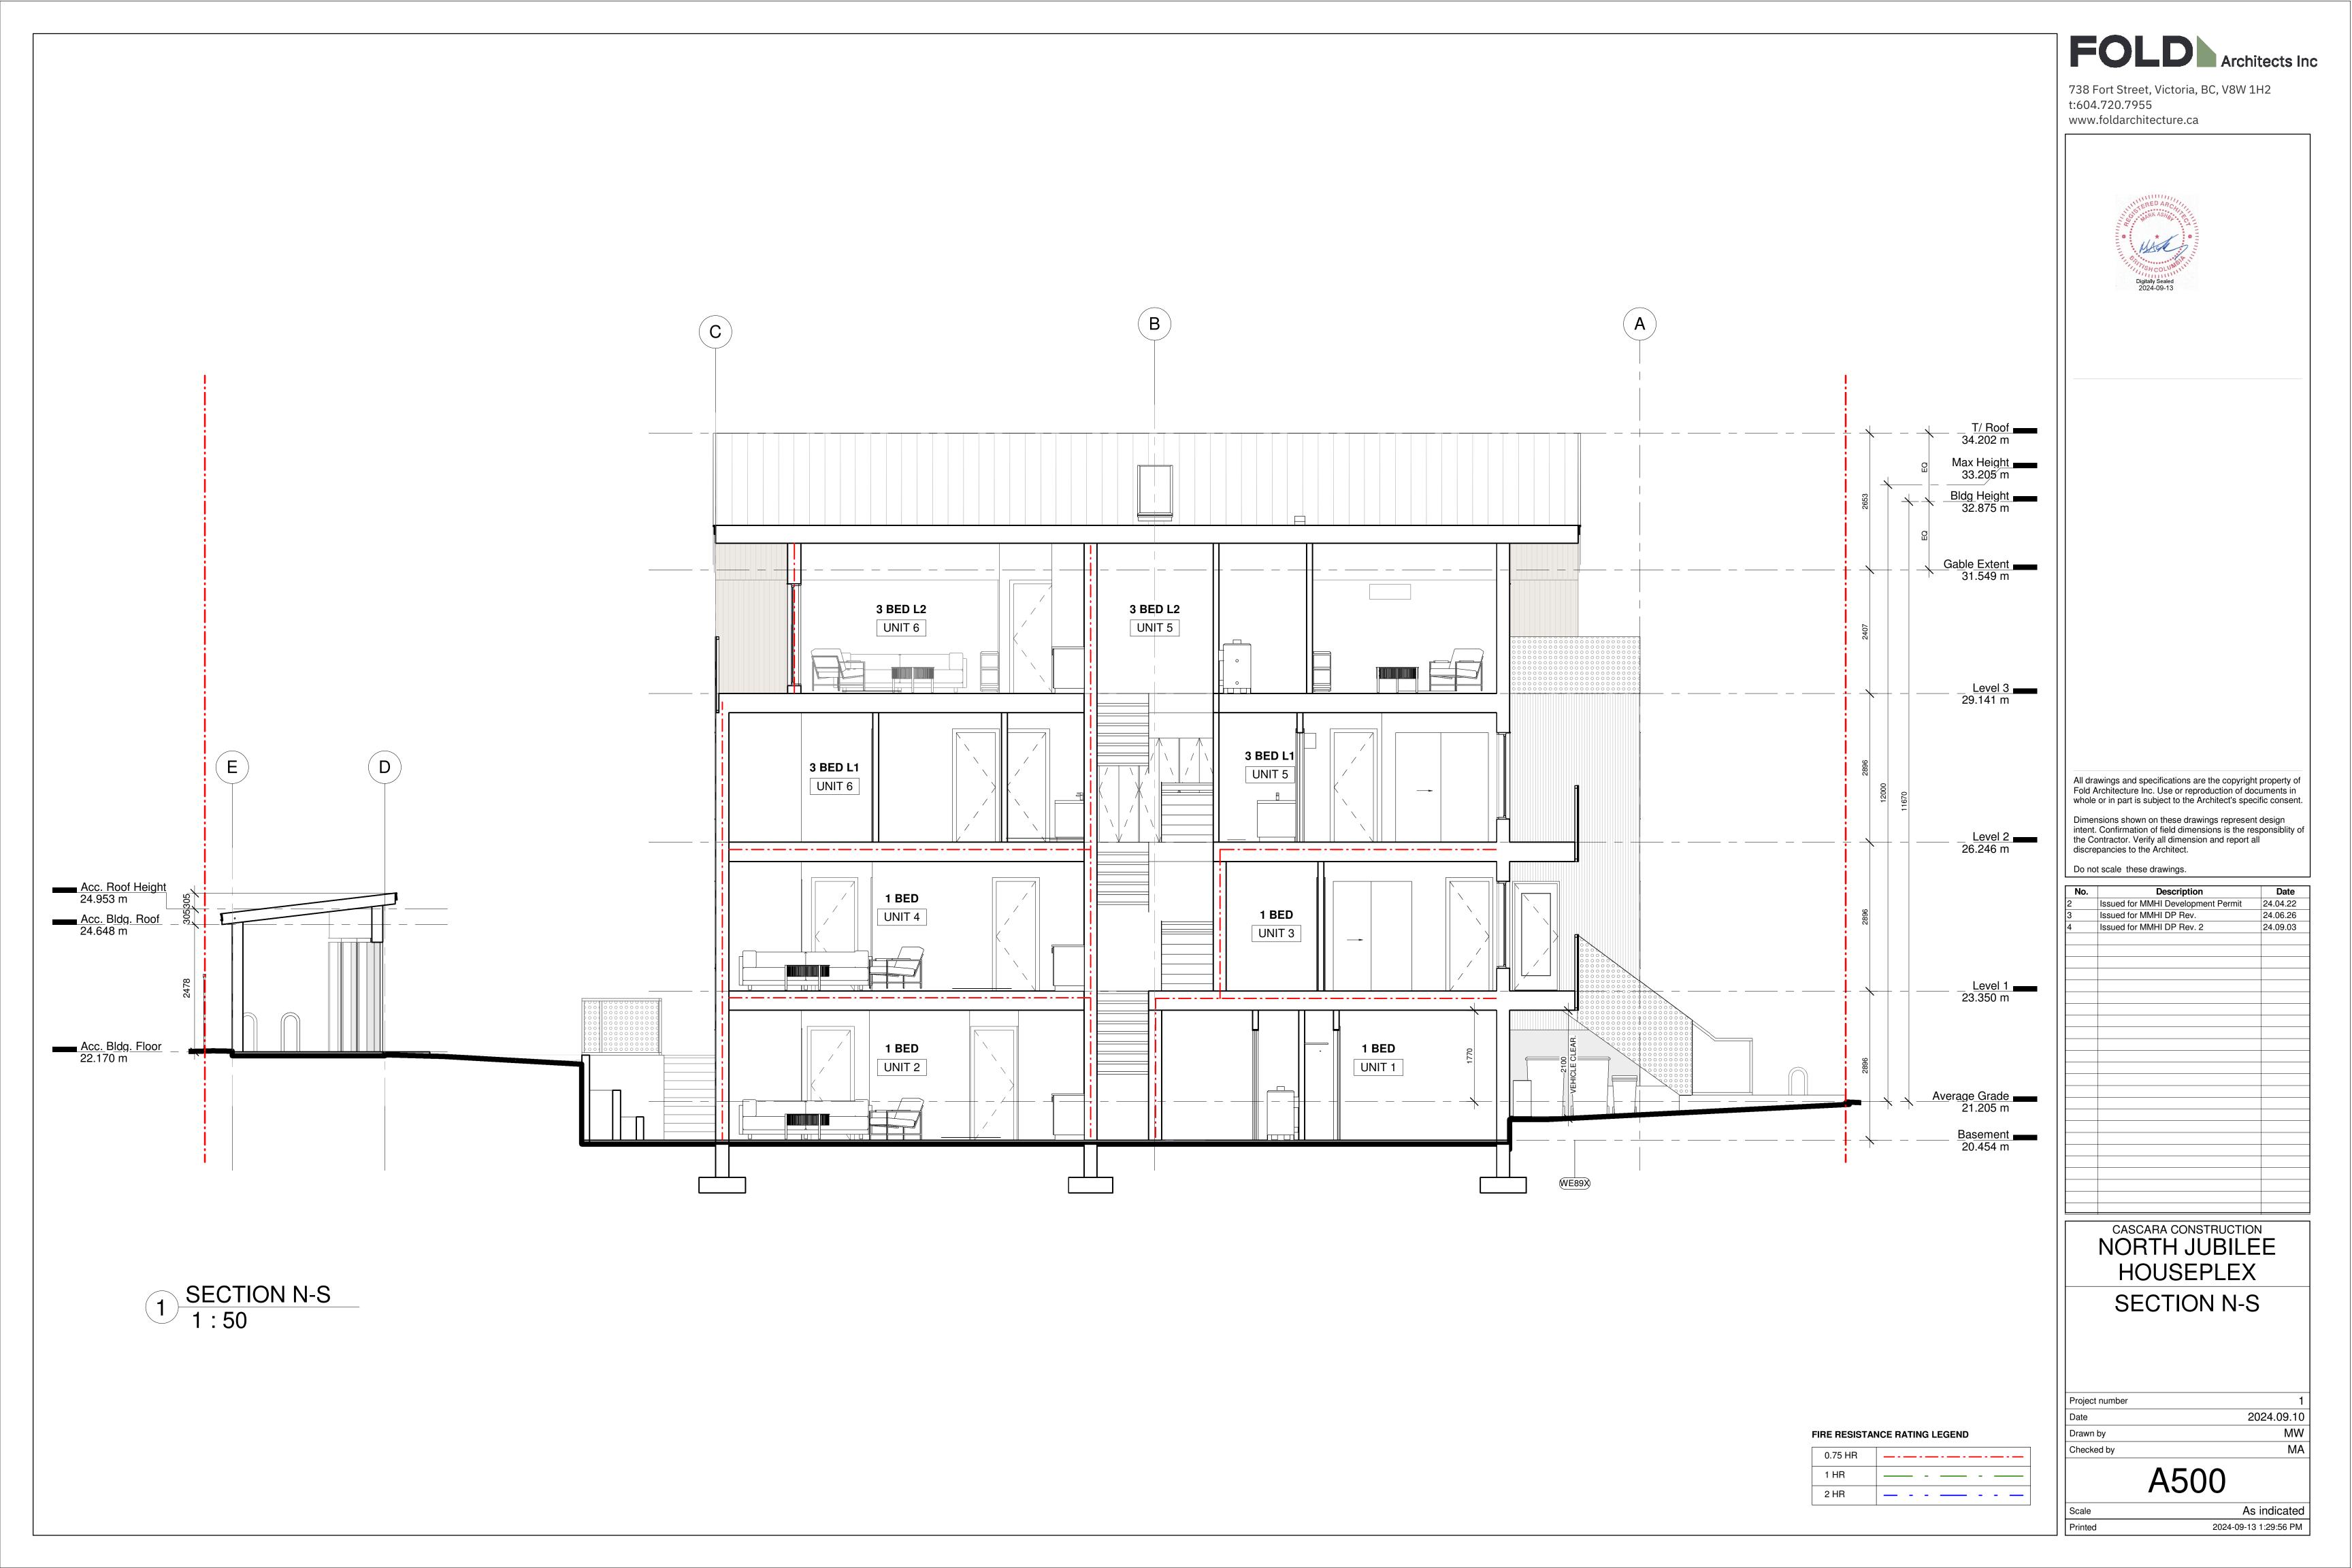

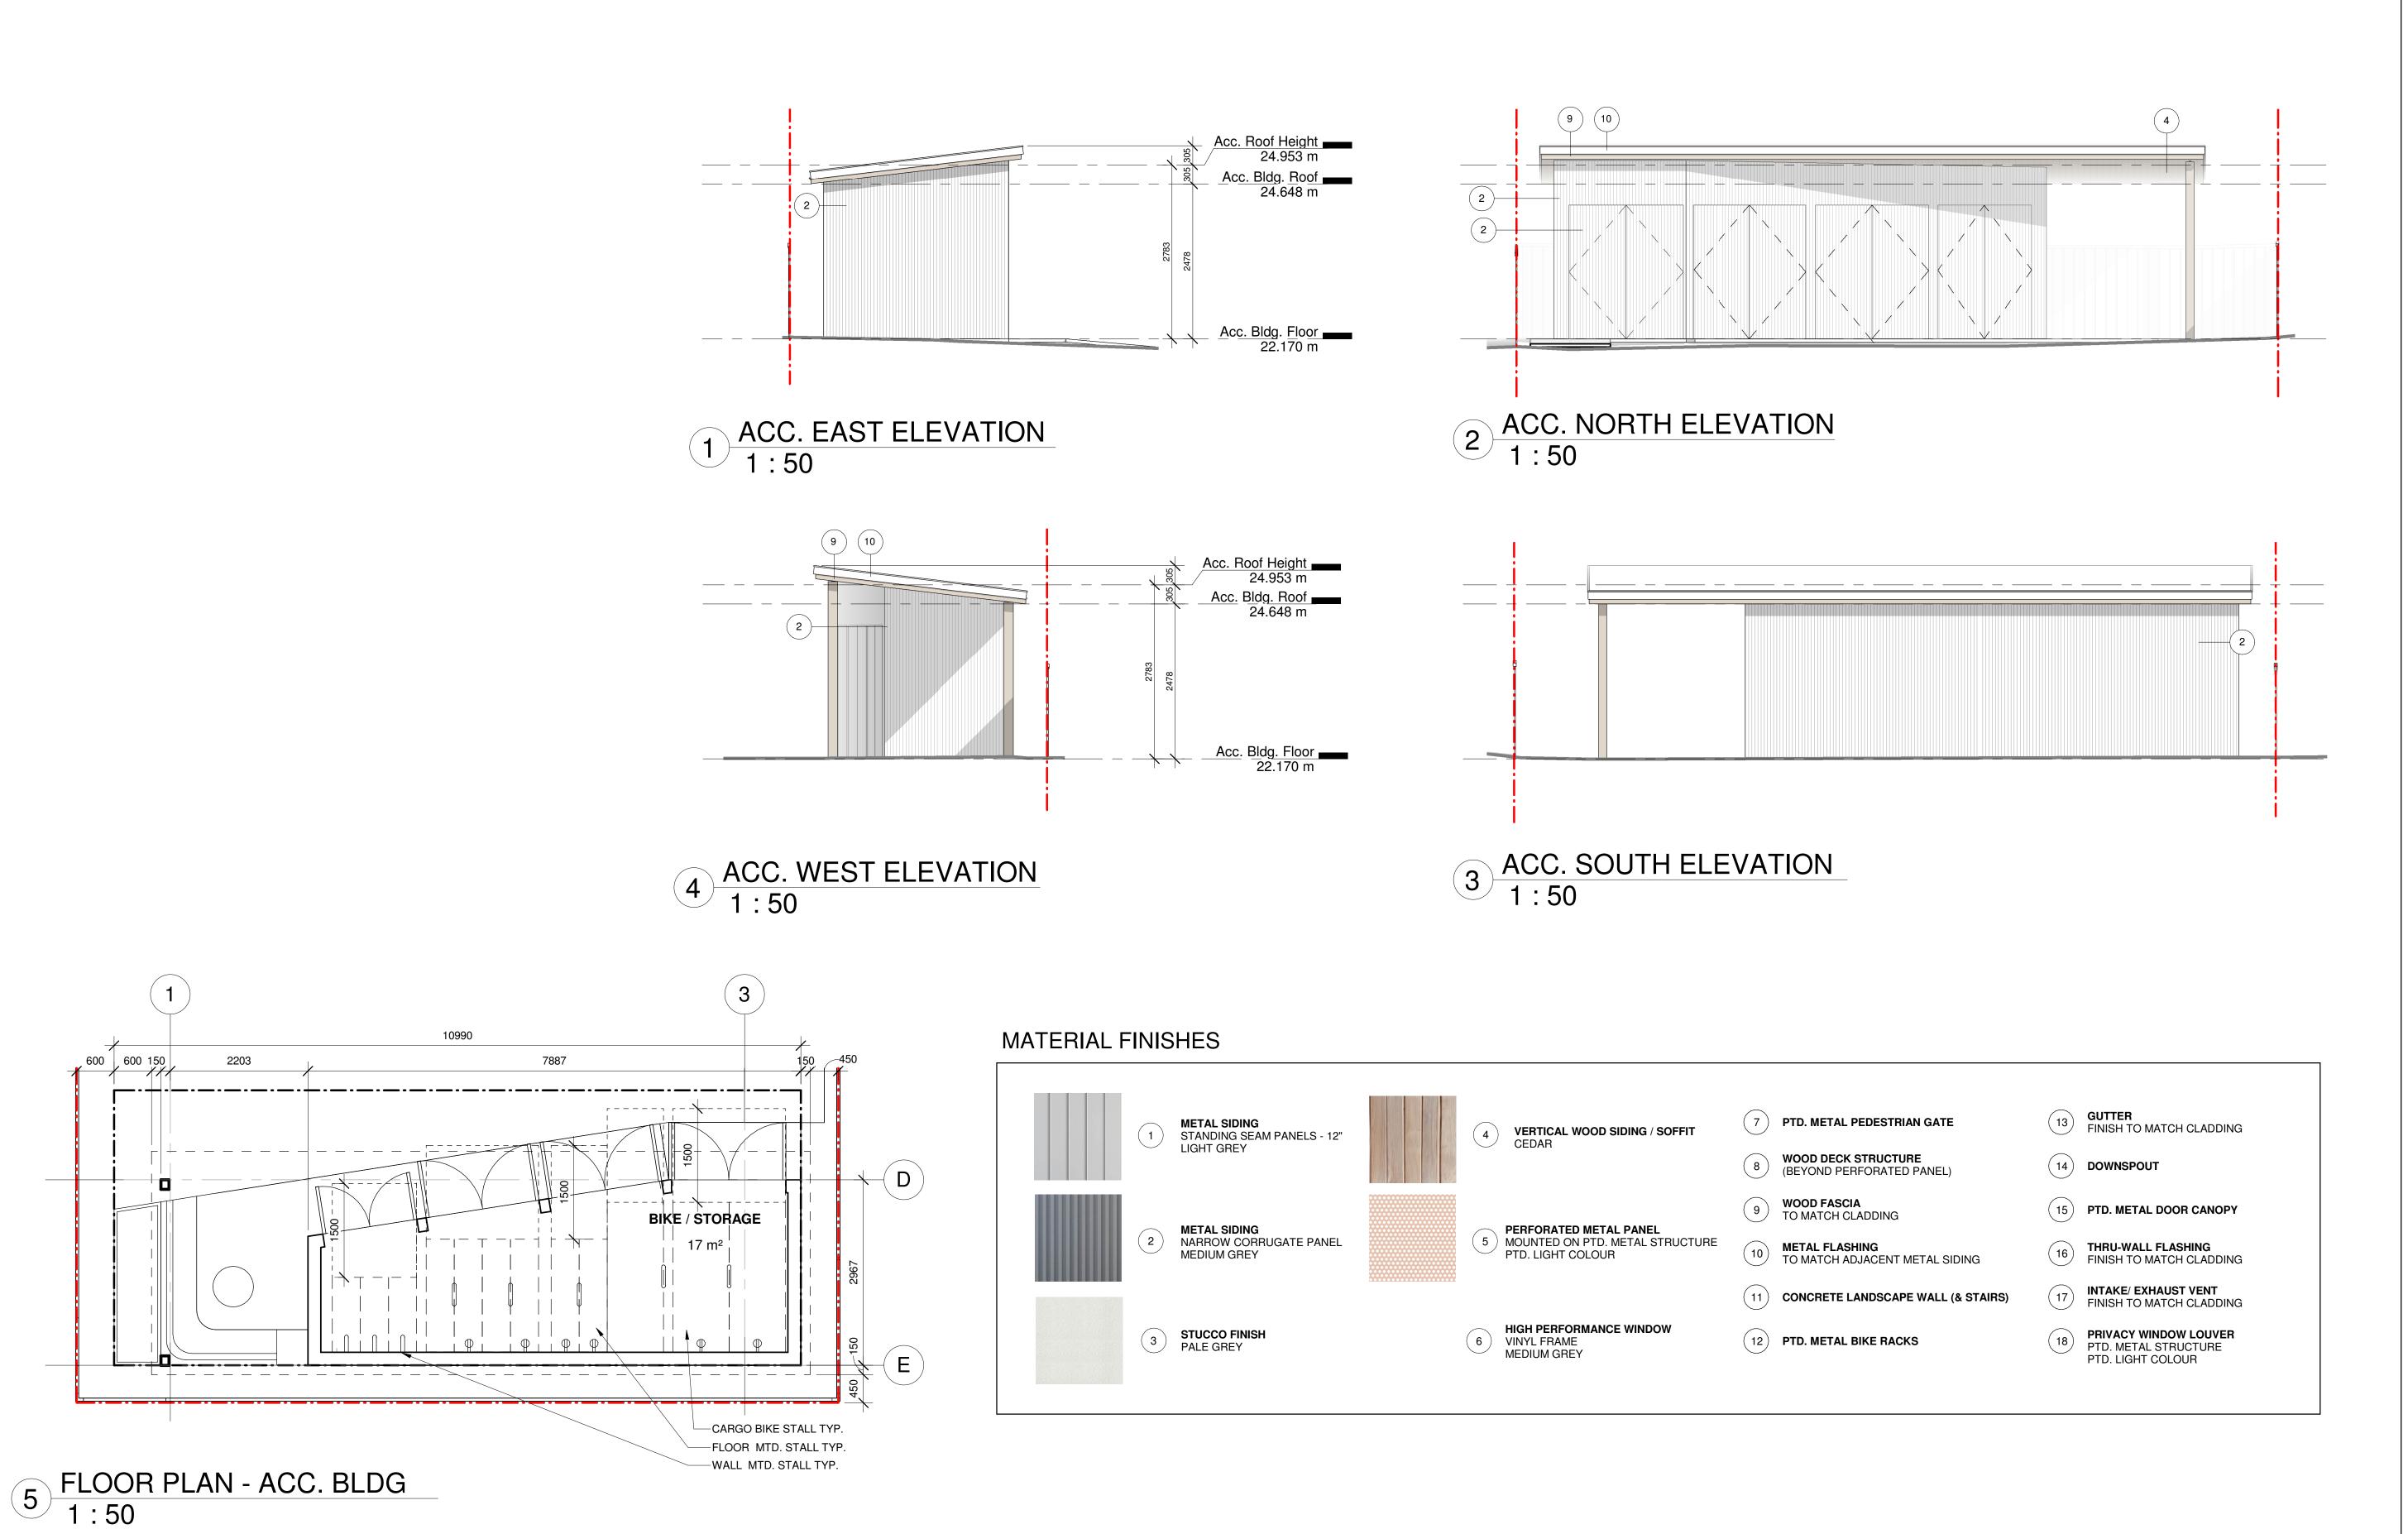



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No.	Description	Date
2	Issued for MMHI Development Permit	24.04.22
3	Issued for MMHI DP Rev.	24.06.26
4	Issued for MMHI DP Rev. 2	24.09.03

NORTH JUBILEE
HOUSEPLEX
ACCESSORY
BUILDING

Project number	
Date	2024.09.10
Drawn by	MV
Checked by	MA

A600

ale 1:50
nted 2024-09-13 1:29:58 PM

NOTES:

LEGEND

PLANTING

AREA ID

PLANTING AREA #1 AREA (m2)

49.24

EXISTING GRADES ARE IN GREEN PROPOSED GRADES ARE IN RED

TREES TO BE REMOVED

CRITICAL ROOT ZONE

ESTIMATED

SOIL VOLUME

49.24

REPLACEMENT TREES PROPOSED

. #MEDIUM E.#SMALL

B.#SMALL

DRIP ZONE


VOLUME MULTIPLIER







GARRY OAK MEADOW PLANTINGS

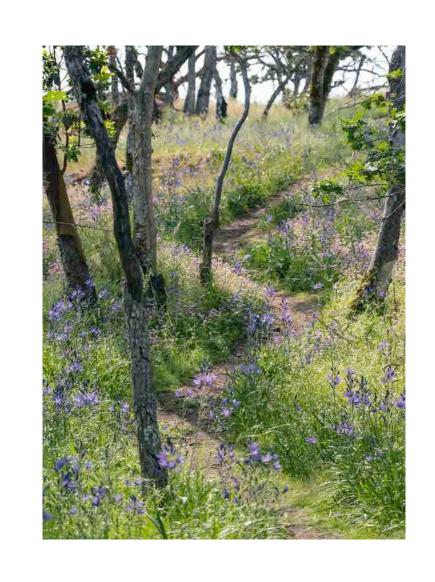



" PROJECT TITLE "


PROPOSED LANDSCAPE PLAN for CASCARA CONSTRUCTION 1721 ADANAC STREET, VICTORIA, BC

PAGE TITLE

SITE AND TREE PLAN, PAGE ONE of THREE

APRIL 10, 2024
Revised APRIL 12, 2024
Revised APRIL 17, 2024
Revised JUNE 25, 2024
Revised JUNE 27, 2024
Revised AUGUST 9, 2024
Revised AUGUST 28, 2024

" SCALE " 1:100

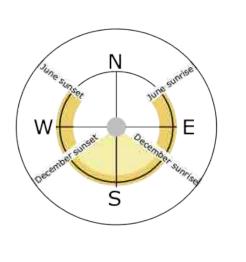

1721 ADANAC STREET - PLANTING PLAN



L GAULTHERIA SHALLON





CORNUS NUTTALLII



POLYSTICHUM MUNITUM



HELLEBORUS ORIENTALIS
'WHITE LADY'





KOELERIA MACRANTHA



ACHILLEA MILLEFOLIUM



MYRICA CALIFORNICA








L DESCHAMPIA CESPITOSA



CERCIDIPHYLLUM LANATUM



HELLEBORUS X HYBRIDUS 'BERRY SWIRL'

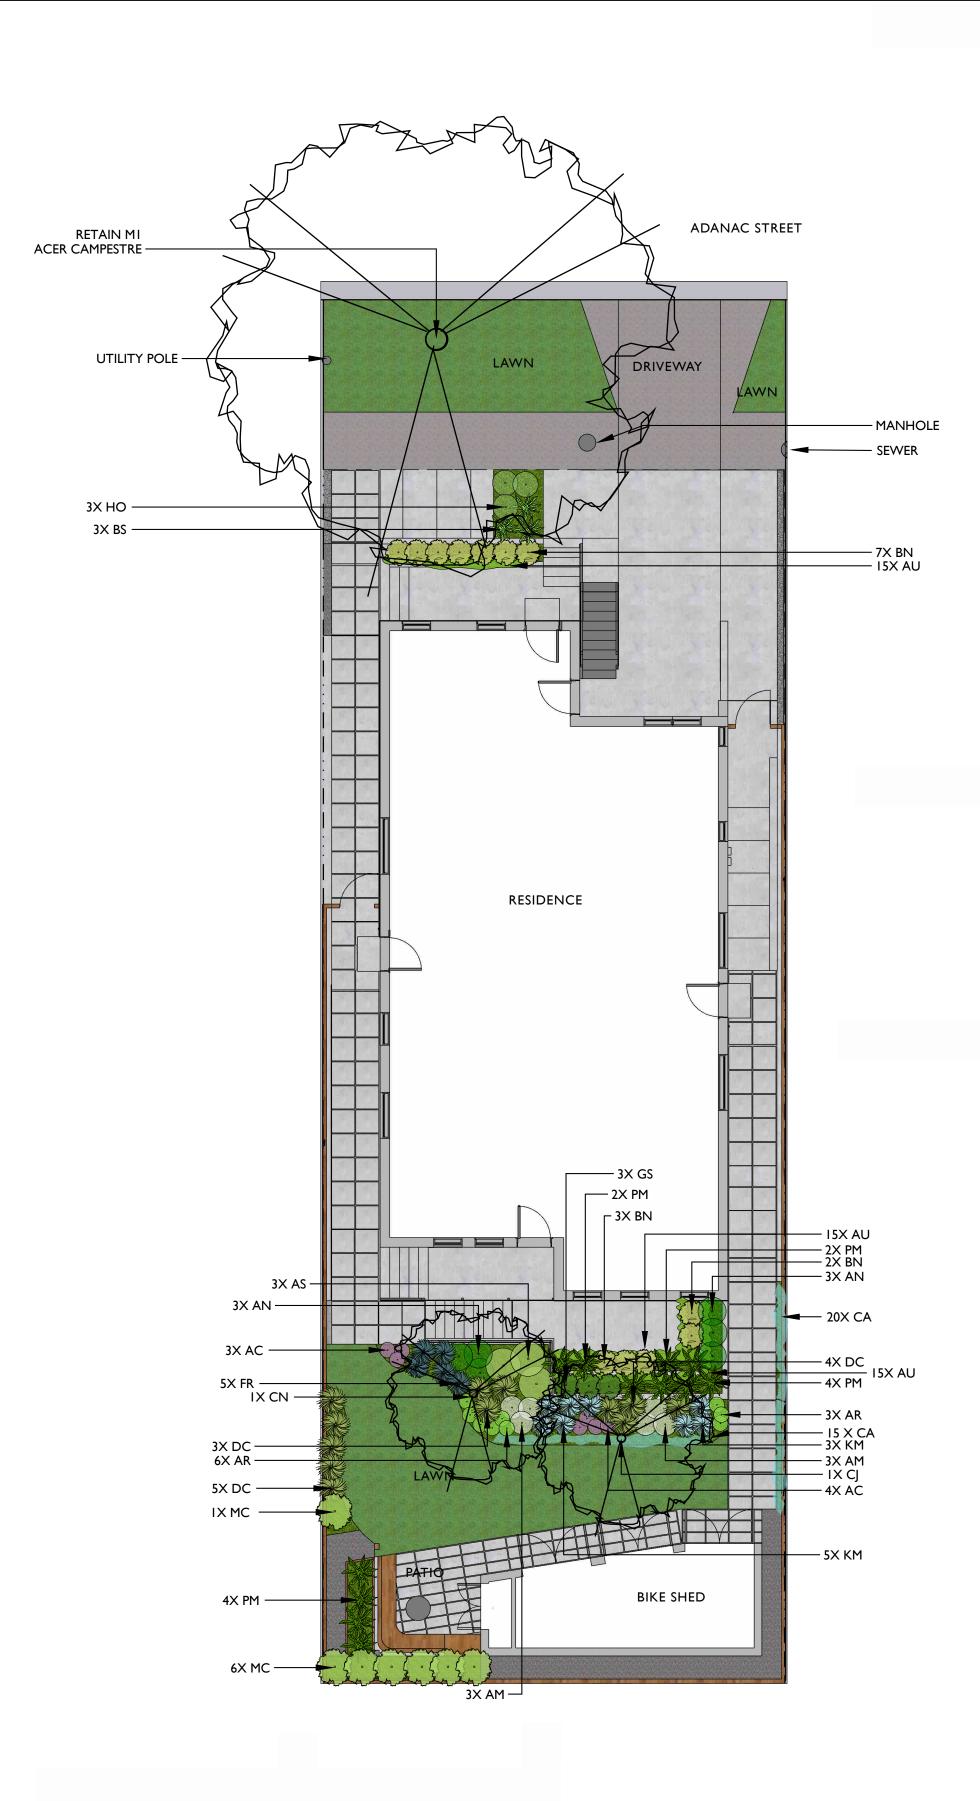

ON-SITE PLANT SCHEDULE

ABB.	QTY.	SIZE	BOTANICAL NAME	COMMON NAME
TREE	S			
CJ	I	6cm.	CERIDIPHYLLUM JAPONICUM	KATSURA TREE
CN	I	6cm.	CORNUS NUTTALLI	PACIFIC DOGWOOD
SHRU	BS			
MC	7	#7	MYRICA CALIFORNICA	PACIFIC WAX MYRTLE
PERE	NNIALS	, BULBS,	FERNS AND GRASSES	
AM	6	#I	ACHILLEA MILLEFOLIUM	YARROW
AC	7	4"	ALLIUM CERNUUM	NODDING ONION
AN	6	# I	ANAPHALIS MARGARITACEA	PEARLY EVERLASTING
AR	9	# I	ARMERIA MARITIMA	SEA THRIFT
AS	3	# I	ARTEMISIA SUKSDORFII	COASTAL MUGWORT
BS	3	# I	BLECHNUM SPICANT	DEER FERN
DC	12	# I	DESCHAMPSIA CESPITOSA	TUFTED HAIR GRASS
FR	5	# I	FESTUCA ROMERI	ROEMER'S FESCUE
НО	3	# I	HELLEBORUS ORIENTALIS 'WHITE LADY'	WHITE LADY LENTON ROSE
KM	8	# I	KOLERIA MACRANTHA	JUNE GRASS
PM	10	#I	POLYSTICHUM MUNITUM	SWORD FERN
GROU	JNDCOV	ERS ANI	DANNUALS	
AU	45	4"	ARCTOSTAPHYLOS UVA-URSI	KINNIKINNICK
BN	12	#I	BERBERIS NERVOSA	CREEPING OREGON GRAPE
CA	35	4"	CERASTIUM ARVENSE	FIELD CHICKWEED
GS	3	#I	GAULTHERIA SHALLON	SALAL



PROJECT TITLE

PROPOSED LANDSACPE PLAN for CASCARA CONSTRUCTION
1721 ADANAC STREET, VICTORIA, BC


PAGE TITLE

PLANTING PLAN, PAGE TWO of THREE

APRIL 10, 2024
Revised APRIL 12, 2024
Revised APRIL 17, 2024
Revised JUNE 25, 2024
Revised JUNE 27, 2024
Revised AUGUST 9, 2024
Revised AUGUST 28, 2024

0 I 2 3 4 5

SCALE 1:100

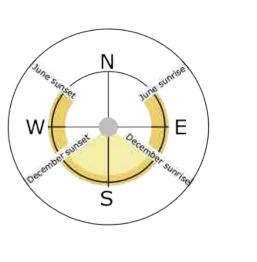

1721 ADANAC STREET - LANDSCAPE NOTES

OVERALL NOTES

- 1. Plantings, landscape installation, and irrigations should all be installed in accordance with the BCLNA/BCSLA standard (2020)
- 2. Any plant substitutions shall be made in consultation with the landscape architect.
- 3. The Landscape and Irrigation Contractor shall determine the location of all underground services prior to the commencement of landscape work and shall be responsible for the repair of all damage caused by landscape work to the Owner's satisfaction.
- 4. All topsoil and plants shall conform to BCNTA / BCSLA specifications.
- 5. BCLNA/BCSLA standard (2020) is the guiding resource for all notes on this page


MATERIALS


CAST-IN-PLACE CONCRETE

- I. Cast-in-place concrete may have a finish of trowel finish, broom finish, exposed aggregate, or parging. To be finished as specified on landscape plans
- 2. Concrete should be reinforced with rebar.

PERMEABLE PAVERS

Permeable pavers should be installed according to figures 12.2, 12.3, or 12.4.

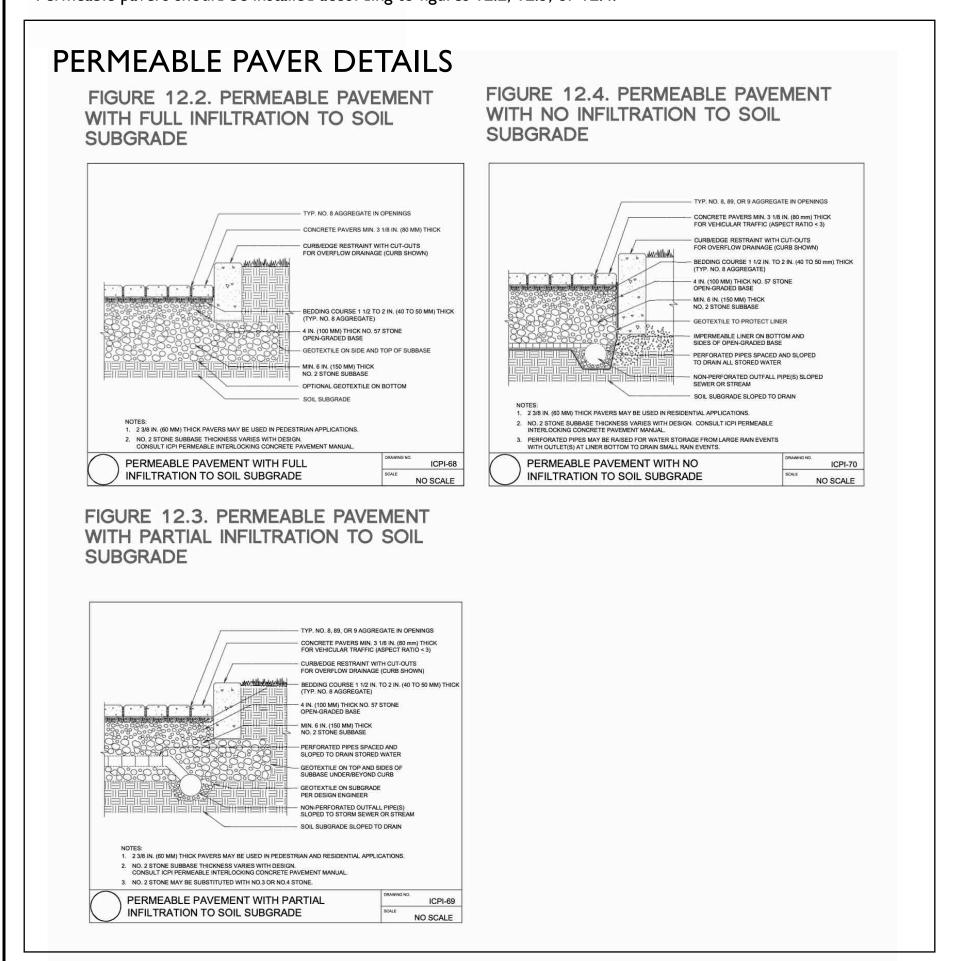

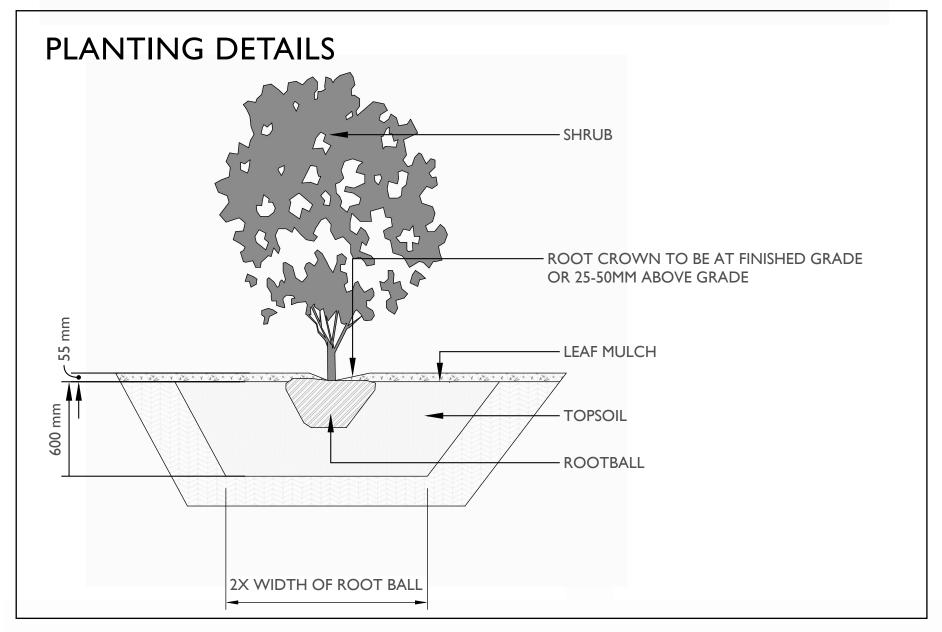

STOCKPILES

- I. Site materials should be stockpiled separately from the growing medium to avoid contaminating the growing medium.
- 2. Ideally, the growing medium is delivered on the day of installation.
- 3. Soils, fill, sand, gravel, or any construction materials should not be stockpiled within the t critical protection zones.
- 4. Soil or subsoil should not be stockpiled in low areas to avoid erosion or water pooling.


TOPSOIL

- I. On-site topsoil should be used if it meets the standards for a growing medium.
- 2. Topsoil should have a pH range of pH 5.5-7.5 and contain not less than 2 % Organic Matter [OM] by weight and a salt conductivity of less than 2.5 dS/m.
- 3. Both imported and on-site topsoil should be tested and amended before landscape work commences on-site by the contractor or soil supplier. Modification costs should be included in the overall budget.
- 4. Topsoil depths shall be as follows: Trees 2m x 2m x 2m soil per tree; shrubs 600 mm depth; ground covers 150 mm depth

MULCH

- I. All planted beds shall be covered with a 55 mm layer of high organic low-wood content mulch.
- 2. 2.Mulch should be a minimum of 10cm (4in.) from the crown of any plant. It is never to be mounded up around the stem of the plant.
- 3. Mulch depths should be at most 10cm (4in.) around larger plants and 5cm (2in.) for smaller plants such as groundcovers.
- 4. Trees installed in lawns should have a mulch ring of 1m diameter that will be maintained for a minimum of 8 years.
- 5. Mulch is to be of a type suitable for the material planted.

TREE PLANTING DETAILS IF NEEDED, USE TWO STAKES AND ARBOR TIE TRUNK FLARE TO BE 2.5-SCM ABOVE FINISHED GRADE EXCAVATE AROUND ROOT BALL AND FILL IS WITH SOIL ROOT BALL ONTOP OF COMPACTED SOIL

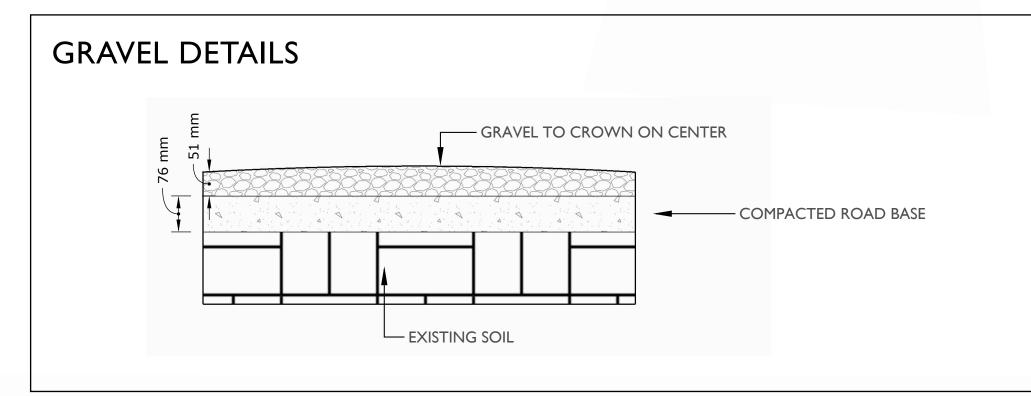

PLANTING.

- I. All trees shall be secured with two 75 mm diameter \times 1.8 m long round poles set 1m into the ground.
- 2. Plants determined to be dead or dying at the end of one year from the installation date shall be replaced by the Contractor at the Contractor's expense.
- 3. Growing media settlement should be corrected prior to mulching.
- 4. Immediately after planting, trees shall be stabilized, ensuring that the tree's crown has free movement, but wind, snow loading, or human force will not disturb the buttress root system or cause the rootball to shift in the ground.
- 5. Trees may not need stabilization if the subsoil and growing medium are stable and can hold the rootball in place, and the rootball is solid and contained and shaped where it can resist shifting.
- 6. Planting debris and materials shall be removed promptly from the site.
- 7. Plants must be watered immediately after planting to the depth of their root systems.
- 8. The contractor is responsible for scheduling the delivery of plants to the site in conformance with the contract documents.
- 9. Plants should spend a minimal amount of time in the storage on site.

SEED

- I. All grass areas shall be seed.
- 2. The finished grade should be smooth, firm against footprints, loose textured, and free of all stones, roots, and branches.
- 3. Areas with heavy compaction should have their surfaces loosened employing thorough scarification, discing, or harrowing to a minimum of 150mm (6in.) depth.
- 4. Slope soil away from house and level soil by dragging a 2x6" board over area, rake the soil even, then roll over the soil three times in opposite directions until soil is firm.
- 5. Add a light dressing of peat moss, just as a measure to retain moisture.
- 6. A mix of 3 grass species is better than one species. The following grasses are known for their hardiness and have been tested for turf quality and resistance to many diseases and insects. A good basic mix wou fescue. These do well in cool-season climates such as ours.
- rescue. These do well in cool-season climates such as ours.
- 7. Seed should be applied at a rate of one pound per 200 square feet and spread in opposite directions.
- 8. After application seed should be lightly and gently raked.
- 9. After seeding the newly seeded area must be watered evenly, and kept moist until lawn is established.

IRRIGATION


- I. All planting beds shall be irrigated with an automatic underground system with automatic rain shut-off.
- 2. Irrigation sleeving is to be 150mm in diameter. Schedule 40 or SDR 28.
- 3. Must be installed 12" below finished grade for all lateral lines and 18" below finished grade for irrigation main lines.
- 4. All irrigation materials and installation methods shall conform to IIABC standards.
- 5. Irrigation within municipal rights of way shall conform to the City of Victoria requirements.
- 6. Backflow preventer requirements for irrigation lines shall conform to Victoria municipality requirements.
- 8. The Irrigation Contractor shall test the irrigation system and ensure that it is fully operational prior to acceptance by the owner.

WATERING

- I. Plants shall be monitored for moisture at delivery and watered as necessary until planting with on-site irrigation during storage.
- 2. Plants and soil moisture should be monitored during the first and second growing seasons for a sufficient irrigation schedule and to ensure that the plants are healthy with the irrigation setup. If the plants are wilting or showing stress due to water, there shall be an increase in watering frequency.
- 3. Watering should reach the depth of the root zone.
- 4. Irrigation schedules may be skipped if rainfall has penetrated the full depth of the root zone.
- 5. Soil moisture should be maintained at 50 to 100 percent field capacity.

LANDSCAPE LIGHTING

I. Landscape lighting must adhere to the Canadian Electrical Code, British Columbia electrical and building codes, and Municipal by-laws regarding electrical, lighting, and light pollution.

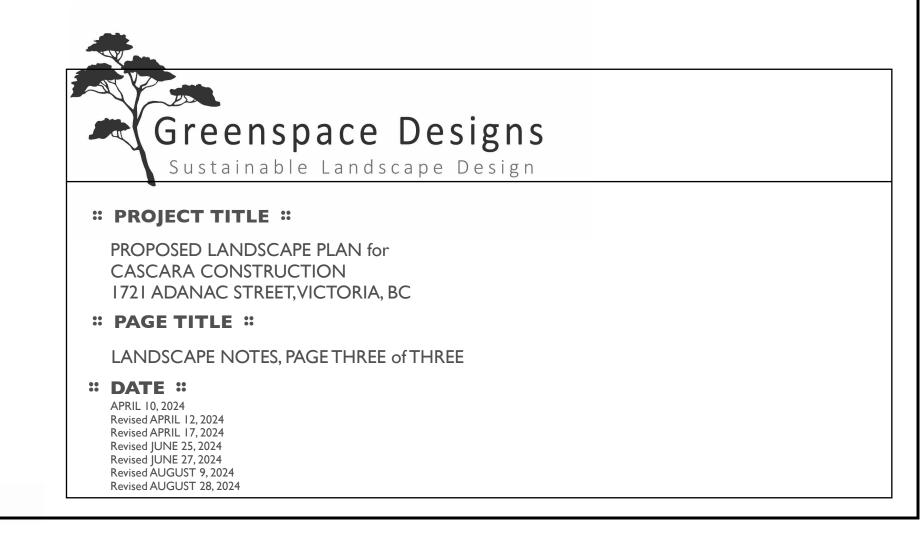

ENVIRONMENTAL NOTES:


- USE BEST MANAGEMENT PRACTICES DURING CONSTRUCTION. ADJUST WORK ACTIVITIES DURING PERIODS OF HEAVY RAIN TO MINIMIZE SEDIMENTS ENTERING THE STORM DRAINAGE SYSTEM.
- CHECK ALL EQUIPMENT FOR FLUID LEAKS PRIOR TO ENTERING THE WORK AREA. NO EQUIPMENT RE-FUELING TO OCCUR IN THE WORK AREA UNLESS SPILL PROTECTION
- A SPILL KIT IS TO BE MAINTAINED ON SITE THROUGHOUT THE CONSTRUCTION PERIOD. SURFACE WATER IS TO BE MANAGED WITHIN THE WORK AREA AND TREATED BEFORE
- COVER EXPOSED SOILS IN INCLEMENT WEATHER IE TARP, HYDRO SEED OR ORGANIC LEAF
- STOCKPILE SOILS AWAY FROM CULVERT INLETS AND ENSURE THEY ARE COVERED IF LEFT

GENERAL CONSTRUCTION NOTES:

- 2. ALL CONSTRUCTION AND MATERIALS SHALL CONFORM TO VICTORIA STANDARD SPECIFICATIONS AND

- REINSTATE ALL PRIVATE PROPERTY AND BOULEVARDS TO PRE-CONSTRUCTION CONDITIONS. 5. CONTACT VICTORIA PARKS DEPARTMENT PRIOR TO WORKING IN AND AROUND TREES.
- 6. ENSURE THE CURRENT MUNICIPAL O.H.&S. GROUND DISTURBANCE PRACTICE AND PROCEDURES ARE

- 9. ENSURE ALL EXISTING SERVICES STAY IN OPERATIONAL CONDITION DURING CONSTRUCTION.

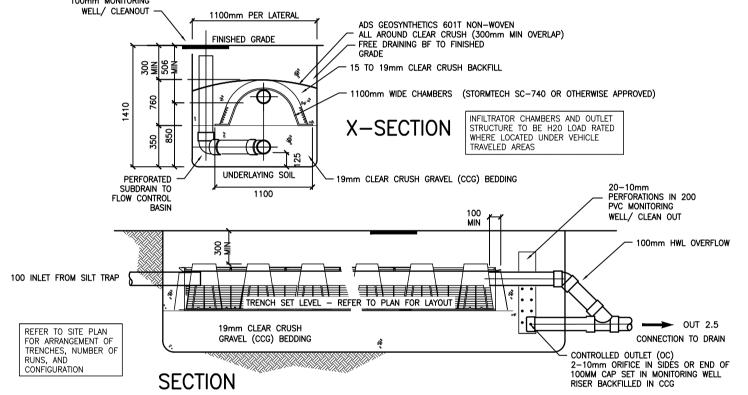

SWM STORAGE/FILTRATION TRENCH - D11C

\rightarrow PROVIDE EFFLUENT FILTER IN OUTLET CONCRETE SUMP FOUNDATION BASE AS REQD FOR SOIL AND BEARING

ON SITE STORMWATER MANAGEMENT (SWM) NOTES

CONTRACTORS OBLIGATION

PRE-CONSTRUCTION MEETING THE CONTRACTOR MUST ARRANGE WITH THE ENGINEER, A PRE-CONSTRUCTION MEETING TO REVIEW THE SWM OBJECTIVES BEFORE SETTING OF ANY FOUNDATION OR BUILDING

REFER TO GENERAL NOTES

SEDIMENT RETENTION DURING CONSTRUCTION AND RE-ESTABLISHMENT OF VEGETATION AND LAWN, SURFACE WATER RUN-OFF FROM DISTURBED AREAS OF THE PROJECT. OR ANY OTHER SOURCE OF SEDIMENT OR POLLUTANT LADEN WATER, SHALL NOT BE ROUTED THROUGH ANY STORMWATER MANAGEMENT SYSTEM. A SEDIMENT POND, TRAP, PERIMETER PROTECTION, SUCH AS SILT FENCES, OR OTHER ENGINEER APPROVED SURFACE TREATMENTS SHALL E

COMMISSIONING OF SWM SYSTEMS TEMPORARY EROSION AND SILT CONTROL TREATMENTS SHALL REMAIN IN PLACE UNTIL THE ENTIRE SITE HAS BEEN STABILIZED AND VEGETATION RE-ESTABLISHED.

SWM OBJECTIVES

ALL LOTS SHALL BE PROVIDED WITH STORMWATER MANAGEMENT SYSTEMS FOR IMPERVIOUS

THIS PLAN SHOWS REPRESENTATIVE EXAMPLES OF TYPICAL SWM CONFIGURATIONS FOR EACH LOT.

THE OWNER AND CONTRACTOR SHALL CONSULT WITH THE ENGINEER REGARDING THE ULTIMATE ARRANGEMENT AND SCOPE OF REQUIRED SWM COMPONENTS.

INTENT OF SWM IS TO REDIRECT ALL HARD LANDSCAPE RUNOFF INTO ENGINEERED SYSTEMS FOR WATER RECHARGE TO SURFACE OR GROUND FOR DISPERSION AND OR INFILTRATION AS WELL AS TO REDUCE THE IMPACT THE DOWNSTREAM MUNICIPAL MAIN.

BUILDING FOUNDATION PERIMETER DRAINS

CONFIRM UNDERGROUND

LOCATIONS WITH

UTILITY COMPANIES

THE LOCATION AND ELEVATION OF THE EXISTING

UNDERGROUND INFRASTRUCTURE SHOWN ON THIS DRAWING MAY NOT BE ACCURATE OR COMPLETE.

THE ACTUAL HORIZONTAL AND VERTICAL LOCATIONS

MUST BE CONFIRMED PRIOR TO THE START OF

ANY EXCAVATION.

THE FOUNDATION PERIMETER DRAINS (PD) FROM BUILDINGS SHALL BE DIRECTLY CONNECTED TO THE COMMON OR MUNICIPAL DRAIN CONNECTION AS APPLICABLE, AND NOT ROUTED THROUGH THE ROOF OR DRIVEWAY DRAIN SYSTEMS.

visting Municipal Infrastructure

roposed Municipal Infrastructure — — — — — — Ditch

xisting External U/G Utilities —e——t——g——c— Sewer

roposed External U/G Utilities — — — — — — — — — Water

Pole Mount ം ◯ →

FOUNDATION DRAINS TO BE PROVIDED OTHERWISE AS REQUIRED BY THE BC BUILDING

BUILDING ROOF DRAINS

NEW DRIVEWAY SURFACE AREAS HAVE BEEN INCLUDED IN STORMWATER STORAGE CALCULATIONS.

EMERGENCY STORM OVERFLOWS MUST BE DIRECTED TO MUNICIPAL SYSTEM AS INDICATED IN D11C.

SWM SYSTEM DESIGN NOTES

PROVIDE ROOF WATER LEADERS AND PERIMETER ROOF DRAINS SUBSTANTIALLY IN ACCORDANCE WITH THE BC AS INDICATED. REFER TO **DETAIL D11C**

Curb —C— | Concrete Box ⊠ | Valve

Ø | Flush Valve →

S/W Wood Box

□ | Culvert

B STORAGE / FILTRATION CHAMBER TRENCHES

LEGEND

– | Drain —D—

Post Top 💠 Pedestrian Signal 📾 Traffic Signal ī Ctrl Monument 🖎 Traverse Hub 🛧 Gas Valve 🤌 Water Meter 🖯

~D*→*

—S—

—₩— | Cleanout

Standard Mount ☺ Traffic Sign ➡ Silt Trap ☐ Cap / Plug → Air Valve

Sidewalk

CHAMBER TRENCHES (TRN) TO BE CONSTRUCTED AS SHOWN IN DETAIL D11C

-EX 200ø VC-S EX 200ø VC — NMC NUNT MUON LADEL __EX 60ø DP/PE_ 1 PLAN 13178 NO.1721 NO.1719 NO.1727 #1720

#1710

#1720

DETAILED CONSTRUCTION NOTES:

REVISIONS

- (1) EXISTING WATER CONNECTION TO BE UPGRADED TO 25mm CONNECTION AND METER BY THE CoV AT APPLICANT
- (2) EXISTING SEWER CONNECTION TO BE CAPPED AT PROPERTY LINE BY COV AT APPLICANTS EXPENSE.
- NEW 100mm SEWER CONNECTION AND IC BY CoV AT APPLICANTS EXPENSE. REFER TO SHEET 2 FOR PROFILE.
- (4) NEW 100mm STORM WATER CONNECTION AND IC BY CoV AT APPLICANTS EXPENSE. REFER TO SHEET 2 FOR
- (5) REMOVE AND REPLACE CURB (MMCD C4 NMC) AND GUTTER ALONG FRONTAGE AND RESURFACE 1.0m STRIP OF ASPHALT TO COV STANDARDS
- STORMWATER MANAGEMENT SYSTEM TO BE INSTALLED AS PART OF BUILDING PERMIT REQUIREMENTS AS SHOWN.

REVISIONS APPROVED

Date

Signed

- (7) NEW 3.5m WIDE DRIVEWAY WITH 1.5m FLARES IN ACCORDANCE WITH STD DRG: TA-64 BY CONTRACTOR
- (8) OVERHEAD HYDRO AND TELECOMS CONNECTION SHOWN SCHEMATICALLY. REFER TO THIRD PARTY UTILITY DRAWINGS FOR DETAILS.

Approved

Manager of Development

Date

Signed

Approved

Manager of Development


PERMIT TO PRACTICE NUM: 1000348

Approved By

Manager of

Development

Coordinator

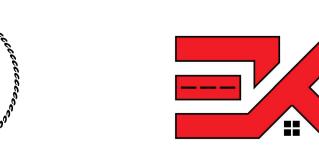

Design: ESK

FOR PROPOSED SERVICES OF EASTERLY 30ft OF LOT 33 & REM LOT 34 , SECTION 25, VICTORIA DISTRICT, PLAN 339 PID 009-141-162 000-151-424

KYLE ENGINEERING SUITE 1, 40 CADILLAC AVE.VICTORIA, BC, V8Z 1T2

Scale: Hor: 1:200 Vertical: 1:40

GENERAL NOTES:

UNLESS OTHERWISE NOTED.

DIMENSIONS ARE METRIC; MILLIMETERS ON DETAIL DRAWINGS; METERS ON 1:200 PLAN AND PROFILE,

INDICATE THE GENERAL ARRANGEMENT OF WORK TO BE CARRIED OUT. AS THE PROJECT PROGRESSES,

REFER TO HOEL ENGINEERING'S "STATEMENT OF CONDITIONS" FOR ADDITIONAL INFORMATION AS TO THE

INFORMATION THAT IS PROVIDED IN OUR PLANS, DESIGNS, OR SPECIFICATIONS IS INTENDED TO

EXISTING SERVICE INFORMATION WITHIN AREAS OF CONSTRUCTION MAY HAVE BEEN SUPPLIED BY OTHERS AND ARE APPROXIMATE ONLY, ADDITIONAL SERVICES MAY BE PRESENT BUT NOT INDICATED ON

REFER TO VICTORIA STANDARD DRAWINGS AND SPECIFICATIONS AND PERMITS, MASTER MUNICIPAL

CONSTRUCTION DOCUMENTS, LATEST EDITION, BC HYDRO, TELUS, SHAW AND FORTIS GAS DRAWINGS

AND SPECIFICATIONS, AND OTHER AGENCIES/ SUB-CONSULTANTS DRAWINGS AND SPECIFICATIONS FOR

ALL OTHER CONSTRUCTION, MATERIAL AND INSTALLATION OF SERVICES NOT COVERED SPECIFICALLY BY

THE BC BUILDING CODE, BC ELECTRICAL CODE, OR BY OTHER BYLAWS OR SPECIFICATIONS SHALL BE

IN GENERAL CONFORMANCE WITH THE MASTER MMCD SPECIFICATIONS/STANDARD DETAIL DRAWINGS, AND

UNLESS OTHERWISE SPECIFIED HEREIN, ALL WORK WITHIN PRIVATE PROPERTY AND EASEMENTS TO BE INSTALLED IN ACCORDANCE WITH THE BC BUILDING CODE AND INSPECTED BY THE MUNICIPAL WORKS

THIS DOCUMENT MAY NOT BE USED, COPIED OR SHARED WITHOUT THE EXPRESS WRITTEN AUTHORITY

OF HOEL ENGINEERING LTD AND AT NO TIME MAY IT BE USED OR REFERENCED IN ANY FORM FOR

CONTACT BC ONE-CALL PRIOR TO CONSTRUCTION FOR FOR SERVICES LOCATE. 1-800-474-6886

THE CONTRACTOR IS TO COORDINATE AND COMMUNICATE WITH THE ENGINEER, ALL UTILITIES, AND AUTHORITIES HAVING JURISDICTION, WELL IN ADVANCE (2-WORKING DAYS MINIMUM) OF THE START OF

THE CONTRACTOR SHALL COORDINATE AND SCHEDULE ALL SUB-CONSULTANTS, CONTRACTORS AND

THE CONTRACTOR SHALL PROVIDE THE REQUIRED QUALITY CONTROL AND CONFORMANCE TESTING

A PERMIT TO CONSTRUCT WORKS ON A MUNICIPAL ROAD ALLOWANCE MUST BE OBTAINED BEFORE

WHEN GIVING ADVANCE NOTIFICATION, THE CONTRACTOR SHALL TAKE INTO CONSIDERATION THE

IN THE EVENT THAT THE CONTRACTOR IS NOT PROVIDING HIS OWN CONSTRUCTION LAYOUT. THE

CONTRACTOR REQUESTED CONSTRUCTION CHANGES MUST BE SUBMITTED AND APPROVED BY THE

CROSSINGS, ROAD BASE, CONCRETE, AND PAVING CONSTRUCTION MATERIALS AND AS OTHERWISE

ALL TESTING IS TO BE PROVIDED BY THE CONTRACTOR AT THE CONTRACTORS EXPENSE.

ALL PUBLIC ROADS ARE TO BE MAINTAINED MUD AND DUST FREE DURING CONSTRUCTION.

ALL LANDSCAPING AND STRUCTURES TO BE REINSTATED TO ORIGINAL CONDITION OR BETTER.

ENGINEER IS TO BE NOTIFIED BY EMAIL OR OTHERWISE IN WRITING AT LEAST 5 DAYS BEFORE ANY

THE CONTRACTOR SHALL NOTIFY THE ENGINEER IMMEDIATELY IF CONDITIONS ARE NOT FAVORABLE TO

CONFORMANCE TESTING IS TO BE PROVIDED BY THE CONTRACTORS TESTING ENGINEER FOR ALL ROAD

A PERMIT TO CROSS OR WORK NEAR FORTIS GAS PIPELINE IS REQUIRED. CONTACT 1-877-599-0996

FAILURE TO COMPLY WITH THESE REQUIREMENTS MAY RESULT IN DELAYS, REJECTION OF THE WORK,

ANY EXCAVATION AND COMMENCEMENT OF EACH PHASE OF CONSTRUCTION.

A TREE BYLAW PERMIT IS TO BE OBTAINED PRIOR TO ANY SITE ACTIVITIES.

SCHEDULING DEMAND AND PRIOR COMMITMENTS OF ALL PARTIES.

OR EXPENSIVE TESTING TO PROVE COMPLIANCE.

CONSTRUCTION LAYOUT IS REQUIRED.

ENGINEER PRIOR TO IMPLEMENTATION.

THE ACHIEVEMENT OF THE DESIGN INTENT.

REQUIRED BY VICTORIA OR THE ENGINEER.

REPORTS TO THE ENGINEER AT THE COMPLETION OF EACH PHASE OF THE WORK.

TRADES REQUIRED FOR THE COMPLETION OF THE WORKS.

THE DEGREE OF DETAIL THAT IS PROVIDED MAY REQUIRE ADDITIONS OR DELETIONS.

USE OF THESE DOCUMENTS AND CONSTRUCTION OF THE WORKS.

INFORMATION NOT COVERED ON THESE DRAWINGS.

DRAWING INFORMATION

THESE DRAWINGS.

INSPECTOR.

ANY LEGAL INSTRUMENT.

WORKS COMMENCE.

CHANGE REQUESTS

COORDINATION REQUIREMENTS

COMMUNICATION AND REPORTING

KEY PLAN - 1:2000 1721 ADANAC STREET

Haultain St

Emerson St

; ⁻	TY OF VICTO	FILE No.	_	
	1721 ADANAC STRE	DESIGN	_	
SE	WER, WATER, STORM AN	No.		
		Elev: 19.407m		
	Drawn: ESK	Checked: ESK	DRAWING No.	1 OF 2

Date: JUNE 2024

E. S. KYLE # 44451

Signed

REVISION # 3

Date

Approved

Manager of Developmen

DESIGN APPROVED Date Signed PROPOSED B.M.: 92B.044.1.4.

DISCHARGED. THIS MAY INCLUDE ONSITE DETENTION AND/OR CULVERT FILTRATION.

FOR MORE THAN 48 HOURS. - PLACE DRAIN ROCK AND FILET FABRIC AT THE IN LET OF CULVERT

SURROUND PROTECTED TREES WITH SNOW FENCING AT DRIP LINE OR CRITICAL ROOT ZONE OF


TREE DURING CONSTRUCTION. CONTACT VICTORIA ARBORIST PRIOR TO BEGINNING CONSTRUCTION. INSTALL SILT FENCING AS PER DETAIL A IN LOCATION SHOWN ON ESC PLAN.

1. CONTACT & NOTIFY ALL HOMEOWNERS AFFECTED BY WORKS 4 WEEKS PRIOR TO CONSTRUCTION.

DRAWINGS UNLESS OTHERWISE NOTED ON THIS DRAWING. 3. REPAIR AND/OR REPLACE ALL INFRASTRUCTURE/PRIVATE PROPERTY DAMAGED OR REMOVED DURING CONSTRUCTION, TO BETTER THAN, OR EQUAL TO PRE-CONSTRUCTION CONDITION.

FOLLOWED. CONTACT BC1 AT 1-800-474-6886 FOR EXTERNAL UTILITY LOCATIONS AT LEAST 72 HOURS PRIOR TO THE START OF CONSTRUCTION. 7. NOTIFY THOSE HOMEOWNERS WHO WILL BE AFFECTED BY CONSTRUCTION 48HRS BEFORE BEGINNING

8. CONFIRM LOCATION AND ELEVATION OF EXISTING UTILITIES AT ALL CROSSINGS AND CONNECTIONS

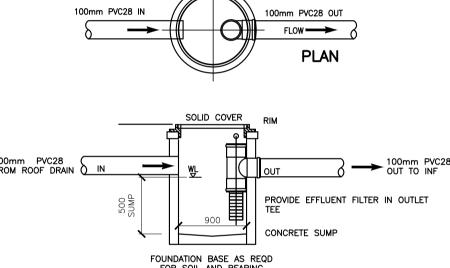

SWM DRAIN SILT TRAP D12B

THE ROOF DOWNSPOUTS (RL) FROM DWELLINGS ARE TO BE SEPARATE FROM THE FOUNDATION PERIMETER DRAIN AND ROUTED THROUGH THE SWM SYSTEMS PRESCRIBED HEREIN.


ON-SITE DRIVEWAYS


FOUNDATION PERIMETER DRAINS PROVIDE DRAINS SUBSTANTIALLY IN ACCORDANCE WITH THE BC PLUMBING CODE UNLESS OTHERWISE APPROVED BY

BUILDING CODE AS SHOWN ON THE APPROVED BUILDING PLANS UNLESS OTHERWISE APPROVED BY THE ENGINEER. DIRECT 100MM ROOF WATER COLLECTION PIPE TO STORAGE/FILTRATION CHAMBER TRENCHES VIA SWM SILT TRAP

STORMWATER MANAGEMENT


SWM RELATED SILT TRAPS (ST) TO BE CONSTRUCTED AS SHOWN IN DETAIL D12B

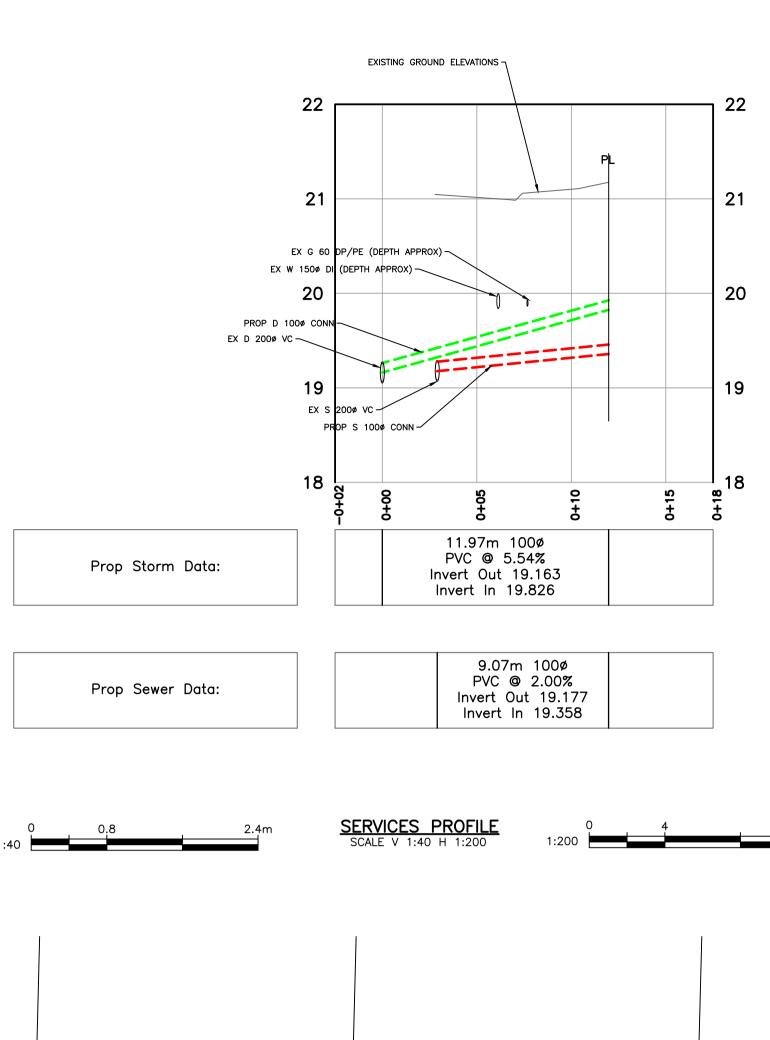

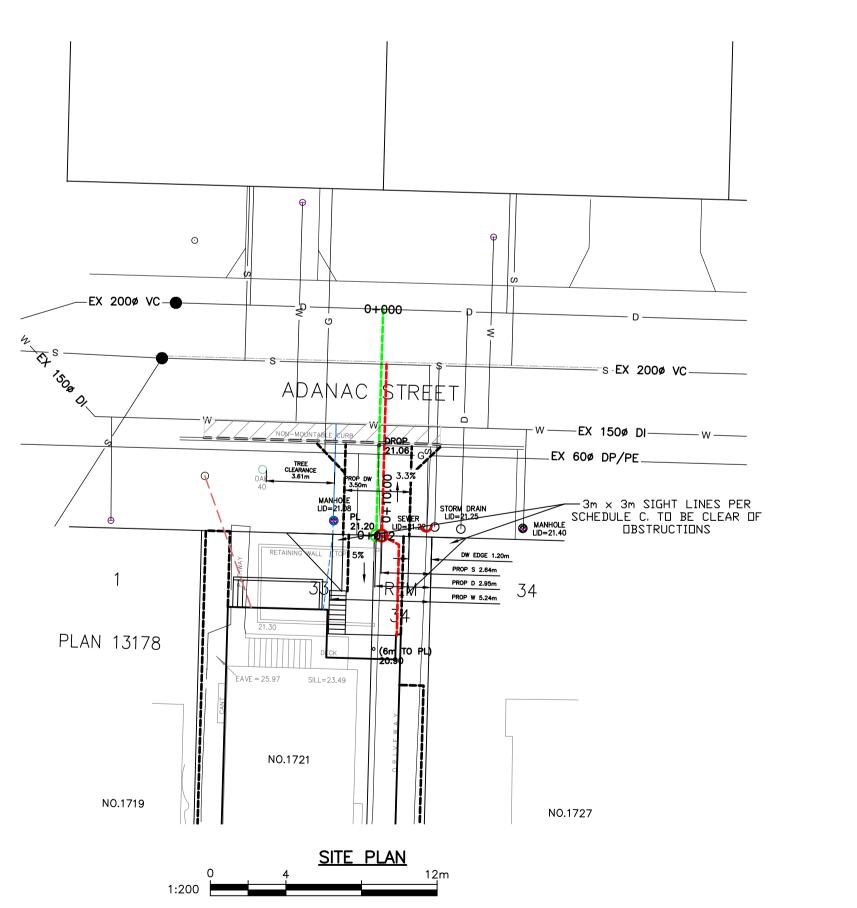

PERMIT TO PRACTICE NUM: 1000348



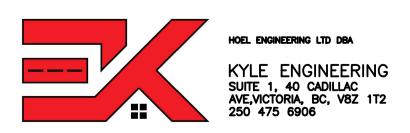

CONFIRM UNDERGROUND LOCATIONS WITH	LEGEND	REVISIONS	R	REVISIONS APPROVE)	DESIG	N APPROVED	CITY OF VICTORIA	FILE No.	_
UTILITY COMPANIES	Existing Municipal Infrastructure — Drain —D— Curb —C— Concrete Box 🗵 Valve 🗵	6	REVISION # 1	REVISION # 2	REVISION # 3	Approved By	Date Signed	1721 ADANAC STREET	DESIGN	
THE LOCATION AND FLEVATION OF THE EXISTING	Proposed Municipal Infrastructure ————————————————————————————————————	4	Approved Date Signed	Approved Date Signed	Approved Date Signed	Design Engineer		PROPOSED SERVICES DETAILS	No.	_
DRAWING MAY NOT BE ACCURATE OR COMPLETE.	Proposed External U/G Utilities — — — — — Water — W Cleanout	3		Engineer Manager of	Engineer Manager of Development	Manager of Development		B.M.: 92B.044.1.4. Elev: 19.407m	DRAWING	2 OF 2
MUSI BE CONFIRMED PRIOR TO THE START OF	Street Lighting Pole Mount № Standard Mount ៚ Traffic Sign ៚ Silt Trap Ø Cap / Plug → Air Valve ❷ Post Top � Pedestrian Signal ඐ Traffic Signal ® Ctrl Monument ⑥ Traverse Hub ♠ Gas Valve ❷ Water Meter ↔	1		Development Coordinator	Development Coordinator	Development Coordinator		Design:ESKChecked:ESKScale:Hor:1:200Vertical:1:40Date:JUNE 2024	No.	2 UF 2