



Urban Design Architecture Interior Design

REISSUED FOR DEVELOPMENT PERMIT APRIL 11, 2022



257 BELLEVILLE STREET

VICTORIA, BRITISH COLUMBIA

Prepared for the City of Victoria on behalf of ADZ Properties Ltd.

Client

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architectural

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Building Sections Building Sections



Received Date:
October 28, 2022
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June 8, 2022

OR DP NOVEMBER 15, 2010

.118 257 BELLEVILLE STREET

set no.

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DRAWING REFERENCE SYMBOLS: SHEET NUMBER WHERE LOCATED A0.0 **ELEVATION NUMBER** SHEET NUMBER WHERE LOCATED A0.0 SECTION NUMBER SHEET NUMBER WHERE LOCATED **ELEVATION NUMBER** INTERIOR ELEVATION NUMBER SHEET NUMBER WHERE LOCATED INTERIOR ELEVATION NUMBER **ELEVATION NUMBER** SHEET NUMBER WHERE LOCATED 1 TITLE - DRAWING TITLE A0.0 SCALE DRAWING SCALE SHEET NUMBER WHERE LOCATED 1- TITLE - DRAWING TITLE A00 SCALE - DRAWING SCALE SHEET NUMBER WHERE LOCATED SHEET NUMBER REFERENCED FROM TITLE -VHEIGHT**→** OBIECT HEIGHT FROM A GIVEN ELEVATION SLOPE UP -SLOPE DIRECTION SLOPE INCRIMENT C1 Q00 AFE HEIGHT ABOVE FINISHED FLOOR 000 A SUB KEYNOTE REFERNECE KEYNOTE REFERENCE NUMBER

> DOOR TYPE (P1) INTERIOR WALL ASSEMBLY (E1) EXTERIOR WALL ASSEMBLY 0000 ROOM NAME (R1) ROOF ASSEMBLY (F1) FLOOR ASSEMBLY 0000 AFF CEILING HEIGHT EL 0000.00 SPOT ELEVATION W1 WINDOW TYPE EXIST'G ELEVATION **—·———** 45 MINUTE FIRE RATING — · · · — · · — 1.5 HOUR FIRE RATING

SYMBOL LEGEND

DIMENSION NOTES:

• ALL WALL DIMENSIONS ARE TO FACE OF CONCRETE OR FACE OF STUD UNLESS OTHERWISE NOTED. • CLEAR DIMENSIONS ARE FROM FINISH SURFACE TO FINISH

• INTERIOR DOOR ROUGH OPENINGS ARE EITHER TO BE CENTRED IN WALL BETWEEN ADJOINING WALLS OR 150mm FROM AN ADJOINING WALL AS SHOWN ON FLOOR PLANS UNLESS NOTED OTHERWISE.

EXTERIOR WALL ASSEMBLY SCHEDULE

EXTERIOR WALL ABOVE GRADE:

 EXTERIOR FINISH - CLADDING TBD 50MM (R10) RIGID INSULATION ON 100 MM Z-GIRTS

 15.9 MM EXTERIOR SHEATHING 152MM STEEL STUDS C/W RSI 3.5 (R20) BATT INSULATION VAPOUR BARRIER GYPSUM WALL BOARD

PAINT FINISH

THE USE OF HIGHLY CONDUCTIVE METAL FRAMING IS OFFSET THROUGH THE USE OF A CONTINUOUS LAYER OF RIGID INSULATION OVER THE MAIN MEMBERS. FOUNDATION WALLS INCLUDE THE CONTINUATION OF RIGID INSULATION FROM THI

FOUNDATION WALL BELOW GRADE:

 DRAINAGE LAYER BENTONITE LAYER (IF REQUIRED) FOUNDATION WATERPROOFING CONCRETE FOUNDATION WALL

WINDOWS

CLEAR ANODIZED ALUMINUM WINDOW-WALL SYSTEM. THE INTERIOR FRAMES MAY BE WOOD CLAD WITH MILLED WOOD SILLS. THE FLANGE SIDE OF EACH WINDOW IS TO CONFORM TO A PRECISE SEQUENCE OF MEMBRANE INSTALLATION. THE VAPOUR BARRIERS, AND AIR BARRIERS MUST TIE INTO THE ROUGH OPENING OF ALL WINDOW SYSTEMS AT THE WINDOW PLANE

THE GLAZING DOUBLE GLAZED WITH A LOW- E COATING ON SURFACE 3 FOR THE SEALED UNIT. CONSIDER GLAZING AND FRAMES OF THE HIGHEST AFFORDABLE INSULATING VALUE AND THERMAL PERFORMANCE. AN ADDITIONAL TINT IS RECOMMENDED ON THE GLASS TO REDUCE SOLAR HEAT GAIN.

DEVICES MAY BE USED ON THE EAST AND WEST FACADES IF REQUIRED AS WELL.

FINALLY, THE SLENDER MASSING AND STEPPING ALLOWS FOR INCREASED DAYLIGHT

HORIZONTAL SOLAR SHADING DEVICES AND OVERHANGS MAY BE USED TO REDUCE SOLAR GAIN EXPOSURE ON THE SOUTH FAÇADE. ADDITIONAL, VERTICAL SHADING

ROOF ASSEMBLY

THE CURRENT ASSEMBLY CONTEMPLATES THE FOLLOWING OPTIONS: OPTION #1 - ROOFS AND DECKS

 BALLAST - GRAVEL, DECKING, OR CONCRETE PAVERS FILTER CLOTH

 DRAINAGE MAT PROTECTION BOARD • 150MM (R 30) RIGID INSULATION SLOPED TO DRAIN

 WATERPROOF PROOFING MEMBRANE (AIR/VAPOUR BARRIER) CONCRETE STRUCTURE RESILIENT CHANNELS

ACOUSTIC INSULATION

 GYPSUM WALL BOARD **OPTION #2 - ROOFS AND DECKS**

 CONCRETE PAVERS SBS ROOFING BASE SHEET FIBER BOARD

> • 150MM (R 30) RIGID INSULATION SLOPED TO DRAIN PROTECTION BOARD • SELF ADHERING AIR / VAPOUR BARRIER MEMBRANE CONCRETE STRUCTURE

 RESILIENT CHANNELS ACOUSTIC INSULATION

TYPICAL ROOF AT LANDSCAPE

 PLANTING SOIL (DEPTH VARIES) FILTER FABRIC

 DRAINAGE MAT 150MM (R 30) RIGID INSULATION SLOPED TO DRAIN WATERPROOF PROOFING MEMBRANE (AIR/VAPOUR BARRIER) • CONCRETE STRUCTURE

GENERAL NOTES AND **ASSEMBLIES**

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257 BELLEVILLE STREET

VICTORIA, BRITISH COLUMBIA

issued for **DEVELOPMENT PERMIT** OCT 23/2012 **DP ADDITIONAL ITEMS** DEC 05/2012 DEVELOPMENT PERMIT MAR 16/2020 REISSUED DEVELOPMENT PERMIT REISSUED DEVELOPMENT PERMIT REISSUED DEVELOPMENT PERMIT

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alan lowe architect inc.



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> Urban Design Architecture Interior Design drawing title

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VIEW FROM BELLEVILLE STREET



VIEW FROM INNER HARBOR




VIEW FROM QUEBEC STREET



VIEW FROM PENDRAY & QUEBEC STREET

VICTORIA, BRITISH COLUMBIA

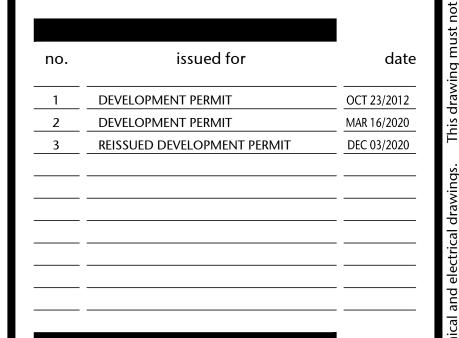



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PERSPECTIVES

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MARCH SHADOW STUDIES

JUNE SHADOW STUDIES

MARCH 21ST 2011 - 10.00am

MARCH 21ST 2011 - 12.00pm



MARCH 21ST 2011 - 2.00pm

JUNE 21ST 2011 - 10.00am



JUNE 21ST 2011 - 12.00pm



JUNE 21ST 2011 - 2.00pm

SEPTEMBER SHADOW STUDIES



SEPTEMBER 21ST 2011 - 10.00am



SEPTEMBER 21ST 2011 - 12.00pm



SEPTEMBER 21ST 2011 - 2.00pm

DECEMBER SHADOW STUDIES



DECEMBER 21ST 2011 - 10.00am




DECEMBER 21ST 2011 - 12.00pm



DECEMBER 21ST 2011 - 2.00pm



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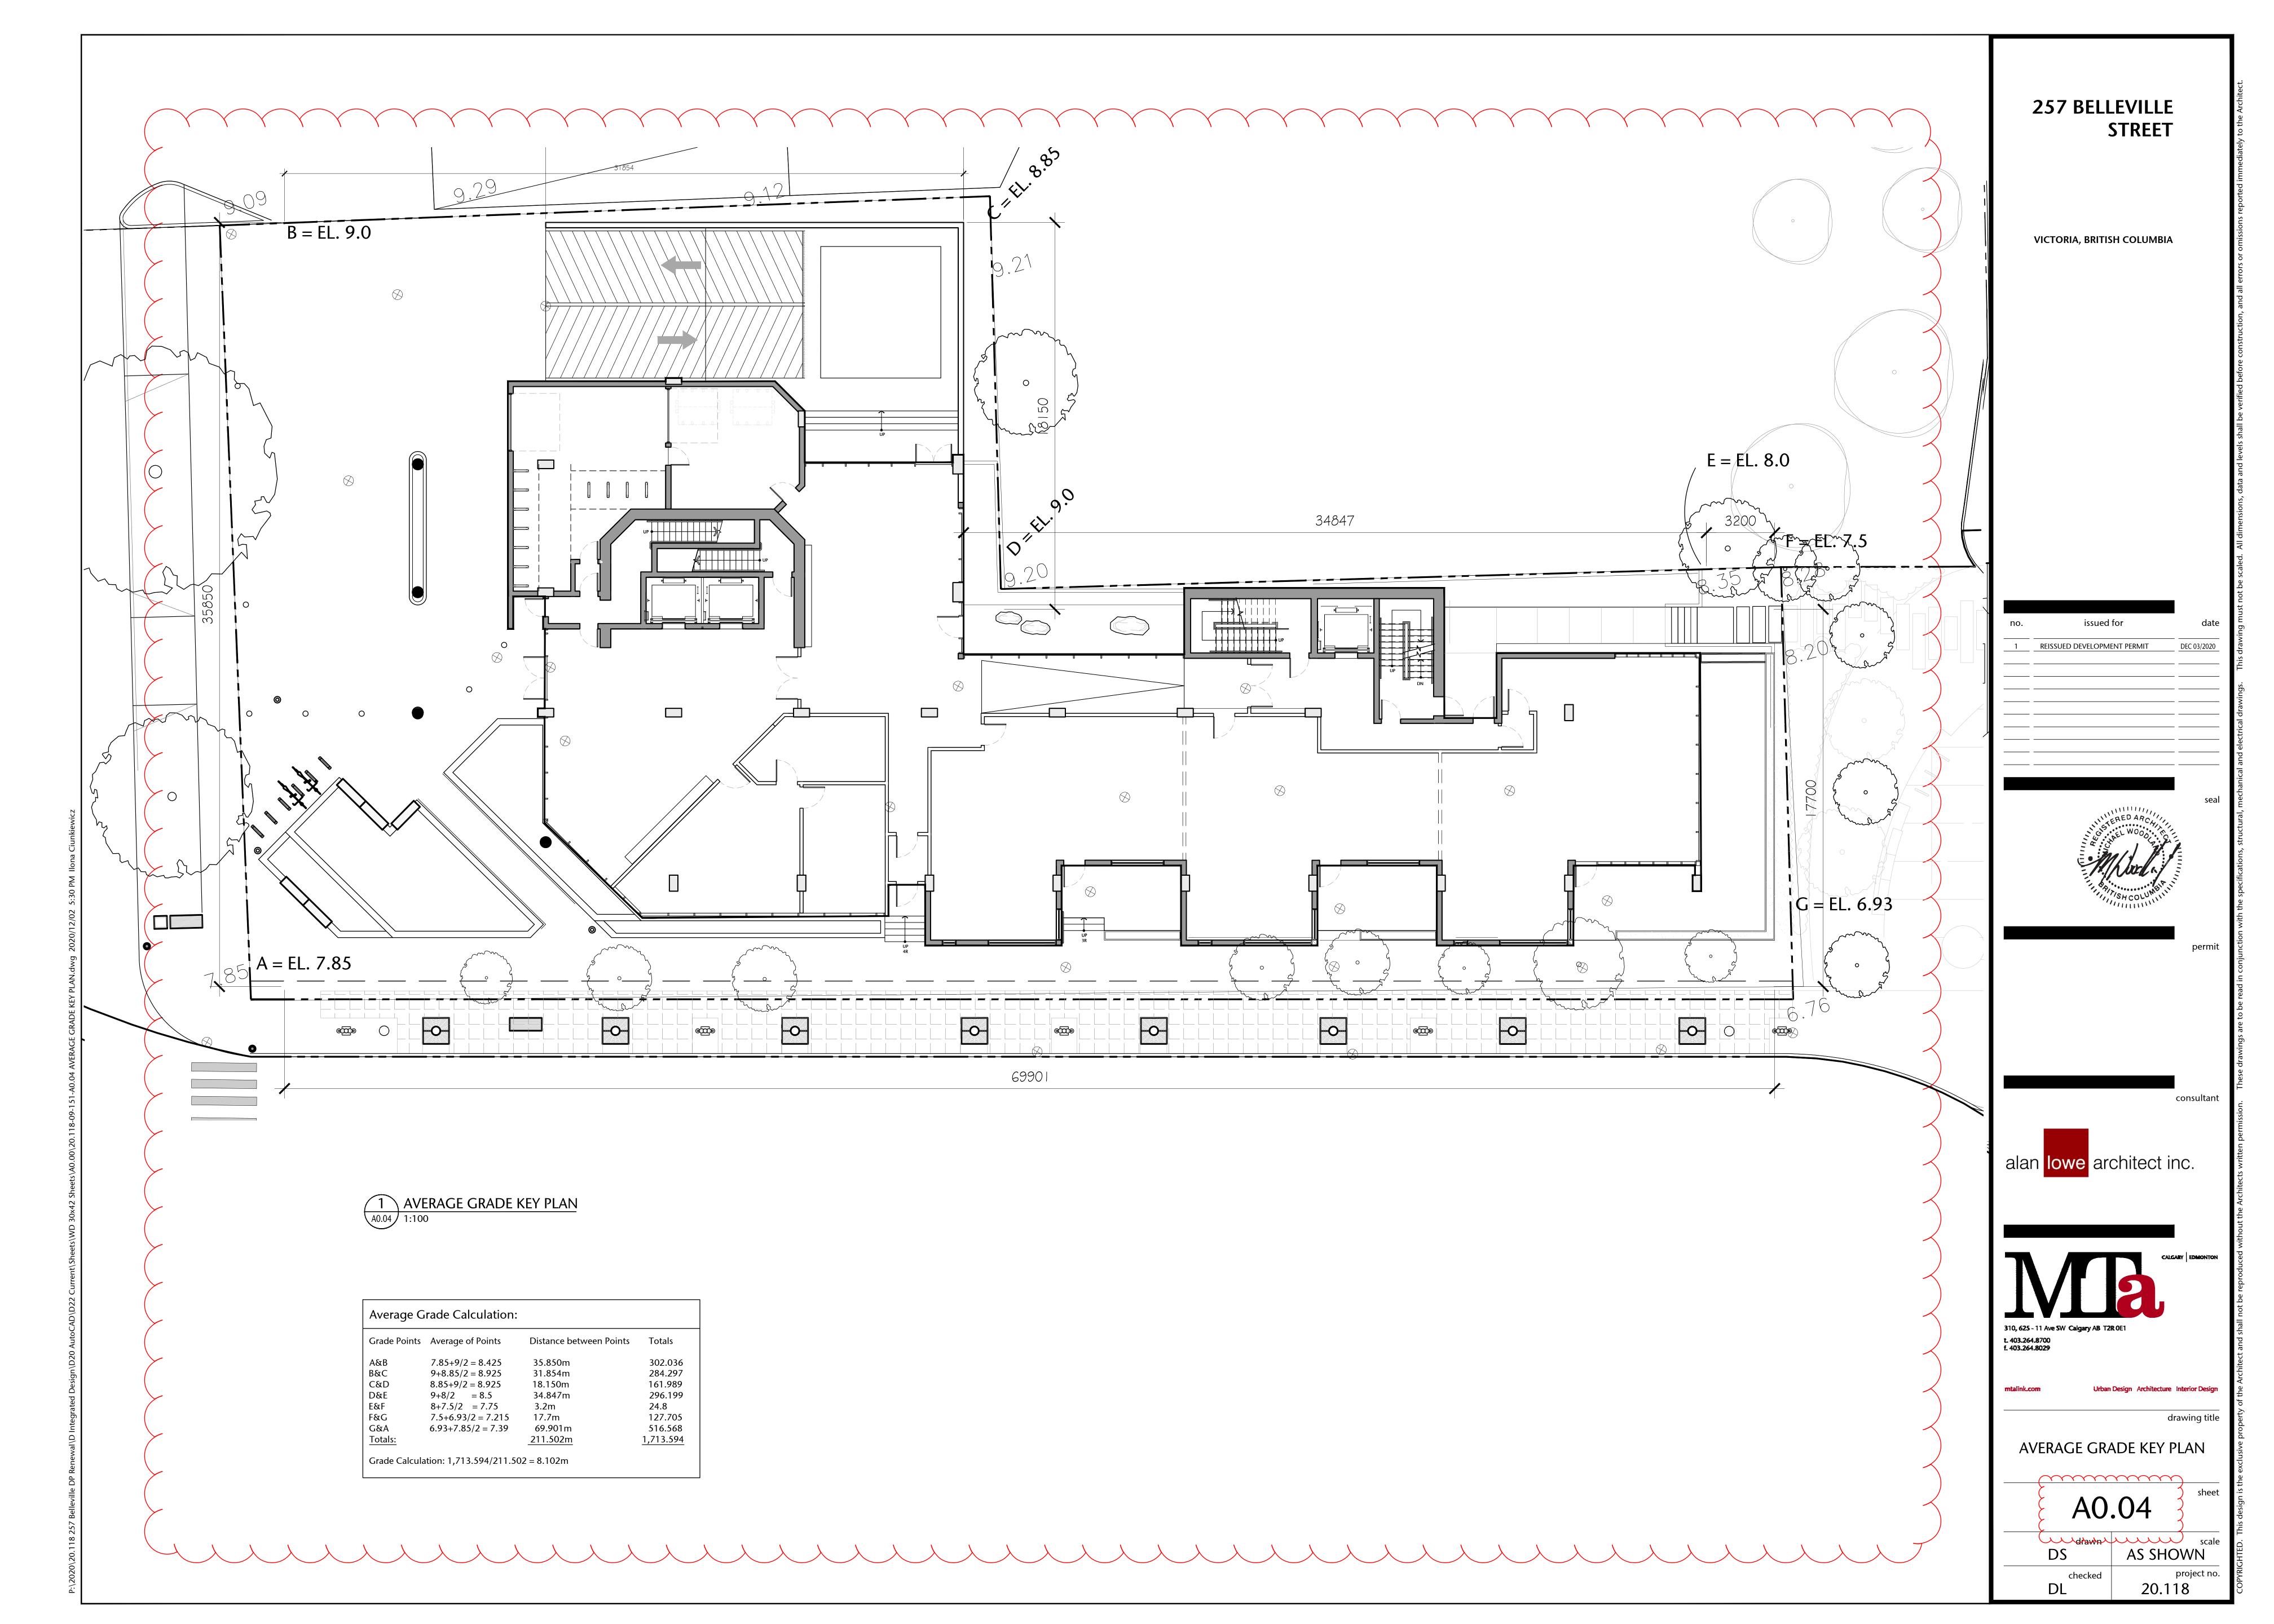
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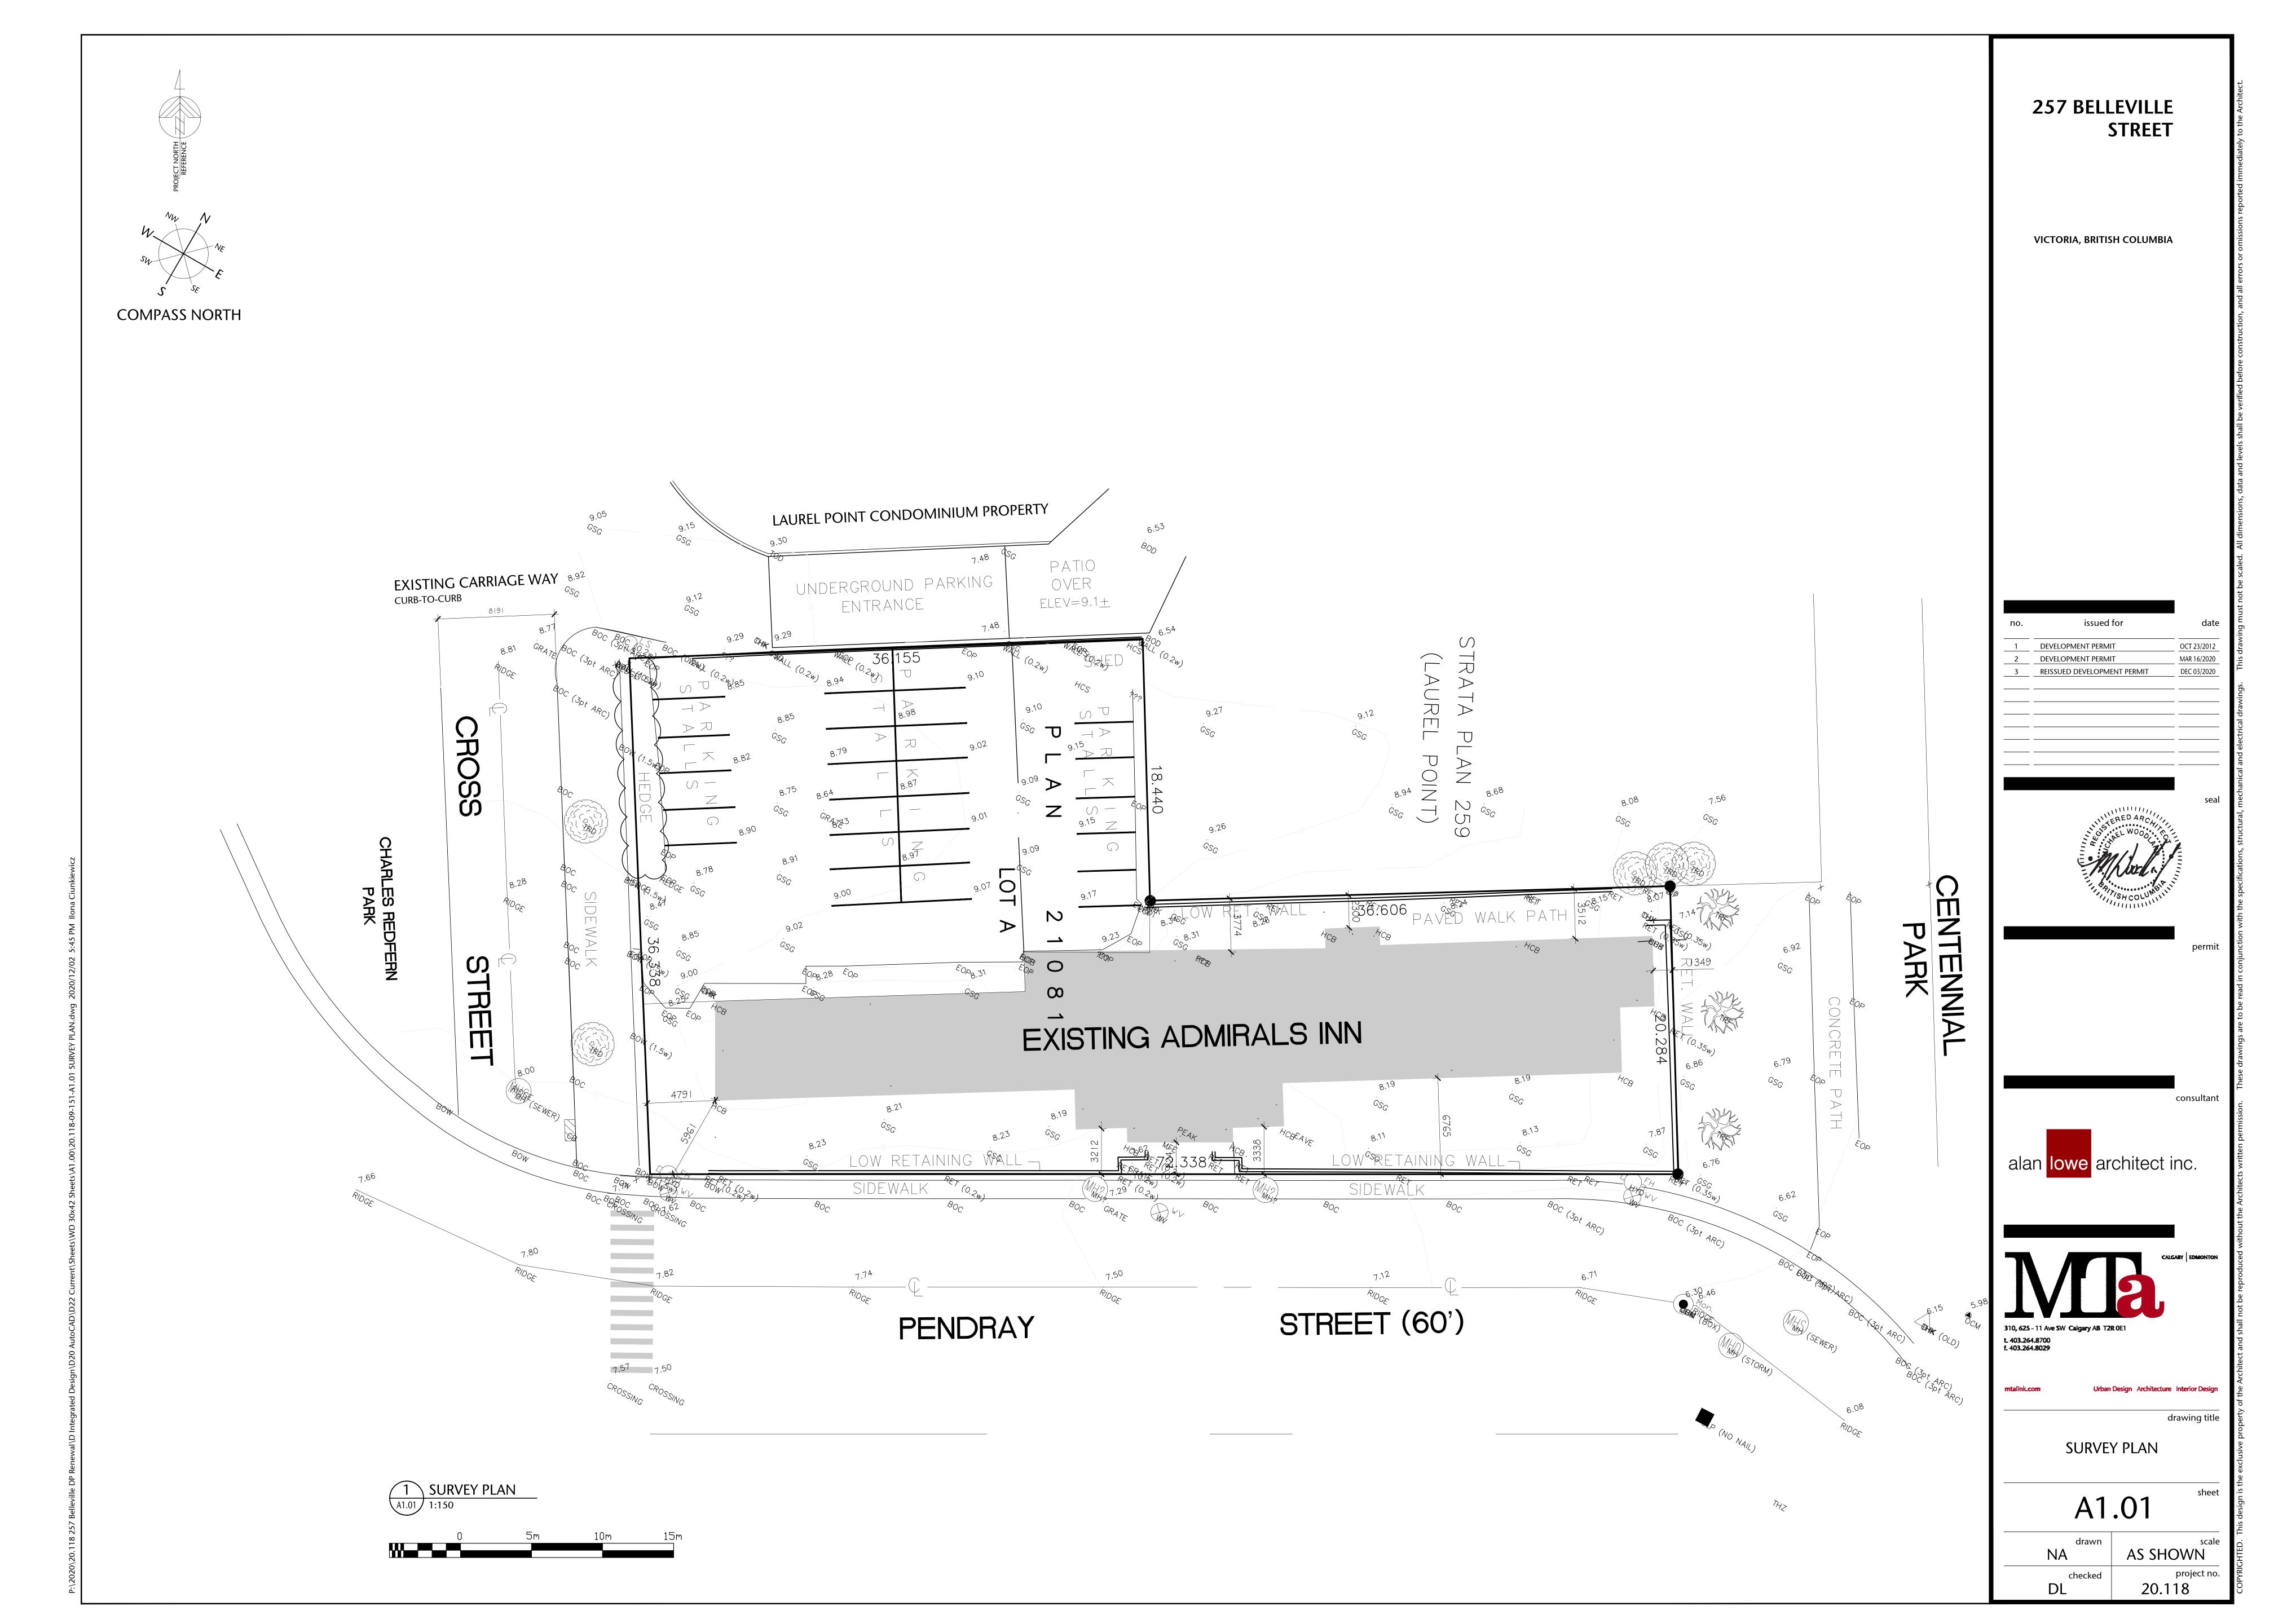
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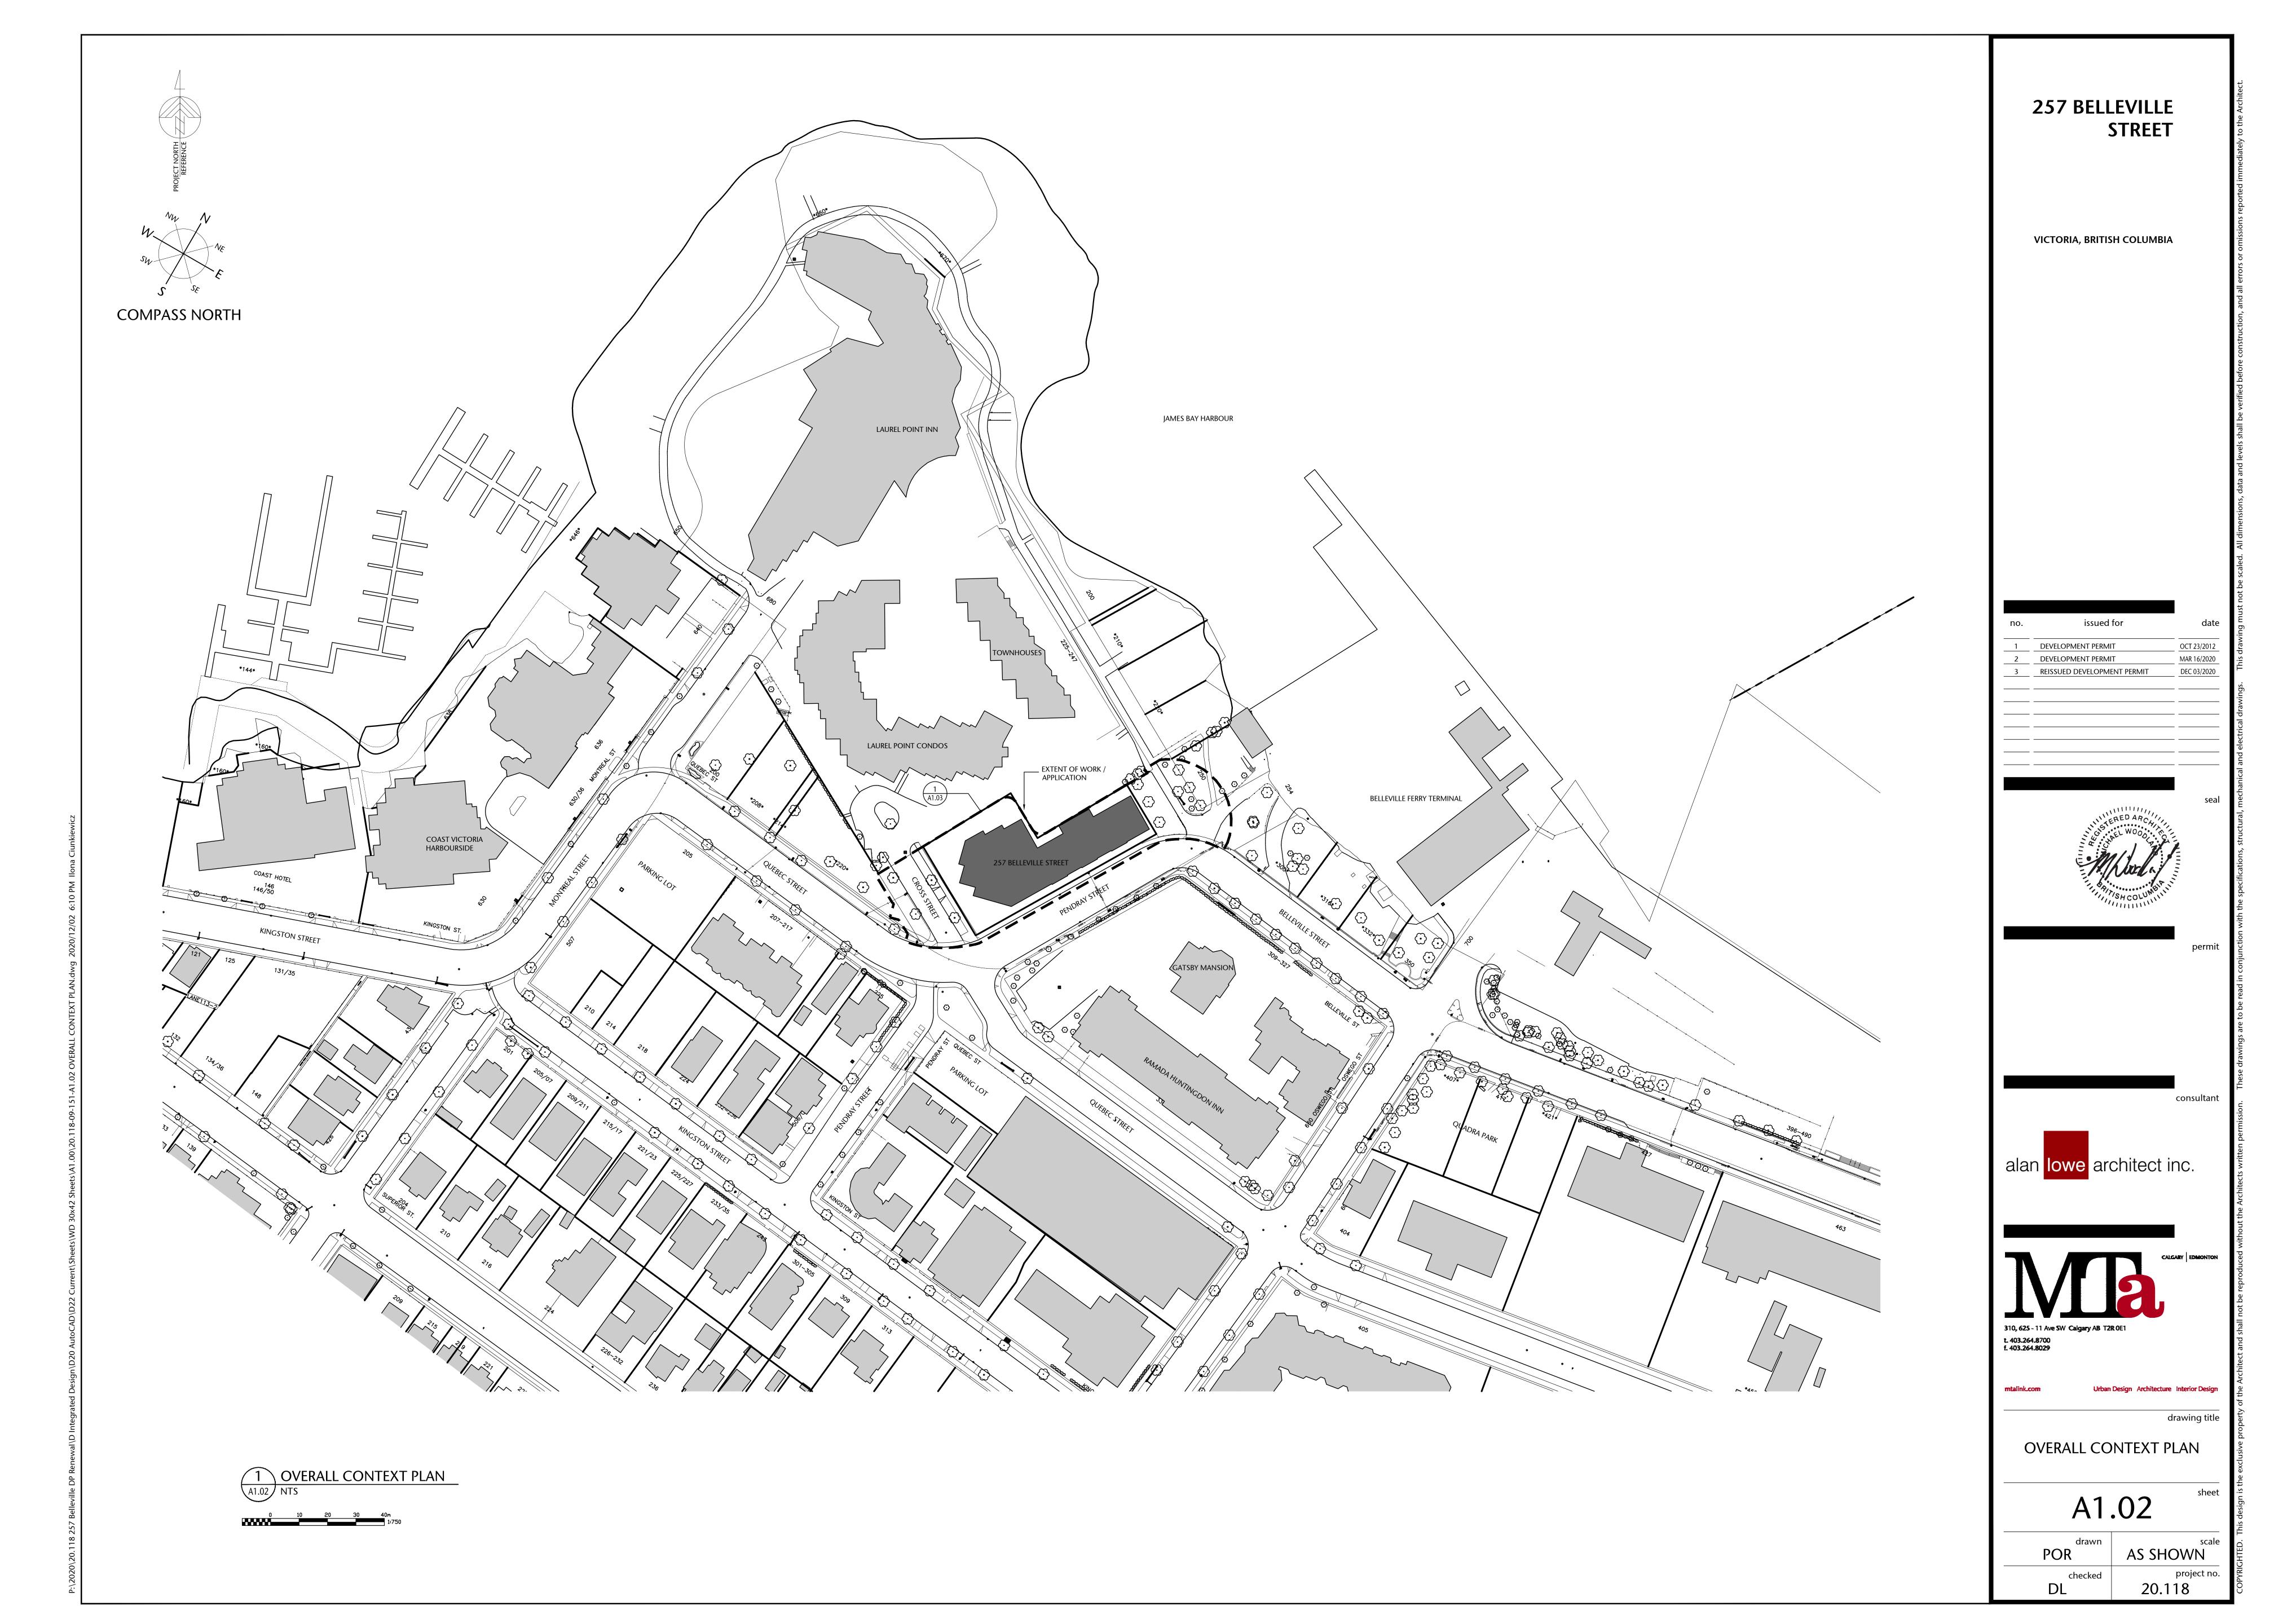
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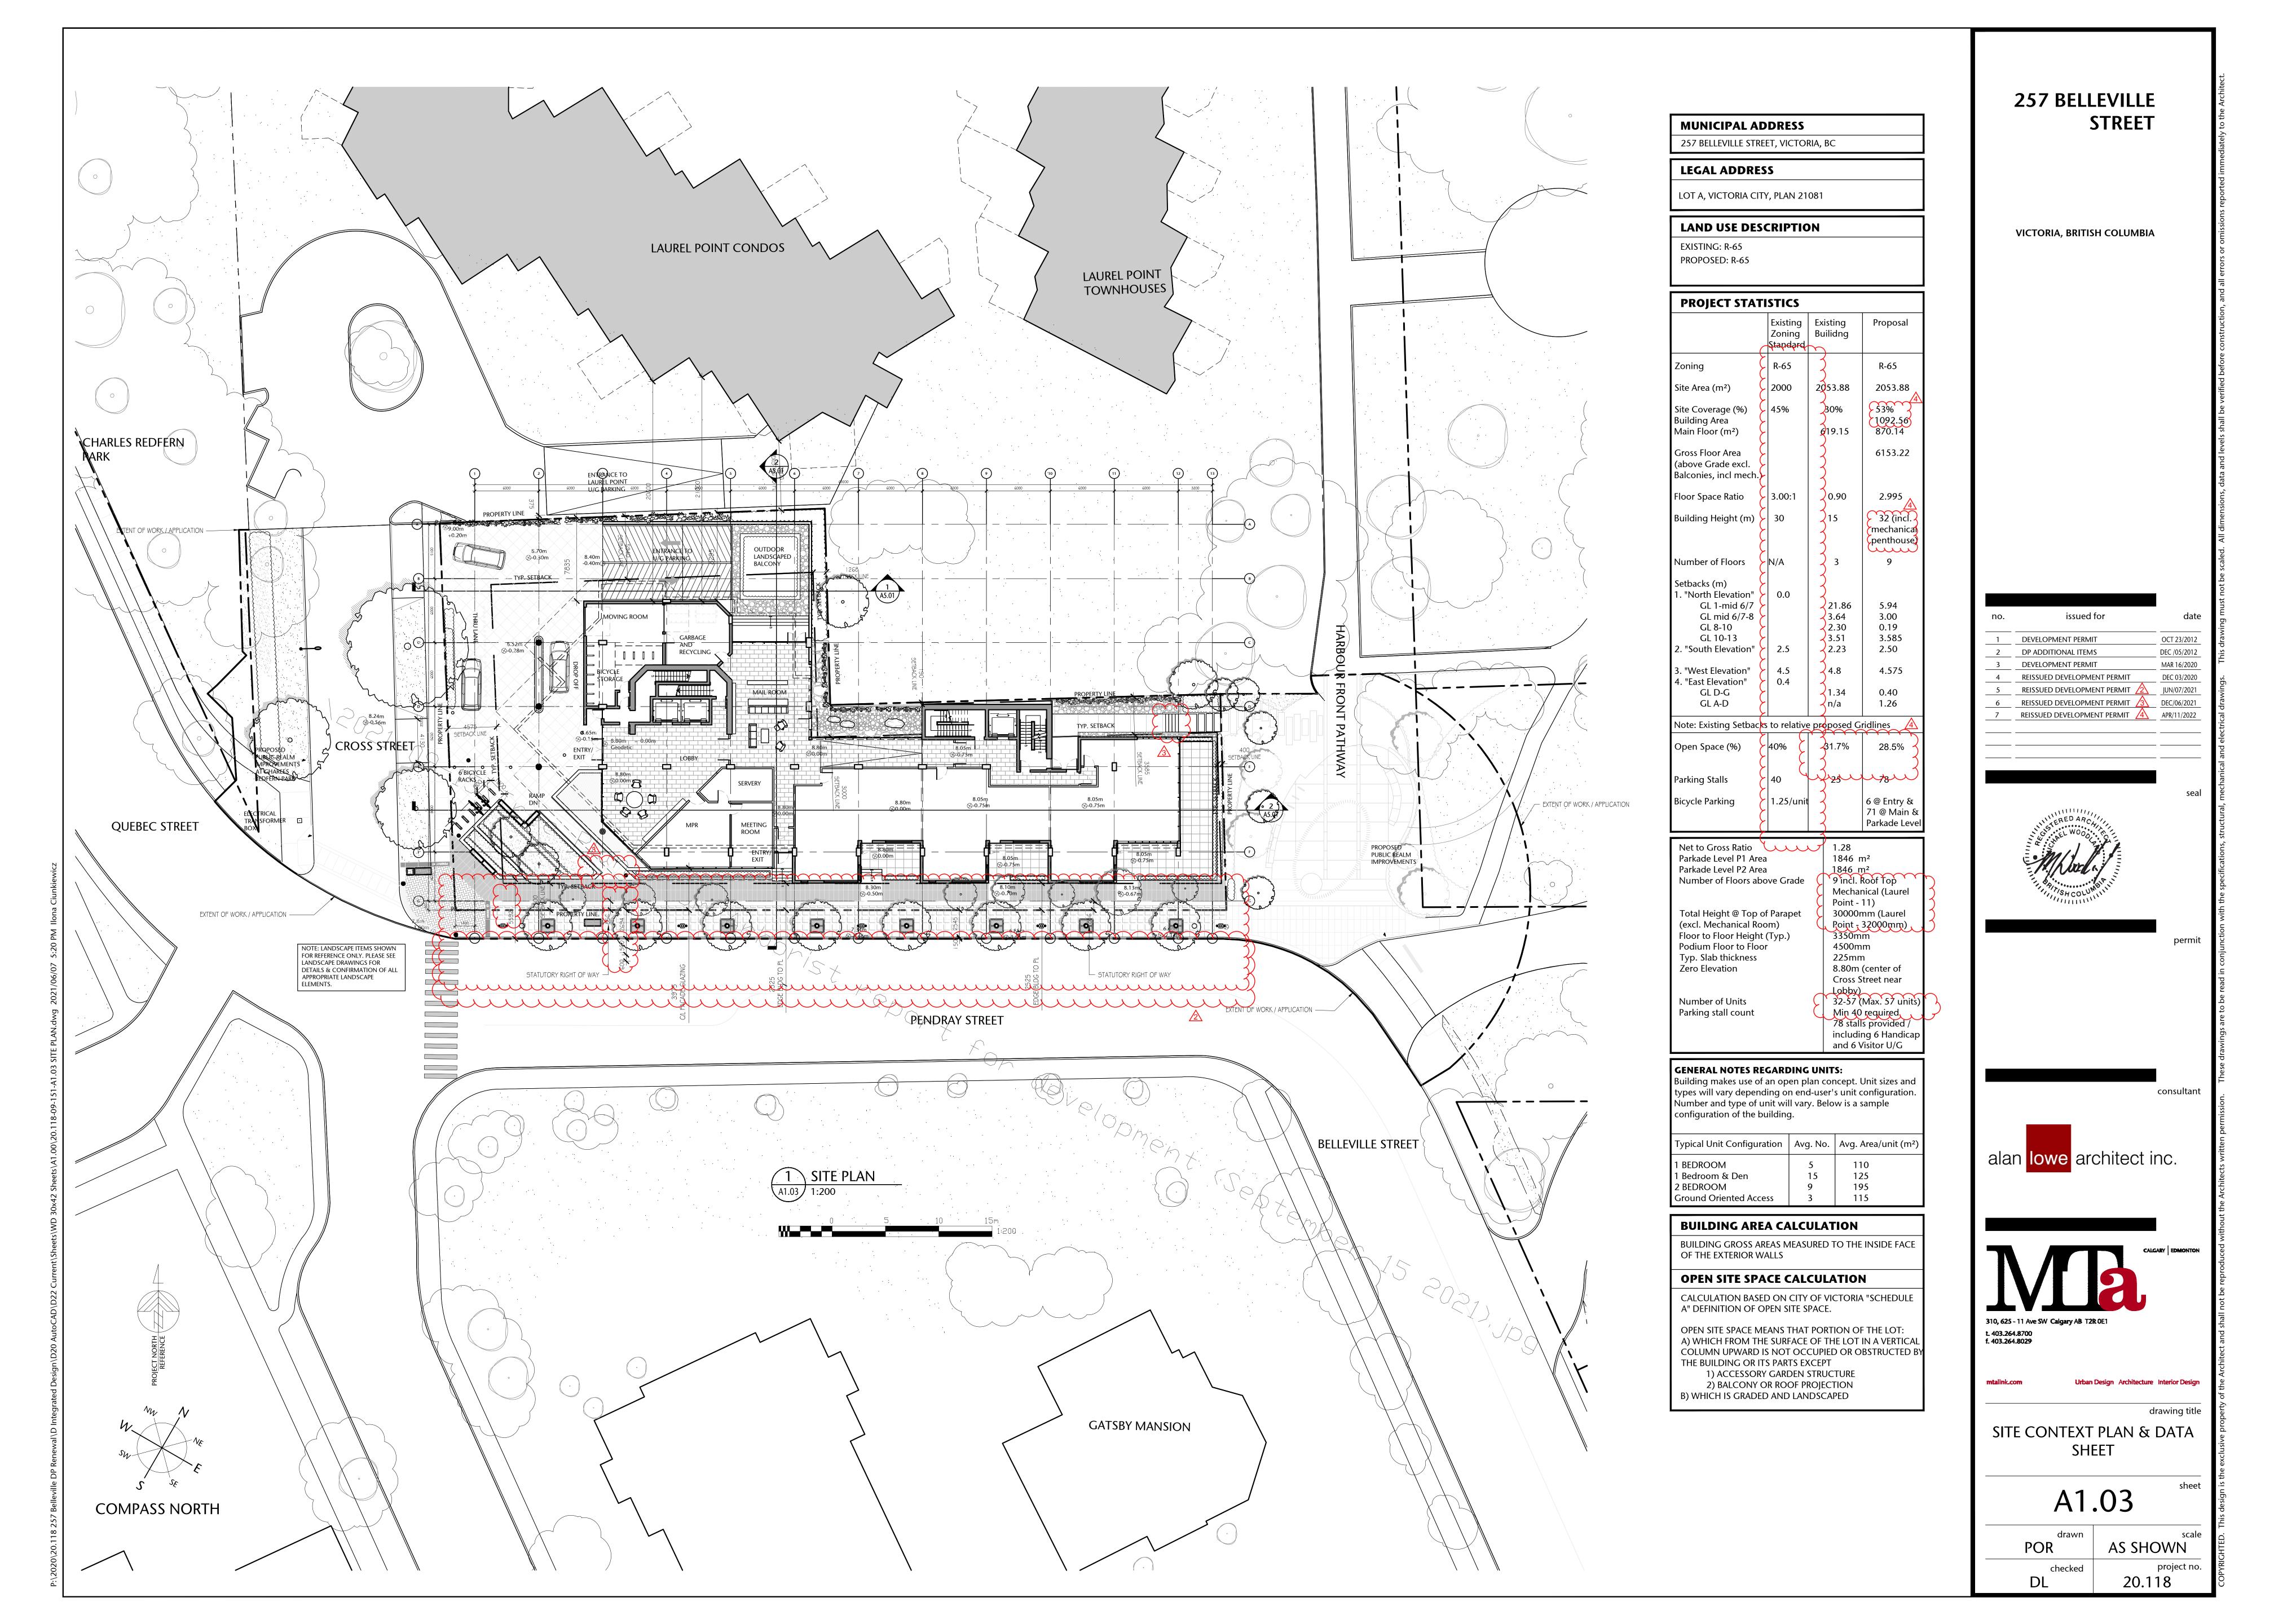
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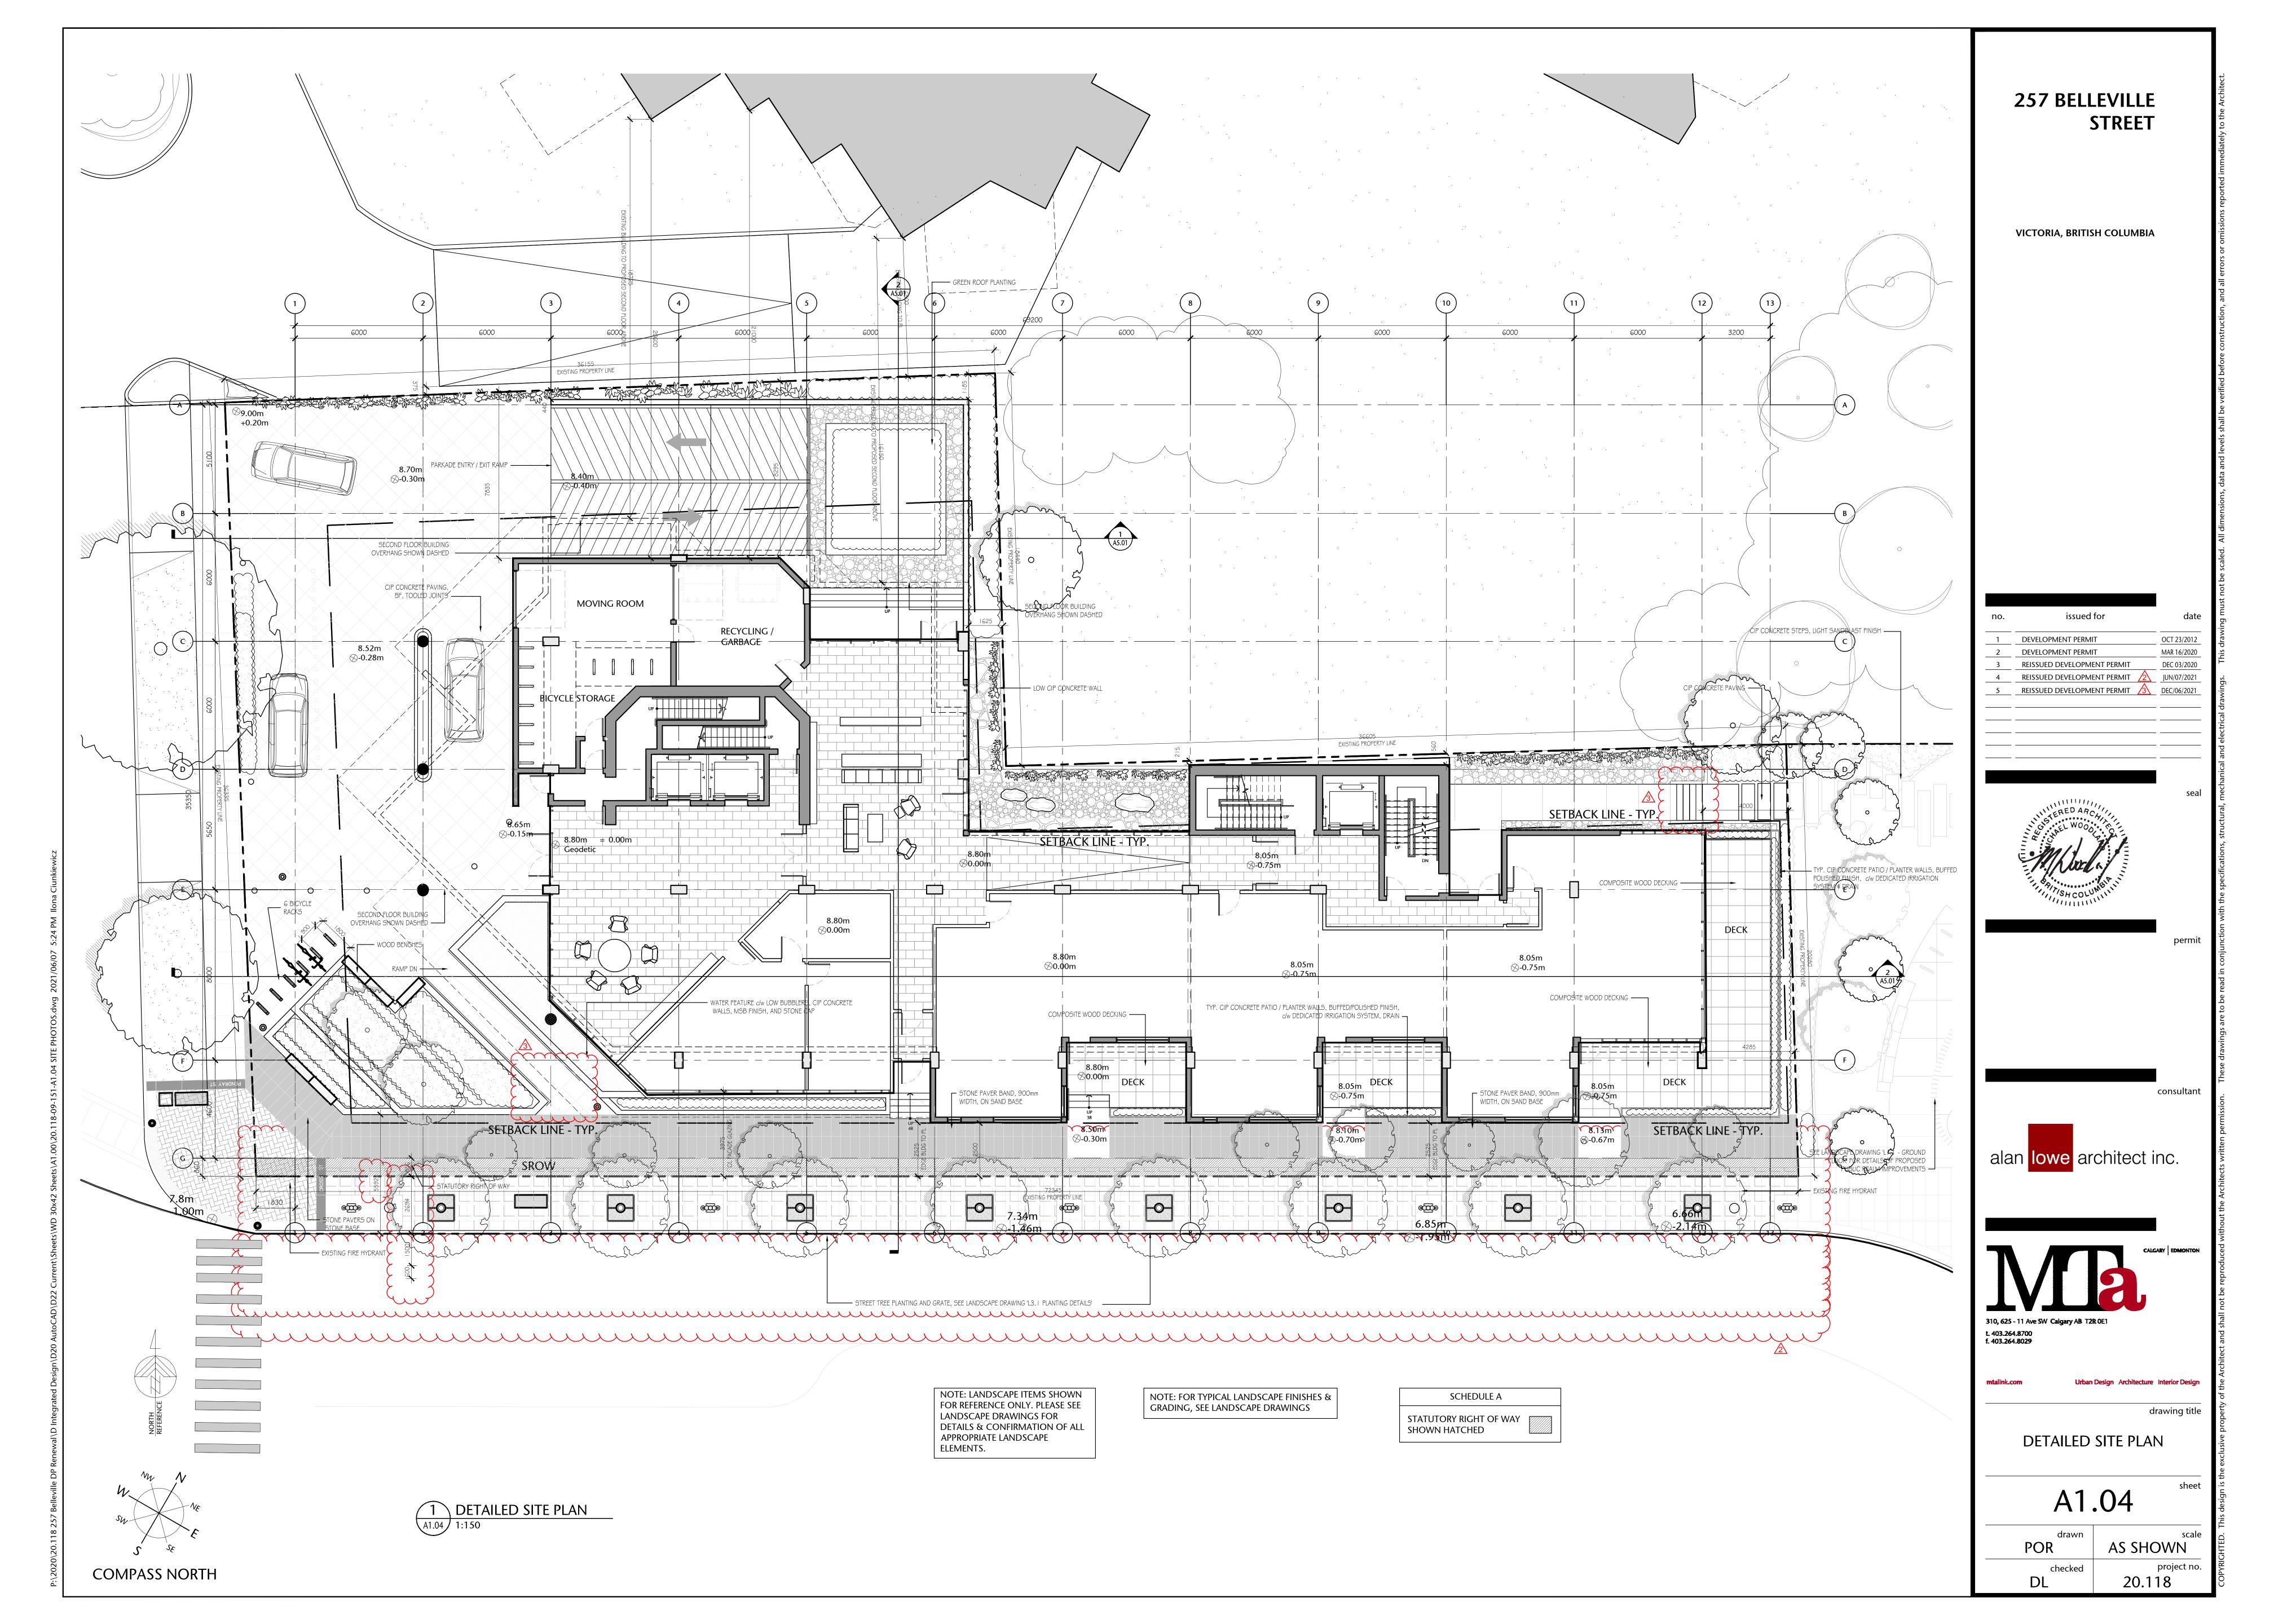
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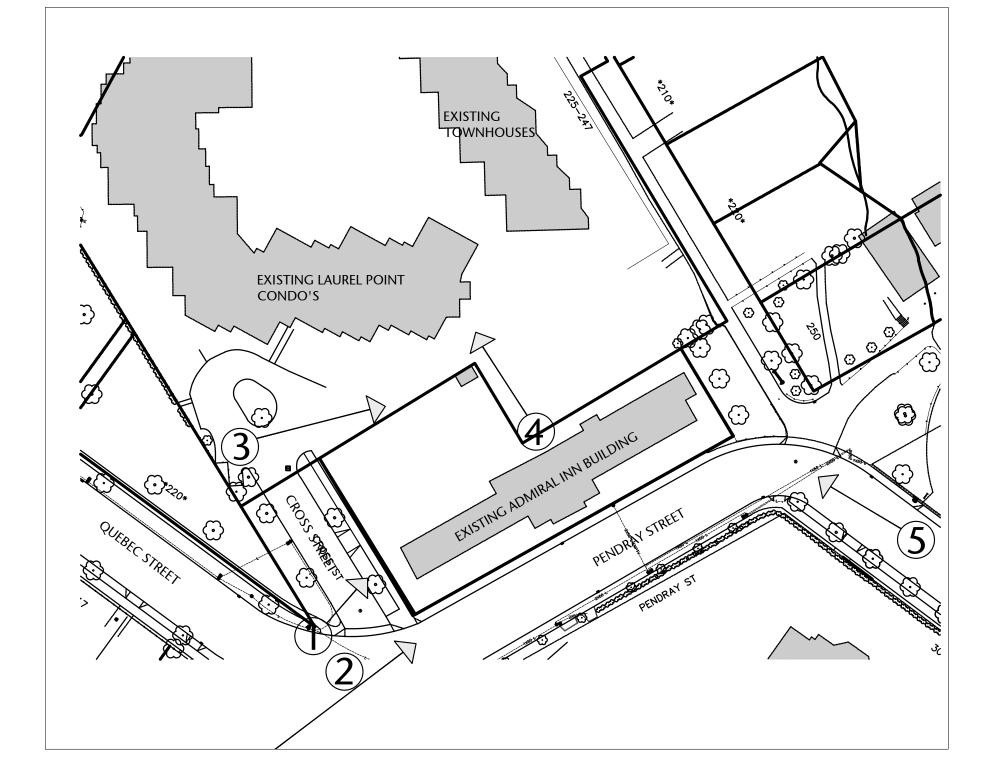


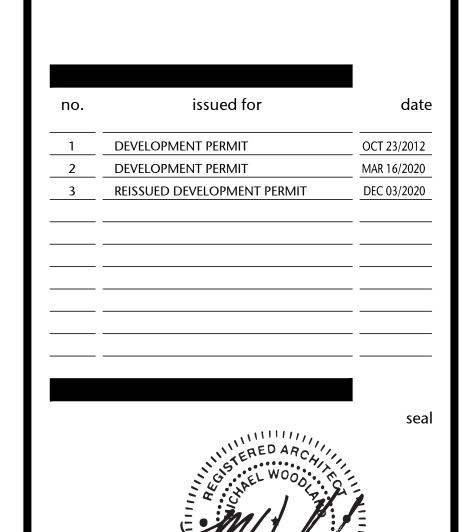PHOTO LOCATION PLAN

NTS



1 QUEBEC STREET LOOKING EAST DOWN PENDRAY STREET

PENDRAY STREET LOOKING NORTH - EXISTING ADMIRAL'S INN BUILDING



3 VIEW LOOKING SOUTH DOWN CROSS STREET

NTS



4 LOOKING NORTH AT ADJACENT LAUREL POINT CONDO'S



5 VIEW LOOKING NORTH UP BELLEVILLE STREET - EXISTING ADMIRAL'S INN BUILDING

257 BELLEVILLE STREET

VICTORIA, BRITISH COLUMBIA





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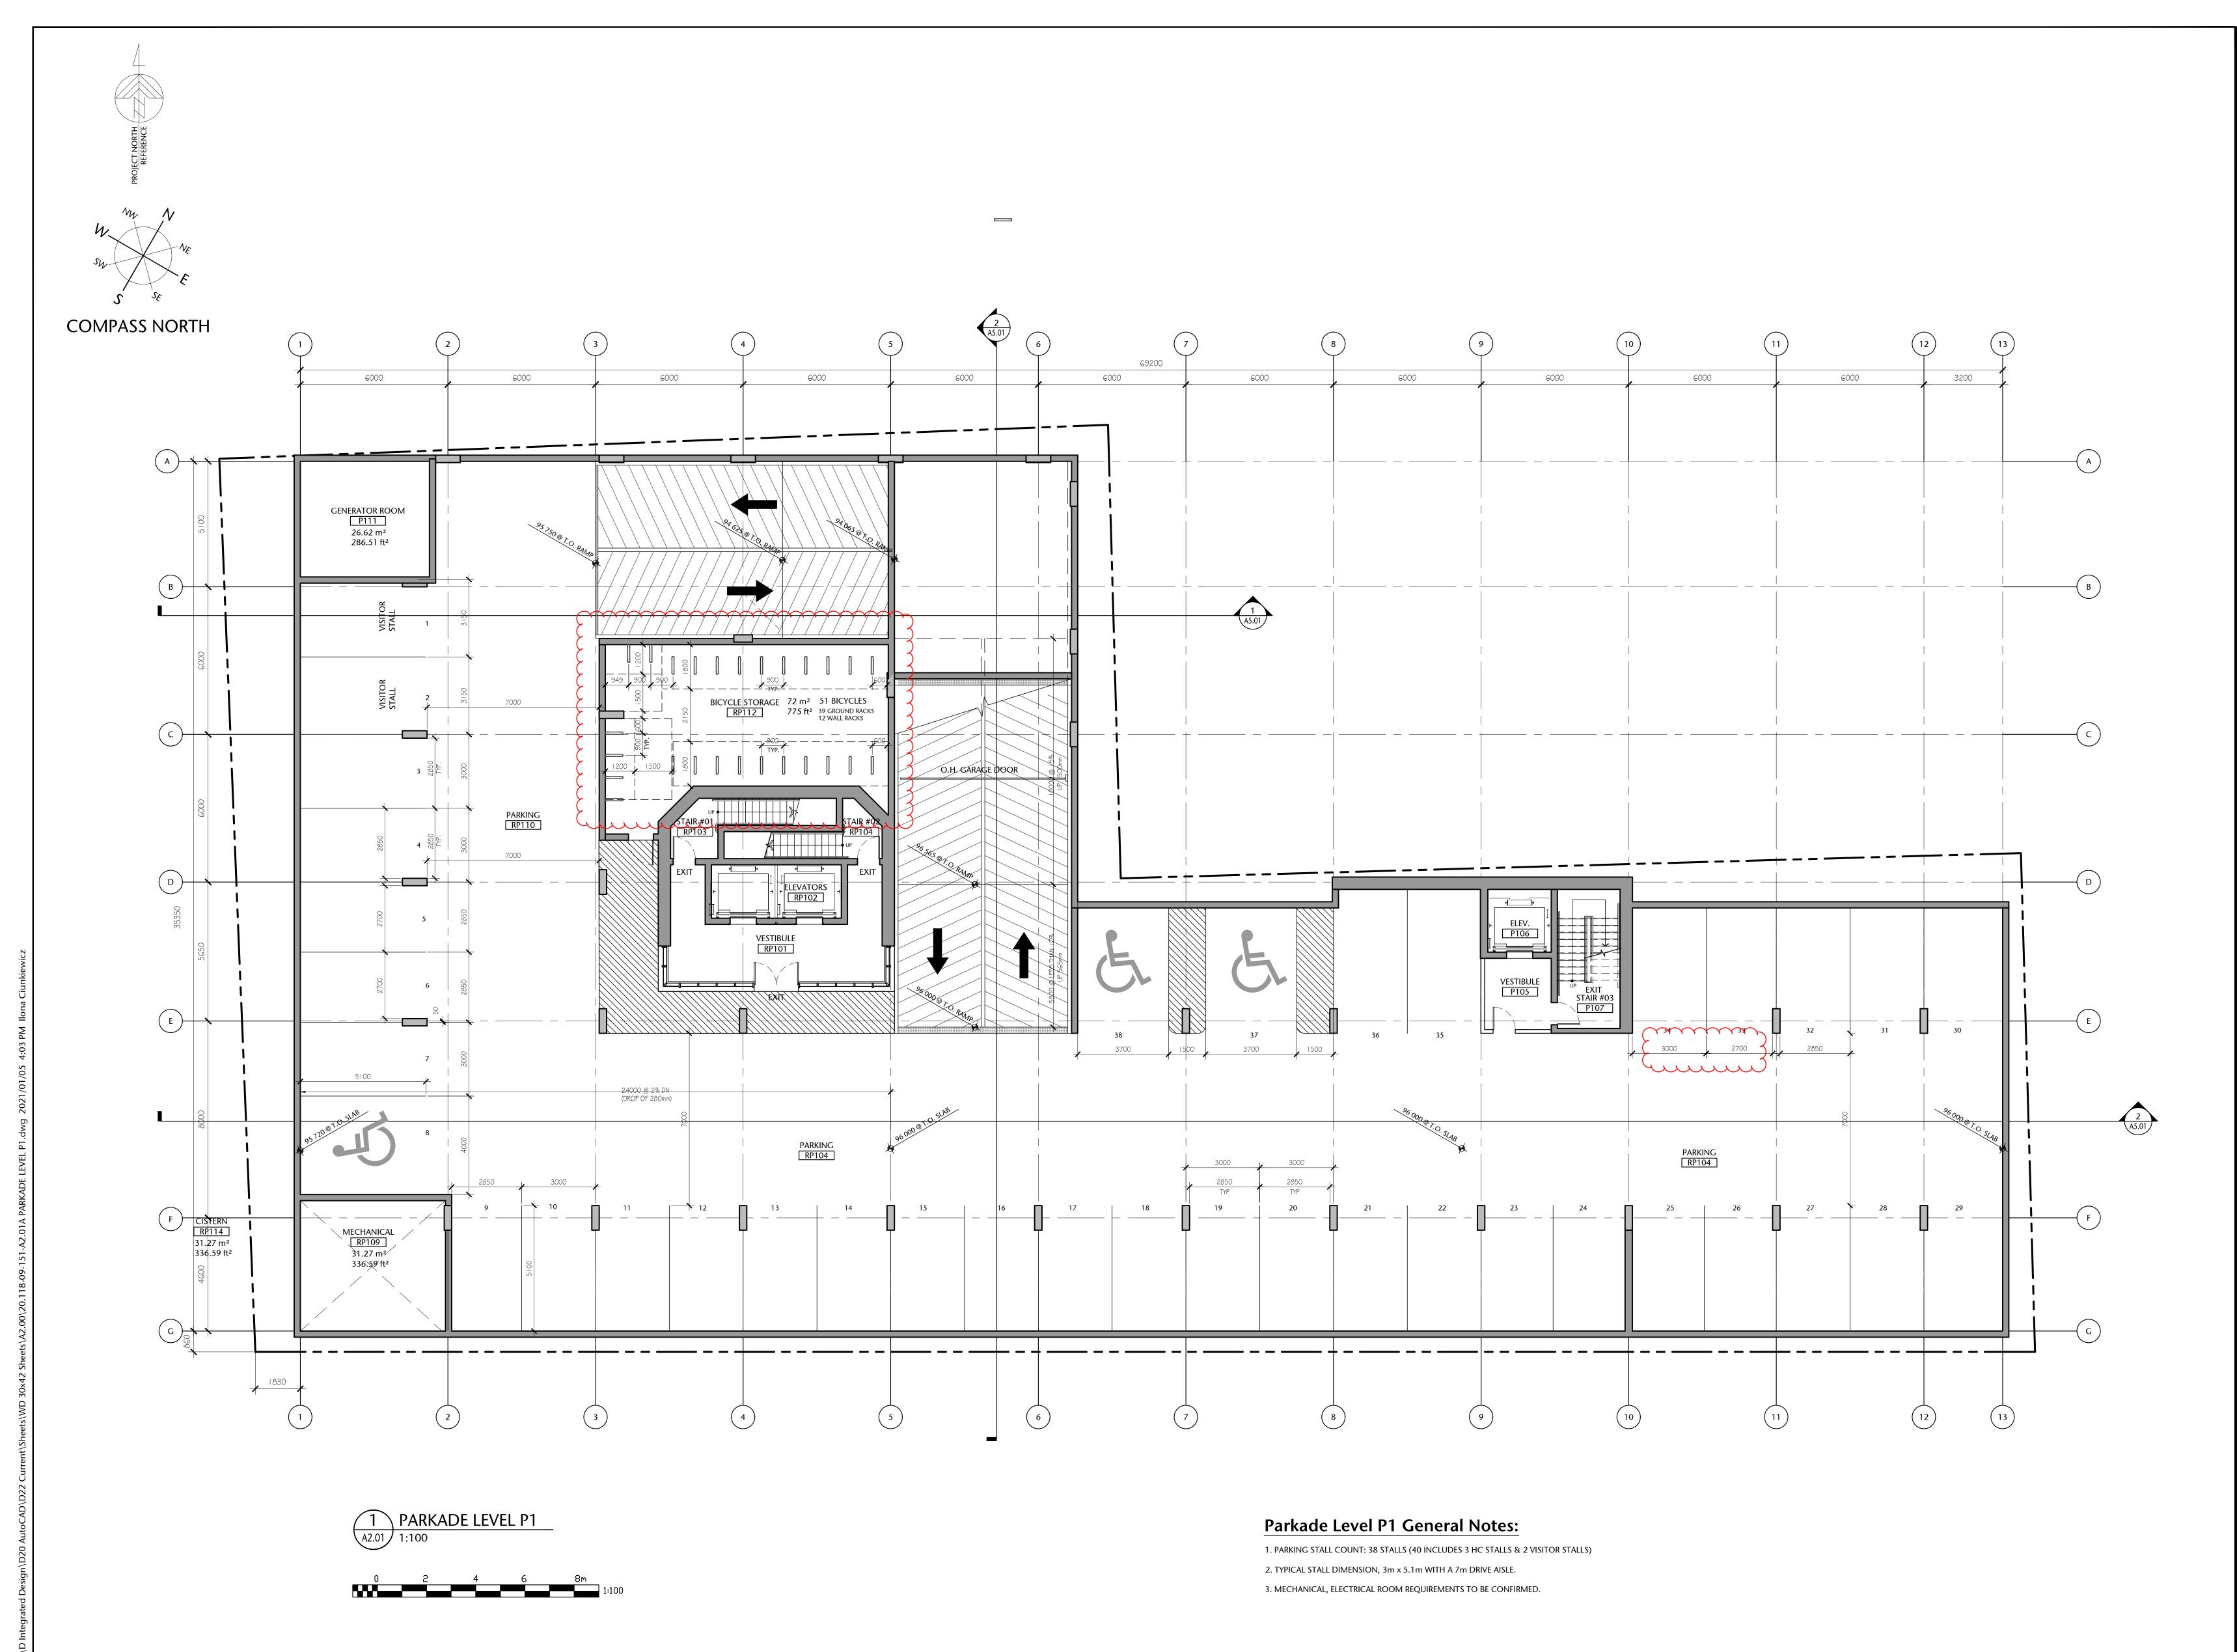
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SITE PHOTOS

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1	DEVELOPMENT PERMIT	OCT 23/2012
2	DP ADDITIONAL ITEMS	DEC 05/2012
3	DP ADDITIONAL ITEMS	DEC 12/2012
4	DEVELOPMENT PERMIT	MAR 16/2020
5	REISSUED DEVELOPMENT PERMIT	DEC 03/2020



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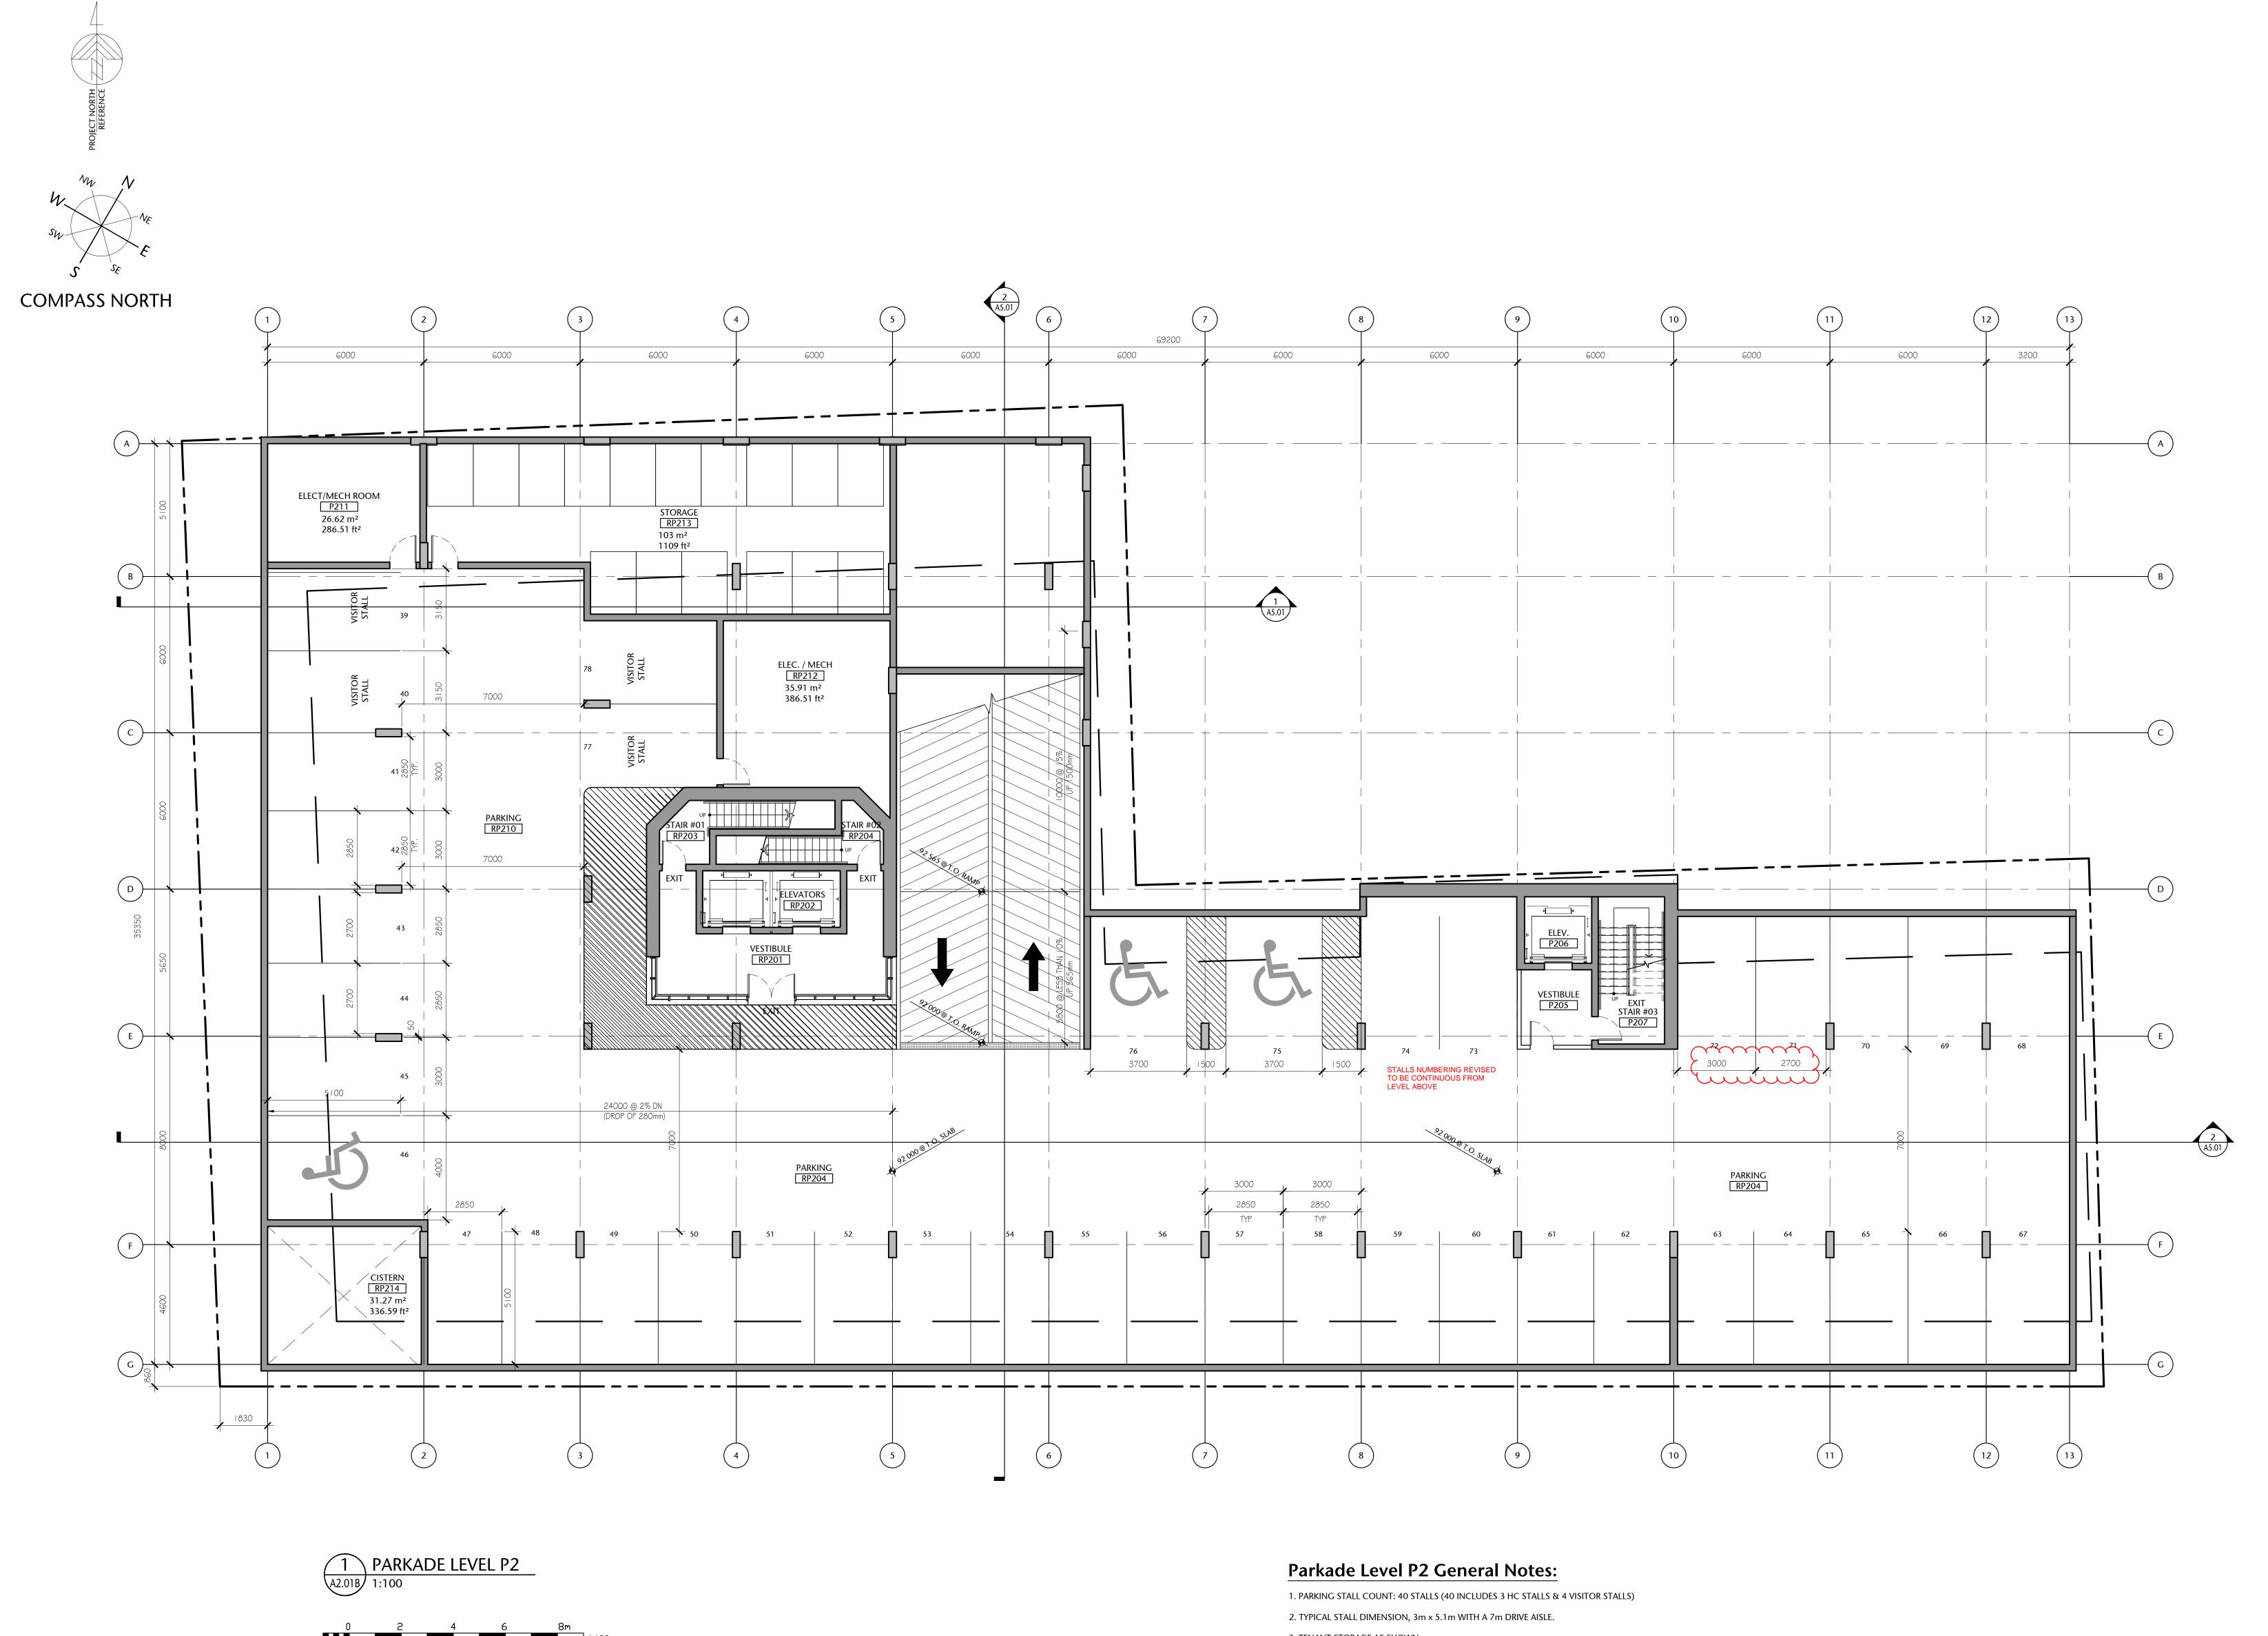
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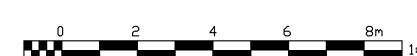
PARKADE LEVEL P1

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checked project no.
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3. TENANT STORAGE AS SHOWN. MECHANICAL, ELECTRICAL ROOM REQUIREMENTS TO BE CONFIRMED.

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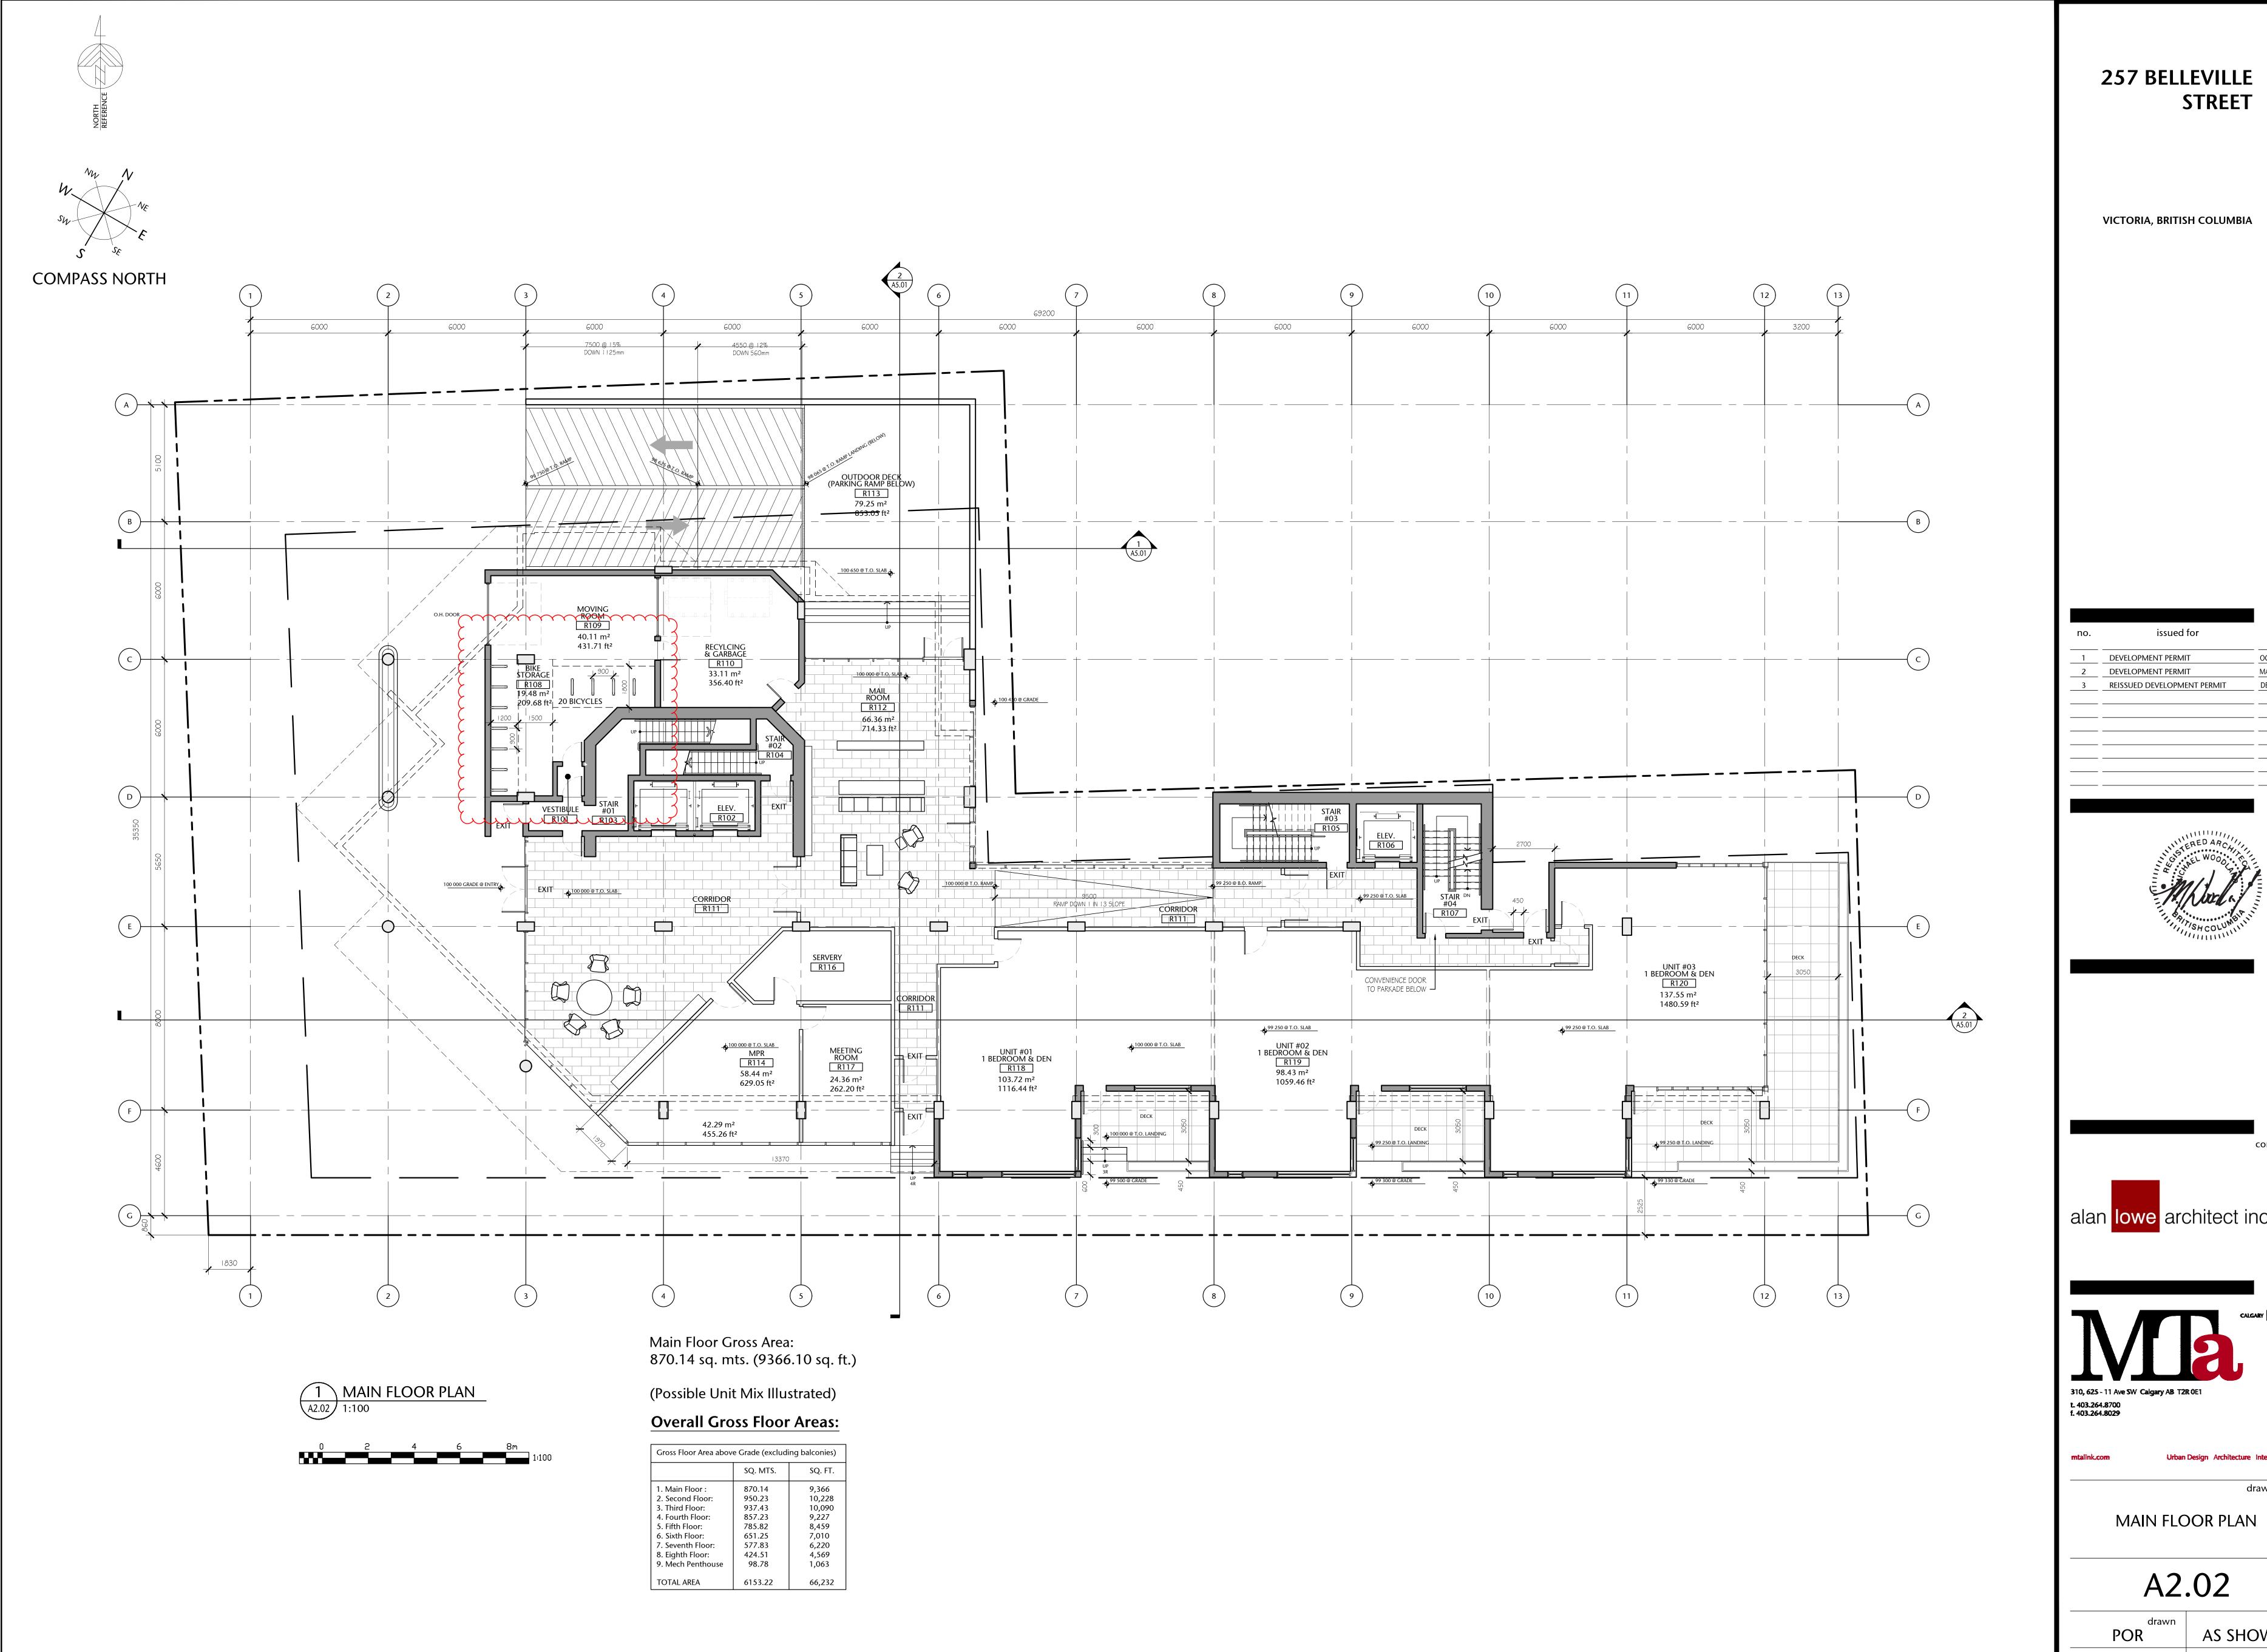
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PARKADE LEVEL P2

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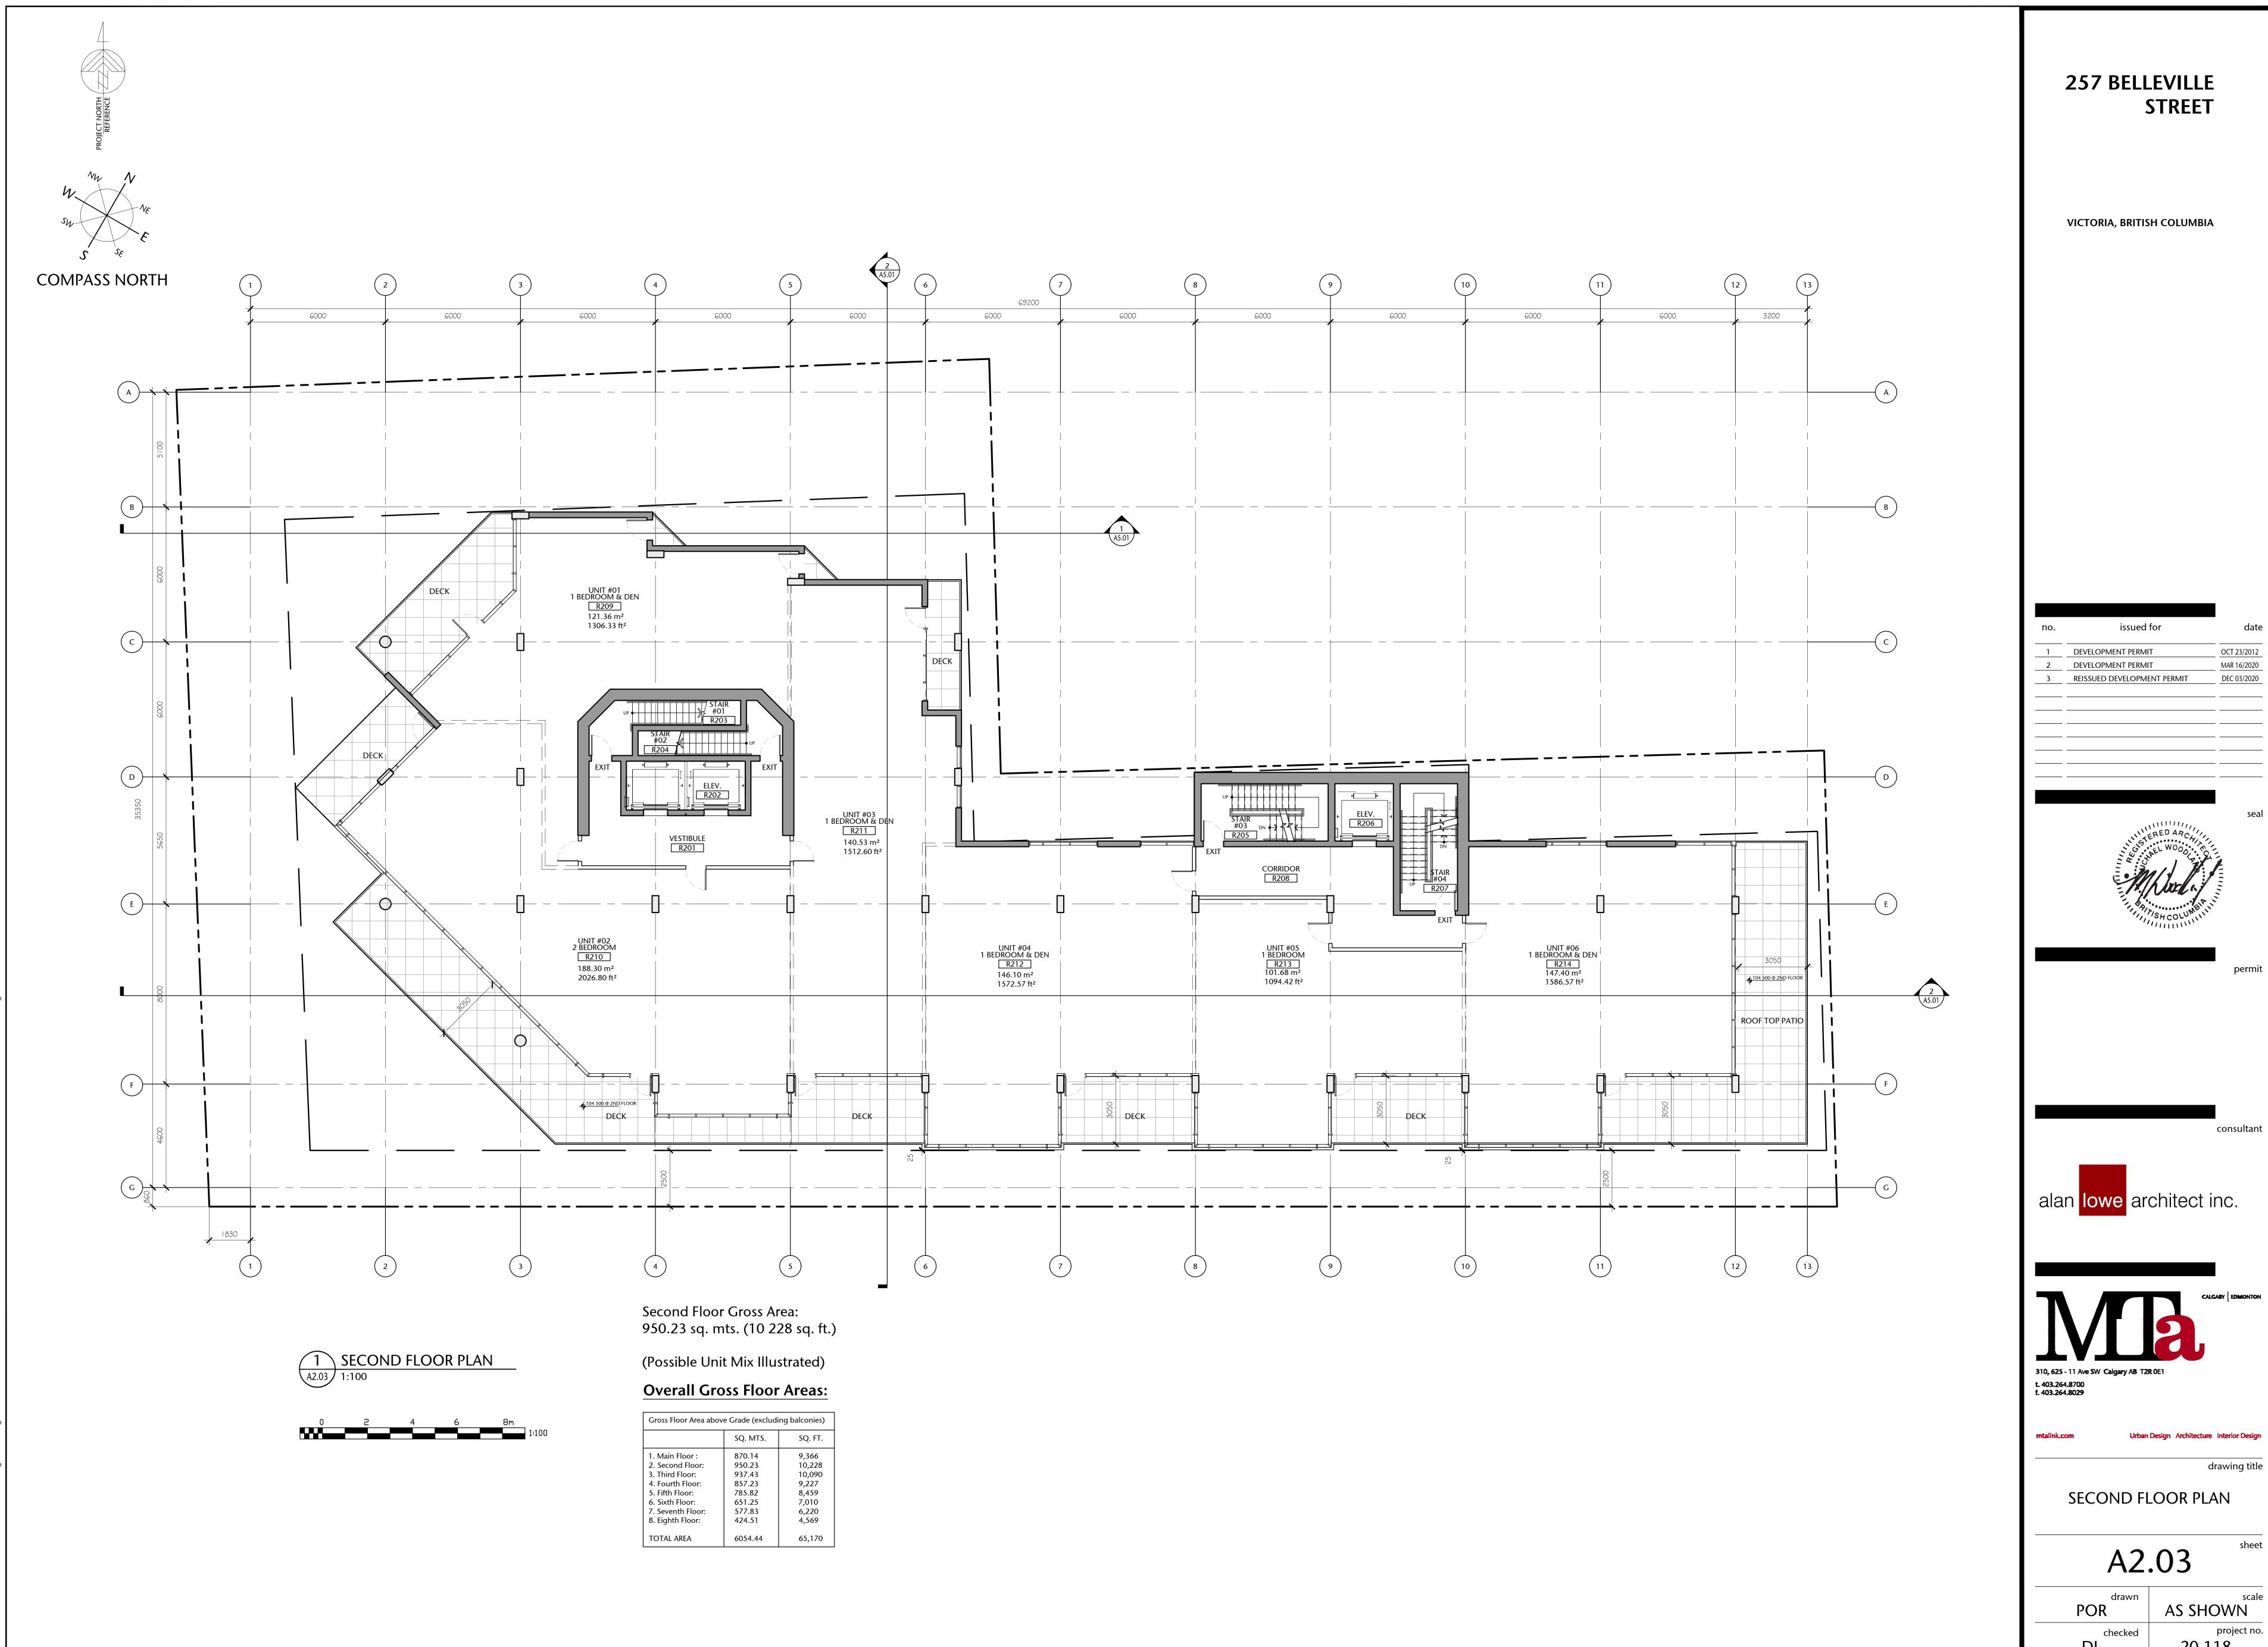





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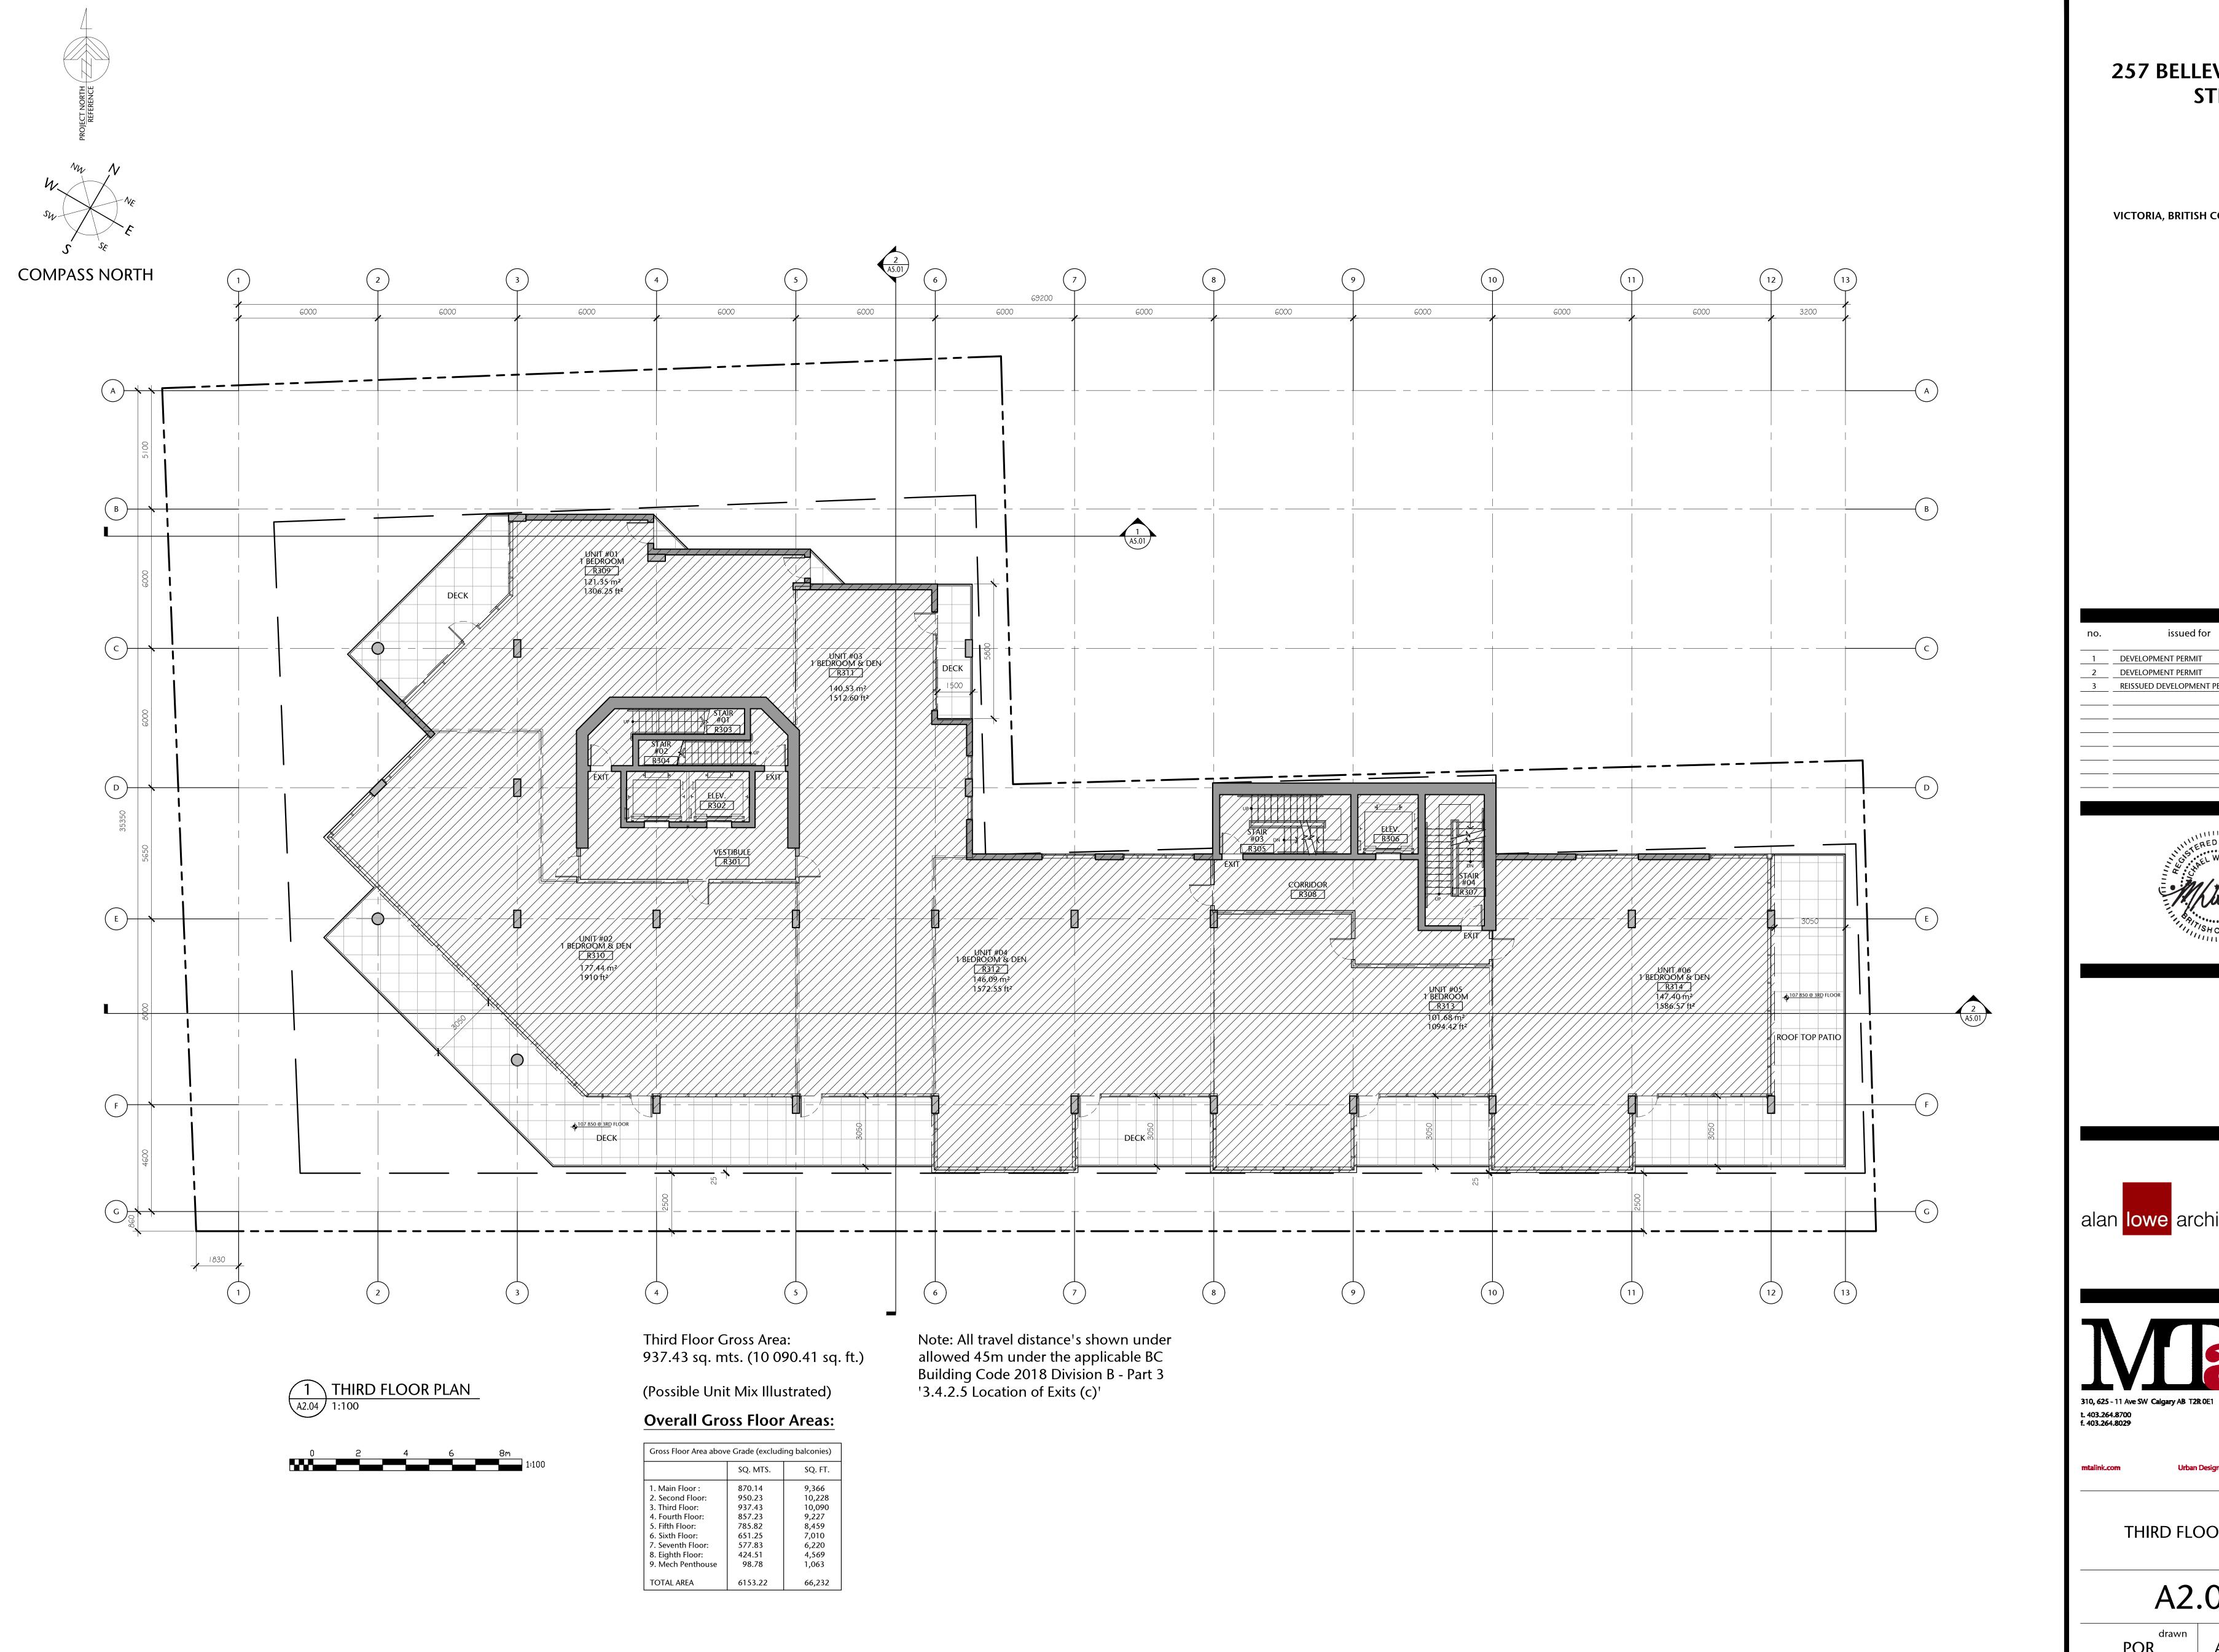
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AS SHOWN project no.



OCT 23/2012



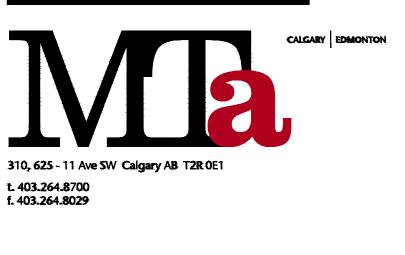

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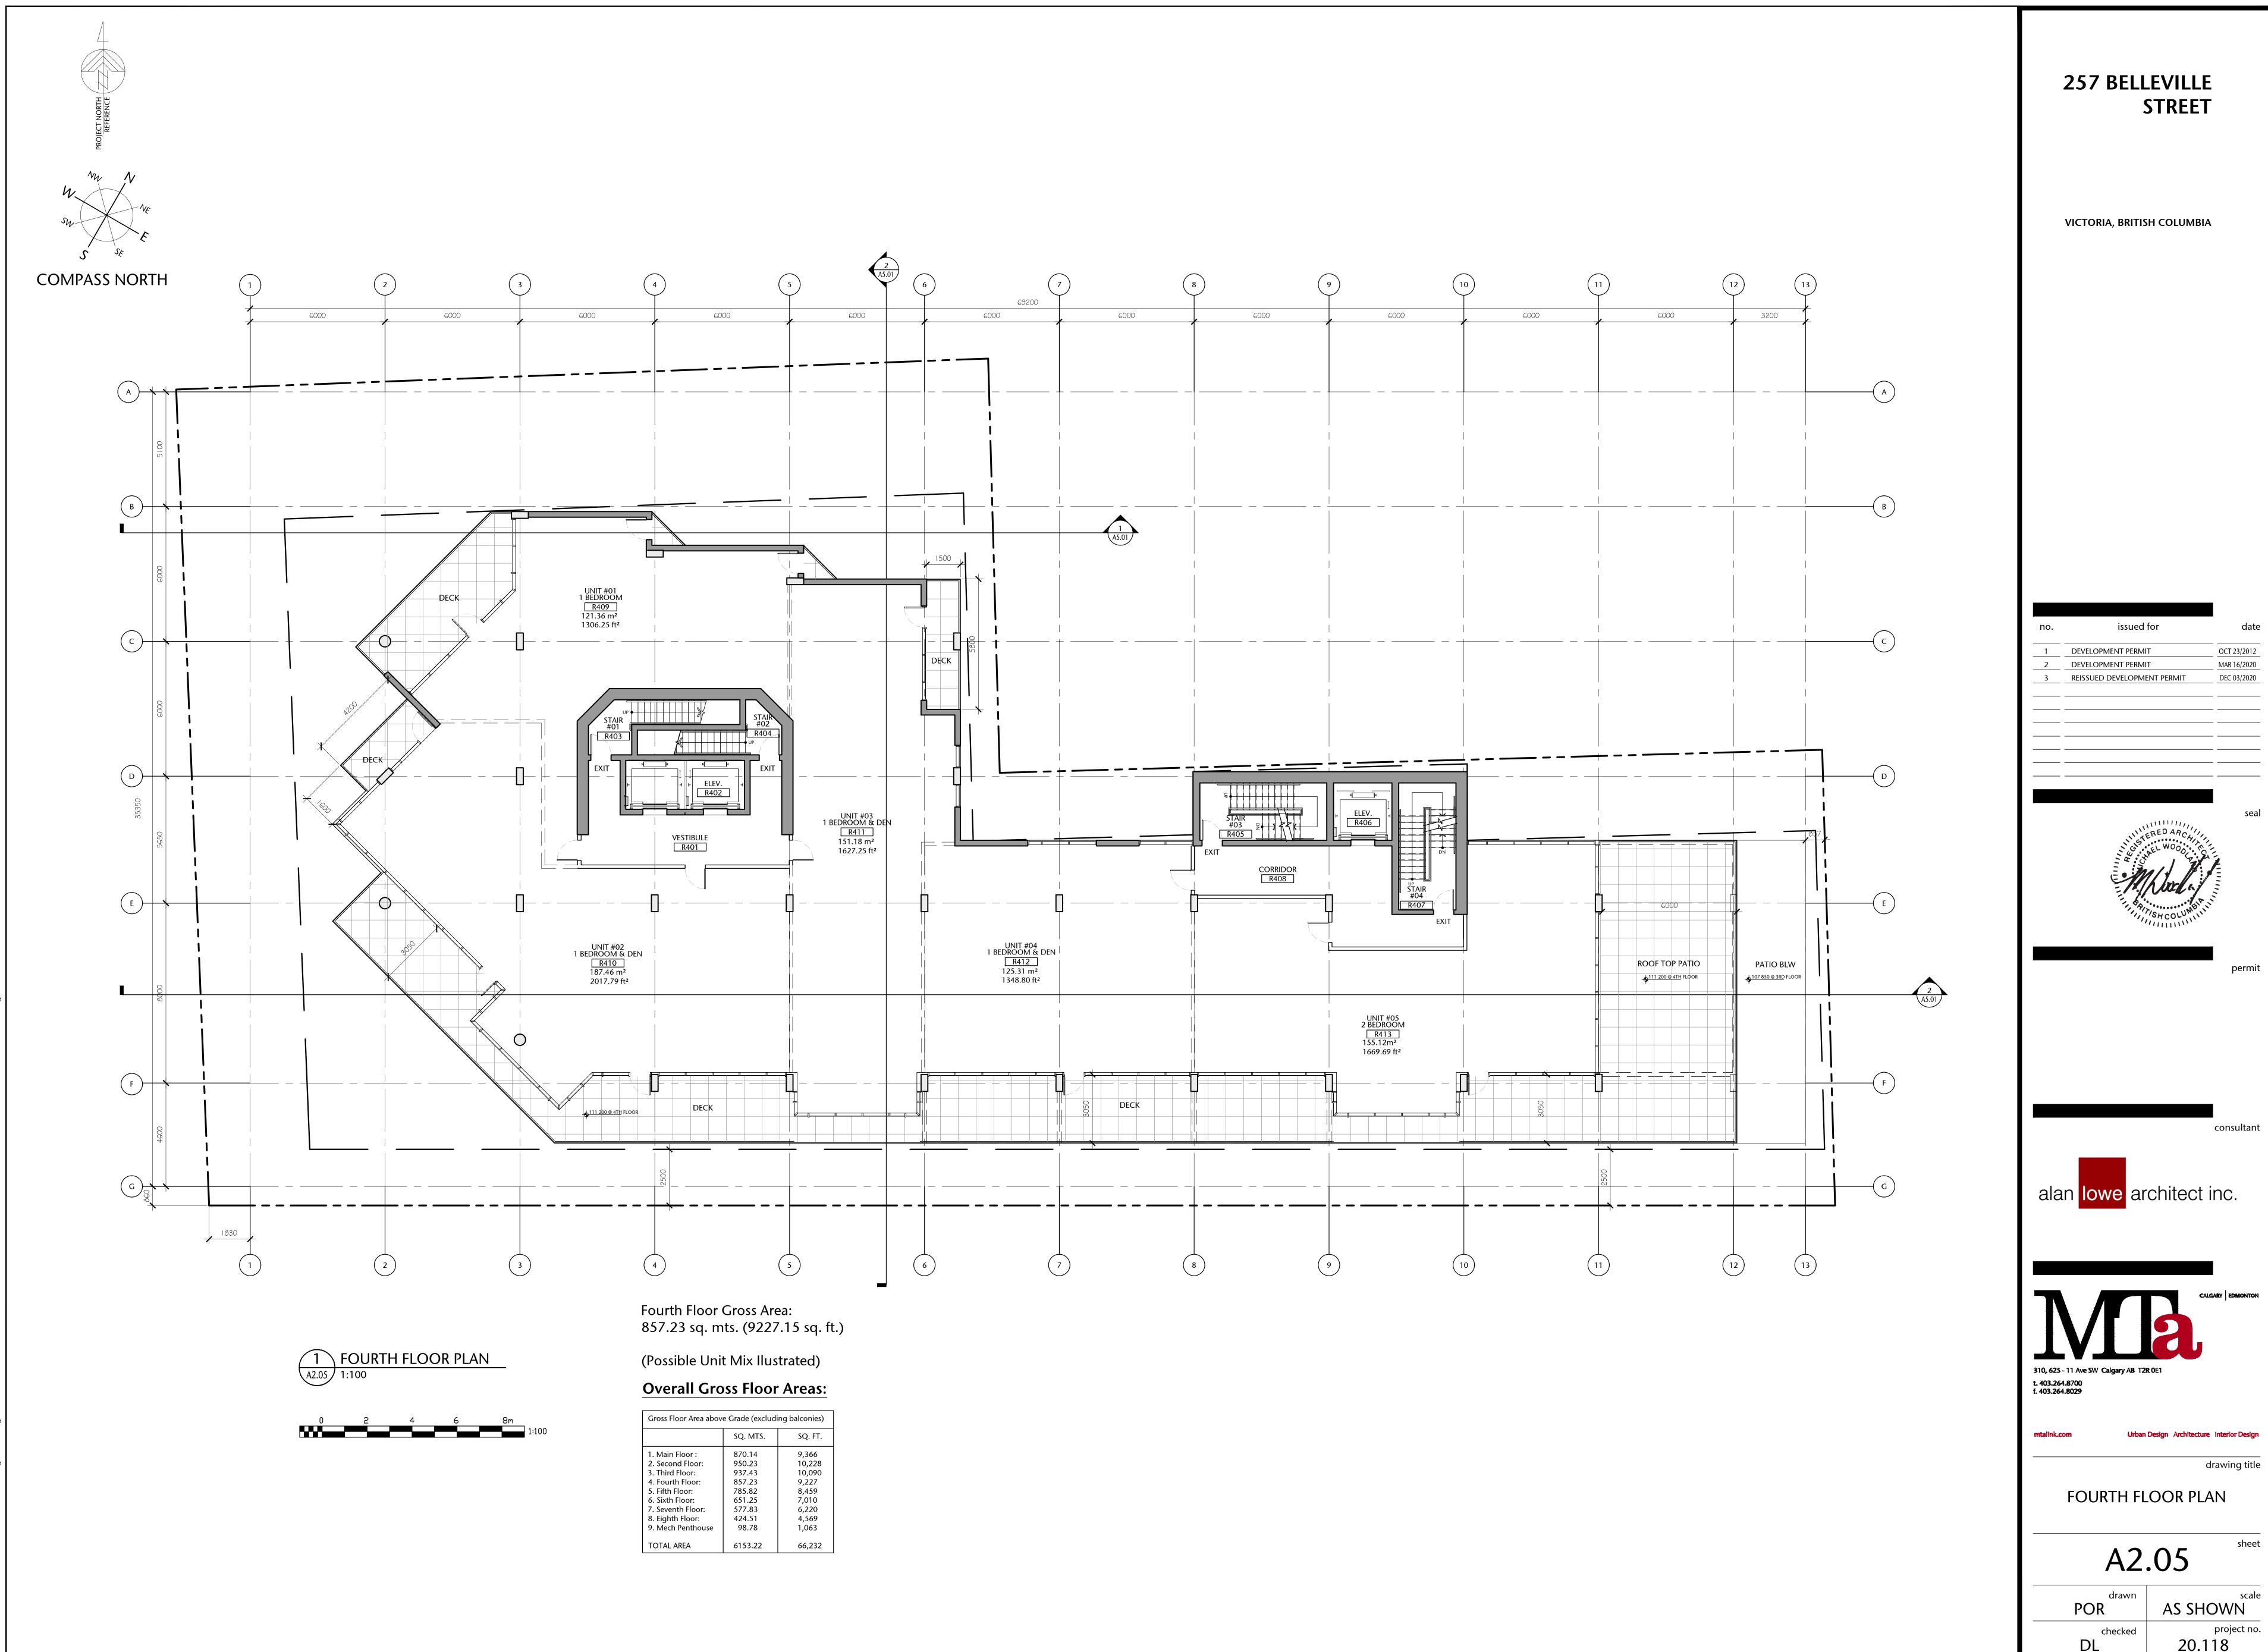


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THIRD FLOOR PLAN


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OCT 23/2012 MAR 16/2020 DEC 03/2020





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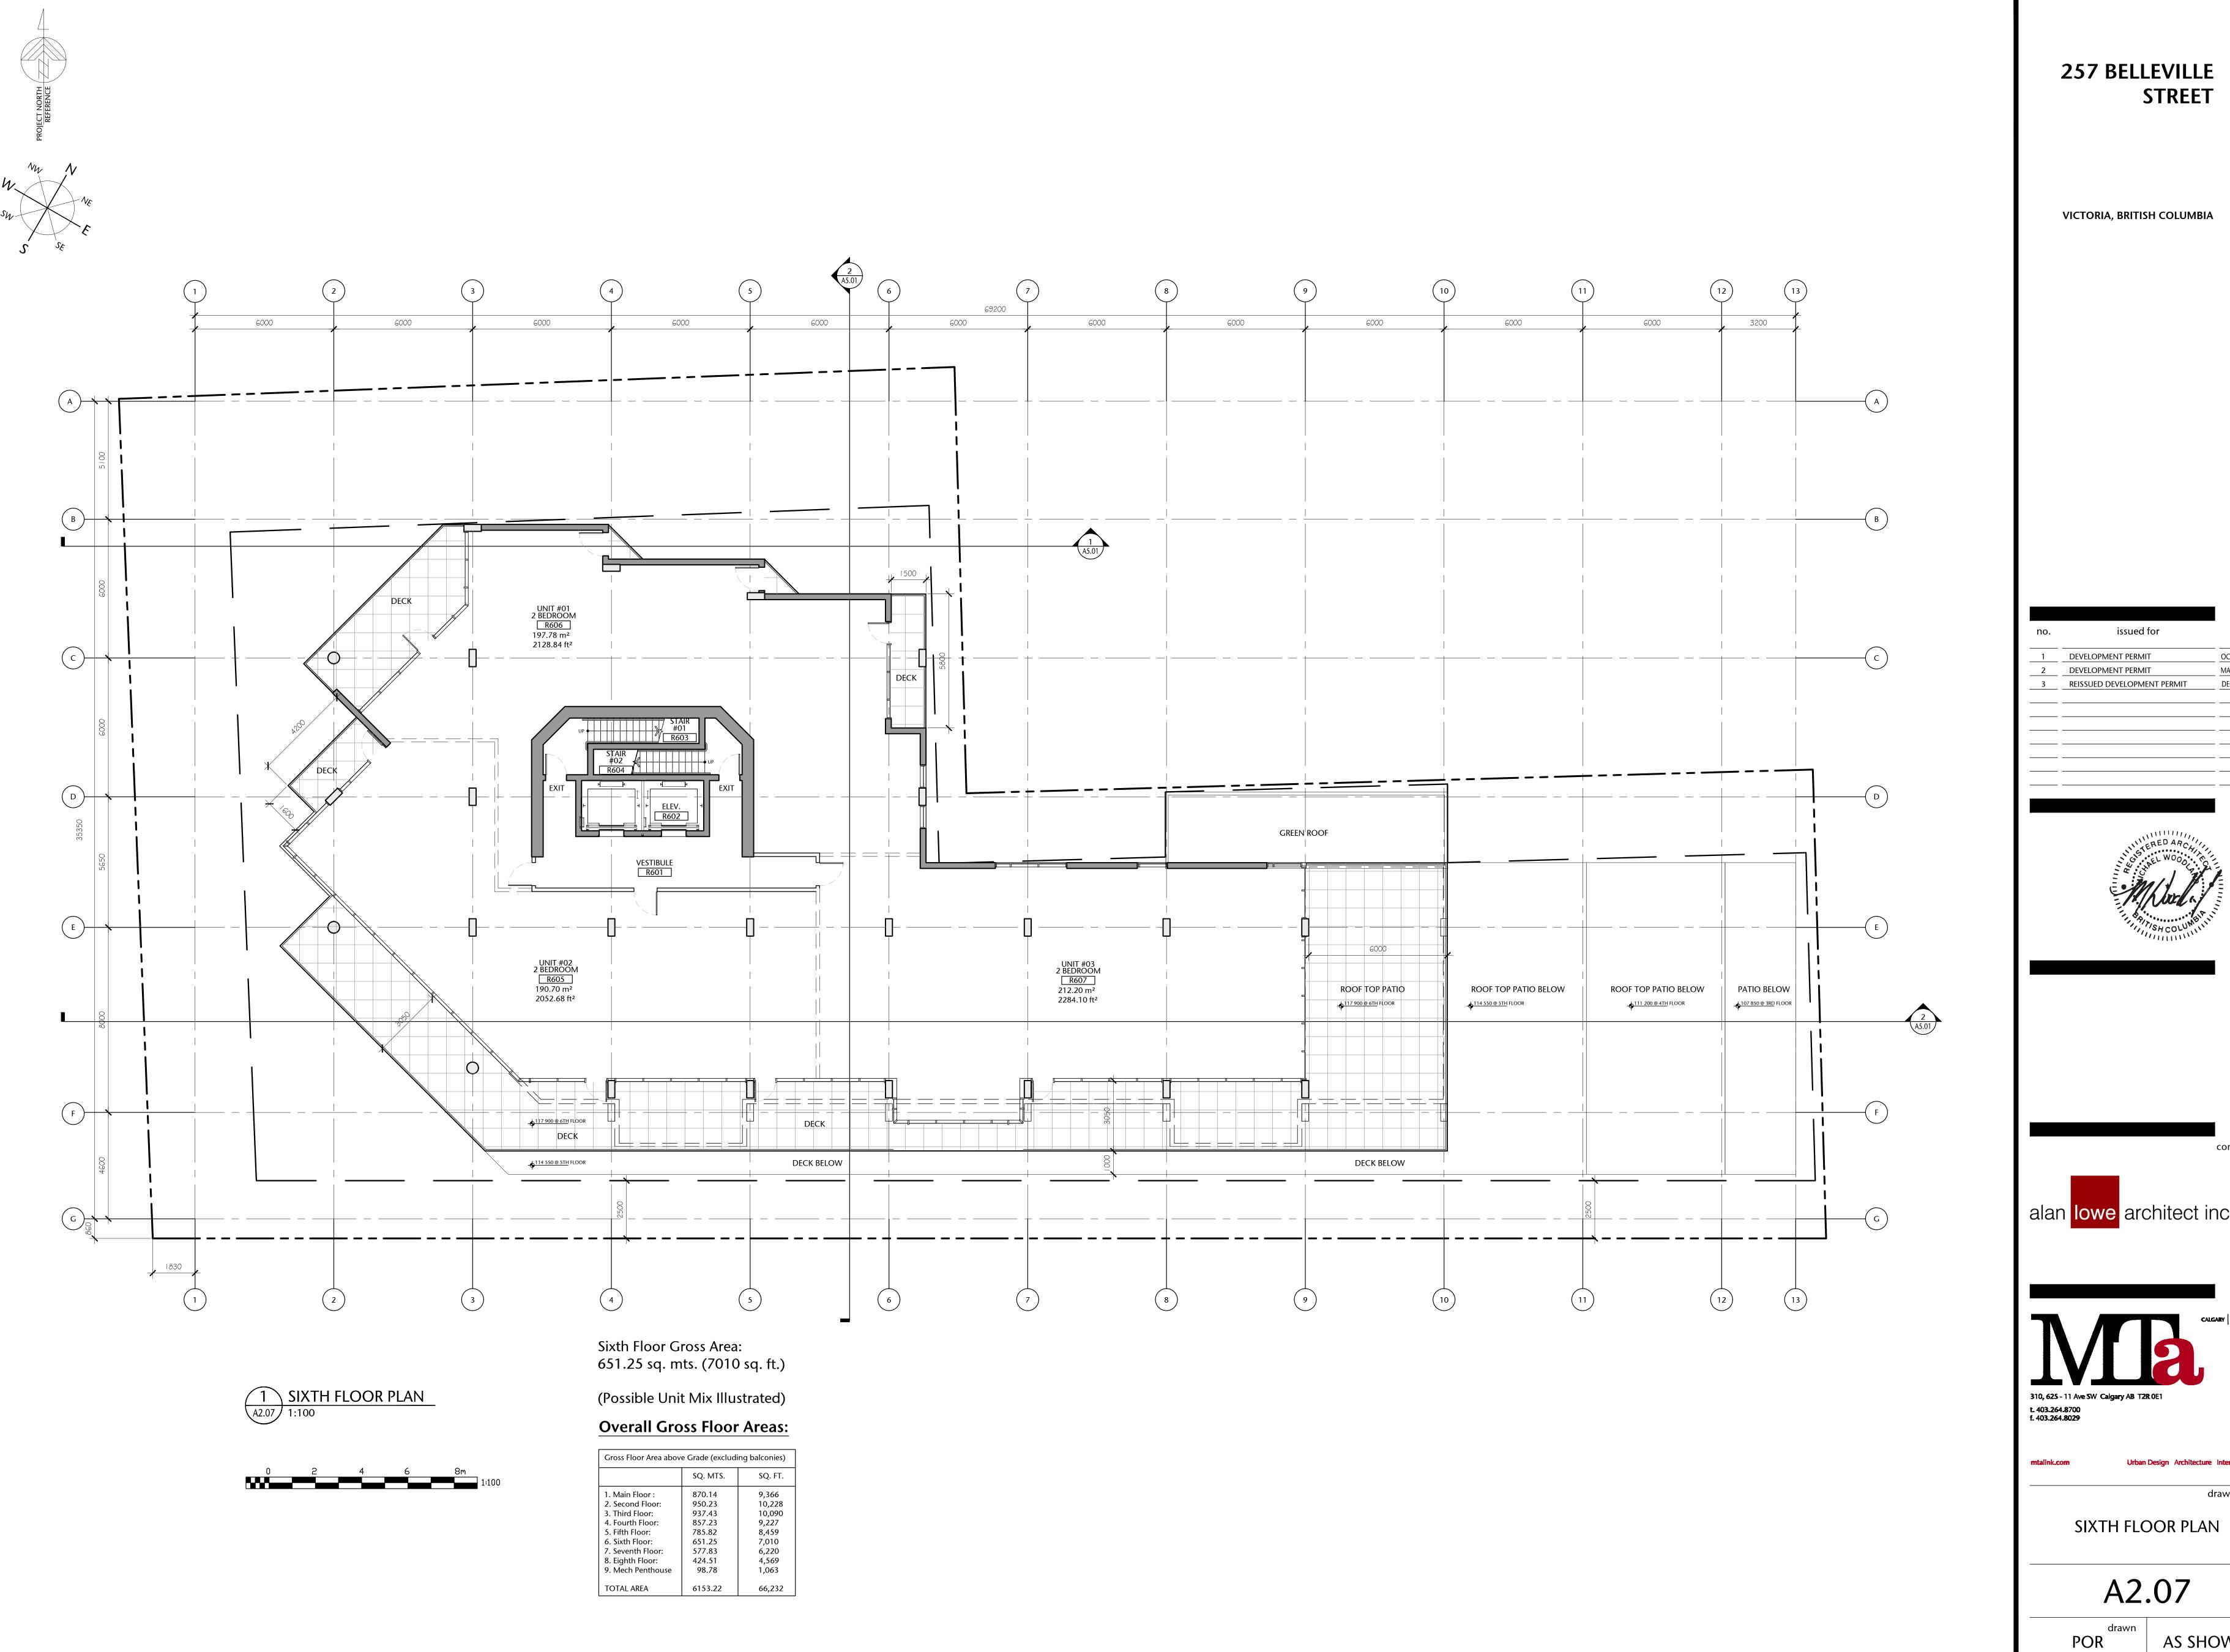
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FIFTH FLOOR PLAN

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AS SHOWN

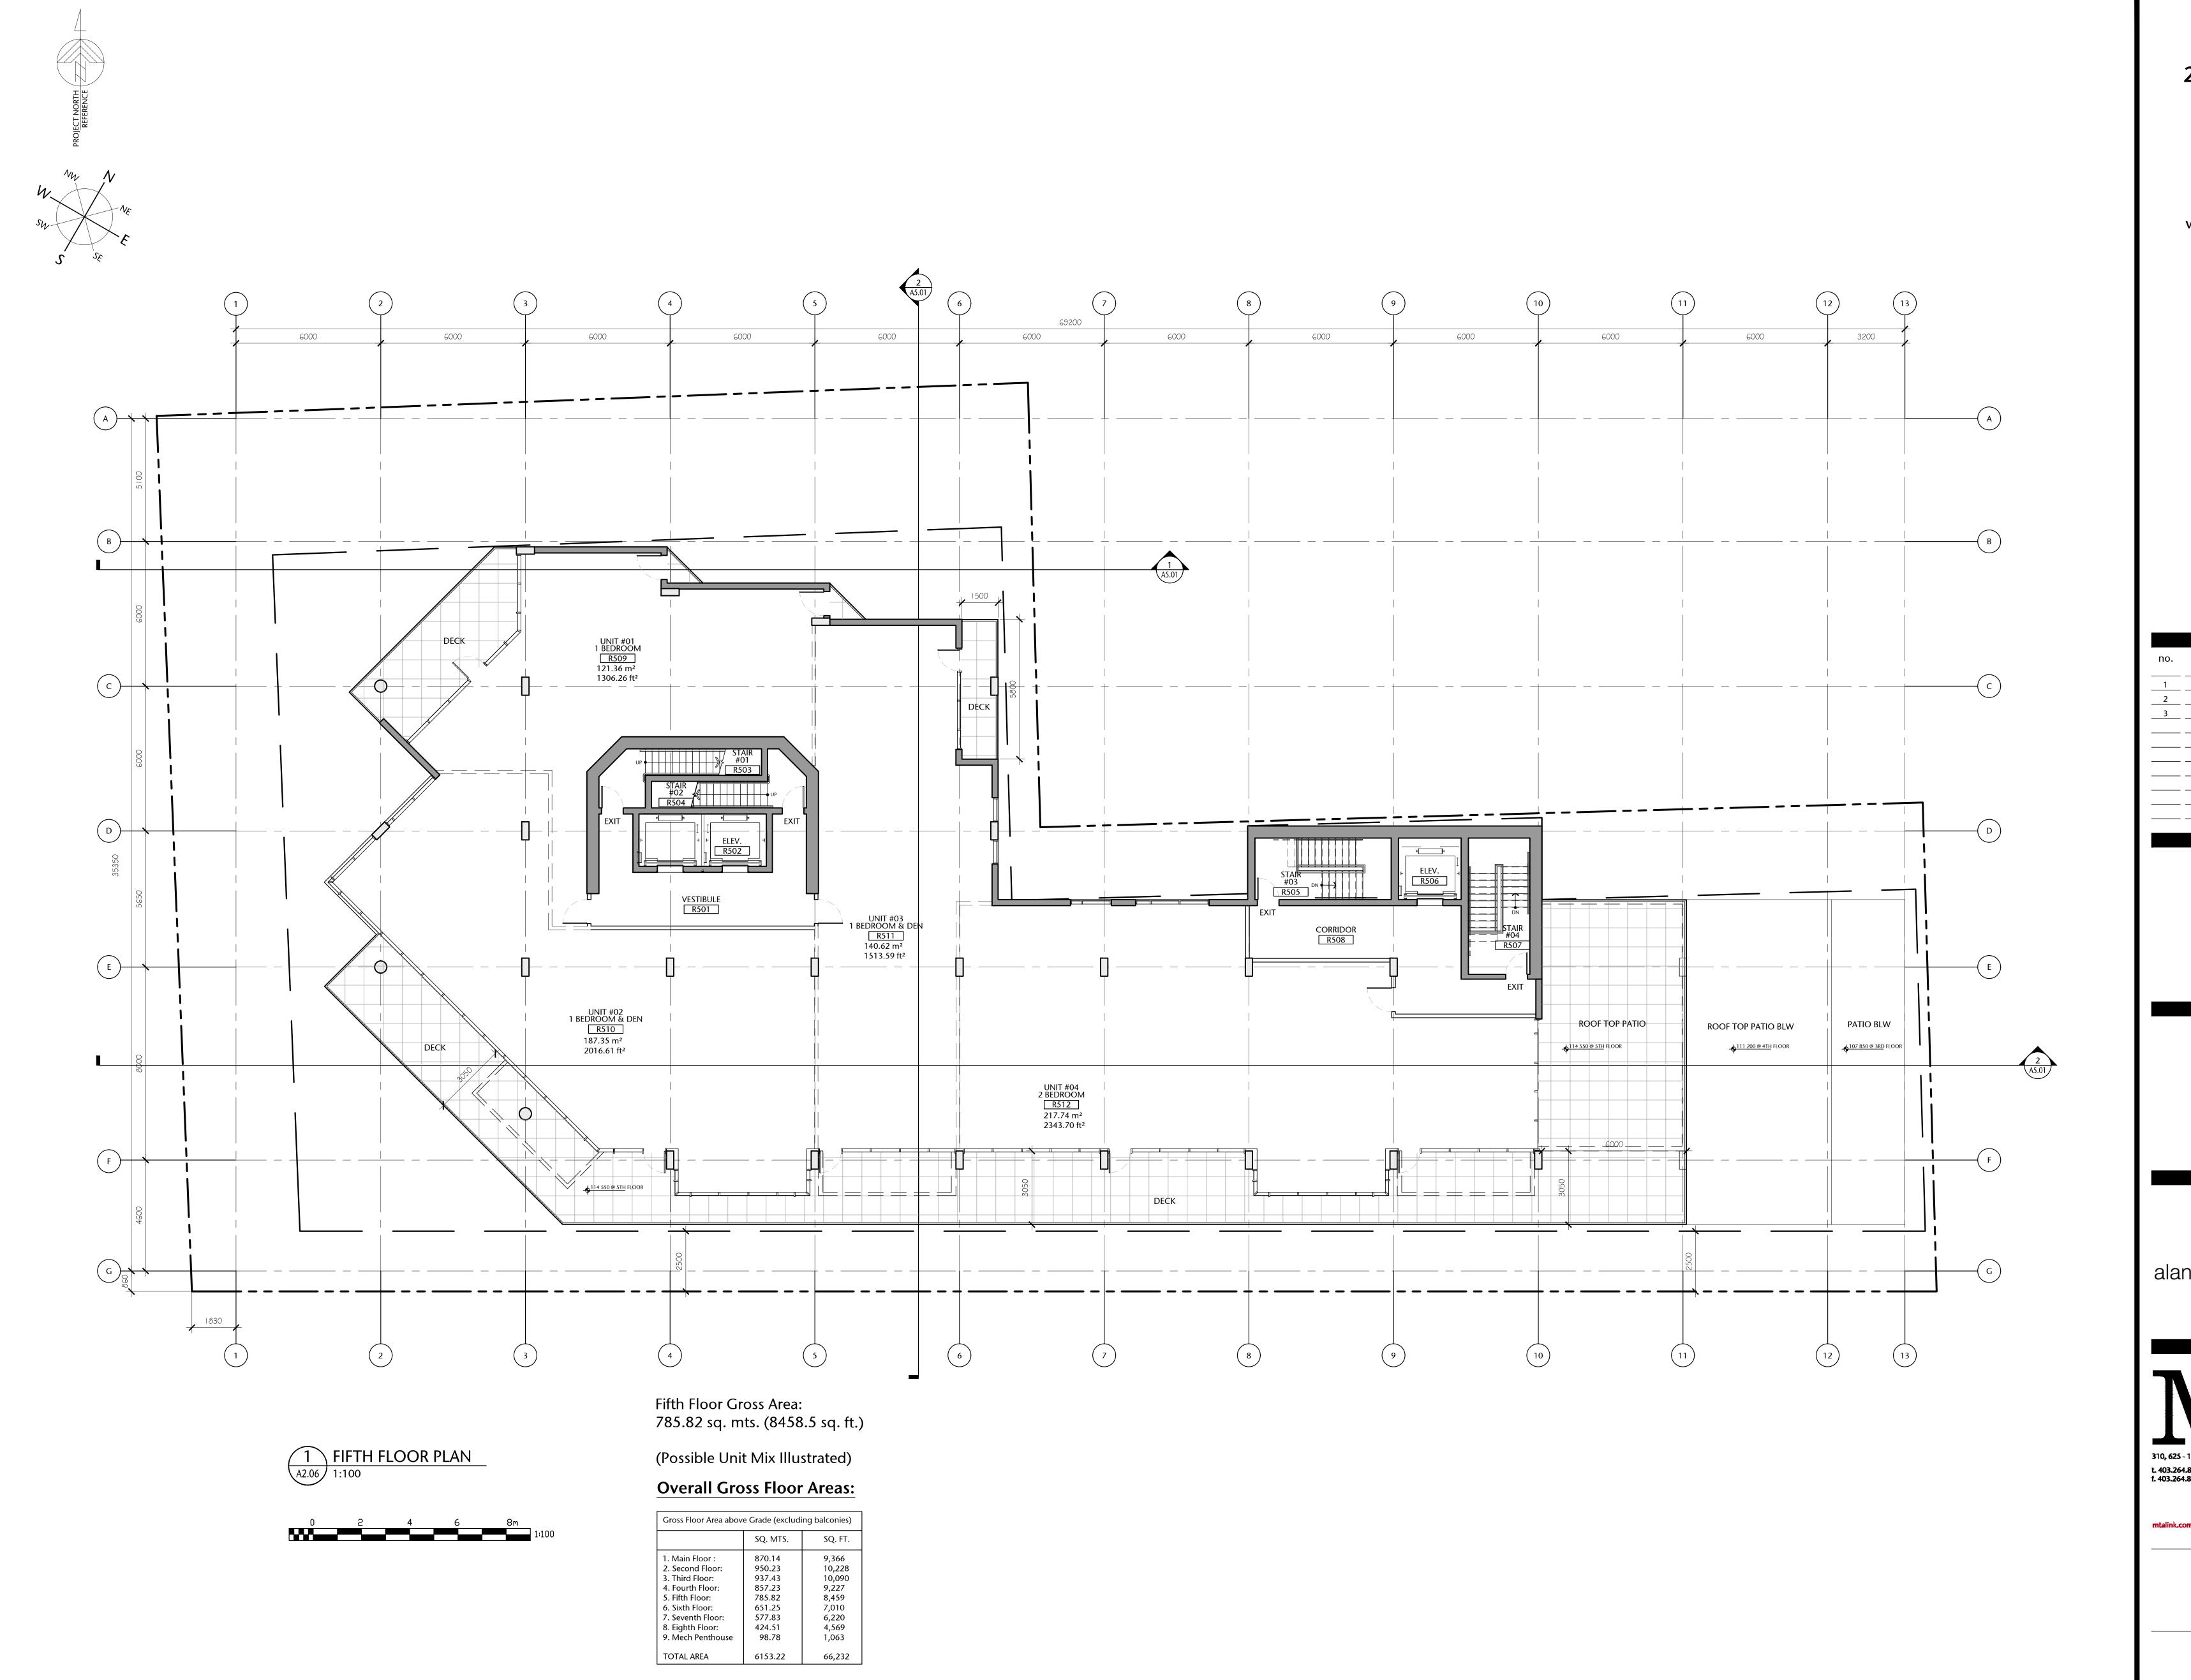


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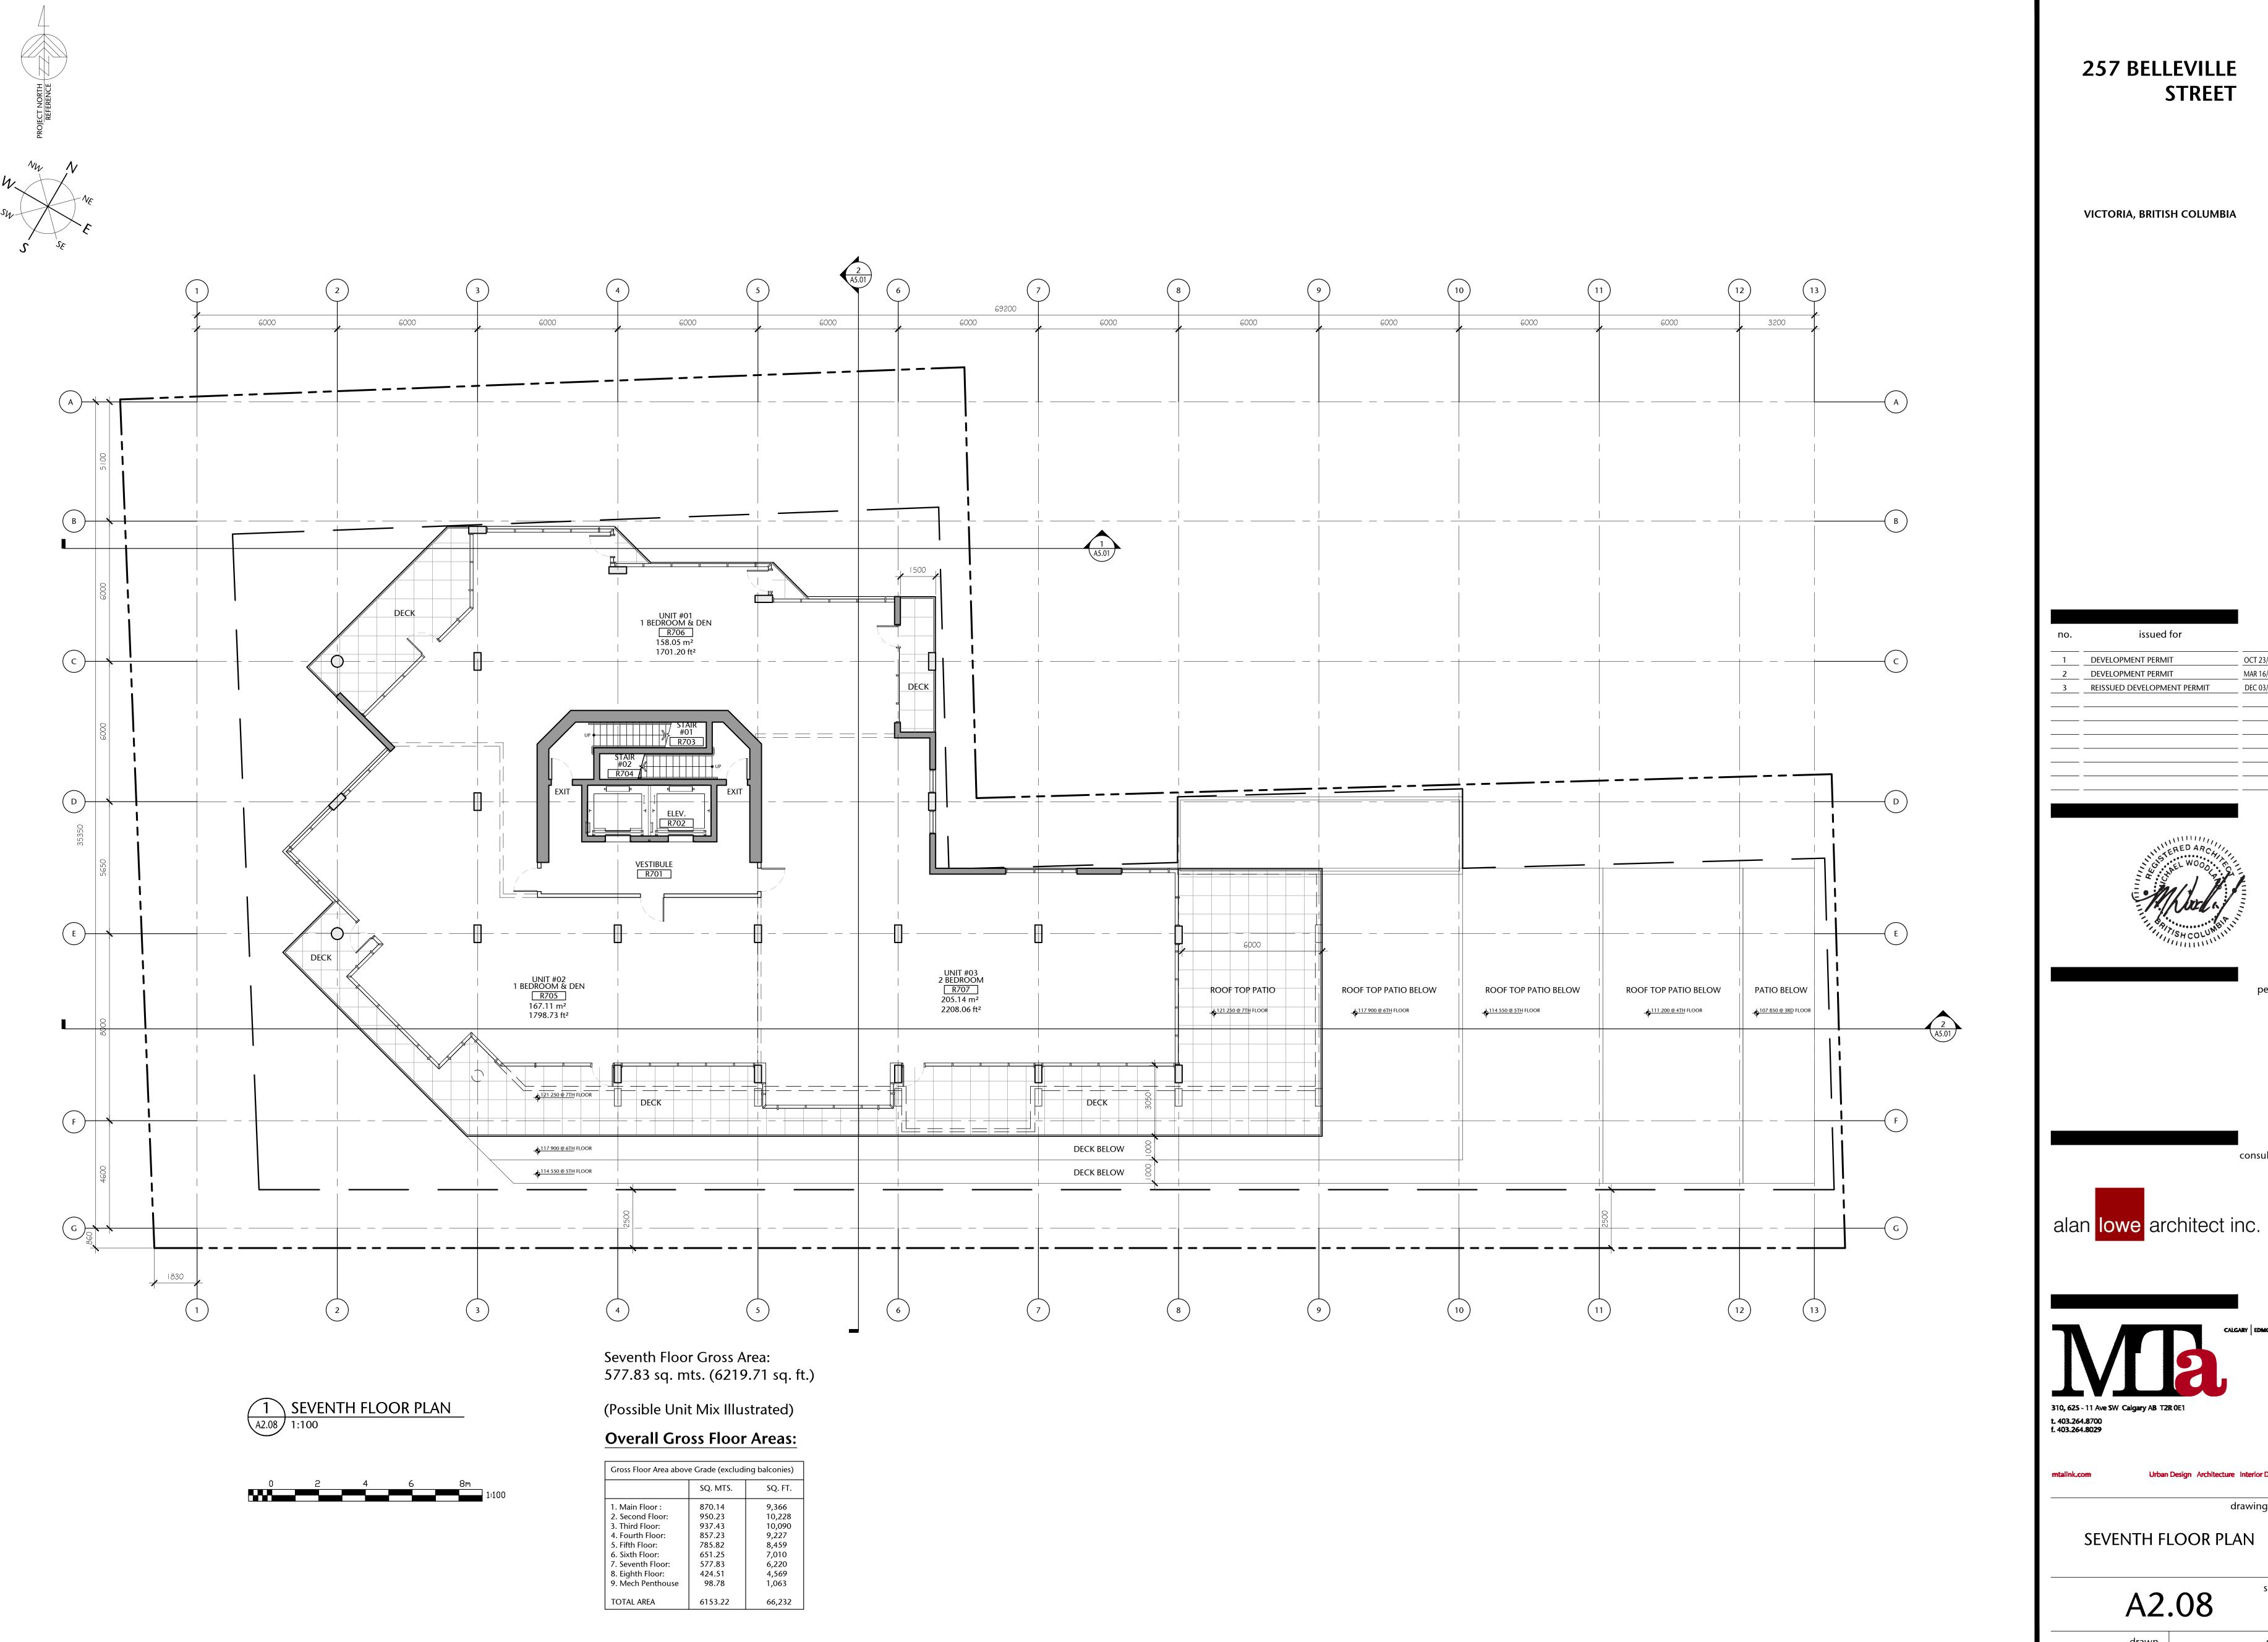
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drawing title

AS SHOWN project no.



VICTORIA, BRITISH COLUMBIA

OCT 23/2012 DEVELOPMENT PERMIT MAR 16/2020 DEC 03/2020 DEVELOPMENT PERMIT REISSUED DEVELOPMENT PERMIT

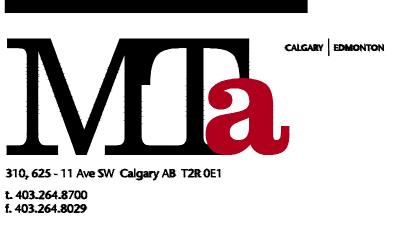




Urban Design Architecture Interior Design


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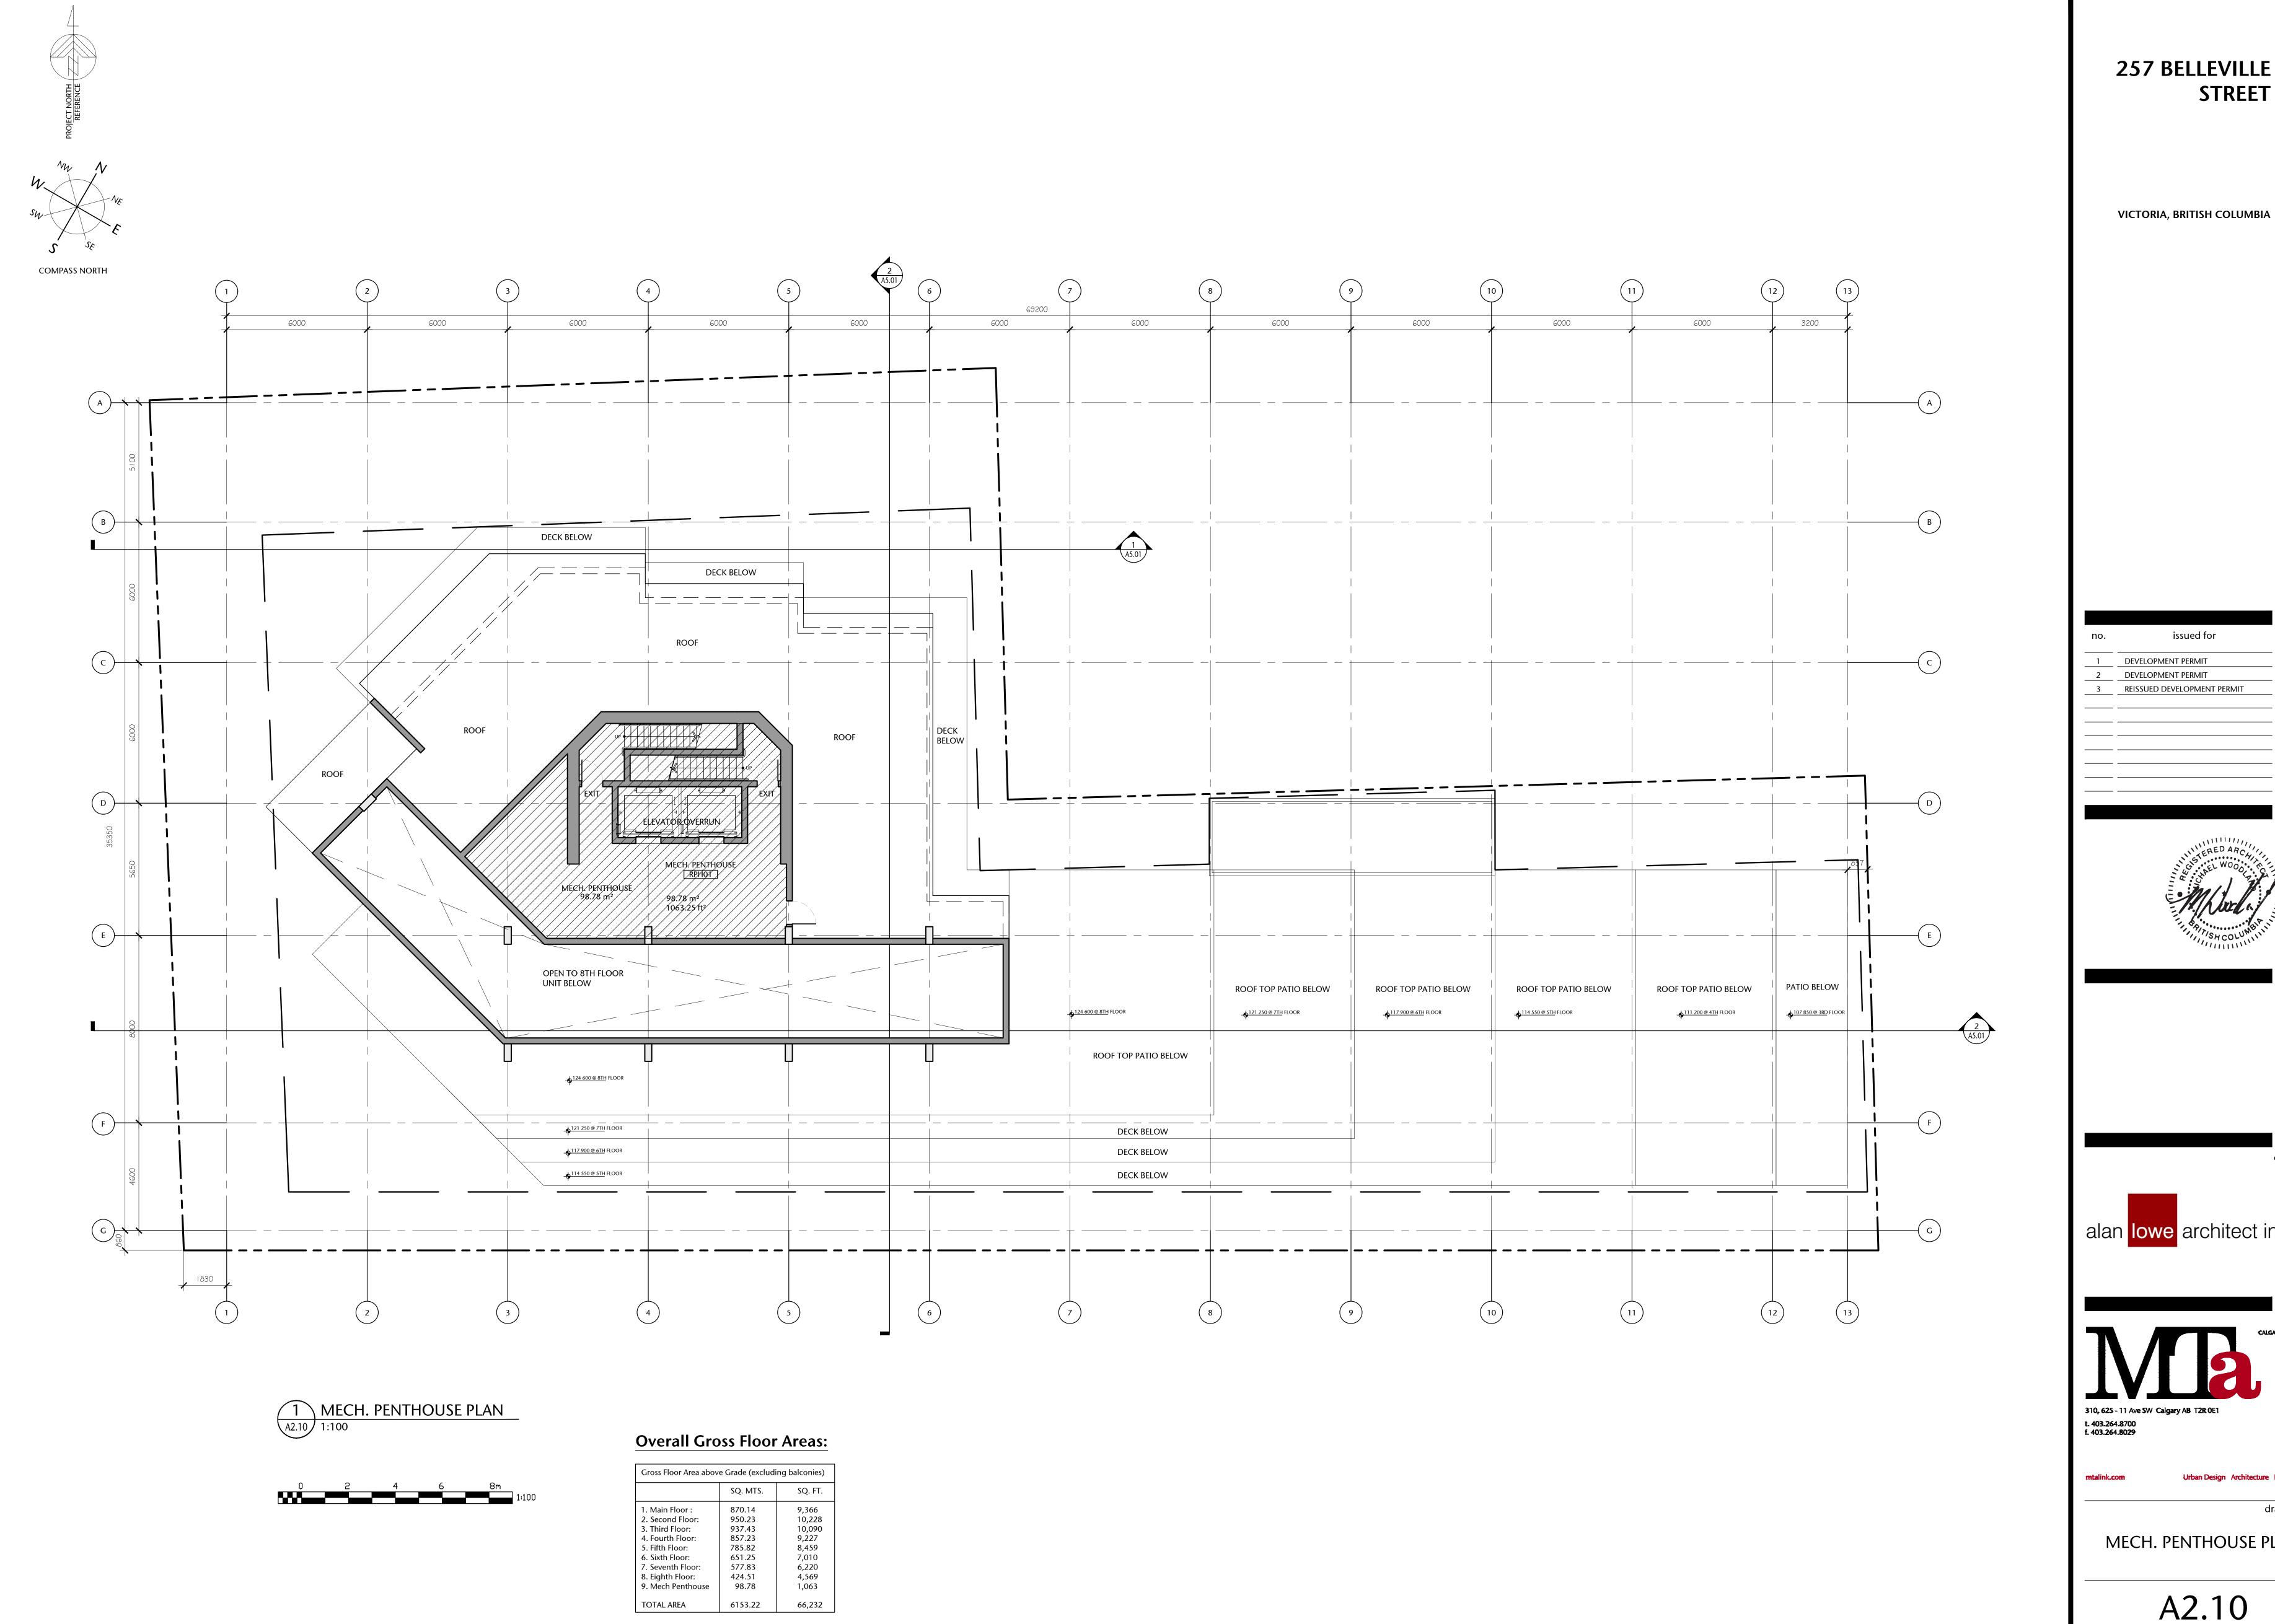
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OCT 23/2012 MAR 16/2020 DEC 03/2020



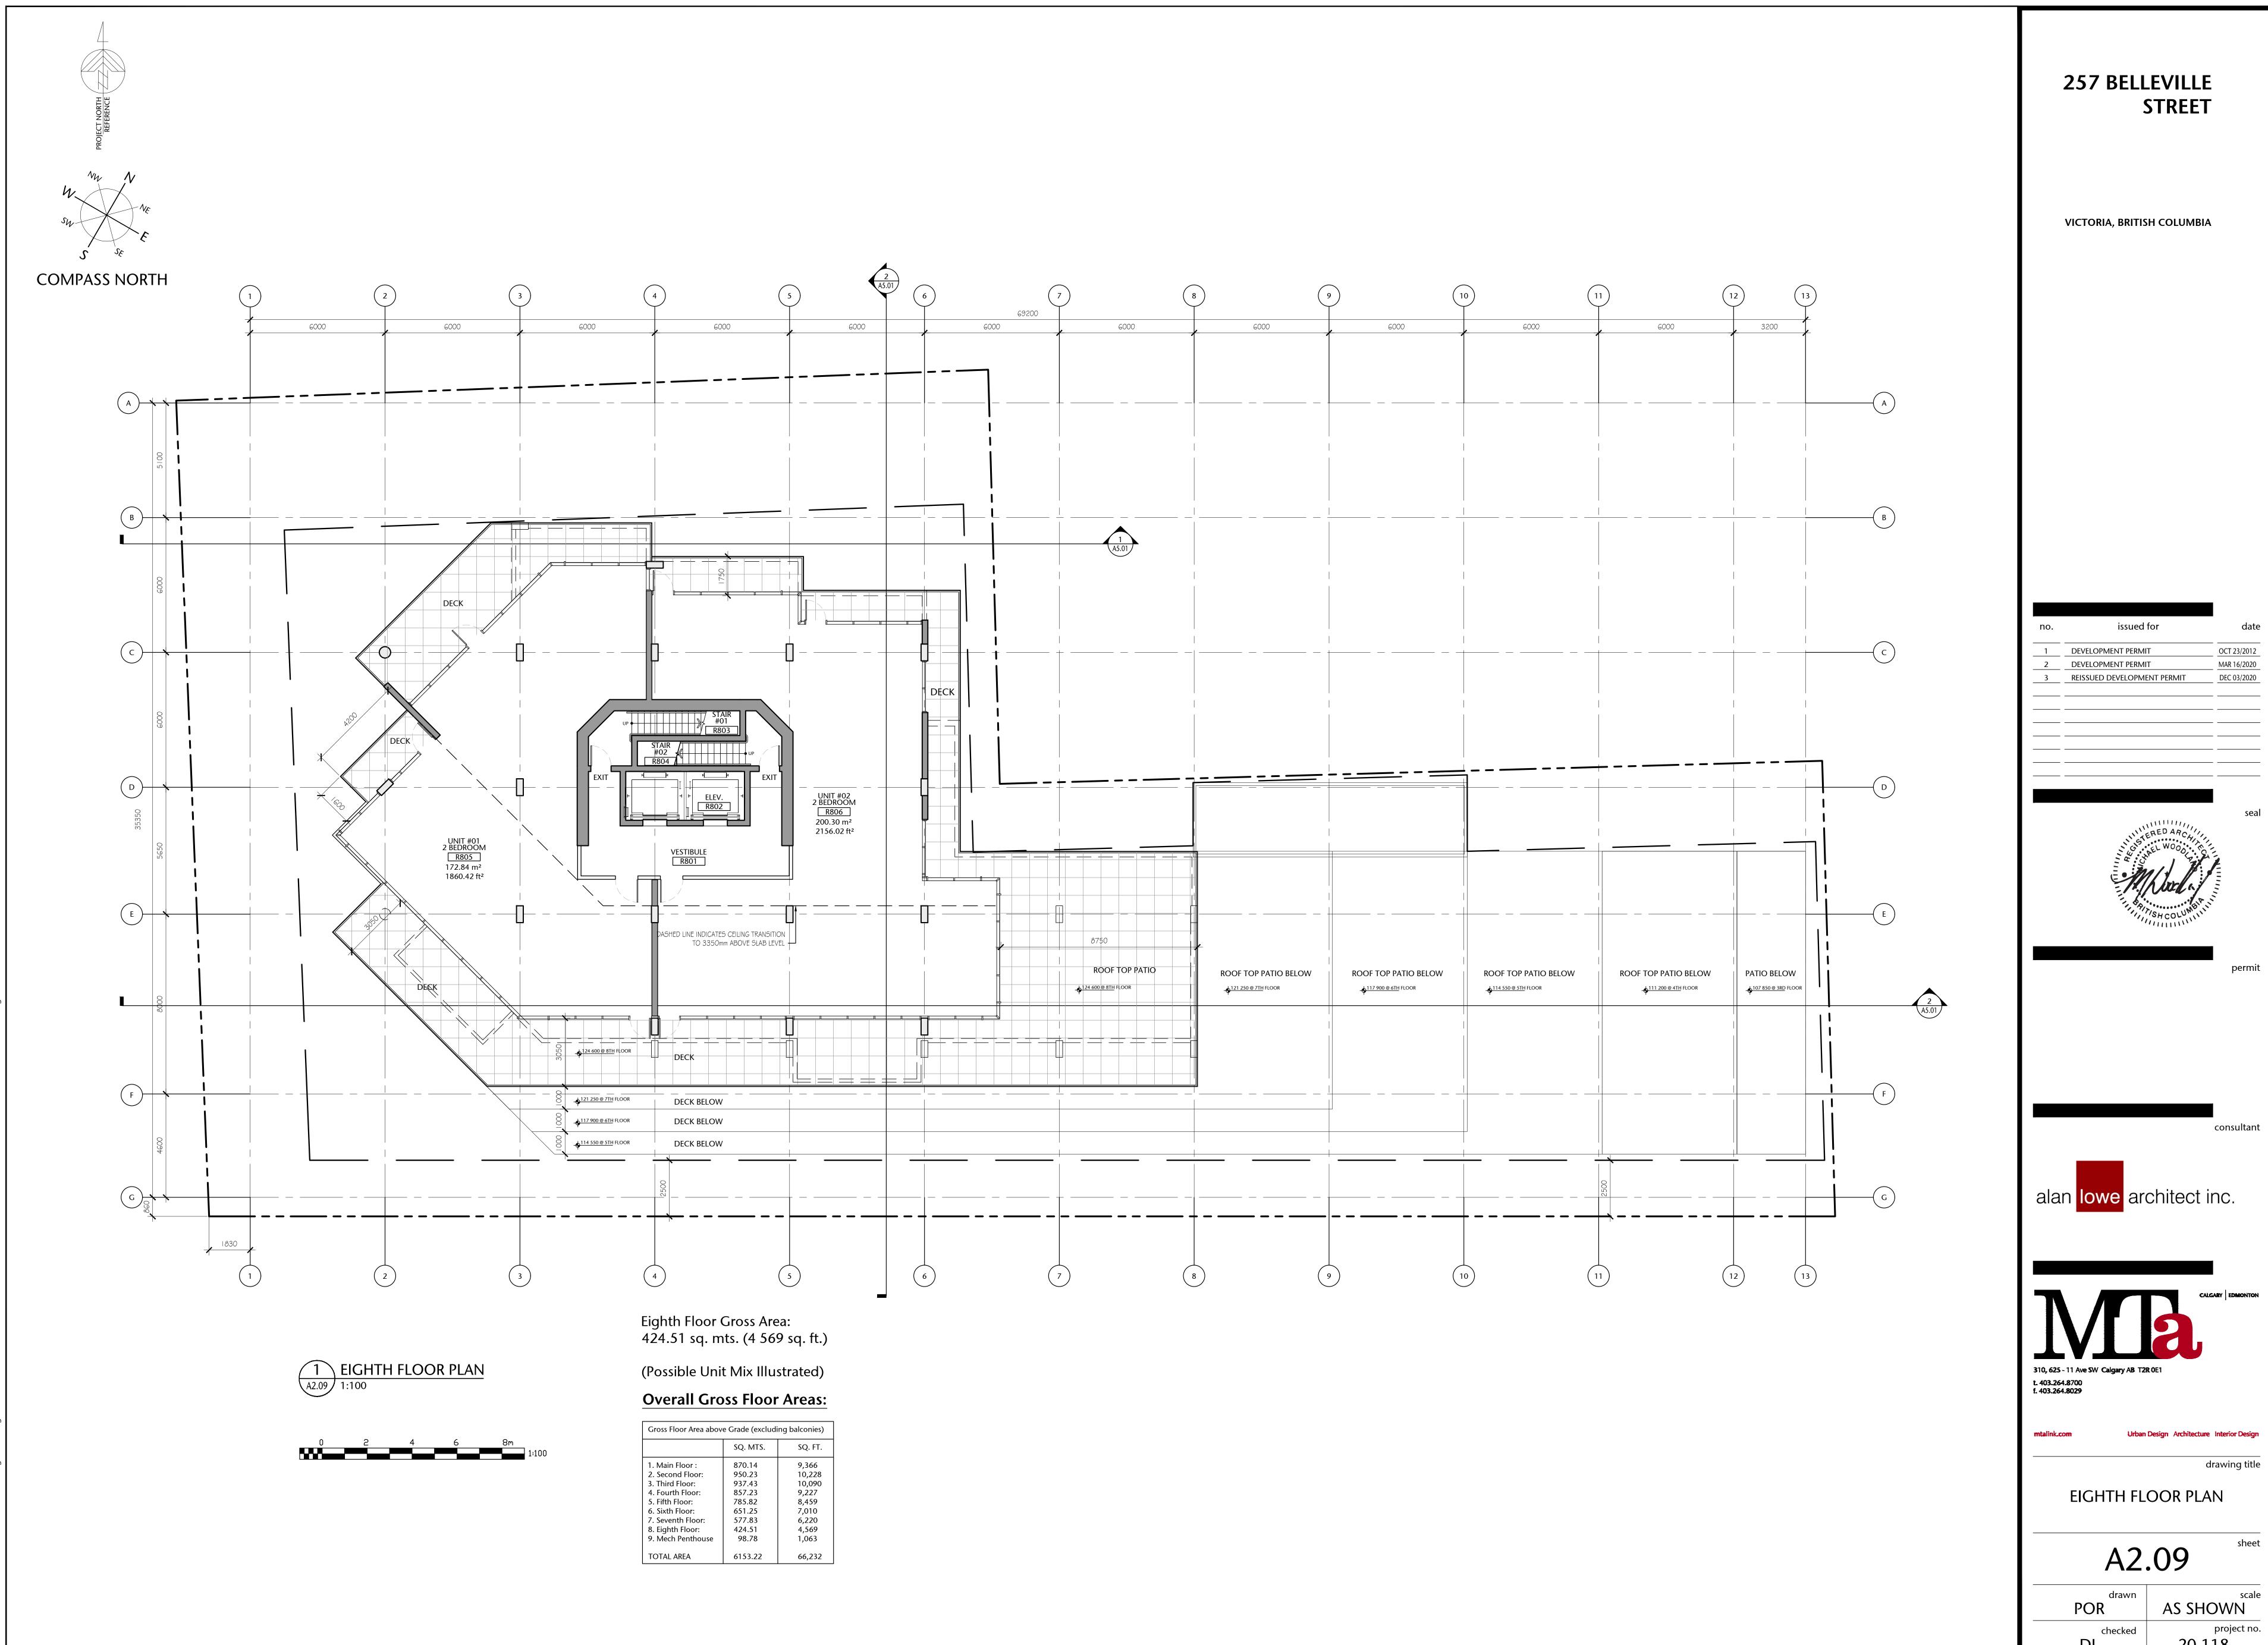

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consultant

drawing title
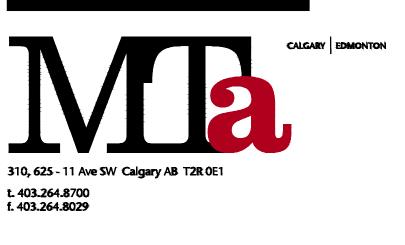
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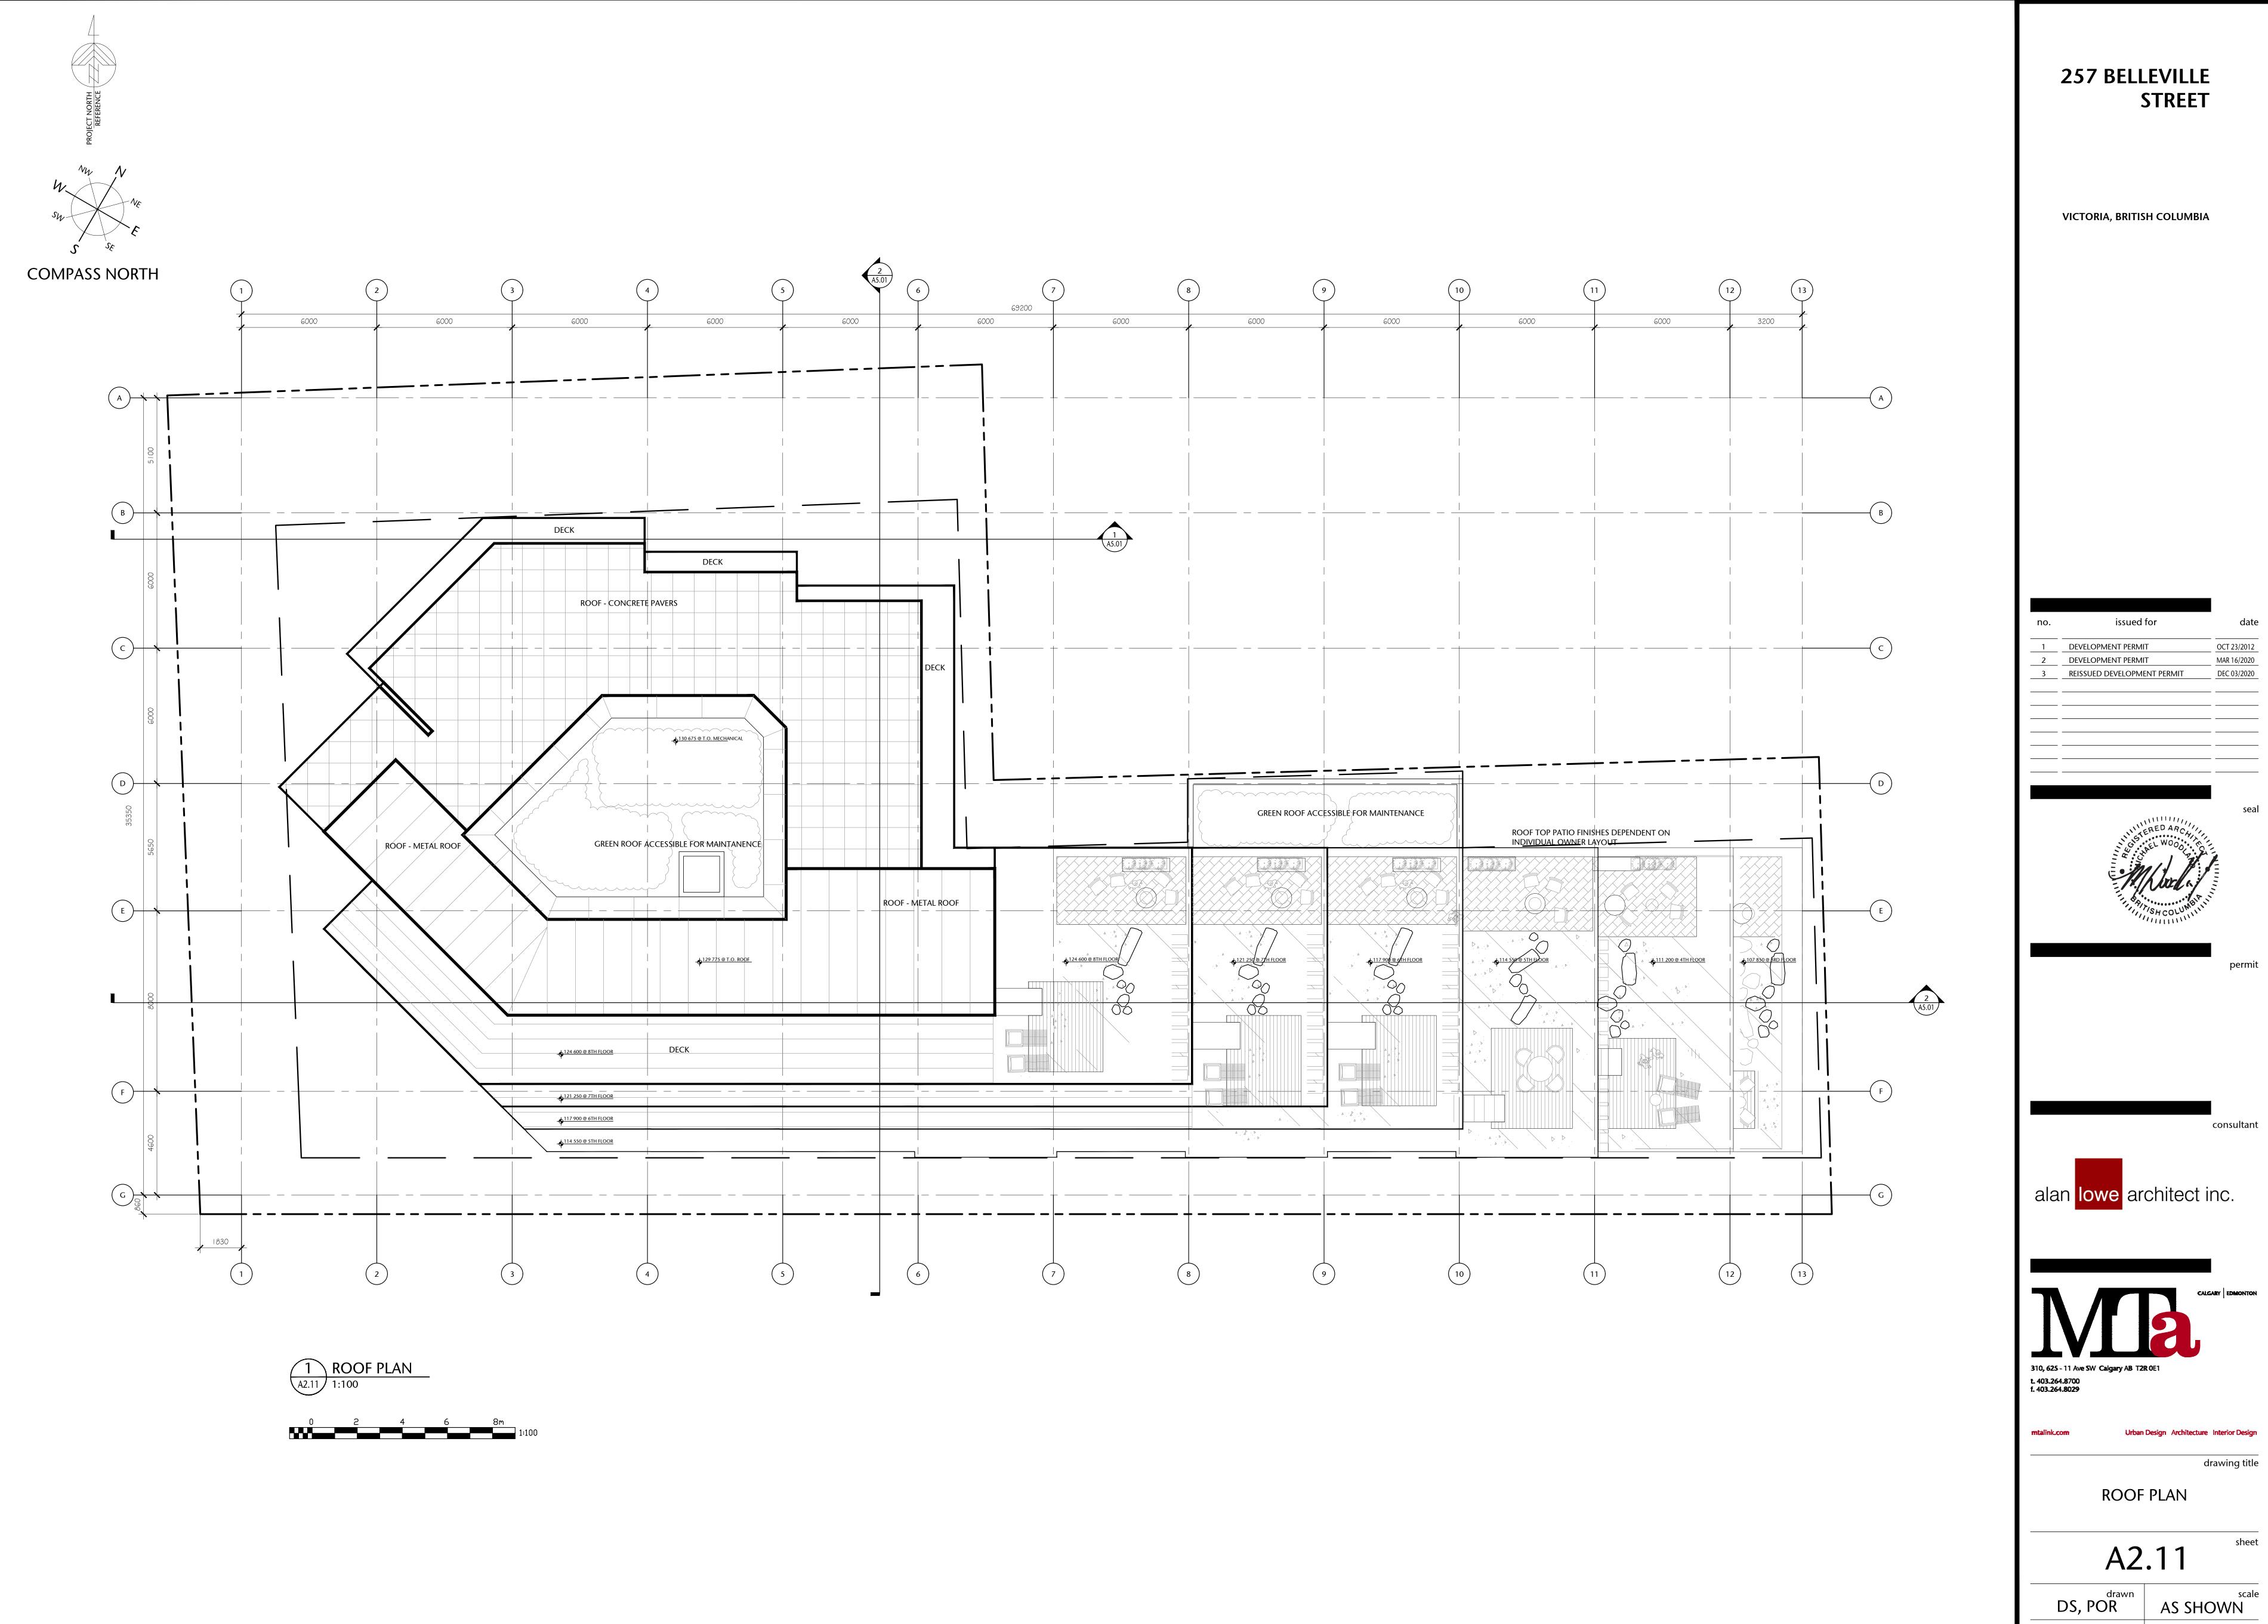


Urban Design Architecture Interior Design

MECH. PENTHOUSE PLAN

A2.10

AS SHOWN project no.




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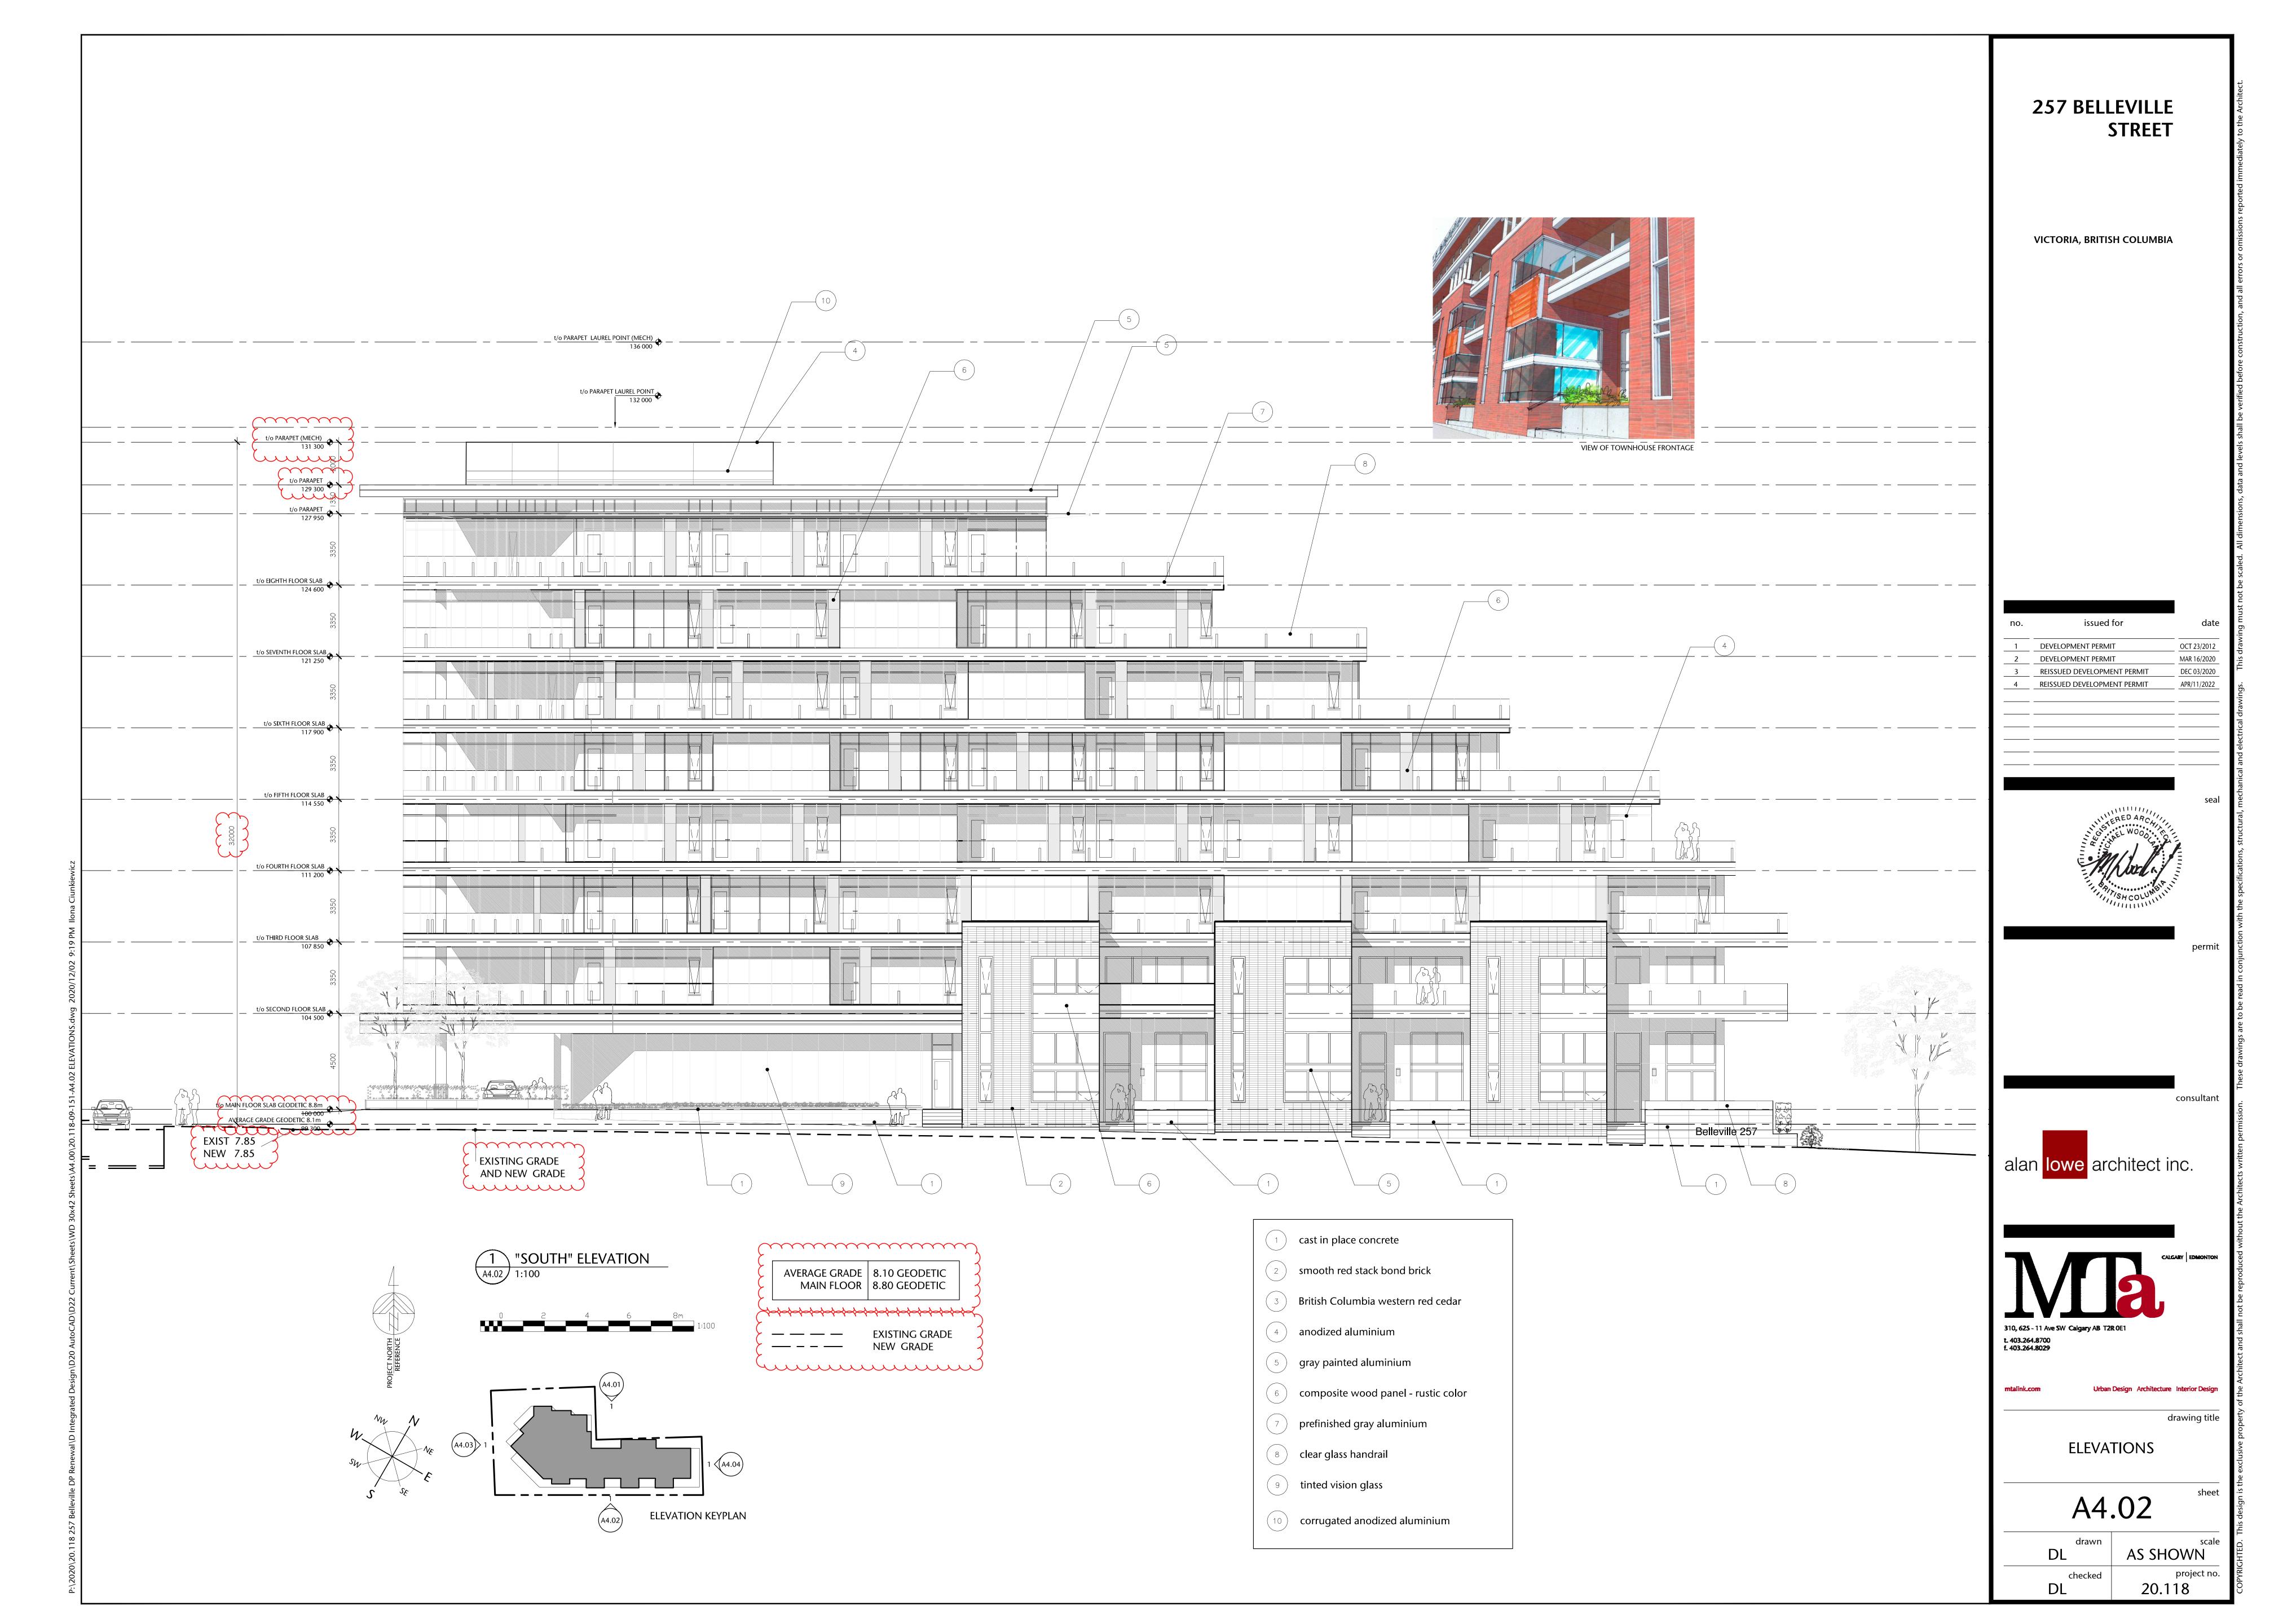
consultant





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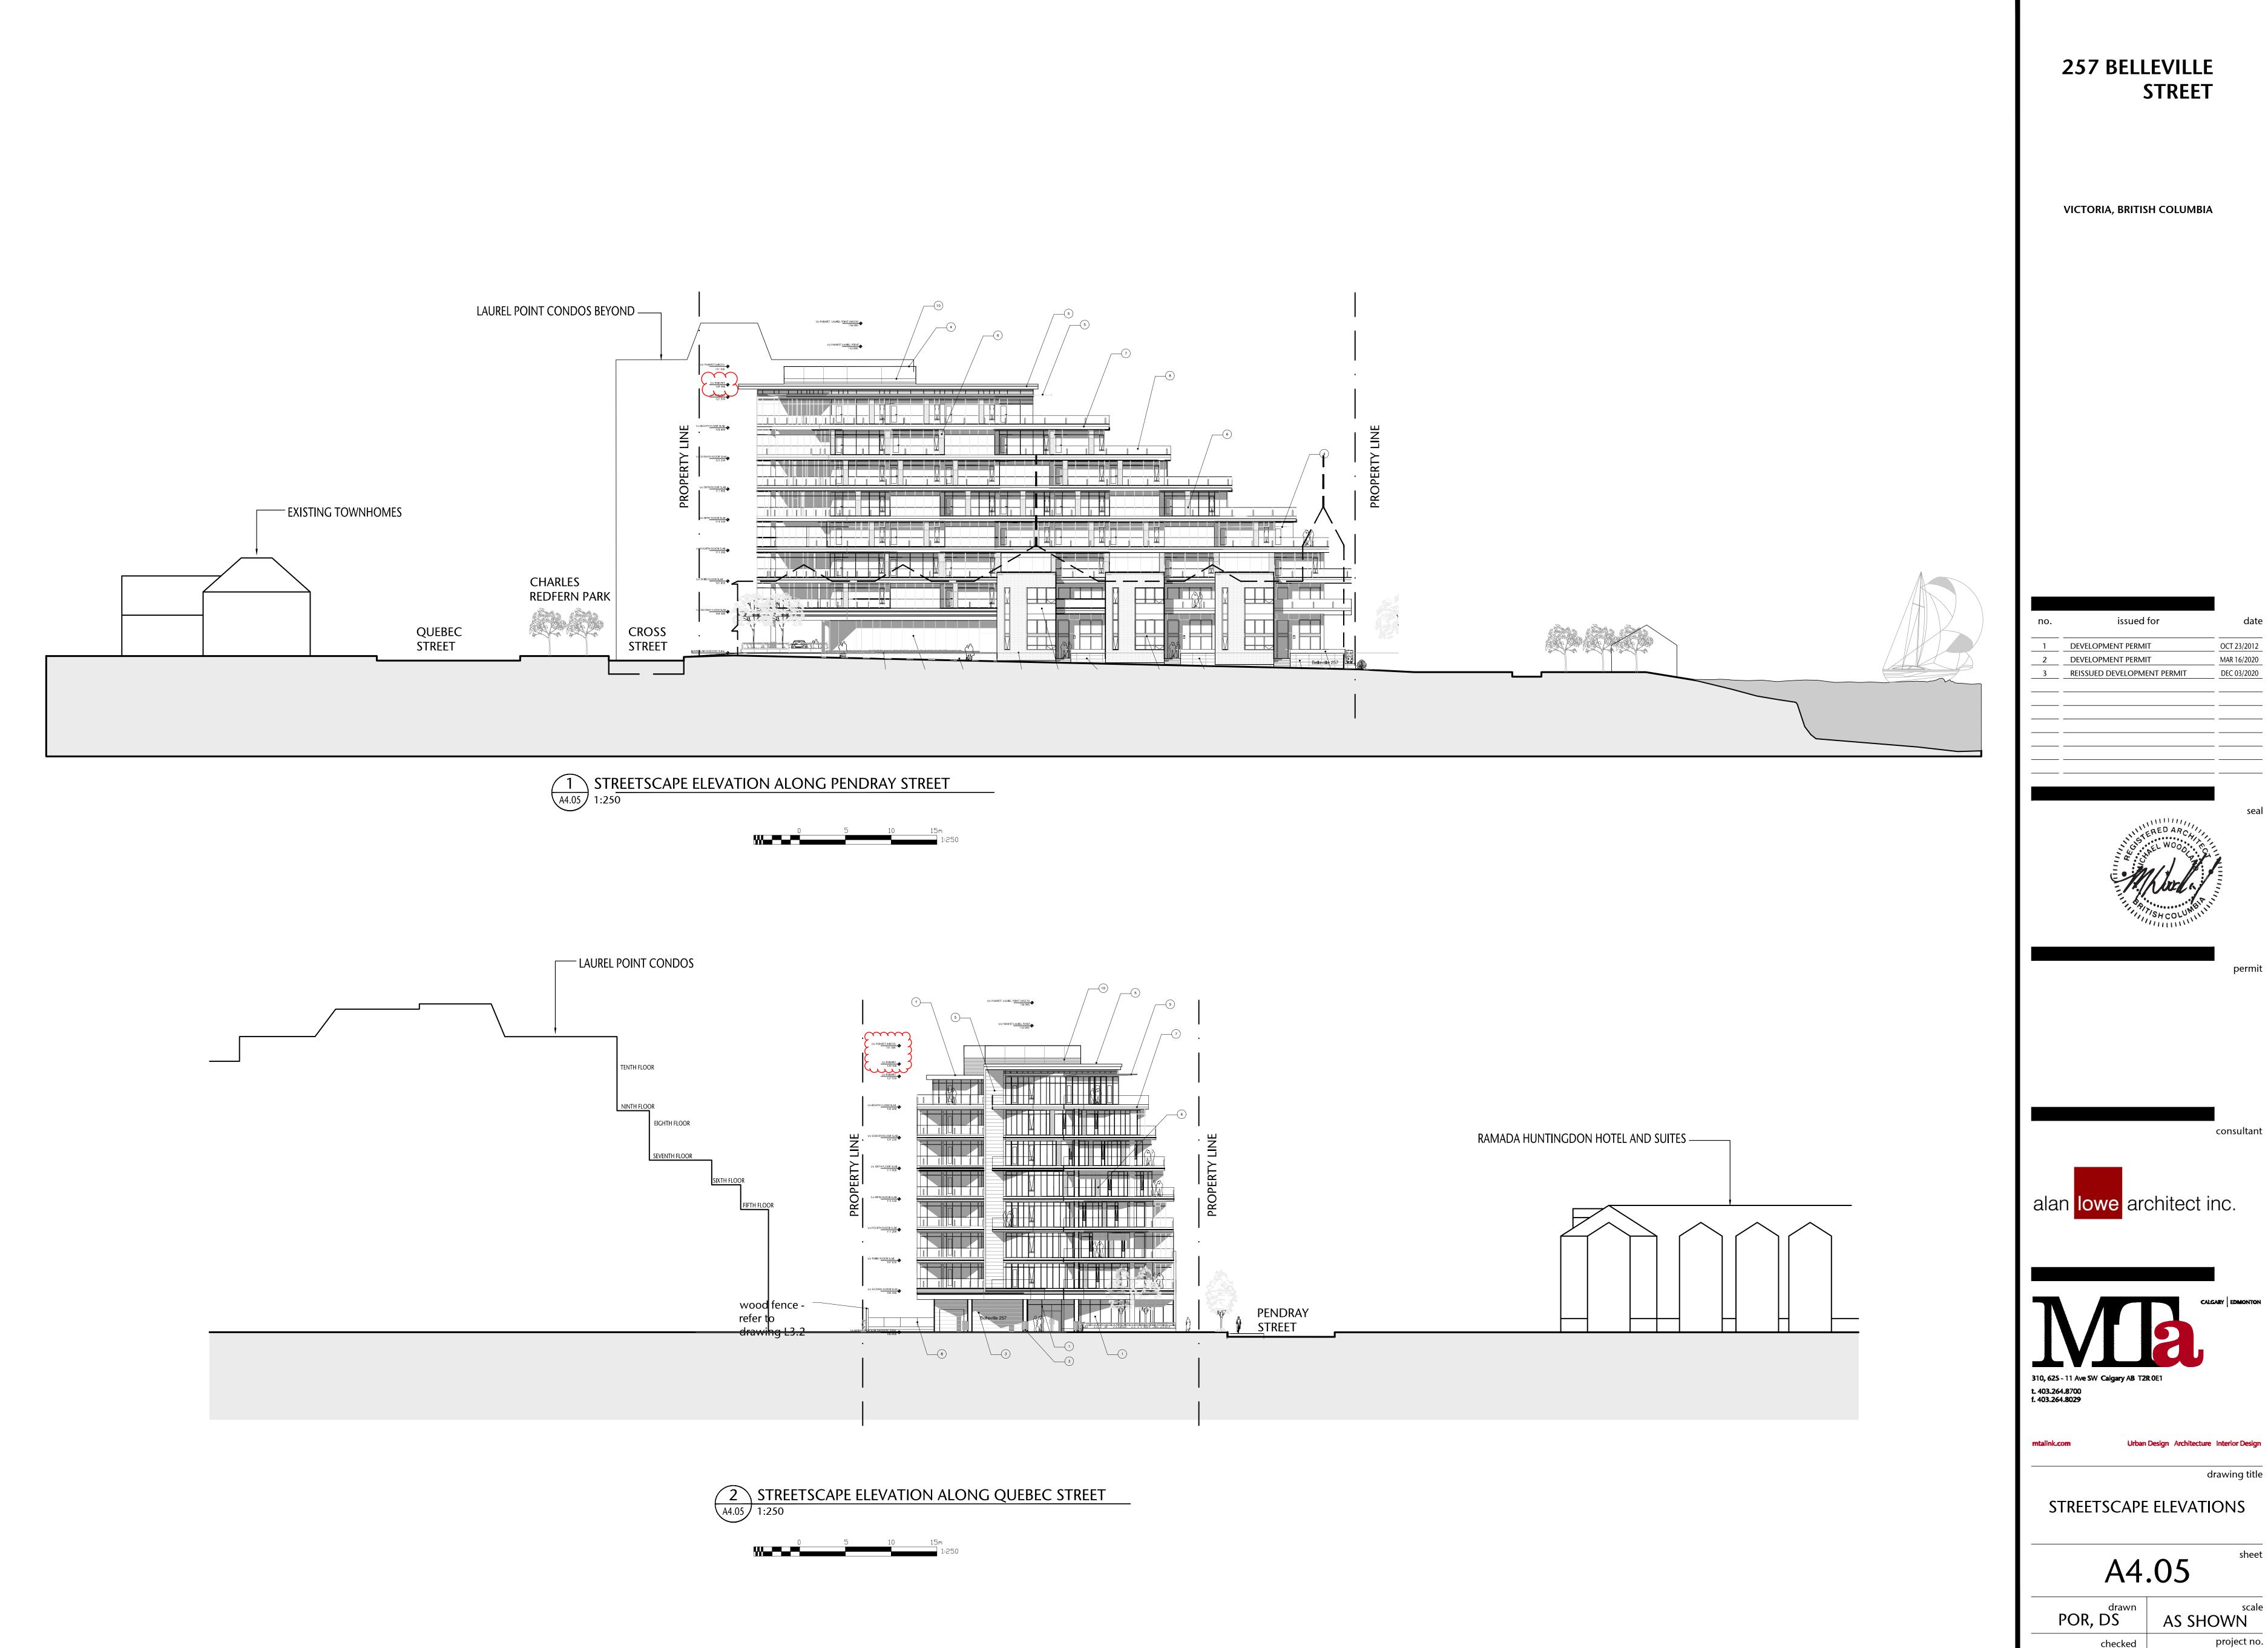
ROOF PLAN





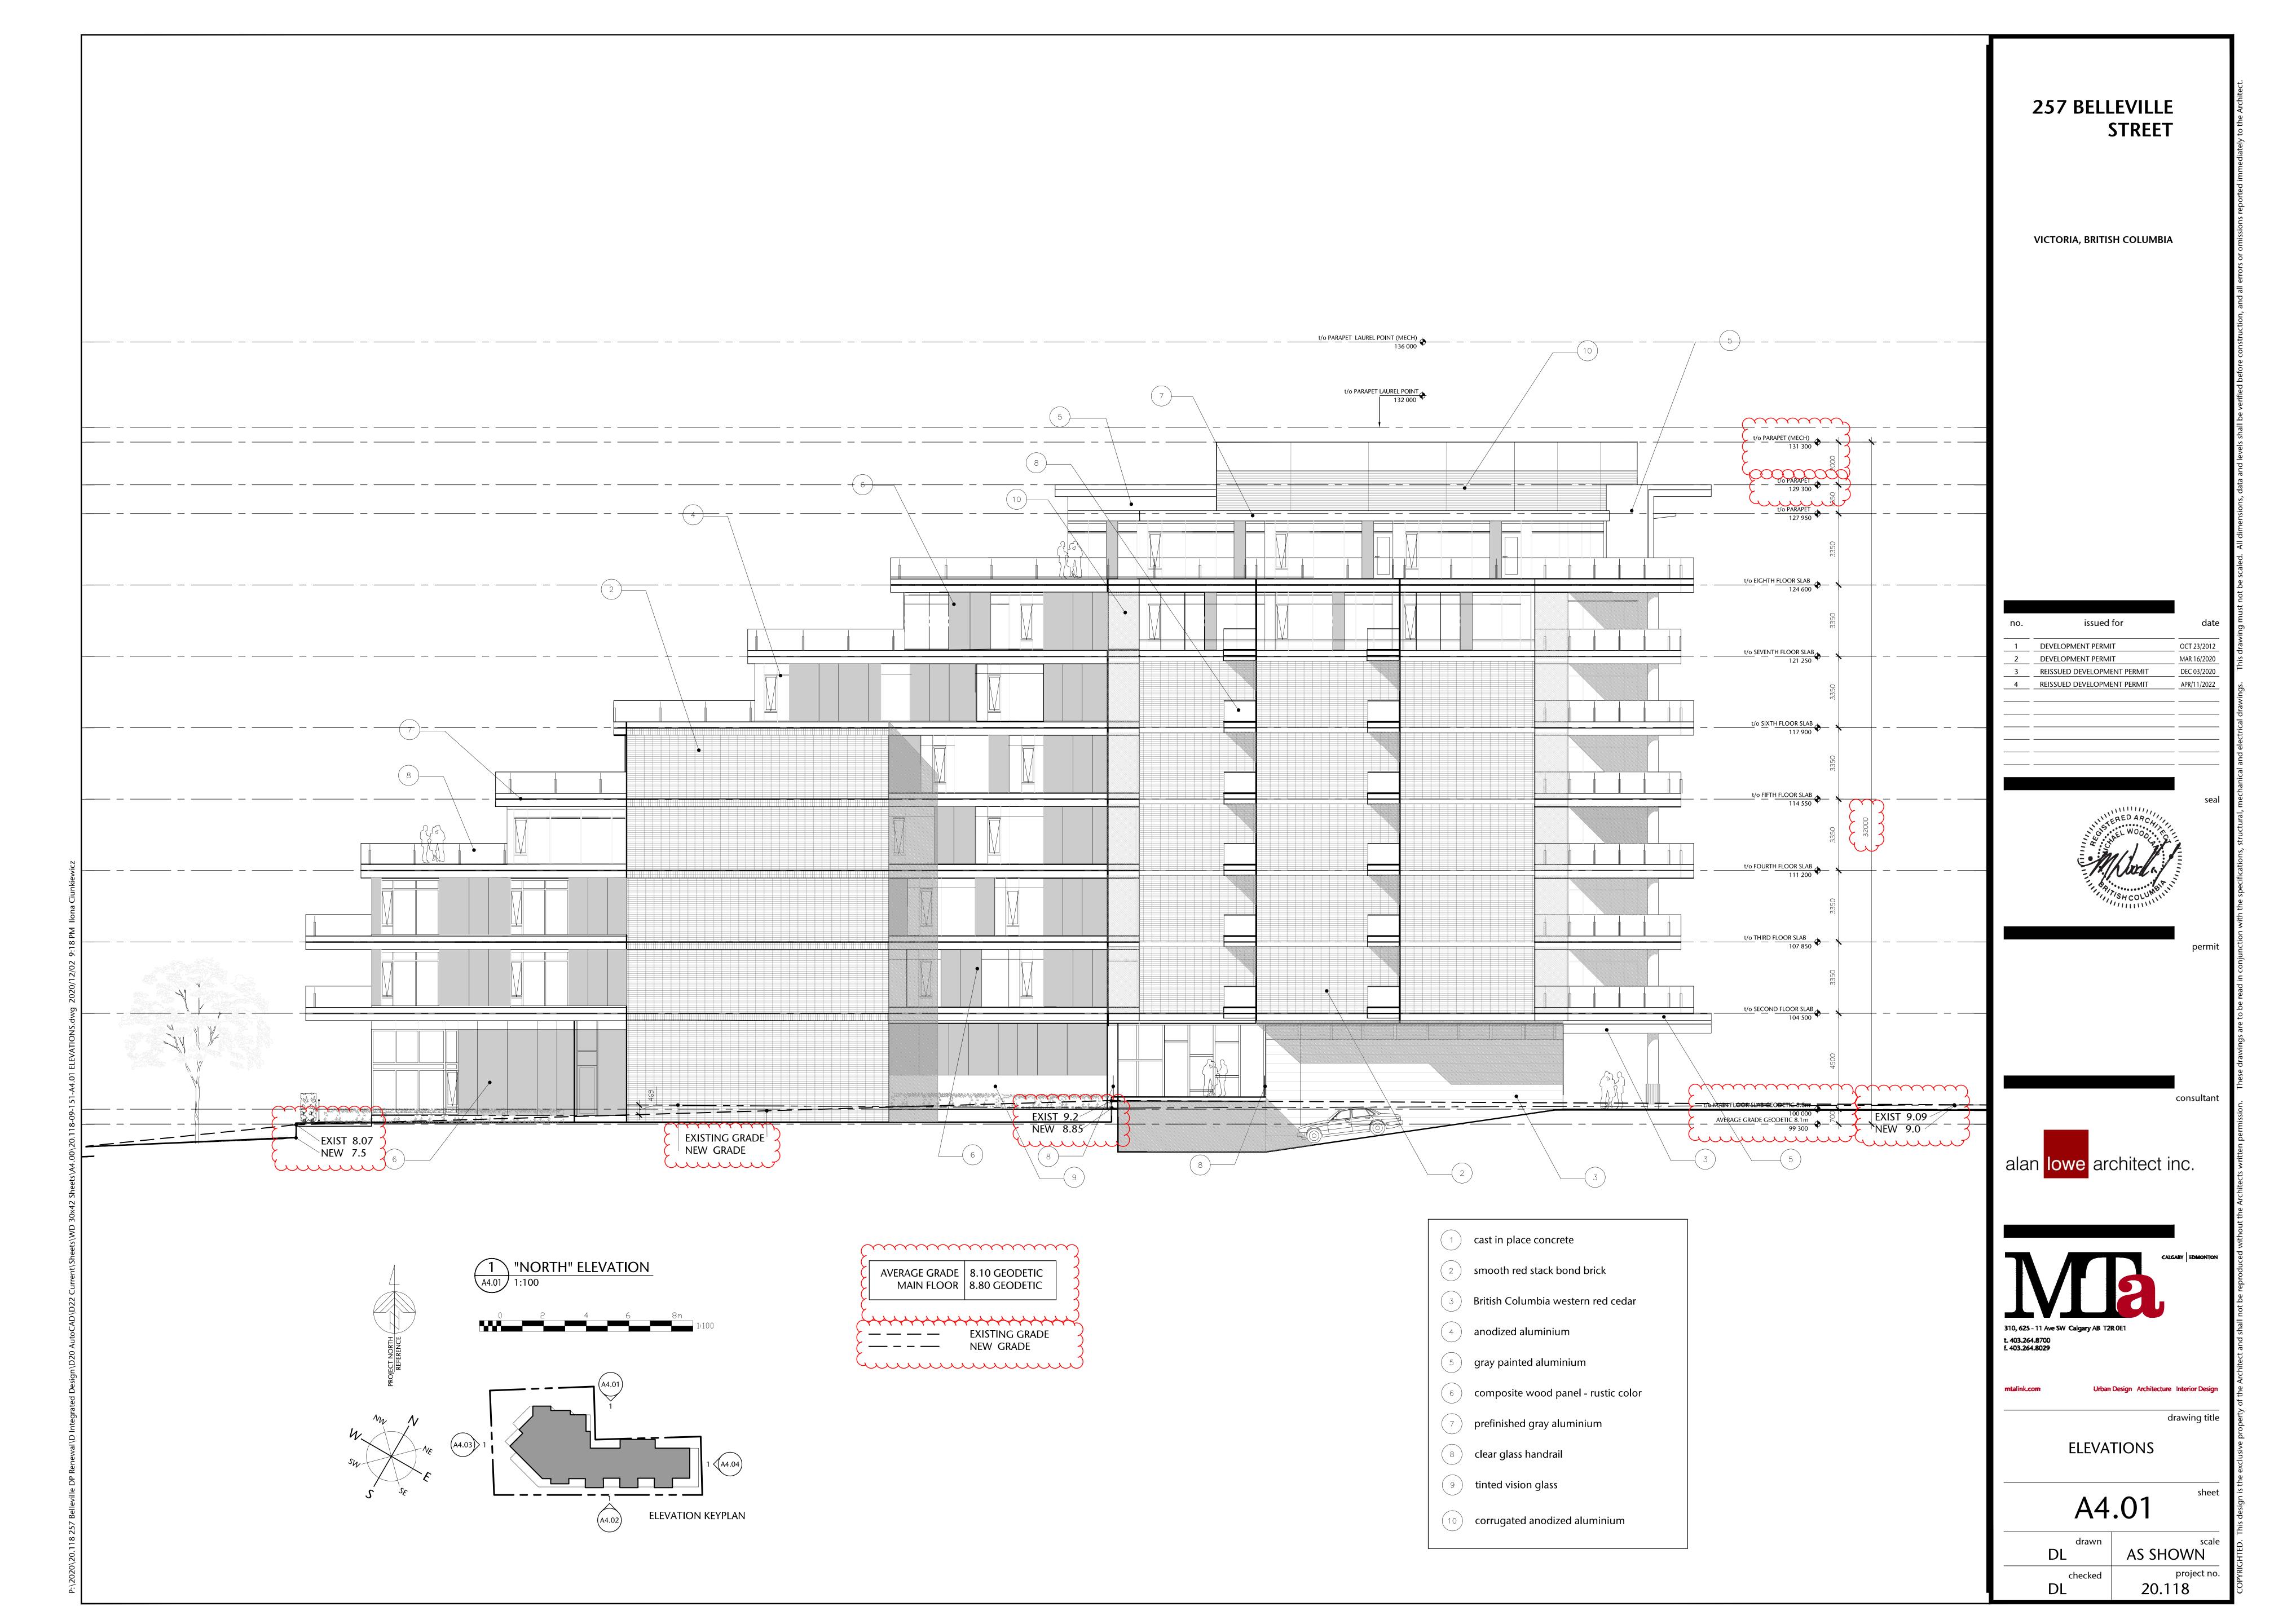

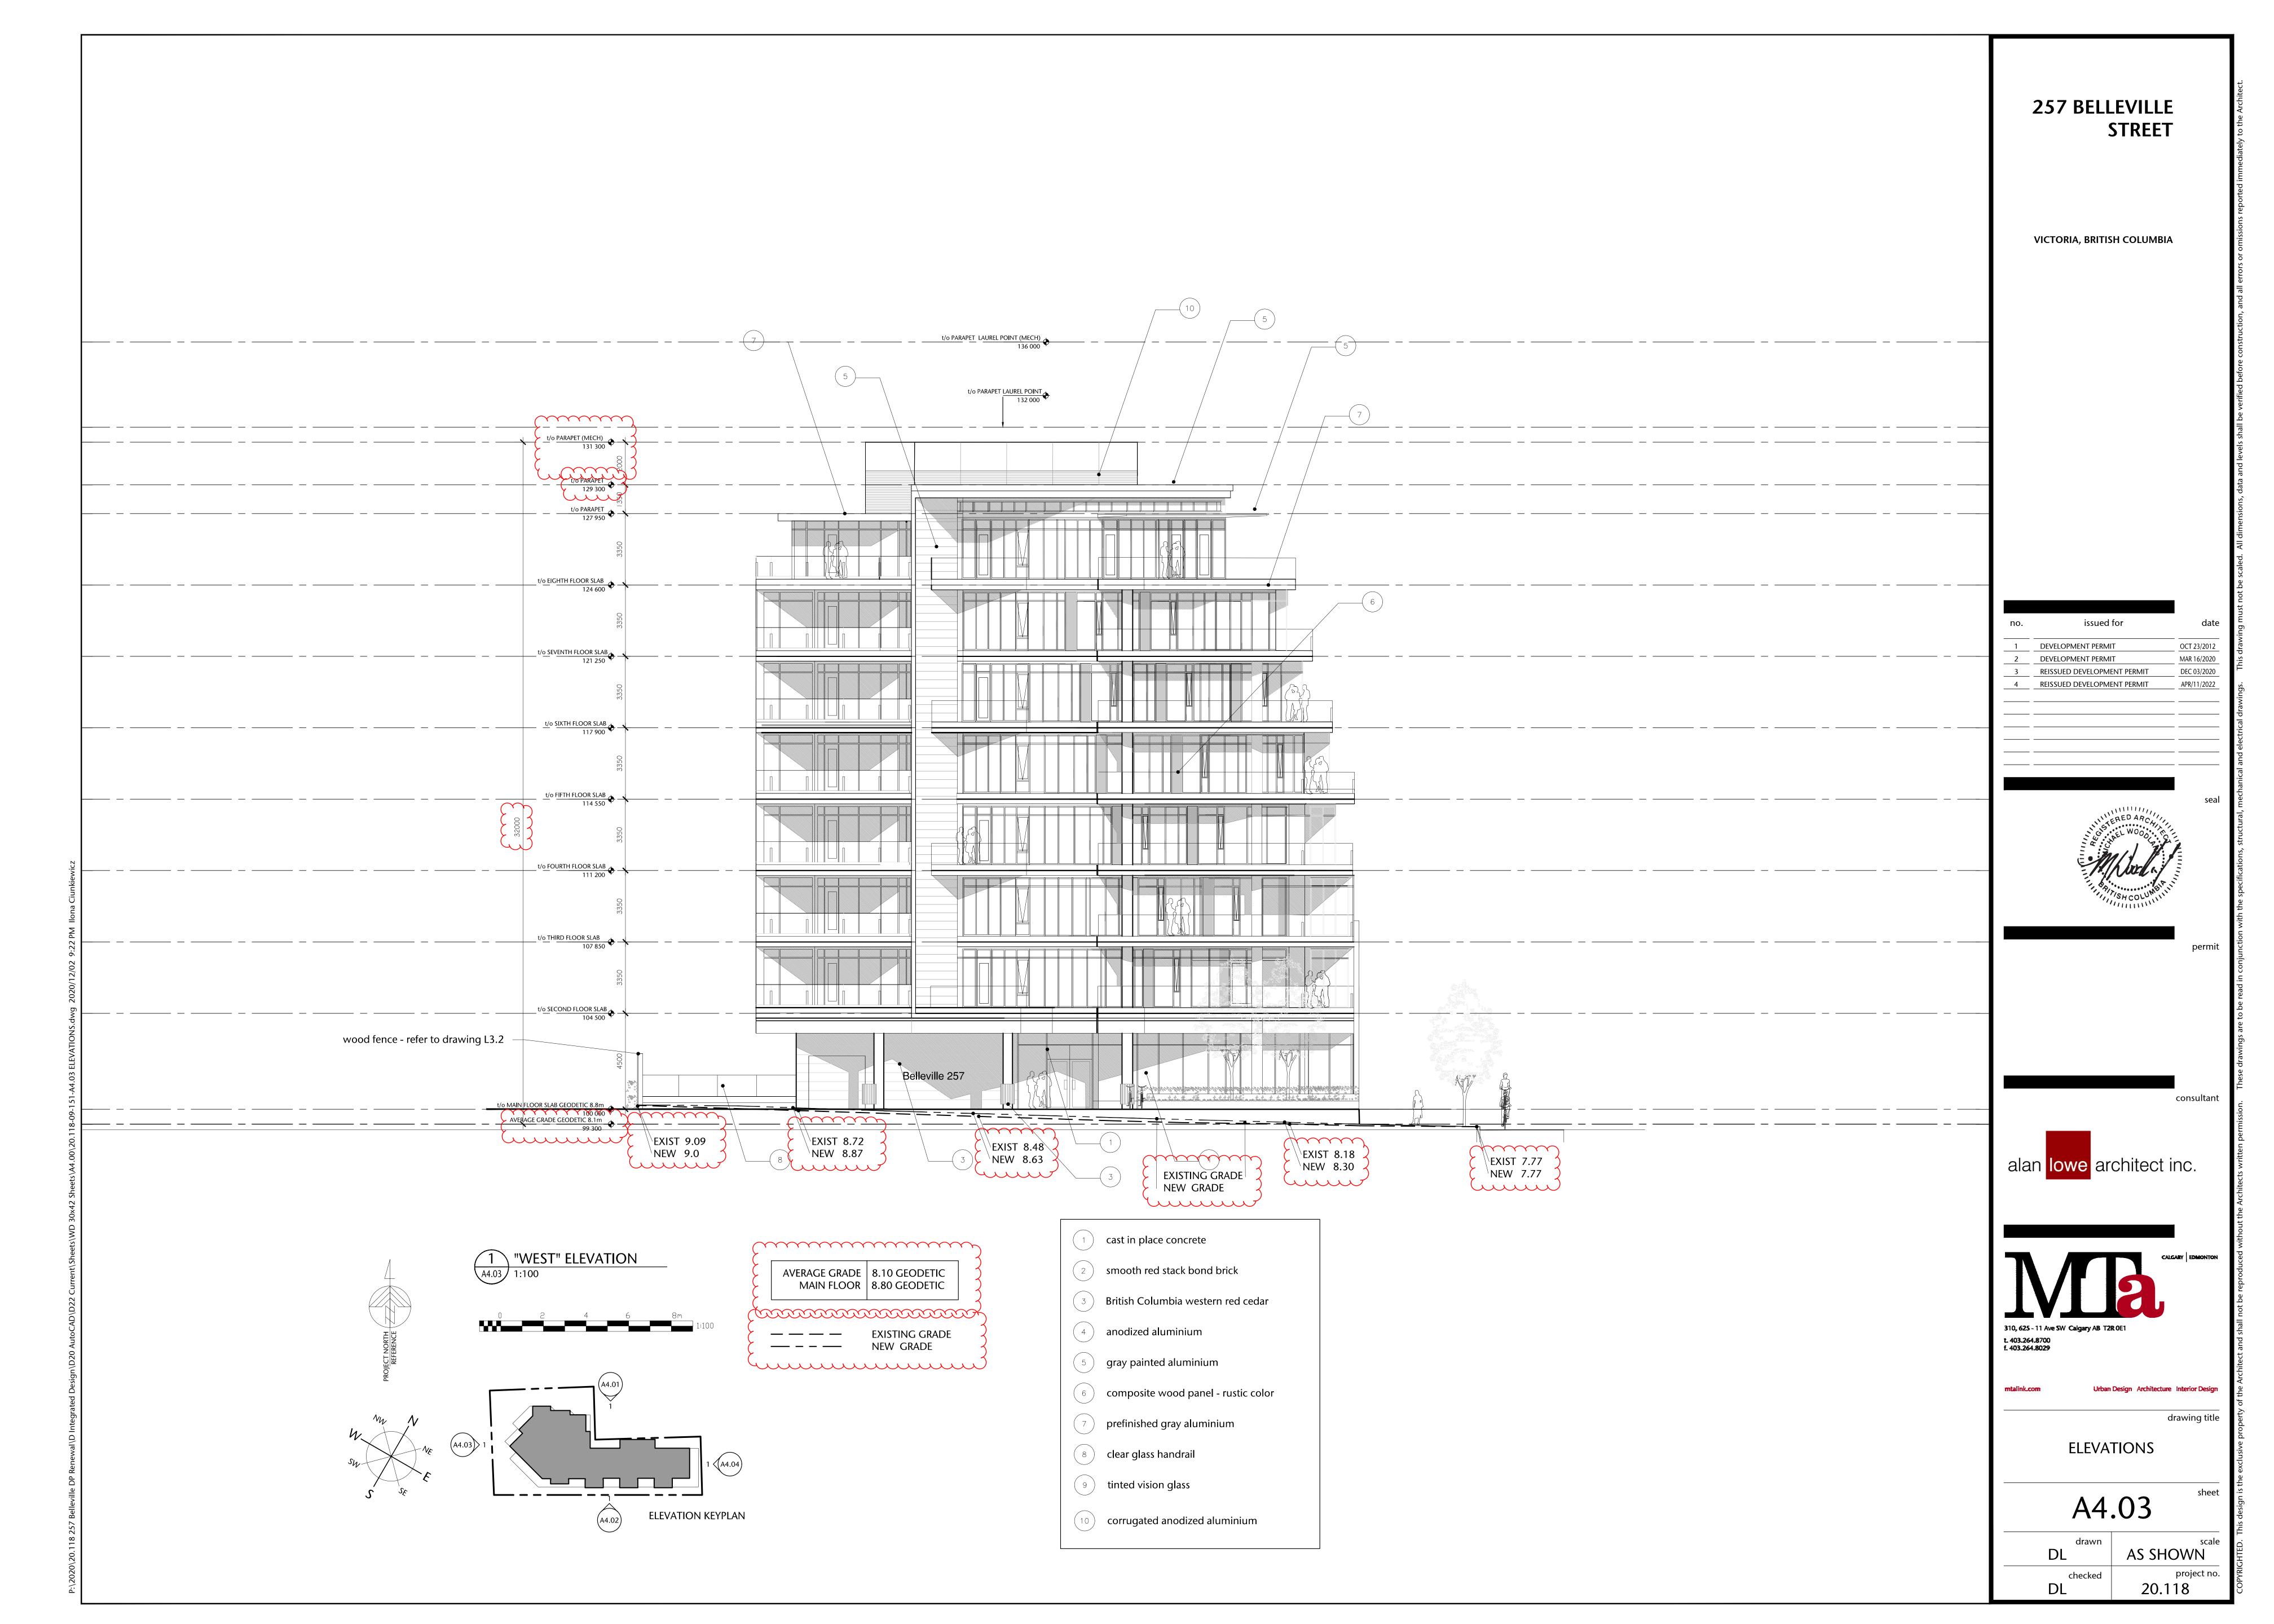

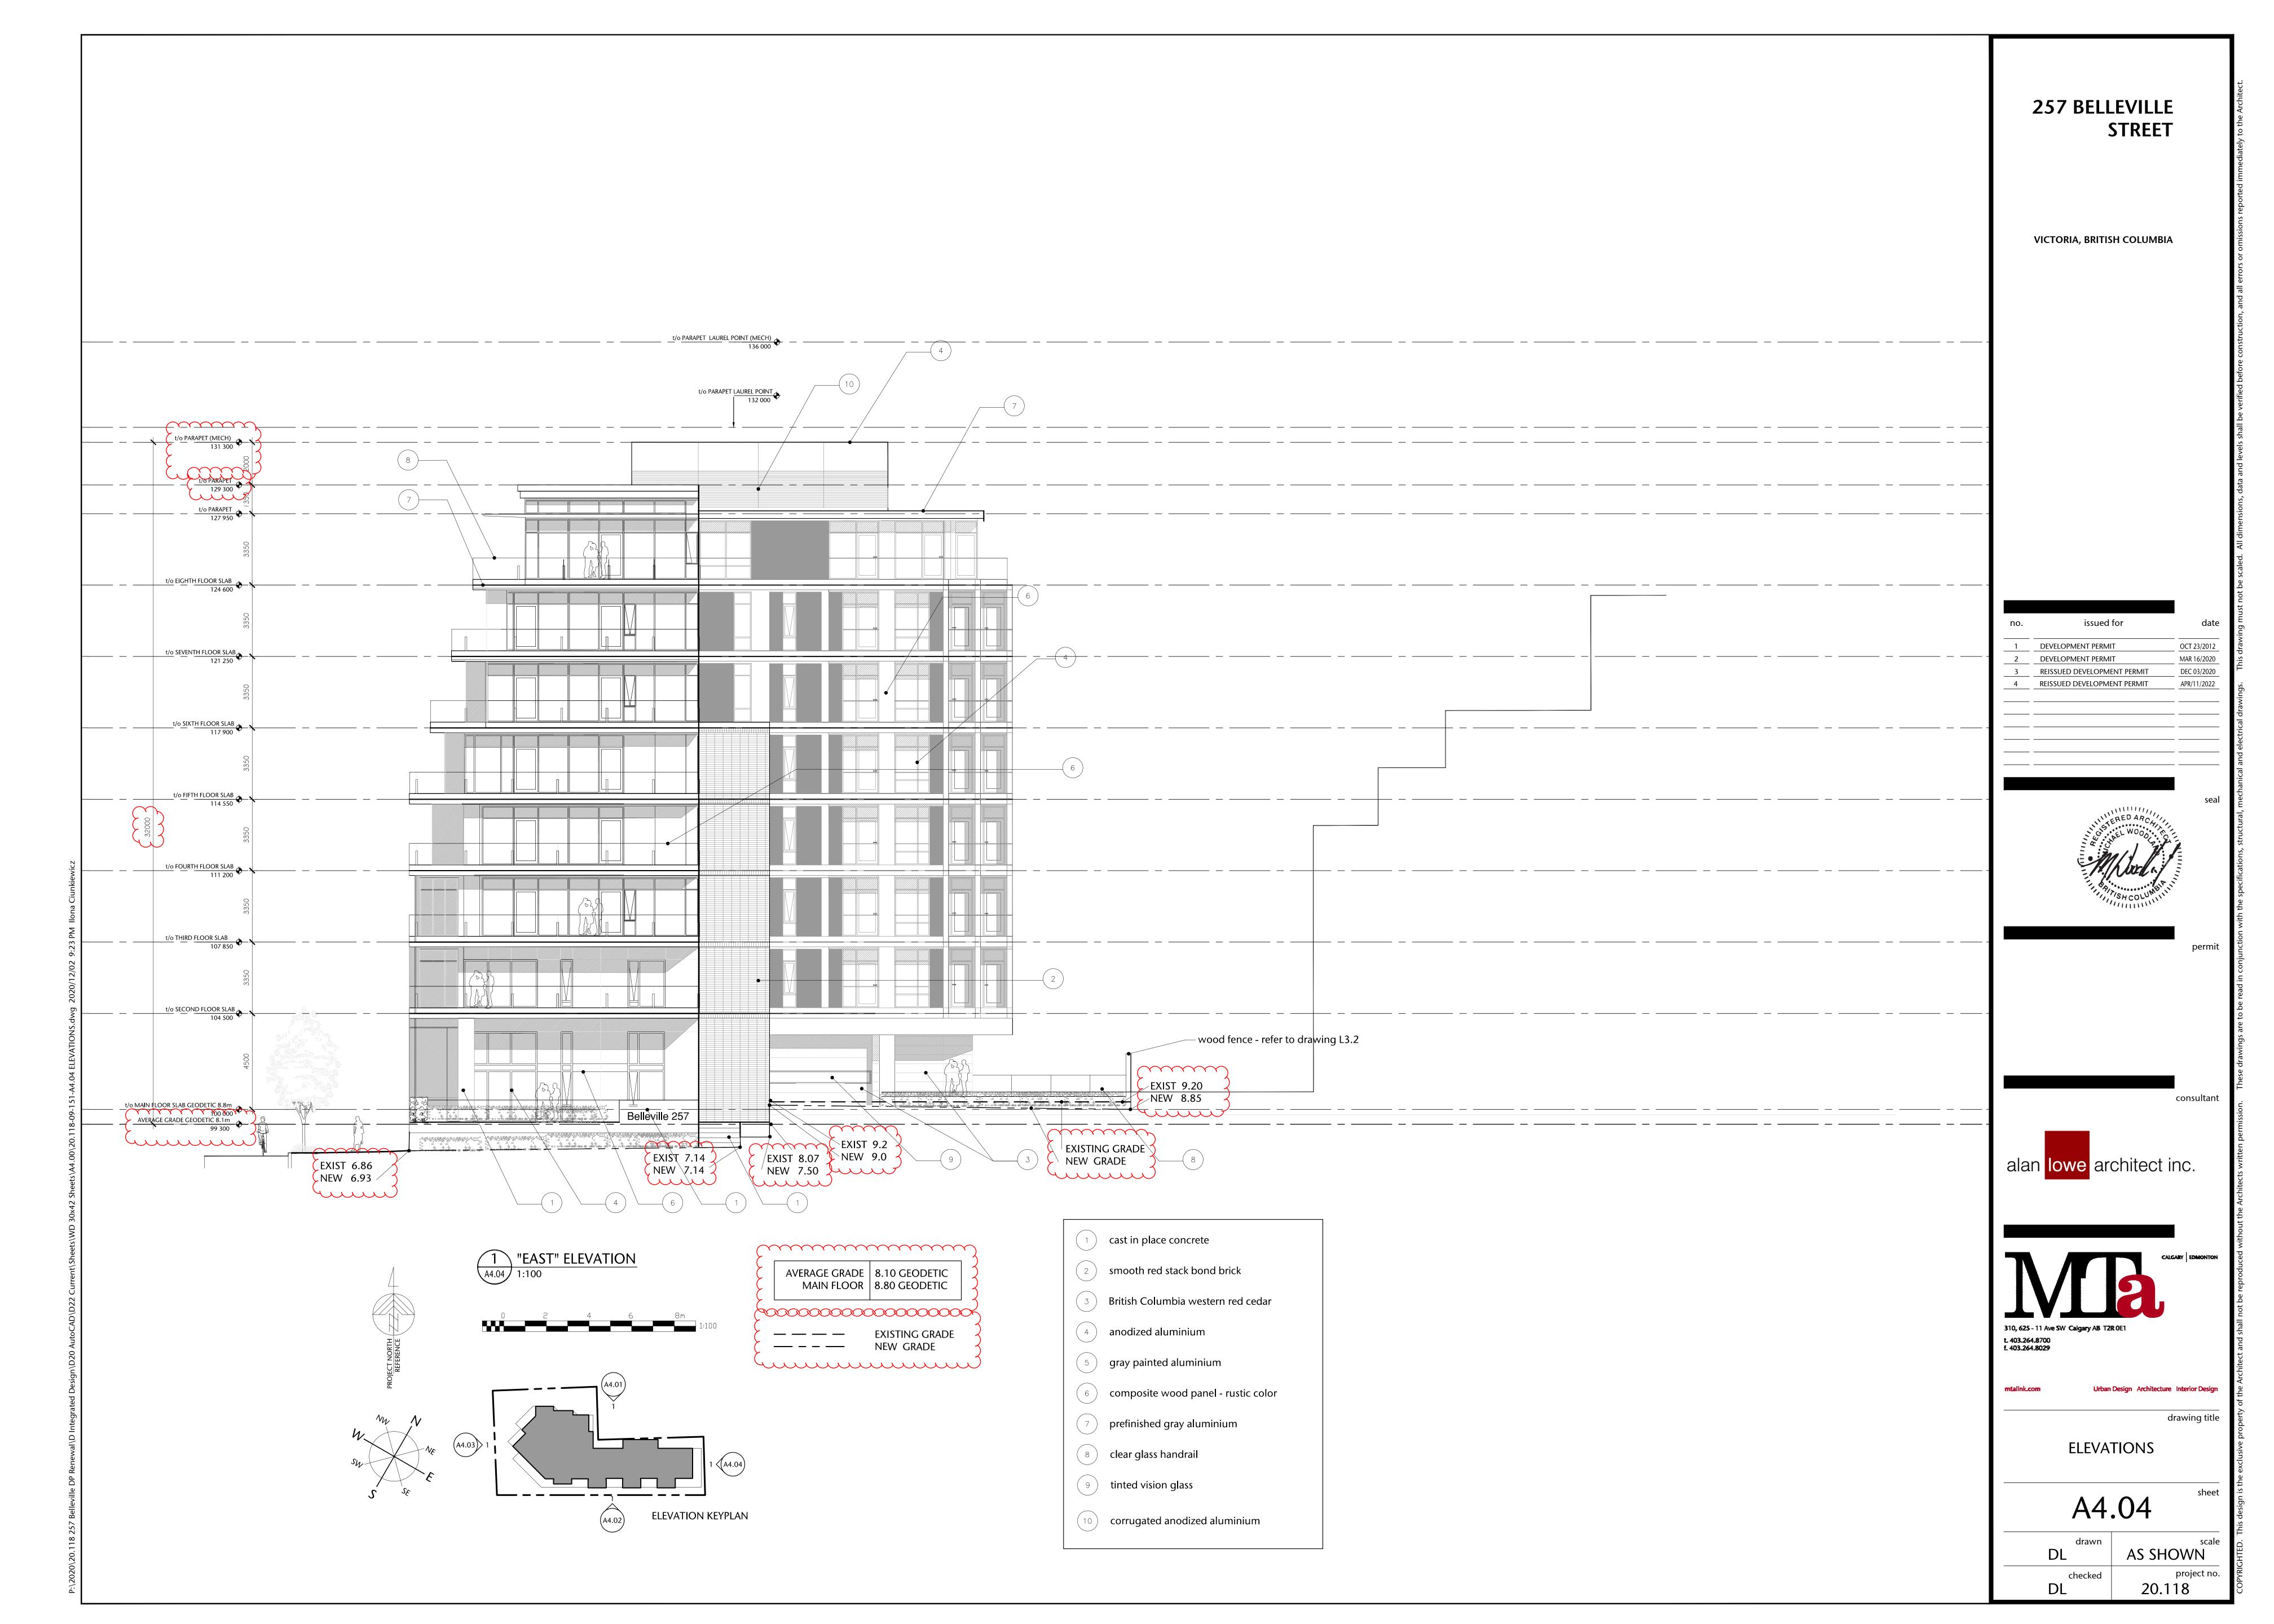


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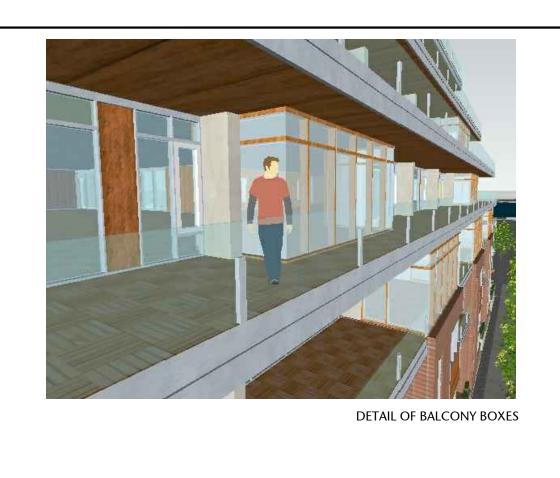





STREETSCAPE ELEVATIONS

AS SHOWN



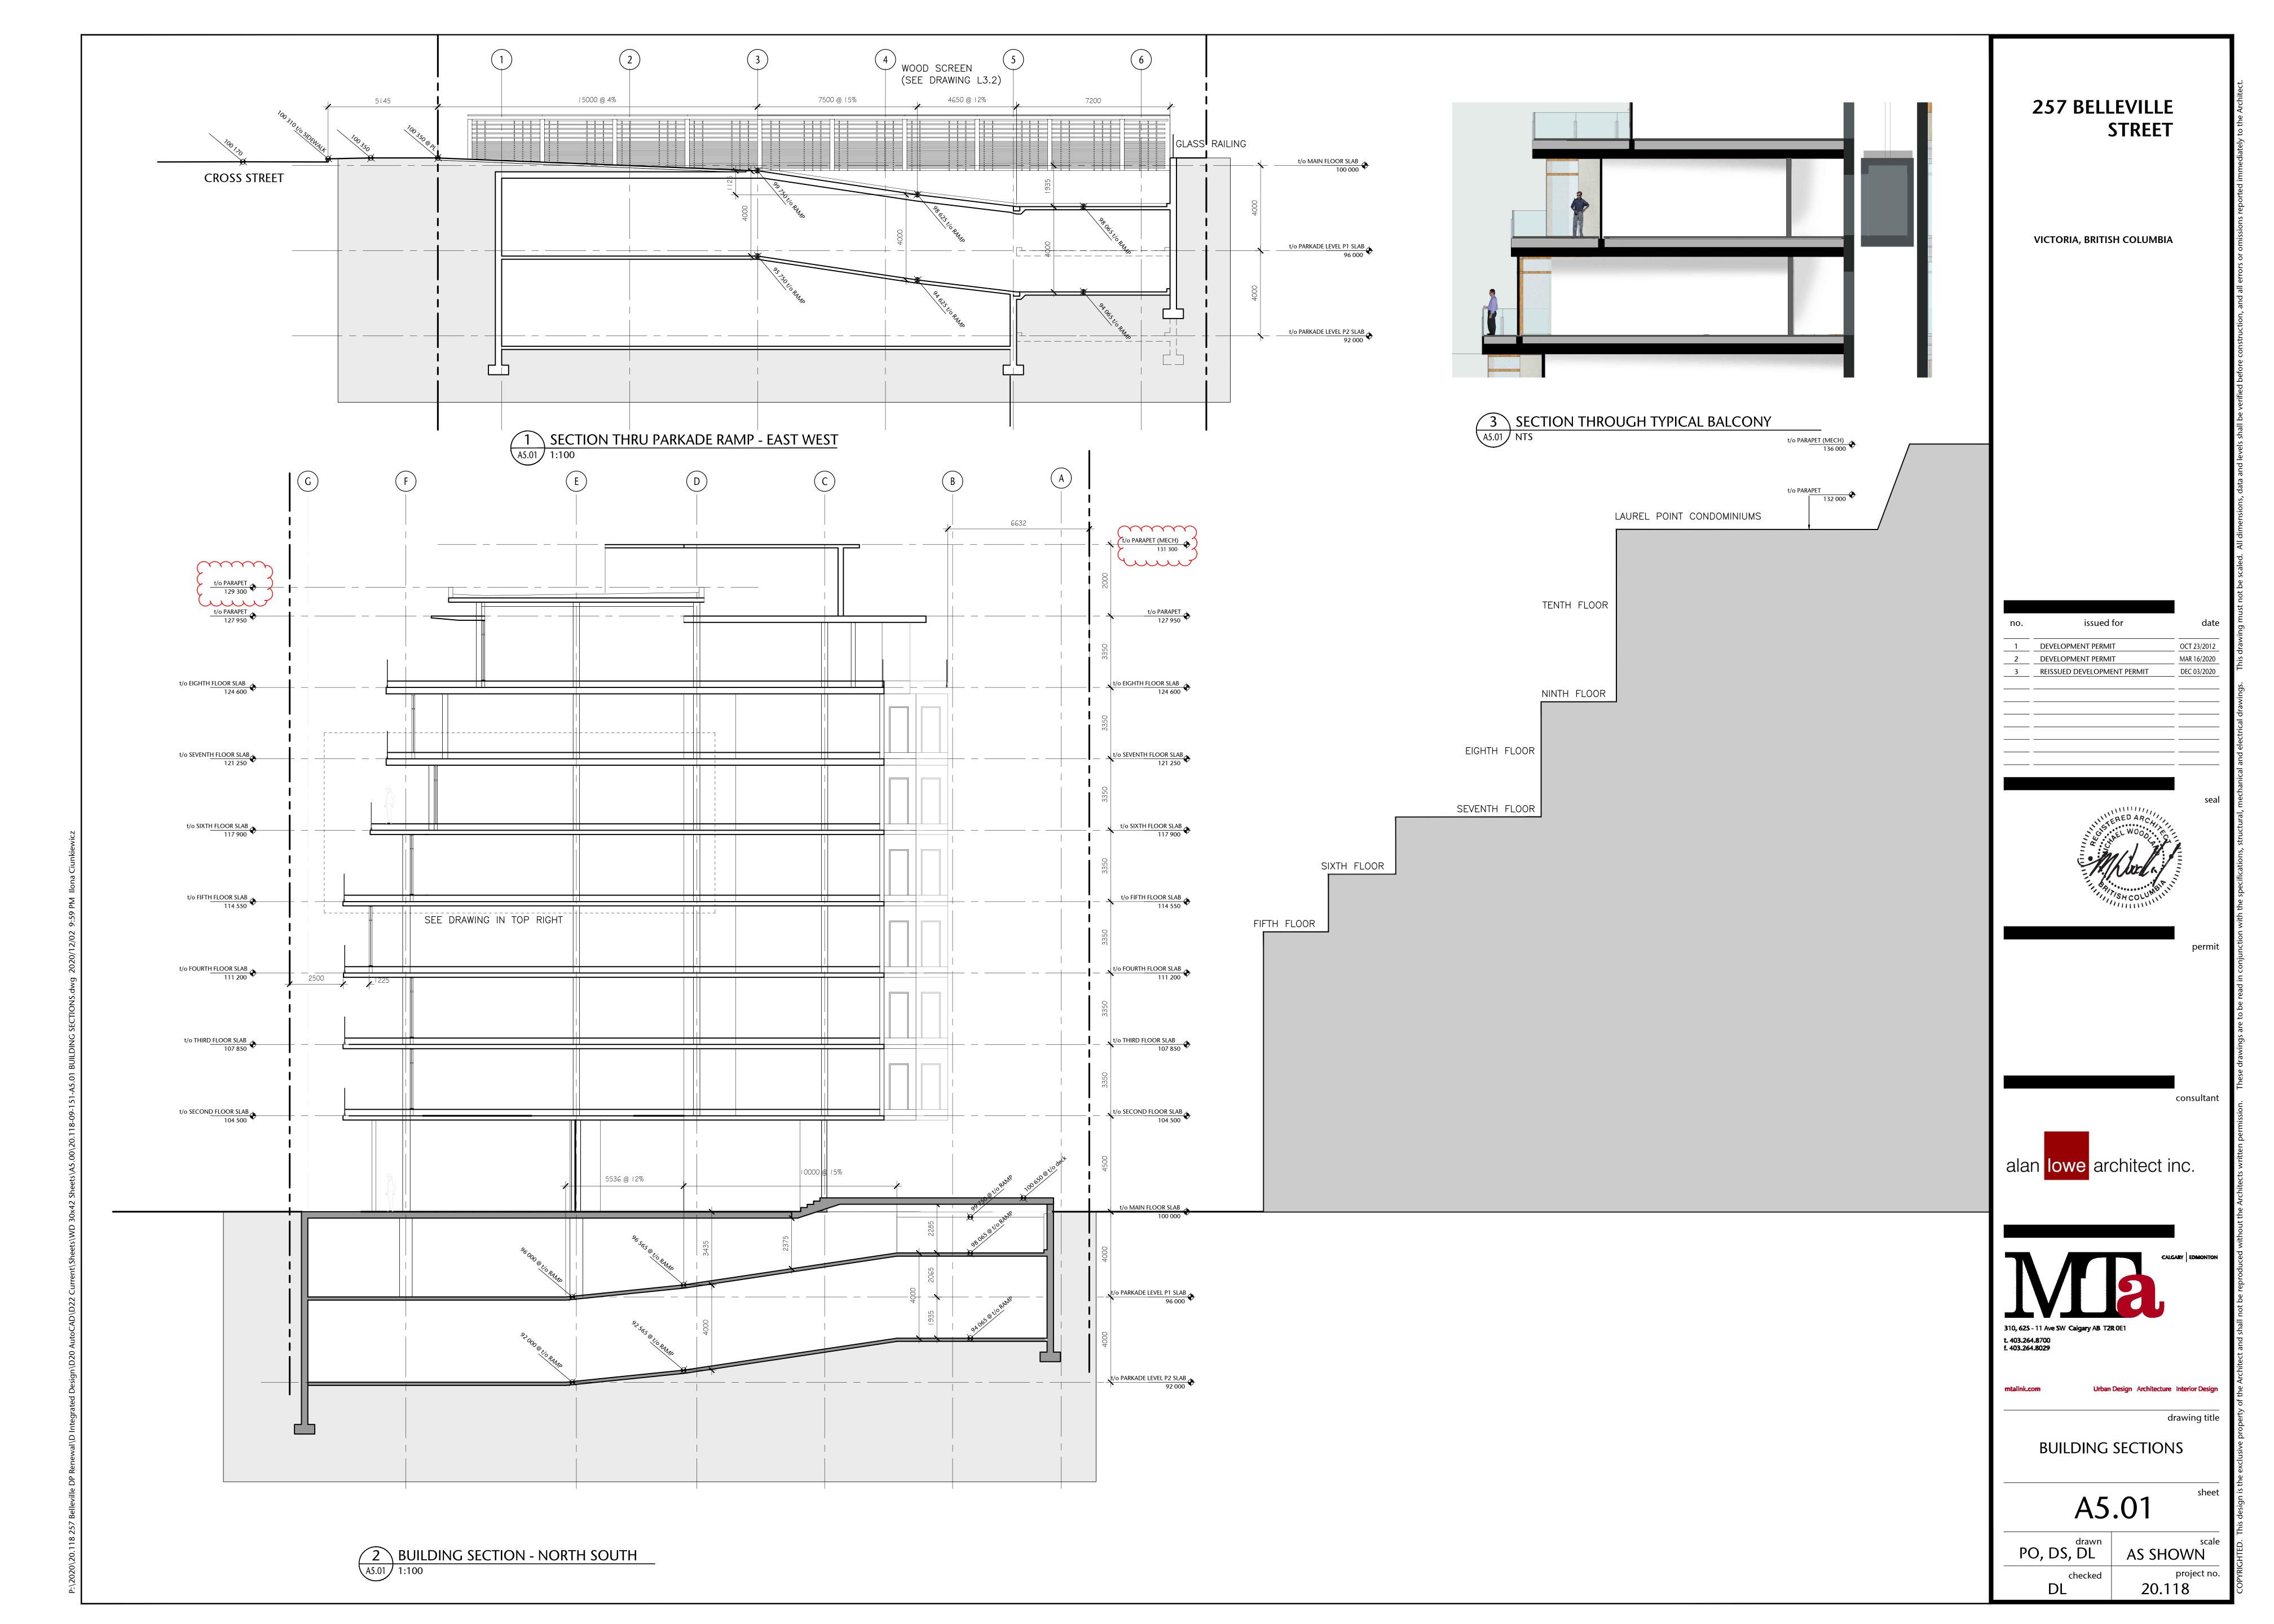


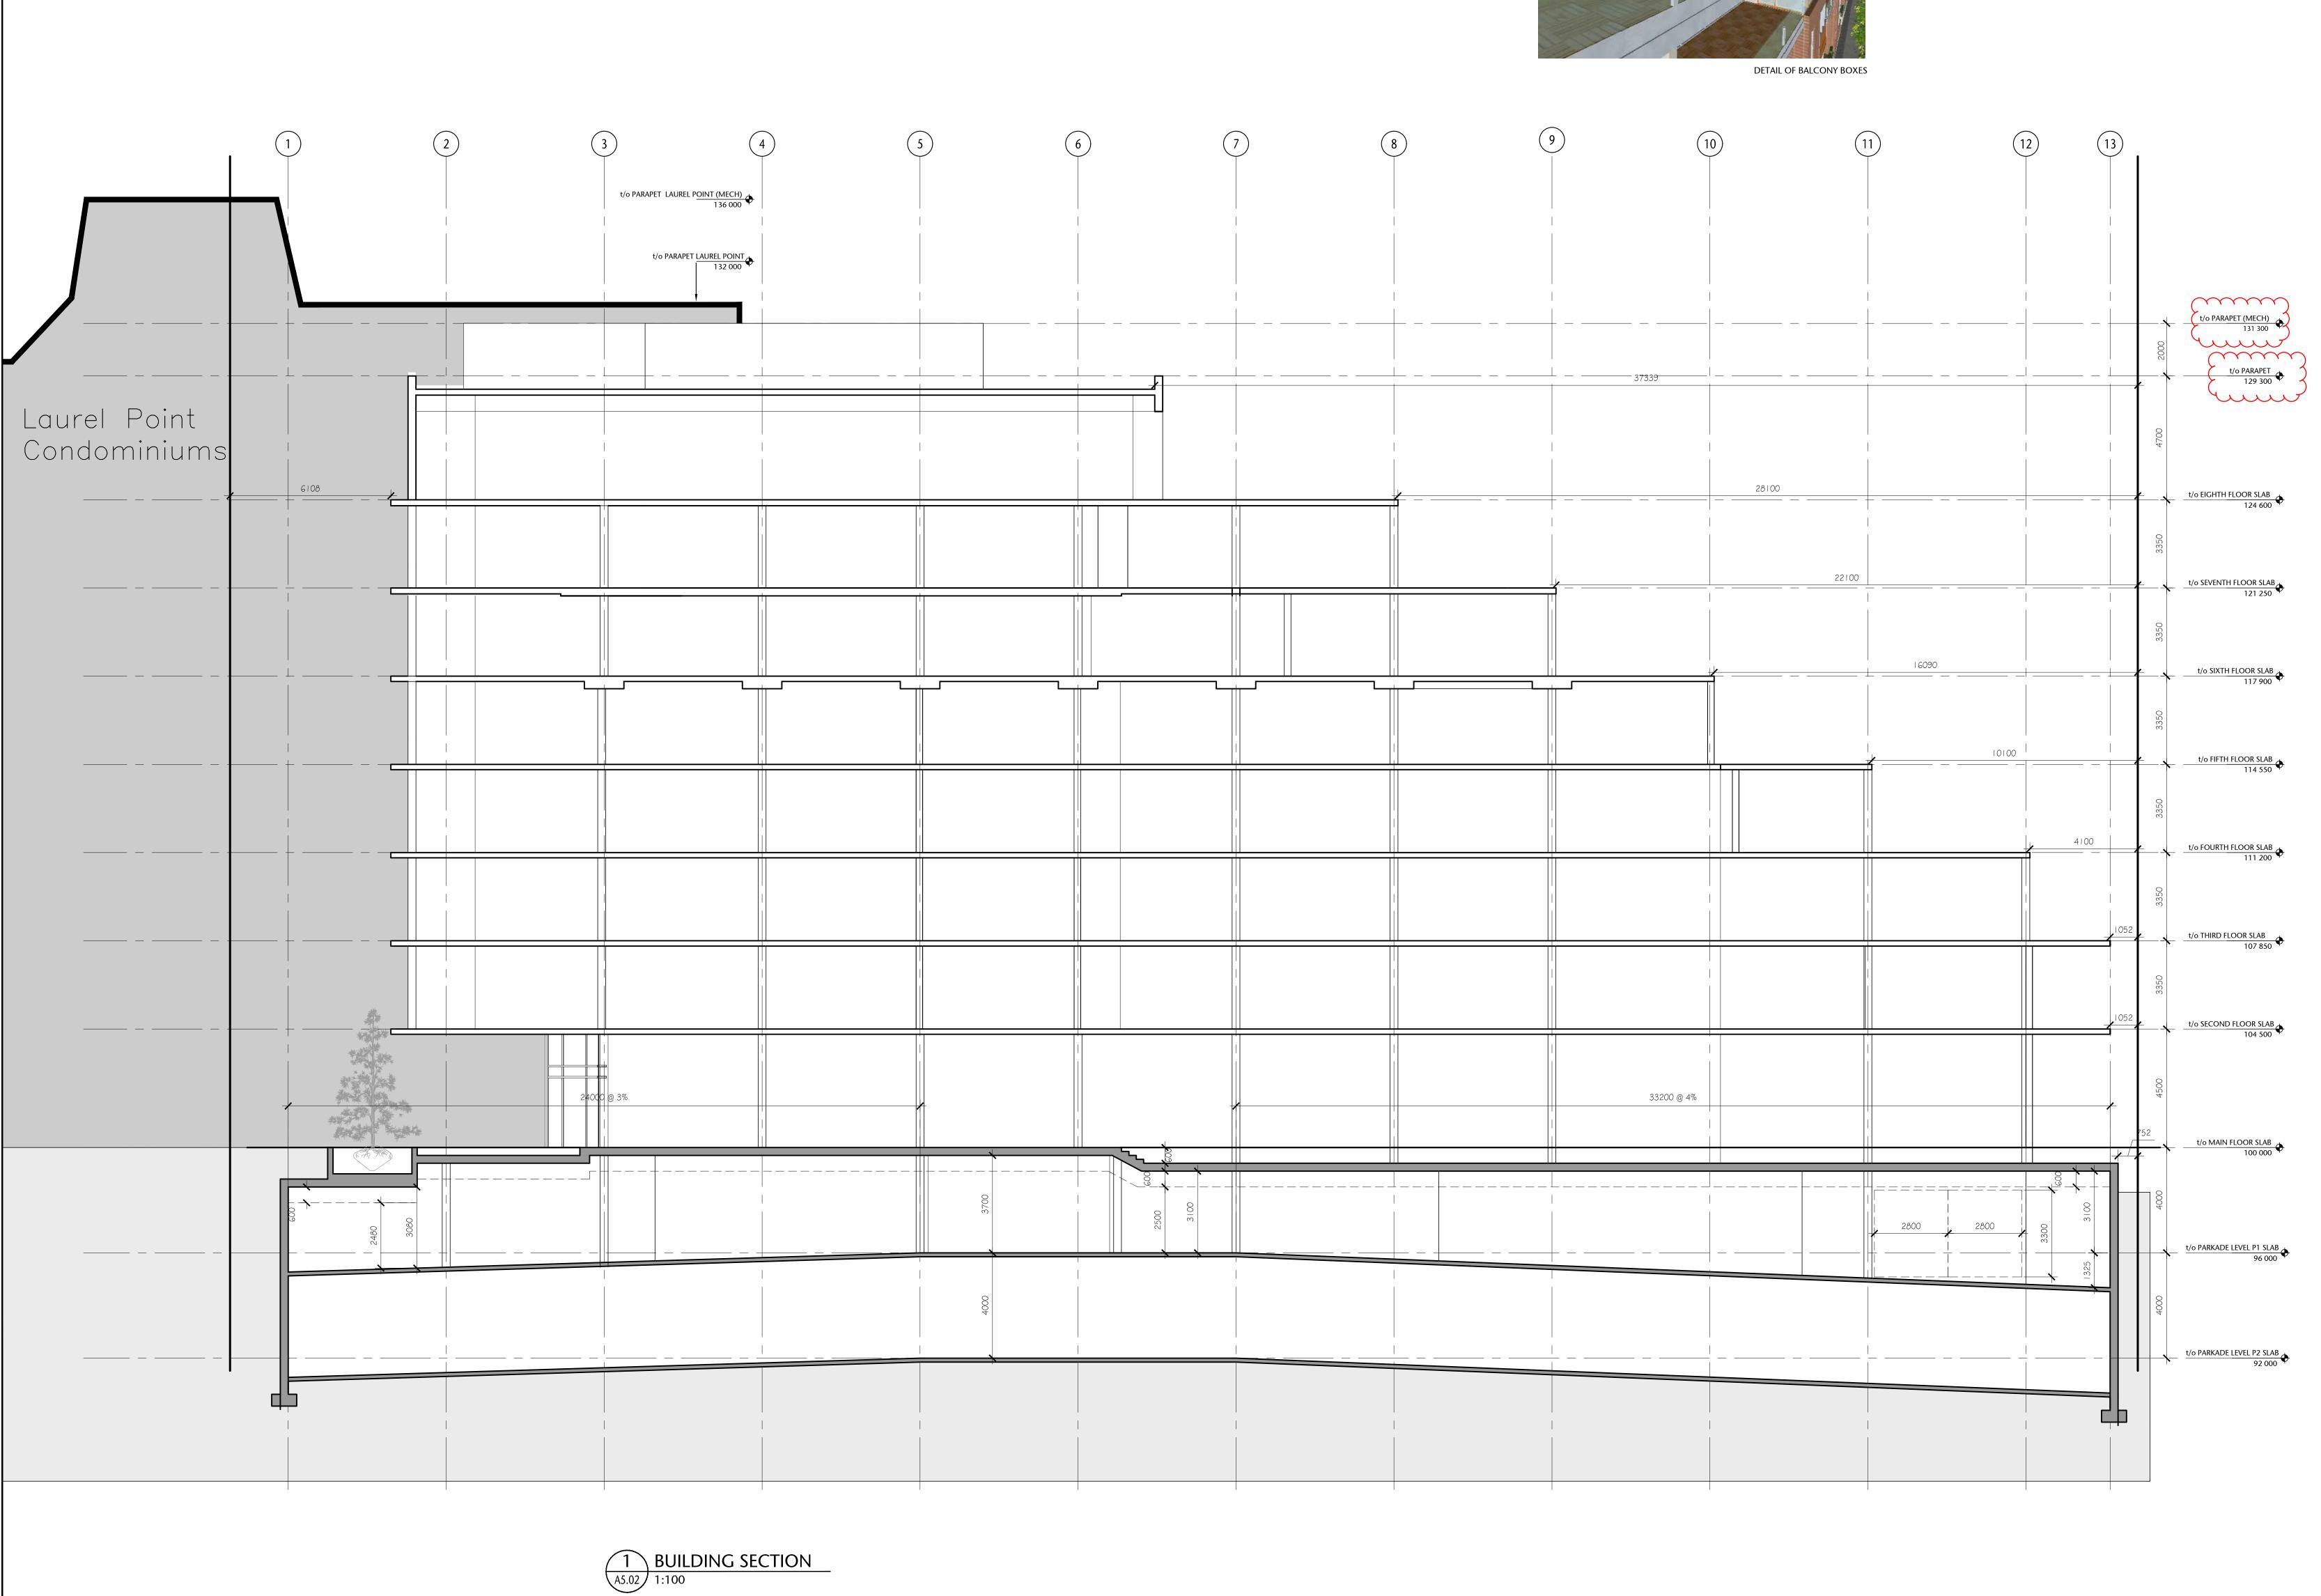



VICTORIA, BRITISH COLUMBIA

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1	DEVELOPMENT PERMIT	OCT 23/2012
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3	REISSUED DEVELOPMENT PERMIT	DEC 03/2020
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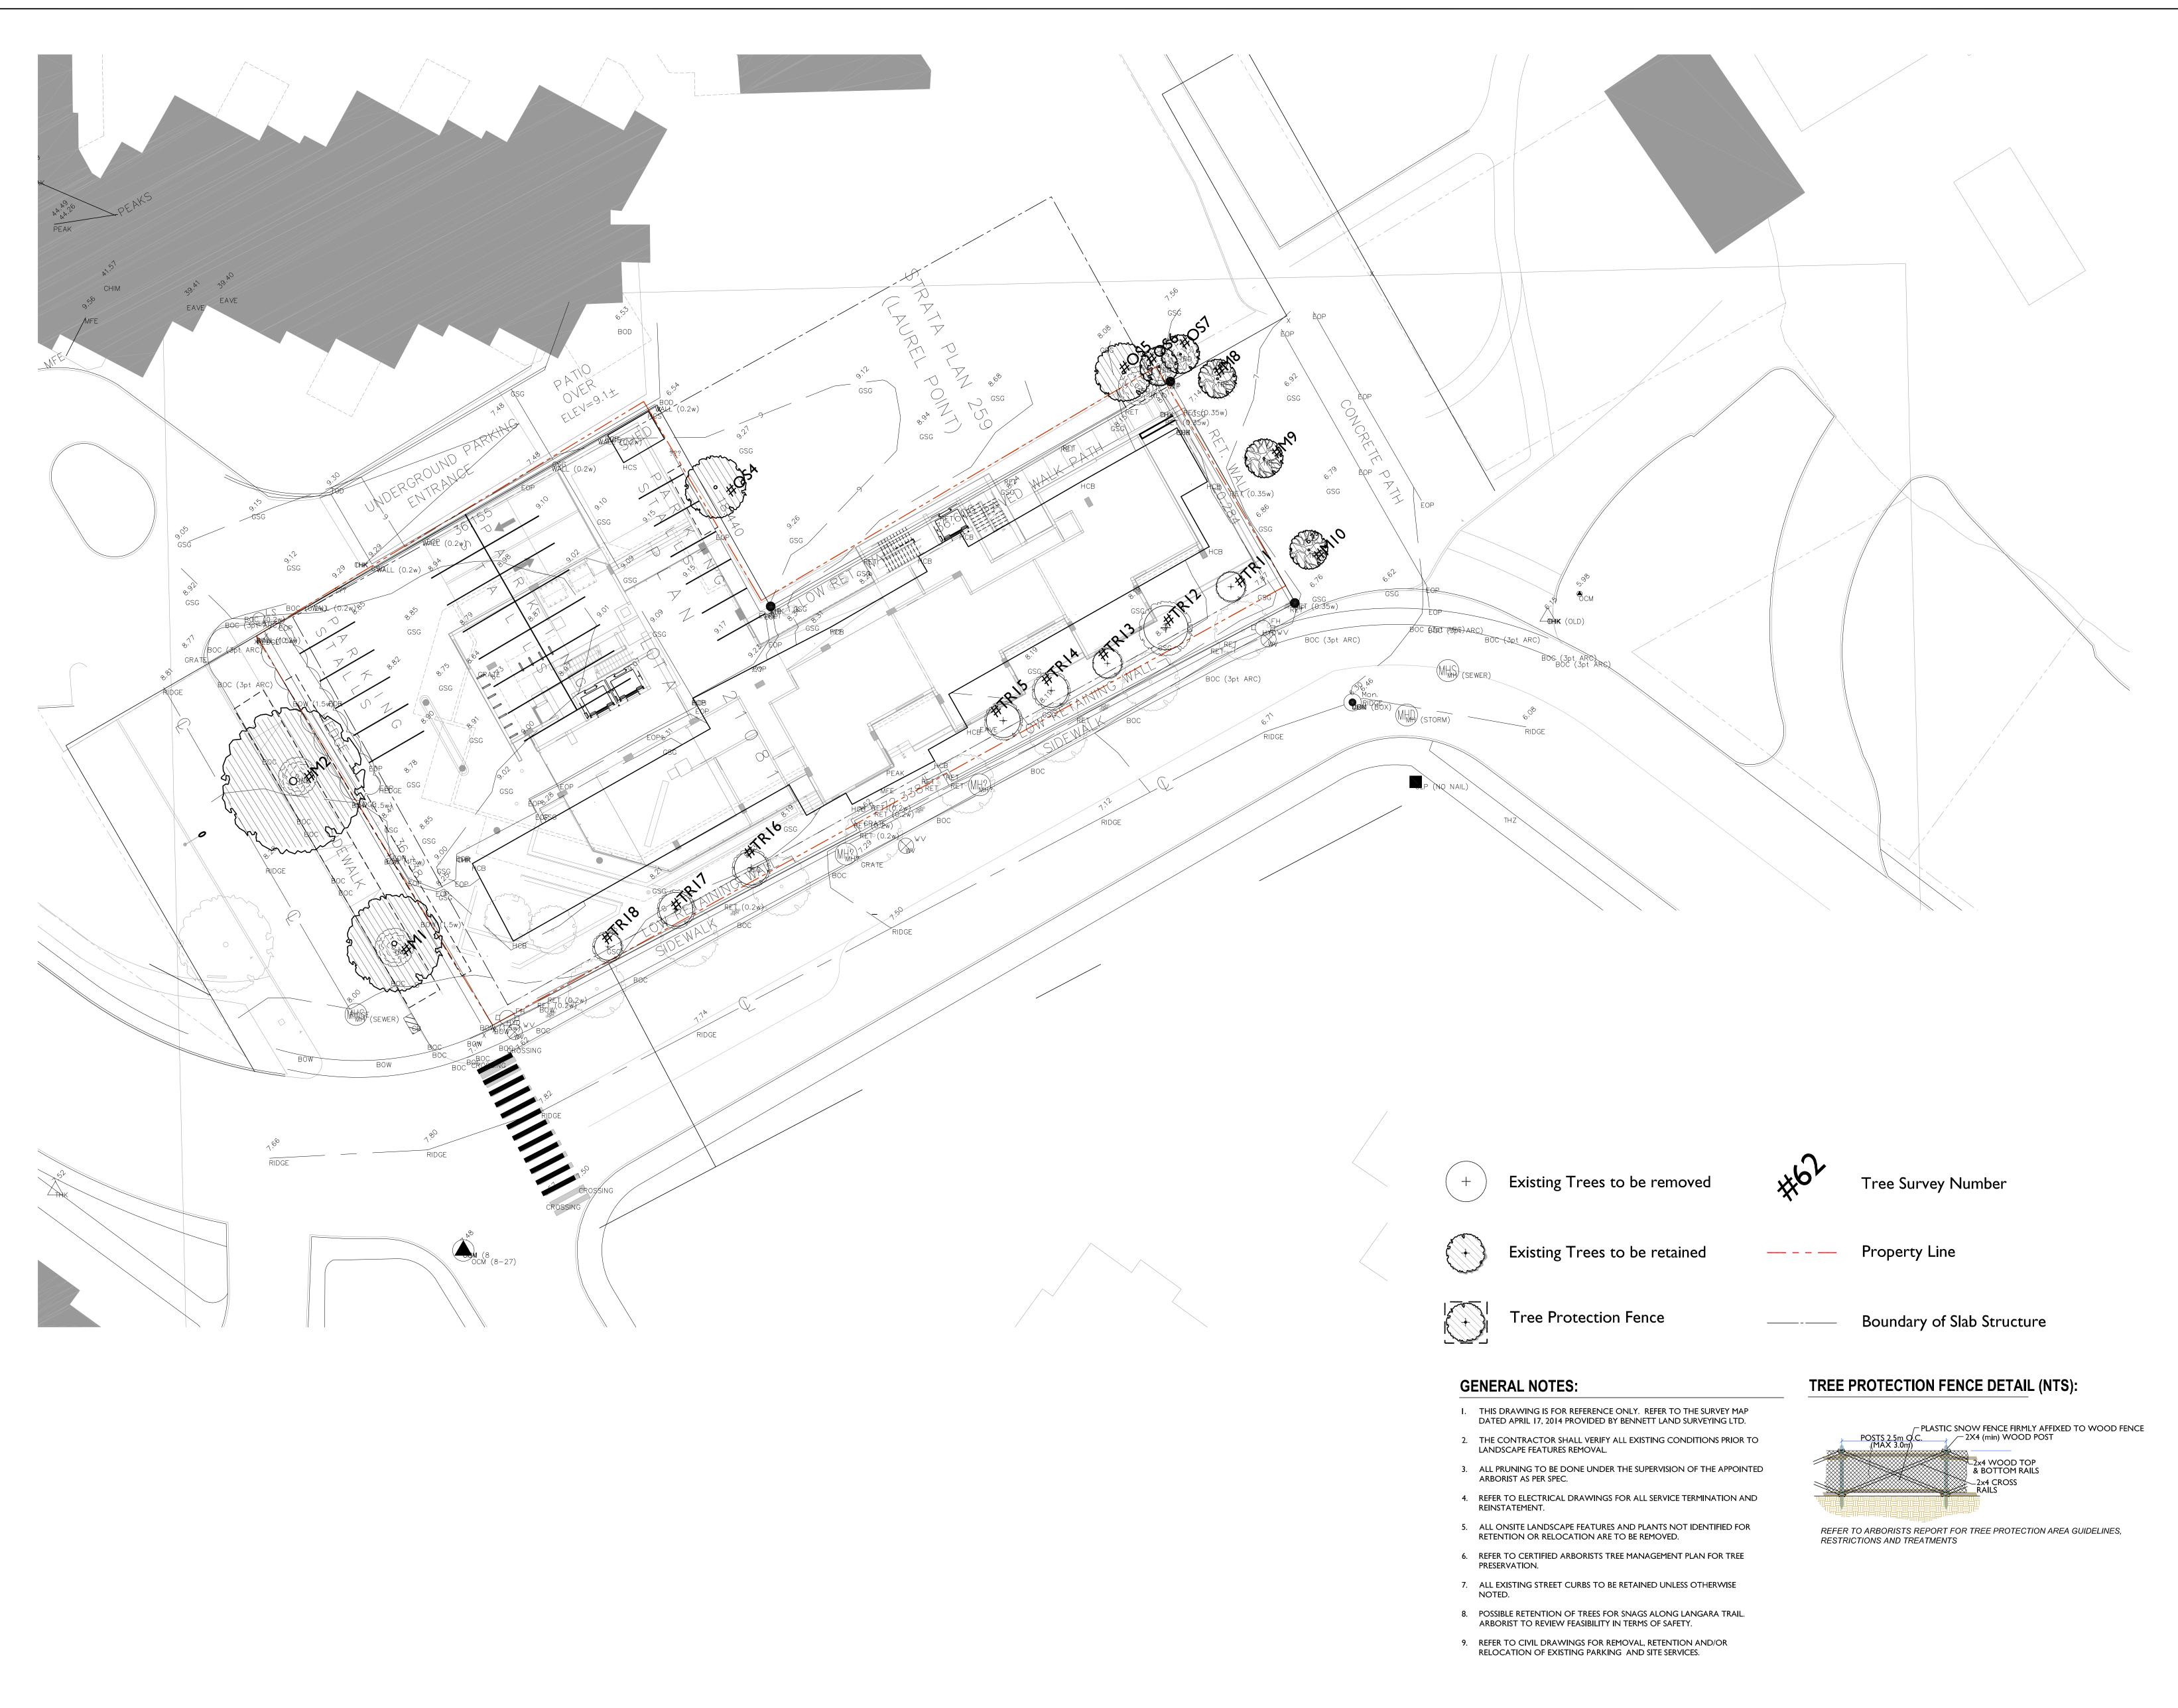
alan lowe architect inc.

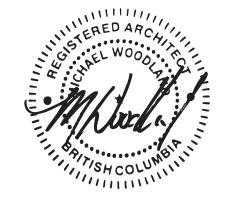

drawing title **BUILDING SECTIONS**

A5.02

PO, DS, DL AS SHOWN



VICTORIA, BRITISH COLUMBIA.

no.		iss	sued for			date
	Deve	lopr	nent Permit		Nov	15/10
	Revised	d De	evelopment Pe	ermit	Feb	04/11
	Revised	d De	evelopment Pe	ermit	Feb	16/11
	Revised	d De	evelopment Pe	ermit	Apr	29/11
	Is	sued	d for Costing		Nov	07/11
F	Re-issued	for	Development	Permit	Dec	05/12
F	Re-issued	for	Development	Permit	Nov	26/20
F	Re-issued	for	Development	Permit	June	03/21
	F	or C	Coordination		July	30/21
F	Re-issued	for	Development	Permit	Dec	06/21



ı permit

____ consultant

PLANNING A LIRBAN DESIGN A LANDSCAPE ARCHITECTURE



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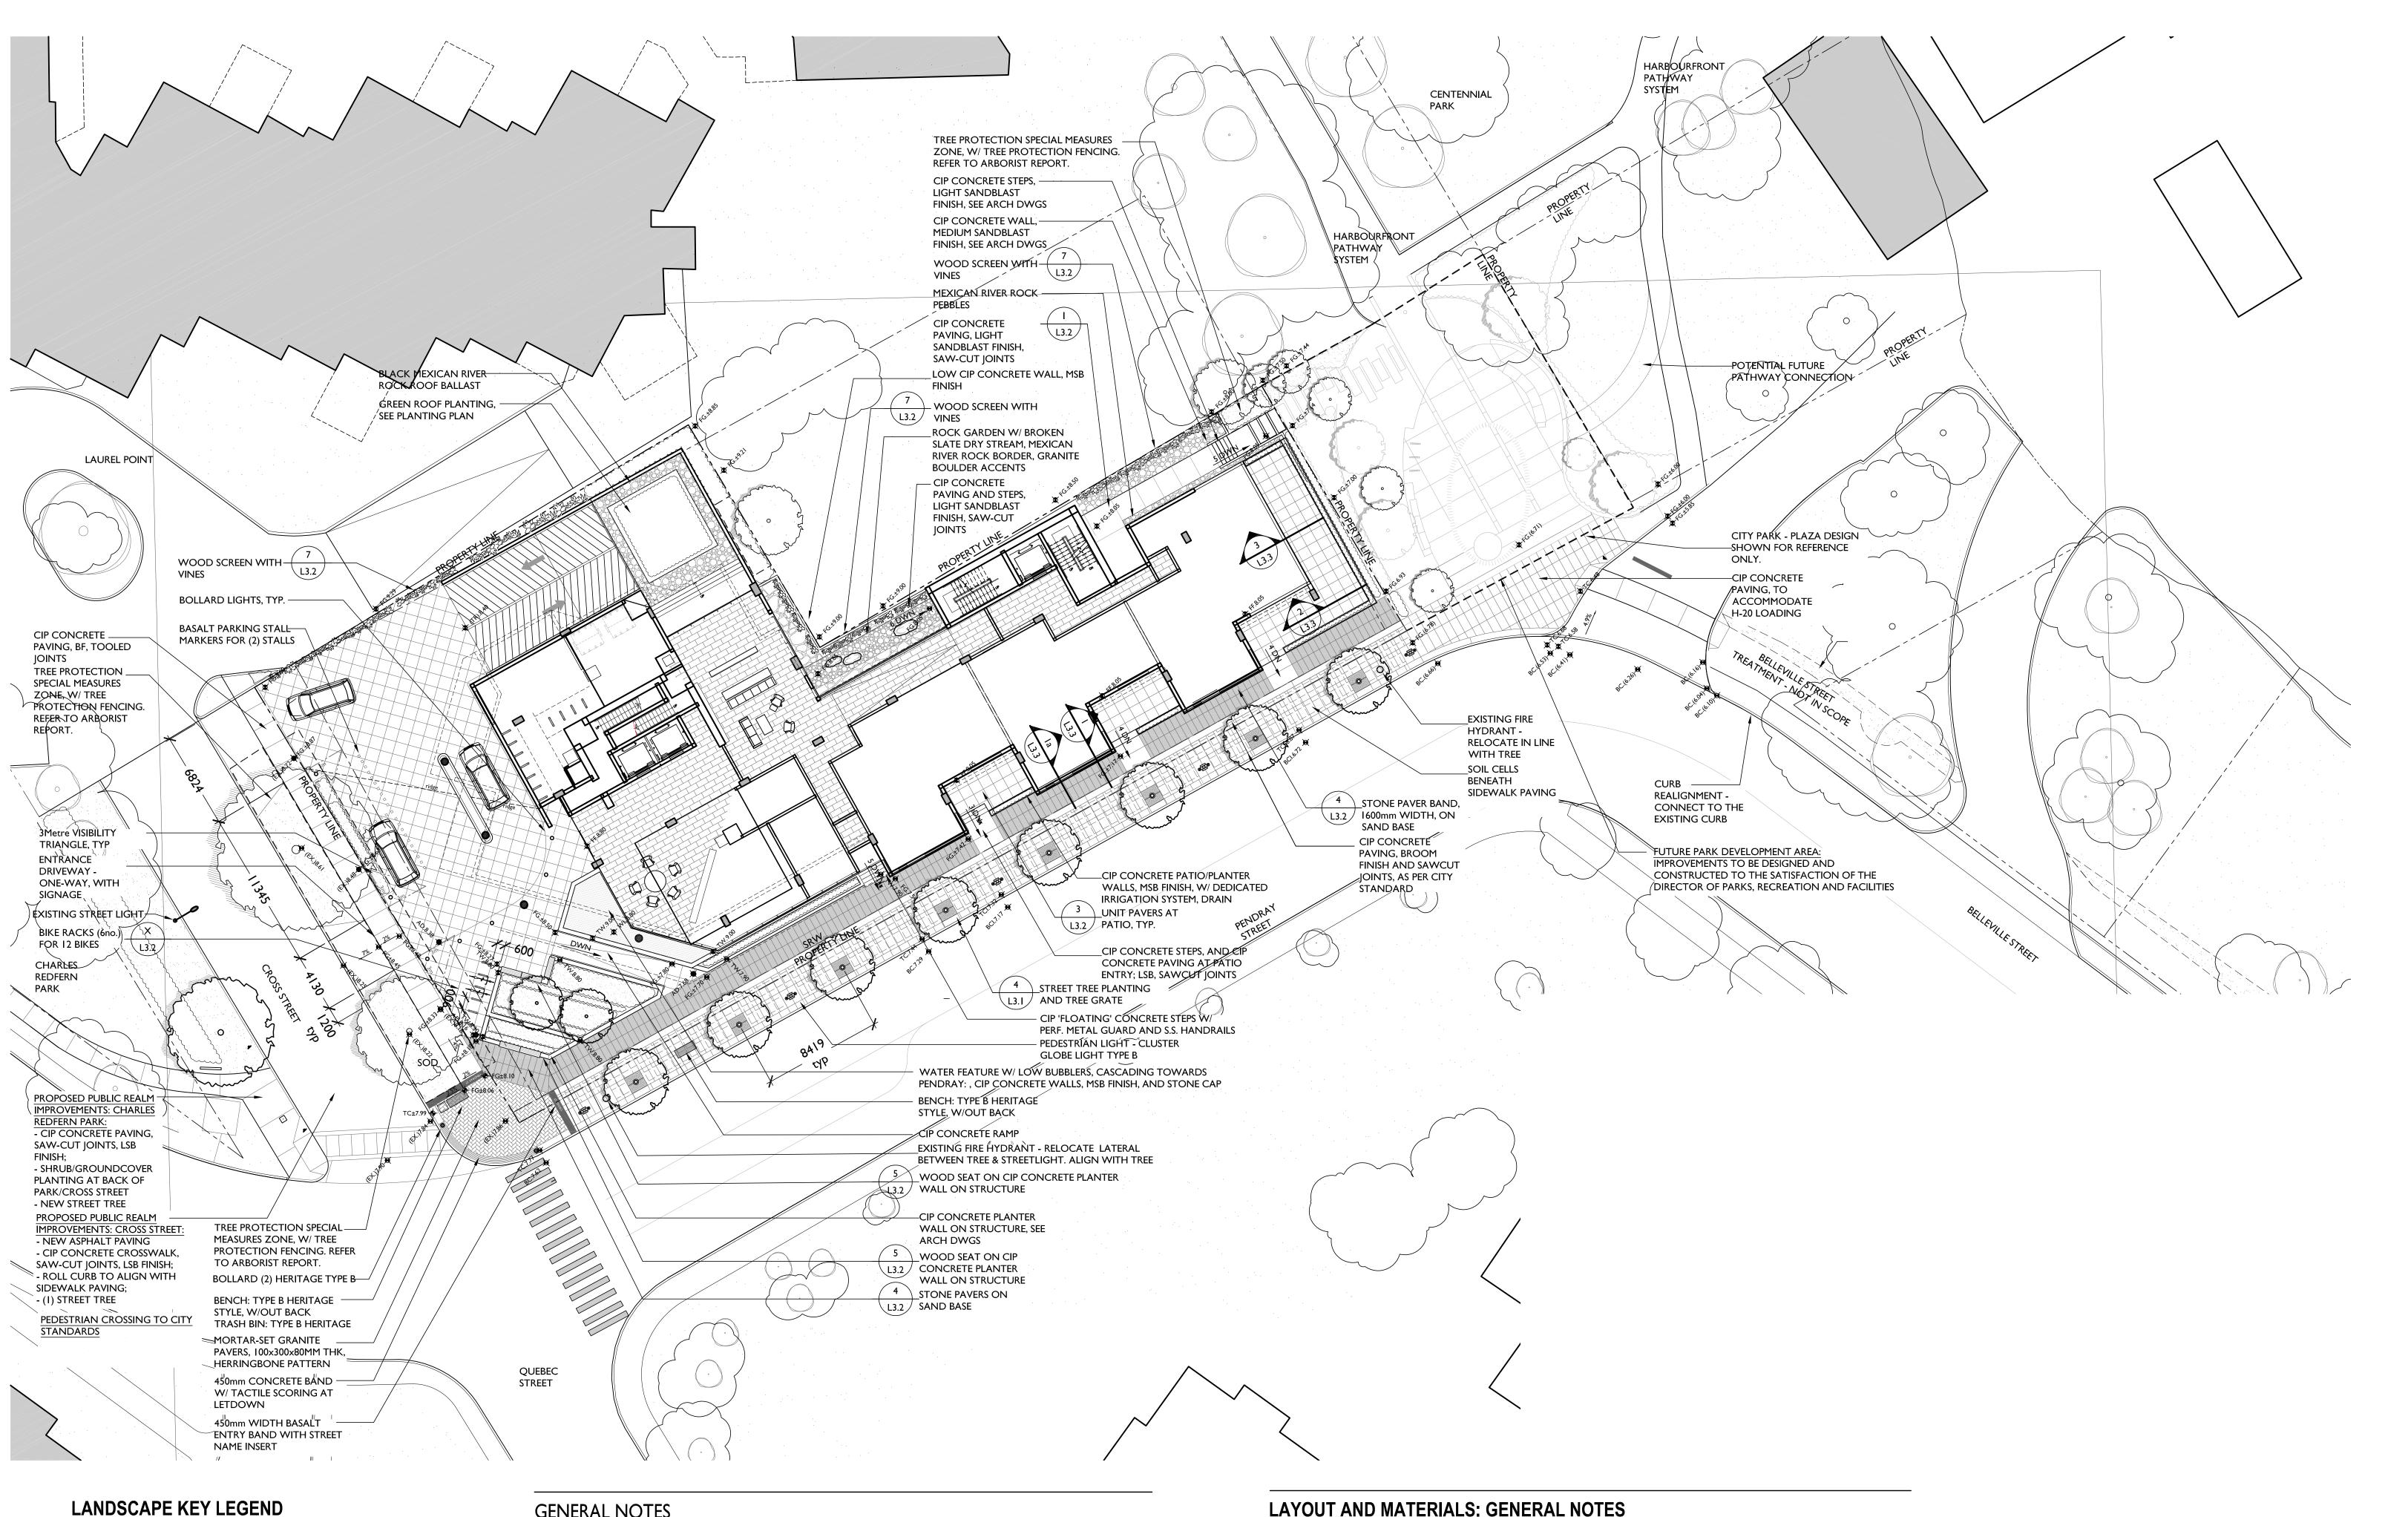
drawing title

TREE MANAGEMENT PLAN

LO. I

MD drawn I:200 scale

CP checked project no.



- CAST-IN-PLACE POOL BOTTOM WATER LEVEL TOP OF STAIR **BOTTOM OF STAIR** TOP OF WALL **BOTTOM OF WALL** TOP OF CURB BOTTOM OF CURB AREA DRAIN
- PROPOSED SPOT ELEVATION (FINISHED GRADE)

PLANT SPECIES PLANT QUANTITY

SECTION NUMBER SET SHEET NO.

DETAIL NUMBER SET SHEET NO.

GENERAL NOTES

I. PROVIDE ADEQUATE SUB-SURFACE DRAINAGE IN ALL LAWN AND PLANTING AREAS. 2. SEE <u>CIVIL AND ARCHITECTURAL</u> DRAWINGS FOR GRADING.

3. ENSURE POSITIVE DRAINAGE 4. STREETSCAPE TO APPROVAL OF ENGINEERING SERVICES. ALL STREET TREES TO HAVE 8' WIDE 18" DEPTH 'DEEP ROOT' ROOT BARRIER, OR PRE-APPROVED EQUIVALENT, AT ALL SIDEWALK LOCATIONS.

5. ALL STREET TREE SPECIES AND SPACING TO CONFORM TO CITY OF VICTORIA STANDARD SPACING AND CLEARANCE. 6. FINAL TREE LOCATIONS TO BE DETERMINED TO THE SATISFACTION OF ENGINEERING SERVICES.

7. AN AUTOMATIC IRRIGATION SYSTEM SHALL BE PROVIDED FOR ALL PLANT MATERIAL, INCLUDING STREETLEVEL PLANTINGS AND GREEN ROOF PLANTINGS. HOSEBIBS SHALL BE PROVIDED IN ALL <u>PRIVATE</u> COURTYARD AND PATIO AREAS. IRRIGATION SYSTEM DESIGN AND INSTALLATION SHALL BE IN ACCORDANCE WITH THE IRRIGATION INDUSTRY OF BC STANDARDS AND

8. ALL PLANT MATERIAL TO CNLA AND CSLA STANDARDS. 9. ROOT BARRIERS TO BE 'DEEP ROOT', 'ROOT SOLUTIONS' OR EQUAL.

IRRIGATION: GENERAL NOTES

I. ALL LANDSCAPE IRRIGATION SHALL CONFORM TO IABC STANDARDS. 2. LANDSCAPE DRIPLINE SHALL BE LOOPED UNLESS OTHERWISE SPECIFIED. 3. ALL IRRIGATION WORK SHALL BE DONE BY A SUITABLY EXPERIENCED AND QUALIFIED IRRIGATION CONTRACTOR ADEQUATE FOR THE SCOPE OF WORK. THE CONTRACTOR SHALL BE A MEMBER IN GOOD STANDING OF THE IRRIGATION INDUSTRY ASSOCIATION OF B.C. AND HAVE MET THE QUALIFICATION STANDARDS CURRENTLY APPLIED TO CONTRACTORS BY THAT ORGANIZATION.

4. UNLESS OTHERWISE SPECIFIED OR INDICATED ON THE DRAWINGS, ALL LANDSCAPE IRRIGATION EQUIPMENT SHALL BE SUPPLIED BY A SINGLE MANUFACTURER. ANY SUBSTITUTIONS WITHOUT THE PRIOR APPROVAL OF THE CONSULTANT WILL BE

LAYOUT AND MATERIALS: GENERAL NOTES

I. DO NOT SCALE DRAWINGS. LAYOUT AS PER DIMENSIONS NOTED ON LANDSCAPE PLANS. REPORT ANY DISCREPANCIES TO THE CONSULTANT FOR REVIEW AND RESPONSE. 2. LAYOUT AND MATERIALS DRAWINGS ARE TO BE READ IN CONJUNCTION WITH LANDSCAPE SPECIFICATIONS FOR

COMPLIANCE. 3. LANDSCAPE DRAWINGS ARE TO BE READ IN CONJUNCTION WITH ARCHITECTURAL AND ENGINEERING DRAWINGS. REPORT ANY DISCREPANCIES TO THE CONSULTANT FOR REVIEW AND RESPONSE. 4. VERIFY ALL DIMENSIONS WITH FIELD CONDITIONS. REPORT ANY DISCREPANCIES TO THE CONSULTANT FOR REVIEW AND RESPONSE.

5. LIGHTING INFORMATION REFERENCED ON LANDSCAPE DRAWINGS IS TO BE READ IN CONJUNCTION WITH ELECTRICAL ENGINEERS DRAWINGS. REPORT ANY DISCREPANCIES TO THE CONSULTANT FOR REVIEW AND RESPONSE. 6. UTILITY AND LIGHTING ARE INDICATED FOR REFERENCE ONLY. REFER TO ENG. DRAWINGS FOR LOCATIONS, DETAILS, AND SPECIFICATIONS. 7. REFERENCE CIVIL ENGINEERS DRAWINGS FOR LAYOUT OF ROAD CURBS AND GUTTERS AND PEDESTRAIN LET-DOWNS.

8. REFER TO ENGINEERING DRAWINGS FOR DETAILS, SUBGRADE, AND REINFORCING OF ALL PAVED SURFACES IN ROADWAYS.

GRADING: GENERAL NOTES

I. CONFIRM ALL EXISTING GRADES PRIOR TO CONSTRUCTION AND REPORT ANY DISCREPANCIES TO THE CONSULTANT TEAM FOR REVIEW AND RESPONSE. 2. UNLESS OTHERWISE NOTED, ALL DRAINS LOCATED IN LAWN OR PLANTED AREA ARE TO BE COMPLETE WITH INSPECTION

CHAMBER AND CLEANOUT. 3. PROVIDE POSITIVE DRAINAGE THROUGHOUT - AWAY FROM BUILDINGS AND TO DRAINAGE STRUCTURES. UNLESS OTHERWISE NOTED, PROVIDE A MINIMUM SLOPE OF 2% ON ALL HARD AND SOFT LANDSACPE SURFACES. 4. UNLESS OTHERWISE NOTED PROVIDE A MAXIMUM SLOPE OF 4:1 (25%) AT ALL SOFT LANDSCAPE AREAS. REPORT ANY

DISCREPANCIES TO THE CONSULTANT TEAM FOR REVIEW AND RESPONSE. 5. ALL GRADING INFORMATION TO BE COORDINATED WITH ARCHITECTURAL DRAWINGS TO ENSURE ADEQUATE SOIL DEPTHS AND POSITIVE DRAINAGE.


STREET

VICTORIA, BRITISH COLUMBIA.

no.	issued for	date
	Development Permit	Nov 15/10
	Revised Development Permit	Feb 04/11
	Revised Development Permit	Feb 16/11
	Revised Development Permit	Apr 29/11
	Issued for Costing	Nov 07/11
	Re—issued for Development Permit	Dec 05/12
	Re—issued for Development Permit	Nov 26/20
	Re—issued for Development Permits	June 03/21
	For Coordination	July 30/21
	Re—issued for Development Permit	Dec 06/21

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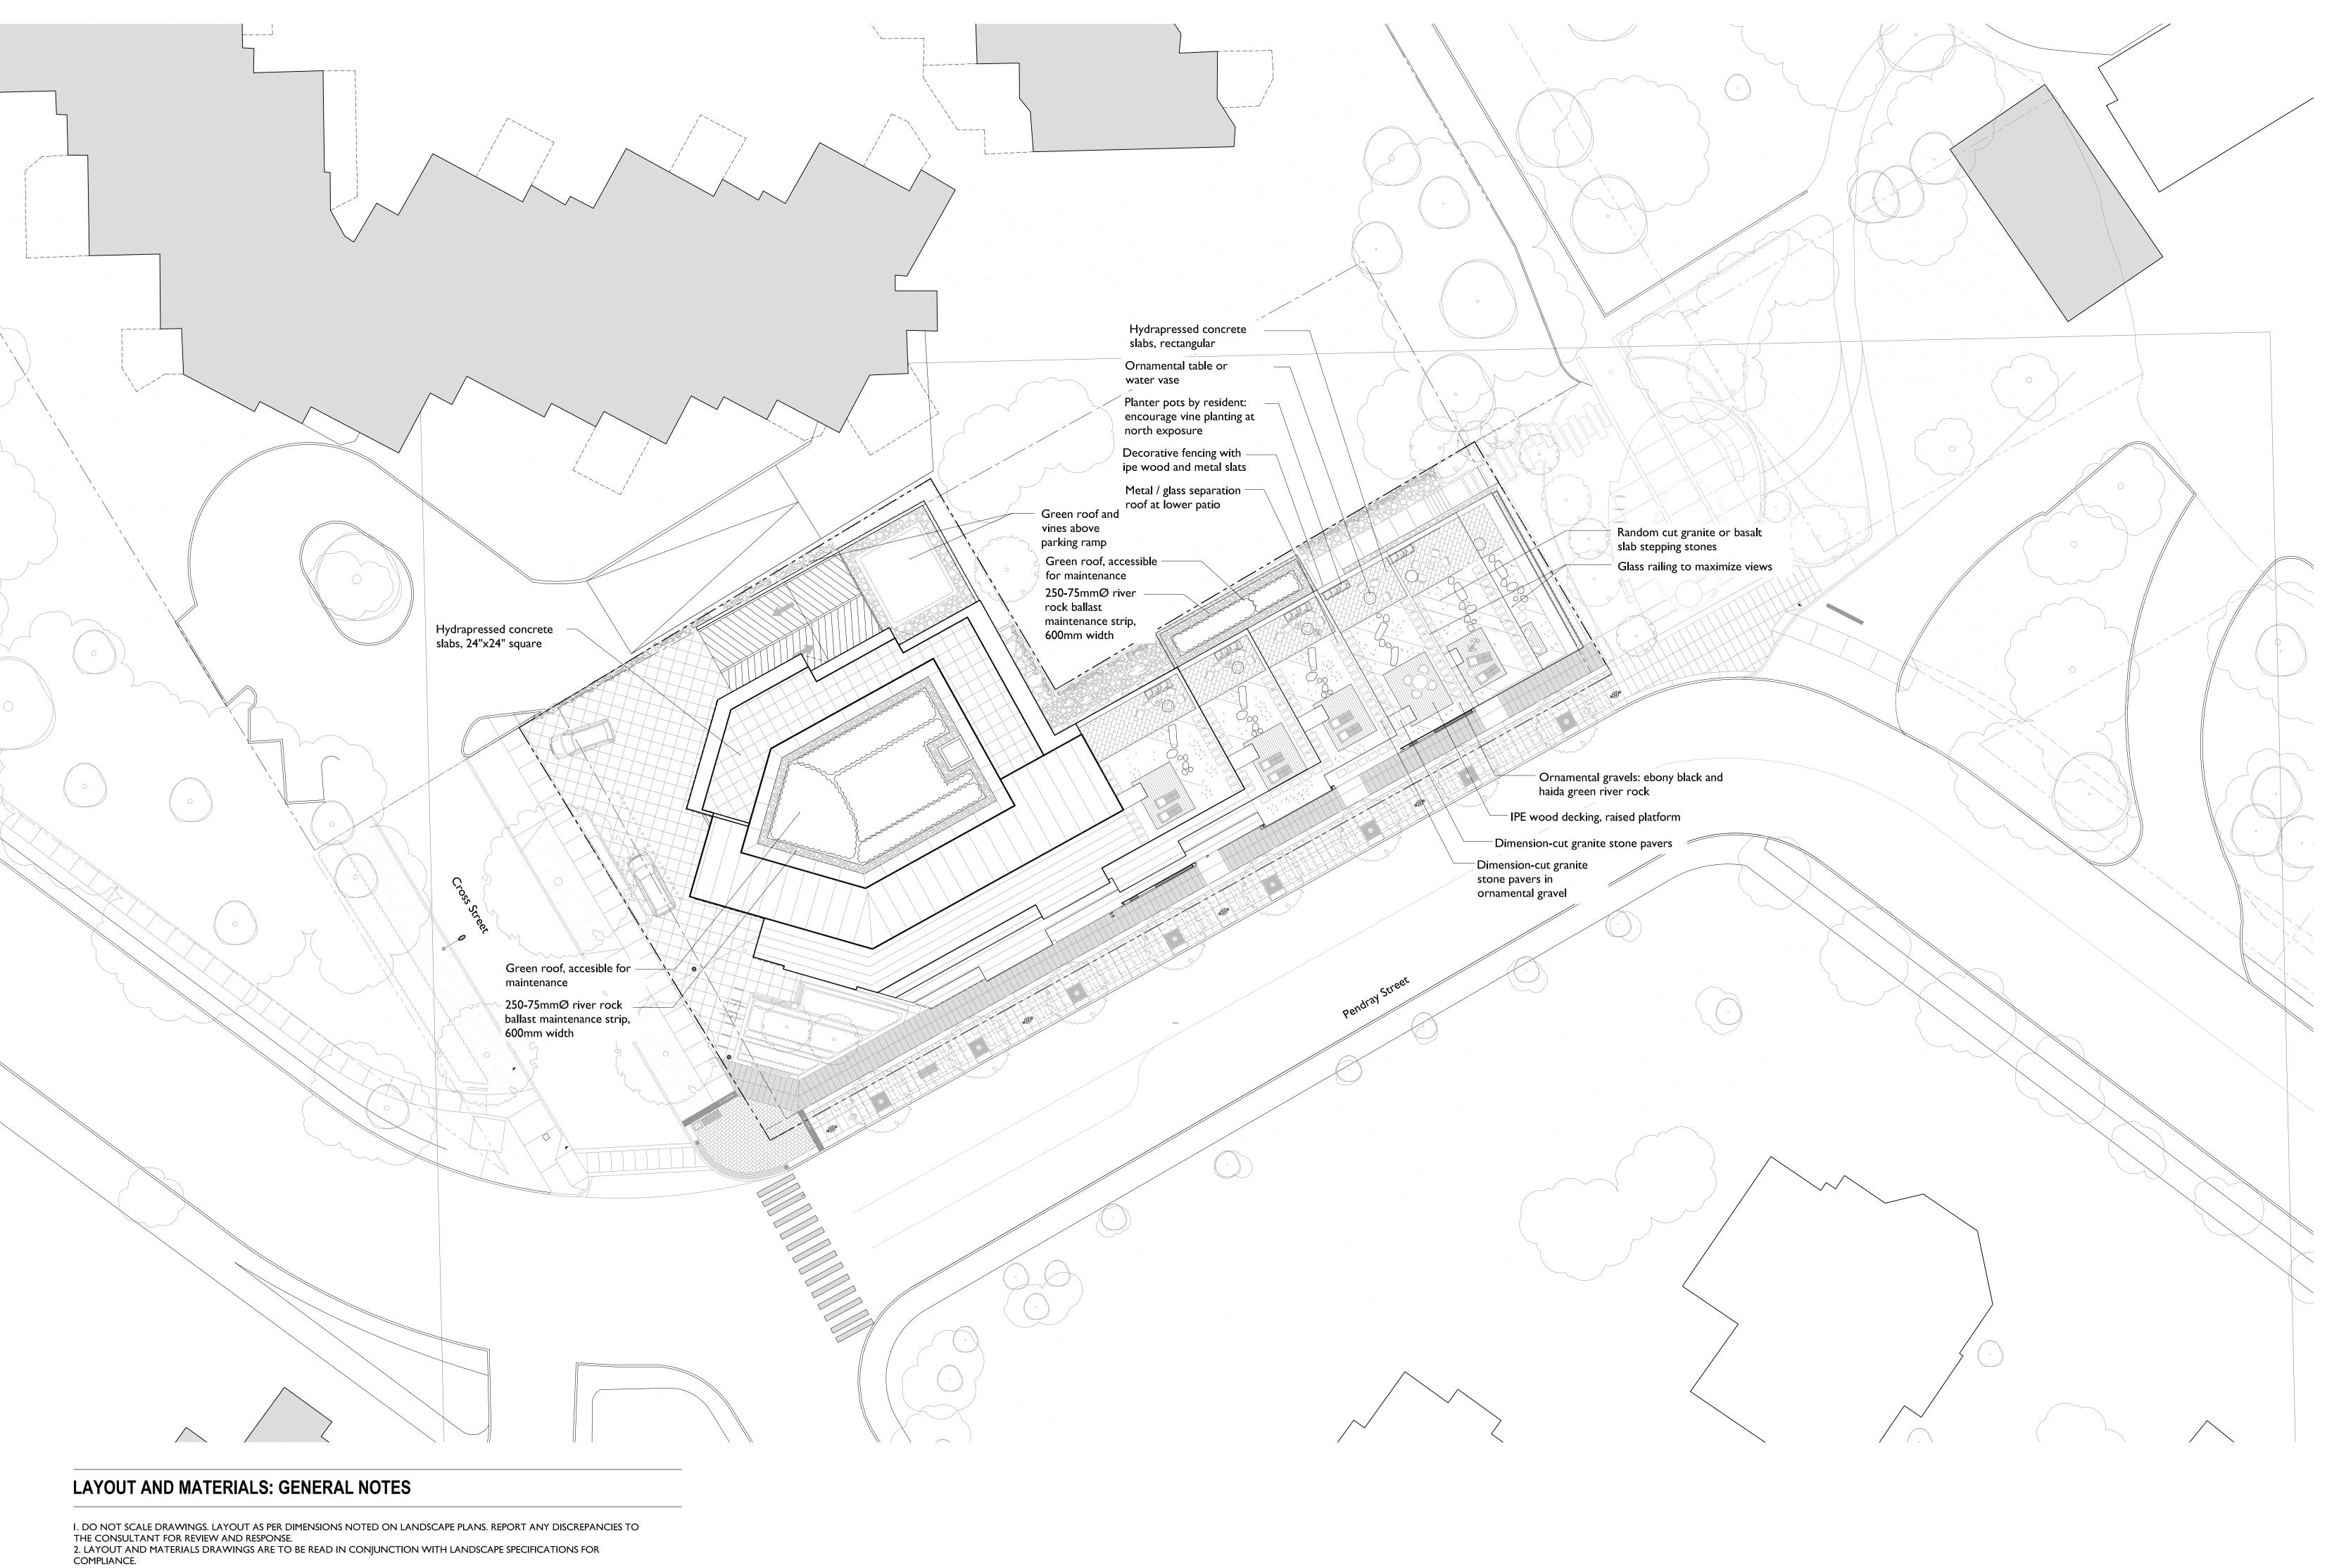
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<u>drawing</u>

LANDSCAPE PLAN -**GROUND FLOOR**

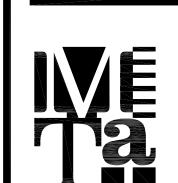sheet drawn scale MD - project checked CP





3. LANDSCAPE DRAWINGS ARE TO BE READ IN CONJUNCTION WITH ARCHITECTURAL AND ENGINEERING DRAWINGS. REPORT ANY DISCREPANCIES TO THE CONSULTANT FOR REVIEW AND RESPONSE.

4. VERIFY ALL DIMENSIONS WITH FIELD CONDITIONS. REPORT ANY DISCREPANCIES TO THE CONSULTANT FOR REVIEW AND

5. LIGHTING INFORMATION REFERENCED ON LANDSCAPE DRAWINGS IS TO BE READ IN CONJUNCTION WITH ELECTRICAL ENGINEERS DRAWINGS. REPORT ANY DISCREPANCIES TO THE CONSULTANT FOR REVIEW AND RESPONSE.

6. UTILITY AND LIGHTING ARE INDICATED FOR REFERENCE ONLY. REFER TO ENG. DRAWINGS FOR LOCATIONS, DETAILS, AND

SPECIFICATIONS.

7. REFERENCE CIVIL ENGINEERS DRAWINGS FOR LAYOUT OF ROAD CURBS AND GUTTERS AND PEDESTRAIN LET-DOWNS.

8. REFER TO ENGINEERING DRAWINGS FOR DETAILS, SUBGRADE, AND REINFORCING OF ALL PAVED SURFACES IN ROADWAYS.

IRRIGATION: GENERAL NOTES

I. ALL LANDSCAPE IRRIGATION SHALL CONFORM TO IABC STANDARDS.

2. LANDSCAPE DRIPLINE SHALL BE LOOPED UNLESS OTHERWISE SPECIFIED.

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3. ALL IRRIGATION WORK SHALL BE DONE BY A SUITABLY EXPERIENCED AND QUALIFIED IRRIGATION CONTRACTOR ADEQUATE FOR THE SCOPE OF WORK. THE CONTRACTOR SHALL BE A MEMBER IN GOOD STANDING OF THE IRRIGATION INDUSTRY ASSOCIATION OF B.C. AND HAVE MET THE QUALIFICATION STANDARDS CURRENTLY APPLIED TO

CONTRACTORS BY THAT ORGANIZATION.
4. UNLESS OTHERWISE SPECIFIED OR INDICATED ON THE DRAWINGS, ALL LANDSCAPE IRRIGATION EQUIPMENT SHALL BE SUPPLIED BY A SINGLE MANUFACTURER. ANY SUBSTITUTIONS WITHOUT THE PRIOR APPROVAL OF THE CONSULTANT WILL BE

REJECTED. 5. GREEN ROOF PLANTING IS TO BE FULLY IRRIGATED.



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> VICTORIA, BRITISH COLUMBIA.

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Apr 29/11	Revised Development Permit	
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une 03/21	Re-issued for Development Permits	
July 30/21	For Coordination	
Dec 06/21	Re-issued for Development Permit	



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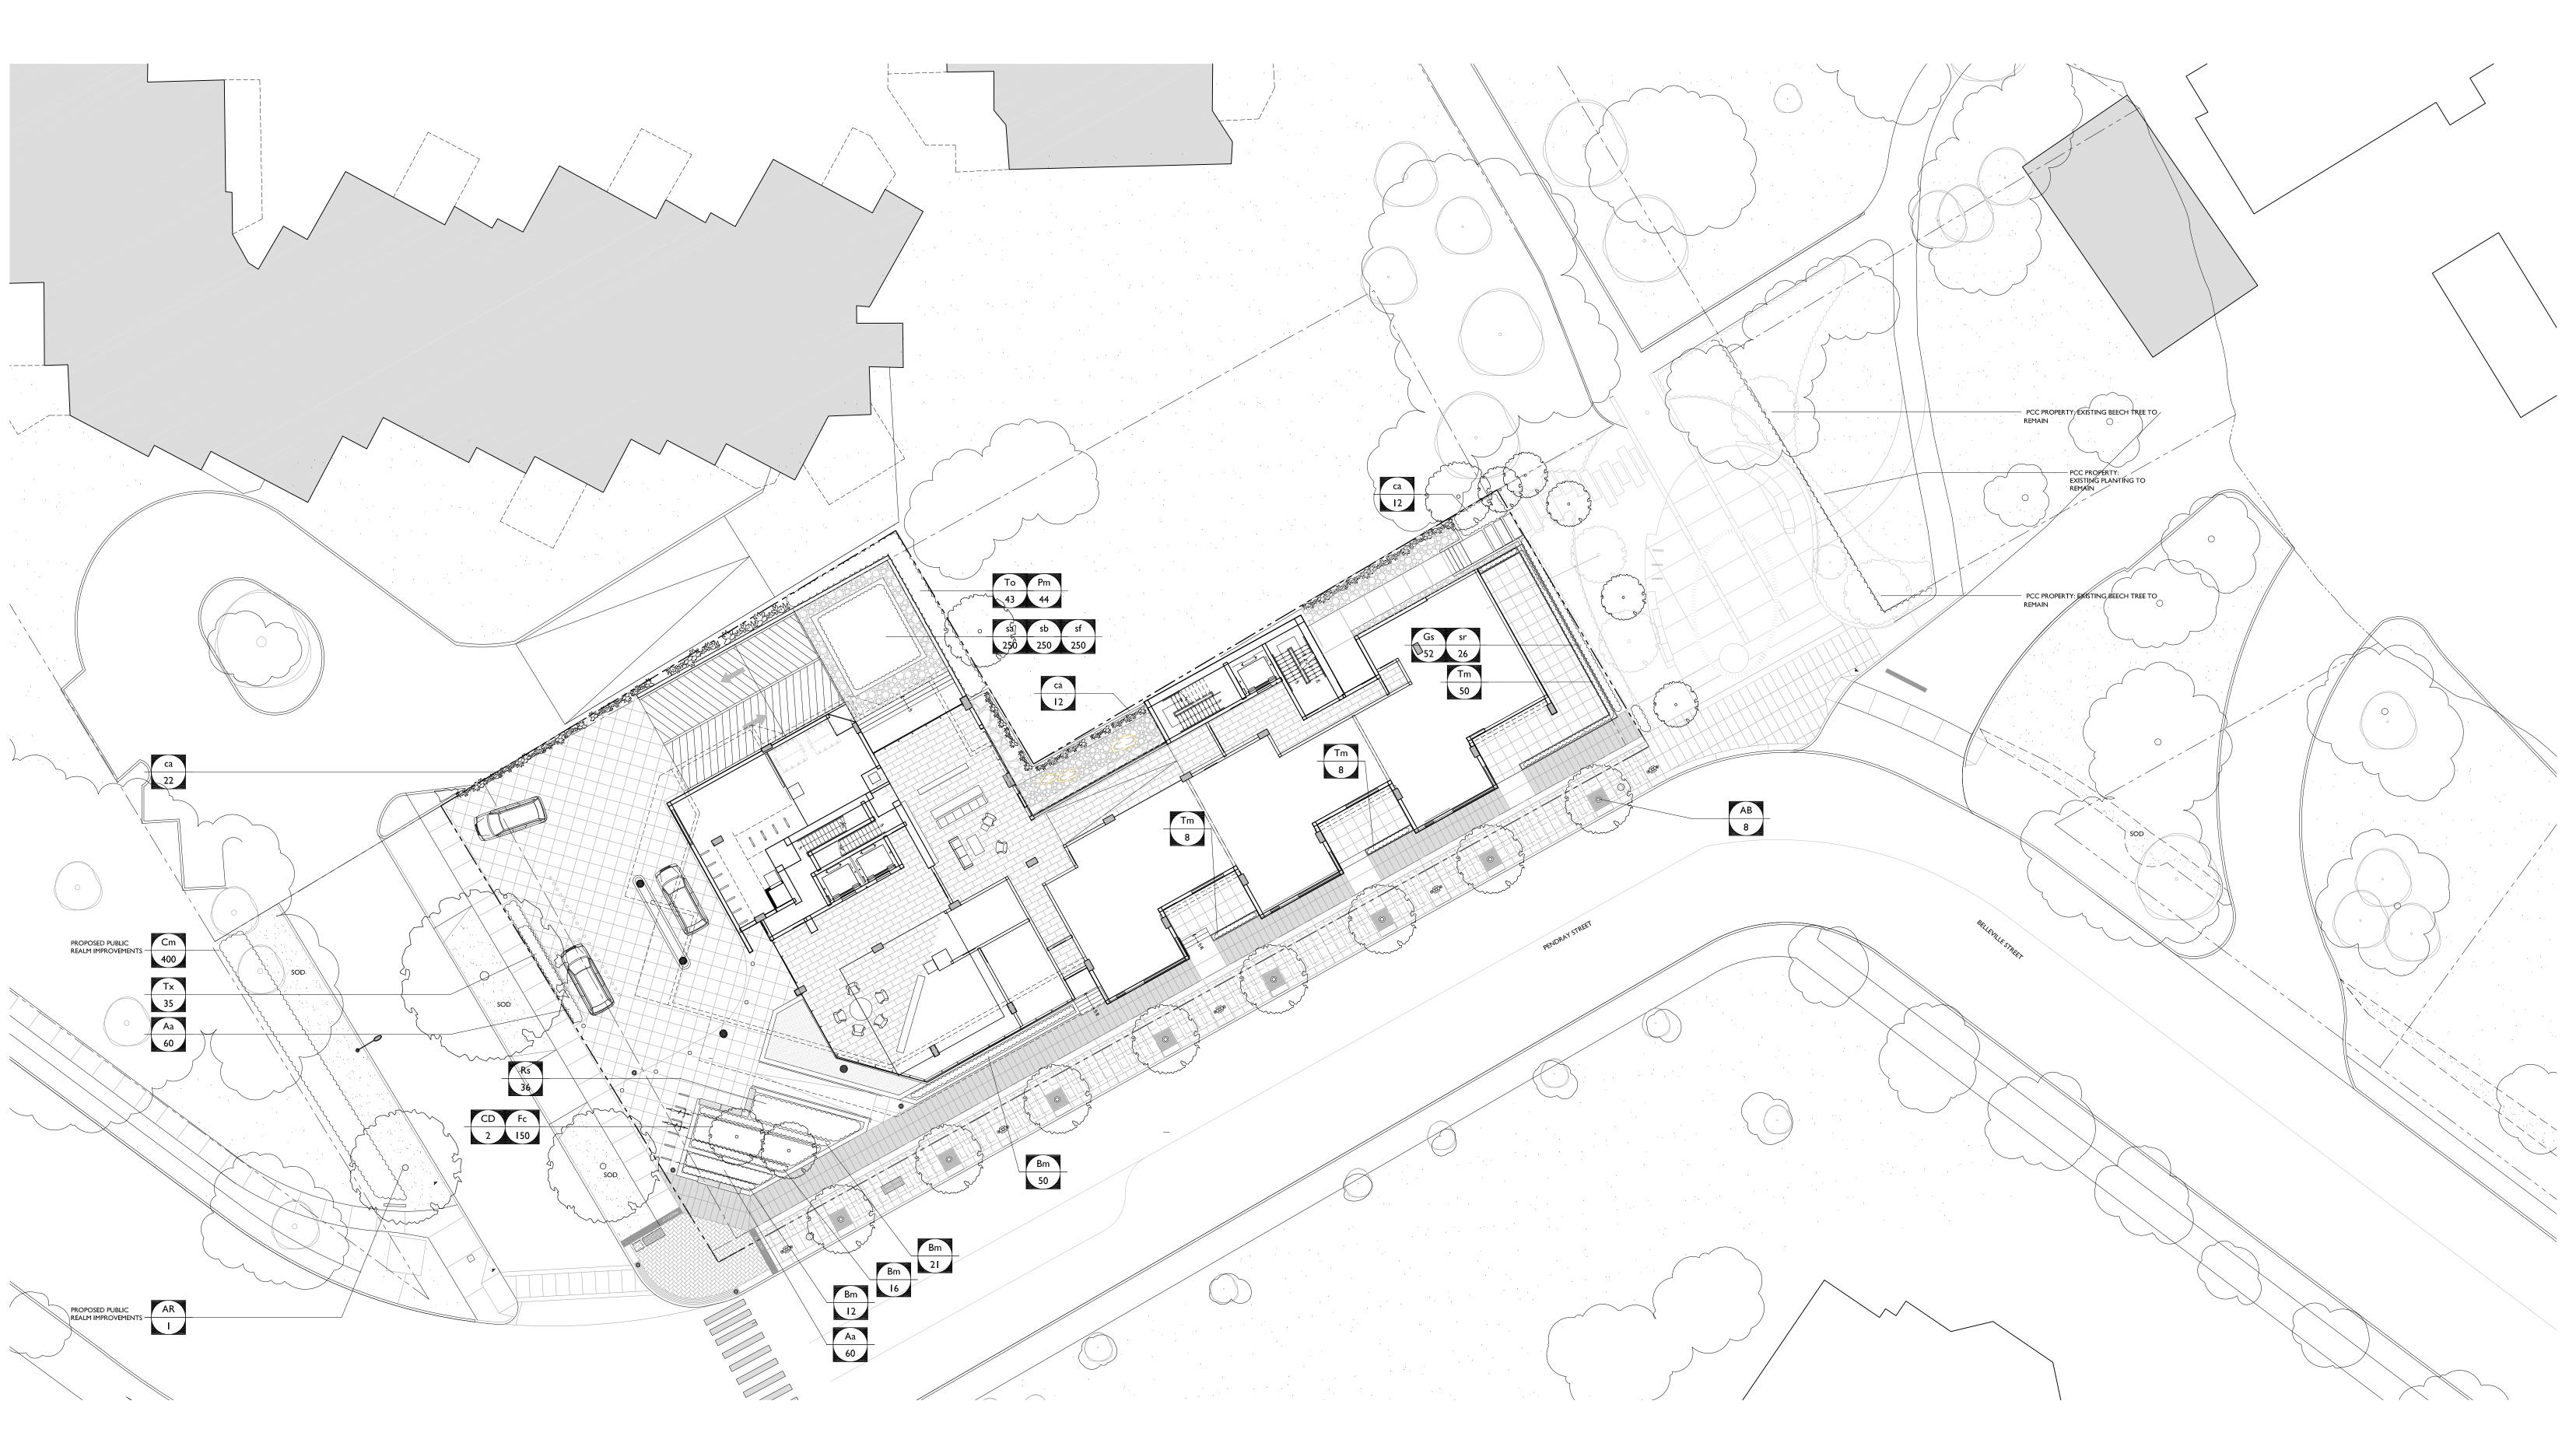
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drawing
title

LANDSCAPE PLAN -ROOF LEVELS

L	1.2		sheet
MD	drawn	I:200	scale
СР	checked	08005	— project no.



PLANT SCHEDULE (*NOT INCLUDING PROPOSED PUBLIC REALM IMPROVEMENTS AT PLAZA)

GREEN ROOF

sa 2450 SEDUM ACRE

850 SEDUM SPECTABILE 'BRILLIANT'

sf 2450 SEDUM FLORIFERUM 'WEINHENSTEPHANER GOLD'

KEY	QTY	BOTANICAL NAME	COMMON NAME	SIZE	DESCRIPTION
TREE	ES				
AB	8	ACER RUBRUM 'BOWHALL'	UPRIGHT RED MAPLE 'BOWHALL'	7 CM STD	MATCHING, FULL
AR	I	ACER RUBRUM 'RED SUNSET'	RED MAPLE 'RED SUNSET'	7CM STD	MATCHING, FULL
CD	2	CRATAEGUS DOUGLASII	BLACK HAWTHORN	7 CM CAL	MATCHING, FULL
SHRU	JBS / C	GROUNDCOVERS			
Aa	120	ARCTOSTAPHYLOS UVA-URSI	KINNIKINNICK	#2 POT	450mm O.C.
Bm	99	BUXUS MICROPHYLLA GREEN BEAUTY	GREEN BEAUTY LITTLE LEAF BUXUS	#3 POT	450mm O.C.
Fc	150	FRAGARIA CHILOENSIS	COASTAL STRAWBERRY	#I POT	300mm O.C.
Gs	52	GAULTHERIA SHALLON	SALAL	#2 POT	300mm O.C.
Pm	44	POLYSTICHUM MINUTUM	WESTERN SWORD FERN	#2 POT	500mm O.C.
Rs	36	RIBES SANGUINEUM	FLOWERING CURRANT	#3 POT	600mm O.C.
Tm	100	TAXUS MEDIA HICKSII, MAL	HICKS YEW	#5 POTS	380mm O.C., MALE
Tx	35	TAXUS MEDIA HICKSII, MAL	HICKS YEW	42" HT., FIELD GROWI	N, FULL, 500mm O.C., MALE
То	43	THUJA OCCIDENTALIS SMARAGD	EMERALD GREEN CEDAR	2.5M HEIGHT	500mm O.C.
GRA	SS / PE	RENNIALS			
Cm	400	CAREX MORROWII 'ICE DANCE'	VARIEGATED JAPANESE SEDGE	#I POTS	370mm O.C.
sr	26	SMILACINA RACEMOSA	FALSE SOLOMON'S SEAL	#2 POTS	450mm O.C.
CLIM	1BERS				
ca	46	CLEMATIS ARMANDII	EVERGREEN CLEMATIS		1200 O.C.

8" O.C.

10" O.C.

8" O.C.

PLANTING: GENERAL NOTES

I. ALL PLANT MATERIAL SHALL CONFORM TO THE STANDARD SPECIFIED IN THE CURRENT EDITION OF THE CANADIAN LANDSCAPE STANDARD. THIS STANDARD IS PUBLISHED JOINTLY BY THE CANADIAN SOCIETY OF LANDSCAPE ARCHITECTS (CSLA) AND THE CANADIAN NURSERY LANDSCAPE ASSOCIATION (CNLA). 2. SEARCH AREA FOR ALL PLANT MATERIAL SHALL BE: PACIFIC NORTHWEST INCLUDING BRITISH COLUMBIA, WASHINGTON, AND OREGON.

3. PLANT MATERIAL SIZES SPECIFIED ARE THE MINIMUM ACCEPTABLE SIZES TO BE SUPPLIED TO THIS PROJECT. 4. ALL PLANT MATERIAL SHALL BE WELL-ESTABLISHED AND UNIFORM IN SHAPE AND SIZE.

5. ALL PLANT MATERIAL SHALL BE NURSERY GROWN UNLESS OTHERWISE NOTED. ONLY CERTIFIED S.O.D. NURSERY STOCK WILL BE ACCEPTED.

6. THE CONTRACTOR SHALL PROVIDE A GROWING MEDIUM ANALYSIS FOR REVIEW BY THE CONSULTANT - AS PER SPECIFICATIONS - PRIOR TO THE START OF CONSTRUCTION. GROWING MEDIUM SUPPLIED TO THE SITE OR INSTALLED ON SITE PRIOR TO CONSULTANT APPROVAL SHALL BE REJECTED AT NO COST TO THE OWNER. 7. THE CONTRACTOR SHALL CONFIRM PLANT QUANTITIES ON THE DRAWINGS CORRESPOND TO THOSE INDICATED ON THE PLANT LIST. ANY DISCREPANCIES ARE TO BE VERIFIED BY THE CONSULTANT FOR REVIEW AND RESPONSE. 8. PLANT LIST TO BE READ IN CONJUCTION WITH SPECIFICATIONS FOR COMPLIANCE.

9. PRIOR TO THE START OF CONSTRUCTION, THE CONTRACTOR SHALL CONFIRM THE AVAILABILITY OF THE PLANT MATERIAL SPECIFIED AS PER SPECIFICATIONS, ALLOWING FOR ANY AND ALL REQUIRED APPROVALS. PLANT SUBSTITUTIONS NOT CONFIRMED AND APPROVED BY THE CONSULTANT WILL BE REJECTED.

10. PROVIDE IRRIGATION TO ALL PLANT MATERIAL AS SHOWN ON LANDSCAPE DRAWINGS AND PLANS. PLANTING BENEATH PATIOS AND OVERHANGS SHALL BE IRRIGATED ON SEPARATELY VALVED IRRIGATION SYSTEM, THROUGH

HEATED GARAGE, WHICH CAN OPERATE DURING WINTER MONTHS. II. IRRIGATION MUST MEET THE STANDARDS FOR IRRIGATION INSTALLATION SET OUT IN THE CITY OF VICTORIA SUPPLEMENTARY SPECIFICATIONS FOR STREET TREES AND IRRIGATION, SCHEDULE C, TO VICTORIA SUBDIVISION AND DEVELOPMENT SERVICING BYLAW.

12. THE PARKS DIVISION MUST INSPECT THE IRRIGATION SYSTEM PRIOR TO BACKFILLING AND AGAIN WHEN THE

SYSTEM IS FUNCTIONING. 13. PUBLIC REALM IMPROVEMENTS, INCLUDING STREET TREES, STREET-SIDE ORNAMENTAL GRASSES, SOD, AND PLAZA PLANTING ARE TO BE IRRIGATED BY AN AUTOMATIC IRRIGATION SYSTEM, FROM A DESIGNATED CITY WATER

SOURCE. 14. AN "AS BUILT" PLAN MUST BE SUBMITTED TO THE PARKS DIVISION AFTER INSTALLATION 15. SIDEWALK AT STREET TREES TO INCLUDE CONTINUOUS STRUCTURAL SOIL TRENCH, FROM BACK OF CURB TO FACE OF BUILDING / PARKING STRUCTURE, TO MIN. 700mm DEPTH.

> PROJECT NORTH

257 BELLEVILLE STREET

> VICTORIA, BRITISH COLUMBIA.

date	issued for	no.
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une 03/21	Re—issued for Development Permits	
July 30/21	For Coordination	
Dec 06/21	Re-issued for Development Permit	



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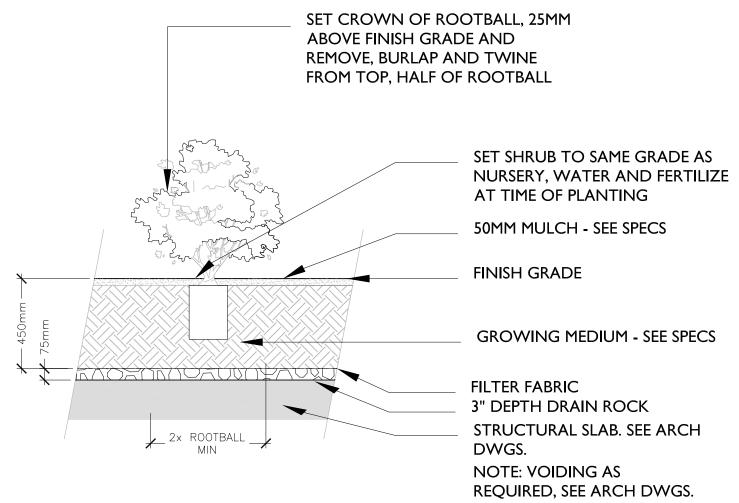
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PLANTING PLAN GROUND FLOOR


sheet drawn scale project checked




SHRUB PLANTING ON GRADE L3.1 SCALE: 1:25




2 SHRUB PLANTING ON SLAB L3.1 SCALE: 1:25

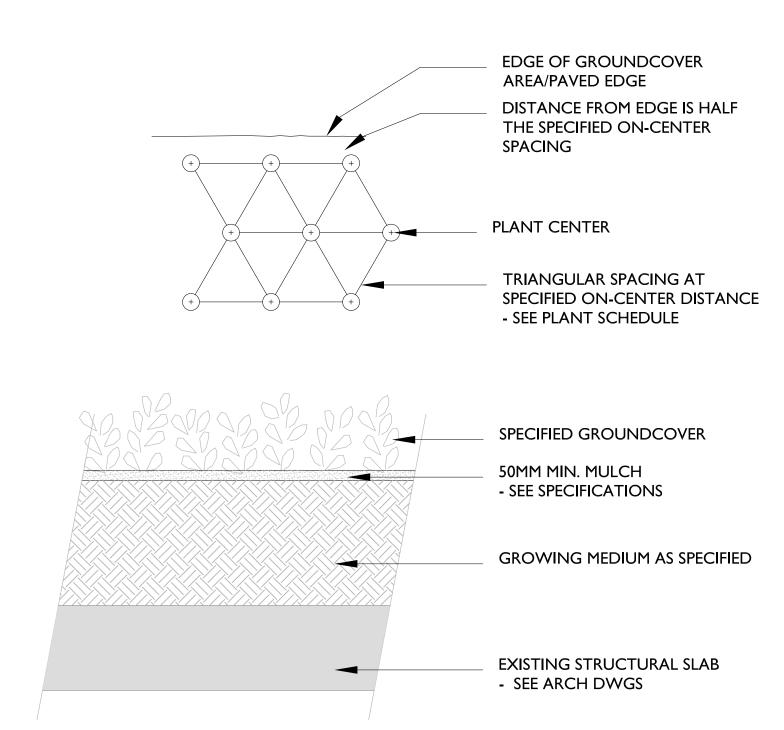

3 GROUNDCOVER ON SLAB
L3.1 SCALE: 1:20

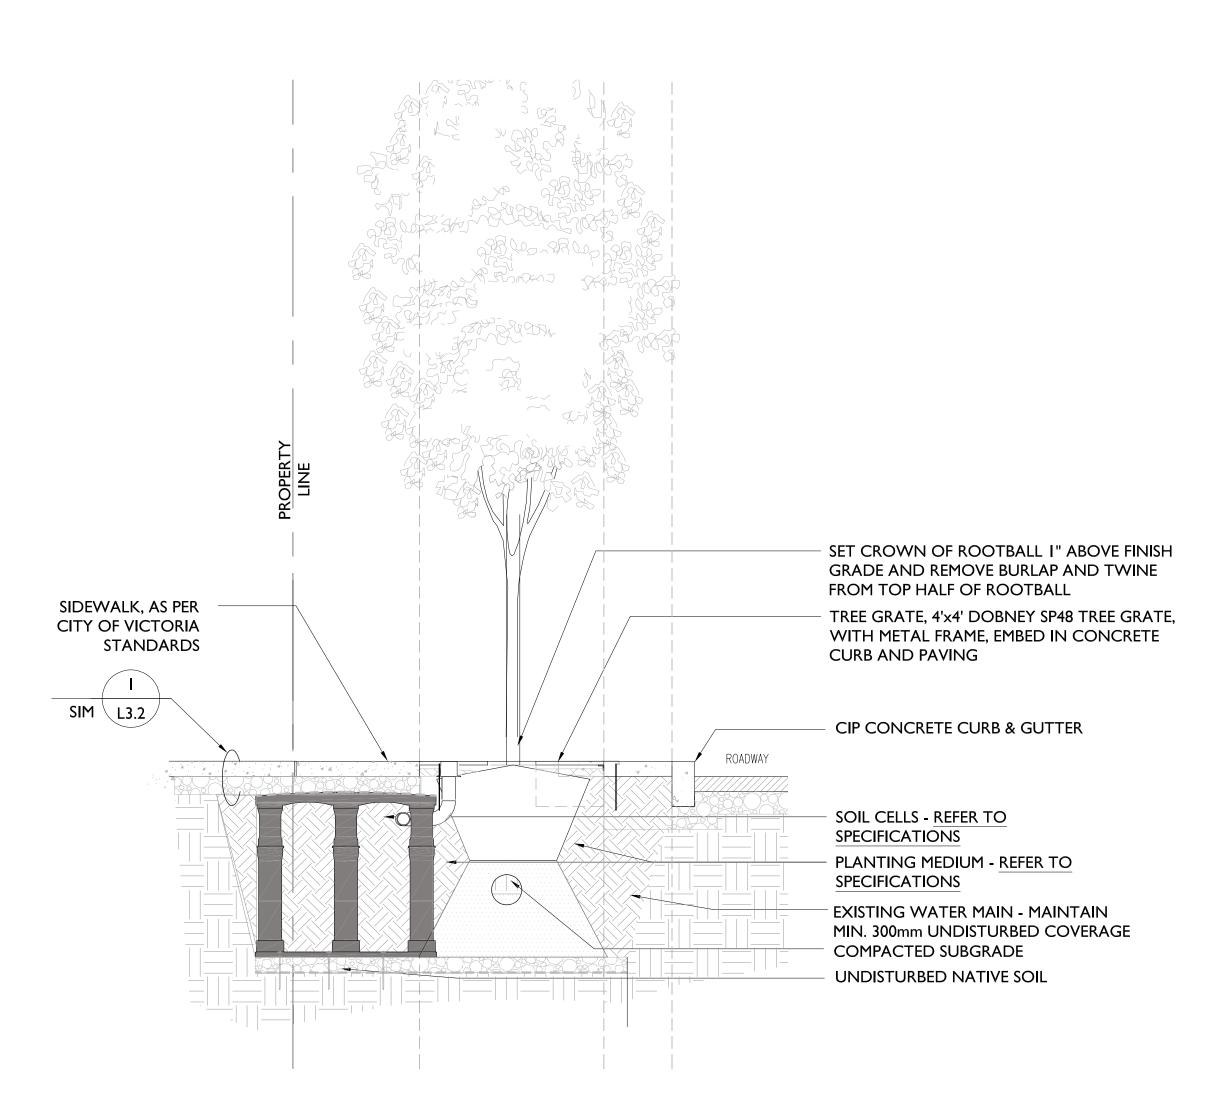

TYPICAL STREET TREE PLANTING
W/ TREE GRATE AND STRUCTURAL SOIL
L3.1 SCALE: 1:25

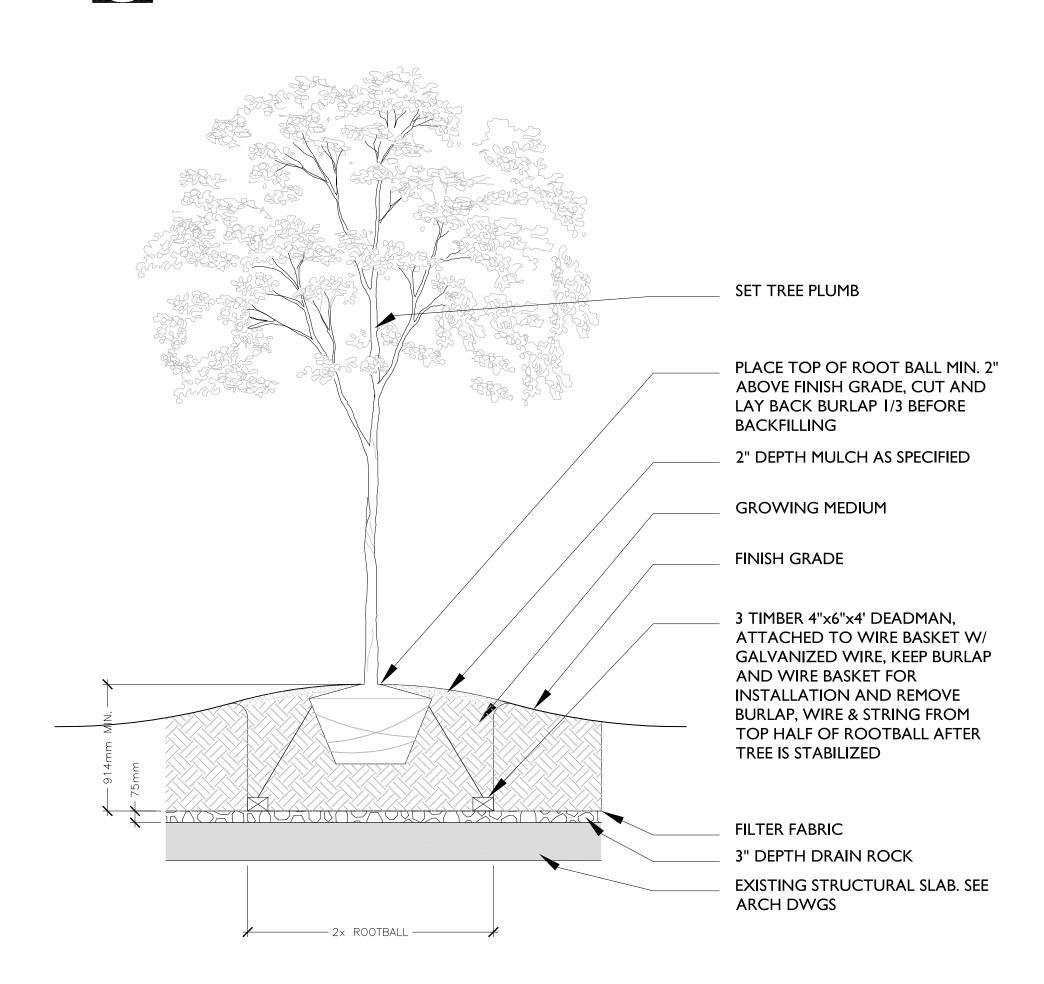

5 DECIDUOUS TREE PLANTING ON SLAB
L3.1 SCALE: 1:25





ACER RUBRUM 'RED SUNSET'

RED SUNSET RED MAPLE

ACER RUBRUM 'BOWHALL'

BOWHALL UPRIGHT RED MAPLE



SHRUBS /
GROUNDCOVERS

STYRAX JAPONICA -JAPANESE SNOWBALL



TAXUS MEDIA 'HICKSII' -HICK'S YEW



BUXUS JAPONICUM -'GREEN BEAUTY' BOXWOOD



STIPA TENNUISIMA -MEXICAN FEATHER GRASS



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	Re-issued for Development Permit	Dec 05/1:
	Re—issued for Development Permit	Nov 26/2
	Re—issued for Development Permit	June 03/2
	For Coordination	July 30/2
	Re—issued for Development Permit	Dec 06/2



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PLANTING DETAILS


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L3.1


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WOOD BENCH ON CONCRETE PLANTER WALL



PRECAST CONCRETE

UNIT HYDROPRESSED

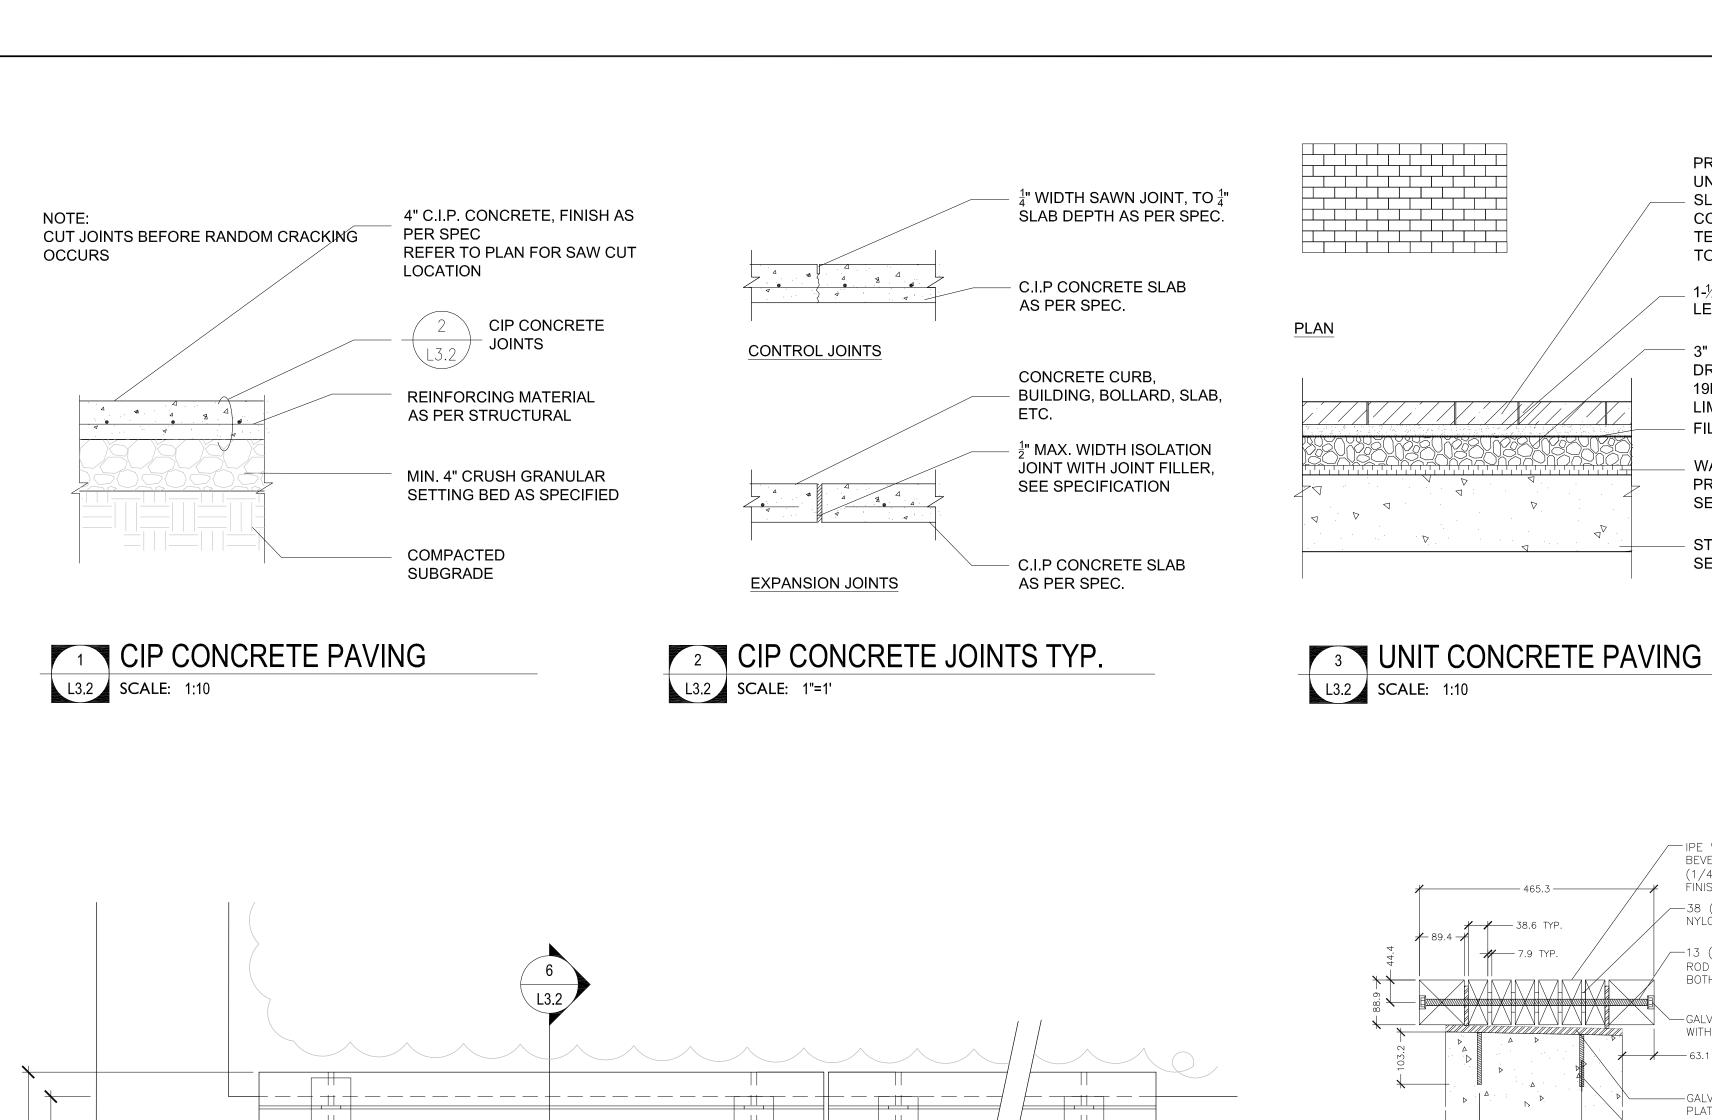COLOUR: CHARCOAL,

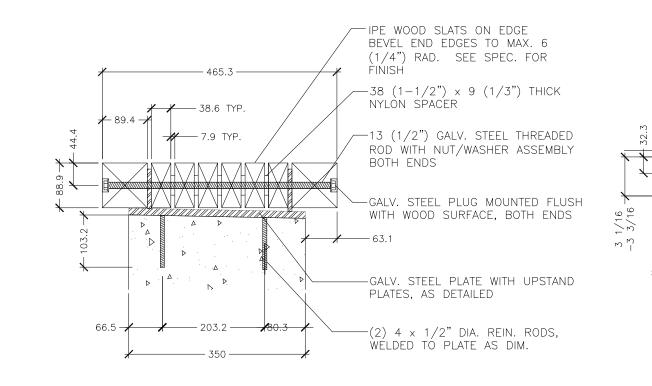TO LAYOUT PLAN

LEVELLING BED

3" MIN. DEPTH DRAINAGE COURSE

19MM Ø CLEAR

FILTER BLANKET

SEE ARCH DWGS

STRUCTURAL SLAB

SEE ARCH DWGS

WATERPROOFING AND

PROTECTION BOARD -


LIMESTONE


TEXADA FINISH REFER


1-1/4" COMPACTED SAND

SLAB PAVERS.



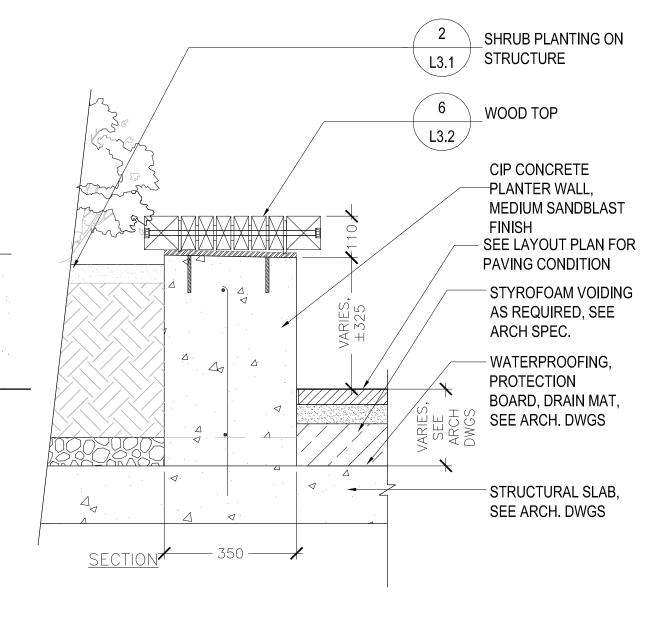

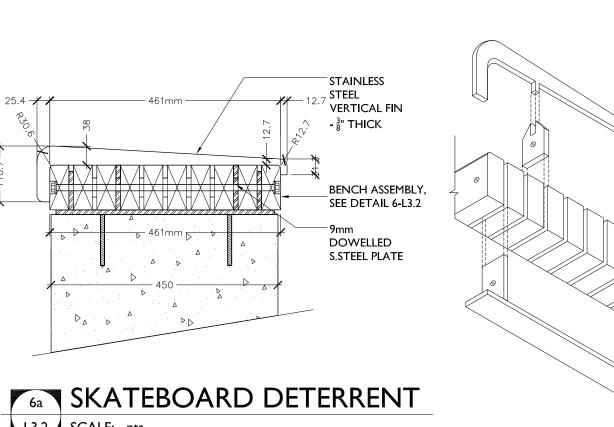

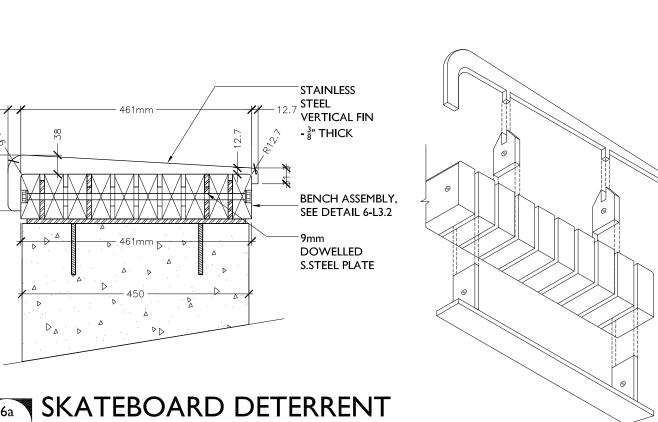

STONE PAVER: GALIANO GREY BASALT STONE, 24"

LAYOUT PLAN AND SPECS.

 $_{-}$ 1- $\frac{1}{4}$ " COMPACTED SAND

3" MIN. DEPTH DRAINAGE

COURSE 19MM Ø CLEAR

VOIDING AS REQUIRED,

x 36" x 1-1/4", FLAME

FINISH, REFER TO

LEVELLING BED

LIMESTONE

- FILTER BLANKET

SEE ARCH. DWGS

WATERPROOFING

AND PROTECTION

ARCH DWGS

STONE PAVING ON STRUCTURE

CORNERS

AT 1/2"

RAD. TYP.


UPSTAND PLATE


/ WELDS


L3.2 SCALE: 1:10


BOARD - SEE ARCH

STRUCTURAL SLAB SEE

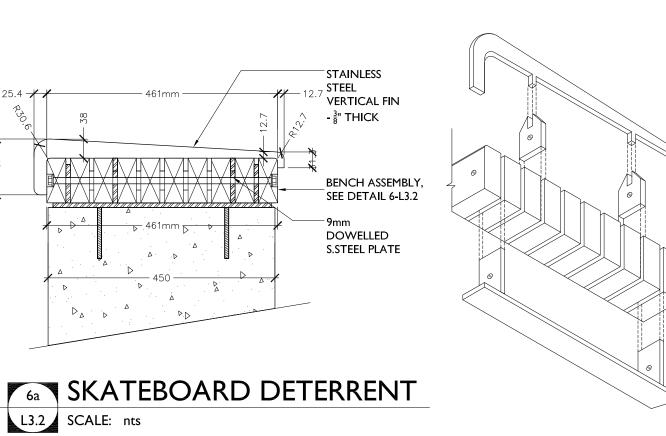

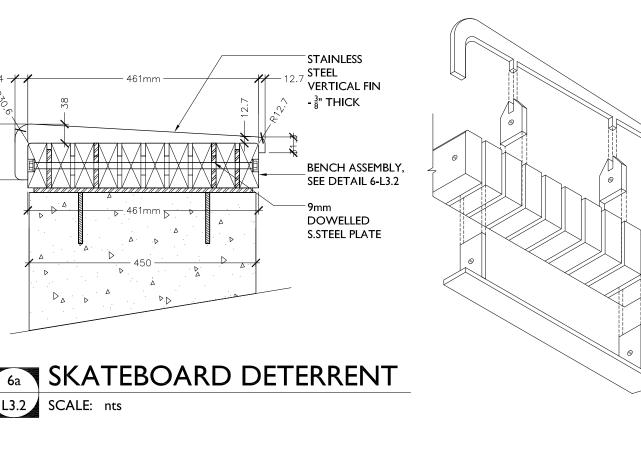


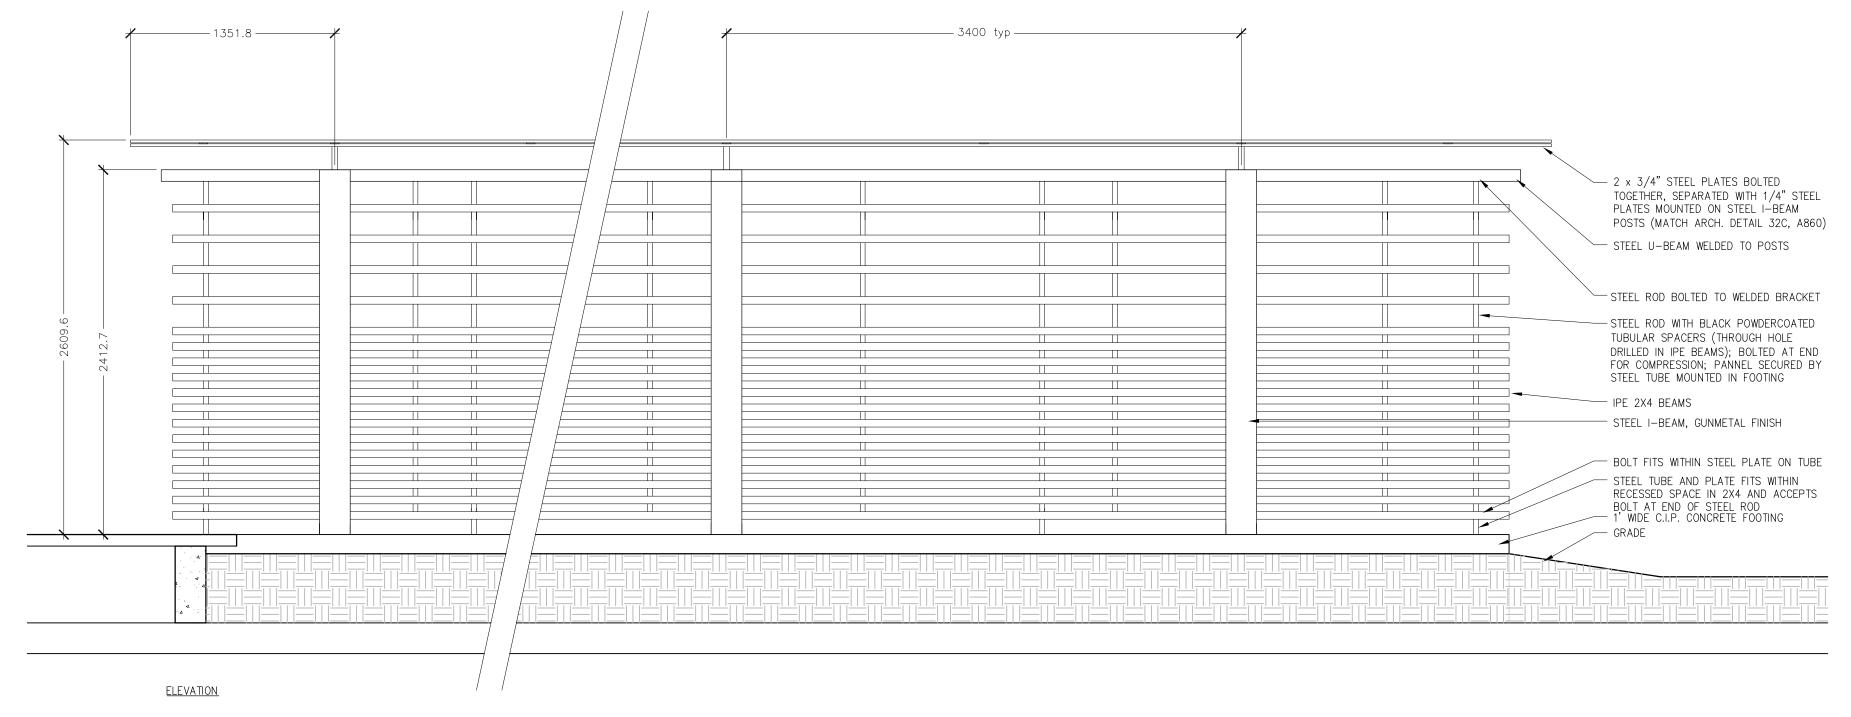

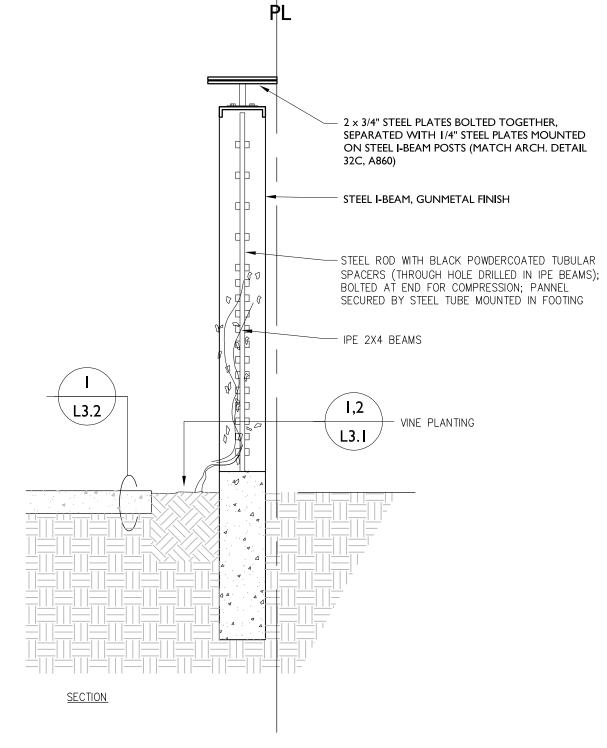




BASALT AND CONCRETE PAVING -**EXAMPLE**

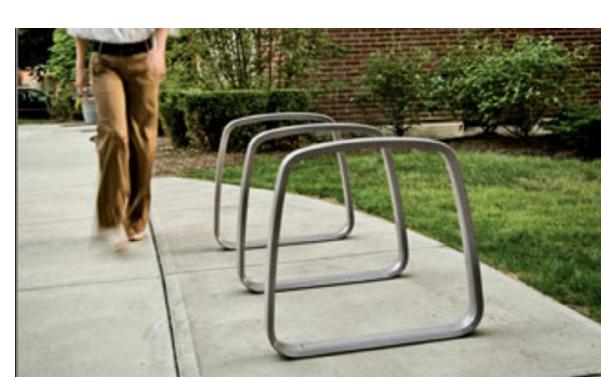

BIKE RACK - EXAMPLE



BOLLARD LIGHT - EXAMPLE

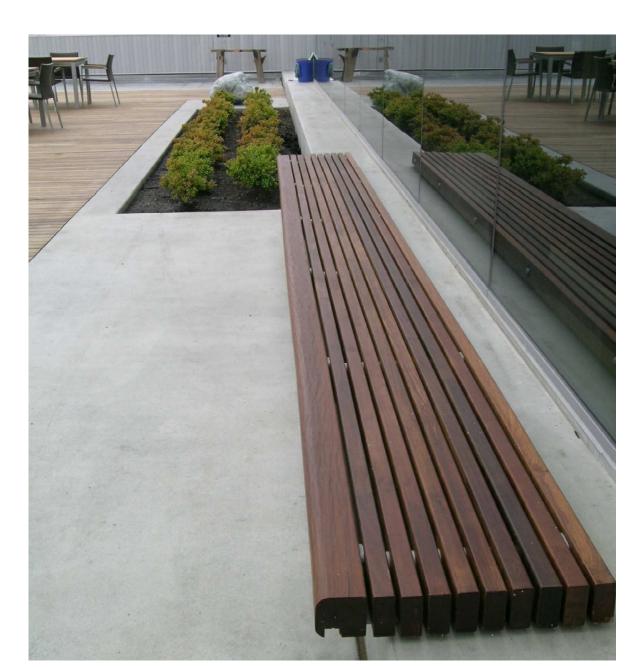

WOOD TOP BENCH - EXAMPLE



WOOD SCREEN - EXAMPLE

VICTORIA, BRITISH COLUMBIA.

STREET

date	issued for	no.
Nov 15/10	Development Permit	
Feb 04/11	Revised Development Permit	
Feb 16/11	Revised Development Permit	
Apr 29/11	Revised Development Permit	
Nov 07/11	Issued for Costing	
Dec 05/12	Re-issued for Development Permit	
Nov 26/20	Re-issued for Development Permit	
June 03/21	Re-issued for Development Permit	
July 30/21	For Coordination	
Dec 06/21	Re-issued for Development Permit	



consultant



CALGARY EDMONTON www.mtalink.com

301, 215 - 10th Ave SW Calgary Alberta T2R 0A4 p 403.264.8700 f 403.264.8029

marshall tittemore architects Creating memorable places

-drawing

LANDSCAPE SECTIONS and DETAILS

- project checked CP

7 WOOD SCREEN L3.2 SCALE: -


_ VARIES, SEE LAYOUT PLAN

_ VARIES, SEE _ LAYOUT PLAN

<u>ELEVATION</u>


L3.2 SCALE: -

191 TYP. -

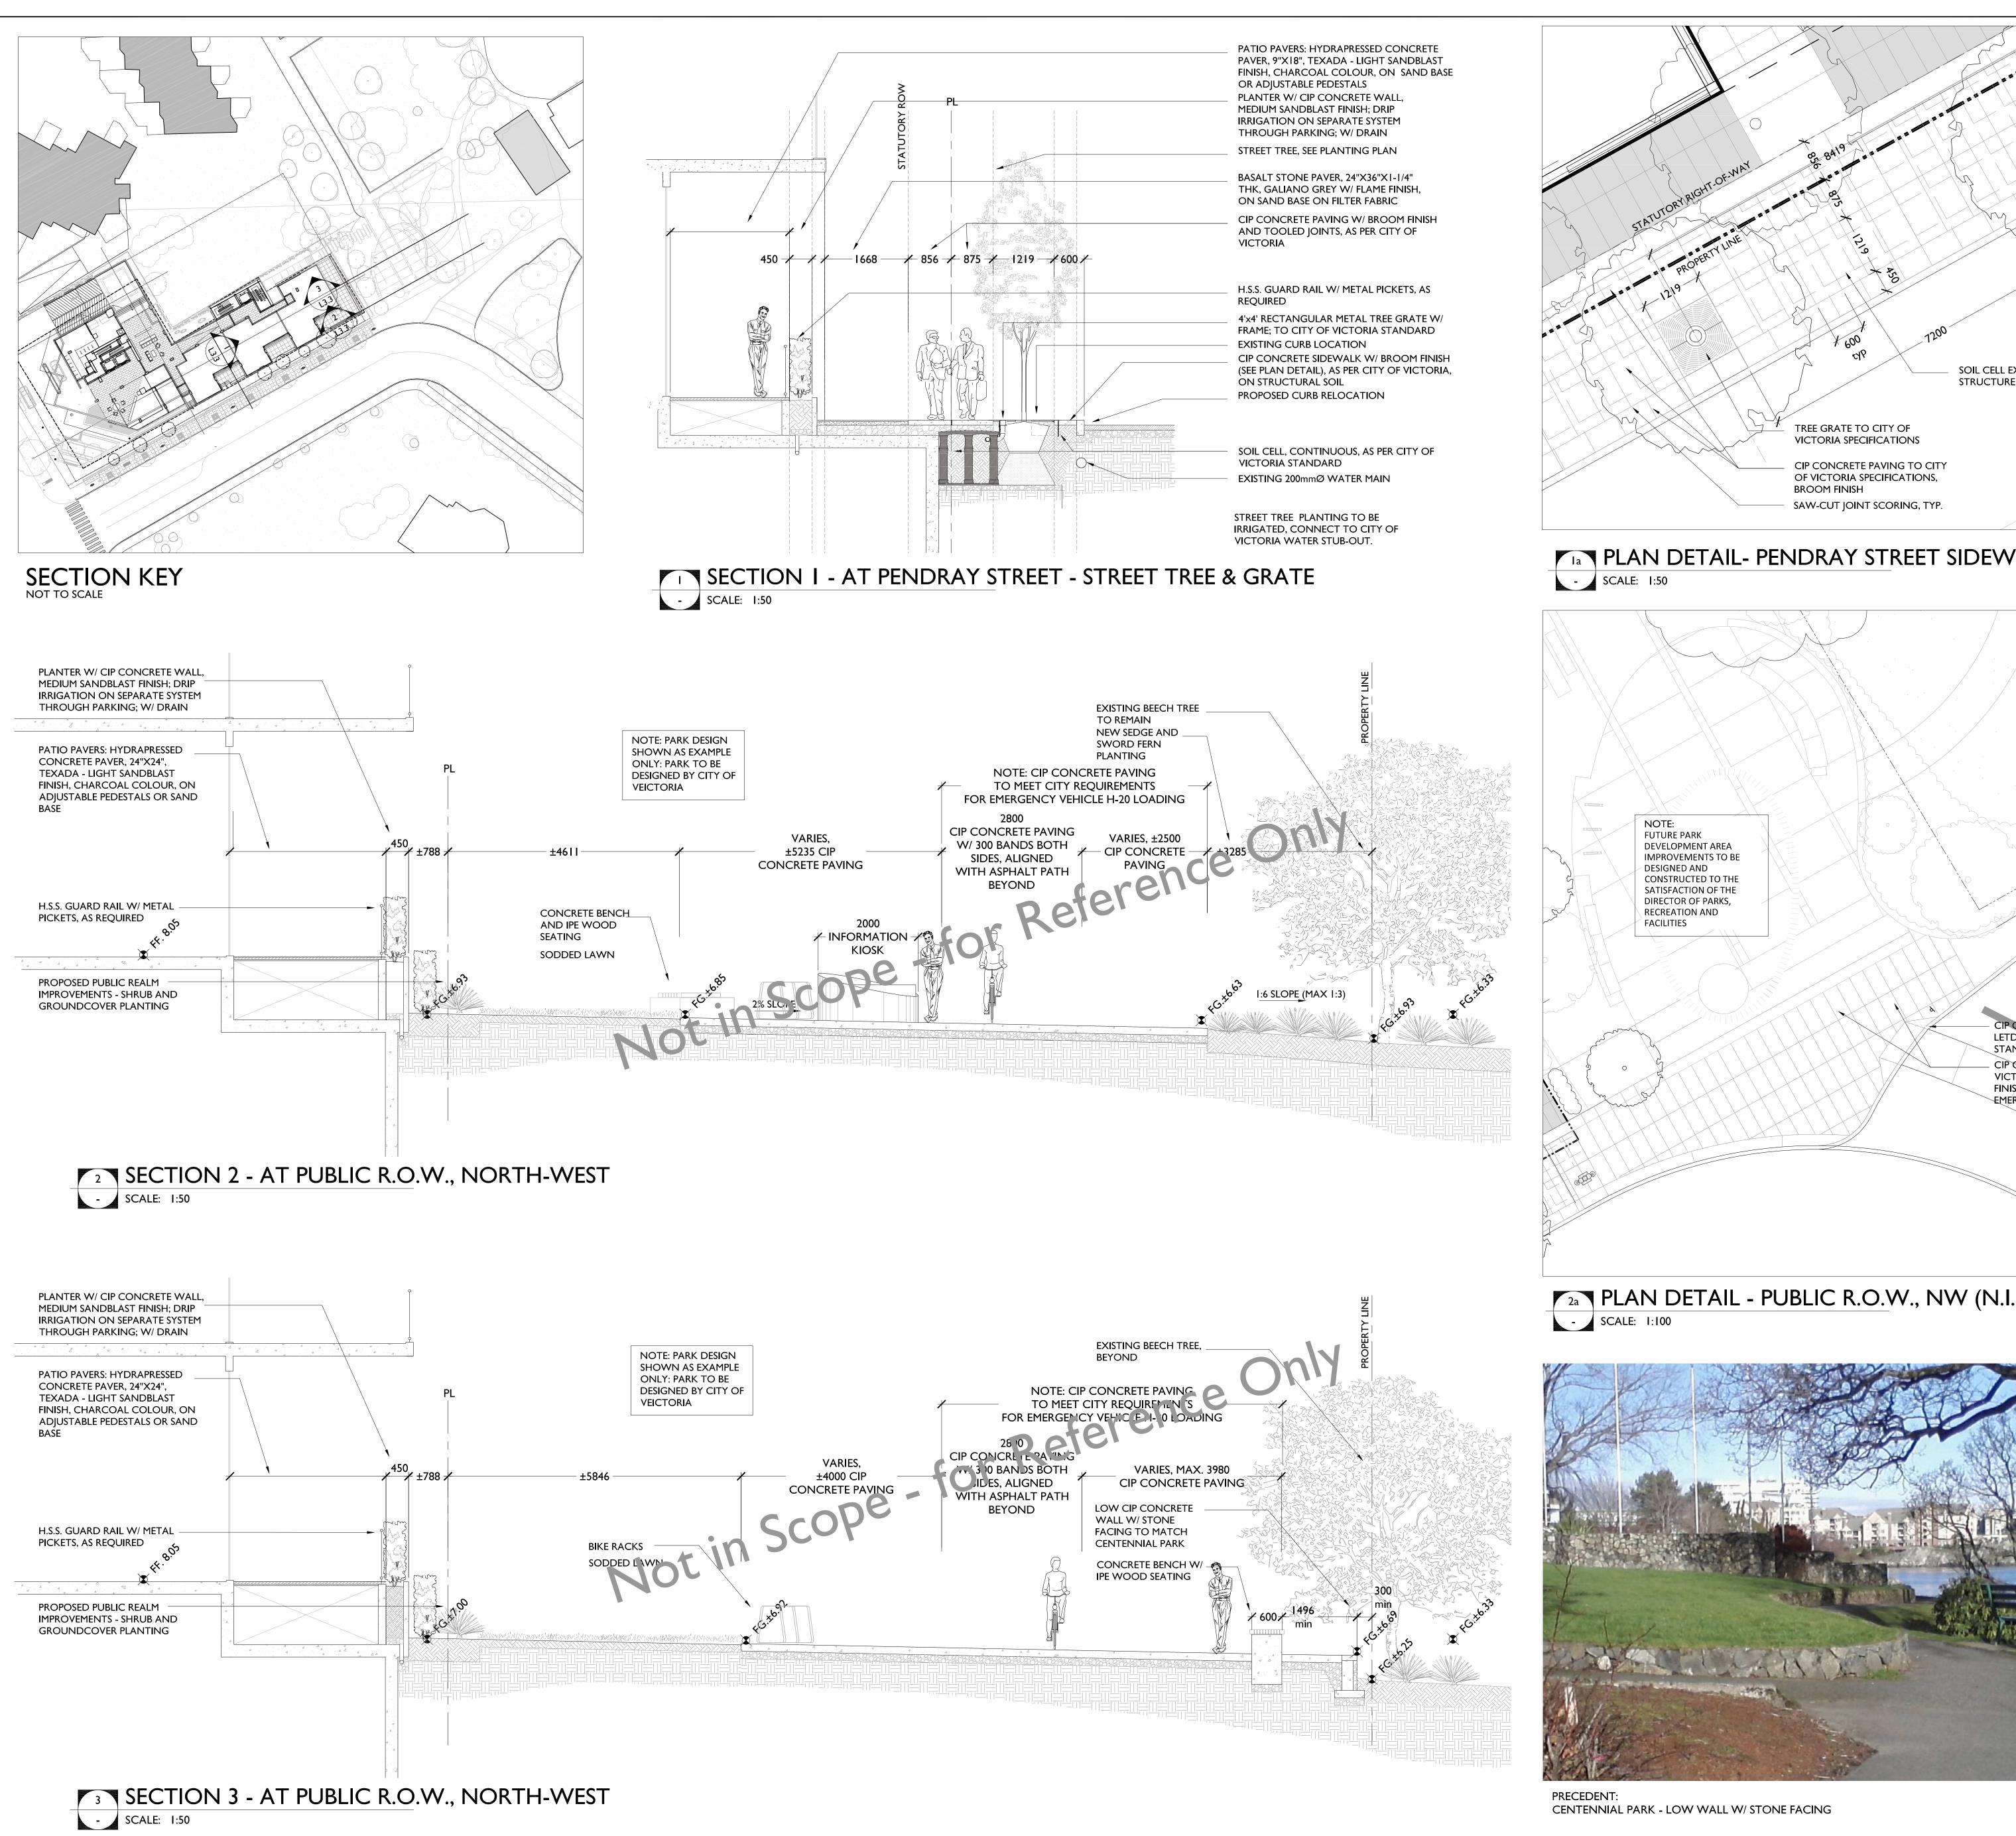


SOIL CELL EXTENT, TO PARKING STRUCTURE / BACK OF CURB

PLAN DETAIL- PENDRAY STREET SIDEWALK PAVING

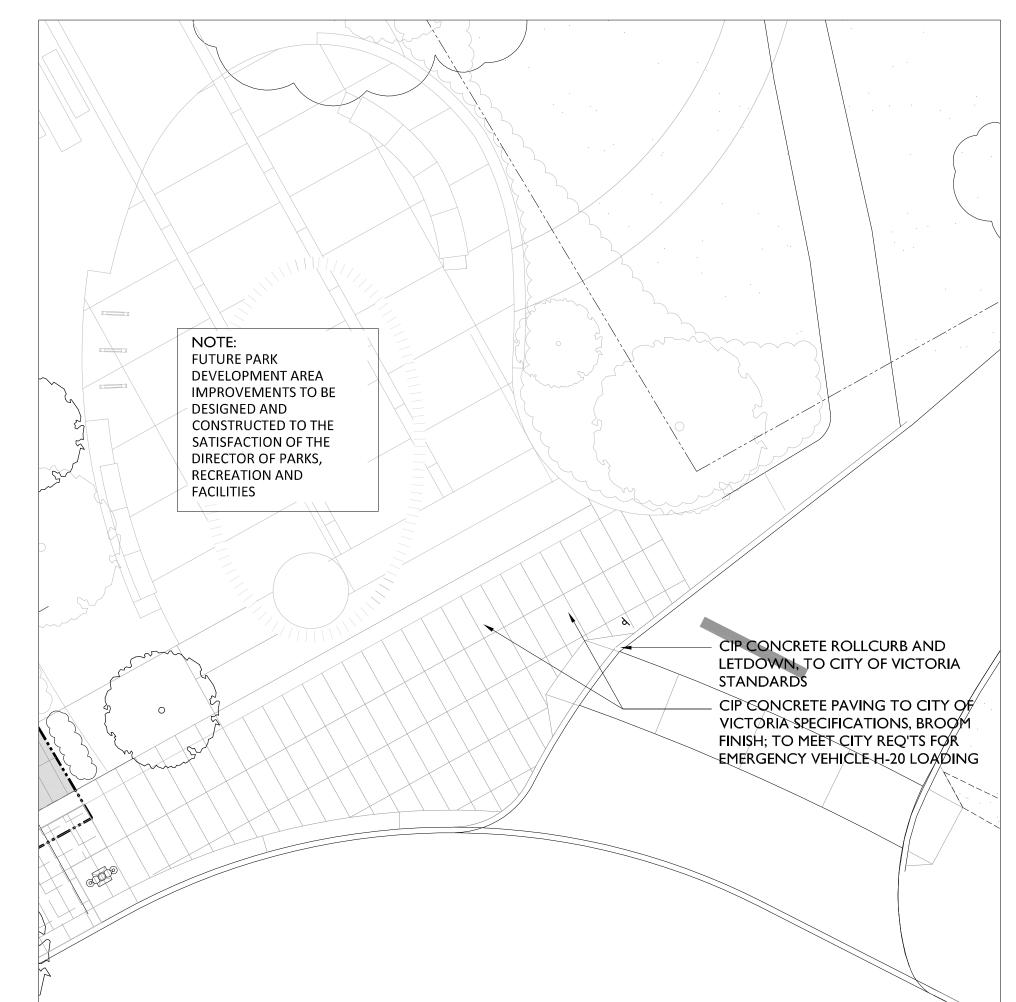

PLAN DETAIL - PUBLIC R.O.W., NW (N.I.C.)

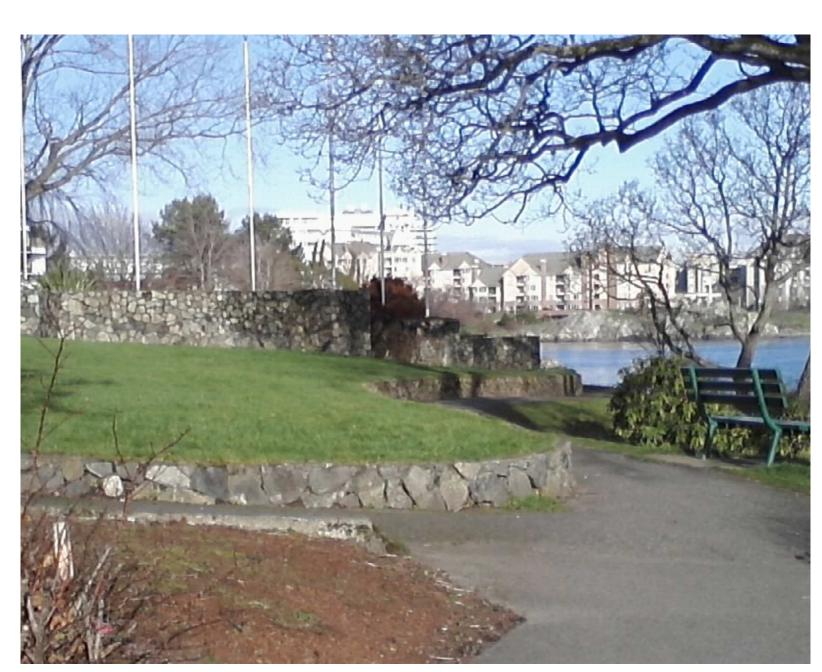

257 BELLEVILLE STREET

VICTORIA, BRITISH COLUMBIA.

issued for Development Permit Revised Development Permit Feb 04/ Revised Development Permit Feb 16/ Re-issued for Development Permit Dec 05 Re-issued for Development Permit Nov 26 Re-issued for Development PermitJune 03 Re-issued for Development Permit Dec 06/

consultant

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LANDSCAPE SECTIONS and DETAILS

L3.3 checked