



cв

- denotes - catch basin


мно 🛞 - denotes - manhole - storm drain


мнs 🛞 - denotes - manhole - sewer

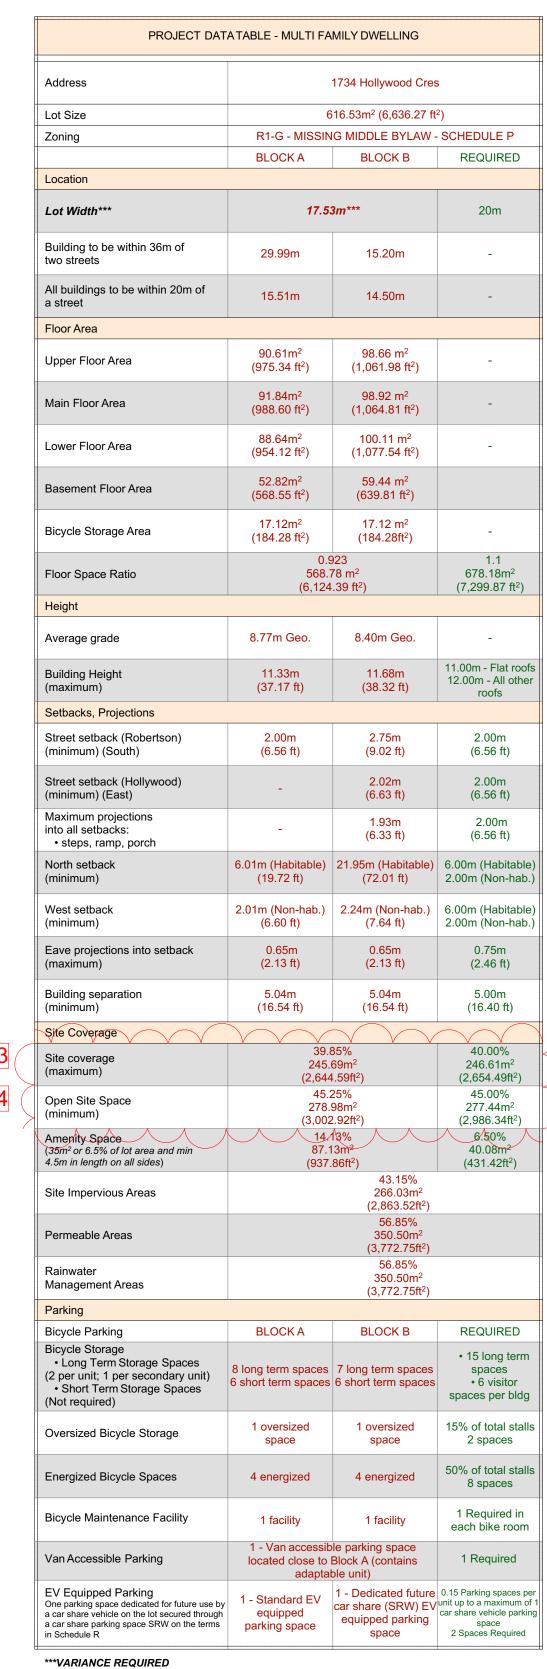


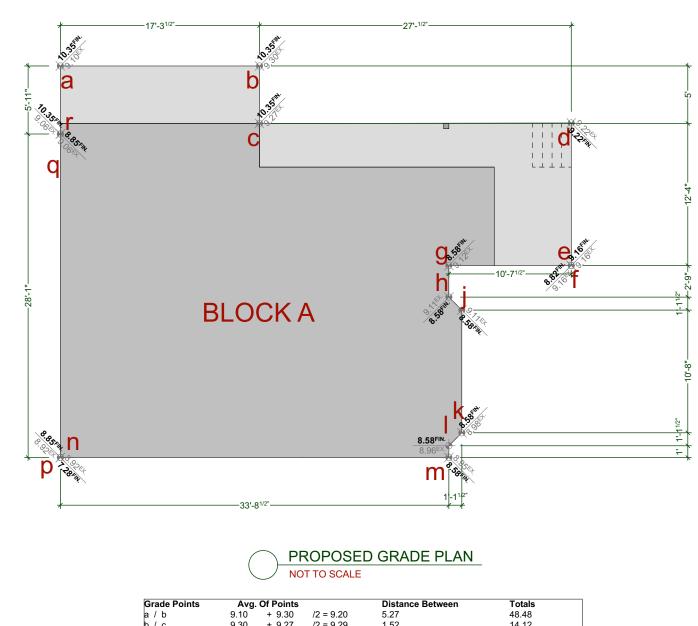

2.92 27.89 2.92 8.58 + 8.58 8.58 + 8.58 8.58 + 7.28 8.85 + 8.85 9.06 + 9.10 /2 = 8.58 /2 = 8.58 /2 = 7.93 /2 = 8.85 Permiter: 47.76 8.77 AVG. GRADE =

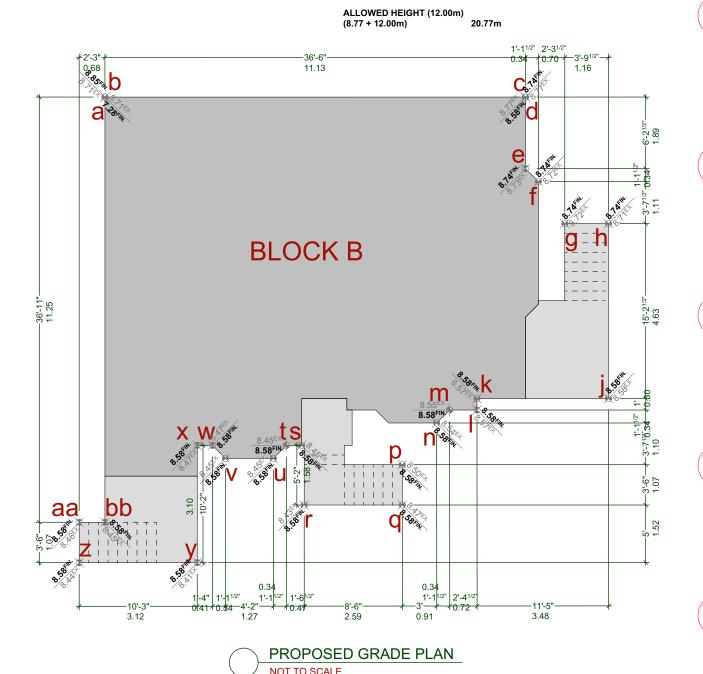

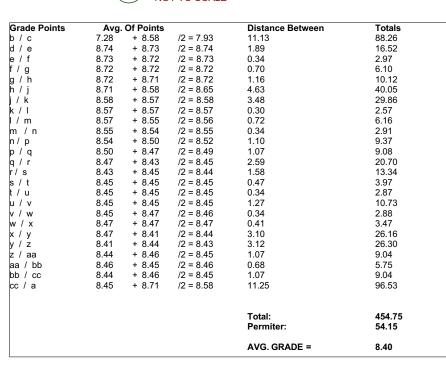

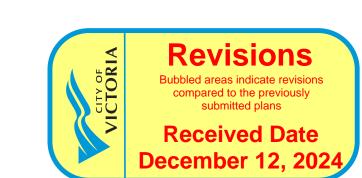

ALL EXPOSED OPENINGS SHALL BE PROVIDED WITH ADEQUATE FLASHING. ALL ROOFING SHALL INCORPORATE STEP FLASHING. ALL PENTRATIONS THROUGH ROOF SHALL INCLUDE APPROPRIATE

> DOORS - ROUGH OPENING SIZES FRAME OPENING 1 1/4" WIDER THAN DOOR FRAME HEIGHT 83" FOR EXTERIOR DOORS AND 82.5" FOR INTERIOR DOORS. FRAME OPENING 1 1/4" WIDER THAN BIFOLD DOORS

AND FRAME HEIGHT 81.5".

ECO-PRIORA®

STANDARD SPECIFICATION

INSTALLATION PATTERNS

AVAILABLE COLORS

PERMEABLE PAVEMENT DESIGN

4 IN. PVC PIPE MIN. 2% SLOPE —

MUTUAL MATERIALS LOCATIONS

South Seattle Spokane Tacoma (Parkland)

For product information and customer service, call 1-888-MUTUALØ (688-8250)

Stones / Pieces / Coverage / Weight / Weight / Net Void sq ft Pallet Pallet Unit Pallet

ASTM NO. 8 BEDDING -2 IN. (50 MM) THICK

CONCRETE PAVERS — 3 1/8 IN. (80 MM) THICK

ASTM NO. 57 BASE — 4 IN. (100 MM) THICK

co-Priora is manufactured to the same high quality specifications as all other Mutual Materia

FOLLOWING:

MUTUAL MATERIALS®

-INFORMATION PROVIDED ON EXISTING BUILDINGS OR SITE. -CONFORMITY OF PLANS TO -ERRORS AND OMMISSIONS -ANY HOUSE BUILT FROM THESE

SHEET

NUMBER

CRESCENT

LOT 1, 1734 HOLLYWOOD VICTORIA

CUSTOMER:

AMIT AND KARISHMA SADDRESS:

DRAWING NAME:
PROPOSED SITE PLAN,
GRADE PLANS AND DATAT

DATE: 8, 2024

DRAWING SCALE SEE DRAWINGS

BY

I I A L

ALL BRACING.

ACCORDING TO MANUFACTURER'S SPECIFICATIONS, INCLUDING

FLASHING.

CARBON MONOXIDE ALARMS TO BE HARDWIRED AND WITHIN 5M OF EACH BEDROOM IN EVERY SUITE AND INTERCONNECTED TO ALL FLOORS. CARBON MONOXIDE ALRAMS TO CONFORM TO CSA 6.19

NAFS REQUIREMENTS:

Performance Grade of 30 Water Test Pressure of 260 Pa GENERAL NOTES

ALL MATERIALS AND CONSTRUCTION METHODS TO CONFORM TO THE CURRENT EDITION OF THE BRITISH COLUMBIA BUILDING CODE AS WELL AS ANY LOCAL BUILDING CODES OR BYLAWS WHICH MAY TAKE

ALL MEASUREMENTS MUST BE VERIFIED ON SITE BY BUILDER PRIOR TO CONSTRUCTION, AND ANY DISCREPENCIES REPORTED TO THE DESIGNER. DIMENSIONS SHALL TAKE PRECEDENCE OVER SCALE

-SMOKE DETECTORS SHALL BE PROVIDED ON EVERY FLOOR

SITE PLAN

ALL LAYOUTS SHOULD BE CONFIRMED BY A REGISTERED B.C. LAND SURVEYOR ALL SETBACKS SHALL BE CONFIRMED BY THE OWNER/BUILDER. ALL GRADE ELEVATIONS ARE THE RESPONSIBILITY OF THE OWNER/BUILDER AND ANY MOFICATIONS ARE TO BE MADE ON SITE.

CONFORMITY OF THESE PLANS TO THE ACTUAL SITE IS THE RESPONSIBILITY OF THE OWNER/BUILDER.

CONCRETE AND FOUNDATIONS

ALL CONCRETE FOOTINGS TO HAVE SOLID BEARING ON COMPACTED, UNDISTURBED INORGANIC SOIL TO A SUITABLE DEPTH BELOW FROST IF SOFTER CONDITIONS APPLY, THE SOLID BEARING CAPACITY AND SIZE OF FOOTINGS ARE TO BE DESIGNED BY A QUALIFIED ENGINEER GARAGE & CARPORT FLOORS AND EXTERIOR STEPS SHALL NOT BE LESS

FOUNDATION CONCRETE SHALL HAVE MIN. COMPRESSIVE STRENGTH OF 2900 psi (20MPa) AT 28 DAYS, MIXED, PLACED AND TESTED IN ACCORDANCE WITH CAN3-A438.

ALL WALLS ARE 8" CONCRETE UNLESS OTHERWISE NOTED. ALL GRADES ARE ESTIMATED ONLY AND SHALL BE ADJUSTED ON SITE. ALL WOOD IN CONTACT WITH CONCRETE SHALL BE TREATED OR SEPARATED BY A MOISTURE RESISTANT GASKET MATERIAL

LUMBER, FRAMING AND BEAMS

BUILDING FRAMES TO BE ANCHORED TO FOUNDATION BY FASTENING SILL PLATE TO FOUNDATION WITH NOT LESS THAN 12.7mm DIAM ANCHOR BOLTS AT NOT MORE THAN 2.4M O.C.

ALL ENGINEERED BEAMS TO BE SIZED BY SUPPLIER.


ALL SPANS SHALL CONFORM TO THE TABLES SET OUT IN "THE SPAN BOOK" AND THE NATIONAL BUILDING CODE OF CANADA AND VERIFICATIONS OF ALL SPANS IS THE RESPONSIBILITY OF THE OWNER/BUILDER.


ALLOWED HEIGHT (12.00m)
20.40m TRUSSES AND LAYOUT ARE TO BE ENGINEERED AND INSTALLED

ALL ROOFING SHALL BE APPLIED TO MANUFACTURER'S SPECIFICATION AND SHALL INCLUDE EAVE PROTECTION FROM ICE DAMS AND SNOW BUILD UP.

ANY ELECTRICAL SHOWN ON PLANS IS TO SERVE AS A GUIDE ONLY AND MUST BE INSTALLED BY A QUALIFIED PERSONNEL.

NEITHER JAVADESIGNS INC. NOR THE DESIGNER ACCEPT RESPONSIBILITY FOR THE

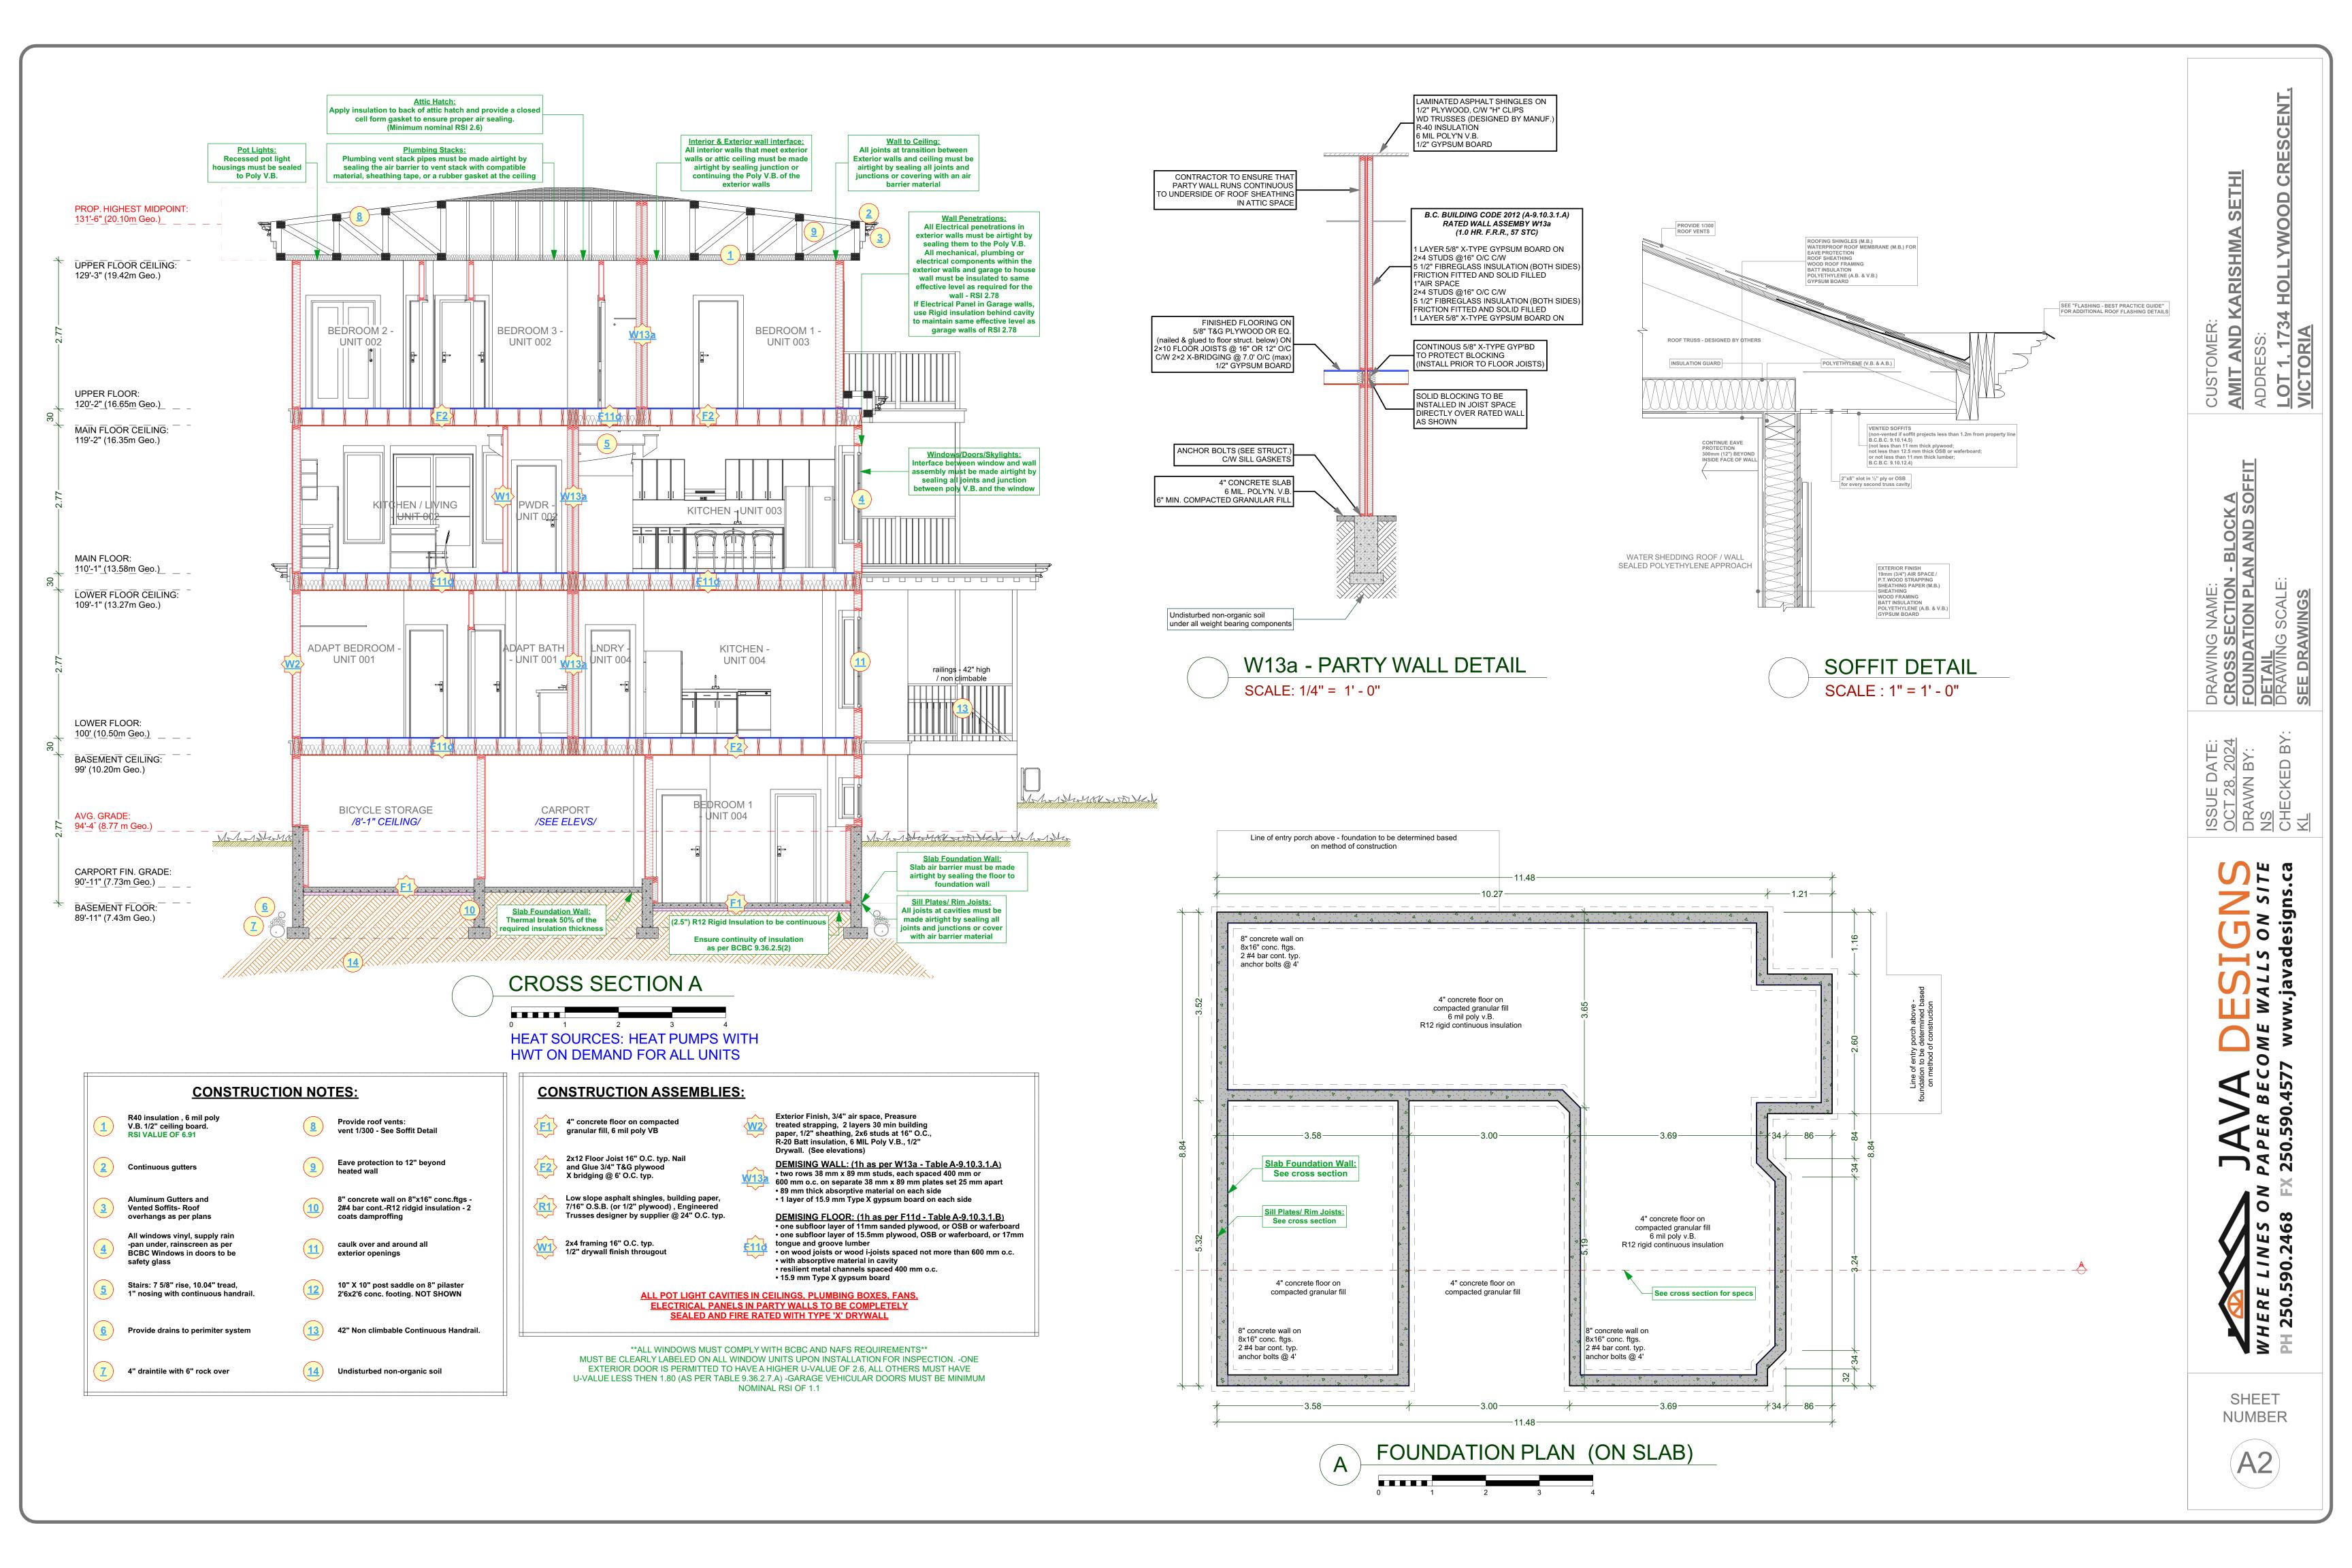

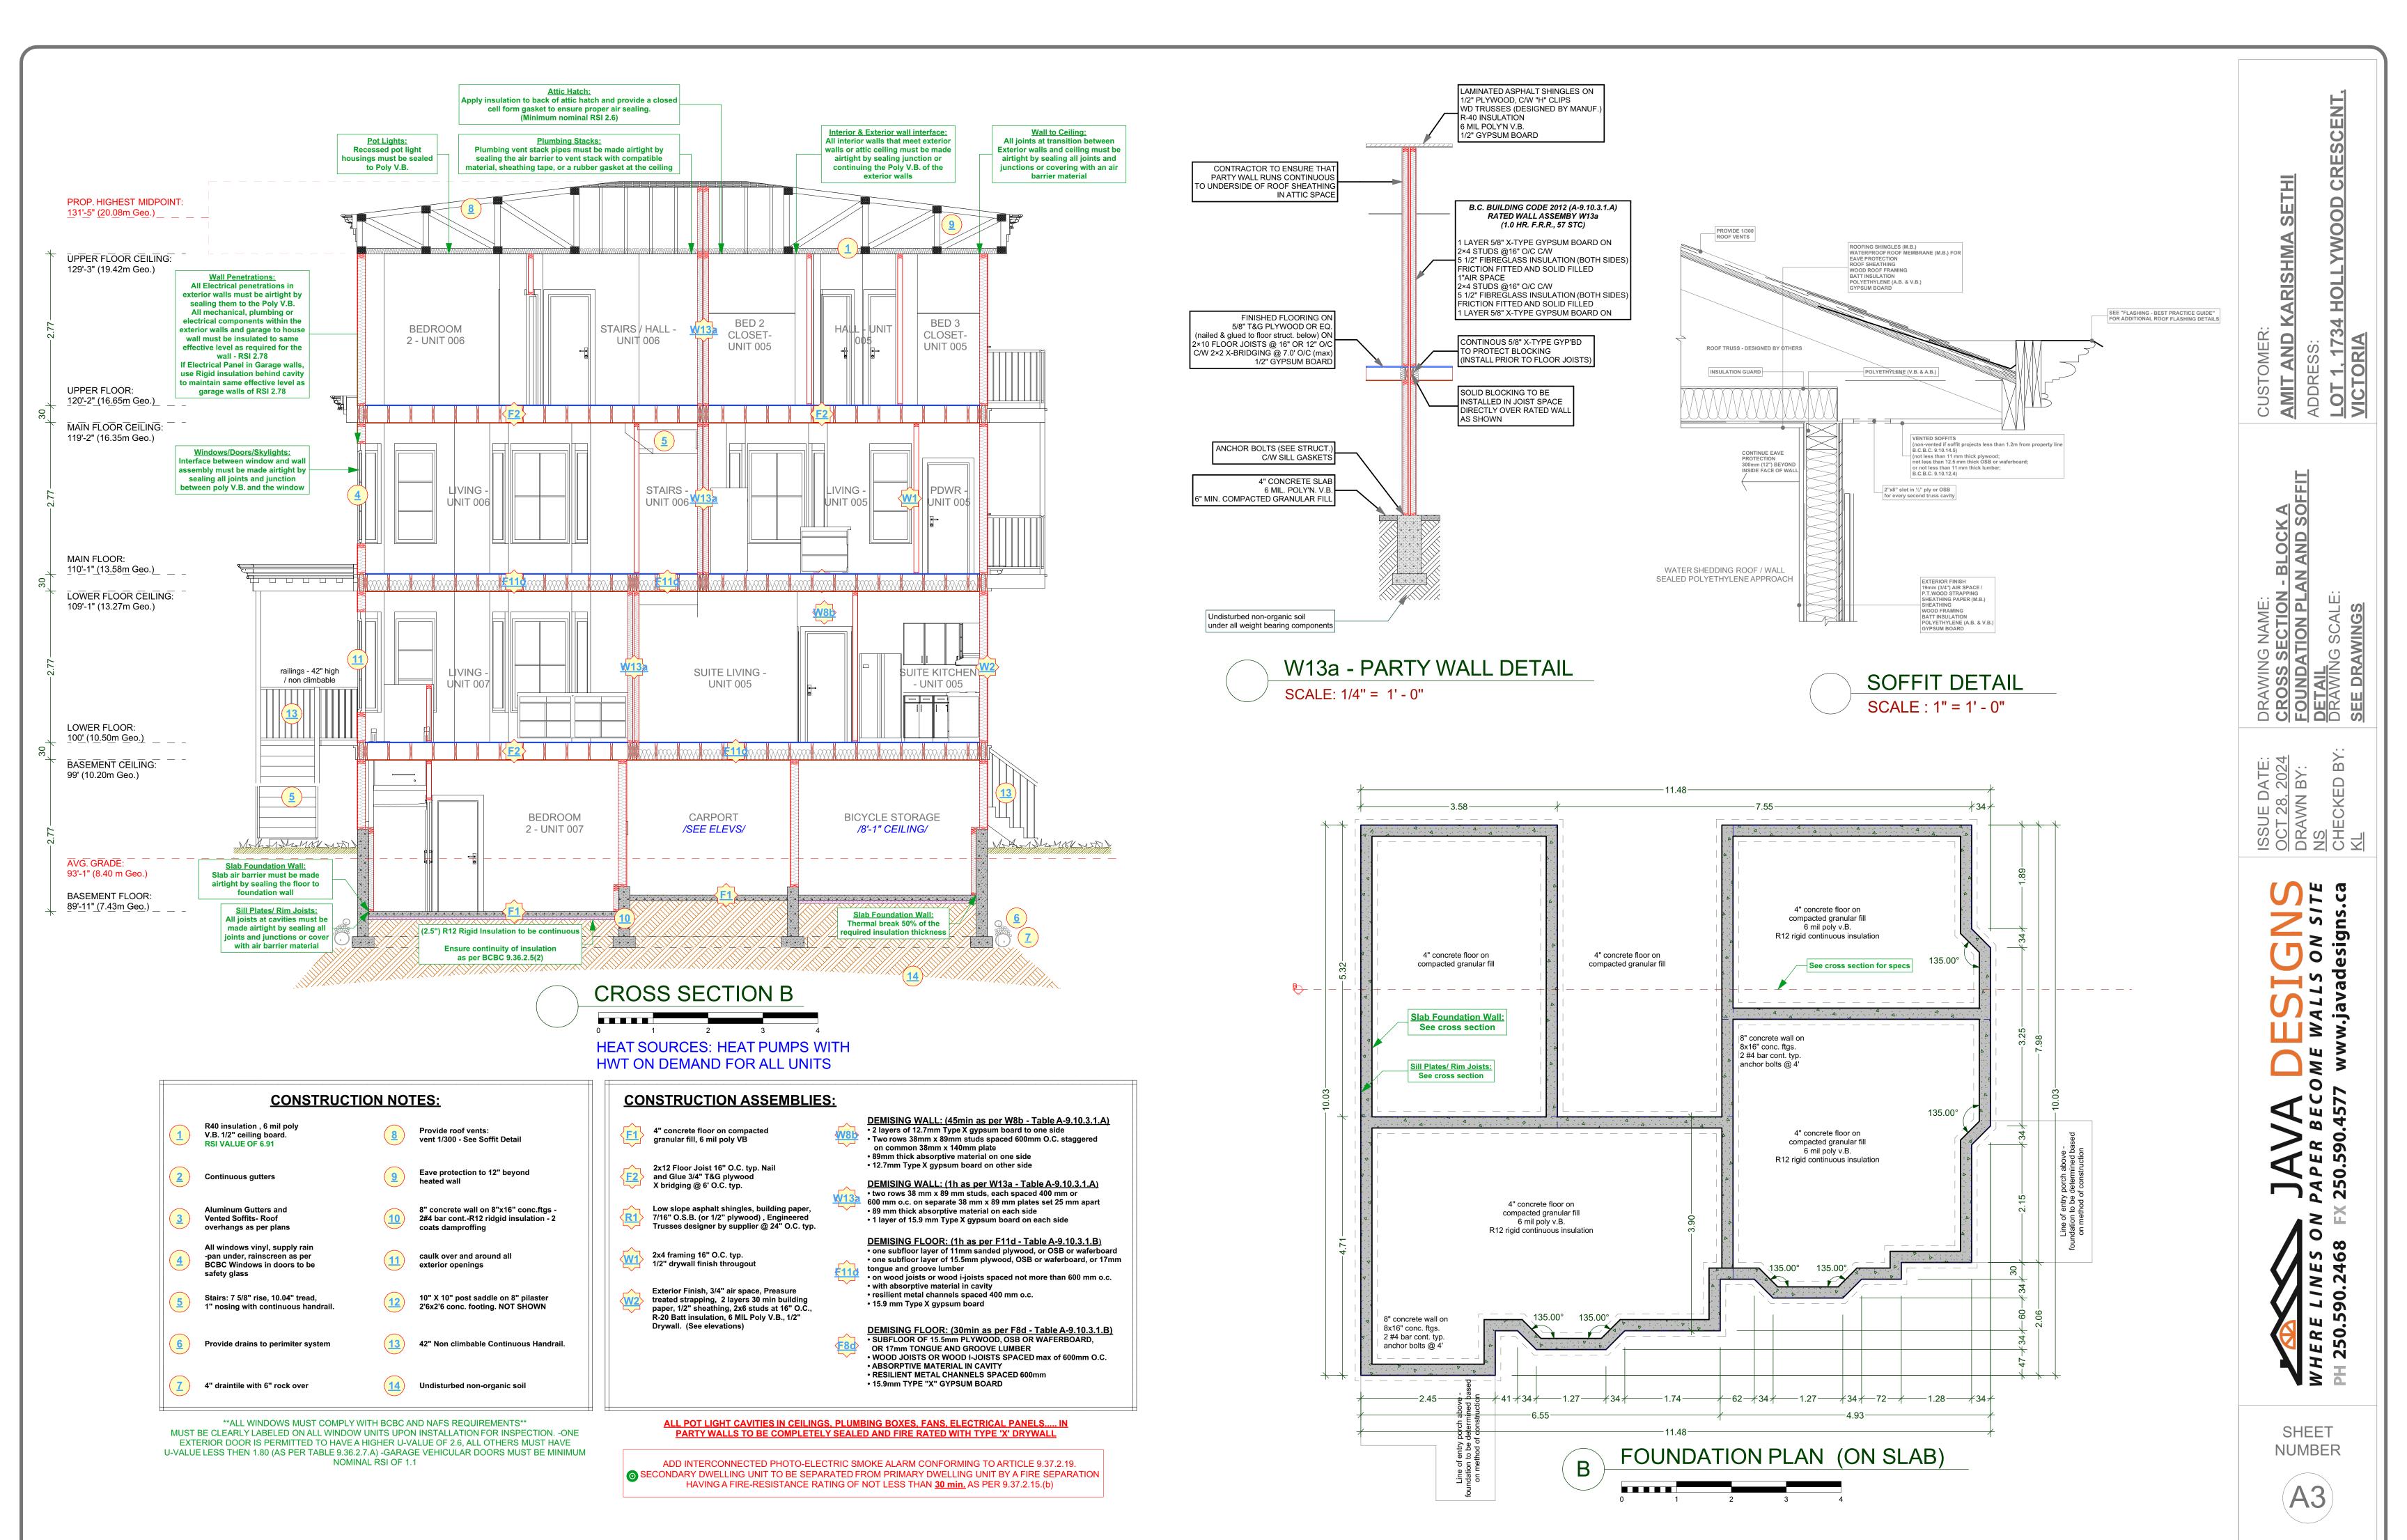

BASEMENT FLOOR PLAN

UNIT 007 AREA: 639.81 Sq Ft BICYCLE AREA: 184.28 Sq Ft

В

DEMISING WALL: (1h as per W13a - Table A-9.10.3.1.A)

• two rows 38 mm x 89 mm studs, each spaced 400 mm or
600 mm o.c. on separate 38 mm x 89 mm plates set 25 mm apart
• 89 mm thick absorptive material on each side
• 1 layer of 15.9 mm Type X gypsum board on each side


DEMISING FLOOR: (1h as per F11d - Table A-9.10.3.1.B)

• one subfloor layer of 11mm sanded plywood, or OSB or waferboard

• one subfloor layer of 15.5mm plywood, OSB or waferboard, or 17mm tongue and groove lumber

• on wood joists or wood i-joists spaced not more than 600 mm o.c.

one subfloor layer of 15.5mm plywood, OSB or waferboard, or 17ml tongue and groove lumber
 on wood joists or wood i-joists spaced not more than 600 mm o.c.
 with absorptive material in cavity
 resilient metal channels spaced 400 mm o.c.
 15.9 mm Type X gypsum board

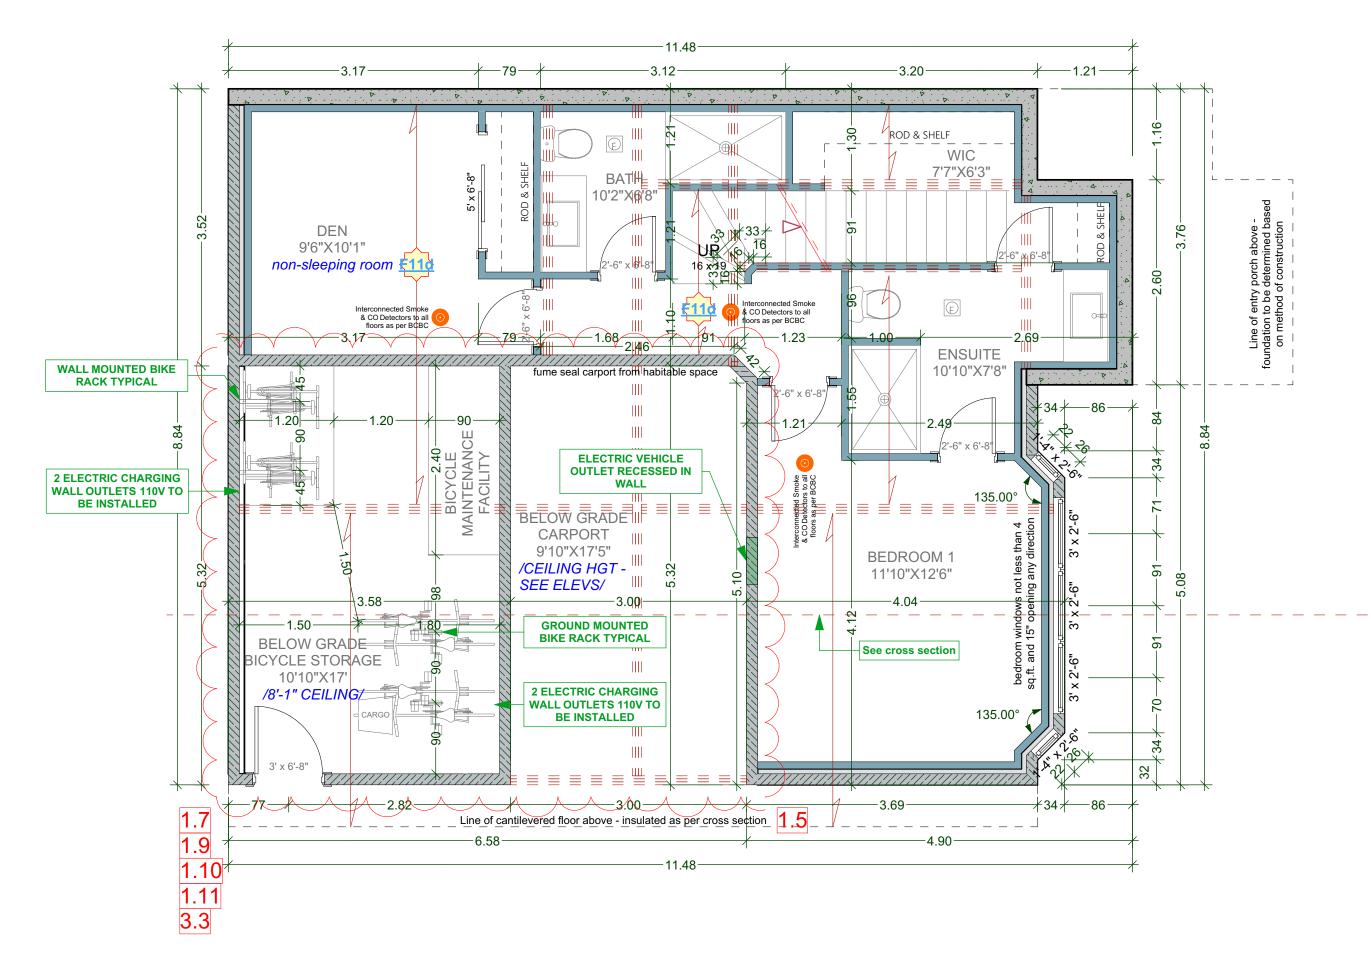



UNIT 004 AREA: 568.55 Sq Ft BICYCLE AREA: 184.28 Sq Ft

ALL POT LIGHT CAVITIES IN CEILINGS, PLUMBING BOXES, FANS, ELECTRICAL PANELS IN PARTY WALLS TO BE COMPLETELY SEALED AND FIRE RATED WITH TYPE 'X' DRYWALL

DEMISING WALL: (1h as per W13a - Table A-9.10.3.1.A)

• two rows 38 mm x 89 mm studs, each spaced 400 mm or 600 mm o.c. on separate 38 mm x 89 mm plates set 25 mm apart

• 89 mm thick absorptive material on each side

• 1 layer of 15.9 mm Type X gypsum board on each side

DEMISING FLOOR: (1h as per F11d - Table A-9.10.3.1.B)

• one subfloor layer of 11mm sanded plywood, or OSB or waferboard

• one subfloor layer of 15.5mm plywood, OSB or waferboard, or 17mm

tongue and groove lumber

on wood joists or wood i-joists spaced not more than 600 mm o.c.
with absorptive material in cavity
resilient metal channels spaced 400 mm o.c.

15.9 mm Type X gypsum board

CUSTOMER:

AMIT AND KARISHMA SETHI
ADDRESS:

OOR PLANS ADDR

DRAWING NAME:
PROPOSED
BASEMENT FLOOR PLA
DRAWING SCALE:

ISSUE DATE:

OCT 28, 2024

DRAWN BY:

NS

CHECKED BY:


KL

S PAPER BECOME WALLS ON SITE S EX 250.590.4577 www.javadesigns.ca







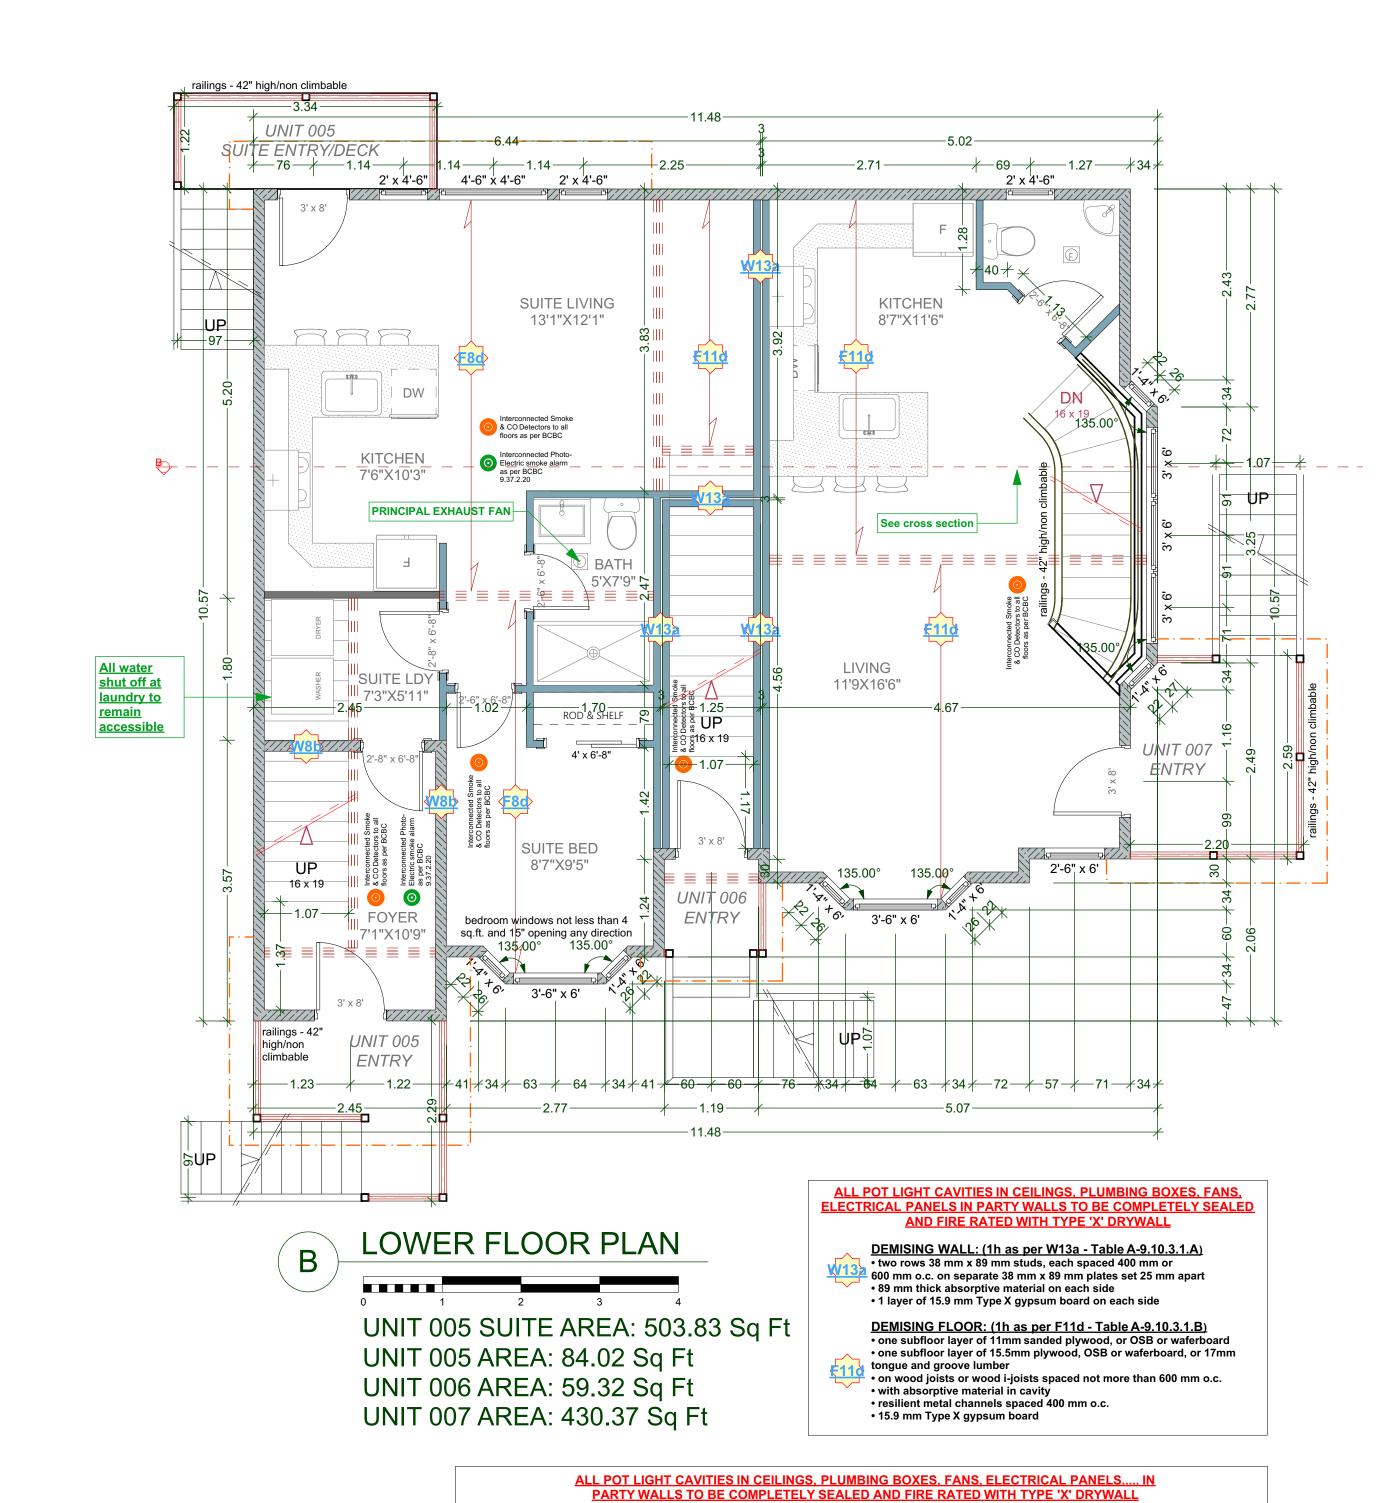

DEMISING FLOOR: (30min as per F8d - Table A-9.10.3.1.B)

• WOOD JOISTS OR WOOD I-JOISTS SPACED max of 600mm O.C.

• SUBFLOOR OF 15.5mm PLYWOOD, OSB OR WAFERBOARD,

OR 17mm TONGUE AND GROOVE LUMBER

• RESILIENT METAL CHANNELS SPACED 600mm

ABSORPTIVE MATERIAL IN CAVITY

• 15.9mm TYPE "X" GYPSUM BOARD

DEMISING WALL: (45min as per W8b - Table A-9.10.3.1.A)


• Two rows 38mm x 89mm studs spaced 600mm O.C. staggered

• 2 layers of 12.7mm Type X gypsum board to one side

on common 38mm x 140mm plate

• 89mm thick absorptive material on one side

• 12.7mm Type X gypsum board on other side

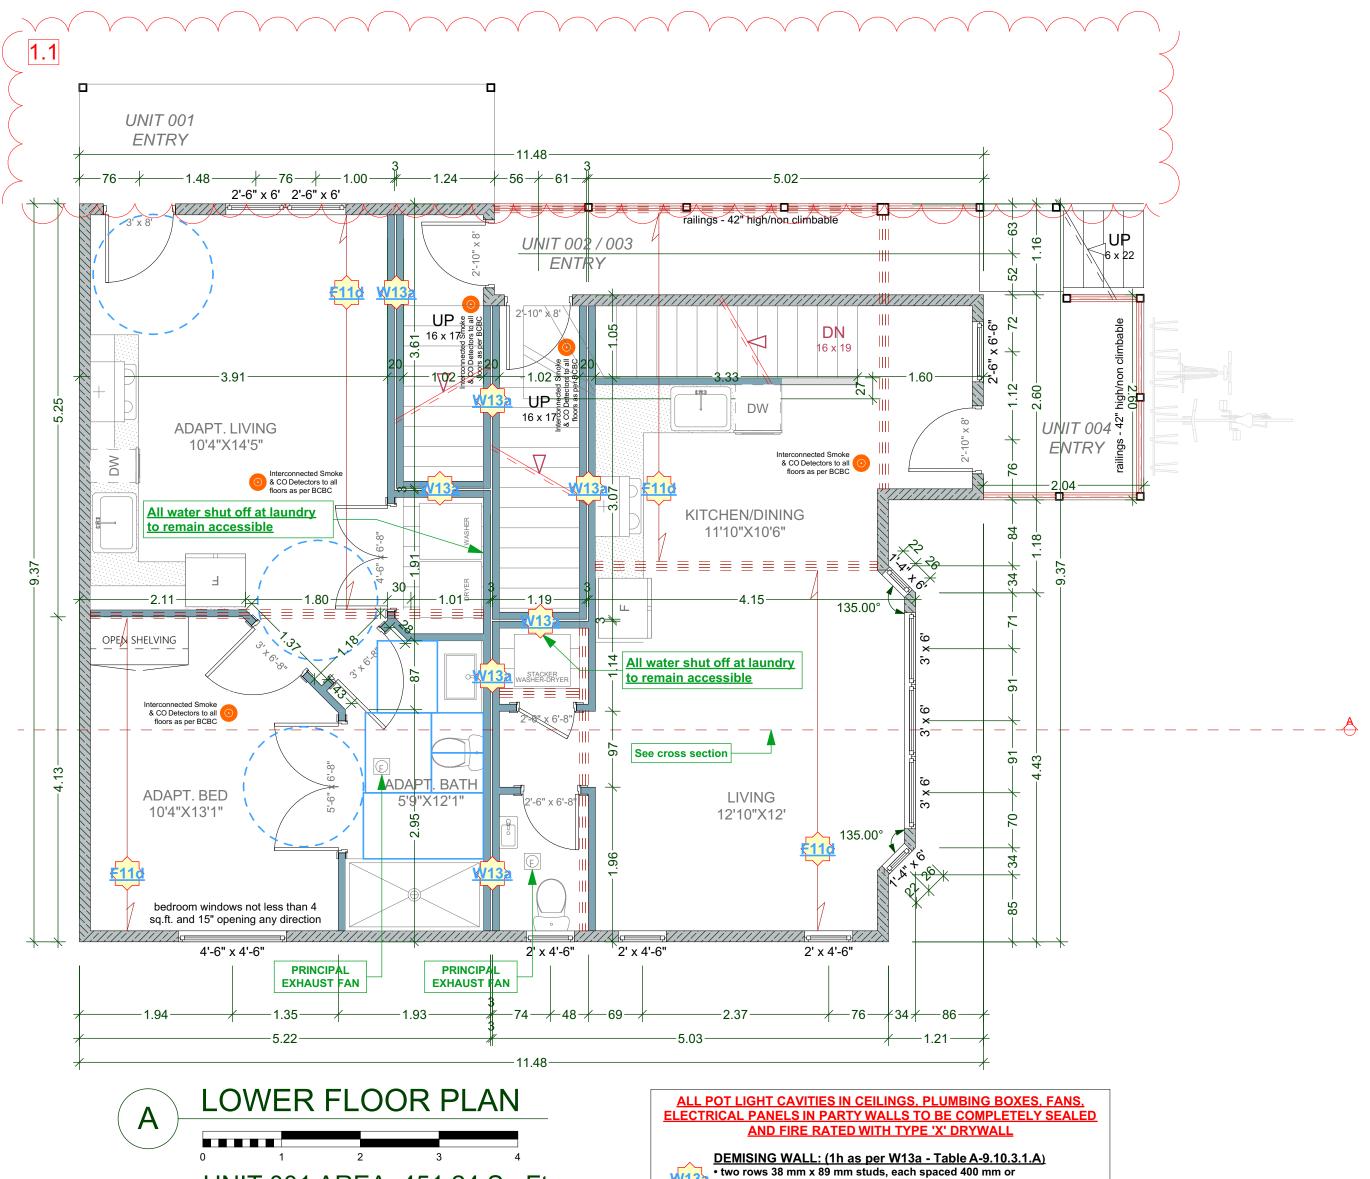

UNIT 001 AREA: 451.24 Sq Ft UNIT 002 AREA: 43.52 Sq Ft UNIT 003 AREA: 51.14 Sq Ft UNIT 004 AREA: 408.22 Sq Ft 2 600 mm o.c. on separate 38 mm x 89 mm plates set 25 mm apart 89 mm thick absorptive material on each side • 1 layer of 15.9 mm Type X gypsum board on each side

DEMISING FLOOR: (1h as per F11d - Table A-9.10.3.1.B) • one subfloor layer of 11mm sanded plywood, or OSB or waferboard • one subfloor layer of 15.5mm plywood, OSB or waferboard, or 17mm tongue and groove lumber • on wood joists or wood i-joists spaced not more than 600 mm o.c. with absorptive material in cavity • resilient metal channels spaced 400 mm o.c. • 15.9 mm Type X gypsum board


tongue and groove lumber

with absorptive material in cavity

• 15.9 mm Type X gypsum board


resilient metal channels spaced 400 mm o.c.

• on wood joists or wood i-joists spaced not more than 600 mm o.c.

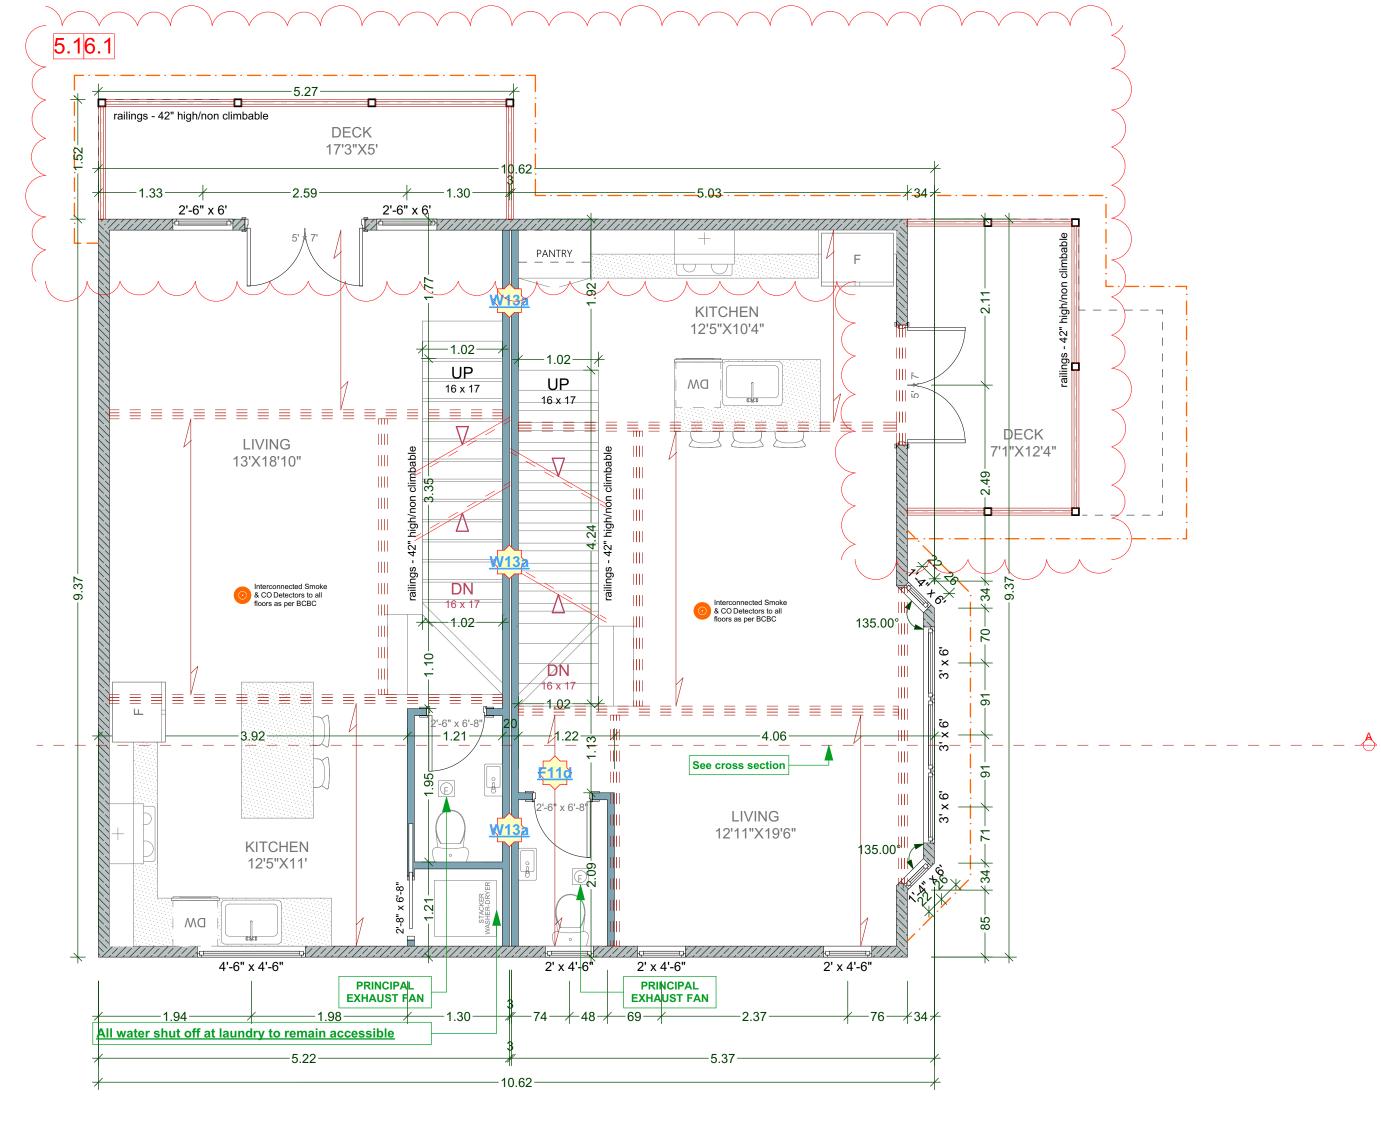



UNIT 003 AREA: 491.44 Sq Ft

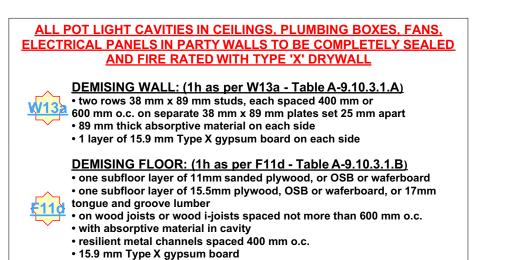

ADDRESS:

DRAWING NAME:
PROPOSED

MAIN FLOOR PLAN

BY:
DRAWING SCALE:


ISSUE DATE:
OCT 28, 2024
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CHECKED BY:
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S FX 250.590.4577 www.javadesigns.


WHERE PH 250.5



NUMBER

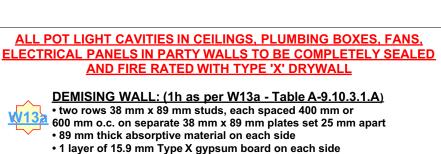

2'-6" x 6'

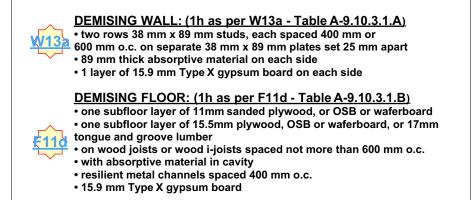

BEDROOM 3

Interconnected Smoke & CO Detectors to all floors as per BCBC

See cross section -

Interconnected Smoke & CO Detectors to all floors as per BCBC

BEDROOM 1 12'8"X10'4"

bedroom windows not less than 4 sq.ft. and 15" opening any direction 135.00°

3'-6" x 6'

BEDROOM 2 8'X9'

9'X9'2"

4'-6" x 4'-6"

bedroom windows not less than 4

sq.ft. and 15" opening any direction

BEDROOM 2

ENSUITÉ

5'9"X6'

____11.48 _______

2'-6" x 4'-6"

9'X9'4"

Interconnected Smoke & CO Detectors to all floors as per BCBC

ENSUITE 8'11"X5'

bedroom windows not less than 4 sq.ft. and 15" opening any direction 135.00° 135.00°

3'-6" x 6'

UNIT 005 AREA: 537.99 Sq Ft

UNIT 006 AREA: 523.99 Sq Ft

BEDROOM 1

12'5"X9'6"

4' x 6'-8"

4'-6" x 4'-6"

bedroom windows not less than 4 sq.ft. and 15" opening any direction


BEDROOM 3

9'X9'6"


4' x 6'-8"

_ _ _ _ _

5.16.1

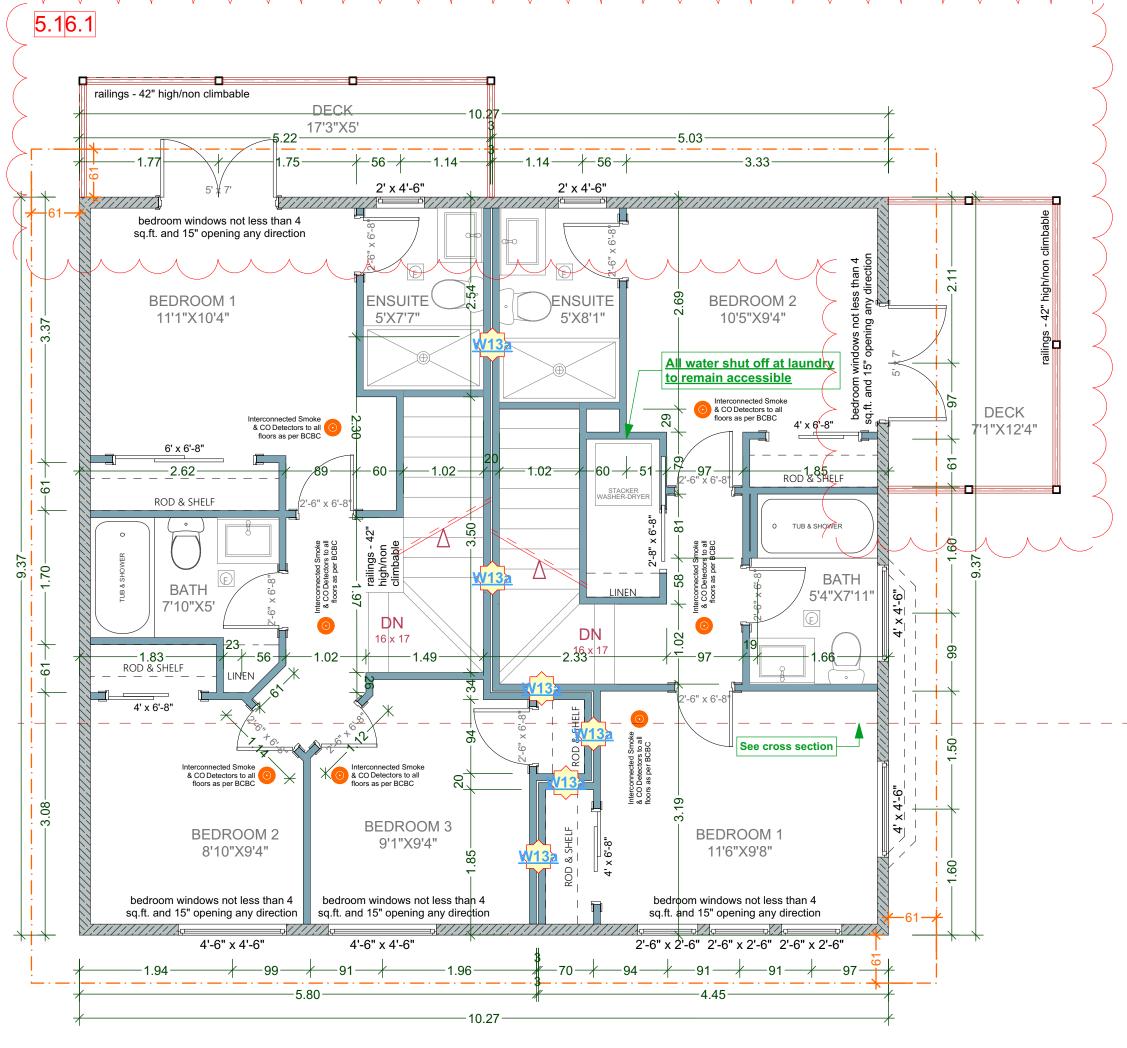



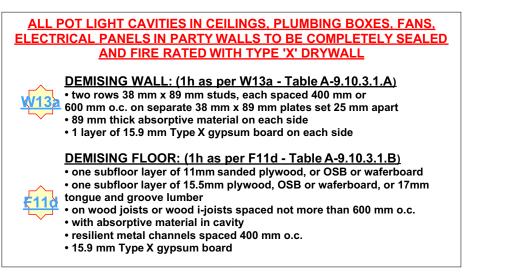

CUSTOMER:

AMIT AND KARISHMA S


ADDRESS:

DRAWING NAME:
PROPOSED
UPPER FLOOR F

ISSUE DA OCT 28. DRAWN INS CHECKE





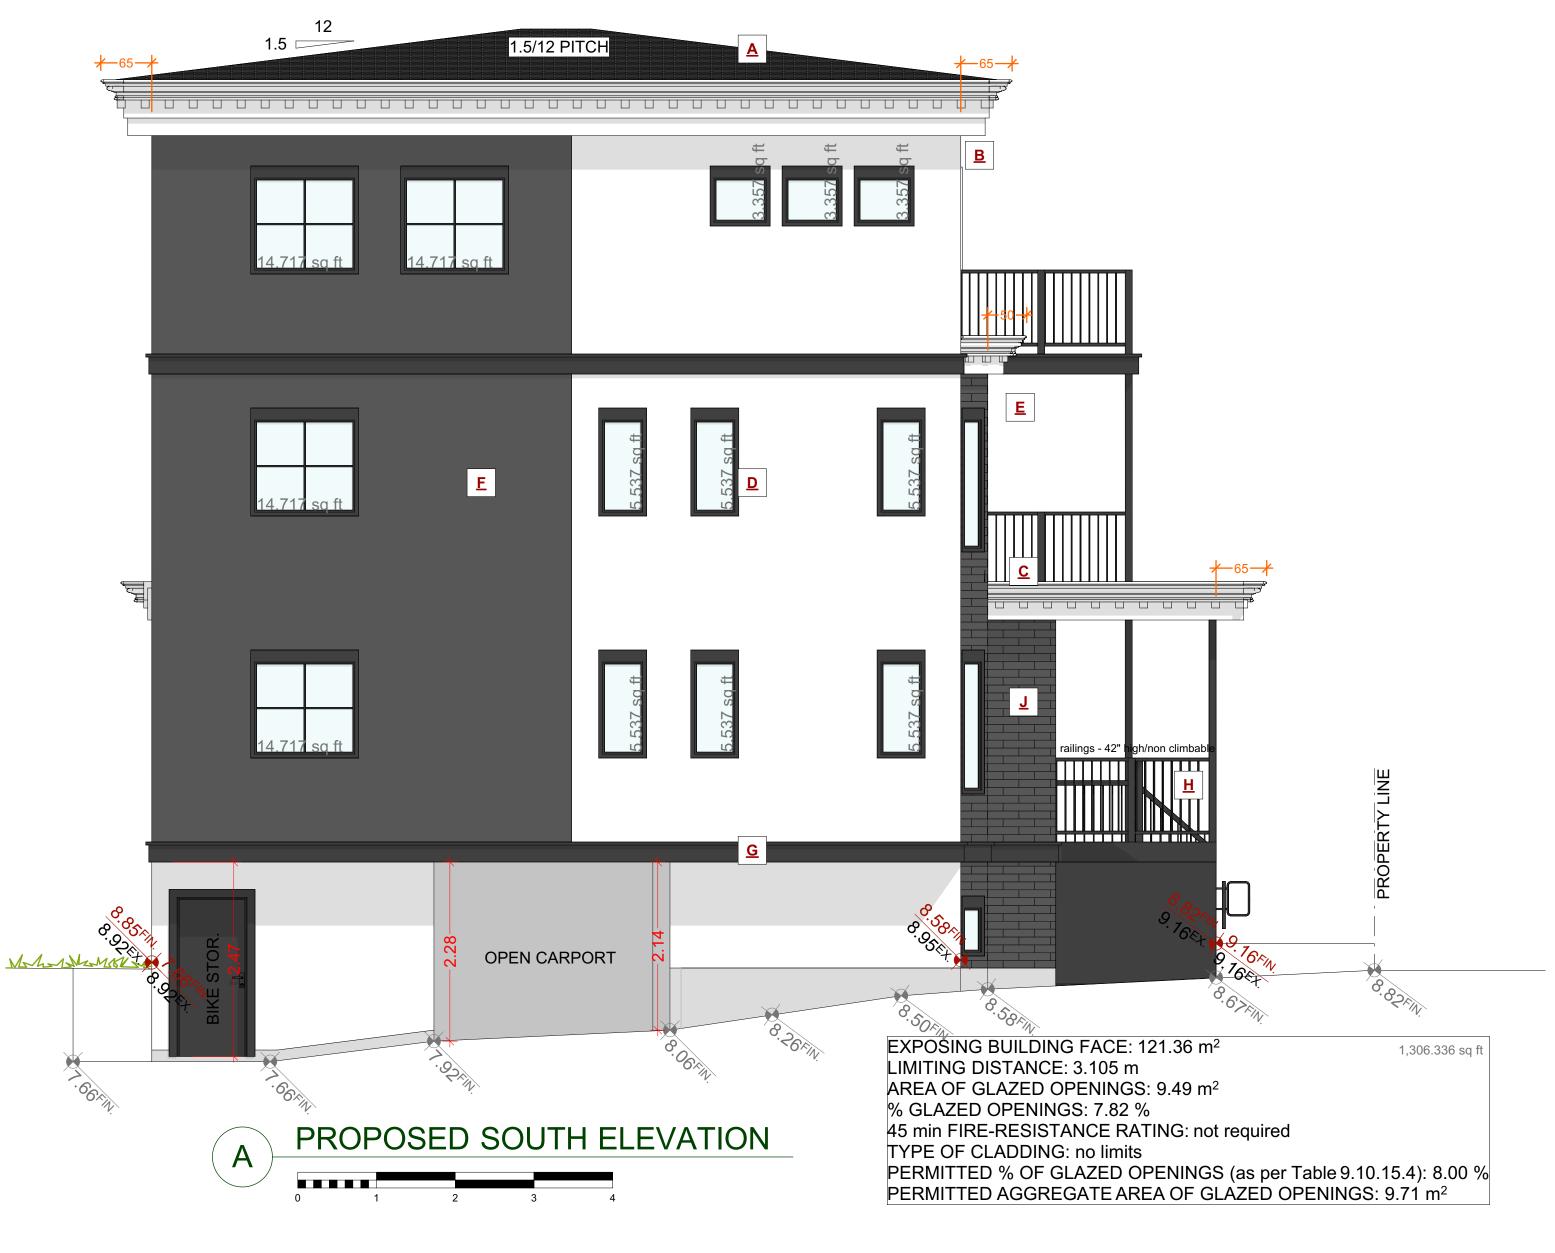



ALL WINDOWS MUST COMPLY WITH BCBC AND NAFS REQUIREMENTS MUST BE CLEARLY LABELED ON ALL WINDOW UNITS UPON INSTALLATION FOR INSPECTION. -ONE EXTERIOR DOOR IS PERMITTED TO HAVE A HIGHER U-VALUE OF 2.6, ALL OTHERS MUST BE LOWER. -GARAGE VEHICULAR DOORS MUST BE MINIMUM NOMINAL RSI OF 1.1

0

DRAWING NAME:
PROPOSED SOUTH ELEVATIONS DRAWING SCALE: 1/4"=1'-0" ISSUE DATE:
OCT 28, 2024
DRAWN BY:
NS
CHECKED BY:
KL

LOT 1, 1734 HOLLYWOOD CRESCENT, VICTORIA

CUSTOMER:

AMIT AND KARISHMA SETHI
ADDRESS:

√ o E





1726 HOLLYWOOD CRES SCALE: 1/4" = 1' - 0"





ALL WINDOWS MUST COMPLY WITH BCBC AND NAFS REQUIREMENTS
MUST BE CLEARLY LABELED ON ALL WINDOW UNITS UPON INSTALLATION FOR INSPECTION. -ONE EXTERIOR DOOR IS PERMITTED TO HAVE A HIGHER U-VALUE OF 2.6, ALL OTHERS MUST BE LOWER.
-GARAGE VEHICULAR DOORS MUST BE MINIMUM NOMINAL RSI OF 1.1

CUSTOMER:

AMIT AND KARISHMA SETHI


ADDRESS:

LOT 1, 1734 HOLLYWOOD CRESCENT,

VICTORIA

DRAWING NAME:
PROPOSED HOLLYWOOD
CRES STREETSCAPE

ISSUE DATE:
OCT 28, 2024
DRAWN BY:
NS
CHECKED BY:
KL

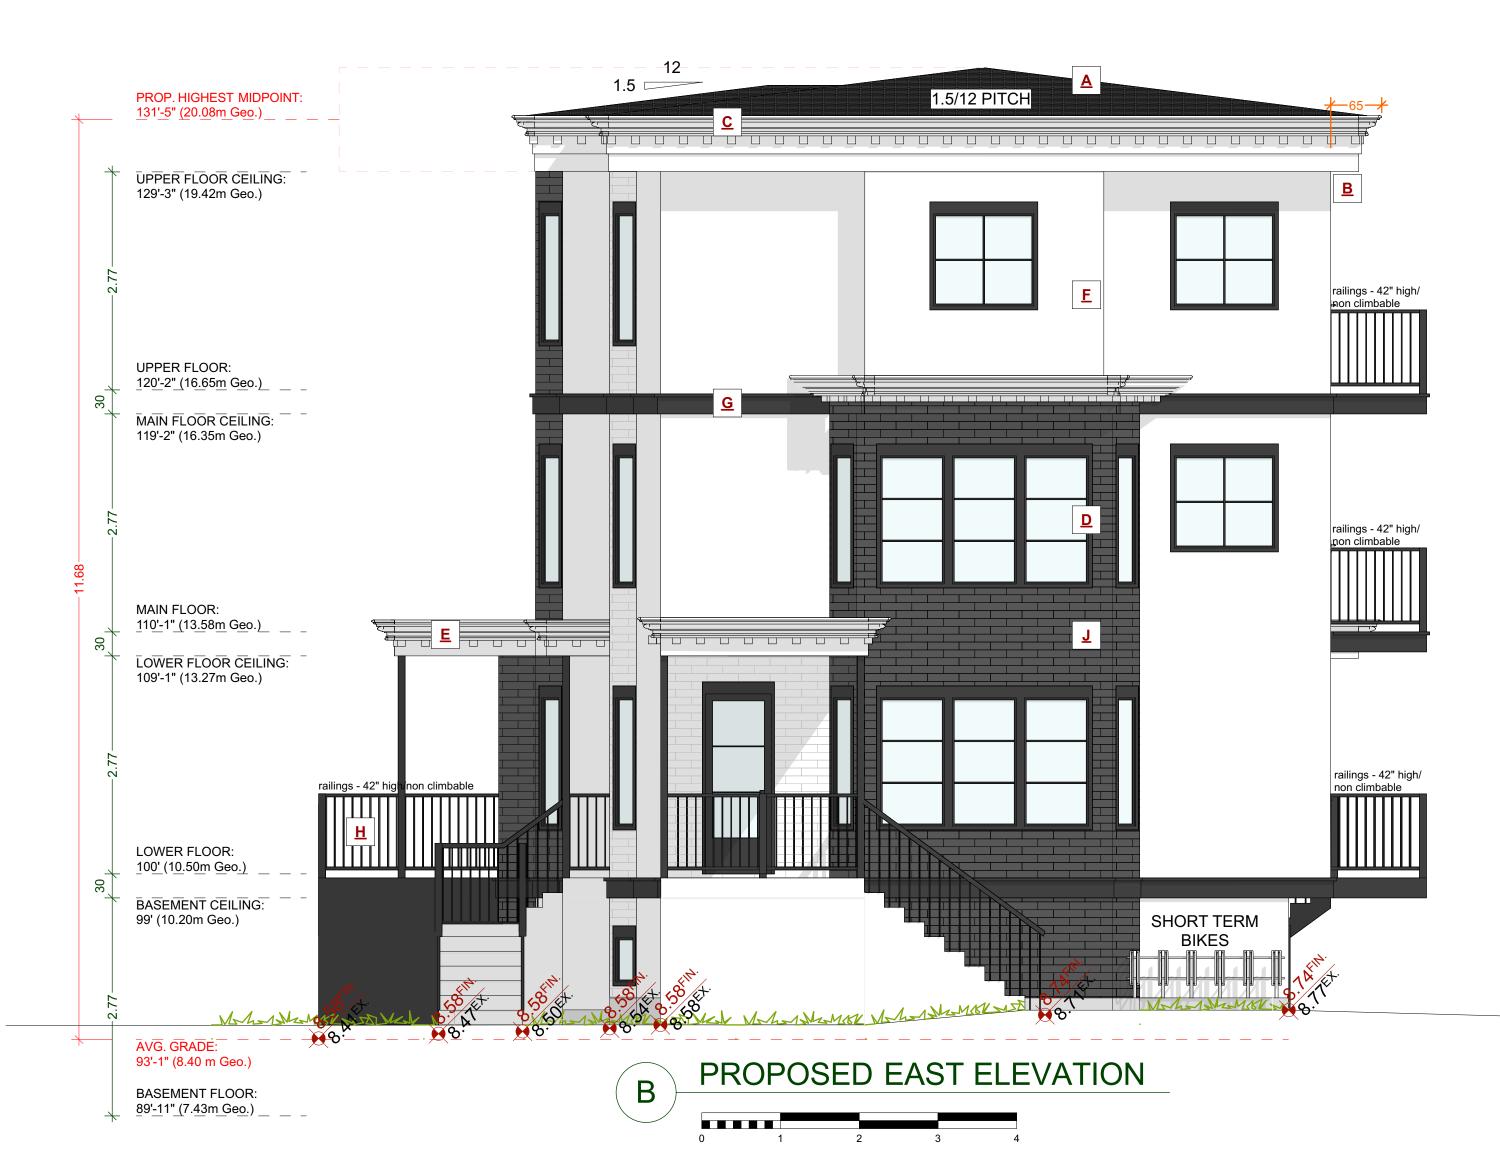





ALL WINDOWS MUST COMPLY WITH BCBC AND NAFS REQUIREMENTS MUST BE CLEARLY LABELED ON ALL WINDOW UNITS UPON INSTALLATION FOR INSPECTION. -ONE EXTERIOR DOOR IS PERMITTED TO HAVE A HIGHER U-VALUE OF 2.6, ALL OTHERS MUST BE LOWER. -GARAGE VEHICULAR DOORS MUST BE MINIMUM NOMINAL RSI OF 1.1


SHEET NUMBER

LOT 1, 1734 HOLLYWOOD CRESCENT, VICTORIA

SETHI

DRAWING NAME:
PROPOSED REAR AND
RIGHT ELEVATIONS

BY:

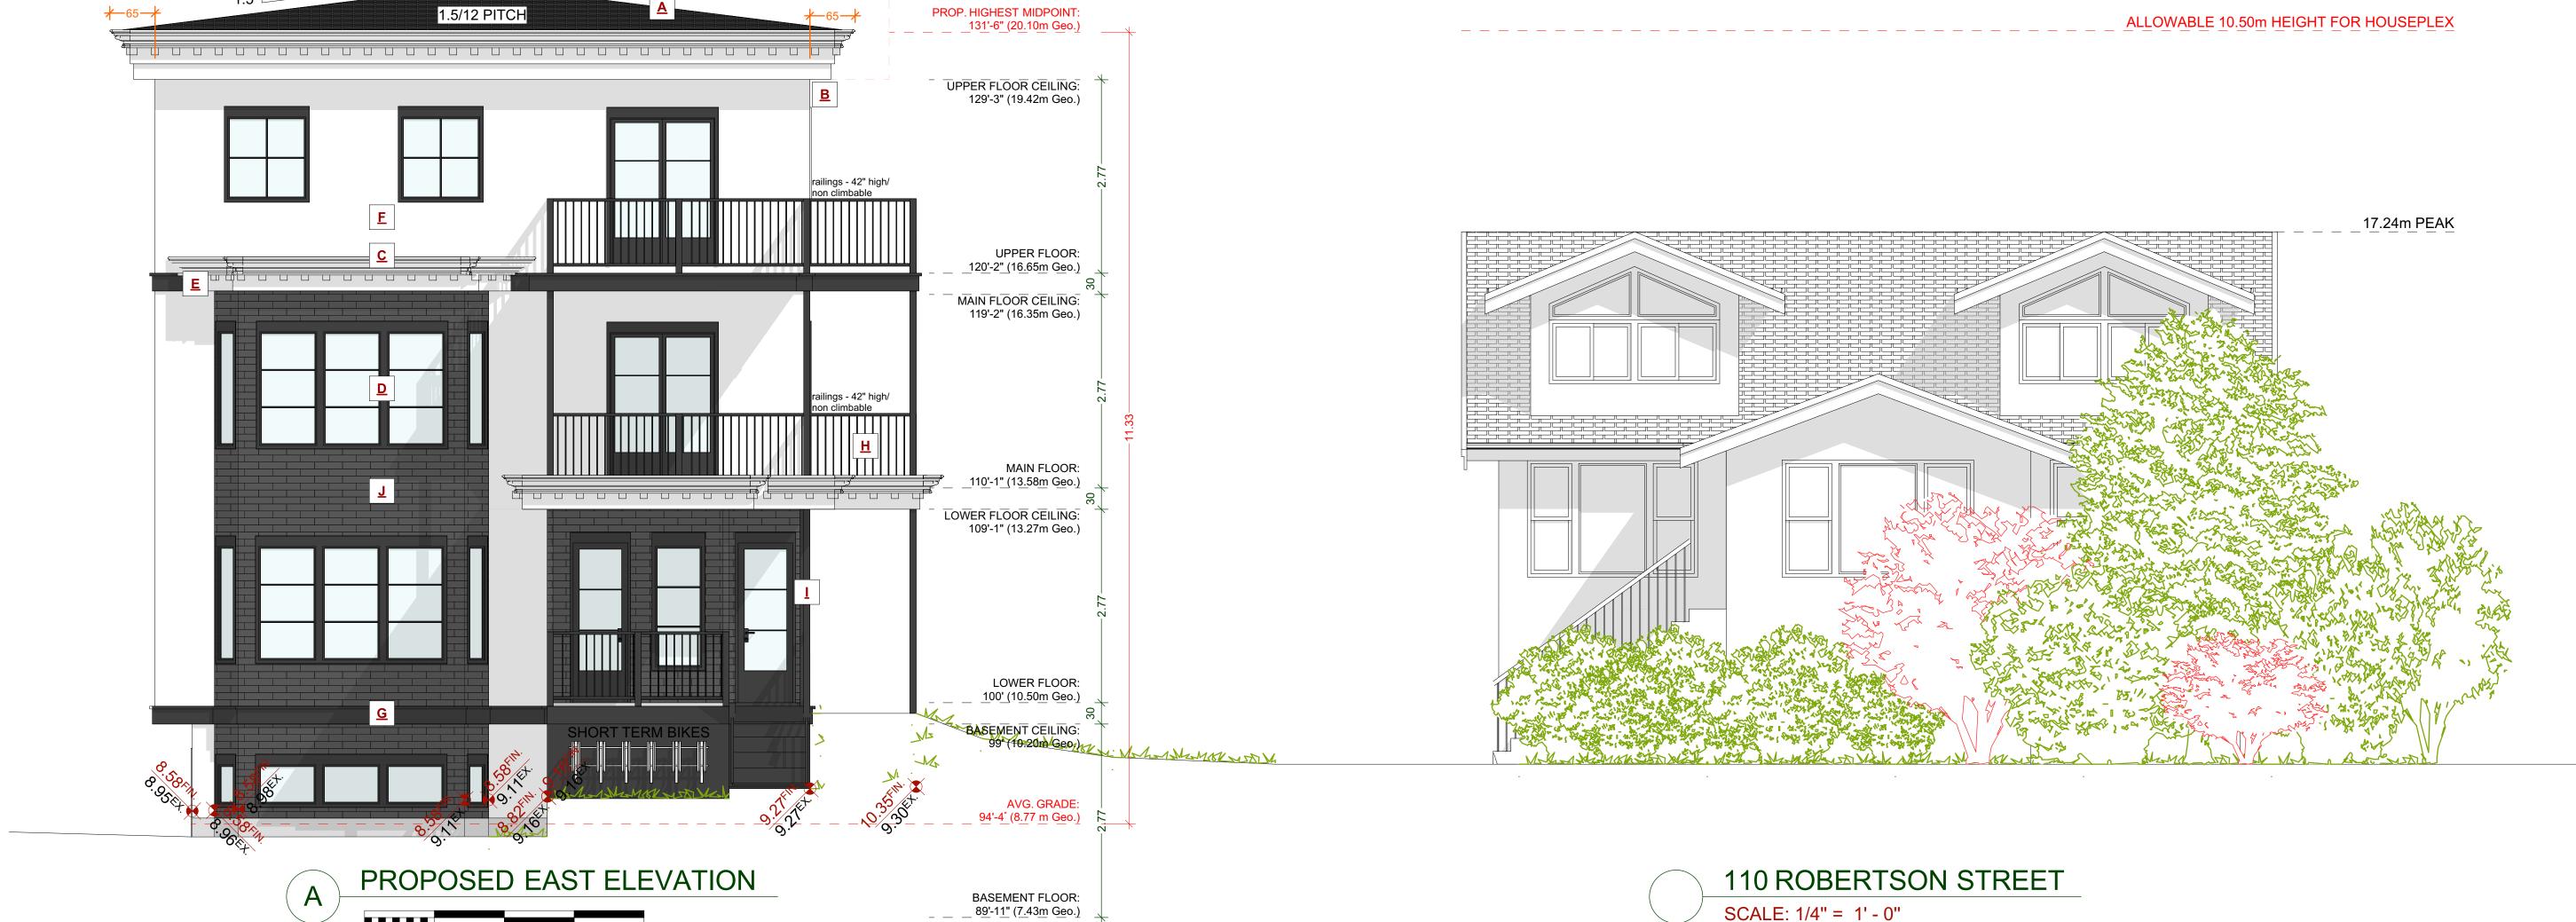

SCALE: 1/4" = 1' - 0"

EXTERIOR FINISHES SCHEDULE SMOOTH ACRYLIC STUCCO - SEE OWNER FOR TEXTURE / FINISH -RAIN SCREEN AS PER BCBC LOW SLOPE ASPHALT ROOFING WITH RAISED RIDGE & HIP CAPS & MEMBRANE A ROOFING: AS PER MANF SPECS 2x10 BELLY BAND W/ 2X2 DETAILS PAINTED C/W FLASHING, COLOUR AS PER OWNERS SPECS HIDDEN GUTTER WITH TJI RIM BOARD AND 1x10 FASCIA BOARD. ALUMINUM SOFFITS - VENTED, SEE ELEVATIONS **GUTTER & SOFFIT:** CUSTOM ROOF MOULDING DESIGNED AS PER ELEVATIONS - PAINTED AS PER ALUMINIUM RAILINGS - 42" HIGH/ CROWN MOULDING: NON CLIMBABLE OWNERS SPECS PAINTED WOOD POSTS - SEE ELEVATIONS/PLANS FOR SIZE 1x4 TRIM BOARDS - PAINTED/ WINDOW & DOOR TRIM: 3X4 DECORATIVE DENTAL BLOCKS W/IN ROOF MOULDING AND TRIM - PAINTED / STAINED AS PER OWNERS SPECS - SEE

BRICK FASCIA: ACCENT BRICK FASCIA - OWNER TO E DENTAL BLOCKS: CONFIRM MATERIAL AND FINISH - SEE

ROBERTSON STREET

ALL WINDOWS MUST COMPLY WITH BCBC AND NAFS REQUIREMENTS MUST BE CLEARLY LABELED ON ALL WINDOW UNITS UPON INSTALLATION FOR INSPECTION. -ONE EXTERIOR DOOR IS PERMITTED TO HAVE A HIGHER U-VALUE OF 2.6, ALL OTHERS MUST BE LOWER.
-GARAGE VEHICULAR DOORS MUST BE MINIMUM NOMINAL RSI OF 1.1 CUSTOMER:

AMIT AND KARISHMA S
ADDRESS:

LOT 1, 1734 HOLLYWOOD CRESCENT, VICTORIA

DRAWING NAME:
PROPOSED ROBERTSON
SREET STREETSCAPE

ISSUE DATE
OCT 28, 202
DRAWN BY:
NS
CHECKED E







PERMITTED AGGREGATE AREA OF GLAZED OPENINGS: 10.58 m²



ALL WINDOWS MUST COMPLY WITH BCBC AND NAFS REQUIREMENTS MUST BE CLEARLY LABELED ON ALL WINDOW UNITS UPON INSTALLATION FOR INSPECTION. -ONE EXTERIOR DOOR IS PERMITTED TO HAVE A HIGHER U-VALUE OF 2.6, ALL OTHERS MUST BE LOWER. -GARAGE VEHICULAR DOORS MUST BE MINIMUM NOMINAL RSI OF 1.1


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ISSUE DAT OCT 28, 20, DRAWN BY NS CHECKED I

AMIT AND KARISHMA SADDRESS

10 E



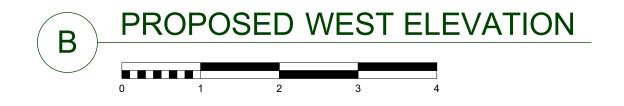

EXPOSING BUILDING FACE: 108.29 m² 1,165.612 sq ft LIMITING DISTANCE: 3.29 m AREA OF GLAZED OPENINGS: 2.10 m² % GLAZED OPENINGS: 1.94 % 45 min FIRE-RESISTANCE RATING: not required TYPE OF CLADDING: no limits

93'-1" (8.40 m Geo.)

BASEMENT FLOOR: 89'-1<u>1"</u> (<u>7.43m</u> Geo.)

EXTERIOR FINISHES SCHEDULE SMOOTH ACRYLIC STUCCO - SEE LOW SLOPE ASPHALT ROOFING WITH RAISED RIDGE & HIP CAPS & MEMBRANE A ROOFING: OWNER FOR TEXTURE / FINISH -RAIN SCREEN AS PER BCBC AS PER MANF SPECS 2x10 BELLY BAND W/ 2X2 DETAILS HIDDEN GUTTER WITH TJI RIM BOARD AND 1x10 FASCIA BOARD. ALUMINUM **G** BELLY BAND: PAINTED C/W FLASHING, COLOUR AS **GUTTER & SOFFIT:** PER OWNERS SPECS SOFFITS - VENTED, SEE ELEVATIONS ALUMINIUM RAILINGS - 42" HIGH/ NON CLIMBABLE CUSTOM ROOF MOULDING DESIGNED RAILINGS: AS PER ELEVATIONS - PAINTED AS PER CROWN MOULDING: OWNERS SPECS PAINTED WOOD POSTS - SEE ELEVATIONS/PLANS FOR SIZE 1x4 TRIM BOARDS - PAINTED/ WINDOW & DOOR TRIM: STAINED 3X4 DECORATIVE DENTAL BLOCKS W/IN ROOF MOULDING AND TRIM - PAINTED / BRICK FASCIA: ACCENT BRICK FASCIA - OWNER TO CONFIRM MATERIAL AND FINISH - SEE E DENTAL BLOCKS:

BASEMENT FLOOR:

89'-11" (7.43m Geo.)

ALL WINDOWS MUST COMPLY WITH BCBC AND NAFS REQUIREMENTS MUST BE CLEARLY LABELED ON ALL WINDOW UNITS UPON INSTALLATION FOR INSPECTION. -ONE EXTERIOR DOOR IS PERMITTED TO HAVE A HIGHER U-VALUE OF 2.6, ALL OTHERS MUST BE LOWER. -GARAGE VEHICULAR DOORS MUST BE MINIMUM NOMINAL RSI OF 1.1

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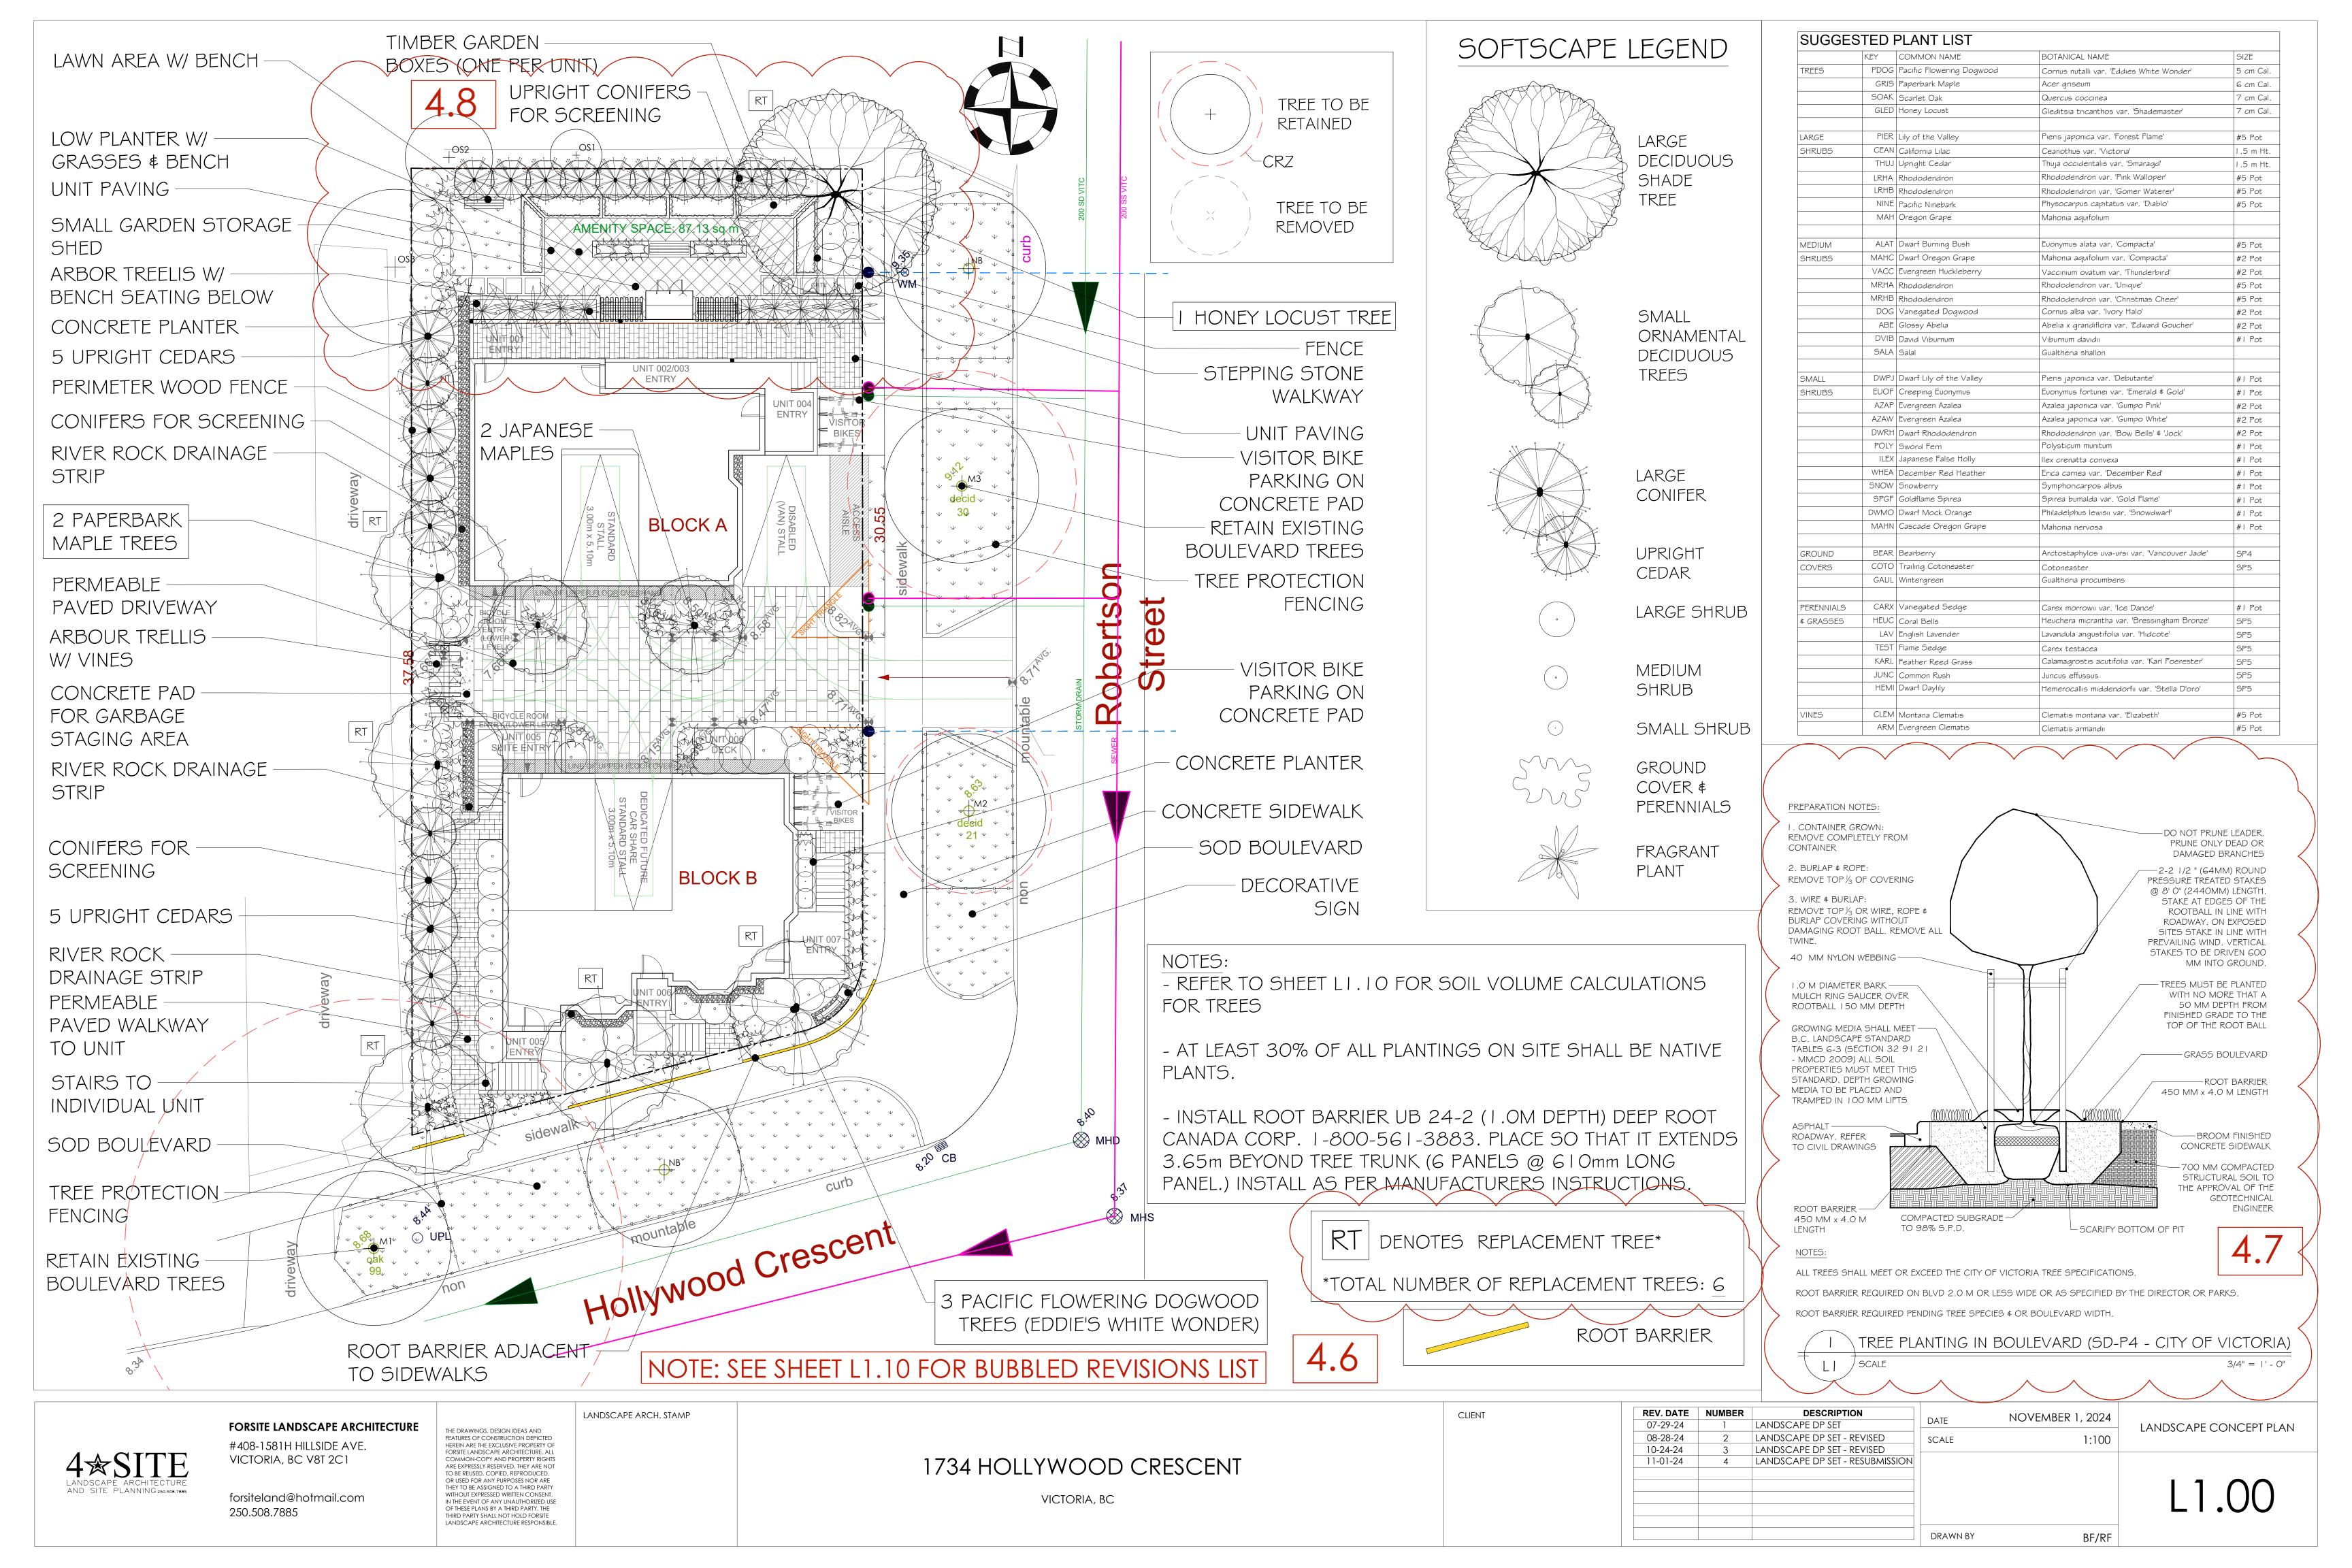
LOT 1, 1734 HOLLYWOOD CRESCENT, VICTORIA


CUSTOMER:

AMIT AND KARISHMA S

ADDRESS:

EVATIONS



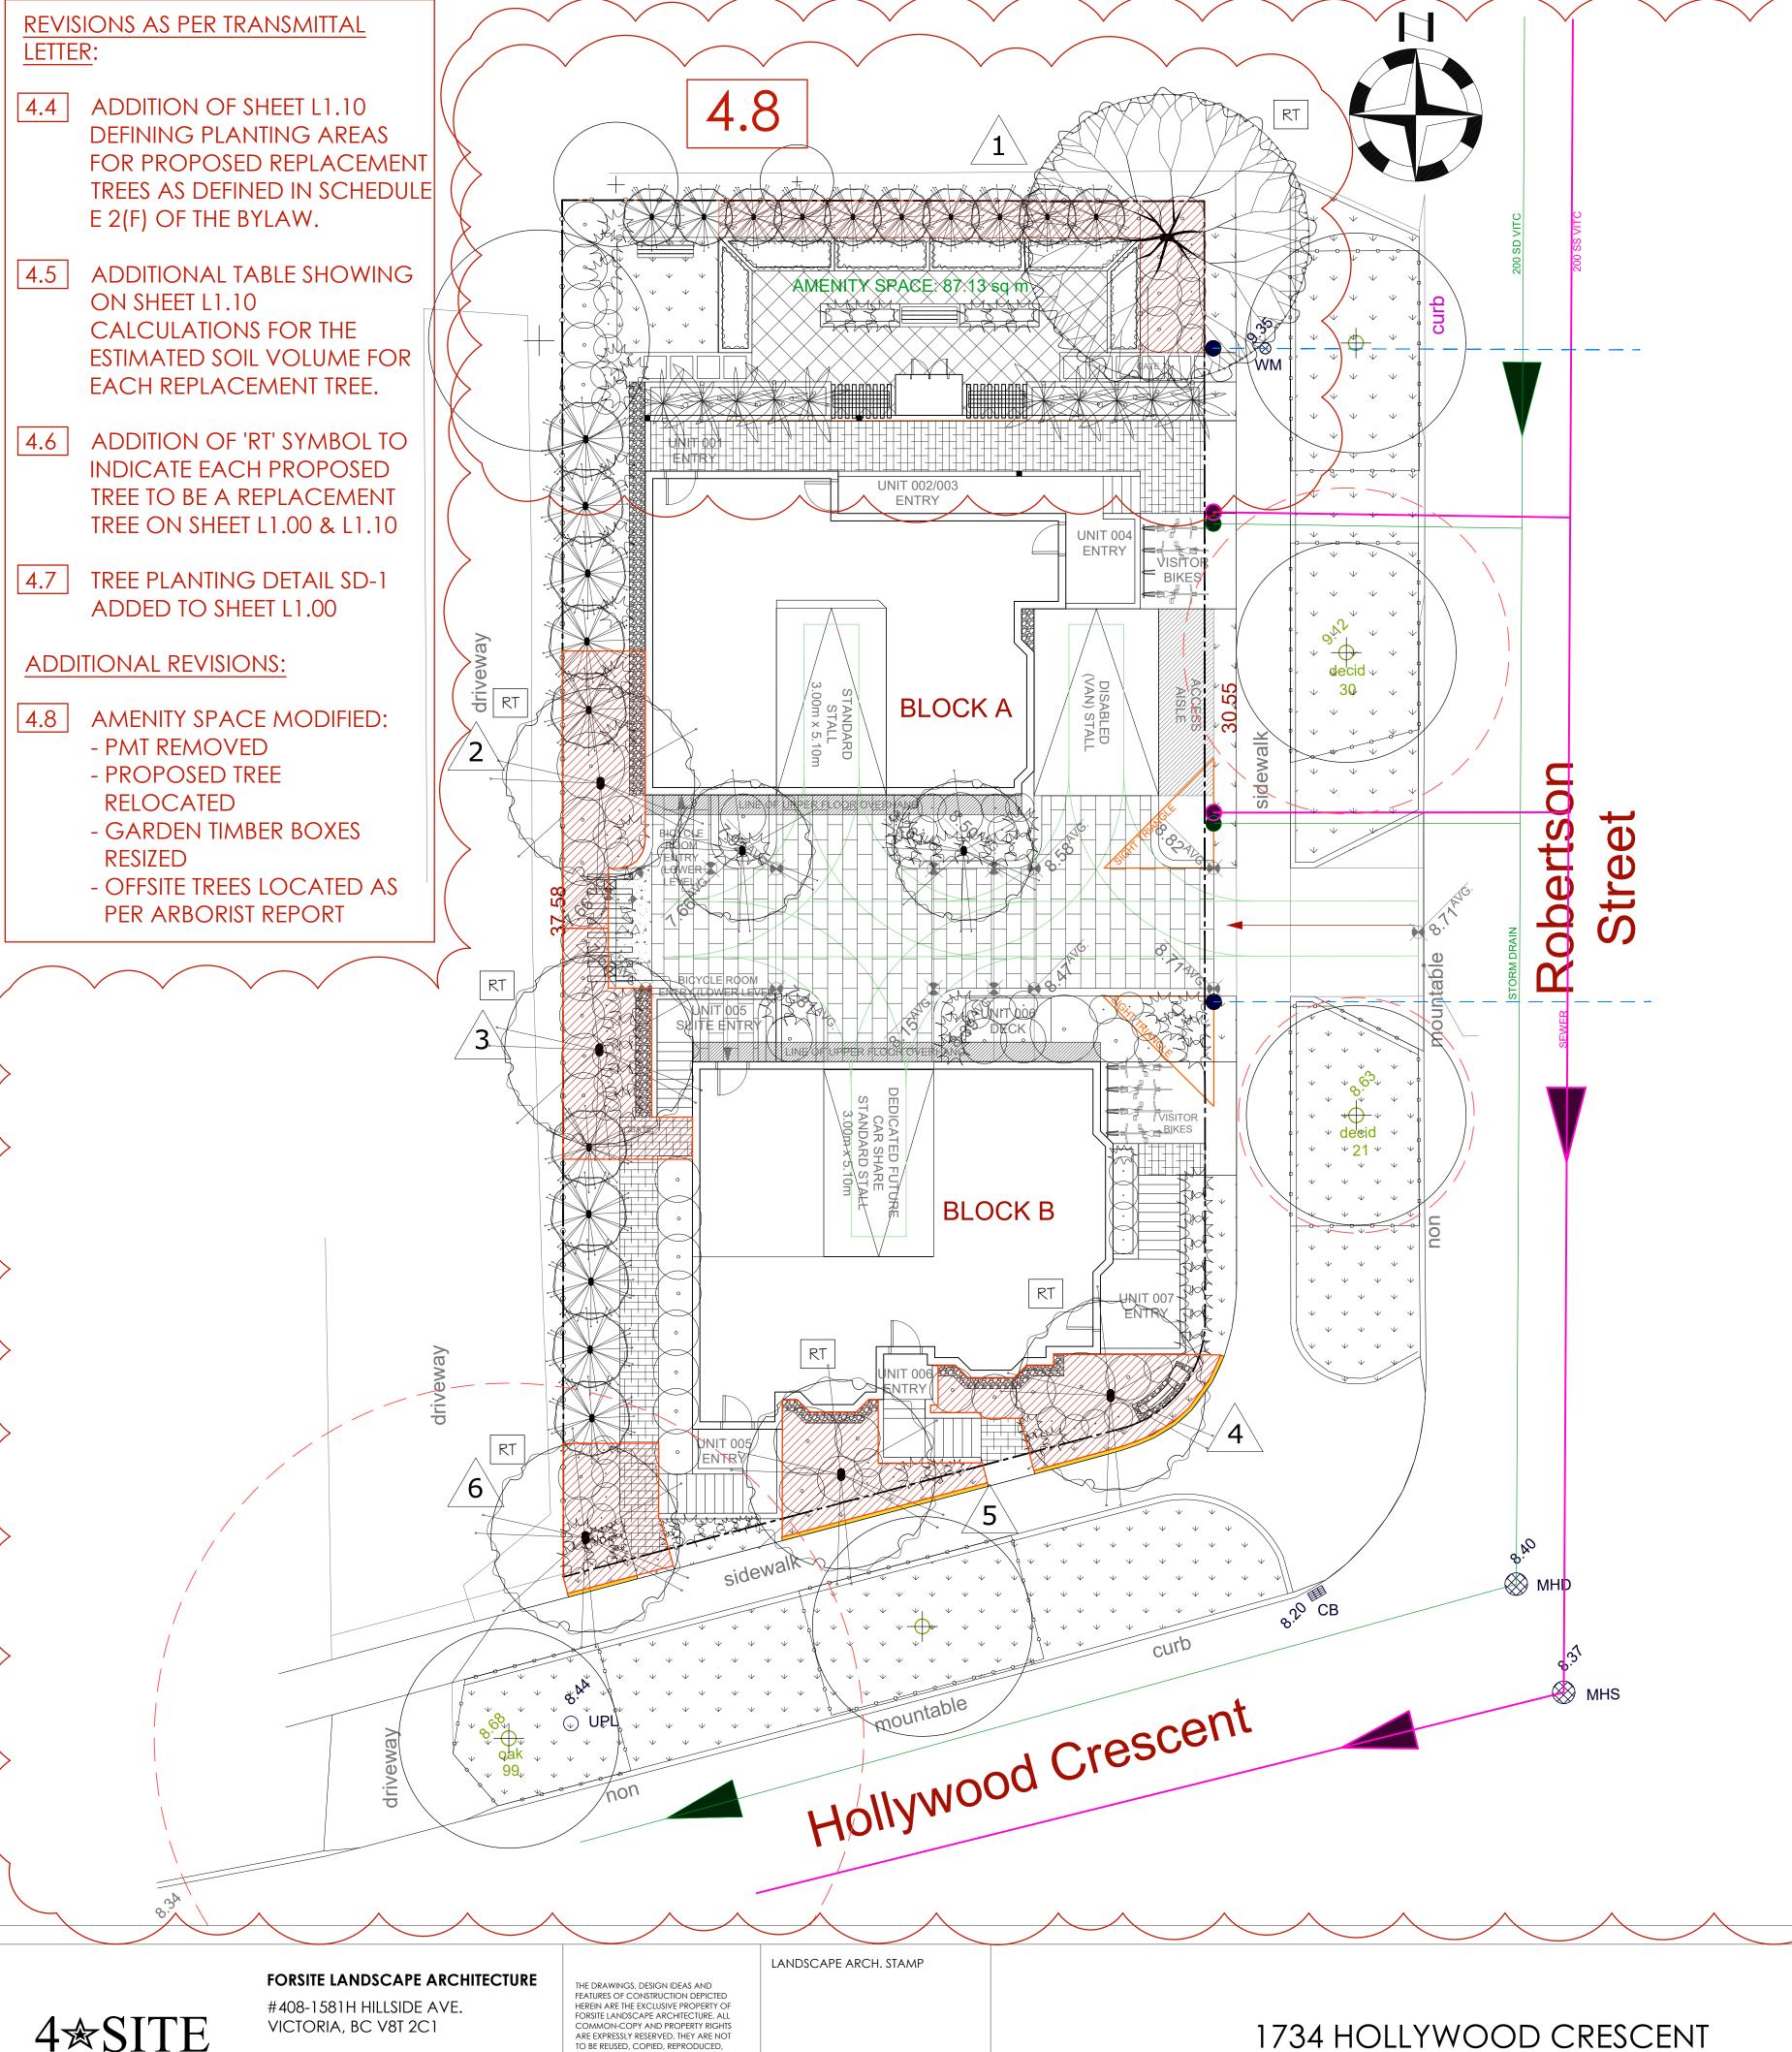

	REPLACEMENT TREE SPACING*	
ROW#	TREE SIZE	MIN. SPACING
1	SMALL TREE (SCHEDULE "E", PART 2)	2.0M
2	MEDIUM TREES (SCHEDULE "E", PART I)	4.0M
3	LARGE TREES (SCHEDULE "E", PART 1)	6.0M

NOTE: SOIL CELLS TO BE STRATAVAULT 45 STRUCTURAL MODULES (450 kPa/65.3 psi loads) CONTACT: CITY GREEN URBAN LANDSCAPE SOLUTIONS PHONE: 1-888-999-3990

SOIL VOLUME REQUIREMENTS*							
ROW#	TREE SIZE	MIN. SOIL VOLUME (M3)	SHARED OR IRRIGATED SOIL VOLUME (M3				
1	SMALL TREE (SCHEDULE "E", PART 2)	8.0M	6.0				
2	MEDIUM TREES (SCHEDULE "E", PART I)	20.0M	15.0				
3	LARGE TREES (SCHEDULE "E", PART 1)	35.0M	30.0				

				Replacement Trees Proposed			Soil Volume Required (m ³)			
Planting Area ID	Area (m²)	Soil Volume Multiplier*	A Estimated Soil Vol. (m³)	B # Small	C # Medium	D # Large	B # Small	C # Medium	D # Large	Total**
	ONSITE									
1	20	1.5M	30		1			1		30
2	15	1.0M	15		1			1		15
3	15	1.0M	15		1			1		15
4	15	1.0M	15		1			1		15
5	12	1.5M	18		1			1		15
6	10	1.5M	15		1			1		15

Notes:

- (I) All soil volume calculations are for replacement trees only
- (2) All replacement trees are ONSITE
- (3) Soil volumes are calculated based on 'shared or irrigated soil volumes' numbers shown on table
- (4) All replacement trees meet soil volume requirements for this project.



CLIENT

4.6

USABLE PLANTING SOIL VOLUME FOR EACH REPLACEMENT TREE

forsiteland@hotmail.com 250.508.7885

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VICTORIA, BC

REV. DATE NUMBER DESCRIPTION 07-29-24 LANDSCAPE DP SET LANDSCAPE DP SET - REVISED SCALE LANDSCAPE DP SET - REVISED 10-24-24 LANDSCAPE DP SET - RESUBMISSION

SOIL VOLUMES PLAN 1:100

BF/RF

NOVEMBER 1, 2024

DRAWN BY