VERIFY ALL DIMENSIONS. DO NOT SCALE THIS DRAWING.

REPORT INCONSISTENCIES AND OMISSIONS TO THE ARCHITECT FOR CLARIFICATION BEFORE COMMENCING WITH THE WORK.



2019-06-19 Issued for DP 2019-09-16 Revised & Re-Issued for DP 2019-10-21 Revised & Re-Issued for DP Revised & Re-Issued for DP 2020-04-29 Revised & Re-Issued for DP 2020-09-21 Revised & Re-Issued for DP 2021-07-20 Revised & Re-Issued for DP 2021-11-21 Revised & Re-Issued for DP 2021-12-16 Revised & Re-Issued for DP 2022-03-30 Revised & Re-Issued for DP 2022-04-11 Revised & Re-Issued for DP 2022-05-10 Revised & Re-Issued for DP

2022-10-10 Revised & Re-Issued for DP
2022-11-04 Revised & Re-Issued for DP
2022-11-14 Revised & Re-Issued for DP
2022-11-25 Revised & Re-Issued for DP 2023-12-21 ISSUED FOR BP 2024-02-17 BP REVISION "A" 2024-05-30 ISSUED FOR DP

Project Name:

LeParc

KIPLING ST & THURLOW ST

2025-04-17













1400 LE PARC (349 KIPLING)

349 KIPLING ST, VICTORIA, BC

SHEET LIST

L3.01 SOIL DEPTH PLAN L0.00 COVER SHEET

L0.01 TREE MANAGEMENT & REMOVAL PLAN L4.01 HARDSCAPE AND SITE FURNISING DETAILS

L0.02 ARBORIST TREE MANAGEMENT PLAN L4.02 SOFSCAPE DETAILS

L1.01 MATERIALS PLAN

L2.01 TREE PLANTING PLAN

GENERAL LANDSCAPE NOTES

GENERAL:

- 1. DO NOT PROCEED IN UNCERTAINTY. 2. DO NOT SCALE DRAWINGS.
- 3. DRAWINGS AND SPECIFICATIONS ARE TO BE READ IN CONJUNCTION WITH ALL OTHER DRAWINGS/SPECIFICATIONS IN THIS PROJECT SET. ANY DISCREPANCIES AMONG DRAWINGS, SPECIFICATIONS AND INDUSTRY BEST PRACTICES TO BE REPORTED TO THE PROJECT / CONSTRUCTION MANAGER AND THE LANDSCAPE CONSULTANT FOR DIRECTION.
- 4. ALL LANDSCAPE SPECIFICATION SECTIONS AND DRAWINGS ARE AFFECTED BY REQUIREMENTS OF DIVISION 01 SECTIONS (PROVIDED IN THE PROJECT MANUAL).
- 5. CONTRACTOR TO FAMILIARIZE THEMSELVES WITH ALL SITE CONDITIONS, INCLUDING THE LIMITS OF WORK AND EXISTING FEATURES TO BE PROTECTED, PRIOR TO SUBMITTING BIDS/QUOTES. 6. CONTRACTOR TO CONFIRM LOCATION AND ELEVATION OF ALL UNDERGROUND UTILITIES/FEATURES PRIOR TO COMMENCING WORK.
- 7. CONTRACTOR TO TAKE NECESSARY PRECAUTIONS TO PROTECT SITE FEATURES / CONDITIONS, WITHIN AND BEYOND THE LIMITS OF WORK EXISTING AT THE TIME OF CONSTRUCTION. ALL DISTURBED SURFACES, AREAS, STRUCTURES, VEGETATION, HABITAT ETC. ON PUBLIC / PRIVATE PROPERTY TO PROMPTLY BE RESTORED TO EQUAL OR BETTER CONDITION THAN EXISTING AND TO THE SATISFACTION OF THE MUNICIPALITY HAVING JURISDICTION / PROPERTY OWNER.
- 8. CONTRACTOR TO MAINTAIN THE SITE IN A SAFE AND TIDY CONDITION AT ALL TIMES. DO NOT OBSTRUCT PEDESTRIAN OR VEHICULAR CIRCULATION. DO NOT LEAVE UNPROTECTED HOLES / PITS / OPENINGS OVERNIGHT. ALL EXCESS MATERIALS AND REFUSE TO BE REMOVED FROM THE SITE DAILY UNLESS OTHERWISE DIRECTED BY THE CONSTRUCTION MANAGER.

STANDARDS:

- 1. ALL WORK ON MUNICIPAL PROPERTY TO CONFORM TO THE CITY OF VICTORIA DEVELOPMENT STANDARDS (AUTHORITY HAVING JURISDICTION) INCLUDING BUT NOT LIMITED TO:
- 1.1. CITY OF VICTORIA SUPPLEMENTARY SPECIFICATIONS SCHEDULE 'B' TO THE SUBDIVISION AND DEVELOPMENT SERVICING BYLAW NO. 12-042
- 1.2. CITY OF VICTORIA SUPPLEMENTAL DRAWINGS
- 1.3. CITY OF VICTORIA SUPPLEMENTARY SPECIFICATIONS FOR STREET TREES AND IRRIGATION, SCHEDULE C. 2. ALL LANDSCAPE WORK ON THE DEVELOPMENT SITE TO CONFORM TO THE CURRENT EDITION AT TIME OF ISSUE OF THE Canadian Landscape Standard (CLS), UNLESS SPECIFICALLY STATED OTHERWISE IN WRITTEN
- SPECIFICATIONS AND ON DRAWINGS. 3. ALL HARD SURFACE (INCLUDING BUT NOT LIMITED TO PAVING, CONCRETE RETAINING WALLS AND CONCRETE PLANTERS) TO CONFORM TO THE Master Municipal Construction Documents Association PLATINUM EDITION (MMCD) AND MMCD SUPPLEMENTAL DRAWINGS AND SPECIFICATIONS, UNLESS SPECIFICALLY STATED OTHERWISE IN WRITTEN SPECIFICATIONS AND ON DRAWINGS.
- 4. IN CASES OF CONFLICT BETWEEN THE CLS AND THE MMCD, THE MORE STRINGENT REQUIREMENT WILL TAKE PRECEDENCE.
- 5. LANDSCAPE CONTRACTOR TO BE FAMILIAR WITH MUNICIPAL DEVELOPMENT STANDARDS AND BE IN POSSESSION OF THE CLS AND MMCD MANUALS AND SUPPLEMENTAL DRAWINGS AND SPECIFICATIONS.
- 6. GROWING MEDIUM AND GROWING MEDIUM TESTING TO CLS Section 5. 7. IRRIGATION DESIGN AND INSTALLATION TO IIABC STANDARDS AND CLS Section 10.

1. CONTRACTOR TO COORDINATE INSTALLATION OF IRRIGATION AND ELECTRICAL SLEEVES WITH ARCHITECTURAL, MECHANICAL, ELECTRICAL AND CIVIL WORKS.

1. CONTRACTOR TO PROVIDE SAMPLES, TEST RESULTS AND SHOP DRAWINGS TO LANDSCAPE CONSULTANT FOR REVIEW AND APPROVAL 45 DAYS PRIOR TO INSTALLATION.

2. SEE ALSO SUBMITTALS TABLE BELOW FOR ADDITIONAL INFORMATION.

GROWING MEDIUM TESTING: 1. GROWING MEDIUM TEST RESULTS ARE MANDATORY.

- TEST RESULTS TO INCLUDE ANALYSIS OF ALL GROWING MEDIUM NUTRIENTS NOTED IN CLS 5.2.7 AND ARE TO BE REPORTED IN THE SAME UNITS AS NOTED IN THAT SECTION.
- 3. TEST RESULTS TO INCLUDE ANALYSIS OF SOIL TEXTURE, ORGANIC CONTENT AND ACIDITY AS PER CLS 5.3.5 AND BE REPORTED IN THE SAME UNITS AS NOTED IN THAT SECTION.
- 4. TEST RESULTS TO INCLUDE RECOMMENDATIONS FOR AMENDMENTS TO MEET THE REQUIREMENTS FOR EACH GROWING MEDIUM TYPE. 5. RECOMMENDED GROWING MEDIUM TESTING FACILITY: Pacific Soil Analysis Inc. 11720 Voyageur Way, Richmond, BC V6X 3G9 OR APPROVED EQUAL.

COMPACTION TESTING:

1. COMPACTION TESTS FOR HARD SURFACE SUBGRADE, GRANULAR SUB-BASE, AND GRANULAR BASE ARE MANDATORY.

1. CONTRACTOR TO ALERT THE LANDSCAPE CONSULTANT A MINIMUM OF 3 WORKING DAYS PRIOR TO REQUIRED LANDSCAPE INSPECTIONS.


1. REQUESTS FOR SUBSTITUTIONS TO CONFORM TO THE DIVISION 01 SECTION AND BE SUBMITTED TO THE LANDSCAPE CONSULTANT, THROUGH THE PROJECT ADMINISTRATOR, A MINIMUM OF 45 DAYS PRIOR TO SCHEDULED

2. PLEASE NOTE THAT SOME SUBSTITUTIONS MAY REQUIRE MUNICIPAL APPROVAL.

1. CONTRACTOR SHALL WARRANTY ALL WORKMANSHIP AND MATERIALS FOR 1 FULL YEAR FOLLOWING THE DATE OF TOTAL PERFORMANCE AS PER MMCD UNLESS SPECIFICALLY NOTED OTHERWISE. FAULTY MATERIALS AND WORKMANSHIP SHALL BE PROMPTLY REPAIRED / REPLACED TO THE SATISFACTION OF THE LANDSCAPE CONSULTANT.

ENVIRONMENTAL PROTECTION:

1.1. CONTRACTOR TO INSTALL AND MAINTAIN SEDIMENTATION FILTRATION MEASURES AS REQUIRED FOR LANDSCAPE WORKS TO PREVENT MATERIALS FROM LEAVING THE SITE AND / OR ENTERING STORM DRAINS; STOCKPILED LANDSCAPE MATERIALS ARE TO BE KEPT TARPED.

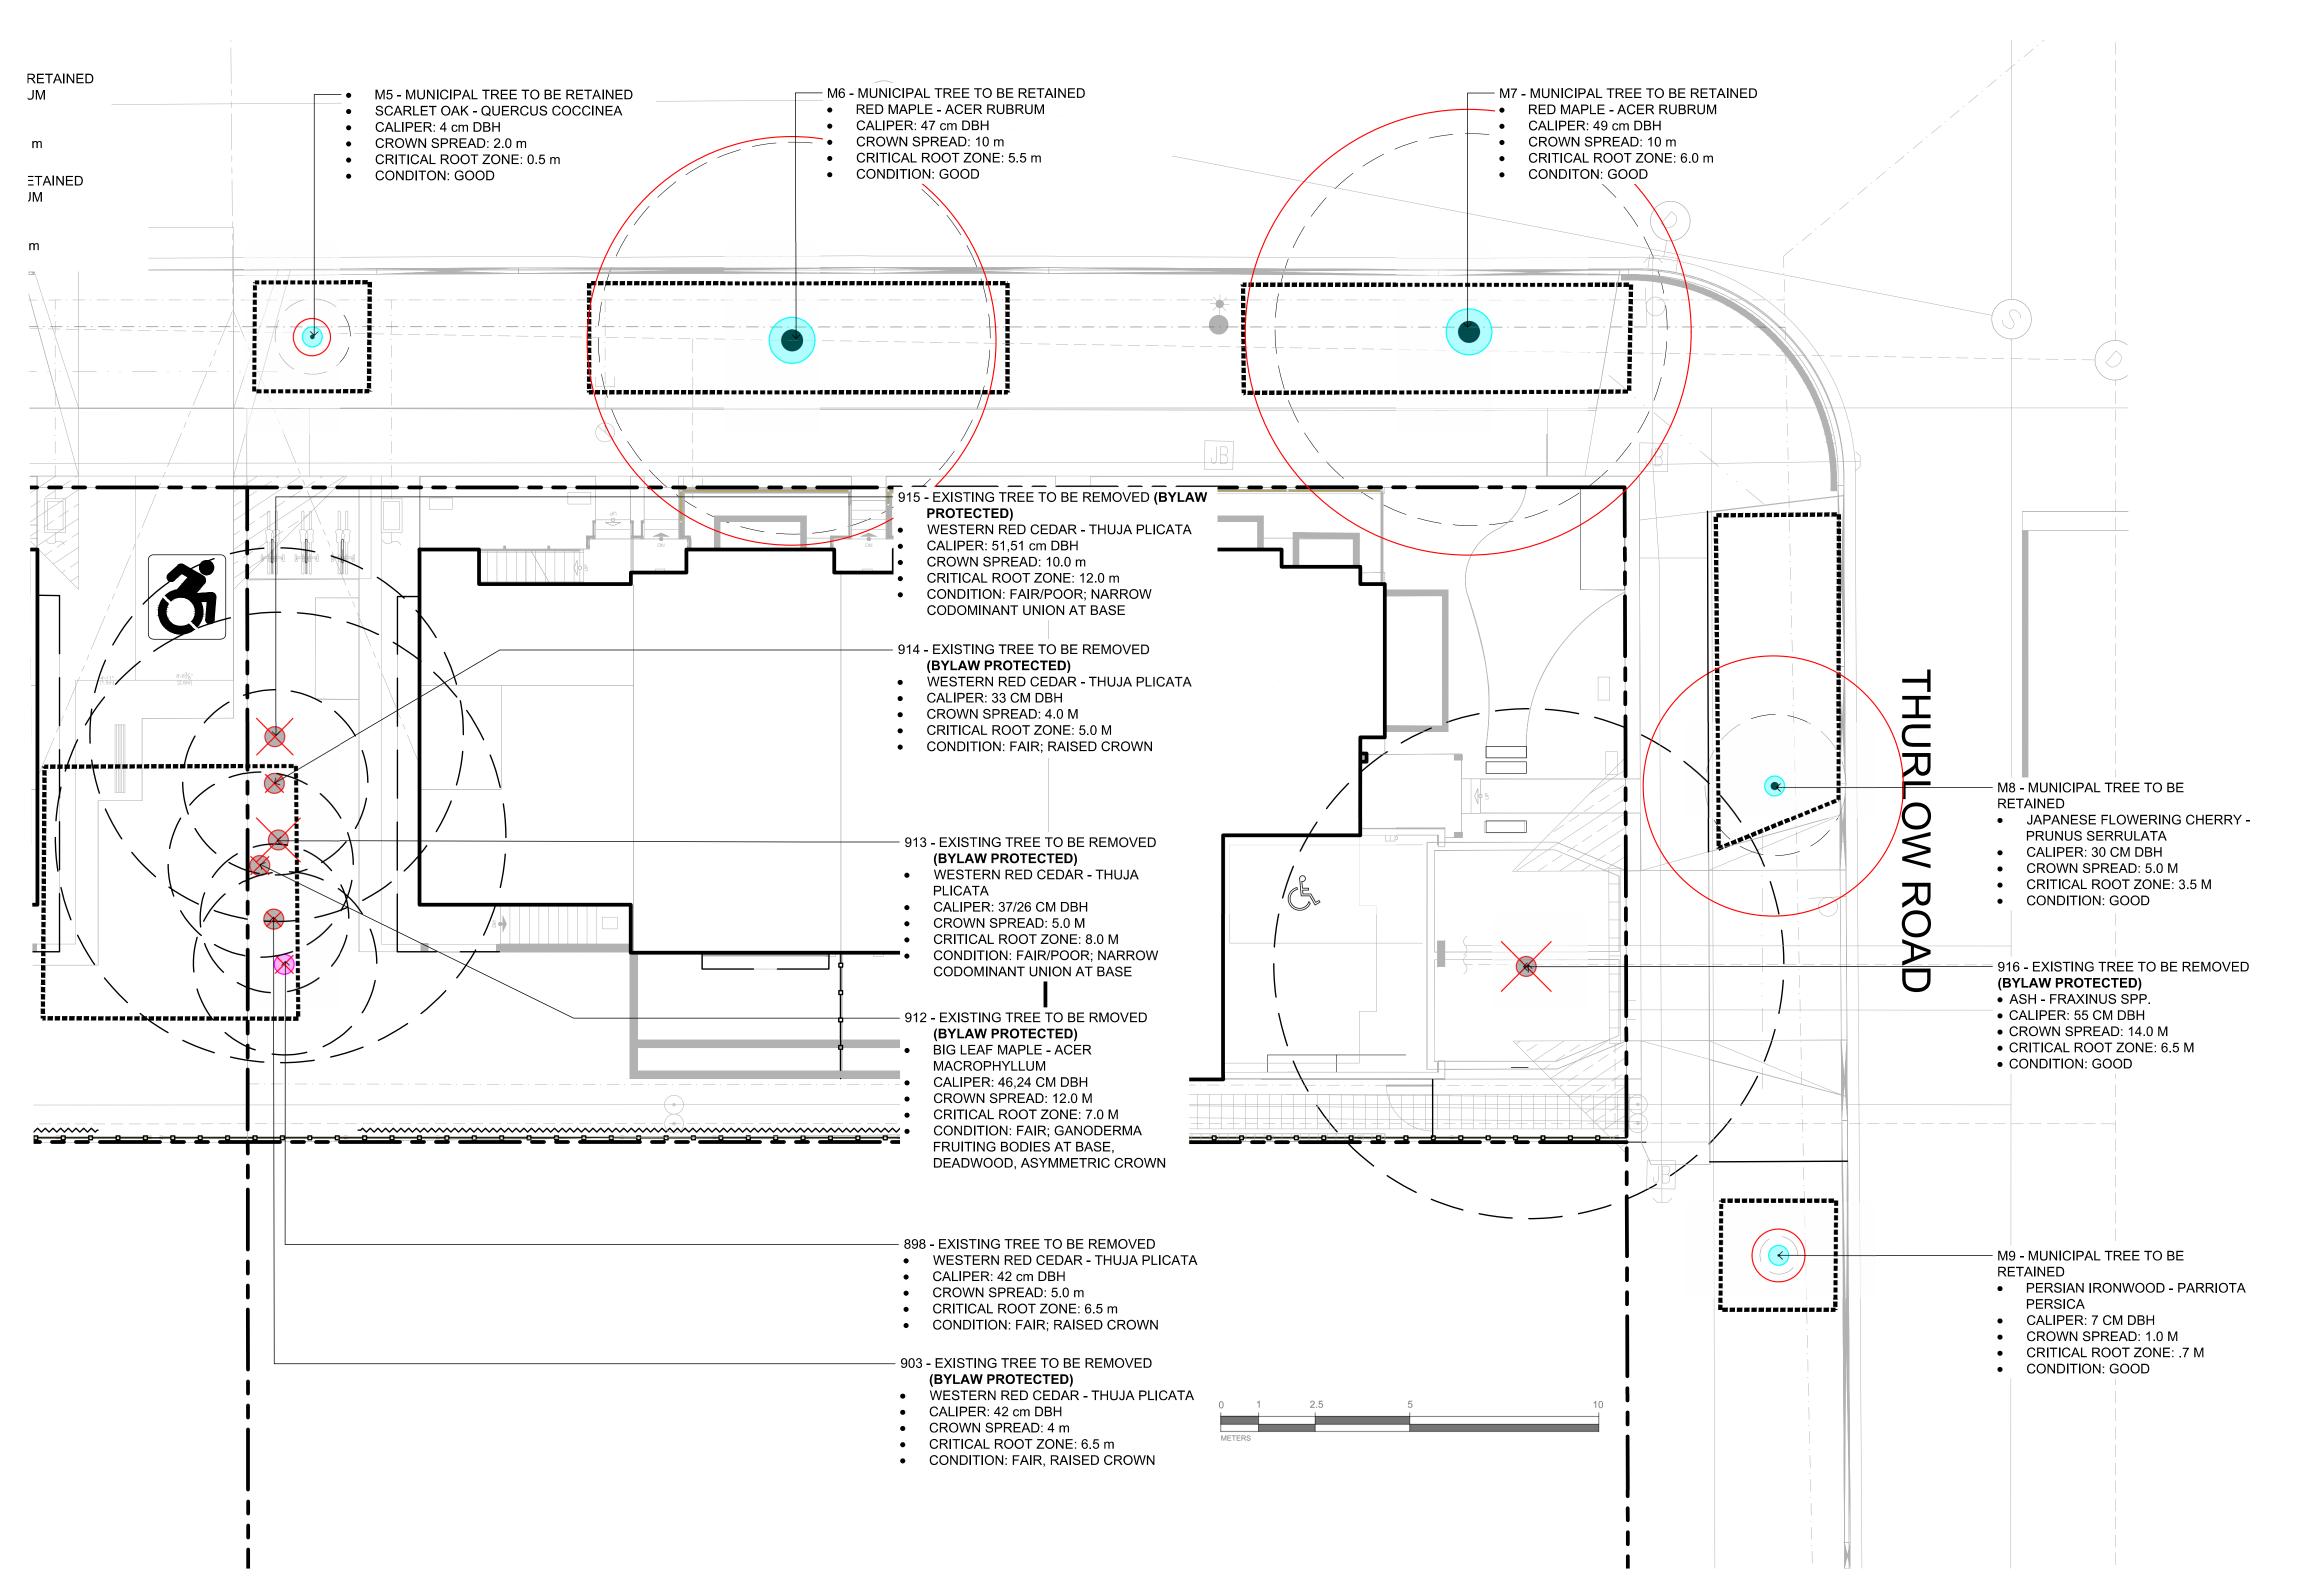

LEGEND

EXISTING TREE QUANTITIES

REPLACEMENT TREES REQUIRED: 7


BYLAW PROTECTED TREES TO BE REMOVED: 6


EXISTING TREES = 7

MUNICIPAL BOULEVARD: • EXISTING TREES = 5


TREES TO BE REMOVED = 7

• TREES TO BE REMOVED = 0

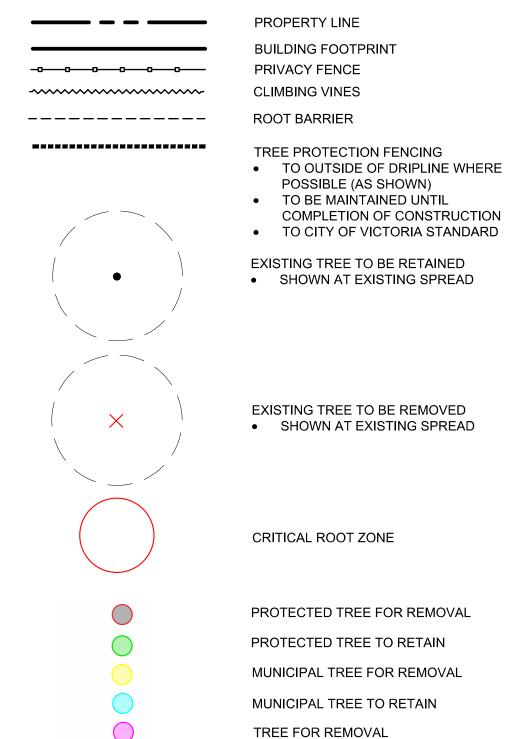

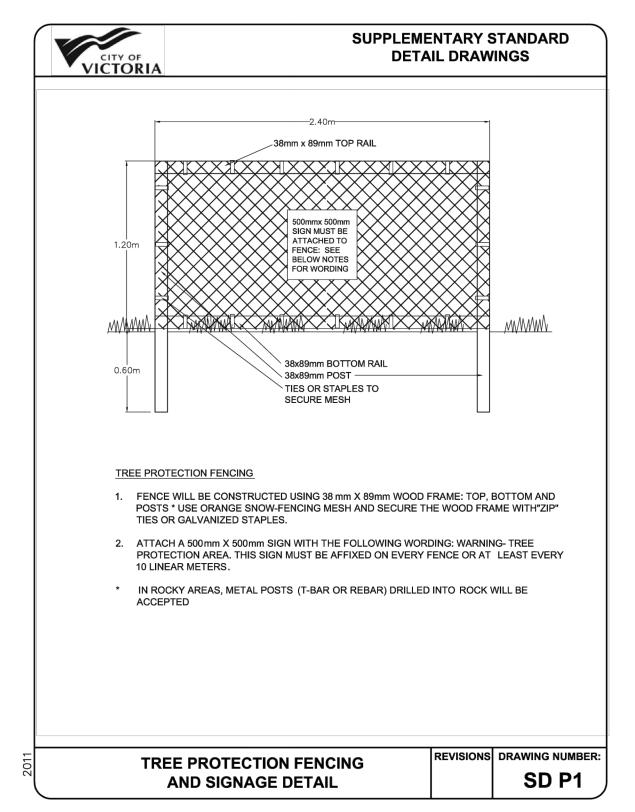

TREE PROTECTION FENCING AND SIGNAGE DETAIL

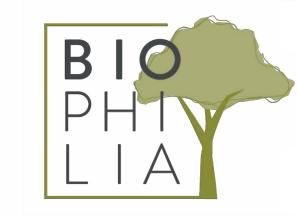

1608 Camosun Street, Victoria BC V8T 3E6 Info@biophiliacollective.ca 250 590 1156

OWNER/CLIENT:

BREIA HOLDINGS LTD.

PROJECT NAME:

LE PARC

PROJECT ADDRESS:

349 KIPLING

DESIGNED BY: BIANCA BODLEY

DRAWN BY: LB

NO.	ISSUE	YY/MM/DD
1	ISSUED FOR BP 50%	23/11/01
2	ISSUED FOR BP 75%	23/11/15
3	ISSUED FOR BP	23/12/21
4	ISSUED FOR COORDINATION	24/05/15
5	ISSUED FOR RZ/DP	24/06/06
6	RE-ISSUED FOR REVIEW	24/09/27
7	REVISED AND RE-ISSUED FOR DP	24/10/29
8	ISSUED FOR REVIEW	25/03/06
9	RE- ISSUED FOR DP	25/03/12



NORTH ARROW



DRAWING TITLE:

TREE DEMOLITION PLAN


DWG NO:

SCALE: 1:100

ARBORIST SUPERVISION NOTES:

- ALL EXCAVATION OCCURRING WITHIN THE CRITICAL ROOT ZONES OF PROTECTED TREES SHOULD BE COMPLETED UNDER SUPERVISION BY THE PROJECT ARBORIST. IN PARTICULAR, THE FOLLOWING ACTIVITIES SHOULD BE COMPLETED UNDER THE DIRECTION OF THE PROJECT ARBORIST:
- A. ANY EXCAVATION WITHIN THE CRZS OF MUNICIPAL TREES NT7-9 FOR CONSTRUCTION OF THE NEW 6-UNIT BUILDING, LANDSCAPE FEATURES, OR DRIVEWAY OFF THURLOW ROAD B. ANY EXCAVATION FOR THE ABANDONING OF EXISTING UNDERGROUND SERVICES OR INSTALLATION OF NEW SERVICES WITHIN THE CRZS OF TREES TO BE RETAINED.
- PRUNING ROOTS: ANY SEVERED ROOTS MUST BE PRUNED BACK TO SOUND TISSUE TO REDUCE WOUND SURFACE AREA AND ENCOURAGE RAPID COMPARTMENTALIZATION OF THE WOUND. BACKFILLING THE EXCAVATED AREA AROUND THE ROOTS SHOULD BE DONE AS SOON AS POSSIBLE TO KEEP THE ROOTS MOIST AND AID IN ROOT REGENERATION. EXPOSED ROOTS SHOULD BE KEPT MOIST UNTIL THE AREA IS BACKFILLED, ESPECIALLY IF EXCAVATION OCCURS DURING A PERIOD OF DROUGHT. THIS CAN BE ACCOMPLISHED IN A NUMBER OF WAYS, INCLUDING WRAPPING THE ROOTS IN BURLAP OR INSTALLING A ROOT CURTAIN OF WIRE MESH LINED WITH BURLAP, AND KEEPING THE AREA MOIST THROUGHOUT THE CONSTRUCTION PROCESS.
- MINIMIZING SOIL COMPACTION: IN AREAS WHERE CONSTRUCTION TRAFFIC MUST ENCROACH INTO THE CRITICAL ROOT ZONES OF TREES TO BE RETAINED, EFFORTS MUST BE MADE TO REDUCE SOIL COMPACTION WHERE POSSIBLE BY DISPLACING THE WEIGHT OF MACHINERY AND FOOT TRAFFIC. THIS CAN BE ACHIEVED BY ONE OF THE FOLLOWING METHODS:
- INSTALLING A LAYER OF HOG FUEL OR COARSE WOOD CHIPS AT LEAST 20 CM IN DEPTH AND MAINTAINING IT IN GOOD CONDITION UNTIL CONSTRUCTION IS COMPLETE.
- PLACING MEDIUM WEIGHT GEOTEXTILE CLOTH OVER THE AREA TO BE USED AND INSTALLING A LAYER OF CRUSHED ROCK TO A DEPTH OF 15 CM OVER TOP. PLACING TWO LAYERS OF 19MM PLYWOOD. PLACING STEEL PLATES.
- LANDSCAPING AND IRRIGATION SYSTEMS: THE PLANTING OF NEW TREES AND SHRUBS SHOULD NOT DAMAGE THE ROOTS OF RETAINED TREES. THE INSTALLATION OF ANY IN-GROUND IRRIGATION SYSTEM MUST TAKE INTO ACCOUNT THE CRITICAL ROOT ZONES OF THE TREES TO BE RETAINED. PRIOR TO INSTALLATION, WE RECOMMEND THE IRRIGATION TECHNICIAN CONSULT WITH THE PROJECT ARBORIST ABOUT THE MOST SUITABLE LOCATIONS FOR THE IRRIGATION LINES AND HOW BEST TO MITIGATE THE IMPACTS ON THE TREES TO BE RETAINED. THIS MAY REQUIRE THE PROJECT ARBORIST SUPERVISE THE EXCAVATIONS ASSOCIATED WITH INSTALLING THE IRRIGATION SYSTEM. EXCESSIVE FREQUENT IRRIGATION AND IRRIGATION WHICH WETS THE TRUNKS OF TREES CAN HAVE A DETRIMENTAL
- IMPACT ON TREE HEALTH AND CAN LEAD TO ROOT AND TRUNK DECAY. ARBORIST ROLE: IT IS THE RESPONSIBILITY OF THE CLIENT OR HIS/HER REPRESENTATIVE TO CONTACT THE PROJECT ARBORIST FOR THE PURPOSE OF:
- LOCATING THE BARRIER FENCING
- REVIEWING THE REPORT WITH THE PROJECT FOREMAN OR SITE SUPERVISOR • LOCATING WORK ZONES, WHERE REQUIRED
- SUPERVISING ANY EXCAVATION WITHIN THE CRITICAL ROOT ZONES OF TREES TO BE RETAINED
- REVIEWING AND ADVISING OF ANY PRUNING REQUIREMENTS FOR MACHINE CLEARANCES • REVIEW AND SITE MEETING: ONCE THE PROJECT RECEIVES APPROVAL, IT IS IMPORTANT THAT THE PROJECT ARBORIST MEET WITH THE PROJECT TO REVIEW THE INFORMATION CONTAINED HEREIN. IT IS ALSO IMPORTANT THAT THE ARBORIST MEET WITH THE SITE FOREMAN OR SUPERVISOR BEFORE ANY SITE CLEARING, TREE REMOVAL, DEMOLITION, OR OTHER CONSTRUCTION ACTIVITY OCCURS AND TO CONFIRM THE LOCATIONS OF THE TREE PROTECTION BARRIER FENCING.
- SEE ARBORIST REPORT FOR ADDITIONAL INFORMATION, REQUIREMENTS AND RECOMMENDATIONS.

		1					B					Ba (aution			
Tag or	Surveyed?		Bylaw protected?	Name		dbh	diameter	Critical root zone radius	Relative	Condition		Retention Suitability (on-		Tree retention / location	Retention
ID#	(Yes/No)	City)	(Yes/No)	Common	Botanical	(cm)	(m)	(m)	Tolerance	Health	Structural	site trees)	observations/remarks	comments	status
														Possible impacts from adjacent	
695	Yes	On-site	Yes	Apple	Malus spp.	20, 12	4	3.3	Moderate	Fair	Fair/poor	Conditional	12cm stem resting on shed, decay on limbs	tree removals; relatively poor structure.	Retain*
					Araucaria				_					Within proposed parking stall	
799	Yes	On-site	Yes	Monkey Puzzle	araucana	31	5	4.7	Poor	Good	Good	Unsuitable		footprint.	X
800	Yes	On-site	No	Colorado Blue Spruce	Picea pungens	~25	5	3	Moderate	Good	Good	Unsuitable	Leaning	Within proposed building footprint.	x
					, ,										
				Western Red										Conflict with proposed building footprint & parking stalls;	
898	Yes	On-site	No	Cedar	Thuja plicata	42	5	5	Moderate	Fair	Fair	Unsuitable	Raised, asymmetric crown		X
														Conflict with proposed building	
903	Yes	On-site	Yes	Western Red Cedar	Thuja plicata	42	4	5	Moderate	Fair	Fair	Unsuitable	Raised crown	footprint & parking stalls; adjacent tree removals.	x
	100		100	Coddi	maja piioata				Mederate			Onoditable	raised crown	Root & canopy conflict with	
					Acer								Ganoderma fruiting bodies at base,	proposed building footprint, likely elevated risk due to new	
912	Yes	On-site	Yes	Big Leaf Maple		46, 24	12	7	Moderate	Fair	Fair/poor	Unsuitable	deadwood, asymmetric crown	targets.	X
														Conflict with proposed building	
913	Yes	On-site	Yes	Western Red Cedar	Thuja plicata	37, 26	5	6.3	Moderate	Fair	Fair/poor	Unsuitable	Raised crown, narrow codominant union at base	footprint & parking stalls; adjacent tree removals.	x
				Western Red										Conflict with proposed building footprint & parking stalls;	
914	Yes	On-site	Yes	Cedar	Thuja plicata	33	4	4	Moderate	Fair	Fair	Unsuitable	Raised crown	adjacent tree removals.	X
915	Yes	On-site	Yes	Western Red Cedar	Thuja plicata	51, 51	10	9.8	Moderate	Fair	Fair/poor	Unsuitable	Raised, asymmetric crown, narrow codominant union at base	Conflict with proposed building footprint & parking stalls.	x
													Next to stump of removed tree,	Within proposed driveway	
916	Yes	On-site	Yes	Ash	Fraxinus spp.	55	14	5.5	Good	Good	Good	Unsuitable	epicormic growth		X
				Japanese											
M1 /NT1	Yes	Municipal	Municipal	Flowering Cherry	Prunus serrulata	48	8	5.8	Moderate	Fair	Poor	N/A	Municipal (ID: 16970), basal wound	Conflict with frontage improvements; poor structure.	x
	100	Warnorpai	Матюрат	Onony	Tranas sorralata	10		0.0	Moderate	ı dıı	1 001	14// 1	Mariopar (IB. 10070), Badar Woulla	improvementa, poor ou dotare.	
M2/NT 3	Yes	Municipal	Municipal	Ginkgo	Ginkgo biloba	7	2	0.7	Good	Good	Good	N/A	Municipal (ID: 16967)		Retain
BAO /NIT 4	V	NAinin al	Manufatual	A - I-	5	_	4	0.0	04	0	0	N1/A	Municipal, growing between sidewalk		v
M 3/NT4	Yes	Municipal		Ash	Fraxinus spp.	5		0.3	Good	Good	Good	N/A	and fence	footprint.	Х
Tag or	Surveyed?	Location (On, Off, Shared,	Bylaw protected?	Name		dbh	1	Critical root zone radius	Relative	Condition		Retention Suitability (on-	Ge neral field	Tree retention / location	Retention
ID#	(Yes/No)	City)	(Yes/No)	Common	Botanical	(cm)	(m)	(m)	Tolerance	Health	Structural	- '	observations/remarks	comments	status
M4/NT 5	Yes	Municipal	Municipal	Red Maple	Acer rubrum	8	2	1	Moderate	Good	Good	N/A	Municipal (ID: 34935)		Retain
111-7/1410	100	Hamopa	Mamorpai	rtoa mapie	Acor rabiani		=	•	Moderate	2004	Cood	14// \	manopar (ib. 0-1000)		IXGUIII
					Quercus										
M5 /NT6	Yes	Municipal	Municipal	Scarlet Oak	coccinea	7	2	0.5	Moderate	Good	Good	N/A	Municipal (ID: 16622)		Retain
MCAITT	Van	Municipal	Municipal	Red Manla	A oo a makaran	47	10	E C	Moderate	Cood	Good	N/A	Municipal (ID: 46620)		Botoin
M6/NT7	res	Municipal	Municipal	Red Maple	Acer rubrum	41	10	5.6	Moderate	Good	Good	IN/A	Municipal (ID: 16620)		Retain
M7 /NT8	Yes	Municipal	Municipal	Red Maple	Acer rubrum	49	10	5.9	Moderate	Good	Good	N/A	Municipal (ID: 16618)		Retain
				Japanese											
				Flowering								.			
M8/NT9	Yes	Municipal	Municipal	Cherry	Prunus serrulata	30	5	3.6	Moderate	Good	Good	N/A	Municipal (ID: 16656)	Potential impacts from driveway.	Retain*
				Devel											
M9	No	Municipal	Municipal	Persian ironwood	Parrotia persica	7	1	0.7	Good	Good	Good	N/A	Municipal (ID: 16655)	~3m from east PL.	Retain
														Detential increase for 110	
													Municipal (ID: 6346) Topped	Potential impacts from U/G hydro. 1.8m from sidewalk	
M10	No	Municipal	Municipal	Red Maple	Acer rubrum	16	5	1.9	Moderate	Good	Fair	N/A	historically, trunk wound.	edge.	Retain*
													Municipal (ID: 6345) Some hydro		Retain* as
	No	Municipal	Municipal	Red Maple	Acer rubrum	36	10	4.3	Moderate	Good	Fair	N/A	clearance pruning (topping) west side; canopy weighted east.	Likely conflict with U/G hydro. 1.8m from sidewalk edge.	per Parks direction
M11	110			22 mapio	IGNIGIII			<u>-</u>					, James J. Holginton Guoti		
M11	140														
M11	140												Municipal (ID: 34936) Lower trunk	Potential impacts from U/G hvdro. 1.8m from sidewalk	
		Municipal	Municipal	Red Maple	Acer rubrum	8	2	1	Moderate	Fair	Fair	N/A	Municipal (ID: 34936) Lower trunk wound.	Potential impacts from U/G hydro. 1.8m from sidewalk edge.	Retain*
		Municipal	Municipal	Red Maple	Acer rubrum	8	2	1	Moderate	Fair	Fair	N/A	wound.	hydro. 1.8m from sidewalk	Retain*
	No	Municipal Municipal	Municipal Municipal		Acer rubrum Acer rubrum	8		0.6		Fair Good		N/A		hydro. 1.8m from sidewalk	Retain*

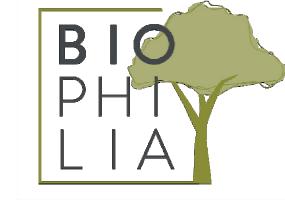

1608 Camosun Street, Victoria BC V8T 3E6 Info@biophiliacollective.ca 250 590 1156

OWNER/CLIENT:

BREIA HOLDINGS LTD.

PROJECT NAME:

LE PARC

PROJECT ADDRESS:

349 KIPLING

DESIGNED BY: **BIANCA BODLEY** DRAWN BY: **LB**


9	RE- ISSUED FOR DP	25/03/12
8	ISSUED FOR REVIEW	25/03/06
7	REVISED AND RE-ISSUED FOR DP	24/10/29
6	RE-ISSUED FOR REVIEW	24/09/27
5	ISSUED FOR RZ/DP	24/06/06
4	ISSUED FOR COORDINATION	24/05/15
3	ISSUED FOR BP	23/12/21
2	ISSUED FOR BP 75%	23/11/15
1	ISSUED FOR BP 50%	23/11/01
NO.	ISSUE	YY/MM/DD





DRAWING TITLE:

ARBORIST TREE INVENTORY TABLE

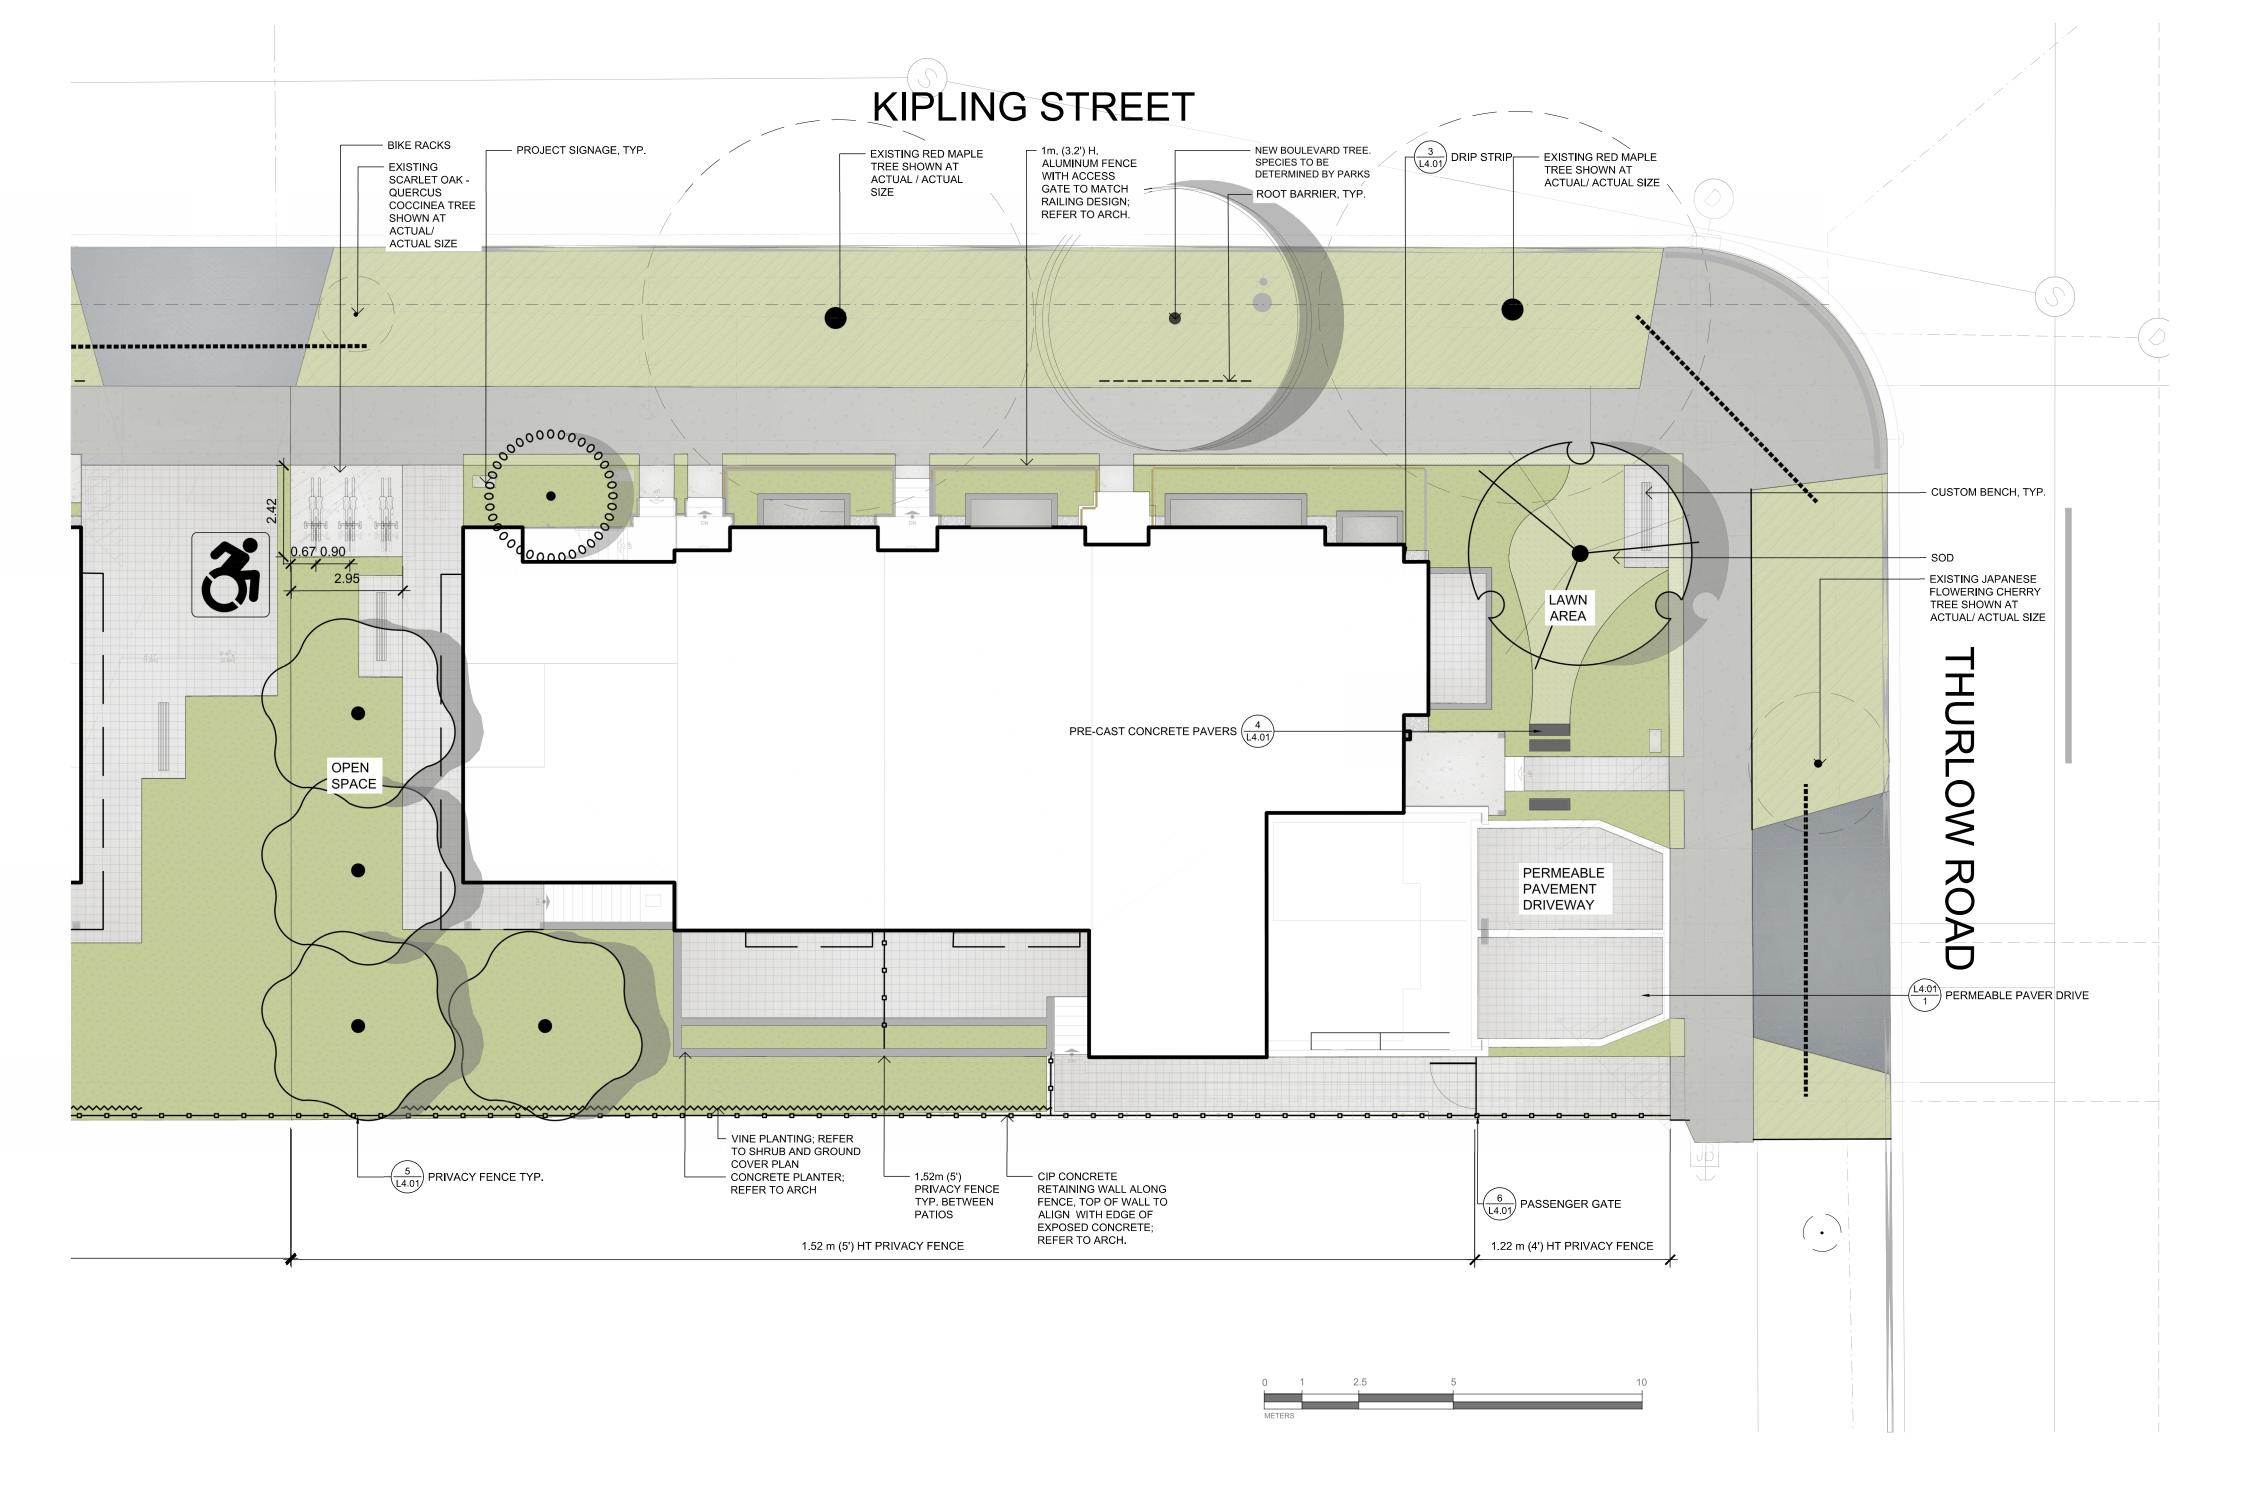

BOULEVARD TREE PLANTING NOTES:

 STREET TREES MUST HAVE ONE DOMINANT CENTRAL LEADER OR SINGLE STRAIGHT TRUNK, 6-8 CM DIAMETER CALIPER MEASURED 15 CM ABOVE GROUND, A WELL-BALANCED CROWN WITH BRANCHING STARTING AT 1.8 M - 2.5 M ABOVE GROUND AND BE PLANTED PER THE CITY OF VICTORIA SUPPLEMENTAL DRAWING SD P4 (TREE PLANTING IN BOULEVARD) AND THE CANADIAN LANDSCAPE STANDARD.

BOULEVARD SEED AND SOD INSPECTION NOTES:

- REQUIRED PARKS INSPECTIONS FOR SEED AND SOD BOULEVARD:
- A. INSPECTION OF EXCAVATED AND SCARIFIED SUBGRADE PRIOR TO BACKFILL.
- B. INSPECTION OF INSTALLED, ROLLED AND PREPARED GROWING MEDIA PRIOR SODDING. C. INSPECTION WHEN THE INSTALLED TURFGRASS MEETS THE CONDITIONS FOR TOTAL PERFORMANCE AS REQUIRED IN THE CURRENT EDITION OF THE CANADIAN LANDSCAPE STANDARD.

BOULEVARD INSPECTION TREE PLANTING NOTES:

- REQUIRED PARKS INSPECTIONS FOR SEED AND SOD BOULEVARD:
- A. INSPECTION OF SOIL AND PLANTING AREA PRIOR TO PLANTING. B. INSPECTION OF TREE STOCK PRIOR TO PLANTING.
- C. INSPECTION OF INSTALLED TREE. TREES MUST BE IN GOOD HEALTH AND CONDITION WITH NO VISIBLE SIGNS OF DISEASE, INSECT PESTS, OR DAMAGE, AND COMPLY WITH THE LATEST VERSION OF THE CANADIAN LANDSCAPE STANDARD.

GROWING MEDIUM NOTES:

• A SOIL TEST FOR THE GROWING MEDIA, FOR EACH LANDSCAPE APPLICATION ON CITY PROPERTY MUST BE SUBMITTED TO THE CITY PARKS TREEPERMITS@VICTORIA.CA FOR REVIEW AT LEAST ONE WEEK PRIOR TO SOIL PLACEMENT. GROWING MEDIA MUST MEET THE STANDARDS FOR EACH SPECIFIC LANDSCAPE APPLICATION AS REQUIRED IN THE CURRENT EDITION OF THE CANADIAN LANDSCAPE STANDARD.

BOULEVARD IRRIGATION NOTES:

- AUTOMATIC IRRIGATION TO BE PROVIDED TO THE 4 NEW BOULEVARD TREES FROM A DEDICATED 19MM METERED WATER SERVICE LOCATED WITHIN THE KIPLING FRONTAGE BOULEVARD.
- SEE CIVIL FOR WATER SERVICE LOCATION. SEE IRRIGATION PLAN AND DETAILS.

ON-SITE IRRIGATION NOTES:


 ALL SOFT LANDSCAPE AREAS TO BE IRRIGATED BY AN AUTOMATIC IRRIGATION SYSTEM DESIGNED AND INSTALLED TO HABC STANDARDS. SEE IRRIGATION PLAN AND DETAILS.

THE VICTORIA SUBDIVISION AND DEVELOPMENT SERVICING BYLAW NO. 12-042 AND THE ASSOCIATED SCHEDULES CAN BE FOUND ON THE CITY OF VICTORIA BYLAWS WEBPAGE


LEGEND

PROPERTY LINE

BUILDING FOOTPRINT IRRIGATION SLEEVE CLIMBING VINES PRIVACY FENCE ROOT BARRIER

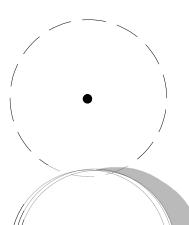


EXISTING TREE TO BE RETAINED SHOWN AT EXISTING SPREAD

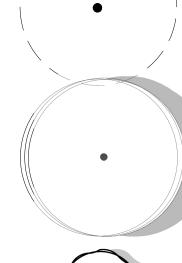

NEW BOULEVARD TREE SPECIES TO BE DETERMINED BY PARKS. TO BE INSTALLED BY CITY OF VICTORIA AT

DEVELOPER'S EXPENSE

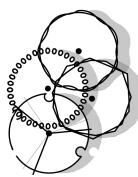

PROPOSED TREES

MATERIALS SCHEDULE

SYMBOL	DESCRIPTION	QTY
01 Genera	<u>I</u>	
	ON-SITE PLANTING - SHRUB BED	152.6 m²
	OFF-SITE PLANTING -SOD	12.3 m²
	ON-SITE PLANTING - SOD	14.4 m²
	BOULEVARD PLANTING -SOD	171.8 m²
4 4 4	PAVING TYPE A: CIP CONCRETE - LIGHT BROOM FINISH - SAW CUT CONCRETE CRACK CONTROL JOINTS	2.9 m²
	PAVING TYPE B: MUNICIPAL SIDEWALK - TO CITY OF VICTORIA STANDARDS - REFER TO CIVIL	131.7 m²
	PAVING TYPE C - PERMEABLE CONCRETE PAVER - PRODUCT: SF RIMA™ GRID - COLOR: GRAY	84.4 m²
	PAVING TYPE D: CONCRETE DRIVEWAY APRON -REFER TO CIVIL	23.6 m²
	PAVING TYPE E: PRE-CAST CONCRETE PAVERS	1.0 m²
	PAVING TYPE F: DRIP STRIP - 300 mm WASHED ROCK RIVER	1.5 m²
	PAVING TYPE G: GRAVEL	6.8 m²
Site Furnis	hings	
	BIKE RACK	3
0	PRIVACY FENCE - 5' (1.52 m) HT AS NOTED - 4' (1.22 m) HT AS NOTED	REFER TO PLA

- SOLID WOOD FENCING

MAINTENANCE GATE

CUSTOM BENCH



1608 Camosun Street, Victoria BC V8T 3E6 Info@biophiliacollective.ca 250 590 1156

OWNER/CLIENT:

BREIA HOLDINGS LTD.

PROJECT NAME:

LE PARC


PROJECT ADDRESS:

349 KIPLING

DRAWN BY: LB

DESIGNED BY: BIANCA BODLEY

9	RE- ISSUED FOR DP	25/03/12
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1	ISSUED FOR BP 50%	23/11/01
NO.	ISSUE	YY/MM/DD

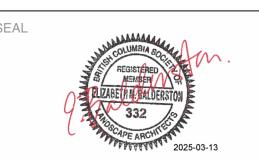

NORTH ARROW




DRAWING TITLE:

MATERIALS PLAN

DWG NO:

SCALE: 1:100

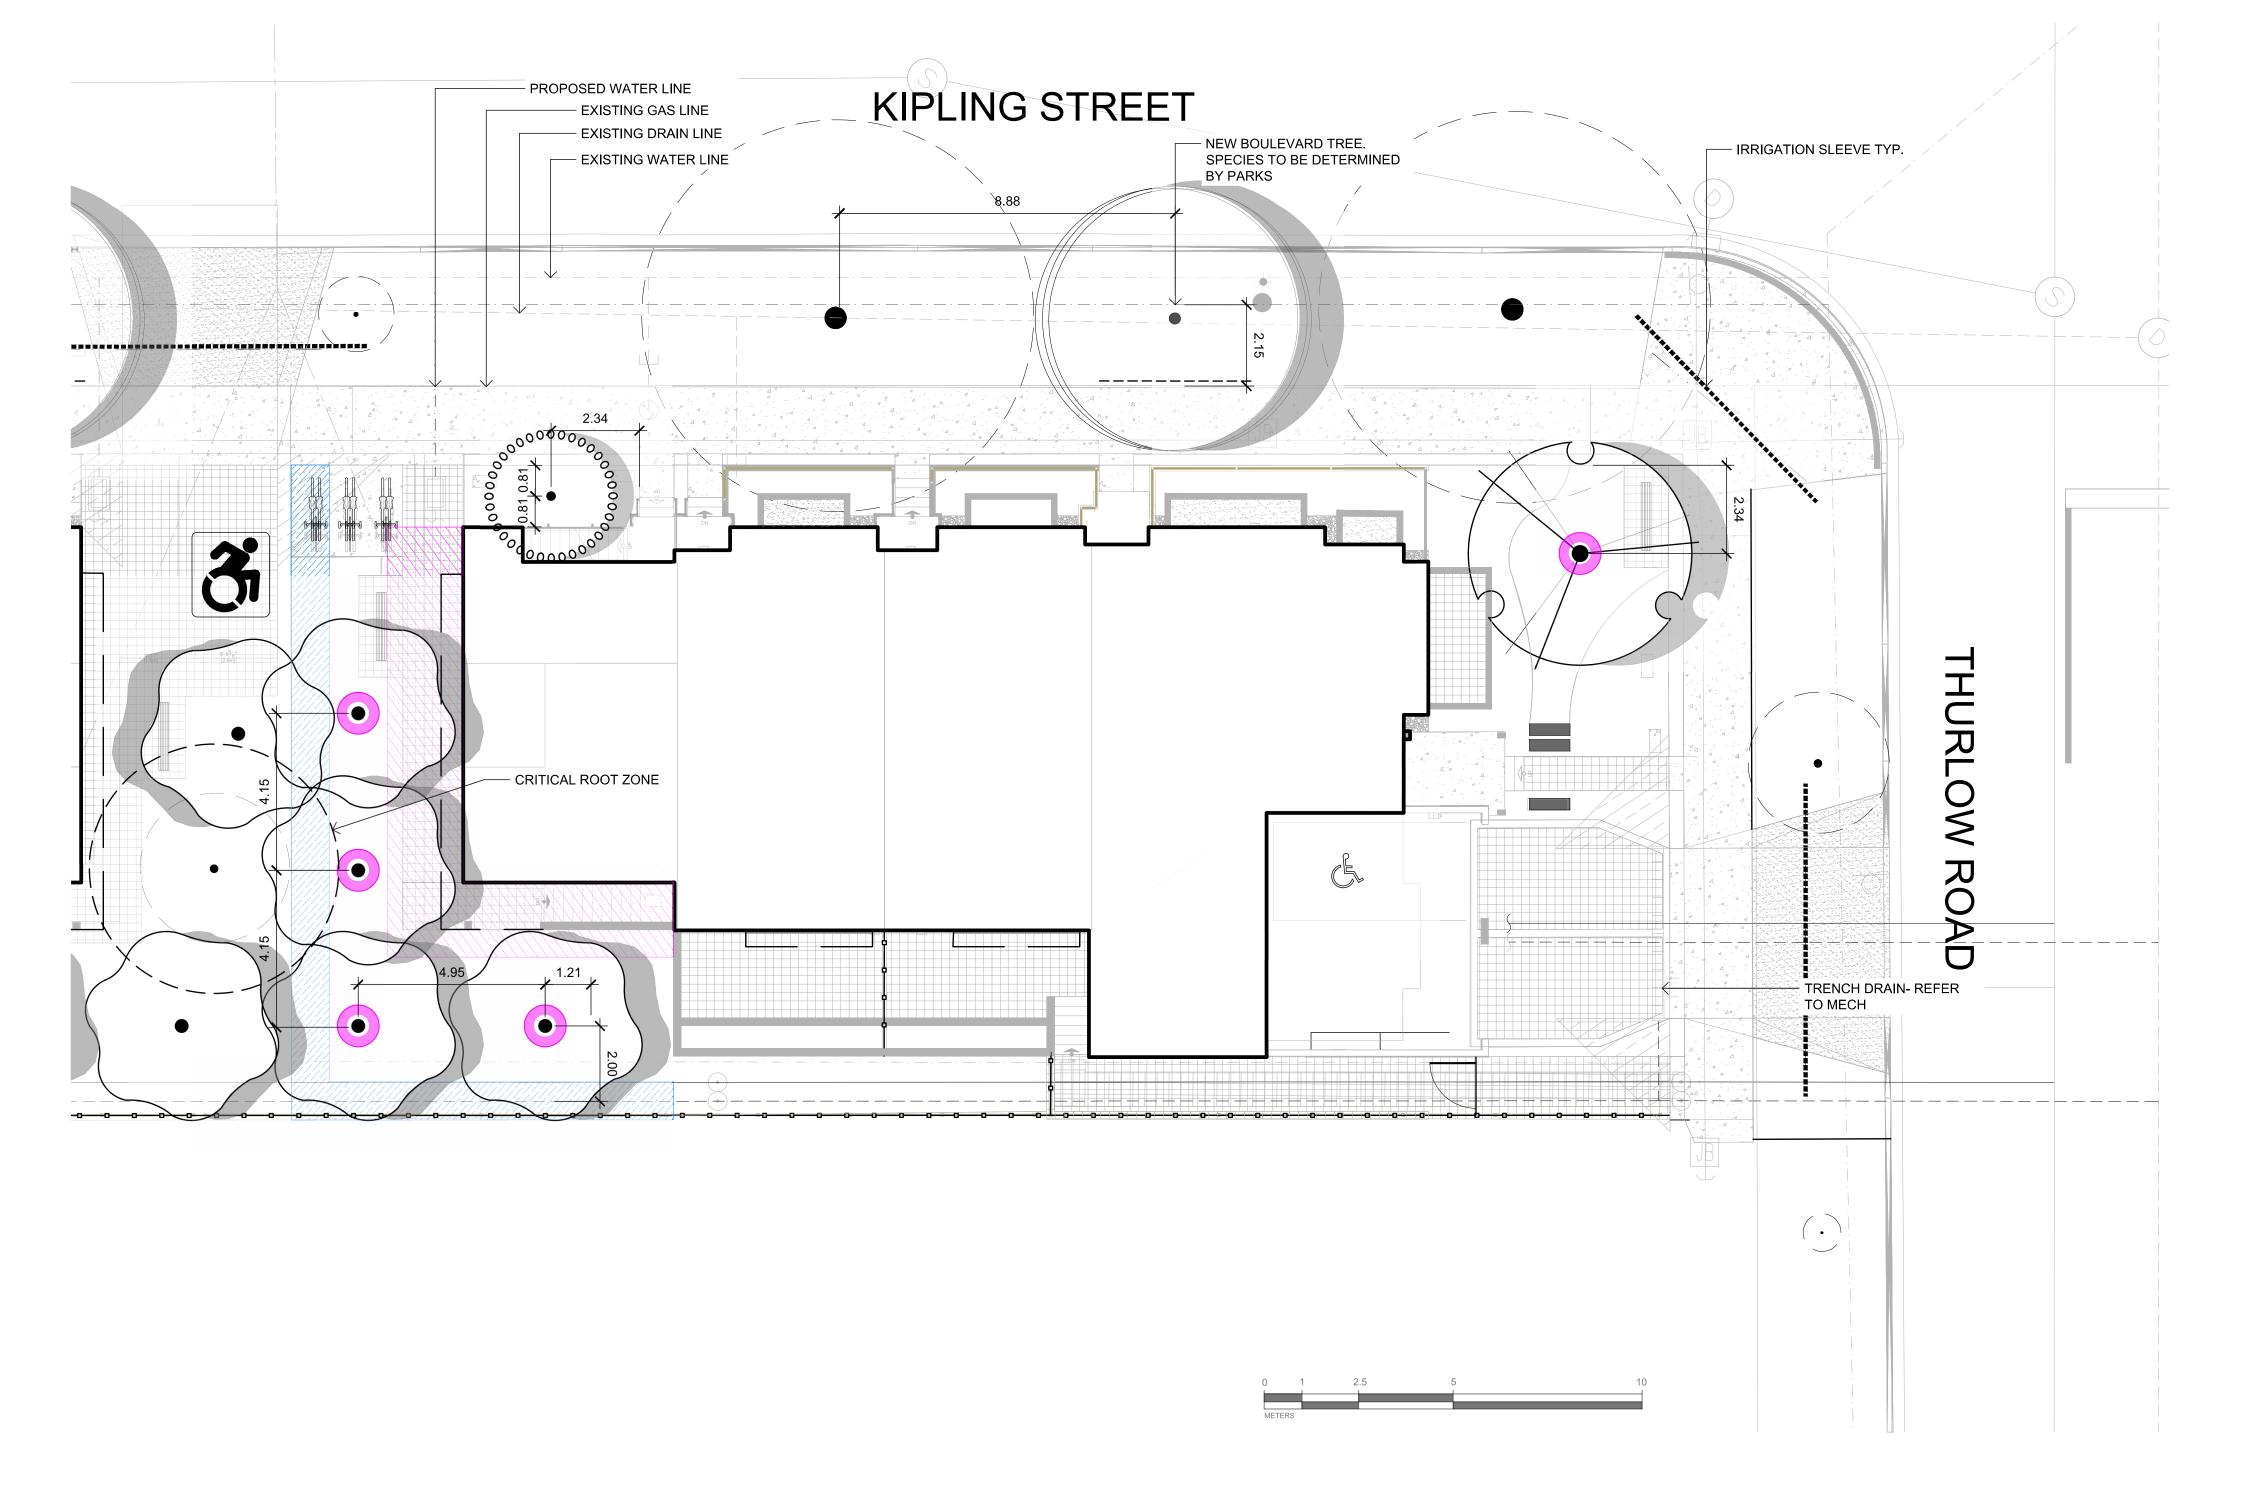


LEGEND


PROPERTY LINE

-0--0--0--0--

BUILDING FOOTPRINT IRRIGATION SLEEVE CLIMBING VINES PRIVACY FENCE **ROOT BARRIER**

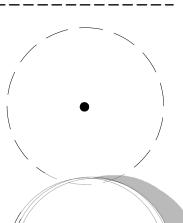

EXISTING TREE TO BE RETAINED SHOWN AT EXISTING SPREAD

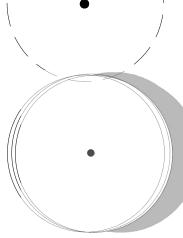

NEW BOULEVARD TREE SPECIES TO BE DETERMINED BY PARKS. TO BE INSTALLED BY CITY OF VICTORIA AT DEVELOPER'S EXPENSE



DESIGNATED REPLACEMENT TREES

1 m. DISTANCE FROM ANY PROPERTY LINE OF A LOT, ABOVE AND UNDERGROUND \UTILITIES, DRIVEWAYS AND ANOTHER SURFACES

2m. DISTANCE FROM BUILDING FOUNDATION WALL



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BREIA HOLDINGS LTD.

PROJECT NAME:

LE PARC

PROJECT ADDRESS:

349 KIPLING

DESIGNED BY: BIANCA BODLEY DRAWN BY: LB

PLANT SCHEDULE

SYMBOL	BOTANICAL / COMMON NAME	SIZE	SPACING	COMMENTS	QTY
TREES	Betula nigra 'BNMTF' / Dura Heat® River Birch	60cm Ht.	B&B	B&B, Well Established	4
000000000000000000000000000000000000000	Magnolia grandiflora 'Little Gem' / Little Gem Dwarf Southern Magnolia	40mm Cal.	Pot	B&B, Well Established	1
S S	Quercus garryana / Oregon White Oak	As Available	Pot		1

TREE PLANTING NOTES:

- 1. PLANTS IN PLANT LISTS ARE SPECIFIED ACCORDING TO THE CANADIAN NURSERY LANDSCAPE ASSOCIATION CANADIAN STANDARDS FOR NURSERY STOCK AND SECTION 12, CONTAINER GROWN PLANTS FROM THE BC LANDSCAPE STANDARD, CURRENT EDITION.
- 2. ALL LANDSCAPE AREAS TO BE IRRIGATED WITH AN AUTOMATIC IRRIGATION SYSTEM DESIGNED TO IIABC
- STANDARDS. SEE IRRIGATION PLAN AND DETAILS 3. ALL PROPOSED BOULEVARD TREES TO HAVE 10m3 MIN. GROWING MEDIUM. SEE SOIL DEPTH PLAN
- 4. THE STORM DRAIN HAS BEEN LINED, IS FULLY SEALED AND CONFIRMED BY ENGINEERING TO BE OKAY TO PLANT OVER TOP. CARE MUST BE TAKEN DURING DIGGING FOR TREE PLANTING.

PLANT IMAGERY









MAGNOLIA GRANDINFLORA CORNUS NUTTALLIII **BETULA NIGRA**

SOIL VOLUME				REPLACE PROPOSI	EMENT TRE ED	ES	SOIL VO	SOIL VOLUME REQUIRED (m3)		
PLANTING AREA ID	AREA (m²)	SOIL VOLUME MULTIPLIER	A.ESTIMATED SOIL VOLUME	B. # SMALL	C. # MEDIUM	D.# LARGE	E. SMALL	F. MEDIUM	G. LARGE	TOTAL
	1		ON-SIT	E AREA						
PLANTING AREA C	39m²	1	39m³	0	0	1	0	0	35m³	35m³
PLANTING AREA D	76m²	1	76m³	0	4	0	0	60m³	0	60m³
		OFFS	SITE AREA (EXCLU	DING CITY	PROPERT	Y)		1	ı	
PLANTING AREA OSA X	N/A	N/A	N/A	N/A	N/A	N/A	N/A	N/A	N/A	N/A
CALCULATION INSTRUCT	IONS:						Е	F	G	TOTAL
							IF B=1, B X 8 IF B>1, B X 6	If C=1, Cx20 If C>1, Cx15	If D=1, Dx35 If D>1, Dx30	E+F+G

EXISTING TREE QUANTITIES

ON SITE:

EXISTING TREES = 7

 TREES TO BE REMOVED = 7 BYLAW PROTECTED TREES TO BE REMOVED: 6

MUNICIPAL BOULEVARD:

 EXISTING TREES = 5 • TREES TO BE REMOVED = 0

REPLACEMENT TREES REQUIRED: 7

DRAWING TITLE: TREE PLANTING PLAN

RE- ISSUED FOR DP ISSUED FOR REVIEW

ISSUED FOR RZ/DP

ISSUED FOR BP 75%

ISSUED FOR BP 50%

ISSUED FOR BP

RE-ISSUED FOR REVIEW

ISSUED FOR COORDINATION

REVISED AND RE-ISSUED FOR DP

DWG NO:

NORTH ARROW

25/03/06

24/10/29


24/09/27

24/06/06

23/12/21

23/11/15 23/11/01



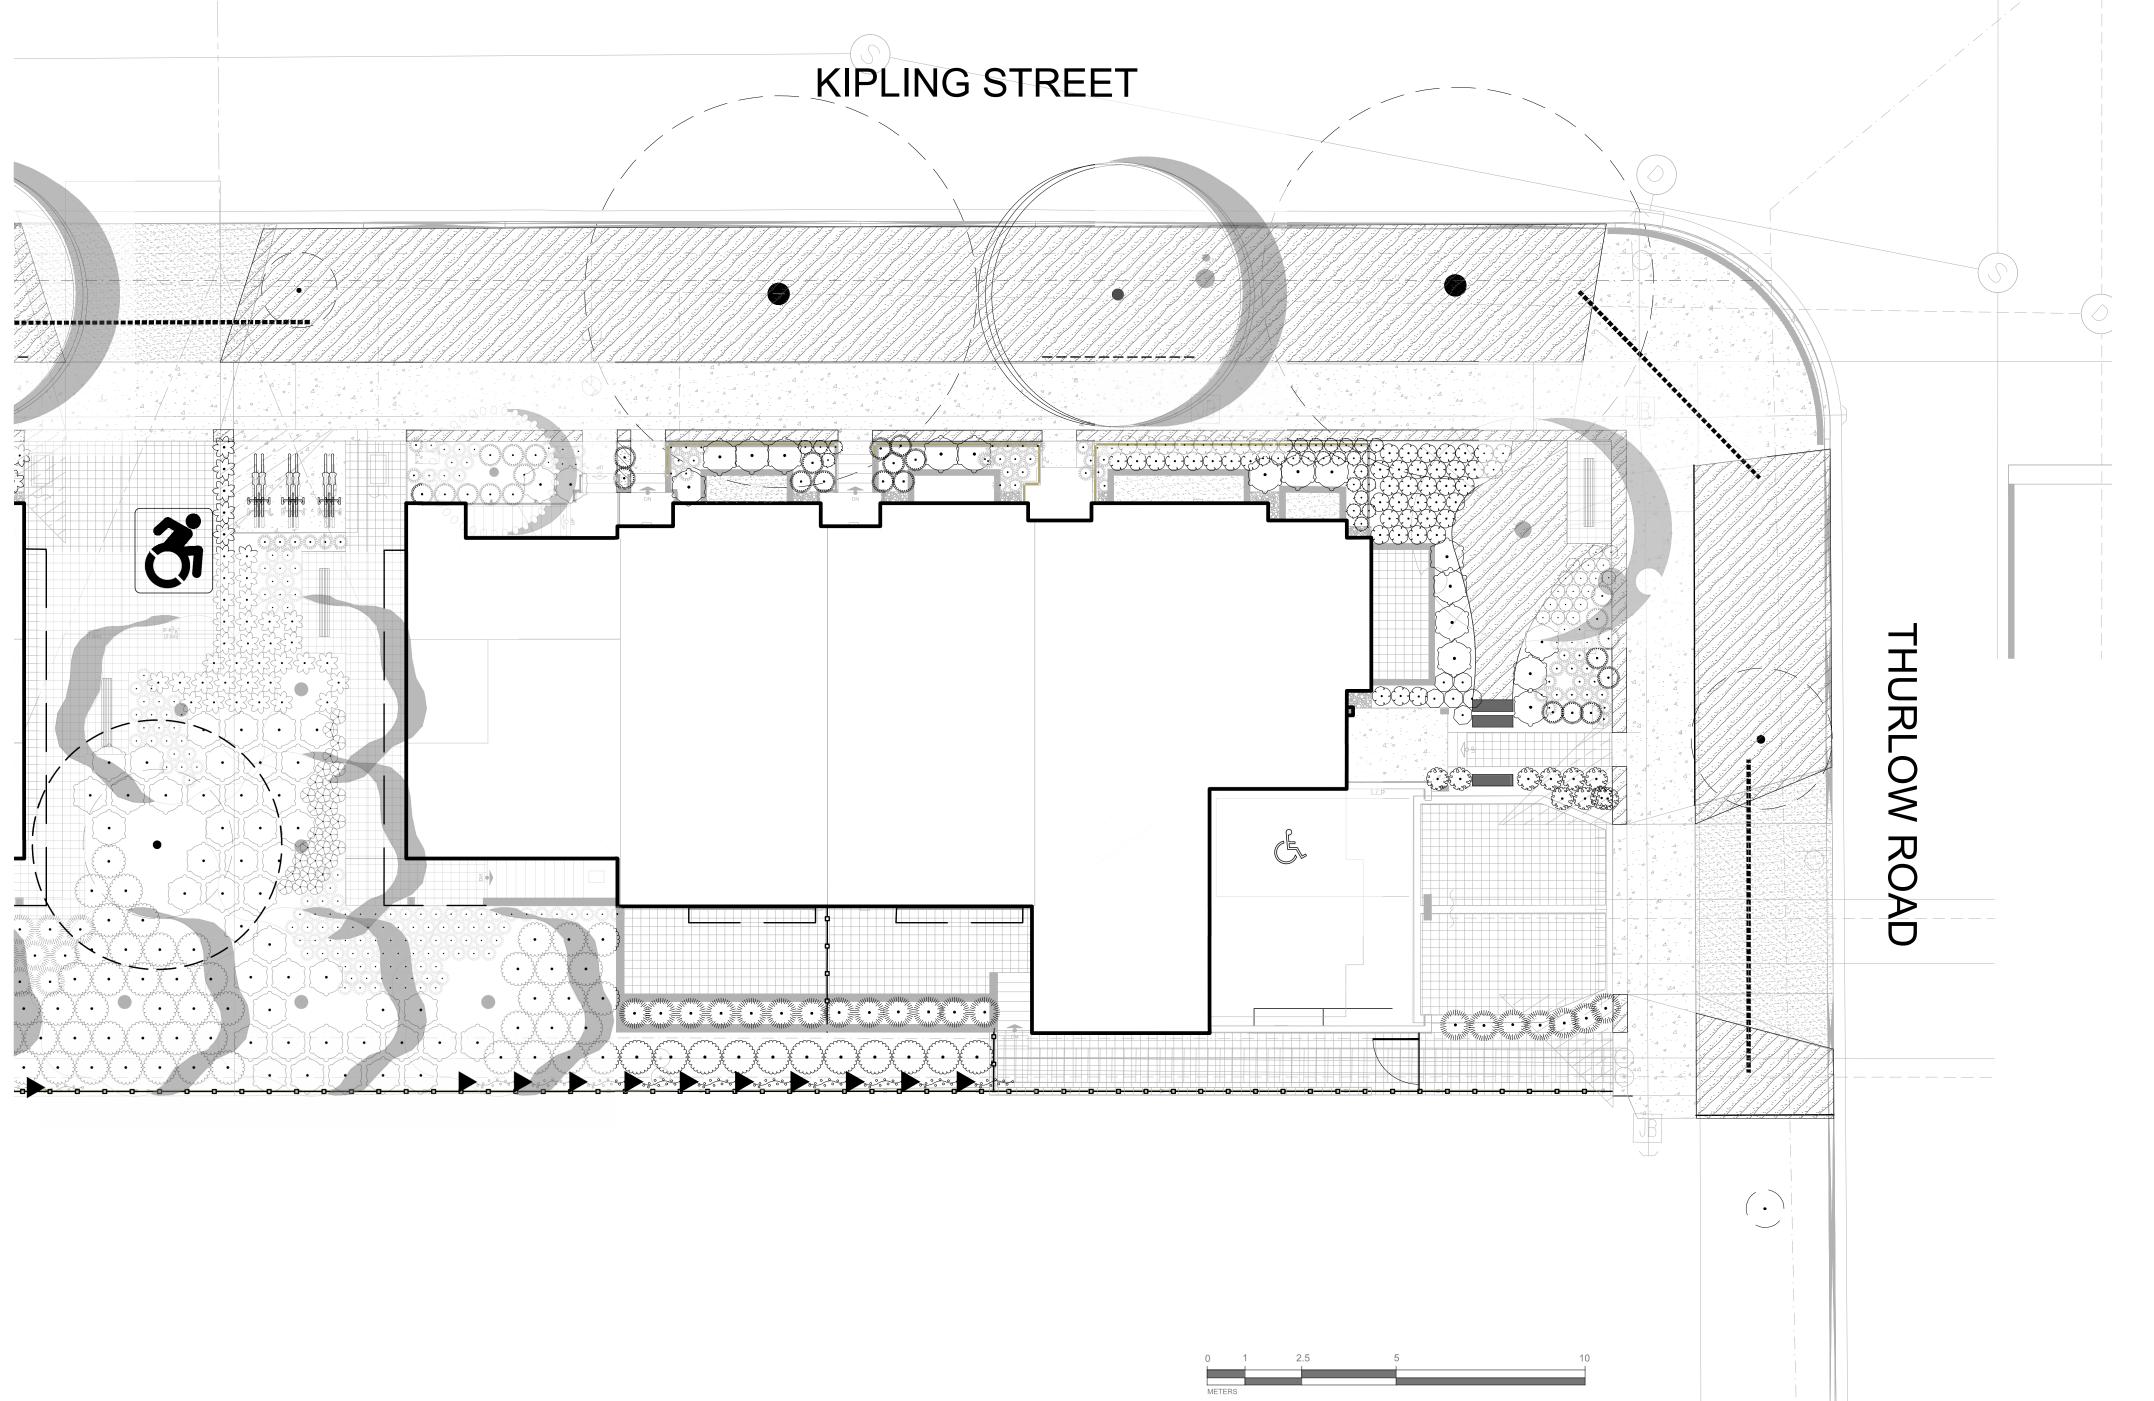

<u>QTY</u>

28

SPACING QTY

195.5 m²


Pollinator, Fruit Bearing and Native

Pollinator, Fruit Bearing and Native

LEGEND

PROPERTY LINE

BUILDING FOOTPRINT IRRIGATION SLEEVE **CLIMBING VINES** PRIVACY FENCE ROOT BARRIER

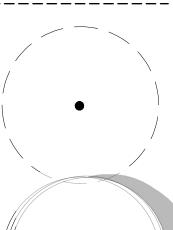


EXISTING TREE TO BE RETAINED SHOWN AT EXISTING SPREAD

NEW BOULEVARD TREE

SPECIES TO BE DETERMINED BY PARKS.TO BE INSTALLED BY CITY OF VICTORIA AT DEVELOPER'S EXPENSE

PLANT IMAGERY

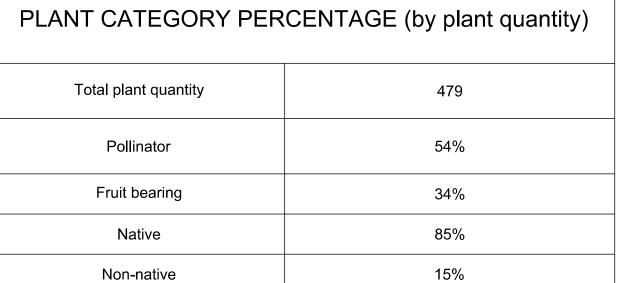





GAURA LINDHEIMERI

'BLUSH PINK'





VANCOUVERIA HEXANDRA DESCHAMPSIA CESPITOSA

	Gaura lindheimeri 'Blush Pink' / Steffi™ Blush Pink Gaura	#2 cont.	0.4m	Pollinator	29
	Lonicera pileata / Privet Honeysuckle	#3 cont.	0.5m	Pollinator, Fruit Bearing and Native	50
£	Rosa nutkana / Nootka Rose	#3 cont.	0.6m	Pollinator, Fruit Bearing and Native	27
2 2 2 2 2 2 2 2 2 2 2 2 2 2 2 2 2 2 2	Santolina virens / Green Lavender Cotton	#1 cont.	0.6m	Pollinator	10
•	Vancouveria hexandra / White Insideout Flower	#2 cont.	0.5m	Pollinator, Fruit Bearing and Native	6
FERNS (3)	Polystichum munitum / Western Sword Fern	#1 cont.	0.6m	Native	21
GRASSES	Deschampsia cespitosa / Tufted Hair Grass	#1 Pot	0.4m	Native	175
	Miscanthus sinensis 'Graziella' / Graziella Eulalia Grass	#2 cont.	0.9m	Non-Native	20
GROUNDO	COVERS				
£ .	Asarum canadense / Wild Ginger	#1 Pot	0.4m	Native, Pollinator	46

PLANT SCHEDULE

SYMBOL BOTANICAL / COMMON NAME

Gaultheria shallon / Salal

Hydrangea anomala / Climbing Hydrangea

Turf Seed Drought Tolerant Dwarf Fescue Blend

SYMBOL BOTANICAL / COMMON NAME

Arctostaphylos uva-ursi 'Massachusetts' / Massachusetts Kinnikinnick #1 cont. 0.6m

PLA	AN H	ING	NO	IES:

Pollinator

Fruit bearing

Native

LANDSCAPE STANDARD, CURRENT EDITION.

DI ANTINO NOTEO

PLANT CATEGORIES


flower producing shrub or perennial

Edible for animals or people

On a recognized Southern Vancouver

Island plant list

1. PLANTS IN PLANT LISTS ARE SPECIFIED ACCORDING TO THE CANADIAN NURSERY LANDSCAPE ASSOCIATION CANADIAN STANDARDS FOR NURSERY STOCK AND SECTION 12, CONTAINER GROWN PLANTS FROM THE BC

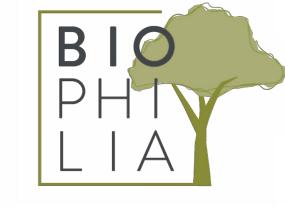

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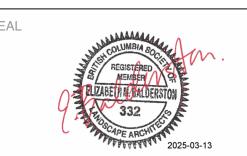
LE PARC

PROJECT ADDRESS:

349 KIPLING

DESIGNED BY: BIANCA BODLEY DRAWN BY: LB

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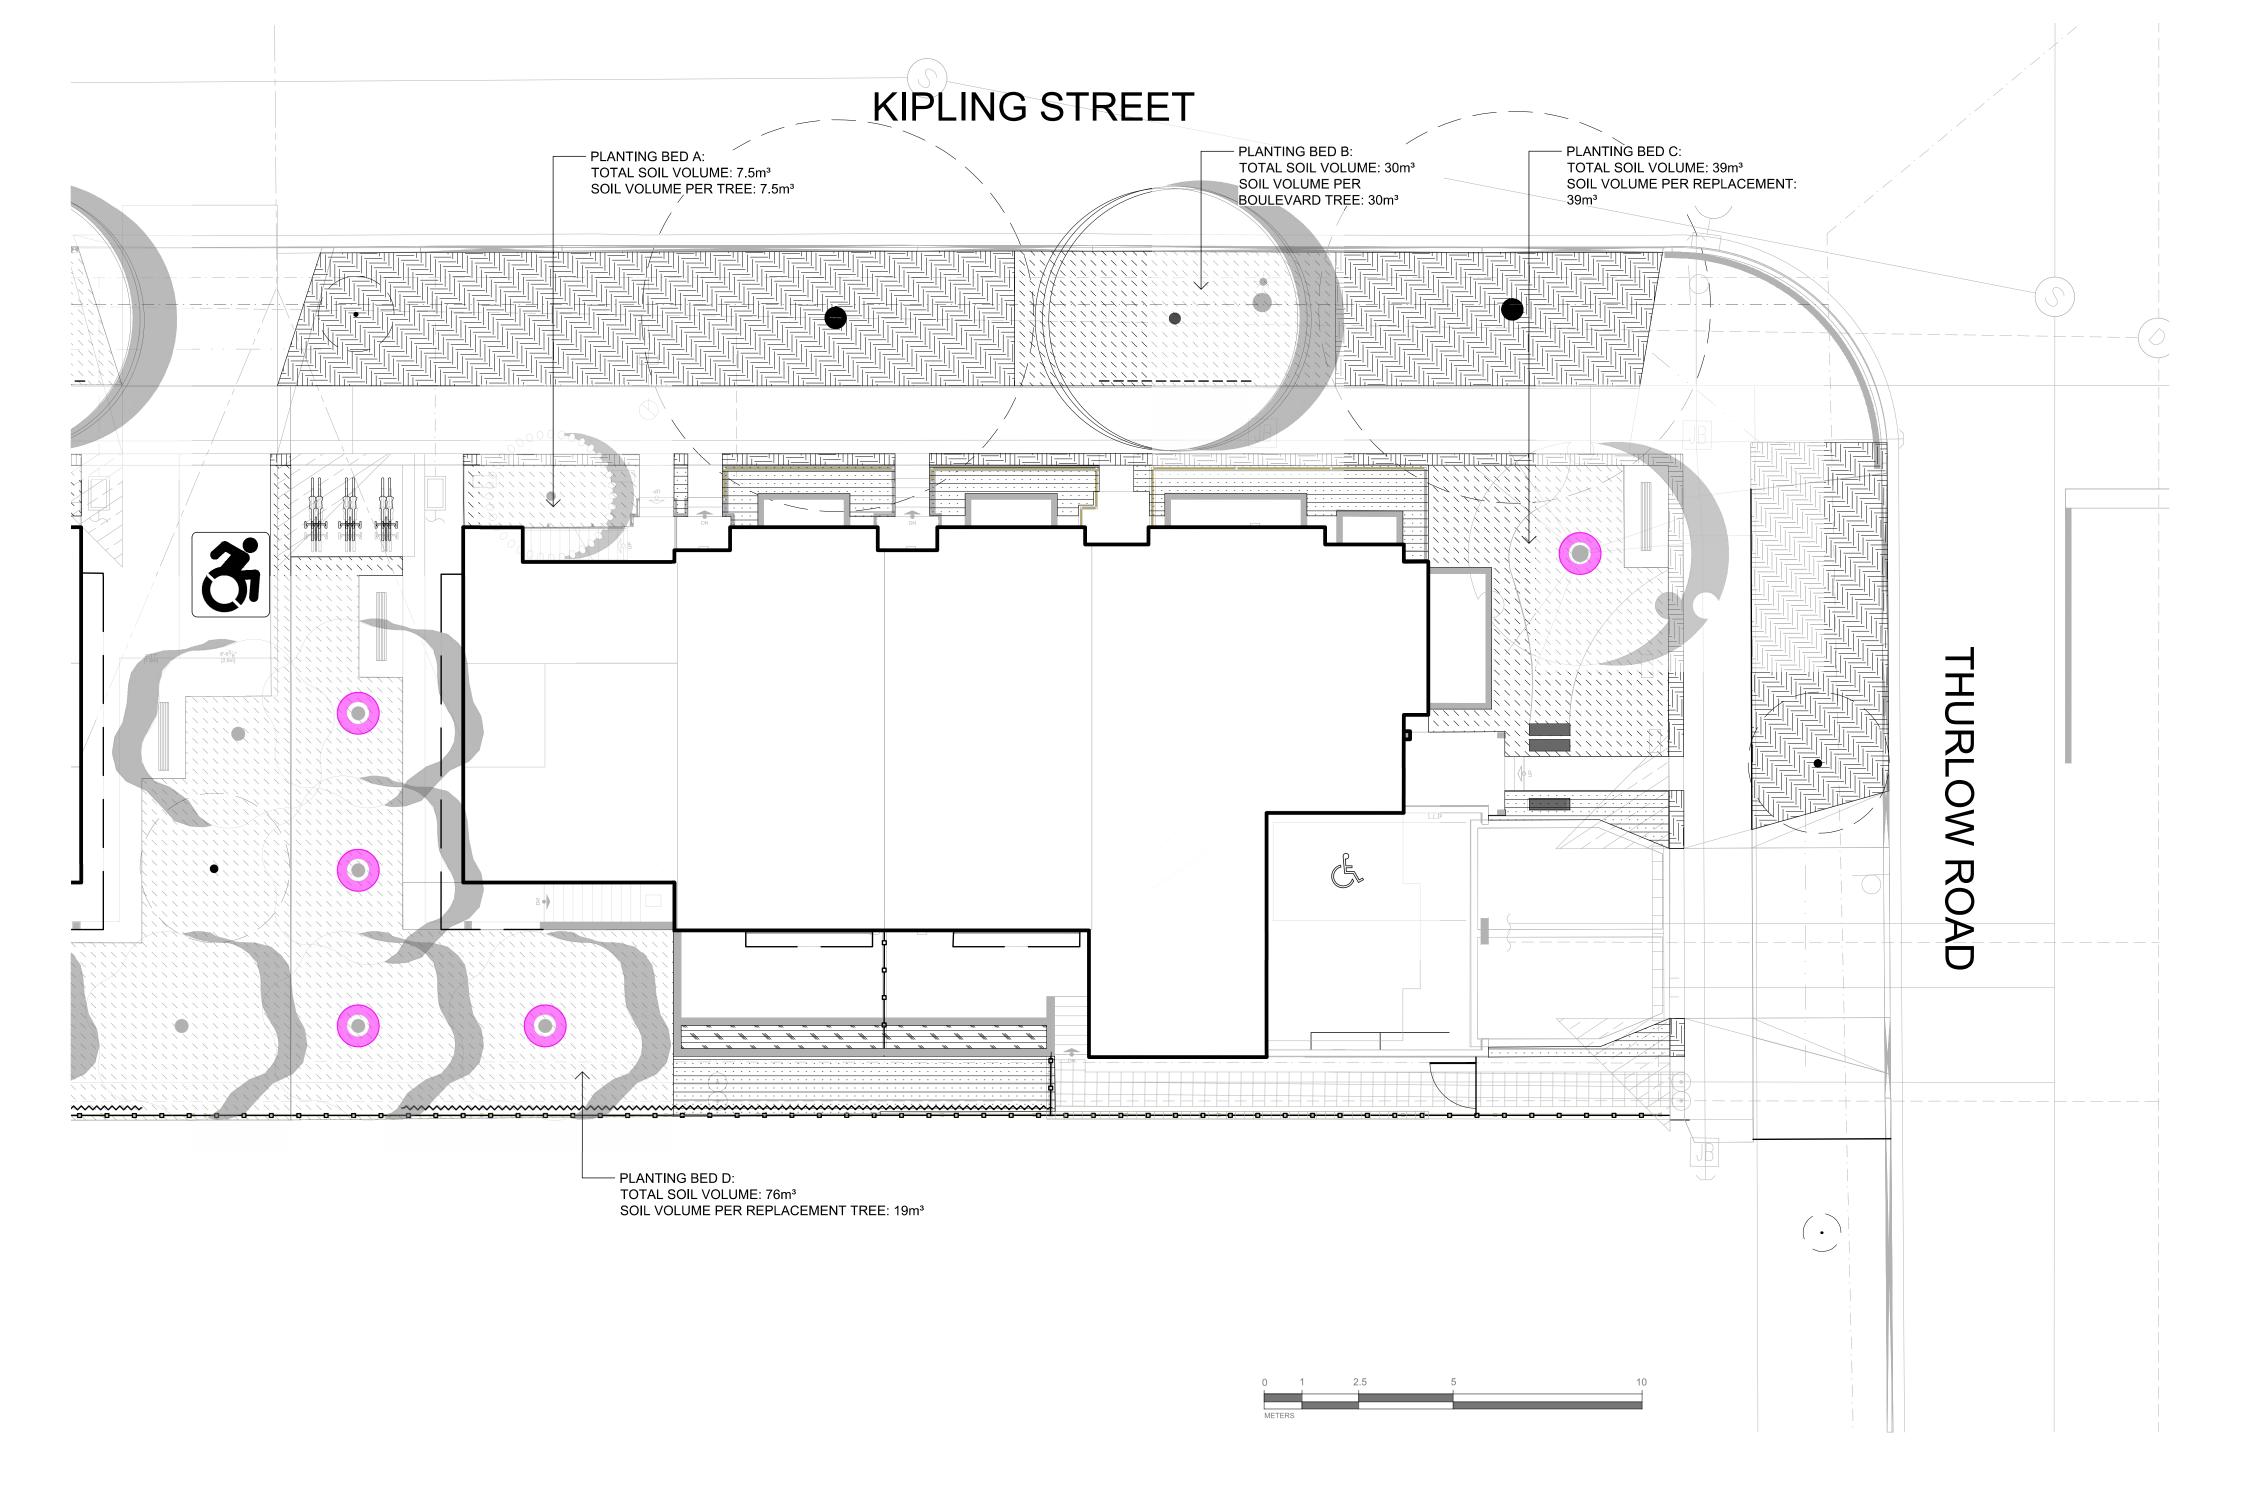


DRAWING TITLE:

PLANTING PLAN

DWG NO:

SCALE: 1:100



SOIL DEPTH SCHEDULE


SYMBOL DESCRIPTION	QTY
1000 mm Soil Depth - Growing medium to Canadian Landscape Standards - Refer to specifications	152.5 m²
600 mm Soil Depth Growing medium to Canadian Landscape Standards Refer to specifications	39.7 m²
450 mm Soil Depth - Growing medium to Canadian Landscape Standards - Refer to specifications	5.9 m²
150 mm Soil Depth - Growing medium to Canadian Landscape Standards - Refer to specifications	144.8 m²

SOIL VOLUME				REPLACE PROPOSI	MENT TRE	ES	SOIL VO	SOIL VOLUME REQUIRED (m3)		
PLANTING AREA ID	AREA (m²)	SOIL VOLUME MULTIPLIER	A.ESTIMATED SOIL VOLUME	B. # SMALL	C. # MEDIUM	D. # LARGE	E. SMALL	F. MEDIUM	G. LARGE	TOTAL
			ON-SIT	E AREA						
PLANTING AREA C	39m²	1	39m³	0	0	1	0	0	35m³	35m³
PLANTING AREA D	76m²	1	76m³	0	4	0	0	60m³	0	60m³
		OFFS	SITE AREA (EXCLU	DING CITY	PROPERT\	()				
PLANTING AREA OSA X	N/A	N/A	N/A	N/A	N/A	N/A	N/A	N/A	N/A	N/A
						•	1	1		
CALCULATION INSTRUCT	IONS:						E	F	G	TOTAL
							IF B=1, B X 8 IF B>1, B X 6	If C=1, Cx20 If C>1, Cx15	If D=1, Dx35 If D>1, Dx30	E+F+G

LEGEND

PROPERTY LINE BUILDING FOOTPRINT

IRRIGATION SLEEVE **CLIMBING VINES** PRIVACY FENCE **ROOT BARRIER**

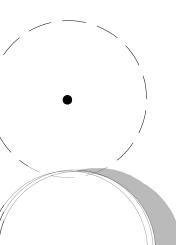

EXISTING TREE TO BE RETAINED SHOWN AT EXISTING SPREAD

NEW BOULEVARD TREE

SPECIES TO BE DETERMINED BY PARKS.

TO BE INSTALLED BY CITY OF VICTORIA AT DEVELOPER'S EXPENSE

DESIGNATED REPLACEMENT TREES



1608 Camosun Street, Victoria BC V8T 3E6 Info@biophiliacollective.ca 250 590 1156

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PROJECT NAME:

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NO.	ISSUE	YY/MM/DD








DRAWING TITLE:

SOIL DEPTH PLAN

SCALE: 1:100

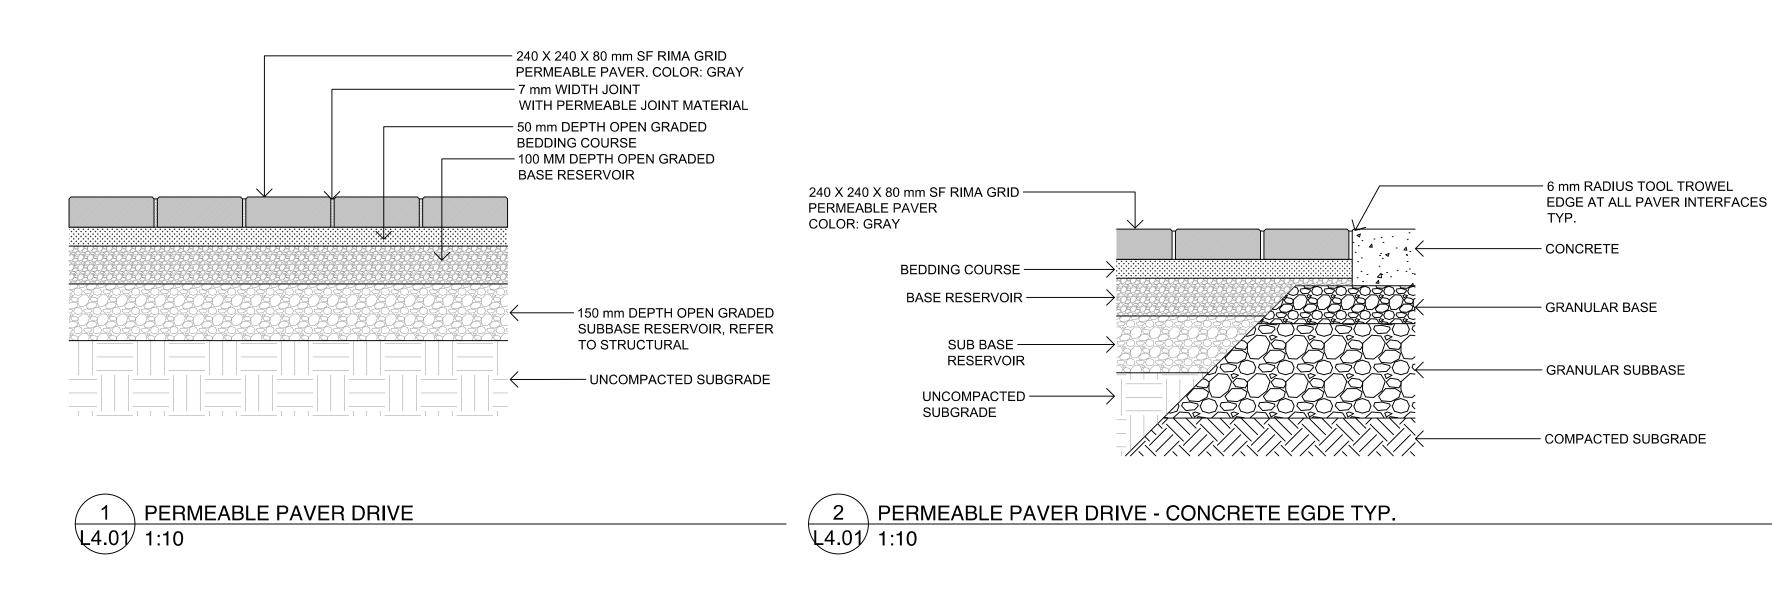

—— 6"x6" POST TYP.

2"x4" HORIZONTAL FENCE BOARD TYP.

PLAN VIEW

6"x6" POST TYP. 2"x4" HORIZONTAL FENCE BOARD TYP.

- 100mm H x 304.8mm W x 1.069 mm L PRE-CAST CONCRETE PAVERS

GROWING MEDIUM BETWEEN PAVERS

6"x6" POST TYP.

PLANTING MATERIAL,

REFER TO PLANTING PLAN

- 50mm SAND COURSE

- 150mm GRANULAR BASE

COMPACTED SUBGRADE

-1 X 4 WOOD SUPPORT FOR EDGER – 102 mm (4') DEPTH ALUMINIUM EDGER – FINISH GRADE OF ADJACENT LANDSCAPE — GROWING MEDIUM - FILTER FABRIC SUBGRADE DRIP STRIP

L4.01/ 1:10

- FILTER FABRIC WRAPPED OVER DRAIN MAT IF REQUIRED - SEE

ARCHITECTURAL

ROCK

- 4 - 6" WASHED RIVER

• LANDSCAPE EDGER TO BE: PERMALOC CleanLine Commercial Grade Landscape Edging OR APPROVED EQUAL. • 4.8mm (3/16") THICKNESS; 102mm (4") HEIGHT; 4.8m (16') LENGTH;

NATURAL MILL FINISH; 305mm (12") STAKE.

 INSTALL EDGER AS PER MANUFACTURER'S INSTRUCTIONS 1 X 4 WOOD SUPPORT TO BE STAKED IN PLACE AND USED TO ENSURE EDGER IS INSTALLED IN A STRAIGHT LINE AND MAINTAINS A STRAIGHT ALIGNMENT DURING THE INSTALLATION OF GROWING MEDIUM AND RIVER ROCK. MAY BE SCRAP WOOD AS LONG AS IT IS STRAIGHT.

FILTER FABRIC TO BE POLYPROPYLENE FIBRE NONWOVEN GEOTEXTILE,

SUCH AS NILEX 4551 OR APPROVED EQUAL

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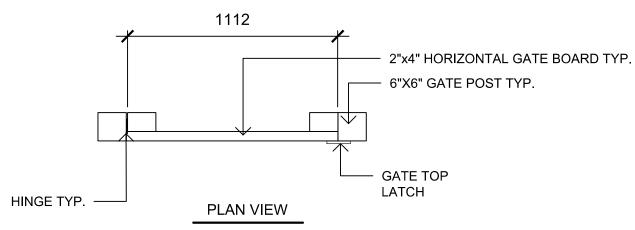
LE PARC


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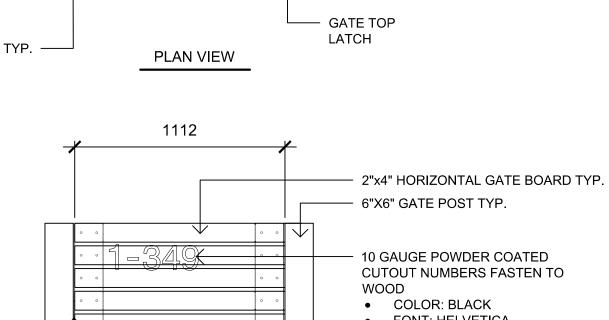
349 KIPLING

DESIGNED BY: BIANCA BODLEY

DRAWN BY: LB





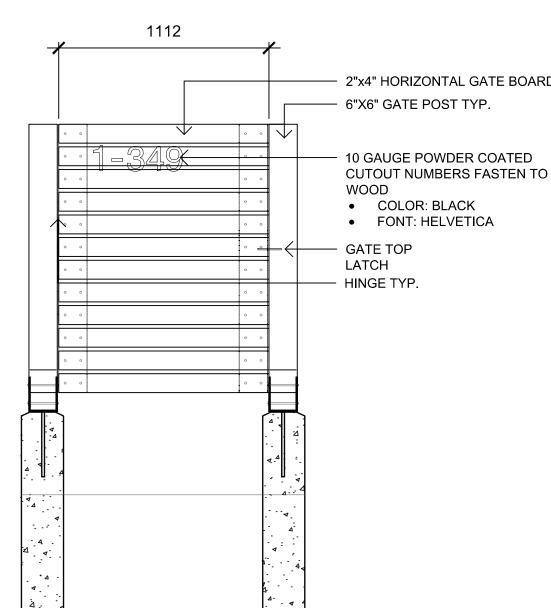

NOTES:

1. REFER TO MATERIALS PLAN FOR FENCE

LOCATIONS AND HEIGHT. 2. FINISHED SIDE OF VERTICAL FENCE BOARDS

TO FACE INTO PROPERTY. 3. ALL LUMBER TO BE SMOOTH, FINISHED 4

SIDES, CLEAR GRADE SEASONED CEDAR -

ALL RIPPED BOARDS TO BE PLANED SMOOTH 4. ALL SCREWS TO BE STAINLESS STEEL

EXTERIOR WOOD SCREWS

5. ALL NUTS AND WASHERS TO BE SELF LOCKING STAINLESS STEEL


6. POST BASE ANCHOR TO BE BLACK POWDERCOATED STEEL

7. WOOD FINISH: NANO PENETRATING WOOD SEALER

8. WOOD STAINT TINT: CLEAR MATTE.

HTTPS://SEAL-ONCE.COM/NANO-PENETRATING-WOOD-SEALER-WOOD-STAIN/

> RE- ISSUED FOR DP 25/03/12 25/03/06 ISSUED FOR REVIEW REVISED AND RE-ISSUED FOR DP 24/10/29 RE-ISSUED FOR REVIEW 24/09/27 ISSUED FOR RZ/DP 24/06/06 ISSUED FOR COORDINATION 24/05/15 23/12/21 ISSUED FOR BP 23/11/15 ISSUED FOR BP 75% 23/11/01 ISSUED FOR BP 50% NO. ISSUE

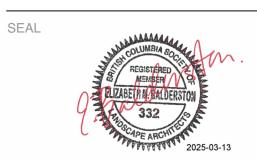



DRAWING TITLE:

HARDSCAPE AND SITE FURNISHINGS DETAILS

DWG NO:

SCALE: 1:100

6 PASSENGER GATE L4.01 1:20

4 PRE-CAST CONCRETE PAVERS

1. REFER TO MATERIALS PLAN FOR FENCE LOCATIONS AND HEIGHT.

3. ALL SCREWS TO BE STAINLESS STEEL EXTERIOR WOOD SCREWS

4. ALL NUTS AND WASHERS TO BE SELF LOCKING STAINLESS STEEL

5. POST BASE ANCHOR TO BE BLACK POWDERCOATED STEEL

6. WOOD FINISH: NANO PENETRATING WOOD SEALER

7. WOOD STAINT TINT: CLEAR MATTE .

SEASONED CEDAR - ALL RIPPED BOARDS TO BE PLANED SMOOTH

HTTPS://SEAL-ONCE.COM/NANO-PENETRATING-WOOD-SEALER-WOOD-

2"x4" HORIZONTAL FENCE BOARD TYP.

FINISHED

FENCE FACE

MACHINE BOLT

POST BASE ANCHOR


PITCH SURFACE TO DRAIN -

CONCRETE FOOTING 8" -DIAMETER SONOTUBE TYP.

2. ALL LUMBER TO BE SMOOTH, FINISHED 4 SIDES, CLEAR GRADE

L4.01/ 1:10

NOTES:

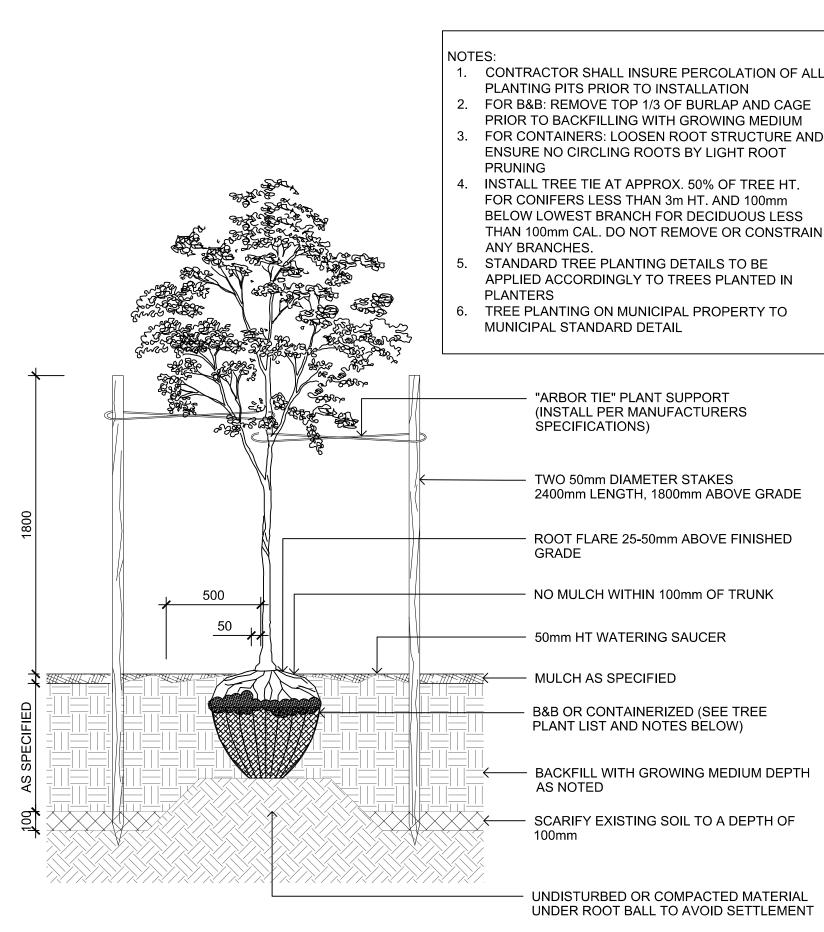


1 TREE PLANTING DETAIL L4.02/ 1:10

5 SOD ON GRADE


. SHRUB PLANTING AS PER WRITTEN SPECIFICATIONS GROWING MEDIUM AND MULCH AS PER WRITTEN SPECIFICATIONS

SHRUB PLANTING DETAIL

L4.02 1:10

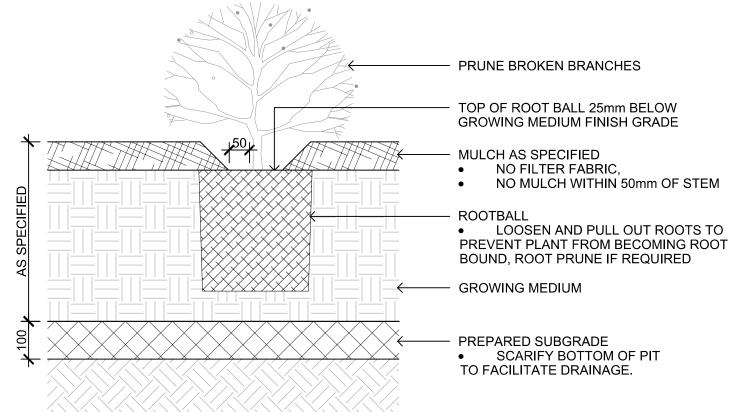

1. PLACE AND COMPACT SUBGRADE AS PER WRITTEN SPECIFICATIONS 2. SUBGRADE TO BE COMPACTED TO A CONSISTENT 80% M.P.D 3. GROWING MEDIUM AND MULCH AS PER WRITTEN SPECIFICATIONS

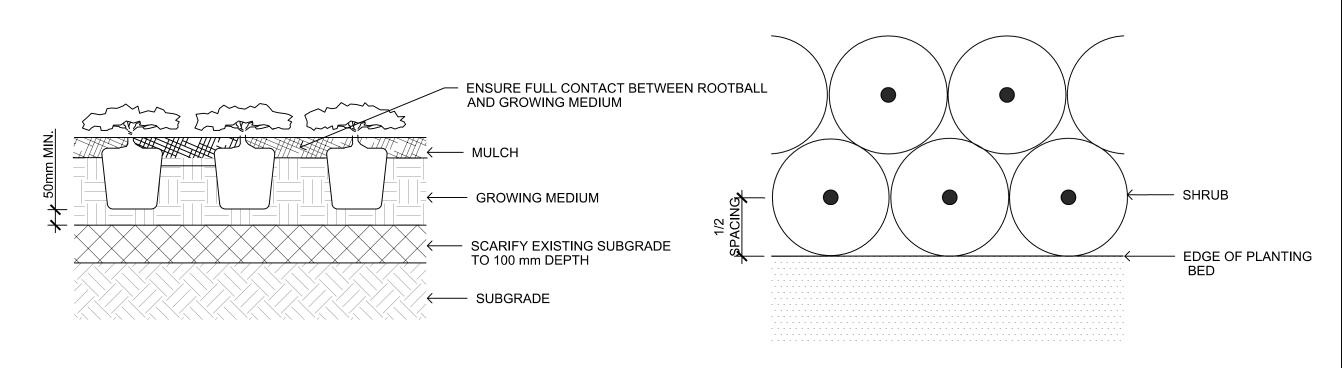


VICTORIA


GROUND COVER PLANTING DETAIL L4.02 1:10


 ${f igcelow}$ 4 ${igcelow}$ SPACING PLANTING DETAIL L4.02/ 1:10


SUPPLEMENTARY STANDARD

DETAIL DRAWINGS

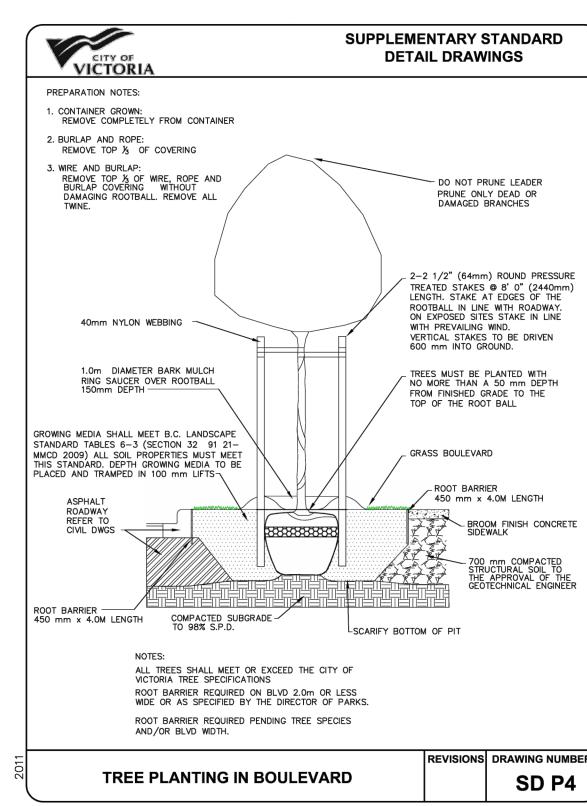

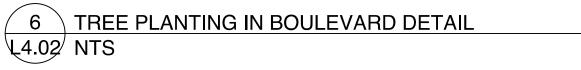

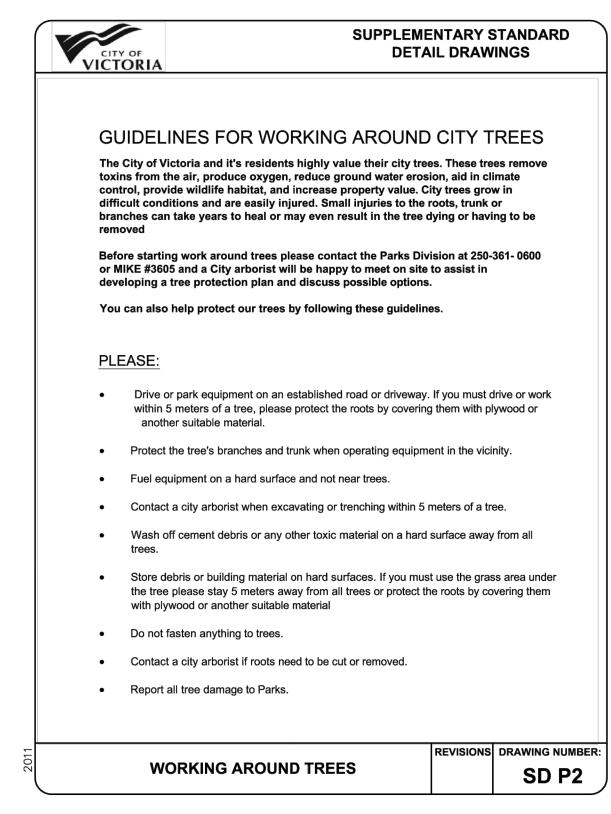

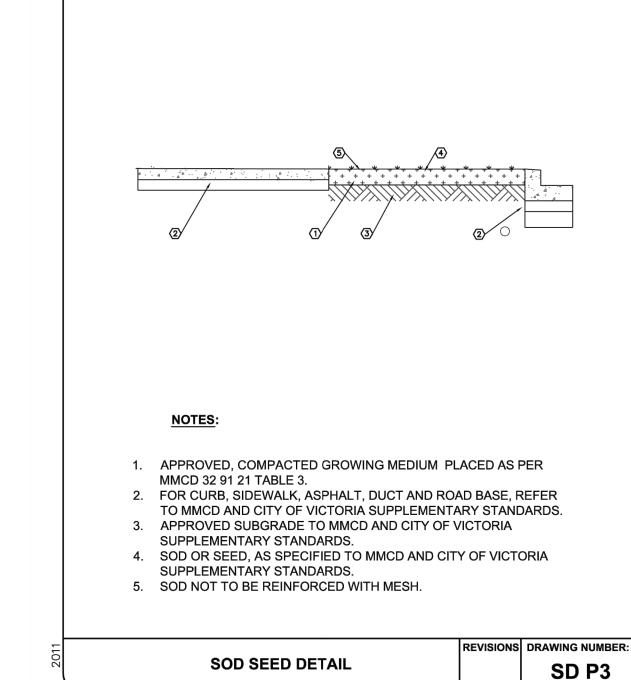





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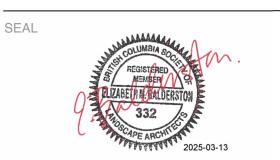
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DRAWN BY: LB

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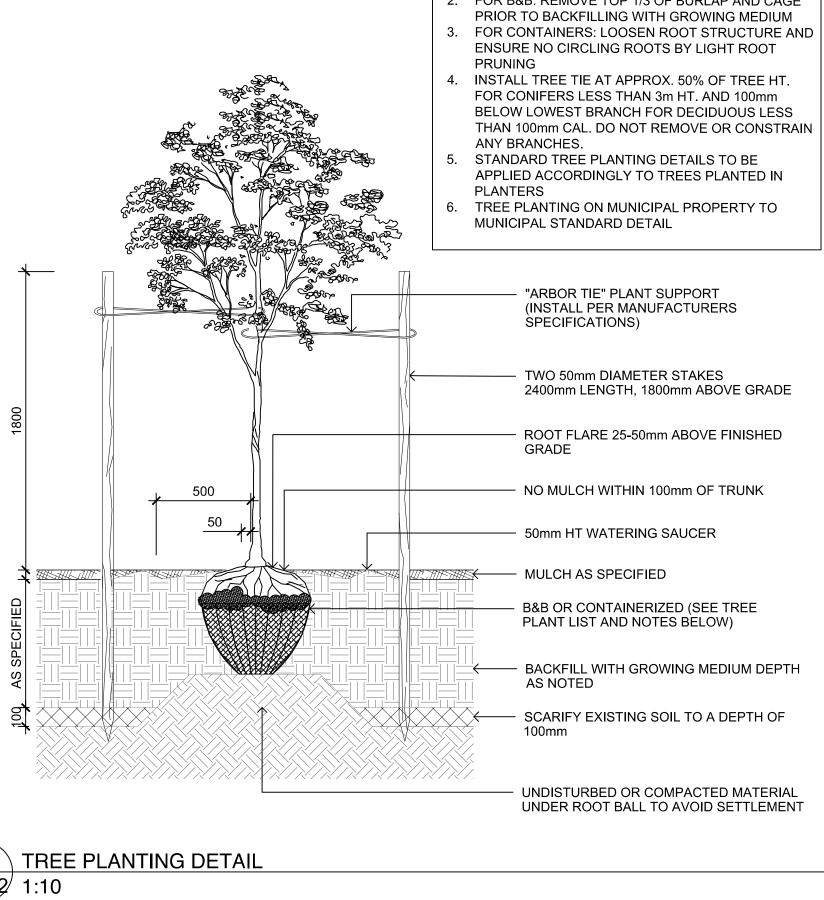
NORTH ARROW

DRAWING TITLE:

SOFTSCAPE DETAILS

DWG NO:


SCALE: 1:100



- 300 mm MIN.

- COMPACTED SUBGRADE

GROWING MEDIUM

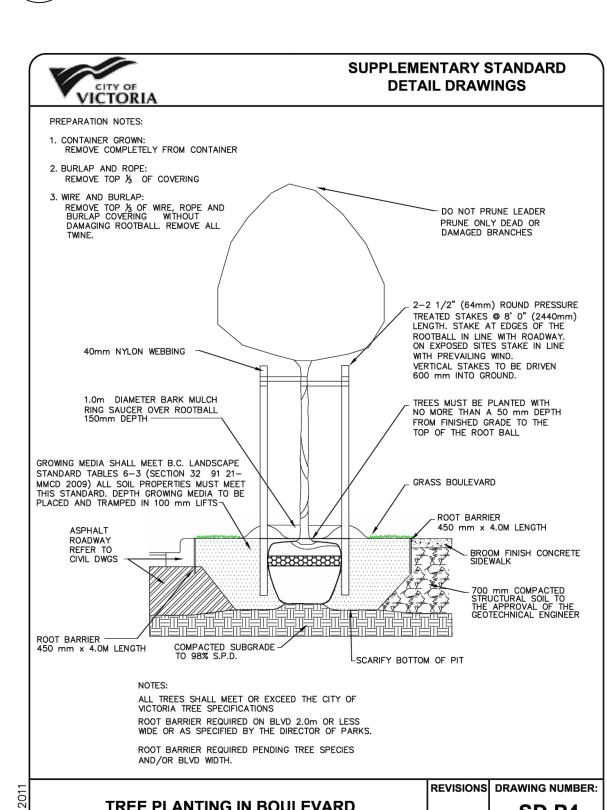

7 WORKING AROUND TREES

