

# LE PARC

# 7 - UNIT RENTAL TOWN HOME DEVELOPMENT

THURLOW RD AND KIPLING ST, VICTORIA, BC

### **CIVIC ADDRESSES**

#### 349 KIPLING

UNIT 1

UNIT 3

UNIT 5

UNIT 6

UNIT 7

#### CODES, BYLAWS & REGULATIONS

ALL WORK SHALL COMPLY WITH THE REQUIREMENTS OF THE CURRENT EDITIONS OF:

 THE NATIONAL BUILDING CODE (NBC); 2. THE BC BUILDING CODE (BCBC);

3. THE BC PLUMBING CODE;

4. THE BC ELECTRICAL CODE; AND 5. ANY AND ALL OTHER AUTHORITIES' REQUIREMENTS HAVING JURISDICTION

1. "ALIGN" SHALL MEAN TO ACCURATELY LOCATE FINISH FACES IN THE SAME PLANE

2. "CLEAR" SHALL MEAN THAT ALL DIMENSIONS IDENTIFIED AS SUCH SHALL BE MAINTAINED AND SHALL ALLOW FOR THICKNESS OF FINISHES.

3. "SIMILAR" OR "SIM." SHALL MEAN COMPARABLE CHARACTERISTICS FOR THE CONDITIONS NOTED.

#### 4. "TYPICAL" OR TYP." SHALL MEAN THAT THE CONDITION IS REPRESENTATIVE FOR SIMILAR CONDITIONS THROUGHOUT, UNLESS OTHERWISE NOTED (U.O.N.).

#### **ABBREVIATIONS**

(E)	EXISTING	IN.	INCHES
A-B	AIR-BARRIER	M-B	MOISTURE-BARRIER
A.F.F.	ABOVE FINISH FLOOR	MANUF.	MANUFACTURER
ALUM	ALUMINUM	MAX	MAXIMUM
AV.	AVERAGE	MIN	MINIMUM
BASEBD	BASEBOARD	MTL	METAL
BCBC	BRITISH COLUMBIA BUILDING CODE	O.C.	ON CENTRE
BD	BOARD	0/	OVER
BLDG	BUILDING	O/LAP	OVERLAP
BTWN	BETWEEN	P.T.	PRESSURE-TREATED
BULKHD	BULKHEAD	PLYWD	PLYWOOD
C.I.P.	CAST-IN-PLACE	PT	POINT
C/W	COMPLETE WITH	REQ'D	REQUIRED
C'BORE	COUNTERBORE	REQ'T	REQUIREMENT
CAB'T	CABINET(S)	S-A	SELF-ADHERED
CALC(S)	CALCULATION(S)	SF	SQUARE FEET
CLR	CLEAR	SM	SQUARE METER(S)
COORD.	COORDINATION/ATE/ATED	ST STL	STAINLESS STEEL
DBL	DOUBLE	STL	STEEL
DDP	DATUM DETERMINATION PT	STRX	STRUCTURE OR STRUCTURAL
DEMO	DEMOLITION	SUBFLR	SUB-FLOOR
DIA	DIAMETER	T&G	TONGUE & GROOVE
DR	DOOR	THRU	THROUGH
EQ	EQUAL	TYP.	TYPICAL
FD	FLOOR DRAIN	U.O.N.	UNLESS OTHERWISE NOTED
FIN. FLR	FINISHED FLOOR	U/	UNDER
FLR	FLOOR	UNFIN.	UNFINISHED
FSR	FLOOR SPACE RATIO	V-B	VAPOUR-BARRIER
G1S	GOOD-1-SIDE	VERT.	VERTICAL
GALV	GALVANIZED	W/	WITH
GWB	GYPSUM WALL BOARD	W/IN	WITHIN
HGT	HEIGHT	W/OUT	WITHOUT
HORIZ.	HORIZONTAL	WD	WOOD
IGU	INSULATED GLASS UNIT	WDW	WINDOW

### **DP LIST OF DRAWINGS (349 KIPLING)**

COVER SHEET

A1.1	SURVEY PLAN	1:200
A1.2	CONTEXT PLAN	1:200
A1.3	CONTEXT STREETSCAPE	1:150
A1.4	SOLAR STUDY	1:500
A1.5	WINDOW OVERLAY	1:120
A1.6	SUSTAINABILITY STRATEGY	NTS
A1.7	AVERAGE GRADE CALCULATION	1:100
A2.0	SITE PLAN	1:100
A2.1	SITE COVERAGE &	1:120
A2.2	FLOOR AREA RATIO	1:150
A3.0	FLOOR PLANS	1:100
A4.0	ELEVATIONS	1:50
A4.1	ELEVATIONS	1:50
A4.2	ELEVATIONS	1:50
A4.3	SECTIONS	1:50
A5.0	UNIT 2 FLOOR PLANS	1:50
A5.1	UNIT 1,2 FLOOR PLANS	1:50
A5.2	UNIT 3 & 4 FLOOR PLANS	1:50
A5.3	UNIT 5 & 6 FLOOR PLANS	1:50
A5.4	UNIT 7 FLOOR PLANS	1:50
A6.0	CONCEPT RENDERINGS	NTS
22	SHEETS IN SET	

#### **TEAM OF CONSULTANTS**

SÉBASTIEN GARON ARCHITECTURE + DESIGN INC SÉBASTIEN GARON, ARCHITECT AIBC (604) 812-1869

#### LANDSCAPE

BIOPHILIA DESIGN COLLECTIVE LTD BIANCA BODLEY (250) 590-1156 BIANCA@BIOPHILIACOLLECTIVE.CA

#### ARBORIST

TALBOT MACKENZIE & ASSOCIATES NOAH BORGES, ISA CERTIFIED ARBORIST (250) 479-8733 TMTREEHELP@GMAIL.COM

#### GEOTECHNICAL

RYZUK GEOTECHNICAL SCOTT CURRIE, P. ENG. (250)-475-3131 SCOTT@RYZUK.COM

#### **CIVIL ENGINEER**

WESTBROOK CONSULTING LTD. IVA KVARTUC, B. ENG. (250) 391-8592 EXT. #235 IKVARTUC@WBROOK.CA

## **STRUCTURAL**

SKYLINE ENGINEERING WADE GRIFFIN (250)-590-4133 EXT. 103

#### ELECTRICAL

JAY SINGH (778) 433-9391 JAY.SINGH@E2ENG.CA

#### MECHANICAL

M3 MECHANICAL CONSULTANTS INC. BRENTON WILLIAMS, P.ENG (250) 940-2256 BCW@M3MECH.CA


#### **BUILDING ENVELOPE** EVOKE

JOHN LITTLE, EIT, RSE (250) 882-8884 JLITTLE@EVOKEBUILDINGS.COM

#### SURVEYOR

J.E.ANDERSON & ASSOCIATES (250) 727-2214 INFO@JEANDERSON.COM



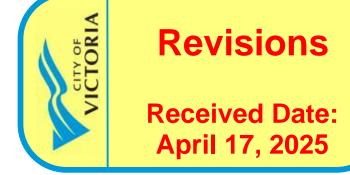

THIS DRAWING IS COPYRIGHTED AND MUST NOT BE USED, REPRODUCED, OR REVISED WITHOUT WRITTEN PERMISSION. VERIFY ALL DIMENSIONS.

DO NOT SCALE THIS DRAWING. REPORT INCONSISTENCIES AND

OMISSIONS TO THE ARCHITECT FOR CLARIFICATION BEFORE COMMENCING WITH THE WORK.



2019-12-12 Revised & Re-Issued for DP 2020-09-21 Revised & Re-Issued for DP Revised & Re-Issued for DP 2022-04-11 Revised & Re-Issued for DP Revised & Re-Issued for DP Revised & Re-Issued for DP 2022-11-25 Revised & Re-Issued for DP ISSUED FOR BP 2024-02-17 BP REVISION "A"

2024-05-30 ISSUED FOR DP

Project Name:

LeParc

KIPLING ST & THURLOW

Project No: 19.015 Drawn By: SG/TD 2025-04-17 NTS Sheet No:

SITE PLAN

This sketch does not constitute a redefinition of the legal boundaries hereon described and is not to be used in any matter which would assume same. J.E. Anderson & Associates accepts no responsibility or liability for any damages that may be suffered by a third party as a result of any decision made, or actions taken based on this document. Subject to charges, legal notations, and interests shown on: Title No. ET59777 (P.I.D. 008-292-345) Lot 13 Title No. CA6094211 (P.I.D. 005-209-510) Lot 35

The intended plot size of this plan is 432mm in width by 560mm

in height, (C size), when plotted at a scale of 1:200.

(604) 812-1869 info@ www.SGAD.ca S

40

R C H

THIS DRAWING IS COPYRIGHTED AND MUST NOT BE USED, REPRODUCED, OR REVISED WITHOUT WRITTEN PERMISSION.

VERIFY ALL DIMENSIONS. DO NOT SCALE THIS DRAWING.

REPORT INCONSISTENCIES AND OMISSIONS TO THE ARCHITECT FOR CLARIFICATION BEFORE COMMENCING WITH THE WORK.



Issued 2019-06-19 Issued for DP

2022-11-25

2019-09-16 Revised & Re-Issued for DP 2019-10-21 Revised & Re-Issued for DP Revised & Re-Issued for DP 2019-12-12 2020-04-29 Revised & Re-Issued for DP 2020-09-21 Revised & Re-Issued for DP 2021-07-20 Revised & Re-Issued for DP 2021-11-21 Revised & Re-Issued for DP 2021-12-16 Revised & Re-Issued for DP 2022-03-30 Revised & Re-Issued for DP 2022-04-11 Revised & Re-Issued for DP 2022-05-10 Revised & Re-Issued for DP 2022-10-06 Revised & Re-Issued for DP 2022-11-04 Revised & Re-Issued for DP 2022-11-14 Revised & Re-Issued for DP

Revised & Re-Issued for DP ISSUED FOR BP 2024-02-17 BP REVISION "A"

2024-05-30 ISSUED FOR DP

Project Name:


LeParc

KIPLING ST & THURLOW

Project No: 19.015 Drawn By: SG/TD Plot Date: 2025-04-17

Sheet No:

1:200

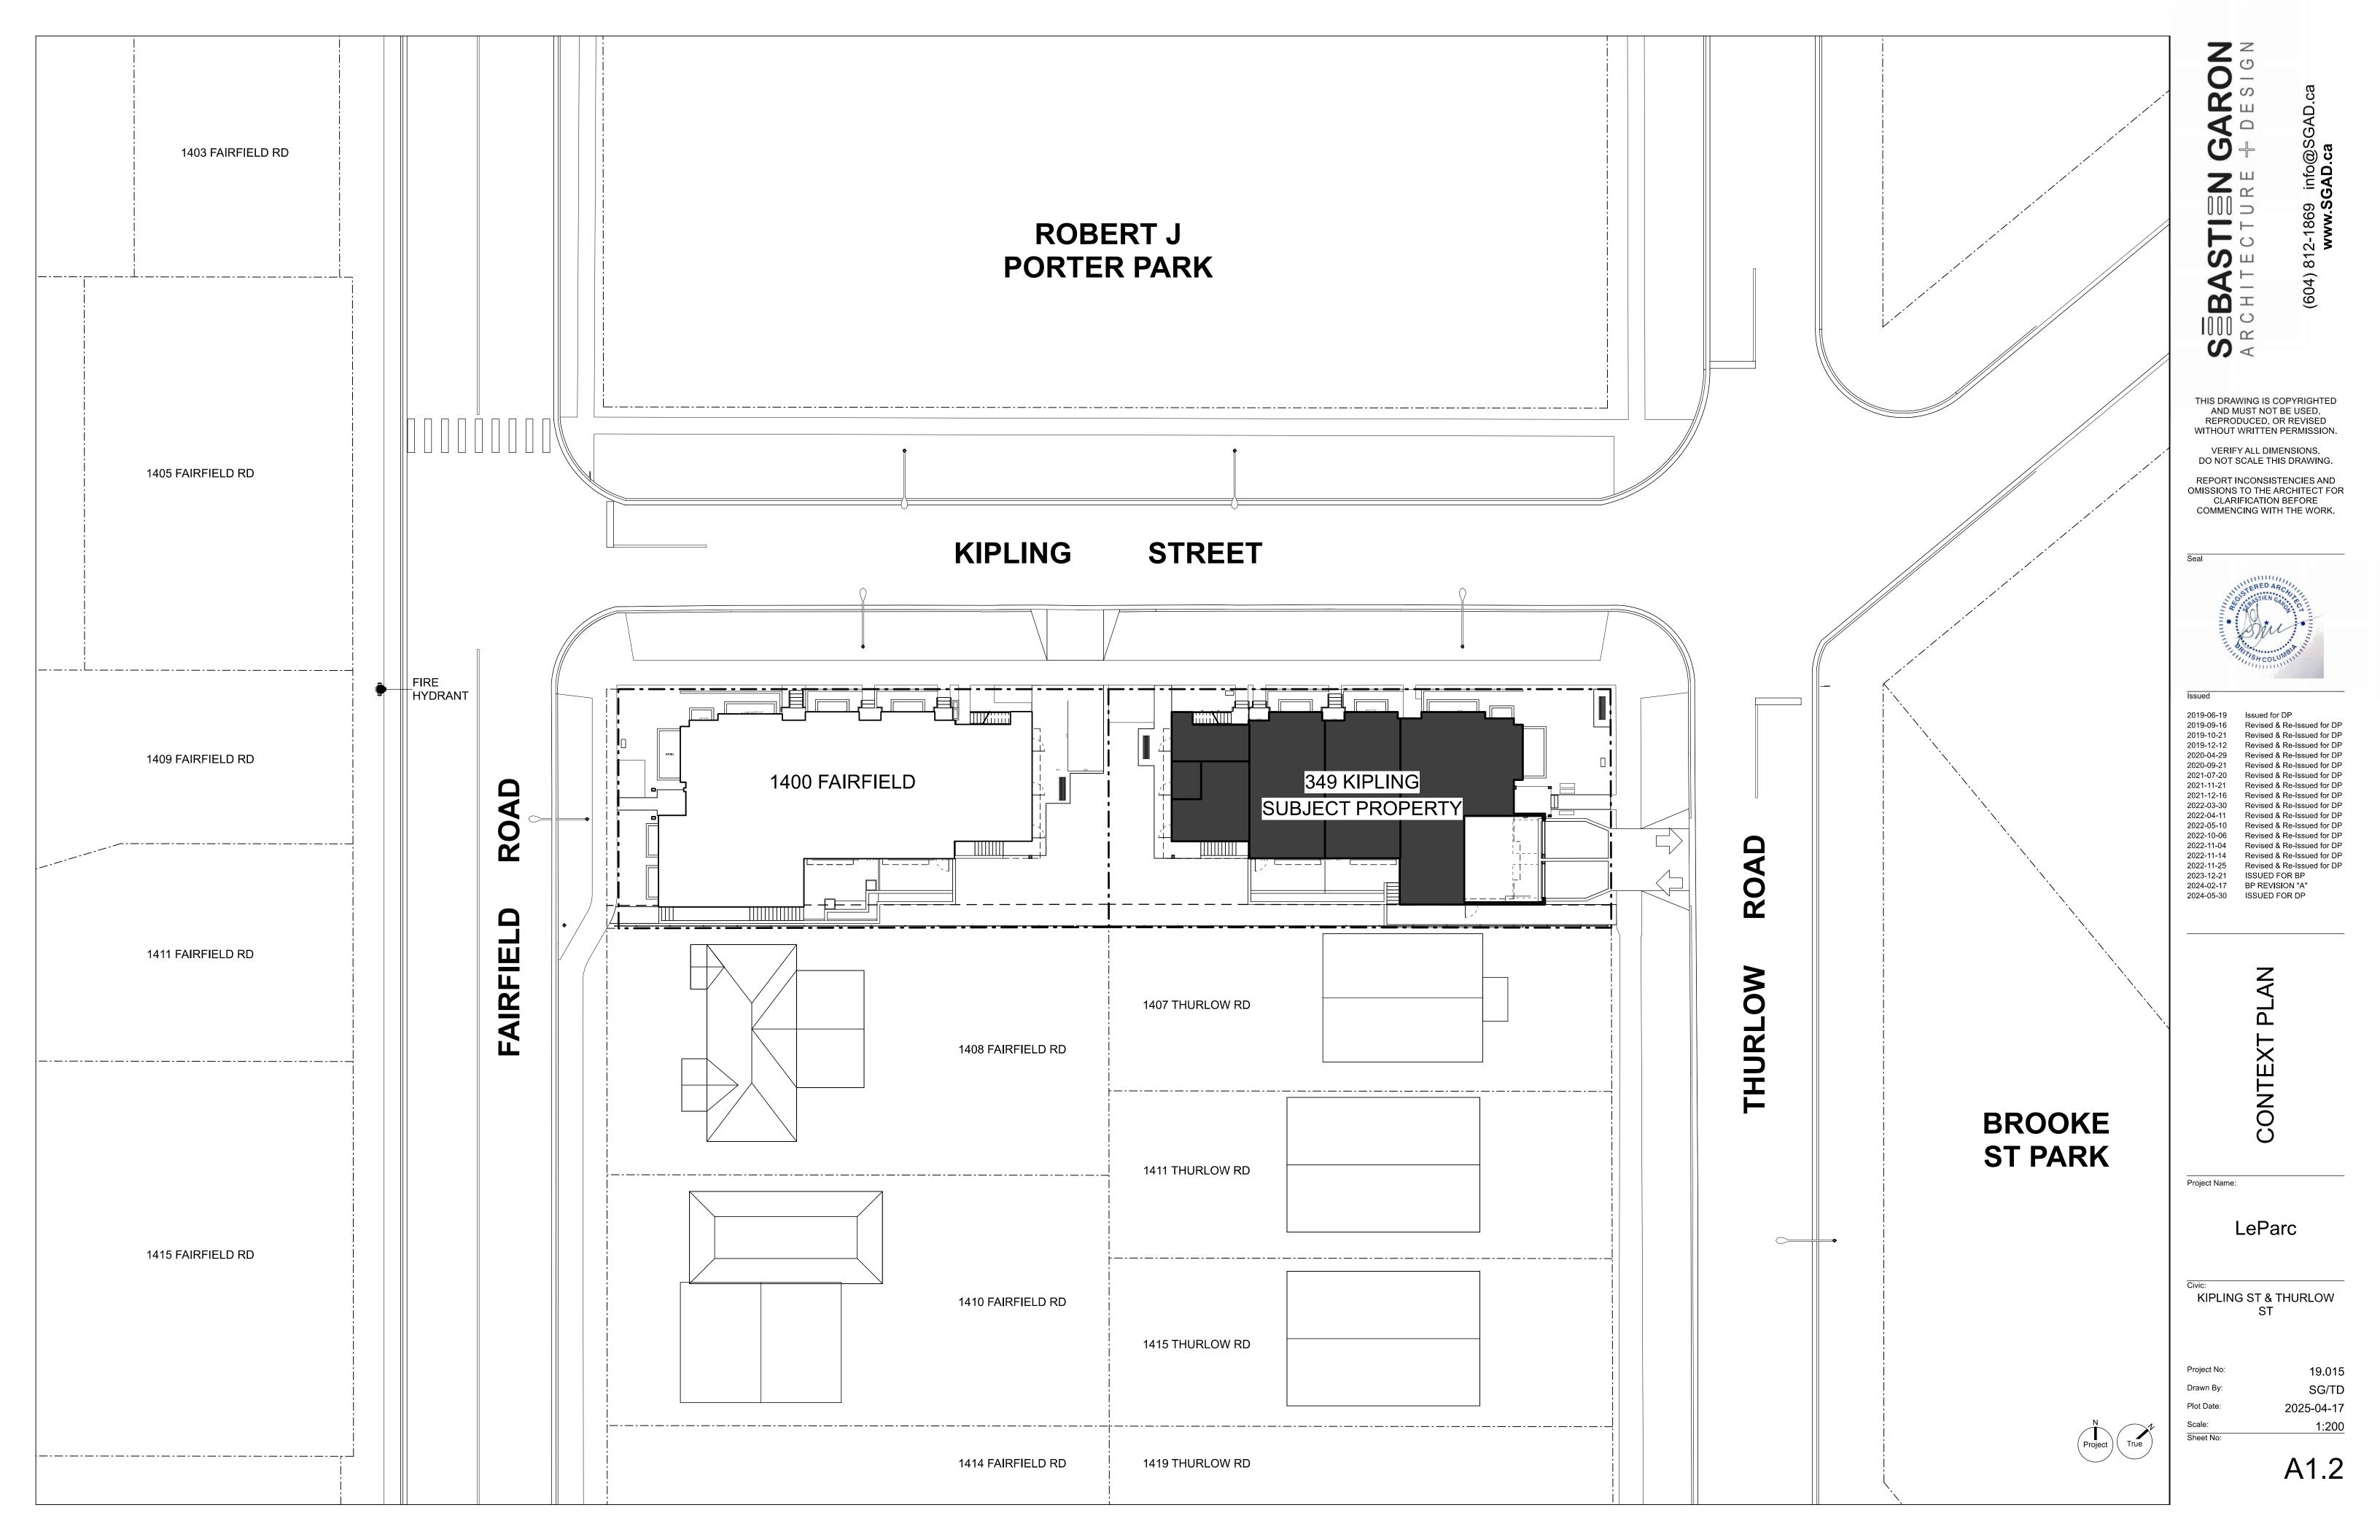

# Streetscape Kipling Street



# Streetscape Thurlow Road Scale: 1:150

SBB

(604) 812-1869 info@SGAD, www.**SGAD.ca** 

THIS DRAWING IS COPYRIGHTED
AND MUST NOT BE USED,
REPRODUCED, OR REVISED
WITHOUT WRITTEN PERMISSION.

VERIFY ALL DIMENSIONS. DO NOT SCALE THIS DRAWING.

REPORT INCONSISTENCIES AND OMISSIONS TO THE ARCHITECT FOR CLARIFICATION BEFORE COMMENCING WITH THE WORK.



2019-06-19 Issued for DP Revised & Re-Issued for DP 2019-09-16 Revised & Re-Issued for DP Revised & Re-Issued for DP 2019-12-12 Revised & Re-Issued for DP 2020-09-21 Revised & Re-Issued for DP 2021-07-20 Revised & Re-Issued for DP 2021-11-21 Revised & Re-Issued for DP 2021-12-16 Revised & Re-Issued for DP 2022-03-30 Revised & Re-Issued for DP 2022-04-11 Revised & Re-Issued for DP 2022-05-10 Revised & Re-Issued for DP 2022-10-06 Revised & Re-Issued for DP Revised & Re-Issued for DP 2022-11-04 2022-11-14 Revised & Re-Issued for DP Revised & Re-Issued for DP 2023-12-21 ISSUED FOR BP 2024-02-17 BP REVISION "A" 2024-05-30 ISSUED FOR DP


Project Name:

LeParc


KIPLING ST & THURLOW ST

Project No: 19.015 SG/TD 2025-04-17 1:150


### MARCH EQUINOX

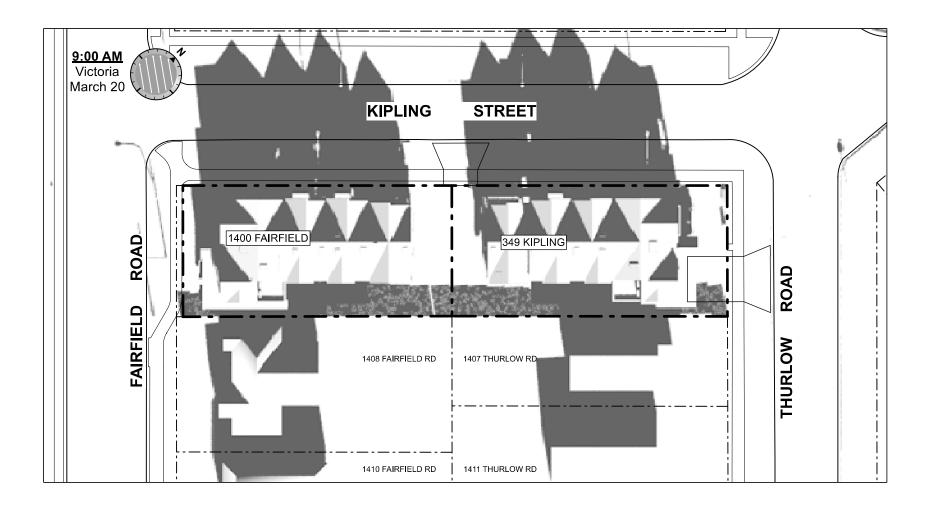



### JUNE SOLSTICE

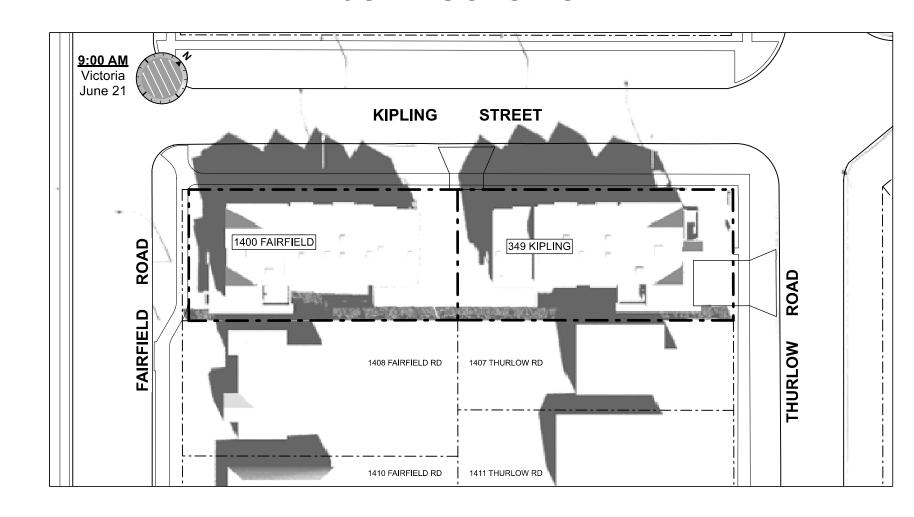



### DECEMBER SOLSTICE

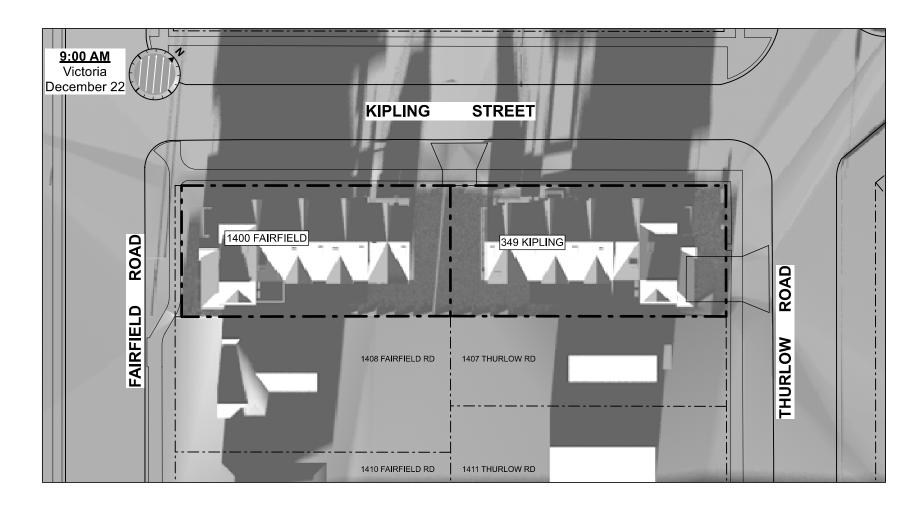


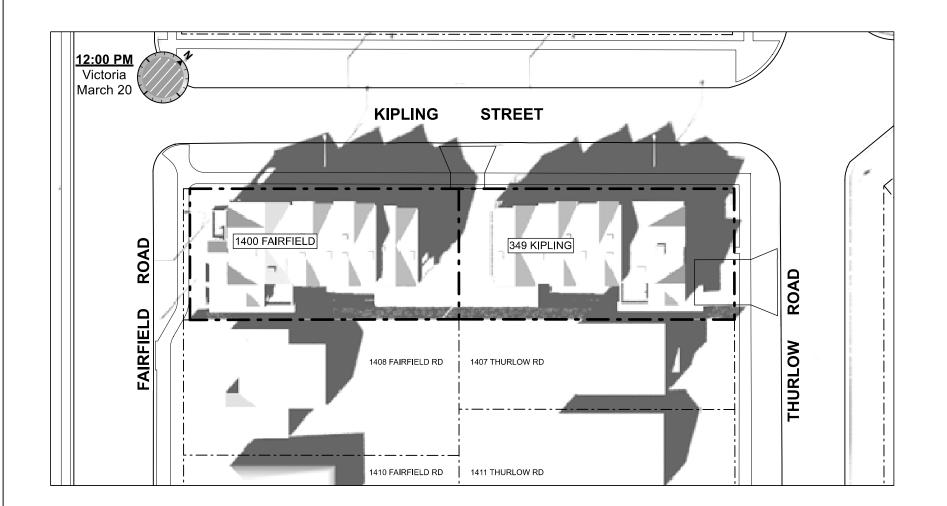


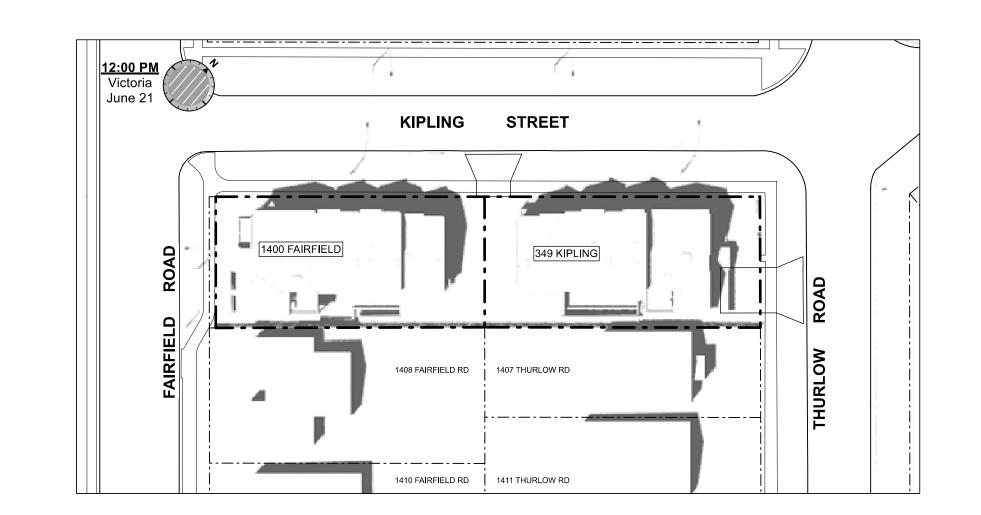

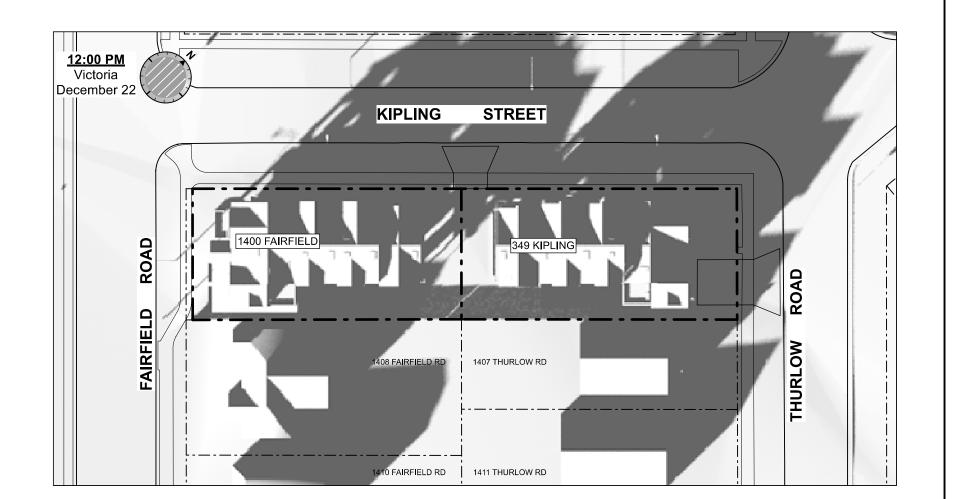

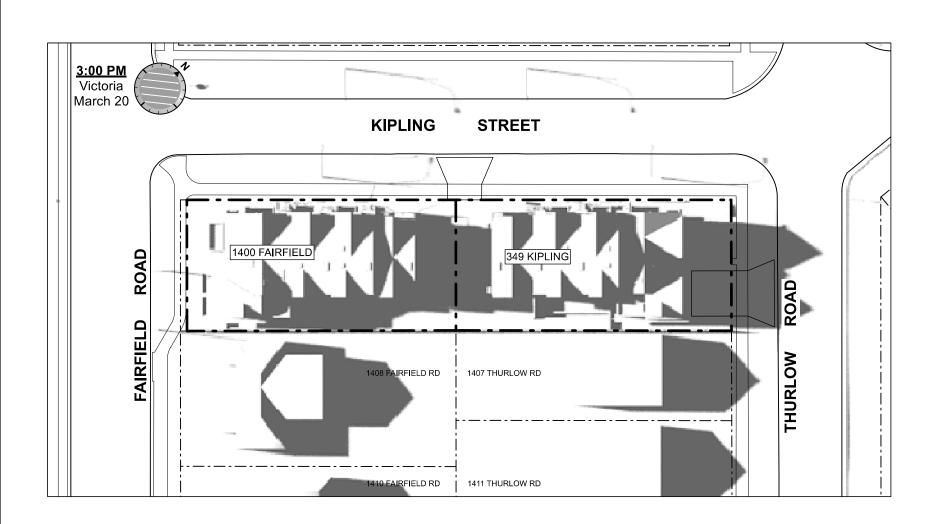

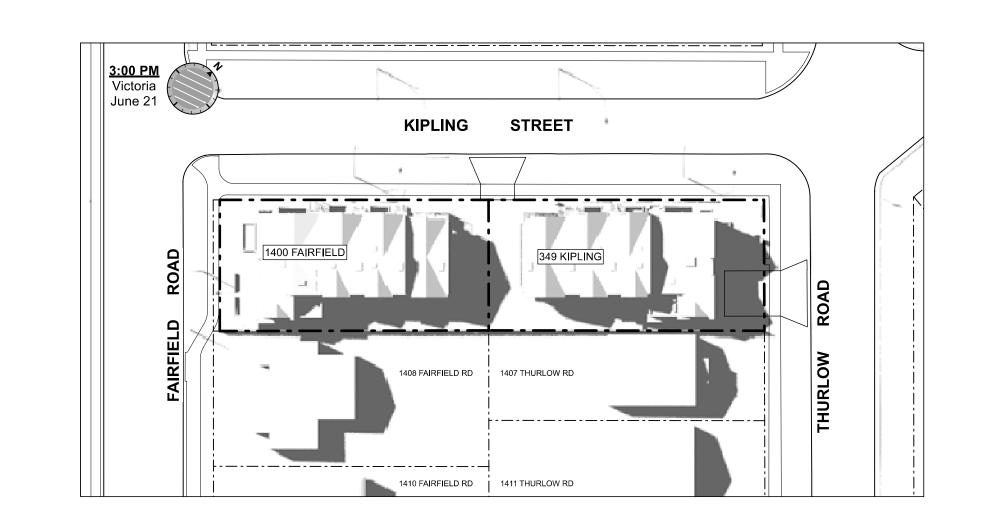

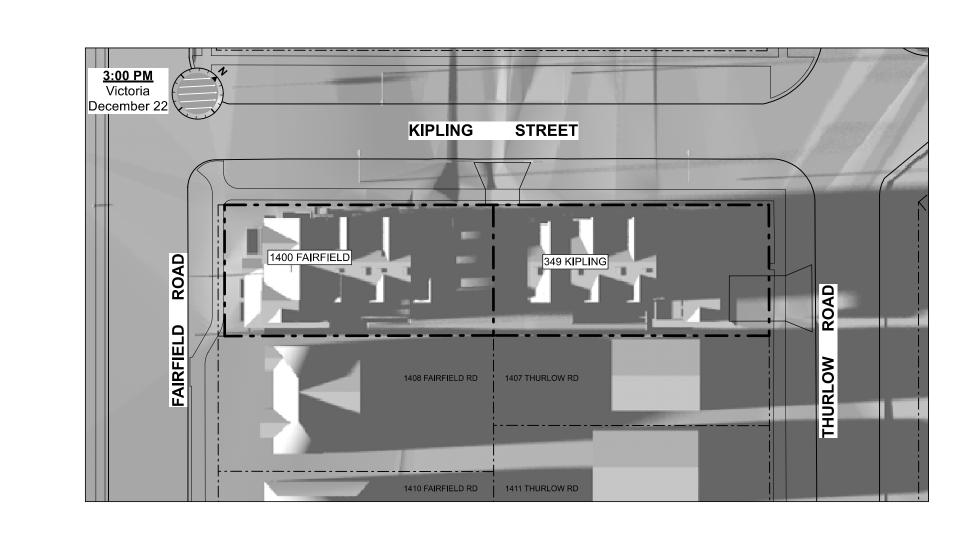

THIS DRAWING IS COPYRIGHTED AND MUST NOT BE USED, REPRODUCED, OR REVISED WITHOUT WRITTEN PERMISSION.

VERIFY ALL DIMENSIONS. DO NOT SCALE THIS DRAWING.

REPORT INCONSISTENCIES AND OMISSIONS TO THE ARCHITECT FOR CLARIFICATION BEFORE COMMENCING WITH THE WORK.

Seal



2019-06-19 Issued for DP
2019-09-16 Revised & Re-Issued for DP
2019-10-21 Revised & Re-Issued for DP
2019-12-12 Revised & Re-Issued for DP

2019-12-12 Revised & Re-Issued for DP Revised & Re-Issued for DP 2020-09-21 Revised & Re-Issued for DP 2021-07-20 Revised & Re-Issued for DP 2021-11-21 Revised & Re-Issued for DP 2021-12-16 Revised & Re-Issued for DP 2022-03-30 2022-04-11 Revised & Re-Issued for DP Revised & Re-Issued for DP 2022-10-06 Revised & Re-Issued for DP 2022-11-04 2022-11-14 Revised & Re-Issued for DP 2022-11-25

2022-11-25 Revised & Re-Issued for DP 2023-12-21 ISSUED FOR BP 2024-02-17 BP REVISION "A" 2024-05-30 ISSUED FOR DP

R STUDY

Project Name:

LeParc

KIPLING ST & THURLOW ST

 Project No:
 19.015

 Drawn By:
 SG/TD


 Plot Date:
 2025-04-17

 Scale:
 1:500

 Sheet No:

REPORT INCONSISTENCIES AND OMISSIONS TO THE ARCHITECT FOR CLARIFICATION BEFORE

COMMENCING WITH THE WORK.

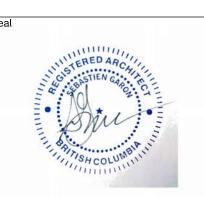

 Issued

 2019-06-19
 Issued for DP

 2019-09-16
 Revised & Re-Issued for DP

 2019-10-21
 Revised & Re-Issued for DP

 2019-12-12
 Revised & Re-Issued for DP

 2020-04-29
 Revised & Re-Issued for DP

 2020-09-21
 Revised & Re-Issued for DP

 2021-07-20
 Revised & Re-Issued for DP

2020-09-21 2021-07-20 Revised & Re-Issued for DP Revised & Re-Issued for DP 2021-12-16 Revised & Re-Issued for DP Revised & Re-Issued for DP 2022-03-30 2022-04-11 Revised & Re-Issued for DP Revised & Re-Issued for DP 2022-10-06 Revised & Re-Issued for DP 2022-11-04 Revised & Re-Issued for DP Revised & Re-Issued for DP 2022-11-25 Revised & Re-Issued for DP

2022-11-14 Revised & Re-Issued for 2022-11-25 Revised & Re-Issued for 2023-12-21 ISSUED FOR BP 2024-02-17 BP REVISION "A" 2024-05-30 ISSUED FOR DP

/INDOW OVERLAY

Project Name:

LeParc

Civic:
KIPLING ST & THURLOW
ST

 Project No:
 19.015


 Drawn By:
 SG/TD

 Plot Date:
 2025-04-17

 Scale:
 1:120

A1.5

### **KIPLING STREET**

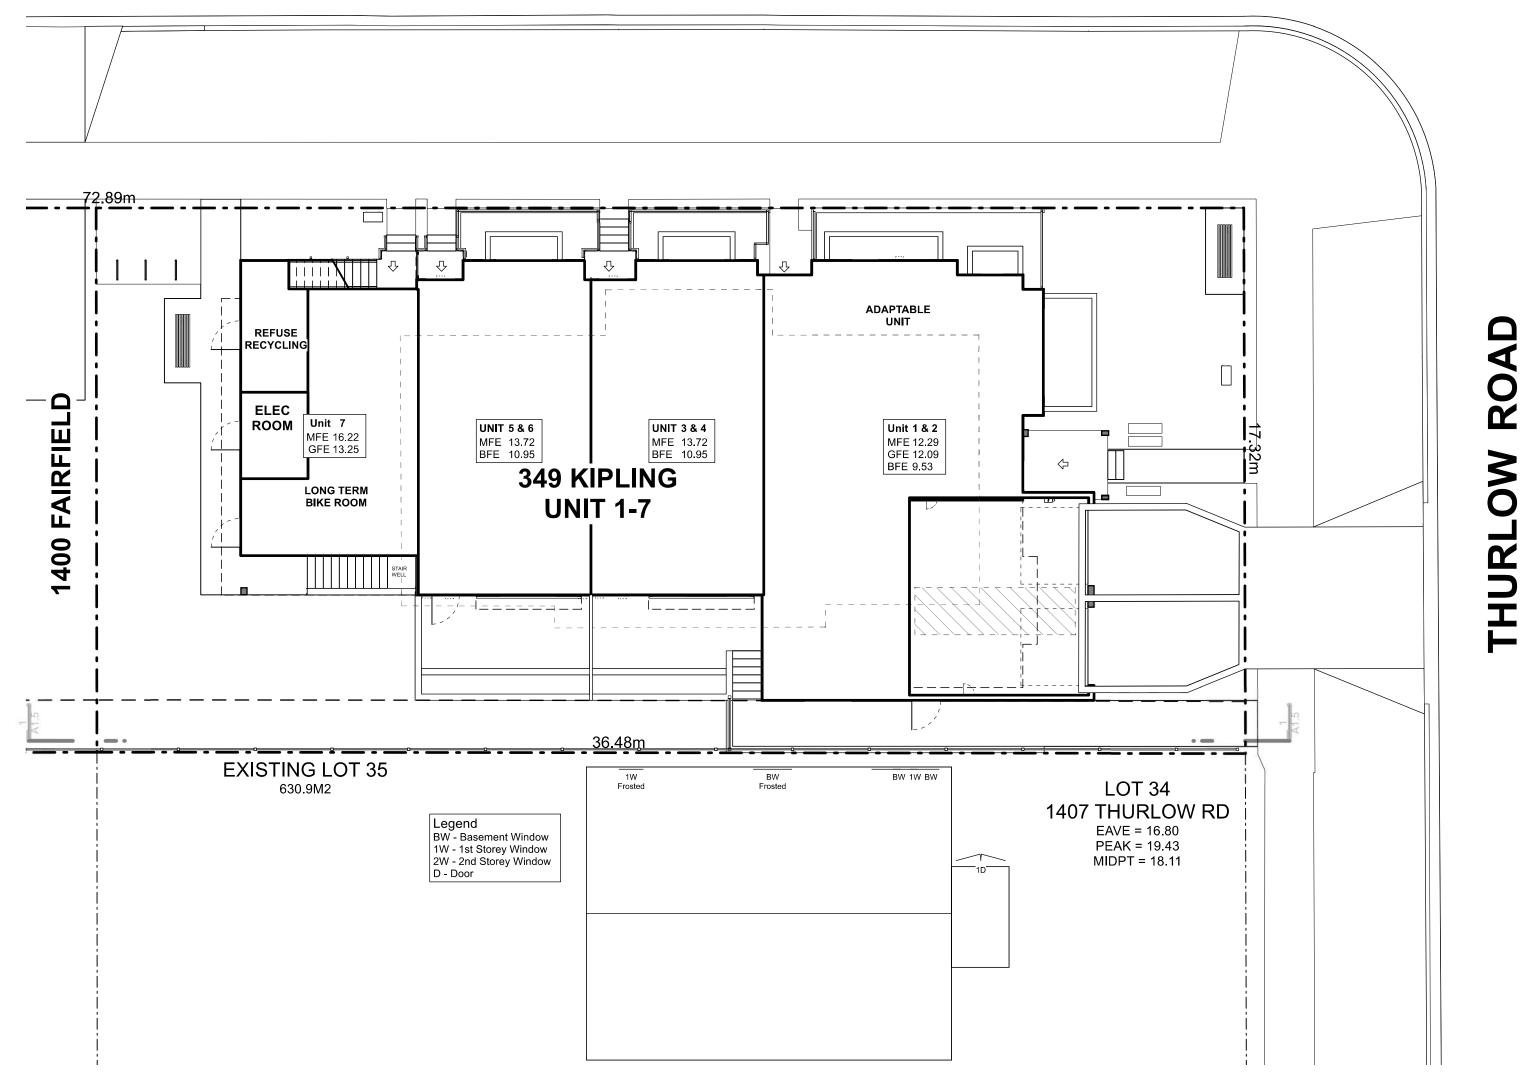

NOTE: DIAGRAMS AS SHOWN ARE FOR ILLUSTRATIVE PURPOSES ONLY. WINDOW LOCATIONS ARE APPROXIMATE AND HAVE NOT BEEN SURVEYED.





### LEGEND

### NO. DESCRIPTION

- 1 READY FOR SOLAR PANELS (ROUGH-IN)
- 2 READY FOR ELECTRIC CAR CHARGING OUTLETS (ROUGH-IN)
- 3 WATER EFFICIENT LANDSCAPING
- 4 ENHANCED BIKE PARKING
- 5 ENHANCED NATURAL LIGHT
- 6 ENERGY EFFICIENT LIGHT FIXTURES
- 7 WATER EFFICIENT PLUMBING FIXTURES
- 8 LOW-VOC INTERIOR FINISHES

STIEN GARON

THIS DRAWING IS COPYRIGHTED AND MUST NOT BE USED, REPRODUCED, OR REVISED WITHOUT WRITTEN PERMISSION.

VERIFY ALL DIMENSIONS. DO NOT SCALE THIS DRAWING.

REPORT INCONSISTENCIES AND OMISSIONS TO THE ARCHITECT FOR CLARIFICATION BEFORE COMMENCING WITH THE WORK.

Seal



#### Issued

 2019-06-19
 Issued for DP

 2019-09-16
 Revised & Re-Issued for DP

 2019-10-21
 Revised & Re-Issued for DP

 2019-12-12
 Revised & Re-Issued for DP

 2020-04-29
 Revised & Re-Issued for DP

 2020-09-21
 Revised & Re-Issued for DP

 2021-07-20
 Revised & Re-Issued for DP

 2021-11-21
 Revised & Re-Issued for DP

 2021-12-16
 Revised & Re-Issued for DP

 2022-03-30
 Revised & Re-Issued for DP

 2022-04-11
 Revised & Re-Issued for DP

 2022-05-10
 Revised & Re-Issued for DP

 2022-11-04
 Revised & Re-Issued for DP

 2022-11-04
 Revised & Re-Issued for DP

 2022-11-14
 Revised & Re-Issued for DP

 2022-11-25
 Revised & Re-Issued for DP

 2023-12-21
 ISSUED FOR BP

2023-12-21 ISSUED FOR BP 2024-02-17 BP REVISION "A" 2024-05-30 ISSUED FOR DP

SUSTAINABILITY

Project Name:

LeParc

KIPLING ST & THURLOW ST


 Project No:
 19.015

 Drawn By:
 SG/TD

 Plot Date:
 2025-04-17

 Scale:
 NTS


 Sheet No:

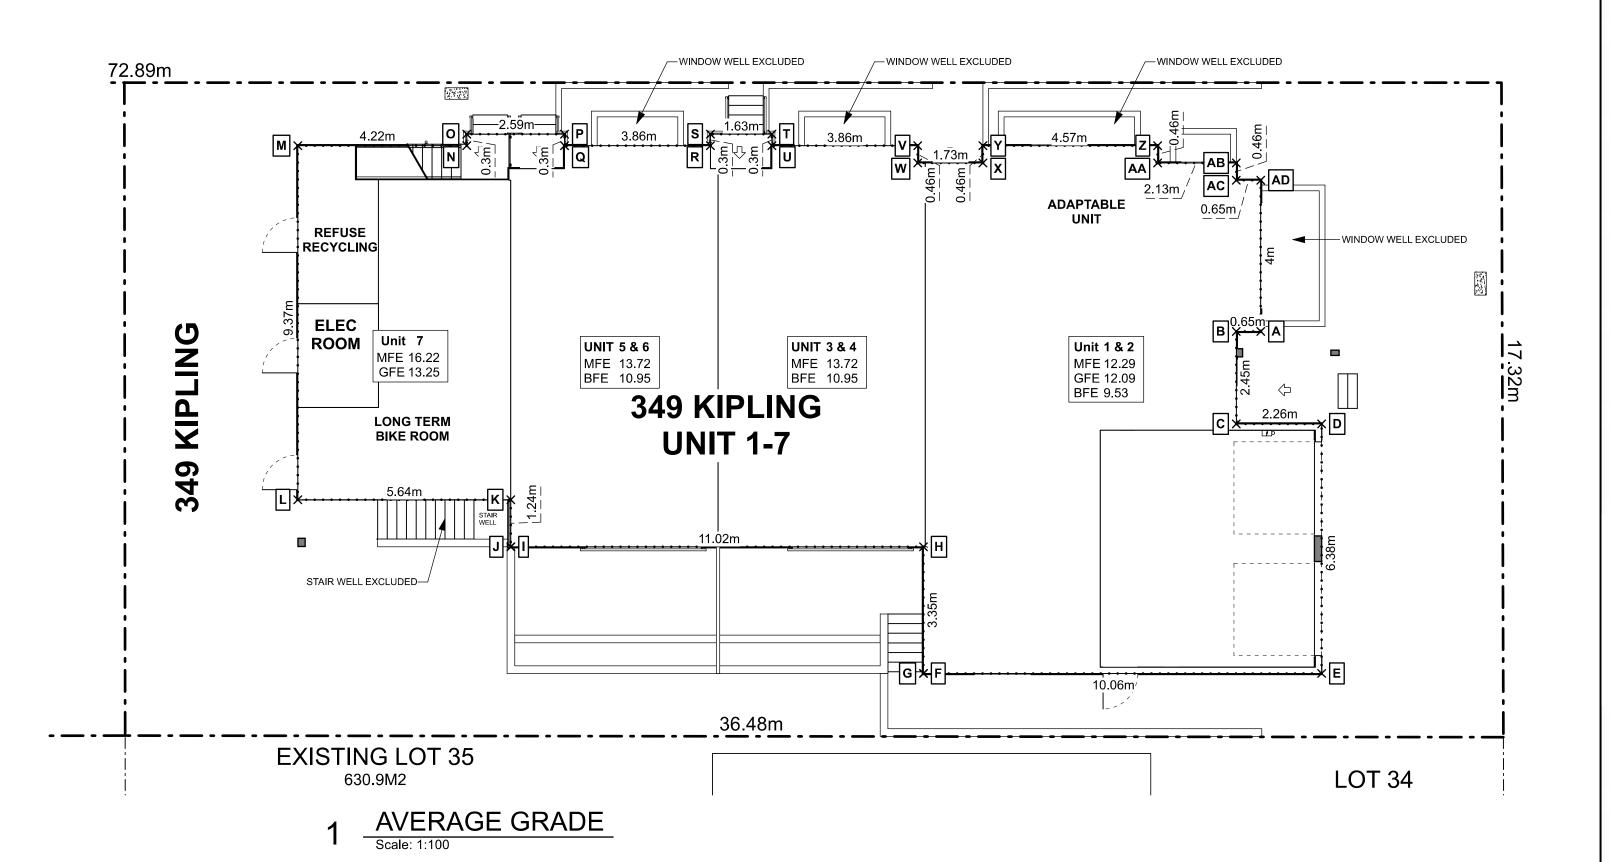

"Grade" means the elevation calculated by averaging the elevation of <u>natural grade</u> or <u>finished grade</u>, whichever is lower at any points at which any part of a building comes into contact with the surface of a lot, excluding any artificial mounds of earth or rocks placed at or near the wall of a building, and excluding the minimum window well width and depth required by the British Columbia Building Code." building = 65m Artificial Mound(s) Horizontal distance above existing grade between grade points -(Not Included) → CExisting & Finished Grade **Grade Points** Grade Point A: 19.0 Grade Point D: 19.2 Grade Point G: 20.2 Grade Point B: 17.5 Grade Point E: 19.3 Grade Point H: 20.4 Grade Point C: 17.5 Grade Point F: 20.0 Grade Point J: 20.4 **Calculation Example** Average of Points Distance Between Totals **Grade Points**  $((17.5 + 17.5) \div 2)$  x 3.5m Points B & C: = 61.25 Points D & E: ((19.2 + 19.3) ÷ 2) x 10m = 192.5 Points E & F:  $((19.3 + 20.0) \div 2)$  x 14m = 275.1 Points F & G: ((20.0 + 20.2) ÷ 2) x 6m = 120.6 Points G & H: ((20.2 + 20.4) ÷ 2) x 5m = 101.5 Points H & J: ((20.4 + 20.4) ÷ 2) x 7.5m = 153.0 Points J & A: ((20.4 + 19.0) ÷ 2) x 19m = 374.3= 1278.25 **Grade Calculation** Street 1278.25 ÷ 65m (permiter of building) = 19.67

#### **GRADE CALCULATIONS**

	Graue	Grade	Grade	Grade	_			
Α	12.36 m	12.09 m	12.09 m —>	<b>B</b> 12.09 m	12.09 m	x 0.65 m	7.86	
В	12.30 m	12.09 m	12.09 m —>	<b>C</b> 12.09 m	12.09 m	x 2.45 m	29.62	
С	12.30 m	12 <b>.</b> 09 m	12.09 m —>	<b>D</b> 12.09 m	12.09 m	x 2.26 m	27.32	
D	12.33 m	12.09 m	12.09 m —>	<b>E</b> 12.09 m	12.09 m	x 6.38 m	77.12	
E	12.30 m	12.09 m	12.09 m —>	<b>F</b> 12.09 m	12.09 m	x 10.06 m	121.62	
F	12.56 m	12.09 m	12.09 m —>	<b>G</b> 10.80 m	Step Up			
G	12.60 m	10.80 m	10.80 m —>	<b>H</b> 10.80 m	10.80 m	x 3.35 m	36.20	
н	12.49 m	10.80 m	10.80 m —>	I 10.80 m	10.80 m	x 11.02 m	119.07	
3.€	40 70	40.00	40.00	1 44 00	0111-			
						Roof Peak		
					( *-	Mid Point		1
					Height			
					Ť	Eave		
				1				
Height		a		ght	<b>b</b>		ght	Œ
H.		Flat Roo	f	Height	Pitched Roo	of	Height	Roof with

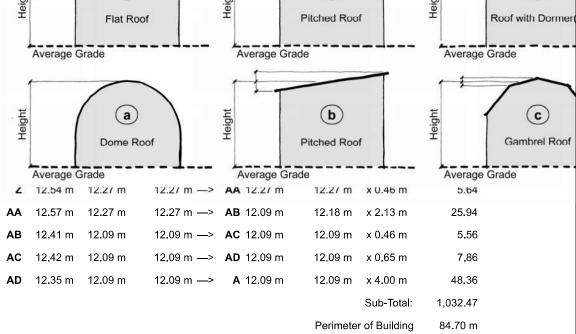

Average Grade 12.19 m

CHITECTURE & DESIGN

THIS DRAWING IS COPYRIGHTED AND MUST NOT BE USED, REPRODUCED, OR REVISED WITHOUT WRITTEN PERMISSION.

S

VERIFY ALL DIMENSIONS. DO NOT SCALE THIS DRAWING.

REPORT INCONSISTENCIES AND OMISSIONS TO THE ARCHITECT FOR CLARIFICATION BEFORE COMMENCING WITH THE WORK.

Seal



2019-09-16 Revised & Re-Issued for DP Revised & Re-Issued for DP Revised & Re-Issued for DP 2019-12-12 Revised & Re-Issued for DP 2020-09-21 Revised & Re-Issued for DP 2021-07-20 Revised & Re-Issued for DP Revised & Re-Issued for DP 2021-12-16 Revised & Re-Issued for DP 2022-03-30 Revised & Re-Issued for DP 2022-04-11 Revised & Re-Issued for DP 2022-05-10 Revised & Re-Issued for DP 2022-10-06 Revised & Re-Issued for DP 2022-11-04 Revised & Re-Issued for DP

2022-11-25 Revised & Re-Issued for DP
2023-12-21 ISSUED FOR BP
2024-02-17 BP REVISION "A"
2024-05-30 ISSUED FOR DP

Revised & Re-Issued for DP

AVERAGE GRADE

Project Name:

LeParc

KIPLING ST & THURLOW ST

 Project No:
 19.015

 Drawn By:
 SG/TD

 Plot Date:
 2025-04-17

 Scale:
 1:100

### PROJECT DATA - 349 KIPLING

	GFA Area (SF)	Zoning Area (SF)	Site Area (SF)	FAR	Bedrm
Unit 1-7	9,498	7,242	6,791	1.06	15
Basement	1,893	0			-
Main Floor	2,222	2,326			
Second Floor	2,937	2,794			
Third Storey	2,446	2,122			
Garage	419	187	Excluded from FAR		
Refuse	75	75	Excluded from FAR		
Electrical Room	54	116	Excluded from FAR		
Bike Room	339	700	Excluded from FAR		
Total Floor Area	10,384		All Included		

Floor Space Ratio; The building area is measured to the interior side of the exterior wall and interior face of demising walls. Basements excluded.

### ZONING RECONCILIATION - SCHEDULE P

349 KIPLING				
CIVIC ADDRESS:	VARIES			
LEGAL ADDRESS:	Lot 35 Fairfield Farn	n		
	Estate Victoria VIP8	84		
EXISTING ZONING:	R1-B			
SITE AREA:	630.9 M2			
FSR	MAX 1.1		PROPOSED:	1.06
SITE OPEN SPACE	MIN 45%		45.6%	287.50 M2
LOT COVERAGE	MAX 50%		49.8%	314.09 M2
SETBACKS	MINIMUM		PROPOSED	
FRONT YARD	2.00 m		4.35 m	14.27 FT
REAR YARD	2.00 m		4.59 m	15.06 FT
EXTERIOR SIDE YARD	2.00 m		1.67 m	5.48 FT
INTERIOR SIDE YARD	2.00 m		1.66 m	5.45 FT
BUILDING HEIGHT	MAXIMUM	12.00 m	PROPOSED	11.46 m
VEHICLE PARKING	REQUIRED:	1 stalls	PROPOSED:	1 stalls
ACCESSIBLE PARKING	1 REQUIRED	1 stalls		1 stalls
VISTOR	0 REQUIRED	0.0 stalls		0 stalls
BICYCLE PARKING	REQUIRED:	14 stalls	PROPOSED:	14 stalls

LONG TERM DWELLING UNIT 2 / Unit 14 stalls 14 stalls

NO BIKE REQUIRED WITH A DWELLING THAT HAS A PRIVATE GARAGE

15% ARE REQUIRED TO BE OVERSIZED 2.1 stalls 3.0 stalls

50% ARE REQUIRED TO BE HAVE BIKE CHARGING STATION

BICYCLE MAINTENANCE FACILITY TO BE PROVIDED 0.9MX2.4M WITH GAUCET AND DRAIN

FACILITY TO BE PROVIDED 0.9MX2.4M WITH GAUCET AND DRAIN

6 stalls

6 stalls

VERIFY ALL DIMENSIONS.
DO NOT SCALE THIS DRAWING.

REPORT INCONSISTENCIES AND OMISSIONS TO THE ARCHITECT FOR

THIS DRAWING IS COPYRIGHTED AND MUST NOT BE USED,

REPRODUCED, OR REVISED

WITHOUT WRITTEN PERMISSION.

CLARIFICATION BEFORE COMMENCING WITH THE WORK.



Issued	
2019-06-19	Issued for DP
2019-09-16	Revised & Re-Issued for DP
2019-10-21	Revised & Re-Issued for DP
2019-12-12	Revised & Re-Issued for DP
2020-04-29	Revised & Re-Issued for DP
2020-09-21	Revised & Re-Issued for DP
2021-07-20	Revised & Re-Issued for DP
2021-11-21	Revised & Re-Issued for DP
2021-12-16	Revised & Re-Issued for DP
2022-03-30	Revised & Re-Issued for DP
2022-04-11	Revised & Re-Issued for DP
2022-05-10	Revised & Re-Issued for DP
0000 40 00	D : 10D 1 16 DD

2022-11-14 Revised & Re-Issued for DP
2022-11-25 Revised & Re-Issued for DP
2023-12-21 ISSUED FOR BP
2024-02-17 BP REVISION "A"
2024-05-30 ISSUED FOR DP

E PLAN

Project Name:

LeParc

Civic:
KIPLING ST & THURLOW
ST

 Project No:
 19.015


 Drawn By:
 SG/TD


 Plot Date:
 2025-04-17

 Scale:
 1:100


A SITE SECTION A

Scale: 1:100

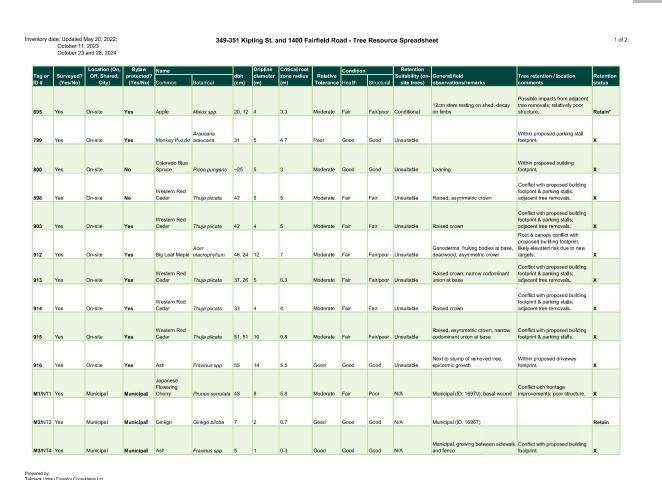

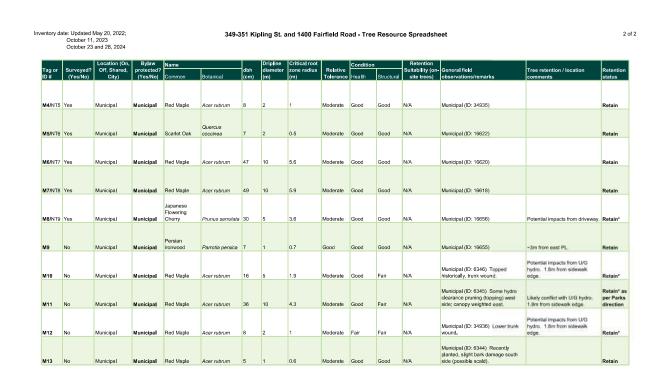

Prepared by:
Talmack Urben Forestry Consultants Ltd.
Box 46153. RPO Uptown
Victoria, BC V8Z 7H6
Ph: (250) 479-9733 - Fax: (250) 479-7050
Email: Intreohelp@gmail.com

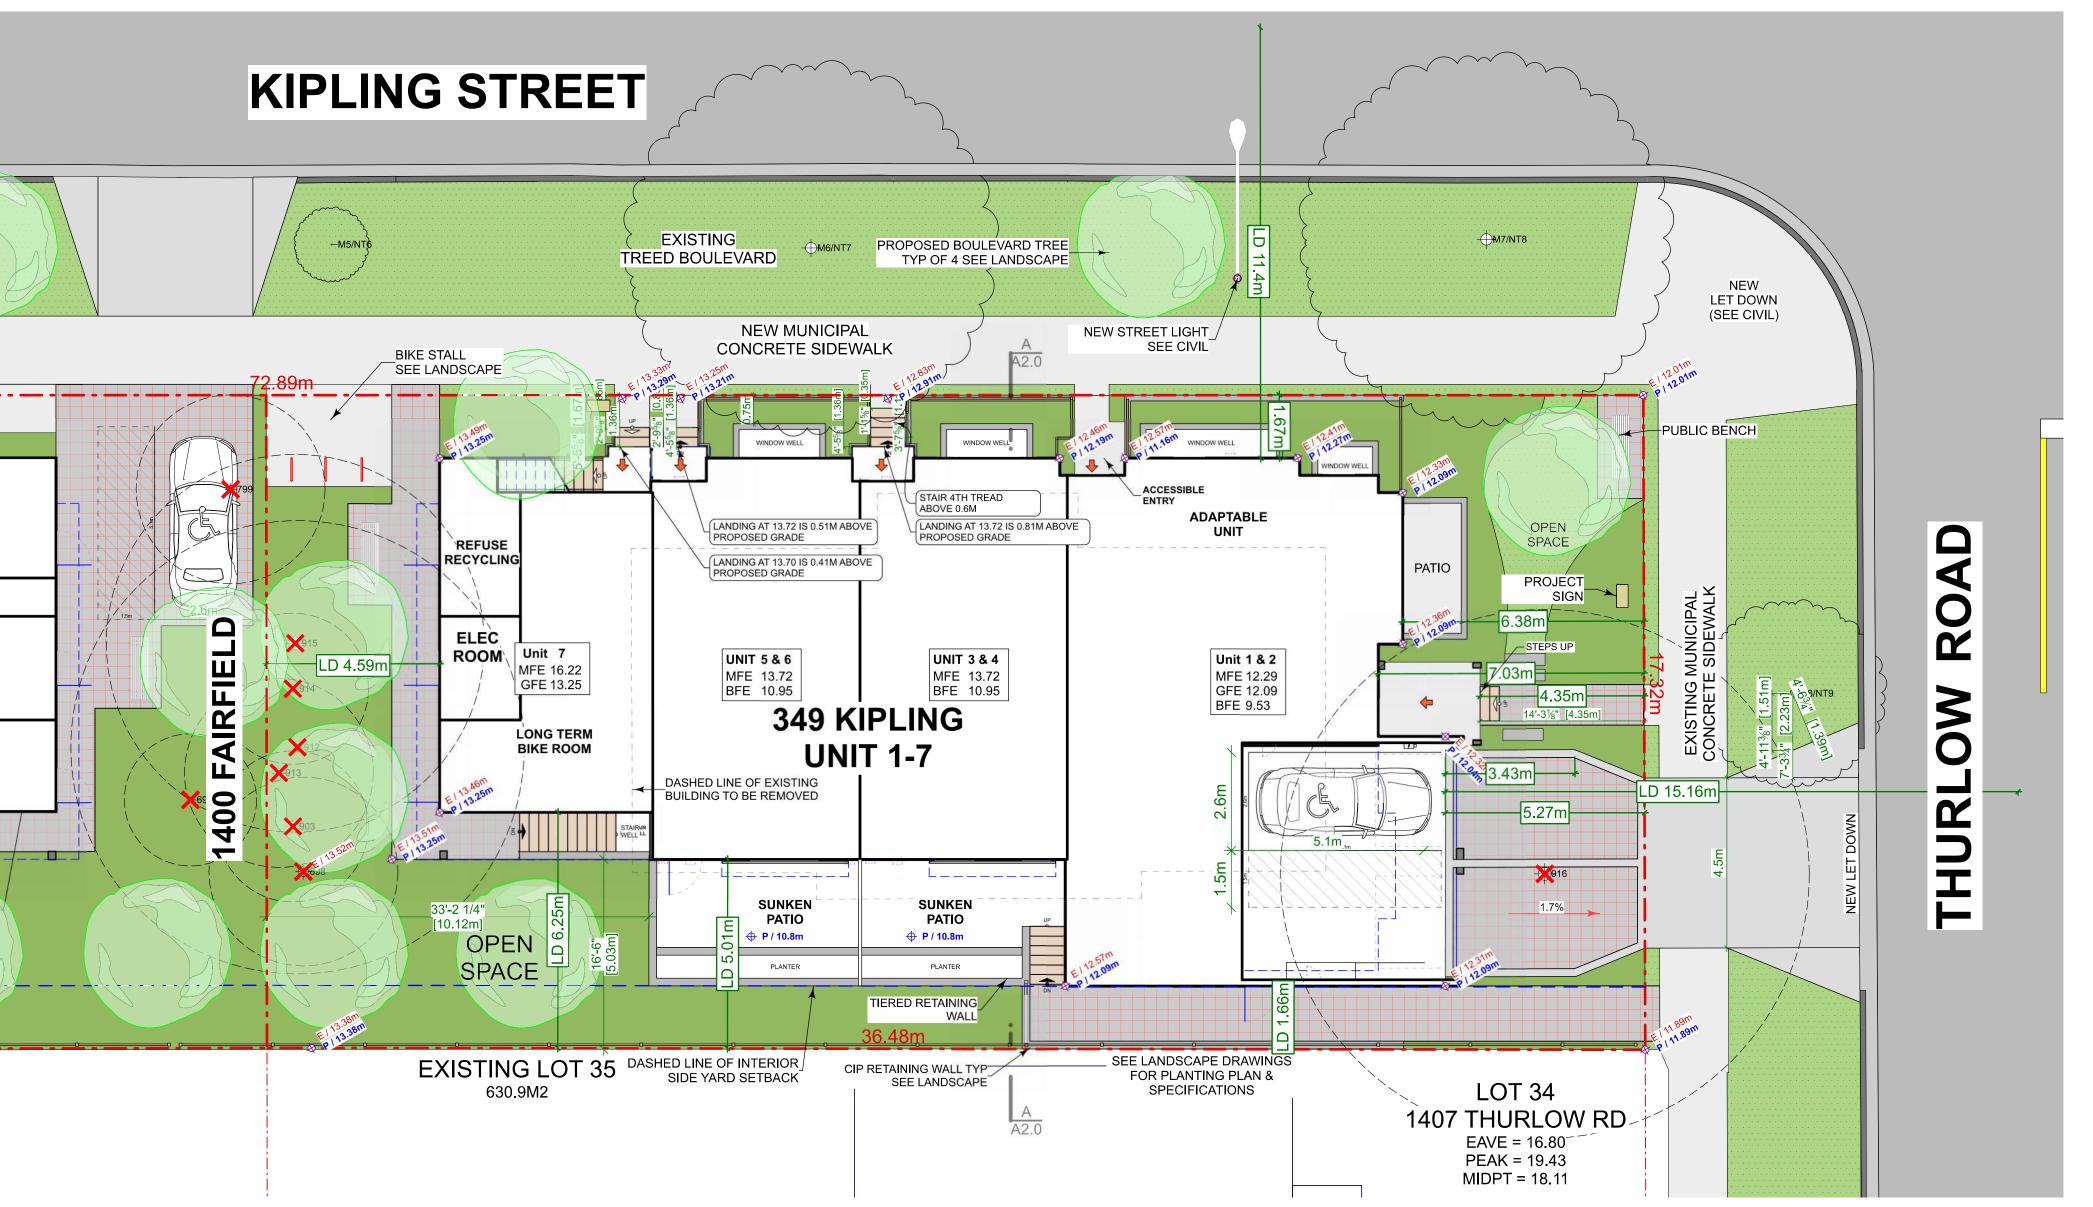



OPEN SITE SPACE

"OPEN SITE SPACE" MEANS THAT PORTION OF A LOT WHICH IS LANDSCAPED AND NOT OCCUPIED OR OBSTRUCTED BY ANY BUILDING OR PORTION OF BUILDING, DRIVEWAY OR PARKING LOT; EXCLUDING ACCESSORY GARDEN STRUCTURES, BALCONIES AND ROOF PROJECTIONS.

S

THIS DRAWING IS COPYRIGHTED AND MUST NOT BE USED, REPRODUCED, OR REVISED WITHOUT WRITTEN PERMISSION.

VERIFY ALL DIMENSIONS. DO NOT SCALE THIS DRAWING.

REPORT INCONSISTENCIES AND OMISSIONS TO THE ARCHITECT FOR CLARIFICATION BEFORE COMMENCING WITH THE WORK.



2019-06-19 Issued for DP 2019-09-16 Revised & Re-Issued for DP 2019-10-21 Revised & Re-Issued for DP 2019-12-12 Revised & Re-Issued for DP 2020-04-29 Revised & Re-Issued for DP 2020-09-21 Revised & Re-Issued for DP 2021-07-20 Revised & Re-Issued for DP 2021-11-21 Revised & Re-Issued for DP 2021-12-16 Revised & Re-Issued for DP Revised & Re-Issued for DP 2022-03-30 2022-04-11 Revised & Re-Issued for DP 2022-05-10 Revised & Re-Issued for DP 2022-10-06 Revised & Re-Issued for DP 2022-11-04 Revised & Re-Issued for DP 2022-11-14 Revised & Re-Issued for DP 2022-11-25 Revised & Re-Issued for DP 2023-12-21 ISSUED FOR BP 2024-02-17 BP REVISION "A" 2024-05-30 ISSUED FOR DP

> ∞ Ш SITE COVERAGE OPEN SITE SPAC


Project Name:


LeParc

KIPLING ST & THURLOW

Project No: 19.015 Drawn By: SG/TD 2025-04-17 1:120 Sheet No:

A2.1

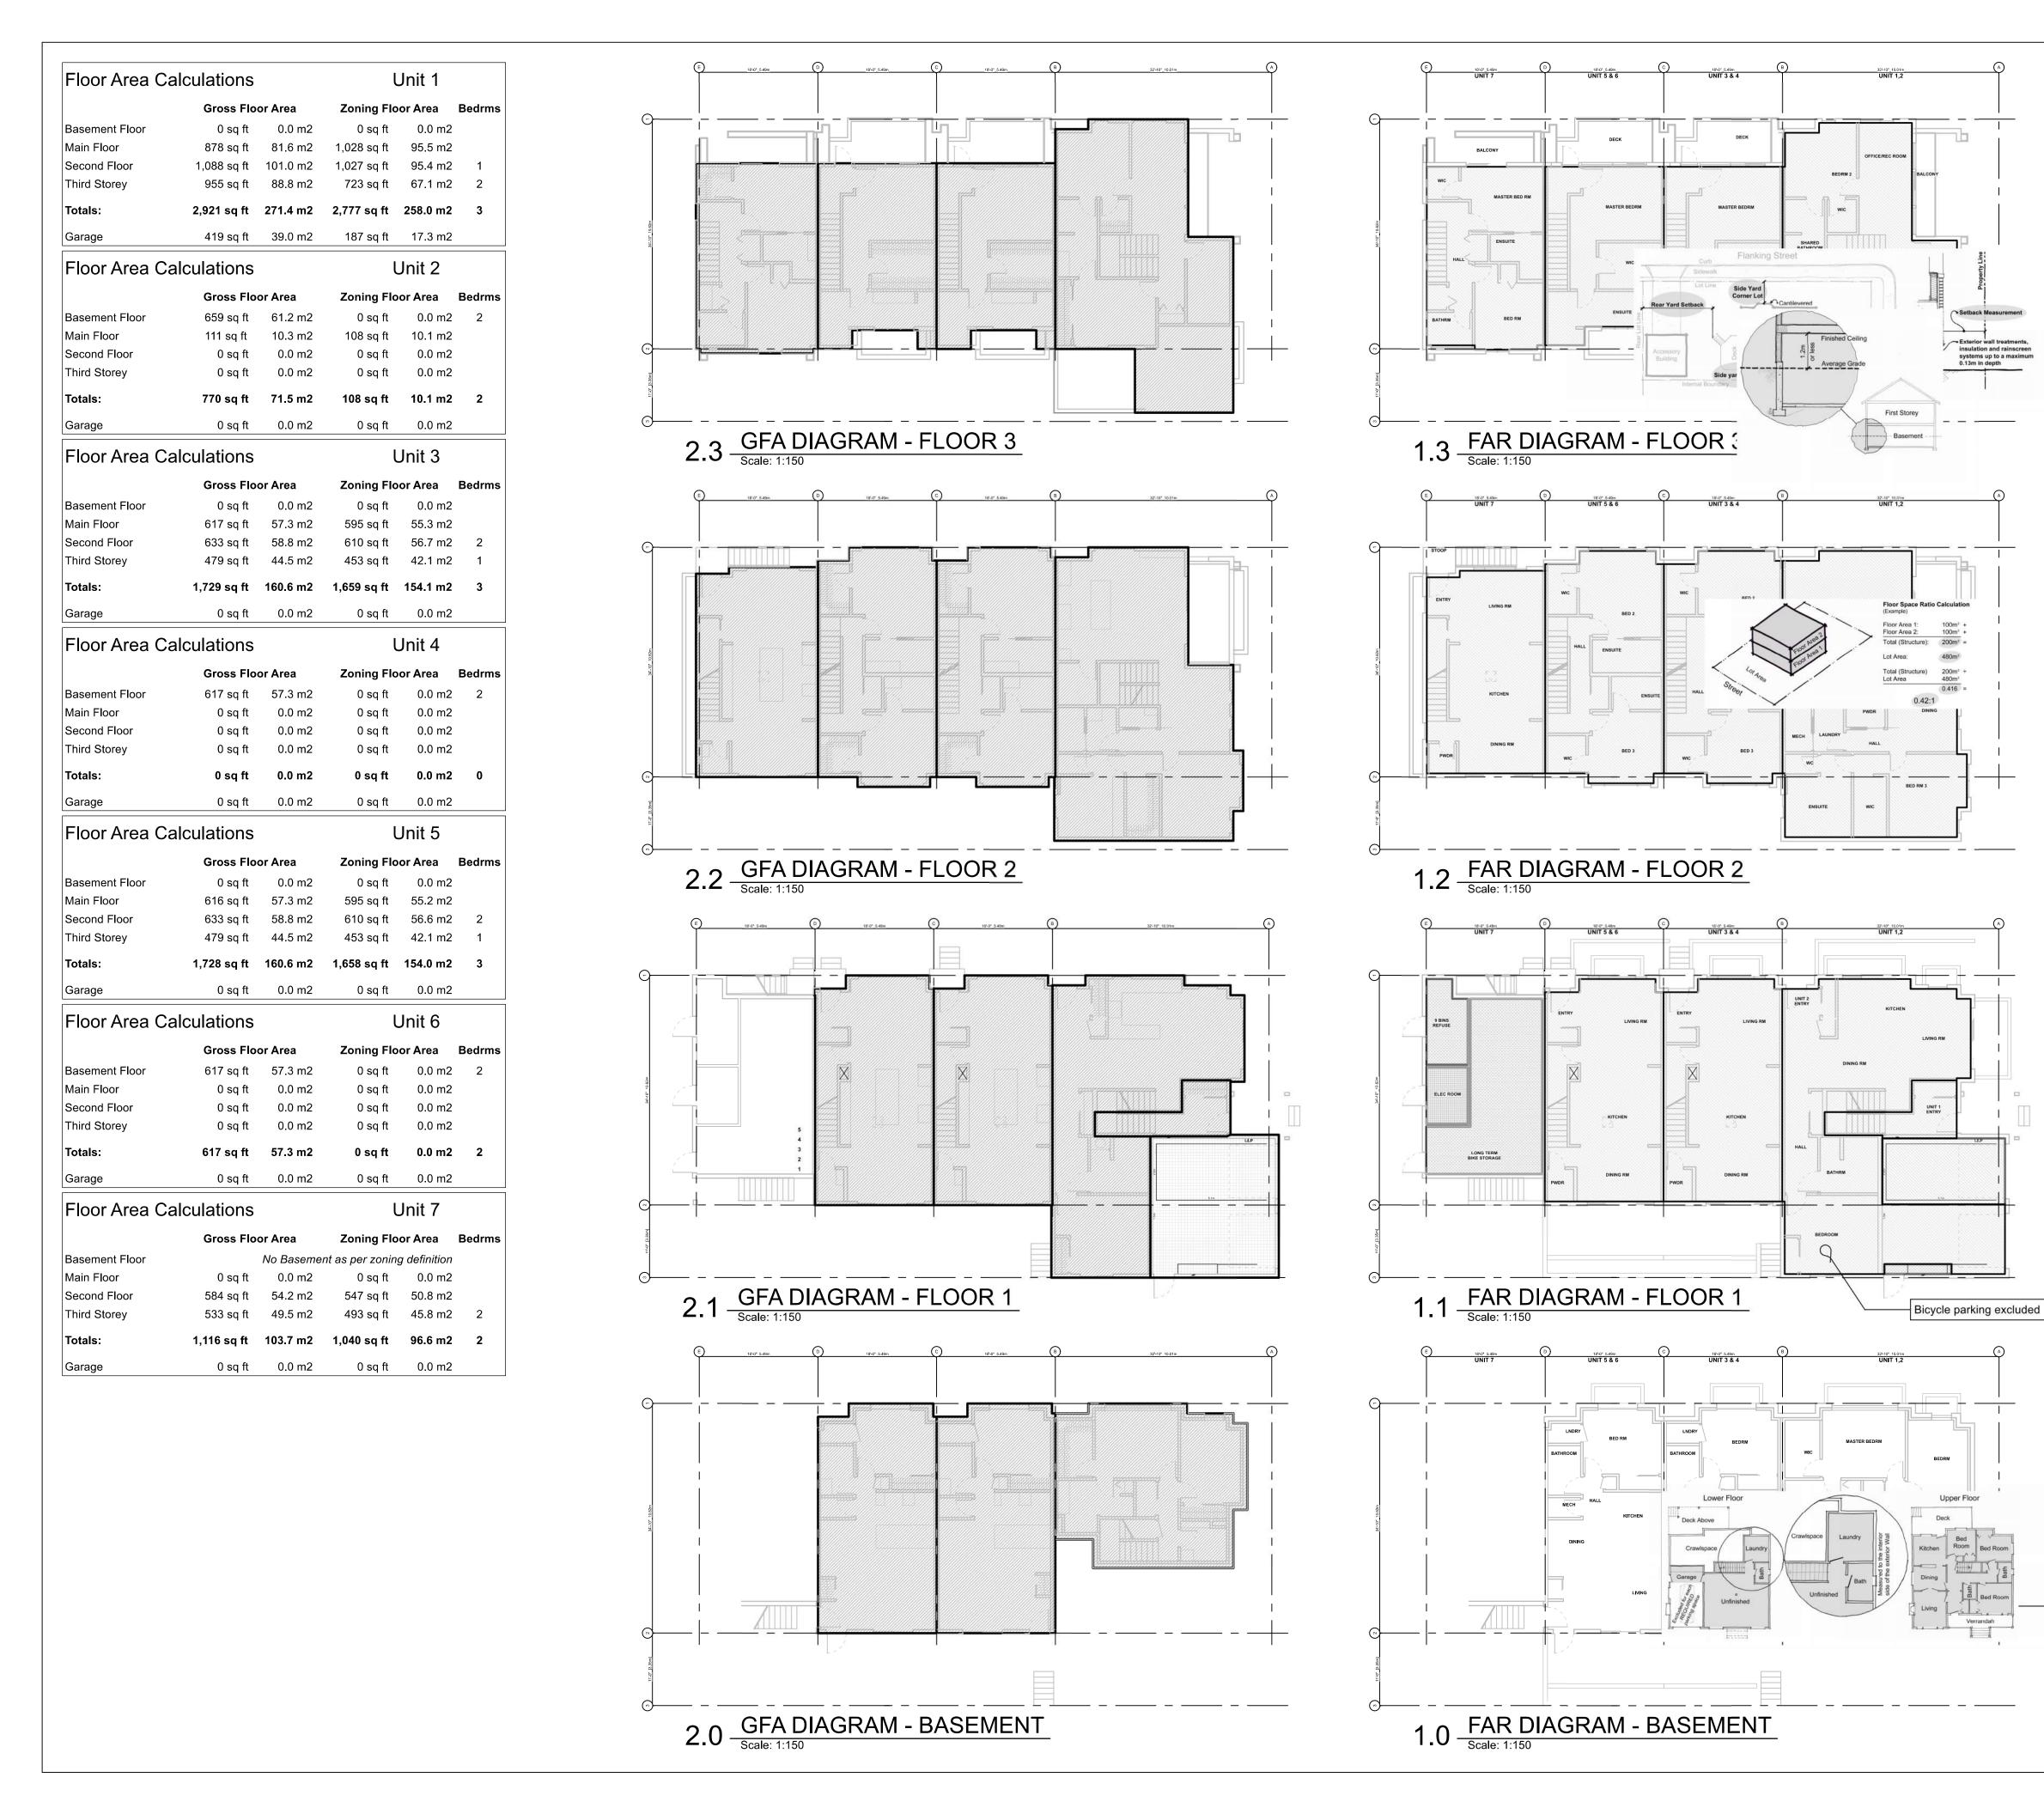


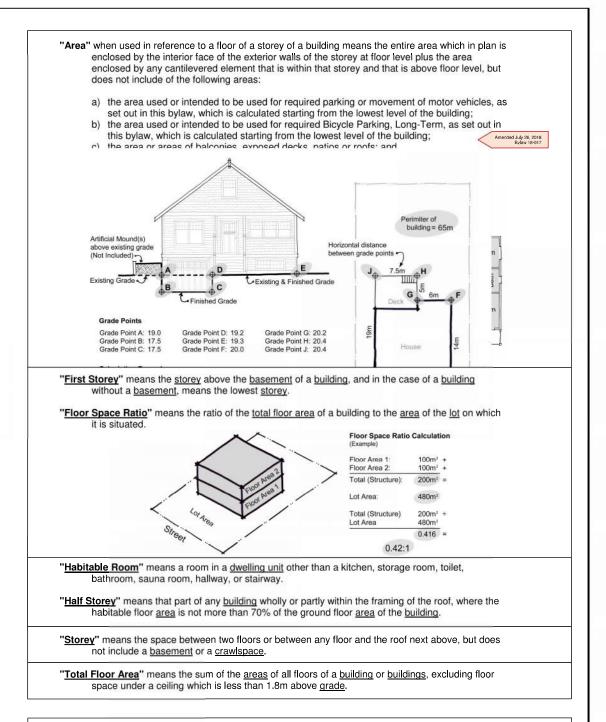


### PROJECT DATA - 349 KIPLING

	GFA Area (SF)	Zoning Area (SF)		ite Area (SF)	FAR	Bedrm
Unit 1-7	9,498	7,242		6,791	1.06	15
Basement	1,893	0				
Main Floor	2,222	2,326				
Second Floor	2,937	2,794				
Third Storey	2,446	2,122				
Garage	419	187	Excluded from	FAR		
Refuse	75	75	Excluded from	FAR		
Electrical Room	54	116	Excluded from	FAR		
Bike Room	339	700	Excluded from	FAR		
Total Floor Area	10,384		All Included			

wall and interior face of demising walls. Basements excluded.

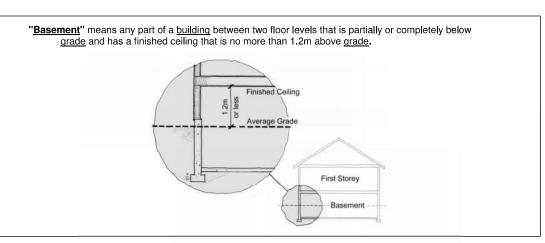

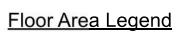

Area counted towards zoning floor ratio
Area of refuse
Area of garage
Area of Bike Parking
Area of electrical room
Area Less than 1.8m ceiling height

All basements are less than 1.8m below grade, excluded. See sections

Project No:

Drawn By:


Plot Date:

Scale:

EBASTIEN GAROIR CHITECTURE ← DESIGNWW.SGAD.ca

+----

THIS DRAWING IS COPYRIGHTED AND MUST NOT BE USED, REPRODUCED, OR REVISED WITHOUT WRITTEN PERMISSION.

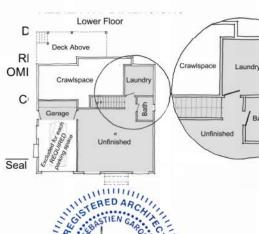

| Issued | 2019-06-19 | Issued for DP | 2019-09-16 | Revised & Re-Issued for DP | 2019-10-21 | Revised & Re-Issued for DP | 2019-12-12 | Revised & Re-Issued for DP | 2020-04-29 | Revised & Re-Issued for DP | 2020-09-21 | Revised & Re-Issued for DP | 2021-07-20 | Revised & Re-Issued

2021-11-21 Revised & Re-Issued for DP Revised & Re-Issued for DP 2021-12-16 2022-03-30 Revised & Re-Issued for DP 2022-04-11 Revised & Re-Issued for DP 2022-05-10 Revised & Re-Issued for DP 2022-10-06 Revised & Re-Issued for DP 2022-11-04 Revised & Re-Issued for DP 2022-11-14 Revised & Re-Issued for DP 2022-11-25 Revised & Re-Issued for DP 2023-12-21

2022-11-14 Revised & Re-Issued 2022-11-25 Revised & Re-Issued 2023-12-21 ISSUED FOR BP 2024-02-17 BP REVISION "A" 2024-05-30 ISSUED FOR DP


Name: Street RATI

Civic: KIPLING ST & THURLOW ST

ject No: 19.015
win By: SG/TD

It Date: 2025-04-17
ale: 1:150

A2.2

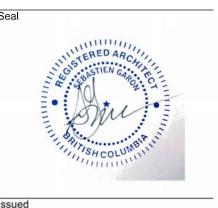

2019-06-19 Issued for DP 2019-09-16 Revised & Re-Issued for DP 2019-10-21 Revised & Re-Issued for DP

2019-12-12 Revised & Re-Issued for DP Revised & Re-Issued for DP 2020-04-29 2020-09-21 Revised & Re-Issued for DP 2021-07-20 Revised & Re-Issued for DP 2021-11-21 Revised & Re-Issued for DP 2021-12-16 Revised & Re-Issued for DP 2022-03-30 Revised & Re-Issued for DP 2022-04-11 Revised & Re-Issued for DP 2022-05-10 Revised & Re-Issued for DP 2022-10-06 Revised & Re-Issued for DP 2022-11-04 Revised & Re-Issued for DP

2022-11-14 Revised & Re-Issued for DP 2022-11-25 Revised & Re-Issued for DP 2023-12-21 ISSUED FOR BP 2024-02-17 BP REVISION "A" 2024-05-30 ISSUED FOR DP

Project Name:

LeParc

KIPLING ST & THURLOW ST

19.015 SG/TD 2025-04-17 1:100


Sheet No:

A3.0

**DIMENSION NOTES:** 


1) EXTERIOR DIMENSIONS TO FACE OF PLYWOOD SHEATHING WHICH IS IN LINE WITH CONCRETE FOUNDATION WALL. 2) INTERIOR DIMENSIONS TO CENTRE LINE OF WALL OR


FACE OF FINISHED WALL. 3) WALLS ARE DRAWN FULL WIDTH INCLUDING DRYWALL. 4) GRIDLINES TO FACE OF FOUNDATION WALL OR C/L OF DEMISING WALLS

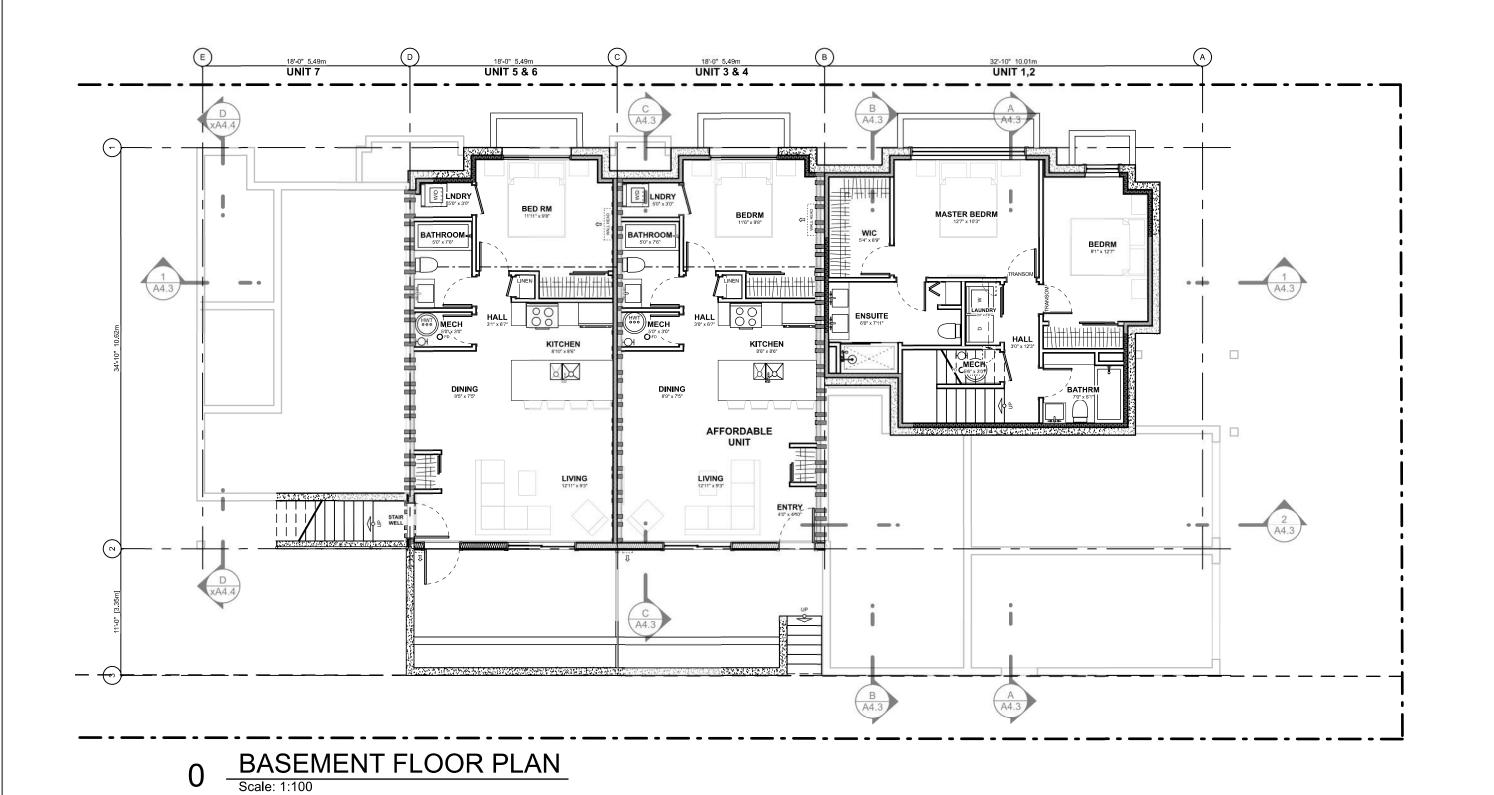

ROOF DECK DINING RM 12'8" x 7'11"

2 SECOND FLOOR PLAN
Scale: 1:100

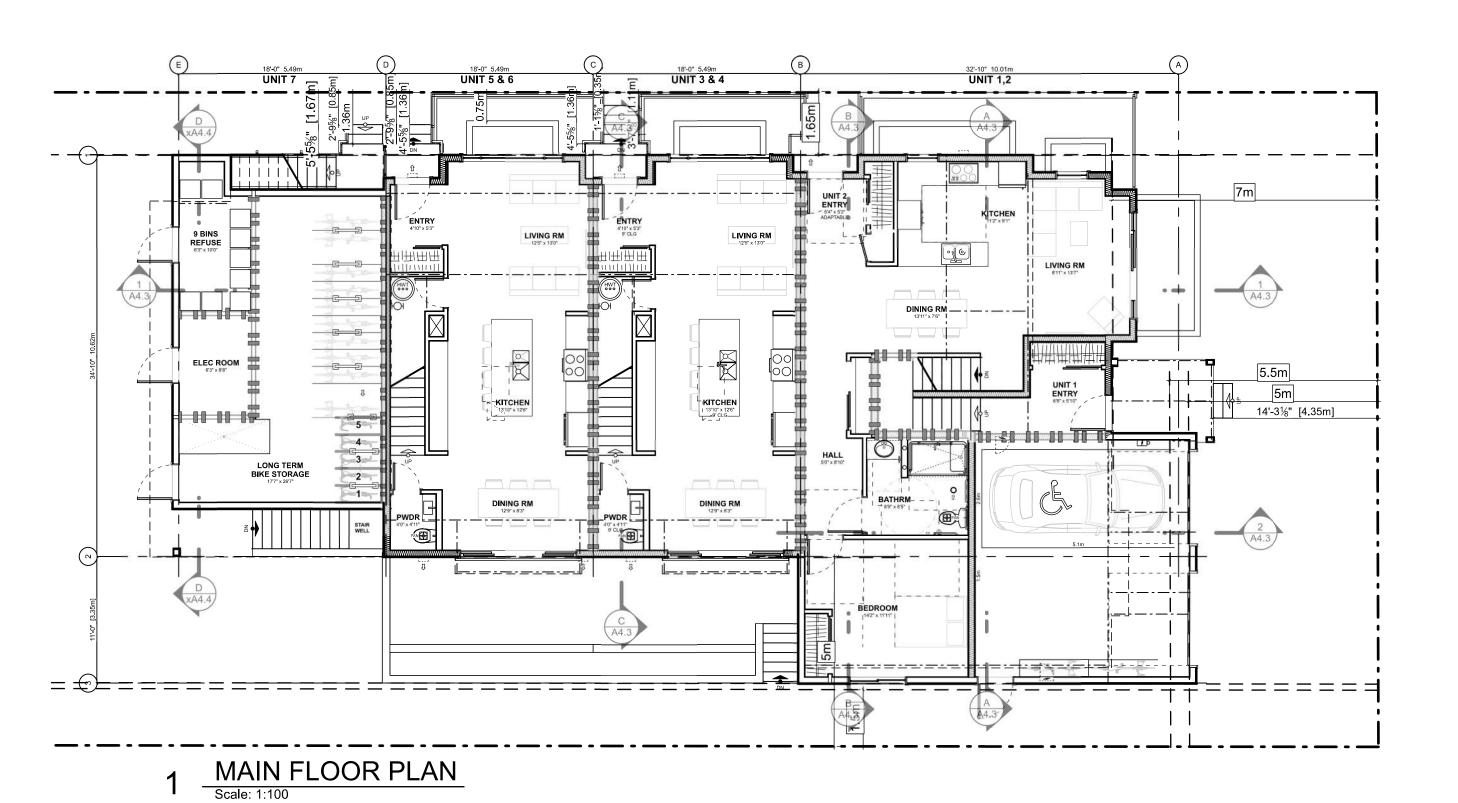

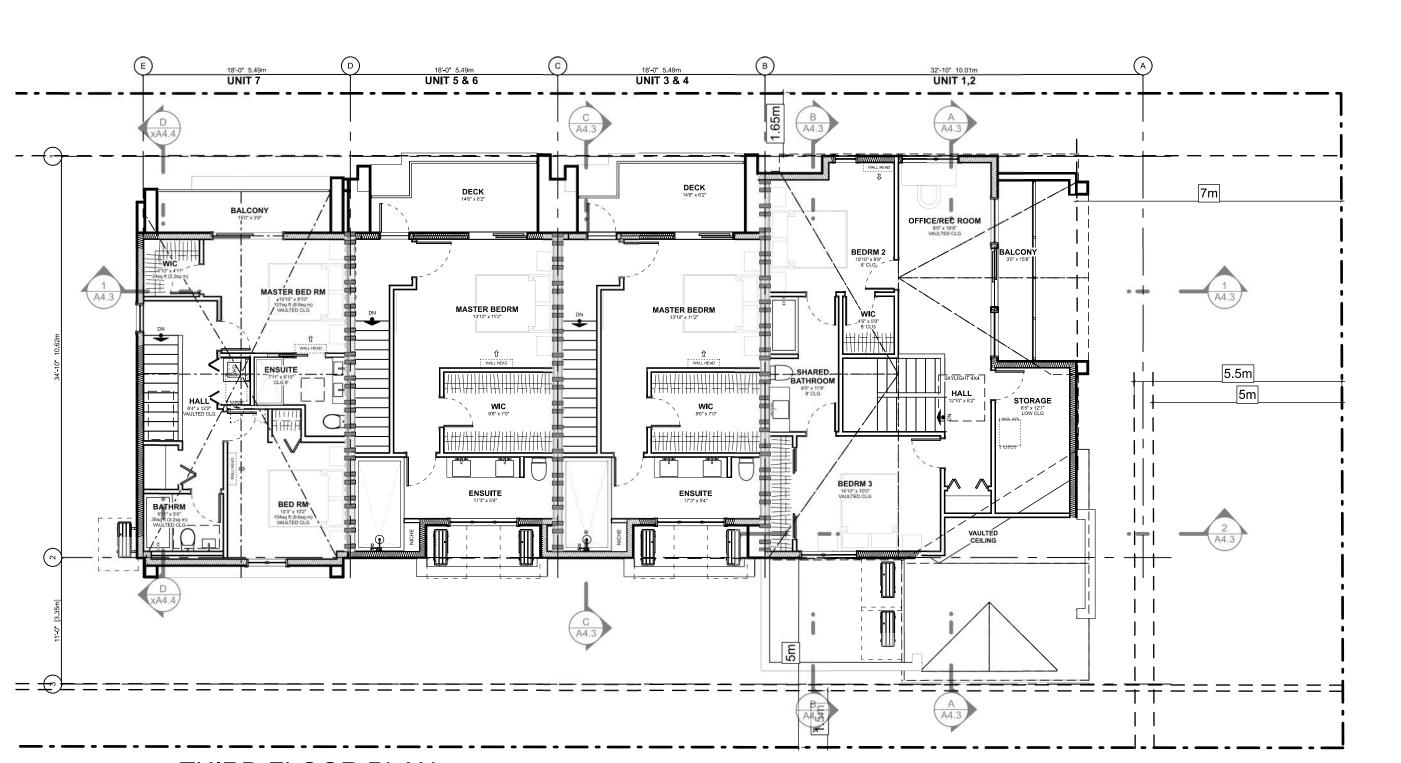

3 THIRD FLOOR PLAN
Scale: 1:100

NO.	DESCRIPTION	MATERIAL	COLOUR
1	CLADDING SHINGLES	CEMENTITIOUS HARDIE STAGGERED EDGE	GOLDEN BEHIVE (TBC BY THE ARCHITECT)
2	CLADDING VERTICAL SIDING	CEMENTITIOUS NICHIHA LATURA V-GROOVE	WHITE
3	FASCIA	CEMENTITIOUS HARDIE SMOOTH	ARTIC WHITE
4	TRIMS & PANELS	CEMENTITIOUS HARDIE SMOOTH	ARTIC WHITE
5	CLADDING HORIZONTAL	CEDAR 1X4	CLEAR
6	WINDOW FRAME	VINYL	WHITE
7	GLASS RAILING	GUARDRAIL WITH ALUMINUM FRAME ALL GUARDRAILS TO HAVE 1/2" GLASS AND TO BE DESIGNED AND SEALED BY P.ENG. SCHEDULE "S-B" TO BE PROVIDED UNDER ARCHITECT'S SCHEDULE "B"	WHITE
8	METAL CAP FLASHING		WHITE
9	METAL CLADDING	STANDING SEAM	WHITE
10	METAL ROOF	STANDING SEAM	WHITE
11	EXPOSED CONCRETE	CAST IN PLACE CONCRETE	GREY
12	SKYLIGHT	VINYL	WHITE
13	<b>GUTTER &amp; DOWNSPOUT</b>		WHITE
14	HEAT PUMP	SEE MECHANICAL	
15	WALL VENT	SEE MECHANICAL	WHITE
16	GARAGE DOOR		WHITE


1X4 T&G PLANKS WESTERN RED CEDAR CLEAR

### SPATIAL SEPARATION (9.10.14.) - BLOCK 01 (NOT SPRINKLERED)

COMPARTMENT AREA OF LIMITING DISTANCE (		LIMITING DISTANCE (LD)	UNPROTECTED	UNPROTECTED OPENINGS		CLADDING
	FACADL		PERMITTED	ACTUAL	OF BUILDING FACE	
NORTH FACADE						
(N) UNIT 1	59.4 m2	11.40 m TO C/L KIPLING ST	LD EXCEEDS 8.0M, UPO A	LLOWED > 100%	C, 45 MIN	C or NC
(N) UNIT 3	131.5 m2	11.40 m TO C/L KIPLING ST	LD EXCEEDS 8.0M, UPO A	LLOWED > 100%	C, 45 MIN	C or NC
(N) UNIT 5	54.5 m2	11.40 m TO C/L KIPLING ST	LD EXCEEDS 8.0M, UPO A	LLOWED > 100%	C, 45 MIN	C or NC
(N) UNIT 7	46.9 m2	11.40 m TO C/L KIPLING ST	LD EXCEEDS 8.0M, UPO A	LLOWED > 100%	C, 45 MIN	C or NC
EAST FACADE						
(E) UNIT 1	95.8 m2	15.16 m TO THURLOW RD	LD EXCEEDS 12.0M, UPO	ALLOWED > 100%	C, 45 MIN	C or NC
SOUTH FACADE						
(S) UNIT 1	45.3 m2	1.66 m TO PL	8.6 % 3.9 m2	3.7 % 1.7 m2	C, 60 MIN	NC
(S) UNIT 3	48.1 m2	5.01 m TO PL	42.6 % 20.5 m2	20.7 % 10.0 m2	C, 45 MIN	C or NC
(S) UNIT 4	14.2 m2	5.01 m TO PL	63.7 % 9.0 m2	31.3 % 4.4 m2	C, 45 MIN	C or NC
(S) UNIT 5	48.1 m2	5.01 m TO PL	42.6 % 20.5 m2	20.8 % 10.0 m2	C, 45 MIN	C or NC
(S) UNIT 6	14.2 m2	5.01 m TO PL	63.7 % 9.1 m2	31.2 % 4.4 m2	C, 45 MIN	C or NC
(S) UNIT 7	31.4 m2	6.25 m TO PL	72.9 % 22.9 m2	57.2 % 17.9 m2	C, 45 MIN	C or NC
WEST FACADE						
(W) UNIT 7	54.4 m2	4.95 m TO PL	26.1 % 14.2 m2	4.5 % 2.4 m2	C, 45 MIN	C or NC
(W) REFUSE	21.0 m2	4.95 m TO PL	63.7 % 13.4 m2	9.3 % 2.0 m2	C, 45 MIN	C or NC
(W) ELEC RM	8.4 m2	4.95 m TO PL	63.7 % 5.4 m2	23.2 % 2.0 m2	C, 45 MIN	C or NC
(W) BIKE RM	8.4 m2	4.95 m TO PL	63.7 % 5.4 m2	22.1 % 1.9 m2	C, 45 MIN	C or NC
0.40.44.0.(0) EIDE		MENTO ADE TO DE A MINI OF A	** LIMITING D	ISTANCE SQUARED		

LIMITING DISTANCE SQUARED 9.10.14.2.(2) FIRE COMPARTMENTS ARE TO BE A MIN. OF 45MIN FRR

9.10.14.3. ASSUMES FIRE DEPARTMENT RESPONSE TIME IS < 10MIN

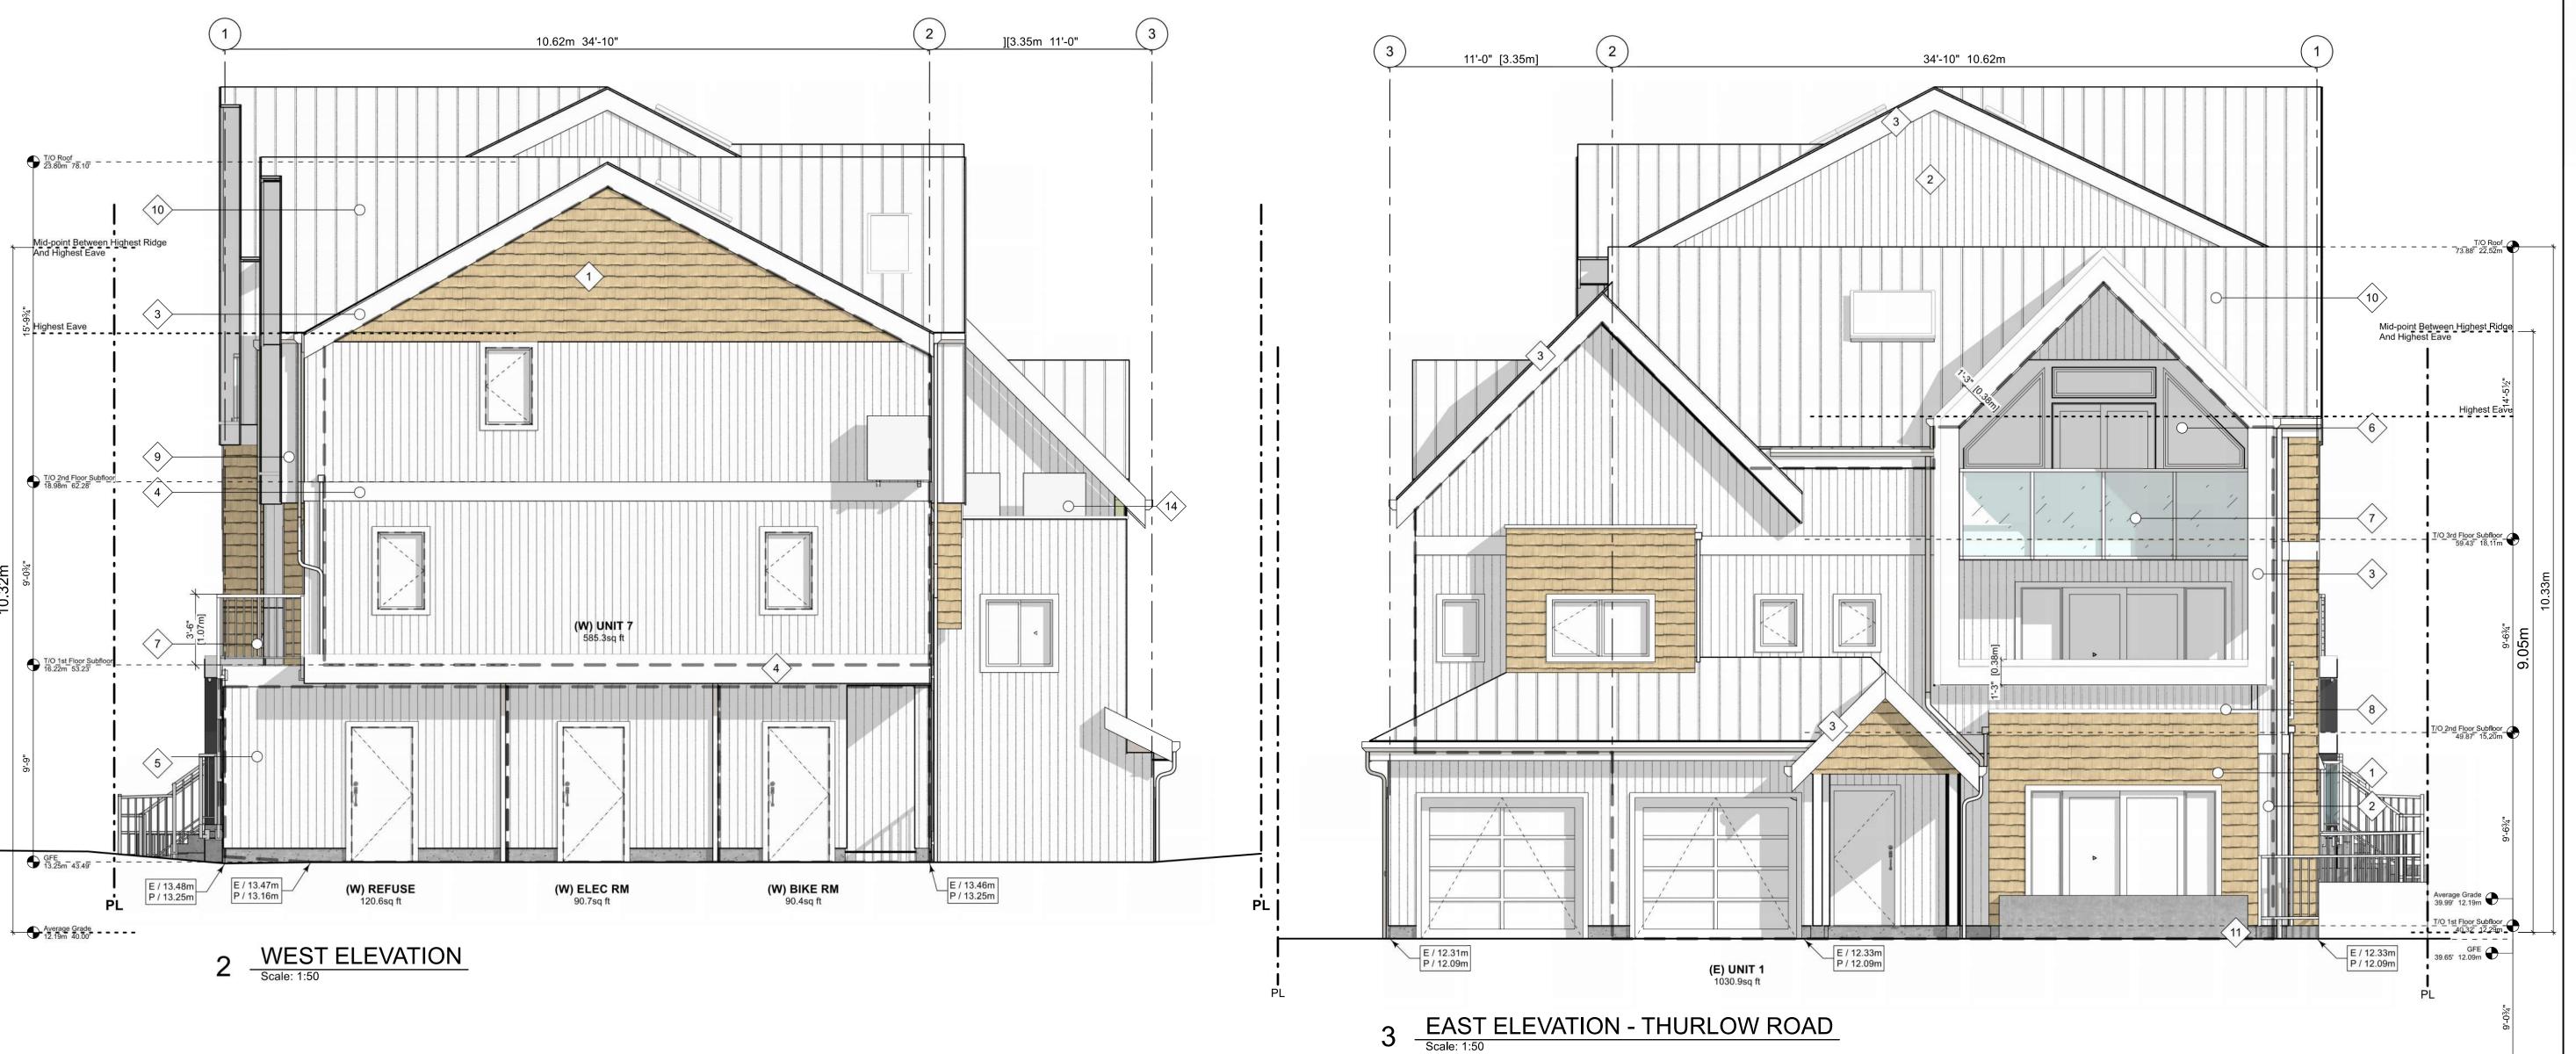

17 SOFFITS, WOOD

ALL MATERIALS AS NOTED OR APPROVED ALTERNATE

THIS DRAWING IS COPYRIGHTED AND MUST NOT BE USED, REPRODUCED, OR REVISED

VERIFY ALL DIMENSIONS. DO NOT SCALE THIS DRAWING.

WITHOUT WRITTEN PERMISSION.

REPORT INCONSISTENCIES AND OMISSIONS TO THE ARCHITECT FOR CLARIFICATION BEFORE COMMENCING WITH THE WORK.



Revised & Re-Issued for DP Revised & Re-Issued for DP

Revised & Re-Issued for DP 2019-12-12 Revised & Re-Issued for DP 2020-09-21 Revised & Re-Issued for DP 2021-07-20 Revised & Re-Issued for DP Revised & Re-Issued for DP Revised & Re-Issued for DP 2022-03-30 Revised & Re-Issued for DP 2022-04-11 Revised & Re-Issued for DP Revised & Re-Issued for DP Revised & Re-Issued for DP 2022-11-04

2022-11-14

2022-11-25

Revised & Re-Issued for DP Revised & Re-Issued for DP 2023-12-21 ISSUED FOR BP 2024-02-17 BP REVISION "A" 2024-05-30 ISSUED FOR DP

Project Name:

LeParc

KIPLING ST & THURLOW ST

19.015 SG/TD 2025-04-17

A4.0

### **EXTERIOR MATERIALS SUMMARY**

ALL MATERIALS AS NOTED OR APPROVED ALTERNATE

Ο.	DESCRIPTION	MATERIAL	COLOUR
	CLADDING SHINGLES	CEMENTITIOUS HARDIE STAGGERED EDGE	GOLDEN BEHIVE (TBC BY THE ARCHITECT)
	CLADDING VERTICAL SIDING	CEMENTITIOUS NICHIHA LATURA V-GROOVE	WHITE
	FASCIA	CEMENTITIOUS HARDIE SMOOTH	ARTIC WHITE
	TRIMS & PANELS	CEMENTITIOUS HARDIE SMOOTH	ARTIC WHITE
	CLADDING HORIZONTAL	CEDAR 1X4	CLEAR
i	WINDOW FRAME	VINYL	WHITE
	GLASS RAILING	GUARDRAIL WITH ALUMINUM FRAME ALL GUARDRAILS TO HAVE 1/2" GLASS AND TO BE DESIGNED AND SEALED BY P.ENG. SCHEDULE "S-B" TO BE PROVIDED UNDER ARCHITECT'S SCHEDULE "B"	WHITE
	METAL CAP FLASHING		WHITE
ı	METAL CLADDING	STANDING SEAM	WHITE
)	METAL ROOF	STANDING SEAM	WHITE
1	EXPOSED CONCRETE	CAST IN PLACE CONCRETE	GREY
2	SKYLIGHT	VINYL	WHITE
3	GUTTER & DOWNSPOUT		WHITE
4	HEAT PUMP	SEE MECHANICAL	
5	WALL VENT	SEE MECHANICAL	WHITE
3	GARAGE DOOR		WHITE
7	SOFFITS, WOOD	1X4 T&G PLANKS WESTERN RED CEDAR	CLEAR

### SPATIAL SEPARATION (9.10.14.) - BLOCK 01 (NOT SPRINKLERED)

COMPARTMENT	AREA OF	AREA OF LIMITING DISTANCE (LD) FACADE		UNPROTECTED	OPENINGS	CONSTRUCTION	CLADDING
	FACADE			PERMITTED	ACTUAL	OF BUILDING FACE	
NORTH FACADE							
(N) UNIT 1	59.4 m2	11.40 m	TO C/L KIPLING ST.	LD EXCEEDS 8.0M, UPO	ALLOWED > 100%	C, 45 MIN	C or NC
(N) UNIT 3	131.5 m2	11.40 m	TO C/L KIPLING ST.	LD EXCEEDS 8.0M, UPO	ALLOWED > 100%	C, 45 MIN	C or NC
(N) UNIT 5	54.5 m2	11.40 m	TO C/L KIPLING ST.	LD EXCEEDS 8.0M, UPO	ALLOWED > 100%	C, 45 MIN	C or NC
(N) UNIT 7	46.9 m2	11.40 m	TO C/L KIPLING ST.	LD EXCEEDS 8.0M, UPO	ALLOWED > 100%	C, 45 MIN	C or NC
EAST FACADE							
(E) UNIT 1	95.8 m2	15.16 m	TO THURLOW RD	LD EXCEEDS 12.0M, UPO	ALLOWED > 100%	C, 45 MIN	C or NC
SOUTH FACADE							
(S) UNIT 1	45.3 m2	1.66 m	TO PL	8.6 % 3.9 m2	3.7 % 1.7 m2	C, 60 MIN	NC
(S) UNIT 3	48.1 m2	5.01 m	TO PL	42.6 % 20.5 m2	20.7 % 10.0 m2	C, 45 MIN	C or NC
(S) UNIT 4	14.2 m2	5.01 m	TO PL	63.7 % 9.0 m2	31.3 % 4.4 m2	C, 45 MIN	C or NC
(S) UNIT 5	48.1 m2	5.01 m	TO PL	42.6 % 20.5 m2	20.8 % 10.0 m2	C, 45 MIN	C or NC
(S) UNIT 6	14.2 m2	5.01 m	TO PL	63.7 % 9.1 m2	31.2 % 4.4 m2	C, 45 MIN	C or NC
(S) UNIT 7	31.4 m2	6.25 m	TO PL	72.9 % 22.9 m2	57.2 % 17.9 m2	C, 45 MIN	C or NC
WEST FACADE							
(W) UNIT 7	54.4 m2	4.95 m	TO PL	26.1 % 14.2 m2	4.5 % 2.4 m2	C, 45 MIN	C or NC
(W) REFUSE	21.0 m2	4.95 m	TO PL	63.7 % 13.4 m2	9.3 % 2.0 m2	C, 45 MIN	C or NC
(W) ELEC RM	8.4 m2	4.95 m	TO PL	63.7 % 5.4 m2	23.2 % 2.0 m2	C, 45 MIN	C or NC
(W) BIKE RM	8.4 m2	4.95 m	TO PL	63.7 % 5.4 m2	22.1 % 1.9 m2	C, 45 MIN	C or NC
				** LIMITING [	DISTANCE SQUARED		

9.10.14.2.(2) FIRE COMPARTMENTS ARE TO BE A MIN. OF 45MIN FRR

9.10.14.3. ASSUMES FIRE DEPARTMENT RESPONSE TIME IS < 10MIN



RCHITECTURE + DESIG

THIS DRAWING IS COPYRIGHTED AND MUST NOT BE USED, REPRODUCED, OR REVISED WITHOUT WRITTEN PERMISSION.

VERIFY ALL DIMENSIONS. DO NOT SCALE THIS DRAWING.

REPORT INCONSISTENCIES AND OMISSIONS TO THE ARCHITECT FOR CLARIFICATION BEFORE COMMENCING WITH THE WORK.

Seal



9-06-19 Issued for DP 9-09-16 Revised & Re-Is

Revised & Re-Issued for DP Revised & Re-Issued for DP 2019-12-12 Revised & Re-Issued for DP Revised & Re-Issued for DP 2020-09-21 Revised & Re-Issued for DP 2021-07-20 Revised & Re-Issued for DP Revised & Re-Issued for DP Revised & Re-Issued for DP 2022-03-30 Revised & Re-Issued for DP 2022-04-11 Revised & Re-Issued for DP Revised & Re-Issued for DP 2022-10-06 Revised & Re-Issued for DP Revised & Re-Issued for DP 2022-11-25 Revised & Re-Issued for DP

2024-02-17 BP REVISION "A" 2024-05-30 ISSUED FOR DP

LEVATIONS

Project Name:

LePard

Civic:
KIPLING ST & THURLOW
ST

roject No: 19.015
rawn By: SG/TD
lot Date: 2025-04-17
cale: 1:50

A4.1

### **EXTERIOR MATERIALS SUMMARY**

ALL MATERIALS AS NOTED OR APPROVED ALTERNATE

NO.	DESCRIPTION	MATERIAL	COLOUR
1	CLADDING SHINGLES	CEMENTITIOUS HARDIE STAGGERED EDGE	GOLDEN BEHIVE (TBC BY THE ARCHITECT)
2	CLADDING VERTICAL SIDING	CEMENTITIOUS NICHIHA LATURA V-GROOVE	WHITE
3	FASCIA	CEMENTITIOUS HARDIE SMOOTH	ARTIC WHITE
4	TRIMS & PANELS	CEMENTITIOUS HARDIE SMOOTH	ARTIC WHITE
5	CLADDING HORIZONTAL	CEDAR 1X4	CLEAR
6	WINDOW FRAME	VINYL	WHITE
7	GLASS RAILING	GUARDRAIL WITH ALUMINUM FRAME ALL GUARDRAILS TO HAVE 1/2" GLASS AND TO BE DESIGNED AND SEALED BY P.ENG. SCHEDULE "S-B" TO BE PROVIDED UNDER ARCHITECT'S SCHEDULE "B"	WHITE
8	METAL CAP FLASHING		WHITE
9	METAL CLADDING	STANDING SEAM	WHITE
10	METAL ROOF	STANDING SEAM	WHITE
11	EXPOSED CONCRETE	CAST IN PLACE CONCRETE	GREY
12	SKYLIGHT	VINYL	WHITE
13	GUTTER & DOWNSPOUT		WHITE
14	HEAT PUMP	SEE MECHANICAL	
15	WALL VENT	SEE MECHANICAL	WHITE
16	GARAGE DOOR		WHITE
17	SOFFITS, WOOD	1X4 T&G PLANKS WESTERN RED CEDAR	CLEAR


### SPATIAL SEPARATION (9.10.14.) - BLOCK 01 (NOT SPRINKLERED)

COMPARTMENT	AREA OF	LIMIT	ING DISTANCE (LD)	UNPROTECTED	OPENINGS	CONSTRUCTION OF BUILDING FACE	CLADDING
	FACADE			PERMITTED	ACTUAL	OF BUILDING FACE	
NORTH FACADE							
(N) UNIT 1	59.4 m2	11.40 m	TO C/L KIPLING ST.	LD EXCEEDS 8.0M, UPO	ALLOWED > 100%	C, 45 MIN	C or NC
(N) UNIT 3	131.5 m2	11.40 m	TO C/L KIPLING ST.	LD EXCEEDS 8.0M, UPO	ALLOWED > 100%	C, 45 MIN	C or NC
(N) UNIT 5	54.5 m2	11.40 m	TO C/L KIPLING ST.	LD EXCEEDS 8.0M, UPO	ALLOWED > 100%	C, 45 MIN	C or NC
(N) UNIT 7	46.9 m2	11.40 m	TO C/L KIPLING ST.	LD EXCEEDS 8.0M, UPO	ALLOWED > 100%	C, 45 MIN	C or NC
EAST FACADE							
(E) UNIT 1	95.8 m2	15.16 m	TO THURLOW RD	LD EXCEEDS 12.0M, UPC	ALLOWED > 100%	C, 45 MIN	C or NC
SOUTH FACADE							
(S) UNIT 1	45.3 m2	1.66 m	TO PL	8.6 % 3.9 m2	3.7 % 1.7 m2	C, 60 MIN	NC
(S) UNIT 3	48.1 m2	5.01 m	TO PL	42.6 % 20.5 m2	20.7 % 10.0 m2	C, 45 MIN	C or NC
(S) UNIT 4	14.2 m2	5.01 m	TO PL	63.7 % 9.0 m2	31.3 % 4.4 m2	C, 45 MIN	C or NC
(S) UNIT 5	48.1 m2	5.01 m	TO PL	42.6 % 20.5 m2	20.8 % 10.0 m2	C, 45 MIN	C or NC
(S) UNIT 6	14.2 m2	5.01 m	TO PL	63.7 % 9.1 m2	31.2 % 4.4 m2	C, 45 MIN	C or NC
(S) UNIT 7	31.4 m2	6.25 m	TO PL	72.9 % 22.9 m2	57.2 % 17.9 m2	C, 45 MIN	C or NC
WEST FACADE							
(W) UNIT 7	54.4 m2	4.95 m	TO PL	26.1 % 14.2 m2	4.5 % 2.4 m2	C, 45 MIN	C or NC
(W) REFUSE	21.0 m2	4.95 m	TO PL	63.7 % 13.4 m2	9.3 % 2.0 m2	C, 45 MIN	C or NC
(W) ELEC RM	8.4 m2	4.95 m	TO PL	63.7 % 5.4 m2	23.2 % 2.0 m2	C, 45 MIN	C or NC
(W) BIKE RM	8.4 m2	4.95 m	TO PL	63.7 % 5.4 m2	22.1 % 1.9 m2	C, 45 MIN	C or NC
				**	DICTANCE COLLADED		

9.10.14.2.(2) FIRE COMPARTMENTS ARE TO BE A MIN. OF 45MIN FRR

\*\* LIMITING DISTANCE SQUARED

9.10.14.3. ASSUMES FIRE DEPARTMENT RESPONSE TIME IS < 10MIN

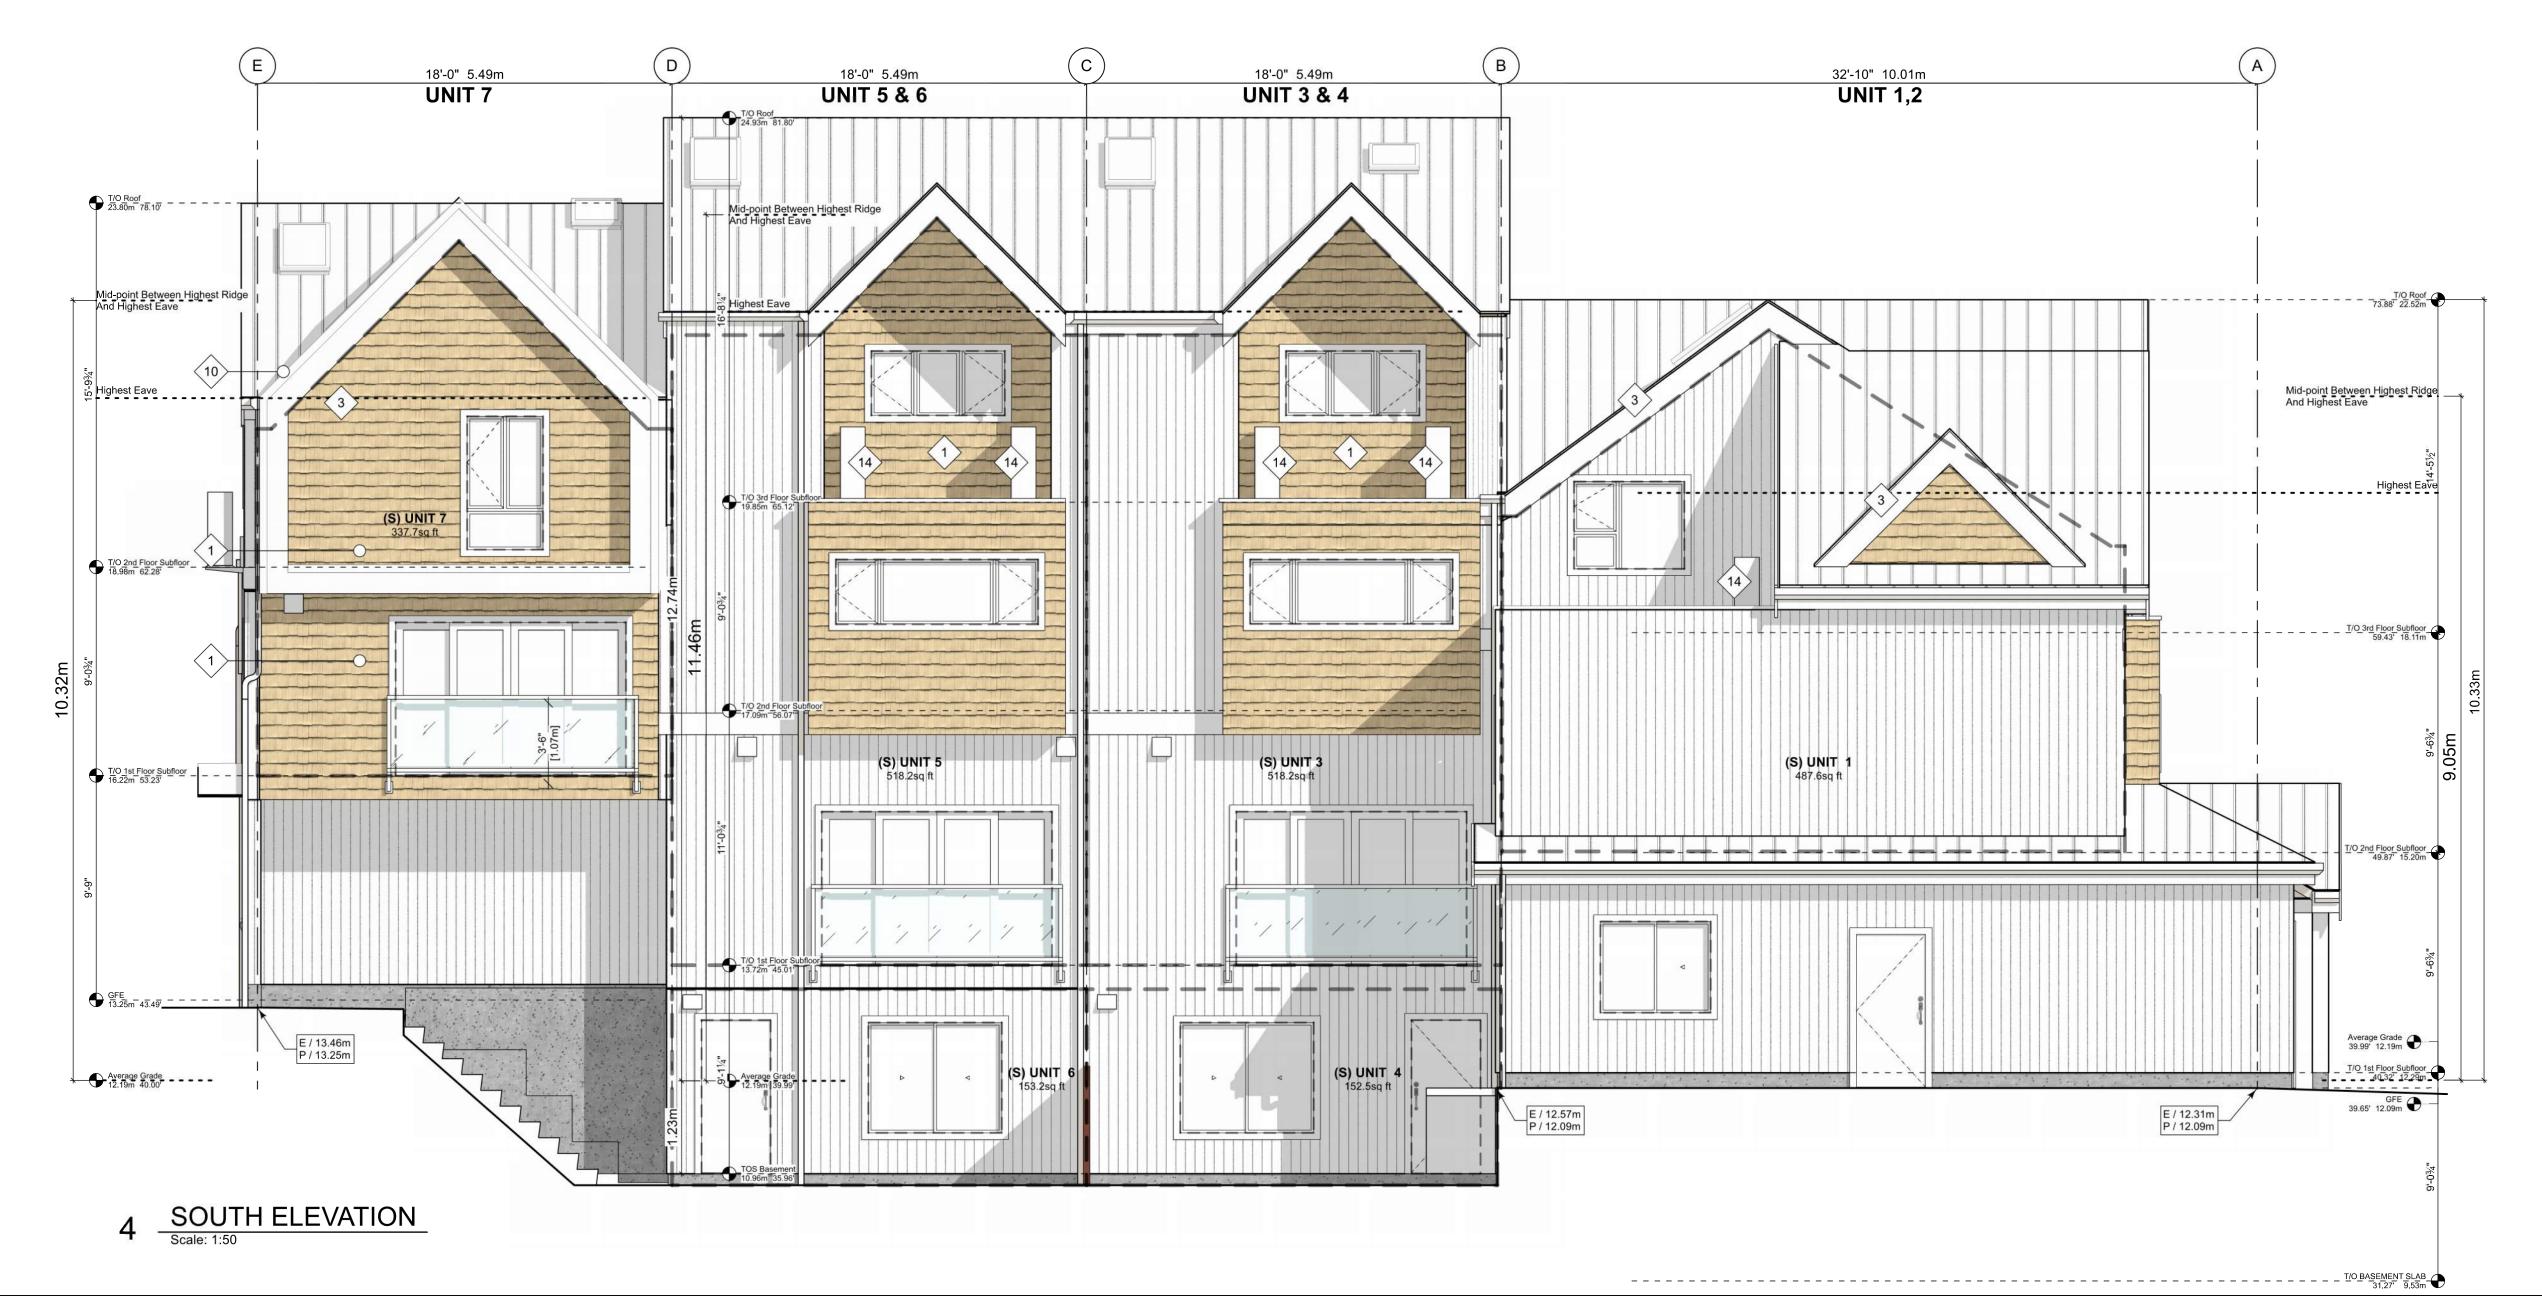

THIS DRAWING IS COPYRIGHTED AND MUST NOT BE USED, REPRODUCED, OR REVISED WITHOUT WRITTEN PERMISSION.

VERIFY ALL DIMENSIONS. DO NOT SCALE THIS DRAWING.

REPORT INCONSISTENCIES AND OMISSIONS TO THE ARCHITECT FOR CLARIFICATION BEFORE COMMENCING WITH THE WORK.

Seal



19-06-19 Issued for DP
19-09-16 Revised & Re-Issued for DP

Revised & Re-Issued for DP 2019-12-12 Revised & Re-Issued for DP 2020-09-21 Revised & Re-Issued for DP 2021-07-20 Revised & Re-Issued for DP Revised & Re-Issued for DP Revised & Re-Issued for DP 2022-03-30 Revised & Re-Issued for DP 2022-04-11 Revised & Re-Issued for DP 2022-11-25

2023-12-21 ISSUED FOR BP 2024-02-17 BP REVISION "A" 2024-05-30 ISSUED FOR DP

EVATIONS

Project Name:


LeParc

Civic:
KIPLING ST & THURLOW
ST

ject No: 19.015
win By: SG/TD

t Date: 2025-04-17
ale: 1:50

A4.2

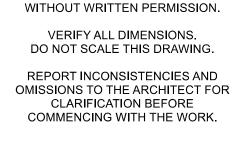

REPRODUCED, OR REVISED

2019-06-19 Issued for DP 2019-09-16 Revised & Re-Issued for DP Revised & Re-Issued for DP 2019-12-12 Revised & Re-Issued for DP Revised & Re-Issued for DP 2020-09-21 Revised & Re-Issued for DP 2021-07-20 Revised & Re-Issued for DP 2021-11-21 Revised & Re-Issued for DP 2021-12-16 Revised & Re-Issued for DP 2022-03-30 Revised & Re-Issued for DP

2022-04-11 Revised & Re-Issued for DP Revised & Re-Issued for DP 2022-10-06 Revised & Re-Issued for DP 2022-11-04 Revised & Re-Issued for DP 2022-11-14 Revised & Re-Issued for DP 2022-11-25 Revised & Re-Issued for DP 2023-12-21 ISSUED FOR BP 2024-02-17 BP REVISION "A" 2024-05-30 ISSUED FOR DP

Project Name:

LeParc

KIPLING ST & THURLOW

Project No: 19.015 SG/TD 2025-04-17 1:50 Sheet No:



18'-0" 5.49m

UNIT 3 & 4

32'-10" 10.01m

**UNIT 1,2** 

18'-0" 5.49m

UNIT 7

18'-0" 5.49m

**UNIT 5 & 6** 

VERIFY ALL DIMENSIONS. DO NOT SCALE THIS DRAWING.

S <

REPORT INCONSISTENCIES AND OMISSIONS TO THE ARCHITECT FOR CLARIFICATION BEFORE COMMENCING WITH THE WORK.

STIEN GAROLO

### 2019-06-19 Issued for DP 2019-09-16 Revised & Re-Is

2019-09-16 Revised & Re-Issued for DP 2019-10-21 Revised & Re-Issued for DP 2019-12-12 Revised & Re-Issued for DP 2020-04-29 Revised & Re-Issued for DP 2020-09-21 Revised & Re-Issued for DP 2021-07-20 Revised & Re-Issued for DP 2021-11-21 Revised & Re-Issued for DP 2021-12-16 Revised & Re-Issued for DP Revised & Re-Issued for DP 2022-03-30 2022-04-11 Revised & Re-Issued for DP 2022-05-10 Revised & Re-Issued for DP 2022-10-06 Revised & Re-Issued for DP 2022-11-04 Revised & Re-Issued for DP 2022-11-14 Revised & Re-Issued for DP

2022-11-14 Revised & Re-Issued for DP
2022-11-25 Revised & Re-Issued for DP
2023-12-21 ISSUED FOR BP
2024-02-17 BP REVISION "A"
2024-05-30 ISSUED FOR DP

OR

UNIT 2 FLOOF PLANS

Project Name:

LeParc

KIPLING ST & THURLOW ST

 Project No:
 19.015


 Drawn By:
 SG/TD

 Plot Date:
 2025-04-17

 Scale:
 1:50

 Sheet No:

A5.0

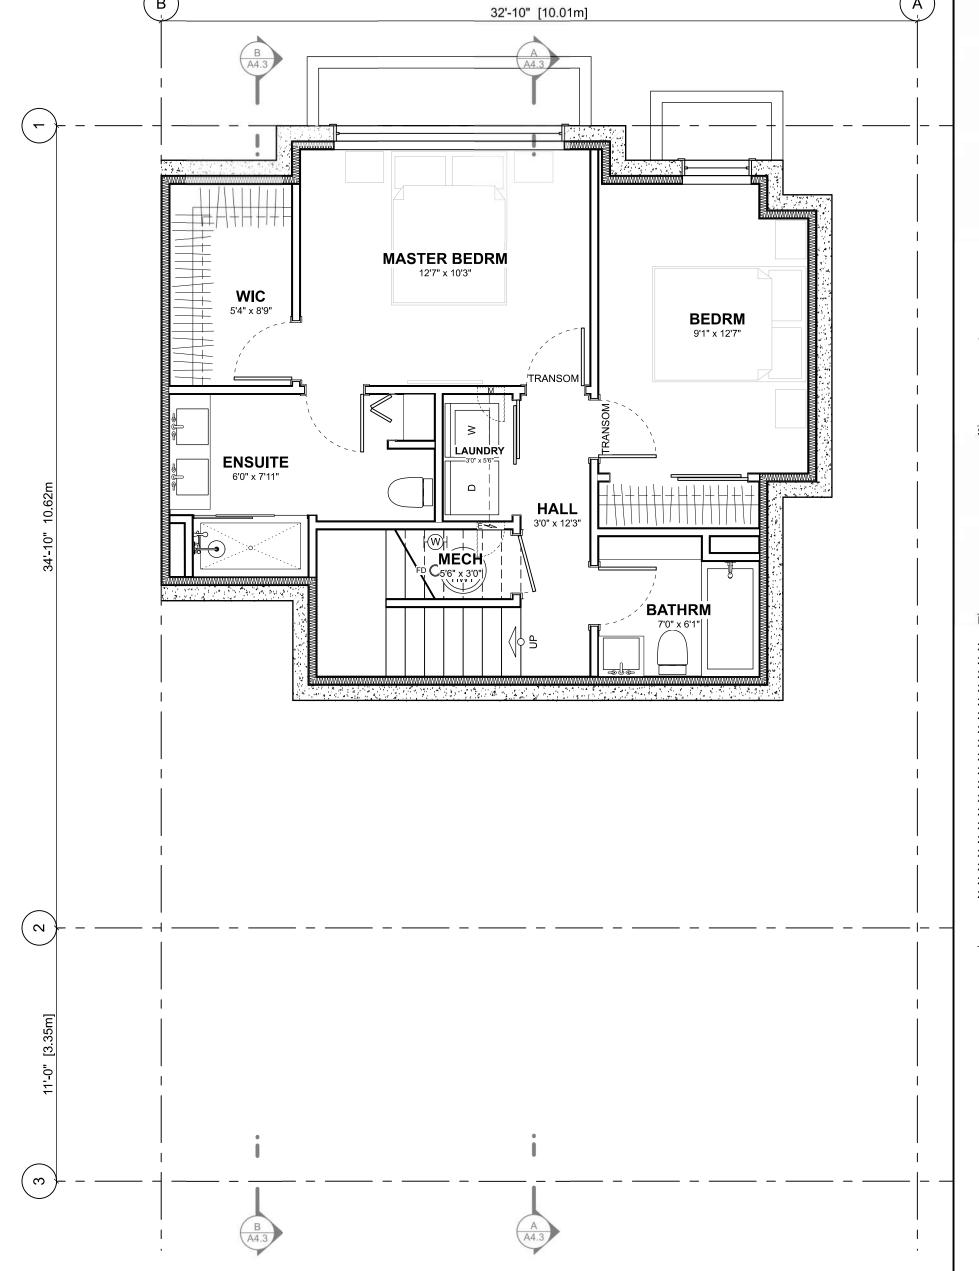

**DIMENSION NOTES:** 

FACE OF FINISHED WALL.

C/L OF DEMISING WALLS

 EXTERIOR DIMENSIONS TO FACE OF PLYWOOD SHEATHING WHICH IS IN LINE WITH CONCRETE FOUNDATION WALL.
 INTERIOR DIMENSIONS TO CENTRE LINE OF WALL OR

3) WALLS ARE DRAWN FULL WIDTH INCLUDING DRYWALL.

4) GRIDLINES TO FACE OF FOUNDATION WALL OR

# 1 BASEMENT FLOOR PLAN Scale: 1:50

Floor Area Ca	alculations	Unit 2				
	Gross Flo	or Area	Zoning Flo	Zoning Floor Area		
Basement Floor	659 sq ft	61.2 m2	0 sq ft	0.0 m2	2	
Main Floor	111 sq ft	10.3 m2	108 sq ft	10.1 m2		
Second Floor	0 sq ft	0.0 m2	0 sq ft	0.0 m2		
Third Storey	0 sq ft	0.0 m2	0 sq ft	0.0 m2		
Totals:	770 sq ft	71.5 m2	108 sq ft	10.1 m2	2	
Garage	0 sq ft	0.0 m2	0 sq ft	0.0 m2		

S

CLARIFICATION BEFORE COMMENCING WITH THE WORK.

REPORT INCONSISTENCIES AND

OMISSIONS TO THE ARCHITECT FOR



2019-06-19 Issued for DP 2019-09-16 Revised & Re-Issued for DP 2019-10-21 Revised & Re-Issued for DP 2019-12-12 Revised & Re-Issued for DP 2020-04-29 Revised & Re-Issued for DP 2020-09-21 Revised & Re-Issued for DP 2021-07-20 Revised & Re-Issued for DP 2021-11-21 Revised & Re-Issued for DP 2021-12-16 Revised & Re-Issued for DP 2022-03-30 Revised & Re-Issued for DP 2022-04-11 Revised & Re-Issued for DP 2022-05-10 Revised & Re-Issued for DP 2022-10-06 Revised & Re-Issued for DP

2022-11-04

Revised & Re-Issued for DP 2022-11-14 Revised & Re-Issued for DP 2022-11-25 Revised & Re-Issued for DP 2023-12-21 ISSUED FOR BP 2024-02-17 BP REVISION "A" 2024-05-30 ISSUED FOR DP


Project Name:

LeParc

KIPLING ST & THURLOW


Project No: 19.015 SG/TD 2025-04-17 1:50

A5.1

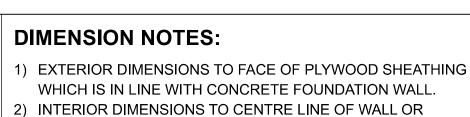

C/L OF DEMISING WALLS

FACE OF FINISHED WALL. WALLS ARE DRAWN FULL WIDTH INCLUDING DRYWALL. 4) GRIDLINES TO FACE OF FOUNDATION WALL OR

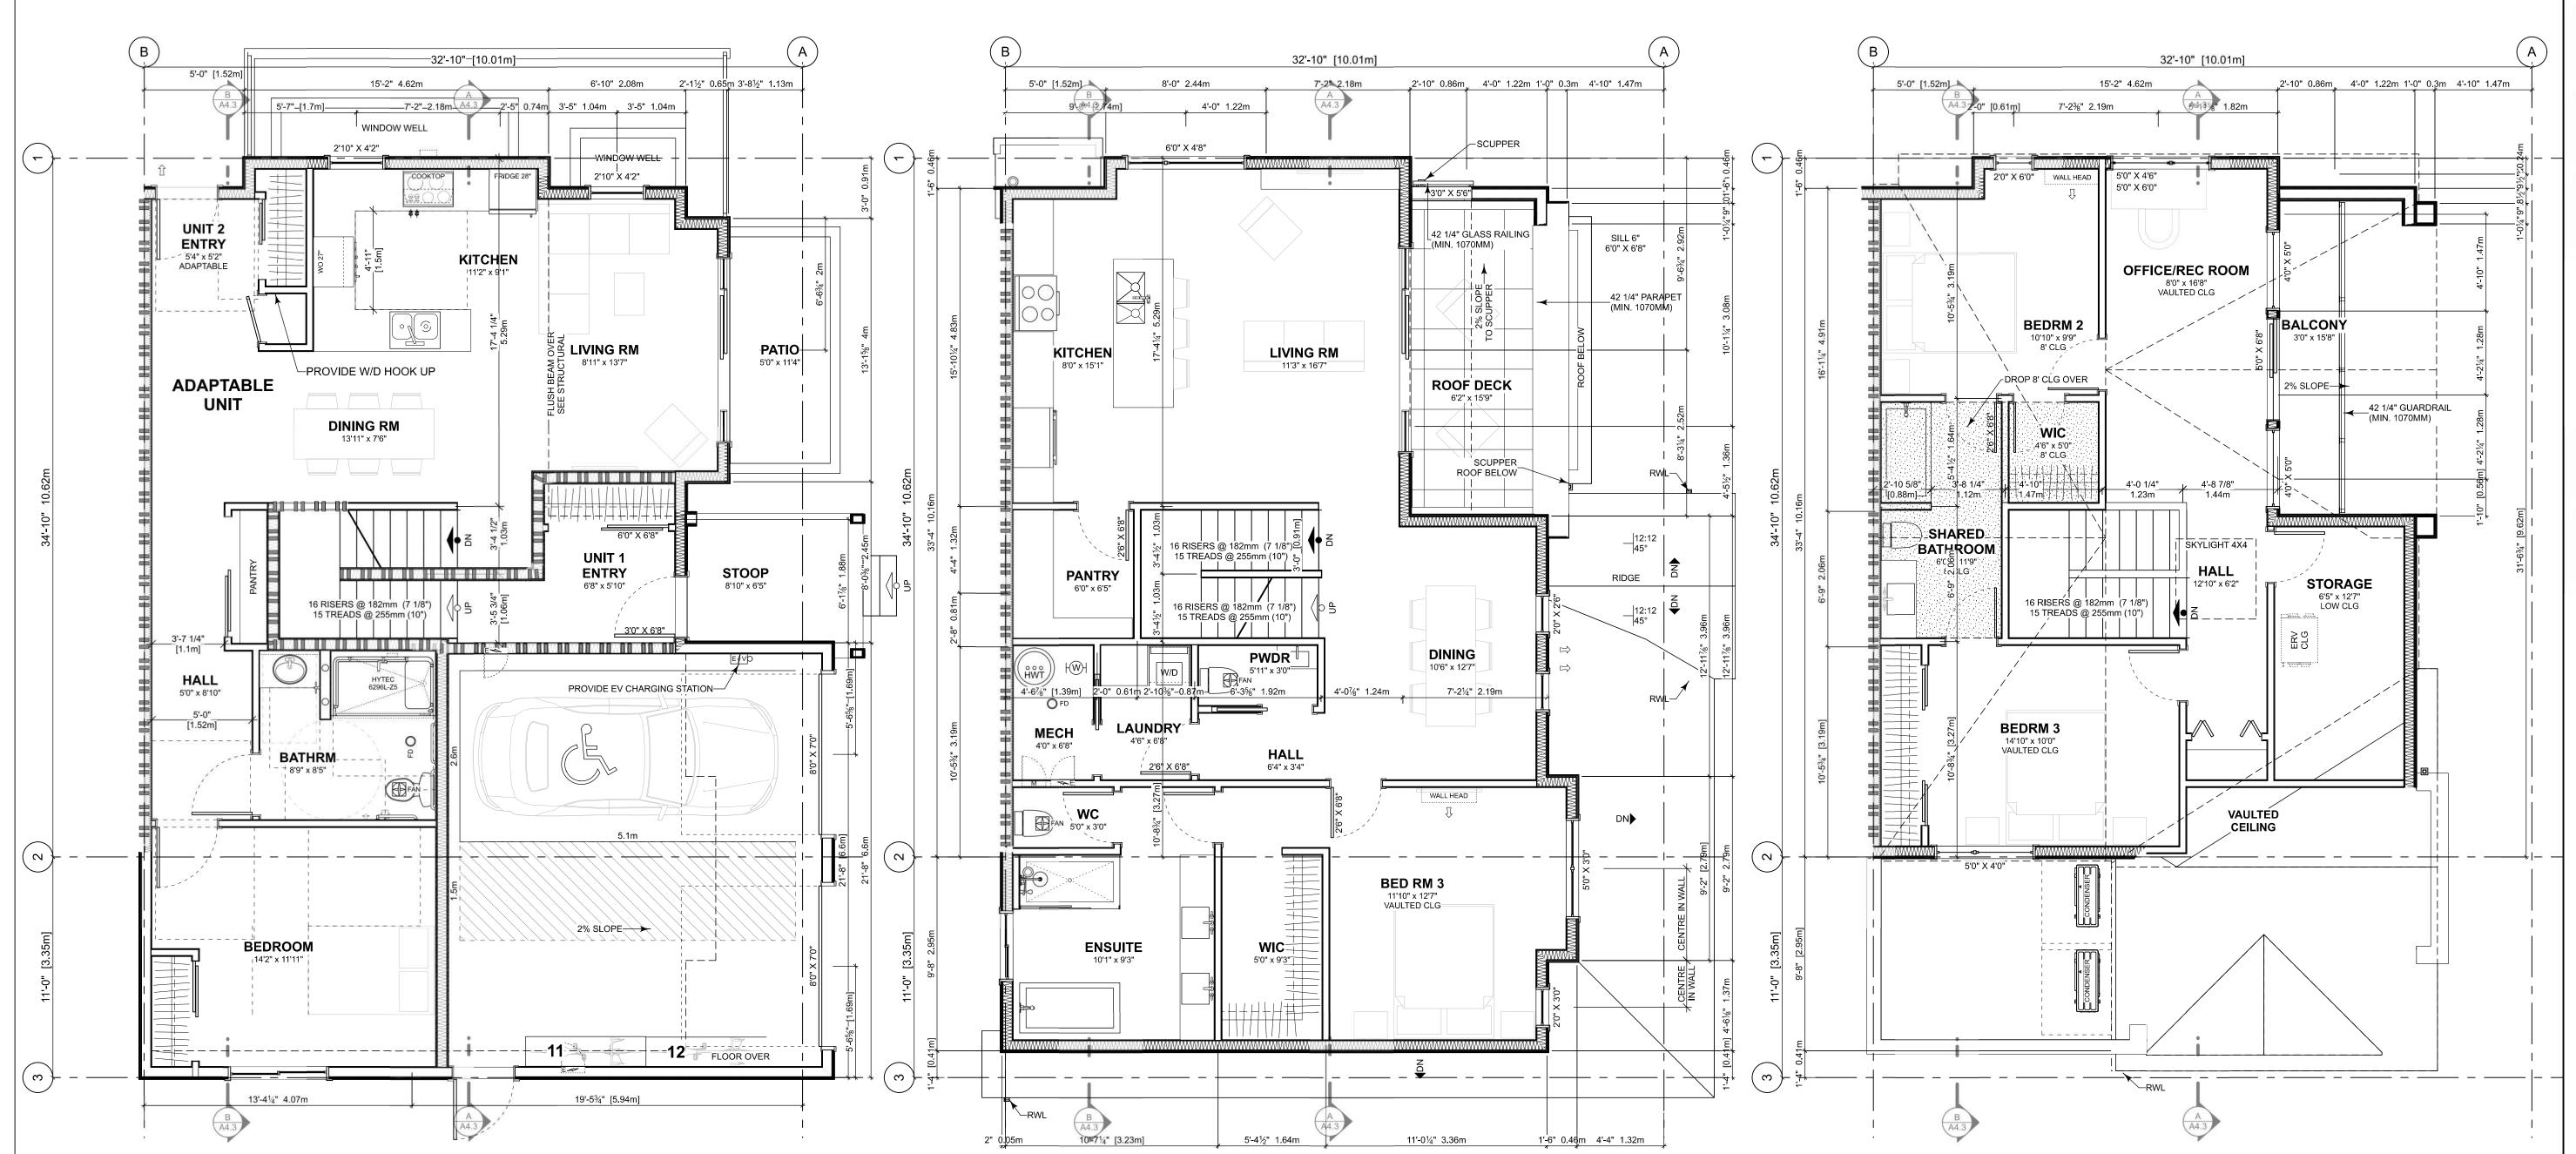


MAIN FLOOR PLAN
Scale: 1:50

2 SECOND FLOOR PLAN
Scale: 1:50

# 3 THIRD FLOOR PLAN Scale: 1:50

Floor Area C	alculations		ı	Unit 1		Floo
	Gross Flo	or Area	Zoning Flo	or Area	Bedrms	
Basement Floor	0 sq ft	0.0 m2	0 sq ft	0.0 m2		Basem
Main Floor	878 sq ft	81.6 m2	1,028 sq ft	95.5 m2		Main F
Second Floor	1,088 sq ft	101.0 m2	1,027 sq ft	95.4 m2	1	Second
Third Storey	955 sq ft	88.8 m2	723 sq ft	67.1 m2	2	Third S
Totals:	2,921 sq ft	271.4 m2	2,777 sq ft	258.0 m2	3	Totals
Garage	419 sq ft	39.0 m2	187 sq ft	17.3 m2		Garage

Į	Jnit 1		Floor Area Ca	alculations	Unit 2			
ing Flo	or Area	Bedrms		Gross Floo	or Area	Zoning Flo	or Area	Bedrms
sq ft	0.0 m2		Basement Floor	659 sq ft	61.2 m2	0 sq ft	0.0 m2	2
sq ft	95.5 m2		Main Floor	111 sq ft	10.3 m2	108 sq ft	10.1 m2	
sq ft	95.4 m2	1	Second Floor	0 sq ft	0.0 m2	0 sq ft	0.0 m2	
sq ft	67.1 m2	2	Third Storey	0 sq ft	0.0 m2	0 sq ft	0.0 m2	
sq ft	258.0 m2	3	Totals:	770 sq ft	71.5 m2	108 sq ft	10.1 m2	2
sq ft	17.3 m2		Garage	0 sq ft	0.0 m2	0 sq ft	0.0 m2	

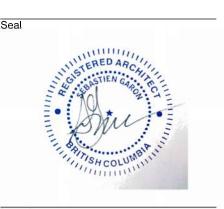

2019-06-19 Issued for DP 2019-09-16 Revised & Re-Issued for DP 2019-10-21 Revised & Re-Issued for DP Revised & Re-Issued for DP 2019-12-12 2020-04-29 Revised & Re-Issued for DP 2020-09-21

Revised & Re-Issued for DP 2021-07-20 Revised & Re-Issued for DP 2021-11-21 Revised & Re-Issued for DP 2021-12-16 Revised & Re-Issued for DP 2022-03-30 Revised & Re-Issued for DP Revised & Re-Issued for DP 2022-04-11 2022-05-10 Revised & Re-Issued for DP 2022-10-06 Revised & Re-Issued for DP 2022-11-04 Revised & Re-Issued for DP 2022-11-14 Revised & Re-Issued for DP

2022-11-25 Revised & Re-Issued for DP 2023-12-21 ISSUED FOR BP 2024-02-17 BP REVISION "A" 2024-05-30 ISSUED FOR DP


Project Name:

LeParc


KIPLING ST & THURLOW ST


Project No: 19.015 SG/TD 2025-04-17 1:50

A5.2

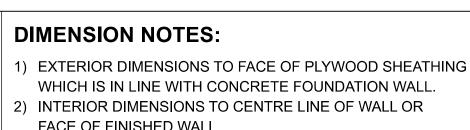

2) INTERIOR DIMENSIONS TO CENTRE LINE OF WALL OR FACE OF FINISHED WALL. 3) WALLS ARE DRAWN FULL WIDTH INCLUDING DRYWALL. 4) GRIDLINES TO FACE OF FOUNDATION WALL OR C/L OF DEMISING WALLS

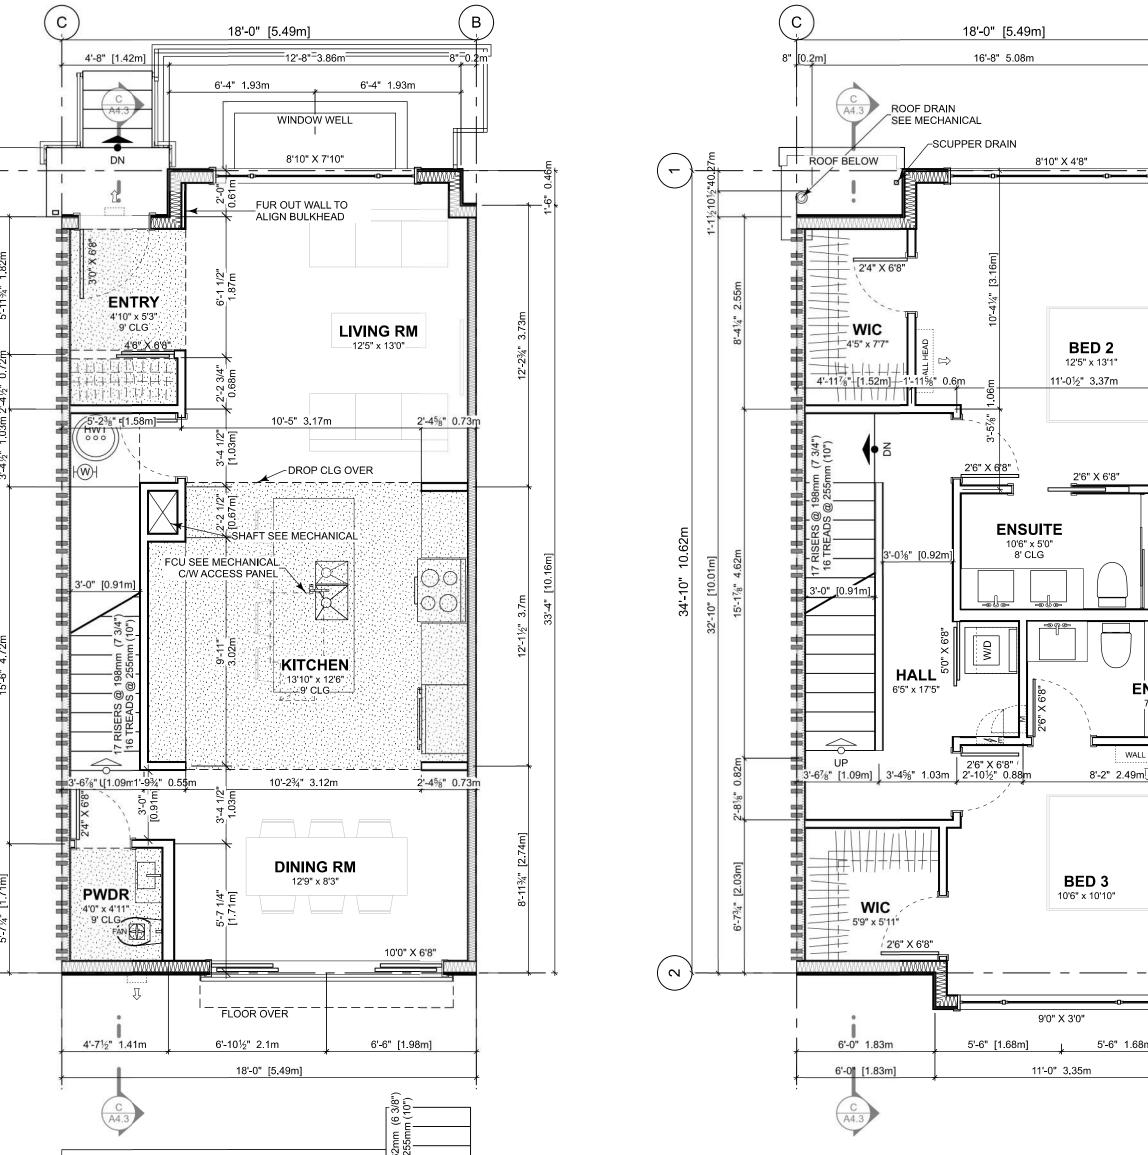


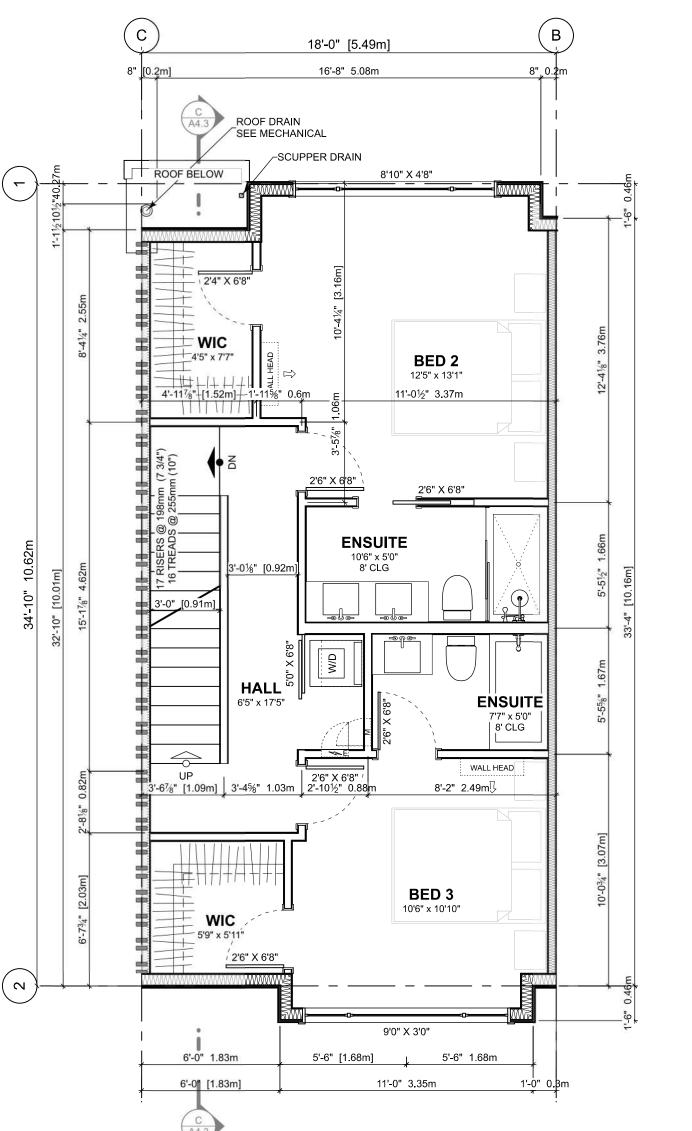

SECOND FLOOR PLAN
Scale: 1:50

Floor Garage

or Area C	alculations		ı	Unit 3		Floor Area Ca	lculations		U	nit 4	
	Gross Flo	or Area	Zoning Flo	oor Area	Bedrms		Gross Floo	or Area	Zoning Floo	r Area	Bedrms
ment Floor	0 sq ft	0.0 m2	0 sq ft	0.0 m2		Basement Floor	617 sq ft	57.3 m2	0 sq ft	0.0 m2	2
Floor	617 sq ft	57.3 m2	595 sq ft	55.3 m2		Main Floor	0 sq ft	0.0 m2	0 sq ft	0.0 m2	
nd Floor	633 sq ft	58.8 m2	610 sq ft	56.7 m2	2	Second Floor	0 sq ft	0.0 m2	0 sq ft	0.0 m2	
Storey	479 sq ft	44.5 m2	453 sq ft	42.1 m2	1	Third Storey	0 sq ft	0.0 m2	0 sq ft	0.0 m2	
s:	1,729 sq ft	160.6 m2	1,659 sq ft	154.1 m2	3	Totals:	0 sq ft	0.0 m2	0 sq ft	0.0 m2	0
ae	0 sa ft	0.0 m2	0 sa ft	0.0 m2		Garage	0 sa ft	0.0 m2	0 sa ft	0.0 m2	

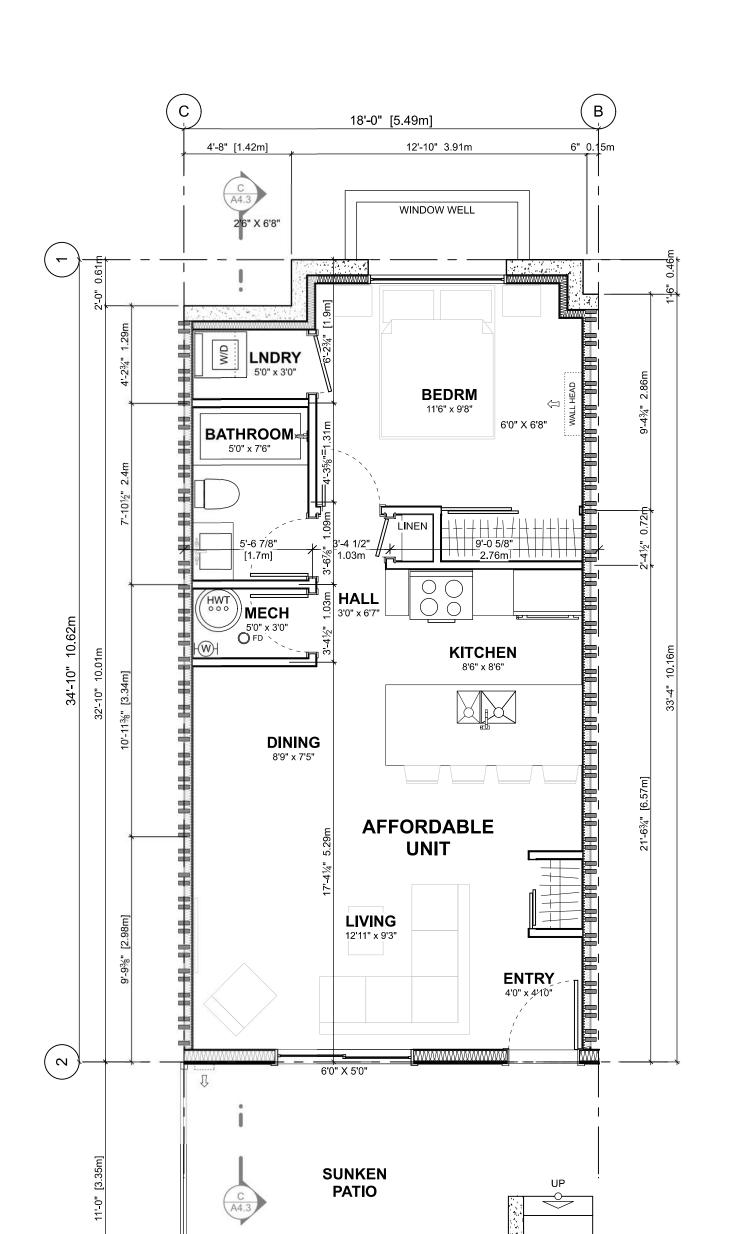



PLANTER

18'-0" [5.49m] **DECK** 14'6" x 6'2" 5'0" X 6'8" MASTER BEDRM 13'10" x 11'2" WALL HEAD


WIC

9'6" x 7'0"

**ENSUITE** 

THIRD FLOOR PLAN
Scale: 1:50

MAIN FLOOR PLAN
Scale: 1:50

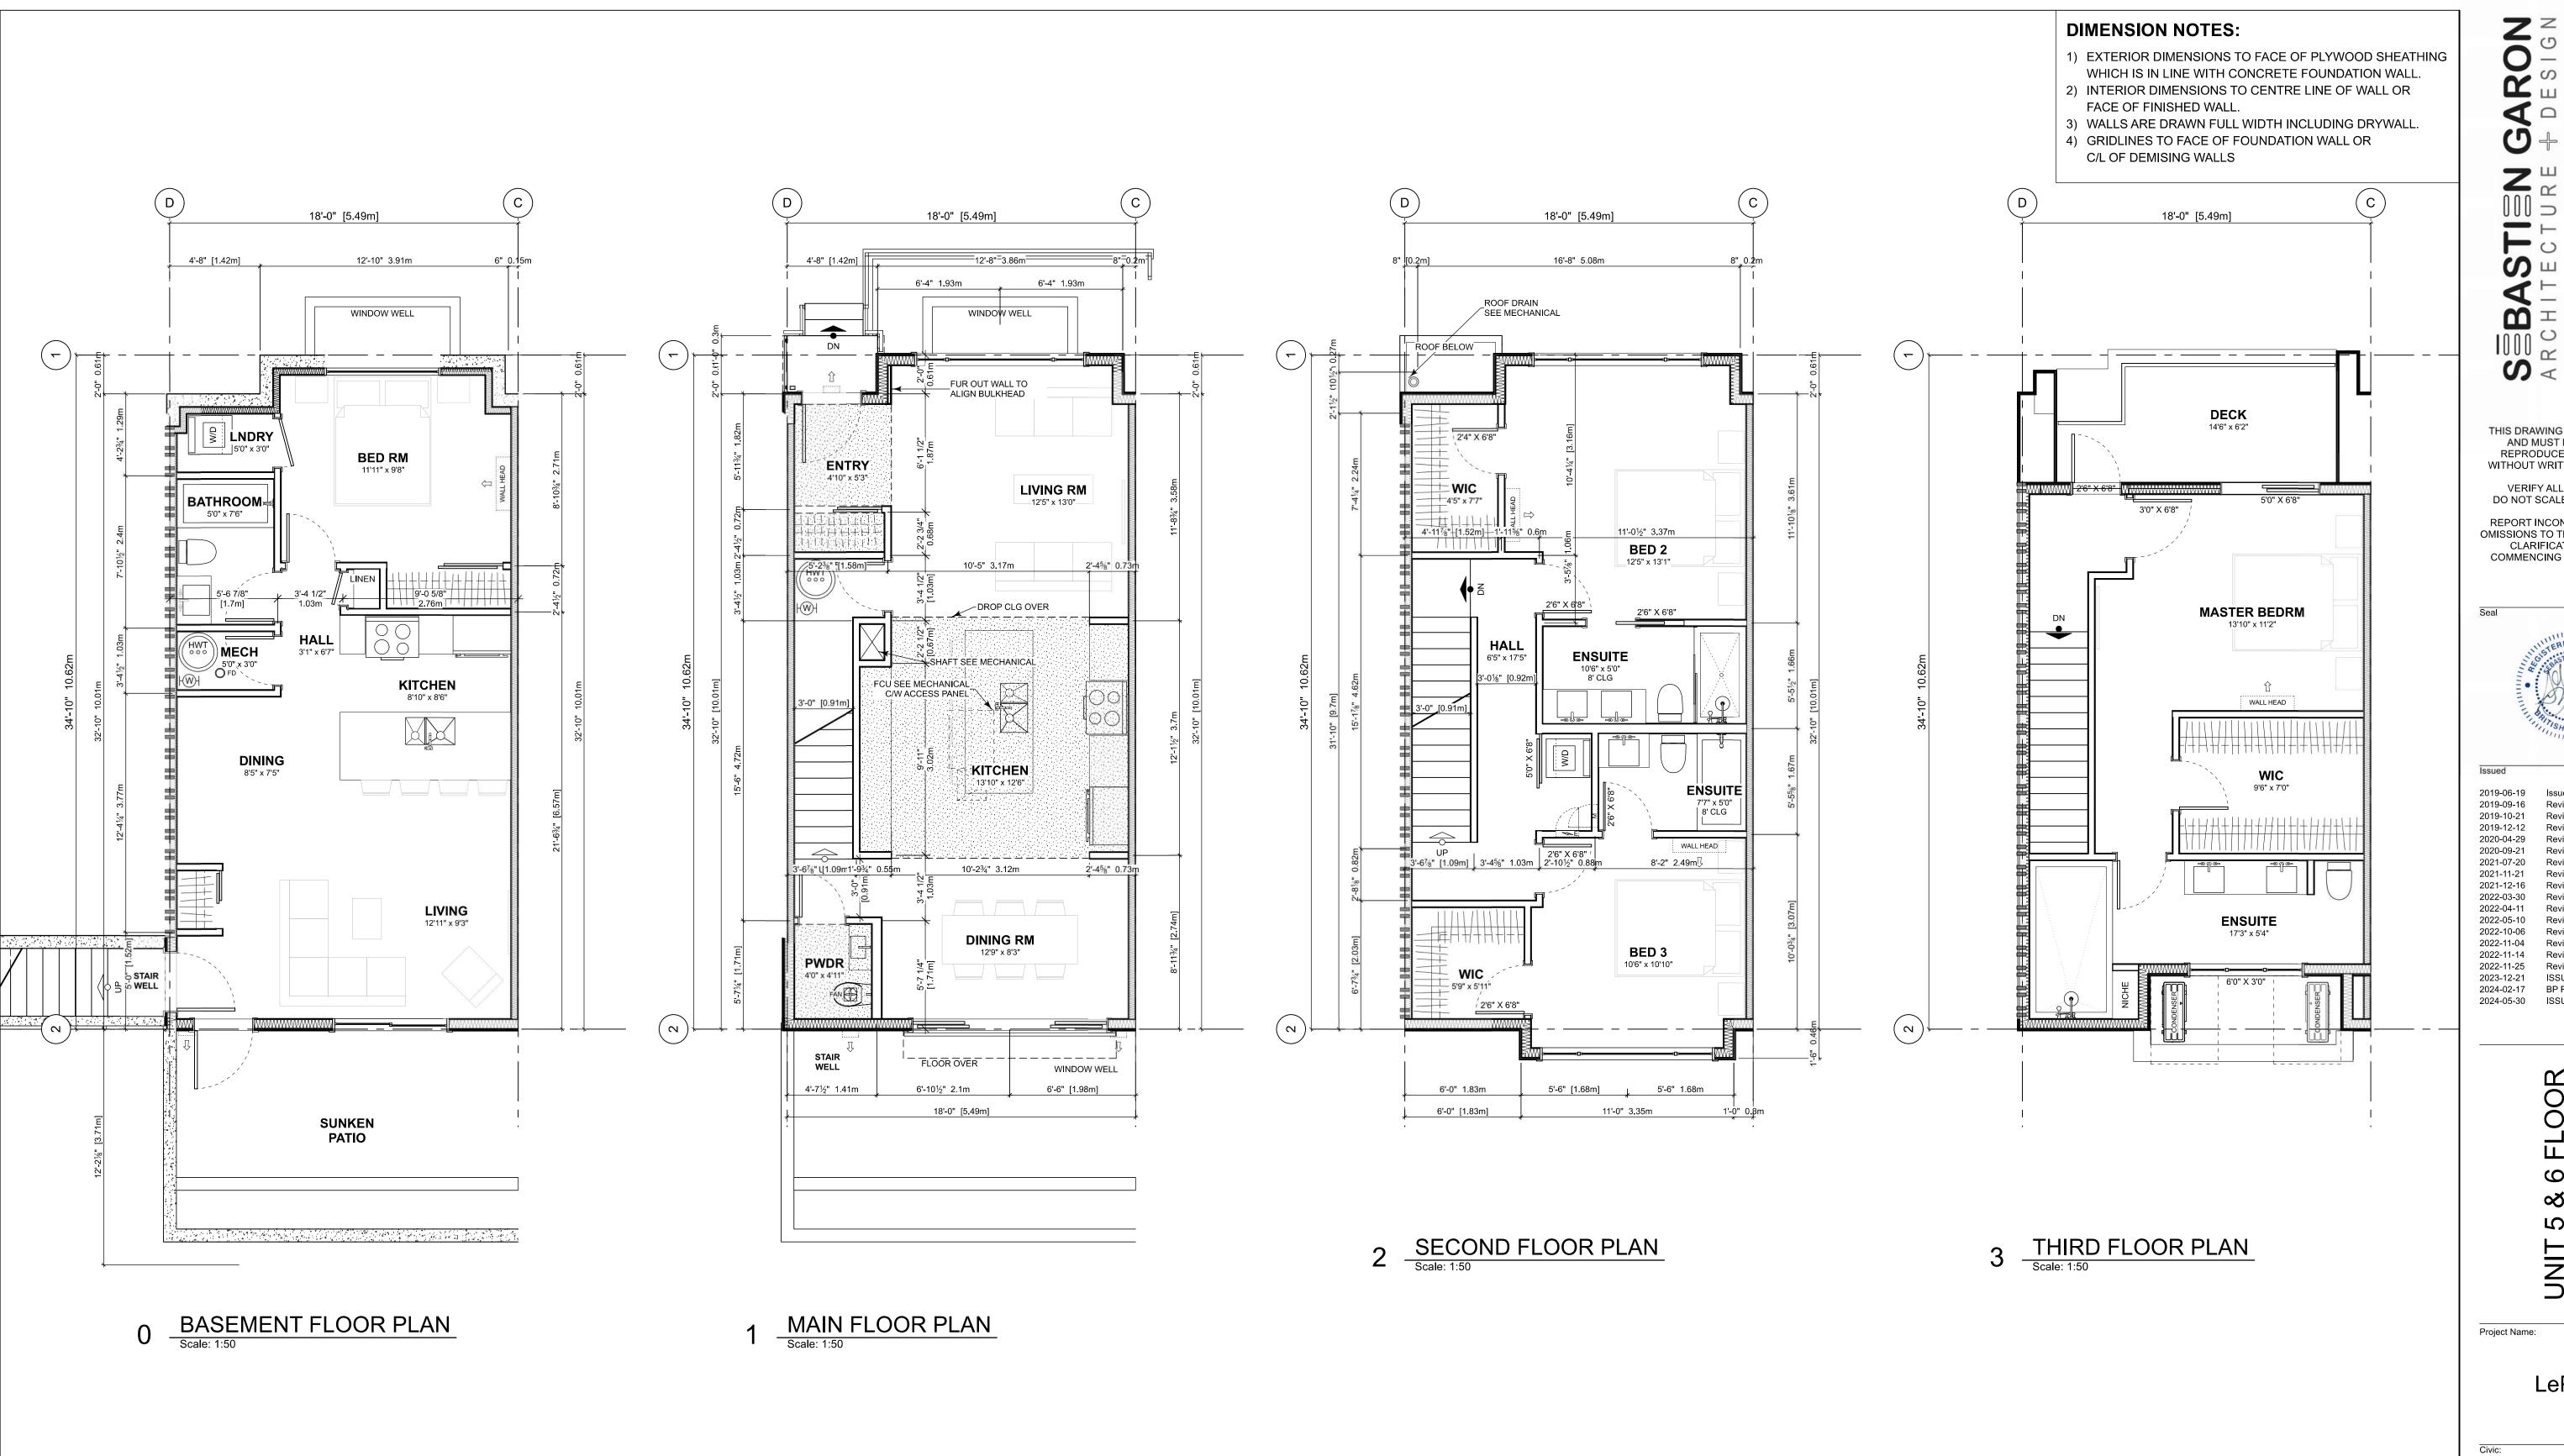

Floor Area Cald	culations		l	Jnit 5		F
	Gross Flo	or Area	Zoning Flo	or Area	Bedrms	
Basement Floor	0 sq ft	0.0 m2	0 sq ft	0.0 m2		Ва
Main Floor	616 sq ft	57.3 m2	595 sq ft	55.2 m2		Ma
Second Floor	633 sq ft	58.8 m2	610 sq ft	56.6 m2	2	Se
Third Storey	479 sq ft	44.5 m2	453 sq ft	42.1 m2	1	Th
Totals:	1,728 sq ft	160.6 m2	1,658 sq ft	154.0 m2	3	То
Garage	0 sq ft	0.0 m2	0 sq ft	0.0 m2		Ga

oor Area Calculations Unit 6								
	Gross Floo	or Area	Zoning Floo	Bedrms				
sement Floor	617 sq ft	57.3 m2	0 sq ft	0.0 m2	2			
ain Floor	0 sq ft	0.0 m2	0 sq ft	0.0 m2				
cond Floor	0 sq ft	0.0 m2	0 sq ft	0.0 m2				
ird Storey	0 sq ft	0.0 m2	0 sq ft	0.0 m2				
tals:	617 sq ft	57.3 m2	0 sq ft	0.0 m2	2			
arage	0 sq ft	0.0 m2	0 sq ft	0.0 m2				

THIS DRAWING IS COPYRIGHTED AND MUST NOT BE USED, REPRODUCED, OR REVISED WITHOUT WRITTEN PERMISSION.

VERIFY ALL DIMENSIONS. DO NOT SCALE THIS DRAWING.

REPORT INCONSISTENCIES AND OMISSIONS TO THE ARCHITECT FOR CLARIFICATION BEFORE COMMENCING WITH THE WORK.



2019-06-19 Issued for DP 2019-09-16

Revised & Re-Issued for DP 2019-10-21 Revised & Re-Issued for DP Revised & Re-Issued for DP 2019-12-12 Revised & Re-Issued for DP 2020-04-29 2020-09-21 Revised & Re-Issued for DP 2021-07-20 Revised & Re-Issued for DP 2021-11-21 Revised & Re-Issued for DP 2021-12-16 Revised & Re-Issued for DP 2022-03-30 Revised & Re-Issued for DP Revised & Re-Issued for DP 2022-04-11 2022-05-10 Revised & Re-Issued for DP 2022-10-06 Revised & Re-Issued for DP

Revised & Re-Issued for DP 2022-11-14 Revised & Re-Issued for DP 2022-11-25 Revised & Re-Issued for DP 2023-12-21 ISSUED FOR BP 2024-02-17 BP REVISION "A" 2024-05-30 ISSUED FOR DP

UNIT 5 & 6 FLOOR PLANS

Project Name:

LeParc

KIPLING ST & THURLOW

Project No: 19.015 SG/TD 2025-04-17 1:50

A5.3

S

DO NOT SCALE THIS DRAWING.

Project Name:

LeParc

Civic:
KIPLING ST & THURLOW
ST

 Project No:
 19.015


 Drawn By:
 SG/TD


 Plot Date:
 2025-04-17


 Scale:
 1:50


 Sheet No:

A5.4

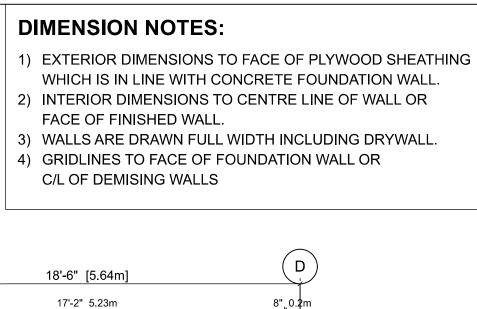

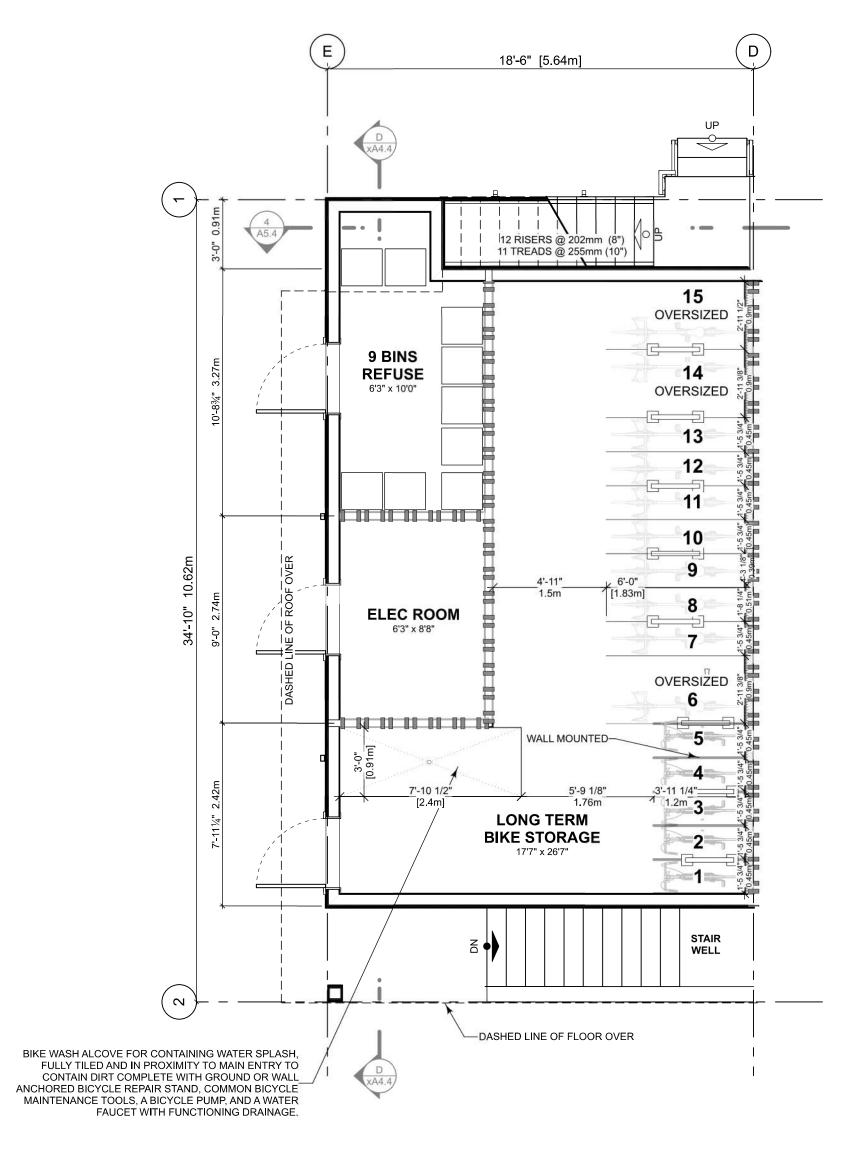

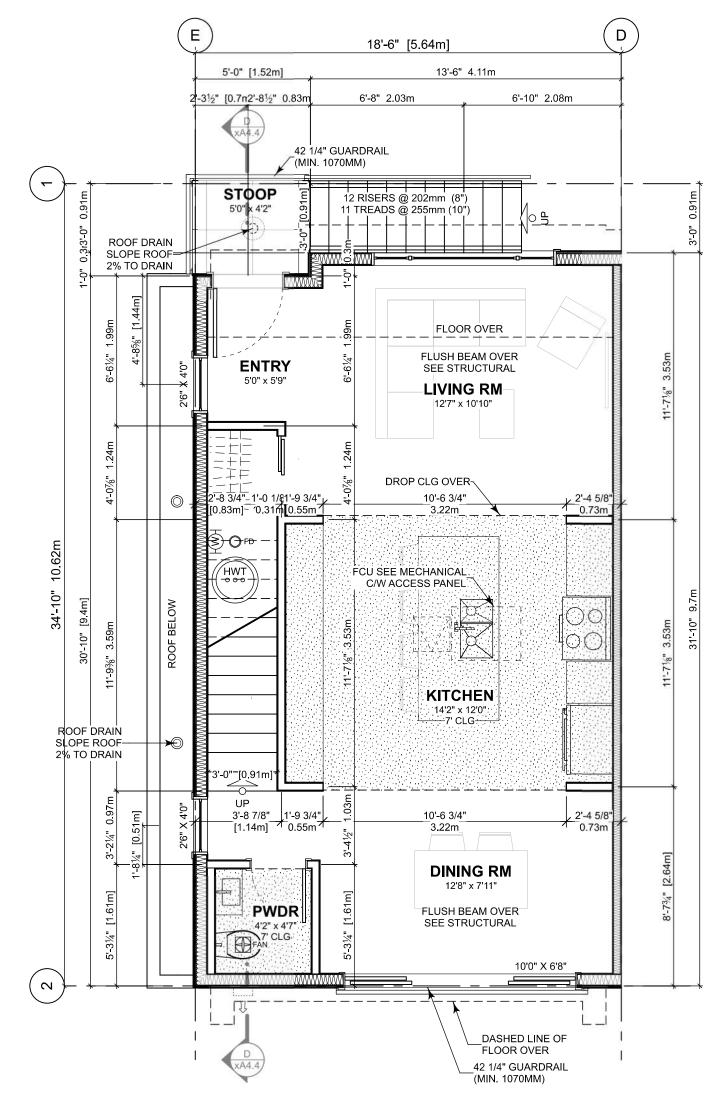

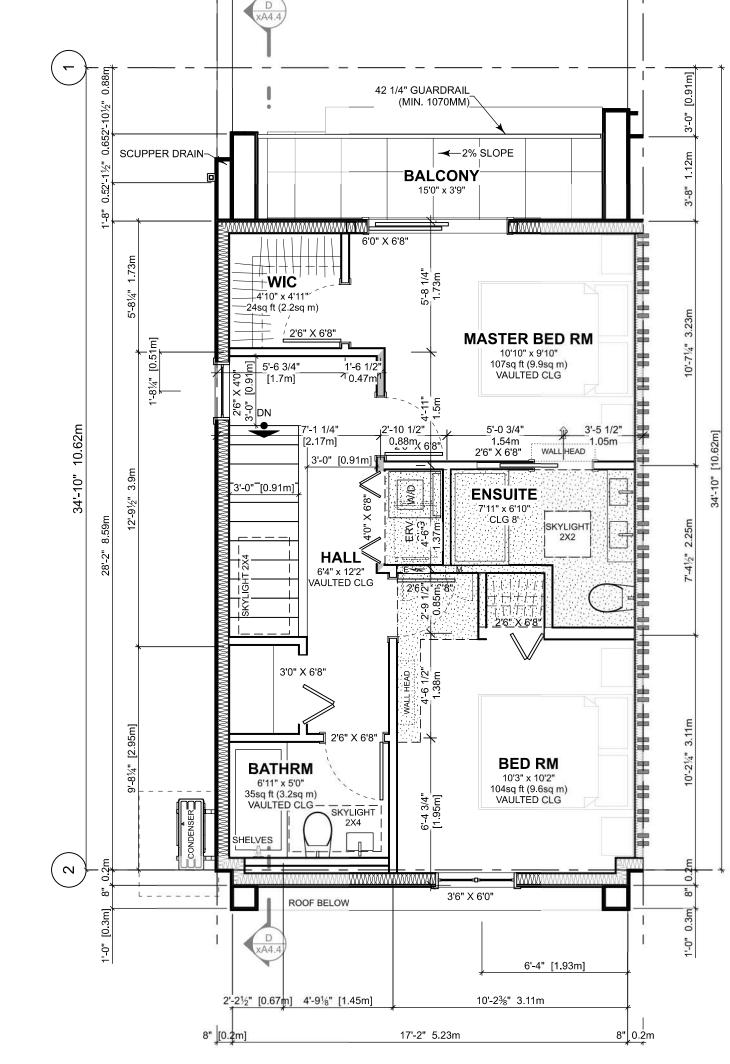

MAIN FLOOR PLAN
Scale: 1:50

2 SECOND FLOOR PLAN
Scale: 1:50

THIRD FLOOR PLAN
Scale: 1:50

Floor Area C	alculations	Unit 7						
	Gross Flo	or Area	Zoning Flo	Bedrms				
Basement Floor	No Basement as per zoning definition							
Main Floor	0 sq ft	0.0 m2	0 sq ft	0.0 m2				
Second Floor	584 sq ft	54.2 m2	547 sq ft	50.8 m2				
Third Storey	533 sq ft	49.5 m2	493 sq ft	45.8 m2	2			
Totals:	1,116 sq ft	103.7 m2	1,040 sq ft	96.6 m2	2			
Garage	0 sq ft	0.0 m2	0 sq ft	0.0 m2				