



1400 LE PARC (1400 FAIRFIELD)

1404 FAIRFIELD RD, VICTORIA, BC

SHEET LIST

L3.01 SOIL DEPTH PLAN L0.00 COVER SHEET

L0.01 TREE MANAGEMENT & REMOVAL PLAN L4.01 HARDSCAPE AND SITE FURNISING DETAILS

L0.02 ARBORIST TREE INVENTORY LIST L4.02 SOFSCAPE DETAILS

L1.01 MATERIALS PLAN

L2.01 TREE PLANTING PLAN

GENERAL LANDSCAPE NOTES

GENERAL:

- 1. DO NOT PROCEED IN UNCERTAINTY. 2. DO NOT SCALE DRAWINGS.
- 3. DRAWINGS AND SPECIFICATIONS ARE TO BE READ IN CONJUNCTION WITH ALL OTHER DRAWINGS/SPECIFICATIONS IN THIS PROJECT SET. ANY DISCREPANCIES AMONG DRAWINGS, SPECIFICATIONS AND INDUSTRY BEST PRACTICES TO BE REPORTED TO THE PROJECT / CONSTRUCTION MANAGER AND THE LANDSCAPE CONSULTANT FOR DIRECTION.
- 4. ALL LANDSCAPE SPECIFICATION SECTIONS AND DRAWINGS ARE AFFECTED BY REQUIREMENTS OF DIVISION 01 SECTIONS (PROVIDED IN THE PROJECT MANUAL).
- 5. CONTRACTOR TO FAMILIARIZE THEMSELVES WITH ALL SITE CONDITIONS, INCLUDING THE LIMITS OF WORK AND EXISTING FEATURES TO BE PROTECTED, PRIOR TO SUBMITTING BIDS/QUOTES.
- 6. CONTRACTOR TO CONFIRM LOCATION AND ELEVATION OF ALL UNDERGROUND UTILITIES/FEATURES PRIOR TO COMMENCING WORK.
- 7. CONTRACTOR TO TAKE NECESSARY PRECAUTIONS TO PROTECT SITE FEATURES / CONDITIONS, WITHIN AND BEYOND THE LIMITS OF WORK EXISTING AT THE TIME OF CONSTRUCTION. ALL DISTURBED SURFACES, AREAS, STRUCTURES, VEGETATION, HABITAT ETC. ON PUBLIC / PRIVATE PROPERTY TO PROMPTLY BE RESTORED TO EQUAL OR BETTER CONDITION THAN EXISTING AND TO THE SATISFACTION OF THE MUNICIPALITY HAVING JURISDICTION / PROPERTY OWNER.
- 8. CONTRACTOR TO MAINTAIN THE SITE IN A SAFE AND TIDY CONDITION AT ALL TIMES. DO NOT OBSTRUCT PEDESTRIAN OR VEHICULAR CIRCULATION. DO NOT LEAVE UNPROTECTED HOLES / PITS / OPENINGS OVERNIGHT. ALL EXCESS MATERIALS AND REFUSE TO BE REMOVED FROM THE SITE DAILY UNLESS OTHERWISE DIRECTED BY THE CONSTRUCTION MANAGER.

STANDARDS:

- 1. ALL WORK ON MUNICIPAL PROPERTY TO CONFORM TO THE CITY OF VICTORIA DEVELOPMENT STANDARDS (AUTHORITY HAVING JURISDICTION) INCLUDING BUT NOT LIMITED TO:
- 1.1. CITY OF VICTORIA SUPPLEMENTARY SPECIFICATIONS SCHEDULE 'B' TO THE SUBDIVISION AND DEVELOPMENT SERVICING BYLAW NO. 12-042
- 1.2. CITY OF VICTORIA SUPPLEMENTAL DRAWINGS
- 1.3. CITY OF VICTORIA SUPPLEMENTARY SPECIFICATIONS FOR STREET TREES AND IRRIGATION, SCHEDULE C. 2. ALL LANDSCAPE WORK ON THE DEVELOPMENT SITE TO CONFORM TO THE CURRENT EDITION AT TIME OF ISSUE OF THE Canadian Landscape Standard (CLS), UNLESS SPECIFICALLY STATED OTHERWISE IN WRITTEN
- SPECIFICATIONS AND ON DRAWINGS. 3. ALL HARD SURFACE (INCLUDING BUT NOT LIMITED TO PAVING, CONCRETE RETAINING WALLS AND CONCRETE PLANTERS) TO CONFORM TO THE Master Municipal Construction Documents Association PLATINUM EDITION (MMCD)
- AND MMCD SUPPLEMENTAL DRAWINGS AND SPECIFICATIONS, UNLESS SPECIFICALLY STATED OTHERWISE IN WRITTEN SPECIFICATIONS AND ON DRAWINGS. 4. IN CASES OF CONFLICT BETWEEN THE CLS AND THE MMCD, THE MORE STRINGENT REQUIREMENT WILL TAKE PRECEDENCE.
- 5. LANDSCAPE CONTRACTOR TO BE FAMILIAR WITH MUNICIPAL DEVELOPMENT STANDARDS AND BE IN POSSESSION OF THE CLS AND MMCD MANUALS AND SUPPLEMENTAL DRAWINGS AND SPECIFICATIONS.
- 6. GROWING MEDIUM AND GROWING MEDIUM TESTING TO CLS Section 5. 7. IRRIGATION DESIGN AND INSTALLATION TO IIABC STANDARDS AND CLS Section 10.

1. CONTRACTOR TO COORDINATE INSTALLATION OF IRRIGATION AND ELECTRICAL SLEEVES WITH ARCHITECTURAL, MECHANICAL, ELECTRICAL AND CIVIL WORKS.

- 1. CONTRACTOR TO PROVIDE SAMPLES, TEST RESULTS AND SHOP DRAWINGS TO LANDSCAPE CONSULTANT FOR REVIEW AND APPROVAL 45 DAYS PRIOR TO INSTALLATION.
- 2. SEE ALSO SUBMITTALS TABLE BELOW FOR ADDITIONAL INFORMATION.

GROWING MEDIUM TESTING:

- 1. GROWING MEDIUM TEST RESULTS ARE MANDATORY.
- TEST RESULTS TO INCLUDE ANALYSIS OF ALL GROWING MEDIUM NUTRIENTS NOTED IN CLS 5.2.7 AND ARE TO BE REPORTED IN THE SAME UNITS AS NOTED IN THAT SECTION.
- 3. TEST RESULTS TO INCLUDE ANALYSIS OF SOIL TEXTURE, ORGANIC CONTENT AND ACIDITY AS PER CLS 5.3.5 AND BE REPORTED IN THE SAME UNITS AS NOTED IN THAT SECTION.
- 4. TEST RESULTS TO INCLUDE RECOMMENDATIONS FOR AMENDMENTS TO MEET THE REQUIREMENTS FOR EACH GROWING MEDIUM TYPE. 5. RECOMMENDED GROWING MEDIUM TESTING FACILITY: Pacific Soil Analysis Inc. 11720 Voyageur Way, Richmond, BC V6X 3G9 OR APPROVED EQUAL.

COMPACTION TESTING:


1. COMPACTION TESTS FOR HARD SURFACE SUBGRADE, GRANULAR SUB-BASE, AND GRANULAR BASE ARE MANDATORY.

1. CONTRACTOR TO ALERT THE LANDSCAPE CONSULTANT A MINIMUM OF 3 WORKING DAYS PRIOR TO REQUIRED LANDSCAPE INSPECTIONS.

- 1. REQUESTS FOR SUBSTITUTIONS TO CONFORM TO THE DIVISION 01 SECTION AND BE SUBMITTED TO THE LANDSCAPE CONSULTANT, THROUGH THE PROJECT ADMINISTRATOR, A MINIMUM OF 45 DAYS PRIOR TO SCHEDULED
- 2. PLEASE NOTE THAT SOME SUBSTITUTIONS MAY REQUIRE MUNICIPAL APPROVAL.


1. CONTRACTOR SHALL WARRANTY ALL WORKMANSHIP AND MATERIALS FOR 1 FULL YEAR FOLLOWING THE DATE OF TOTAL PERFORMANCE AS PER MMCD UNLESS SPECIFICALLY NOTED OTHERWISE. FAULTY MATERIALS AND WORKMANSHIP SHALL BE PROMPTLY REPAIRED / REPLACED TO THE SATISFACTION OF THE LANDSCAPE CONSULTANT.

1. CONTRACTOR TO INSTALL AND MAINTAIN SEDIMENTATION FILTRATION MEASURES AS REQUIRED FOR LANDSCAPE WORKS TO PREVENT MATERIALS FROM LEAVING THE SITE AND / OR ENTERING STORM DRAINS; STOCKPILED LANDSCAPE MATERIALS ARE TO BE KEPT TARPED.

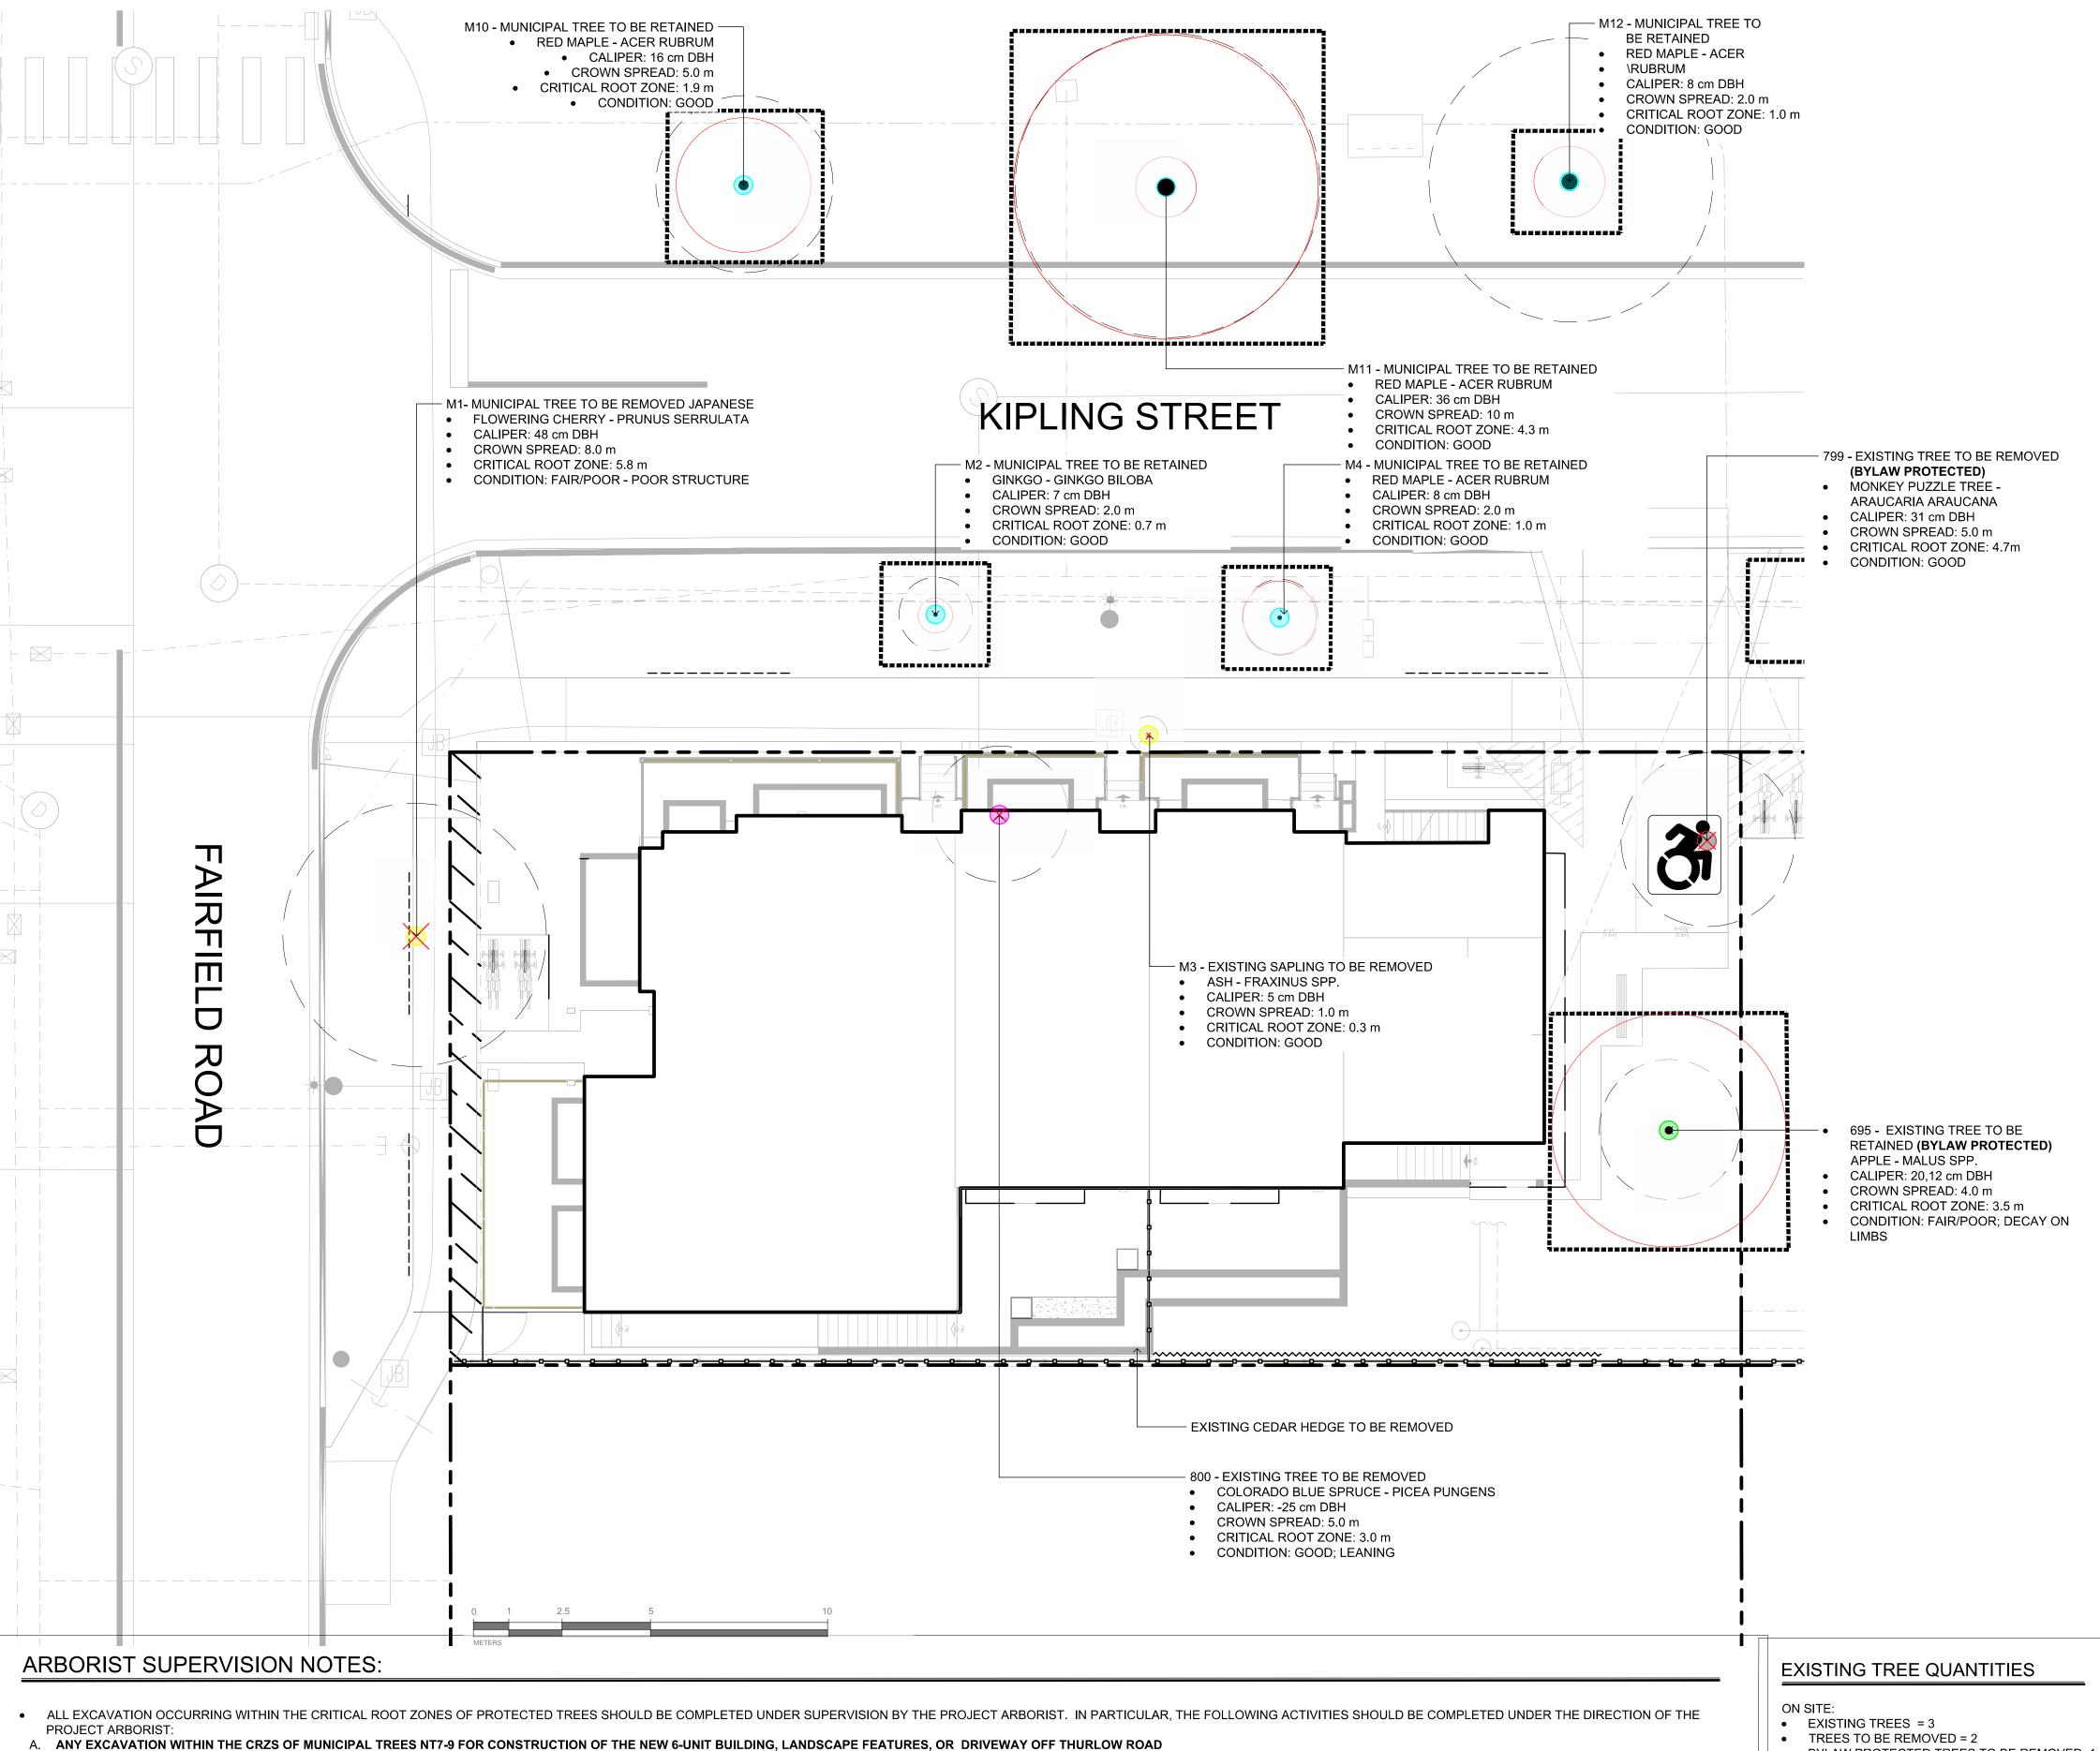

LEGEND

PROPERTY LINE **BUILDING FOOTPRINT** PRIVACY FENCE CLIMBING VINES **ROOT BARRIER** -----TREE PROTECTION FENCING TO OUTSIDE OF DRIPLINE WHERE POSSIBLE (AS SHOWN) TO BE MAINTAINED UNTIL COMPLETION OF CONSTRUCTION TO CITY OF VICTORIA STANDARD **EXISTING TREE TO BE RETAINED** SHOWN AT EXISTING SPREAD EXISTING TREE TO BE REMOVED SHOWN AT EXISTING SPREAD CRITICAL ROOT ZONE PROTECTED TREE FOR REMOVAL PROTECTED TREE TO RETAIN MUNICIPAL TREE FOR REMOVAL

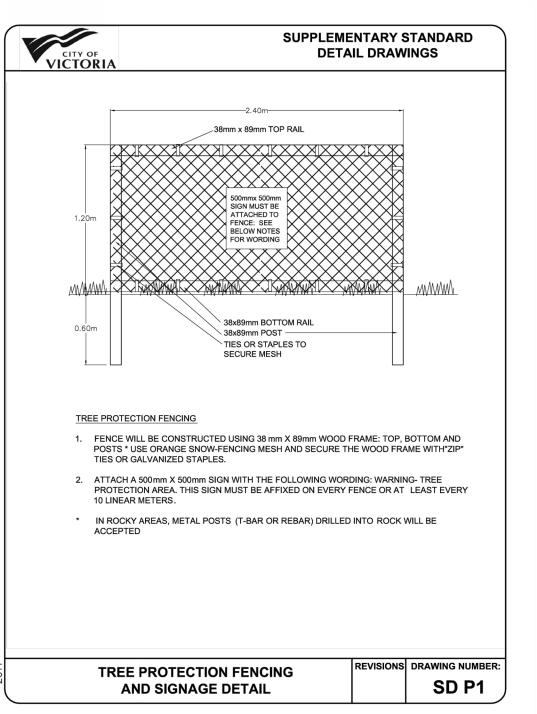

MUNICIPAL TREE TO RETAIN

TREE FOR REMOVAL

TREE PROTECTION FENCING AND SIGNAGE DETAIL



1608 Camosun Street, Victoria BC V8T 3E6 Info@biophiliacollective.ca 250 590 1156

OWNER/CLIENT:

BREIA HOLDINGS LTD.

PROJECT NAME:

LE PARC

PROJECT ADDRESS:

1400 FAIRFIELD

DESIGNED BY: BIANCA BODLEY

DRAWN BY: LB

RE- ISSUED FOR DP **ISSUED FOR REVIEW** 25/03/06 REVISED AND RE-ISSUED FOR DP 24/10/29 RE-ISSUED FOR REVIEW ISSUED FOR RZ/DP 24/06/06 ISSUED FOR COORDINATION 24/05/15 ISSUED FOR BP 23/12/21 23/11/15 ISSUED FOR BP 75% 23/11/01 ISSUED FOR BP 50%

NORTH ARROW



DRAWING TITLE:

TREE MANAGEMENT PLAN

DWG NO:

SCALE: 1:100

- BYLAW PROTECTED TREES TO BE REMOVED: 1
- REPLACEMENT TREES REQUIRED: 3
- MUNICIPAL BOULEVARD:

NEW STREET PLANTED: 4

• EXISTING TREES = 7 • TREES TO BE REMOVED = 3 (M1,M3,M11)

MACHINERY AND FOOT TRAFFIC. THIS CAN BE ACHIEVED BY ONE OF THE FOLLOWING METHODS: • INSTALLING A LAYER OF HOG FUEL OR COARSE WOOD CHIPS AT LEAST 20 CM IN DEPTH AND MAINTAINING IT IN GOOD CONDITION UNTIL CONSTRUCTION IS COMPLETE.

B. ANY EXCAVATION FOR THE ABANDONING OF EXISTING UNDERGROUND SERVICES OR INSTALLATION OF NEW SERVICES WITHIN THE CRZS OF TREES TO BE RETAINED.

- PLACING MEDIUM WEIGHT GEOTEXTILE CLOTH OVER THE AREA TO BE USED AND INSTALLING A LAYER OF CRUSHED ROCK TO A DEPTH OF 15 CM OVER TOP. • PLACING TWO LAYERS OF 19MM PLYWOOD. • PLACING STEEL PLATES.
- LANDSCAPING AND IRRIGATION SYSTEMS: THE PLANTING OF NEW TREES AND SHRUBS SHOULD NOT DAMAGE THE ROOTS OF RETAINED TREES. THE INSTALLATION OF ANY IN-GROUND IRRIGATION SYSTEM MUST TAKE INTO ACCOUNT THE CRITICAL ROOT ZONES OF THE TREES TO BE RETAINED. PRIOR TO INSTALLATION, WE RECOMMEND THE IRRIGATION TECHNICIAN CONSULT WITH THE PROJECT ARBORIST ABOUT THE MOST SUITABLE LOCATIONS FOR THE IRRIGATION LINES AND HOW BEST TO MITIGATE THE IMPACTS ON THE TREES TO BE RETAINED. THIS MAY REQUIRE THE PROJECT ARBORIST SUPERVISE THE EXCAVATIONS ASSOCIATED WITH INSTALLING THE IRRIGATION SYSTEM. EXCESSIVE FREQUENT IRRIGATION AND IRRIGATION WHICH WETS THE TRUNKS OF TREES CAN HAVE A DETRIMENTAL IMPACT ON TREE HEALTH AND CAN LEAD TO ROOT AND TRUNK DECAY.
- ARBORIST ROLE: IT IS THE RESPONSIBILITY OF THE CLIENT OR HIS/HER REPRESENTATIVE TO CONTACT THE PROJECT ARBORIST FOR THE PURPOSE OF:
- LOCATING THE BARRIER FENCING
- REVIEWING THE REPORT WITH THE PROJECT FOREMAN OR SITE SUPERVISOR
- LOCATING WORK ZONES, WHERE REQUIRED
- SUPERVISING ANY EXCAVATION WITHIN THE CRITICAL ROOT ZONES OF TREES TO BE RETAINED
- REVIEWING AND ADVISING OF ANY PRUNING REQUIREMENTS FOR MACHINE CLEARANCES

NUMBER OF WAYS, INCLUDING WRAPPING THE ROOTS IN BURLAP OR INSTALLING A ROOT CURTAIN OF WIRE MESH LINED WITH BURLAP, AND KEEPING THE AREA MOIST THROUGHOUT THE CONSTRUCTION PROCESS.

- REVIEW AND SITE MEETING: ONCE THE PROJECT RECEIVES APPROVAL, IT IS IMPORTANT THAT THE PROJECT ARBORIST MEET WITH THE PROJECT TO REVIEW THE INFORMATION CONTAINED HEREIN. IT IS ALSO IMPORTANT THAT THE ARBORIST MEET WITH THE SITE FOREMAN OR SUPERVISOR BEFORE ANY SITE CLEARING, TREE REMOVAL, DEMOLITION, OR OTHER CONSTRUCTION ACTIVITY OCCURS AND TO CONFIRM THE LOCATIONS OF THE TREE PROTECTION BARRIER FENCING.
 - SEE ARBORIST REPORT FOR ADDITIONAL INFORMATION, REQUIREMENTS AND RECOMMENDATIONS.

• PRUNING ROOTS: ANY SEVERED ROOTS MUST BE PRUNED BACK TO SOUND TISSUE TO REDUCE WOUND SURFACE AREA AND ENCOURAGE RAPID COMPARTMENTALIZATION OF THE WOUND. BACKFILLING THE EXCAVATED AREA AROUND THE ROOTS SHOULD BE DONE AS SOON AS POSSIBLE TO KEEP THE ROOTS MOIST AND AID IN ROOT REGENERATION. EXPOSED ROOTS SHOULD BE KEPT MOIST UNTIL THE AREA IS BACKFILLED, ESPECIALLY IF EXCAVATION OCCURS DURING A PERIOD OF DROUGHT. THIS CAN BE ACCOMPLISHED IN A

MINIMIZING SOIL COMPACTION: IN AREAS WHERE CONSTRUCTION TRAFFIC MUST ENCROACH INTO THE CRITICAL ROOT ZONES OF TREES TO BE RETAINED, EFFORTS MUST BE MADE TO REDUCE SOIL COMPACTION WHERE POSSIBLE BY DISPLACING THE WEIGHT OF

Гаg or	Surveyed?	Location (On, Off, Shared,	Bylaw protected?	Name		dbh		Critical root zone radius	Relative	Condition		Retention Suitability (on-	General field	Tree retention / location	Retentior
D#	(Yes/No)	City)	(Yes/No)	Common	Botanical	(cm)	(m)	(m)	Tolerance	Health	Structural	100 000	observations/remarks	comments	status
95	Yes	On-site	Yes	Apple	Malus spp.	20, 12	4	3.3	Moderate	Fair	Fair/poor	Conditional	12cm stem resting on shed, decay on limbs	Possible impacts from adjacent tree removals; relatively poor structure.	Retain*
99	Yes	On-site	Yes	Monkey Puzzle	Araucaria araucana	31	5	4.7	Poor	Good	Good	Unsuitable		Within proposed parking stall footprint.	x
300	Yes	On-site	No	Colorado Blue Spruce	Picea pungens	~25	5	3	Moderate	Good	Good	Unsuitable	Leaning	Within proposed building footprint.	x
398	Yes	On-site	No	Western Red Cedar	Thuja plicata	42	5	5	Moderate	Fair	Fair	Unsuitable	Raised, asymmetric crown	Conflict with proposed building footprint & parking stalls; adjacent tree removals.	X
03	Yes	On-site	Yes	Western Red Cedar	Thuja plicata	42	4	5	Moderate	Fair	Fair	Unsuitable	Raised crown	Conflict with proposed building footprint & parking stalls; adjacent tree removals.	X
112	Yes	On-site	Yes	Big Leaf Maple	Acer macrophyllum	46, 24	12	7	Moderate	Fair	Fair/poor	Unsuitable	Ganoderma fruiting bodies at base, deadwood, asymmetric crown	Root & canopy conflict with proposed building footprint, likely elevated risk due to new targets.	x
	Yes	On-site	Yes	Western Red Cedar		37, 26		6.3		Fair	·	Unsuitable	Raised crown, narrow codominant union at base	Conflict with proposed building footprint & parking stalls; adjacent tree removals.	X
914	Yes	On-site	Yes	Western Red Cedar	Thuja plicata	33	4	4	Moderate	Fair	Fair	Unsuitable	Raised crown	Conflict with proposed building footprint & parking stalls; adjacent tree removals.	x
015	Yes	On-site	Yes	Western Red Cedar	Thuja plicata	51, 51	10	9.8	Moderate	Fair	Fair/poor	Unsuitable	Raised, asymmetric crown, narrow codominant union at base	Conflict with proposed building footprint & parking stalls.	x
916	Yes	On-site	Yes	Ash	Fraxinus spp.	55	14	5.5	Good	Good	Good	Unsuitable	Next to stump of removed tree, epicormic growth	Within proposed driveway footprint.	X
//1/ NT1	Yes	Municipal	Municipal	Japanese Flowering Cherry	Prunus serrulata	48	8	5.8	Moderate	Fair	Poor	N/A	Municipal (ID: 16970), basal wound	Conflict with frontage improvements; poor structure.	x
M2/N T3	Yes	Municipal	Municipal	Ginkgo	Ginkgo biloba	7	2	0.7	Good	Good	Good	N/A	Municipal (ID: 16967)		Retain
M3 /NT4	Yes	Municipal	Municipal	Ash	Fraxinus spp.	5	1	0.3	Good	Good	Good	N/A	Municipal, growing between sidewalk and fence	Conflict with proposed building footprint.	X
		Location (On,	Bylaw	Name				Critical root		Condition		Retention			
「ag or D #	Surveyed? (Yes/No)	Off, Shared, City)	protected? (Yes/No)	Common		dbh (cm)	diameter (m)	zone radius (m)	Relative Tolerance	Health	Structural	Suitability (on- site trees)	General field observations/remarks	Tree retention / location comments	Retention status
/14/ NT5	Yes	Municipal	Municipal	Red Maple	Acer rubrum	8	2	1	Moderate	Good	Good	N/A	Municipal (ID: 34935)		Retain
M5/ NT6	Yes	Municipal	Municipal	Scarlet Oak	Quercus coccinea	7	2	0.5	Moderate	Good	Good	N/A	Municipal (ID: 16622)		Retain
/16/ NT7	Yes	Municipal	Municipal	Red Maple	Acer rubrum	47	10	5.6	Moderate	Good	Good	N/A	Municipal (ID: 16620)		Retain
/17/ NT8	Yes	Municipal	Municipal	Red Maple	Acer rubrum	49	10	5.9	Moderate	Good	Good	N/A	Municipal (ID: 16618)		Retain
//8/ NT9	Yes	Municipal	Municipal	Japanese Flowering Cherry	Prunus serrulata	30	5	3.6	Moderate	Good	Good	N/A	Municipal (ID: 16656)	Potential impacts from driveway.	Retain*
М 9	No	Municipal	Municipal	Persian ironwood	Parrotia persica	7	1	0.7	Good	Good	Good	N/A	Municipal (ID: 16655)	~3m from east PL.	Retain
v 110	No	M unicipal	Municipal	Red Maple	Acer rubrum	16	5	1.9	Moderate	Good	Fair	N/A	Municipal (ID: 6346) Topped historically, trunk wound.	Potential impacts from U/G hydro. 1.8m from sidewalk edge.	Retain*
И11	No	Municipal	Municipal	Red Maple	Acer rubrum	36	10	4.3	Moderate	Good	Fair	N/A	Municipal (ID: 6345) Some hydro clearance pruning (topping) west side; canopy weighted east.	Likely conflict with U/G hydro. 1.8m from sidewalk edge.	Retain* a per Parks direction
/ 112	No	Municipal	Municipal	Red Maple	Acer rubrum	8	2	1	Moderate	Fair	Fair	N/A	Municipal (ID: 34936) Lower trunk wound.	Potential impacts from U/G hydro. 1.8m from sidewalk edge.	Retain*
													Municipal (ID: 6344) Recently planted, slight bark damage south		



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OWNER/CLIENT:

BREIA HOLDINGS LTD.

PROJECT NAME:

LE PARC

PROJECT ADDRESS:

349 KIPLING

DESIGNED BY: **BIANCA BODLEY** DRAWN BY: **LB**


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6	RE-ISSUED FOR REVIEW	24/09/27
5	ISSUED FOR RZ/DP	24/06/06
4	ISSUED FOR COORDINATION	24/05/15
3	ISSUED FOR BP	23/12/21
2	ISSUED FOR BP 75%	23/11/15
1	ISSUED FOR BP 50%	23/11/01
NO.	ISSUE	YY/MM/DE





DRAWING TITLE:

ARBORIST TREE INVENTORY TABLE

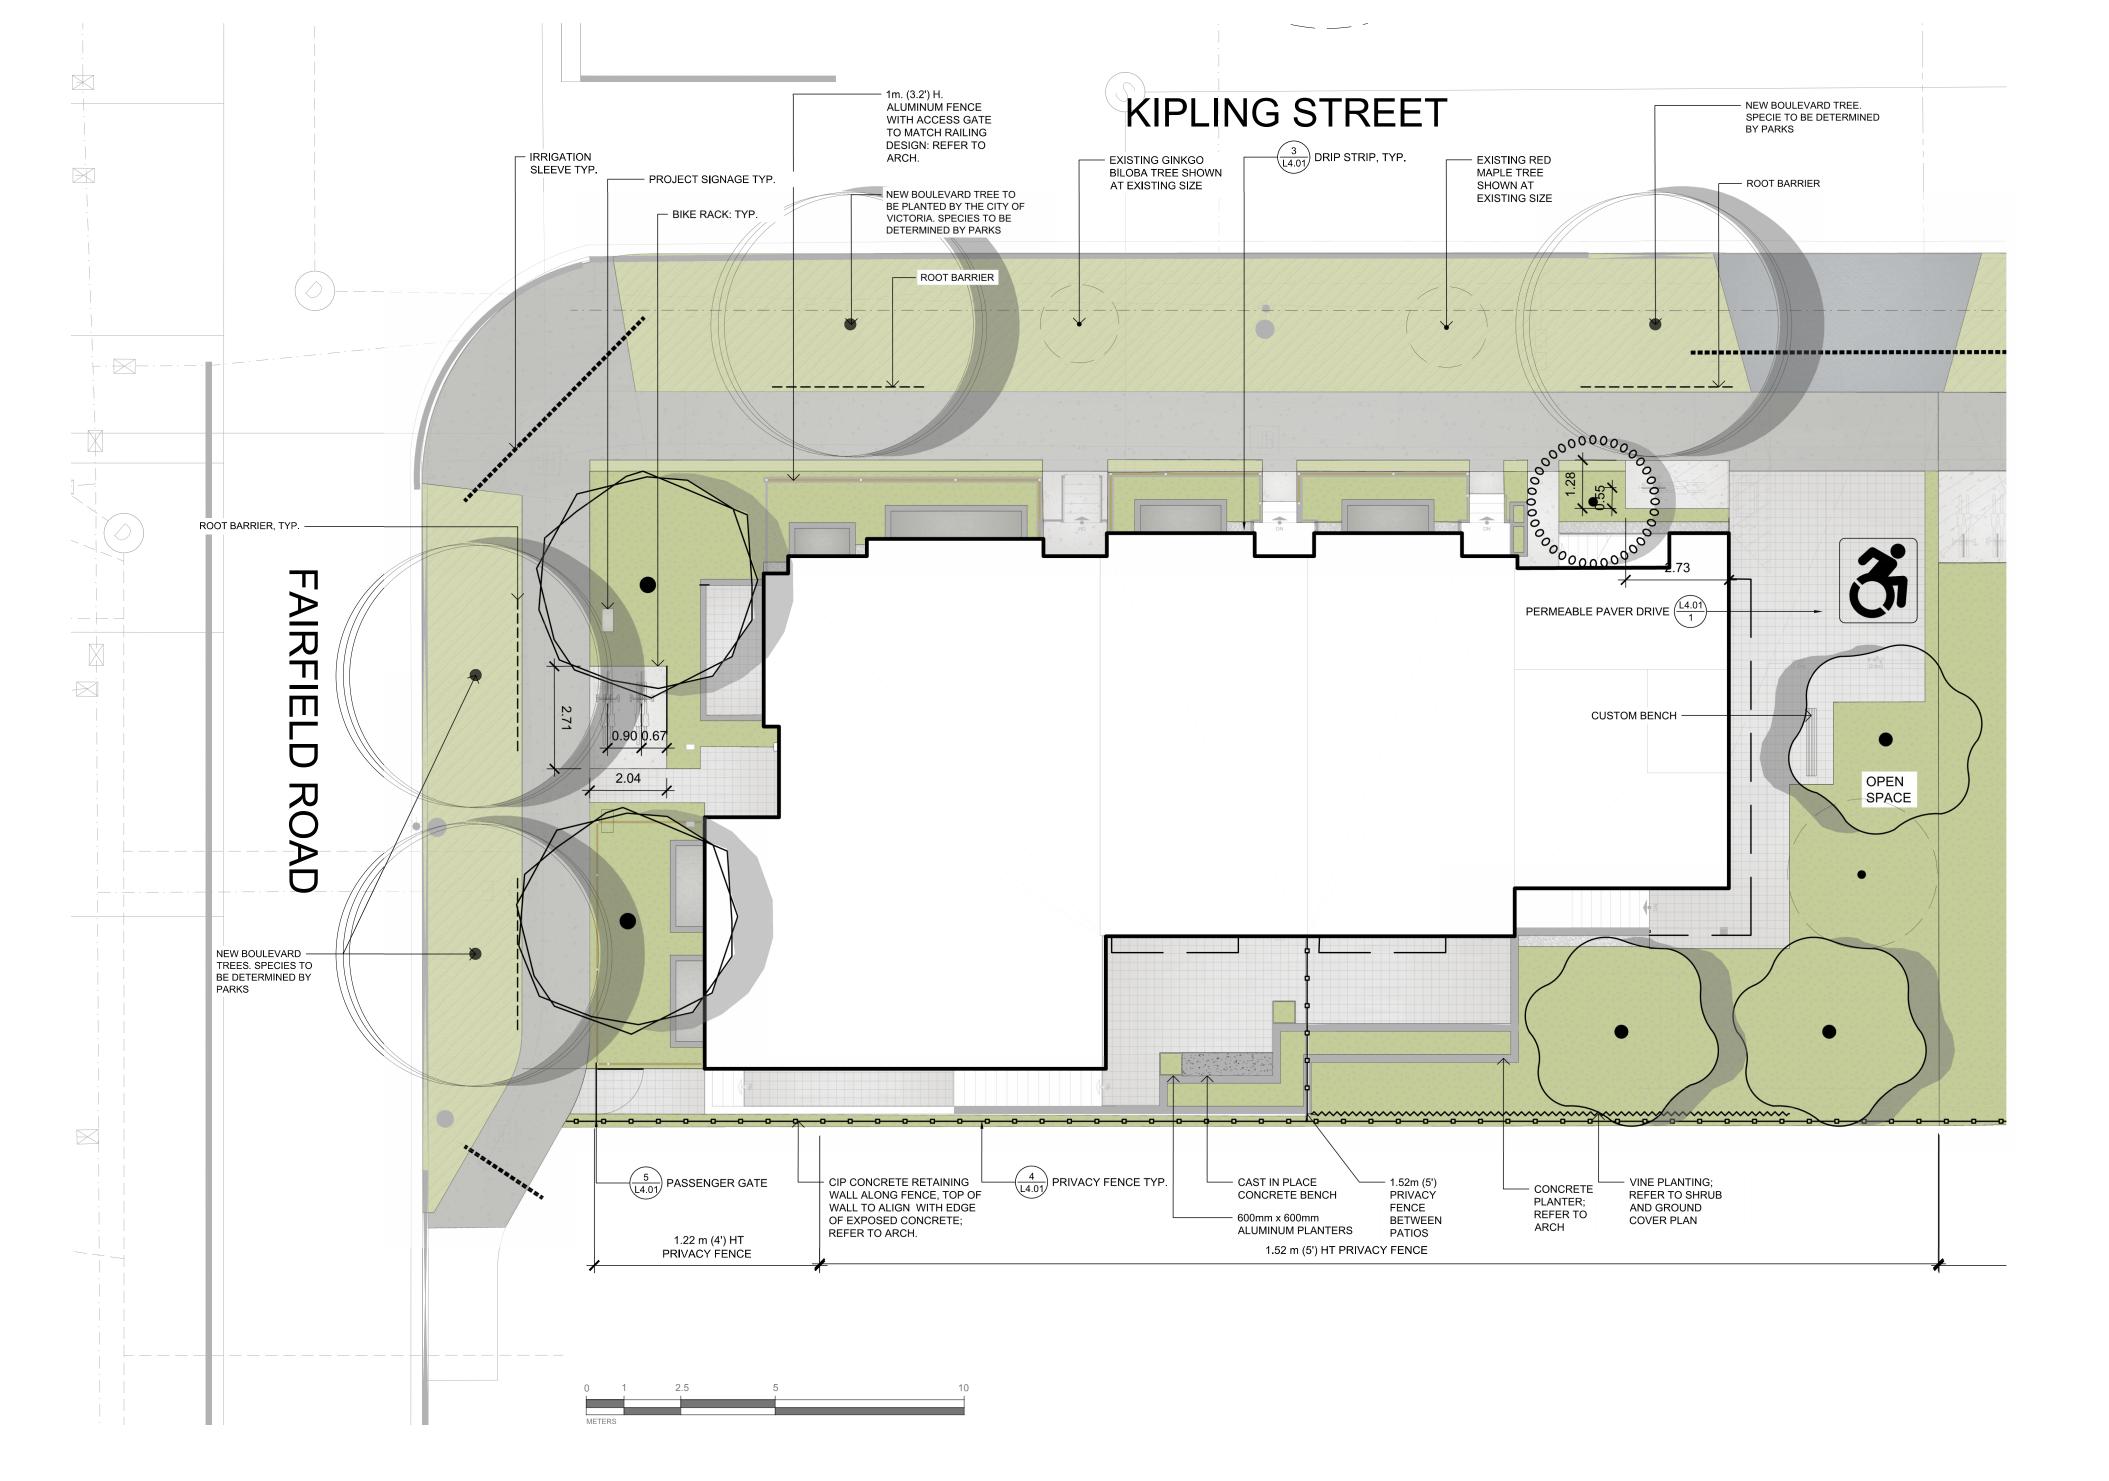

BOULEVARD TREE PLANTING NOTES:

 STREET TREES MUST HAVE ONE DOMINANT CENTRAL LEADER OR SINGLE STRAIGHT TRUNK, 6-8 CM DIAMETER CALIPER MEASURED 15 CM ABOVE GROUND, A WELL-BALANCED CROWN WITH BRANCHING STARTING AT 1.8 M - 2.5 M ABOVE GROUND AND BE PLANTED PER THE CITY OF VICTORIA SUPPLEMENTAL DRAWING SD P4 (TREE PLANTING IN BOULEVARD) AND THE CANADIAN LANDSCAPE STANDARD.

BOULEVARD SEED AND SOD INSPECTION NOTES:

- REQUIRED PARKS INSPECTIONS FOR SEED AND SOD BOULEVARD:
- A. INSPECTION OF EXCAVATED AND SCARIFIED SUBGRADE PRIOR TO BACKFILL.
- B. INSPECTION OF INSTALLED, ROLLED AND PREPARED GROWING MEDIA PRIOR SODDING. C. INSPECTION WHEN THE INSTALLED TURFGRASS MEETS THE CONDITIONS FOR TOTAL PERFORMANCE AS REQUIRED IN THE CURRENT EDITION OF THE CANADIAN LANDSCAPE STANDARD.

BOULEVARD INSPECTION TREE PLANTING NOTES:

- REQUIRED PARKS INSPECTIONS FOR SEED AND SOD BOULEVARD:
- A. INSPECTION OF SOIL AND PLANTING AREA PRIOR TO PLANTING. B. INSPECTION OF TREE STOCK PRIOR TO PLANTING.
- C. INSPECTION OF INSTALLED TREE. TREES MUST BE IN GOOD HEALTH AND CONDITION WITH NO VISIBLE SIGNS OF DISEASE, INSECT PESTS, OR DAMAGE, AND COMPLY WITH THE LATEST VERSION OF THE CANADIAN LANDSCAPE STANDARD.

GROWING MEDIUM NOTES:

• A SOIL TEST FOR THE GROWING MEDIA, FOR EACH LANDSCAPE APPLICATION ON CITY PROPERTY MUST BE SUBMITTED TO THE CITY PARKS TREEPERMITS@VICTORIA.CA FOR REVIEW AT LEAST ONE WEEK PRIOR TO SOIL PLACEMENT. GROWING MEDIA MUST MEET THE STANDARDS FOR EACH SPECIFIC LANDSCAPE APPLICATION AS REQUIRED IN THE CURRENT EDITION OF THE CANADIAN LANDSCAPE STANDARD.

BOULEVARD IRRIGATION NOTES:

- AUTOMATIC IRRIGATION TO BE PROVIDED TO THE 4 NEW BOULEVARD TREES FROM A DEDICATED 19MM METERED WATER SERVICE LOCATED WITHIN THE KIPLING FRONTAGE BOULEVARD.
- SEE CIVIL FOR WATER SERVICE LOCATION. SEE IRRIGATION PLAN AND DETAILS.


ON-SITE IRRIGATION NOTES:

- ALL SOFT LANDSCAPE AREAS TO BE IRRIGATED BY AN AUTOMATIC IRRIGATION SYSTEM DESIGNED AND INSTALLED TO HABC STANDARDS. SEE IRRIGATION PLAN AND DETAILS.
- THE VICTORIA SUBDIVISION AND DEVELOPMENT SERVICING BYLAW NO. 12-042 AND THE ASSOCIATED SCHEDULES CAN BE FOUND ON THE CITY OF VICTORIA BYLAWS WEBPAGE


LEGEND

PROPERTY LINE **BUILDING FOOTPRINT**

IRRIGATION SLEEVE **CLIMBING VINES** PRIVACY FENCE **ROOT BARRIER**

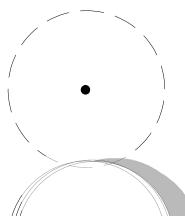


EXISTING TREE TO BE RETAINED SHOWN AT EXISTING SPREAD

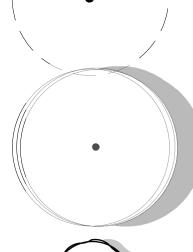

NEW BOULEVARD TREE SPECIES TO BE DETERMINED BY PARKS. TO BE INSTALLED BY CITY OF VICTORIA AT

DEVELOPER'S EXPENSE

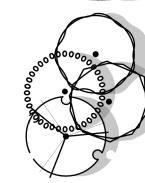

PROPOSED TREES

MATERIALS SCHEDULE

- SOLID WOOD FENCING

MAINTENANCE GATE

CUSTOM BENCH

SYMBOL	DESCRIPTION	QTY
01 General	<u>I</u>	
	ON-SITE PLANTING - SHRUB BED	160.9 m²
	OFF-SITE PLANTING -SOD	7.0 m²
	BOULEVARD PLANTING -SOD	154.6 m²
4 4	PAVING TYPE A: CIP CONCRETE - LIGHT BROOM FINISH - SAW CUT CONCRETE CRACK CONTROL JOINTS	31.4 m²
	PAVING TYPE B: MUNICIPAL SIDEWALK - TO CITY OF VICTORIA STANDARDS - REFER TO CIVIL	126.6 m²
	PAVING TYPE C - PERMEABLE CONCRETE PAVER - PRODUCT: SF RIMA™ GRID - COLOR: GRAY	88.6 m²
	PAVING TYPE D: CONCRETE DRIVEWAY APRON -REFER TO CIVIL	19.4 m²
	PAVING TYPE F: DRIP STRIP - 300 mm WASHED ROCK RIVER	3.3 m²
	PAVING TYPE G: GRAVEL	10.0 m²
Site Furnis	hings	
	BIKE RACK	4
	PRIVACY FENCE - 5' (1.52 m) HT AS NOTED - 4' (1.22 m) HT AS NOTED	REFER TO PLAI



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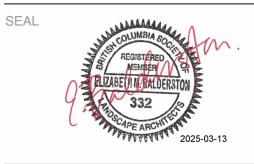
PROJECT ADDRESS:

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DESIGNED BY: BIANCA BODLEY

DRAWN BY: LB

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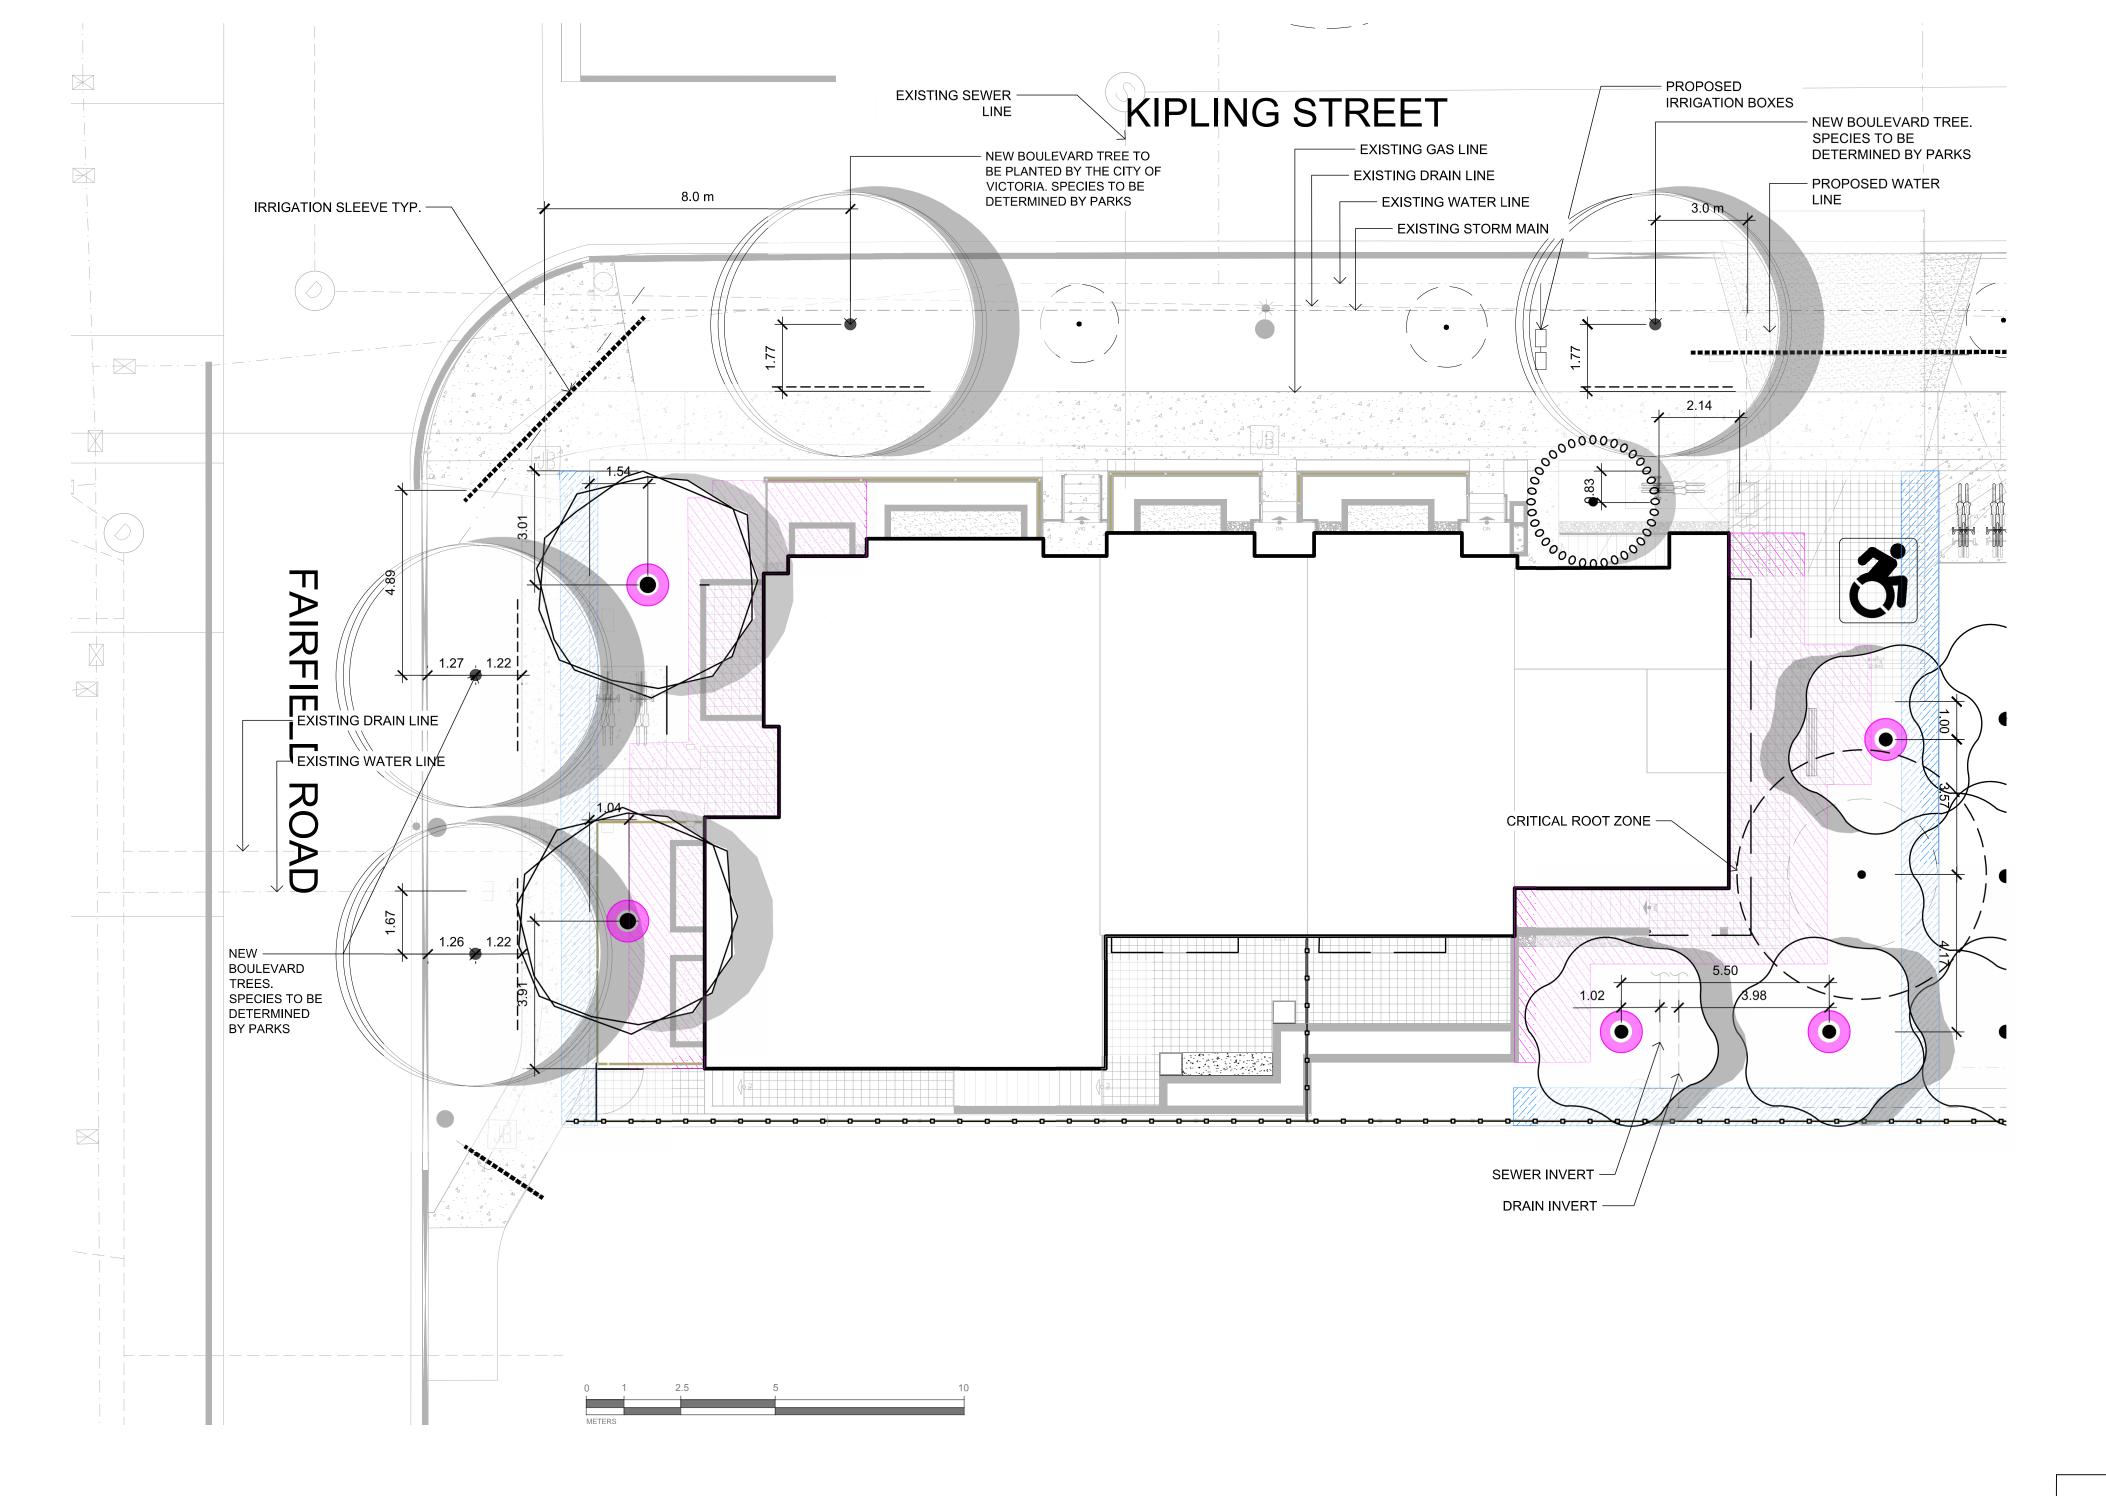




DRAWING TITLE:

MATERIALS PLAN

DWG NO:



PLANT SCHEDULE

SYMBOL	BOTANICAL / COMMON NAME	SIZE	SPACING	COMMENTS	QTY
TREES					
	Betula nigra 'BNMTF' / Dura Heat® River Birch	60cm Ht.	B&B	B&B, Well Established	3
\bigcirc	Gleditsia triacanthos / Honey Locust	60mm Cal.	As Shown	B&B, Well Established	2
000000000000000000000000000000000000000	Magnolia grandiflora 'Little Gem' / Little Gem Dwarf Southern Magnolia	40mm Cal.	Pot	B&B, Well Established	1

TREE PLANTING NOTES:

1. PLANTS IN PLANT LISTS ARE SPECIFIED ACCORDING TO THE CANADIAN NURSERY LANDSCAPE ASSOCIATION CANADIAN STANDARDS FOR NURSERY STOCK AND SECTION 12, CONTAINER GROWN PLANTS FROM THE BC LANDSCAPE STANDARD, CURRENT EDITION.

2. ALL LANDSCAPE AREAS TO BE IRRIGATED WITH AN AUTOMATIC IRRIGATION SYSTEM DESIGNED TO IIABC STANDARDS. SEE IRRIGATION PLAN AND DETAILS

OVER TOP. CARE MUST BE TAKEN DURING DIGGING FOR TREE PLANTING.

3. ALL PROPOSED BOULEVARD TREES TO HAVE 10m³ MIN. GROWING MEDIUM. SEE SOIL DEPTH PLAN 4. THE STORM DRAIN HAS BEEN LINED, IS FULLY SEALED AND CONFIRMED BY ENGINEERING TO BE OKAY TO PLANT

PLANT IMAGERY









BETULA NIGRA

MAGNOLIA GRANDINFLORA PARRIOTA PERSICA


SOIL VOLUME					REPLACEMENT TREES PROPOSED			SOIL VOLUME REQUIRED (m3)		
PLANTING AREA ID	AREA (m²)	SOIL VOLUME MULTIPLIER	A.ESTIMATED SOIL VOLUME	B. # SMALL	C. # MEDIUM	D. # LARGE	E. SMALL	F. MEDIUM	G. LARGE	TOTAL
			ON-SIT	E AREA						
PLANTING AREA B	23.6m²	1	23.6m³	0	1	0	0	20m³	0	20m³
PLANTING AREA E	26m²	1	26m³	0	1	0	0	20m³	0	20m³
PLANTING AREA F	82m²	1	82m³	0	3	0	0	45m³	0	45m³
	'	OFFS	SITE AREA (EXCLU	IDING CITY	PROPERTY	Y)				
PLANTING AREA OSA X	N/A	N/A	N/A	N/A	N/A	N/A	N/A	N/A	N/A	N/A
									_	
CALCULATION INSTRUCT	TIONS:						E	F	G	TOTAL
							IF B=1, B X 8 IF B>1, B X 6	If C=1, Cx20 If C>1, Cx15	If D=1, Dx35 If D>1, Dx30	E+F+G

LEGEND


PROPERTY LINE

-0--0--0--0--

BUILDING FOOTPRINT IRRIGATION SLEEVE CLIMBING VINES PRIVACY FENCE **ROOT BARRIER**

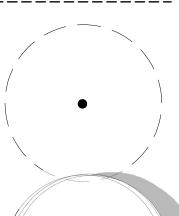

EXISTING TREE TO BE RETAINED SHOWN AT EXISTING SPREAD

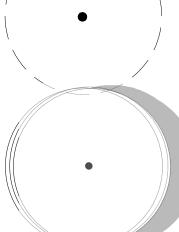

NEW BOULEVARD TREE

 SPECIES TO BE DETERMINED BY PARKS. TO BE INSTALLED BY CITY OF VICTORIA AT DEVELOPER'S EXPENSE



EXISTING TREE QUANTITIES

REPLACEMENT TREES REQUIRED: 3

• TREES TO BE REMOVED = 3 (M1,M3,M11)

BYLAW PROTECTED TREES TO BE REMOVED: 1

ON SITE:

 EXISTING TREES = 3 • TREES TO BE REMOVED = 2

MUNICIPAL BOULEVARD: EXISTING TREES = 7

NEW STREET PLANTED: 4

DESIGNATED REPLACEMENT TREES

1 m. DISTANCE FROM ANY PROPERTY LINE OF A LOT, ABOVE AND UNDERGROUND \UTILITIES, DRIVEWAYS AND ANOTHER SURFACES

2m. DISTANCE FROM BUILDING FOUNDATION WALL



1608 Camosun Street, Victoria BC V8T 3E6 Info@biophiliacollective.ca 250 590 1156

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BREIA HOLDINGS LTD.

PROJECT NAME:

LE PARC


PROJECT ADDRESS:

1400 FAIRFIELD

DESIGNED BY: BIANCA BODLEY

DRAWN BY: LB

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6	RE-ISSUED FOR REVIEW	24/09/27
5	ISSUED FOR RZ/DP	24/06/06
4	ISSUED FOR COORDINATION	24/05/15
3	ISSUED FOR BP	23/12/21
2	ISSUED FOR BP 75%	23/11/15
1	ISSUED FOR BP 50%	23/11/01
NO.	ISSUE	YY/MM/DC

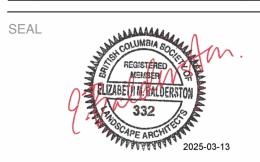






DRAWING TITLE:

TREE PLANTING PLAN

SCALE: 1:100

DWG NO:

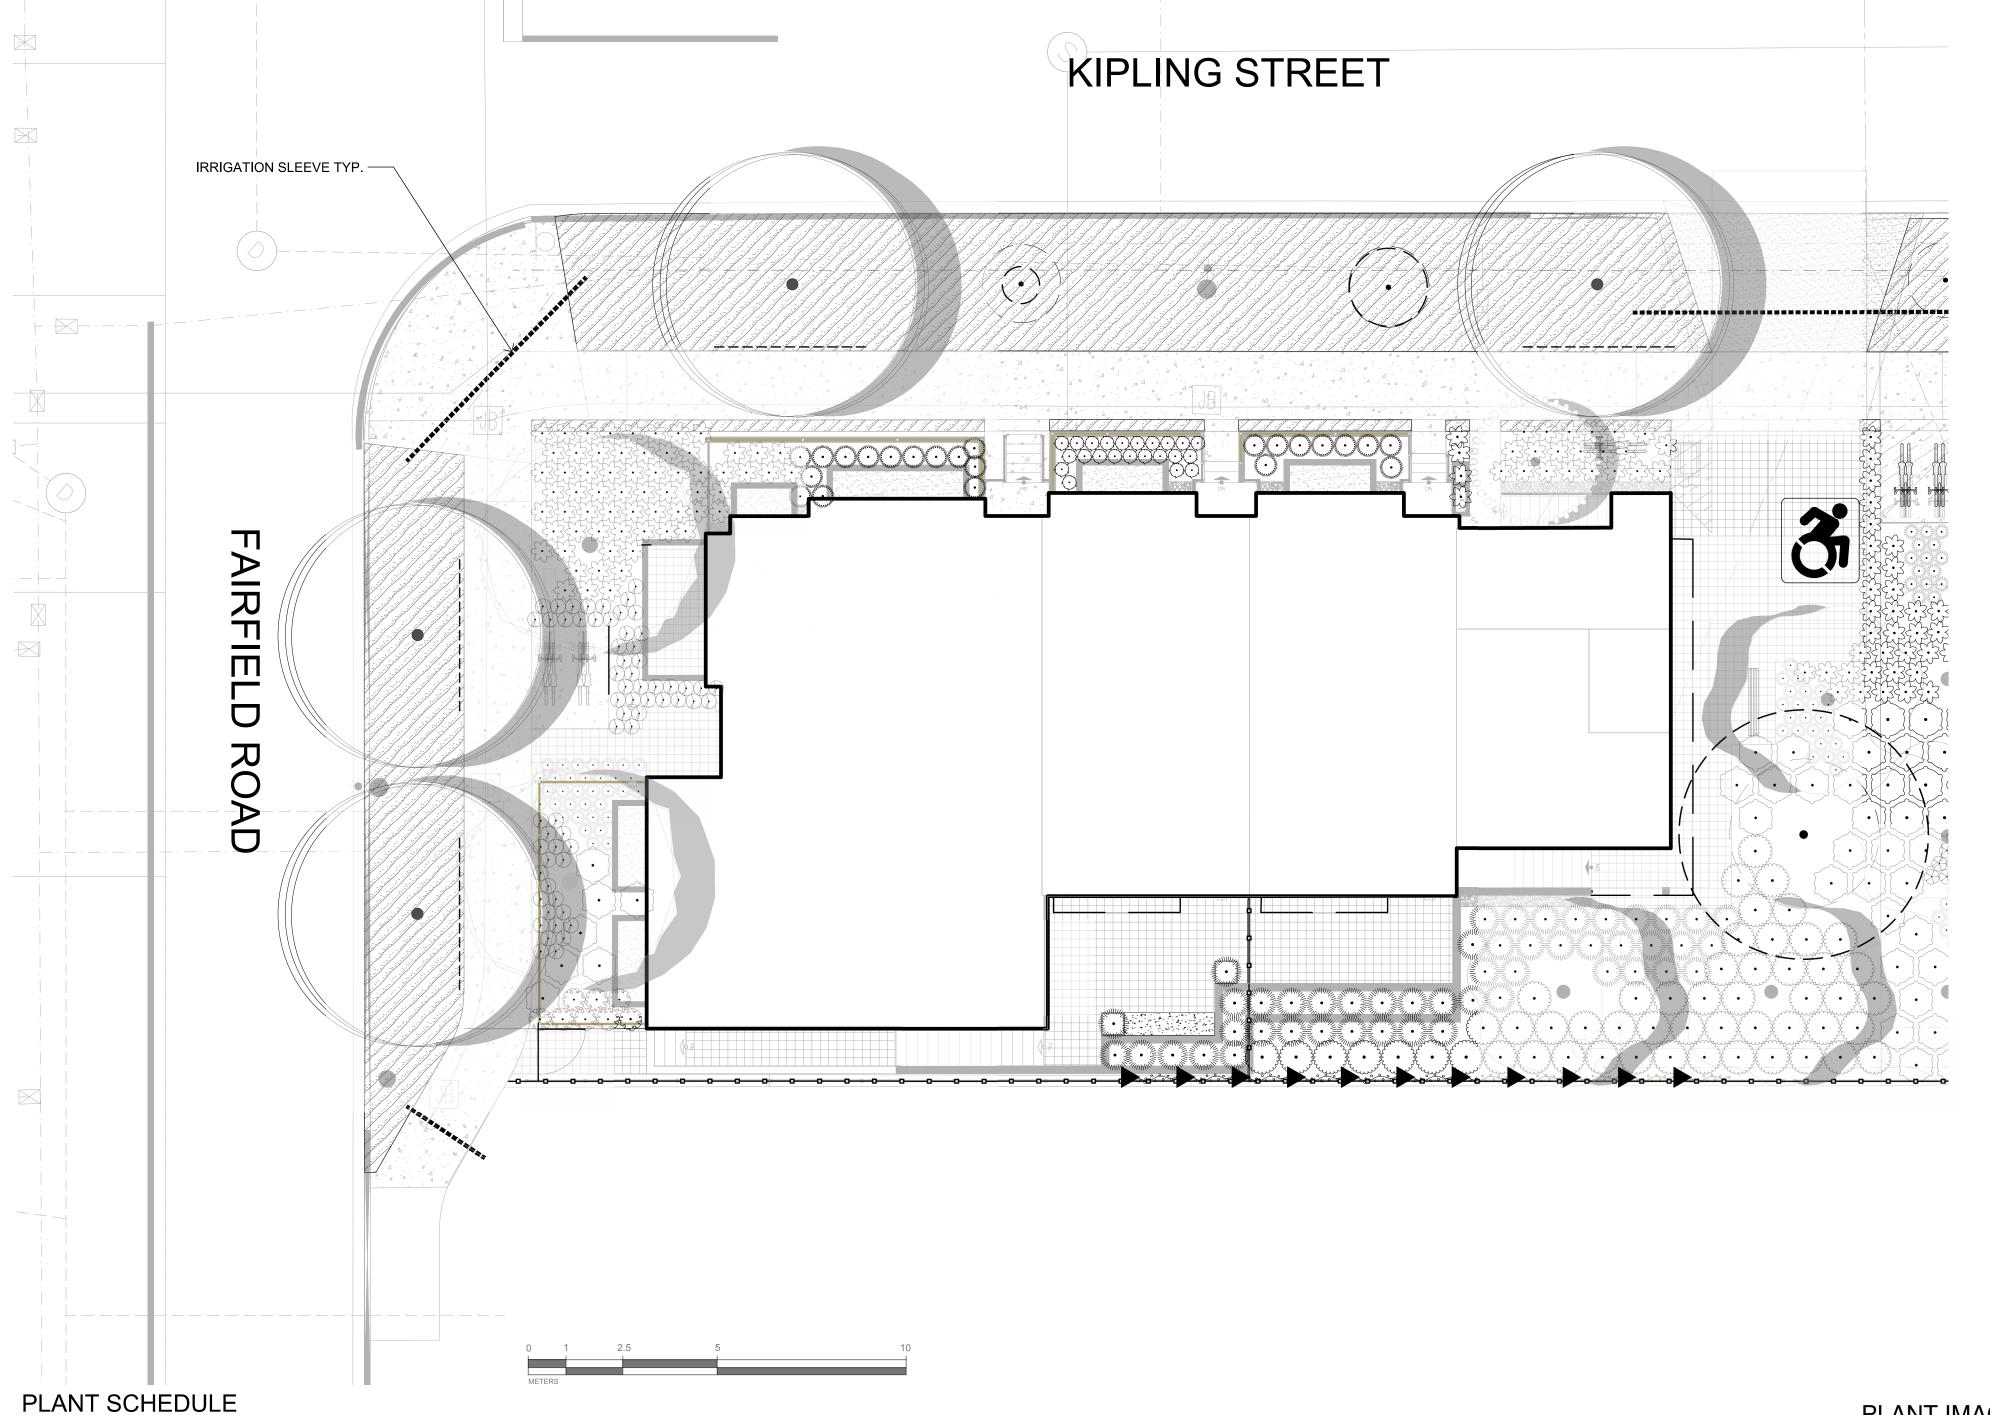

<u>QTY</u>

23


20

LEGEND

PROPERTY LINE

-0--0--0--0--

BUILDING FOOTPRINT IRRIGATION SLEEVE CLIMBING VINES PRIVACY FENCE **ROOT BARRIER**

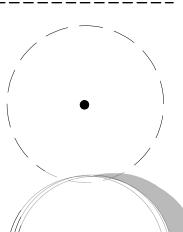

EXISTING TREE TO BE RETAINED SHOWN AT EXISTING SPREAD

NEW BOULEVARD TREE SPECIES TO BE DETERMINED BY PARKS.

 TO BE INSTALLED BY CITY OF VICTORIA AT DEVELOPER'S EXPENSE

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1	ISSUED FOR BP 50%	23/11/01
NO.	ISSUE	YY/MM/DE







DRAWING TITLE:

PLANT IMAGERY







GAURA LINDHEIMERI 'BLUSH PINK'





VANCOUVERIA HEXANDRA DESCHAMPSIA CESPITOSA GAULTHERIA SHALLON



PLANTING PLAN

DWG NO:

SCALE: 1:100

£ •	Rosa nutkana / Nootka Rose	#3 cont.	0.6m	Pollinator, Fruit Bearing and Native	53
6. 6. 5. 5. 5. 5. 5. 5. 5. 5. 5. 5. 5. 5. 5.	Santolina virens / Green Lavender Cotton	#1 cont.	0.6m	Pollinator	8
FERNS	_	#1 cont.	0.6m	Native	106
GRASS	SES				
	Danthonia californica / California Oatgrass	#1 cont.	0.4m	Native	63
3000g	Deschampsia cespitosa / Tufted Hair Grass	#1 Pot	0.4m	Native	57
MINIMI Spoure	Miscanthus sinensis 'Graziella' / Graziella Eulalia Grass	#2 cont.	0.9m	Non-Native	49
GROUI	NDCOVERS				
Arman San Carlot	Asarum canadense / Wild Ginger	#1 Pot	0.4m	Native, Pollinator	23

SPACING COMMENTS

Pollinator, Fruit Bearing and Native

Pollinator, Fruit Bearing and Native

SYMBOL BOTANICAL / COMMON NAME

Gaultheria shallon / Salal

Arctostaphylos uva-ursi 'Massachusetts' / Massachusetts Kinnikinnick #1 cont. 0.6m

<u>VINES</u>						
	- Hydrangea anomala / Climbing Hydrangea	#1 cont.	1.5m	Non-Native		11
SYMBOL	BOTANICAL / COMMON NAME	SIZE	SPACING		SPACING	QTY

SHRUB AREAS		
Turf Seed Drought Tolerant Dwarf Fescue Blend		161.5 n
Tun Seed Drought Tolerant Dwart Lescue Diend		10.101

PLANTING NOTES:

Total plant quantity

Pollinator

Fruit bearing

Native

Non-native

Pollinator

Fruit bearing

Native

PLANT CATEGORIES

flower producing shrub or perennial

Edible for animals or people

On a recognized Southern Vancouver

Island plant list

1. PLANTS IN PLANT LISTS ARE SPECIFIED ACCORDING TO THE CANADIAN NURSERY LANDSCAPE ASSOCIATION CANADIAN STANDARDS FOR NURSERY STOCK AND SECTION 12, CONTAINER GROWN PLANTS FROM THE BC LANDSCAPE STANDARD, CURRENT EDITION.

PLANT CATEGORY PERCENTAGE (by plant quantity)


455

38%

23%

81%

8%

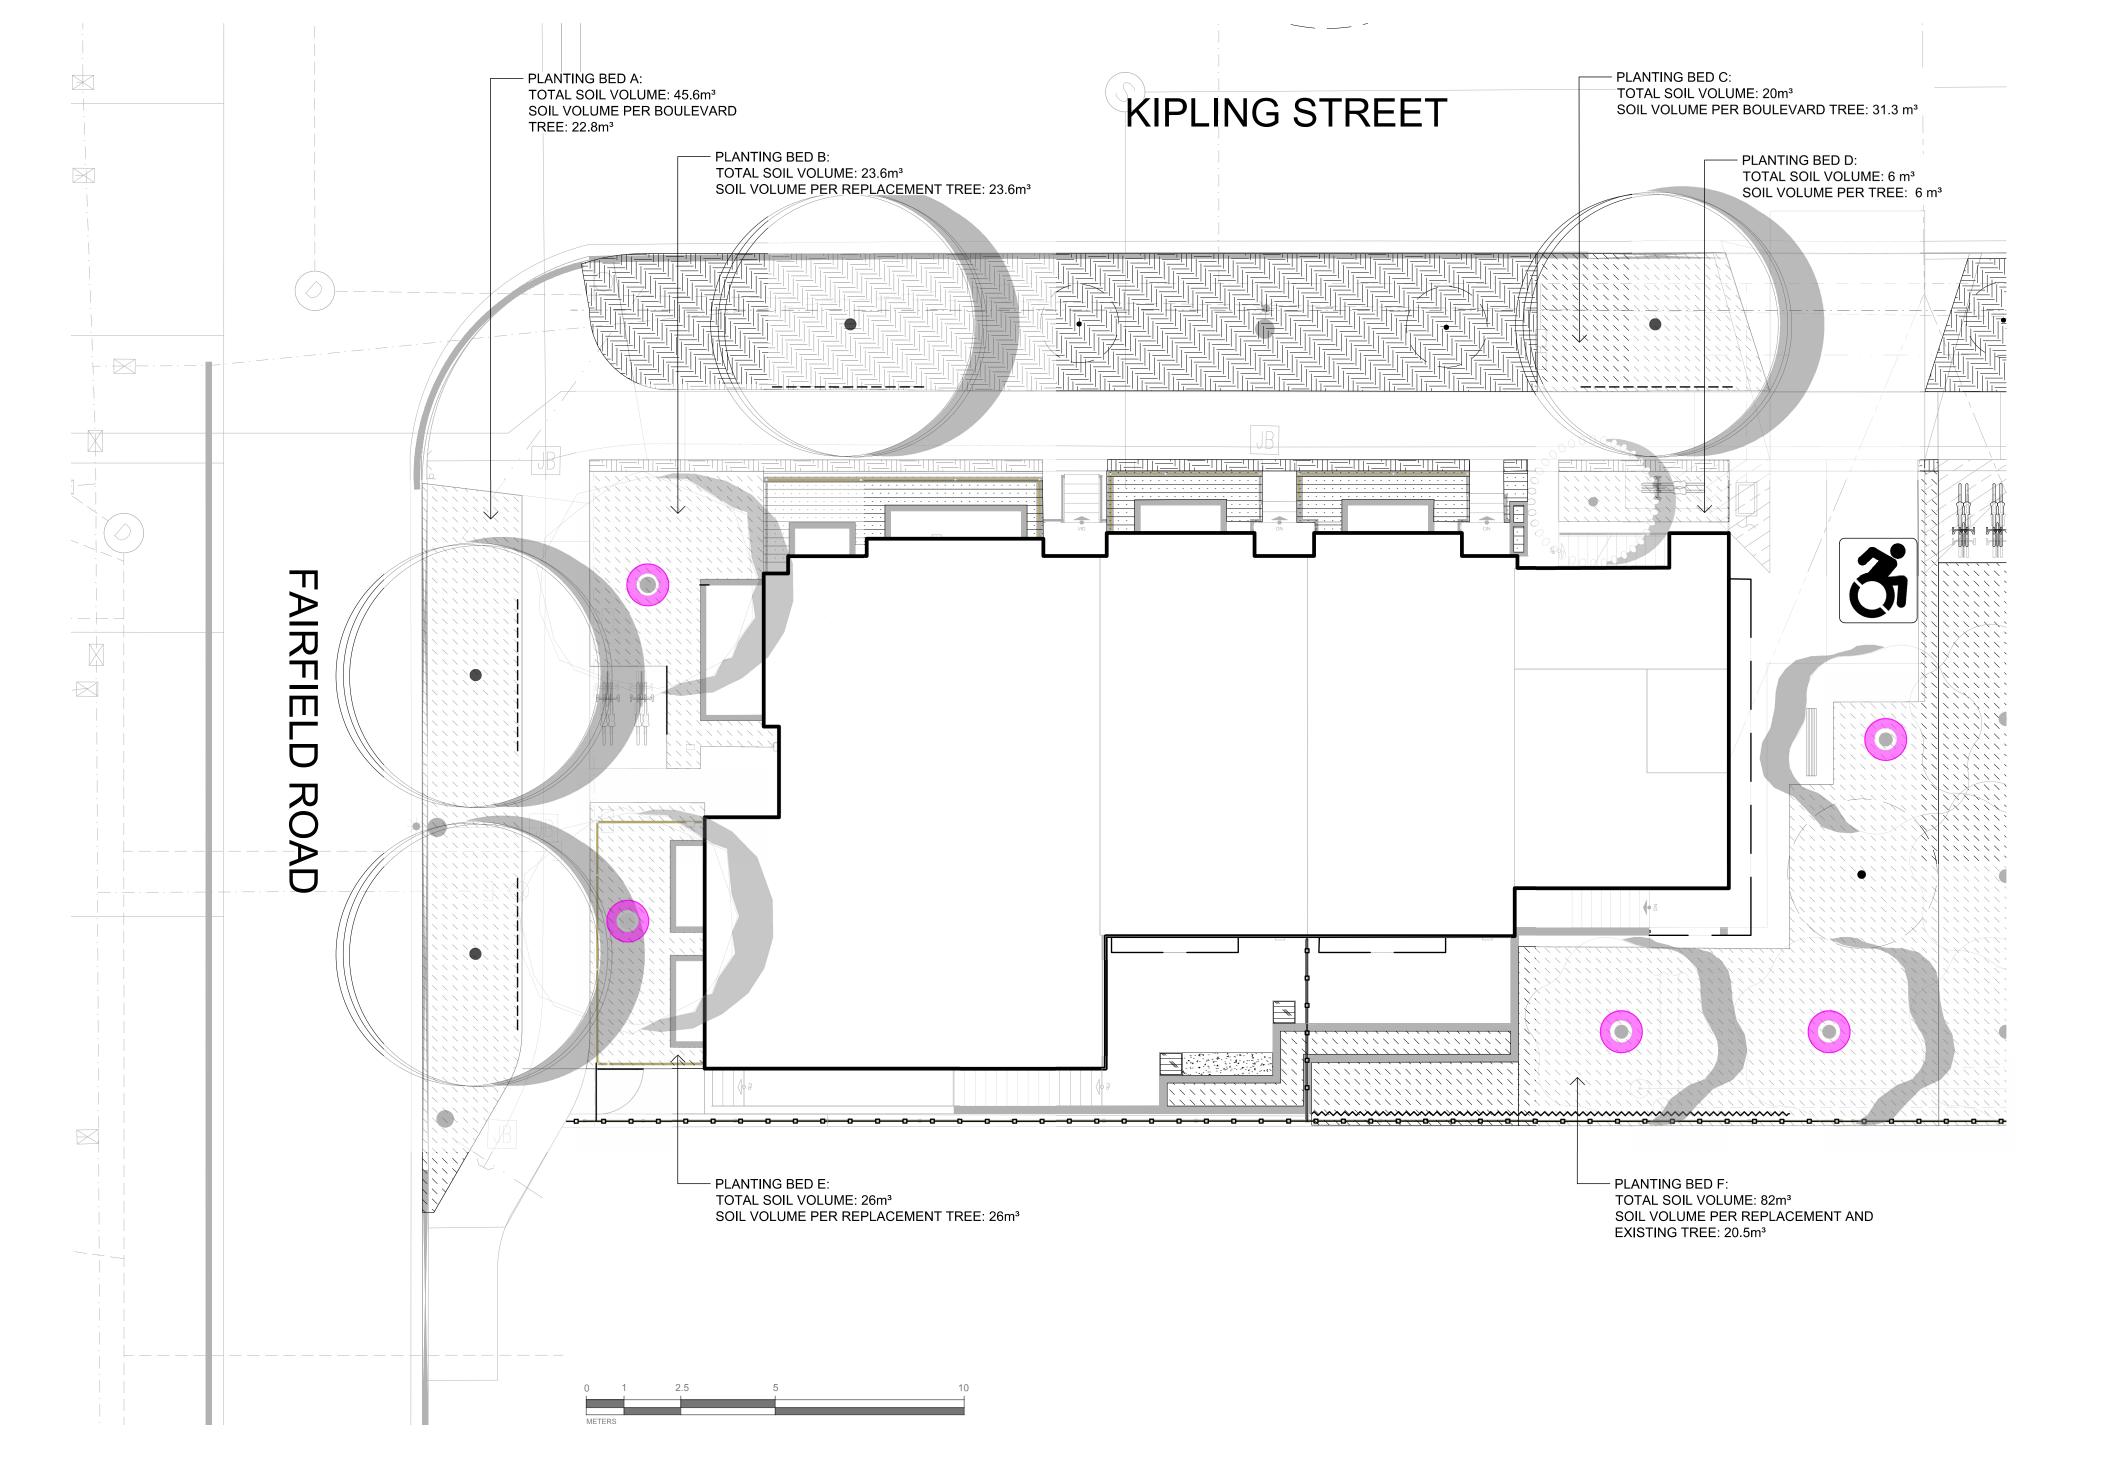

SOIL DEPTH SCHEDULE

SOIL DEPTH SCHEDULE							
SYMBOL	DESCRIPTION	<u>QTY</u>					
	1000 mm Soil Depth - Growing medium to Canadian Landscape Standards - Refer to specifications	208.5 m²					
	600 mm Soil Depth - Growing medium to Canadian Landscape Standards - Refer to specifications	19.8 m²					
	450 mm Soil Depth - Growing medium to Canadian Landscape Standards - Refer to specifications	0.6 m²					
	150 mm Soil Depth - Growing medium to Canadian Landscape Standards - Refer to specifications	97.9 m²					


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PLANTING AREA ID	AREA (m²)	SOIL VOLUME MULTIPLIER	A.ESTIMATED SOIL VOLUME	B. # SMALL	C. # MEDIUM	D. # LARGE	E. SMALL	F. MEDIUM	G. LARGE	TOTAL
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PLANTING AREA F	82m²	1	82m³	0	3	0	0	45m³	0	45m³
		OFFS	SITE AREA (EXCLUD	ING CITY	PROPERTY	()	,	•		
PLANTING AREA OSA X	N/A	N/A	N/A	N/A	N/A	N/A	N/A	N/A	N/A	N/A
CALCULATION INSTRUCTIONS:						E	F	G	TOTAL	
							IF B=1, B X 8 IF B>1, B X 6	If C=1, Cx20 If C>1, Cx15	If D=1, Dx35 If D>1, Dx30	E+F+G

LEGEND

PROPERTY LINE BUILDING FOOTPRINT IRRIGATION SLEEVE

-0-0-0-0-0-

CLIMBING VINES PRIVACY FENCE **ROOT BARRIER**

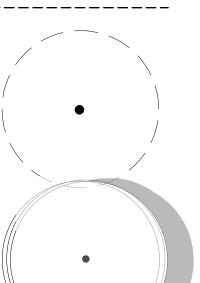

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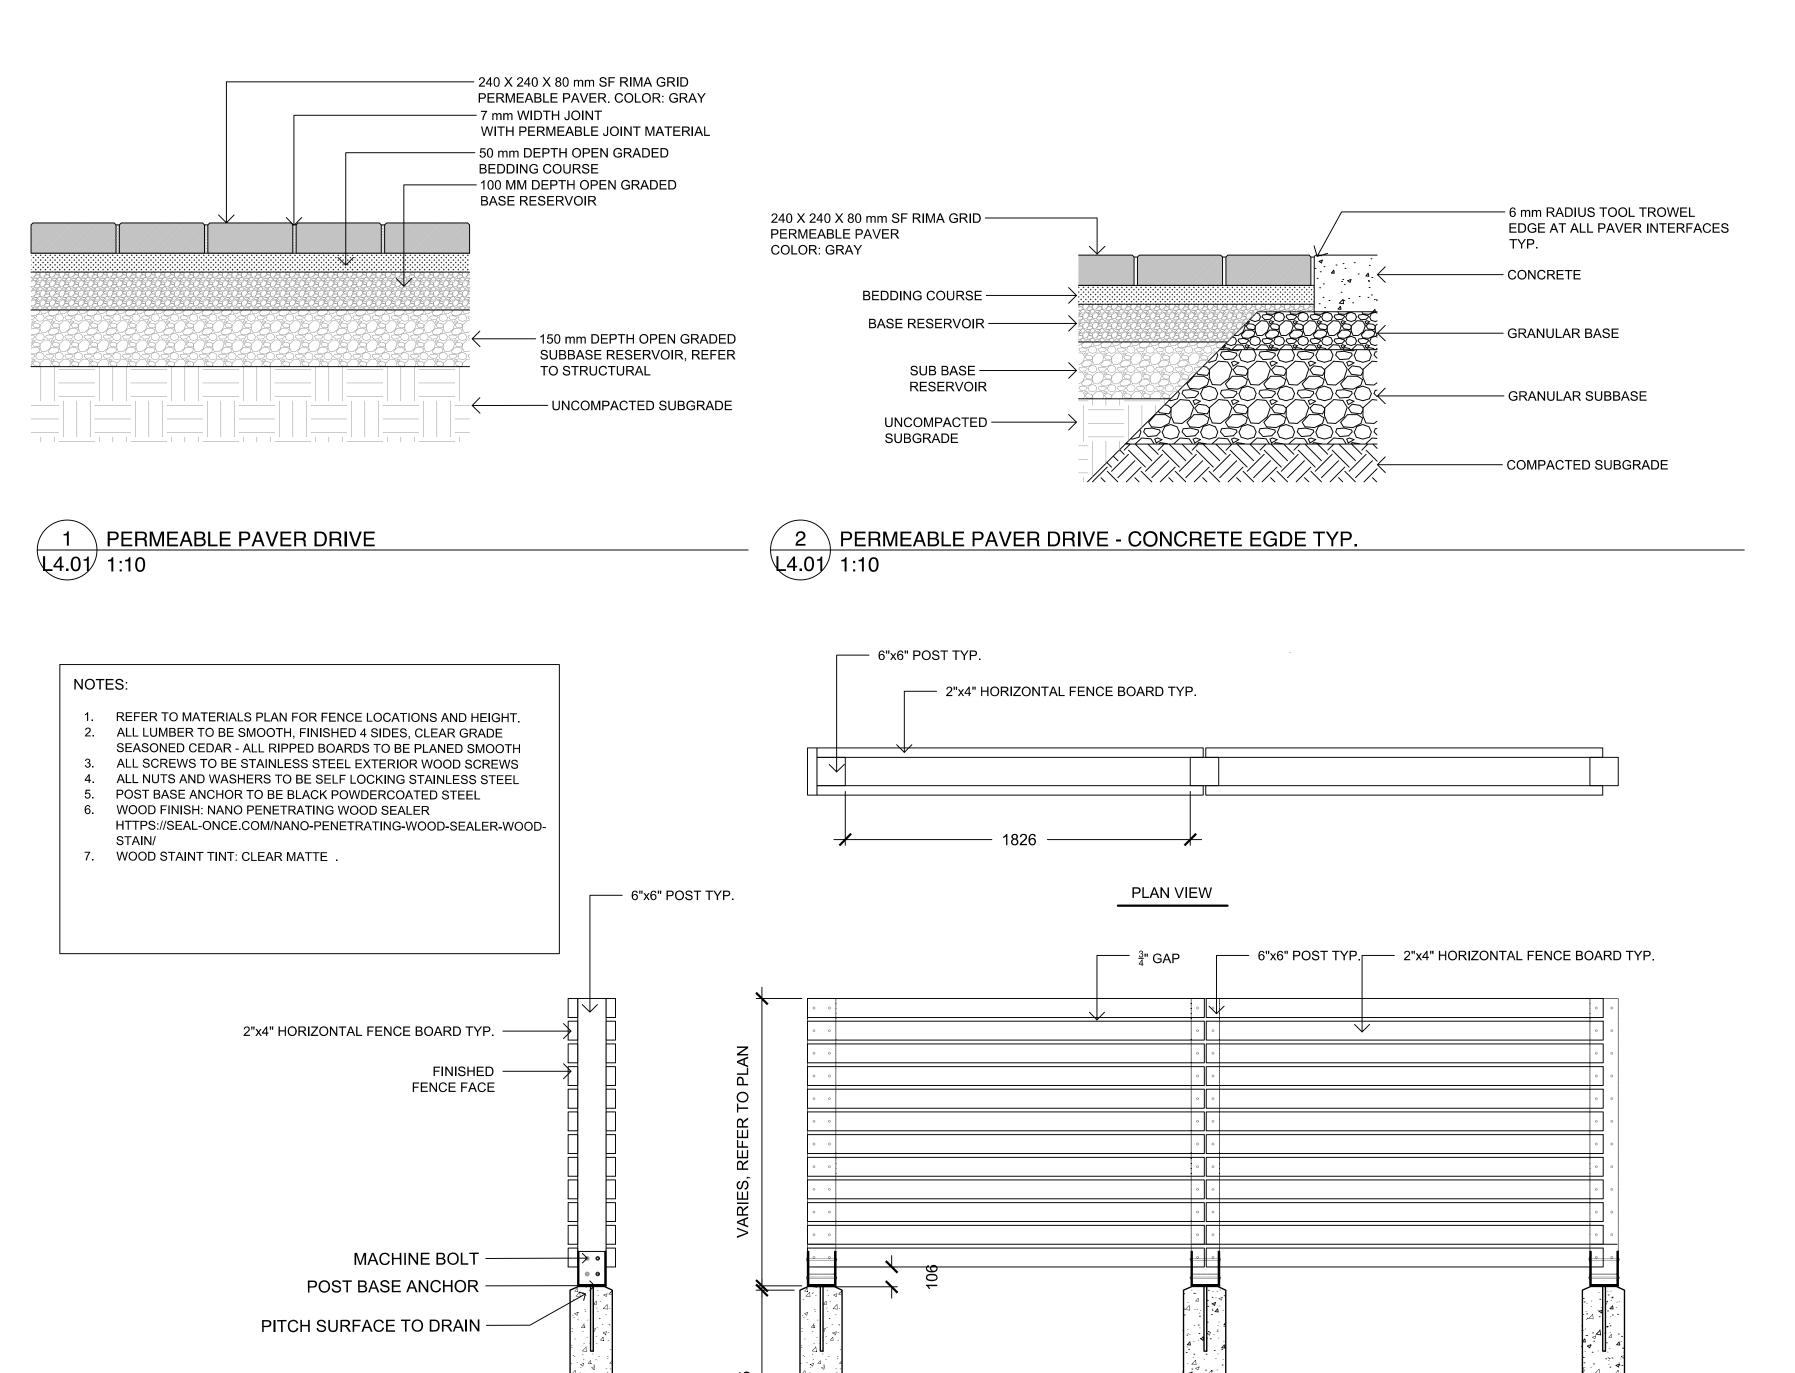







DRAWING TITLE:

SOIL DEPTH PLAN



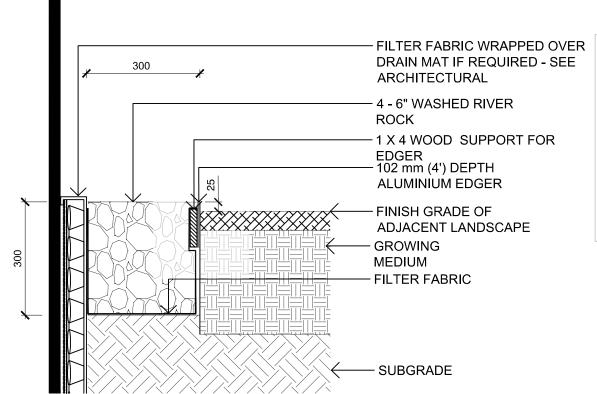

LANDSCAPE EDGER TO BE: PERMALOC CleanLine Commercial Grade

Landscape Edging OR APPROVED EQUAL. • 4.8mm (3/16") THICKNESS; 102mm (4") HEIGHT; 4.8m (16') LENGTH;


NATURAL MILL FINISH; 305mm (12") STAKE. INSTALL EDGER AS PER MANUFACTURER'S INSTRUCTIONS


• 1 X 4 WOOD SUPPORT TO BE STAKED IN PLACE AND USED TO ENSURE EDGER IS INSTALLED IN A STRAIGHT LINE AND MAINTAINS A STRAIGHT ALIGNMENT DURING THE INSTALLATION OF GROWING MEDIUM AND

RIVER ROCK. MAY BE SCRAP WOOD AS LONG AS IT IS STRAIGHT. FILTER FABRIC TO BE POLYPROPYLENE FIBRE NONWOVEN GEOTEXTILE,

SUCH AS NILEX 4551 OR APPROVED EQUAL

3 DRIP STRIP \(\(\delta\).01\(\frac{1}{1}\):10

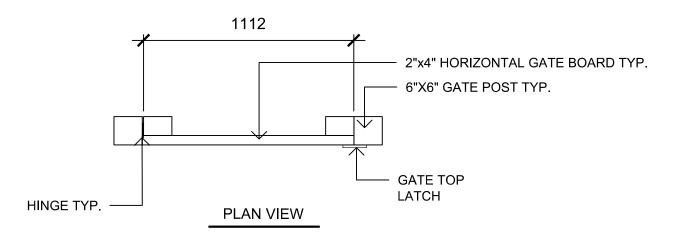

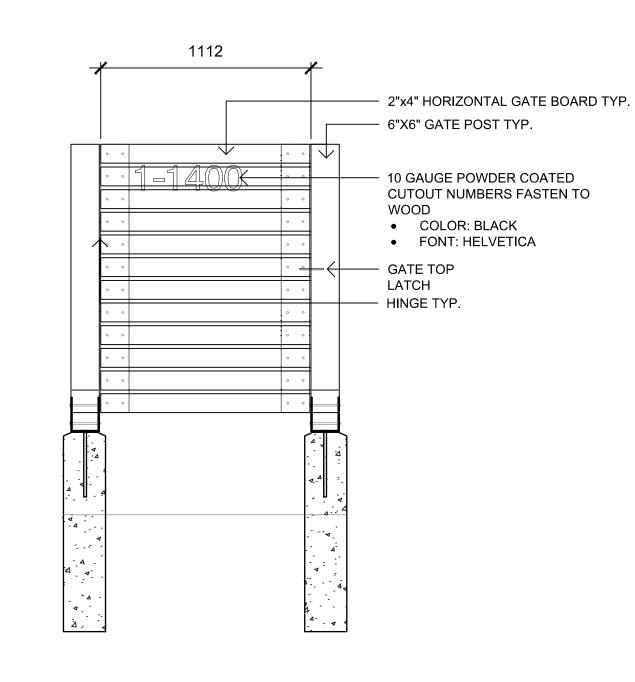

NOTES:

- 1. REFER TO MATERIALS PLAN FOR FENCE
- LOCATIONS AND HEIGHT. 2. FINISHED SIDE OF VERTICAL FENCE BOARDS
- TO FACE INTO PROPERTY. 3. ALL LUMBER TO BE SMOOTH, FINISHED 4
- SIDES, CLEAR GRADE SEASONED CEDAR -ALL RIPPED BOARDS TO BE PLANED SMOOTH
- 4. ALL SCREWS TO BE STAINLESS STEEL EXTERIOR WOOD SCREWS
- 5. ALL NUTS AND WASHERS TO BE SELF LOCKING STAINLESS STEEL
- 6. POST BASE ANCHOR TO BE BLACK POWDERCOATED STEEL
- 7. WOOD FINISH: NANO PENETRATING WOOD SEALER
- HTTPS://SEAL-ONCE.COM/NANO-PENETRATING-

WOOD-SEALER-WOOD-STAIN/ 8. WOOD STAINT TINT: CLEAR MATTE.

> RE- ISSUED FOR DP 25/03/12 25/03/06 ISSUED FOR REVIEW REVISED AND RE-ISSUED FOR DP 24/10/29 RE-ISSUED FOR REVIEW 24/09/27 ISSUED FOR RZ/DP 24/06/06 ISSUED FOR COORDINATION 24/05/15 23/12/21 ISSUED FOR BP 23/11/15 ISSUED FOR BP 75% 23/11/01 ISSUED FOR BP 50% NO. ISSUE

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DRAWN BY: LB



NORTH ARROW

DRAWING TITLE:

HARDSCAPE AND SITE FURNISHINGS DETAILS


DWG NO:

5 PASSENGER GATE 1:20

4 PRIVACY FENCE

CONCRETE FOOTING 8" —

DIAMETER SONOTUBE TYP.

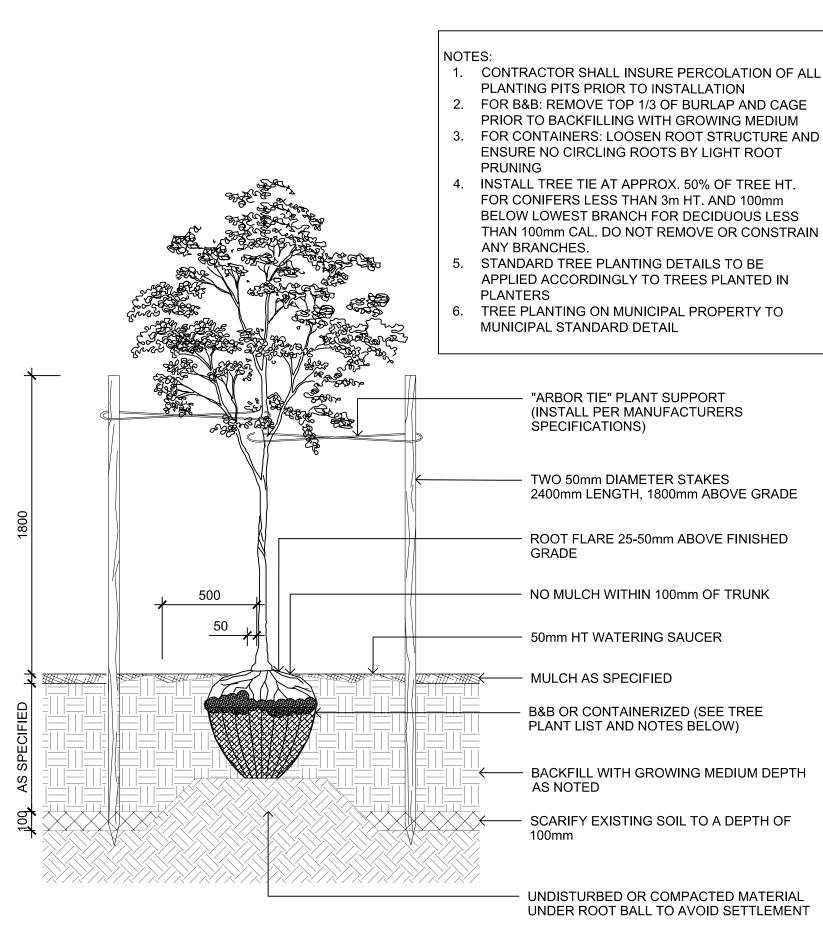


1 TREE PLANTING DETAIL L4.02/ 1:10

5 SOD ON GRADE


. SHRUB PLANTING AS PER WRITTEN SPECIFICATIONS GROWING MEDIUM AND MULCH AS PER WRITTEN SPECIFICATIONS

SHRUB PLANTING DETAIL

L4.02 1:10

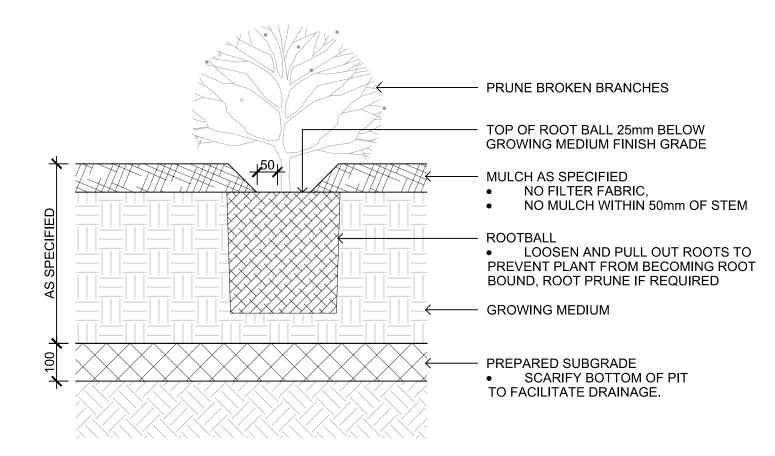

1. PLACE AND COMPACT SUBGRADE AS PER WRITTEN SPECIFICATIONS 2. SUBGRADE TO BE COMPACTED TO A CONSISTENT 80% M.P.D 3. GROWING MEDIUM AND MULCH AS PER WRITTEN SPECIFICATIONS

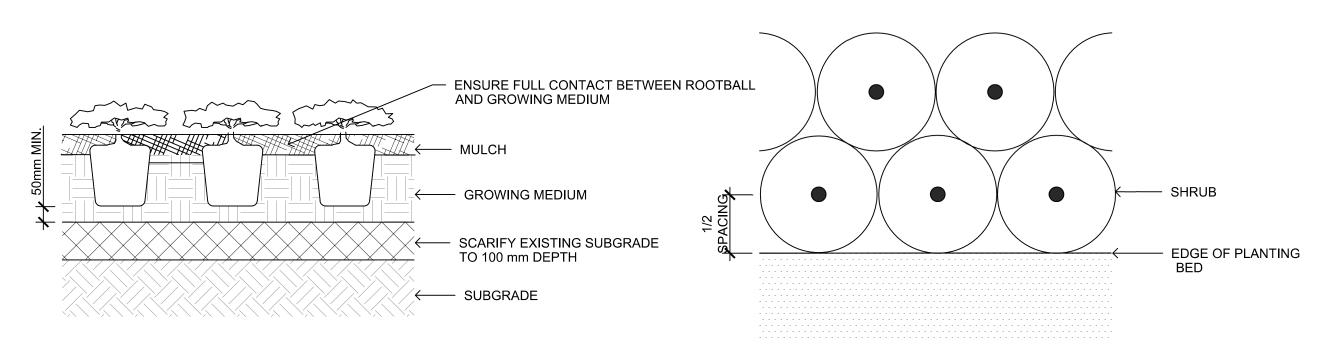

CITY OF VICTORIA


GROUND COVER PLANTING DETAIL L4.02 1:10


 ${f igcelowright}$ ${f igcelowright}$ SPACING PLANTING DETAIL L4.02/ 1:10


SUPPLEMENTARY STANDARD


DETAIL DRAWINGS

SD P3

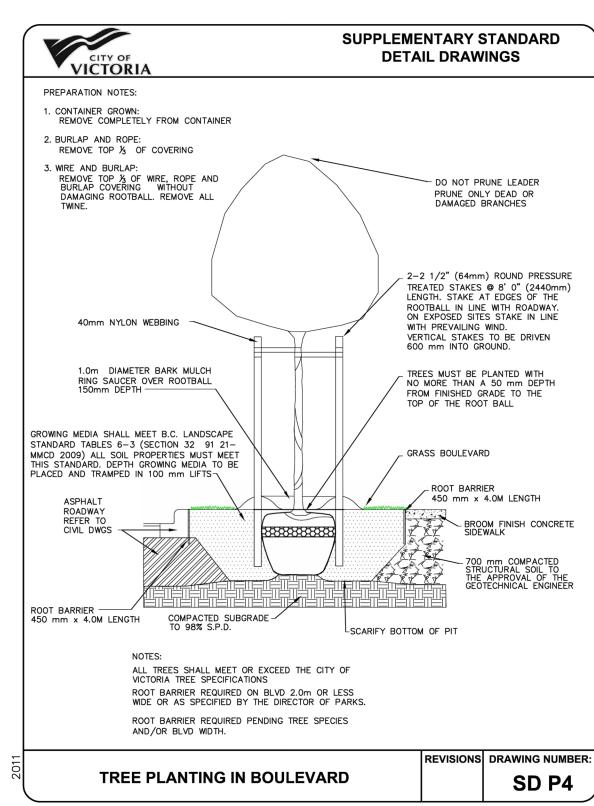

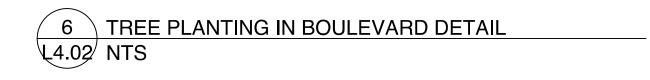

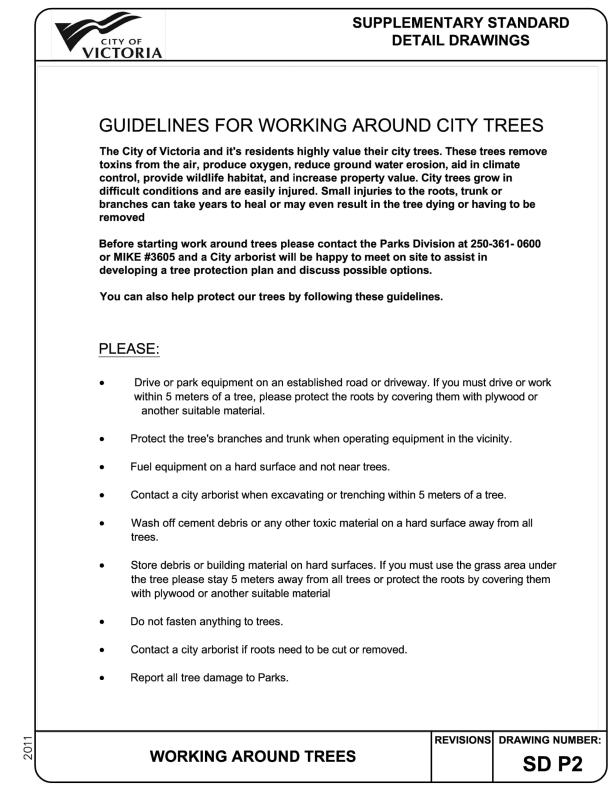

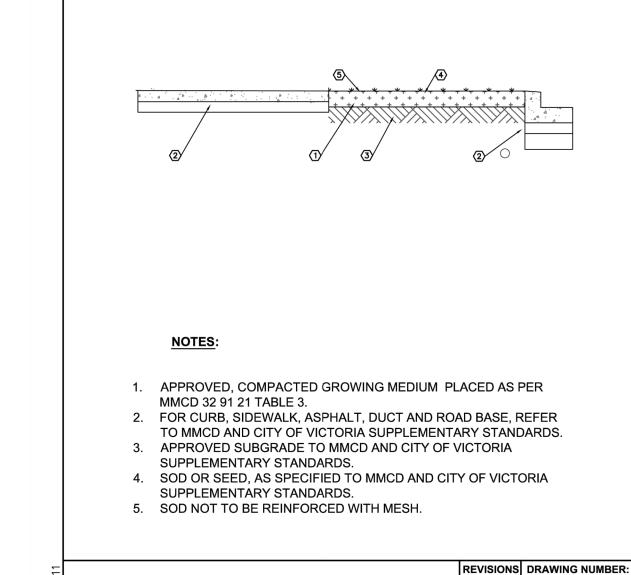



SOD SEED DETAIL



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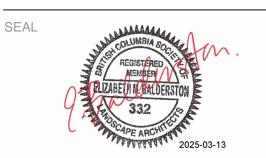
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NORTH ARROW




DRAWING TITLE:

SOFTSCAPE DETAILS

DWG NO:


SCALE: 1:100

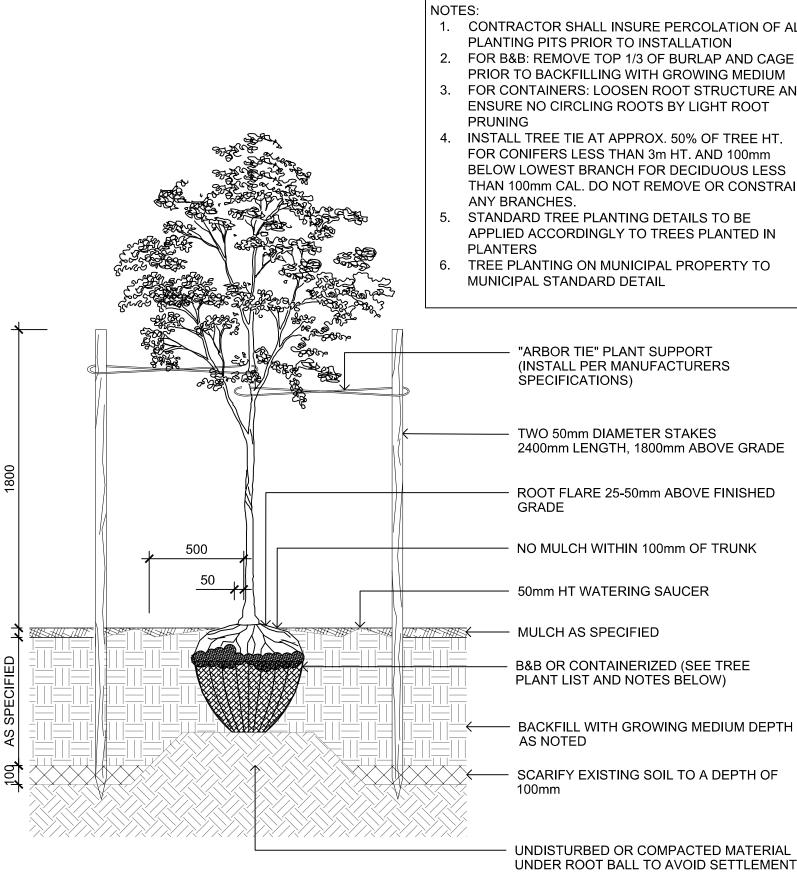

- 300 mm MIN.

- COMPACTED SUBGRADE

GROWING MEDIUM

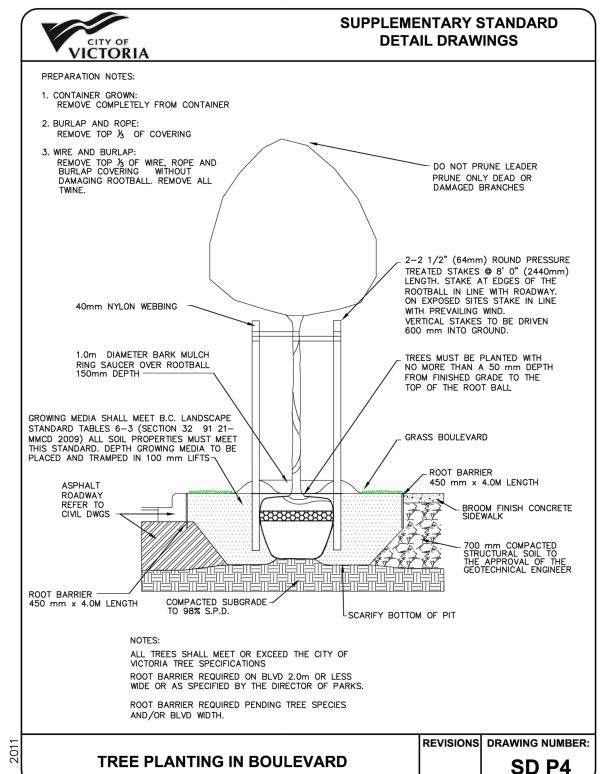

7 WORKING AROUND TREES

