

# LE PARC

## 8 - UNIT RENTAL TOWN HOME DEVELOPMENT

FAIRFIELD RD AND KIPLING ST, VICTORIA, BC

#### **CIVIC ADDRESSES**

#### 1400 FAIRFIELD

UNIT 1

UNIT 2

UNIT 5

UNIT 6

UNIT 7 UNIT 8

#### CODES, BYLAWS & REGULATIONS

ALL WORK SHALL COMPLY WITH THE REQUIREMENTS OF THE CURRENT EDITIONS OF:

 THE NATIONAL BUILDING CODE (NBC); 2. THE BC BUILDING CODE (BCBC);

3. THE BC PLUMBING CODE;

4. THE BC ELECTRICAL CODE; AND 5. ANY AND ALL OTHER AUTHORITIES' REQUIREMENTS HAVING JURISDICTION

#### **DEFINITIONS**

1. "ALIGN" SHALL MEAN TO ACCURATELY LOCATE FINISH FACES IN THE SAME PLANE

2. "CLEAR" SHALL MEAN THAT ALL DIMENSIONS IDENTIFIED AS SUCH SHALL BE MAINTAINED AND SHALL ALLOW FOR THICKNESS OF FINISHES.

3. "SIMILAR" OR "SIM." SHALL MEAN COMPARABLE CHARACTERISTICS FOR THE CONDITIONS NOTED. 4. "TYPICAL" OR TYP." SHALL MEAN THAT THE CONDITION IS REPRESENTATIVE FOR SIMILAR CONDITIONS THROUGHOUT, UNLESS OTHERWISE NOTED (U.O.N.).

#### **ABBREVIATIONS**

(E)	EXISTING	IN.	INCHES
A-B	AIR-BARRIER	M-B	MOISTURE-BARRIER
A.F.F.	ABOVE FINISH FLOOR	MANUF.	MANUFACTURER
ALUM	ALUMINUM	MAX	MAXIMUM
AV.	AVERAGE	MIN	MINIMUM
BASEBD	BASEBOARD	MTL	METAL
BCBC	BRITISH COLUMBIA BUILDING CODE	O.C.	ON CENTRE
BD	BOARD	0/	OVER
BLDG	BUILDING	O/LAP	OVERLAP
BTWN	BETWEEN	P.T.	PRESSURE-TREATED
BULKHD	BULKHEAD	PLYWD	PLYWOOD
C.I.P.	CAST-IN-PLACE	PT	POINT
C/W	COMPLETE WITH	REQ'D	REQUIRED
C'BORE	COUNTERBORE	REQ'T	REQUIREMENT
CAB'T	CABINET(S)	S-A	SELF-ADHERED
CALC(S)	CALCULATION(S)	SF	SQUARE FEET
CLR	CLEAR	SM	SQUARE METER(S)
COORD.	COORDINATION/ATE/ATED	ST STL	STAINLESS STEEL
DBL	DOUBLE	STL	STEEL
DDP	DATUM DETERMINATION PT	STRX	STRUCTURE OR STRUCTURAL
DEMO	DEMOLITION	SUBFLR	SUB-FLOOR
DIA	DIAMETER	T&G	TONGUE & GROOVE
DR	DOOR	THRU	THROUGH
EQ	EQUAL	TYP.	TYPICAL
FD	FLOOR DRAIN	U.O.N.	UNLESS OTHERWISE NOTED
FIN. FLR	FINISHED FLOOR	U/	UNDER
FLR	FLOOR	UNFIN.	UNFINISHED
FSR	FLOOR SPACE RATIO	V-B	VAPOUR-BARRIER
G1S	GOOD-1-SIDE	VERT.	VERTICAL
GALV	GALVANIZED	W/	WITH
GWB	GYPSUM WALL BOARD	W/IN	WITHIN
HGT	HEIGHT	W/OUT	WITHOUT
HORIZ.	HORIZONTAL	WD	WOOD
IGU	INSULATED GLASS UNIT	WDW	WINDOW

#### **DP LIST OF DRAWINGS (1400 FAIRFIELD)**

COVER SHEET

SURVEY PLAN

, , , , , ,	0011121112111	1.200
A1.2	CONTEXT PLAN	1:200
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A4.3	SECTIONS	1:50
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A5.3	UNIT 6 & 7 FLOOR PLANS	1:50
A5.4	UNIT 8 FLOOR PLANS	1:50
A6.0	CONCEPT RENDERINGS	NTS
22	SHEETS IN SET	

#### **TEAM OF CONSULTANTS**

SÉBASTIEN GARON ARCHITECTURE + DESIGN INC SÉBASTIEN GARON, ARCHITECT AIBC (604) 812-1869

LANDSCAPE

BIOPHILIA DESIGN COLLECTIVE LTD BIANCA BODLEY (250) 590-1156 BIANCA@BIOPHILIACOLLECTIVE.CA

ARBORIST

TALBOT MACKENZIE & ASSOCIATES NOAH BORGES, ISA CERTIFIED ARBORIST (250) 479-8733 TMTREEHELP@GMAIL.COM

GEOTECHNICAL RYZUK GEOTECHNICAL

SCOTT CURRIE, P. ENG. (250)-475-3131 SCOTT@RYZUK.COM **CIVIL ENGINEER** 

WESTBROOK CONSULTING LTD. IVA KVARTUC, B. ENG.

(250) 391-8592 EXT. #235 IKVARTUC@WBROOK.CA

JAY.SINGH@E2ENG.CA MECHANICAL M3 MECHANICAL CONSULTANTS INC. BRENTON WILLIAMS, P.ENG

**BUILDING ENVELOPE** 

(250) 940-2256

BCW@M3MECH.CA

**STRUCTURAL** 

ELECTRICAL

JAY SINGH

(778) 433-9391


SKYLINE ENGINEERING

WADE GRIFFIN

(250)-590-4133 EXT. 103

EVOKE JOHN LITTLE, EIT, RSE (250) 882-8884 JLITTLE@EVOKEBUILDINGS.COM

SURVEYOR J.E.ANDERSON & ASSOCIATES (250) 727-2214 INFO@JEANDERSON.COM

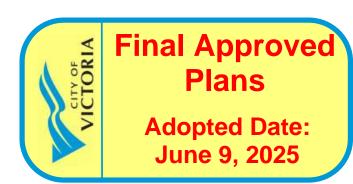



Revisions

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2022-11-25

2019-12-12 Revised & Re-Issued for DP 2020-09-21 Revised & Re-Issued for DP Revised & Re-Issued for DP 2022-04-11 Revised & Re-Issued for DP

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2024-02-17 BP REVISION "A" 2024-05-30 ISSUED FOR DP

Project Name:

LeParc

KIPLING ST & THURLOW

Project No: 19.015 Drawn By: SG/TD 2025-04-17 NTS Sheet No:

#### SITE PLAN

This sketch does not constitute a redefinition of the legal boundaries hereon described and is not to be used in any matter which would assume same. J.E. Anderson & Associates accepts no responsibility or liability for any damages that may be suffered by a third party as a result of any decision made, or actions taken based on this document. Subject to charges, legal notations, and interests shown on: Title No. ET59777 (P.I.D. 008-292-345) Lot 13 Title No. CA6094211 (P.I.D. 005-209-510) Lot 35

The intended plot size of this plan is 432mm in width by 560mm in height, (C size), when plotted at a scale of 1:200.

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2022-11-14

2022-11-25

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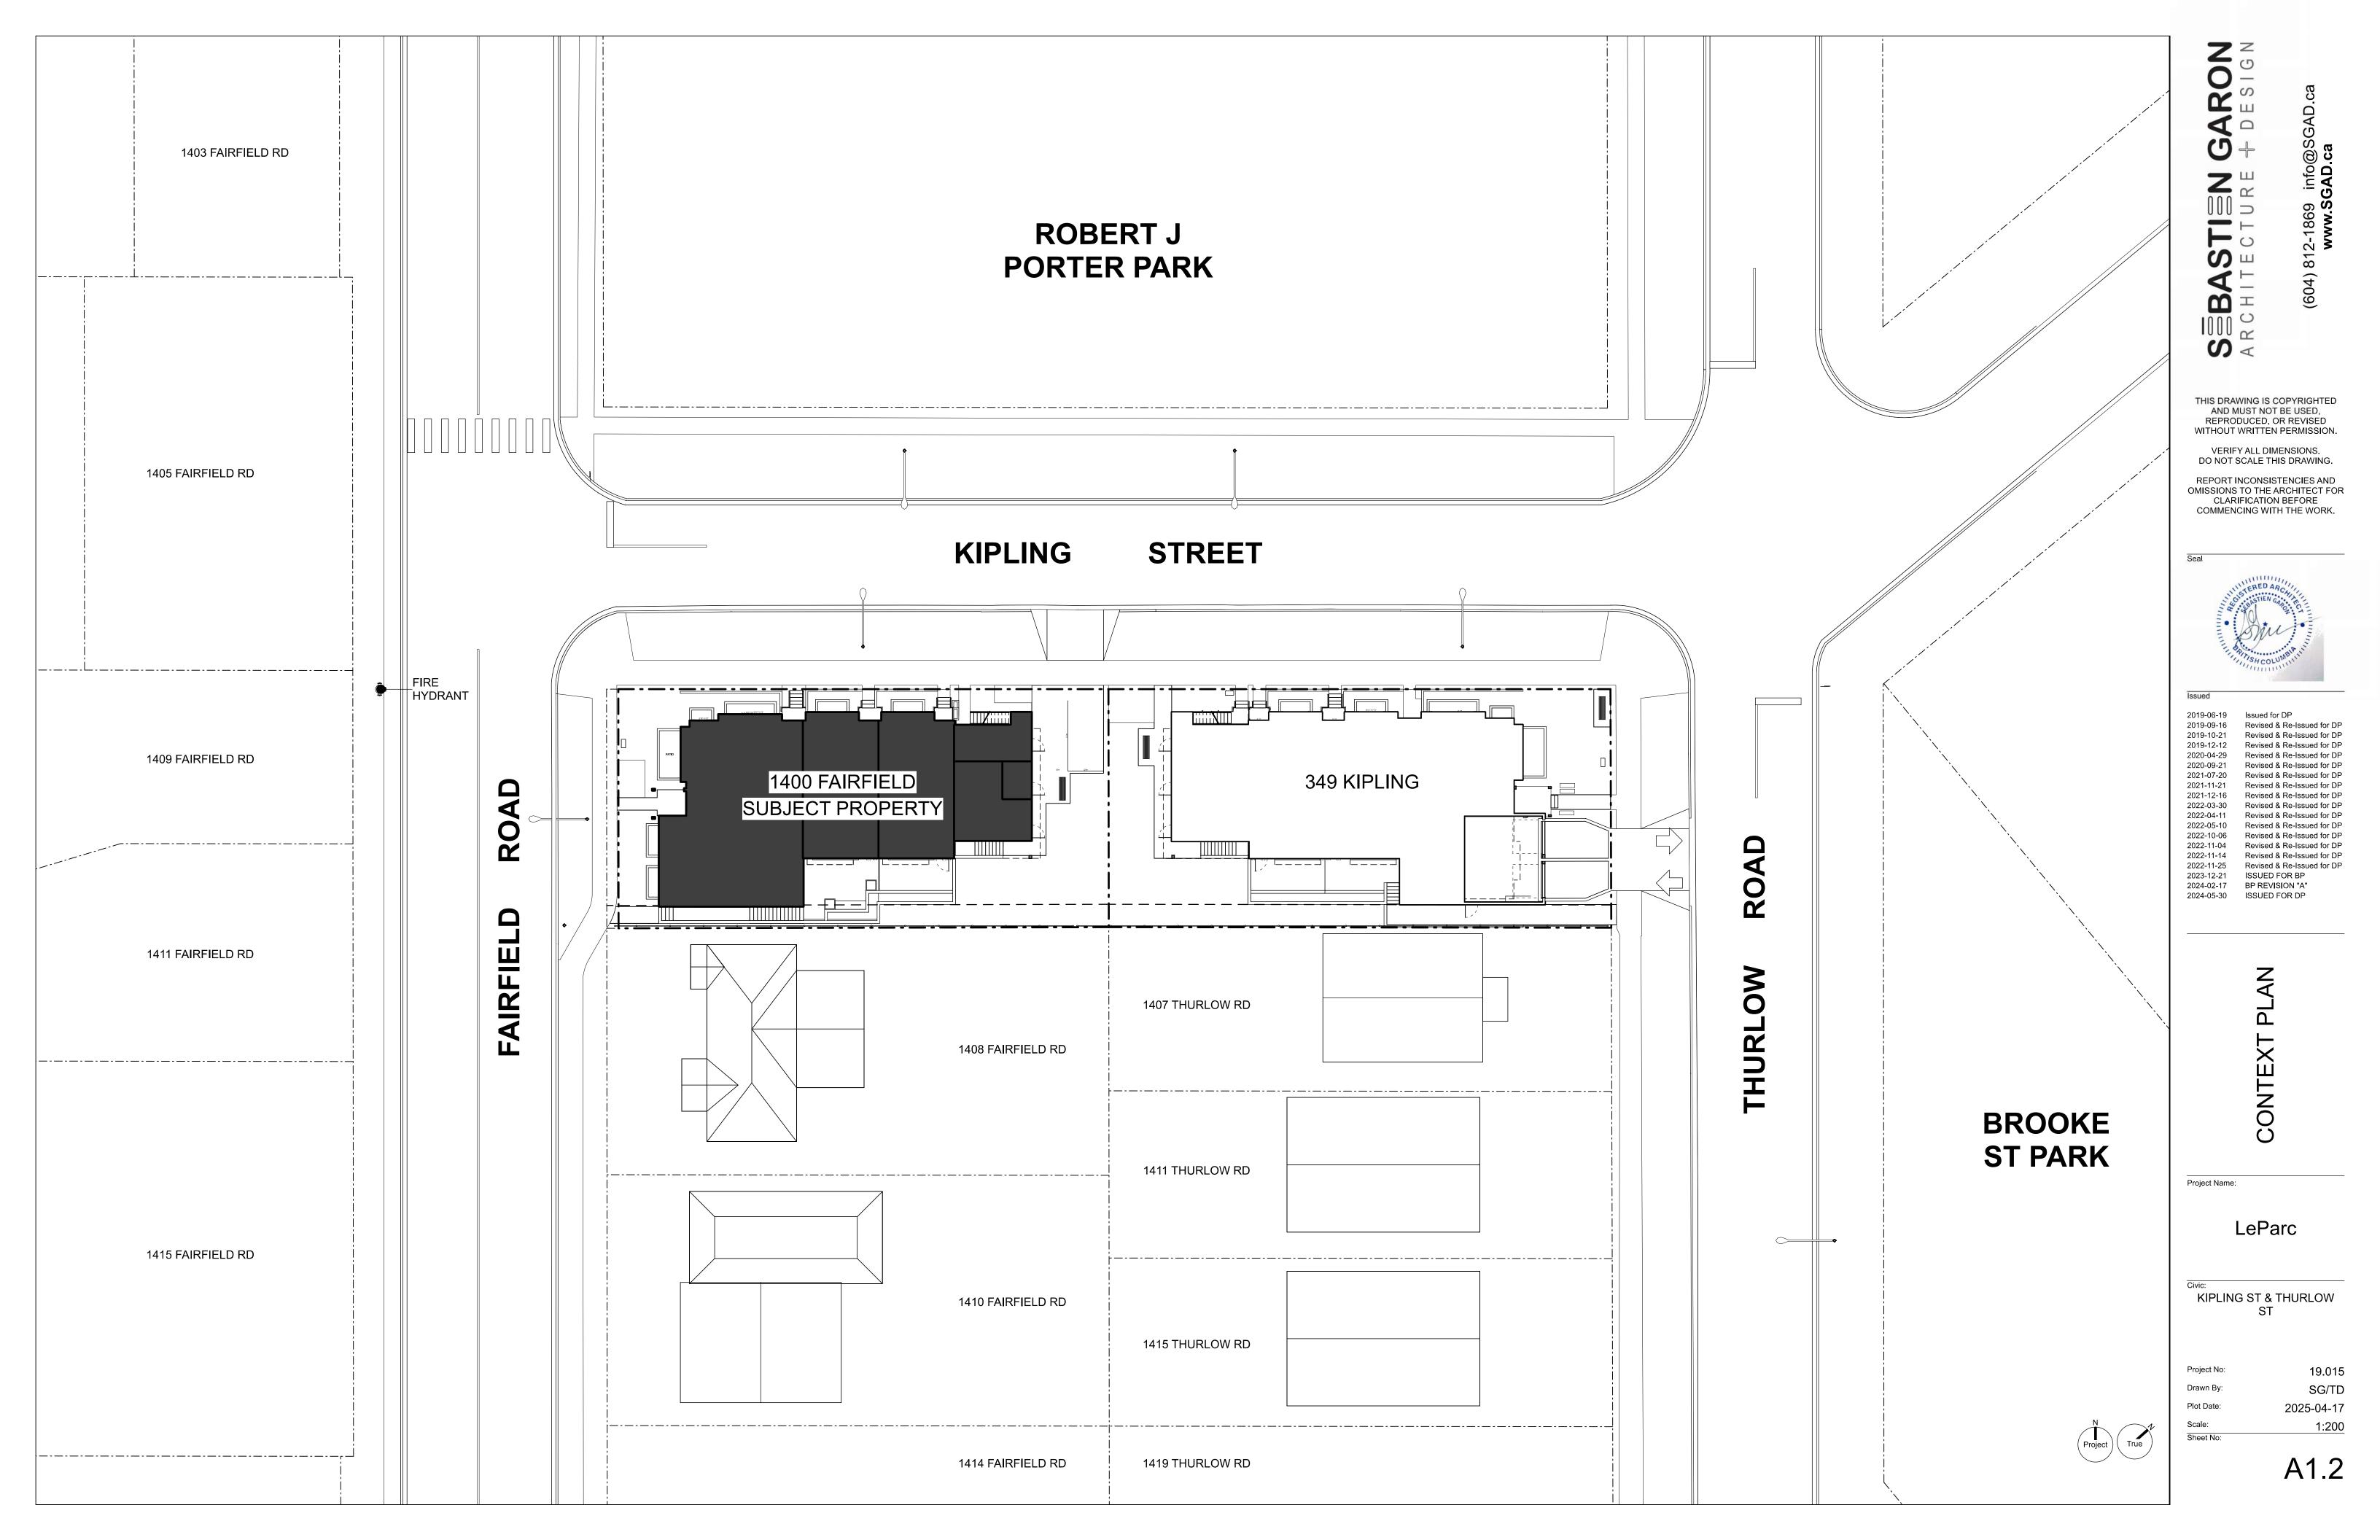
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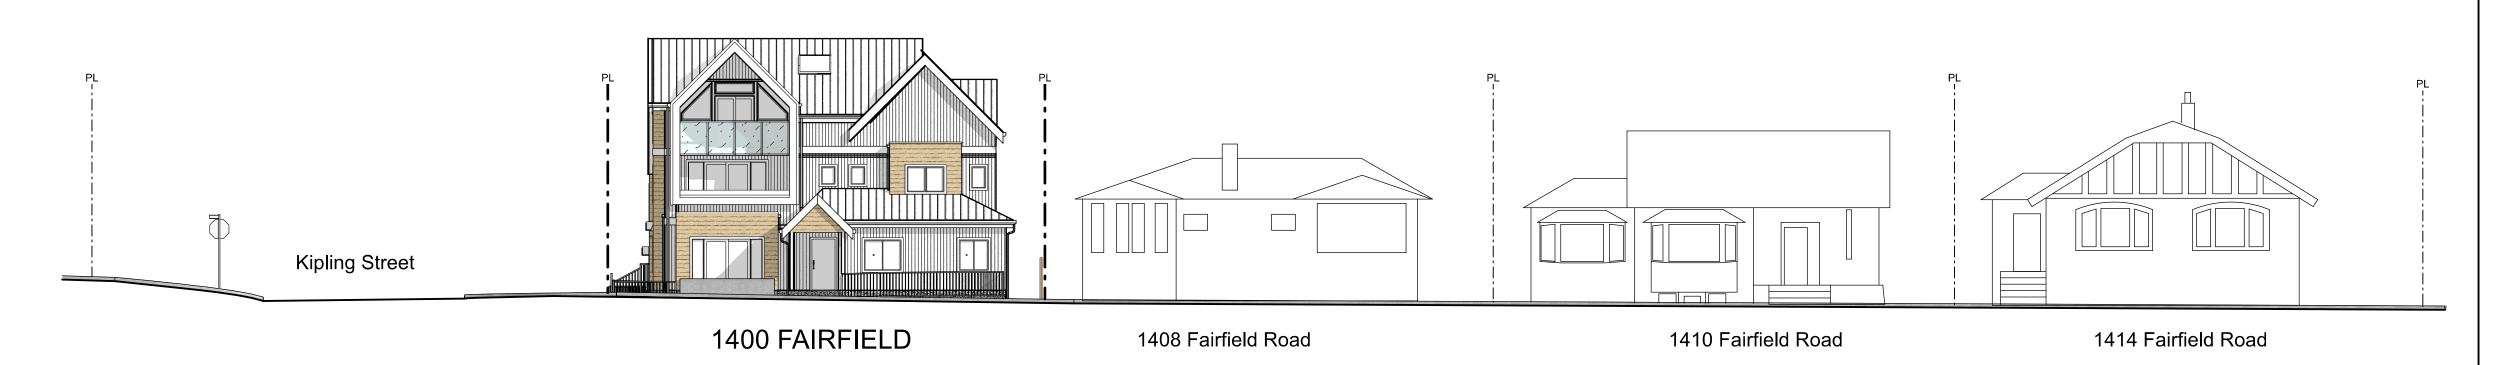
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1:200



## 1 Streetscape Kipling Street Scale: 1:150



## 2 Streetscape Fairfield Road Scale: 1:150

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CONTEXT

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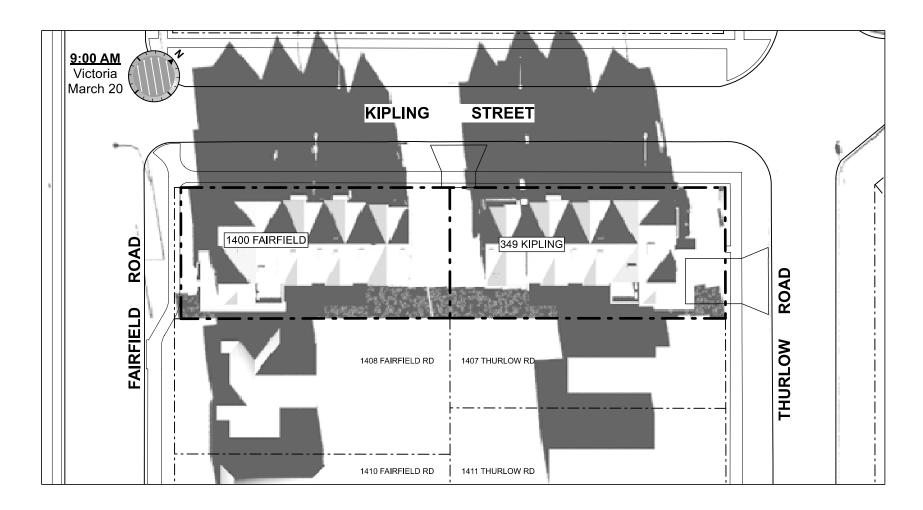
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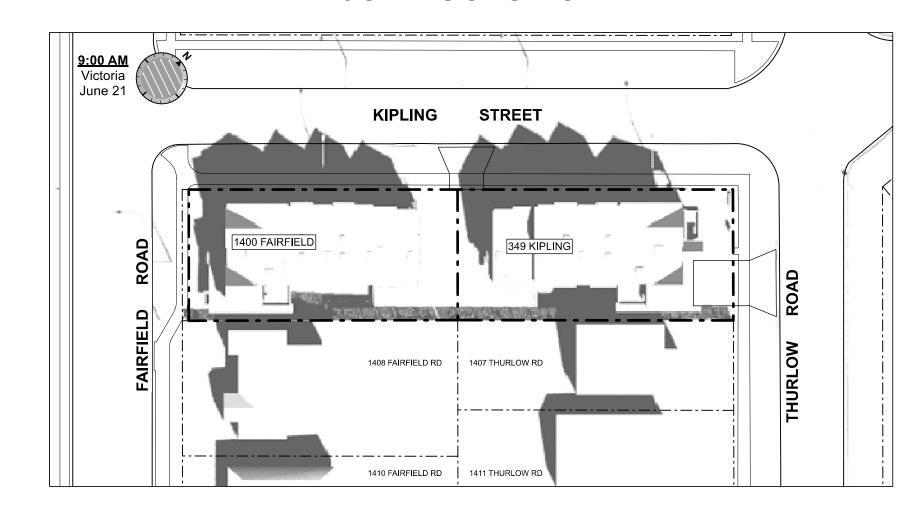
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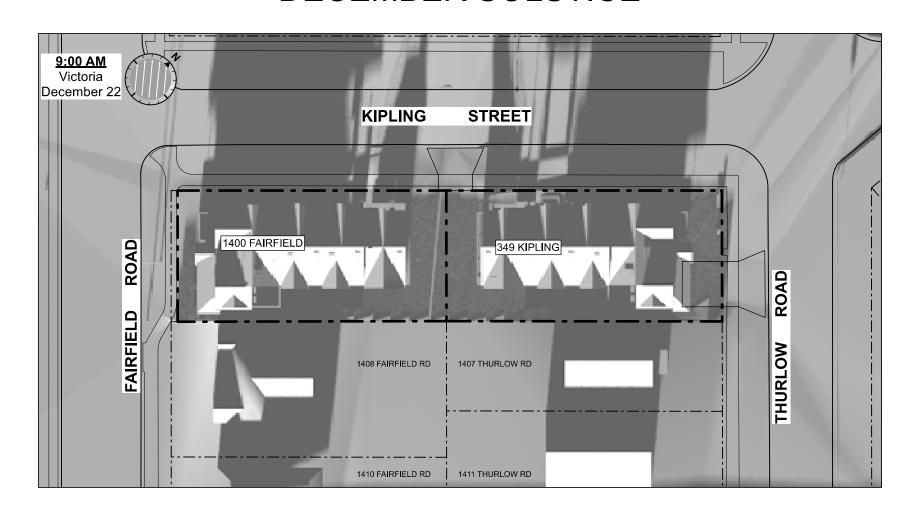
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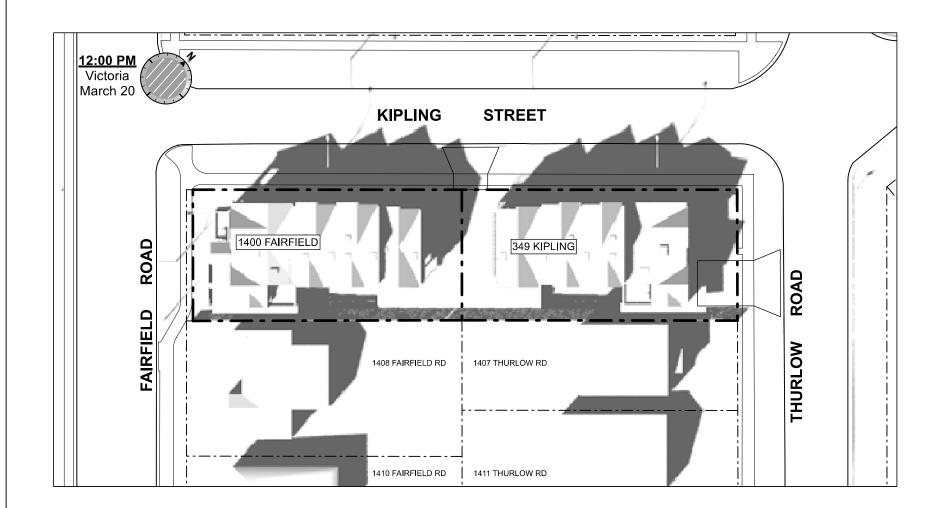



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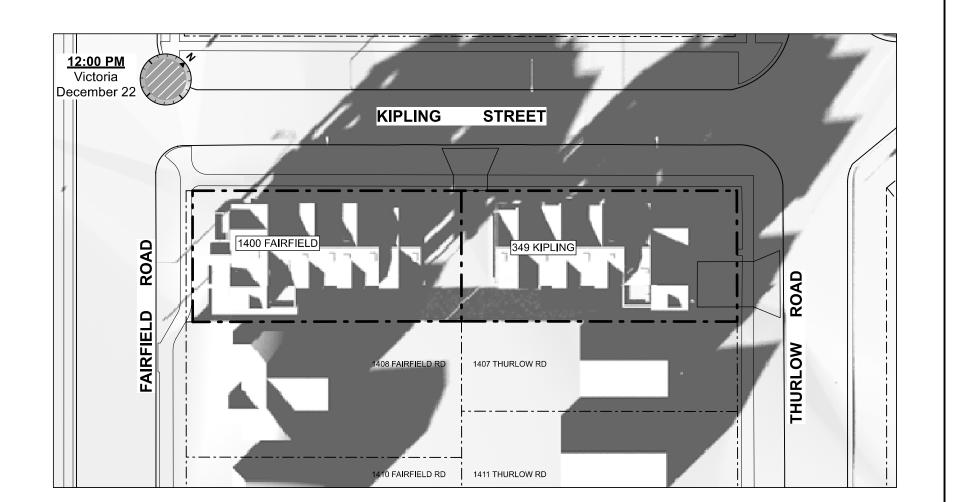



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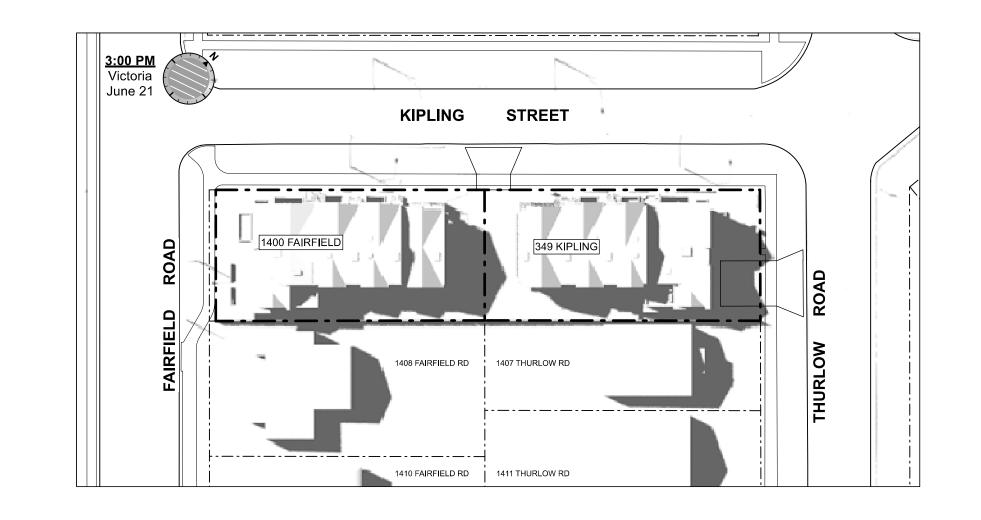









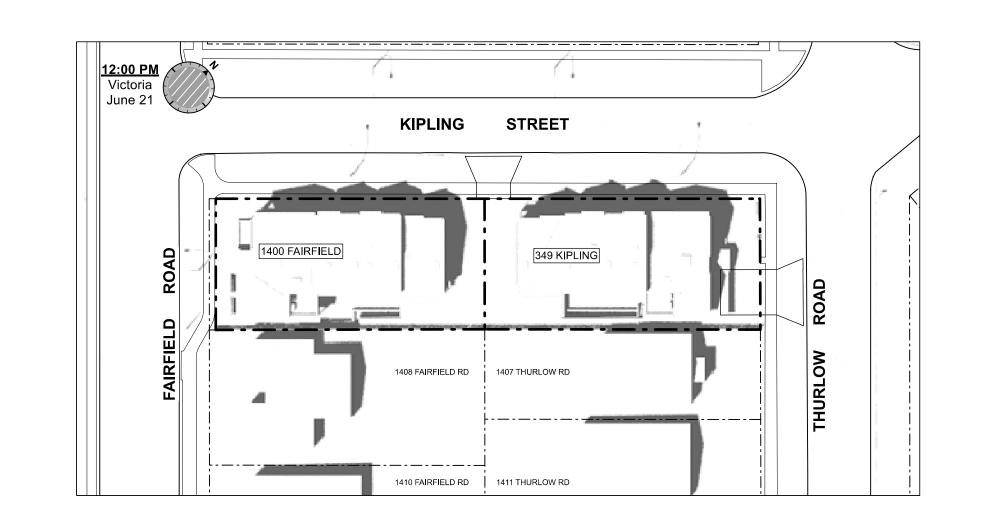

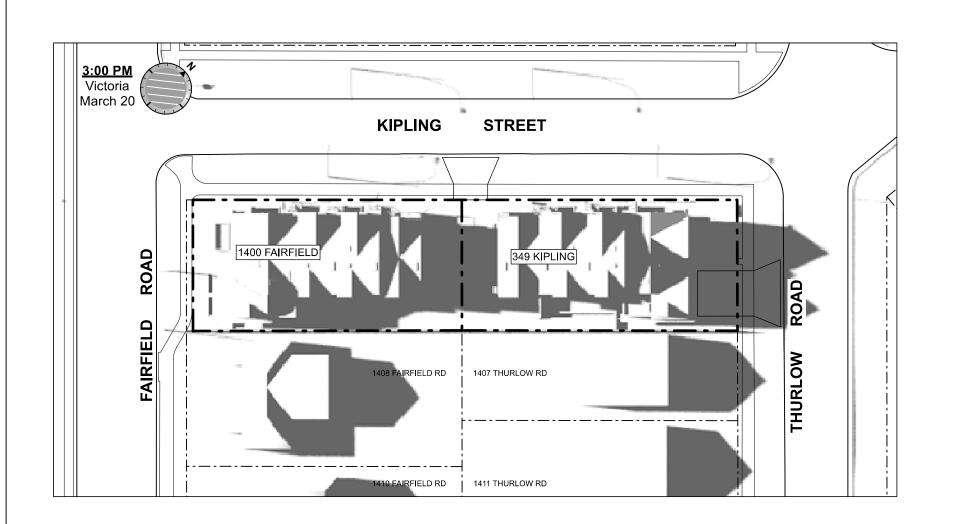

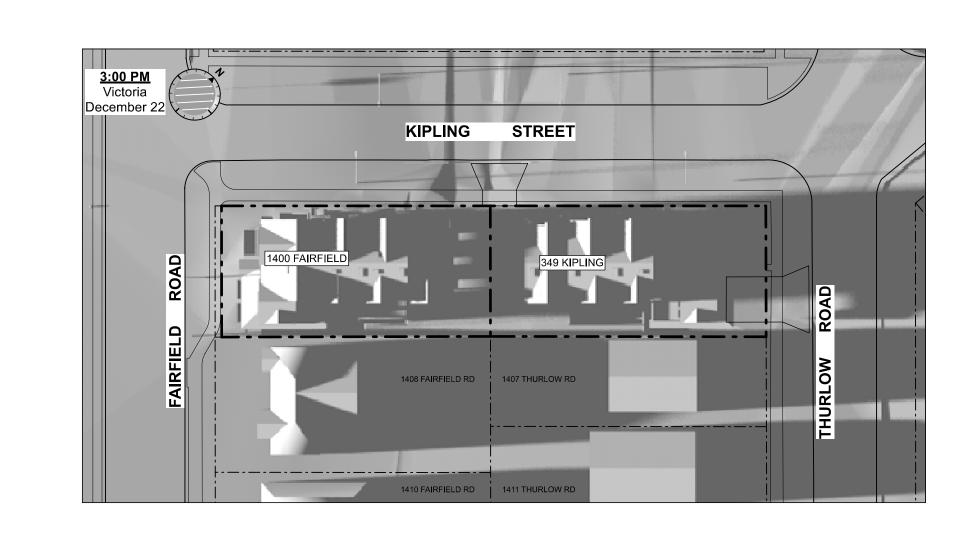

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SOLAR STUDY

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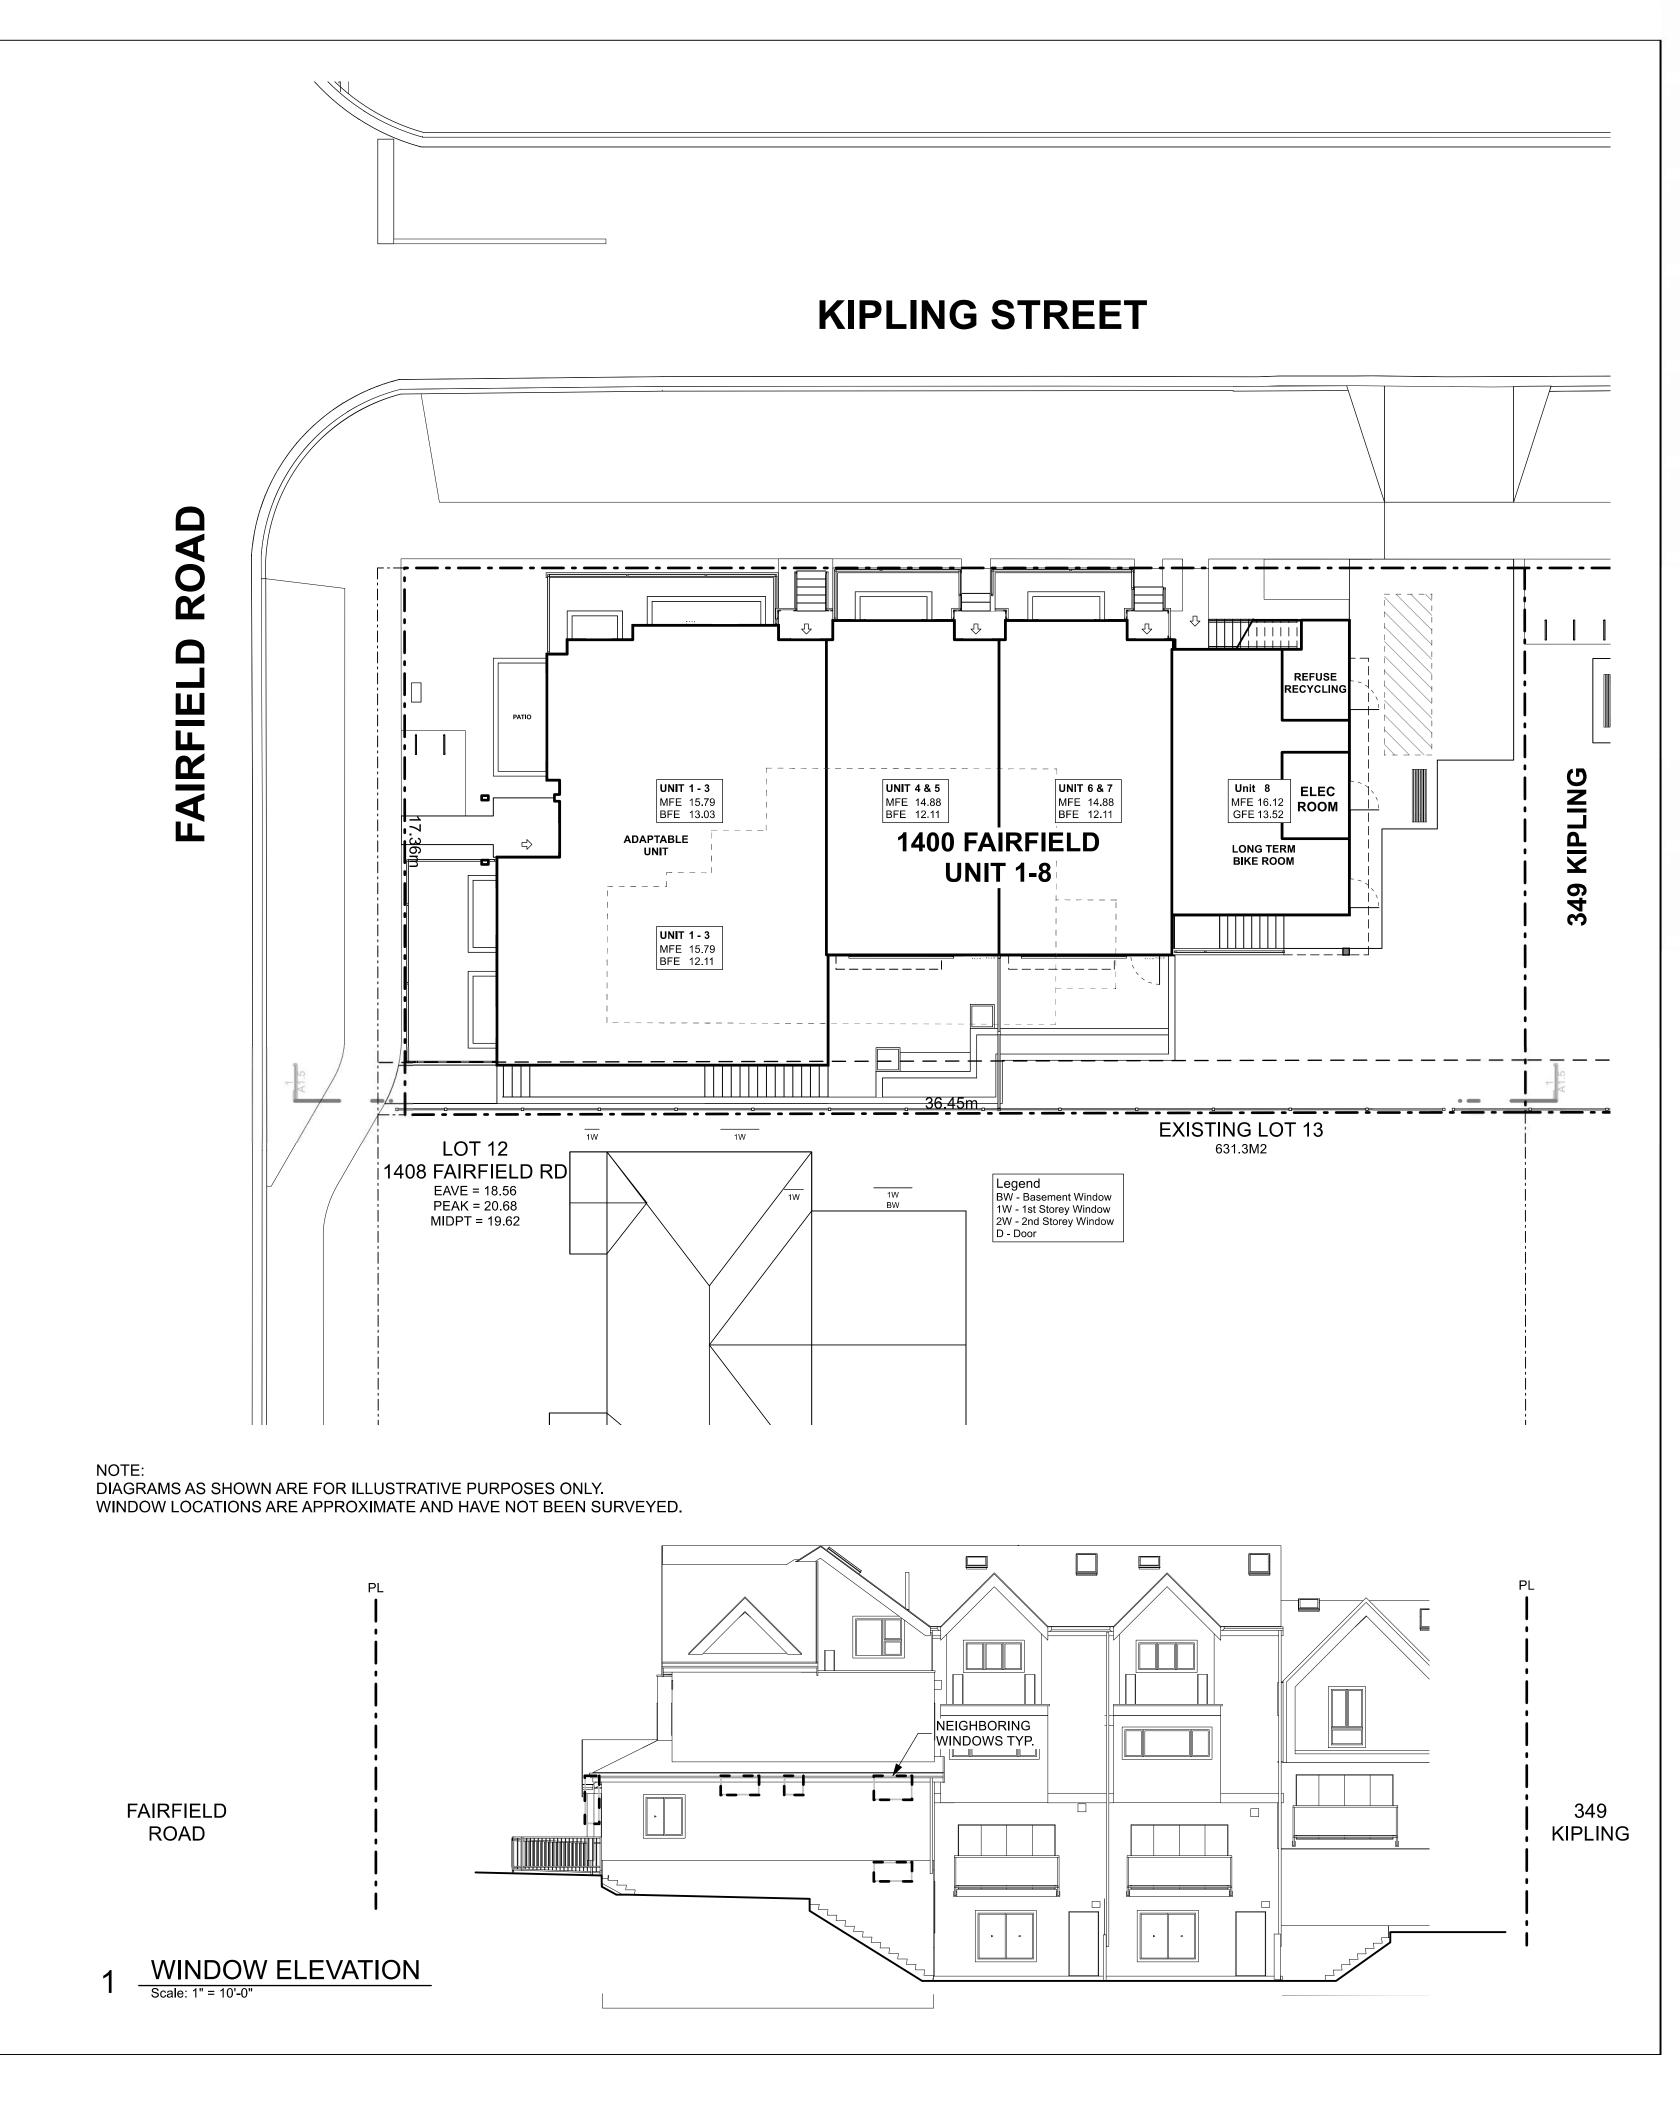
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KIPLING ST & THURLOW ST

Project No: 19.015 SG/TD 2025-04-17 1:120



#### LEGEND

#### NO. DESCRIPTION

- 1 READY FOR SOLAR PANELS (ROUGH-IN)
- 2 READY FOR ELECTRIC CAR CHARGING OUTLETS (ROUGH-IN)
- 3 WATER EFFICIENT LANDSCAPING
- 4 ENHANCED BIKE PARKING
- 5 ENHANCED NATURAL LIGHT
- 6 ENERGY EFFICIENT LIGHT FIXTURES
- 7 WATER EFFICIENT PLUMBING FIXTURES
- 8 LOW-VOC INTERIOR FINISHES

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 2020-04-29
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 2021-07-20
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 2021-11-21
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 2021-12-16
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 2022-03-30
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 2022-04-11
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 2022-05-10
 Revised & Re-Issued for DP

 2022-10-06
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 2022-11-04
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STAINABILITY

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KIPLING ST & THURLOW ST

 Project No:
 19.015

 Drawn By:
 SG/TD

 Plot Date:
 2025-04-17

 Scale:
 NTS

 Sheet No:



#### PROJECT DATA - 1400 FAIRFIELD

	GFA Area (SF)	Zoning Area (SF)	Site Area (SF)	FAR	Bedrm	S	
Unit 1-7	10,691	7,437	6,635	1.12	21	NET SITE	
Basement	2,661	0			_		
Main Floor	2,647	2,532					
Second Floor	2,937	2,793					
Third Storey	2,446	2,112					
Garage	0	0 E	xcluded from FAR				
Refuse	54	54 E	xcluded from FAR				
Electrical Room	116	116 E:	xcluded from FAR				
Bike Room	720	720 E	xcluded from FAR				
Total Floor Area	11,581	A	II Included				

Floor Space Ratio; The building area is measured to the interior side of the exterior wall and interior face of demising walls. Basements excluded.

## **ZONING RECONCILIATION - SCHEDULE P**

1400 FAIRFIELD				
CIVIC ADDRESS:	VARIES			
LEGAL ADDRESS:	Lot 13 Plan 884			
	Section Ffld Victor	ia		
XISTING ZONING:	R1-B			
GROSS SITE AREA:	631.3 M2	6795.6 SF		
ROAD DEDICATION:	14.9 M2	160.7 SF		
IET SITE AREA:	616.4 M2	6634.9 SF		
SR (GROSS SITE)	MAX 1.1		PROPOSEI	D: 1.09
FSR (NET SITE)	MAX 1.1		PROPOSEI	D: 1.12
SITE OPEN SPACE	MIN 45%		44.6%	275.14 M2
LOT COVERAGE	MAX 50%		50.7%	312.73 M2
SETBACKS	MINIMUM		PROPOSED	
FRONT YARD	2.00 m		5.38 m	17.65 FT
REAR YARD	2.00 m		5.57 m	18.27 FT
EXTERIOR SIDE YARD	2.00 m		1.67 m	5.48 FT
NTERIOR SIDE YARD	2.00 m		1.71 m	5.61 FT
BUILDING HEIGHT	MAXIMUM	12.00 m	PROPOSED	10.52 m
VEHICLE PARKING	REQUIRED:	1 stalls	PROPOSED:	1 stalls

LONG TERM DWELLING UNIT 2 / Unit NO BIKE REQUIRED WITH A DWELLING THAT HAS A PRIVATE GARAGE 15% ARE REQUIRED TO BE OVERSIZED 50% ARE REQUIRED TO BE HAVE BIKE CHARGING STATION

1 stalls

0 stalls

BICYCLE MAINTENANCE FACILITY TO BE PROVIDED 0.9MX2.4M WITH GAUCET AND DRAIN 6 stalls

ACCESSIBLE PARKING



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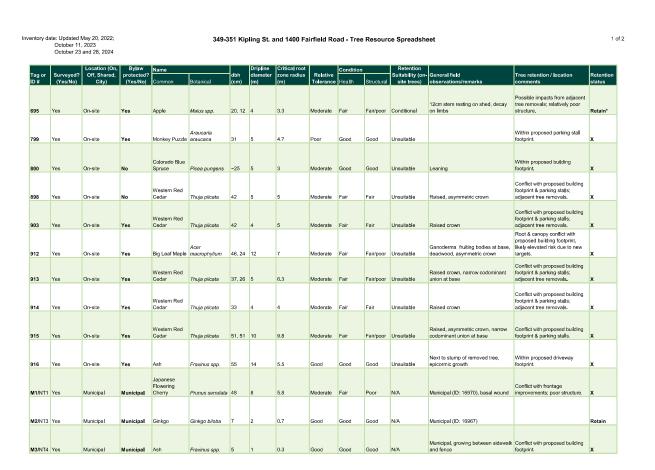
Project Name:

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KIPLING ST & THURLOW


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SITE SECTION A
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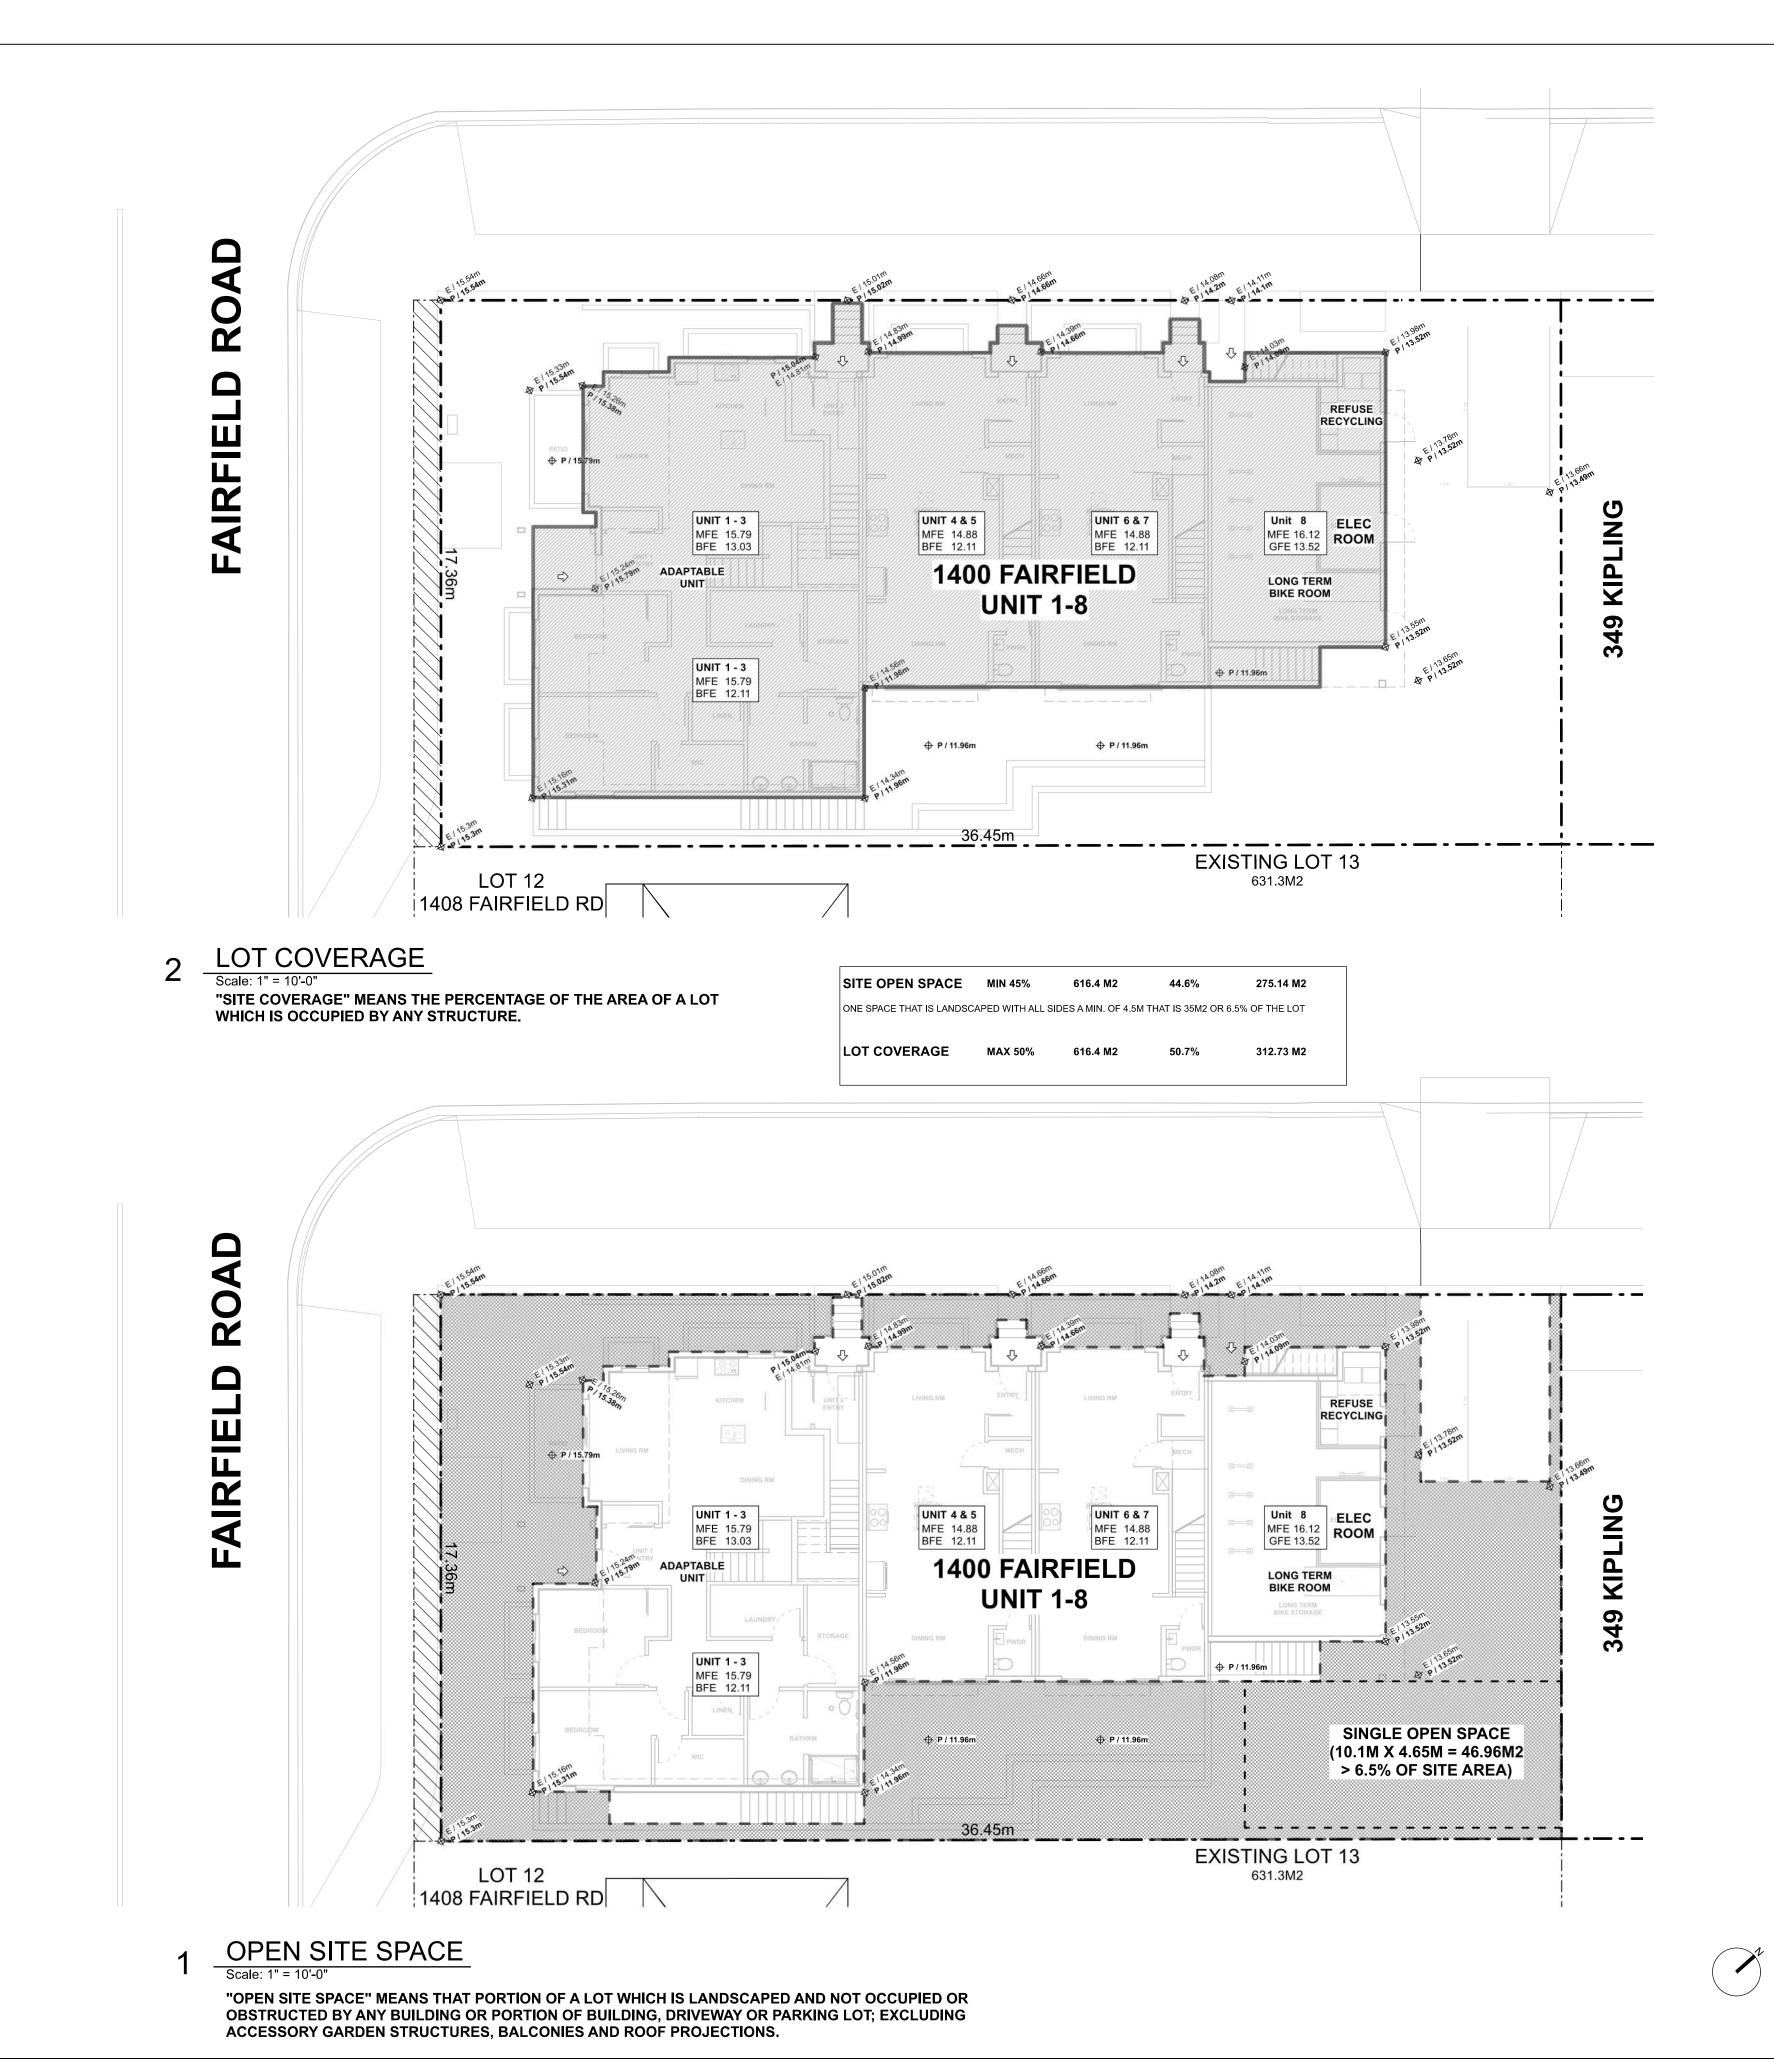


349-351 Kipling St. and 1400 Fairfield Road - Tree Resource Spreadsheet

Prepared by: Talmack Urban Forestry Consultants Ltd. Box 48163 RPO Uptown Victoria, BC V82 7H6 Ph: (250) 479-8733 - Fax: (250) 479-7050 Email: Introrohelp@gmail.com



SITE PLAN
Scale: 1:100

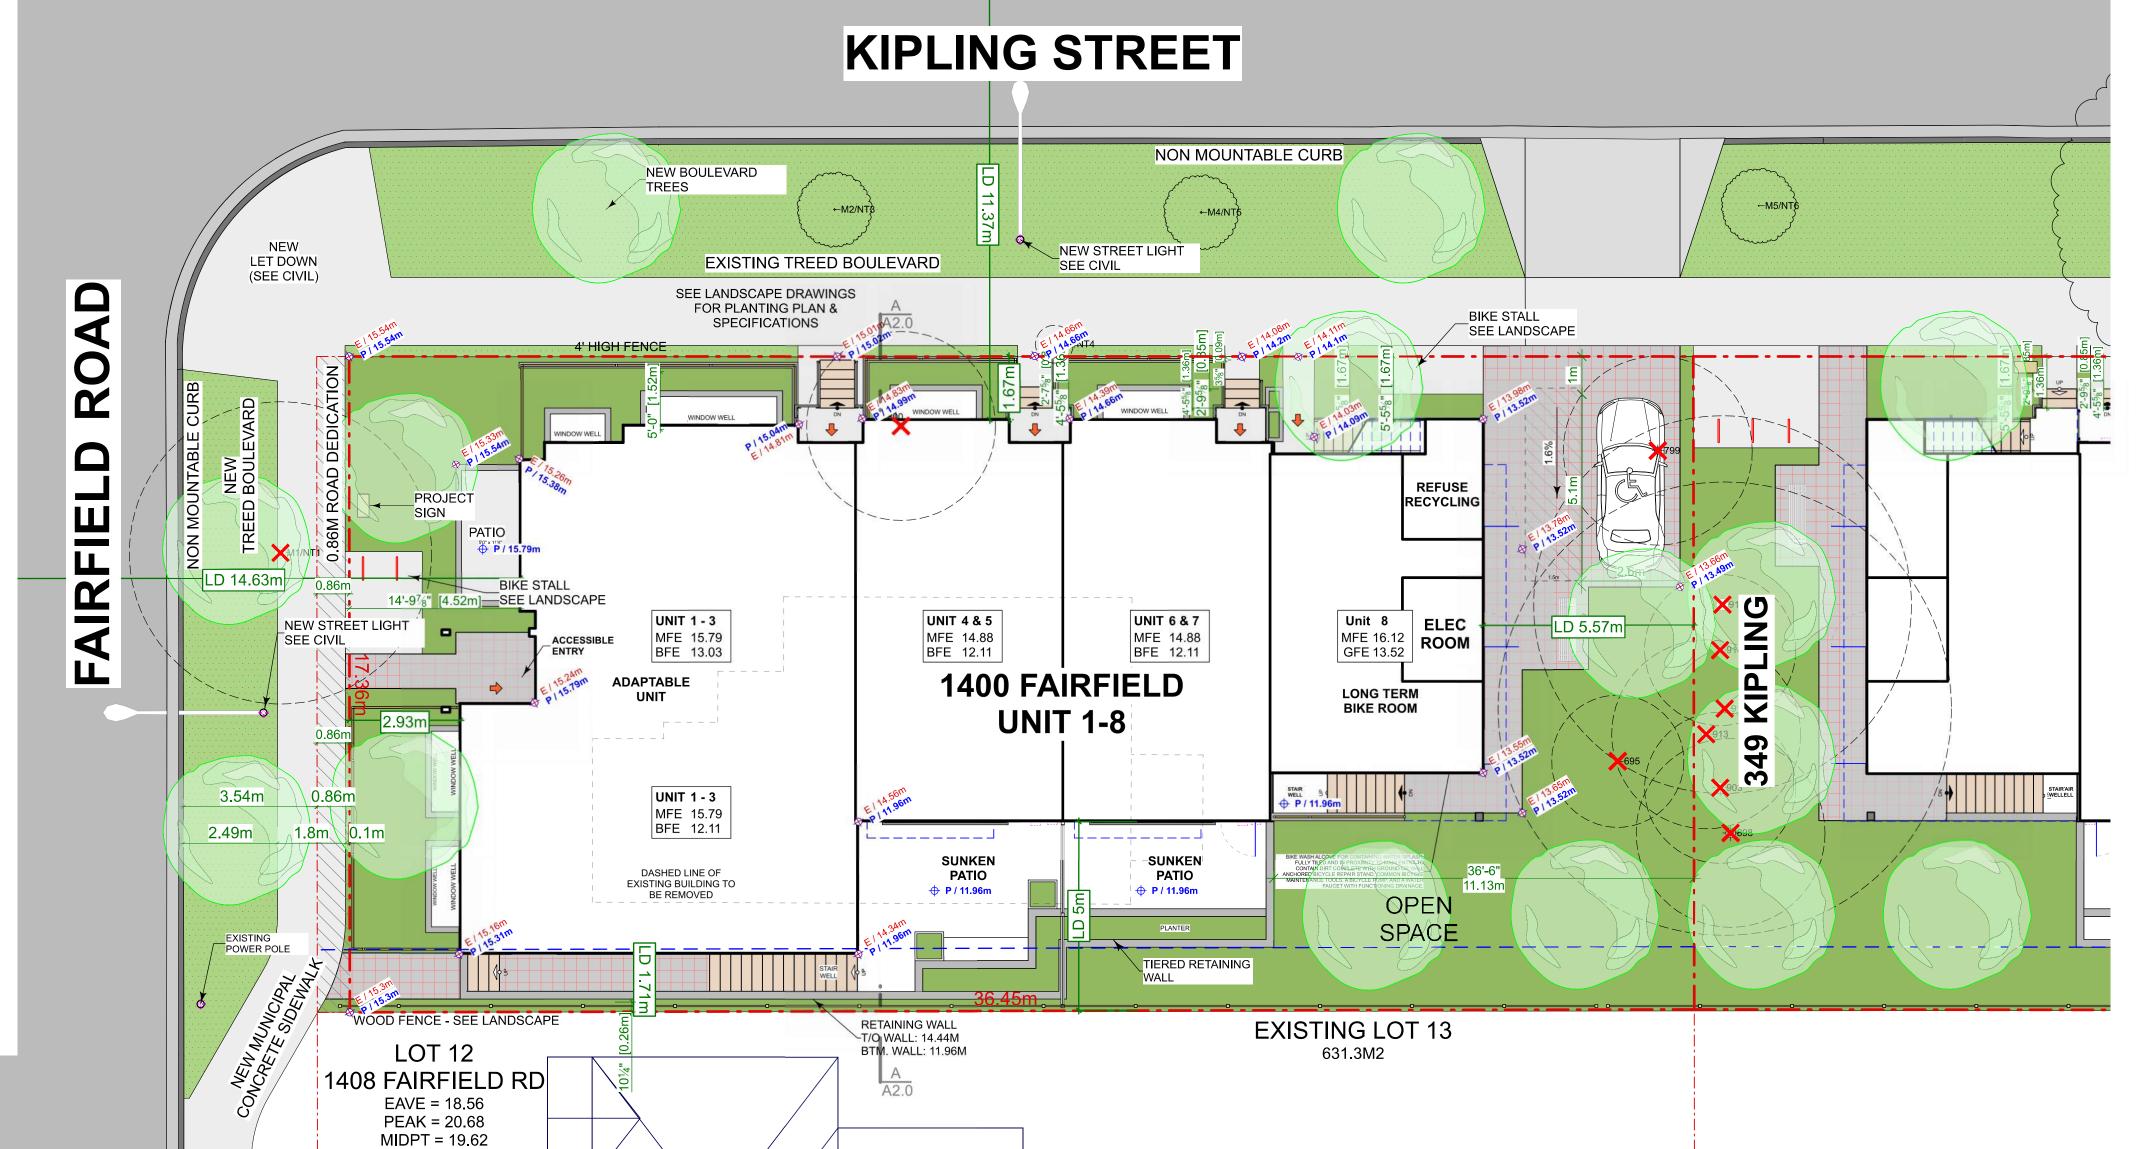

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SITE COVERAGE & OPEN SITE SPACE

Project Name:

LeParc

Civic:
KIPLING ST & THURLOW
ST

 Project No:
 19.015


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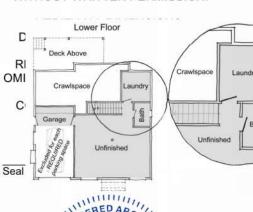


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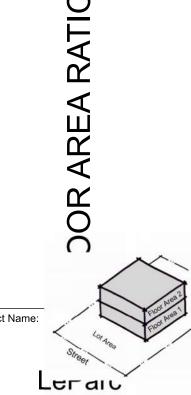
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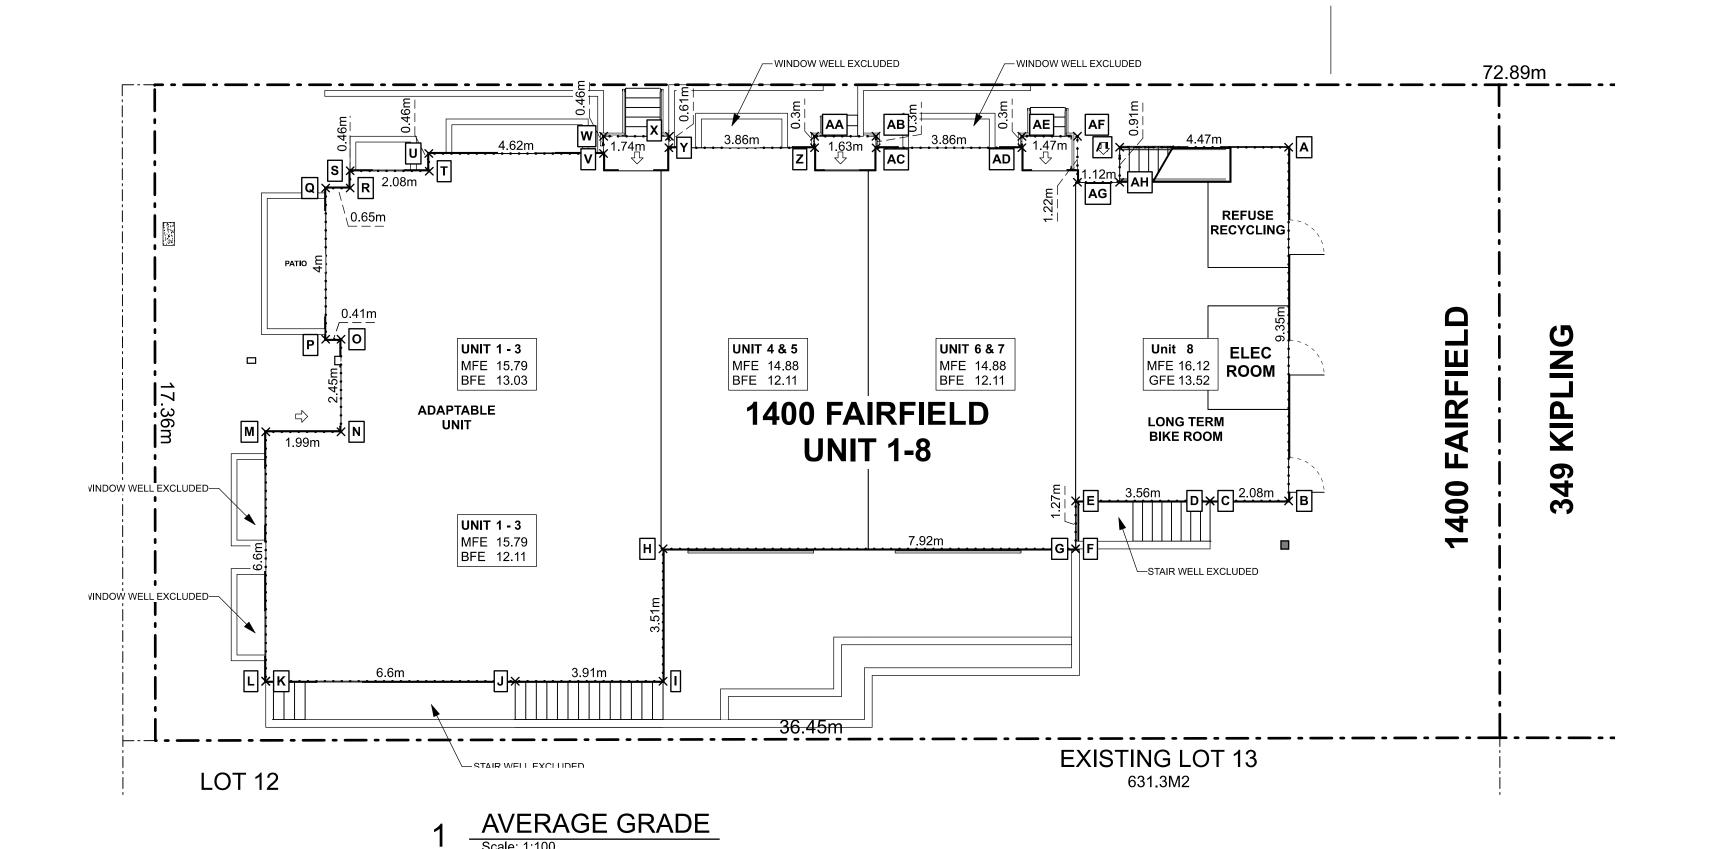
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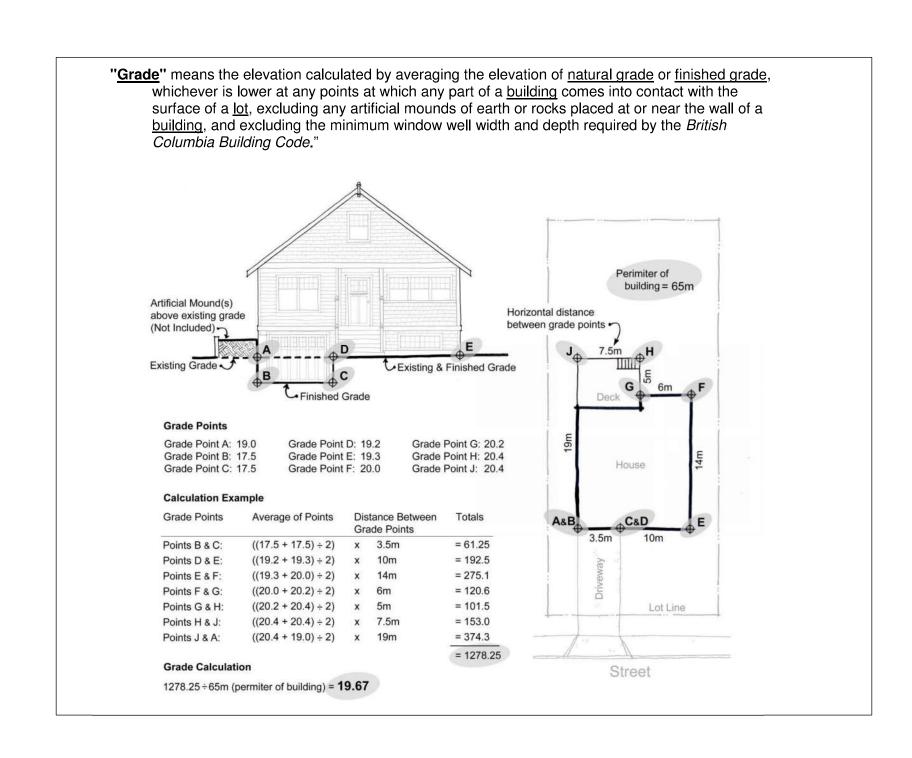


KIPLING ST & THURLOW

19.015 SG/TD 2025-04-17 1:150

A2.2

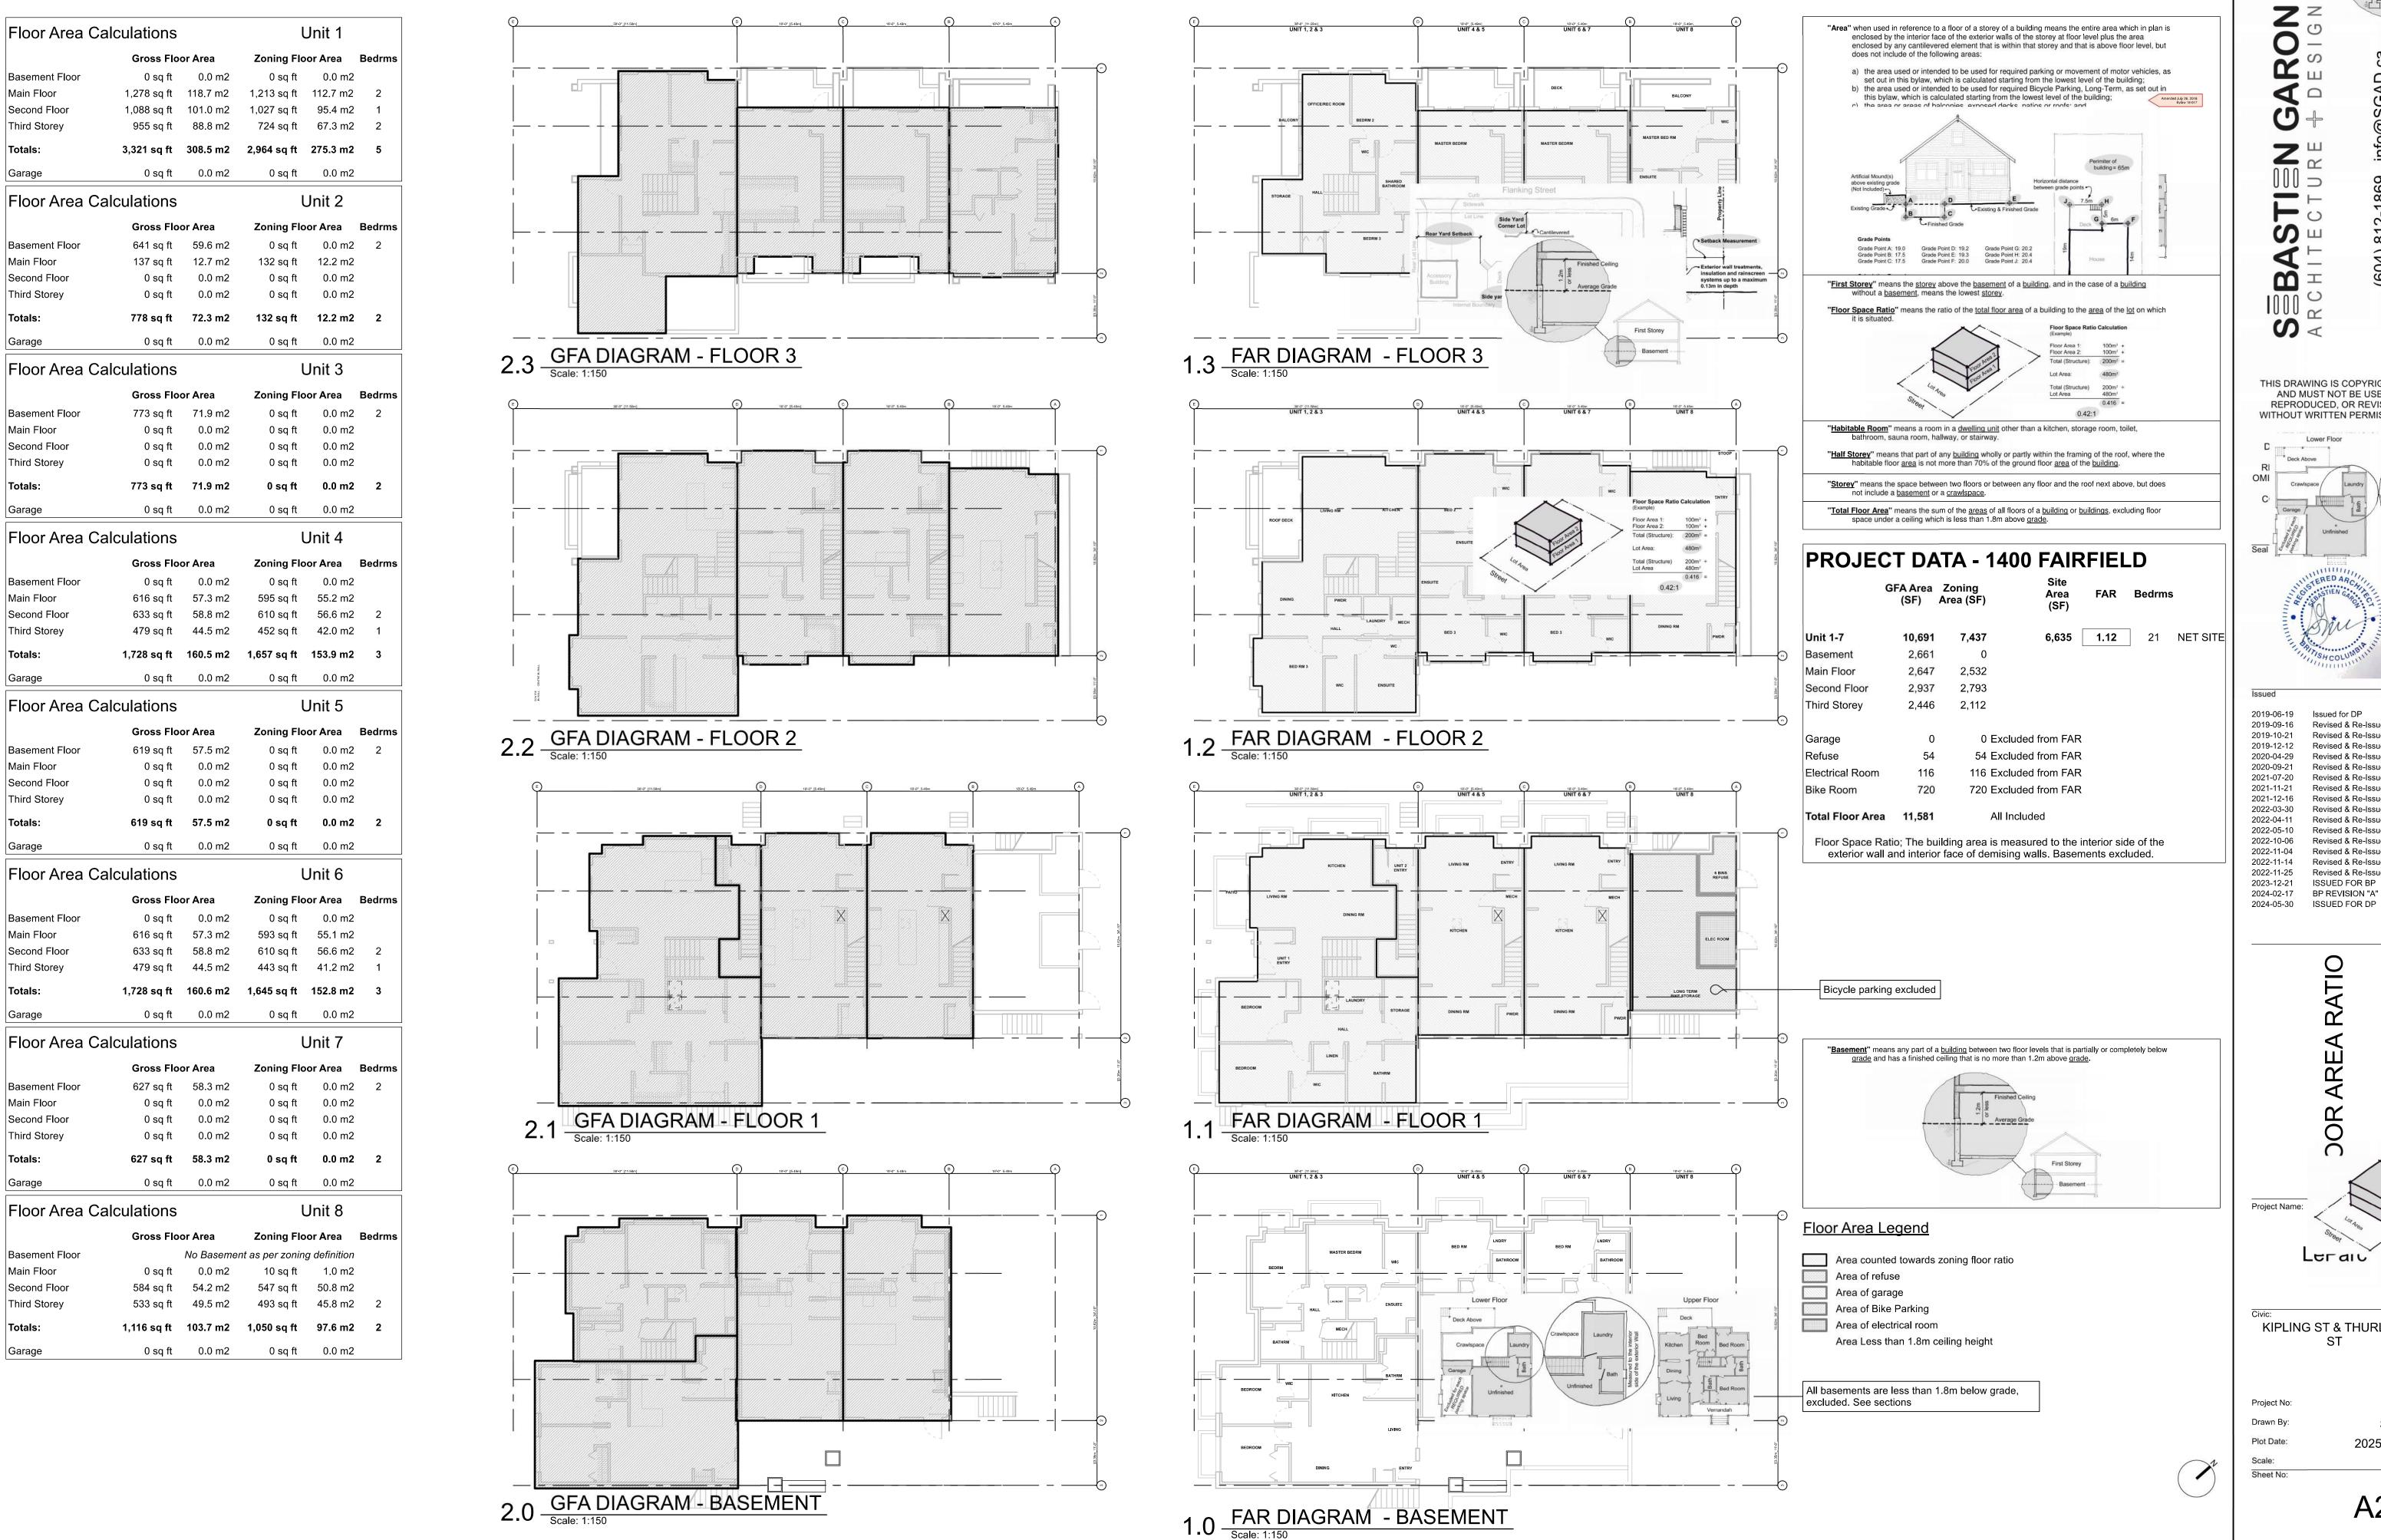



#### GRADE CALCULATIONS

**AG** 14.04 m 13.04 m 13.04 m -> **AH** 14.03 m

**AH** 14.03 m 14.10 m 14.03 m —> **AI** 14.09 m

**Al** 14.09 m 14.10 m 14.09 m —> **A** 13.52 m

	Orado	Grade	Ordao	Orago				
Α	13.98 m	13.52 m	13.52 m —>	<b>B</b> 13.52 m	13.52 m	x 9.35 m	126.41	
В	13.55 m	13.52 m	13.52 m —>	<b>C</b> 13.41 m	13.47 m	x 2.08 m	28.01	
С	13.41 m	13,52 m	13.41 m —>	<b>D</b> 13,56 m	Step Dow	n		
D	13.56 m	15.01 m	13.56 m —>	<b>E</b> 12.71 m	13.13 m	x 3.56 m	46.76	
E	14.19 m	12.71 m	12.71 m —>	<b>F</b> 13.52 m	13.12 m	x 1.27 m	16.66	
F	14.26 m	13.52 m	13.52 m —>	<b>G</b> 11.97 m	Step Up			
G	14.36 m	11.97 m	11.97 m —>	<b>H</b> 11.97 m	11.97 m	x 7.92 m	94.80	
н	14.16 m	11.97 m	11.97 m —>	I 11.97 m	11.97 m	x 3.51 m	42.01	
5.0	44.00	44 07	44 07	1 44 40	40.00		C4 44	I
						Roof Peak Mid Point		
					Height	Eave		
ight		a		aight	<b>b</b>	1	ight	<b>b</b>

Pitched Roof

13.80 m x 4.47 m

AVERAGE GRA

(604) 812-1869 info@ www.SGAD.ca

SEB ARCH

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2022-11-25 Revised & Re-Issued for DP

2023-12-21 ISSUED FOR BP 2024-02-17 BP REVISION "A" 2024-05-30 ISSUED FOR DP

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Revised & Re-Issued for DP Revised & Re-Issued for DP

2019-09-16

2019-12-12

2020-09-21

2021-07-20

2021-12-16

2022-03-30


2022-04-11

2022-05-10

2022-10-06

2022-11-04

2022-11-14

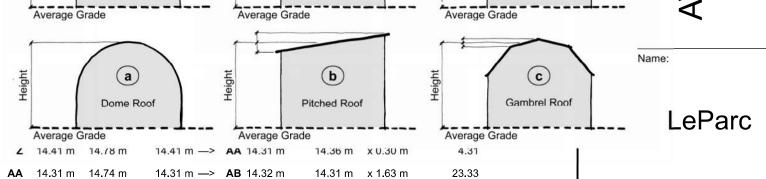

Sub-Total: 1,177.50

Average Grade 13.99 m

Perimeter of Building 84.17 m

Civic:
KIPLING ST & THURLOW
ST

Drawn By:
Plot Date:
Scale:
Sheet No:

Project No:

**A O** 4

19.015

SG/TD

2025-04-17

**DIMENSION NOTES:** 

FACE OF FINISHED WALL.

C/L OF DEMISING WALLS

1) EXTERIOR DIMENSIONS TO FACE OF PLYWOOD SHEATHING WHICH IS IN LINE WITH CONCRETE FOUNDATION WALL. 2) INTERIOR DIMENSIONS TO CENTRE LINE OF WALL OR

3) WALLS ARE DRAWN FULL WIDTH INCLUDING DRYWALL.

4) GRIDLINES TO FACE OF FOUNDATION WALL OR

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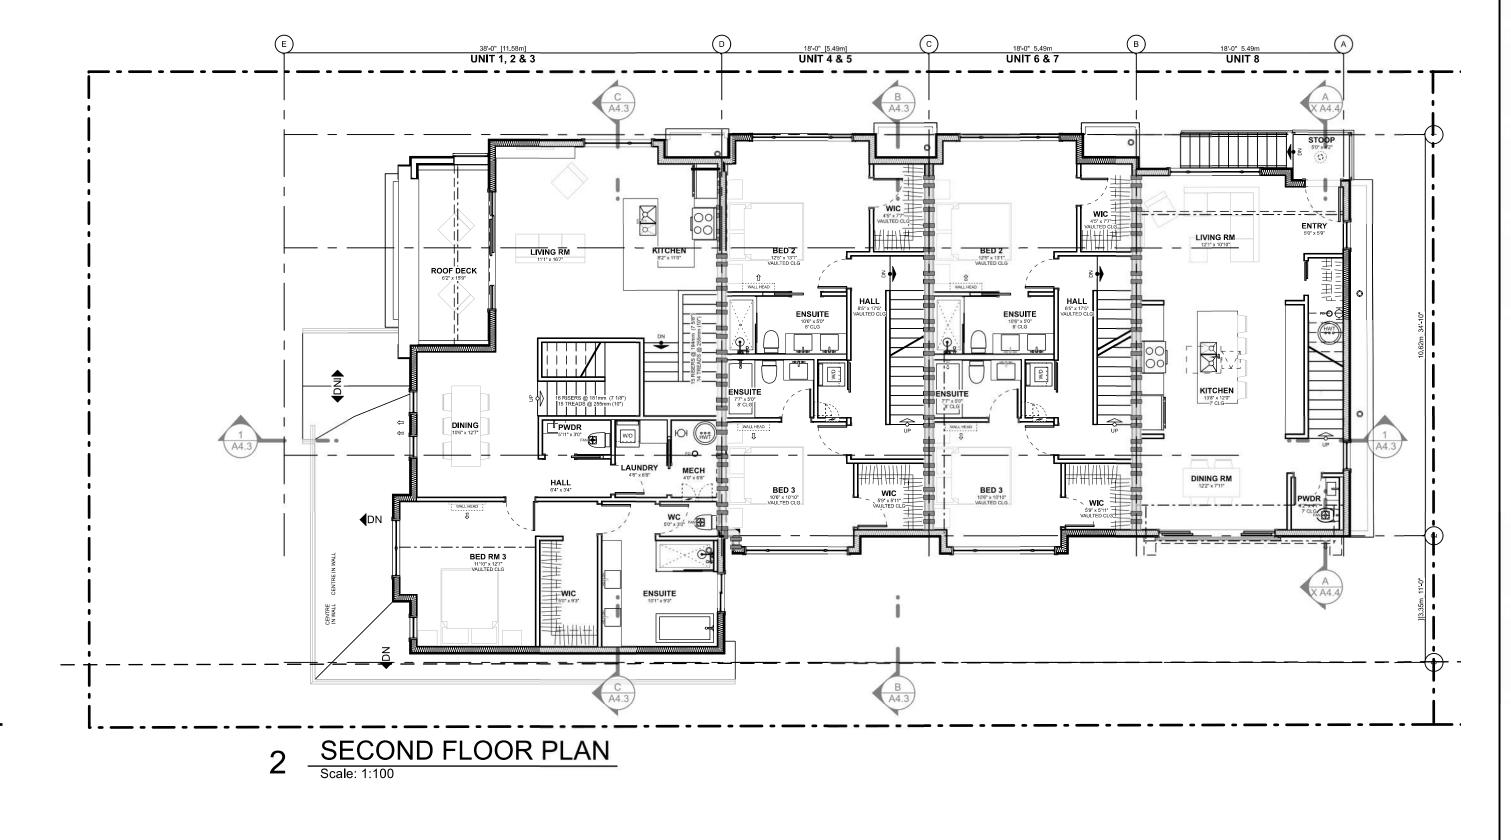
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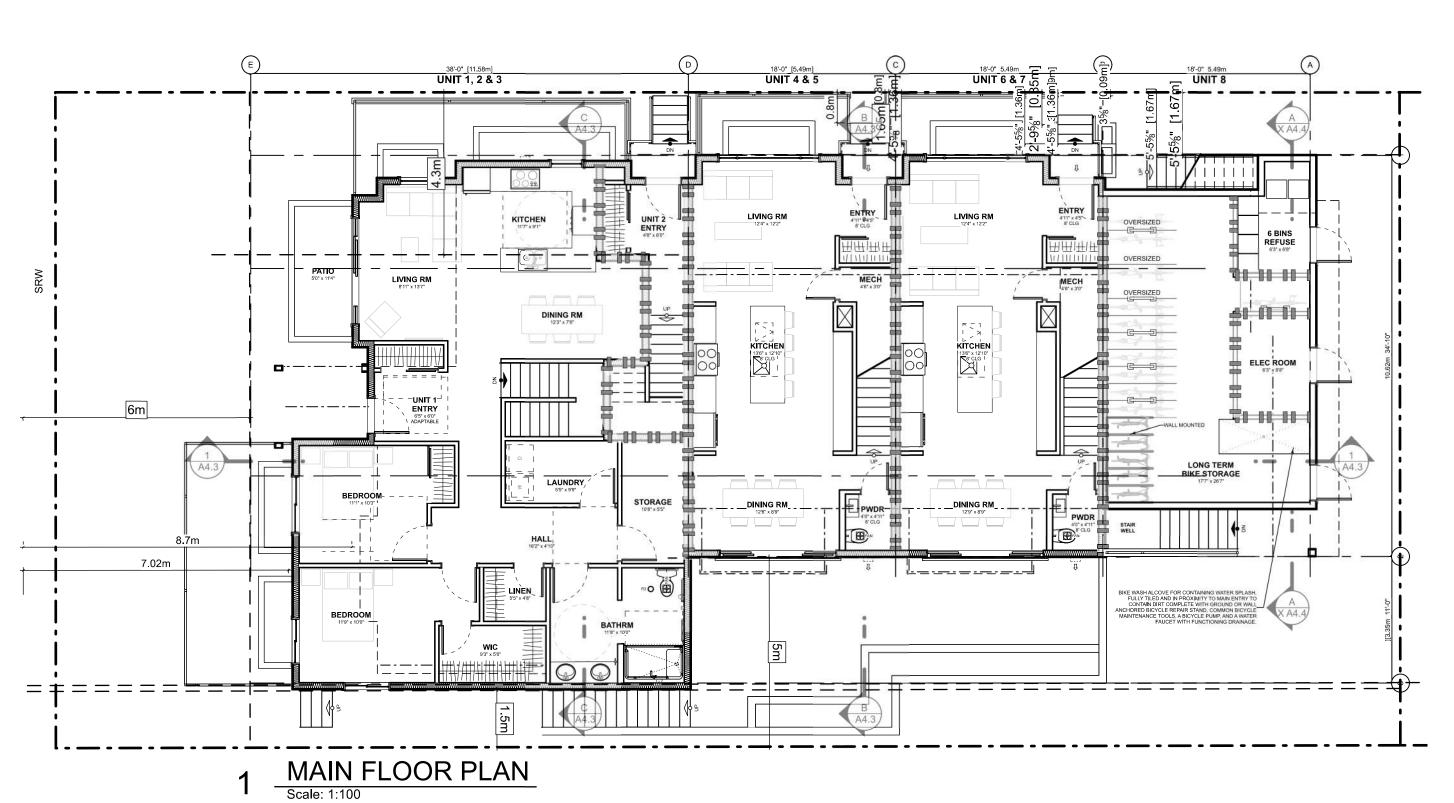
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KIPLING ST & THURLOW ST


19.015 SG/TD 2025-04-17 1:100

A3.0





O BASEMENT FLOOR PLAN
Scale: 1:100

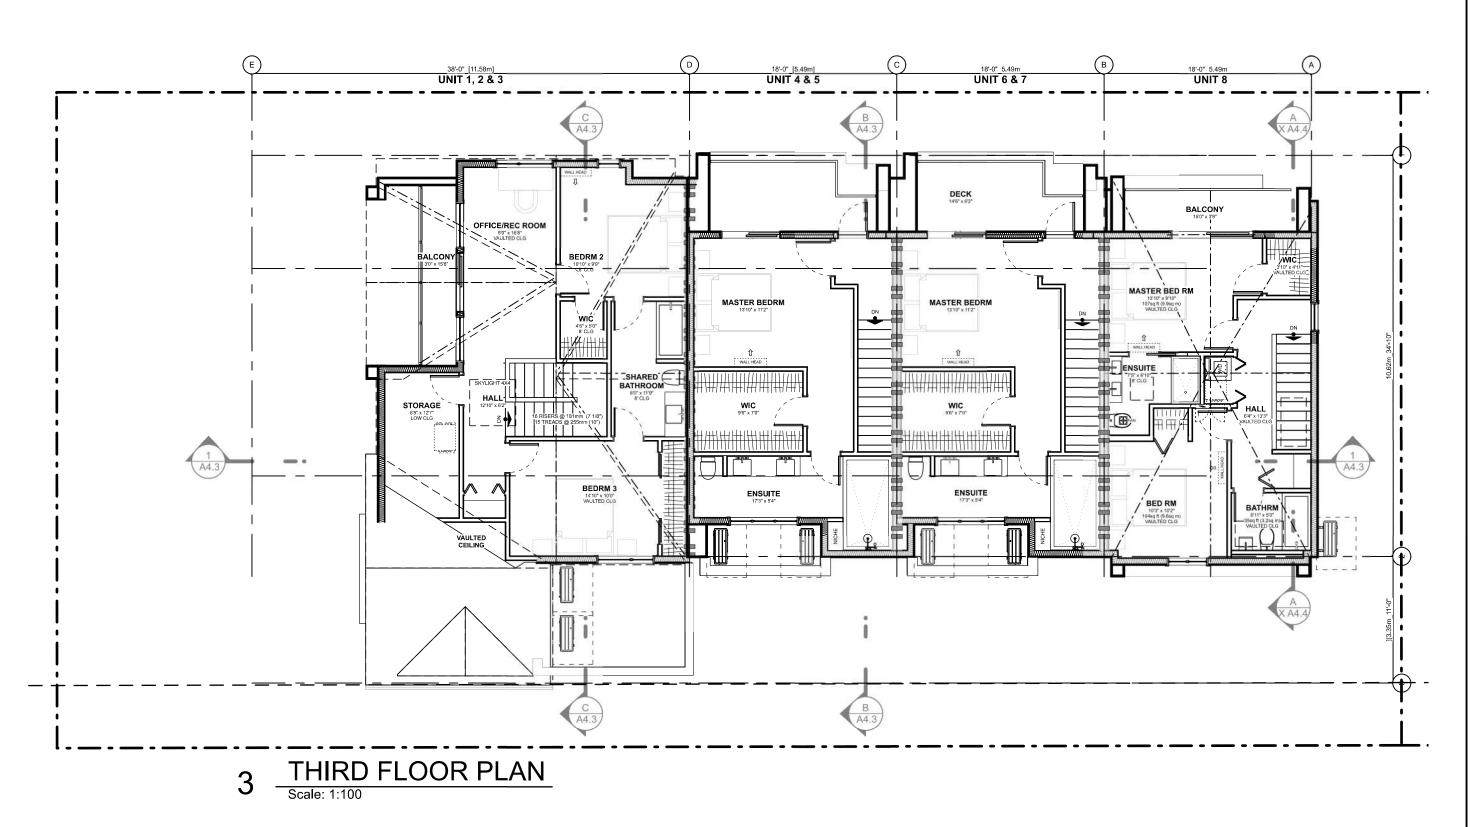

COMPARTMENT	AREA OF FACADE	LIIVIII	ING DISTANCE (LD)			CONSTRUCTION OF BUILDING FACE	CLADDING
	1710/102			PERMITTED	ACTUAL	or bolebillo rivol	
NORTH FACADE							
(N) UNIT 3	56.1 m2	11.37 m	to C/L KIPLING ST.	95.0 % 53.3 m2	17.9 % 10.1 m2	C, 45 MIN	C or NC
(N) UNIT 4	50.0 m2	11.37 m	to C/L KIPLING ST.	95.0 % 47.5 m2	38.6 % 19.3 m2	C, 45 MIN	C or NC
(N) UNIT 6	52.4 m2	11.37 m	to C/L KIPLING ST.	95.0 % 49.8 m2	36.9 % 19.3 m2	C, 45 MIN	C or NC
(N) UNIT 8	45.4 m2	11.37 m	to C/L KIPLING ST.	LD EXCEEDS 8.0M, UPO	ALLOWED > 100%	C, 45 MIN	C or NC
EAST FACADE							
(E) UNIT 6	54.6 m2	5.75 m	TO PL	32.0 % 17.5 m2	4.4 % 2.4 m2	C, 60 MIN	C or NC
(E) REFUSE	20.9 m2	5.75 m	TO PL	81.9 % 17.1 m2	8.9 % 1.9 m2	C, 45 MIN	C or NC
(E) ELEC RM	7.7 m2	5.75 m	TO PL	81.9 % 6.3 m2	24.2 % 1.9 m2	C, 45 MIN	C or NC
(E) BIKE RM	6.3 m2	5.75 m	TO PL	81.9 % 5.1 m2	29.7 % 1.9 m2	C, 45 MIN	C or NC
SOUTH FACADE							
(S) UNIT 1	93.3 m2	1.71 m	to PL	8.4 % 7.9 m2	3.3 % 3.1 m2	C, 45 MIN	C or NC
(S) UNIT 4	62.6 m2	5.00 m	to PL	26.0 % 16.3 m2	23.0 % 14.4 m2	C, 45 MIN	C or NC
(S) UNIT 6	62.6 m2	5.00 m	to PL	26.0 % 16.3 m2	23.0 % 14.4 m2	C, 45 MIN	C or NC
(S) UNIT 8	51.0 m2	5.00 m	to PL	26.0 % 13.3 m2	15.6 % 8.0 m2	C, 45 MIN	C or NC
WEST FACADE							
(W) UNIT 2	42.0 m2	14.63 m	TO C/L FAIRFIELD RD	LD EXCEEDS 8.0M, UPO	ALLOWED > 100%	C, 45 MIN	C or NC

C, 45 MIN

C or NC

\*\* LIMITING DISTANCE SQUARED 9.10.14.2.(2) FIRE COMPARTMENTS ARE TO BE A MIN. OF 45MIN FRR

53.0 m2 14.63 m TO C/L FAIRFIELD RD. LD EXCEEDS 12.0M, UPO ALLOWED > 100%

9.10.14.3. ASSUMES FIRE DEPARTMENT RESPONSE TIME IS < 10MIN

][3m 9'-10" 5.49m 18'-0" ][5.49m 18'-0" 5.49m 18'-0" ][3m 9'-10" ][5.49m 18'-0" Mid-point Between Highest Ridge
And Highest Eave 2020-09-21 2021-07-20 2021-11-21 2021-12-16 Highest Eave 2022-03-30 2022-04-11 2022-10-06 2022-11-04 2022-11-14 T/O 3rd Floor Subfloor \_ 19.23m 63.10 (E) UNIT T/O 1st Floor Subt 16.48m 54.05 E / 15.26m P / 15.38m E / 15.16m P / 15.31m Average Grade 13.99m 45.90' E / 13.98m P / 13.52m (E) BIKE RM 67.4sq ft (E) ELEC RM 82.6sq ft (E) REFUSE 119.8sq ft

**EXTERIOR MATERIALS SUMMARY** 

MATERIAL

CEDAR 1X4

STANDING SEAM

STANDING SEAM

SEE MECHANICAL

SEE MECHANICAL

CAST IN PLACE CONCRETE

CEMENTITIOUS HARDIE STAGGERED

GUARDRAIL WITH ALUMINUM FRAME ALL GUARDRAILS TO HAVE 1/2" GLASS AND TO BE DESIGNED AND SEALED BY P.ENG. SCHEDULE "S-B" TO BE PROVIDED UNDER ARCHITECT'S SCHEDULE "B"

1X4 T&G PLANKS WESTERN RED CEDAR

CEMENTITIOUS NICHIHA LATURA V-GROOVE

CEMENTITIOUS HARDIE SMOOTH CEMENTITIOUS HARDIE SMOOTH COLOUR

ARTIC WHITE

ARTIC WHITE

WHITE

CLEAR

WHITE

WHITE

WHITE

WHITE

GREY

WHITE

WHITE

WHITE

WHITE

CLEAR

3 WEST ELEVATION - FAIRFIELD ROAD

Scale: 1:50

GOLDEN BEHIVE (TBC BY THE ARCHITECT)

NO. DESCRIPTION

4 TRIMS & PANELS 5 CLADDING HORIZONTAL

6 WINDOW FRAME

7 GLASS RAILING

8 METAL CAP FLASHING

11 EXPOSED CONCRETE

13 GUTTER & DOWNSPOUT

ALL MATERIALS AS NOTED OR APPROVED ALTERNATE

9 METAL CLADDING

10 METAL ROOF

12 SKYL**I**GHT

14 HEAT PUMP

15 WALL VENT

16 GARAGE DOOR

17 SOFFITS, WOOD

3 FASCIA

1 CLADDING SHINGLES

2 CLADDING VERTICAL SIDING

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Project Name:

LeParc

KIPLING ST & THURLOW

19.015 SG/TD 2025-04-17

A4.0

EAST ELEVATION - DRIVEWAY
Scale: 1:50

#### **EXTERIOR MATERIALS SUMMARY**

١٥.	DESCRIPTION	MATERIAL	COLOUR
1	CLADDING SHINGLES	CEMENTITIOUS HARDIE STAGGERED EDGE	GOLDEN BEHIVE (TBC BY THE ARCHITECT)
2	CLADDING VERTICAL SIDING	CEMENTITIOUS NICHIHA LATURA V-GROOVE	WHITE
3	FASCIA	CEMENTITIOUS HARDIE SMOOTH	ARTIC WHITE
4	TRIMS & PANELS	CEMENTITIOUS HARDIE SMOOTH	ARTIC WHITE
5	CLADDING HORIZONTAL	CEDAR 1X4	CLEAR
6	WINDOW FRAME	VINYL	WHITE
7	GLASS RAILING	GUARDRAIL WITH ALUMINUM FRAME ALL GUARDRAILS TO HAVE 1/2" GLASS AND TO BE DESIGNED AND SEALED BY P.ENG. SCHEDULE "S-B" TO BE PROVIDED UNDER ARCHITECT'S SCHEDULE "B"	WHITE
8	METAL CAP FLASHING		WHITE
9	METAL CLADDING	STANDING SEAM	WHITE
10	METAL ROOF	STANDING SEAM	WHITE
11	EXPOSED CONCRETE	CAST IN PLACE CONCRETE	GREY
12	SKYLIGHT	VINYL	WHITE
13	<b>GUTTER &amp; DOWNSPOUT</b>		WHITE
14	HEAT PUMP	SEE MECHANICAL	
15	WALL VENT	SEE MECHANICAL	WHITE
16	GARAGE DOOR		WHITE
17	SOFFITS, WOOD	1X4 T&G PLANKS WESTERN RED CEDAR	CLEAR

### SPATIAL SEPARATION (9.10.14.) - BLOCK 02 (NOT SPRINKLERED)

COMPARTMENT	AREA OF FACADE	LIMITING DISTANCE (L	D) UNPROTECTE	O OPENINGS	CONSTRUCTION OF BUILDING FACE	CLADDING
	TACADE		PERMITTED	ACTUAL	OF BOILDING FACE	
NORTH FACADE						
(N) UNIT 3	56.1 m2	11.37 m to C/L KIPLING S	ST. 95.0 % 53.3 m2	17.9 % 10.1 m2	C, 45 MIN	C or NC
(N) UNIT 4	50.0 m2	11.37 m to C/L KIPLING S	ST. 95.0 % 47.5 m2	38.6 % 19.3 m2	C, 45 MIN	C or NC
(N) UNIT 6	52.4 m2	11.37 m to C/L KIPLING S	ST. 95.0 % 49.8 m2	36.9 % 19.3 m2	C, 45 MIN	C or NC
(N) UNIT 8	45.4 m2	11.37 m to C/L KIPLING S	ST. LD EXCEEDS 8.0M, UPO	ALLOWED > 100%	C, 45 MIN	C or NC
EAST FACADE						
(E) UNIT 6	54.6 m2	5.75 m TO PL	32.0 % 17.5 m2	4.4 % 2.4 m2	C, 60 MIN	C or NC
(E) REFUSE	20.9 m2	5.75 m TO PL	81.9 % 17.1 m2	8.9 % 1.9 m2	C, 45 MIN	C or NC
(E) ELEC RM	7.7 m2	5.75 m TO PL	81.9 % 6.3 m2	24.2 % 1.9 m2	C, 45 MIN	C or NC
(E) BIKE RM	6.3 m2	5.75 m TO PL	81.9 % 5.1 m2	29.7 % 1.9 m2	C, 45 MIN	C or NC
SOUTH FACADE						
(S) UNIT 1	93.3 m2	1.71 m to PL	8.4 % 7.9 m2	3.3 % 3.1 m2	C, 45 MIN	C or NC
(S) UNIT 4	62.6 m2	5.00 m to PL	26.0 % 16.3 m2	23.0 % 14.4 m2	C, 45 MIN	C or NC
(S) UNIT 6	62.6 m2	5.00 m to PL	26.0 % 16.3 m2	23.0 % 14.4 m2	C, 45 MIN	C or NC
(S) UNIT 8	51.0 m2	5.00 m to PL	26.0 % 13.3 m2	15.6 % 8.0 m2	C, 45 MIN	C or NC
WEST FACADE						
(W) UNIT 2	42.0 m2	14.63 m TO C/L FAIRFIEL	D RD. LD EXCEEDS 8.0M, UPO	ALLOWED > 100%	C, 45 MIN	C or NC
(W) UNIT 3	53.0 m2	14.63 m TO C/L FAIRFIEL	D RD. LD EXCEEDS 12.0M, UPC	O ALLOWED > 100%	C, 45 MIN	C or NC
			** · · · · · ·	DICTANCE COLLADED		

9.10.14.2.(2) FIRE COMPARTMENTS ARE TO BE A MIN. OF 45MIN FRR

\*\* LIMITING DISTANCE SQUARED

9.10.14.3. ASSUMES FIRE DEPARTMENT RESPONSE TIME IS < 10MIN



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SEBASTIEN GARON

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2024-02-17 BP REVISION "A" 2024-05-30 ISSUED FOR DP

LEVATIONS

Project Name:

LeParc

Civic:
KIPLING ST & THURLOW
ST

 Project No:
 19.01

 Drawn By:
 SG/TI

 Plot Date:
 2025-04-1

 Scale:
 1:50

 Sheet No:

#### **EXTERIOR MATERIALS SUMMARY**

NO.	DESCRIPTION	MATERIAL	COLOUR
1	CLADDING SHINGLES	CEMENTITIOUS HARDIE STAGGERED EDGE	GOLDEN BEHIVE (TBC BY THE ARCHITECT)
2	CLADDING VERTICAL SIDING	CEMENTITIOUS NICHIHA LATURA V-GROOVE	WHITE
3	FASCIA	CEMENTITIOUS HARDIE SMOOTH	ARTIC WHITE
4	TRIMS & PANELS	CEMENTITIOUS HARDIE SMOOTH	ARTIC WHITE
5	CLADDING HORIZONTAL	CEDAR 1X4	CLEAR
6	WINDOW FRAME	VINYL	WHITE
7	GLASS RAILING	GUARDRAIL WITH ALUMINUM FRAME ALL GUARDRAILS TO HAVE 1/2" GLASS AND TO BE DESIGNED AND SEALED BY P.ENG. SCHEDULE "S-B" TO BE PROVIDED UNDER ARCHITECT'S SCHEDULE "B"	WHITE
8	METAL CAP FLASHING		WHITE
9	METAL CLADDING	STANDING SEAM	WHITE
10	METAL ROOF	STANDING SEAM	WHITE
11	EXPOSED CONCRETE	CAST IN PLACE CONCRETE	GREY
12	SKYLIGHT	VINYL	WHITE
13	<b>GUTTER &amp; DOWNSPOUT</b>		WHITE
14	HEAT PUMP	SEE MECHANICAL	
15	WALL VENT	SEE MECHANICAL	WHITE
16	GARAGE DOOR		WHITE
17	SOFFITS, WOOD	1X4 T&G PLANKS WESTERN RED CEDAR	CLEAR

### SPATIAL SEPARATION (9.10.14.) - BLOCK 02 (NOT SPRINKLERED)

COMPARTMENT	AREA OF	LIMITING DISTANCE (LD)		UNPROTECTED OPENINGS			CONSTRUCTION	CLADDING
	FACADE				PERMITTED	ACTUAL	OF BUILDING FACE	
NORTH FACADE								
(N) UNIT 3	56.1 m2	11.37 m	to C/L KIPLING ST.		95.0 % 53.3 m2	17.9 % 10.1 m2	C, 45 MIN	C or NC
(N) UNIT 4	50.0 m2	11.37 m	to C/L KIPLING ST.		95.0 % 47.5 m2	38.6 % 19.3 m2	C, 45 MIN	C or NC
(N) UNIT 6	52.4 m2	11.37 m	to C/L KIPLING ST.		95.0 % 49.8 m2	36.9 % 19.3 m2	C, 45 MIN	C or NC
(N) UNIT 8	45.4 m2	11.37 m	to C/L KIPLING ST.	LD	EXCEEDS 8.0M, UPO	ALLOWED > 100%	C, 45 MIN	C or NC
EAST FACADE								
(E) UNIT 6	54.6 m2	5.75 m	TO PL		32.0 % 17.5 m2	4.4 % 2.4 m2	C, 60 MIN	C or NC
(E) REFUSE	20.9 m2	5.75 m	TO PL		81.9 % 17.1 m2	8.9 % 1.9 m2	C, 45 MIN	C or NC
(E) ELEC RM	7.7 m2	5.75 m	TO PL		81.9 % 6.3 m2	24.2 % 1.9 m2	C, 45 MIN	C or NC
(E) BIKE RM	6.3 m2	5.75 m	TO PL		81.9 % 5.1 m2	29.7 % 1.9 m2	C, 45 MIN	C or NC
SOUTH FACADE								
(S) UNIT 1	93.3 m2	1.71 m	to PL		8.4 % 7.9 m2	3.3 % 3.1 m2	C, 45 MIN	C or NC
(S) UNIT 4	62.6 m2	5.00 m	to PL		26.0 % 16.3 m2	23.0 % 14.4 m2	C, 45 MIN	C or NC
(S) UNIT 6	62.6 m2	5.00 m	to PL		26.0 % 16.3 m2	23.0 % 14.4 m2	C, 45 MIN	C or NC
(S) UNIT 8	51.0 m2	5.00 m	to PL		26.0 % 13.3 m2	15.6 % 8.0 m2	C, 45 MIN	C or NC
WEST FACADE								
(W) UNIT 2	42.0 m2	14.63 m	TO C/L FAIRFIELD RE	D. LD	EXCEEDS 8.0M, UPO	ALLOWED > 100%	C, 45 MIN	C or NC
(W) UNIT 3	53.0 m2	14.63 m	TO C/L FAIRFIELD RE	D. LD	EXCEEDS 12.0M, UPO	ALLOWED > 100%	C, 45 MIN	C or NC
9.10.14.2.(2) FIRE	COMPART	MENTS ARI	E TO BE A MIN. OF 45M	ΛIN FI	** LIMITING	DISTANCE SQUARED		

9.10.14.2.(2) FIRE COMPARTMENTS ARE TO BE A MIN. OF 45MIN FRR

9.10.14.3. ASSUMES FIRE DEPARTMENT RESPONSE TIME IS < 10MIN



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2022-04-11

2022-10-06

2022-11-04



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Project Name:

LeParc

KIPLING ST & THURLOW

2025-04-17

A4.2

REPORT INCONSISTENCIES AND OMISSIONS TO THE ARCHITECT FOR

DMISSIONS TO THE ARCHITECT FOR CLARIFICATION BEFORE COMMENCING WITH THE WORK.

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 2019-06-19
 Issued for DP

 2019-09-16
 Revised & Re-Issued for DP

 2019-10-21
 Revised & Re-Issued for DP

 2019-12-12
 Revised & Re-Issued for DP

Revised & Re-Issued for DP 2020-04-29 2020-09-21 Revised & Re-Issued for DP 2021-07-20 Revised & Re-Issued for DP 2021-11-21 Revised & Re-Issued for DP 2021-12-16 Revised & Re-Issued for DP 2022-03-30 Revised & Re-Issued for DP 2022-04-11 Revised & Re-Issued for DP 2022-05-10 Revised & Re-Issued for DP 2022-10-06 Revised & Re-Issued for DP 2022-11-04 Revised & Re-Issued for DP 2022-11-14 Revised & Re-Issued for DP

2022-11-14 Revised & Re-issued for DP
2022-11-25 Revised & Re-issued for DP
2023-12-21 ISSUED FOR BP
2024-02-17 BP REVISION "A"
2024-05-30 ISSUED FOR DP

ECTIONS

Project Name:

LeParc

Civic:
KIPLING ST & THURLOW
ST

 Project No:
 19.015

 Drawn By:
 SG/TD

 Plot Date:
 2025-04-17

 Scale:
 1:50

A4.3



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2022-11-14 Revised & Re-Issued for DP 2022-11-25 Revised & Re-Issued for DP 2023-12-21 ISSUED FOR BP 2024-02-17 BP REVISION "A" 2024-05-30 ISSUED FOR DP


Project Name:

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KIPLING ST & THURLOW

Project No: 19.015 SG/TD 2025-04-17 1:50

A5.0

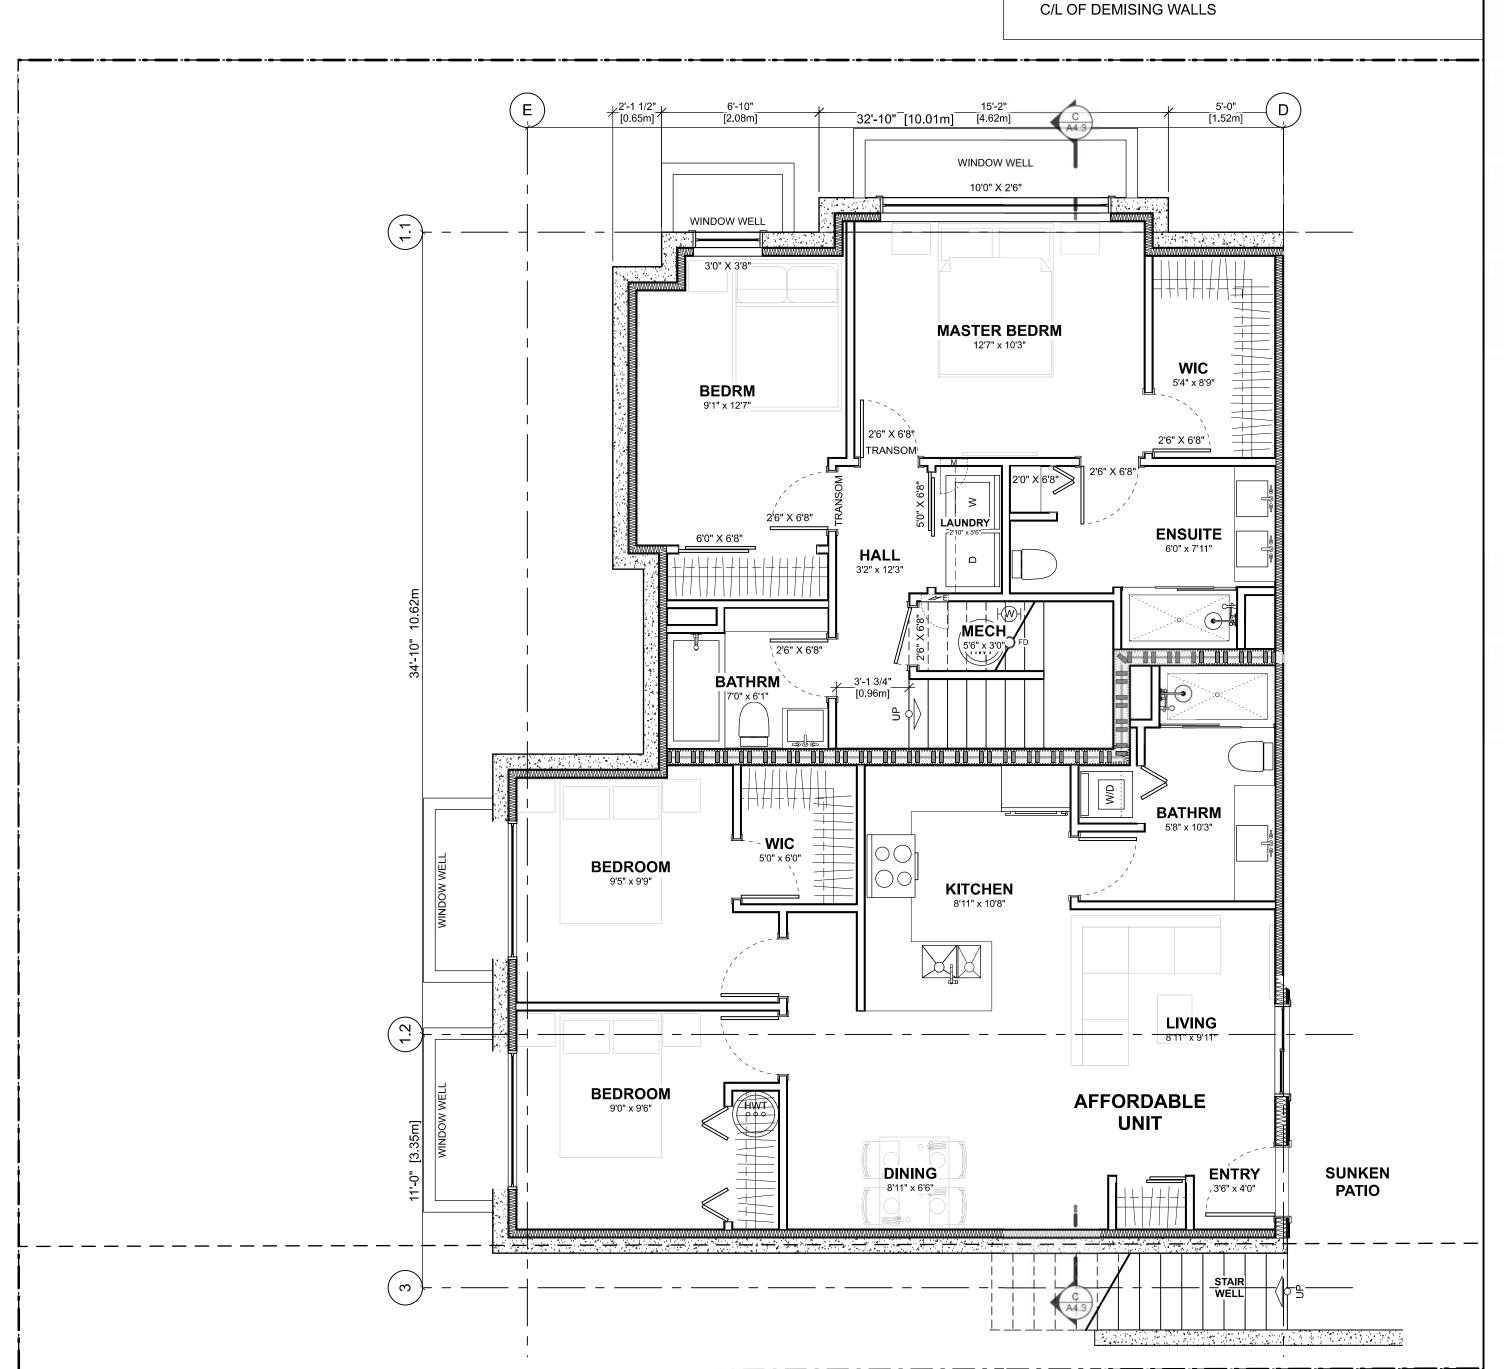

## BASEMENT FLOOR PLAN Scale: 1:50

Floor Area C	alculations	Unit 1			
	Gross Flo	Gross Floor Area		Zoning Floor Area	
Basement Floor	0 sq ft	0.0 m2	0 sq ft	0.0 m2	
Main Floor	1,278 sq ft	118.7 m2	1,213 sq ft	112.7 m2	2
Second Floor	1,088 sq ft	101.0 m2	1,027 sq ft	95.4 m2	1
Third Storey	955 sq ft	88.8 m2	724 sq ft	67.3 m2	2
Totals:	3,321 sq ft	308.5 m2	2,964 sq ft	275.3 m2	5
Garage	0 sq ft	0.0 m2	0 sq ft	0.0 m2	

**DIMENSION NOTES:** 

FACE OF FINISHED WALL.

1) EXTERIOR DIMENSIONS TO FACE OF PLYWOOD SHEATHING WHICH IS IN LINE WITH CONCRETE FOUNDATION WALL. 2) INTERIOR DIMENSIONS TO CENTRE LINE OF WALL OR

3) WALLS ARE DRAWN FULL WIDTH INCLUDING DRYWALL.

4) GRIDLINES TO FACE OF FOUNDATION WALL OR

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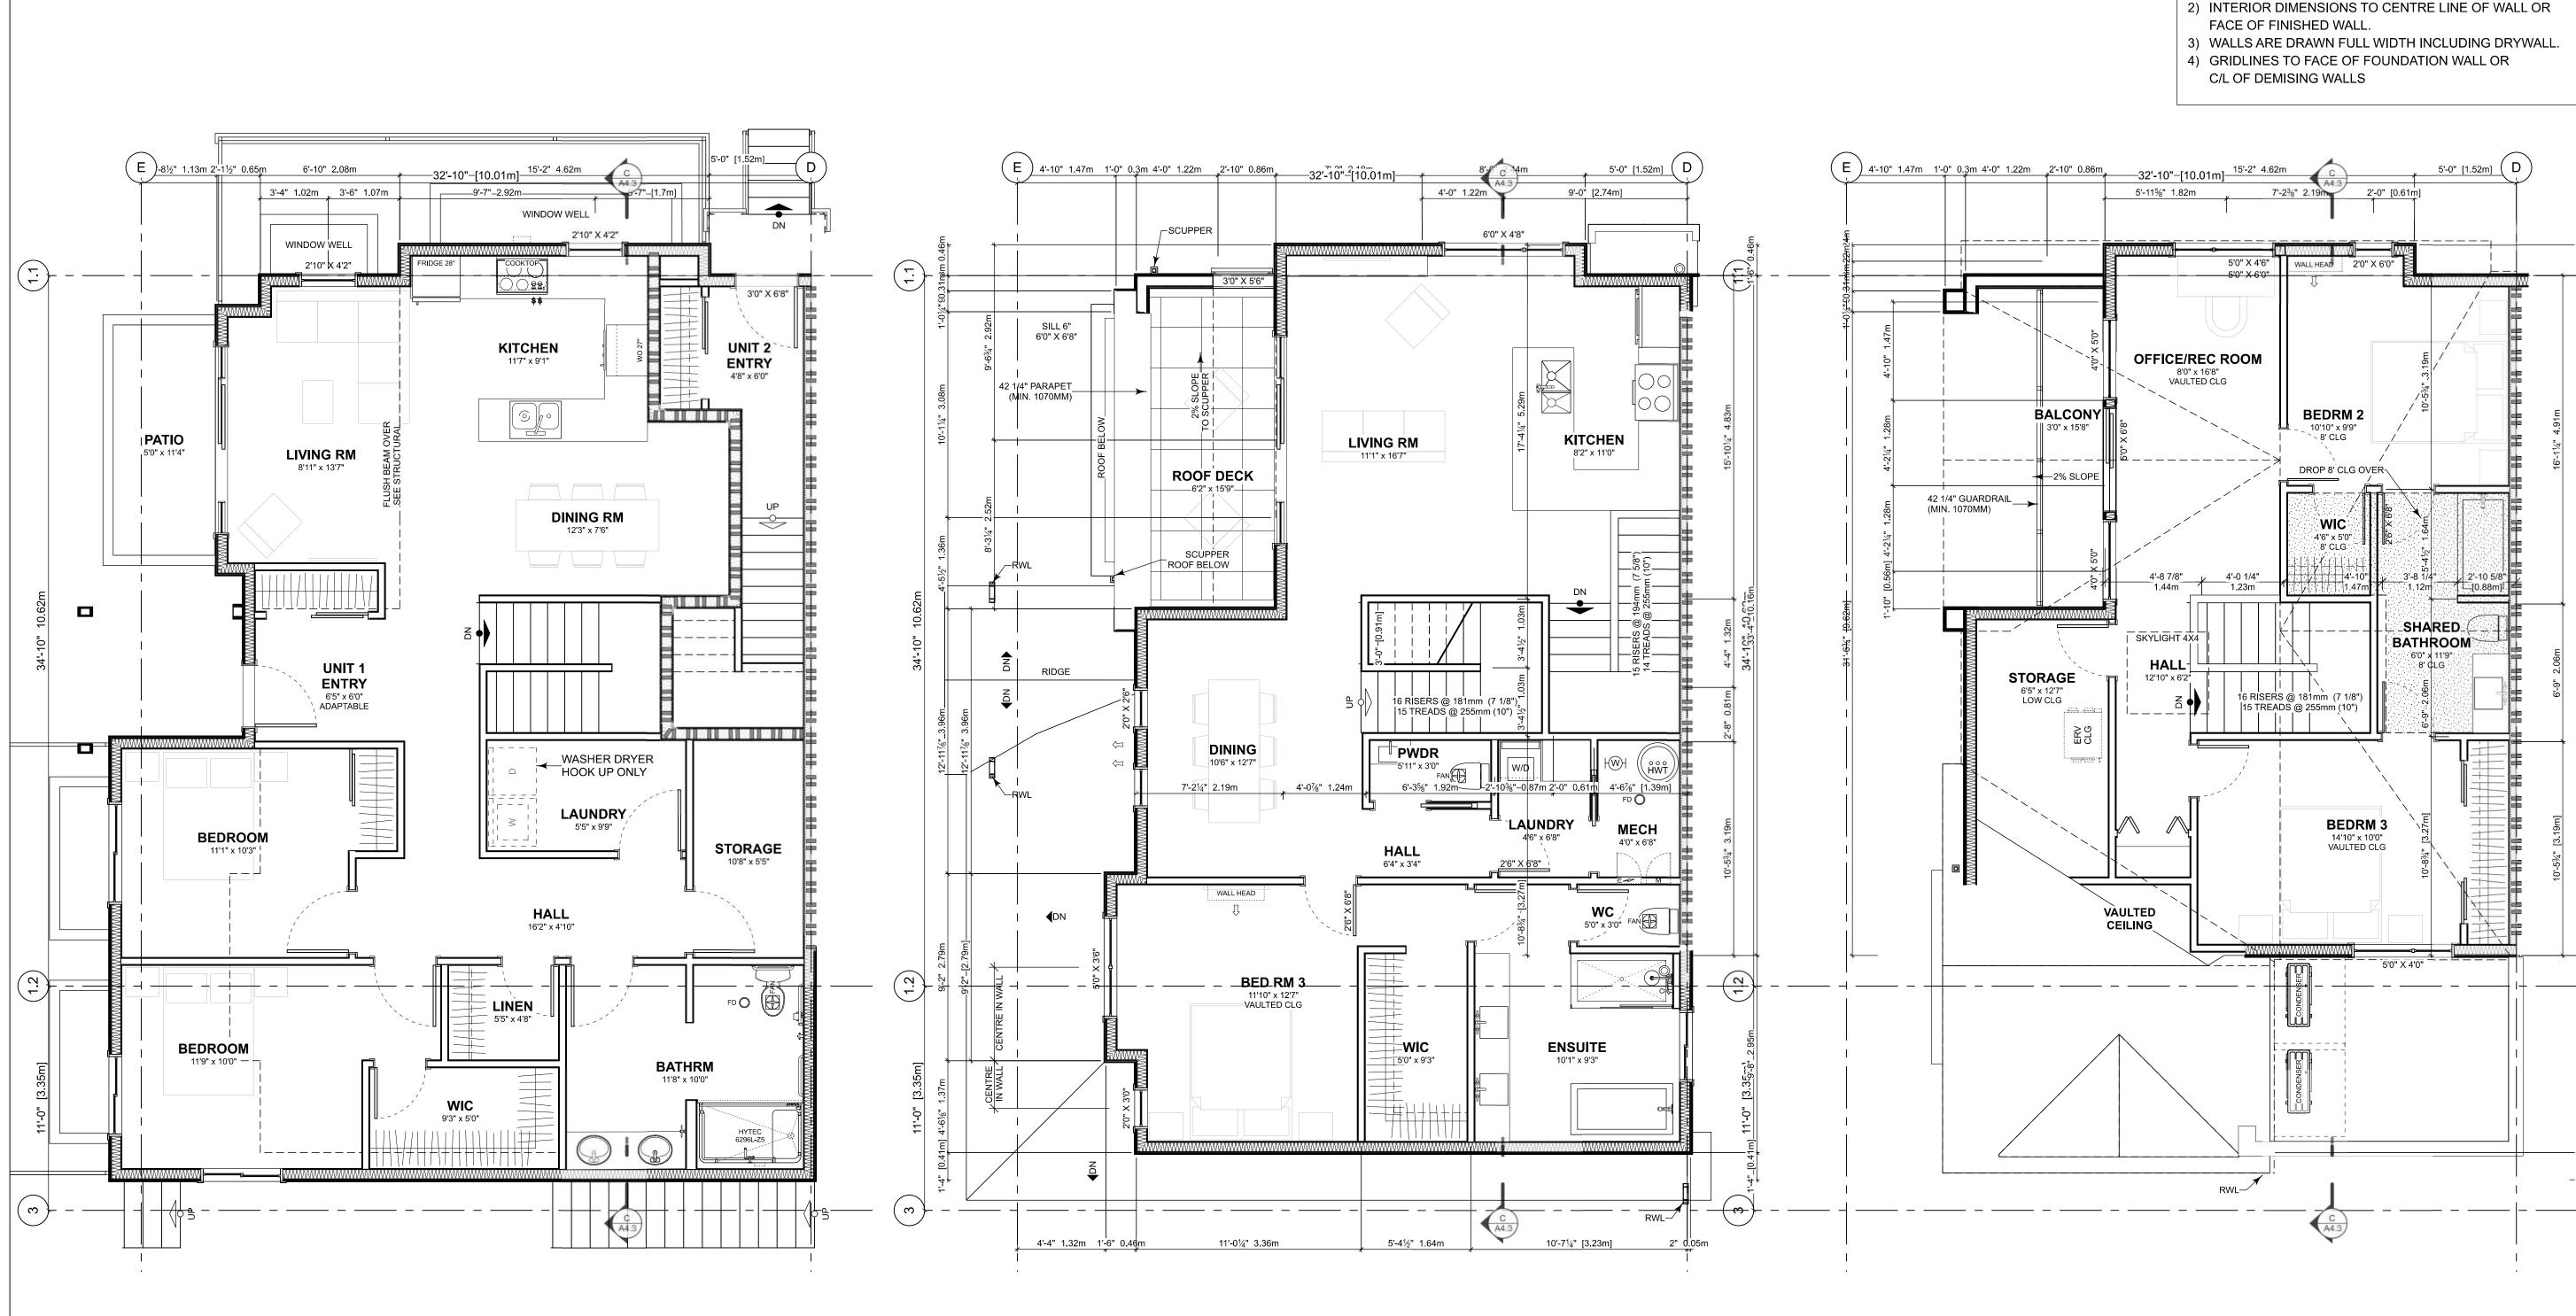
Project Name:

LeParc

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Project No: 19.015 SG/TD 2025-04-17 1:50

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SECOND FLOOR PLAN	
Scale: 1:50	

MAIN FLOOR PLAN
Scale: 1:50

3 THIRD FLOOR PLAN
Scale: 1:50

Floor Area C	Unit 1				
	Gross Floor Area		Zoning Floor Area		Bedrms
Basement Floor	0 sq ft	0.0 m2	0 sq ft	0.0 m2	
Main Floor	1,278 sq ft	118.7 m2	1,213 sq ft	112.7 m2	2
Second Floor	1,088 sq ft	101.0 m2	1,027 sq ft	95.4 m2	1
Third Storey	955 sq ft	88.8 m2	724 sq ft	67.3 m2	2
Totals:	3,321 sq ft	308.5 m2	2,964 sq ft	275.3 m2	5
Garage	0 sq ft	0.0 m2	0 sq ft	0.0 m2	

DIMENSION NOTES:

1) EXTERIOR DIMENSIONS TO FACE OF PLYWOOD SHEATHING WHICH IS IN LINE WITH CONCRETE FOUNDATION WALL.

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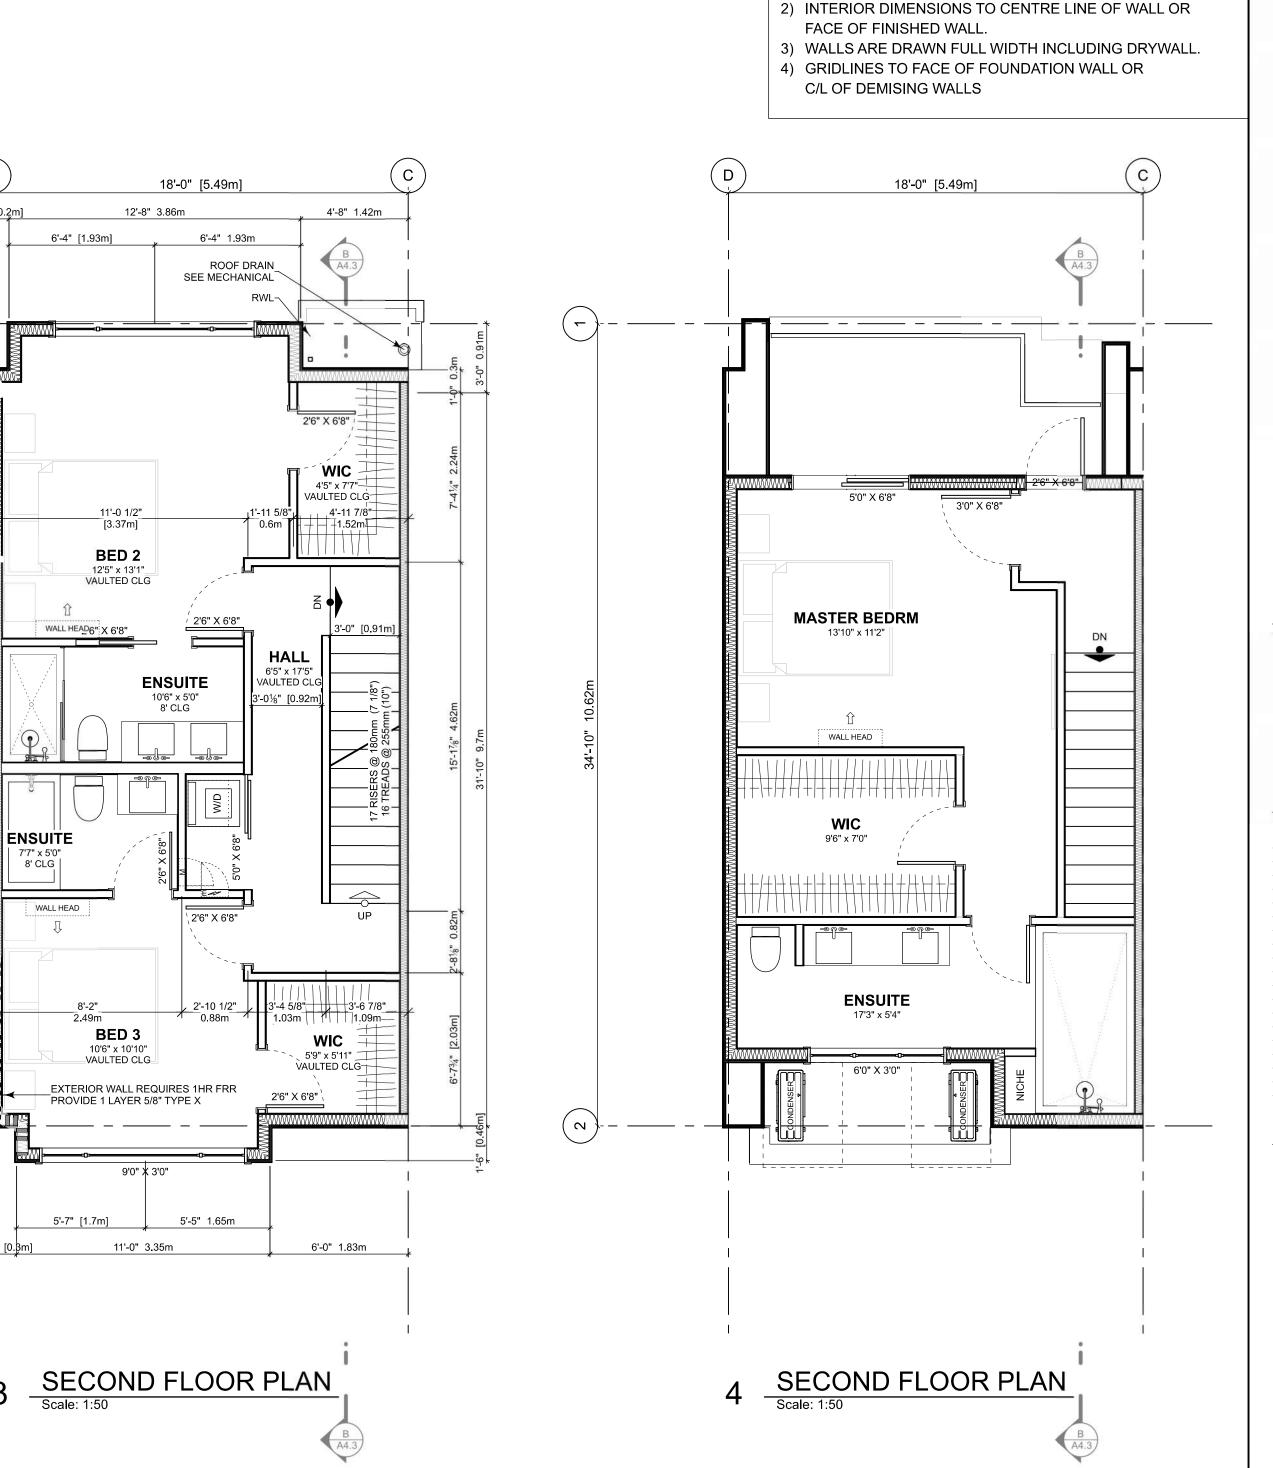
Project Name:

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DIMENSION NOTES:

1) EXTERIOR DIMENSIONS TO FACE OF PLYWOOD SHEATHING WHICH IS IN LINE WITH CONCRETE FOUNDATION WALL.

18'-0" [5.49m]


ATTIC

SPACE

(4)

8' CLG

Floor Area Calculations Unit 4 Zoning Floor Area Bedrms 0 sq ft 0.0 m2 Basement Floor 616 sq ft 57.3 m2 Main Floor 595 sq ft 55.2 m2 633 sq ft 58.8 m2 610 sq ft 56.6 m2 Second Floor 452 sq ft 42.0 m2 479 sq ft 44.5 m2 1,728 sq ft 160.5 m2 1,657 sq ft 153.9 m2 3 Totals: 0 sq ft 0.0 m2 0 sq ft 0.0 m2 Garage

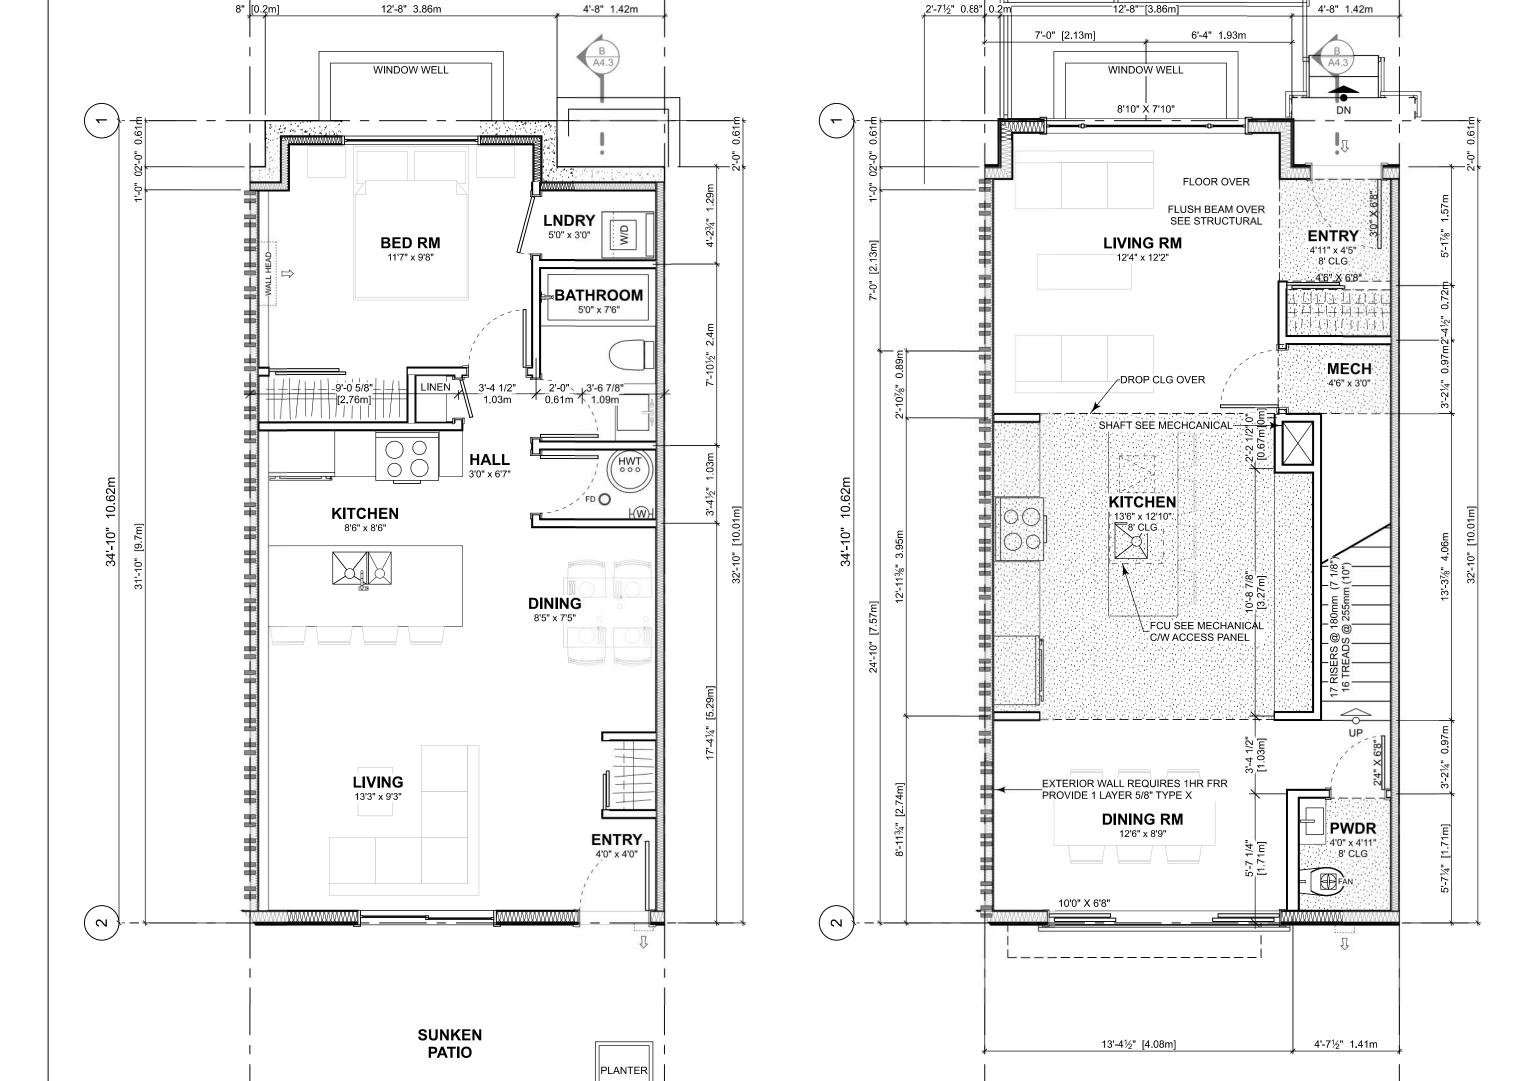

18'-0" [5.49m]

PLANTER

BENCH

PLANTER

BASEMENT FLOOR PLAN
Scale: 1:50

2 MAIN FLOOR PLAN
Scale: 1:50

STAIR WELL

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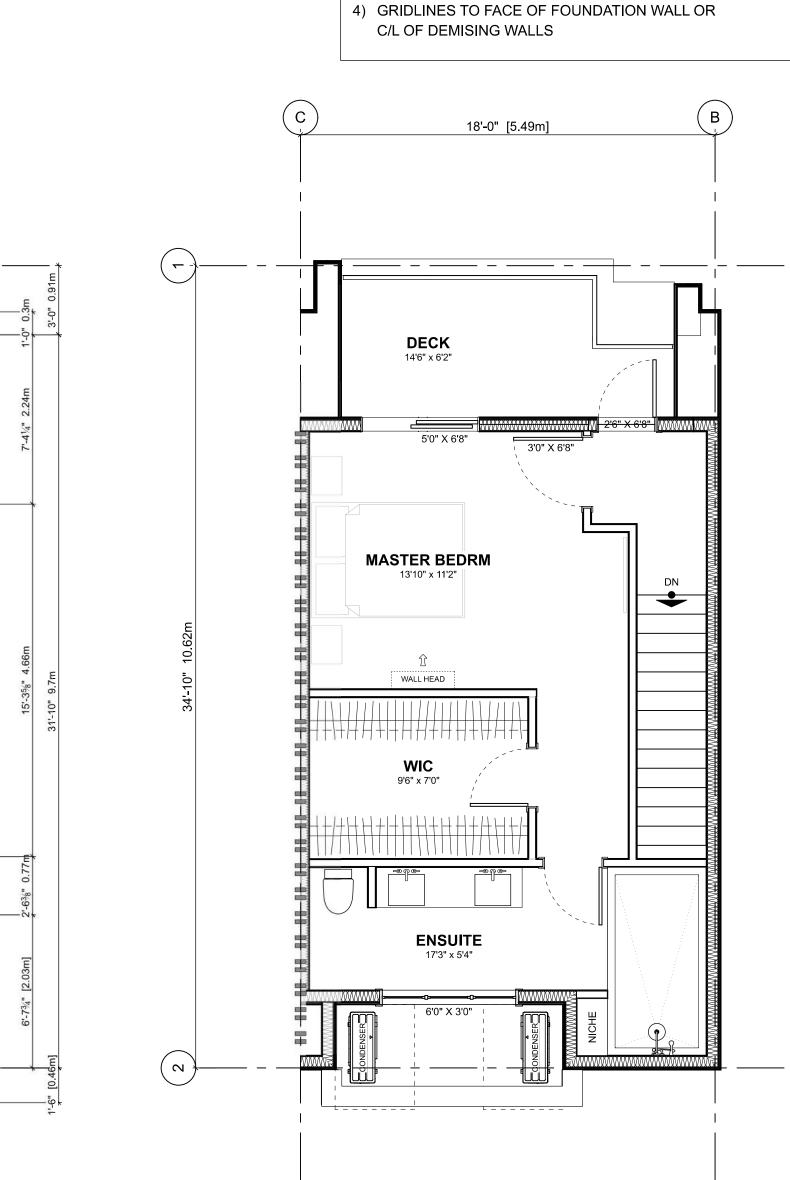
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**DIMENSION NOTES:** 

FACE OF FINISHED WALL.


1) EXTERIOR DIMENSIONS TO FACE OF PLYWOOD SHEATHING WHICH IS IN LINE WITH CONCRETE FOUNDATION WALL. 2) INTERIOR DIMENSIONS TO CENTRE LINE OF WALL OR

3) WALLS ARE DRAWN FULL WIDTH INCLUDING DRYWALL.

4 THIRD FLOOR PLAN
Scale: 1:50

6'-0" 1.83m

Floor Area Calculations Unit 6 Zoning Floor Area Bedrms 0 sq ft 0.0 m2 Basement Floor 616 sq ft 57.3 m2 Main Floor 593 sq ft 55.1 m2 633 sq ft 58.8 m2 610 sq ft 56.6 m2 Second Floor 479 sq ft 44.5 m2 443 sq ft 41.2 m2 1,728 sq ft 160.6 m2 1,645 sq ft 152.8 m2 3

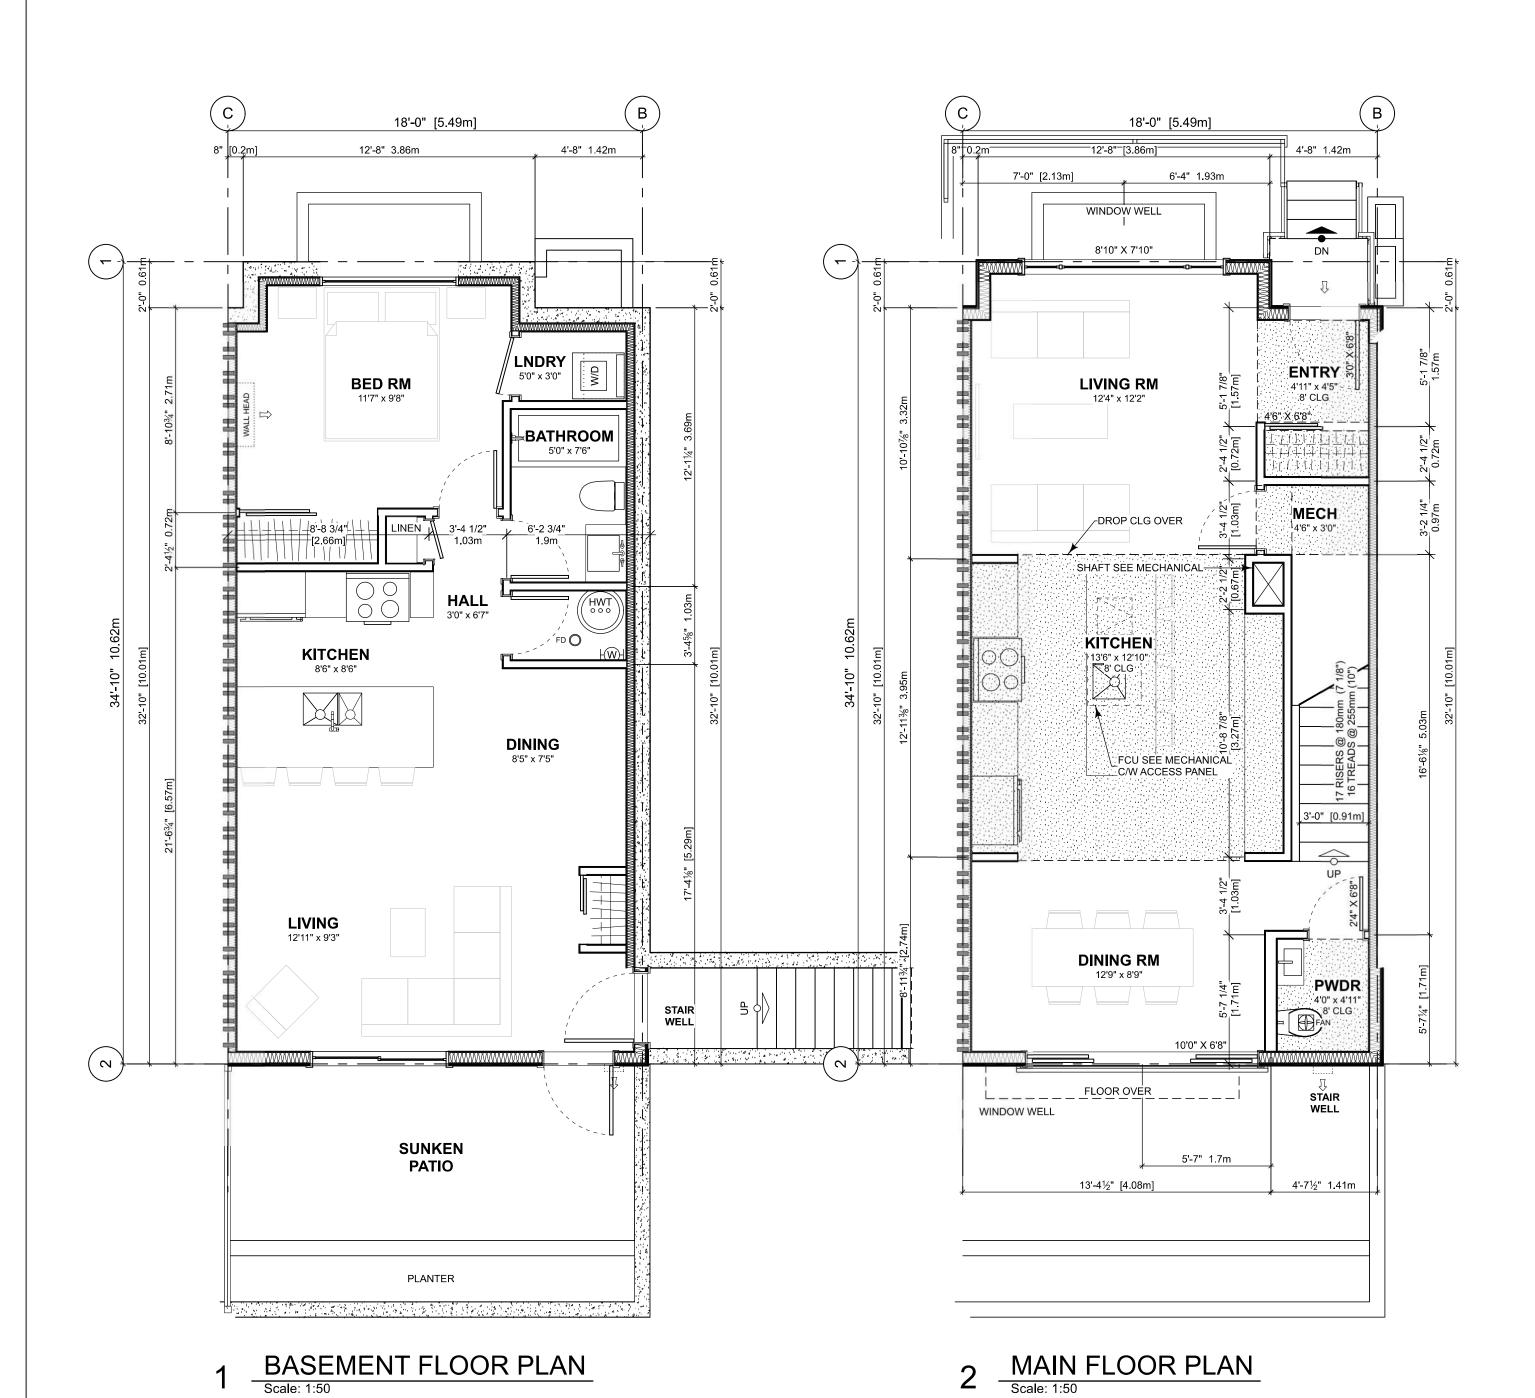

18'-0" [5.49m] 12'-8" 3.86m 4'-8" 1.42m 6'-4" [1.93m] 6'-4" 1.93m ROOF DRAIN SEE MECHANICAL 4'5" x 7'7"-VAULTED CLG\_ BED 2 12'5" x 13'1" VAULTED CLG 11'-0½" [3.37m] 3'-4%" 1.03m; \$\oldsymbol{\phi} 3'-6\%" 1.09 WALL HEAD!'6" X 6'8" 6'5" x 17'5" **ENSUITE** VAULTED CL '-0¼" [0.92m ENSUITE SKYLIGHT 7'7" x 5'0" 8' CLG WALL HEAD \ 2'6" X 6'8" 2'-10 1/2" 7 6'-4 1/4" BED 3 10'6" x 10'10" 5'9" x 5'11"
VAULTED CLG
2'6" X 6'8" 5'-5" 1.65m

SECOND FLOOR PLAN
Scale: 1:50

11'-0" 3.35m

0 sq ft 0.0 m2 0 sq ft 0.0 m2 Garage

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 Revised & Re-Issued for DP

 2022-11-25
 Revised & Re-Issued for DP

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 ISSUED FOR BP

 2024-02-17
 BP REVISION "A"

 2024-05-30
 ISSUED FOR DP

2024-02-17 BP REVISION "A" 2024-05-30 ISSUED FOR DP

> NIT 8 FLOOR PLANS

Project Name:

Unit 8

Zoning Floor Area Bedrms

10 sq ft 1.0 m2

493 sq ft 45.8 m2 2

547 sq ft 50.8 m2

0 sq ft 0.0 m2

No Basement as per zoning definition

1,116 sq ft 103.7 m2 1,050 sq ft 97.6 m2 2

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 19.015


 Drawn By:
 SG/TD

 Plot Date:
 2025-04-17

 Scale:
 1:50

 Sheet No:

A5.4

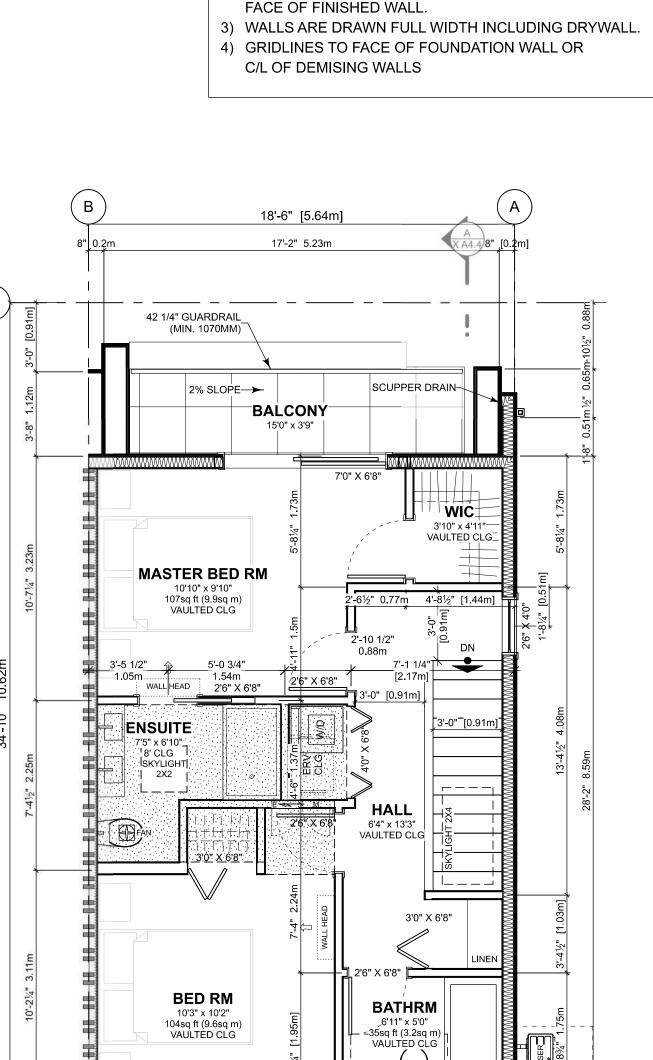

17'-2" 5.23m

3 THIRD FLOOR PLAN
Scale: 1:50

Floor Area Calculations

Basement Floor

Main Floor

Second Floor

Third Storey

Totals:

Garage

**Gross Floor Area** 

0 sq ft 0.0 m2

0 sq ft 0.0 m2

584 sq ft 54.2 m2

DIMENSION NOTES:

 EXTERIOR DIMENSIONS TO FACE OF PLYWOOD SHEATHING WHICH IS IN LINE WITH CONCRETE FOUNDATION WALL.
 INTERIOR DIMENSIONS TO CENTRE LINE OF WALL OR



BIKE WASH ALCOVE FOR CONTAINING WATER SPLASH,
FULLY TILED AND IN PROXIMITY TO MAIN ENTRY TO
CONTAIN DIRT COMPLETE WITH GROUND OR WALL\_
ANCHORED BICYCLE REPAIR STAND, COMMON BICYCLE
MAINTENANCE TOOLS, A BICYCLE PUMP, AND A WATER

FAUCET WITH FUNCTIONING DRAINAGE.

18'-6" [5.64m]

SLAB ON GRADE

NO BASEMENT

LONG TERM

**BIKE STORAGE** 

17'7" x 26'7"

---WALL MOUNTED

6 BINS

**REFUSE** 

6'3" x 6'8"

**ELEC ROOM** 

70 00 00 00 00 00

7'-10 1/2"

12 RISERS @ 189mm (7 1/2") 11 TREADS @ 255mm (10")

15

14

**OVERSIZED** 

13

**OVERSIZED** 

10

45m 4

OVERSIZED &

## 2 SECOND FLOOR PLAN Scale: 1:50

18'-6" [5.64m]

12 RISERS @ 189mm (7 1/2")

13'-6" 4.11m

\_ FLOOR OVER\_

FLUSH BEAM OVER

SEE STRUCTURAL

LIVING RM

12'1" x 10'10"

-DROP CLG OVER

FCU SEE MECHANICAL

C/W ACCESS PANEL

KITCHEN

13'8" x 12'0" 7' CLG

10'-10 5/8"

3.22m + 0.55m

10'-6 3/4"

DINING 12'2" x 7'	[m] PW	1.5 (4.77)	5	0.2m 10'-21/4" 3.7
7'-0" [2.13m]	42 1/4" GUARDRAIL (MIN. 1070MM) 11'-6" 3.51m	A A A A A A A A A A A A A A A A A A A		8"_0.2m

STOOP

**ENTRY** 

5'0" x 5'9"

3'-8 7/8"-

[1.14m]

- <del>FD-(}</del>

HWT

- 4

UP

2% TO DRAIN

ROOF DRAIN

SLOPE ROOF









SEB ARCH

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