



Pacific Arbour Six Pacific Arbour Six Ltd


829-891-899 Fort Street and 846-858 Broughton Street, Victoria BC



This document has been digitally certified with digital certificate and encryption technology authorized by the Architectural Institute of BC. The authoritative original has been transmitted to you in digital form. Any printed version can be relied upon as a true copy of the original when supplied by the architect, bearing images of the professional seal and digital certificate, or when printed from the digitally-certified electronic file provided by the architect. This document may not be forwarded to others, transmitted, or reproduced in any way without the express written permission of the copyright owner Low Hammond Rowe Architects Inc.

250512 1 DRA (CALUC) SUBMISSION 250721 2 RZ/DP SUBMISSION 251029 3 RZ/DP SUBMISSION 2

Elevation East (Quadra Street) A402b

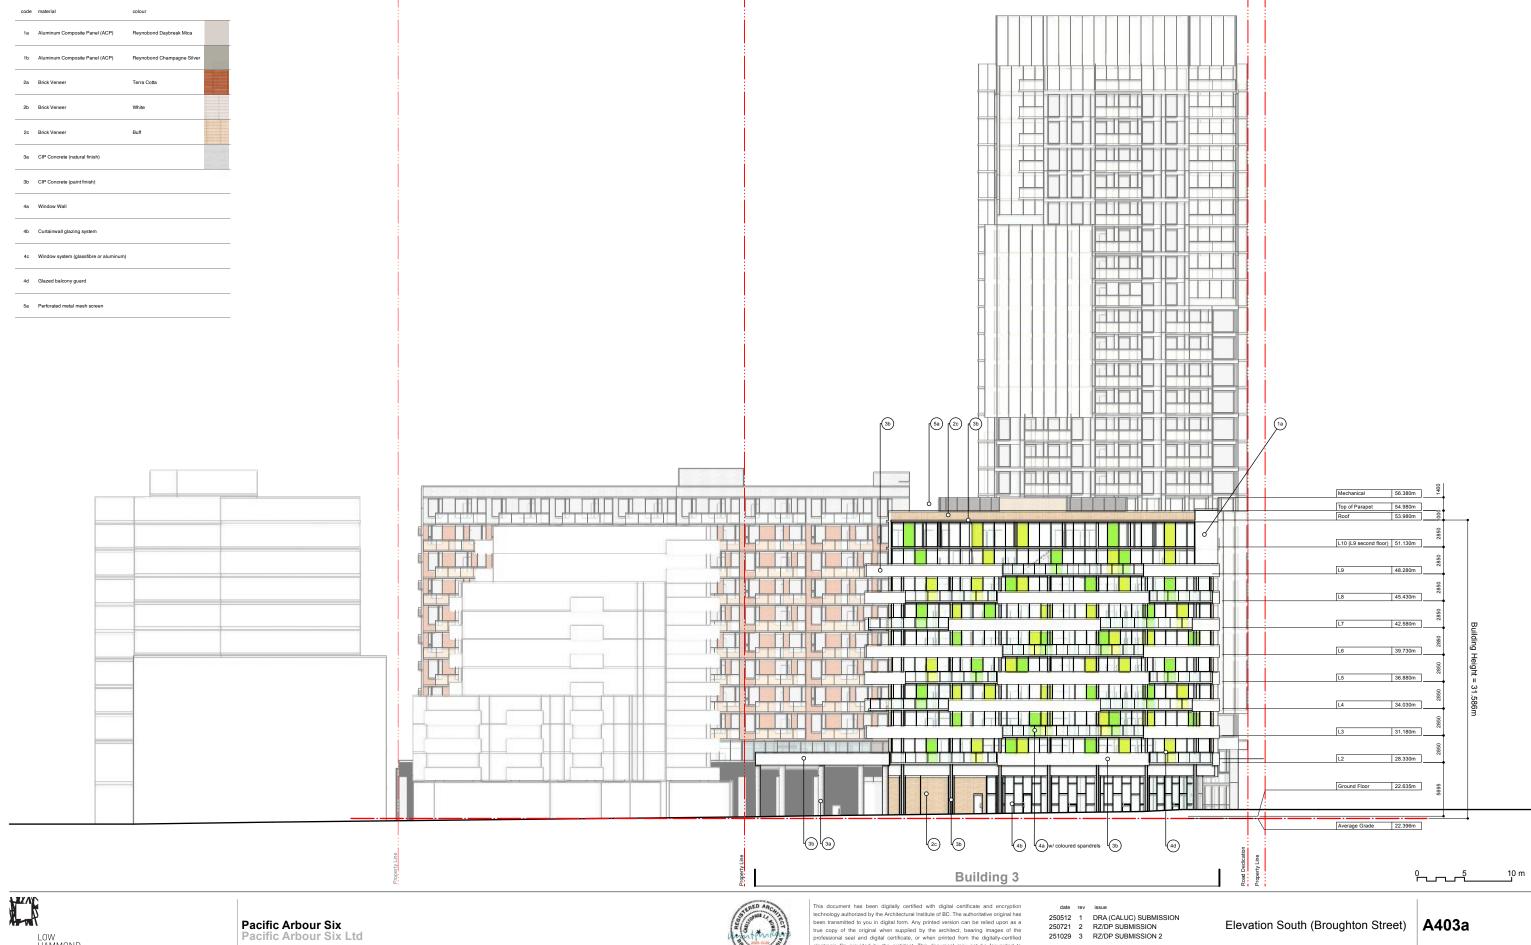

829-891-899 Fort Street and 846-858 Broughton Street, Victoria BC



true copy of the original when supplied by the architect, bearing images of the professional seal and digital certificate, or when printed from the digitally-certified electronic file provided by the architect. This document may not be forwarded to others, transmitted, or reproduced in any way without the express written permission of he copyright owner Low Hammond Rowe Architects Inc





Pacific Arbour Six Pacific Arbour Six Ltd

829-891-899 Fort Street and 846-858 Broughton Street, Victoria BC




This document has been digitally certified with digital certificate and encryption This document has been digitally certified with digital certificate and encryption technology authorized by the Architectural Institute of BC. The authorizative original has been transmitted to you in digital form. Any printed version can be relied upon as a true copy of the original when supplied by the architect, bearing images of the professional seal and digital certificate, or when printed from the digitally-certified electronic file provided by the architect. This document may not be forwarded to others, transmitted, or reproduced in any way without the express written permission of the copyright owner Low Hammond Rowe Architects Inc

250512 1 DRA (CALUC) SUBMISSION 250721 2 RZ/DP SUBMISSION

251029 3 RZ/DP SUBMISSION 2

Elevation South (Broughton Street) **A404b** 

0\_\_\_\_5 10 m

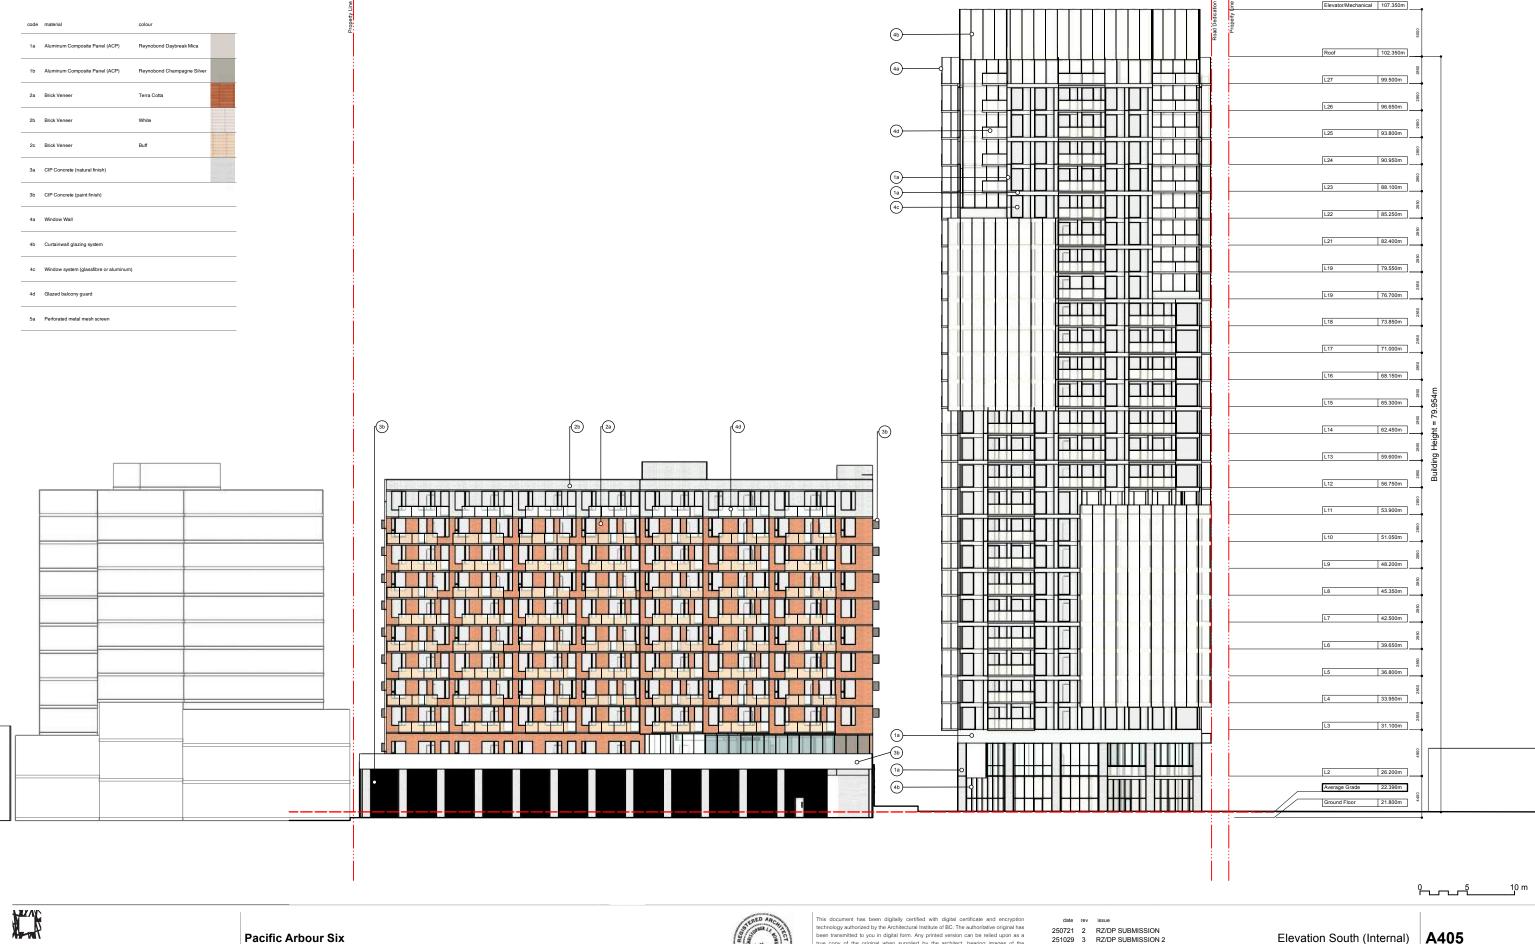





829-891-899 Fort Street and 846-858 Broughton Street, Victoria BC



true copy of the original when supplied by the architect, bearing images of the professional seal and digital certificate, or when printed from the digitally-certified electronic file provided by the architect. This document may not be forwarded to others, transmitted, or reproduced in any way without the express written permission of the copyright owner Low Hammond Rowe Architects Inc



Pacific Arbour Six Ltd

829-891-899 Fort Street and 846-858 Broughton Street, Victoria BC




true copy of the original when supplied by the architect, bearing images of the professional seal and digital certificate, or when printed from the digitally-certified electronic file provided by the architect. This document may not be forwarded to others, transmitted, or reproduced in any way without the express written permission of the copyright owner Low Hammond Rowe Architects Inc



829-891-899 Fort Street and 846-858 Broughton Street, Victoria BC



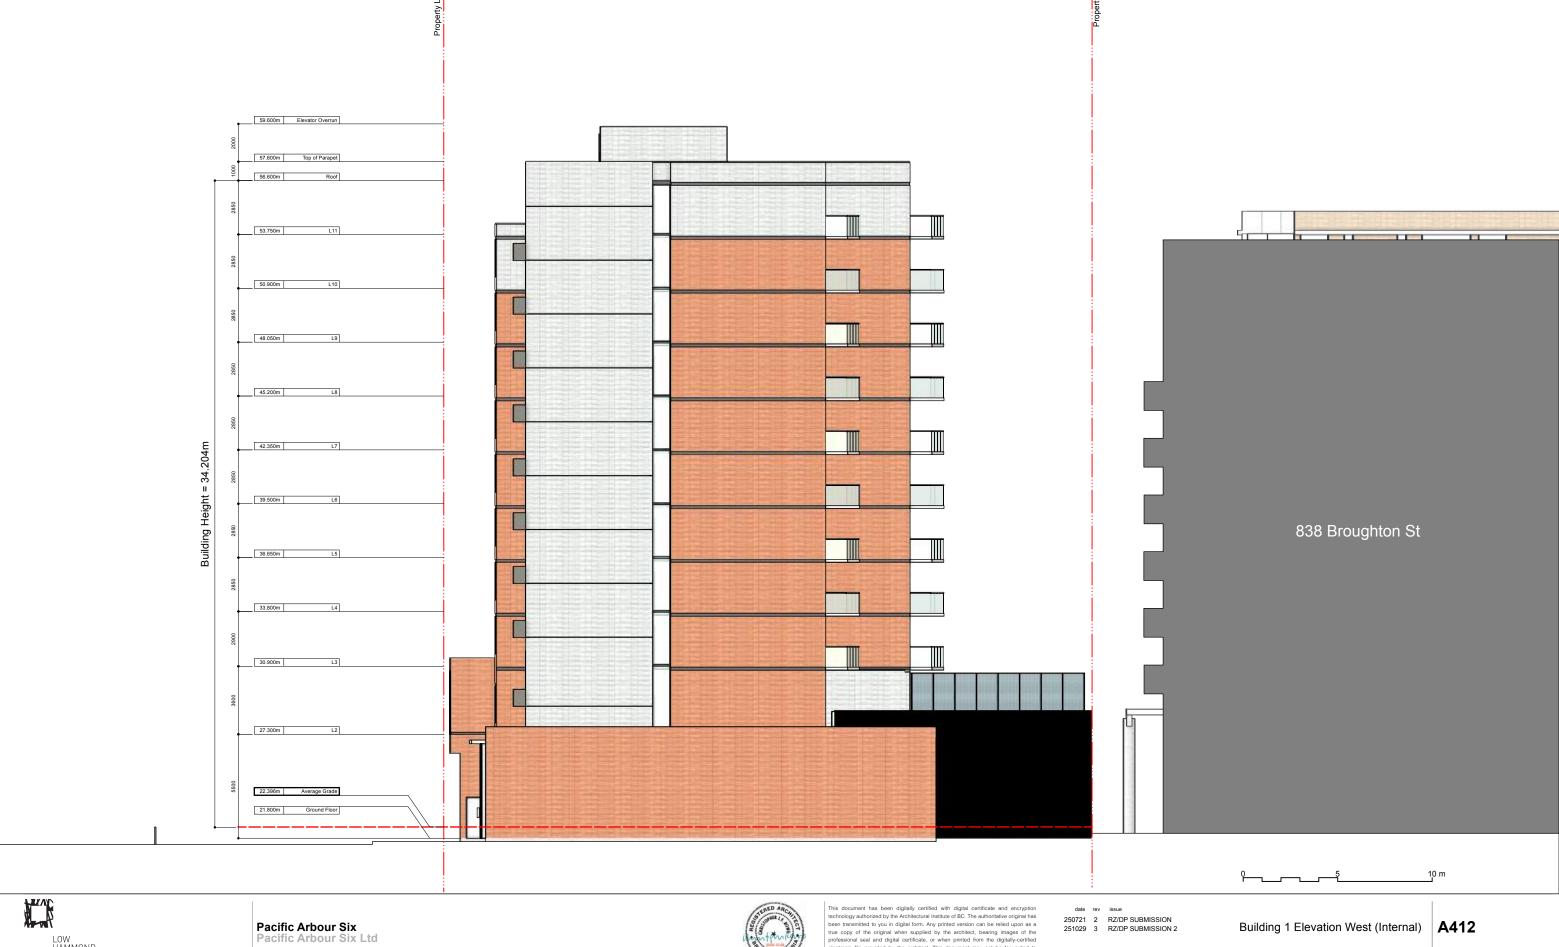

829-891-899 Fort Street and 846-858 Broughton Street, Victoria BC



This document has been digitally certified with digital certificate and encryption technology authorized by the Architectural Institute of BC. The authoritative original has been transmitted to you in digital form. Any printed version can be relied upon as a true copy of the original when supplied by the architect, bearing images of the professional seal and digital certificate, or when printed from the digitally-certified electronic file provided by the architect. This document may not be forwarded to others, transmitted, or reproduced in any way without the express written permission of the copyright owner Low Hammond Rowe Architects Inc





Pacific Arbour Six

Pacific Arbour Six Ltd

829-891-899 Fort Street and 846-858 Broughton Street, Victoria BC




This document has been digitally certified with digital certificate and encryption technology authorized by the Architectural Institute of BC. The authoritative original has been transmitted to you in digital form. Any printed version can be relied upon as a true copy of the original when supplied by the architect, bearing images of the professional seal and digital certificate, or when printed from the digitally-certified electronic file provided by the architect. This document may not be forwarded to others, transmitted, or reproduced in any way without the express written permission of the copyright owner Low Hammond Rowe Architects Inc.

250721 2 RZ/DP SUBMISSION 251029 3 RZ/DP SUBMISSION 2

Building 1 Elevation North **A413** 

project num 2426

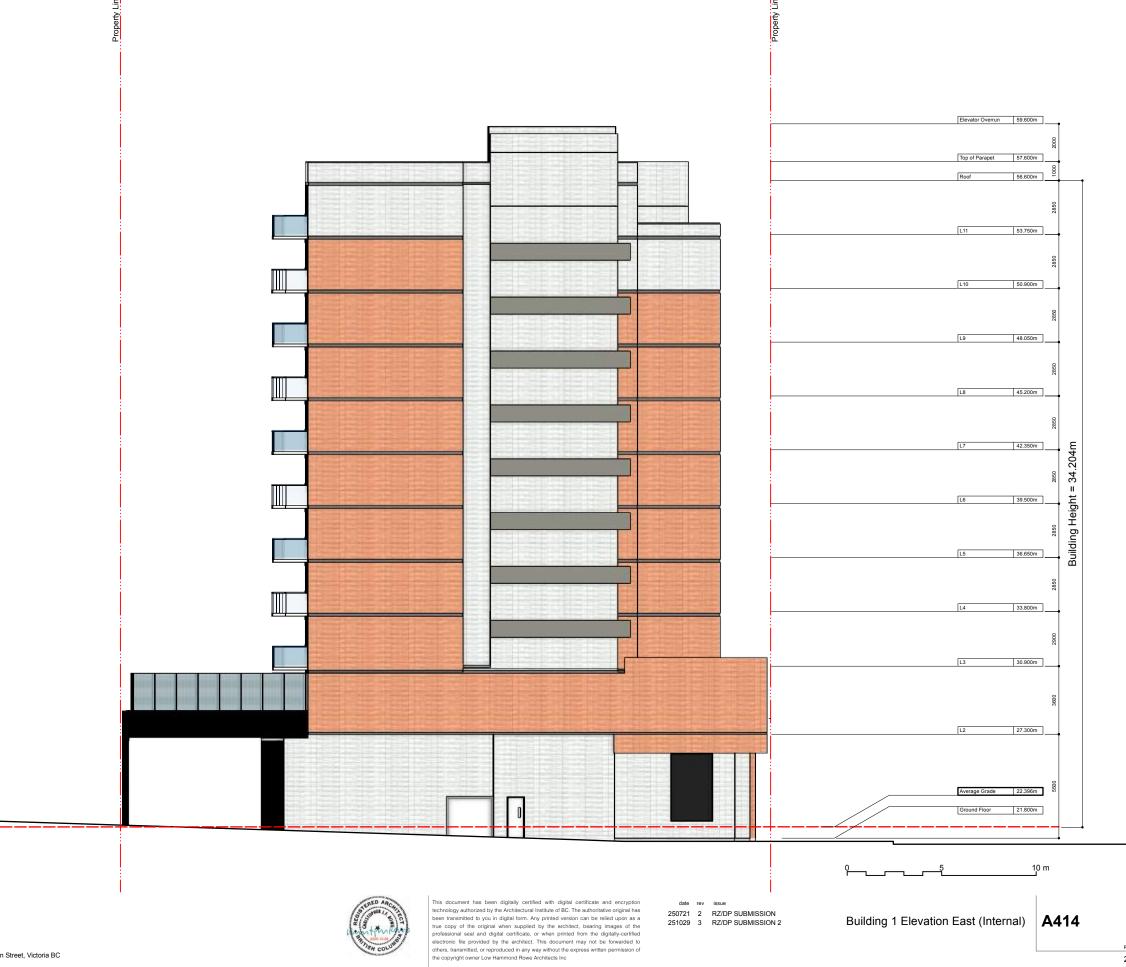



Pacific Arbour Six

Pacific Arbour Six Ltd

829-891-899 Fort Street and 846-858 Broughton Street, Victoria BC



829-891-899 Fort Street and 846-858 Broughton Street, Victoria BC





This document has been digitally certified with digital certificate and encryption technology authorized by the Architectural Institute of BC. The authoritative original has been transmitted to you in digital form. Any printed version can be relied upon as a true copy of the original when supplied by the architect, bearing images of the professional seal and digital certificate, or when printed from the digitally-certified electronic file provided by the architect. This document may not be forwarded to others, transmitted, or reproduced in any way without the express written permission of the copyright owner Low Hammond Rowe Architects Inc.




829-891-899 Fort Street and 846-858 Broughton Street, Victoria BC



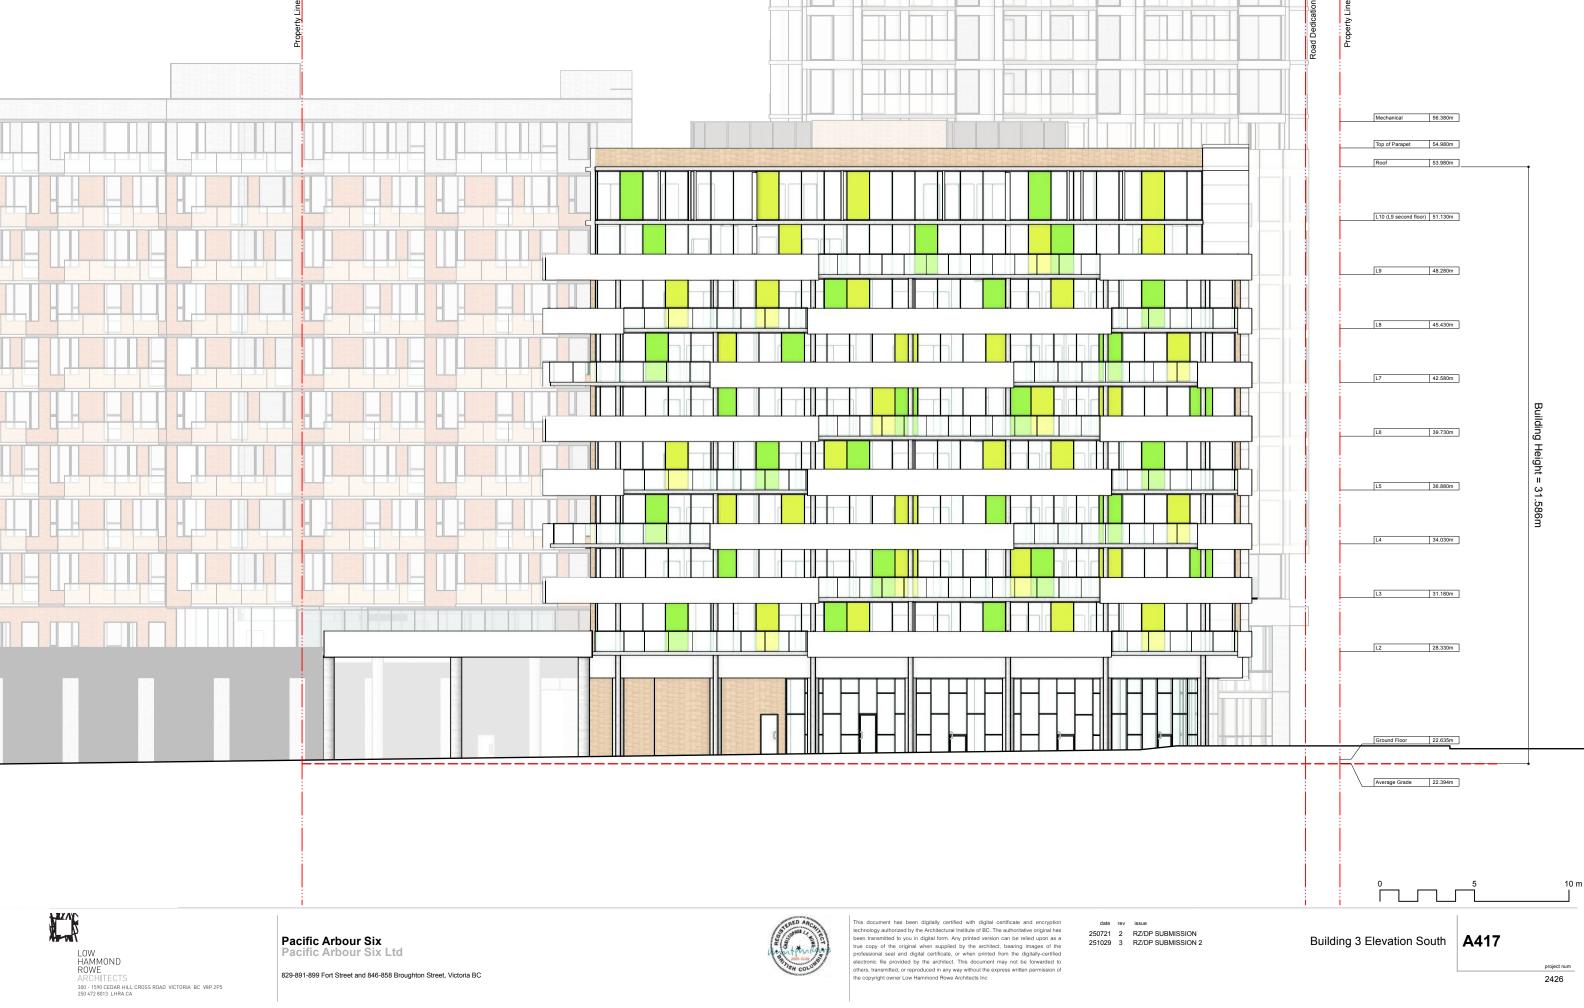

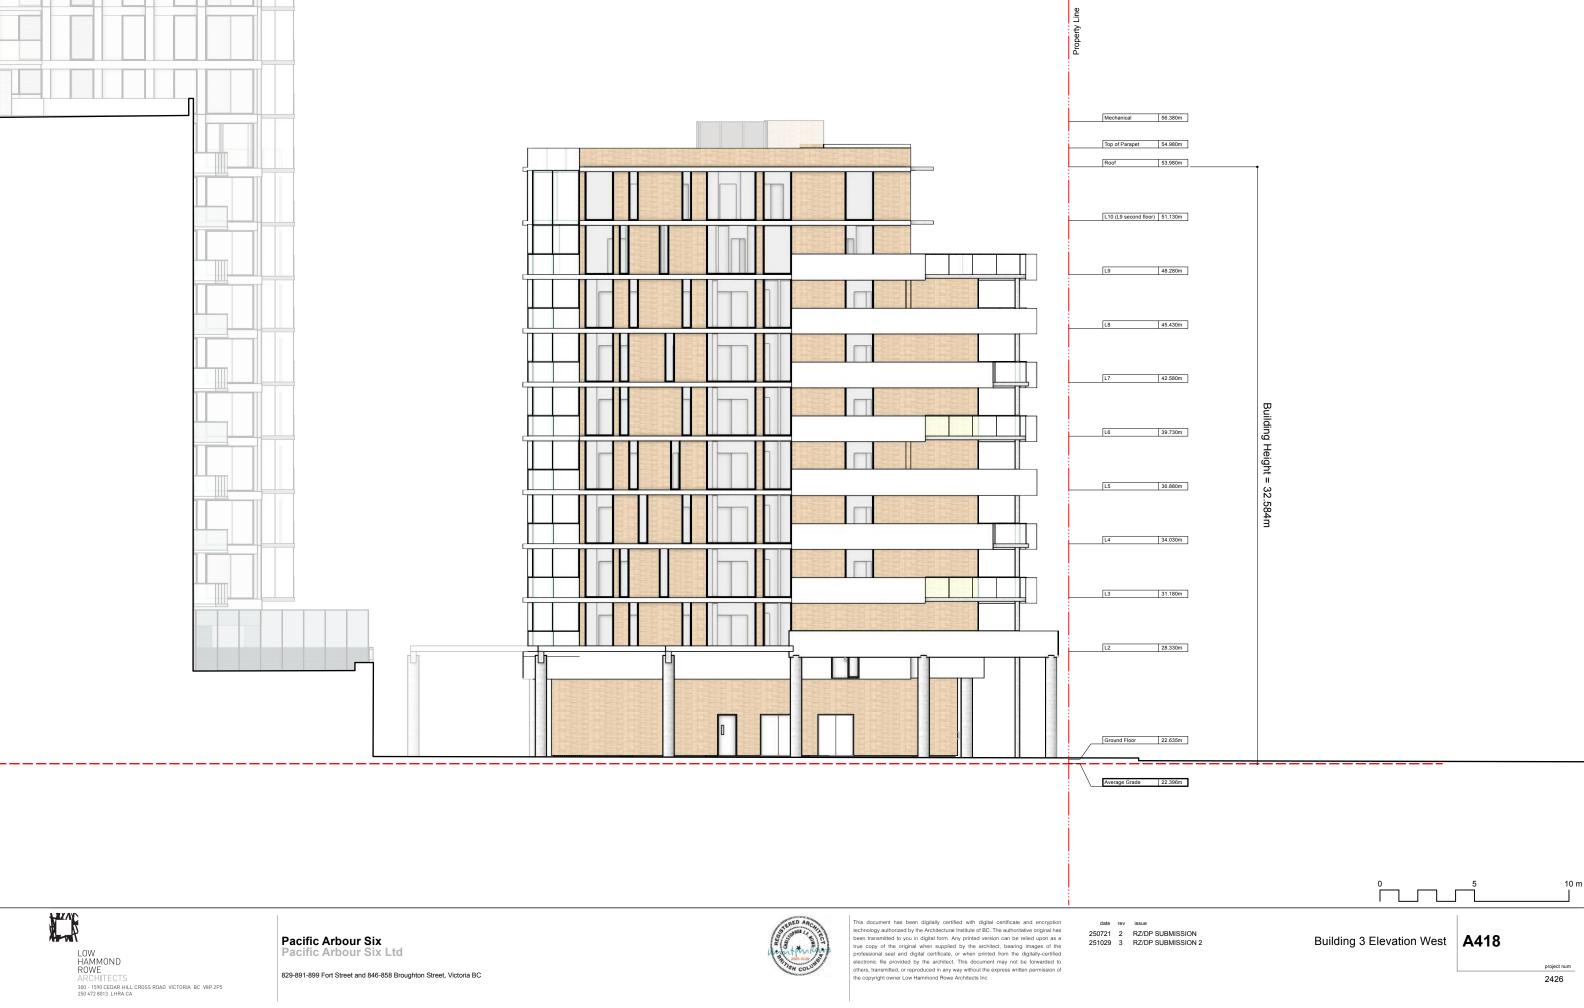

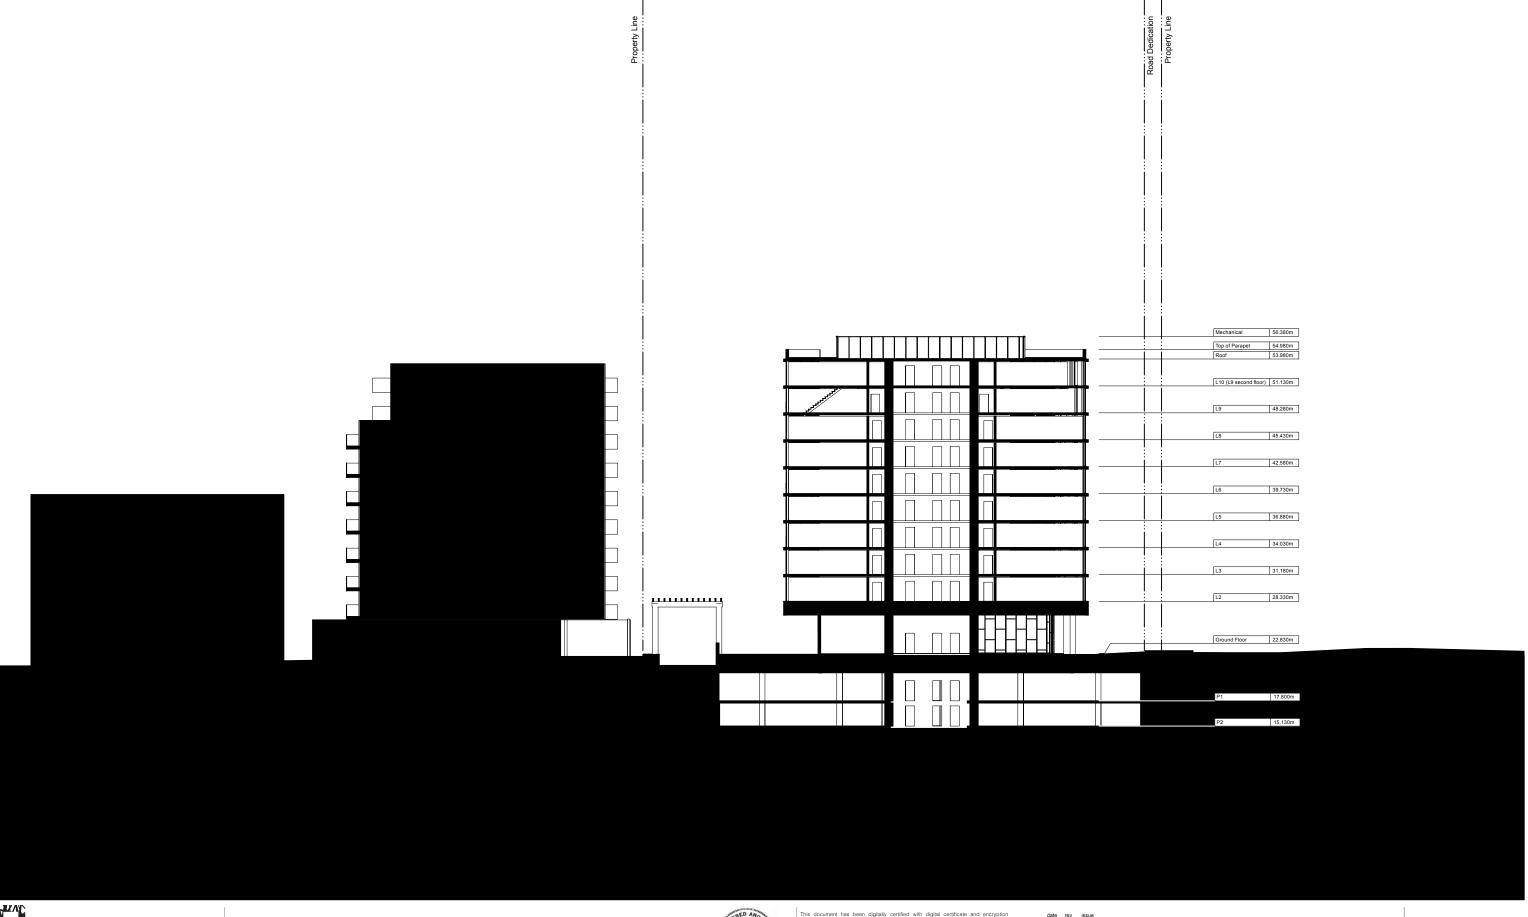



Pacific Arbour Six Pacific Arbour Six Ltd


829-891-899 Fort Street and 846-858 Broughton Street, Victoria BC



This document has been digitally certified with digital certificate and encryption technology authorized by the Architectural Institute of BC. The authoritative original has been transmitted to you in digital form. Any printed version can be relied upon as a true copy of the original when supplied by the architect, bearing images of the professional seal and digital certificate, or when printed from the digitally-certified electronic file provided by the architect. This document may not be forwarded to others, transmitted, or reproduced in any way without the express written permission of the copyright owner Low Hammond Rowe Architects inc

250721 2 RZ/DP SUBMISSION 251029 3 RZ/DP SUBMISSION 2

Section East-West A601

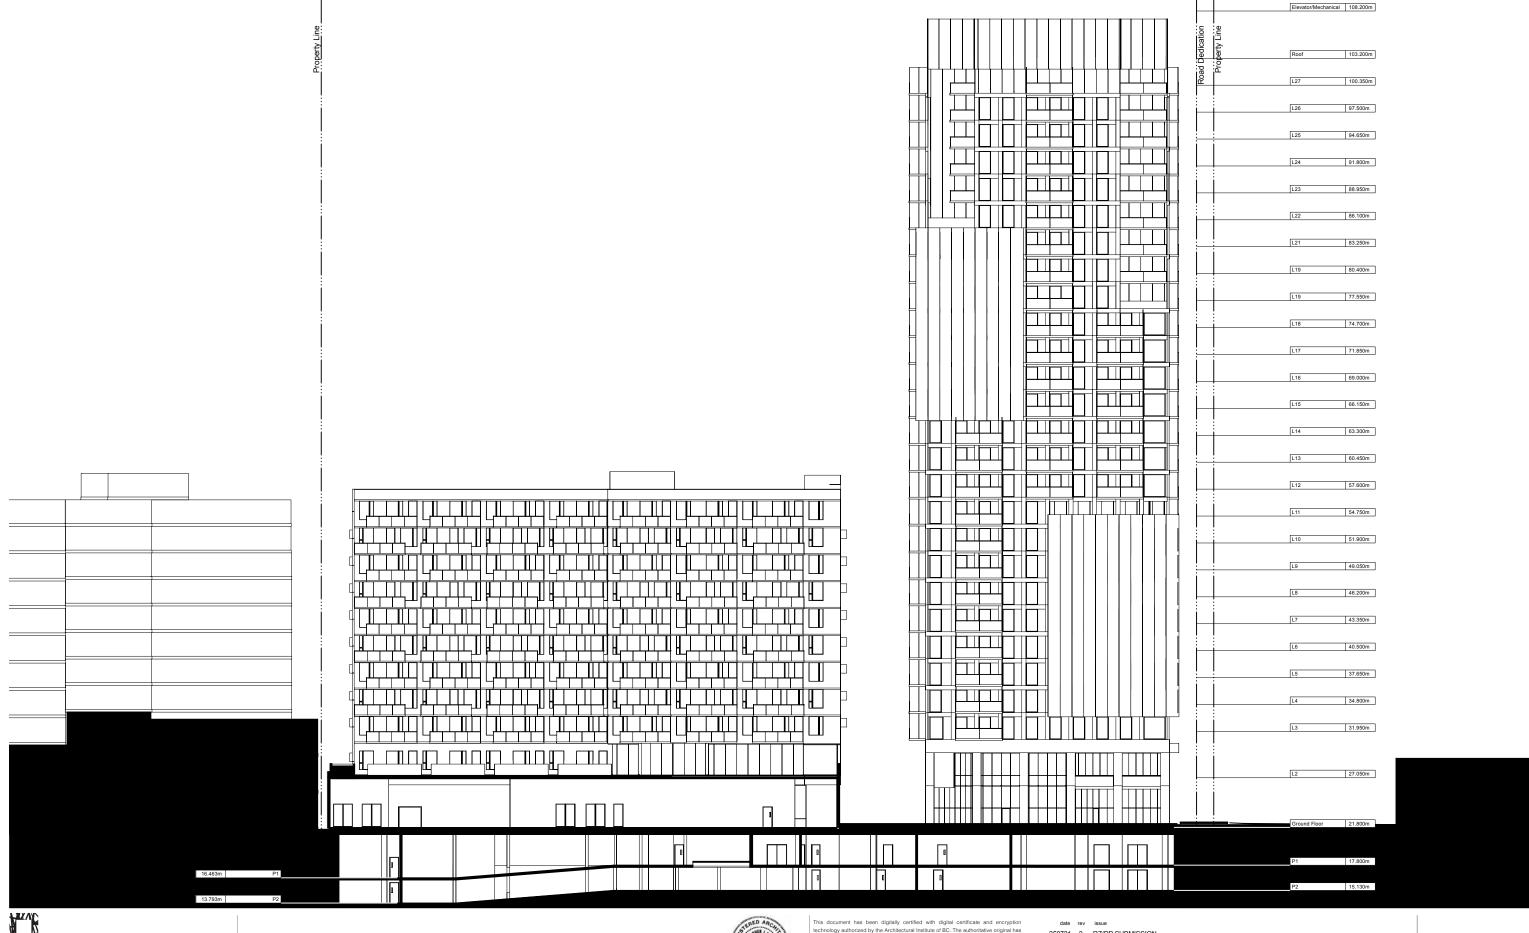



**Pacific Arbour Six** Pacific Arbour Six Ltd

829-891-899 Fort Street and 846-858 Broughton Street, Victoria BC




technology authorized by the Architectural Institute of BC. The authoritative original has been transmitted to you in digital form. Any printed version can be relied upon as a true copy of the original when supplied by the architect, bearing images of the professional seal and digital certificate, or when printed from the digitally-certified electronic file provided by the architect. This document may not be forwarded to others, transmitted, or reproduced in any way without the express written permission of the copyright owner Low Hammond Rowe Architects Inc

250721 2 RZ/DP SUBMISSION

251029 3 RZ/DP SUBMISSION 2

Section East-West

A602

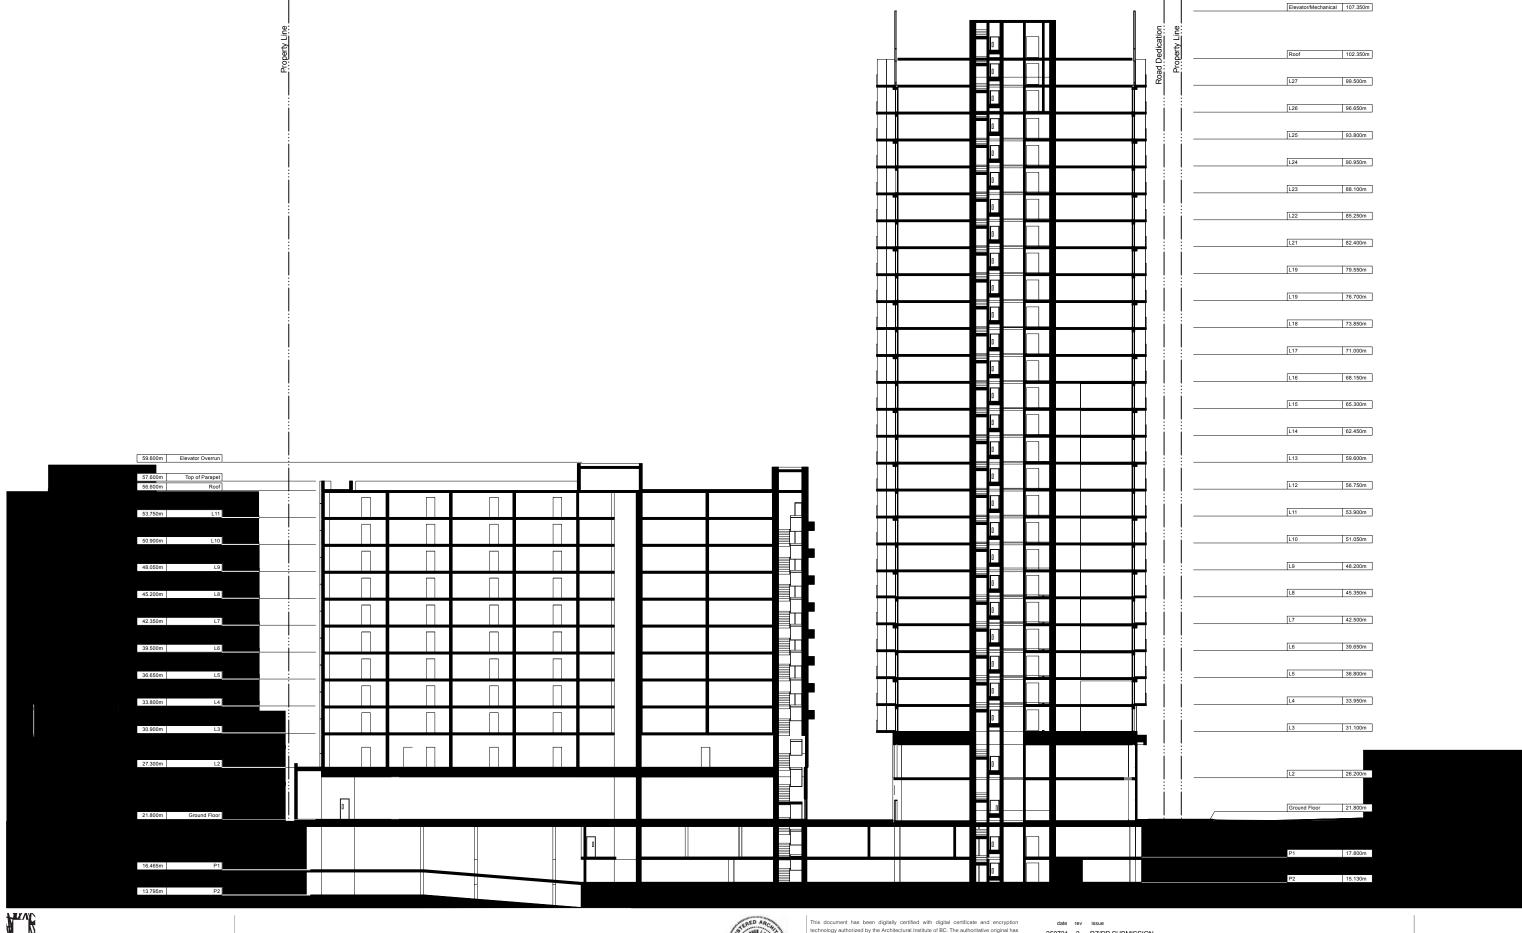






829-891-899 Fort Street and 846-858 Broughton Street, Victoria BC



Inis document has been digitally certified with digital certificate and encryption technology authorized by the Architectural Institute of BC. The authoritative original has been transmitted to you in digital form. Any printed version can be relied upon as a true copy of the original when supplied by the architect, bearing images of the professional seal and digital certificate, or when printed from the digitally-certified electronic file provided by the architect. This document may not be forwarded to others, transmitted, or reproduced in any way without the express written permission of the copyright owner Low Hammond Rowe Architects Inc

250721 2 RZ/DP SUBMISSION 251029 3 RZ/DP SUBMISSION 2

Section East-West A603

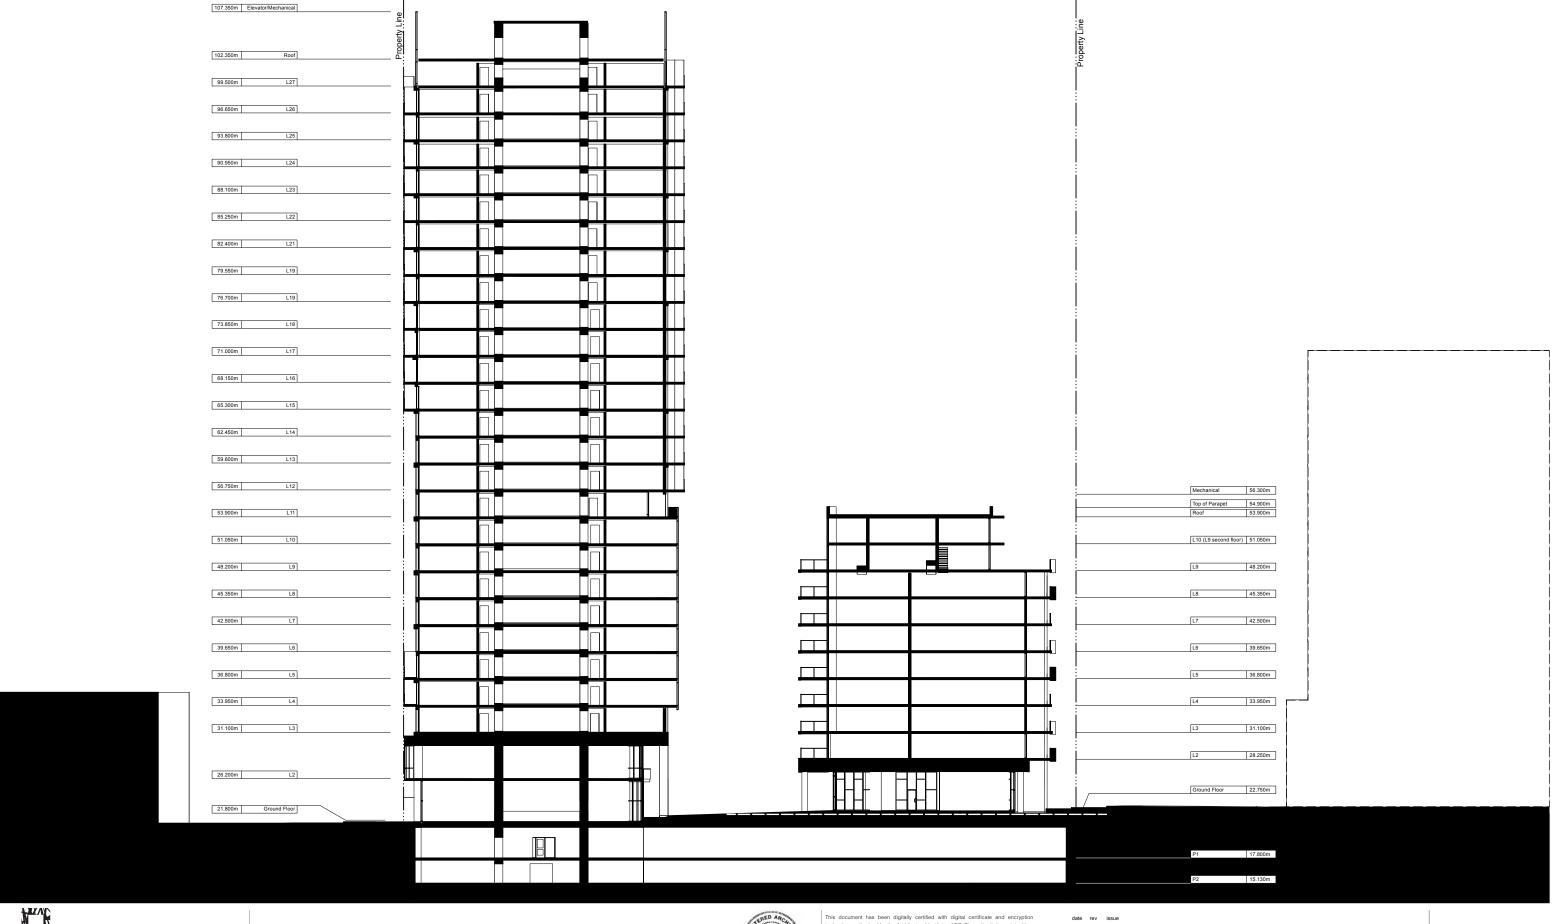






829-891-899 Fort Street and 846-858 Broughton Street, Victoria BC



This document has been digitally certified with digital certificate and encryption technology authorized by the Architectural Institute of BC. The authoritative original has been transmitted to you in digital form. Any printed version can be relied upon as a true copy of the original when supplied by the architect, bearing images of the professional seal and digital certificate, or when printed from the digitally-certified electronic file provided by the architect. This document may not be forwarded to others, transmitted, or reproduced in any way without the express written permission of the copyright owner Low Hammond Rowe Architects Inc

250721 2 RZ/DP SUBMISSION 251029 3 RZ/DP SUBMISSION 2

Section North-South A604

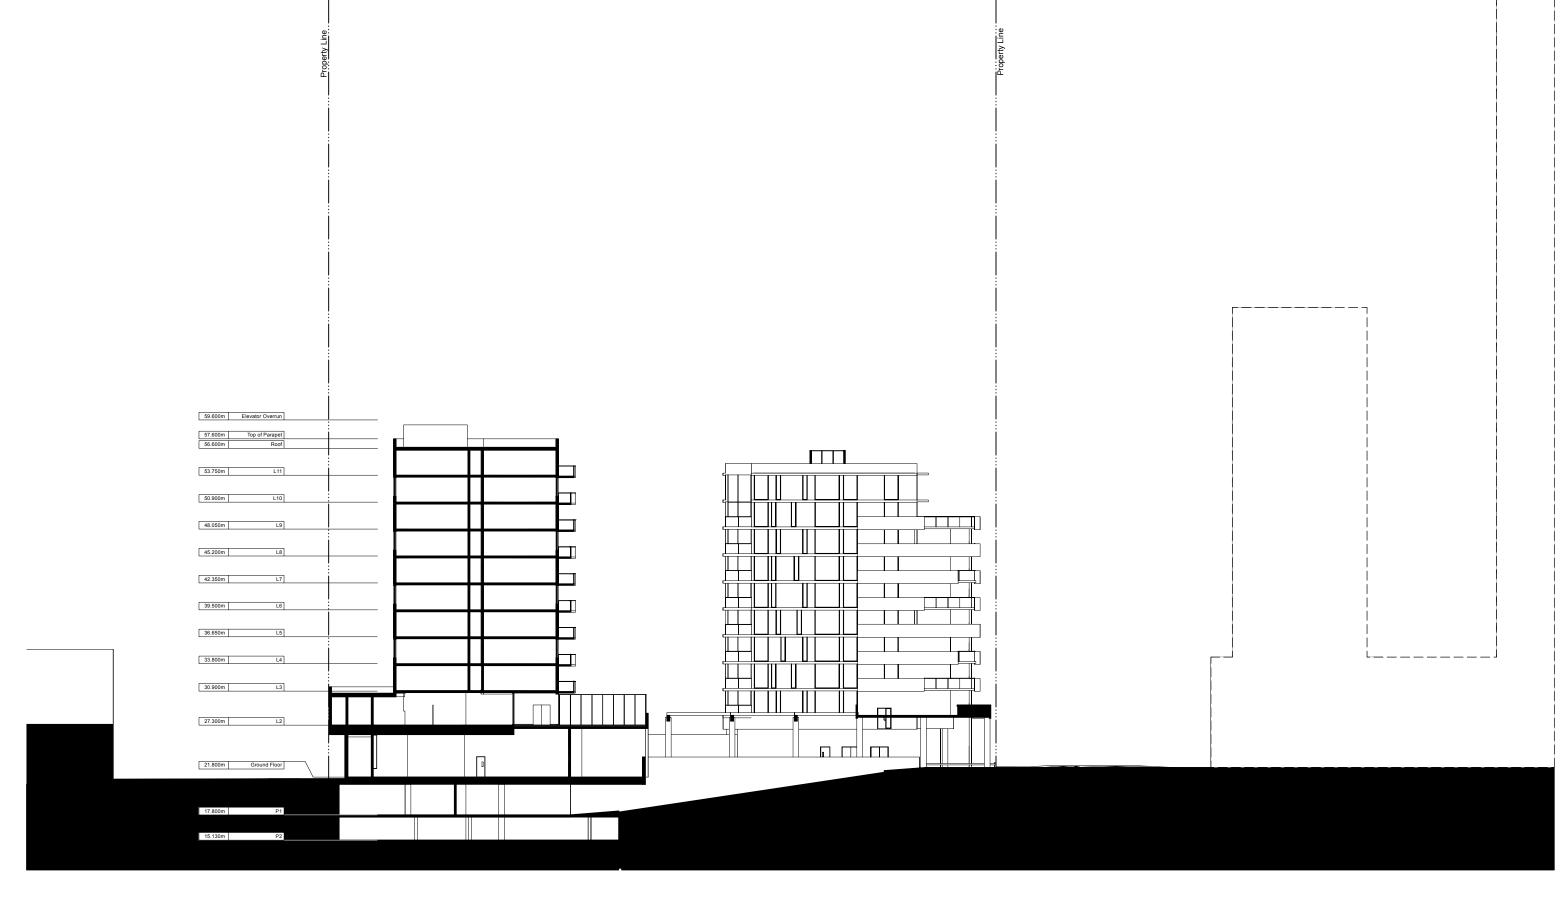






Pacific Arbour Six Ltd

This document has been digitally certified with digital certificate and encryption technology authorized by the Architectural Institute of BC. The authoritative original has been transmitted to you in digital form. Any printed version can be relied upon as a true copy of the original when supplied by the architect, bearing images of the professional seal and digital certificate, or when printed from the digitally-certified electronic file provided by the architect. This document may not be forwarded to others, transmitted, or reproduced in any way without the express written permission of the copyright owner Low Hammond Rowe Architects Inc.

250721 2 RZ/DP SUBMISSION 251029 3 RZ/DP SUBMISSION 2

Section North-South A605

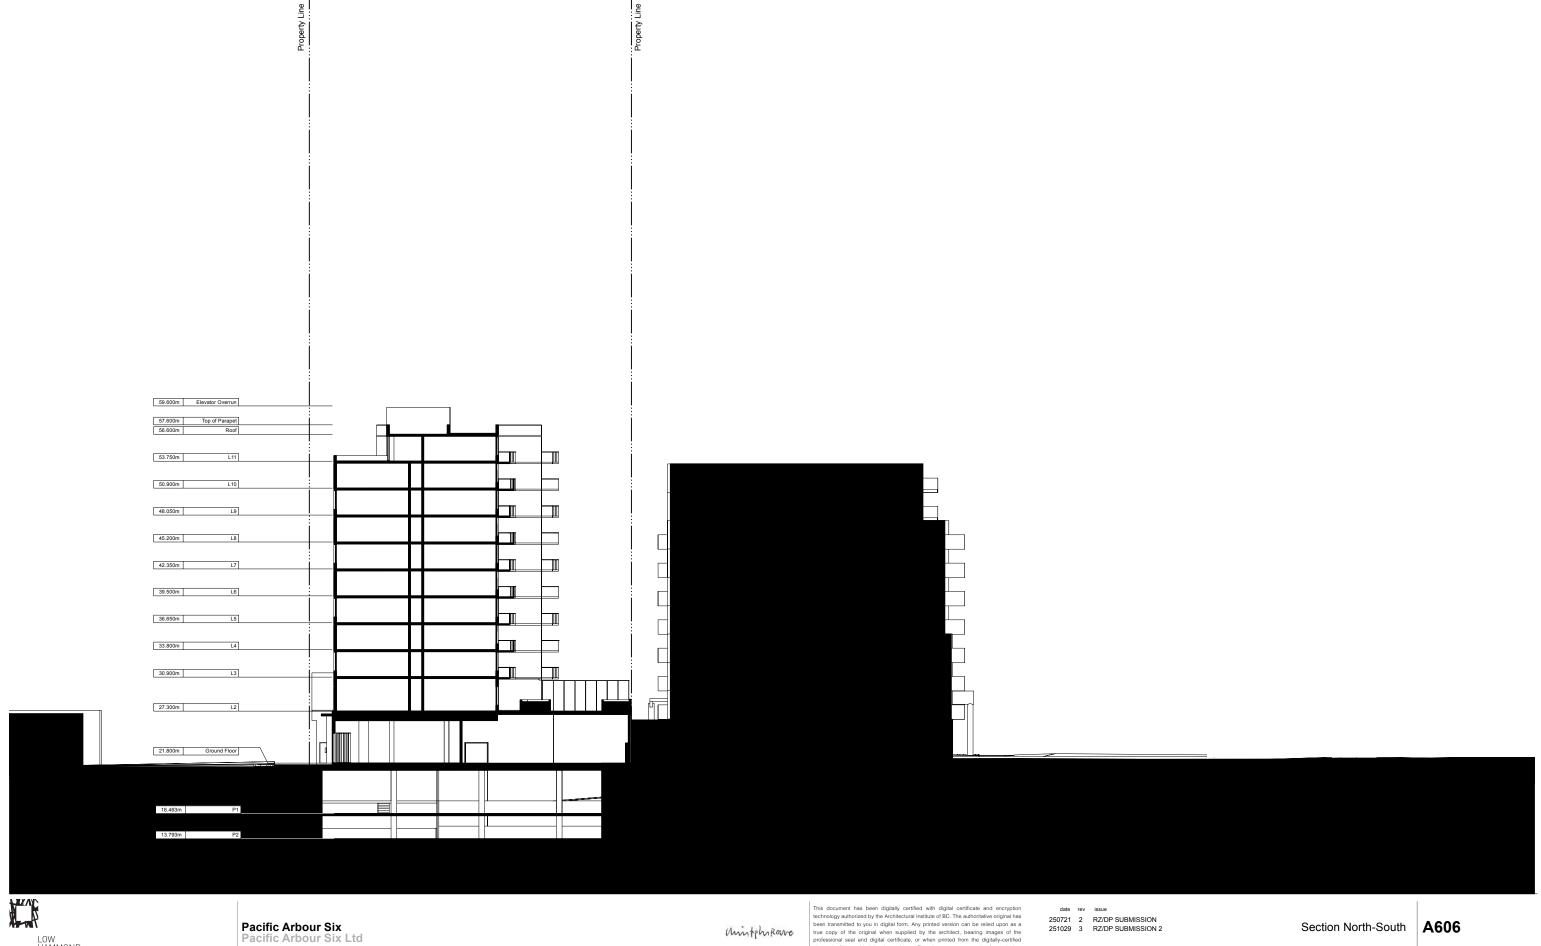

829-891-899 Fort Street and 846-858 Broughton Street, Victoria BC

This document has been digitally certified with digital certificate and encryption technology authorized by the Architectural Institute of BC. The authoritative original has been transmitted to you in digital form. Any printed version can be relied upon as a true copy of the original when supplied by the architect, bearing images of the professional seal and digital certificate, or when printed from the digitally-certified electronic file provided by the architect. This document may not be forwarded to others, transmitted, or reproduced in any way without the express written permission of the copyright owner Low Hammond Rowe Architects Inc

# PARC VICTORIA

Victoria, BC

Landscape She		
Sheet No.	Sheet Title	
L0.00	Cover	
L0.01	General Information Sheet	
L0.02	Tree Replacement	
L0.03	Stormwater Management	
L1.01	Landscape Materials Ground Level	
L1.02	Landscape Materials - L2	
L1.03	Landscape Materials - L3	
L1.04	Landscape Materials - L9, 11 & 12	
L1.05	Landscape Materials - Tower	
L2.01	Landscape Grading & Drainage	
L2.02	Landscape Sections	Sheet added.
L3.01	Planting Ground	
L3.02	Planting L2 and L3	
L3.03	Planting - Upper Roofs	
L4.01	Landscape Details: Rain Garden	Sheets added.
L4.02	Landscape Details: Boulevard Rain Garden	Sneets added.
L4.03	Landscape Details: Planting	
L4.04	Landscape Details: Soil Cells	

# **KEY PLAN**





NOT FOR CONSTRUCTION

4	DP Submission 2	2025-10-29
3	Development Permit	2025-07-23
2	CALUC	2025-04-30
1	Pre-Application	2024-11-15
No.	Issued For	Issue Date

client

# PARC Communities Management Ltd.

project


PARC VICTORIA 829-891-899 Fort Street and 846-858 Broughton Street, Victoria BC


sheet title

### Cover

project no.		124.27
scale	1: 400	@ 24"x36"
drawn by		SC
checked by		ТВ
sheet no.		

L0.00

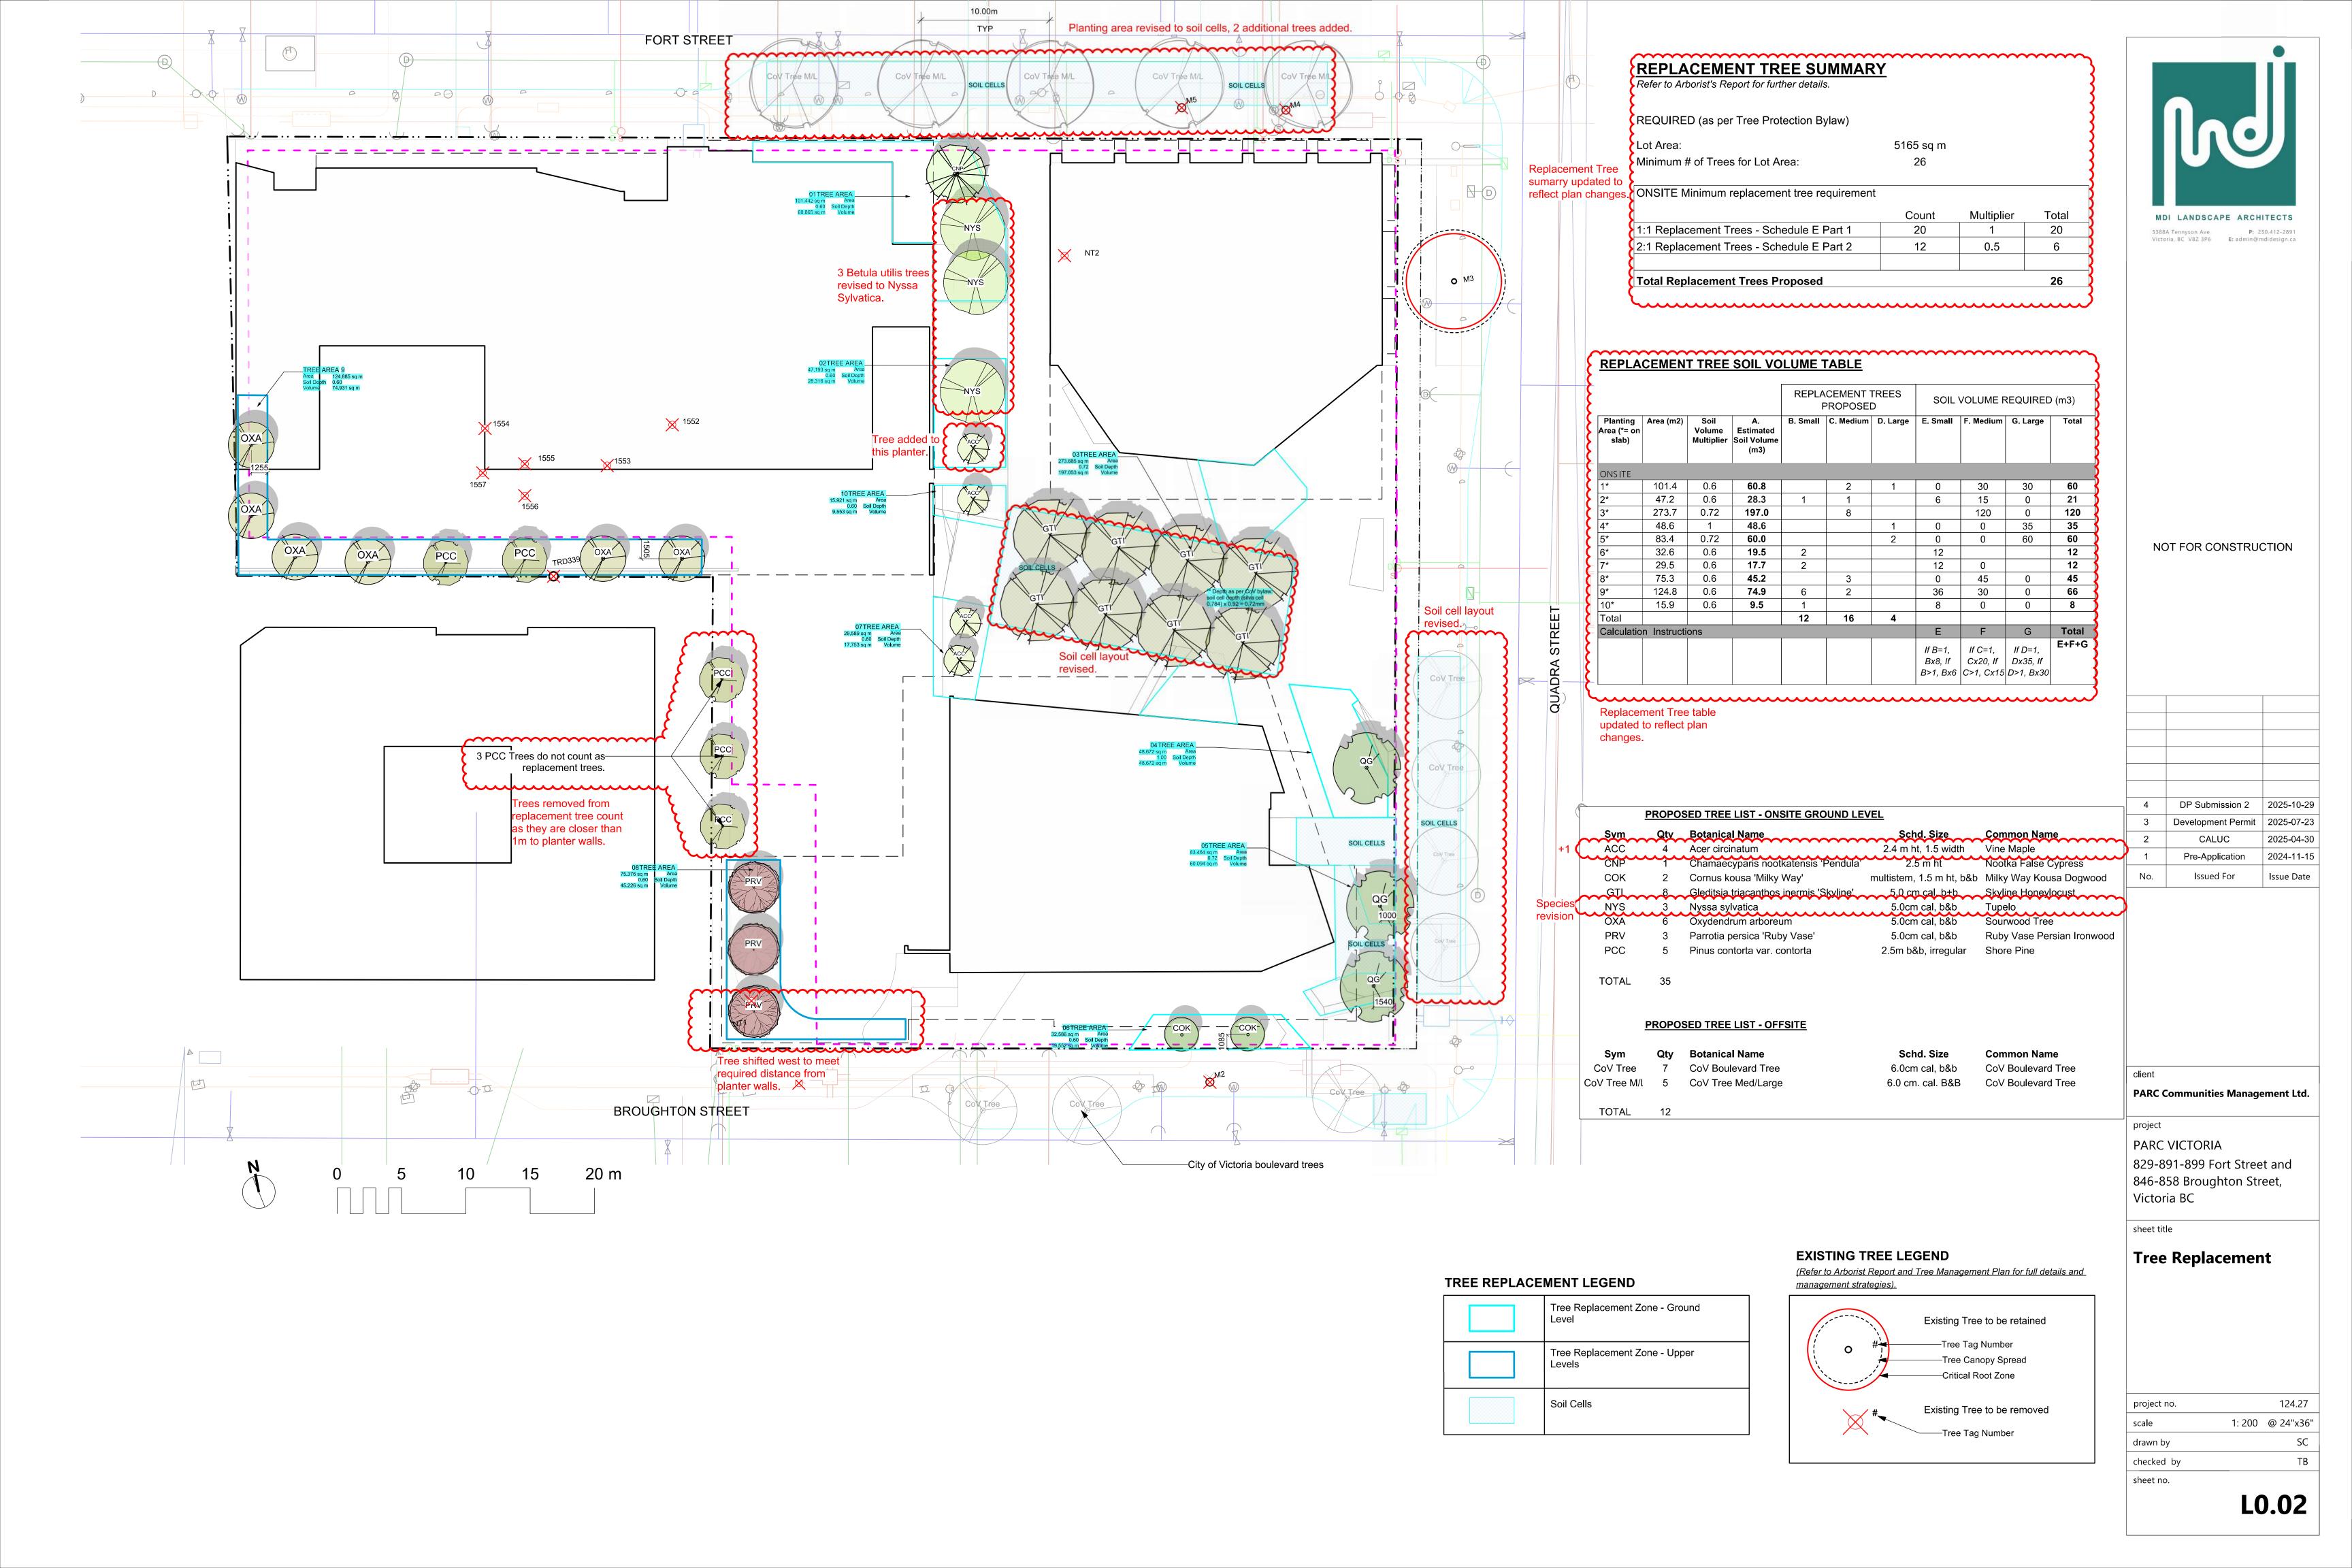

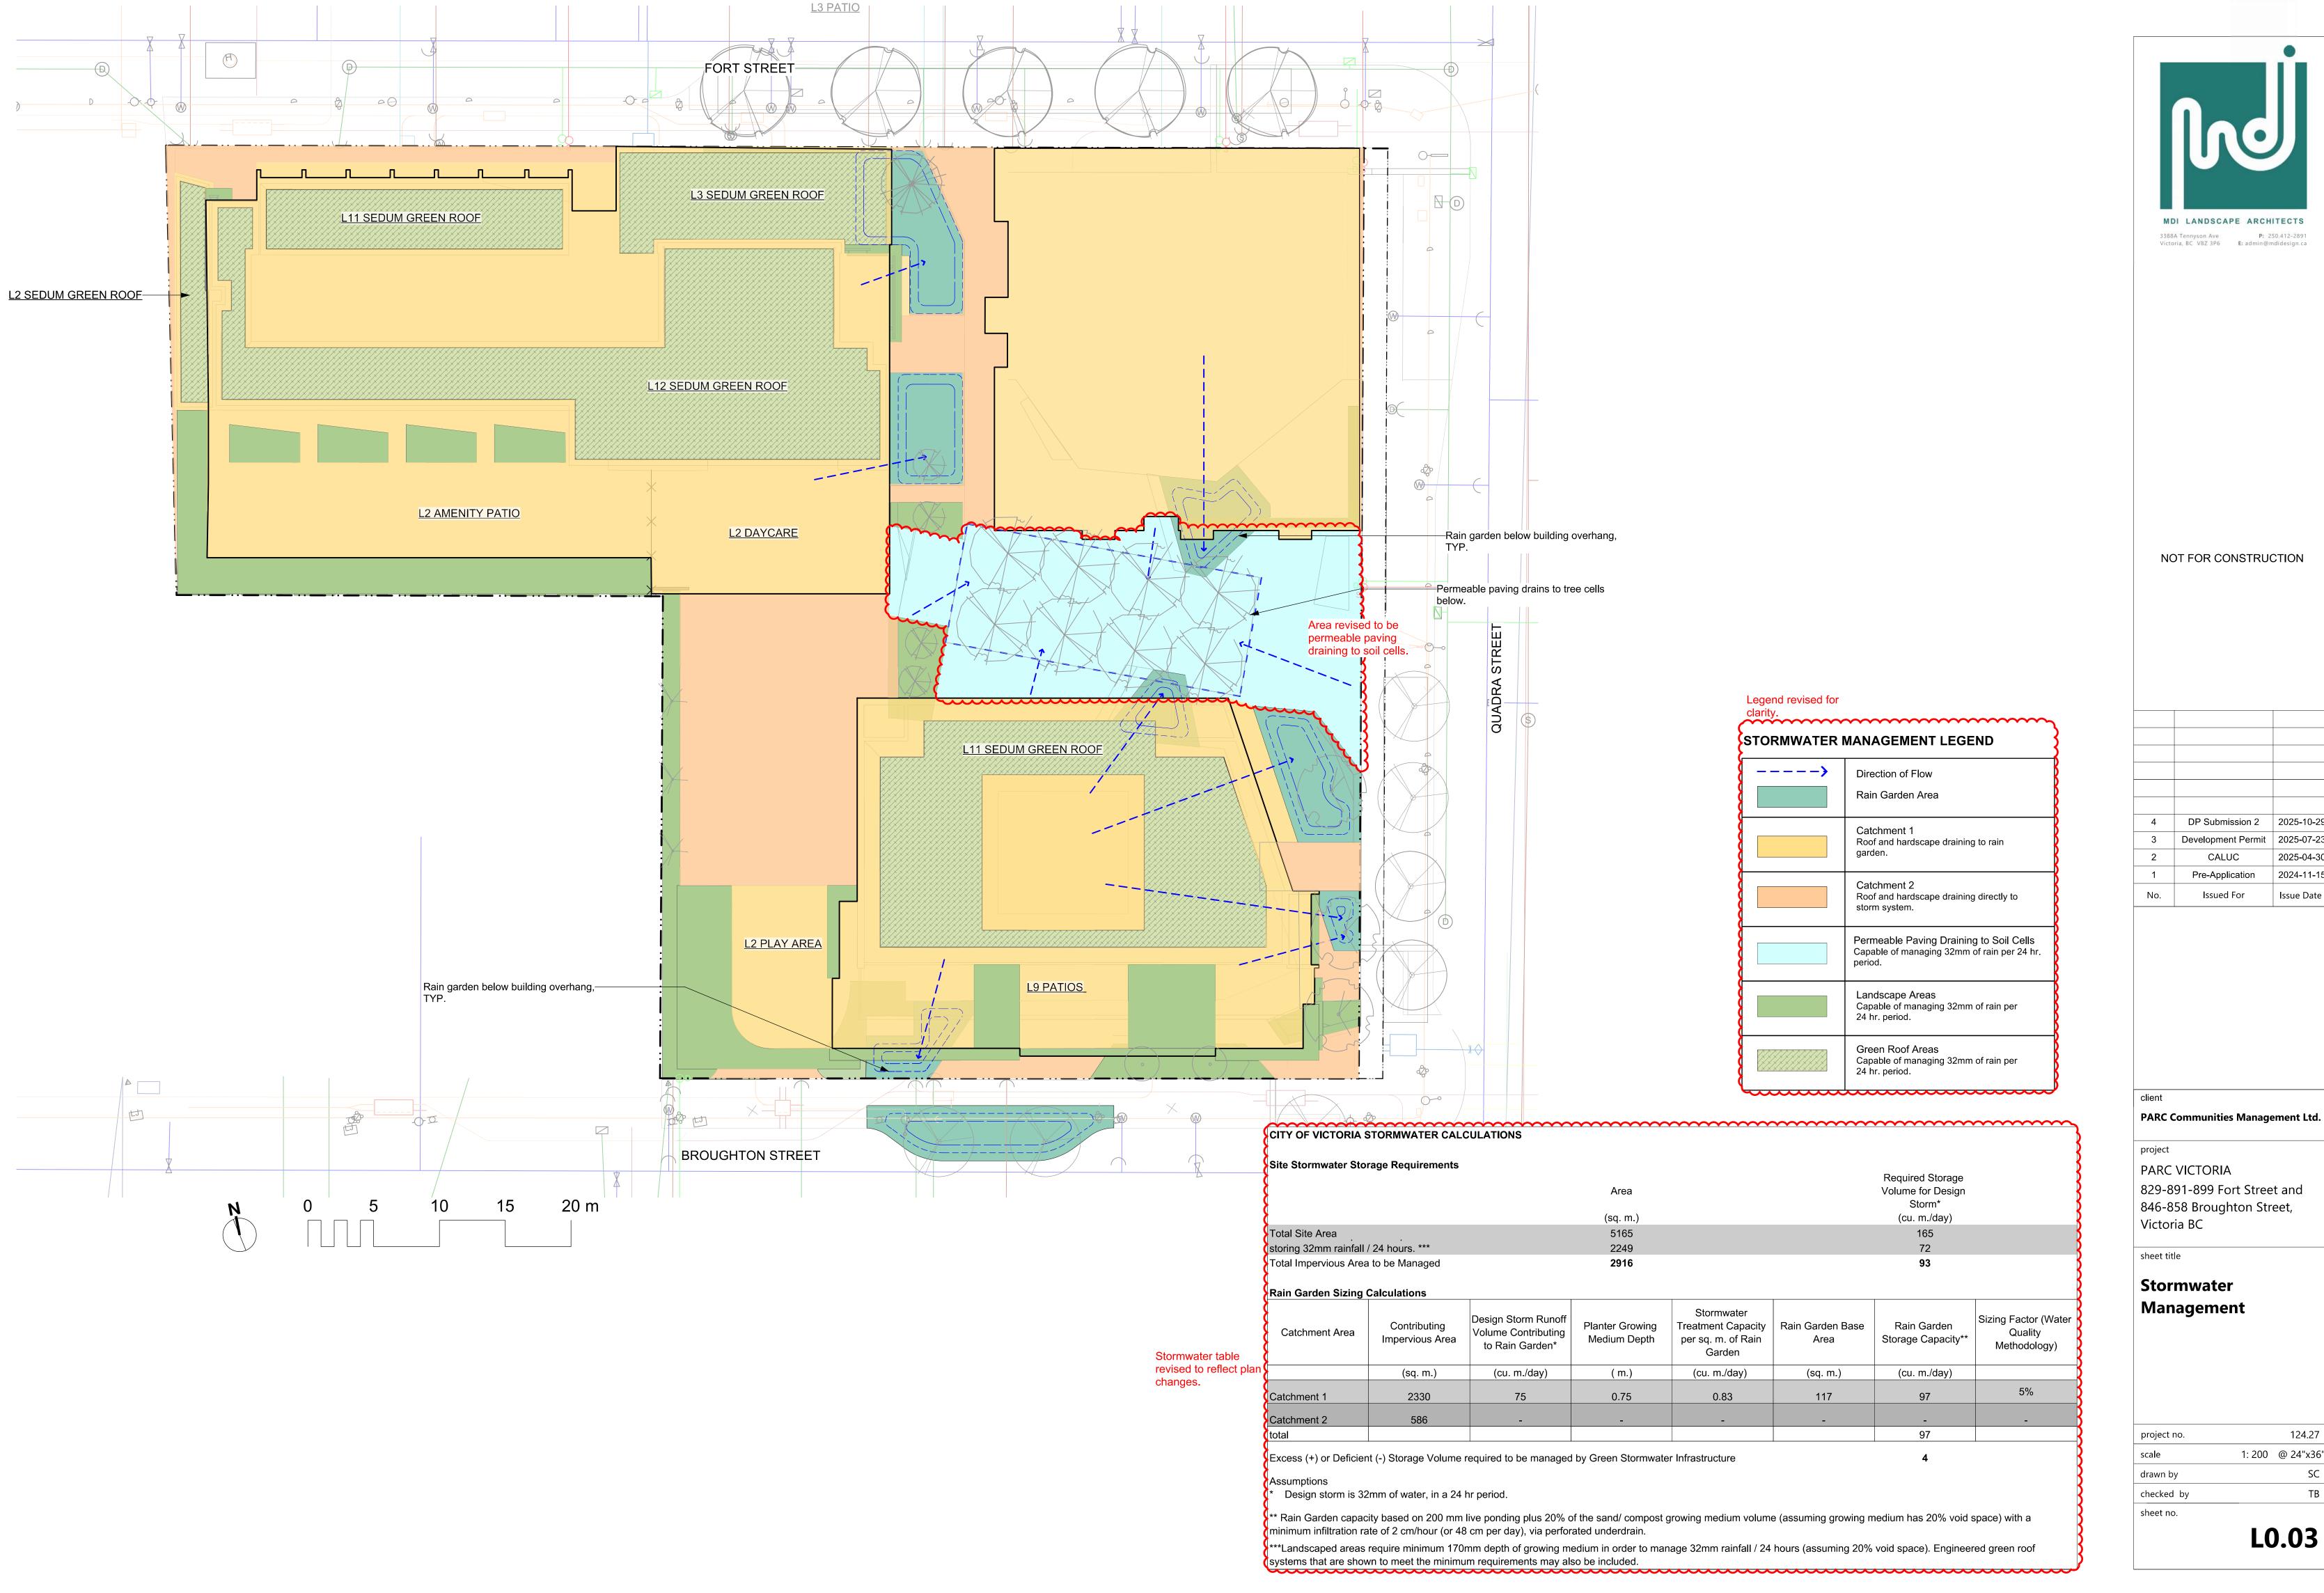



NOT FOR CONSTRUCTION

4	DP Submission 2	2025-10-29
3	Development Permit	2025-07-23
2	CALUC	2025-04-30
1	Pre-Application	2024-11-15
No.	Issued For	Issue Date
	·	


PARC VICTORIA 829-891-899 Fort Street and 846-858 Broughton Street,

sheet title

Stormwater Management

124.27 project no. 1: 200 @ 24"x36" scale drawn by checked by sheet no.

**L0.03** 

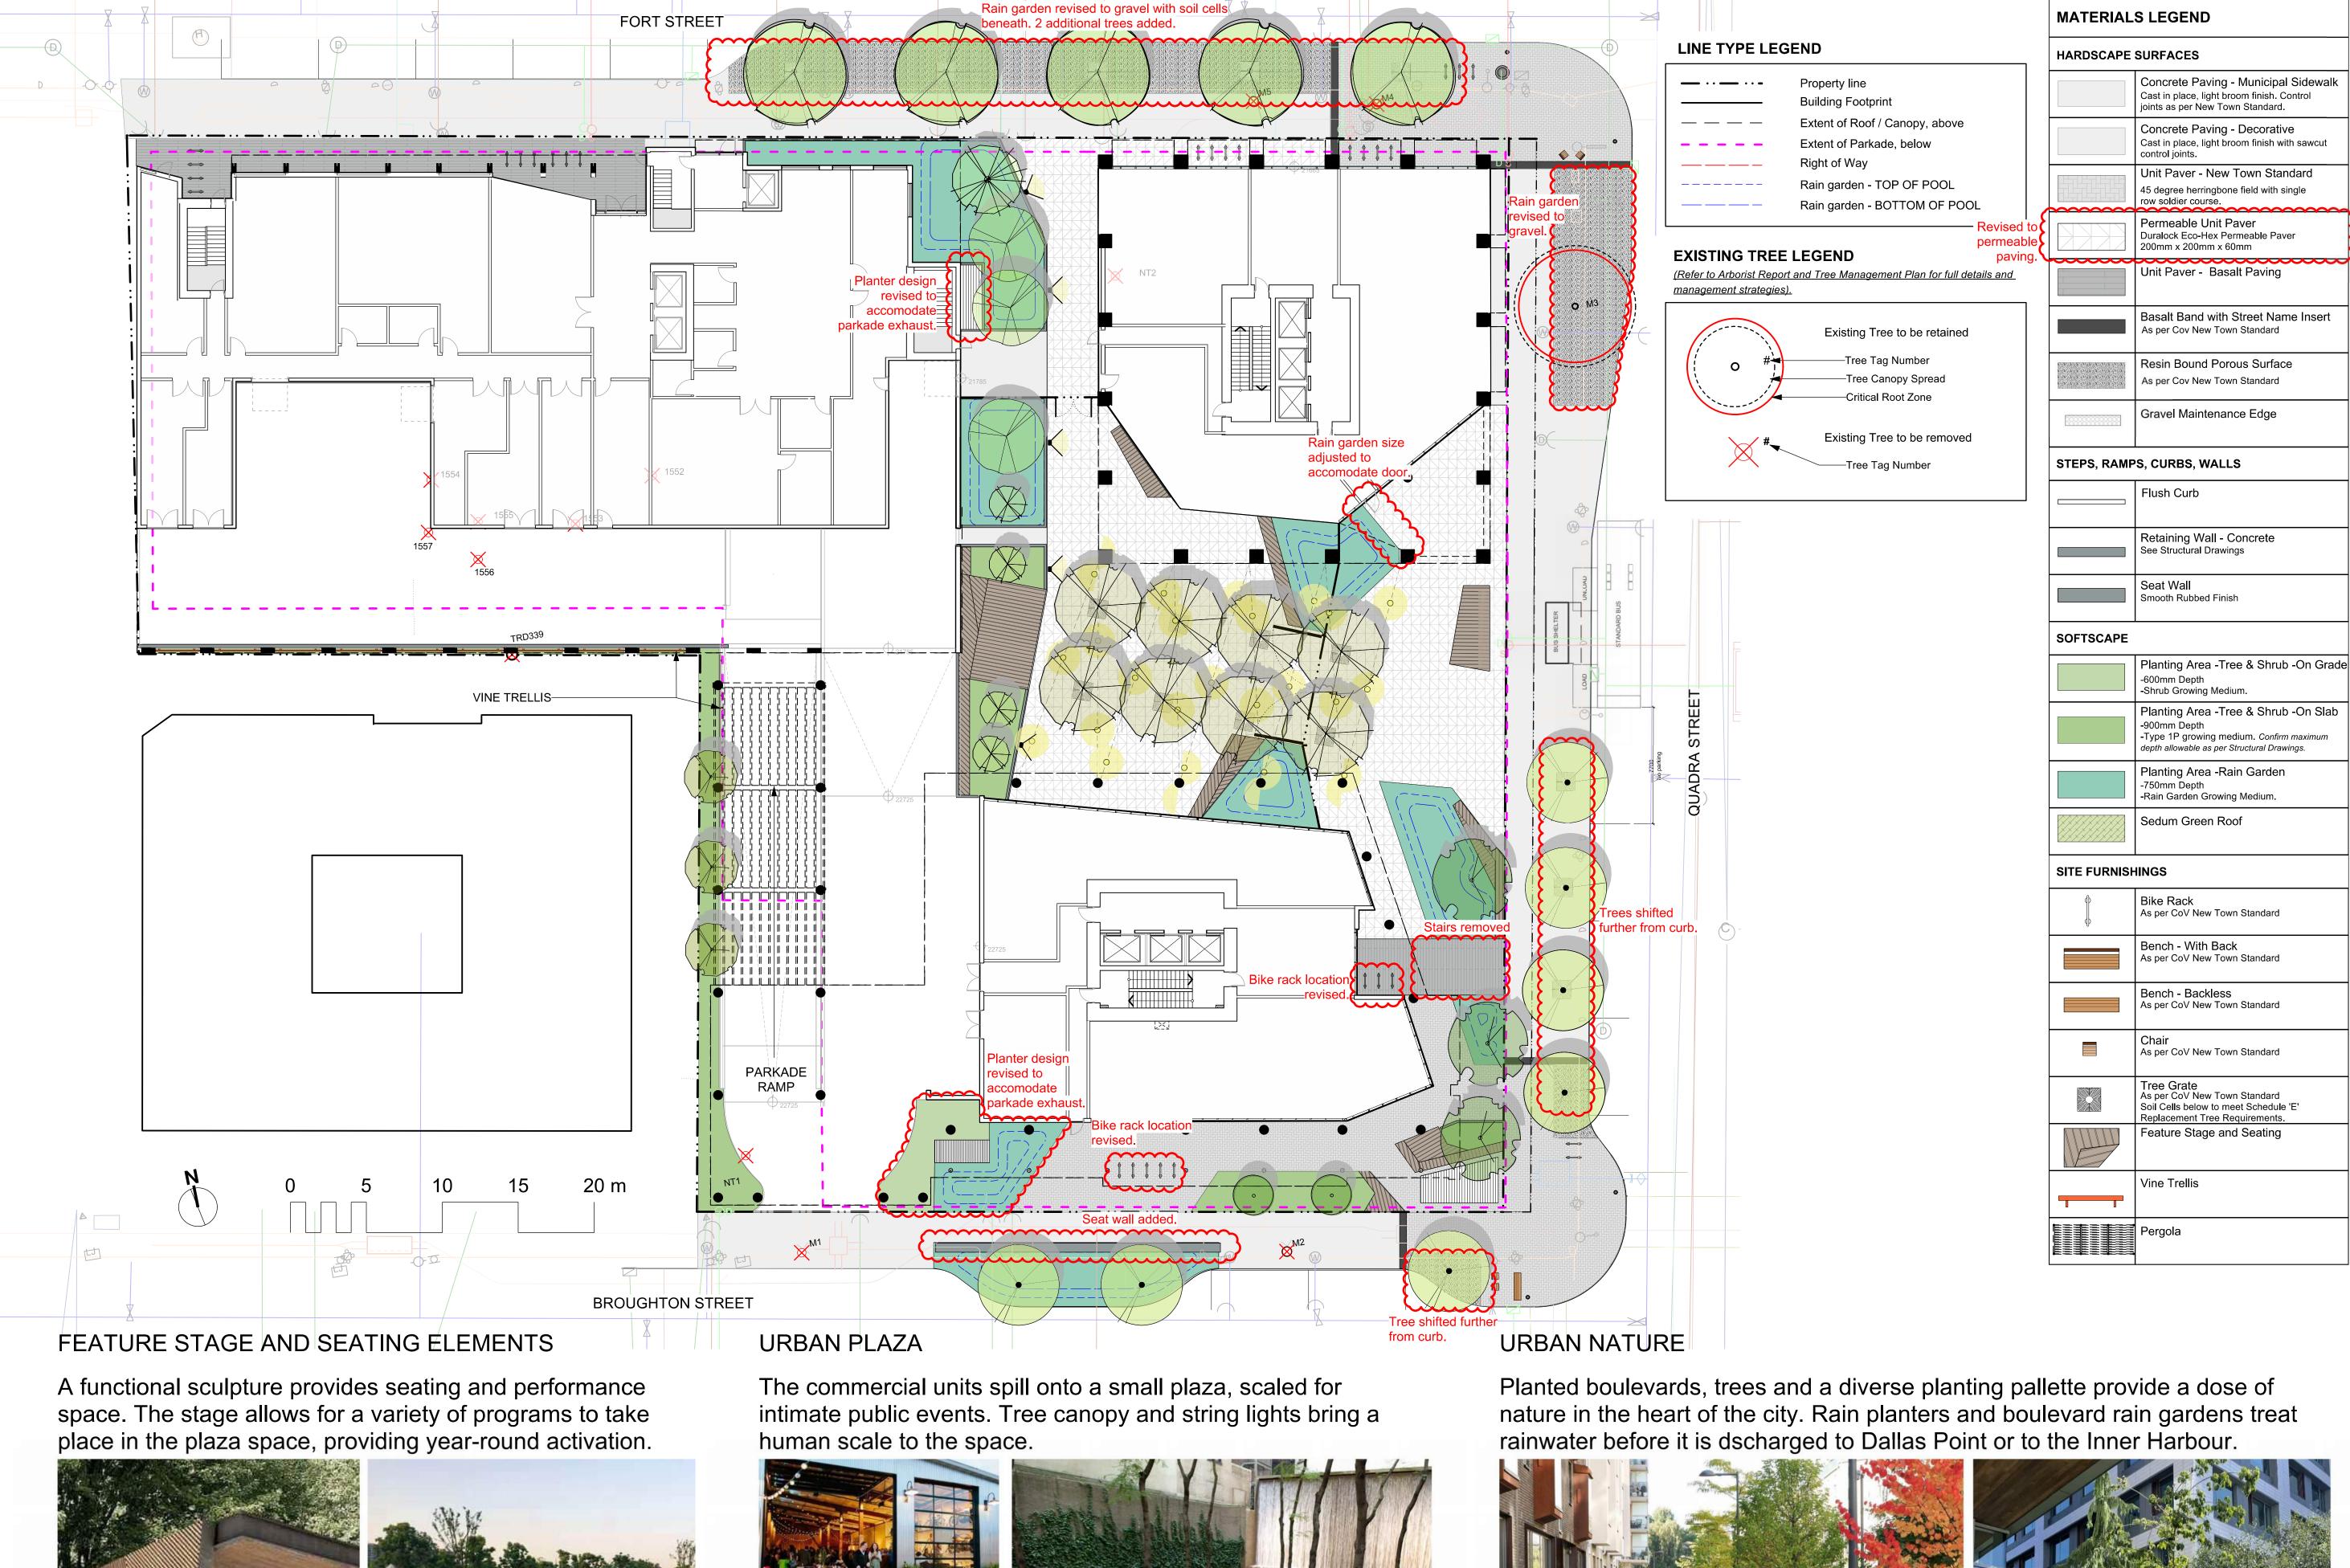

Planted boulevards, trees and a diverse planting pallette provide a dose of nature in the heart of the city. Rain planters and boulevard rain gardens treat







NOT FOR CONSTRUCTION

4	DP Submission 2	2025-10-29
3	Development Permit	2025-07-23
2	CALUC	2025-04-30
1	Pre-Application	2024-11-15
No.	Issued For	Issue Date


**PARC Communities Management Ltd.** 

PARC VICTORIA 829-891-899 Fort Street and 846-858 Broughton Street, Victoria BC

sheet title

Landscape **Materials Ground** Leve

sheet no.	L1	.01
checked by		ТВ
drawn by		SC
scale	1:200	@ 24"x36"
project no.		124.27

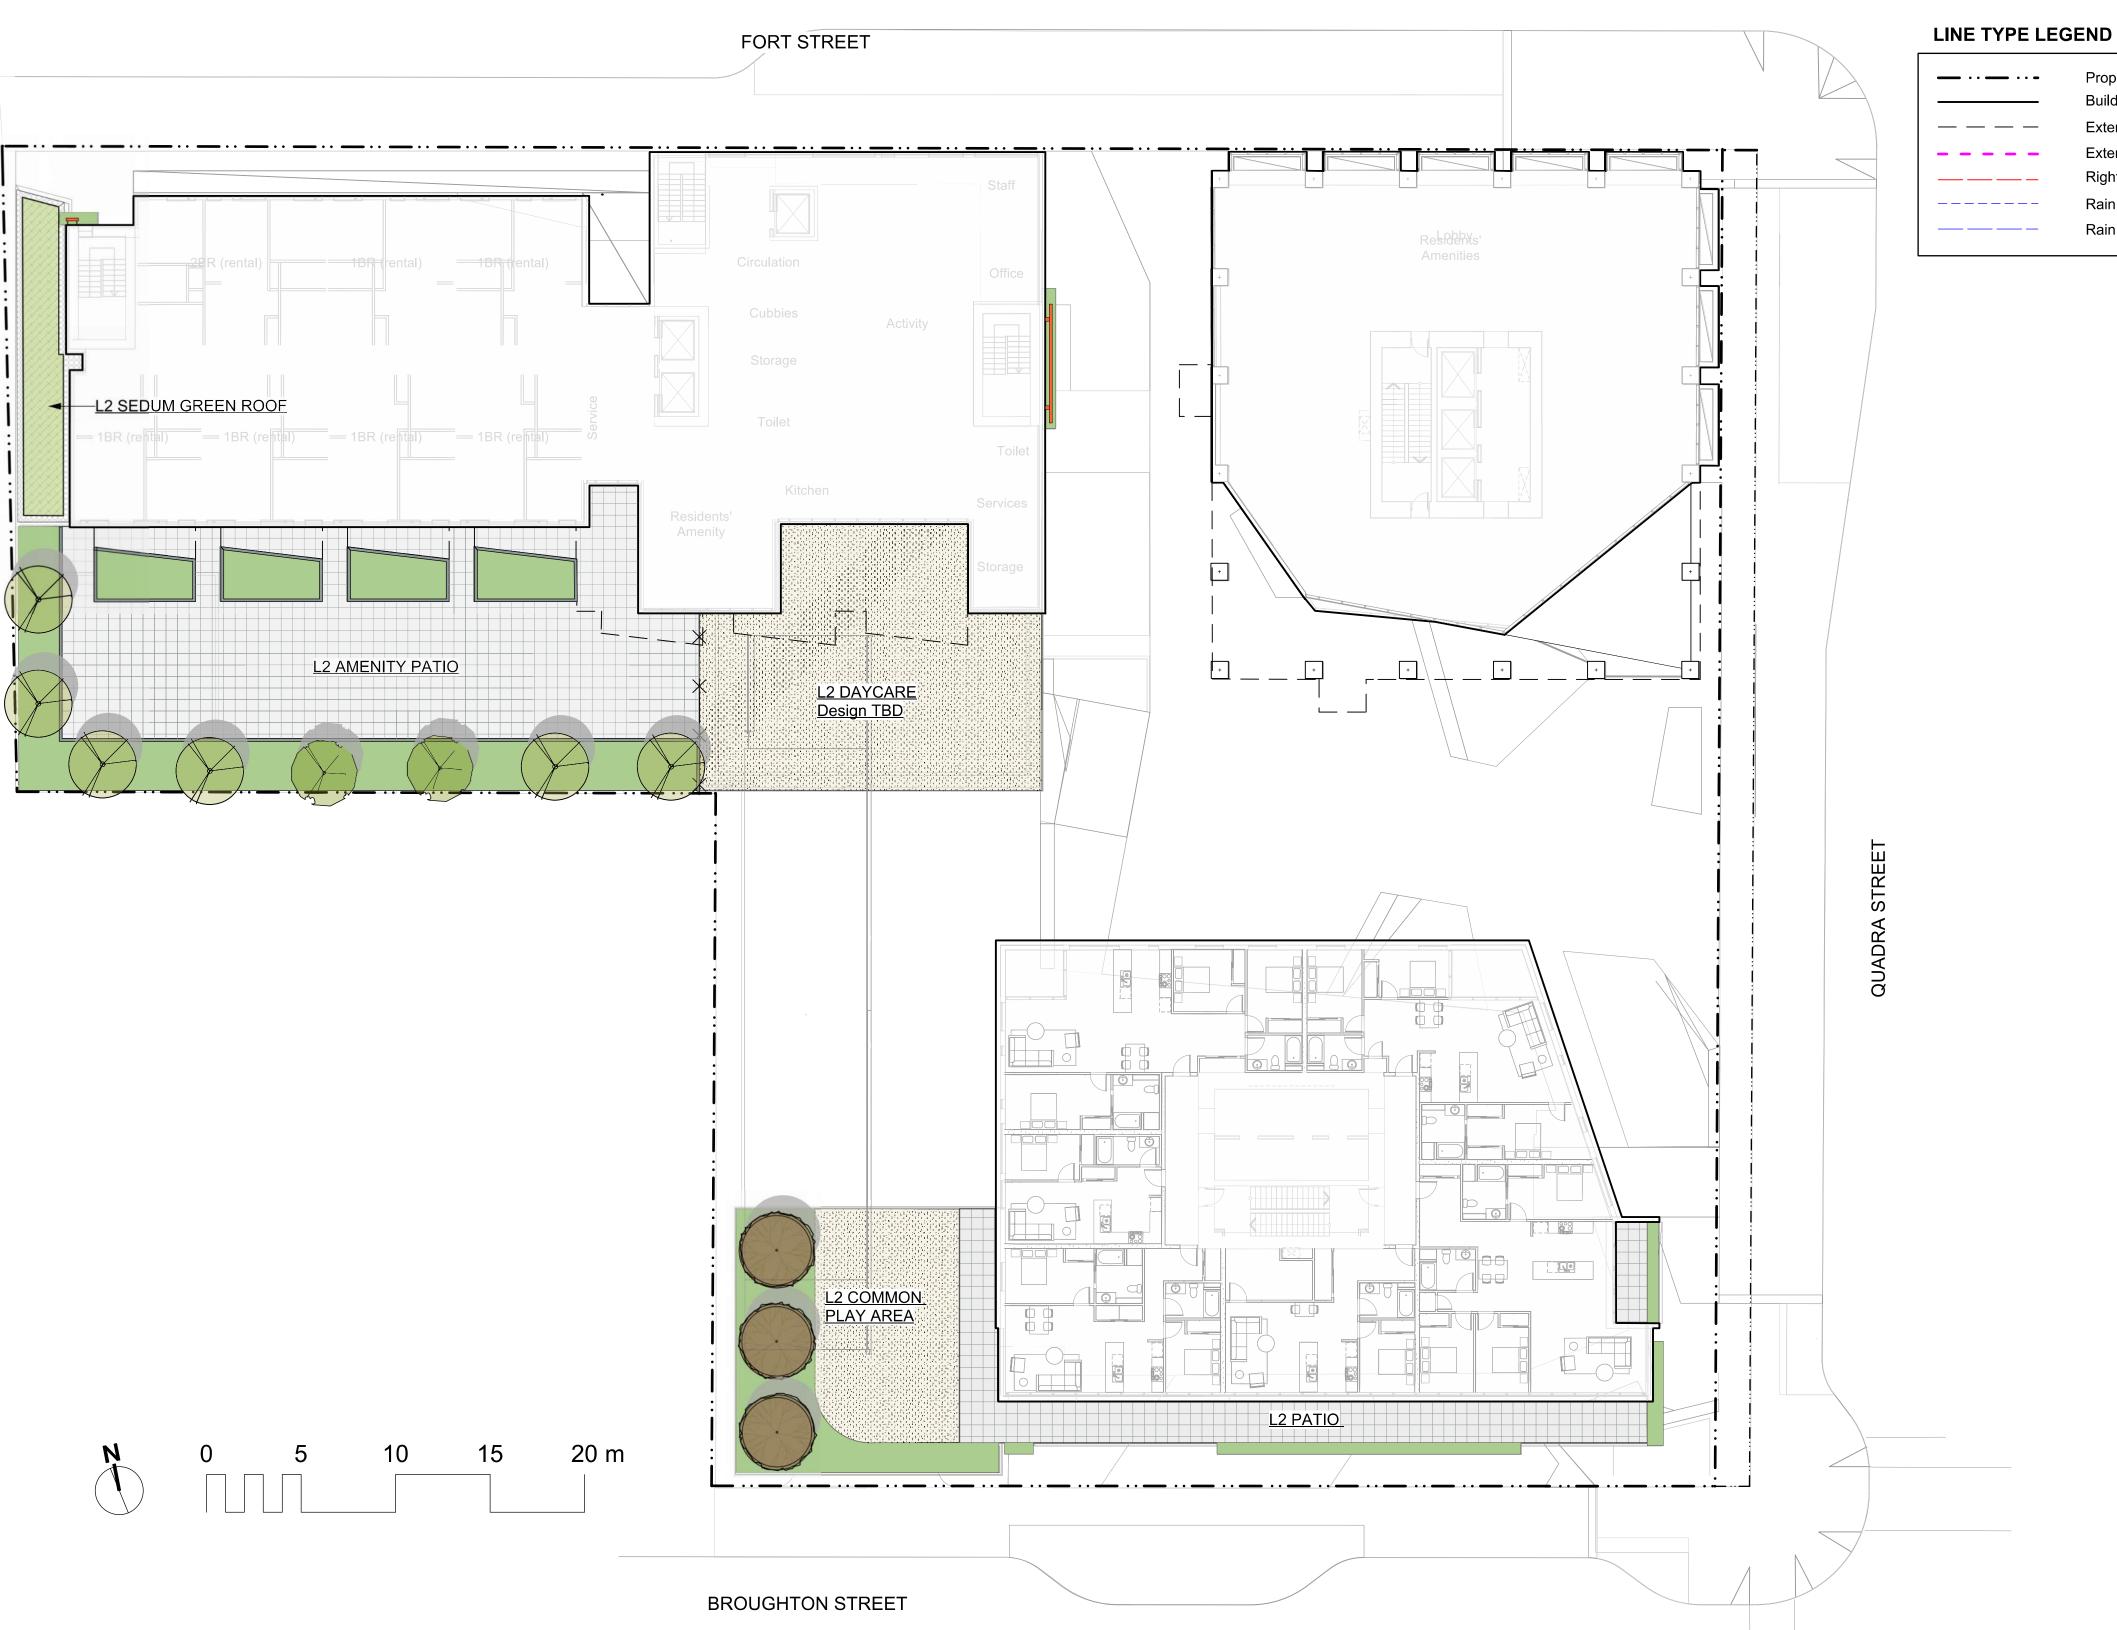

# RESIDENTIAL AMENITY PATIO AND GARDENS

A generous, south-facing amenity patio provides a mix of programs to foster active aging and community building. Spaces allow for activities including quiet relaxation, dining, gardening, and gathering.



# DAYCARE OUTDOOR SPACE

Outdoor play spaces provide air and sunshine for children attending the daycare. A mix of quiet areas and active play areas are provided, all surrounded by planting and child-friendly gardens.



# Green Architecture

A sedum roof provides green views from above. Planters on Level two allow for plants to drape down and green the plaza.

**MATERIALS LEGEND** 

HARDSCAPE SURFACES

Concrete Paving - Municipal Sidewalk

Cast in place, light broom finish. Control joints as per New Town Standard.

Cast in place, light broom finish with sawcut

Unit Paver - New Town Standard

45 degree herringbone field with single

Duralock Eco-Hex Permeable Paver

Basalt Band with Street Name Insert

Unit Paver - Basalt Paving

As per Cov New Town Standard

Resin Bound Porous Surface
As per Cov New Town Standard

Gravel Maintenance Edge

Retaining Wall - Concrete

Planting Area -Tree & Shrub -On Grade

Planting Area -Tree & Shrub -On Slab

-Type 1P growing medium. Confirm maximum depth allowable as per Structural Drawings.

Planting Area -Rain Garden

-Rain Garden Growing Medium.

Bench - With Back As per CoV New Town Standard

Bench - Backless As per CoV New Town Standard

Chair
As per CoV New Town Standard

Tree Grate
As per CoV New Town Standard
Soil Cells below to meet Schedule 'E'

Sedum Green Roof

See Structural Drawings

Smooth Rubbed Finish

-Shrub Growing Medium.

STEPS, RAMPS, CURBS, WALLS

Flush Curb

Seat Wall

-600mm Depth

-900mm Depth

-750mm Depth

Bike Rack

SOFTSCAPE

SITE FURNISHINGS

Concrete Paving - Decorative

control joints.

row soldier course.

Permeable Unit Paver

200mm x 200mm x 60mm

Property line

**Building Footprint** 

Extent of Roof / Canopy, above

Rain garden - TOP OF POOL

Rain garden - BOTTOM OF POOL

Extent of Parkade, below



# MDI LANDSCAPE ARCHITECTS 3388A Tennyson Ave Victoria, BC V82 3P6 P: 250.412-2891 E: admin@mdidesign.ca

NOT FOR CONSTRUCTION

4 DP Submission 2 2025-10-29
3 Development Permit 2025-07-23
2 CALUC 2025-04-30
1 Pre-Application 2024-11-15
No. Issued For Issue Date

client

PARC Communities Management Ltd.


roject

PARC VICTORIA
829-891-899 Fort Street and
846-858 Broughton Street,
Victoria BC

sheet title

Landscape Materials - L2

project no.		124.27
scale	1: 200	@ 24"x36"
drawn by		SC
checked by		ТВ
sheet no.		

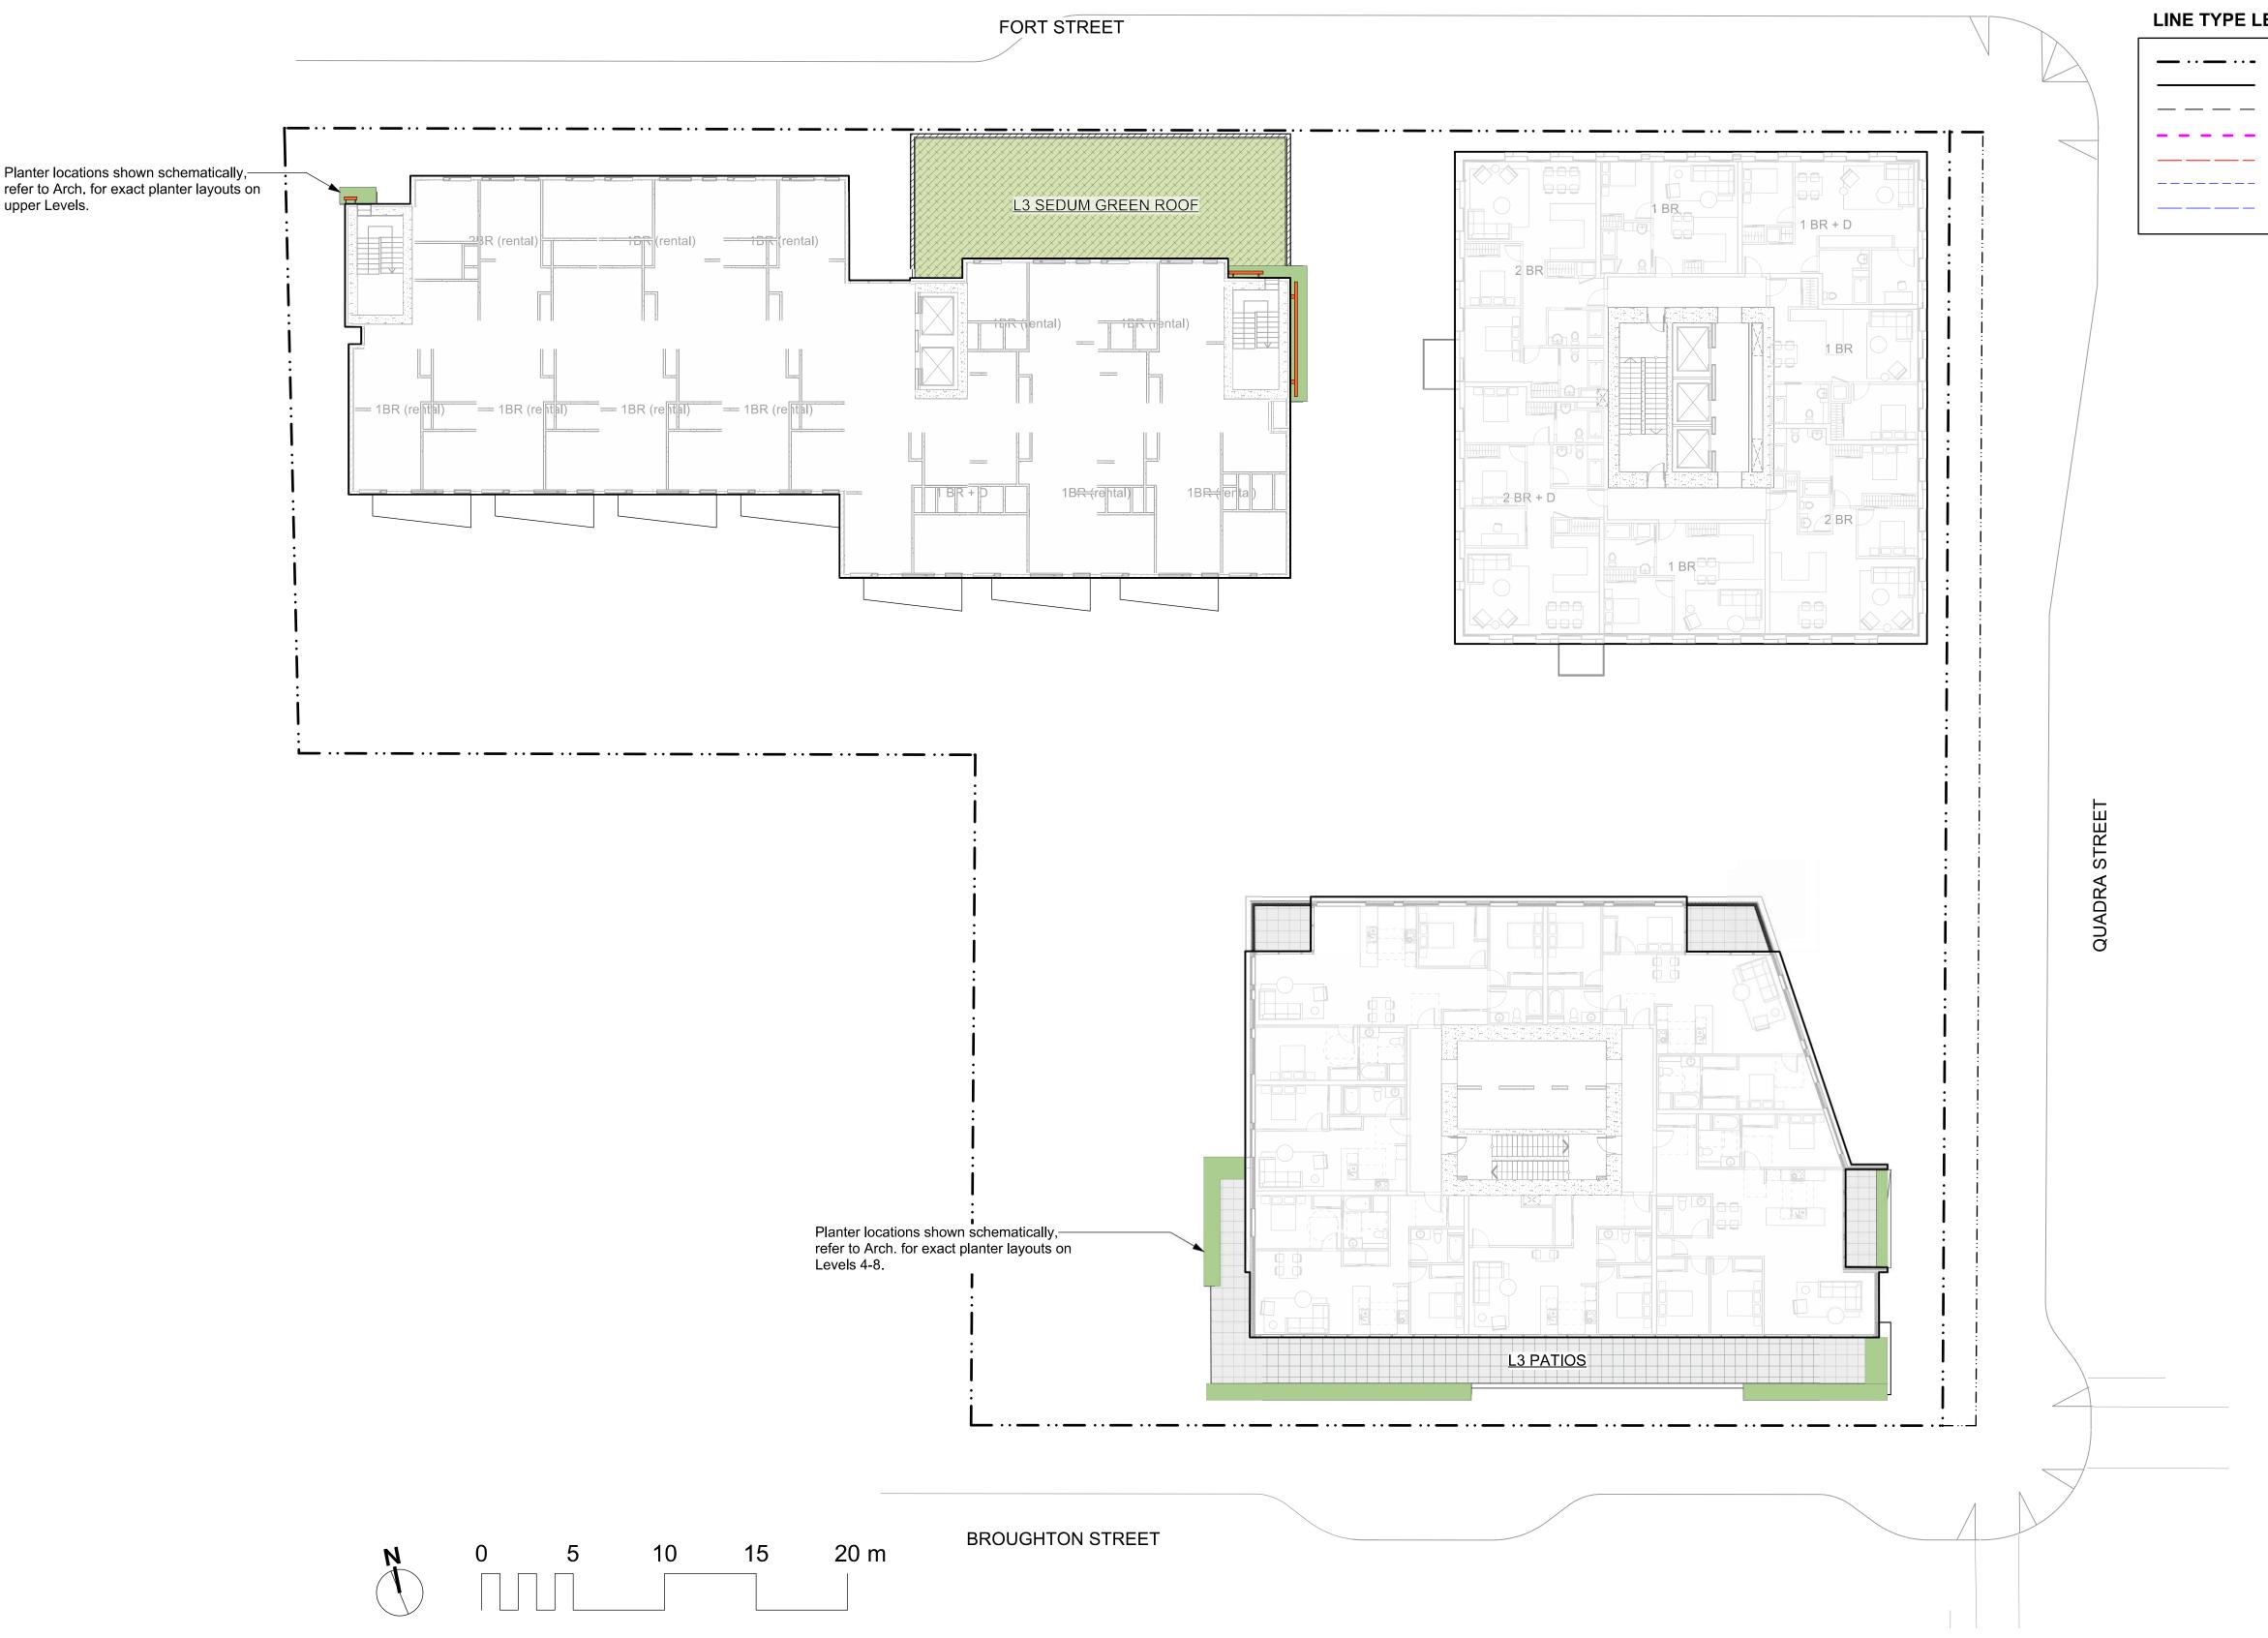

Planter locations shown schematically,-

upper Levels.

### **LINE TYPE LEGEND**

**— · · · · · ·** Property line **Building Footprint** Extent of Roof / Canopy, above Extent of Parkade, below Right of Way Rain garden - TOP OF POOL

Rain garden - BOTTOM OF POOL

MATERIALS LEGEND HARDSCAPE SURFACES Concrete Paving - Municipal Sidewalk
Cast in place, light broom finish. Control
joints as per New Town Standard. Concrete Paving - Decorative Cast in place, light broom finish with sawcut control joints. Unit Paver - New Town Standard 45 degree herringbone field with single row soldier course. Permeable Unit Paver Duralock Eco-Hex Permeable Paver 200mm x 200mm x 60mm Unit Paver - Basalt Paving Basalt Band with Street Name Insert As per Cov New Town Standard Resin Bound Porous Surface As per Cov New Town Standard Gravel Maintenance Edge STEPS, RAMPS, CURBS, WALLS Flush Curb Retaining Wall - Concrete See Structural Drawings Seat Wall Smooth Rubbed Finish SOFTSCAPE Planting Area -Tree & Shrub -On Grade -600mm Depth -Shrub Growing Medium. Planting Area -Tree & Shrub -On Slab -900mm Depth -Type 1P growing medium. Confirm maximum depth allowable as per Structural Drawings. Planting Area -Rain Garden -750mm Depth -Rain Garden Growing Medium. Sedum Green Roof SITE FURNISHINGS Bike Rack As per CoV New Town Standard Bench - With Back As per CoV New Town Standard Bench - Backless As per CoV New Town Standard Chair
As per CoV New Town Standard Tree Grate
As per CoV New Town Standard
Soil Cells below to meet Schedule 'E'
Replacement Tree Requirements. Feature Stage and Seating Vine Trellis

Pergola



NOT FOR CONSTRUCTION

4	DP Submission 2	2025-10-29
3	Development Permit	2025-07-23
2	CALUC	2025-04-30
1	Pre-Application	2024-11-15
No.	Issued For	Issue Date

PARC Communities Management Ltd.


project

PARC VICTORIA 829-891-899 Fort Street and 846-858 Broughton Street, Victoria BC

sheet title

Landscape Materials - L3

project no.		124.27
scale	1: 200	@ 24"x36"
drawn by		SC
checked by		ТВ
sheet no.		

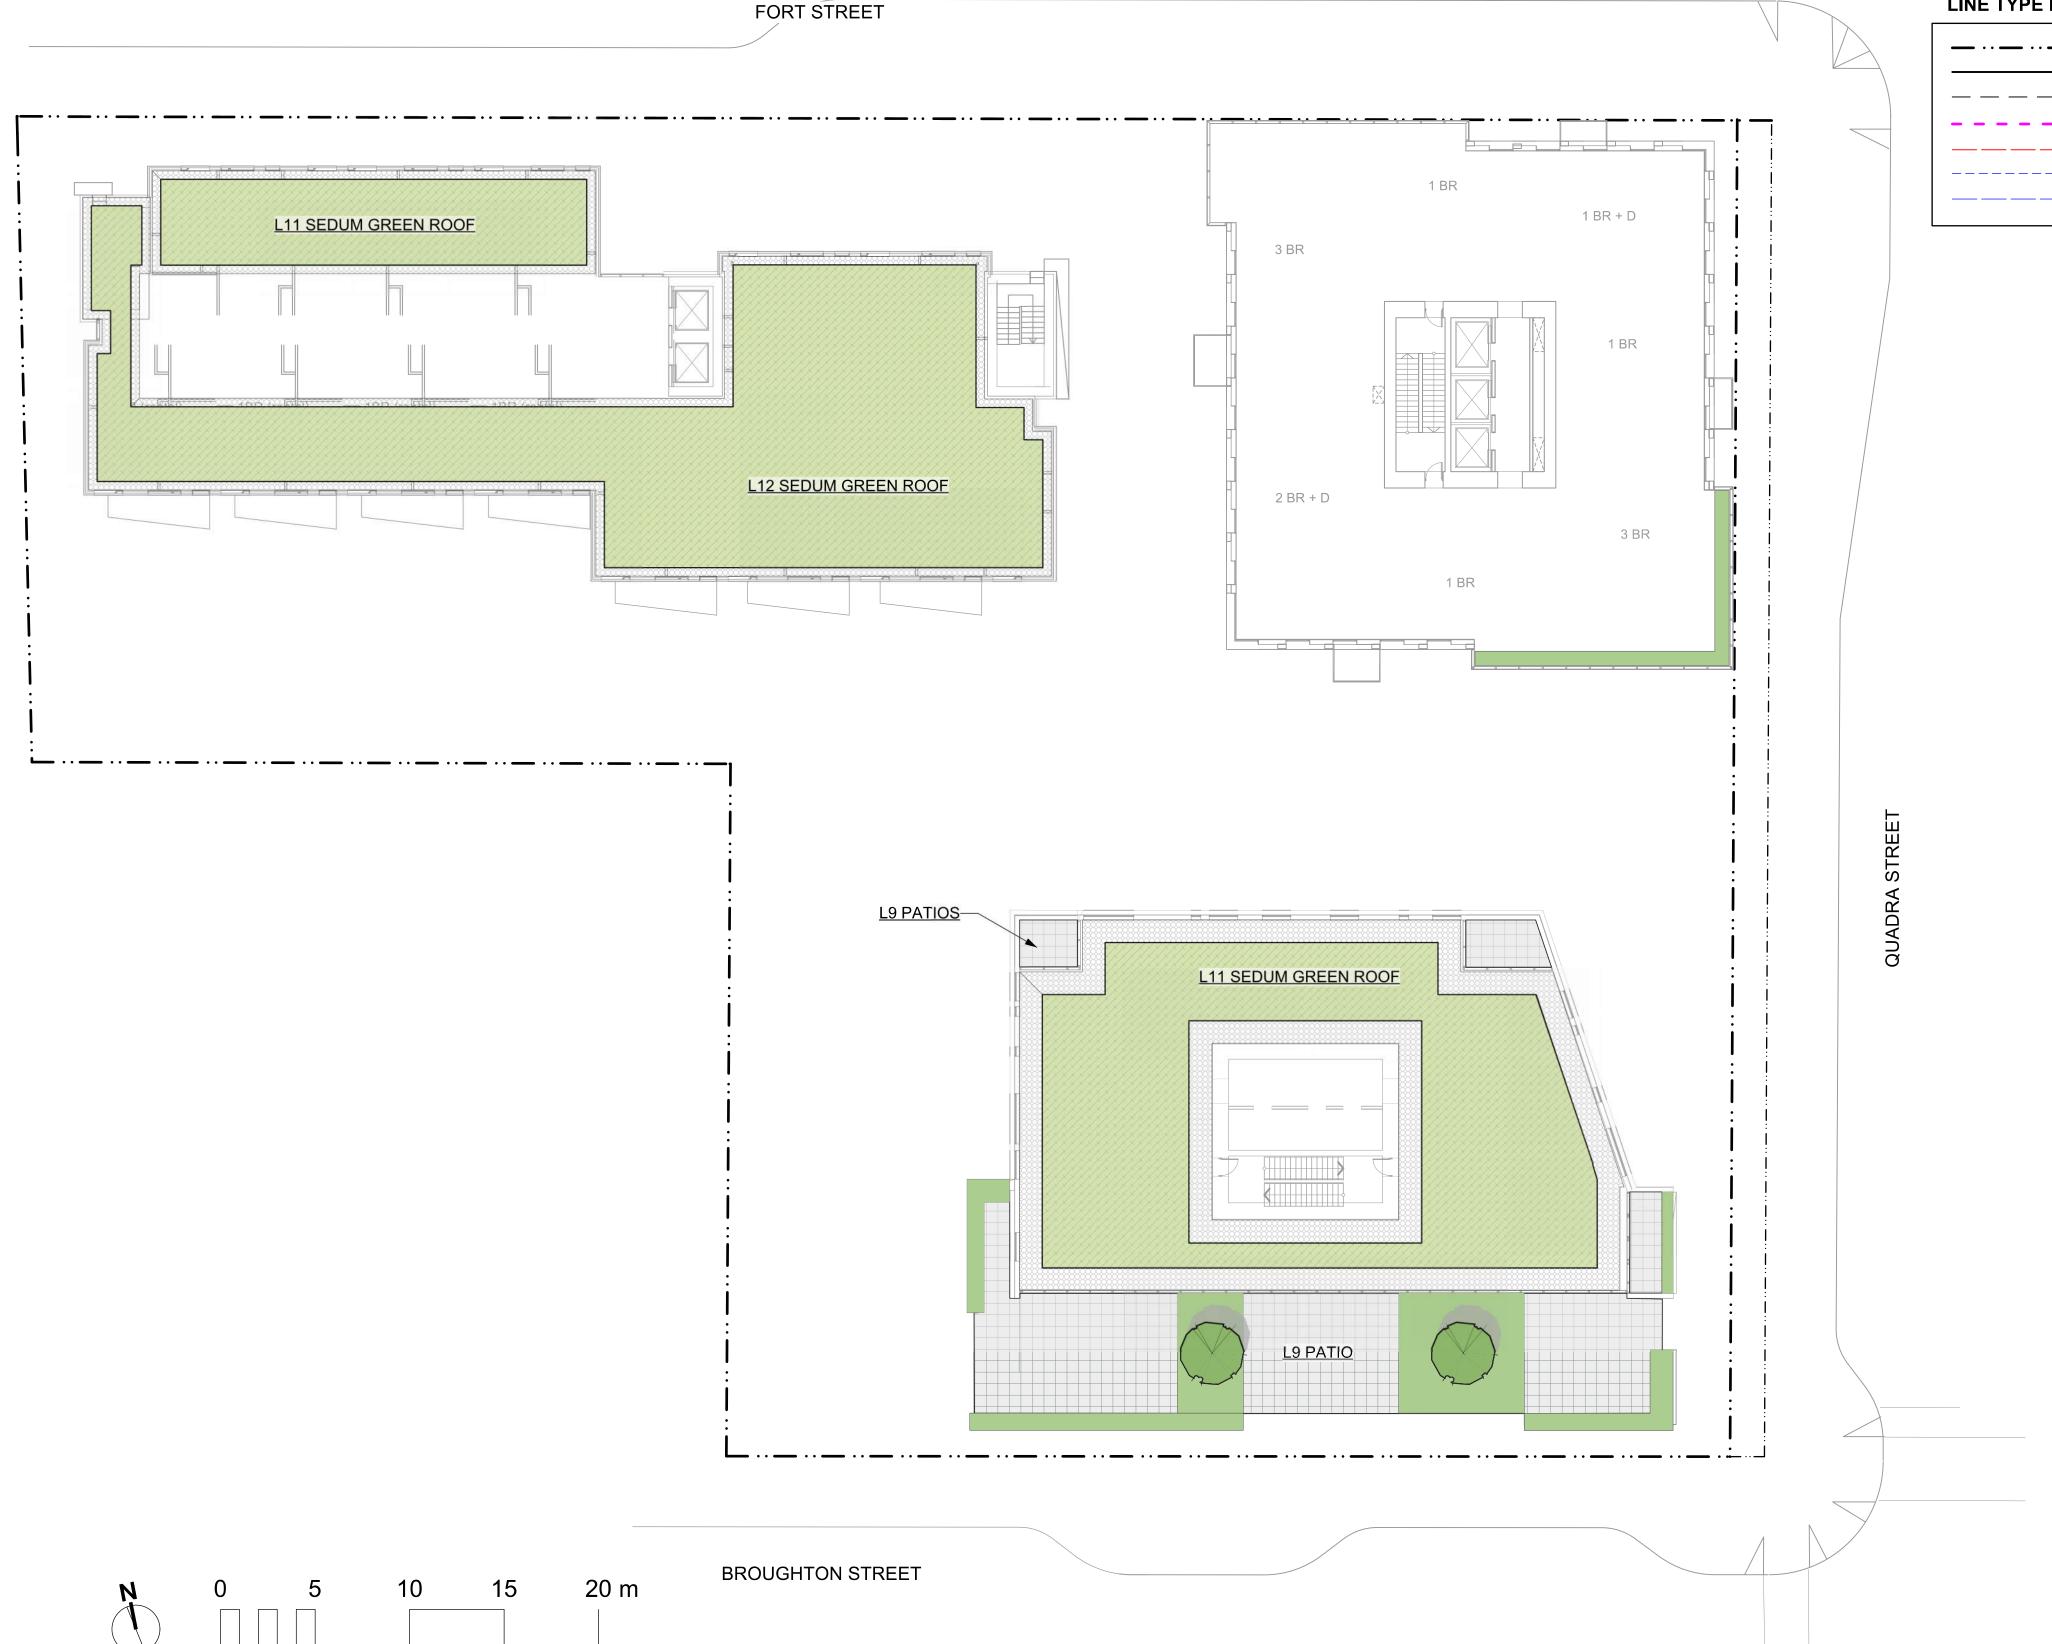

### **LINE TYPE LEGEND**

Property line
Building Footprint
Extent of Roof / Canopy, above
Extent of Parkade, below
Right of Way
Rain garden - TOP OF POOL

Rain garden - BOTTOM OF POOL

MATERIALS LEGEND HARDSCAPE SURFACES Concrete Paving - Municipal Sidewalk
Cast in place, light broom finish. Control
joints as per New Town Standard. Concrete Paving - Decorative Cast in place, light broom finish with sawcut control joints. Unit Paver - New Town Standard 45 degree herringbone field with single row soldier course. Permeable Unit Paver Duralock Eco-Hex Permeable Paver 200mm x 200mm x 60mm Unit Paver - Basalt Paving Basalt Band with Street Name Insert As per Cov New Town Standard Resin Bound Porous Surface As per Cov New Town Standard Gravel Maintenance Edge STEPS, RAMPS, CURBS, WALLS Flush Curb Retaining Wall - Concrete See Structural Drawings Seat Wall Smooth Rubbed Finish SOFTSCAPE Planting Area -Tree & Shrub -On Grade -600mm Depth -Shrub Growing Medium. Planting Area -Tree & Shrub -On Slab -900mm Depth -Type 1P growing medium. Confirm maximum depth allowable as per Structural Drawings. Planting Area -Rain Garden -750mm Depth -Rain Garden Growing Medium. Sedum Green Roof SITE FURNISHINGS Bike Rack As per CoV New Town Standard Bench - With Back As per CoV New Town Standard Bench - Backless As per CoV New Town Standard Chair
As per CoV New Town Standard Tree Grate
As per CoV New Town Standard
Soil Cells below to meet Schedule 'E'
Replacement Tree Requirements. Feature Stage and Seating Vine Trellis

Pergola



PARC Communities Management Ltd.

CALUC

Pre-Application

Issued For

2025-04-30

2024-11-15

Issue Date

project

2

No.


PARC VICTORIA
829-891-899 Fort Street and
846-858 Broughton Street,
Victoria BC


sheet title

Landscape Materials - L9, 11 & 12


project no.		124.27
scale	1: 200	@ 24"x36"
drawn by		SC
checked by		ТВ
sheet no.		


LEVEL 11 LEVEL 14

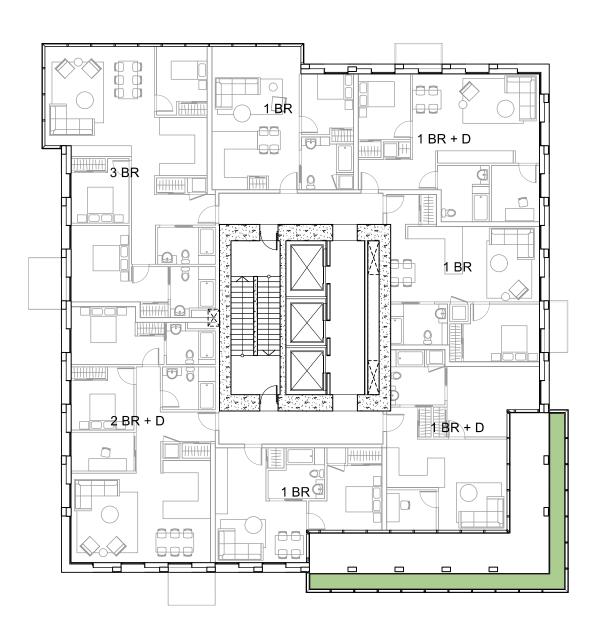


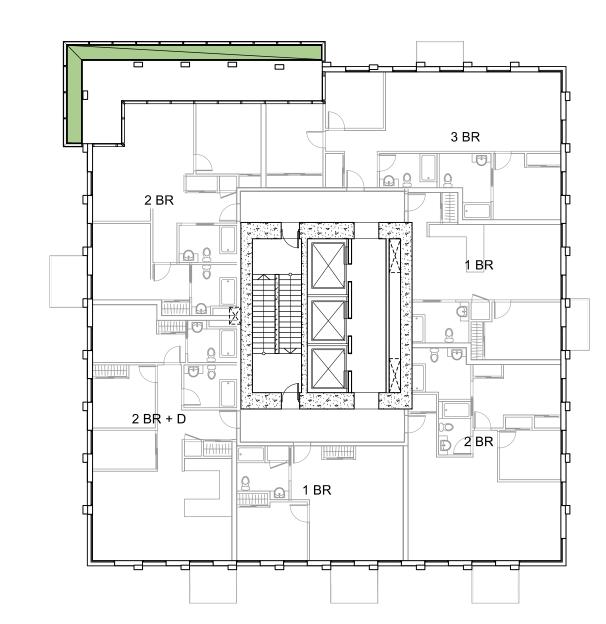

LEVEL 19 LEVEL 22

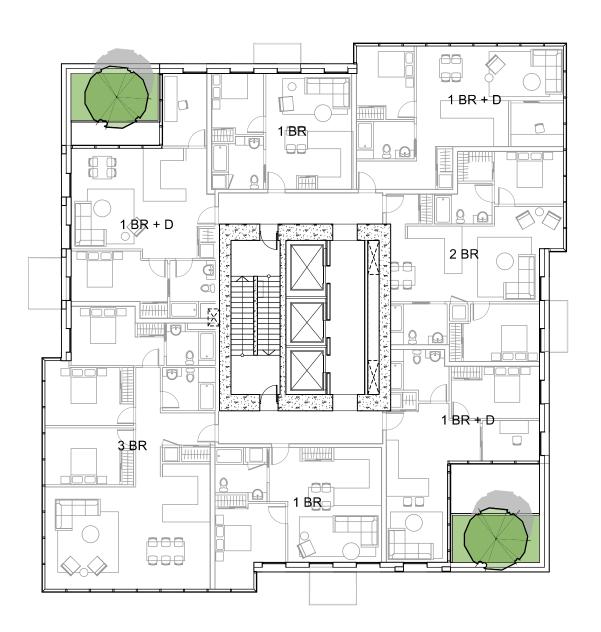

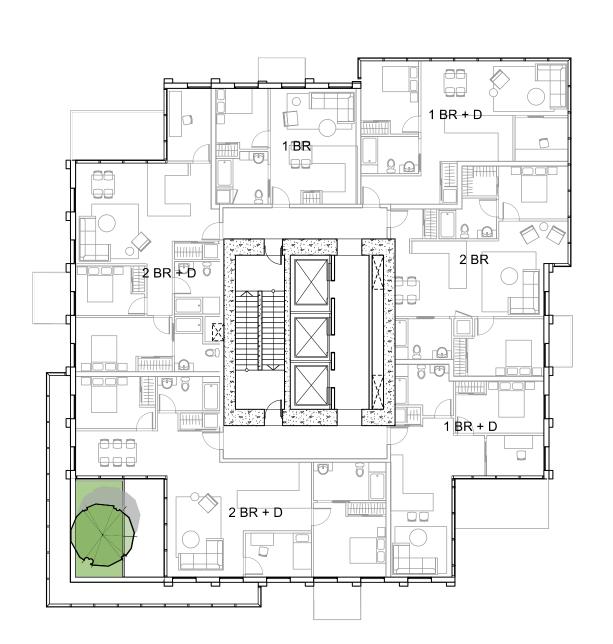

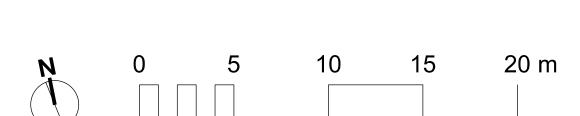

### **LINE TYPE LEGEND**

LEVEL 27


2 BR + D

2 BR

1 BR + D

Property line
Building Footprint
Extent of Roof / Canopy, above
Extent of Parkade, below
Right of Way
Rain garden - TOP OF POOL
Rain garden - BOTTOM OF POOL

**MATERIALS LEGEND** HARDSCAPE SURFACES Concrete Paving - Municipal Sidewalk Cast in place, light broom finish. Control joints as per New Town Standard. Concrete Paving - Decorative Cast in place, light broom finish with sawcut control joints. Unit Paver - New Town Standard 45 degree herringbone field with single row soldier course. Permeable Unit Paver Duralock Eco-Hex Permeable Paver 200mm x 200mm x 60mm Unit Paver - Basalt Paving Basalt Band with Street Name Insert As per Cov New Town Standard Resin Bound Porous Surface As per Cov New Town Standard Gravel Maintenance Edge STEPS, RAMPS, CURBS, WALLS Flush Curb Retaining Wall - Concrete See Structural Drawings Seat Wall Smooth Rubbed Finish SOFTSCAPE Planting Area -Tree & Shrub -On Grade -600mm Depth -Shrub Growing Medium. Planting Area -Tree & Shrub -On Slab -900mm Depth -Type 1P growing medium. Confirm maximum depth allowable as per Structural Drawings. Planting Area -Rain Garden -750mm Depth -Rain Garden Growing Medium. Sedum Green Roof SITE FURNISHINGS Bike Rack As per CoV New Town Standard Bench - With Back As per CoV New Town Standard Bench - Backless As per CoV New Town Standard

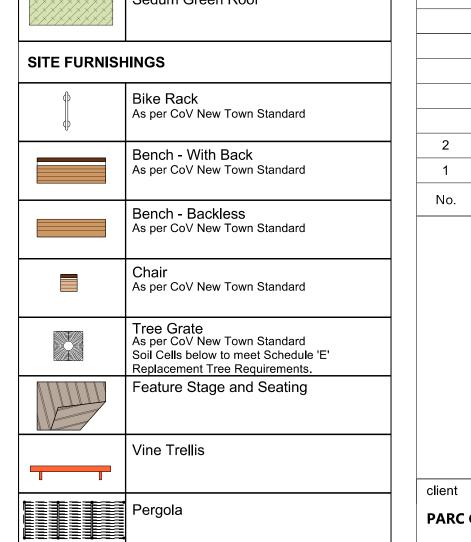



client

PARC Communities Management Ltd.

CALUC

Pre-Application

Issued For


2024-11-15

PARC VICTORIA
829-891-899 Fort Street and
846-858 Broughton Street,
Victoria BC

sheet title

Landscape Materials - Tower

project no.		124.27
scale	1: 200	@ 24"x36"
drawn by		SC
checked by		ТВ
sheet no.		

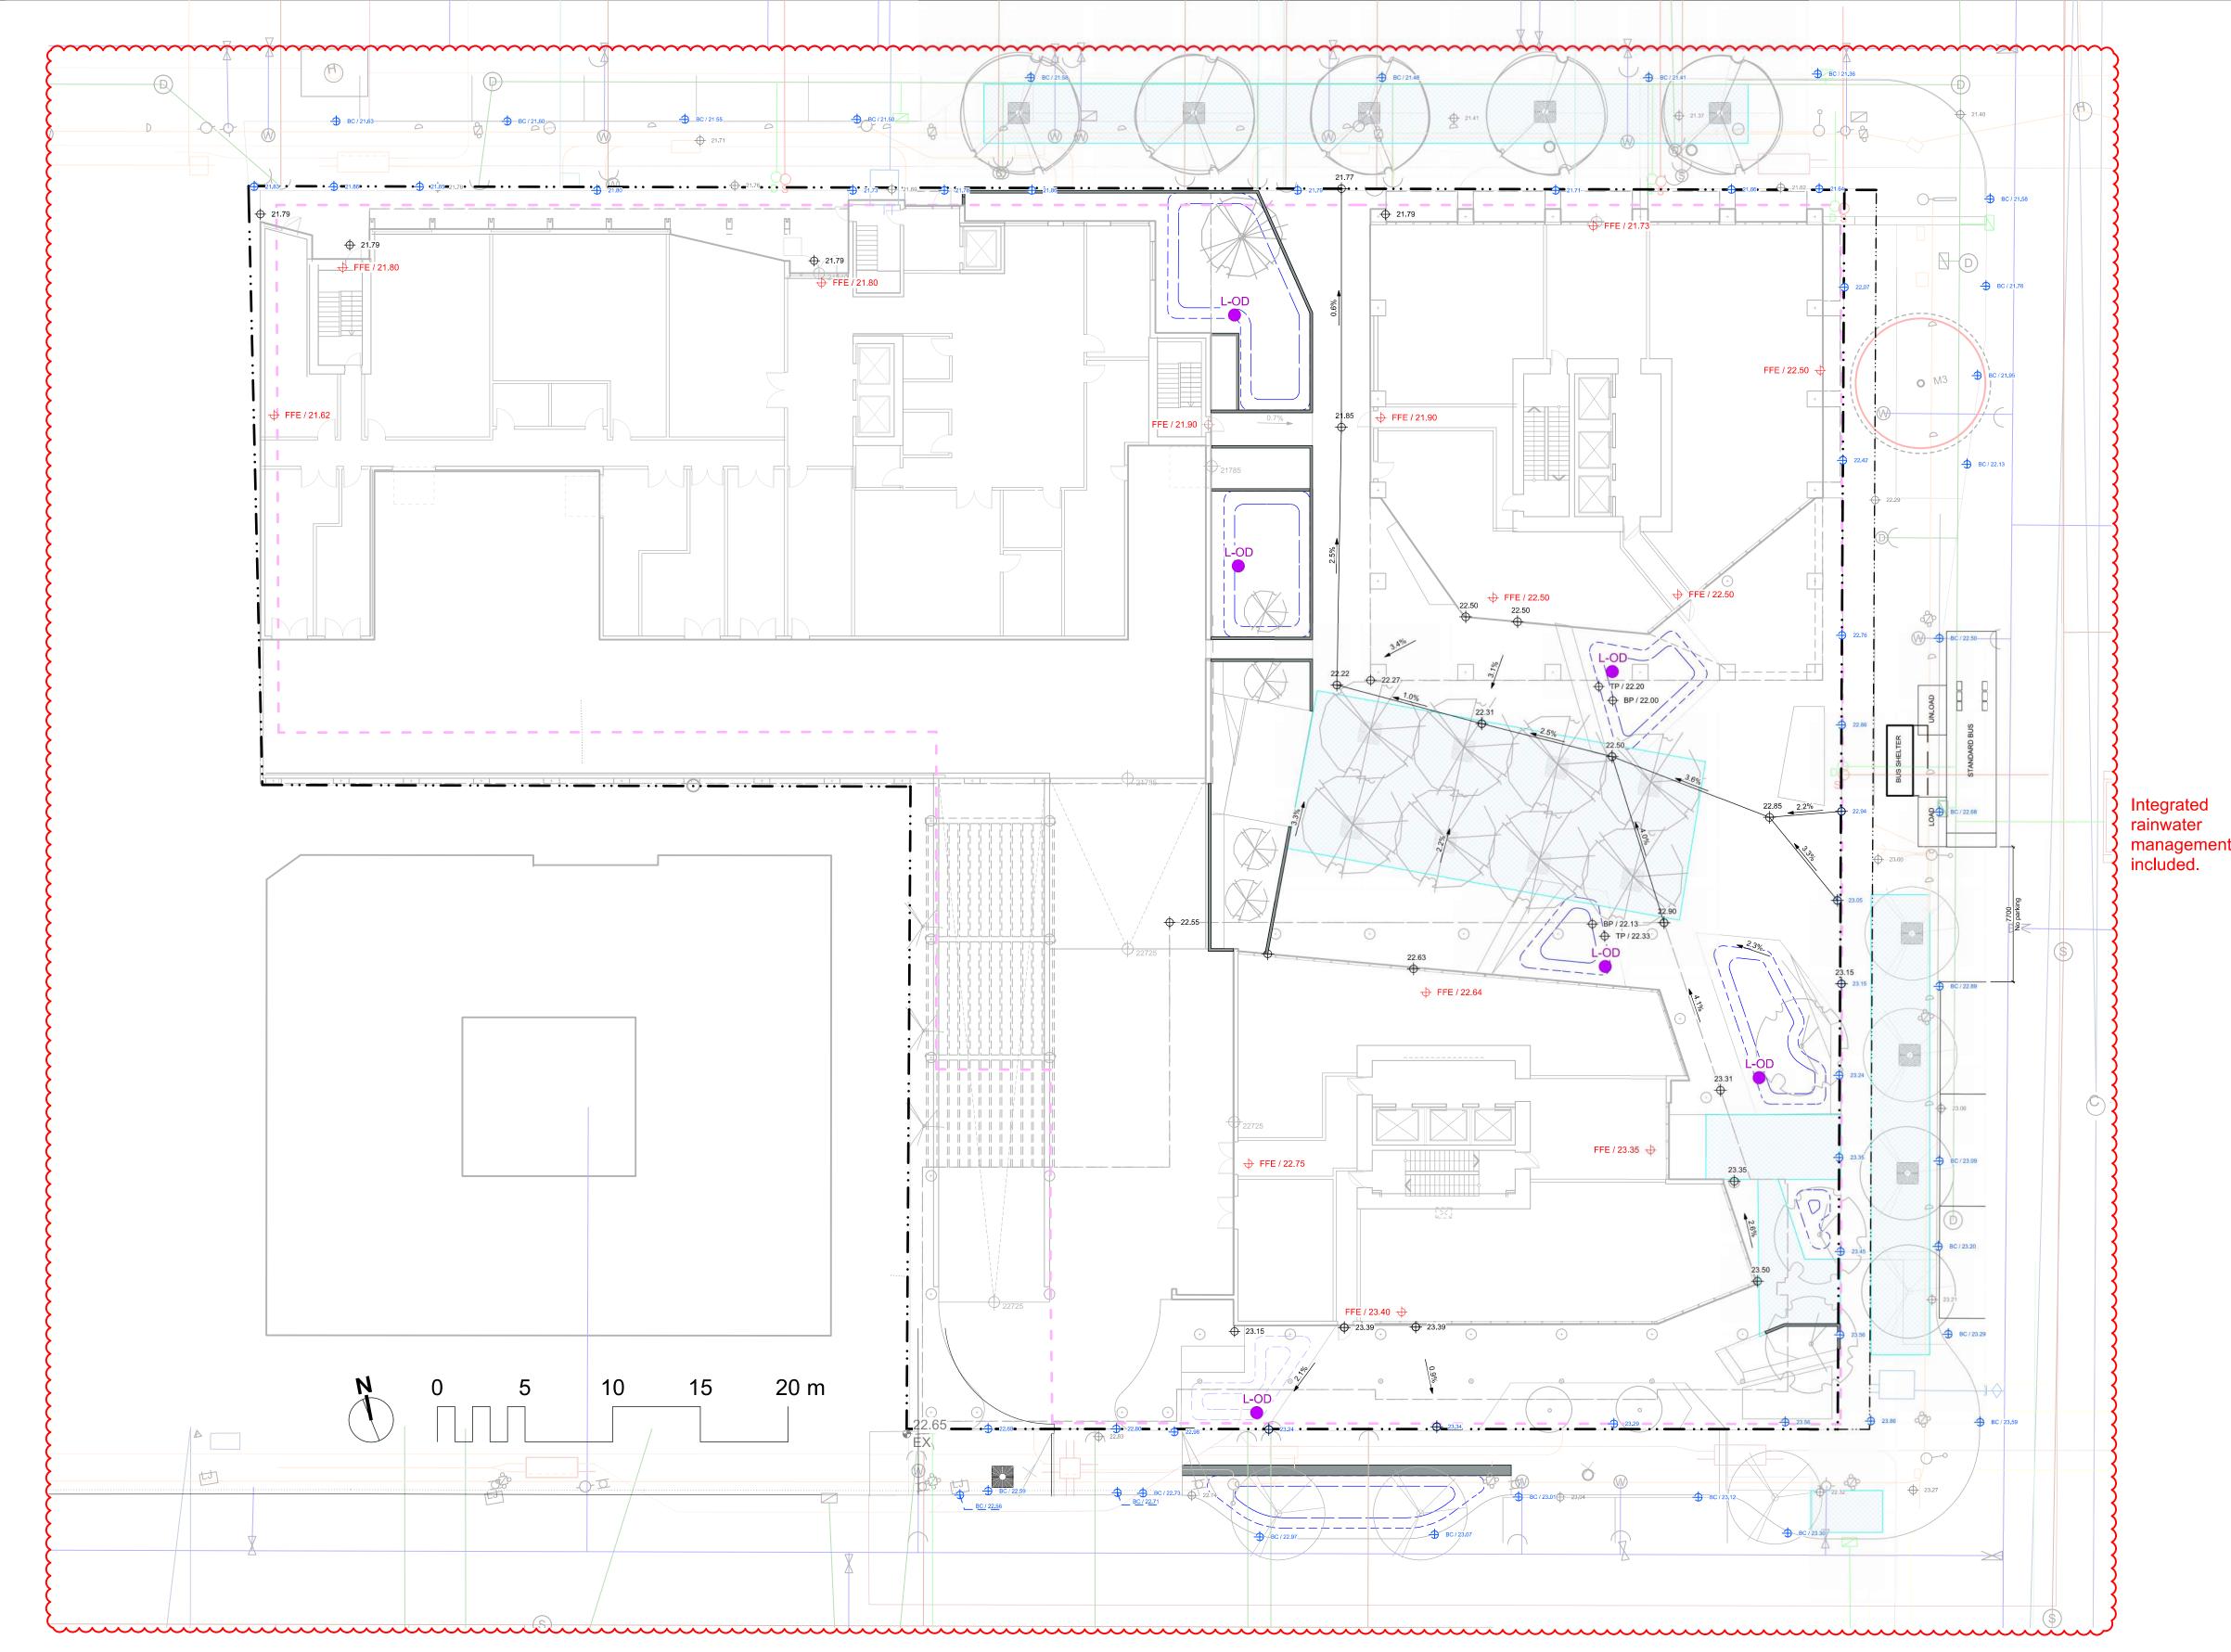

Building FFE's and accompanying grades revised to accomodate Civil sidewalk grades.

### **GRADING LEGEND**

25.25	Proposed Landscape Grade
25.25 36.7% 24.25	TOW Top of Wall BP Bottom of Pool BW Bottom of Wall TS Top of Stairs TOC Top of Curb BS Bottom of Stairs BC Bottom of Curb HP High Point TP Top of Pool LP Low Point
25.25	Existing Grade
25.25	Architectural grade, for reference only
<del>(</del> d)→ 25.25	Civil Grade, for reference only

### **LINE TYPE LEGEND**

 Property line Building Footprint
 Extent of Roof / Canopy, above
 Extent of Parkade, below
 Right of Way
 Rain garden - TOP OF POOL
 Rain garden - BOTTOM OF POOL

### LANDSCAPE INFRASTRUCTURE LEGEND

$\sim$	<del></del>	000000000000000000000000000000000000000	~~~	$\sim$	
nt <b>{</b>		Tree Soil Cells with Integrated Rainwater Management	1-L4.04	3	)
~~	L-OD	Overflow Drain with Beehive Grate	2x-L4.01		



DRAFT

NOT FOR CONSTRUCTION

4	DP Submission 2	2025-10-29
3	Development Permit	2025-07-23
2	CALUC	2025-04-30
1	Pre-Application	2024-11-15
No.	Issued For	Issue Date
		•

ient

PARC Communities Management Ltd.

oject


PARC VICTORIA
829-891-899 Fort Street and
846-858 Broughton Street,
Victoria BC


sheet title


Landscape Grading & Drainage

project no.		124.27
scale	1: 200	@ 24"x36"
drawn by		SC
checked by		ТВ
sheet no.		

L2.01

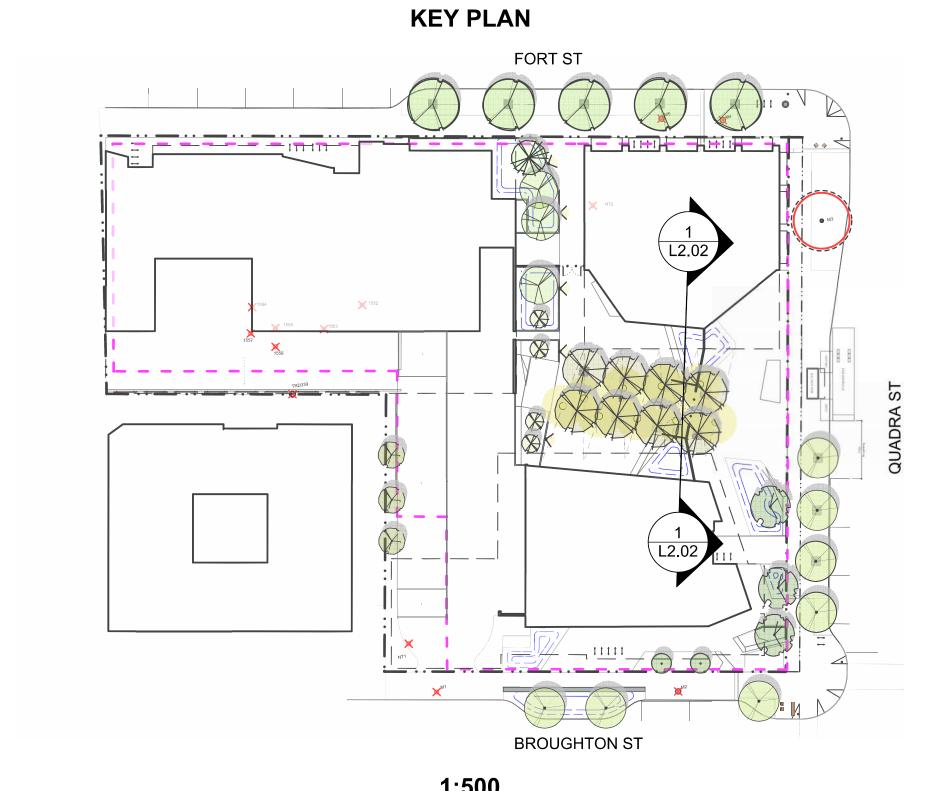

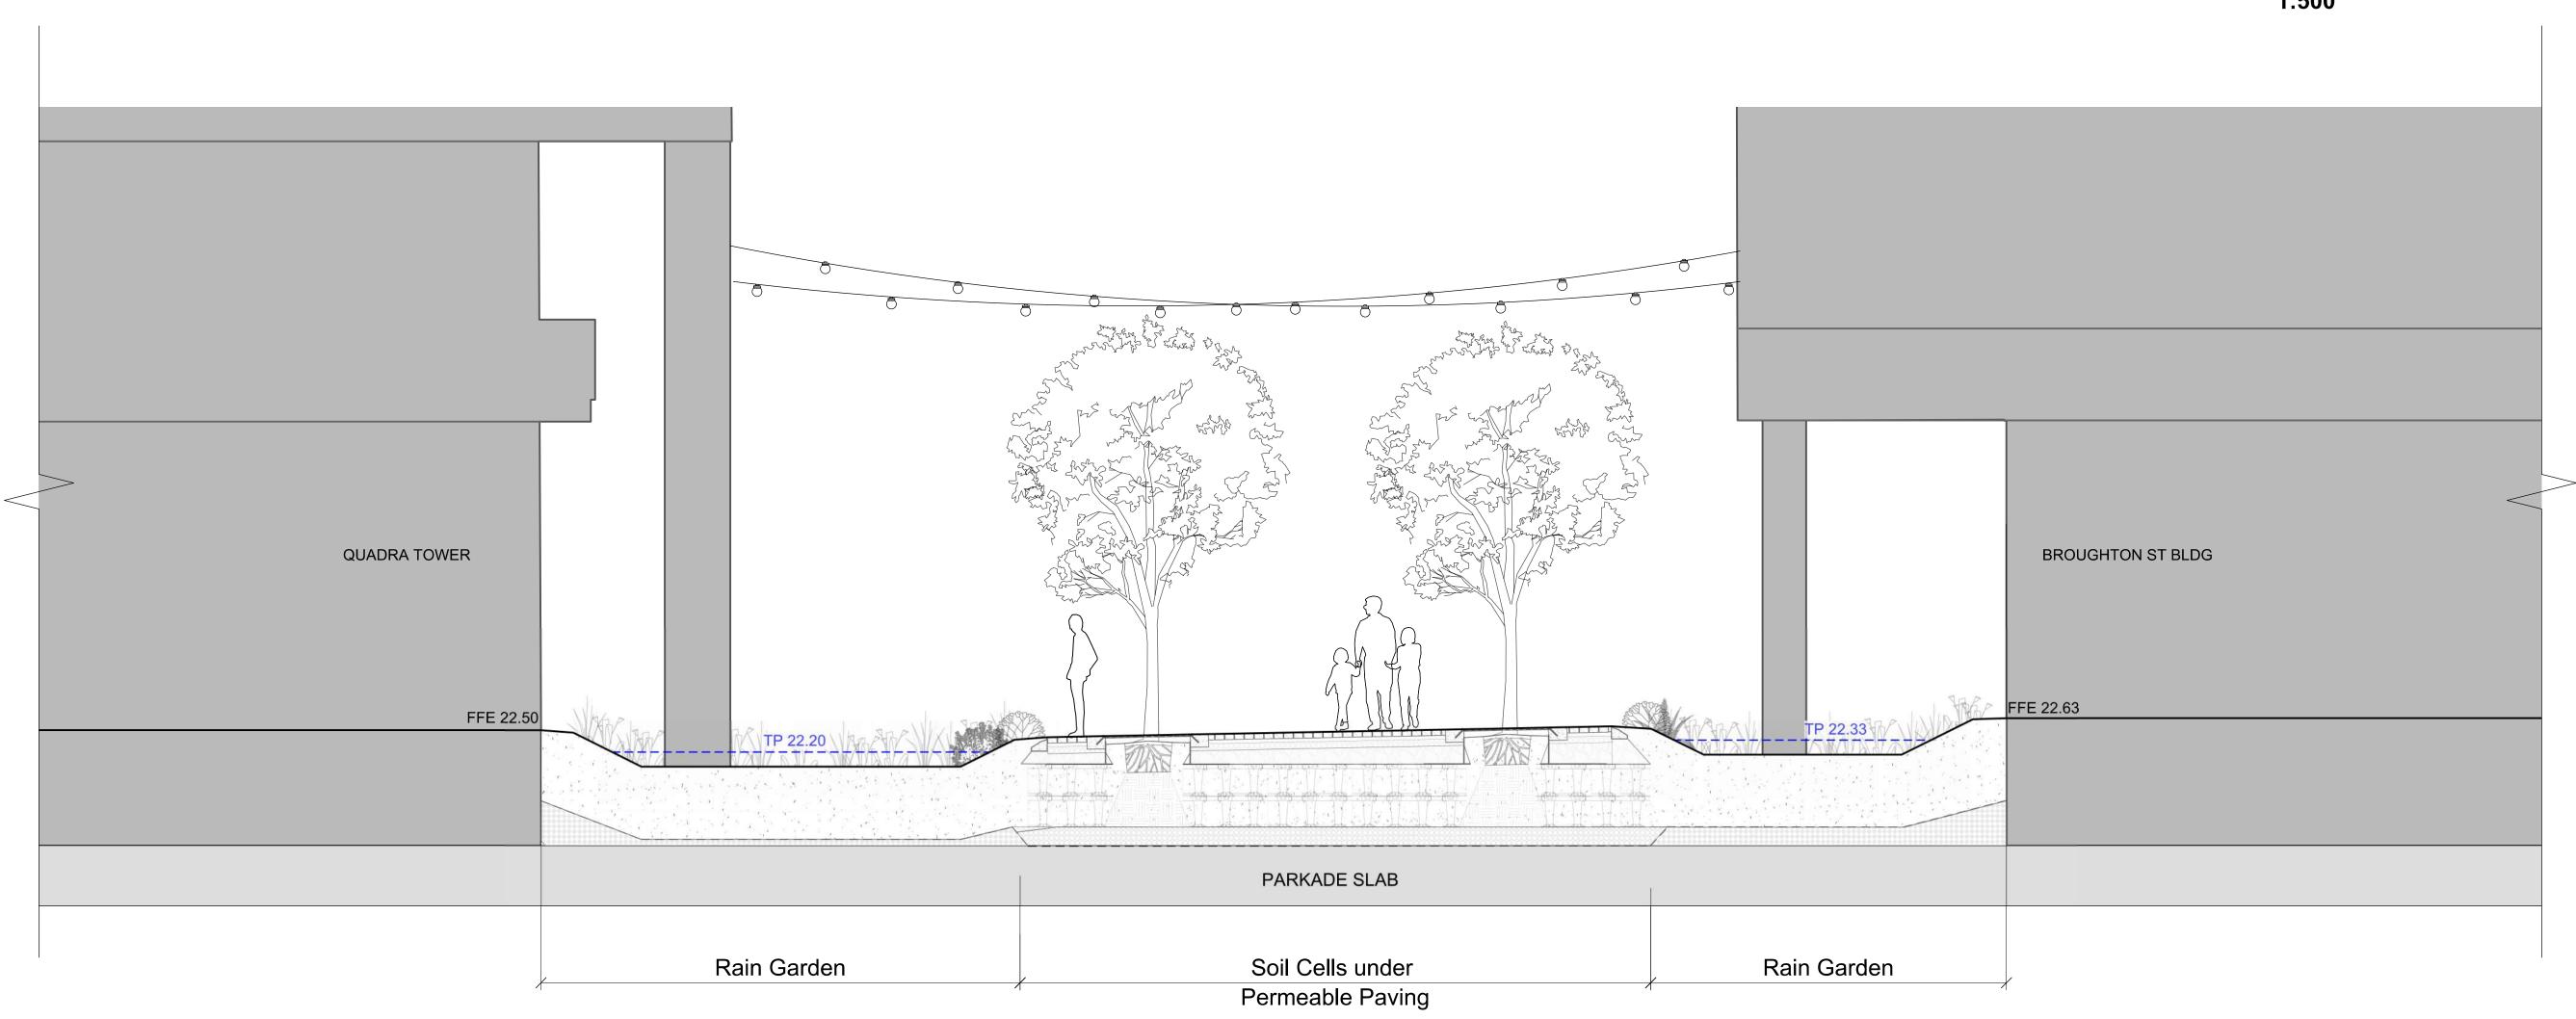

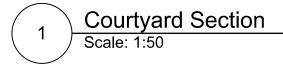

Section added.



NOT FOR CONSTRUCTION

3	Development Permit	2025-07-23
2	CALUC	2025-04-30
1	Pre-Application	2024-11-15
No.	Issued For	Issue Date
	·	·

PARC Communities Management Ltd.

project

PARC VICTORIA
829-891-899 Fort Street and
846-858 Broughton Street,
Victoria BC

sheet title

## **Landscape Sections**

project no.		124.27
scale	AS NOTED	@ 24"x36"
drawn by		SC
checked by		ТВ
sheet no.		

L2.02



Boulevard shrubs removed, 2 additional boulevard trees added

MDI LANDSCAPE ARCHITECTS

NOT FOR CONSTRUCTION

4	DP Submission 2	2025-10-29
3	Development Permit	2025-07-23
2	CALUC	2025-04-30
1	Pre-Application	2024-11-15
No.	Issued For	Issue Date


### **PARC Communities Management Ltd.**

PARC VICTORIA 829-891-899 Fort Street and 846-858 Broughton Street,

### **Planting Ground**

project no.			124.27
scale	1: 200	)	@ 24"x36"
drawn by			SC
checked by			ТВ
sheet no.			

L3.01

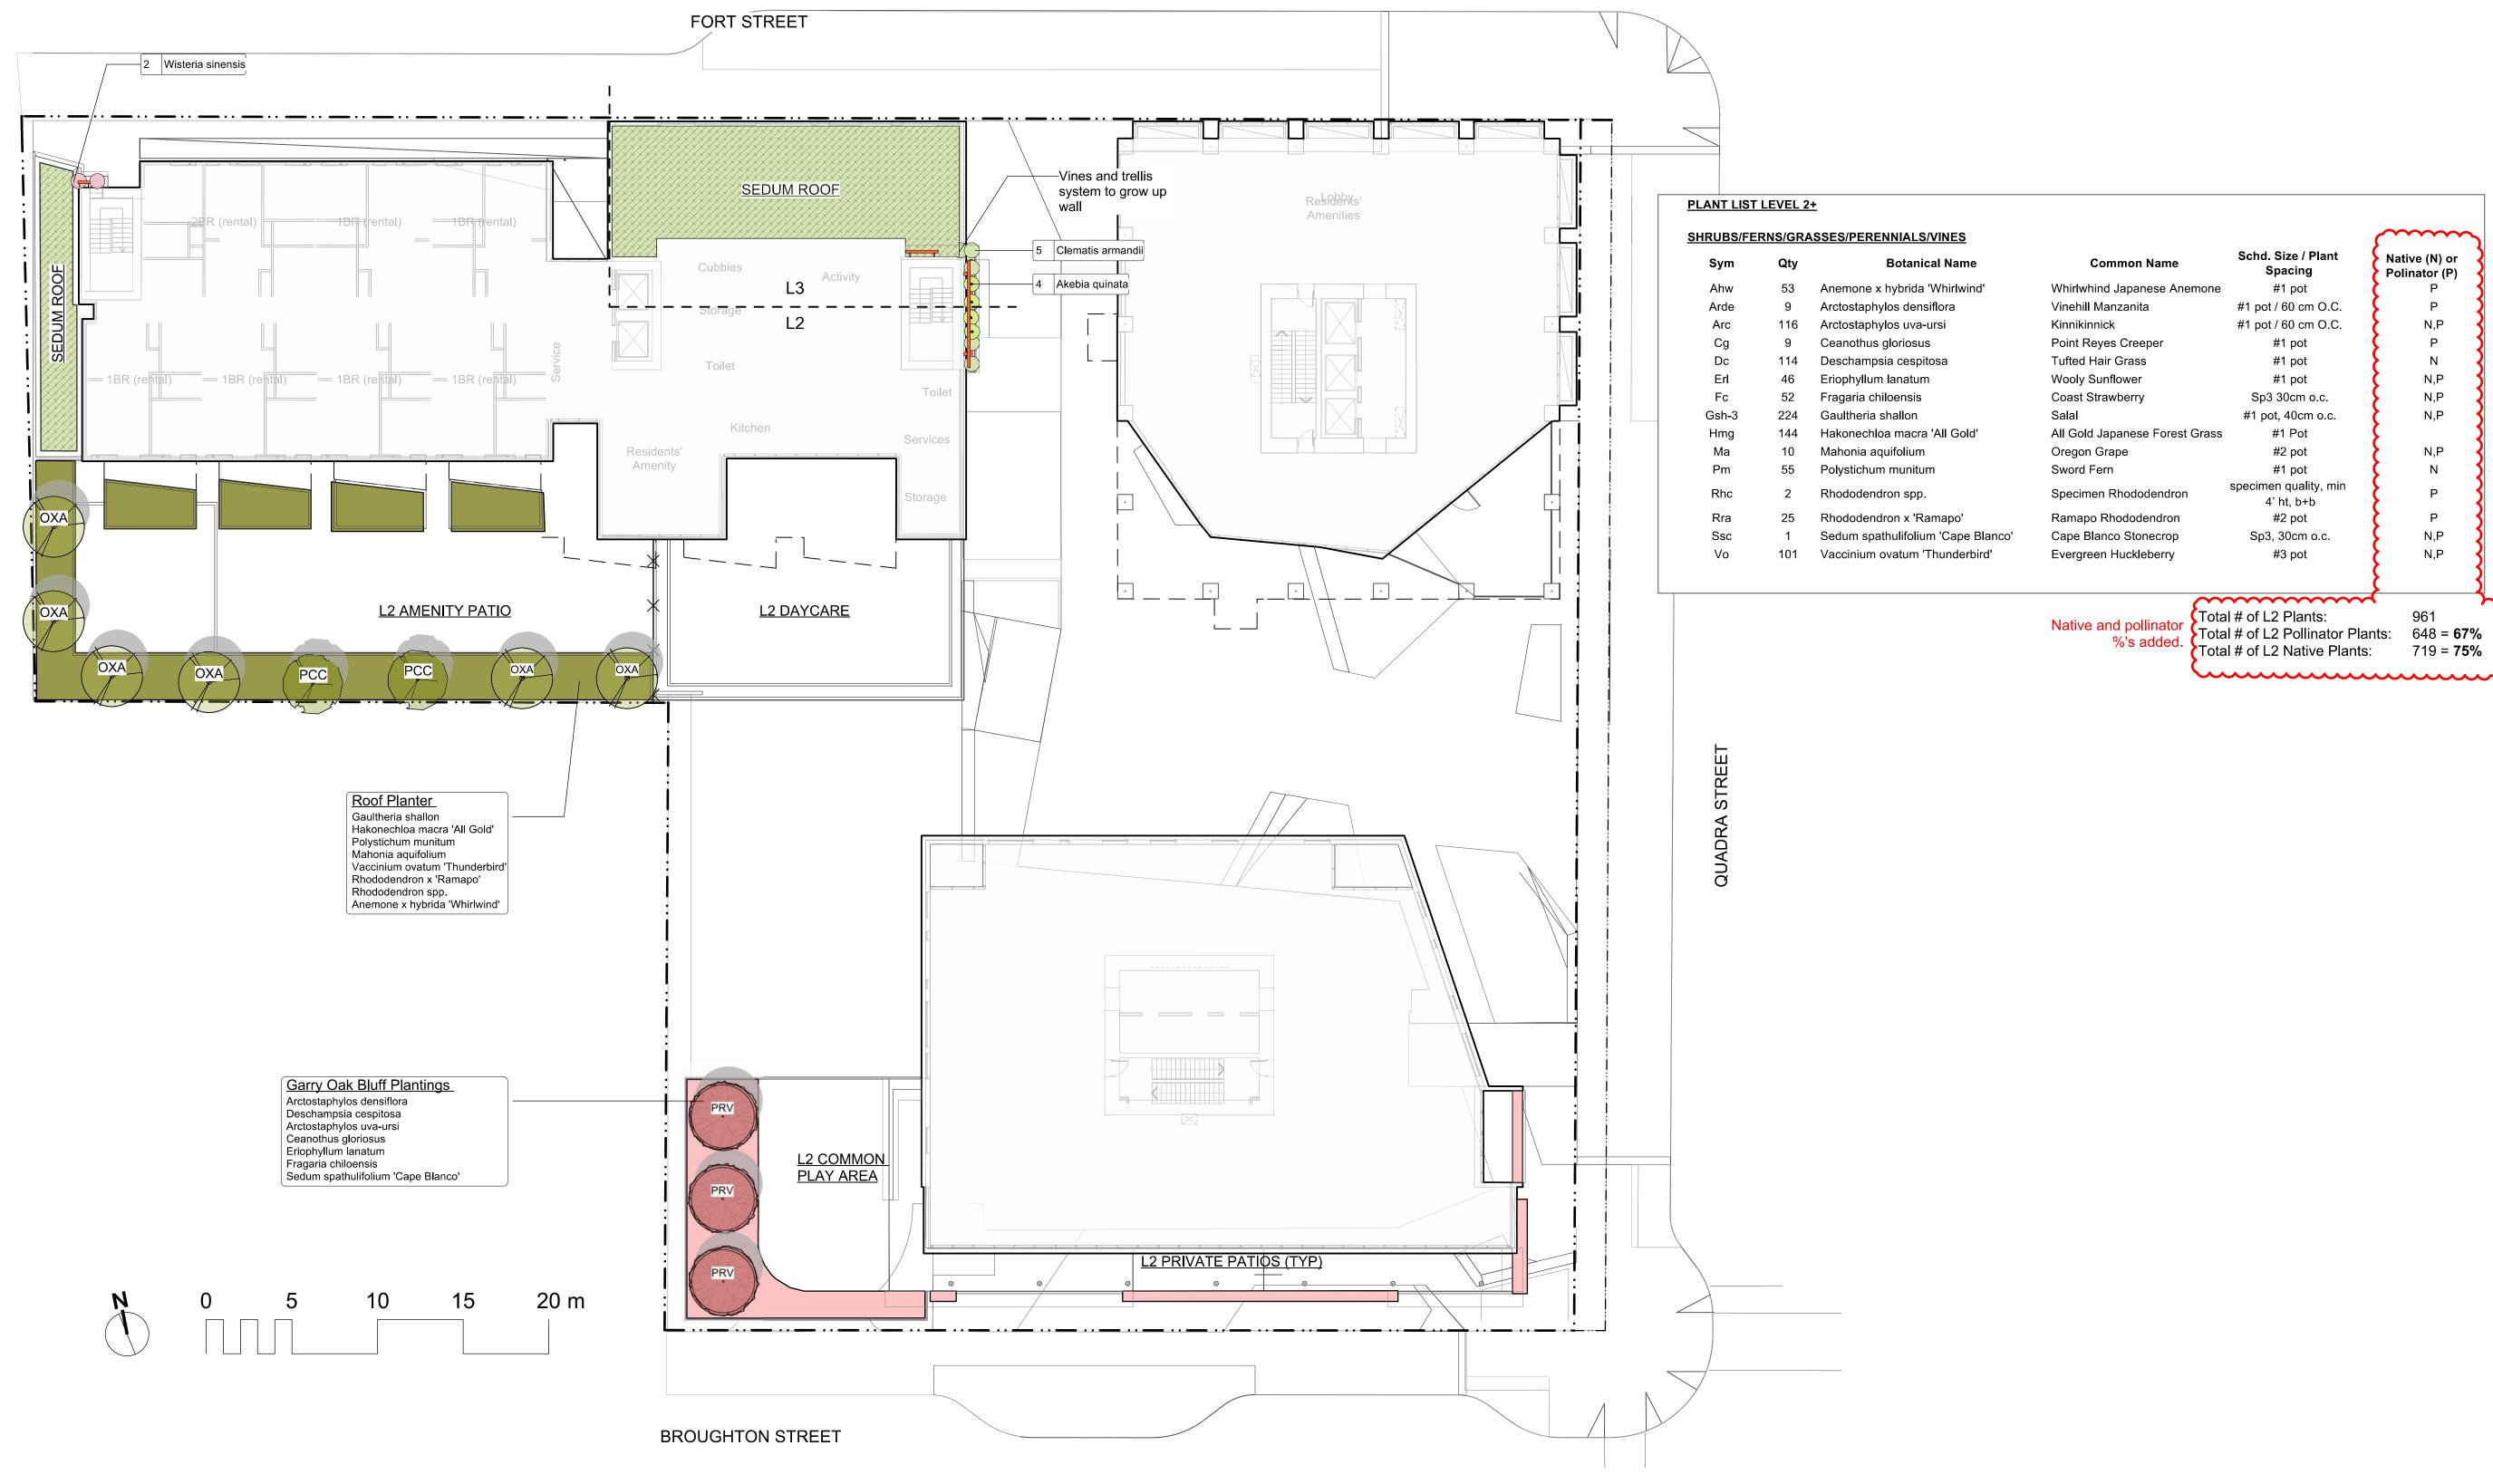

# GARRY OAK BLUFF PLANTINGS

The Broughton building's facade is imagined as a Garry Oak bluff ecosystem, with trailing plants like Kinnickinnick, coastal strawberry and Malahat mat, native sedums, flowers, and grasses. These form a vibrant green wall and provide plenty of nature for the building residents.









# **ROOF PLANTER**

A mix of small trees, evergreen shrubs and grasses, and native shrubs to provide a plant palette that looks great year-round.







Native (N) or

Polinator (P)

N,P

N,P

N,P

N,P

719 = **75%** 

NOT FOR CONSTRUCTION

4	DP Submission 2	2025-10-29
3	Development Permit	2025-07-23
2	CALUC	2025-04-30
1	Pre-Application	2024-11-15
No.	Issued For	Issue Date
	1	1

**PARC Communities Management Ltd.** 


PARC VICTORIA 829-891-899 Fort Street and 846-858 Broughton Street, Victoria BC

sheet title

Planting L2 and L3

1	project no.		124.27
	scale	1: 200	@ 24"x36"
	drawn by		SC
	checked by		ТВ
	sheet no.		
		13	ハフ

L3.UZ

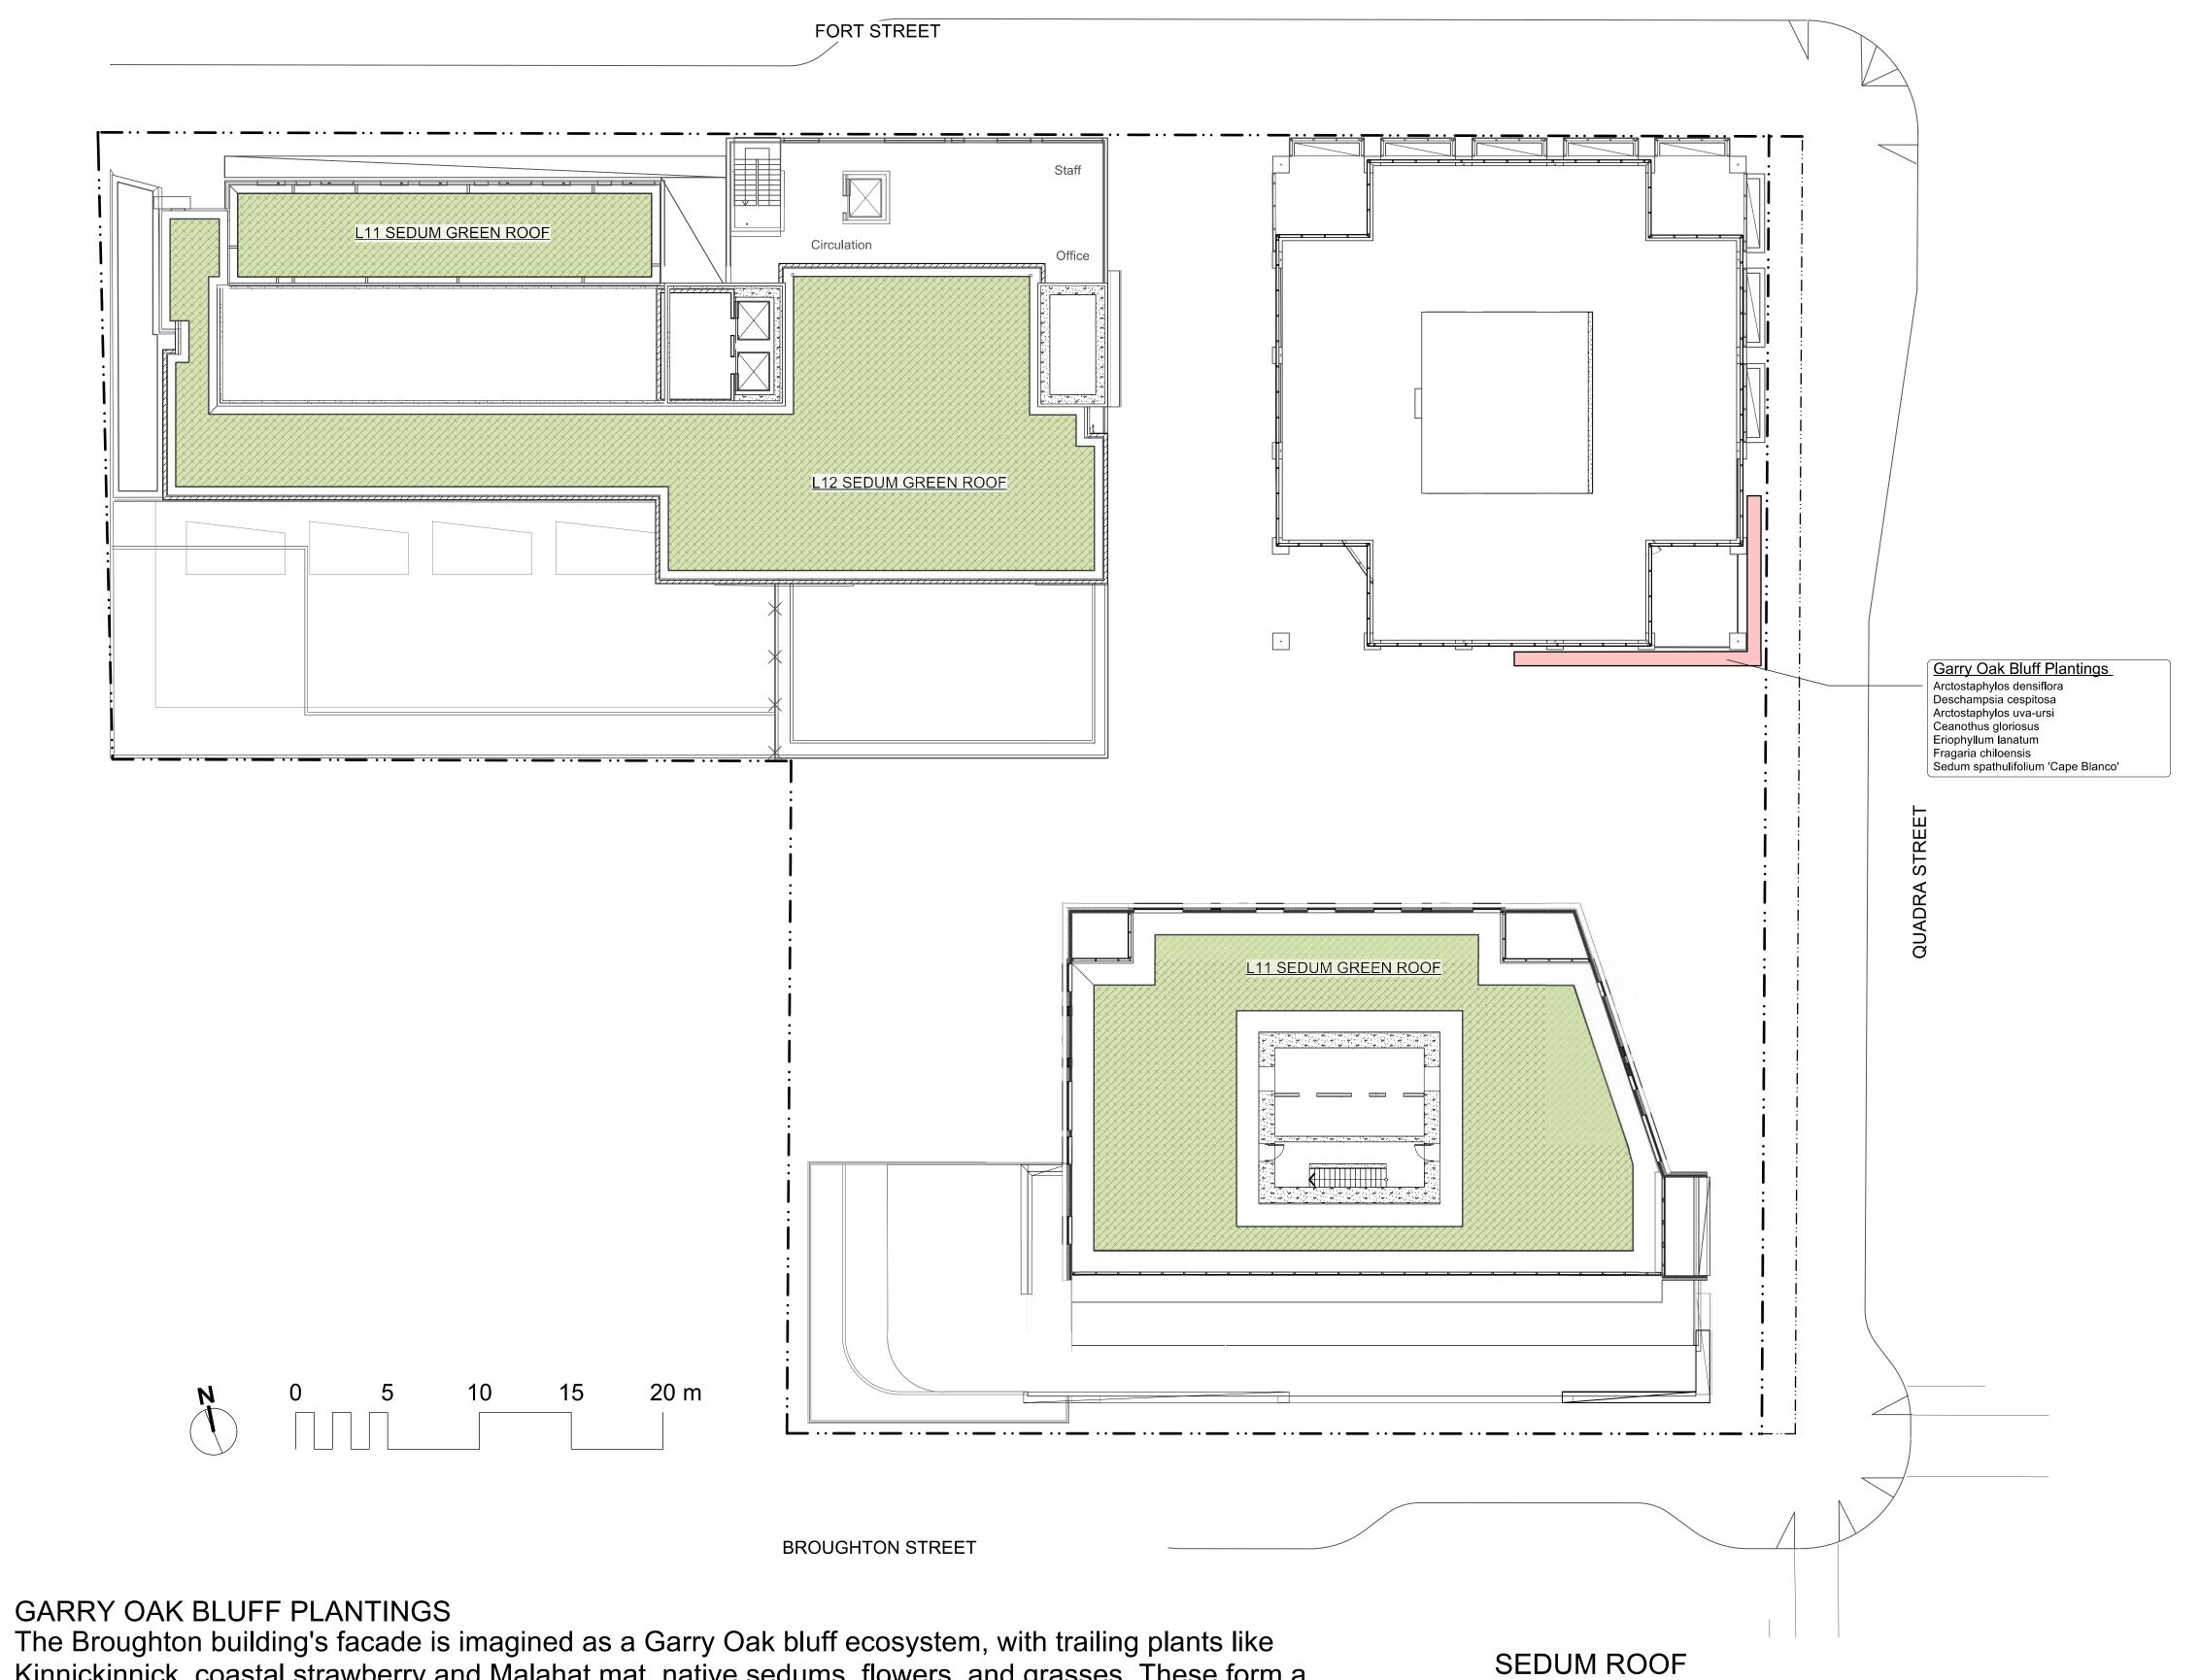

The Broughton building's facade is imagined as a Garry Oak bluff ecosystem, with trailing plants like Kinnickinnick, coastal strawberry and Malahat mat, native sedums, flowers, and grasses. These form a vibrant green wall and provide plenty of nature for the building residents.













NOT FOR CONSTRUCTION

4	DP Submission 2	2025-10-2
3	Development Permit	2025-07-2
2	CALUC	2025-04-3
1	Pre-Application	2024-11-1
No.	Issued For	Issue Date

PARC Communities Management Ltd.


PARC VICTORIA 829-891-899 Fort Street and 846-858 Broughton Street, Victoria BC


sheet title

**Planting - Upper** Roofs

project no.		124.27
scale	1: 200	@ 24"x36"
drawn by		SC
checked by		ТВ
sheet no.		


L3.03

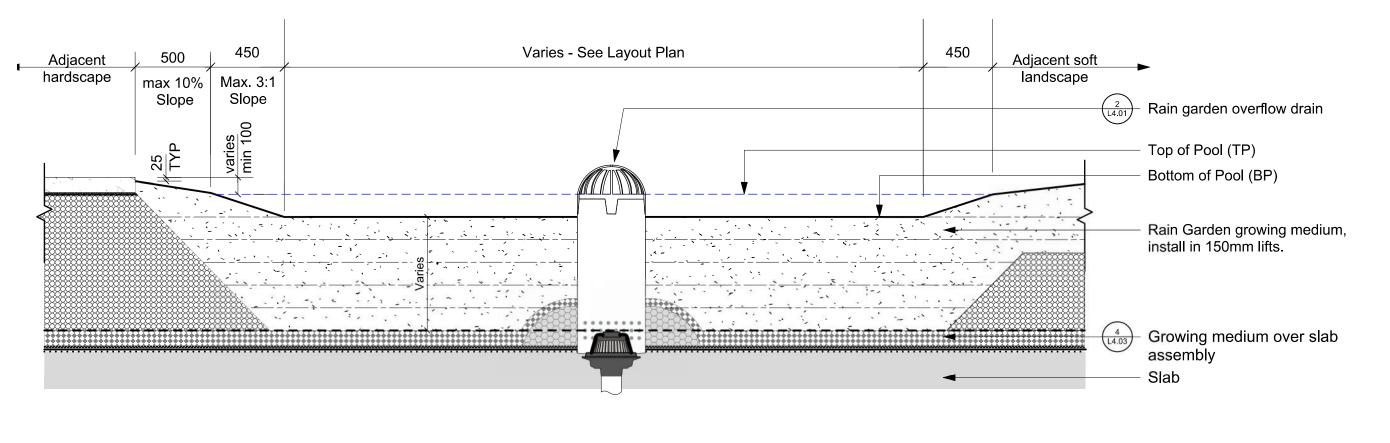


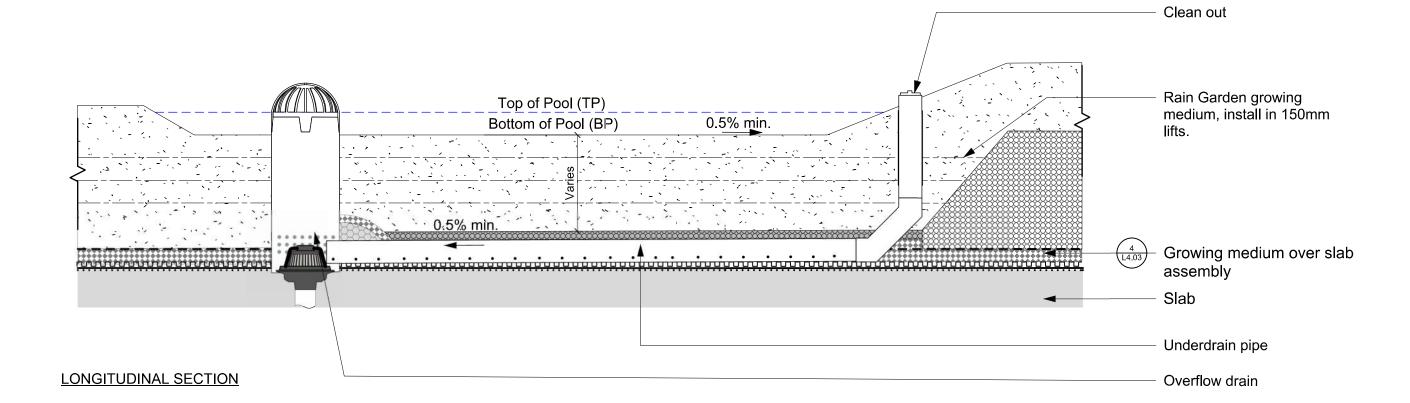


**CROSS SECTION** 

Typical Rain Garden
Scale: 1:25

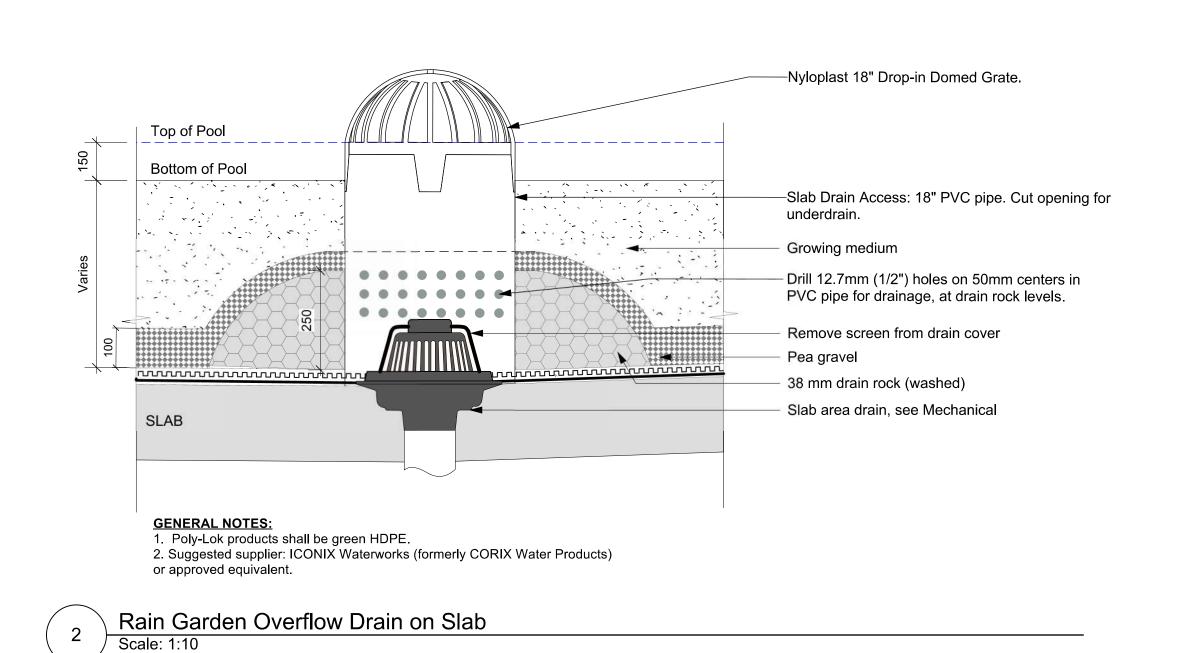

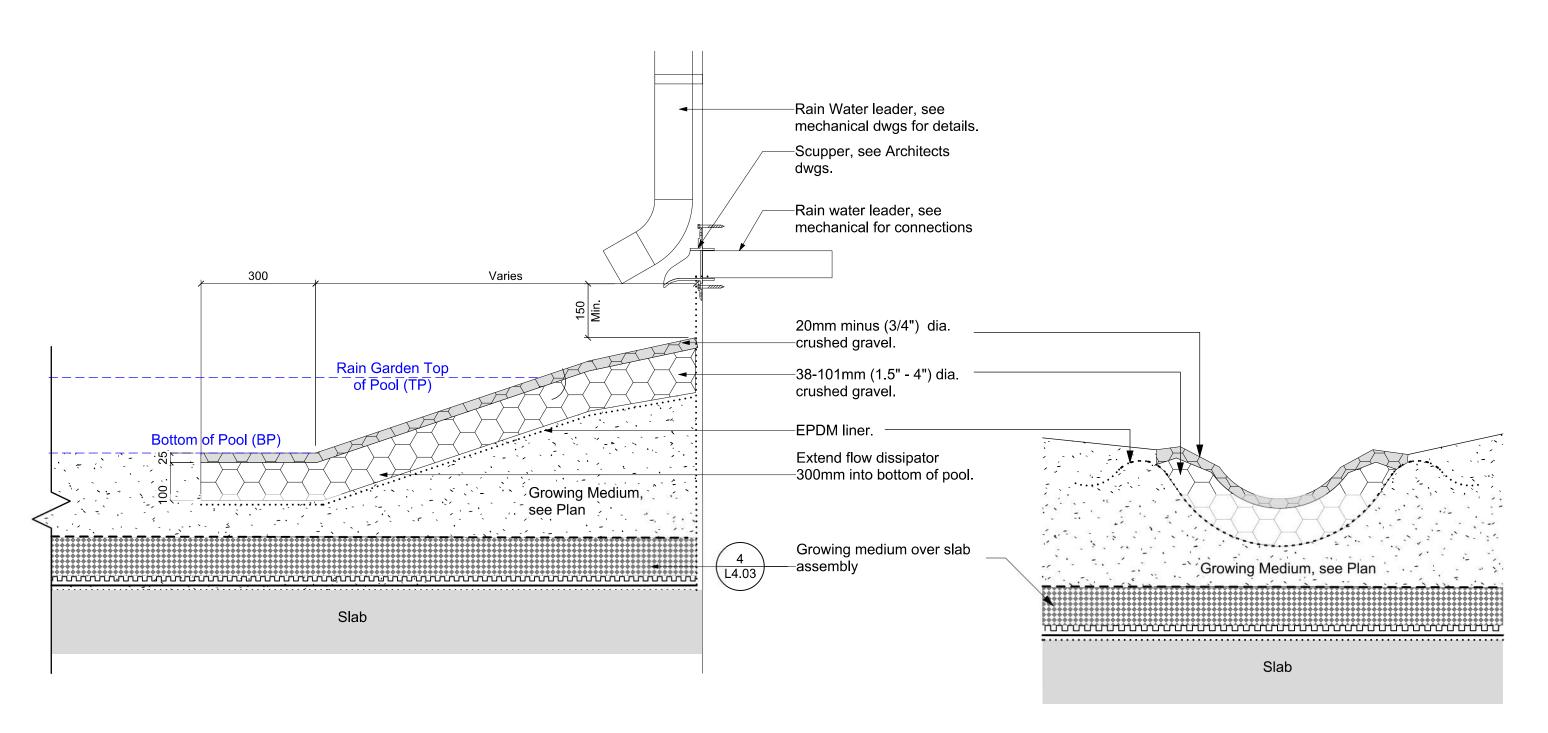


**Gravel Flow Dissipator** 

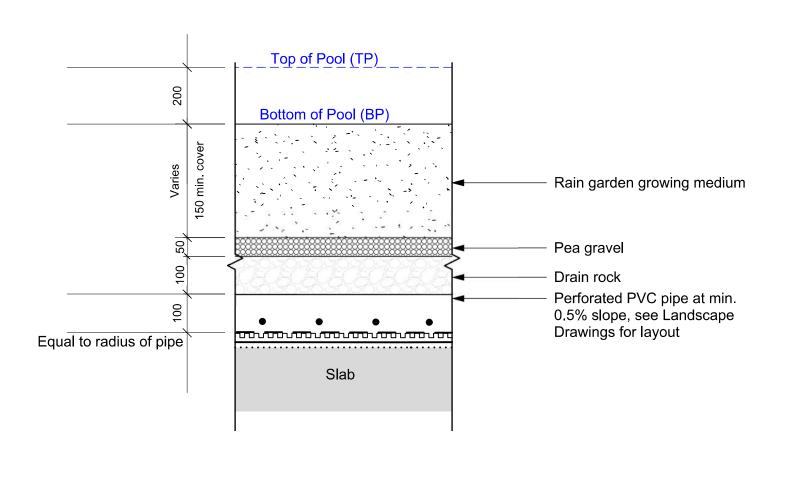


Rain Garden Underdrain Pipe

Scale: 1:10

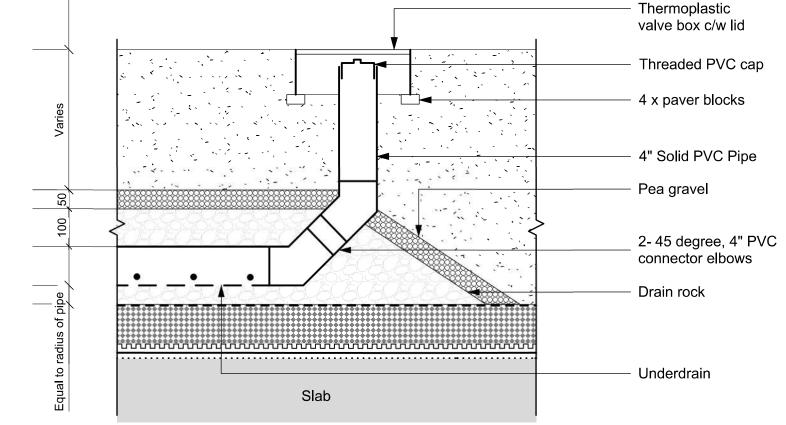

Scale: 1:10

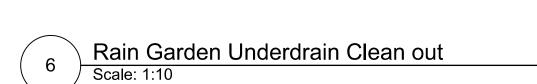

Sheet added.



NOT FOR CONSTRUCTION

4	DP Submission 2	2025-10-
3	Development Permit	2025-07-
2	CALUC	2025-04-
1	Pre-Application	2024-11-
No.	Issued For	Issue Dat


**PARC Communities Management Ltd.** 

PARC VICTORIA 829-891-899 Fort Street and 846-858 Broughton Street, Victoria BC


sheet title

**Landscape Details:** Rain Garden

	L	1.01
sheet no.		
checked by		ТВ
drawn by		SC
scale	AS SHOWN	@ 24"x36"
project no.		124.27

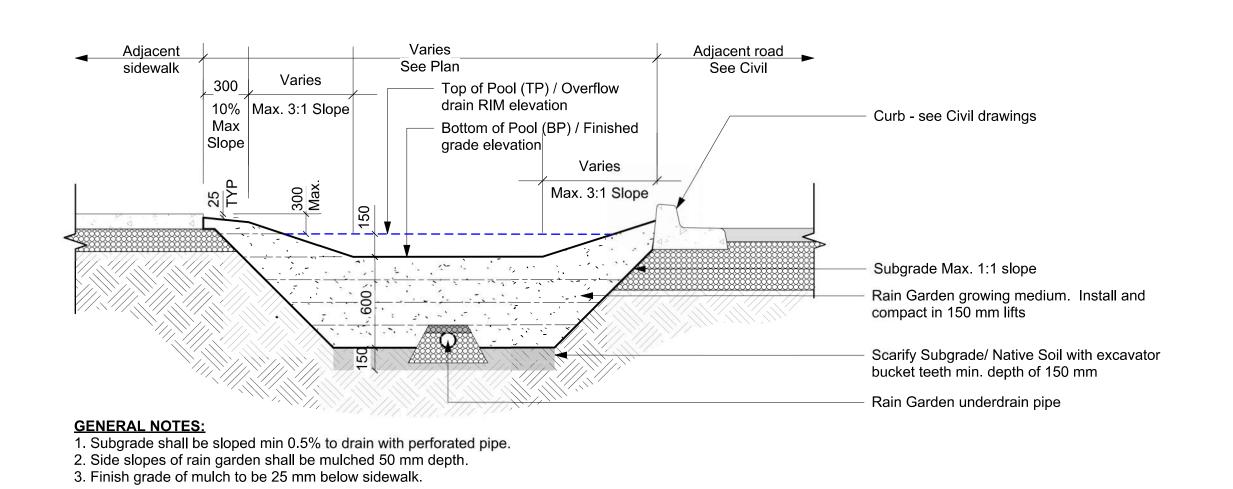

Boulevard Rain Garden Cross Section
Scale: 1:25

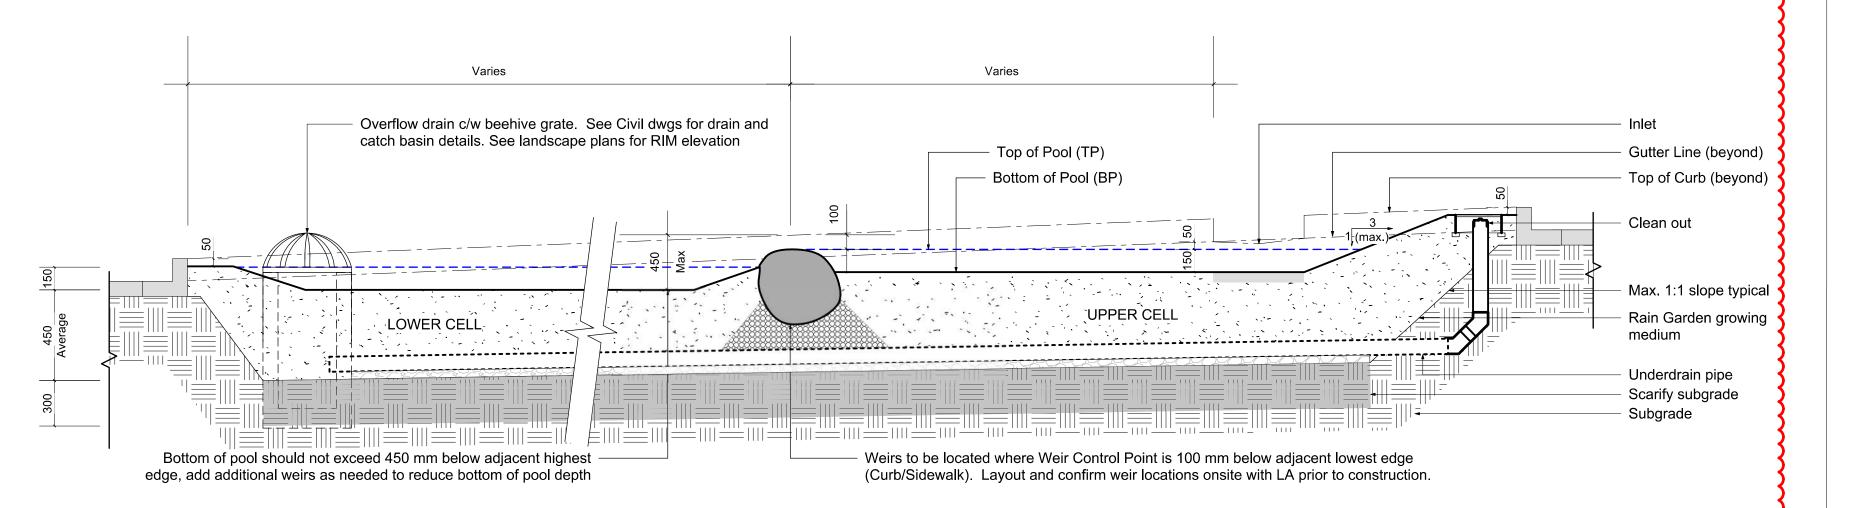

MDI LANDSCAPE ARCHITECTS

3388A Tennyson Ave P: 250.412-2891 Victoria, BC V8Z 3P6 E: admin@mdidesign.ca

NOT FOR CONSTRUCTION

4	DP Submission 2	2025-10-29
3	Development Permit	2025-07-23
2	CALUC	2025-04-30
1	Pre-Application	2024-11-15
No	Issued For	Issue Date

client

PARC Communities Management Ltd.

oroject

PARC VICTORIA
829-891-899 Fort Street and
846-858 Broughton Street,
Victoria BC


sheet title


Landscape Details: Boulevard Rain Garden


project no.		124.27
scale	AS SHOWN	@ 24"x36"
drawn by		SC
checked by		ТВ
sheet no.		
	L	1.02

Sheet added.

Civil Contract ◀	Landscape Contract			road g	Cast in place concrete curb inlet. See Civil dwgs.  ———————————————————————————————————	
slope  A. A	500	Top of Pool  Bottom of pool.  2'x2' concrete paver  Growing Medium	009 A			<b>▲</b> A'
SECTION A-A' Rain Garden Curb Inlet			F	PLAN VIEW		

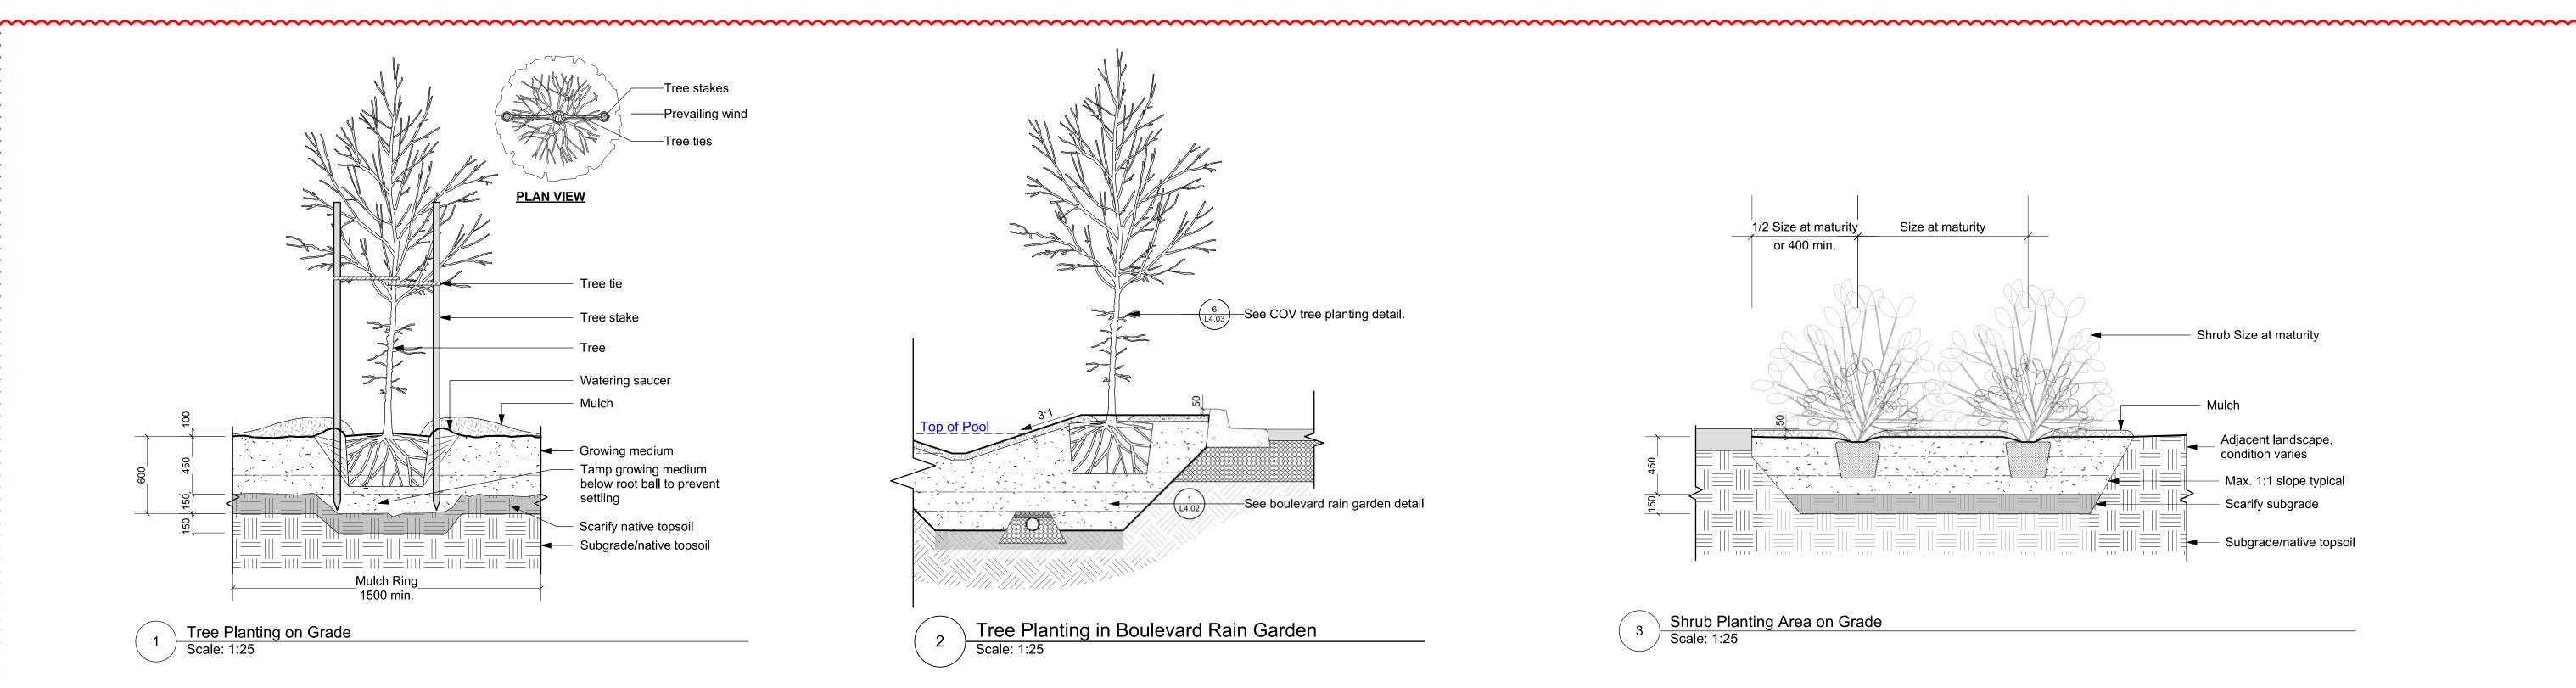

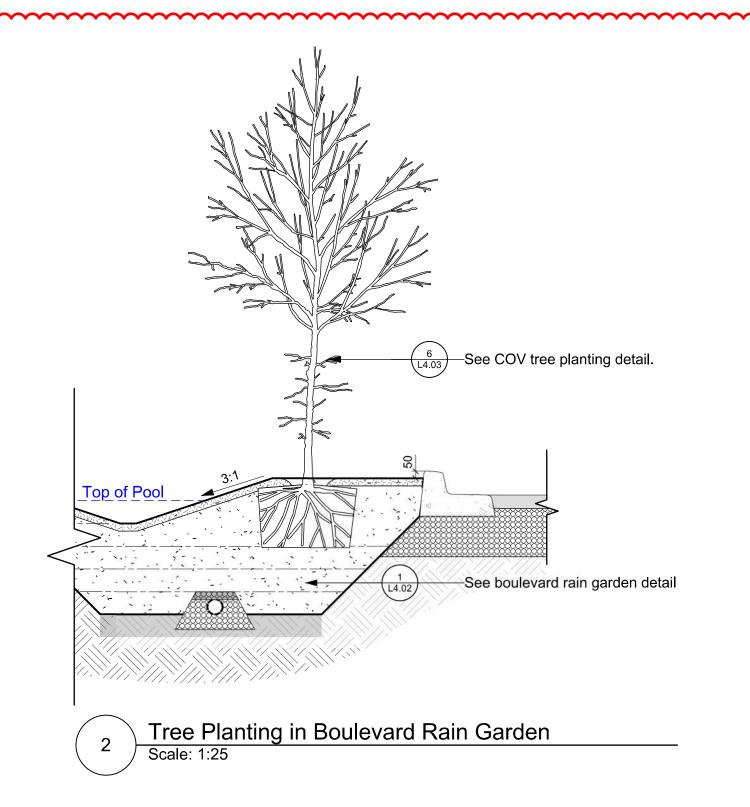

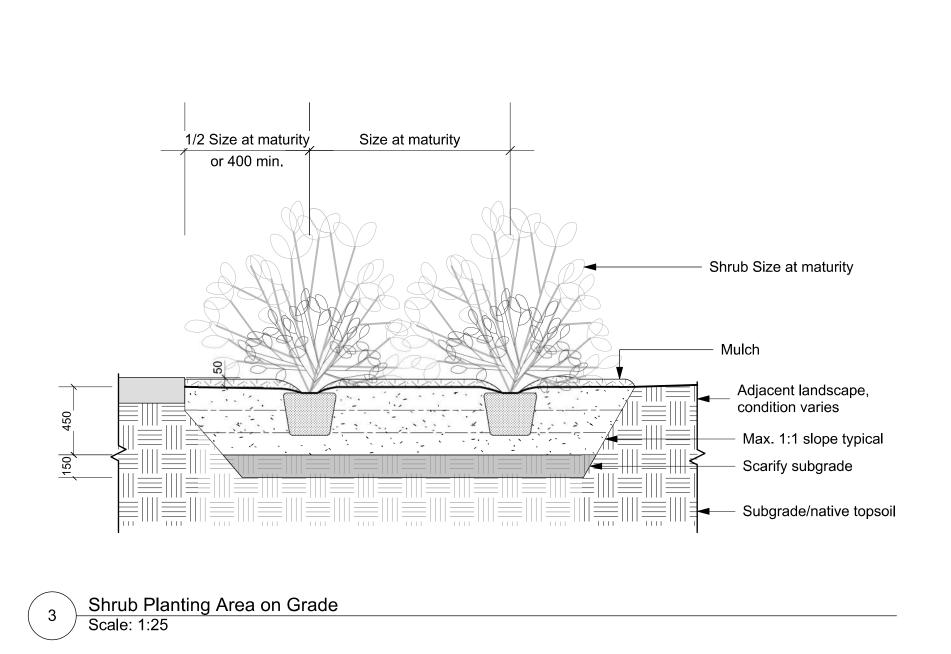



NOT FOR CONSTRUCTION

4	DP Submission 2	2025-10-29
3	Development Permit	2025-07-23
2	CALUC	2025-04-30
1	Pre-Application	2024-11-15
No.	Issued For	Issue Date

PARC Communities Management Ltd
client

project PARC VICTORIA

829-891-899 Fort Street and 846-858 Broughton Street, Victoria BC

sheet title


**Landscape Details: Planting** 

	124.27
AS SHOWN	@ 24"x36"
	SC
	ТВ
	AS SHOWN


**L4.03** 


Growing medium Landscape Fabric w/ 2' cut/slash every 25 sq. ft. \* Pea Gravel Slab, waterproofing, drainage and protection layers, see Architectural Slab

Growing Medium over Slab Assembly

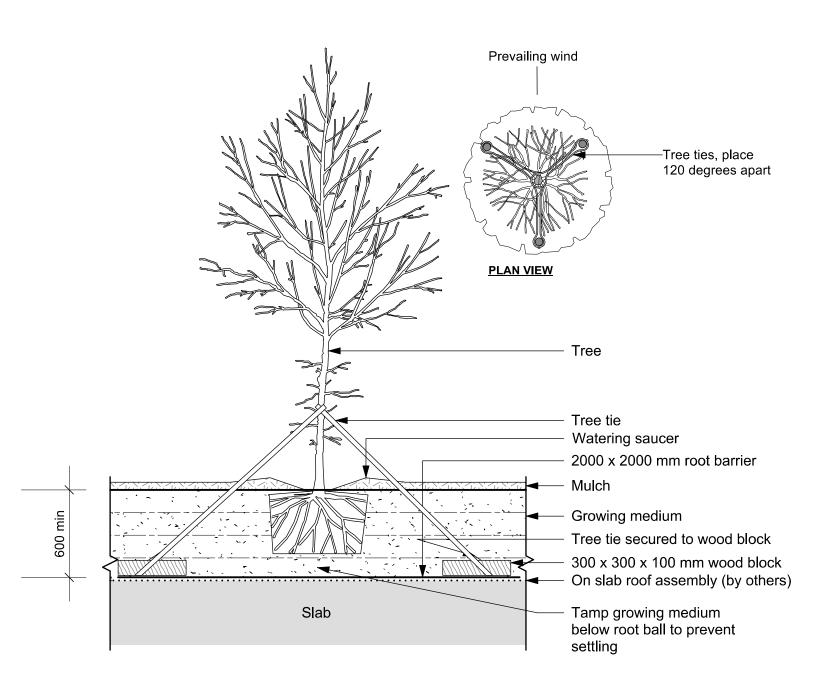

Tree Planting on Slab

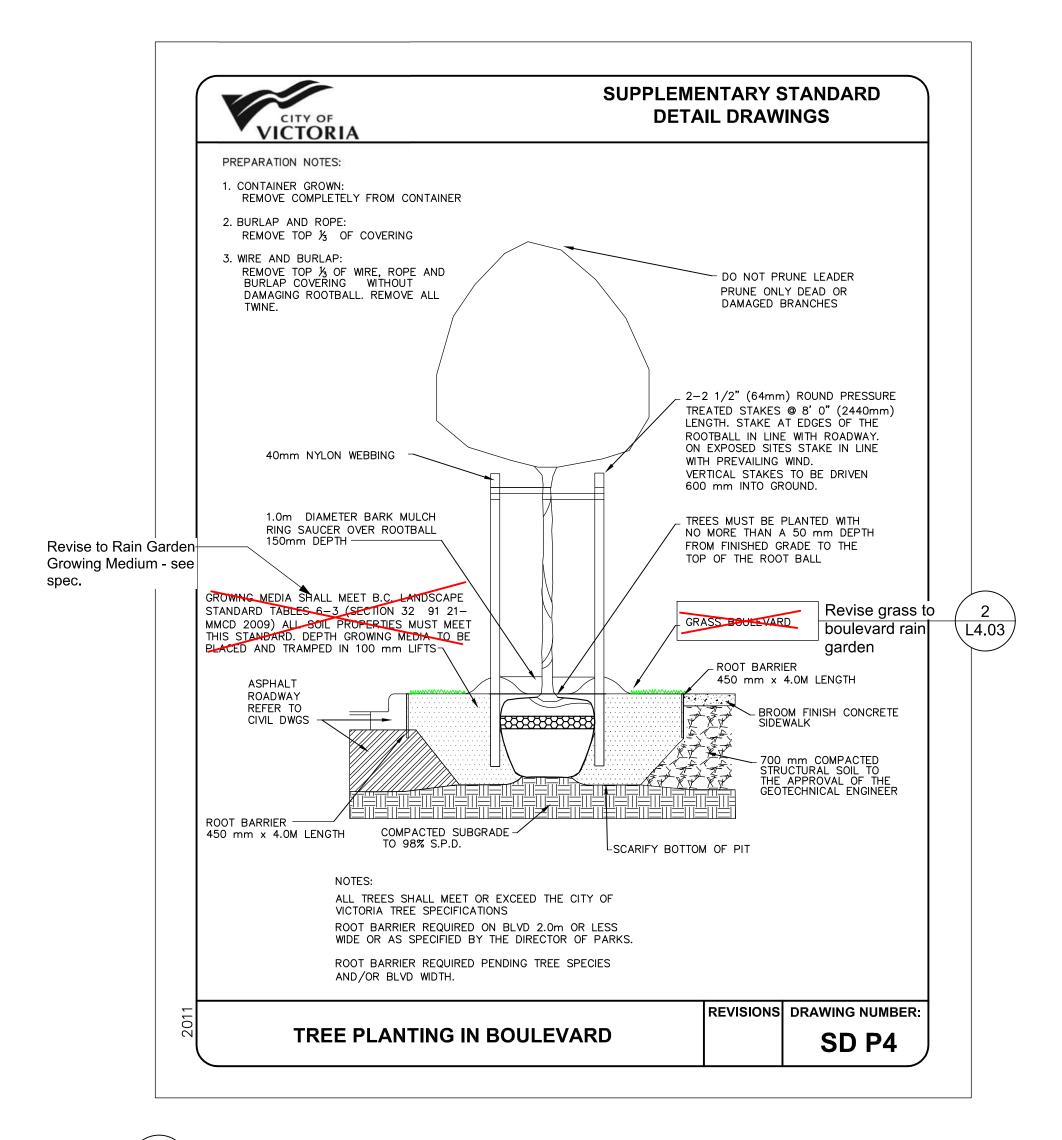


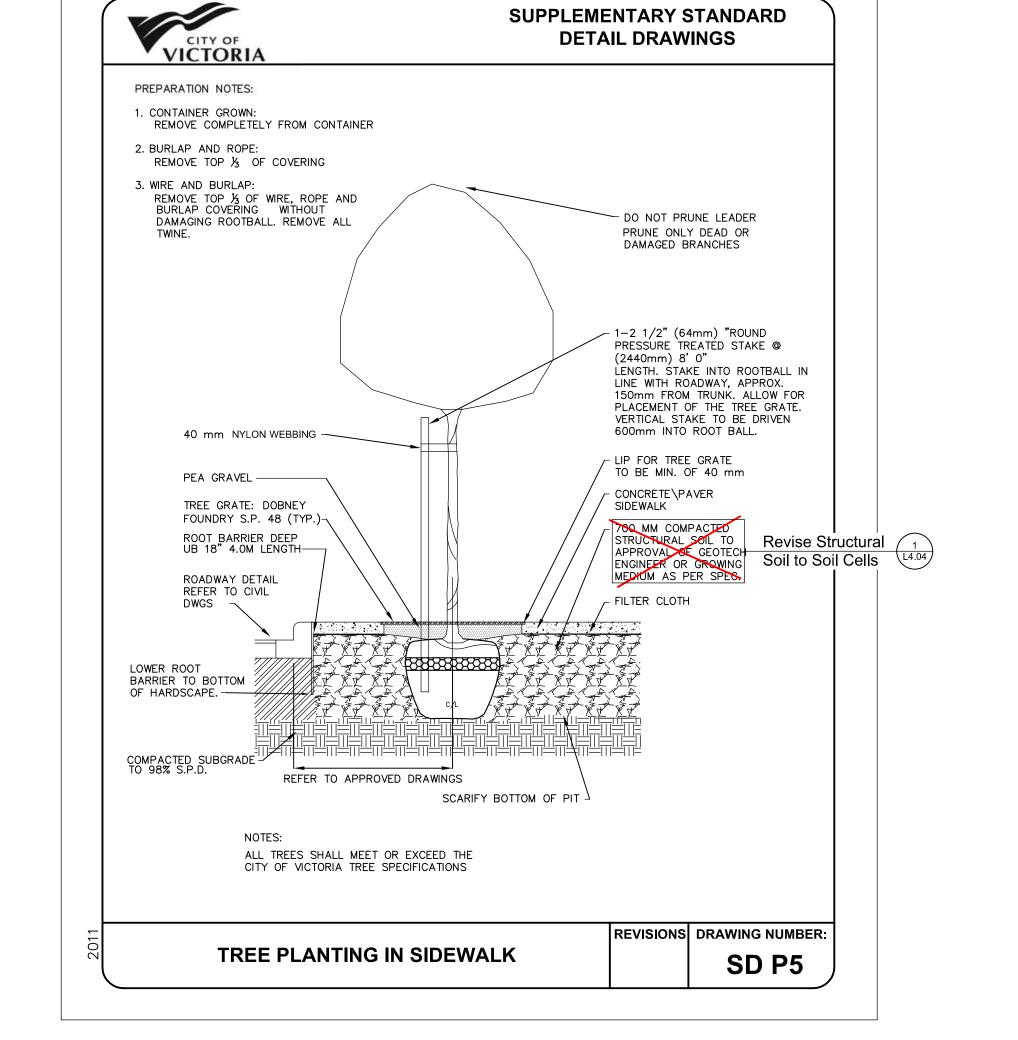

SUPPLEMENTARY STANDARD

DETAIL DRAWINGS

CoV Boulevard Tree Planting Scale: 1:25

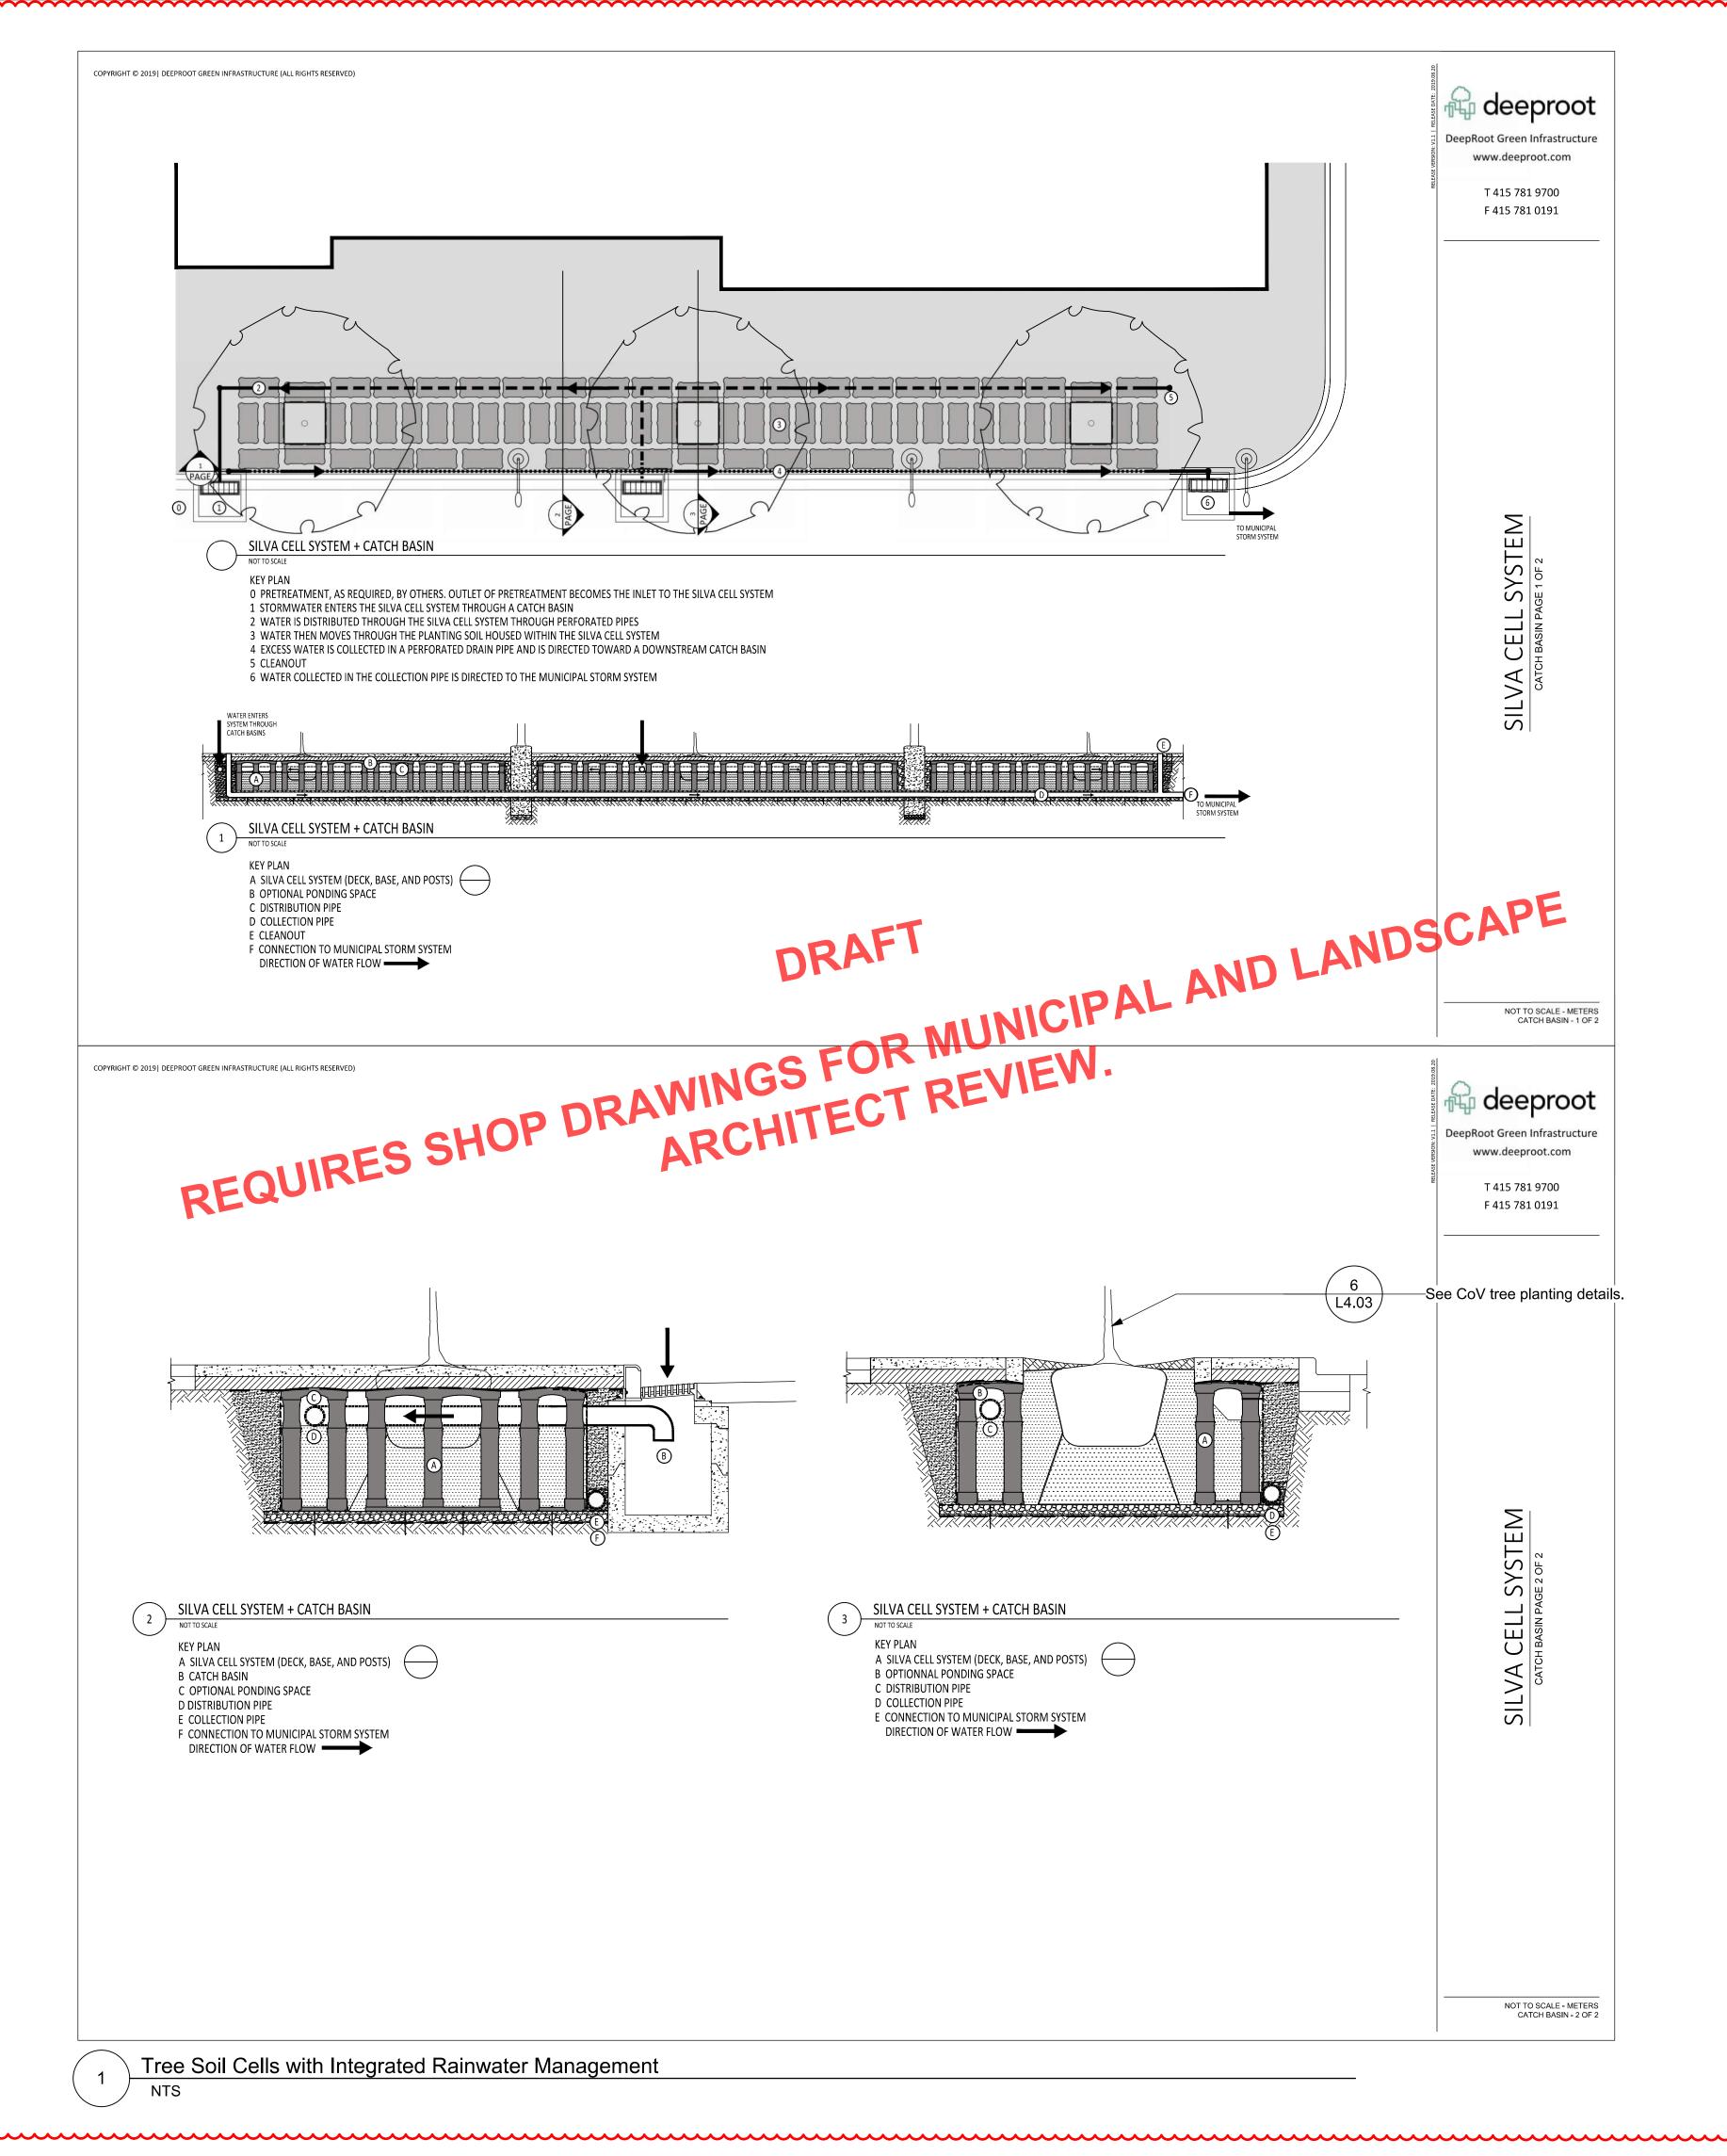



NOT FOR CONSTRUCTION

4	DP Submission 2	2025-10-29
3	Development Permit	2025-07-23
2	CALUC	2025-04-30
1	Pre-Application	2024-11-15
No.	Issued For	Issue Date

client

PARC Communities Management Ltd.

project

PARC VICTORIA
829-891-899 Fort Street and
846-858 Broughton Street,
Victoria BC

sheet ti

Landscape Details: Soil Cells

project no.		124.27
scale	AS SHOWN	@ 24"x36"
drawn by		SC
checked by		ТВ
sheet no.		
	L	1.04

PLAN - SITE LEGEND LAMP STANDARD +LS -DITCH CLEANOUT CATCHBASIN 🖂 MANHOLE MOUNTABLE CURB

PREVIOUS BC HYDRO REDLINE SHOWN. BC HYDRO HAS BEEN ENGAGED TO REVIEW REDLINE WITH RESPECT TO UPDATED BUILDING.

TITLE SHEET

Eng. Project No. 32776-2



SURVEYORS - ENGINEERS VICTORIA NANAIMO PARKSVILLE CAMPBELL RIVER PHONE: 250-727-2214 info@jeanderson.com

**ISSUED FOR DEVELOPMENT PERMIT** 

