#### **GENERAL NOTES**

- 1. ALL CONSTRUCTION IS TO COMPLY WITH THE 2018 BRITISH COLUMBIA BUILDING CODE (BCBC), AS WELL AS OTHER LOCAL GOVERNING CODES, BYLAWS, AND ORDINANCES.
- 2. ALL WORK TO BE OF THE BEST PRACTICES OF THE LOCAL TRADES INVOLVED.
- 3. WRITTEN DIMENSIONS TAKE PRECEDENCE. DO NOT SCALE DRAWINGS. DETAILS SHALL GOVERN OVER PLANS AND ELEVATIONS.
- 4. CONTRACTOR TO VERIFY ALL DIMENSIONS AND CONDITIONS ON SITE. DO NOT SCALE DRAWINGS.
- 5. ALL DRAWINGS SHOULD BE READ IN CONJUNCTION WITH STRUCTURAL, MECHANICAL, ELECTRICAL, PLUMBING, CIVIL, AND LANDSCAPE DRAWINGS, SPECIFICATIONS, GEOTECHNICAL AND ARBORIST REPORTS. ANY DISCREPENCIES MUST BE REPORTED TO ARCHITECT BEFORE PROCEEDING WITH WORK.
- 6. ALL EXTERIOR DIMENSIONS ARE TO FACE OF EXTERIOR SHEATHING. UNLESS NOTED OTHERWISE.
- 7. ALL INTERIOR DIMENSIONS ARE TO CENTERLINE OF STUD. UNLESS NOTED OTHERWISE.
- 8. ALL WALLS ARE TO EXTEND TO U/S OF STRUCTURE. UNLESS NOTED OTHERWISE.
- 9. ALL WINDOWS AND DOORS ON PLAN ARE DIMENSIONED TO THE CENTRE OF ROUGH OPENING (R.O.). UNLESS NOTED OTHERWISE.
- 10. ALL WINDOWS ARE DIMENSIONED ON THE FLOOR PLANS ROUGH OPENING (R.O.). UNLESS NOTED OTHERWISE.
- 11. ALL DOORS ARE A MIN. OF 4" (100 mm) FROM FACE OF ADJACENT WALLS. UNLESS NOTED OTHERWISE.

DRAWIN	DRAWING INDEX					
ARCHITEC	TURAL					
SHEET NO.	SHEET TITLE	SCALE				
A0.00	Cover Sheet	As Noted				
A0.02	Site Context	AS NOTED				
A0.03	Shadow Studies	As Noted				
A1.01	Existing Site Plan	AS NOTED				
A1.02	Site Plan	As Noted				
A2.01	Main Floor Plan	As Noted				
A2.02	2nd Floor Plan	As Noted				
A2.03	3rd Floor Plan	As Noted				
A2.04	4th Floor Plan	As Noted				
A2.05	5th Floor Plan	As Noted				
A2.06	6th Floor Plan	As Noted				
A2.07	Roof Plan	As Noted				
A3.01	Building Elevations	As Noted				
A3.02	Building Elevations	As Noted				
A3.03	Building Elevations	As Noted				
A3.04	Building Elevations	As Noted				
A4.01	Building Sections	As Noted				
A7.01	Perspectives	As Noted				
A7.02	Perspectives	As Noted				
A8.01	Window Schedule	As Noted				

As Noted

A8.02

Door Schedule

# PROJECT TEAM

#### DEVELOPER

NVision Properties 301-1106 Cook St., Victoria, BC V8V 3Z9

T 250.883.5579

#### **ARCHITECT**

Stuart Howard Architects Inc. 405, 375 West 5th Avenue. Vancouver, BC V5Y 1J6 604-688-5585

#### LANDSCAPE ARCHITECT

Murdoch de Greeff Inc. 200-524 Culduthel Road Victoria, BC V8Z 1G1 250.412.2891

#### **SURVEYOR**

Powell & Associates 250-2950 Douglas Street Victoria BC V8T 4N4 250.382.8855





# REZONING APPLICATION

Received Date:
January 17, 2020

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CONTRACTOR TO VERIFY DIMENSIONS BEFORE PROCEEDING AND
NOTIFY THE ARCHITECTS OF ANY DISCREPANCIES.

STUART HOWARD ARCHITECTS INC.

MEMBERS AIBC - RAIC - AIA

405 - 375 West 5th Avenue phone - 604.688.5585 Vancouver B.C. V5Y 136 fax - 604.688.7486

20.01.09 Re-Issued for Rezoning
19.09.12 Re-Issued for Rezoning
19.07.05 Re-Issued for Rezoning

No. Date Issue Notes

eal

1301 Hillside Ave.

1301 Hillside Ave. Victoria, BC

et Title

**Cover Sheet** 

Scale As Noted

ile name: 2020.01.06 1301 Hillside (ta





# 1 JUNE 21 - 9 AM NTS



# 2 JUNE 21 - 12 PM NTS





#### MAR/SEPT 21 - 9 AM NTS



### 5 MAR/SEPT 21 - 12 pm NTS



6 MAR/SEPT 21 - 3 pm NTS NOTES:
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3 20.01.09 Re-Issued for Rezoning
2 19.09.12 Re-Issued for Rezoning
1 19.07.05 Re-Issued for Rezoning
No. Date Issue Notes

Consultant

Architect



Seal


1301 Hillside Ave.


1301 Hillside Ave. Victoria, BC


Shadow Studies

Sue Date
Plot Date
2020.01.09
Sheet No.

Reviewed By NR
Checked By NR
Scale As Noted

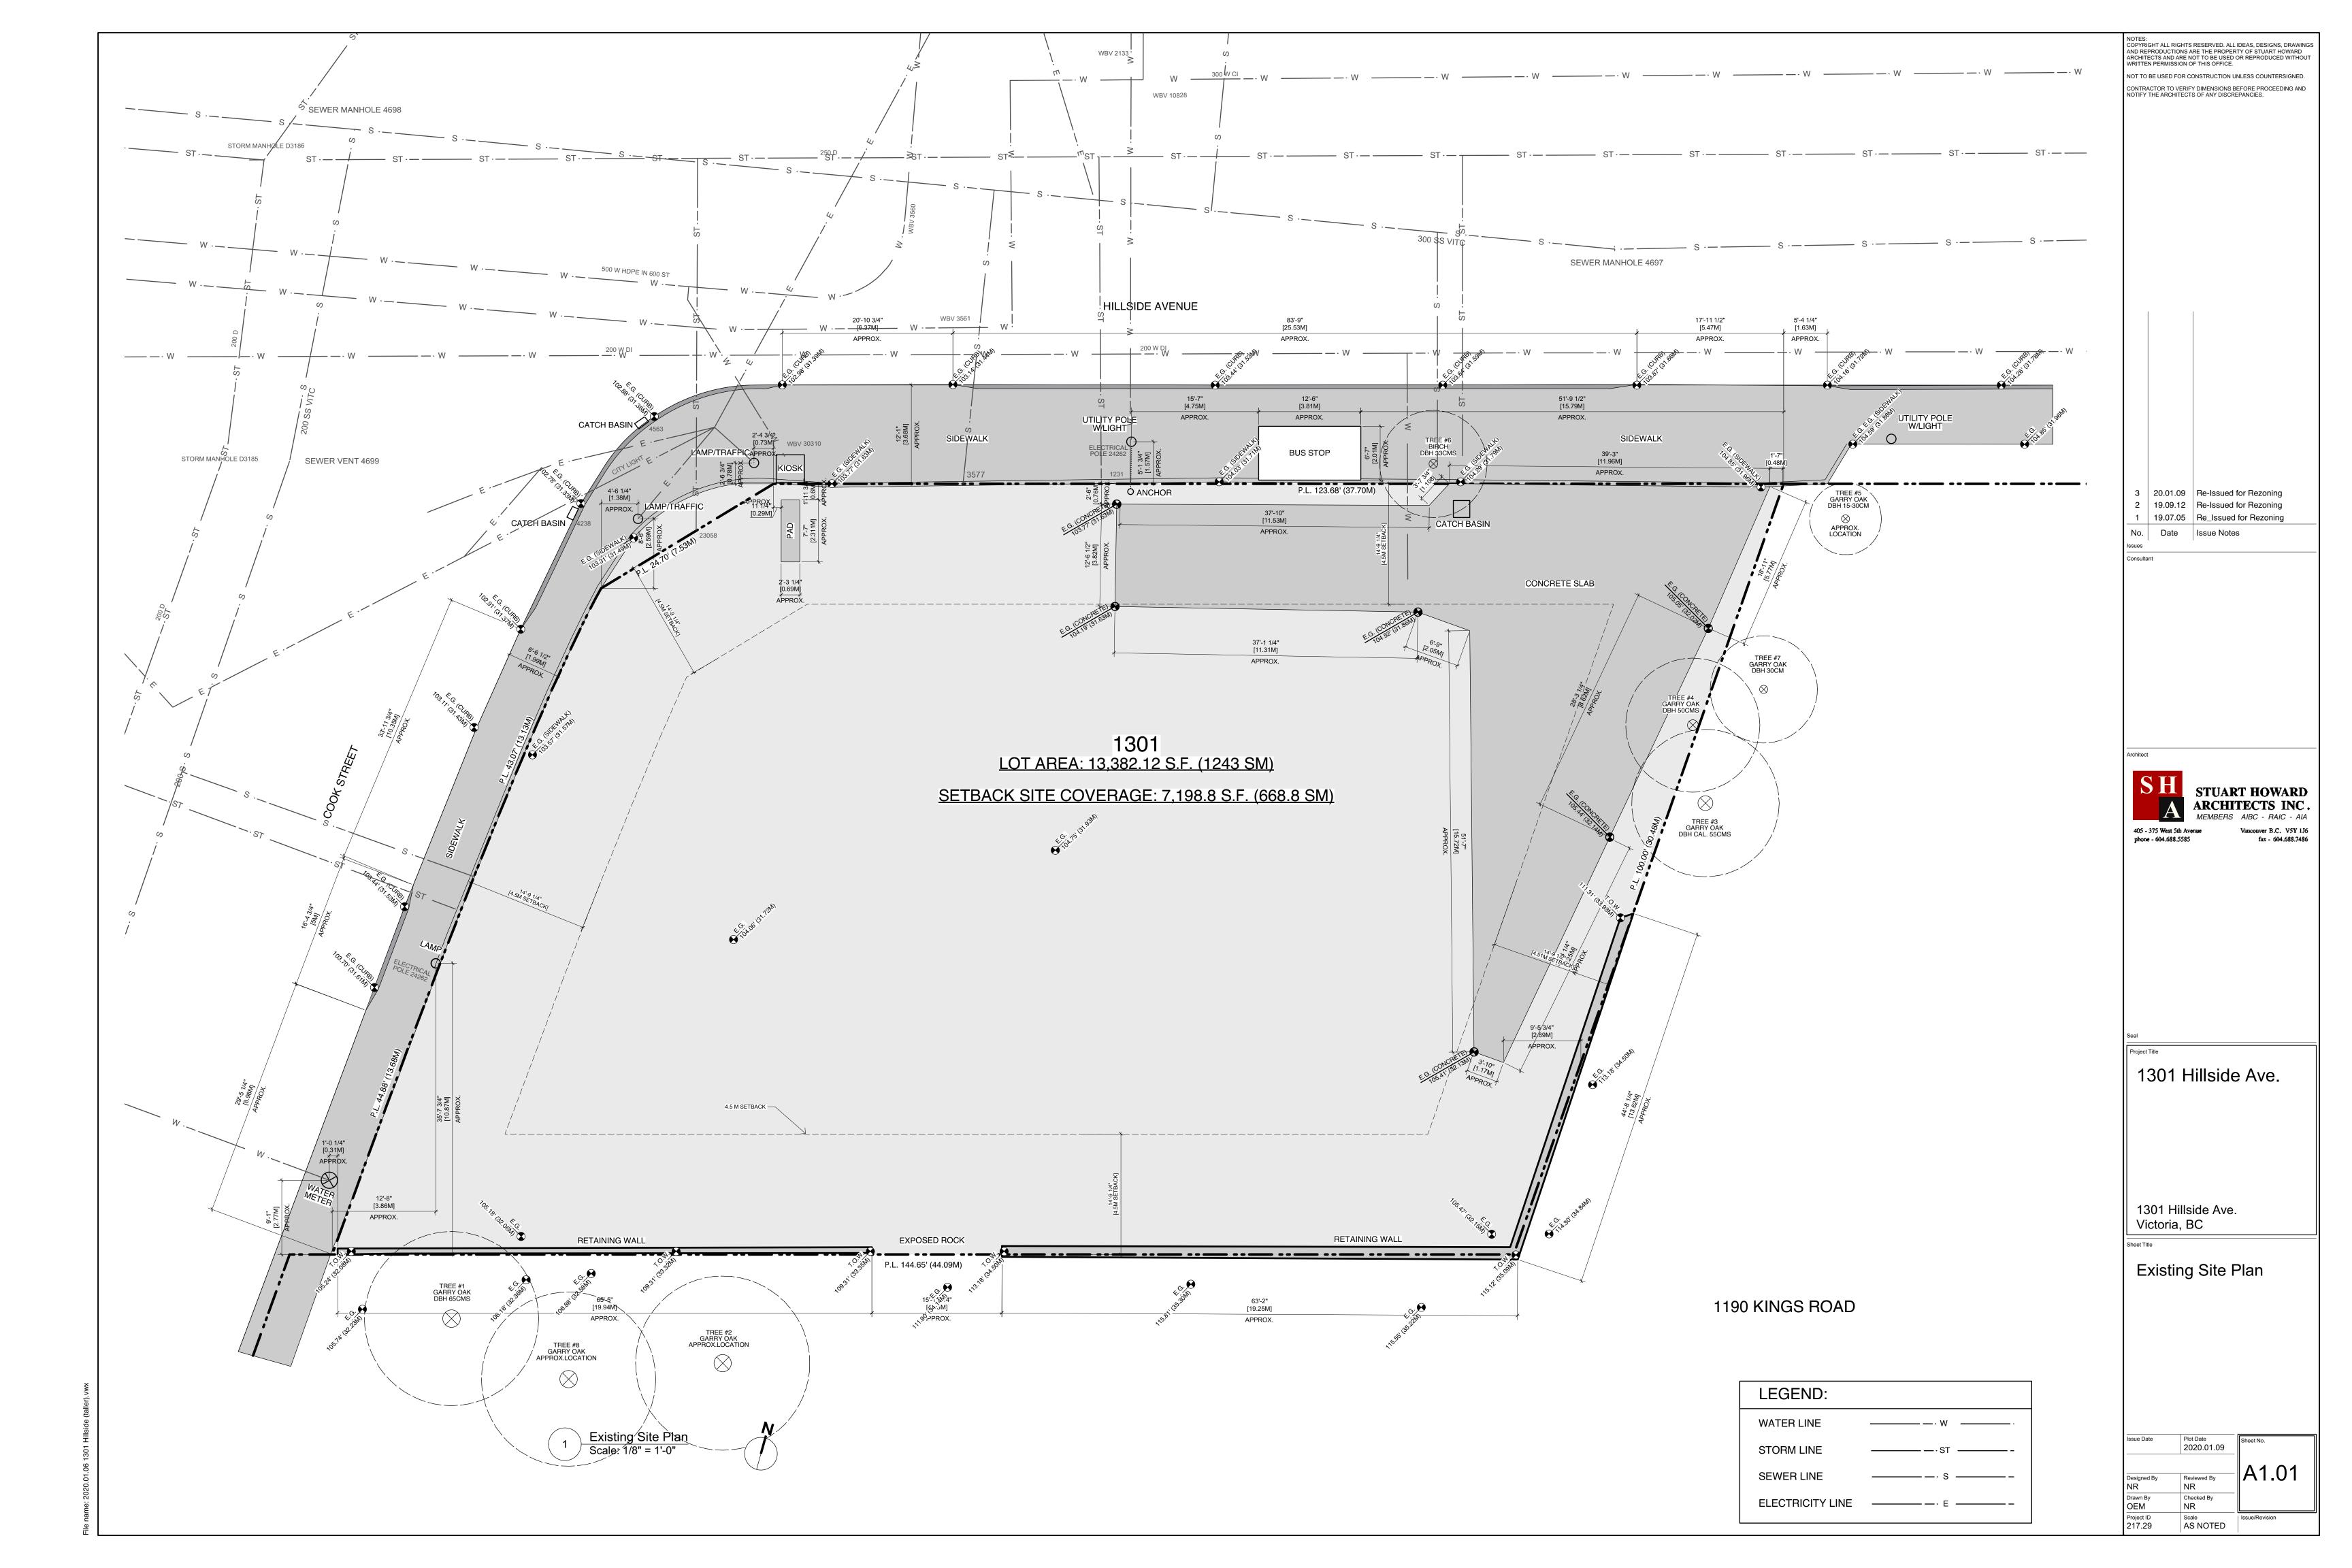

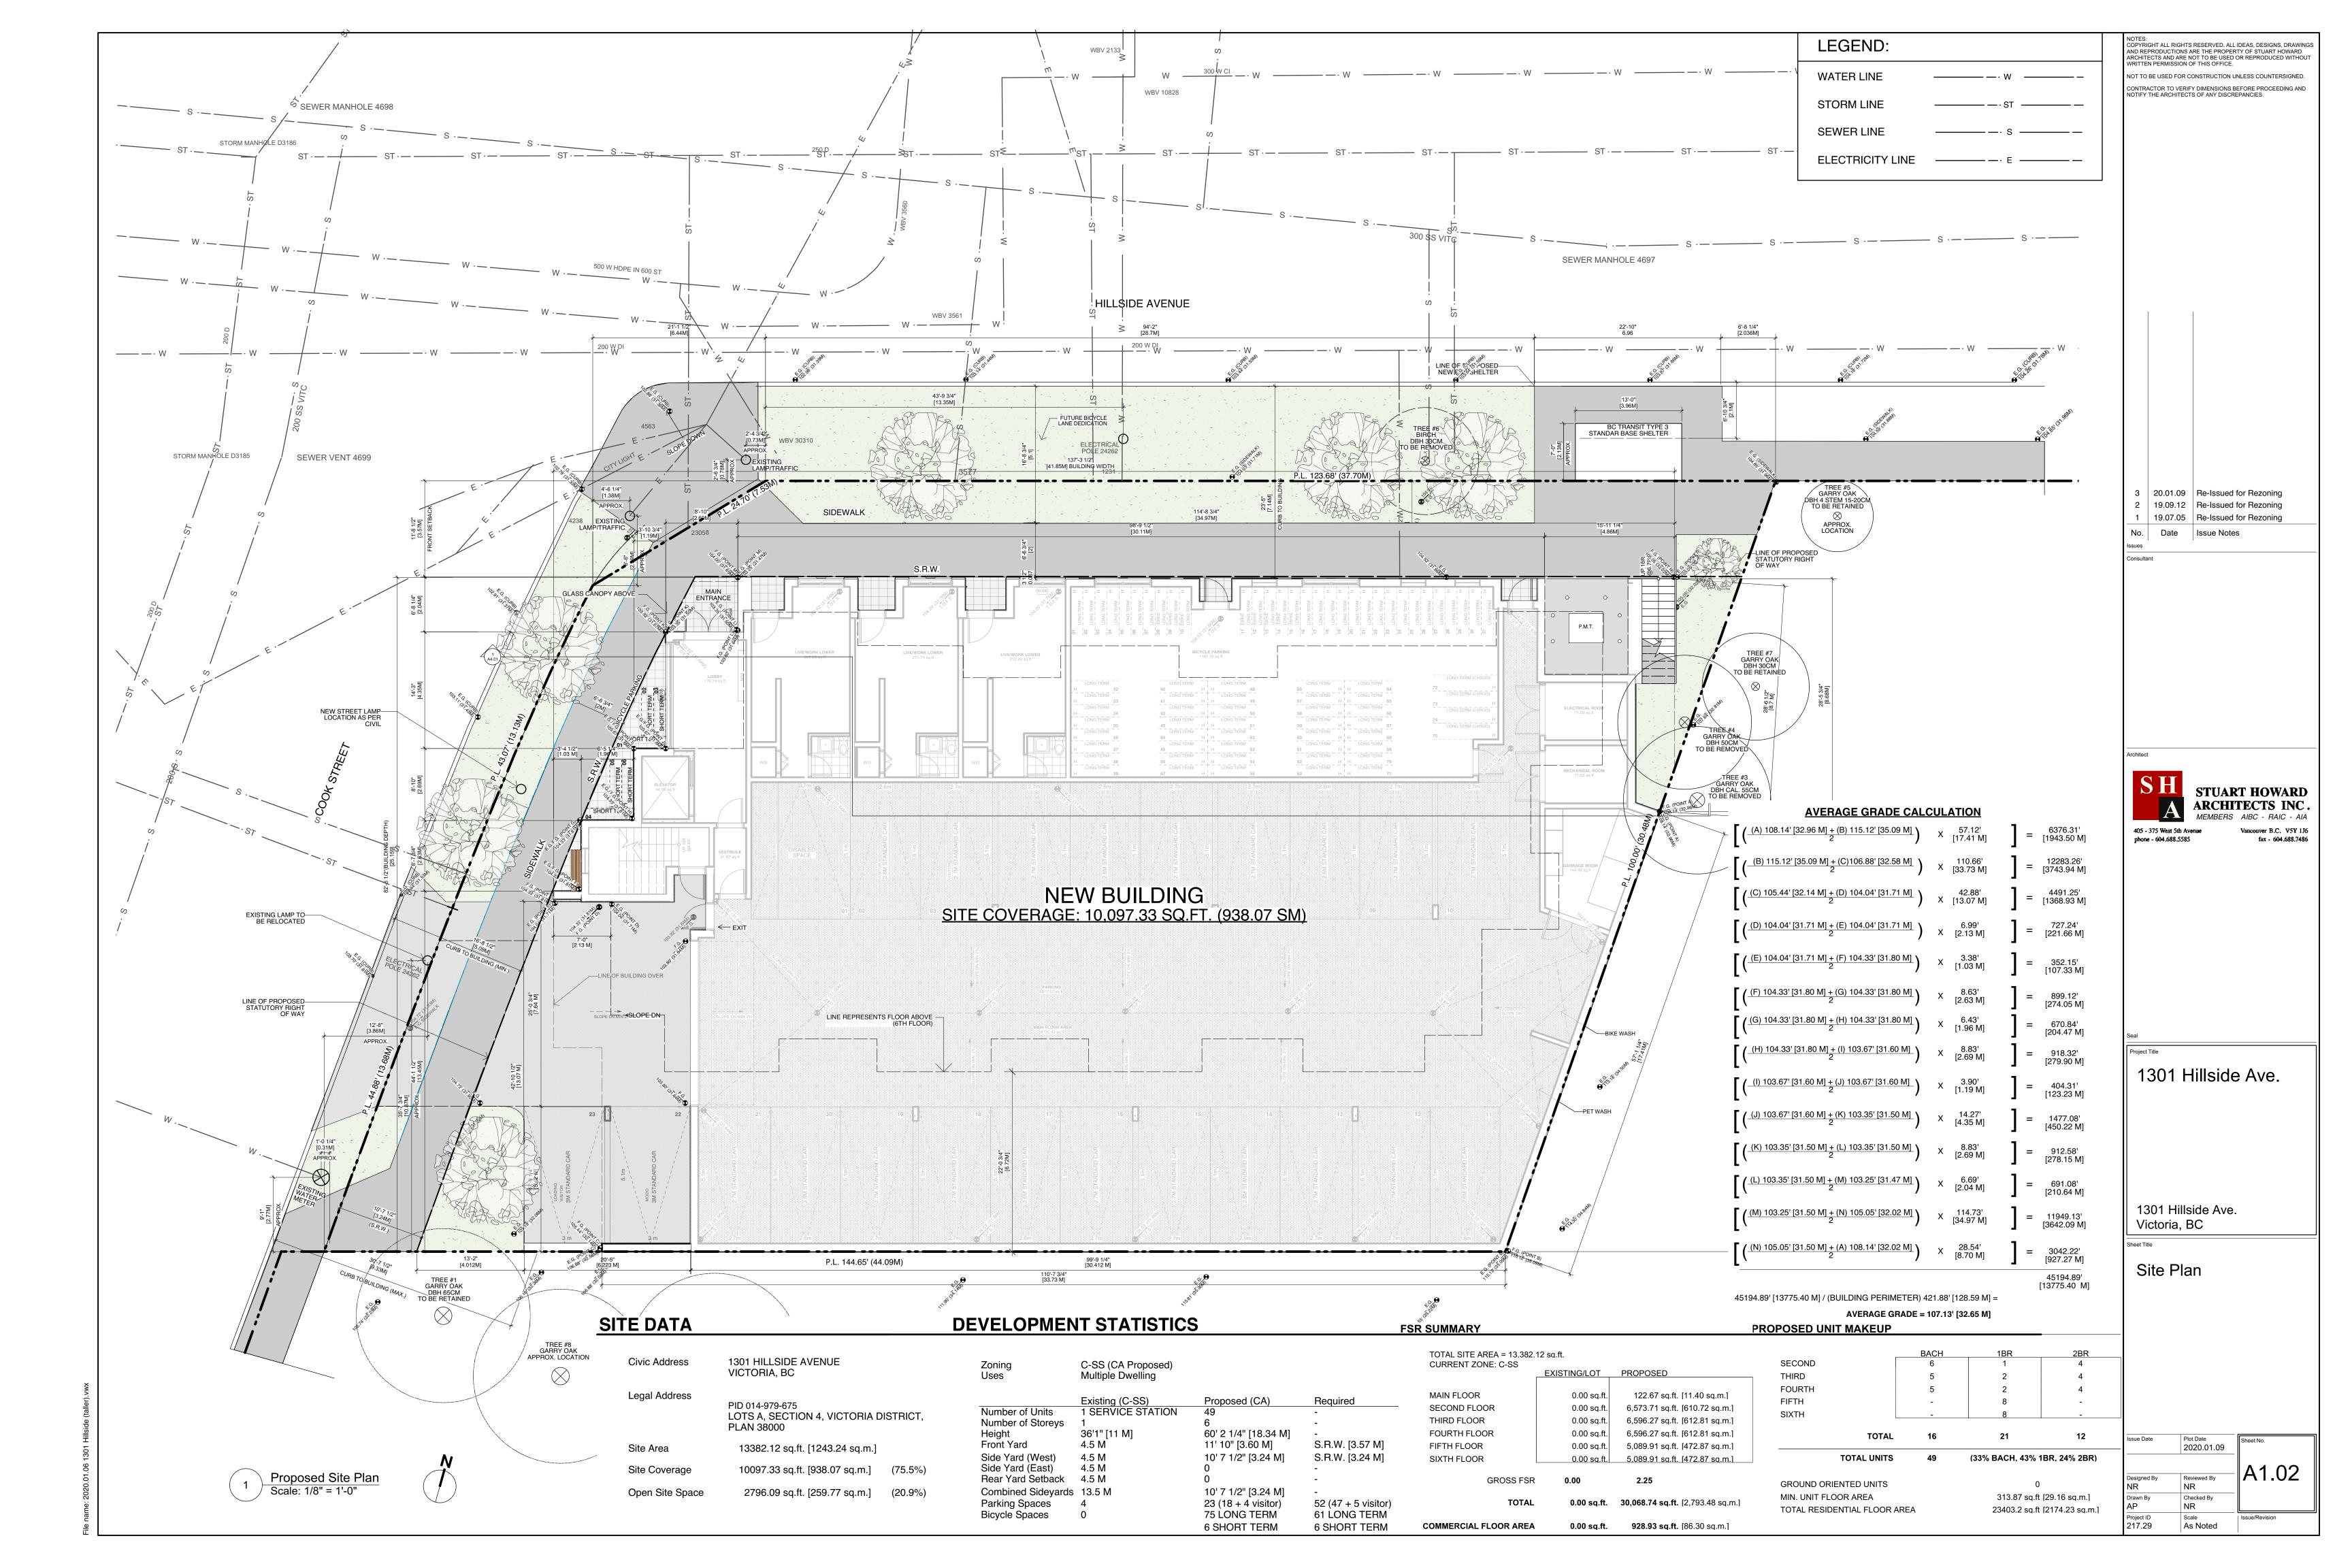


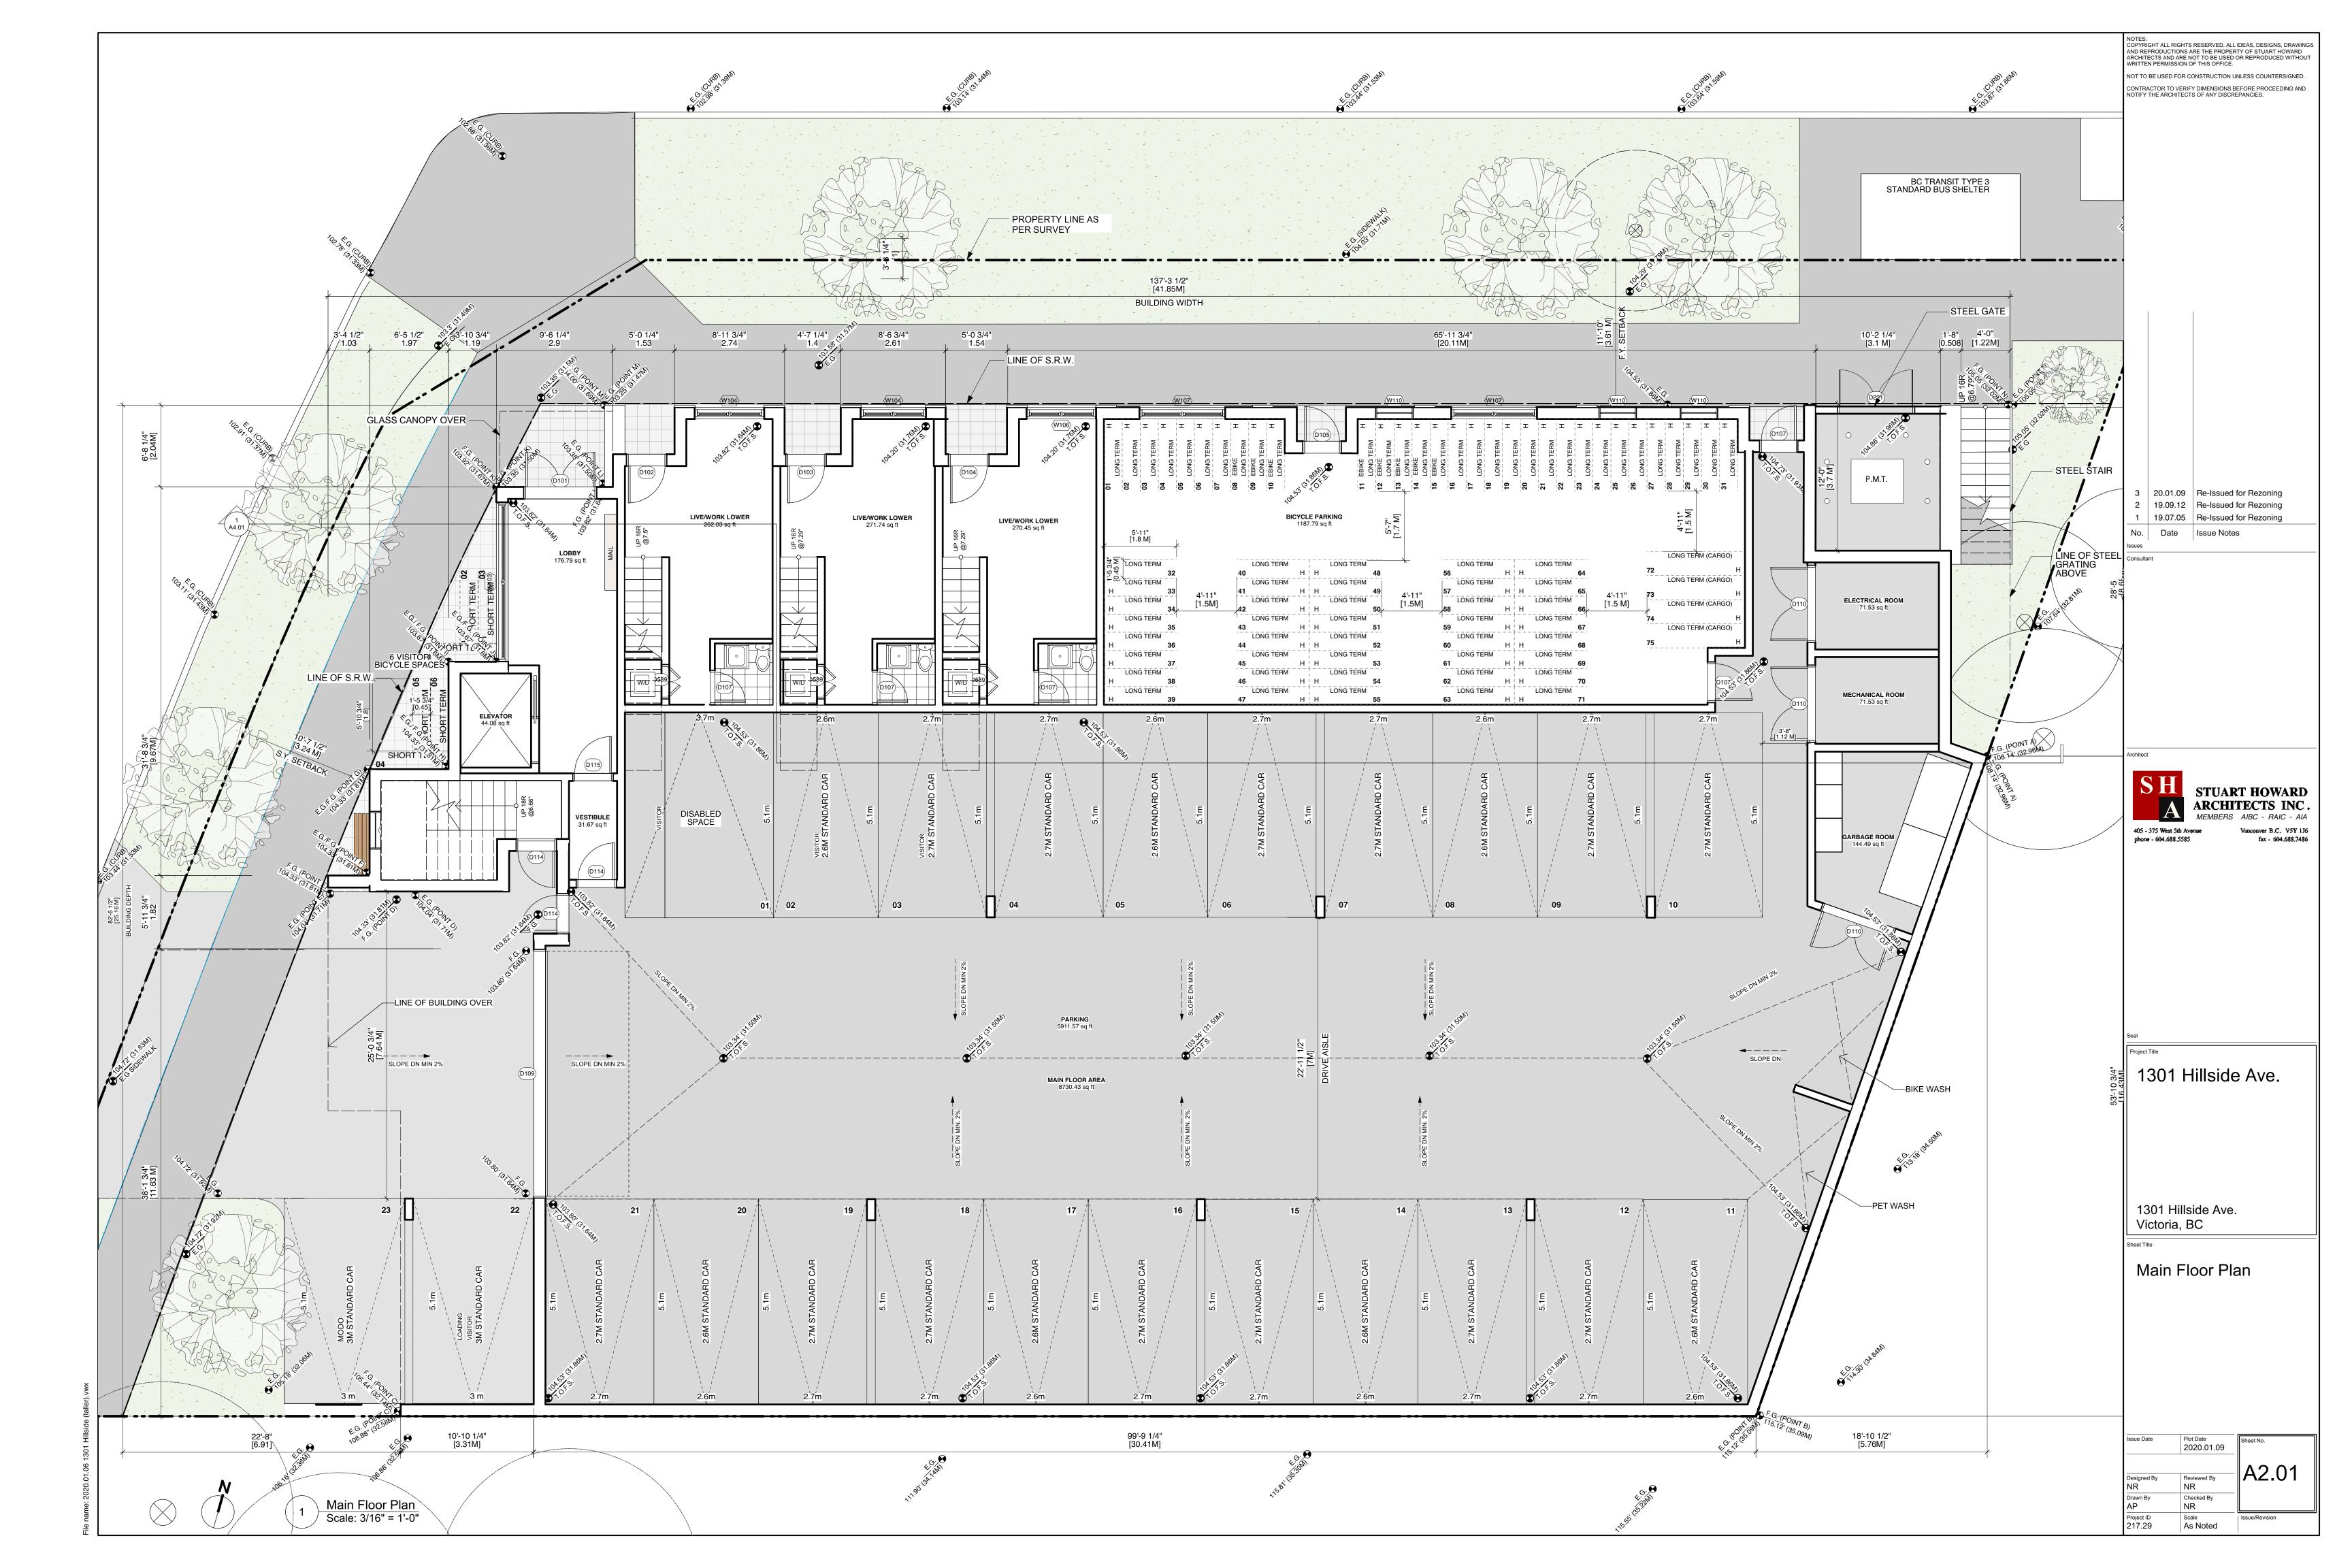









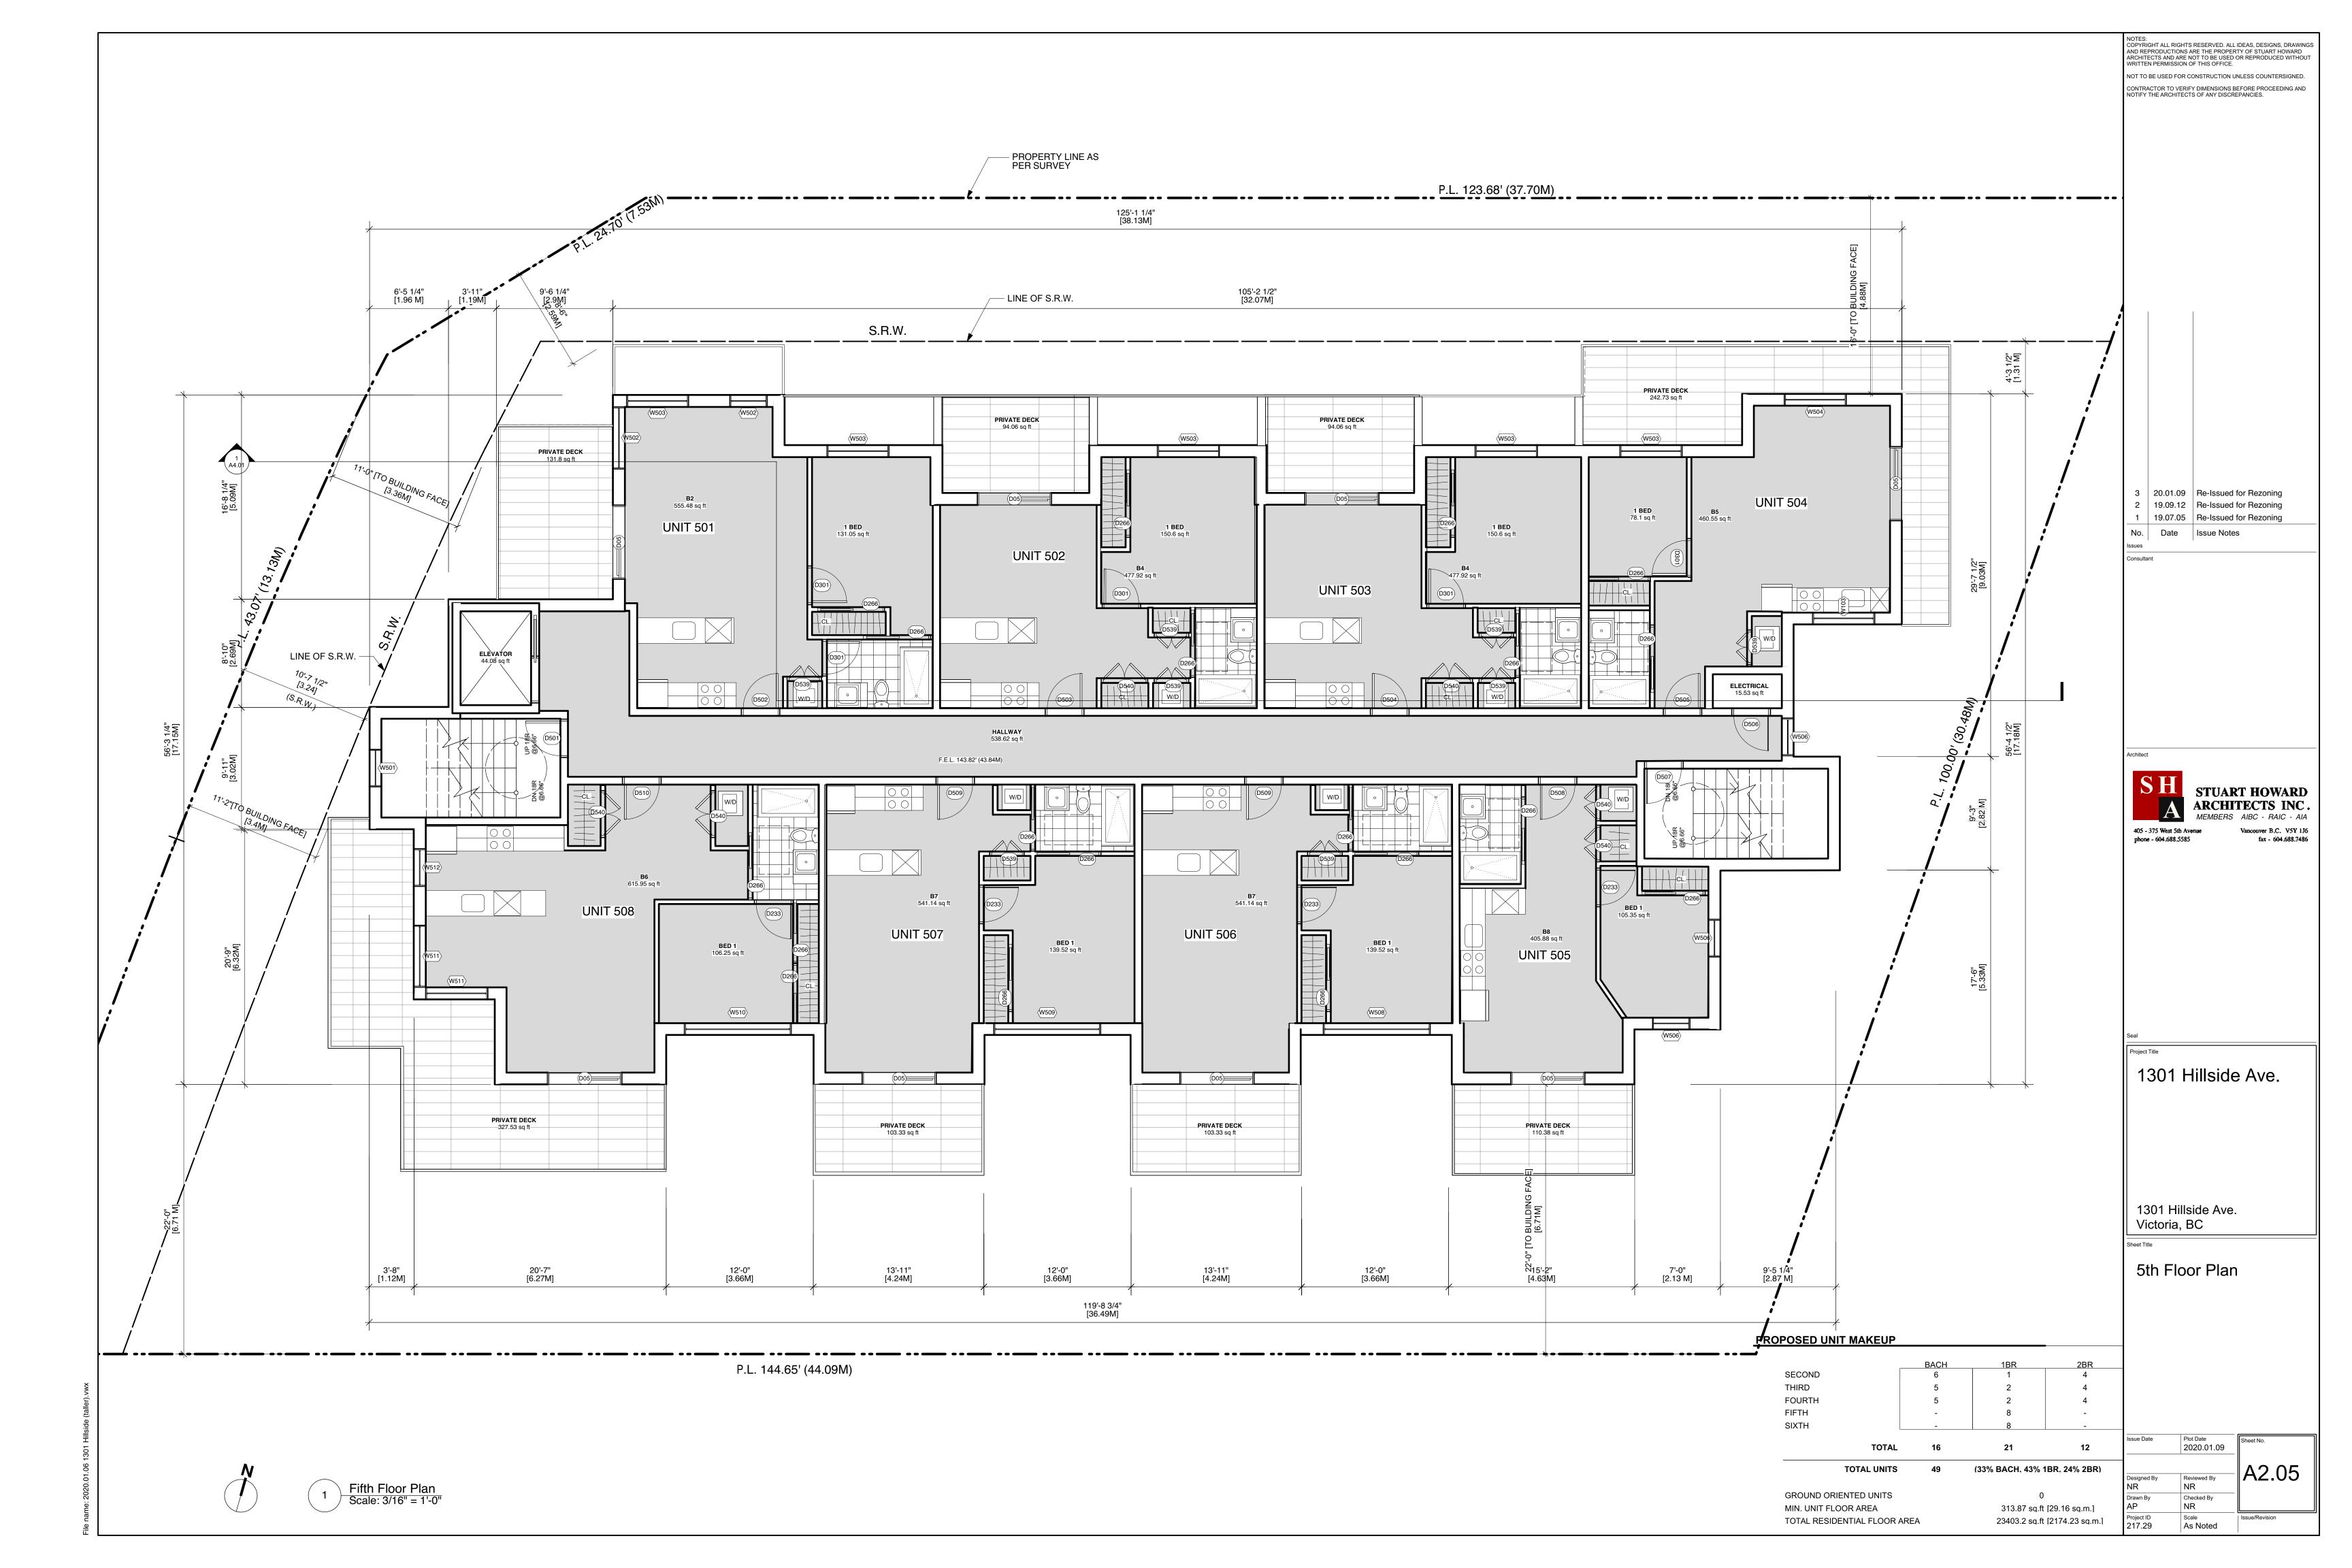

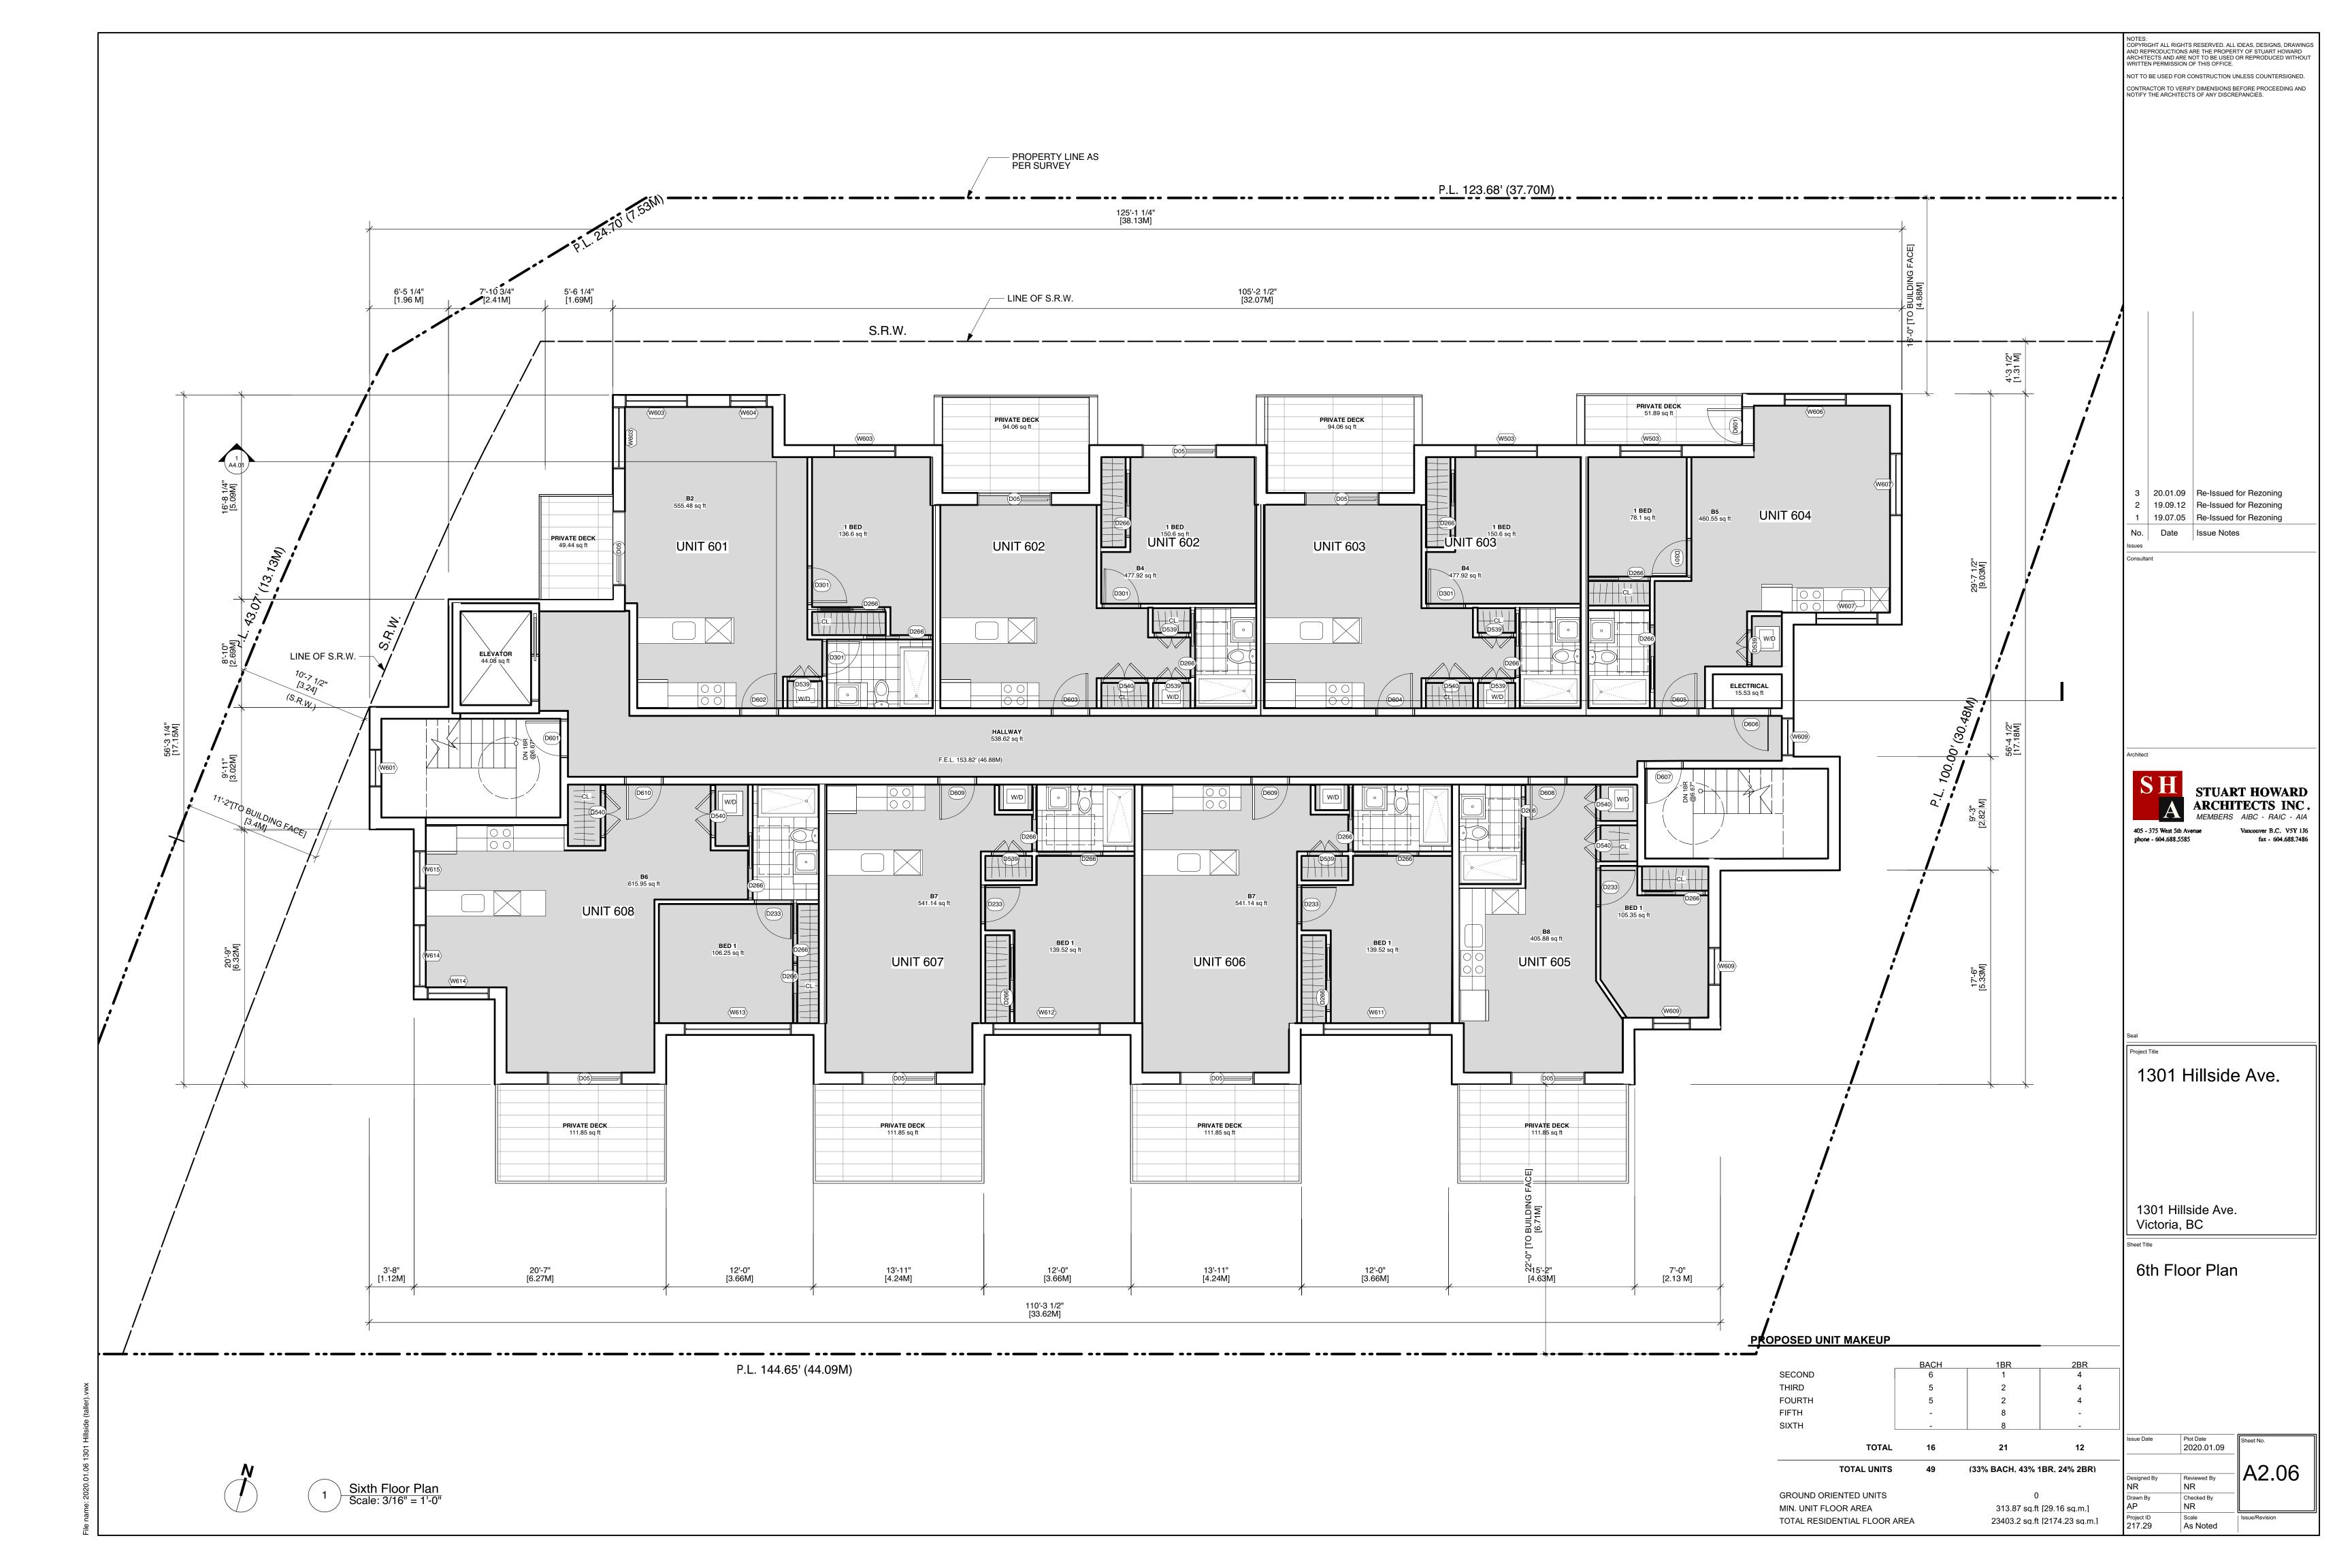

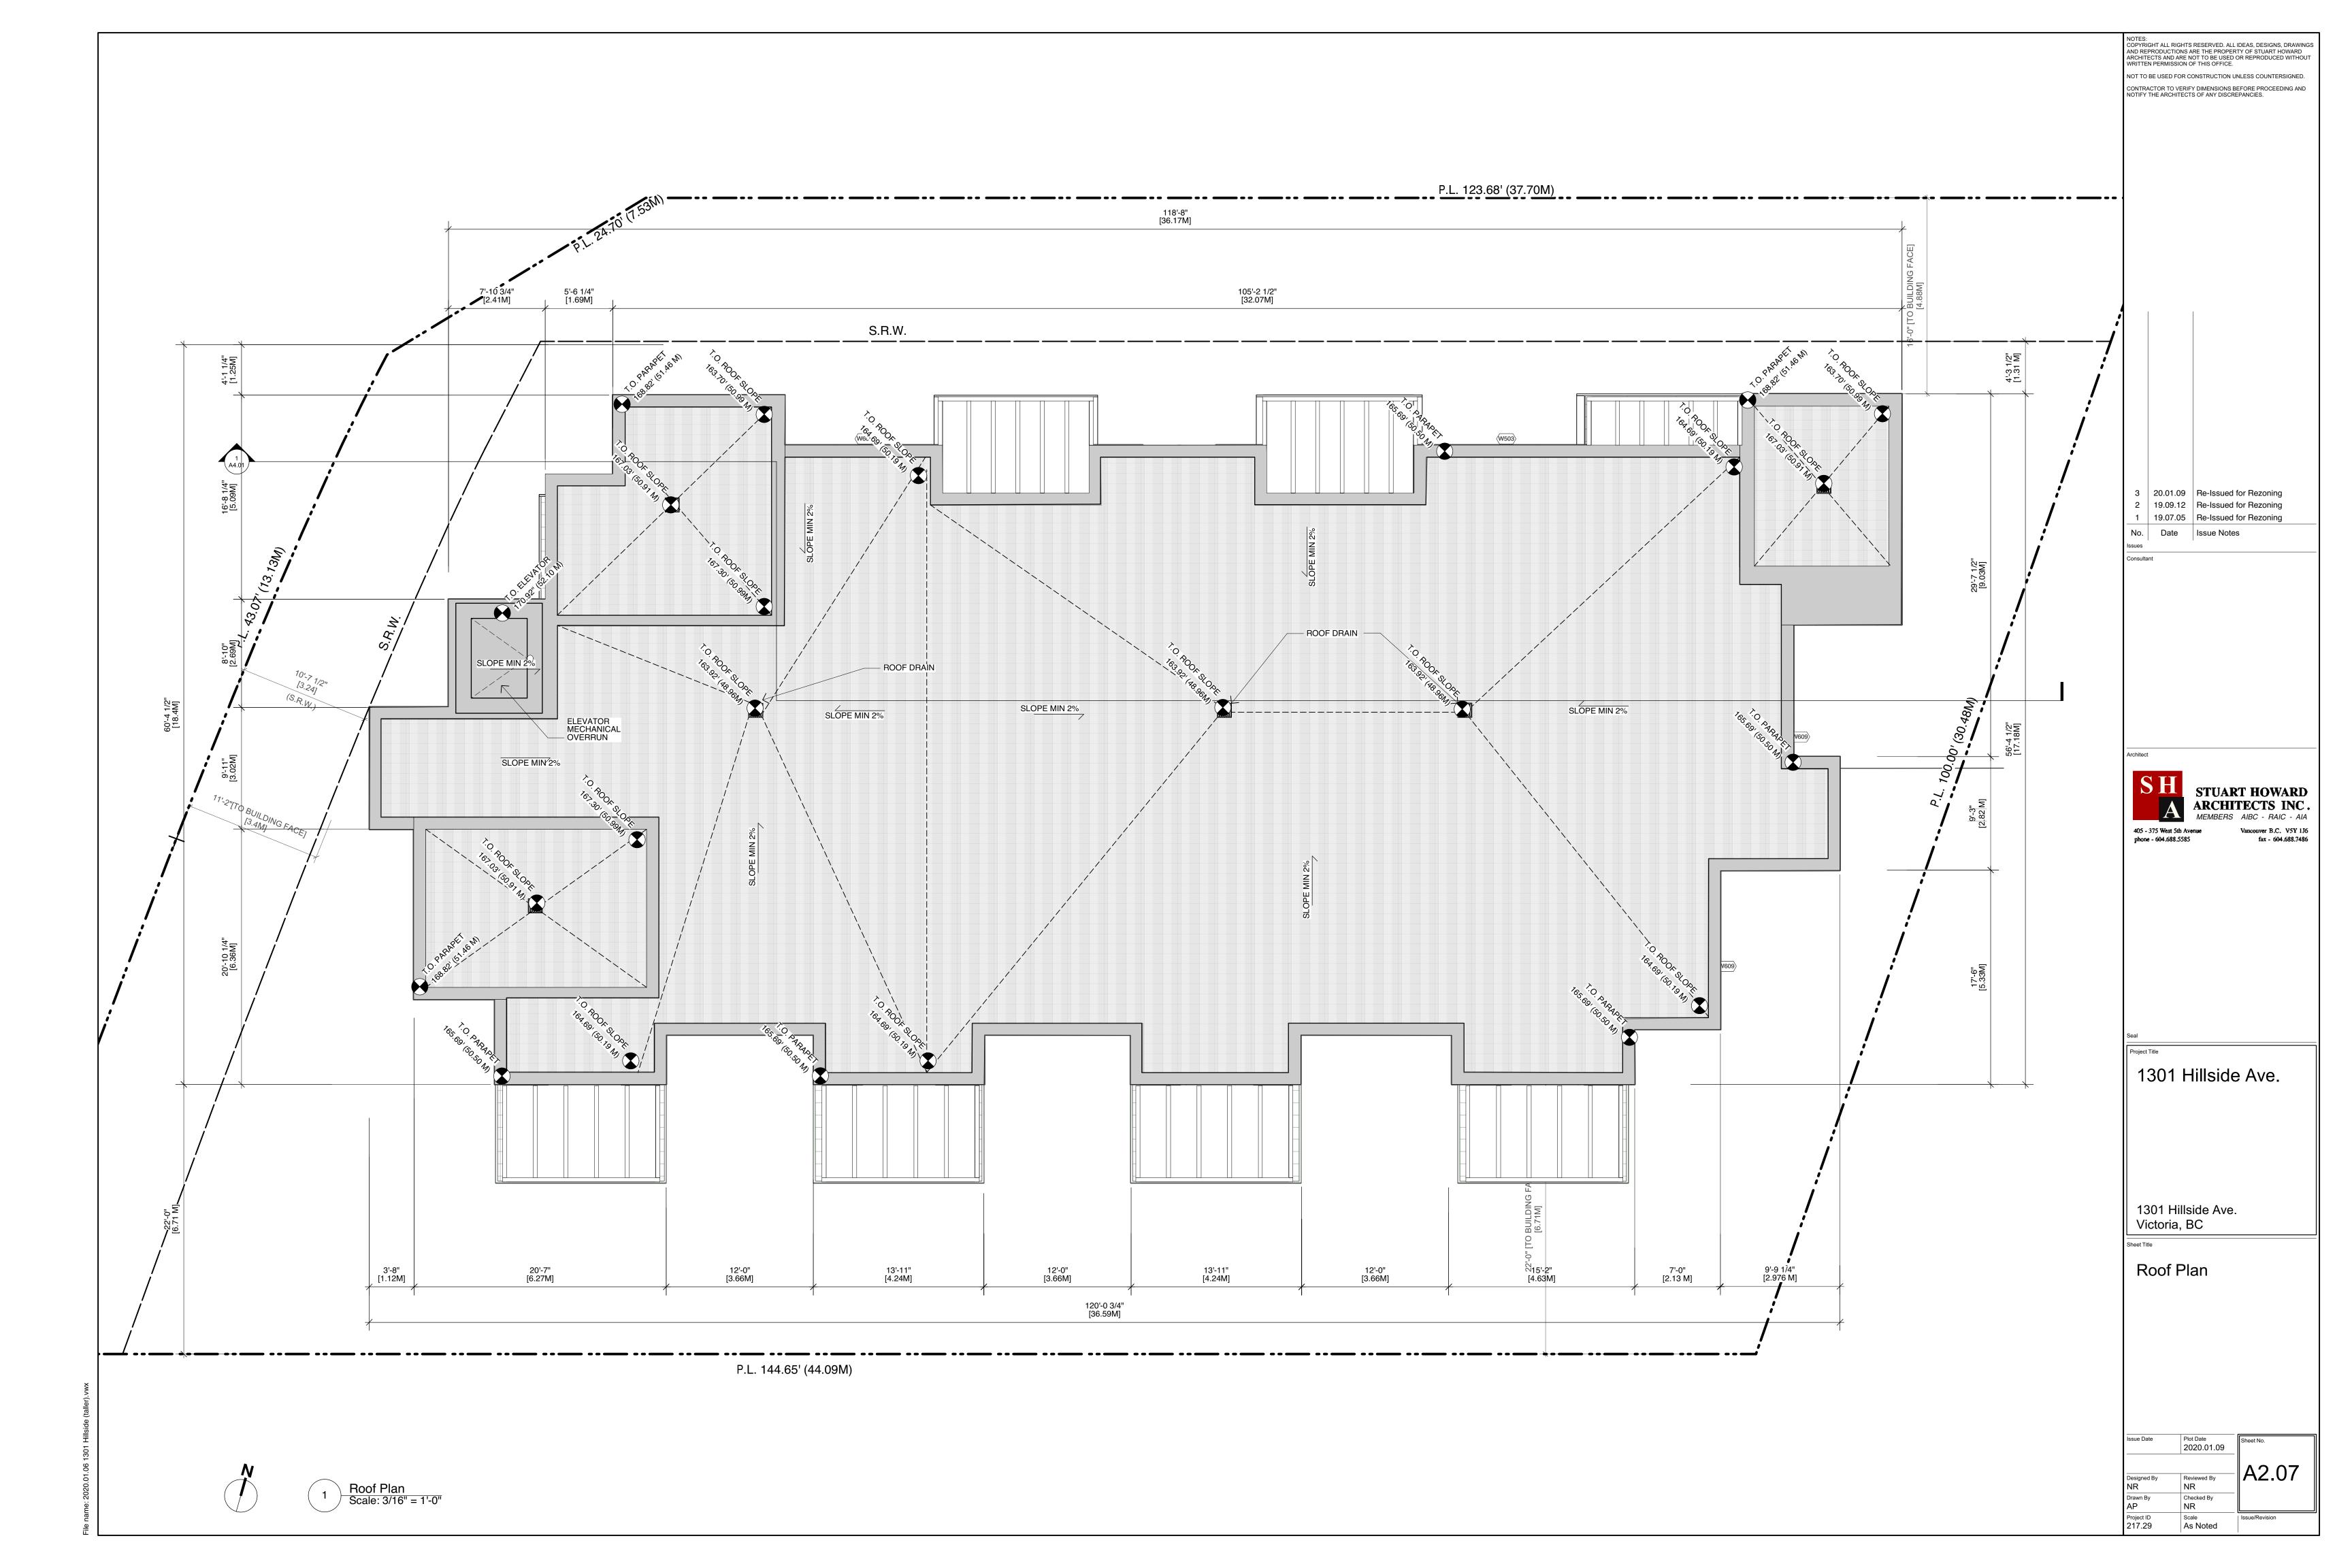










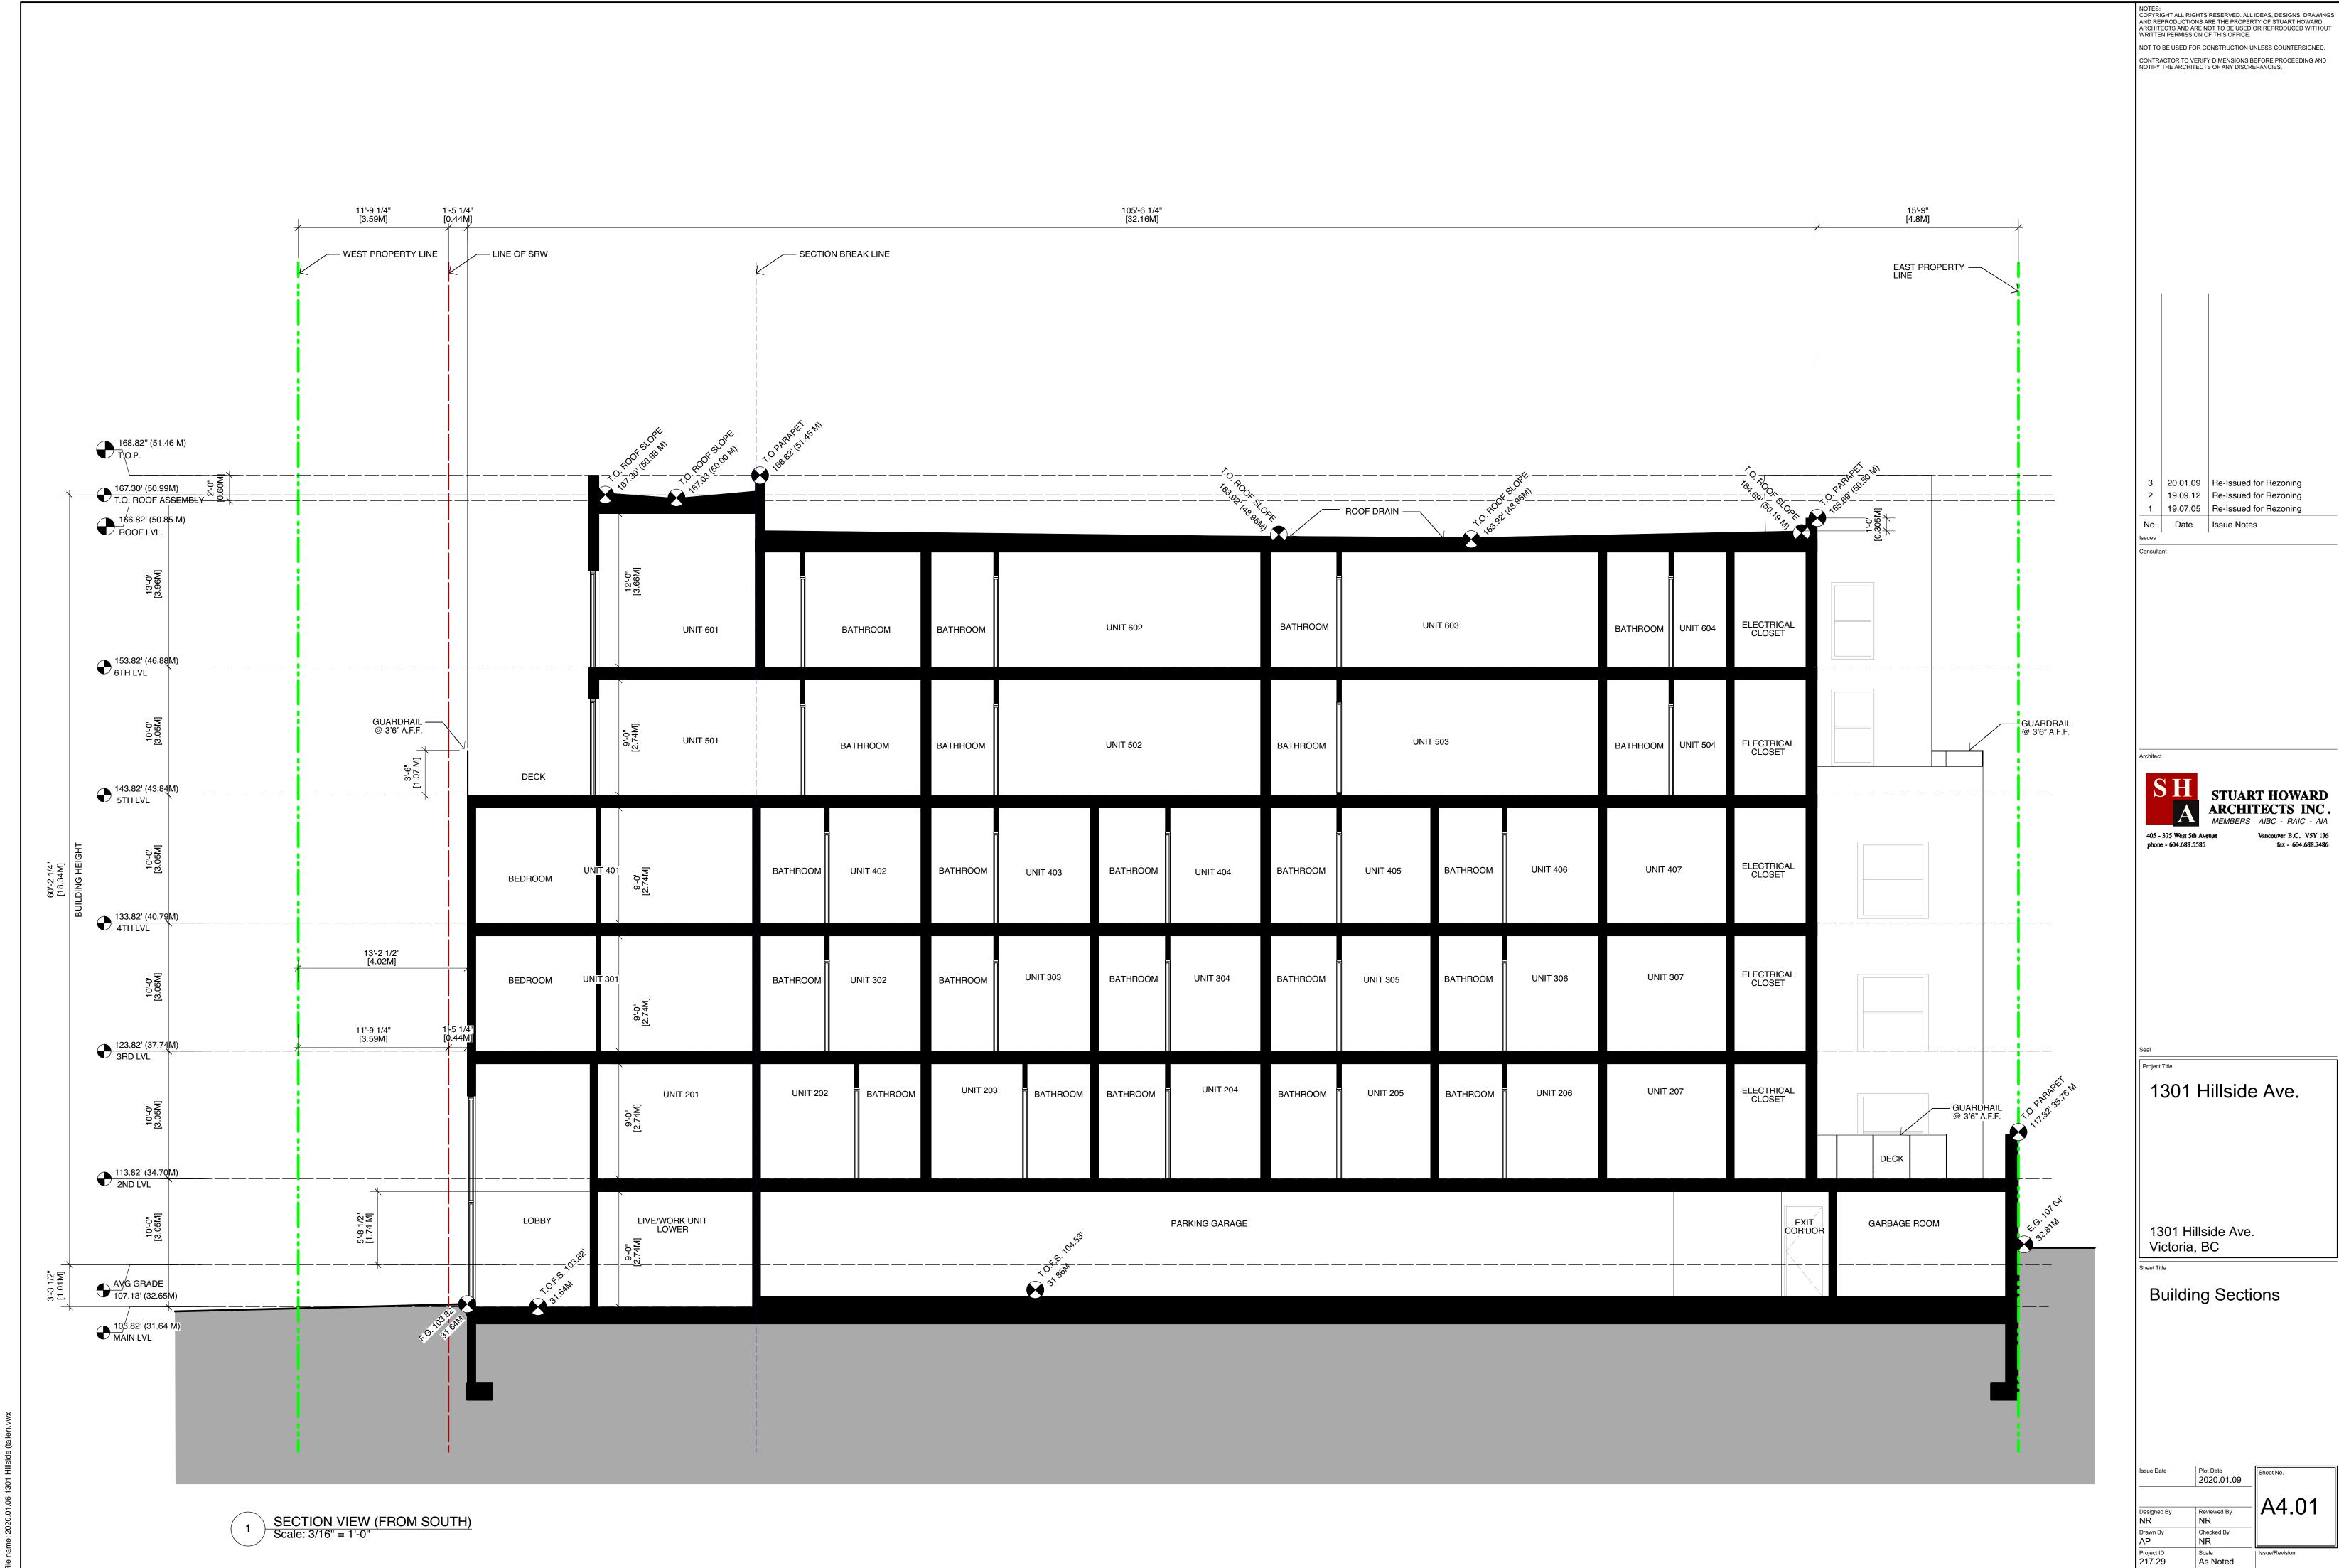





3 SW Corner - Aerial NTS



4 NE - Aerial NTS

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3 20.01.09 Re-Issued for Rezoning
2 19.09.12 Re-Issued for Rezoning
1 19.07.05 Re-Issued for Rezoning
No. Date Issue Notes

Consultant

Architect



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1301 Hillside Ave.

1301 Hillside Ave. Victoria, BC

Sheet Title

Drawn By
AP
Project ID
217.29

Perspectives

Plot Date 2020.01.09

Reviewed By NR
Checked By NR
Scale As Noted

Reviewed By NR
Issue/Revision

name: 2020.01.06 1301 Hillside (tal

2 NW Corner - Street Level NTS

1 NW Corner - Aerial NTS





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> 3 20.01.09 Re-Issued for Rezoning 2 19.09.12 Re-Issued for Rezoning 1 19.07.05 Re-Issued for Rezoning

No. Date Issue Notes

SH
STUART HOWARD
ARCHITECTS INC.

1301 Hillside Ave.

1301 Hillside Ave. Victoria, BC

Perspectives

Plot Date 2020.01.09

Scale As Noted

	HEDULE	WINDOW SPEC		Size		Window Data	3		
>					ħ				
QUANTITY	WINDOW NO.	WINDOW ID.		о.а. wіртн	O.A. Height				
	<u> </u>			_		Mfr	Model No.	Accessories	Notes
1	W	103 103		5'0" 13'0"	7'6" 4'0"	-	-		-
1	W	104		5'8" 5'4"	4'0" 4'0"	-	-		-
1		104		5'4"	4'0"	-	-		-
1	W	107		7'0"	4'0"	-	-		-
1		107 110		7'0" 3'0"	4'0" 7'6"	-	-		-
1	W	110		3'0"	7'6"				
1		110 110		3'0" 3'0"	7'6" 7'6"				
1	W	201		3'0"	7'6"				
1		204		13'0" 8'0"	7'6" 7'6"				
1	V	206		3'0"	7'6"				
1		207		3'0"	7'6"				
1 1		208		3'0" 5'0"	7'6" 7'6"				
1		209		5'0"	7'6"				
1	W	210 211		3'0" 5'0"	7'6" 7'6"				
1	W	213		7'0"	7'6"				
1		215 217		7'0" 7'0"	7'6" 7'6"				
1	W	218		5'0"	7'6"				
1	W	219 219		3'0" 3'0"	7'6" 7'6"				
1	W	220		5'0"	7'6"	<u>L</u>			<u>L</u>
1	W	223 224		8'8"	7'6"				
1	W	225		8'8" 8'8"	7'6" 7'6"	+	1		1
1	W	226 227		8'8"	7'6"				
1	W	228		5'0" 3'0"	7'6" 7'6"	+	1		+
1	W	228		3'0"	7'6"	1			
1	VA.	229 301		8'8" 3'0"	7'6" 7'6"	+	<u> </u>		
1	W	302		5'0"	7'6"				
1	W	303		3'0" 5'0"	7'6" 7'6"				
1	W	304 305 306		3'0"	7'6"				
1	W	306		8'8"	7'6"				
1	W	307 308		5'0" 5'0"	7'6" 7'6"				
1	W	308		5'0"	7'6"				
1	W	309 310		3'0" 5'0"	7'6" 7'6"				
1	W	312		8'8"	7'6"				
1	W W	312 312		8'8" 8'8"	7'6" 7'6"				
1	W	313		8'8"	7'6"				
1	W	314		8'8"	7'6"				
1	W	315 316		8'8" 5'0"	7'6" 7'6"				
1	W	317		3'0"	7'6"				
1	W	318 319		8'8" 3'0"	7'6" 7'6"				
1	W	401		3'0"	7'6"				
1	W W	402		5'0" 3'0"	7'6" 7'6"				
1	W	404		5'0"	7'6"				
1	W	405		3'0" 8'8"	7'6" 7'6"				
1	W	407		5'0"	7'6"				
1	W	408 409		5'0" 5'0"	7'6" 7'6"				
1	W	410		3'0"	7'6"				
1	W	411		5'0"	7'6"				
1	W	413		8'8" 8'8"	7'6" 7'6"				
1	W	413		8'8"	7'6"				
1	W.	414 415		8'8" 8'8"	7'6" 7'6"	+	-		-
1	W	416		8'8"	7'6"				
1	W	417 418		5'0" 3'0"	7'6" 7'6"				
1	W	419		8'8"	7'6"	<u> </u>			
1	W	420 501		3'0" 3'0"	7'6" 7'6"				
1	W	502		5'0"	7'6"				
1	W	502 503		3'0" 5'0"	7'6" 7'6"				
1	W	503		5'0"	7'6"	<u> </u>			L
1	W	503		5'0"	7'6"				
1	W W	503 503		5'0" 5'0"	7'6" 7'6"	+	1		1
1	W	503 503		5'0"	7'6"				
1	W	503 504		5'0" 5'0"	7'6" 7'6"	+			
1	W	506		3'0"	7'6"				
1	VA.	506 506		3'0" 3'0"	7'6" 7'6"	+			
1	W	506 508		8'8"	7'6"				
1	W	509 510		8'8" 8'8"	7'6"				
1	W	511		8'8" 5'0"	7'6" 7'6"				
1	W	511		5'0"	7'6"				
1	W	512 601		3'0" 3'0"	7'6" 7'6"	1	1		
1	W	603		5'0"	7'6"				
1	V NA	603 603		5'0" 5'0"	7'6" 7'6"	+	1		
1	W	604		3'0"	7'6"				
1	W	606		5'0"	7'6"				
1	W	607 607		5'0" 5'0"	7'6" 7'6"	<u> </u>	<u>L</u>		<u>L</u> _
1	W	609		3'0"	7'6"				
1	W.	609 609		3'0" 3'0"	7'6" 7'6"	+	<del> </del>		<del>                                     </del>
1	W	611		8'8"	7'6"				
1	W	612		8'8" 8'8"	7'6" 7'6"				
1	W	613 614		8'8" 5'0"	7'6" 7'6"	+			
1		614	i	5'0"	7'6"	1	İ	1	1

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ARCHITECTS INC.
MEMBERS AIBC - RAIC - AIA 405 - 375 West 5th Avenue phone - 604.688.5585 Vancouver B.C. V5Y 1J6 fax - 604.688.7486 1301 Hillside Ave. 1301 Hillside Ave. Victoria, BC Window Schedule Plot Date 2020.01.09

A8.01

Reviewed By
NR
Checked By
NR
Scale
As Noted

name: 2020.01.06 1301 Hillside (taller).vwx

	CHEDULE DOOR SPE	C.			NO	OMINAL SIZ	<u>E</u>	DOOF	STYLE	DOOR	H/	ARDWARE DESCRIP	TION
QUANTITY		DOOR NO.	DOOR NO.	OR TYPE	F WIDTH	F HEIGHT	THICKNESS						
184 0	Door Name	184	184	O DOOR	709	1291	24	Door Operation	Slab Style	JAMB THICK	JAMB DEPTH	Accessories	Notes
1 1		D D	107		3	7	0 0	Swing Simple Swing Simple		0 0	1 1		0
1 1		D D	101		6 3	8 7	0	Swing Bi-part Swing Simple		0	1 1		
1 1		D	115		3	7	0	Swing Simple Swing Simple		0	1 1		
1 1		D D	104 539		3	7	0	Swing Simple Swing Bi-part		0	1 1		
1 1		D D	539 539		3	7	0	Swing Bi-part Swing Bi-part		0	1 1		
1 1		D D	110		6	7	0	Swing Bi-part Swing Bi-part		0	1 1		
1 1		D	107		3	8	0	Swing Simple Swing Simple		0	0		
1 1		D D	107		3	8	0	Swing Simple Swing Simple		0	0		
1 1		D D	110		6 3	7	0	Swing Bi-part Swing Simple		0	1 1		
1 1		D D	109		20	7	0	Overhead Swing Simple		0	1 1		
1 1		D D	107		3 6	7	0	Swing Simple Swing Bi-part		0	1 1		
1 1		D	115		3	7	0	Swing Simple Swing Simple		0	1 1		
1 1		D D	115 115		3	7	0	Swing Simple Swing Simple		0	1 1		
1 1		D D	115 106		3	7	0	Swing Simple Swing Simple		0	1 1		
1 1		D D	115 219		3	7	0	Swing Simple Swing Simple		0	1 0		
1 1		D D	218 214		3	7	0	Swing Simple Swing Simple		0	0		
1 1		D D	216 215		3 4	7	0	Pocket Simple Slider		0	0		
1 1		D D	217 220		3 4	7	0	Swing Bi-part Slider		0	0		
1 1		D D	264 267		3	7	0	Swing Simple Swing Simple		0	0		
1 1		D D	266 260		3	7	0	Pocket Simple Swing Simple		0	0		
1 1		D D	265 268		4 4	7	0	Slider Slider		0	0		
1 1		D D	263 262		4 3	7	0	Slider Swing Bi-part		0	0		
1 1		D D	261 202		3	7	0	Pocket Simple Swing Simple		0	0		
1 1		D D	204		3	7	0	Swing Simple Swing Simple		0	1 1		
1 1		D D	205		3	7	0	Swing Simple Swing Simple		0	1 1		
1 1		D D	206		3	7	0	Swing Simple Swing Simple		0	1 1		
1 1		D D	209		3	7	0	Swing Simple Swing Simple		0 0	1 1		
1 1		D D	215 216		3	7	0	Swing Simple Swing Simple		0	1 1		
1 1		D D	212 05		3 6	7 8	0	Swing Simple Slider	-	0 0	1 1		-
1 1		D D	05 05		6	8	0	Slider Slider	-	0 0	1 1		-
1 1		D D	201 05		3 6	7 8	0	Swing Simple Slider	-	0 0	1 1		-
1 1		D D	05 210		6 3	8 7	0	Slider Swing Simple	-	0	1 1		-
1 1		D D	211 05		3	7 8	0	Swing Simple Slider	-	0	1		-
1 1		D D	222 218		3	7	0	Swing Simple Swing Simple		0	1 1		
1		D D	219 221		3	7	0	Swing Simple Swing Simple		0	1 1		
1		D D	05 05		7	8	0	Slider Slider	-	0	1 1		-
1 1		D D	05 305		7 3	8	0	Slider Swing Bi-part	-	0	1 0		-
1 1		D D	303 302		4 3	7	0	Slider Swing Simple		0	0		
1 1		D D	304 366		3	7	0	Pocket Simple Swing Simple		0	0		
1 1		D D	369 367		3	7	0	Swing Simple Pocket Simple		0	0		
1 1		D D	368 370		4	7	0	Slider Slider		0	0		
1		D D	365 364		4 3	7	0	Slider Swing Bi-part		0	0		
1		D D	361 362		3	7 7	0	Pocket Simple Swing Simple		0	0		
1		D D	334 328		4 3	7 7	0	Slider Swing Simple		0	0		
1		D D	332 333		3	7	0	Swing Simple Pocket Simple		0	0		
1 1		D D	329 331		3 4	7	0	Swing Bi-part Slider		0	0		
1 1		D D	330 336		3	7	0	Pocket Simple Swing Simple		0	0		
1 1		D D	337 301		4 3	7	0	Slider Swing Simple		0	0		
1 1		D D	05 05		6 6	8	0	Slider Slider	-	0	1 1		-
1 1		D D	05 301		6 3	8 7	0	Slider Swing Simple	-	0	1 1		-
1 1		D D	315 314		3	7	0	Swing Simple Swing Simple		0	1 1		
1 1		D D	313 311		3	7	0	Swing Simple Swing Simple		0	1 1		
1 1		D D	302 308		3	7	0	Swing Simple Swing Simple		0	1 1		
1		D D	307 306		3	7	0	Swing Simple Swing Simple		0	1		
1		D D	305 304		3	7	0	Swing Simple Swing Simple		0	1		
1		D D	303 309		3	7	0	Swing Simple Swing Simple		0	1		
1		D D	05 05		7	8	0	Slider Slider	-	0	1		-
1		D D	05 05		7	8	0	Slider Slider	-	0	1		-
1		D D	05 05		7	8	0	Slider Slider	-	0	1 1		-
1		D D	301 310		3	7	0	Swing Simple Swing Simple		0	1 1		
1 1		D D	401 416		3	7	0	Swing Simple Swing Simple		0	1 1		
1 1		D D	05 05		6 6	8	0	Slider Slider	-	0	1		-
1 1	=-	D D	05 301		6 3	8 7	0	Slider Swing Simple	-	0	1 1		-
1 1		D D	402 408		3	7	0	Swing Simple Swing Simple		0	1 1		
1 1		D D	407 406		3	7	0	Swing Simple Swing Simple		0	1		
1 1		D D	405 404		3	7	0	Swing Simple Swing Simple		0	1 1		
1 1		D D	403 409		3	7	0	Swing Simple Swing Simple		0 0	1 1		
1 1		D D	05 05		6	8	0	Slider Slider	-	0	1 1		-
1 1		D D	05 05		6	8	0	Slider Slider	-	0	1 1		-
1 1		D D	05 05		6	8	0	Slider Slider	-	0	1 1		-
1 1		D D	415 414		3	7	0	Swing Simple Swing Simple		0	1 1		
1		D D	413		3 3	7 7	0	Swing Simple Swing Simple Swing Simple		0 0	1 1		
1 1		D D	411 410 501		3 3	7 7	0 0	Swing Simple Swing Simple Swing Simple		0 0	1 1		
1 1		D D	05 05		6 6	8	0 0	Slider Slider	-	0 0	1 1		-
1 1		D D	510 509		3 3	7	0 0	Swing Simple Swing Simple		0 0	1 1		
1		D D	509 508 509		3	7 7	0 0	Swing Simple Swing Simple Swing Simple		0 0	1 1		
1		ן ט		1 1	3	1	, U	LOWING ONLINE	1	, U			i i
1 1 1		D D	505 504		3	7	0	Swing Simple Swing Simple		0	1 1		

			 			1	1			
1	D	05	6	8	0	Slider	-	0	1	-
1	D	05	6	8	0	Slider	-	0	1	-
1	D	507	3	7	0	Swing Simple		0	1	
1	D	05	6	8	0	Slider		0	1	-
1	D	05	6	8	0	Slider	=	0	1	-
1	D	05	6	8	0	Slider	-	0	1	-
1	D	05	6	8	0	Slider	-	0	1	-
1	D	601	3	7	0	Swing Simple		0	1	
1	D	05	6	8	0	Slider		0	1	-
1	D	610	3	7	0	Swing Simple		0	1	
1	D	609	3	7	0	Swing Simple		0	1	
1	D	608	3	7	0	Swing Simple		0	1	
1	D	609	3	7	0	Swing Simple		0	1	
1	D	605	3	7	0	Swing Simple		0	1	
1	D	604	3	7	0	Swing Simple		0	1	
1	D	603	3	7	0	Swing Simple		0	1	
1	D	606	3	7	0	Swing Simple		0	1	
1	D	602	3	7	0	Swing Simple		0	1	
1	D	601	3	7	0	Swing Simple		0	1	
1	D	607	3	7	0	Swing Simple		0	1	
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1	D	05	6	8	0	Slider	-	0	1	-
1	D	05	6	8	0	Slider	-	0	1	-
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1	D	05	6	8	0	Slider	-	0	1	-
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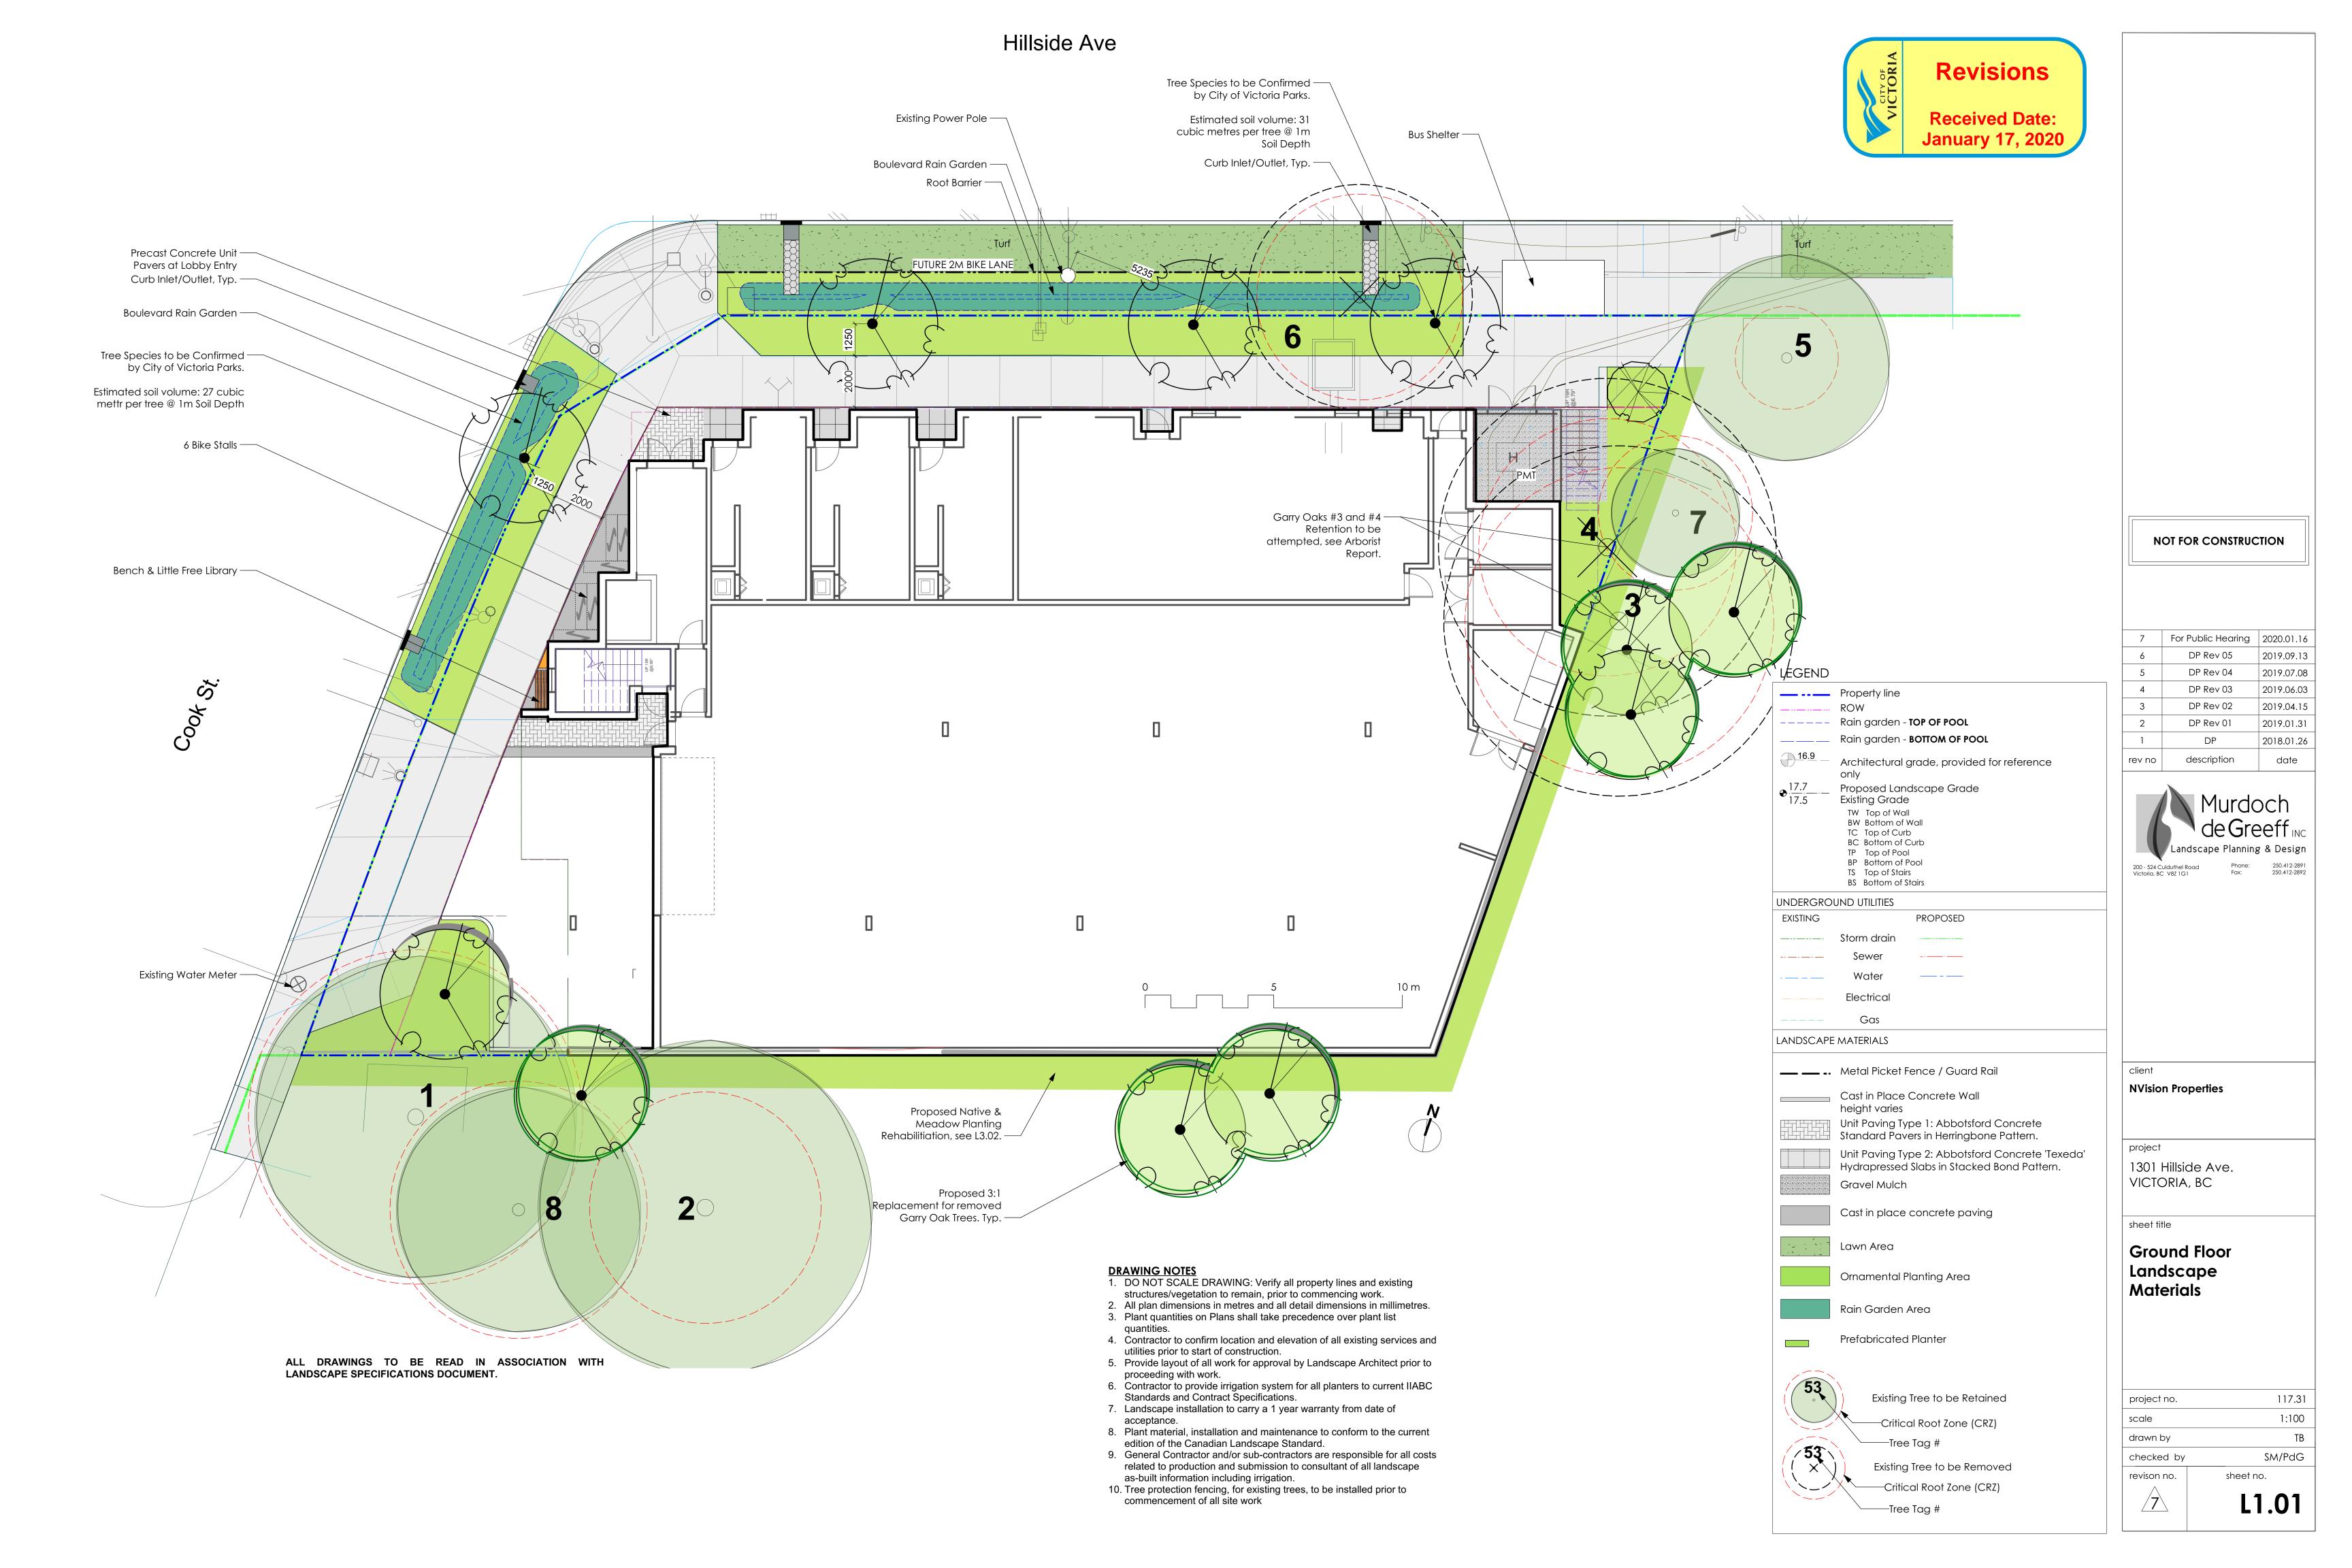
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STUART HOWARD
ARCHITECTS INC.
MEMBERS AIBC - RAIC - AIA 405 - 375 West 5th Avenue phone - 604.688.5585 Vancouver B.C. V5Y 1J6 fax - 604.688.7486 1301 Hillside Ave. 1301 Hillside Ave. Victoria, BC Door Schedule Plot Date 2020.01.09

A8.02

Designed By
NR
Drawn By
AS
Project ID
217.29

Scale As Noted

ıame: 2020.01.06 1301 Hillside (taller).vw›





NOT FOR CONSTRUCTION

7	For Public Hearing	2020.01.16
6	DP Rev 05	2019.09.13
5	DP Rev 04	2019.07.08
4	DP Rev 03	2019.06.03
3	DP Rev 02	2019.04.15
2	DP Rev 01	2019.01.31
1	DP	2018.01.26
ev no	description	date



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**NVision Properties** 

project


1301 Hillside Ave. VICTORIA, BC

sheet title

Second Floor Landscape Materials

project no.	117.31
scale	1:100
drawn by	TB
checked by	SM/PdG
revison no.	sheet no.
7	L1.02



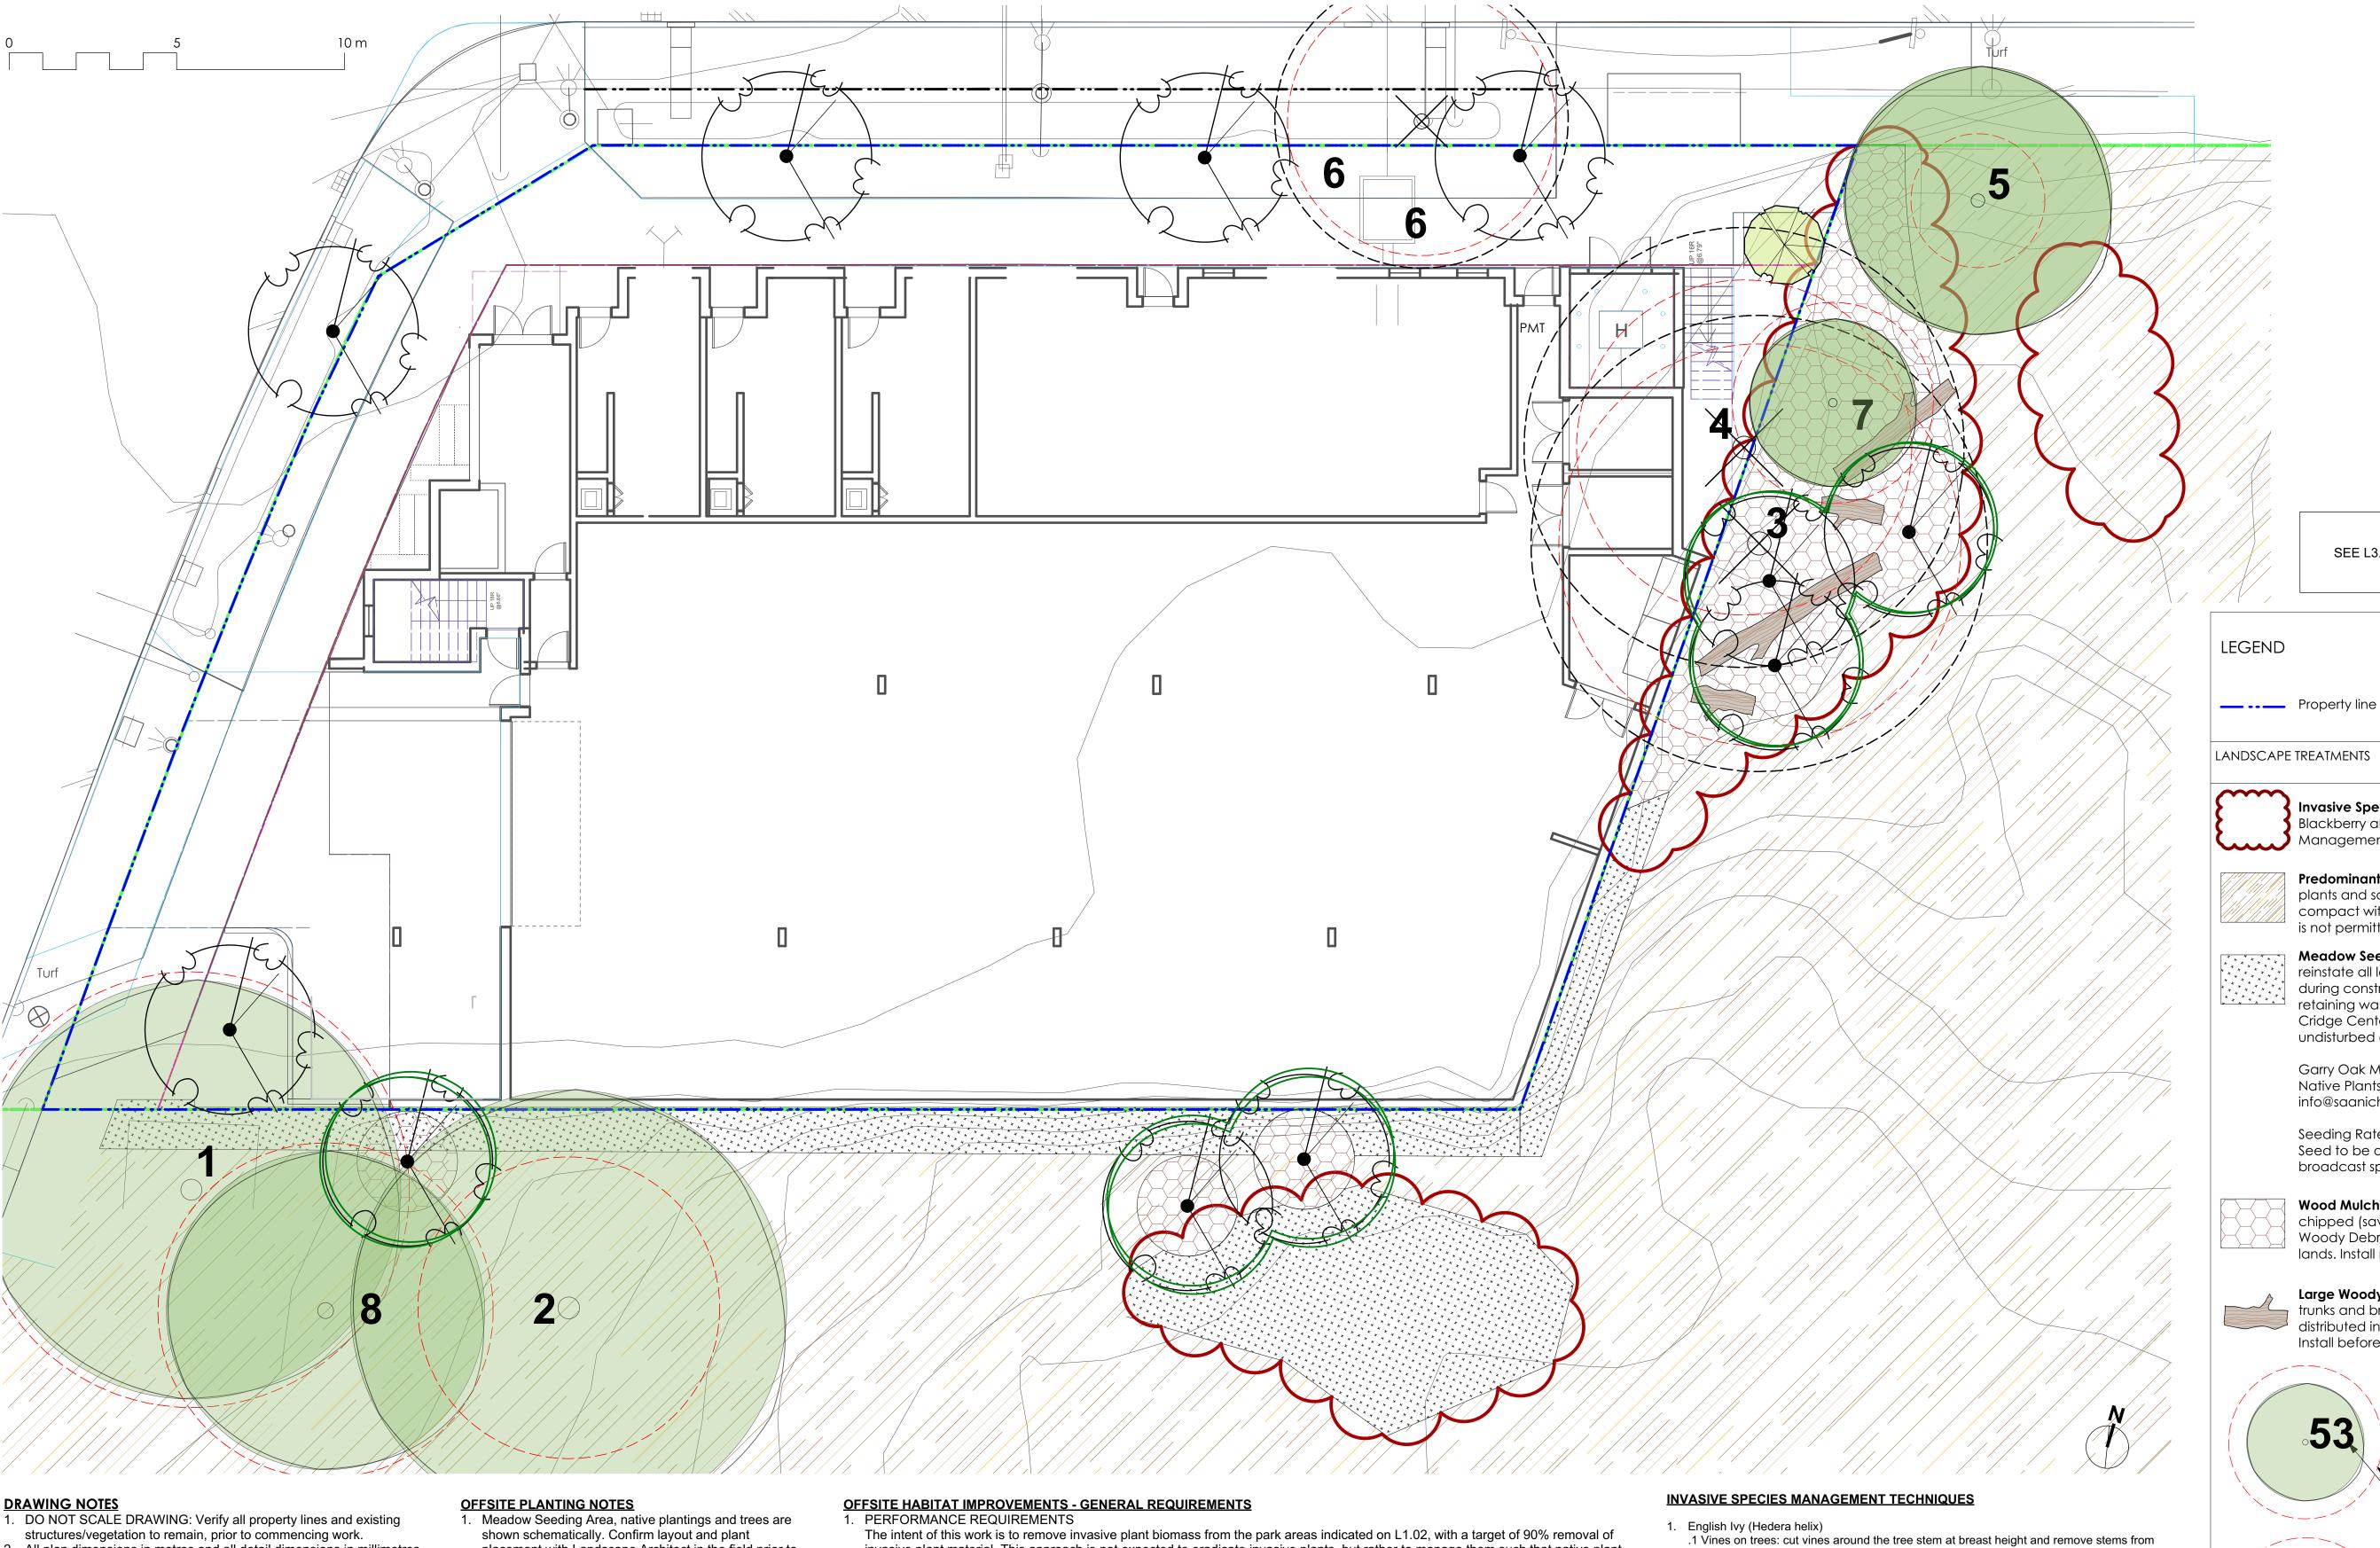

quantities.

- 2. All plan dimensions in metres and all detail dimensions in millimetres. 3. Plant quantities on Plans shall take precedence over plant list
- 4. Contractor to confirm location and elevation of all existing services and
- utilities prior to start of construction. 5. Provide layout of all work for approval by Landscape Architect prior to
- proceeding with work. 6. Contractor to provide irrigation system for all planters to current IIABC
- Standards and Contract Specifications.
- 7. Landscape installation to carry a 1 year warranty from date of acceptance.
- 8. Plant material, installation and maintenance to conform to the current
- edition of the Canadian Landscape Standard.
- 9. General Contractor and/or sub-contractors are responsible for all costs related to production and submission to consultant of all landscape as-built information including irrigation.
- 10. Tree protection fencing, for existing trees, to be installed prior to commencement of all site work

- placement with Landscape Architect in the field prior to
- 2. All trees to be irrigated with double ring drip irriation
- system c/w double check valve. 3. Meadow Seeding Areas and Shrub plantings do not require irrigation. Install in Fall or Spring to coincide with
- may be required during establishment year. 4. Design and installation of offsite irrigation system to
- meet current IIABC and Municipal Specifications.
- 5. Design/build drawings for offsite irrigation to be submitted to Landscape Architect in PDF and .dwg formats, at least two weeks prior to commencement of irrigation installation and will be reviewed by municipal

rainy season. Supplemental hand-watering of shrubs

invasive plant material. This approach is not expected to eradicate invasive plants, but rather to manage them such that native plant material can become established.

#### 2. QUALITY ASSURANCE

- Do construction occupational health and safety in accordance with WorkSafe BC.
- Safety Requirements: worker protection. Workers must wear protection included but not limited to eye protection, thick, long sleeved clothing; safety boots, and gloves.
- 3. STORAGE AND PROTECTION Prevent damage to existing trees, root systems of trees, shrubs and flowering bulbs which are to remain.
- Existing patches of Camas within work area are to be staked off prior to commencement of offsite work. Planting placement to be field-fit
- All grubbing within critical root zone of existing trees to be completed in consultation with project Arborist.

#### Replace trees and shrubs designated to remain, if damaged, as directed by Landscape Architect. 4. WASTE MANAGEMENT AND DISPOSAL

All removed plant material to be placed directly onto tarps or into bags, to avoid spreading of seed, roots, or stems. On completion and verification of performance of installation, remove surplus materials, excess materials, rubbish, tools and equipment. Disposal of invasive plant material to be in accordance with Saanich Invasive Plant Disposal guidelines. Guidelines available through Saanich Planning Department.

#### 5. FINISHED SURFACE

.1 Fill depressions made by grubbing with suitable material and to make new surface conform with existing adjacent surface of ground. .2 For areas disturbed by grubbing or other removal technique, leave ground surface in condition suitable for mulching to approval or

Landscape Architect. 6. MAINTENANCE PERIOD

.1 Maintenance Period is in effect for 1 year following Substantial Completion of the offsite work.

.2 Maintain irrigation for a period of 1 year. .3 Remove invasive species that resprout or regerminate following initial removal efforts. breast height to ground, leaving the remainder on tree to desiccate. Pull/remove roots from a 1m diameter around the base of the stem. .2 Small patches on ground: Remove by pulling vines and digging roots from the soil. It is best to work from the outside edge of the patch inwards to contain the spread.

2. Himalayan Blackberry (Rubus armeniacus) .1 Large patches of canes: grub with small excavator to remove canes and as much root as possible without harming tree roots. Work with project arborist around trees. Less accessible patches can be cut with brush saw.

.2 Smaller patches of canes: cut cane at base.

#### NOT FOR CONSTRUCTION

SEE L3.01 FOR OFFSITE PLANTING

**Invasive Species Management Area:** Himalayan Blackberry and/or English Ivy. See Invasive Species

**Predominantly Native Plants:** Do not disturb native plants and soils, including dormant bulbs. Do not compact with excessive foot traffic. Vehicular traffic

**Meadow Seeding Area:** Install growing medium to reinstate all landscape areas that are damaged during construction activities. Backfill against

retaining walls as required to meet existing grade at Cridge Center lands. Feather growing medium to

Garry Oak Meadow Seed Mix: Supplier: Saanich

info@saanichnativeplants.com) prior to installation.

Seeding Rate: approx. 600 seeds / square meter. Seed to be diluted with sand or vermiculite if using

**Wood Mulch:** Removed Garry Oak trees to be chipped (save trunks and large branches for Large Woody Debris) and used as mulch on Cridge Center

Large Woody Debris: Removed Garry Oak tree trunks and branches over 150mm diam. to be distributed in wood mulch areas as habitat logs.

Existing Tree to be Retained

-Tree Tag #

Existing Tree to be Removed

-Tree Tag #

-Critical Root Zone (CRZ)

-Critical Root Zone (CRZ)

Proposed Garry Oak replacement

tree (3:1 replacement for all

removed Garry Oak Trees)

Native Plants. Confirm species (contact

lands. Install mulch 50-100mm thick.

Install before applying mulch.

Management Techniques.

is not permitted.

undisturbed areas.

broadcast spreader.

7	For Public Hearing	2020.01.16
6	DP Rec 05	2019.09.13
5	DP Rev 04	2019.07.08
4	DP Rev 03	2019.06.04
3	DP Rev 02	2019.04.15
2	DP Rev 01	2019.01.31
1	DP	2018.01.26
rev no	description	date



**NVision Properties** 

project


1301 Hillside Ave. VICTORIA, BC

sheet title

# Offsite Habitat Improvements Plan

project no.	117.31
scale	1:100
drawn by	ТВ
checked by	SM/PdG
revison no.	sheet no.
$\wedge$	

L3.02

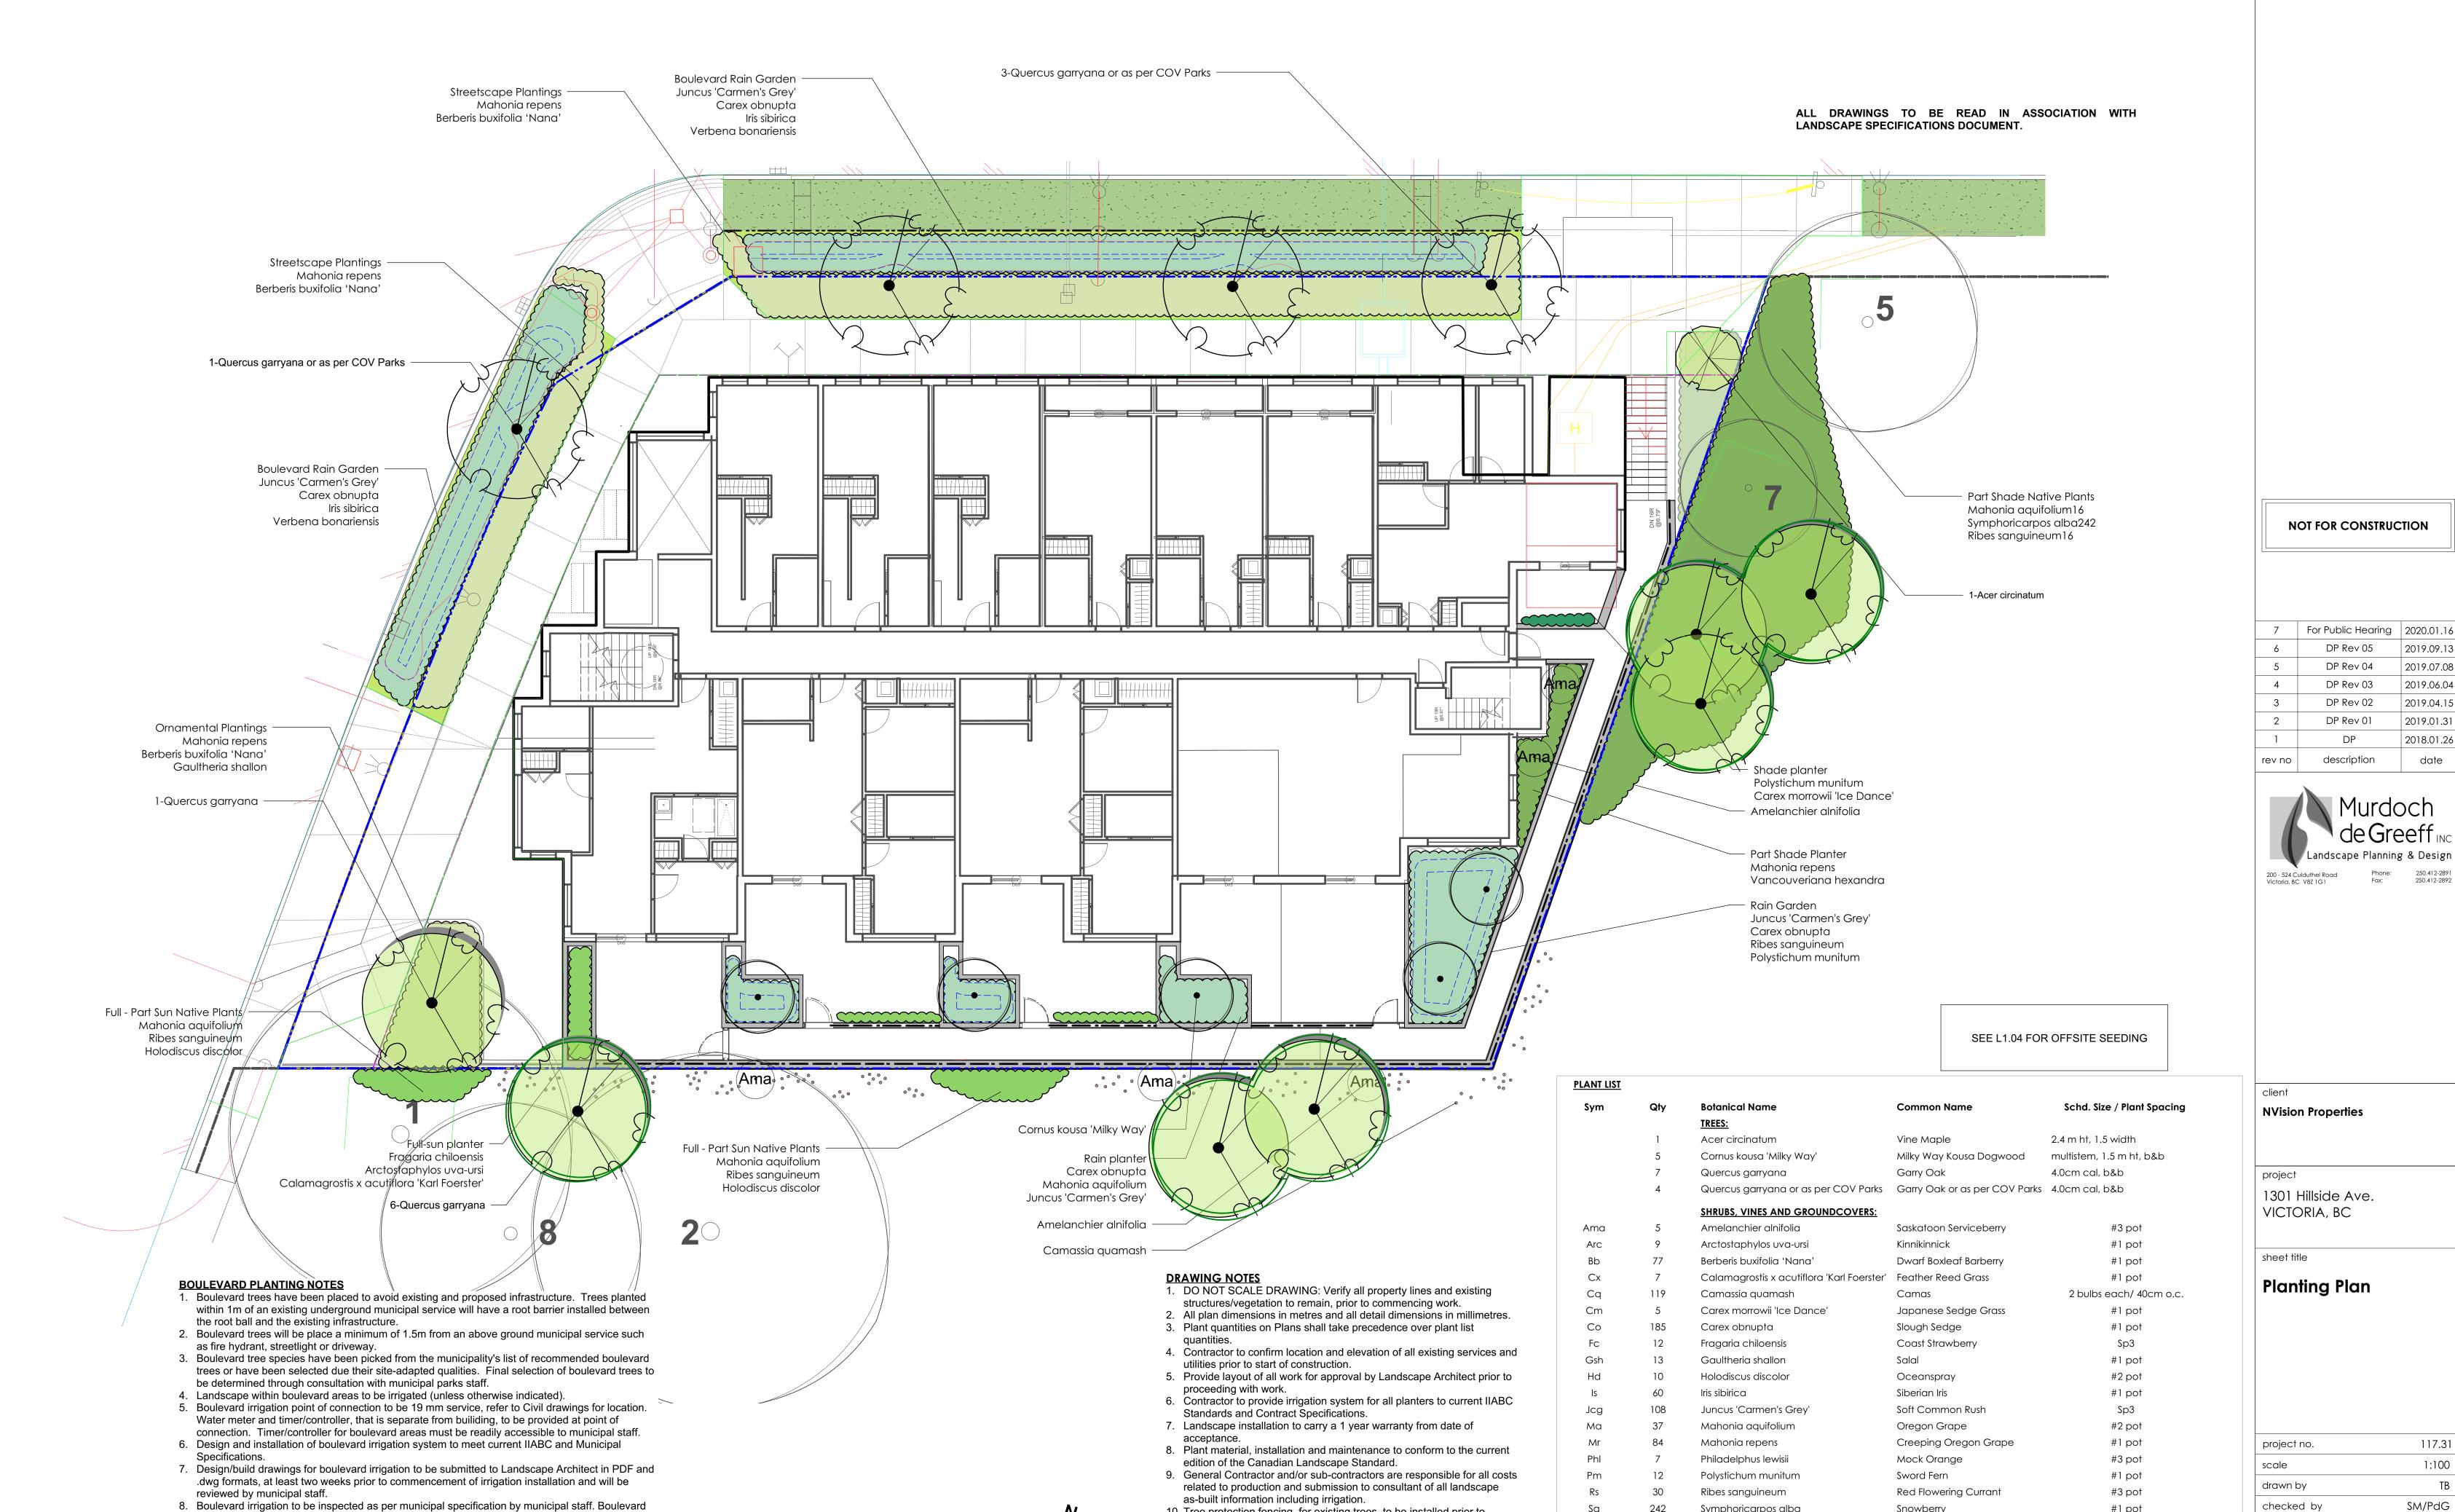

10. Tree protection fencing, for existing trees, to be installed prior to

commencement of all site work

tree irrigation system will be maintained and operated by municipality, after it is inspected and

9. All trees within boulevard to be irrigated with double ring drip irriation system c/w double check

approved by municipal staff.

checked by

sheet no.

L3.01

revison no.

#1 pot

Sp3

#1 pot

Snowberry

Tall Verbena

Inside-out Flower


Symphoricarpos alba

Verbena bonariensis

Vbo

30

Vancouveriana hexandra

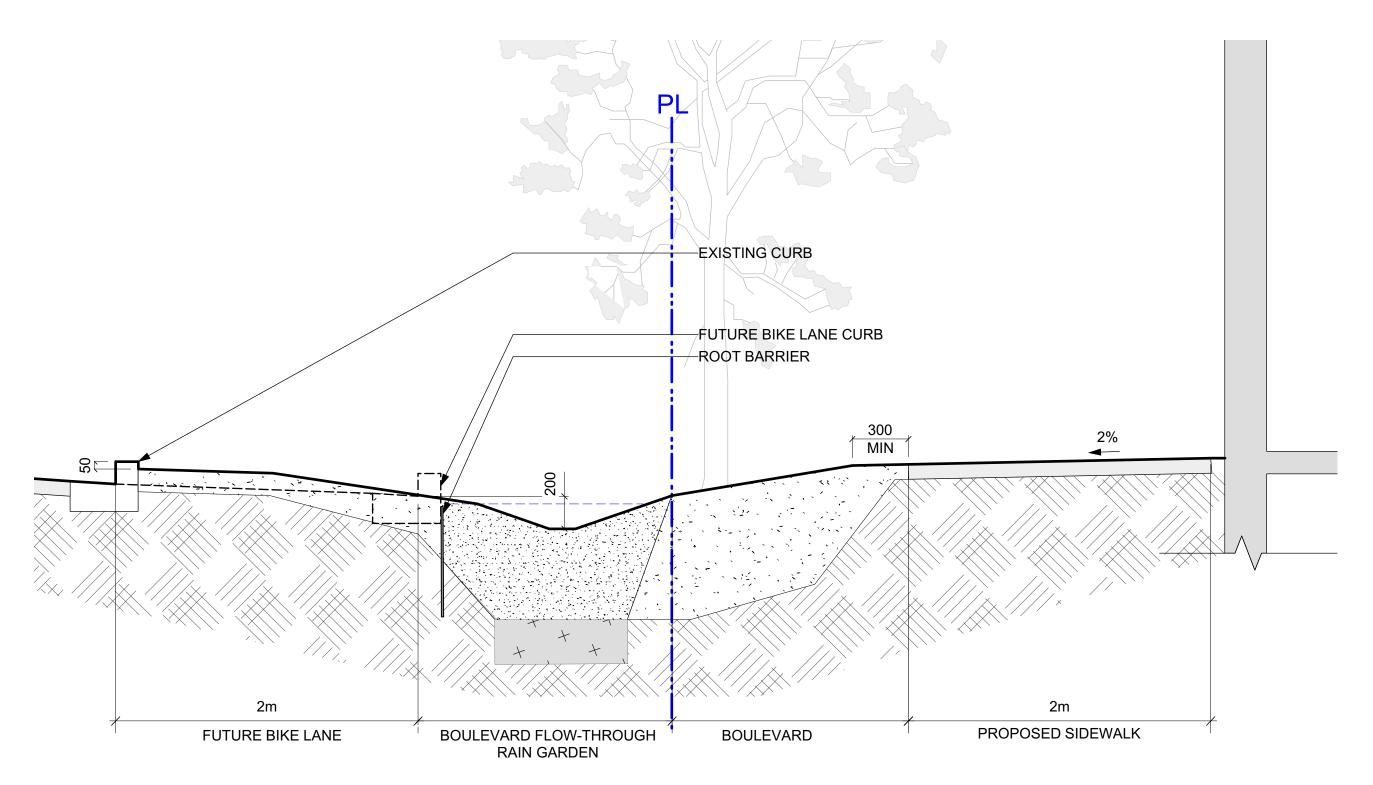

Rain Garden Cells with multiple inlets are to be graded relative to the lowest inlet (BP 200 mm below linet Elevation). BP (Bottom of Pool) will be >200 mm below all other inlet elevations.

Curb beyond

Top of Pool (TP)

Bottom of Pool (BP)

RAIN GARDEN CELL

Bottom of pool should not exceed 450 mm below adjacent surfaces, add weirs as needed to reduce bottom of pool depth.

BOULEVARD RAIN GARDEN TYPICAL DETAIL
Scale: 1:25

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Curb, as per MMCD C4.

Extended Concrete Curb with Metal
Curb Inlet. See Civil detail 3/C1.15.


—610 x 610 x 50 mm hydrapressed or
concrete slab. Top of slab to be 150 mm
below inlet elevation.

—100 mm (4\*) tall aluminum edge restraint.

A

A

600

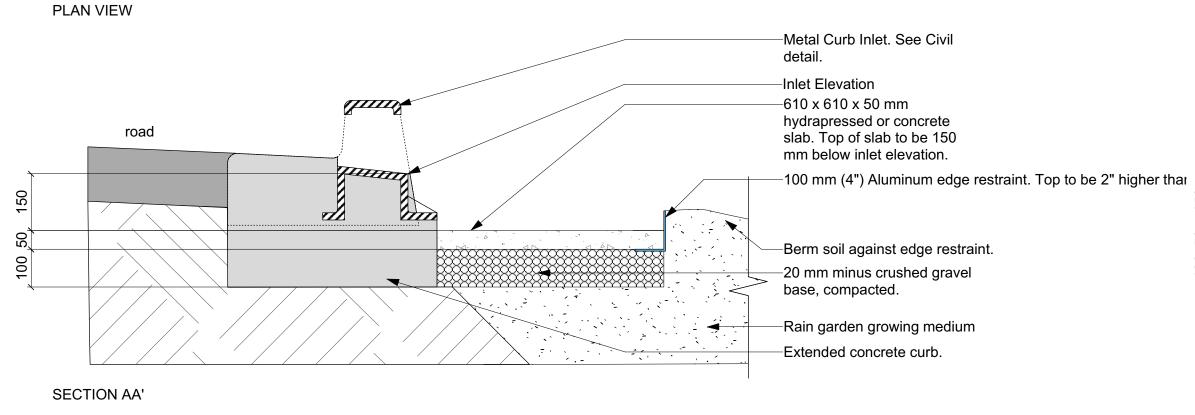

4 HILLSIDE AVENUE CURB INLET / OUTLET
Scale: 1:10

Curb inlet and slab as per Cook Street Curb Inlet /
Outlet detail.
Growing medium behind (max 3:1 slope all sides).

Flow Dissipator- 75 mm (3") cobble at 150 mm depth.

SECTION AA'

3 COOK STREET CURB INLET / OUTLET
Scale: 1:10

Typical Boulevard Cross-Section at Hillside Scale: 1:25

NOT FOR CONSTRUCTION

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2	DP Rev 01	2019.01.31
1	DP	2018.01.26
rev no	description	date



NVision Properties

project

1301 Hillside Ave. VICTORIA, BC

sheet title

# Ground Floor Landscape Materials

revison no.	sheet no.
drawn by checked by	TB SM/PdG
scale	1:100
project no.	117.31

