






This document has been digitally certified with digital certificate and encryption technology authorized by the Architectural Institute of BC. The authoritative original has been transmitted to you in digital form. Any printed version can be relied upon as a true copy of the original when supplied by the architect, bearing images of the professional seal and digital certificate, or when printed from the digitally-certified electronic file provided by the architect. This document may not be forwarded to others, transmitted, or reproduced in any way without the express written permission of the copyright owner Low Hammond Rowe Architects Inc

250721 2 RZ/DP SUBMISSION

Context Elevation - Quadra Street A301

Pacific Arbour Six

Pacific Arbour Six Ltd

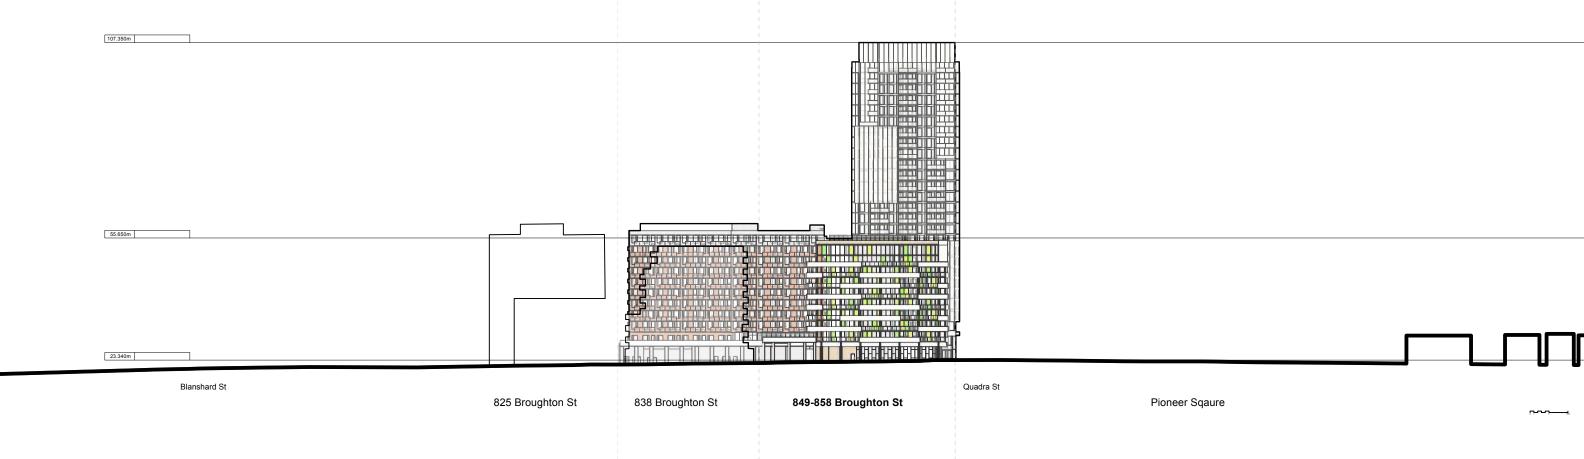









This document has been digitally certified with digital certificate and encryption technology authorized by the Architectural institute of BC. The authoritative original has been transmitted to you in digital form. Any printed version can be relied upon as a true copy of the original when suspiled by the architect, bearing images of at the professional seal and digital certificate, or when printed from the digitally-certified electronic file provided by the architect. This document may not be forwarded to others, transmitted, or reproduced in any way without the express written permission of the copyright owner Low Hammond Rowe Architects Inc

250721 2 RZ/DP SUBMISSION

Context Elevation - Broughton Street | A302





300 - 1590 CEDAR HILL CROSS ROAD VICTORIA BC V8P 2P5 250 472 8013 LHRA.CA




This document has been digitally certified with digital certificate and encryption technology authorized by the Architectural institute of BC. The authoritative original has been transmitted to you in digital form. Any printed version can be relied upon as a true copy of the original when supplied by the architect, bearing images of the professional seal and digital certificate, or when printed from the digitally-certified electronic file provided by the architect. This document may not be forwarded to others, transmitted, or reproduced in any way without the express written permission of the copyright owner Low Hammond Rowe Architects Inc

250721 2 RZ/DP SUBMISSION

Context Elevation - Fort Street | A303

Pacific Arbour Six Pacific Arbour Six Ltd

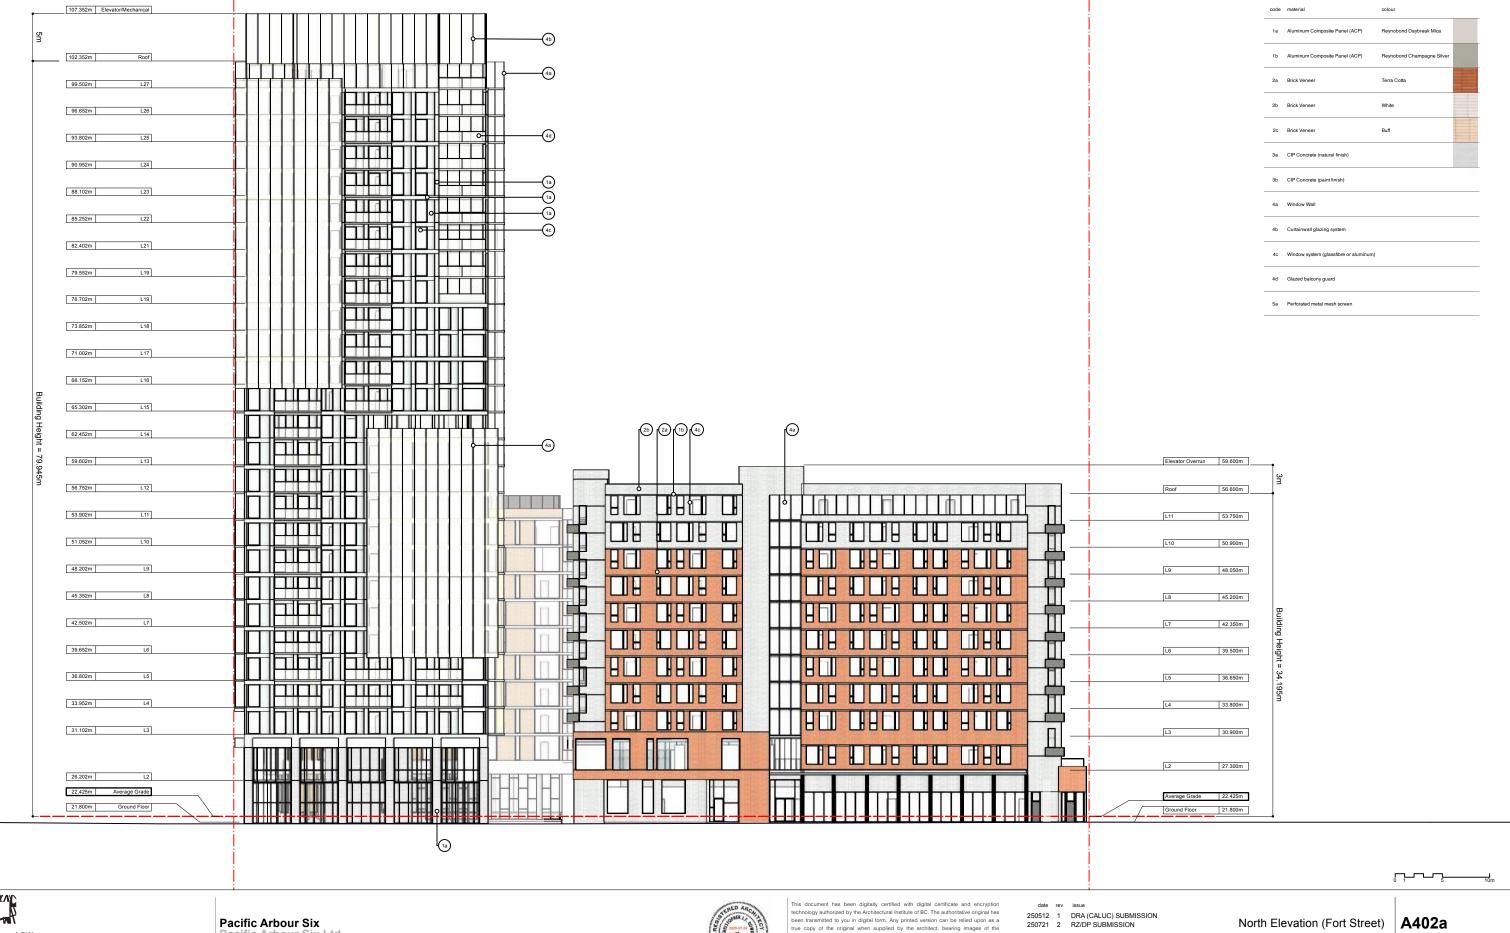

300 - 1590 CEDAR HILL CROSS ROAD VICTORIA BC V8P 2P5 250 472 8013 LHRA.CA

Pacific Arbour Six Ltd

829-891-899 Fort Street and 846-858 Broughton Street, Victoria BC



professional seal and digital certificate, or when printed from the digitally-certified electronic file provided by the architect. This document may not be forwarded to others, transmitted, or reproduced in any way without the express written permission of the copyright owner Low Hammond Rowe Architects Inc












This document has been digitally certified with digital certificate and encryption technology authorized by the Architectural Institute of BC. The authoritative original has been transmitted to you in digital form. Any printed version can be relied upon as a true copy of the original when supplied by the architect, bearing images of the professional seal and digital certificate, or when printed from the digitally-certified electronic file provided by the architect. This document may not be forwarded to others, transmitted, or reproduced in any way without the express written permission of the copyright owner Low Hammond Rowe Architects Inc


250512 1 DRA (CALUC) SUBMISSION 250721 2 RZ/DP SUBMISSION

North Elevation (Fort Street)

A402b

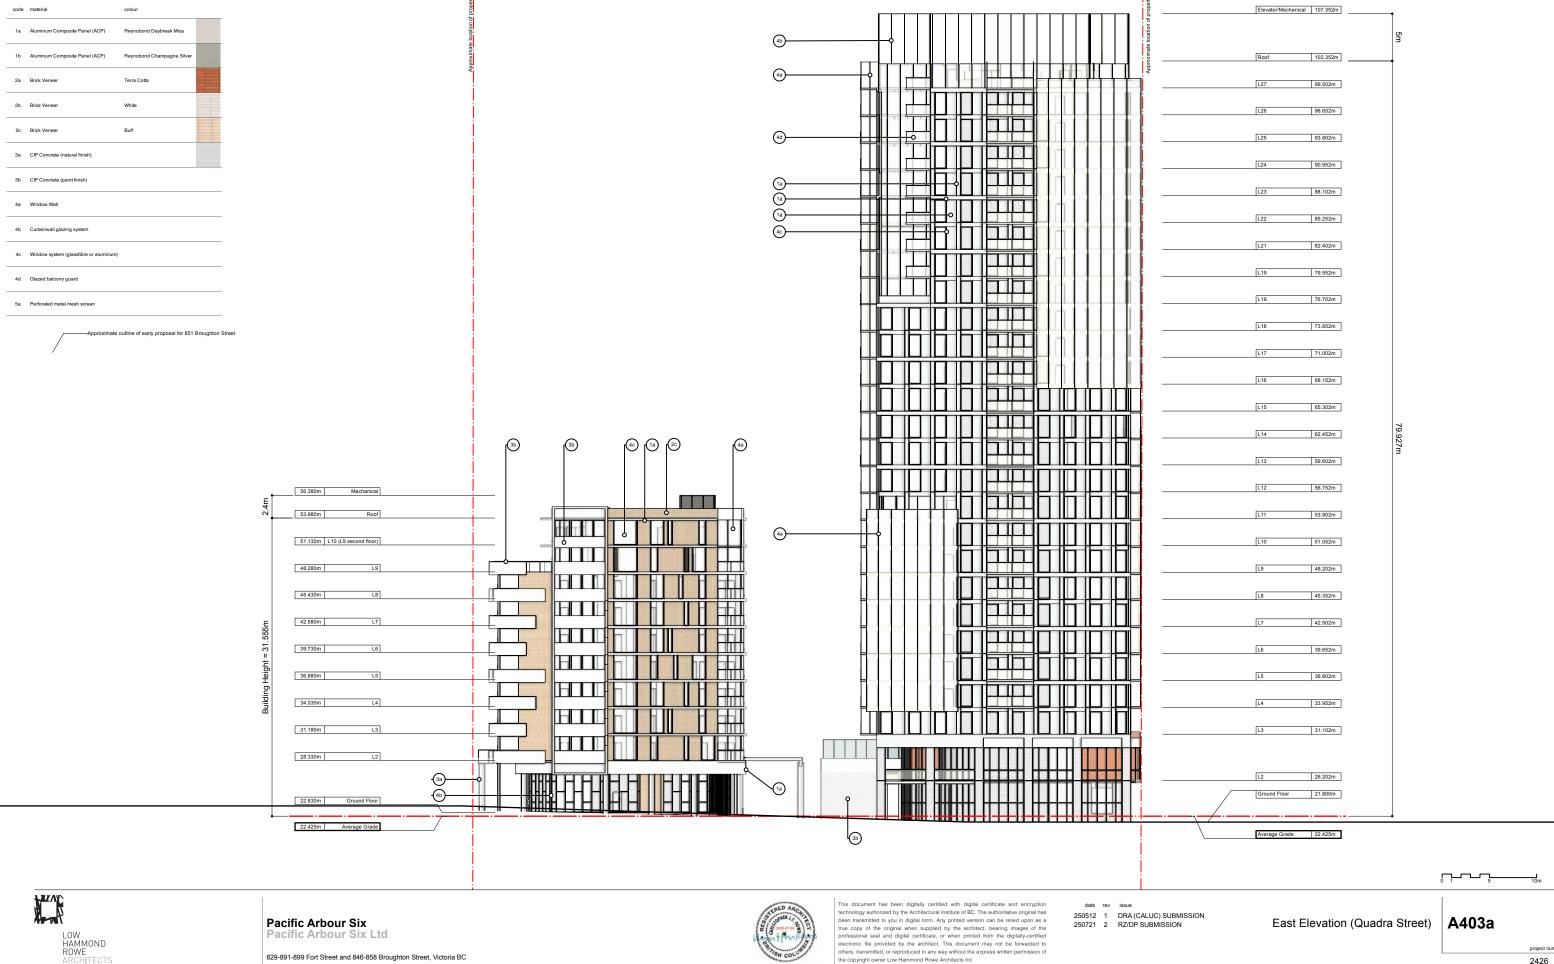

300 - 1590 CEDAR HILL CROSS ROAD VICTORIA BC V8P 2P5 250 472 8013 LHRA.CA

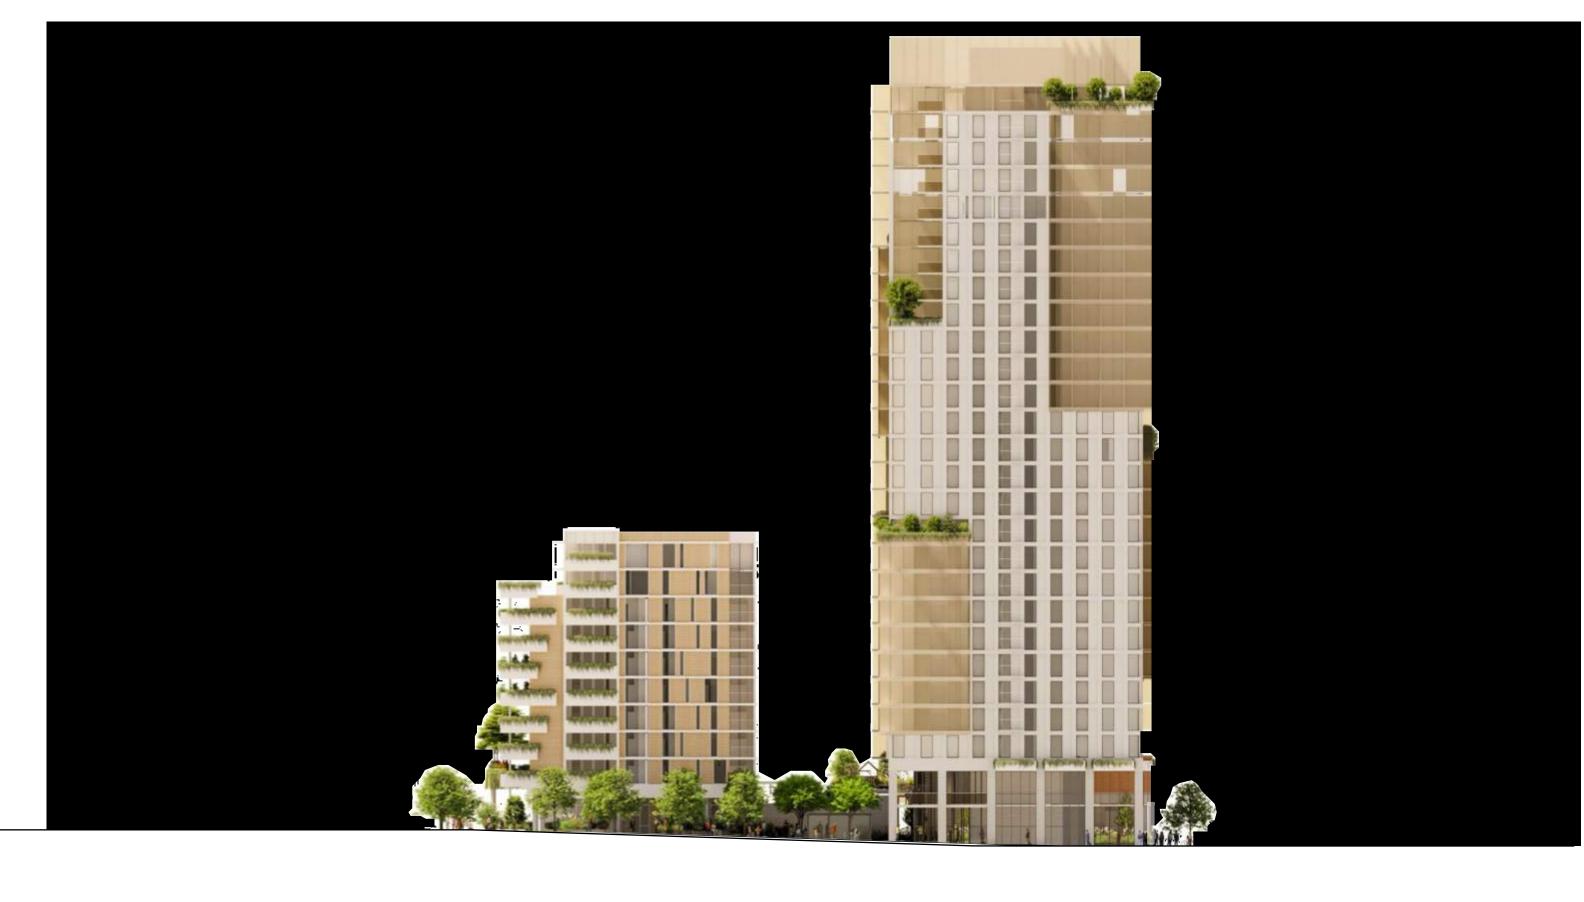





829-891-899 Fort Street and 846-858 Broughton Street, Victoria BC




This document has been digitally certified with digital certificate and encryption technology authorized by the Architectural Institute of BC. The authoritative original has been transmitted to you in digital form. Any printed version can be relied upon as a true copy of the original when supplied by the architect, bearing images of the professional seal and digital certificate, or when printed from the digitally-certified electronic file provided by the architect. This document may not be forwarded to others, transmitted, or reproduced in any way without the express written permission of the copyright owner Low Hammond Rowe Architects Inc.

250512 1 DRA (CALUC) SUBMISSION 250721 2 RZ/DP SUBMISSION

East Elevation (Quadra Street)

A403b

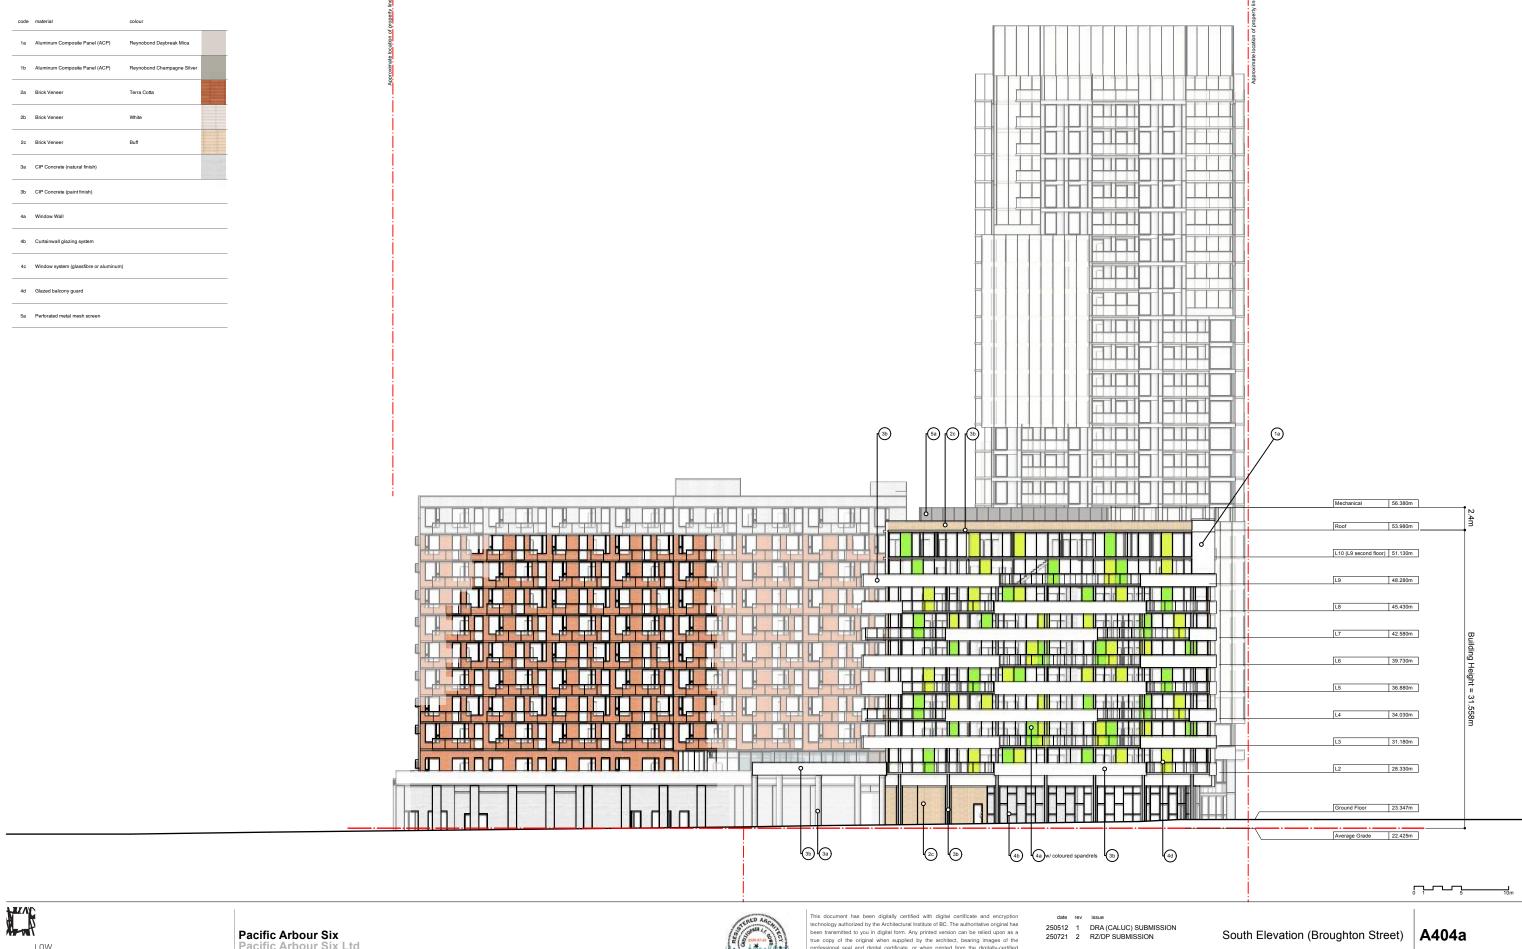


300 - 1590 CEDAR HILL CROSS ROAD VICTORIA BC V8P 2P5 250 472 8013 LHRA.CA

Pacific Arbour Six Ltd

829-891-899 Fort Street and 846-858 Broughton Street, Victoria BC



professional seal and digital certificate, or when printed from the digitally-certified electronic file provided by the architect. This document may not be forwarded to others, transmitted, or reproduced in any way without the express written permission of he copyright owner Low Hammond Rowe Architects Inc

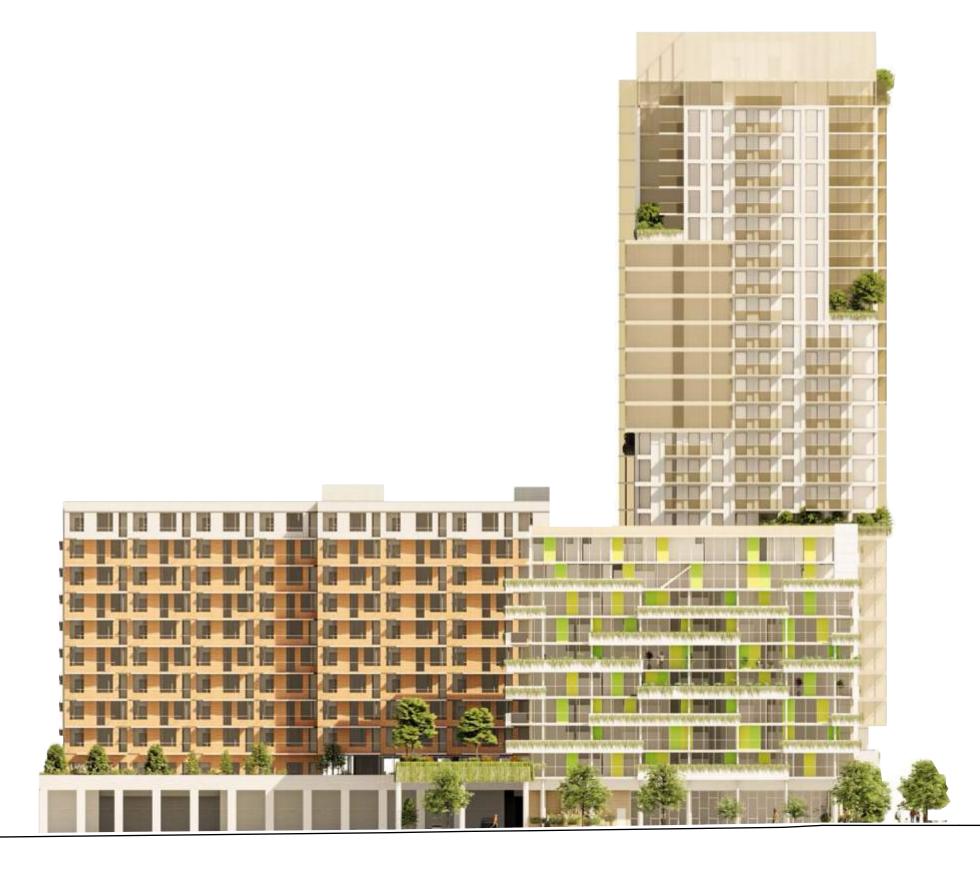






This document has been digitally certified with digital certificate and encryption technology authorized by the Architectural Institute of Bc. The authoritative original has been transmitted to you in digital form. Any printed version can be relied upon as a true copy of the original when supplied by the architect, bearing images of the professional seal and digital certificate, or when printed from the digitally-certified electronic file provided by the architect. This document may not be forwarded to others, transmitted, or reproduced in any way without the express written permission of the copyright owner Low Hammond Rowe Architects Inc This document has been digitally certified with digital certificate and encryption

250512 1 DRA (CALUC) SUBMISSION 250721 2 RZ/DP SUBMISSION

South Elevation (Broughton Street)

A404b



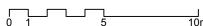



LOW
HAMMOND
ROWE
ARCHITECTS
300 - 1590 cedar hill cross road victoria BC V8P 2P5
250 472 8013 LHRA CA

Pacific Arbour Six Pacific Arbour Six Ltd

829-891-899 Fort Street and 846-858 Broughton Street, Victoria BC




This document has been digitally certified with digital certificate and encryption technology authorized by the Architectural institute of BC. The authoritative original has been transmitted to you in digital form. Any printed version can be relied upon as a true copy of the original when susplied by the architect, bearing images of the professional seal and digital certificate, or when printed from the digitally-certified electronic file provided by the architect. This document may not be forwarded to others, transmitted, or reproduced in any way without the express written permission of the copyright owner Low Hammond Rowe Architects Inc

250721 2 RZ/DP SUBMISSION

North Elevation - Building 1

A405

100

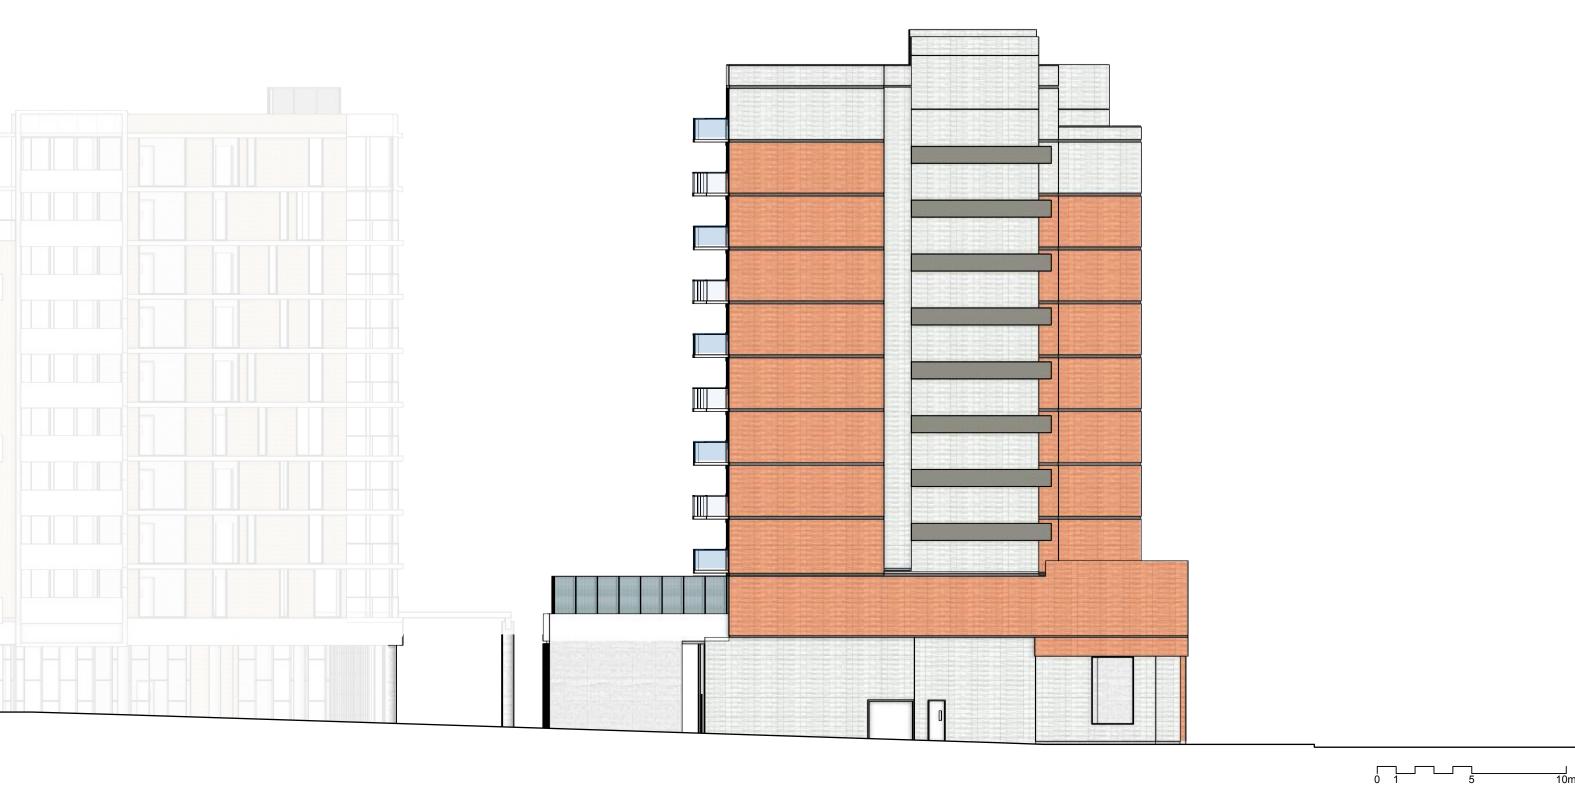

Pacific Arbour Six Pacific Arbour Six Ltd

829-891-899 Fort Street and 846-858 Broughton Street, Victoria BC



This document has been digitally certified with digital certificate and encryption technology authorized by the Architectural Institute of BC. The authoritative original has been transmitted to you in digital form. Any printed version can be relied upon as a true copy of the original when susplied by the architect, bearing images of the professional seal and digital certificate, or when printed from the digitally-certified electronic file provided by the architect. This document may not be forwarded to others, transmitted, or reproduced in any way without the express written permission of the copyright owner Low Hammond Rowe Architects Inc

date rev issue
250721 2 RZ/DP SUBMISSION

East Elevation - Building 1 A406

A406





Pacific Arbour Six Pacific Arbour Six Ltd

829-891-899 Fort Street and 846-858 Broughton Street, Victoria BC



This document has been digitally certified with digital certificate and encryption technology authorized by the Architectural Institute of BC. The authoritative original has been transmitted to you in digital form. Any printed version can be relied upon as a true copy of the original when supplied by the architect, bearing images of the professional seal and digital certificate, or when printed from the digitally-certified electronic file provided by the architect. This document may not be forwarded to others, transmitted, or reproduced in any way without the express written permission of the copyright owner Low Harmond Rowa Architects Inc.

date rev issue
250721 2 RZ/DP SUBMISSION

South Elevation - Building 1

Building 1 **A407**

A407

2426

____ 10m








This document has been digitally certified with digital certificate and encryption technology authorized by the Architectural institute of BC. The authoritative original has been transmitted to you in digital form. Any printed version can be relied upon as a true copy of the original when susplied by the architect, bearing images of the professional seal and digital certificate, or when printed from the digitally-certified electronic file provided by the architect. This document may not be forwarded to others, transmitted, or reproduced in any way without the express written permission of the copyright owner Low Hammond Rowe Architects Inc

date rev issue
250721 2 RZ/DP SUBMISSION

West Elevation - Building 1 A408

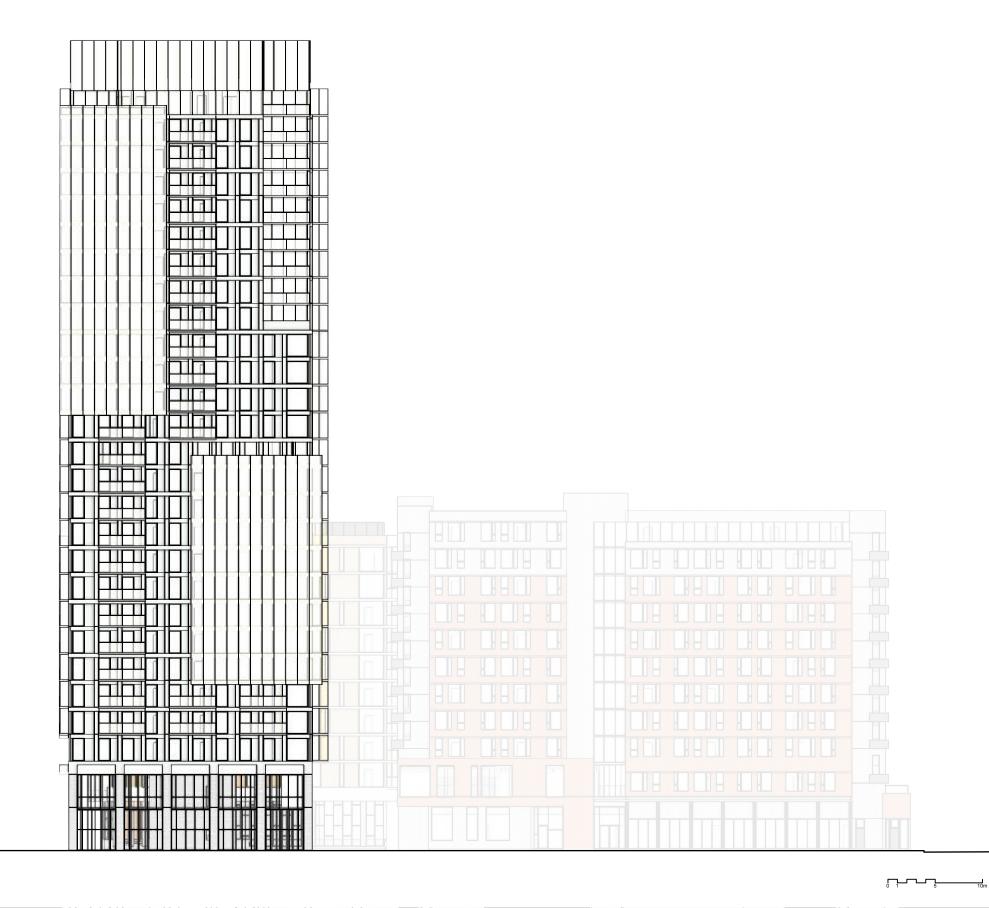











This document has been digitally certified with digital certificate and encryption Inis accument has been digitally certified with original certificate and encryption technology authorized by the Architectural Institute of Bc. The authoritative original has been transmitted to you in digital form. Any printed version can be relied upon as a true copy of the original when supplied by the architect, bearing images of the professional seal and digital certificate, or when printed from the digitally-certified electronic file provided by the architect. This document may not be forwarded to others, transmitted, or reproduced in any way without the express written permission of the copyright owner Low Hammond Rowe Architects Inc

250721 2 RZ/DP SUBMISSION

North Elevation - Building 2

A409

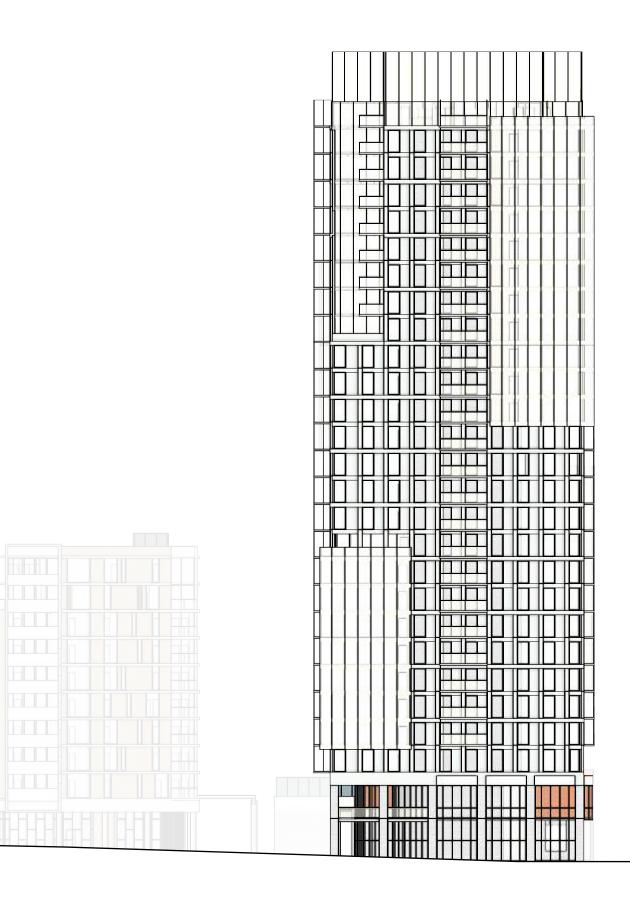


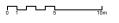




This document has been digitally certified with digital certificate and encryption Inis document has been digitally certified with digital certificate and encryption technology authorized by the Architectural Institute of BC. The authoritative original has been transmitted to you in digital form. Any printed version can be relied upon as a true copy of the original when supplied by the architect, bearing images of the professional seal and digital certificate, or when printed from the digitally-certified electronic file provided by the architect. This document may not be forwarded to others, transmitted, or reproduced in any way without the express written permission of the copyright owner Low Hammond Rowe Architects Inc

250721 2 RZ/DP SUBMISSION

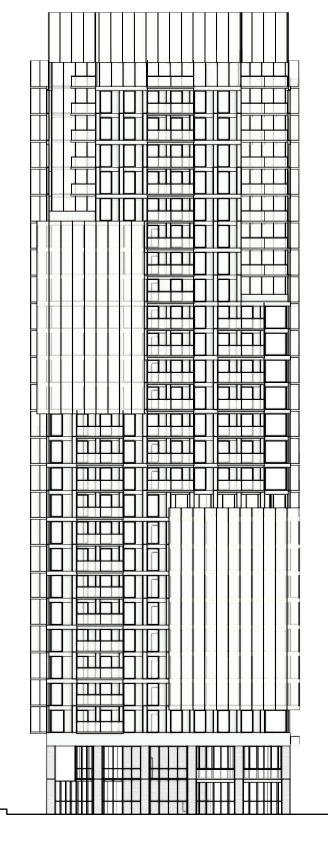

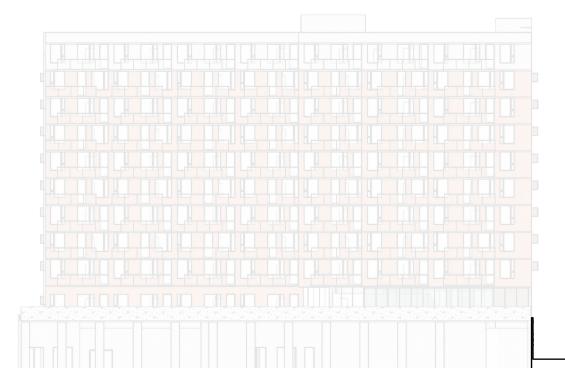





829-891-899 Fort Street and 846-858 Broughton Street, Victoria BC



Inis accument has been digitally certified with original certificate and encryption technology authorized by the Architectural Institute of Bc. The authoritative original has been transmitted to you in digital form. Any printed version can be relied upon as a true copy of the original when supplied by the architect, bearing images of the professional seal and digital certificate, or when printed from the digitally-certified electronic file provided by the architect. This document may not be forwarded to others, transmitted, or reproduced in any way without the express written permission of the copyright owner Low Hammond Rowe Architects Inc

This document has been digitally certified with digital certificate and encryption

250721 2 RZ/DP SUBMISSION

South Elevation - Building 2 **A411**





300 - 1590 CEDAR HILL CROSS ROAD VICTORIA BC V8P 2P5 250 472 8013 LHRA.CA








This document has been digitally certified with digital certificate and encryption This document has been digitally certified with digital certificate and encryption technology authorized by the Architectural institute of BC. The authoritative original has been transmitted to you in digital form. Any printed version can be relied upon as a true copy of the original when supplied by the architect, bearing images of the professional seal and digital certificate, or when printed from the digitally-certified electronic file provided by the architect. This document may not be forwarded to others, transmitted, or reproduced in any way without the express written permission of the copyright owner Low Hammond Rowe Architects Inc

250721 2 RZ/DP SUBMISSION

West Elevation - Building 2 **A412**



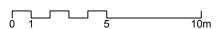





829-891-899 Fort Street and 846-858 Broughton Street, Victoria BC




This document has been digitally certified with digital certificate and encryption technology authorized by the Architectural institute of BC. The authoritative original has been transmitted to you in digital form. Any printed version can be relied upon as a true copy of the original when susplied by the architect, bearing images of the professional seal and digital certificate, or when printed from the digitally-certified electronic file provided by the architect. This document may not be forwarded to others, transmitted, or reproduced in any way without the express written permission of the copyright owner Low Hammond Rowe Architects Inc

date rev issue 250721 2 RZ/DP SUBMISSION

North Elevation - Building 3 **A413**



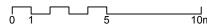



LOW
HAMMOND
ROWE
ARCHITECTS
300 - 1590 CEDAR HILL CROSS ROAD VICTORIA BC VBP 2P5
250 472 8013 LHRA.CA



829-891-899 Fort Street and 846-858 Broughton Street, Victoria BC




This document has been digitally certified with digital certificate and encryption technology authorized by the Architectural institute of BC. The authoritative original has been transmitted to you in digital form. Any printed version can be relied upon as a true copy of the original when susplied by the architect, bearing images of the professional seal and digital certificate, or when printed from the digitally-certified electronic file provided by the architect. This document may not be forwarded to others, transmitted, or reproduced in any way without the express written permission of the copyright owner Low Hammond Rowe Architects Inc

date rev issue

250721 2 RZ/DP SUBMISSION

East Elevation - Building 3 A414



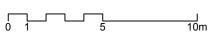





829-891-899 Fort Street and 846-858 Broughton Street, Victoria BC




This document has been digitally certified with digital certificate and encryption technology authorized by the Architectural Institute of BC. The authoritative original has been transmitted to you in digital form. Any printed version can be relied upon as a true copy of the original when supplied by the architect, bearing images of the professional seal and digital certificate, or when printed from the digitally-certified electronic file provided by the architect. This document may not be forwarded to others, transmitted, or reproduced in any way without the express written permission of the copyright owner Low Hammond Rowe Architects Inc.

250721 2 RZ/DP SUBMISSION


South Elevation - Building 3 **A415**



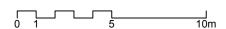





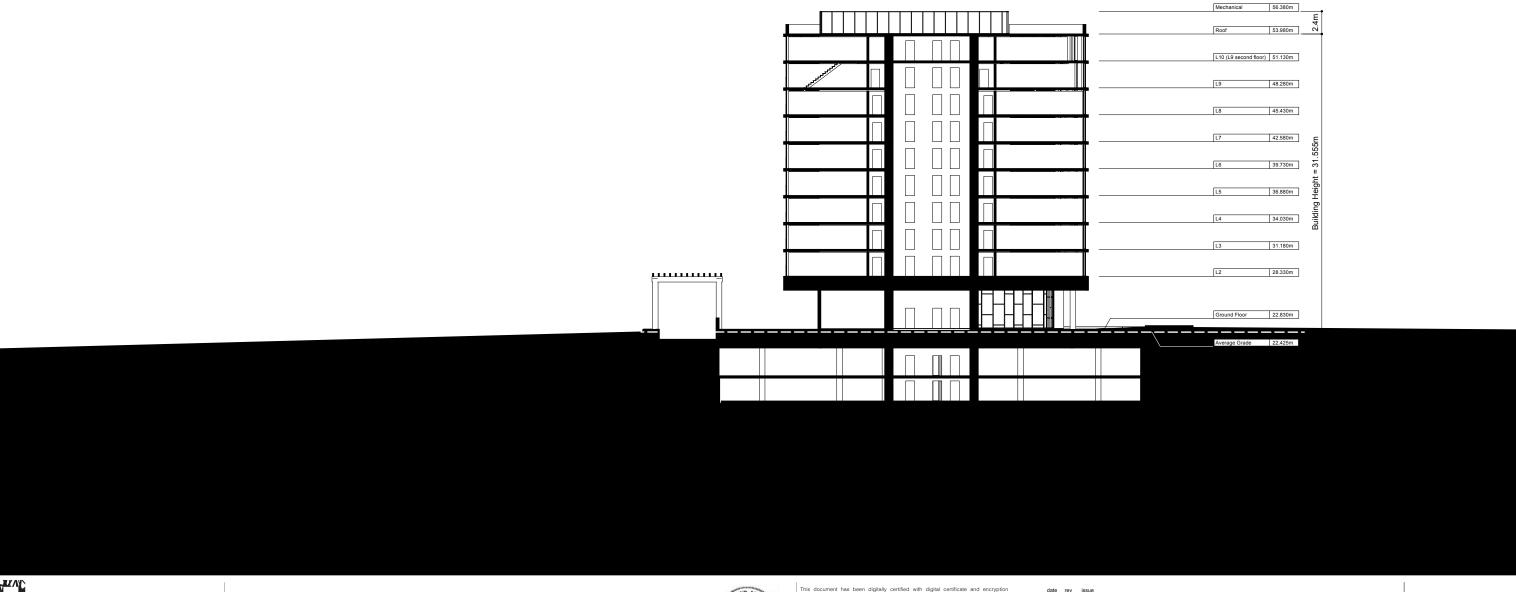



Pacific Arbour Six Pacific Arbour Six Ltd


829-891-899 Fort Street and 846-858 Broughton Street, Victoria BC





This document has been digitally certified with digital certificate and encryption technology authorized by the Architectural institute of BC. The authoritative original has been transmitted to you in digital form. Any printed version can be relied upon as a true copy of the original when supplied by the architect, bearing images of the professional seal and digital certificate, or when printed from the digitally-certified electronic file provided by the architect. This document may not be forwarded to others, transmitted, or reproduced in any way without the express written permission of the copyright owner Low Hammond Rowe Architects Inc

250721 2 RZ/DP SUBMISSION

East-West Section A601

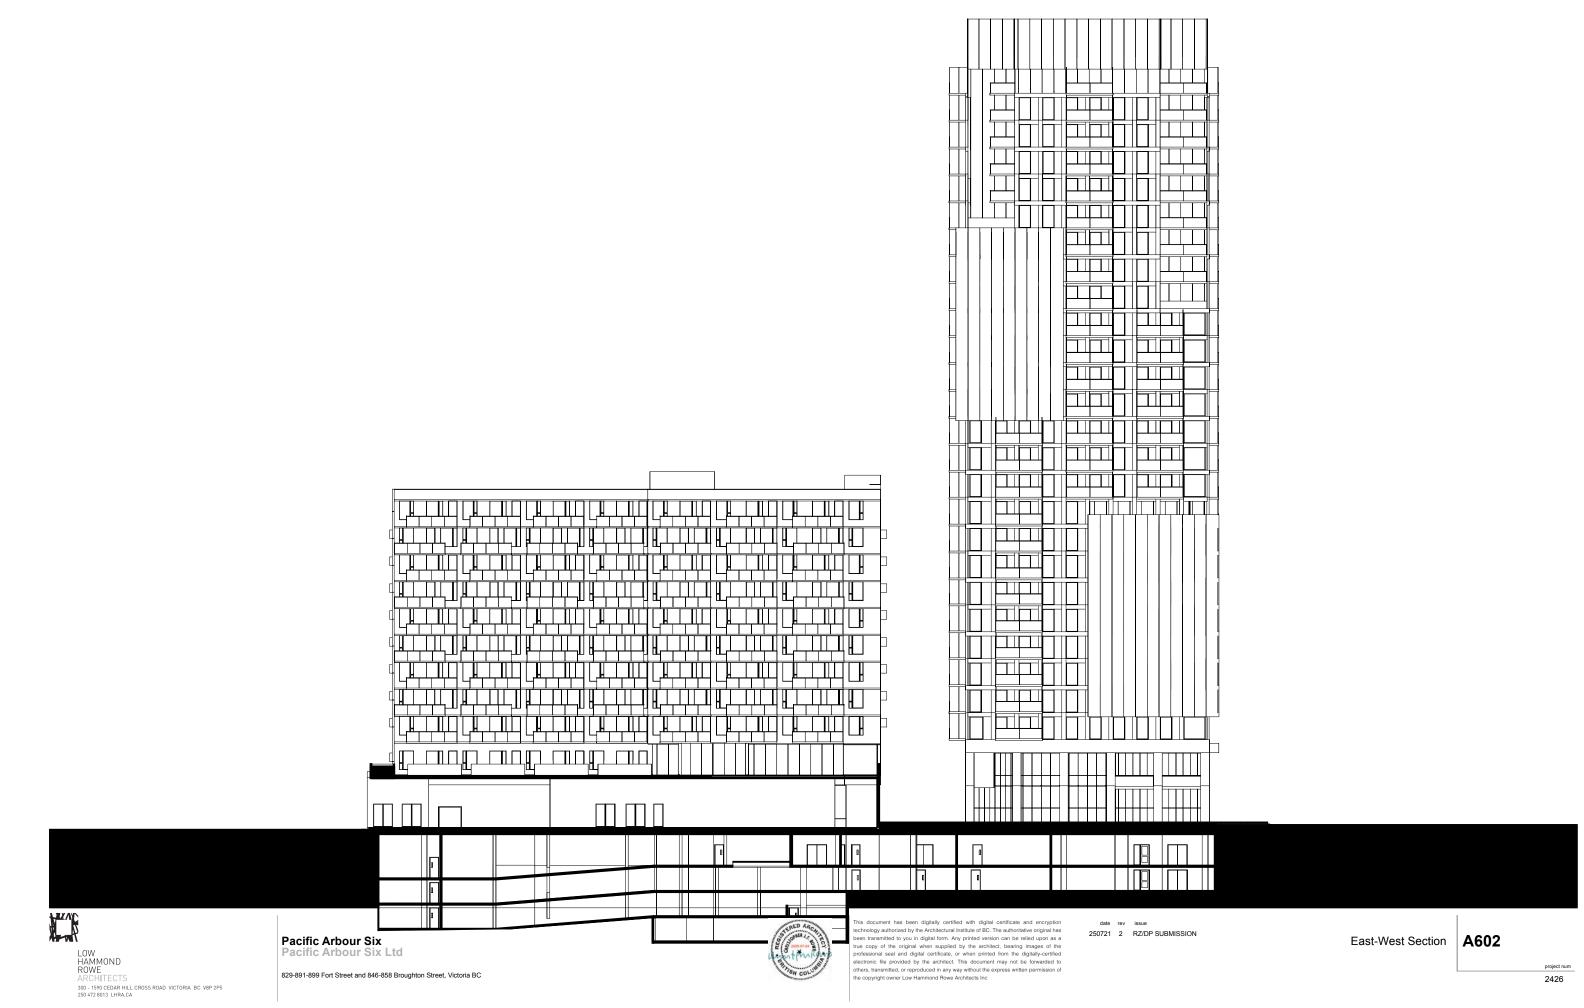

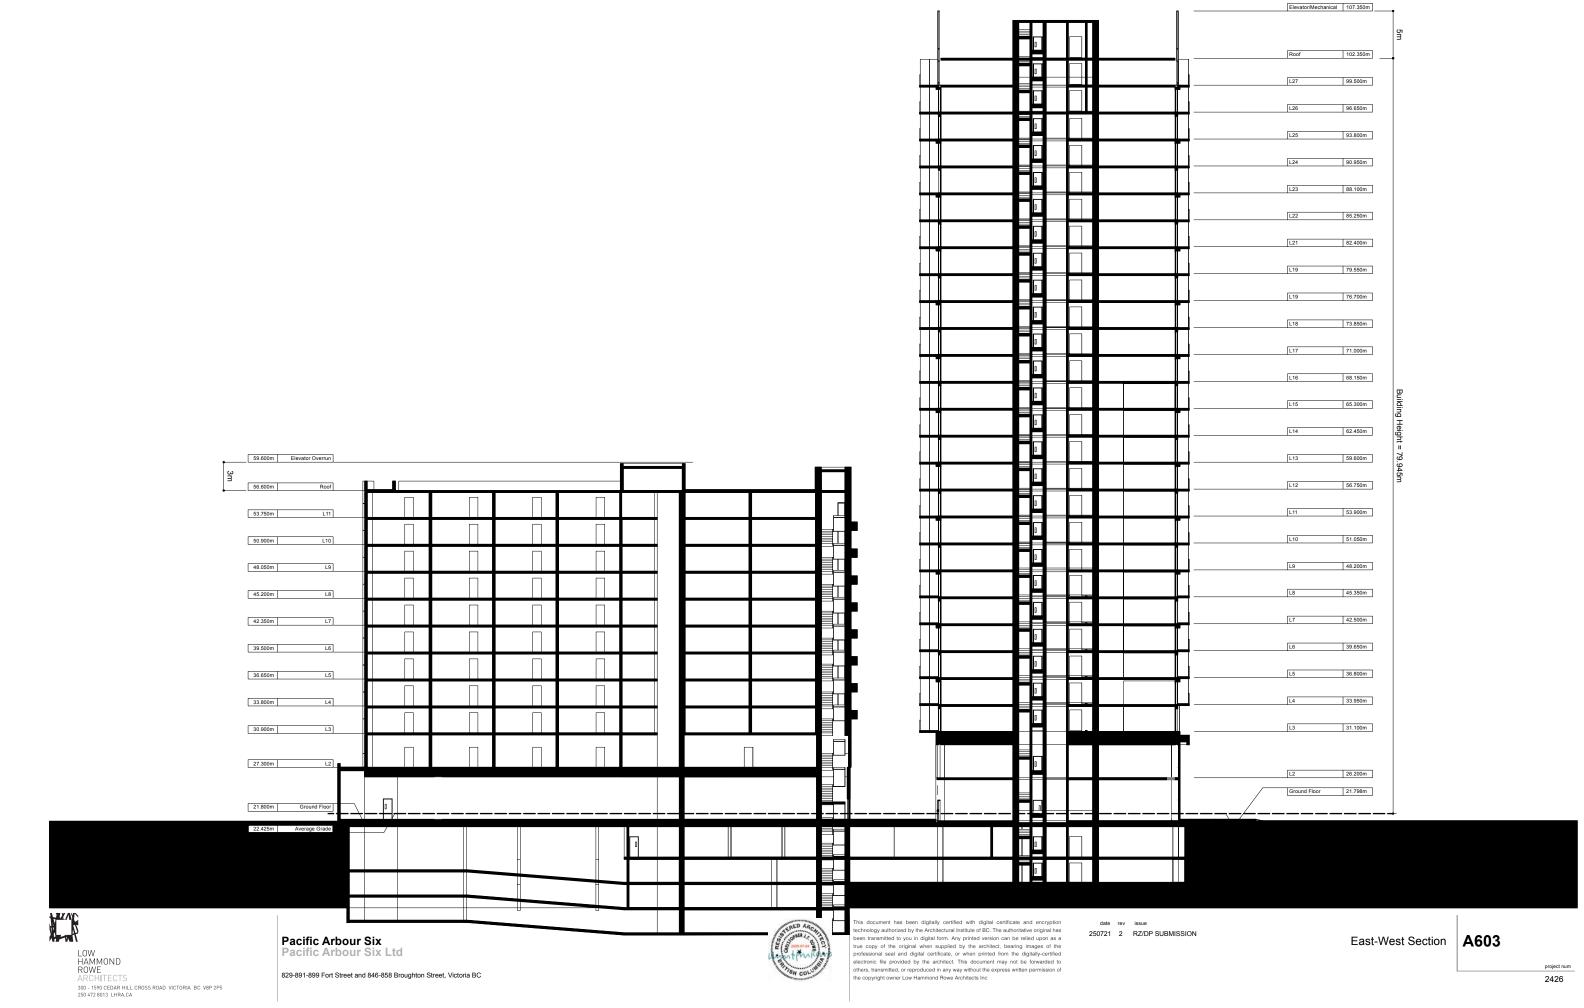

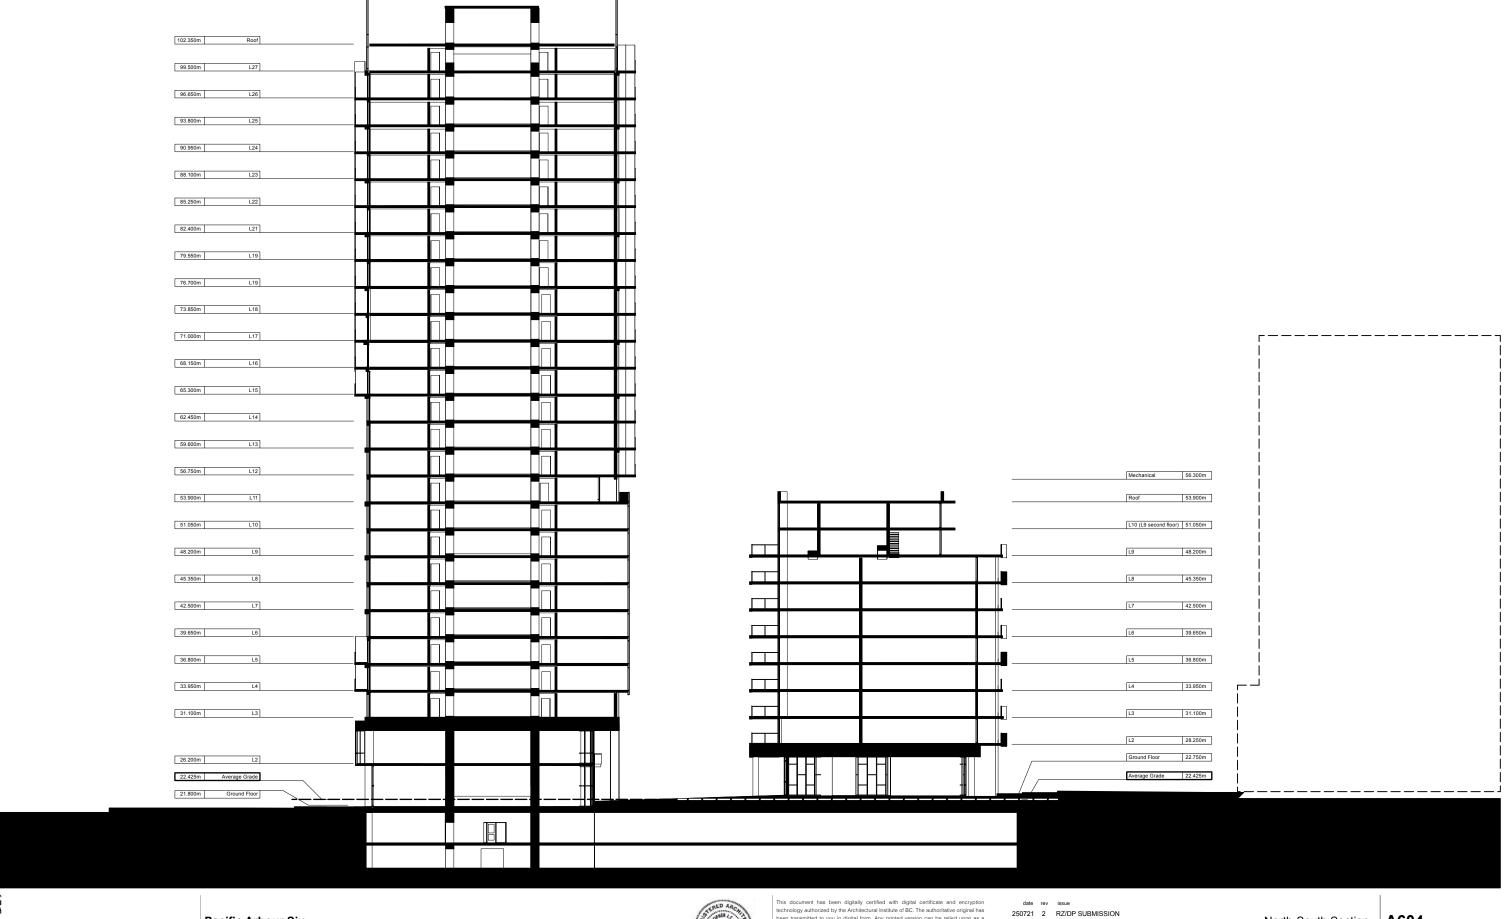






107.350m Elevator/Mechanical

829-891-899 Fort Street and 846-858 Broughton Street, Victoria BC



Inis document has been digitally certified with digital certificate and encryption technology authorized by the Architectural Institute of BC. The authoritative original has been transmitted to you in digital form. Any printed version can be relied upon as a true copy of the original when supplied by the architect, bearing images of the professional seal and digital certificate, or when printed from the digitally-certified electronic file provided by the architect. This document may not be forwarded to others, transmitted, or reproduced in any way without the express written permission of the copyright owner Low Hammond Rowe Architects Inc

North-South Section | A604

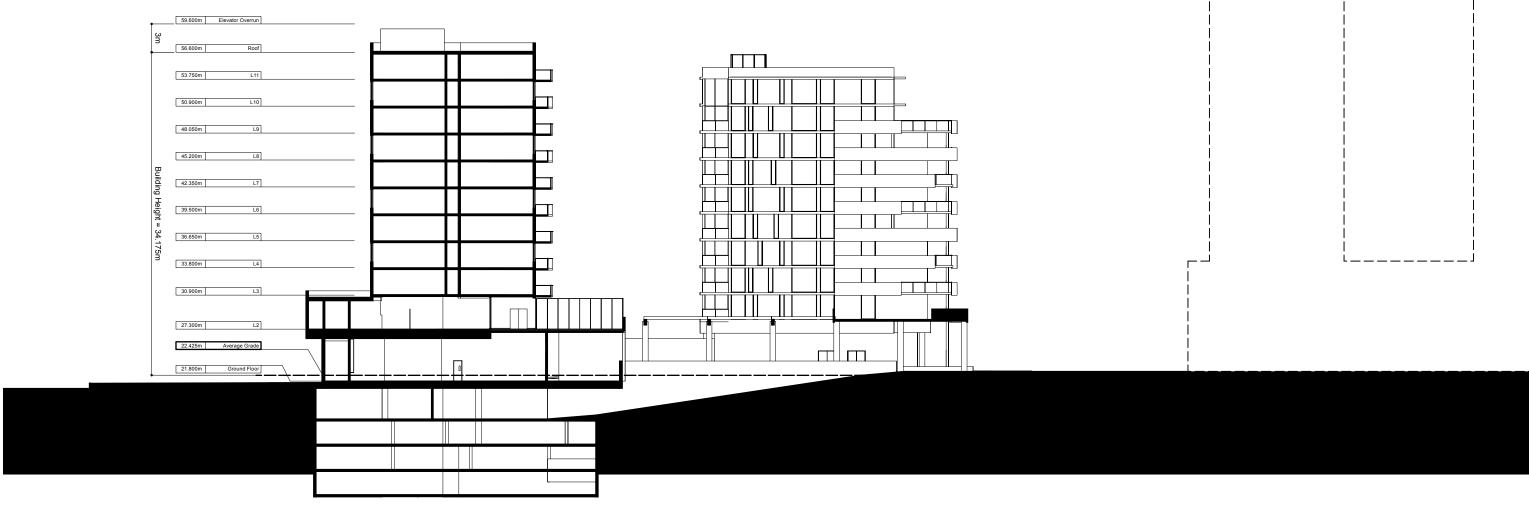






829-891-899 Fort Street and 846-858 Broughton Street, Victoria BC



This document has been digitally certified with digital certificate and encryption technology authorized by the Architectural institute of BC. The authoritative original has been transmitted to you in digital form. Any printed version can be relied upon as a true copy of the original when susplied by the architect, bearing images of the professional seal and digital certificate, or when printed from the digitally-certified electronic file provided by the architect. This document may not be forwarded to others, transmitted, or reproduced in any way without the express written permission of the copyright owner Low Hammond Rowe Architects Inc

250721 2 RZ/DP SUBMISSION

North-South Section A605

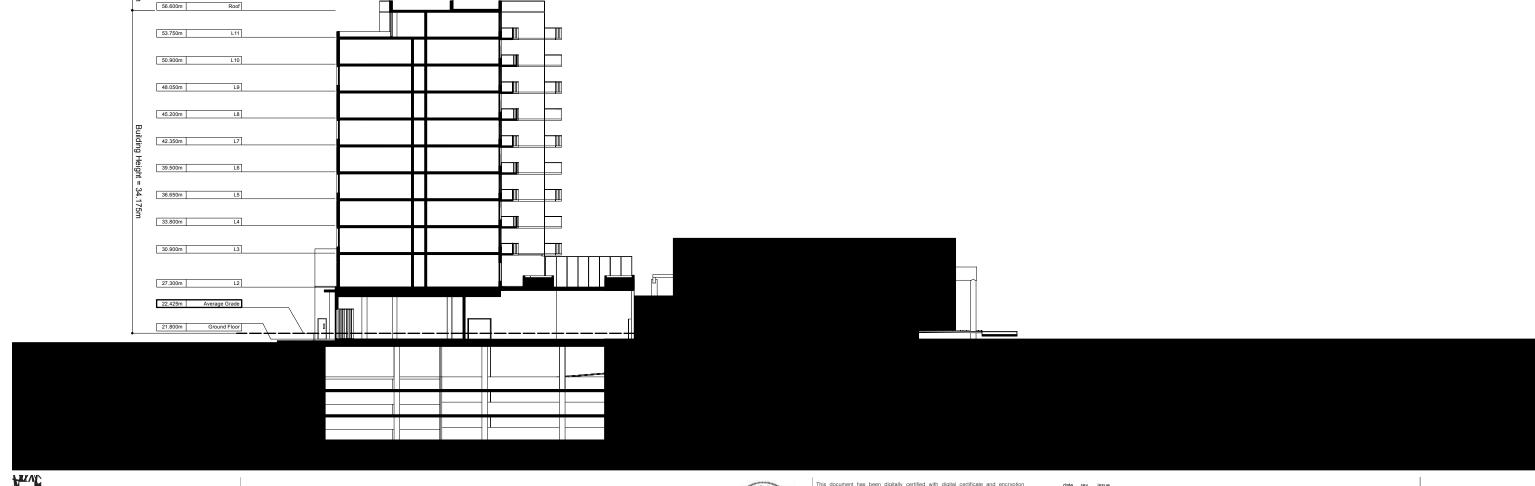



59.600m Elevator Overrun

Pacific Arbour Six Pacific Arbour Six Ltd

829-891-899 Fort Street and 846-858 Broughton Street, Victoria BC



This document has been digitally certified with digital certificate and encryption technology authorized by the Architectural Institute of BC. The authoritative original has been transmitted to you in digital form. Any printed version can be relied upon as a true copy of the original when supplied by the architect, bearing images of the professional seal and digital certificate, or when printed from the digitally-certified electronic file provided by the architect. This document may not be forwarded to others, transmitted, or reproduced in any way without the express written permission of the copyright owner Low Hammond Rowe Architects Inc


250721 2 RZ/DP SUBMISSION

North-South Section A606

PARC VICTORIA

Victoria, BC

KEY PLAN

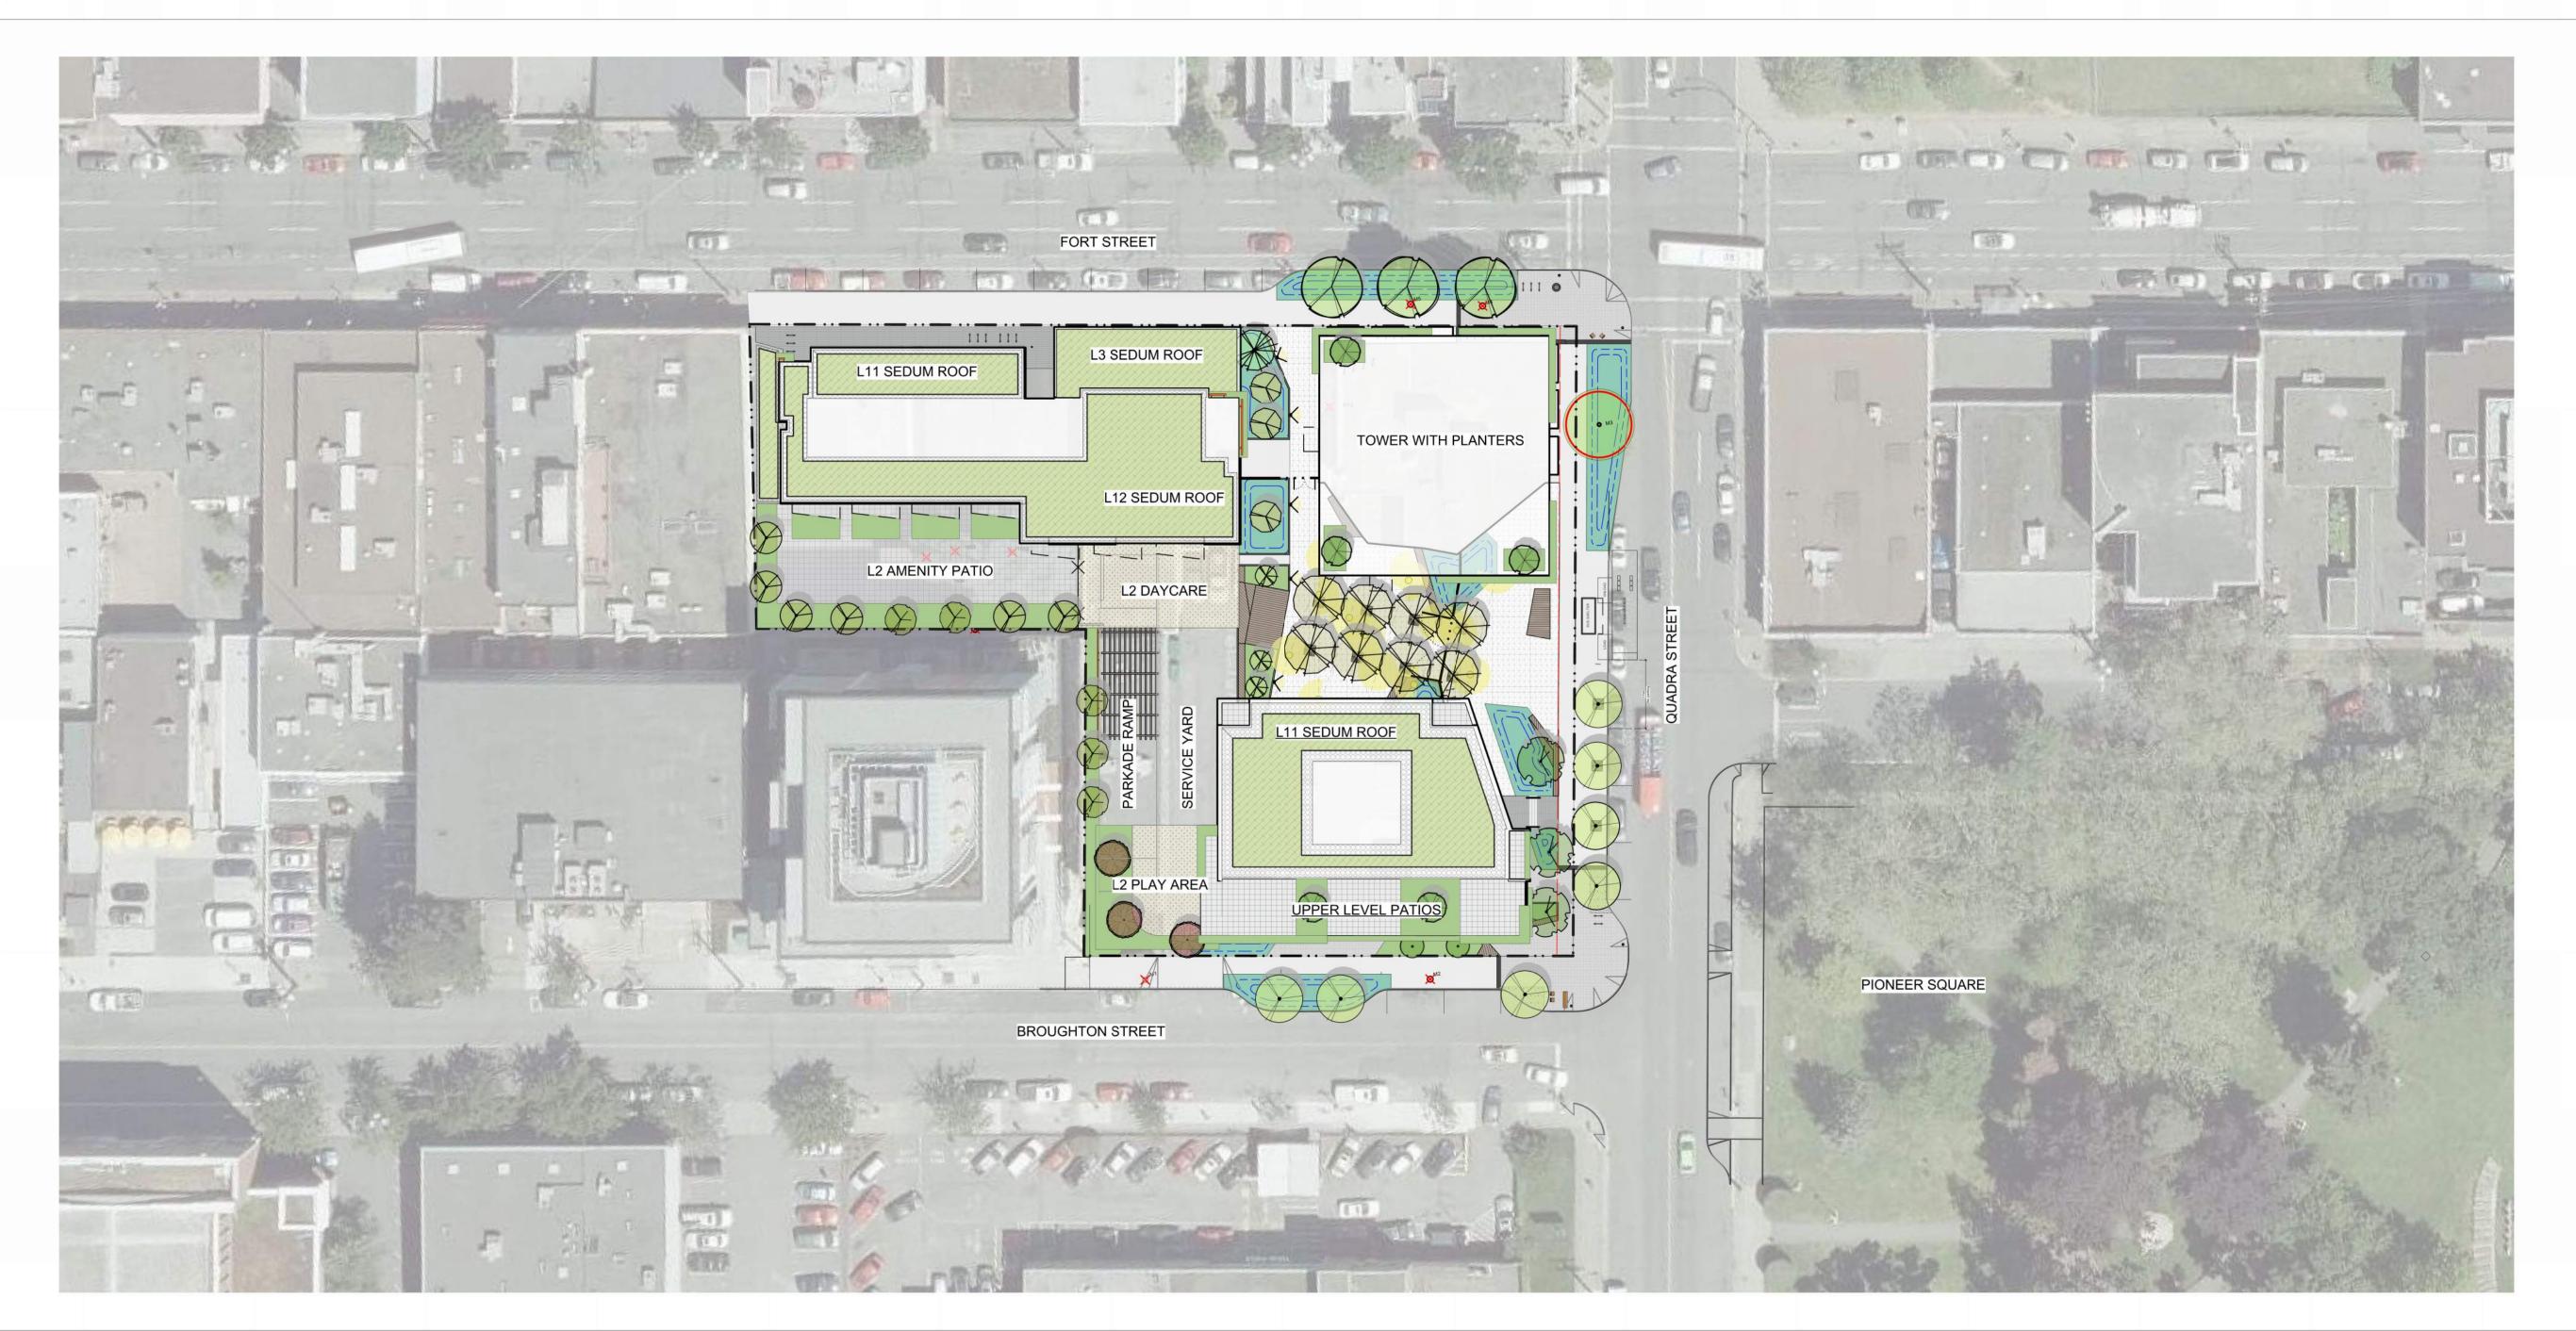



NOT FOR CONSTRUCTION

3	Development Permit	2025-07-23
2	CALUC	2025-04-30
1	Pre-Application	2024-11-15
No.	Issued For	Issue Date



ent

PARC Communities Management Ltd.

project


PARC VICTORIA 829-891-899 Fort Street and 846-858 Broughton Street, Victoria BC


sheet title

Cover

1: 400	@ 24"x36"
	SC
	ТВ

L0.00

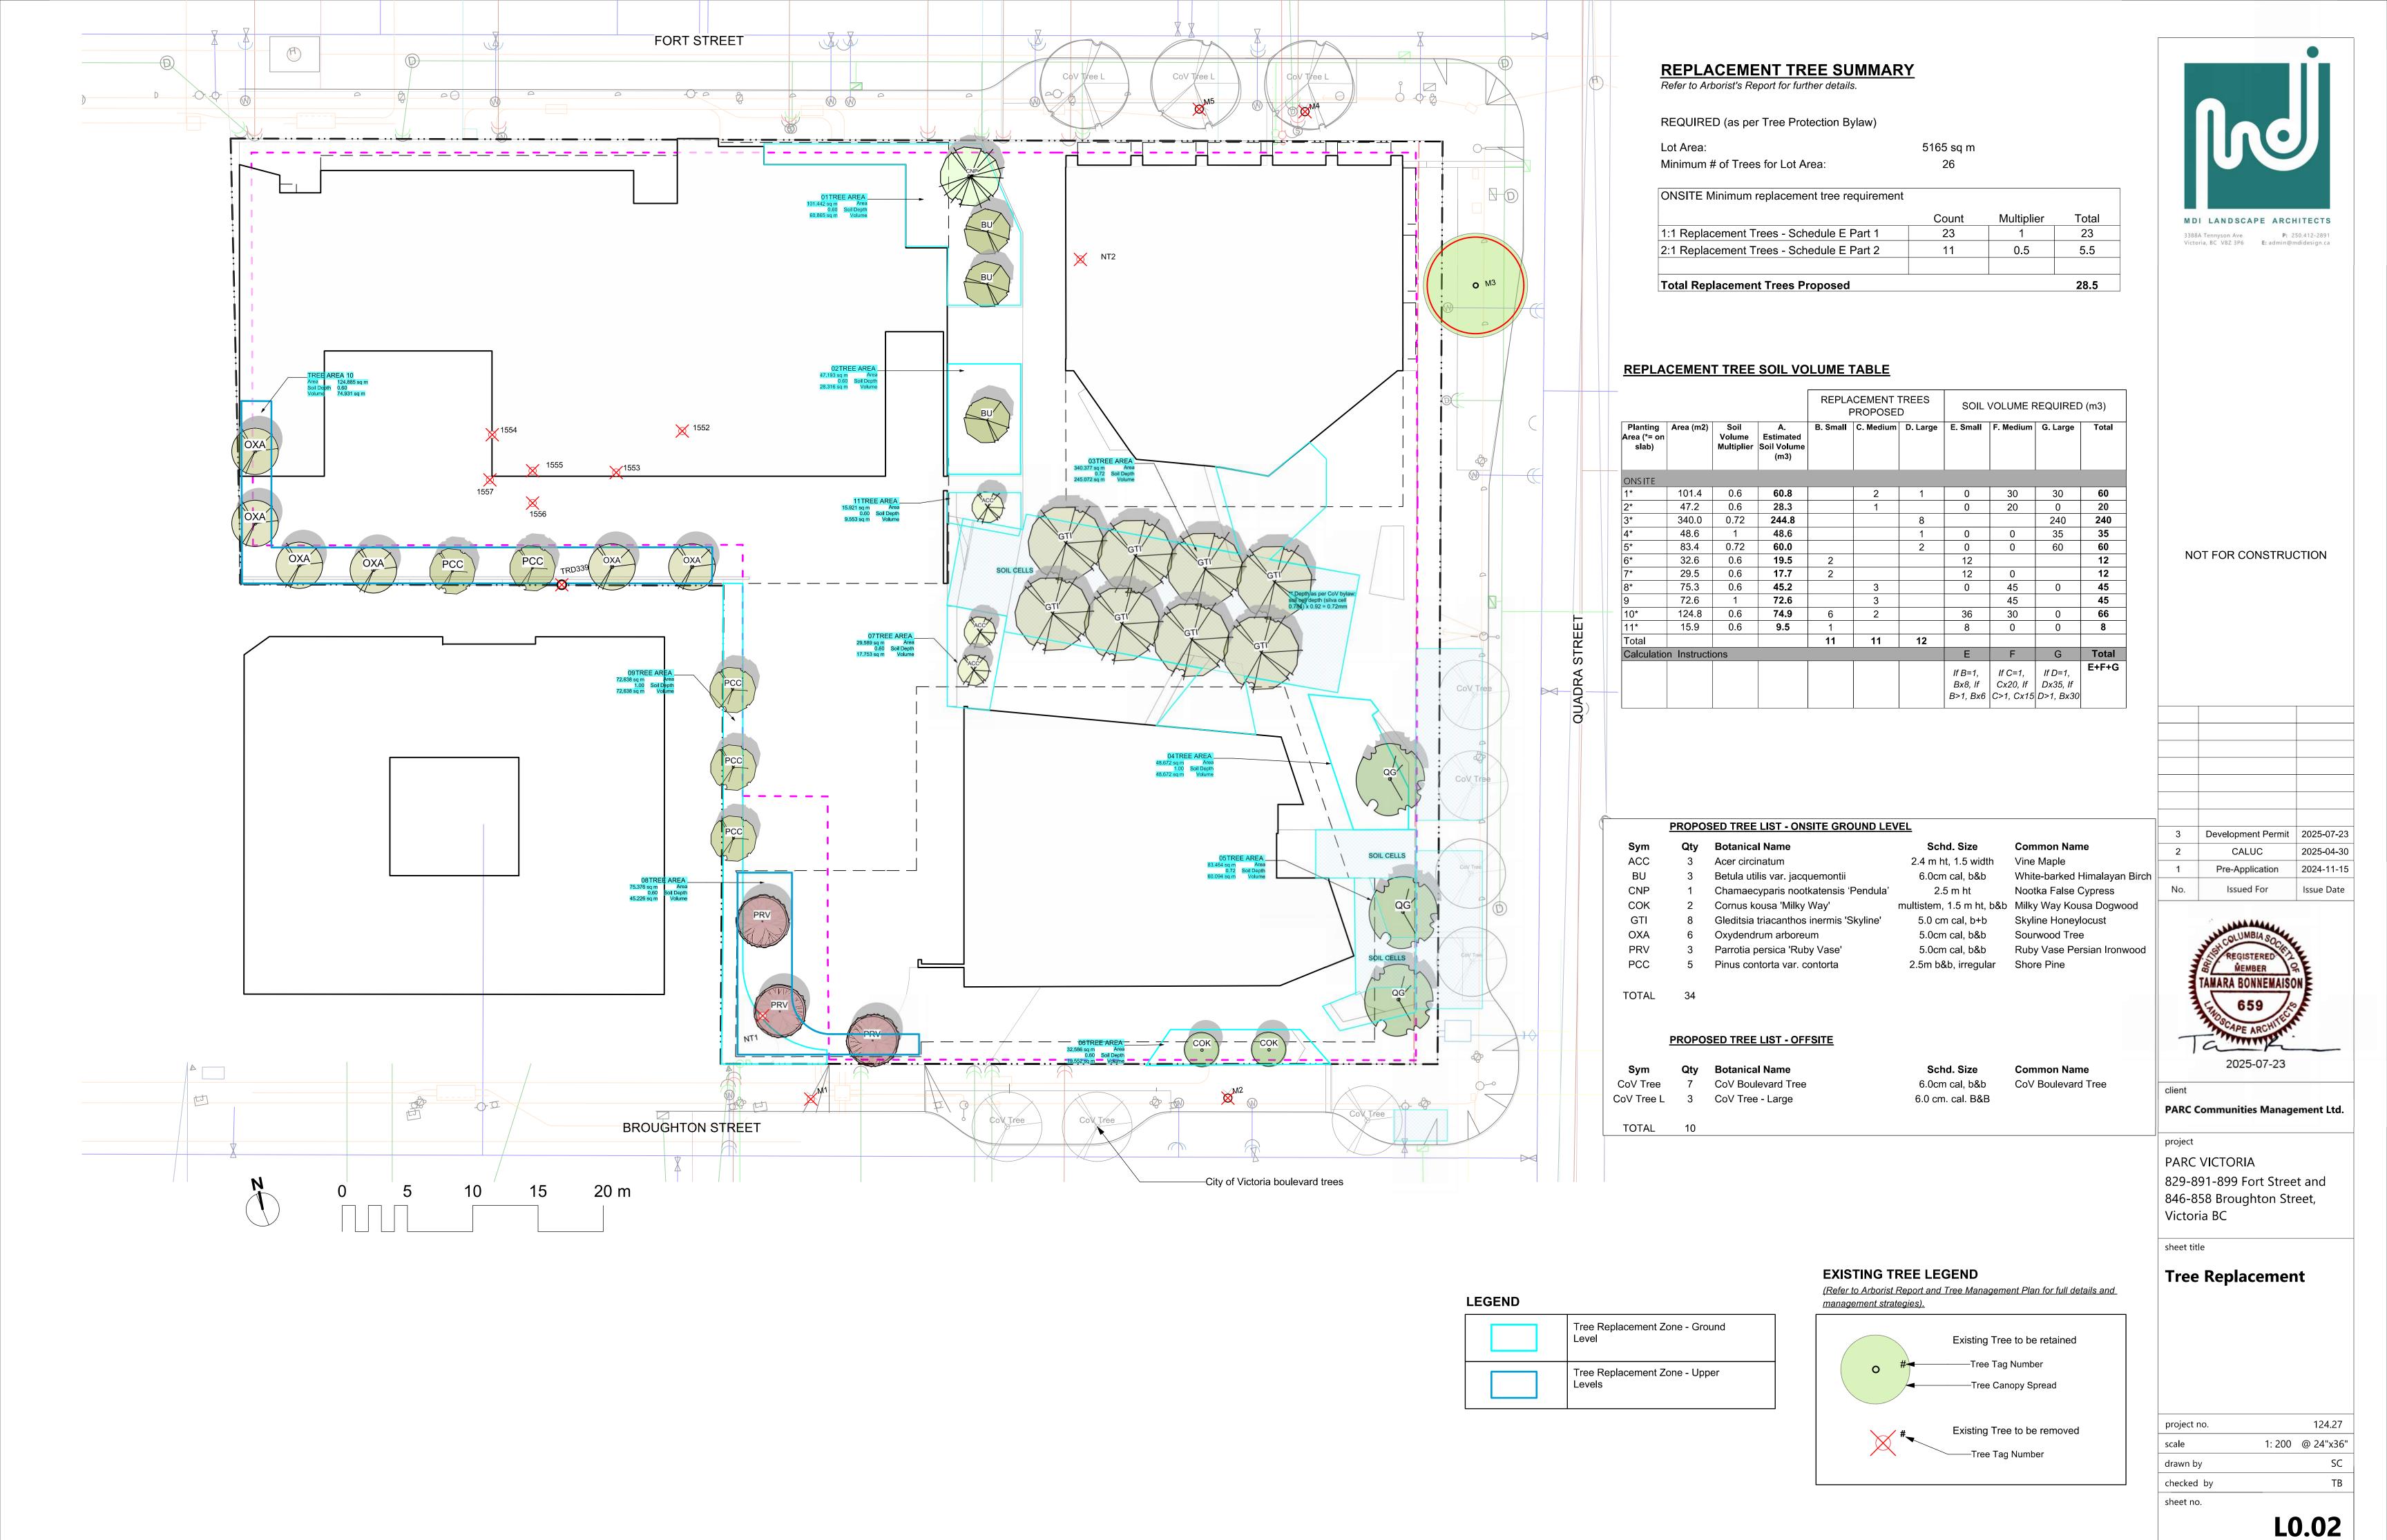

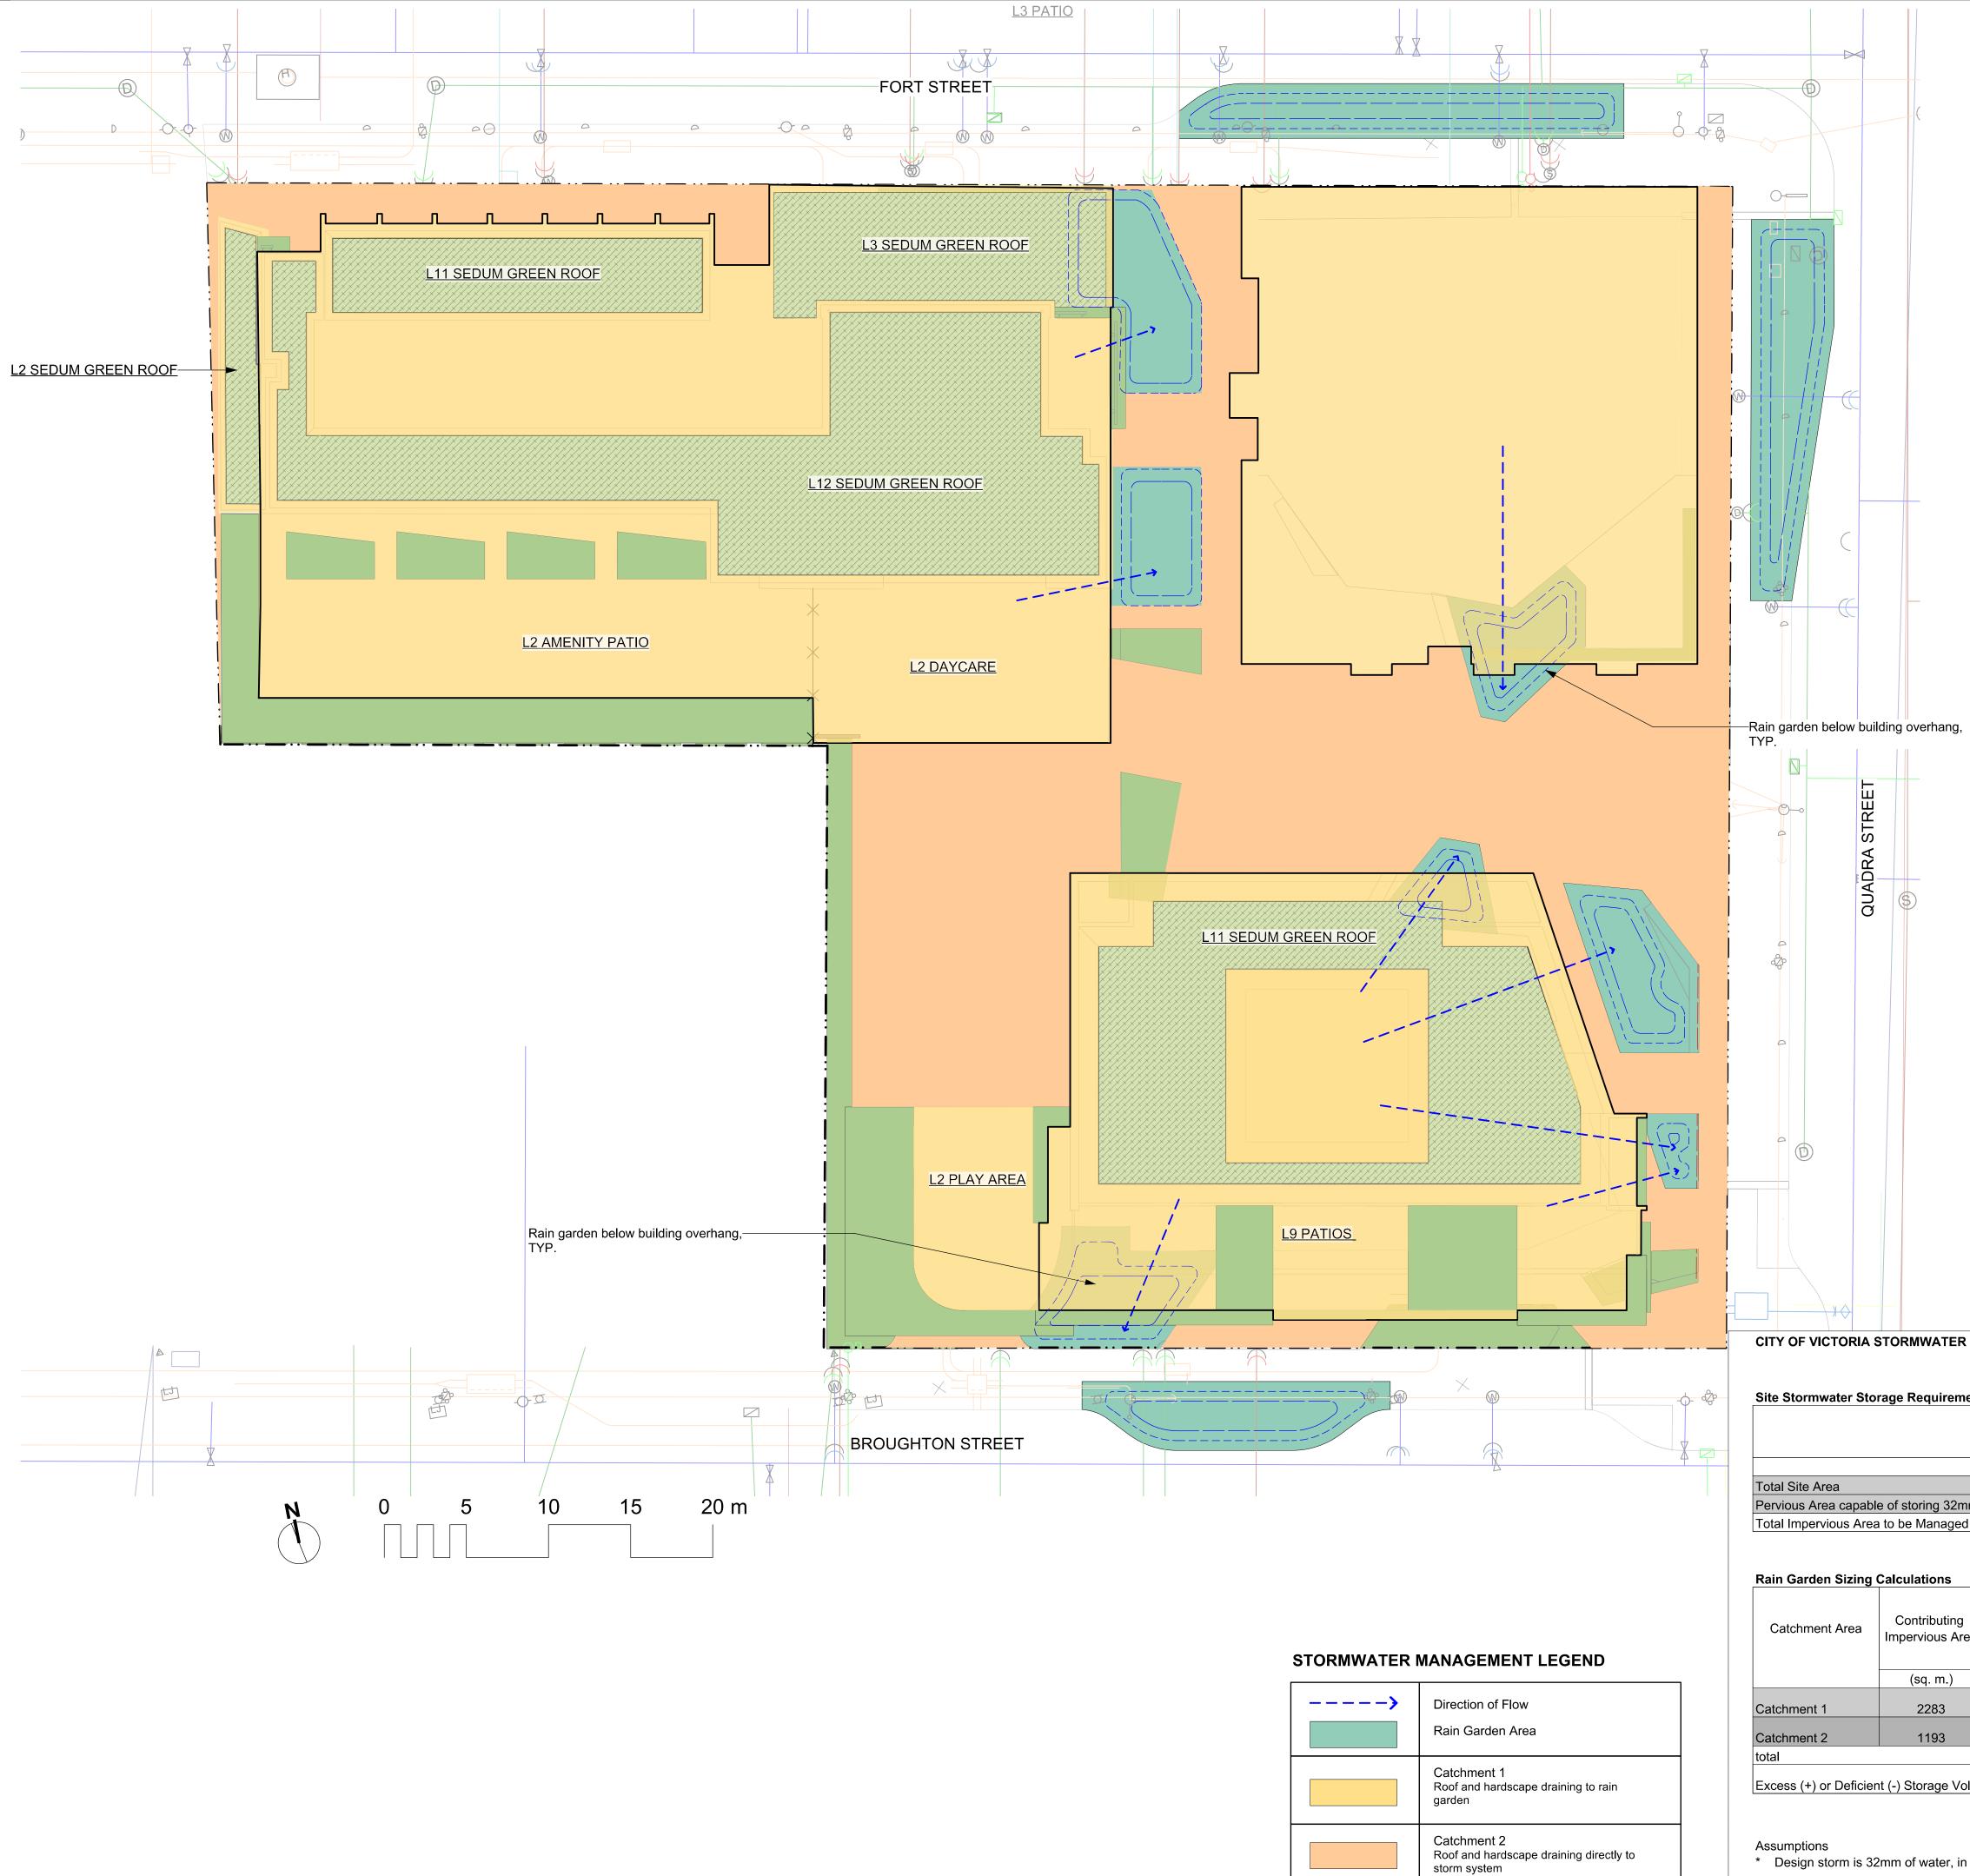


RAIN WATER MANAGEMENT NOTES

Water collected from road areas, building roofs, flow to the rain gardens located throughout the site.

Rain gardens are integrated building landscapes and landscape bulges within streetscape areas and are designed to capture, slow flows, and treat runoff from roadways.

Rain gardens will be designed with underdrains and a high-capacity overflow drain that will be connected to the onsite piped drainage system.

The rain gardens are sized such that the bottom of the rain garden is 5% of the impervious area.

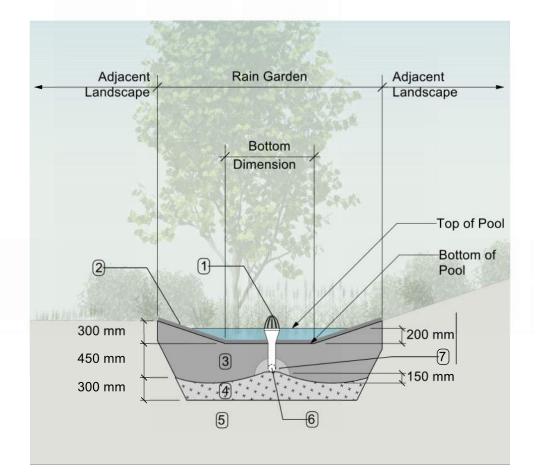

- RAIN GARDEN MATERIALS
- 1. Overflow drain, 200 mm domed grate + adapter
- 2. Composted mulch, 50 -70 mm depth
- 3. Bio-retention growing medium, 450 mm depth 4. Scarified/tilled subgrade, 300 mm depth
- 5. Existing subgrade/native material
- 6. 100 mm diameter (min) perforated pipe
- 7. 25 mm diameter drain rock, 100 mm depth

Typical Rain Garden Scale: 1:50



NOT FOR CONSTRUCTION

3	Development Permit	2025-07-23
2	CALUC	2025-04-30
	Pre-Application	2024-11-15
0.	Issued For	Issue Date



2025-07-23

PARC Communities Management Ltd.

PARC VICTORIA 829-891-899 Fort Street and 846-858 Broughton Street,

sheet title

Victoria BC

Stormwater Management

project no.		124.27
scale	1: 200	@ 24"x36"
drawn by		SC
checked by		ТВ
sheet no.		

L0.03

CITY OF VICTORIA STORMWATER CALCULATIONS

Site Stormwater Storage Requirements

		Required Storage
	Area	Volume for
		Design Storm*
	(sq. m.)	(cu. m./day)
Total Site Area	5165	165
Pervious Area capable of storing 32mm rainfall / 24 hours. ***	1689	54
Total Impervious Area to be Managed	3476	111

Catchment Area	Contributing Impervious Area	Design Storm Runoff Volume Contributing to Rain Garden*	Planter Growing Medium Depth	Stormwater Treatment Capacity per sq. m. of Rain Garden	Rain Garden Base Area	Rain Garden Capacity**	Sizing Factor (Water Quality Methodology)
	(sq. m.)	(cu. m./day)	(m.)	(cu. m./day)	(sq. m.)	(cu. m./day)	
Catchment 1	2283	73	0.75	0.83	138	114	6%
Catchment 2	1193	-	-	-	-	-	_
total						114	

Excess (+) or Deficient (-) Storage Volume required to be managed by Green Stormwater Infrastructure


* Design storm is 32mm of water, in a 24 hr period.

Landscape Areas Capable of managing 32mm of rain per

24 hr. period

** Rain Garden capacity based on 200 mm live ponding plus 20% of the sand/ compost growing medium volume (assuming growing medium has 20% void space) with a minimum infiltration rate of 2 cm/hour (or 48 cm per day), via perforated underdrain.

***Landscaped areas require minimum 170mm depth of growing medium in order to manage 32mm rainfall / 24 hours (assuming 20% void space). Engineered green roof systems that are shown to meet the minimum requirements may also be included.

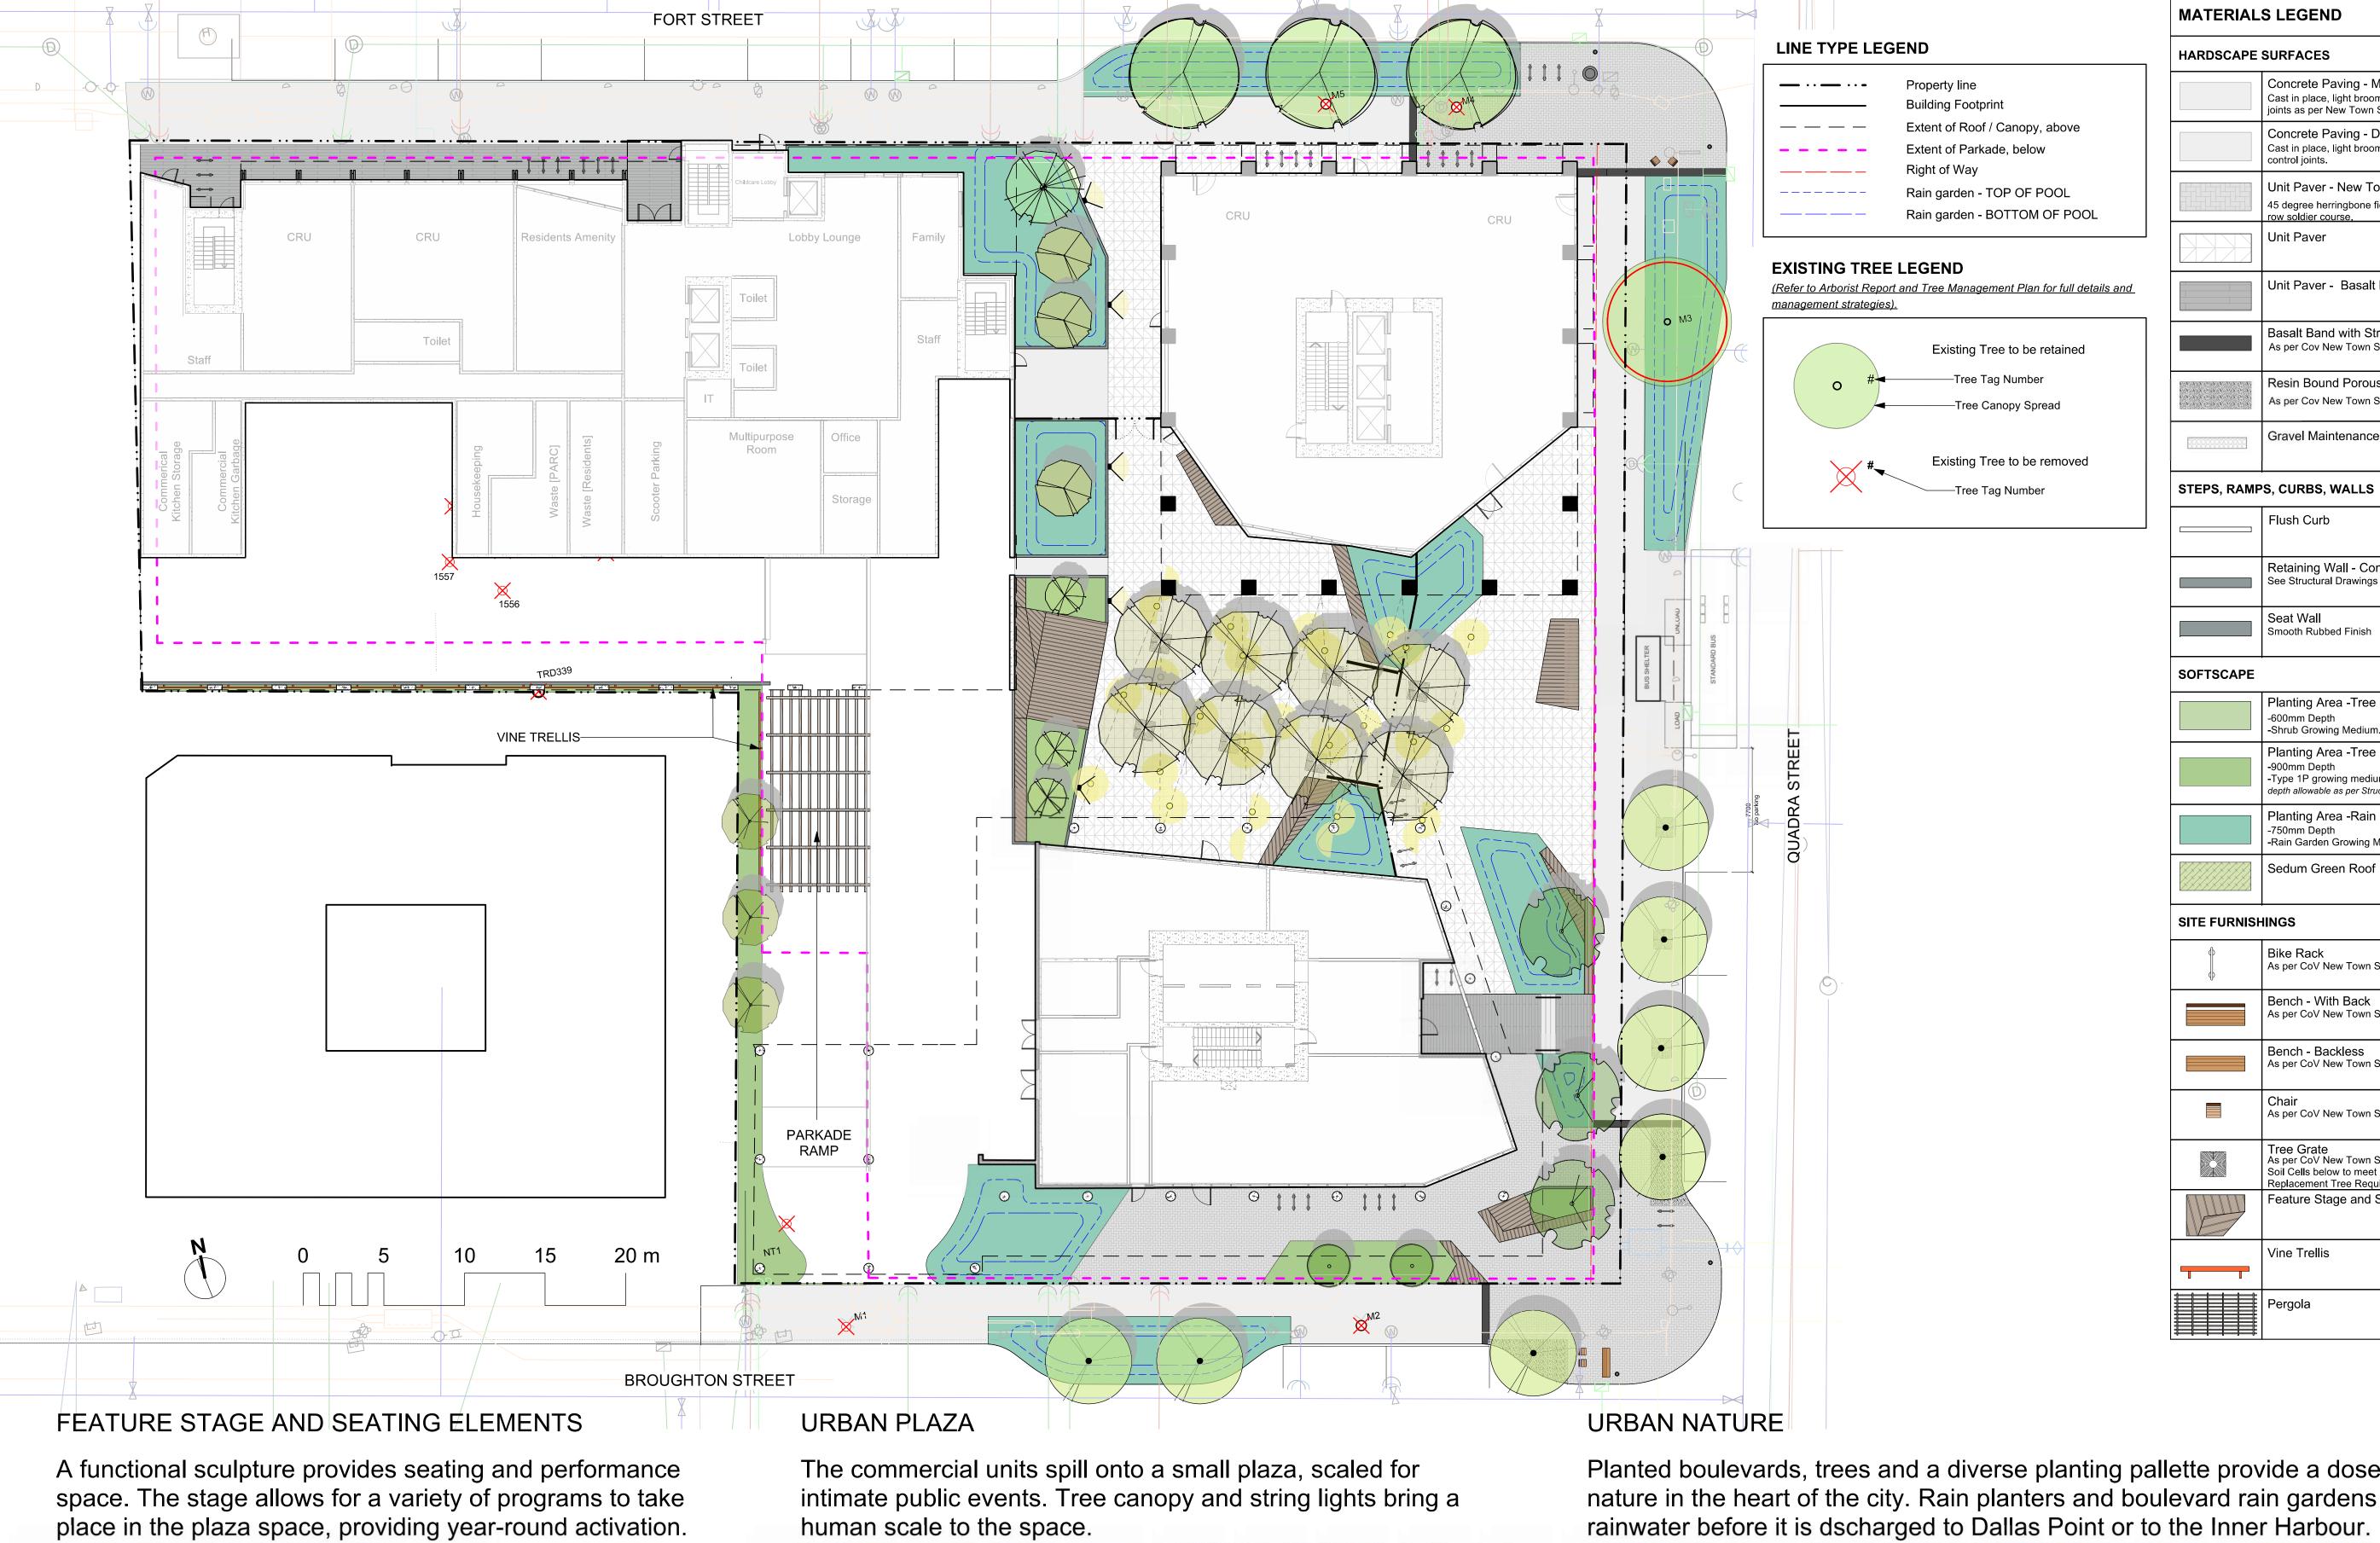










Planted boulevards, trees and a diverse planting pallette provide a dose of nature in the heart of the city. Rain planters and boulevard rain gardens treat rainwater before it is dscharged to Dallas Point or to the Inner Harbour.



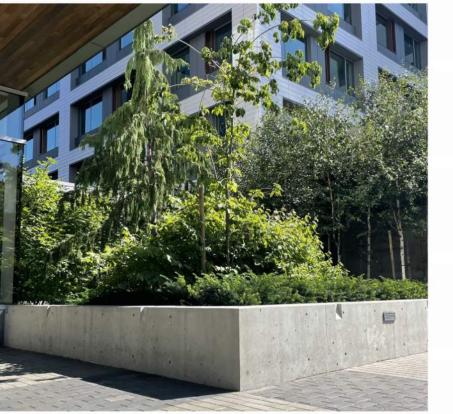



Concrete Paving - Municipal Sidewalk

Cast in place, light broom finish. Control joints as per New Town Standard.

Cast in place, light broom finish with sawcut

Unit Paver - New Town Standard

45 degree herringbone field with single

Unit Paver - Basalt Paving

As per Cov New Town Standard

Resin Bound Porous Surface As per Cov New Town Standard

Gravel Maintenance Edge

Retaining Wall - Concrete See Structural Drawings

Planting Area -Tree & Shrub -On Grade

Planting Area -Tree & Shrub -On Slab

-Type 1P growing medium. Confirm maximum depth allowable as per Structural Drawings.

Planting Area -Rain Garden

-Rain Garden Growing Medium.

As per CoV New Town Standard

Bench - With Back As per CoV New Town Standard

Bench - Backless As per CoV New Town Standard

As per CoV New Town Standard

Feature Stage and Seating

Sedum Green Roof

Smooth Rubbed Finish

-Shrub Growing Medium.

Basalt Band with Street Name Insert

Concrete Paving - Decorative

control joints.

row soldier course.

Unit Paver

Flush Curb

Seat Wall

-600mm Depth

-900mm Depth

-750mm Depth

Bike Rack

NOT FOR CONSTRUCTION





PARC Communities Management Ltd.

PARC VICTORIA 829-891-899 Fort Street and 846-858 Broughton Street, Victoria BC

sheet title

Landscape **Materials Ground** Leve

	11	01
sheet no.		
checked by		ТВ
drawn by		SC
scale	1:200	@ 24"x36"
project no.		124.27



RESIDENTIAL AMENITY PATIO AND GARDENS

A generous, south-facing amenity patio provides a mix of programs to foster active aging and community building. Spaces allow for activities including quiet relaxation, dining, gardening, and gathering.



DAYCARE OUTDOOR SPACE

Outdoor play spaces provide air and sunshine for children attending the daycare. A mix of quiet areas and active play areas are provided, all surrounded by planting and child-friendly gardens.



Green Architecture

A sedum roof provides green views from above. Planters on Level two allow for plants to drape down and green the plaza.

MATERIALS LEGEND

HARDSCAPE SURFACES

Concrete Paving - Municipal Sidewalk

Cast in place, light broom finish. Control joints as per New Town Standard.

Cast in place, light broom finish with sawcut

Unit Paver - New Town Standard
45 degree herringbone field with single

Concrete Paving - Decorative

Unit Paver - Basalt Paving

As per Cov New Town Standard

Resin Bound Porous Surface
As per Cov New Town Standard

Gravel Maintenance Edge

Retaining Wall - Concrete

Planting Area -Tree & Shrub -On Grade

Planting Area -Tree & Shrub -On Slab

-Type 1P growing medium. Confirm maximum depth allowable as per Structural Drawings.

Planting Area -Rain Garden

-Rain Garden Growing Medium.

Bench - With Back As per CoV New Town Standard

Bench - Backless As per CoV New Town Standard

Chair
As per CoV New Town Standard

Tree Grate
As per CoV New Town Standard
Soil Cells below to meet Schedule 'E'
Replacement Tree Requirements.

Feature Stage and Seating

Sedum Green Roof

See Structural Drawings

Smooth Rubbed Finish

-Shrub Growing Medium.

Basalt Band with Street Name Insert

control joints.

row soldier course.

Unit Paver

STEPS, RAMPS, CURBS, WALLS

Flush Curb

Seat Wall

-600mm Depth

-900mm Depth

-750mm Depth

Bike Rack

SOFTSCAPE

SITE FURNISHINGS

Property line

Right of Way

Building Footprint

Extent of Roof / Canopy, above

Rain garden - TOP OF POOL

Rain garden - BOTTOM OF POOL

Extent of Parkade, below



MDI LANDSCAPE ARCHITECTS 3388A Tennyson Ave Victoria, BC V8Z 3P6 E: admin@mdidesign.ca

NOT FOR CONSTRUCTION

3	Development Permit	2025-07-23
2	CALUC	2025-04-30
1	Pre-Application	2024-11-15
No.	Issued For	Issue Date



client

PARC Communities Management Ltd.


roject

PARC VICTORIA
829-891-899 Fort Street and
846-858 Broughton Street,
Victoria BC

sheet title

Landscape Materials - L2

project no.		124.27
scale	1: 200	@ 24"x36"
drawn by		SC
checked by		ТВ
sheet no.	1 1	1 02

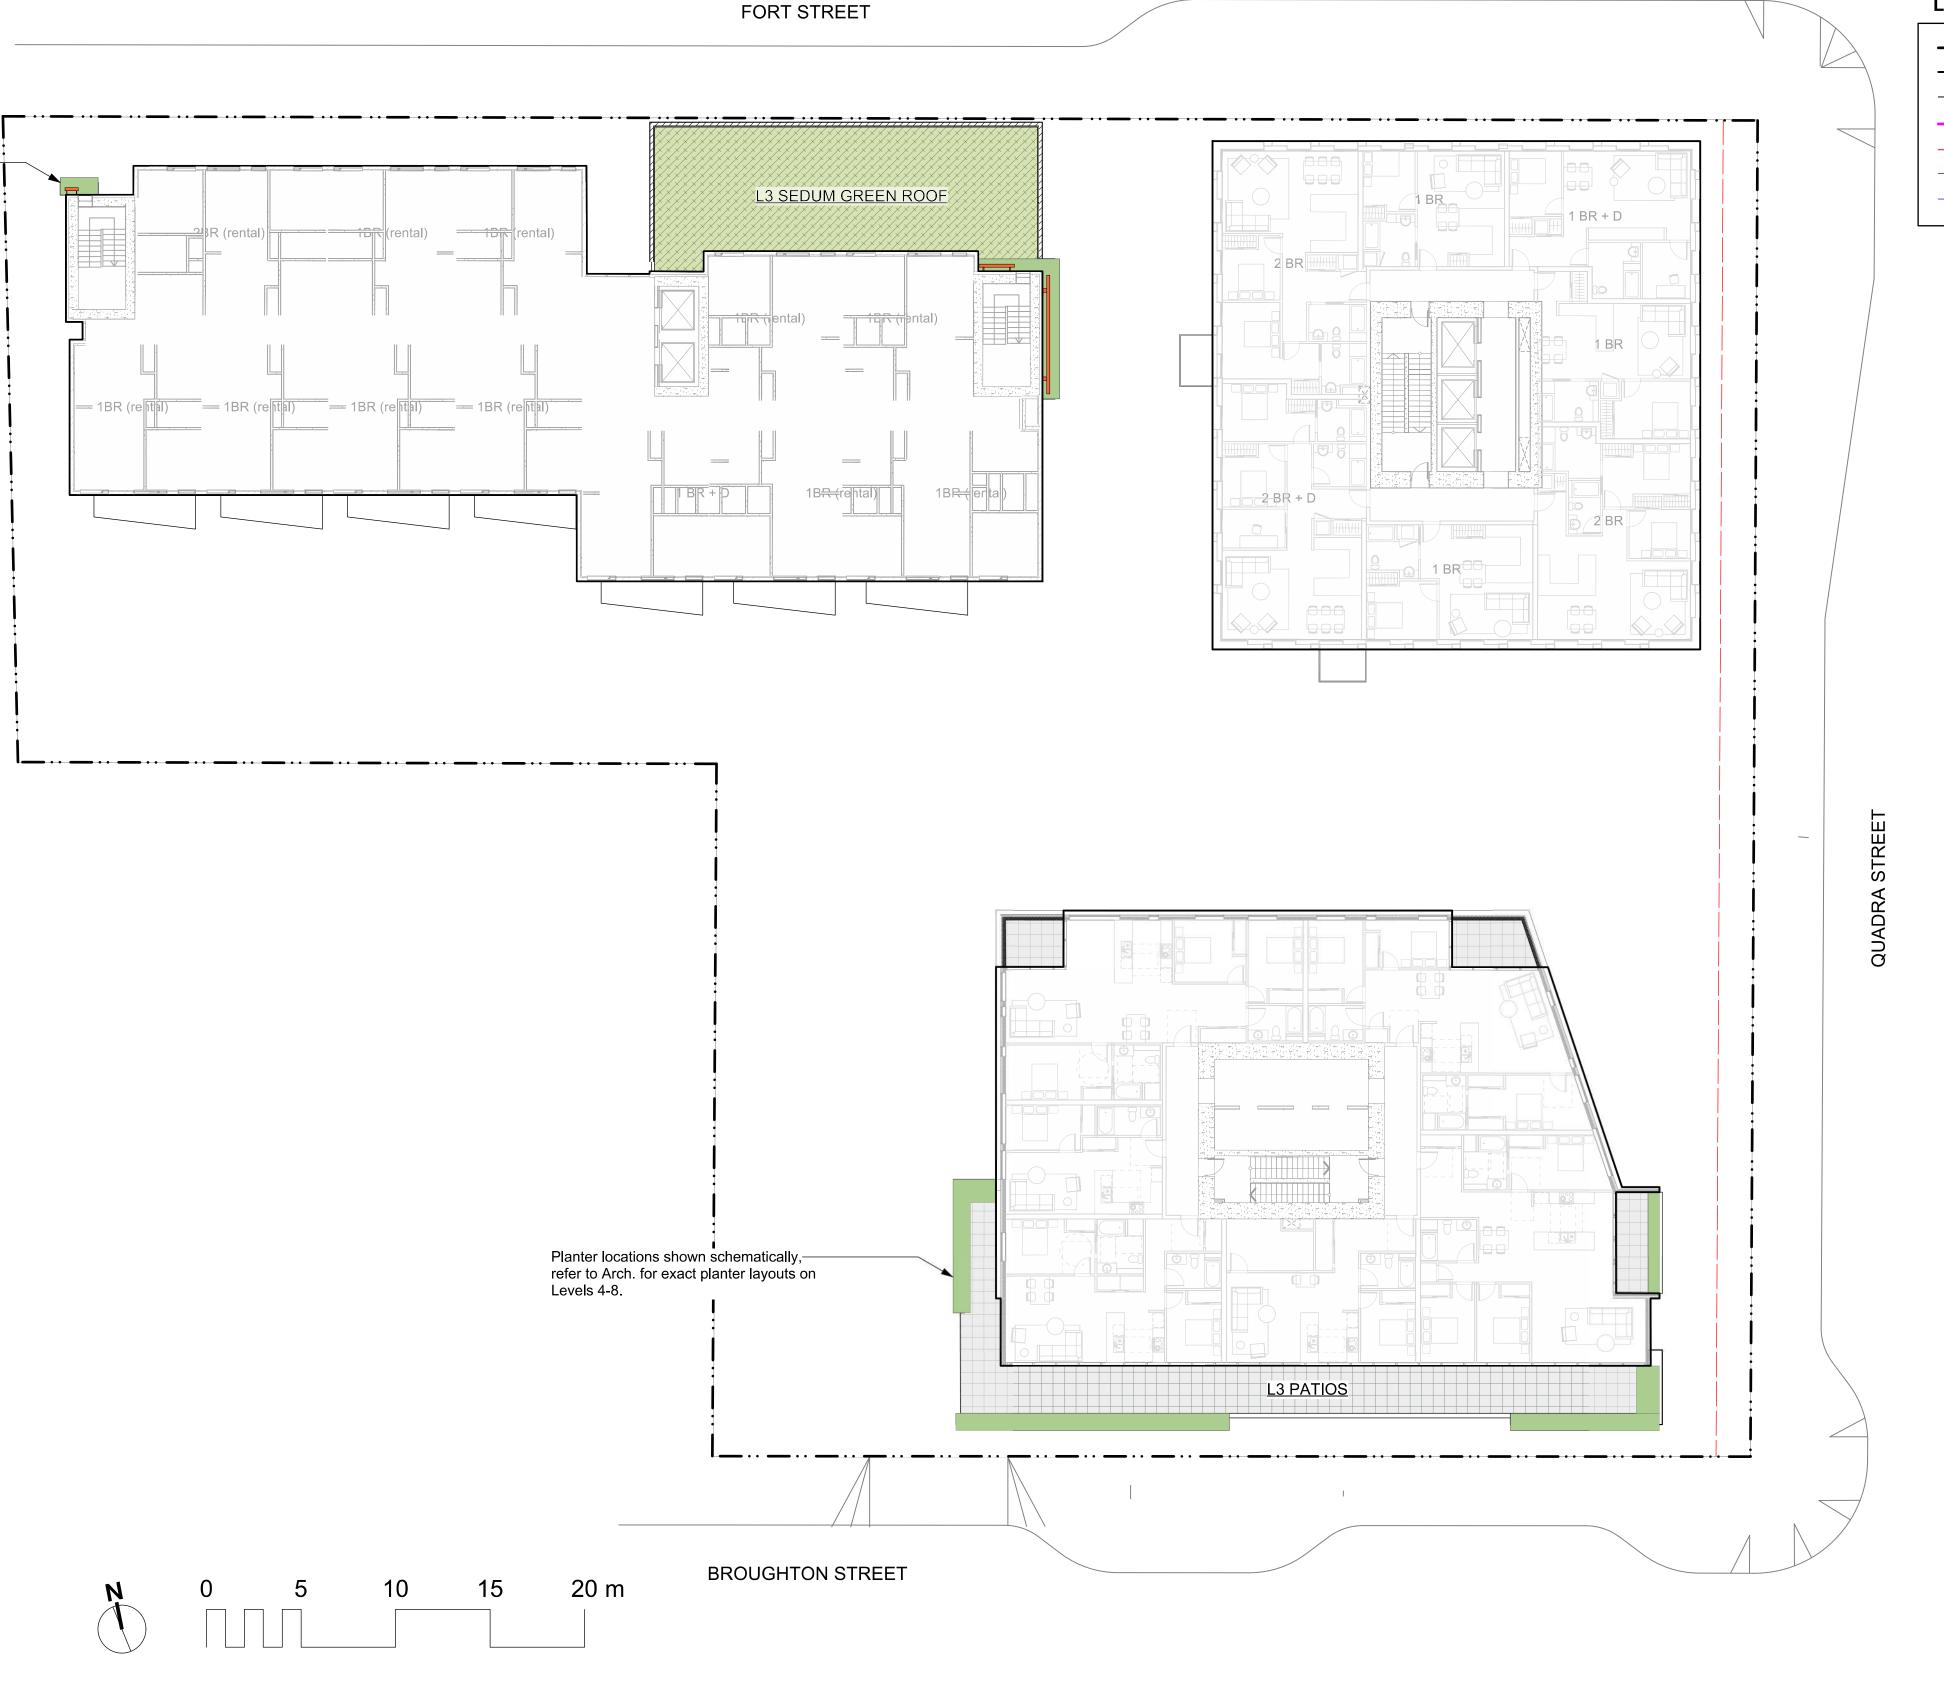

Planter locations shown schematically,-

upper Levels.

refer to Arch. for exact planter layouts on

LINE TYPE LEGEND

Property line
Building Footprint
Extent of Roof / Canopy, above
Extent of Parkade, below
Right of Way
Rain garden - TOP OF POOL


Rain garden - BOTTOM OF POOL

MATERIALS LEGEND HARDSCAPE SURFACES Concrete Paving - Municipal Sidewalk
Cast in place, light broom finish. Control
joints as per New Town Standard. Concrete Paving - Decorative Cast in place, light broom finish with sawcut control joints. Unit Paver - New Town Standard 45 degree herringbone field with single row soldier course. Unit Paver Unit Paver - Basalt Paving Basalt Band with Street Name Insert As per Cov New Town Standard Resin Bound Porous Surface As per Cov New Town Standard Gravel Maintenance Edge STEPS, RAMPS, CURBS, WALLS Flush Curb Retaining Wall - Concrete See Structural Drawings Seat Wall Smooth Rubbed Finish SOFTSCAPE Planting Area -Tree & Shrub -On Grade -600mm Depth -Shrub Growing Medium. Planting Area -Tree & Shrub -On Slab -900mm Depth -Type 1P growing medium. Confirm maximum depth allowable as per Structural Drawings. Planting Area -Rain Garden -750mm Depth -Rain Garden Growing Medium. Sedum Green Roof SITE FURNISHINGS Bike Rack As per CoV New Town Standard Bench - With Back As per CoV New Town Standard Bench - Backless As per CoV New Town Standard Chair
As per CoV New Town Standard Tree Grate
As per CoV New Town Standard
Soil Cells below to meet Schedule 'E'
Replacement Tree Requirements. Feature Stage and Seating Vine Trellis

Pergola



NOT FOR CONSTRUCTION

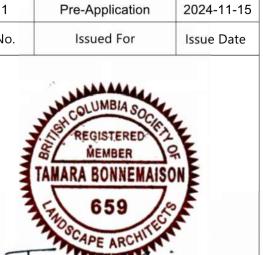

Development Permit | 2025-07-23 |

CALUC

2025-04-30

2025-07-23

PARC Communities Management Ltd.

2


PARC VICTORIA
829-891-899 Fort Street and
846-858 Broughton Street,
Victoria BC

sheet title

project

Landscape Materials - L3

project no.		124.27
scale	1: 200	@ 24"x36"
drawn by		SC
checked by		ТВ
sheet no.		

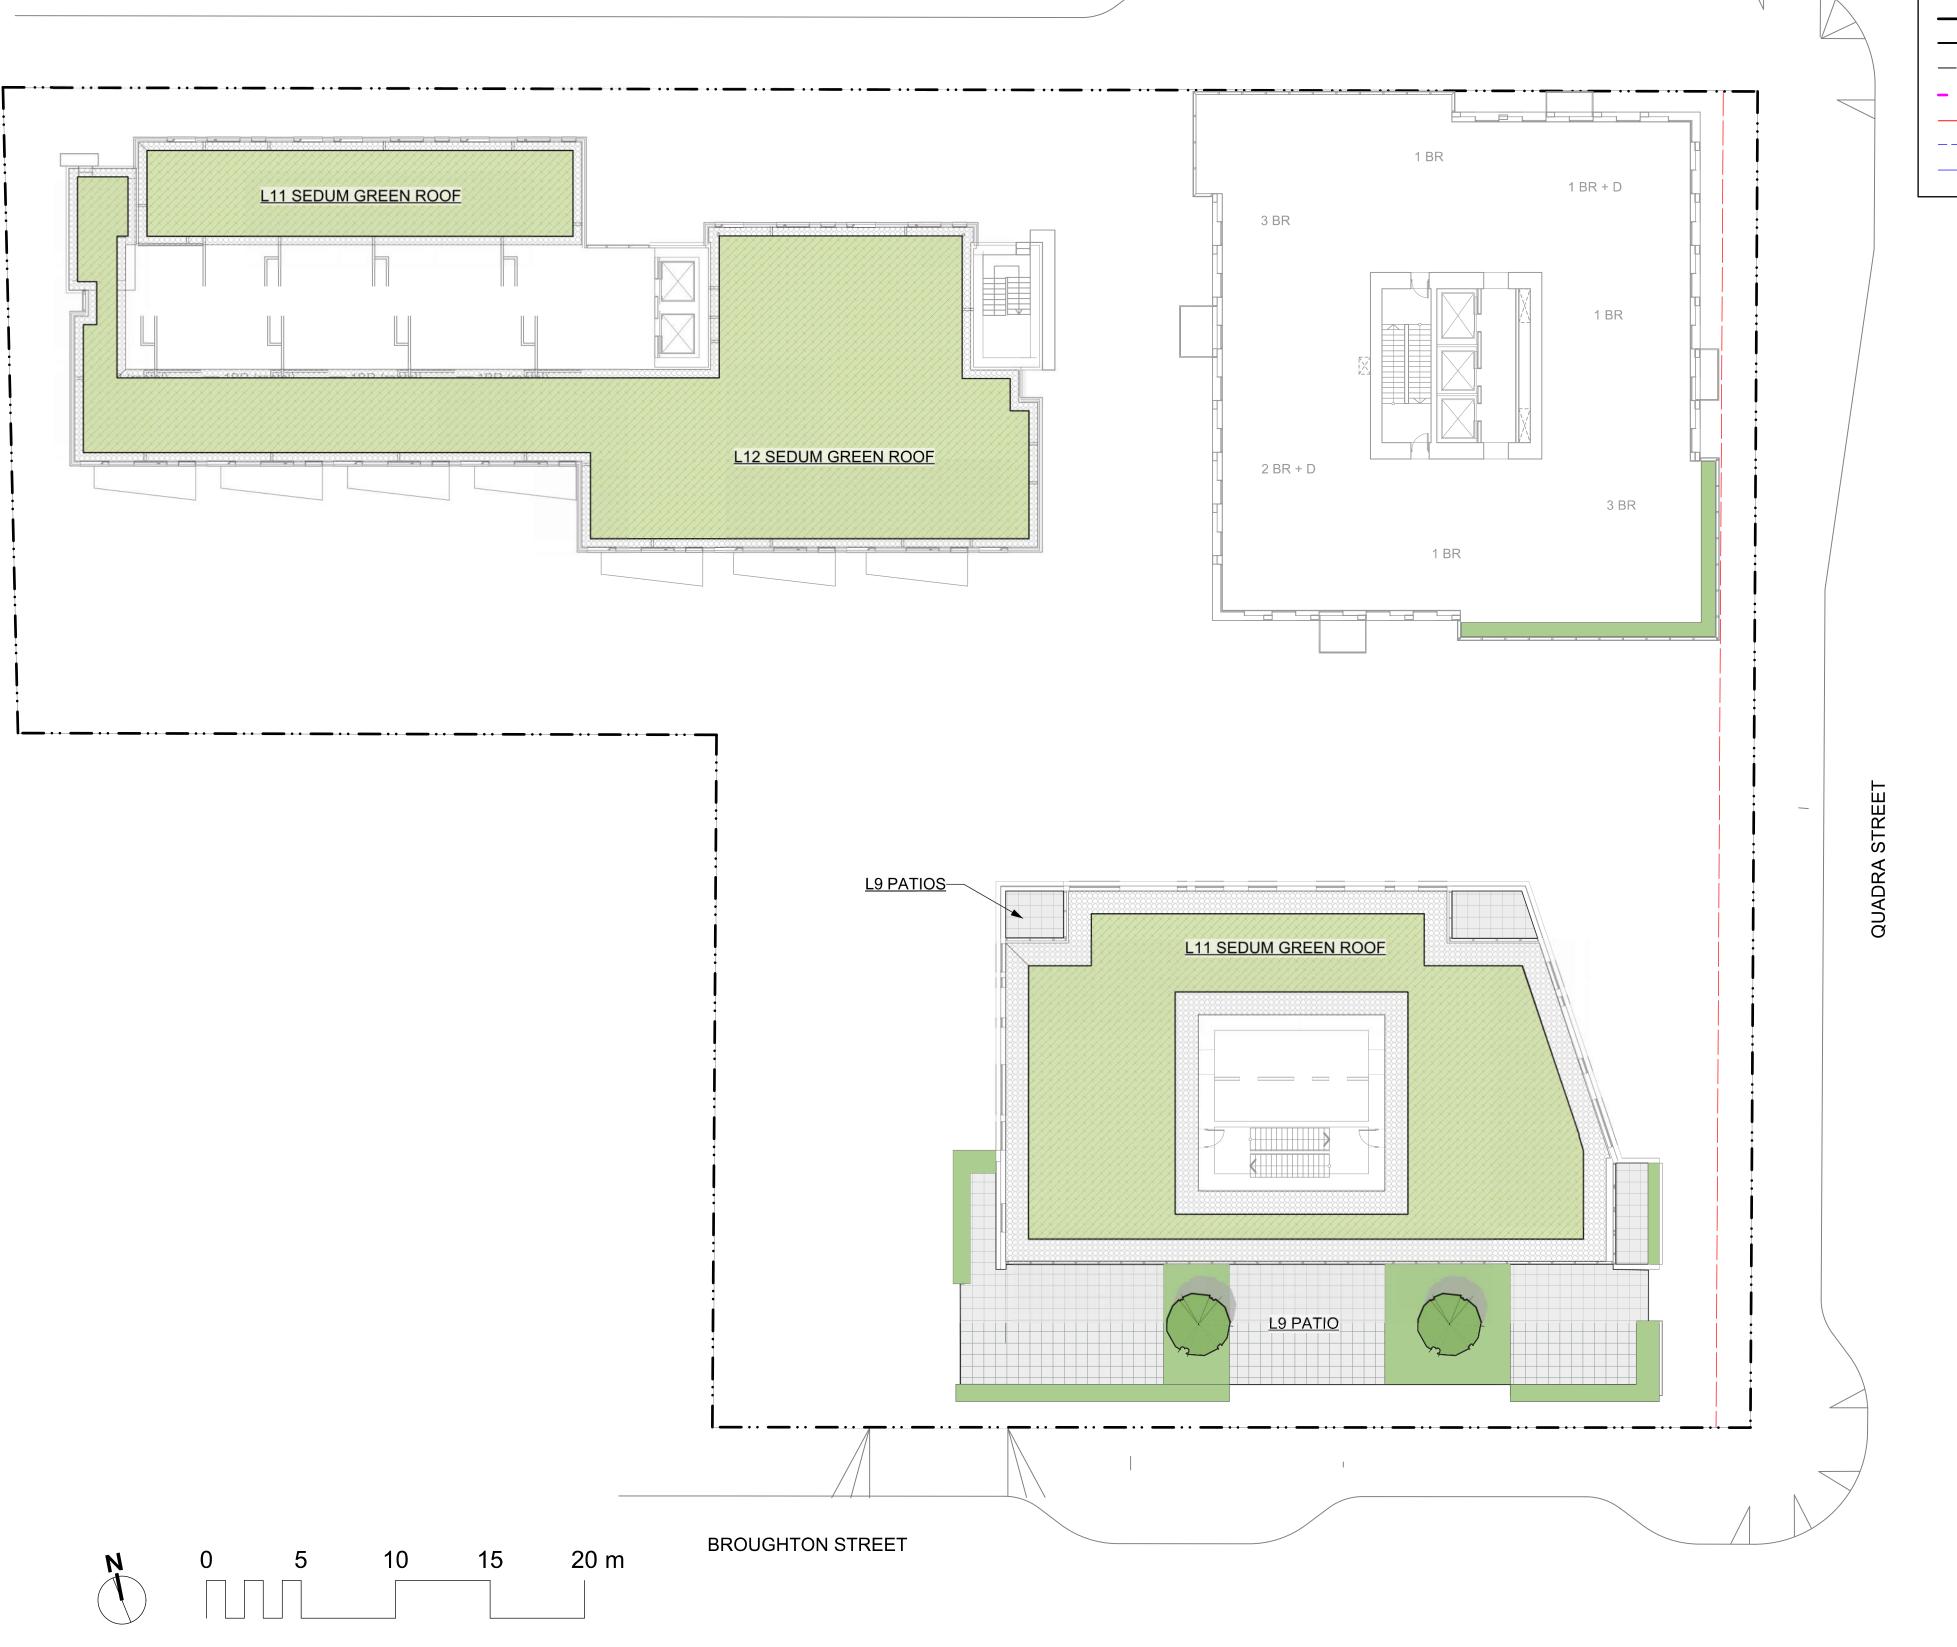

FORT STREET

LINE TYPE LEGEND


Property line
Building Footprint
Extent of Roof / Canopy, above
Extent of Parkade, below
Right of Way
Rain garden - TOP OF POOL

Rain garden - BOTTOM OF POOL

MATERIALS LEGEND HARDSCAPE SURFACES Concrete Paving - Municipal Sidewalk
Cast in place, light broom finish. Control
joints as per New Town Standard. Concrete Paving - Decorative Cast in place, light broom finish with sawcut control joints. Unit Paver - New Town Standard 45 degree herringbone field with single row soldier course. Unit Paver Unit Paver - Basalt Paving Basalt Band with Street Name Insert As per Cov New Town Standard Resin Bound Porous Surface As per Cov New Town Standard Gravel Maintenance Edge STEPS, RAMPS, CURBS, WALLS Flush Curb Retaining Wall - Concrete See Structural Drawings Seat Wall Smooth Rubbed Finish SOFTSCAPE Planting Area -Tree & Shrub -On Grade -600mm Depth -Shrub Growing Medium. Planting Area -Tree & Shrub -On Slab -900mm Depth -Type 1P growing medium. Confirm maximum depth allowable as per Structural Drawings. Planting Area -Rain Garden -750mm Depth -Rain Garden Growing Medium. Sedum Green Roof SITE FURNISHINGS Bike Rack As per CoV New Town Standard Bench - With Back As per CoV New Town Standard Bench - Backless As per CoV New Town Standard Chair
As per CoV New Town Standard Tree Grate
As per CoV New Town Standard
Soil Cells below to meet Schedule 'E'
Replacement Tree Requirements. Feature Stage and Seating Vine Trellis

Pergola



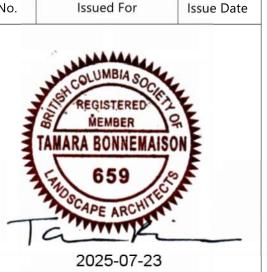

CALUC

Pre-Application

2025-04-30

2024-11-15

PARC Communities Management Ltd.

project

2


PARC VICTORIA
829-891-899 Fort Street and
846-858 Broughton Street,
Victoria BC


sheet title

Landscape Materials - L9, 11 & 12

project no.		124.27
scale	1: 200	@ 24"x36"
drawn by		SC
checked by		ТВ
sheet no.		


LEVEL 11 LEVEL 14

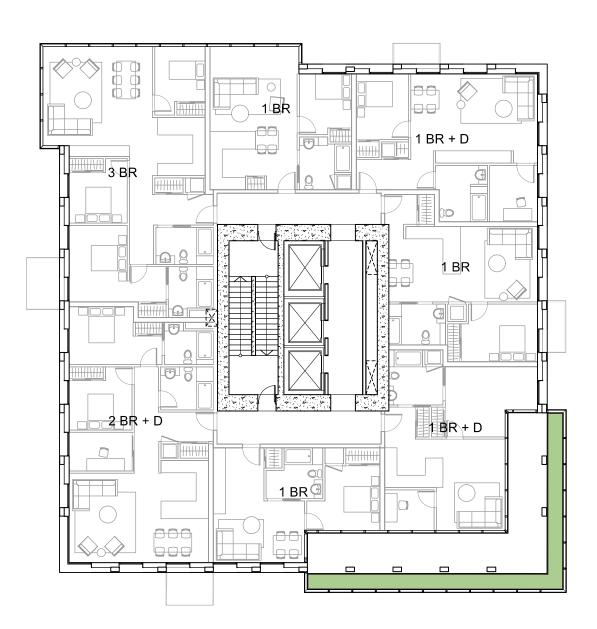


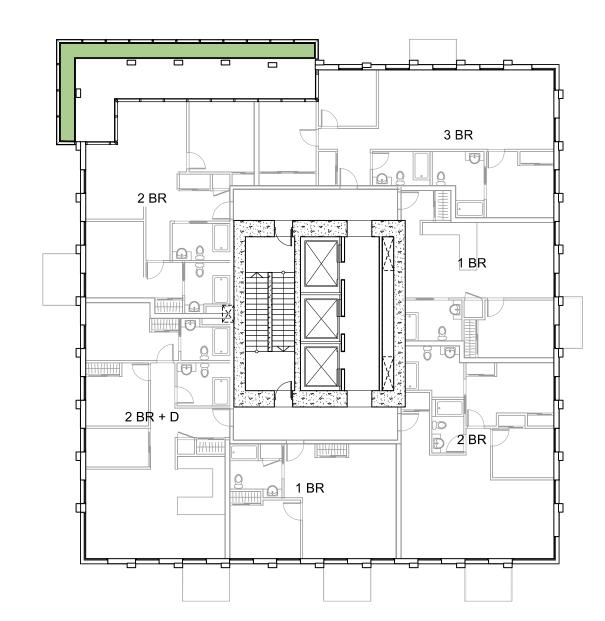

LEVEL 19 LEVEL 22



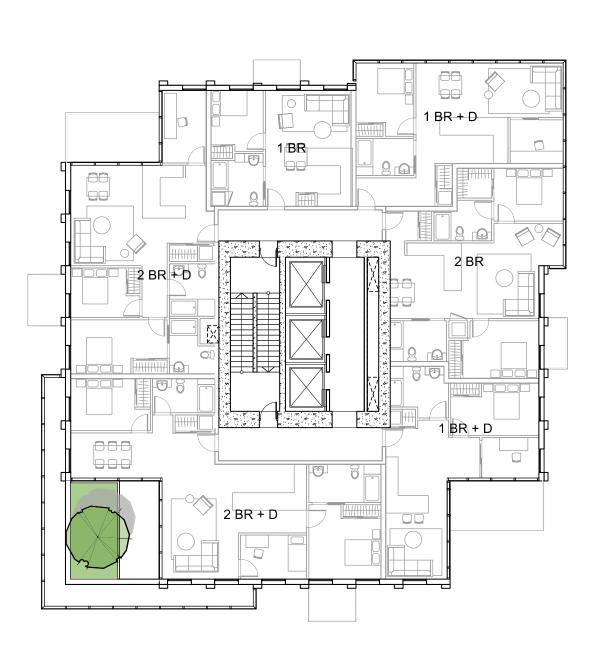


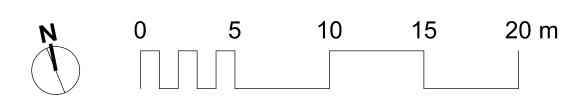

LINE TYPE LEGEND

Property line
Building Footprint
Extent of Roof / Canopy, above
Extent of Parkade, below
Right of Way
Rain garden - TOP OF POOL
Rain garden - BOTTOM OF POOL

LEVEL 27

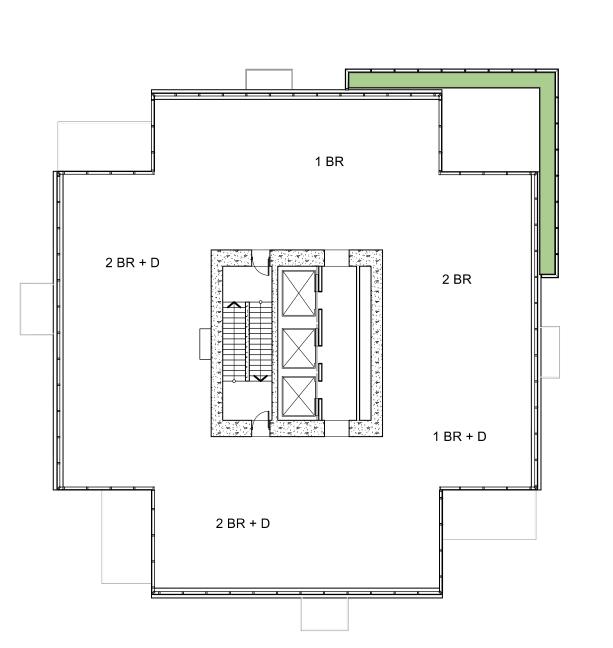

HARDSCAPE SURFACES

Concrete Paving - Municipal Sidewalk
Cast in place, light broom finish. Control
joints as per New Town Standard.

Concrete Paving - Decorative
Cast in place, light broom finish with sawcut
control joints.


MDI LANDSCAPE ARCHITECTS

3388A Tennyson Ave P: 250.412-2891 Victoria, BC V8Z 3P6 E: admin@mdidesign.ca

Unit Paver - New Town Standard

45 degree herringbone field with single row soldier course.

Unit Paver

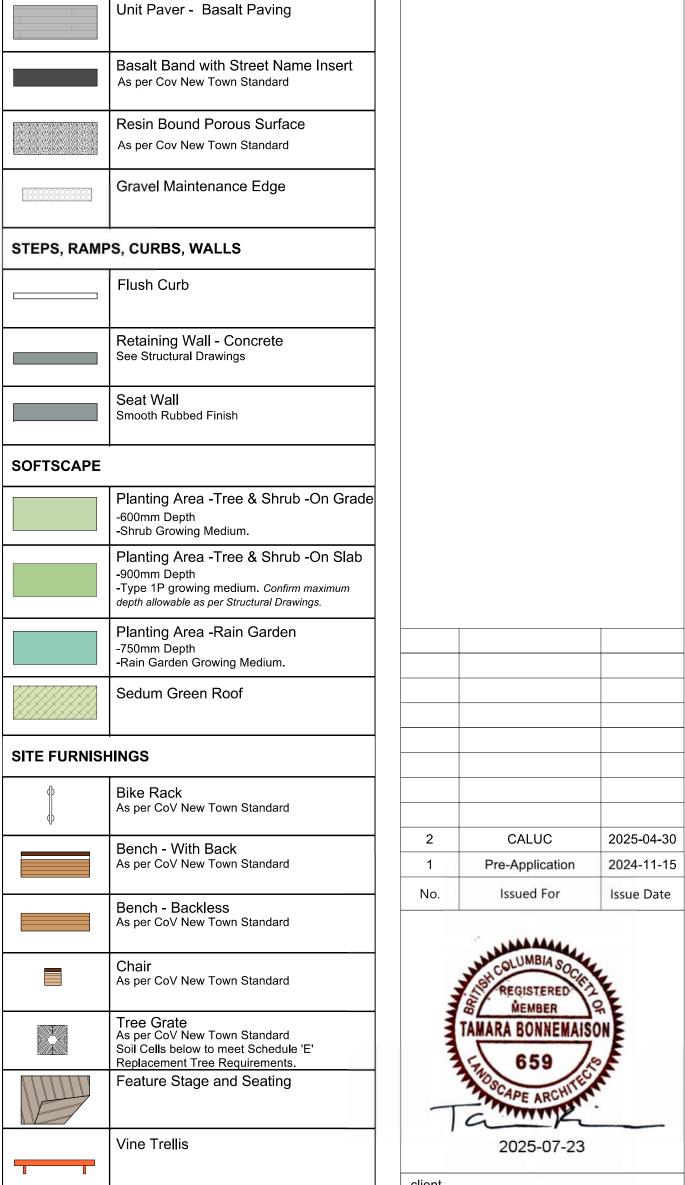

PARC Communities Management Ltd.


project

PARC VICTORIA
829-891-899 Fort Street and
846-858 Broughton Street,
Victoria BC

sheet title

Landscape Materials - Tower

	124.27
1: 200	@ 24"x36"
	SC
	ТВ
	1: 200

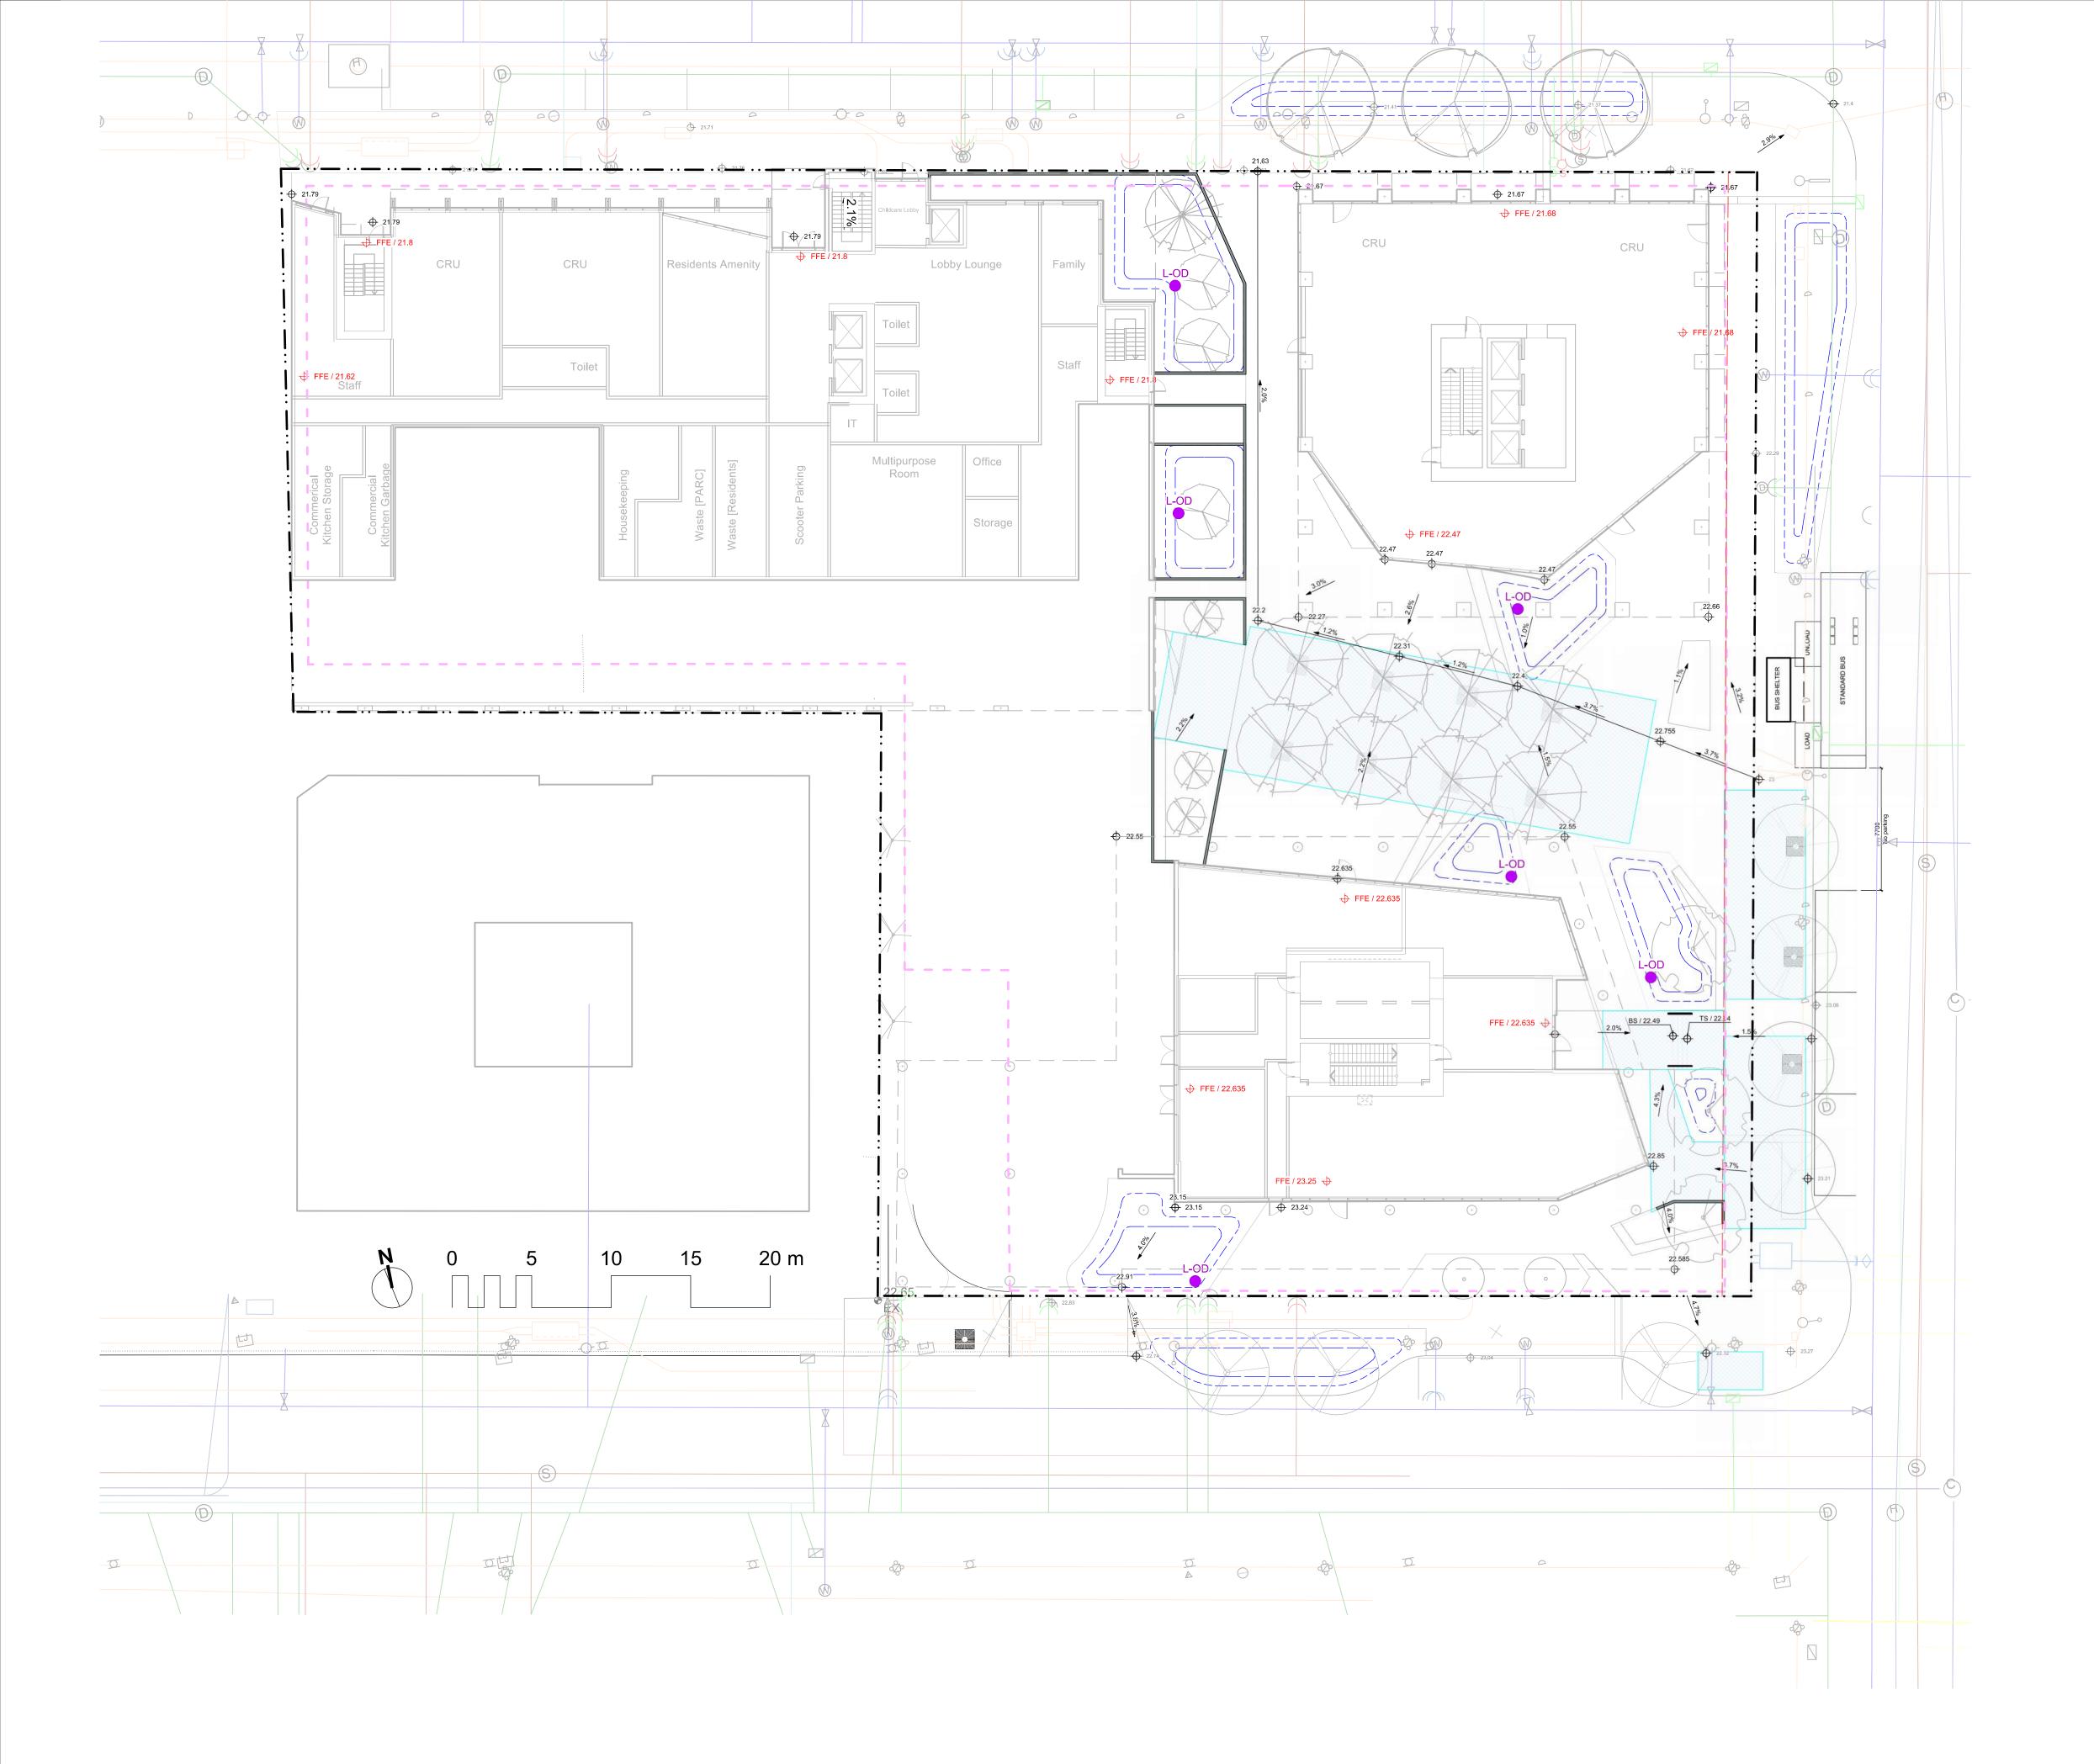

GRADING LEGEND

25.25	Proposed Landscape Grade		
25.25 36.7%	TOW Top of Wall BP Bottom of Pool BW Bottom of Wall TS Top of Stairs TOC Top of Curb BS Bottom of Stairs BC Bottom of Curb HP High Point TP Top of Pool LP Low Point		
25.25	Existing Grade		
25.25	Architectural grade, for reference only		
√ 25.25	Civil Grade, for reference only		

LINE TYPE LEGEND


— · · — · · ·	Property line
	Building Footprint
	Extent of Roof / Canopy, above
	Extent of Parkade, below
	Right of Way
	Rain garden - TOP OF POOL
	Rain garden - BOTTOM OF POOL

LANDSCAPE INFRASTRUCTURE LEGEND

	Tree Soil Cells	
L-OD	Overflow Drain with Beehive Grate	



NOT FOR CONSTRUCTION

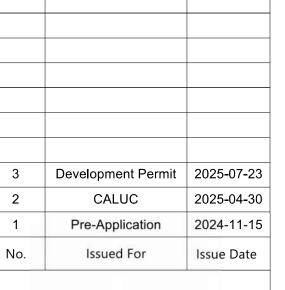



PARC Communities Management Ltd.

project


PARC VICTORIA
829-891-899 Fort Street and
846-858 Broughton Street,
Victoria BC

sheet title

Landscape Grading & Drainage

project no.		124.27
scale	1: 200	@ 24"x36"
drawn by		SC
checked by		ТВ
sheet no.		

L2.01

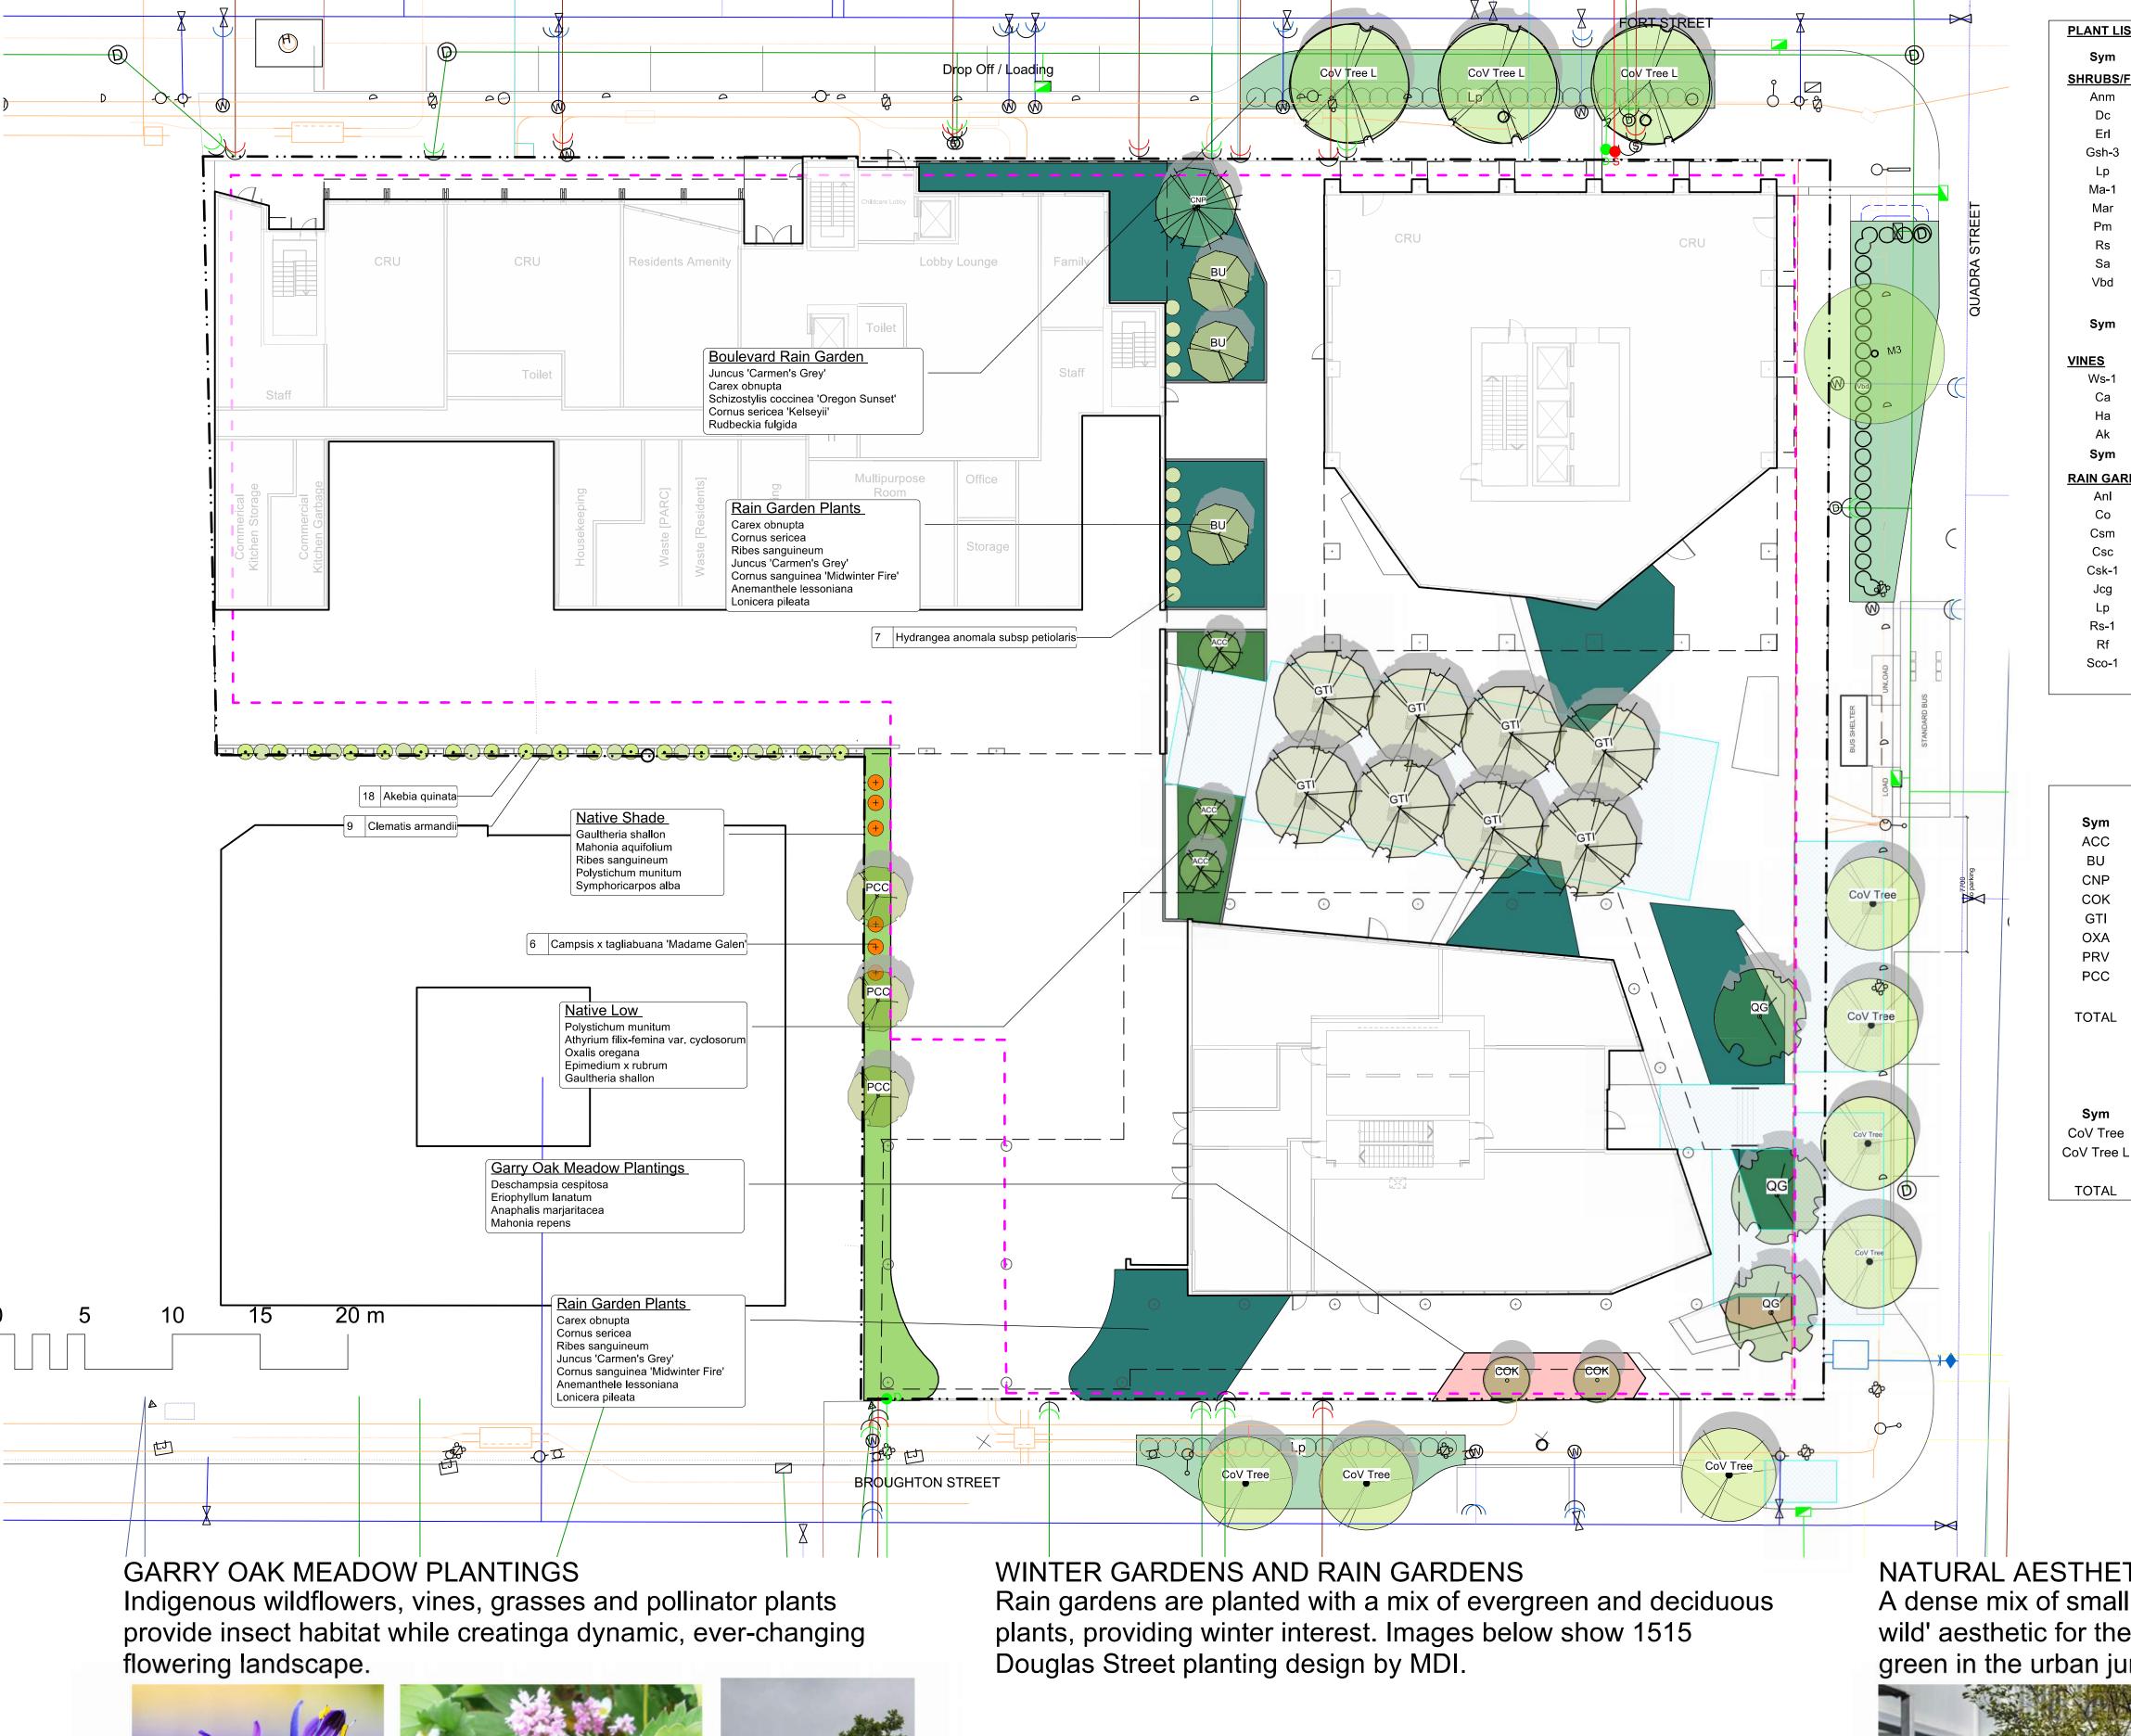

PLANT LIST GROUND LEVEL Qty Botanical Name **Common Name** chd. Size / Plant Spacing SHRUBS/FERNS/GRASSES/PERENNIALS 18 Anaphalis marjaritacea Pearly everlasting #1 pot **Tufted Hair Grass** 43 Deschampsia cespitosa #1 pot 17 Eriophyllum lanatum Wooly Sunflower #1 pot Gaultheria shallon #1 pot, 40cm o.c. Lonicera pileata Privet Honeysuckle #2 pot Mahonia aquifolium Oregon Grape #2 pot Mahonia repens Prostrate Oregon Grape #1 pot Polystichum munitum Sword Fern #1 pot Ribes sanguineum Red Flowering Currant #3 pot 22 Symphoricarpos alba Snowberry #1 pot Viburnum davidii David Viburnum #2 pot chd. Size / Plant Spacing **Botanical Name Common Name** Campsis x tagliabuana 'Madame Gale Trumpet Vine #3 pot Clematis armandii **Evergreen Clematis** #2 pot Hydrangea anomala subsp petiolaris Climbing Hydrangea #2 pot Chocolate vine #2 pot chd. Size / Plant Spacing **Botanical Name Common Name** Pheasant's Tail Grass #1 pot Anemanthele lessoniana 203 Carex obnupta #1 pot Slough Sedge Cornus sanguinea 'Midwinter Fire' Midwinter Fire Dogwood #1 pot Cornus sericea Red-twig Dogwood #2 pot Dwarf Red-twigged Dogwood Cornus sericea 'Kelseyii' #1 pot Soft Common Rush Juncus 'Carmen's Grey' #1 pot Privet Honeysuckle #2 pot Lonicera pileata Red Flowering Currant #3 pot 151 Rudbeckia fulgida Black-Eyed Susan #1 pot 68 Schizostylis coccinea 'Oregon Sunset Crimson Flag #1 pot

NOT FOR CONSTRUCTION

MDI LANDSCAPE ARCHITECTS

	PROPO	SED TREE LIST - ONSITE GROUND LE	<u>VEL</u>	
Sym	Qty	Botanical Name	Schd. Size	Common Name
ACC	3	Acer circinatum	2.4 m ht, 1.5 width	Vine Maple
BU	3	Betula utilis var. jacquemontii	6.0cm cal, b&b	White-barked Himalayan Birch
CNP	1	Chamaecyparis nootkatensis 'Pendula'	2.5 m ht	Nootka False Cypress
COK	2	Cornus kousa 'Milky Way'	multistem, 1.5 m ht, b&b	Milky Way Kousa Dogwood
GTI	8	Gleditsia triacanthos inermis 'Skyline'	5.0 cm cal, b+b	Skyline Honeylocust
OXA	6	Oxydendrum arboreum	5.0cm cal, b&b	Sourwood Tree
PRV	3	Parrotia persica 'Ruby Vase'	5.0cm cal, b&b	Ruby Vase Persian Ironwood
PCC	5	Pinus contorta var. contorta	2.5m b&b, irregular	Shore Pine
TOTAL	34			
	<u>PROPO</u>	SED TREE LIST - OFFSITE		
Sym	Qty	Botanical Name	Schd. Size	Common Name
CoV Tree	7	CoV Boulevard Tree	6.0cm cal, b&b	CoV Boulevard Tree

6.0 cm. cal. B&B

AMARA BONNEMA 2025-07-23

CALUC

Pre-Application

Issued For

Development Permit | 2025-07-23

PARC Communities Management Ltd.

PARC VICTORIA 829-891-899 Fort Street and 846-858 Broughton Street, Victoria BC

sheet title

Planting Ground


	13	3.01
sheet no.		
checked by		ТВ
drawn by		SC
scale	1: 200	@ 24"x36"
project no.		124.27

NATURAL AESTHETIC

A dense mix of small trees, vines and groundcovers provides an 'urban wild' aesthetic for the project. The plaza space is a wild cacophony of green in the urban jungle.





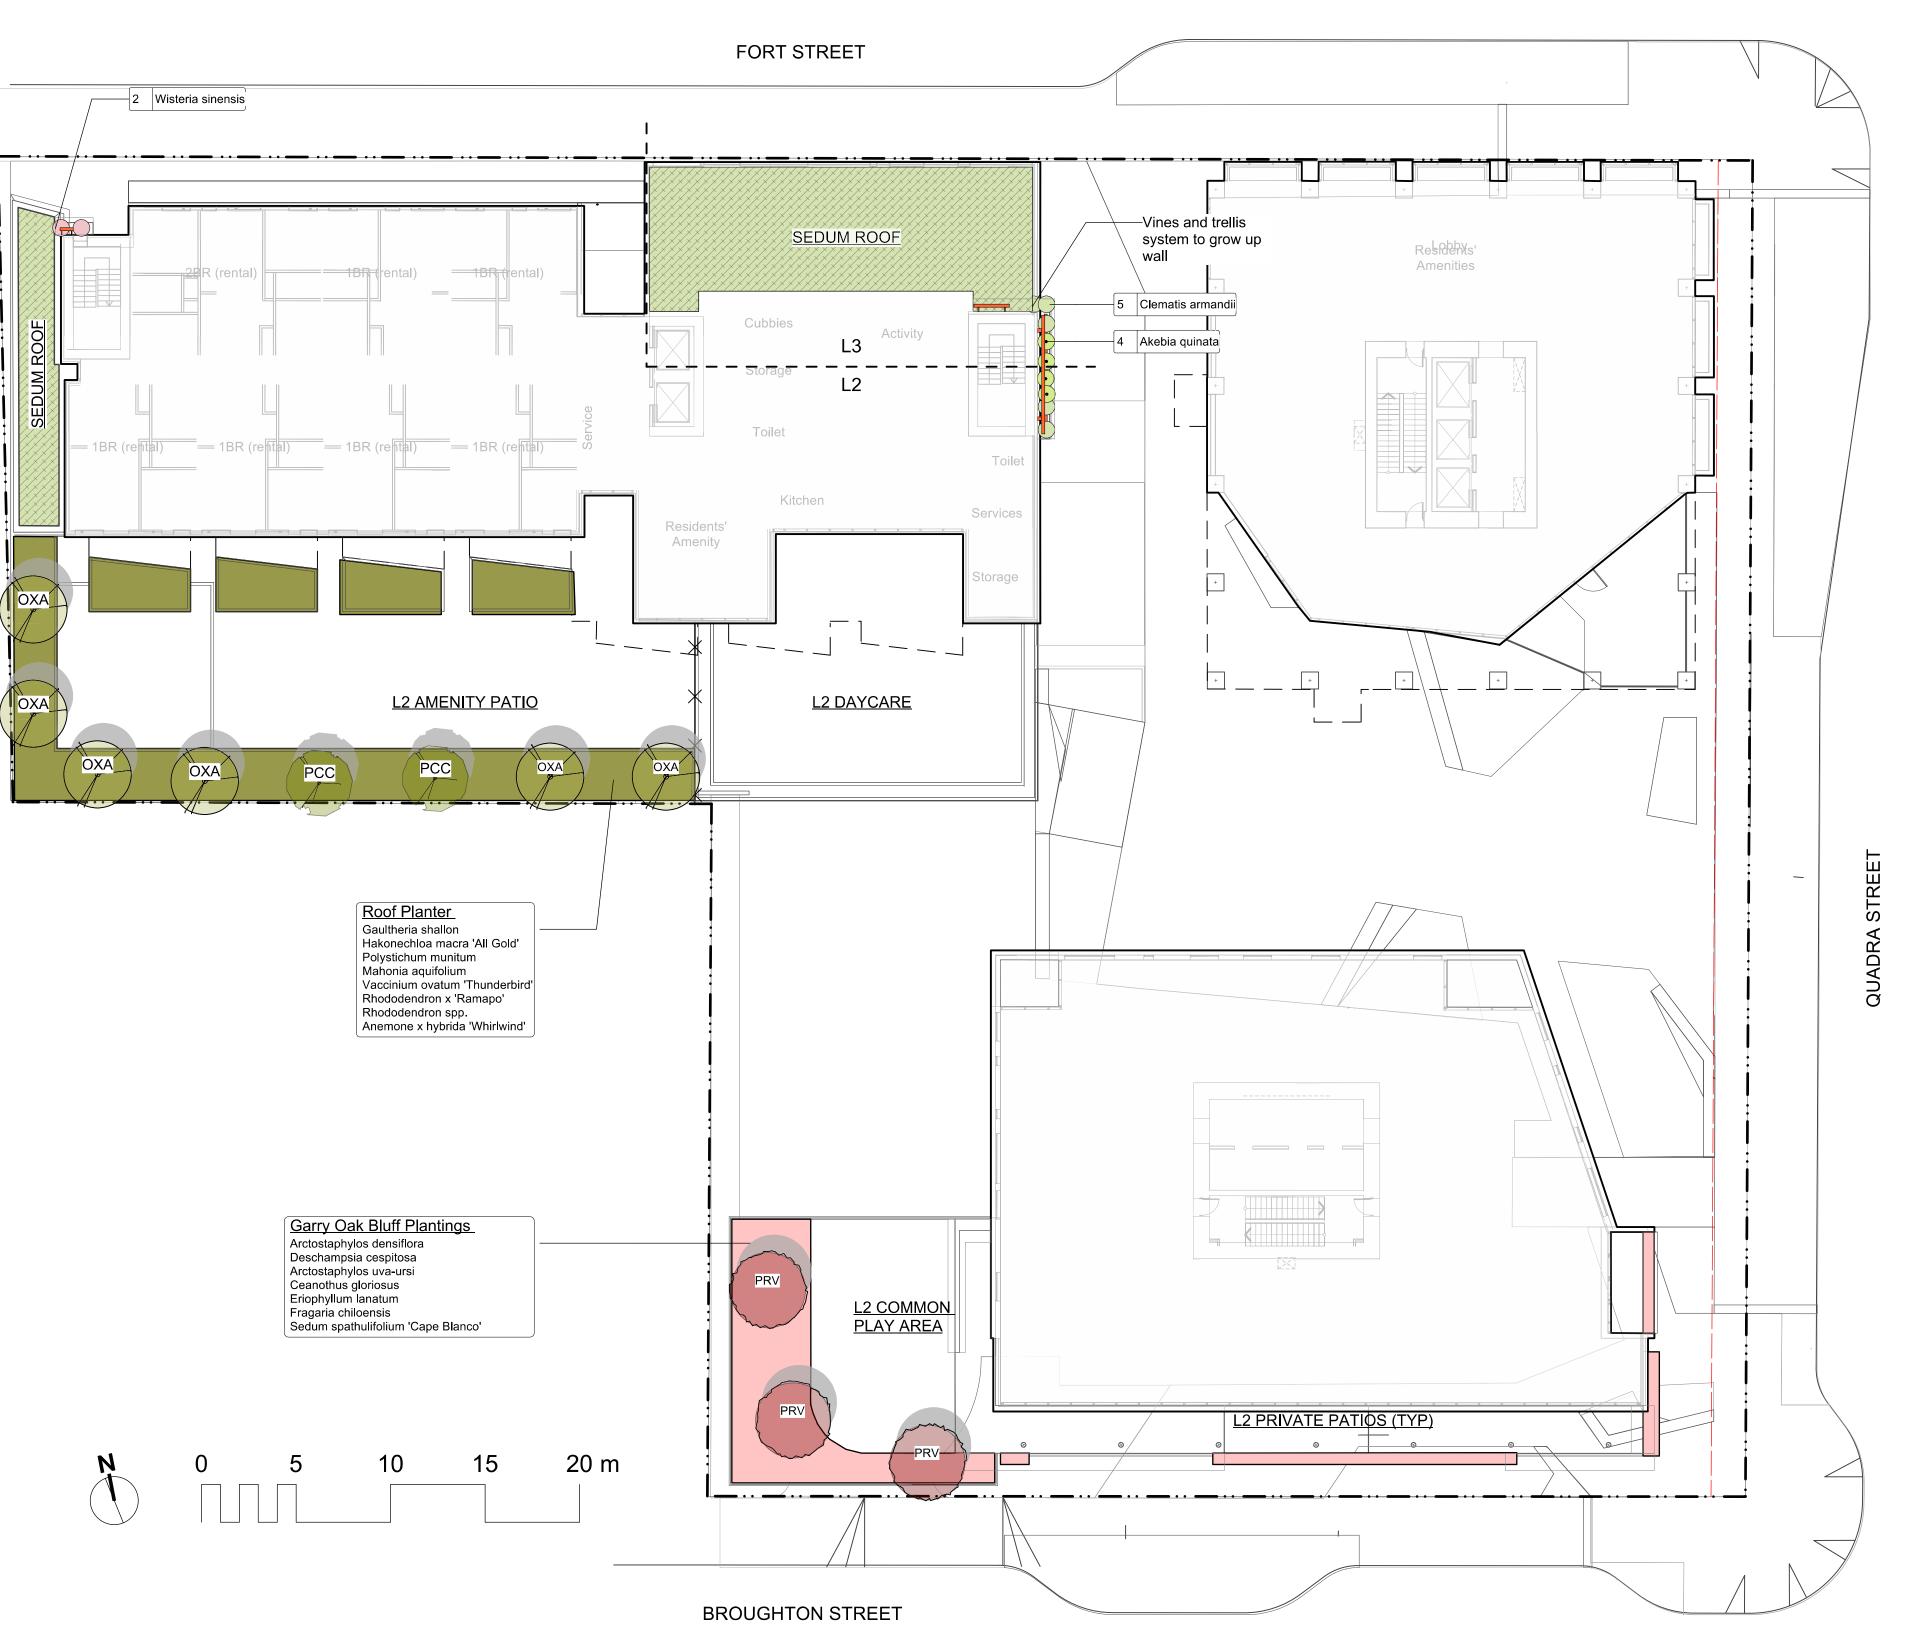

PLANT LIST LEVEL 2+ SHRUBS/FERNS/GRASSES/PERENNIALS/VINES 53 Anemone x hybrida 'Whirlwind' Whirlwhind Japanese Anemone #1 pot 9 Arctostaphylos densiflora Vinehill Manzanita #1 pot / 60 cm O.C. 116 Arctostaphylos uva-ursi Kinnikinnick #1 pot / 60 cm O.C. 9 Ceanothus gloriosus Point Reyes Creeper 0.7 114 Deschampsia cespitosa **Tufted Hair Grass** #1 pot 46 Eriophyllum lanatum Wooly Sunflower #1 pot 52 Fragaria chiloensis Coast Strawberry 0.35 #1 pot, 40cm o.c. 224 Gaultheria shallon 144 Hakonechloa macra 'All Gold' All Gold Japanese Forest Grass #1 Pot 10 Mahonia aquifolium Oregon Grape #2 pot Polystichum munitum Sword Fern #1 pot Rhododendron spp. Specimen Rhododendron cimen quality, min 4' ht, b+b Rhododendron x 'Ramapo' Ramapo Rhododendron #2 pot 1 Sedum spathulifolium 'Cape Blanco' Cape Blanco Stonecrop Sp3, 30cm o.c. 101 Vaccinium ovatum 'Thunderbird' Evergreen Huckleberry #3 pot

PROPOSED TREE LIST - ONSITE ROOF LEVELS **L2 TREES** Qty Botanical Name Schd. Size Common Name 5.0cm cal, b&b Oxydendrum arboreum Sourwood Tree 2.5m b&b, irregular Shore Pine 2 Pinus contorta var. contorta 3 Parrotia persica 'Ruby Vase' 5.0cm cal, b&b Ruby Vase Persian Ironwood TOTAL 11

NOT FOR CONSTRUCTION

MDI LANDSCAPE ARCHITECTS

Development Permit | 2025-07-23 Pre-Application



PARC Communities Management Ltd.

PARC VICTORIA 829-891-899 Fort Street and 846-858 Broughton Street, Victoria BC

Planting L2 and L3


		L3	.02
	sheet no.		
	checked by		ТВ
	drawn by		SC
1	scale	1: 200	@ 24"x36"
1	project no.		124.27

sheet title

project no.		124.27
scale	1: 200	@ 24"x36"
drawn by		SC
checked by		ТВ
sheet no.		

GARRY OAK BLUFF PLANTINGS

The Broughton building's facade is imagined as a Garry Oak bluff ecosystem, with trailing plants like Kinnickinnick, coastal strawberry and Malahat mat, native sedums, flowers, and grasses. These form a vibrant green wall and provide plenty of nature for the building residents.

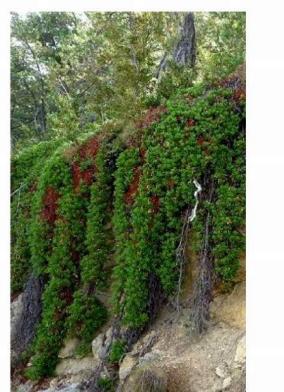








ROOF PLANTER

A mix of small trees, evergreen shrubs and grasses, and native shrubs to provide a plant palette that looks great year-round.





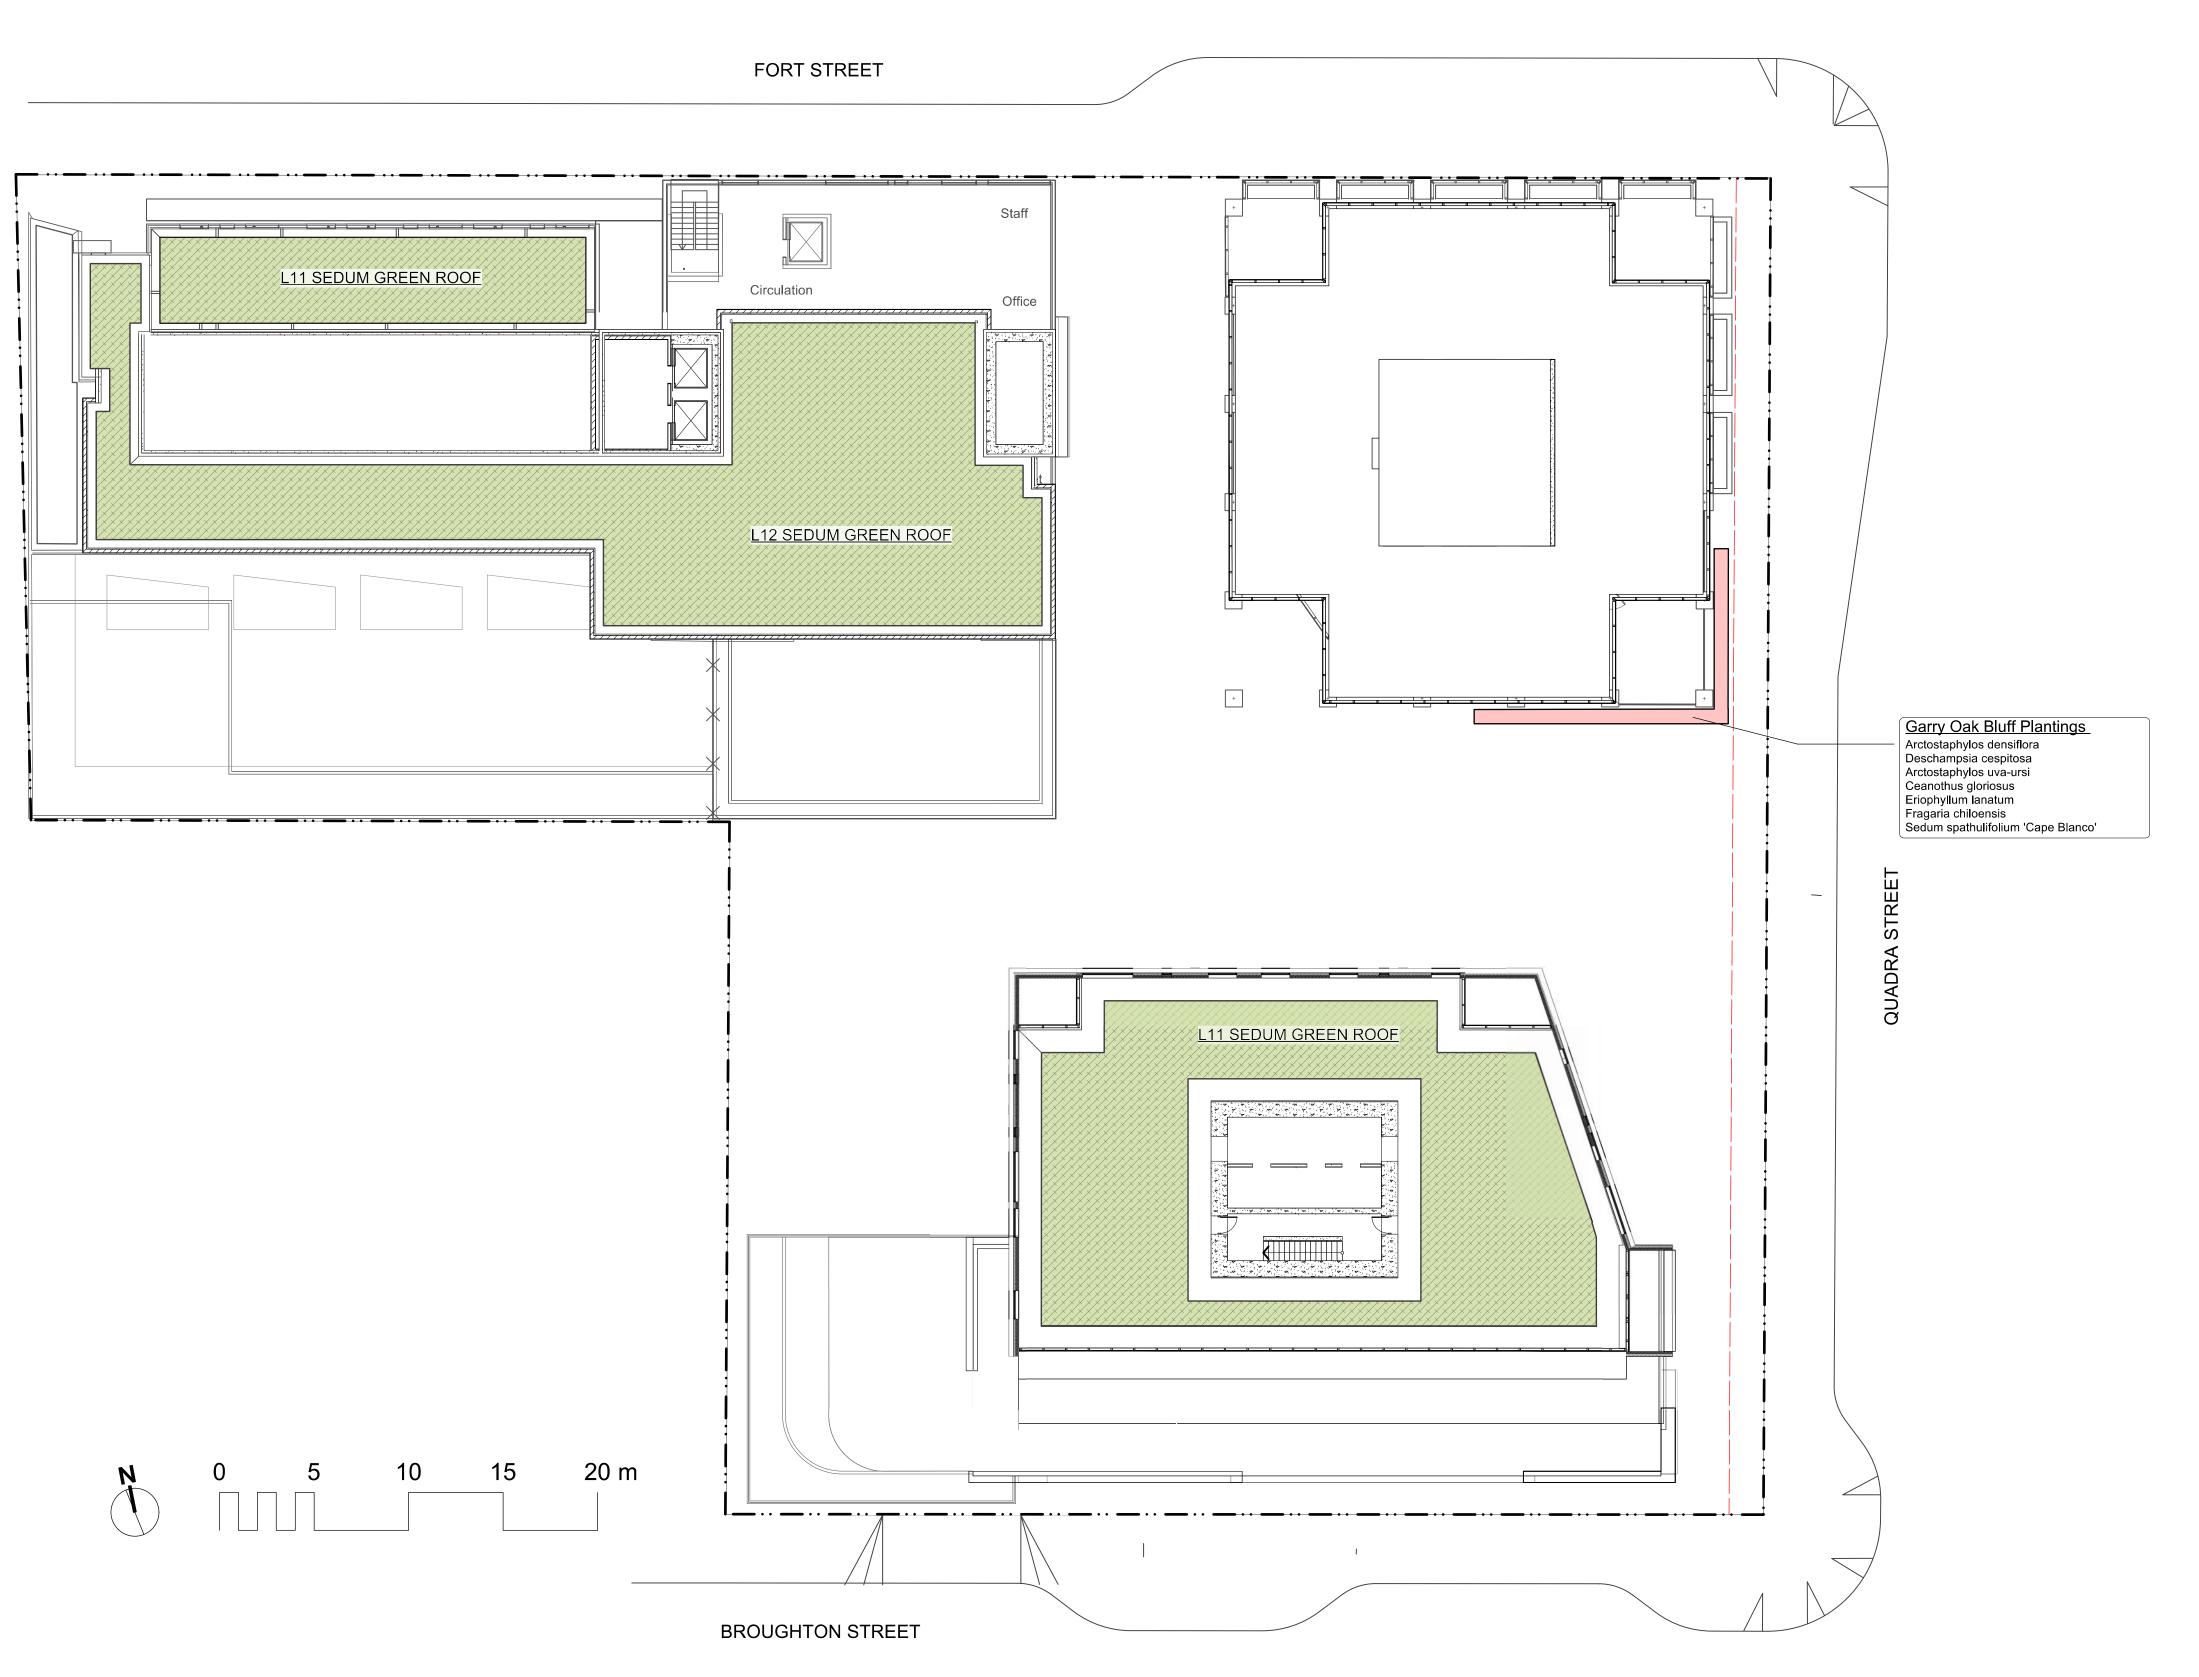

GARRY OAK BLUFF PLANTINGS

The Broughton building's facade is imagined as a Garry Oak bluff ecosystem, with trailing plants like Kinnickinnick, coastal strawberry and Malahat mat, native sedums, flowers, and grasses. These form a vibrant green wall and provide plenty of nature for the building residents.










SEDUM ROOF



MDI LANDSCAPE ARCHITECTS

3388A Tennyson Ave Victoria, BC V8Z 3P6 E: admin@mdidesign.ca

NOT FOR CONSTRUCTION

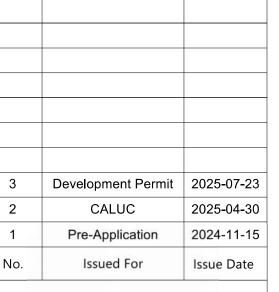



PARC Communities Management Ltd.

project

PARC VICTORIA
829-891-899 Fort Street and
846-858 Broughton Street,
Victoria BC

sheet title

Planting - Upper Roofs

project no.		124.27
scale	1: 200	@ 24"x36"
drawn by		SC
checked by		ТВ
sheet no.		

L3.03

□ v € PREVIOUS BC HYDRO REDLINE SHOWN. BC HYDRO HAS BEEN ENGAGED TO REVIEW REDLINE WITH RESPECT TO UPDATED BUILDING. TITLE SHEET PLAN - SITE LEGEND Eng. Project No. 32776-2 LAMP STANDARD +LS -CLEANOUT JE ANDERSON & CATCHBASIN **ASSOCIATES** SERVICE RISER **ISSUED FOR DEVELOPMENT PERMIT** SURVEYORS - ENGINEERS MOUNTABLE CURB VICTORIA NANAIMO PARKSVILLE CAMPBELL RIVER info@jeanderson.com PHONE: 250-727-2214

