

OWNER

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LIST OF DRAWINGS

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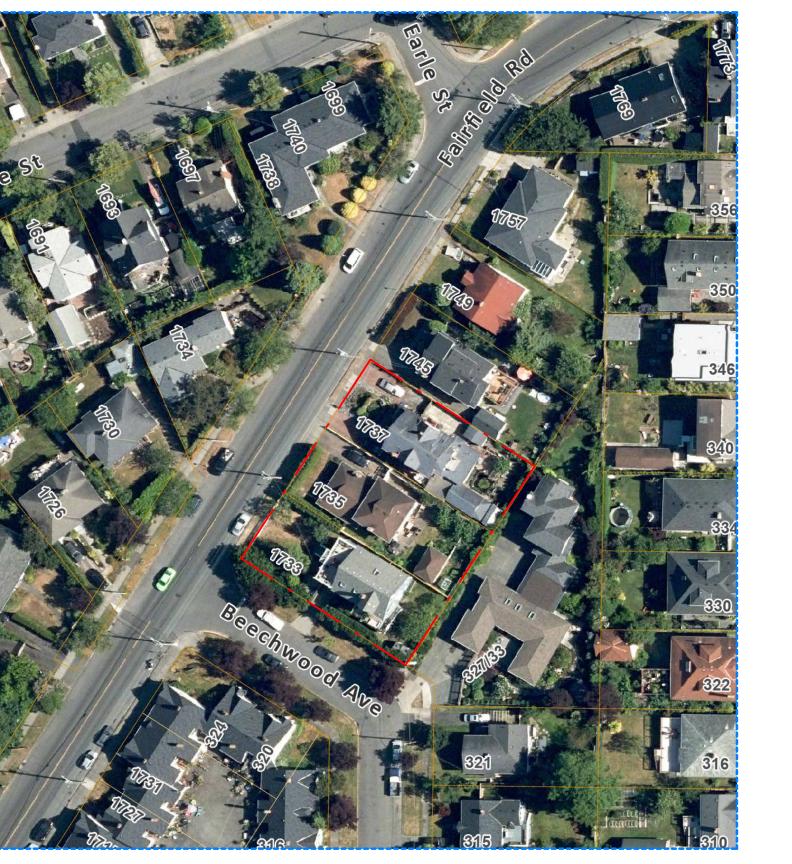
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PROJECT LOCATION PLAN (NTS)

PROJECT SITE (NTS)



1 BEECHWOOD ELEVATION PERSPECTIVE
SCALE = 1:100





17	DP/RZ Rev5	Feb 21, 2024
13	DP/RZ Rev4	Jan 18, 2024
4	DP/RZ Rev2	Jan 26, 2023
3	DP/RZ Rev1	July 20, 2022
2	DP/RZ Submission	April 29, 202
1	Development Tracker Application	March 7, 202
NO.	DESCRIPTION	DATE



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1733-1737 Fairfield Rd

PERSPECTIVES


JUNE 25, 2024

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DATA

MUNICIPALITY	CITY OF VICTORIA
MUNICIPAL ADDRESS	1733-37 FAIRFIELD ROAD, VICTORIA BC
LEGAL DESCRIPTION	LOT 9, 10, 11, PLAN 1280, SECTION 68 VICTORIA
PROJECT DESCRIPTION	4 STOREY MULTI UNIT RESIDENTIAL BUILDING

PROJECT INFORMATION

ZONE (EXISTING)	R1-G	
PROPOSED ZONE	UNKNOWN	
SITE AREA (m²)	1,741.93m²	
TOTAL FLOOR AREA (m²)	3113.67m ²	
COMMERCIAL FLOOR AREA (m²)	0	
FLOOR SPACE RATIO	1.79:1	
SITE COVERAGE (%)	65%	
OPEN SITE SPACE (%)	23%	
HEIGHT (m)	13.39m	
NUMBER OF STOREYS	4	
	REQUIRED	PROVIDED
PARKING STALLS (#) TOTAL ON SITE		23 (+1sml)
PARKING STALLS - VISITOR (#) ON SITE	3	2
BICYCLE PARKING (#) SHORT TERM	6	6
BICYCLE PARKING (#) LONG TERM	37	51

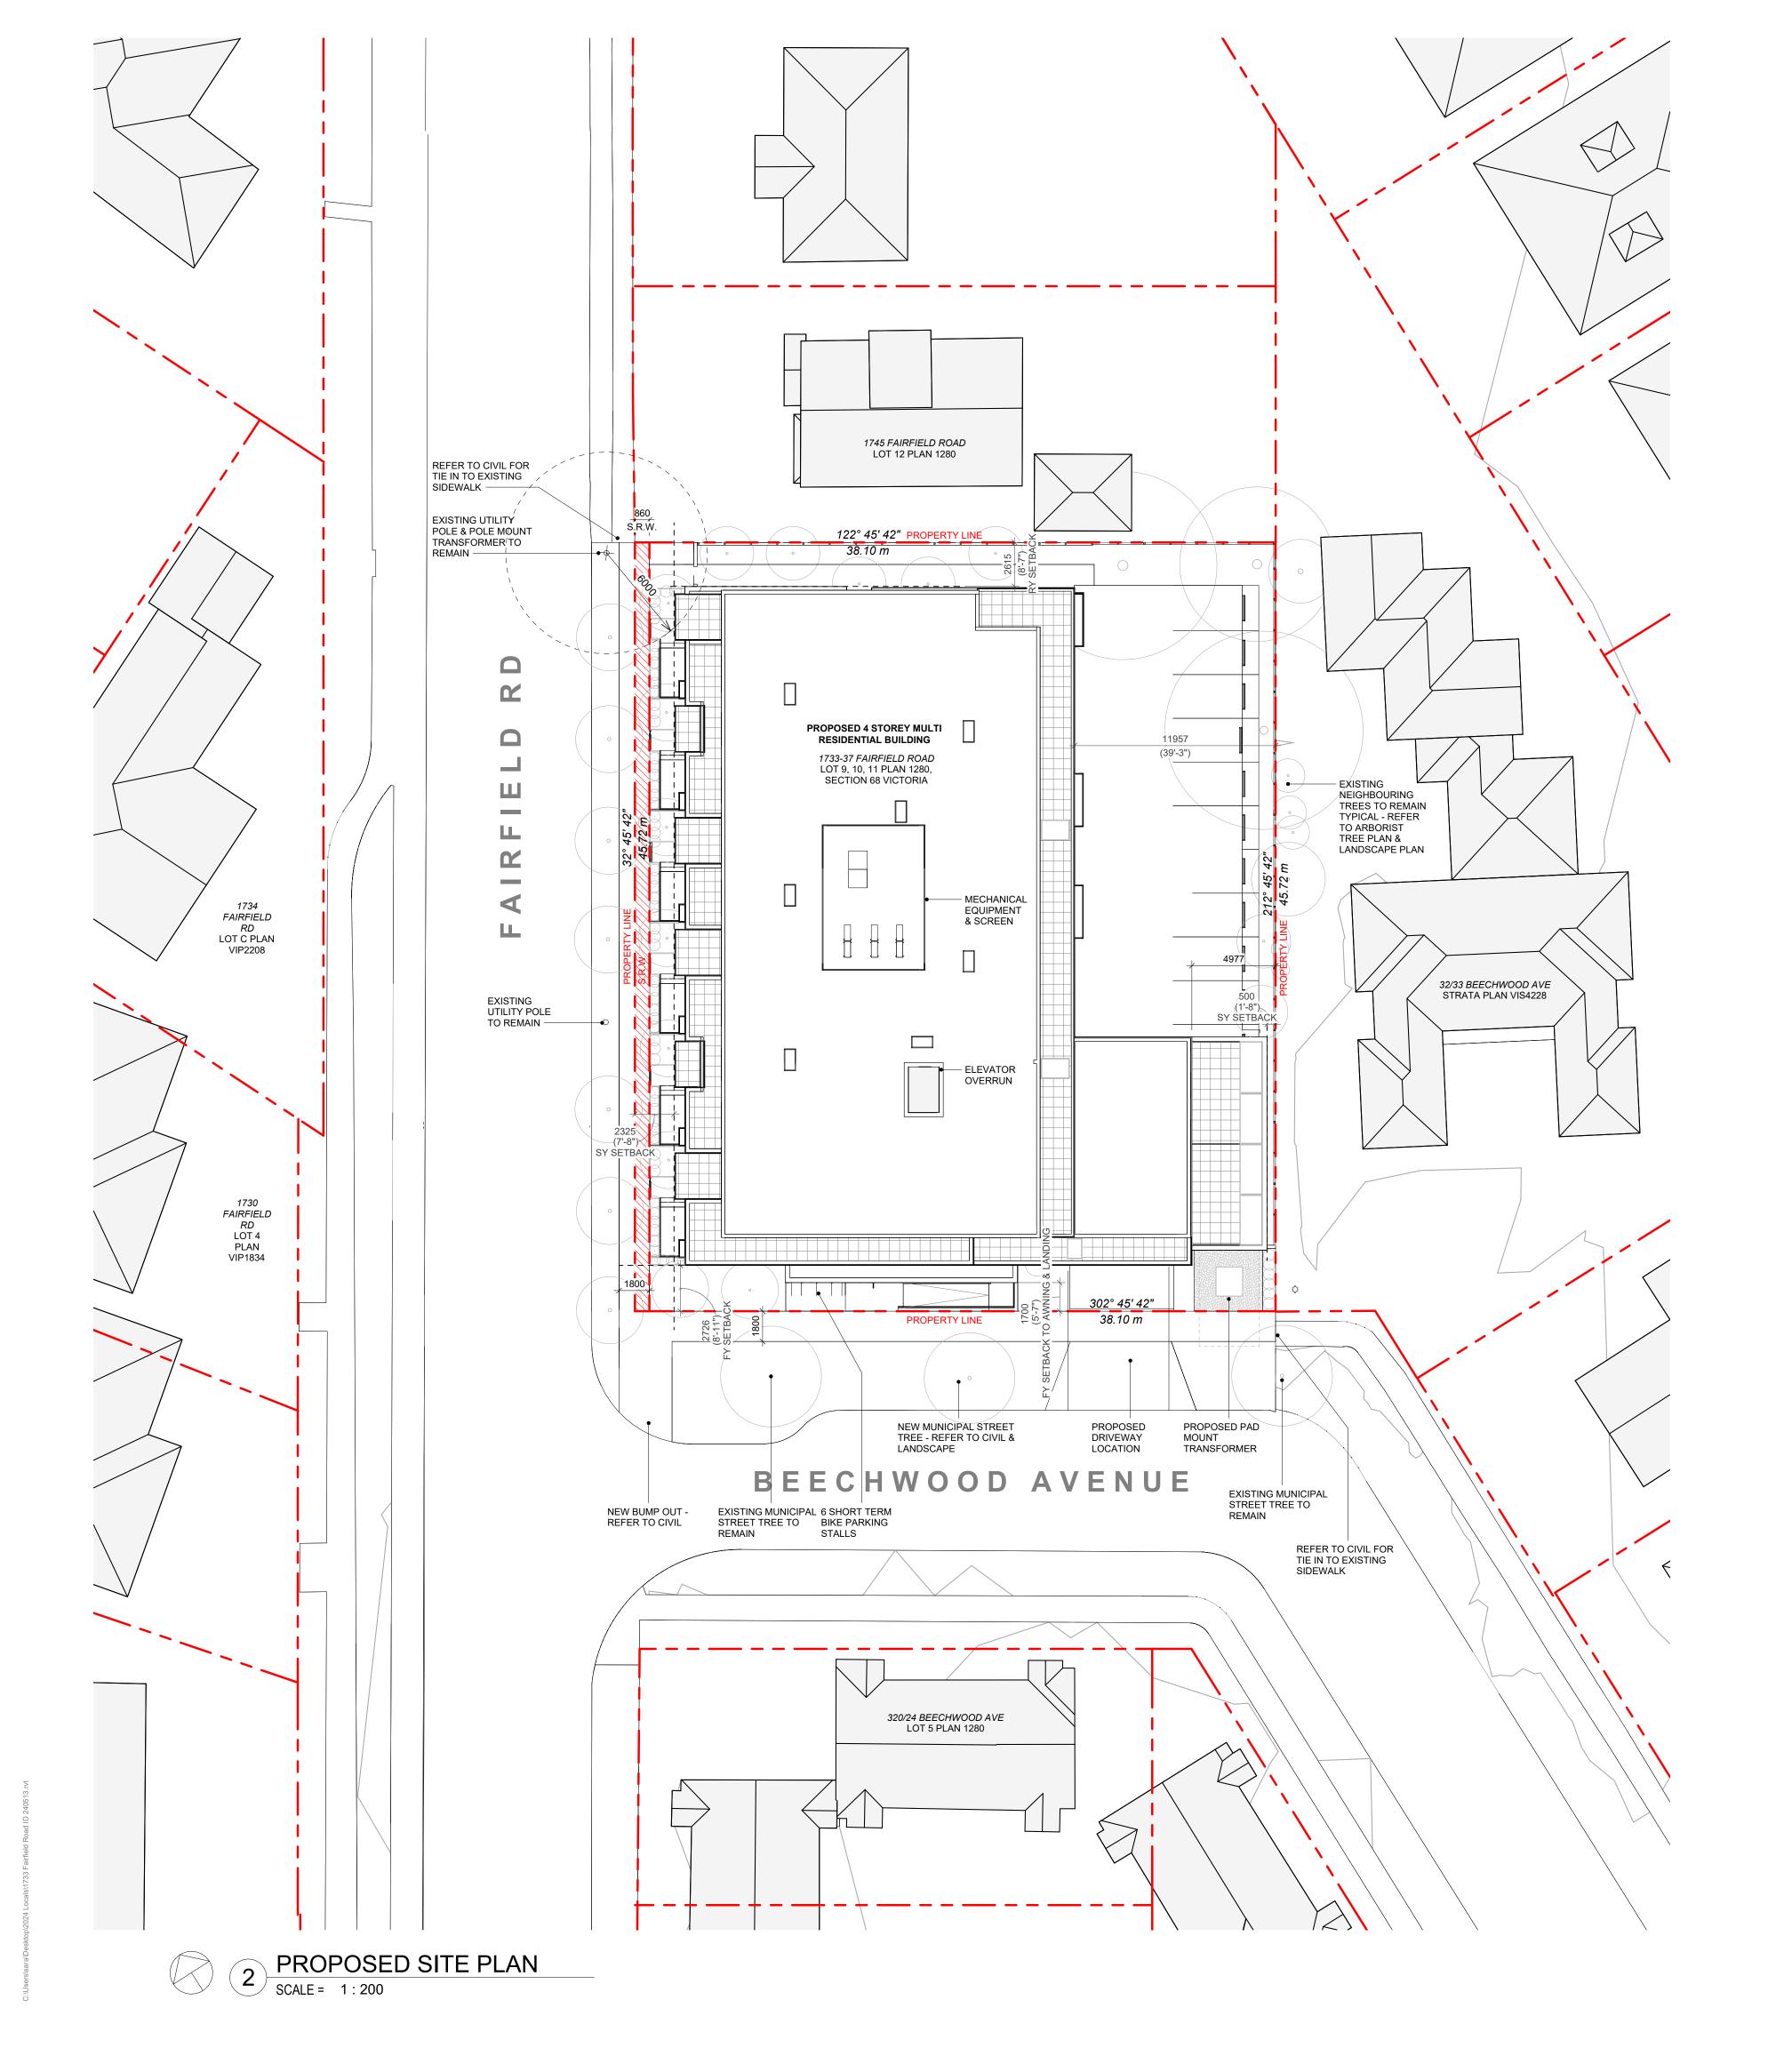BUILDING SETBACKS (m)

	PROPOSED
FRONT YARD (BEECHWOOD AVE)	2.73m
FRONT YARD (TO AWNING/LANDING)	1.70m
INTERNAL SIDE YARD (TO BALCONY)	0.50m
INTERNAL SIDE YARD (TO BUILDING FACE)	4.78m
SIDE YARD (FAIRFIELD RD)	2.33m
REAR YARD	2.62m
COMBINED SIDE YARDS	2.83m

RESIDENTIAL USE DETAILS

TOTAL NUMBER OF UNITS	29
UNIT TYPE	TOWNHOMES (6), 1 BEDS (10), 2 BEDS (13),
GROUND-ORIENTATED UNITS	6
MINIMUM UNIT FLOOR AREA (m²)	51m²

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SITE PLAN & PROJECT

DATA

Scale JUNE 25, 2024

Scale Project #


As indicated 2123

CRY L.F. O.

Feb 21, 2024

Sheet #


A-050

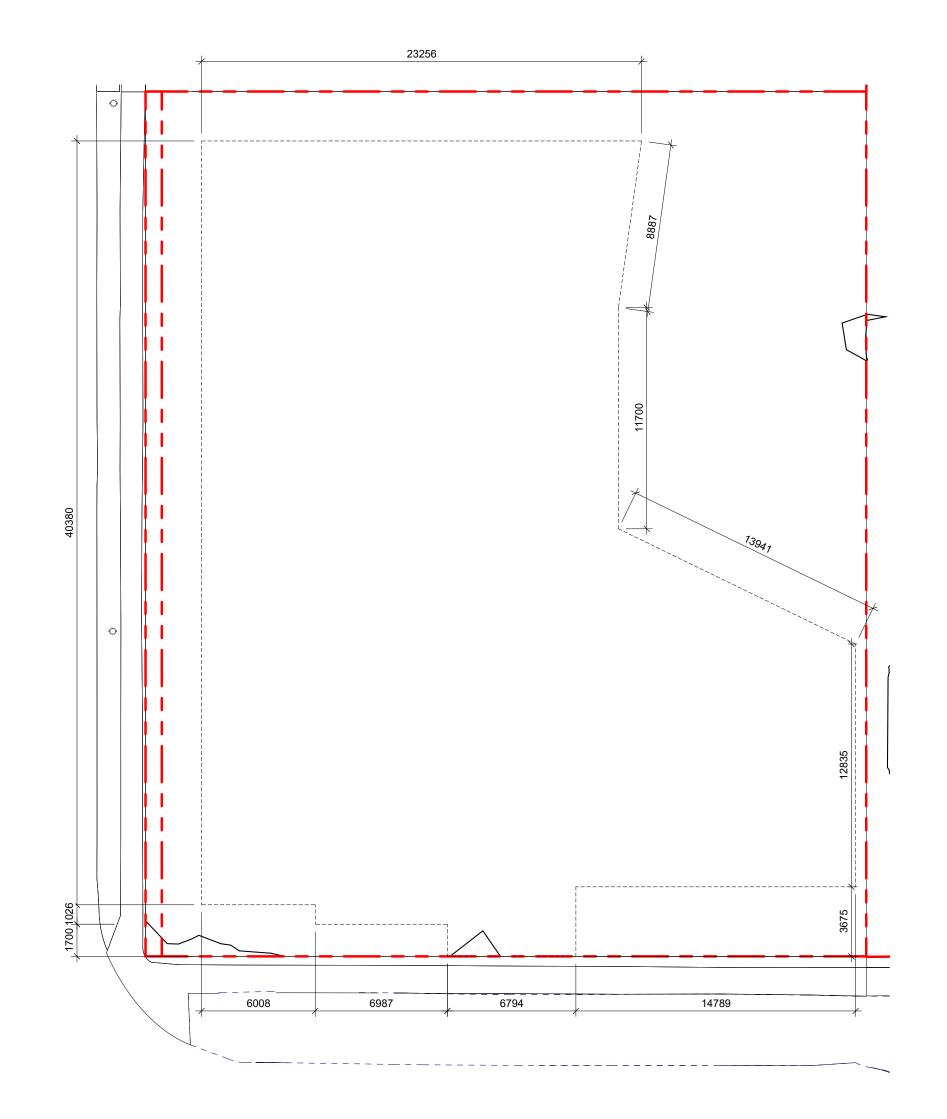


1 DISTANCE BTWN POINTS KEY PLAN
SCALE = 1:200


POINT NAME	NATURAL	PROPOSED	DISTANCE BI	etween points	AVE. OF POINTS
Α	14.209	14.42	Point A & B	6.008	85.20
В	14.332	14.15	Point B & C	1.026	14.50
C	14.208	14.12	Point C & D	7.381	103.92
D	14.04	14.11	Point D & E	1.7	23.83
E.	13.997	14.10	Point E & F	6.4	89.96
F	14.75	14.11	Point F & G	3.63	51.72
G	14.38	14.44	Point G & H	13.35	191.33
H	14.346	14.28	Point H & I	12.88	183.90
<u>I</u>	14.273	14.41	Point I & J	12.663	181.52
J	14.397	14.69	Point J & K	11.7	167.72
K	14.273	14.64	Point K & L	8.887	126.40
L.	14.172	14.62	Point L & M	23.256	332.30
M	14.406	14.64	Point M & N	40.38	577.74

2130.03 **Total** 149.26 **Average Grade** 14.27 *NOTE: Lowest grade point governs per Schedule A definition

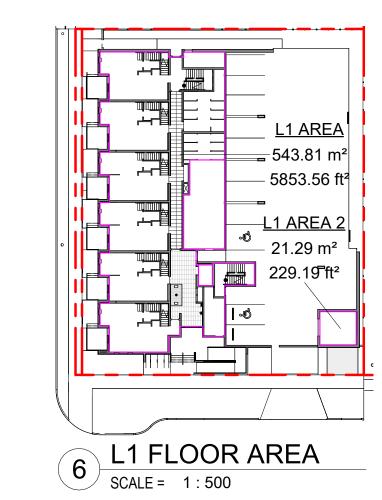


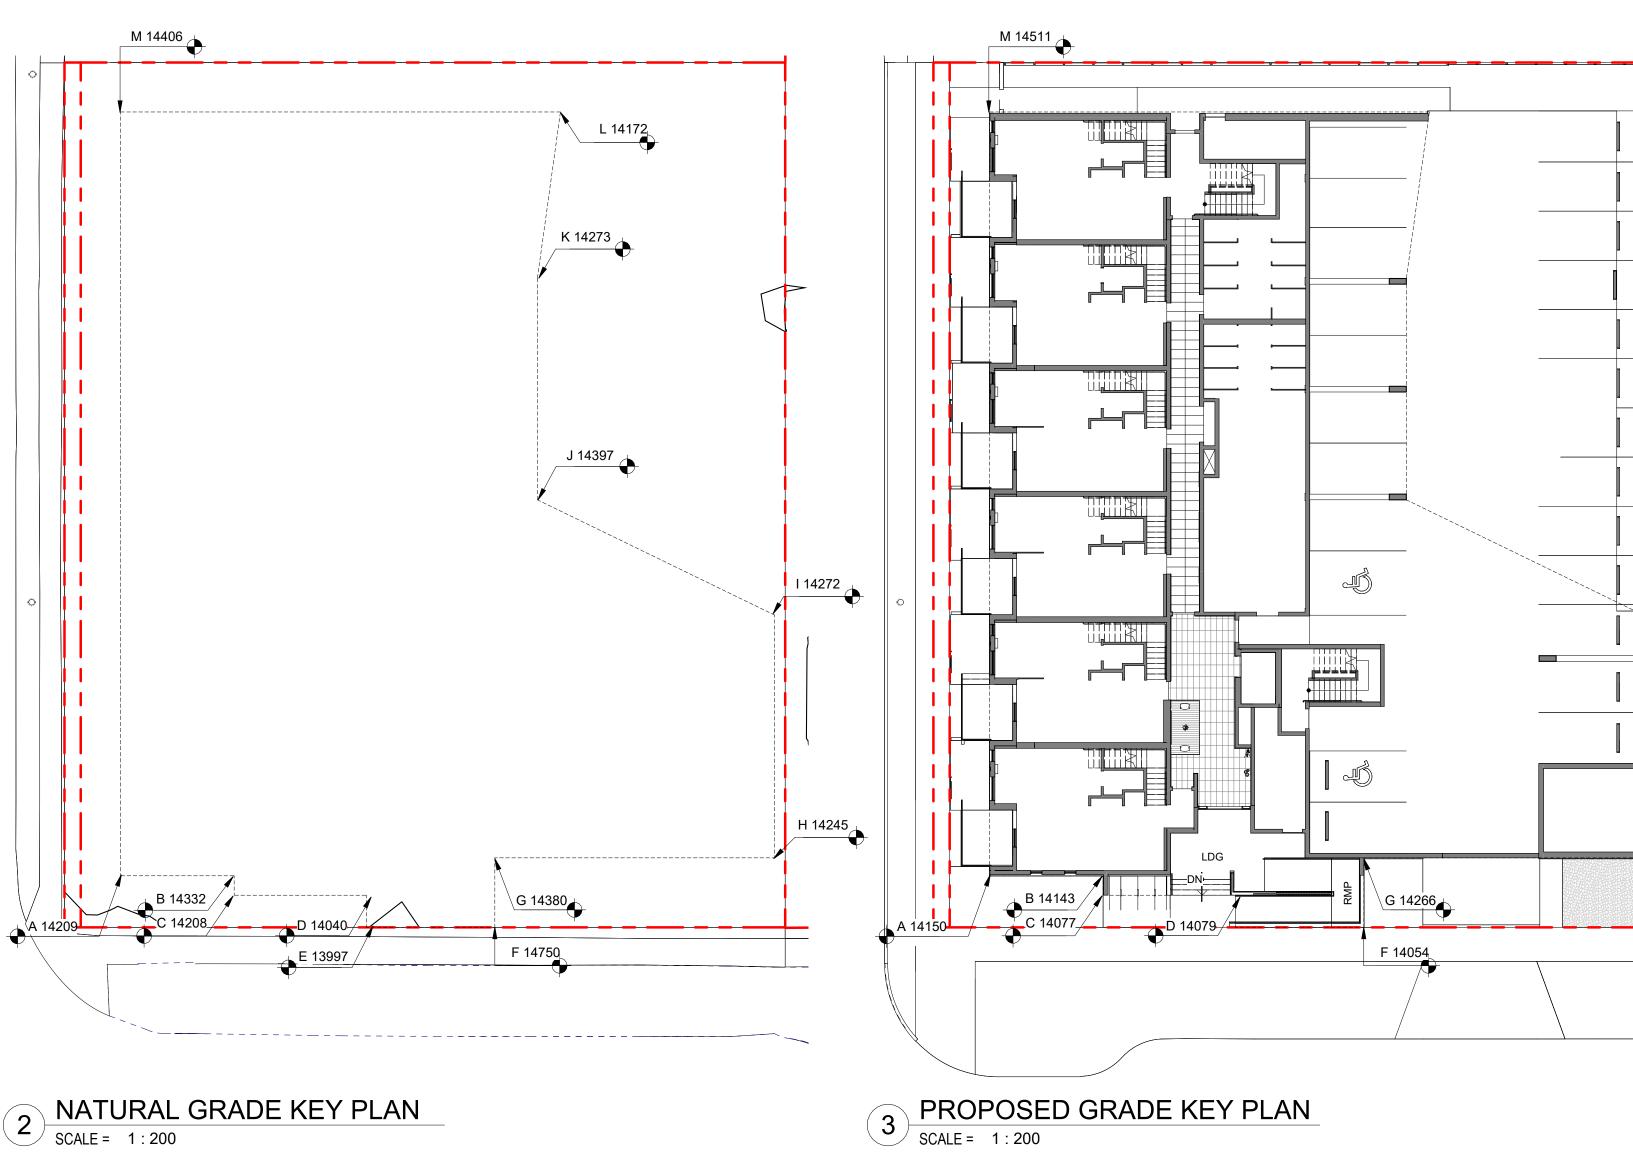


2 NATURAL GRADE KEY PLAN
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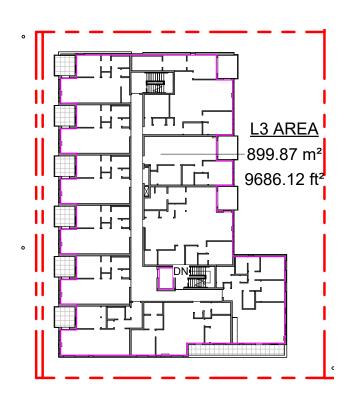
OPEN SITE SPACE SCALE = 1:500

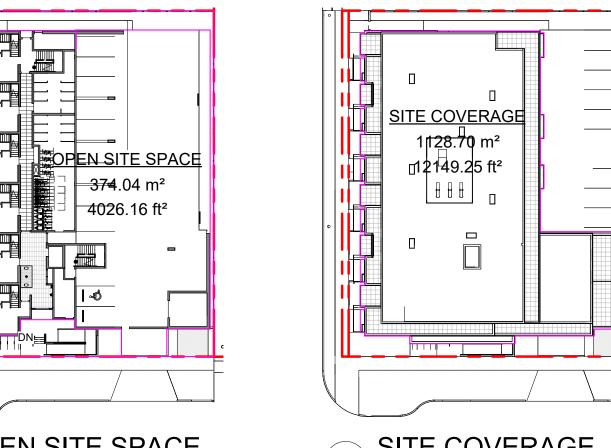


7 L2 FLOOR AREA SCALE = 1:500

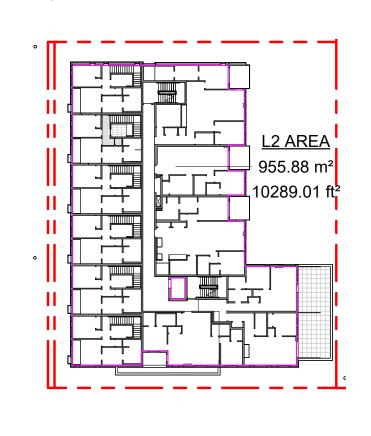

5 SITE COVERAGE SCALE = 1:500

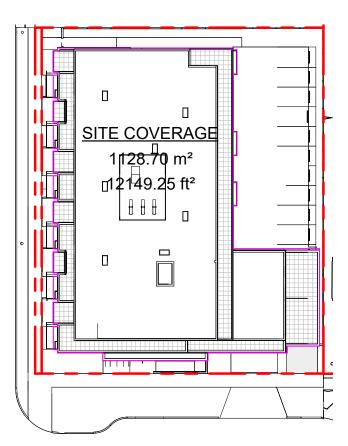

8 L3 FLOOR AREA
SCALE = 1:500

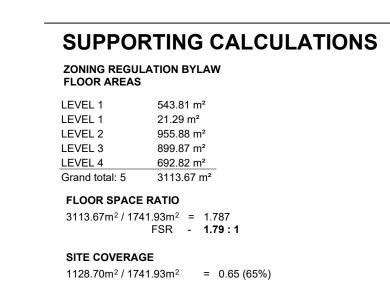


14750 - 14200*(PROPOSED)* = 550mm 14750 - 14171*(EXISTING)* = 579mm LDG (LANDING AT PRIMARY ENTRANCE) 14750 - 14114*(PROPOSED)* = 636mm 14750 - 14040 *(EXISTING)* = 710mm RMP (INTERMEDIARY RAMP LANDING) 14507 - 14114*(PROPOSED)* = 393mm 14507 - 14280 *(EXISTING)* = 227mm **OPEN SITE SPACE** $395.01m^2 / 1741.93m^2 = 0.23 (23\%)$

HEIGHT OF PATIOS, STAIRS, & RAMP TO

1TH PATIO (WORST CASE GRADING ALONG FAIRFIELD RD - THEREFORE ALL <600mm)

EXISTING & PROPOSED GRADE REFER TO GRADE KEY PLANS

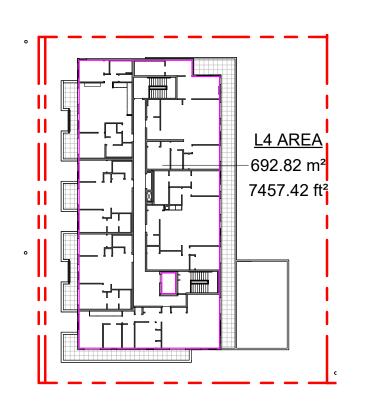

9 L4 FLOOR AREA

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ZONING CALCULATIONS


JUNE 25, 2024 As indicated

Feb 21, 2024

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1 L1 CODE REVIEW KEY PLAN
SCALE = 1:250

MINIMUM EXIT WIDTH:


accessible path of travel)

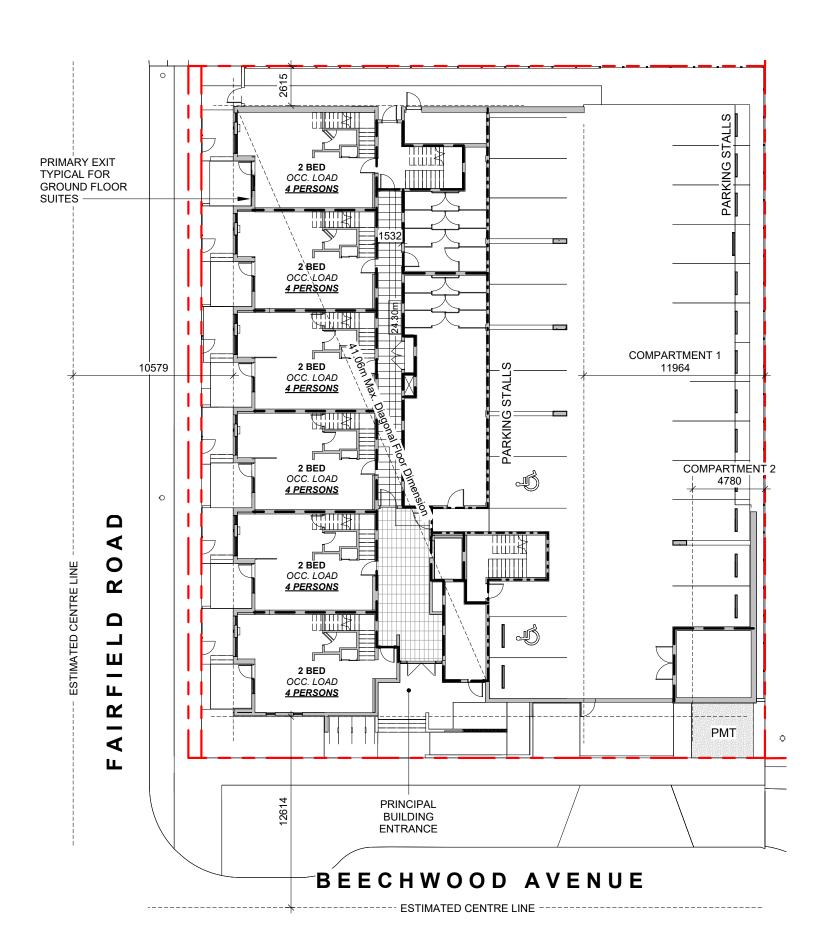Ramps, Corridors, Passageways
the greater of 6.1mm x 24 = 146.4mm
or 1100mm (minimum 1500mm for or 1100mm

OCCUPANT LOAD:


= 24 persons

Occupancy: Group C
12 Bedrooms x 2 persons/bedroom

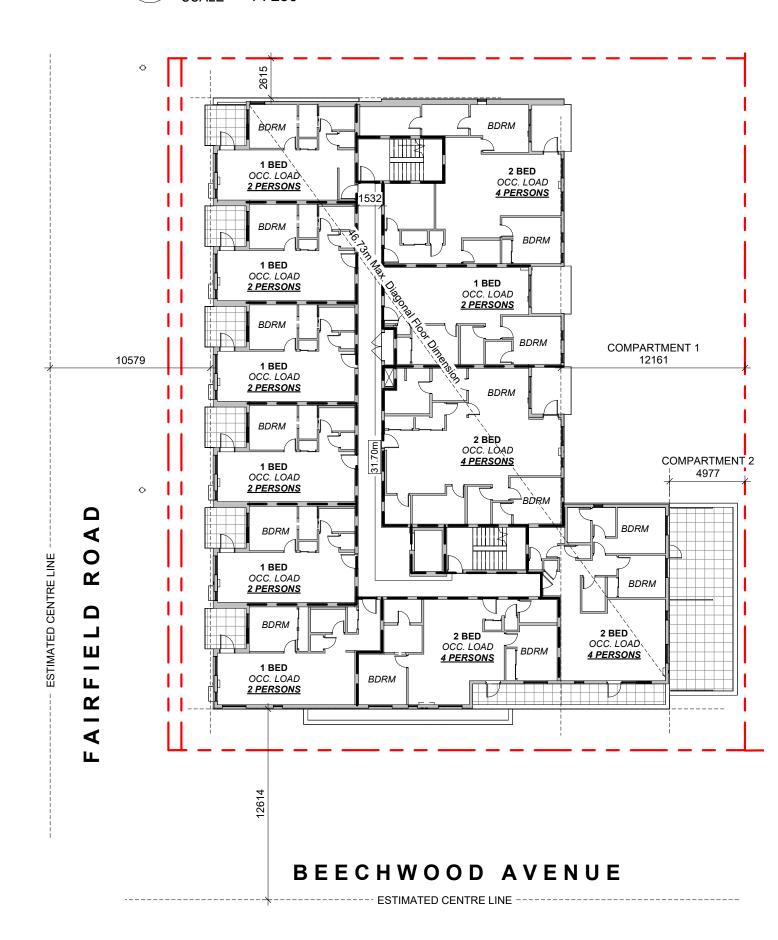

OCCUPANT LOAD: MINIMUM EXIT WIDTH: Ramps, Corridors, Passageways
the greater of 6.1mm x 30 = 183mm
the greater of 8mm x 30 = 240mm Occupancy: Group C 15 Bedrooms x 2 persons/bedroom or 1100mm (minimum 1500mm for or 1100mm = 30 persons accessible path of travel)

3 L3 CODE REVIEW KEY PLAN
SCALE = 1:250

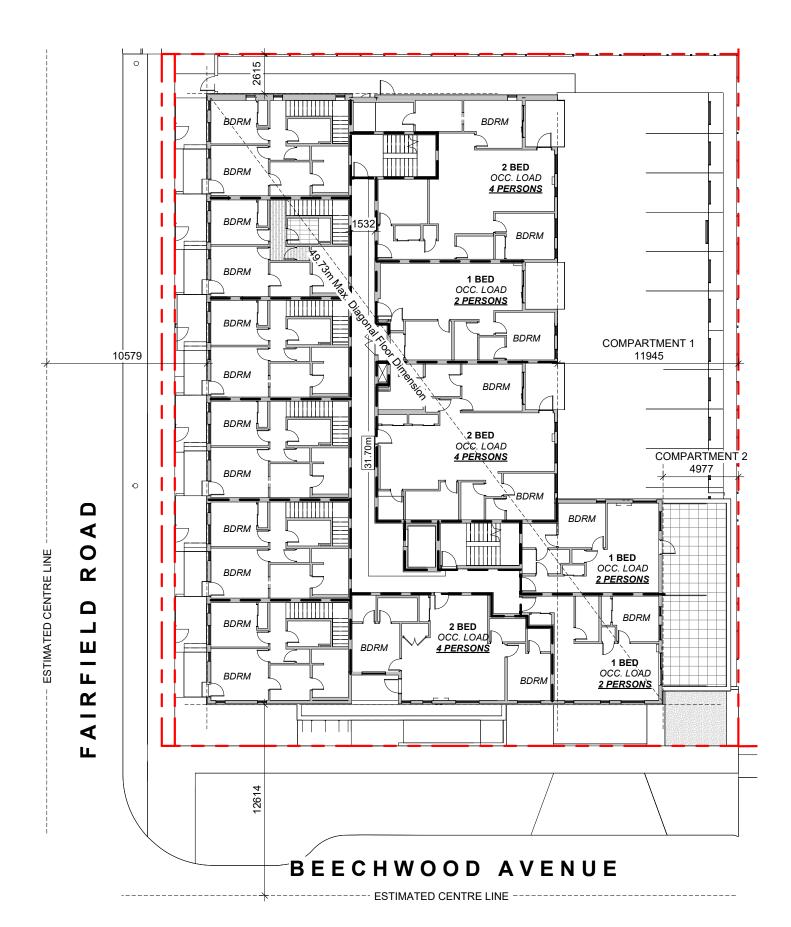


OCCUPANT LOAD: Occupancy: Group C 9 Bedrooms x 2 persons/bedroom = 18 persons

MINIMUM EXIT WIDTH:

accessible path of travel)

Ramps, Corridors, Passageways
the greater of 6.1mm x 18 = 109.8mm
the greater of 8mm x 18 = 144.0mm or 1100mm (minimum 1500mm for or 1100mm

L2 CODE REVIEW KEY PLAN

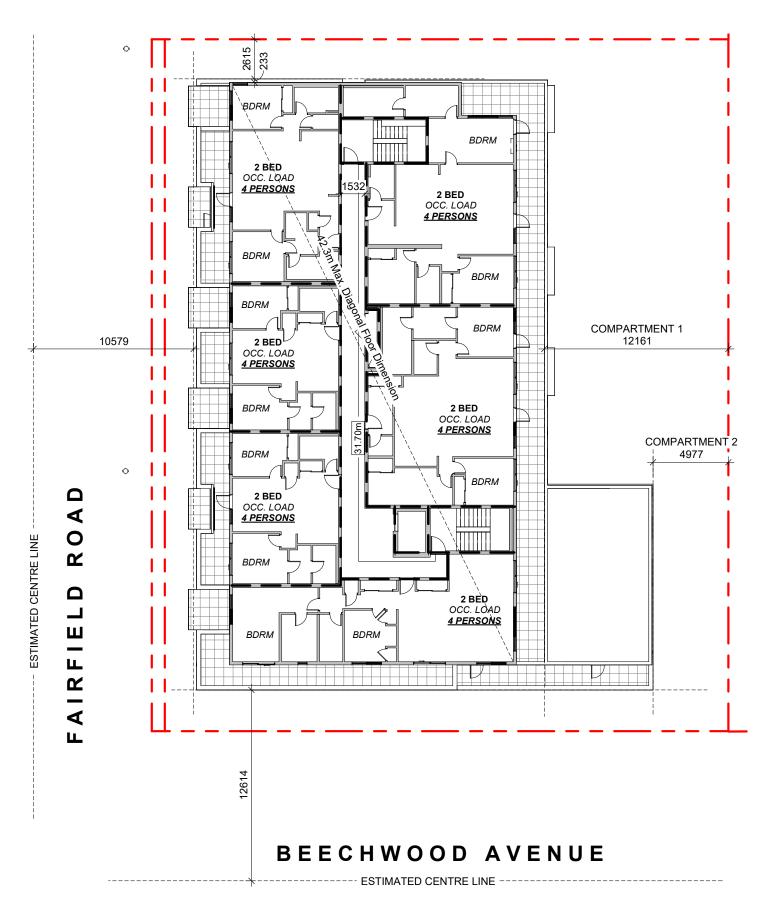

OCCUPANT LOAD: Occupancy: Group C 12 Bedrooms x 2 persons/bedroom

MINIMUM EXIT WIDTH: or 1100mm (minimum 1500mm for accessible path of travel)

Ramps, Corridors, Passageways
the greater of 6.1mm x 24 = 146.4mm
the greater of 8mm x 24 = 184mm

L4 CODE REVIEW KEY PLAN SCALE = 1:250

BUILDING CODE ANALYSIS

PROJECT TYPE	NEW CONSTRUCTION RENOVATION ADDITION	Ν
GOVERNING BUILDING CODE	2018 BC BUILDING CODE	
MAJOR OCCUPANCY	A1 A2 A3 A4 B1 B2 B3 C D E F1 F2 F3	3.1.2.1
BUILDING AREA	1,004 m ² (approx)	1.4.1.2
GRADE	18.75 m geodetic	1.4.1.2
BUILDING HEIGHT (STOREYS)	4 STOREYS ABOVE GRADE 0 STOREYS BELOW GRADE	1.4.1.2

BUILDING FIRE SAFETY & CONSTRUCTION CLASSIFICATION

CLASSIFICATION	GROUP C, UP TO 4 STOREYS, SPRINKLERED	3.2.2.51
MAXIMUM BUILDING AREA	1800 m ²	3.2.2.51
No. OF STREETS FACING	1 (BEECHWOOD AVE UNDER 9M MINIMUM STREET WIDTH)	3.2.2.10
CONSTRUCTION TYPES PERMITTED	✓ COMBUSTIBLE NON-COMBUSTIBLE	3.2.2.51
FIRE ALARM SYSTEM	YES NO	3.2.4.1
STANDPIPE SYSTEM	YES NO	3.2.5.8
HIGH BUILDING	YES NO	3.2.6.1
INTERCONNECTED FLOOR SPACE	YES NO EXCEPT WITHIN AT GRADE RESIDENTIAL UNITS	3.2.8


FIRE RESISTANCE RATINGS

HORIZONTAL SEPARATIONS	1 hr FLOORS 1 hr MEZZANINE Unrated ROOF	3.2.2.51
LOADBEARING WALLS, COLUMNS & ARCHES	1 hr (NOT LESS THAN THAT REQUIRED FOR SUPPORTED STRUCTURE)	3.2.2.51
EXITS	1 hr	3.4.4.1

EXITS FROM FLOOR AREAS

NUMBER OF EXITS REQUIRED	2	3.4.2.1
SEPARATION OF EXITS (MIN.)	1/2 MAX. DIAGONAL FLOOR AREA, BUT NEED NOT BE > 9 m	3.4.2.3
MAX. TRAVEL DISTANCE ALLOWED	m, GROUP C	3.4.2.5
MEZZANINE	YES NO	3.2.8

FIRE RESISTANCE RATING - KEY - - - - - - UNRATED FIRE SEPARATIONS 1.5 HOUR _----2 HOUR

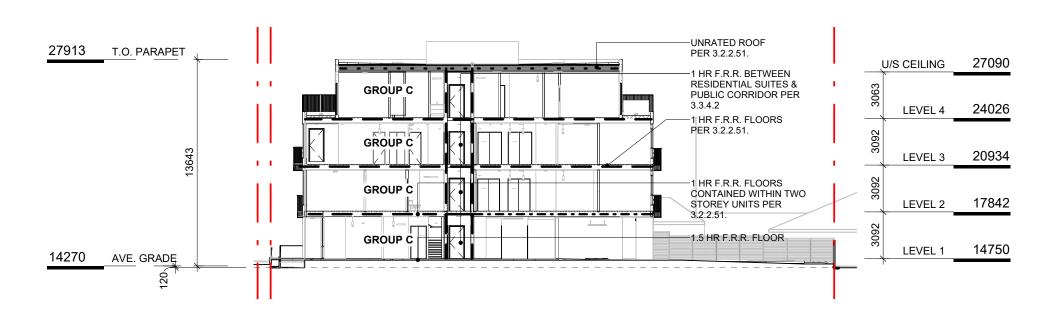

5 CODE REVIEW KEY SECTION

SCALE = 1:250

Jan 26, 2023 April 29, 2022 DP/RZ Rev2 DP/RZ Submission NO. DESCRIPTION DATE



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CODE REVIEW


As indicated

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JUNE 25, 2024


2123




NW ELEVATION - LD KEY SCALE = 1:200

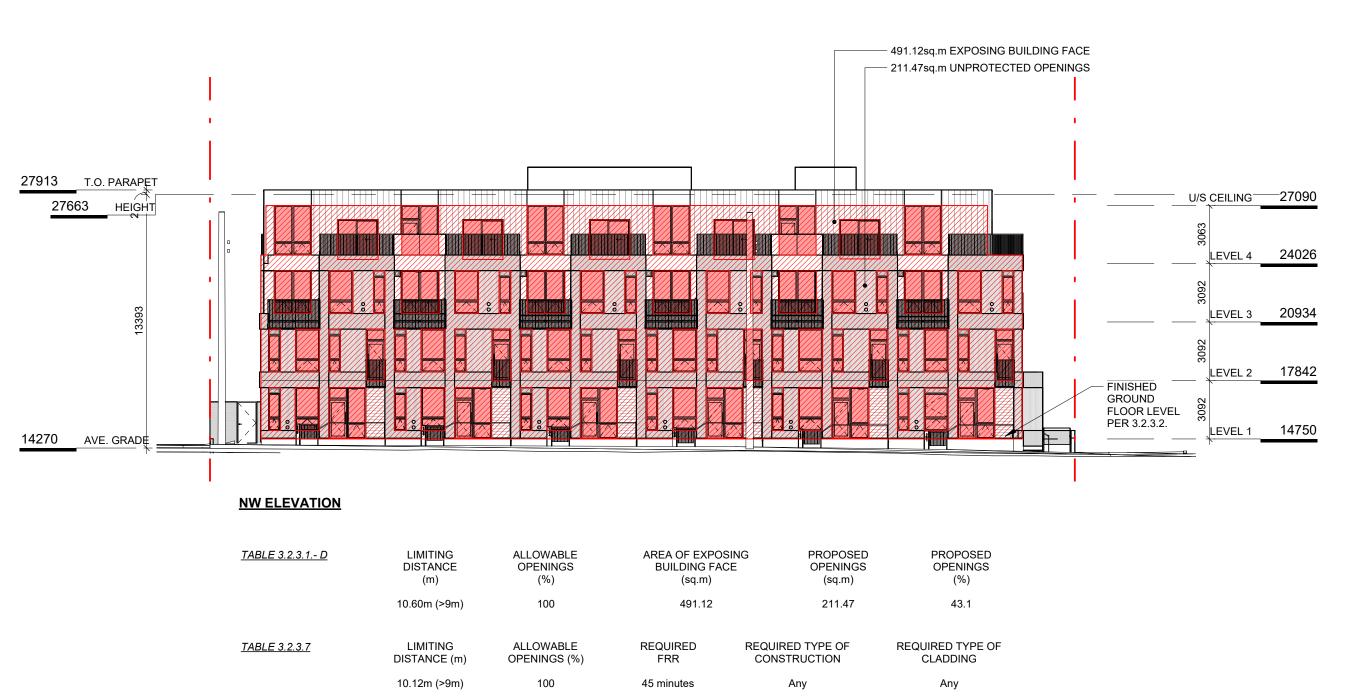
SE ELEVATION - LD KEY

SCALE = 1:200

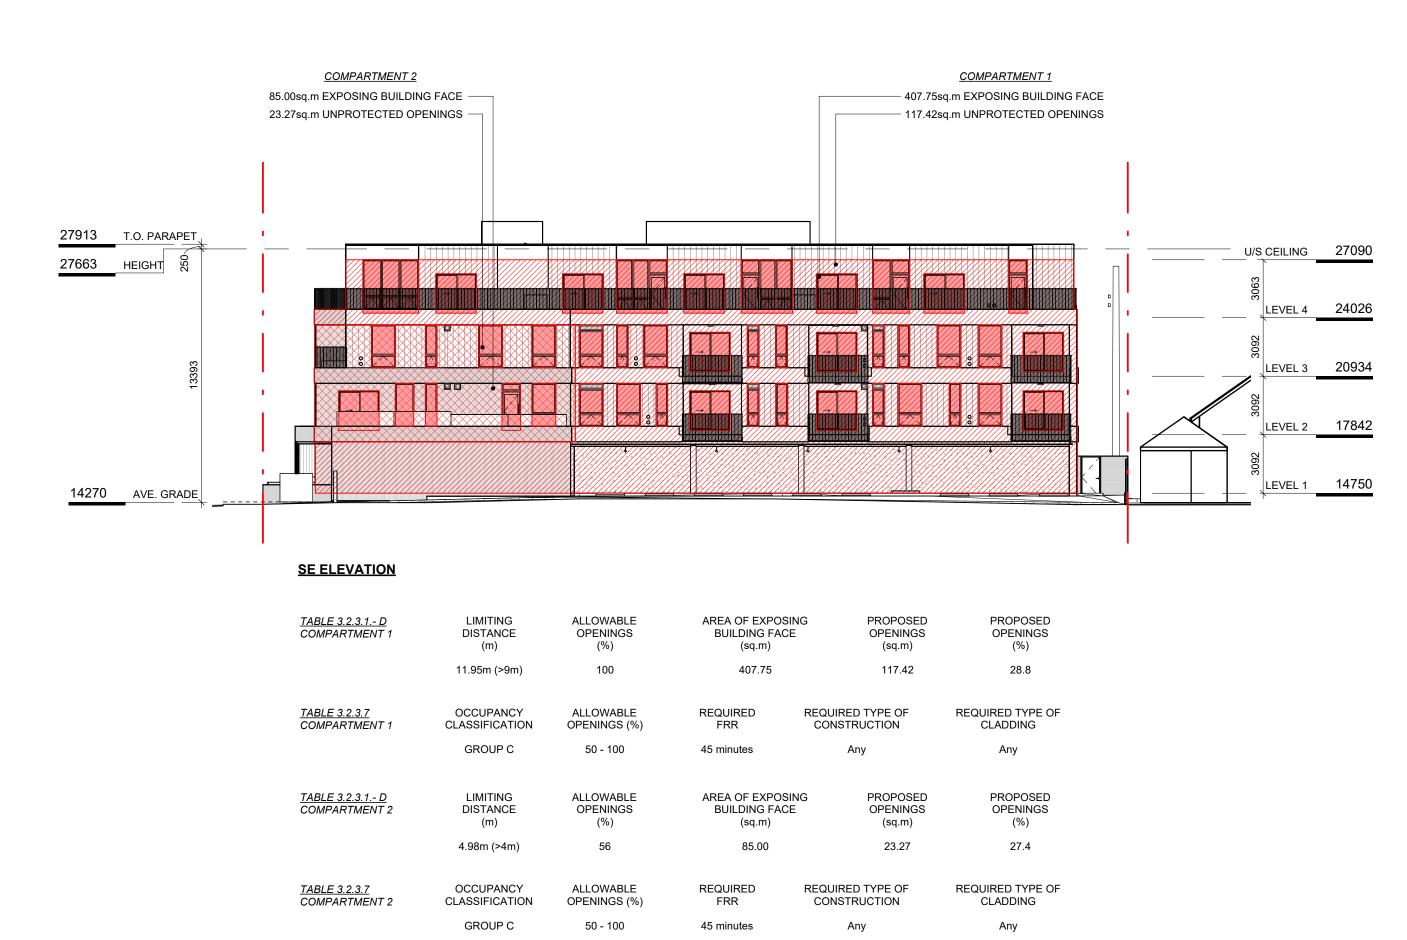

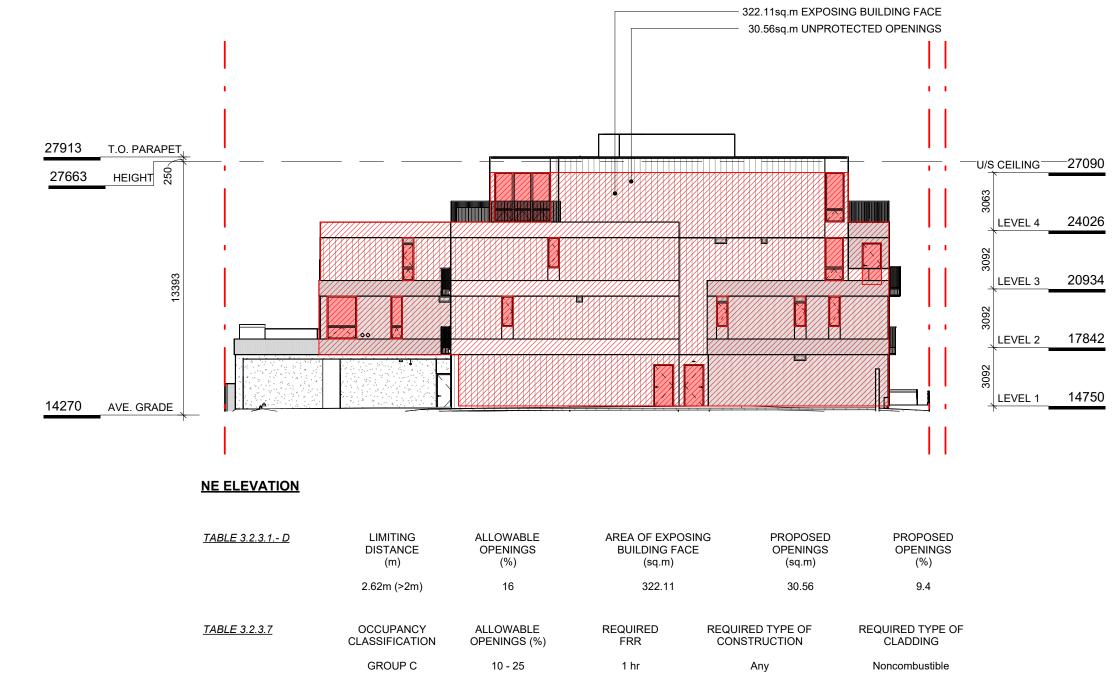

2 NE ELEVATION - LD KEY SCALE = 1:200

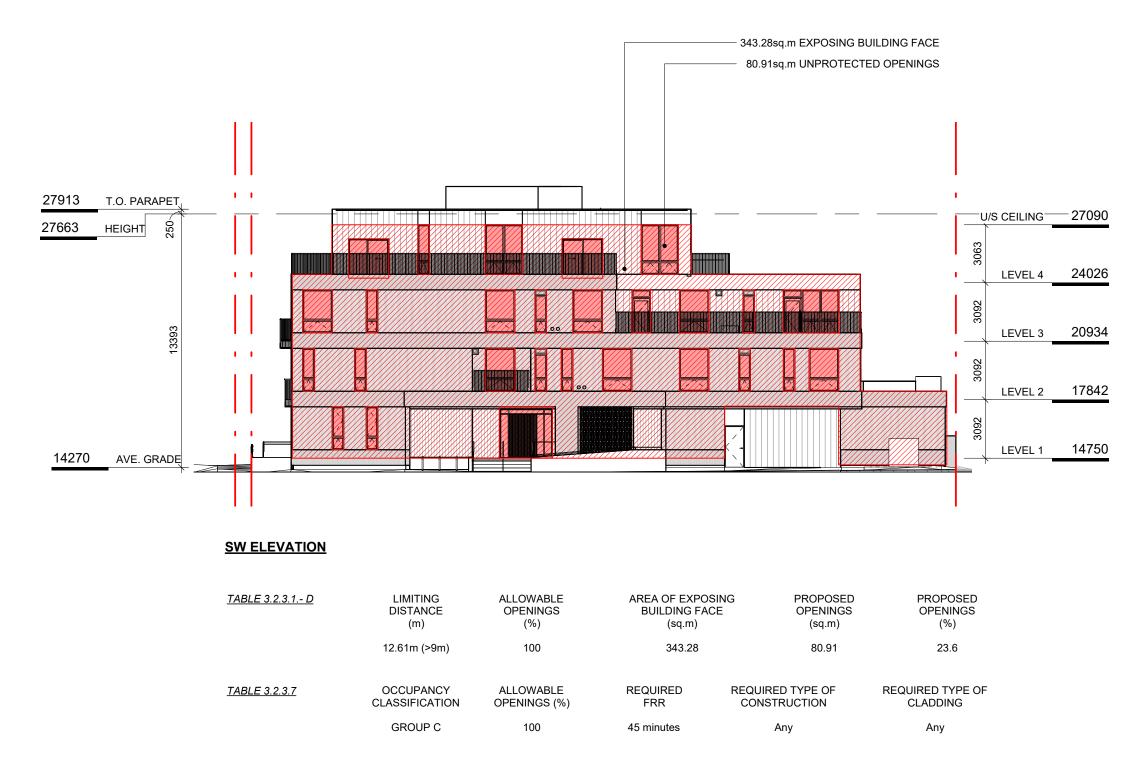

3 SW ELEVATION - LD KEY



DP/RZ Rev2 DP/RZ Rev1

NO.

DP/RZ Submission

DESCRIPTION

Aug 10, 2023 Jan 26, 2023 July 20, 2022 April 29, 2022 DATE



NO.	DESCRIPTION	DATE
1	Development Tracker Application	March 7, 2022
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4	DP/RZ Rev2	Jan 26, 2023
5	DP/RZ Rev3	Aug 10, 2023
13	DP/RZ Rev4	Jan 18, 2024
17	DP/RZ Rev5	Feb 21, 2024
19	DP/RZ Rev6	May 27, 2024



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LEVEL 1 PROPOSED PLAN

JUNE 25, 2024


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Revision

May 27, 2024

Sheet #

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1 L2 PROPOSED PLAN
SCALE = 1:100

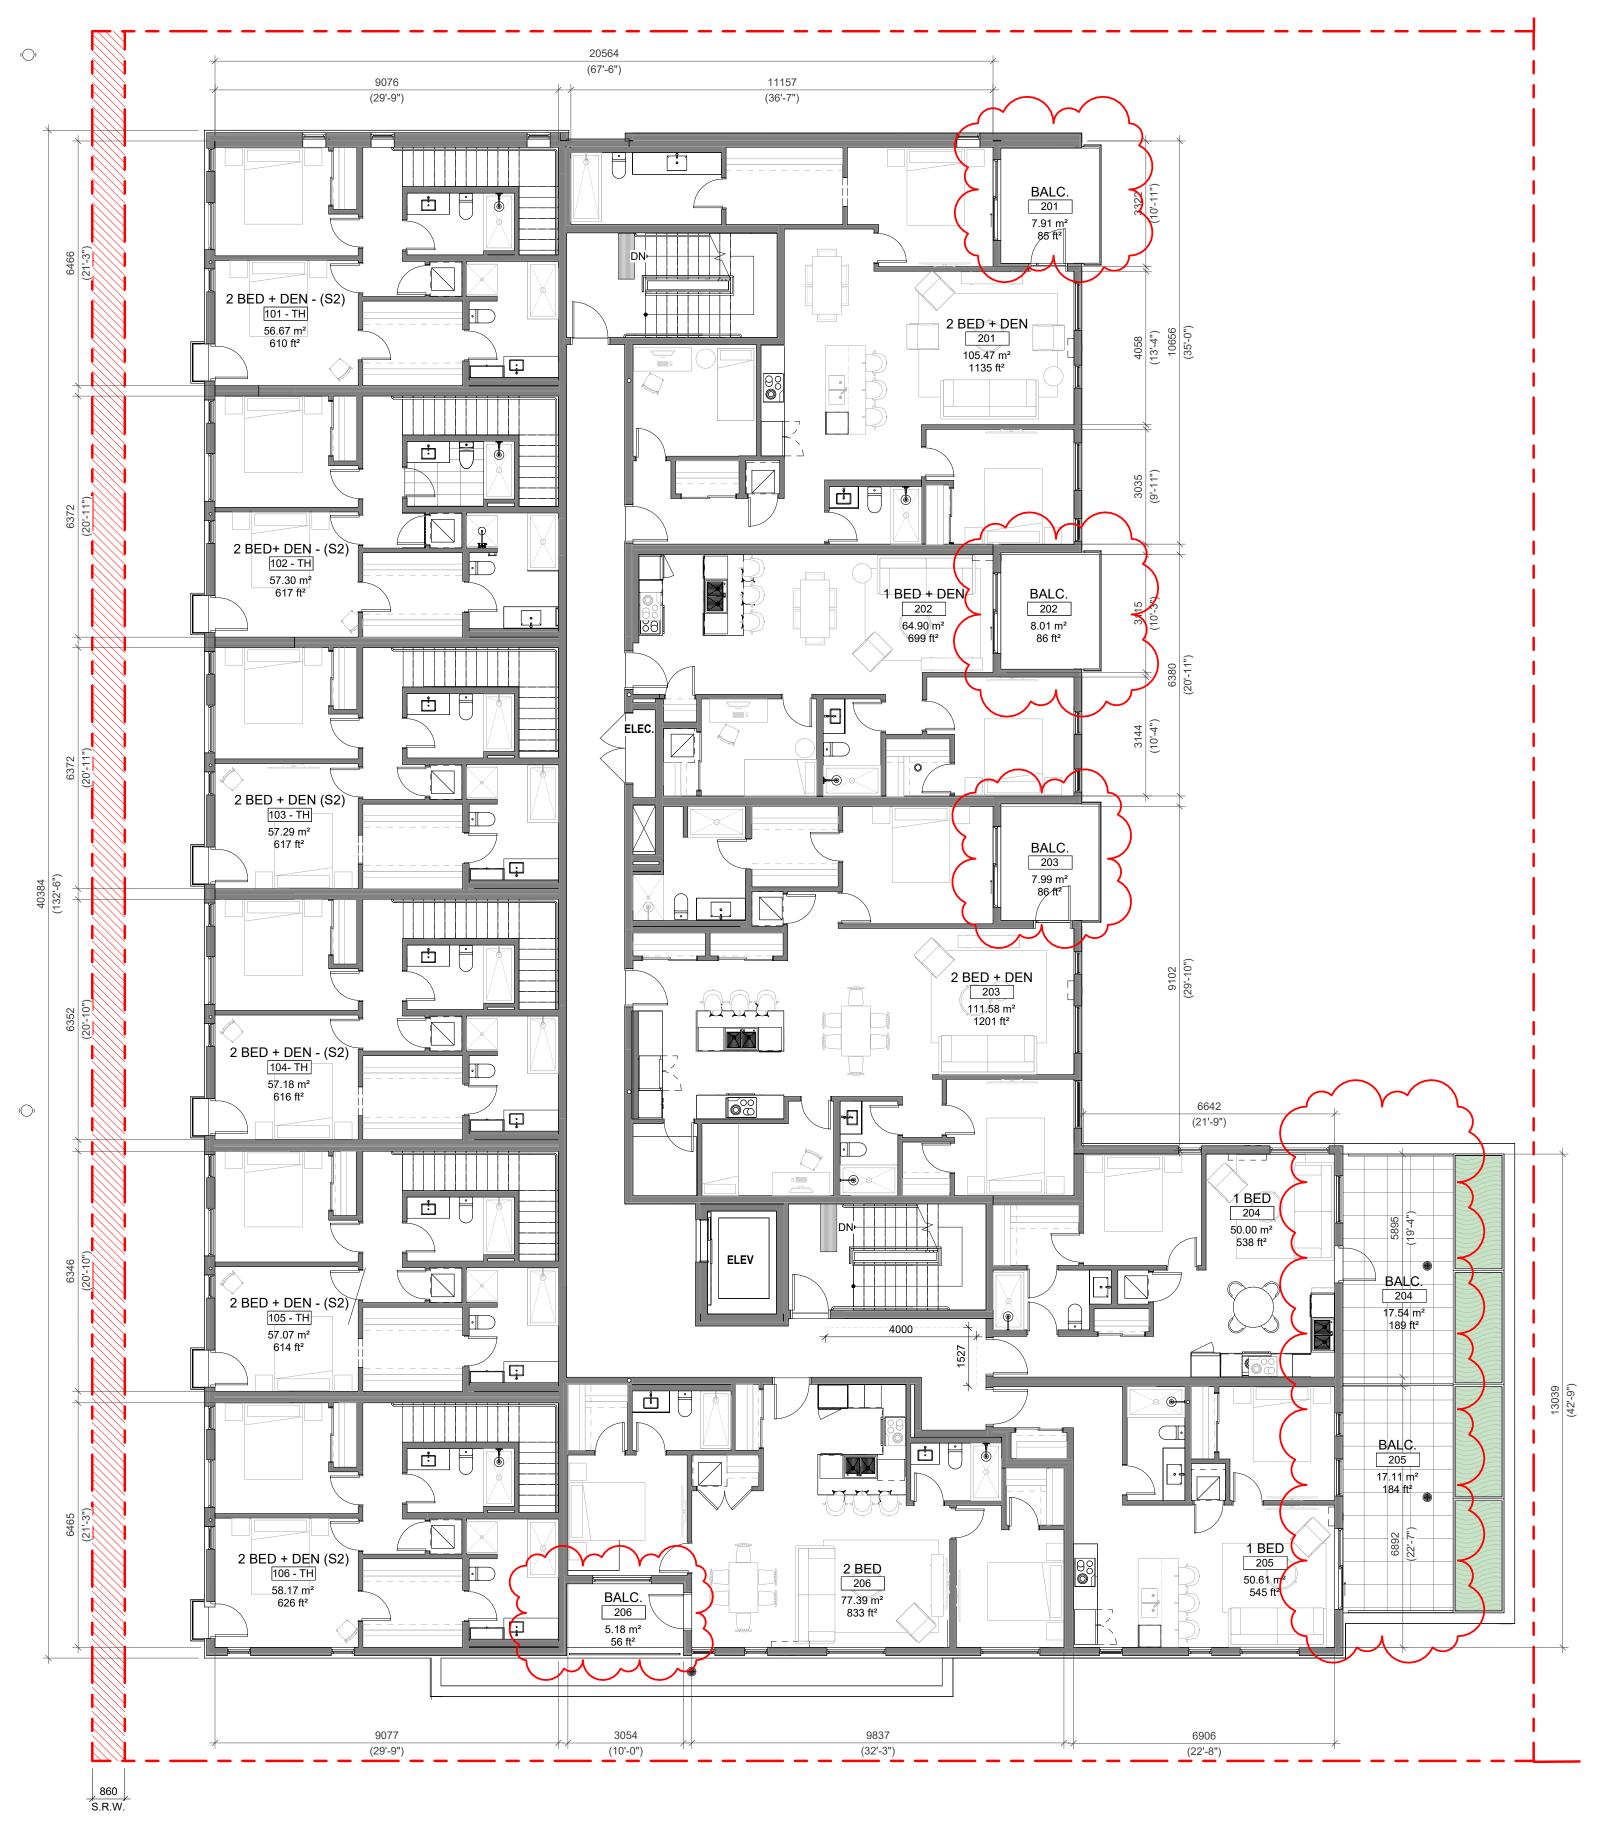

NO.	DESCRIPTION	DATE
1	Development Tracker Application	March 7, 2022
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19	DP/RZ Rev6	May 27, 2024



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LEVEL 2 PROPOSED PLAN

JUNE 25, 2024


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May 27, 2024 /19

A-102

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19	DP/RZ Rev6	May 27, 2024
13	DP/RZ Rev4	Jan 18, 2024
4	DP/RZ Rev2	Jan 26, 2023
3	DP/RZ Rev1	July 20, 2022
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1	Development Tracker Application	March 7, 2022
NO.	DESCRIPTION	DATE



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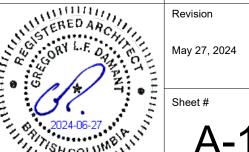
1733-1737 Fairfield Rd
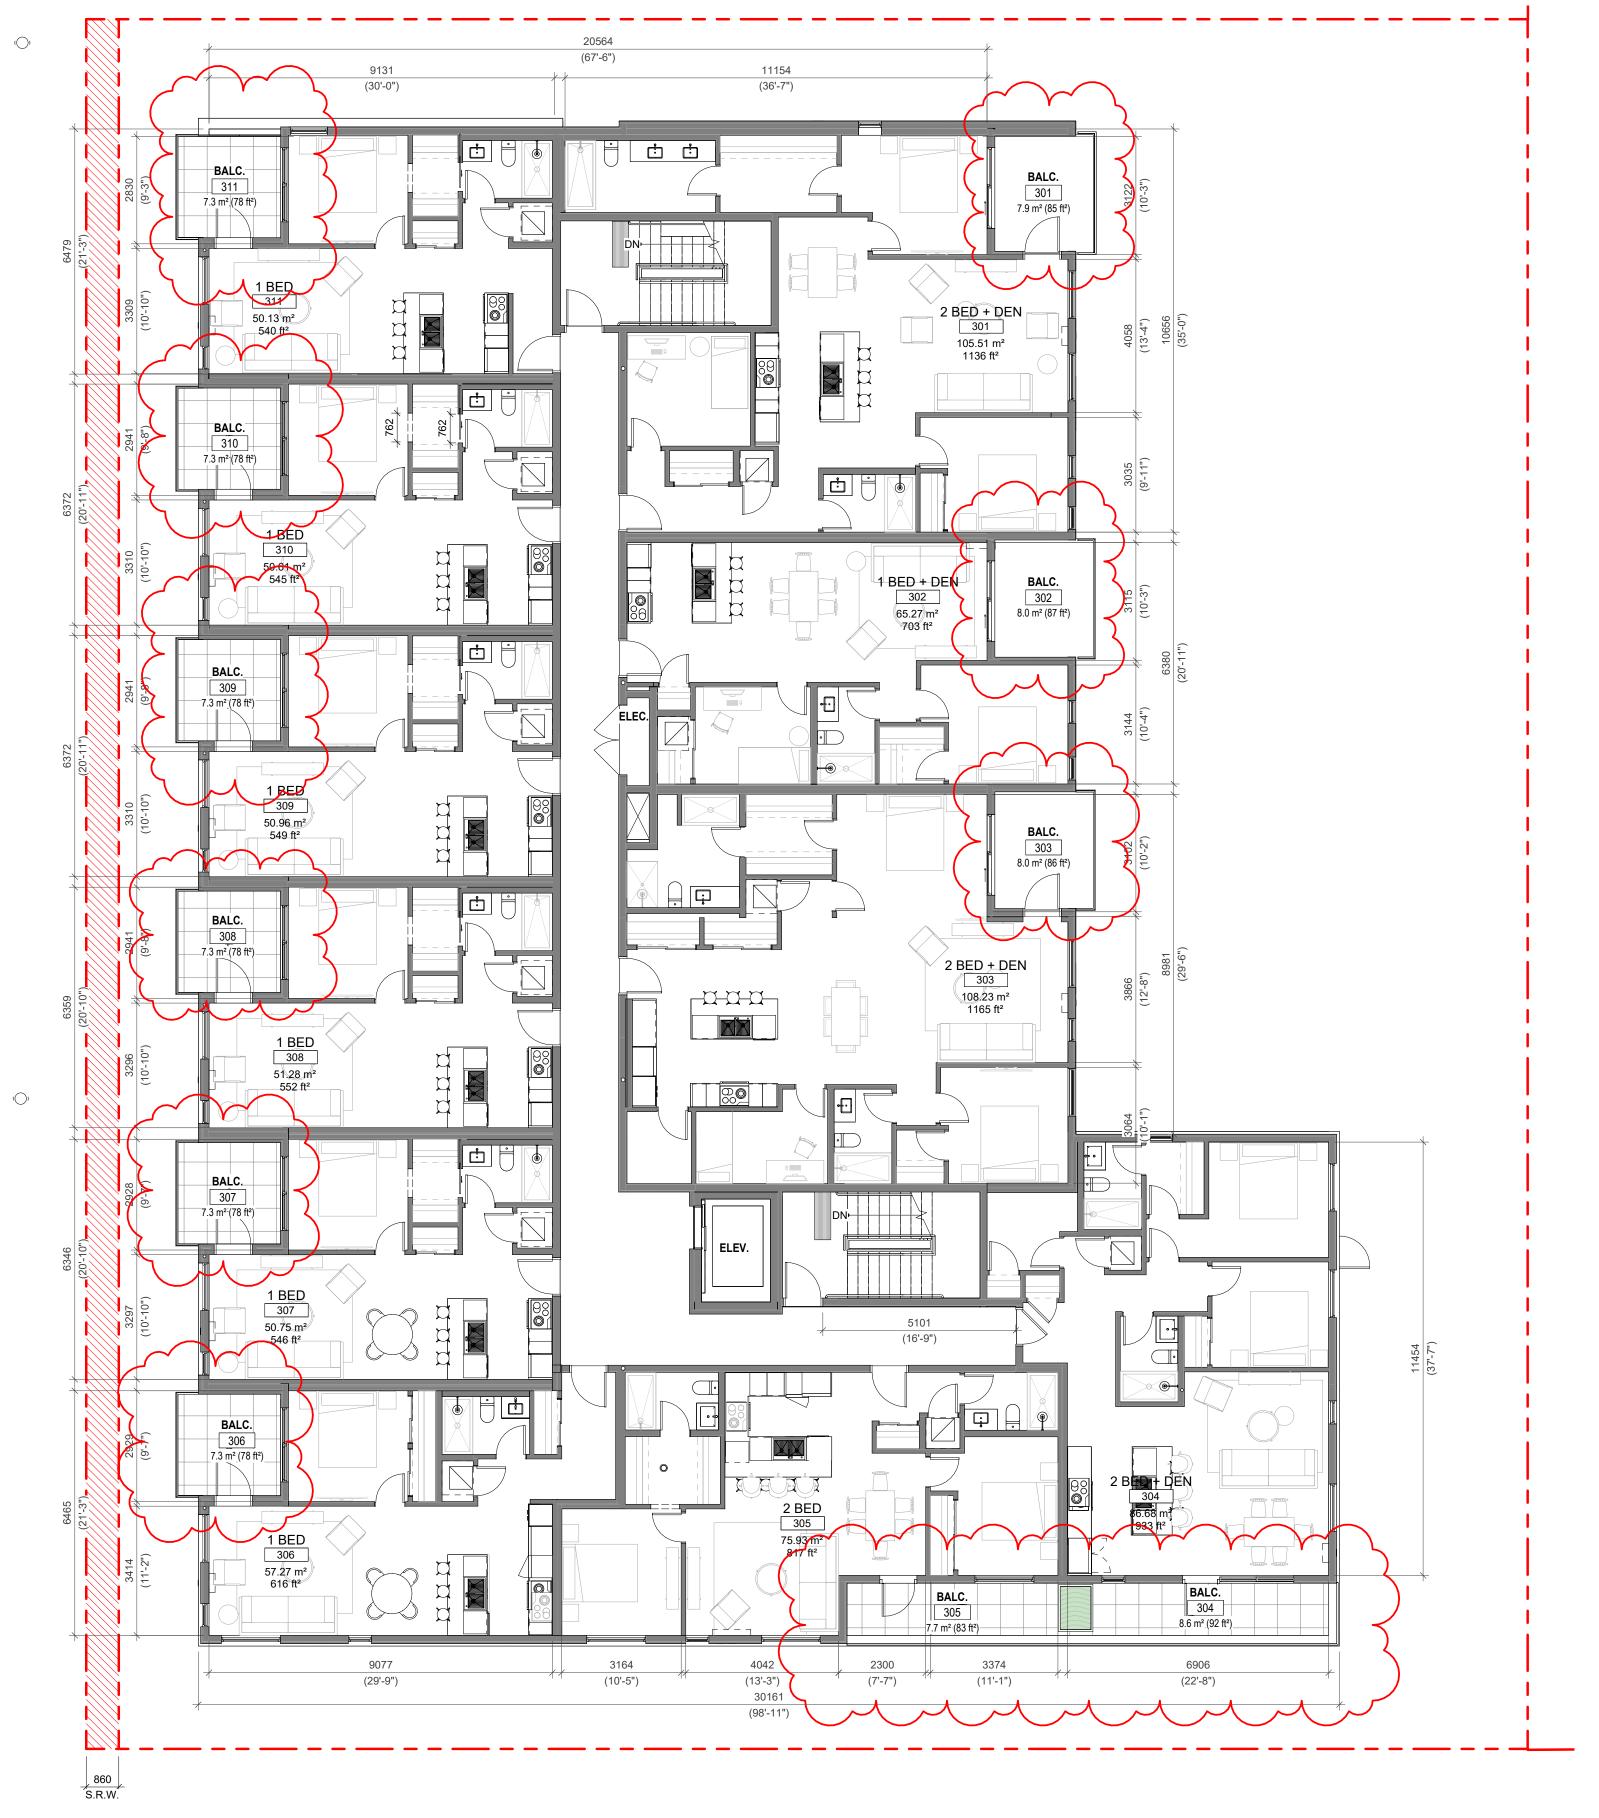
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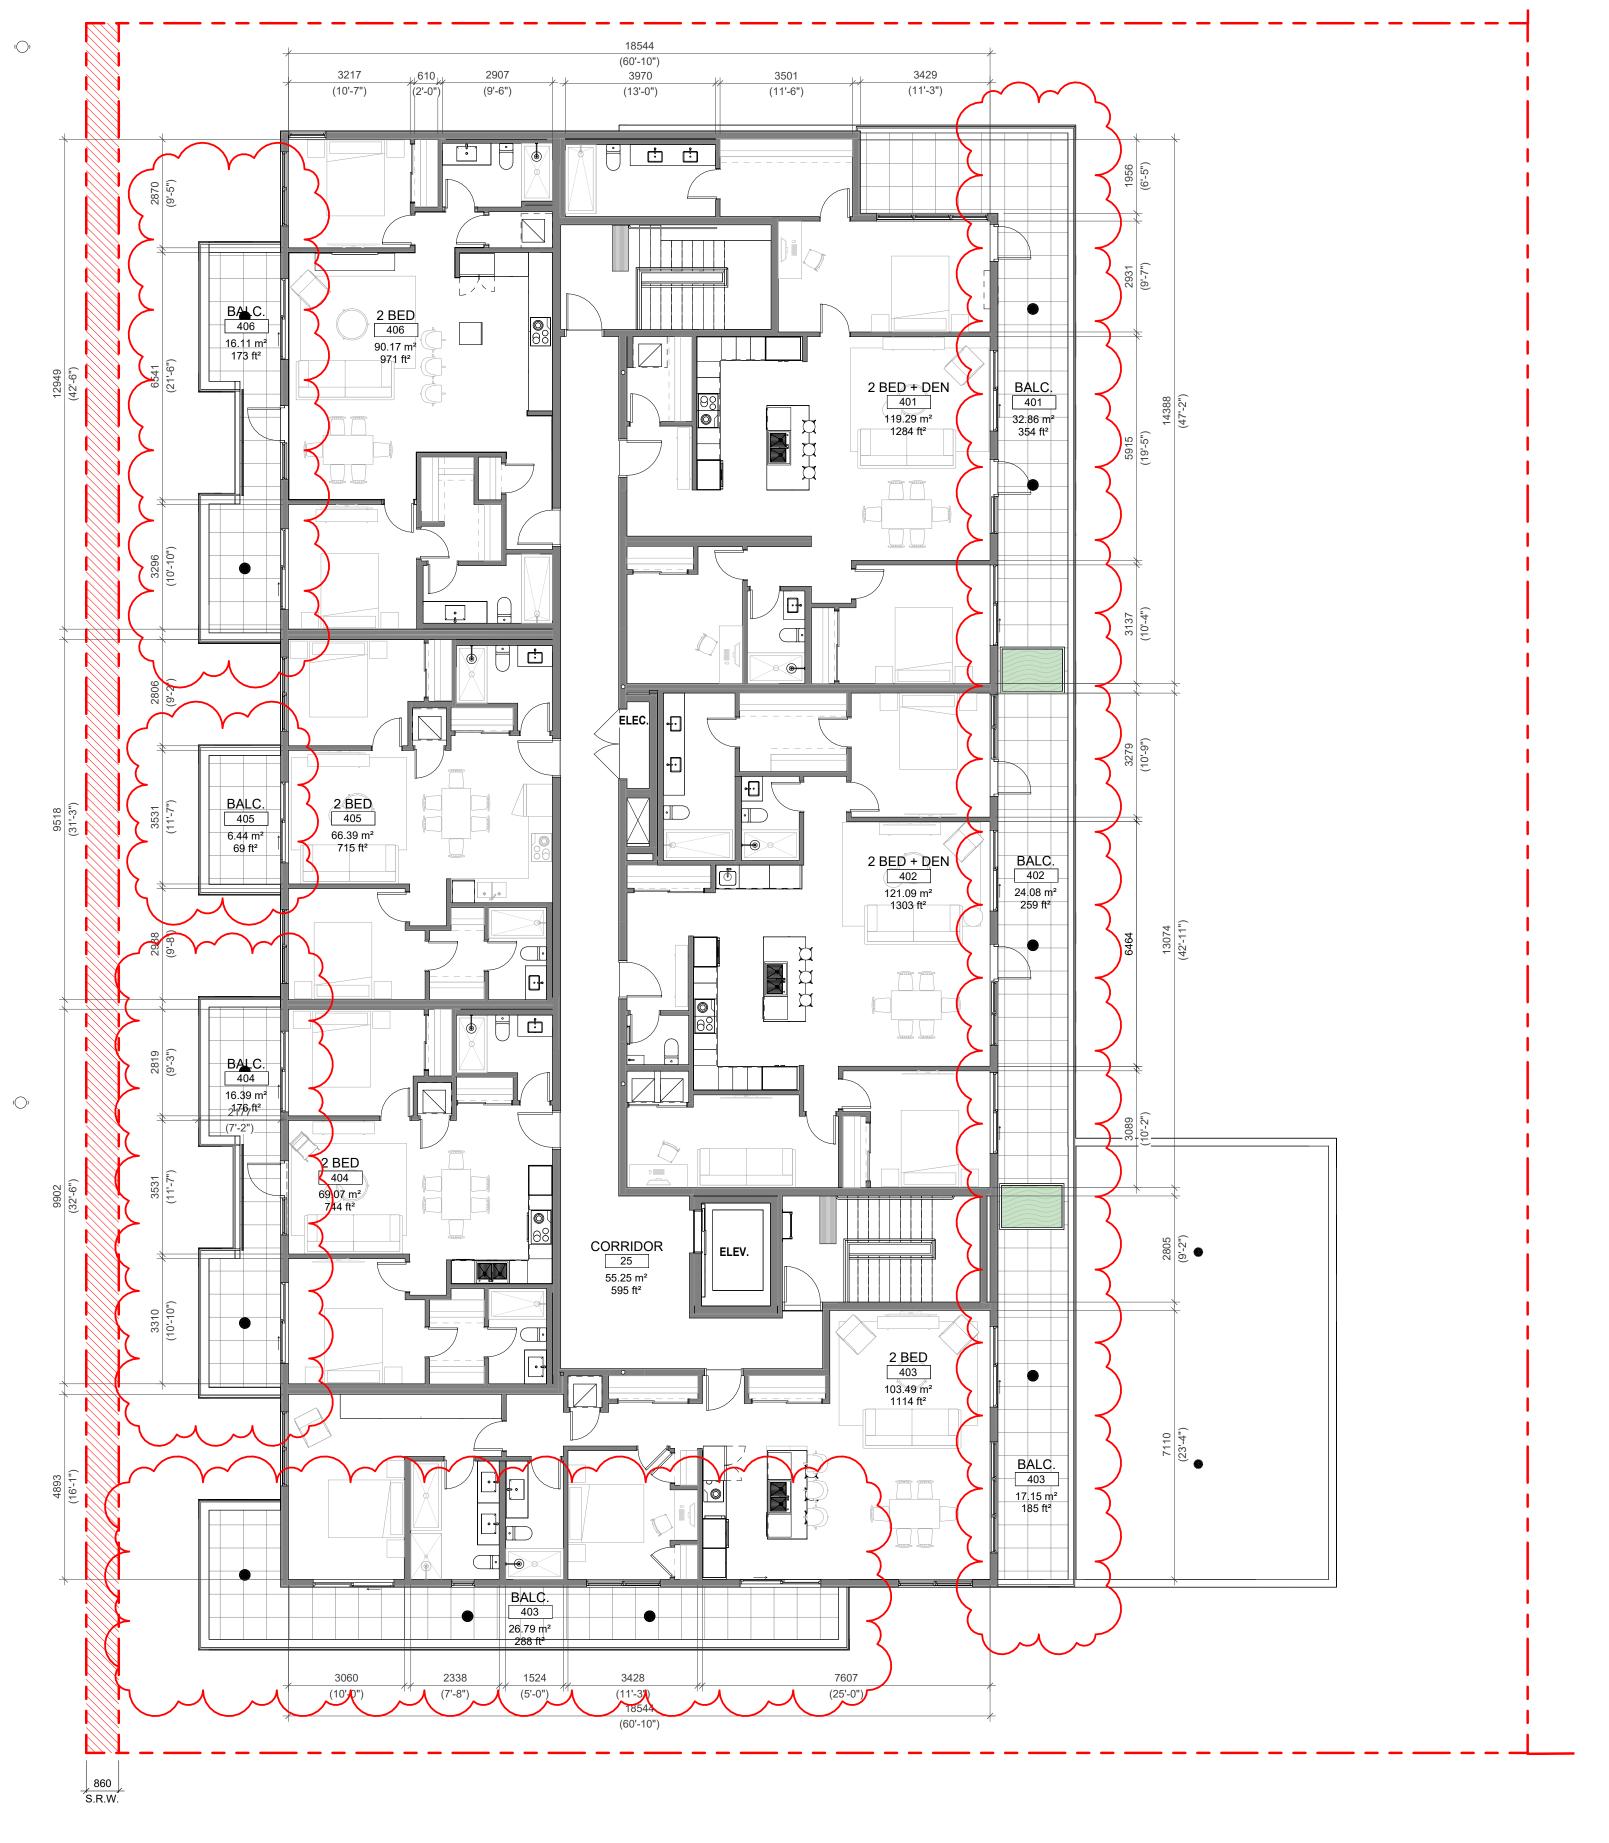
LEVEL 3 PROPOSED PLAN


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1733-1737 Fairfield Rd

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LEVEL 4 PROPOSED PLAN

JUNE 25, 2024

1:100


May 27, 2024

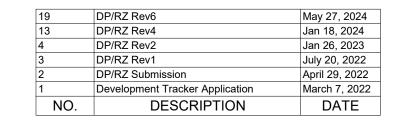
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1 L4 PROPOSED PLAN
SCALE = 1:100







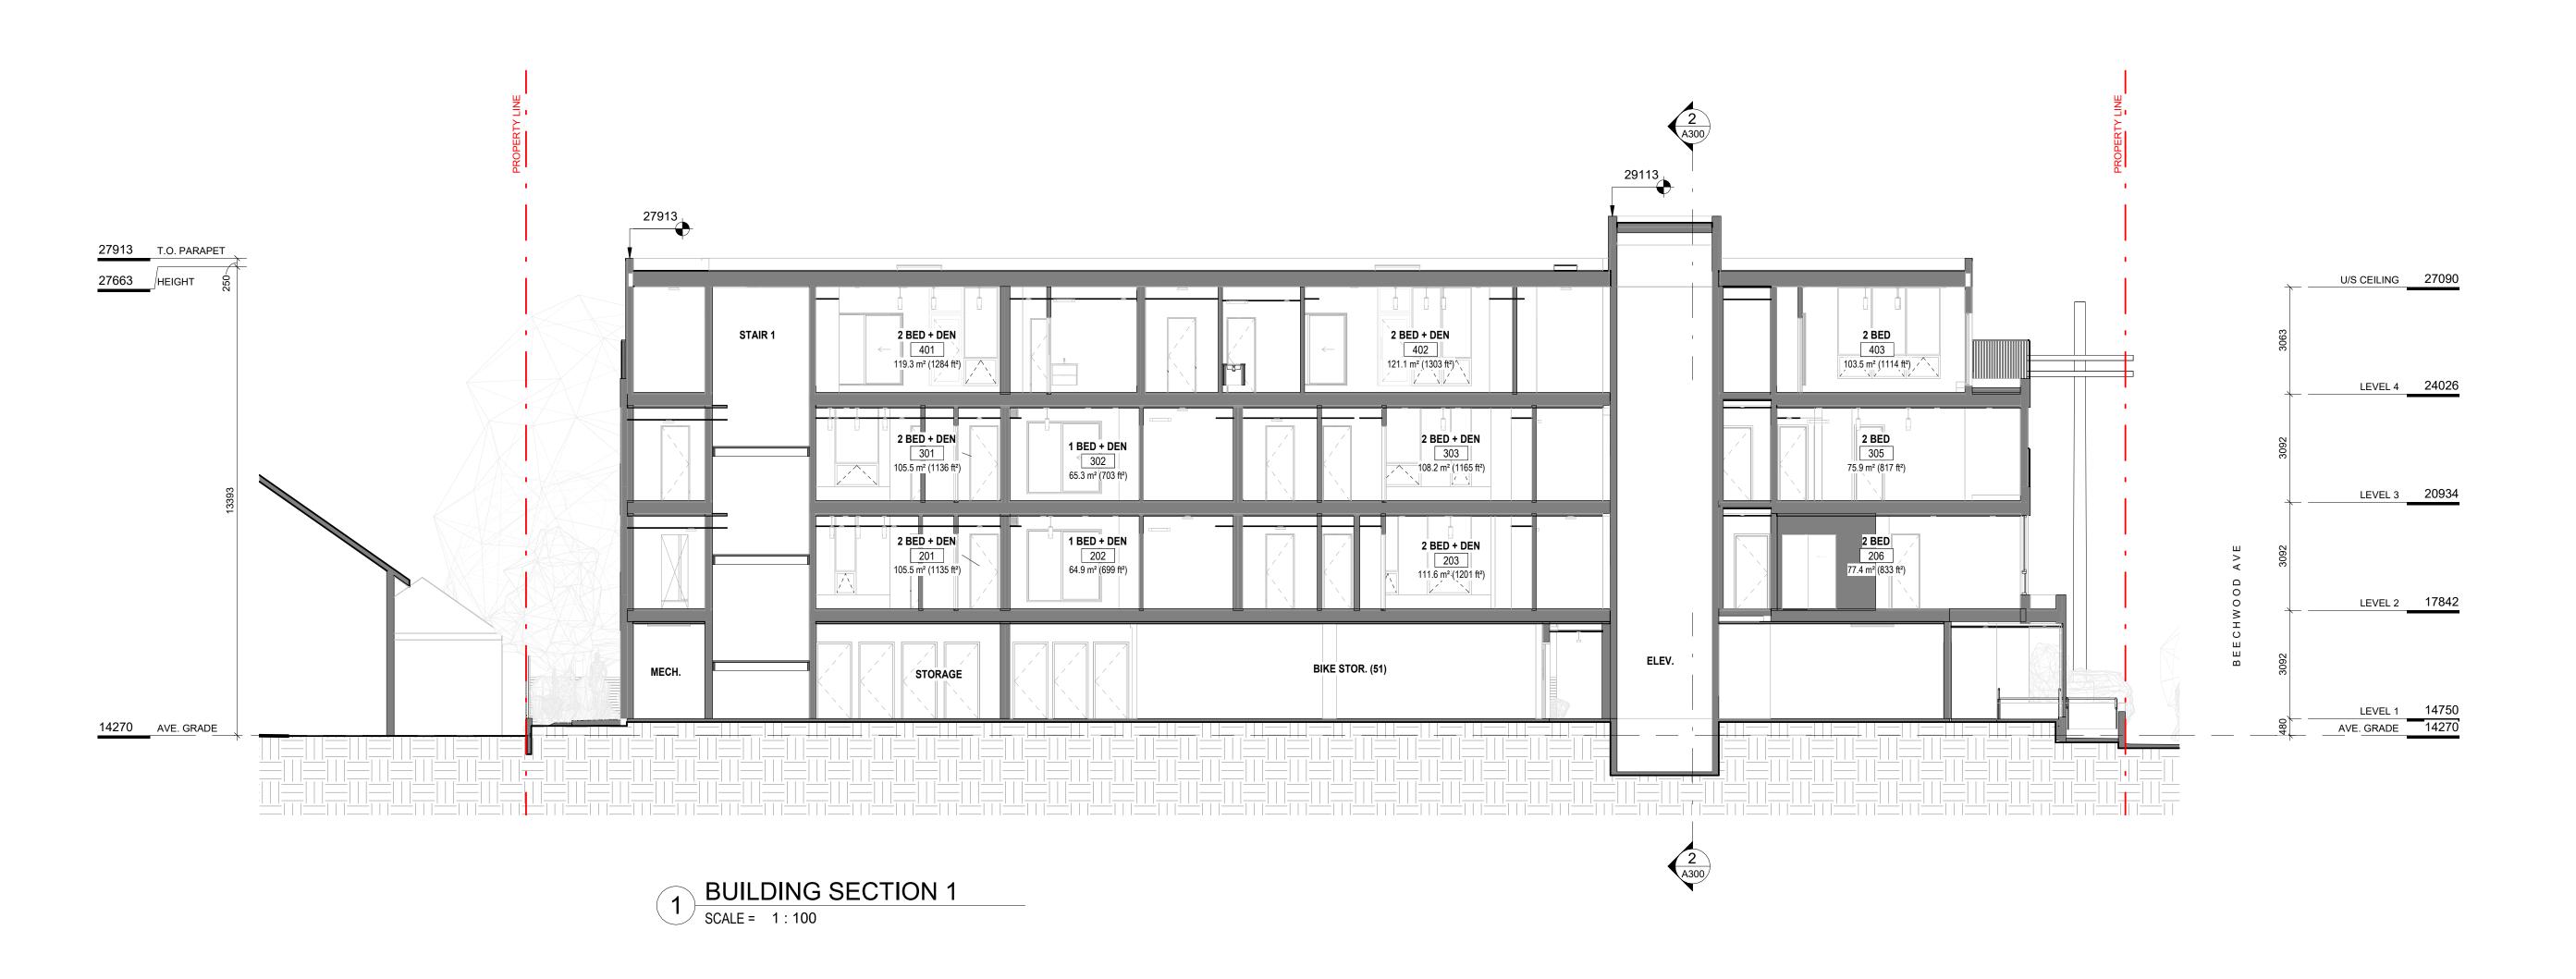

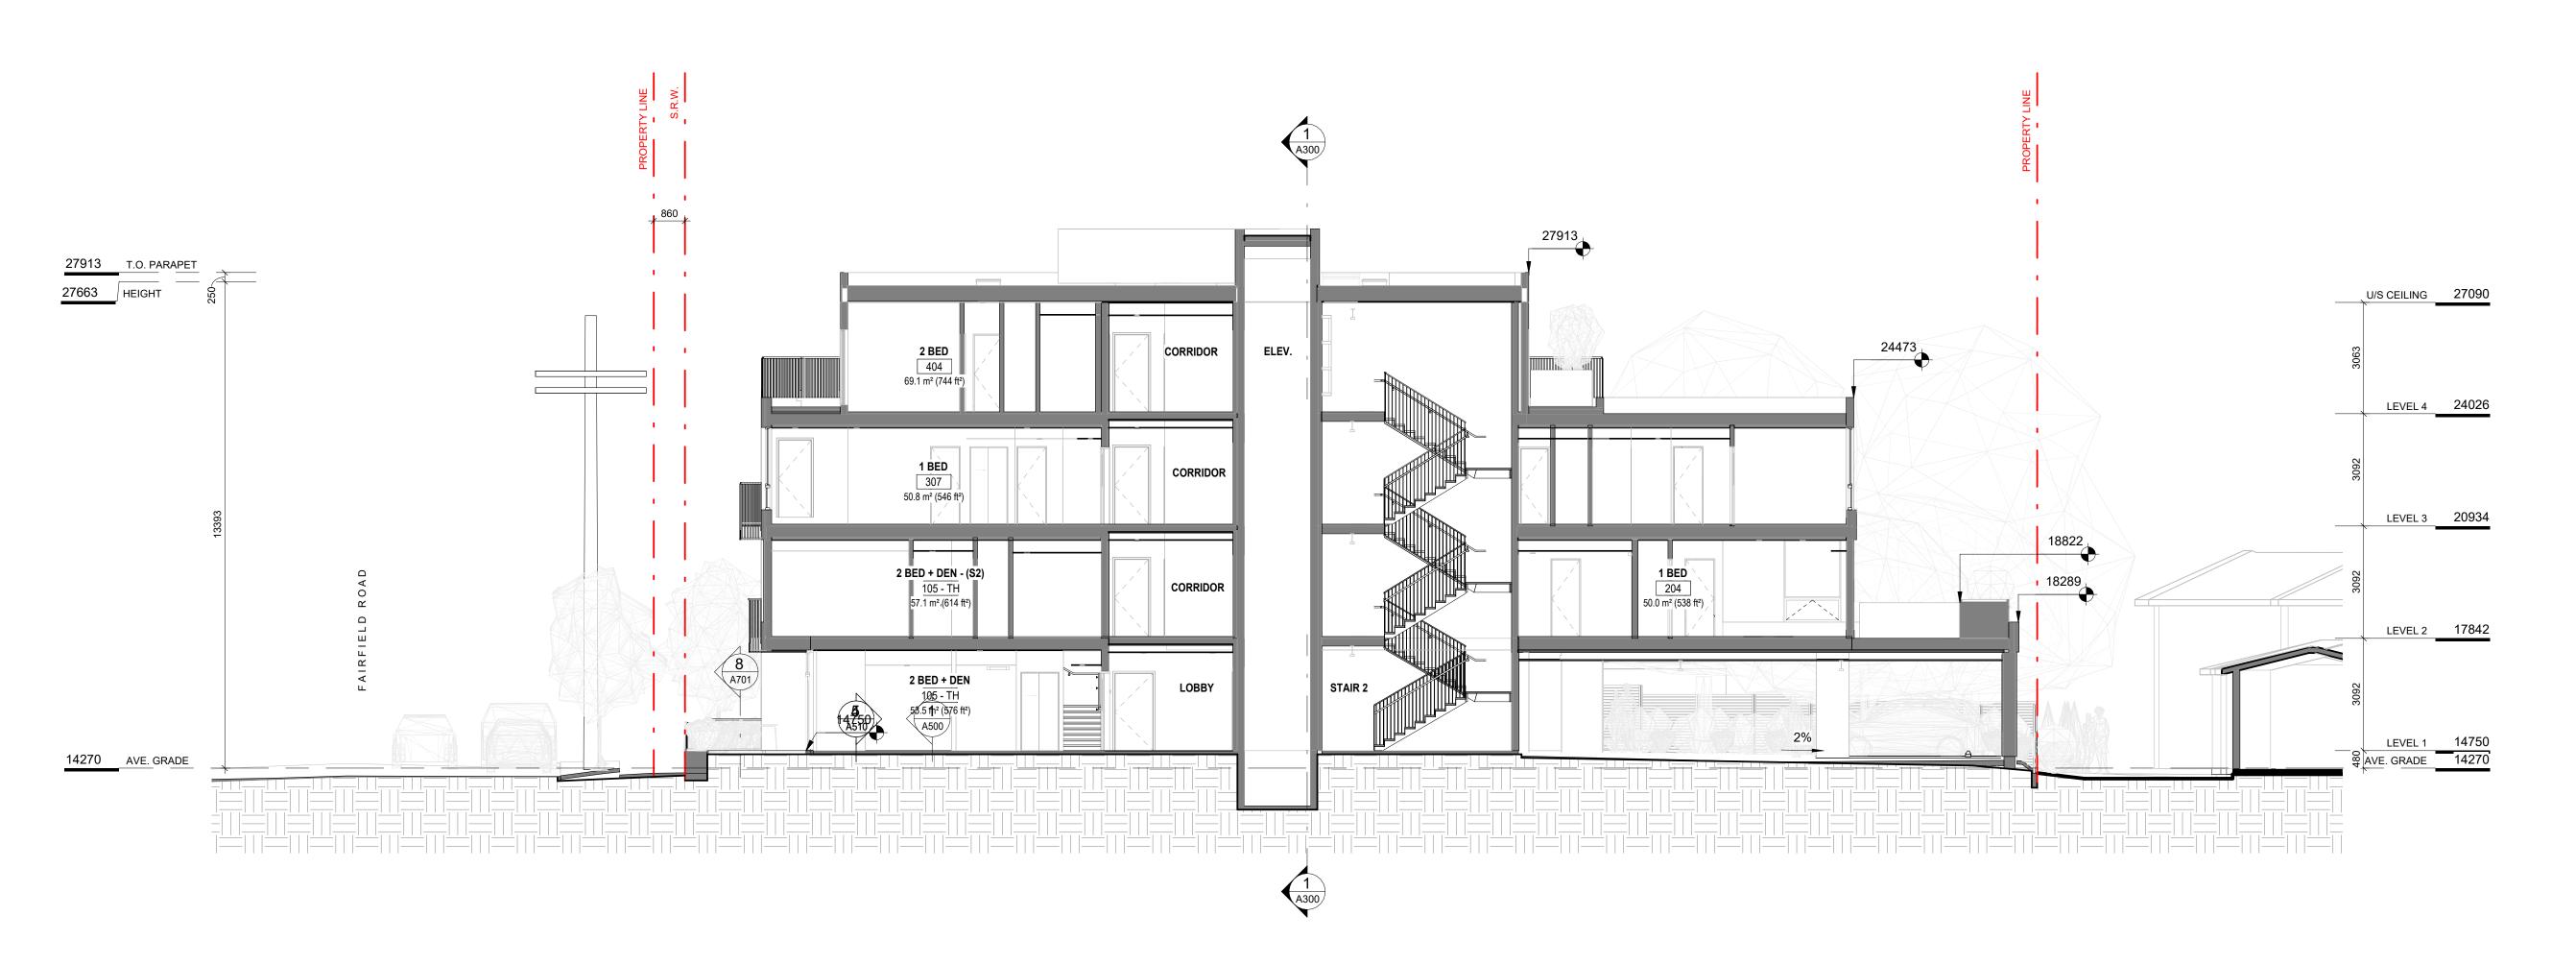

DP/RZ Rev2
DP/RZ Rev1
DP/RZ Submission

NO.

Development Tracker Application

DESCRIPTION

Jan 18, 2024 Jan 26, 2023 July 20, 2022 April 29, 2022 March 7, 2022 DATE

Date		II INI	E 25, 2024
		30141	L ZJ, ZUZ4
Scale		Project #	
	1:100		2123



Revision

Jan 18, 2024


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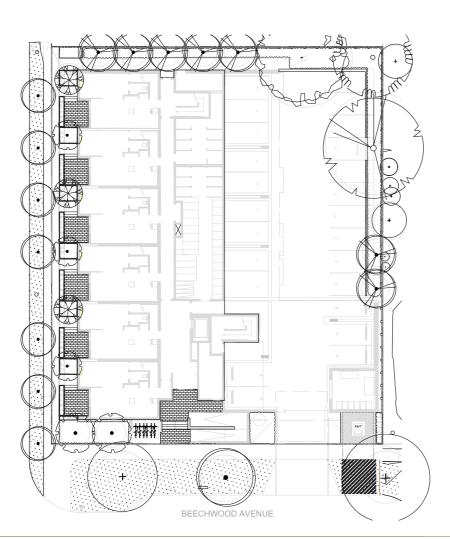
A-301


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2 BUILDING SECTION 2
SCALE = 1:100

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MATERIAL SPECIFICATIONS

ON-SITE GROWING MEDIUM:

- ON-SITE GROWING MEDIUM:

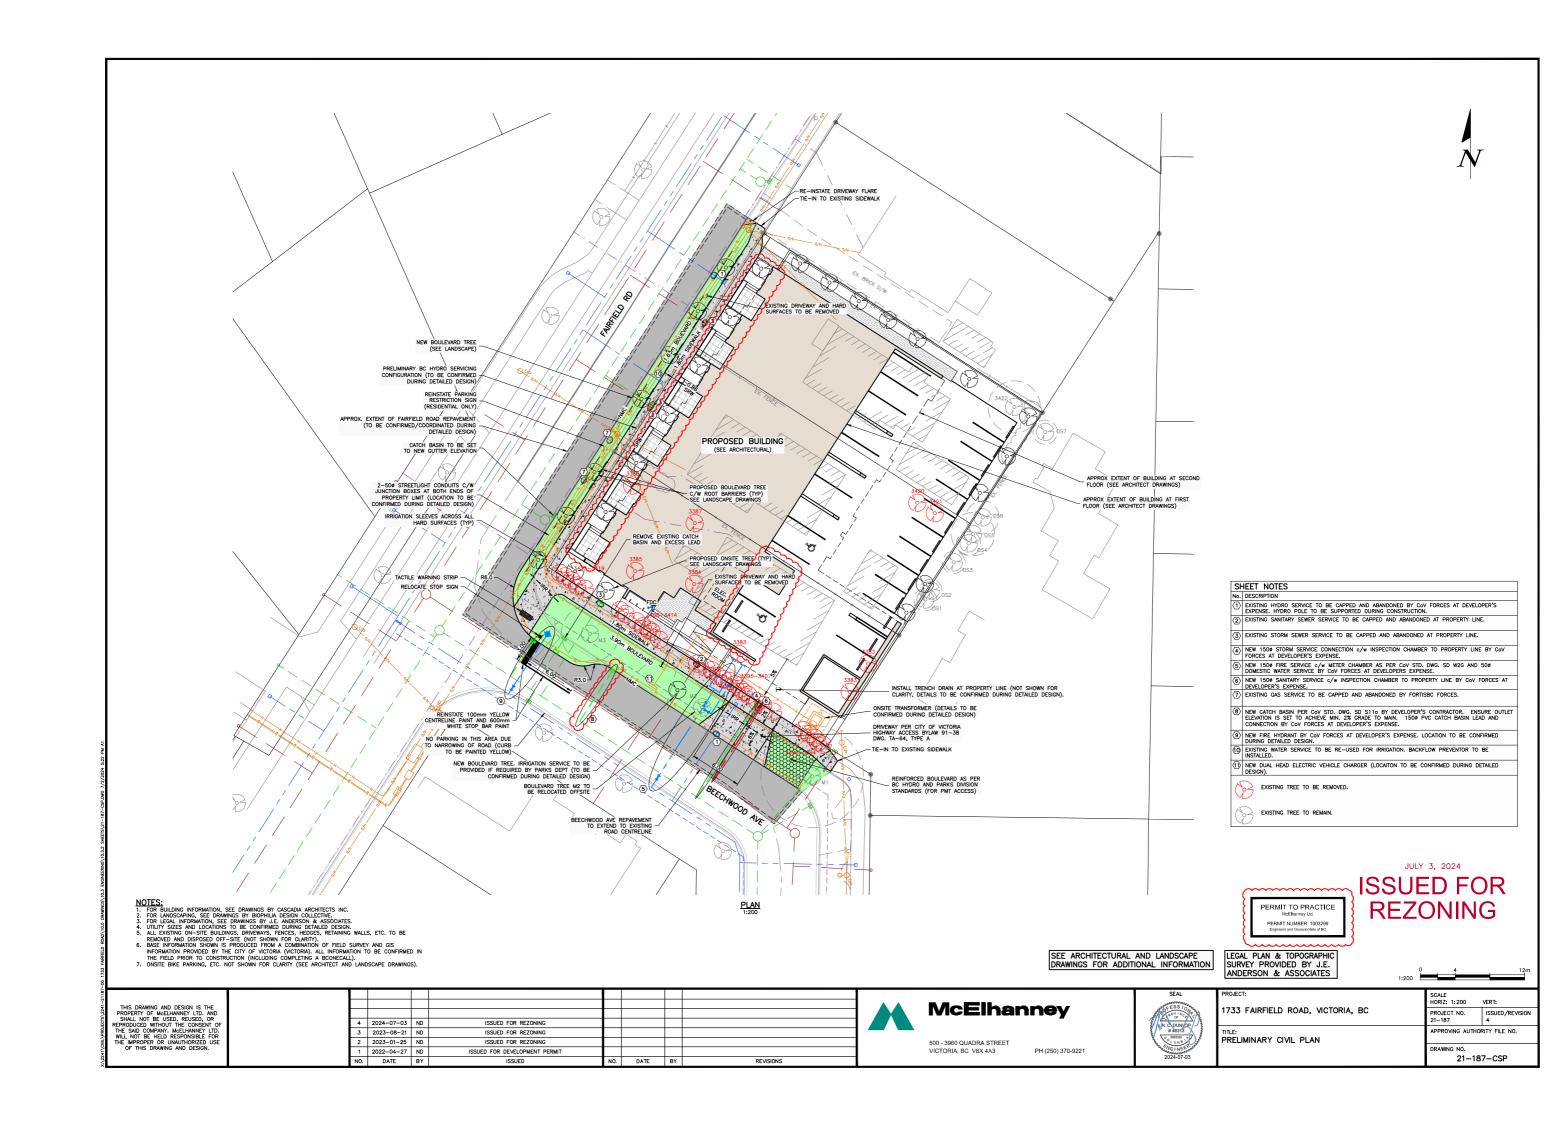 1. GROWING MEDIUM TESTING, MIXING, HANDLING AND PLACEMENT TO CLS SECTION 6.

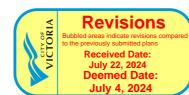 2. ON SITE GROWING MEDIUM TYPE TO BE: AS PER DRAWNING LEGEND.

 3. PLANTER GROWING MEDIUM TO BE:

 50% BY VOLUME 1H HIGH TRAFFIC LAWN GROWING MEDIUM
 50% BY VOLUME 7H HIGH TRAFFIC LAWN GROWING MEDIUM
 50% BY VOLUME Pro-Mix HP Mychorrizae OR APPROVED EQUAL

- OFF-SITE GROWING MEDIUM:

 1. BOULEVARD GROWING MEDIUM TO BE:

 1. MMCD Planting Areas Growing Medium to City of Victoria Supplementary Specifications Schedule 'B', Table 2.

 2. AS PER MUNICIPAL STANDARD.

 3. IF NO MUNICIPAL STANDARD, GROWING MEDIUM TO CLS SECTION 6 2L LOW TRAFFIC LAWN AREAS.

MULCH: 1. MULCH IN ALL OTHER AREAS TO BE: Mitchell Excavating Ltd. Fine Bark Mulch - fir/hemlock OR APPROVED EQUAL. 2. HANDLING AND PLACEMENT TO CLS Section 10 - Mulching/Mulch

- MUNICIPAL SOD TO BE: No. 1 Premium Grade Nursery Turfgrass.
 HANDLING AND PLACEMENT TO BCLS Section 8 Turfgrass Sod.
 SHALL BE SUITED TO THE LOCALITY, SITE CONDITIONS AND INTENDED FUNCTION OF THE PROJECT AREA.

ROOT BARRIER TO BE: Deeproot 18" Universal Guide OR APPROVED EQUAL

FILTER FABRIC TO BE: Soprema Soprafiltre non-woven geotextile OR APPROVED EQUAL
 INSTALL AS PER MANUFACTURER'S SPECIFICATIONS AND LANDSCAPE DETAILS.

AGGREGATE:

1. PLANTER DRAIN ROCK TO BE: 19 mm MINUS GRANULAR BASE (TO MMCD SPECIFICATION)

2. GREEN ROOF DRAIN ROCK TO BE: 6 mm WASHED DRAIN ROCK

SUBMITTALS

PLANT MATERIAL AND PLANTING:

- ANT MATERIAL AND PLANTING:
 ALL PRODUCTS AND WORKMANSHIP, INCLUDING: PLANT MATERIAL, TRANSPORTATION, HANDLING AND PROTECTION,
 SCHEDULING AND STORAGE, WATERING AND IRRIGATION, TIME OF PLANTING, PLANTING, CONDITIONS FOR ACCEPTANCE,
 AND INSECTS PESTS AND DISEASE CONTROL, TO BCLS SECTION 9 PLANTS AND PLANTING, WRITTEN SPECIFICATIONS AND
- LANDSCAPE DETAILS.

 CONDITIONS FOR TOTAL PERFORMANCE TO MMCD SECTION PLANTING OF TREES, SHRUBS AND GROUNDCOVERS.

 IN THE EVENT OF A DISCREPANCY BETWEEN QUANTITIES LISTED ON THE PLANTING PLAN AND IN THE PLANT LIST, THE PLANTING PLAN QUANTITIES TO TAKE PRECEDENCE.

ALL CAST IN PLACE CONCRETE AND ASSOCIATED WORK AND MATERIALS TO CONFORM TO MMCD SPECIFICATIONS; ASSOCIATED WORK INCLUDES GRADING. SUBGRADE COMPACTION, GRANULAR BASE MATERIALS AND COMPACTION.

IRRIGATION - DESIGN BUILD

- IT IS THE INTENTION OF THE PROJECT THAT THE LANDSCAPE CONTRACTOR FURNISH A FUNCTIONAL AUTOMATIC IRRIGATION
- SYSTEM TO ALL ON-SITE AND OFF SITE LANDSCAPE AREAS AS DESCRIBED ON THE LANDSCAPE PRAVMINGS AND IN THIS SECTION. THE SCOPE OF WORK INCLUDES SUPPLY AND INSTALLATION OF BACKFLOW PREVENTER. CONTROLLER, ALL IRRIGATION COMPONENTS, IRRIGATION SLEEVEST YEAR MAINTENANCEWARRANTY (SEE WRITTEN SPECIFICATIONS AND REQUIREMENTS
- THE IRRIGATION CONTRACTOR SHALL COORDINATE WITH THE GENERAL CONTRACTOR AND ELECTRICAL CONTRACTOR FOR THE INSTALLATION OF IRRIGATION SLEEVES.

- AINTENANCE

 UPON COMPLETION OF IRRIGATION INSTALLATION, CONTRACTOR TO SUBMIT AS-CONSTRUCTED DRAWINGS, OPERATION AND MAINTENANCE MANUAL, TOOLS PROVIDED BY THE MANUFACTURER AND BASE IRRIGATION SCHEDULE TO IABC STANDARDS (SECTION 5 OF BCLS).

 INSPECT AND CALIBRATE IRRIGATION SYSTEM AS PER SEASONAL REQUIREMENTS.

 INSPECT GROWING MEDIUM FREQUENTLY (MINIMUM MONTHLY AND WEEKLY DURING PERIODS OF DROUGHT AND HIGH HEAT) FOR MOISTURE CONTENT AND ADJUST IRRIGATION SCHEDULE AS OFTEN AS REQUIRED TO MAINTAIN THE HEALTH OF THE PLANT MATERIAL DUE TO: RAPID DRAINAGE IN THE GROWING MEDIUM, ABSENCE OF A WATER TABLE, FINITE AMOUNT OF GROWING MEDIUM, AND EXPOSURE TO CUIMATIC CONDITIONS.

 CONTRACTOR TO COORDINATE WITH THE OWNER'S MAINTENANCE REPRESENTATIVE AND TOGETHER PERFORM ONE WINTERIZATION AND ONE SPRING START-UP DURING THE ONE YEAR WARRANTY PERIOD.





SUBMITTALS					
SPECIFICATION SECTION	TITLE	SHOP DRAWINGS	MOCK-UP	SUBMITTALS	FOR APPROVAL
MMCD 03 30 20	CONCRETE WALKS, CURBS AND GUTTERS				
MMCD 03 30 53	CAST IN PLACE CONCRETE				
MMCD 31 02 17	AGGREGATES AND GRANULAR MATERIALS				
MMCD 31 22 01	SITE GRADING				
MMCD 31 24 13	ROADWAY EXCAVATION, EMBANKMENT AND COMPACTION				
MMCD 32 11 23	GRANULAR BASE				
MMCD 32 14 01	UNIT PAVING		yes	yes	product cut sheets, mockup 3.0m paved area on site
CLS 4	GRADING AND DRAINAGE				
CLS 5	IRRIGATION	yes			irrigation design for approval
CLS 6	GROWING MEDIUM			yes	supplier name, growing medium test results
CLS 7	LAWNS AND GRASS (HYDRAULIC SEEDING)			yes	supplier name, product information
CLS 8	TURFGRASS SOD			yes	supplier name, product information
CLS 9	PLANTS AND PLANTING		yes	yes	nursery name, tree and shrub layout on site prior to planting
CLS 10	MULCHING			yes	
CLS 11	LANDSCAPE OVER STRUCTURES - GREEN ROOFS				
CLS 12	CONTAINER GROWN PLANTS				

1733 FAIRFIELD

1733 FAIRFIELD ROAD, VICTORIA, BC

SHEET LIST

L0.1 TREE MANAGEMENT & REMOVAL PLAN

I 1 1 MATERIAI S PLAN - LEVEL 1

L1.2 MATERIALS PLAN - UPPER LEVELS

1211AYOUT PLAN L3.1 GRADING PLAN

L4.1 SOIL VOLUME PLAN

L4.2 TREE PLANTING PLAN

L4.3 PLANTING PLAN - LEVEL 1

L4.4 PLANTING PLAN - UPPER LEVELS

L5.1 LIGHTING PLAN

161 IRRIGATION PLAN - LEVEL 1

L6,2 IRRIGATION PLAN - UPPER LEVELS

171 PAVING DETAILS

L7.2 SITE FURNISHINGS DETAILS

L7.3 PLANTING DETAILS

GENERAL LANDSCAPE NOTES

GENERAL

- DO NOT PROCEED IN UNCERTAINTY.
 DO NOT SCALE DRAWINGS.
- DO NOT SCALE DIRAWINGS.
 DRAWINGS AND SPECIFICATIONS ARE TO BE READ IN CONJUNCTION WITH ALL OTHER DRAWINGS/SPECIFICATIONS IN THIS PROJECT SET. ANY DISCREPANCIES AMONG DRAWINGS,
- SPECIFICATIONS AND INDUSTRY BEST PRACTICES TO BE REPORTED TO THE PROJECT / CONSTRUCTION MANAGER AND THE LANDSCAPE CONSULTANT FOR DIRECTION.
 ALL LANDSCAPE SPECIFICATION SECTIONS AND DRAWINGS ARE AFFECTED BY REQUIREMENTS OF DIVISION OF SECTIONS (PROVIDED IN THE PROJECT MANUAL)
 CONTRACTOR TO FAMILIARIZE THEMSELVES WITH ALL SITE CONDITIONS, INCLUDING THE LIMITS OF WORK AND EXISTING FEATURES TO BE PROTECTED, PRIOR TO SUBMITTING
- CONTRACTOR TO FAMILIARIZE HEMSELVES WITH ALL SITE CONDITIONS, INCLUDING THE LIMITS OF WORK AND EXISTING PERFORMED TO BE PROTECTED, PRIOR TO SOURCE TIMES BIDSIQUOTES.

 CONTRACTOR TO CONFIRM LOCATION AND ELEVATION OF ALL UNDERGROUND UTILITIES/FEATURES PRIOR TO COMMENCING WORK.

 CONTRACTOR TO TAKE NECESSARY PRECAUTIONS TO PROTECT SITE FEATURES / CONDITIONS, WITHIN AND BEYOND THE LIMITS OF WORK EXISTING AT THE TIME OF CONSTRUCTION, ALL DISTURBED SURFACES, AREAS, STRUCTURES, VEGETATION, HABITAT ETC. ON PUBLIC / PRIVATE PROPERTY TO PROMPTLY BE RESTORED TO EQUAL OR BETTER CONDITION THAN EXISTING AND TO THE SATISFACTION OF THE MUNICIPALITY HAVING JURISDICTION / PROPERTY OWNER.

 CONTRACTOR TO MAINTAIN THE SITE IN A SAFE AND TIDY CONDITION AT ALL TIMES, DO NOT OBSTRUCT PEDESTRIAN OR VEHICULAR CIRCULATION. DO NOT LEAVE UNPROTECTED HOLES / PITS / OPENINGS OVERNIGHT, ALL EXCESS MATERIALS AND REFUSE TO BE REMOVED FROM THE SITE DAILY UNLESS OTHERWISE DIRECTED BY THE CONSTRUCTION MANAGER.

- ANDARDS:

 ALL WORK ON MUNICIPAL PROPERTY TO CONFORM TO THE CITY OF VICTORIBEVELOPMENT STANDARDS (AUTHORITY HAVING JURISDICTION)CLUDING BUT NOT LIMITED TO:

 1.1. CITY OF VICTORIA SUPPLEMENTARY SPECIFICATIONS SCHEDULE 'B' TO THE SUBDIVISION AND DEVELOPMENT SERVICING BYLAW NO. 12-042

 1.2. CITY OF VICTORIA SUPPLEMENTAL DRAWINGS

 CITY OF VICTORIA SUPPLEMENTARY SPECIFICATIONS FOR STREET TREES AND IRRIGATION, SCHEDULE C.ALL LANDSCAPE WORK ON THE DEVELOPMENT SITE TO CONFORM TO THE CURRENT EDITION OF THECORAGIAN LANDSCAPE WORK ON THE DEVELOPMENT SITE TO CONFORM TO THE CURRENT EDITION OF THECORAGIAN LANDSCAPE WORK ON THE DEVELOPMENT SITE TO CONFORM TO THE CURRENT EDITION OF THECORAGIAN LANDSCAPE WORK ON THE DEVELOPMENT SITE TO CONFORM TO THE CURRENT EDITION OF THECORAGIAN LANDSCAPE WORK ON THE DEVELOPMENT SITE TO CONFORM TO THE CURRENT END THE CONFORM TO THE CURRENT SITE OF THE CONFORM TO CONFORM TO CONFORM TO CONFORM TO SUPPLEMENTAL DRAWINGS AND SPECIFICATIONS, UNLESS SPECIFICALLY STATED OTHERWISE IN WRITTEN SPECIFICATIONS AND ON DRAWINGS.
- IN CASES OF CONFLICT BETWEEN THE CLS AND THE MMCD. THE MORE STRINGENT REQUIREMENT WILL TAKE PRECEDENCE
- LANDSCAPE CONTRACTOR TO BE FAMILIAR WITH MUNICIPAL DEVELOPMENT STANDARDS AND BE IN POSSESSION OF THE CLS AND MMCD MANUALS AND SUPPLEMENTAL DRAWINGS AND
- WING MEDIUM AND GROWING MEDIUM TESTING TO CLS Section 6. IRRIGATION DESIGN AND INSTALLATION TO HARC STANDARDS AND CLS Section 5

COORDINATION:
1. CONTRACTOR TO COORDINATE INSTALLATION OF IRRIGATION AND ELECTRICAL SLEEVES WITH ARCHITECTURAL, MECHANICAL, ELECTRICAL AND CIVIL WORKS.

BMITTALS:

CONTRACTOR TO PROVIDE SAMPLES, TEST RESULTS AND SHOP DRAWINGS TO LANDSCAPE CONSULTANT FOR REVIEW AND APPROVAL 45 DAYS PRIOR TO INSTALLATION.
SEE ALSO SUBMITTALS TABLE BELOW FOR ADDITIONAL INFORMATION.

- GROWING MEDIUM TESTING:
 1. GROWING MEDIUM TEST RESULTS ARE MANDATORY.
 2. TEST RESULTS TO INCLUDE ANALYSIS OF ALL GROWING MEDIUM NUTRIENTS NOTED IN CLS 6.2,7 AND ARE TO BE REPORTED IN THE SAME UNITS AS NOTED IN THAT SECTION,
 3. TEST RESULTS TO INCLUDE ANALYSIS OF SOIL TEXTURE, ORGANIC CONTENT AND ACIDITY AS PER CLS 6.3,5 AND BE REPORTED IN THE SAME UNITS AS NOTED IN THAT SECTION,
 4. TEST RESULTS TO INCLUDE RECOMMENDATIONS FOR AMENDMENTS TO MEET THE REQUIREMENTS FOR EACH GROWING MEDIUM TYPE,
 5. RECOMMENDED GROWING MEDIUM TESTING FACILITY: PRACTIC SOIL Analysis Inc. 11720 Voyageur Way, Richmond, BC V6X 3G9,

COMPACTION TESTING:
1. COMPACTION TESTS FOR HARD SURFACE SUBGRADE, GRANULAR SUB-BASE, AND GRANULAR BASE ARE MANDATORY.

INSPECTIONS:
1. CONTRACTOR TO ALERT THE LANDSCAPE CONSULTANT A MINIMUM OF 3 WORKING DAYS PRIOR TO REQUIRED LANDSCAPE INSPECTIONS.

JESTITUTIONS:
REQUESTS FOR SUBSTITUTIONS TO CONFORM TO THE DIVISION 01 SECTION AND BE SUBMITTED TO THE LANDSCAPE CONSULTANT, THROUGH THE PROJECT ADMINISTRATOR, A MINIMUM OF 45 DAYS PRIOR TO SCHEDULED WORK.
PLEASE NOTE THAT SOME SUBSTITUTIONS MAY REQUIRE MUNICIPAL APPROVAL.

WARROWN 1.

CONTRACTOR SHALL WARRANTY ALL WORKMANSHIP AND MATERIALS FOR 1 FULL YEAR FOLLOWING THE DATE OF TOTAL PERFORMANCE AS PER MMCD UNLESS SPECIFICALLY NOTED OTHERWISE. FAULTY MATERIALS AND WORKMANSHIP SHALL BE PROMPTLY REPAIRED / REPLACED TO THE SATISFACTION OF THE LANDSCAPE CONSULTANT. ENVIRONMENTAL PROTECTION:
1. CONTRACTOR TO INSTALL AND MAINTAIN SEDIMENTATION FILTRATION MEASURES AS REQUIRED FOR LANDSCAPE WORKS TO PREVENT MATERIALS FROM LEAVING THE SITE AND / OR ENTERING STORM DRAINS; STOCKPILED LANDSCAPE MATERIALS ARE TO BE KEPT TARPED.

ELECTRICAL - DESIGN BUILD

- IT IS THE INTENTION OF THE PROJECT THAT THE LANDSCAPE CONTRACTOR FURNISH A FUNCTIONAL LIGHTING SYSTEM AS DESCRIBED ON THE DRAWINGS AND IN THIS SECTION.
- THE SCOPE OF WORK INCLUDES SUPPLY AND INSTALLATION OF LOW VOLTAGE LIGHTING STOLEMAS DESCRIBED ON THE DRAWINGS AND IN THIS SECTION.
 THE SCOPE OF WORK INCLUDES SUPPLY AND INSTALLATION OF LOW VOLTAGE LIGHTING PRODUCTS, CABLING, TRANSFORMERS) / POWER SUPPLIES / DRIVERS AND ELECTRICAL SLEEVES.
 ELECTRICAL CONTRACTOR IS TO INCLUDE POWER (CONDUIT AND CONDUCTORS) TO LOW VOLTAGE TRANSFORMERS) IN SUPPORT OF THE LANDSCAPE LIGHTING PLAN. THE
 NUMBER OF CONNECTION POINTS IS NOT DETERMINED THIS DEPENDS ON HOW THE LANDSCAPE CONTRACTOR LAYS OUT THE SYSTEM, BUT WILL NOT EXCEED 5, REFER TO THE
- LANDSCAPE LIGHTING PLAN FOR GENERAL INFORMATION.

 15A 1P CIRCUIT FROM HOUSE PANEL, SWITCHED BY A PROGRAMMABLE TIMER INSTALLED IN THE ELECTRICAL ROOM.

 TRANSFORMER TO BE ADEQUATELY SIZED FOR THE LOAD PLUS 40% RESERVE CAPACITY. TRANSFORMERS TO BE ARRANGED SUCH THAT NO LOAD REQUIRES WIRING IN EXCESS OF 75'.

 TIMER FUNCTION ON TRANSFORMER TO BE DISABLED IF PROVIDED.

 TRANSFORMERS, DRIVERS AND POWER SUPPLIES ANE TO BE INSTALLED IN GROUND JUNCTION BOXES, SUPPLIED AND INSTALLED BY THIS DIVISION.

 THE LANDSCAPE CONTRACTOR SHALL COORDINATE WITH THE ELECTRICAL CONTRACTOR FOR AC CIRCUIT TO EACH JUNCTION BOX LOCATION AND WITH THE GENERAL CONTRACTOR FOR THE INSTALLATION OF ELECTRICAL SLEEVES.

 THE USE OF GEL FILLED WIRE NUTS IS REQUIRED.

IRRIGATION COORDINATION:
1. ELECTRICAL CONTRACTOR TO COORDINATE WITH CONSTRUCTION MANAGER AND IRRIGATION DESIGNER/INSTALLER TO PROVIDE ELECTRICAL FOR THE OPERATION OF AN AUTOMATIC IRRIGATION SYSTEM AND CONTROLLER.

Table 1. Tree Inventory

| Previous | Tag or | Surveyed 7 | Condition | Shared, tay 8 | Each of City | City

FAIRFIELD ROAD

WINDMILL PALM REQUESTED TO BE
TRANSPLANTED / REMOVED BY LANDSCAPE
TO ALLOW FOR PLANTING OF LARGE CANOPY
TREE

TREE STATUS LEGEND

EXISTING TREE TO REMAIN

EXISTING TREE TO BE REMOVED

TREE PROTECTION FENCING
TO OUTSIDE OF PRIVAL WHERE
POSSIBLE AS SHOWN)
TO OUTSIDE OF PRIVAL WHERE
POSSIBLE AS SHOWN)
TO BE MAINTAINED UNTIL
COMPLETION OF CONSTRUCTION
TO MUNICIPAL STRADARD

PROTECTED TREE AND SHRUB FOR REMOVAL

MUNICIPAL TREE FOR REMOVAL



1608 Camosun Street, Victoria BC V8T 3E6 Info@biophiliacollective.ca 250 590 1156

IED/CLIENT.

ARYZE DEVELOPMENTS

ECT ADDRESS:

1733 FAIRFIELD, VICTORIA, BC

DESIGNED BY:BIANCA BODLEY DRAWN BY:TYLER YESTAL

NO.	ISSUE	YY\MM\DD
1	ISSUED FOR DEVELOPMENT TRACKER	22\03\04
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7	25% BUILDING PERMIT	2023\10\10
8	ISSUED FOR BP COORDINATION	2023/11/24
9	DP/RZ REV 4	2024/01/12
10	DP/RZ REV 5	2024/02/21
11	ISSUED FOR BUILDING PERMIT	2024/03/01
12	DP/RZ REV 6	2024/07/03

			Location		Name				Critical		Conditio	Condition		tion			
Previous tag #	Tag or	Surveyed ? (Yes / No)	(On, Off, Shared, City)	Bylaw protected ? (Yes / No / City)	Common	Botanical	dbh (cm)	Ht (m)	zone radius (m)	Dripline radius (m)	Health	Structural	Suitability (onsite trees)	Relative	General field observations/remarks	Tree retention comments	Retention
	OS2	Yes	Off	No	Emerald cedar	Thuja occidentalis 'smaragd'	10~	4	1.3	0.5	Fair	Fair		Moderate	Juvenile hedge tree growing within narrow planting strip.	"Parking stall proposed within the crz. Project arborist to supervise all excavation required within the crz.	Retain*
	OS3	Yes	Off	No	Honey locust	Gleditsia triacanthos	10~	8	1.3	2	Good	Good		Moderate	Juvenile hedge tree growing within narrow planting strip.	Project arborist to supervise all excavation required within the crz.	Retain
	OS4	Yes	Off	No	Emerald cedar	Thuja occidentalis 'smaragd'	5, 5, 5, 5~	5	1.4	1	Good	Fair		Moderate	Multiple stems hedge tree growing within narrow planting strip.	Project arborist to supervise all excavation required within the crz.	Retain
	085	Yes	Off	No	Emerald cedar	Thuja occidentalis 'smaraod'	8, 8, 10, 4~	5	2.5	1	Good	Fair		Moderate	Multiple stems hedge tree growing within narrow planting strip.	*Parking stall proposed within the crz. Project arborist to supervise all excavation required within the crz.	Retain*
	OS6	Yes	Off	No	Cherry	Prunus sp.	8, 6,	5	1.9	1	Good	Fair		Moderate	Flowering cherry, growing within narrow planting strip.	"Parking stall proposed within the crz. Project arborist to supervise all excavation required within the crz.	Retain*
	Hedge 2	Yes	On	No	Emerald cedar	Thuja occidentalis 'smaragd'	5 - 10cm	5	0.5	0.5	Good	Fair		Moderate	Hedge row consisting of 14 individual stems. No bylaw stems.	Will be heavily impacted by excavation required to construct the proposed parking stalls	Remove
	OS7	Yes	Off	No	Japanese maple	Acer palmatum	5. 5. 5. 4. 4	5	1.4	2	Good	Fair		Moderate	Multiple stems form at .5m above grade.	Project arborist to supervise all excavation required within the crz.	Retain
	3422	No	On	No	Windmill palm	Trachycarpus fortunei	29	4	30	2	Good	Fair	Unsuitable	Good	Crown raised approx. 50%	"Parking stall proposed within the crz. Possible for retention or transplanted elsewhere. Project arborist to supervise all excavation required within the crz.	Retain*

BEECHWOOD AVENUE

NOTE: SEE ORIGINAL TREE INVENTORY AND TABLES IN REPORT PREPARED BY TALBOT & MACKENZIE

BOULEVARD TREE M2 TO BE REMOVED AND RELOCATED BY CITY OF VICTORIA FOR INSTALLATION OF PROPOSED WATER CONNECTION (SEE CIVIL). REMOVAL TO BE PAID FOR BY DEVELOPER.



NORTH ARROW




DRAWING TITLE:

TREE REMOVAL & PROTECTION PLAN

VG NO:

L0.1

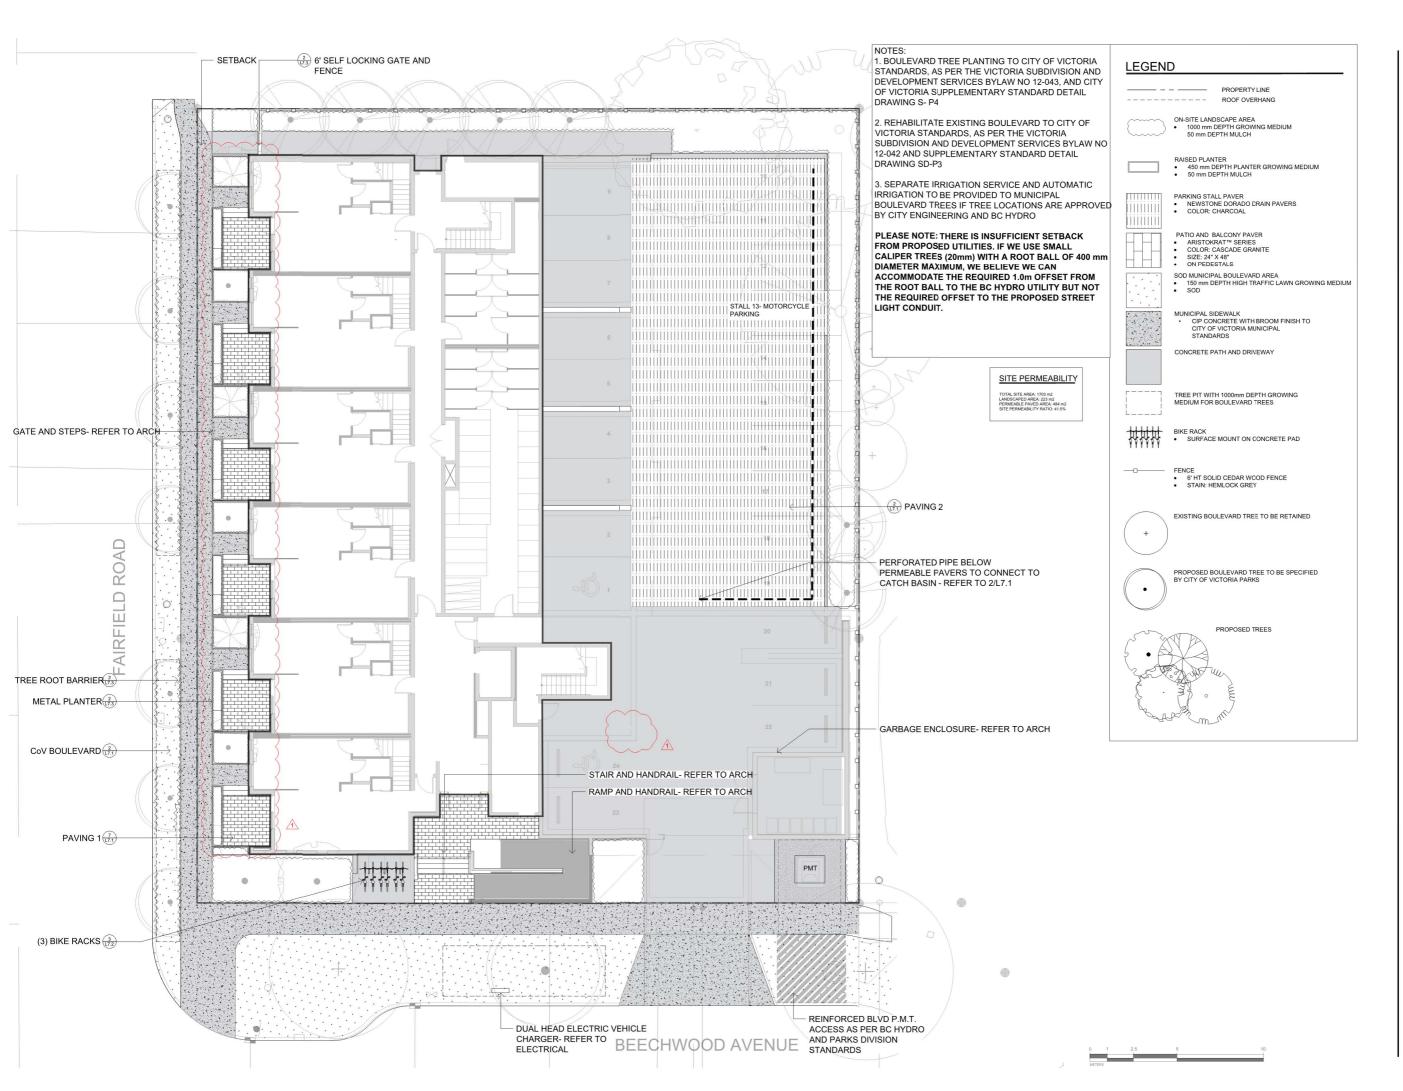



1608 Camosun Street, Victoria BC V8T 3E6

IED/OLIENT

ARYZE DEVELOPMENTS

ECT ADDRESS:

1733 FAIRFIELD, VICTORIA, BC

DESIGNED BY:BIANCA BODLEY DRAWN BY:TYLER YESTAL

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9	DP/RZ REV 4	2024/01/12
10	DP/RZ REV 5	2024/02/21
11	ISSUED FOR BUILDING PERMIT	2024/03/01
12	DP/RZ REV 6 1	2024/07/03




NORTH ARROW

DRAWING TITLE:

LANDSCAPE MATERIALS
PLAN
LEVEL 1

DWG NO:

L1.1

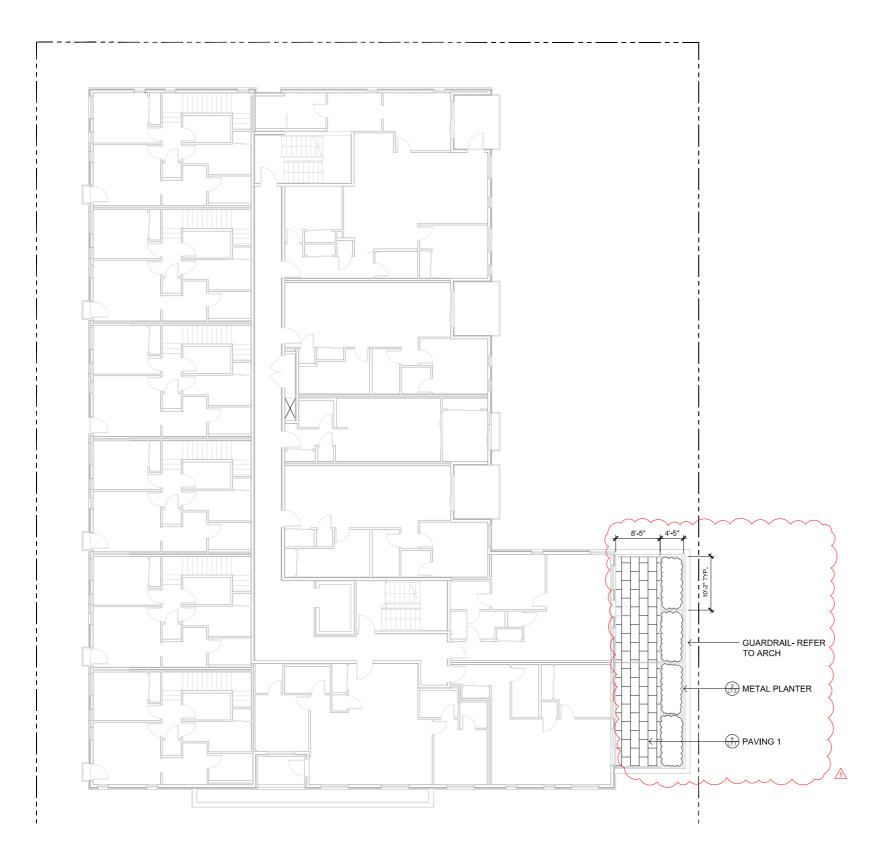

1 LEVEL 2 BALCONY & PLANTER 1:100



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NED/CLIENT:

ARYZE DEVELOPMENTS

ROJECT ADDRESS

1733 FAIRFIELD, VICTORIA, BC

ESIGNED BY: BIANCA BODLEY
RAWN BY: TYLER YESTAL

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10	DP/RZ REV 5	2024/02/2
11	ISSUED FOR BUILDING PERMIT	2024/03/01
12	DP/RZ REV 6 1	2024/07/03









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LANDSCAPE MATERIALS AND LAYOUT PLAN LEVELS 2, 3, & 4

DWG NO:

SCALE: AS NOTED L 1.2



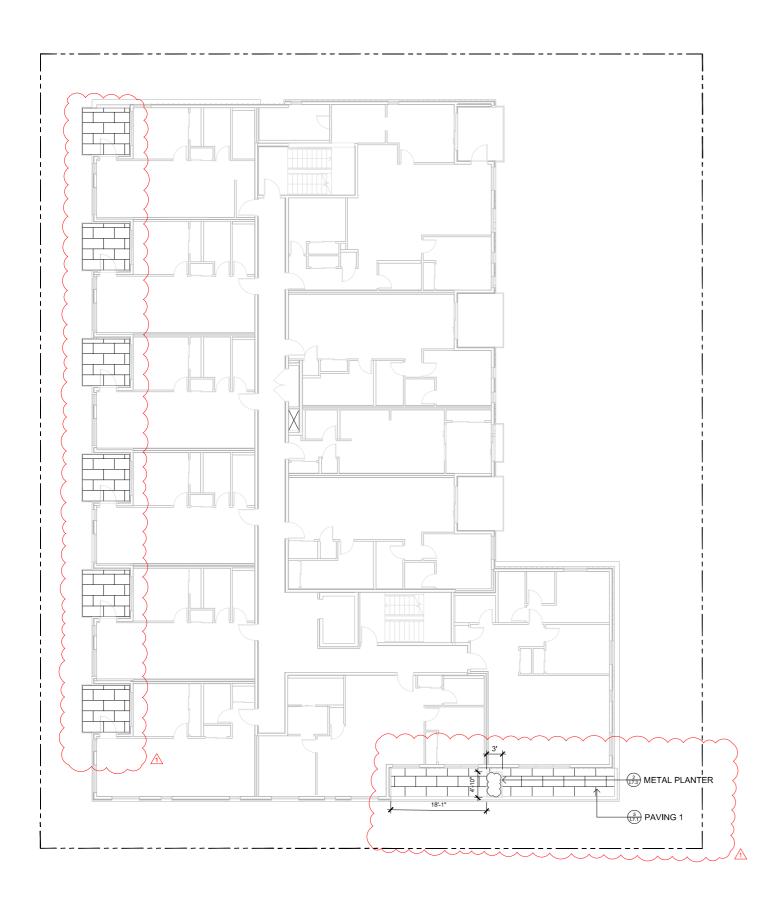

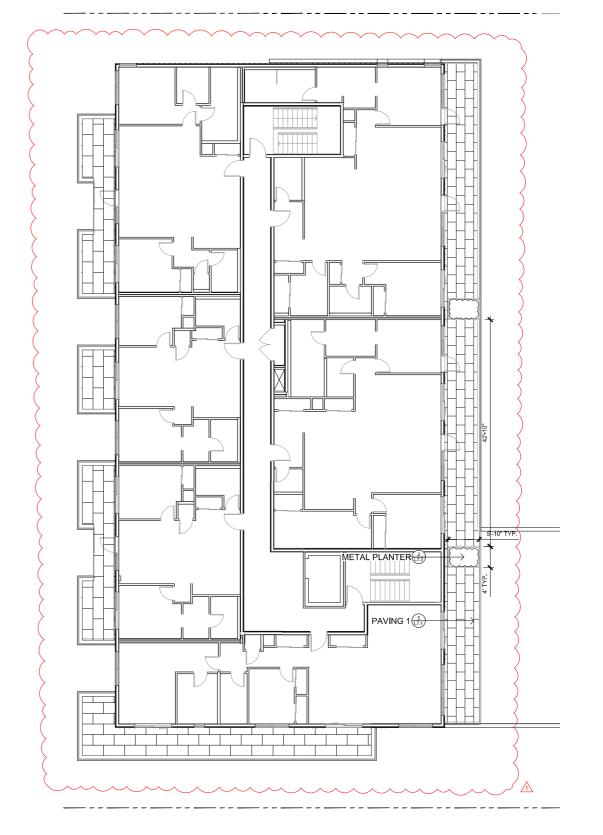2 LEVEL 4 BALCONY & PLANTER 1:100

0 1 2.5 5 10 METERS



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DESIGNED BY:BIANCA BODLEY DRAWN BY:TYLER YESTAL

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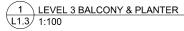





DRAWING TITLE

LANDSCAPE MATERIALS AND LAYOUT PLAN LEVELS 2, 3, & 4

DWG NO:
SCALE: AS NOTED 1 2



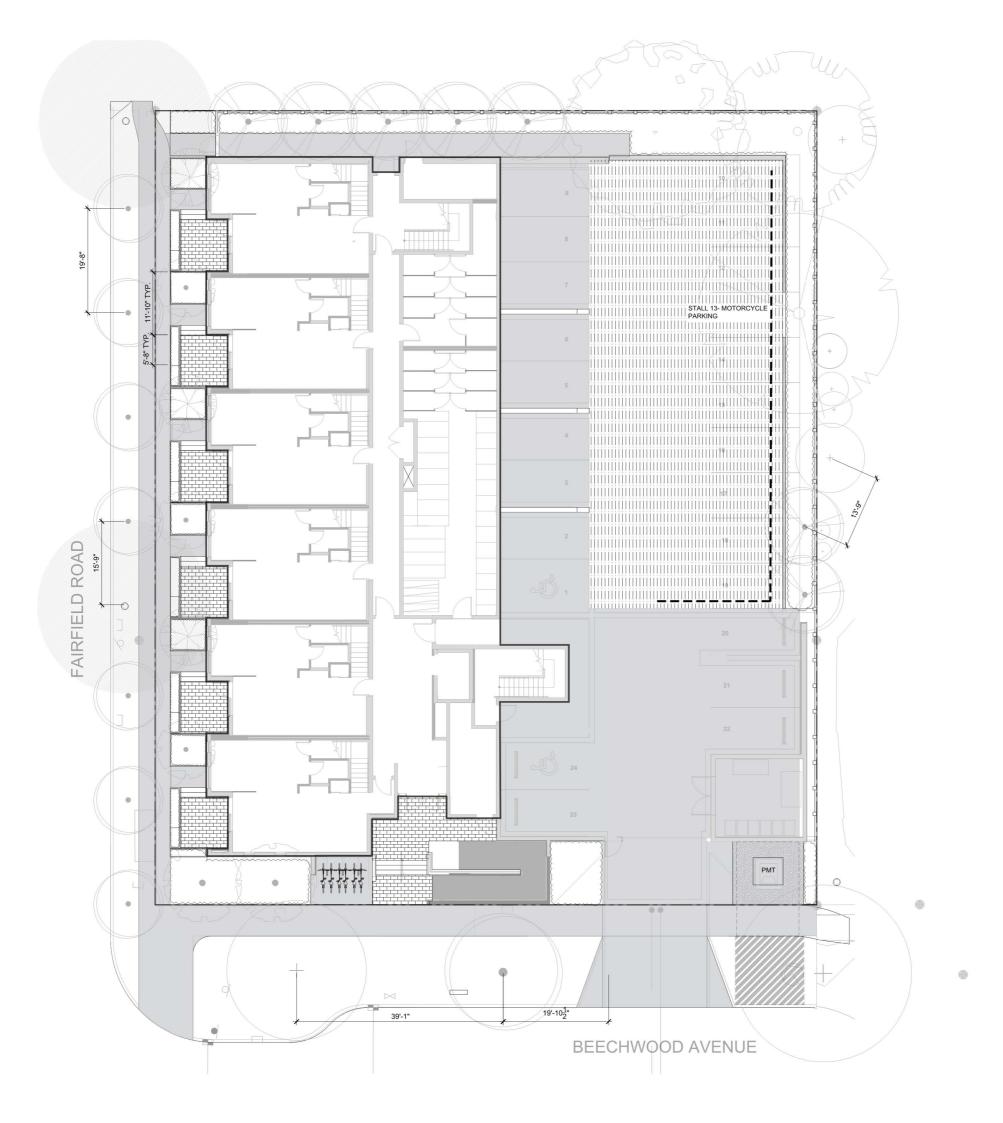



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ARYZE DEVELOPMENTS

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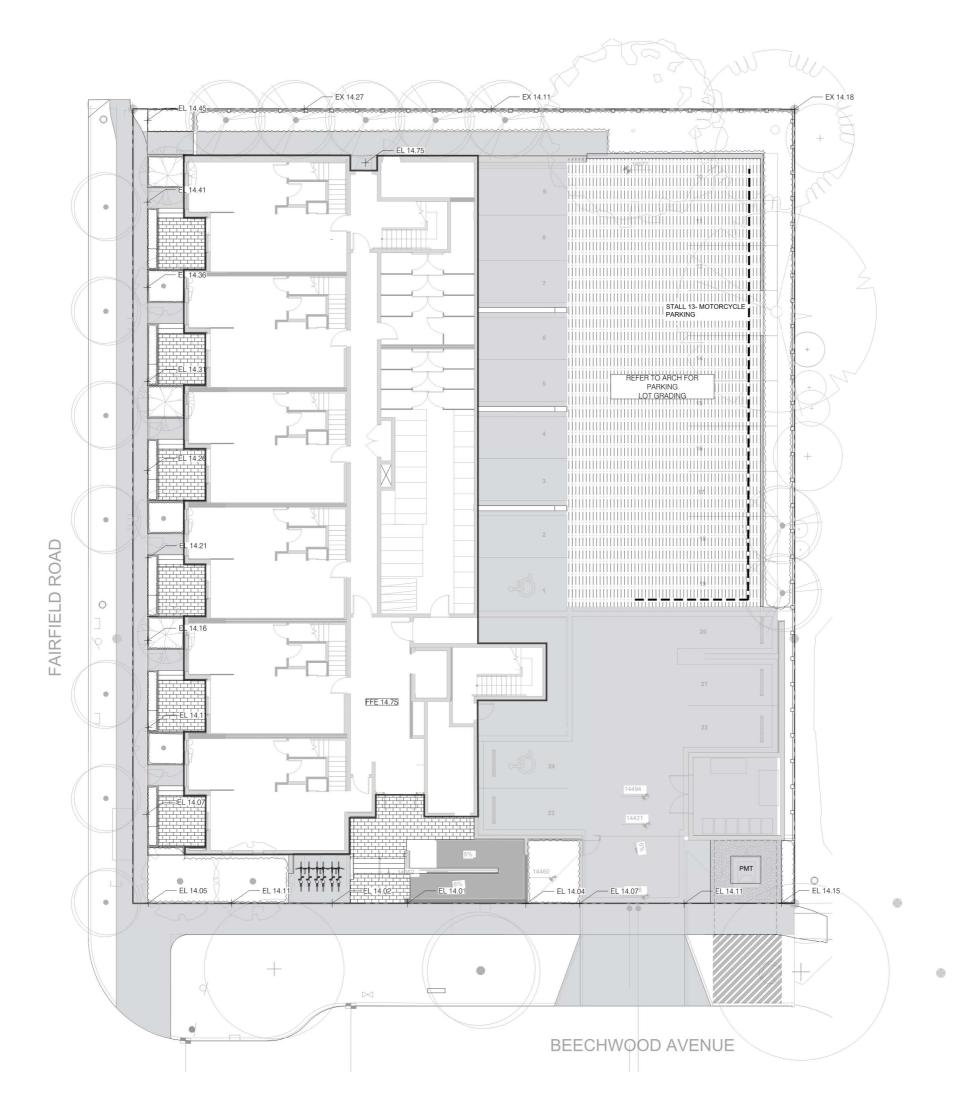
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11	ISSUED FOR BUILDING PERMIT	2024/03/01
12	DP/RZ REV 6	2024/07/03



LAYOUT PLAN NOTES

ALL DIMENSIONS ARE NOMINAL REFER TO GRADING PLAN FOR ELEVATIONS ALL SITE TURNISHINGS TO BE CONFIRMED WITH LANDSCAPE ARCHITECT PRIOR TO INSTALLATION

LAYOUT PLAN





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WIED OUT THAT

ARYZE DEVELOPMENTS

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12	DP/RZ REV 6	2024/07/03



NORTH ARROW



DRAWING TITLE:

GRADING PLAN NOTES

ALL ELEVATIONS ARE NOMINAL. CONTRACTOR TO VERIFY SPOT ELEVATION PRIOR THE START OF CONSTRUCTION.

ALL ELEVATIONS ARE TO TOP OF FINISHED GRADE UNLESS NOTED OTHERWISE.


REFER TO CIVIL FOR ALL OFFISITE AND PARKING LOT GRADING.

REFER TO ARCH FOR ONSITE HARDSCAPE GRADING.

GRADING PLAN

DWG NO:

L3.′

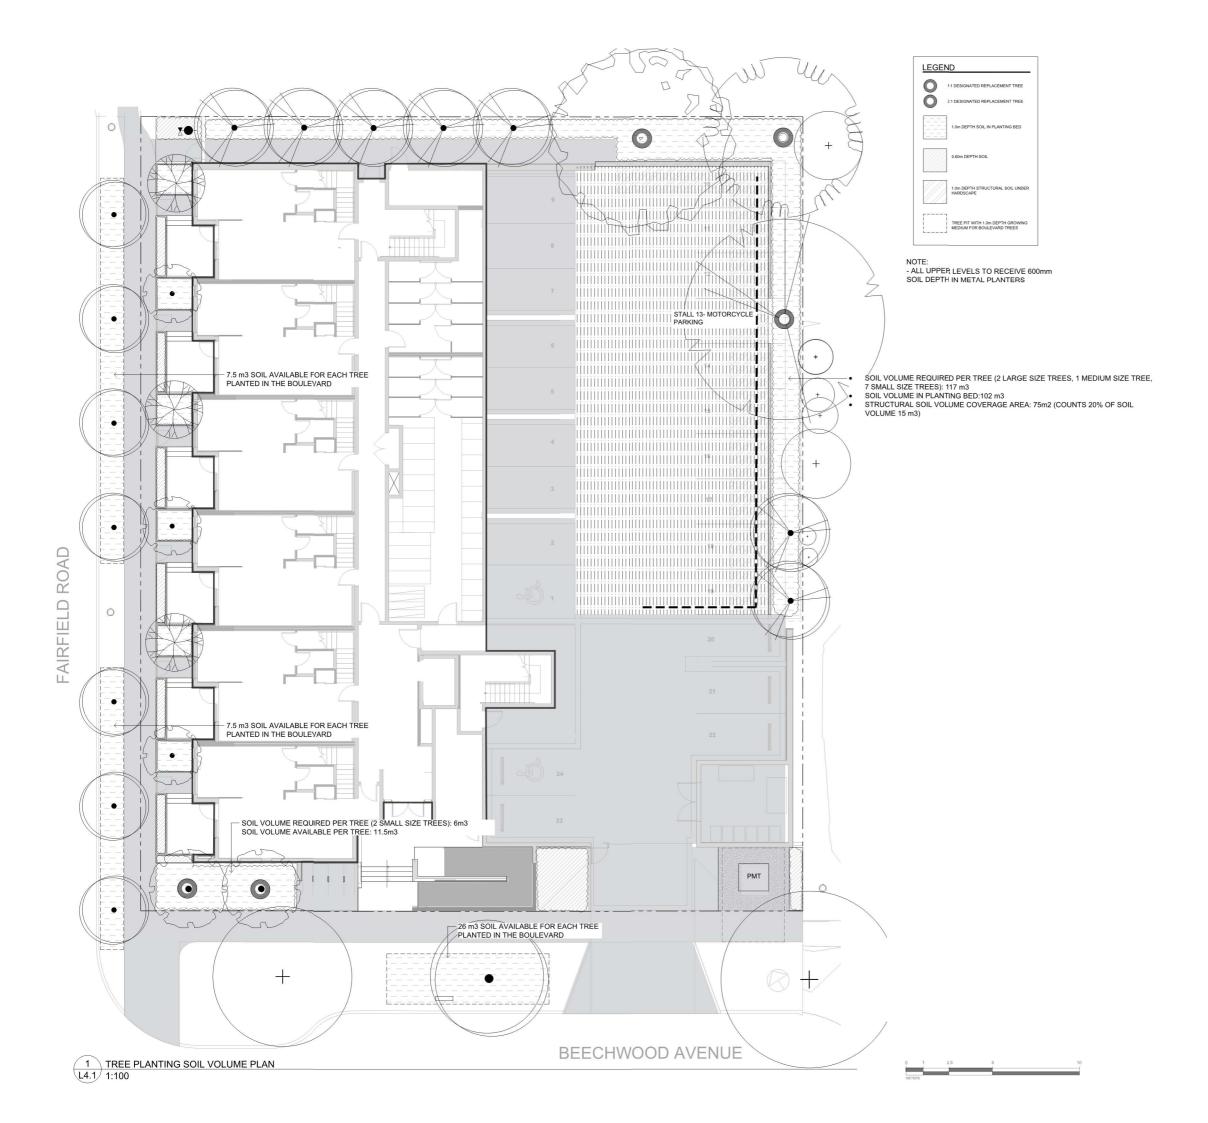



1608 Camosun Street, Victoria BC V8T 3E6 Info@biophiliacollective.ca 250 590 1156

IED/OLIENT

ARYZE DEVELOPMENTS

OJECT ADDRESS:

1733 FAIRFIELD, VICTORIA, BC

ESIGNED BY: BIANCA BODLEY
RAWN BY: TYLER YESTAL

NO.	ISSUE	YY\MM\DD
1	ISSUED FOR DEVELOPMENT TRACKER	22\03\04
2	ISSUED FOR RZ/DP	22\05\02
3	ISSUED FOR COORDINATION	22\07\18
4	ISSUED FOR RZ/ DP	22\07\20
5	ISSUED FOR RZ/ DP RESUBMISSION	23\01\24
6	ISSUED FOR RZ/ DP RESUBMISSION	2023\08\18
7	25% BUILDING PERMIT	2023\10\10
8	ISSUED FOR BP COORDINATION	2023/11/24
9	DP/RZ REV 4	2024/01/12
10	DP/RZ REV 5	2024/02/21
11	ISSUED FOR BUILDING PERMIT	2024/03/01
12	DP/RZ REV 6	2024/07/03




NORTH ARROW


DRAWING TITLE:

SOIL VOLUME PLAN

DWG NO:

SCALE: AS NOTED L4 1

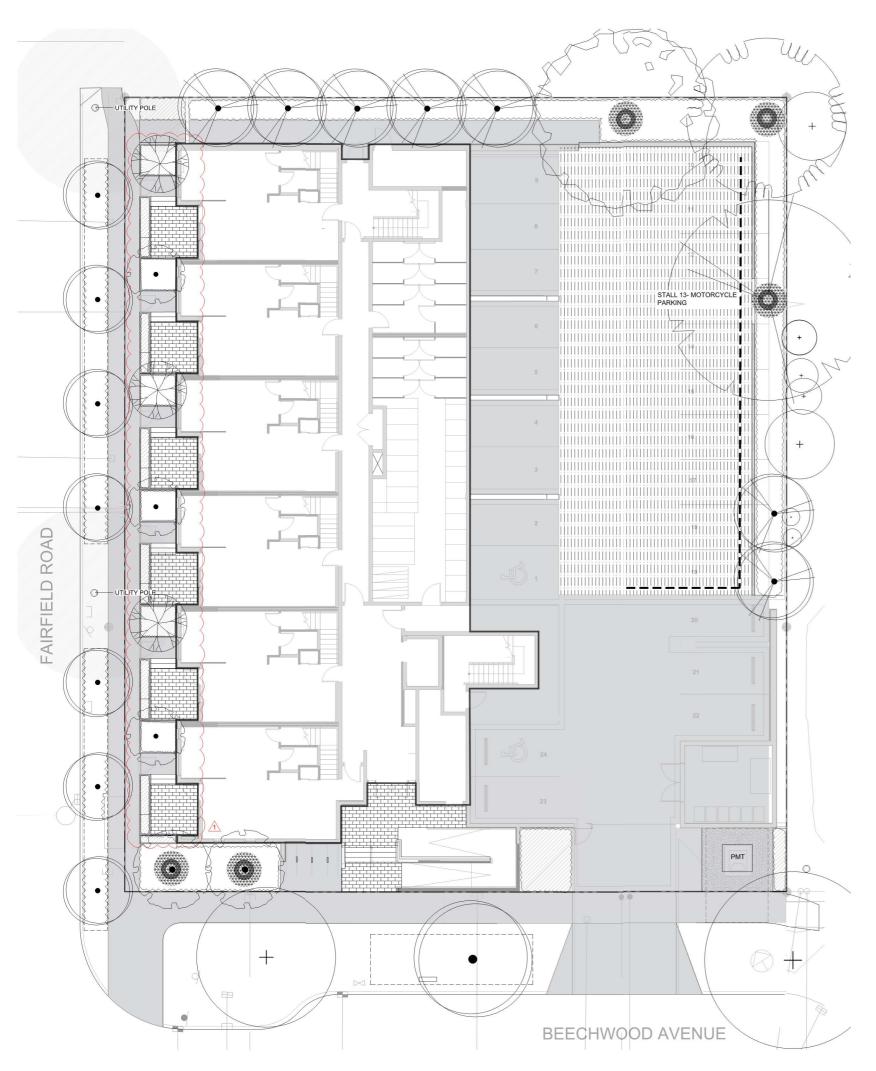

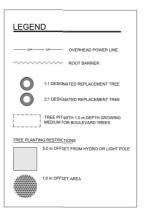

Quantity	Symbol	Latin Name	Common Name	Container	Caliper	Size	Native
5	Service Servic	Acer griseum	Paperbark Maple	B&B	6 cm	>2 m	
1	AND THE STATE OF T	Fraxinus americana 'Autumn Applause'	Autumn Applause white ash	B&B	6 cm	>2 m	
1		Liriodendron tulipifera	Tulip tree	B&B	6 cm	>2 m	
7	\bigcirc	Parrotia persica 'Ruby Vase'	Ruby Vase Parrotia	B&B	6 cm	>2 m	
3		Styrax japonicus	Japanese snowbell	B&B	6 cm	>2 m	
1		Quercus palustris	Pin Oak	B&B	6 cm	>2 m	
8	$\overline{(\cdot)}$	BCULEVARD TREE TO BE DETERMINED BY PARKS AT BP		B&B	TBD		

TREE IMPACT SUMMARY TABLE							
TREE STATUS	TOTAL	TO BE RETAINED	TO BE REMOVED	REPLACEMENTS REQUIRED	MINIMUM REQUIRED FOR LOT SIZE	PRCPOSED	
ON-SITE TREES AND SHRUBS BYLAW PROTECTED	7	0	7	7	9	4	
MUNICIPAL TREES	3	2	1	1		8	
NEIGHBORING TREES, BYLAW PROTECTED	0	0	0	0		0	

ACTUAL NUMBER : 5 2 x LARGE TREE (1:1) 1 x MEDIUM TREE (1:1) 2 x SMALL TREE (2:1)

REPLACEMENT TREES TO BE PLANTED ON SITE	4
REPLACEMENT TREE SHORTFALL	3
TOTAL PROPOSED TREES ON SITE (REPLACEMENT (ACTUAL) + OTHER)	18

- IRRIGATION SYSTEM ON CITY PROPERTY SHALL COMPLY TO CITY OF VICTORIA SUPPLEMENTARY SPECIFICATIONS FOR STREET TREES AND IRRIGATION SCHEDULE C, BYLAW 12-042, SUBDIVISION BYLAW. IRRIGATION DRAWINGS MUST BE SUBMITTED TO PARKS DIVISION FOR REVIEW AND APPROVAL 30 DAYS PRIOR TO INSTALLATION WORK. THE FOLLOWING IRRIGATION AND SLEEVING INSPECTIONS BY PARKS STAFF ARE REQUIRED BY SCHEDULE C.
- IRRIGATION INSPECTION REQUIREMENTS:

 a. THE IRRIGATION SYSTEM AND SLEEVING INSPECTION REQUIREMENTS CAN BE FOUND IN SCHEDULE C OF THE VICTORIA SUBDIVISION AND DEVELOPMENT SERVICING BYLAW NO. 12-042.
- IRRIGATION SLEEVING PRIOR TO BACKFILLING*
- OPEN TRENCH MAIN LINE AND PRESSURE TEST
- OPEN TRENCH LATERAL LINE
 IRRIGATION SYSTEM, CONTROLLER, COVERAGE TEST, BACKFLOW PREVENTER ASSEMBLY TEST REPORT REQUIRED, BACKFLOW ASSEMBLY IS TO HAVE AN INSPECTION TAG COMPLETED AND ATTACHED.
- 100MM SDR 28 PIPE WILL BE USED FOR IRRIGATION SLEEVING UNDER HARD SURFACES. INSTALLATIONS WHERE A 90-DEGREE BEND IS REQUIRED SHOULD BE INSTALLED USING 100MM SDR 28 GSX (22.5 DEGREE) LONG SWEEPS. INSTALL WILL BE AT 400MM DEPTH.





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ARYZE DEVELOPMENTS


1733 FAIRFIELD, VICTORIA, BC

DESIGNED BY:BIANCA BODLEY DRAWN BY: TYLER YESTAL

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11	ISSUED FOR BUILDING PERMIT	2024/03/01
12	DP/RZ REV 6 1	2024/07/03



TREE PLANTING PLAN

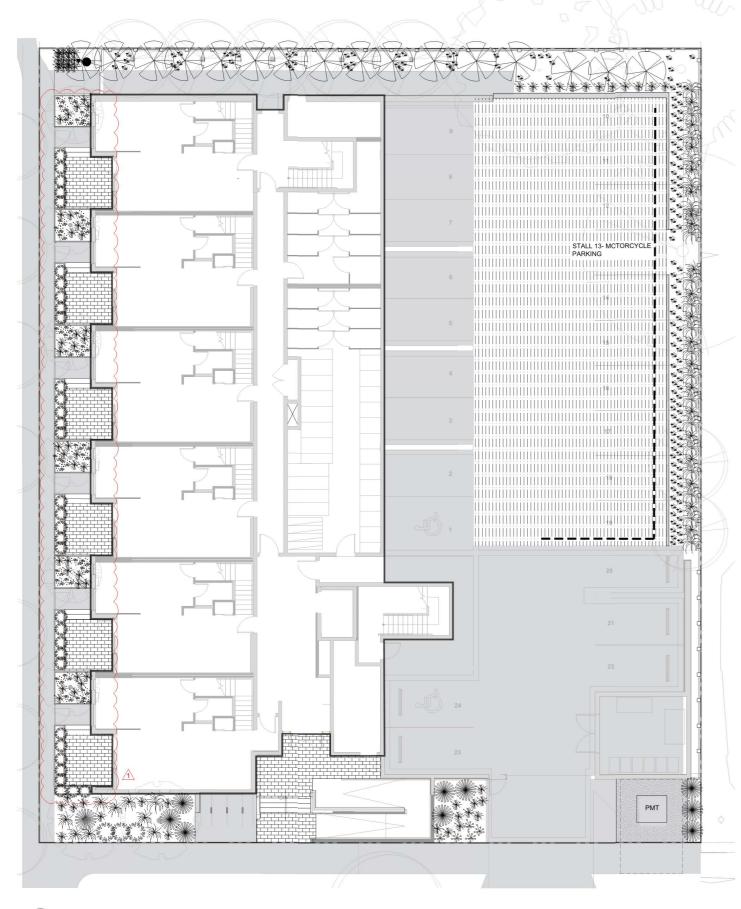

Quantity	Symbol	Latin Name	Common Name	Container	Native	Pollinator
12	***	Armeria maritima 'Alba'	White-flowered Thrift	10cm		у
182	***	Arctostaphylos Uva-Ursi 'Massachusetts'	Kinnikinnick	10cm	у	у
69	*	Carex testacea 'Prairie Fire'	New Zealand hair sedge	#1		
10		Cephalotaxus harringtonia 'Prostrata'	Spreading Japanese plum yew	#2		
16		Choisya ternata	Mexican mock orange	#3		у
36	AN WA	Hebe pinguifolia 'Sutherlandii'	Hebe Sutherlandii	#1		
30	*	Miscanthus sinensis 'Huron Light'	Huron Light maiden grass	#1		
20	*	Miscanthus sinensis 'Morning Light'	Chinese silver grass Morning Light	#1		
5	. He	Verbena bonariensis 'Lollipop'	Dwarf purpletop	#1		Υ

NOTES:

1. PLANTS IN PLANT LISTS ARE SPECIFIED ACCORDING TO THE CANADIAN NURSERY LANDSCAPE
ASSOCIATION CANADIAN STANDARDS FOR NURSERY STOCK AND SECTION 12, CONTAINER GROWN
PLANTS FROM THE BC LANDSCAPE STANDARD, CURRENT EDITION.

- ALL PLANT MATERIAL TO BCSLA STANDARDS.
 THE SEARCH ARE FOR PLANT MATERIAL IS THE PACIFIC NORTHWEST INCLUDING WASHINGTON, OREGON AND BRITISH COLUMBIA.
 CONFIRM PLANTING LAYOUT WITH LANDSCAPE ARCHITECT ON SITE.
 ALL SOIL VOLUMES TO MEET THE STANDARDS OF THE CITY OF VICTORIA. REFER TO SOIL DEPTH PLANS FOR SOIL DEPTH REQUIREMENTS.
 ALL GROWING MEDIUM PROVISION AND INSTALLATION TO BE IN LINE WITH CANADIAN LANDSCAPE STANDARDS.
- STANDARDS
 REFER TO CIVIL AND MECHANICAL FOR DRAINS.
 ALL ONSITE AND OFF-SITE LANDSCAPE AREAS TO BE IRRIGATED BY AN UNDERGROUND AUTOMATIC IRRIGATION SYSTEM IRRIGATION TO BE SUPPLIED BY CONTRACTOR
 PLANTING AROUND EXISTING CRITICAL TREE ROOT ZONES TO BE INSTALLED UNDER THE SUPERVISION OF A CERTIFIED ARBORIST.



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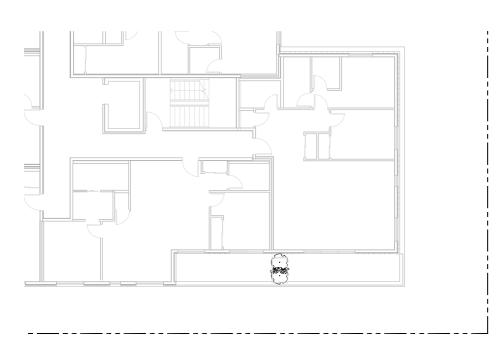


SHRUB PLANTING PLAN LEVEL 1






1 LEVEL TWO PLANTING PLAN L6 1:100



2 LEVEL THREE PLANTING PLAN L6 1:100

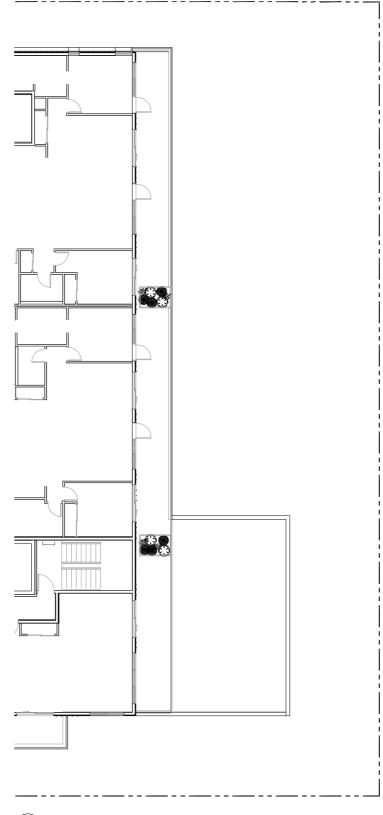

3 LEVEL FOUR PLANTING PLAN
1:100

PLANT S	SCHEDULE					
Quantity	Symbol	Latin Name	Common Name	Container	Native	Pollinato
6	*	Armeria maritima 'Alba'	White-flowered Thrift	10cm		у
10	$\langle \cdot \rangle$	Choisya ternata	Mexican Orange Blossom	#3		у
6	•	Pinus strobus 'Horsford Dwarf'	Horsford Dwarf Eastern white pine	#2		
4	The Market of the Control of the Con	Rhododendron x	Bloom-A-Thon® White Reblooming Azalea	#1		у
8	Jugo	Parthenocussus quinquefolia	Virginia Creeper	#2	·	·

NOTES:

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PLANTS FROM THE BC LANDSCAPE STANDARD, CURRENT EDITION.

- PLANTING PLAN NOTES

 1. ALL PLANT MATERIAL TO BCSLA STANDARDS.
 2. THE SEARCH ARE FOR PLANT MATERIAL IS THE PACIFIC NORTHWEST INCLUDING WASHINGTON, OREGON AND BRITISH COLLMBIA.
 3. CONFIRM PLANTING LAYOUT WITH LANDSCAPE ARCHITECT ON SITE.
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 7. ALL ONSITE AND OFF-SITE LANDSCAPE AREAS TO BE IRRIGATED BY AN UNDERGROUND AUTOMATIC IRRIGATION SYSTEM. RIRIGATION TO BE SUPPLIED BY CONTRACTOR
 8. PLANTING AROUND EXISTING CRITICAL TREE ROOT ZONES TO BE INSTALLED UNDER THE SUPERVISION OF A CERTIFIED ARBORIST.





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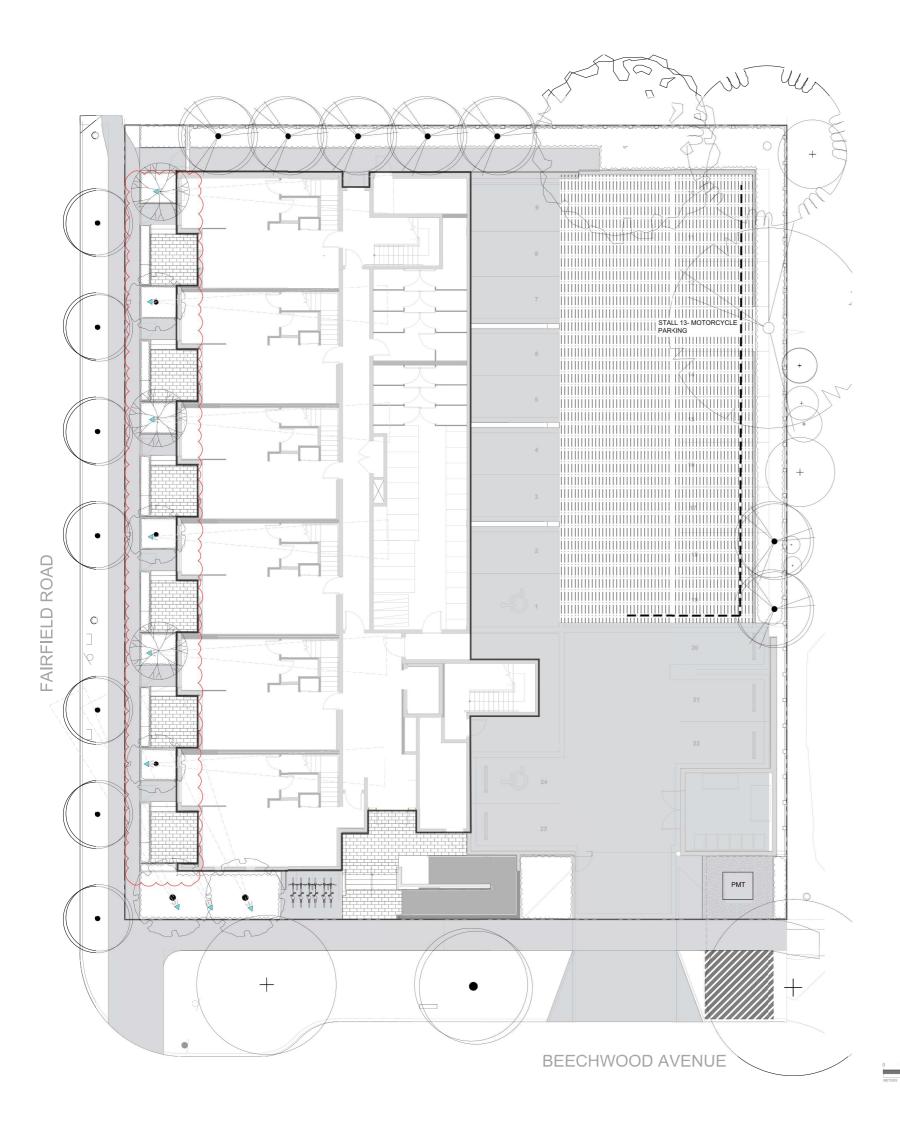
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12	DP/RZ REV 6	2024/07/03







SHRUB PLANTING PLAN LEVELS 2, 3, & 4



LIGHTING SCHEDULE

⊲∈

MANUFACTURER/MODEL/DESCRIPTION WAC Landscape Lighting 5111

QTY DETAIL

LED Accent Mini Landscape Spotlight Order code: 5111, Aluminum Alloy, (BK) Black on Aluminum, Mounting

Lamp: 5111 Integrated LED, 18W|23VA, 2700K, Beamspread: Narrow Accessories: Additional Mounting Stake



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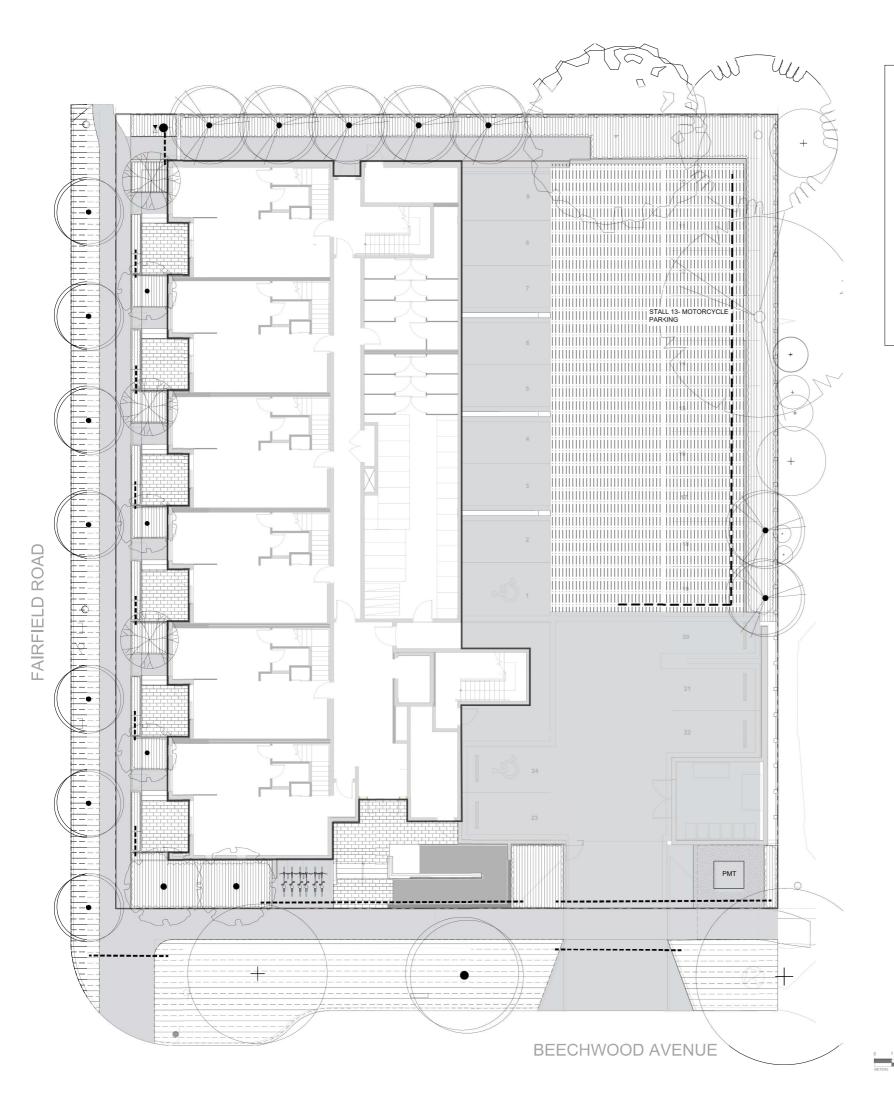
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6	ISSUED FOR RZ/ DP RESUBMISSION	2023\08\1
7	25% BUILDING PERMIT	2023\10\1
8	ISSUED FOR BP COORDINATION	2023/11/2
9	DP/RZ REV 4	2024/01/1
10	DP/RZ REV 5	2024/02/2
11	ISSUED FOR BUILDING PERMIT	2024/03/0
12	DP/RZ REV 6	2024/07/0





LANDSCAPE LIGHTING PLAN

LEVEL 1



LEGEND

THE SIZE OF THE INTERIOR PIPE OF MIN. 50MM DIA.

HOSE BIB

SHUT OFF VALVE

2" PVC POINT OF CONNECTION

AREA TO RECEIVE DRIPLINE- RAIN BIRD XFS-CV-09-12 SUB-SURFACE LANDSCAPE DRIPLINE WITH A HEAVY-DUTY, 3 BAR CHECK VALVE, 3.41 LPH EMITTERS AT 30CM O.C. DRIPLINE LATERALS SPACED AT 30CM APART, WITH EMITTERS OFFSET FOR TRIANGULAR PATTERMN, SPECIFY XF INSERT FITTINGS

TREES IN THIS AREA TO RECEIVE ROTOR

NOTES

- IRRIGATION PLANS TO BE UPDATED PRIOR TO IFC.
- OFFSITE TREES TO BE IRRIGATED BY SEPARATE
IRRIGATION SYSTEM.
- ALL OFFSITE IRRIGATION TO FOLLOW THE CITY OF
VICTORIA STANDARDS
- IRRIGATION DRIPLINE TO BE INSTALLED SUB-SURFACE
AND SLEEVED UNDER METAL PLANTERS
REFER TO MECHANICAL FOR HOSEBIB LOCATIONS



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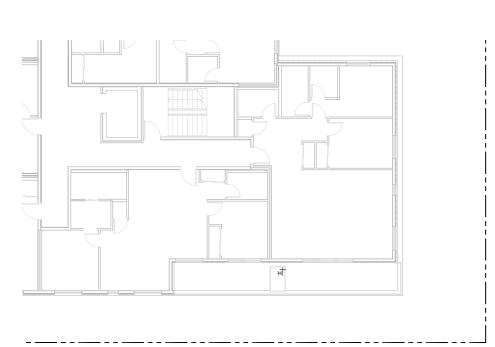





IRRIGATED AREAS PLAN

LEVEL 1






2 LEVEL THREE IRRIGATION PLAN 1:100

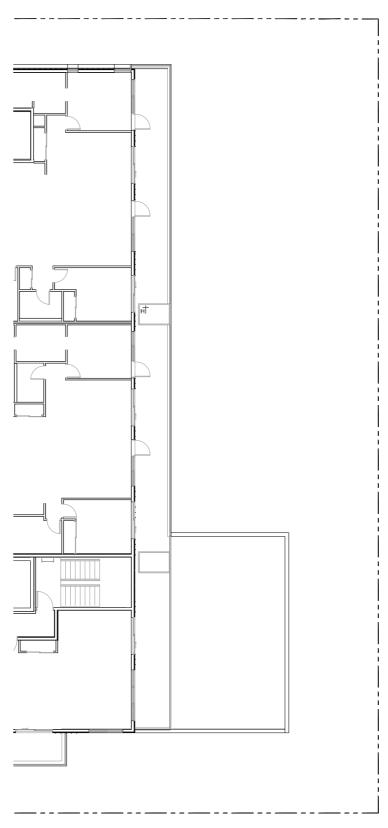

3 LEVEL FOUR IRRIGATION PLAN 1:100

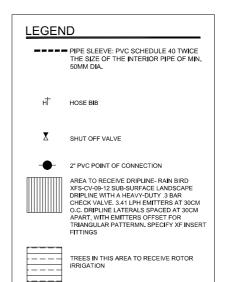

NOTES

- INDITES

 IRRIGATION PLANS TO BE UPDATED PRIOR TO IFC.
 OFFSITE TREES TO BE IRRIGATED BY SEPARATE
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 IRRIGATION DRIPLINE TO BE INSTALLED SUB-SURFACE
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 REFER TO MECHANICAL FOR HOSEBIB LOCATIONS



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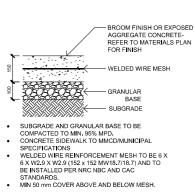
3 ISSUED FOR RZ/DP

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9 DPIRZ REV 4
10 DPIRZ REV 5
11 ISSUED FOR BUILDING PERMIT
12 DPIRZ REV 6






IRRIGATED AREAS PLAN LEVELS 2, 3, & 4




1 CIP CONCRETE

1:10

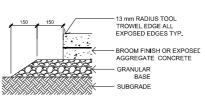




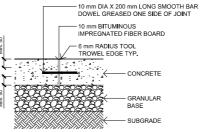

BAR DOWELS @ 450 mm O.C. AND STARTING 300 mm FROM OUTSIDE EDGE OF CONCRETE - CENTER IN CONCRETE SLAB (MIN. 50 mm COVER)




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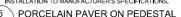
JOINT DEPTH 1/3 SLAB THICKNESS CONTROL JOINT MAXIMUM SPACING 3.0 m JOINTING PATTERN AS PER LAYOUT PLAN

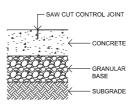
 REFER TO PAVER MANUFACTURER FOR INSTALLATION
CONTROL JOINT MAXIMUM SPACING 3.0 m
JOINTING PATTERN AS PER LAYOUT PLAN






PRIOR TO INSTALLATION, CONTRACTOR TO CONFIRM WITH ARCHITECTURAL / MEMBRANE CONSULTANT IF PROTECTION BOARD IS REQUIRED FOR PAVER PEDESTAL INSTALLATION; IF PROTECTION BOARD IS REQUIRED AND HAS NOT BEEN INSTALLED BY ARCHITECTURAL, CONTRACTOR TO NOTIFY GENERAL CONTRACTOR. ADJUSTABLE PEDESTALS TO BE BlackJack OneStep or BlackJack ScrewJack PEDESTALS AS REQUIRED OR APPROVED EQUAL. INSTALLATION TO MANUFACTURER'S SPECIFICATIONS.

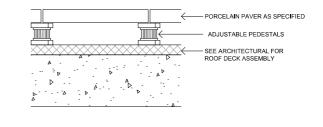


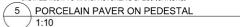


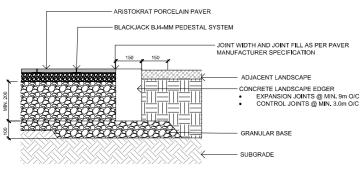

- SUBGRADE AND GRANULAR BASE TO BE COMPACTED TO MIN.
- 95% MPD.
 CONCRETE TO MMCD SPECIFICATION UNLESS NOTED



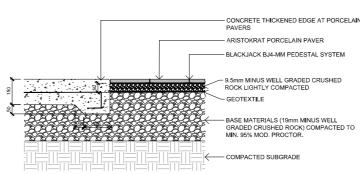

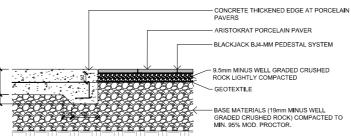

7 PAVER 1

Aristokrat® Series

The Aristokrat® Series is perfect for terraces, roof decks, patios, court yards, swimming pools, water features or any traditional hardscape areas. Porcelain slabs deliver performance, style, versatility and are resistant to staining, fading, marking, chemicals and extreme weather. It is the ideal choice for residential or commercial outdoor applications but can also be used indoors for aesthetic continuity.









COLORS











NEWSTONE --




1:10

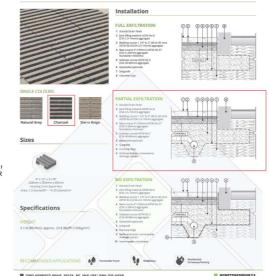

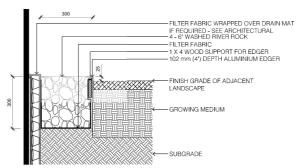

9 DRIP STRIP / 1.10

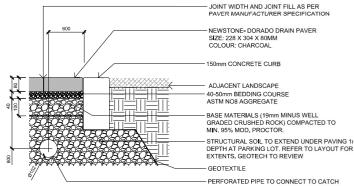

- SUBGRADE AND GRANULAR BASE TO BE COMPACTED TO MIN. 95% MPD. GRANULAR BASE TO BE COMPACED IN MAX. 100mm LIFTS.
 PAVER AND PAVER INSTALLATION TO MMCD AND MANUFACTURER'S

- PAVER AND PAVER INSTALLATION TO MINUS AND MANDFACTURERS
 SPECIFICATION UNLESS NOTED OTHERWISE.
 GEOTECH TO REVIEW PRIOR TO INSTALLATION.
 REFER TO CIVIL FOR CATCH BASIN LOCATIONS,
 DIAMETER OF PERFORATED PIPE TO BE DETERMINED BY STORMWATER ENGINEER.





BI

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ARYZE DEVELOPMENTS

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ISSUED FOR DEVELOPMENT


ISSUED FOR RZ/ DP

ISSUED FOR RZ/ DP RE 7 25% BUILDING PERMIT 8 ISSUED FOR RZ/ DP REV 8 ISSUED FOR RZ/ DP REV 6

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NORTH ARROW

DRAWING TITLE **PAVING DETAILS**

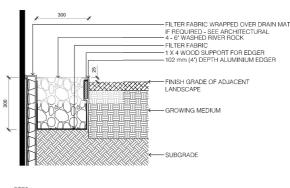



- IOTES:

 LANDSCAPE EDGER TO BE: PERMALOC CleanLine Commercial Grade Landscape Edging OR APPROVED EQUAL.

 4.8mm (3/16") THICKNESS: 102mm (4") HEIGHT; 4.8m (16") LENGTH; NATURAL MILL FINISH; 305mm (12") STAKE.
 INSTALL EDGER AS PER MANUFACTURER'S INSTRUCTIONS.
 IX 4 WOOD SUPPORT TO BE STAKED IN PLACE AND USED TO ENSURE EDGER IS INSTALLED IN A STRAIGHT
 LINE AND MAINTAINS A STRAIGHT ALIGNMENT DURING THE INSTALLATION OF GROWING MEDIUM AND RIVER
 ROCK. MAY BE SCAPA WOOD AS LONG AS IT IS STRAIGHT.


 FILTER FABRIC TO BE POLYPROPYLENE FIBRE NONWOVEN GEOTEXTILE, SUCH AS NILEX 4551 OR APPROVED

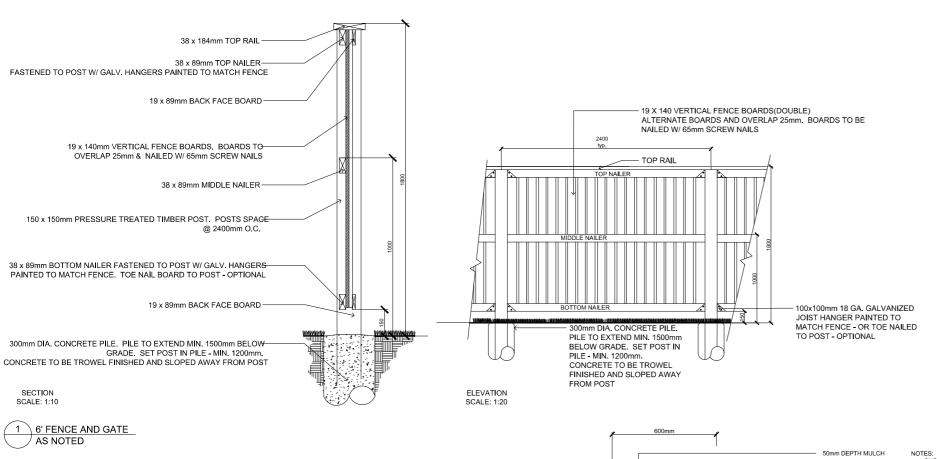

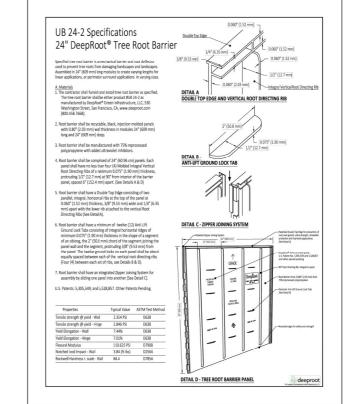




OTES:
SHOP DRAWINGS REQUIRED
SAMPLE OF FINISH REQUIRED
FINISH: POWDER COATED CHARCOAL
SUPPORT FIN AND BRACE TO BE 3/8" METAL
SECURELY TACK WELDED TO PLANTER FRAME
NO FINISH REQUIRED ON SUPPORT STRUCTURES

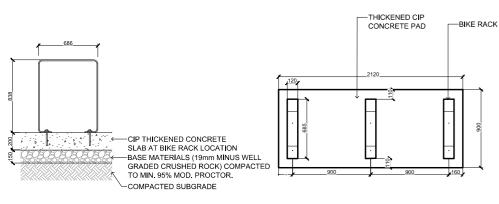


- NOTES:

 1. STEEL TO BE 50/10 THICKNESS; HOT-DIPPED GALVANIZED AS PER ASTM A123
 AND HAND GROUND AFTER GALVANIZATION, PRIMED WITH A ZINC-RICH
 EPOXY PRIMER AND POWDERCOATED WITH A POLYESTER TRY-GLICIDYLISOCYANURATE (TGIC) FINISH 4mm THICK. COLOUR: AGED

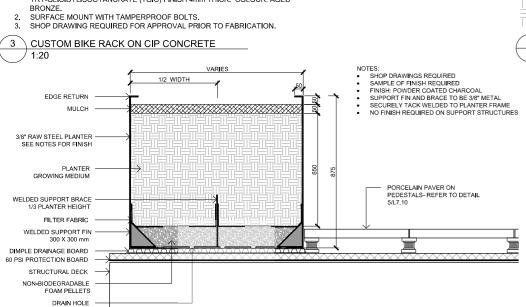

5 METAL PLANTER-UPPER LEVELS / 1:10

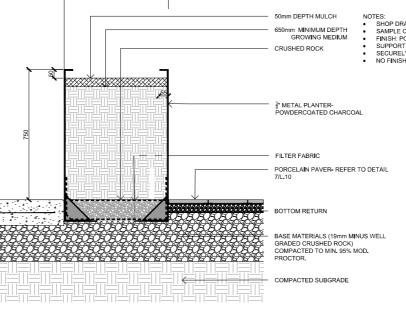

4 METAL PLANTER AT GROUND LEVEL

DRAWING TITLE:

SITE FURNISHINGS DETAILS


Info@biophiliacollective.ca 250 590 1156

ARYZE DEVELOPMENTS

1733 FAIRFIELD, VICTORIA, BC

DESIGNED BY: BIANCA BODLEY DRAWN BY: TYLER YESTAL

NO.	ISSUE	YY\MM\DE
1	ISSUED FOR DEVELOPMENT TRACKER	22\03\04
2	ISSUED FOR RZ/DP	22\05\02
3	ISSUED FOR COORDINATION	22\07\18
4	ISSUED FOR RZ/ DP	22\07\20
5	ISSUED FOR RZ/ DP RESUBMISSION	23\01\24
6	ISSUED FOR RZ/ DP RESUBMISSION	2023\08\18
7	25% BUILDING PERMIT	2023\10\10
8	ISSUED FOR RZ/ DP REV 5	2024\02\2
8	ISSUED FOR RZ/ DP REV 6	2024\07\19

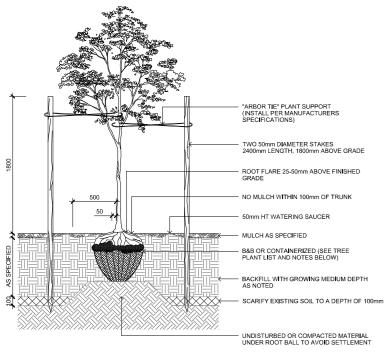

NOTES:

1. CONTRACTOR SHALL INSURE PERCOLATION OF ALL PLANTING PITS PRIOR TO INSTALLATION

2. FOR BAB: REMOVE TOP 1/3 OF BURLAP AND CAGE PRIOR TO BACKFILLING WITH GROWING MEDIUM


3. FOR CONTAINERS: LOOSEN ROOT STRUCTURE AND ENSURE NO CIRCLING ROOTS BY LIGHT ROOT PRUNING

4. INSTALL TREE TIE AT APPROX. 50% OF TREE HT. FOR CONIFERS LESS THAN 3m HT. AND 100mm BELOW LOWEST BRANCH FOR DECIDIOUS LESS THAN 100mm CAL, DO NOT REMOVE OR CONSTRAIN ANY BRANCHES.


5. STANDARD TREE PLANTING DETAILS TO BE APPLIED ACCORDINGLY TO TREES PLANTED IN PLANTERS

6. TREE PLANTING ON MUNICIPAL PROPERTY TO MUNICIPAL STANDARD DETAIL.

1 TREE PLANTING ON GRADE 1:20

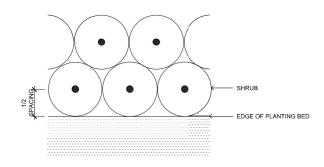



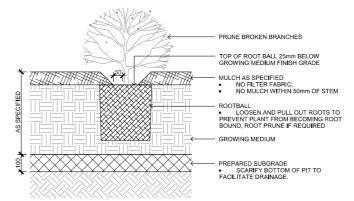


NOTES:

1. SHRUB PLANTING AS PER WRITTEN SPECIFICATIONS

2. GROWING MEDIUM AND MULCH AS PER WRITTEN SPECIFICATIONS

2 SHRUB PLANTING 1:10

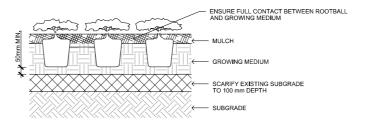

NOTES:

1. PLACE AND COMPACT SUBGRADE AS PER WRITTEN SPECIFICATIONS
2. SUBGRADE TO BE COMPACTED TO A CONSISTENT 80% M.P.D.
3. GROWING MEDIUM AND MULCH AS PER WRITTEN SPECIFICATIONS





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ARYZE DEVELOPMENTS

1733 FAIRFIELD, VICTORIA, BC

DESIGNED BY:BIANCA BODLEY DRAWN BY:TYLER YESTAL

NO. ISSUE

1 ISSUED FOR DEVELOPMENT TRAC

2 ISSUED FOR RZ/DP

3 ISSUED FOR COORDINATION 4 ISSUED FOR RZ/ DP ISSUED FOR RZ/ DP RESUBMISSION
 ISSUED FOR RZ/ DP RESUBMISSION
 25% BUILDING PERMIT
 ISSUED FOR RZ/ DP REV 5
 ISSUED FOR RZ/ DP REV 6





DRAWING TITLE:

PLANTING DETAILS