



Biophilia Design Collective Ltd. 250.590.1156
Info@biophiliacollective.ca

CLIENT
H Development Group Ltd.

ADDRESS 1270 Pandora St

DESIGNED BY

Bianca Bodley

Victoria, BC


DRAWN BY


EB/ KT







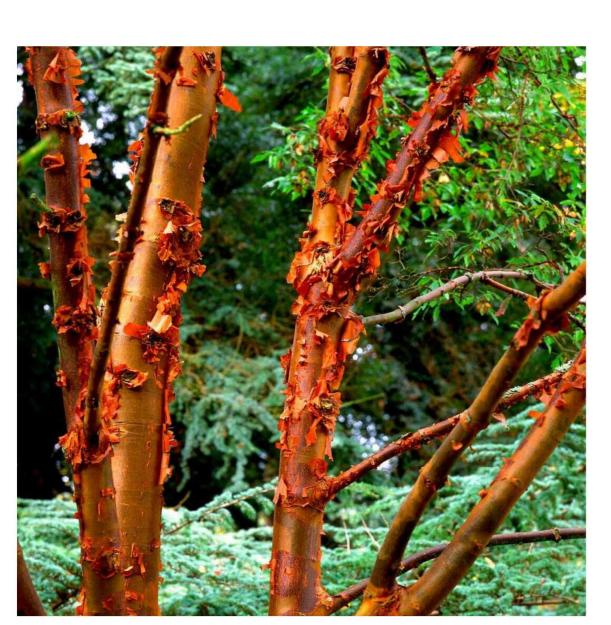

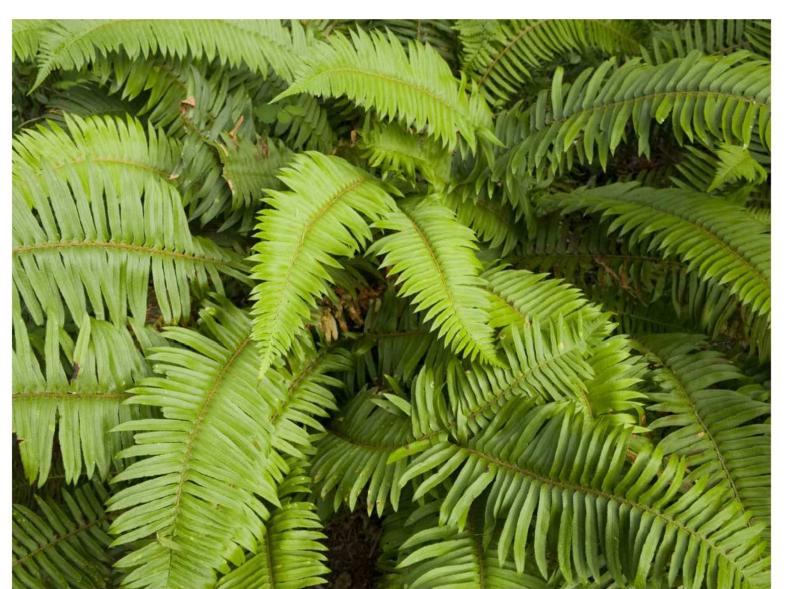


ISSUED FOR


1 DEVELOPMENT PERMIT 21/12/21
2 DEVELOPMENT PERMIT RESUBMISSION 22/04/04
3 DEVELOPMENT PERMIT RESUBMISSION 22/12/19
4 DEVELOPMENT PERMIT RESUBMISSION 23/02/08

DEVELOPMENT PERMIT RESUBMISSION February 08, 2023



Cover

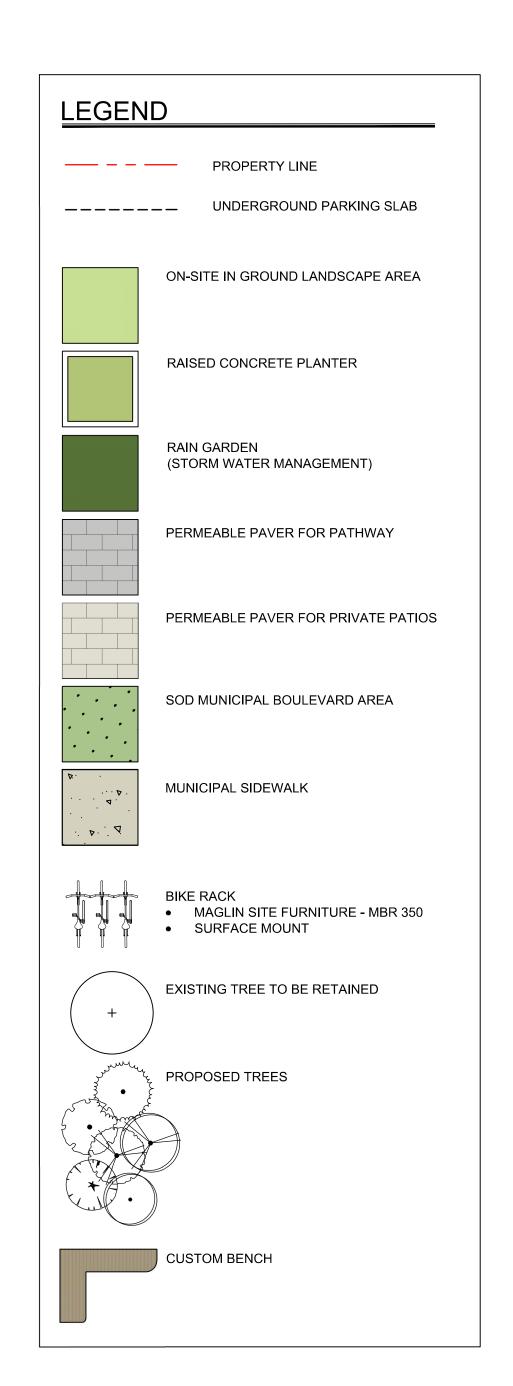

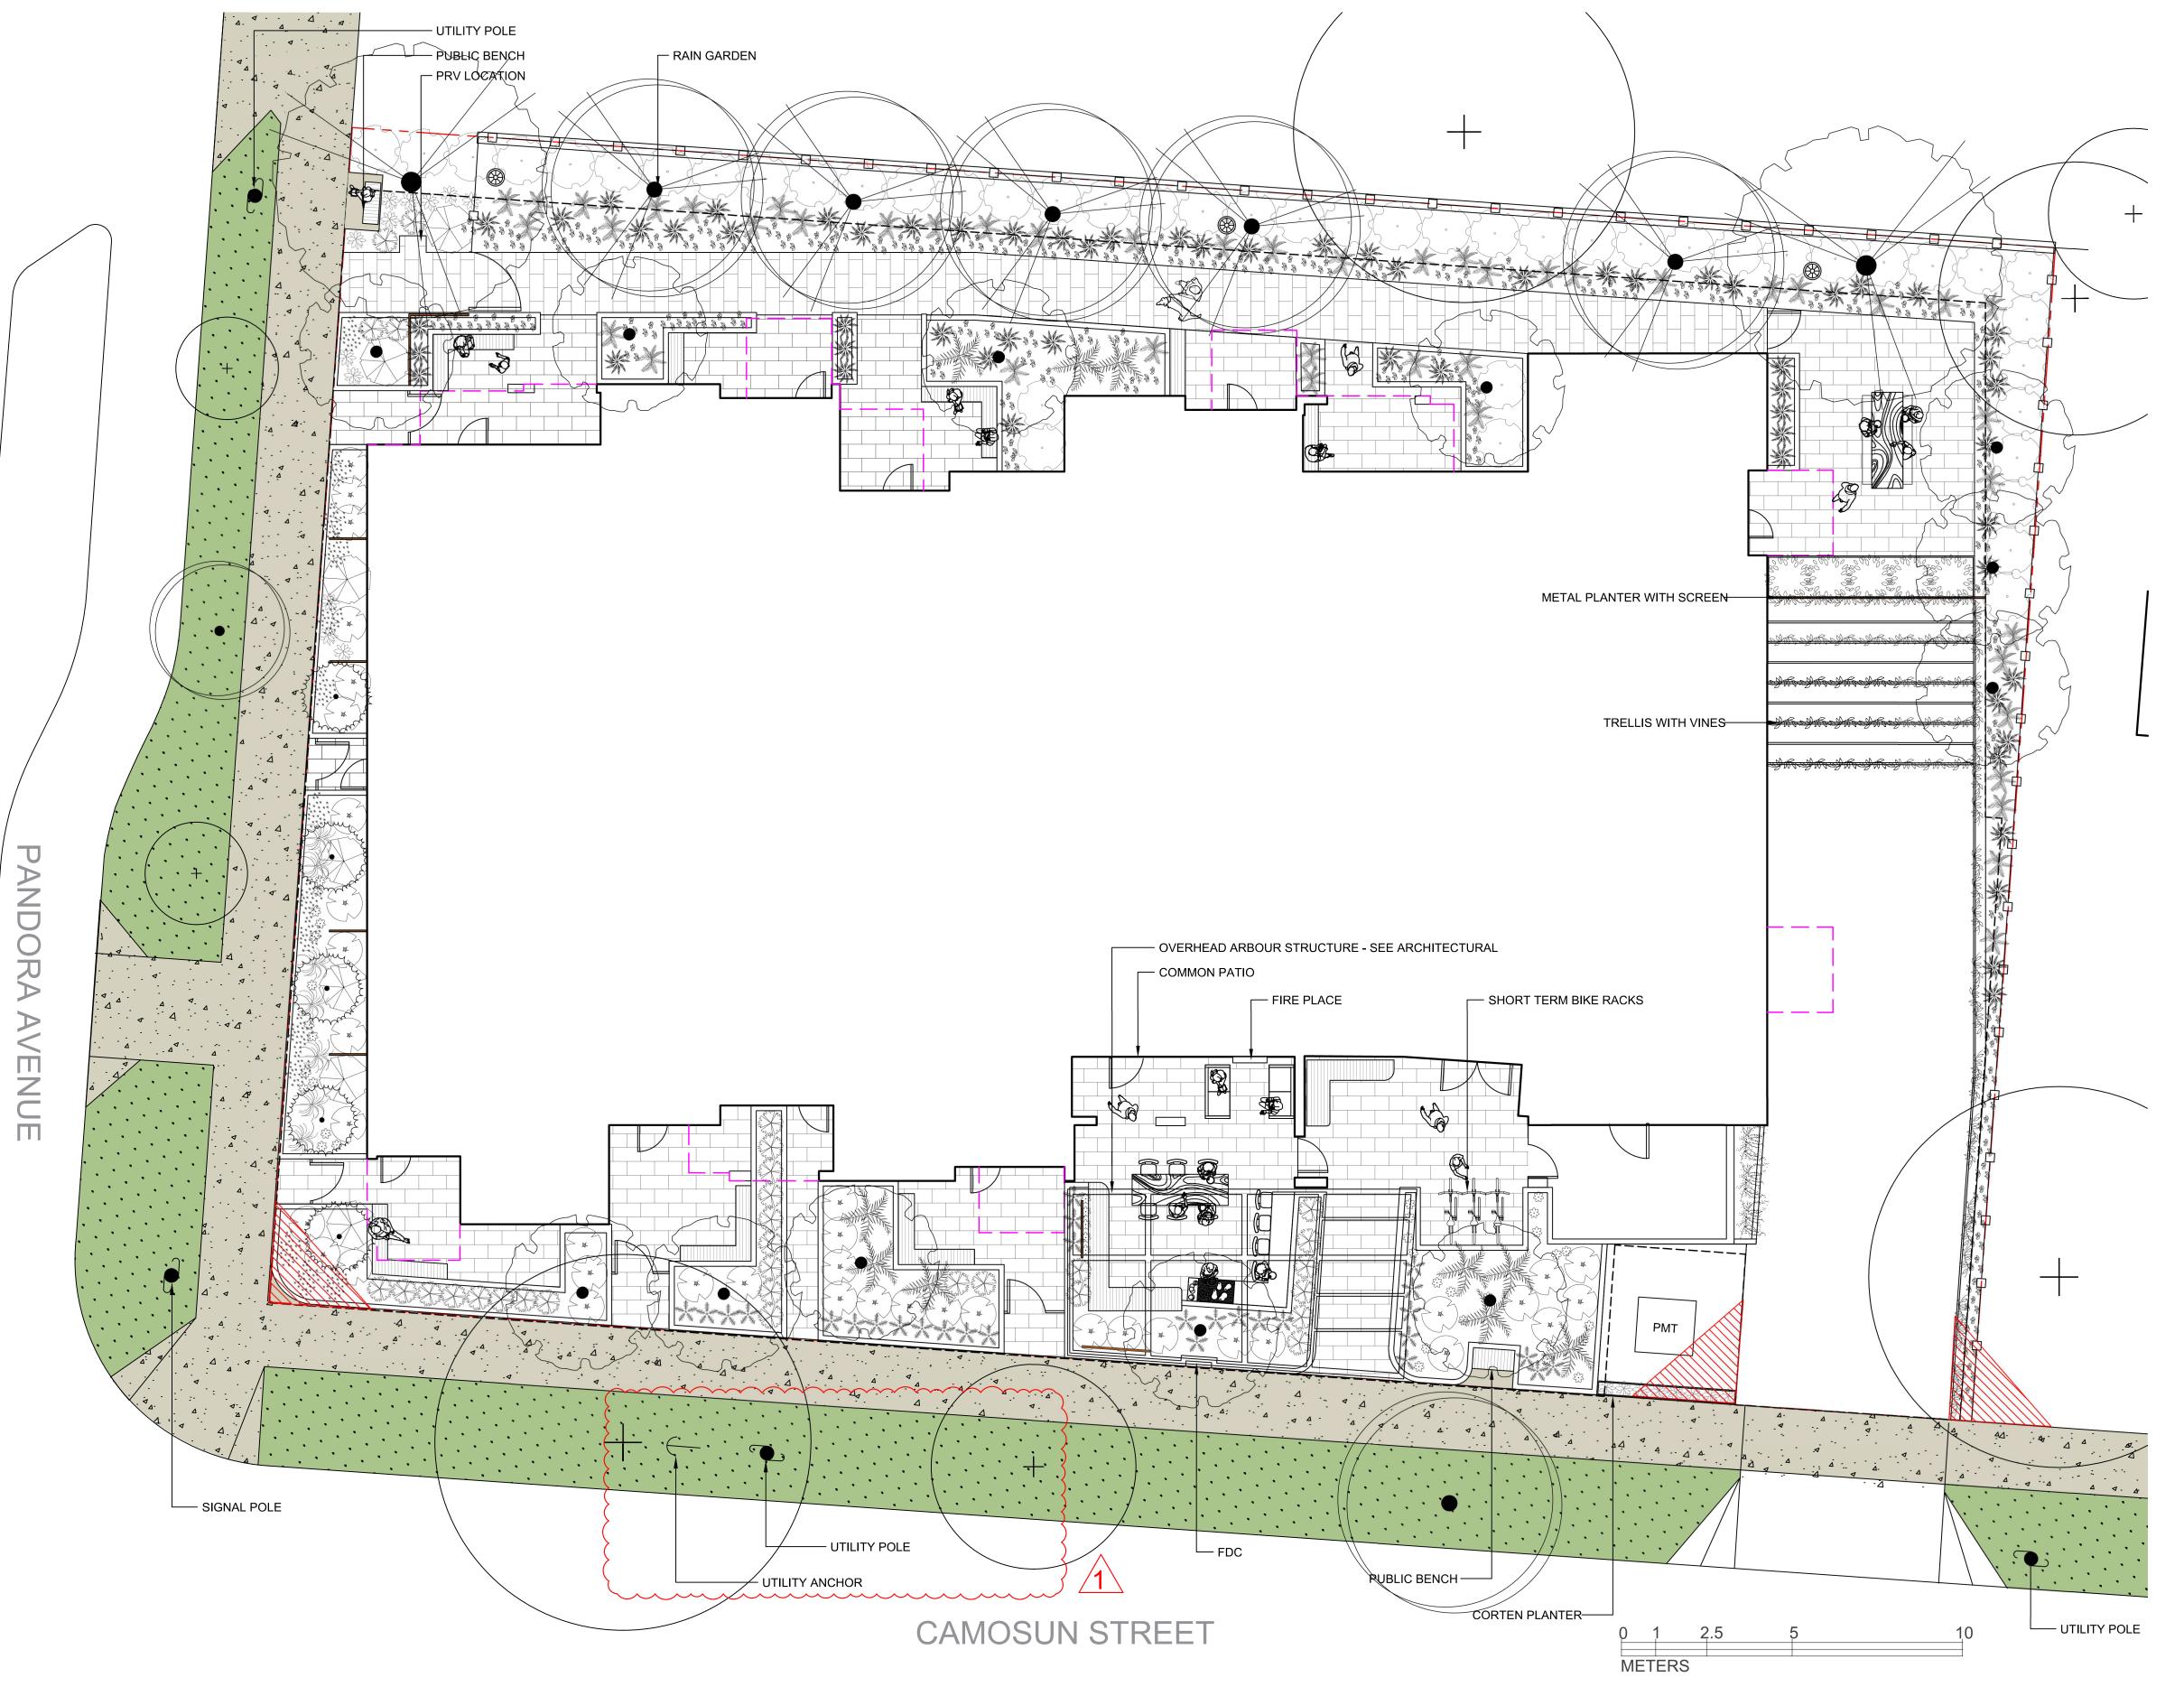

1 LANDSCAPE SITE PLAN 1:100



Biophilia Design Collective Ltd. 250.590.1156
Info@biophiliacollective.ca

CLIENT
H Development Group Ltd.

ADDRESS 1270 Pandora St Victoria, BC

DESIGNED BY

Bianca Bodley

DRAWN BY

EB/ KT

ISSUED FOR

1 DEVELOPMENT PERMIT 21/12/21

2 DEVELOPMENT PERMIT RESUBMISSION 22/04/04

3 DEVELOPMENT PERMIT RESUBMISSION 22/12/19

4 DEVELOPMENT PERMIT RESUBMISSION 23/02/08


DEVELOPMENT PERMIT RESUBMISSION February 08, 2023

Scale: 1:100




Landscape Site Plan



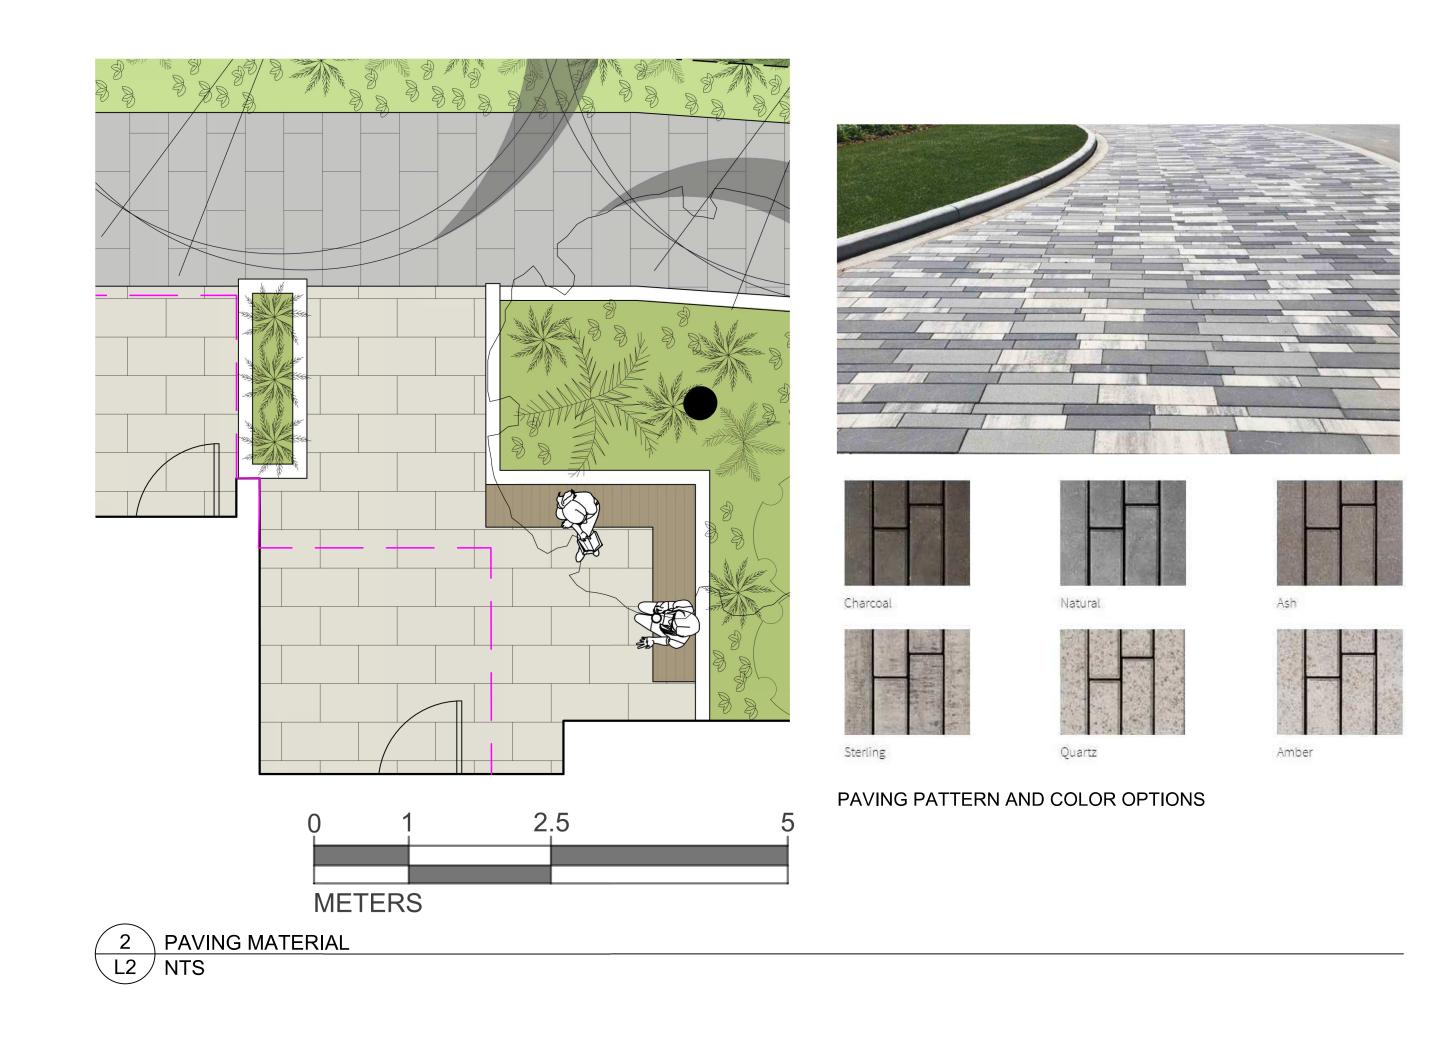



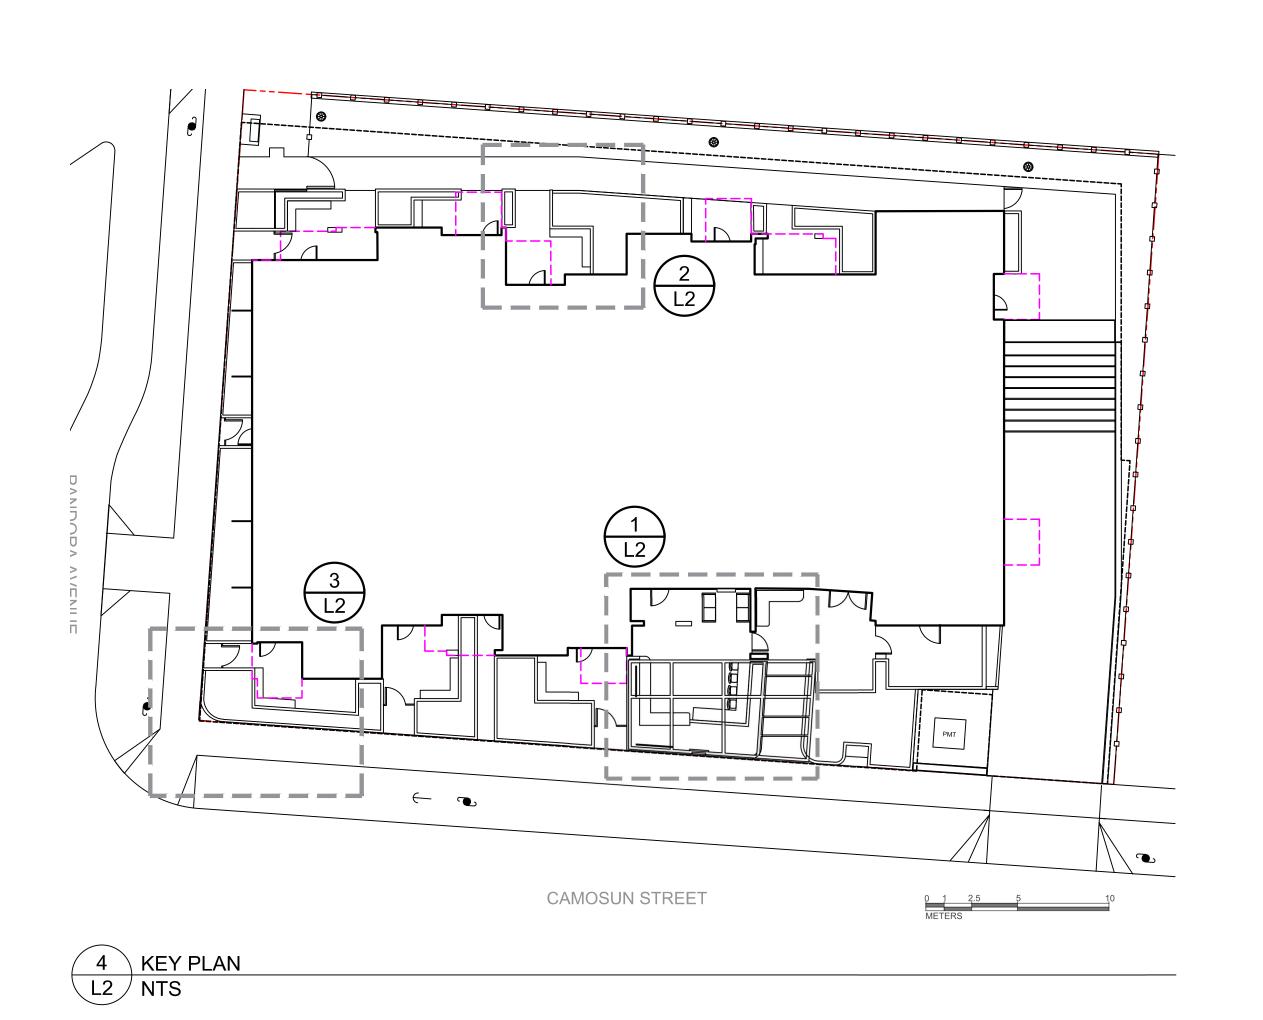

Biophilia Design Collective Ltd. 250.590.1156
Info@biophiliacollective.ca

CLIENT
H Development Group Ltd.

ADDRESS

DESIGNED BY

1270 Pandora St

Victoria, BC

Bianca Bodley

DRAWN BY

EB/ KT



	ISSUED FOR	
1	DEVELOPMENT PERMIT	21/12/21
2	DEVELOPMENT PERMIT RESUBMISSION	22/04/04
3	DEVELOPMENT PERMIT RESUBMISSION	22/12/19
4	DEVELOPMENT PERMIT RESUBMISSION	23/02/08

DEVELOPMENT PERMIT RESUBMISSION February 08, 2023

Scale: AS NOTED





Biophilia Design Collective Ltd. 250.590.1156 Info@biophiliacollective.ca

H Development Group Ltd.

1270 Pandora St

DESIGNED BY

Bianca Bodley



	ISSUED FOR	
1	DEVELOPMENT PERMIT	21/12/21
2	DEVELOPMENT PERMIT RESUBMISSION	22/04/04
3	DEVELOPMENT PERMIT RESUBMISSION	22/12/19
4	DEVELOPMENT PERMIT RESUBMISSION	23/02/08


DEVELOPMENT PERMIT RESUBMISSION February 08, 2023

Scale: 1:100



DATE: February, 2023

PREPARED BY: GYE AND ASSOCIATES

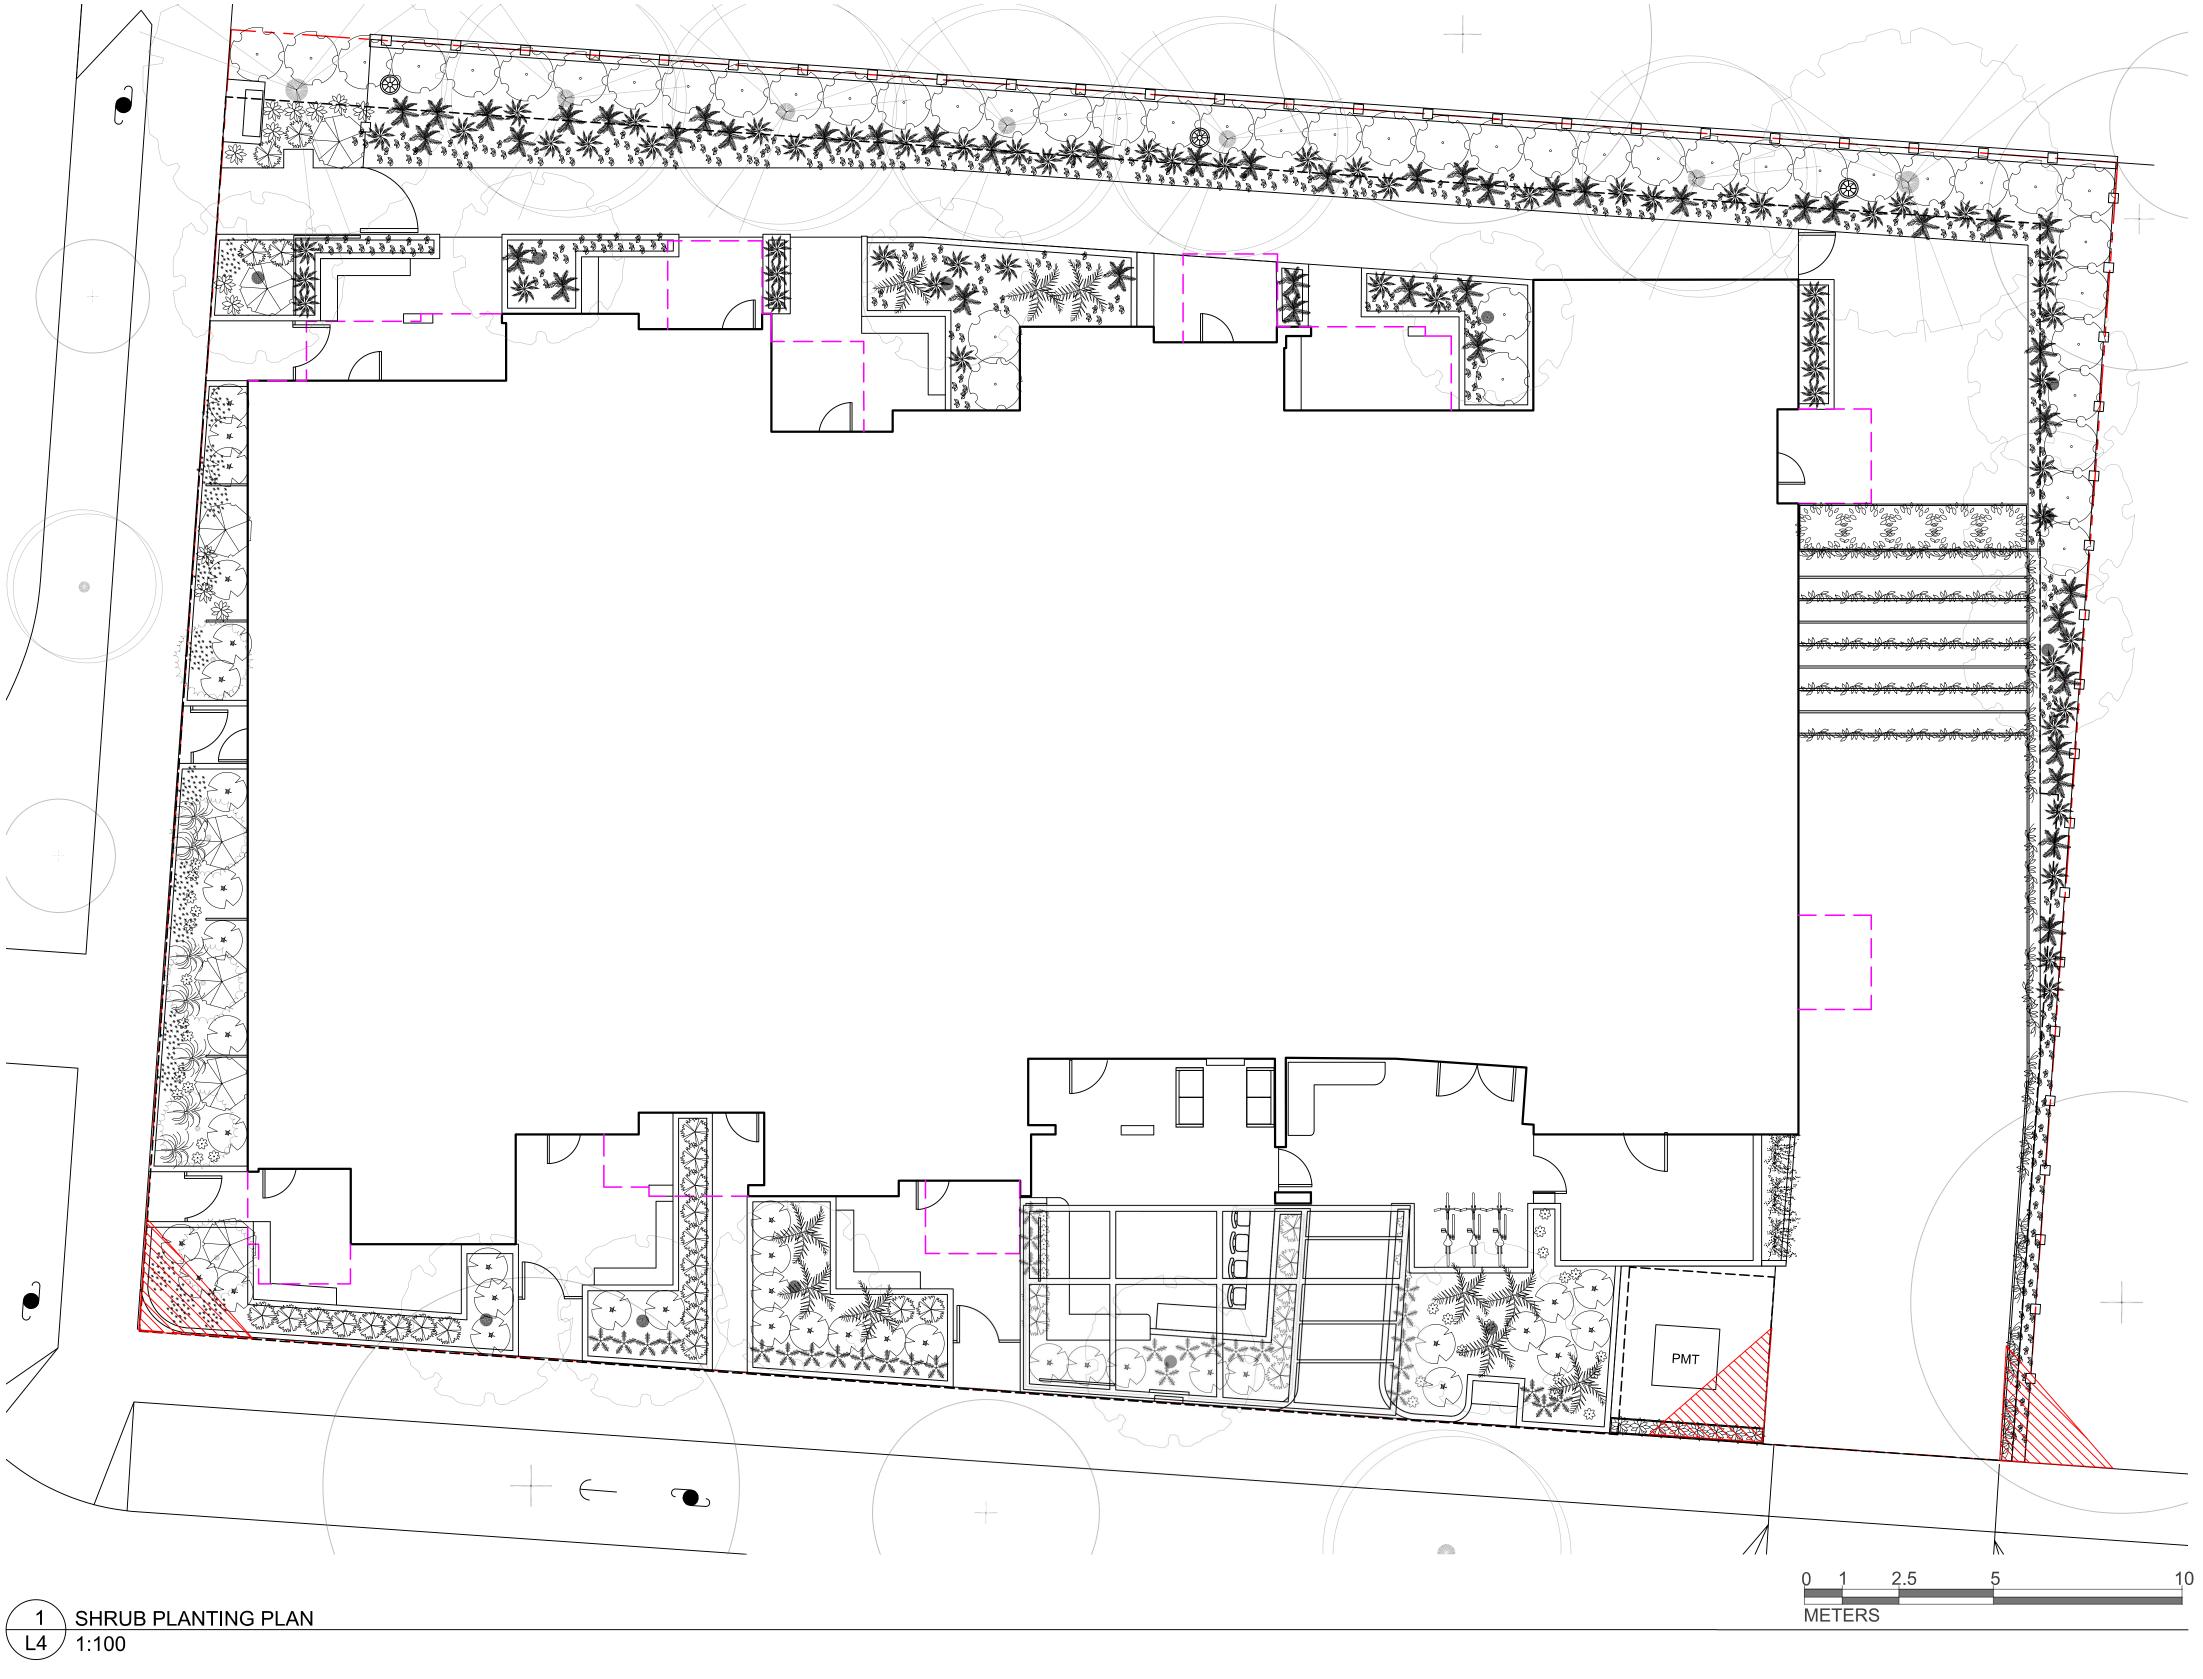

Quantity	Symbol	Latin Name	Common Name	Container	Native	Pollinator	Height at Maturity (m)	Spread a Maturity (m)
30	Miscanthus sinensis 'Little Kitten' Chinese Silver Grass		Chinese Silver Grass	#2			0.6-0.9	0.3-0.6
100	**	Arctostaphylos uva-ursi 'Massachusetts'	Massachusetts Kinnikinnick			Yes	0.3	4.5
33		Choisya ternata	Mexican Orange Blossom	#3		Yes	1.2-2.4	1.2-2.4
35	₩	Rudbeckia hirta	Black-eyed Susan	#1		Yes	0.9	0.6
15		Cephalotaxus harringtonia 'Prostrata'	Spreading Japanese Plum Yew	#3			0.6-0.9	0.9-1.2
80	## #	Asarum canadense	Canadian Wild Ginger	10cm	Yes		0.15-0.3	0.3-0.6
60	*	Adiantum aleuticum	Maidenhair Fern	#2	#2 Yes		0.3-0.9	0.3-0.9
20	*	Pinus mugo	Dwarf Mugo Pine	#2	#2		0.5-1.2	1-1.2
52	*	Polystichum munitum	Western Sword Fern	#2	#2 Yes		0.6-1.2	0.6-1.2
16	×	Polystichum polyblepharum	Japanese Tassel Fern	#1			0.6-0.9	0.6-0.9
42	The state of the s	Prostanthera cuneata	Australian Mint	#1		Yes	0.9	1.8
5		Taxus x media 'Hicksii'	Hicks Yew	#2			2.5-3	0.9-1
45		Vaccinium ovatum	Evergreen Huckleberry	#3	Yes	Yes	1.5	1.2
8	*	Erica carnea	Winter Heath	#1		Yes	0.3	0.6
20	ANG	Hydrangea anomala	Creeping Hydrangea	#1			9-11	1-2
50	<i>***</i> *********************************	Thymus pseudolanuginosus	Woolly Thyme	10cm		Yes	0.05-0.07	0.25-0.3

Biophilia Design Collective Ltd. 250.590.1156 Info@biophiliacollective.ca

CLIENT H Development Group Ltd.

ADDRESS 1270 Pandora St Victoria, BC

DESIGNED BY

Bianca Bodley

DRAWN BY

EB/ KT



DEVELOPMENT PERMIT	21/12/21
	,,
DEVELOPMENT PERMIT RESUBMISSION	22/04/04
DEVELOPMENT PERMIT RESUBMISSION	22/12/19
DEVELOPMENT PERMIT RESUBMISSION	23/02/08
	DEVELOPMENT PERMIT RESUBMISSION DEVELOPMENT PERMIT RESUBMISSION DEVELOPMENT PERMIT RESUBMISSION

DEVELOPMENT PERMIT RESUBMISSION February 08, 2023


Scale: 1:100



L4 SHRUB PLANTING PLAN

DATE: February, 2023

SUN PLANTING PALETTE

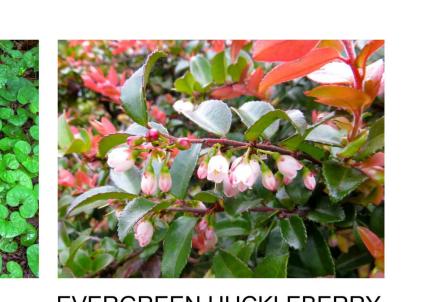














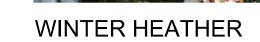

MEXICAN ORANGE FOUNTAIN GRASS BLOSSOM 'LITTLE KITTEN'

RUDBECKIA

AUSTRALIAN MINT BUSH


DWARF MUGO PINE



SHADE PLANTING PALETTE

FERN



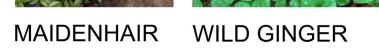

EVERGREEN HUCKLEBERRY









UPPER PATIO DESIGN INSPIRATION

۱T	SCHEDULE	- OUTDOOR PAT	IO PLANTERS				
ity	Symbol	Latin Name	Common Name	Container	Height at Maturity (m)	Spread at Maturity (m)	
		Olea europaea	Olive tree	B&B	6-9	4-7	
							A COLLEGE



OLIVE TREE



Quantity	Symbol	Latin Name	Common Name	Container	Height at Maturity (m)	Spread at Maturity (m)
4		Olea europaea	Olive tree	B&B	6-9	4-7
25		Lavandula angustifolia	English Lavender	10cm	70cm	90cm
35	300E	Thymus vulgaris	Thyme	10cm	0.15-0.3m	0.15-0.3m
30	**** ****	Salvia officinalis	Common Sage	10cm	50cm	30cm

1. PLANTS IN PLANT LISTS ARE SPECIFIED ACCORDING TO THE CANADIAN NURSERY LANDSCAPE ASSOCIATION CANADIAN STANDARDS FOR NURSERY STOCK AND SECTION 12, CONTAINER GROWN PLANTS FROM THE BC LANDSCAPE STANDARD, CURRENT EDITION.

SAGE



Biophilia Design Collective Ltd.

Info@biophiliacollective.ca

H Development Group Ltd.

250.590.1156

CLIENT

ADDRESS

Victoria, BC


1270 Pandora St

DESIGNED BY


Bianca Bodley

DRAWN BY

EB/ KT

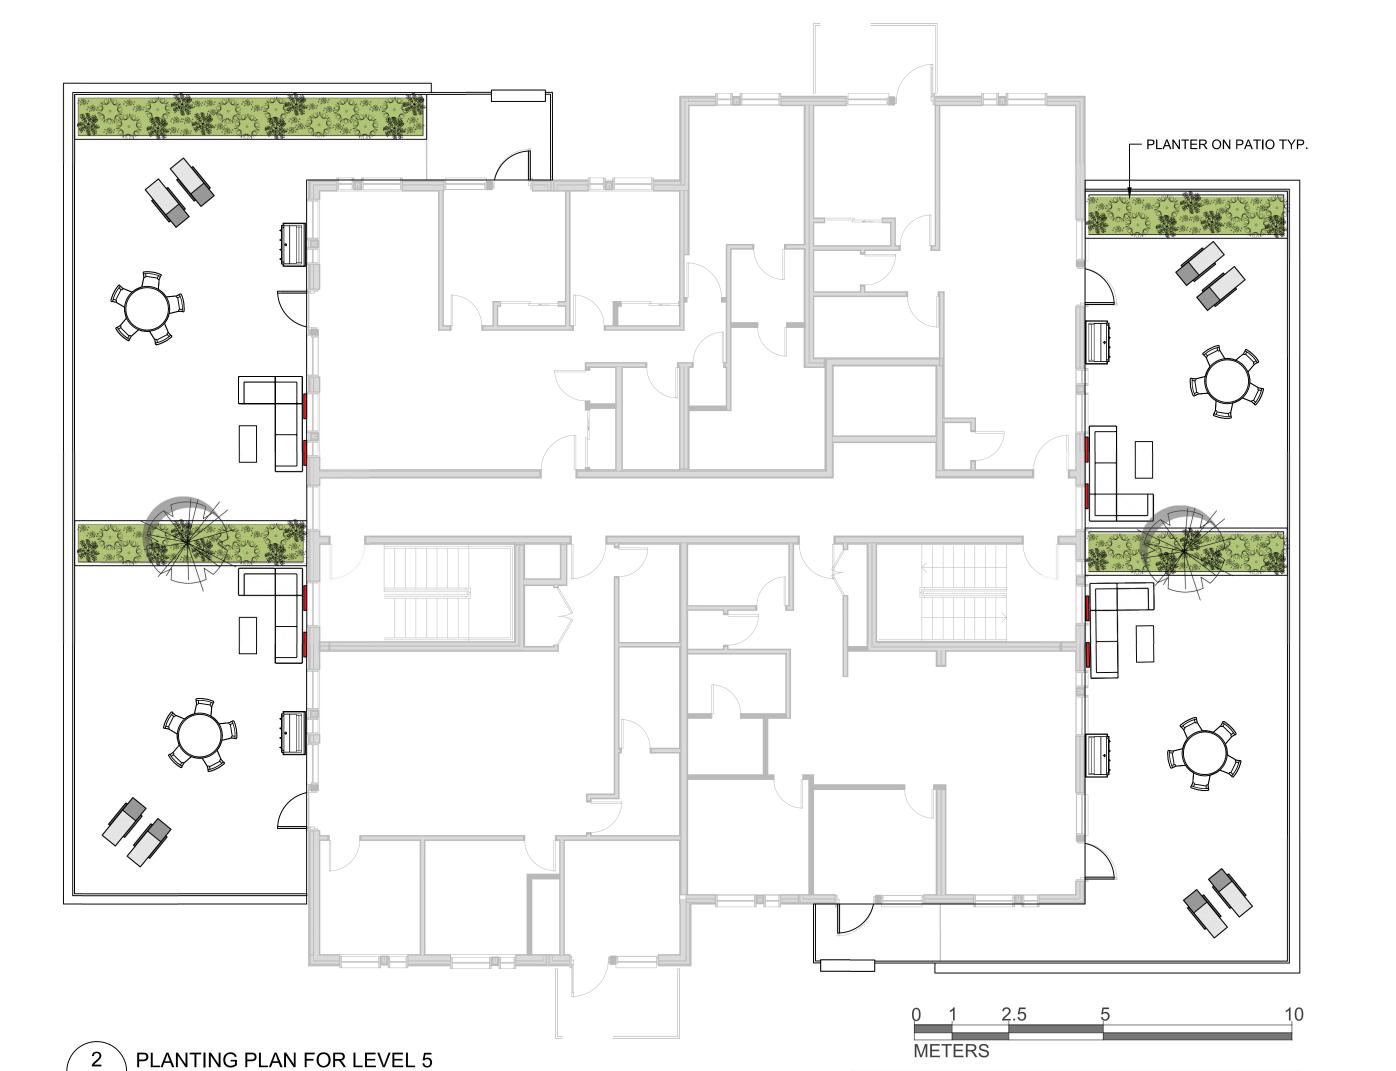

L5 1:100

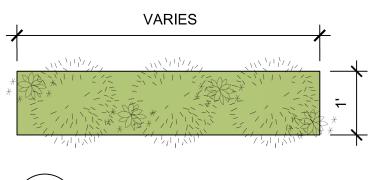









KINNIKINNICK

PLANT	PLANT SCHEDULE - BALCONY RAILING PLANTERS											
Quantity	Symbol	Latin Name	Common Name	Container	Height at Maturity (m)	Spread at Maturity (m)						
99		llex crenata 'Dwarf Pagoda'	Dwarf Pagoda Japanese Holly	#1	0.6	0.6						
30	****	Arctostaphylos uva-ursi	Kinnikinnick	10cm	0.2	4.5						
NOTES:		I			I	<u> </u>						

1. PLANTS IN PLANT LISTS ARE SPECIFIED ACCORDING TO THE CANADIAN NURSERY LANDSCAPE ASSOCIATION CANADIAN STANDARDS FOR NURSERY STOCK AND SECTION 12, CONTAINER GROWN PLANTS FROM THE BC LANDSCAPE STANDARD CURRENT EDITION.

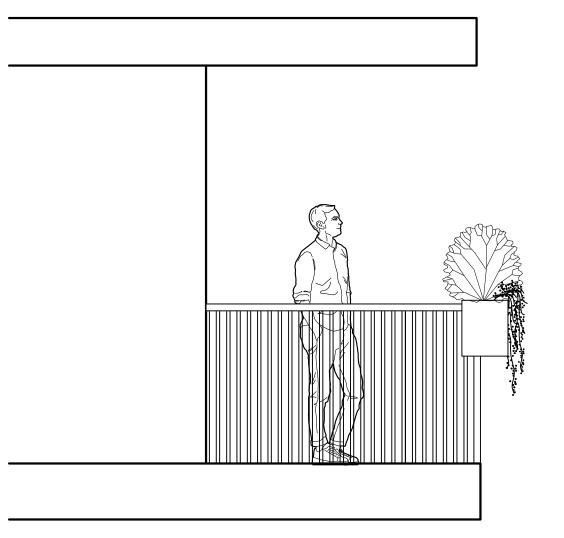


RAILING PLANTER SECTION

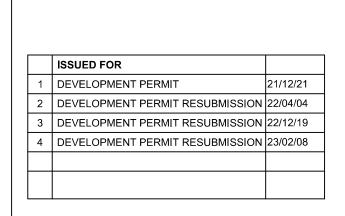



DEVELOPMENT PERMIT RESUBMISSION February 08, 2023

Scale: 1:100



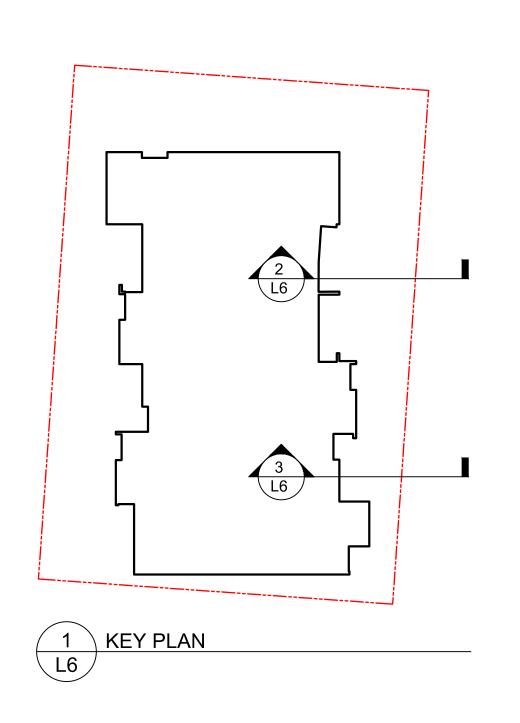

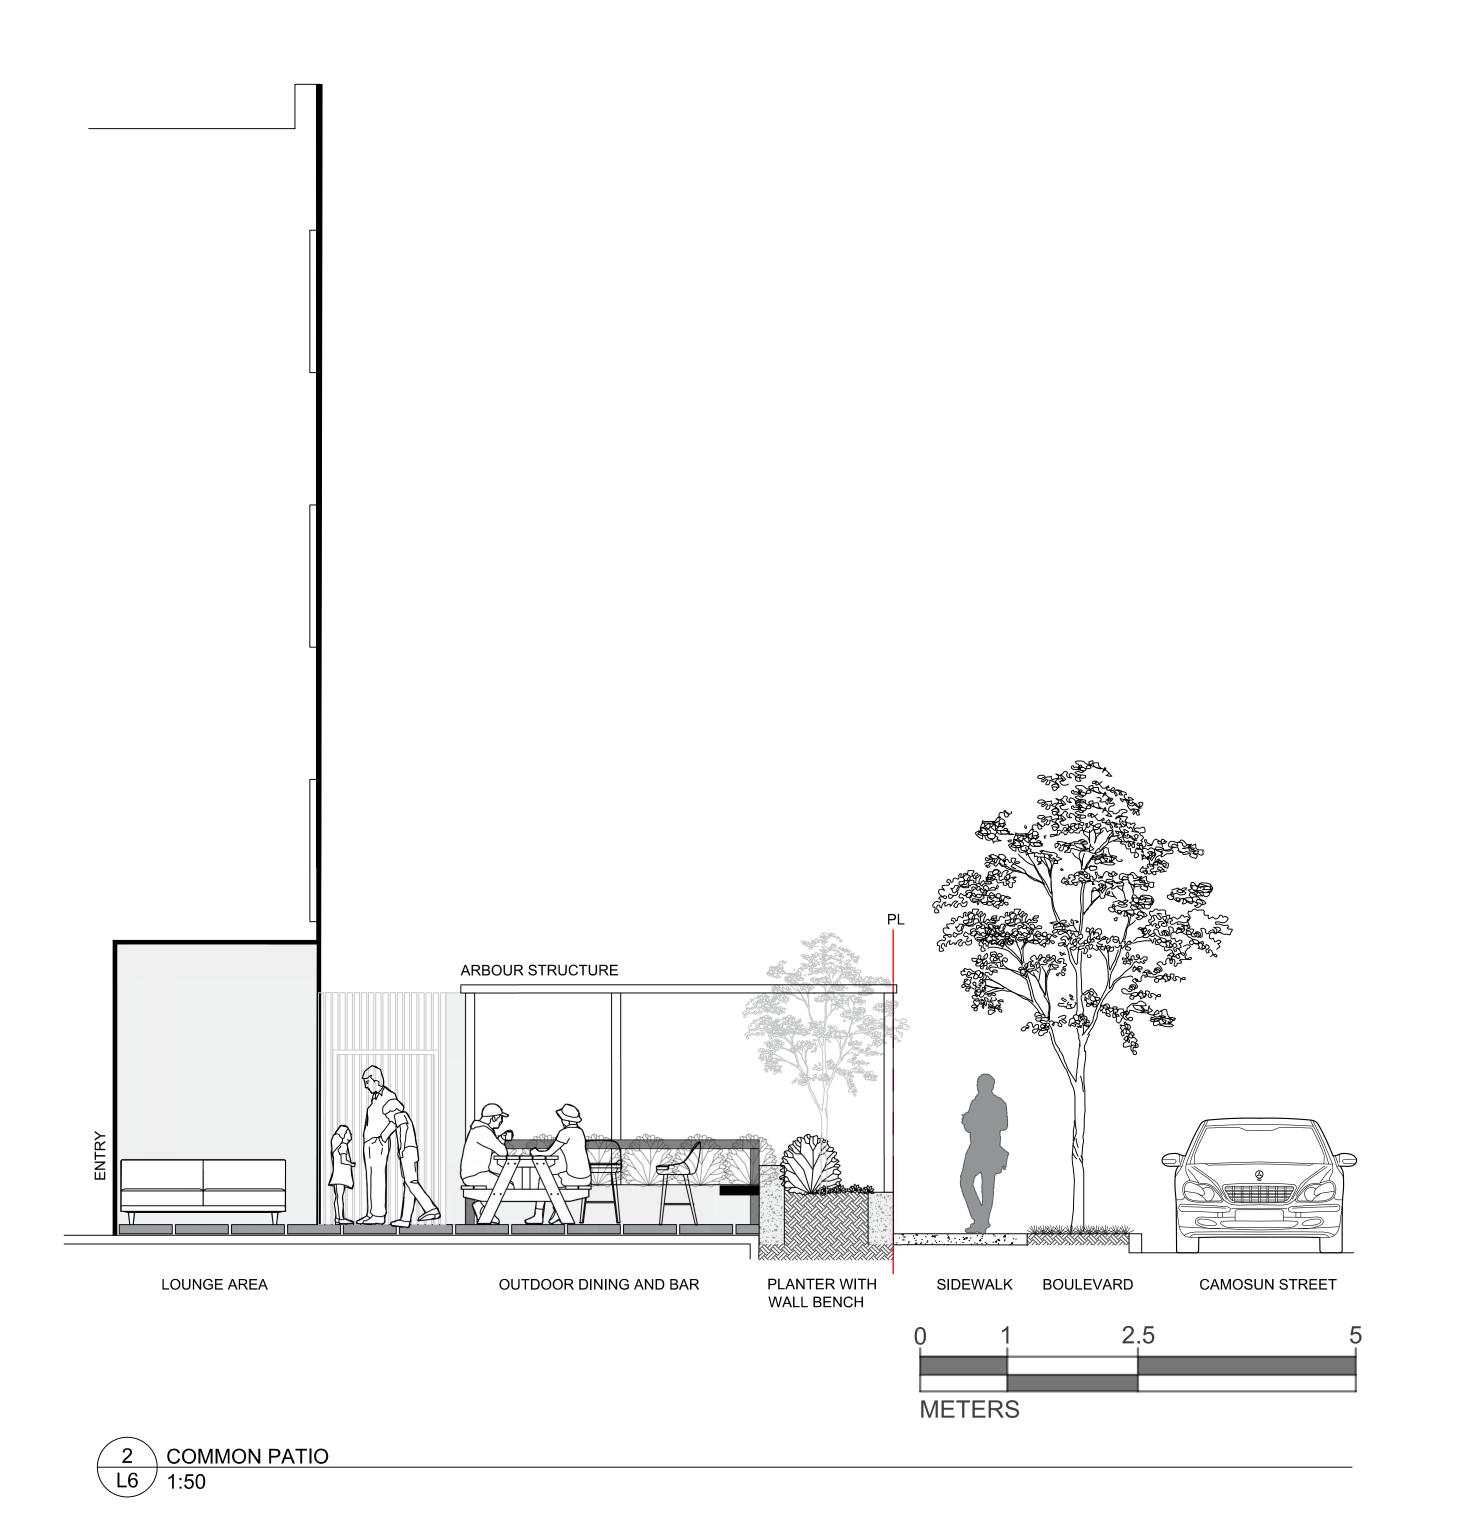

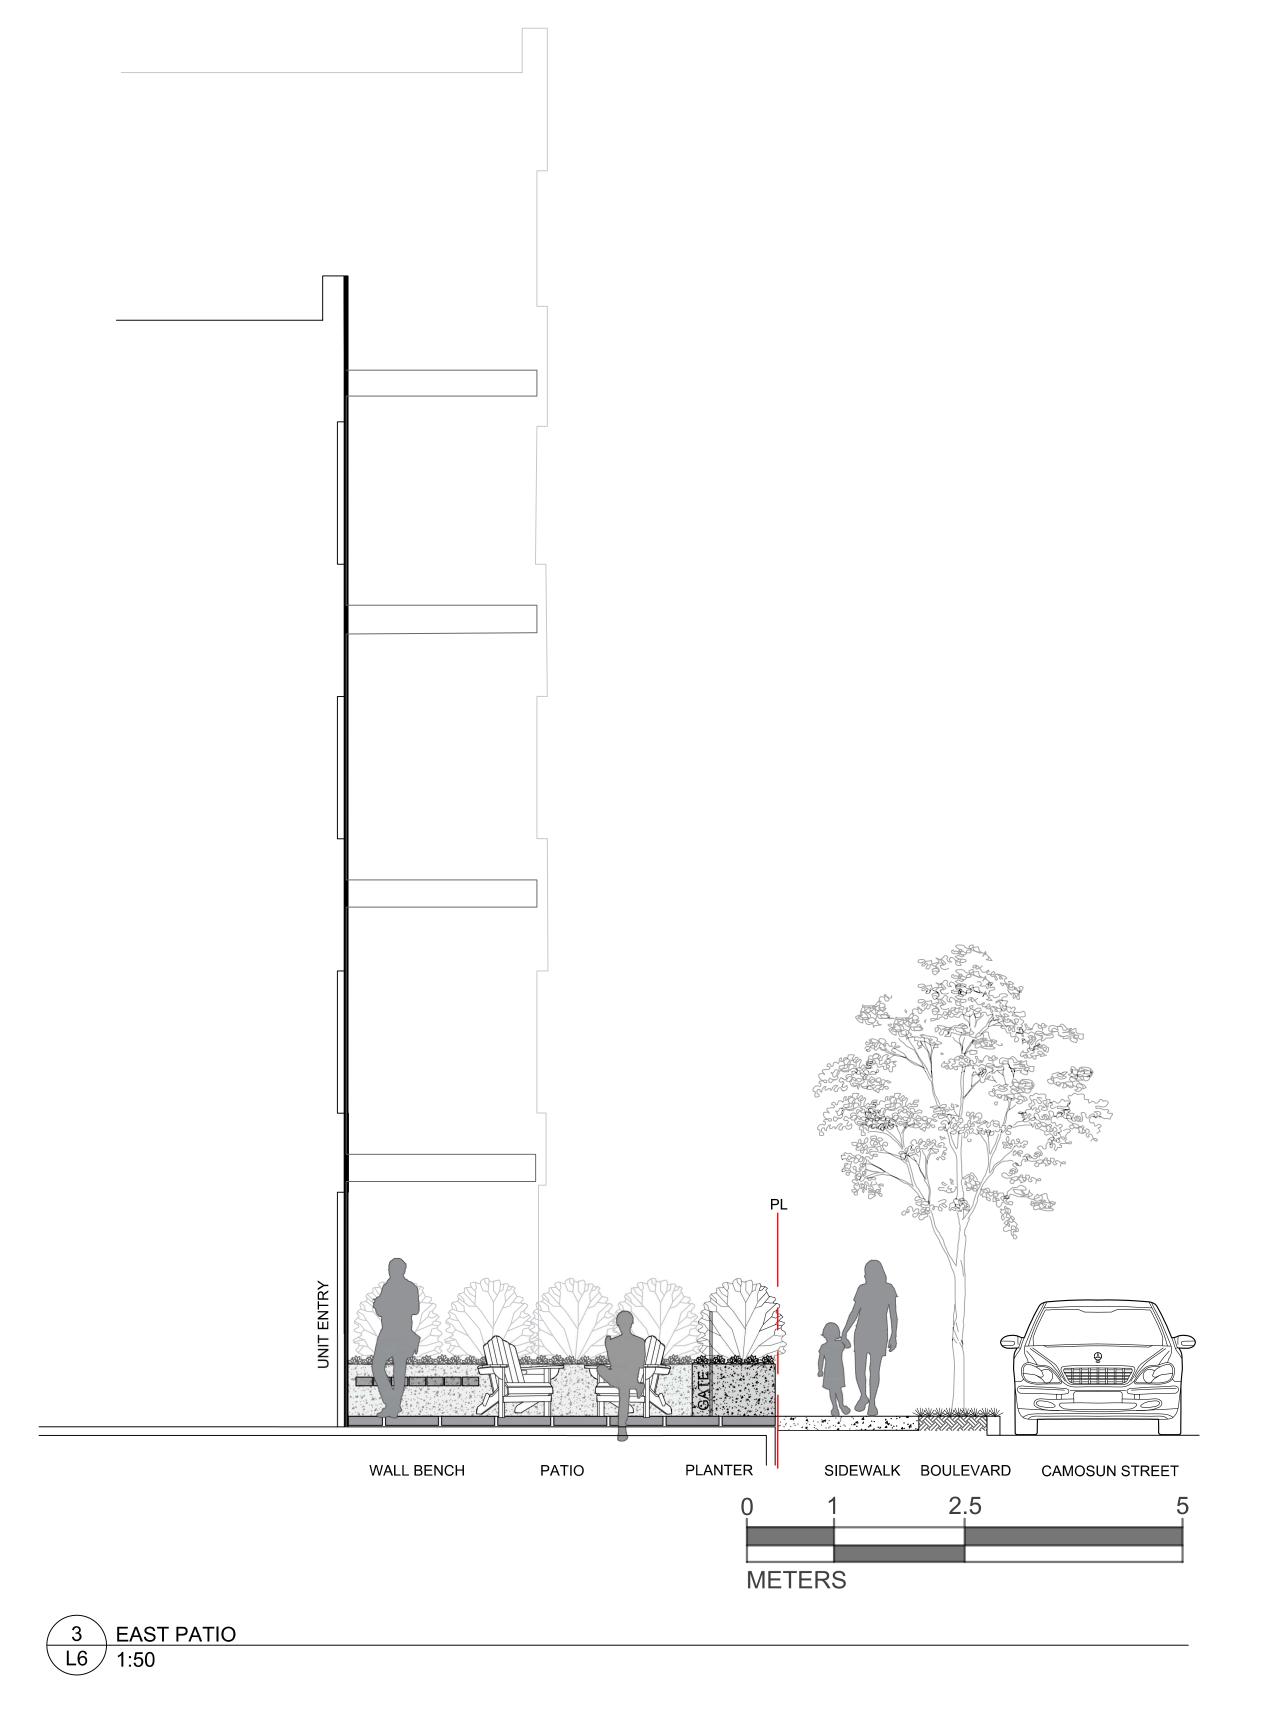



Biophilia Design Collective Ltd. 250.590.1156
Info@biophiliacollective.ca

CLIENT
H Development Group Ltd.

ADDRESS 1270 Pandora St Victoria, BC

DESIGNED BY

Bianca Bodley

DRAWN BY


EB/ KT




	ISSUED FOR	
1	DEVELOPMENT PERMIT	21/12/21
2	DEVELOPMENT PERMIT RESUBMISSION	22/04/04
3	DEVELOPMENT PERMIT RESUBMISSION	22/12/19
4	DEVELOPMENT PERMIT RESUBMISSION	23/02/08

DEVELOPMENT PERMIT RESUBMISSION February 08, 2023

Scale: AS NOTED

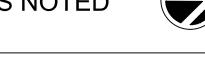

L6 SECTIONS/ ELEVATION

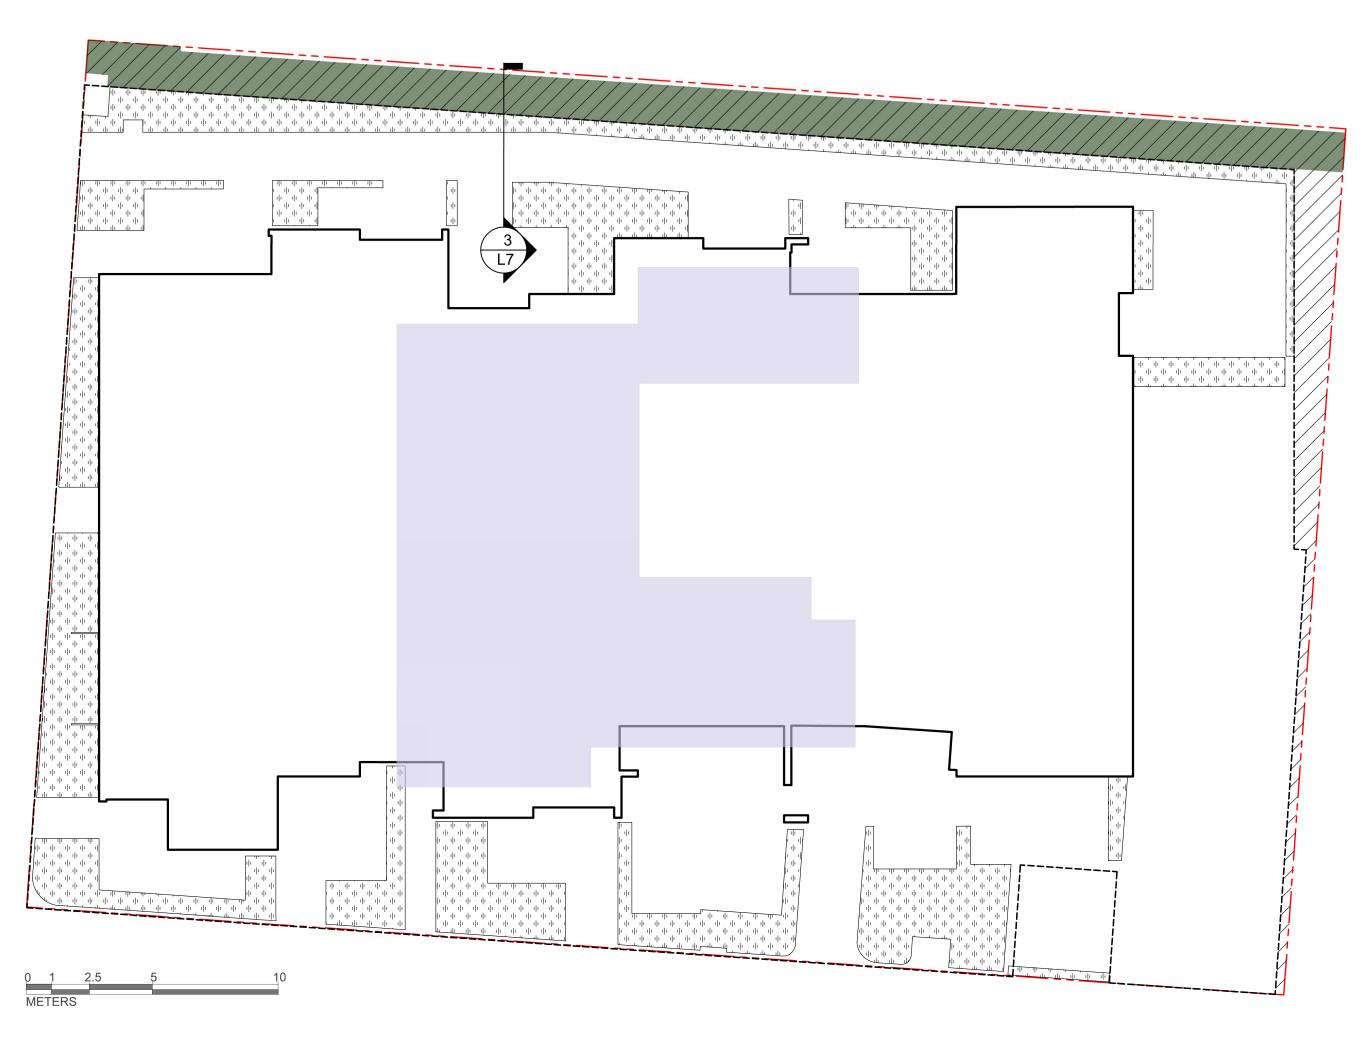

LEGEND RAIN GARDEN PERMEABLE AREA - 107m2/6% OF SITE AREA EXTENSIVE GREEN ROOF - 200m2/ 12% OF SITE AREA ROOF AREA DRAINED TO THE RAIN GARDEN - 269m2


1 STORMWATE MANAGEMENT PLAN L7 1:150

RAIN GARDEN ADJACENT LANDSCAPE ADJACENT LANDSCAPE BOTTOM DIMENSION RAIN GARDEN MATERIALS


1. OVERFLOW DRAIN, 200 MM DOMED GRATE + ADAPTER COMPOSTED MULCH, 50-70 MM DEPTH

3. BIO - RETENTION GROWING MEDIUM, 450 MM DEPTH
4. SCARIFIED/ TILLED SUBGRADE, 300 MM DEPTH
5. EXISTING SUBGRADE/ NATIVE MATERIAL
6. 100 MM DIAMETER (MIN) PERFORATEDPIPE
7. 25 MM DIAMETER DRAIN ROCK, 100 MM DEPTH

2 BIOSWALE DETAIL NTS

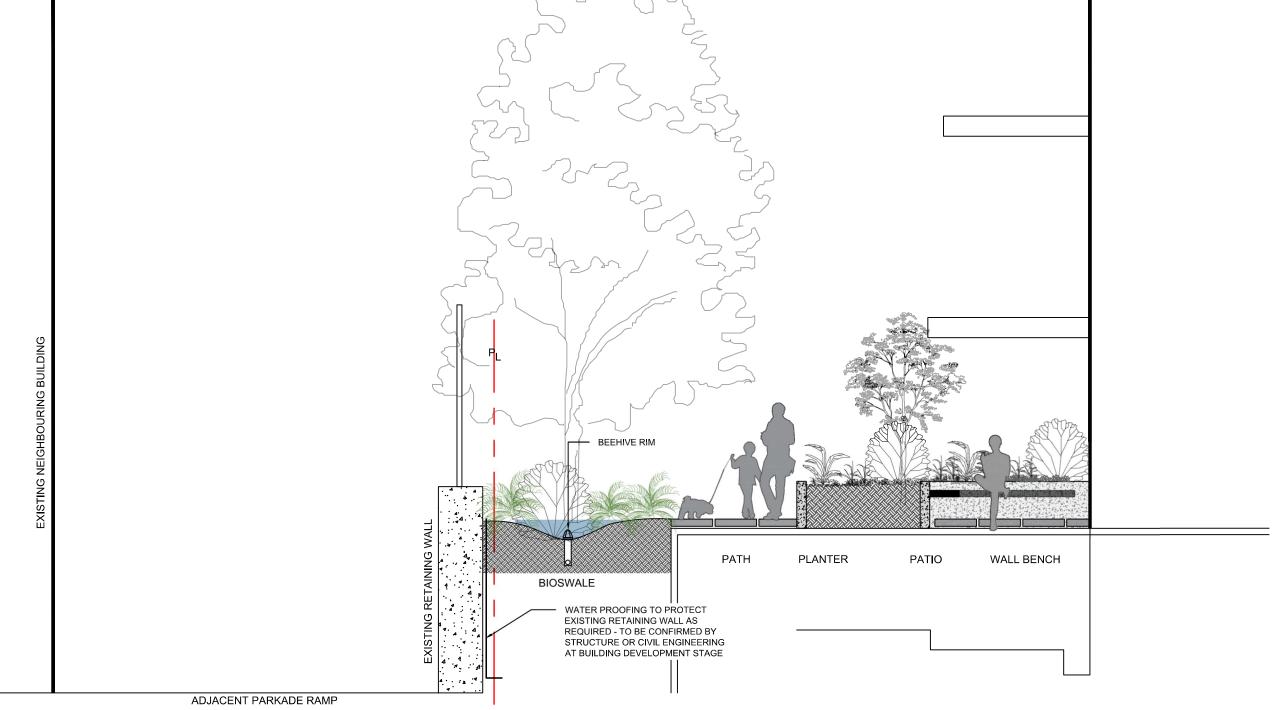

3 WEST PATIO SECTION L7 1:50

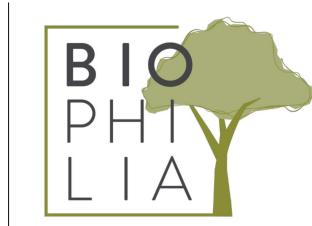

Biophilia Design Collective Ltd. 250.590.1156
Info@biophiliacollective.ca

CLIENT H Development Group Ltd.

ADDRESS 1270 Pandora St Victoria, BC

DESIGNED BY

Bianca Bodley

DRAWN BY

EB/ KT




	ISSUED FOR	
1	DEVELOPMENT PERMIT	21/12/21
2	DEVELOPMENT PERMIT RESUBMISSION	22/04/04
3	DEVELOPMENT PERMIT RESUBMISSION	22/12/19
4	DEVELOPMENT PERMIT RESUBMISSION	23/02/08

DEVELOPMENT PERMIT RESUBMISSION February 08, 2023


Scale: AS NOTED





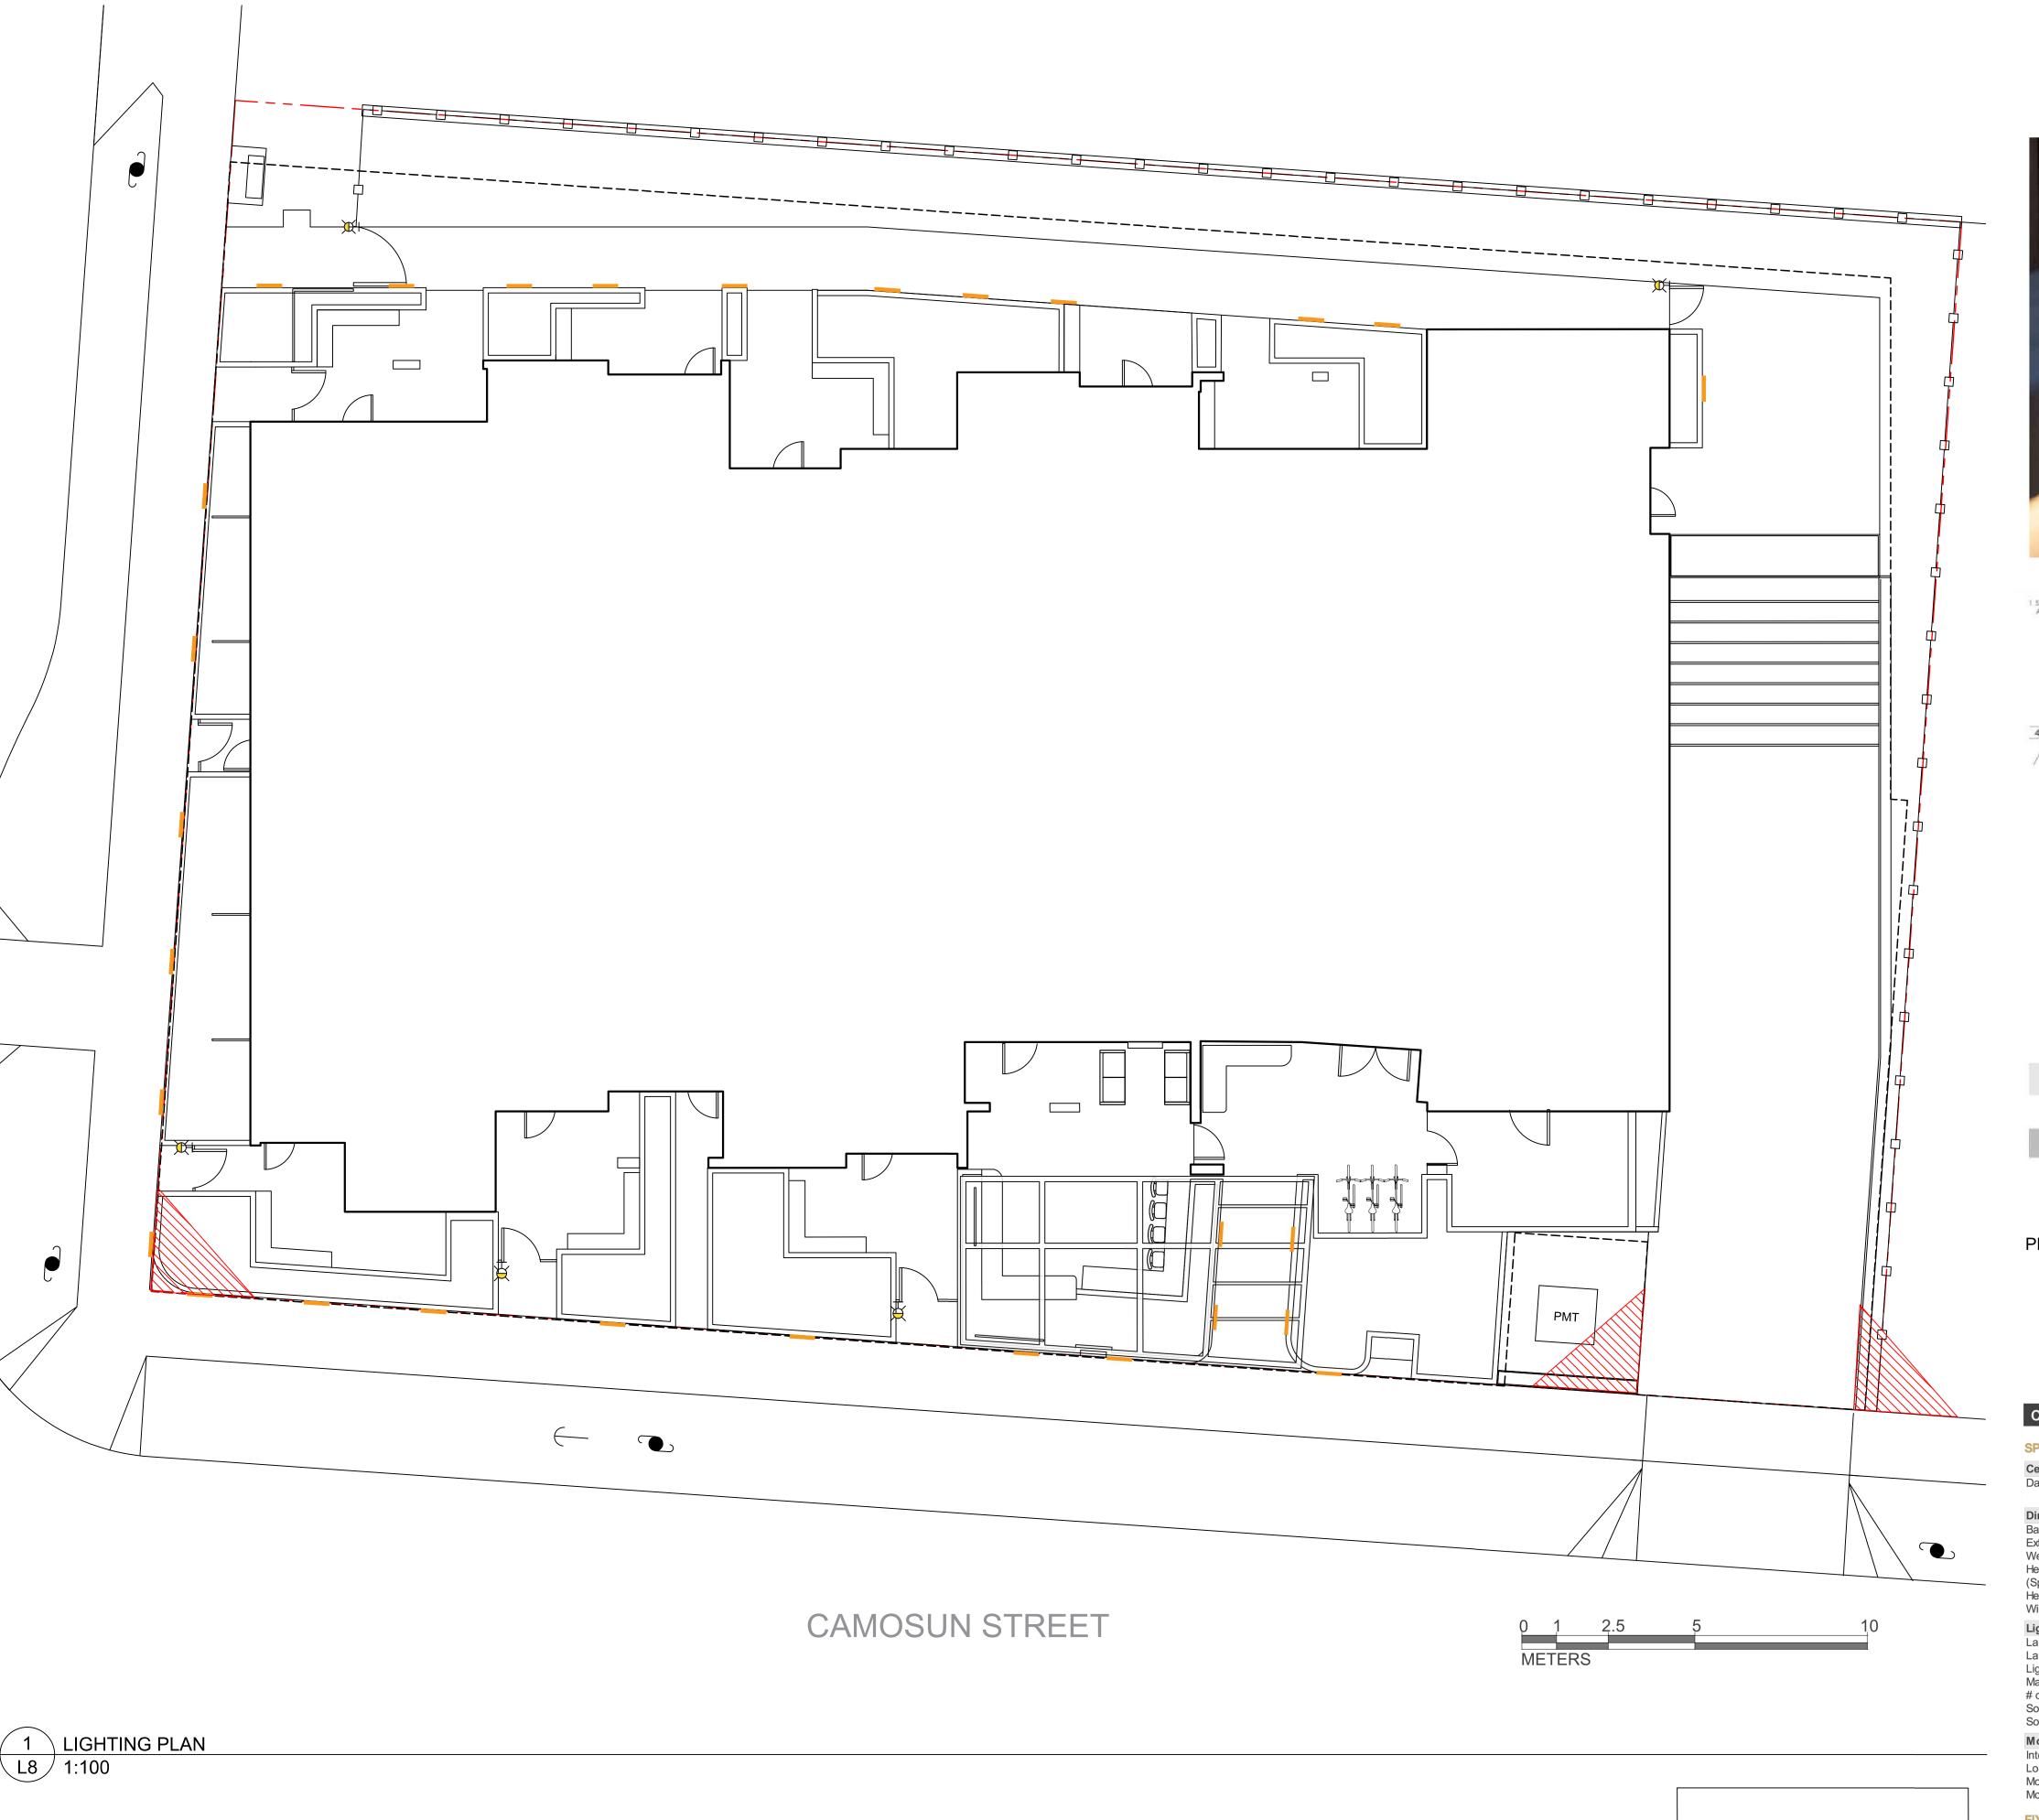



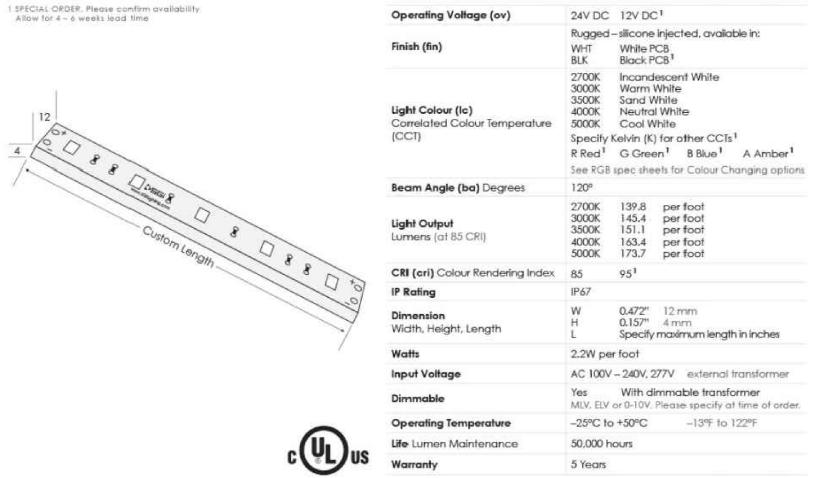

Recommended Tracks LP1707					ANG2618	
Part Number Confi	guration — FLEX — P	-REG - ov - fin - lc - eri				
Category	Family	Operating Voltage (ov)	Finish (fin)	Light Colour (Ic)	CRI (cri)	
FLEX-P Professional	REG	12VDC ¹ 24VDC	WHT White BLK Black ¹	2700K IW 3000K WW 3500K SW 4000K NW 5000K CW R ¹ G ¹ B ¹ A ¹	85 95 ¹	

Cylinder 7" 1 Light Wall Light Black

SPECIFICATIONS Certifications/Qualifications Dark Sky Compliant www.kichler.com/warranty **Dimensions**Base Backplate Base Backplate 5.00 X 4.75
Extension 7.00"
Weight 0.95 LBS
Height from center of Wall opening 3.50" (Spec Sheet) 7.00" 4.75" Light Source Lamp Included Not Included Lamp Type Light Source Incandescent Max or Nominal Watt # of Bulbs/LED Modules Socket Type Socket Wire Interior/Exterior Location Rating Mounting Style Mounting Weight Wall Mount 0.95 LBS

Mounting Style
Mounting Weight

0.95 LBS

FIXTURE ATTRIBUTES

Housing
Primary Material

Product/Ordering Information
SKU

9234BK

GATE DOWNLIGHT



Biophilia Design Collective Ltd. 250.590.1156 Info@biophiliacollective.ca

CLIENT
H Development Group Ltd.

ADDRESS 1270 Pandora St Victoria, BC

DESIGNED BY

Bianca Bodley

DRAWN BY

EB/ KT

REGISTERED AND ALIVERSTON SCAPE ARCHITECT

ISSUED FOR

1 DEVELOPMENT PERMIT 21/12/21
2 DEVELOPMENT PERMIT RESUBMISSION 22/04/04
3 DEVELOPMENT PERMIT RESUBMISSION 22/12/19
4 DEVELOPMENT PERMIT RESUBMISSION 23/02/08


DEVELOPMENT PERMIT RESUBMISSION February 08, 2023

Scale: 1:100



L8 LIGHTING PLAN

DATE: February, 2023

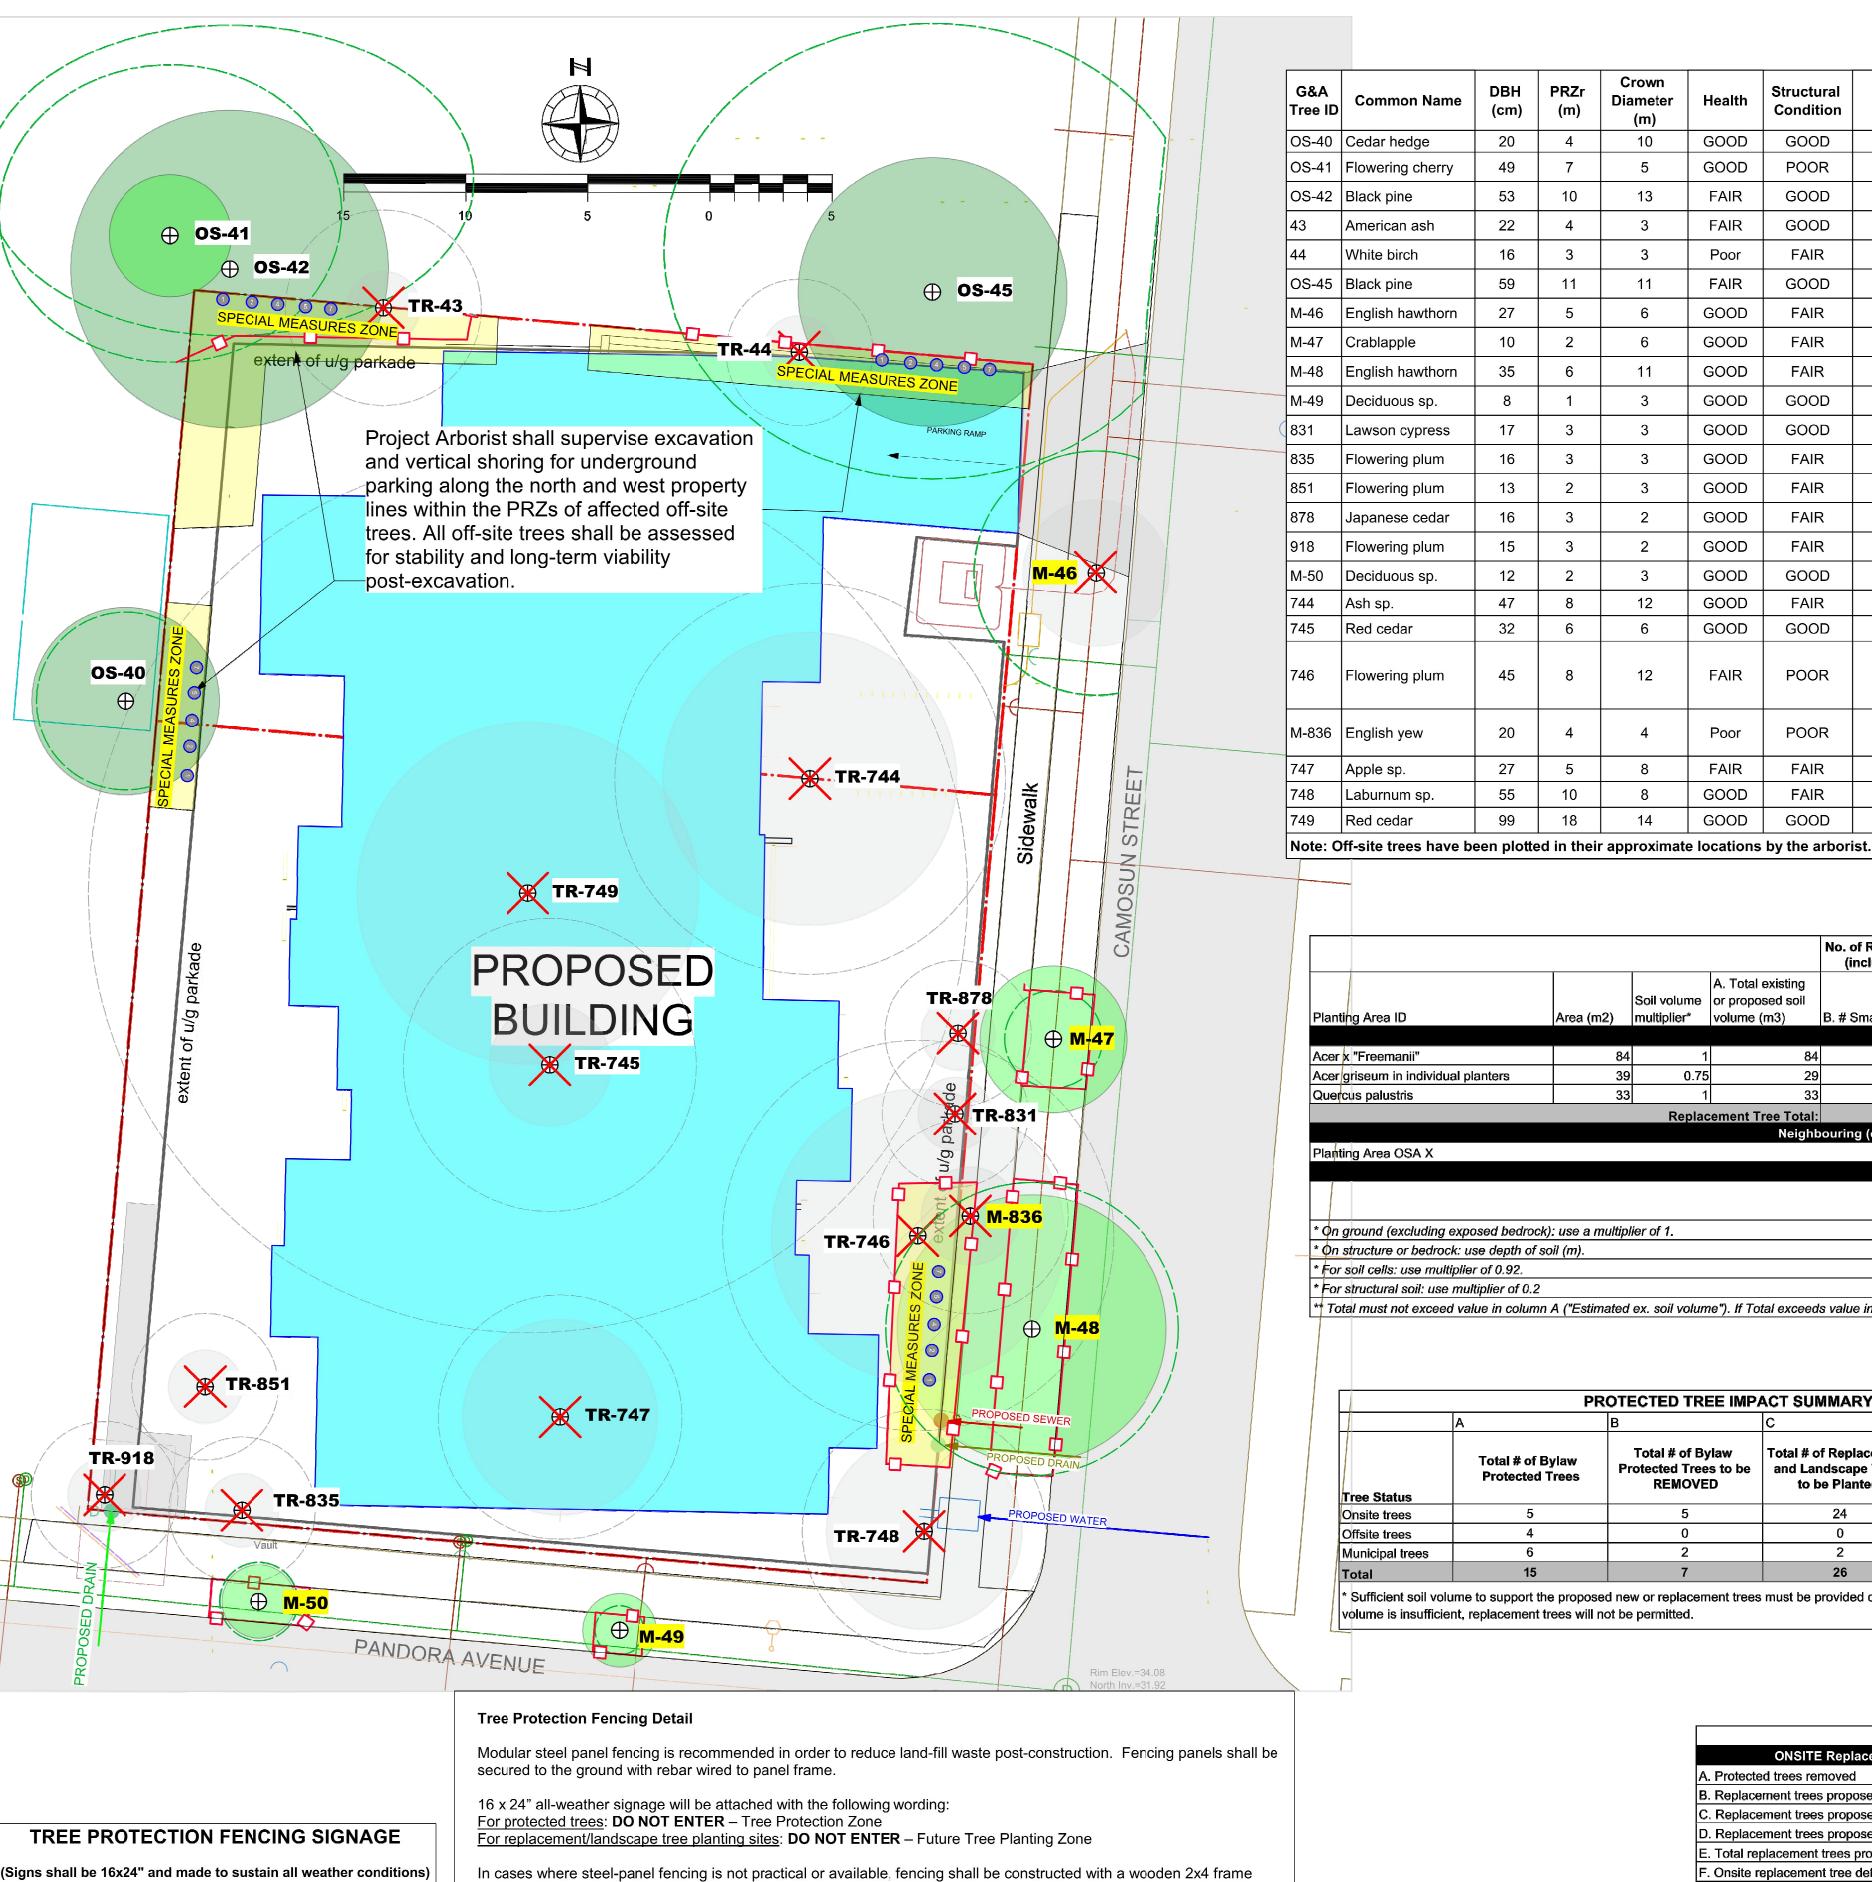

(side, top and bottom rails) and back-bracing supports as required to ensure robust placement. Snow-fencing will then be

affixed to the frame using battens, zip-ties, staples, wire or nails.

Tree Protection Zone

Project Arborist: Gye and Associates Ltd. 250.883.4533

NO EXCAVATING

TREE INVENTORY TABLES

G&A Tree ID	Common Name	DBH (cm)	PRZr (m)	Crown Diameter (m)	Health	Structural Condition	Location	Retention Suitability	Species tolerance of disturbance	Comments	Action
OS-40	Cedar hedge	20	4	10	GOOD	GOOD	Off-site Non-Bylaw	SUITABLE	GOOD	Located above and behind ex. retaining wall	Retain
OS-41	Flowering cherry	49	7	5	GOOD	POOR	Off-site Non-Bylaw	SUITABLE	POOR	Overmature	Retain
OS-42	Black pine	53	10	13	FAIR	GOOD	Off-site Non-Bylaw	SUITABLE	GOOD		Retain
43	American ash	22	4	3	FAIR	GOOD	Boundary Non-Bylaw	SUITABLE	MODERATE	Conflicts with proposed parkade	Remove
44	White birch	16	3	3	Poor	FAIR	On-site Non-Bylaw	SUITABLE	POOR	Conflicts with proposed parkade	Remove
OS-45	Black pine	59	11	11	FAIR	GOOD	Off-site Bylaw	SUITABLE	GOOD		Retain
M-46	English hawthorn	27	5	6	GOOD	FAIR	Municipal Tree	SUITABLE	GOOD		Remove
M-47	Crablapple	10	2	6	GOOD	FAIR	Municipal Tree	SUITABLE	GOOD		Retain
M-48	English hawthorn	35	6	11	GOOD	FAIR	Municipal Tree	SUITABLE	GOOD		Retain
M-49	Deciduous sp.	8	1	3	GOOD	GOOD	Municipal Tree	SUITABLE	MODERATE		Retain
831	Lawson cypress	17	3	3	GOOD	GOOD	On-site Non-Bylaw	SUITABLE	GOOD		Remove
835	Flowering plum	16	3	3	GOOD	FAIR	On-site Non-Bylaw	SUITABLE	MODERATE	Recent crown reduction with heading cuts	Remove
851	Flowering plum	13	2	3	GOOD	FAIR	On-site Non-Bylaw	SUITABLE	MODERATE	Recent crown reduction with heading cuts	Remove
878	Japanese cedar	16	3	2	GOOD	FAIR	On-site Non-Bylaw	SUITABLE	MODERATE		Remove
918	Flowering plum	15	3	2	GOOD	FAIR	On-site Non-Bylaw	SUITABLE	MODERATE	Recent crown reduction with heading cuts	Remove
M-50	Deciduous sp.	12	2	3	GOOD	GOOD	Municipal Tree	SUITABLE	MODERATE		Retain
744	Ash sp.	47	8	12	GOOD	FAIR	On-site Bylaw	UNSUITABLE	MODERATE	Located within proposed building footprint	Remove
745	Red cedar	32	6	6	GOOD	GOOD	On-site Bylaw	SUITABLE	GOOD	Located within proposed building footprint	Remove
746	Flowering plum	45	8	12	FAIR	POOR	On-site Bylaw	UNSUITABLE	POOR	Located within proposed building footprint. Significant decay within main stem.	Remove - Hazard Tree
M-836	English yew	20	4	4	Poor	POOR	Municipal Tree	SUITABLE	GOOD	Co-dependent with Tree 746. Conflicts with proposed parkade.	Remove
747	Apple sp.	27	5	8	FAIR	FAIR	On-site Non-Bylaw	SUITABLE	GOOD	Located within proposed building footprint	Remove
748	Laburnum sp.	55	10	8	GOOD	FAIR	On-site Bylaw	UNSUITABLE	GOOD	Located within proposed building footprint	Remove
749	Red cedar	99	18	14	GOOD	GOOD	On-site Bylaw	SUITABLE	MODERATE	Located within proposed building footprint	Remove

SOIL VOLUME CALCULUS

If B=1, Bx8 | If C=1, Cx20 | If D=1, Dx35 | E+F+G

If B>1, Bx6 | If C>1, Cx15 | If D>1, Dx30

									Total Soil Volume Surplus/Deficit (m3)		
Area (m2)	Soil volume	or proposed soil	B. # Small	C. # Medium	D. # Large	E. Small	F. Medium	G. Large	Total**		
Planting Area ID Area (m2) multiplier* volume (m3) B. # Small C. # Medium D. # Large E. Small F. Medium G. Large Total** Onsite trees											
84	1	84	0	5	0	N/A	5 x 15	N/A	75	9	
39	0.75	29	2	0	0	2 x 6	N/A	N/A	12	27	
33	1	33	0	2	0	N/A	2 x 15	N/A	30	3	
	Replac	ement Tree Total:	9		_			_			
	Area (m2) 84 39	Area (m2) Soil volume multiplier* 84 1 39 0.75 33 1	84 1 84 39 0.75 29 33 1 33	A. Total existing Soil volume or proposed soil volume (m3) B. # Small	A. Total existing A. T	Soil volume or proposed soil volume (m3) B. # Small C. # Medium D. # Large	A. Total existing A. Total existing Soil volume multiplier* volume (m3) B. # Small C. # Medium D. # Large E. Small	A. Total existing or proposed soil volume (m3) B. # Small C. # Medium D. # Large E. Small F. Medium	A. Total existing or proposed soil volume (m3) B. # Small C. # Medium D. # Large E. Small F. Medium G. Large	Area (m2) Soil volume multiplier* A. Total existing or proposed soil volume (m3) B. # Small C. # Medium D. # Large E. Small F. Medium G. Large Total**	

* On ground (excluding exposed bedrock): use a multiplier of 1.

 * ϕ n structure or bedrock: use depth of soil (m).

* For soil cells: use multiplier of 0.92.

*† Total must not exceed value in column A ("Estimated ex. soil volume"). If Total exceeds value in column A, then the number or size of proposed replacement trees must be reduced.

PROTECTED TREE IMPACT SUMMARY TABLE (focus on Replacement trees)									
	А	В	c	D	E	F			
Tree Status	Total # of Bylaw Protected Trees	Total # of Bylaw Protected Trees to be REMOVED	Total # of Replacement and Landscape Trees to be Planted*	# of EXISTING Non-Protected Trees Nominated as Replacement Trees	RESIDUAL (POST-CONSTRUCTION) TREE TOTAL (A-B+C+D)	NET CHANGE (C+D)-B			
Onsite trees	5	5	24	0	24	19			
Offsite trees	4	0	0	0	4	0			
Municipal trees	6	2	2	0	6	0			
Total	15	7	26	0	34	19			

* Sufficient soil volume to support the proposed new or replacement trees must be provided on site and demonstrated by the calculations made in Schedule "E"(g). If soil volume is insufficient, replacement trees will not be permitted.

REPLACEMENT TREE CALCULUS

	Count	Multiplier	Total	
ONSITE Replacement tree requirement (including "Tree	Minimum"	')		
A. Protected trees removed	5	X 1		
B. Replacement trees proposed per Schedule "E", B. Part 1	0	X 1		
C. Replacement trees proposed per Schedule "E", C. Part 2	0	X 0.5		
D. Replacement trees proposed per Schedule "E", D. Part 3	9	X 1		
E. Total replacement trees proposed (B + C + D) Round down to nearest whole number				
F. Onsite replacement tree deficit (A - E) Record 0 if negative number				
ONSITE Minimum trees per lot requirement (or	nsite trees)		
G. Tree minimum on lot*				
H. Protected trees retained (other than specimen trees)	0	X 1		
I. Specimen trees retained	0	Х3		
J. Trees per lot deficit (G - (B + C + H + I)) Record 0 if negative number				
OFFSITE Minimum replacement tree requirement	(offsite tre	es)		
K. Protected trees removed (municipal)	1	X 1		
L. Replacement trees proposed per Schedule "E", Part 1 or Part 3	1	X 1		
M. Replacement trees proposed per Schedule "E", Part 2	0	X 0.5		
N. Total replacement trees proposed (L + M) Round down to nearest whole number				
O. Offsite replacement tree deficit (K - N) Record 0 if negative number				
Cash-in-lieu requirement				
P. Onsite trees proposed for cash-in-lieu Enter F. or J., whichever is the	greater nur	nber		
Q. Offsite trees proposed for cash-in-lieu Enter O.	-			
R. Cash-in-lieu proposed ((P + Q) X \$2,000)			\$	
* Refer to Schedule "F"				

TREE PRESERVATION MEASURES City of Victoria Tree Bylaw 21-035

- 1. Pre-construction meeting to review Tree Plan: Before demolition and site preparation begins, the owner and contractor shall meet with the arborist to review the placement of fencing and other tree protection measures within this plan.
- a) The Project Arborist shall clearly mark the boundaries of all areas to be fenced and protected.
- b) Access routes and areas for trade parking and materials storage will be identified with the contractor.

2. Tree Fencing:

a) Tree protection fencing shall be installed to the Ciity of Victoria standards at the locations indicated on this drawing prior to demolition or building permit being issued (see fencing detail on plan).

- b) Tree protection fencing and armouring shall be maintained in good condition throughout the duration of the project.
- c) Requests to temporarily remove or move tree fencing must be reviewed by the project arborist for approval.

3. Tree Management Plan posting:

- a) A full-sized weather-proof copy of this tree plan shall be posted in plain sight in the site office.
- b) The general contractor shall ensure that all relevant sub-trades are familiar with the drawing and tree protection measures.
- 4. Site servicing and excavations: The project arborist shall be present to oversee excavation, service trenching, stump removal, site grading within, or adjacent to, the tree protection areas (TPAs). Areas of sensitivty are indicated on the plan as SPECIAL MEASURES


5. Root & branch pruning and protection:

- a) Any tree roots or branches damaged during site work shall be pruned back to undamaged tissue by the arborist.
- b) The vertical face of excavated cuts adjacent to the TPAs shall be securely covered with heavy plastic sheeting to prevent soil desiccation and erosion.
- . Mulching & Irrigation: Retained trees adjacent to the excavated areas shall be top-dressed with 100mm of leaf mould or clean (disease-free) tree chip mulch and irrigated bi-weekly during the dry summer period to a minimum effective depth of 30cm.
- 8. **Temporary access:** If temporary access is required within a tree protection area (TPA), the contractor shall notify the project arborist in advance and review the access requirements and any additional protective measures prescribed by the arborist.
- 9. Soil armouring: If it is not possible to fence the entire PRZ, the unprotected portion of the PRZ shall be armoured with two overlapping layers of 3/4" plywood. (See drawing for recommended soil armouring locations.)
- 10. Storage restrictions: No equipment, materials or excavated soil shall be placed or stored within the TPAs.
- 11. Replacement planting: Nine (9) replacement trees will be planted in compensation for the removal of five (5) protected trees and to achieve the City's "Tree Minimum" requirement for this site area. The size of the replacement trees shall respect the City of Victoria Tree Protection Bylaw standards. Tree types and planting locations shall be approved by the City of Victoria and detailed in the Tree Replacement and Landscape Planting Plan drawings prepared by the Landscape

OF




ALL-TREE SUMMARY STATISTICS

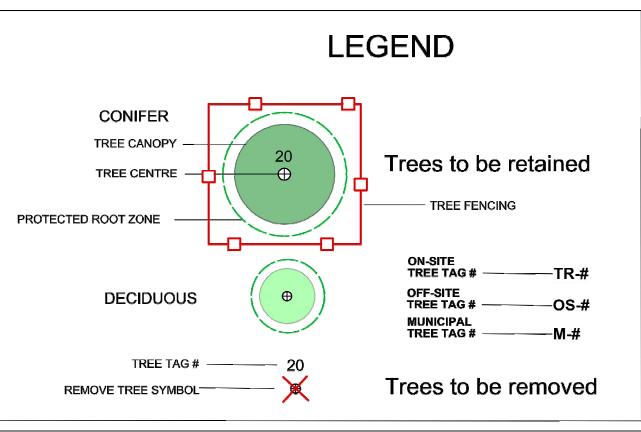



1270/1286 Pandora Ave + 1516 Camosun St, Victoria, BC

Tree Management Plan for BPA

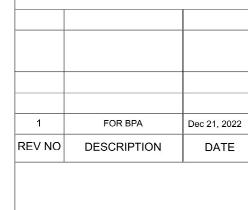

PROJECT NO. 20-078 DATE April 8 2022 SCALE 1:150 DRAWN BY LM SHEET NO. T - 1