956 HEYWOOD

PROJECT NUMBER: 2101

ISSUED FOR DEVELOPMENT PERMIT- 2021.09.07

CONTACTS

DRAWING LIST

| CLIENT | ARYZE DEVELOPMENTS | ARCHITECTUR | AL | CIVIL | |
|-----------|---|-------------|---------------------------------|------------|-------------|
| | 1839 FAIRFIELD RD, | A000 | COVER | 21-006-CSP | CONCEPTUA |
| | VICTORIA BC, V8S 1G9 CONT: LUKE MARI | A001 | AREA CALCULATIONS | | |
| | TEL: 250 881 6077 | A002 | SPATIAL SEPARATION CALCULATIONS | LANDCAPE | |
| | EMAIL: luke@aryze.ca | A003 | SHADOW STUDY AND STREETSCAPE | LO | TREE REMOV |
| | | A101 | EXISTING SITE PLAN | L1 | LANDSCAPE |
| ARCHITECT | COLIN HARPER ARCHITECT | A102 | PROPOSED SITE PLAN | L2 | LANDSCAPE |
| | 302-666 COOK STREET, | A201 | BASEMENT FLOOR PLAN | L3 | TREE PLANTI |
| | VICTORIA, BC, V8V 3Y7 CONT: COLIN HARPER | A202 | LEVEL 1 FLOOR PLAN | L4 | SHRUB PLAN |
| | TEL: 778 584 0582 | A203 | LEVEL 2 FLOOR PLAN | | |
| | EMAIL: charper@charch.ca | A204 | LEVEL 3 FLOOR PLAN | SURVEY | |
| | 1 0 | A205 | LEVEL 4/ROOF PLAN | | SITE PLAN |
| CIVIL | MCELHANNEY | A301 | NORTH & SOUTH ELEVATIONS | | |
| | 3960 Quadra St #500, | A302 | EAST & WEST ELEVATIONS | | |
| | VICTORIA, BC V8X 4A3 CONT: NATHAN DUNLOP | A303 | MATERIAL BOARD | | |
| | TEL: 778 746 7417 | A304 | RENDERINGS | | |
| | EMAIL: ndunlop@mcelhanney.com | A305 | NEIGHBOUR OPENINGS | | |
| | | A401 | SECTIONS | | |
| | | | | | |

LANDSCAPE **BIOPHILIA COLLECTIVE** 1608 CAMOSUN ST VICTORIA BC, V8T 3E6 CONT: BIANCA BODLEY TEL: 250 589 8244 EMAIL: bianca@biophiliacollective.ca






PROJECT NOTES

- 1. ALL DIMENSIONS AND AREAS ARE APPROXIMATE AND AREAS TO BE VERIFIED WITH SURVEY INFORMATION;
- 2. THIS IS NOT A COMPLETE DESIGN AND AS SUCH ANY ACTIONS OR DECISIONS ON PURCHASE OR SALE OF LAND/DEVELOPMENT ARE NOT THE RESPONSIBILITY OF THE ARCHITECT.
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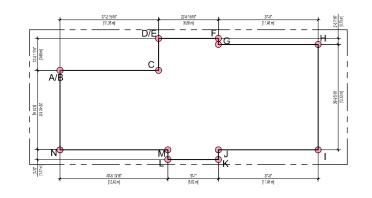
AERIAL CONTEXT



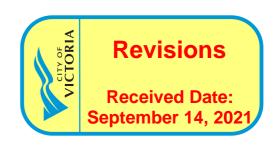

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OVAL AND PROTECTION PLAN PE PLAN PE SECTIONS AND IMAGERY ITING PLAN ANTING PLAN





UNIT A - EXEMPT 19.55m² (214,696f)

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UNIT A - EXEMP 19.95m² (214.696


25.93m² (279.15s)

OGED PARK 25.93e2 (2


4 BASEMENT FLOOR AREA CALC

ELEC. EXEMPT TOTAL - EXEMPT 152.24m² (1,638.70st)

| ZC | ONING GRADE CALCULATION | | | | | GRADES | | | | |
|----|-------------------------|--------|------|-----------|------------------------------|--------|--------------|----------|----------|-------|
| GR | ADE POI | NTS (m |) | LENGTH(m) | GRADE CALCS | | Grade Points | Existing | Proposed | Grade |
| в | 8.27 | C | 6.66 | 11.35 | (8.27 + 6.66) + 2 x 11.35m - | 84.73 | Points A | 8.43 | 8.43 | 8.43 |
| c | 6.66 | D | 6.66 | 3.68 | (6.66 + 6.66) + 2 x 3.68m = | 24.51 | Points B | 8.43 | 8.27 | 8.27 |
| E | 8.05 | F | 7.75 | 6.68 | 18 C5 + 7.75) ÷ 2 x €.88m = | 54.35 | Points C | 8.17 | 6.66 | 6.66 |
| F | 7.75 | G | 7.75 | 0.70 | (7.75 + 7.75) ÷ 2 x C.7m = | 5.43 | Points D | 8.05 | 6.66 | 6.66 |
| G | 7.75 | н | 7.55 | 11.48 | (7.75 + 7.55) + 2 x 11.48m = | 87.82 | Points E | 8.05 | 8.05 | 8.05 |
| н | 7.55 | T. | 7.54 | 12.12 | (7.55 + 7.54) + 2 x 12.12m - | 91.45 | Points F | 7.75 | 7.75 | 7.75 |
| | 7.54 | J | 8.12 | 11.48 | (7.54 + 8.12) ÷ 2 x 11.48m = | 89.89 | Points G | 7.75 | 7.75 | 7.75 |
| J | B.12 | к | 8.10 | 1.17 | (8.12 + 8.1) + 2 x 1.17m = | 9.49 | Points H | 7.55 | 7.67 | 7.55 |
| ĸ | B.10 | L | 8.25 | 5.82 | (8.1 + 8.25) + 2 × 5.82m = | 47.58 | Points I | 7.54 | 7.67 | 7.54 |
| L | 8.25 | М | 8.25 | 1.17 | (8.25 + 8.25) ÷ 2 x 1.17m = | 9.65 | Points J | 8.12 | 8.12 | 8.12 |
| М | 8.25 | N | 8.69 | 12.42 | 18.25 + 8.69) + 2 x 12.42m = | 105.20 | Points K | 8.10 | 8.10 | 8.10 |
| N | 8.69 | A | 8.43 | 9.10 | (8.69 + 8.43) + 2 x 9.1m = | 77.90 | Points L | 8.25 | 8.25 | 8.25 |
| го | TALS | | | 87.37 | = 699/87 | 687.98 | Points M | 8.25 | 8.25 | 8.25 |
| ٩v | ERAGE G | RADE | | | | 7.87 | Points N | 8.69 | 8.69 | 8.69 |

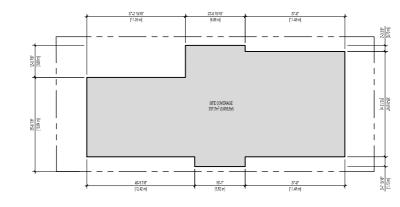




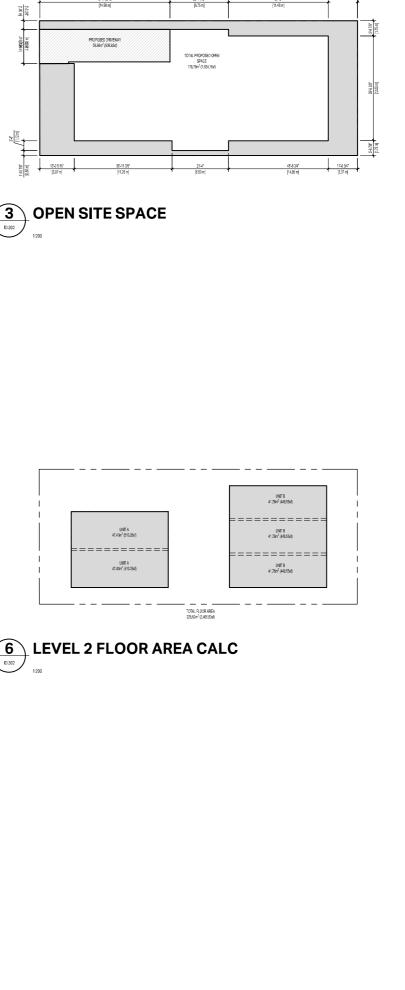








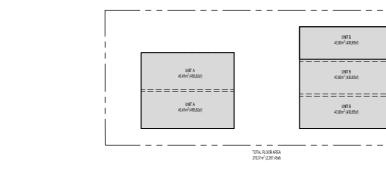

5 LEVEL 1 FLOOR AREA CALC

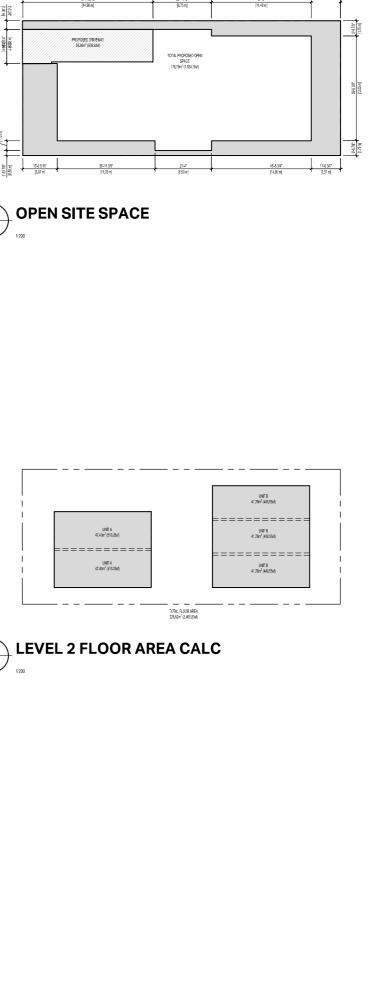

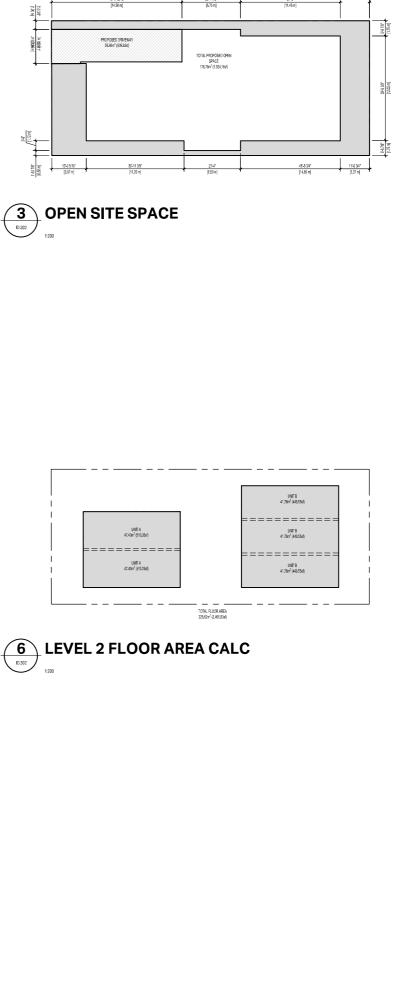

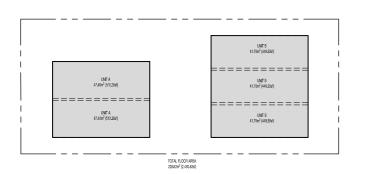


UNIT A - EXEMP 17.56m² (189.01s ===

UNIT A - EXEMPT 17*5*8m² (189,01sf)

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UNIT A - EXEMPT 17.56m² (189.01sf)







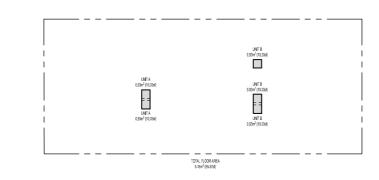

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| COLIN HARPER ARCHITECT 302-666 Cook Street, Victoria, BC, V8V 3Y7 | 302-666 Cook Street, | victoria, BC, V8 | V 3Y7 |
| 778-584-0582 info@charch.ca charch.ca DRAWINGTITLE: | | charch.ca char | rch.ca |
| AREA CALCULATIONS | AREA CALC | ULATIO | NS |
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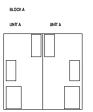


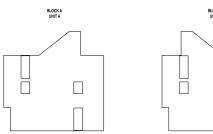

| UNIT A-SOUTH ELEVATION Spatial separation calculation BCBC 2018 PART 9 TABLE 9.10.15 | | UNIT B-SOUTH ELEVATION Spatial separation calculation BCBC 2018 PART 9 TABLE 9.10.15 | |
|--|---------------------------------------|--|---------------------------------------|
| AREA OF EXPOSED BUILDING FACE: | 105.97m ² (1.140.67so,ft) | AREA OF EXPOSED BUILDING FACE: | 105.97m ² (1.140.67sq.ft) |
| LIMITING DISTANCE: | 1.75m (5.74ft) | LIMITING DISTANCE: | 1.75m (5.74ft) |
| ALLOWABLE OPENINGS: | 7.5% (7.90m ² (85.5so,ft)) | ALLOWABLE OPENINGS: | 7.5% (7.90m ²)85.5sq.ft)] |
| PROPOSED OPENINGS: | 7.4% (7.96m ² (84.5so,ft)) | PROPOSED OPENINGS: | 7.4% (7.86m ²)84.5sq.ft)] |
| FIRE RESISTANCE RATING | NA | FIRE RESISTANCE RATING | NA |
| CLADDING PER 9.10.15.5.(2) | NA | CLADDING PER 9.10.15.5.(2) | NA |
| CLADDING PER 9.10.15.5.(3) | NA | CLADDING PER 9.10.15.5.(3) | NA |

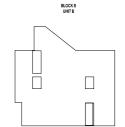









AREA OF EXPOSED BUILDING FACE: LIMITING DISTANCE: ALLOWABLE OPENINGS: PROPOSED OPENINGS: FIRE RESISTANCE RATING CLADDING PER 9.10.15.5.(2) CLADDING PER 9.10.15.5.(3)

1:200

39.27m² (422.75sq.ft) 3.38m (11.81t) 25.9% (10.2m²(109.3sq.ft)) 25.5% (10.0m²(107.8sq.ft))



NA NA

UNIT B-NORTH ELEVATION Spatial separation calculation BCBC 2018 Part 9 Table 9.10.15 AREA OF EXPOSED BUILDING FACE: LIMITING DISTANCE: ALLOWABLE OPENINGS: PROPOSED OPENINGS: 105.97m²(1.140.67sq.ft) 1.75m (5.74ft) 7.5% (7.90m²)85.5sq.ft] 7.4% (7.86m²)84.5sq.ft] FIRE RESISTANCE RATING CLADDING PER 9.10.15.5.(2) CLADDING PER 9.10.15.5.(3) NA NA

BLOCK B UNIT B

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BLOCK B UNITB

UNIT B

UNIT B - EAST ELEVATION Spatial Separation Calculation BCBC 2018 Part 9 Table 9.10.15 AREA OF EXPOSED BUILDING FACE: LIMITING DISTANCE: ALLOWABLE OPENINGS: PROPOSED OPENINGS:

1:200

FIRE RESISTANCE RATING CLADDING PER 9,10,15,5,(2) CLADDING PER 9,10,15,5,(3)


UNIT B

34.67m² (373, 14sq.ft) 3.38m (11ft) 28.2% (9.6m² (105,3sq.ft)) 28.1% (9.6m² (105,0sq.ft))

NA NA


5 BLOCK B - EAST ELEVATION




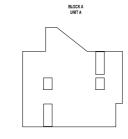

UNIT A-NORTH ELEVATION SPATIAL SEPARATION CALCULATION BCBC 2018 PART 9 TABLE 9.10.15 AREA OF EXPOSED BUILDING FACE: LINTING DISTANCE: ALLOWABLE OPENINGS: PROPOSED OPENINGS: 105.97m²(1,140,67sq,8) 1.75m (5.74f) 7.5% (7.90m²)85.5sq,ft]) 7.4% (7,96m²)84.5sq,ft])

FIRE RESISTANCE RATING CLADDING PER 9.10.15.5.[2] CLADDING PER 9.10.15.5.[3] NA NA NA

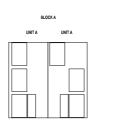

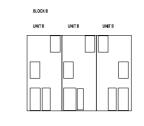

UNIT A-WEST ELEVATION Spatial separation calculation BCBC 2018 Part 9 Table 9.10.15 AREA OF EXPOSED BUILDING FACE: LIMITING DISTANCE: ALLOWABLE OPENINGS: PROPOSED OPENINGS: 39.27m² (422.75sq.ft) 14,02m (46,00ft) 100% (39.2m² (422.7sq.ft)) 40.6% [15.93m²(171.44sq.ft)] FIRE RESISTANCE RATING CLADDING PER 9.10.15.5J2) CLADDING PER 9.10.15.5J3) NA NA





UNIT B- WEST ELEVATION SPATIAL SEPARATION CALCULATION BCBC 2018 PART 9 TABLE 9.10.15

1:200

34.67m² (373.14sq.ft) 3,38m (11.09ft) 28.2% [9.8m²(105.3sq.ft]] 27.7% [9.6m²(103.5sq.ft]] NA NA

BLOCK B - WEST ELEVATION

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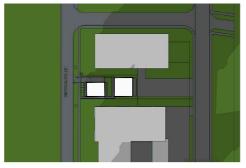








DECEMBER 21 - 12:00PM

JUNE 21 - 12:00PM





DECEMBER 21 - 3:00PM

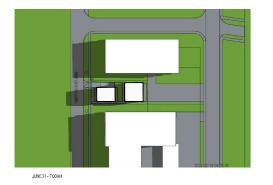


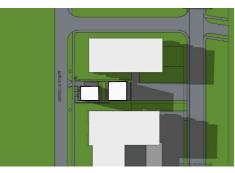

JUNE 21 - 6:00PM

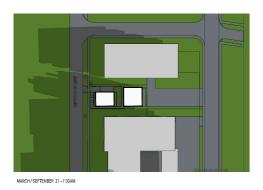

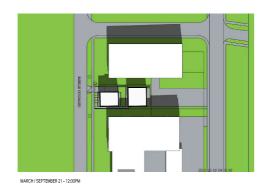

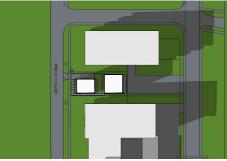


MARCH / SEPTEMBER 21 - 4:30 PM







1 SHADOW STUDY

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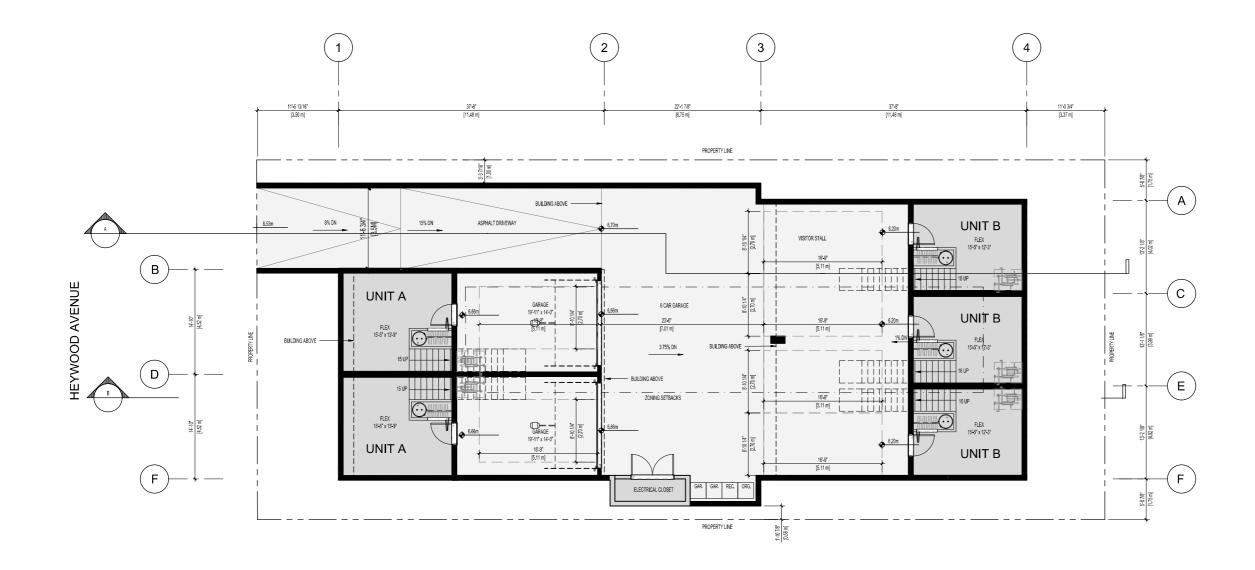

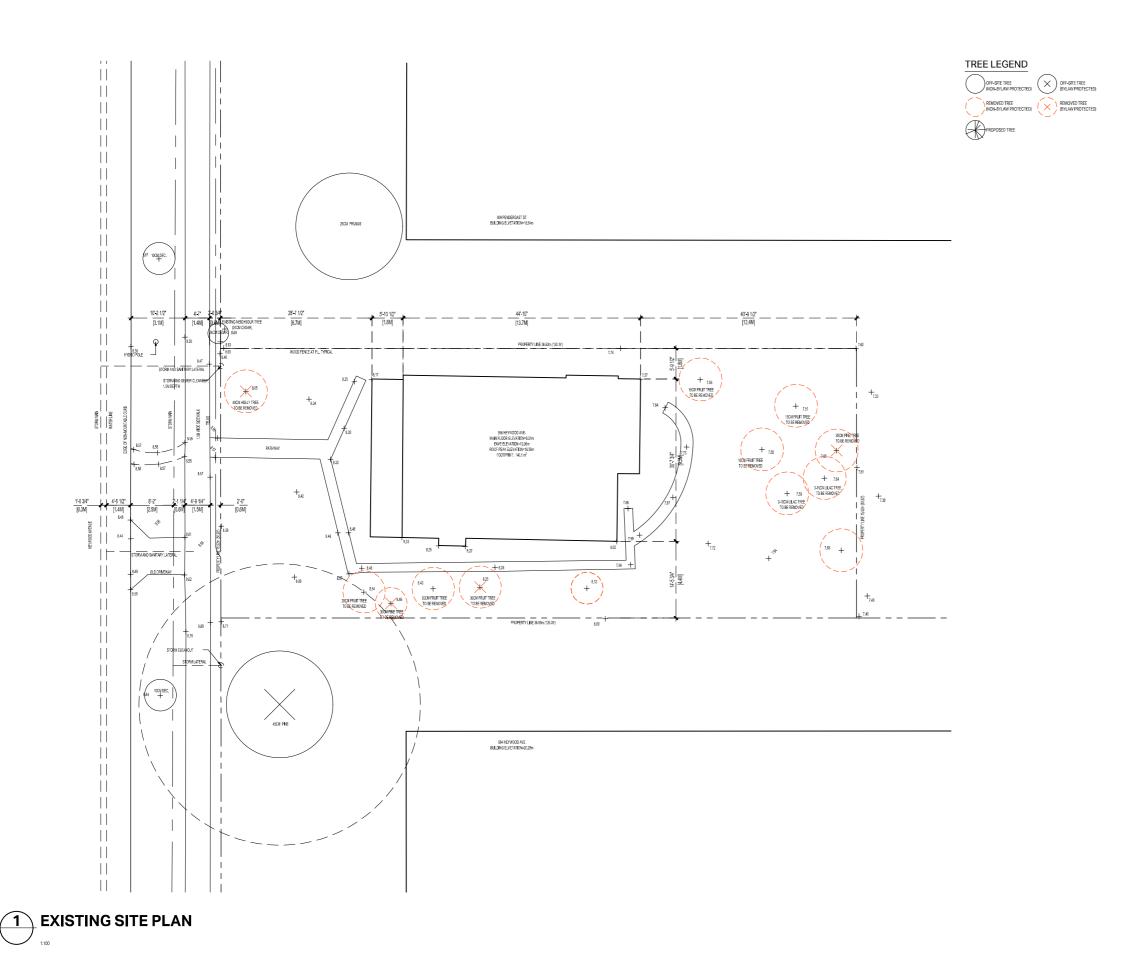
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956 HEYWOOD AVENUE, VICTORIA BC LOT 36 OF LOT 1694, VICTORIA, PLAN 24


DPA 16 - GENERAL FORM AND CHARACTER
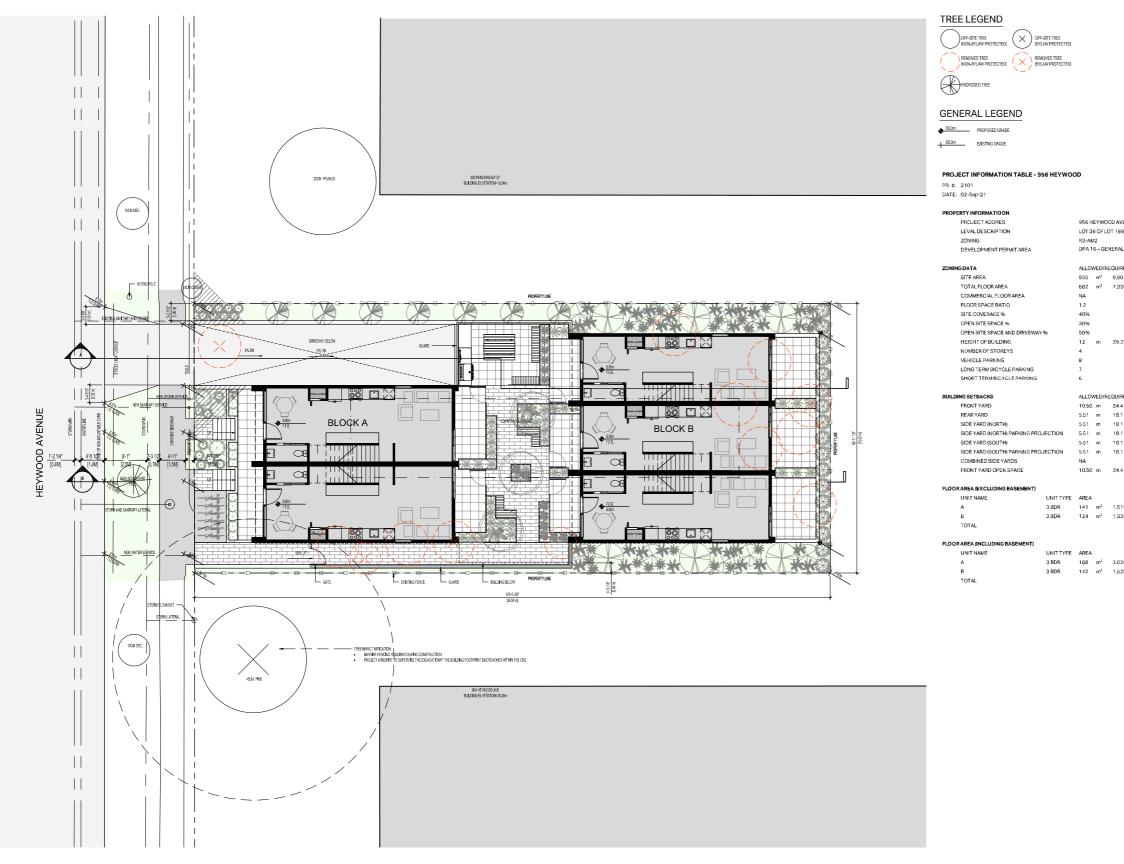
| JIRED | | PROP | ÓSED | | | VARIANO | СE | | |
|--------|-------|------|----------------|-------|-----------------|---------|-------|-------|----|
| 902.79 | sq.ft | 568 | m ² | 6.114 | sq.ft | NA | | | |
| 336.67 | sq.ft | 681 | m² | 7.335 | sq.ft | -0.185 | -2 | sq.ft | |
| | | | | | | | | | |
| | | 1.20 | | | | NA | | | |
| | | 59% | | | | 19% | | | |
| | | 3196 | | | | NA | | | |
| | | 42% | | | | 8% | | | |
| 9.37 | ft | 11.0 | m | 36.15 | ft | NA | | | |
| | | 4 | | | | NA | | | |
| | | 6 | | | | 2 | | | |
| | | 10 | | | | NA | | | |
| | | 6 | | | | NA | | | |
| | | | | | | | | | |
| JIRED | | PROP | OSED | | | VARIANO | CE | | |
| 4.4 | ft | 3.50 | m | 11.5 | ft | 7.00 | m | 23.0 | ft |
| 8.1 | ft | 3.37 | m | 11.1 | ft | 2.14 | m | 7.0 | ft |
| B.1 | ft | 1.75 | m | 5.7 | ft | 3.76 | m | 12.3 | ft |
| B.1 | ft | 1.00 | m | 3.3 | ft | 4.51 | m | 14.8 | ft |
| 8.1 | ft | 1.75 | m | 5.7 | ft | 3.76 | m | 12.3 | ft |
| B.1 | ft | 0.58 | m | 1.9 | ft | 4.93 | m | 16.2 | ft |
| | | | | | | | | | |
| 4.4 | ft | 3.50 | m | 11.5 | ft | 7.00 | m | 23.0 | ft |
| | | | | | | | | | |
| | | | | | | | | | |
| | | COUN | IT | TOTA | LAREA | | | | |
| 519.4 | sq.ft | 2 | | 282 | m² | 3,038.7 | sq.ft | | |
| 339.7 | sq.ft | з | | 373 | rm² | 4,019.2 | sq.ft | | |
| | | 5 | | 656 | rm² | 7,057.9 | sq.ft | | |
| | | | | | | | | | |
| | | | | | | | | | |
| | | COUN | т | ΤΟΤΑ | LAREA | | | | |
| 020.8 | sq.ft | 2 | | 375 | rm² | 4,041.6 | sq.ft | | |
| 528.7 | sq.ft | 3 | | 426 | rm ² | 4,586.2 | sq.ft | | |
| | | 5 | | 802 | m² | 8,627.8 | sq.ft | | |
| | | | | | | | | | |

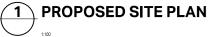







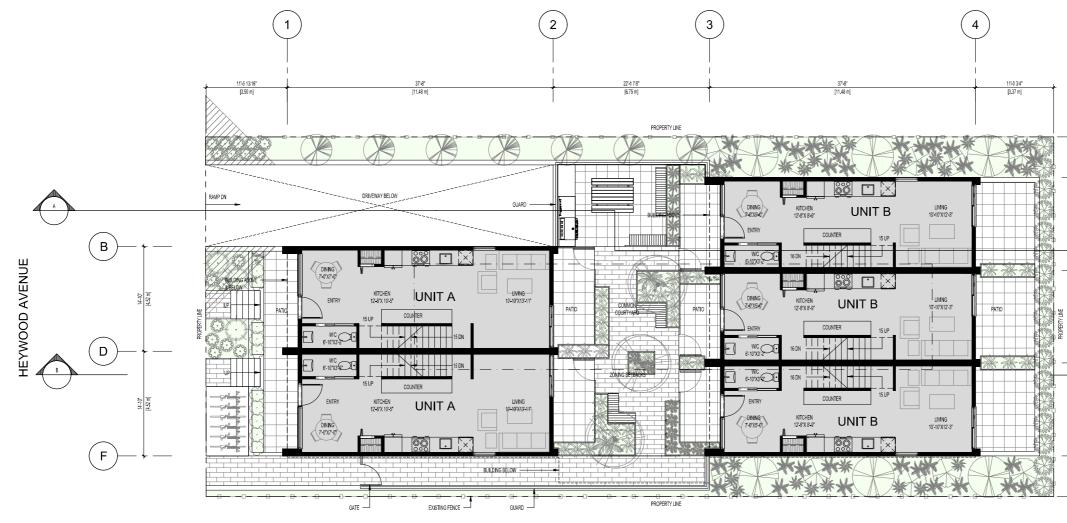




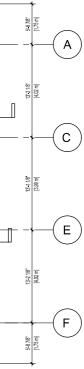


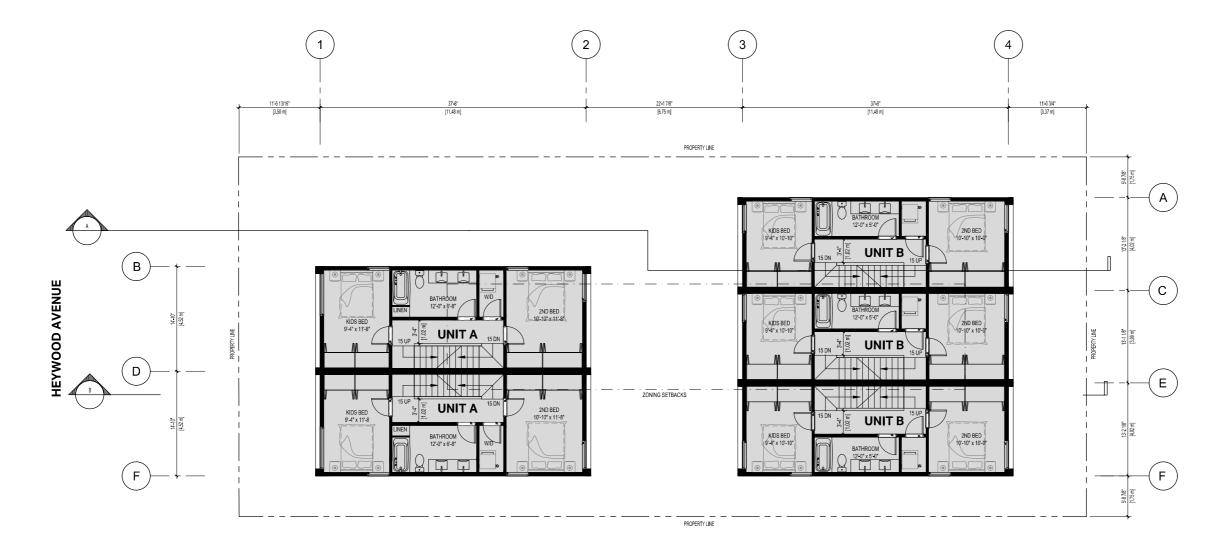



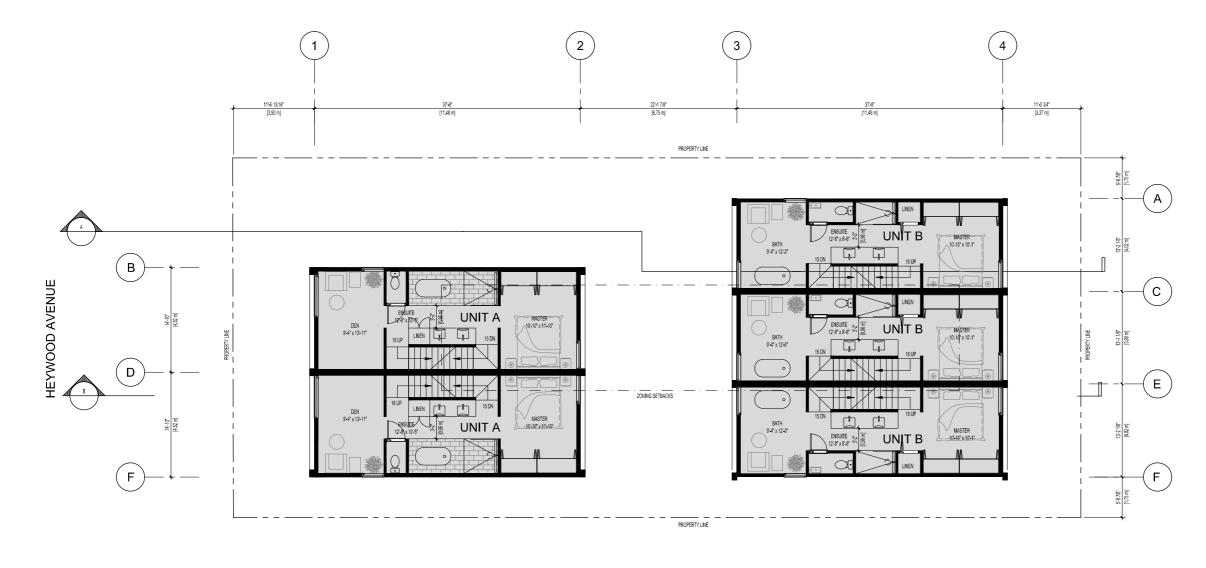




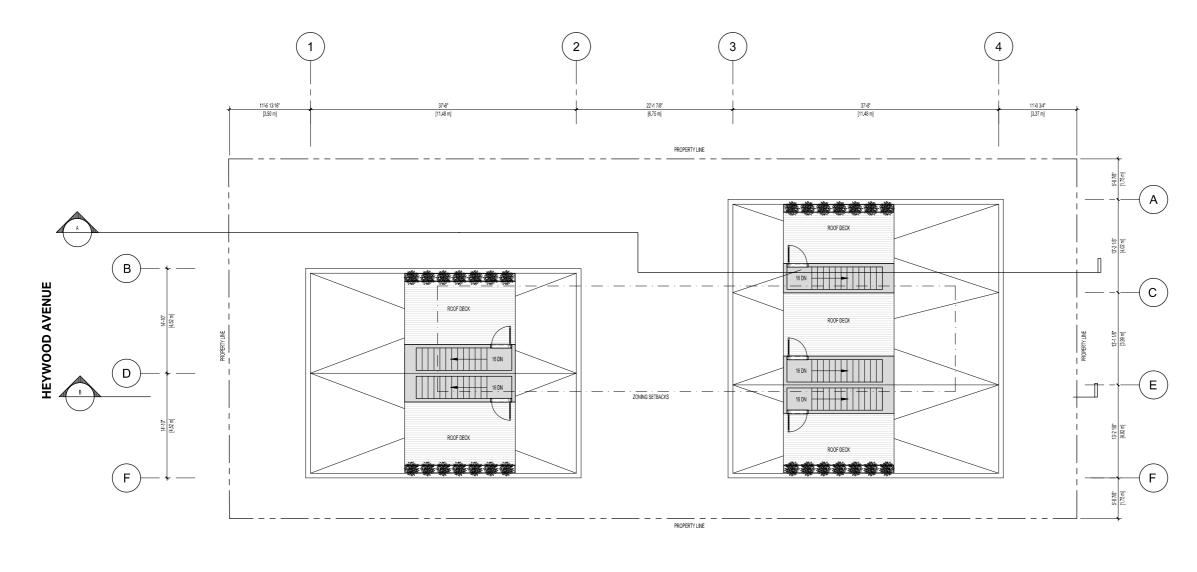






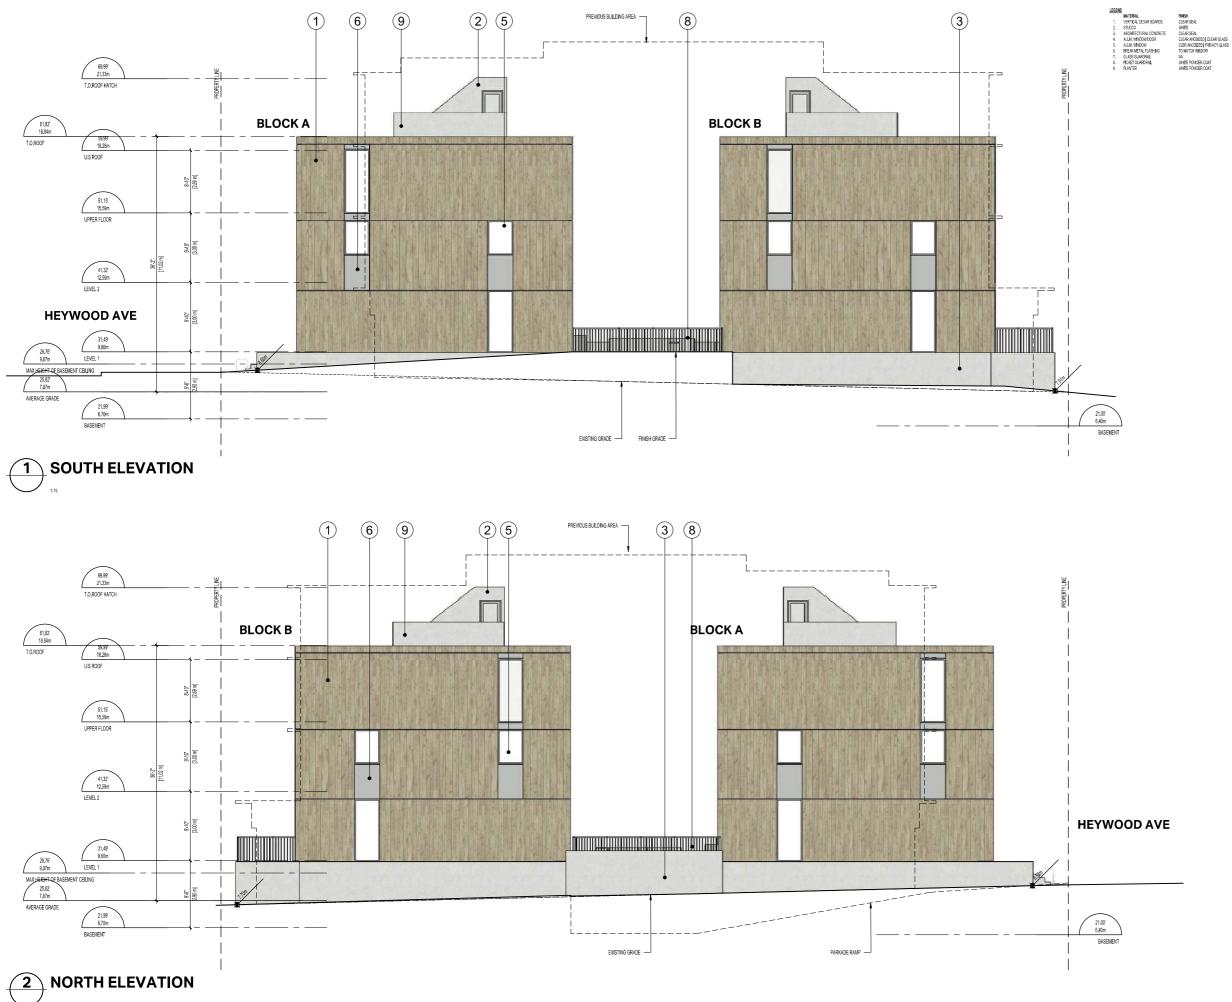

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| NO. PRC | | VICI | | | | |
| NO. PRC | JECT AD | | | | | |
| NO. PRC | JECT AD | VICT DRESS: WOOD | | | | |
| NO. PRC | JECT AD | VICT DRESS: WOOD | | | | |
| NO. PRC | JECT AD | VICT DRESS: WOOD | | | | |
| NO. PRC | JECT AD | | | А, В | | |
| PRO. 956 VIC | JECT AD | | | A, B | С | |
| PRO. 956 VIC | JECT AD 6 HEYY TORI, 72-666 8-584 | VICT DRESS: WOOD A, BC COLIN 5 Cook St 1-0582 in | HARP | A, B ER AR | | 3Y7 |
| PRO. 956 VIC | JECT AD | VICT DRESS: WOOD A, BC COLIN 6 Cook St 1-0582 in | HARP reet,Vio | A, B ER AR etoria, B arch.ca | C C C C C C C V 8 V C | 3Y7 |
| PRO. 956 VIC | JECT AD 6 HEYY TORI, 72-666 8-584 | VICT DRESS: WOOD A, BC COLIN 5 Cook St 1-0582 in | HARP reet,Vio | A, B ER AR etoria, B arch.ca | C C C C C C C V 8 V C | 3Y7 |
| PRO. 956 VIC 30 77 DRAW | JECT AD HEYY TORI , 12–666 8–584 ING TITLE: | VICT DRESS: WOOD A, BC COLIN 5 Cook St 1-0582 ir ELE | HARPP Freet,Violech VAT | A, B ER AR Storia, B arch.ca | C C C C C C C V 8 V C | 3Y7 |
| NO. PRC 970 956 VIC 300 77 DRAW | JECT AD HEYY TORI, 12-666 8-584 NG TITLE: TORIO: | VICT DRESS: WOOD A, BC COLIN 6 Cook St 1-0582 in | HARPP Freet,Violech VAT | A, B ER AR etoria, B arch.ca | C C C C C C C V 8 V C | ' 3Y7 ch.ca |

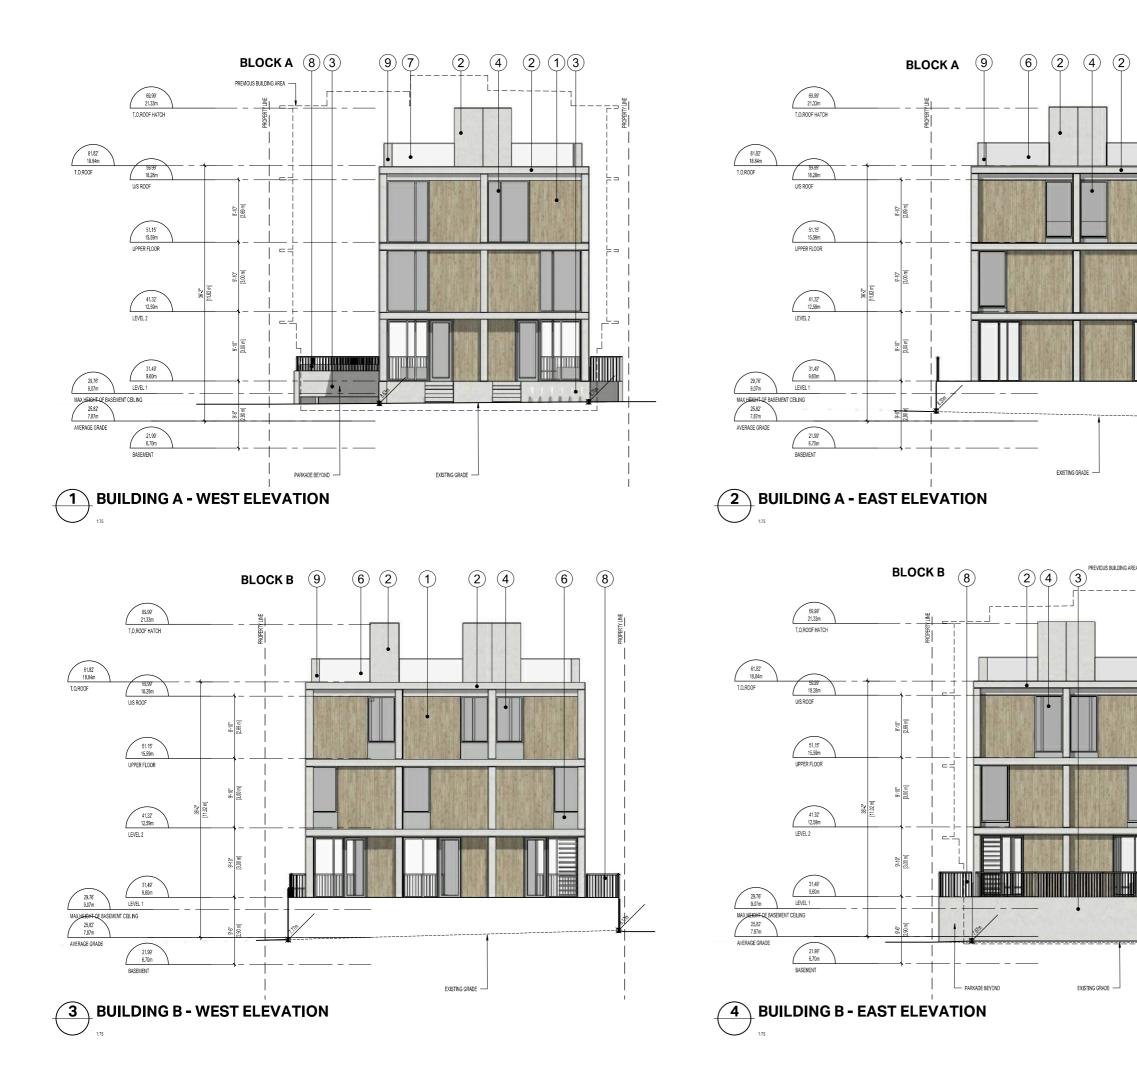

FINISH CLEAR SEAL WHITE CLEAR SEAL CLEAR ANODIZED | CLE CLEAR ANODIZED | CLE CLEAR ANODIZED | CRI CLEAR ANODIZED | CLE VIIITE POWDER COAT WHITE POWDER COAT 2 MATERIAL VERTICAL CEDAR BOARDS STUDCO ARCHITECTURAL CONCRETE ALLIA, WINDOWIDOR ALLIA, WINDOWIDOR BERKINETA, FLASHNO GLASS QUARDRALL & PICKET GLARDRALL 8. PLANTER opyright reserved. All parts of this drawing are the exclusive operty of Colin Harper Architect and shall not be used without the 8 3 ect's written permission. All dimensions shall be verified by th Y LINE THIS DOCUMENT HAS DEEN MOTIVATION CERTIFICATE AND ENCRYPTION TECHNOLOGY AN ARCHITECTURAL INSTITUTE OF BC AND THE ENC CENSCIENTISTS BC. THE AUTHORITATIVE ONCH OWNER/CLIENT: ARYZE DEVELOPMENTS 250.940.3568 (2)(1)(6)(9)09/07/20 WD/Y ISSUED FOR DEVELOPMENT PERMIT REVISION NO. PROJECT NAME 956 HEYWOOD VICTORIA, BC PROJECT ADDRESS: 956 HEYWOOD VICTORIA, BC COLIN HARPER ARCHITECT 302-666 Cook Street, Victoria, BC, V8V 3Y7 778-584-0582 | info@charch.ca | charch.ca ELEVATIONS PARKADE BEYOND 1 PROJECT NO: 2101 CH SCALE: 1:64 REVIEW BY: CH A302 DRAWING NO:

(1)





PRODUCT


- VERTICAL CEDAR BOARDS 1. 2. STUCCO 3. ARCHITECTURAL CONCRETE 4. ALUMINUM WINDOW/DOOR 5. ALUMINUM WINDOW/DOOR BRAKE METAL FLASHING
- GLASS GUARDRAIL 7.
- 8. METAL PICKET GUARDRAIL
- 9. PLANTER
- PAVERS 10.


6.

11. FENCE

COLOUR / SPEC

CLEAR SEAL WHITE CLEAR SEAL CLEAR ANODIZED | CLEAR GLASS CLEAR ANODIZED | PRIVACY GLASS MATCH WINDOW FRAME NA WHITE POWDER COAT WHITE POWDER COAT PER LANDSCAPE EXISTING

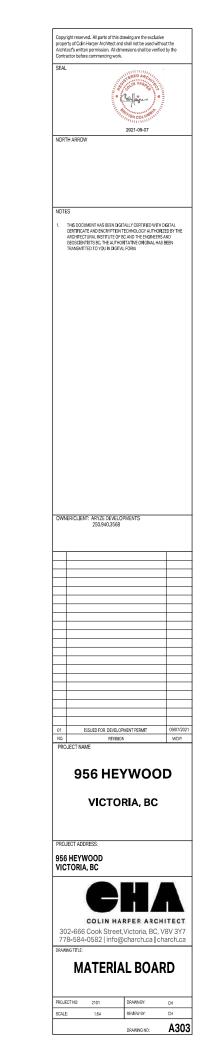

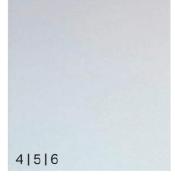





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2 NORTH ELEVATION


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 ISSUED FOR DEVELOPMENT PERMIT
 09/07/2021


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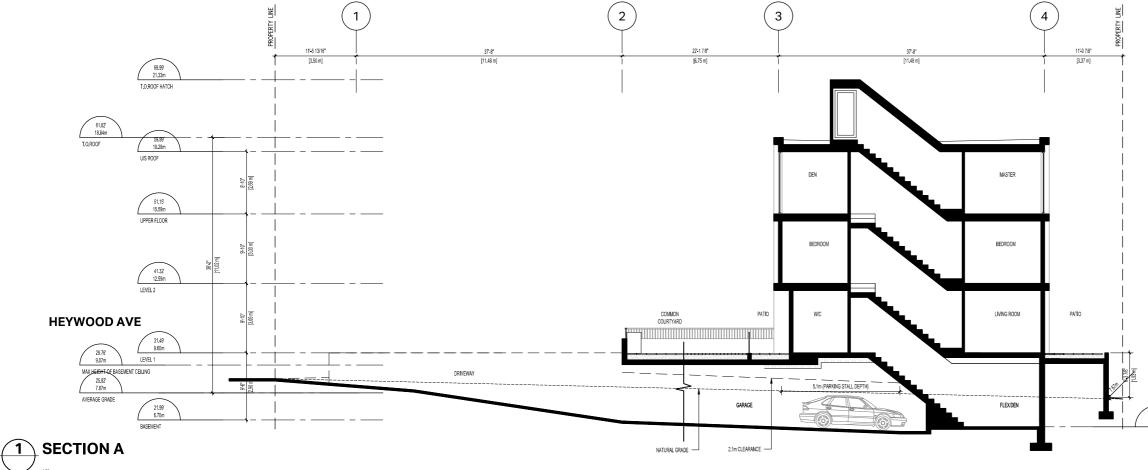
 PROJECT NAME
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 956 HEYWOOD VICTORIA, BC PROJECT ADDRESS: 956 HEYWOOD VICTORIA, BC ¢, COLIN HARPER ARCHITECT 302-666 Cook Street,Victoria, BC, V8V 3Y7 778-584-0582 | info@charch.ca | charch.ca DRAWING TITLE: **NEIGHBOUR OPENINGS**
 PROJECT NO:
 2101
 DRAWN BY:
 CH

 SCALE:
 1:64
 REVIEW BY:
 CH
 DRAWING NO: A305

PROPERTY LIN



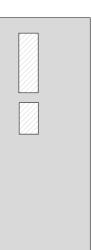


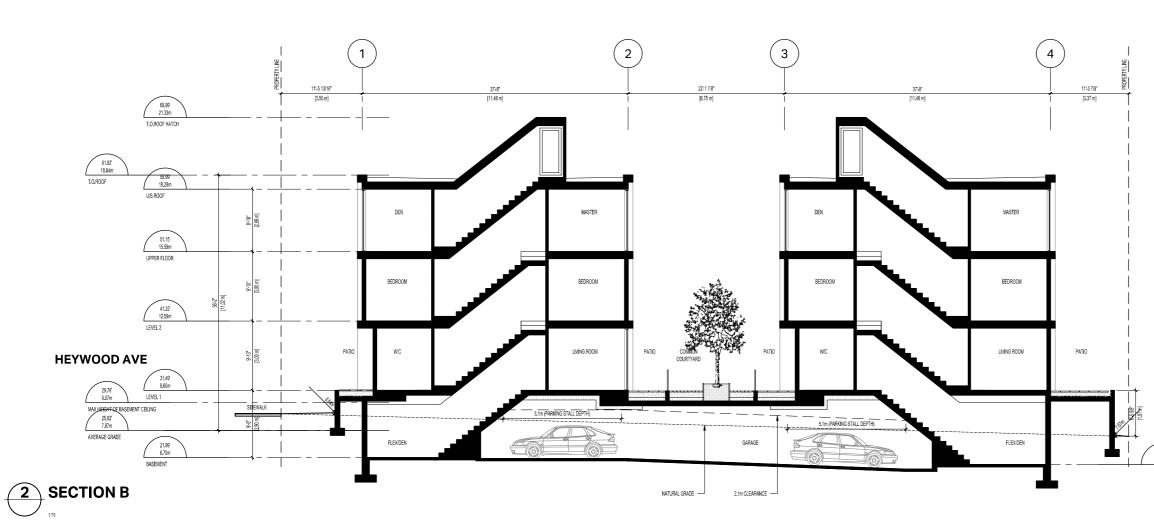


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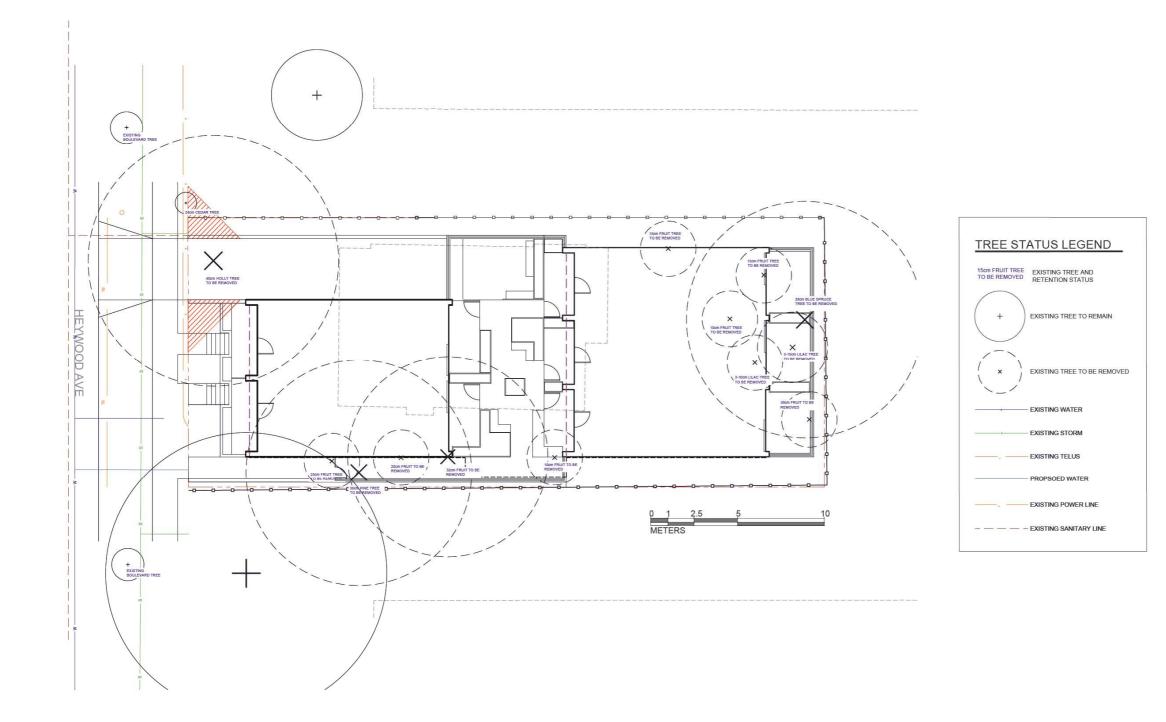
21.00' 6.40m BASEMENT





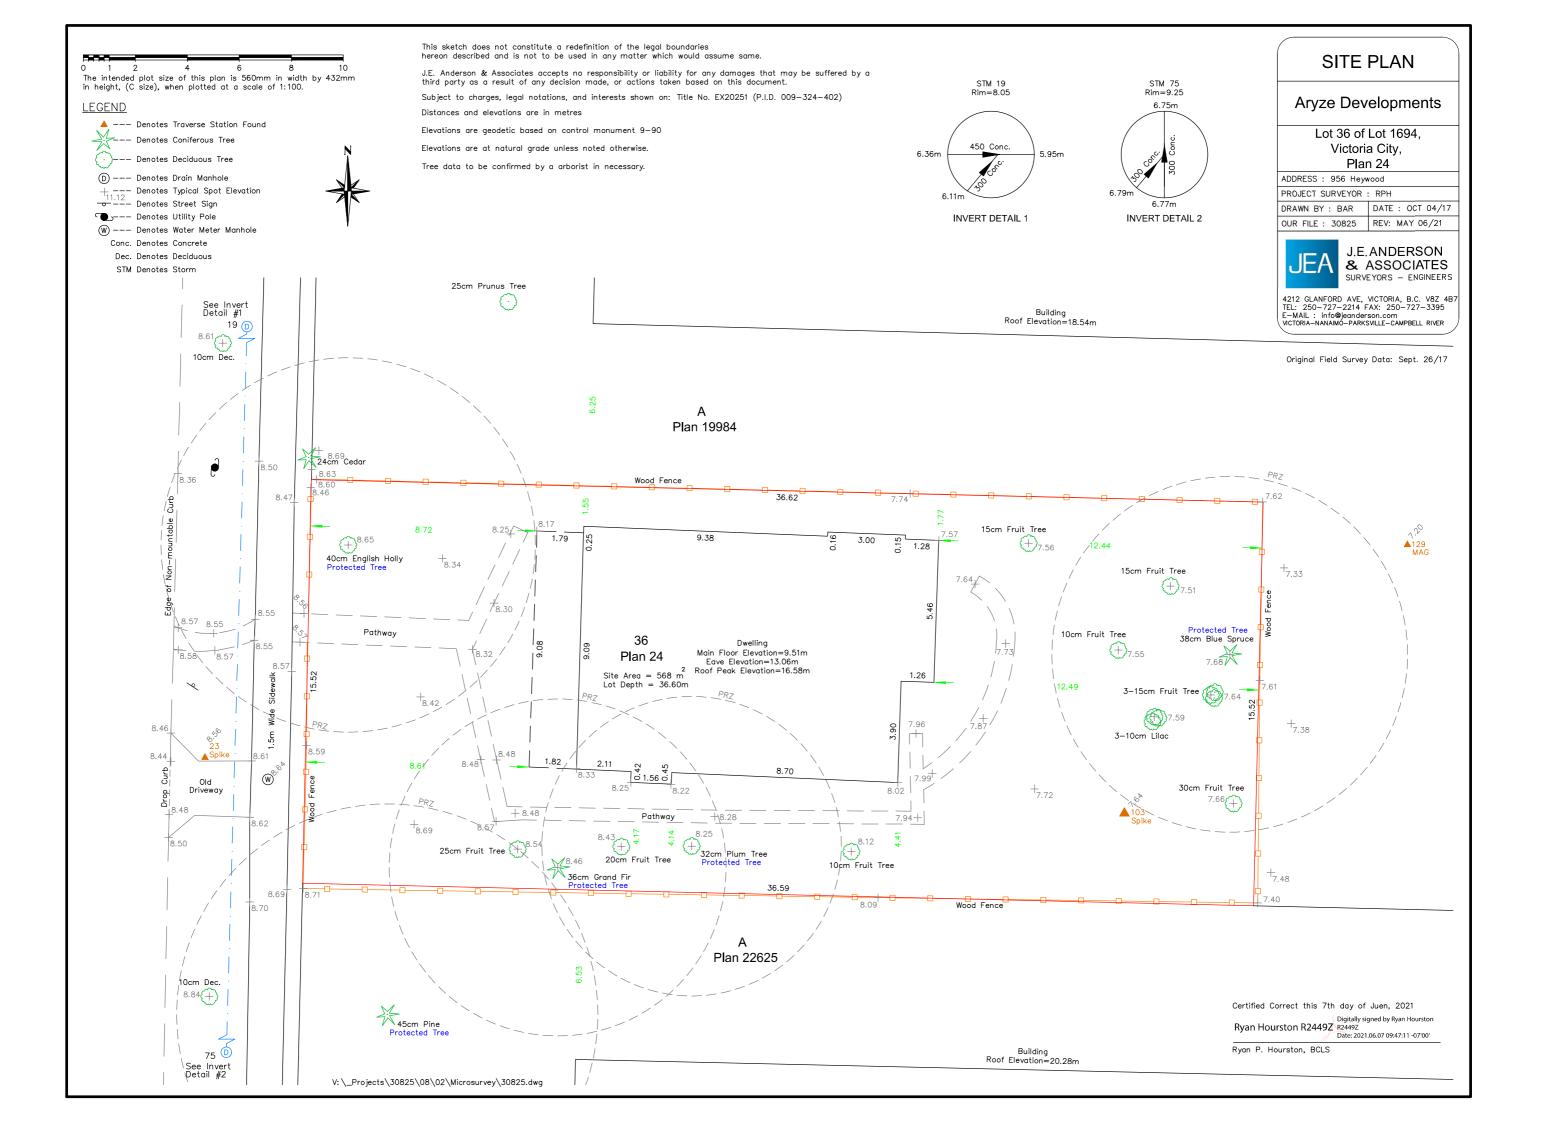

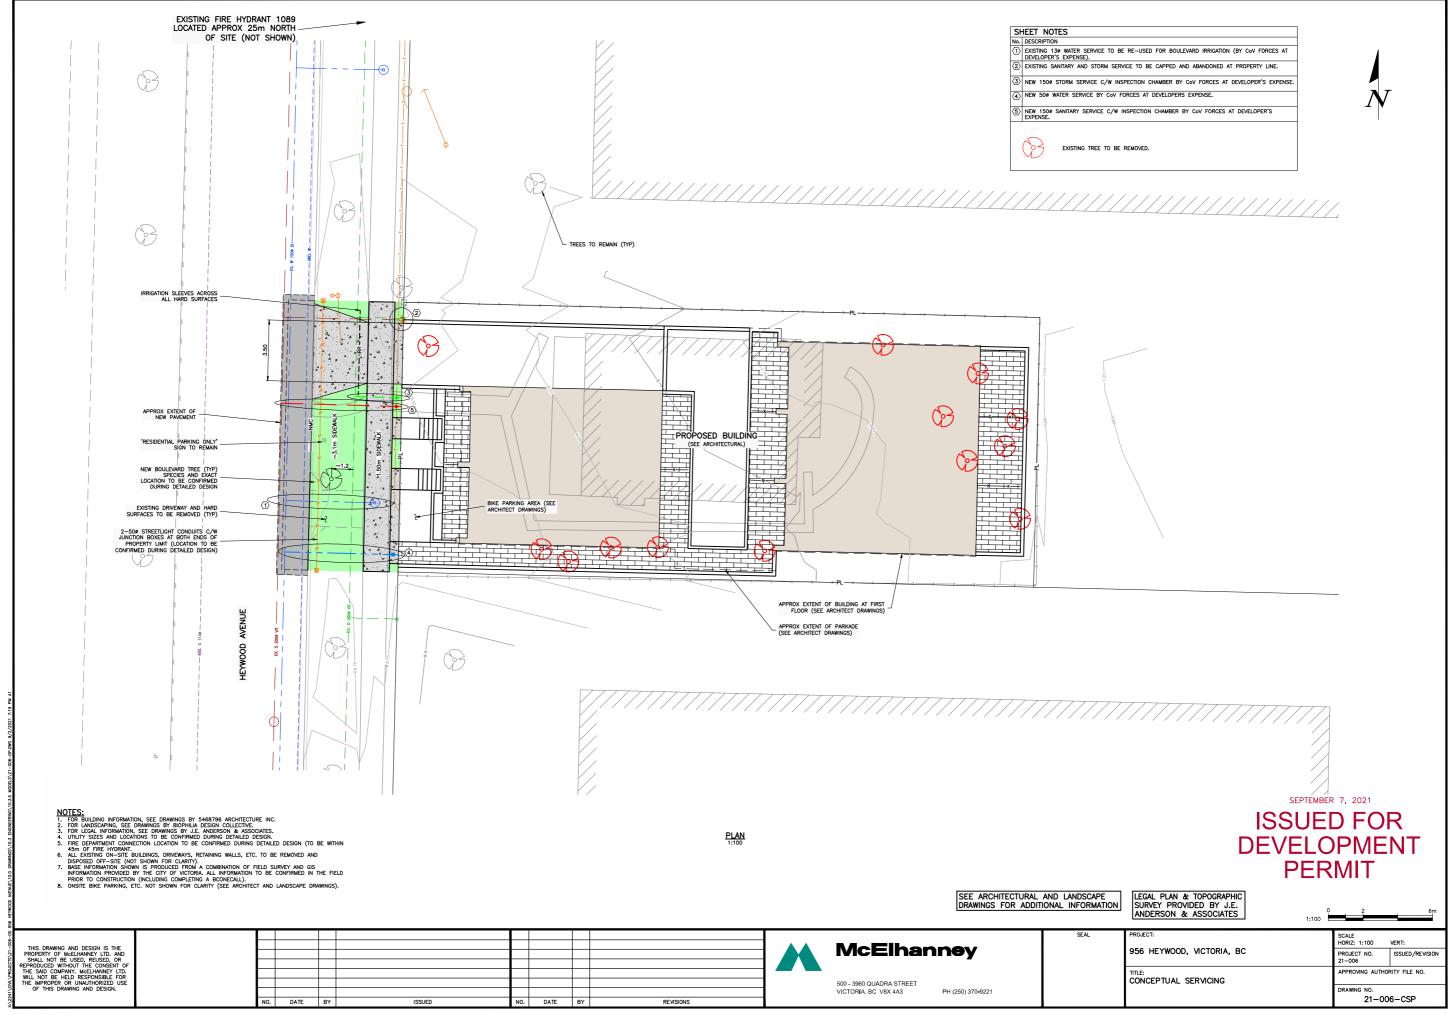





1608 Camosun Street, Victoria BC V8T 3E6 Info@biophiliacollective.ca 250 590 1156

owner/client

PROJECT NAME: Heywood Townhome

956 Heywood Ave Victoria, BC

DESIGNED BY: BIANCA BODLEY DRAWN BY: KIM TANG

| NO. | ISSUED FOR | DATE |
|-----|--------------------|----------|
| 1 | Development Permit | 9/7/2021 |
| | | |
| | | |
| | | |
| | | |
| | | |



NORTHARROV



DRAWING TITLE:

TREE REMOVAL & PROTECTION PLAN

L0

DWG NO:



ASHPHALT DRIVEWAY

MUNICIPAL SIDEWALK

SOD

SOD MUNICIPAL BOULEVARD AREA 150 mm DEPTH LOW TRAFFIC LAWN GROWING MEDIUM (MMCD)

CIP CONCRETE WITH BROOM FINISH TO CITY OF VICTORIA MUNICIPAL STANDARDS

.

ON-SITE LANDSCAPE AREA • 450 600 mm DEPTH 1L GROWING MEDIUM (BCLS)

50 mm DEPTH MULCH

RAISED PLANTER • 450 mm DEPTH PLANTER GROWING MEDIUM • 50 mm DEPTH MULCH

PRIVATE PATIOS

EXISTING FENCING

I ANDOWNERS

PROPOSED TREES

DEVELOPER AGREES TO REPLACE FENCING IF REQUESTED BY, AND IN CONSULTATION WITH, ADJACENT

-0-





PRIVATE PATIO PAVER

PATHWAY PAVER





BUILT IN BENCH

METAL PLANTER



DOWN LIGHT IN BENCH

DOWN LIGHT IN WALL

LANDSCAPE NOTES

PROPOSED BOULEVARD TREES


- PROPOSED BOULEVARD TREES TREE SPECIES TO BE COORDINATED WITH PARKS PRIOR TO PLANTING TREES MUST HAVE ONE DOMINANT CENTRAL LEADER OR SINGLE STRAIGHT TRUNK, 5-8 cm DIAMETER, CALIPER MEASURED 15 cm ABOVE GROUND, WELL BALANCED CROWN WITH BRANCHING STARTING AT 1.5m-25m ABOVE GROUND TREES TO BE PLANTED AS PER PLANTIG OF TREES, SHRUBS AND GROUND COVERS (32 93 01 MMCD 2009 AND CITY OF VICTORIA SUPPLEMENTAL DRAWINGS SD P3 AND SD P4) PARKS WILL REQUIRE (3) INSPECTIONS FOR TREE PLANTING: 1) INSPECTION OF SOIL AND PLANTING AREA, 2) INSPECTION OF STOCK UPON DELIVERY, 3) INSPECTIONS FOR TREE PLANTING: 1) INSPECTION OF SOIL AND FLANTING AREA, 2) INSPECTION OF STOCK UPON DELIVERY, 3) INSPECTIONS FOR TREE PLANTING: 1) INSPECTION OF SOIL AND FLANTING AREA, 2) INSPECTION OF STOCK UPON DELIVERY, 3) INSPECTIONS FOR TREE PLANTING: 1) INSPECTION OF SOIL AND FLANTING AREA, 2) INSPECTION OF STOCK UPON DELIVERY, 3) INSPECTIONS FOR TREE PLANTING: 1) INSPECTION OF SOIL AND FLANTING AREA, 2) INSPECTION OF STOCK UPON DELIVERY, 3) INSPECTIONS FOR TREE INSPECTION OF SOIL AND FLANTING AREA, 2) INSPECTION OF STOCK UPON DELIVERY, 3) INSPECTIONS FOR TREE INSPECTION OF SOIL AND FLANTING AREA, 2) INSPECTION OF SOIL THE APPLICANT MUST MAINTAIN THE TREE IN GOOD HEALTH AND STRUCTURAL CONDITION FOR 1 YEAR FROM THE SUBSTANTIAL COMPLETION TO BE ELIGIBLE FOR DEPOSIT RETURN.

- BOULEAVARDIRRIGATION
 SEE IRRIGATION PLAN IRRIGATEON PLAN TO BE SUBMITTED AT DP STACE
 MUNICIPAL BOULEVARD TO BE IRRIGATED BY A SEPARATE SYSTEM FROM A SEPARATE CITY SOURCE CONFORMING TO THE CITY OF VICTORIA SUPPLEMENTARY SPECIFICATIONS FOR STREET TREES AND IRRIGATION SCHEDULE C TO BYLAW 12-042, SUBDIVISION BYLAW.
 IRRIGATION DESIGN DRAWINGS MUST BE SENT TO PARKS FOR REVIEW 30 DAYS PRIOT O INSTALLATION.
 DRAWINGS SHOULD INDICATE ALL COMPONENTS, MODELS AND MATERIALS FORM WATER SUPPLY TO IRRIGATION HEADS.
 THE CITY WILL REQUIRE 4 INSPECTIONS FOR IRRIGATION MALLATION.
 DOPEN TRENCH AND LATERAL LINE, 4) OPERATION AND COVERAGE, AND BACKFLOW PREVENTER ASSEMBLY TEST REPORT.

HARD SURFACE TREATMENT

FURNITURE/ STRUCTURES

LIGHTINGS

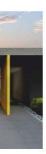



DOWN LIGHT IN BENCH




1608 Camosun Street Victoria BC V8T 3F6 Info@biophiliacollective.ca 250 590 1156

OWNER/CLIENT Aryze

ROJECT NAME Heywood Townhome

JECT ADDRESS: 956 Heywood Ave Victoria, BC

DESIGNED BY: BIANCA BODLEY DRAWN BY: KIM TANG

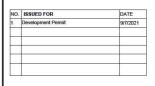




DRAWING TITLE:

LANDSCAPE PLAN

DWG NO:

SCALE: 1:100

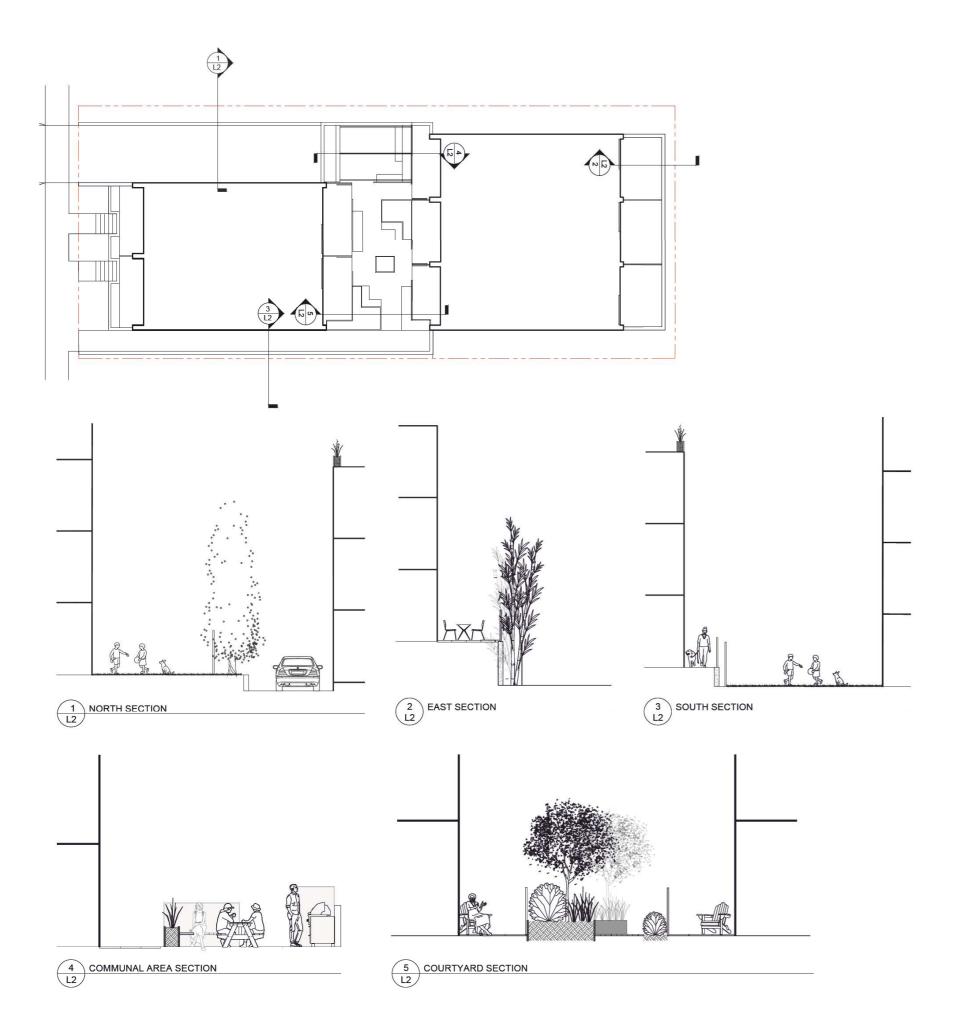



1608 Camosun Street, Victoria BC V8T 3E6 Info@biophiliacollective.ca 250 590 1156

owner/client

PROJECT NAME: Heywood Townhome

PROJECT ADDRESS: 956 Heywood Ave Victoria, BC

DESIGNED BY: BIANCA BODLEY DRAWN BY: KIM TANG

| NO. | ISSUED FOR | DATE |
|-----|--------------------|----------|
| 1 | Development Permit | 9/7/2021 |
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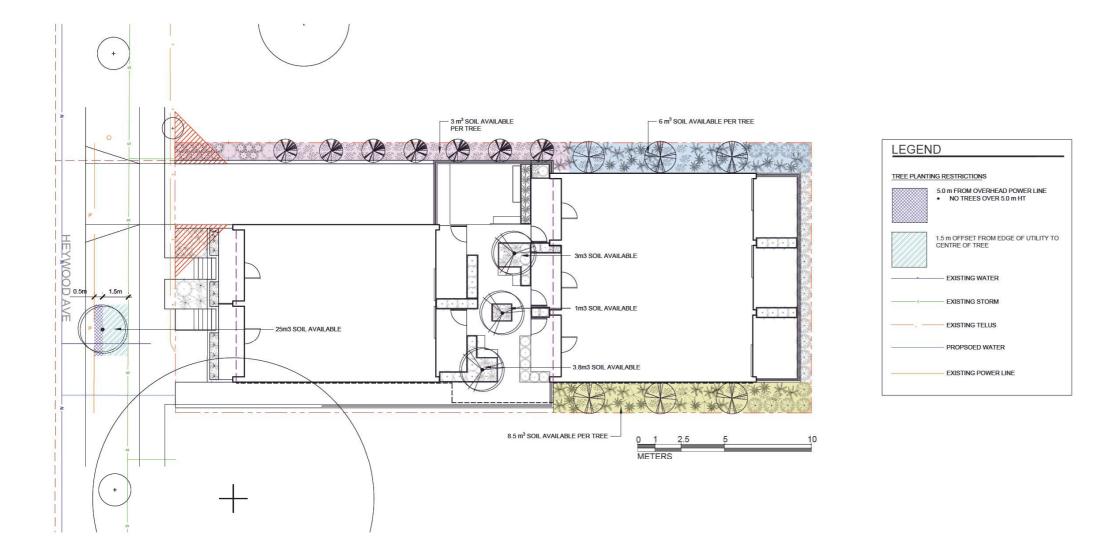
DRAWING TITLE:

LANDSCAPE SECTIONS AND IMAGERY

_2

DWG NO:

SCALE: NTS



| Quantity | Symbol | Latin Name | Common Name | Height | Caliper | Native | Height at Maturity (m) | Spread at Maturity (m |
|----------|------------|--|---------------------------------|--------|---------|--------|---------------------------|--------------------------|
| 1 | \odot | BOULEVARD TREE TO BE DETERMINED BY PARKS AT BP | | | | | | |
| 7 | | Liquidambar styraciflua 'Slender Silhouette' | Slender Silhouette Sweet Gum | | 60mm | | 15m | 3m |
| 6 | | Cupressus nootkatensis 'Pendula' | Weeping Nootka Cypress | 3.5m | | | 8m | 3m |
| 3 | \bigcirc | Styrax japonicus | Japanese Snowbell | | 50mm | | 3m | 3m |



WEEPING NOOTKA CYPRESS



JAPANESE SNOWBELL



SLENDER SILHOUETTE SWEETGUM



1608 Camosun Street, Victoria BC V8T 3E6 Info@biophiliacollective.ca 250 590 1156

OWNER/CLIENT Aryze

PROJECT NAME Heywood Townhome

PROJECT ADDRESS: 956 Heywood Ave Victoria, BC

DESIGNED BY: BIANCA BODLEY DRAWN BY: KIM TANG

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| 1 | Development Permit | 9/7/2021 |
| - | | |
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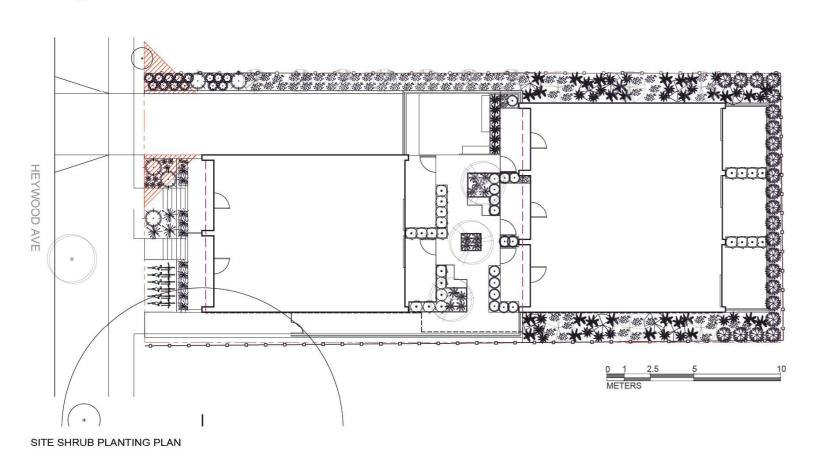
DRAWING TITLE:


TREE PLANTING PLAN

_3


DWG NO:

SCALE: 1:100



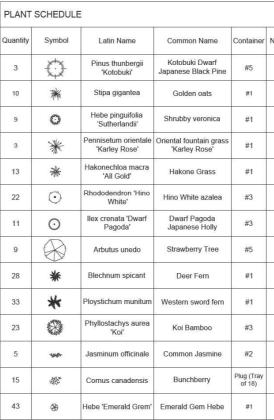

NOTES: 1. PLANTS IN PLANT LISTS ARE SPECIFIED ACCORDING TO THE CANADIAN NURSERY LANDSC CANADIAN STANDARDS FOR NURSERY STOCK AND SECTION 12, CONTAINER GROWN PLANTS LANDSCAPE STANDARD, CURRENT EDITION.

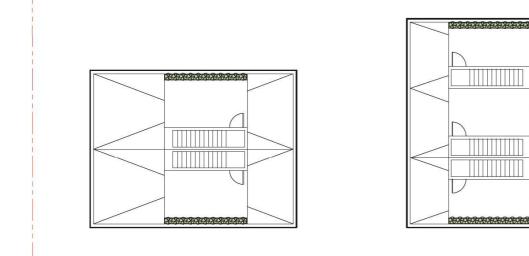

ROOF PLANTING PLAN

















ARBUTUS UNEDO

KOI BAMBOO WHITE JASMINE BUNCHBERRY



DEER FERN

DWARF JAPANESE **BLACK PINE** STIPA GIGANTEA

HEBE SUTHERLANDII

HAKONE GRASS

| lative | Pollinator | Height at Maturity (m) | Spread at Maturity (m) |
|--------|------------|------------------------------|------------------------------|
| | | 1 | 1 |
| | | 1.5 | 0.6 |
| | х | 0.6 | 0.9 |
| | | 0.6-0.9 | 0.6-0.9 |
| Î | | 0.5 | 0.5 |
| | х | 1.2m | 1.2m |
| | | 1.2 | 0.9 |
| | x | 4-5 | 4-5 |
| | | 0.3-0.45 | 0.3-0.6 |
| x | | 0.6-1.2 | 0.6-1.2 |
| | | 7 | 1 |
| | х | 9 | 4.5 |
| x | x | 0.15 | 0.3 |
| | | 0.5 | 0.5 |





1608 Camosun Street, Victoria BC V8T 3E6 Info@biophiliacollective.ca 250 590 1156

OWNER/CLIENT Aryze

JECT NAME Heywood Townhome

ECT ADDRESS: 956 Heywood Ave Victoria, BC

DESIGNED BY: BIANCA BODLEY DRAWN BY: KIM TANG

| NO. | ISSUED FOR | DATE |
|-----|--------------------|----------|
| 1 | Development Permit | 9/7/2021 |
| _ | | |
| | | |
| _ | | |
| | | |



DRAWING TITLE:

SHURB PLANTING PLAN

DWG NO:



SCALE: NTS