

CONTACT INFORMATION

REGISTERED OWNER
 Capital Region Housing Corporation (CRHC)
 631 Fisgard Street
 Victoria B.C.
 V8W 2S6

Paul Kitson
 tel: 250.416.1493
 fax: 250.361.4970
 pkitson@crd.bc.ca

ARCHITECT
 de Hoog & Kierulf architects
 977 Fort Street
 Victoria, BC
 V8V 3K3

Charles Kierulf
 tel: 250.658-3367
 fax: 250.658-3397
 crk@dhk.ca

LANDSCAPE ARCHITECT
 LADR Landscape Architects
 2B-485 Dupplin Road
 Victoria, BC
 V8Z 1B8

Bev Windjack
 tel: 250.595-0105
 email: bwindjack@ladrla.ca

CIVIL ENGINEER
 Gwaii Engineering
 485C Garbally Road
 Victoria, BC
 V8T 2J9

Corey Brown
 tel: 250.886-0049
 email: cbrown@gwaiieng.com

PROJECT INFORMATION

CIVIC ADDRESS:
 310 -338 MICHIGAN STREET, VICTORIA, BC

LEGAL DESCRIPTION:
 Lot A of Lots 1864, 1871 - 1876, Victoria City
 Plan 42136 (P.I.D. 001-225-197)

SITE AREA: 5,074.1 SM

PROJECT DESCRIPTION:
 THE CURRENT DEVELOPMENT CONSISTS OF FOUR MULTI-FAMILY RESIDENTIAL BUILDINGS ABOVE A SINGLE STOREY PARKADE. THE PROPOSED DEVELOPMENT WILL RETAIN ONE OF THE EXISTING BUILDINGS, DEMOLISH THREE OF THE BUILDINGS, AND CONSTRUCT TWO NEW FOUR STOREY MULTI-FAMILY RESIDENTIAL BUILDING ABOVE THE EXISTING PARKADE. THE PORTION OF THE EXISTING PARKADE BELOW THE NEW BUILDING WILL BE PARTIALLY DEMOLISHED AND RECONSTRUCTED IN ORDER TO SUPPORT THE NEW DEVELOPMENT. ALL UNITS WITHIN BOTH THE PROPOSED AND EXISTING TO REMAIN WILL BE AFFORDABLE DWELLING UNITS TO BE SECURED IN PERPETUITY THROUGH LEGAL AGREEMENT.

BUILDING HEIGHT
 4 STOREYS
 12.88 M
 (14.76 M AS MEASURED FROM AVERAGE GRADE.)

BUILDING AREA
 EXISTING TO REMAIN - 342.3 SM
 PROPOSED WEST BUILDING - 1001.0 SM
 PROPOSED EAST BUILDING - 797.2 SM
 PARKADE - 3165 SM

RESIDENTIAL UNIT SUMMARY			
	EXISTING TO REMAIN	PROPOSED	TOTAL
STUDIO	0	3 (35-44 SM)	3
STUDIO ACCESSIBLE	0	4 (43 SM)	4
1 BEDROOM	5	30 (46-50 SM)	35
1 BED ACCESSIBLE	0	3 (55-58 SM)	3
2 BEDROOM	3	47 (68-78 SM)	30
3 BEDROOM	1	10 (88-91 SM)	11
TOTAL	9	97	106

VICTORIA ZONING BYLAW SUMMARY

ZONING:
 EXISTING: R3-2 MULTIPLE DWELLING DISTRICT
 PROPOSED: R3-2 MULTIPLE DWELLING DISTRICT WITH VARIANCES

USES:
 RESIDENTIAL
 STORAGE (PARKADE).

DEVELOPMENT PERMIT AREA: DPA 16

SITE AREA: 5,074.1 SM

FLOOR SPACE RATIO:
 EXISTING TO REMAIN 0.16 : 1 FSR (798 SM/ 5074.1 SM)
 PROPOSED: 1.40 : 1 FSR (7122 SM/ 5074.1 SM)
 TOTAL: 1.56 : 1 FSR (7920 SM/ 5074.1 SM)

SITE COVERAGE :
 EXISTING TO REMAIN: 6.8% (342.3 / 5074.1 SM)
 PROPOSED: 36.7% (1035+829 / 5074.1 SM)
 SITE COVERAGE TOTAL : 43.5%

OPEN SITE SPACE: 55.5%

AVERAGE GRADE: 5.52 M (GEODETIC)
 See Site Plan for Grade Calculation

HEIGHT OF BUILDING: 14.76 M (FROM AVERAGE GRADE)

NUMBER OF STOREYS: 4 STOREYS

PARKING:
 REQUIRED: 57 resident + 11 visitor = 68
 PROPOSED: 70

BICYCLE PARKING:
 REQUIRED: 131 long-term + 11 short-term
 PROVIDED: 131 long-term + 11 short-term

SETBACKS :
 FRONT (Michigan Street): 5.50 m
 REAR (North): 5.78 m
 SIDE (East): 6.0 m
 SIDE (West): 6.0 m

BUILDING CODE SUMMARY

REFERENCE DOCUMENT:
 BRITISH COLUMBIA BUILDING CODE 2018 - PART 3

OCCUPANCY CLASSIFICATIONS (TABLE 3.1.2.1)
 GROUP C - RESIDENTIAL (FLOORS 1 - 4)
 GROUP F , DIVISION 2 - LOW HAZARD INDUSTRIAL (PARKADE)

OCCUPANCY SEPARATIONS (TABLE 3.1.3.1)
 PARKADE CONSIDERED AS A SEPARATE BUILDING AND SEPARATED FROM THE OCCUPANCIES ABOVE AND ADJACENT BY A 2 HOUR FIRE SEPARATION IN ACCORDANCE WITH 3.2.1.2.

BUILDING SIZE AND CONSTRUCTION RELATIVE TO OCCUPANCY 3.2.2.50 - GROUP C, UP TO 6 STOREYS, SPRINKLERED
 FIRE SUPPRESSION - FULLY SPRINKLERED
 ALLOWABLE HEIGHT - 6 STOREYS & 18 M
 ALLOWABLE AREA - 2250 SM (BASED ON FOUR STOREYS)
 CONSTRUCTION - COMBUSTIBLE OR NON COMBUSTIBLE
 FLOOR ASSEMBLIES - 1 HOUR
 SUPPORTING WALLS AND STRUCTURE - 1 HOUR
 ROOF ASSEMBLY - 1 HOUR

ACTUAL SIZE AND CONSTRUCTION
 PARKADE -
 FIRE SUPPRESSION - FULL SPRINKLERED
 HEIGHT - 1 STOREY
 AREA - 3165 SM
 CONSTRUCTION - NON COMBUSTIBLE
 FLOOR ASSEMBLY - 2 HOUR
 SUPPORTING WALLS AND STRUCTURE - 2 HOUR


PROPOSED BUILDING -
 FIRE SUPPRESSION - FULLY SPRINKLERED
 HEIGHT - 4 STOREYS, 12.02 M
 AREA - 1844 SM
 CONSTRUCTION - COMBUSTIBLE
 FLOOR ASSEMBLY - 1 HOUR
 SUPPORTING WALLS AND STRUCTURE - 1 HOUR
 ROOF ASSEMBLY - 1 HOUR

DRAWING INDEX

- ARCHITECTURAL**
 A001 PROJECT INFORMATION
 A002 SURVEY PLAN
 A100 DEMOLITION PLAN
 A101 PARKADE PLAN
 A102 SUSPENDED SLAB PLAN
 A103 PRELIMINARY EXCAVATION PLAN
 A201 ARCHITECTURAL SITE PLAN
 A202 L1 PLAN
 A203 L2 - L3 PLANS
 A204 L4 PLAN
 A205 ROOF PLAN
 A250 ENLARGED PARKADE PLAN - WEST
 A251 ENLARGED PARKADE PLAN - EAST
 A252 ENLARGED L1 PLAN - WEST BUILDING
 A253 ENLARGED L2-3 PLANS - WEST BUILDING
 A254 ENLARGED L4 PLAN - WEST BUILDING
 A255 ENLARGED L1 PLAN - EAST BUILDING
 A256 ENLARGED L2-L4 PLANS - EAST BUILDING
 A301 SECTIONS - WEST BUILDING
 A302 SECTIONS - EAST BUILDING
 A303 SITE SECTION
 A401 ELEVATIONS - WEST BUILDING
 A402 ELEVATIONS - WEST BUILDING
 A403 ELEVATIONS - EAST BUILDING
 A404 ELEVATIONS - EAST BUILDING
 A405 CONTEXT ELEVATIONS
 A501 PERSPECTIVES
 A505 SHADOW STUDIES
 A506 SHADOW STUDIES

CIVIL
 CONCEPTUAL SERVICING PLAN

LANDSCAPE
 L1 LANDSCAPE CONCEPT PLAN
 L2 TREE PRESERVATION PLAN




Revisions
 Bubbled areas indicate revisions compared to the previously submitted plans
Received Date:
 June 30, 2020
Deemed Date:
 January 21, 2020



Final Approved Plans
Adopted Date:
 October 22, 2020



1 Location Plan
 A001 Scale: 1:750

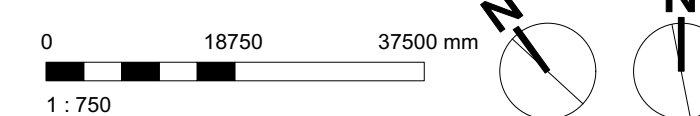

Rev	Date	Description

ISSUED FOR
 DEVELOPMENT VARIANCE

de Hoog & Kierulf architects

VICTORIA OFFICE
 977 Fort Street
 Victoria BC V8V 3K3
 T 1-250-858-3387


NANAIMO OFFICE
 102-5190 Dublin Way
 Nanaimo BC V9T 2K6
 T 1-250-858-5810

Project Name
 Michigan St
 310-338 Michigan St. & 333 Superior St.
 Victoria BC

Project Data
 Drawing No. A001
 Revision No. -

McElhanney ANS D - 15/06/23

DATE: 2023.06.15 10:48:00 AM FILE: P:\310-338 Michigan Street\10.0 DRAWINGS\10.1 CAD\3D File\3D Model\3D V.I. S.dwg

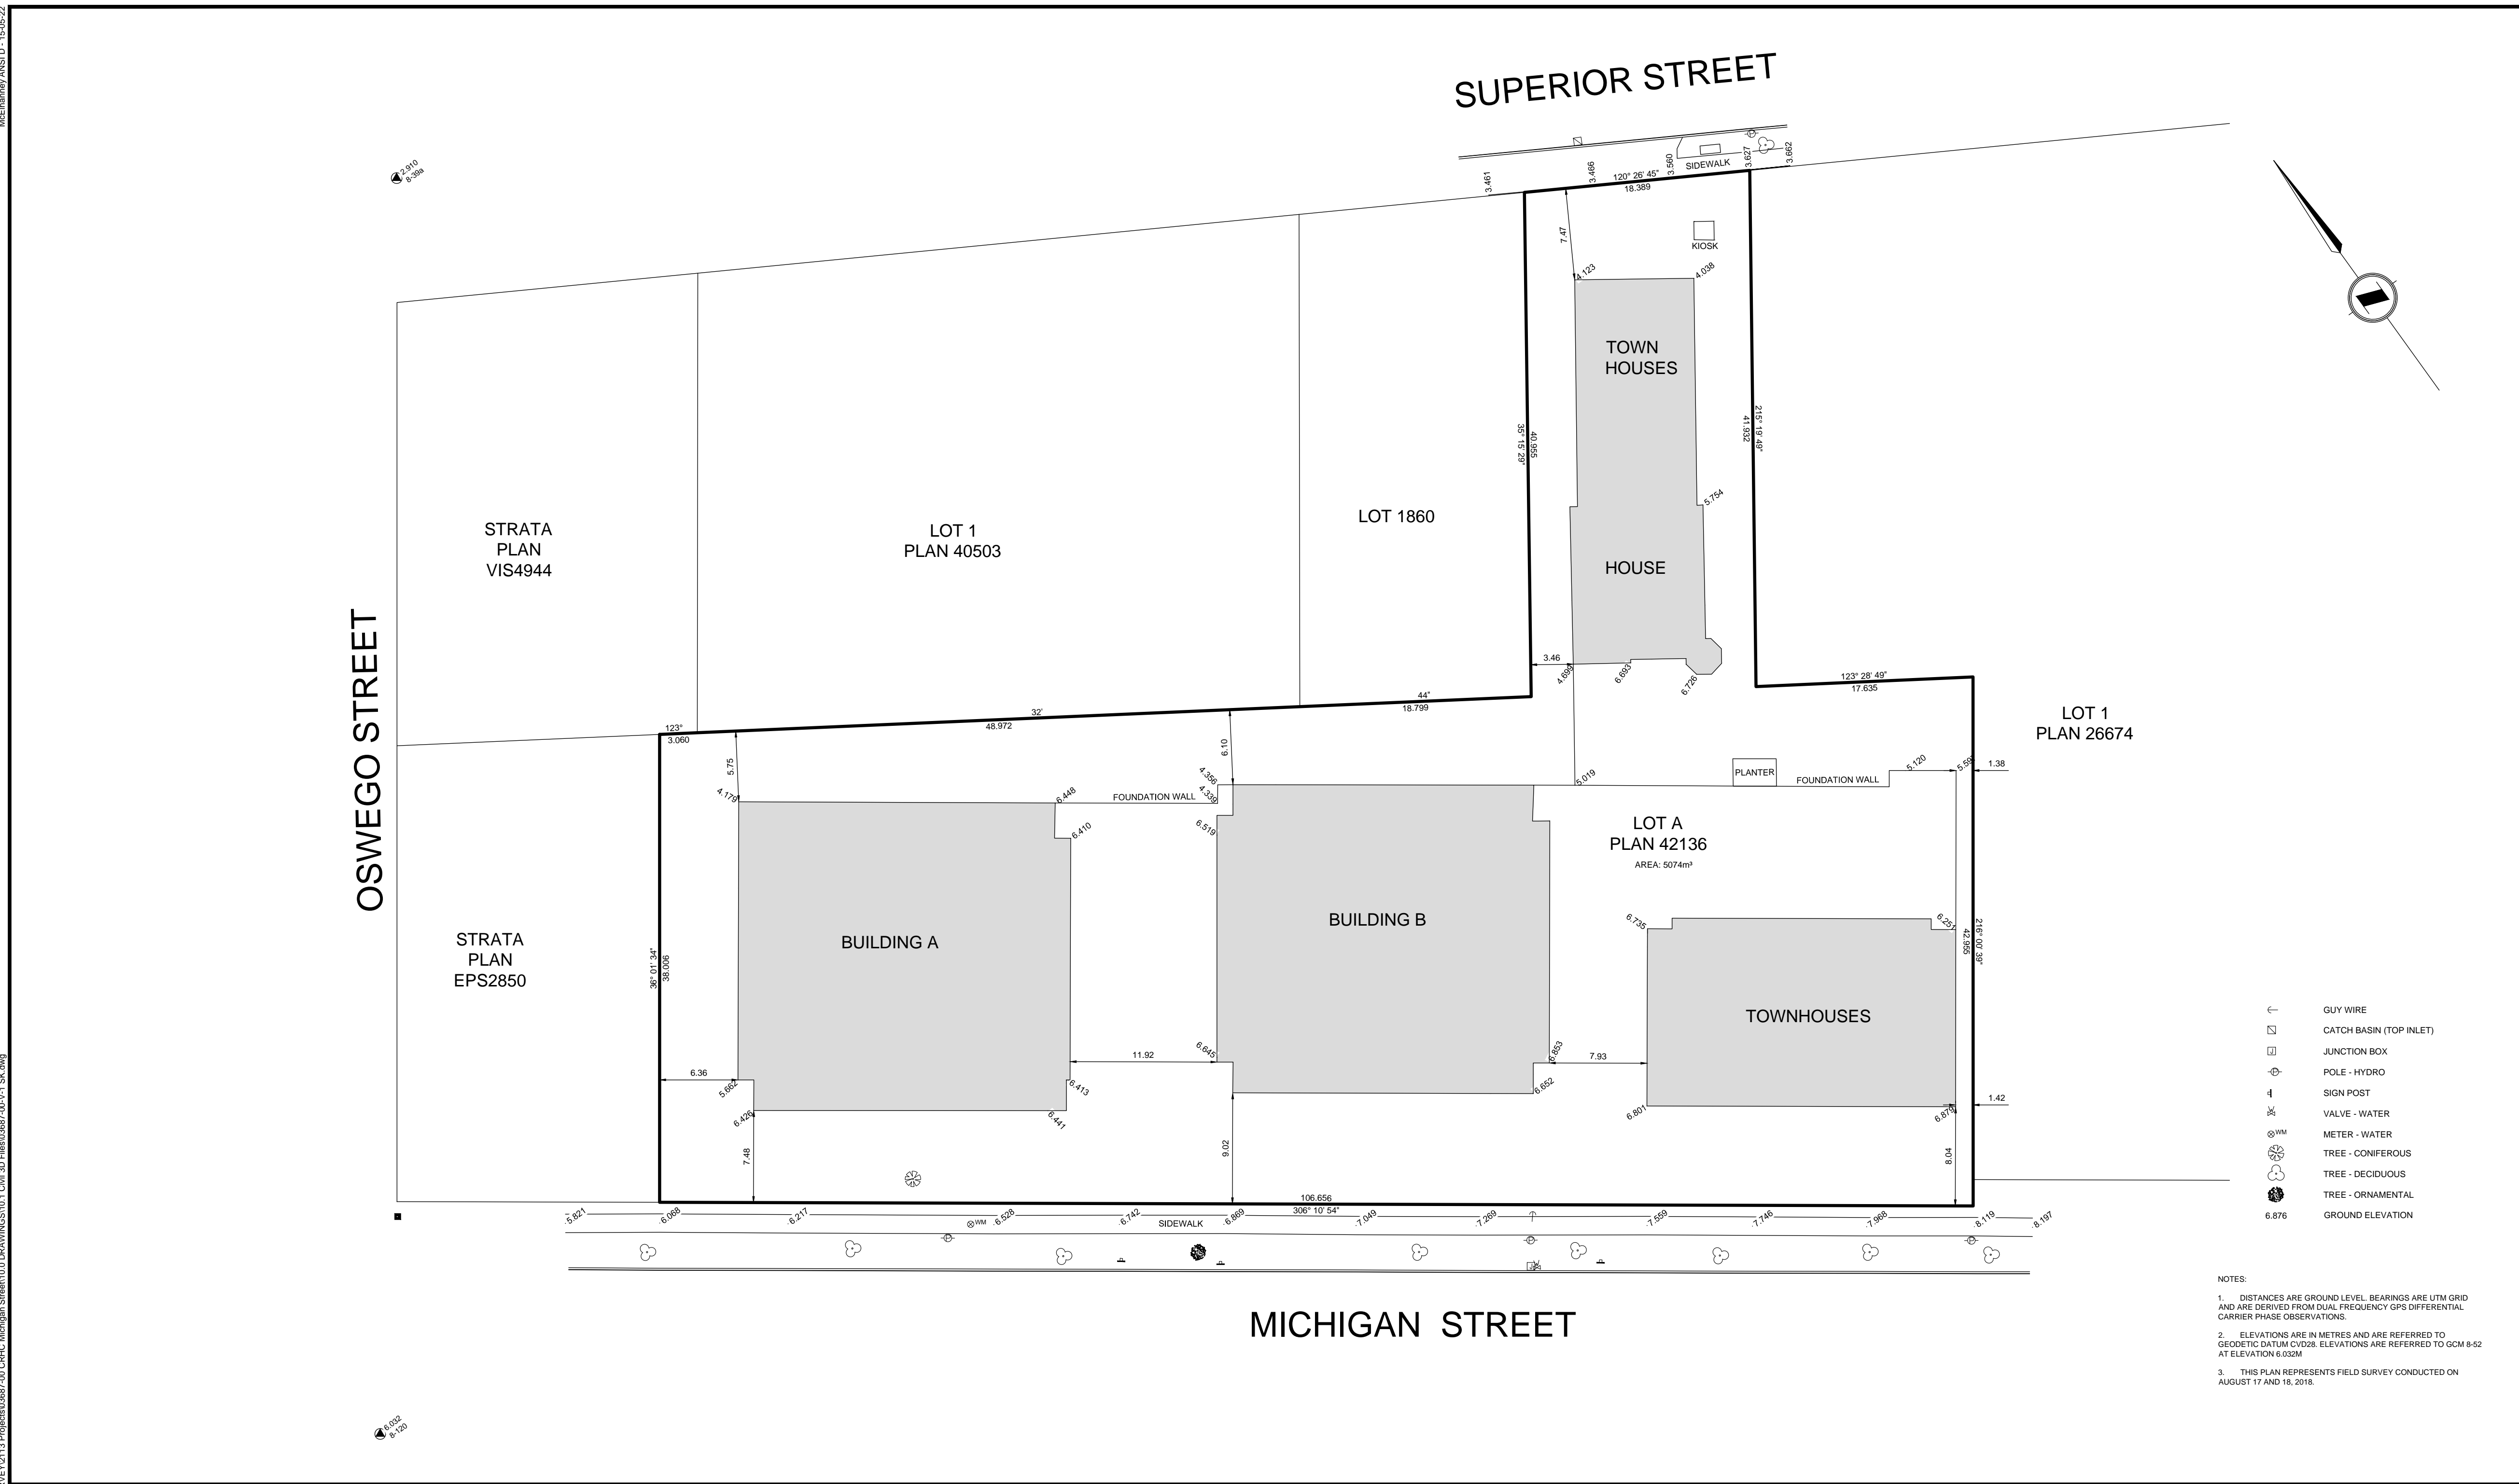

- GUY WIRE
- ☐ CATCH BASIN (TOP INLET)
- ☐ JUNCTION BOX
- ⊕ POLE - HYDRO
- ⊕ SIGN POST
- ⊕ VALVE - WATER
- ⊕ METER - WATER
- ⊕ TREE - CONIFEROUS
- ⊕ TREE - DECIDUOUS
- ⊕ TREE - ORNAMENTAL
- 6.876 GROUND ELEVATION

NOTES:

- DISTANCES ARE GROUND LEVEL. BEARINGS ARE UTM GRID AND ARE DERIVED FROM DUAL FREQUENCY GPS DIFFERENTIAL CARRIER PHASE OBSERVATIONS.
- ELEVATIONS ARE IN METRES AND ARE REFERRED TO GEODETIC DATUM CH2008. ELEVATIONS ARE REFERRED TO GCM 8-52 AT ELEVATION 6.022M.
- THIS PLAN REPRESENTS FIELD SURVEY CONDUCTED ON AUGUST 17 AND 18, 2015.

Rev	Date	Description
0	18-09-04	ORIGINAL ISSUE

de Hoog & Kierulff architects

VICTORIA OFFICE
977 Fort Street
Victoria BC V8V 3K3
T 1-250-858-3387

NANAIMO OFFICE
102-5190 Dublin Way
Nanaimo BC V9T 2K6
T 1-250-885-5810

Michigan St
310-338 Michigan St. & 333 Superior St.
Victoria BC

Survey

Project Number: 2113-03687-00
Rev: 0

Copyright Reserved. THESE PLANS AND DESIGNS ARE AND AT ALL TIMES REMAIN THE PROPERTY OF DE HOOG & KIERULFF ARCHITECTS. NO REUSE OR REPRODUCTION OF ANY PART OF THESE PLANS FOR THE PROJECT SHOWN AND MAY BE MADE WITHOUT WRITTEN PERMISSION.

A002

DATE	REV	DESCRIPTION	BY	CHKD	APPD
18-09-04	0	ORIGINAL ISSUE	JC	LMVE	GO

THIS DRAWING AND DESIGN IS THE PROPERTY OF MCELHANEY CONSULTING SERVICES LTD. (MCELHANEY) AND SHALL NOT BE USED, REPRODUCED OR REPRODUCED WITHOUT THE CONSENT OF MCELHANEY. MCELHANEY WILL NOT BE HELD RESPONSIBLE FOR THE IMPROPER OR UNAUTHORIZED USE OF THIS DRAWING AND DESIGN. THE DRAWING AND DESIGN HAS BEEN PREPARED FOR THE CLIENT IDENTIFIED TO MEET THE STANDARDS AND REQUIREMENTS OF THE APPLICABLE PUBLIC AGENCIES AT THE TIME OF PREPARATION. MCELHANEY, ITS EMPLOYEES, SUBCONTRACTORS AND AGENTS WILL NOT BE LIABLE FOR ANY LOSSES OR OTHER CONSEQUENCES RESULTING FROM THE USE OR RELIANCE UPON, OR ANY CHANGES MADE TO, THIS DRAWING, BY ANY THIRD PARTY, INCLUDING CONTRACTORS, SUPPLIERS, CONSULTANTS AND STANDALONES, OR THEIR EMPLOYEES OR AGENTS, WITHOUT MCELHANEY'S PRIOR WRITTEN CONSENT. INFORMATION ON EXISTING UNDERGROUND FACILITIES MAY NOT BE COMPLETE OR ACCURATE. MCELHANEY, ITS EMPLOYEES AND DIRECTORS ARE NOT RESPONSIBLE NOR LIABLE FOR THE LOCATION OF ANY UNDERGROUND CONCRETE, PIPES, CABLES OR OTHER FACILITIES WHETHER SHOWN OR OMITTED FROM THIS PLAN. PRIOR TO CONSTRUCTION CONTRACTOR SHALL EXPOSE LOCATIONS OF ALL EXISTING FACILITIES BY HAND DIGGING OR HYDROVAC AND ADVISE THE ENGINEER OF POTENTIAL CONFLICTS.

McElhanney
McElhanney Consulting Services Ltd.

Suite 500
3960 Quadra Street
Victoria BC
Canada V8X 4A3
Tel 250.370.9221

Scale: 1:250

ORIGINAL DWG SIZE: ANSI D (22" x 34")
ALL DIMENSIONS ARE IN METRES

CAPITAL REGIONAL HOUSING CORP
631 FISGARD STREET, PO BOX 1000, VICTORIA BC


**330-336 MICHIGAN STREET
SITE PLAN**

330-336 MICHIGAN STREET AND 333 SUPERIOR STREET
VICTORIA BC

Approved Sealed

Drawing No. **03687-V-1**

Project Number: 2113-03687-00
Rev: 0

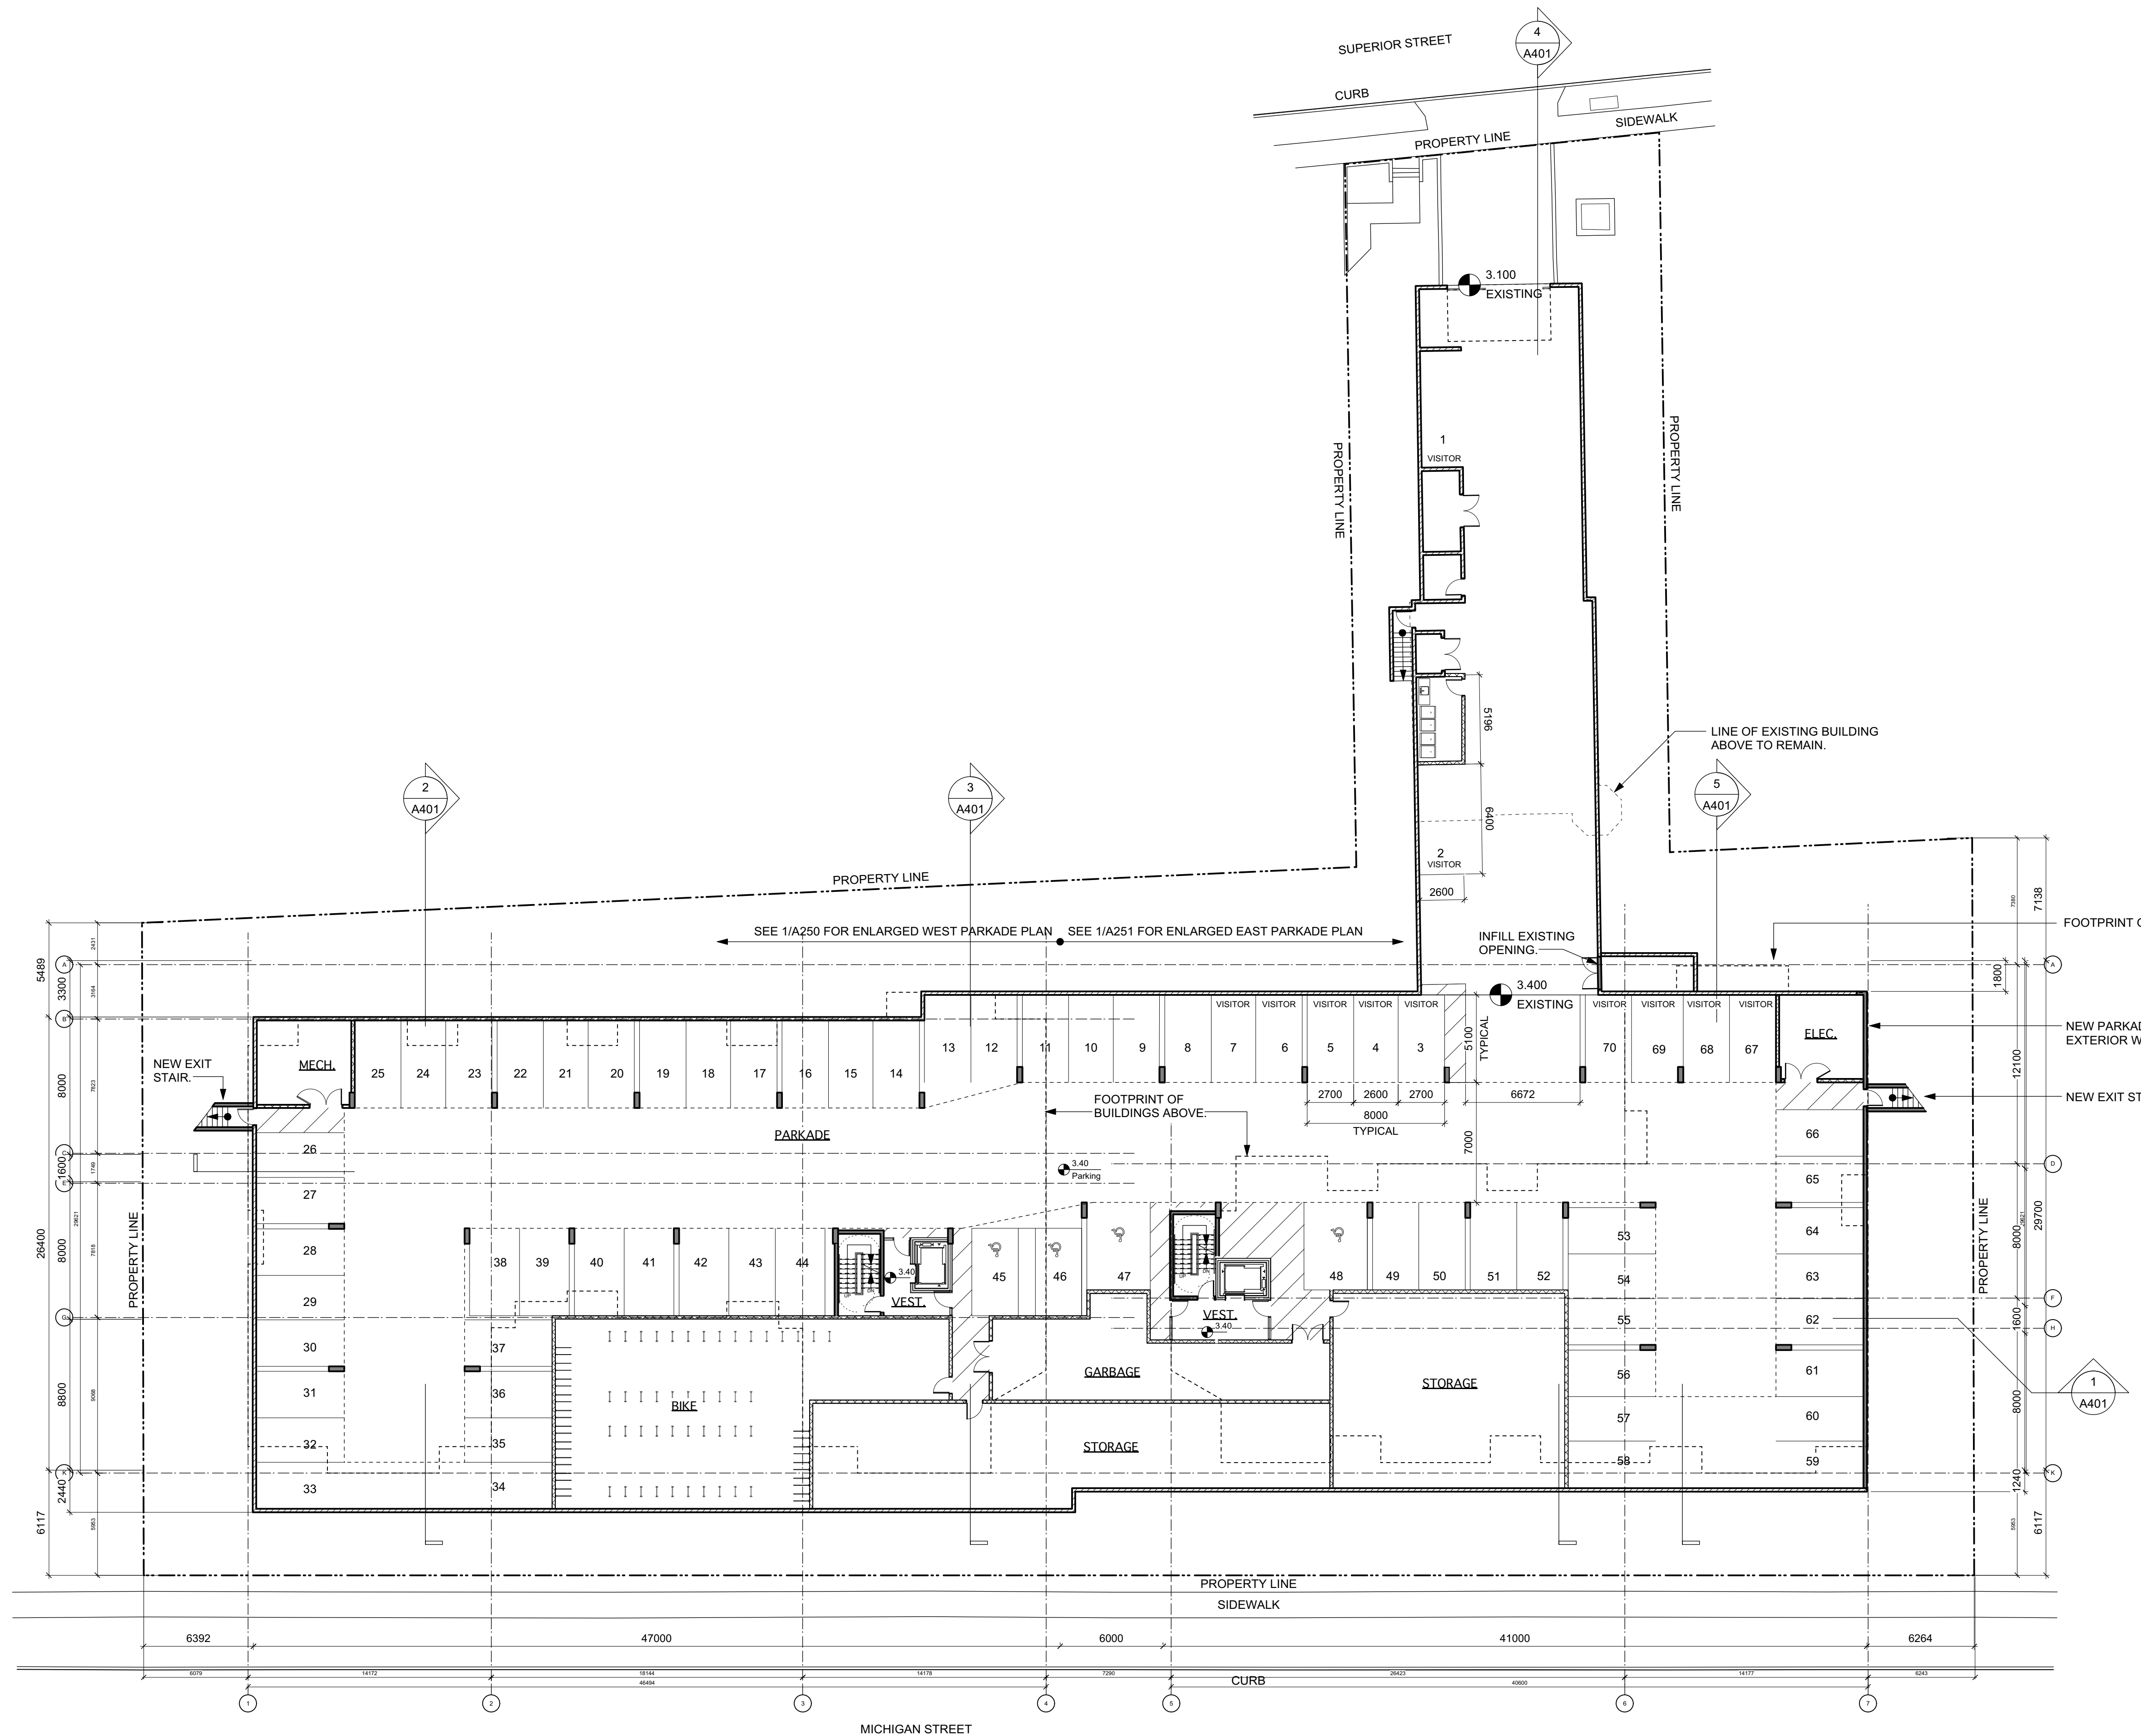

VEHICLE PARKING CALCULATION

UNITS < 45 SM	7 X 2 = 1
UNITS 45-70 SM	76 X 5 = 38
UNITS > 70 SM	23 X 75 = 17
VISITOR	106 X 1 = 11
TOTAL REQUIRED	67
PROVIDED	70

LONG TERM BIKE PARKING CALCULATION

UNITS < 45 SM	5 X 1 = 5
UNITS > 45 SM	101 X 1.25 = 126
TOTAL REQUIRED	131
PROVIDED	131

Rev	Date	Description
1	NOV 2019	1815 A200 Floor Plans view
2	MAF, FWP	checked by RAW
3	AS SHOWN	project number 1815

NOTE: All dimensions are shown in millimeters.

dHKarchitects

VICTORIA OFFICE
977 Fort Street
Victoria BC V8V 3K3
T 1-250-858-3387

NANAIMO OFFICE
102-5190 Dublin Way
Nanaimo BC V9T 2K6
T 1-250-858-5810

project name
Michigan St
310-338 Michigan St. & 333 Superior St.
Victoria BC


Parkade Plan

Copyright reserved. These drawings and designs are and all in them remain the property of dHKarchitects. No part of these drawings may be reproduced without written consent.

sheet no. **A101**

1 Parkade
A101 Scale: 1:200

0 5000 10000 mm
1:200

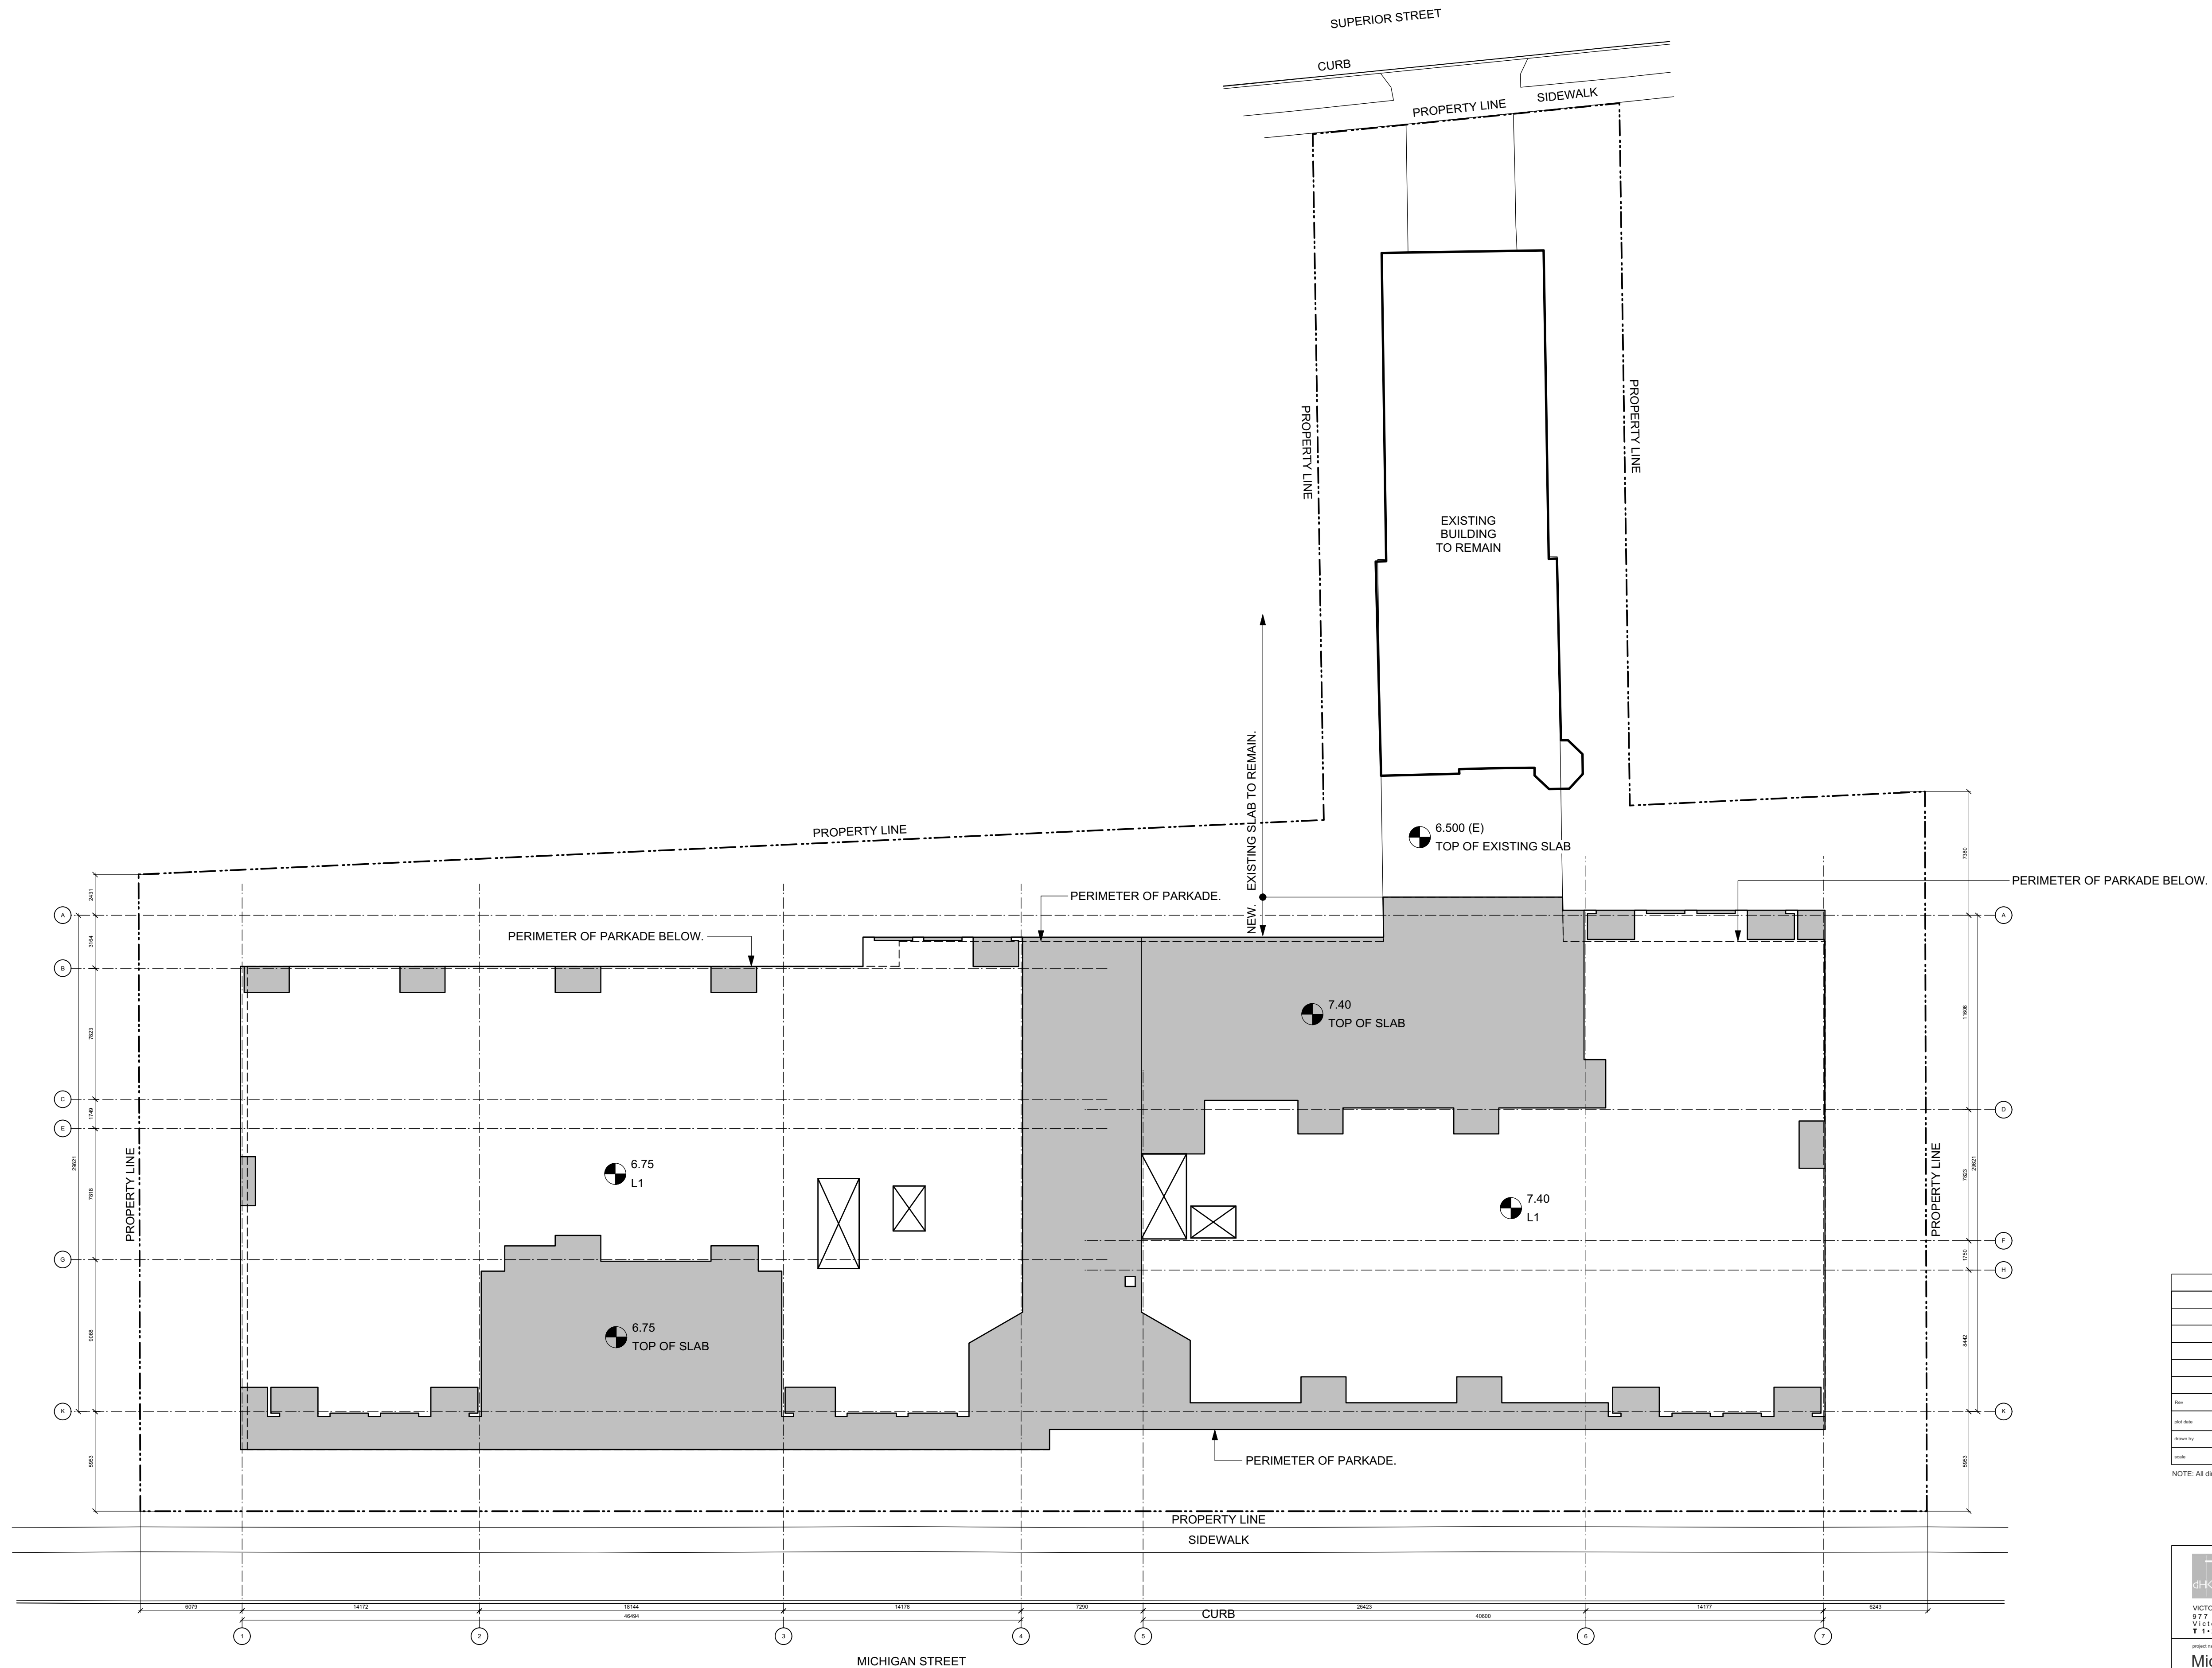

Rev	Date	Description
1	NOV 2019	1815 A200 Floor Plans - view
2	MAF, FWP	checked by RAW
3	AS SHOWN	project number 1815

NOTE: All dimensions are shown in millimeters.

dHk Architects

VICTORIA OFFICE
977 Fort Street
VICTORIA BC V8V 3K3
T 1-250-858-3387

NANAIMO OFFICE
102-5190 Dublin Way
NANAIMO BC V9T 2K6
T 1-250-855-5810

project name
Michigan St
310-338 Michigan St. & 333 Superior St.
Victoria BC

Suspended Slab Plan

sheet no. **A102**

1
A102


Suspended Slab Plan
Scale: 1:200

0 5000 10000 mm
1:200

N

SIDE	corner grade point	+ corner grade point	/2	average grade per side	X length of side	TOTAL
AB	4.2	4.50	2	4.35	37	161.0
BC	4.5	4.40	2	4.45	1.5	6.7
CD	4.4	5.9	2	5.15	30.8	158.6
DE	5.9	3.00	2	4.45	41.1	182.9
EF	3	3.40	2	3.20	9.7	31.0
FG	3.4	6.65	2	5.03	41.2	207.0
GH	6.65	5.00	2	5.83	15.6	90.9
HI	5	6.90	2	5.95	29.7	176.7
IJ	6.9	6.8	2	6.85	37.9	259.6
JK	6.8	6.75	2	6.78	2.2	14.9
KL	6.75	6.70	2	6.73	3.4	22.9
LM	6.7	6.70	2	6.70	7.1	47.6
MN	6.7	6.60	2	6.65	3.7	24.6
NO	6.6	6.60	2	6.60	4.9	32.3
OP	6.6	6.45	2	6.53	11.2	73.1
PQ	6.45	6.50	2	6.48	8.5	55.0
QR	6.5	6.20	2	6.35	17.9	113.7
RS	6.2	6.30	2	6.25	8.5	53.1
ST	6.3	6.00	2	6.15	14.4	88.6
Perimeter					326.3	1800.2


GRADE = TOTAL/Perimeter
5.52

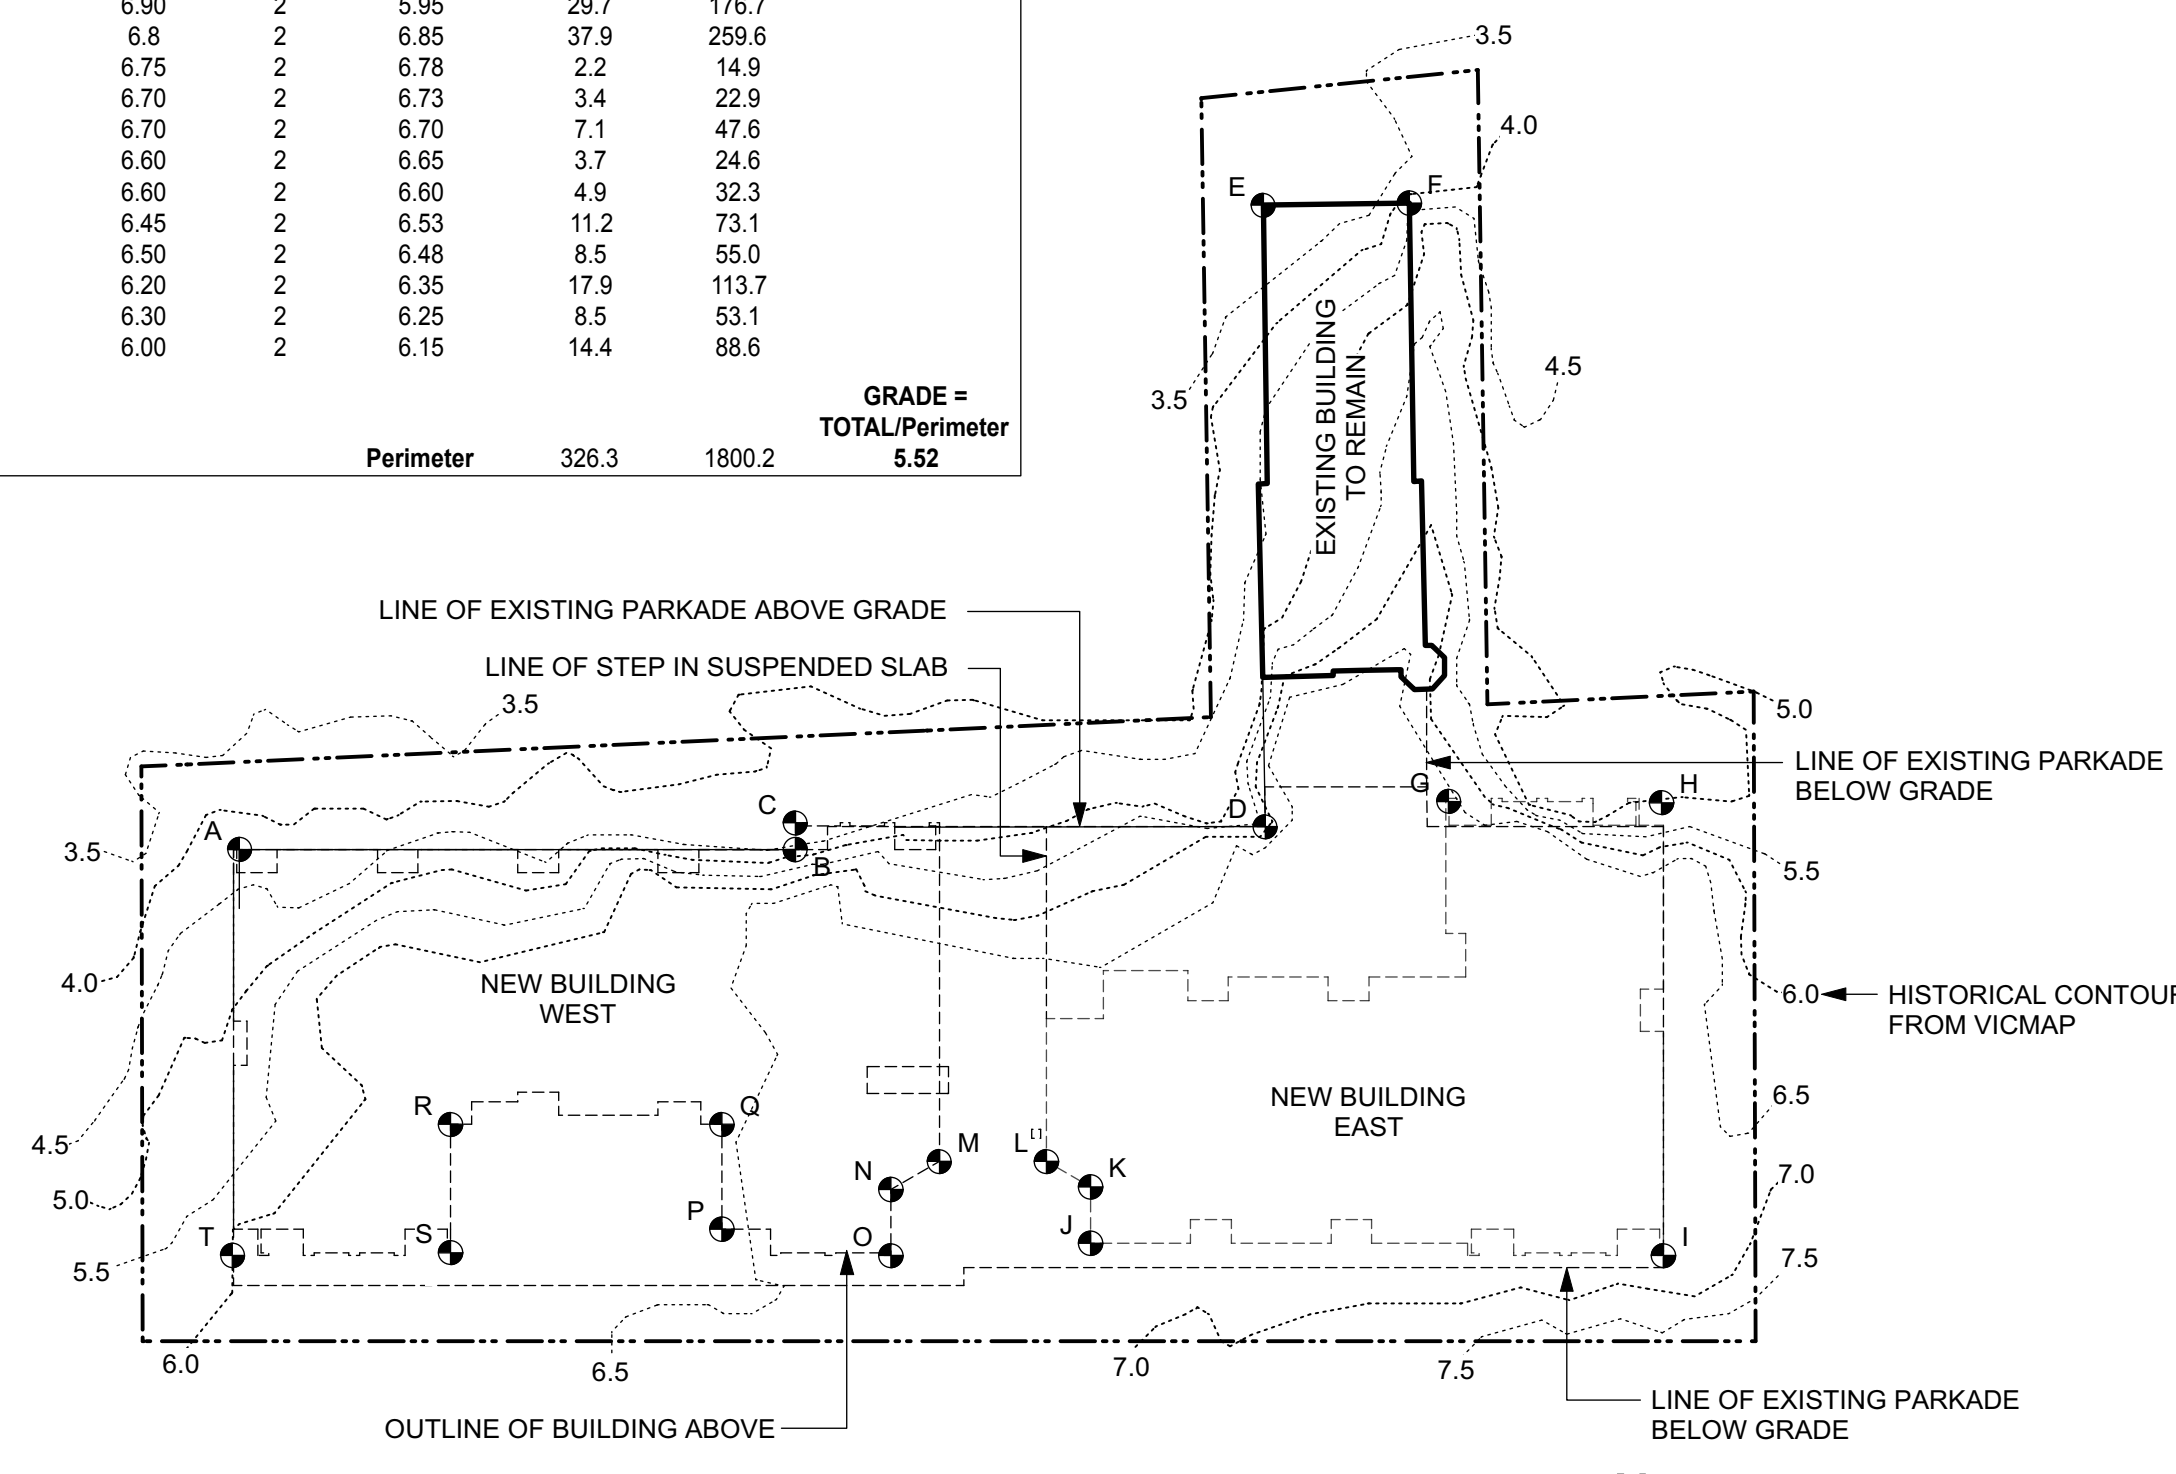



2 Average Grade Calculation
Scale: 1:500

PROJECT INFORMATION TABLE	
ZONE (EXISTING)	R3-2 MULTIPLE DWELLING DISTRICT
PROPOSED ZONE	R3-2 MULTIPLE DWELLING WITH VARIANCES
SITE AREA (SM)	5074.1
TOTAL FLOOR AREA (SM)	7920 SM (7122 sm NEW + 798 sm EXISTING)
COMMERCIAL FLOOR AREA (SM)	0
FLOOR SPACE RATIO	1.56
SITE COVERAGE (%)	43.5
OPEN SITE SPACE (%)	55.5
HEIGHT OF NEW BUILDING (M) - WEST BUILDING	12.88 (14.76 AS MEASURED FROM AVERAGE GRADE)
HEIGHT OF NEW BUILDING (M) - EAST BUILDING	12.88 (14.11 AS MEASURED FROM AVERAGE GRADE)
NUMBER OF STOREYS	4
PARKING STALLS (NUMBER) ON SITE	70
BICYCLE PARKINGS NUMBER (CLASS 1 AND CLASS 2)	142 (131 long term + 11 short term)
NEW BUILDING SETBACKS (M)	
FRONT YARD (SOUTH)	5.50
REAR YARD (NORTH)	5.78
SIDE YARD (WEST)	6
SIDE YARD (EAST)	6
COMBINED SIDE YARDS	12
NEW RESIDENTIAL USE DETAILS	
TOTAL NUMBER OF NEW UNITS	97
NEW UNIT TYPES	STUDIO, ONE, TWO, & THREE BEDROOM
NEW GROUND ORIENTED UNITS	23
MINIMUM NEW UNIT FLOOR AREA (SM)	35
TOTAL NEW RESIDENTIAL FLOOR AREA (SM)	6051

SHORT TERM BIKE PARKING CALCULATION	
TOTAL REQUIRED	116 X 0.1 = 11
PROVIDED	11

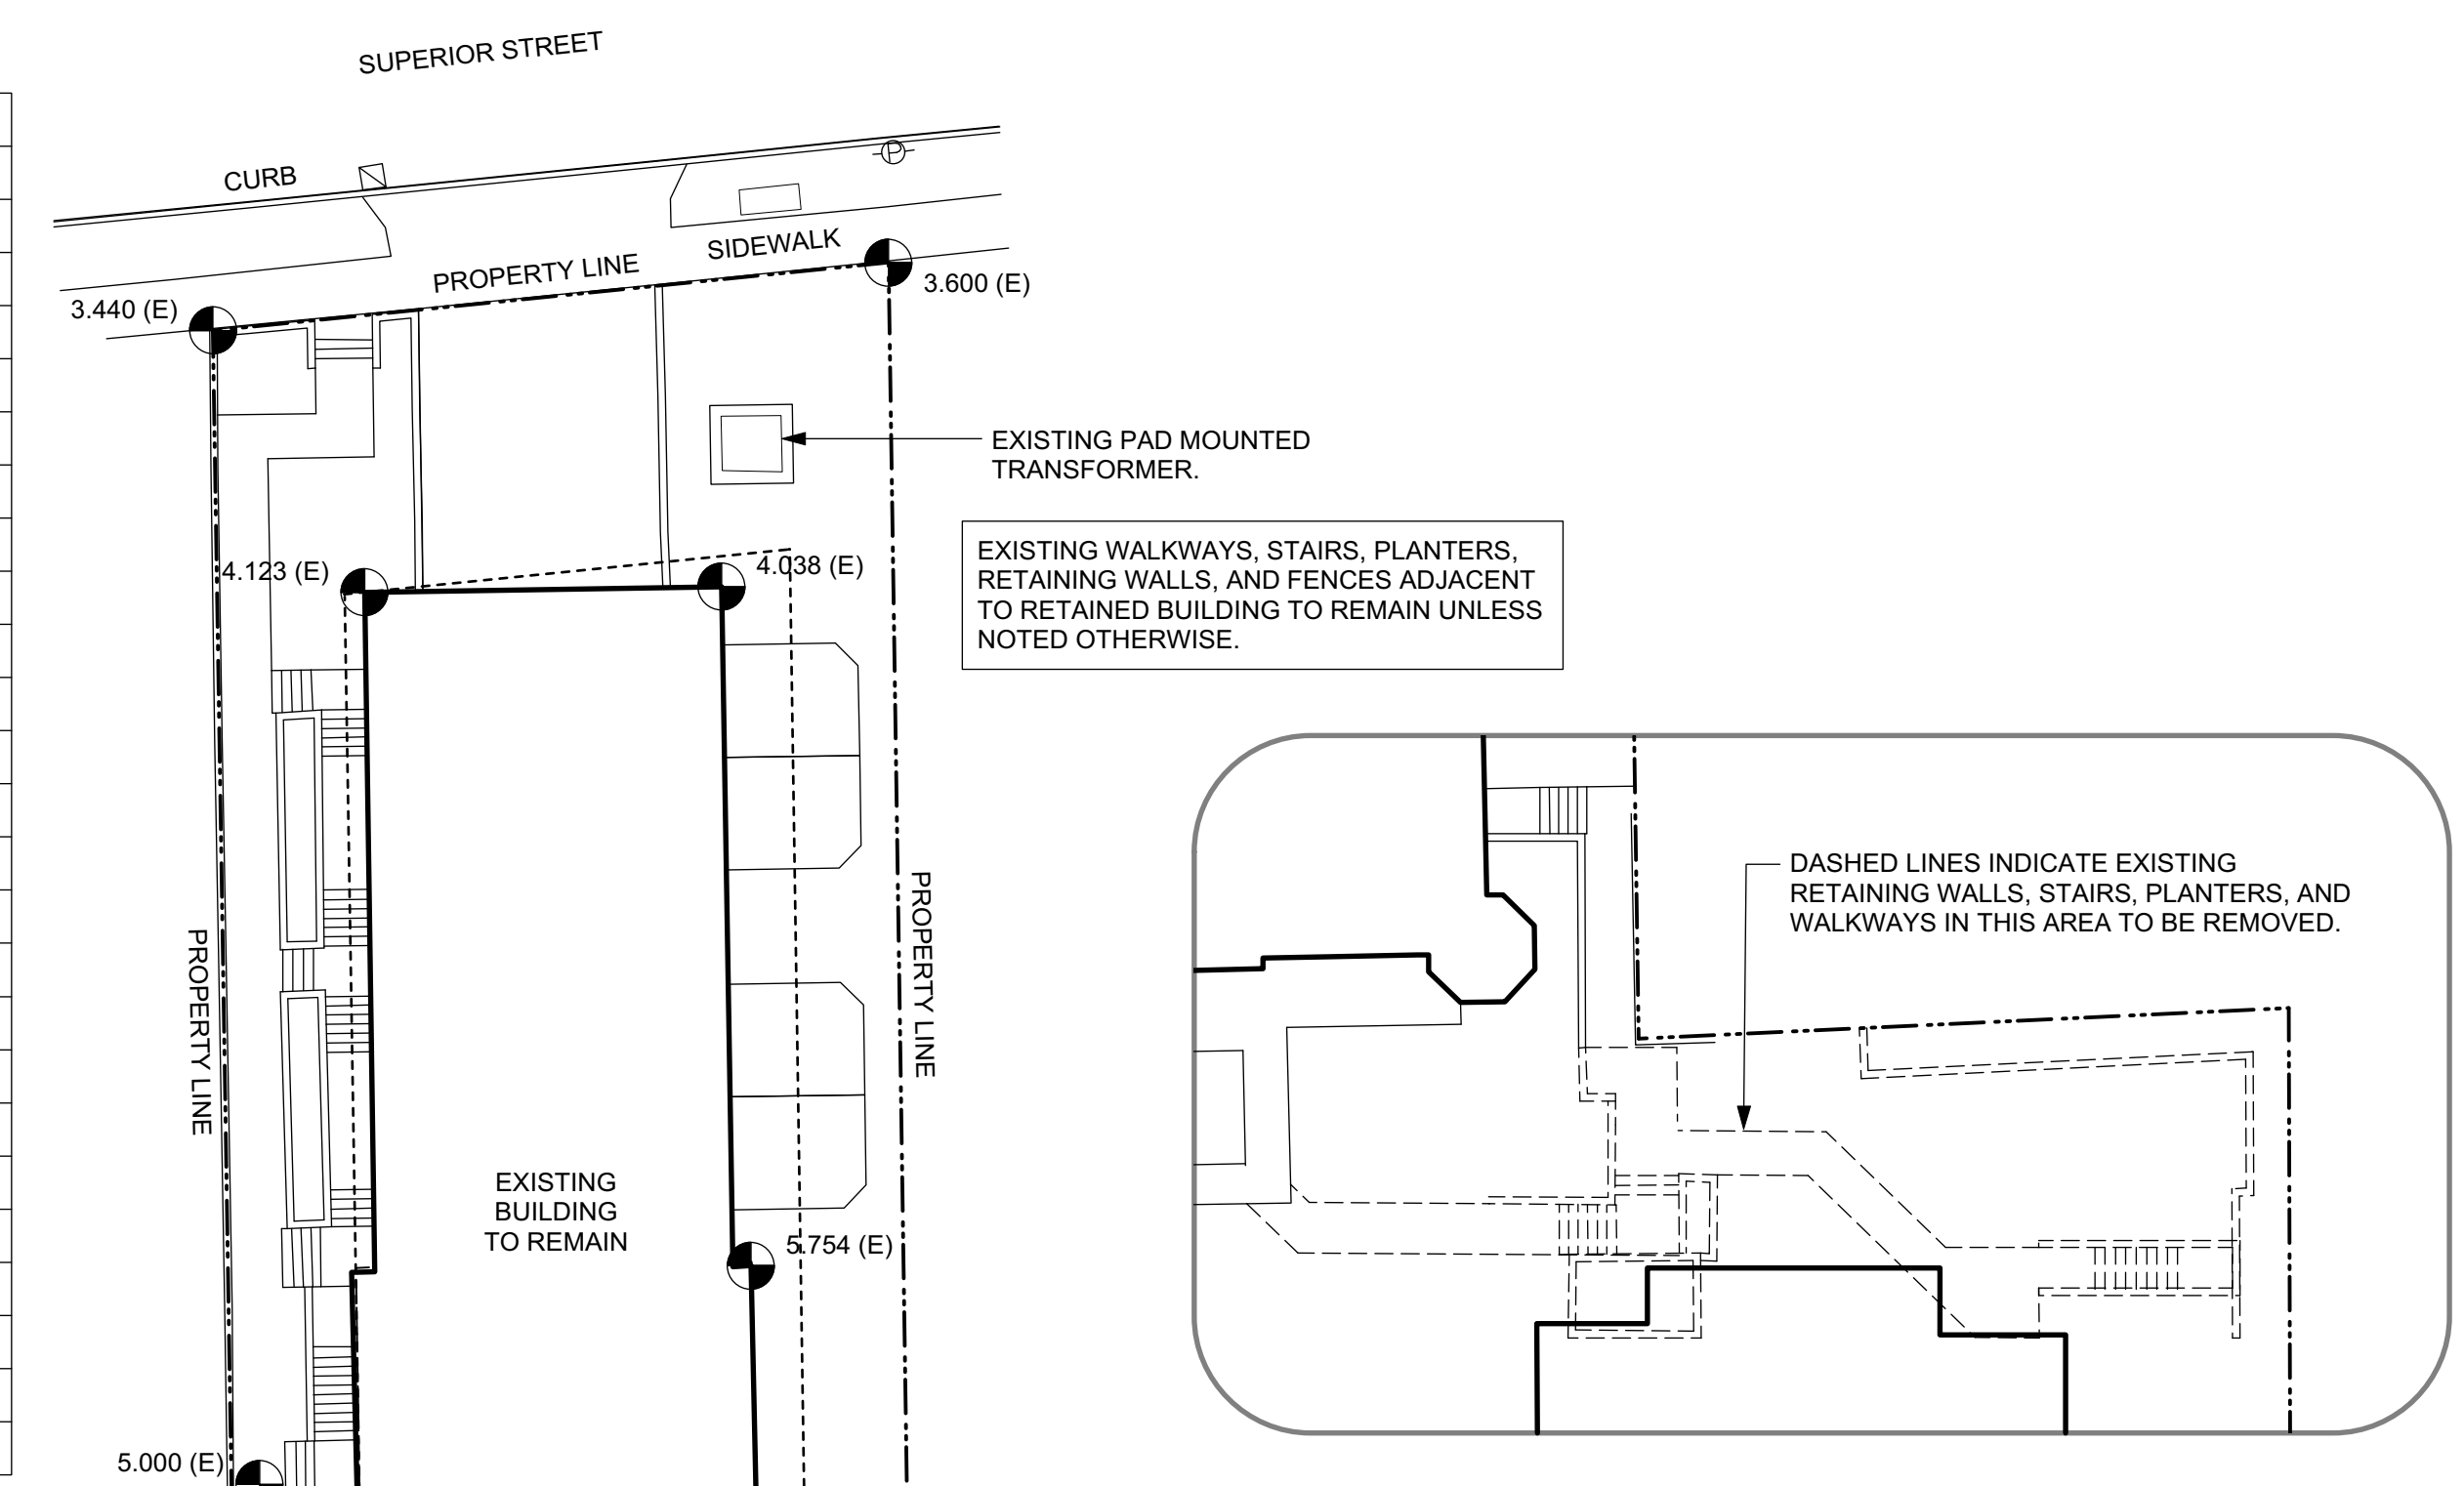

EXISTING WALKWAYS, STAIRS, PLANTERS, RETAINING WALLS, AND FENCES ADJACENT TO RETAINED BUILDING TO REMAIN UNLESS NOTED OTHERWISE.

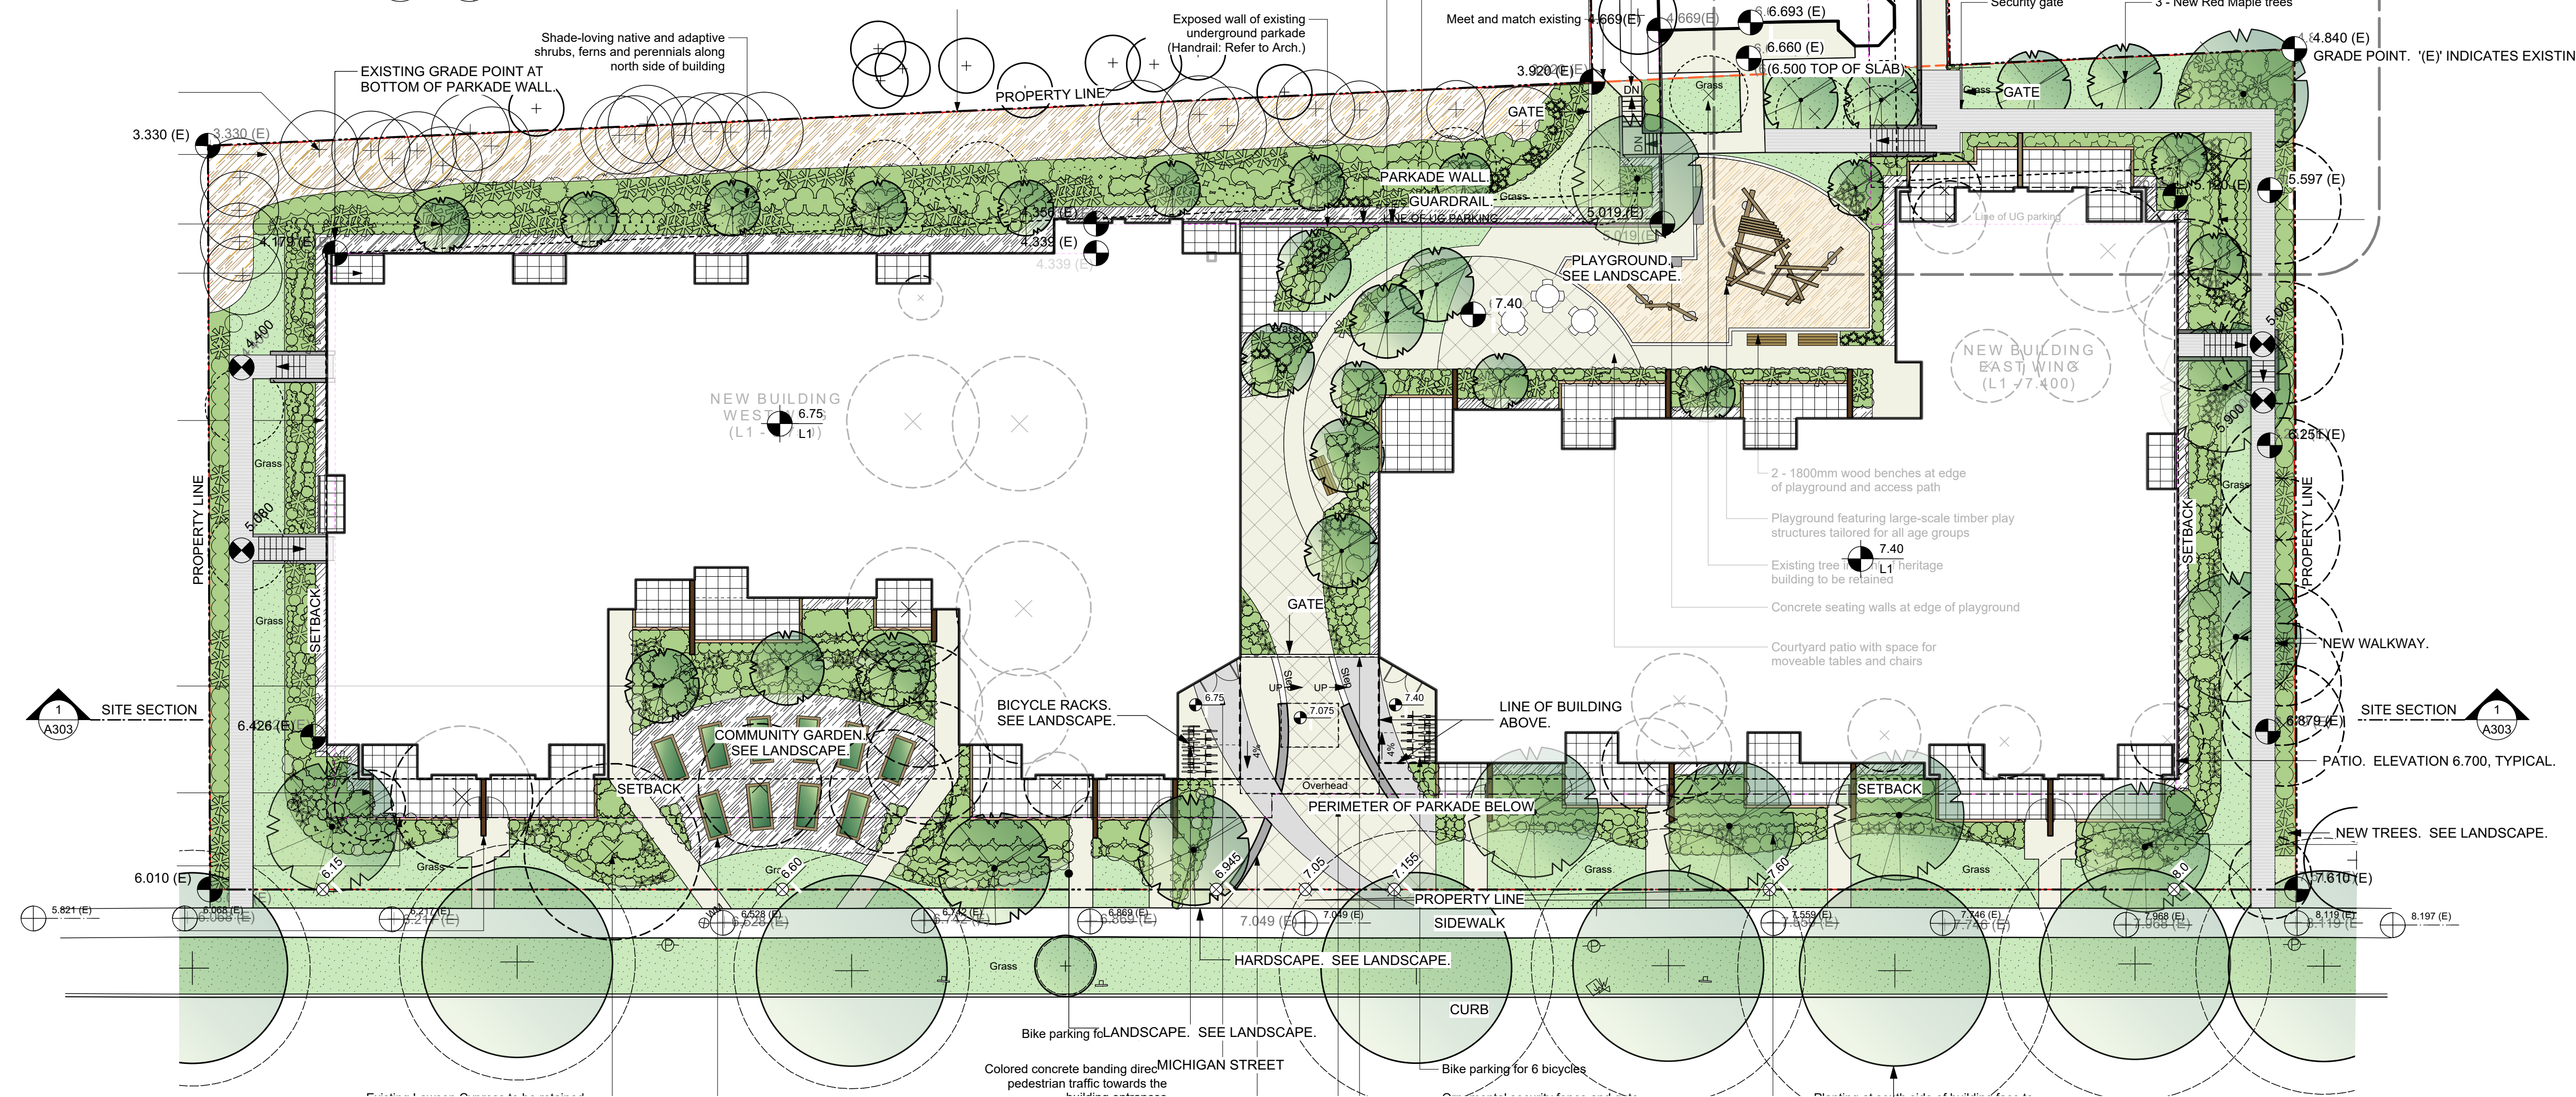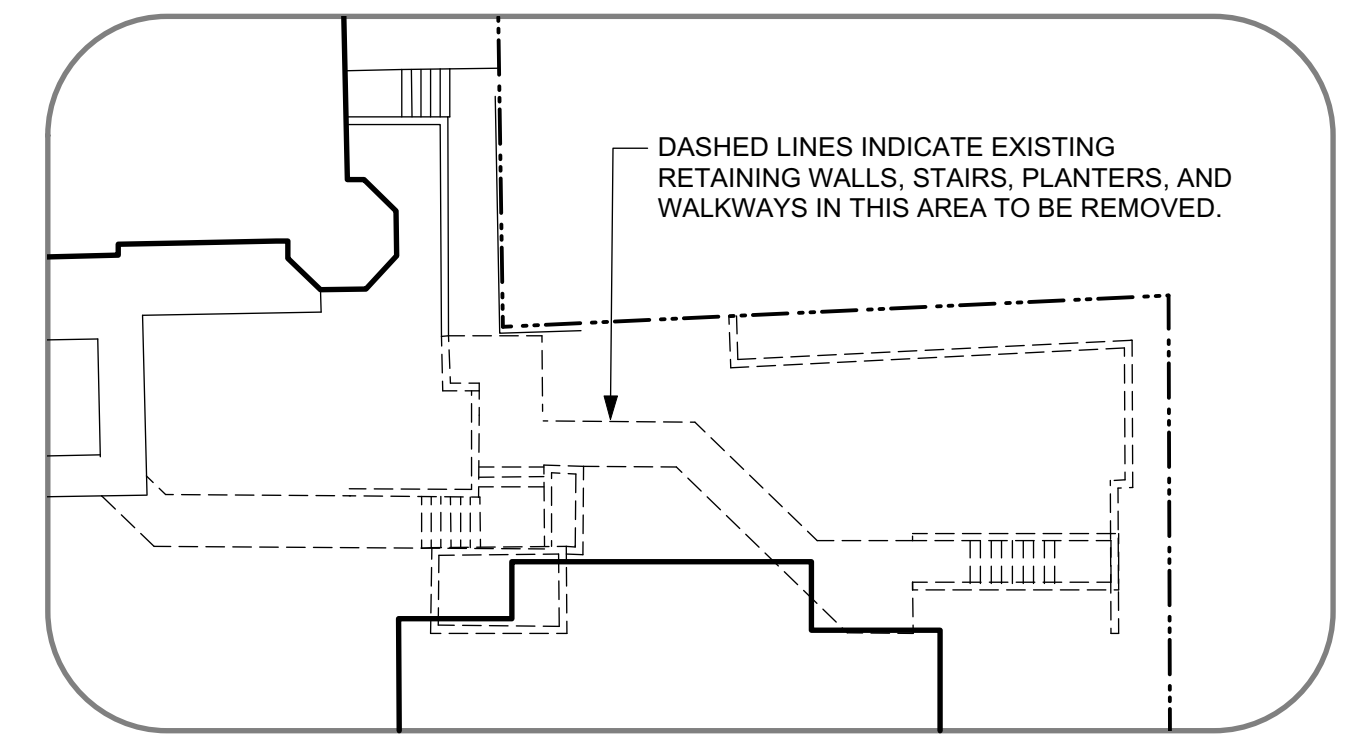

1 SITE SECTION A303

1 SITE SECTION A303

1 Site Plan
Scale: 1:200

Scale: 1:200

Rev	Date	Description

DATE: JUN 2020
DRAWING NO: 1815 A200 Floor Plans view
DESIGNER: MAF, FWP
CHECKED BY: RAW
SCALE: AS SHOWN
PROJECT NUMBER: 1815
NOTE: All dimensions are shown in millimeters.

dHKarchitects

VICTORIA OFFICE
977 Fort Street
VICTORIA BC V8V 3K3
T 1-250-858-3387

NANAIMO OFFICE
102-5190 Dublin Way
NANAIMO BC V9T 2K6
T 1-250-858-5810

Michigan St
310-338 Michigan St. & 333 Superior St.
Victoria BC

Architectural Site Plan

Project Name: Michigan St
Drawing No: A201



BUILDING 1 (WEST) UNIT COMPOSITION

UNIT/LEVEL	L1	L2-L3	L4	TOTAL
STUDIO	3	0	0	3
ONE BED	3	12	5	20
TWO BED	5	12	7	24
THREE BED	1	4	1	6
TOTAL	12	28	13	53

* INCLUDES 3 HANDICAPPED ACCESSIBLE UNITS

BUILDING 2 (EAST) UNIT COMPOSITION

UNIT/LEVEL	L1	L2-L4	TOTAL
STUDIO	1	3	4
ONE BED	4	9	13
TWO BED	5	18	23
THREE BED	1	3	4
TOTAL	11	33	44

* INCLUDES 4 HANDICAPPED ACCESSIBLE UNITS

Rev	Date	Description
01	NOV 2019	1815 A200 Floor Plans - view
02	MAF, FWP	checked by RAW
03	AS SHOWN	project number 1815

NOTE: All dimensions are shown in millimeters.

dHk Architects

VICTORIA OFFICE
977 Fort Street
VICTORIA BC V8V 3K3
T 1-250-858-3387

dHk Architects

NANAIMO OFFICE
102-5190 Dublin Way
NANAIMO BC V9T 2K6
T 1-250-858-5810



project name
Michigan St
310-338 Michigan St. & 333 Superior St.
Victoria BC

L1 Plan

Copyright reserved. These plans and designs are not to be used, copied, reproduced, or otherwise disseminated without the prior written consent of dHk Architects.


A202	-
------	---

1
A202
L1 - Main Floor
Scale: 1:200

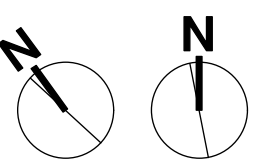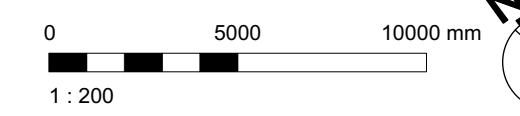



1 L2 - L4 Floors
A203 Scale: 1:200

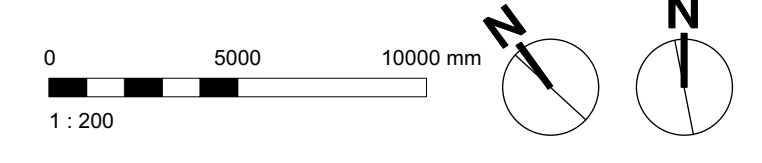

Rev	Date	Description
1	NOV 2019	1815 A200 Floor Plans.vrx
2	MAF, FWP	checked by RAW
3	AS SHOWN	project number 1815

NOTE: All dimensions are shown in millimeters.

dHKA

VICTORIA OFFICE
977 Fort Street
Victoria BC V8V 3K3
T 1-250-858-3387


dHKarchitects

NANAIMO OFFICE
102-5190 Dublin Way
Nanaimo BC V9T 2K6
T 1-250-885-5810


project name
Michigan St
310-338 Michigan St. & 333 Superior St.
Victoria BC

L2 - L3 Plans


sheet no.	A203	total sheets	-
-----------	-------------	--------------	---

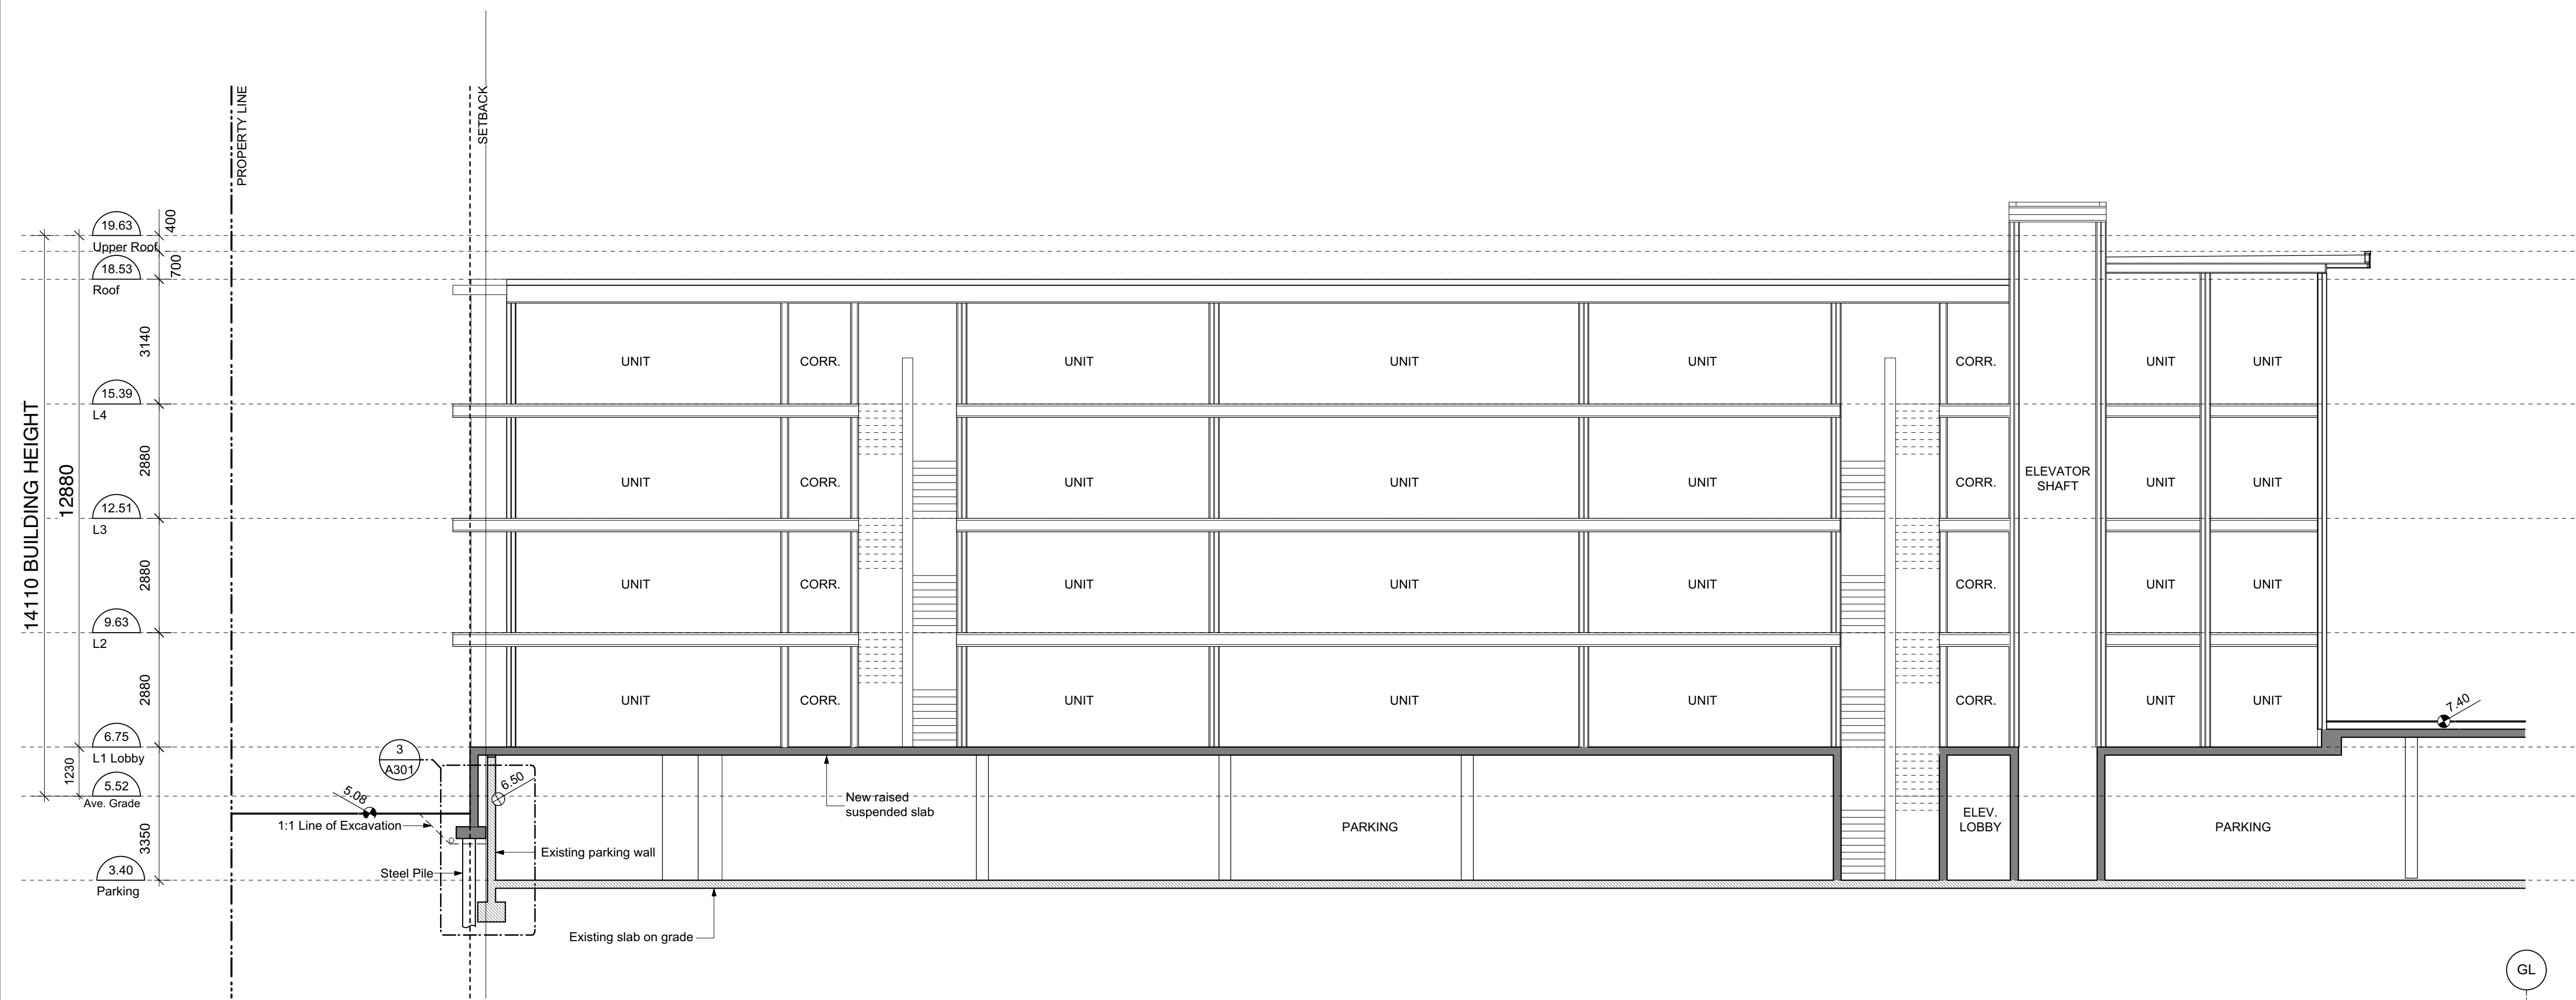

1 Section 1 - West Building
Scale: 1:100

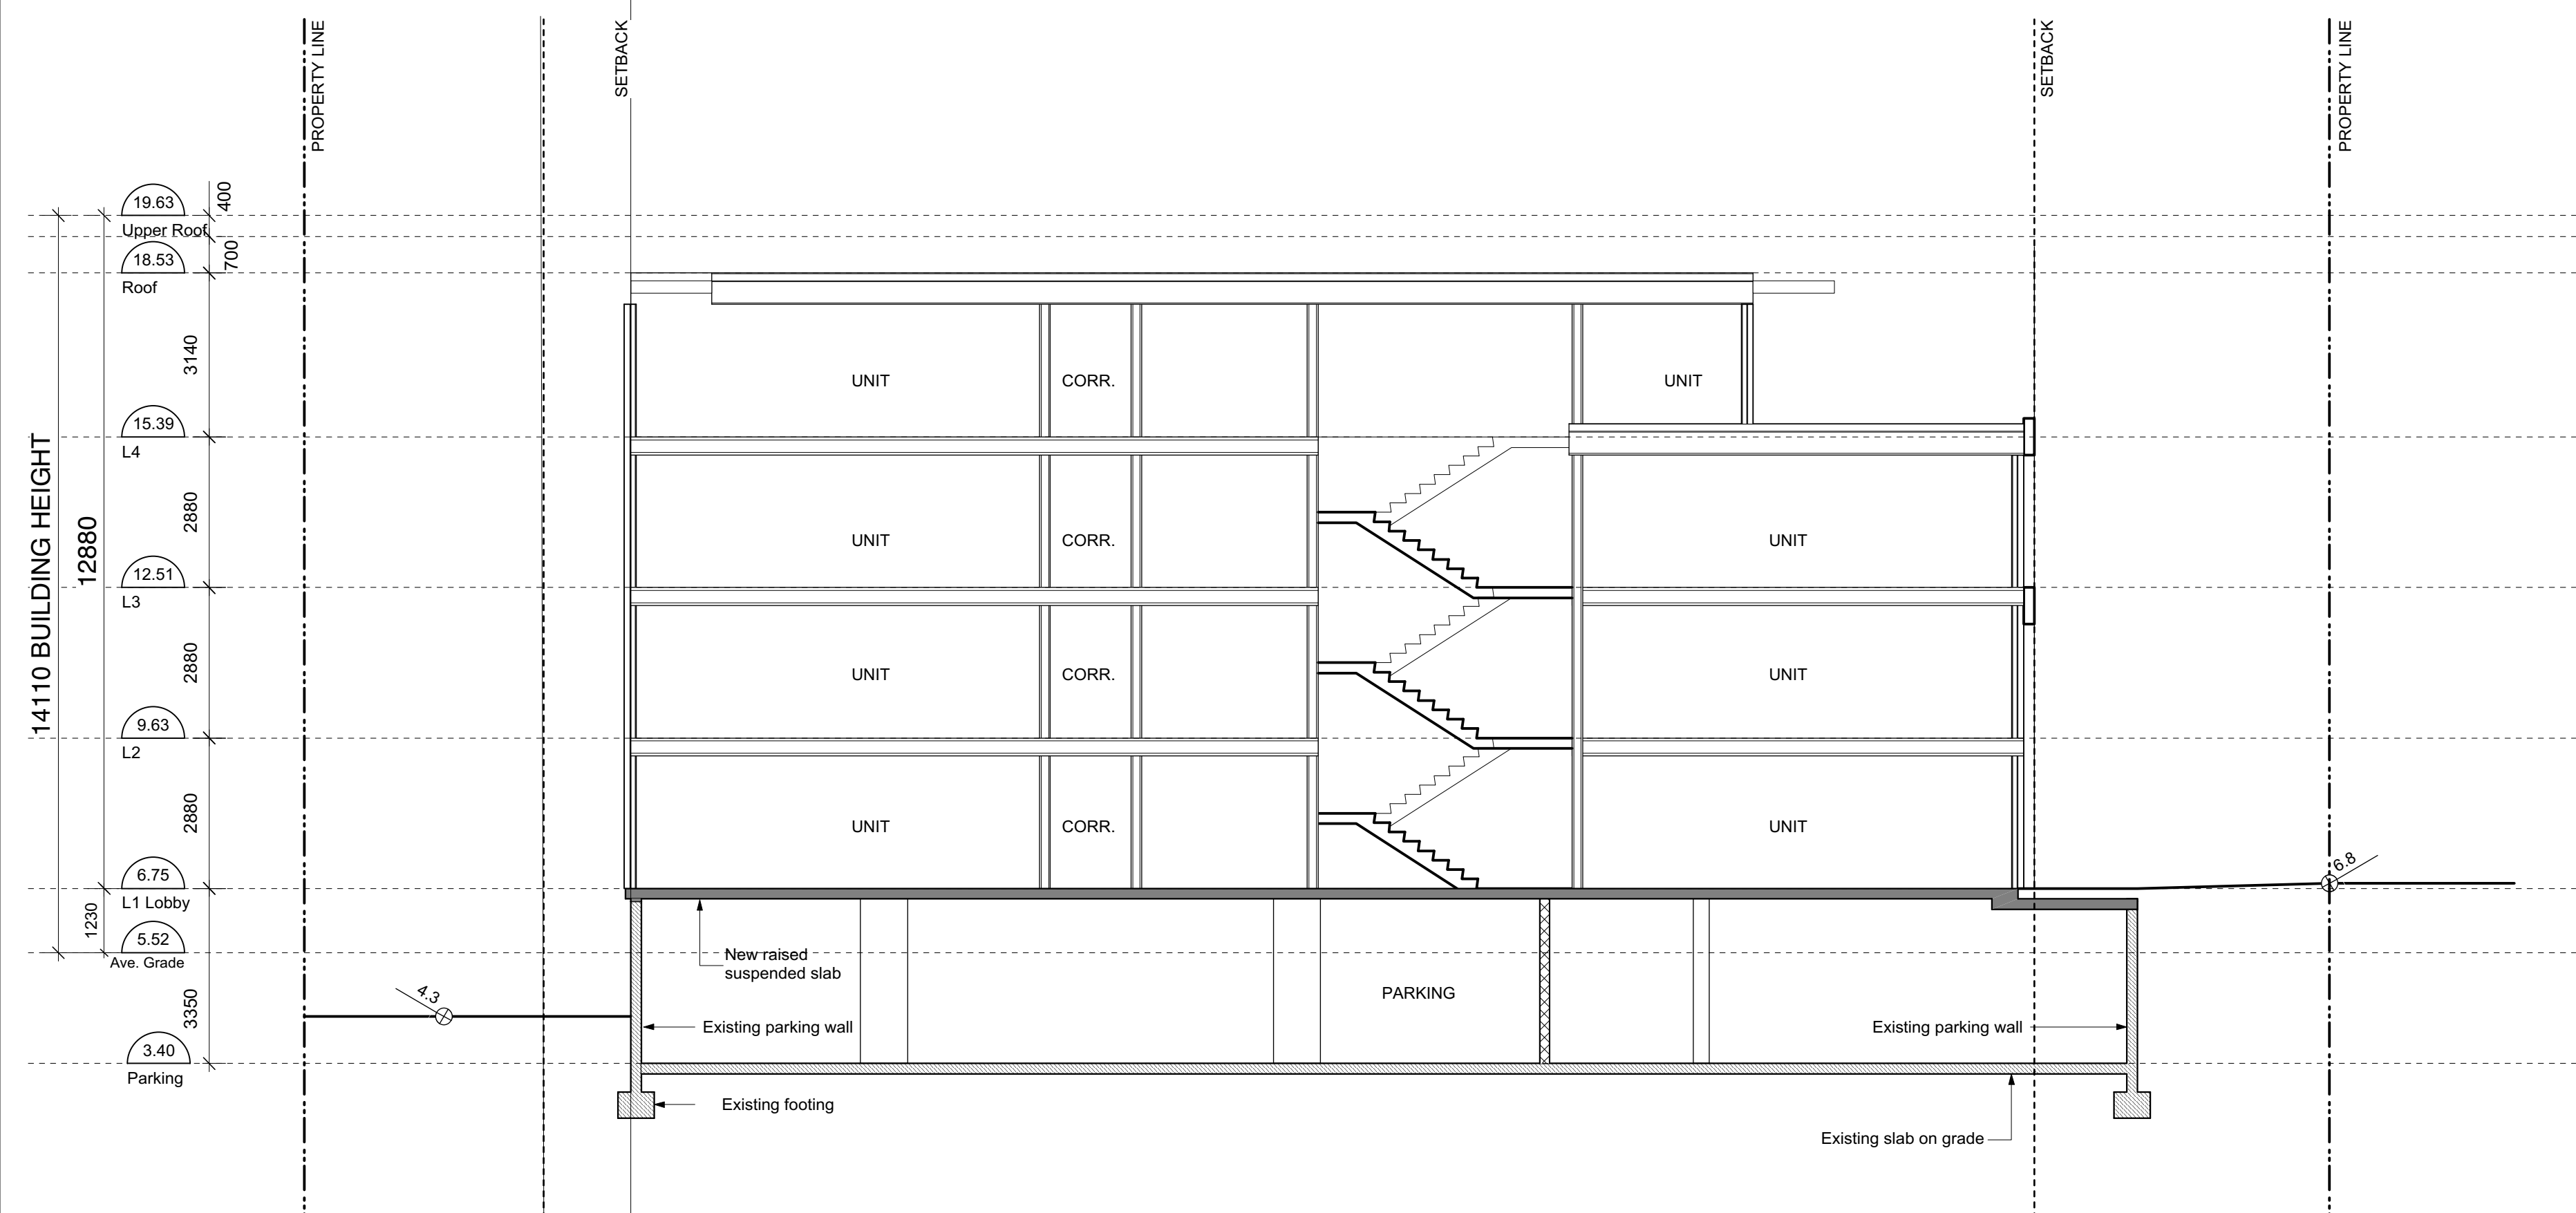

2 Section 2 - West Building
Scale: 1:100

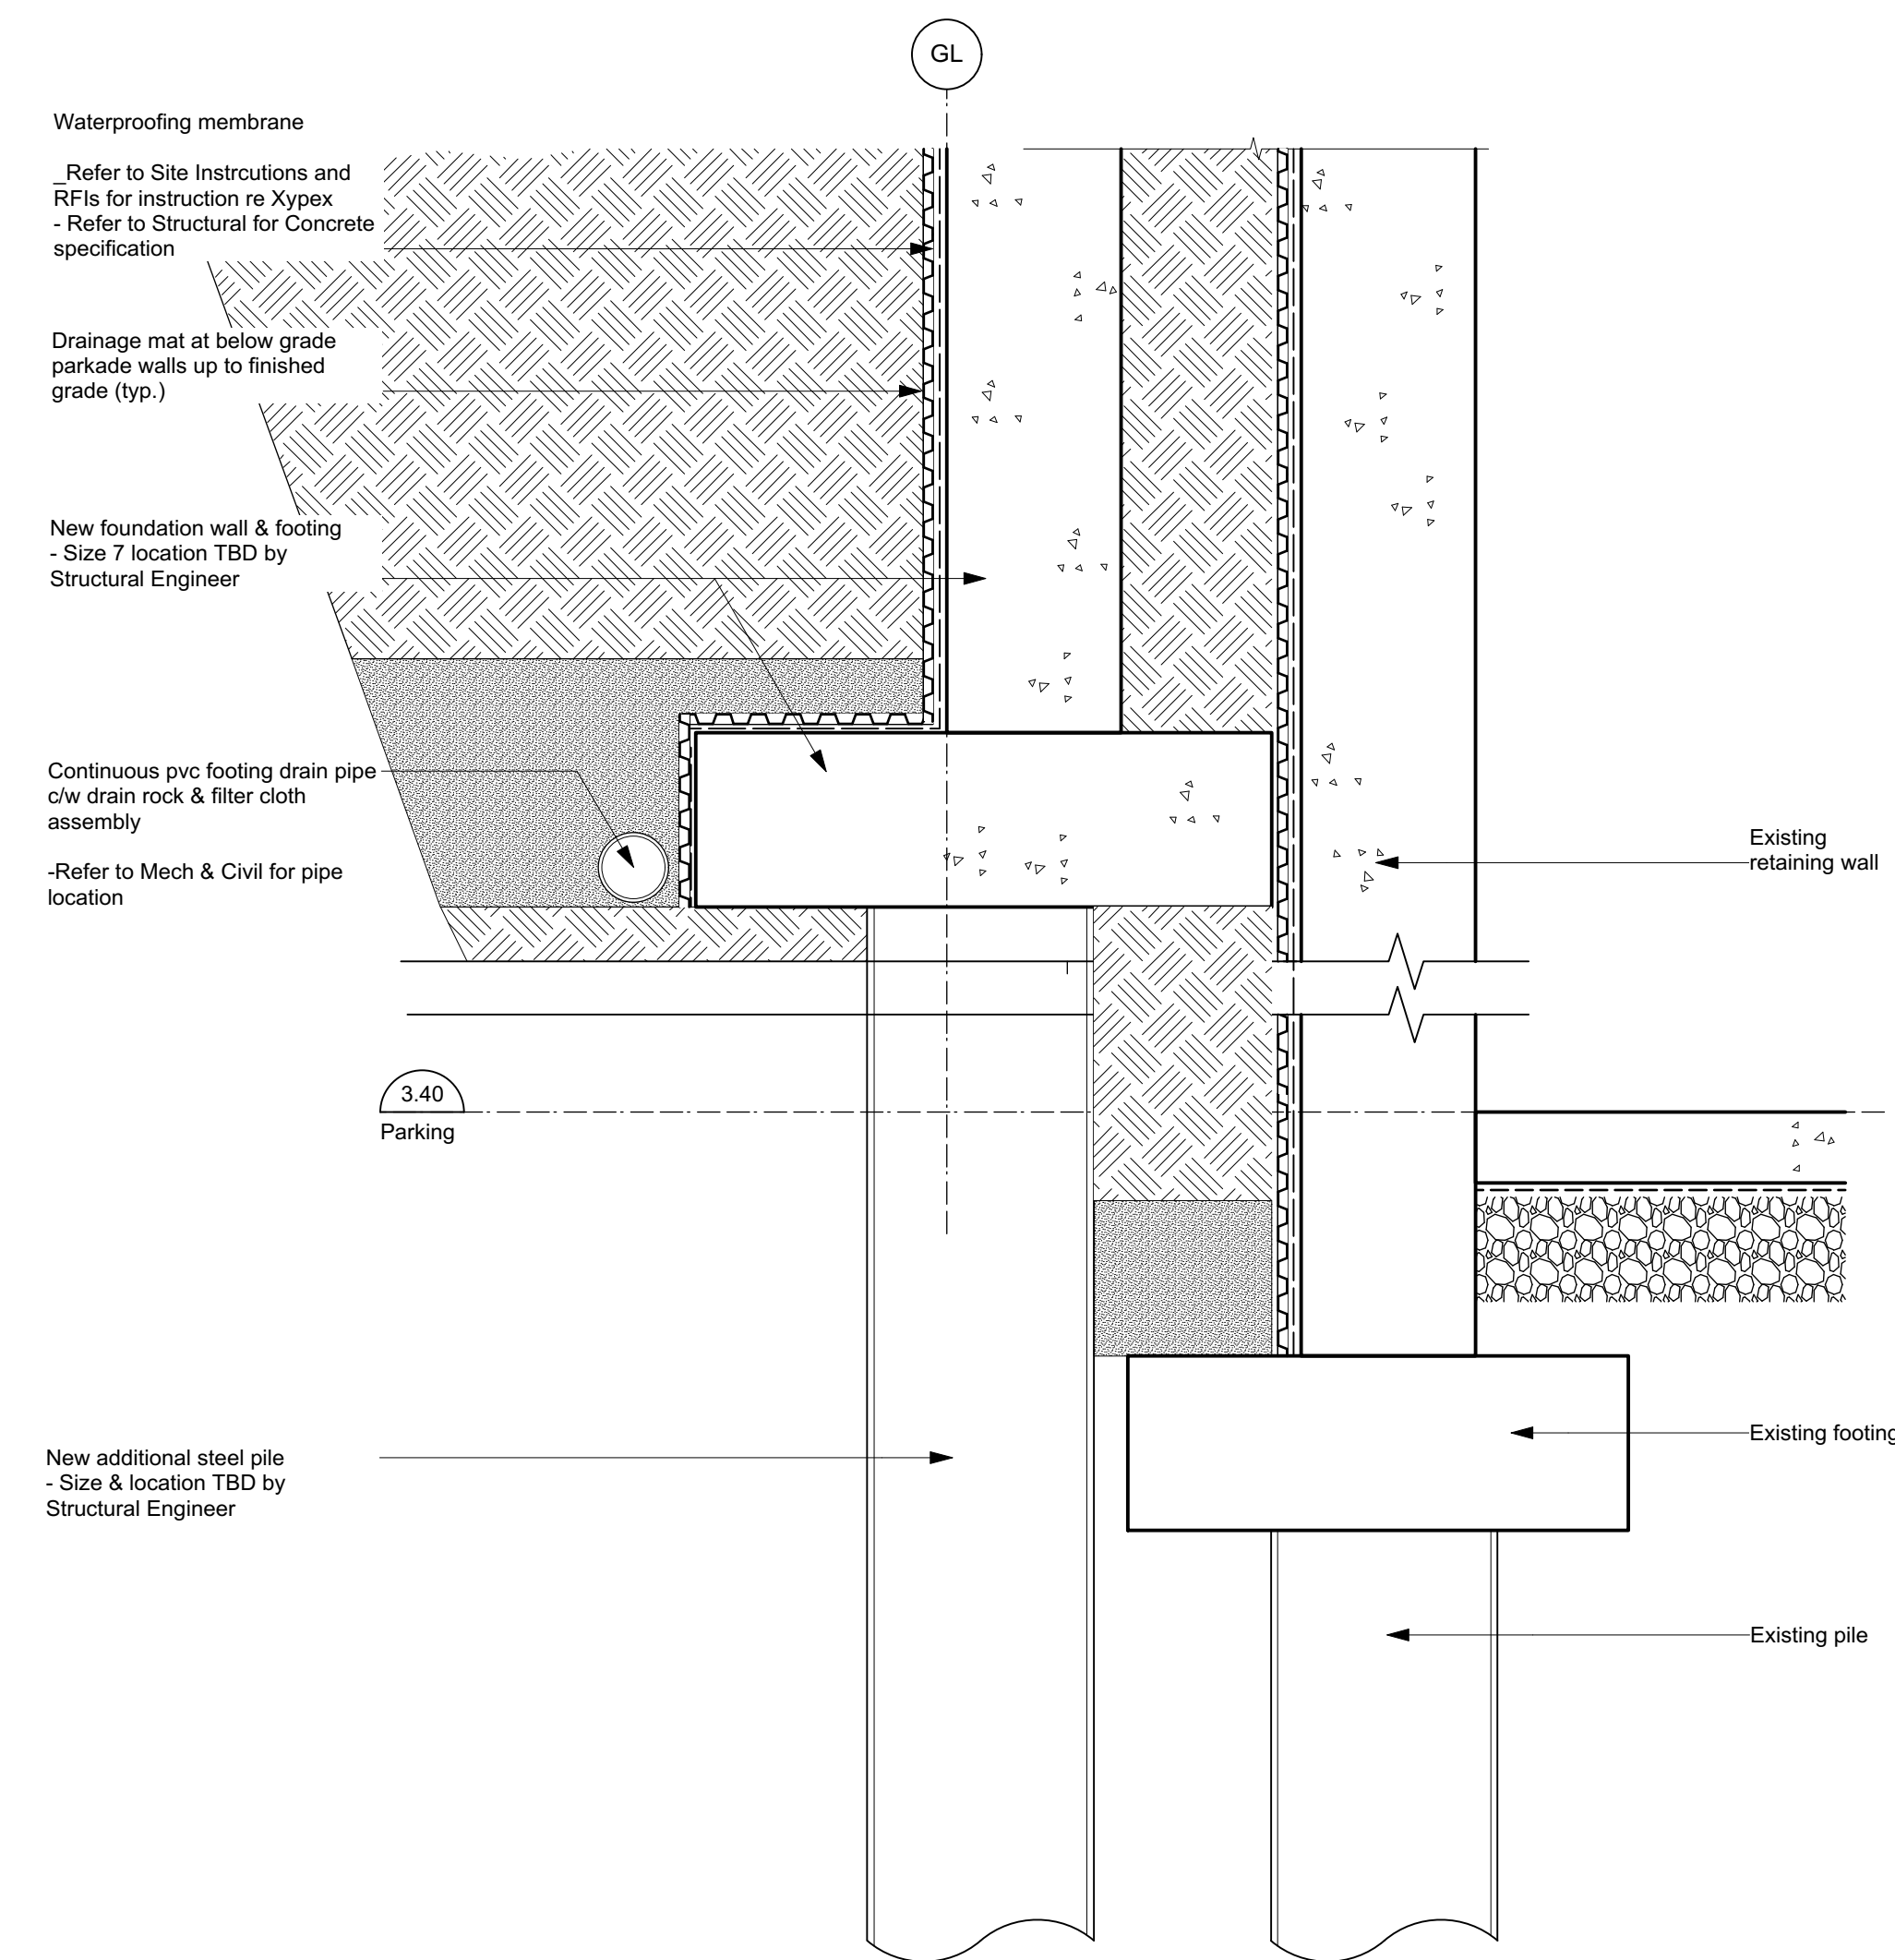

3 Cross Section
Scale: 1:10

Date	Description
JUN 2020	1815 A300 Sections.vwk
MAF	RAW
AS SHOWN	1815

NOTE: All dimensions are shown in millimeters.

dHKarchitects


VICTORIA OFFICE
977 Fort Street
Victoria BC V8V 3K3
T 1-250-658-3367

NANAIMO OFFICE
102-5190 Durbin Way
Nanaimo BC V9T 2W6
T 1-250-585-5810


Michigan St
310-338 Michigan St. & 333 Superior St.
Victoria BC

Sections - West Building

Project No: A301

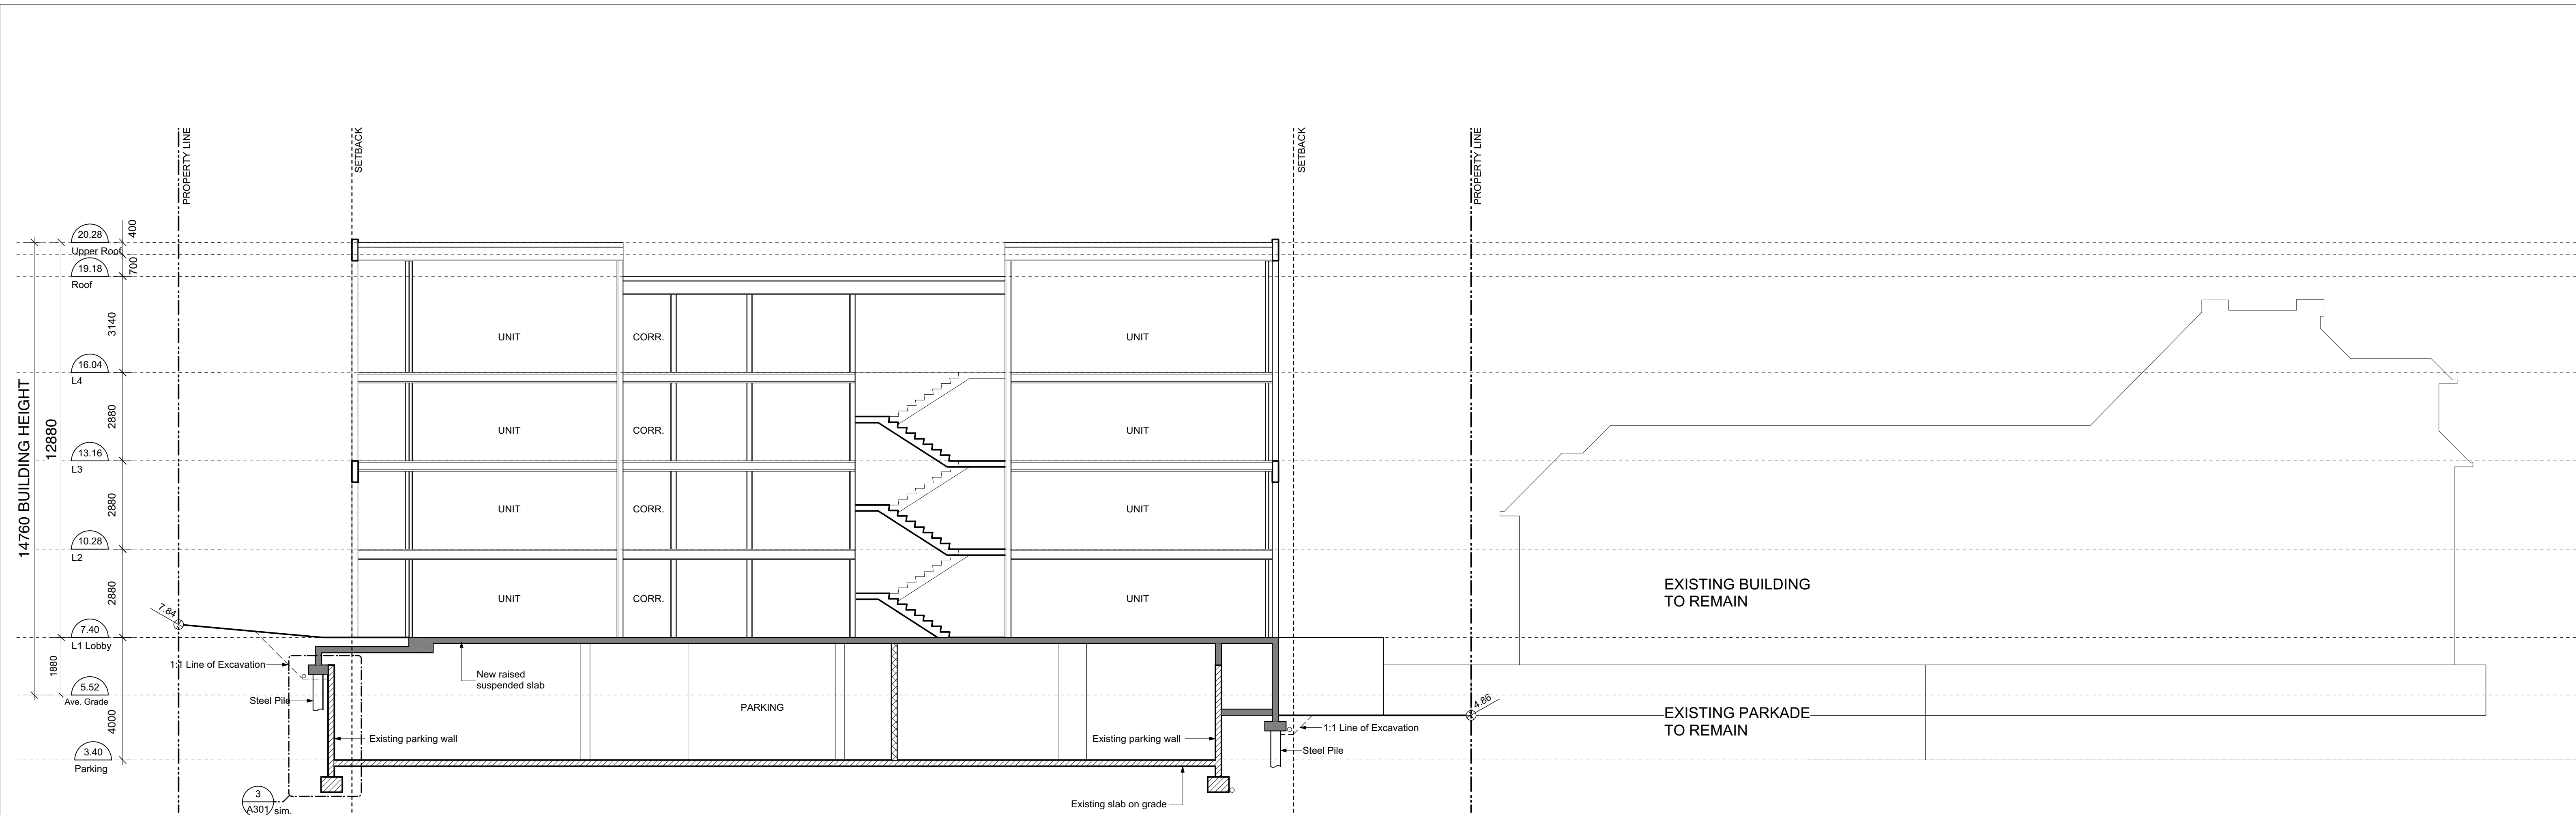

1 Section 3 - East Building
A302 Scale: 1:100

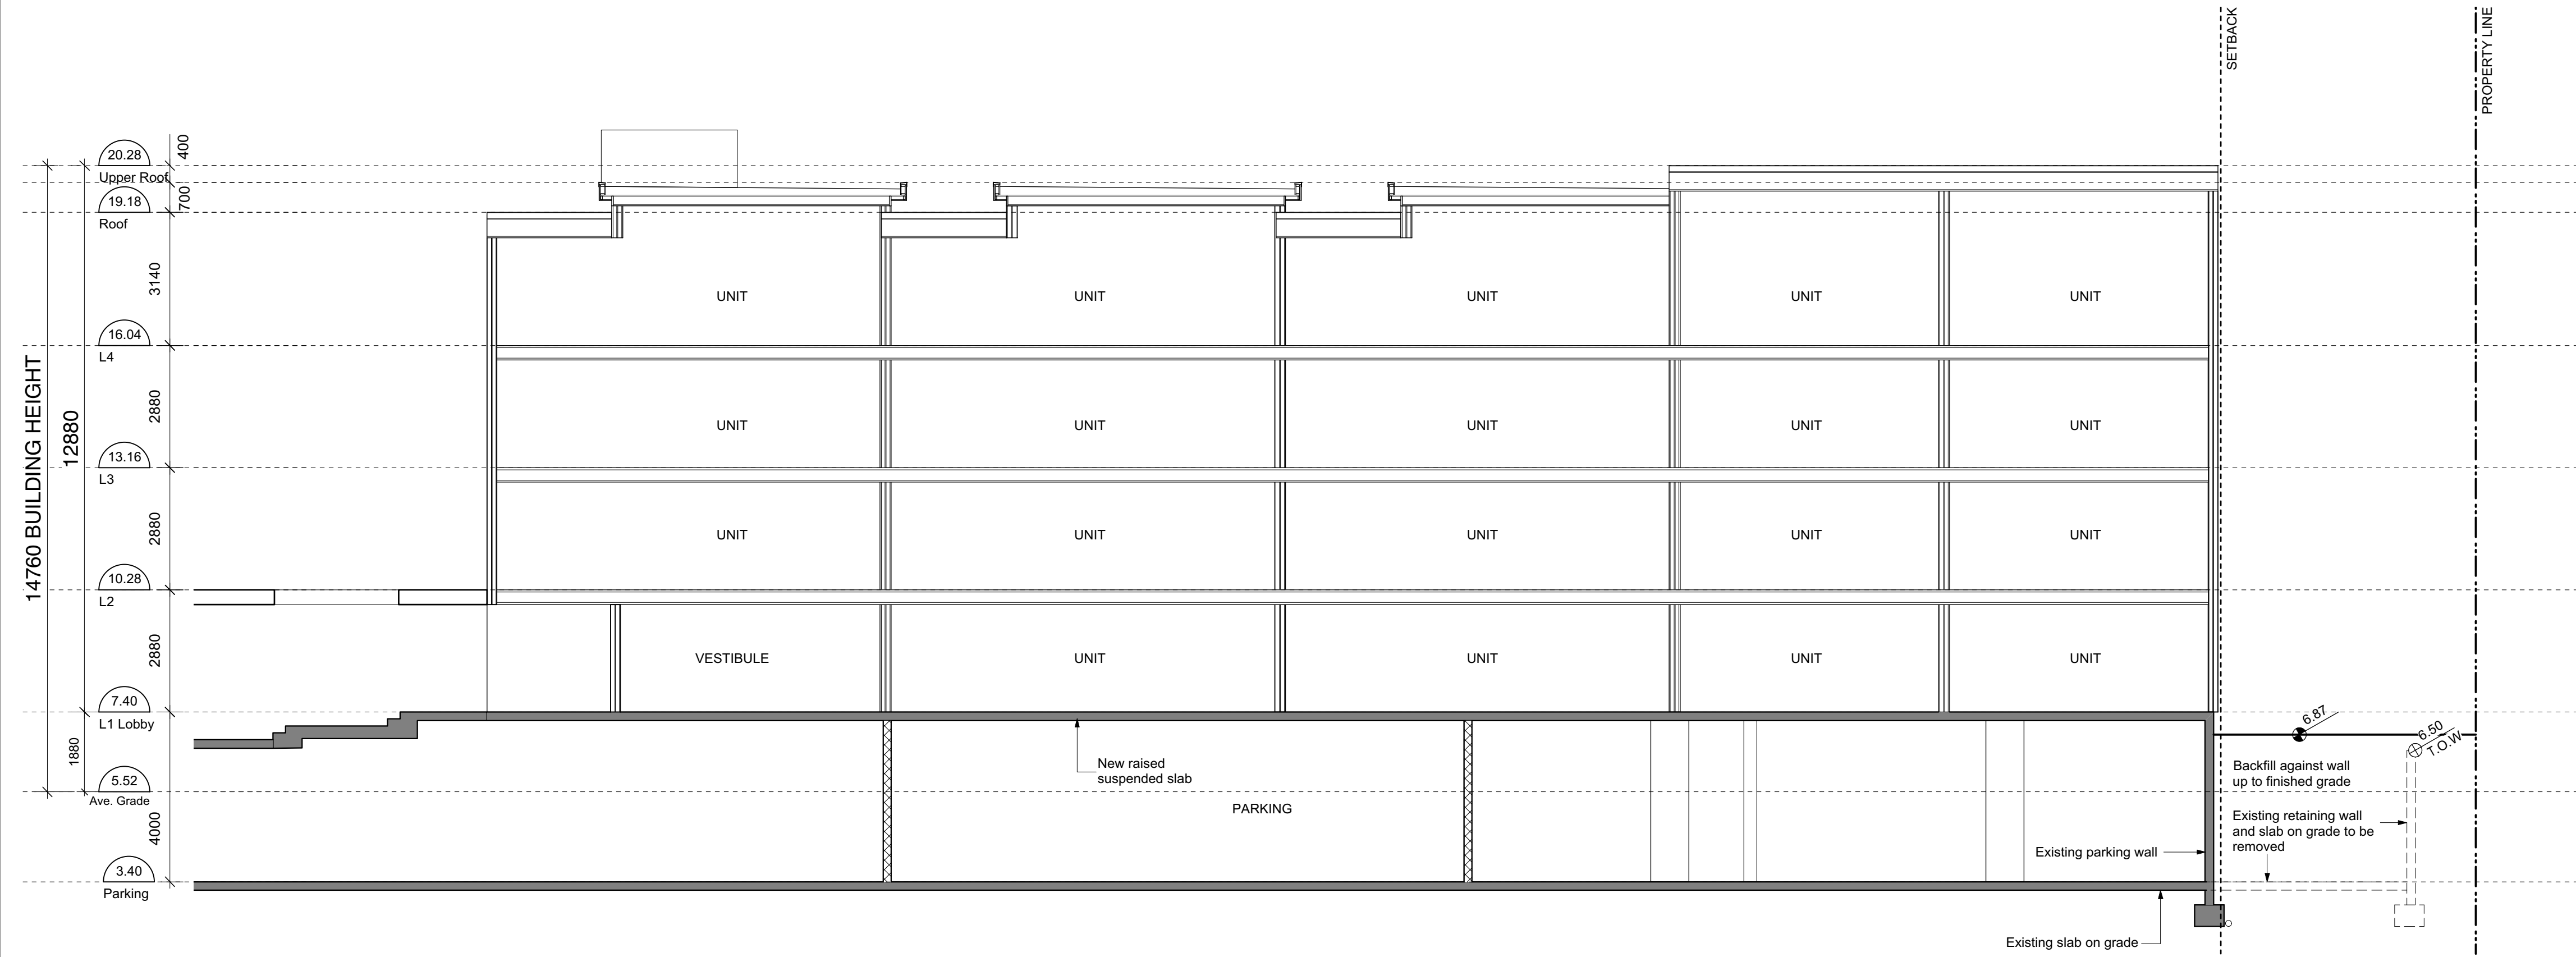

2 Section 4 - East Building
A302 Scale: 1:100

Date	By	Description
JUN 2020	MAF	1815 A300 Sections v1xk
AS SHOWN	MAF	1815

NOTE: All dimensions are shown in millimeters.

dhKarchitects

VICTORIA OFFICE
977 Fort Street
Victoria BC V8V 2K3
T 1-250-658-3367

NANAIMO OFFICE
102-5190 Durbin Way
Nanaimo BC V9T 2W6
T 1-250-585-5810

Michigan St
310-338 Michigan St. & 333 Superior St.
Victoria BC

Sections - East Building

A302	-
------	---

Recommended Nursery Stock

Trees

Total:	Botanical Name	Common Name	Size
38	Acer circinatum	Vine Maple	6cm cal., 3 stem
	Acer rubrum 'Karpick'	Karpick Maple	6cm cal.
	Acer rubrum 'October Glory'	October Glory Red Maple	6cm cal.
	Malus fusca	Pacific Crabapple	6cm cal.
	Stewartia pseudocamellia	Japanese Stewartia	6cm cal.

Medium Shrubs

Total:	Botanical Name	Common Name	Size
207	Choisya ternata	Mexican Orange Blossom	# 7 pot
	Mahonia aquifolium	Tall Oregon Grape	# 5 pot
	Vaccinium ovatum	Evergreen Huckleberry	# 1 pot



Small Shrubs

Total:	Botanical Name	Common Name	Size
1118	Gaultheria shallon	Salal	# 1 pot
	Lavandula officinalis	English Lavender	# 5 pot
	Mahonia nervosa	Low Oregon Grape	# 1 pot
	Mahonia repens	Creeping Oregon Grape	# 1 pot
	Nandina domestica 'Wood's Dwarf'	Wood's Dwarf Heavenly Bamboo	# 1 pot
	Rosmarinus officinalis	Rosemary	# 5 pot

Perennials, Annuals and Ferns

Total:	Botanical Name	Common Name	Size
674	Achillea millefolium	Common Yarrow	# 1 pot
	Crococsmia 'Babylon'	Babylon Montbretia	# 3 pot
	Echinacea purpurea	Purple Coneflower	# 1 pot
	Helictotrichon sempervirens	Blue Oat Grass	# 1 pot
	Leucanthemum x 'Becky'	Becky Shasta Daisy	# 1 pot
	Perovskia atriplicifolia	Russian Sage	# 1 pot
	Polystichum munitum	Sword Fern	# 3 pot

- Notes:**
 1. All work to be completed to current BCSLA Landscape Standards
 2. All soft landscape to be irrigated with an automatic irrigation system

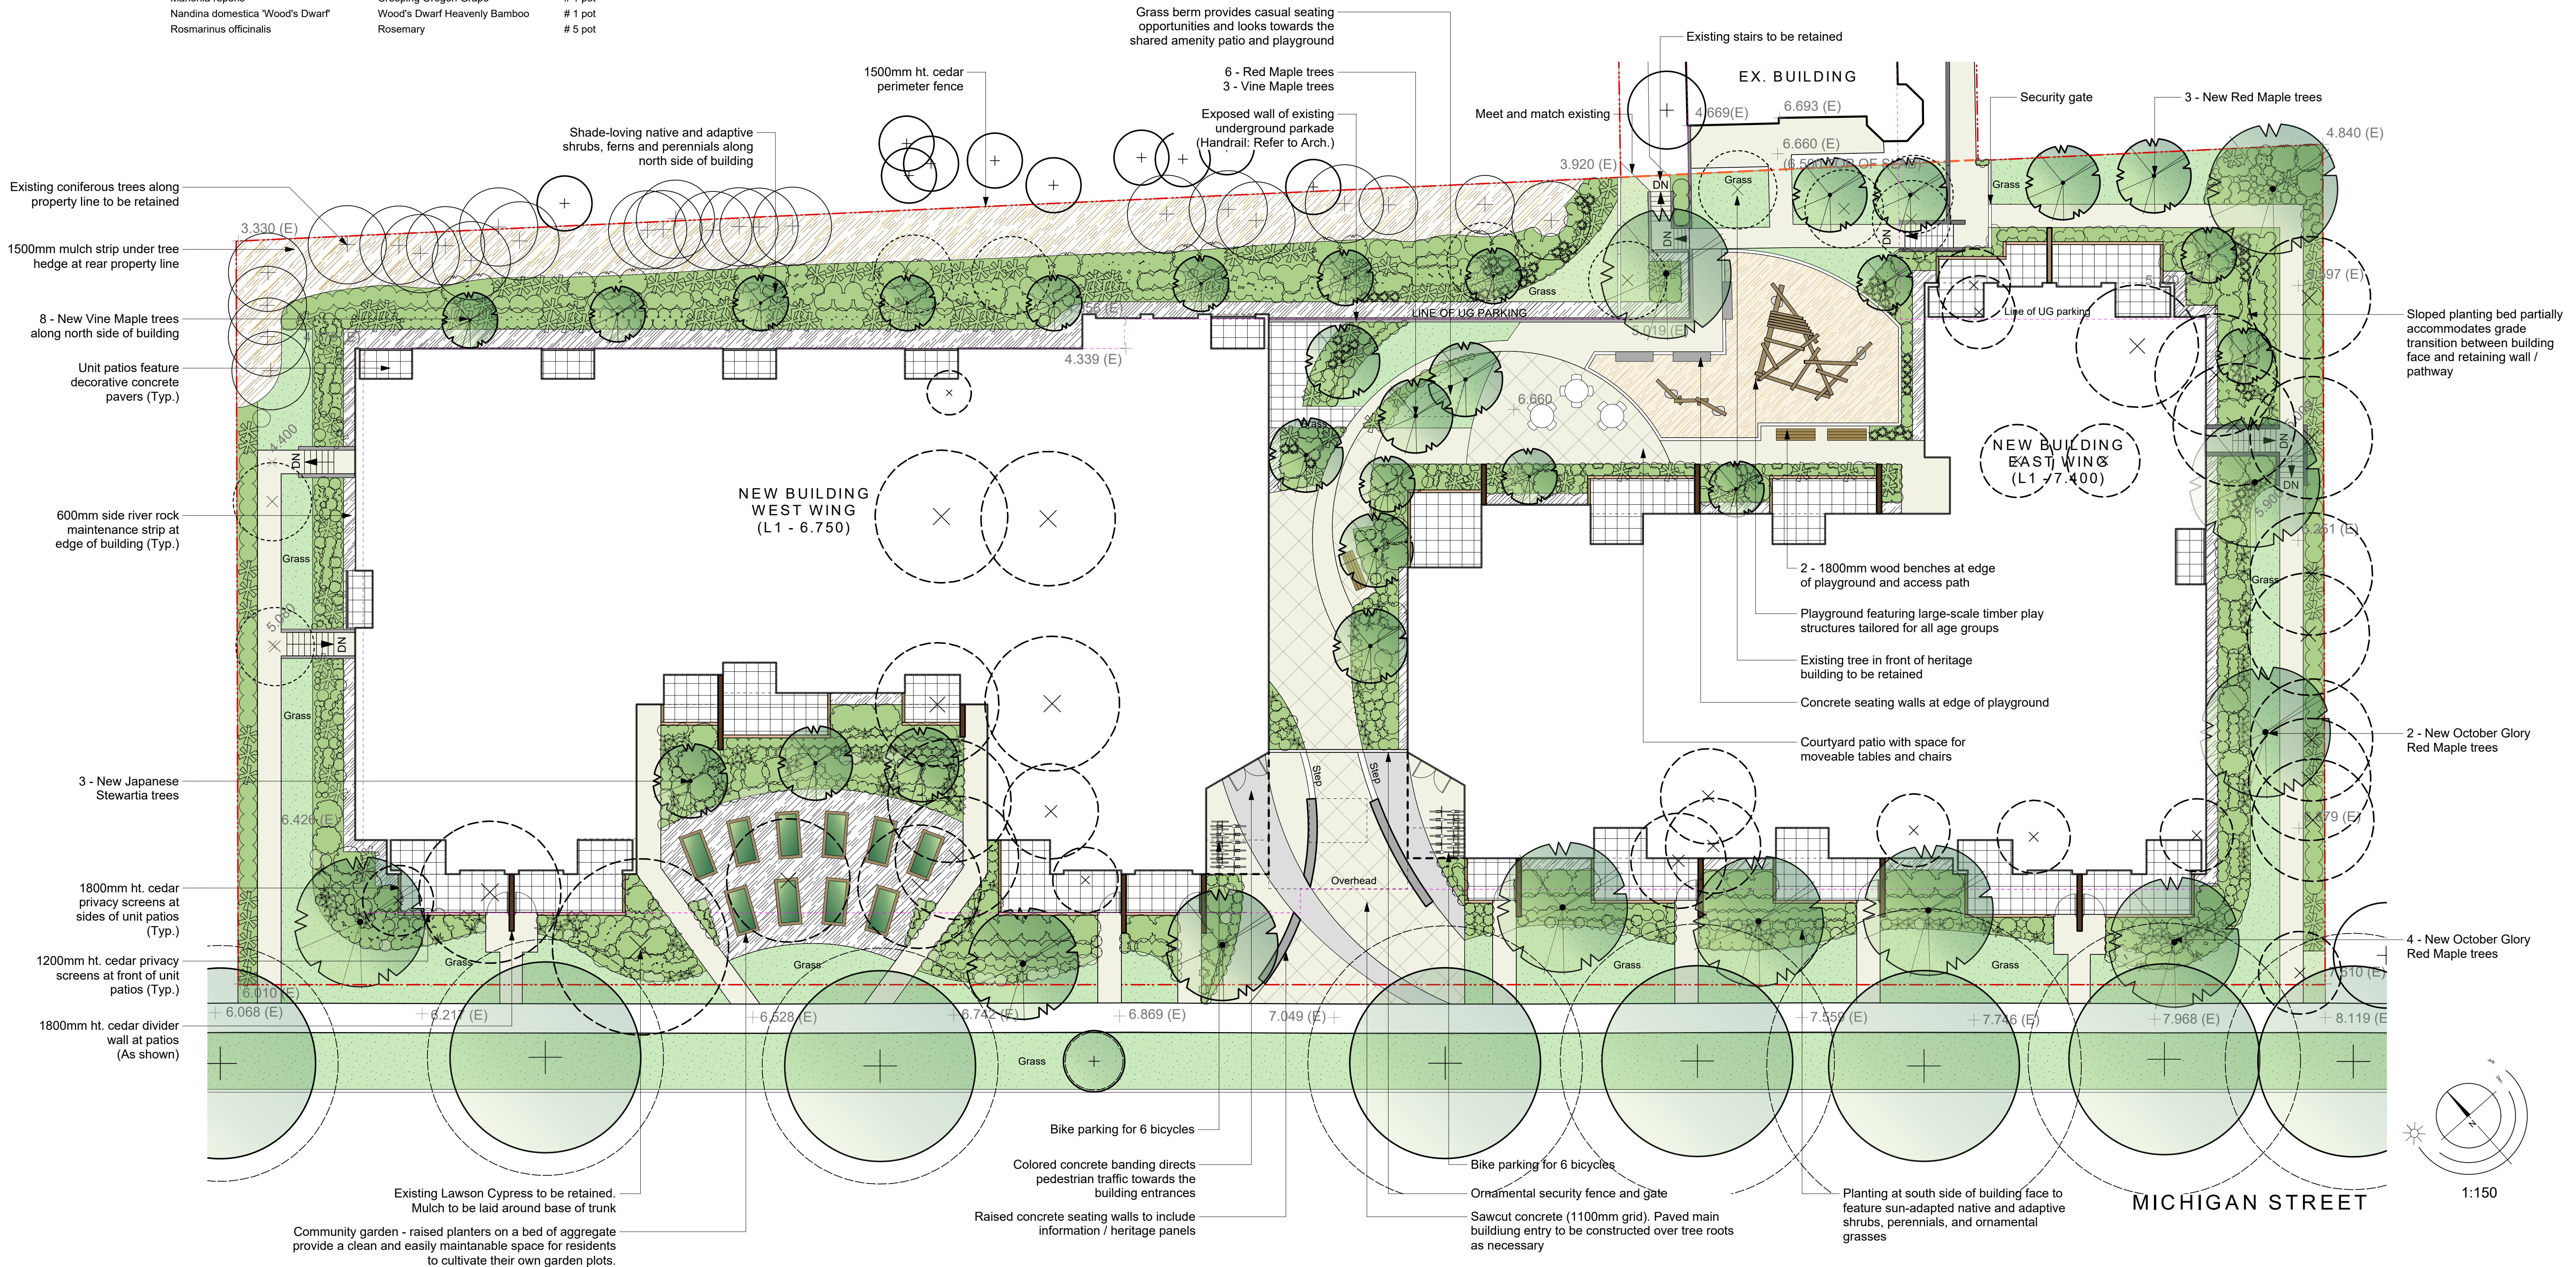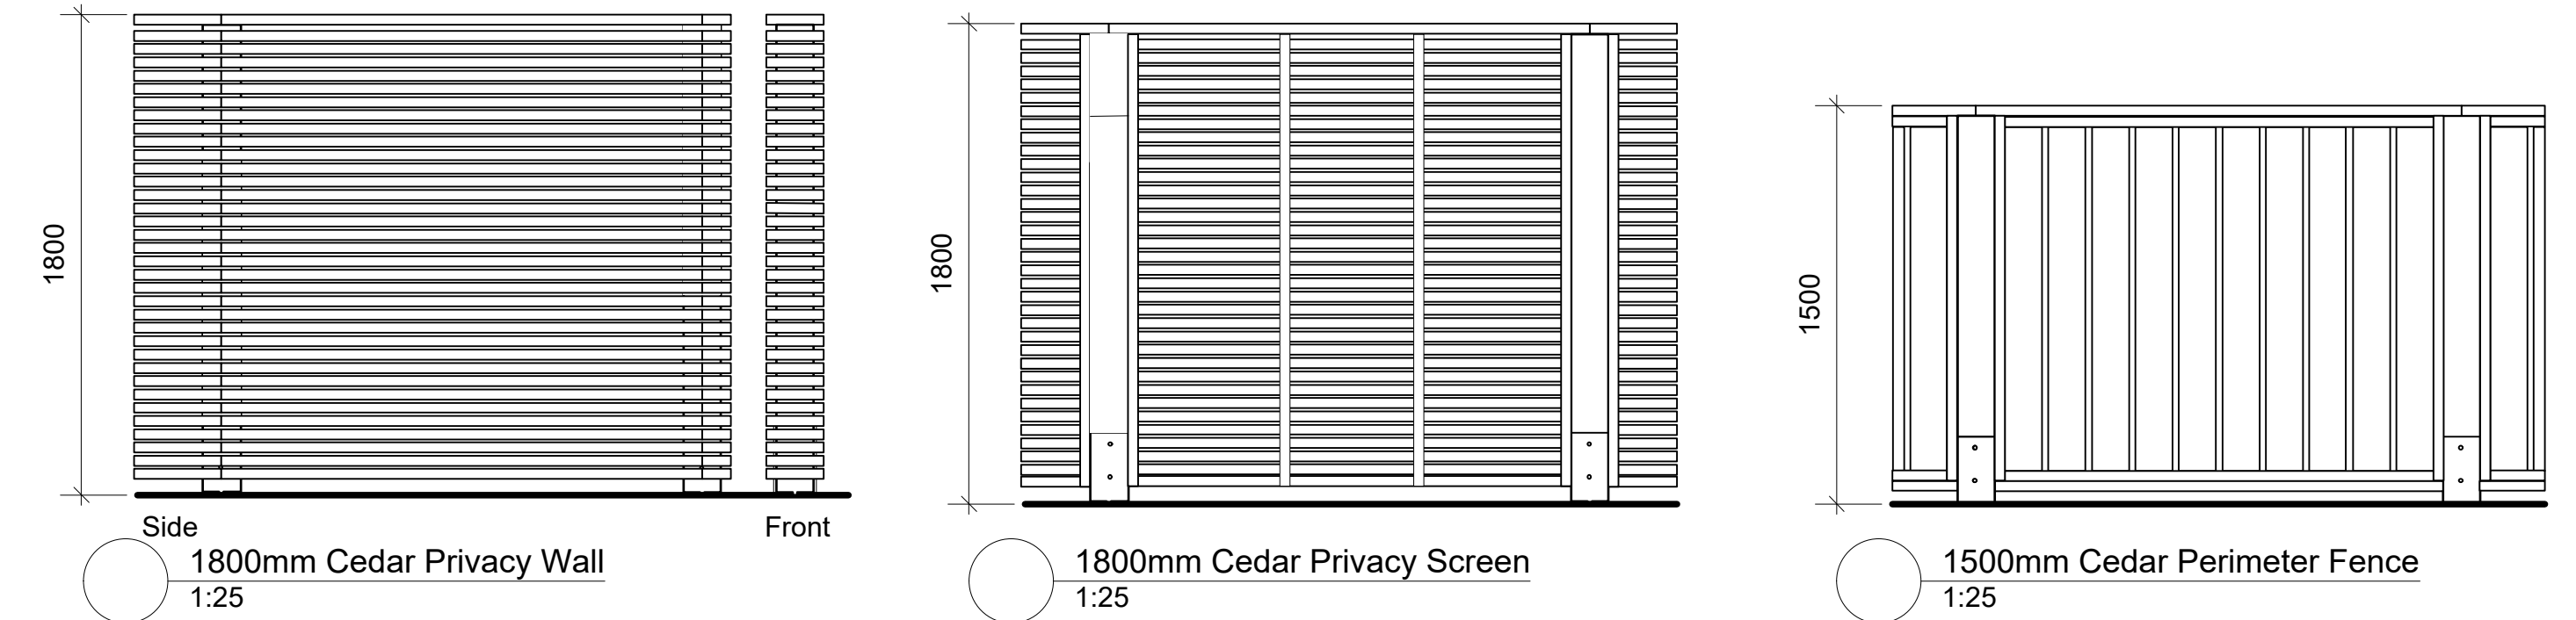

310-338 Michigan St. | Landscape Concept Plan

