CIVIC ADDRESS 1230 GRANT STREET 1209,1218,1219,1220, and 1226 NORTH PARK STREET 1219 VINING STREET 1235 CALEDONIA AVENUE USE 1211 GLADSTONE AVENUE **LEGAL DESCRIPTION** LOT 4 VIP205 SECTION SR VICTORIA LOT 5 VIP205 SECTION SR VICTORIA LOT 6 VIP205 SECTION SR VICTORIA LOT 7 VIP205 SECTION SR VICTORIA N 56' OF LOT 8 VIP205 SECTION SR VICTORIA REM LOT 8 VIP205 SECTION SR VICTORIA LOT 9 VIP205 SECTION SR VICTORIA LOT 18 VIP205 SECTION SR VICTORIA LOT A SECTION 53, SPRING RIDGE, VIP55528 SITE AREA 8681.1 SM PROJECT DESCRIPTION THE PROJECT INVOLVES THE DEVELOPMENT OF 158 AFFORDABLE HOUSING RESIDENTIAL UNITS AND SUPPORT FACILITIES IN 2 APARTMENT AND 3 TOWNHOUSE BUILDINGS OVER ONE BASEMENT LEVEL OF PARKADE. ZONING **BUILDING HEIGHTS APARTMENT 1** 4 STOREYS 4 STOREYS, 12.30 M **APARTMENT 2** 5 STOREYS 5 STOREYS, 14.98 M **TOWNHOUSE 1** 3 STOREYS 4 STOREYS, 11.05 M 3 STOREYS **TOWNHOUSE 2** 3 STOREYS, 10.65 M **TOWNHOUSE 3** 3 STOREYS 3 STOREYS, 9.40 M **BCBC BUILDING AREAS APARTMENT 1** 872 SM **APARTMENT 2** 875 SM TOWNHOUSE 1 653 SM **TOWNHOUSE 2** 652 SM **TOWNHOUSE 3** 260 SM GROSS BUILDING AREAS ZONING **PARKADE** 275 SM* * AREA OF PARKADE EXCLUDING EXTERIOR WALLS, VEHICLE **TOWNHOUSE 3** AND BICYCLE PARKING AND CIRCULATION. **APARTMENT 1** 800 SM 776 SM LEVEL 1 LEVEL 2 872 SM 850 SM LEVEL 3 872 SM 850 SM LEVEL 4 723 SM 704 SM 3267 SM 3180 SM **TOTAL** PROVIDED **APARTMENT 2** 789 SM LEVEL 1 765 SM LEVEL 2 656 SM 637 SM LEVEL 3 831 SM 809 SM 831 SM 809 SM LEVEL 4 LEVEL 5 690 SM **TOTAL** 3797 SM 3692 SM TOTAL PROVIDED **TOWNHOUSE 1** LEVEL 0 601 SM 566 SM* LEVEL 1 603 SM 581 SM LEVEL 2 608 SM 592 SM LEVEL 3 645 SM **TOTAL** 2457 SM 2372 SM ** DOES NOT CONTRIBUTE TO FSR. **TOWNHOUSE 2** 645 SM 606 SM** LEVEL 0 LEVEL 1 607 SM 590 SM LEVEL 2 607 SM 590 SM 645 SM LEVEL 3 632 SM 2504 SM 2418 SM ** DOES NOT CONTRIBUTE TO FSR. **TOWNHOUSE 3** 222 SM LEVEL 1 231 SM LEVEL 2 243 SM 235 SM LEVEL 3 253 SM **TOTAL** 727 SM 703 SM **RESIDENTIAL UNIT SUMMARY APARTMENTS 1 & 2** 14 STUDIO @ 47 - 49 SM 38 ONE BED @ 7 ACCESSIBLE ONE BED @ 53 SM 15 TWO BED @ 61 - 78 SM 5 ACCESSIBLE TWO BED @ 11 THREE BED @ 88 - 98 SM 1 ACCESSIBLE THREE BED @ 98 SM 6 FOUR BED @ 97 TOTAL <u>TOWNHOUSES 1 -3</u> 81 - 90 SM 55 TWO BED @ 2 ACCESSIBLE TWO BED @ 104 SM 2 THREE BED @ 118 SM 130 SM 2 FOUR BED @ 61 TOTAL **VEHICLE PARKING** PARKADE 112 SURFACE TOTAL 117 **BICYCLE PARKING** LONG TERM 194

SHORT TERM

TOTAL

PROJECT INFORMATION

VICTORIA ZONING BYLAW SUMMARY CODE ANALYSIS

ZONING

R-2

RESIDENTIAL

FLOOR SPACE RATIO GROSS BUILDING FLOOR AREA (ZONING) / SITE AREA 11193/8681.1 = 1.29

SITE COVERAGE

(SEE A202b FOR CALCULATION) AREA OF LOT OCCUPIED BY ANY STRUCTURE/ SITE AREA 4957/8681.1 = 57%

OPEN SITE SPACE (SEE A202c FOR CALCULATION)

SITE AREA - (BUILDING AREA + SURFACE PARKING AREA) 8681.1 - 5225 = 3456.1 OPEN SITE SPACE/ SITE AREA 3456.1/8681.1 = 40%

AVERAGE GRADE (GEODETIC) (SEE A202a FOR CALCULATION)

APARTMENT 1 **APARTMENT 2** TOWNHOUSE **TOWNHOUSE 3**

PORTION OF PARKADE ABOVE NATURAL GRADE (>33.2 M) BUILDING 1 33.2 M

9.400 M

TOWNHOUSE 2 BUILDING 2 32.6 M

HEIGHT OF BUILDINGS (AS MEASURED FROM AVERAGE GRADE) **APARTMENT 1** 12.300 M **APARTMENT 2** 14.980 M TOWNHOUSE ' 11.050 M TOWNHOUSE 2 10.650 M (no change)

VEHICLE PARKING < 45 SM .2 X 14 = 2.845 - 70 SM .5 X 58 = 29 > 70 SM .75 X 86 = 64.5 SUBTOTAL 96.3 (96) .1 X 158 = 15.8 (16) VISITOR **TOTAL REQUIRED** 112

BICYCLE PARKING LONG TERM < 45 SM 14 X 11 = 14 > 45 SM 1.25 X 144 = 180 TOTAL LONG TERM REQUIRED

SHORT TERM RESIDENTIAL (THE GREATER OF) .1 X 158 OR 6 X 5 TOTAL SHORT TERM REQUIRED TOTAL PROVIDED

117

CONSTRUCTION - COMBUSTIBLE OR NON COMBUSTIBLE FLOOR ASSEMBLIES - 1 HOUR SUPPORTING WALLS AND STRUCTURE - 1 HOUR ROOF ASSEMBLY - 1 HOUR

3.2.2.50 - GROUP C, UP TO 6 STOREYS, SPRINKLERED

ALLOWABLE HEIGHT - 6 STOREYS & 18 M

FIRE SUPPRESSION - FULLY SPRINKLERED

REFERENCE DOCUMENT BCBC 2018

BELOW GRADE PARKADE -

OCCUPANCY CLASSIFICATIONS (TABLE 3.1.2.1)

FIRE SEPARATION IN ACCORDANCE WITH 3.2.1.2.

ALLOWABLE HEIGHT - ANY HEIGHT

CONSTRUCTION - NON COMBUSTIBLE

ALLOWABLE AREA - ANY AREA

FLOOR ASSEMBLIES - 2 HOUR

ACTUAL SIZE AND CONSTRUCTION

FLOOR ASSEMBLY - 2 HOUR

GROUP C - RESIDENTIAL

HEIGHT - 1 STOREY

AREA - 3905 SM

APARTMENT 1

FIRE SUPPRESSION - FULL SPRINKLERED

FIRE SUPPRESSION - FULL SPRINKLERED

CONSTRUCTION - NON COMBUSTIBLE

OCCUPANCY CLASSIFICATIONS (TABLE 3.1.2.1)

3.2.2.51 - GROUP C, UP TO 4 STOREYS, SPRINKLERED

FIRE SUPPRESSION - FULLY SPRINKLERED

FIRE SUPPRESSION - FULLY SPRINKLERED

SUPPORTING WALLS AND STRUCTURE - 1 HOUR

SUPPORTING WALLS AND STRUCTURE - 1 HOUR

BUILDING SIZE AND CONSTRUCTION RELATIVE TO OCCUPANCY

ALLOWABLE AREA - 1800 SM (BASED ON FIVE STOREYS)

OCCUPANCY SEPARATIONS (TABLE 3.1.3.1)

ALLOWABLE HEIGHT - 4 STOREYS

FLOOR ASSEMBLIES - 1 HOUR

CONSTRUCTION - COMBUSTIBLE

OCCUPANCY CLASSIFICATIONS (TABLE 3.1.2.1)

OCCUPANCY SEPARATIONS (TABLE 3.1.3.1)

FLOOR ASSEMBLY - 1 HOUR

ROOF ASSEMBLY - NONE

GROUP C - RESIDENTIAL

ACTUAL SIZE AND CONSTRUCTION

ROOF ASSEMBLY - NONE

ACTUAL SIZE AND CONSTRUCTION

HEIGHT - 4 STOREYS

AREA - 872 SM

APARTMENT 2

OCCUPANCY SEPARATIONS (TABLE 3.1.3.1)

GROUP F, DIVISION 3 - LOW HAZARD INDUSTRIAL

BUILDING SIZE AND CONSTRUCTION RELATIVE TO OCCUPANCY

SUPPORTING WALLS AND STRUCTURE - 2 HOUR

SUPPORTING WALLS AND STRUCTURE - 2 HOUR

BUILDING SIZE AND CONSTRUCTION RELATIVE TO OCCUPANCY

ALLOWABLE AREA - 1800 SM (BASED ON FOUR STOREYS)

CONSTRUCTION - COMBUSTIBLE OR NON COMBUSTIBLE

BELOW GRADE PARKADE CONSIDERED AS A SEPARATE BUILDING AND

SEPARATED FROM THE FLOORS OF ALL BUILDINGS ABOVE BY A 2 HOUR

3.2.2.78 - GROUP F. DIVISION 3 - ANY HEIGHT, ANY AREA, SPRINKLERED

PARKADE

FIRE SUPPRESSION - FULLY SPRINKLERED HEIGHT - 5 STOREYS, 14.96 M AREA - 831 SM CONSTRUCTION - COMBUSTIBLE FLOOR ASSEMBLY - 1 HOUR SUPPORTING WALLS AND STRUCTURE - 1 HOUR ROOF ASSEMBLY - 1 HOUR

CODE ANALYSIS CONTINUED

TOWNHOUSE 1 OCCUPANCY CLASSIFICATIONS (TABLE 3.1.2.1) GROUP C - RESIDENTIAL

OCCUPANCY SEPARATIONS (TABLE 3.1.3.1)

BUILDING SIZE AND CONSTRUCTION RELATIVE TO OCCUPANCY 3.2.2.54 - GROUP C. UP TO 3 STOREYS. SPRINKLERED

FIRE SUPPRESSION - FULLY SPRINKLERED ALLOWABLE HEIGHT - 3 STOREYS ALLOWABLE AREA - 1800 SM (BASED ON THREE STOREYS) CONSTRUCTION - COMBUSTIBLE OR NON COMBUSTIBLE FLOOR ASSEMBLIES - 45 MIN. SUPPORTING WALLS AND STRUCTURE - 45 MIN. ROOF - NONE

ACTUAL SIZE AND CONSTRUCTION

FIRE SUPPRESSION - FULLY SPRINKLERED HEIGHT - 3 STOREYS WITH BASEMENT AREA - 645 SM **CONSTRUCTION - COMBUSTIBLE** FLOOR ASSEMBLY - 45 MIN. SUPPORTING WALLS AND STRUCTURE - 45 MIN. **ROOF ASSEMBLY - NONE**

TOWNHOUSE 2

OCCUPANCY CLASSIFICATIONS (TABLE 3.1.2.1) GROUP C - RESIDENTIAL

OCCUPANCY SEPARATIONS (TABLE 3.1.3.1)

BUILDING SIZE AND CONSTRUCTION RELATIVE TO OCCUPANCY

3.2.2.54 - GROUP C, UP TO 3 STOREYS, SPRINKLERED FIRE SUPPRESSION - FULLY SPRINKLERED ALLOWABLE HEIGHT - 3 STOREYS ALLOWABLE AREA - 1800 SM (BASED ON THREE STOREYS) CONSTRUCTION - COMBUSTIBLE OR NON COMBUSTIBLE FLOOR ASSEMBLIES - 45 MIN. SUPPORTING WALLS AND STRUCTURE - 45 MIN. ROOF - NONE

ACTUAL SIZE AND CONSTRUCTION FIRE SUPPRESSION - FULLY SPRINKLERED HEIGHT - 3 STOREYS WITH BASEMENT AREA - 645 SM

CONSTRUCTION - COMBUSTIBLE FLOOR ASSEMBLY - 45 MIN. SUPPORTING WALLS AND STRUCTURE - 45 MIN. **ROOF ASSEMBLY - NONE**

OCCUPANCY CLASSIFICATIONS (TABLE 9.10.2.1) GROUP C - RESIDENTIAL

FIRE-RESISTANCE RATINGS (TABLE 9.10.8.1) USE - RESIDENTIAL (GROUP C)

MAXIMUM HEIGHT - 3 STOREYS MAXIMUM AREA - 600 SM CONSTRUCTION - COMBUSTIBLE OR NON COMBUSTIBLE FLOOR ASSEMBLIES - 45 MIN. SUPPORTING WALLS AND STRUCTURE - 45 MIN. **ROOF ASSEMBLY - NONE**

ACTUAL SIZE AND CONSTRUCTION

FIRE SUPPRESSION - FULLY SPRINKLERED **HEIGHT - 3 STOREYS WITH BASEMENT** AREA - 253 SM **CONSTRUCTION - COMBUSTIBLE** FLOOR ASSEMBLY - 45 MIN. SUPPORTING WALLS AND STRUCTURE - 45 MIN. **ROOF ASSEMBLY - NONE**

SITE LOCATION

DRAWING INDEX

ARCHITECTURAL A001 PROJECT INFORMATION A002 SURVEY

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A201 ARCHITECTURAL SITE PLAN A202a AVERAGE GRADE CALCULATIONS A202b SITE COVERAGE CALCULATIONS A202c OPEN SPACE CALCULATIONS A203 L1 PLAN

A204 L2 PLAN **A205 L3 PLAN** A206 L4 PLAN **A207 L5 PLAN**

A208 ROOF PLAN

A301 ELEVATIONS - APARTMENT 1 A302 ELEVATIONS - APARTMENT 2 A303 ELEVATIONS - APARTMENT 2 A304 ELEVATIONS - TOWNHOUSE 1 A305 ELEVATIONS - TOWNHOUSE 2 A306 ELEVATIONS - TOWNHOUSE 3

A307 SHADOW STUDIES A308 VIEW ANALYSIS A309 VIEW ANALYSIS A310 VIEW ANALYSIS A311 PERSPECTIVE STUDIES A312 PERSPECTIVE STUDIES

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A403 BUILDING SECTIONS A404 BUILDING SECTIONS A601 L1 PLAN - APARTMENTS

A602 L2 PLAN - APARTMENTS A603 L3 PLAN - APARTMENTS A604 L4 PLAN - APARTMENTS A605 L5 PLAN - APARTMENTS A606 TOWNHOUSE 1 A607 TOWNHOUSE 1 A608 TOWNHOUSE 2 A609 TOWNHOUSE 2

A610 TOWNHOUSE 3

A701 APARTMENT UNIT PLANS A702 APARTMENT UNIT PLANS A703 TOWNHOUSE S 1 & 2 UNIT PLANS A704 TOWNHOUSE 3 UNIT PLANS

A705 AMENITY ROOM

CIVIL

19-028-REZONING CONCEPTUAL SERVICING

LANDSCAPE L1.01 LANDSCAPE OVERVIEW PLAN

L1.02 LANDSCAPE MATERIALS SOUTH L1.03 LANDSCAPE MATERIALS NORTH L1.04 STORMWATER MANAGEMENT L1.05 TREE RETENTION & REMOVAL PLAN

L3.01 PLANTING PLAN SOUTH L3.02 PLANTING PLAN NORTH L5.01 LANDSCAPE SECTIONS

Revisions Bubbled areas indicate revisions compared to the previously submitted plans **Received Date** September 16, 2020

> RE-ISSUED FOR COTW 20/03/13 RE-ISSUED FOR COTW ISSUED FOR COTW ISSUED FOR ADP 20/01/15 RESPONSE TO PLANNING REVIEW 1907 PROJECT INFORMATION SEPTEMBER 2020 FWP/NLC SEE DRAWING


ISSUED FOR DP & REZONING



Location Plan


Recalculated average grades as per Planning request. Building areas consolidated as per area of parkade above natural grade. Δ Corresponding data, including building heights updated accordingly. Adjustment made due to notation error. No change to actual data. Site coverage and open site space recalculated as per Planning request. See Revision Note #1.


REVISIONS LIST

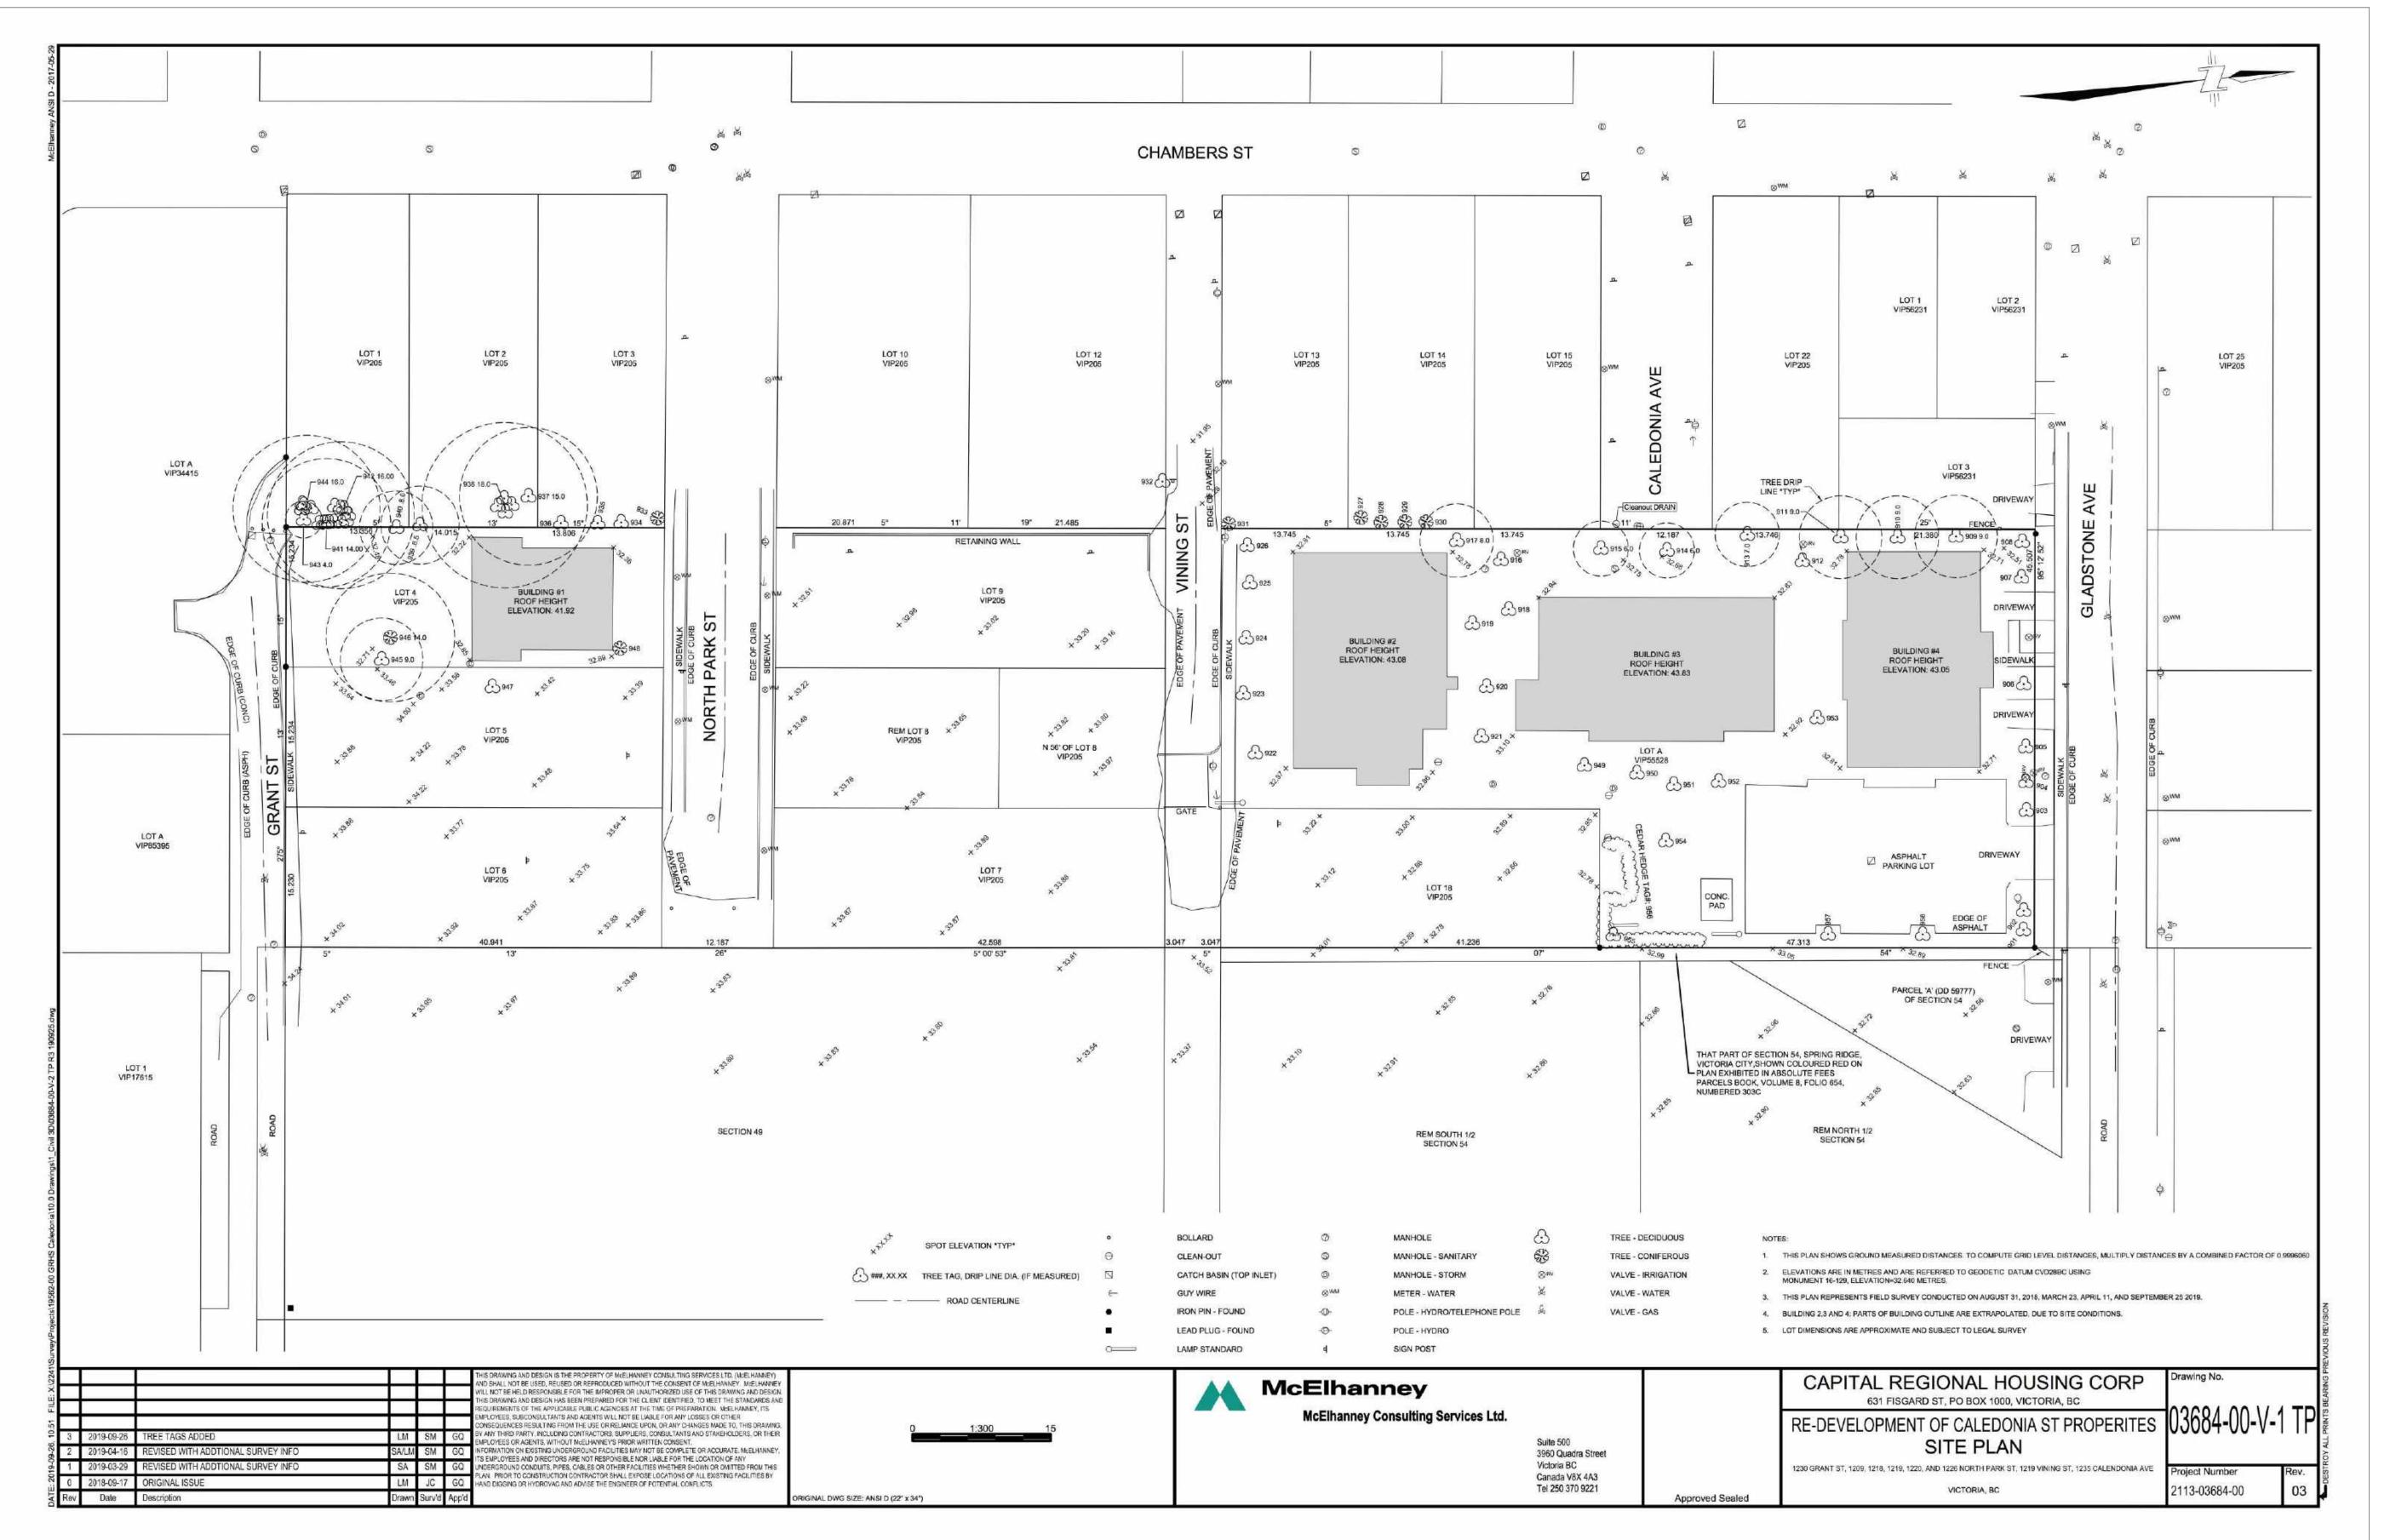

5	20/09/01	RE-ISSUED FOR COTW
4	20/03/13	RE-ISSUED FOR COTW
3	20/02/06	ISSUED FOR COTW
2	20/01/15	ISSUED FOR ADP
1	19/12/16	RESPONSE TO PLANNING REVIEW
Rev	Date	Description
plot date	SEPTEMBER 2020	drawing file 1907 PROJECT INFORATION
drawn by	NLC	checked by RAW
scale	SEE DRAWING	project number 1907

≪ KEZ		
dHKa	dHKarc	hitects
VICTORIA OFFICE 977 Fort Street Victoria BC V8V3K3 T 1.250.658.3367	NANAIMO OFFICE 102-5190 Du Nanaimo BC T 1•250•585	blin Way V9T2K8
Caledonia		
Victoria, BC		
Survey		
COPYRIGHT RESERVED. THESE PLANS AND DESIGNS ARE AND AT ALL TIMES REMAIN THE PROPERTY OF DHIKARCHITECTS TO BE USED FOR THE PROJECT SHOWN AND MAY NOT BE REPRODUCED WITHOUT WRITTEN CONSENT	A002	revision no.

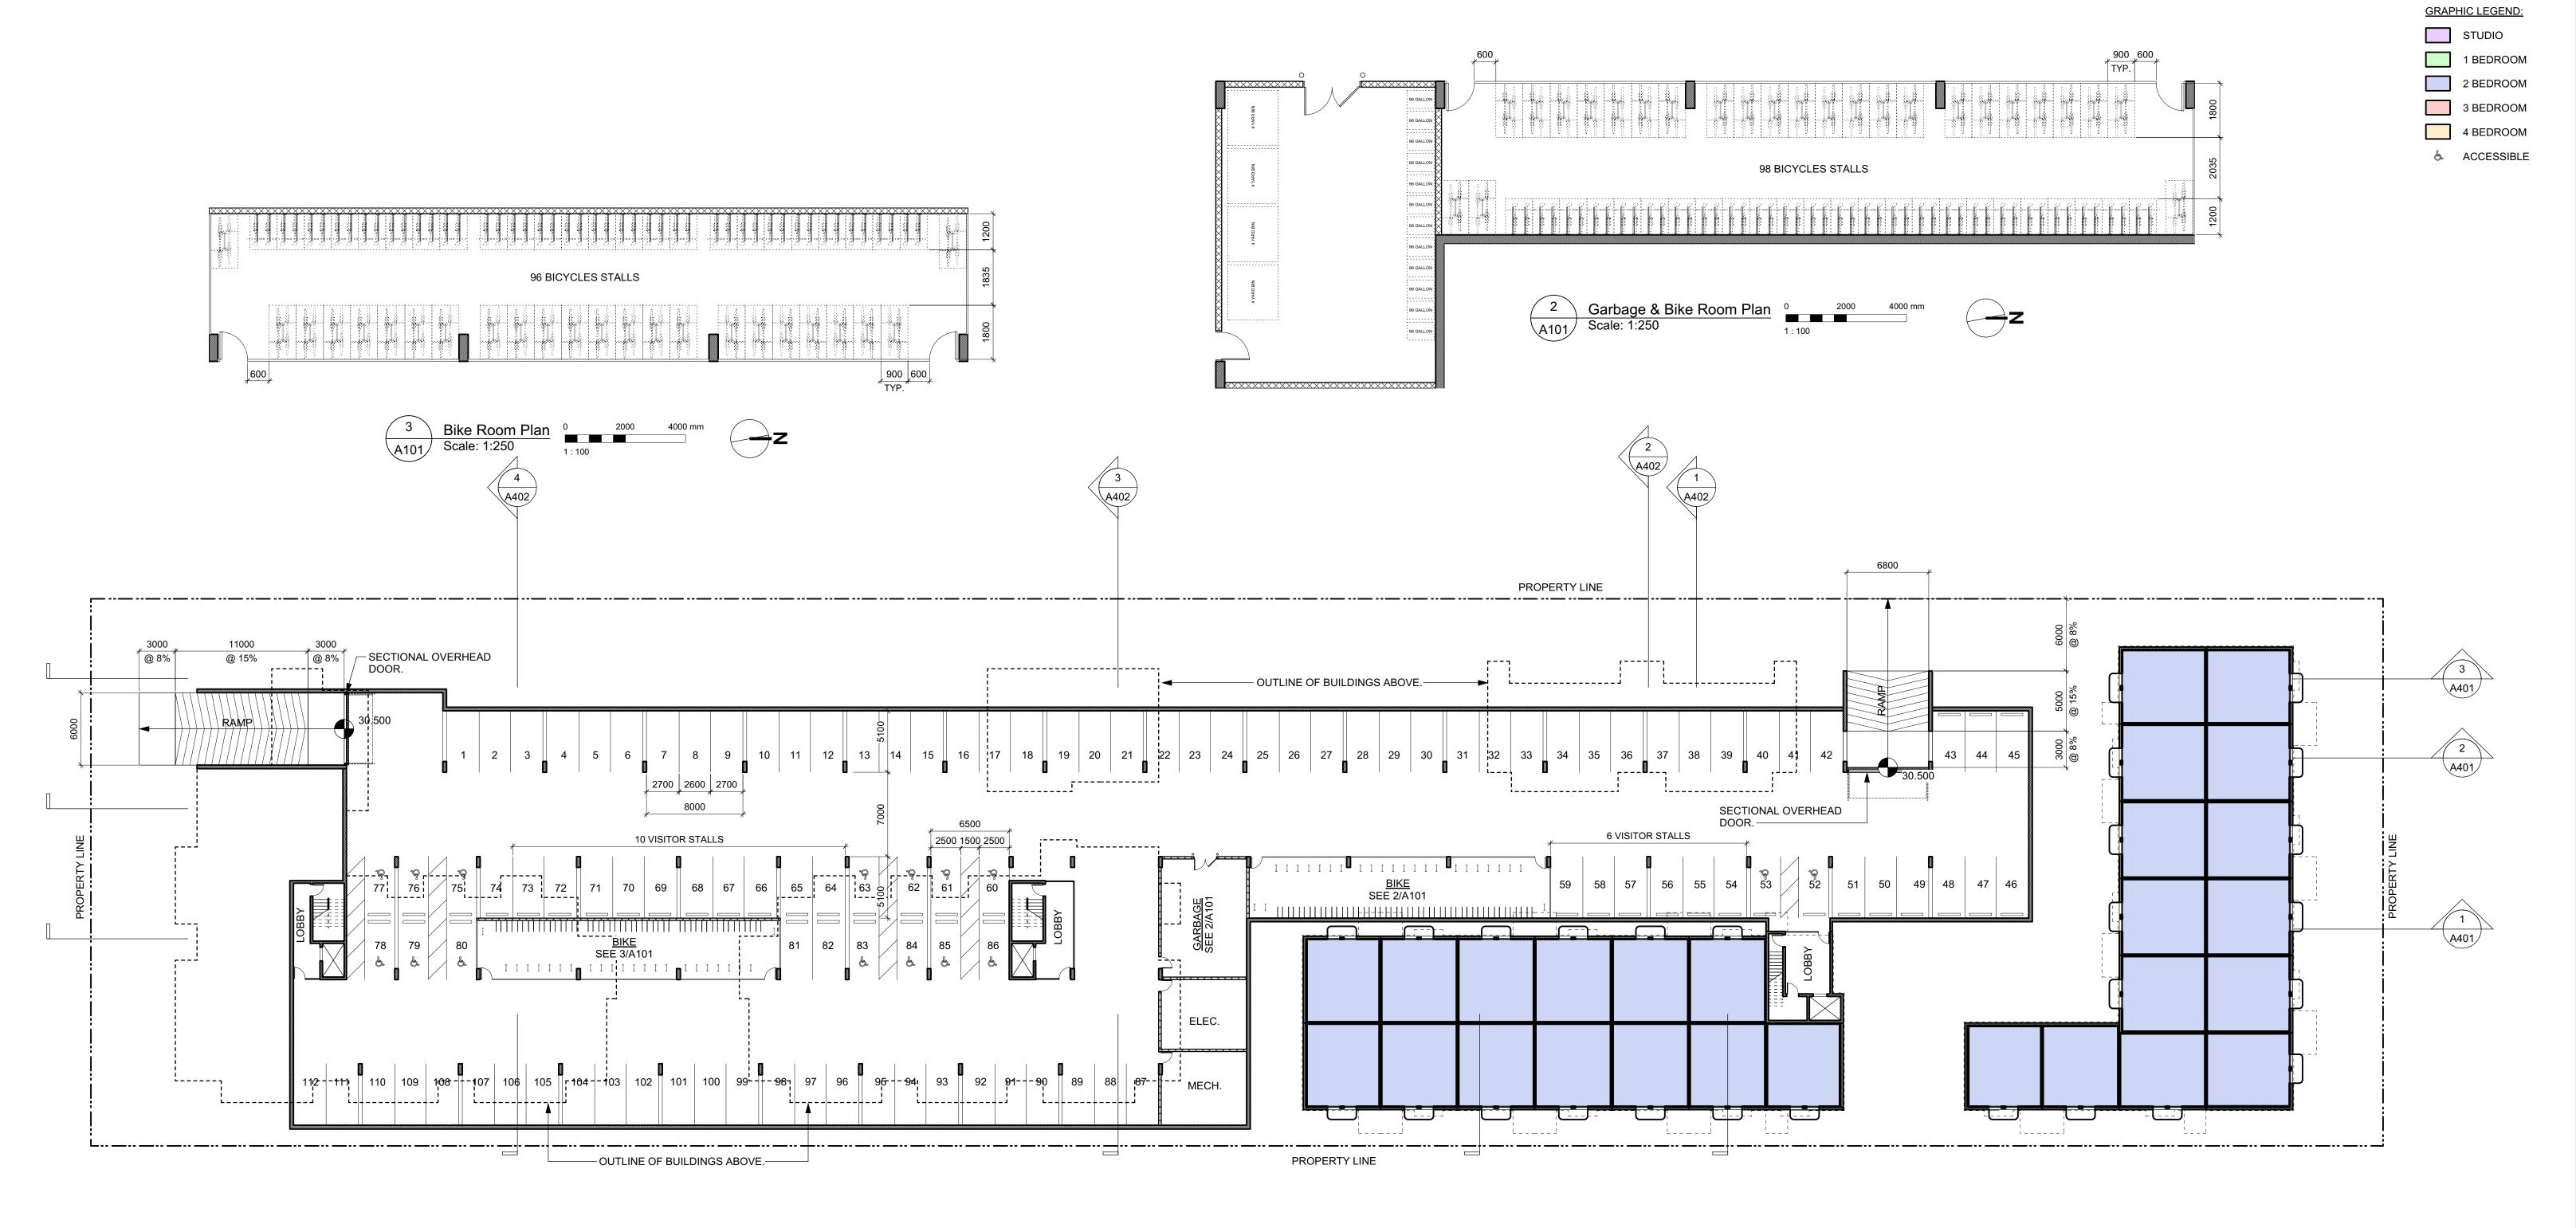

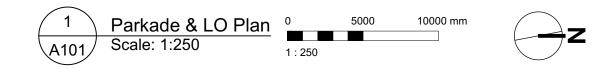



VEHICLE PARKING C	CALCULATION
UNITS < 45 SM UNITS 45-70 SM UNITS >70 SM SUBTOTAL	14 X .2 = 2.8 58 X .5 = 29 86 X .75 = 64.5 96.3 (96)
VISITOR TOTAL REQUIRED PROVIDED LONG TERM BIKE PA	158 X .1 = 15.8 (16) 112 117 (5 SURFACE) ARKING CALCULATION
UNITS < 45 SM UNITS > 45 SM TOTAL REQUIRED PROVIDED	14 X 1 = 14 144 X 1.25 = 180

5	20/09/01		RE-ISSUED FOR COTV
4	20/03/13		RE-ISSUED FOR COTV
3	20/02/06		ISSUED FOR COTV
2	20/01/15		ISSUED FOR AD
1	19/12/16	RESPONSE	TO PLANNING REVIEW
Rev	Date	Description	
plot date	SEPTEMBER 2020	drawing file	1907.2 A200 Plans.vw
drawn by	FWP	checked by	RAV
scale	AS SHOWN	project number	190

ISSUED FOR DP
& REZONING



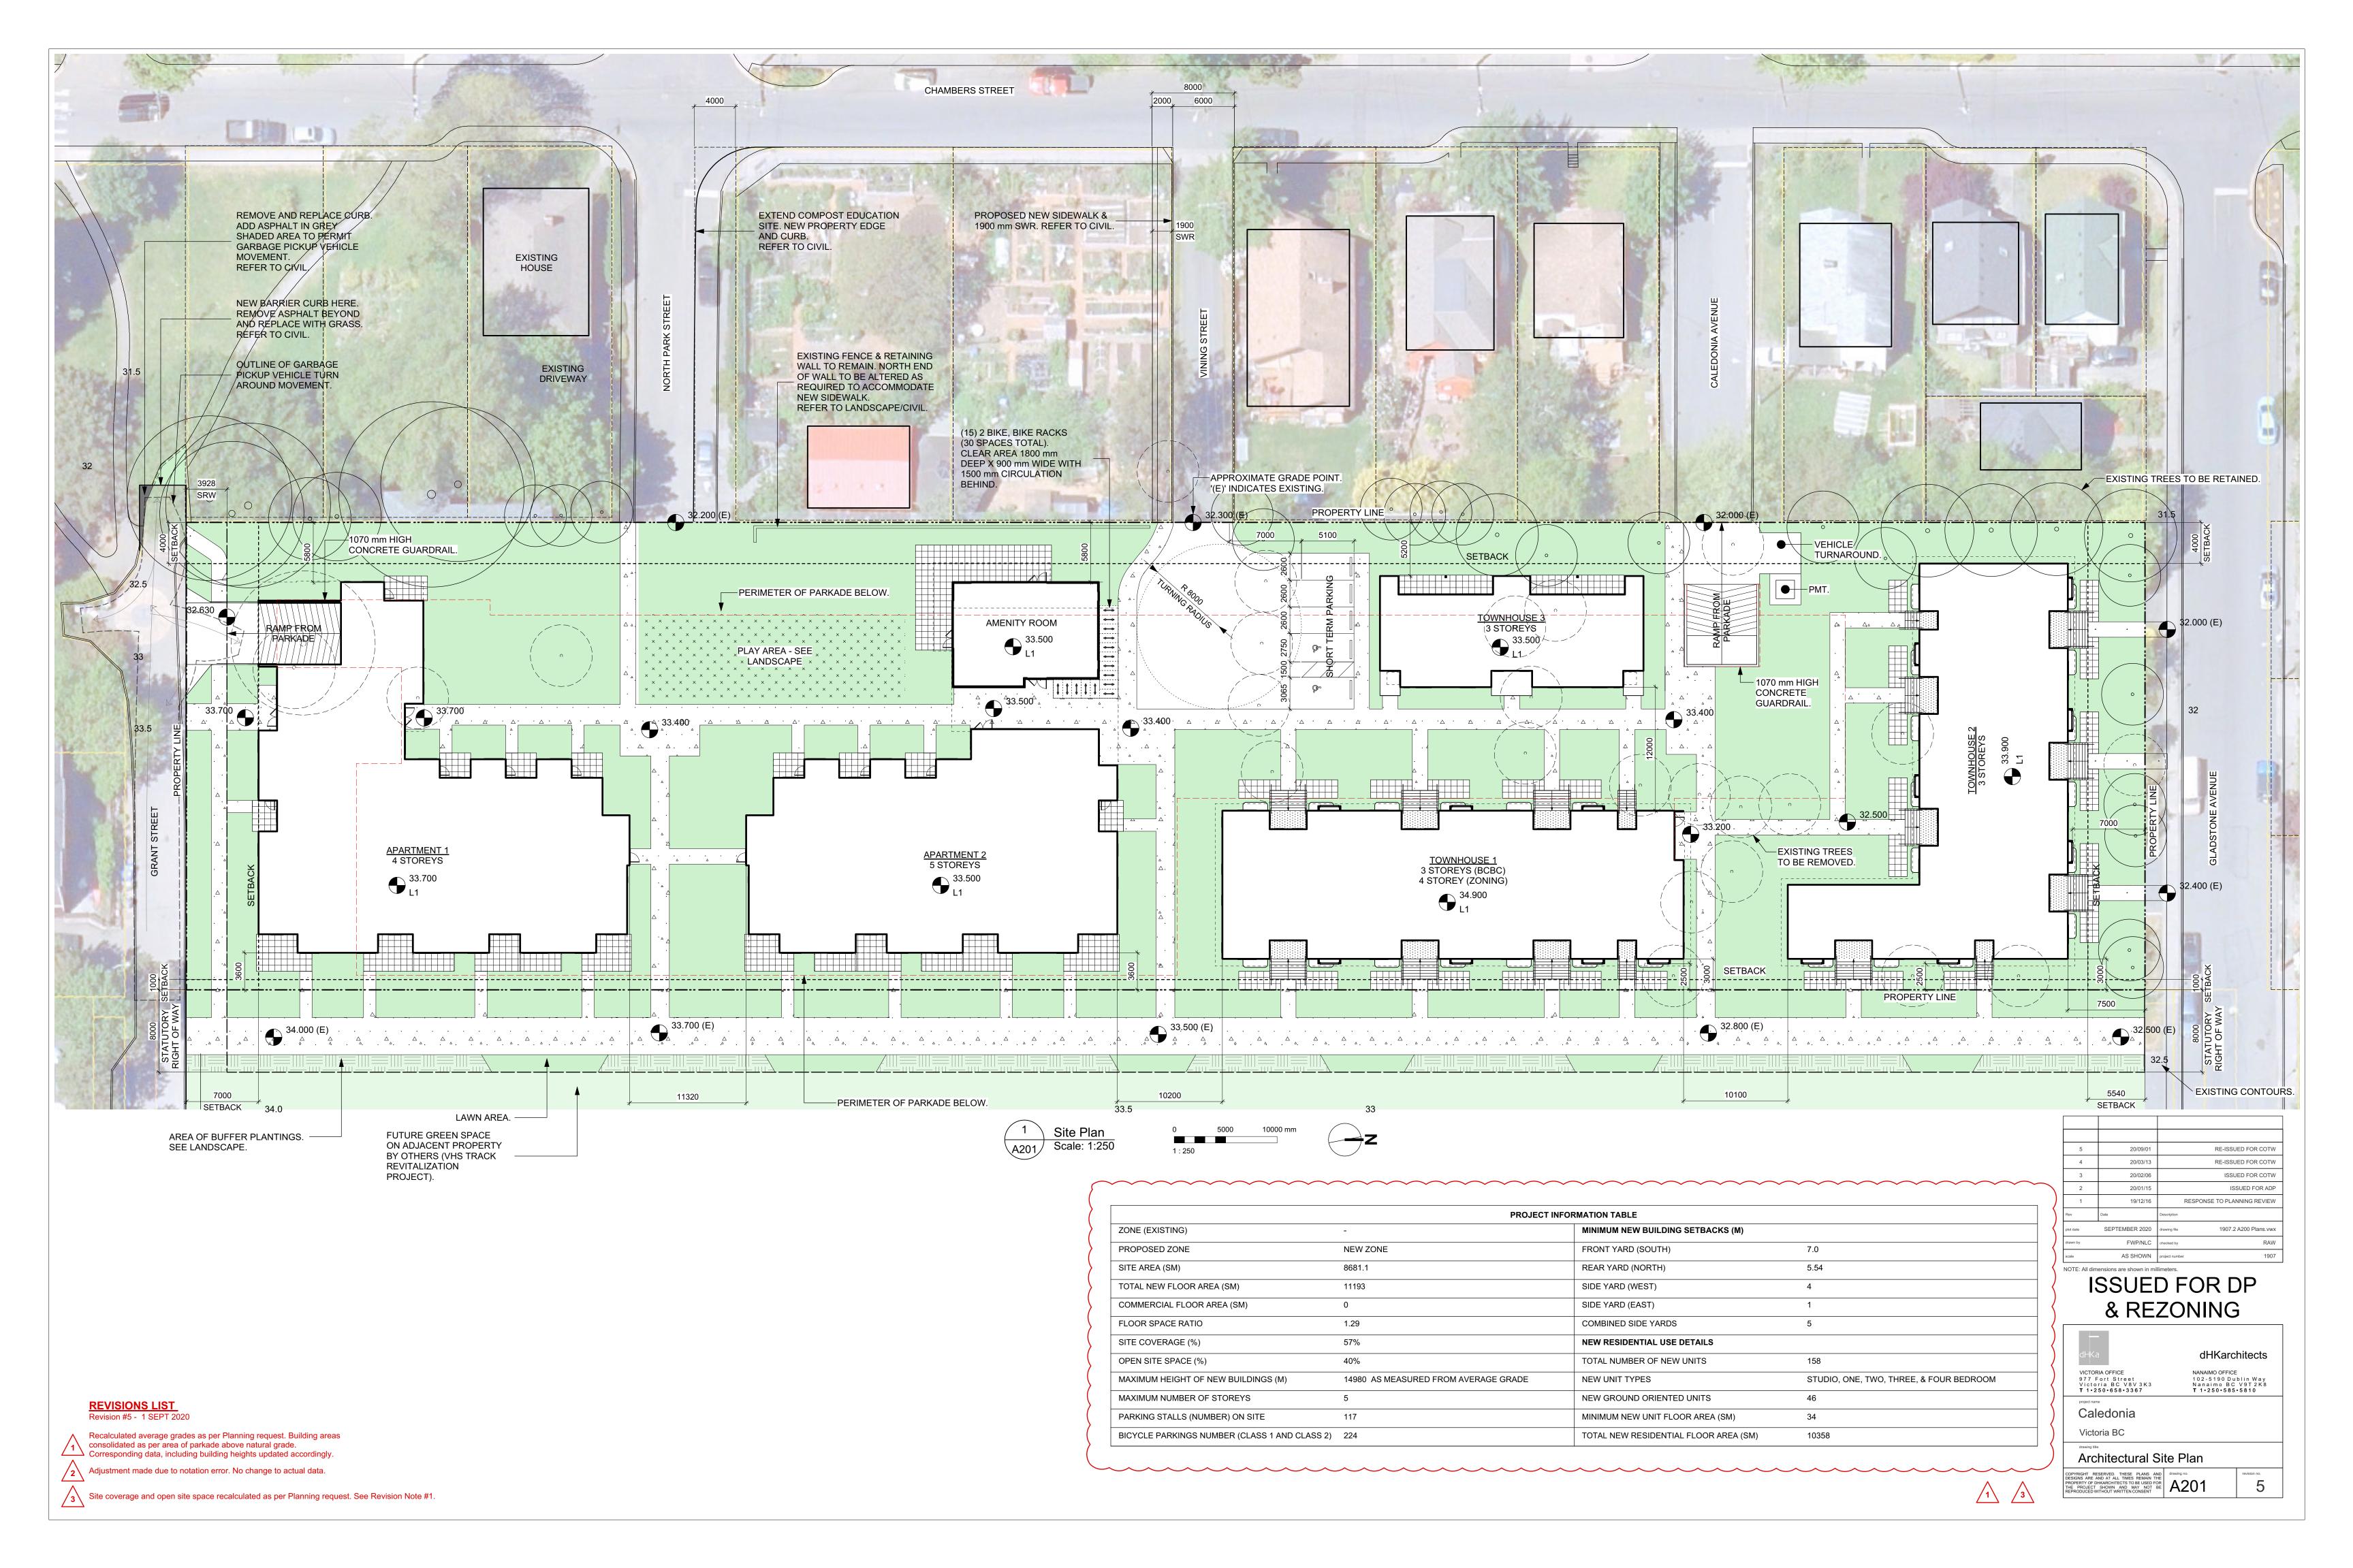

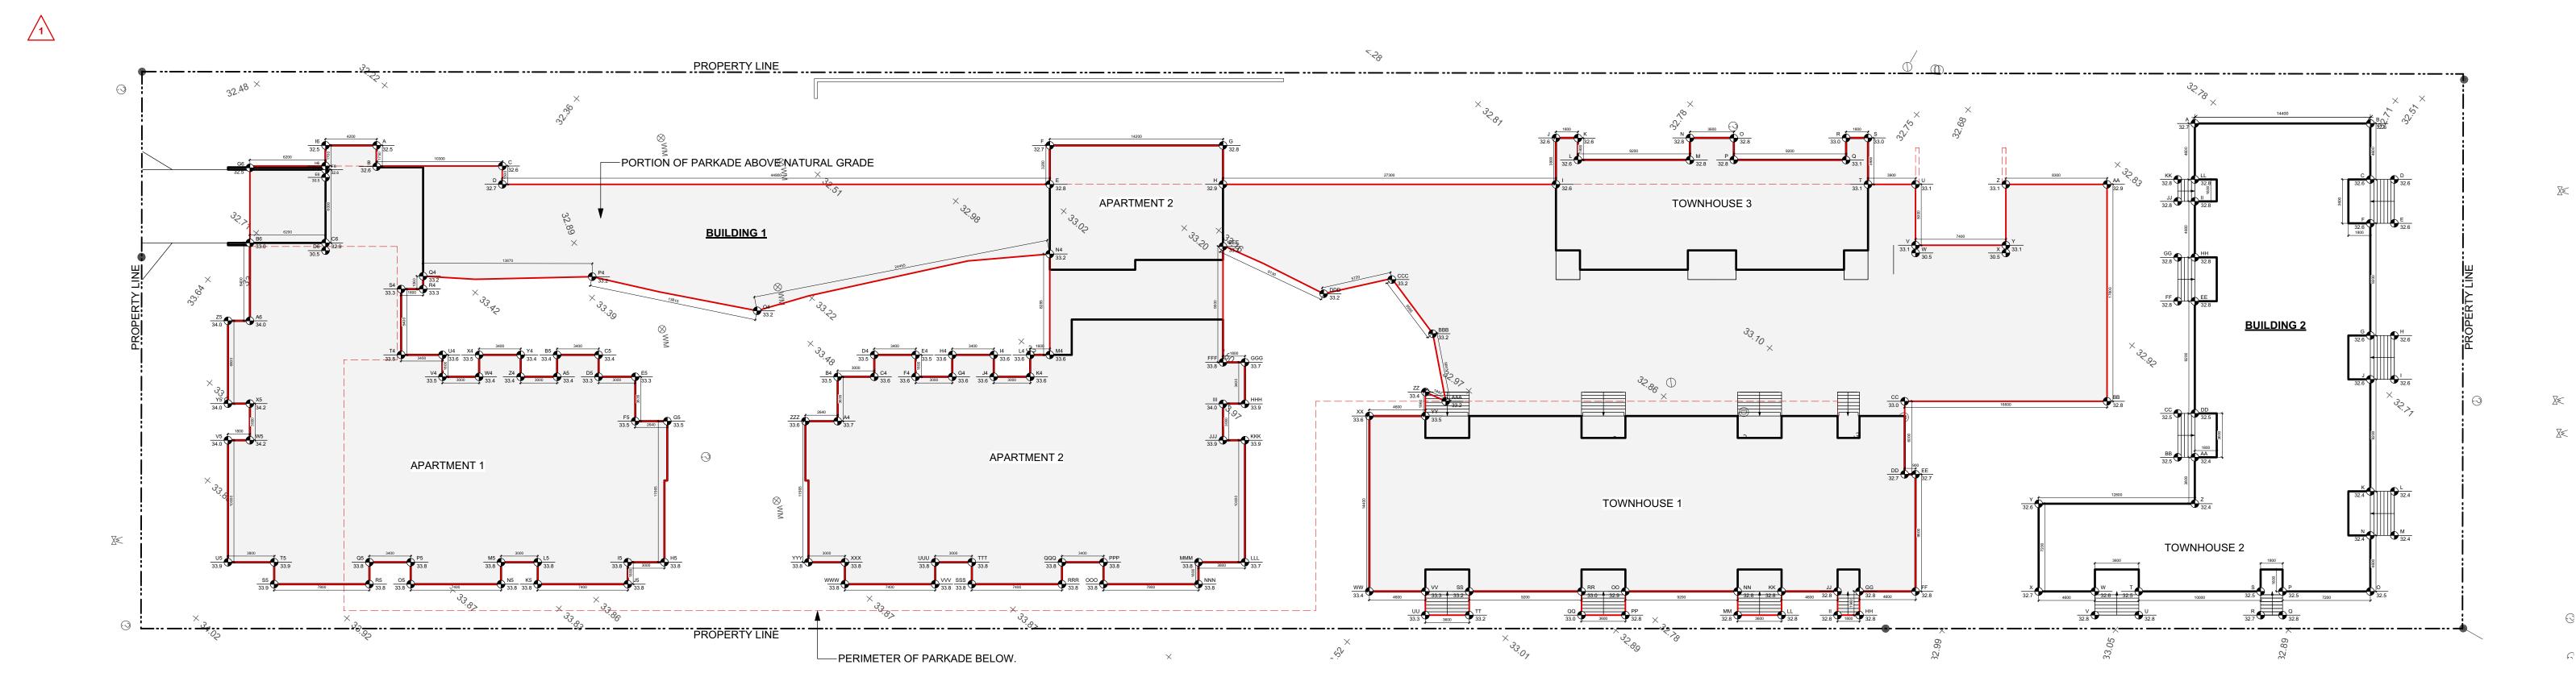

BUILDING 1 - AVERAGE GRADE CALCULATION

INCLUDES SUM OF ALL PORTION OF BUILDINGS OVER PARKADE:

- 1.) APARTMENT 1 2.) APARTMENT 2 3.) TOWNHOUSE 1
- 4.) TOWNHOUSE 3
 5.) PORTION OF PARKADE ABOVE NATURAL GRADE (>33.2 m)

side	corner grade point	+ corner grade point	/ 2	average grade per side	X length of side	TOTAL
A&B	32.5	32.6	2	32.6	1.8	57.0
B&C	32.6	32.6	2	32.6	10.3	335.8
C&D	32.6	32.7	2	32.7	1.5	49.0
D&E	32.7	32.8	2	32.8	44.9	1470.5
E&F	32.8	32.7	2	32.8	3.2	104.8
F&G	32.7	32.8	2	32.8	14.2	465.1
G&H	32.8	32.9	2	32.9	3.2	105.1
H&I	32.9	32.6	2	32.8	27.3	894.1
I&J	32.6	32.6	2	32.6	3.8	123.9
J&K	32.6	32.6	2	32.6	1.8	58.7
K&L	32.6	32.6	2	32.6	1.8	58.7
L&M	32.6	32.8	2	32.7	9.2	300.8
M&N	32.8	32.8	2	32.8	1.8	59.0
N&O	32.8	32.8	2	32.8	3.6	118.1
O&P	32.8	32.8	2	32.8	1.8	59.0
P&Q	32.8	33.1	2	33.0	9.2	303.1
Q&R	33.1	33.0	2	33.1	1.8	59.5
R&S	33.0	33.0	2	33.0	1.8	59.4
S&T	33.0	33.1	2	33.1	3.8	125.6
T&U	33.1	33.1	2	33.1	3.9	129.1
U&V	33.1	33.1	2	33.1	5.0	165.5
V&W	33.1	30.5	2	31.8	0.0	0.0
W&X	30.5	30.5	2	30.5	7.4	225.7
X&Y	30.5	33.1	2	31.8	0.0	0.0
Y&Z	33.1	33.1	2	33.1	5.0	165.5
Z&AA	33.1	32.9	2	33.0	8.3	273.9
AA&BB	32.9	32.8	2	32.9	17.8	584.7
BB&CC	32.8	33.0	2	32.9	16.6	546.1
CCⅅ	33.0	32.7	2	32.9	6.0	197.1
DD&EE	32.7	32.7	2	32.7	0.9	29.4
EE&FF	32.7	32.8	2	32.8	9.6	314.4
FF&GG	32.8	32.8	2	32.8	4.6	150.9
GG&HH	32.8	32.8	2	32.8	2.0	64.3
HH&II	32.8	32.8	2	32.8	1.8	59.0
II&JJ	32.8	32.8	2	32.8	2.0	64.3
JJ&KK	32.8	32.8	2	32.8	4.6	150.9
KK&LL	32.8	32.8	2	32.8	2.0	64.3
LL&MM	32.8	32.8	2	32.8	3.6	118.1
MM&NN	32.8	32.8	2	32.8	2.0	64.3
NN&OO	32.8	32.9	2	32.9	9.2	302.2
OO&PP	32.9	32.8	2	32.9	2.0	64.4
PP&QQ	32.8	33.0	2	32.9	3.6	118.4
QQ&RR	33.0	33.0	2	33.0	2.0	64.7
RR&SS	33.0	33.2	2	33.1	9.2	304.5
SS&TT	33.2	33.2	2	33.2	2.0	65.1
TT&UU	33.2	33.3	2	33.3	3.6	119.7
UU&VV	33.3	33.3	2	33.3	2.0	65.3
VV&WW	33.3	33.4	2	33.4	4.6	153.4
WW&XX	33.4	33.6	2	33.5	14.4	482.4
XX&YY	33.6	33.5	2	33.6	4.6	154.3
YY&ZZ	33.5	33.4	2	33.5	2.0	65.6

ZZ&AAA	33.4	33.2	2	33.3	1.8	61.3
AAA&BBB	33.2	33.2	2	33.2	5.6	187.4
BBB&CCC	33.2	33.2	2	33.2	5.6	184.8
CCC&DDD	33.2	33.2	2	33.2	5.7	189.2
DDD&EEE	33.2	33.2	2	33.2	9.1	303.1
EEE&FFF	33.2	33.8	2	33.5	9.5	318.3
FFF&GGG	33.8	33.7	2	33.8	1.8	60.8
GGG&HHH	33.7	33.9	2	33.8	3.4	114.9
HHH&III	33.9	34.0	2	34.0	1.8	61.1
III&JJJ	34.0	33.9	2	34.0	3.0	101.9
JJJ&KKK	33.9	33.9	2	33.9	1.8	61.0
KKK&LLL	33.9	33.7	2	33.8	10.0	338.0
LLL&MMM	33.7	33.8	2	33.8	3.8	128.3
MMM&NNN	33.8	33.8	2	33.8	1.8	60.8
NNN&OOO	33.8	33.8	2	33.8	7.8	263.6
OOO&PPP	33.8	33.8	2	33.8	1.8	60.8
PPP&QQQ	33.8	33.8	2	33.8	3.4	114.9
QQQ&RRR	33.8	33.8	2	33.8	1.8	60.8
RRR&SSS	33.8	33.8	2	33.8	7.4	250.1
SSS&TTT	33.8	33.8	2	33.8	1.8	60.8
TTT&UUU	33.8	33.8	2	33.8	3.0	101.4
UUU&VVV	33.8	33.8	2			
VVV&WWW			2	33.8	1.8	60.8 250.1
WWW&XXX	33.8	33.8	2	33.8	7.4	
	33.8	33.8	2	33.8	1.8	60.8
XXX&YYY	33.8	33.8	2	33.8	3.0	101.4
YYY&ZZZ	33.8	33.6		33.7	11.6	389.7
ZZZ&A4	33.6	33.7	2	33.7	2.6	88.8
A4&B4	33.7	33.5	2	33.6	3.6	122.1
B4&C4	33.5	33.6	2	33.6	3.0	100.7
C4&D4	33.6	33.5	2	33.6	1.8	60.4
D4&E4	33.5	33.5	2	33.5	3.4	113.9
E4&F4	33.5	33.6	2	33.6	1.8	60.4
F4&G4	33.6	33.6	2	33.6	3.0	100.8
G4&H4	33.6	33.6	2	33.6	1.8	60.5
H4&I4	33.6	33.6	2	33.6	3.4	114.2
I4&J4	33.6	33.6	2	33.6	1.8	60.5
J4&K4	33.6	33.6	2	33.6	3.0	100.8
K4&L4	33.6	33.6	2	33.6	1.8	60.5
L4&M4	33.6	33.6	2	33.6	1.6	53.8
M4&N4	33.6	33.2	2	33.4	8.3	276.7
N4&O4	33.2	33.2	2	33.2	24.5	811.9
O4&P4	33.2	33.2	2	33.2	13.8	458.5
P4&Q4	33.2	33.2	2	33.2	13.9	460.5
Q4&R4	33.2	33.3	2	33.3	1.1	35.2
R4&S4	33.3	33.3	2	33.3	1.8	59.9
S4&T4	33.3	33.8	2	33.6	5.4	181.2
T4&U4	33.8	33.6	2	33.7	3.4	114.6
U4&V4	33.6	33.5	2	33.6	1.8	60.4
V4&W4	33.5	33.4	2	33.5	3.0	100.4
W4&X4	33.4	33.5	2	33.5	1.8	60.2
X4&Y4	33.5	33.4	2	33.5	3.4	113.7
Y4&Z4	33.4	33.4	2	33.4	1.8	60.1
Z4&A5	33.4	33.4	2	33.4	3.0	100.2

A5&B5	33.4	33.4	2	33.4	1.8	60.1
B5&C5	33.4	33.4	2	33.4	3.4	113.6
C5&D5	33.4	33.3	2	33.4	1.8	60.0
D5&E5	33.3	33.3	2	33.3	3.0	99.9
E5&F5	33.3	33.5	2	33.4	3.6	121.4
F5&G5	33.5	33.5	2	33.5	2.6	88.4
G5&H5	33.5	33.8	2	33.7	11.7	392.
H5&I5	33.8	33.8	2	33.8	3.0	101.4
I5&J5	33.8	33.8	2	33.8	1.8	60.8
J5&K5	33.8	33.8	2	33.8	7.4	250.
K5&L5	33.8	33.8	2	33.8	1.8	60.8
L5&M5	33.8	33.8	2	33.8	3.0	101.4
M5&N5	33.8	33.8	2	33.8	1.8	60.8
N5&O5	33.8	33.8	2	33.8	7.4	250.
O5&P5	33.8	33.8	2	33.8	1.8	60.8
P5&Q5	33.8	33.8	2	33.8	3.4	114.9
Q5&R5	33.8	33.8	2	33.8	1.8	60.8
R5&S5	33.8	33.9	2	33.9	7.8	264.0
S5&T5	33.9	33.9	2	33.9	1.8	61.0
T5&U5	33.9	33.9	2	33.9	3.8	128.8
U5&V5	33.9	34.0	2	34.0	10.0	339.
V5&W5	34.0	34.2	2	34.1	1.8	61.4
W5&X5	34.2	34.2	2	34.2	3.0	102.
X5&Y5	34.2	34.0	2	34.1	1.8	61.4
Y5&Z5	34.0	34.0	2	34.0	6.8	231.2
Z5&A6	34.0	34.0	2	34.0	1.8	61.2
A6&B6	34.0	33.0	2	33.5	6.4	214.4
B6&C6	33.0	32.9	2	33.0	6.2	204.
C7&D6	32.9	30.5	2	31.7	0.0	0.0
D6&E6	30.5	30.5	2	30.5	6.0	183.0
E6&F6	30.5	32.6	2	31.6	0.0	0.0
F6&G6	32.6	32.5	2	32.6	6.2	201.
G6&H6	32.5	32.6	2	32.6	6.2	201.
H6&I6	32.6	32.5	2	32.6	1.7	55.3
16&A	32.5	32.5	2	32.5	4.2	136.

	X length of side	TOTAL	
			GRADE = TOTAL/Perimeter
Perimeter	682.2	22637.9	33.2

	REVISIONS LIST Revision #5 - 1 SEPT 2020
7	Recalculated average grades as per Planning request. Building areas consolidated as per area of parkade above natural grade. Corresponding data, including building heights updated accordingly.
7	Adjustment made due to notation error. No change to actual data.
\	Site coverage and onen site space recalculated as per Planning request. See Revis

BUILDING 2 - AVERAGE GRADE CALCULATION

INCLUDES:

1.) TOWNHOUSE 2

TOWNHOUS	SF 2					
side	corner grade point	+ corner grade point	/ 2	average grade per side	X length of side	TOTAL
A&B	32.7	32.6	2	32.7	14.4	471.6
B&C	32.6	32.6	2	32.6	4.6	150.0
C&D	32.6	32.6	2	32.6	2.0	63.9
D&E	32.6	32.6	2	32.6	3.6	117.4
E&F	32.6	32.6	2	32.6	2.0	63.9
F&G	32.6	32.6	2	32.6	9.2	299.9
G&H	32.6	32.6	2	32.6	2.0	63.9
H&I	32.6	32.6	2	32.6	3.6	117.4
I&J	32.6	32.6	2	32.6	2.0	63.9
J&K	32.6	32.4	2	32.5	9.2	299.0
K&L	32.4	32.4	2	32.4	2.0	63.5
L&M	32.4	32.4	2	32.4	3.6	116.6
M&N	32.4	32.4	2	32.4	2.0	63.5
N&O	32.4	32.5	2	32.5	4.6	149.3
O&P	32.5	32.5	2	32.5	7.2	234.0
P&Q	32.5	32.8	2	32.7	2.0	64.0
Q&R	32.8	32.7	2	32.8	1.8	59.0
R&S	32.7	32.5	2	32.6	2.0	63.9
S&T	32.5	32.5	2	32.5	10.0	325.0
T&U	32.5	32.8	2	32.7	2.0	64.0
U&V	32.8	32.8	2	32.8	3.6	118.1
V&W	32.8	32.6	2	32.7	2.0	64.1
W&X	32.6	32.7	2	32.7	4.6	150.2
X&Y	32.7	32.6	2	32.7	7.2	235.1
Y&Z	32.6	32.4	2	32.5	12.8	416.0
Z&AA	32.4	32.4	2	32.4	3.8	123.1
AA&BB	32.4	32.5	2	32.5	1.6	51.9
BB&CC	32.5	32.5	2	32.5	3.6	117.0
CCⅅ	32.5	32.5	2	32.5	1.6	52.0
DD&EE	32.5	32.8	2	32.7	9.2	300.4
EE&FF	32.8	32.8	2	32.8	1.6	52.5
FF&GG	32.8	32.8	2	32.8	3.6	118.1
GG&HH	32.8	32.8	2	32.8	1.6	52.5
HH&II	32.8	32.8	2	32.8	4.6	150.9
II&JJ	32.8	32.8	2	32.8	1.6	52.5
JJ&KK	32.8	32.8	2	32.8	1.8	59.0
KK&LL	32.8	32.8	2	32.8	1.6	52.5
LL&A	32.8	32.7	2	32.8	4.6	150.7


AVERAGE GRADE FOR BUIL	LDING 2		
	X length of	TOTAL	

	X length of side	TOTAL	
			GRADE = TOTAL/Perimeter
Perimeter	160.4	5230.0	32.6

5	20/09/01	RE-ISSUED FOR C	ОТ
4	20/03/13	RE-ISSUED FOR C	ОТ
3	20/02/06	ISSUED FOR C	ОТ
2	20/01/15	ISSUED FOR	ΑD
1	19/12/16	RESPONSE TO PLANNING REV	/IE
Rev	Date	Description	
plot date	SEPTEMBER 2020	drawing file 1907.2 A200 Plans	s.vv
drawn by	NLC	checked by	RA
scale	AS SHOWN	project number	190

NOTE: All dimensions are shown in millimeters. ISSUED FOR DP & REZONING

O I L		•
– dHKa	dHKarc	hitects
VICTORIA OFFICE 977 Fort Street Victoria BC V8V3K3 T 1.250.658.3367	NANAIMO OFFICE 102-5190 Du Nanaimo BC T 1•250•585	blin Way V9T 2K8
Caledonia		
Victoria BC		
Average Grade	Calculations	
DYPRIGHT RESERVED. THESE PLANS AND SIGNS ARE AND AT ALL TIMES REMAIN THE ROPERTY OF DHKARCHITECTS TO BE USED FOR IE PROJECT SHOWN AND MAY NOT BE EXPONED TO THE PROJECT SHOWN AND MAY NOT BE EXPONED TO THE PROJECT SHOWN THE PROJECT OF THE PROJECT SHOWN THE PROJECT SHOWS THE PROJECT OF THE PROJECT SHOWS THE PROJECT OF THE	drawing no.	revision no.

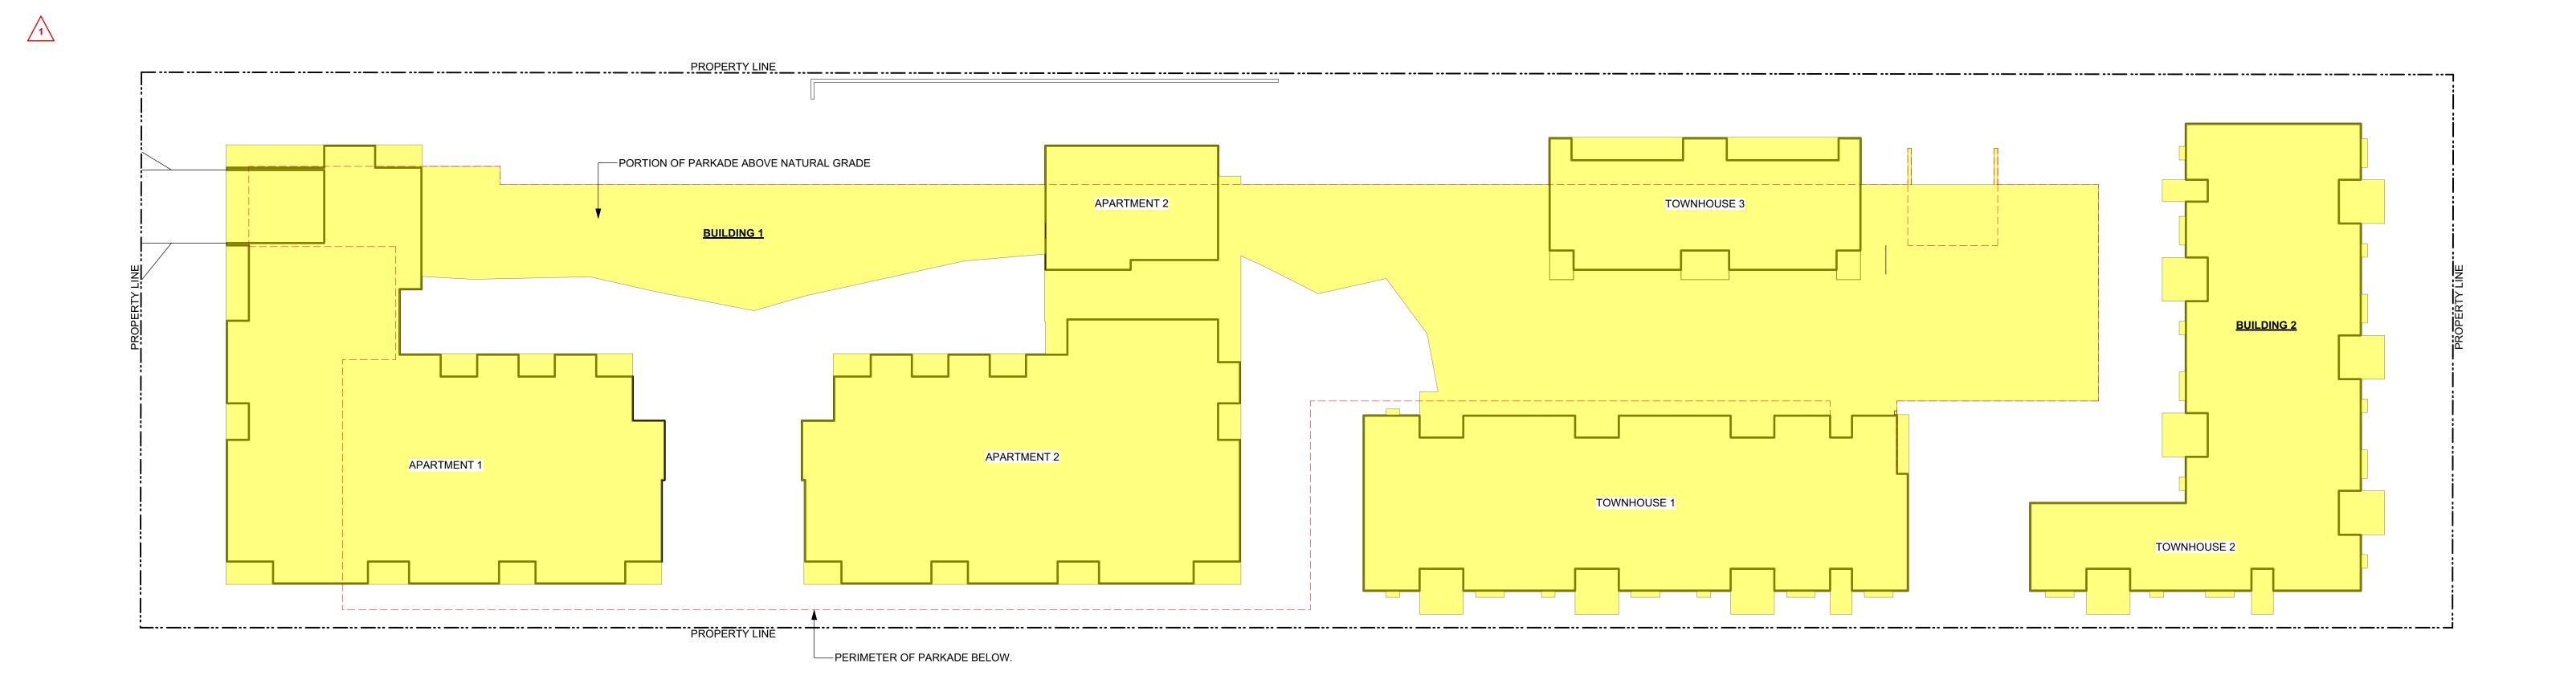

SITE COVERAGE - CALCULATION


SUM OF GROSS AREA OF LOT OCCUPIED BY ANY STRUCTURE INCLUDING:

- 1.) APARTMENT 1 2.) APARTMENT 2
- 3.) TOWNHOUSE 1
- 4.) TOWNHOUSE 3
- 5.) PORTION OF PARKADE ABOVE NATURAL GRADE (>33.2 m)

CURRENT:
BUILDING AREA 4,957 m²/LOT 8681.14 m² = 57%

5	20/09/01	RE-ISSUED FOR COT
4	20/03/13	RE-ISSUED FOR COT
3	20/02/06	ISSUED FOR COT
2	20/01/15	ISSUED FOR AD
1	19/12/16	RESPONSE TO PLANNING REVIE
Rev	Date	Description
plot date	SEPTEMBER 2020	drawing file 1907.2 A200 Plans.vw
drawn by	NLC	checked by RAV
scale	AS SHOWN	project number 190
NOTE: All d	imensions are shown in mi	llimotors

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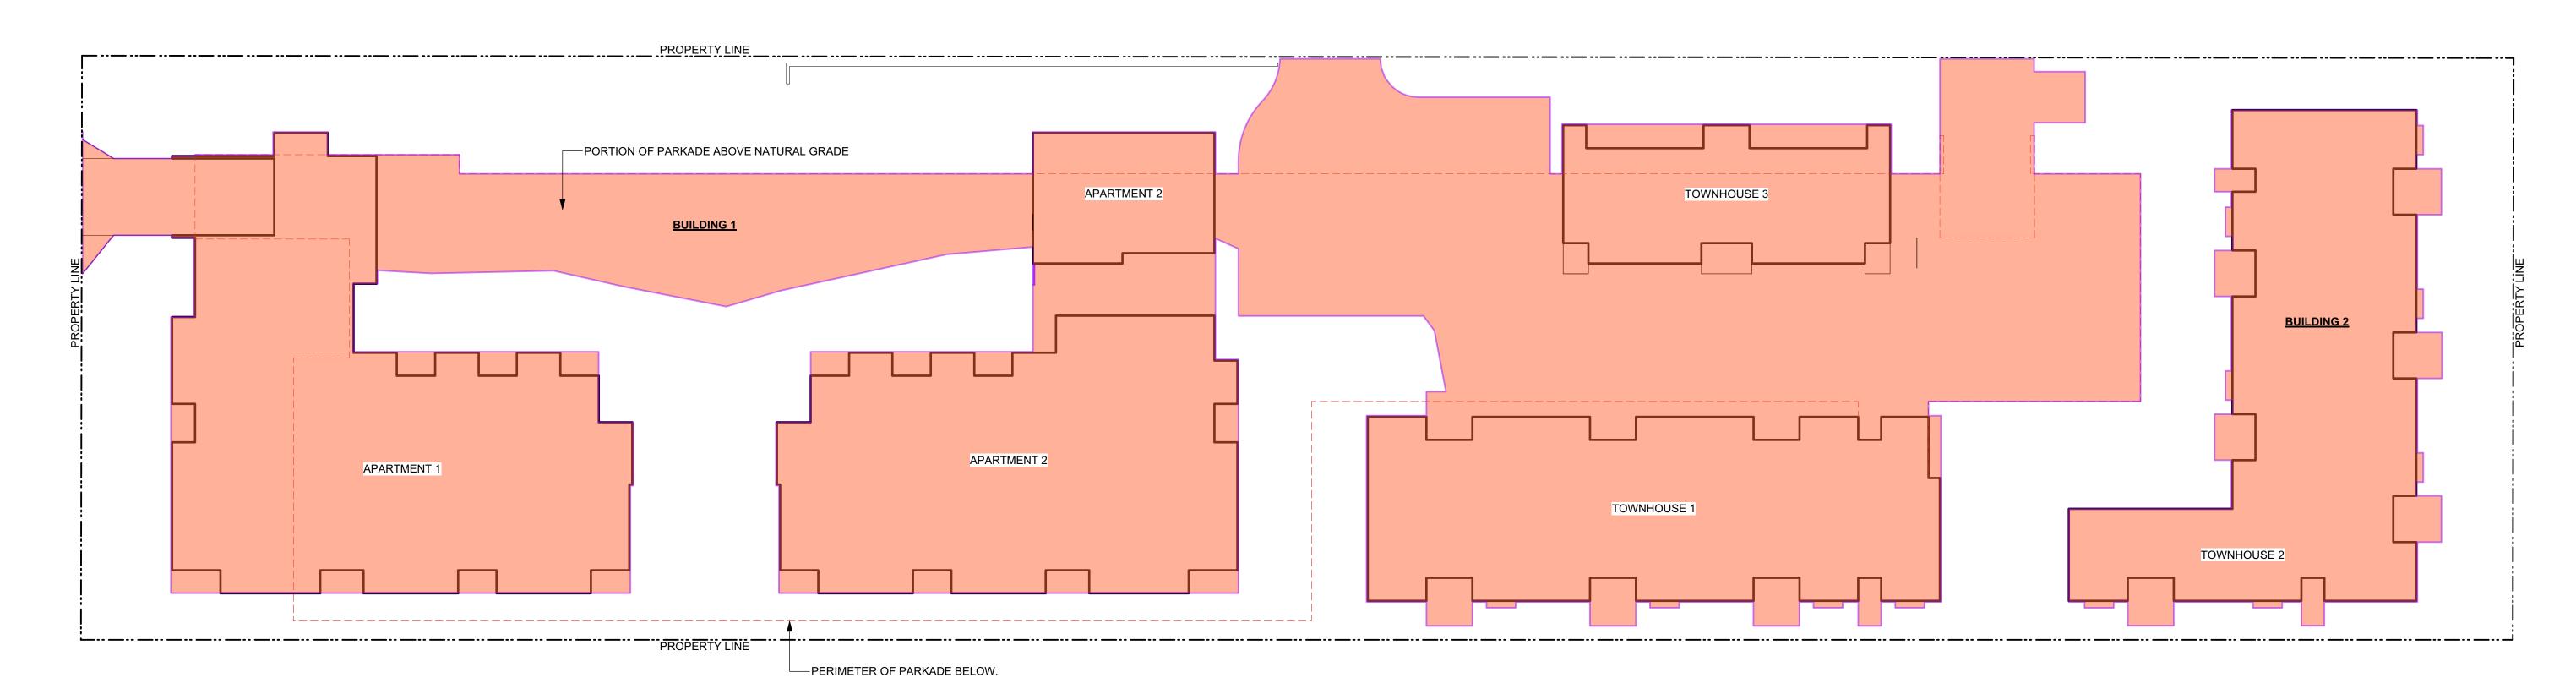
REVISIONS LIST
Revision #5 - 1 SEPT 2020

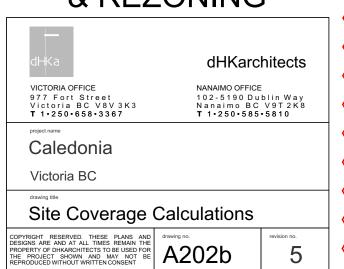Recalculated average grades as per Planning request. Building areas consolidated as per area of parkade above natural grade.
Corresponding data, including building heights updated accordingly.

/2 Adjustment made due to notation error. No change to actual data.

 $\frac{1}{3}$ Site coverage and open site space recalculated as per Planning request. See Revision Note #1.





OPEN SITE SPACE - CALCULATION

PORTION OF THAT'S LANDSCAPED AND NOT OCCUPIED OR OBSTRUCTED LOT OCCUPIED BY ANY BUILDING OR PORTION OF BUILDING.

AREA INCLUDES

- 1.) APARTMENT 1
- 2.) APARTMENT 2 3.) TOWNHOUSE 1
- 4.) TOWNHOUSE 3 5.) PORTION OF PARKADE ABOVE NATURAL GRADE (>33.2 m)

CURRENT: LOT 8,681.1m² - BUILDINGS, DRIVEWAYS & SURFACE PARKING 5,225 m² = 3,456.1 m²/8681.1 = 40%

RE-ISSUED FOR COT
RE-ISSUED FOR COT
ISSUED FOR COT
ISSUED FOR AD
ONSE TO PLANNING REVIE
1907.2 A200 Plans.vv
RA
190

ISSUED FOR DP & REZONING




REVISIONS LIST
Revision #5 - 1 SEPT 2020

Recalculated average grades as per Planning request. Building areas consolidated as per area of parkade above natural grade.
Corresponding data, including building heights updated accordingly.

/2 Adjustment made due to notation error. No change to actual data.

Site coverage and open site space recalculated as per Planning request. See Revision Note #1.



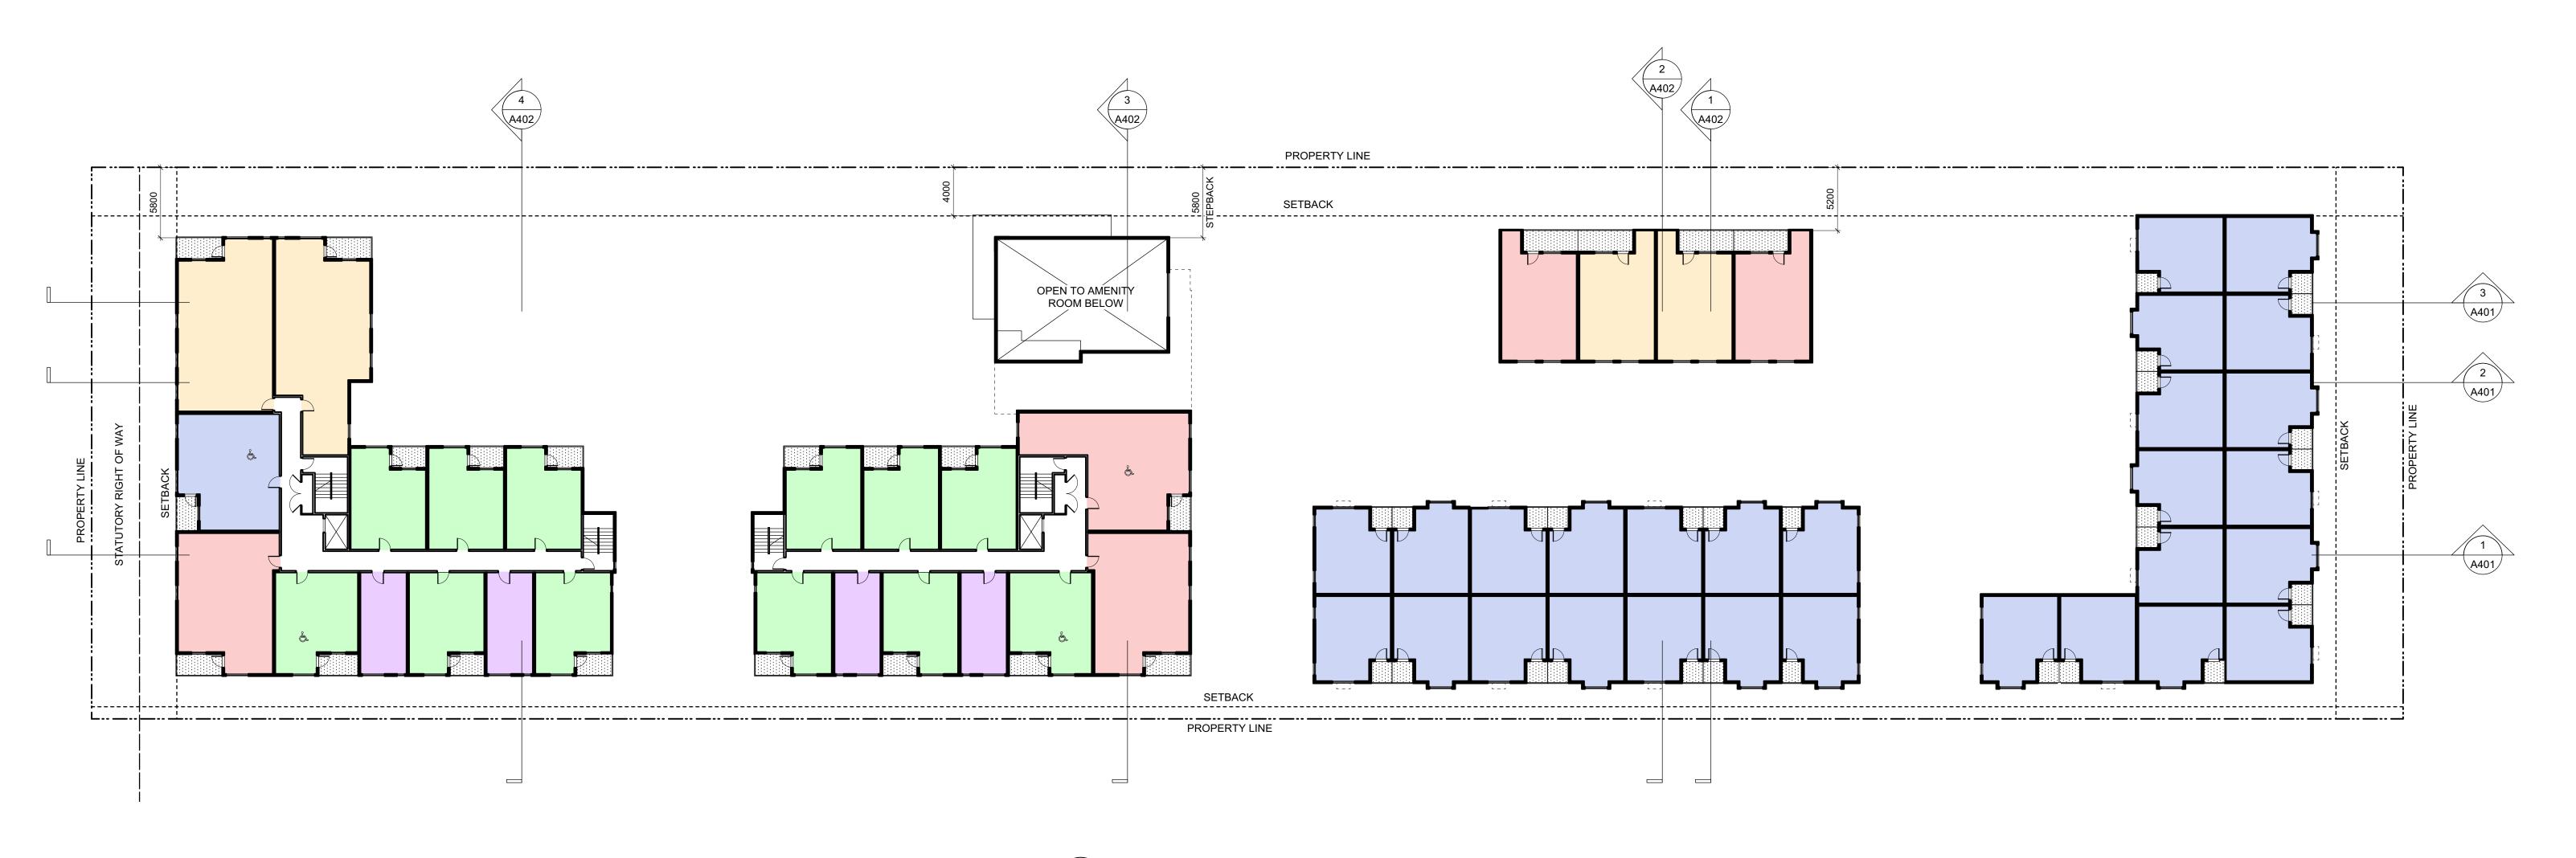




5	20/09/01	RE-ISSUED FOR COTW
4	20/03/13	RE-ISSUED FOR COTW
3	20/02/06	ISSUED FOR COTW
2	20/01/15	ISSUED FOR ADP
1	19/12/16	RESPONSE TO PLANNING REVIEW
Rev	Date	Description
plot date	SEPTEMBER 2020	drawing file 1907.2 A200 Plans.vwx
drawn by	FWP	checked by RAW
scale	AS SHOWN	project number 1907

NOTE: All dimensions are shown in millimeters. ISSUED FOR DP & REZONING

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caledonia		
Victoria BC		
L2 Plan		
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GRAPHIC LEGEND:

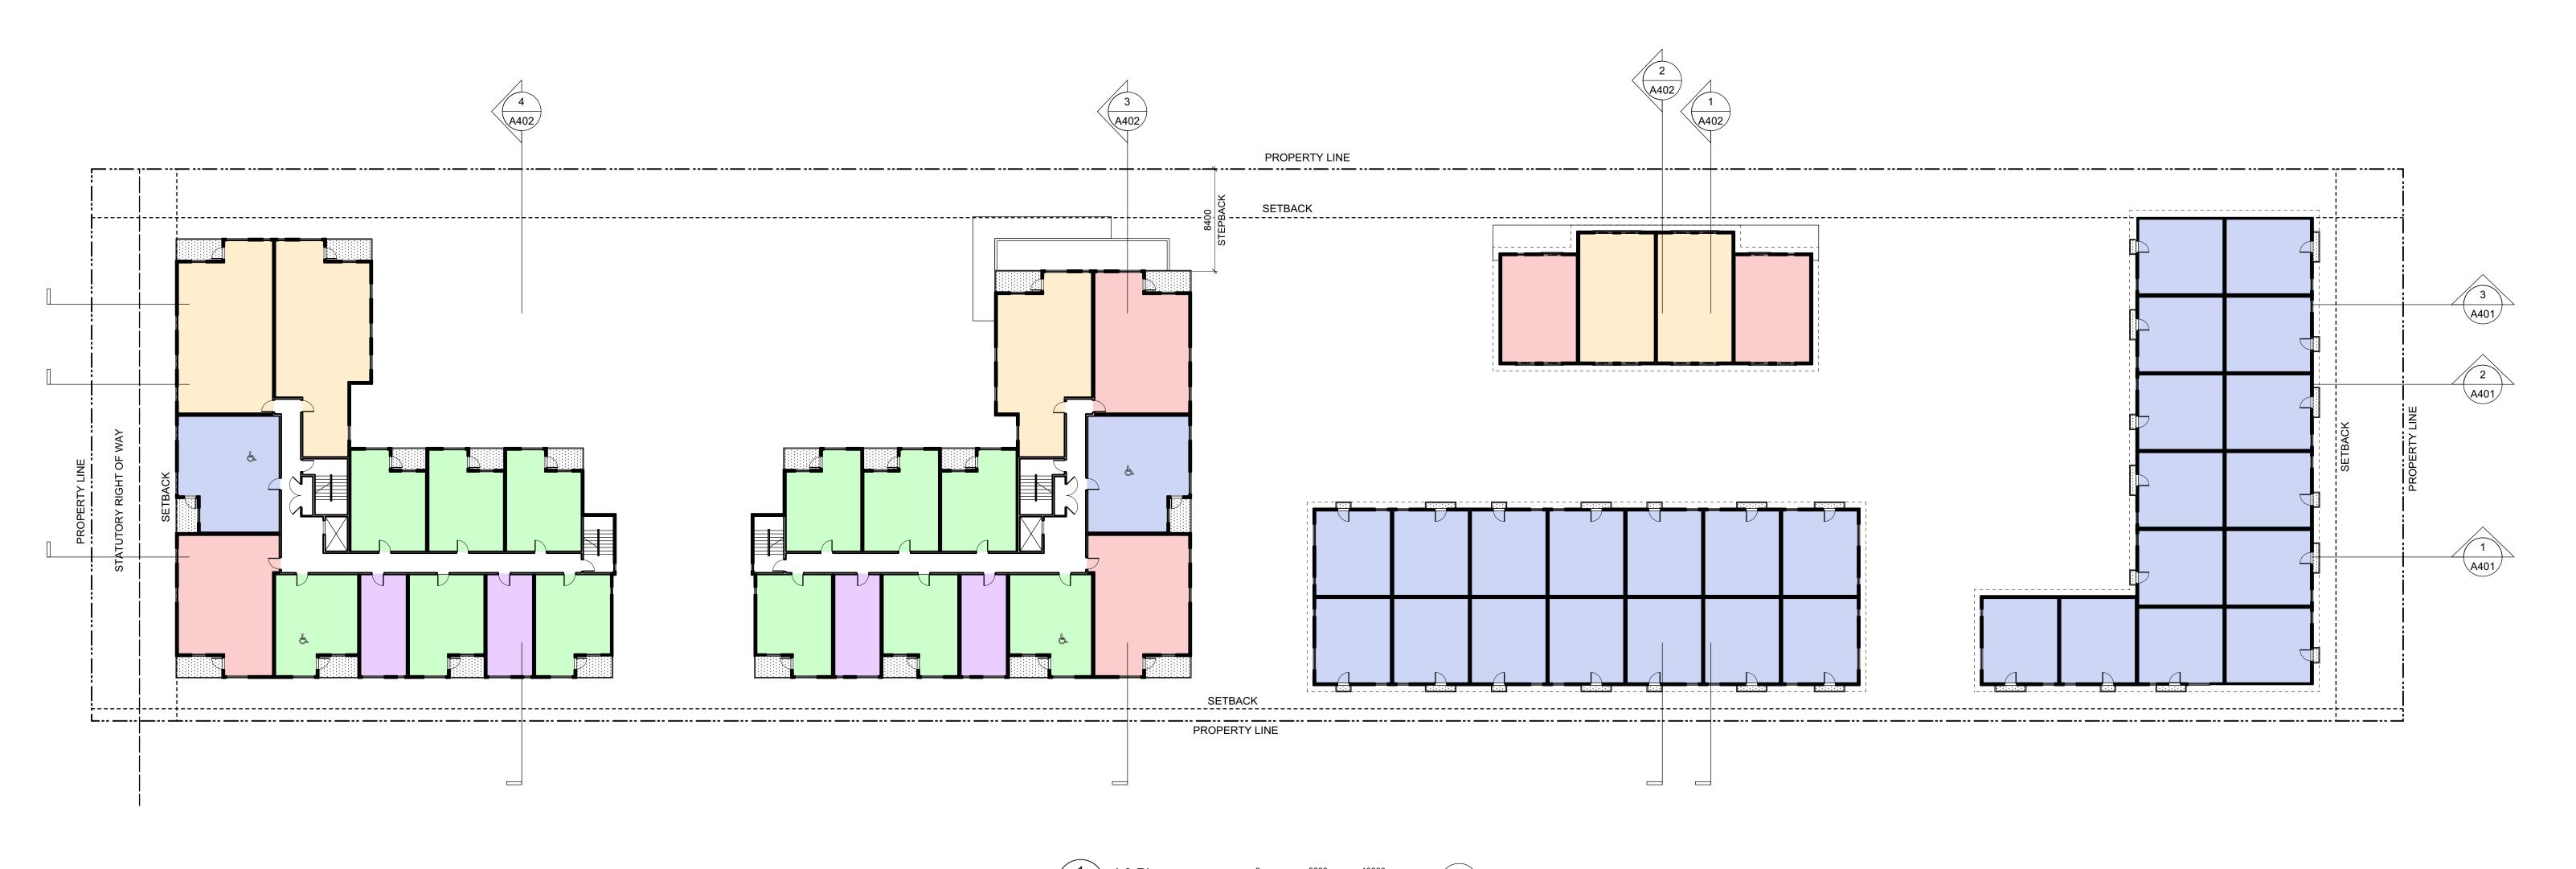STUDIO

1 BEDROOM

2 BEDROOM


3 BEDROOM

4 BEDROOM

ACCESSIBLE

5	20/09/01	RE-ISSUED FOR COTW
5	20/09/01	
4	20/03/13	RE-ISSUED FOR COTW
3	20/02/06	ISSUED FOR COTW
2	20/01/15	ISSUED FOR ADF
1	19/12/16	RESPONSE TO PLANNING REVIEW
Rev	Date	Description
plot date	SEPTEMBER 2020	drawing file 1907.2 A200 Plans.vwx
drawn by	FWP	checked by RAW
scale	AS SHOWN	project number 1907

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VICTORIA OFFICE 977 Fort Street Victoria BC V8V3K3 T 1.250.658.3367	NANAIMO OFFICE 102-5190 Du Nanaimo BC T 1•250•585	blin Way V9T2K8
project name		
Caledonia		
Victoria BC		
drawing title		
L3 Plan		
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THE PROJECT SHOWN AND MAY NOT BE REPRODUCED WITHOUT WRITTEN CONSENT	A205	5

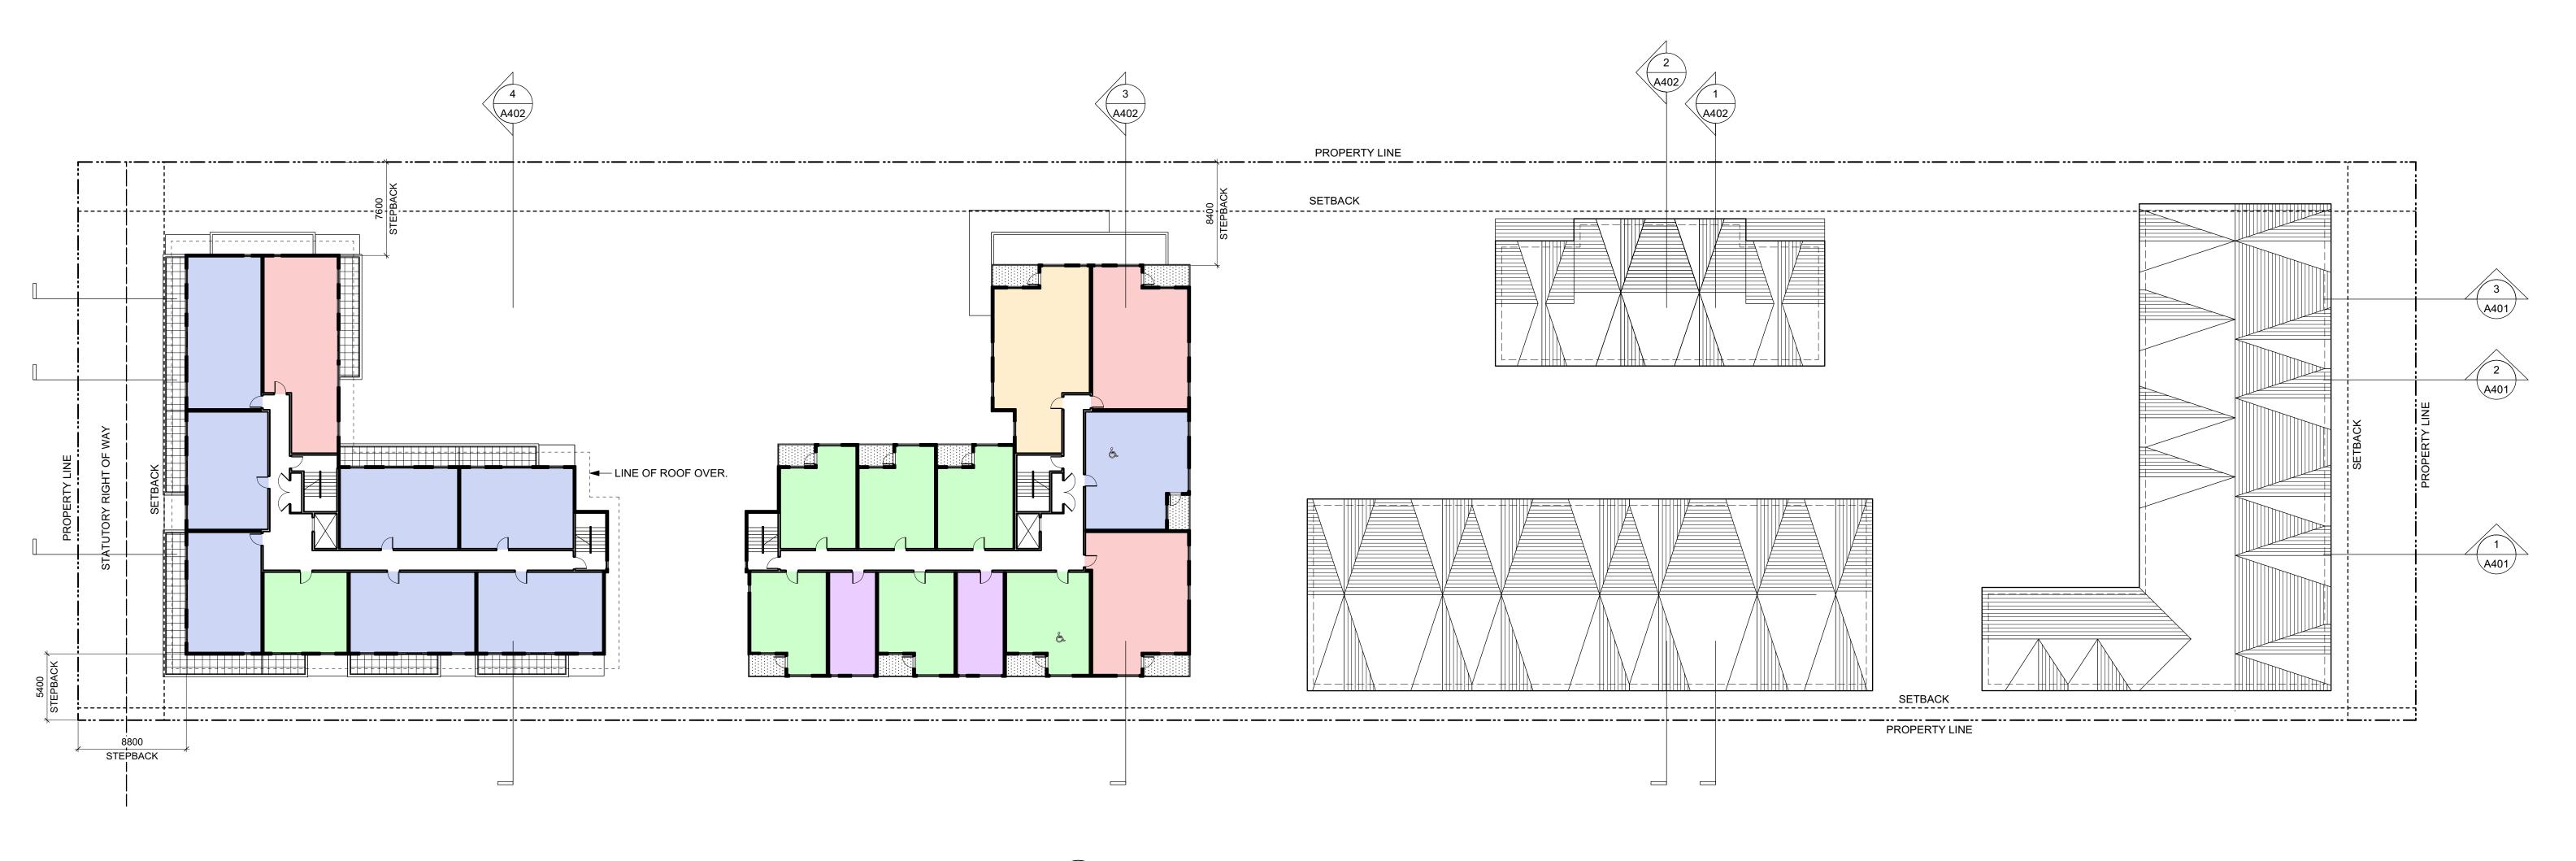

GRAPHIC LEGEND:

STUDIO

1 BEDROOM

2 BEDROOM

3 BEDROOM


4 BEDROOM

ACCESSIBLE

5	20/09/01	RE-ISSUED FOR COTV
4	20/03/13	RE-ISSUED FOR COTV
3	20/02/06	ISSUED FOR COTW
2	20/01/15	ISSUED FOR ADD
1	19/12/16	RESPONSE TO PLANNING REVIEW
Rev	Date	Description
plot date	SEPTEMBER 2020	drawing file 1907.2 A200 Plans.vw
drawn by	FWP	checked by RAW
scale	AS SHOWN	project number 190


NOTE: All dimensions are shown in millimeters. ISSUED FOR DP & REZONING


A INLZ		
dHKa	dHKarc	hitects
VICTORIA OFFICE 977 Fort Street Victoria BC V8V 3K3 T 1.250.658.3367	NANAIMO OFFICE 102-5190 Du Nanaimo BC T 1•250•585	blin Way V9T2K8
project name		
Caledonia		
Victoria BC		
drawing title		
L4 Plan		
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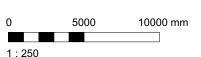


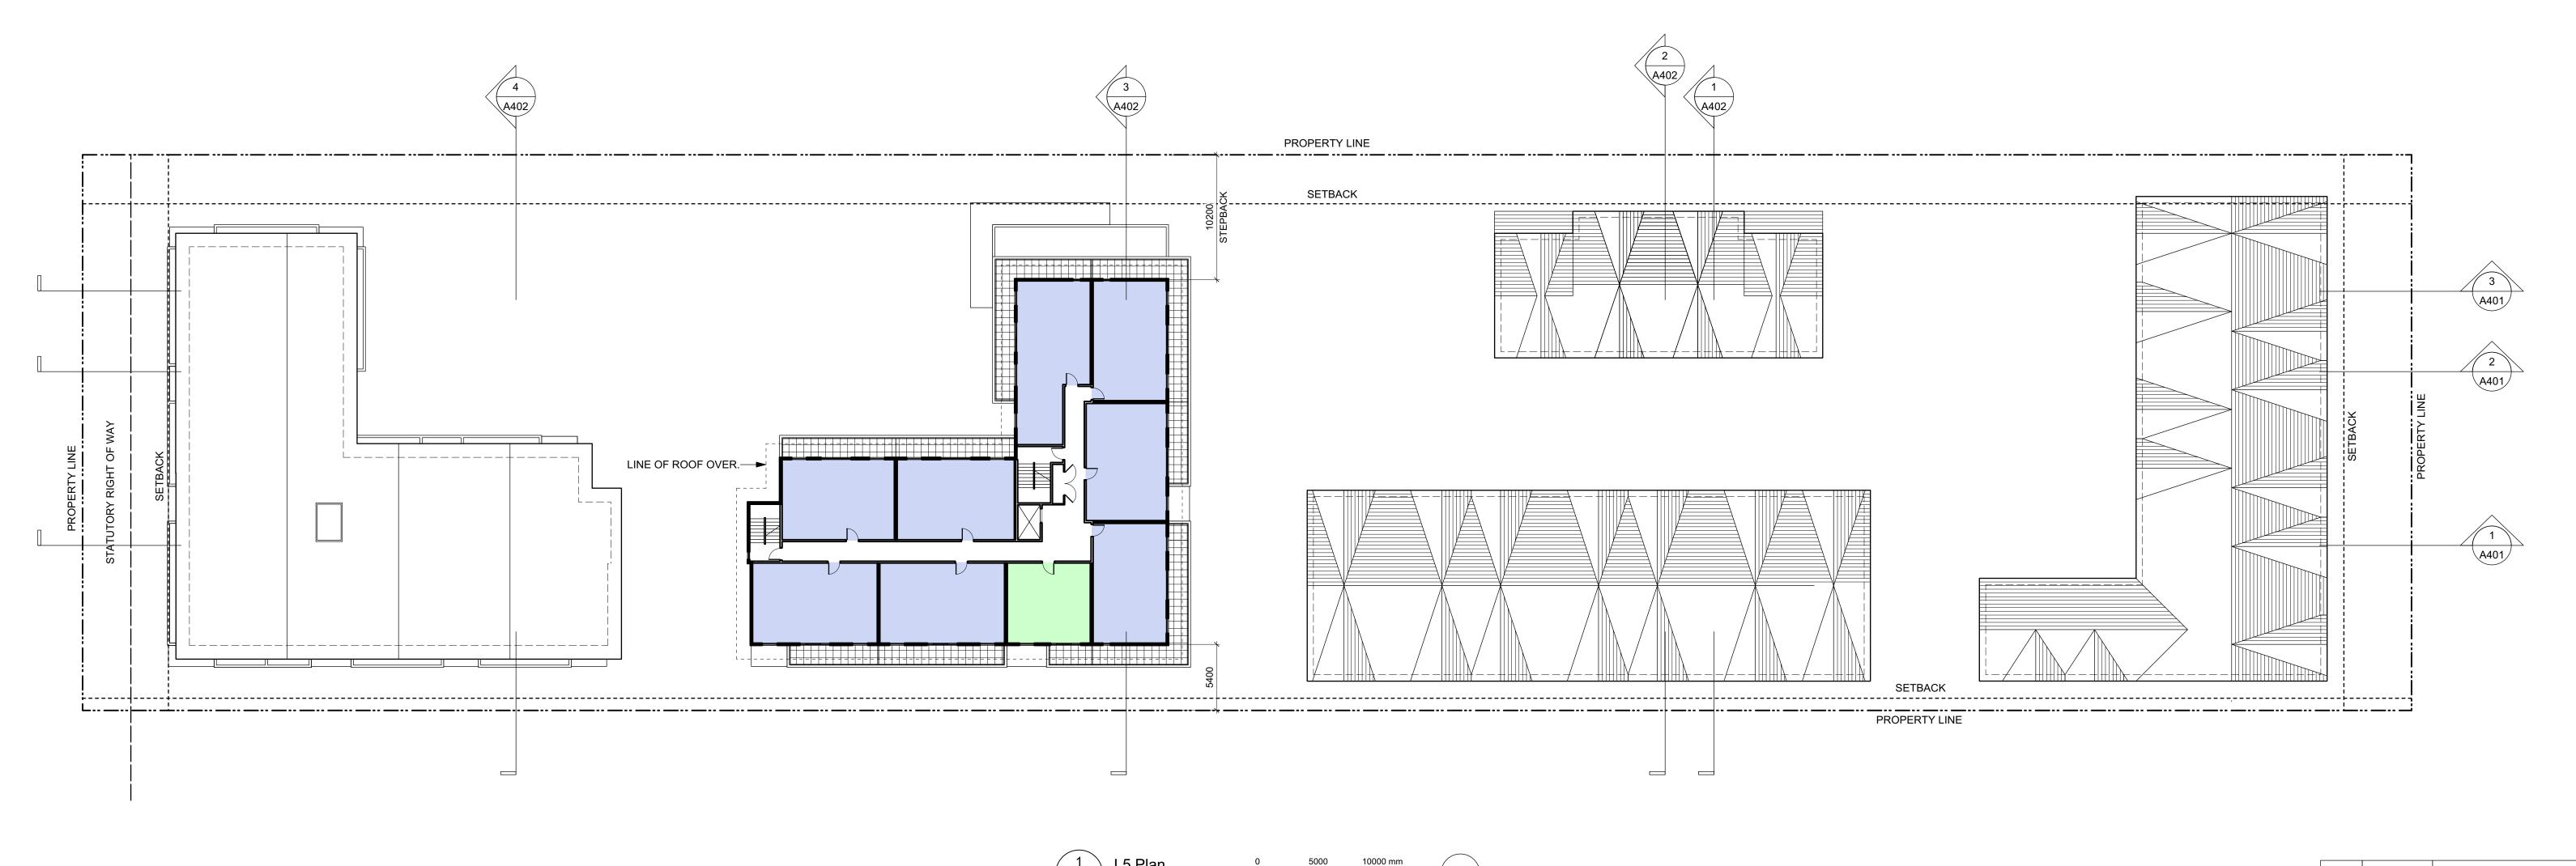PHIC LEGEND:				
STUDIO	5	20/09/01		RE-ISSUED FOR COTW
	4	20/03/13		RE-ISSUED FOR COTW
1 BEDROOM	3	20/02/06		ISSUED FOR COTW
2 BEDROOM	2	20/01/15		ISSUED FOR ADP
Z BEBITOOM	1	19/12/16	RESPONSE	TO PLANNING REVIEW
3 BEDROOM	Rev	Date	Description	
4 BEDROOM	plot date	SEPTEMBER 2020	drawing file	1907.2 A200 Plans.vwx
4 DEDITOOM	drawn by	FWP	checked by	RAW
ACCESSIBLE	scale	AS SHOWN	project number	1907
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Caledonia		
Victoria BC		
L5 Plan		
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5	20/09/01	RE-ISSUED FOR COT
4	20/03/13	RE-ISSUED FOR COT
3	20/02/06	ISSUED FOR COT
2	20/01/15	ISSUED FOR AD
1	19/12/16	RESPONSE TO PLANNING REVIE
Rev	Date	Description
plot date	SEPTEMBER 2020	drawing file 1907.2 A200 Plans.vw
drawn by	FWP	checked by RAV
scale	AS SHOWN	project number 190

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VICTORIA OFFICE 977 Fort Street Victoria BC V8V3K3 T 1.250.658.3367	NANAIMO OFFICE 102-5190 Dublin Way Nanaimo BC V9T2K8 T 1•250•585•5810
project name	
Caledonia	
Victoria BC	
drawing title	
Roof Plan	



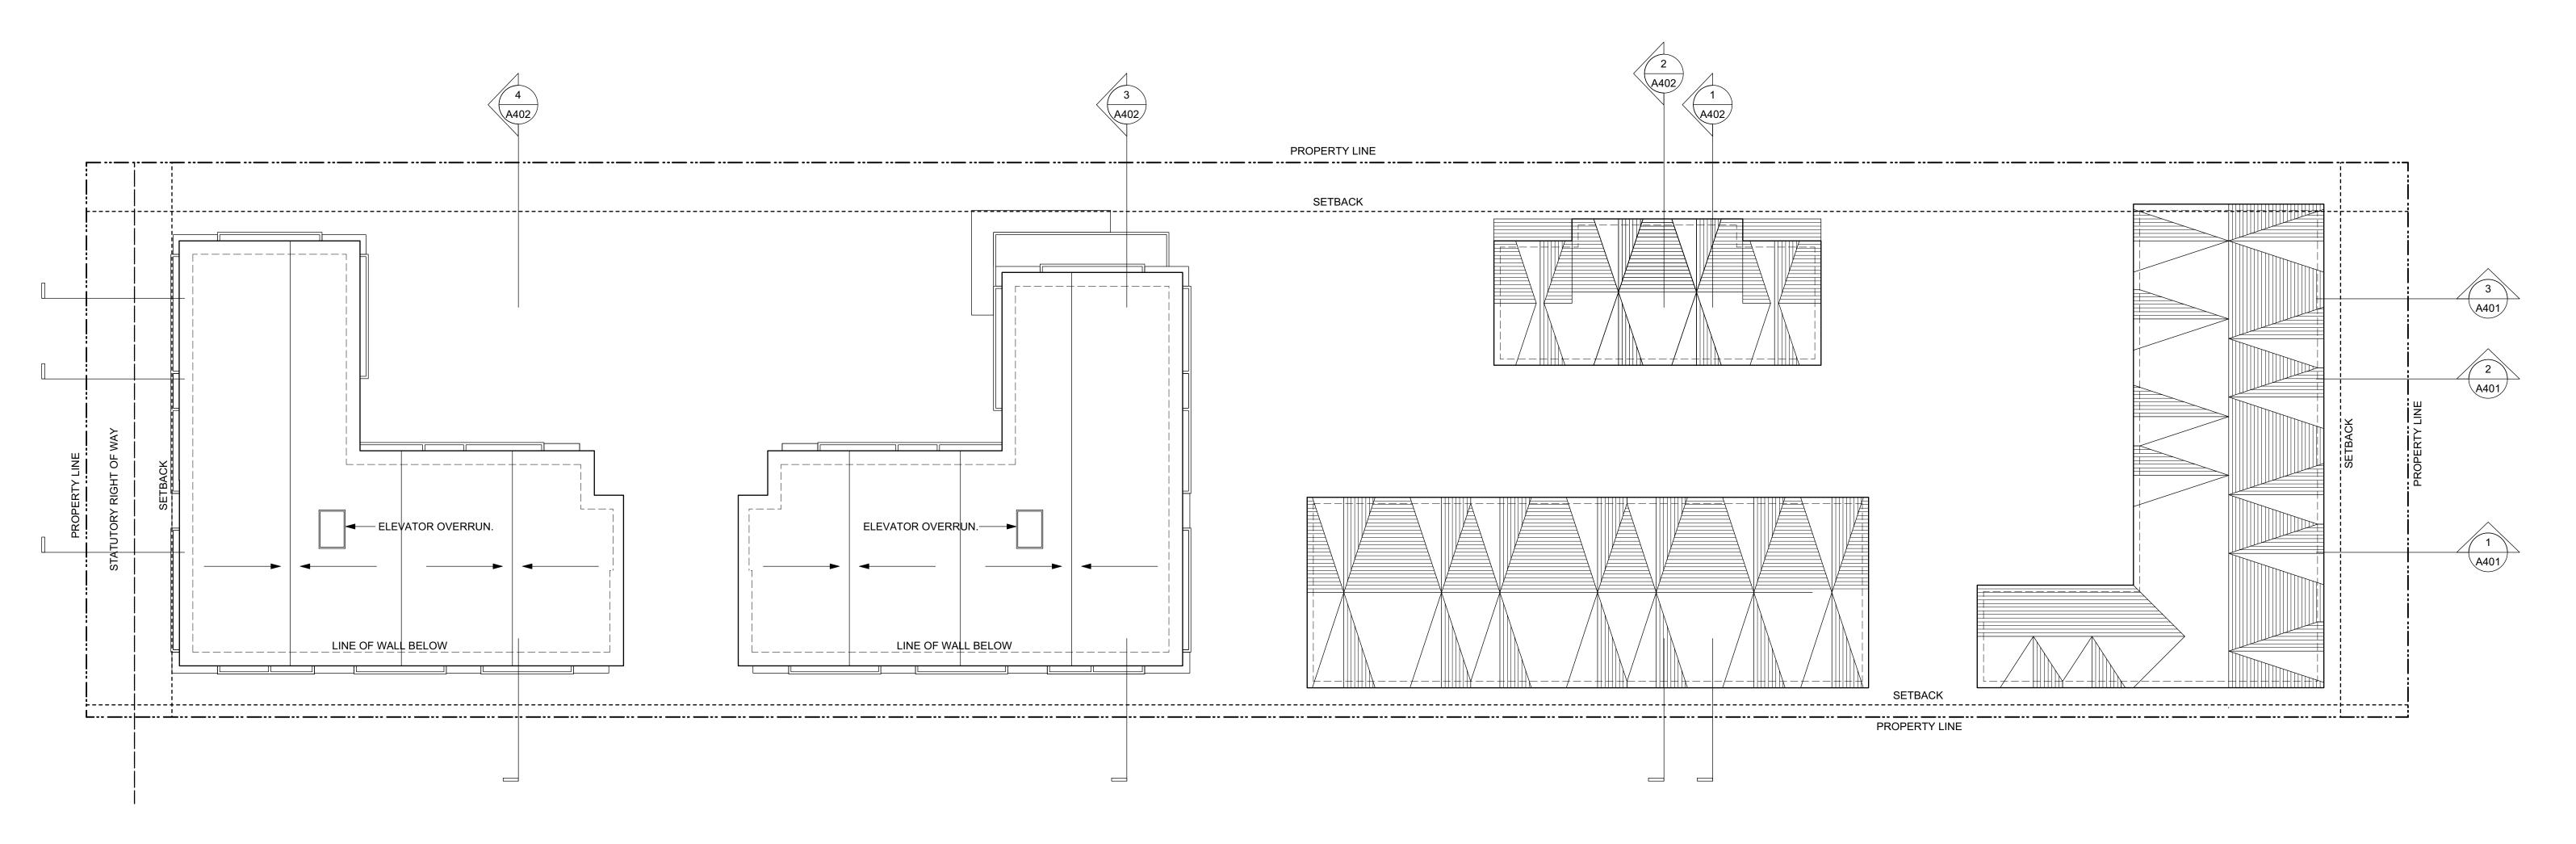

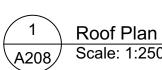



- 1 BRICK VENEER Red Apartment 1 Only
- 2 FIBRE CEMENT PANEL Teal
- 3 VINYL WINDOWS & DOORS Teal
- PREFINISHED ALUMINUM GUARD, FRAME & PICKETS Teal
- 5 METAL FLASHING Teal
- 6 ACCENT PAINT COLOUR Rust
- 7 FIBRE CEMENT LAP SIDING Soft Brown
- 8 FIBRE CEMENT PANEL Warm Grey Apartment 2 Only
- 9 SOFFIT Warm Grey Apartment 2 Only
- 10 PAINTED CONCRETE Warm Grey
- 11 FIBRE CEMENT PANEL Warm White
- SOFFIT Warm White
- 13 FIBRE CEMENT LAP SIDING Medium Blue-Grey

- 14 FIBRE CEMENT LAP SIDING White
- 15 VINYL WINDOWS & DOORS Dark Grey
- PREFINISHED ALUMINUM GUARD & FRAME Dark Grey
- 17 METAL FLASHING Dark Grey
- 18 ASPHALT SHINGLES Warm Grey
- 19 FIBRE CEMENT SHINGLES Warm Grey
- VINYL WINDOWS & DOORS White
- METAL DOWNSPOUT & FLASHING Light Warm Grey
- FIBRE CEMENT PANEL Dark Grey
- 23 FIBRE CEMENT PANEL Light Grey
- ACCENT PAINT COLOUR Bright Orange
- ACCENT PAINT COLOUR Bright Blue
- 26 ACCENT PAINT COLOUR Chartreuse

5	20/09/01	RE-ISSUED FOR COT
4	20/03/13	RE-ISSUED FOR COT
3	20/02/06	ISSUED FOR COT
2	20/01/15	ISSUED FOR AD
1	19/12/16	RESPONSE TO PLANNING REVIE
Rev	Date	Description
plot date	SEPTEMBER 2020	drawing file 1907.2 A200 Plans.vv
drawn by	NLC	checked by RA
scale	AS SHOWN	project number 190
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977 Fort Street Victoria BC V8V 3K3	102-5190 Du Nanaimo BC	blin Way V9T 2K8
T 1.250.658.3367	T 1.250.585	
project name		
Caledonia		
Victoria BC		
drawing title		
Elevations - Ap	artment 1	
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1 BRICK VENEER - Red - Apartment 1 Only

BRICK VENEER - Red - Apartment

2 FIBRE CEMENT PANEL - Teal

3 VINYL WINDOWS & DOORS - Teal

PREFINISHED ALUMINUM GUARD, FRAME & PICKETS - Teal

5 METAL FLASHING - Teal

6 ACCENT PAINT COLOUR - Rust

7 FIBRE CEMENT LAP SIDING - Soft Brown

8 FIBRE CEMENT PANEL - Warm Grey - Apartment 2 Only

9 SOFFIT - Warm Grey - Apartment 2 Only

10 PAINTED CONCRETE - Warm Grey

11 FIBRE CEMENT PANEL - Warm White

12 SOFFIT - Warm White

13 FIBRE CEMENT LAP SIDING - Medium Blue-Grey

14 FIBRE CEMENT LAP SIDING - White

15 VINYL WINDOWS & DOORS - Dark Grey

16 PREFINISHED ALUMINUM GUARD & FRAME - Dark Grey

17 METAL FLASHING - Dark Grey

18 ASPHALT SHINGLES - Warm Grey

19 FIBRE CEMENT SHINGLES - Warm Grey

20 VINYL WINDOWS & DOORS - White

21 METAL DOWNSPOUT & FLASHING - Light Warm Grey

22 FIBRE CEMENT PANEL - Dark Grey

23 FIBRE CEMENT PANEL - Light Grey

ACCENT PAINT COLOUR - Bright Orange

25 ACCENT PAINT COLOUR - Bright Blue

26 ACCENT PAINT COLOUR - Chartreuse

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1:100			

5	20/09/01	RE-ISSUED FOR COTW
4	20/03/13	RE-ISSUED FOR COTW
3	20/02/06	ISSUED FOR COTW
2	20/01/15	ISSUED FOR ADP
1	19/12/16	RESPONSE TO PLANNING REVIEW
Rev	Date	Description
plot date	SEPTEMBER 2020	drawing file 1907.2 A200 Plans.vwx
drawn by	NLC	checked by RAW
scale	AS SHOWN	project number 1907

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caledonia	
Victoria BC	
drawing title	when a salt O

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Recalculated average grades as per Planning request. Building areas consolidated as per area of parkade above natural grade.
Corresponding data, including building heights updated accordingly.

Adjustment made due to notation error. No change to actual data.

Site coverage and open site space recalculated as per Planning request. See Revision Note #1.

REVISIONS LIST
Revision #5 - 1 SEPT 2020



1 BRICK VENEER - Red - Apartment 1 Only

2 FIBRE CEMENT PANEL - Teal

3 VINYL WINDOWS & DOORS - Teal

4 PREFINISHED ALUMINUM GUARD, FRAME & PICKETS - Teal

5 METAL FLASHING - Teal

6 ACCENT PAINT COLOUR - Rust

7 FIBRE CEMENT LAP SIDING - Soft Brown

8 FIBRE CEMENT PANEL - Warm Grey - Apartment 2 Only

9 SOFFIT - Warm Grey - Apartment 2 Only

10 PAINTED CONCRETE - Warm Grey

11 FIBRE CEMENT PANEL - Warm White

SOFFIT - Warm White

13 FIBRE CEMENT LAP SIDING - Medium Blue-Grey

14 FIBRE CEMENT LAP SIDING - White

15 VINYL WINDOWS & DOORS - Dark Grey

PREFINISHED ALUMINUM GUARD & FRAME - Dark Grey

17 METAL FLASHING - Dark Grey

18 ASPHALT SHINGLES - Warm Grey

19 FIBRE CEMENT SHINGLES - Warm Grey

20 VINYL WINDOWS & DOORS - White

21 METAL DOWNSPOUT & FLASHING - Light Warm Grey


22 FIBRE CEMENT PANEL - Dark Grey

23 FIBRE CEMENT PANEL - Light Grey

ACCENT PAINT COLOUR - Bright Orange

25 ACCENT PAINT COLOUR - Bright Blue

26 ACCENT PAINT COLOUR - Chartreuse

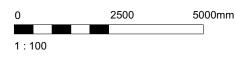

5	20/09/01	RE-ISSUED FOR COTW
4	20/03/13	RE-ISSUED FOR COTW
3	20/02/06	ISSUED FOR COTV
2	20/01/15	ISSUED FOR ADF
1	19/12/16	RESPONSE TO PLANNING REVIEW
Rev	Date	Description
plot date	SEPTEMBER 2020	drawing file 1907.2 A200 Plans.vw
drawn by	NLC	checked by RAW
scale	AS SHOWN	project number 1907

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Recalculated average grades as per Planning request. Building areas consolidated as per area of parkade above natural grade. Corresponding data, including building heights updated accordingly.

REVISIONS LIST
Revision #5 - 1 SEPT 2020





Townhouse 1 - East
A304 Scale: 1:100



4 Townhouse 1 - West
A304 Scale: 1:100

COLOUR & MATERIALS LEGEND

- 1 BRICK VENEER Red Apartment 1 Only
- 2 FIBRE CEMENT PANEL Teal
- 3 VINYL WINDOWS & DOORS Teal
- PREFINISHED ALUMINUM GUARD, FRAME & PICKETS Teal
- 5 METAL FLASHING Teal
- 6 ACCENT PAINT COLOUR Rust
- 7 FIBRE CEMENT LAP SIDING Soft Brown
- 8 FIBRE CEMENT PANEL Warm Grey Apartment 2 Only
- 9 SOFFIT Warm Grey Apartment 2 Only
- 10 PAINTED CONCRETE Warm Grey
- 11 FIBRE CEMENT PANEL Warm White
- SOFFIT Warm White
- 13 FIBRE CEMENT LAP SIDING Medium Blue-Grey

- 14 FIBRE CEMENT LAP SIDING White
- 15 VINYL WINDOWS & DOORS Dark Grey
- PREFINISHED ALUMINUM GUARD & FRAME Dark Grey
- 17 METAL FLASHING Dark Grey
- 18 ASPHALT SHINGLES Warm Grey
- 19 FIBRE CEMENT SHINGLES Warm Grey
- VINYL WINDOWS & DOORS White
- METAL DOWNSPOUT & FLASHING Light Warm Grey
- FIBRE CEMENT PANEL Dark Grey
- 23 FIBRE CEMENT PANEL Light Grey
- ACCENT PAINT COLOUR Bright Orange
- ACCENT PAINT COLOUR Bright Blue
- 26 ACCENT PAINT COLOUR Chartreuse

	1:100	
5	20/09/01	RE-ISSUED FOR COTW
4	20/03/13	RE-ISSUED FOR COTW
3	20/02/06	ISSUED FOR COTW
2	20/01/15	ISSUED FOR ADP
1	19/12/16	RESPONSE TO PLANNING REVIEW
Rev	Date	Description
plot date	SEPTEMBER 2020	drawing file 1907.2 A200 Plans.vwx

NLC checked by AS SHOWN project number

ISSUED FOR DP & REZONING



Recalculated average grades as per Planning request. Building areas consolidated as per area of parkade above natural grade. Corresponding data, including building heights updated accordingly. Adjustment made due to notation error. No change to actual data.

REVISIONS LIST
Revision #5 - 1 SEPT 2020

 $\sqrt{3}$ Site coverage and open site space recalculated as per Planning request. See Revision Note #1.





Townhouse 2 - East
A305 Scale: 1:100



4 Townhouse 2 - West A305 Scale: 1:100

COLOUR & MATERIALS LEGEND

- 1 BRICK VENEER Red Apartment 1 Only
- 2 FIBRE CEMENT PANEL Teal
- 3 VINYL WINDOWS & DOORS Teal
- PREFINISHED ALUMINUM GUARD, FRAME & PICKETS Teal
- 5 METAL FLASHING Teal
- 6 ACCENT PAINT COLOUR Rust
- 7 FIBRE CEMENT LAP SIDING Soft Brown
- 8 FIBRE CEMENT PANEL Warm Grey Apartment 2 Only
- 9 SOFFIT Warm Grey Apartment 2 Only
- 10 PAINTED CONCRETE Warm Grey
- 11 FIBRE CEMENT PANEL Warm White
- SOFFIT Warm White
- 13 FIBRE CEMENT LAP SIDING Medium Blue-Grey

- 14 FIBRE CEMENT LAP SIDING White
- 15 VINYL WINDOWS & DOORS Dark Grey
- PREFINISHED ALUMINUM GUARD & FRAME Dark Grey
- 17 METAL FLASHING Dark Grey
- 18 ASPHALT SHINGLES Warm Grey
- 19 FIBRE CEMENT SHINGLES Warm Grey
- VINYL WINDOWS & DOORS White
- METAL DOWNSPOUT & FLASHING Light Warm Grey
- FIBRE CEMENT PANEL Dark Grey
- 23 FIBRE CEMENT PANEL Light Grey
- ACCENT PAINT COLOUR Bright Orange
- ACCENT PAINT COLOUR Bright Blue
- 26 ACCENT PAINT COLOUR Chartreuse

5	20/09/01		RE-ISSUED FOR COTW
4	20/03/13		RE-ISSUED FOR COTW
3	20/02/06		ISSUED FOR COTW
2	20/01/15		ISSUED FOR ADP
1	19/12/16		RESPONSE TO PLANNING REVIEW
Rev	Date	Description	
plot date	SEPTEMBER 2020	drawing file	1907.2 A200 Plans.vwx

ISSUED FOR DP & REZONING

NLC checked by AS SHOWN project number

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VICTORIA OFFICE 977 Fort Street Victoria BC V8V 3K3 T 1•250•658•3367	NANAIMO OFFICE 102-5190 Dublin Way Nanaimo BC V9T 2K8 T 1•250•585•5810
Caledonia	
Victoria BC	
Elevations - Tow	nhouse 2

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	REVISIONS LIST Revision #5 - 1 SEPT 2020
1	Recalculated average grades as per Planning request. Building areas consolidated as per area of parkade above natural grade. Corresponding data, including building heights updated accordingly.
2	Adjustment made due to notation error. No change to actual data.
3	Site coverage and open site space recalculated as per Planning request. See Revision Note #1.



- 1 BRICK VENEER Red Apartment 1 Only
- 2 FIBRE CEMENT PANEL Teal
- 3 VINYL WINDOWS & DOORS Teal
- PREFINISHED ALUMINUM GUARD, FRAME & PICKETS Teal
- 5 METAL FLASHING Teal
- 6 ACCENT PAINT COLOUR Rust
- 7 FIBRE CEMENT LAP SIDING Soft Brown
- 8 FIBRE CEMENT PANEL Warm Grey Apartment 2 Only
- 9 SOFFIT Warm Grey Apartment 2 Only
- 10 PAINTED CONCRETE Warm Grey
- PAINTED CONCRETE Warm Grey

 FIBRE CEMENT PANEL Warm White
- SOFFIT Warm White
- 13 FIBRE CEMENT LAP SIDING Medium Blue-Grey

- 14 FIBRE CEMENT LAP SIDING White
- 15 VINYL WINDOWS & DOORS Dark Grey
- PREFINISHED ALUMINUM GUARD & FRAME Dark Grey
- 17 METAL FLASHING Dark Grey
- 18 ASPHALT SHINGLES Warm Grey
- 19 FIBRE CEMENT SHINGLES Warm Grey
- 20 VINYL WINDOWS & DOORS White
- 21 METAL DOWNSPOUT & FLASHING Light Warm Grey
- 22 FIBRE CEMENT PANEL Dark Grey
- FIBRE CEMENT PANEL Light Grey
- ACCENT PAINT COLOUR Bright Orange
- 25 ACCENT PAINT COLOUR Bright Blue
- 26 ACCENT PAINT COLOUR Chartreuse

RE-ISSUED FOR COTV	20/09/01	5
RE-ISSUED FOR COTV	20/03/13	4
ISSUED FOR COTV	20/02/06	3
ISSUED FOR ADI	20/01/15	2
RESPONSE TO PLANNING REVIEW	19/12/16	1

ISSUED FOR DP
& REZONING

1907.2 A200 Plans.vwx

SEPTEMBER 2020 drawing file

NLC checked by

AS SHOWN project number


 dHKa	dHKarchitects
VICTORIA OFFICE 977 Fort Street Victoria BC V8V3K3 T 1•250•658•3367	NANAIMO OFFICE 102-5190 Dublin Way Nanaimo BC V9T2K8 T 1•250•585•5810
Caledonia	
Victoria BC	


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EXISTING GLADSTONE VIC HIGH TRACK GRANT


9:00AM - SEPTEMBER 21ST



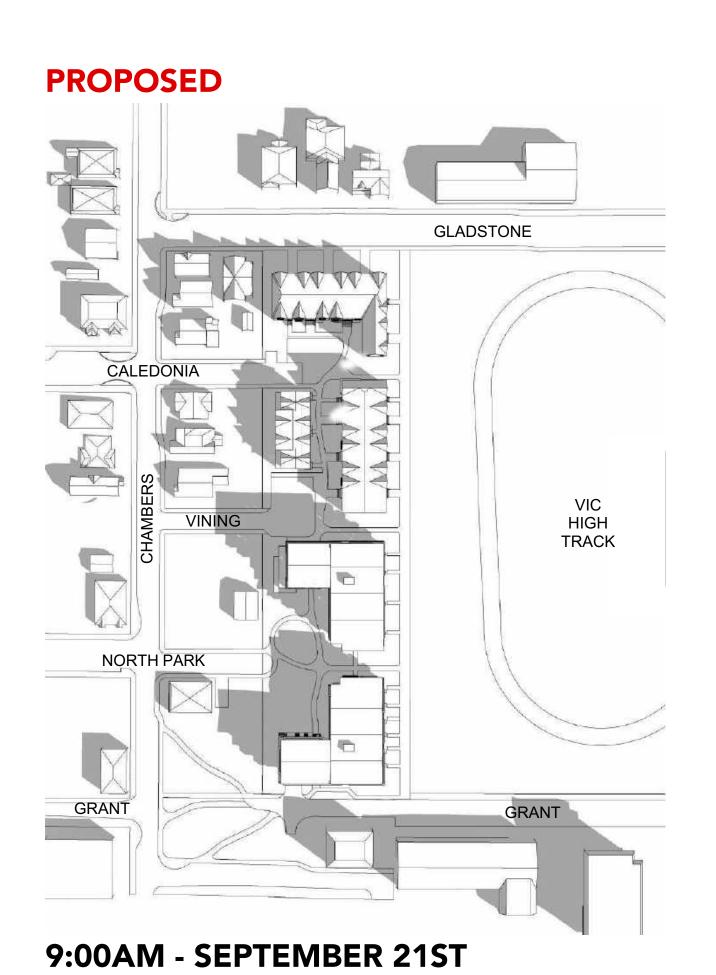


12:00PM - SEPTEMBER 21ST

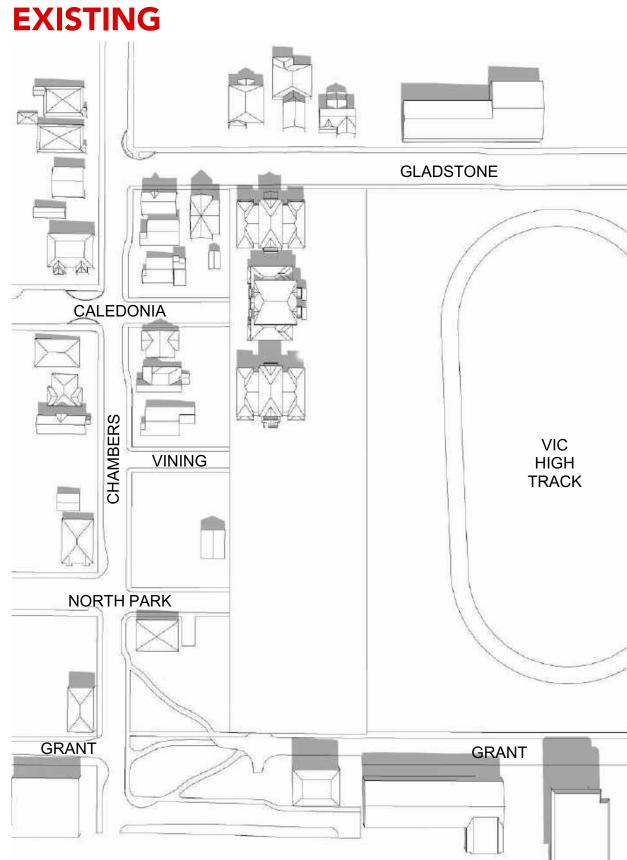

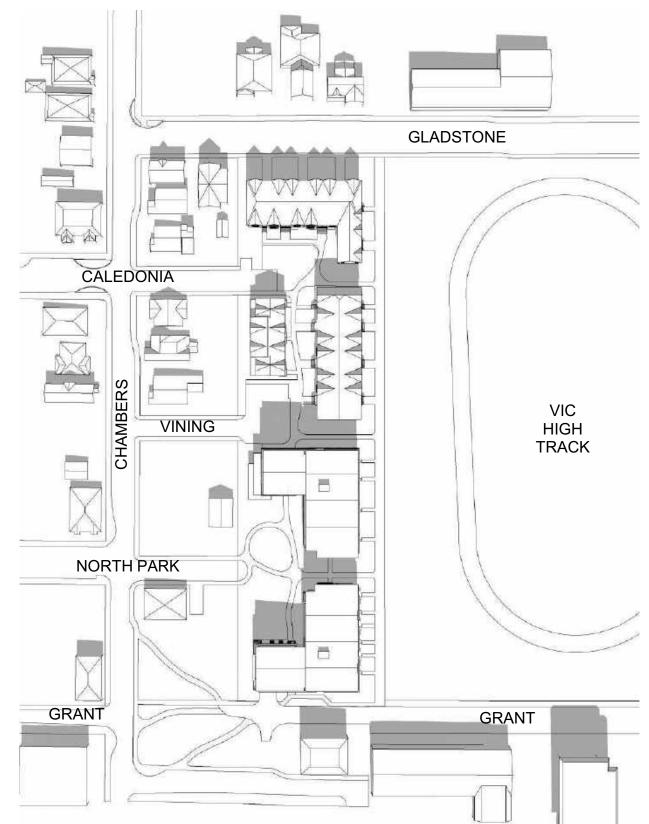


12:00PM - SEPTEMBER 21ST

EXISTING

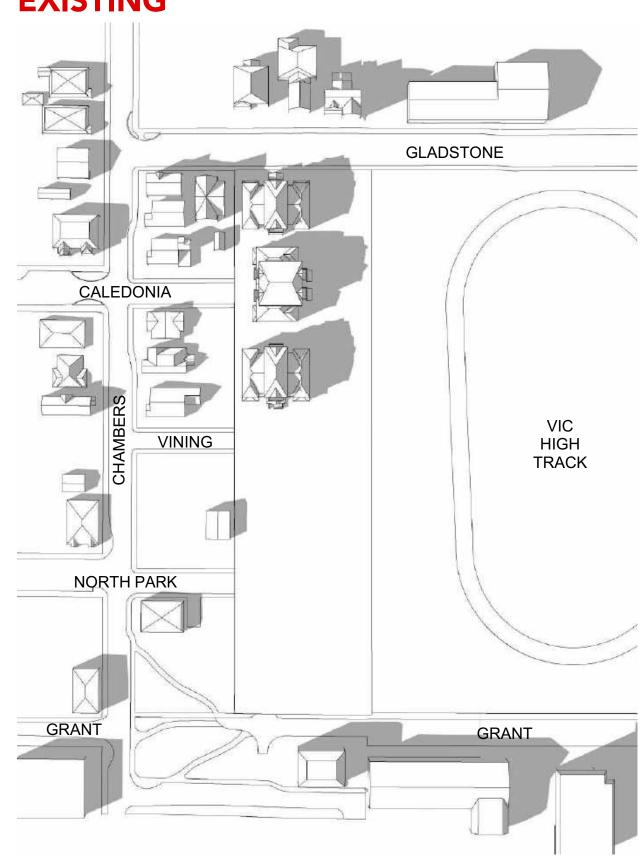

4:00PM - SEPTEMBER 21ST


PROPOSED

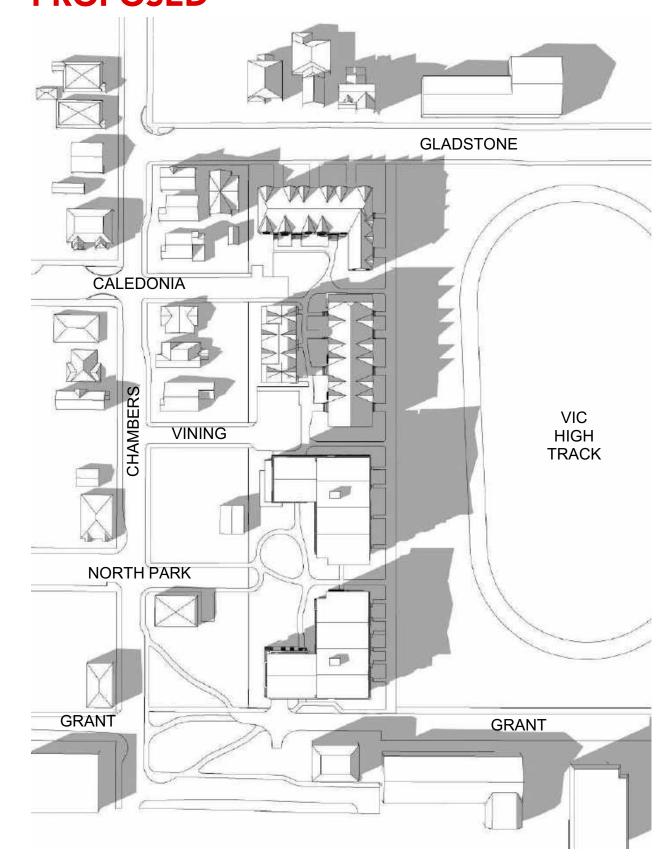

4:00PM - SEPTEMBER 21ST

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RE-ISSUED FOR COTW		20/03/13	4
ISSUED FOR COTW		20/02/06	3
ISSUED FOR ADP		20/01/15	2
ESPONSE TO PLANNING REVIEW	F	19/12/16	1
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1907 A307 Shadow Studies.vwx	drawing file	SEPTEMBER 2020	lot date
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ISSUED FOR DP & REZONING



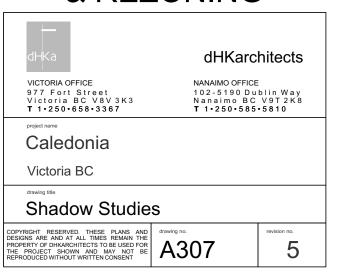

BEFORE - LOOKING WEST - FROM VIC HIGH



AFTER - LOOKING WEST - FROM VIC HIGH

5	20/09/01	RE-ISSUED FOR COTW
4	20/03/13	RE-ISSUED FOR COTW
3	20/02/06	ISSUED FOR COTW
2	20/01/15	ISSUED FOR ADP
1	19/12/16	RESPONSE TO PLANNING REVIEW
Rev	Date	Description
plot date	SEPTEMBER 2020	drawing file 1907 A307 Shadow Studies.vwx
drawn by	NLC	checked by RAW
scale	n.t.s.	project number 1907
NOTE: All dim	ensions are shown in mil	limeters.

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VICTORIA OFFICE 977 Fort Street Victoria BC V8V3K3 T 1•250•658•3367	NANAIMO OFFICE 102-5190 Du Nanaimo BC T 1•250•585	blin Way V9T2K8
Caledonia		
Victoria BC		
View Analysis		
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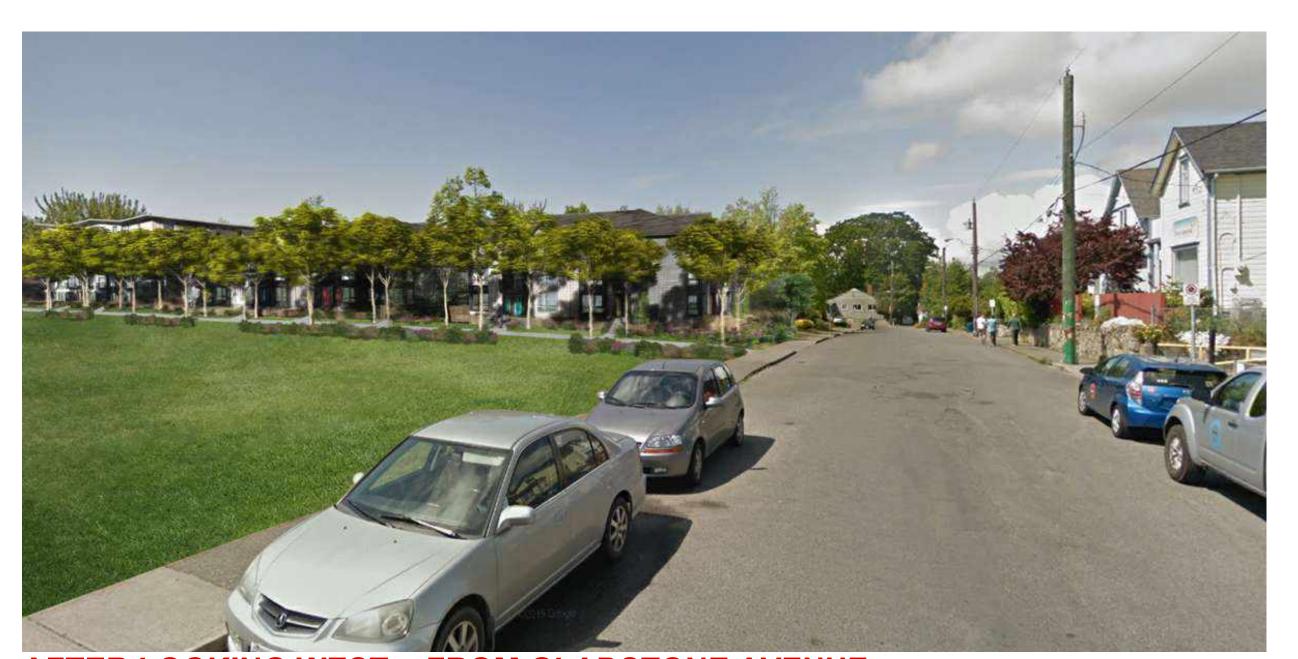
BEFORE LOOKING WEST - FROM GRANT STREET



BEFORE - LOOKING WEST - FROM GLADSTONE AVENUE




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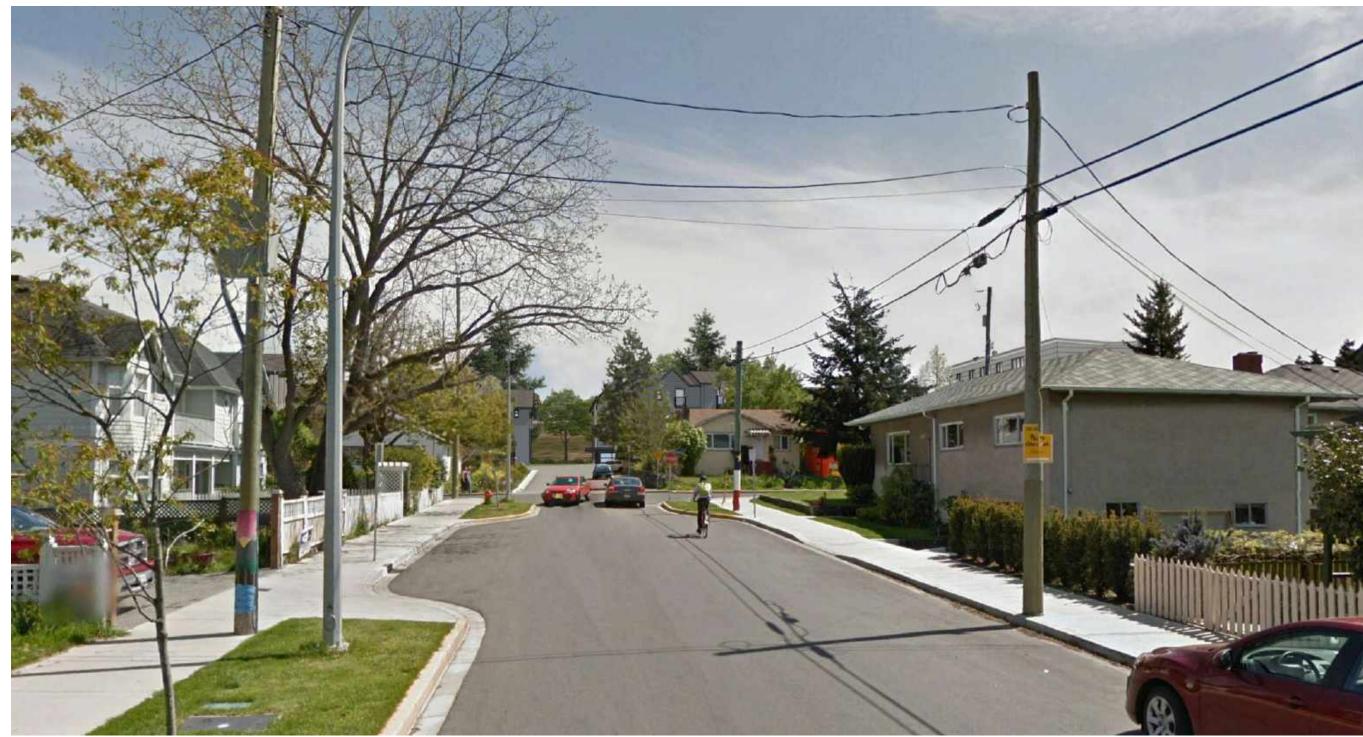
AFTER LOOKING WEST - FROM GLADSTONE AVENUE

5	20/09/01	RE-ISSUED FOR COTW		
4	20/03/13	RE-ISSUED FOR COTW		
3	20/02/06	ISSUED FOR COTW		
2	20/01/15	ISSUED FOR ADP		
1	19/12/16	RESPONSE TO PLANNING REVIEW		
Rev	Date	Description		
plot date	SEPTEMBER 2020	drawing file 1907 A307 Shadow Studies.vwx		
drawn by	NLC	checked by RAW		
scale	n.t.s.	project number 1907		
NOTE: All din	NOTE: All dimensions are shown in millimeters			

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VICTORIA OFFICE 977 Fort Street Victoria BC V8V3K3 T 1-250-658-3367	NANAIMO OFFICE 102-5190 Du Nanaimo BC T 1•250•585	blin Way V9T 2K8
Caledonia Victoria BC		
View Analysis		
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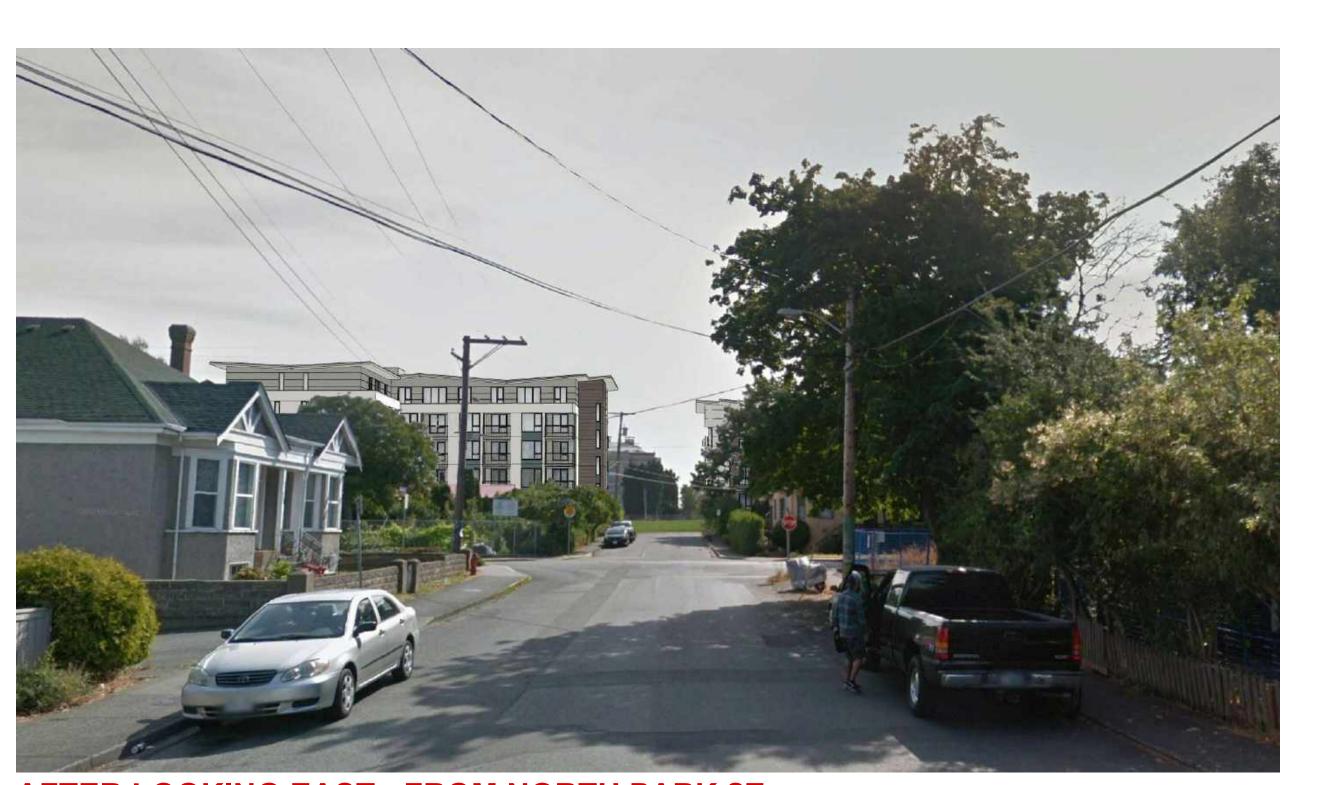
BEFORE LOOKING EAST - FROM CALEDONIA AVE.



AFTER LOOKING EAST - FROM CALEDONIA AVE.

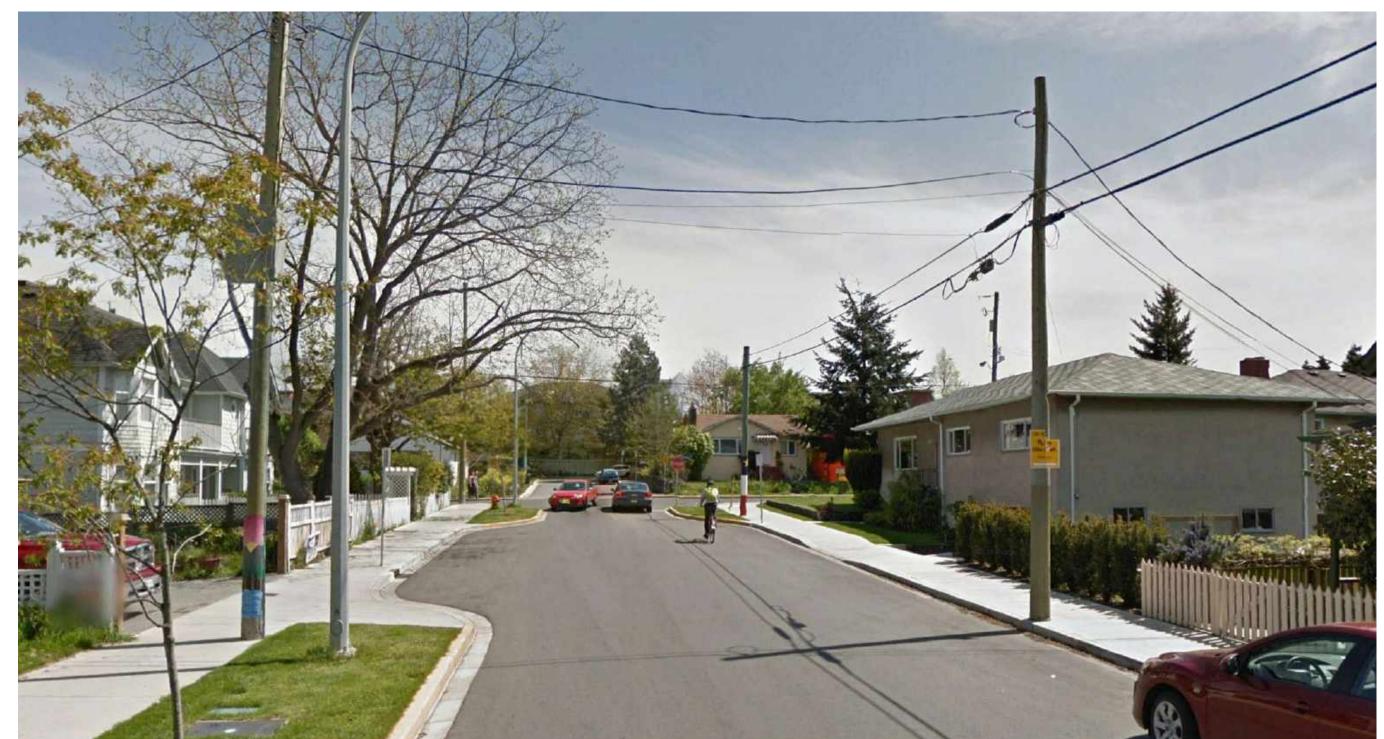

BEFORE LOOKING EAST - FROM NORTH PARK ST.



AFTER LOOKING EAST - FROM NORTH PARK ST.

RE-ISSUED FOR COTW	20/09/01	5
RE-ISSUED FOR COTW	20/03/13	4
ISSUED FOR COTW	20/02/06	3
ISSUED FOR ADP	20/01/15	2
RESPONSE TO PLANNING REVIEW	19/12/16	1
iption	Date	Rev
1907 A307 Shadow Studies.vwx	SEPTEMBER 2020	plot date
ed by RAW	NLC	drawn by
t number 1907	n.t.s.	scale

NOTE: All dimensions are shown in millimeters. ISSUED FOR DP & REZONING

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- dHKa	dHKarc	hitects
VICTORIA OFFICE 977 Fort Street Victoria BC V8V3K3 T 1.250.658.3367	NANAIMO OFFICE 102-5190 Du Nanaimo BC T 1•250•585	blin Way V9T 2K8
Caledonia		
Victoria BC		
View Analysis		
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LOOKING SOUTH - GLADSTONE AVENUE



LOOKING EAST - NORTH PARK STREET



20/09/01 RE-ISSUED FOR COTW		5
20/03/13 RE-ISSUED FOR COTW		4
20/02/06 ISSUED FOR COTW		3
20/01/15 ISSUED FOR ADP		2
19/12/16 RESPONSE TO PLANNING REVIEW		1
Description	Date	Rev
IBER 2020 drawing file 1907 A307 Shadow Studies.vwx	SEPTEMB	plot date
NLC checked by RAW		drawn by
n.t.s. project number 1907		scale

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VICTORIA OFFICE 977 Fort Street Victoria BC V8V3K3 T 1.250.658.3367	NANAIMO OFFICE 102-5190 Dublin Way Nanaimo BC V9T2K8 T 1•250•585•5810
caledonia	
Victoria BC	
Perspective Stu	ıdies
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LOOKING EAST - VINING STREET



TOWNHOUSES - AT GLADSTONE AVENUE



APARTMENT - AT GRANT STREET



INTERIOR COURTYARD - LOOKING NORTH



PLAYGROUND & AMENITY AREA - LOOKING NORTH

5	20/09/01	RE-ISSUED FOR COTW
4	20/03/13	RE-ISSUED FOR COTW
3	20/02/06	ISSUED FOR COTW
2	20/01/15	ISSUED FOR ADP
1	19/12/16	RESPONSE TO PLANNING REVIEW
Rev	Date	Description
plot date	SEPTEMBER 2020	drawing file 1907 A307 Shadow Studies.vwx
drawn by	NLC	checked by RAW
scale	n.t.s.	project number 1907
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& REZONING

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102-5190 Du Nanaimo BC	blin Way V9T 2K8
udies	
A312	revision no.
	dHKarc NANAIMO OFFICE 102-5190 Du Nanaimo BC T 1-250-585



1	Context Elevations
A313	Scale: 1: 300

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4	20/03/13	RE-ISSUED FOR COTW
3	20/02/06	ISSUED FOR COTW
2	20/01/15	ISSUED FOR ADP
1	19/12/16	RESPONSE TO PLANNING REVIEW
Rev	Date	Description
plot date	SEPTEMBER 2020	drawing file 1907.2 A200 Plans.vwx
drawn by	FWP/NLC	checked by RAW
scale	AS SHOWN	project number 1907

All dimensions are shown in millimeters. ISSUED FOR DP & REZONING

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TORIA OFFICE	NANAIMO OFFICE
7 Fort Street	102-5190 Dublin Way Nanaimo BC V9T 2K8

977 Fort Street
Victoria BC V8V 3K
T 1-250-658-3367

project name
Caledonia

Victoria BC

Streetscape Elevations


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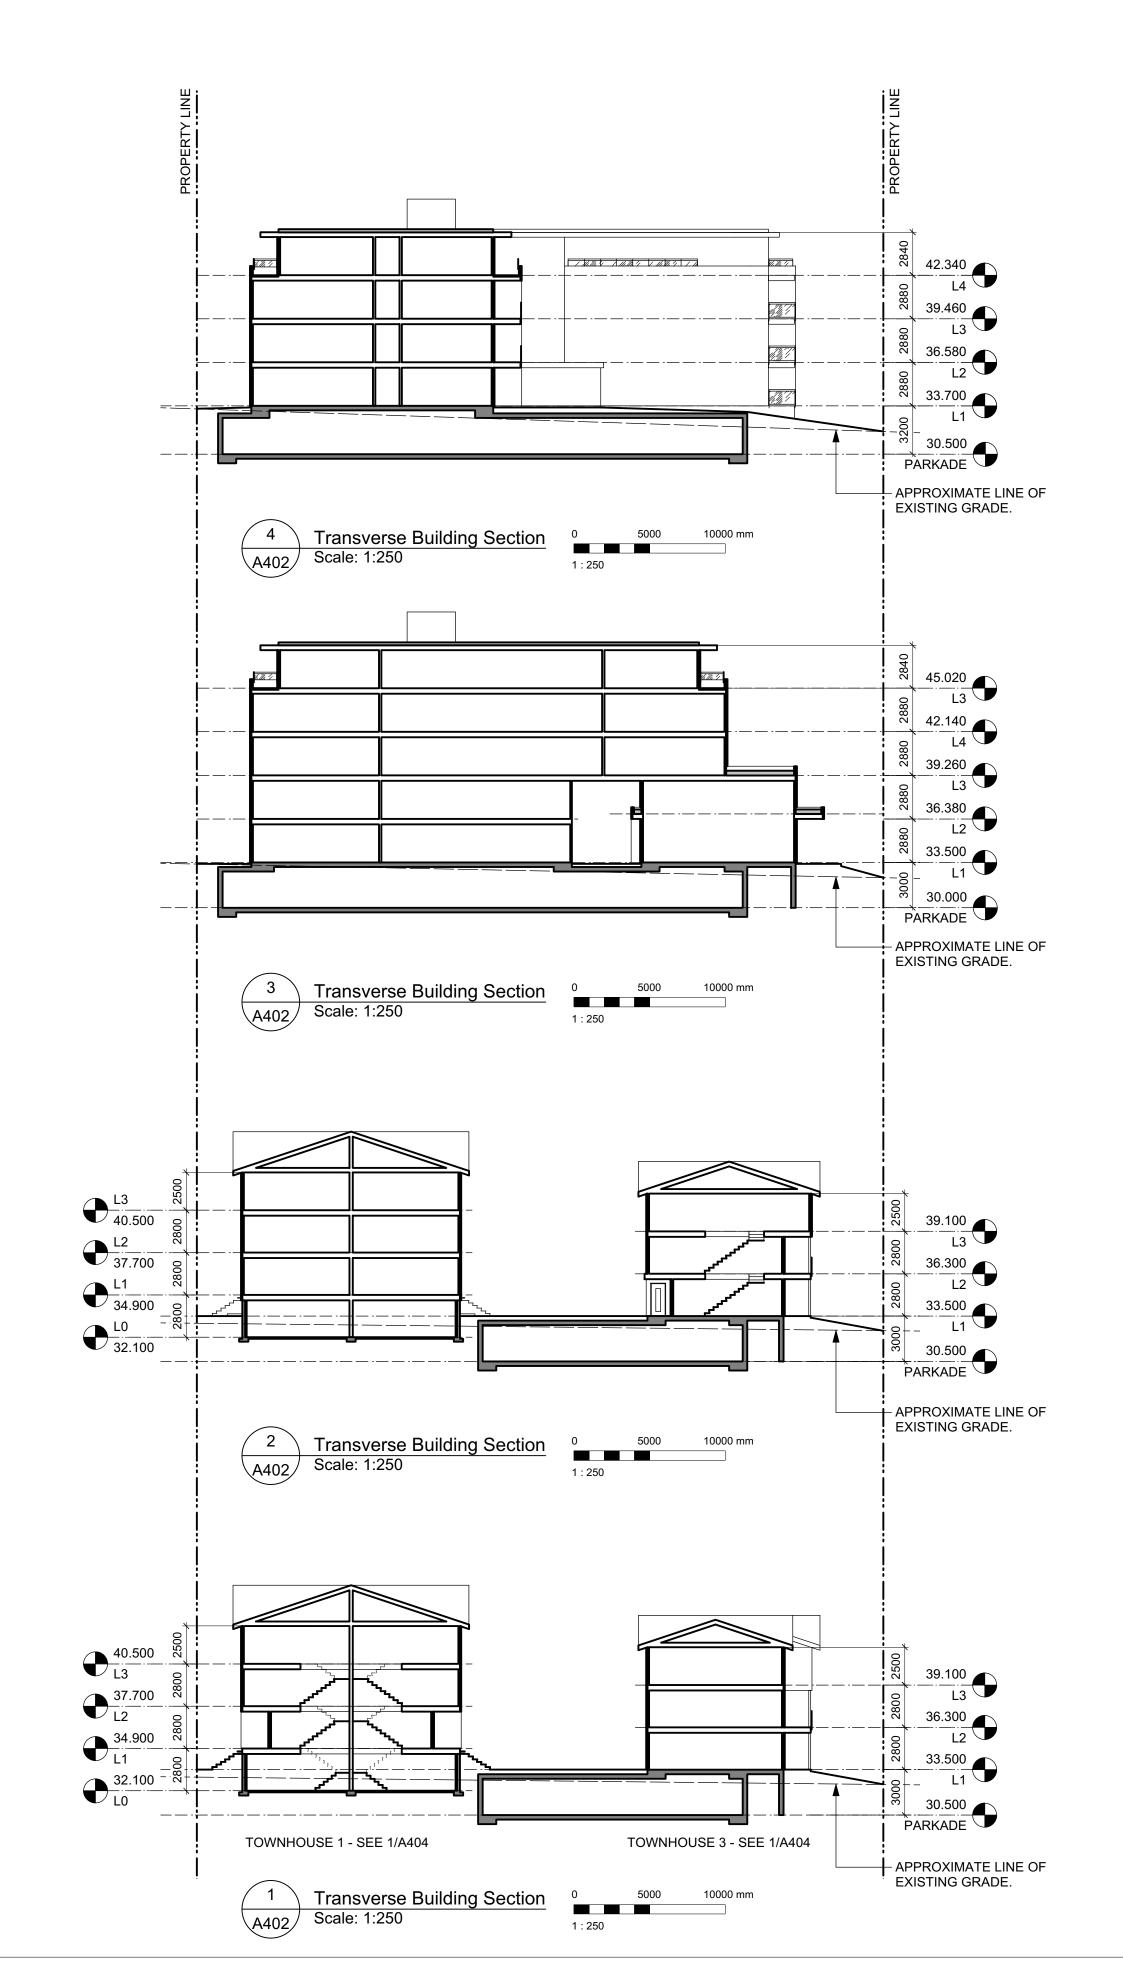
Recalculated average grades as per Planning request. Building areas consolidated as per area of parkade above natural grade.
Corresponding data, including building heights updated accordingly.

Adjustment made due to notation error. No change to actual data.

Site coverage and open site space recalculated as per Planning request. See Revision Note #1.


REVISIONS LIST
Revision #5 - 1 SEPT 2020



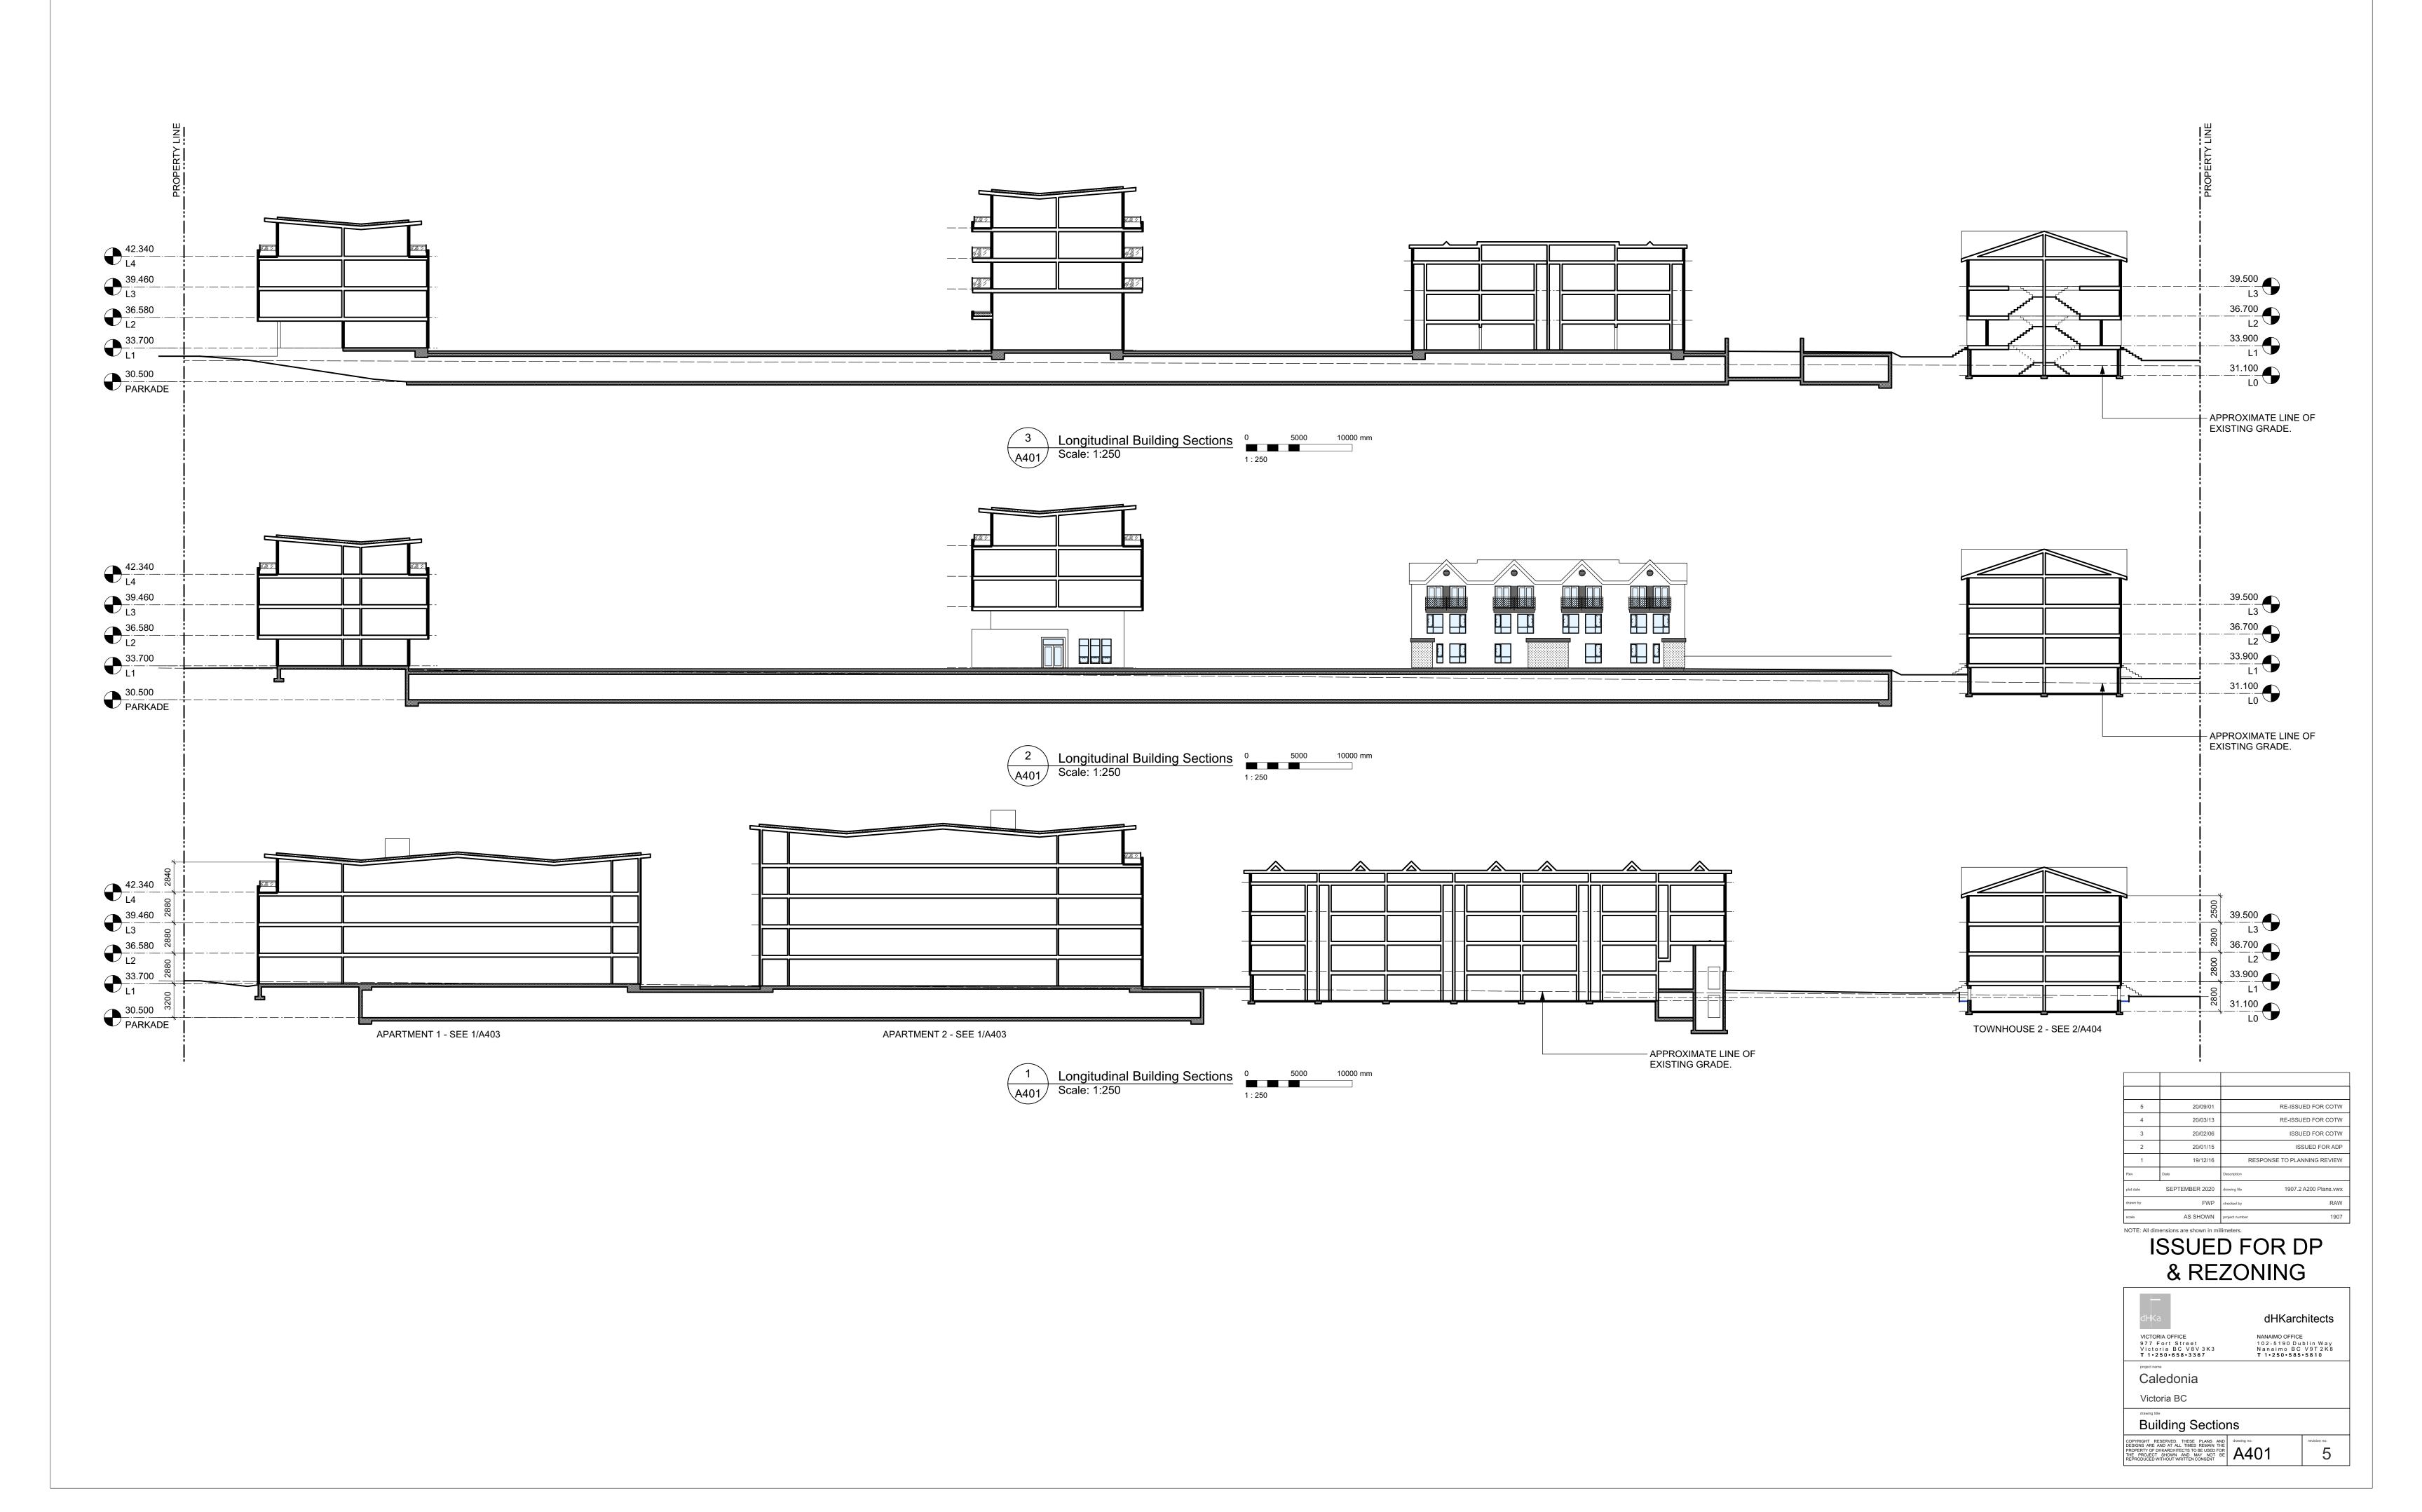




VICTORIA OFFICE 977 Fort Street Victoria BC V8V 3K3	dHKarc NANAIMO OFFICE 102-5190 DU Nanaimo BC	E blin Way		
r 1.250.658.3367 project name Caledonia	T 1-250-585			
Victoria BC				
Building Sections				
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REVISIONS LIST
Revision #5 - 1 SEPT 2020

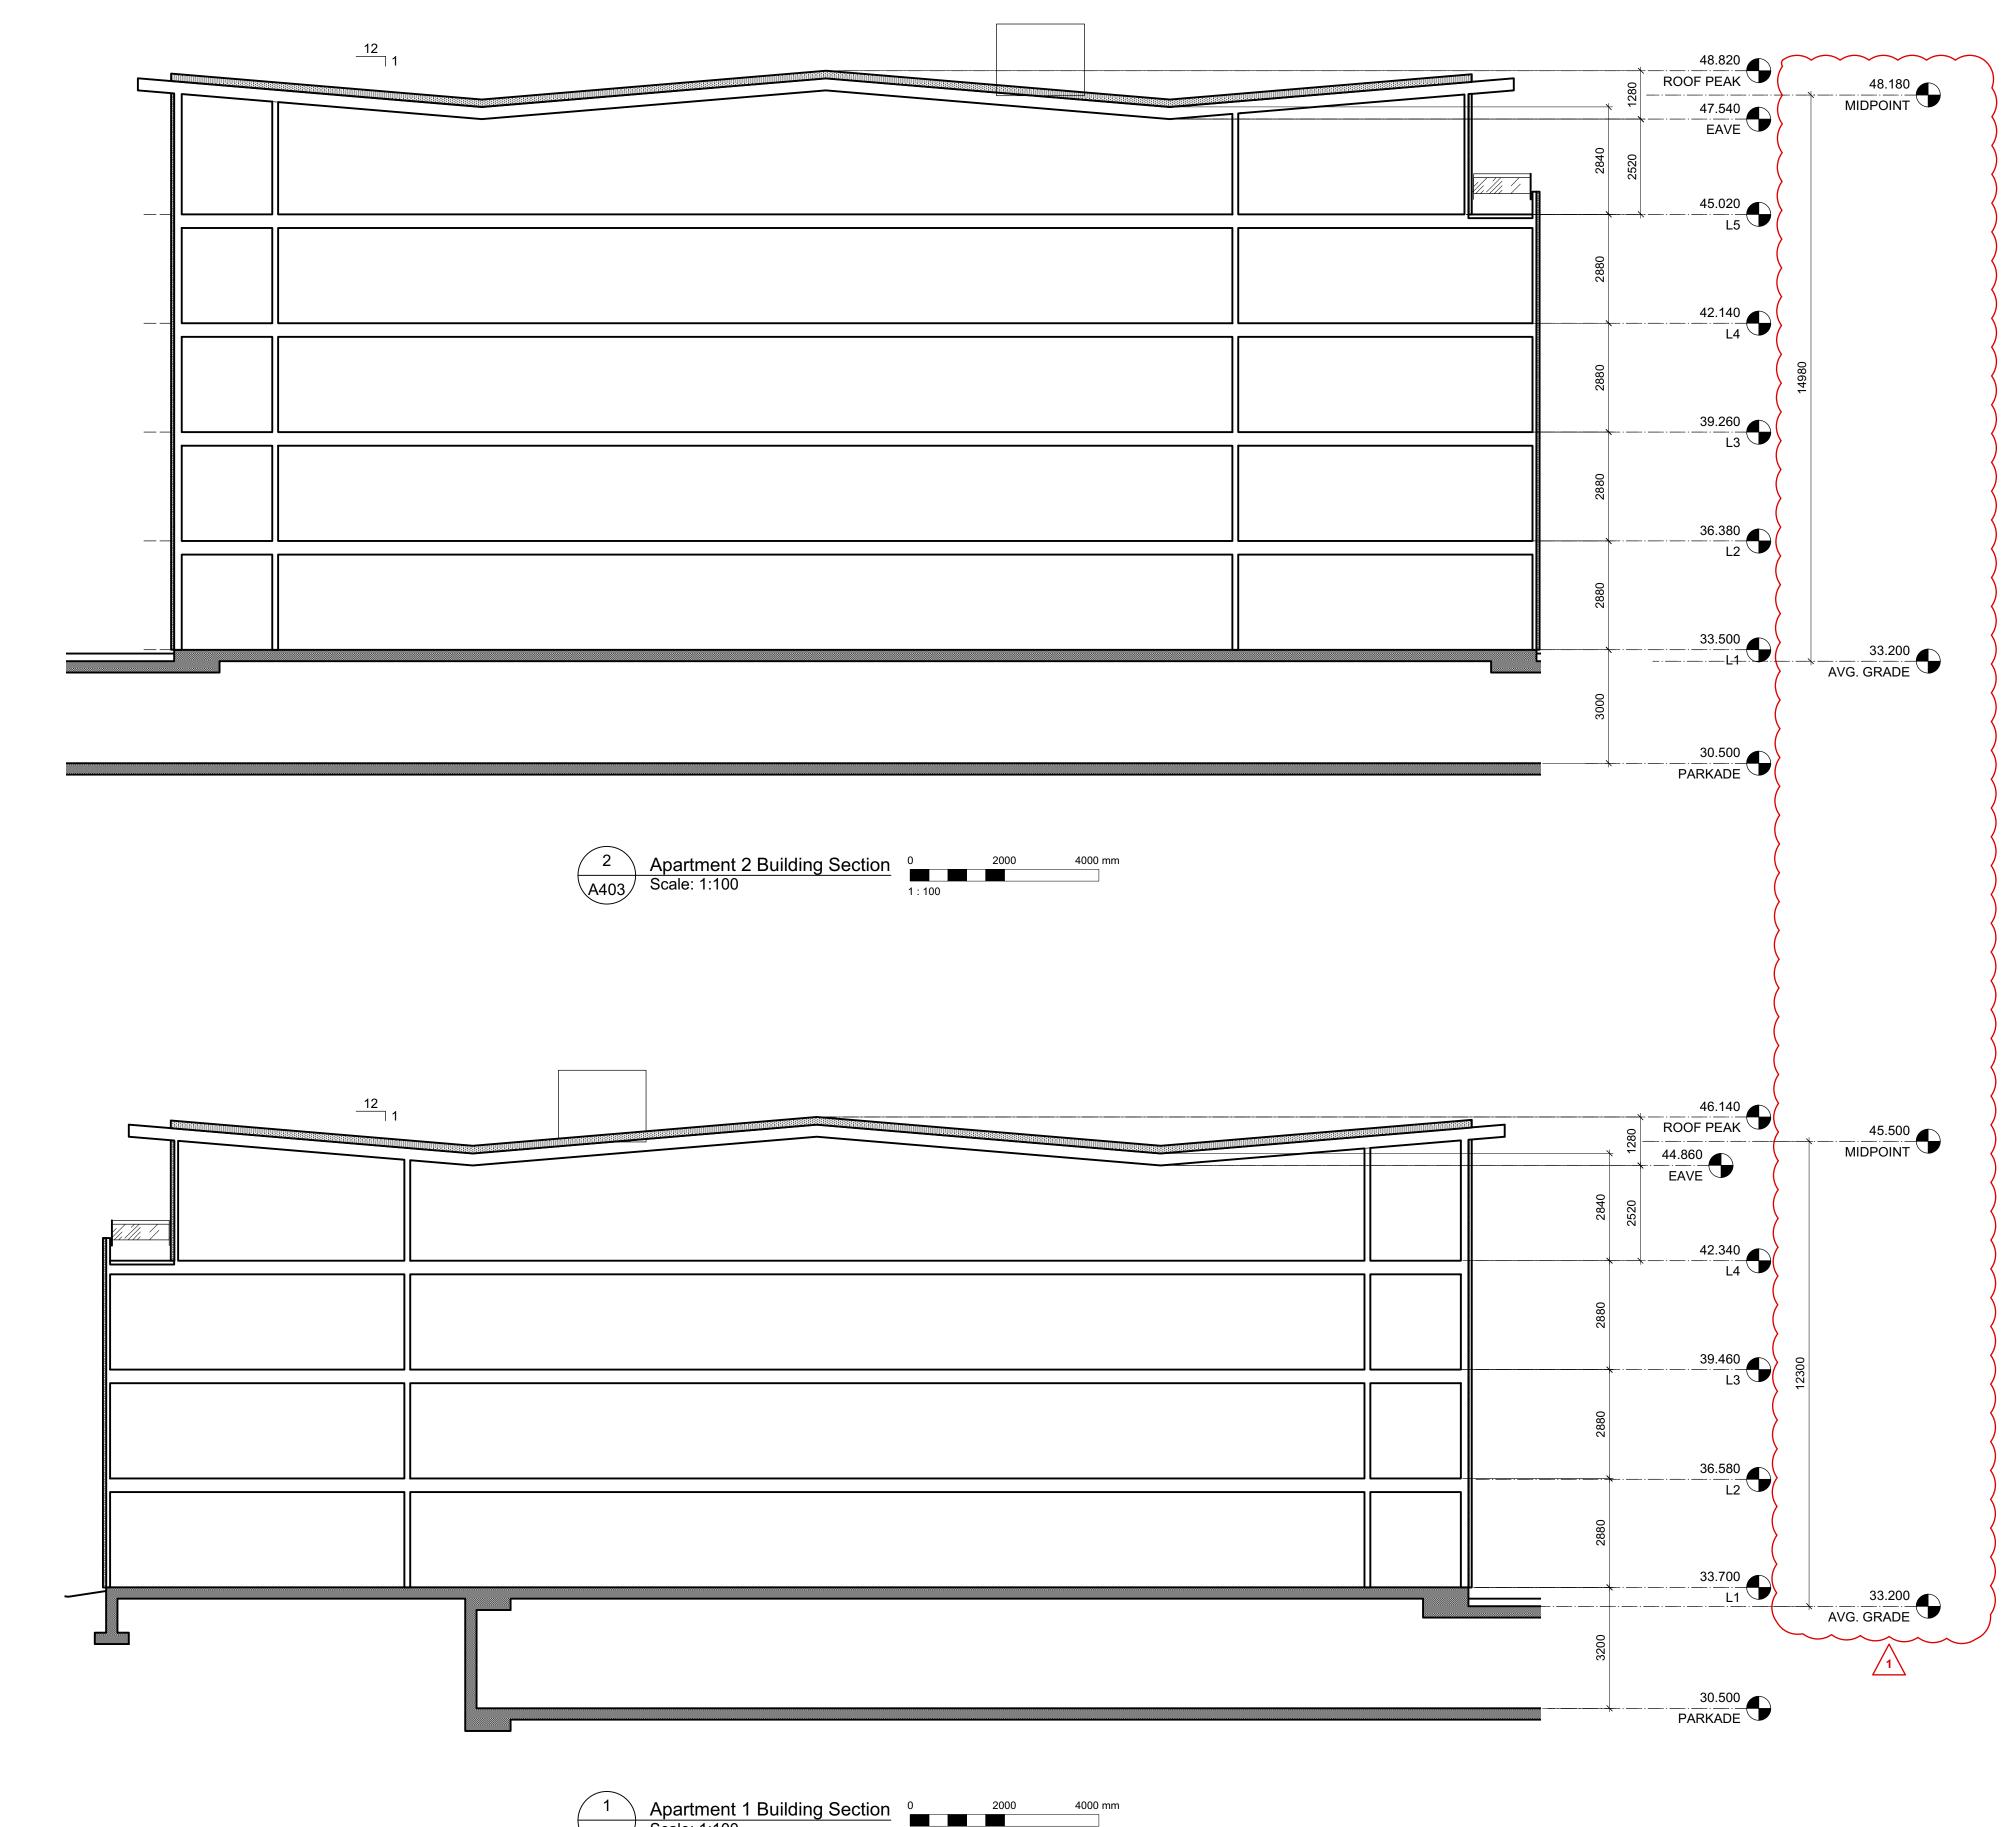Recalculated average grades as per Planning request. Building areas consolidated as per area of parkade above natural grade.


Corresponding data, including building heights updated accordingly. Adjustment made due to notation error. No change to actual data. Site coverage and open site space recalculated as per Planning request. See Revision Note #1.





RE-ISSUED FOR COTW		20/09/01	5
RE-ISSUED FOR COTW		20/03/13	4
ISSUED FOR COTW		20/02/06	3
ISSUED FOR ADP		20/01/15	2
RESPONSE TO PLANNING REVIEW		19/12/16	1
	Description	Date	Rev
1907.2 A200 Plans.vwx	drawing file	SEPTEMBER 2020	plot date
RAW	checked by	FWP/NLC	drawn by
per 1907	project number	AS SHOWN	scale

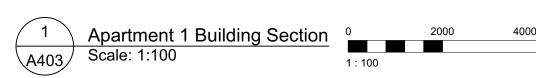NOTE: All dimensions are shown in millimeters. ISSUED FOR DP & REZONING



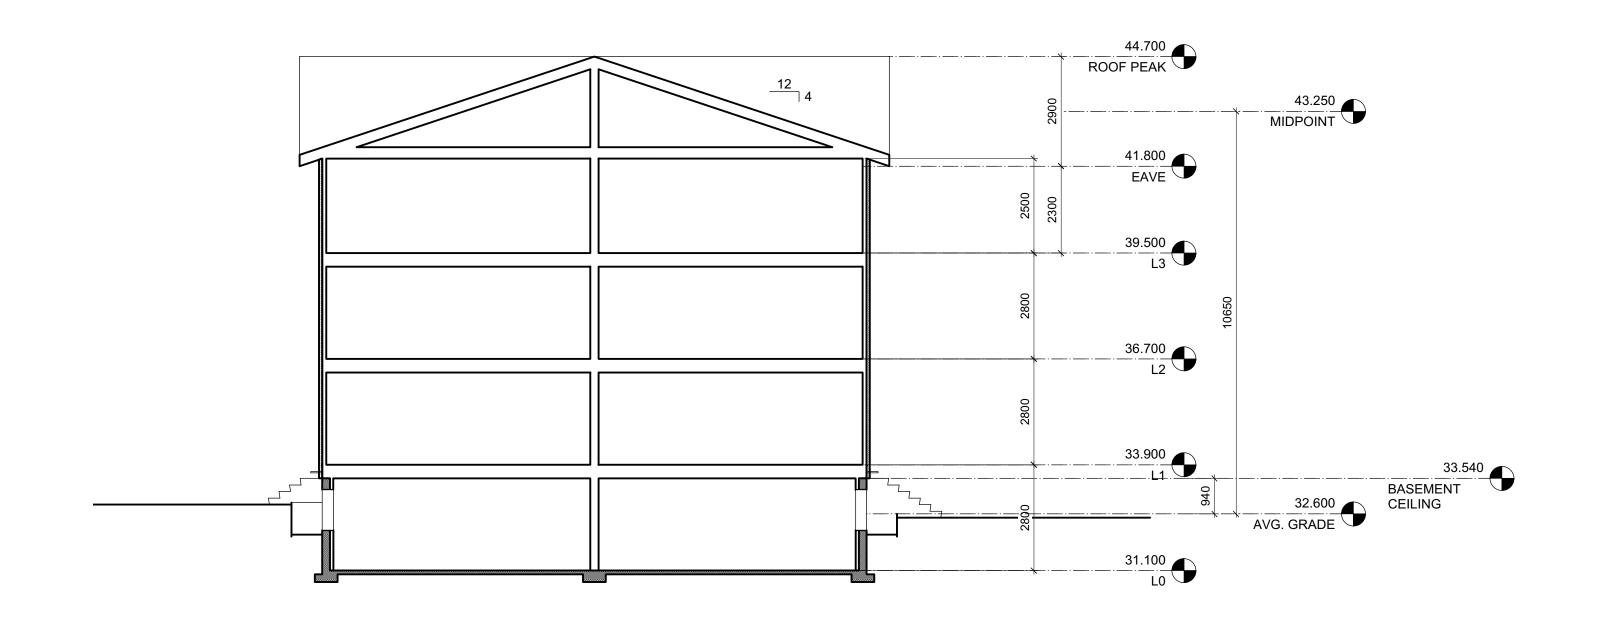

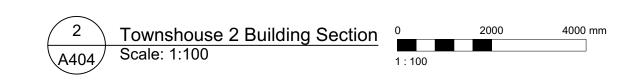

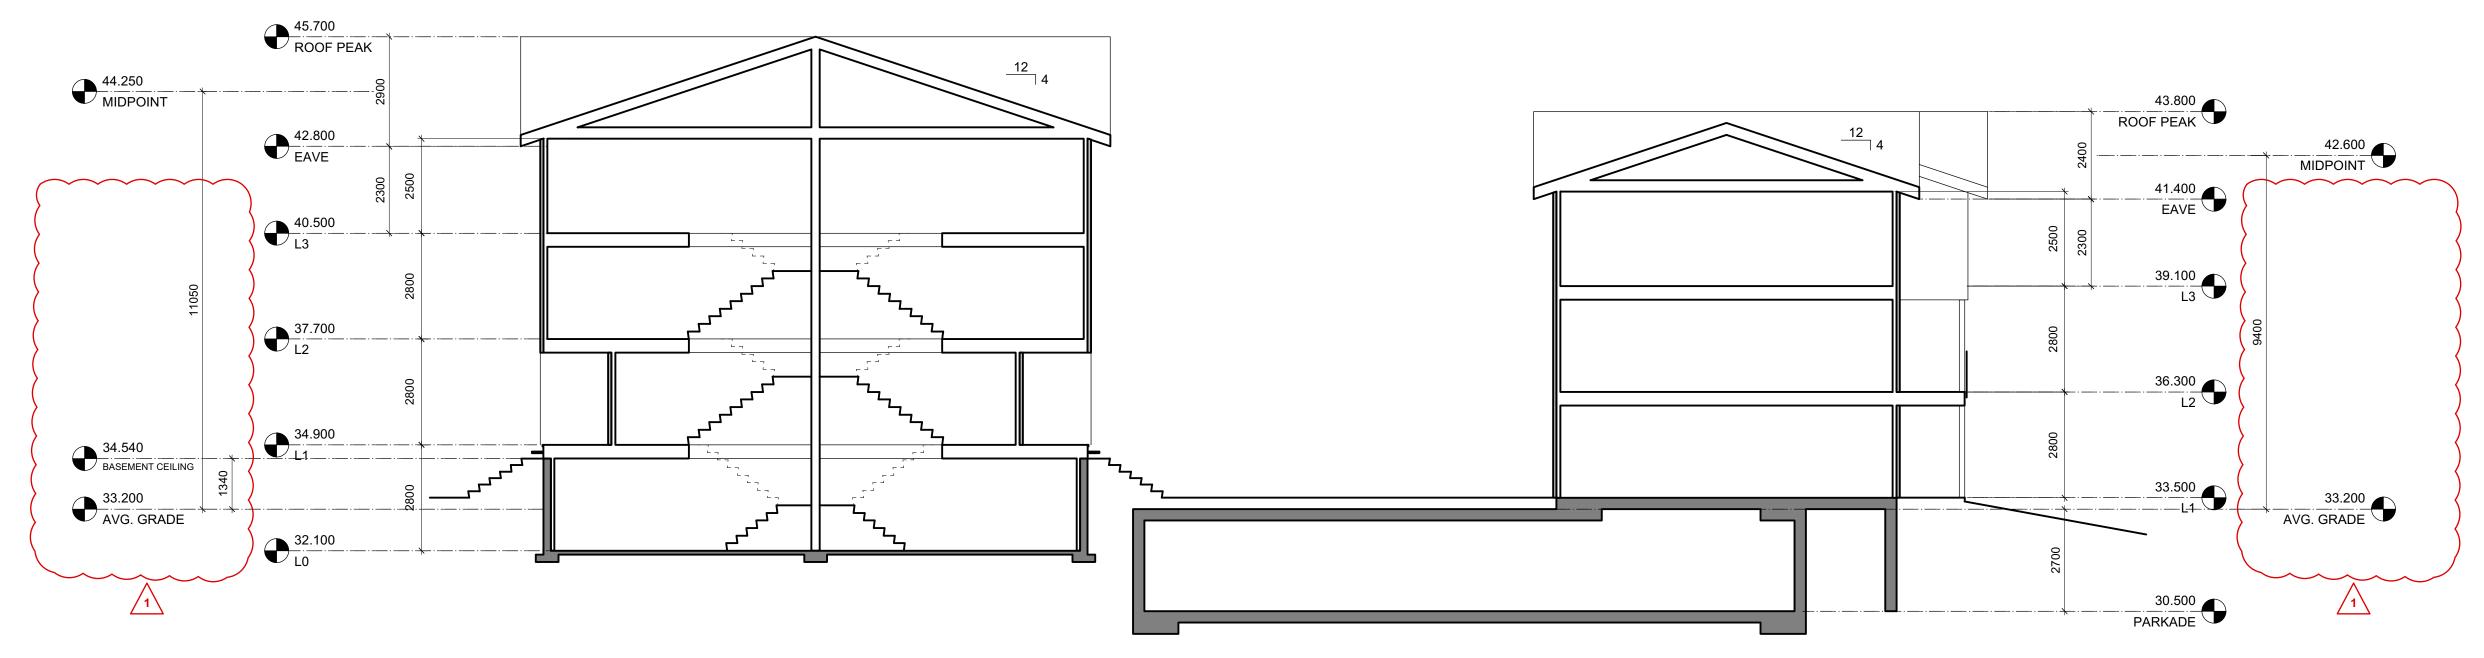

5	20/09/01	RE-ISSUED FOR COTW
4	20/03/13	RE-ISSUED FOR COTW
3	20/02/06	ISSUED FOR COTW
2	20/01/15	ISSUED FOR ADP
1	19/12/16	RESPONSE TO PLANNING REVIEW
Rev	Date	Description
plot date	SEPTEMBER 2020	drawing file 1907.2 A200 Plans.vwx
drawn by	FWP/NLC	checked by RAW
scale	AS SHOWN	project number 1907
NOTE: All dim	ensions are shown in mi	limeters

NOTE: All dimensions are shown in millimeters. ISSUED FOR DP & REZONING

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VICTORIA OFFICE 977 Fort Street Victoria BC V8V 3K3 T 1.250.658.3367	NANAIMO OFFICE 102-5190 Du Nanaimo BC T 1•250•585	blin Way V9T 2K8		
Caledonia Victoria BC				
Building Section	ns			
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REVISIONS LIST
Revision #5 - 1 SEPT 2020

Recalculated average grades as per Planning request. Building areas consolidated as per area of parkade above natural grade. Corresponding data, including building heights updated accordingly.

Adjustment made due to notation error. No change to actual data.

Site coverage and open site space recalculated as per Planning request. See Revision Note #1.


Townhouses 1 & 3 Building Section
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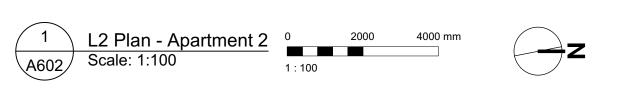
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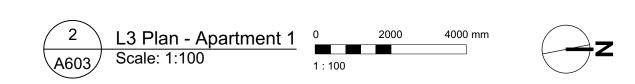
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4	20/03/13	RE-ISSUED FOR COTW
3	20/02/06	ISSUED FOR COTW
2	20/01/15	ISSUED FOR ADP
1	19/12/16	RESPONSE TO PLANNING REVIEW
Rev	Date	Description
plot date	SEPTEMBER 2020	drawing file 1907.2 A200 Plans.vwx
drawn by	FWP	checked by RAW
scale	AS SHOWN	project number 1907

PHIC LEGEND:			
]	STUDIO		
	1 BEDROOM		
	2 BEDROOM		
	3 BEDROOM		
	4 BEDROOM		
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VICTORIA OFFICE 977 Fort Street Victoria BC V8V3K3 T 1•250•658•3367	NANAIMO OFFICE 102-5190 Du Nanaimo BC T 1•250•585	blin Way V9T 2K8
caledonia		
Victoria BC		
drawing title		
L2 Plan - Apartments		
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4	20/03/13	RE-ISSUED FOR COTW
3	20/02/06	ISSUED FOR COTW
2	20/01/15	ISSUED FOR ADP
1	19/12/16	RESPONSE TO PLANNING REVIEW
Rev	Date	Description
plot date	SEPTEMBER 2020	drawing file 1907.2 A200 Plans.vwx
drawn by	FWP	checked by RAW
scale	AS SHOWN	project number 1907

dHKarchitects


NANAIMO OFFICE 102-5190 Dublin Way Nanaimo BC V9T2K8 **T** 1•250•585•5810


revision no.

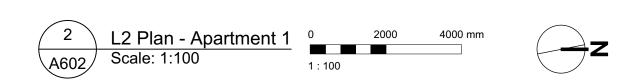GRAPHIC LEGEND:	
STUDIO	dHKa dHKa
1 BEDROOM	VICTORIA OFFICE NANAIMO O 977 Fort Street 102-5196 Victoria BC V8V 3K3 Nanaimo T 1-250.658-3367 T 1-250.
2 BEDROOM	project name
3 BEDROOM	Caledonia
4 BEDROOM	Victoria BC
& ACCESSIBLE	L3 Plan - Apartments
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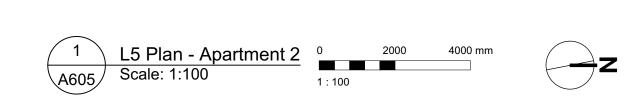


5	20/09/01	RE-ISSUED FOR COTW
4	20/03/13	RE-ISSUED FOR COTW
3	20/02/06	ISSUED FOR COTW
2	20/01/15	ISSUED FOR ADF
1	19/12/16	RESPONSE TO PLANNING REVIEW
Rev	Date	Description
plot date	SEPTEMBER 2020	drawing file 1907.2 A200 Plans.vwx
drawn by	FWP	checked by RAW
scale	AS SHOWN	project number 1907

GRAP	HIC LEGEND:	<u> </u>
	STUDIO	dHKa
	1 BEDROOM	VICTORIA OFFICE 977 Fort Street Victoria BC V8V3K
	2 BEDROOM	T 1 • 2 5 0 • 6 5 8 • 3 3 6 7
	3 BEDROOM	Caledonia
	4 BEDROOM	Victoria BC
Ğ	ACCESSIBLE	L4 Plan - Ap
		COPYRIGHT RESERVED. THESE PLANS DESIGNS ARE AND AT ALL TIMES REMAI

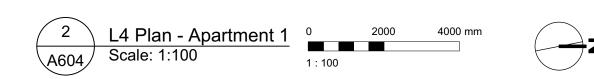& INEZOMINO		
- dHKa	dHKarc	hitects
VICTORIA OFFICE 977 Fort Street Victoria BC V8V3K3 T 1.250.658.3367	NANAIMO OFFICE 102-5190 Du Nanaimo BC T 1•250•585	blin Way V9T 2K8
Caledonia		
Victoria BC		
L4 Plan - Apartments		
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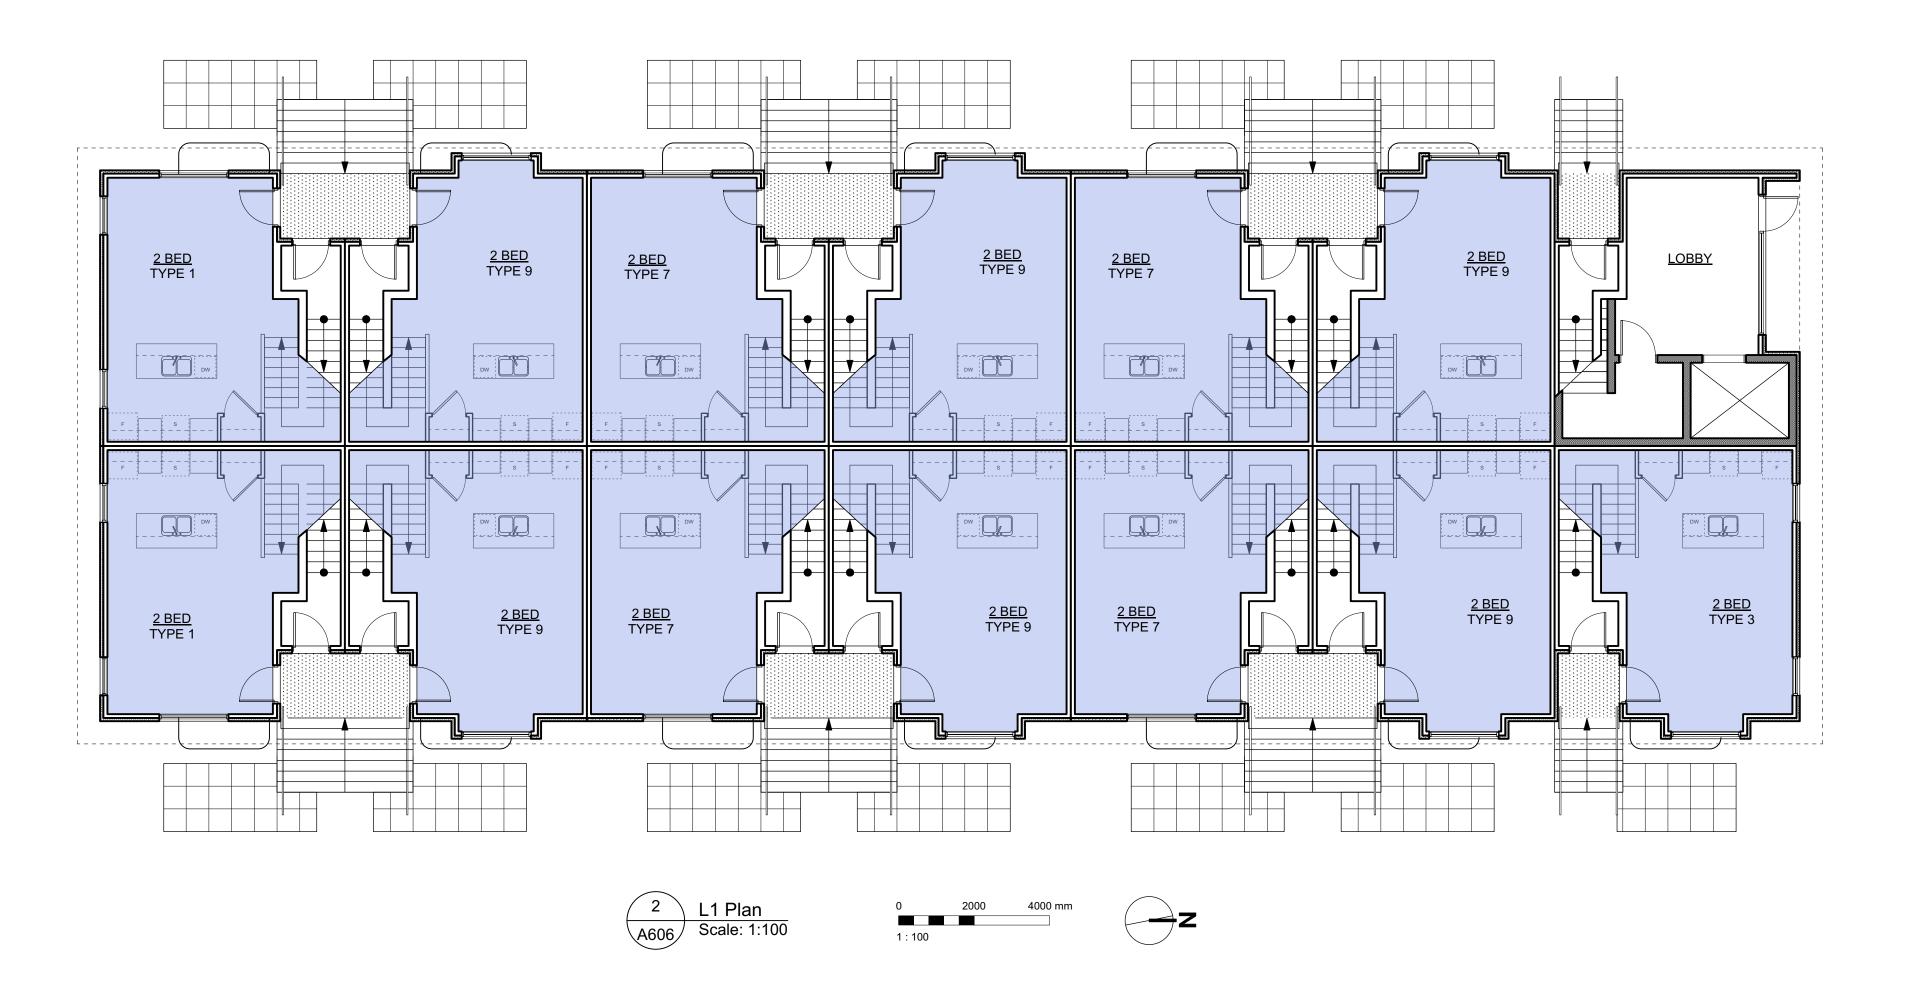


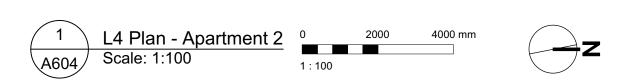
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4	20/03/13	RE-ISSUED FOR COTW
3	20/02/06	ISSUED FOR COTW
2	20/01/15	ISSUED FOR ADP
1	19/12/16	RESPONSE TO PLANNING REVIEW
Rev	Date	Description
plot date	SEPTEMBER 2020	drawing file 1907.2 A200 Plans.vwx
drawn by	FWP	checked by RAW
scale	AS SHOWN	project number 1907
NOTE: All dim	ensions are shown in mi	llimeters.


dHKa	dHKarc	
VICTORIA OFFICE 977 Fort Street Victoria BC V8V 3K3 T 1.250.658.3367	NANAIMO OFFICE 102-5190 Du Nanaimo BC T 1•250•585	blin Way V9T 2K8
Caledonia		
Victoria BC		
L5 Plan - Apart	ments	
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GRAP	HIC LEGEND
	STUDIO
	1 BEDROO
	2 BEDROO
	3 BEDROO
	4 BEDROO
Ġ.	ACCESSIBI








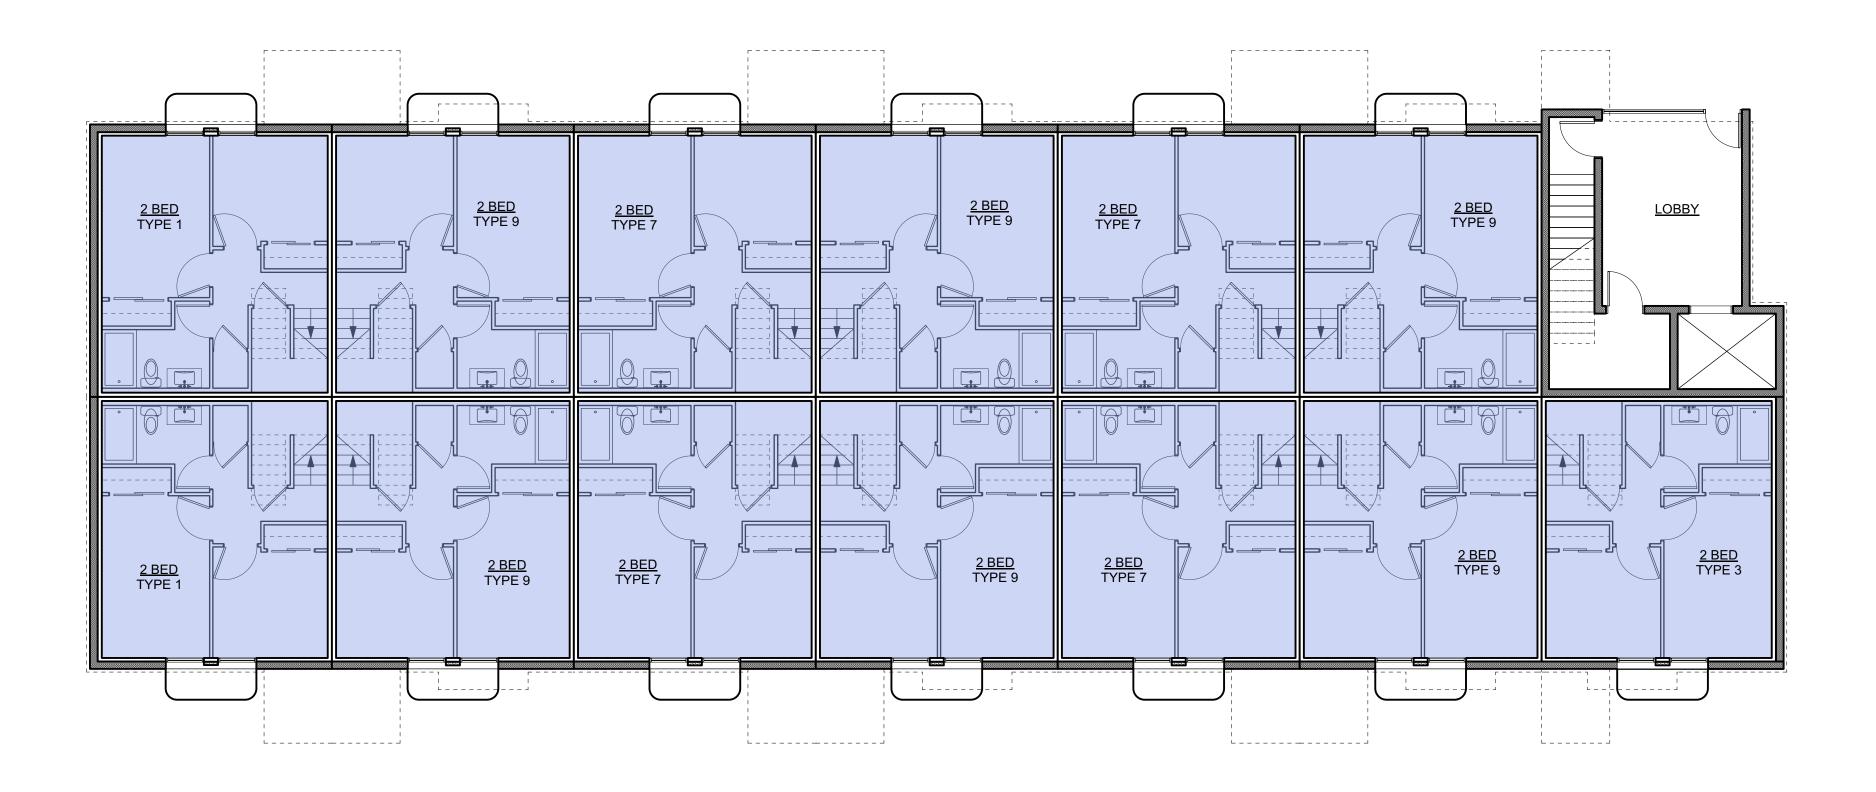


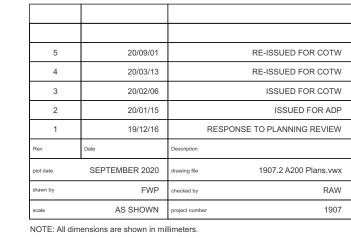




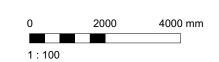




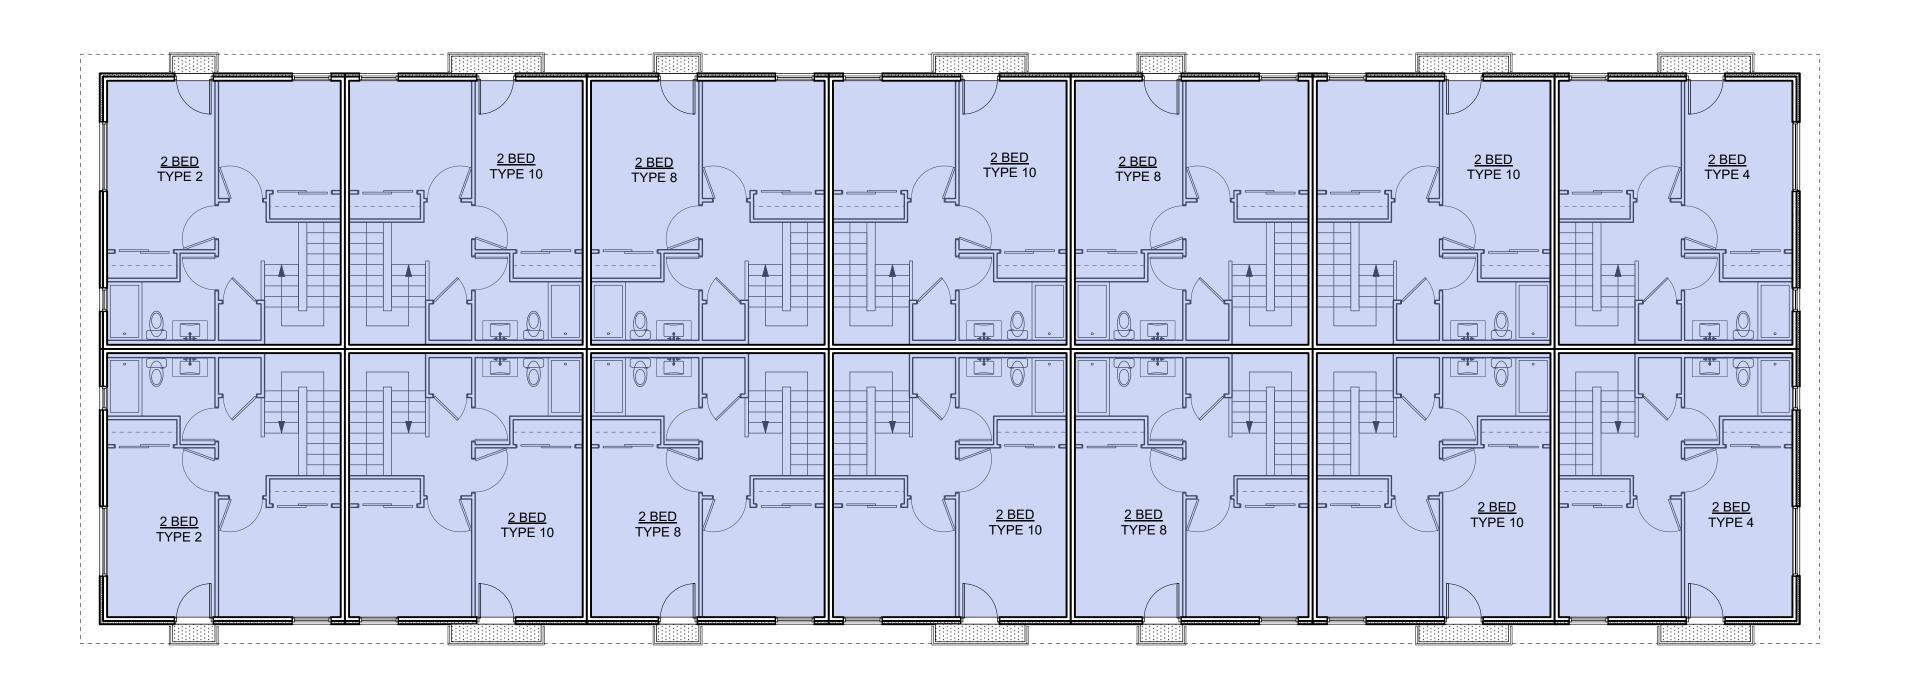




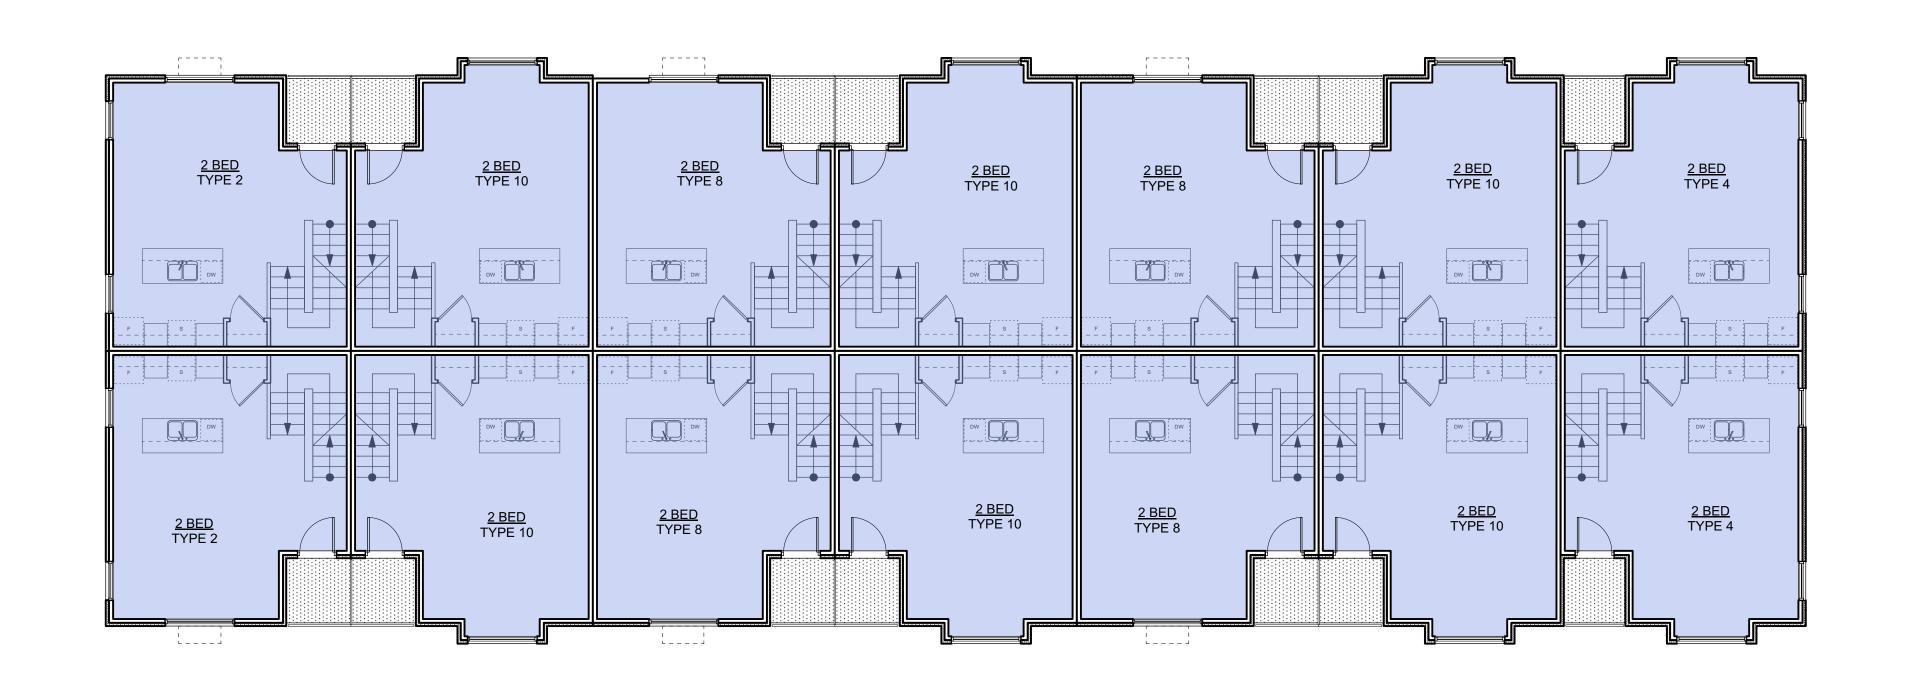

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2	20/01/15	ISSUED FOR ADP	
1	19/12/16	RESPONSE TO PLANNING REVIEW	
Rev	Date	Description	
plot date	SEPTEMBER 2020	drawing file 1907.2 A200 Plans.vwx	
drawn by FWP		checked by RAW	
scale AS SHOWN		project number 1907	
NOTE: All dimensions are shown in millimeters.			

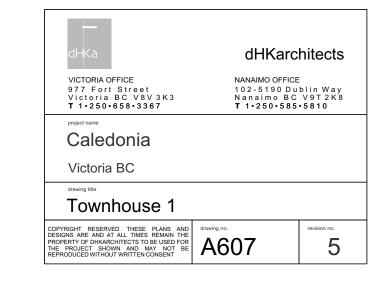





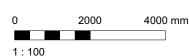






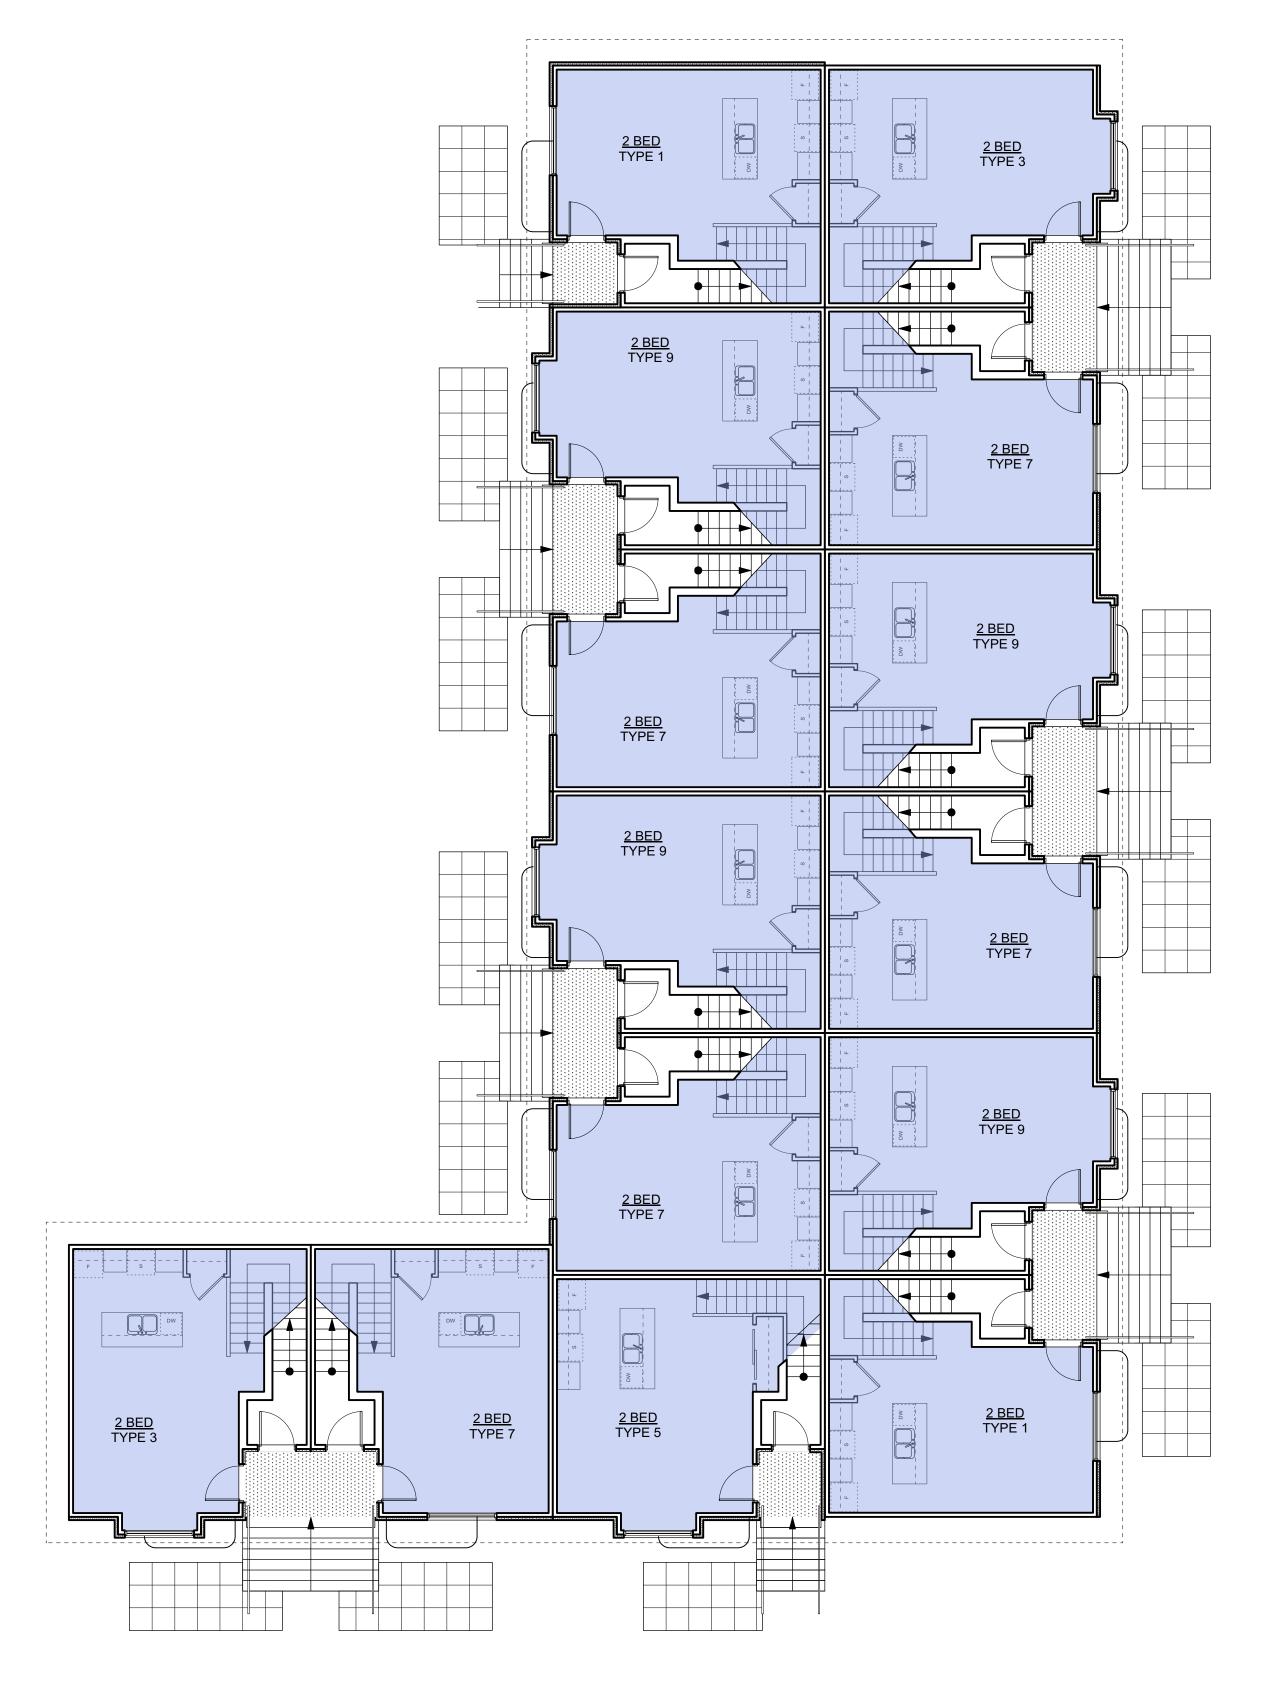


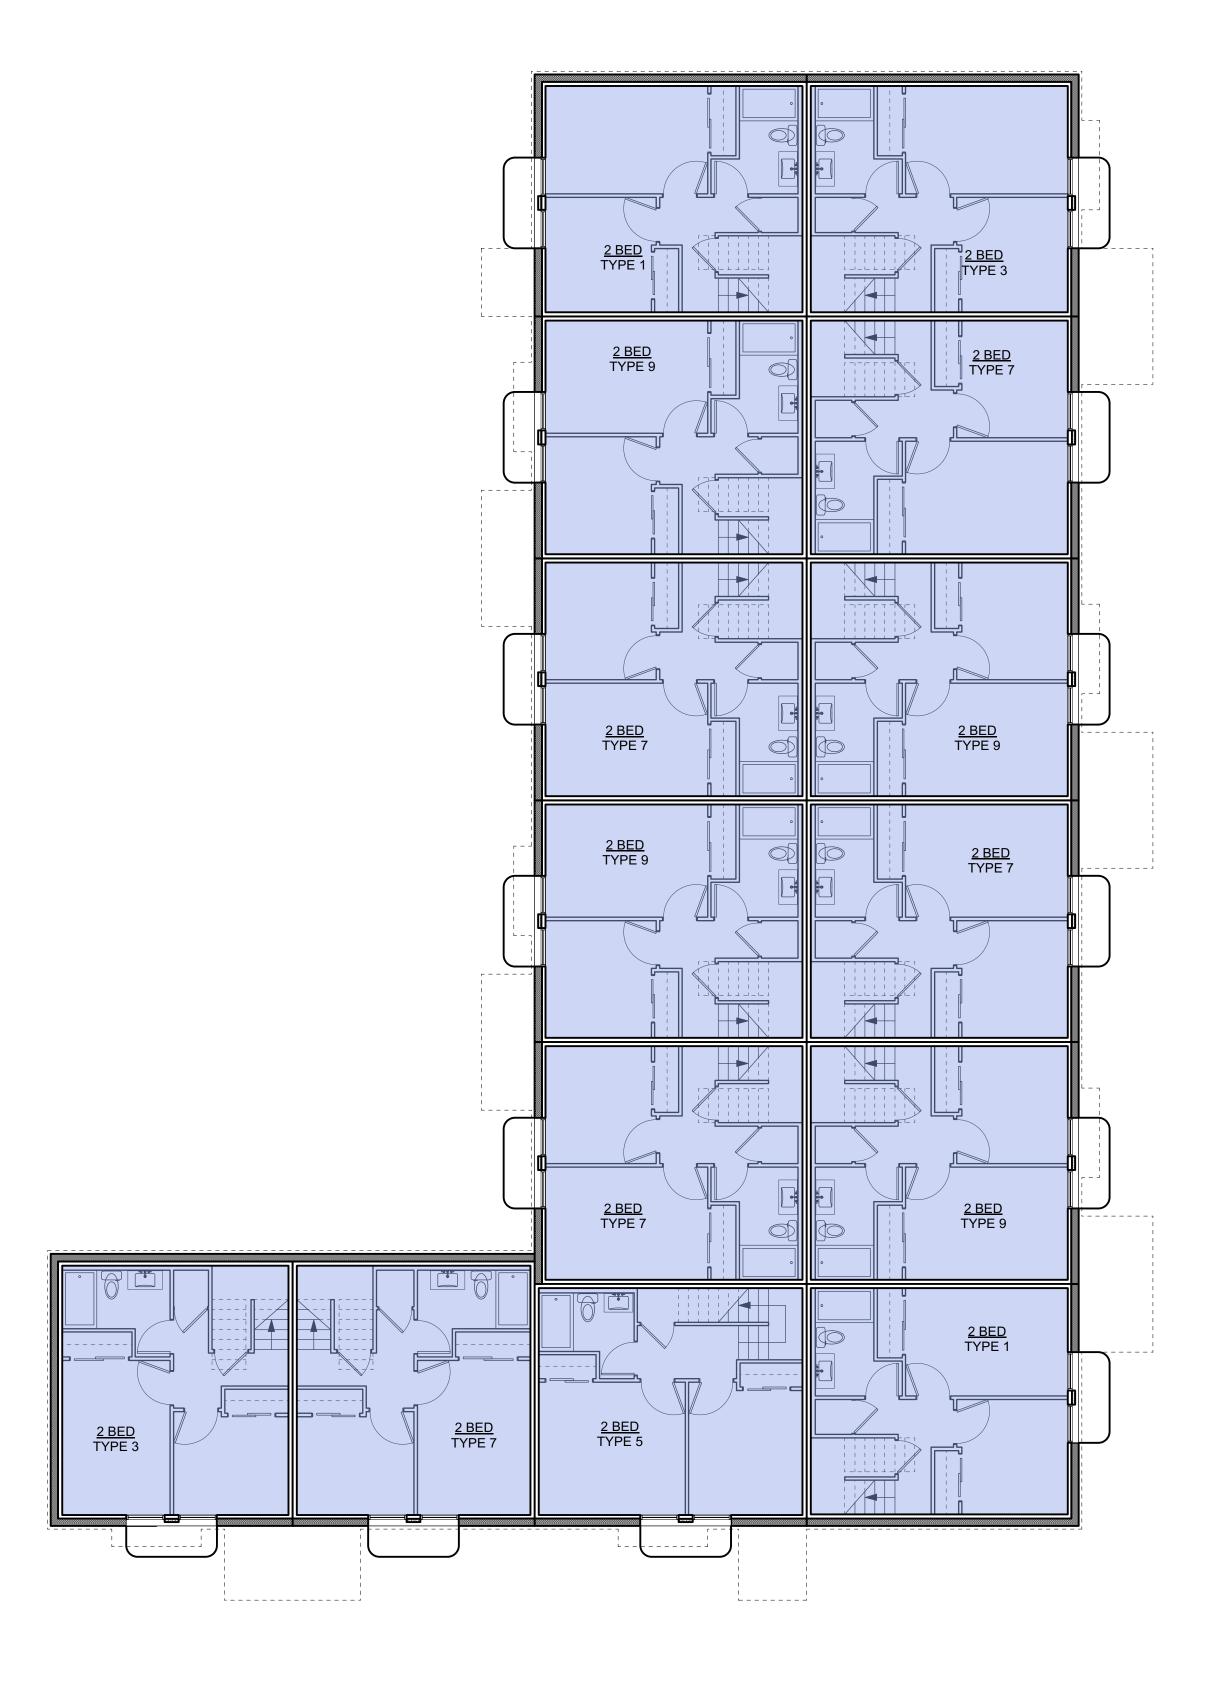

5	20/09/01	RE-ISSUED FOR C
4	20/03/13	RE-ISSUED FOR CO
3	20/02/06	ISSUED FOR CO
2	20/01/15	ISSUED FOR
1	19/12/16	RESPONSE TO PLANNING REV
Rev	Date	Description
plot date	SEPTEMBER 2020	drawing file 1907.2 A200 Plans
drawn by	FWP	checked by
scale	AS SHOWN	project number



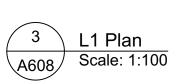

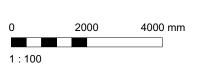












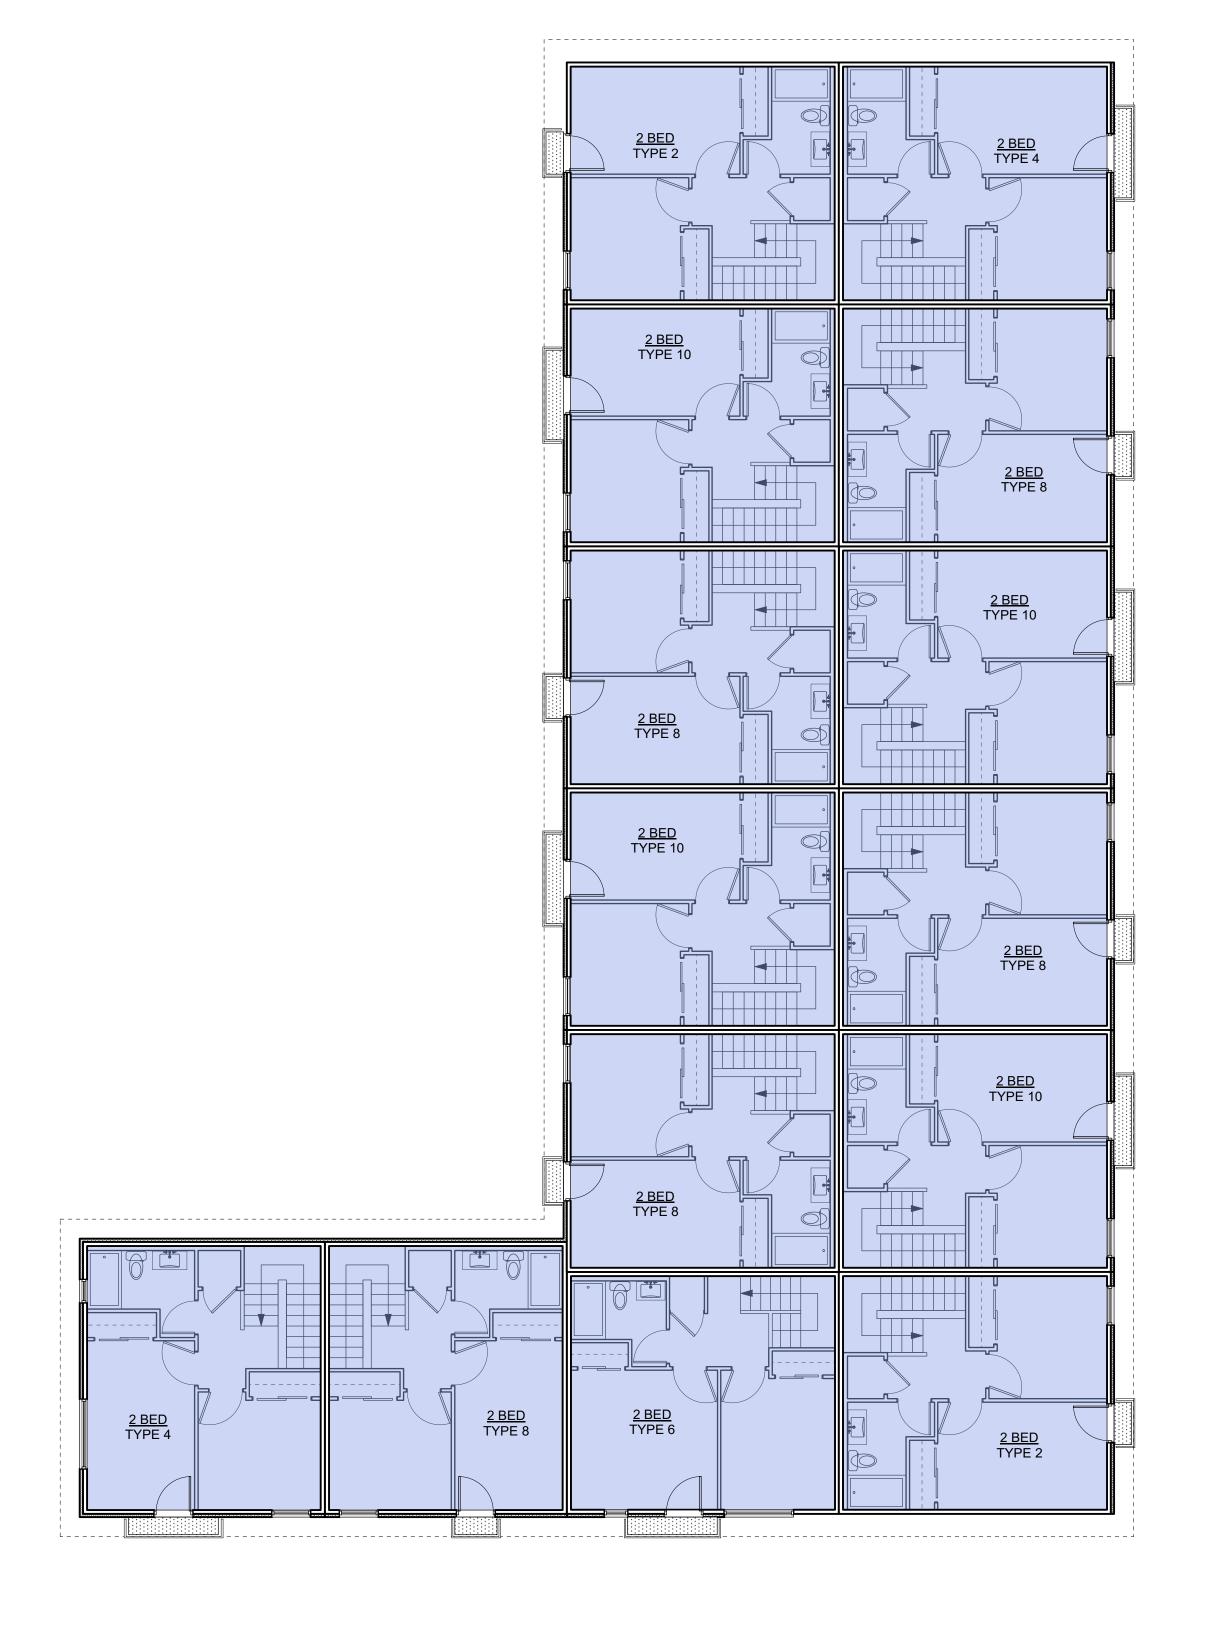


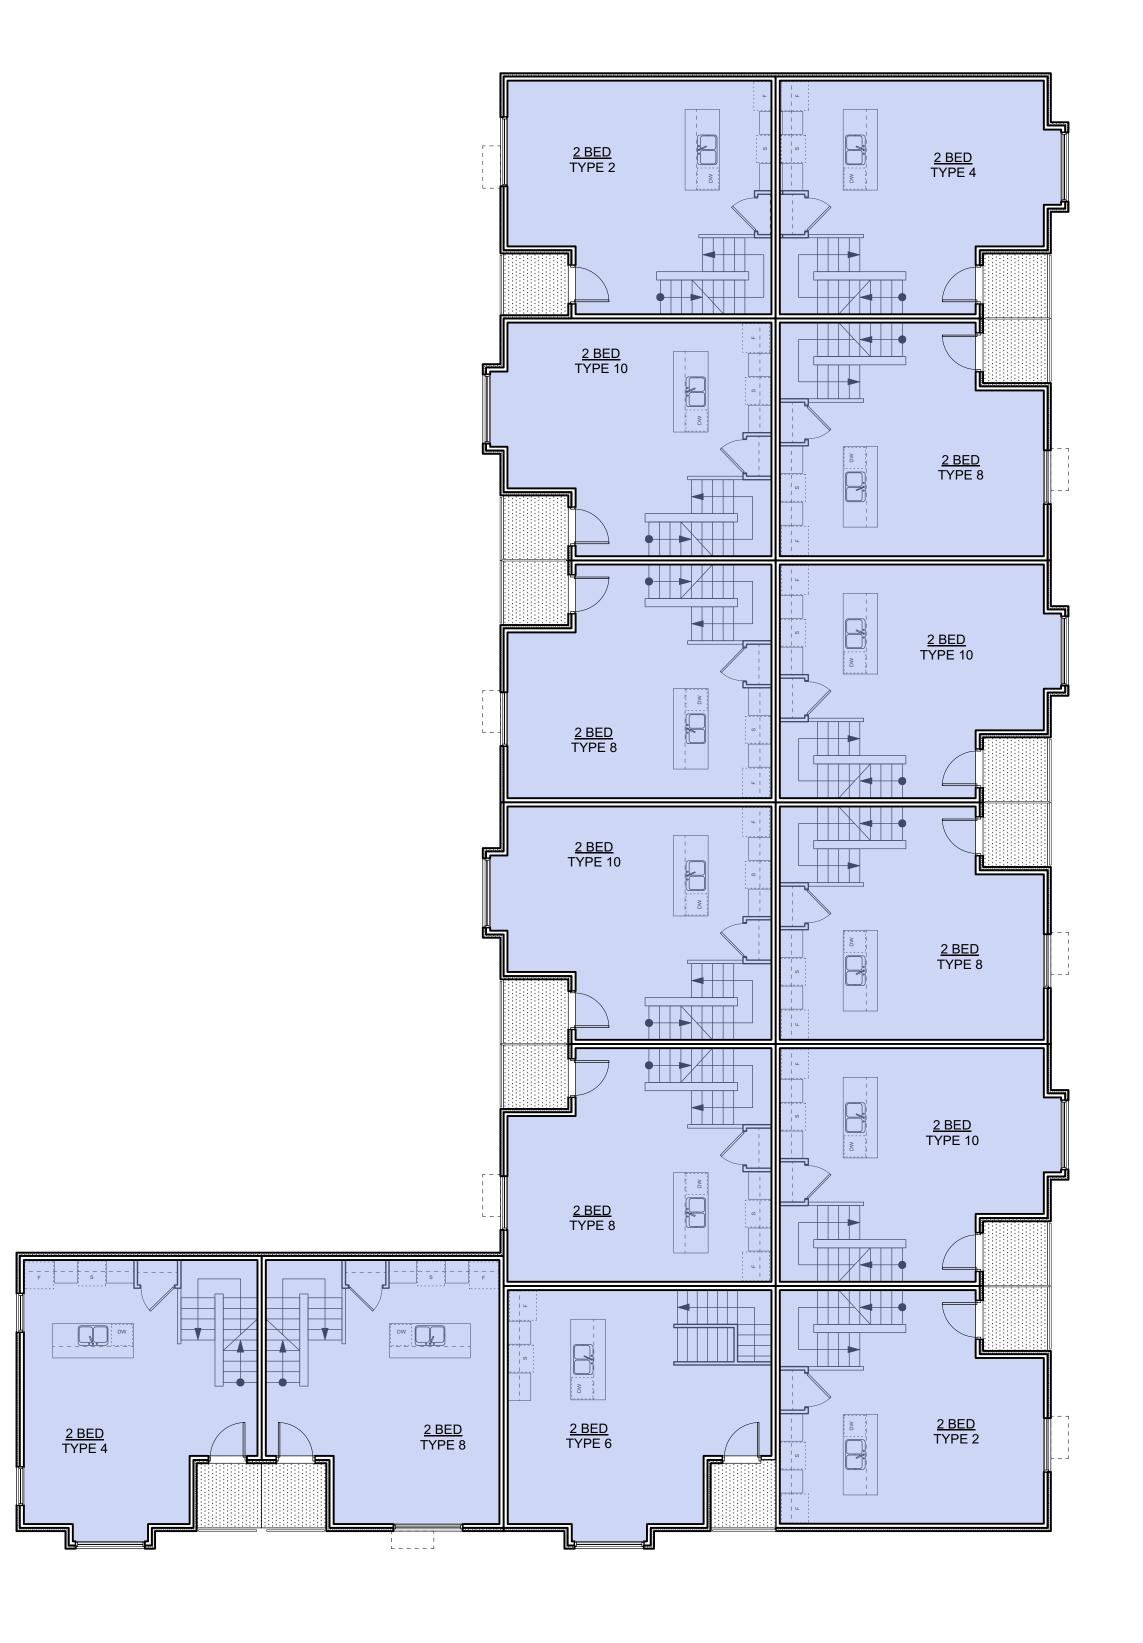


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4	20/03/13	RE-ISSUED FOR COTW
3	20/02/06	ISSUED FOR COTW
2	20/01/15	ISSUED FOR ADP
1	19/12/16	RESPONSE TO PLANNING REVIEW
Rev	Date	Description
plot date	SEPTEMBER 2020	drawing file 1907.2 A200 Plans.vwx
drawn by	FWP	checked by RAW
scale	AS SHOWN	project number 1907
		•



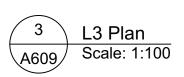


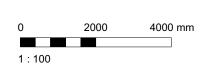




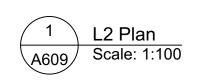




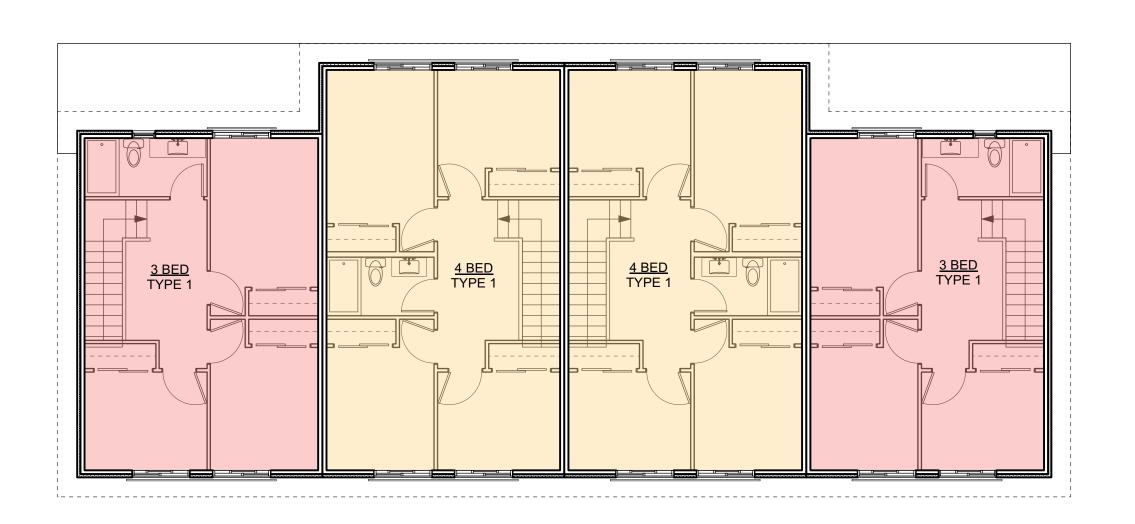



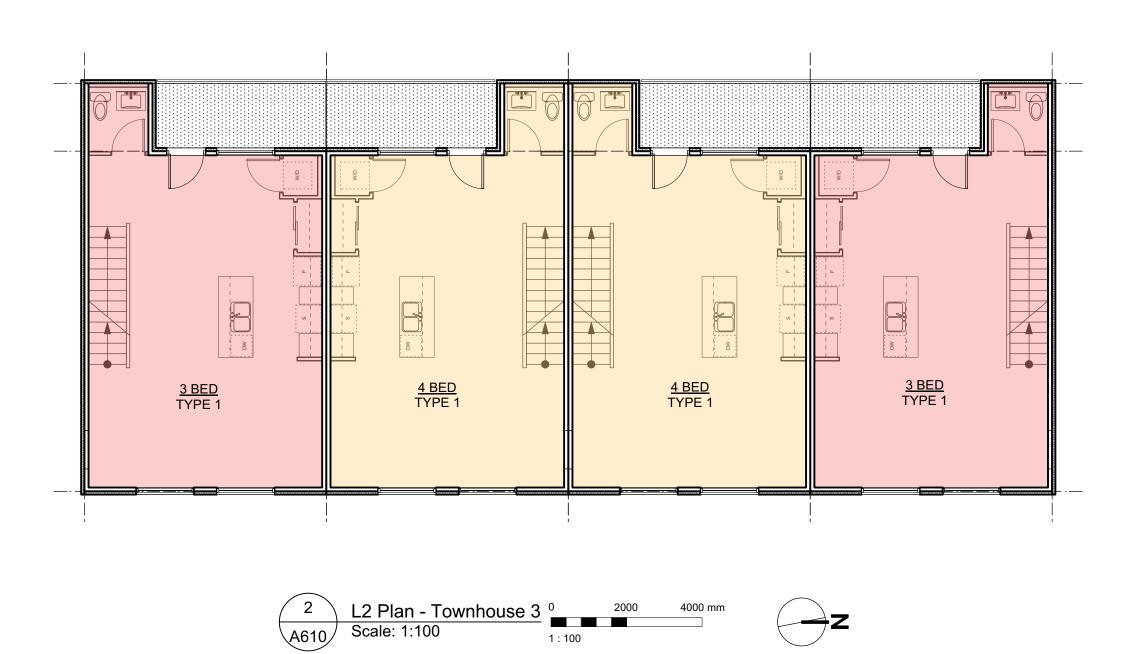

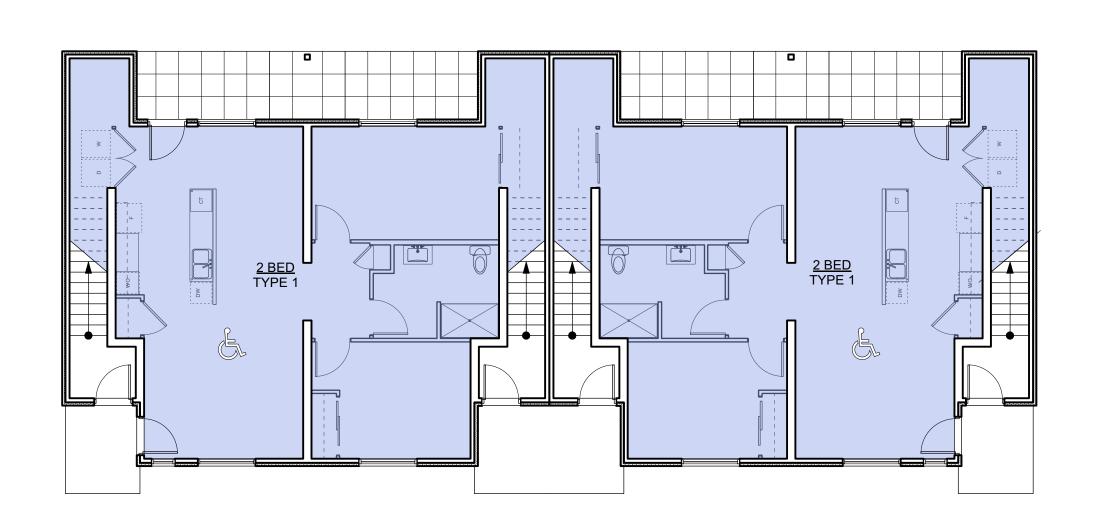



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4	20/03/13	RE-ISSUED FOR COTV
3	20/02/06	ISSUED FOR COTV
2	20/01/15	ISSUED FOR ADA
1	19/12/16	RESPONSE TO PLANNING REVIEW
Rev	Date	Description
plot date	SEPTEMBER 2020	drawing file 1907.2 A200 Plans.vw
drawn by	FWP	checked by RAV
scale	AS SHOWN	project number 190

GRAPHIC LEGEND:

1 BEDROOM

2 BEDROOM

3 BEDROOM


4 BEDROOM

& ACCESSIBLE

STUDIO


dHKa	dHKarc	hitect
VICTORIA OFFICE 977 Fort Street Victoria BC V8V 3K3 T 1.250.658.3367	NANAIMO OFFICE 102-5190 Du Nanaimo BC T 1•250•585	blin Way V9T2K
Caledonia		
Victoria BC		
Townhouse 3		
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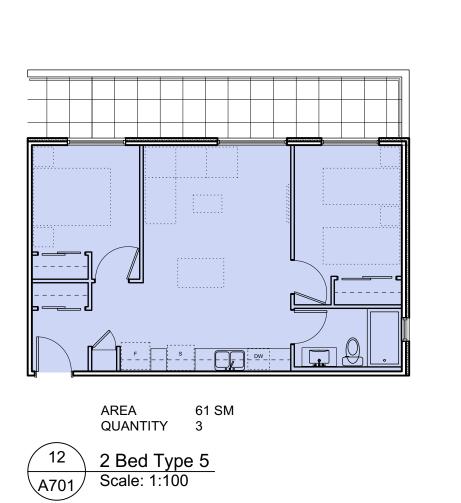


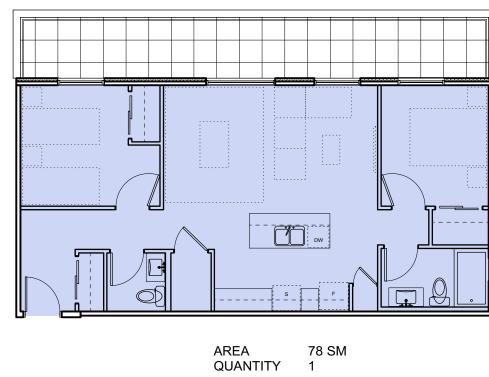



QUANTITY 1


14
2 Bed Type 7
A701 Scale: 1:100




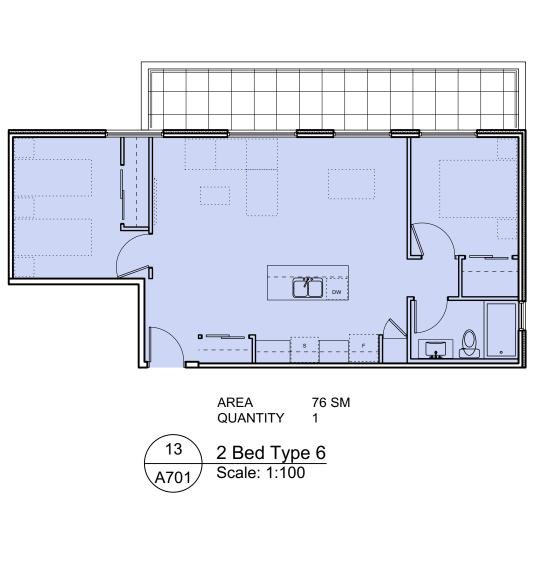


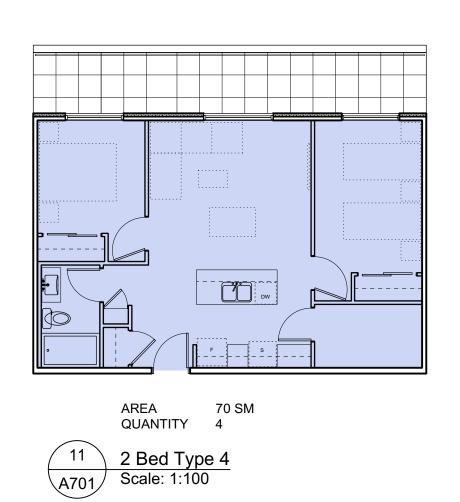

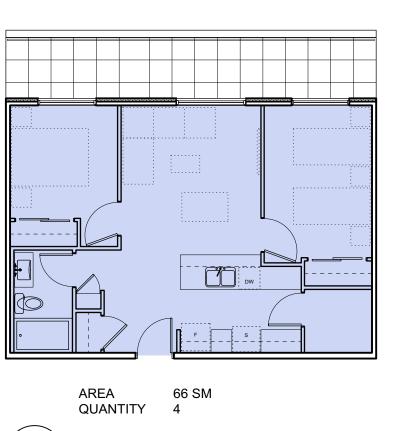

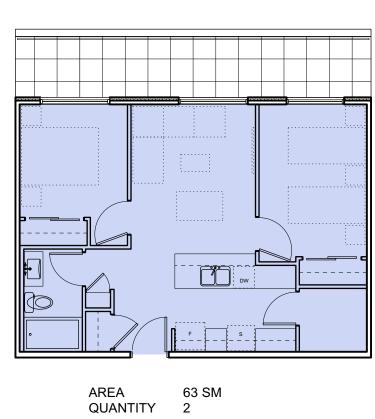

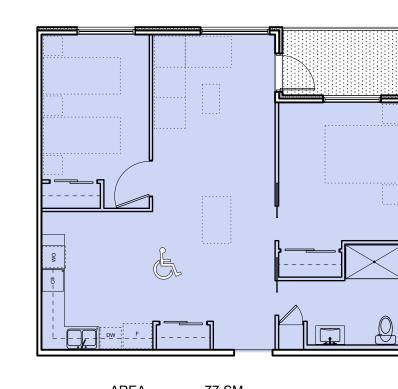


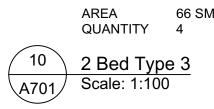



9 2 Bed Type 2 A701 Scale: 1:100


AREA 77 SM
QUANTITY 5


8 2 Bed Type 1 - Accessible
A701 Scale: 1:100

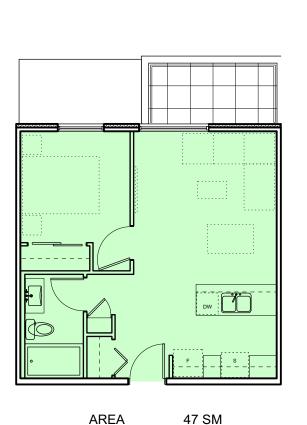


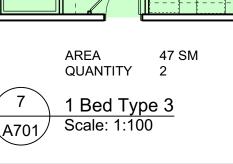

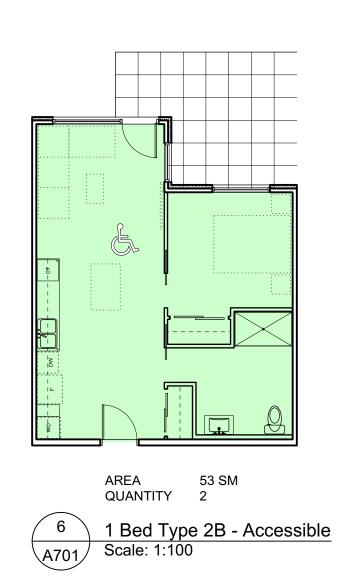


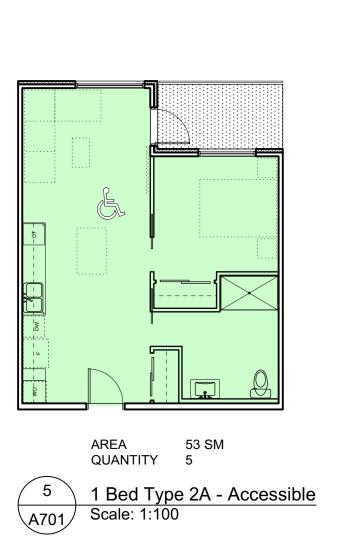

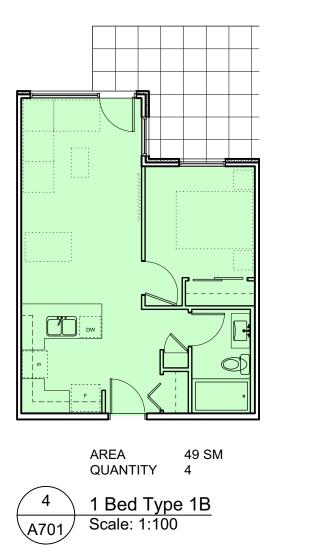

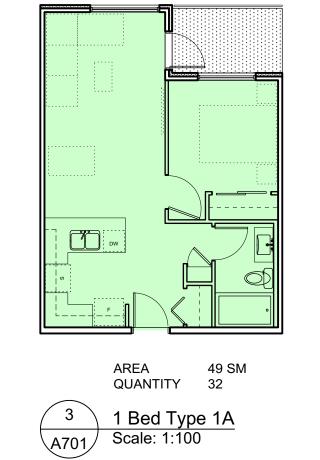



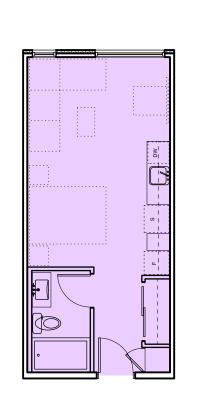

	AREA QUANTITY	34 SM 10			
1	Studio Typ	e 1A	0	2000	4000 mn
A701	Scale: 1:100		1 : 100		

1.5	SSUFI	D FOR DP
NOTE: All dim	ensions are shown in mi	llimeters.
scale	AS SHOWN	project number 19
drawn by	FWP	checked by RA
plot date	SEPTEMBER 2020	drawing file 1907.2 A200 Plans.vv
Rev	Date	Description
1	19/12/16	RESPONSE TO PLANNING REVIE
2	20/01/15	ISSUED FOR AI
3	20/02/06	ISSUED FOR COT
4	20/03/13	RE-ISSUED FOR COT


RE-ISSUED FOR COTW

20/09/01

dHKa	dHKarchitects
VICTORIA OFFICE 977 Fort Street Victoria BC V8V 3K3 T 1.250.658.3367	NANAIMO OFFICE 102-5190 Dublin Way Nanaimo BC V9T2K8 T 1•250•585•5810
project name	
Caledonia	
Victoria BC	
drawing title	
Apartment Unit	Plans







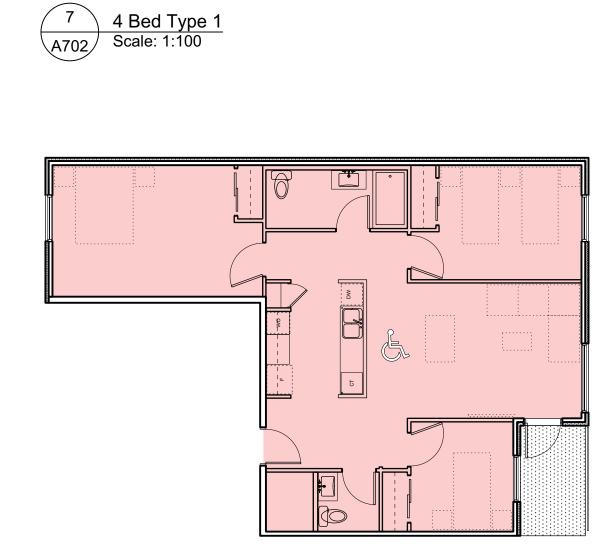



AREA 108 SM QUANTITY 2




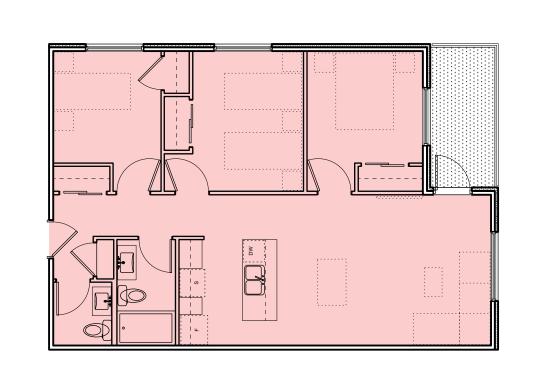


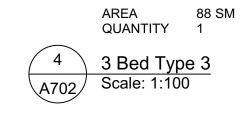


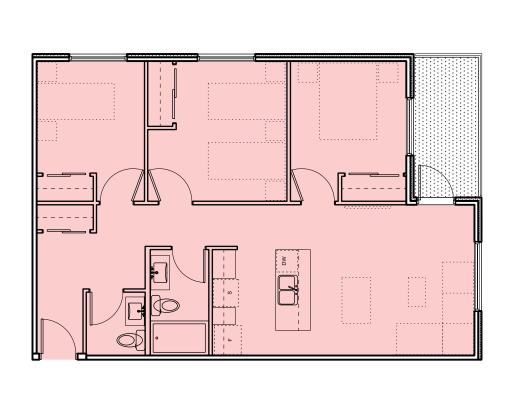

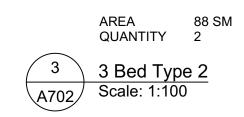

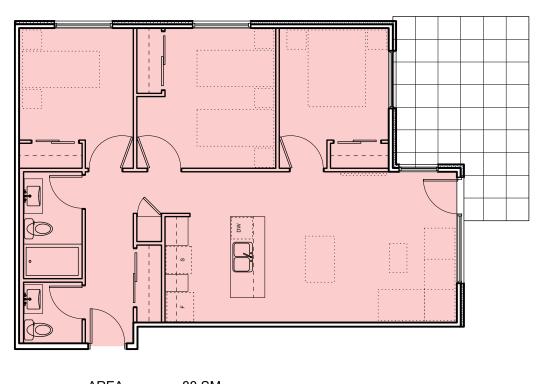

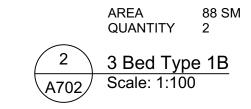

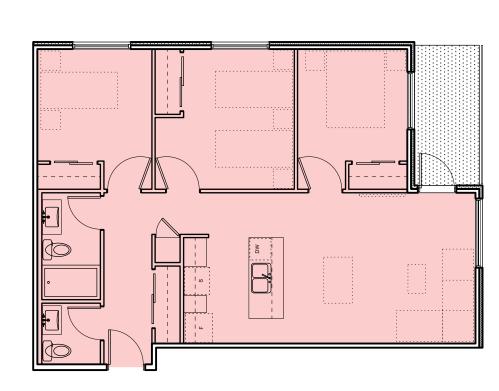

	AREA QUANTITY	88 SM 5		
A702	3 Bed Type Scale: 1:100		2000	4000 mm

RE-ISSUED FOR COTW	20/09/01	5
RE-ISSUED FOR COTW	20/03/13	4
ISSUED FOR COTW	20/02/06	3
ISSUED FOR ADP	20/01/15	2
RESPONSE TO PLANNING REVIEW	19/12/16	1
Description	Date	Rev
drawing file 1907.2 A200 Plans.vwx	SEPTEMBER 2020	plot date
checked by RAW	FWP	drawn by
project number 1907	AS SHOWN	scale

ISSUED FOR DP
& REZONING

- dHKa	dHKarchitects	
VICTORIA OFFICE 977 Fort Street Victoria BC V8V 3K3 T 1•250•658•3367	NANAIMO OFFICE 102-5190 Dublin Way Nanaimo BC V9T2K8 T 1•250•585•5810	
project name		
Caledonia		
Victoria BC		
drawing title		
Apartment Unit	Plans	
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GRAPHIC LEGEND:

1 BEDROOM

2 BEDROOM

3 BEDROOM

4 BEDROOM

& ACCESSIBLE

RE-ISSUED FOR COTW RE-ISSUED FOR COTW

ISSUED FOR COTW

1907.2 A200 Plans.vwx

dHKarchitects

NANAIMO OFFICE 102-5190 Dublin Way Nanaimo BC V9T2K8 **T** 1•250•585•5810

ISSUED FOR ADP

20/03/13

20/01/15

19/12/16

FWP checked by


& REZONING

AS SHOWN project number


SEPTEMBER 2020 de


STUDIO



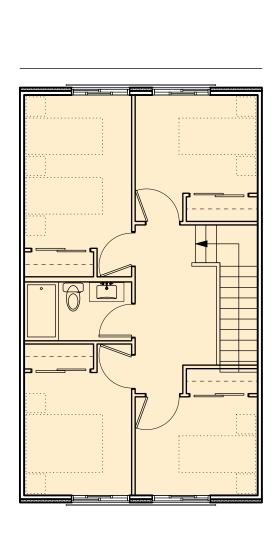




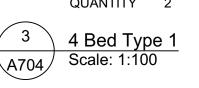

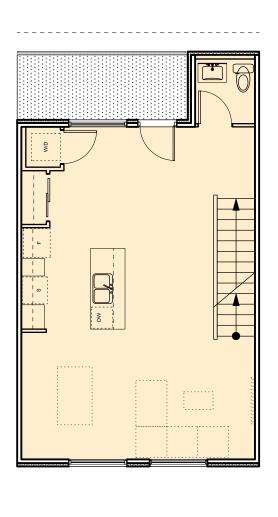



L0 - FIRST FLOOR

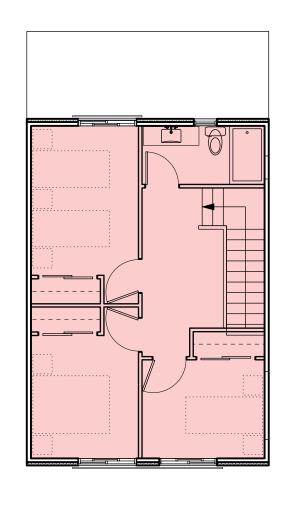

L1 - SECOND FLOOR

AREA 118 SM
QUANTITY 2

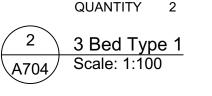


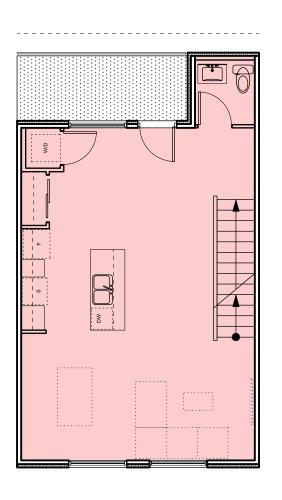


L0 - FIRST FLOOR



AREA	104 SM
OLIANITITY	2

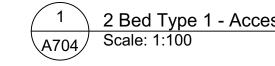


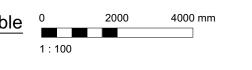



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4	20/03/13	RE-ISSUED FOR COTW
3	20/02/06	ISSUED FOR COTW
2	20/01/15	ISSUED FOR ADF
1	19/12/16	RESPONSE TO PLANNING REVIEW
Rev	Date	Description
plot date	SEPTEMBER 2020	drawing file 1907.2 A200 Plans.vwx
drawn by	FWP	checked by RAW
scale	AS SHOWN	project number 1907

ISSUED FOR DP
& REZONING

<u>α Ι</u>	.OMING
dHKa	dHKarchitects
VICTORIA OFFICE 977 Fort Street Victoria BC V8V3K3 T 1.250.658.3367	NANAIMO OFFICE 102-5190 Dublin Way Nanaimo BC V9T2K8 T 1•250•585•5810
Caledonia	
Victoria BC	
Townhouse 3 U	nit Plans
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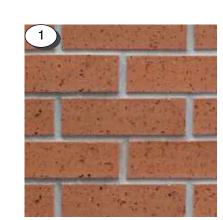


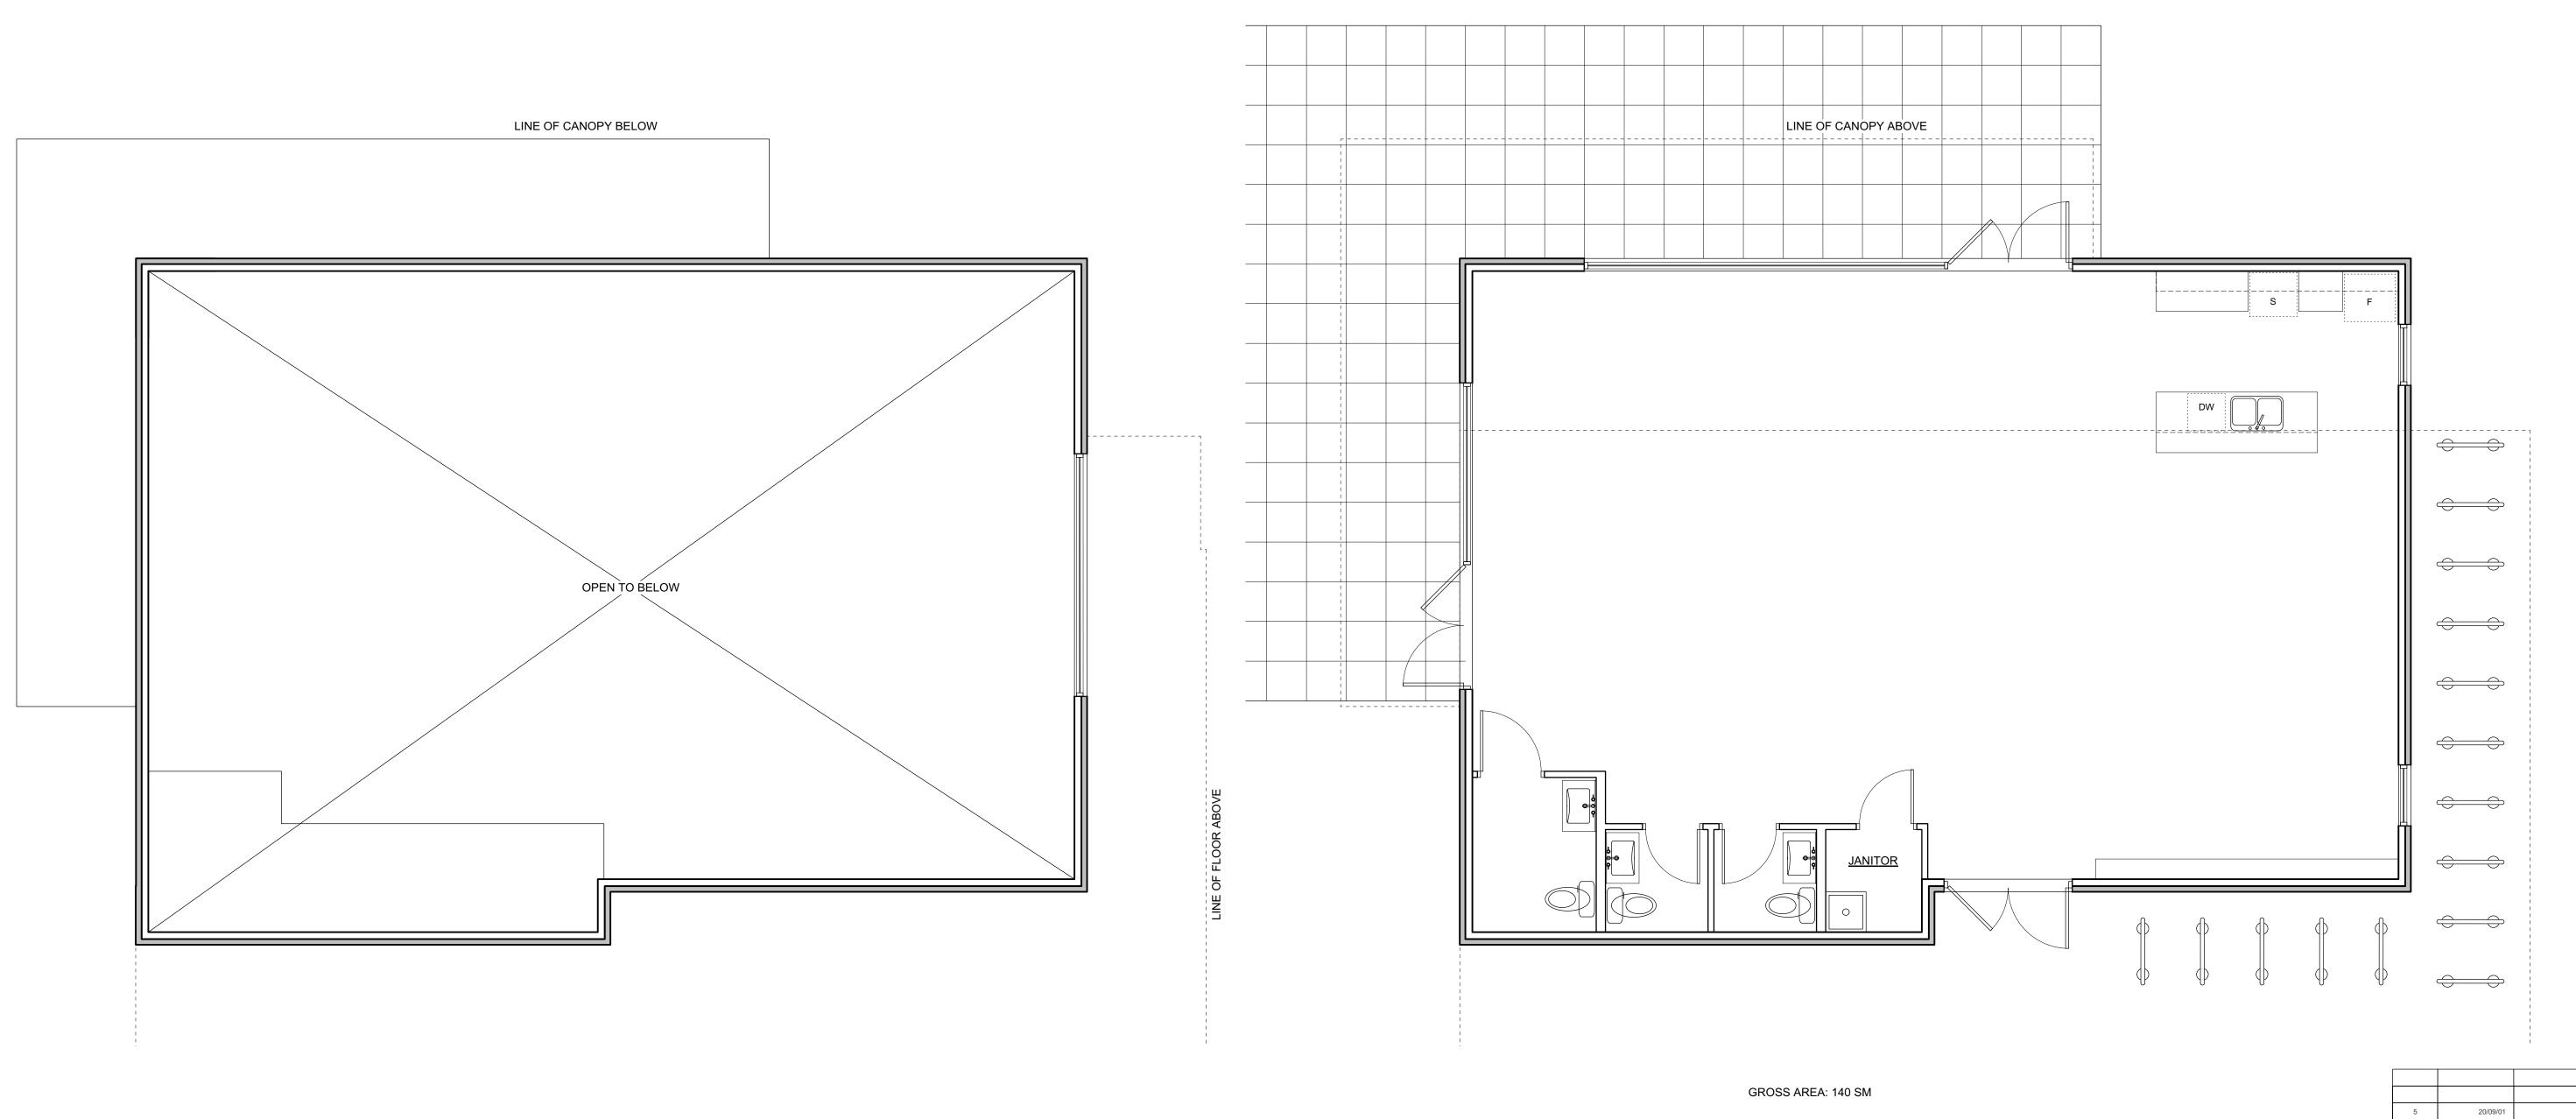
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4	20/03/13	RE-ISSUED FOR COTV
3	20/02/06	ISSUED FOR COTV
2	20/01/15	ISSUED FOR AD
1	19/12/16	RESPONSE TO PLANNING REVIEW
Rev	Date	Description
plot date	SEPTEMBER 2020	drawing file 1907.2 A200 Plans.vw
drawn by	FWP	checked by RAV
scale	AS SHOWN	project number 190

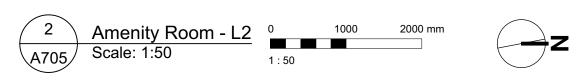
dHKa	dHKarc	hitects
VICTORIA OFFICE 977 Fort Street Victoria BC V8V3K3 T 1.250.658.3367	NANAIMO OFFICE 102-5190 Du Nanaimo BC T 1•250•585	blin Way V9T2K8
Caledonia		
Victoria BC		
Amenity Room		
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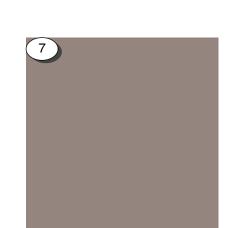
APARTMENTS 1 & 2

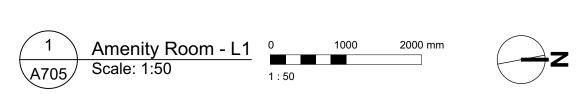







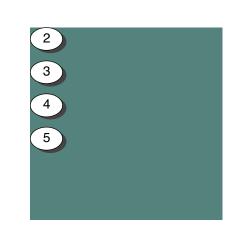

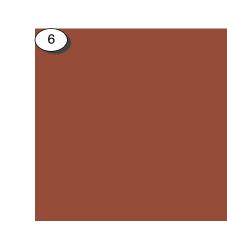

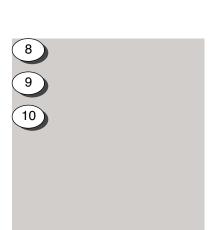

APARTMENT 2

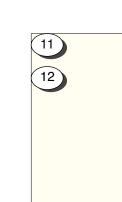

COLOUR & MATERIAL LEGEND

- BRICK VENEER Red Apartment 1 Only
- FIBRE CEMENT PANEL Teal
- **3** VINYL WINDOWS & DOORS Teal
- 4 PREFINISHED ALUMINUM GUARD, FRAME & PICKETS Teal
- METAL FLASHING Teal
- **OUTPAINT COLOUR Rust**

- SOFFIT Warm Grey Apartment 2 Only
- PAINTED CONCRETE Warm Grey
- 1 FIBRE CEMENT PANEL Warm White
- ¹² SOFFIT Warm White
- ¹³ FIBRE CEMENT LAP SIDING Medium Blue-Grey


TOWNHOUSES 1, 2 & 3



- 14 FIBRE CEMENT LAP SIDING White
- UNYL WINDOWS & DOORS Dark Grey
- ¹⁶ PREFINISHED ALUMINUM GUARD & FRAME Dark Grey
- 17 METAL FLASHING Dark Grey
- ASPHALT SHINGLES Warm Grey
- ¹⁹ FIBRE CEMENT SHINGLES Warm Grey
- ²⁰ VINYL WINDOWS & DOORS White
- ²¹ METAL DOWNSPOUT & FLASHING Light Warm Grey
- 22 FIBRE CEMENT PANEL Dark Grey
- ²³ FIBRE CEMENT PANEL Light Grey
- 24 ACCENT PAINT COLOUR Bright Orange
- ACCENT PAINT COLOUR Bright Blue
- ²⁶ ACCENT PAINT COLOUR Chartreuse

		•
5	20/09/01	RE-ISSUED FOR COTW
4	20/03/13	RE-ISSUED FOR COTW
3	20/02/06	ISSUED FOR COTW
2	20/01/15	ISSUED FOR ADP
1	19/12/16	RESPONSE TO PLANNING REVIEW
Rev	Date	Description
plot date	SEPTEMBER 2020	drawing file 1907.2 A200 Plans.vwx
drawn by	NLC	checked by RAW
scale	AS SHOWN	project number 1907

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VICTORIA OFFICE 977 Fort Street Victoria BC V8V 3K3 T 1.250.658.3367	NANAIMO OFFICE 102-5190 Du Nanaimo BC T 1•250•585	blin Way V9T 2K8
caledonia		
Victoria BC		
Colours & Mate	erials	
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LANDSCAPE TYPOLOGIES

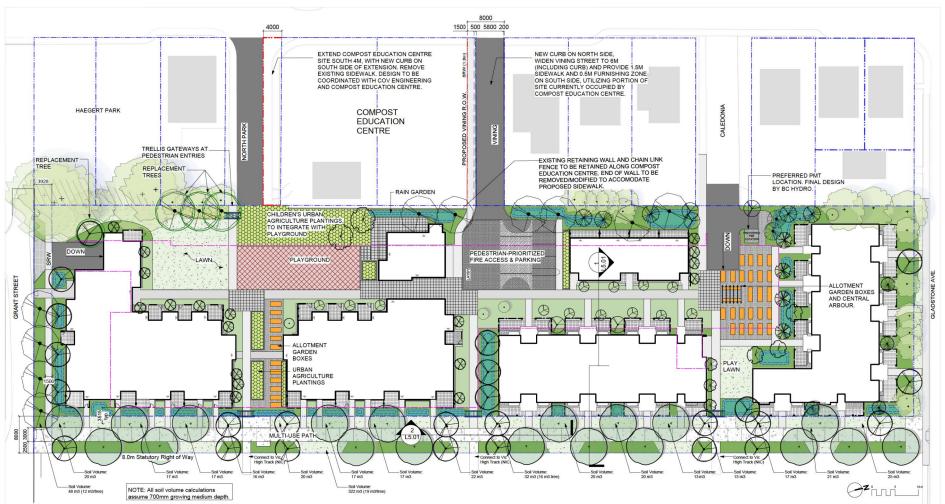

PLAY PLACES that foster fun and



RAIN GARDENS that slow & cleanse rainwater.



PERSONAL CUTDOOR AREAS that can be modified, beautified and funklified.



GATHERING PLACES that help neighbours get to know each other and support each other.



BICYCLE FACILITIES that make it easy for people of all ages to hop on their bikes.



take PLANTINGS that to provide food for birds, bees and butterflies.



OUTDOOR SOCIAL SPACES for gethering and sharing food.



PLANTINGS that provide beauty and food for people.



ACTIVE PLAY SPACES that support community



PUBLIC ART that celebrates Fernwood's artistic spirit.



COMMUNITY GARDEN
PLOTS that boost local food
security.

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revison no.	sheet no.	
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drawn by		TB
scale	1: 250	@ 24"x36"
project no.		119.18

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rev no	description	date
1	Rezoning/DP	19.09.26
2	RZ/DP Revision	19.12.16
3	Issued for ADP	20.01.15
4	Issued for ADP	20.01.15
5	For COTW	20.02.04
6	RZ/DP Revision	20.04.03
7	RZ/DP Revision	20.04.07
8	RZ/DP Revision	20.04.27
9	RZ/DP Revision	20.07.10
10	RZ/DP Revision	20.11.24





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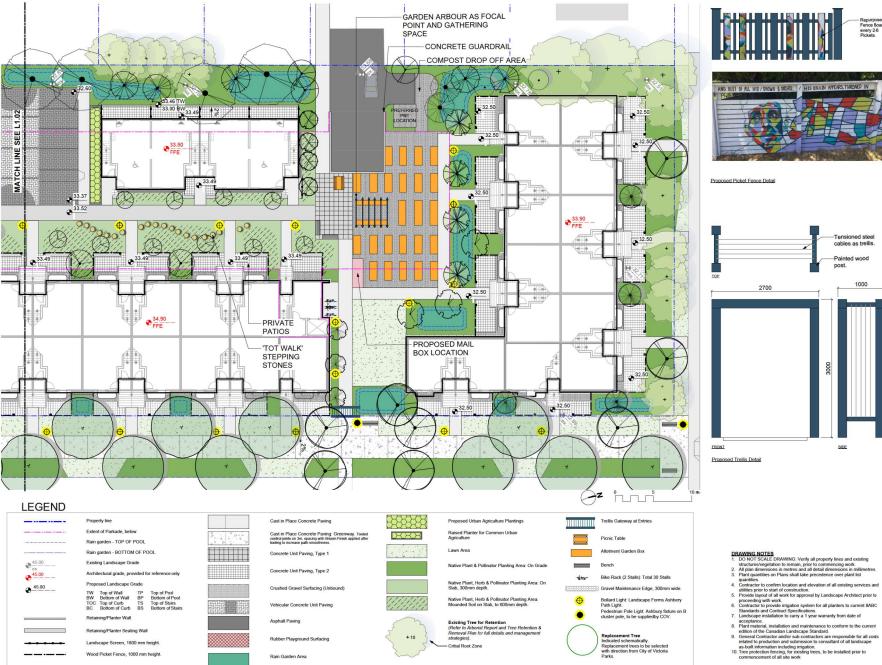
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project
Caledonia Redevelopment
Caledonia Ave.
Victoria, BC

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Landscape Overview Plan





Existing Tree for Retention (Refer to Arborist Report and Tree Retention & Removal Plan for full details and management

- Critial Root Zone

+10

Retaining/Planter Wall

Retaining/Planter Seating Wall

Landscape Screen, 1800 mm height.

Wood Picket Fence, 1000 mm height.


Asphalt Paving

Rain Garden Area

Rubber Playground Surfacing

Fence Board every 2-6 Pickets.



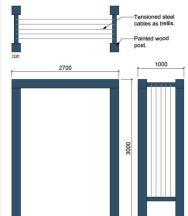

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10	RZ/DP Revision	20.11.24
8	RZ/DP Revision	20.04.27
7	RZ/DP Revision	20.04.07
6	RZ/DP Revision	20.04.03
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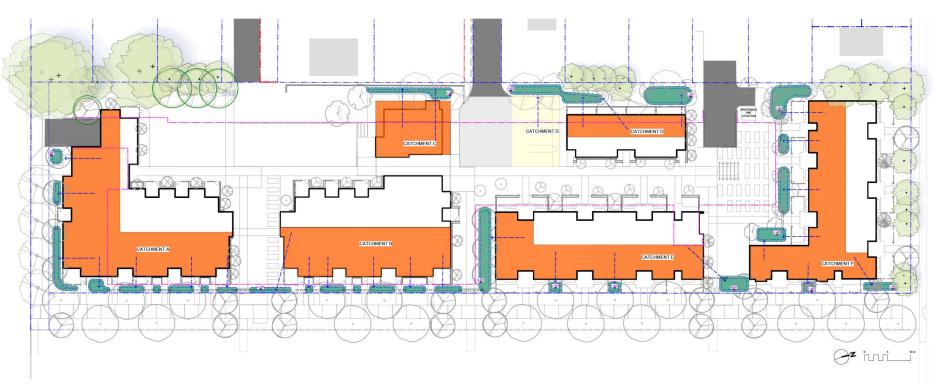


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Landscape **Materials North**

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Catchment Area	Contributing Impervious Area	Design Storm Runoff Volume Contributing to Rain Garden	Planter Growing Medium Depth	Stormwater Treatment Capacity per sq. m. of Rain Garden	Rain Garden Area	Rain Garden Capacity	Excess (+) or Deficient (-) Capacity	Soil Volume
	(sq. m.)	(cu. m./day)	(m.)	(cu. m./day)	(sq. m.)	(cu. m./day)	(cu.m./day)	(cu.m.)
Catchment A	560.0	28.0	0.60	0.8	40.0	30.0	2.0	24.0
Catchment B	360.0	18.0	0.60	0.8	25.0	18.8	0.8	15.0
Catchment C	190.0	9.5	0.60	0.8	13.0	9.8	0.3	7.8
Catchment D	280.0	14.0	0.60	0.8	30.0	22.5	8.5	18.0
Catchment E	365.0	18.3	0.60	0.8	33.0	18.5	0.3	19.8
Catchment F	415.0	20.8	0.60	0.8	63.0	47.3	26.5	37.8
otal	2170.0	108,5			204.0	146.8	38.3	122.4

- Assumptions
- Design storm is a 2 year storm event which equals 5 cm of water, in a 24 hr period.
- Rain Garden design based on 150 mm live ponding plus 20% of the sand/ compost growing medium volume (assuming growing medium has 20% void space) with a minimum infiltration rate of 2 cm/hour (or 48 cm per day), via perforated underdrain.

RAIN WATER MANAGEMENT NOTES

Water collected from portions of the building roofs flow to the rain gardens located throughout the site. Rain gardens have been situated on-grade.

Rain garders are designed to capture slow flows, and treat most. Bain gardens will be designed with underdrains and a high capacity owner that the designed with underdrains and a high capacity owner drain that will be connected to the onsite piped drainage system. The rain gardens are sized such that the bottom of the rain garden is 5% of the impervious area, which is the area required to manage Victoria's 2 year storm event.

Portions of the roof which cannot be easily connected to rain gardens will be drained directly to the storm system. The roof catchments are shown schematically and will be refined during detailed design.

Rain Garden

RAIN GARDEN MATERIALS

- RAIN CARDEN IMATERIALS

 1. Overflow drain, 200 mm domed graite + adapter

 2. Composted mulch, 50-70 mm depth

 3. Bio refeintion growing medium, 600 mm depth

 4. Scarifiedtilled subgrade, 300 mm depth

 5. Existing subgrade/native material

 6. 100 mm dameter (min) perforated pipe

 7. 25 mm diameter drain rock, 100 mm depth

1 Typical Rain Garden Scale: 1:50

LEGEND



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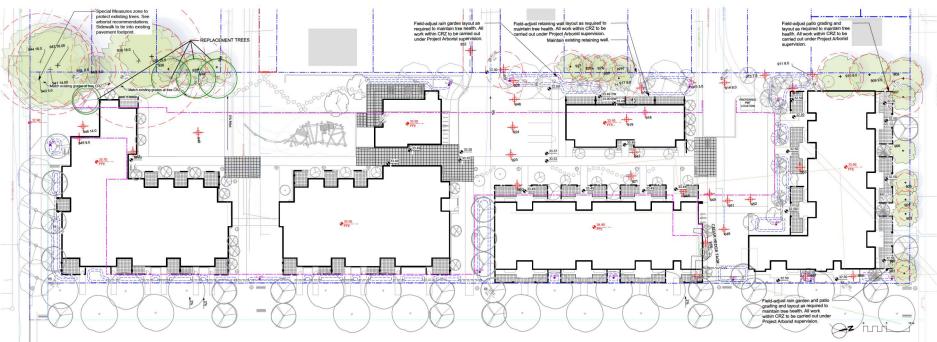
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Stormwater Management

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project no.		119.18



- DRAWING NOTES
 1. DO NOT SCALE DRAWING: Venify all properly lines and existing structures/veglation to remain, prior to commencing work.
 2. All plan dimensions in metres and all detail dimensions in millimetres.
 3. Plant quantities on Plans shall take precedence over plant list quantities.
 4. Contractor to confirm location and elevation of all existing services and

- utilities prior to start of construction.

 5. Provide layout of all work for approval by Landscape Architect prior to


- Provide Isyout of all work for approval by Landscape Archhet prior to
 proceeding with work.
 Contractor to provide impalion system for all planters to current IIABC
 Standards and Contract Specifications.
 Acceptance.
 Plant material contract specifications of the Contract Specification of the Contractor and Contractor Specification.
 Plant material, installation and maintenance to conform to the current
 edition of the Canadian Landscape Standard.
 General Contractor and ros sub-contractors are responsible for all costs
 related to production and submission to consultant of all landscape
 as buil information including impacts.
 Contractor and costs occurrated in the contractors are responsible for all costs
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 as built information including impacts.

TREE SUMMARY*

TOTAL TREES TO BE REMOVED:	31
TOTAL TREES TO BE RETAINED:	27
TOTAL BYLAW-PROTECTED TREES TO BE REMOVED:	2
TOTAL PROPOSED REPLACEMENT TREES:	4

* Based on Arborist's Report recieved from Talbot Mackenzie & Associates.

LEGEND

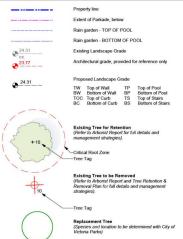

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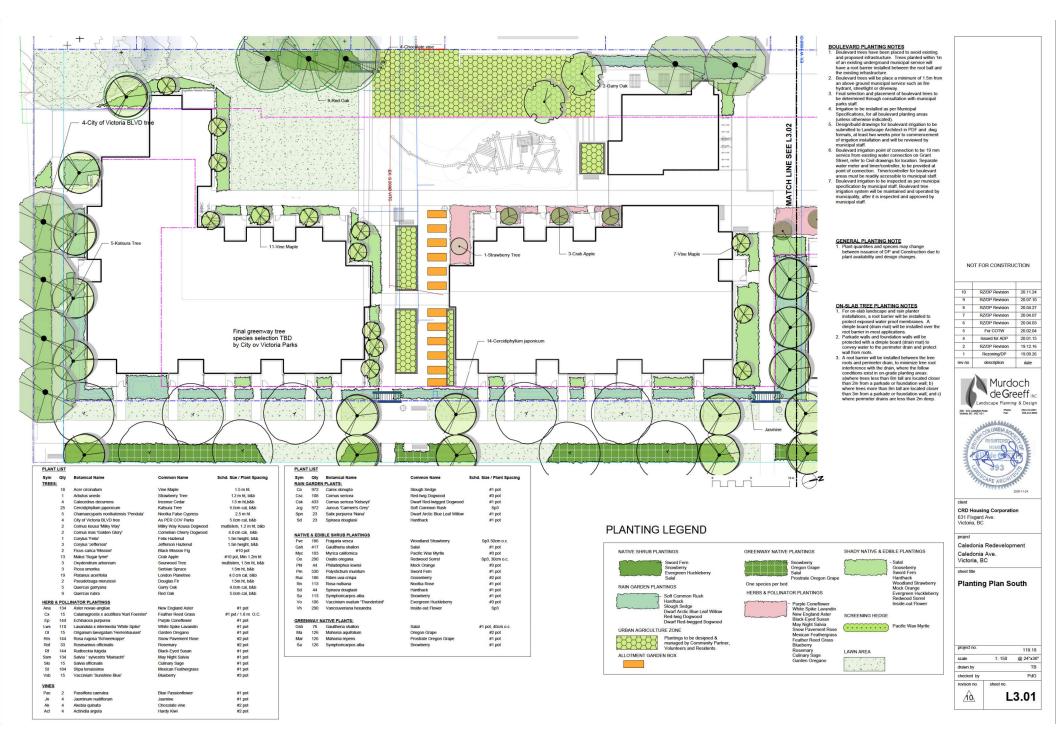



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Tree Retention & Removal Plan

project no.		119.18
scale	1: 250	@ 24"x36"
drawn by		ТВ
checked by		PdG
revison no.	sheet no.	
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White Spike Lavandin New England Aster Black-Eyed Susan May Night Salvia Snow Pavement Rose Mexican Feathergrass Feather Reed Grass Blueberry Rosemary Culinary Sage Garden Oregano

URBAN AGRICULTURE ZONE Plantings to be designed & managed by Community Partner, Volunteers and Residents.

ALLOTMENT GARDEN BOX

SCREENING HEDGE Pacific Wax Myrtle

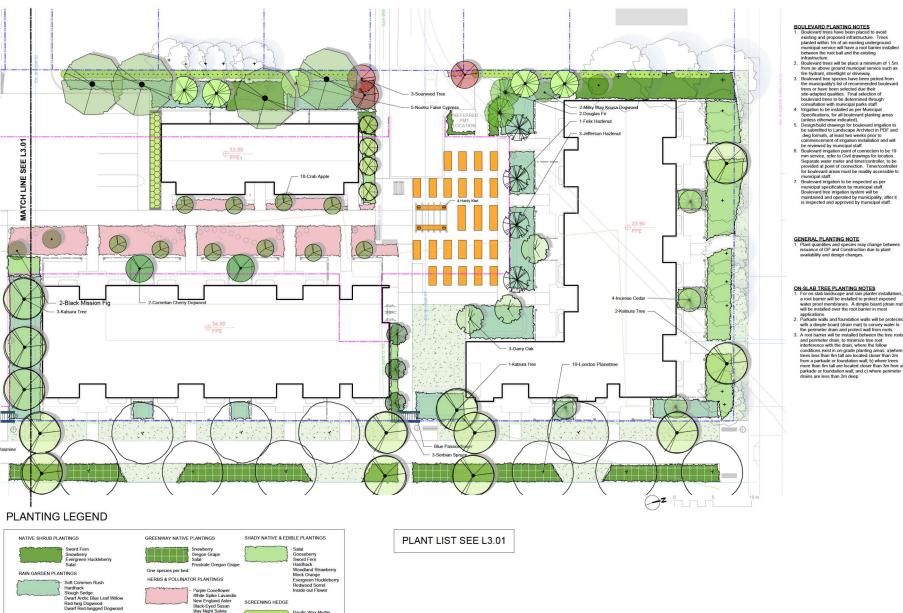LAWN AREA

BOULEVARD PLANTING NOTES

GENERAL PLANTING NOTE

Plant quantities and species may change between issuance of DP and Construction due to plant availability and design changes.

ON-SLAB TREE PLANTING NOTES

1. For on-slab landscape and rain planter installations, a root barrier will be installed to protect exposed water proof membranes. A dimple board (drain rrat) will be installed over the root barrier in most

will be installed over the root barrier in most applications.

2. Parkade walls and foundation walls will be protected with a dimple board (drain mart) to convey water to the perimeter drain and protect wall from roots.

3. A root barrier will be installed between the time roots and perimeter drain, to maintain the renormal to the control of the roots and perimeter drain, to maintain the root of the from a parkade or foundation wall; b) where trees more than 8m tall are located closer than 3m from a parkade or foundation wall; and c) where perimeter drains are less than 2m deep.

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Planting Plan North

project no.		119.18
scale	1: 150	@ 24"x36"
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10	L3.02	



Section at Pedestrian Allee and Townhouses
Scale: 1:50



2 Section at Pedestrian Walkway Scale: 1:50

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client

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oject

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sheet title

Landscape Sections

project no.		119.18
scale	1: 250	@ 24"x36"
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revison no.	sheet no.	
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