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Architectural Landscape

L0.00 Cover

L3.01 Planting

General Information Sheet

Stormwater Management

Landscape Grading & Drainage

Landscape Materials L1

Tree Replacement

L1.03 Landscape Materials L5 & L6

A0.2 Zoning Area Diagrams & Average Grade A0.3 Shadow Analysis Context Elevations Rendered Views A0.10 Building Code Information

A1.0 Site Plan

A2.1 Level 1 A2.2 Levels 2 to 4 A2.3 Level 5 A2.4 Level 6 A2.5 Roof

A4.0 East Wing - East and West Elevations North and South Elevations A4.2 West Wing - East and West Elevations

A5.0 Building Sections

Civil

C1.0 Existing Site Plan and Demolition Plan

C1.1 Site Servicing Plan

C1.2 Surface Works C1.3 Intersection Detail

C1.4 Civil Details

Evergreen DA-D (Phase 1) Victoria, BC





General Notes

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Refer to landscape architectural drawings for paving and plant materials information.

Refer to civil engineering site servicing drawing for utilities and frontage design information.

For bicycle parking stall dimensions refer to drawing A2.1 - Level 1.


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Evergreen DA-D (Phase 1)

Victoria, BC

sheet title Survey

2442 1 : 100 ត្រ DS/MZ/GB date issued 25/07/10 A0.1

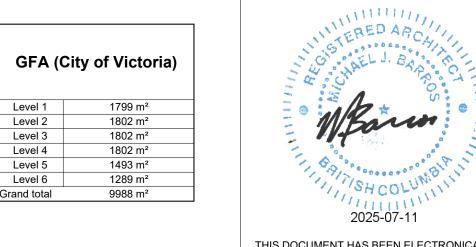

Level 1
Level 2
Level 3
Level 4
Level 5
Level 6

1802 m² 1802 m² 1802 m² 1493 m² 1289 m²

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Level 1 - Floor Area Plan
1:400

GFA - City of Victoria

6 Level 1 - Site Coverage
1:400

Site Coverage = Area of Structure / Site Area = 2753.05m ² / 4334.00m² = **63.35**%

2 Level 2 to 4 - Floor Area Plan
1:400

Lot Area: 4334.00m² -Bldg. + Parking: 2122.71m² OPEN SITE SPACE: 2211.29m²

 Open Site Space:
 2211.29m² /

 Lot Area:
 4334.00m²

 OPEN SITE SPACE:
 51%


GFA - City of Victoria

5 Level 1 - Open Space

Level 5 - Floor Area Plan

Level 6 - Floor Area Plan



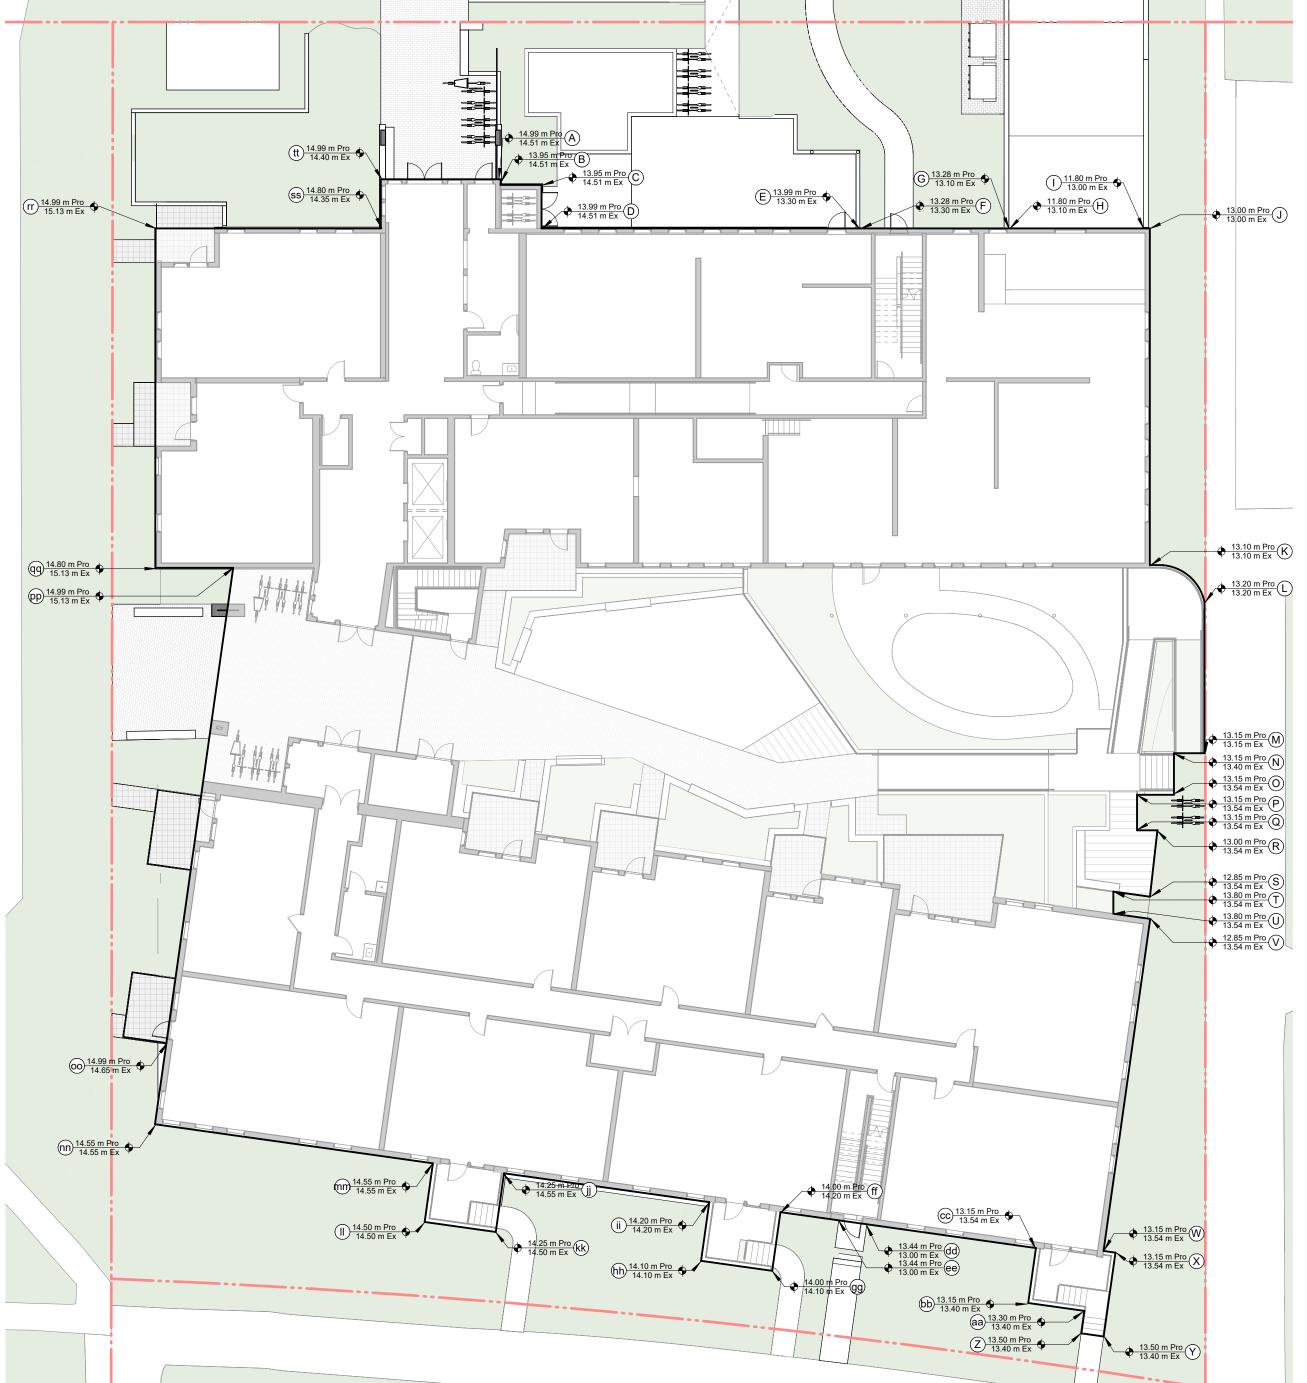

ID	Grade (m)	Interval	Average Grade	Distance (m)	Subtotal
Α	14.51	A-B	14.23	0	0
В	13.95	B-C	13.95	2.469	34.44255
С	13.95	C-D	13.97	2.3	32.131
D	13.99	D-E	13.645	16.84	229.7818
E	13.3	E-F	13.29	0	0
F	13.28	F-G	13.19	7.9	104.201
G	13.1	G-H	12.45	0	0
Н	11.8	H-I	11.8	7.1	83.78
1	11.8	I-J	12.4	0	0
J	13	J-K	13.05	1.724	22.4982
К	13.1	K-L	13.15	3.504	46.0776
L	13.2	L-M	13.175	0.2	2.635
М	13.15	M-N	13.15	12.4	163.06
N	13.15	N-O	13.15	3.081	40.51515
0	13.15	O-P	13.15	3.076	40.4494
P	13.15	P-Q	13.15	10.715	140.90225
Q	13.15	Q-R	13.075	2.41	31.51075
R	13	R-S	12.925	3.441	44.474925
S	12.85	S-T	13.195	1.418	18.71051
Т	13.54	T-U	13.54	8.334	112.84236
U	13.54	U-V	13.195	5.884	77.63938
V	12.85	V-W	13	5.632	73.216
w	13.15	W-X	13.15	8.684	114.1946
х	13.15	X-Y	13.275	1.83	24.29325
Υ	13.4	Y-Z	13.4	0.4	5.36
Z	13.4	Z-aa	13.35	7.914	105.6519
aa	13.3	aa-bb	13.225	11.552	152.7752
bb	13.15	bb-cc	13.15	0.628	8.2582
сс	13.15	cc-dd	13.295	9.038	120.16021
dd	13.44	dd-ee	13.44	1.5	20.16
ee	13.44	ee-ff	13.72	3.12	42.8064
ff	14	ff-gg	14	3.136	43.904
gg	14	gg-hh	14.05	3.8	53.39
hh	14.1	hh-ii	14.15	3.136	44.3744
ii	14.2	ii-jj	14.225	10.97	156.04825
jj	14.25	jj-kk	14.25	3.136	44.688
kk	14.25	kk-II	14.375	3.8	54.625
II	14.5	II-mm	14.525	3.136	45.5504
mm	14.55	mm-nn	14.55	14.852	216.0966
nn	14.55	nn-oo	14.6	4.275	62.415
00	14.65	оо-рр	14.82	25.455	377.2431
рр	14.99	pp-qq	14.895	4.119	61.352505
qq	14.8	qq-rr	14.895	17.962	267.54399
rr	14.99	rr-ss	14.67	11.931	175.02777
SS	14.35	ss-tt	14.375	2.6	37.375
tt	14.4	tt-A	14.455	6.338	91.61579
			Subtot	al 261.74	3623.7774

Average Grade 13.845

Project Data 2025-07-08

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Evergreen DA-D (Phase 1)

Victoria, BC

Sheet title
Zoning Area Diagrams
& Average Grade

2442 project no. As indicated DS/MZ/GB date issued 25/07/10 A0.2




7 Average Grade Calculation
1:200

SUMMER SOLSTICE • 9AM



EQUINOX • 10AM

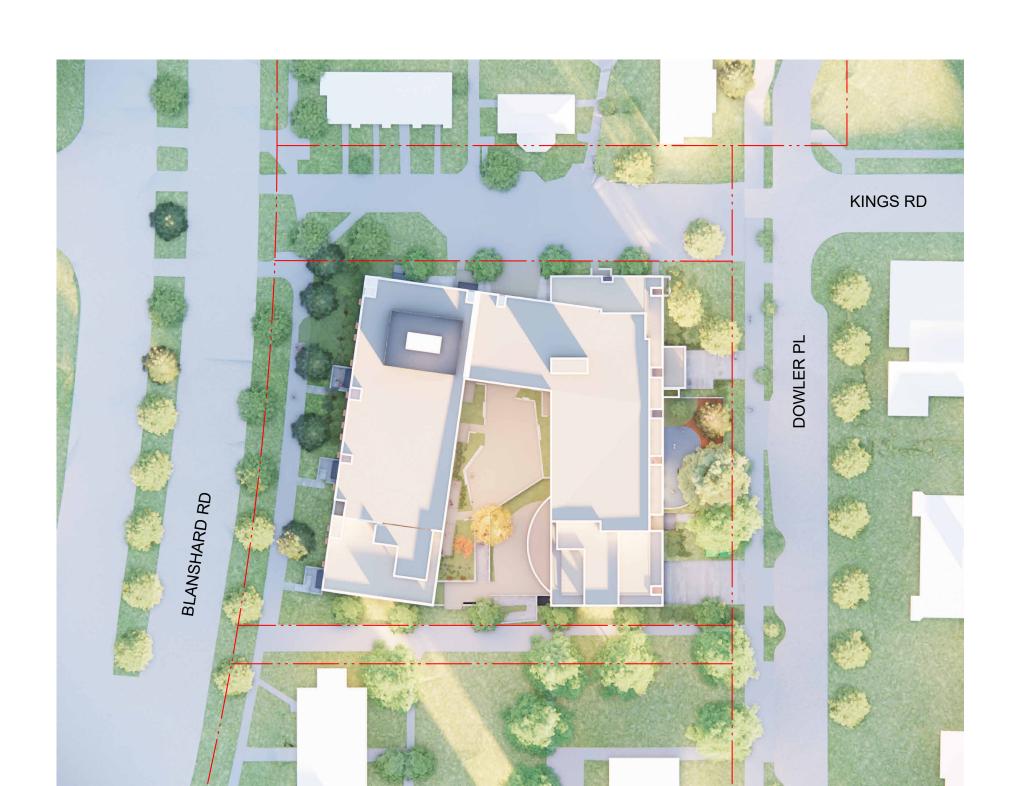

WINTER SOLSTICE • 10AM



SUMMER SOLSTICE • 12PM



EQUINOX • 12PM




WINTER SOLSTICE • 12PM



SUMMER SOLSTICE • 5PM



EQUINOX • 4PM

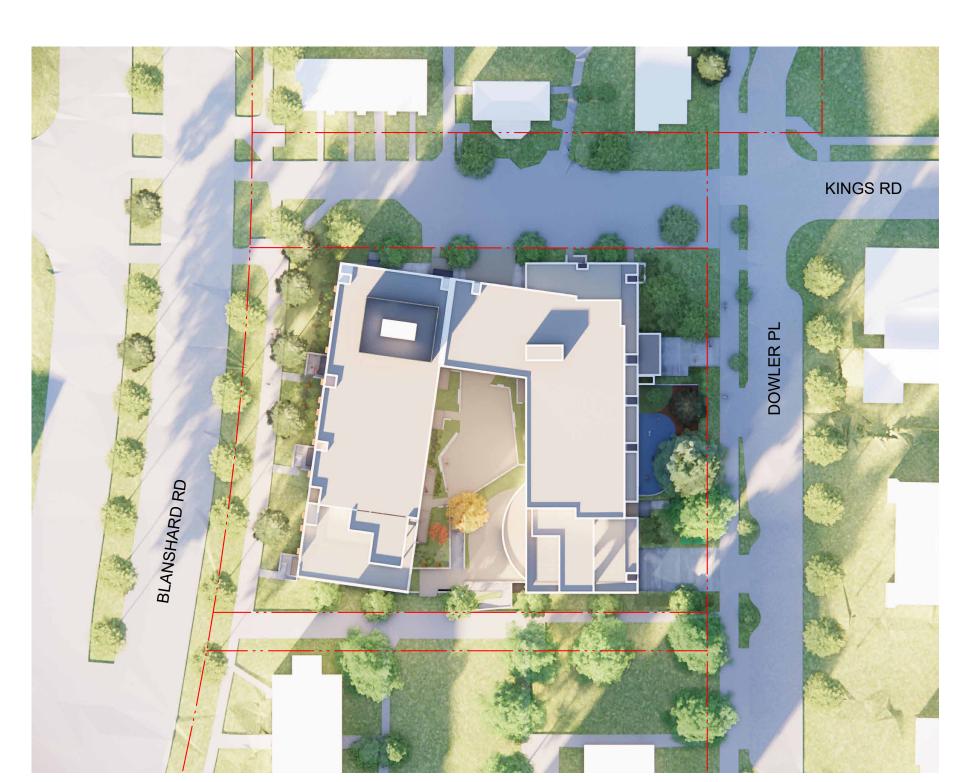

WINTER SOLSTICE • 3PM






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Evergreen DA-D (Phase 1)

Victoria, BC

sheet title
Shadow Analysis

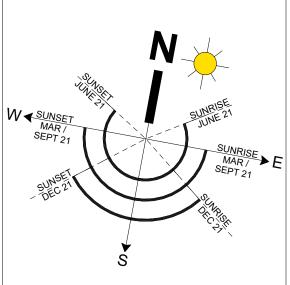project no.	2442	Ma
scale	1 : 100	3.58
drawn by	GK	5.03
date issued	sheet no.	7-10
25/07/10	A0.3	2025-07-10 5:03:58 PM

Context Elevations - Dowler Place



2 Context Elevations - Kings Road
1:200



1 Context Elevations - Blanshard Street

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Victoria, BC

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Context Elevations

As indicated sheet no. date issued A0.4 25/07/10




1. View to Southeast from Blanshard Street



2. View to Main Entrance from Dowler Street



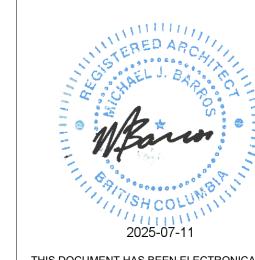

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Issued for DDP Application 25/07/10 description date

rev no description date

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project name

Evergreen DA-D (Phase 1)

Victoria, BC

sheet title
Rendered Views

project no.	2442
scale	As indicated
drawn by	GK
date issued	sheet no.
25/07/10	A0.5




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drawing A2.1 - Level 1.





Level 6 (30415)

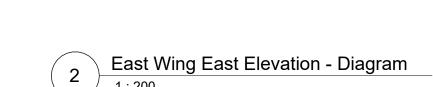Level 4 (24249)

Level 2 (18083)

East Elevation >9m from street = 100% Unprotected Openings permitted.

Courtyard - Firewall West Elevation

Courtyard - Firewall South Elevation



West Elevation >9m from street = 100% Unprotected Openings permitted.



South Elevation - Diagram

SPACIAL SEPARATION AND EXPOSURE CALCULATIONS

West Wing West Elevation - Diagram

Building Level	Face	Occupancy	Height	Width	LD	Area	Unprotected Openings	Sprinklered	Actual Openings	Permitted Openings	Cladding Requirements	Construction Requirements	Notes:
Space or Suite			(m)	(m)	(m)	(m2)	(m2)	(Y/N)	(%)	(%)			
Level 1													
Entrance Lobby	E	С	2.72	5.80	8.37	15.8	8.2	Υ	52%	100%	NC		
Childcare	S	A2	3.72	17.50	3.00	65.1	14.2	Y	22%	28%	NC		
Unit D2	S	С	2.72	9.50	3.66	25.8	4.7	Y	18%	46%	NC		
Unit C1	N	С	2.72	7.70	2.39	20.9	3.2	Υ	15%	28%*	NC		* Table 3.2.3.1-D max area of 30% and average developed for 2.39m LD
Unit A5	N	С	2.72	9.20	4.63	25.0	6.7	Υ	27%	90%	NC		
Level 2													
						0.0		Υ			NC		
Unit B8	N	С	2.72	9.55	2.39	26.0	6.7	Υ	26%	28.8%*	NC		* Table 3.2.3.1-D max area of 30% and average developed for 2.39m LD
Unit A2	N	С	2.72	9.20	5.10*	25.0	8.3	Υ	33%	100%	NC		
Unit C1	N	С	2.72	7.70		20.9	3.2	Υ	15%	28%*	NC		
Level 3													
Unit B4	N	С	2.72	11.30	5.80*	30.7	8.3	Y	27%	100%	NC		
Unit B2	C-E	C	2.72	6.70	2.50*	18.2	5.1	Υ	28%	60%	NC		*Refer to BCBC 3.1.10.6
Unit B5	C-S	C	2.72	13.30	2.50*	36.2	9.9	Y	27%	40%	NC		*Refer to BCBC 3.1.10.6
Unit C1	S	C	2.72	7.70	3.00	20.9	3.2	Υ	15%	52%			
Level 4													
Unit D1	S	С	2.72	9.50	3.00	25.8	4.8	Υ	19%	46%	NC		
Level 5													
Level 6													
		С	2.72	6.8	8.9	18.5	8.1	Υ	44%	100%	NC		∤

PROJECT DESCRIPTION

This project is a multi-family residential rental building with a ground floor assembly occupancy (childcare). The building contains 106 dwelling units consisting of 1bedroom, 2-bedroom, 3-bedroom and 4-bedroom suites. The building provides 29% adaptable suites ranging from 1 to 4 bedroom suites and 11% accessible suites, ranging from 1 and 2 bedroom suites. The project qualifies for the BCBC extension on adaptable suite and seismic building requirements posted September 20, 2024 and confirmed with city staff October 7, 2024.

The bullding is six (6) storeys and includes private and shared roof decks on Levels 5 and 6.

GOVERNING CODE

BCBC 2024 unless noted otherwise.

Project qualifies for the BCBC extension on adaptable suites and seismic building requirements posted September 20, 2024 and confirmed with city staff October 7

GOVERNING CODE PART

Division B, Part 3 (1.3.3.2.(1)(c)) (Six storeys and greater than 600m² in building area).

Building Size and Construction Relative to Occupancy 3.2.2.51 Group C, Up to 6 storeys, Sprinklered. A firewall will limit building area to not more than 1500fn permit construction under Article 3.2.2.51. 3.1.2.8 Group A, Division 2 for Daycare Facilities.

MAJOR OCCUPANCY

Group C (Residential) Group A, Division 2 (Daycare Facility) Exempt: Less than 10% not considered a Major Occupancy per 3.2.2.8(2)

BUILDING AREA

10,269m² (including 429m² Daycare Facility)

BUILDING HEIGHT (by BCBC)

Six (6) Storeys over one (1) level underground parking. 18m max. height from level of first storey to top storey (3.2.2.51) 25m max. height from level of the first storey to the top of the highest roof assembly (3.2.2.51)

MEANS OF EGRESS & EXIT

Two (2) Means of Egress with Two (2) separate exits and One (1) horizontal exit required per 3.3.1.3. Travel distance to be not more than 45m per 3.4.2.4. Horizontal exits to conform with 3.4.6.10 Three (3) Means of Egress and Three (3) separate exits required for parking level per 3.3.1.3. Travel distance to be not more than 45m per 3.4.2.4. One (1) Means of Egress provided for rooftop occupancies with occupant load limited to less than 60 persons and less than 200mper 3.3.1.3(6) and 3.3.1.3(9).

CONSTRUCTION

Combustible and Non-Combustible.

Fire alarm required per 3.2.4.1(1)

SPRINKLERS

FIRE ALARM

sections.

Sprinklers required per 3.2.2.18(1), 3.2.2.51 and 3.3.2.18(1)

Smoke detectors required per 3.3.2.18(3)

FIRE RESISTENANCE RATINGS

Residential Suite to Suite	1hr (3.3.4.2.(1)
Residential Suite to Daycare Facility	2hr (3.1.3.1)
Residential Suite to Corridor	1hr (3.3.1.4)
Roof Assemblies	1hr (3.2.2.51.2(b)
Exit Stair	1hr (3.4.4.1
Public Corridor	1hr (3.3.4.2)
Elevator	1hr (3.5.3.1)
Electrical Room	1hr (3.6.2.1)
Electrical Closets	0hr
Mechanical Room (Fire safety systems)	1hr (3.6.2.1)
Janitor's Room	0hr (3.3.1.22.(3)
Parking to other occupancies (storage)	1.5hr (3.3.5.6)

Loadbearing walls, columns and beams are to have the same fire resistance rating as the assembly they support.

Where loadbearing columns are located within a wall assembly, the entire length of wall is to have a fire resistance rating equal to that required for the column. Non-loadbearing exterior walls require a fire resistance rating where they are exposing building face. Refer to exposing building face calculations, plans and

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Building Code Information

2442 project no. As indicated scale Author drawn by date issued 25/07/10

Notes on spacial separation and exposure calculations


As permitted by sentence 3.2.3.2.(2), the exposing building face is ccalculated for each fire compartment with fire separations having a fire resistance rating of 45min or more. 1. Only the most restrictive fire compartment conditions are represented for each building level and exposure direction.



Project In	formation Table				
Zone (existing)		R3-2			
Proposed zone or site specific zone		Site Specific			
Site area (m2)		4334			
Total floor area (m2)		9988.00			
Future Childcare area (m2)		421			
Floor space ratio		2.30			
Site Coverage (%)		63.40%			
Open site space (%)		51.00%			
Height of building (m)		20.1m			
Number of storeys		6			
Parking stalls (number) on site		61			
Bicycle parking number (Class 1 & 2)	Class	s 1 = 158 Cla	ss 2 = 32		
Building	Setbacks (m)				
Front yard		12.23			
Rear yard		8.4			
Side yard (north)		2.39			
Side yard (south)		3.02			
Combined side yards	bined side yards 5.41				
Resident	ial Use Details				
Total number of units		106			
Unit type, e.g., 1 bedroom		1, 2, 3 and 4-Bdrm			
Ground-oriented units		12			
Minimum unit floor area (m2)		46			
Total residential floor area (m2)		9567.00			
	sq.m.	sq.m.	Qty		
	(min.)	(max.)			
One-bedroom	46.5	49.0	16		
One-bedroom Adapt.	49.0	52.5	9		
One-bedroom Access.	52.3	54.3	6		
Two-bedroom	65.4	66.5	16		
Two-bedroom Adapt.	67.5	72.8	15		
Two-bedroom Access.	73.8	75.0	6		
Three-bedroom	83.0	85.7	24		
Three-bedroom Adapt.	89.5	91.2	4		
Four-bedroom	107.8	107.8	7		
Four-bedroom Adapt.	110.6	113.0	3		
			106		

*All Areas taken to inside face of exterior walls; Parti walls between units ** Site area subject to subdivision

*** Project meets BC Housing requirements for Adaptability; project qualifies for BCBC 2024 extension

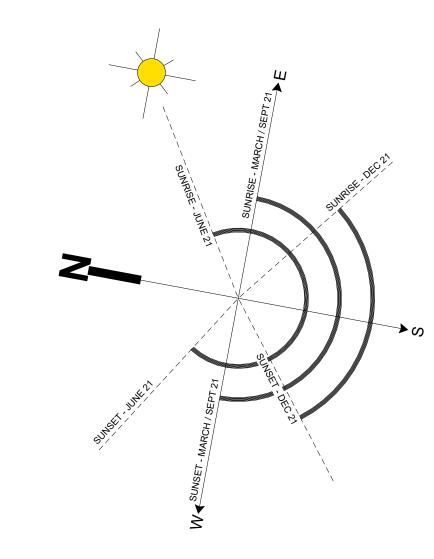





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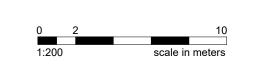
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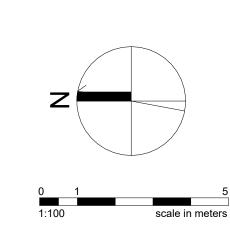
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25/07/10	A1.0	2025-07-10



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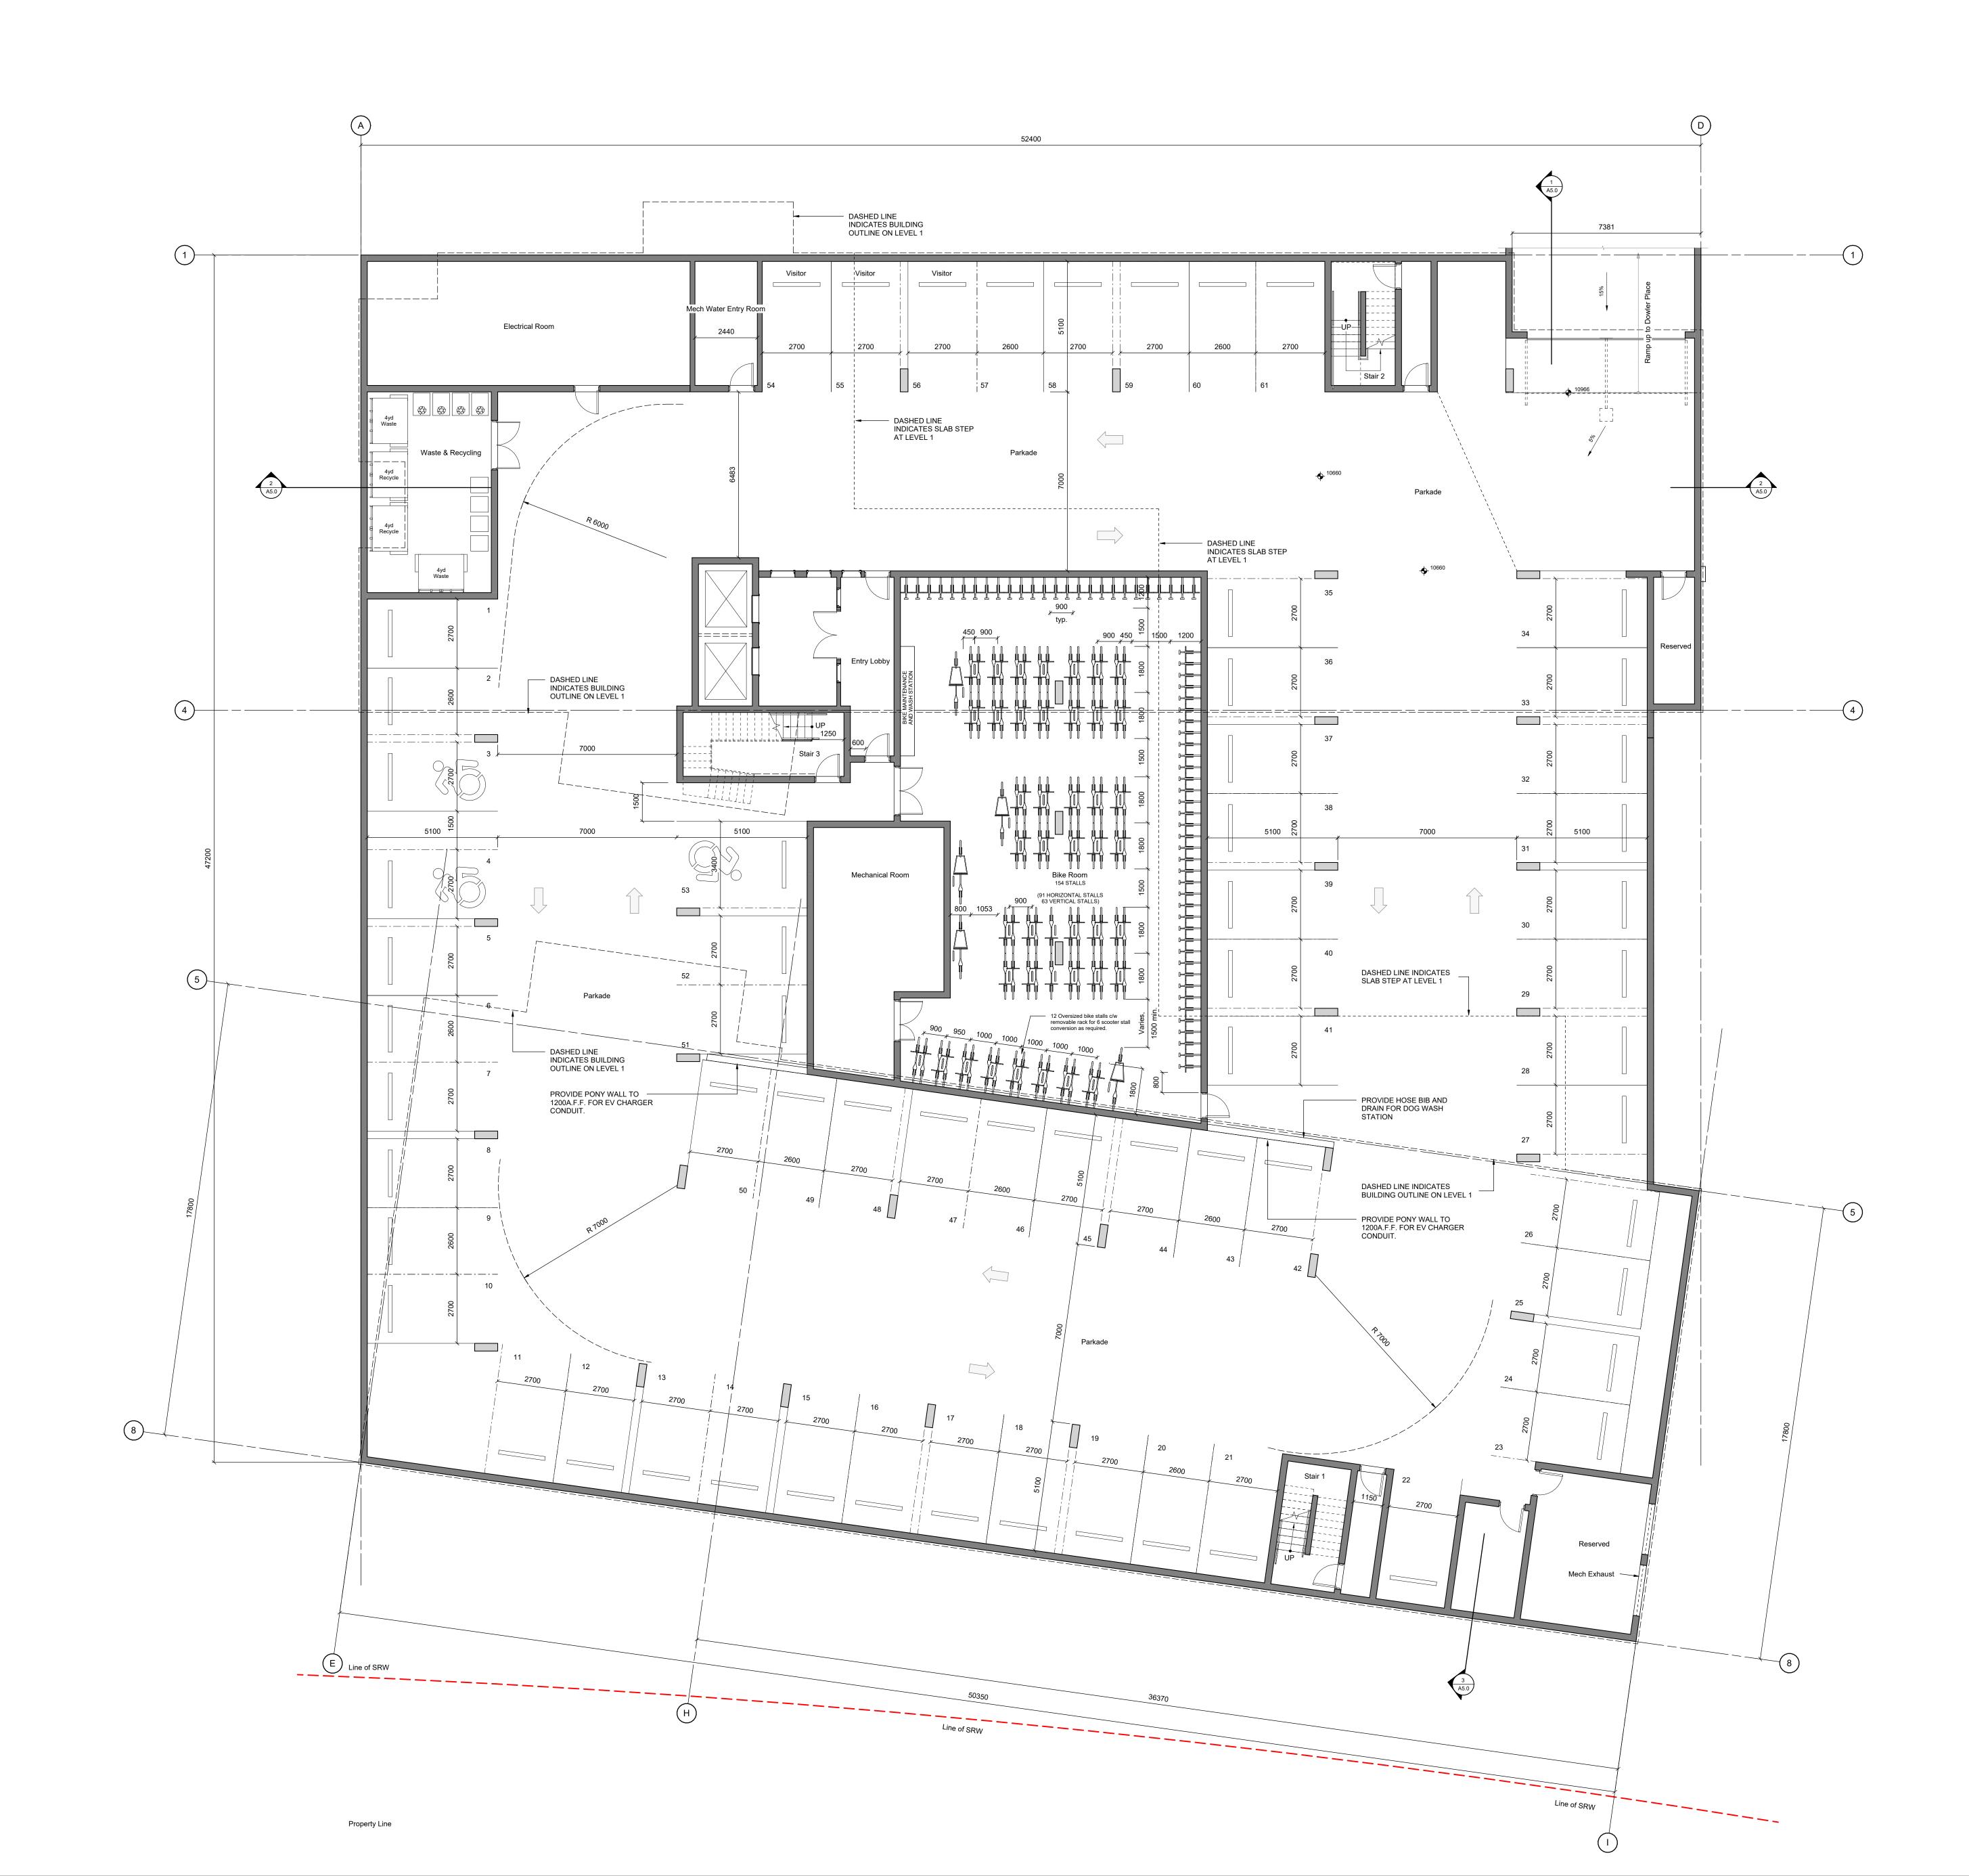
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Victoria, BC

sheet title
P1 Plan

1:100 Author

sheet no. date issued A2.0 25/07/10




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- For bicycle parking stall dimensions refer to drawing A2.1 Level 1.



7 Issued for DDP Application 25/07/10
3 Preapplication Review 25/03/06
rev no description date

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project name

FVERGREEN DA-D

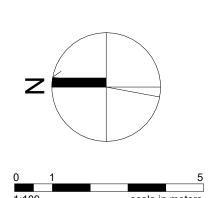Evergreen DA-D (Phase 1)

Victoria, BC

sheet title
Level 1

project no. 2442

scale 1:100

drawn by DS/MZ/GB

date issued sheet no. 25/07/10


A2.1





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Evergreen DA-D (Phase 1)

Victoria, BC

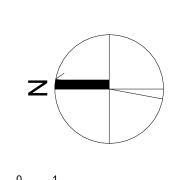sheet title
Levels 2 to 4


2442 1 : 100 DS/MZ/GB sheet no. date issued A2.2 25/07/10





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Evergreen DA-D (Phase 1)


Victoria, BC

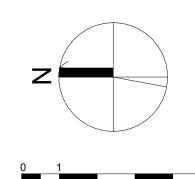sheet title Level 5

DS/MZ/GB sheet no. date issued


A2.3 25/07/10



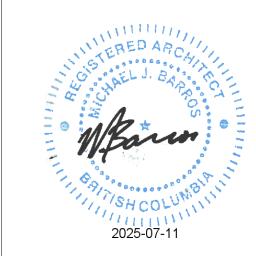

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Evergreen DA-D (Phase 1)

Victoria, BC

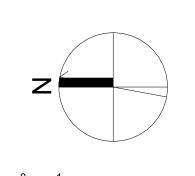sheet title Level 6


1:100 DS/MZ/GB sheet no. date issued A2.4 25/07/10



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Evergreen DA-D (Phase 1)

Victoria, BC

sheet title Roof

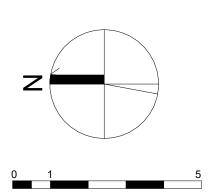1:100 DS/MZ/GB sheet no. date issued A2.5 25/07/10



1 East Wing West Elevation
1:100




East Wing East Elevation
1:100





MATERIAL LEGEND

Fibre Cement Panels
'Fiotto - Cream'

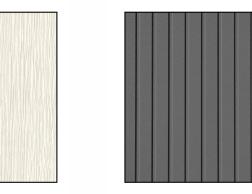


Fibre Cement Panels '8 Reveal - Charcoal'

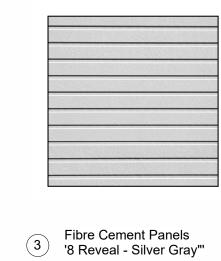


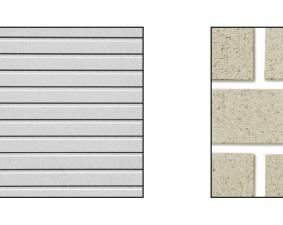

Brick Veneer
Norman Running Bond
'Castle Gray'



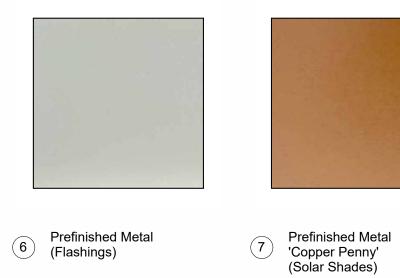

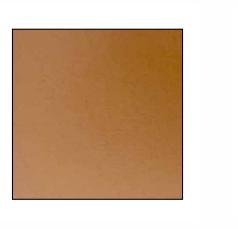



8 Vinyl Doors and Windows Charcoal Grey



9 Vinyl Doors and Windows White



Aluminum Frame Glass Guard

(D-loopies)

M

Aluminum Fra
(Balconies)



Metal Picket Guard
'Charcoal Grey'
(Patios and Amenity)



(12) Glazing



Metal Mechanical Screen 'Silver Grey'

sheet title
East Wing - East and
West Elevations project no. scale

Victoria, BC

2442 1:100 DS/MZ/GB drawn by sheet no. date issued A4.0 25/07/10

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For bicycle parking stall dimensions refer to drawing A2.1 - Level 1.

General Notes


contract documentation.






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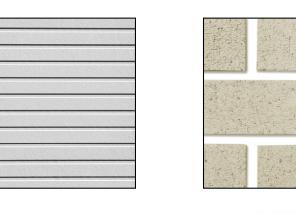
Fibre Cement Panels
'Fiotto - Cream'

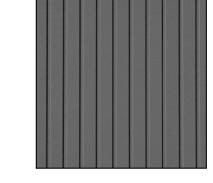


Fibre Cement Panels
'8 Reveal - Charcoal'

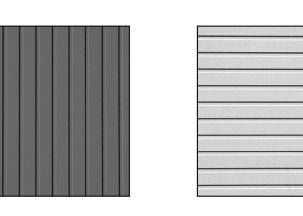

Fibre Cement Panels
'8 Reveal - Silver Gray"



Brick Veneer
Norman Running Bond
'Castle Gray'

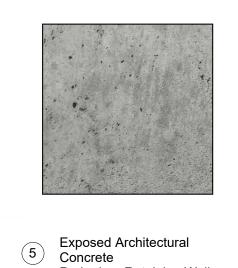

Parkade + Retaining Walls



Prefinished Metal


6 Prefinished Mo (Flashings)



Prefinished Metal
'Copper Penny'
(Solar Shades)



8 Vinyl Doors and Windows Charcoal Grey

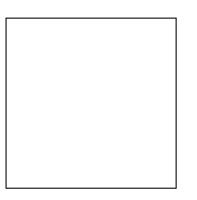

9 Vinyl Doors and Windows White






Aluminum Frame Glass Guard (Balconies)

Metal Picket Guard 'Charcoal Grey' (Patios and Amenity)





Glazing

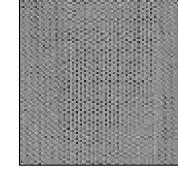

Metal Mechanical Screen 'Silver Grey'

2442 project no. 1:100 8 scale DS/MZ/GB drawn by sheet no. date issued A4.1 25/07/10

7 Issued for DDP Application 25/07/10


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Evergreen DA-D (Phase 1)

sheet title
North and South

Victoria, BC

Elevations

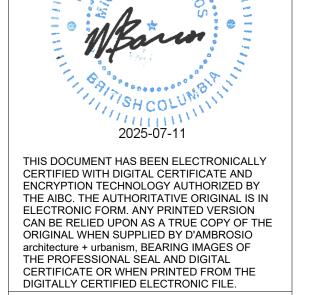

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Refer to civil engineering site servicing drawing for utilities and frontage design information. For bicycle parking stall dimensions refer to drawing A2.1 - Level 1.

West Wing East Elevation
1:100





West Wing West Elevation


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MATERIAL LEGEND






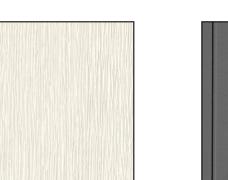

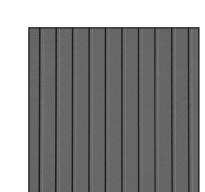


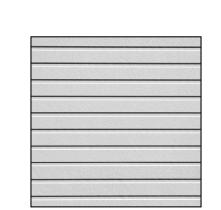

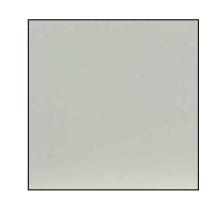





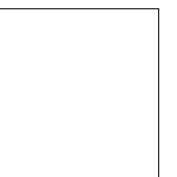










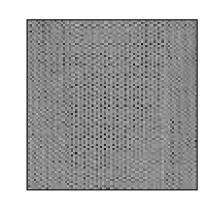

Victoria, BC sheet title
West Wing - East and West Elevations

> 2442 project no. 1:100 scale DS/MZ/GB drawn by sheet no. date issued A4.2

25/07/10

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For bicycle parking stall dimensions refer to drawing A2.1 - Level 1.

General Notes


contract documentation.

Fibre Cement Panels
'8 Reveal - Silver Gray" Brick Veneer
Norman Running Bond
'Castle Gray' Exposed Architectural
Concrete
Parkade + Retaining Walls Prefinished Metal
'Copper Penny'
(Solar Shades) Aluminum Frame Glass Guard (Balconies) Metal Picket Guard 'Charcoal Grey' (Patios and Amenity) Fibre Cement Panels
'Fiotto - Cream' Fibre Cement Panels
'8 Reveal - Charcoal' 6 Prefinished Metal (Flashings) 8 Vinyl Doors and Windows Charcoal Grey 9 Vinyl Doors and Windows White Metal Mechanical Screen 'Silver Grey' Glazing




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East West Section
1:100

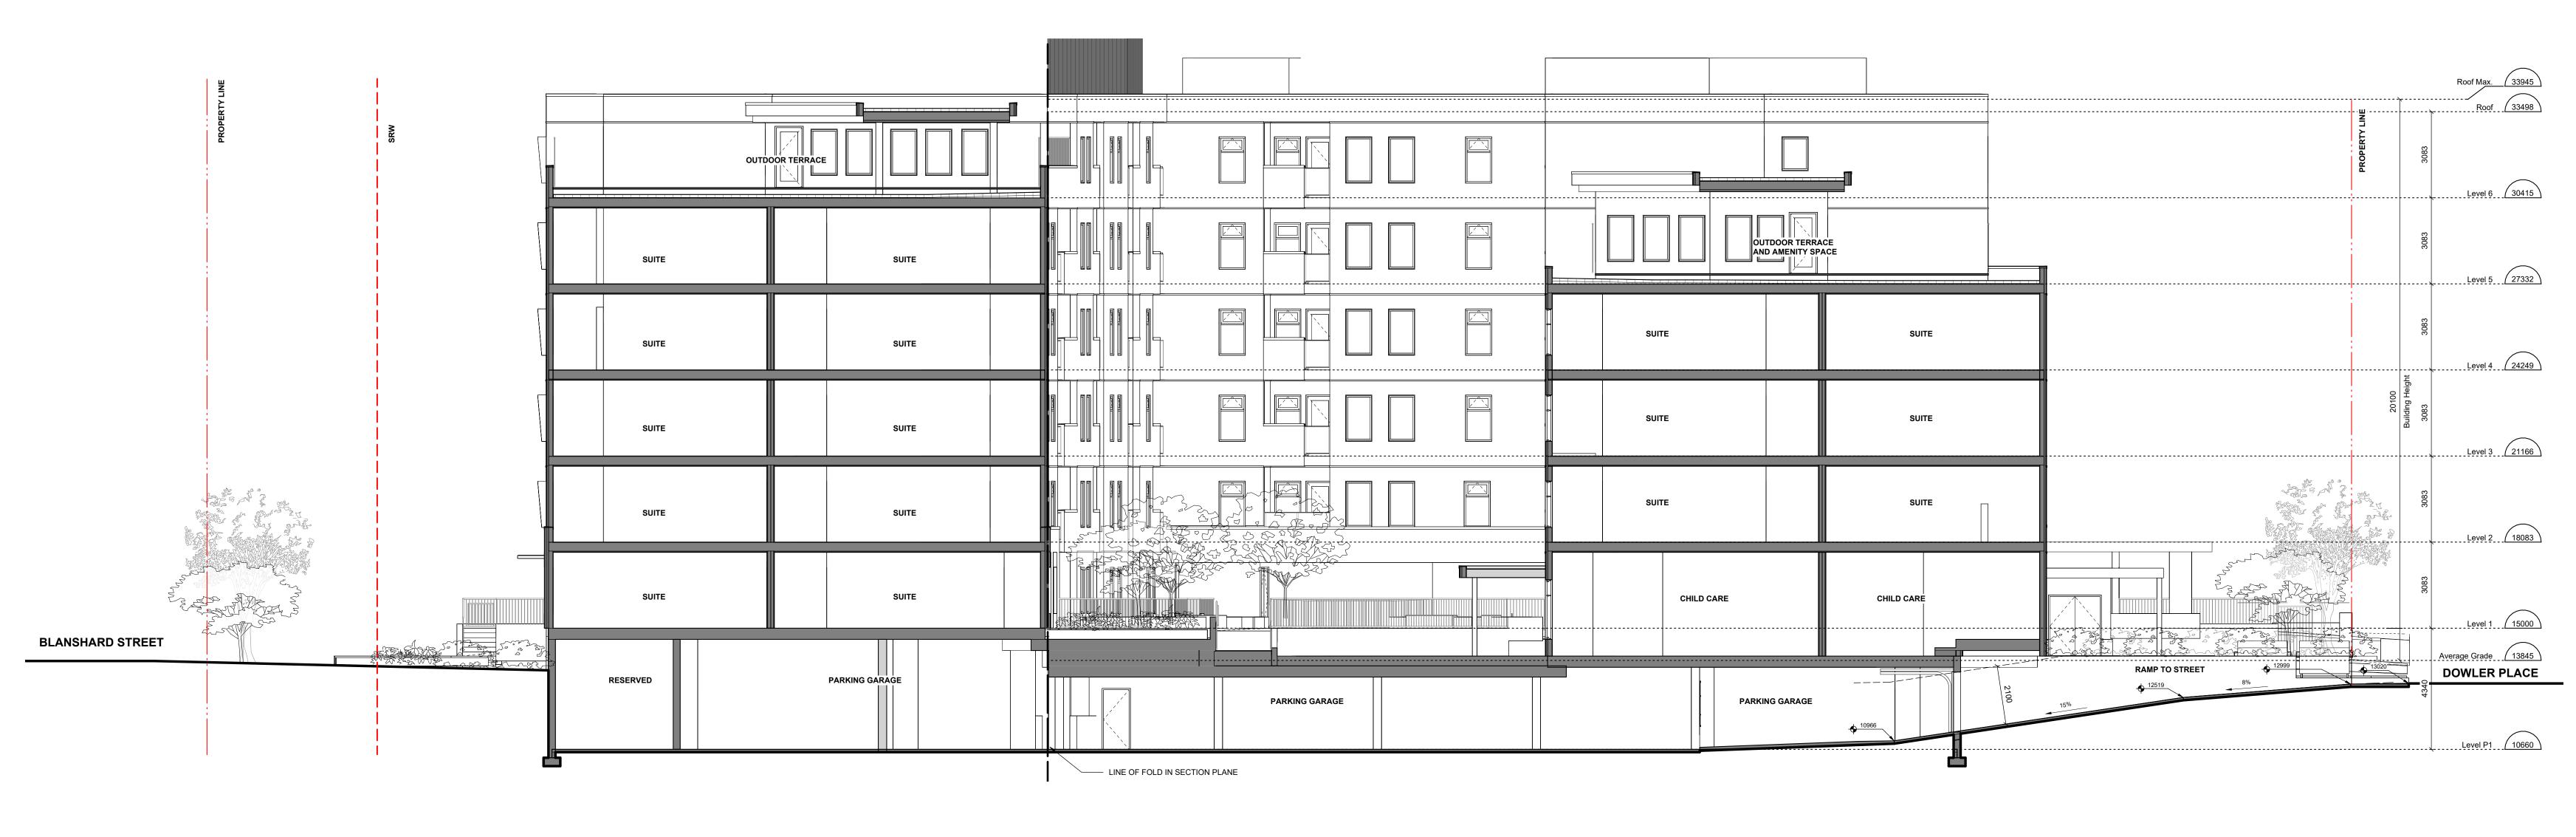

North South Section

1:100

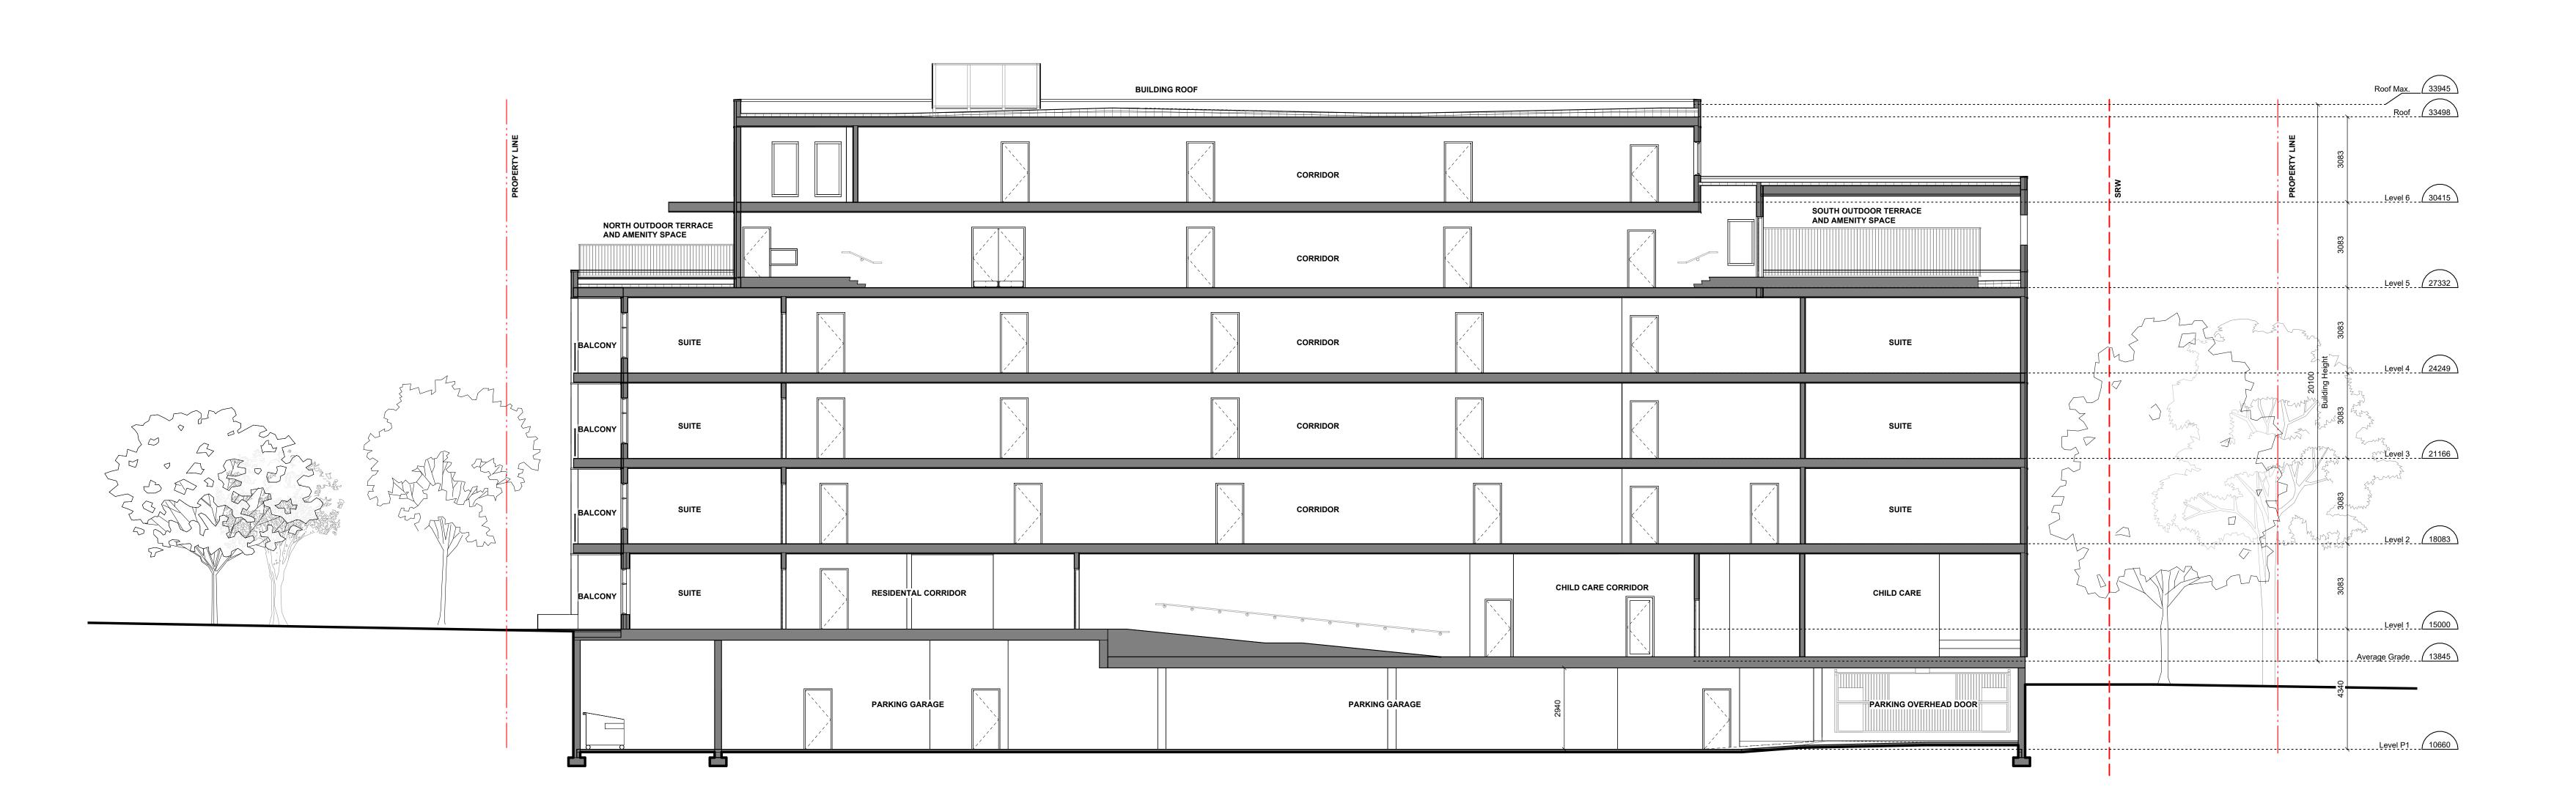	0 1 1:100 scale in m	eters
7	Issued for DDP Application	25

rev no description date

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project name

eroject name

Evergreen DA-D

(Phase 1)

Victoria, BC

sheet title

Building Sections


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Landscape Sheets					
Sheet No.	Sheet Title				
L0.00	Cover				
L0.01	General Information Sheet				
L0.02	Tree Replacement				
L0.03	Stormwater Management				
L1.01	Landscape Materials L1				
L1.03	Landscape Materials L5 & L6				
L2.01	Landscape Grading & Drainage				
L3.01	Planting				

BC Housing/CMHA

Evergreen DA-D (PHASE 1)

Victoria, BC



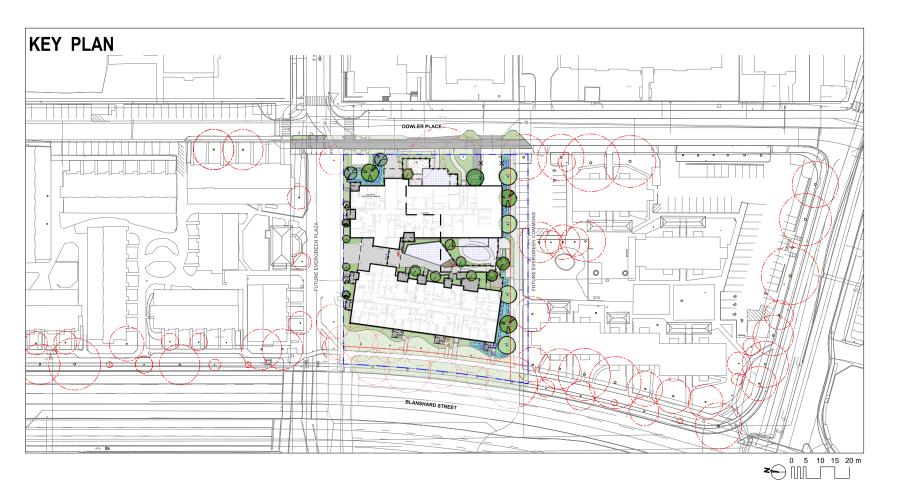

NOTFORCONSTRUCTION

_		
5	Issued for DDP	2025-07-08
4	DD Progress Set	2025-06-06
3	BP 50% Review	2025-05-07
2	BC Hydro Review	2025-03-27
1	DDP Progress Set	2025-02-28
No.	Issued For	Issue Date



BC Housing/CMHA 201-3440 Douglas St Victoria, BC

EVERGREEN DA-D (PHASE 1)

Cover

project no.		124.10
scale	1: 400	@ 24"x36"
drawn by		KR/JD
checked by		SM/JD
sheet no.		

- ESPECAL NOTES

 1. Note performed shall comply with the following; a) These General Notes, and Construction
 1. Note performed shall comply with the following; a) These General Notes, and Construction
 1. Note performed the Specifications; b) Canadism Landscape Standards, Current Editor (CLS-CE); and c)
 1. all applicable tools provincial, and offental codes, confidences, and regulations.
 2. Confractor shall be responsible for verifying all existing site conditions including location of all property lines, existing structures, sultiles, and burdent firstantiver. Verify all field conditions prior to
- commercing work.

 Contractor is expossible for determining means and methods for construction. These drawings may incideate a limit of proposed improvements or limit of work for the delineation of expected activits of incident and incident

- the construction size after extensing the occurrents are treately available for review by the unintercepted Architect and governing agency. Contactor is responsible for construction of all designs, durings, specifications and other documents. Experimentally, and the production of based, any discrepancies with the drawings endire specifications and sile conditions shall be brought to the attention of the Landscape Architect, prior to proceeding with construction. The drawings and appointances are complementary to one another and impliced to correspond with one another. Any discrepancies should be brought to the attention of the Landscape Architect for resolution immediately.
- General Contractor and/or sub-contractors are responsible for all costs related to production and submission to consultant of all landscape as-built information including irrigation.

TREE RETENTION AND REMOVAL NOTES

1. Tree protection fencing, for existing trees, to be installed prior to commencement of all site work. Refer to Arborist's plans for location of tree protection fencing, and protection fencing detail.

2. Refer to arborist's report for detailed information for existing tree resources.

- SITE GRADING AND DRAINAGE NOTES

 1. All elevations are in meters.
 2. Refer to Architectural plans, sections and elevations for top of slab elevations. Stab elevations indicated on Landscape drawings are for reference only. Report any discrepancies to consultant for
- review and response.

 All road, public walkway and vehicular drive aisles and parking area elevations indicated on the Landscape drawings are for reference only. Refer to Civil Engineering drawings. Report any discrepancies to consultant for review and response.

 Confirm all existing grades prior to contruction. Report any discrepancies to consultant for review and
- response.

 So Unless otherwise noted provide a minimum slope of 2% on all hard and soft Landscape areas to ensure positive drainage away from buildings, to rain gardens, or to drainage devices.

 All landscape areas shall not exceed a maximum slope of 3.1 in all instance,

 Upon discovery, contractor to orfain from blasting rock to meet landscape subgrades. Contractor to contact Landscape subgrades. Contractor to contact Landscape withing on the opposed in each instance.

RRIGATION NOTES

- Contractor to provide irrigation system for all planters to current IIABC Standards and Contract Specifications.
- All specified work to meet the project specifications, and all standards or specifications established in
- All specified work to meet the project specifications, and all standards or specifications established in the project of the pro

- damaged utilities shall be made at the contractor's expense, to the satisfaction of the coner's representatives.

 For presentatives.

 Grant of a damage for electrical service.

 Enter to Mechanical Room, unless otherwise notes.

 Enter to Mechanical drawings for sites and location of irrigation service.

 Certained to verify pressure and they prior to installation of irrigation service.

 Certained to verify pressure and they prior to installation of irrigation and notify owner's representative services.

 Sleewer shall be installed at the noiseasy depths, point to prevenent construction. Sleewing shall exceed 300 mm from edge of paving into planting area, and shall have ends marked above grade unless otherwise shown.

 Selevate shall be installed at the noiseasy depths, point positions to review the contraction of the prevention of t cessible until successful completeition of inspection or test.
- 11. Over soray onto hardscape areas to be minimized. Use drip irrigation within small planting areas to
- 11.0 We spary our law-business was as to be irrigated with spray heads.
 12. Trees within struct parties or rain garden areas to be irrigated with spray heads.
 13. Trees in Plaza in hard pawement (soil cells below) to recieve temporary irrigation system around root collar and permanent drip irrigation system.

GROWING MEDIUM NOTES

- Refer to Landscape Specifications for growing medium properties by soil type
- Advise Contract Administrator of sources of growing medium to be utilized 14 days in advance of starting work

- starting work.

 Growing medium properties and handling shall meet CLS-CE (see Section 6 CLS-CE).

 Contractor is responsible for soid analysis and ammediment requirements to supply, suitable growing medium, as specified by besting agency. Soil analysis and mendment costs shall be included in the submitted to the Landscape Architect a copy of the soil analysis report from Pacific Soil Analysis Inc. 5-11720 Voragenet Way, Richmond, EQ, WX Soils, 16-64 279-32428. The analysis shalls for feets also one on the proposed growing medium from stratified samples taken from the supply source. Costs of the shalls and all subsequent tests to insure complainers with the specifications shall be for their start of the shall and all subsequent tests to insure complainers with the specifications shall be for their shall shall subsequent tests to insure complainers with the specifications shall be formed by
- we currenced? Contract Administrator will collect sample of growing medium in place and determine acceptance of material, depth of growing medium and finish grading. Approval of growing medium material subject to soil testing and analysis. Planting is not to occur until finished grades have been approved by Contract Administrator.

- Provide layout of all work for approval by Contract Administrator prior to proceeding with work.

 Requests for site review as required 48 hours in advance of performing any work, unless otherwise
- noted on this sheet.

 2. Layout and verify dimensions prior to construction. Bring discrepancies to the attention of the Contract
- Written dimensions take precedence over scale. Do not scale drawings.

 All plan dimensions in metres and all detail dimensions in millimetres, unless otherwise noted.
- Where dimensions are called as 'equal' or 'eq', space referenced items equally, measured to centre

GENERAL PLANTING NOTES

- Plant quantities on Plans shall take precedence over plant list quantities. Provide layout of all work for approval by Contract Administrator prior to proceeding with work. Plant material, installation and maintenance to conform to the current edition of the Canadian

- ON-SLAB TREE PLANTING NOTES

 1. For on-slab landscape, a root barrier will be installed to protect exposed water proof membranes. A dimple board (drain mat) will be installed over the root barrier.

 2. Parkade walls and foundation walls will be protected with a dimple board (drain mat) to convey water
- Faircase walls and roundary walls will be protected with a unimps obard grain mart, to convey water to the perimeter found and protect will from hosts.

 And the perimeter foundation and protect will found the protection of the p

- AVING NO. I.S.
 Final concrete control joint layout to be confirmed by Landscape Architect prior to installation. Control joints to logically align with edges, corners, and intersections of Landscape and Architectural elements and/or as indicated on plan. Contractor to obtain layout approval by Landscape Architectural elements. installation. Contractor to pour concrete pavement in alternating panels as required to achieve control
- oint design and to prevent cracking. joint design and to prevent cracking.

 Cast in place concrete areas that are subject to vechicular loading shall be structurally reinforced for applicable vehicular loading requirements. See Structural Engineering drawings.

WARRANTY AND MAINTENANCE NOTES

- or is responsible for Maintenance from installation to Acceptance of the work by the Contract
- Administrator.

 2. Refer to Landscape Specifications for Maintenance Period following Acceptance.

 3. Landscape installation to carry a 1-year warranty from date of acceptance. This warranty is based on adequate maintenance by the Owner after Acceptance, as determined by the Landscape Architect.

 The Contractor will not be responsible for plant loss or damage to other products by causes out of the Contractor control such as vandalism, "dats of God", "excessive wear and test", or abuse.

 4. Contractor is responsible for plant carrage, failure and death due to poor delivery, storage and handling, and a other installation related aspects by unit the End of Vitarrary period.
- Plant material, installation and maintenance to conform with the current edition of the Canadian Landscape Standards, and the Contract Specifications

- OFF SITE IRRIGATION NOTES

 1. All boulevard irrigation work, including required inspections, shall comply to "City of Victoria Supplementary Specifications for Street Trees and Irrigation Schedule C, Bylaw 12-042, Subdivision Bylaw".
- Bylav.

 2. The irrigation system and sleeving inspection requirements can be found in Schedule
 C of the Victoria Subdivision and Development Servicing Bylav No. 12-642. Irrigation inspections
 required for all selevenit, open trends mainter and testing report). Call CoV Parts 250-361-3600 min. 2 days in
 Development of the inspection tag and testing report). Call CoV Parts 250-361-3600 min. 2 days in
 Development of the inspection tag and testing report). Call CoV Parts 250-361-3600 min. 2 days in
 Development of the inspection of t

- municipal statt.

 Boulevard Ingation electric zone valves to be RainBird PGA, except tree drip valves: Rainbird Low Flow Control Zone Kit w/ PR Filter; XCZLF-100-PRF 1.
- 100mm diameter PVC Sleeving is required for all irrigation piping installed under hard surfaces. Extend sleeve 300mm beyond edge of hard surface into soft landscape areas.

- OFF-SITE IRRIGATION INSPECTIONS REQUIRED

 1. The following irrigation and sleeving inspections by Parks Staff are required by Schedule C. Please contact. Ton Sherbo, therebody/critica, can and copy treepermits@victoria, ca 46 hours prior to the required inspection time to schedule an inspection.

 (1) inglation deeving prior to acciditing.

 (2) Open treeth intent line and pressure test.

 - (4) irrigation system, controller, coverage test, backflow preventer assembly test report required, backflow assembly is to have an inspection tag completed and attached.

- IDULEVISO DI ANTRO NOTES

 1. The Viction Solutionis and Development Servicing Bylew No. 12-042 and the associated Schedules can be found on the City of Victoria Bylews weekopee.

 2. The finished gaide for bolleverand must be firm against footprints, loose textured, free of all stones, roots, and branches. Please contact from Sherob, sherbodgivictions, and copy on inspection.

 3. As old text for the growing media, for each industages application not City Protey'm must be ubmitted to the City Partis treopermis(sprictorio, can for review at least one week prior to soil placement, Growing media must meet the statisticates for each specifical notation of City Protey must be submitted to edition of the Canadian Landscape Standard

- CFE-SITE HORITCULTURE INSPECTIONS REQUIRED

 1. The following impactions are required for all of-site horizoulture areas:

 1. The following impactions are required for all of-site horizoulture areas:

 (2) Installed and prepared growing media prior to planting.

 (3) Plant material on-site prior to planting.

 (4) Planted landscape prior to much installation.

 - (5) At time that planted and mulched landscape meets the conditions for Total Performance as

JOINT LINEAR FEET

LIST OF A	BBREVIATIONS		
APPROX	APPROXIMATE	м	METRE
ARCH	ARCHITECT	MAX	MAXIMUM
ANCH	AVERAGE	MFR	MANUFACTURER
AVG R&R		MH	MANHOLE
BG BG	BALLED AND BURLAPPED BOTTOM OF CURB	MIN	MINIMUM
		MISC	MISCELLANEOUS
BLDG	BUILDING	MM	MILLIMETRE
	BENCHMARK	N	NORTH
BC	BOTTOM OF CURB	NIC	NOT IN CONTRACT
BR BS	BOTTOM OF RAMP BOTTOM OF STEP	NO	NUMBER
		NOM	NOMINAL
BW	BOTTOM OF WALL	NTS	NOT TO SCALE
CAL	CALIPER	OC	ON CENTER
CB	CATCH BASIN	OD	OUTSIDE DIAMETER
CF	CUBIC FEET	PC	POINT OF CURVATURE
	CAST IN PLACE	PE	POLYURETHANE
CL	CENTER LINE	PI	POINT OF INTERSECTION
CLR	CLEARANCE	PL.	PROPERTY LINE
CM	CENTIMETER	PT	POINT POINT OF TANGENCY
co	CLEAN OUT	PVC	POLYVINYL CHLORIDE
CONT	CONTINUOUS	OTY	QUANTITY
CU M	CUBIC METRE	R	RADIUS
DEG	DEGREE	REF	REFERENCE
DEMO	DEMOLISH, DEMOLITION	REINE	REINFORGE(D)
DIA	DIAMETER	REOD	REQUIRE(D)
DIM	DIMENSION	REV	REVISION
DTL	DETAIL	ROW	RIGHT OF WAY
DWG	DRAWING	8	SOUTH
E	EAST	SAN	SANITARY
EA	EACH	SD	STORM DRAIN
EL	ELEVATION	SE	SQUARE FOOT (FEET)
ENG	ENGINEER	SHT	SHEET
EQ	EQUAL	SIM	SIMILAR
EST	ESTIMATE	SPECS	SPECIFICATIONS
E.W.	EACH WAY	SOM	SQUARE METRE
EXIST	EXISTING	ST	STORM SEWER
EXP	EXPANSION, EXPOSED	STA	STATION
FFE	FINISHED FLOOR ELEVATION	STD	STANDARD
FG	FINISHED GRADE	SYM	SYMMETRICAL
FL	FLOW LINE	TAB	TOP AND BOTTOM
FOC	FACE OF CURB	TC	TOP OF CURR
FT	FOOT (FEET)	TE	TOP OF FOOTING
FTG	FOOTING	TH	THICK
GA	GAUGE	TOPO	TOPOGRAPHY
GEN	GENERAL	TR	TOP OF RAMP
GR	GRADE ELEVATION	TS	TOP OF STEP
HORIZ	HORIZONTAL	TW	TOP OF WALL
HP	HIGH POINT	TYP	TYPICAL
HT	HEIGHT	VAR	VARIES
ID	INSIDE DIAMETER	VAR	VARIES
INV	INVERT ELEVATION	W	WITH
IN	NCH(ES)	WID	WITHOUT
INCI	INCLUDE(D)		
man.	mocoocto,	WT	WEIGHT

CRADING LECEND


GIVADING LEGE	ND
25,25 36,7% 24,25	Proposed Landscape Grade TOW Top of Wal BP Botten of Ped BW Bottom of Wal 18 Top of Saris TOC Toe of Gottom 65 Sorten of Sories BC Bottom Count HP High Point TO Toe of Ped LP Low Point
25,25	Existing Grade
€ 25.25	Architectural grade, for reference only
€ 25.25	Proposed Landscape Grade
X ^(25.25)	Civil Grade, for reference only
∕(8.00)⁄	Proposed Landscape Contour

LANDSCAPE INFRASTRUCTURE LEGEND

	Perforated Underdrain	4-L4.04
	Sched 40 PVC	
c/o	Clean Out	6-L4.04
L-AD	Landscape Area Drain 8* Square Drain with ADA Steel Lockable Grate.	8-L4.01
L-OD	Landscape Overflow Drain	2-L4.04
	Trench Drain Aco K100 Trench Drain, Load Class A	
	Culvert 300mm dia. pipe c/w headwal	
	Root Barrier	

LINE TYPE LEGEND

SRW Building Footprint Extent of Roof / Canopy, above Extent of Parkade, below Rain garden - TOP OF POOL Rain garden - BOTTOM OF POOL

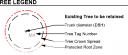

MATERIALS L	.5 & L6
	Tiles on Pedestal 20 mm x 610 mm x 610 mm procellan tile or pedestal system. Enmon - project silver
000000000	Rubber Surfacing with decorative patterning
	Decorative Porcelain Tiles Enmon - project cemento. 24" x 48" x 2cm th plank style procelian tile on pedestal system
	Artificial Turf Syn-Lawn or approved equivalent
SITE FURNISH	INGS L5 & L6
Ħ	Movable Chair Wabash Green Valley Dining Chair. Colour: Cedar/Textured Black - or approved equivalent.
	Movable Dining Table & Chair

Cedan/Textured Black - or approved equivalent.
Movable Dining Table & Chair Wabsah Yorktown Rectangular Slat Table - Colour: Silver or approved equivalent.
Adirondack Chair Wishbone JEM Lounge Chair, Plastic Lumbs Groy, Powder Coat Traffic Yellow - or appro



Metal Planter

Vegetable Planter Green Theory Wide Rectangle Accessible Vegetable Planter ord Accessible Planter: m W x 857mm H - or

TREE LEGEND



MATERIALS L	5 & L6
	Tiles on Pedestal 20 mm x 610 mm x 610 mm proceilan tile on pedestal system. Enmon - project silver
000000000000000000000000000000000000000	Rubber Surfacing with decorative patterning
	Decorative Porcelain Tiles Enmon - project cemento. 24" x 48" x 2cm thick plank style procelian tile on pedestal system.
	Artificial Turf Syn-Lawn or approved equivalent
SITE FURNISH	INGS L5 & L6
Ħ	Movable Chair Wabash Green Valley Dining Chair. Colour: Cedan/Textured Black - or approved equivalent.
	Movable Dining Table & Chair Wabash Yorktown Rectangular Stat Table -



equivalent, or approved equivalent.
Bar Style Table & Chairs Style Table & Chairs eah Green Valley Rectangular Bar Table ar/Textured Black Colour - or approved valent, or approved equivalent.

MATERIALS LEGEND

Municipal Sidewalk (for reference only) Asphalt Paving - Road / Drive Aisle / Parking (for reference only, by others)

HARDSCAPE SURFACES

CIP Concrete olw broom finish and sawo Concrete Unit Pavers Type 1 Newstone Double Standard - Charcoal Colour, 225 mm x 225 mm x 60 mm. Sans and gravel build up Concrete Unit Pavers Type 2 Newstone Standard - Northern Shado Colour. 225 mm x 112.5 mm x 60 mm Sand and gravel build up

Unit Paver - Permeable - Vehicula Newstone 'Eco-Pro' - Natural Colour 200 mm x 100 mm x 70 mm Rubber Safety Surfacing c/w decorative patterning & design



Lookout Deck Wood decking surfacing. Gravel Maintenance Edge

STEPS, RAMPS, CURBS, WALLS

Retaining Wall - Concrete Retaining Wall - Precast Modular Barkman Keystone Linear modular concrete wall system in charcoal color approved equilavent

Ramp with Handrail To meet BCBC requiremen

Boulder Slope Retention/Wei 800 - 1200 mm diameter mini ey 1/3 of base into grade. Concrete Band - Flush

SOFTSCAPE

ree & Shrub Planting Area - on Slab

300-900mm depth, avg. 600mm depth Berm to maximize depth to 750mm when tain Garden Area

Lawn Area 150mm depth unless otherwise noted.

Turfstone Belgard Canada, c/w structural soil base FENCING & RAILS

Fence
1200 mm height. Metal picket, colour to compliment architecture.

Fence 1200 mm height. Metal picket, colour to compliment architecture. Civy panels below to screen underside of raised balcon

Bike Rack Dero 'Hoop Rack' - or approved equivalent. مد Sacked Bench
Retherford Backless Bench, Sand

Wishbone Rutherford Backless Bench, Sand Plastic Lumber - Sand, Powder Coat Gun Metal-or approved equivalent, or approved equivalent, Backless Bench Wishbone Rutherford Backless Bench, Sand Plastic Lumber - Sand, Powder Coat Gun Metalresect Lumber - same, Powder Coat Gun Metal-or approved equivalent, or approved equivalent. Wood Topper on Seat Wall Wishbone Besett Backless Wall Top Bench. Sand Plastic Lumber - Sand, Powder Coat Gun Metal- or approved equivalent, or approved enviselent

SITE LIGHTING

\times	Landscape Bollard Product TBD
\/	Inset Light



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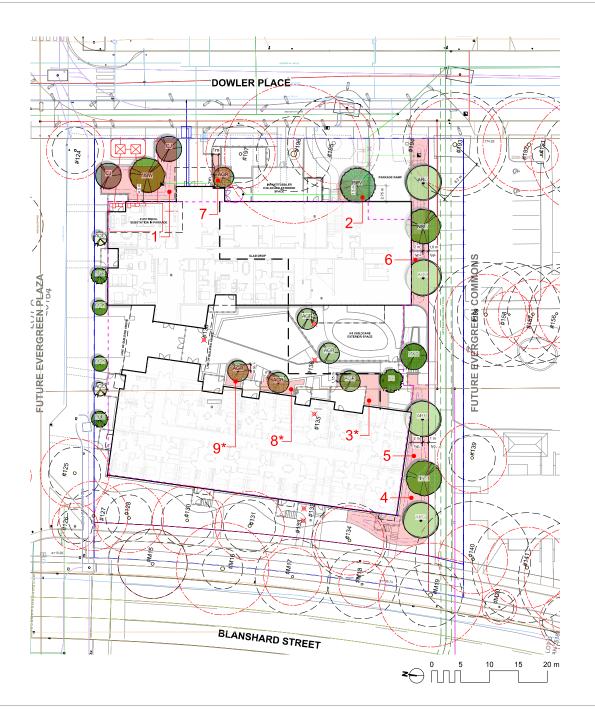
DDP Progress Set 2025-02-28

BC Housing/CMHA 201-3440 Douglas St Victoria, BC


EVERGREEN DA-D (PHASE 1) Victoria, BC

General Information Sheet

project no. 124.10 scale AS SHOWN @ 24"x36" KR/JD SM/JD



EXISTING TREE LEGEND

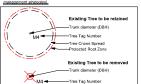

Sym	Qty	Botanical Name	Common Name	Schd. Size / Plant Spacing
TREES:				
ACC	2	Acer circinatum	Vine Maple	multistem, 1,5 m ht, b8b
AGR	6	Acer griseum	Paperbark Maple	4.0cm cal, b&b
ARG	4	Acer rubrum 'Autumn Glory'	Autumn Glory Red Maple	6.0cm cal, b&b
CJ	2	Cercidiphyllum japonicum	Katsura Tree	5.0cm cal, b&b
CNP	2	Chamaeoyparis nootkatensis 'Penduta'	Nootka False Cypress	2,5 m ht
COK	2	Comus kousa Milky Way	Miky Way Kousa Dogwood	multistem, 1.5 m ht, b8b
KP	1	Koefreuteria paniculata	Panicled Goldenraintree	multistem, 1.5 m ht, b&b
MXG	1	Magnolia x 'Galaxy	Galaxy Magnola	multistem, 1.5 m ht, b8b
NSW	3	Nyssa sylvatica 'Wildfre'	Tupelo	5.0cm cal, b&b
DOU	4	Parmitia pareira 'Pulsu Vasa'	Pubu Vare Persian Immunod	5 Dom cell bills

REPLACEMENT TREE SOIL VOLUME TABLE

				REPLACEMENT TREES PROPOSED			SOIL VOLUME REQUIRED (m3)			
Planting Area (*= on slab)	Area (m2)	Soil Volume Multiplier	A. Estimated Soil Volume (m3)	B. Small	C. Medium	D. Large	E. Small	F. Medium	G. Large	Total
ONSITE										
1	86.3	1	86.3		2	1	0	30	30	60
2	18.7	1	18,7	1			- 8	0	0	8
3*	31.5	0.6	18.9	2			16	0	0	16
4	89.0	- 1	89.0		1	-1	0	20	30	50
5	21.7	- 1	21.7		- 1		0	20	0	20
6	85.7	1	85.7		3		0	60	0	60
7	18.1	1	18,1	1			- 8	0	0	8
8*	16.0	0.6	9.6	1			- 8	0	0	8
9*	14.0	0.6	8.4	1			8	0	0	8
Total				6	7	2				

NOTE: Replacement tree quanities was determined during the rezoning stage. The total number of replacement trees for Lot D is 19. Retained onsite trees count towards total number of replacement trees.

REPLACEMENT TREE SUMMARY


REQUIRED (as per Tree Protection Bylaw)

n/a for this project as minimum ntree # set at Rezoning Application

Minimum # of Trees for Lot Area: 19 Number Set at Rezoning Application

ONSITE Minimum replacement tree requirement 1:1 Replacement Trees - Schedule E Part 1 2:1 Replacement Trees - Schedule E Part 2

Total Replacement Trees Proposed NOTE: Refer to Arborist's Report for retained existing tree classification and count.

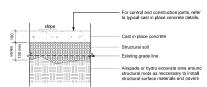

- GENERAL MOTES:

 1. Construction strategies within Tree Protection Zone (T.P.Z) to be approved by Project

 1. Construction strategies within Tree Protection Zone (T.P.Z) to be approved by Project Arborist.

 2. Examation within T.P.Z to be coordinated and supervised by the Project Arborist.

 3. All reasonable efforts to minimize native toppoid disturbance and compaction are to be made.

 All areasonable efforts to minimize native toppoid instructions and compaction are to be made.

 Assem natival deepline may be reduced below 150 mm by Instituting Corological Spotostatio for approved equivalently over native toppoid. Final detail to be confirmed in consultation with Lindscape Architect and Project Architect.





5	Issued for DDP	2025-07-08
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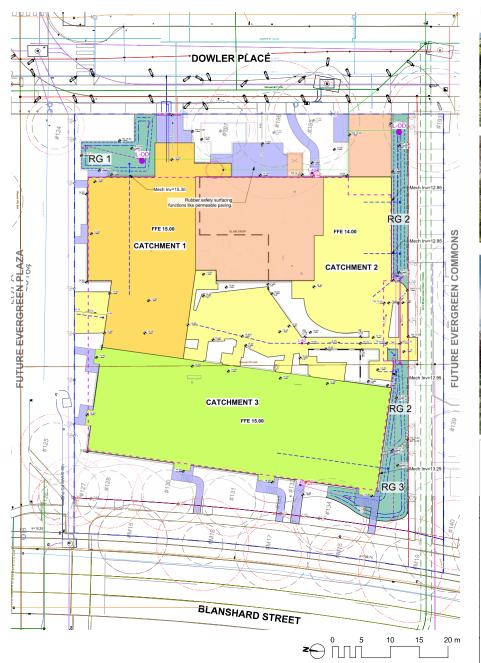


BC Housing/CMHA 201-3440 Douglas St Victoria, BC

EVERGREEN DA-D (PHASE 1) Victoria, BC

Tree Replacement

project no.		124.10
scale	1: 200	@ 24"x36"
drawn by		KR/JD
checked by		SM/JD
cheet no		



RAIN GARDEN PRECEDENTS














STORMWATER MANAGEMENT LEGEND

	Property Line Building Footprint Extent of Roof / Canopy, ABOVE Extent of Parkade, BELOW
	Rain Garden Top of Pool (TP) Rain Garden Bottom of Pool (BP)
17.70 17.70 × 17.70	Existing Grade Proposed Landscape Grade Proposed Civil Grade
>	Direction of Flow Rain Garden Area
L-OD	Overflow Drain See chill drawings

IMPERMEABLE SURFACE AREAS

IIII EKINEMBEE GOTA MOE MAEMO				
	Impervious Area Roof & Paving Areas Draining to Rain Gardens			
	Impervious Area Draining Directly to Storm System			
	Impervious Area Draining to Absorbent Landscape			

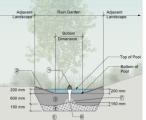

RAIN GARDEN MATERIALS

- IN GARDEN MA I Extra
 Overflow drain ...
 Overflow drain ...
 Composited milch, 50 -70 mm depth ...
 Bio-tetention growing medium, 000 mm depth ...
 Scartificelisted subgrade, 150 mm depth ...
 S. Existing subgrade-native material 6 ...
 100 mm diameter (min) perforated pipe ...
 2 mm diameter drain rook, 100 mm depth ...

1 Typical Rain Garden
Scale: 1:50

CITY OF VICTORIA STORMWATER CALCULATIONS

Site Stormwater Storage Requirements		
		Required Storage
	Area	Volume for Design
		Storm*
	(sq. m.)	(cu. m./day)
Impervious Area Managed by Rain Gardens	2211	71
Impervious Area Draining to Absorbent Landscape	205	
Innered from Asses Businism to Otto Ottom Busin	474	

tain	Garden	Sizing	Calculations

Catchment Area	Contributing Impervious Area	Design Storm Runoff Volume Contributing to Rain Garden*	Planter Growing Medium Depth	Stormwater Treatment Capacity per sq. m. of Rain Garden	Rain Garden Base Area	Rain Garden Capacity***	Sizing Factor (Water Quality Methodology)
	(sq. m.)	(cu. m./day)	(m.)	(cu. m./day)	(sq. m.)	(cu. m./day)	
Catchment 1	569.0	18.2	0.60	0.80	57.1	45.7	10.0%
Catchment 2	715.0	22.9	0.60	0.80	54.0	43.2	7.6%
Catchment 3	927.0	29.7	0.60	0.80	49.7	39.8	5.4%
total						128.6	

Assumptions
* Design storm is 32mm of water, in a 24 hr period.

*** Rain Garden capacity based on 200 mm live ponding plus 20% of the sand/ compost growing medium volume (assuming growing medium has 20% void space) with a minimum infiltration rate of 2 cm/hour (or 48 cm per day), via perforated underdrain.

""Landscaped areas require minimum 170mm depth of growing medium in order to manage 32mm rainfall / 24 hours (assuming 20% void space). Engineered green roof systems that are shown to meet the minimum requirements may also be included.



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BC Housing/CMHA 201-3440 Douglas St Victoria, BC

EVERGREEN DA-D (PHASE 1)

Victoria, BC

Stormwater Management

project no.		124.10
scale	1: 200	@ 24"x36"
drawn by		KR/JD
checked by		SM/JD





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BC Housing/CMHA 201-3440 Douglas St Victoria, BC

EVERGREEN DA-D (PHASE 1)

Victoria, BC

Landscape Materials L1

project no.		124.10
scale	1: 200	@ 24"x36"
drawn by		KR/JD
checked by		SM/JD
sheet no.		

L1.01

LANDSCAPE PRECEDENTS



1.) MOVABLE FURNISHINGS FOR FLEXIBLE AMENITY SPACE THAT CONNECTS WITH MULTI-PURPOSE ROOM



ADAPTABLE MULTI-FUNCTIONAL AMENITY SPACE INTEGRATED WITH TOT PLAY SPACE




(3.) TOT PLAY SPACE ON SAME LEVEL AS MULTI-PURPOSE ROOM




(4.) SHADE AND SHELTER FOR WEATHER PROTECTION (L5 & L6 SOUTH FACING OUTDOOR SPACES)



5. RAISED BEDS FOR GARDENING & FOOD PRODUCTION OPPORTUNITIES

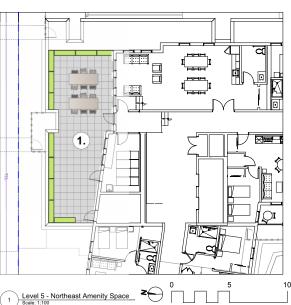



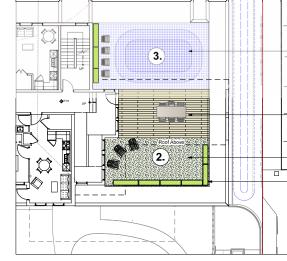



Rubber Surfacing with decorative

Artificial Turf Syn-Lawn or approved equivalent


Decorative Porcelain Tiles Enmon - project comento, 24" x 46" x 2cm this plank style procelan tile on pedestal system.



(6.) FLEXIBLE SOCIAL SPACE INTEGRATED WITH RAISED BEDS



7. PASSIVE RECREATION & HANG OUT SPACE

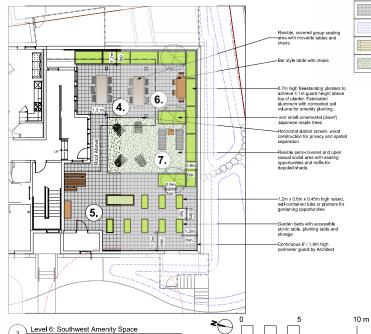



AMENITY SPACE

—Tot (2-5 year old) play space with features such as small mound and trike loop created rubber surfacing pattern design.

Covered area offers an all season social space that could be used for gartherings or sharing meals together associated with the multipurpose room at the adjacent end of the building corridor (same

Flexible and programable open space for recreation opportunities such as yoga, wellness classes and small games.

10 m

-1.2m Ht. Planters



Issued for DDP

DD Progress Set 2025-06-06

BP 50% Review 2025-05-07

DDP Progress Set 2025-02-28

2025-07-08

Issue Date


201-3440 Douglas St Victoria, BC

EVERGREEN DA-D (PHASE 1) Victoria, BC

Landscape Materials L5 & L6

roject no.	124.10
ale	1: 200 @ 24"x36"
rawn by	KR/JD
necked by	SM/JD
neet no.	
	1103

L1.03

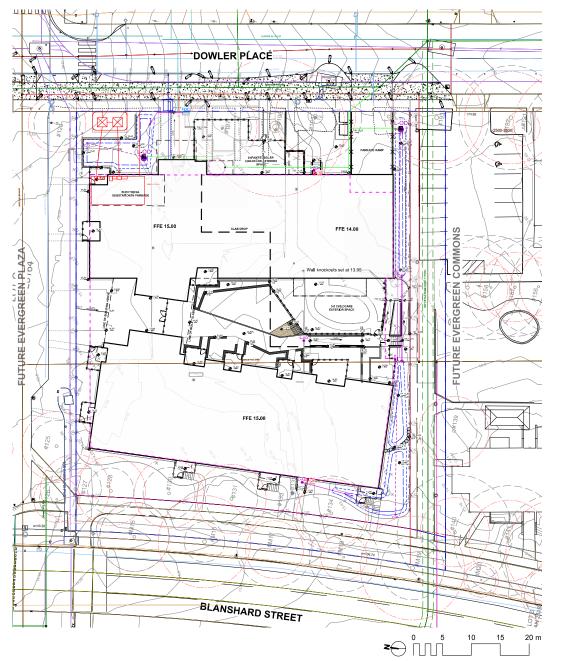

GRADING LEGEND

→ 25.25	Proposed Landscape Grade	
\$\frac{25.25}{\$\infty}\$ 36.7% \$\frac{24.25}{\$\infty}\$\$	TOW Top of Wall BP Bottom of Pool	
→ 25.25	Existing Grade	
⊕ 25.25	Architectural grade, for reference only	
⊕ 25.25	Proposed Landscape Grade	
X ^(25,25)	Civil Grade, for reference only	
/ (8.00)/	Proposed Landscape Contour	

LANDSCAPE INFRASTRUCTURE LEGEND			
	Perforated Underdrain		
1	Sched 40 PVC		
c/o	Clean Out		
L-AD	Landscape Area Drain 8* Square Drain with ADA Steel Lockable Grate.		
L-OD	Landscape Overflow Drain		
	Trench Drain Aco K100 Trench Drain, Load Class W		
Ĭ	Culvert 300mm dia. pipe c/w headwall		
	Root Barrier		



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client

BC Housing/CMHA 201-3440 Douglas St Victoria, BC

project EVERGREEN DA-D (PHASE 1) Victoria, BC

heet title

Landscape Grading & Drainage

project no.		124.10
scale	1: 200	@ 24"x36
drawn by		KR/JD
checked by		SM/JD
sheet no.		

L2.01



PLANT LIST Vine Maple
Paperbark Mayte
Auturnn Glory Red Mapte
Katsura Tree
Nooths False Cypress
Mity Way Kousa Dogwood
Panidos Goldenraintree
Gelasy Magnola
Tupelo
Ruby Vase Persian Ironwood multistem, 1.6 m ht, båb 4.0cm cal, båb 6.0cm cal, båb 5.0cm cal, båb Aper droinssum
Aper griseum
Aper rubrum 'Autumn Glory'
Cercidiphyllum japonicum Chemeecyperis nootkatensis 'Pe Cornus kouse 'Milky Way' Koelreuteria paniculata 2.5 m ht 2.5 m M; multistem, 1.5 m ht, b&b multistem, 1.5 m ht, b&b Magnolia x 'Galaxy' Nyssa sylvatica 'Mildfire' Parrotia persica 'Ruby Vase multistem, 1.5 m ht, b&b 5.0cm cal, b&b 5.0cm cal, b&b Kinnikinnick Northwestern Lady Fern Mexican Orange Barrenwort Salal N/P N Selel Hiddote English Lavender Lily furf Privet Honeysuckle Royal Star Magnolia Oranga Grane Phoasant's Tail Grass Pheasant's Tail Grass
Slough Sedge
Midwinter Fire Dogwood
Red-tvig Dogwood
Soft Common Rush
Privet Honeysuckle
Red Flawering Current NIP

*DENOTES NATIVE/POLLINATOR/EDIBLE PLANTS

- Low Native Planting Aloong Dowler Place Frontage & 3-5 Childcare Space: Sword Fern, Lady Fern, Sorrel, Barrenwort, Salal
- Rain Garden: Slough Sedge, Red-twig Dogwood, Red Flowering Currant, Soft Common Rush, Midwinter Fire Dogwood, Pheasant's Tall Grass, Honeysuckle
- 3 Shade Tolerant Native Planting Along Blanshard & Future PLaza: Salal, Oregon Grape, Red Flowering Currant, Sword Fern, Lady Fern
 Courtyard Planting: Kinnikinnick, Oregon Grape, Salal, Honeysuckle, Lily Turf,
- Courtyard Planting: Kinnikinnick, Oregon Grape, Salal, Honeysuckie, Lil Huckleberry, Rhododendron, Lavender
- 5 Hedging for Courtyard Patios: Yew spp.
- 6 Hedging for North Patios Along Future Plaza: Choisya spp.



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BC Housing/CMHA 201-3440 Douglas St Victoria, BC

EVERGREEN DA-D (PHASE 1) Victoria, BC

sheet title

Planting


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scale	1: 200	@ 24"x36"
drawn by		KR/JD
checked by		SM/JD
cheet no		

L3.01


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project name

Evergreen Phase 1

Victoria, BC

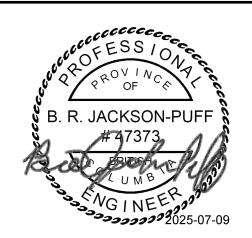sheet title
Existing Site Plan
And Demolition Plan

project no. CA0036198.5231

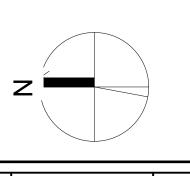scale 1:250

drawn by SG

date issued sheet no. C1.0

2025/07/04


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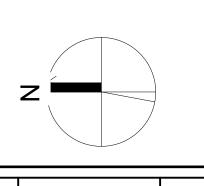
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project name

Evergreen Phase 1

Victoria, BC


Site Servicing Plan

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drawn by	SG/BJP	
date issued	sheet no.	3-12
2025/07/04	C1.1	024-06-12

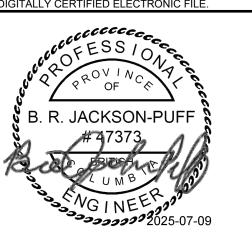
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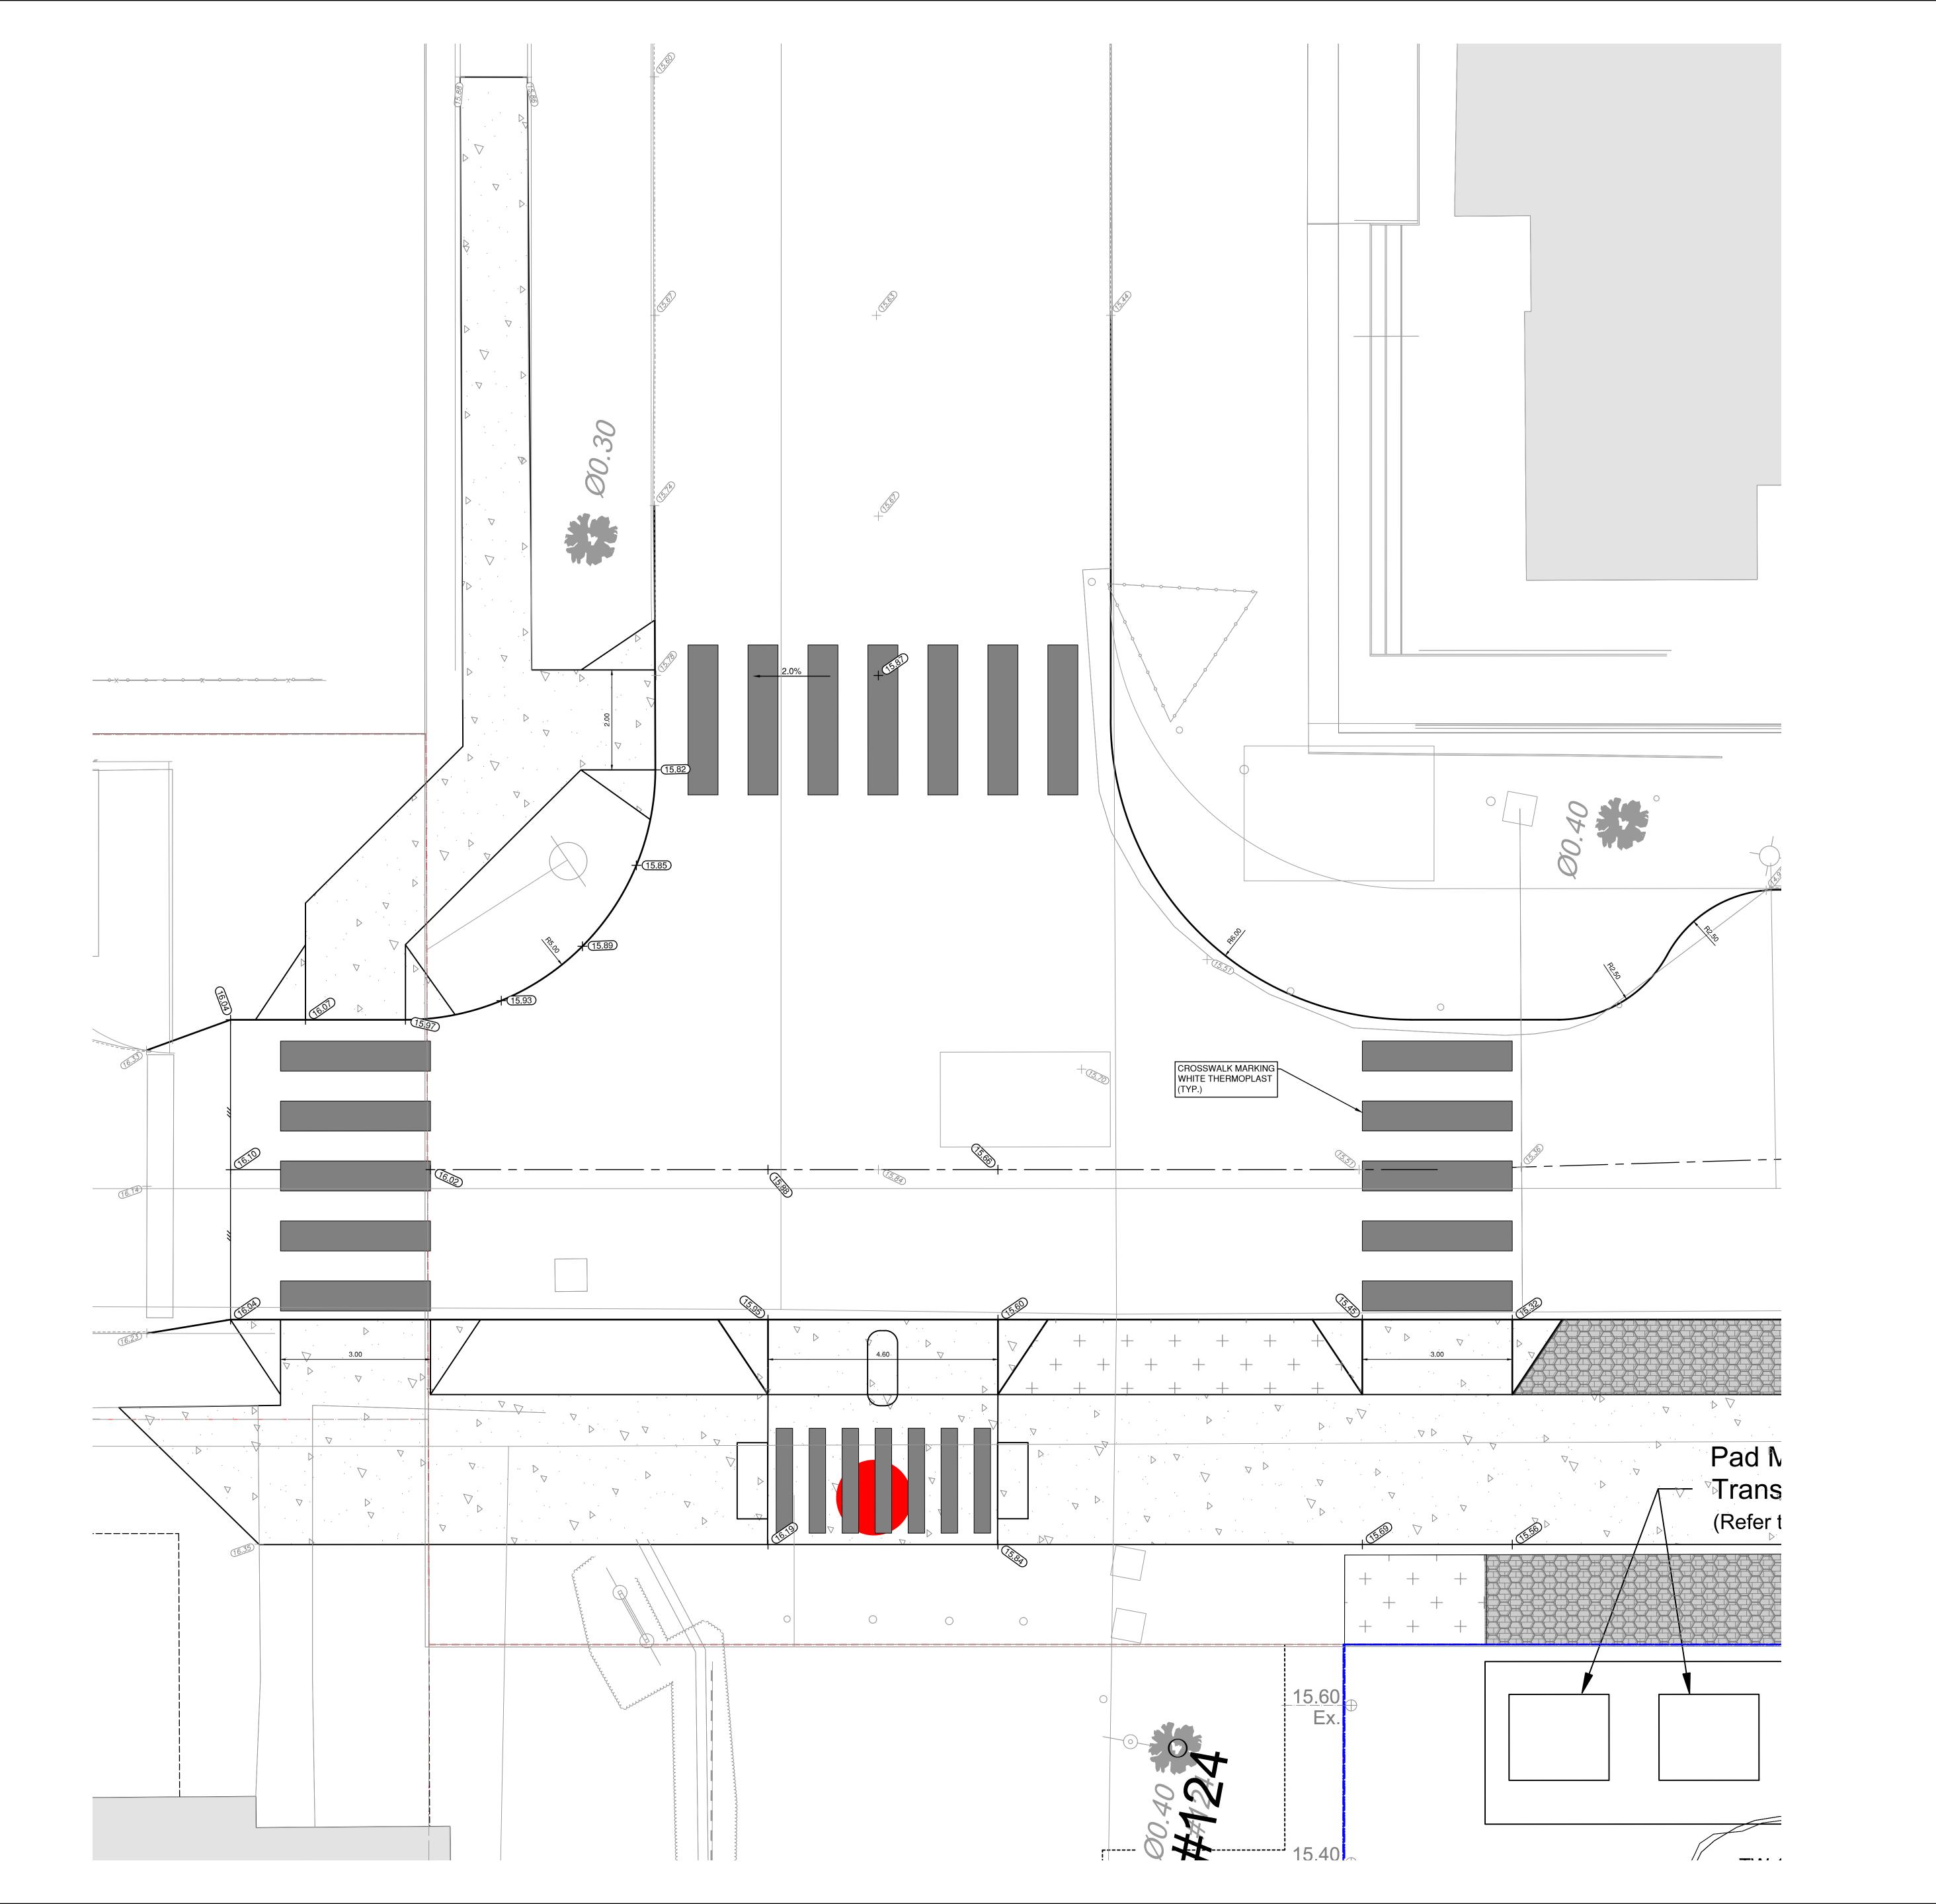
project name

Evergreen Phase 1

Victoria, BC

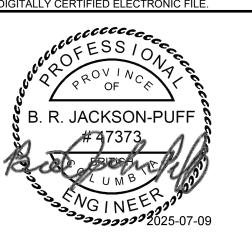Surface Works


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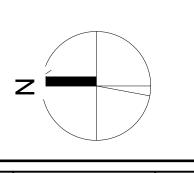
D'AMBROSIO architecture + urbanism
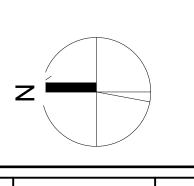
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Evergreen Phase 1

Victoria, BC


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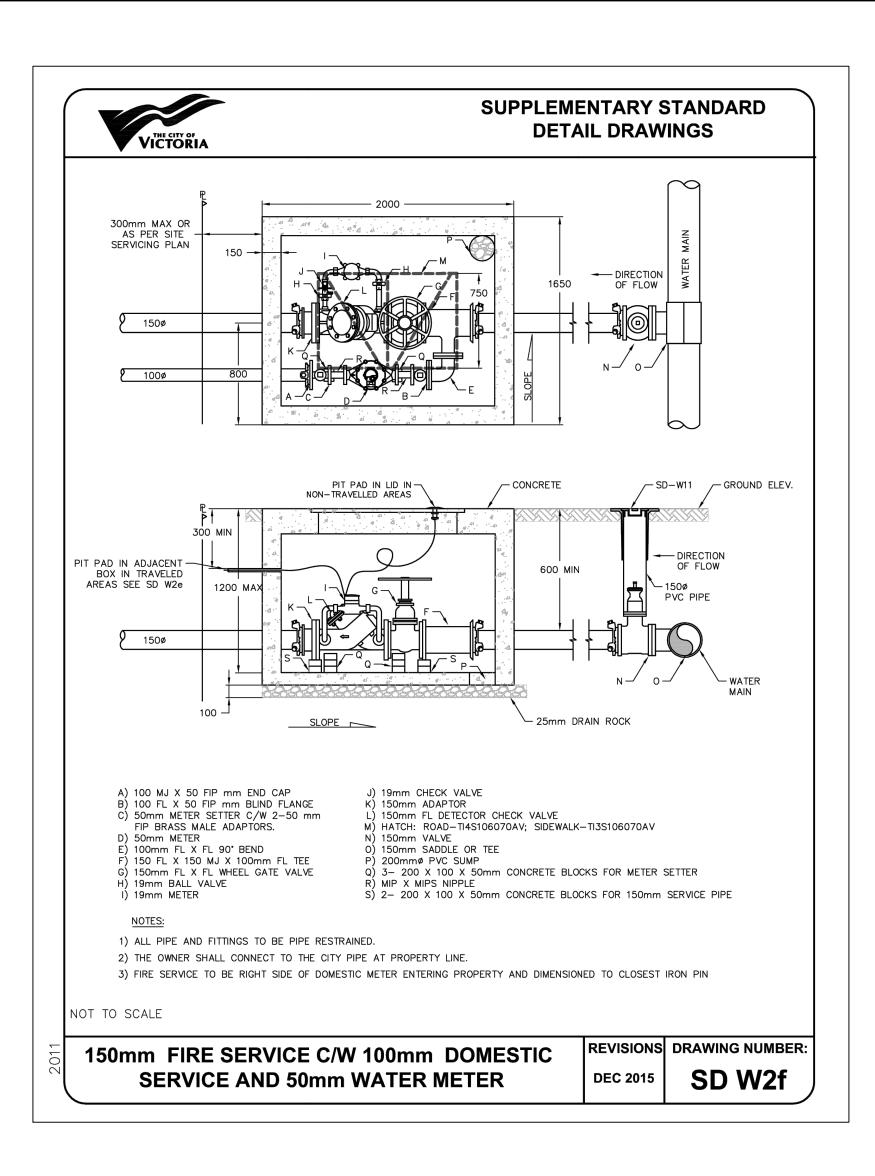
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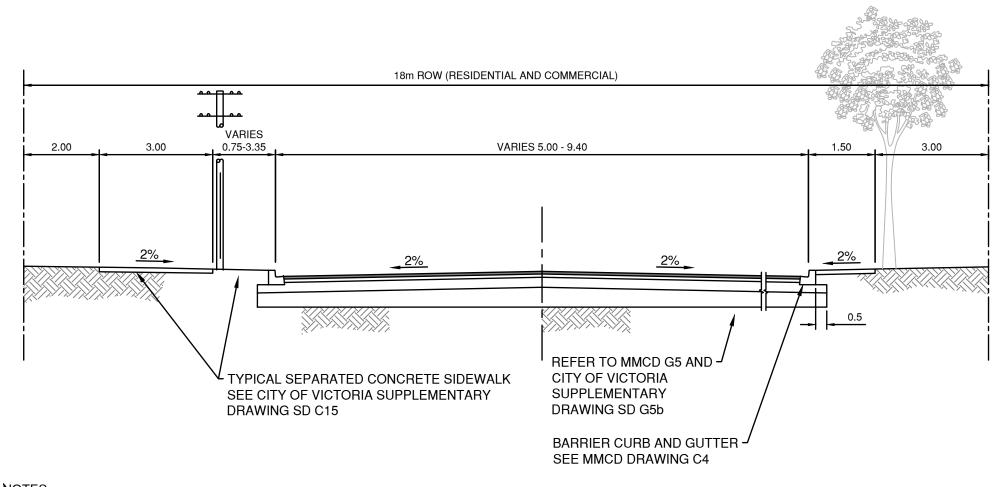
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drawn by SG/BJP

date issued sheet no. C1 3

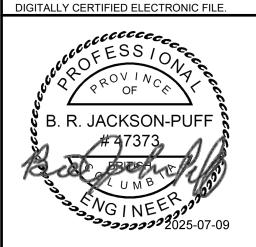



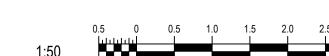


NOTES:

1. ALL DIMENSIONS IN METRES UNLESS NOTED OTHERWISE.


- 2. OVERALL DIMENSIONS AND ROW MAY VARY AT INTERSECTIONS.
- PAVEMENT WIDTHS: SINGLE FAMILY TO LOW DENSITY TOWNHOUSE • HIGH DENSITY TOWNHOUSE TO LOW RISE APARTMENTS AND NEIGHBOURHOOD COMMERCIAL CENTRES

TYPICAL LOCAL STREET

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project name

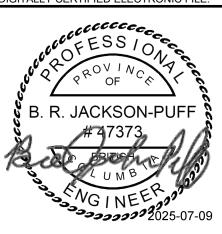Evergreen Phase 1

Victoria, BC

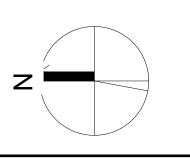sheet title
Civil Details

project no.	CA0036198.5231	AM
scale	1:50	10:48:36 AM
drawn by	SG/BJP	10:4
date issued	sheet no.	3-12
2025/07/04	C1.4	2024-06-12

