


1702 QUADRA STREET + 862 FISGARD STREET

VICTORIA, BC

18.07.2025 ISSUED FOR DDP





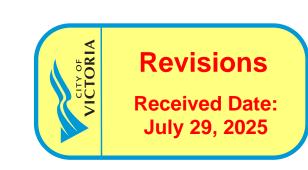

ARCHITECTURAL:

ARCHITECTURE INC

5468796 ARCHITECTURE INC. 266 McDermot Ave Winnipeg, MB. R3B 0S8

P: 204.480.8421 F: 204.480.8876

AG.9

Sasa Radulovic | Principal Architect E: sasa@5468796.ca

Pablo Batista | Architect E: pablo@5468796.ca

COVER **GENERAL NOTES** RENDERINGS AG.2 AG.3 RENDERINGS AG.4 MATERIAL BOARD AG.5 SHADOW STUDIES AG.6 SITE CONTEXT ELEVATIONS AG.7 WINDOW + DOOR SCHEDULE AG.8 ZONING CALCULATIONS

SITE SURVEY

CONTEXT SITE PLAN EXISTING SITE PLAN + DEMOLITION PROPOSED SITE PLAN LEVEL 00 PLAN

LEVEL 01 PLAN LEVEL 02 PLAN LEVEL 03 PLAN LEVEL 04/06/08/10/12 PLAN LEVEL 05/07/09/11 PLAN LEVEL 13 **ROOF PLAN** A1.8

BUILDING ELEVATION BUILDING ELEVATION A2.3 BUILDING ELEVATION BUILDING ELEVATION BUILDING SECTION A3.2 **BUILDING SECTION** A3.3 **BUILDING SECTION BUILDING SECTION**

BUILDING SECTION ENLARGED PLAN - BIKE ROOM

BUILDING SECTION

DEVELOPER:



1839 Fairfield Road Victoria, BC, V8S 1G9 P.250.940.3568 Vinit Jain E: vinit@aryze.ca

ARYZE DEVELOPMENTS INC.

CIVIL:



MCELHANNEY Suite 500 - 3960 Quadra Street Victoria, BC, V8X 4A3 P.778.746.7417

Nathan Dunlop E: ndunlop@mcelhanney.com

CONCEPTUAL SERVICING

ELECTRICAL:



e2 ENGINEERING 549 Herald Street Victoria, BC, V8W 1S5

E: peter.xu@e3eng.ca

MECHANICAL:

Kevin Jackson E: kjackson@avalonmechanical.com

ENVELOPE:



RDH BUILDING SCIENCE 602-740 Hillside Avenue Victoria, BC, V8T 1Z4 P.250.479.1110.

Byron Searle E: bsearle@rdh.com

LANDSCAPE:



BIOPHILIA Victoria, BC, V8T 3E6

P.250.590.1156 Bianca Bodley

Elizabeth Balderson E: elizabeth@biophiliacollective.ca

E: bianca@biophiliacollective.ca

TREE REMOVAL AND PROTECTION PLAN LANDSCAPE SITE PLAN OFF-SITE PLANTING PLAN PRODUCTS AND SITE FURNITURE

ROOFTOP AMENITY AREA

SYMBOL LEGEND:



P.778.433.9391 Peter Xu



AVALON MECHANICAL 300-1245 Esquimalt Road Victoria, BC, V9A 3P2 P.250.940.2976.

BUILDING SECTIONS:

GRIDLINE MARKER

WINDOW TYPE

DOOR NUMBERS

EXISTING DOOR


NEW DOOR

FINIISH TYPE

FLOOR TYPE

ROOF TYPE

NOTES

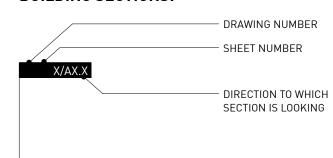


F-1

LABEL


LABEL

SECTIONS: - DRAWING NUMBER - SHEET NUMBER 1/A1.**4** - DIRECTION TO WHICH SECTION IS LOOKING


DETAILS:

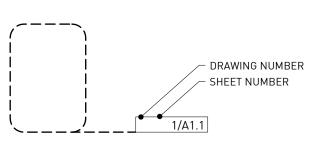


ROOM LABELS:

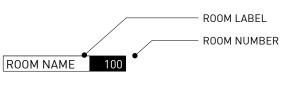



INTERIOR ELEVATIONS:

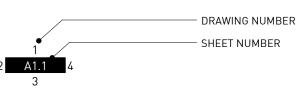

FLOOR CONSTRUCTION ELEVATIONS:

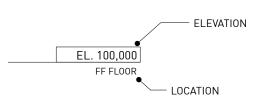

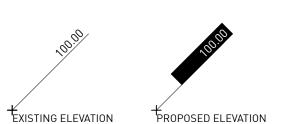

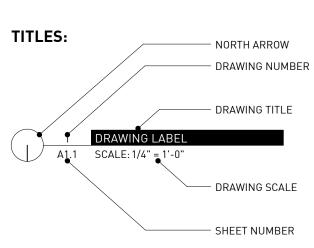

ABBREVIATIONS:	
& ABV AFF ALUM ANOD @ ARCH AT AVB	AND ABOVE ABOVE FINISHED FLOOR ALUMINUM ANODIZED AT ARCHITECTURAL ACOUSTIC TILE AIR/VAPOUR BARRIER
BLDG BLKG BRG BS B TO B	BUILDING BLOCKING BEARING BOTH SIDES BACK TO BACK
CB CF CG CJ CL CLG CLR COL CONC CONC CONN CONT CORR CT C/W	CATCH BASIN CLEAR FINISH CORNER GUARD CONTROL JOINT CENTRE LINE CEILING CLEAR COLUMN CONCRETE CONNECTION CONTINUOUS CORRIDOR CERAMIC TILE COMPLETE WITH
Ø DIM DN DRWG DTL	DIAMETER DIMENSION DOWN DRAWING DETAIL
EL EW EA ELEC EQ EXIST EJ EXT	ELEVATION EACH WAY EACH ELECTRICAL EQUAL EXISTING EXPANSION JOINT EXTERIOR
FDN FE FEJ FIN FD FFD FF FLEX FO FR FRR	FOUNDATION FIRE EXTINGUISHER FLOOR EXPANSION JOINT FINISHED FLOOR DRAIN FUNNEL DRAIN FINISHED FACE FLEXIBLE FACE OF FRIDGE FIRE RESISTANCE RATING
G GA GWB GCB GC	GRILL GAUGE GYPSUM WALL BOARD GYPSUM CEILING BOARD GENERAL CONTRACTOR GLASS
HM HMI HORIZ HR HSDG HSS HSTG	HOLLOW METAL HOLLOW METAL INSULATED HORIZONTAL HOUR HERMETICALLY SEALED DOUBLI HOLLOW STEEL SECTION HERMETICALLY SEALED TRIPLE HEIGHT

BLE GLAZING LE GLAZING HEATING, VENTILATING, AIR CONDITIONING INSIDE DIAMETER INSIDE FACE

INSULATION INTERIOR LENGTH METRE MILLIMETRE MOUNT MATERIAL MAX MAXIMUM MDF MEDIUM DENSITY FIBREBOARD MECH MECHANICAL MINIMUM MISCELLANEOUS MASONRY OPENING NOT IN CONTRACT NUMBER NOM NOMINAL NTS NOT TO SCALE

ON CENTRE

OUTSIDE DIAMETER

OVERHEAD 0PP OPPOSITE OPEN TO ABOVE OTB OPEN TO BELOW OVEN PLAM PLASTIC LAMINATE PLBG PLUMBING PAIR PREFINISHED PRESSED STEEL PRESSURE TREATED PAINTED FINISH PROPERTY LINE RADIUS **ROOF DRAIN** REINF REINFORCED

REQ'D REQUIRED REV REVISION, REVISED, REVERSED ROUGH OPENING SHEET FLOORING SIMILAR SPC'D SPECIFIED SQUARE STEEL STD STANDARD STAIN FINISH STRUCT STRUCTURAL SUSP SUSPENDED TEMP TEMPERED TEMPERED GLASS

TOP OF TYPICAL U/N UNLESS OTHERWISE NOTED UNDERSIDE VARNISHED FINISH VERTICAL

WIDE, WIDTH WASHER/DRYER WHC WOOD HOLLOW CORE WOOD SOLID CORE

7 Issued for DDP 6 Issued for DDP 5 Issued for DDP

EA/MM/AR Checked By: 18.07.2025 Printing Date:

The Contractor shall verify all dimensions, datums

18.07.2025

11.07.2025

08.07.2025

and levels prior to commencement of work. All errors and omissions to be reported to the

Architect before proceeding.

This drawing must not be scaled.

This drawing is the property of the Architect; the copyright in same being reserved to him/her. It is

Any unauthorized alteration of the electronic data which constitute this document will void all responsibility for the altered document by the Architect.

This drawing is not to be used for building purposes until countersigned by:




266 MCDERMOT AVE Winnipeg MB R3B 0S8 P: 204.480.8421 F: 204.480.8876

1702 QUADRA STREET + 862 FISGARD STREET

GENERAL NOTES

0650 Sheet


AG.1

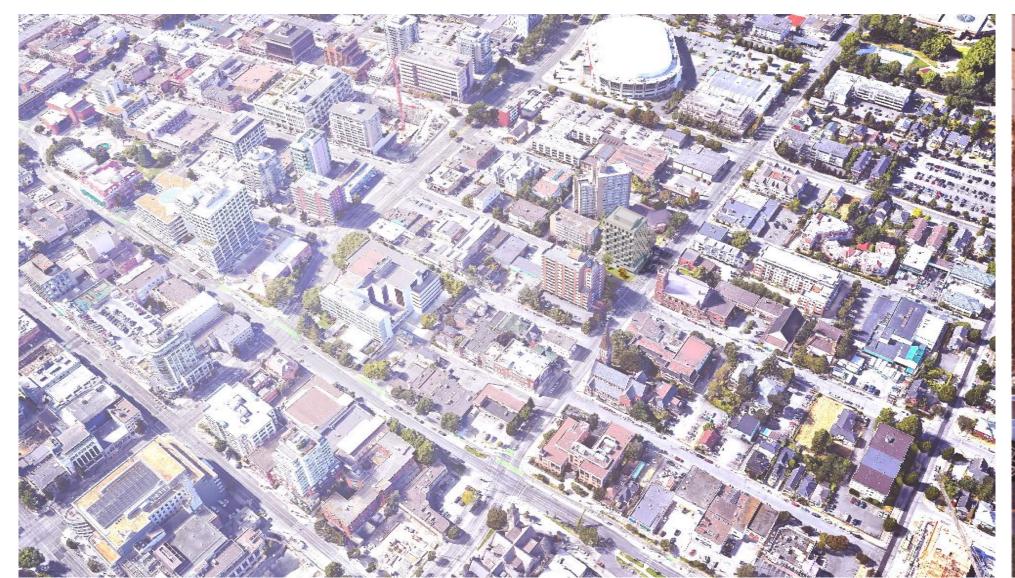




RENDER 5: AERIAL VIEW OF BUILDING

RENDER 3: STREETVIEW EXPERIENCE ALONG QUADRA

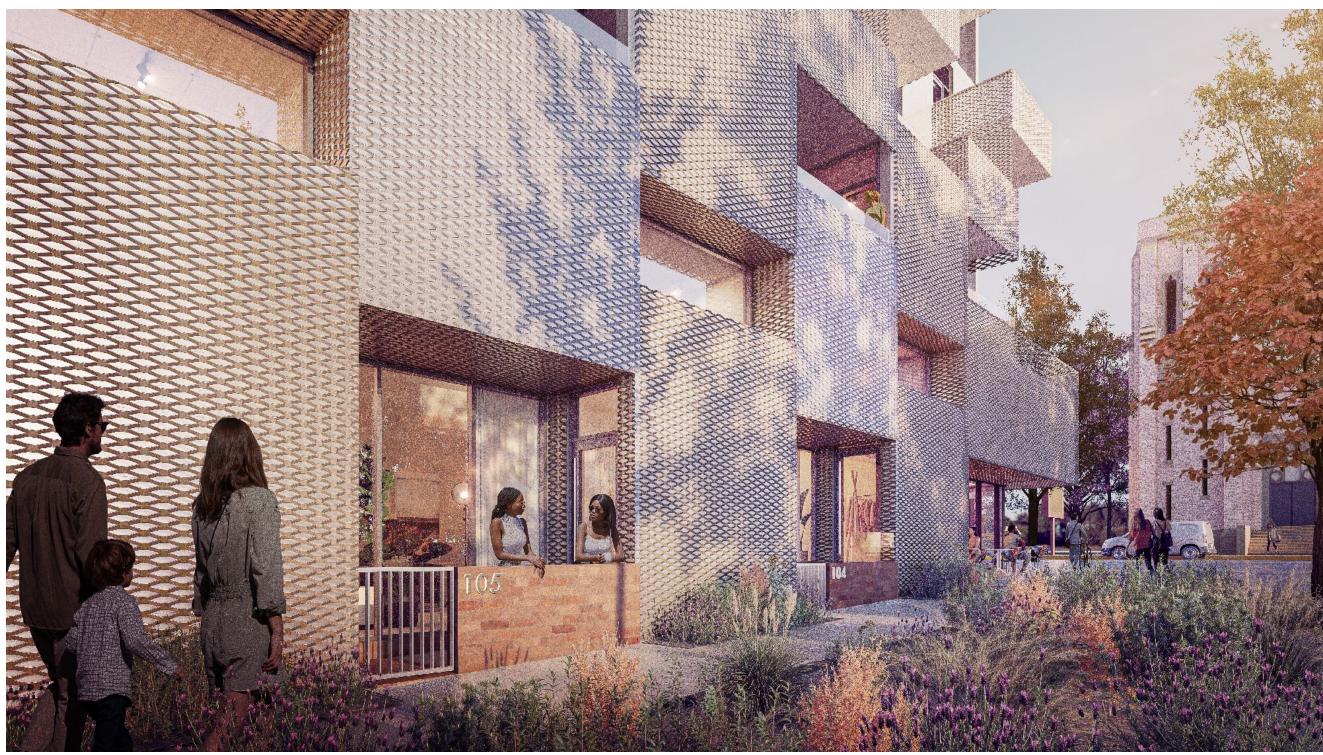

RENDER 4: STREET LEVEL VIEW OF THE BUILDING FROM FISGARD SIDEWALK

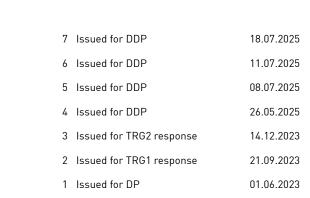

Drawn By: BG / RG
Checked By: PB
Printing Date: 18.07.2025

The Contractor shall verify all dimensions, datums and levels prior to commencement of work.

All errors and omissions to be reported to the Architect before proceeding.


This drawing must not be scaled.


This drawing is the property of the Architect; the copyright in same being reserved to him/her. It is

not to be reproduced without his/her permission.

Any unauthorized alteration of the electronic data which constitute this document will void all responsibility for the altered document by the Architect.

This drawing is not to be used for building purposes until countersigned by:

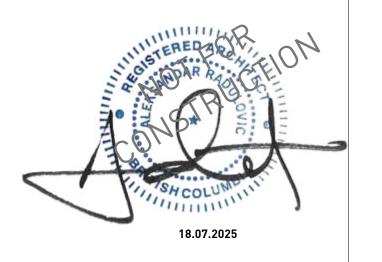

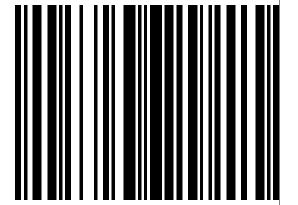

1702 QUADRA STREET + 862 FISGARD STREET

RENDERINGS

0650 Sheet AG.2

7 Issued for DDP 18.07.2025 6 Issued for DDP 11.07.2025

5 Issued for DDP

Drawn By: BG / RG
Checked By: PB
Printing Date: 18.07.2025

08.07.2025

The Contractor shall verify all dimensions, datums and levels prior to commencement of work.

All errors and omissions to be reported to the Architect before proceeding.


This drawing must not be scaled.

This drawing is the property of the Architect; the

copyright in same being reserved to him/her. It is not to be reproduced without his/her permission.

Any unauthorized alteration of the electronic data which constitute this document will void all responsibility for the altered document by the Architect.

This drawing is not to be used for building purposes until countersigned by:

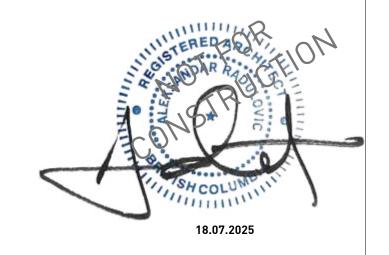

5 4 6 8 7 9 6 A R C H I T E C T U R E I N C 266 MCDERMOT AVE Winnipeg MB R3B 0S8 P: 204.480.8421 F: 204.480.8876


1702 QUADRA STREET + 862 FISGARD STREET

RENDERINGS


Project 0650 Sheet AG.3





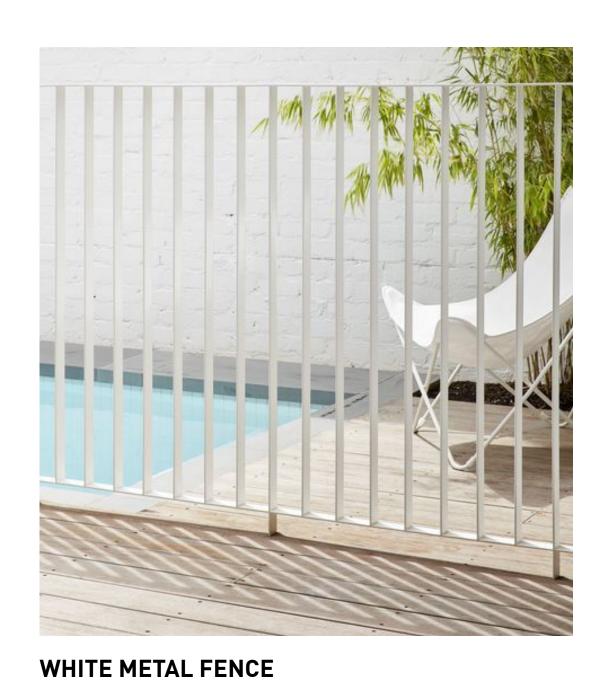



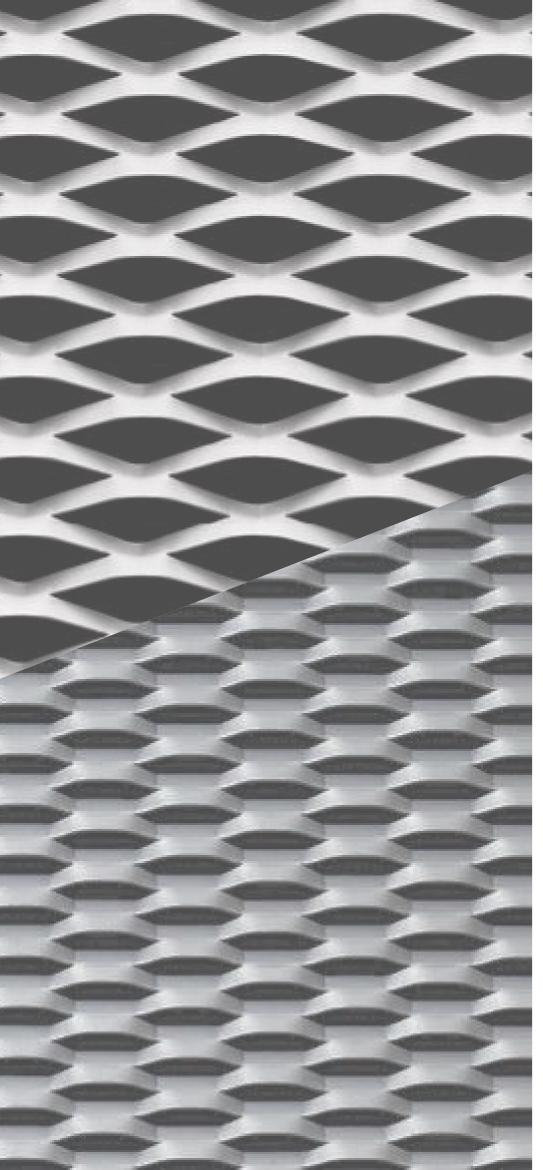







BRICK





EXPANDED METAL [ALUMINUM FINISH]



7 Issued for DDP

6 Issued for DDP

5 Issued for DDP

The Contractor shall verify all dimensions, datums and levels prior to commencement of work.

This drawing is the property of the Architect; the copyright in same being reserved to him/her. It is

Any unauthorized alteration of the electronic data which constitute this document will void all responsibility for the altered document by the Architect.

This drawing is not to be used for building purposes until countersigned by:

All errors and omissions to be reported to the Architect before proceeding.


This drawing must not be scaled.

18.07.2025

11.07.2025

08.07.2025

AR / RG PB 18.07.2025

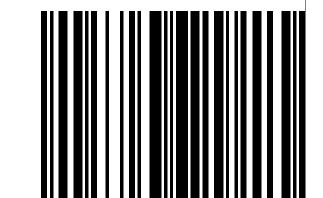

266 MCDERMOT AVE Winnipeg MB R3B 0S8 P: 204.480.8421 F: 204.480.8876

1702 QUADRA STREET + 862 FISGARD STREET

MATERIALS

Project 0650 Sheet AG.4



MARCH 20 9:00 AM



MARCH 20 12:00 PM



MARCH 20 4:00 PM





JUNE 21 9:00 AM



JUNE 21 12:00 PM



JUNE 21 4:00 PM



SEPTEMBER 22 9:00 AM



SEPTEMBER 22 12:00 PM



SEPTEMBER 22 4:00 PM



DECEMBER 21 9:00 AM




DECEMBER 21 12:00 PM



DECEMBER 21 4:00 PM



7 Issued for DDP 18.07.2025 6 Issued for DDP 11.07.2025 5 Issued for DDP 08.07.2025

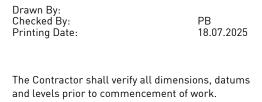


All errors and omissions to be reported to the Architect before proceeding.

This drawing must not be scaled.

This drawing is the property of the Architect; the copyright in same being reserved to him/her. It is

Any unauthorized alteration of the electronic data which constitute this document will void all responsibility for the altered document by the Architect.

This drawing is not to be used for building purposes until countersigned by:

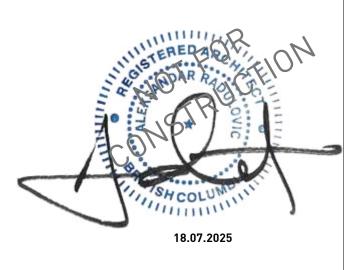

266 MCDERMOT AVE Winnipeg MB R3B 0S8 P: 204.480.8421 F: 204.480.8876


1702 QUADRA STREET + 862 FISGARD STREET

SHADOW STUDIES

Project 0650 Sheet

AG.5



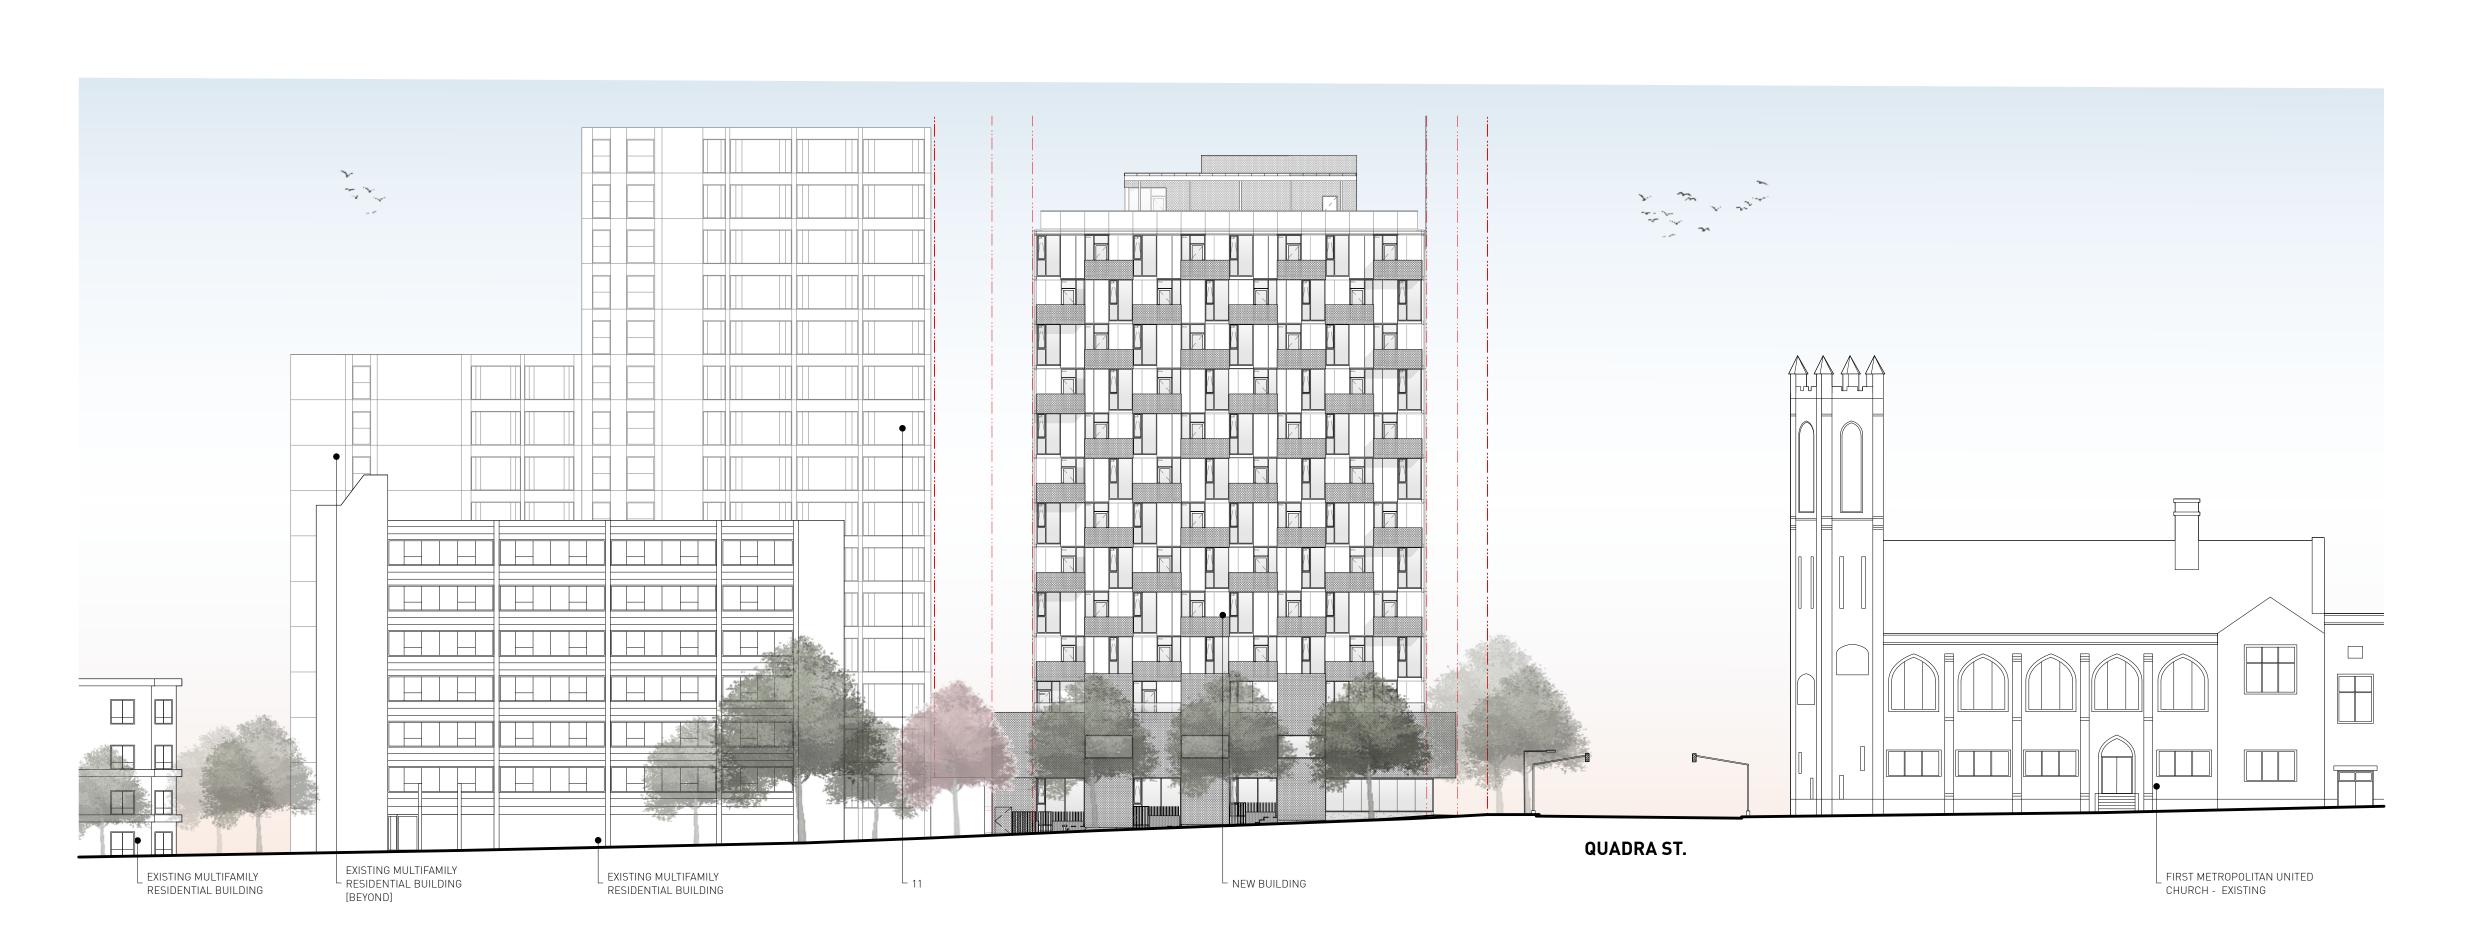

FISGARD ST ELEVATION [SOUTH FACADE]

7 Issued for DDP 18.07.2025 6 Issued for DDP 11.07.2025 5 Issued for DDP 08.07.2025

EA / AR

Drawn By: Checked By: Printing Date: PB 18.07.2025

The Contractor shall verify all dimensions, datums

and levels prior to commencement of work. All errors and omissions to be reported to the


Architect before proceeding.


This drawing must not be scaled.

This drawing is the property of the Architect; the copyright in same being reserved to him/her. It is

Any unauthorized alteration of the electronic data which constitute this document will void all responsibility for the altered document by the

This drawing is not to be used for building purposes until countersigned by:

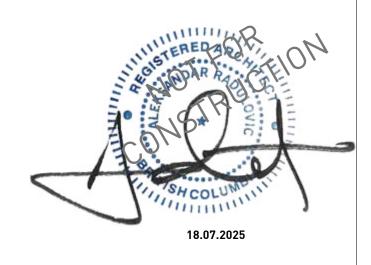

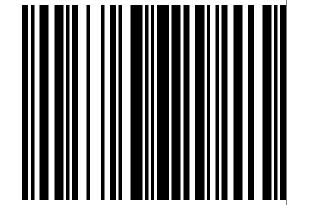

266 MCDERMOT AVE Winnipeg MB R3B 0S8 P: 204.480.8421 F: 204.480.8876

1702 QUADRA STREET + 862 FISGARD STREET

CONTEXT ELEVATIONS

Sheet AG.6

RESIDENTIAL WINDOW SCHEDULE

• ALL GLAZING TO BE HSTG, LOW E ON SURFACE 2, ARGON-FILLED W/ SUPERSPACERS, LOW REFLECTIVITY COATING TO REDUCE INTERNAL GLARE

ALUMINUM WINDOW WALL SYSTEM

• REFER TO WINDOW SUPPLIER CUT SHEETS FOR TEMPERING REQUIREMENTS

PROVIDE PRE-FINISHED ALUMINUM FLASHING AT HEADS AND SILLS, COLOUR TO BE SELECTED BY ARCHITECT
 GLASS TO BE 3mm CLEAR [UNLESS OTHERWISE NOTED OR REQUIRED BY MANUFACTURING ENGINEER]

• ALL INTERIOR CASINGS TO BE GYPSUM BOARD RETURN

ALL WINDOWS TO MEET NAFS-17 & CANADIAN TEST STANDARDS. ENVELOPE CONSULTANT TO REVIEW TESTING DATA.
 ALL WINDOW SPECIFICATIONS MUST COMPLY OR SURPASS ENERGY CODE CONSULTANT'S ENERGY MODEL ASSUMPTIONS

• REFER TO ENVELOPE CONSULTANT WINDOW INSTALLATION GUIDELINES FOR SILL AND THREE SIDES MEMBRANE DETAILING FOR ALL RESIDENTIAL WINDOWS

ENVELOPE CONSULTANT TO REVIEW ALL RESIDENTIAL AND COMMERCIAL GLAZING SHOP DRAWINGS

• ALUMICOR THERMALLY BROKEN STOREFRONT OR APPROVED EQUAL, SSG, ANTI-ROTATION BLOCKS TO BE ALUMINUM OR PVC

• ALL GLAZING TO BE HSTG, LOW E ON SURFACE 2, ARGON-FILLED W/ SUPERSPACERS, LOW REFLECTIVITY COATING TO REDUCE INTERNAL GLARE

ALL EXTERIOR CURTAINWALL TO BE TEMPERED, BLACK FRAME
GLASS TO BE 6mm CLEAR & TEMPERED


COMMERCIAL WINDOW SCHEDULE

ALL WINDOW SPECIFICATIONS MUST COMPLY OR SURPASS ENERGY CODE CONSULTANT'S ENERGY MODEL ASSUMPTIONS


• SUPPLY SPANDREL PANEL AS REQUIRED FOR MECHANICAL GRILLE PENETRATIONS OF CURTAIN WALL.


ENVELOPE CONSULTANT TO REVIEW ALL RESIDENTIAL AND COMMERCIAL GLAZING SHOP DRAWINGS


RESIDENTIAL WINDOW WALL

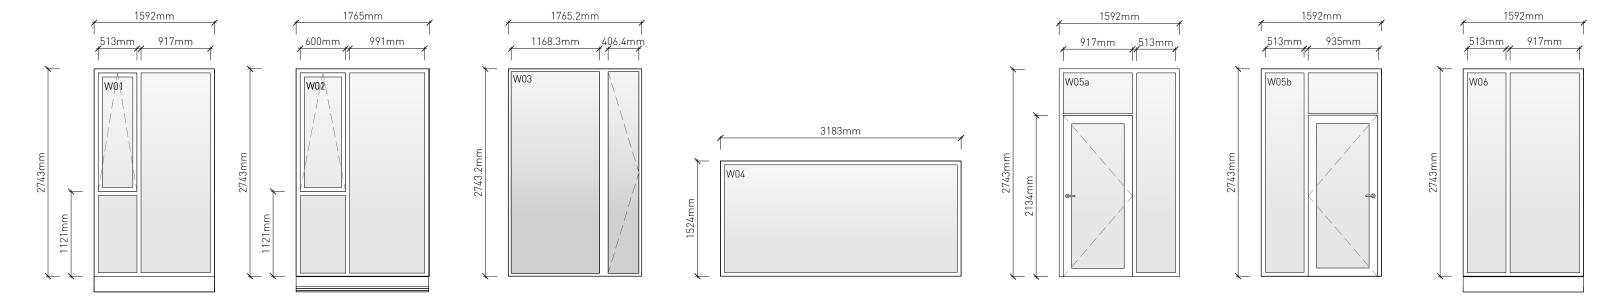


COMMERCIAL STOREFRONT

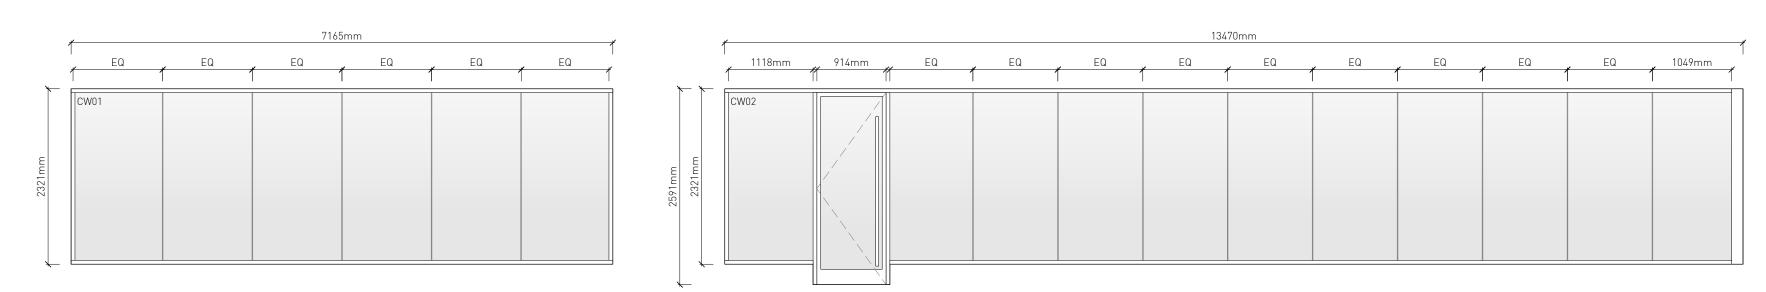

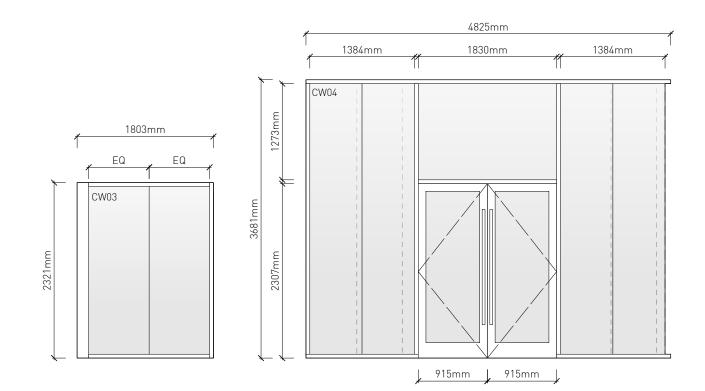


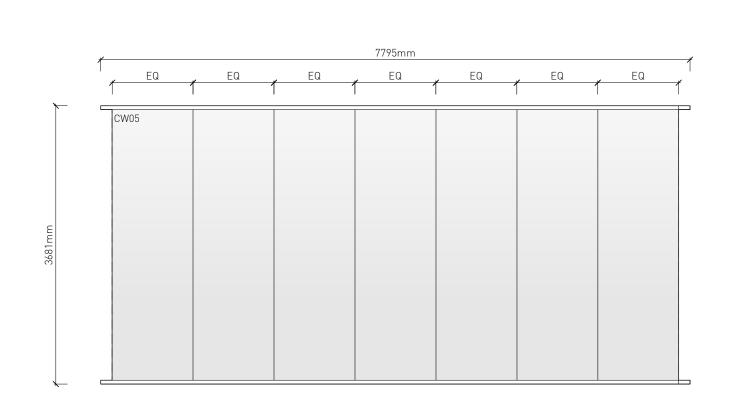



LIVE WORK STOREFRONT

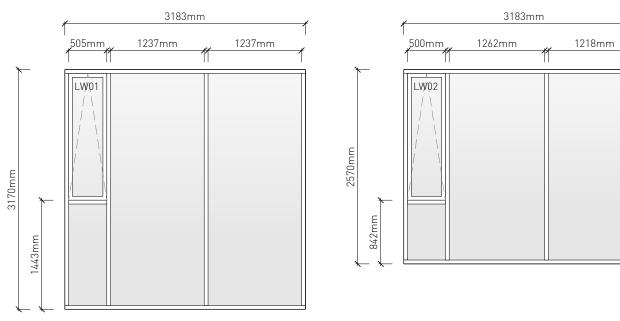

PENTHOUSE STOREFRONT

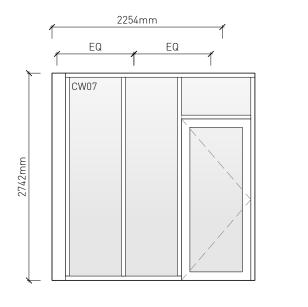

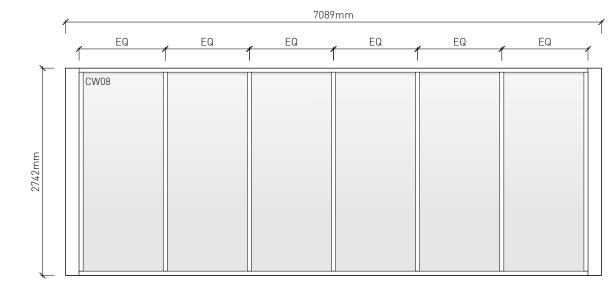

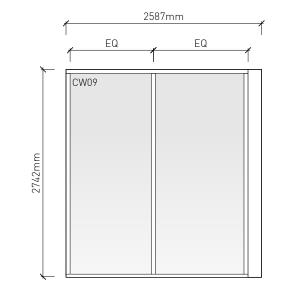



7 Issued for DDP6 Issued for DDP

5 Issued for DDP

Drawn By: Checked By:

Printing Date:

The Contractor shall verify all dimensions, datums and levels prior to commencement of work.

All errors and omissions to be reported to the

This drawing is the property of the Architect; the copyright in same being reserved to him/her. It is

Any unauthorized alteration of the electronic data which constitute this document will void all responsibility for the altered document by the

This drawing is not to be used for building purposes until countersigned by:

Architect before proceeding.

This drawing must not be scaled.


18.07.2025

11.07.2025

08.07.2025

PB 18.07.2025

18.07.2025

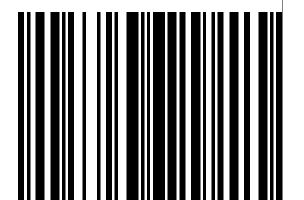



ARCHITECTURE INC 266 MCDERMOT AVE Winnipeg MB R3B 0S8 P: 204.480.8421 F: 204.480.8876

1702 QUADRA STREET + 862 FISGARD STREET


WINDOW & DOOR SCHEDULE

Sheet AG.7

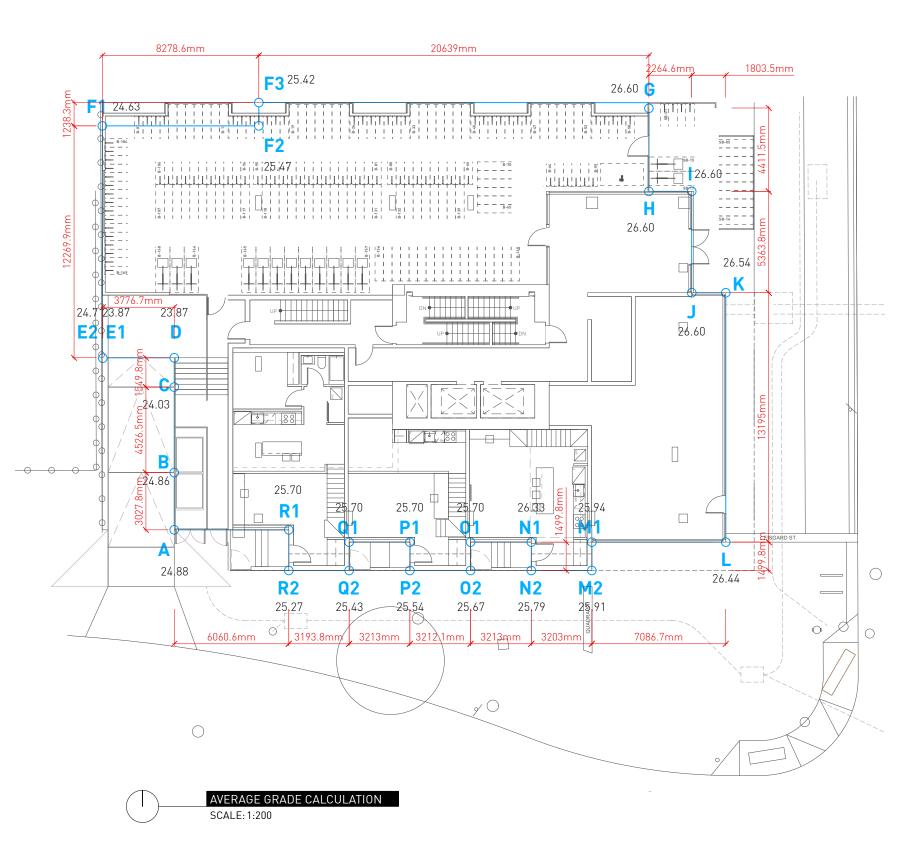

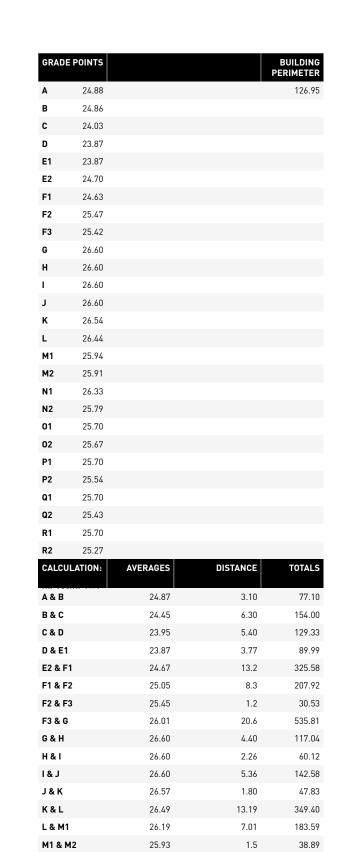


M2 & N2

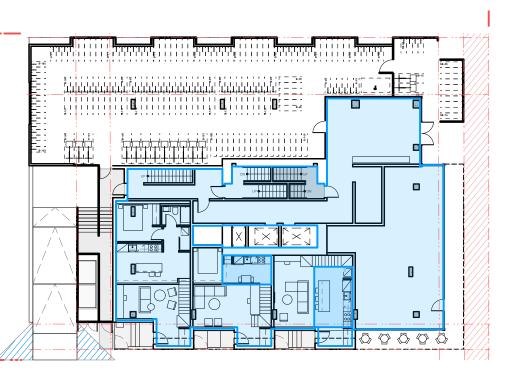


384.00 m²



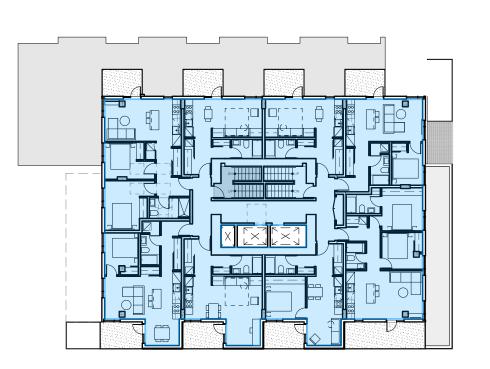


445.46 m²



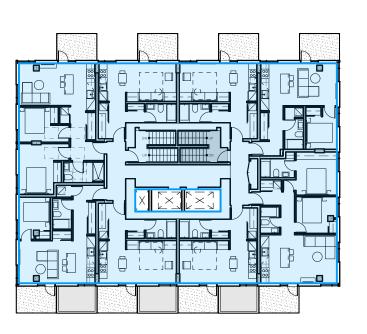

428.50 m²



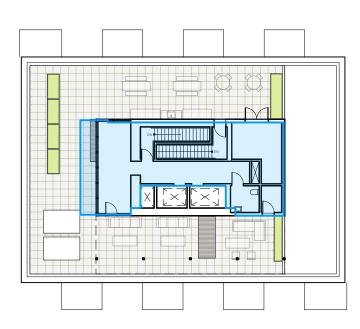

102.5 m²



PROJECT STATS:

LEGAL DESCRIPTION	ZONING: R3-C	L0TS: A, 1, 2	SUBURBAN LOT: 4	PLAN: CITY 01516011
CIVIC ADDRESS	1702 QUADRA STR	EET, VICTORIA, BC		
70,111,0	oupp.			4500 0114 004 000 1507 07470
ZONING	CURR [R-3C, RESIDEN FAMI	NTIAL MULTI-		1702 QUADRA PROJECT STATS
SITE AREA [m²]				947.78
GROSS FLOOR AREA [m²]				5217.01
FLOOR SPACE RATIO	3.0)		5.50
SITE COVERAGE (%)				76.5%
OPEN SITE SPACE (%)				23.5%
AVERAGE GRADE				24.59 m
BUILDING HEIGHT	NO BUILDING SH METRES IN			13 STOREYS [42.88m]
SETBACKS				
NORTH [SIDE]	6.01	m		4.85m [[EXCLUDING BIKE PARKING ENCLOSURE]
EAST [FRONT]	4.51	m		2.0m [BASE] 4.0m [TOWER]
SOUTH [FLANKING]	4.51	m		0.85m [BASE] 2.85m [TOWER]
WEST [REAR]	6.0r	m		3.8m [BASE - EXCLUDING BIKE PARKING ENCLOSURE] 6.5m [TOWER]

UNIT TYPES	AVERAGE AREA (M²)	UNIT COUNT	TOTAL AREA (M²)
RESIDENTIAL			
BACHELOR	34.72	43	1,492.85
1 BEDROOM UNIT	47.27	24	1,134.38
2 BEDROOM UNIT	65.19	21	1,368.95
OTHER			
COMMERCIAL UNIT [S]	183.40	1	183.40
WORK / LIVE	57.85	3	173.55
TOTAL		92	
TOTAL RENTABLE AREA			4,353.13

RESIDENTIAL UNIT MIX	UNIT COUNT	%
BACHELOR	43	47%
1 BEDROOM UNIT	24	26%
2 BEDROOM UNIT	21	23%

SITE DATA	
	AREA [m ²]
EVEL 01	384.00
EVEL 02	445.46
EVEL 03	428.50
EVEL 04	428.50
EVEL 05	428.50
EVEL 06	428.50
EVEL 07	428.50
EVEL 08	428.50
EVEL 09	428.50
EVEL 10	428.50
EVEL 11	428.50
EVEL 12	428.50
EVEL 13	102.55
OTAL GROSS FLOOR AREA	5217.01
UILDING FOOTPRINT	724.88

TOTAL PROPOSED

	UNIT COUNT	RATE	REQUIRED STALLS
RESIDENTIAL			
UNIT < 45 M ²	44	0.5 STALLS / UNIT	22
UNIT 45-70 M ²	47	0.6 STALLS / UNIT	29
UNIT > 70 M ²	0	1.45 STALLS / UNIT	0
VISITOR	91	0.1 STALLS / UNIT	9
COMMERCIAL			
RESTAURANT	183.40	1.0 STALLS / 40m ²	5
TOTAL REQUIRED			65

	UNIT COUNT	RATE	REQUIRED STALLS
LONG TERM			
UNIT < 45 M ²	44	1.0 STALLS / UNIT	44
UNIT => 45 M ²	47	1.25 STALLS / UNIT	59
RESTAURANT	183.40	1.0 STALLS / 400m ²	1
TOTAL REQUIRED			104

			·
SHORT TERM			
RESIDENT	91	0.1 STALLS / UNIT	9.1
RESTAURA	NT 183.40	1.0 STALLS / 100m ²	2
TOTAL REQUIRED			12
TOTAL PROPOSED			14

18.07.2025 7 Issued for DDP 6 Issued for DDP 11.07.2025 5 Issued for DDP 08.07.2025

Drawn By: Checked By: 18.07.2025 Printing Date:

The Contractor shall verify all dimensions, datums

EA / PB

and levels prior to commencement of work. All errors and omissions to be reported to the Architect before proceeding.

This drawing must not be scaled.


This drawing is the property of the Architect; the copyright in same being reserved to him/her. It is

Any unauthorized alteration of the electronic data which constitute this document will void all responsibility for the altered document by the

This drawing is not to be used for building purposes until countersigned by:



18.07.2025

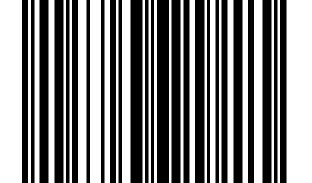


266 MCDERMOT AVE Winnipeg MB R3B 0S8 P: 204.480.8421 F: 204.480.8876

1702 QUADRA STREET + 862 FISGARD STREET

ZONING CALCULATIONS Project 0650

AG.8

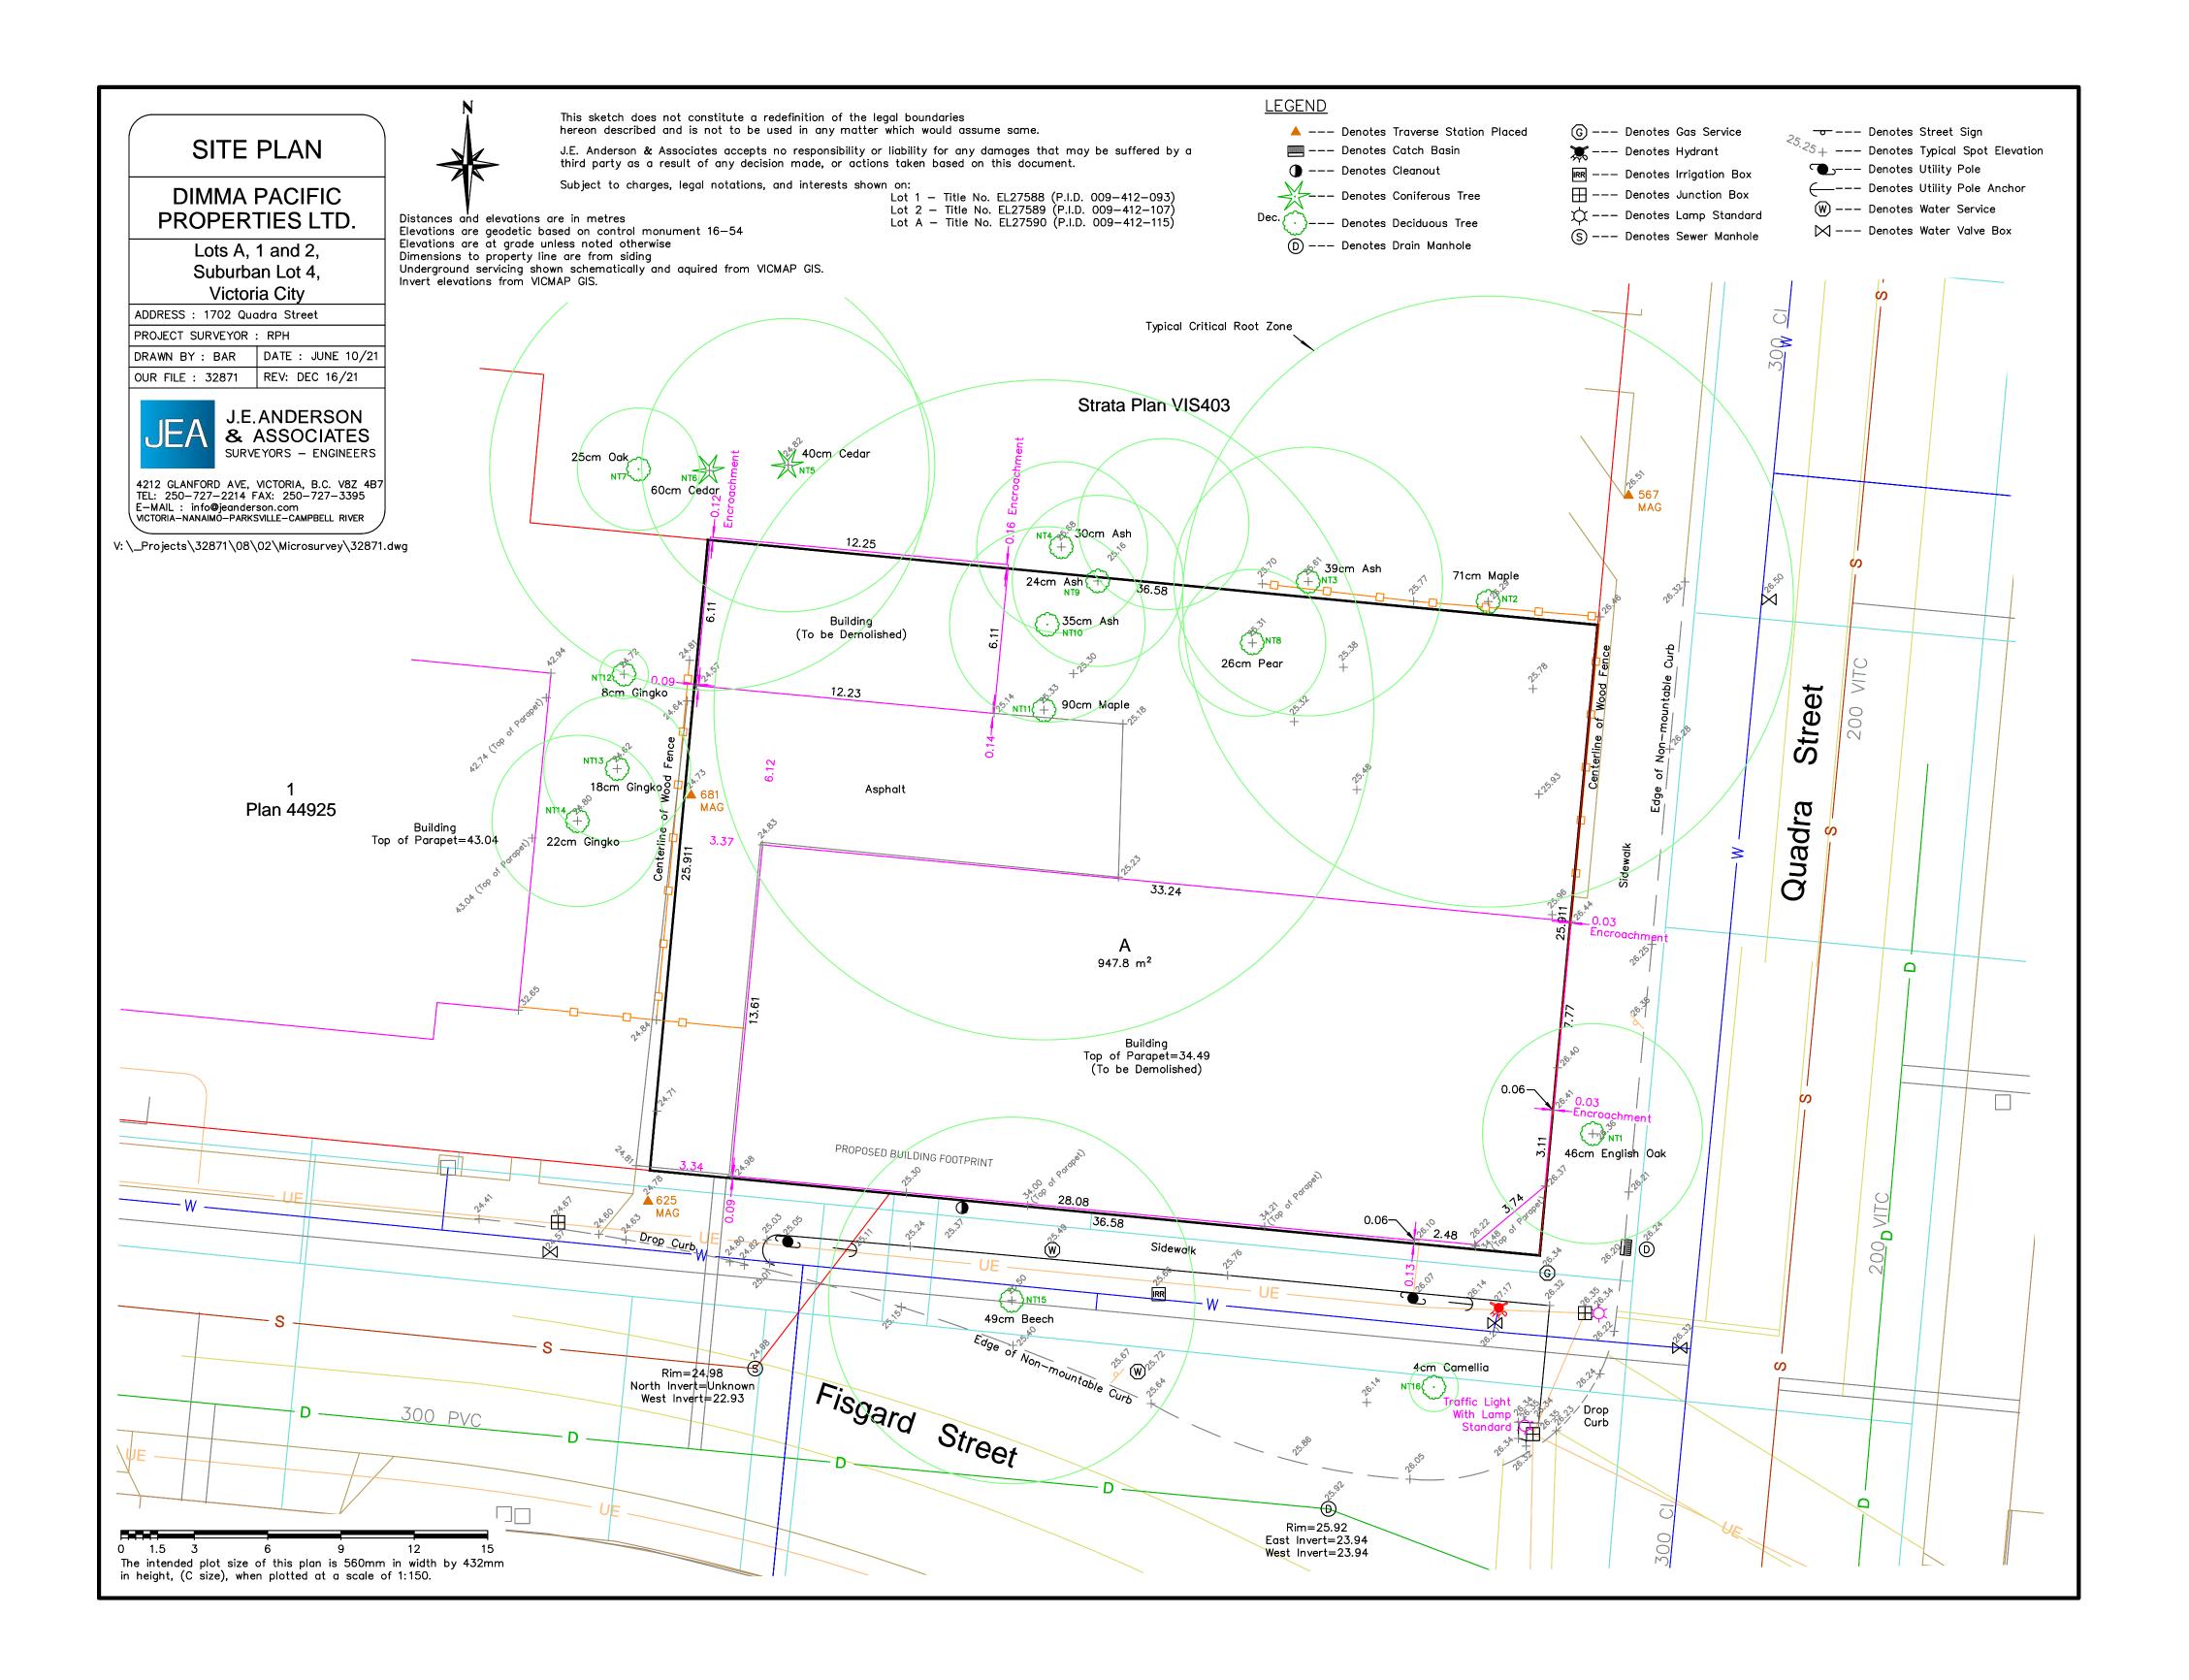

1 SITE SURVEY BY OTHERS
AG.5 SCALE: NTS

7 Issued for DDP 18.07.2025
6 Issued for DDP 11.07.2025
5 Issued for DDP 08.07.2025
4 Issued for DDP 26.05.2025

Drawn By: EA
Checked By: PB
Printing Date: 18.07.2025

The Contractor shall verify all dimensions, datums and levels prior to commencement of work.

All errors and omissions to be reported to the


Architect before proceeding.


This drawing must not be scaled.

This drawing is the property of the Architect; the copyright in same being reserved to him/her. It is not to be reproduced without his/her permission.

Any unauthorized alteration of the electronic data which constitute this document will void all responsibility for the altered document by the Architect

This drawing is not to be used for building purposes until countersigned by:

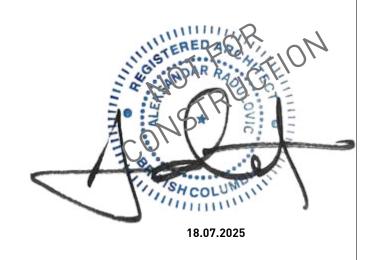

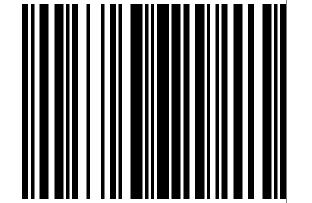


ARCHITECTURE INC 266 MCDERMOT AVE Winnipeg MB R3B 0S8 P: 204.480.8421 F: 204.480.8876

1702 QUADRA STREET + 862 FISGARD STREET

SITE SURVEY

O650 Sheet

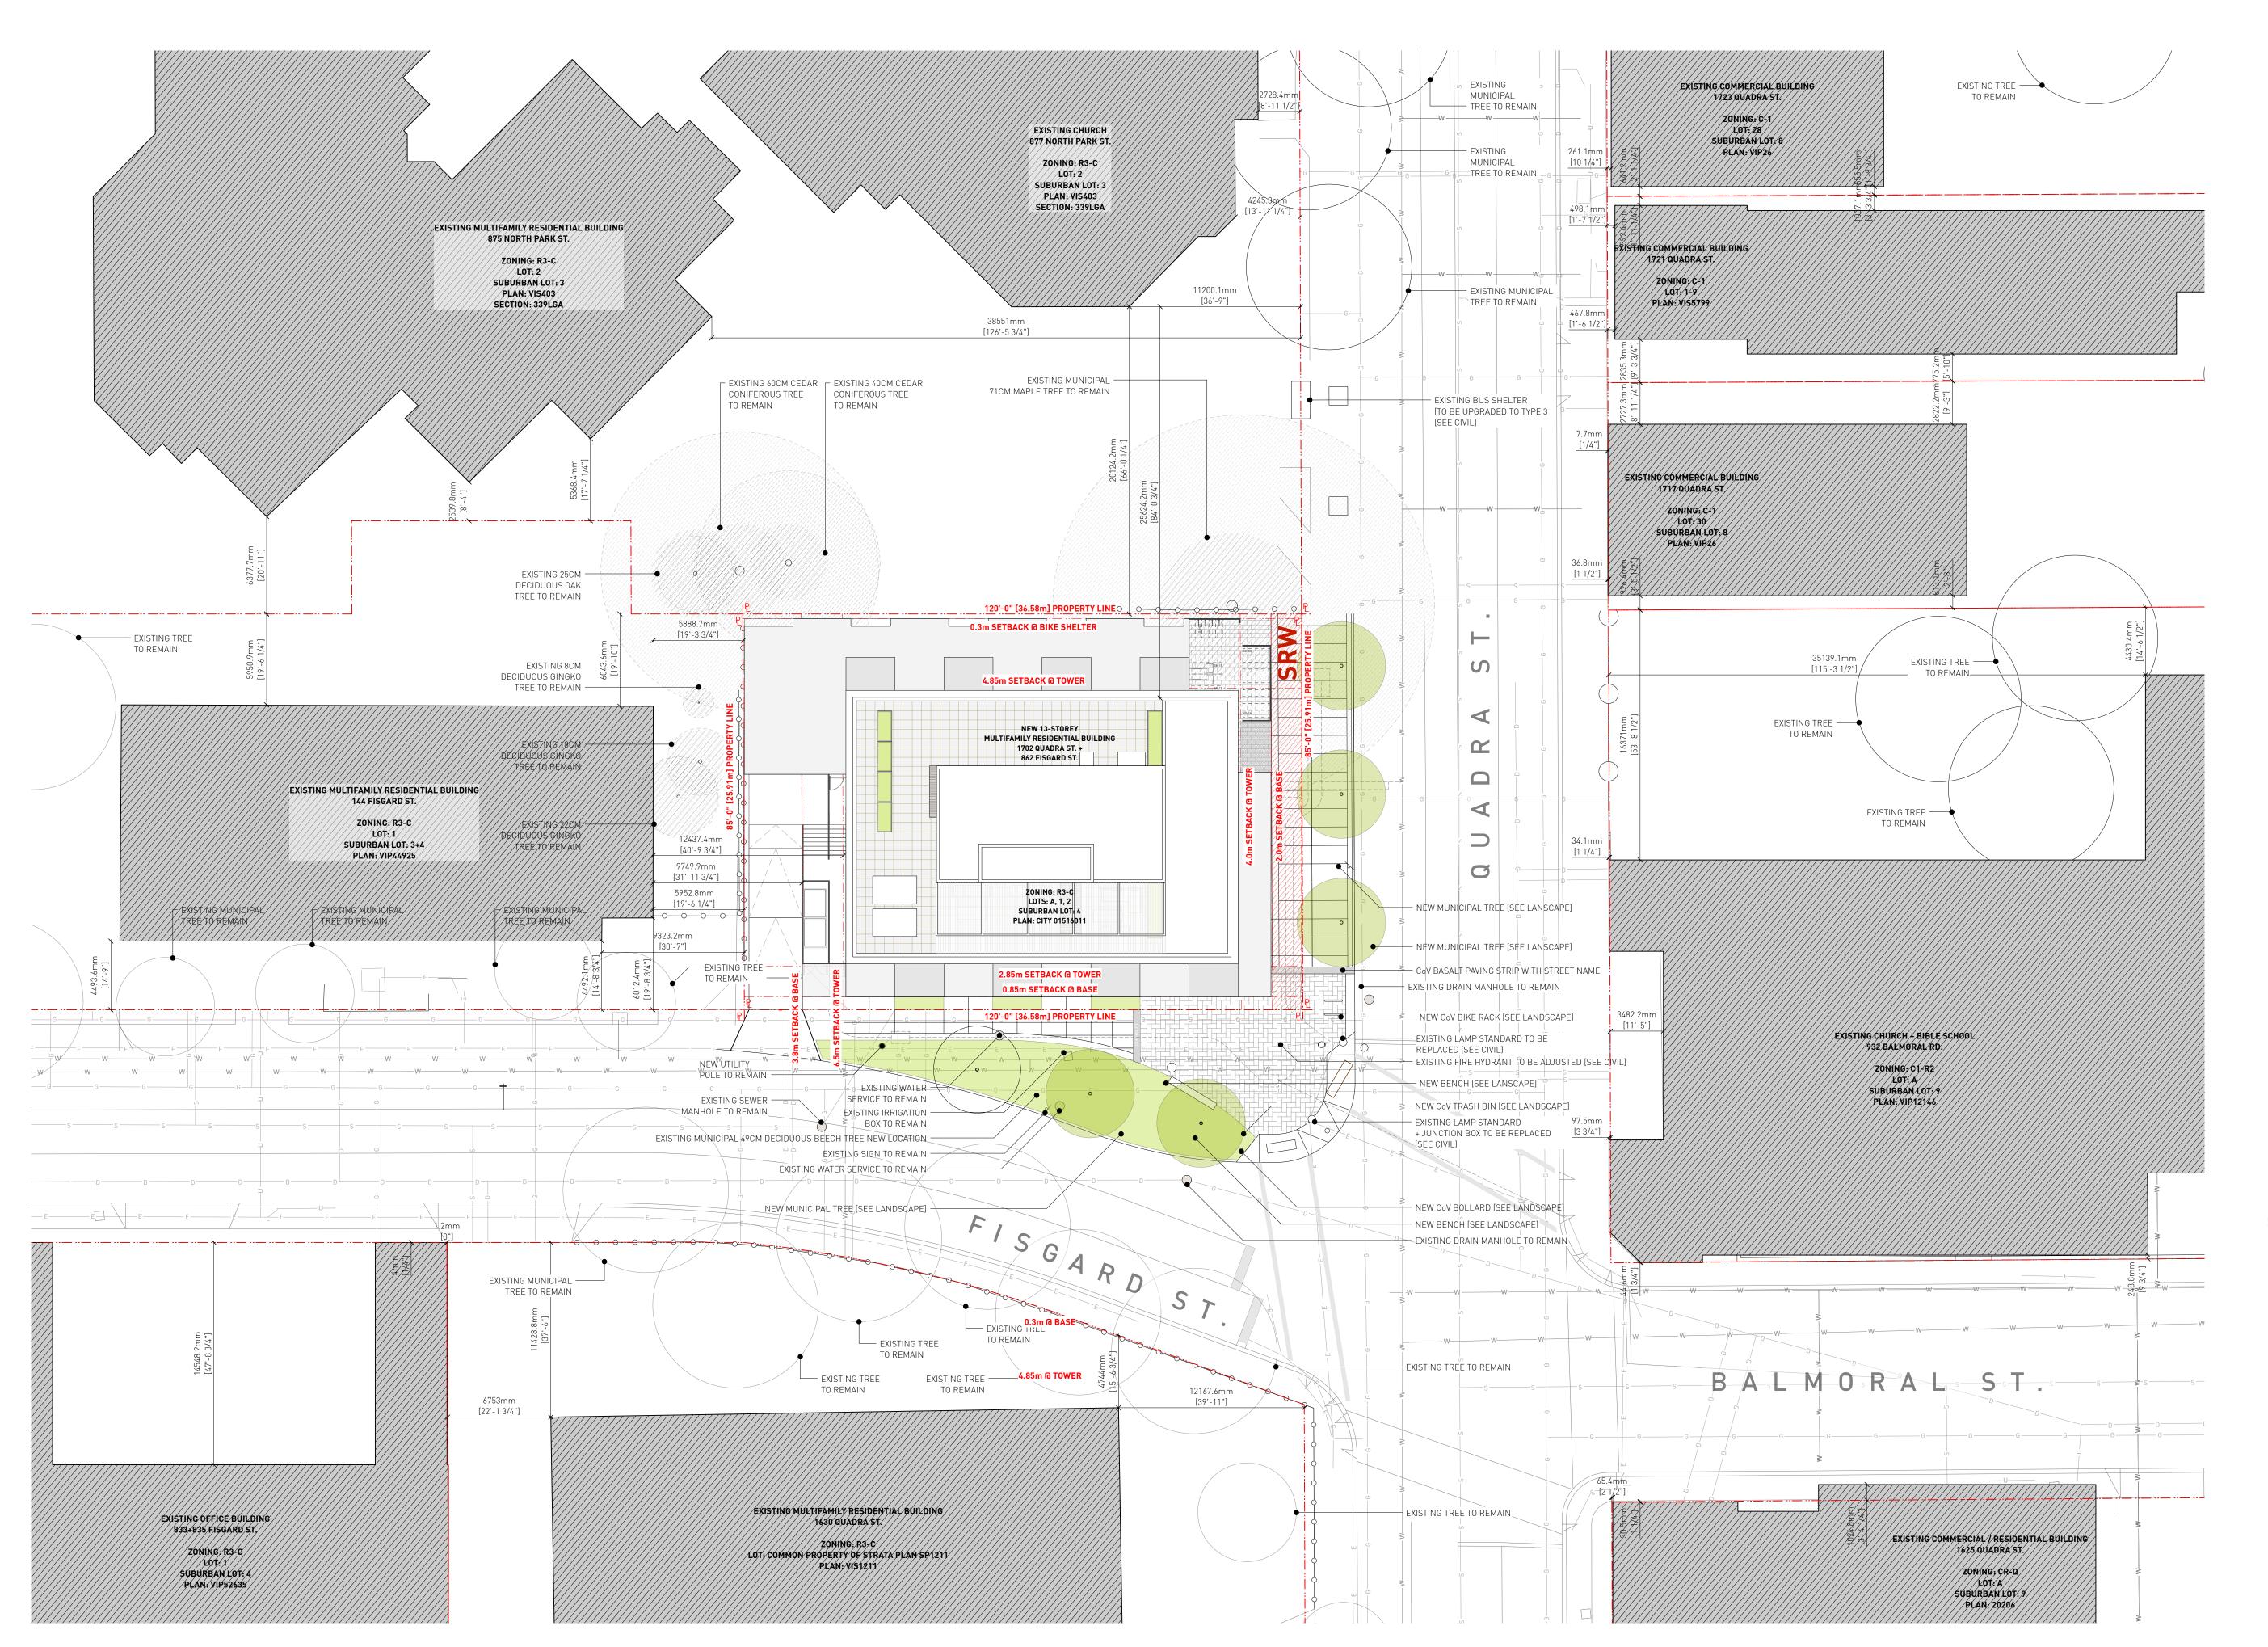

EXISTING BUILDING [TO BE DEMOLISHED]

EXISTING BUILDING

EXISTING GAS LINE

EXISTING DRAIN LINE

EXISTING TREE [TO BE REMOVED]

EXISTING TREE

EXISTING TREE ROOT AREA

EXISTING TREE ROOT AREA [TO BE REMOVED]

EXISTING HYDRO POLE

EXISTING FIRE HYDRANT

5 Issued for DDP

7 Issued for DDP 18.07.2025
6 Issued for DDP 11.07.2025

08.07.2025

EA/MM/AR

Checked By: PB
Printing Date: 18.07.2025

The Contractor shall verify all dimensions, datums

and levels prior to commencement of work.


All errors and omissions to be reported to the Architect before proceeding.


This drawing must not be scaled.

This drawing is the property of the Architect; the copyright in same being reserved to him/her. It is not to be reproduced without his/her permission

Any unauthorized alteration of the electronic data which constitute this document will void all responsibility for the altered document by the Architect.

This drawing is not to be used for building purposes until countersigned by:

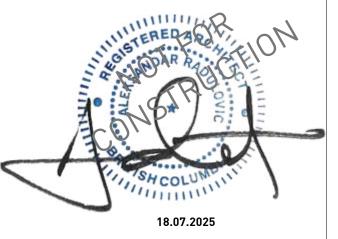

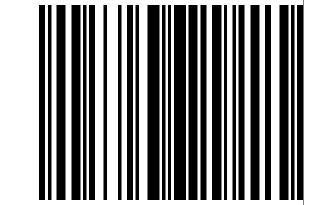


ARCHITECTURE INC 266 MCDERMOT AVE Winnipeg MB R3B 0S8 P: 204.480.8421 F: 204.480.8876


1702 QUADRA STREET + 862 FISGARD STREET


CONTEXT SITE PLAN

Project 0650 Sheet

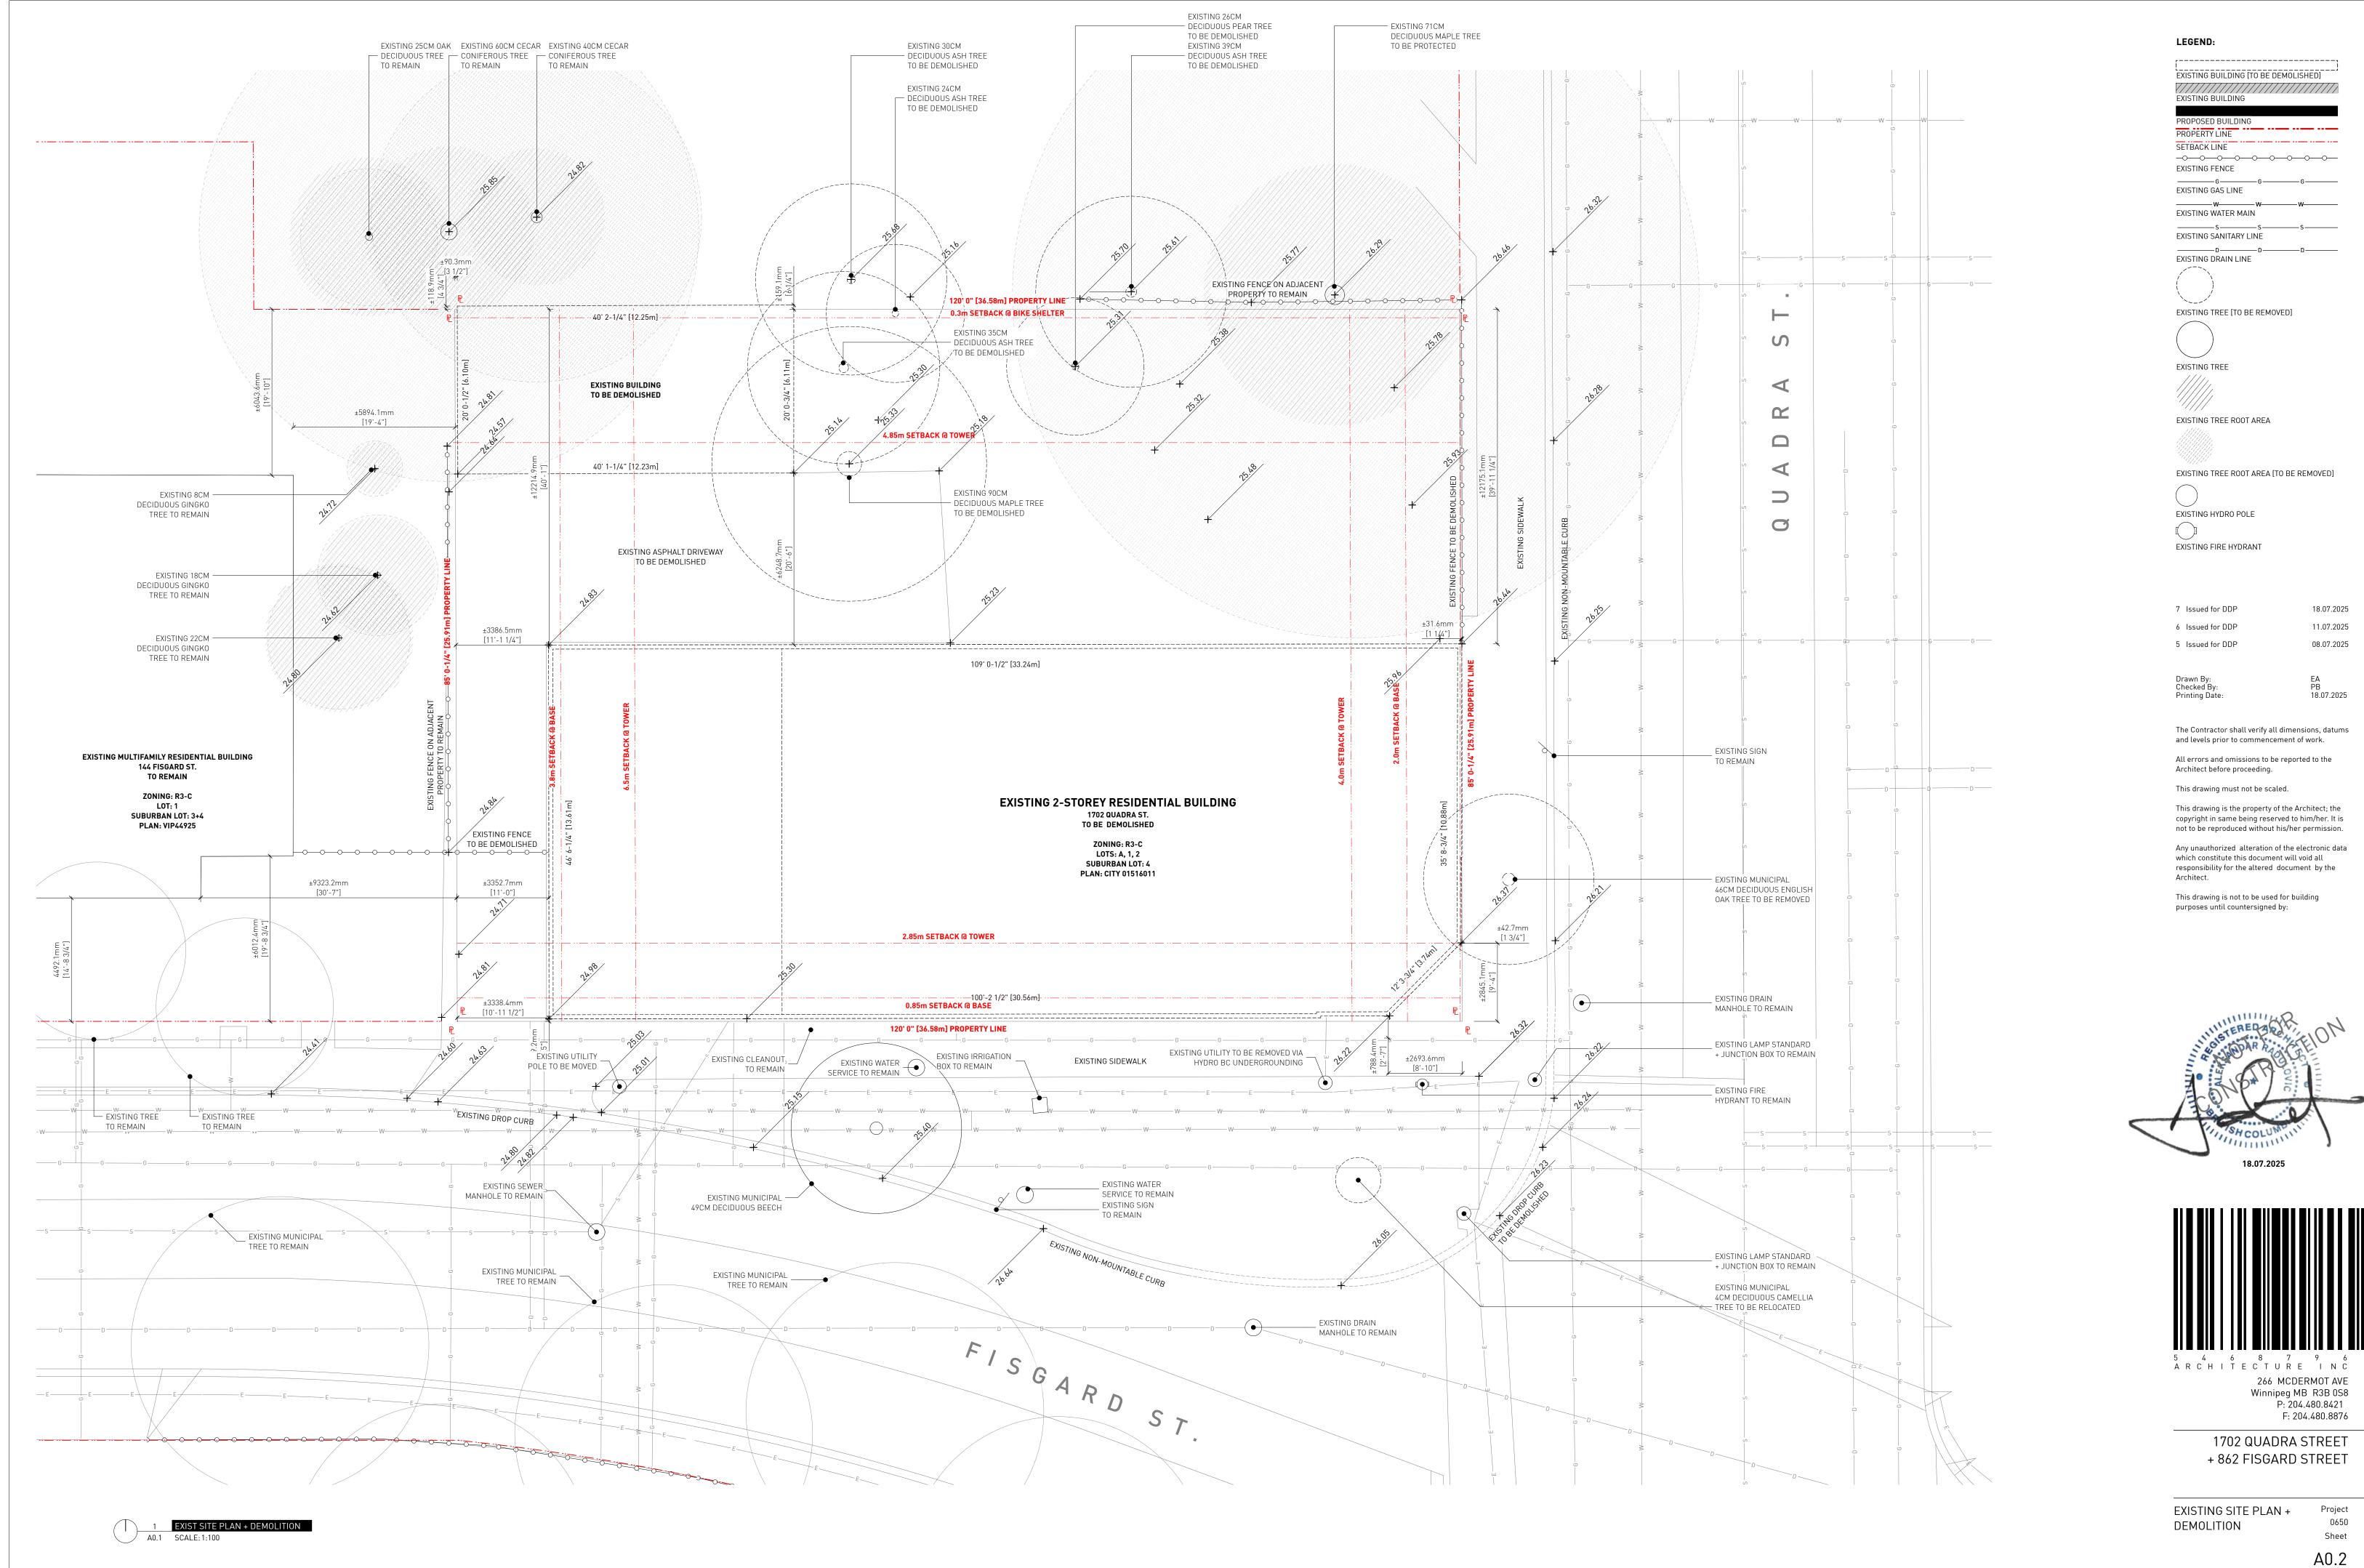




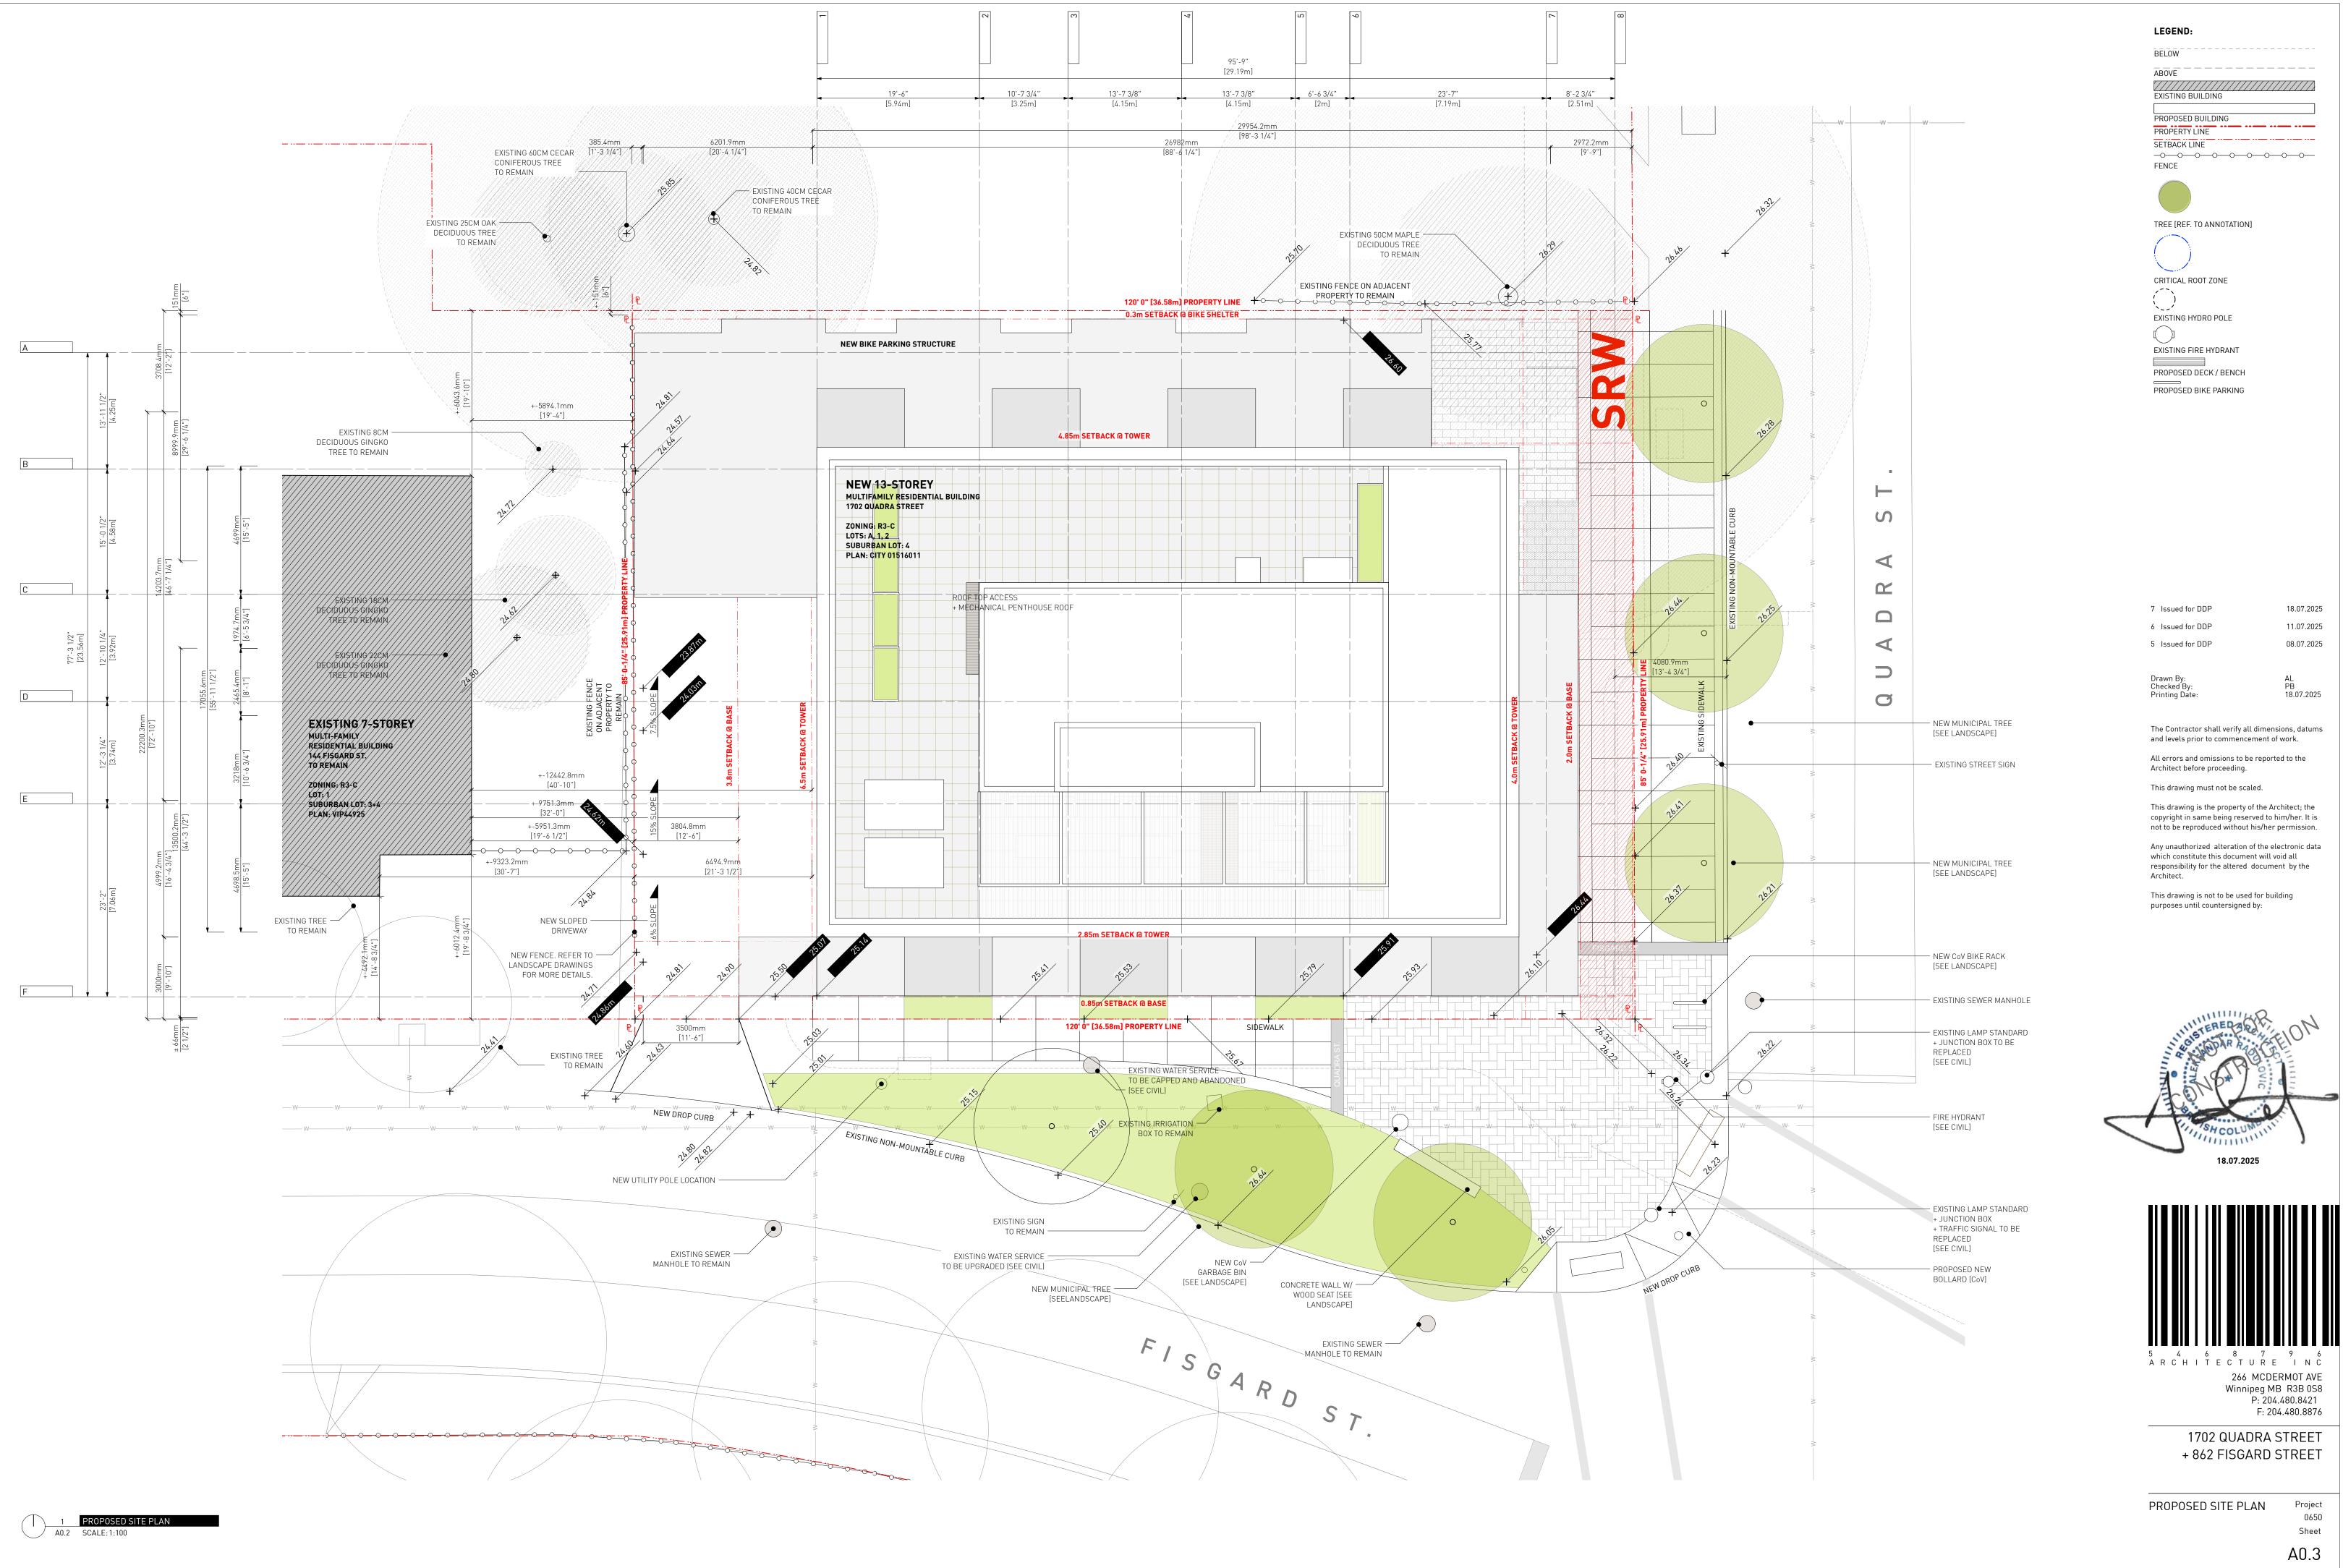

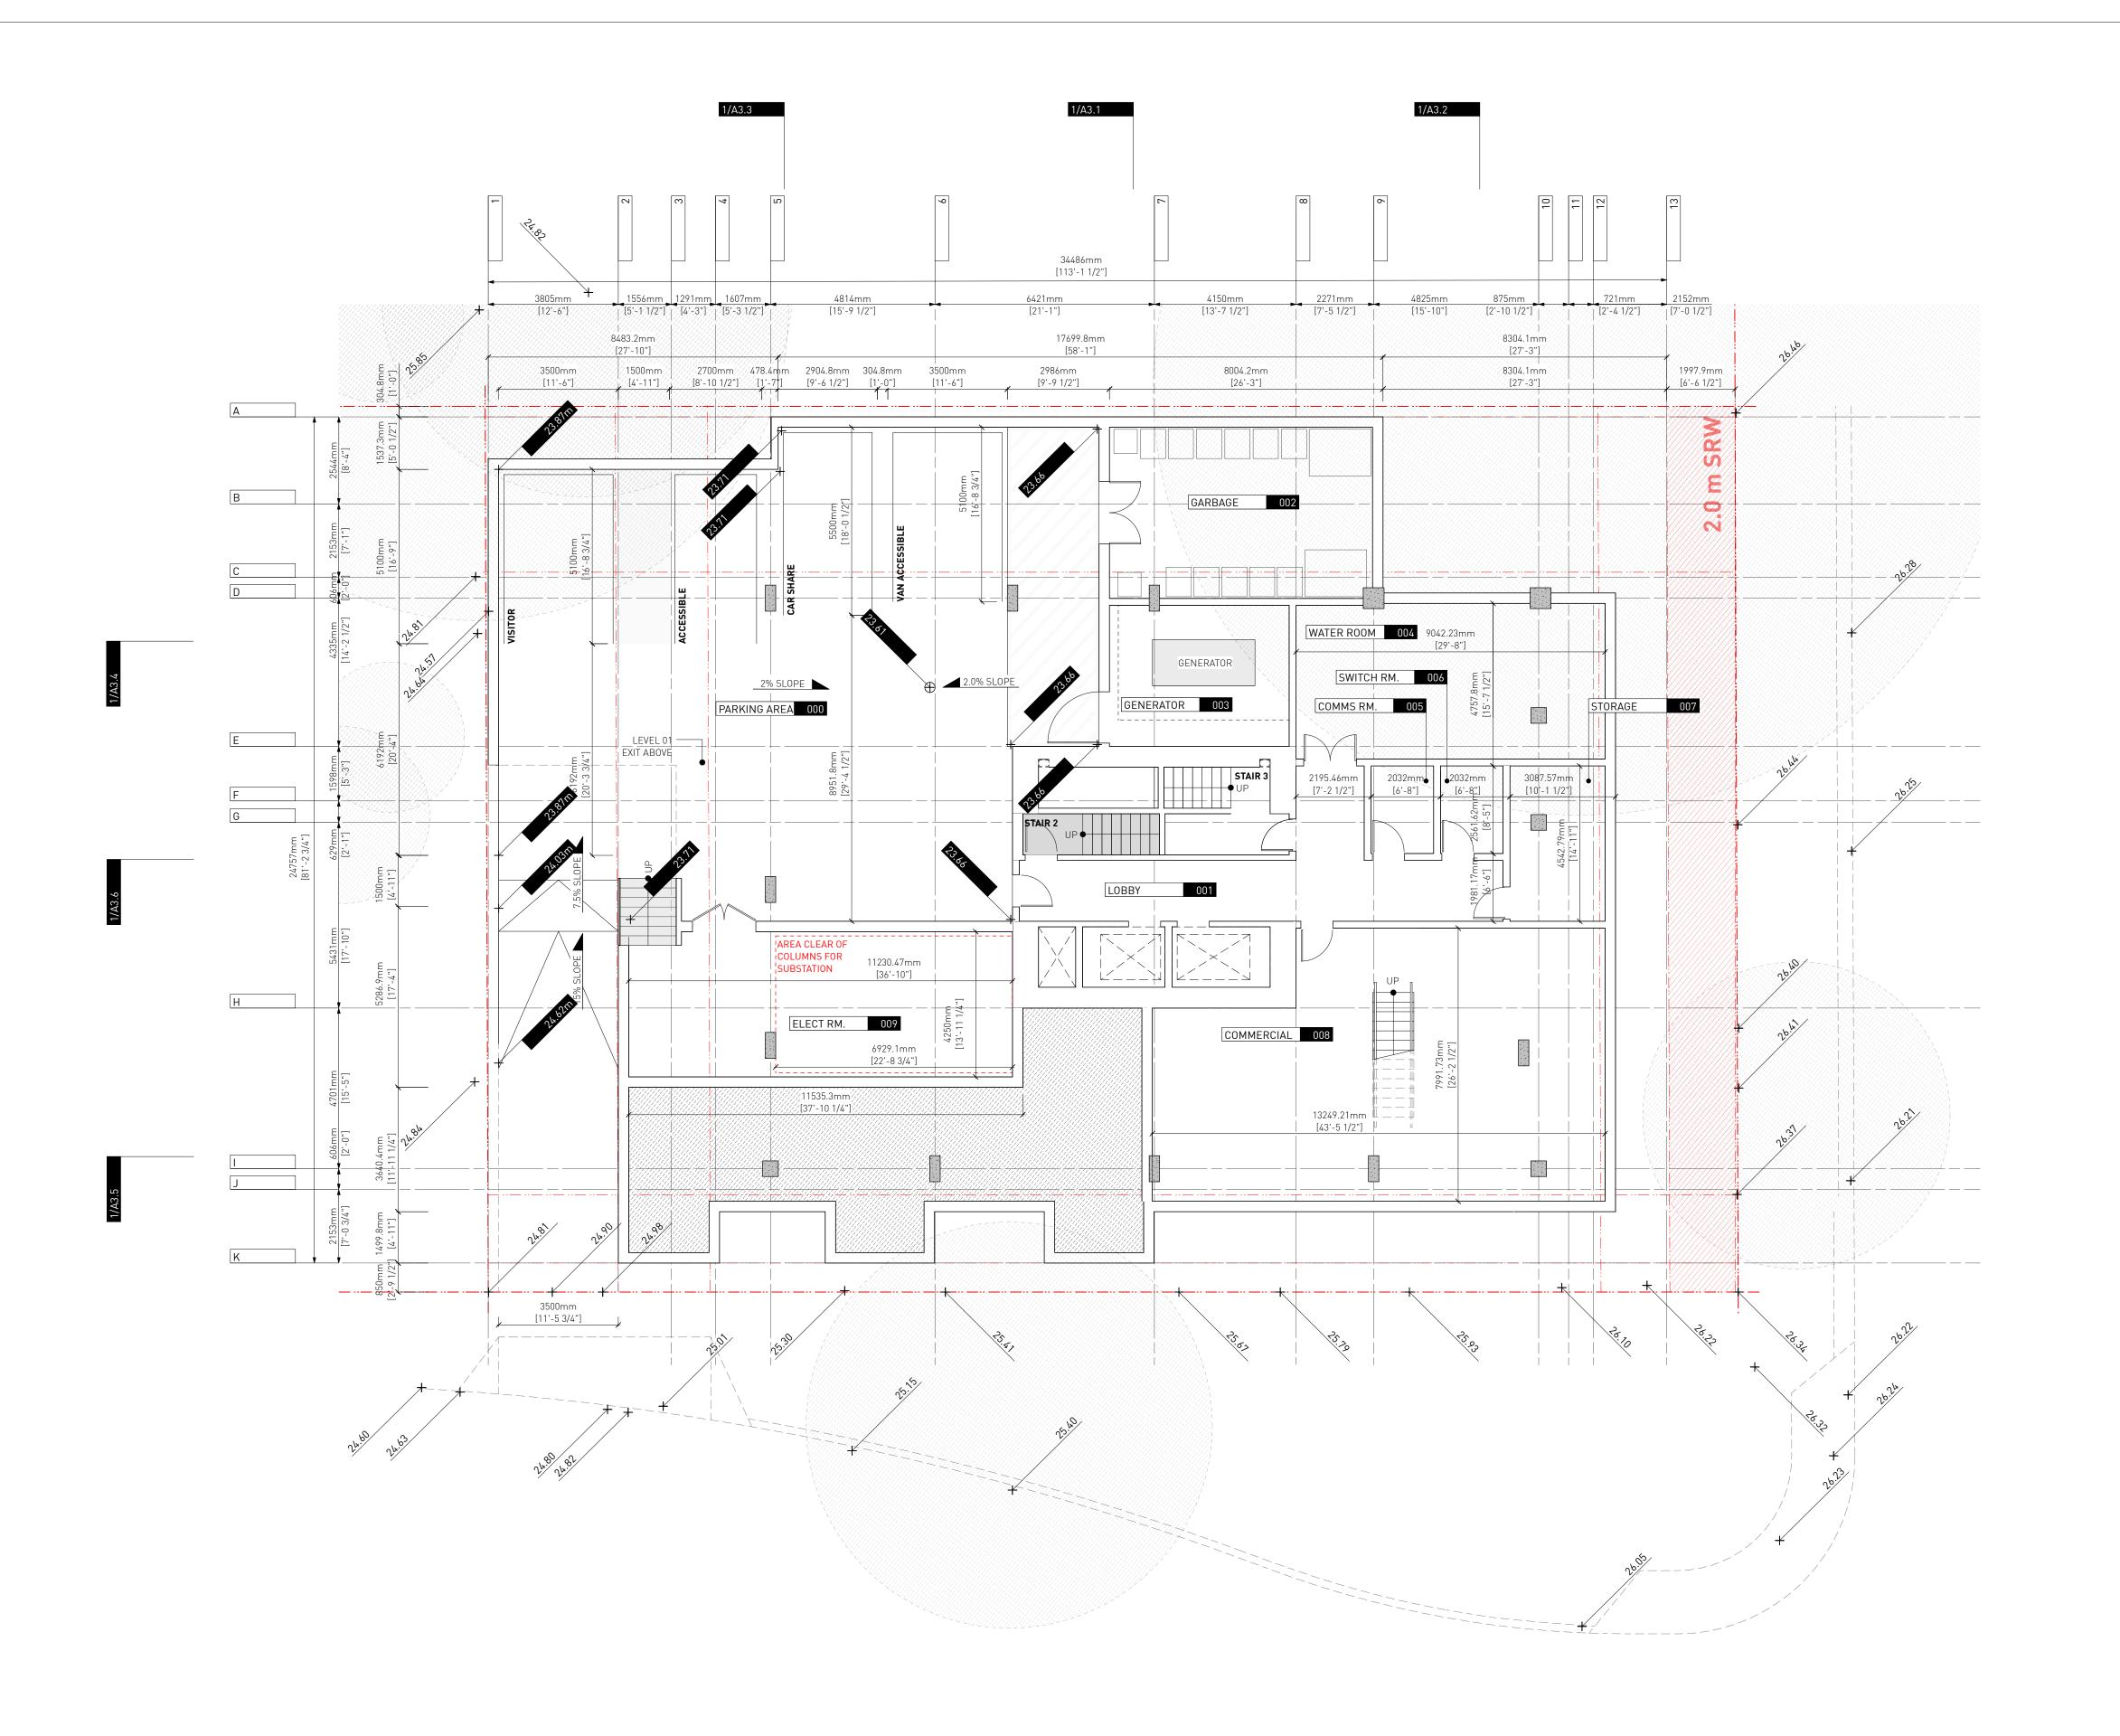

EXISTING BUILDING

PROPOSED BUILDING
PROPERTY LINE

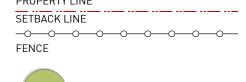



TREE [REF. TO ANNOTATION]



EXISTING HYDRO POLE

EXISTING FIRE HYDRANT

PROPOSED DECK / BENCH PROPOSED BIKE PARKING

7 Issued for DDP 18.07.2025 6 Issued for DDP 11.07.2025 5 Issued for DDP 08.07.2025

Drawn By: Checked By: Printing Date: PB 18.07.2025 The Contractor shall verify all dimensions, datums

EA / PB

and levels prior to commencement of work. All errors and omissions to be reported to the


Architect before proceeding.

This drawing must not be scaled.

This drawing is the property of the Architect; the copyright in same being reserved to him/her. It is

Any unauthorized alteration of the electronic data which constitute this document will void all responsibility for the altered document by the Architect.

This drawing is not to be used for building purposes until countersigned by:

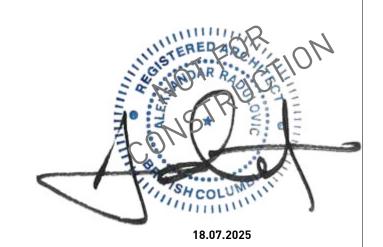


266 MCDERMOT AVE Winnipeg MB R3B 0S8 P: 204.480.8421 F: 204.480.8876

1702 QUADRA STREET + 862 FISGARD STREET

LEVEL 00 PLAN

Project 0650 Sheet A1.1

1 LEVEL 00 PLAN
A1.1 SCALE: 1:100

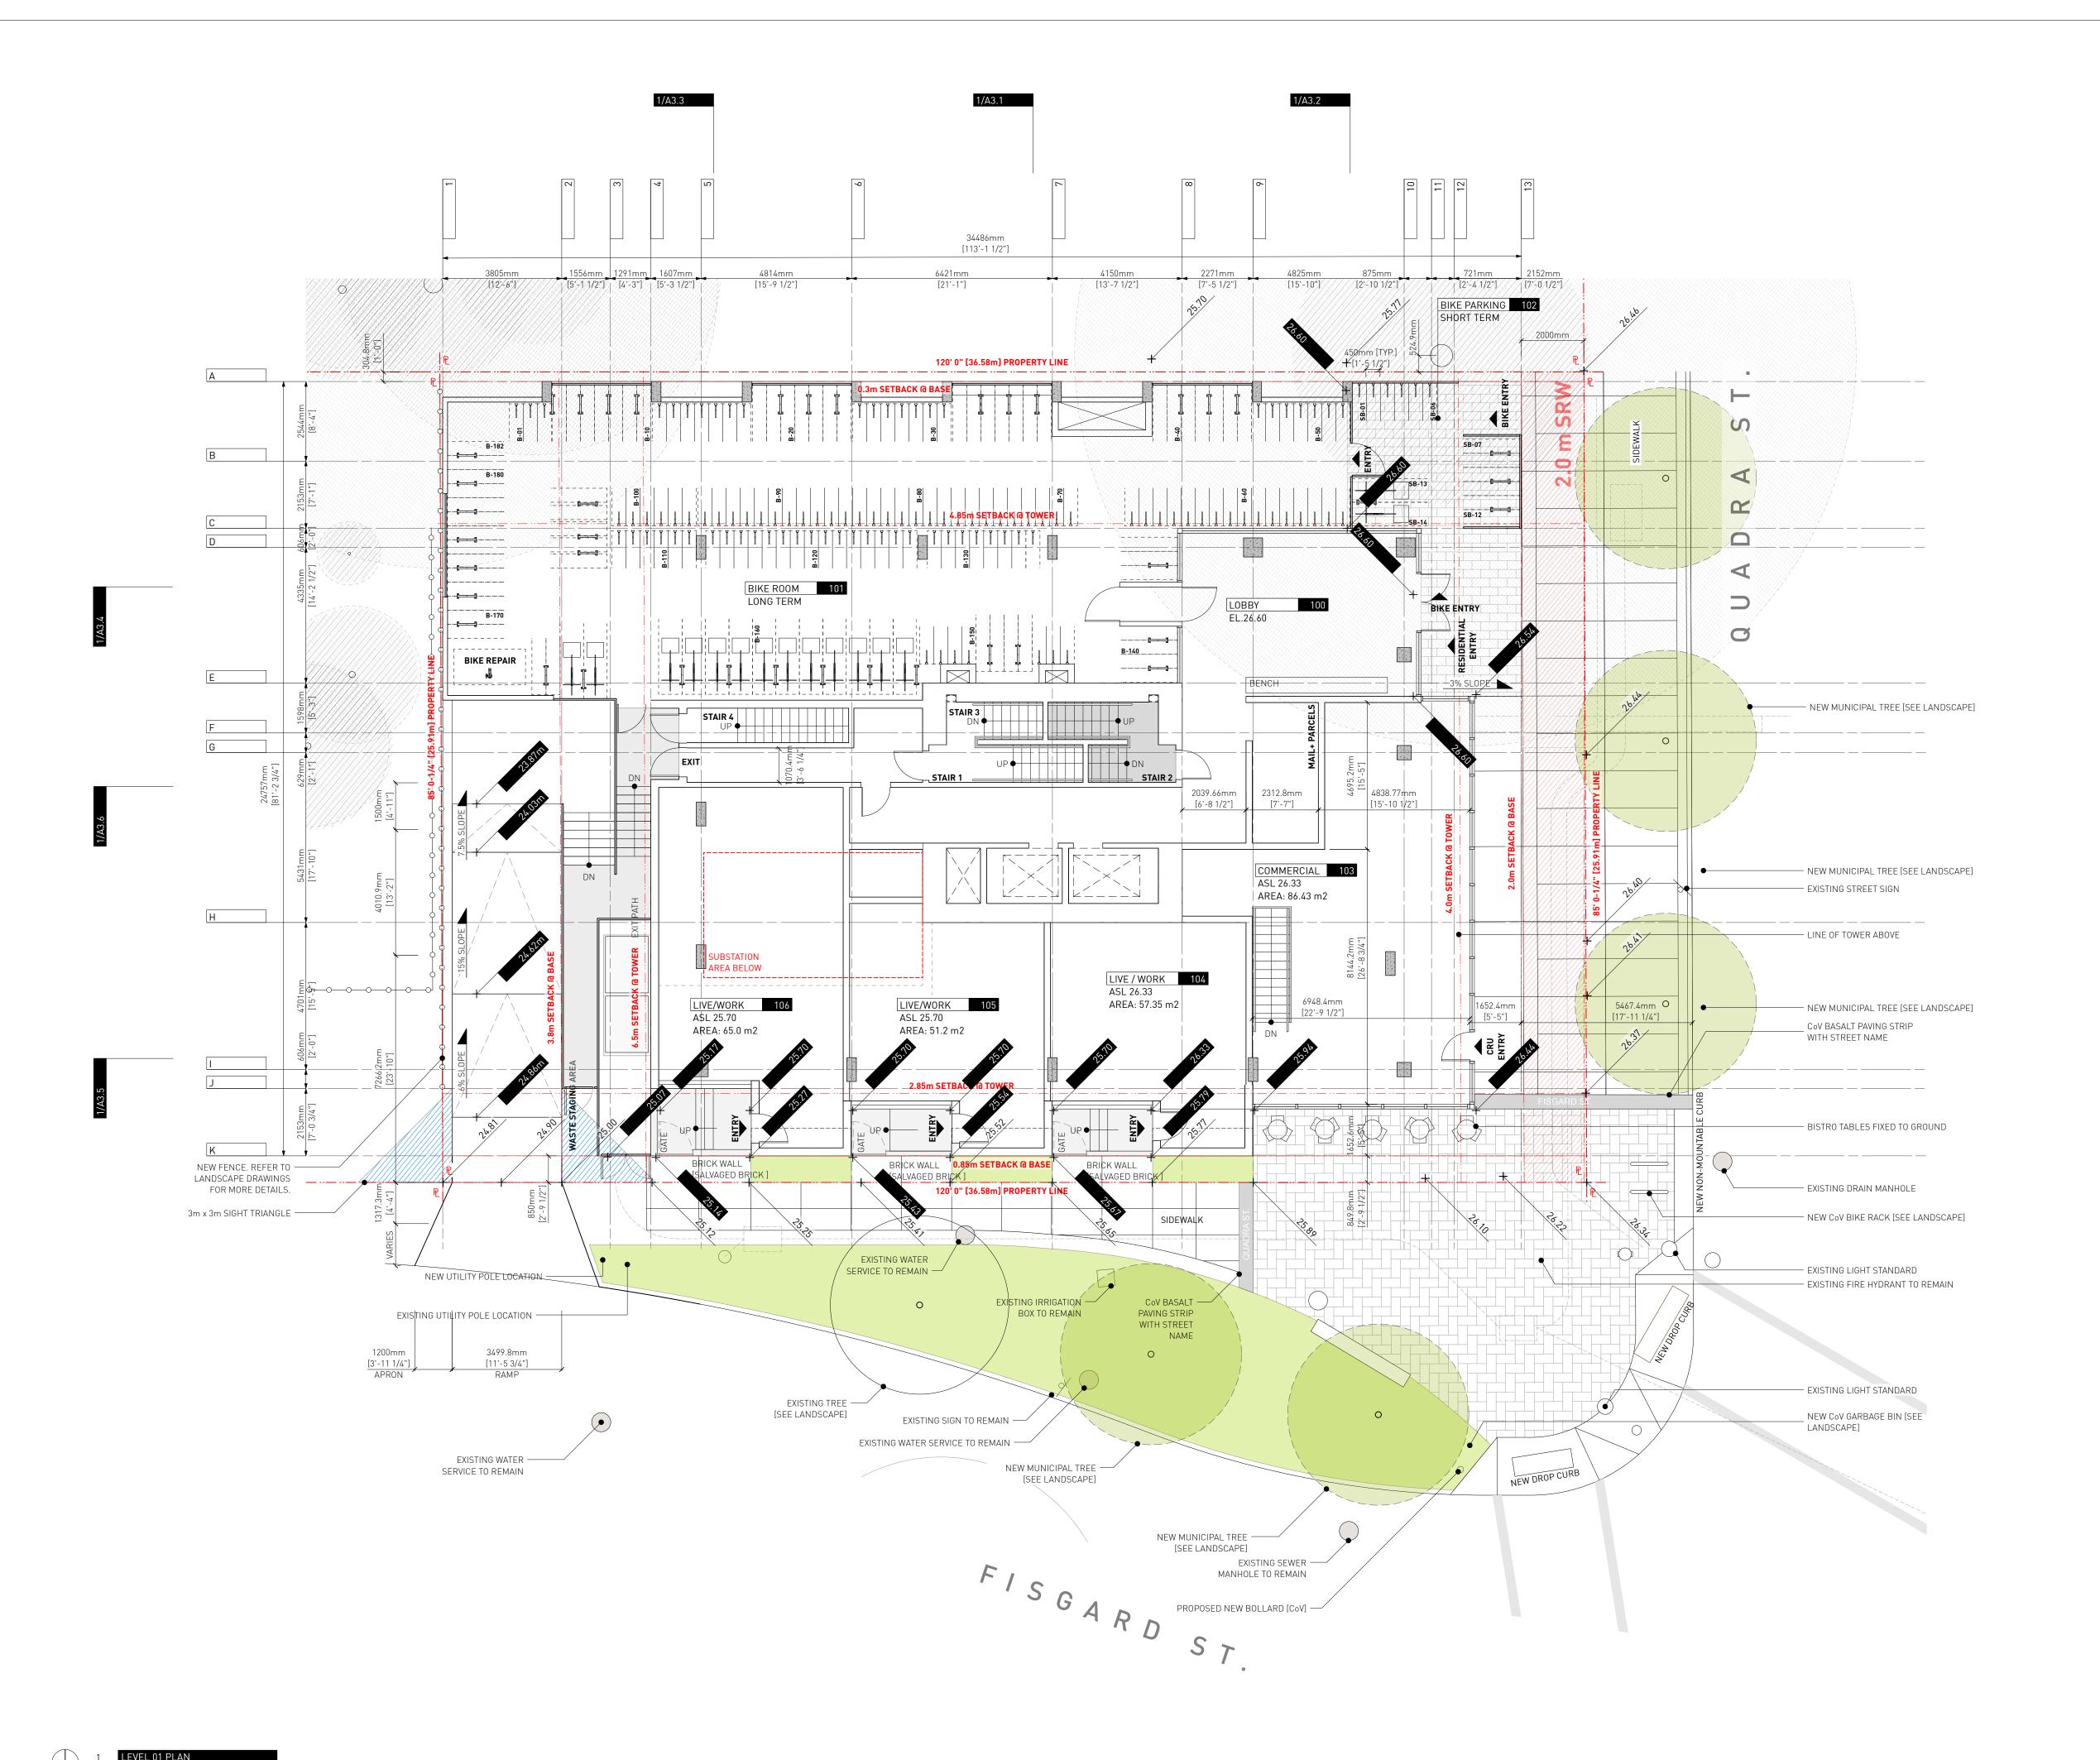

EXISTING BUILDING

PROPOSED BUILDING PROPERTY LINE SETBACK LINE

TREE [REF. TO ANNOTATION]

CRITICAL ROOT ZONE

EXISTING HYDRO POLE

EXISTING FIRE HYDRANT

PROPOSED DECK / BENCH

PROPOSED BIKE PARKING

18.07.2025 7 Issued for DDP 6 Issued for DDP 11.07.2025

Drawn By: Checked By: 18.07.2025 Printing Date:

08.07.2025

EA / PB

The Contractor shall verify all dimensions, datums and levels prior to commencement of work.

All errors and omissions to be reported to the Architect before proceeding.


This drawing must not be scaled.


5 Issued for DDP

This drawing is the property of the Architect; the copyright in same being reserved to him/her. It is

Any unauthorized alteration of the electronic data which constitute this document will void all responsibility for the altered document by the

This drawing is not to be used for building purposes until countersigned by:

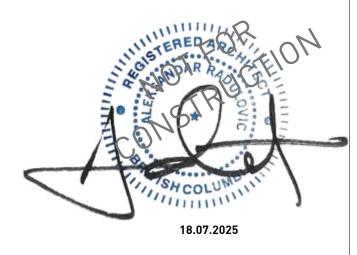

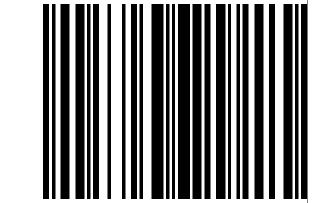


266 MCDERMOT AVE Winnipeg MB R3B 0S8 P: 204.480.8421 F: 204.480.8876

1702 QUADRA STREET + 862 FISGARD STREET

LEVEL 01 PLAN

Project 0650 Sheet

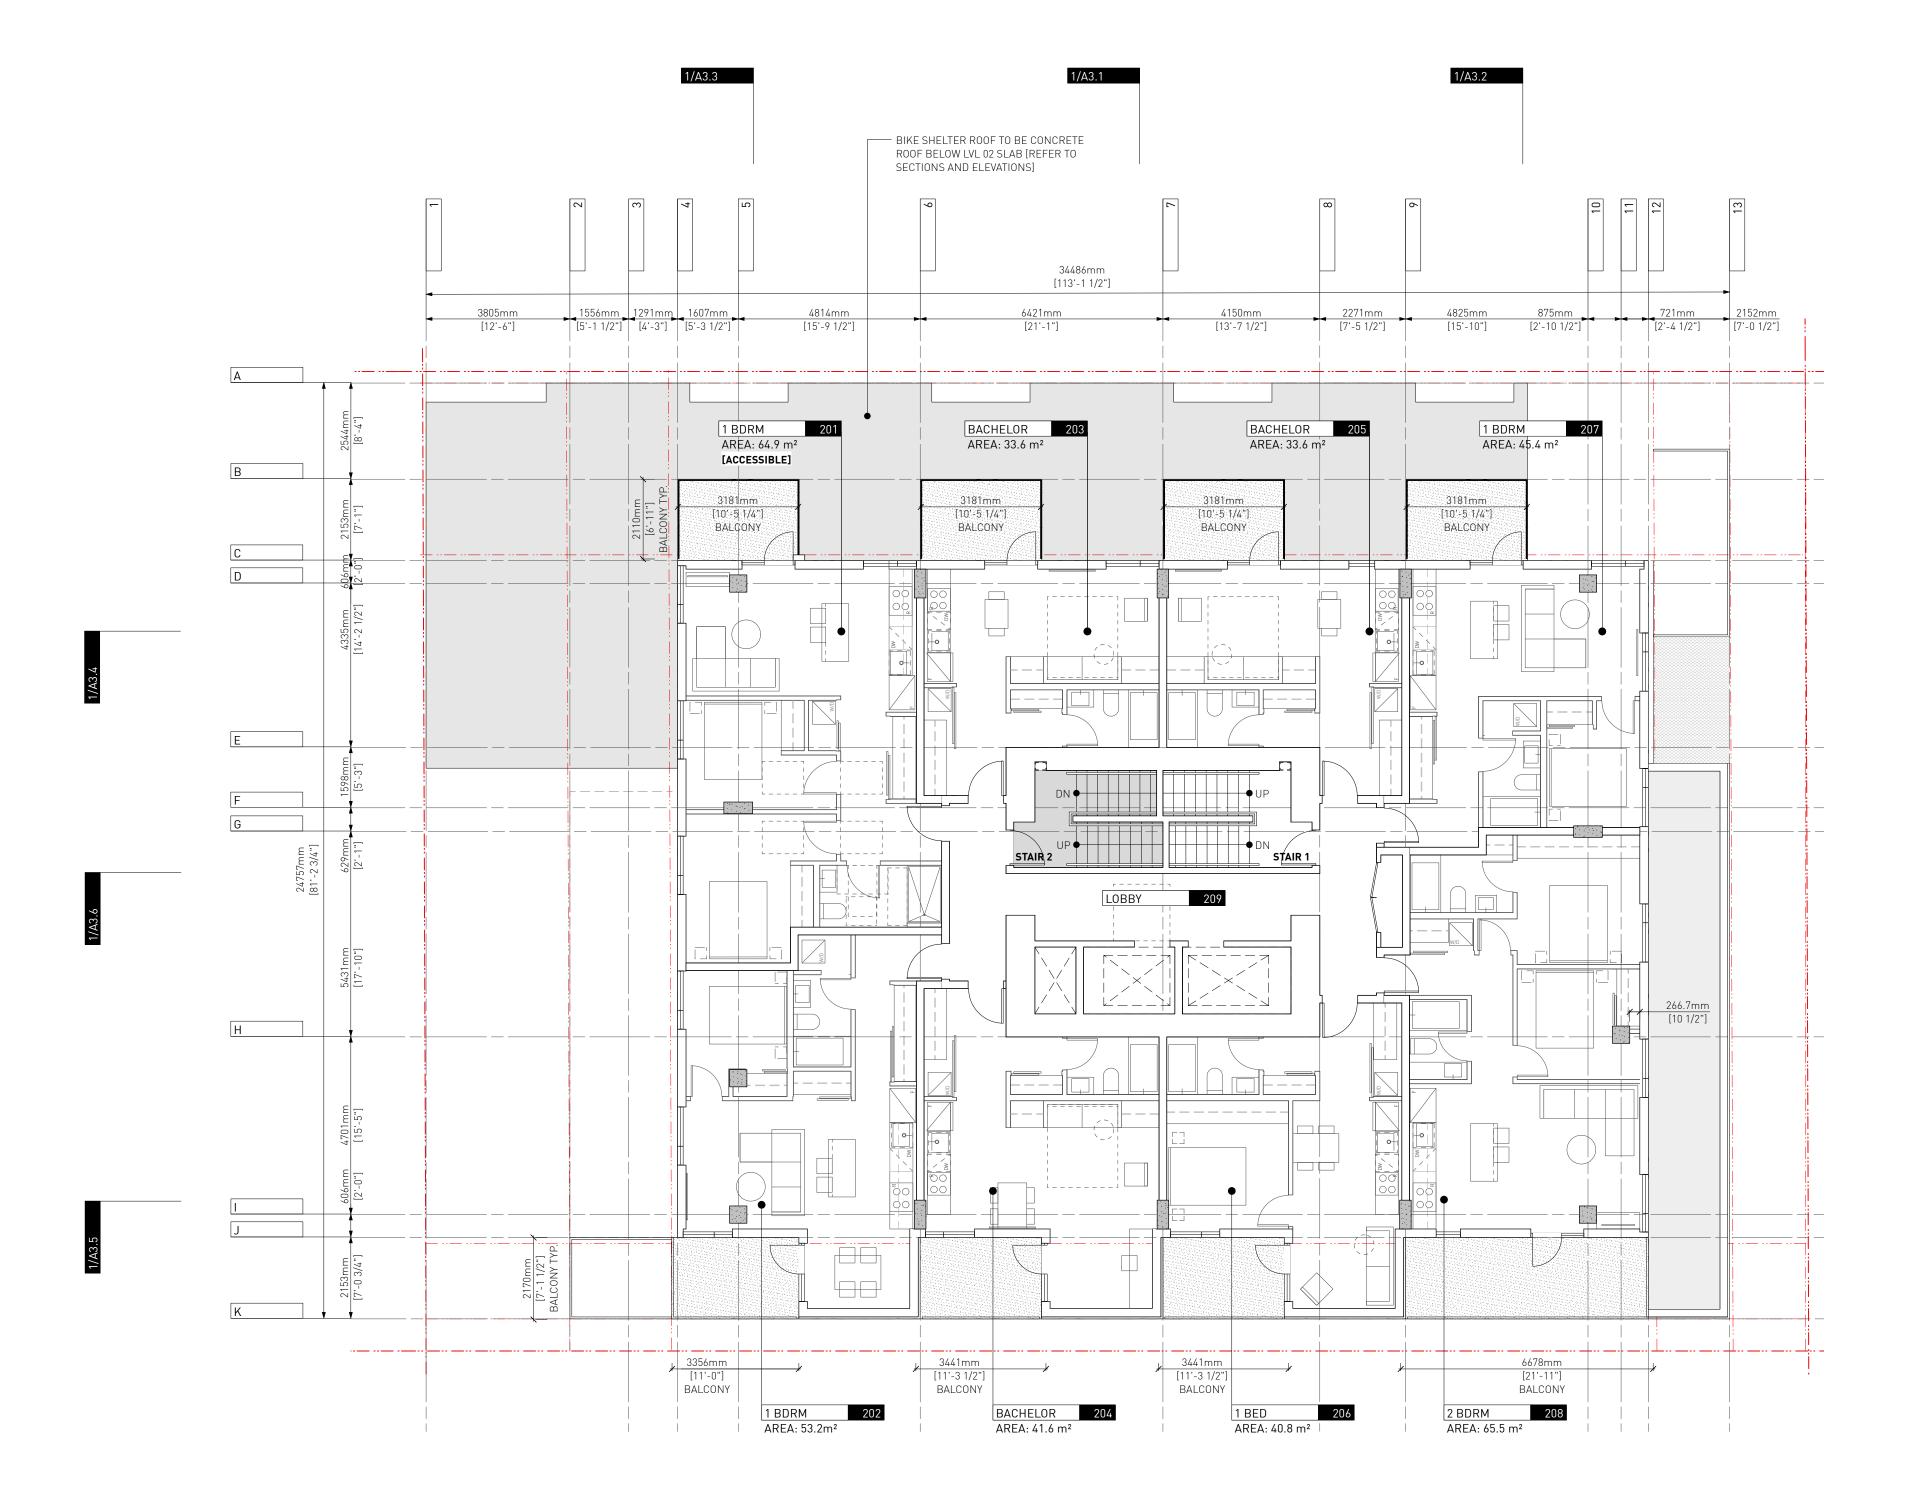

EXISTING BUILDING

PROPOSED BUILDING

7 Issued for DDP

6 Issued for DDP

5 Issued for DDP

Drawn By: Checked By: Printing Date:

Architect.

18.07.2025

11.07.2025

08.07.2025

EA / MM PB 18.07.2025

PROPERTY LINE SETBACK LINE

The Contractor shall verify all dimensions, datums and levels prior to commencement of work.

All errors and omissions to be reported to the

This drawing is the property of the Architect; the copyright in same being reserved to him/her. It is

Any unauthorized alteration of the electronic data which constitute this document will void all responsibility for the altered document by the


This drawing is not to be used for building

purposes until countersigned by:

Architect before proceeding.

This drawing must not be scaled.

18.07.2025

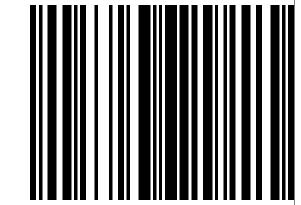


266 MCDERMOT AVE Winnipeg MB R3B 0S8 P: 204.480.8421 F: 204.480.8876

1702 QUADRA STREET + 862 FISGARD STREET

LEVEL 02 PLAN

Project 0650 Sheet A1.3

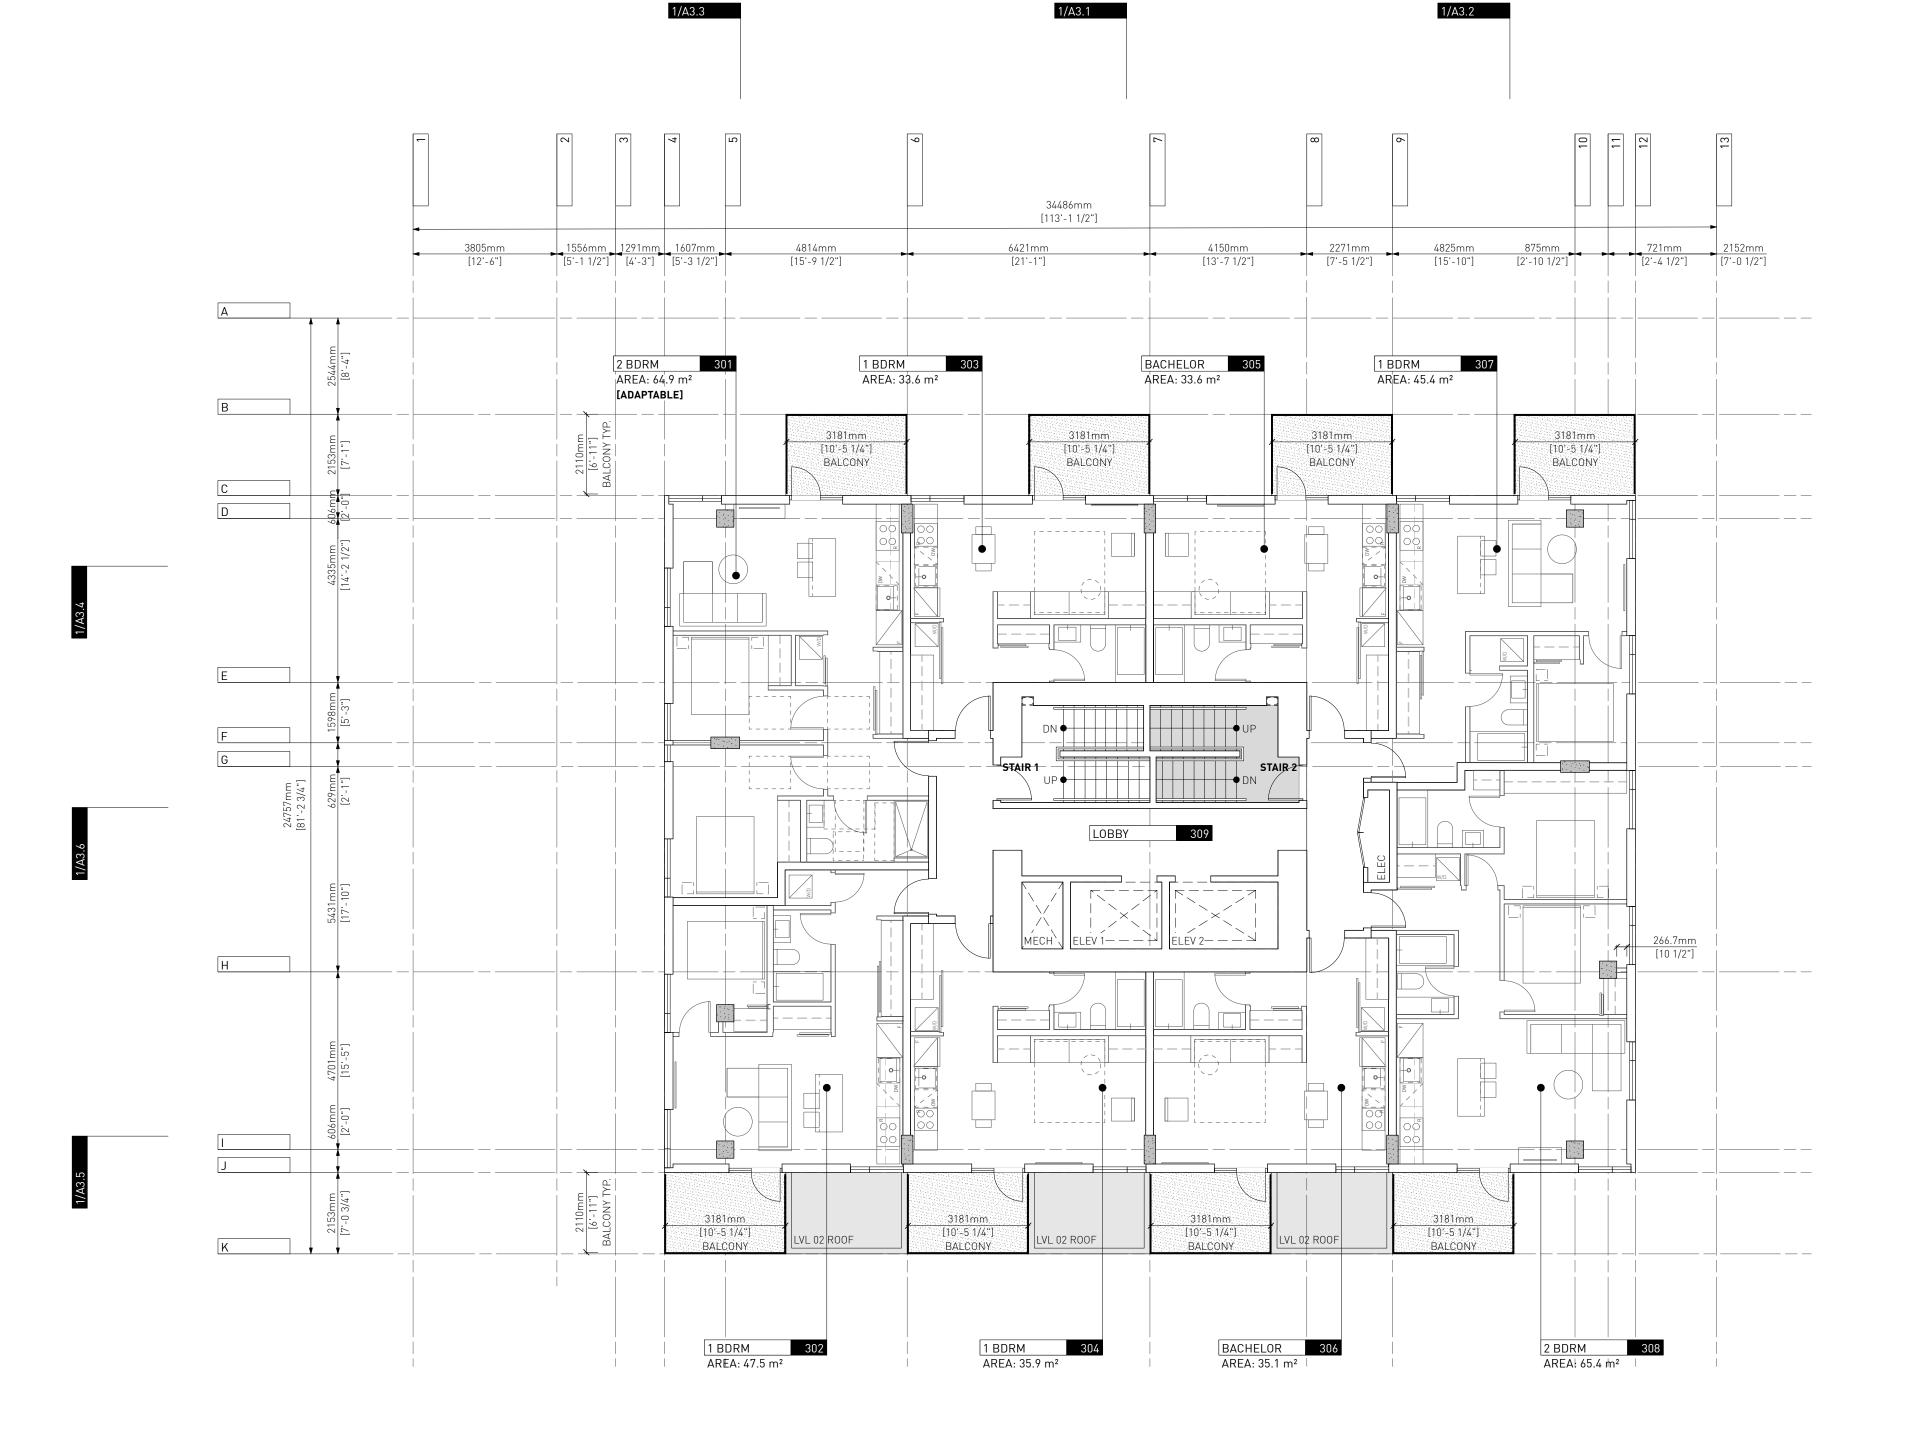



BELOW

EXISTING BUILDING

PROPOSED BUILDING

6 Issued for DDP 11.07.2025
5 Issued for DDP 08.07.2025

Drawn By: EA / MM Checked By: PB Printing Date: 18.07.2025

18.07.2025

7 Issued for DDP

The Contractor shall verify all dimensions, datums and levels prior to commencement of work.

All errors and omissions to be reported to the Architect before proceeding.

This drawing must not be scaled.

This drawing is the property of the Architect; the


copyright in same being reserved to him/her. It is not to be reproduced without his/her permission.

Any unauthorized alteration of the electronic data which constitute this document will void all responsibility for the altered document by the Architect.

This drawing is not to be used for building purposes until countersigned by:



18.07.2025

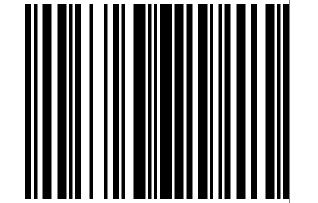


5 4 6 8 7 9 6 A R C H I T E C T U R E I N C 266 MCDERMOT AVE Winnipeg MB R3B 0S8 P: 204.480.8421 F: 204.480.8876

1702 QUADRA STREET + 862 FISGARD STREET

LEVEL 03 PLAN

Project 0650 Sheet

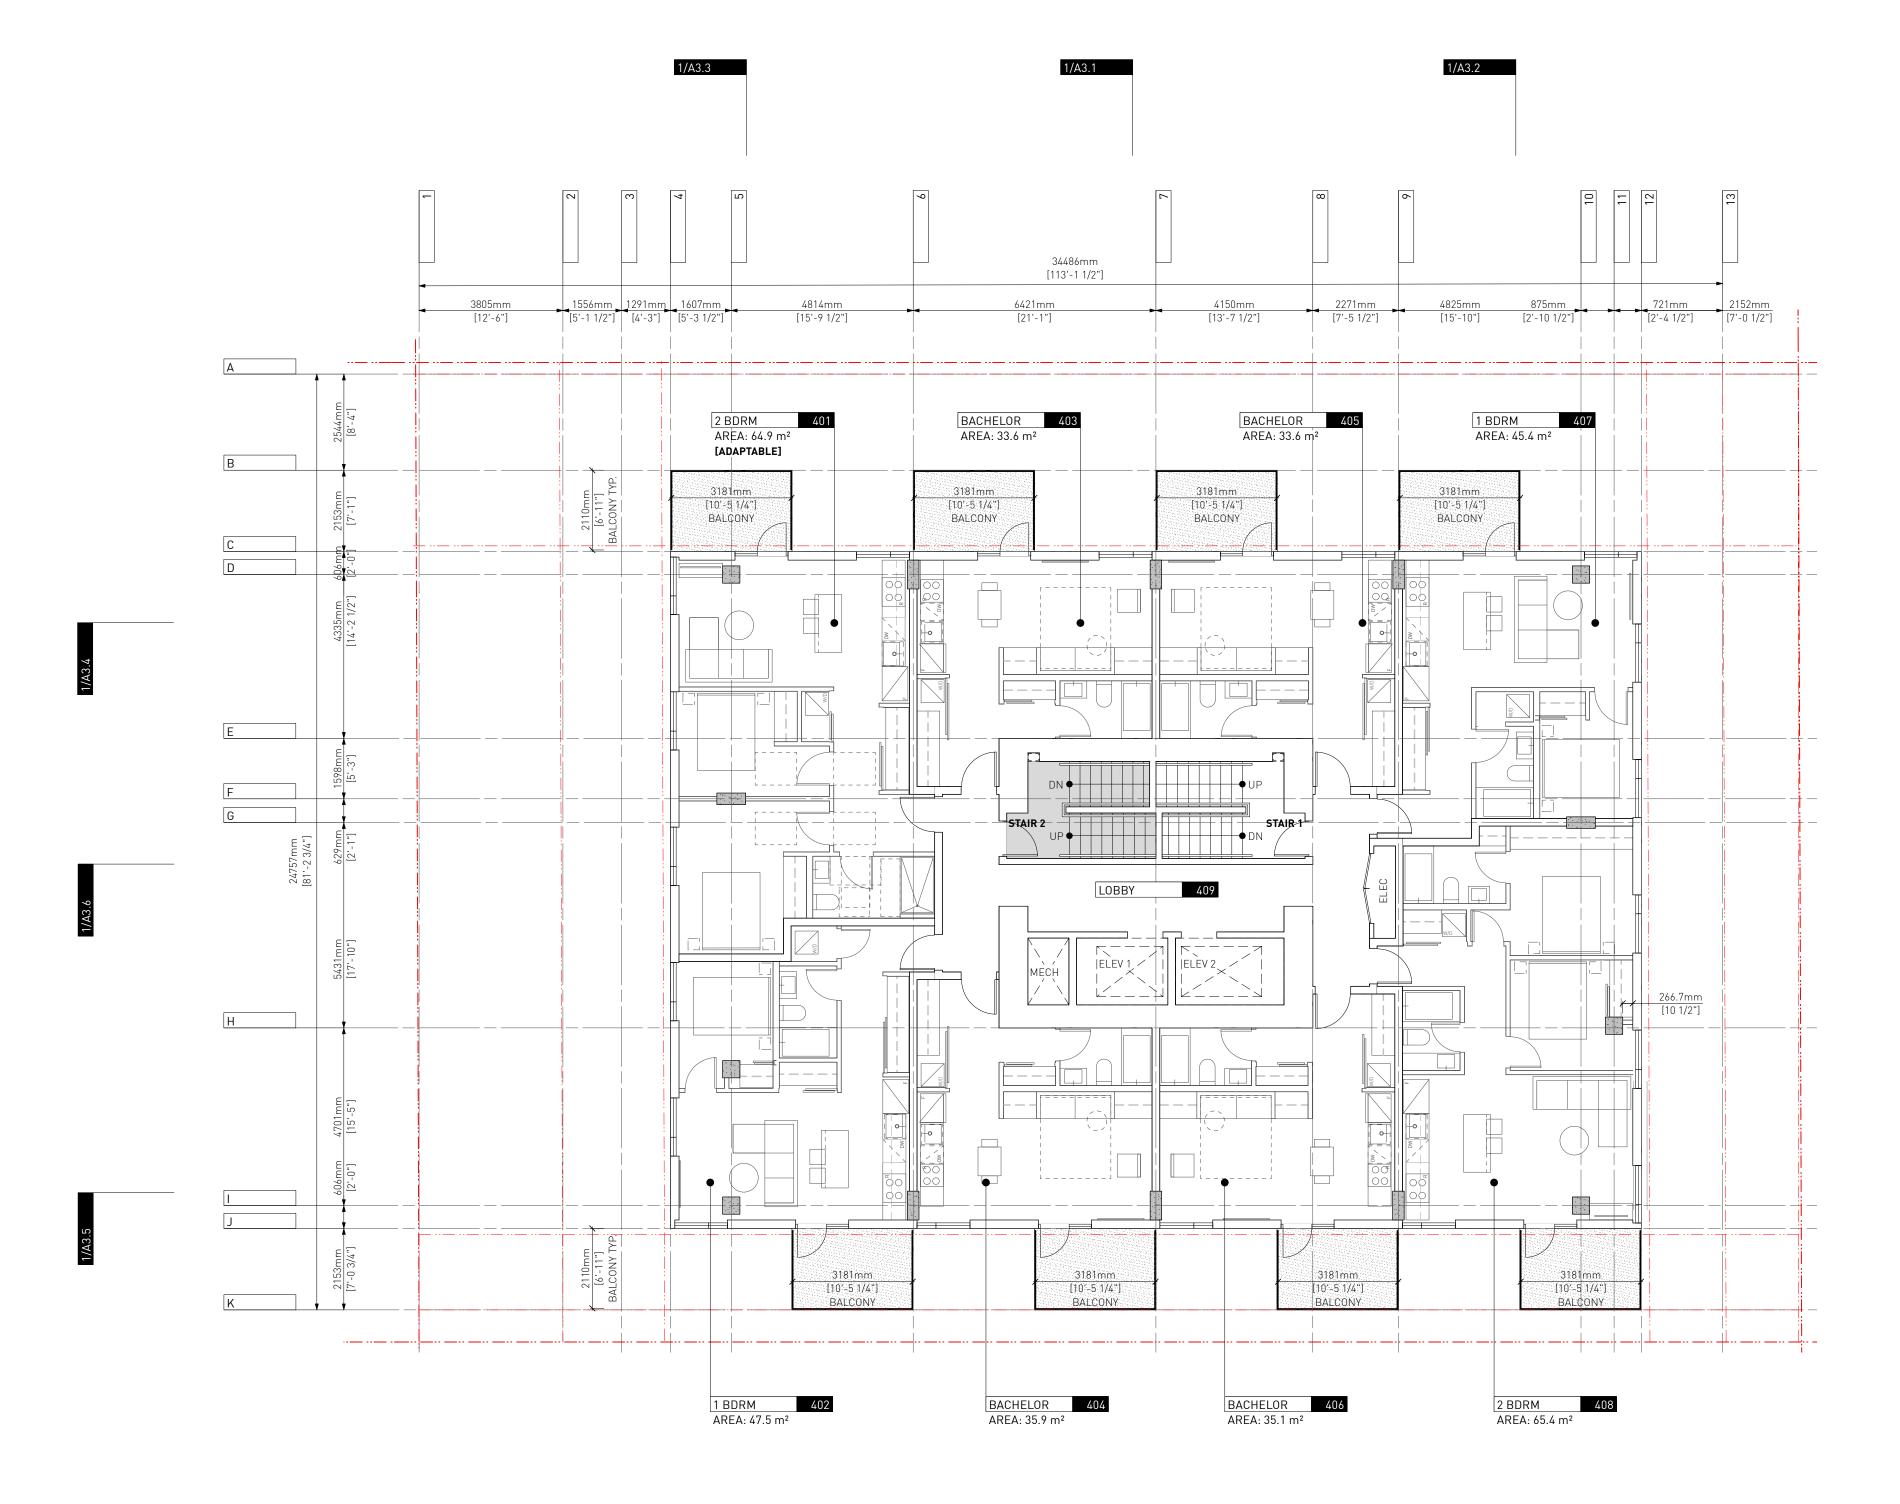

2 LEVEL 04 / 06 / 08 / 10 / 12 A1.5 SCALE: 1:100

LEGEND:

LOW

AB0VE

EXISTING BUILDING

PROPOSED BUILDING
PROPERTY LINE
SETBACK LINE

FENCE

5 Issued for DDP 08.07.2025

Drawn By: EA / MM Checked By: PB Printing Date: 18.07.2025

18.07.2025

11.07.2025

The Contractor shall verify all dimensions, datums and levels prior to commencement of work.

All errors and omissions to be reported to the

Architect before proceeding.

This drawing must not be scaled.

7 Issued for DDP

6 Issued for DDP


This drawing is the property of the Architect; the copyright in same being reserved to him/her. It is not to be reproduced without his/her permission.

Any unauthorized alteration of the electronic data which constitute this document will void all responsibility for the altered document by the Architect.

This drawing is not to be used for building purposes until countersigned by:



18.07.2025

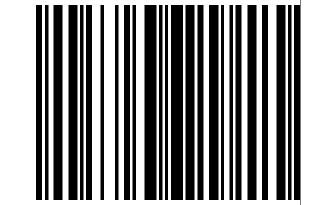


5 4 6 8 7 9 6 A R C H I T E C T U R E I N C 266 MCDERMOT AVE Winnipeg MB R3B 0S8 P: 204.480.8421 F: 204.480.8876

1702 QUADRA STREET + 862 FISGARD STREET

LEVEL 04/06/08/10/12

Sheet A1.5

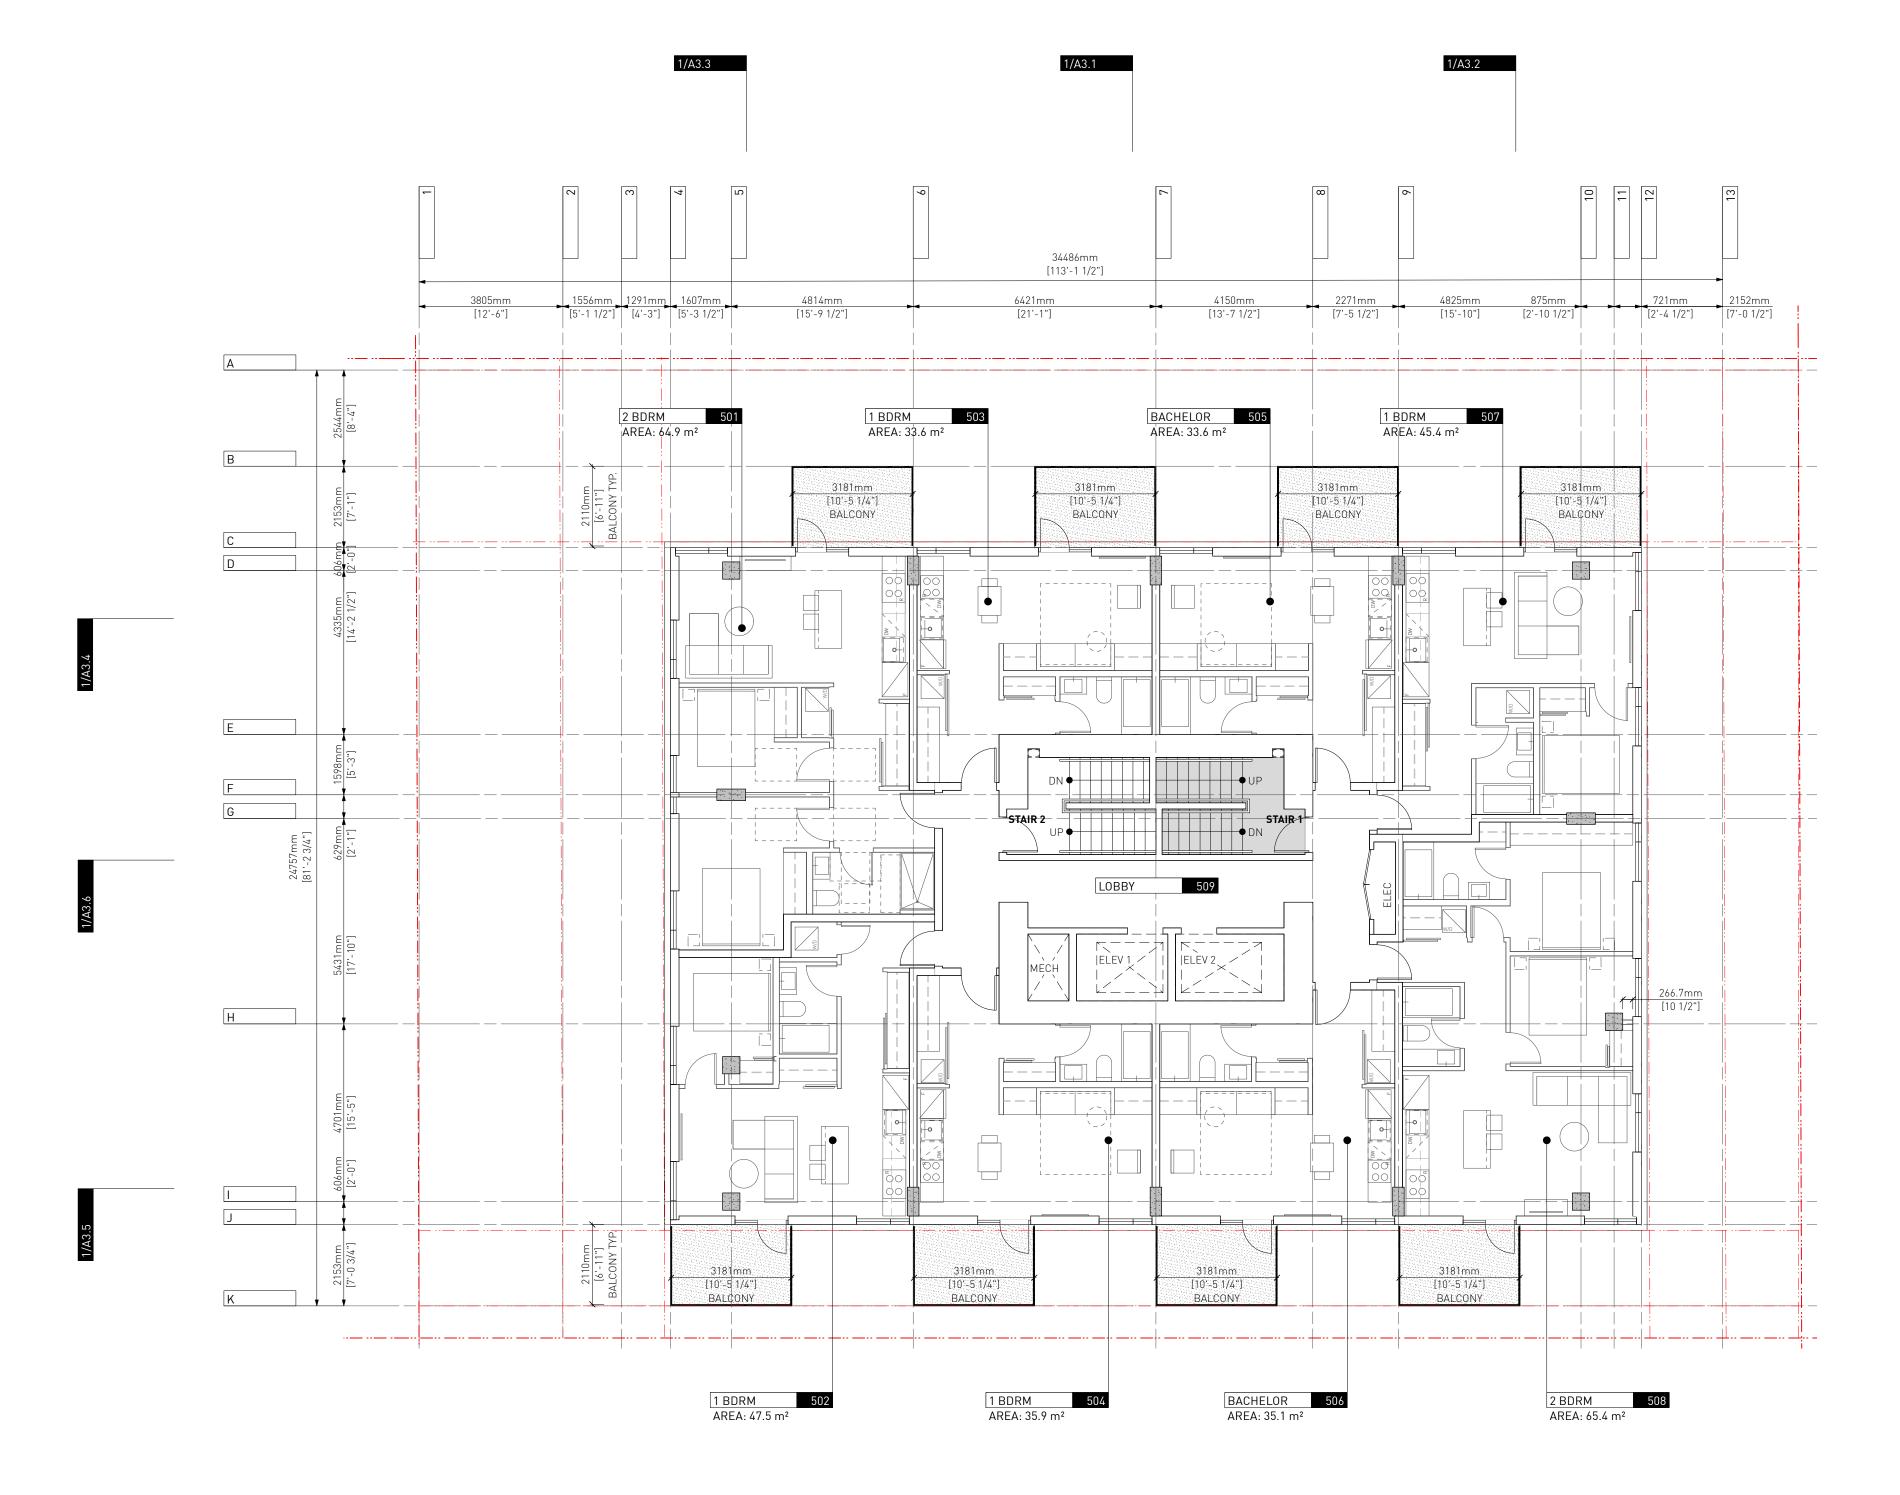

7 Issued for DDP

6 Issued for DDP

5 Issued for DDP

Drawn By: Checked By: Printing Date:

Architect.

The Contractor shall verify all dimensions, datums and levels prior to commencement of work.

All errors and omissions to be reported to the

This drawing is the property of the Architect; the copyright in same being reserved to him/her. It is

Any unauthorized alteration of the electronic data which constitute this document will void all responsibility for the altered document by the

This drawing is not to be used for building

purposes until countersigned by:

Architect before proceeding.

This drawing must not be scaled.

18.07.2025

11.07.2025

08.07.2025

EA / MM PB 18.07.2025

EXISTING BUILDING

PROPOSED BUILDING

PROPERTY LINE SETBACK LINE

18.07.2025


266 MCDERMOT AVE

Winnipeg MB R3B 0S8 P: 204.480.8421 F: 204.480.8876

1702 QUADRA STREET + 862 FISGARD STREET

LEVEL 05/07/09/11

Project 0650 Sheet

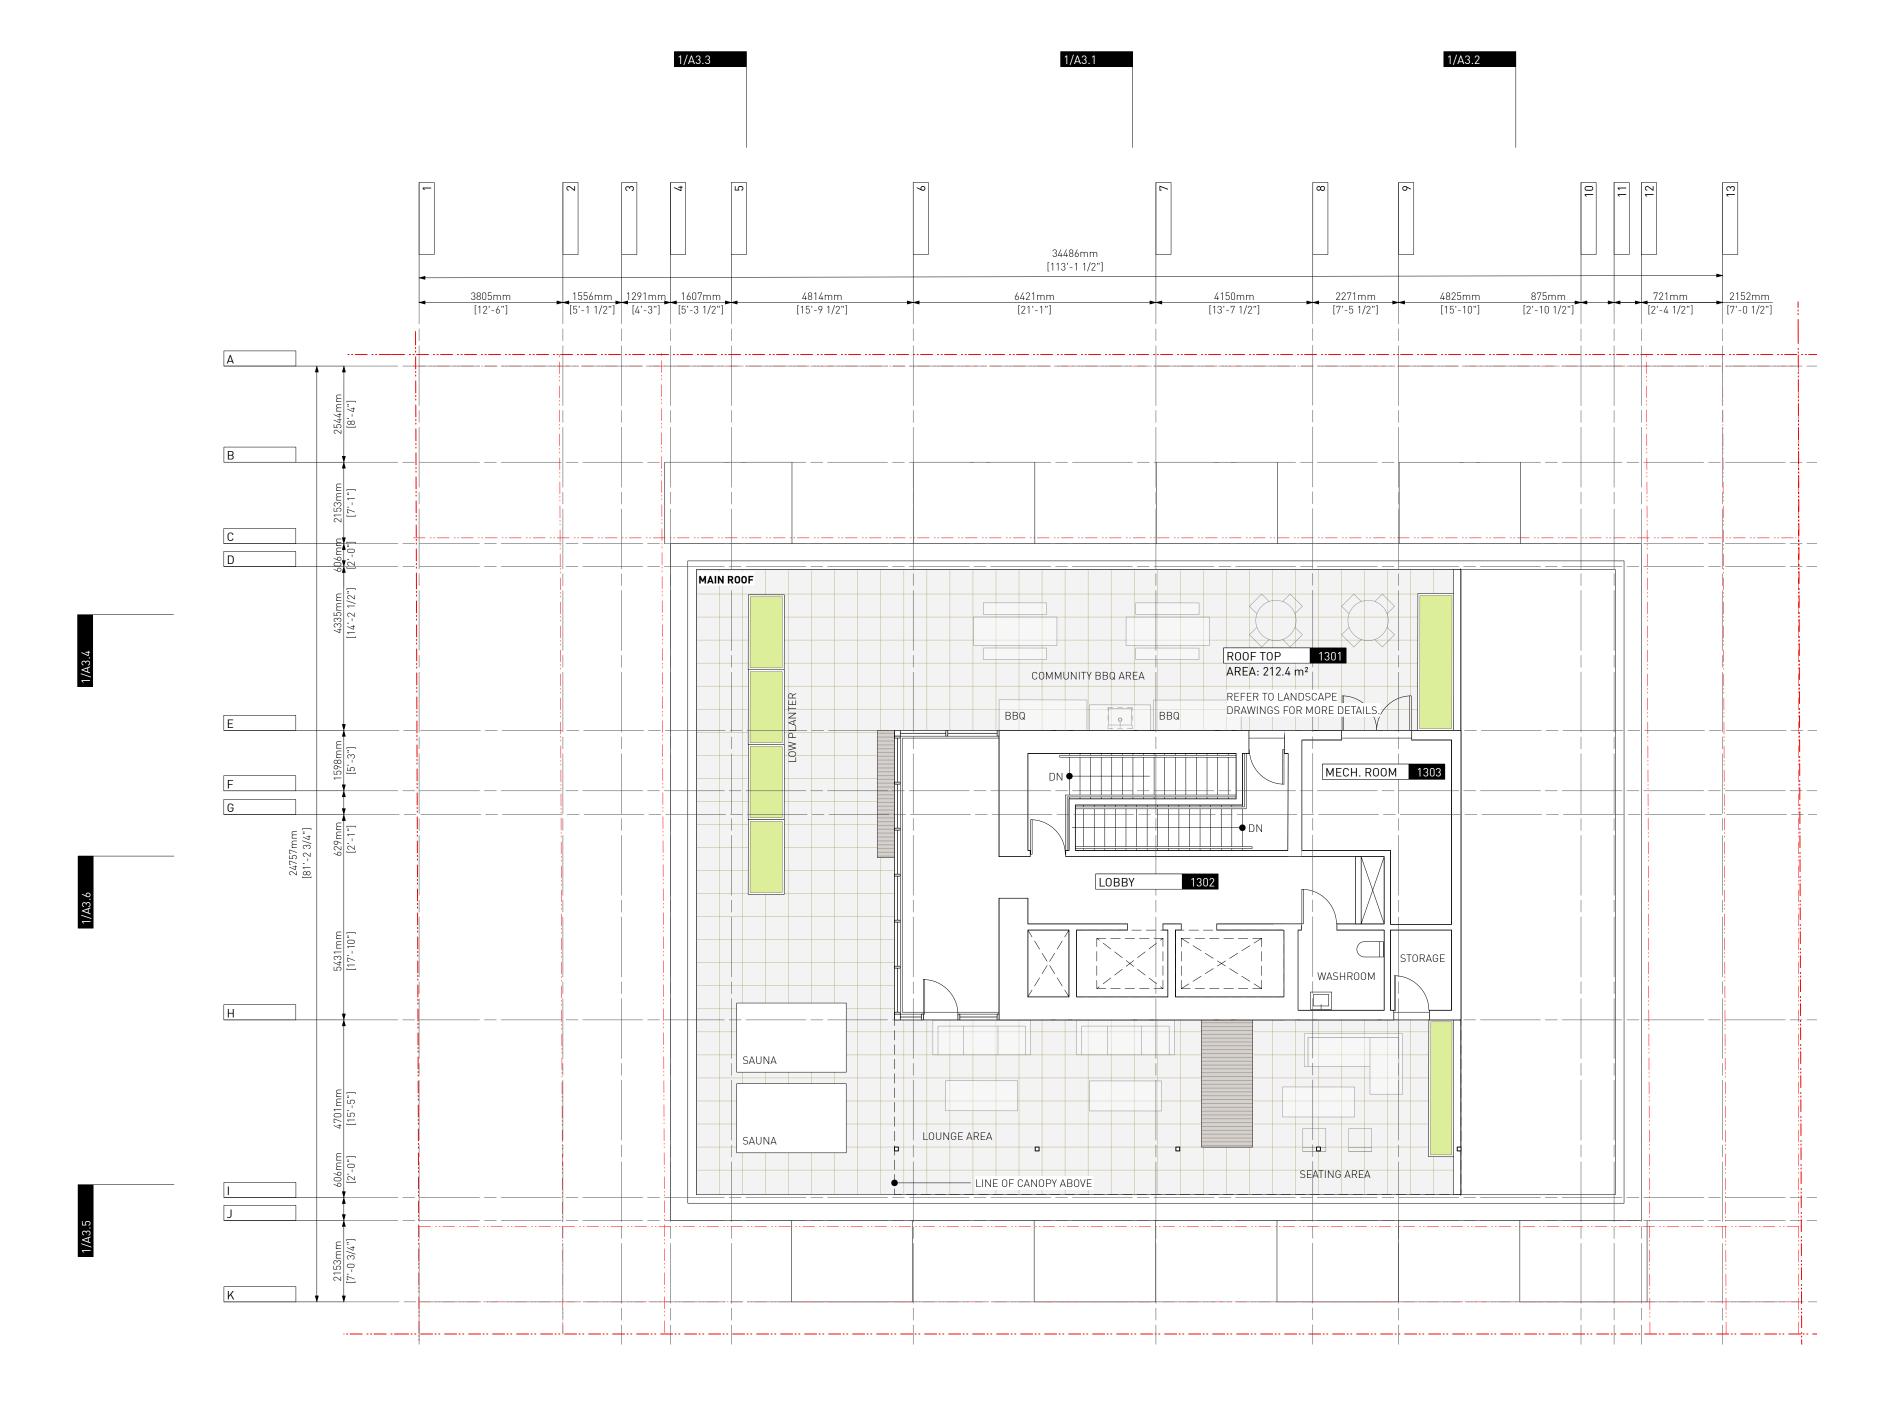

EXISTING BUILDING

PROPOSED BUILDING PROPERTY LINE

SETBACK LINE

7 Issued for DDP 18.07.2025 6 Issued for DDP 11.07.2025 5 Issued for DDP 08.07.2025

Drawn By: Checked By: Printing Date: PB 18.07.2025 The Contractor shall verify all dimensions, datums

EA / MM

and levels prior to commencement of work. All errors and omissions to be reported to the

Architect before proceeding.

This drawing must not be scaled.


This drawing is the property of the Architect; the copyright in same being reserved to him/her. It is

Any unauthorized alteration of the electronic data which constitute this document will void all responsibility for the altered document by the Architect.

This drawing is not to be used for building purposes until countersigned by:



18.07.2025

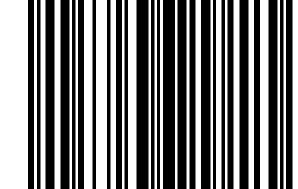


266 MCDERMOT AVE Winnipeg MB R3B 0S8 P: 204.480.8421 F: 204.480.8876

1702 QUADRA STREET + 862 FISGARD STREET

LEVEL 13

Project 0650 Sheet

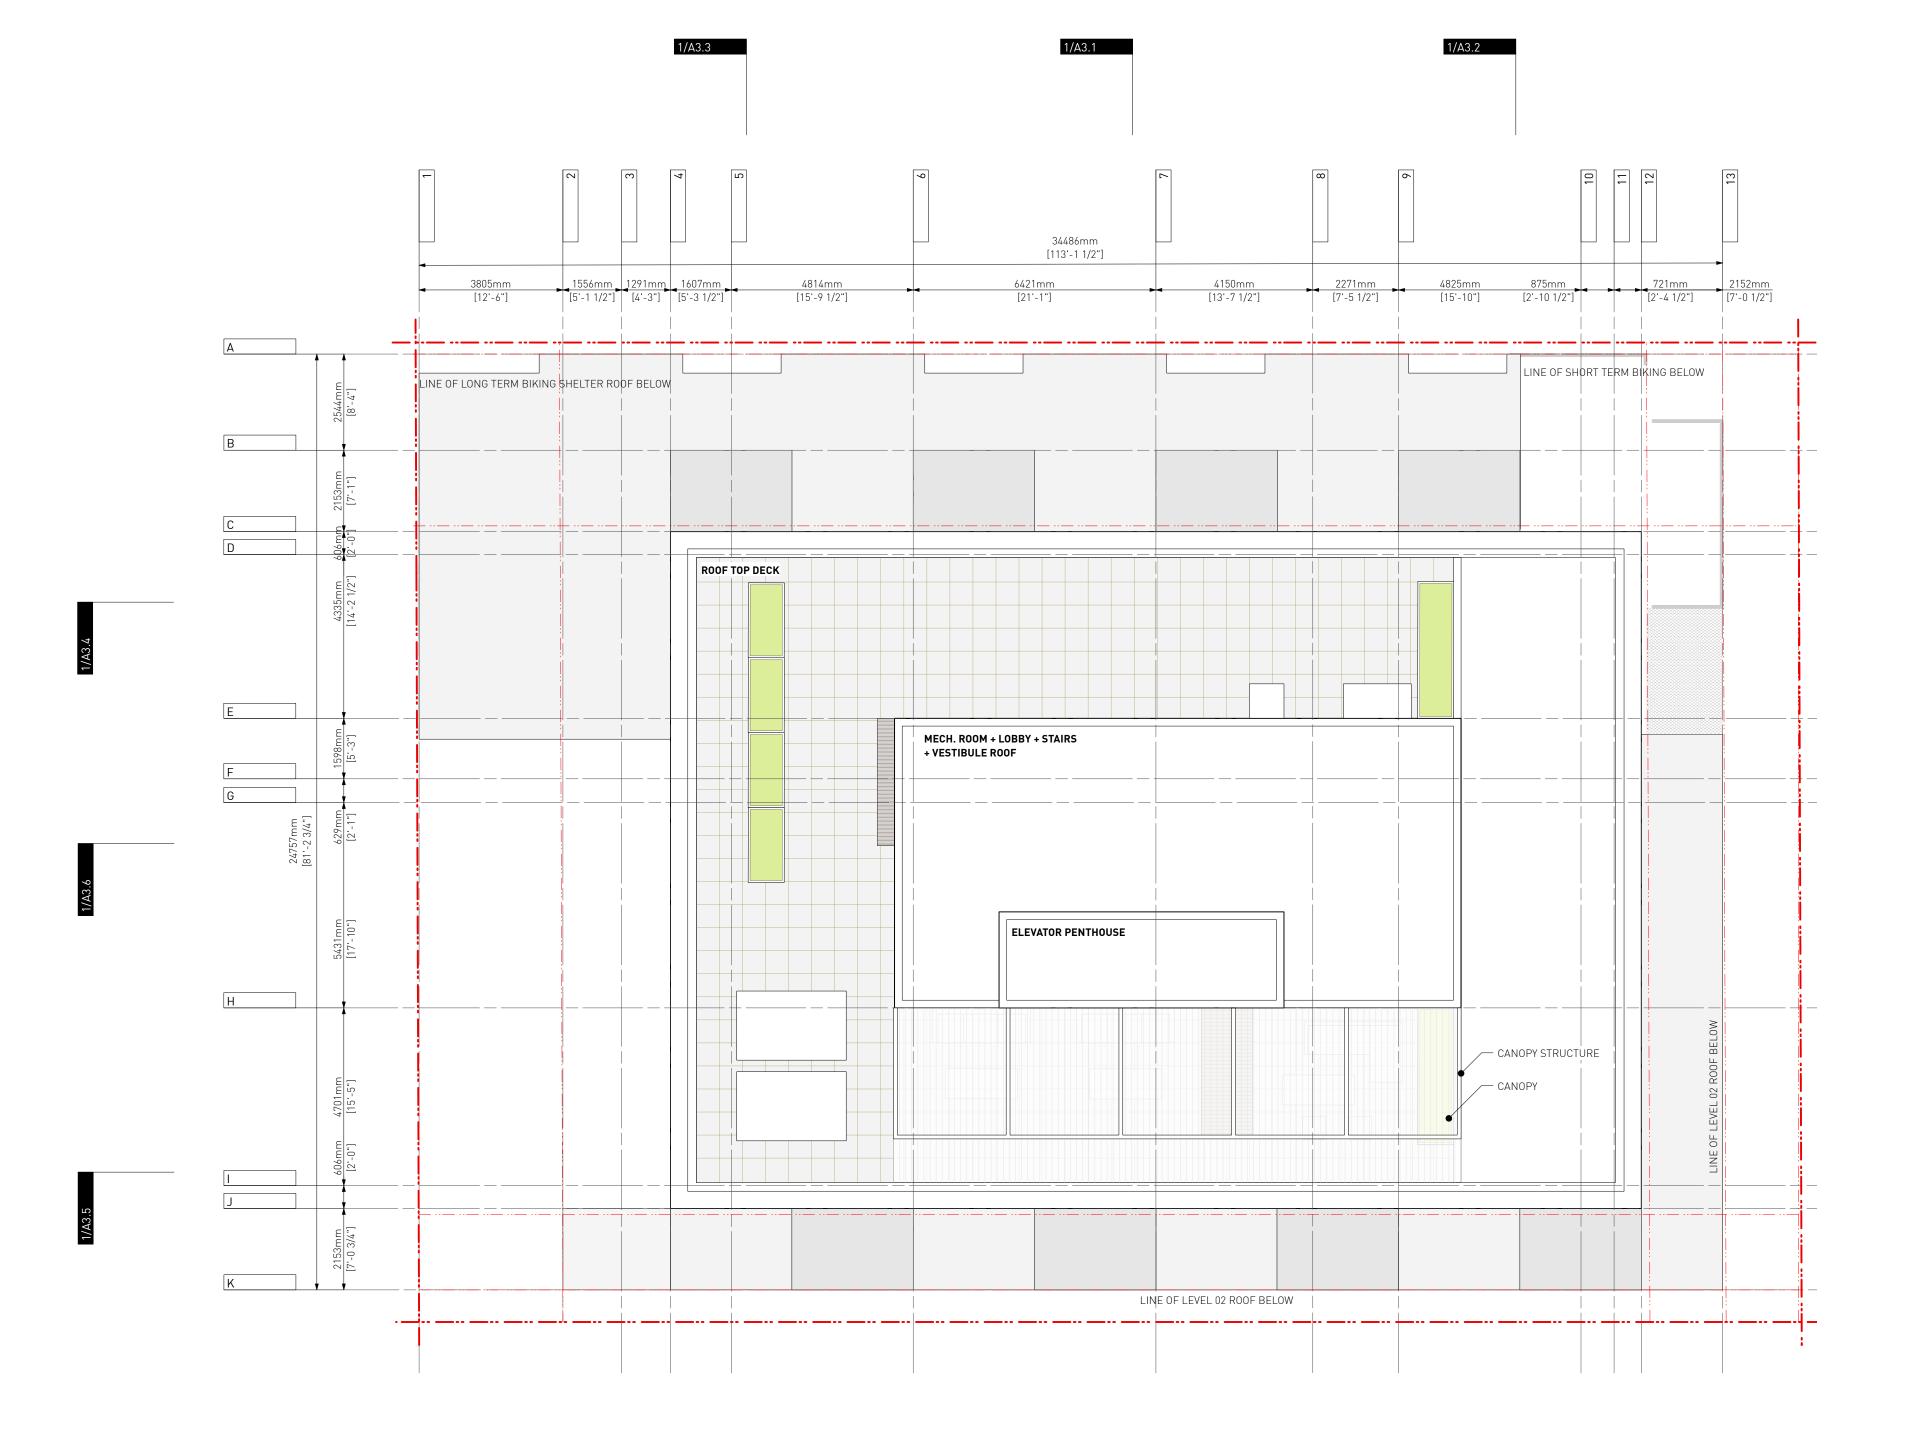

EXISTING BUILDING

PROPOSED BUILDING

PROPERTY LINE SETBACK LINE

7 Issued for DDP 18.07.2025 6 Issued for DDP 11.07.2025 5 Issued for DDP 08.07.2025

The Contractor shall verify all dimensions, datums

and levels prior to commencement of work. All errors and omissions to be reported to the

EA / MM PB 18.07.2025

Architect before proceeding.

This drawing must not be scaled.

Architect.

Drawn By: Checked By: Printing Date:


This drawing is the property of the Architect; the copyright in same being reserved to him/her. It is

Any unauthorized alteration of the electronic data which constitute this document will void all responsibility for the altered document by the

This drawing is not to be used for building purposes until countersigned by:



18.07.2025

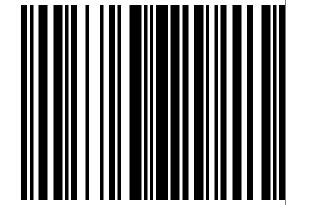



266 MCDERMOT AVE Winnipeg MB R3B 0S8 P: 204.480.8421 F: 204.480.8876

1702 QUADRA STREET + 862 FISGARD STREET

ROOF PLAN

Project 0650 Sheet

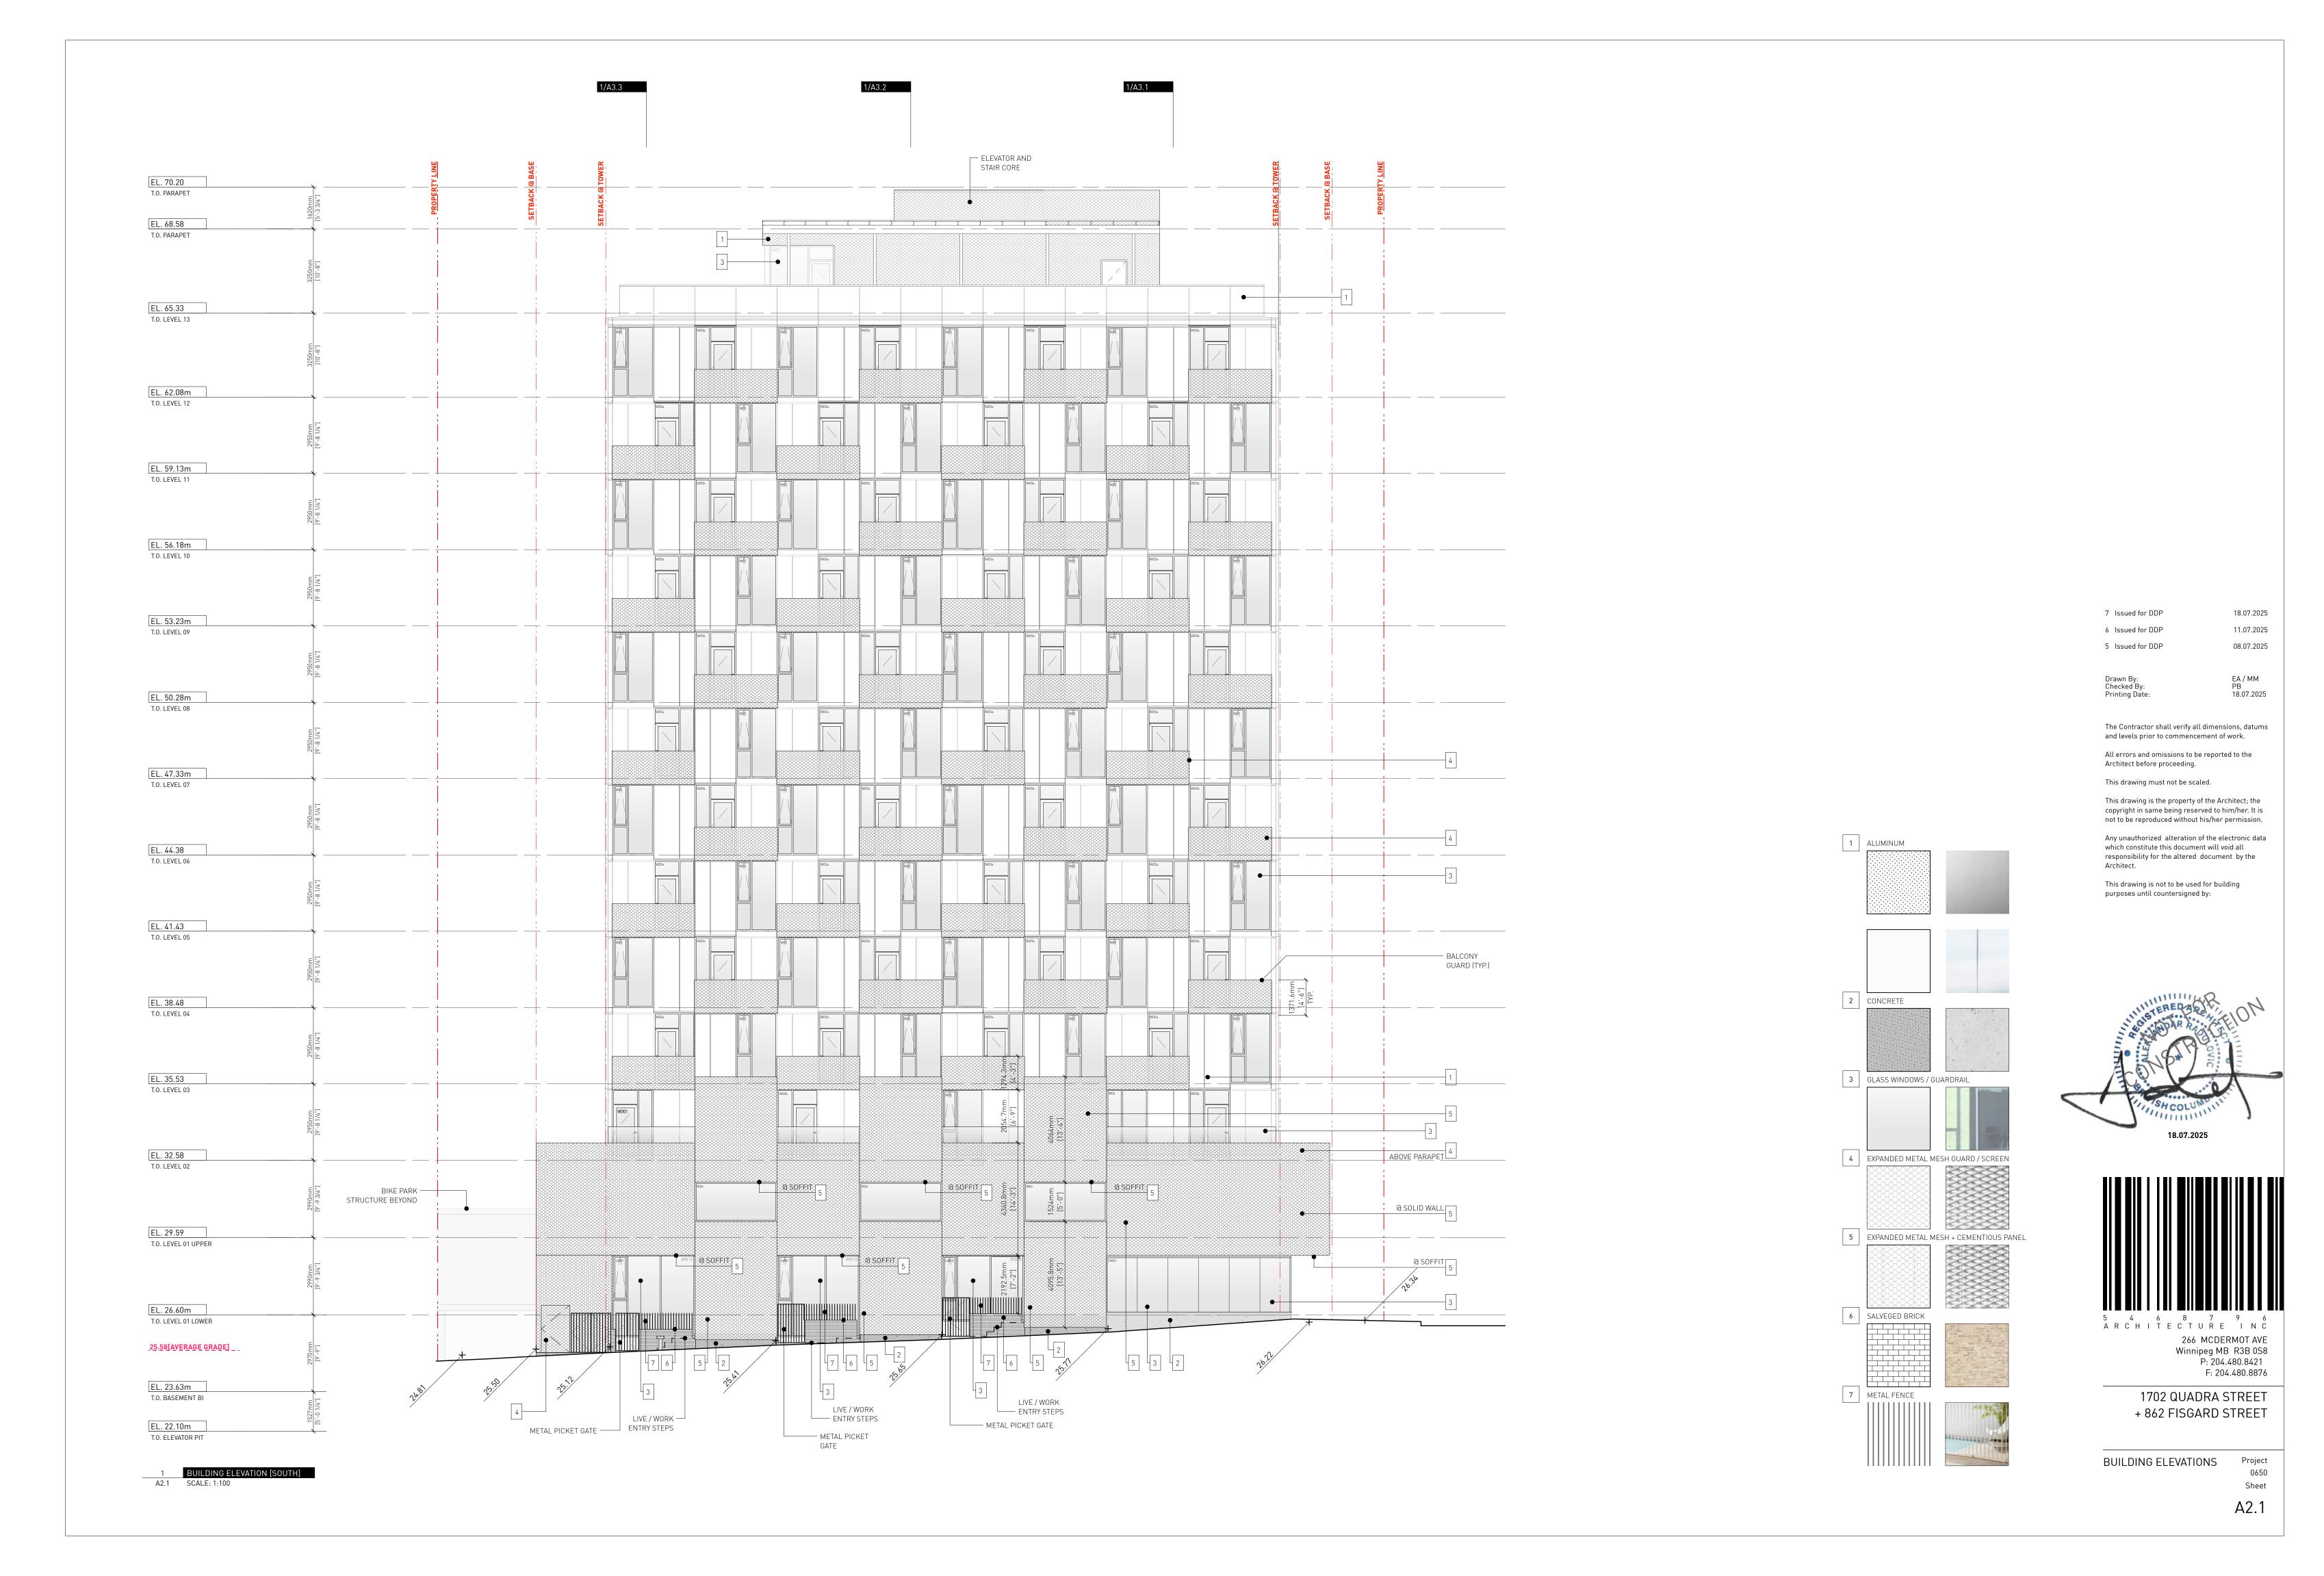

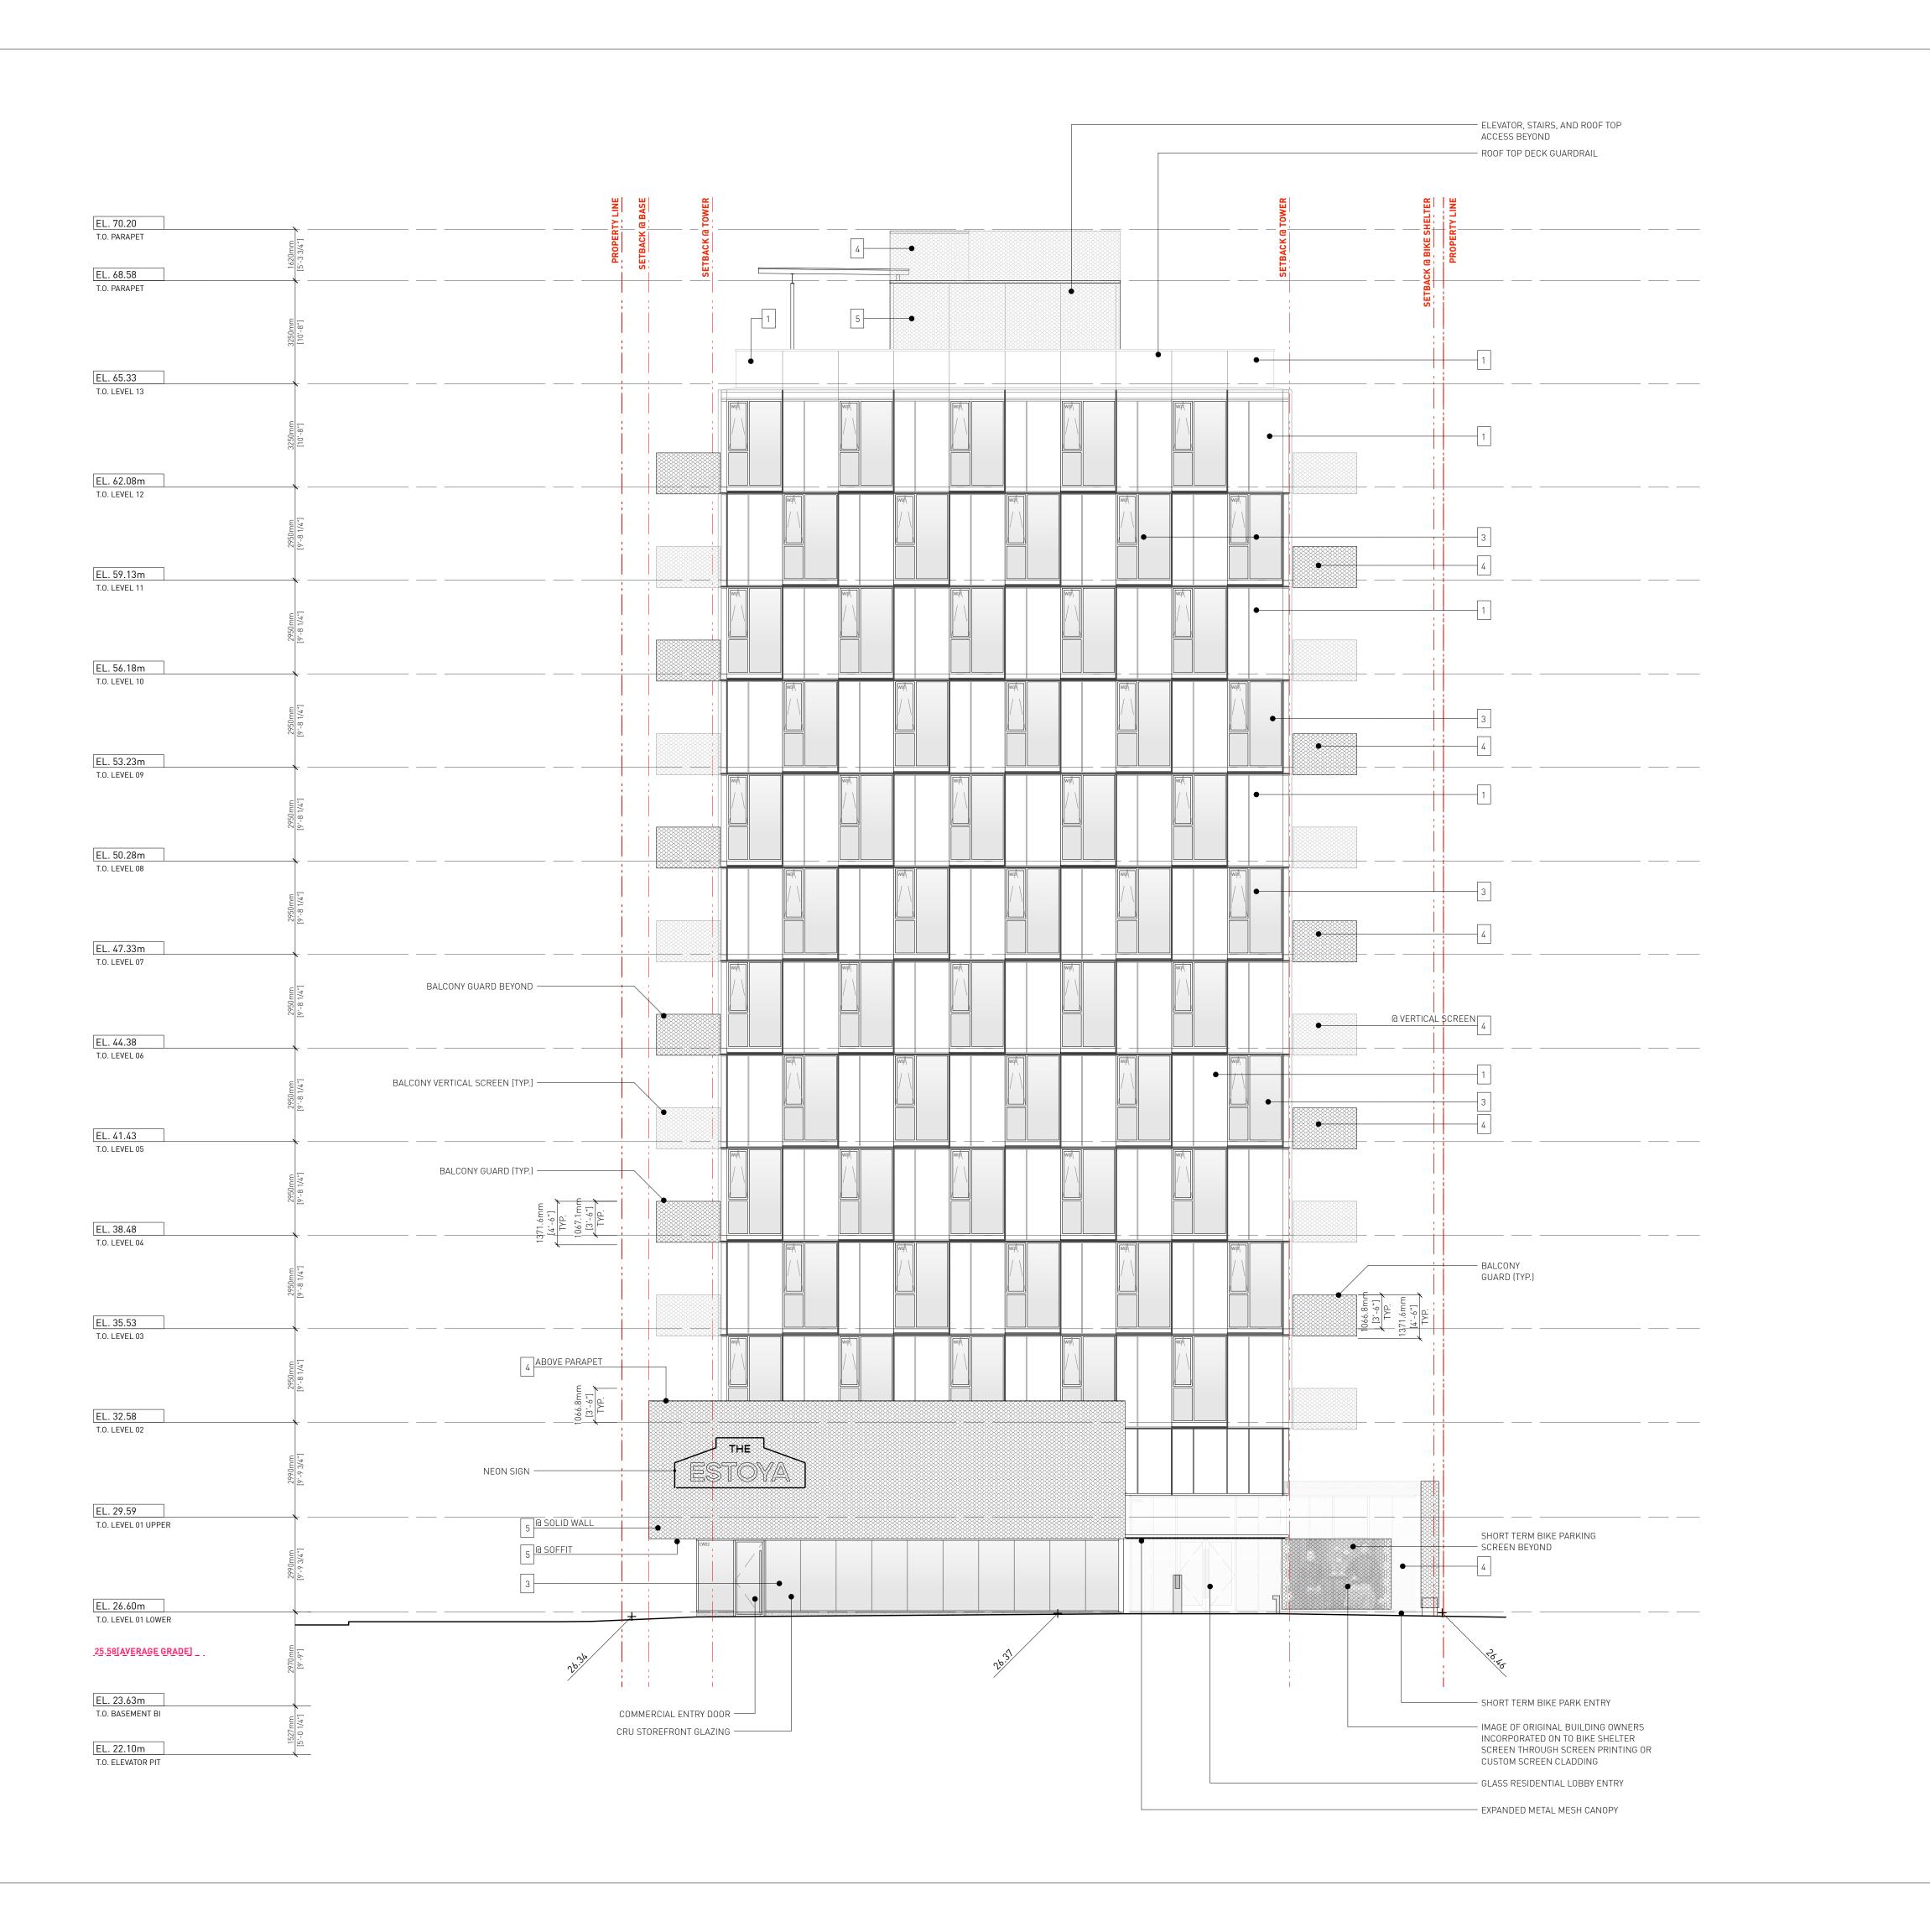

Drawn By: Checked By: Printing Date: EA / MM PB 18.07.2025

The Contractor shall verify all dimensions, datums and levels prior to commencement of work.

All errors and omissions to be reported to the Architect before proceeding.

This drawing must not be scaled.

1 ALUMINUM

2 CONCRETE

3 GLASS WINDOWS / GUARDRAIL

4 EXPANDED METAL MESH GUARD / SCREEN

5 EXPANDED METAL MESH + CEMENTIOUS PANEL


6 SALVEGED BRICK


7 METAL FENCE

This drawing is the property of the Architect; the copyright in same being reserved to him/her. It is

Any unauthorized alteration of the electronic data which constitute this document will void all responsibility for the altered document by the Architect.

This drawing is not to be used for building purposes until countersigned by:

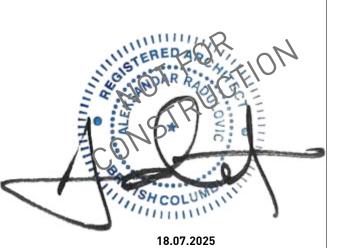

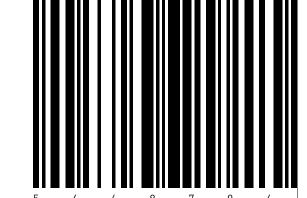


266 MCDERMOT AVE Winnipeg MB R3B 0S8 P: 204.480.8421 F: 204.480.8876

1702 QUADRA STREET + 862 FISGARD STREET

BUILDING ELEVATIONS

Sheet

A2.2

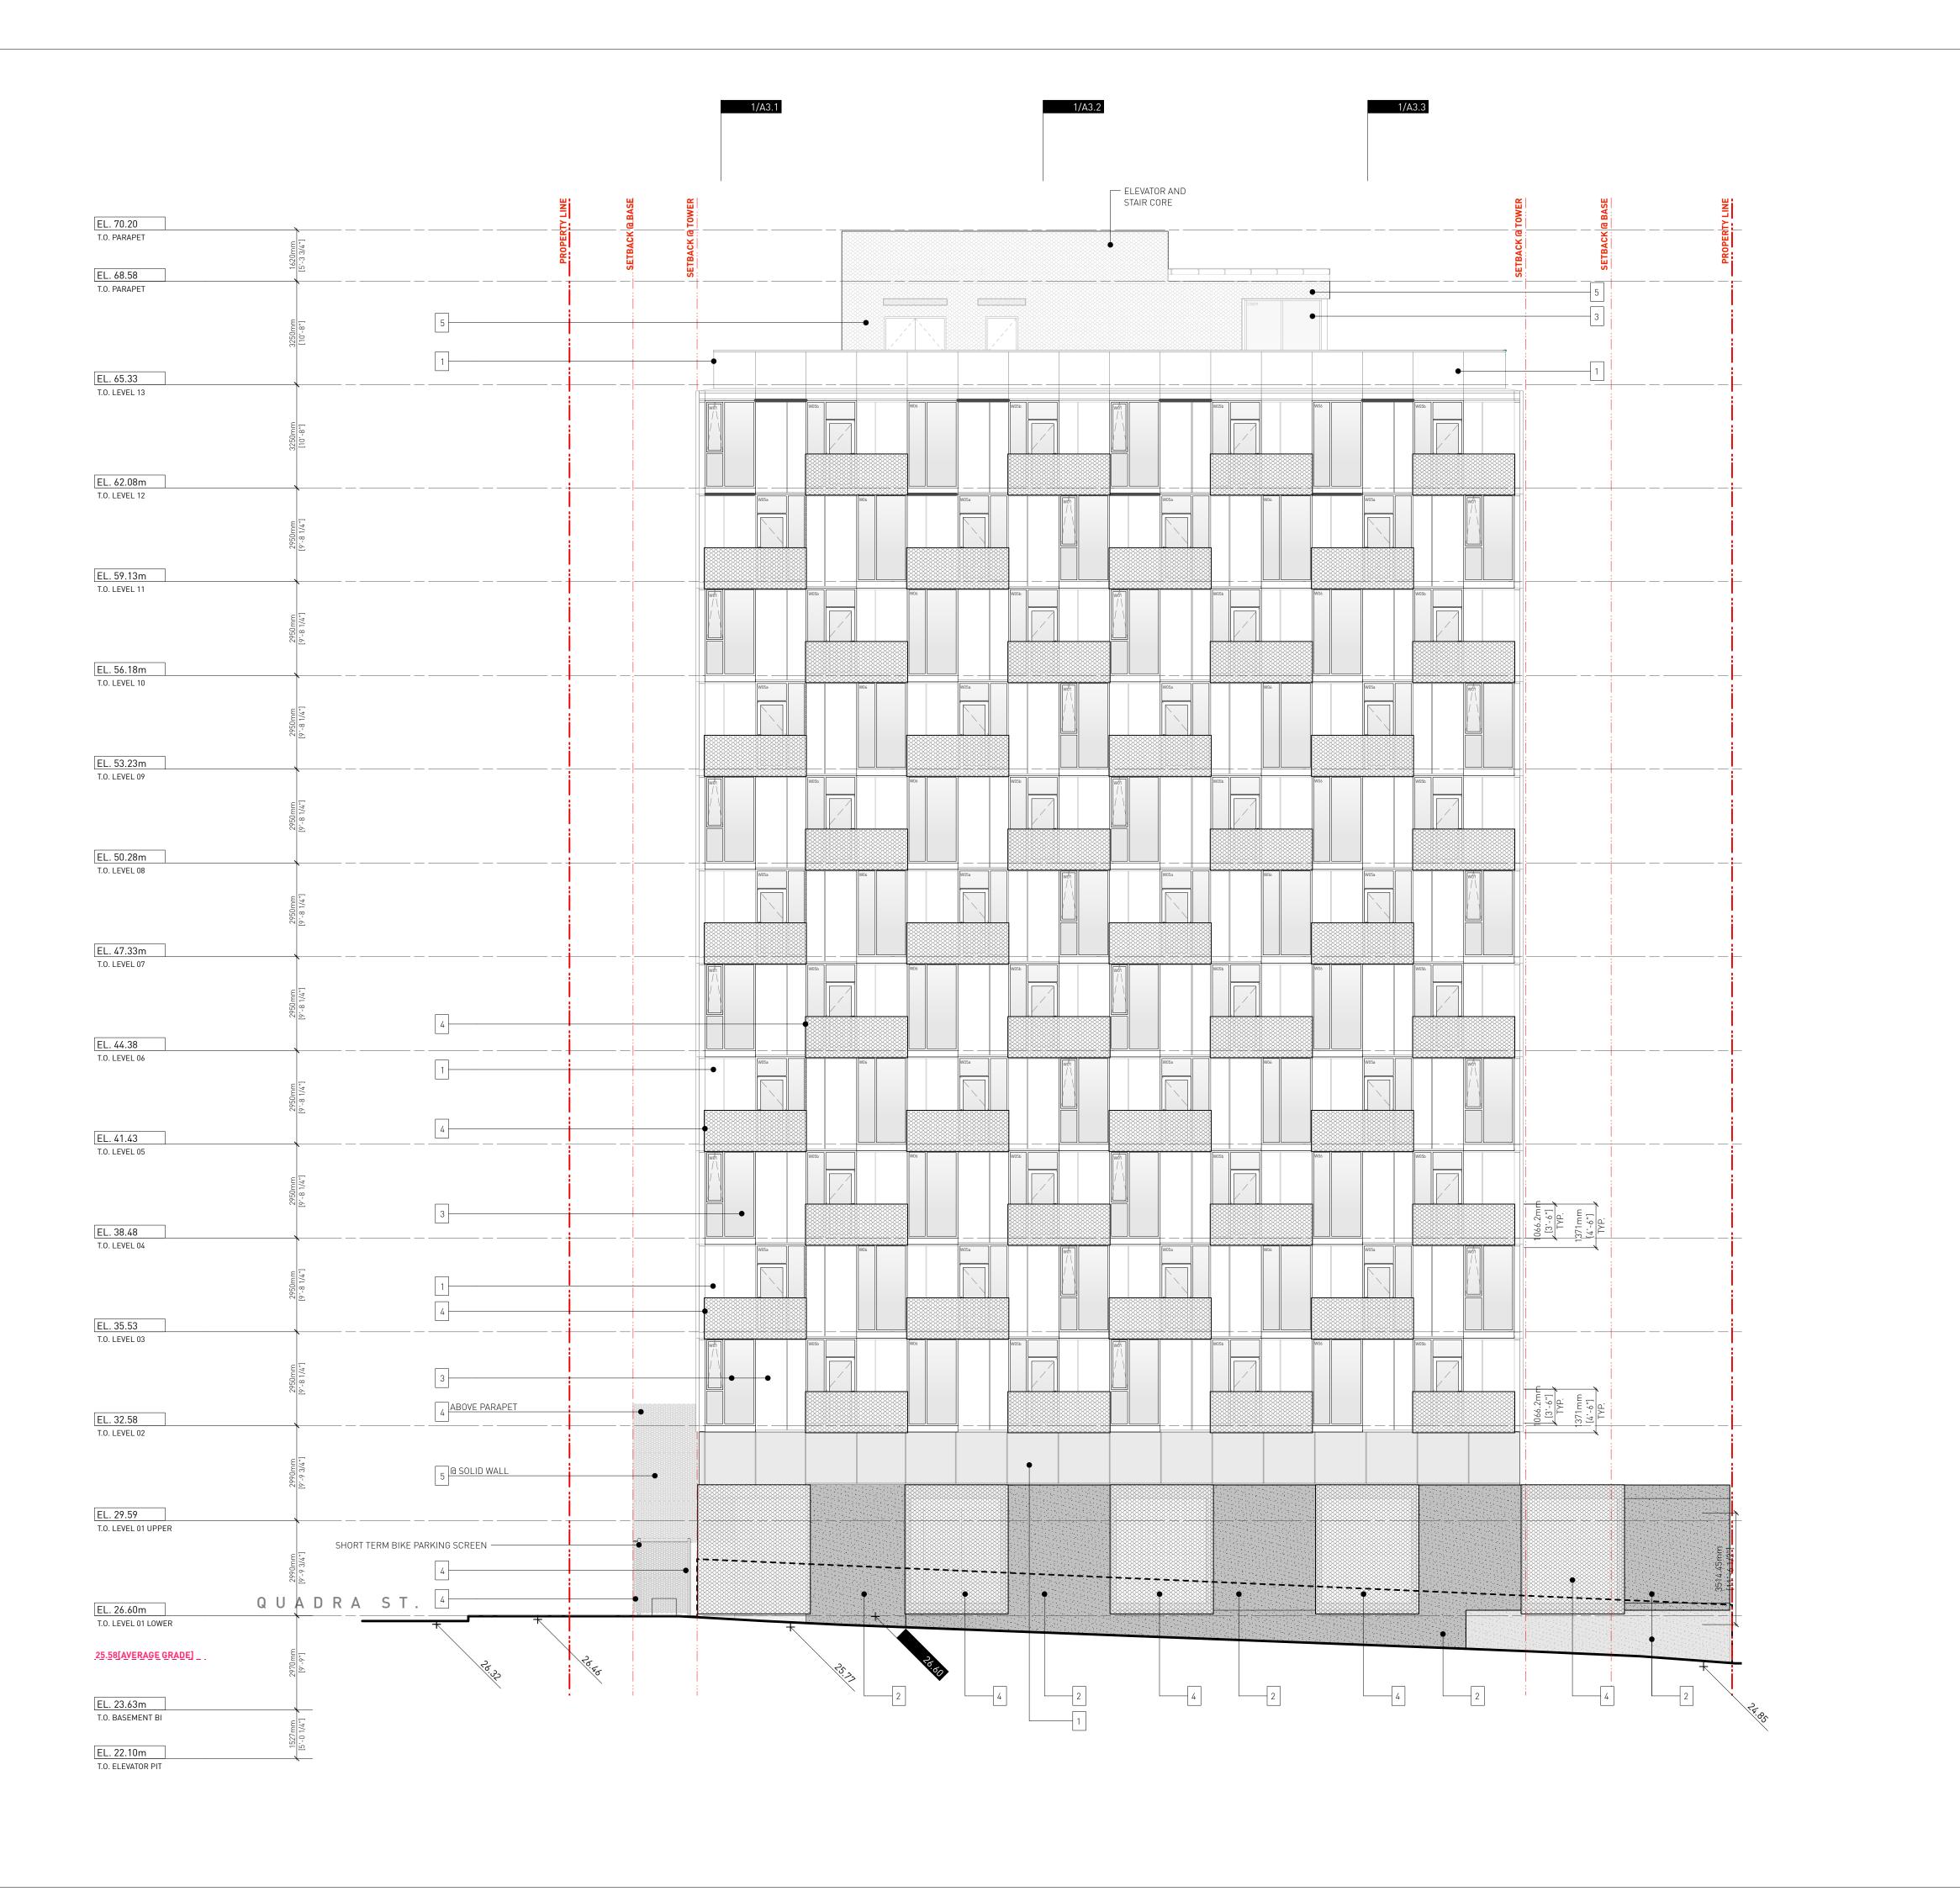

EA / MM

Drawn By: Checked By: Printing Date: PB 18.07.2025

The Contractor shall verify all dimensions, datums and levels prior to commencement of work. All errors and omissions to be reported to the

Architect before proceeding.

This drawing must not be scaled.

1 ALUMINUM

2 CONCRETE

3 GLASS WINDOWS / GUARDRAIL

4 EXPANDED METAL MESH GUARD / SCREEN

5 EXPANDED METAL MESH + CEMENTIOUS PANEL

6 SALVEGED BRICK

7 METAL FENCE

This drawing is the property of the Architect; the copyright in same being reserved to him/her. It is

Any unauthorized alteration of the electronic data which constitute this document will void all responsibility for the altered document by the

This drawing is not to be used for building purposes until countersigned by:



18.07.2025




266 MCDERMOT AVE Winnipeg MB R3B 0S8 P: 204.480.8421 F: 204.480.8876

1702 QUADRA STREET + 862 FISGARD STREET

BUILDING ELEVATIONS

Sheet A2.3

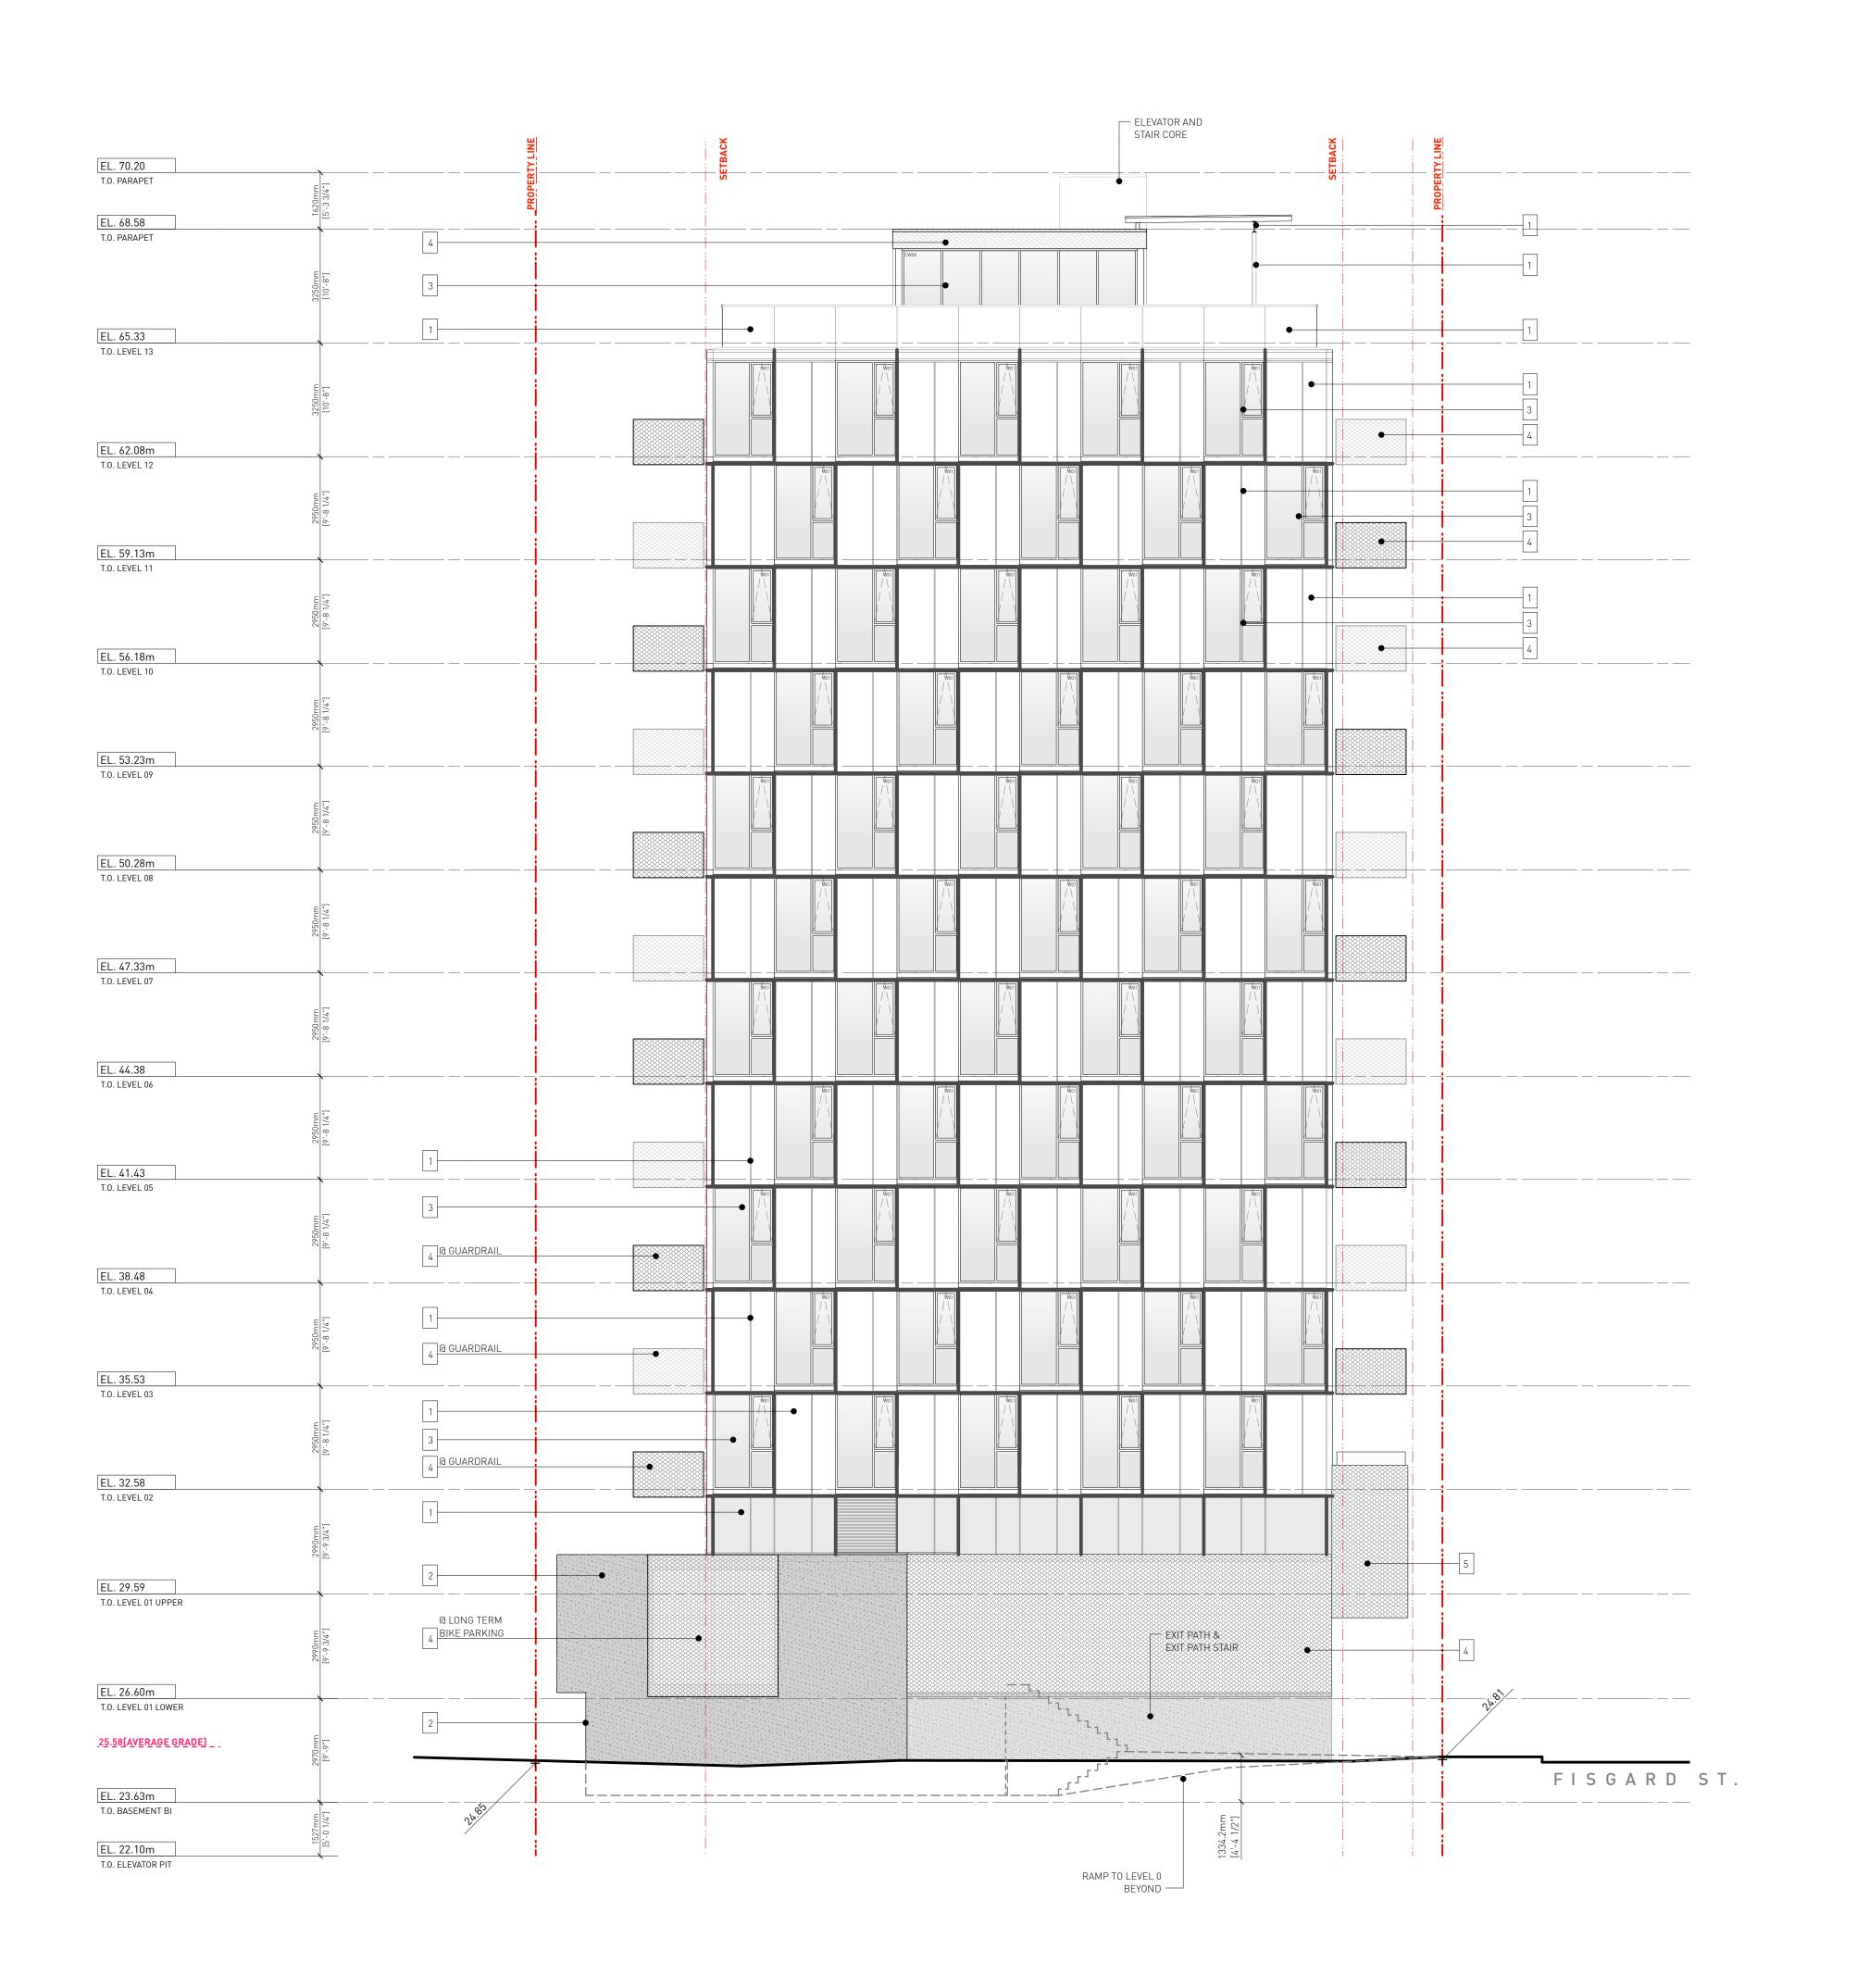

EA / MM

Drawn By: Checked By: Printing Date: PB 18.07.2025

The Contractor shall verify all dimensions, datums

and levels prior to commencement of work. All errors and omissions to be reported to the

Architect before proceeding.

This drawing must not be scaled.

1 ALUMINUM

2 CONCRETE

3 GLASS WINDOWS / GUARDRAIL

4 EXPANDED METAL MESH GUARD / SCREEN

5 EXPANDED METAL MESH + CEMENTIOUS PANEL


6 SALVEGED BRICK


7 METAL FENCE

This drawing is the property of the Architect; the copyright in same being reserved to him/her. It is

Any unauthorized alteration of the electronic data which constitute this document will void all responsibility for the altered document by the Architect.

This drawing is not to be used for building purposes until countersigned by:

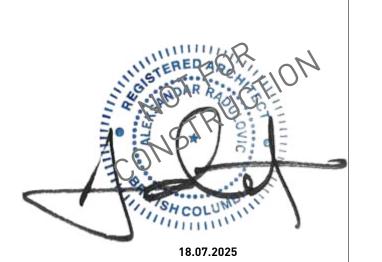

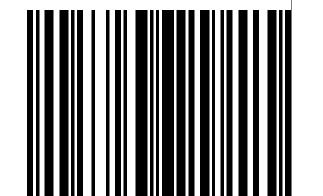



266 MCDERMOT AVE Winnipeg MB R3B 0S8 P: 204.480.8421 F: 204.480.8876

1702 QUADRA STREET + 862 FISGARD STREET

BUILDING ELEVATIONS

Sheet A2.4

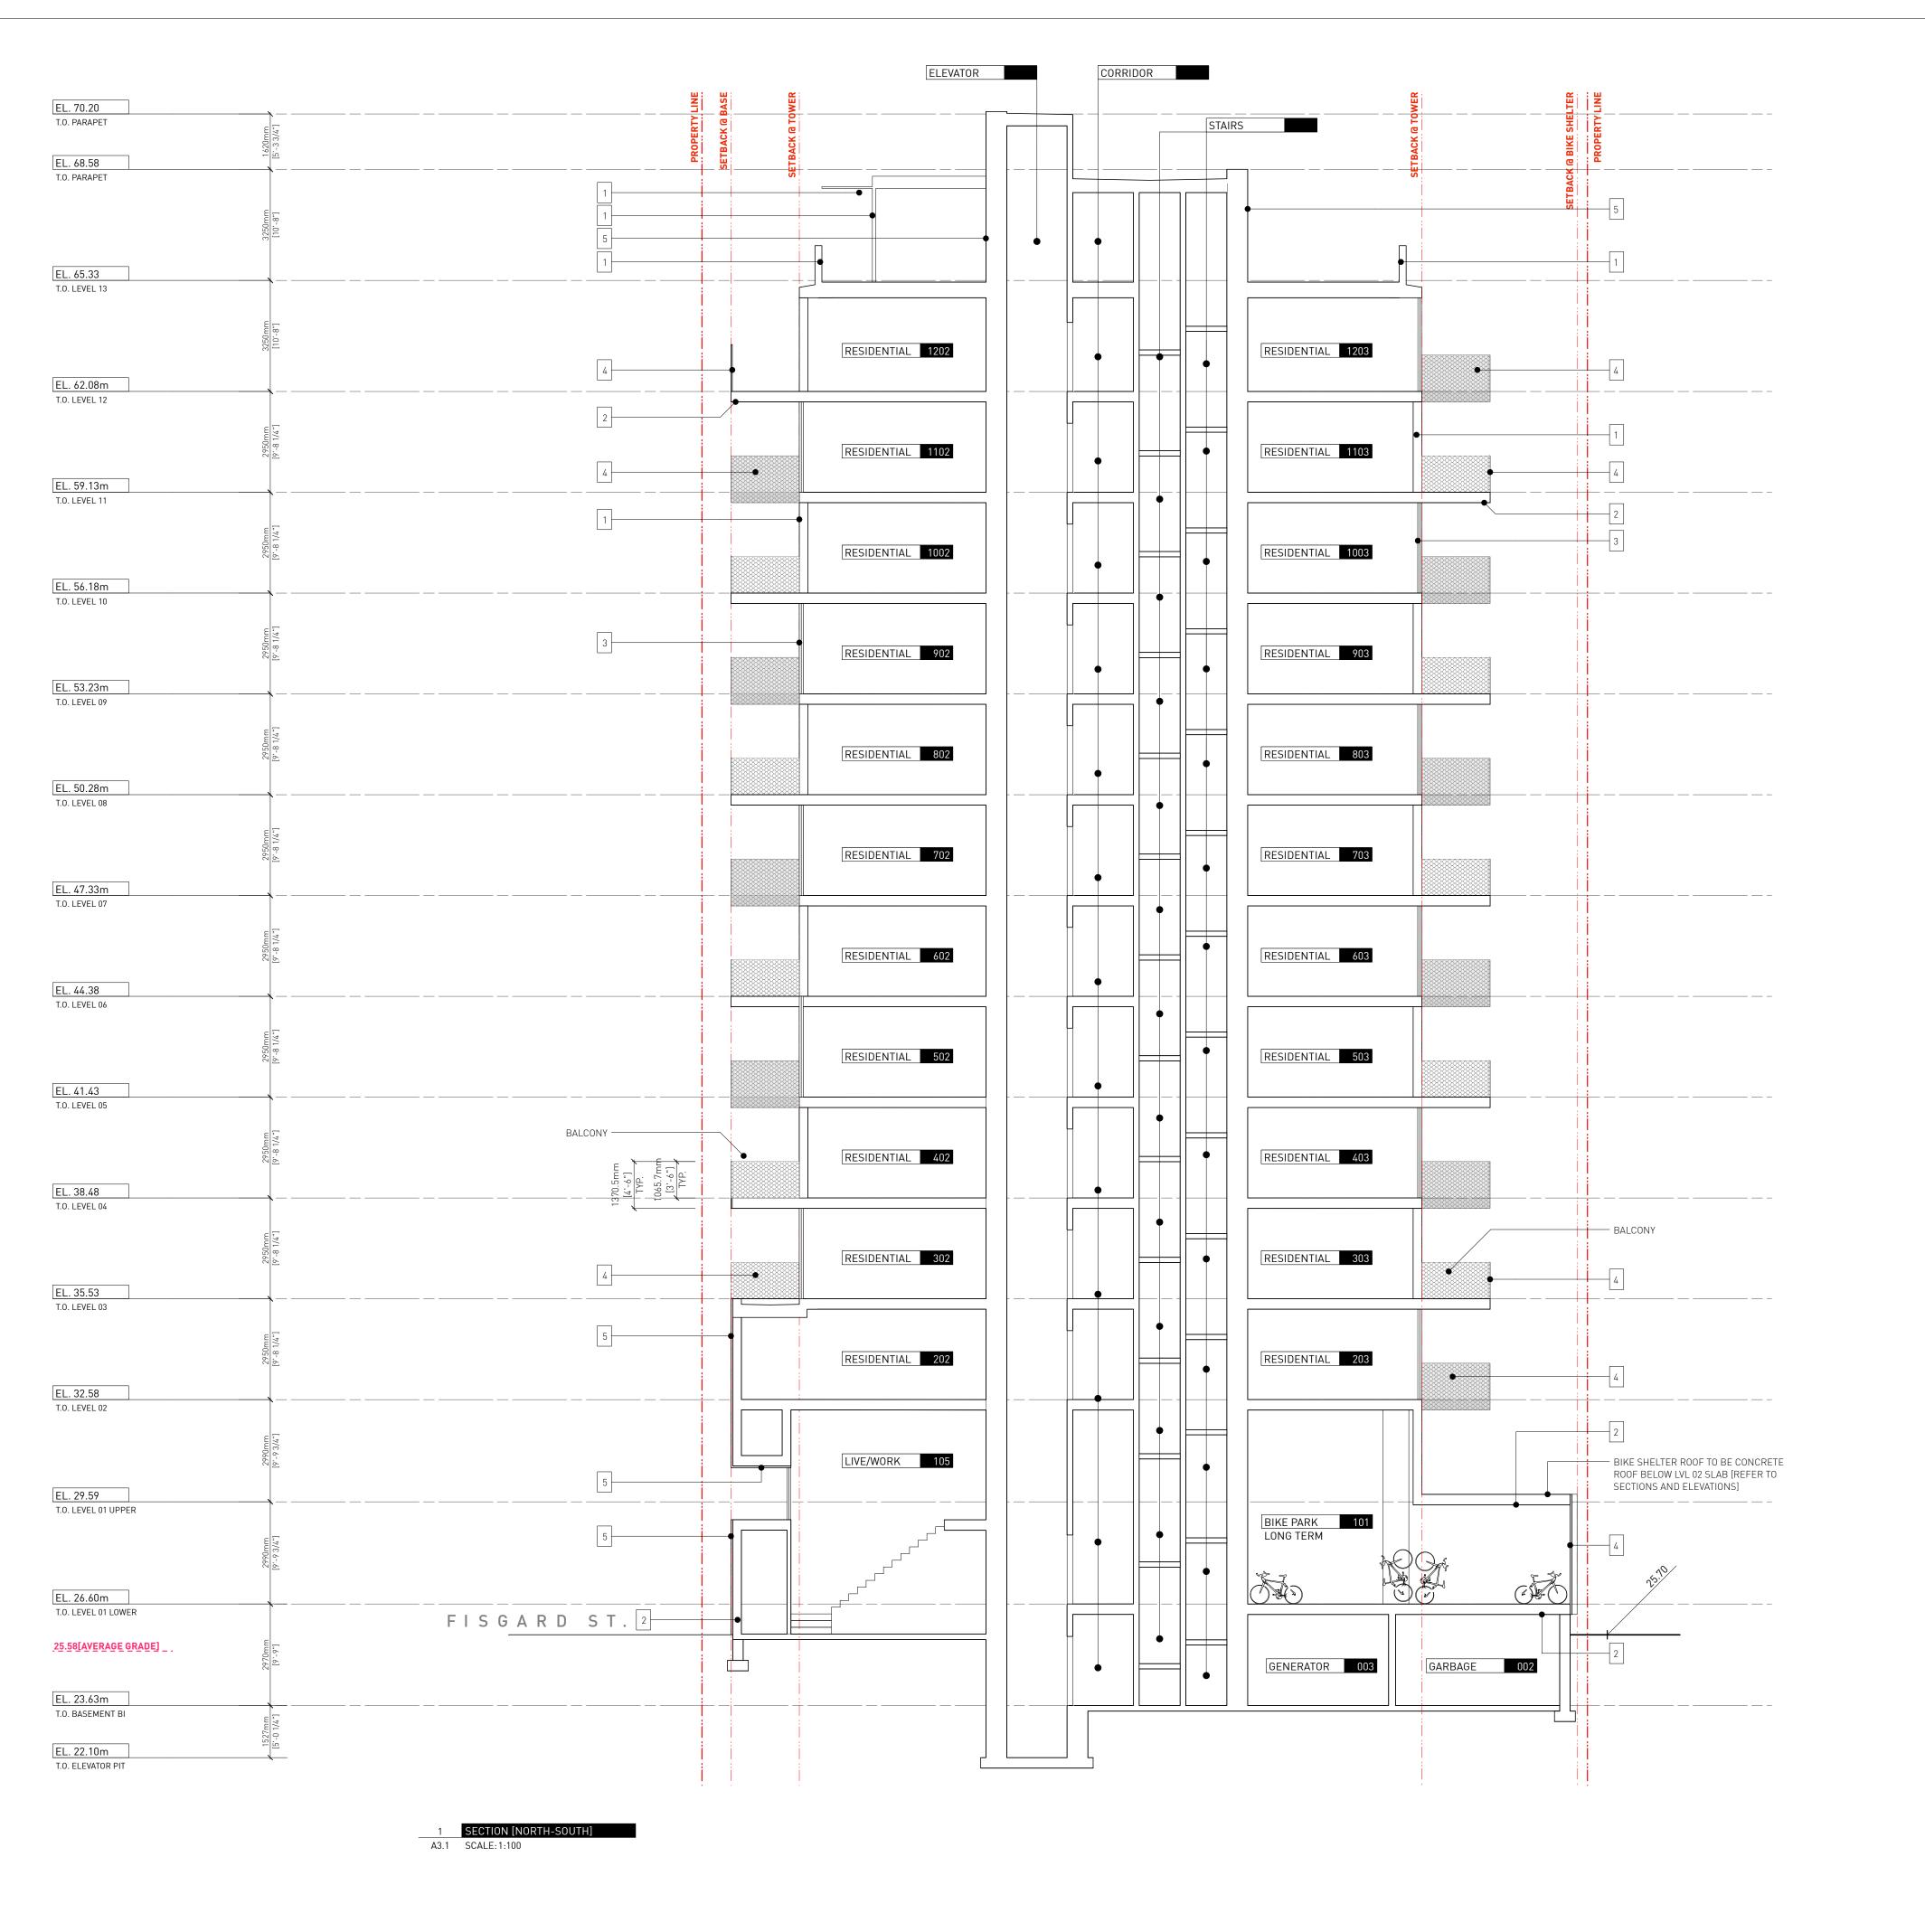

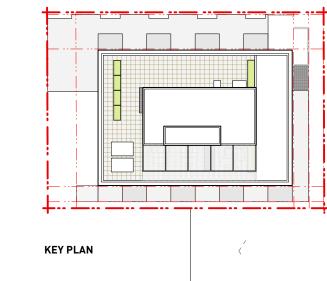

7 Issued for DDP
6 Issued for DDP

5 Issued for DDP

Drawn By:
Checked By:
Printing Date:
PB
18.07.2025

18.07.2025

11.07.2025

08.07.2025

The Contractor shall verify all dimensions, datums and levels prior to commencement of work.

All errors and omissions to be reported to the Architect before proceeding.

This drawing must not be scaled.

1 ALUMINUM

2 CONCRETE

3 GLASS WINDOWS / GUARDRAIL

4 EXPANDED METAL MESH GUARD / SCREEN

5 EXPANDED METAL MESH + CEMENTIOUS PANEL


6 SALVEGED BRICK


7 METAL FENCE

This drawing is the property of the Architect; the copyright in same being reserved to him/her. It is not to be reproduced without his/her permission.

Any unauthorized alteration of the electronic data which constitute this document will void all responsibility for the altered document by the Architect.

This drawing is not to be used for building purposes until countersigned by:

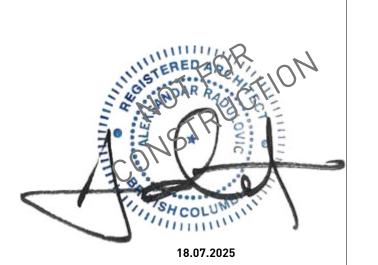

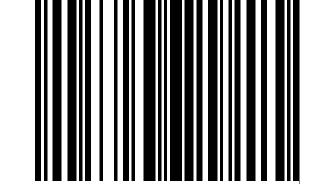



A R C H I T E C T U R E I N C 266 MCDERMOT AVE Winnipeg MB R3B 0S8 P: 204.480.8421 F: 204.480.8876

1702 QUADRA STREET + 862 FISGARD STREET

BUILDING SECTION

Project 0650 Sheet

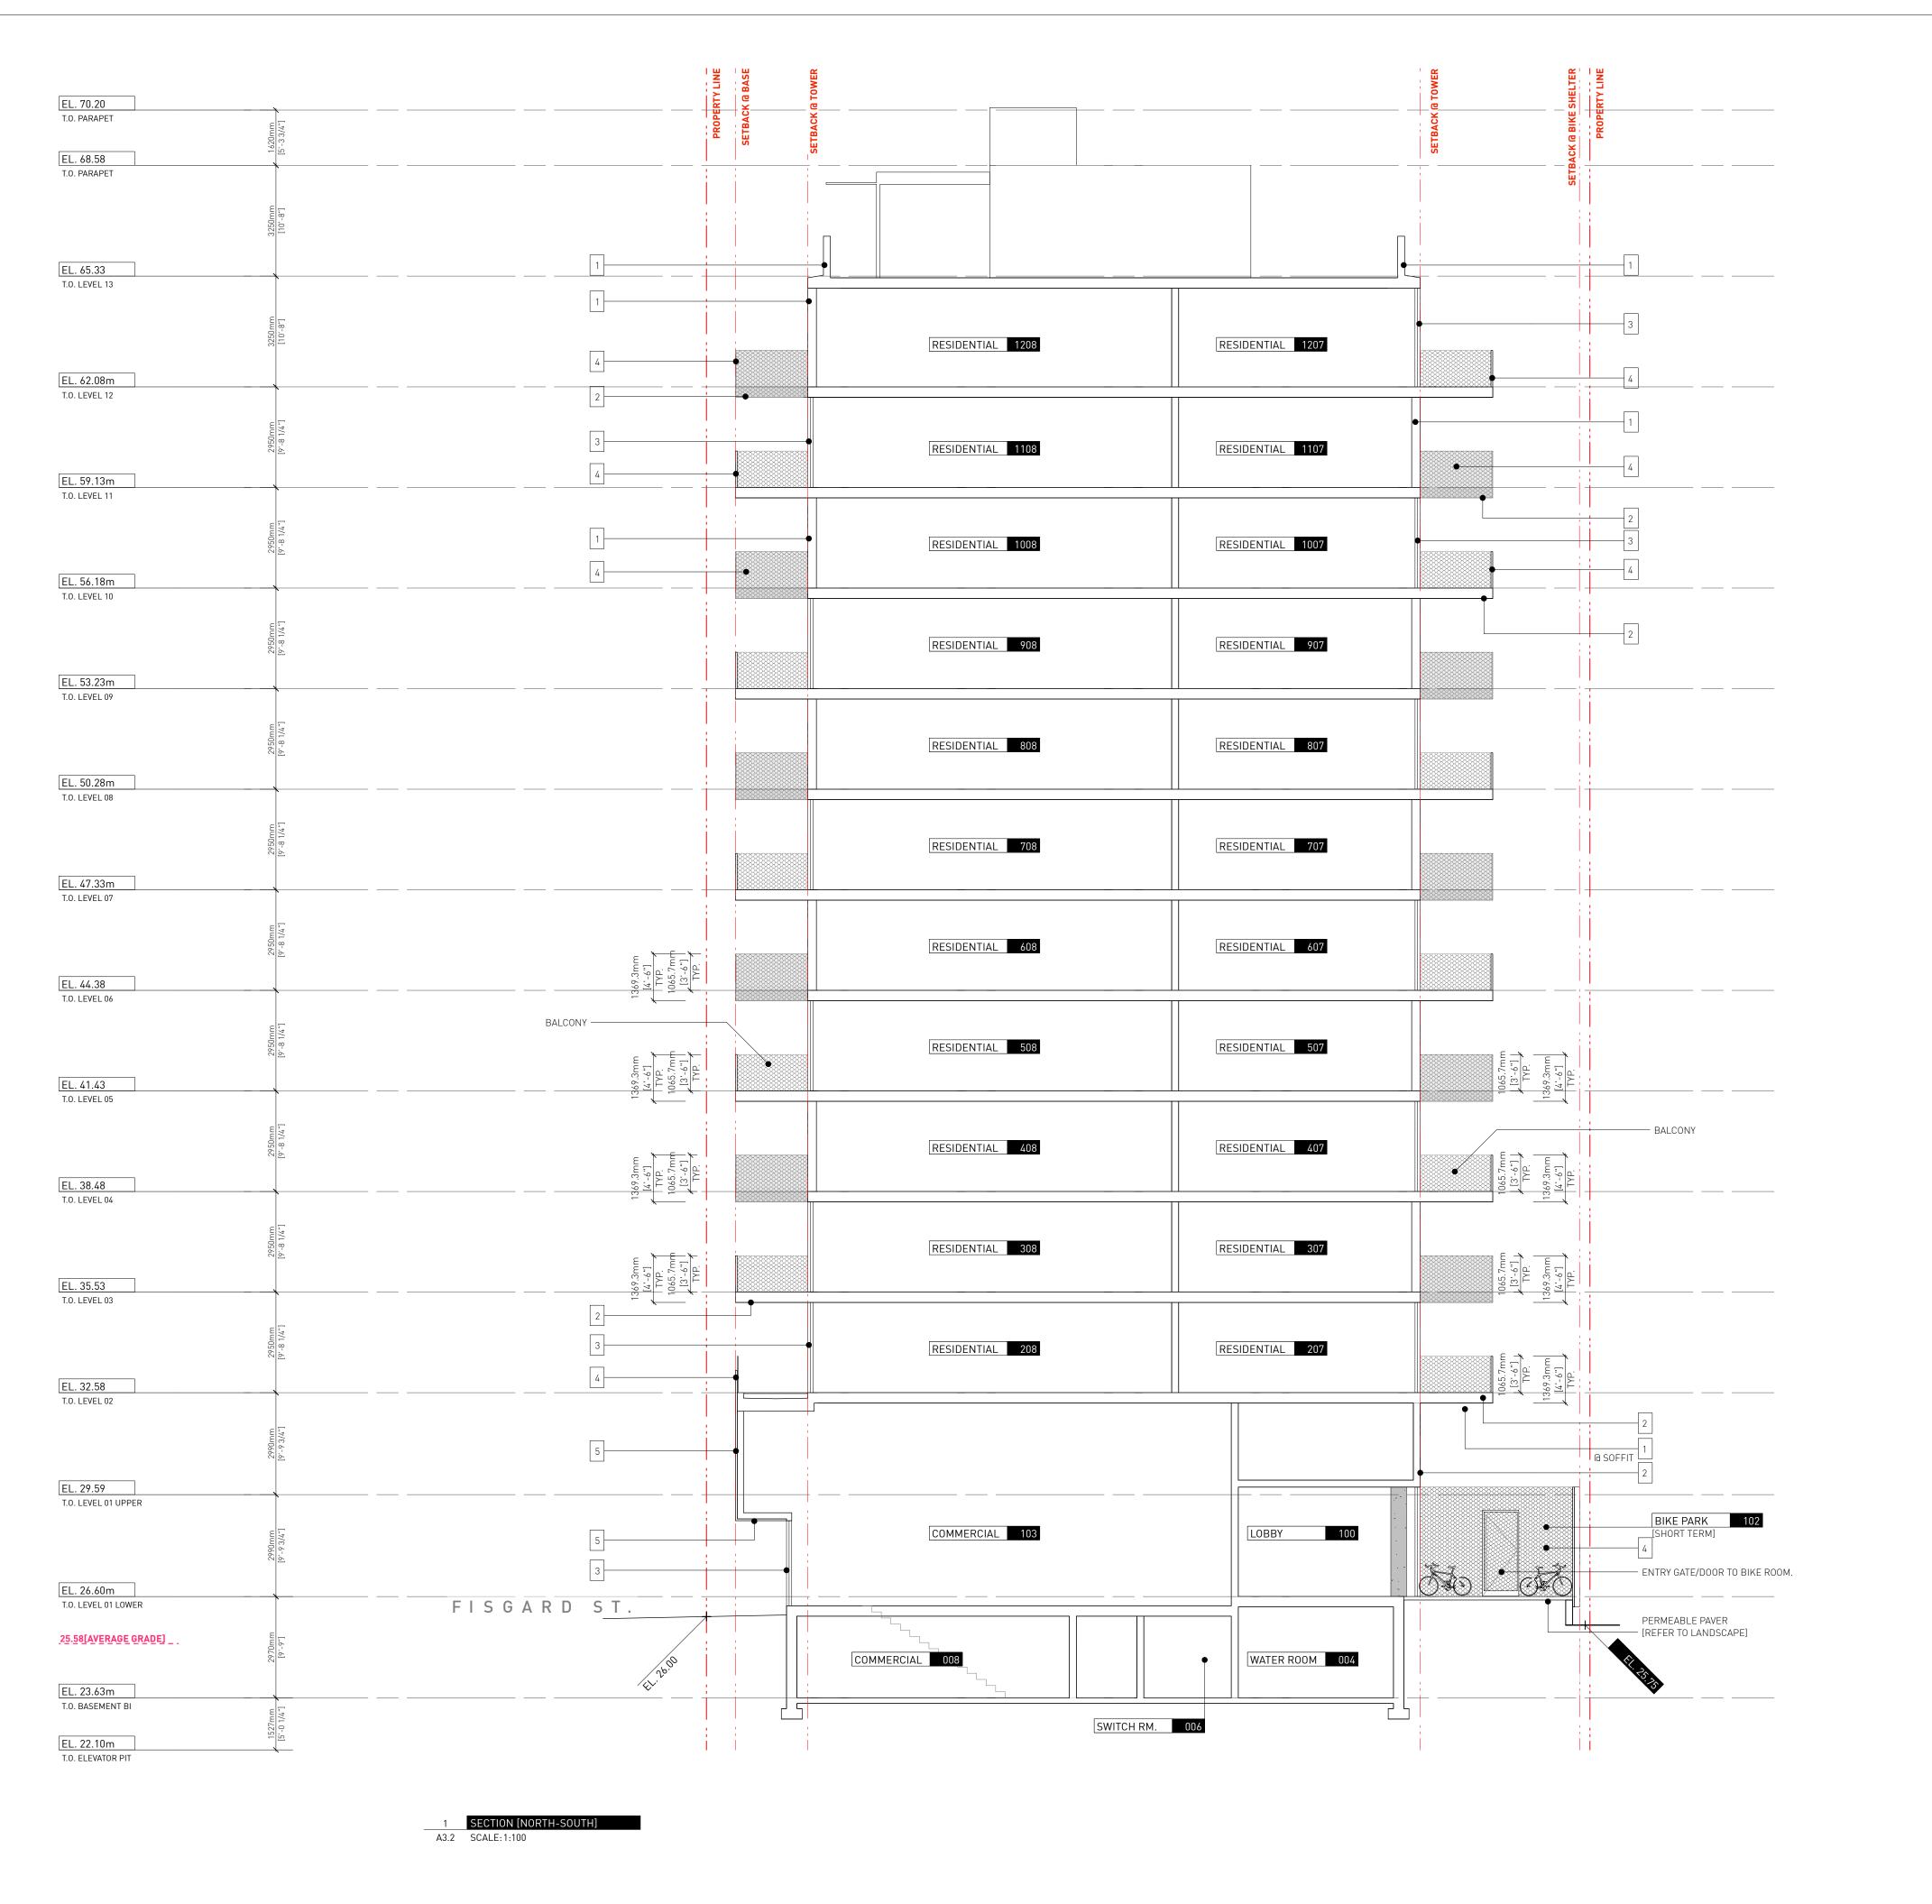

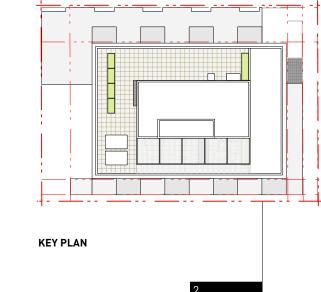

Drawn By: Checked By: Printing Date: PB 18.07.2025

The Contractor shall verify all dimensions, datums and levels prior to commencement of work. All errors and omissions to be reported to the

Architect before proceeding.

This drawing must not be scaled.

1 ALUMINUM

2 CONCRETE

3 GLASS WINDOWS / GUARDRAIL

4 EXPANDED METAL MESH GUARD / SCREEN

5 EXPANDED METAL MESH + CEMENTIOUS PANEL


6 SALVEGED BRICK


7 METAL FENCE

This drawing is the property of the Architect; the copyright in same being reserved to him/her. It is

Any unauthorized alteration of the electronic data which constitute this document will void all responsibility for the altered document by the Architect.

This drawing is not to be used for building purposes until countersigned by:

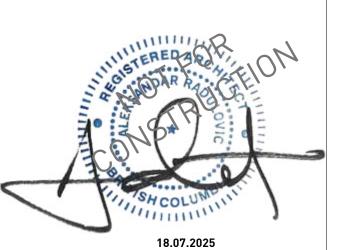

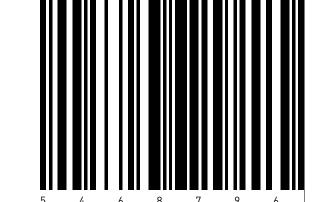


266 MCDERMOT AVE Winnipeg MB R3B 0S8 P: 204.480.8421 F: 204.480.8876


1702 QUADRA STREET + 862 FISGARD STREET

BUILDING SECTION

Project 0650 Sheet

A3.2

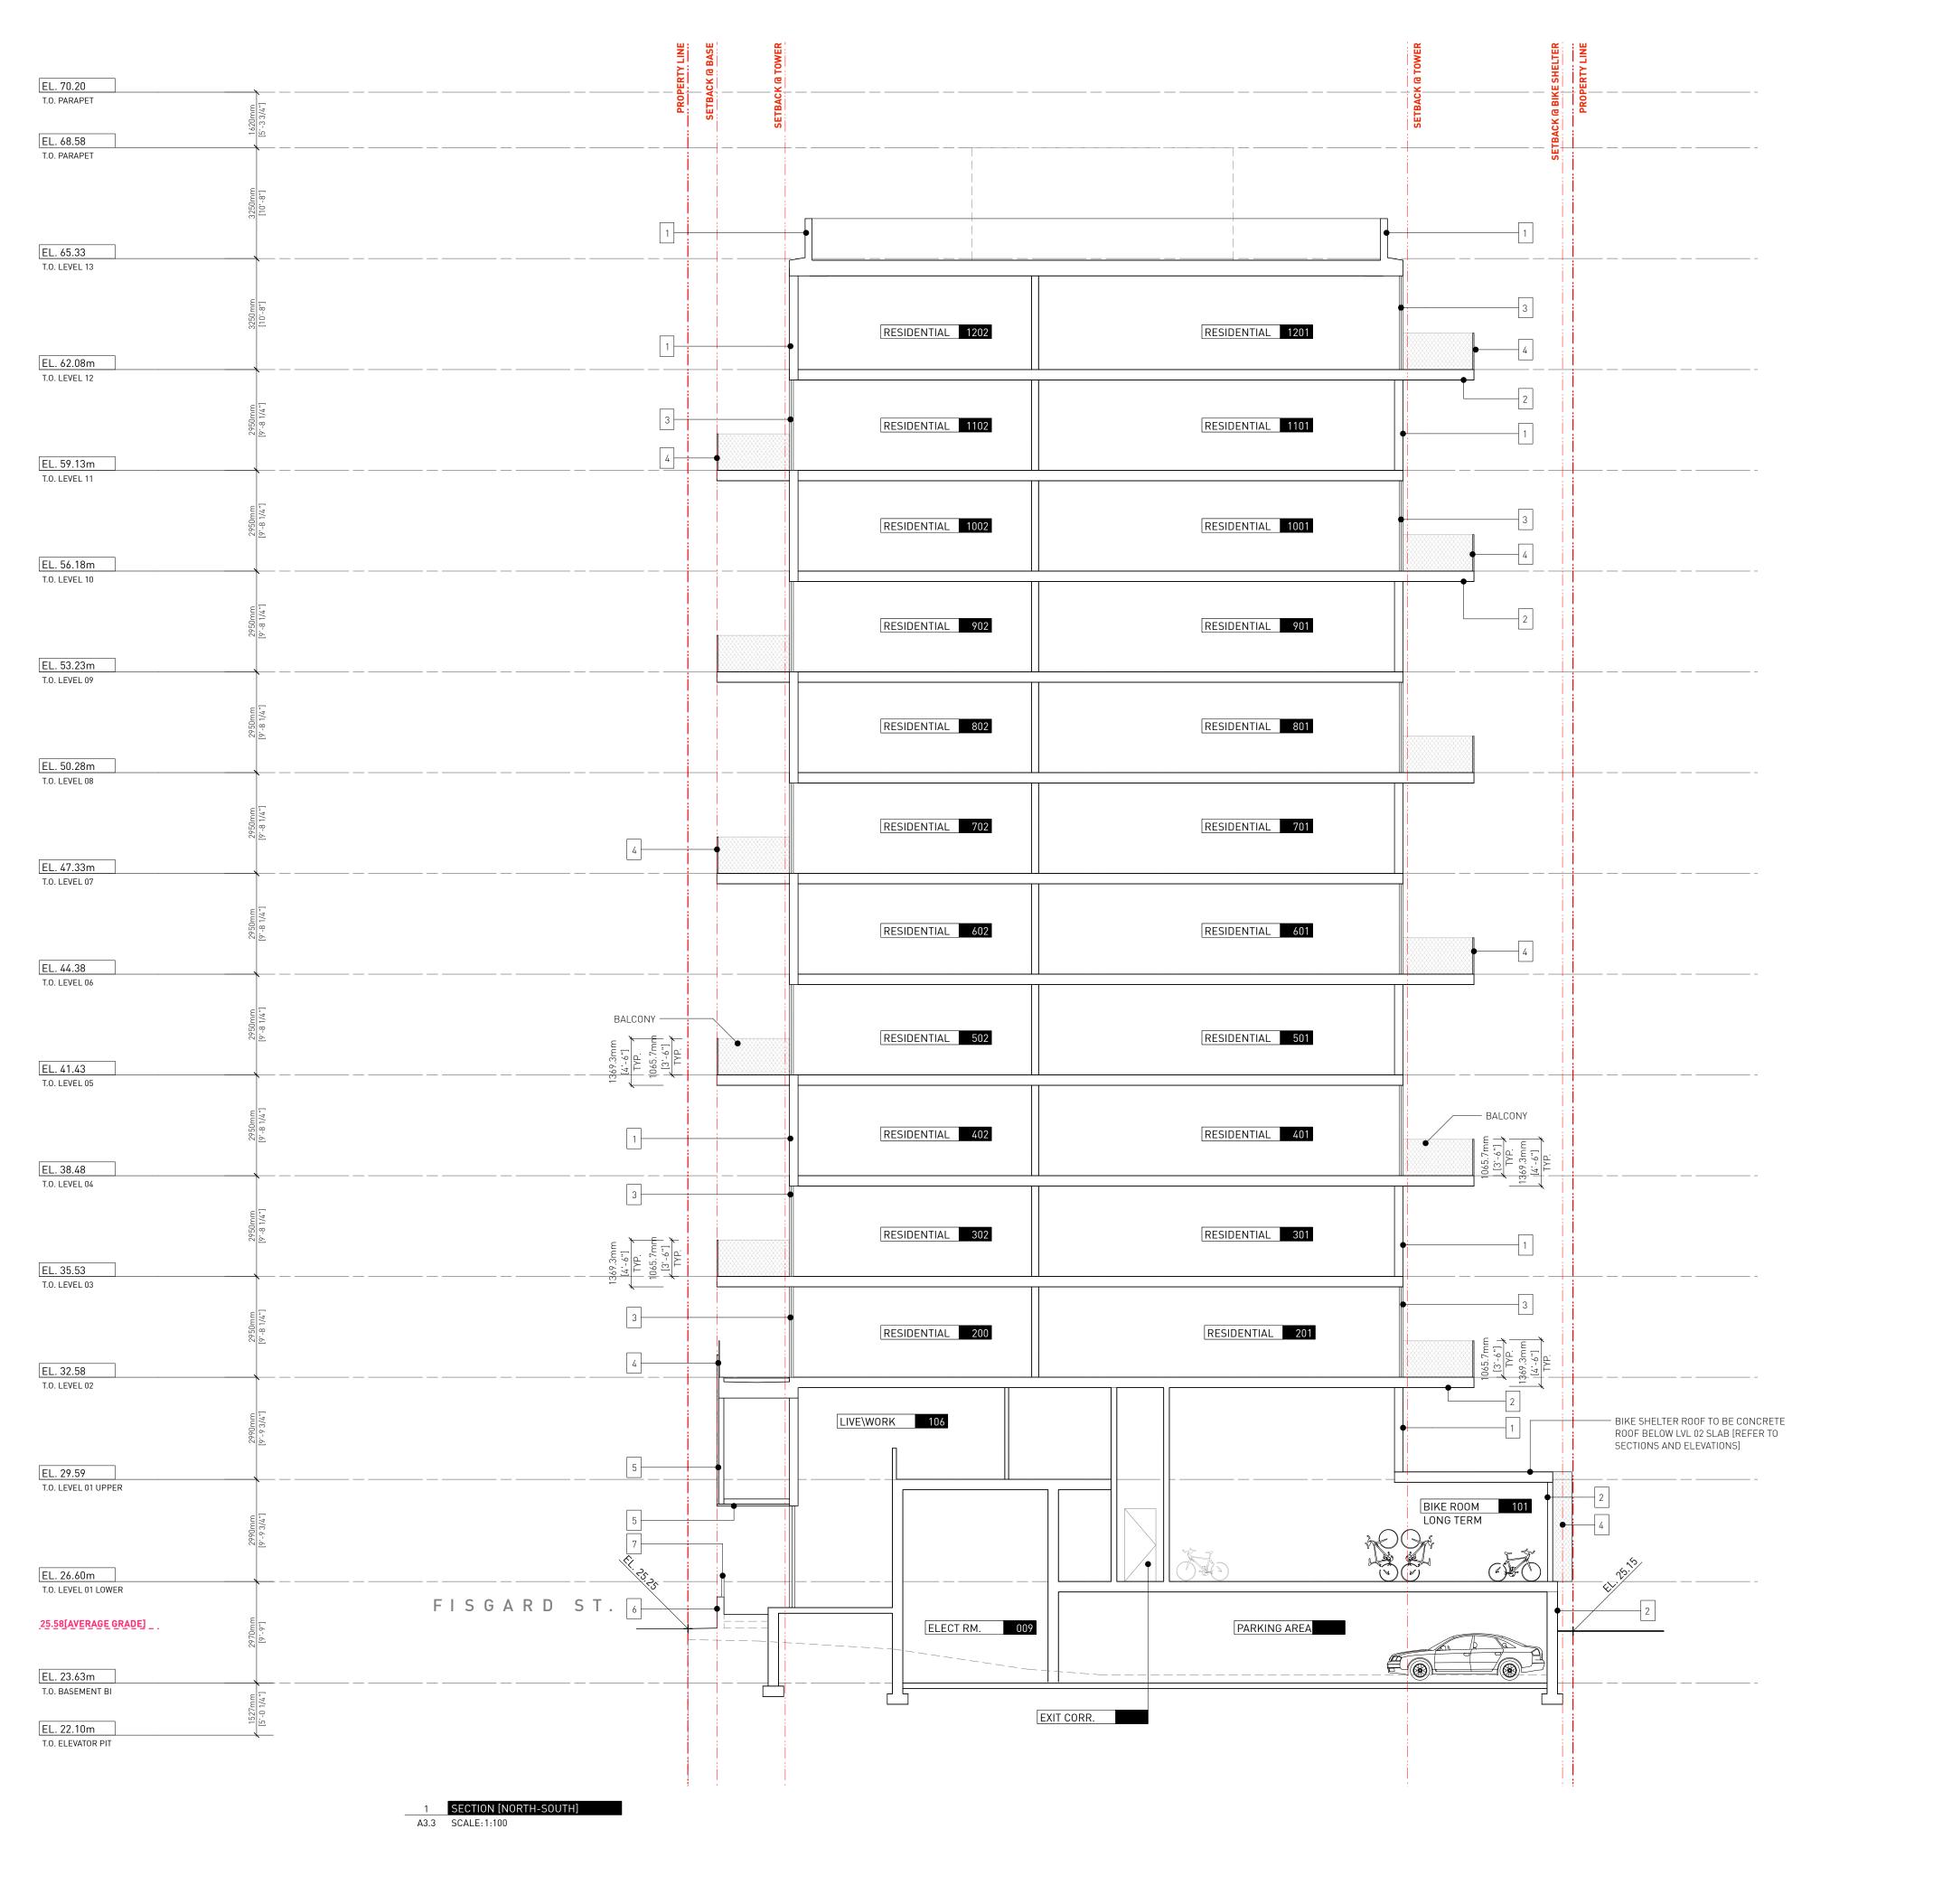

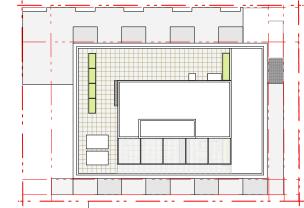

KEY PLAN

7 Issued for DDP 18.07.2025 6 Issued for DDP 11.07.2025

5 Issued for DDP

Drawn By:
Checked By:
Printing Date:
PB
18.07.2025

08.07.2025

The Contractor shall verify all dimensions, datums and levels prior to commencement of work.

All errors and omissions to be reported to the

Architect before proceeding.

This drawing must not be scaled.

This drawing is the property of the Architect; the

1 ALUMINUM

2 CONCRETE

3 GLASS WINDOWS / GUARDRAIL

4 EXPANDED METAL MESH GUARD / SCREEN

5 EXPANDED METAL MESH + CEMENTIOUS PANEL

6 SALVEGED BRICK

7 METAL FENCE


copyright in same being reserved to him/her. It is not to be reproduced without his/her permission.

Any unauthorized alteration of the electronic data which constitute this document will void all responsibility for the altered document by the

This drawing is not to be used for building purposes until countersigned by:



18.07.2025

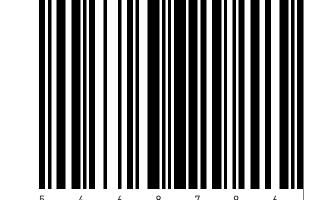

A R C H I T E C T U R E I N C

266 MCDERMOT AVE

Winnipeg MB R3B 0S8


P: 204.480.8421


F: 204.480.8876

1702 QUADRA STREET + 862 FISGARD STREET

BUILDING SECTION

0650 Sheet

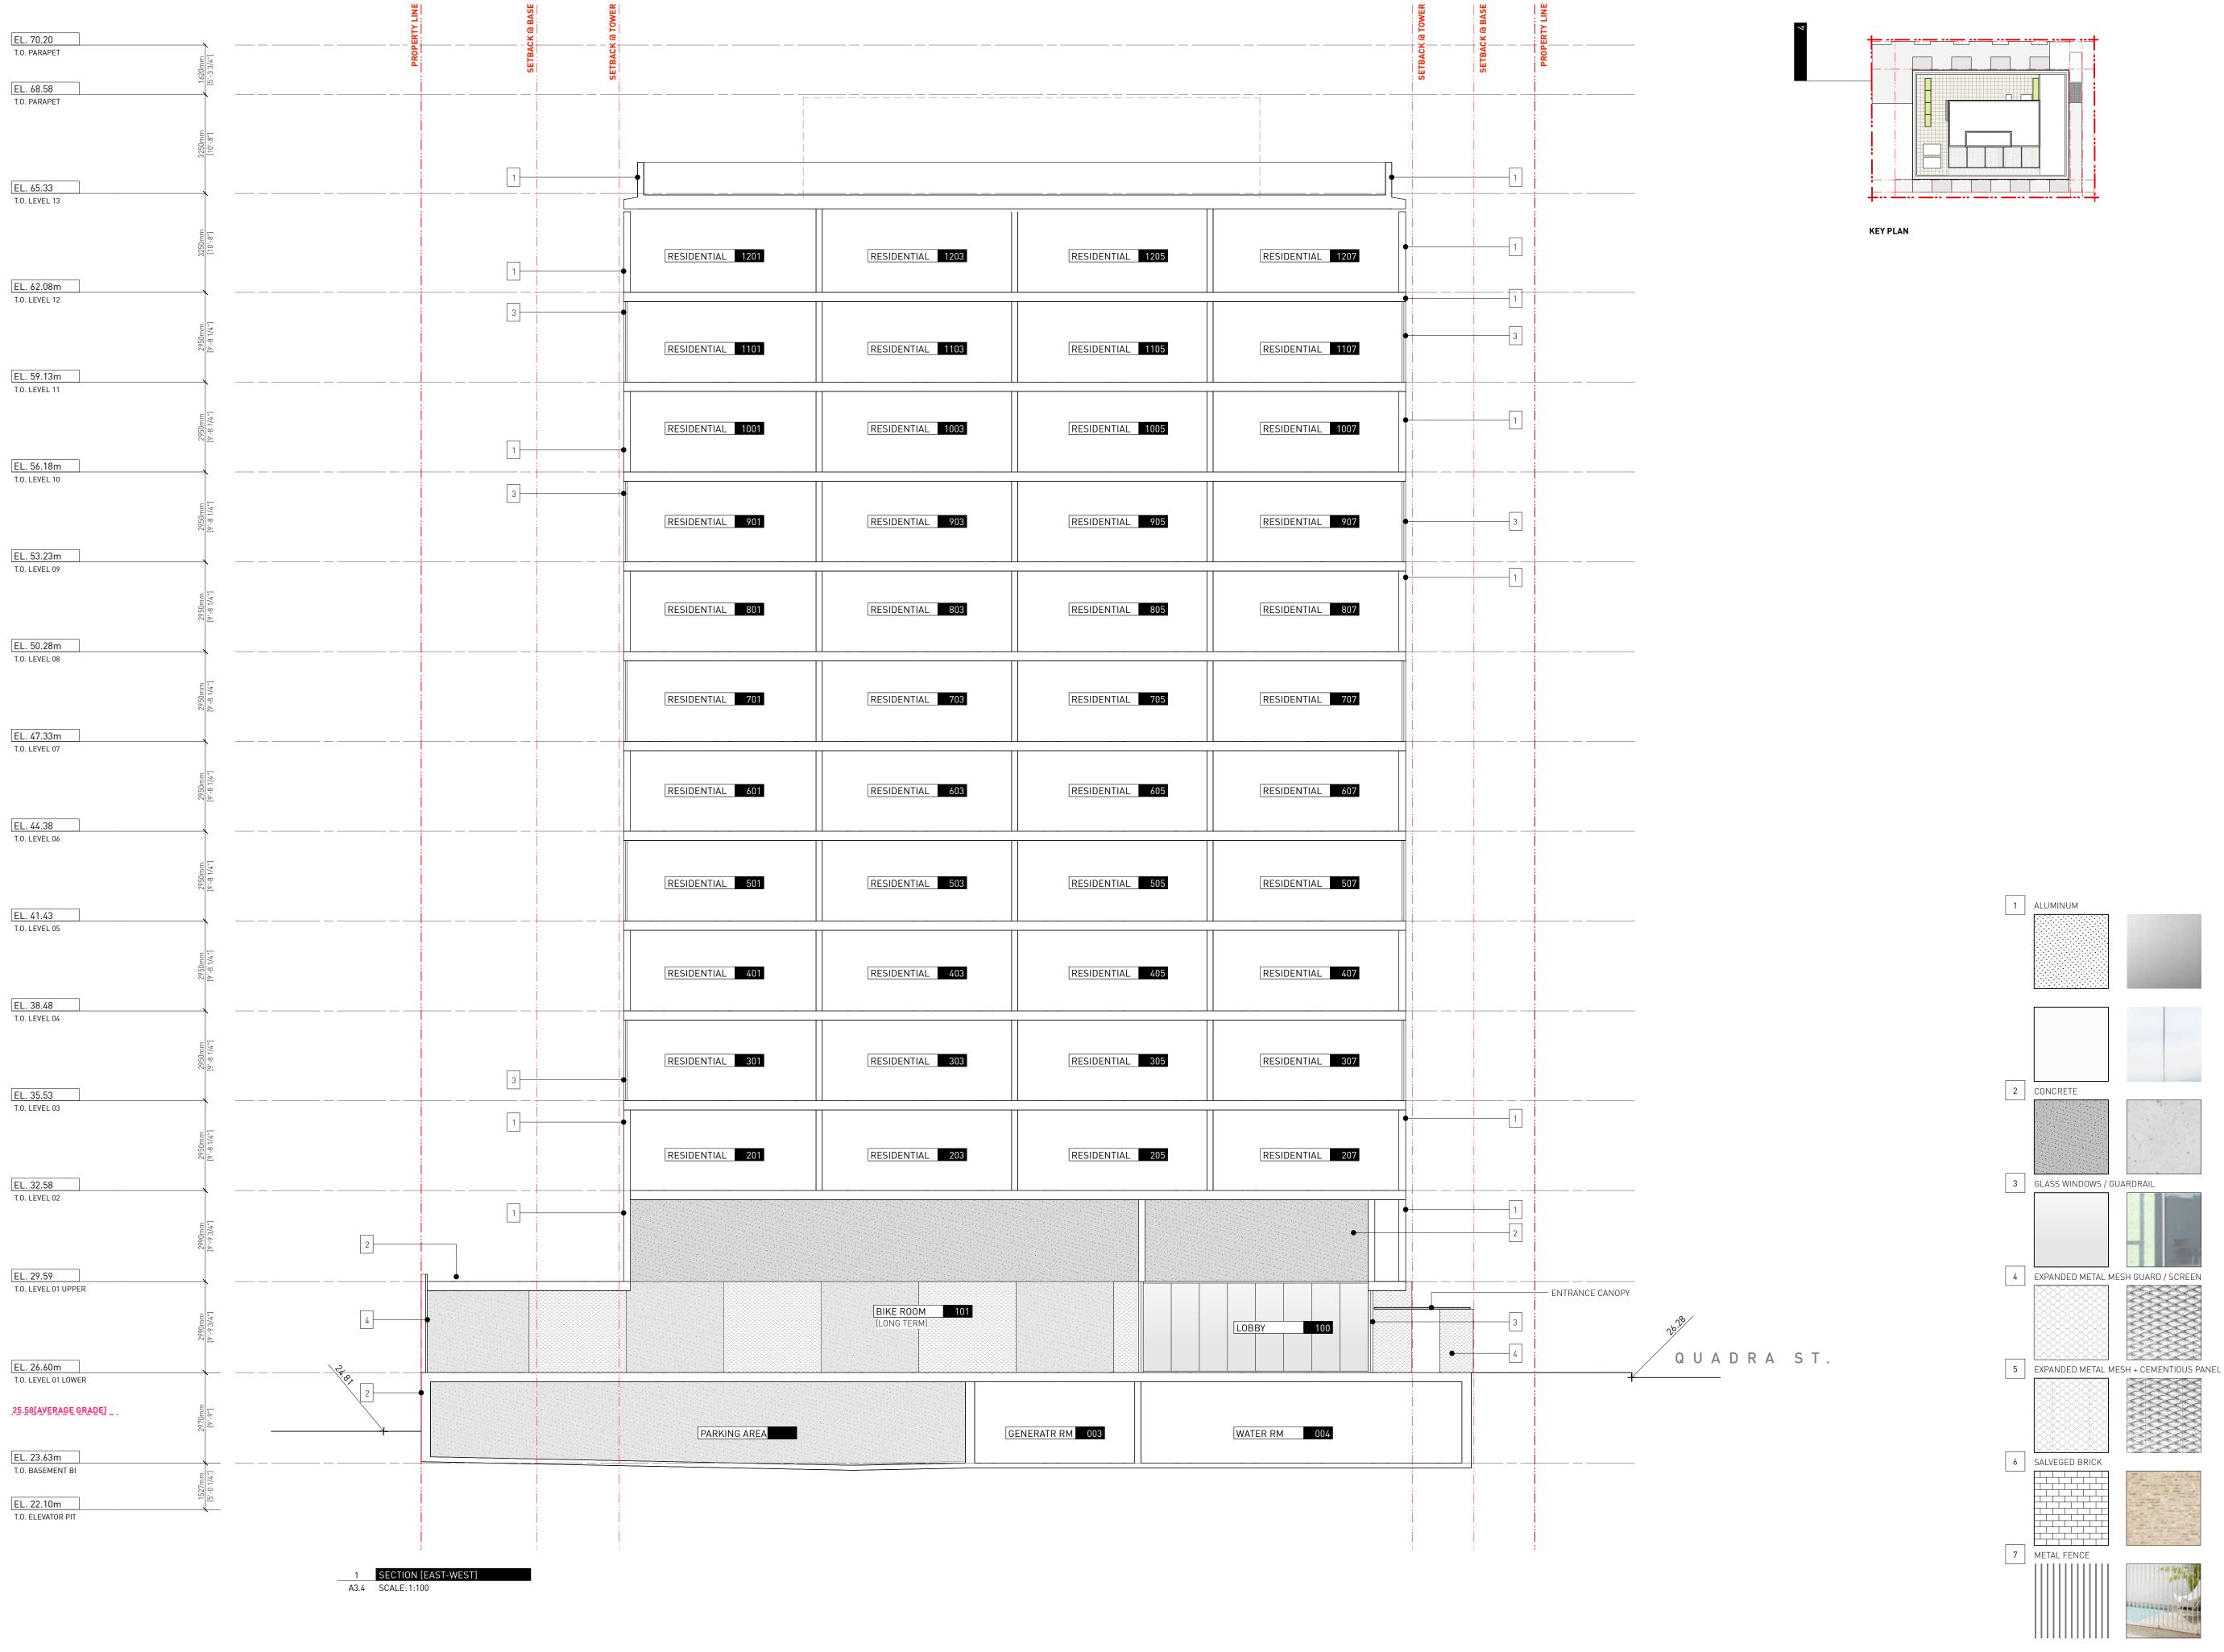

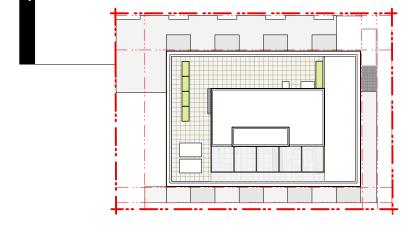

7 Issued for DDP 18.07.2025 6 Issued for DDP 11.07.2025

5 Issued for DDP

Drawn By: Checked By: Printing Date: PB 18.07.2025

The Contractor shall verify all dimensions, datums

08.07.2025

and levels prior to commencement of work. All errors and omissions to be reported to the

Architect before proceeding.

This drawing must not be scaled.

This drawing is the property of the Architect; the copyright in same being reserved to him/her. It is

Any unauthorized alteration of the electronic data which constitute this document will void all responsibility for the altered document by the Architect.

This drawing is not to be used for building purposes until countersigned by:



18.07.2025




266 MCDERMOT AVE Winnipeg MB R3B 0S8 P: 204.480.8421 F: 204.480.8876

1702 QUADRA STREET + 862 FISGARD STREET

BUILDING SECTION

Project 0650 Sheet A3.4

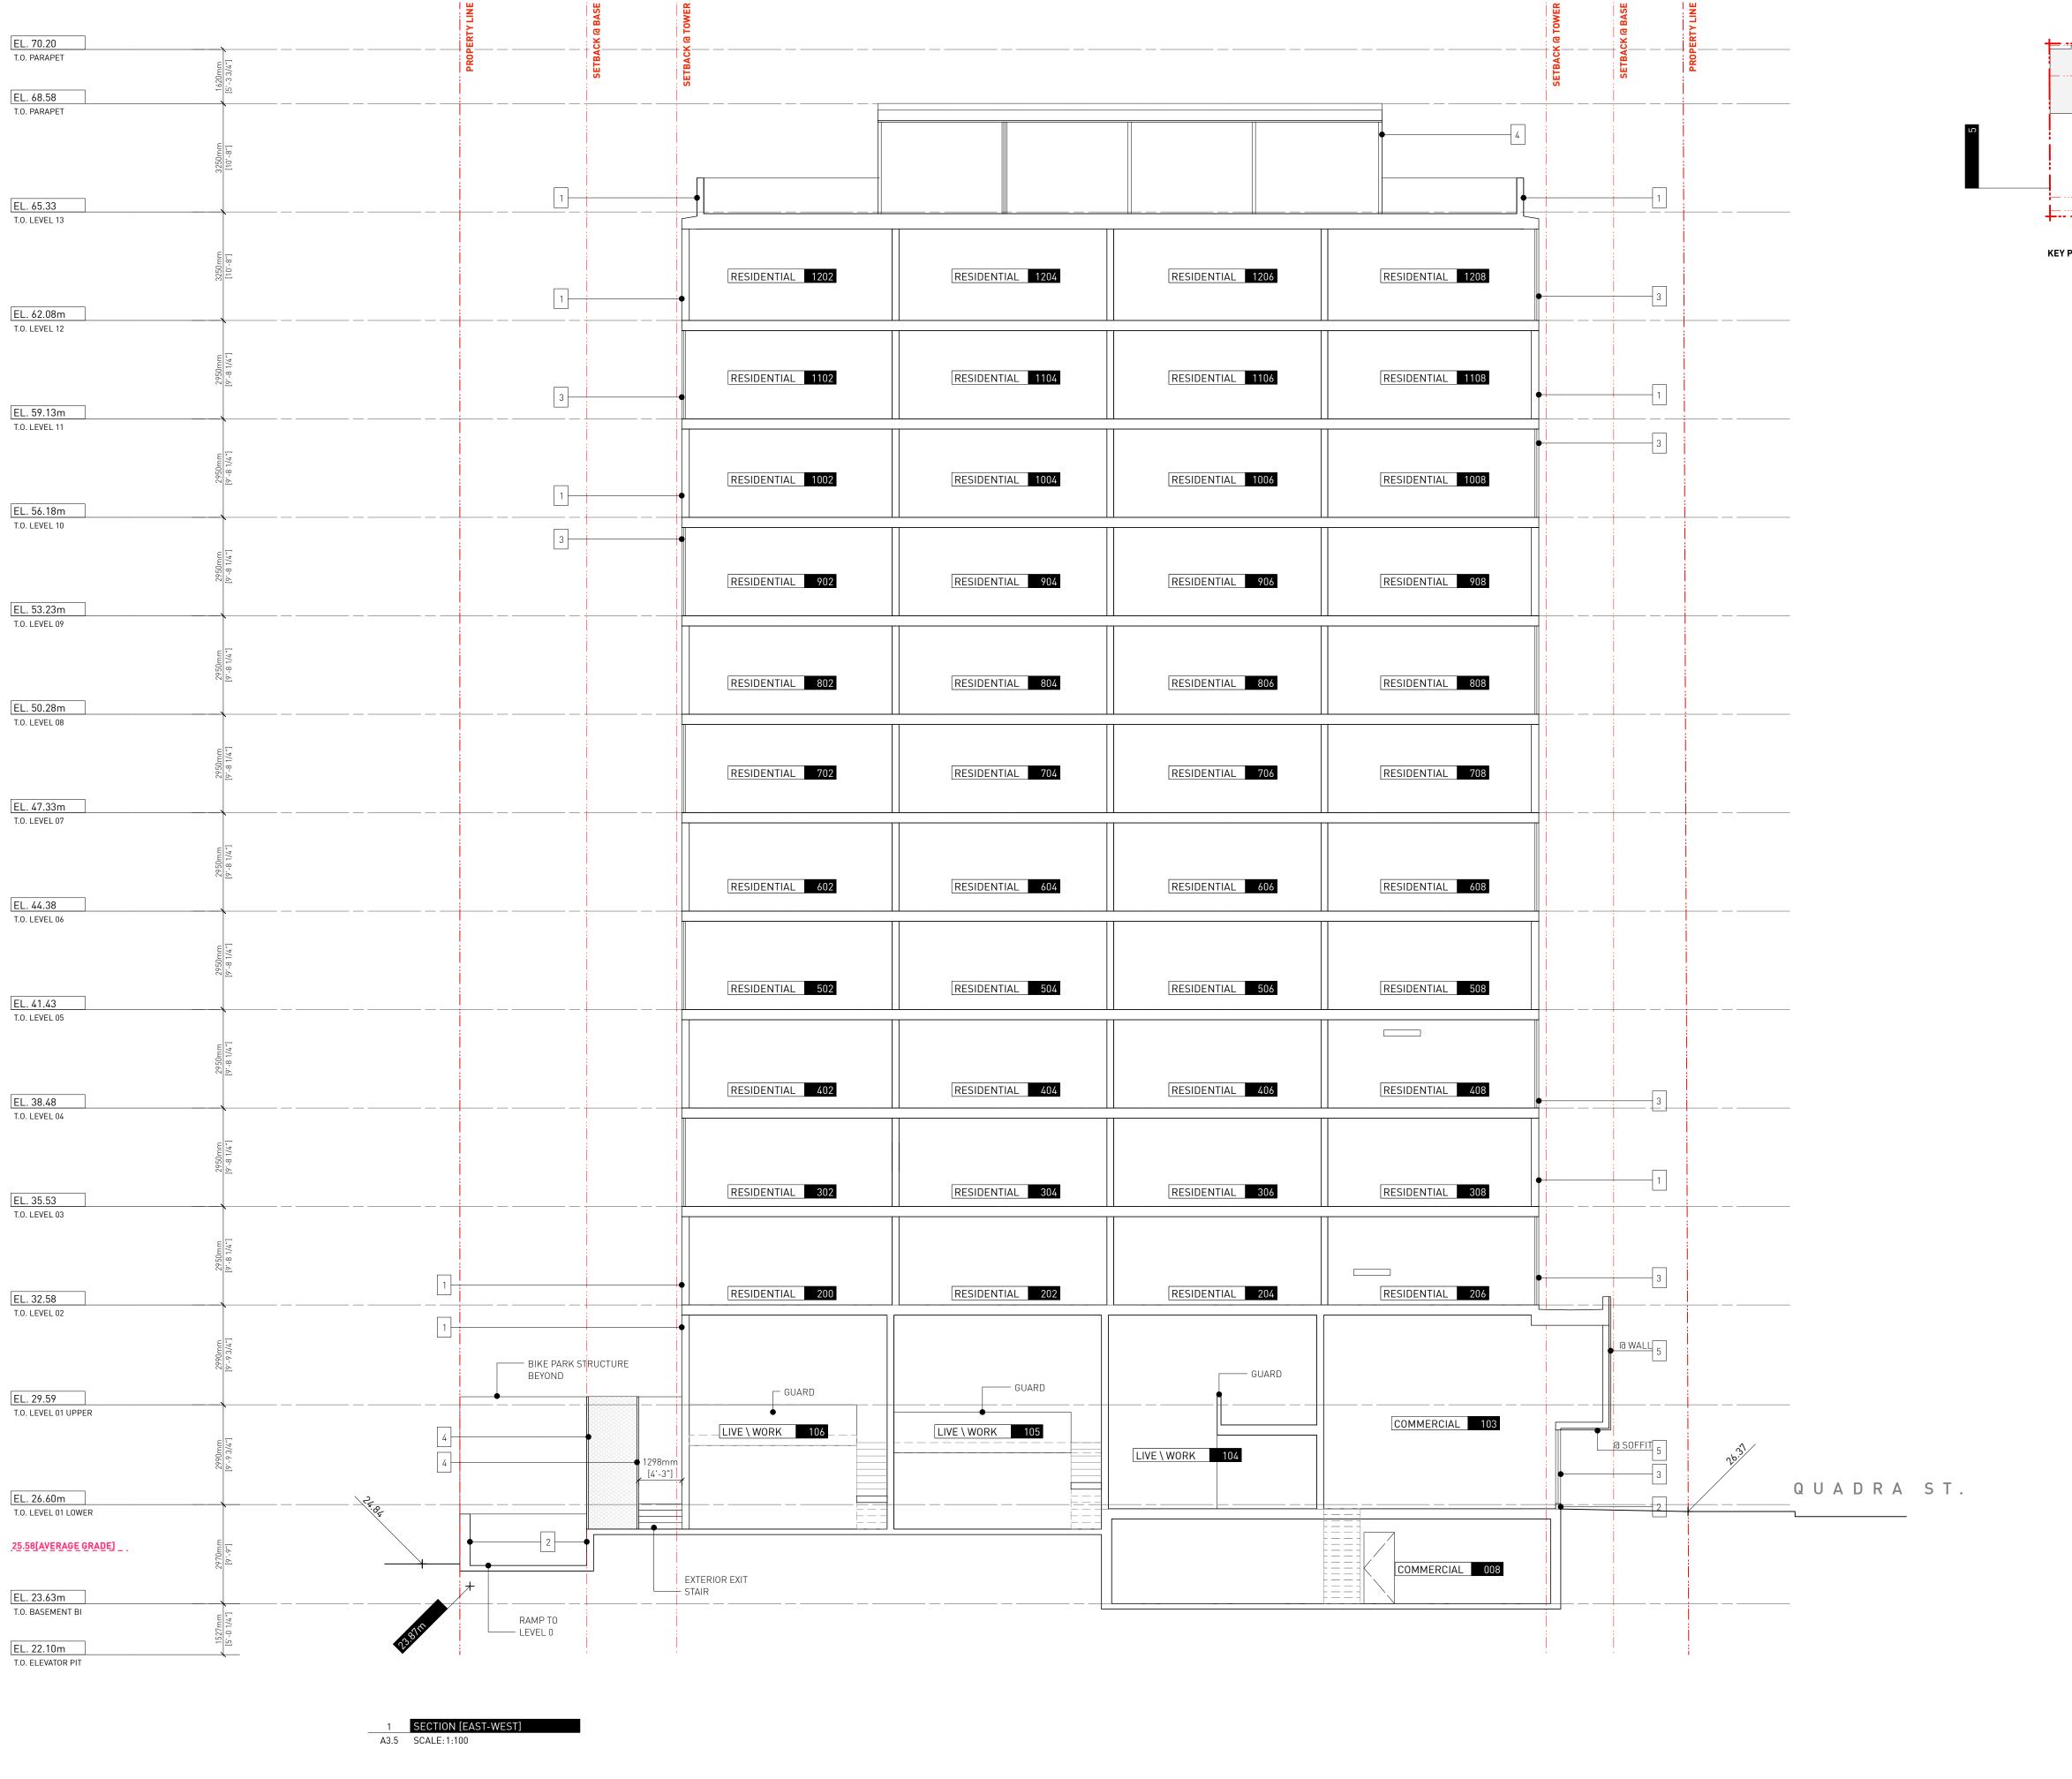



1 ALUMINUM

2 CONCRETE

3 GLASS WINDOWS / GUARDRAIL

4 EXPANDED METAL MESH GUARD / SCREEN

5 EXPANDED METAL MESH + CEMENTIOUS PANEL

6 SALVEGED BRICK

7 METAL FENCE

KEY PLAN

7 Issued for DDP 18.07.2025 6 Issued for DDP 11.07.2025

Drawn By: Checked By: Printing Date: PB 18.07.2025

The Contractor shall verify all dimensions, datums

08.07.2025

and levels prior to commencement of work. All errors and omissions to be reported to the

Architect before proceeding.


This drawing must not be scaled.


5 Issued for DDP

This drawing is the property of the Architect; the copyright in same being reserved to him/her. It is

Any unauthorized alteration of the electronic data which constitute this document will void all responsibility for the altered document by the Architect.

This drawing is not to be used for building purposes until countersigned by:

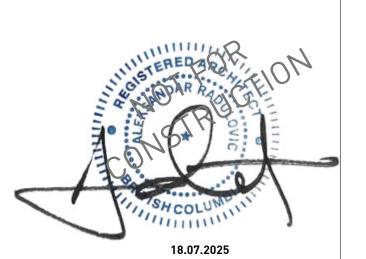

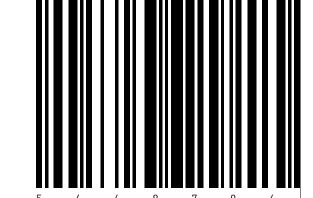


266 MCDERMOT AVE Winnipeg MB R3B 0S8 P: 204.480.8421 F: 204.480.8876

1702 QUADRA STREET + 862 FISGARD STREET

BUILDING SECTION

Project 0650 Sheet

A3.5

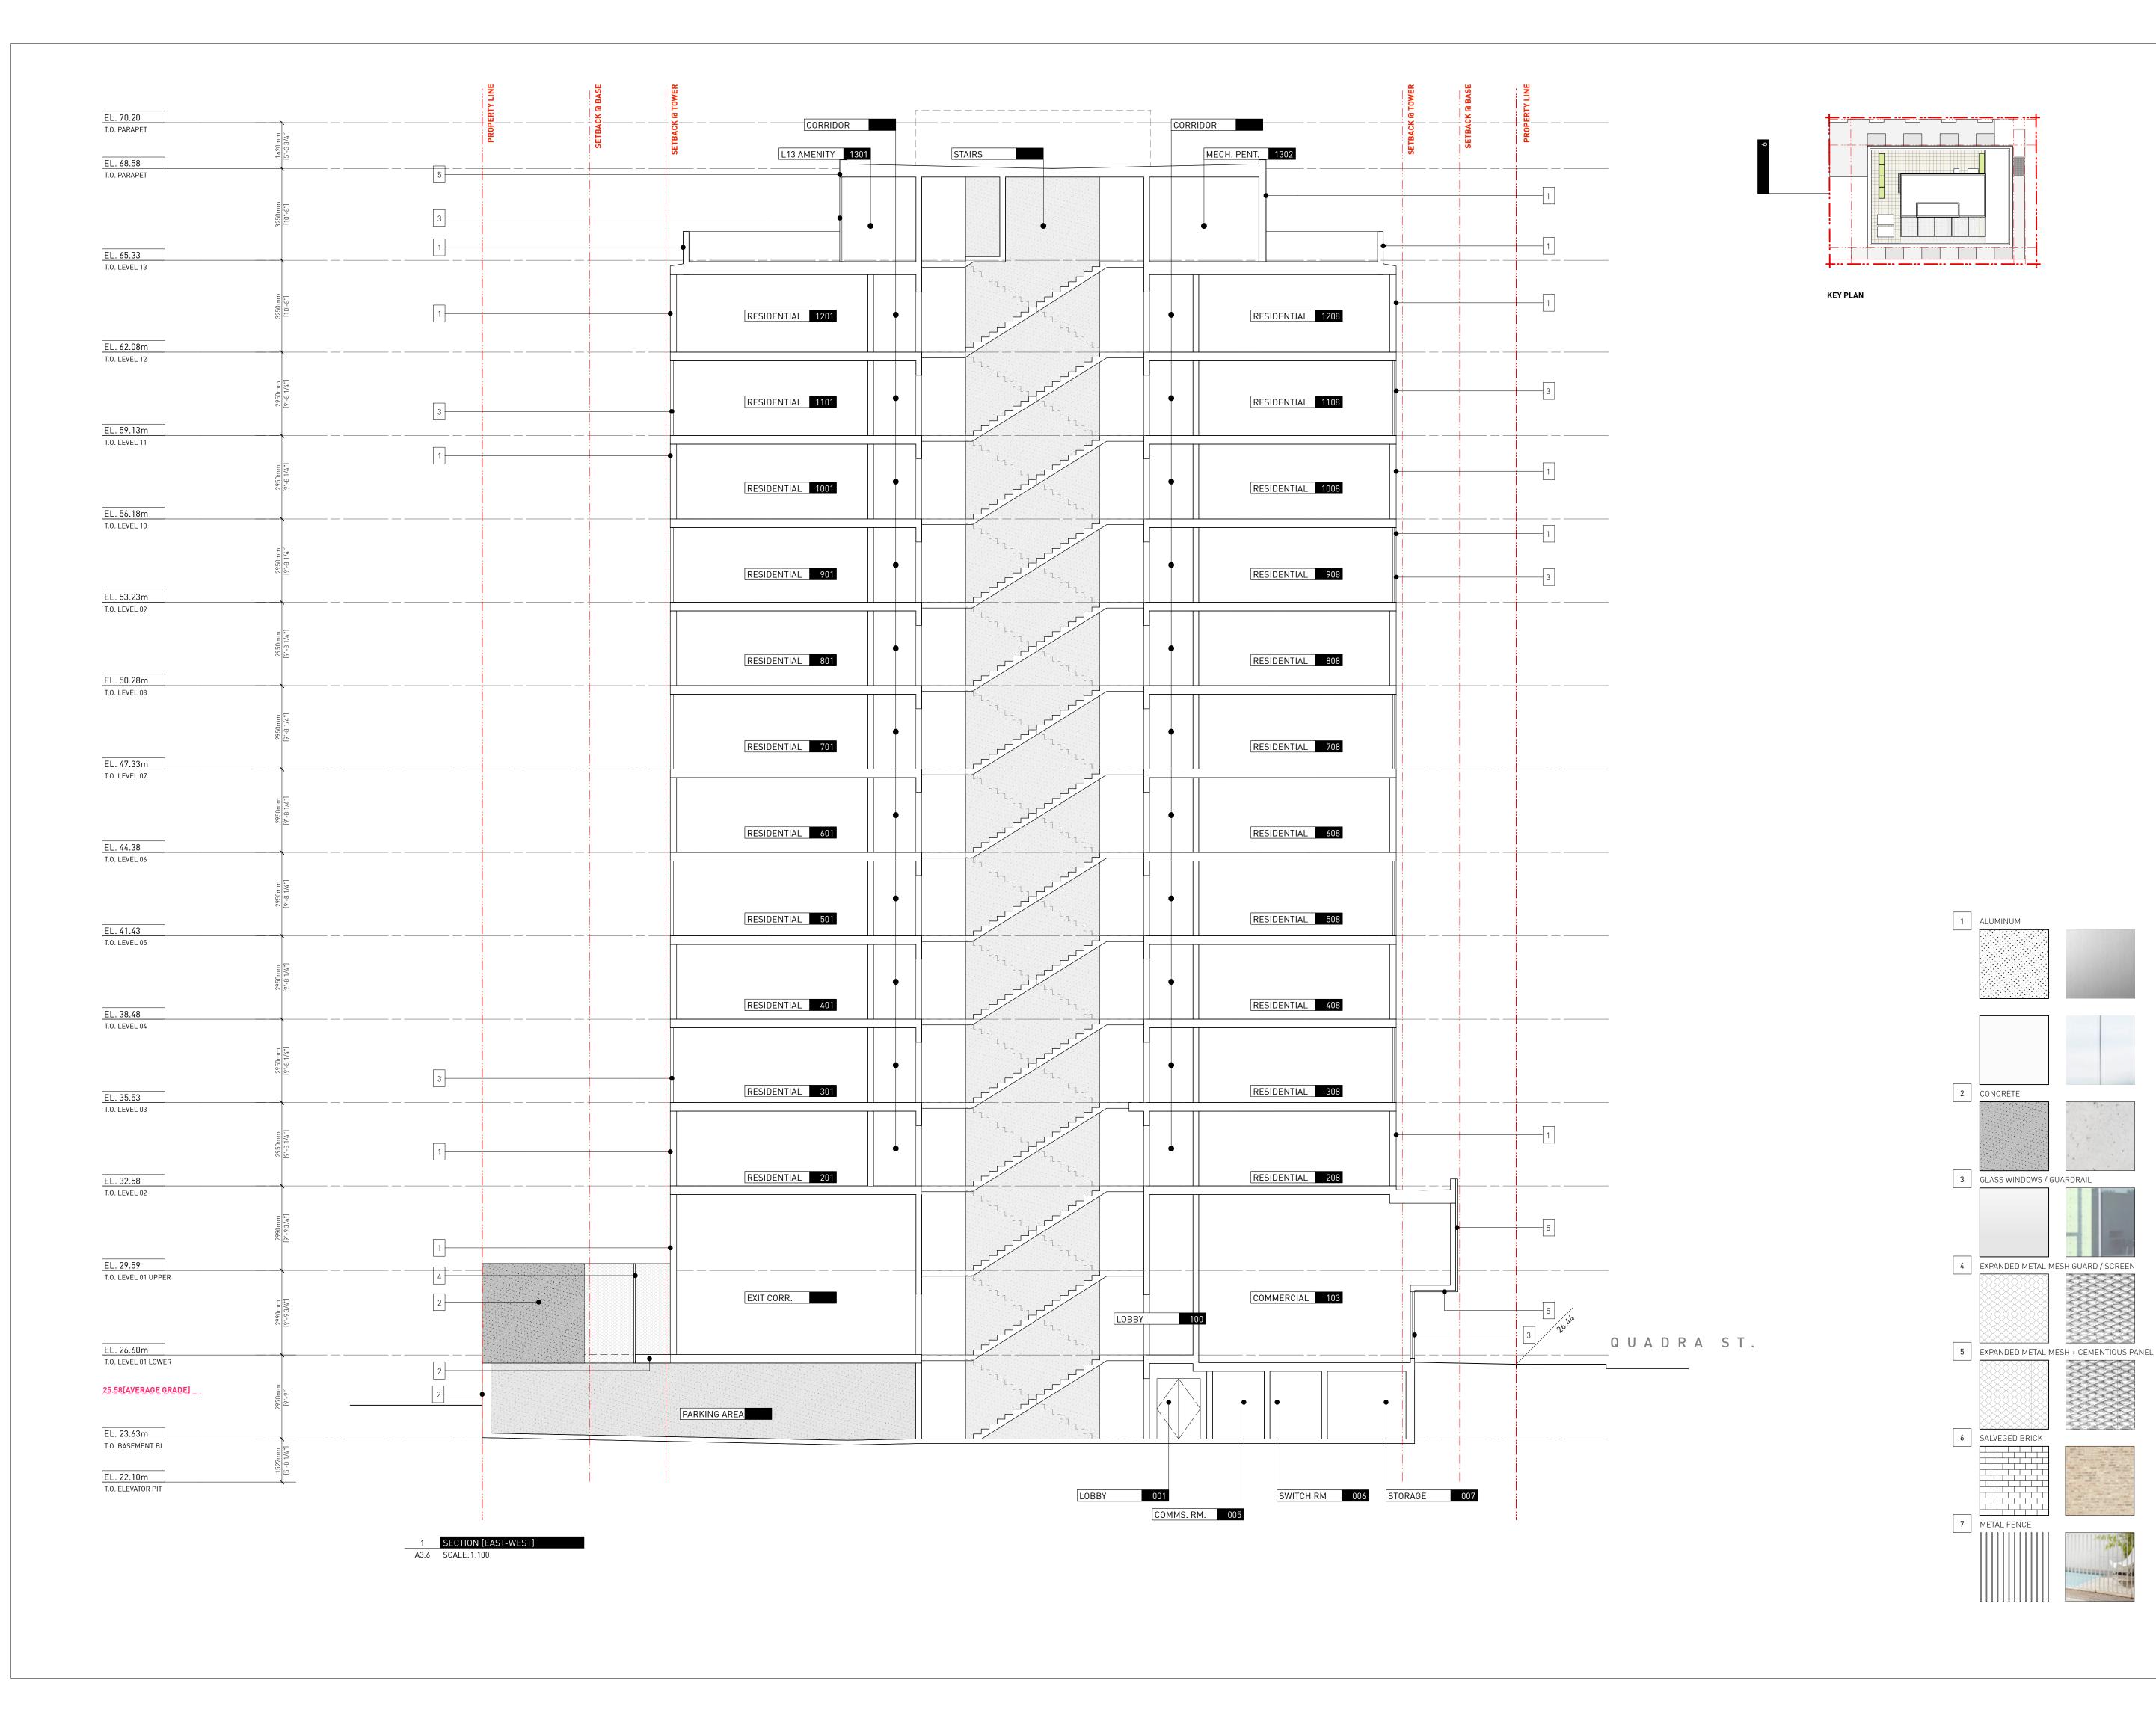

7 Issued for DDP6 Issued for DDP

5 Issued for DDP

18.07.2025

11.07.2025

08.07.2025

Drawn By:
Checked By:
Printing Date:
PB
18.07.2025

The Contractor shall verify all dimensions, datums and levels prior to commencement of work.

All errors and omissions to be reported to the Architect before proceeding.

This drawing must not be scaled.

This drawing is the property of the


This drawing is the property of the Architect; the copyright in same being reserved to him/her. It is not to be reproduced without his/her permission.

Any unauthorized alteration of the electronic data which constitute this document will void all responsibility for the altered document by the Architect.

This drawing is not to be used for building purposes until countersigned by:



18.07.2025

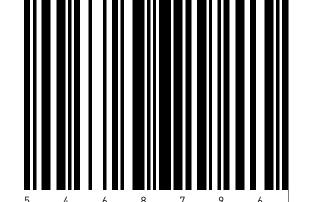


A R C H I T E C T U R E I N C 266 MCDERMOT AVE Winnipeg MB R3B 0S8 P: 204.480.8421 F: 204.480.8876

1702 QUADRA STREET + 862 FISGARD STREET

BUILDING SECTION

0650 Sheet

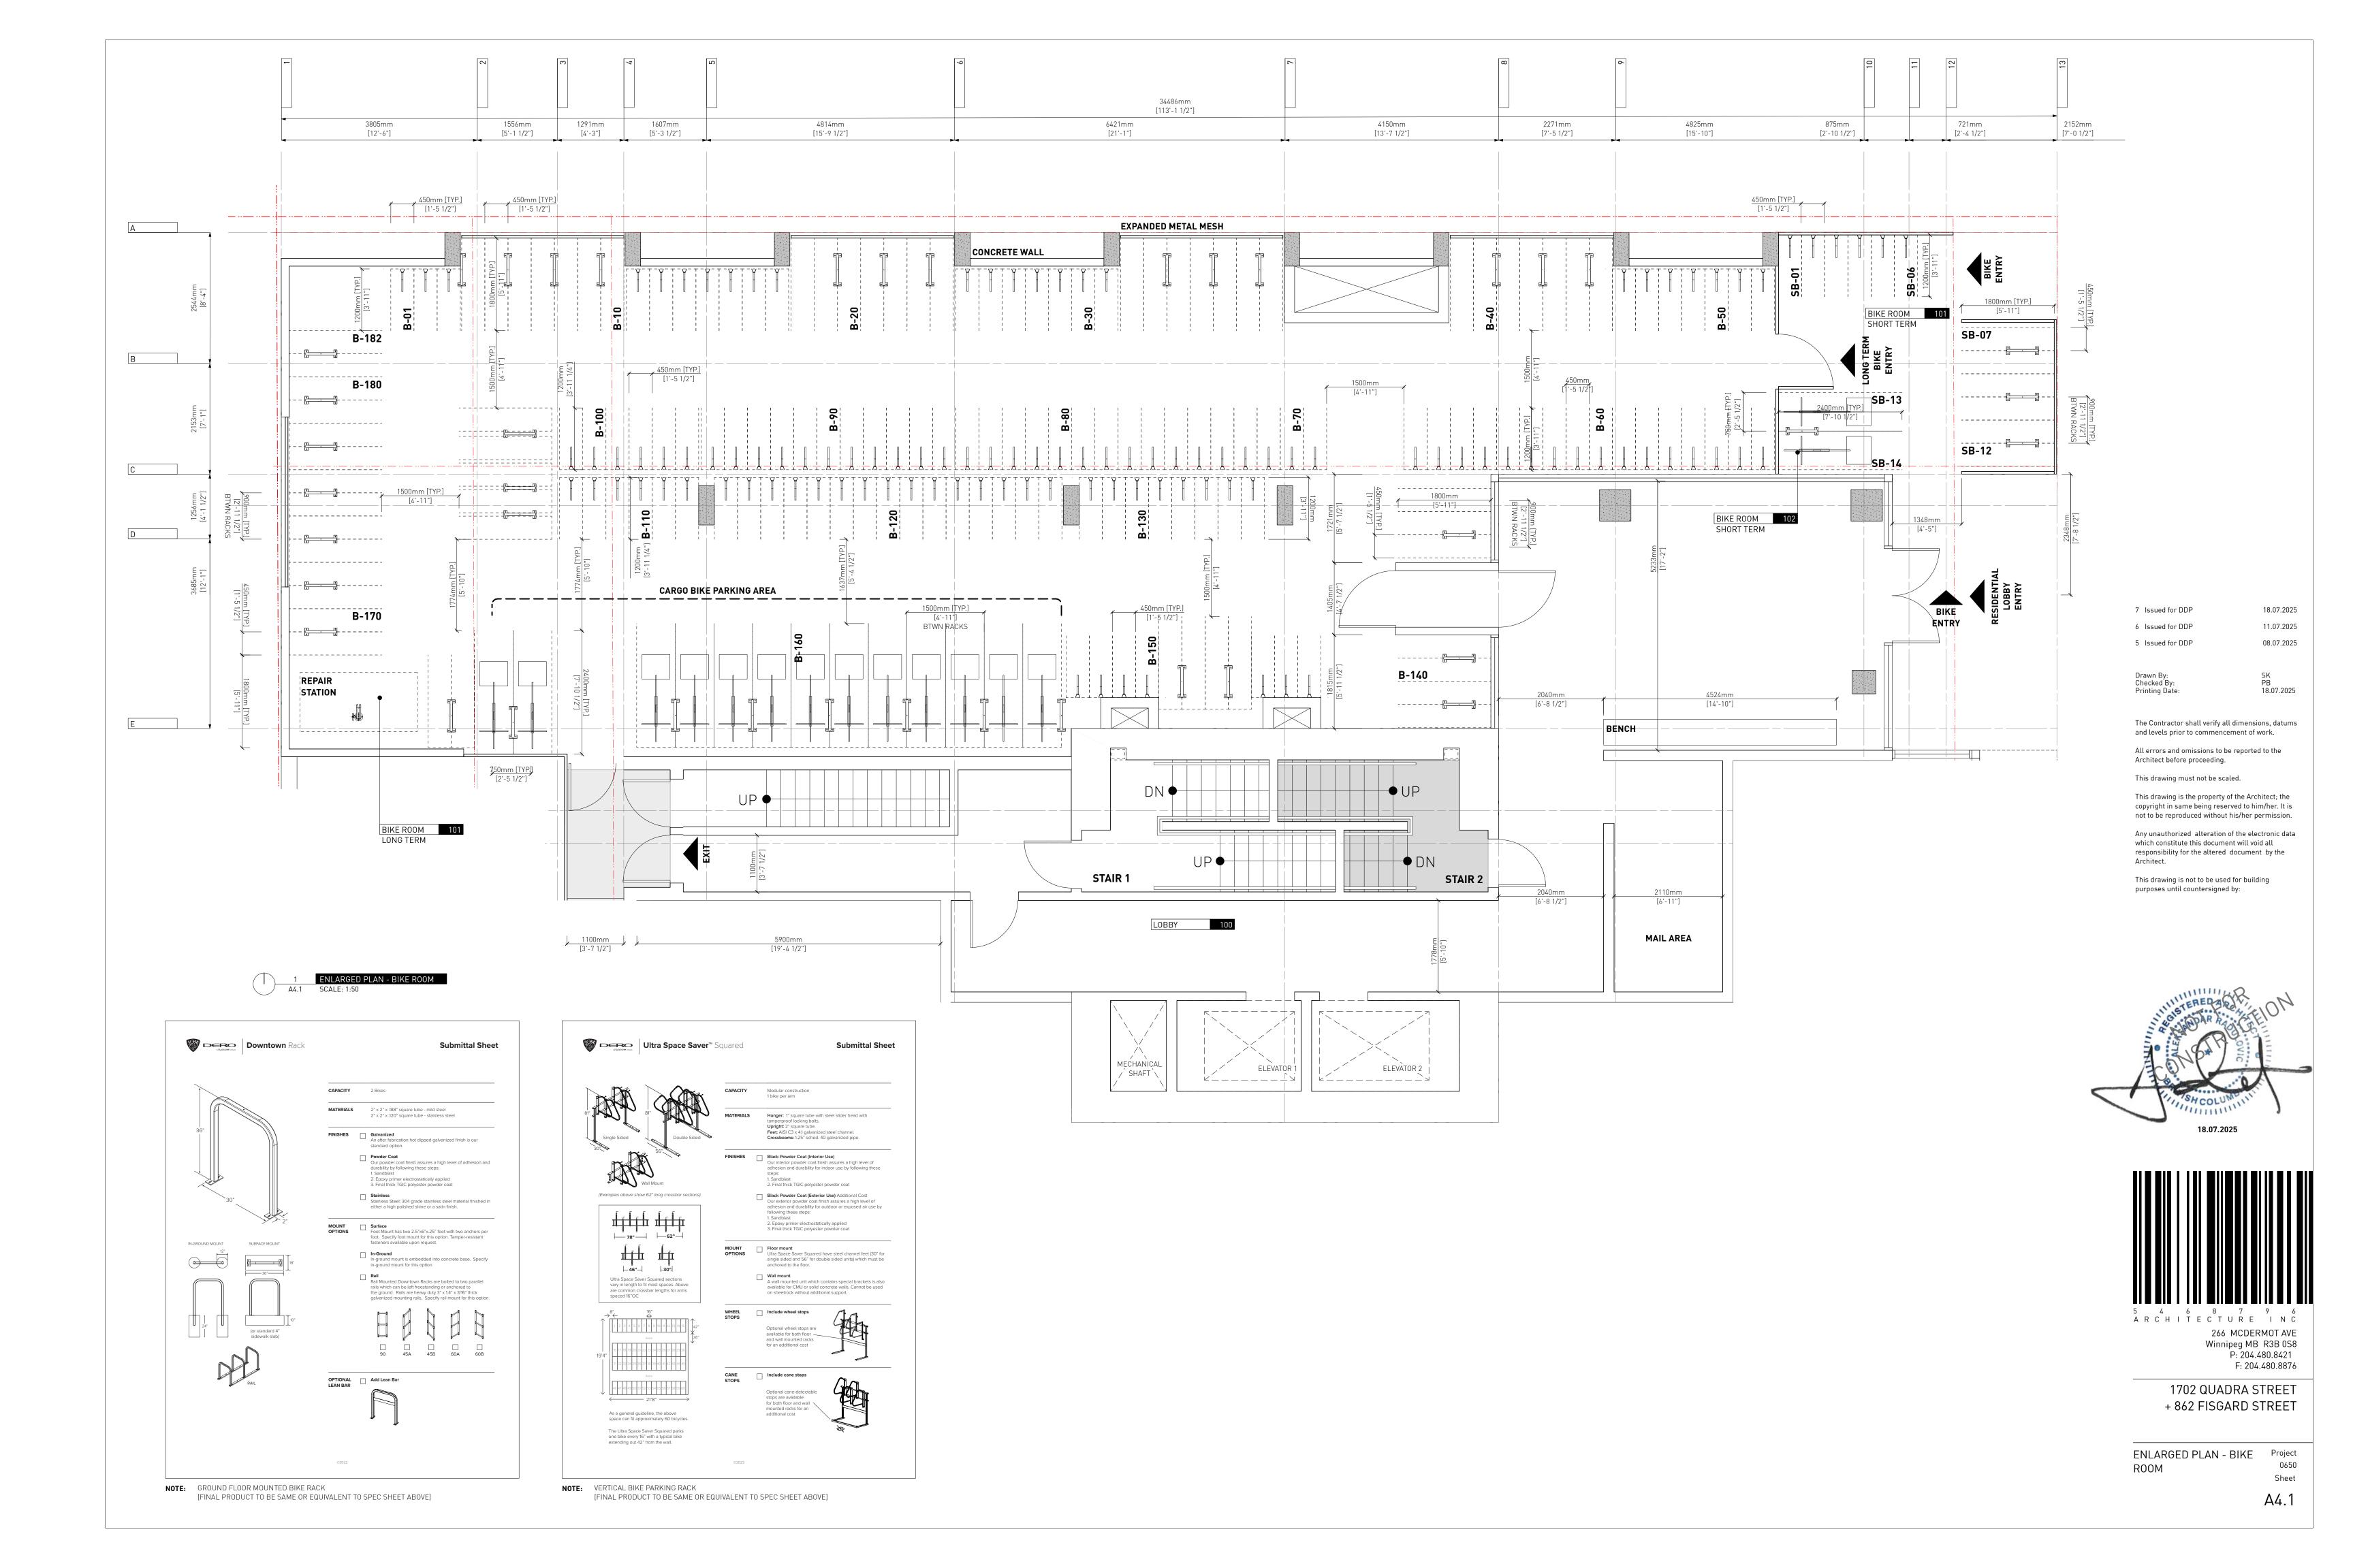

MATERIAL SPECIFICATIONS

ON-SITE GROWING MEDIUM:

- 1. GROWING MEDIUM TESTING, MIXING, HANDLING AND PLACEMENT AS PER WRITTEN SPECIFICATIONS.
- 2. ON SITE GROWING MEDIUM TYPE TO BE: AS PER DRAWING LEGEND.
- PLANTER GROWING MEDIUM TO BE:50% BY VOLUME 1P GROWING MEDIUM (CLS)
- 50% BY VOLUME Pro-Mix HP Mychorrizae OR APPROVED EQUAL

OFF-SITE GROWING MEDIUM:

1. GROWING MEDIUM TESTING, MIXING, HANDLING AND PLACEMENT TO MMCD SECTION GROWING MEDIUM.

AS PER CITY GREEN TECHNICAL SPECIFICATION filler Soil for Citygreen Soil Cell Treepits V2.0.

- 2. BOULEVARD GROWING MEDIUM TO BE:
- MMCD Planting Areas Growing Medium to City of Victoria Supplementary Specifications Schedule 'B', Table 2.
 SOIL CELL GROWING MEDIUM TO BE:

MIII CH:

1. MULCH TO BE: Mitchell Excavating Ltd. Fine Bark Mulch - fir/hemlock OR APPROVED EQUAL. HANDLING AND PLACEMENT AS PER WRITTEN SPECIFICATIONS.

DOOT DADDIED.

- L. ROOT BARRIER TO BE: Deeproot 18" Universal Guide OR APPROVED EQUAL.
- INSTALL AS PER MANUFACTURER'S SPECIFICATIONS AND LANDSCAPE DETAILS.

- 1. FILTER FABRIC TO BE: Soprema Soprafiltre non-woven geotextile OR APPROVED EQUAL.
- 2. COMBIGRID TO BE: TERRAFIX COMBIGRID 4040 OR APPROVED EQUAL
- 3. INSTALL AS PER MANUFACTURER'S SPECIFICATIONS AND LANDSCAPE DETAILS

STRUCTURAL SOIL CELLS:

- 1. SOIL CELLS TO BE: CITY GREEN SOIL CELLS.
- 2. INSTALL AS PER MANUFACTURER'S SPECIFICATIONS AND LANDSCAPE DETAILS.

PLANT MATERIAL AND PLANTING:

- 1. ALL PRODUCTS AND WORKMANSHIP, INCLUDING: PLANT MATERIAL, TRANSPORTATION, HANDLING AND PROTECTION, SCHEDULING AND STORAGE, WATERING AND IRRIGATION, TIME OF PLANTING, PLANTING, CONDITIONS FOR ACCEPTANCE, AND INSECTS PESTS AND DISEASE CONTROL, AS PER WRITTEN SPECIFICATIONS AND LANDSCAPE DETAILS.
- CONDITIONS FOR TOTAL PERFORMANCE AS PER WRITTEN SPECIFICATIONS.
 IN THE EVENT OF A DISCREPANCY BETWEEN QUANTITIES LISTED ON THE PLANTING PLAN AND IN THE PLANT LIST, THE PLANTING PLAN QUANTITIES TO TAKE PRECEDENCE.

CAST IN PLACE CONCRETE:


1. ALL CAST IN PLACE CONCRETE AND ASSOCIATED WORK AND MATERIALS AS PER WRITTEN SPECIFICATIONS; ASSOCIATED WORK INCLUDES GRADING. SUBGRADE COMPACTION. GRANULAR BASE MATERIALS AND COMPACTION.

UNIT PAVERS:

- 1. PAVERS TO BE: AS PER DRAWING LEGEND
- 2. INSTALL AS PER MANUFACTURER'S SPECIFICATIONS AND LANDSCAPE DETAILS.

SUBMITTALS

SUBMITTALS					
SPECIFICATION SECTION	TITLE	SHOP DRAWINGS	MOCK-UP	SUBMITTALS	FOR APPROVAL
03 30 20	CONCRETE WALKS, CURBS AND GUTTERS				
03 30 53	CAST IN PLACE CONCRETE				
06 20 13	EXTERIOR ROUGH CARPENTRY	yes		yes	Shop drawings, colour and material samples
12 93 02	SITE FURNISHINGS	yes		yes	Shop drawings, colour and material samples
12 93 13	BIKE RACKS			yes	Product cutsheet
31 05 17	AGGREGATES AND GRANULAR MATERIALS				
31 22 01	GRADING AND DRAINAGE				
31 24 13	ROADWAY EXCAVATION, EMBANKMENT AND COMPACTION				
32 11 23	GRANULAR BASE				
32 14 10	MORTAR SET UNIT PAVING		yes	yes	Product cutsheet and mockup 3.0 m. paved area on-site
32 14 13	ARCHITECTURAL PAVER ON PEDESTAL		yes	yes	Product cutsheet and mockup 3.0 m. paved area on site
31 22 01	GRADING AND DRAINAGE				
32 91 21	GROWING MEDIUM			yes	Supplier name, growing medium test results
32 93 10	PLANTING OF TREES, SHRUBS AND GROUNDCOVERS		yes	yes	Nursery name, tree and shrub layout on site prior to planting
32 84 00	IRRIGATION SYSTEMS - DESIGN BUILD	yes			Record drawings, maintenance manual, tools, irrigation inspection reports during 1 year maintenance period
32 93 03	LANDSCAPE OVER STRUCTURES				
REFERENCE	STRATAVAULT STRUCTURAL CELL PITS	yes	yes	yes	Supplier shop drawings, supplier installation specifications and details, mockup of minimum 6 cells on site

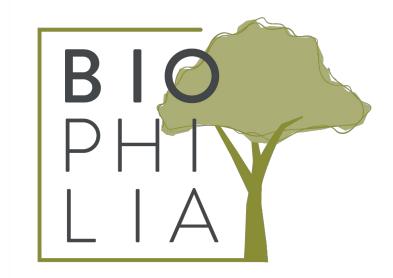



THE ESTOYA

1702 QUADRA STREET, VICTORIA, BC

SHEET LIST

REE REMOVAL AND PROTECTION PLAN	L4.1 HARDSCAPE DETAILS	IR01 - IRRIGATION PLANS
SITE PLAN - GROUND FLOOR	L4.2 CUSTOM SITE FURNITURE DETAILS	IRO2- IRRIGATION SCHEDULES
LAYOUT PLAN - GROUND FLOOR	L4.3 CUSTOM SITE FURNITURE DETAILS	IRO3 - IRRIGATION DETAILS
SITE PLAN - ROOFTOP AMENITY	L4.4 PLANTING DETAILS	
LAYOUT PLAN - ROOFTOP AMENITY	L5.1 STRUCTURAL SOIL CELL DETAILS	
PLANTING PLAN - GROUND FLOOR	L6.1 MUNICIPAL HARDSCAPE DETAILS	
PLANTING PLAN - ROOFTOP AMENITY	L6.2 MUNICIPAL SITE FURNITURE DETAILS	
	L6.3 MUNICIPAL LANDSCAPE DETAILS	

GENERAL LANDSCAPE NOTES

GENERAL:

- DO NOT PROCEED IN UNCERTAINTY.
 DO NOT SCALE DRAWINGS.
- 3. DRAWINGS AND SPECIFICATIONS ARE TO BE READ IN CONJUNCTION WITH ALL OTHER DRAWINGS/SPECIFICATIONS IN THIS PROJECT SET. ANY DISCREPANCIES AMONG DRAWINGS, SPECIFICATIONS AND THE LANDSCAPE CONSTITUTION.
- AND INDUSTRY BEST PRACTICES TO BE REPORTED TO THE PROJECT / CONSTRUCTION MANAGER AND THE LANDSCAPE CONSULTANT FOR DIRECTION.
- 4. ALL LANDSCAPE SPECIFICATION SECTIONS AND DRAWINGS ARE AFFECTED BY REQUIREMENTS OF DIVISION 01 SECTIONS (PROVIDED IN THE PROJECT MANUAL).
- 5. CONTRACTOR TO FAMILIARIZE THEMSELVES WITH ALL SITE CONDITIONS, INCLUDING THE LIMITS OF WORK AND EXISTING FEATURES TO BE PROTECTED, PRIOR TO SUBMITTING BIDS/QUOTES.
 6. CONTRACTOR TO CONFIRM LOCATION AND ELEVATION OF ALL UNDERGROUND UTILITIES/FEATURES PRIOR TO COMMENCING WORK.
- 7. CONTRACTOR TO TAKE NECESSARY PRECAUTIONS TO PROTECT SITE FEATURES / CONDITIONS, WITHIN AND BEYOND THE LIMITS OF WORK EXISTING AT THE TIME OF CONSTRUCTION. ALL DISTURBED SURFACES, AREAS, STRUCTURES, VEGETATION, HABITAT ETC. ON PUBLIC / PRIVATE PROPERTY TO PROMPTLY BE RESTORED TO EQUAL OR BETTER CONDITION THAN EXISTING AND TO THE SATISFACTION OF THE MUNICIPALITY HAVING JURISDICTION / PROPERTY OWNER.
- 8. CONTRACTOR TO MAINTAIN THE SITE IN A SAFE AND TIDY CONDITION AT ALL TIMES. DO NOT OBSTRUCT PEDESTRIAN OR VEHICULAR CIRCULATION. DO NOT LEAVE UNPROTECTED HOLES / PITS / OPENINGS OVERNIGHT. ALL EXCESS MATERIALS AND REFUSE TO BE REMOVED FROM THE SITE DAILY UNLESS OTHERWISE DIRECTED BY THE CONSTRUCTION MANAGER.

STANDARDS:

- 1. ALL WORK ON MUNICIPAL PROPERTY TO CONFORM TO THE CITY OF VICTORIA DEVELOPMENT STANDARDS (AUTHORITY HAVING JURISDICTION) INCLUDING BUT NOT LIMITED TO:
- 1.1. CITY OF VICTORIA SUPPLEMENTARY SPECIFICATIONS SCHEDULE 'B' TO THE SUBDIVISION AND DEVELOPMENT SERVICING BYLAW NO. 12-042
- 1.2. CITY OF VICTORIA SUPPLEMENTAL DRAWINGS1.3. CITY OF VICTORIA SUPPLEMENTARY SPECIFICATIONS FOR STREET TREES AND IRRIGATION, SCHEDULE C.
- 2. ALL LANDSCAPE WORK ON THE DEVELOPMENT SITE TO CONFORM TO THE CURRENT EDITION AT TIME OF ISSUE OF THE *Canadian Landscape Standard* (CLS), UNLESS SPECIFICALLY STATED OTHERWISE IN WRITTEN SPECIFICATIONS AND ON DRAWINGS.
- 3. ALL HARD SURFACE (INCLUDING BUT NOT LIMITED TO PAVING, CONCRETE RETAINING WALLS AND CONCRETE PLANTERS) TO CONFORM TO THE *Master Municipal Construction Documents Association*
- PLATINUM EDITION (MMCD) AND MMCD SUPPLEMENTAL DRAWINGS AND SPECIFICATIONS, UNLESS SPECIFICALLY STATED OTHERWISE IN WRITTEN SPECIFICATIONS AND ON DRAWINGS.
- 4. LANDSCAPE CONTRACTOR TO BE FAMILIAR WITH MUNICIPAL DEVELOPMENT STANDARDS AND BE IN POSSESSION OF THE CLS AND MMCD MANUALS AND SUPPLEMENTAL DRAWINGS AND SPECIFICATIONS.
- 5. GROWING MEDIUM AND GROWING MEDIUM TESTING AS PER WRITTEN SPECIFICATIONS.
- 6. IRRIGATION DESIGN AND INSTALLATION TO HABC STANDARDS AND AS PER WRITTEN SPECIFICATIONS.

COORDINATION: 1. CONTRACTO

1. CONTRACTOR TO COORDINATE INSTALLATION OF IRRIGATION AND ELECTRICAL SLEEVES WITH ARCHITECTURAL, MECHANICAL, ELECTRICAL AND CIVIL WORKS.

SUBMITTALS 1 CONTRA

- CONTRACTOR TO PROVIDE SAMPLES, TEST RESULTS AND SHOP DRAWINGS TO LANDSCAPE CONSULTANT FOR REVIEW AND APPROVAL 45 DAYS PRIOR TO INSTALLATION.
 SEE ALSO SUBMITTALS TABLE BELOW FOR ADDITIONAL INFORMATION.
- GROWING MEDIUM TESTING:

1. GROWING MEDIUM TEST RESULTS ARE MANDATORY.

- 2. TEST RESULTS TO INCLUDE ANALYSIS OF ALL GROWING MEDIUM NUTRIENTS NOTED IN WRITTEN SPECIFICATIONS AND ARE TO BE REPORTED IN THE SAME UNITS AS NOTED IN THAT SECTION.
- TEST RESULTS TO INCLUDE ANALYSIS OF SOIL TEXTURE, ORGANIC CONTENT AND ACIDITY AS PER WRITTEN SPECIFICATIONS AND BE REPORTED IN THE SAME UNITS AS NOTED IN THAT SECTION.
 TEST RESULTS TO INCLUDE RECOMMENDATIONS FOR AMENDMENTS TO MEET THE REQUIREMENTS FOR EACH GROWING MEDIUM TYPE.
- 5. RECOMMENDED GROWING MEDIUM TESTING FACILITY: Pacific Soil Analysis Inc. 11720 Voyageur Way, Richmond, BC V6X 3G9 OR APPROVED EQUAL.

COMPACTION TESTING:

1. COMPACTION TESTING:

1. COMPACTION TESTS FOR HARD SURFACE SUBGRADE, GRANULAR SUB-BASE, AND GRANULAR BASE ARE MANDATORY.

INSPECTIONS:

1. CONTRACTOR TO ALERT THE LANDSCAPE CONSULTANT A MINIMUM OF 3 WORKING DAYS PRIOR TO REQUIRED LANDSCAPE INSPECTIONS.

SUBSTITUTIONS:

1. REQUESTS FOR SUBSTITUTIONS TO CONFORM TO THE DIVISION 01 SECTION AND BE SUBMITTED TO THE LANDSCAPE CONSULTANT, THROUGH THE PROJECT ADMINISTRATOR, A MINIMUM OF 45 DAYS PRIOR TO SCHEDULED WORK.

2. PLEASE NOTE THAT SOME SUBSTITUTIONS MAY REQUIRE MUNICIPAL APPROVAL.

WARRANTY: 1 CONTRACTO

1. CONTRACTOR SHALL WARRANTY ALL WORKMANSHIP AND MATERIALS FOR 1 FULL YEAR FOLLOWING THE DATE OF TOTAL PERFORMANCE AS PER MMCD UNLESS SPECIFICALLY NOTED OTHERWISE. FAULTY MATERIALS AND WORKMANSHIP SHALL BE PROMPTLY REPAIRED / REPLACED TO THE SATISFACTION OF THE LANDSCAPE CONSULTANT.

NVIRONMENTAL PROTECTION:

1. CONTRACTOR TO INSTALL AND MAINTAIN SEDIMENTATION FILTRATION MEASURES AS REQUIRED FOR LANDSCAPE WORKS TO PREVENT MATERIALS FROM LEAVING THE SITE AND / OR ENTERING STORM DRAINS; STOCKPILED LANDSCAPE MATERIALS ARE TO BE KEPT TARPED.

IRRIGATION

RIGATION:

- 1. IT IS THE INTENTION OF THE PROJECT THAT THE LANDSCAPE CONTRACTOR FURNISH A FUNCTIONAL AUTOMATIC IRRIGATION SYSTEM TO ALL ON-SITE AND OFF SITE LANDSCAPE AREAS AS
- DESCRIBED ON THE LANDSCAPE DRAWINGS AND IN THIS SECTION.
 2. SEE IRRIGATION DRAWINGS.
- 3. THE SCOPE OF WORK INCLUDES SUPPLY AND INSTALLATION OF BACKFLOW PREVENTER, CONTROLLER, ALL IRRIGATION COMPONENTS, IRRIGATION SLEEVES, **1 YEAR MAINTENANCE/WARRANTY**
- (SEE WRITTEN SPECIFICATIONS AND REQUIREMENTS BELOW) AND AN OPERATION MANUAL.
 4. THE IRRIGATION CONTRACTOR SHALL COORDINATE WITH THE GENERAL CONTRACTOR AND ELECTRICAL CONTRACTOR FOR THE INSTALLATION OF IRRIGATION SLEEVES.

MAINTENANC

- 5. UPON COMPLETION OF IRRIGATION INSTALLATION, CONTRACTOR TO SUBMIT AS-CONSTRUCTED DRAWINGS, OPERATION AND MAINTENANCE MANUAL, TOOLS PROVIDED BY THE
- MANUFACTURER AND BASE IRRIGATION SCHEDULE TO IIABC STANDARDS (SECTION 10 OF CLS).

 6. INSPECT AND CALIBRATE IRRIGATION SYSTEM AS PER SEASONAL REQUIREMENTS.
- 7. INSPECT GROWING MEDIUM FREQUENTLY (MINIMUM MONTHLY AND WEEKLY DURING PERIODS OF DROUGHT AND HIGH HEAT) FOR MOISTURE CONTENT AND ADJUST IRRIGATION SCHEDULE AS OFTEN AS REQUIRED TO MAINTAIN THE HEALTH OF THE PLANT MATERIAL DUE TO: RAPID DRAINAGE IN THE GROWING MEDIUM, ABSENCE OF A WATER TABLE, FINITE AMOUNT OF GROWING MEDIUM, AND EXPOSURE TO CLIMATIC CONDITIONS.
- 8. CONTRACTOR TO COORDINATE WITH THE OWNER'S MAINTENANCE REPRESENTATIVE AND TOGETHER PERFORM ONE WINTERIZATION AND ONE SPRING START-UP DURING THE ONE YEAR

ELECTRICAL / IRRIGATION COORDINATION

IRRIGATION COORDINA

- 1. ELECTRICAL CONTRACTOR TO COORDINATE WITH CONSTRUCTION MANAGER AND IRRIGATION DESIGNER / INSTALLER TO PROVIDE ELECTRICAL FOR THE OPERATION OF AN AUTOMATIC IRRIGATION SYSTEM AND CONTROLLER.
- 2. IRRIGATION CONTRACTOR TO CONFIRM PIPE SIZE FOR ELECTRICAL.

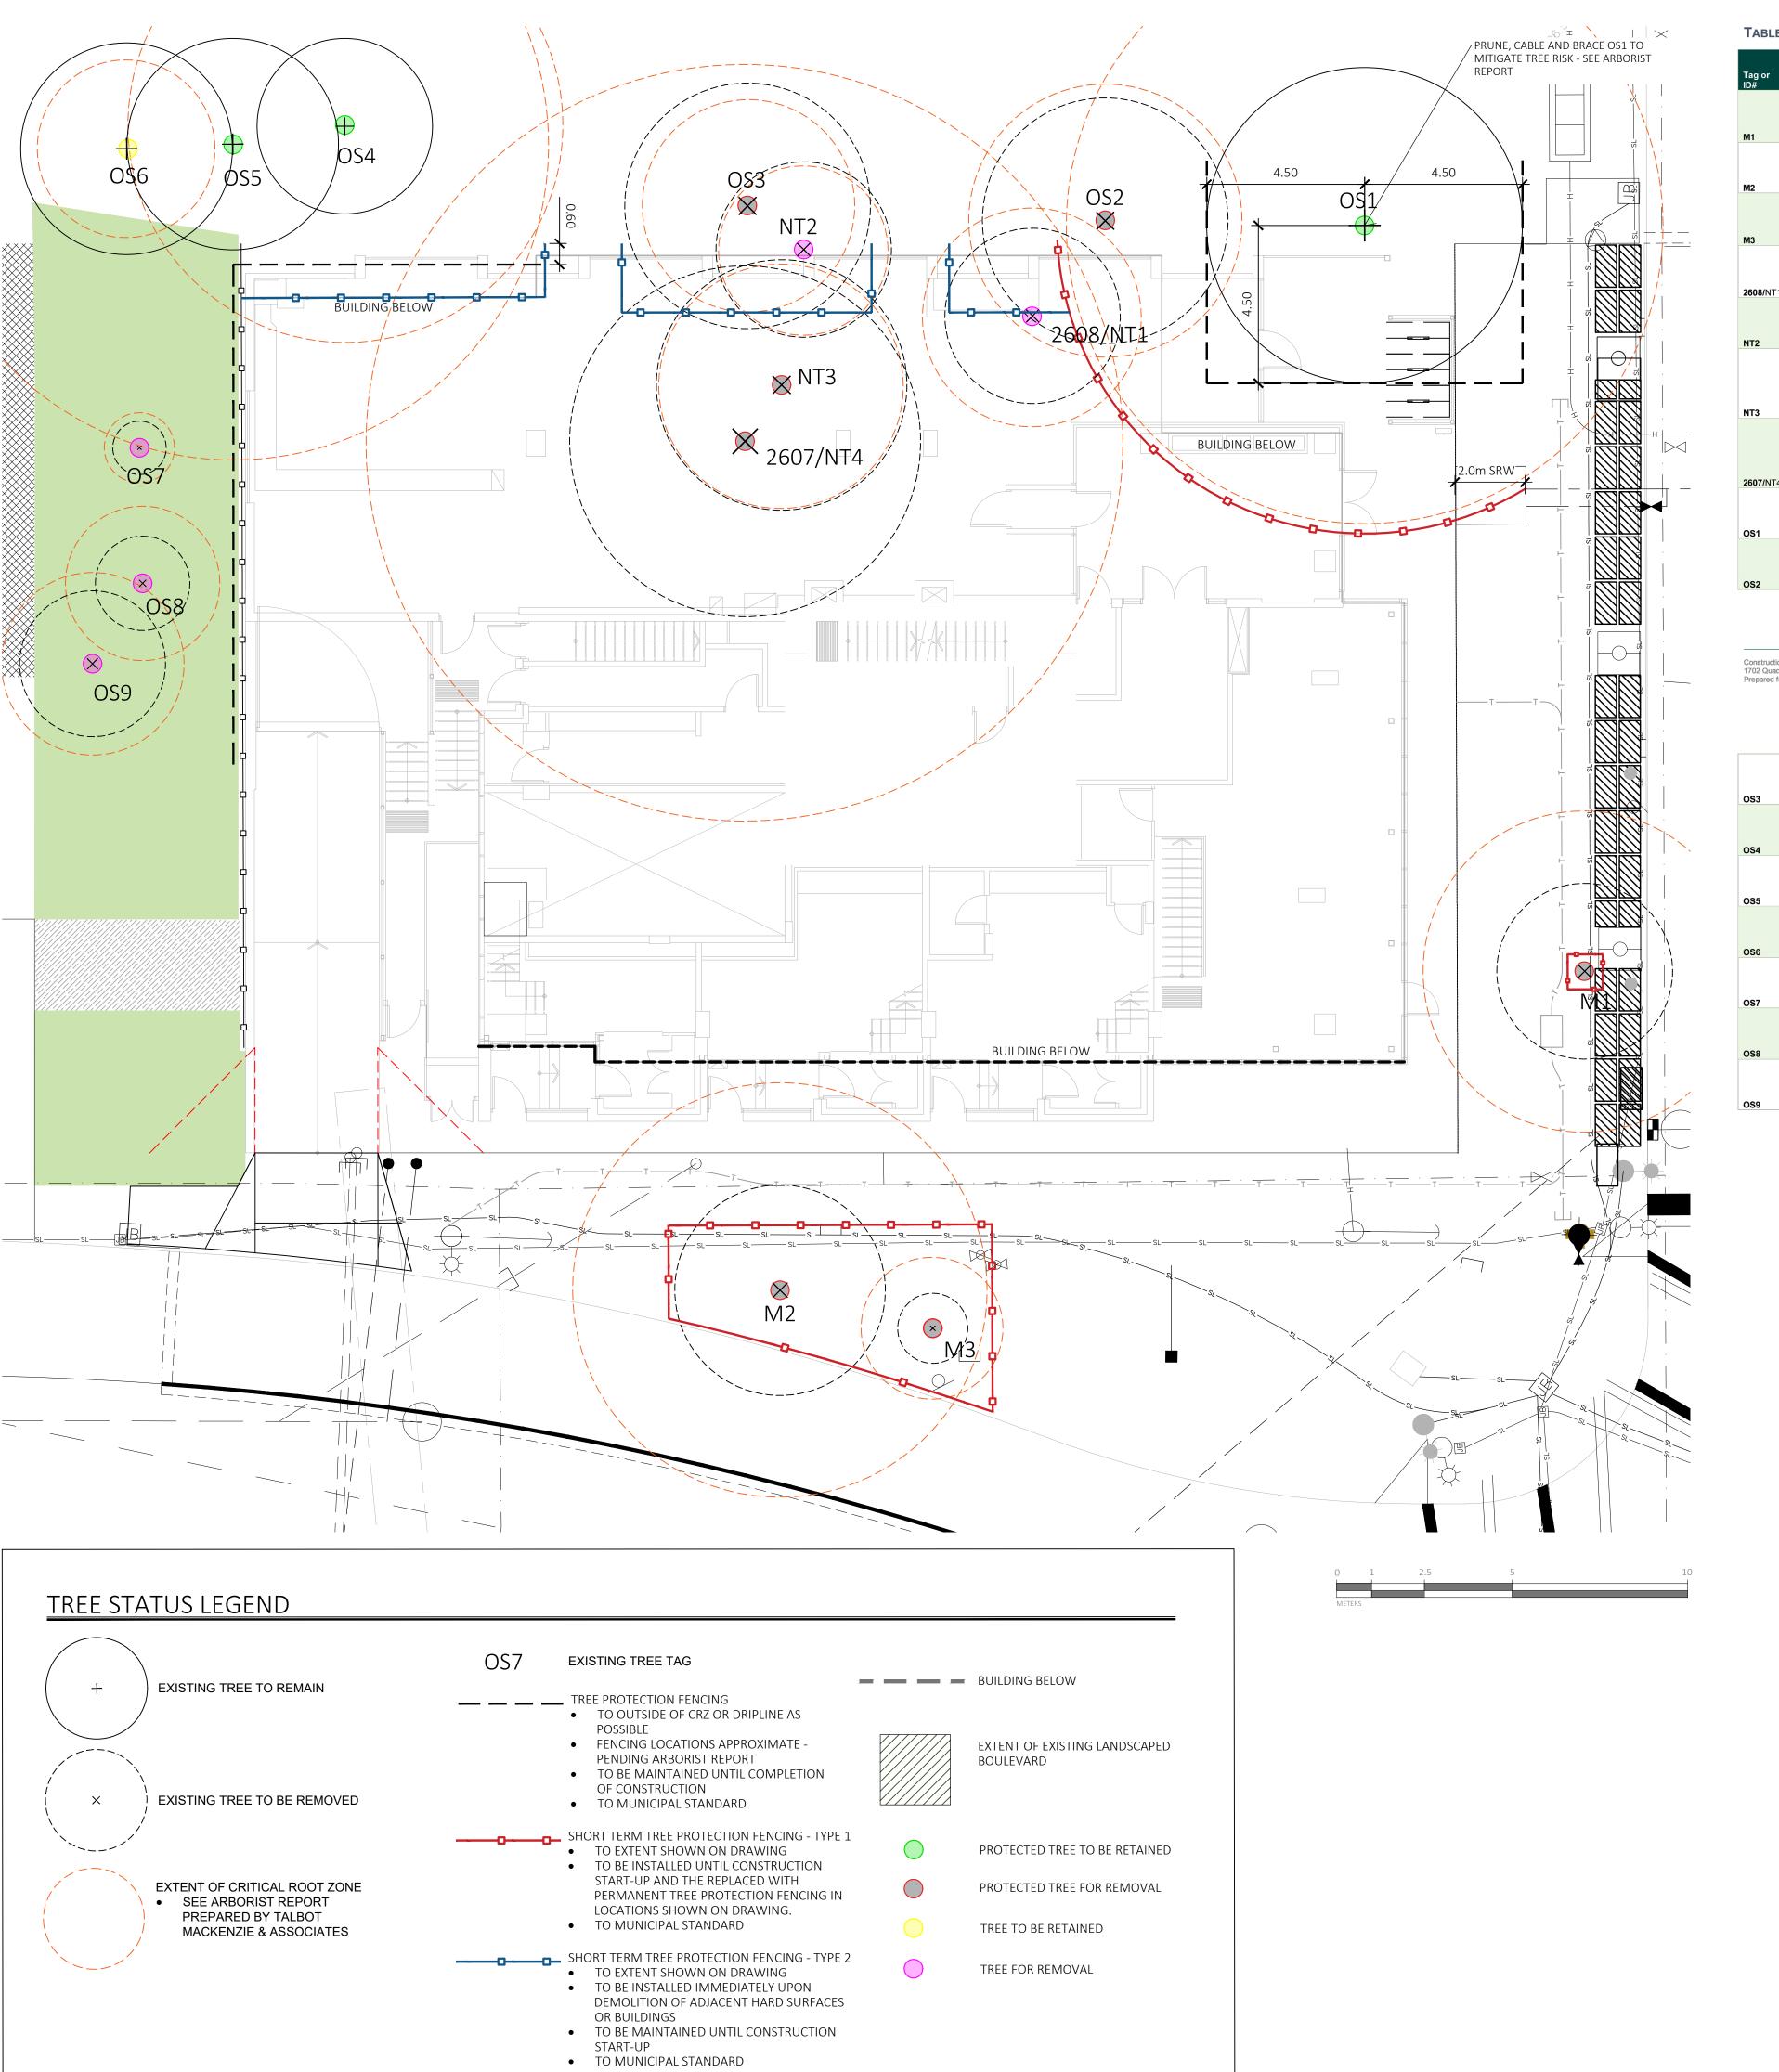


TABLE 1. TREE INVENTORY

		Location (On, Off,		Bylaw			Critical				Retention Suitability				
Tag or ID#	Surveyed? (Yes/No)	Shared, City)	protected? (Yes/No)	Common	Botanical	dbh (cm)	root zone radius (m)	diameter (m)	Health	Structural	(onsite trees)	Relative tolerance	General field observations/remarks	Tree retention / location comments	Retention status
M1	Yes	Municipal	Municipal	English Oak	Quercus robur	46	4.6	5	Fair	Fair	N/A	Good	Columnar form. Clearance pruned away from building.	Conflict with proposed underground hydro.	X
M2	Yes	Municipal	Municipal	Cut-leaf Beech	Fagus sylvatica 'Asplenifolia'	49 (below union)	5.9	6	Good	Fair	N/A	Poor	Measured at 1m. Hydro clearance pruned.	Conflict with proposed underground hydro.	x
M3	Yes	Municipal	Municipal	Deciduous Camellia	Stewartia pseudocamellia	4	1	1	Fair	Fair	N/A	Moderate	Juvenile tree. Weedwacker damage.	Frontage improvements.	X
2608/ NT1		On-site	No	Pear	Pyrus spp.	26	3.1	5	Fair	Fair	Unsuitable	Moderate	Topped. Gravel parking adjacent.	Within building footprint.	X
NT2	Yes	On-site	No	Ash	Fraxinus spp.	~18,10	2.4	5	Fair	Fair-poor	Unsuitable	Good	Located between fence and storage shed. Topped, epicormic growth.	Within building footprint.	X
													Located between storage shed and brick garage. Large seam up trunk, likely from past failure, decaying. Lowest limb actively failing,has been shortened, will rest on garage		
NT3	Yes	On-site	Yes	Ash Big-Leaf	Acer	90 (below	3.5	7	Fair-poor		Unsuitable	Good	Large deadwood/decay north canopy. Pruning stubs and deadwood in primary stem, response growth lower sem Large surface	Within building footprint.	X
2607/NT4	Yes	On-site Off-site	Yes	Maple Big-Leaf Maple	Acer macrophyllum	unions) ~50,35	8.5	9	Fair-poor	Fair-poor	Unsuitable N/A	Moderate Moderate	noots lifting surrounding asphalt. North neighbouring property. Codominant stems, narrow attachments. Previous thinning. Located against fence.	Within building footprint. Conflict with building footprint.	X Retain*
OS2	Yes	Off-site	Yes	Ash	Fraxinus spp.	~30,15	3.9	7	Fair	Fair	N/A	Good	North neighbouing property. Located against fence. Previous thinning and raising. Epicormic growth.	Conflict with building footprint.	x

Construction Impact Assessment and Tree Management Plan
1702 Quadra Street
Prepared for Aryze Developments
Page 4

						1					1				
OS3	Yes	Off-site	Yes (if estimate is correct)	Ash	Fraxinus spp.	~30	3	7	Fair	Fair	N/A	Good	North neighbouring property. Located against fence. Previously topped, epicormic growth, heavy seed crop.	Conflict with building footprint.	x
OS4	Yes	Off-site	Yes	Western Red Cedar	Thuja plicata	56	6	5	Good	Good	N/A	Poor	North neighbouring property.	Potential impacts from building footprint.	Retain*
OS5	Yes	Off-site	Yes	Western Red Cedar	Thuja plicata	60	9	6	Good	Good	N/A	Poor	North neighbouring property, active inclusion in secondary stem attachment.	Potential impacts from building footprint.	Retain*
OS6	Yes	Off-site	No	English Oak	Quercus robur	~25	2.5	6	Good	Fair	N/A	Good	North neighbouring property.	Possibly removed.	Retain
OS7	Yes	Off-site	No	Maidenhair Tree	Gingko biloba	~8	1	2	Good	Fair	N/A	Moderate	West neighbouring property.	,	Retain
OS8	Yes	Off-site	No	Maidenhair Tree	Gingko biloba	~18	2.2	3	Good	Fair	N/A	Moderate	West neighbouring property. Codominant top. Canopy beginning to encroach on driveway on subject property.		Retain
OS9	Yes	Off-site	No	Maidenhair Tree	Gingko biloba	~22	2.6	4	Good	Fair	N/A	Moderate	West neighbouring property. Codominant top. Canopy beginning to encroach on driveway on subject property.		Retain

8.4. TREE IMPACT SUMMARY TABLE

Pursuant to City of Victoria Tree Preservation Bylaw No. 21-035, the tree replacement calculations are as follows:

	Α	В	С	D	
Tree Status	Total # of	# Of Trees	# Of NEW or	# Of EXISTING	NET
	Protected	to be	REPLACEMENT	non-protected	CHANGE
	Trees	REMOVED	Trees to be	Trees Counted as	(A-B+C+D)
			Planted*	Replacements	
Onsite Trees	2	2	0	0	-2
Private Offsite Trees	5	2	2	0	0
Municipal Trees	3	3	6	N/A	3
Total	10	7	4	0	1

Figure 2—Tree Impact Summary Table: Based on bylaw criteria, a lot of this size (947.8m²) requires a 5-tree minimum onsite. Replacement tree/tree minimum requirements will be compensated cash-in-lieu, as there do not appear to be sufficient planting opportunities post-construction. The landscape plan shows the two (2) required Schedule E—Part 1 replacement trees for the neighbouring property at 877 North Park Street and six (6) replacement trees on the Quadra & Fisgard Street municipal boulevards.

NOTES:

- SEE THE CONSTRUCTION IMPACT ASSESSMENT AND TREE MANAGEMENT PLAN, APPENDIX B, PREPARED BY TALMAC, FOR TREE PRESERVATION SUMMARY.
- 2607 (NT4), 2608 (NT1), NT2, AND NT3 ARE PROPOSED FOR REMOVAL AT THE DEMOLITION PHASE.
 ARBORIST SUPERVISION IS REQUIRED AS IDENTIFIED IN THE CONSTRUCTION IMPACT ASSESSMENT



1608 Camosun Street, Victoria BC V8T 3E6 Info@biophiliacollective.ca 250 590 1156

PROJECT NAME:

THE ESTOYA

PROJECT ADDRESS:

1702 QUADRA STREET VICTORIA, BC

DESIGNED BY: BIANCA BODLEY DRAWN BY: KIM TANG

NO.	ISSUED FOR	YY\MM\DD
1	CIS PRESENTATION	12/07/2021
2	DEVELOPMENT PERMIT	12/22/2021
3	ADP MEETING	04/13/2022
4	REVISED AND RE-ISSUED FOR DP	2023/06/01
5	REVISED AND RE-ISSUED FOR DP	2023/09/21
6	REVISED AND RE-ISSUED FOR DP	2023/12/15
7	ISSUED FOR BP RESUBMISSION	2024/04/30
8	ISSUED FOR TENDER	2024/06/28
9	ISSUED FOR BP RESUBMISSION	2024/07/31
10	ISSUED FOR BP RESUBMISSION	2024/09/27
11	ISSUED FOR CONSTRUCTION	2024/10/25
12	ISSUED FOR BP RESUBMISSION	2024/12/19
13	RE-ISSUED FOR CONSTRUCTION	2025/01/22
14	RE-ISSUED FOR BP	2025/06/12
15	ISSUED FOR DDP	2025/07/22



NORTH ARROW


DRAWING TITLE:

TREE REMOVAL & PROTECTION PLAN

DWG NO:

LO

SCALE: 1:100

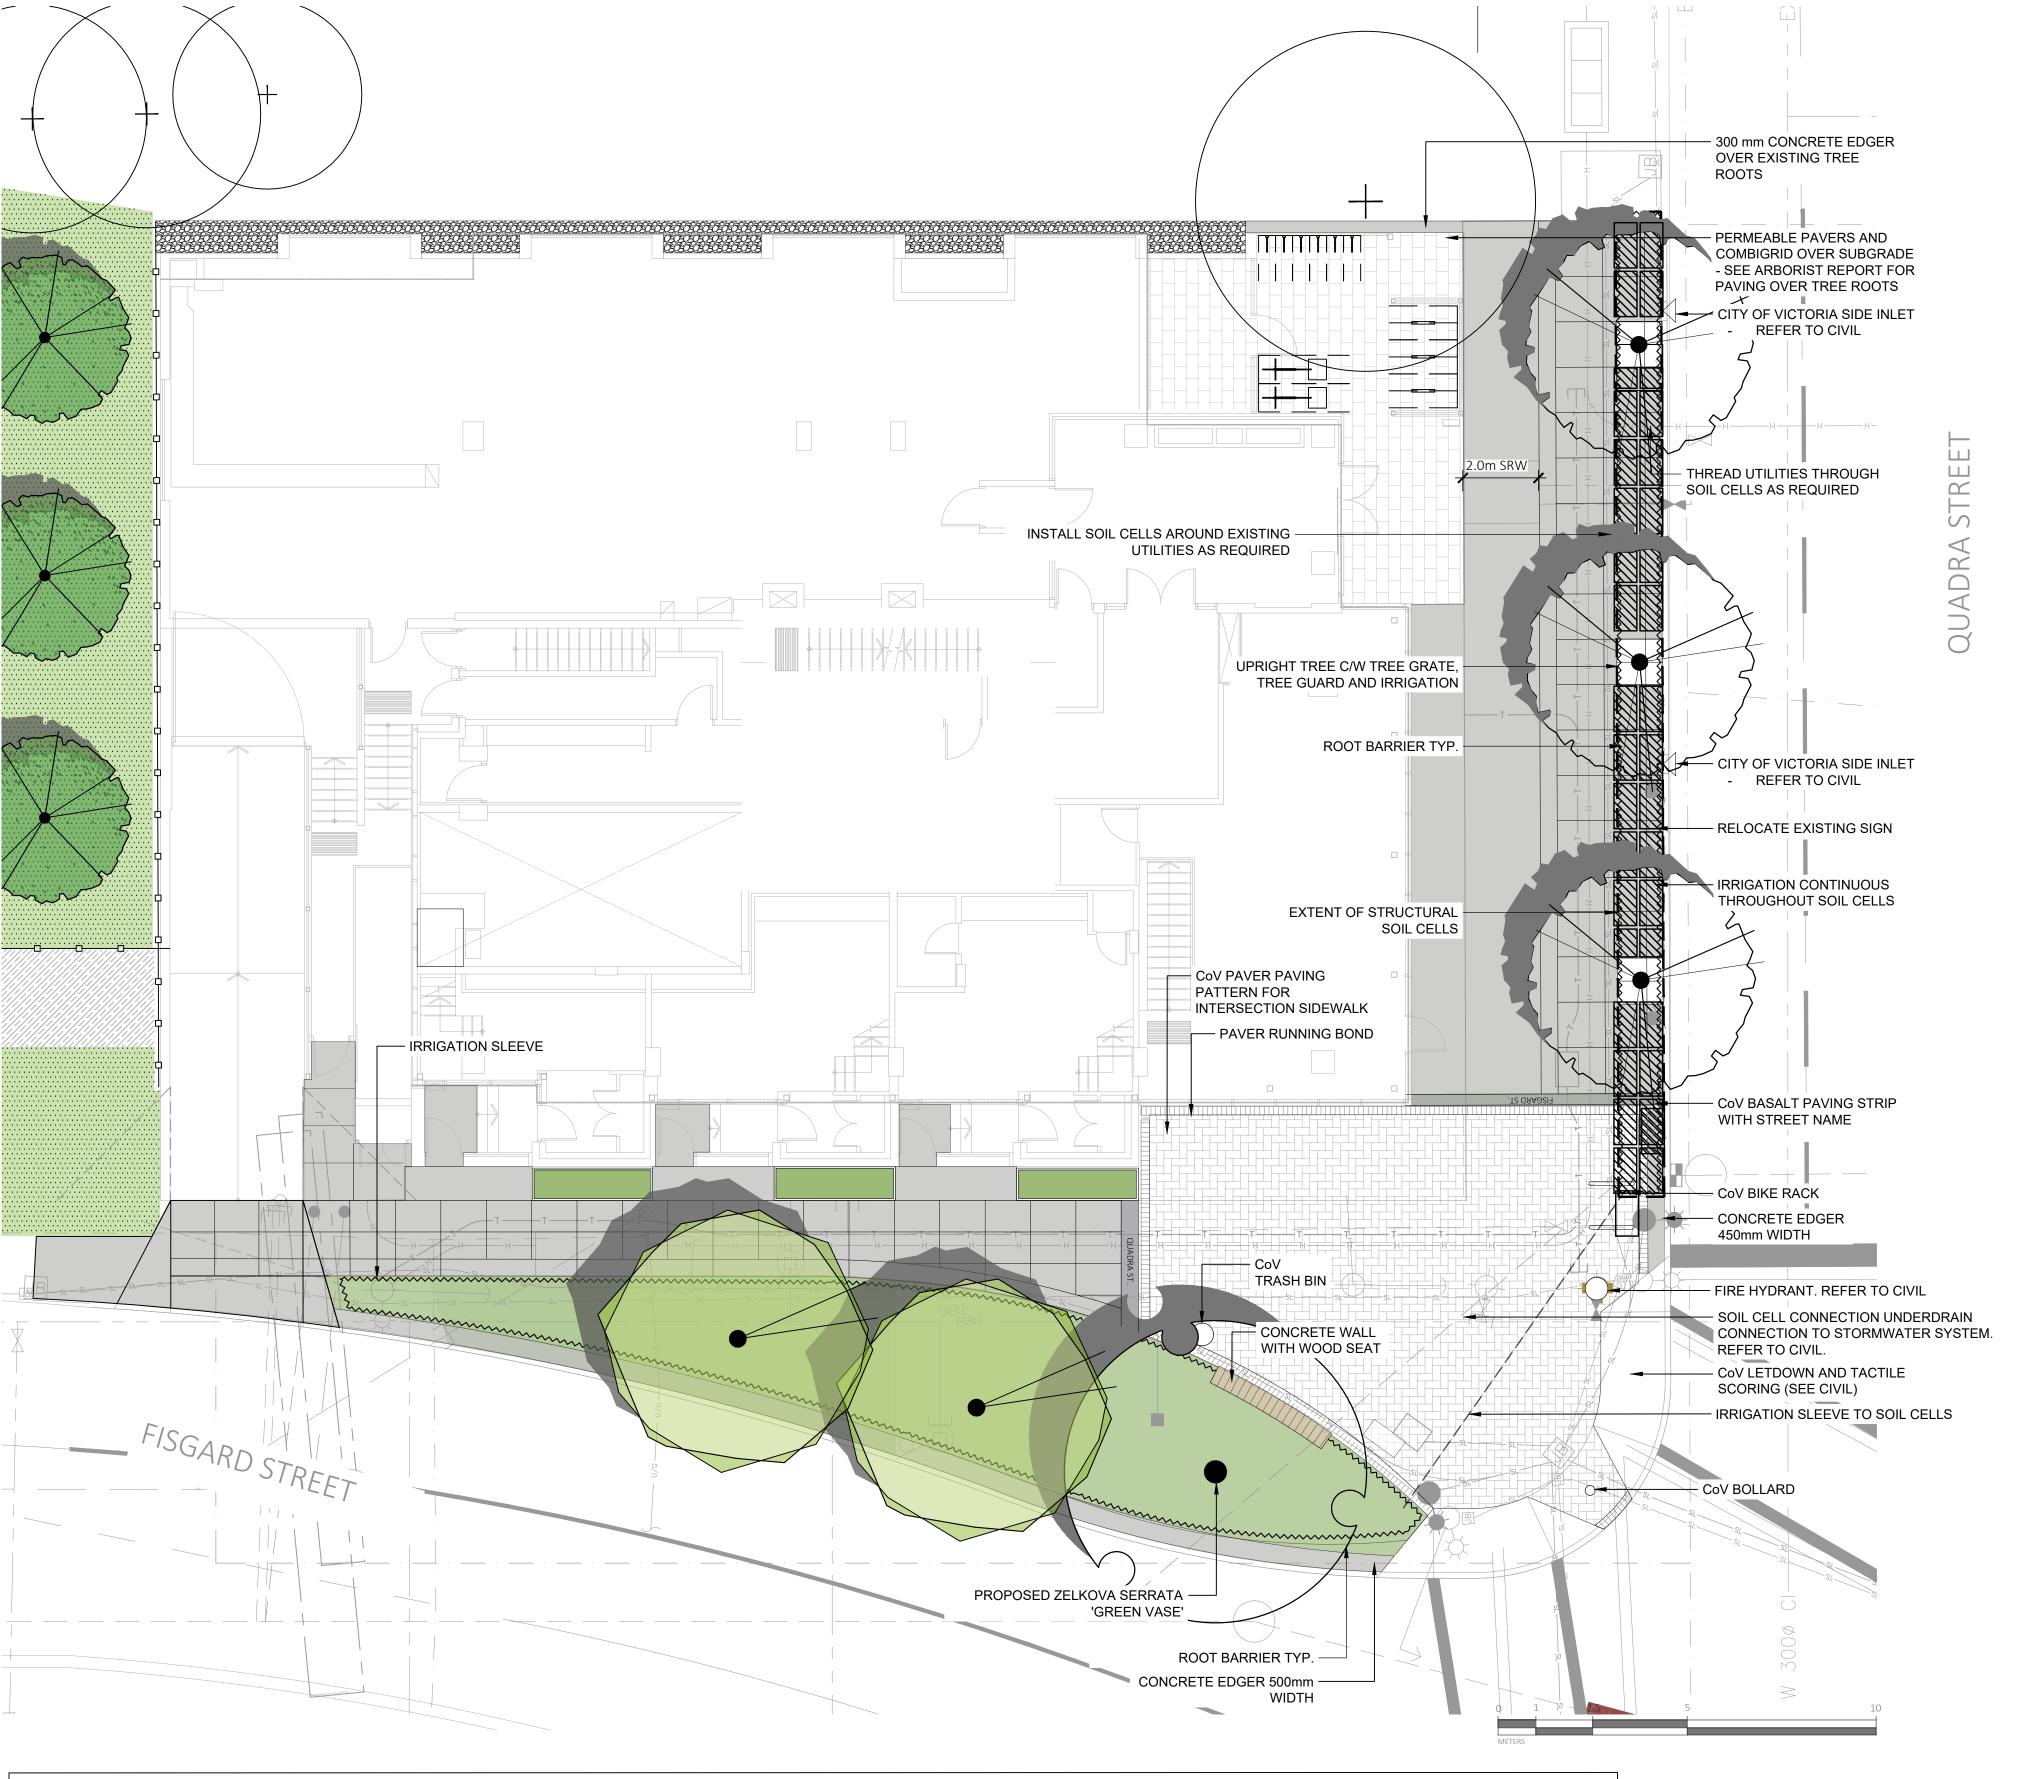

PROPERTY LINE

2.0m WIDTH ON QUADRA STREET

LINE OF FOUNDATIONS

CONCRETE SIDEWALK

 TO CITY OF VICTORIA 'NEW TOWN' DESIGN GUIDELINE STANDARDS SAW CUT JOINTING PATTERN

LIGHT BROOM FINISH

SIDEWALK INTERSECTION PAVING TO CITY OF VICTORIA 'NEW TOWN' DESIGN


GUIDELINE STANDARDS ABBOTSFORD CONCRETE; NATURAL GREY


 PLACED ON SAND BED POLYMERIC SAND JOINTS

SIDEWALK STREET NAME PAVING

MORTAR SET

 TO CITY OF VICTORIA 'NEW TOWN' DESIGN GUIDELINE STANDARDS BASALT PAVING STRIP WITH STREET NAME

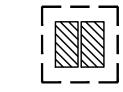

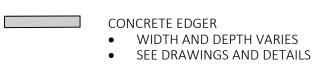

 SEE DRAWINGS AND DETAILS BASALT PAVER BANDING

 450 - 500mm WIDTH - AS NOTED MORTAR SET

ACCENT PAVING


 PERMEABLE PAVER ON COMBIGRID OVER SUBGRADE BELGARD AQUALINE PERMEABLE PAVER

COLOUR: NATURAL

GRAVEL MAINTENANCE STRIP 300mm DEPTH RIVER ROCK ALUMINIUM EDGER

IRRIGATION



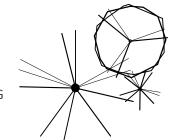



PLANTING BED (55m²)

MEDIUM (CLS)

ON-SITE PLANTING BED


MEDIUM (BCLS)

ROOT BARRIER

• 50 mm DEPTH MULCH

• 700mm DEPTH 1L GROWING

450mm DEPTH 1L GROWING

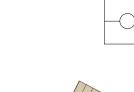



6' HT BLACK METAL FENCING

MUNICIPAL SITE FURNITURE

BOLLARD (2)

TRASH BIN (1)

BIKE RACK (2)

TREE GRATE (3)

• TREE GUARD (3)

ALONG WEST PROPERTY LINE

IRRIGATION

- ALL AT-GRADE LANDSCAPE BEDS AND ROOFTOP PLANTERS TO BE IRRIGATED WITH AN AUTOMATIC IRRIGATION SYSTEM.
- DETAILED IRRIGATION PLAN TO BE SUBMITTED TO PARKS FOR REVIEW A MINIMUM OF 30
- DAYS PRIOR TO INSTALLATION.
- ALL IRRIGATION DESIGNS AND INSTALLATIONS SHALL MEET THE MINIMUM STANDARDS OF THE IRRIGATION INDUSTRY ASSOCIATION OF B.C. (IIABC).

• SEE IRRIGATION PLANS, DETAILS AND WRITTEN SPECIFICATIONS.

- MUNICIPAL PLANTING BED AND STREET TREES TO BE IRRIGATED BY A SEPARATE SYSTEM FROM A SEPARATE CITY SOURCE CONFORMING TO THE CITY OF VICTORIA SUPPLEMENTARY SPECIFICATIONS FOR STREET TREES AND IRRIGATION SCHEDULE C TO BYLAW 12-042, SUBDIVISION BYLAW.
- IRRIGATION DESIGN DRAWINGS MUST BE SENT TO PARKS FOR REVIEW 30 DAYS PRIOR TO
- INSTALLATION. DRAWINGS SHOULD INDICATE ALL COMPONENTS, MODELS AND MATERIALS FROM WATER SUPPLY TO IRRIGATION HEADS.
- THE CITY WILL REQUIRE 4 INSPECTIONS FOR IRRIGATION INSTALLATION:
- 1)SLEEVING,
- 2) OPEN TRENCH MAINLINE AND PRESSURE TEST,
- 3) OPEN TRENCH AND LATERAL LINE,
- 4) OPERATION AND COVERAGE, AND
- 5) BACKFLOW PREVENTER ASSEMBLY TEST REPORT

MUNICIPAL BOULEVARD TREES

- TREES MUST HAVE ONE DOMINANT CENTRAL LEADER OR SINGLE STRAIGHT TRUNK, 5-8 cm DIAMETER, CALIPER MEASURED 15 cm ABOVE GROUND, WELL BALANCED CROWN WITH BRANCHING STARTING AT 1.8m-2.5m ABOVE GROUND
- TREES TO BE PLANTED AS PER PLANTIG OF TREES, SHRUBS AND GROUND COVERS (32 93 01 MMCD 2009 AND CITY OF VICTORIA SUPPLEMENTAL DRAWINGS SD P3 AND SD P4)
- PARKS WILL REQUIRE (3) INSPECTIONS FOR TREE PLANTING: 1) INSPECTION OF SOIL AND PLANTING AREA,
- 2) INSPECTION OF STOCK UPON DELIVERY, AND
- 3) INSPECTION OF INSTALLED TREE WITH MULCH AND STAKING. TRUNK FLARE MUST BE VISIBLE AND PLANTED AT OR SLIGHTLY ABOVE GRADE UPON INSPECTION
- THE APPLICANT IS RESPONSIBLE FOR PROCURING AND PLANTING THE PROPOSED
- BOULEVARD TREES.
- THE APPLICANT MUST MAINTAIN THE TREE IN GOOD HEALTH AND STRUCTURAL CONDITION FOR 1 YEAR FROM THE SUBSTANTIAL COMPLETION TO BE ELIGIBLE FOR DEPOSIT RETURN.

PRE-CONSTRUCTION MEETING

 PARKS REQUIRES A PRE-CONSTRUCTION MEETING TO BE HELD PRIOR TO COMMENCEMENT OF CONSTRUCTING THE FRONTAGE WORKS



1608 Camosun Street, Victoria BC V8T 3E6 Info@biophiliacollective.ca 250 590 1156


PROJECT NAME:

THE ESTOYA

PROJECT ADDRESS:

1702 QUADRA STREET VICTORIA, BC

DESIGNED BY: BIANCA BODLEY DRAWN BY: KIM TANG

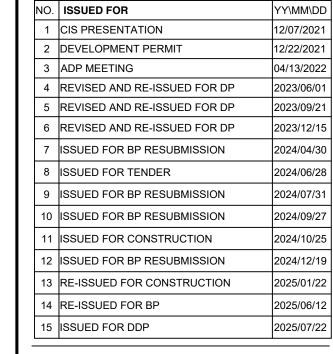





NORTH ARROW





DRAWING TITLE:

LANDSCAPE SITE PLAN

DWG NO:

SCALE: 1:100

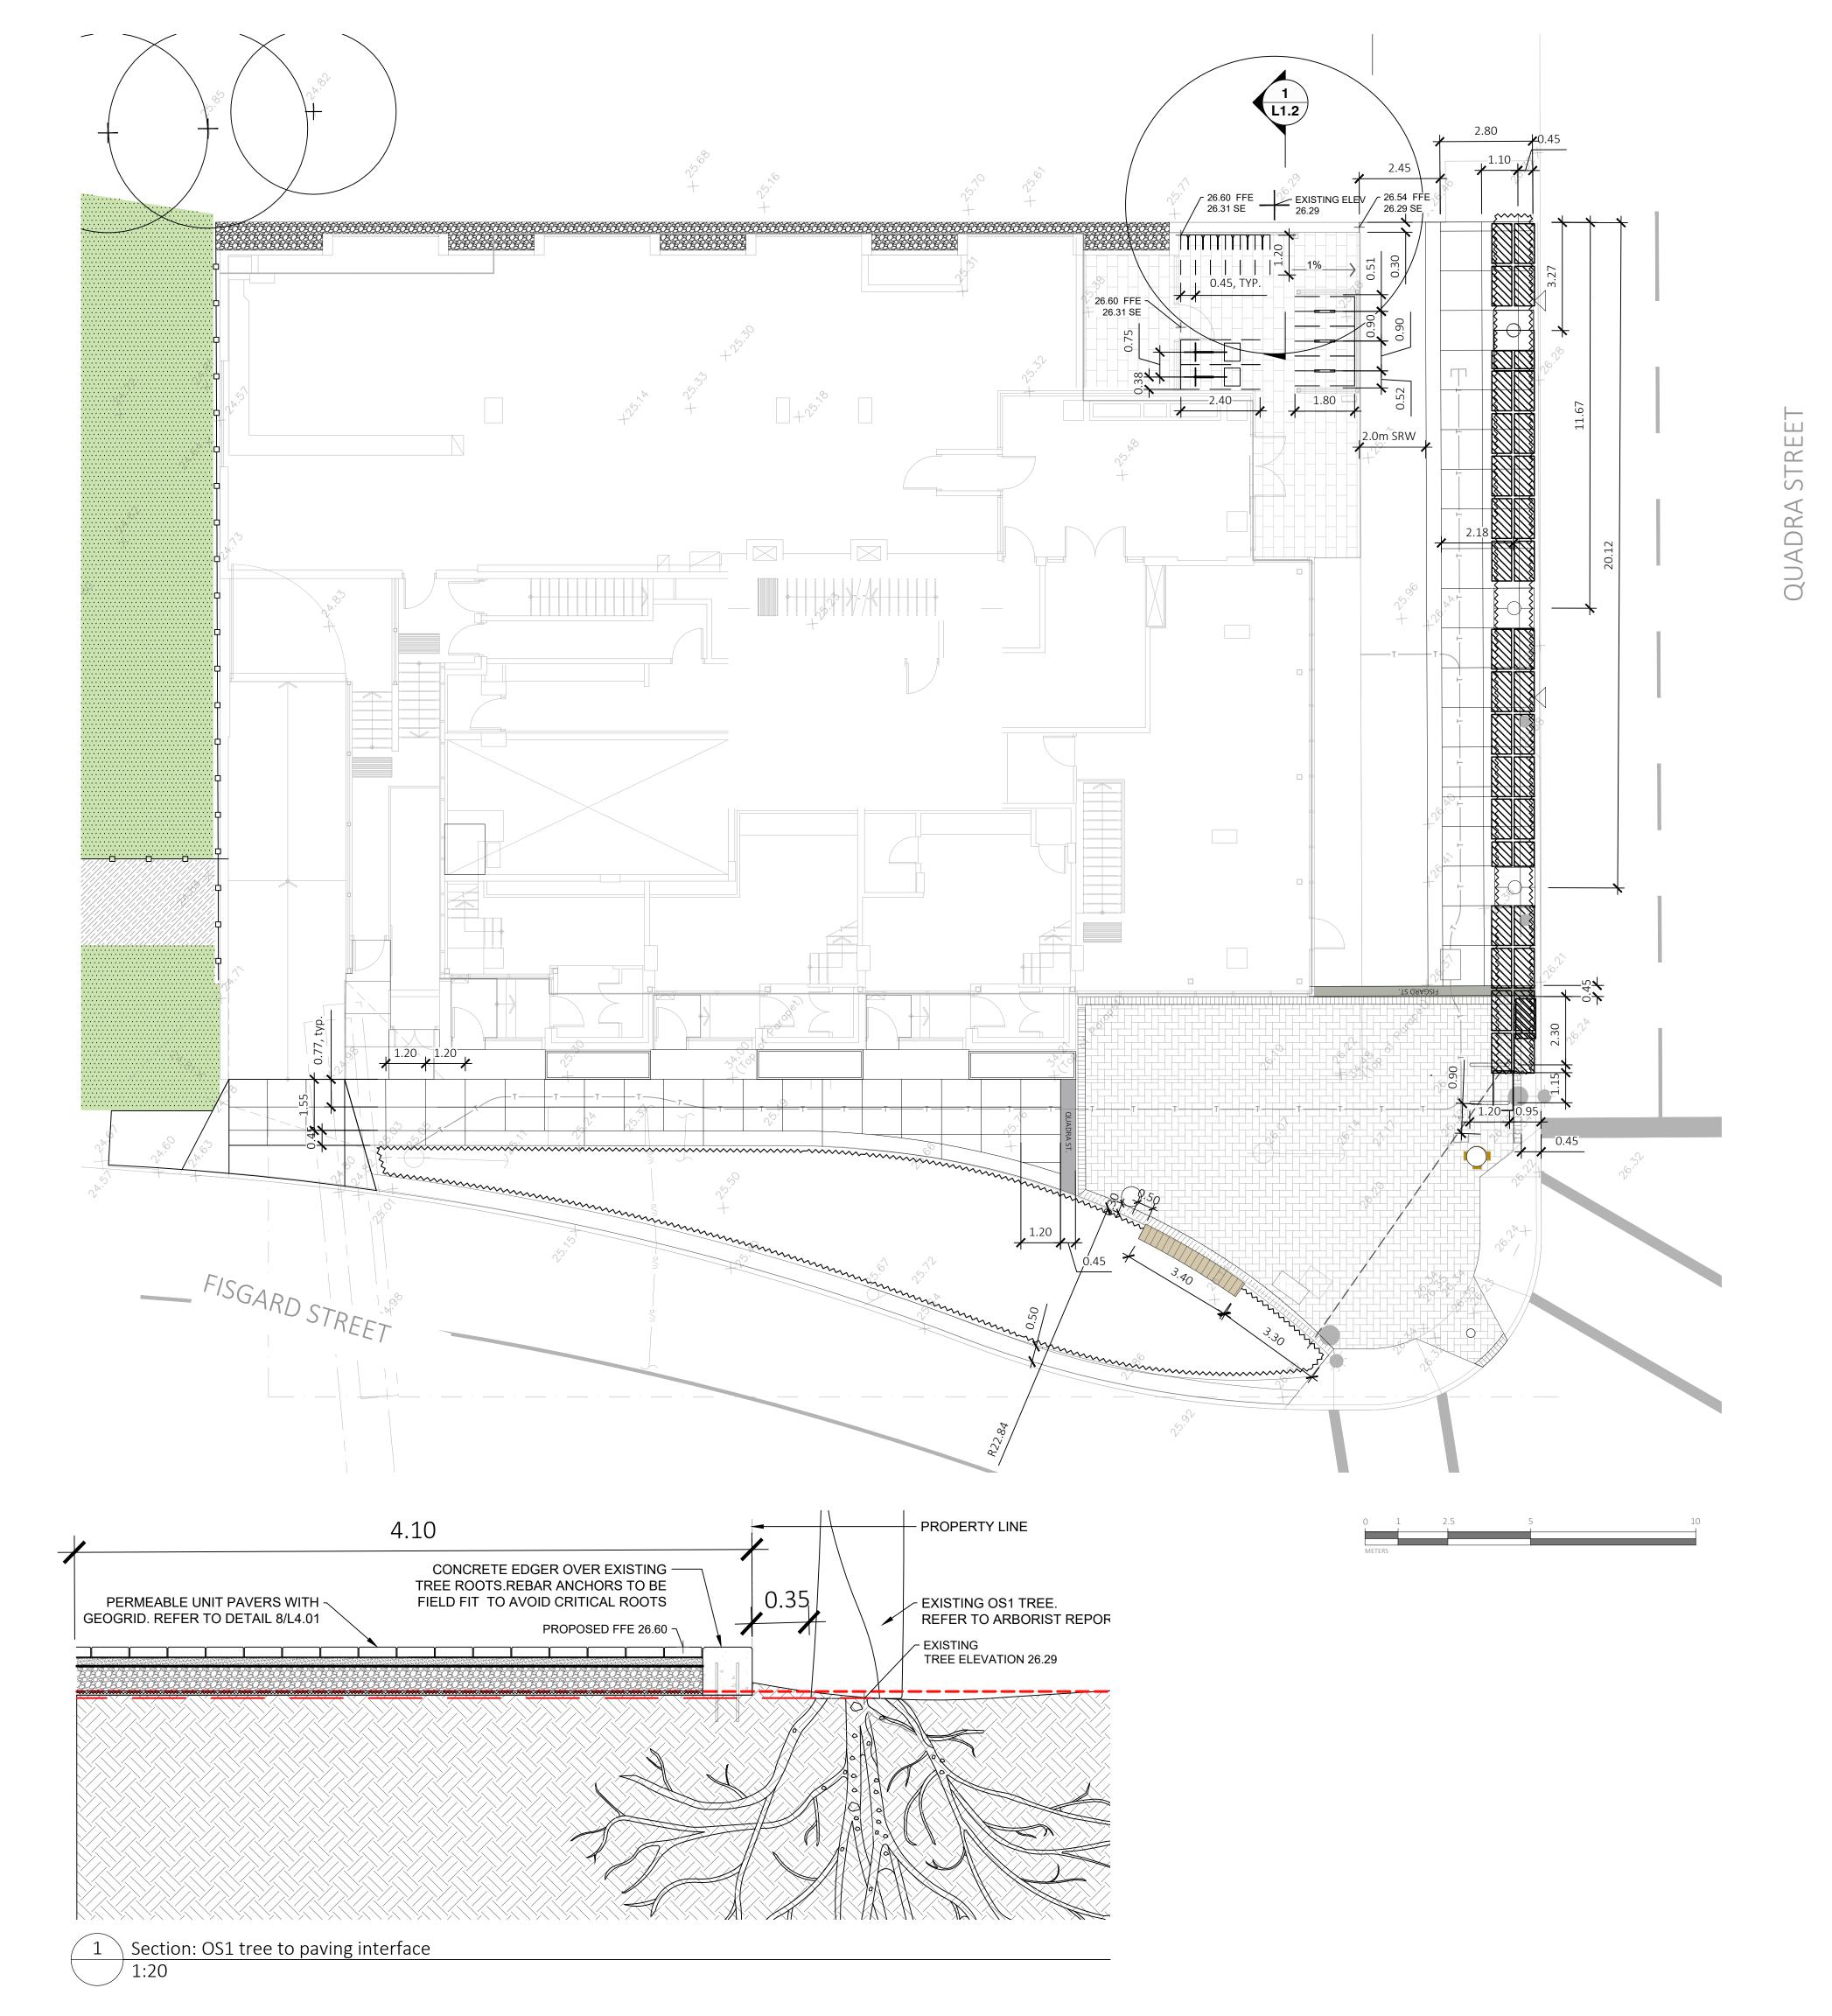

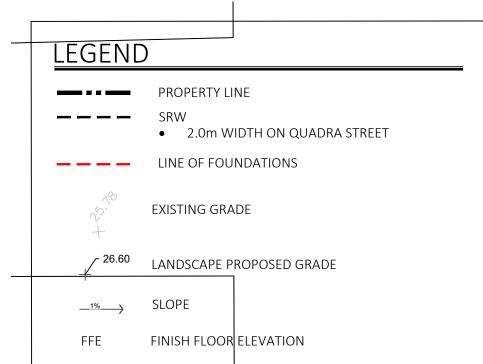

1608 Camosun Street, Victoria BC V8T 3E6 Info@biophiliacollective.ca 250 590 1156

PROJECT NAME:

THE ESTOYA

PROJECT ADDRESS:

1702 QUADRA STREET VICTORIA, BC

DESIGNED BY: BIANCA BODLEY DRAWN BY: KIM TANG

NO.	ISSUED FOR	YY\MM\DD
1	CIS PRESENTATION	12/07/2021
2	DEVELOPMENT PERMIT	12/22/2021
3	ADP MEETING	04/13/2022
4	REVISED AND RE-ISSUED FOR DP	2023/06/01
5	REVISED AND RE-ISSUED FOR DP	2023/09/21
6	REVISED AND RE-ISSUED FOR DP	2023/12/15
7	ISSUED FOR BP RESUBMISSION	2024/04/30
8	ISSUED FOR TENDER	2024/06/28
9	ISSUED FOR BP RESUBMISSION	2024/07/31
10	ISSUED FOR BP RESUBMISSION	2024/09/27
11	ISSUED FOR CONSTRUCTION	2024/10/25
12	ISSUED FOR BP RESUBMISSION	2024/12/19
13	RE-ISSUED FOR CONSTRUCTION	2025/01/22
14	RE-ISSUED FOR BP	2025/06/12
15	ISSUED FOR DDP	2025/07/22





NORTH ARROW


DRAWING TITLE:

LAYOUT AND GRADING PLAN

DWG NO:

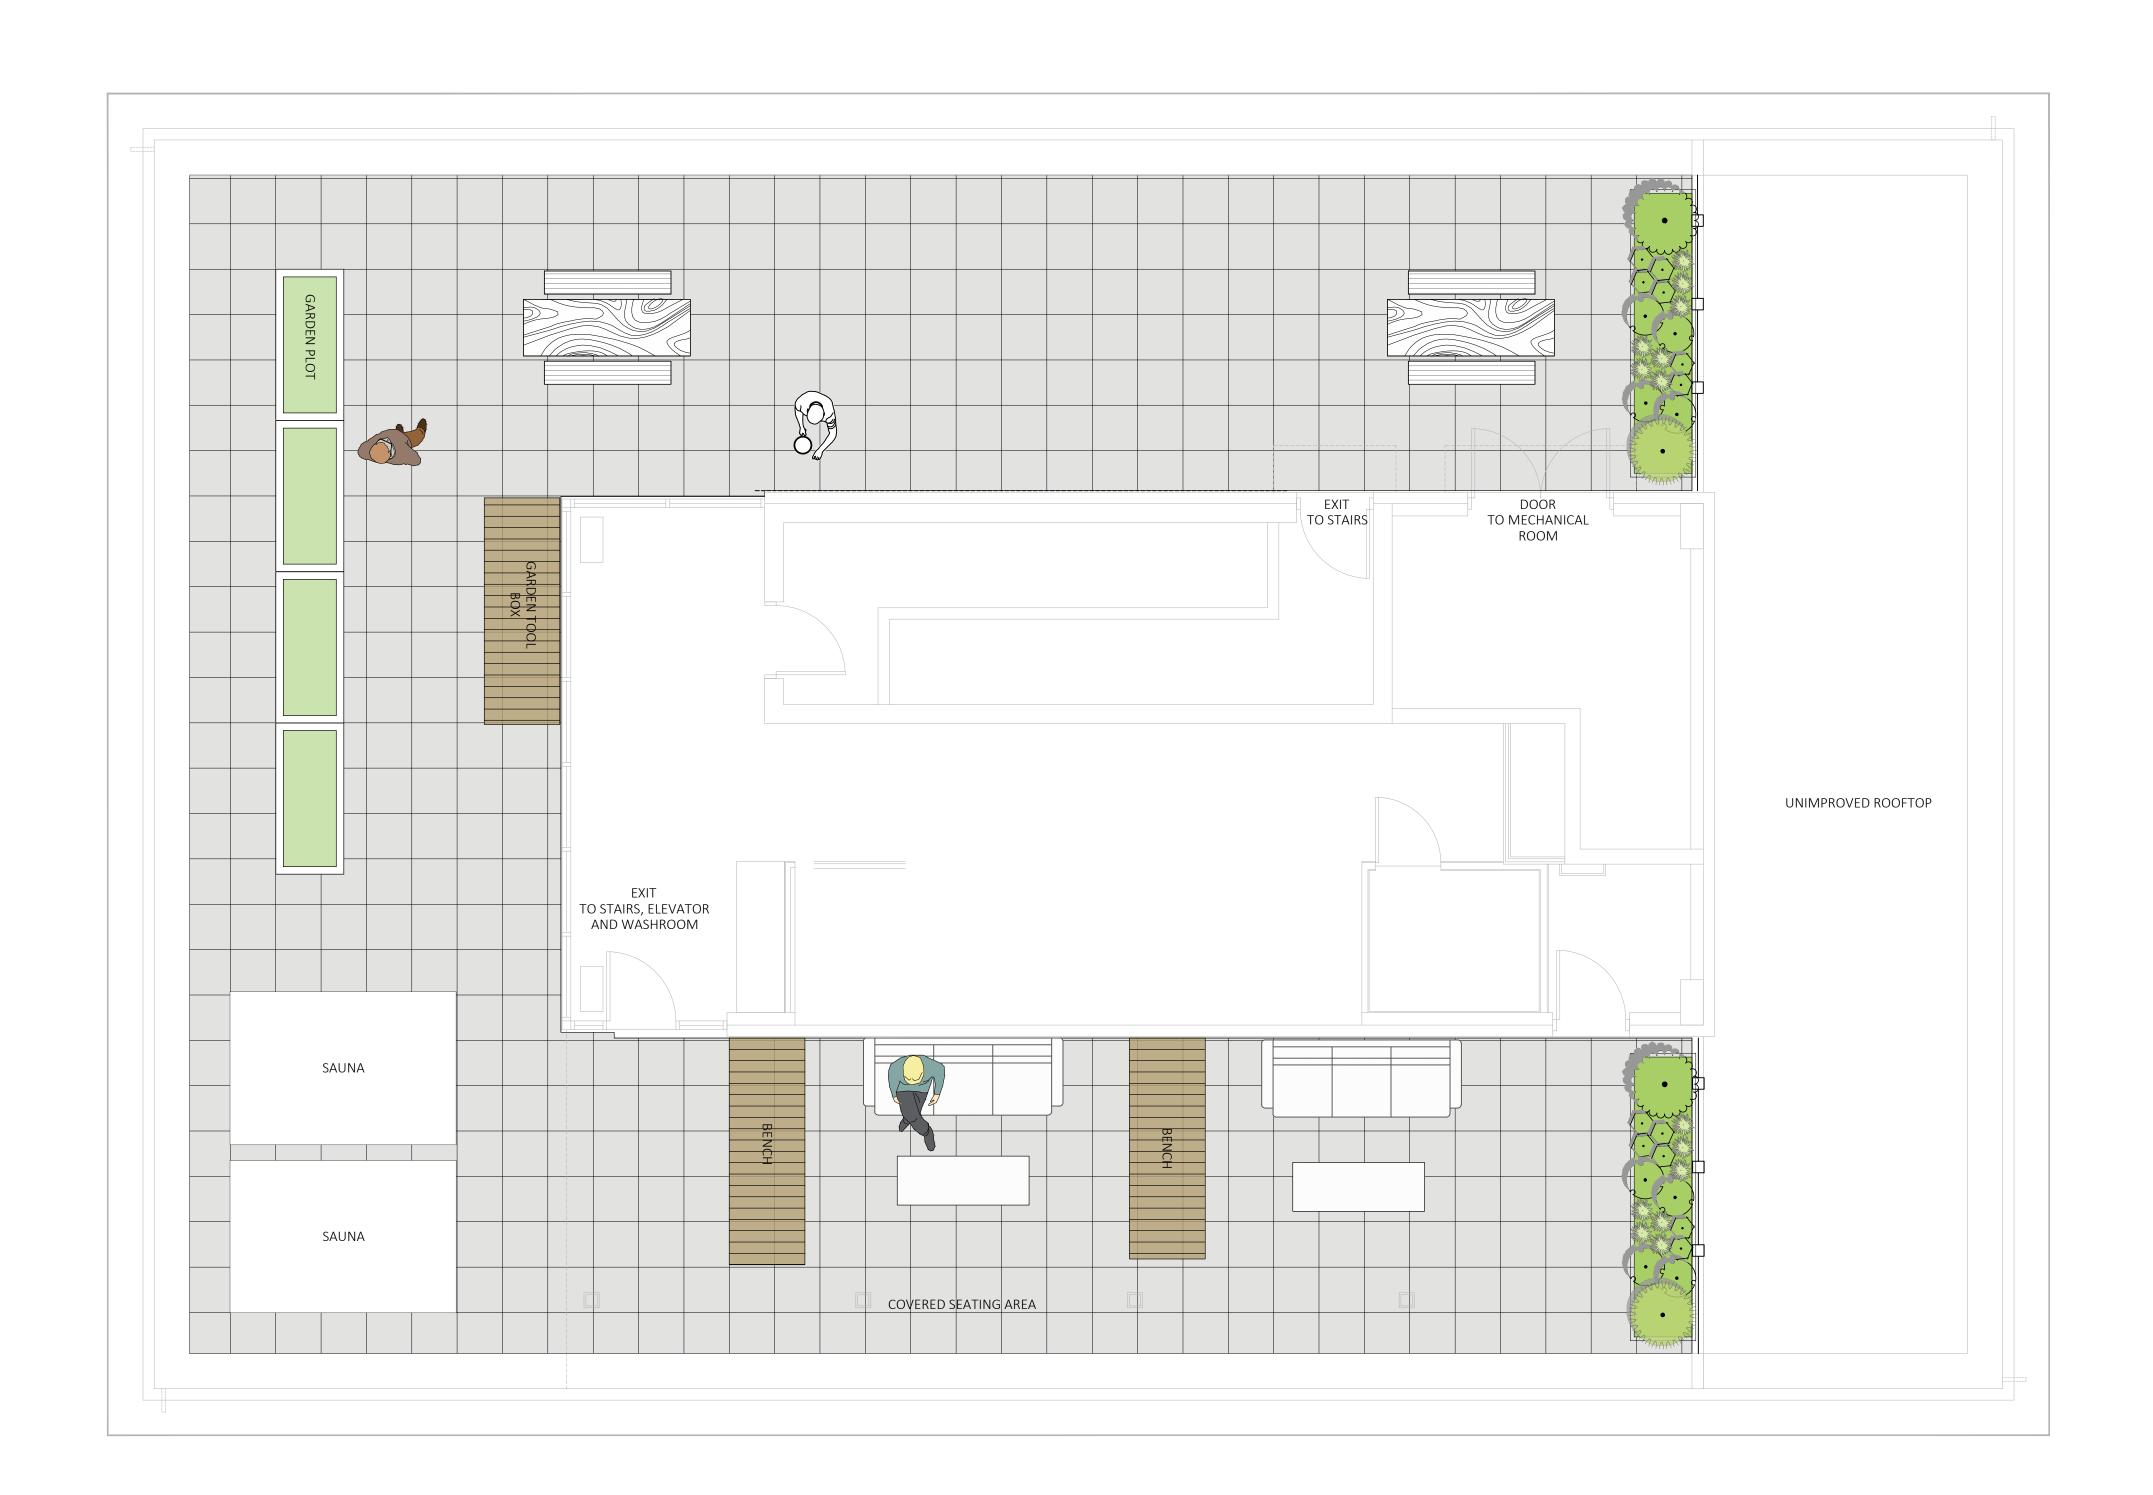

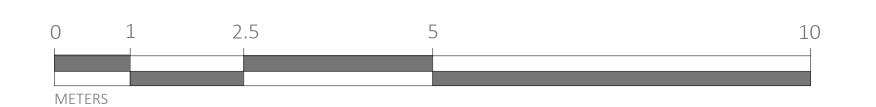

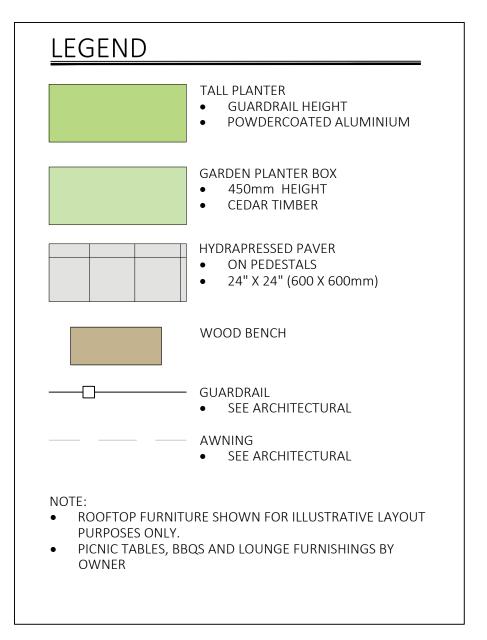



1608 Camosun Street, Victoria BC V8T 3E6 Info@biophiliacollective.ca 250 590 1156

PROJECT NAME:

THE ESTOYA

PROJECT ADDRESS:

1702 QUADRA STREET VICTORIA, BC

DESIGNED BY: BIANCA BODLEY DRAWN BY: KIM TANG


NO.	ISSUED FOR	YY\MM\DD
1	CIS PRESENTATION	12/07/2021
2	DEVELOPMENT PERMIT	12/22/2021
3	ADP MEETING	04/13/2022
4	REVISED AND RE-ISSUED FOR DP	2023/06/01
5	REVISED AND RE-ISSUED FOR DP	2023/09/21
6	REVISED AND RE-ISSUED FOR DP	2023/12/15
7	ISSUED FOR BP RESUBMISSION	2024/04/30
8	ISSUED FOR TENDER	2024/06/28
9	ISSUED FOR BP RESUBMISSION	2024/07/31
10	ISSUED FOR BP RESUBMISSION	2024/09/27
11	ISSUED FOR CONSTRUCTION	2024/10/25
12	ISSUED FOR BP RESUBMISSION	2024/12/19
13	RE-ISSUED FOR CONSTRUCTION	2025/01/22
14	RE-ISSUED FOR BP	2025/06/12
15	ISSUED FOR DDP	2025/07/22






DRAWING TITLE:

SITE PLAN - ROOFTOP AMENITY

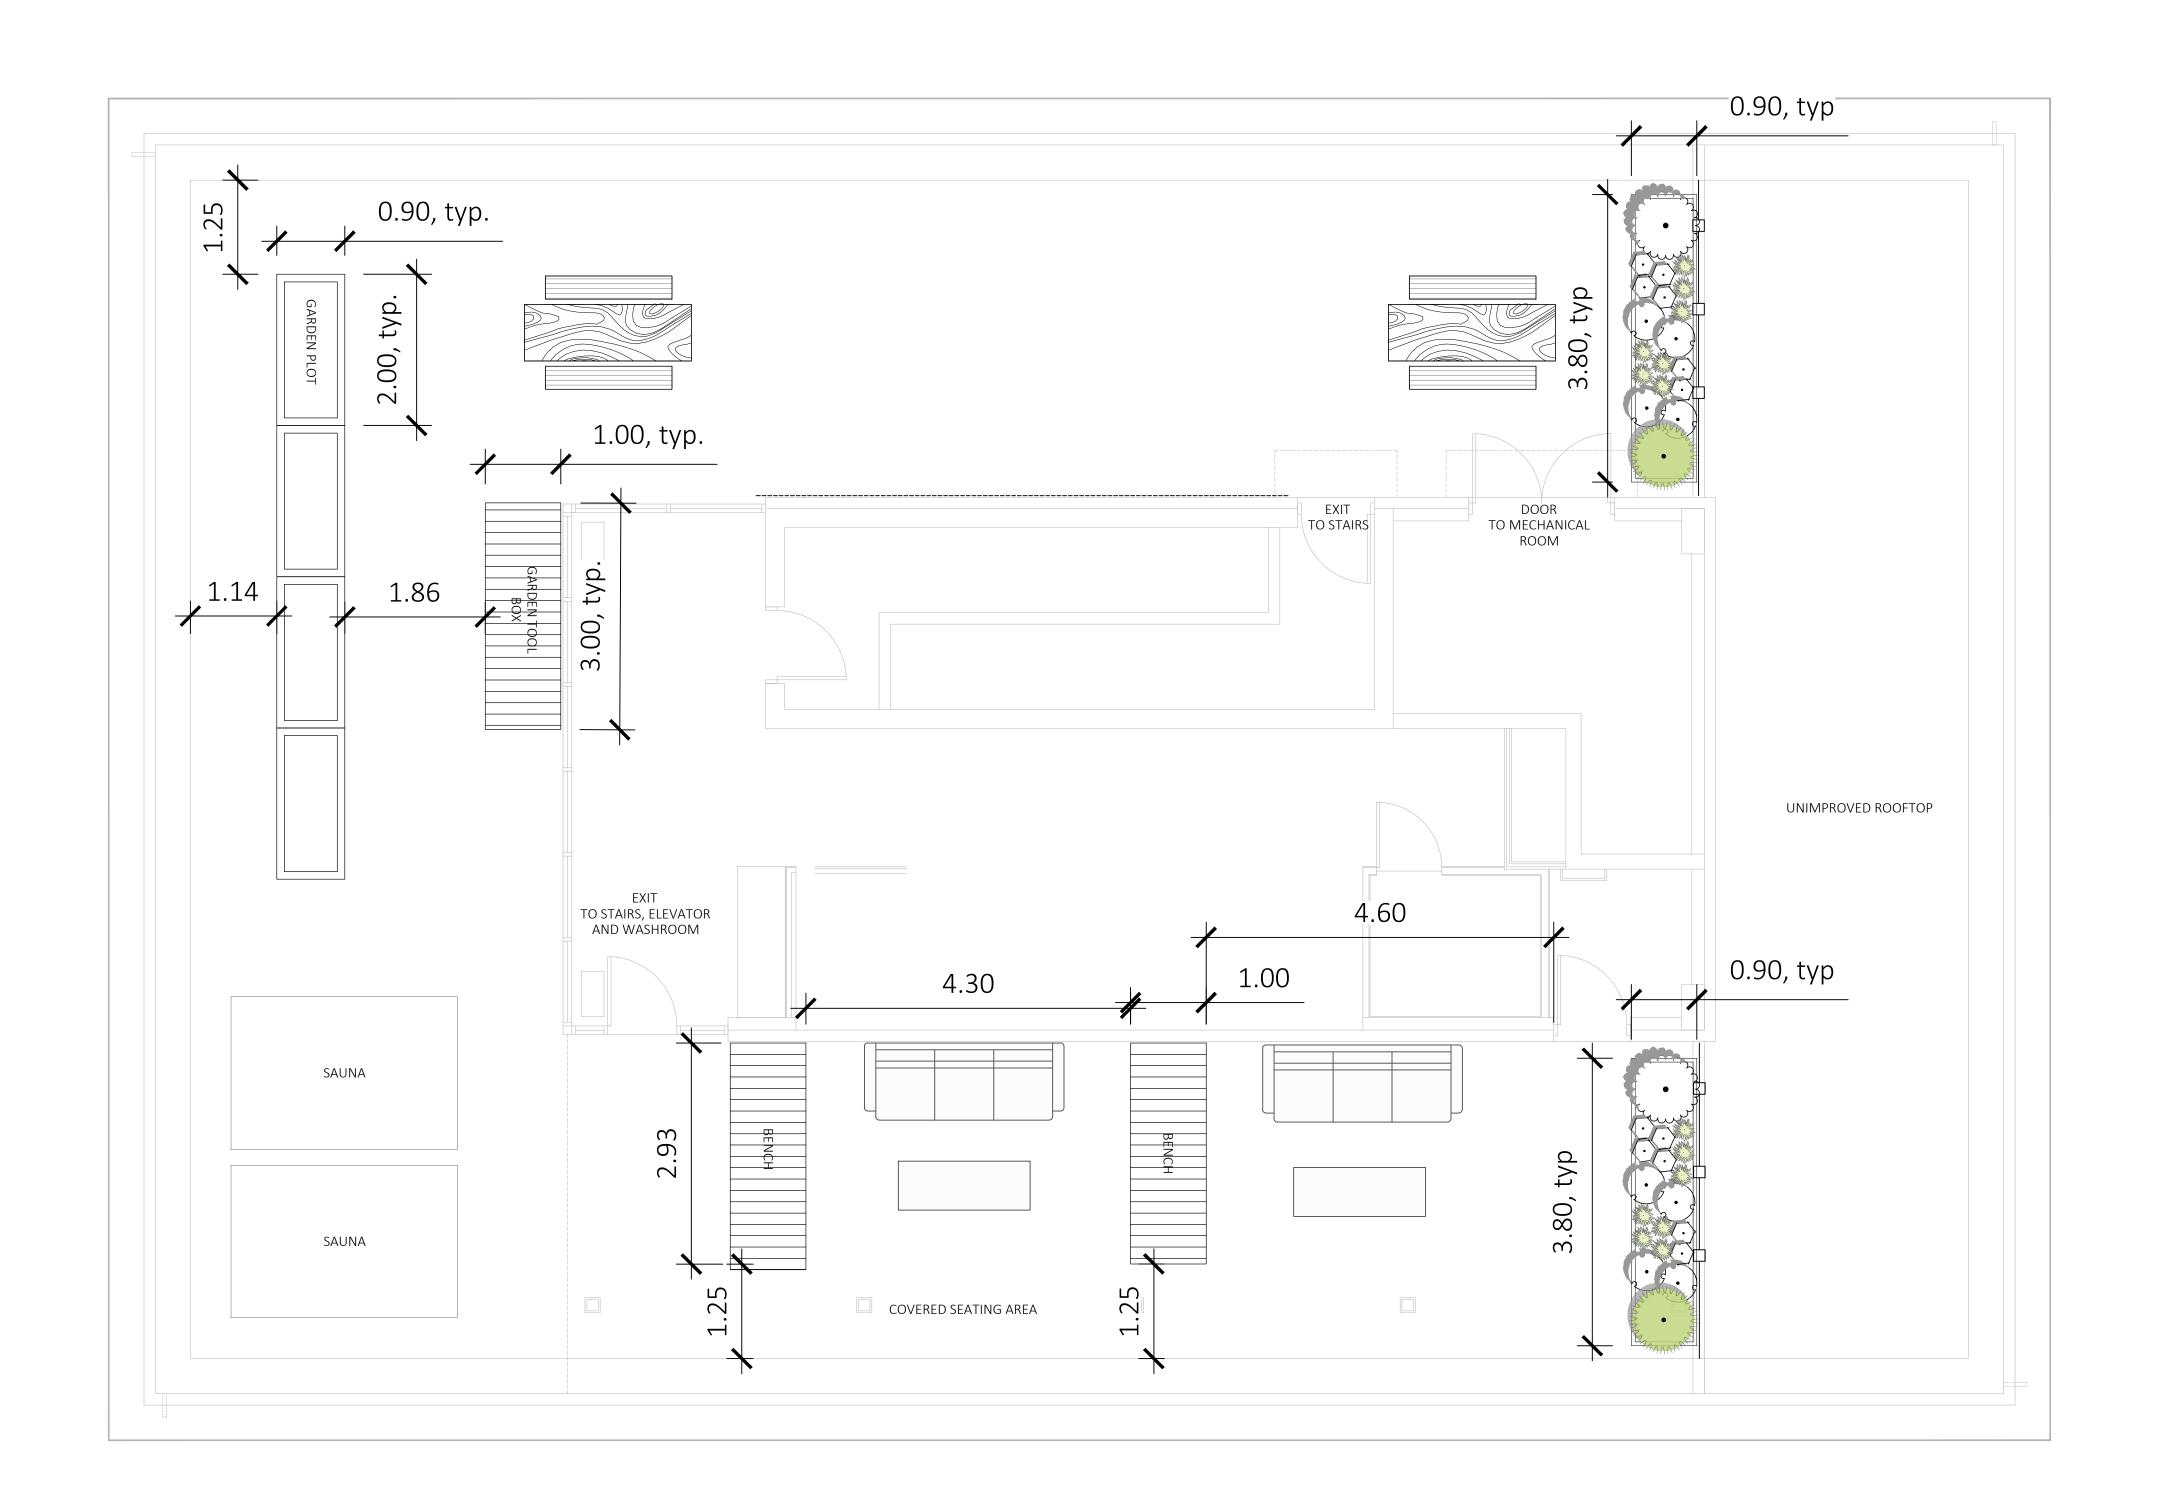

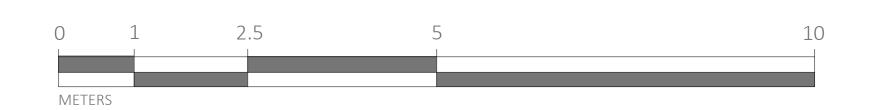



1608 Camosun Street, Victoria BC V8T 3E6 Info@biophiliacollective.ca 250 590 1156

PROJECT NAME:

THE ESTOYA

PROJECT ADDRESS: 1702 QUADRA STREET VICTORIA, BC

DESIGNED BY: BIANCA BODLEY DRAWN BY: KIM TANG

INO.	1990ED FOR	טוווווון ז ז ן
1	CIS PRESENTATION	12/07/202
2	DEVELOPMENT PERMIT	12/22/202
3	ADP MEETING	04/13/202
4	REVISED AND RE-ISSUED FOR DP	2023/06/0
5	REVISED AND RE-ISSUED FOR DP	2023/09/2
6	REVISED AND RE-ISSUED FOR DP	2023/12/1
7	ISSUED FOR BP RESUBMISSION	2024/04/3
8	ISSUED FOR TENDER	2024/06/2
9	ISSUED FOR BP RESUBMISSION	2024/07/3
10	ISSUED FOR BP RESUBMISSION	2024/09/2
11	ISSUED FOR CONSTRUCTION	2024/10/2
12	ISSUED FOR BP RESUBMISSION	2024/12/1
13	RE-ISSUED FOR CONSTRUCTION	2025/01/2
14	RESUSSUEOFFOR BP	2025/06/2
15	ISSUED FOR DDP	2025/07/2

NORTH ARROW

DRAWING TITLE:

LAYOUT PLAN - ROOFTOP AMENITY



SOIL VOLUME					REPLACEM PROPOSED			SOIL VOL	UME REQU	IIRED (m3)	
PLANTING AREA ID	ARE	EA (m2)	197	A.ESTIMATED SOIL VOLUME			D. # LARGE	E. SMALL	F. MEDIUM	G.	TOTAL
				ON-SITE	AREA	•		'	'		
QUADRA STREET SOIL CELLS		34	1.4000	45		3			15		45
FISGARD PLANTING BED		55	1	67	1		1	6		30	36

PLANT RATIOS - OFF SITE

- NATIVE PLANTS
- % BY QUANTITY = 2%
- % BY AREA = 1%

POLLINATOR PLANTS • % BY QUANTITY = 56% % BY AREA = 56%

PLANT RATIOS - ON SITE

NATIVE PLANTS

- % BY QUANTITY = 0%
- % BY AREA = 0%
- POLLINATOR PLANTS % BY QUANTITY = 80%
- % BY AREA = 50%

PLANT SCHEDULE MAIN LEVEL

	SYMBOL	CODE	BOTANICAL / COMMON NAME	SIZE	CONTAINER	QTY
	TREES					
		SP	Stewartia pseudocamellia / Japanese Stewartia	70mm Cal.	As Shown	2
		UL	Ulmus x 'Lobel' / Lobel Elm	70mm Cal.	As Shown	3
H 3		ZG	Zelkova serrata `Green Vase` / Green Vase Japanese Zelkova	70mm Cal.	As Shown	1
	OFF-SITE	SHRUBS				
		He	Hebe x 'Emerald Green' / Emerald Green Hebe	#2 POT	450mm	62
		Mr2	Mahonia repens / Creeping Mahonia	#2 POT	500mm	125
	A AMARAMAN A AN A AN A AN A AN A AN A AN	Mm	Miscanthus sinensis 'Morning Light' / Morning Light Eulalia Grass	#3 POT	900mm	27
	$\langle \cdot \rangle$	Pc	Pinus mugo 'Compacta' / Dwarf Mugo Pine	#3 POT	900mm	16
		Rn	Rosa nutkana / Nootka Rose	#2 POT	1500mm	5
		Vb2	Verbena bonariensis / Tall Verbena	#1 POT	450mm	29
	ON-SITE S	HRUBS				
	•	Ср	Carex testacea 'Prairie Fire' / Prairie Fire Orange Sedge	#1 POT	500mm	8
	AAAAAAAAAAAAAAAAAAAAAAAAAAAAAAAAAAAAAA	Mm2	Miscanthus sinensis 'Morning Light' / Morning Light Eulalia Grass	#3 POT	900mm	3
	£ .	Pc2	Pinus mugo 'Compacta' / Dwarf Mugo Pine	#2 POT	900mm	3
		Vb	Verbena bonariensis / Tall Verbena	#1 POT	450mm	7

1. PLANTS IN PLANT LISTS ARE SPECIFIED ACCORDING TO THE CANADIAN NURSERY LANDSCAPE ASSOCIATION CANADIAN STANDARDS FOR NURSERY STOCK AND SECTION 12, CONTAINER GROWN PLANTS FROM THE BC LANDSCAPE STANDARD, CURRENT EDITION.

IRRIGATION

 ALL AT-GRADE LANDSCAPE BEDS AND ROOFTOP PLANTERS TO BE IRRIGATED WITH AN AUTOMATIC IRRIGATION SYSTEM.

- DETAILED IRRIGATION PLAN TO BE SUBMITTED TO PARKS FOR REVIEW A MINIMUM OF 30 DAYS PRIOR TO INSTALLATION.
- ALL IRRIGATION DESIGNS AND INSTALLATIONS SHALL MEET THE MINIMUM STANDARDS OF THE IRRIGATION INDUSTRY ASSOCIATION OF B.C. (IIABC).
- SEE IRRIGATION PLANS, DETAILS AND WRITTEN SPECIFICATIONS.

OFF-SITE (MUNICIPAL)

- MUNICIPAL PLANTING BED AND STREET TREES TO BE IRRIGATED BY A SEPARATE SYSTEM FROM A SEPARATE CITY SOURCE CONFORMING TO THE **CITY OF VICTORIA** SUPPLEMENTARY SPECIFICATIONS FOR STREET TREES AND IRRIGATION SCHEDULE C TO BYLAW 12-042,
- IRRIGATION DESIGN DRAWINGS MUST BE SENT TO PARKS FOR REVIEW 30 DAYS PRIOR TO
- INSTALLATION. DRAWINGS SHOULD INDICATE ALL COMPONENTS, MODELS AND MATERIALS FROM WATER
- SUPPLY TO IRRIGATION HEADS. THE CITY WILL REQUIRE 4 INSPECTIONS FOR IRRIGATION INSTALLATION:
- 1)SLEEVING, 2) OPEN TRENCH MAINLINE AND PRESSURE TEST,
- 3) OPEN TRENCH AND LATERAL LINE,
- 4) OPERATION AND COVERAGE, AND 5) BACKFLOW PREVENTER ASSEMBLY TEST REPORT.

MUNICIPAL BOULEVARD TREES

- TREES MUST HAVE ONE DOMINANT CENTRAL LEADER OR SINGLE STRAIGHT TRUNK, 5-8 cm DIAMETER, CALIPER MEASURED 15 cm ABOVE GROUND, WELL BALANCED CROWN WITH BRANCHING STARTING AT 1.8m-2.5m ABOVE GROUND
- TREES TO BE PLANTED AS PER PLANTIG OF TREES, SHRUBS AND GROUND COVERS (32 93 01 MMCD 2009 AND CITY OF VICTORIA SUPPLEMENTAL DRAWINGS SD P3 AND SD P4)
- PARKS WILL REQUIRE (3) INSPECTIONS FOR TREE PLANTING:
- 1) INSPECTION OF SOIL AND PLANTING AREA, 2) INSPECTION OF STOCK UPON DELIVERY, AND
- 3) INSPECTION OF INSTALLED TREE WITH MULCH AND STAKING. TRUNK FLARE MUST BE VISIBLE AND PLANTED AT OR SLIGHTLY ABOVE GRADE UPON INSPECTION
- THE APPLICANT IS RESPONSIBLE FOR PROCURING AND PLANTING THE PROPOSED
- BOULEVARD TREES.
- THE APPLICANT MUST MAINTAIN THE TREE IN GOOD HEALTH AND STRUCTURAL CONDITION FOR 1 YEAR FROM THE SUBSTANTIAL COMPLETION TO BE ELIGIBLE FOR DEPOSIT RETURN.

PRE-CONSTRUCTION MEETING

 PARKS REQUIRES A PRE-CONSTRUCTION MEETING TO BE HELD PRIOR TO COMMENCEMENT OF CONSTRUCTING THE FRONTAGE WORKS



1608 Camosun Street, Victoria BC V8T 3E6 Info@biophiliacollective.ca 250 590 1156

PROJECT NAME:


THE ESTOYA

PROJECT ADDRESS:

1702 QUADRA STREET VICTORIA, BC

DESIGNED BY: BIANCA BODLEY DRAWN BY: KIM TANG

NO.	ISSUED FOR	YY\MM\DD
1	CIS PRESENTATION	12/07/2021
2	DEVELOPMENT PERMIT	12/22/2021
3	ADP MEETING	04/13/2022
4	REVISED AND RE-ISSUED FOR DP	2023/06/01
5	REVISED AND RE-ISSUED FOR DP	2023/09/21
6	REVISED AND RE-ISSUED FOR DP	2023/12/15
7	ISSUED FOR BP RESUBMISSION	2024/04/30
8	ISSUED FOR TENDER	2024/06/28
9	ISSUED FOR BP RESUBMISSION	2024/07/31
10	ISSUED FOR BP RESUBMISSION	2024/09/27
11	ISSUED FOR CONSTRUCTION	2024/10/25
12	ISSUED FOR BP RESUBMISSION	2024/12/19
13	RE-ISSUED FOR CONSTRUCTION	2025/01/22
14	RE-ISSUED FOR BP	2025/06/12
15	ISSUED FOR DDP	2025/07/22

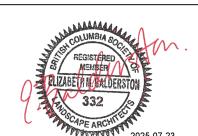



NORTH ARROW



DRAWING TITLE:

PLANTING PLAN -GROUND FLOOR

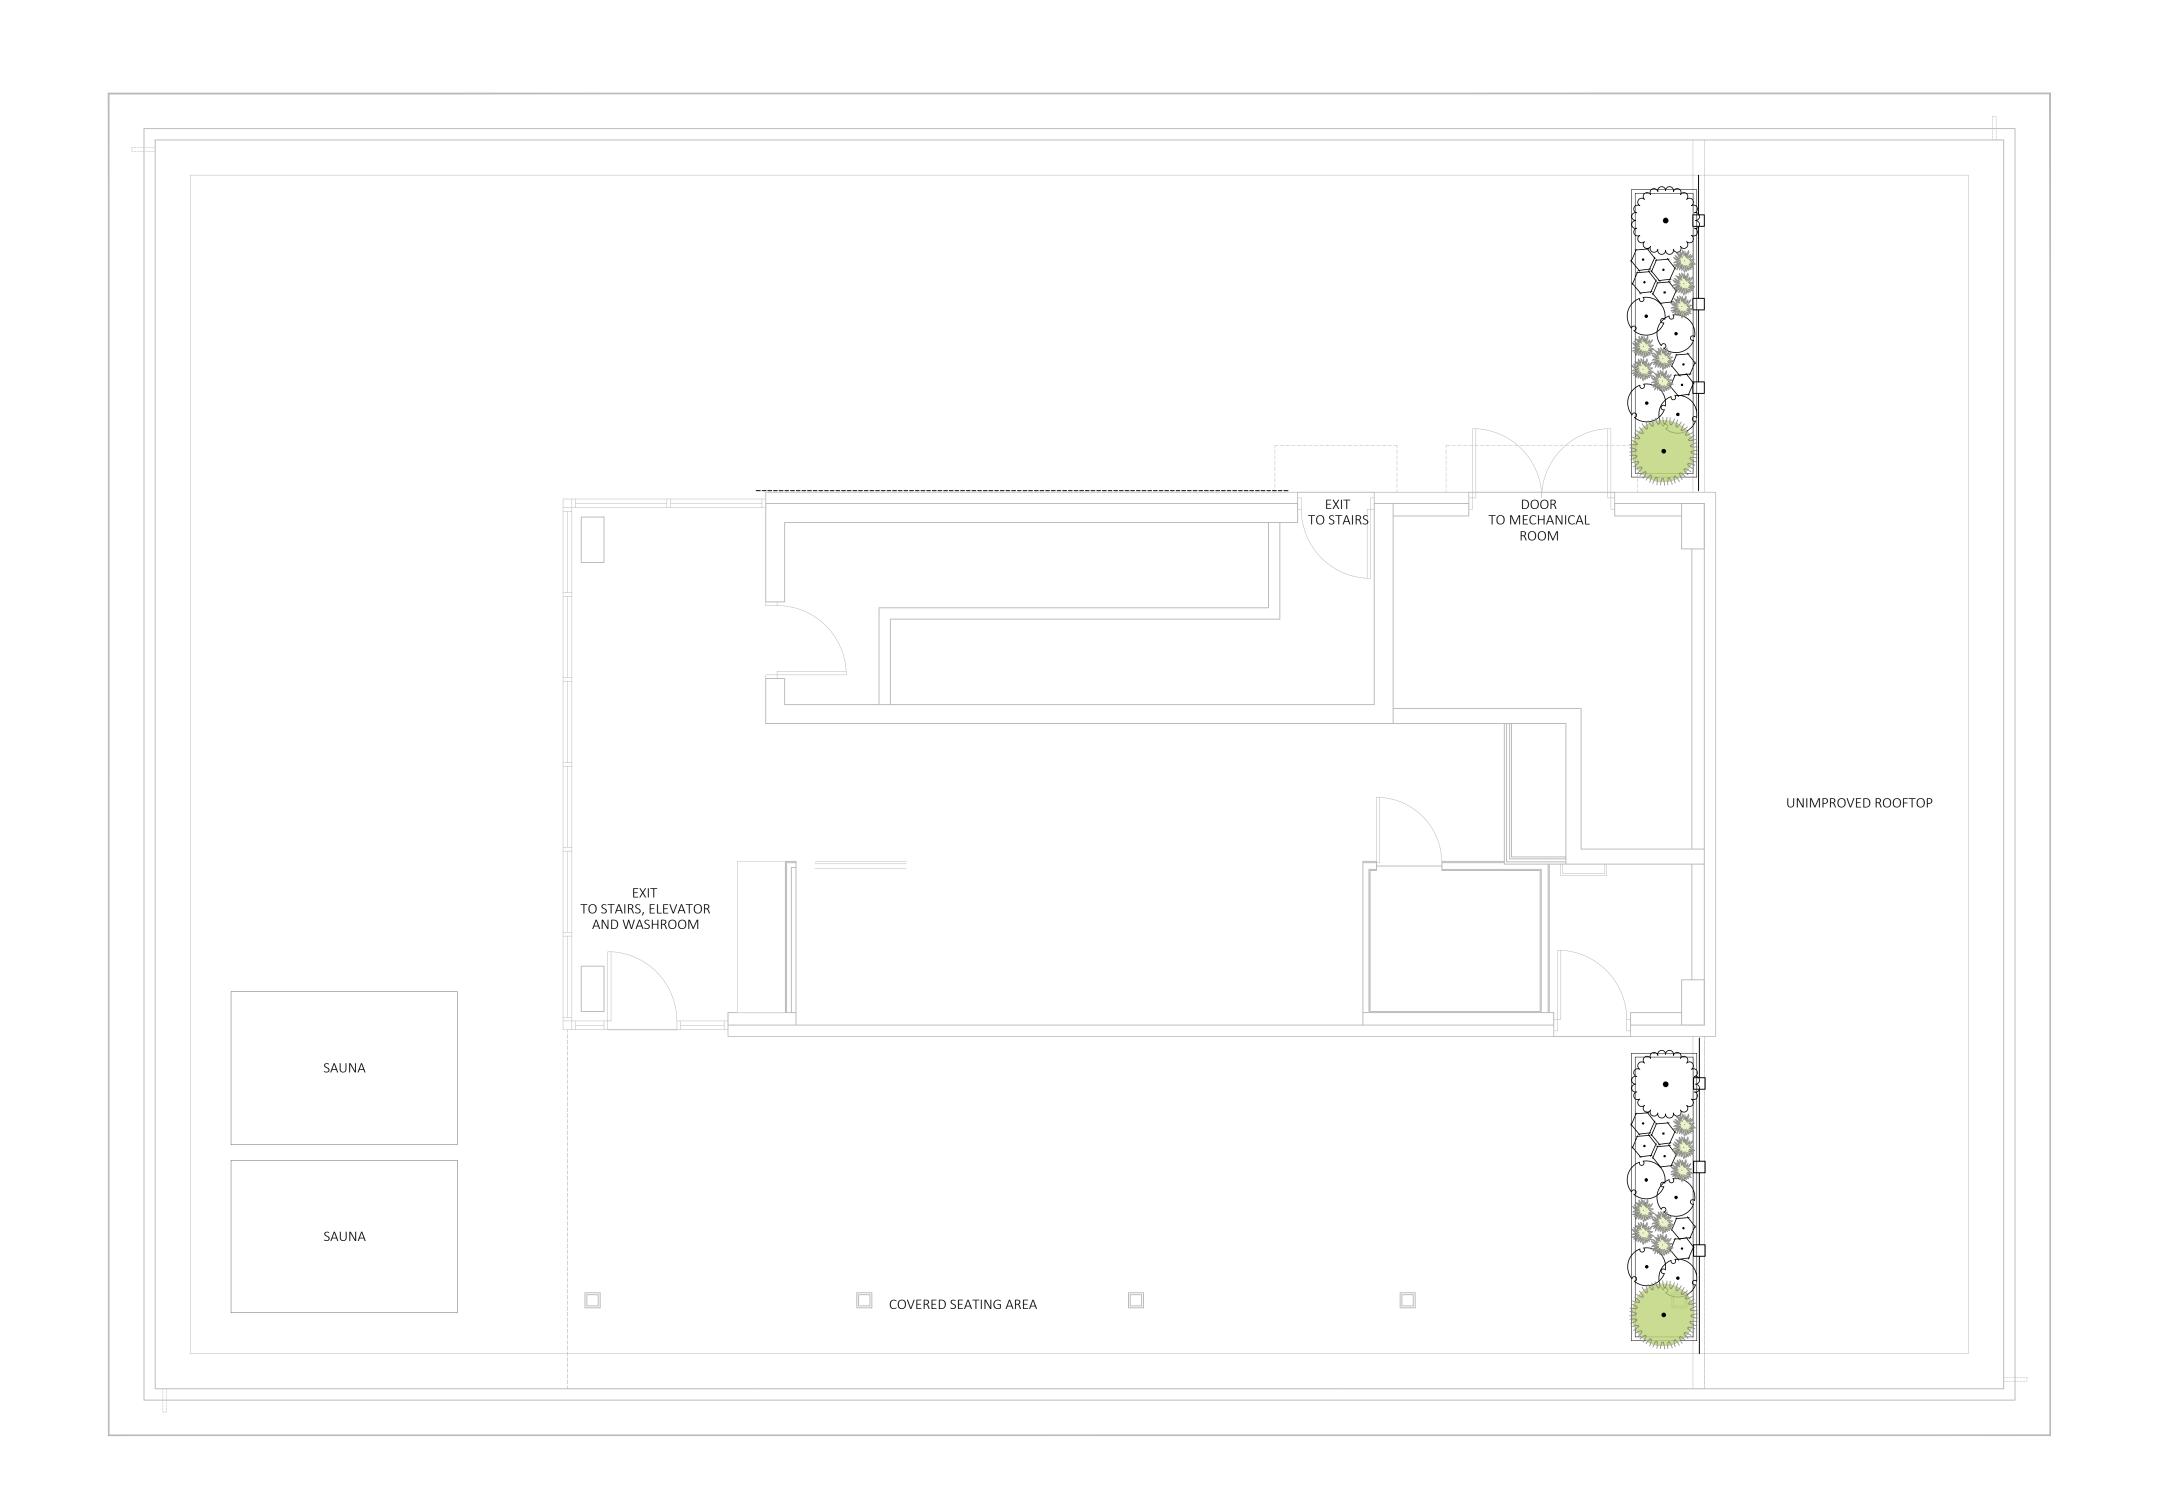

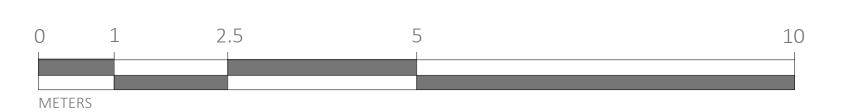

PLANT SCHEDULE ROOFTOP

SYMBOL	CODE	BOTANICAL / COMMON NAME	SIZE	CONTAINER	QTY
ON-SITE S	HRUBS				
$\langle \cdot \rangle$	Cf	Calluna vulgaris 'Firefly' / Firefly Heather	#1 POT	300mm	12
AMAN AMAN AMAN AMAN AMAN AMAN AMAN AMAN	El	Eriophyllum lanatum / Woolly Sunflower	#1 POT	300mm	14
A PARTIE OF THE	Mm2	Miscanthus sinensis 'Morning Light' / Morning Light Eulalia Grass	#3 POT	900mm	2
£	Pc2	Pinus mugo 'Compacta' / Dwarf Mugo Pine	#2 POT	900mm	2
(·)	Vb	Verbena bonariensis / Tall Verbena	#1 POT	450mm	8



1608 Camosun Street, Victoria BC V8T 3E6 Info@biophiliacollective.ca 250 590 1156

PROJECT NAME:

THE ESTOYA

PROJECT ADDRESS:

1702 QUADRA STREET VICTORIA, BC

DESIGNED BY: BIANCA BODLEY DRAWN BY: KIM TANG


		1
1	CIS PRESENTATION	12/07/20
2	DEVELOPMENT PERMIT	12/22/20
3	ADP MEETING	04/13/20
4	REVISED AND RE-ISSUED FOR DP	2023/06
5	REVISED AND RE-ISSUED FOR DP	2023/09
6	REVISED AND RE-ISSUED FOR DP	2023/12
7	ISSUED FOR BP RESUBMISSION	2024/04
8	ISSUED FOR TENDER	2024/06
9	ISSUED FOR BP RESUBMISSION	2024/07
10	ISSUED FOR BP RESUBMISSION	2024/09
11	ISSUED FOR CONSTRUCTION	2024/10
12	ISSUED FOR BP RESUBMISSION	2024/12
13	RE-ISSUED FOR CONSTRUCTION	2025/01
14	RE-ISSUED FOR BP	2025/06
15	ISSUED FOR DDP	2025/07






DRAWING TITLE:

PLANTING PLAN -ROOFTOP AMENITY

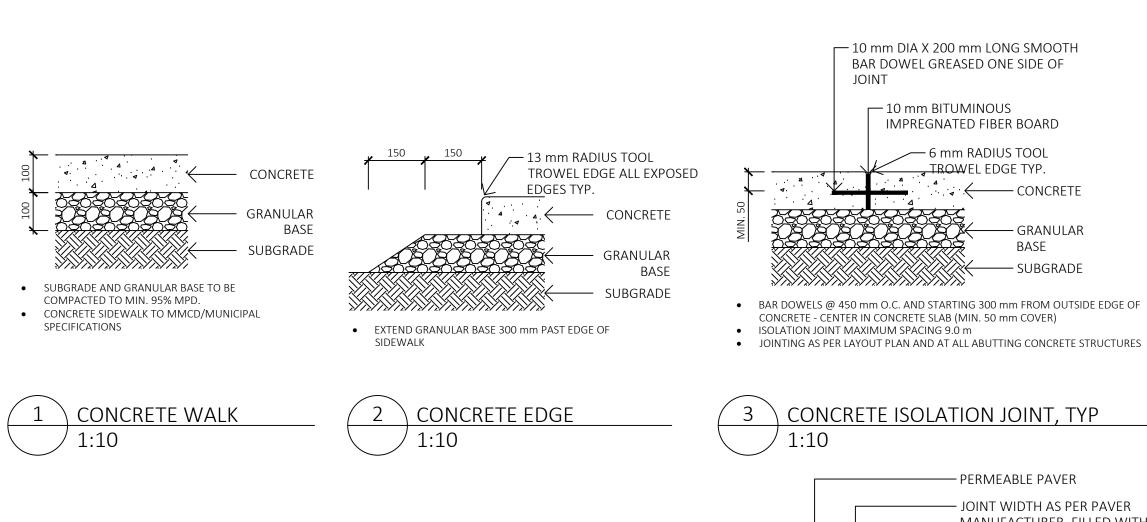


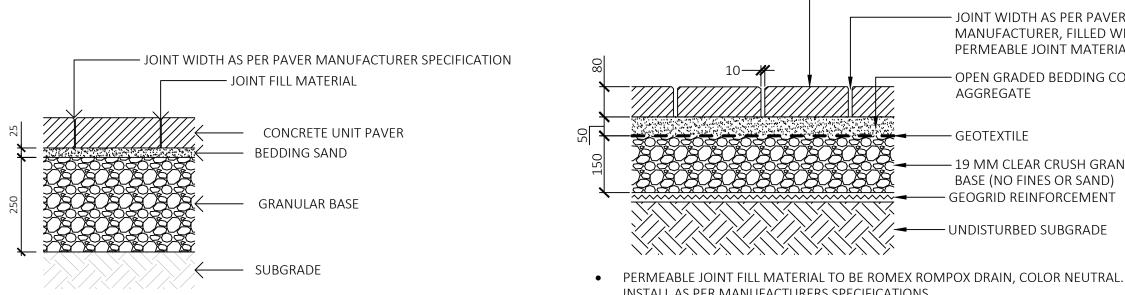

- JOINT FILL MATERIAL TO BE POLYMERIC SAND
- SUBGRADE AND GRANULAR BASE TO BE COMPACTED TO MIN. 95% MPD.
- GRANULAR BASE TO BE COMPACED IN MAX. 100mm LIFTS. PAVER AND PAVER INSTALLATION TO MMCD AND MANUFACTURER'S
- SPECIFICATION UNLESS NOTED OTHERWISE.

PERMEABLE PAVER —




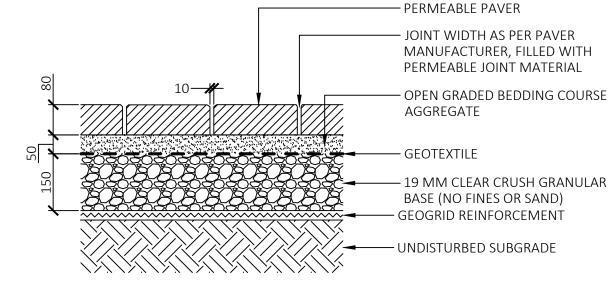

— GRANULAR

- INSTALL AS PER MANUFACTURERS SPECIFICATIONS
- GEOGRID REINFORCEMENT TO BE COMBIGRID 30/30 OR EQUIVALENT SEE ALSO TALMACK - PAVING OVER EXISTING TREE ROOTS DETAIL AND ARBORIST
- REPORT FOR ADDITIONAL SPECIFICATIONS
- SEE WRITTEN SPECIFICATIONS FOR AGGREGATES AGGREGATES COMPACTED TO 95% M.P.D.



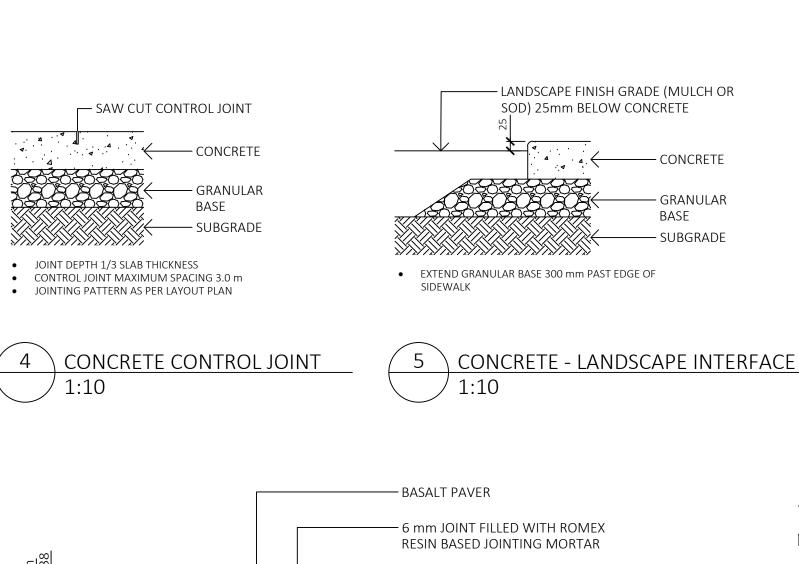




 SUBGRADE AND GRANULAR BASE TO BE COMPACTED TO 95% MPD. RESIN BASED JOINTING MORTAR TO BE ROMPOX-D1, COLOUR: BASALT

COMPACTED SUBGRADE

9 \ MORTAR SET BASALT PAVER (ROMEX)

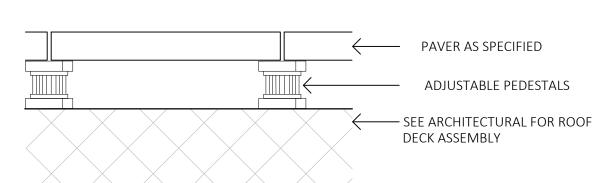

6 CONCRETE EDGER


/ 1:10

• SUBGRADE AND GRANULAR BASE TO BE COMPACTED TO MIN. 95% MPD.

CONCRETE TO MMCD SPECIFICATION UNLESS NOTED OTHERWISE.

- PRIOR TO INSTALLATION, CONTRACTOR TO CONFIRM WITH ARCHITECTURAL / MEMBRANE CONSULTANT IF PROTECTION BOARD IS REQUIRED FOR PAVER PEDESTAL INSTALLATION; IF PROTECTION BOARD IS REQUIRED AND HAS NOT BEEN INSTALLED BY ARCHITECTURAL, CONTRACTOR TO NOTIFY GENERAL CONTRACTOR.
- ADJUSTABLE PEDESTALS TO BE BlackJack OneStep or BlackJack ScrewJack PEDESTALS AS
- REQUIRED OR APPROVED EQUAL.
- INSTALLATION TO MANUFACTURER'S SPECIFICATIONS.



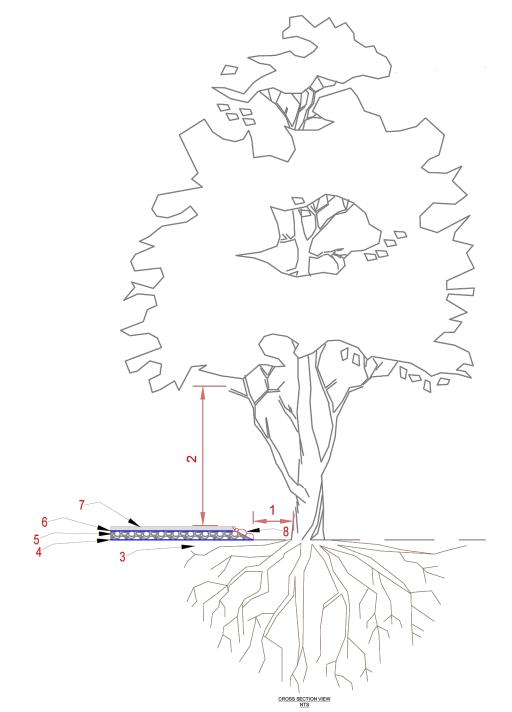

CONCRETE EDGER OVER EXISTING TREE ROOT JOINT WIDTH AS PER PAVER -MANUFACTURER, FILLED WITH - REBAR ANCHORS TO BE PERMEABLE JOINT MATERIAL FIELD FIT TO AVOID CRITICAL OPEN GRADED BEDDING COURSE -ROOTS AGGREGATE — EXISTING UNDISTURBED GRADE GEOTEXTILE 19 MM CLEAR CRUSH GRANULAR -BASE (NO FINES OR SAND) GEOGRID REINFORCEMENT -UNDISTURBED SUBGRADE ──►

CONCRETE EDGER OVER EXISTING TREE ROOTS

HARD SURFACE ABOVE TREE ROOTS NOTES

- 1. Maintain as large a setback between the fill encroachment and the root collar of the tree as possible.
- 2. Review any canopy clearance pruning requirements to accommodate vehicle or pedestrian clearances (Pruning to be performed to ANSI A300 standards).
- 3. Excavate the new footprint of the driveway or sidewalk under the supervision of the project arborist. Excavation will be limited to
- the removal of the existing sod layer. Excavation around root structures must be performed by hand, airspade, or
- 4. Install a two-dimensional (such as Combigrid $\frac{30}{30}$) or Three-dimensional geogrid reinforcement.
- 5. Install a 150mm depth layer of clear crushed gravel (no fines) using 20mm and/or 75mm diameter material or approved equivalent. *Note - the depth may be less than 150mm in some situations (dependant on grading constraints).
- 6. Install meduim weight geotextile fabric (such as Nilex 4535 or similar) over the clear crushed gravel layer to prevent fine particles
- 7. The bedding or base layer and new driveway or sidewalk surface can be installed directly on top of the felted filter fabric.
- 8. Fill slopes where possible install loose stacked boulders to reduce the footprint of the fill slopes that encroach within the critical root zone. Fill slope materials must be permeable to air and water. Do not pile fill material directly against the trunk of a tree.

THE ESTOYA PROJECT ADDRESS: 1702 QUADRA STREET VICTORIA, BC DESIGNED BY: BIANCA BODLEY DRAWN BY: ELIZABETH BALDERSTON

ADJACENT HARD SURFACE

ADJACENT LANDSCAPE

- GRANULAR BASE

SUBGRADE

- CONCRETE LANDSCAPE EDGER

EXPANSION JOINTS @ MIN. 9m O/C

CONTROL JOINTS @ MIN. 3.0m O/C

NO.	ISSUED FOR	YY\MM\DD
1	CIS PRESENTATION	12/07/2021
2	DEVELOPMENT PERMIT	12/22/2021
3	ADP MEETING	04/13/2022
4	REVISED AND RE-ISSUED FOR DP	2023/06/01
5	REVISED AND RE-ISSUED FOR DP	2023/09/21
6	REVISED AND RE-ISSUED FOR DP	2023/12/15
7	ISSUED FOR BP RESUBMISSION	2024/04/30
8	ISSUED FOR TENDER	2024/06/28
9	ISSUED FOR BP RESUBMISSION	2024/07/31
10	ISSUED FOR BP RESUBMISSION	2024/09/26
11	ISSUED FOR CONSTRUCTION	2024/10/25
12	ISSUED FOR BP RESUBMISSION	2024/12/18
13	RE-ISSUED FOR CONSTRUCTION	2025/01/22

1608 Camosun Street, Victoria BC V8T 3E6

PROJECT NAME:


Info@biophiliacollective.ca 250 590 1156

SEAL



DRAWING TITLE: PAVING DETAILS



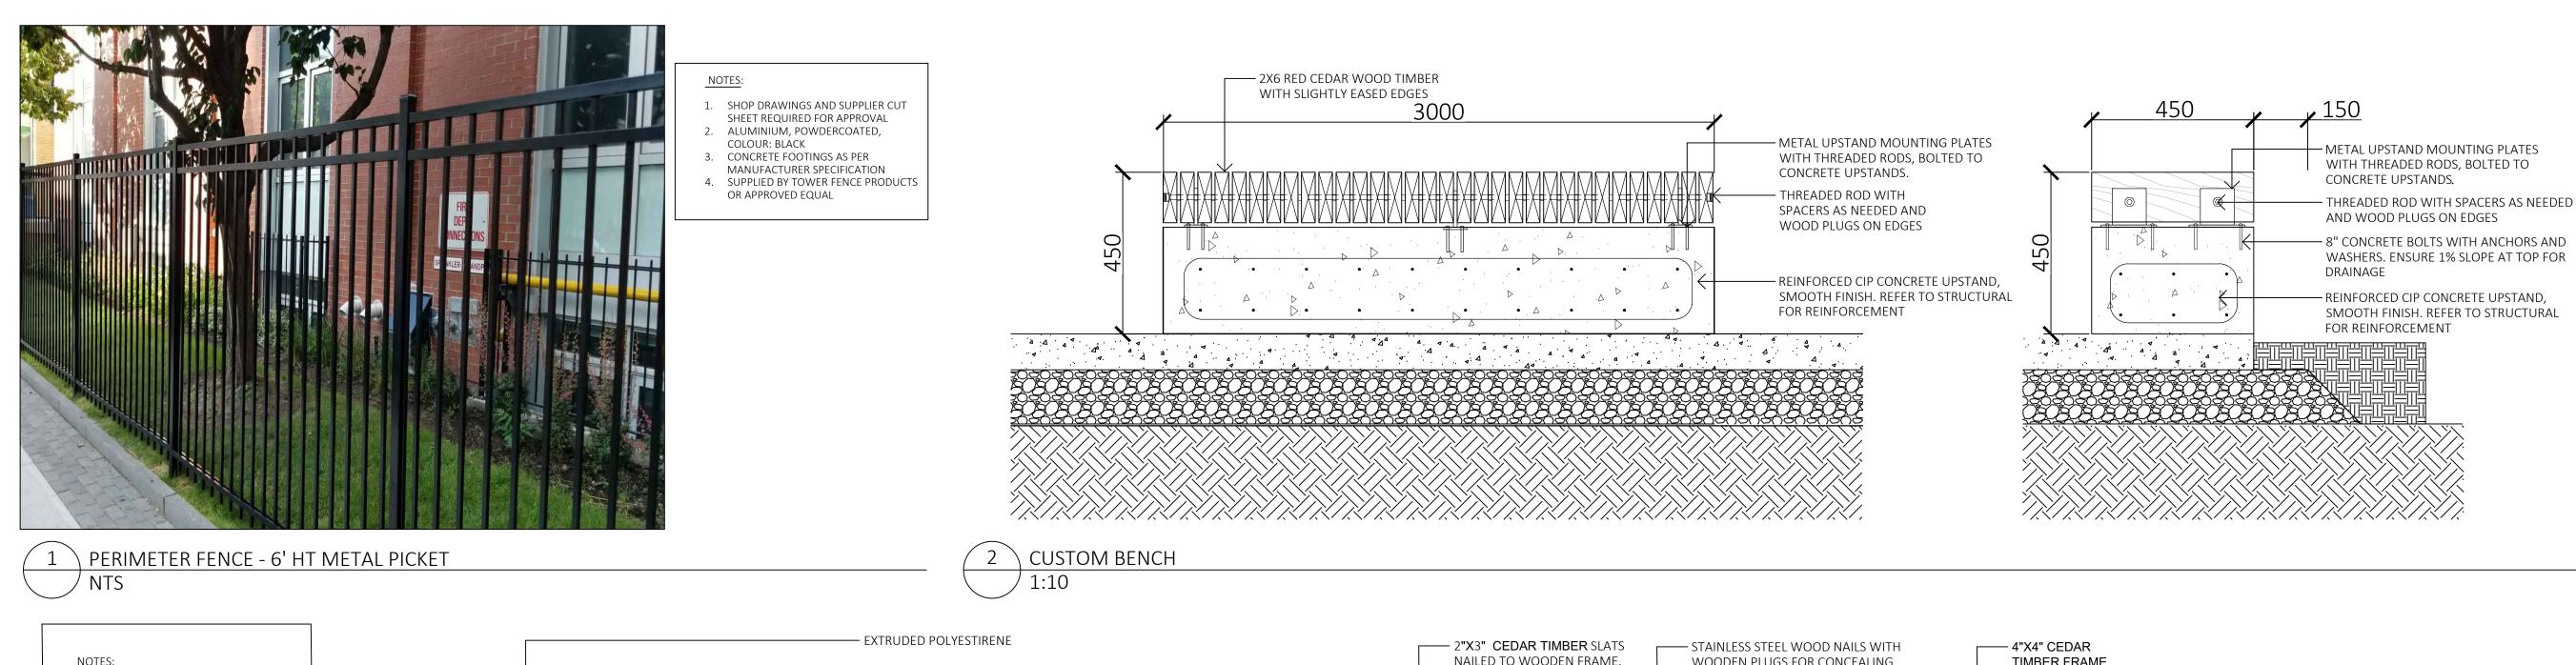



1608 Camosun Street, Victoria BC V8T 3E6 Info@biophiliacollective.ca 250 590 1156

PROJECT NAME:
THE ESTOYA

1. SHOP DRAWINGS REQUIRED FOR

WOOD TIMBERS: TIGHT-KNOT YELLOW

OR RED CEDAR PLANED FOR SMOOTH

FINISH, SLIGHTLY EASED EDGES. SEE

INCLUDING ROD CLIPS ,THREADED

CONCRETE; WITH ARCHITECTURAL

5. PROVIDE CLOSED WOOD PLUGS AT ALL ROD ASSEMBLY CONNECTIONS.

RODS, BOLTS AND NUTS, AND ALL MISC

APPROVAL

HARDWARE;

- 20 mm SEPARATION BETWEEN LIDS

SPECS FOR FINISH;

CONCRETE FINISH.

3. ALL STEEL: STAINLESS STEEL,

4. CONCRETE BASE: 32MPA C-2

PROJECT ADDRESS:

1702 QUADRA STREET VICTORIA, BC

DESIGNED BY: BIANCA BODLEY
DRAWN BY: ELIZABETH BALDERSTON

NO.	ISSUED FOR	YY\MM\DD
1	CIS PRESENTATION	12/07/2021
2	DEVELOPMENT PERMIT	12/22/2021
3	ADP MEETING	04/13/2022
4	REVISED AND RE-ISSUED FOR DP	2023/06/01
5	REVISED AND RE-ISSUED FOR DP	2023/09/21
6	REVISED AND RE-ISSUED FOR DP	2023/12/15
7	ISSUED FOR BP RESUBMISSION	2024/04/30
8	ISSUED FOR TENDER	2024/06/28
9	ISSUED FOR BP RESUBMISSION	2024/07/31
10	ISSUED FOR BP RESUBMISSION	2024/09/26
11	ISSUED FOR CONSTRUCTION	2024/10/25
12	ISSUED FOR BP RESUBMISSION	2024/12/18
13	RE-ISSUED FOR CONSTRUCTION	2025/01/22

SEAL





DRAWING TITLE:


FURNISHING DETAILS


DWG NO:

LE: AS SHOWN L4.2

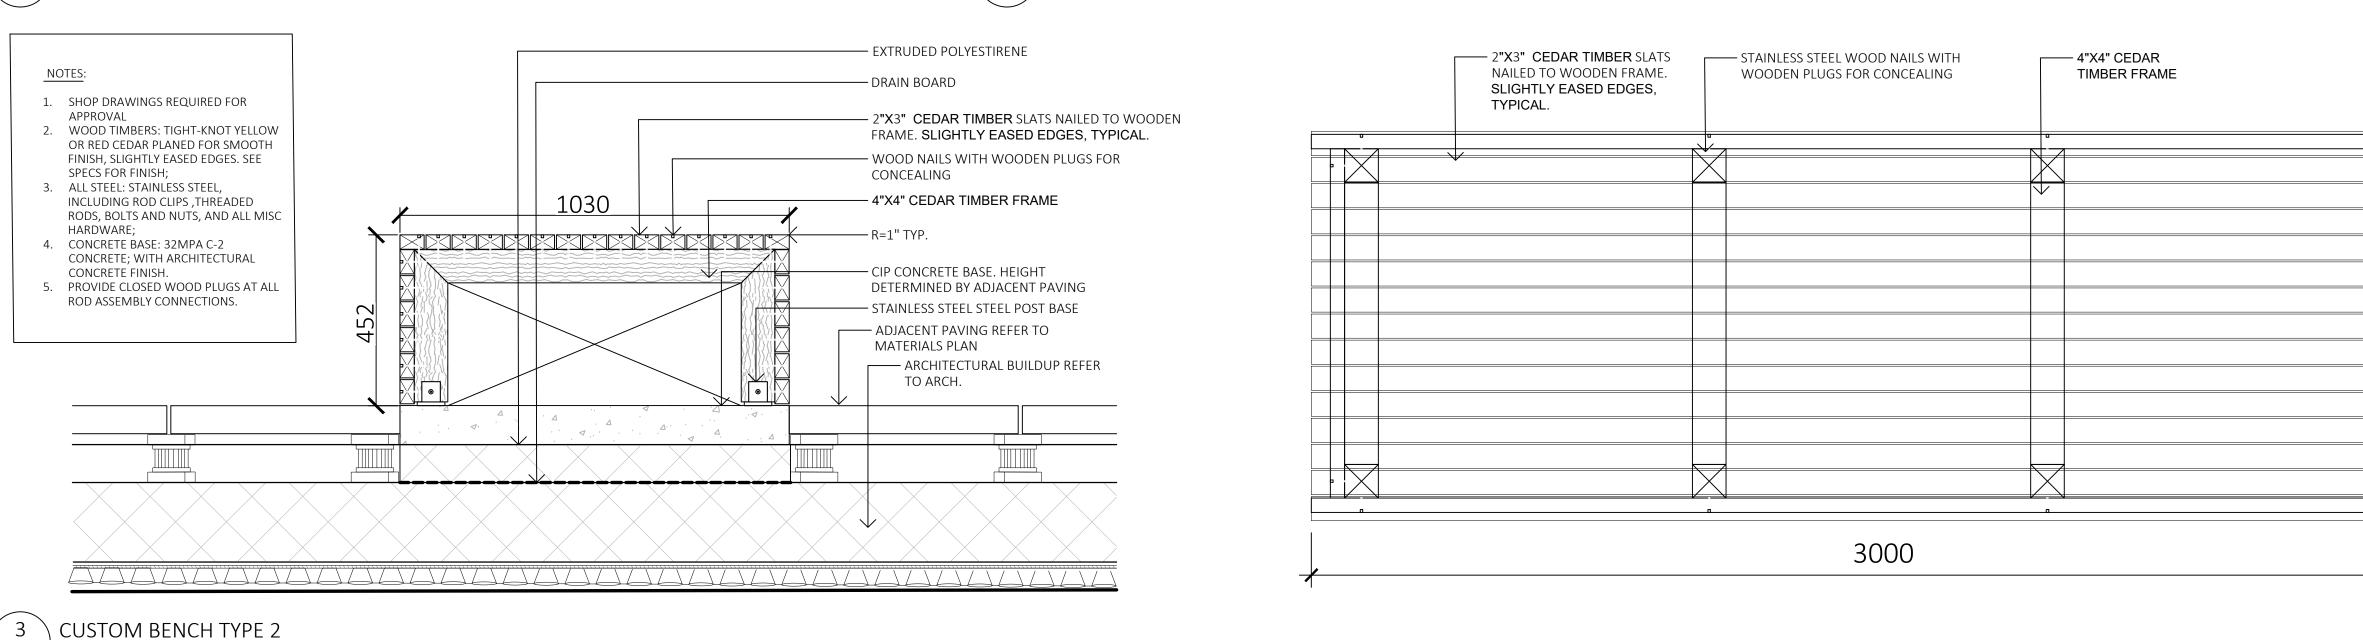

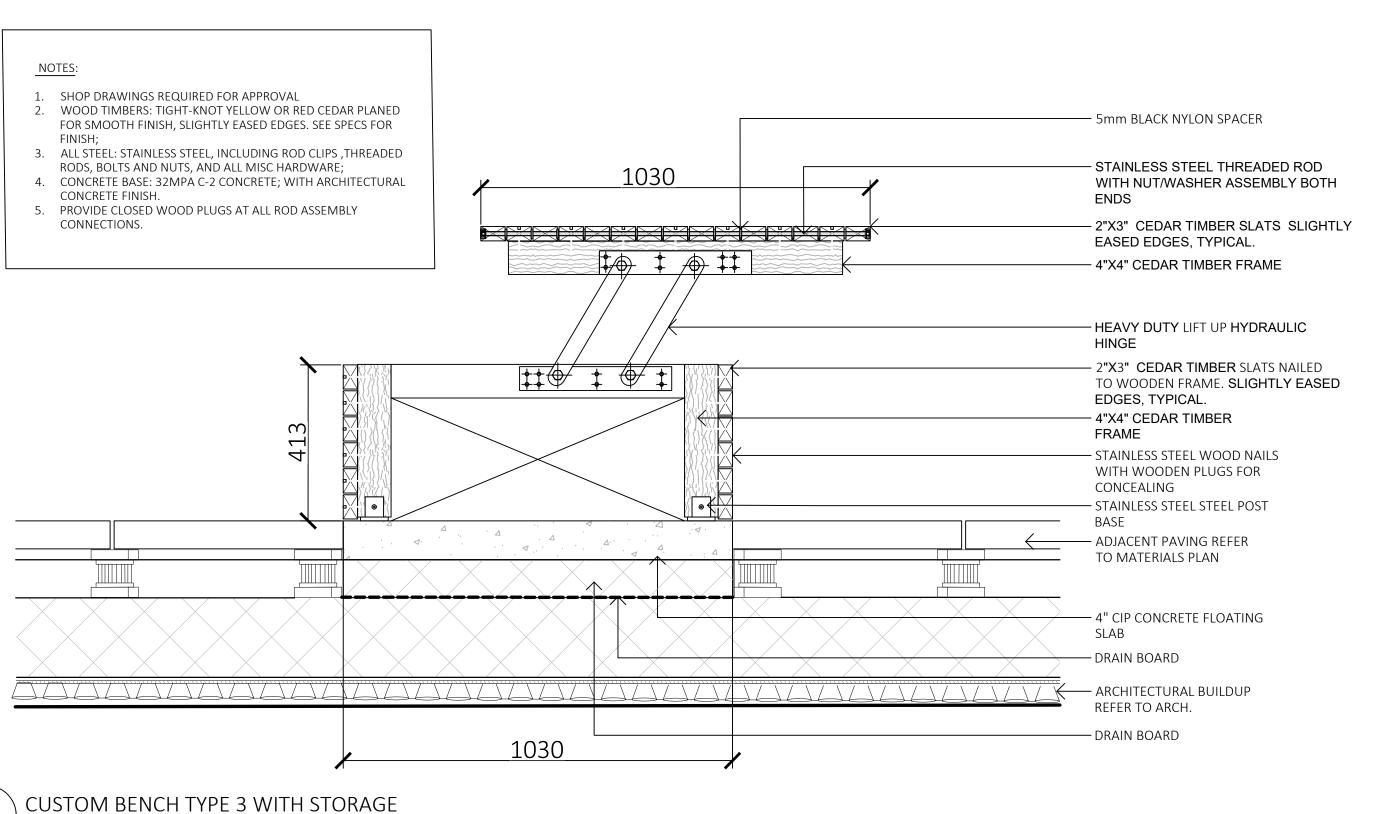

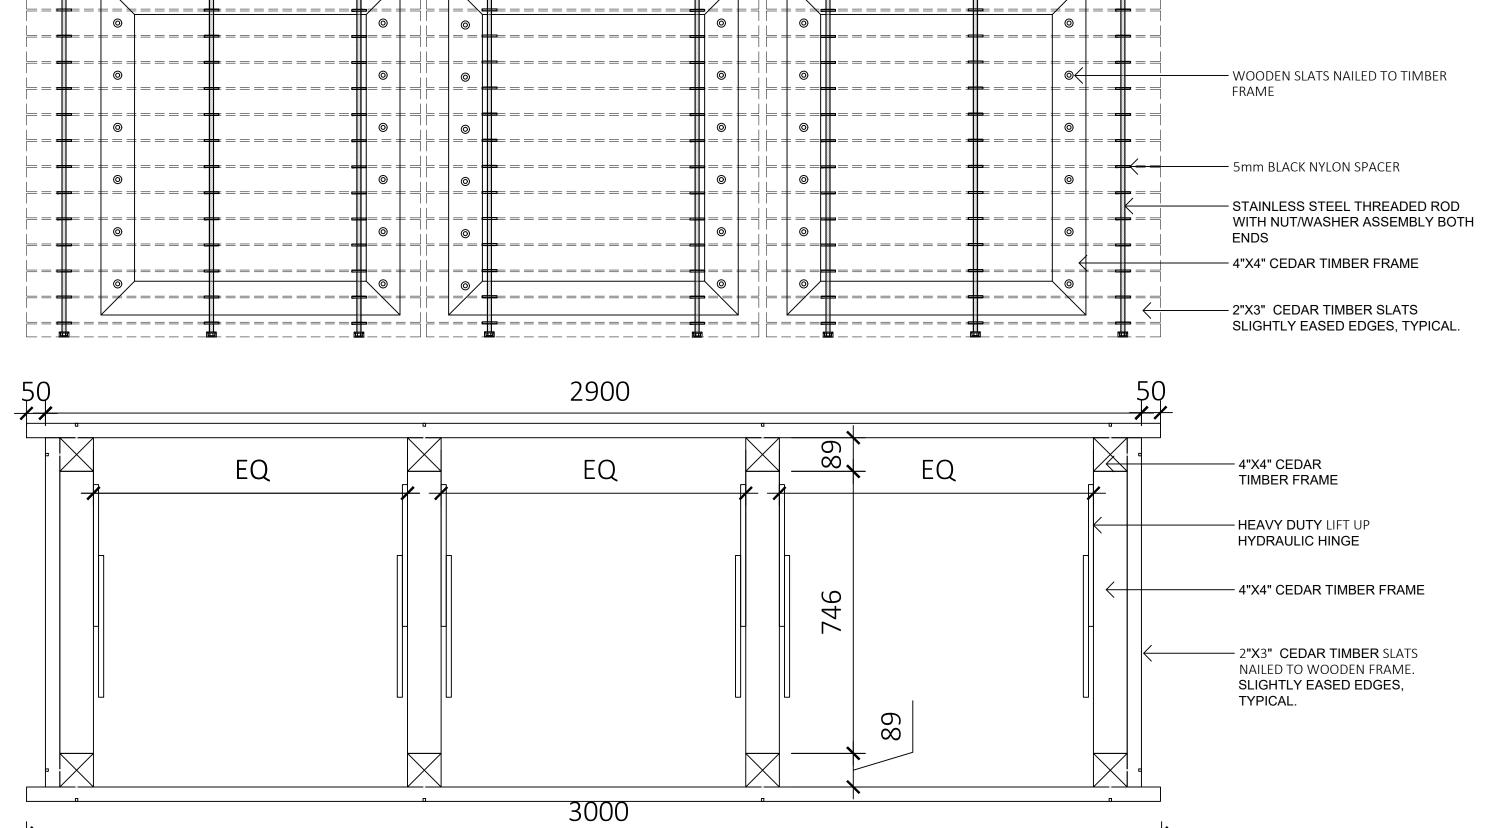


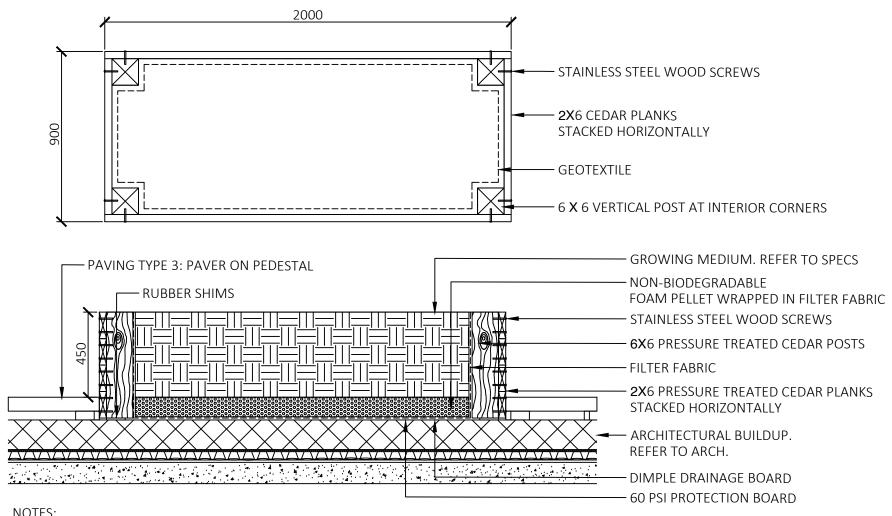

1. WOOD TO BE PRESSURE TREATED RED CEDAR, WITH ROUNDED EDGES ON TOP PLANK.


- FINISH PREPARED BOARDS WITH TWO COATS OF LifeTime Wood Treatment OR APPROVED EQUAL PRIOR TO ASSEMBLY.
- 3. ALL FASTENERS IN CONTACT WITH CEDAR TO BE STAINLESS STEEL.
- 4. SHOP DRAWING AND WOOD SAMPLE REQUIRED FOR APPROVAL PRIOR TO FABRICATION.



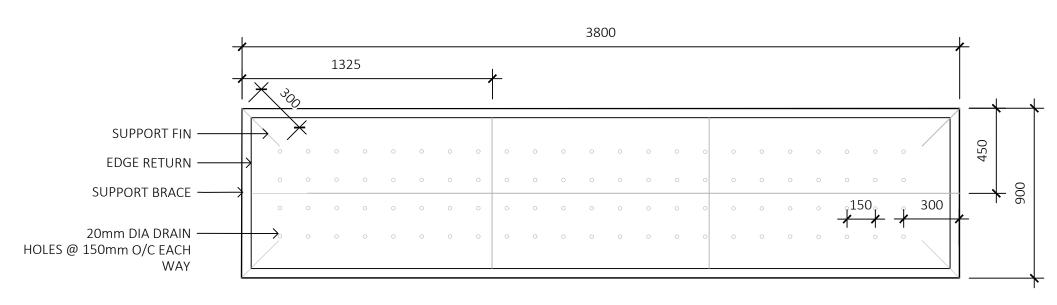


 SHOP DRAWINGS REQUIRED SAMPLE OF FINISH REQUIRED

- FINISH: AGED PATINA WITH MATTE LACQUER SEALANT
- SUPPORT FIN AND BRACE TO BE 1/8" RAW STEEL SECURELY TACK WELDED TO PLANTER FRAME
- NO FINISH REQUIRED ON INTERNAL SUPPORT STRUCTURES

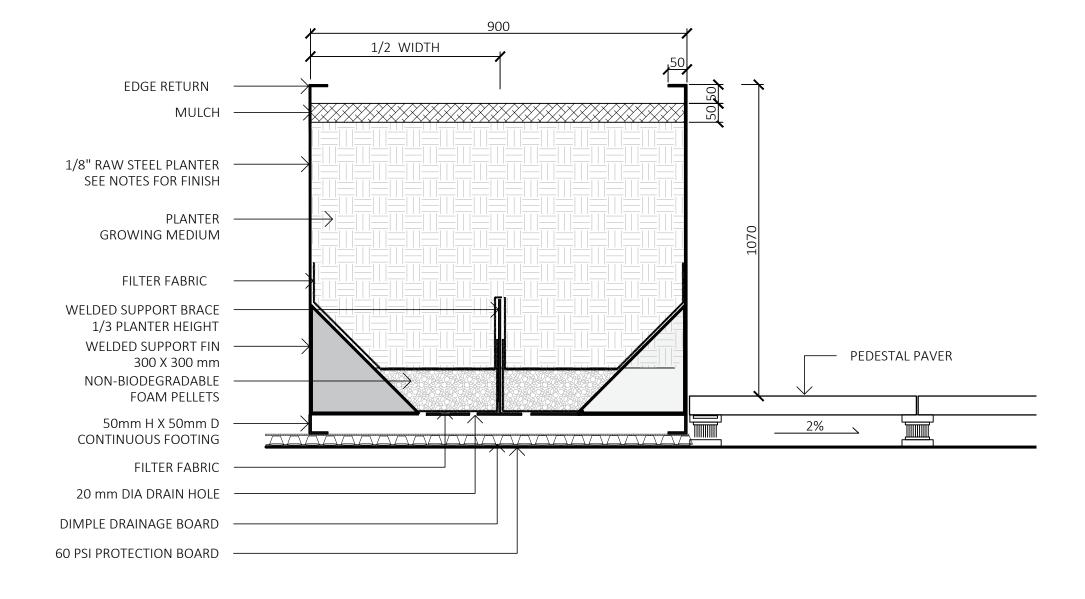



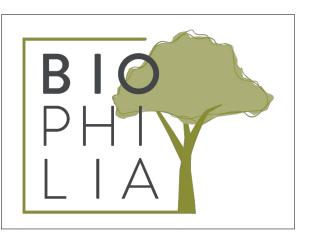

1608 Camosun Street, Victoria BC V8T 3E6 Info@biophiliacollective.ca 250 590 1156

PROJECT NAME: THE ESTOYA

PROJECT ADDRESS: 1702 QUADRA STREET VICTORIA, BC

DESIGNED BY: BIANCA BODLEY DRAWN BY: ELIZABETH BALDERSTON


NO.	ISSUED FOR	YY\MM
1	CIS PRESENTATION	12/07/2
2	DEVELOPMENT PERMIT	12/22/2
3	ADP MEETING	04/13/2
4	REVISED AND RE-ISSUED FOR DP	2023/0
5	REVISED AND RE-ISSUED FOR DP	2023/09
6	REVISED AND RE-ISSUED FOR DP	2023/12
7	ISSUED FOR BP RESUBMISSION	2024/04
8	ISSUED FOR TENDER	2024/06
9	ISSUED FOR BP RESUBMISSION	2024/07
10	ISSUED FOR BP RESUBMISSION	2024/09
11	ISSUED FOR CONSTRUCTION	2024/10
12	ISSUED FOR BP RESUBMISSION	2024/12
13	RE-ISSUED FOR CONSTRUCTION	2025/02

SEAL




DRAWING TITLE:


FURNISHING DETAILS

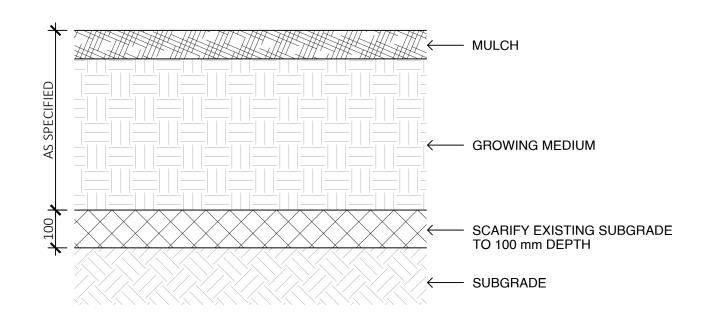


- 1. PLACE AND COMPACT SUBGRADE AS PER WRITTEN SPECIFICATIONS
- 2. SUBGRADE TO BE COMPACTED TO A CONSISTENT 80% M.P.D 3. GROWING MEDIUM AND MULCH AS PER WRITTEN SPECIFICATIONS
- SOIL PROFILE ON GRADE

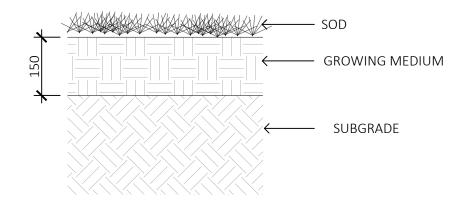



1. SUBGRADE TO BE COMPACTED TO A CONSISTENT 80%

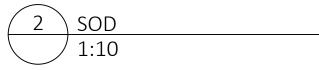

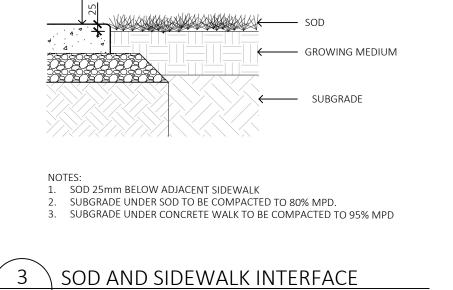

—— CONCRETE WALK

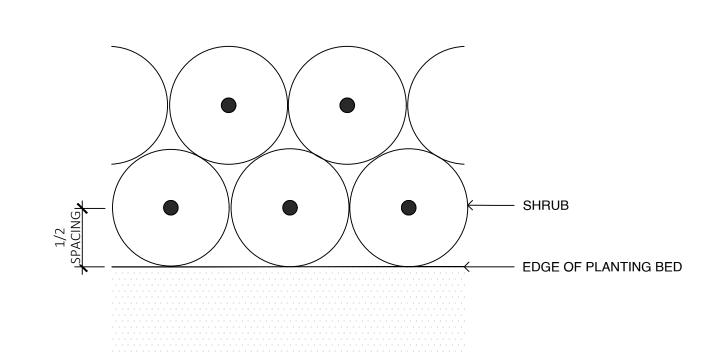

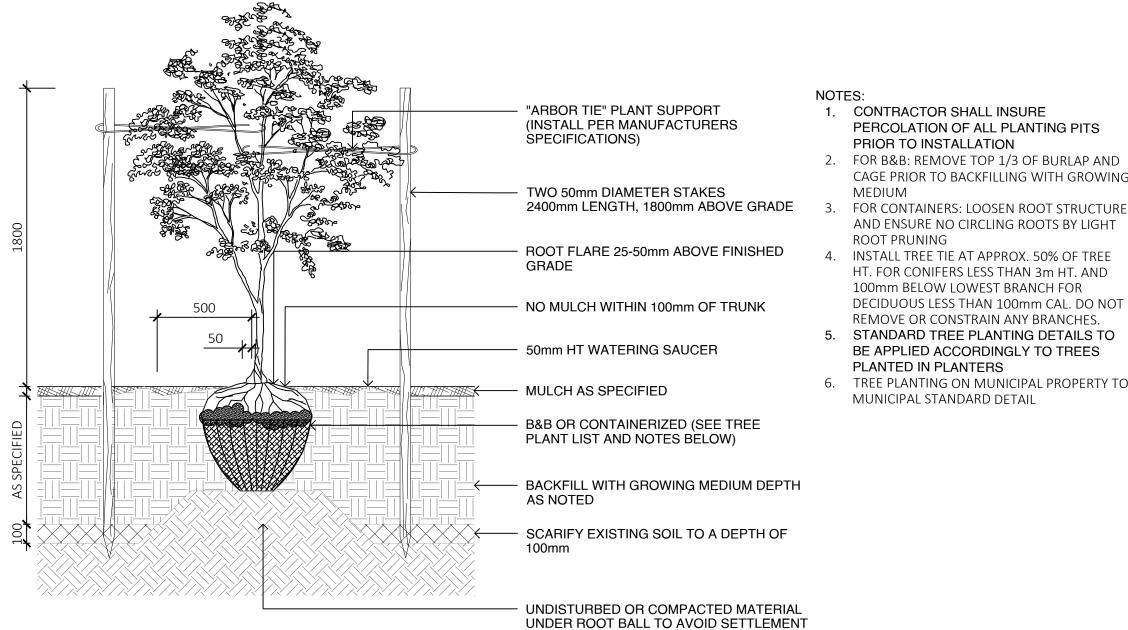

2. FOR B&B: REMOVE TOP 1/3 OF BURLAP AND CAGE PRIOR TO BACKFILLING WITH GROWING MEDIUM AND ENSURE NO CIRCLING ROOTS BY LIGHT ROOT PRUNING 4. INSTALL TREE TIE AT APPROX. 50% OF TREE

HT. FOR CONIFERS LESS THAN 3m HT. AND 100mm BELOW LOWEST BRANCH FOR DECIDUOUS LESS THAN 100mm CAL. DO NOT REMOVE OR CONSTRAIN ANY BRANCHES. 5. STANDARD TREE PLANTING DETAILS TO BE APPLIED ACCORDINGLY TO TREES PLANTED IN PLANTERS

PERCOLATION OF ALL PLANTING PITS

CONTRACTOR SHALL INSURE


PRIOR TO INSTALLATION

6. TREE PLANTING ON MUNICIPAL PROPERTY TO MUNICIPAL STANDARD DETAIL









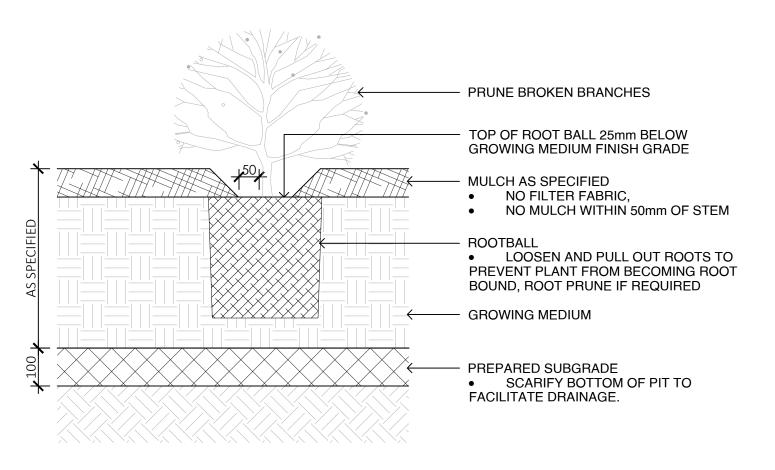


1. SHRUB PLANTING AS PER WRITTEN SPECIFICATIONS 2. GROWING MEDIUM AND MULCH AS PER WRITTEN SPECIFICATIONS

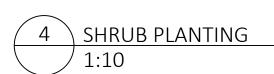

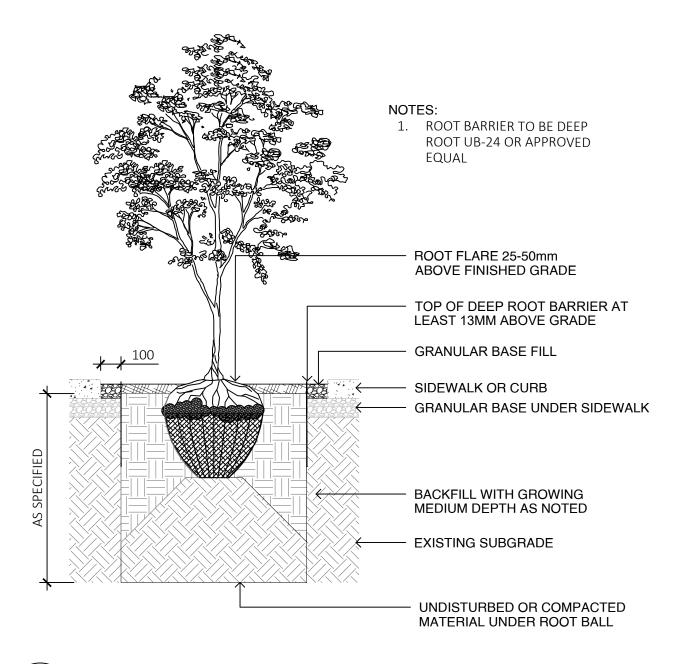

7 ROOT BARRIER */* 1:10

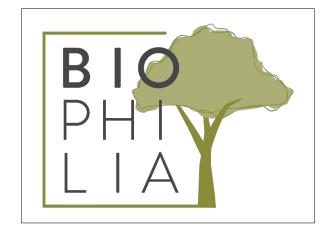

1608 Camosun Street, Victoria BC V8T 3E6 Info@biophiliacollective.ca 250 590 1156

PROJECT NAME: THE ESTOYA

PROJECT ADDRESS: 1702 QUADRA STREET VICTORIA, BC

DESIGNED BY: BIANCA BODLEY DRAWN BY: ELIZABETH BALDERSTON


NO.	ISSUED FOR	YY\MM\D
1	CIS PRESENTATION	12/07/202
2	DEVELOPMENT PERMIT	12/22/202
3	ADP MEETING	04/13/202
4	REVISED AND RE-ISSUED FOR DP	2023/06/0
5	REVISED AND RE-ISSUED FOR DP	2023/09/2
6	REVISED AND RE-ISSUED FOR DP	2023/12/2
7	ISSUED FOR BP RESUBMISSION	2024/04/3
8	ISSUED FOR TENDER	2024/06/2
9	ISSUED FOR BP RESUBMISSION	2024/07/3
10	ISSUED FOR BP RESUBMISSION	2024/09/2
11	ISSUED FOR CONSTRUCTION	2024/10/2
12	ISSUED FOR BP RESUBMISSION	2024/12/2
13	RE-ISSUED FOR CONSTRUCTION	2025/01/2


SEAL



DRAWING TITLE:

PLANTING DETAILS

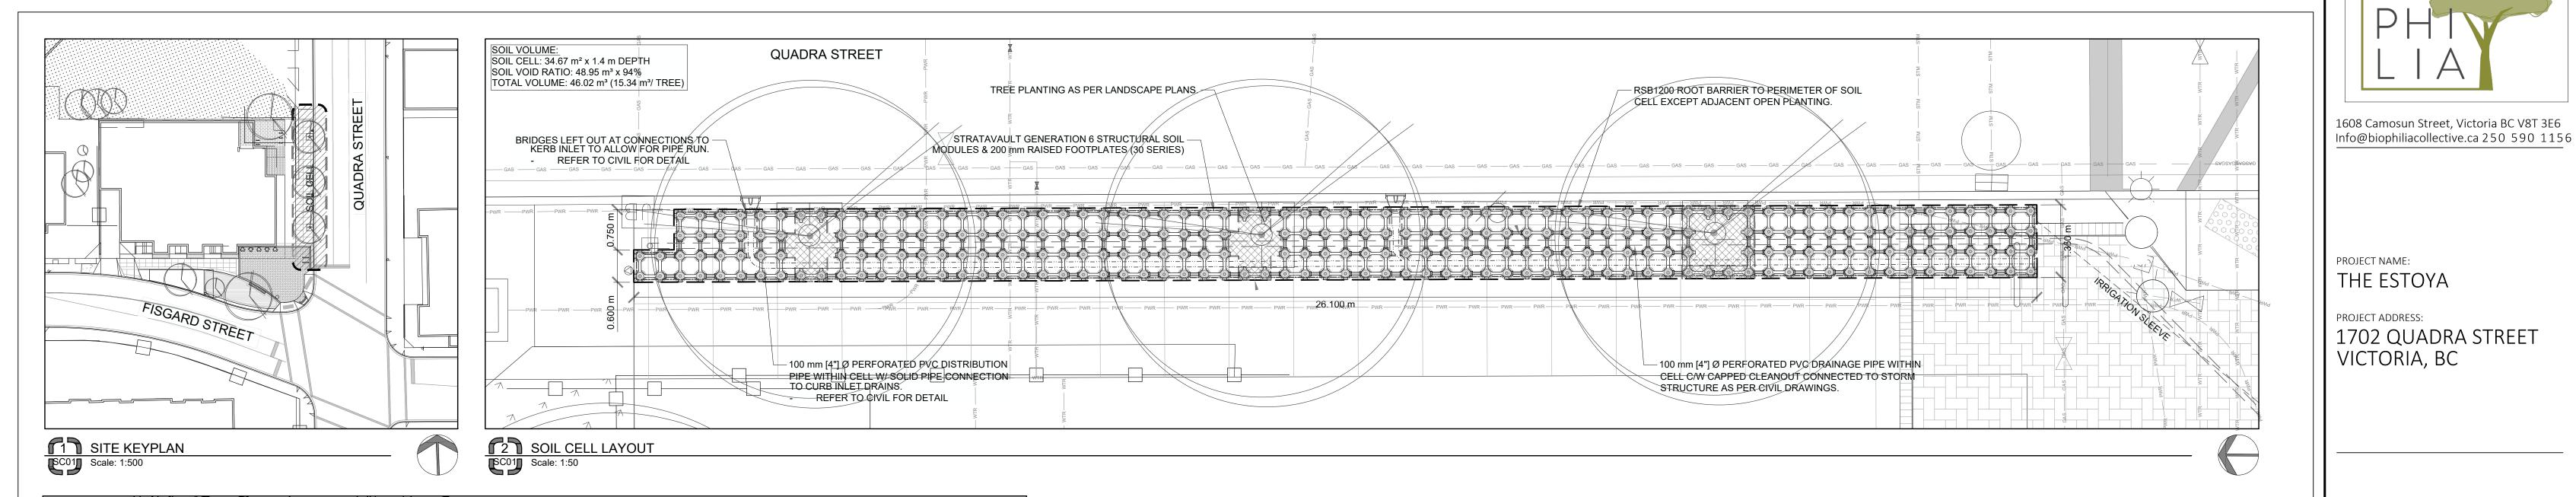

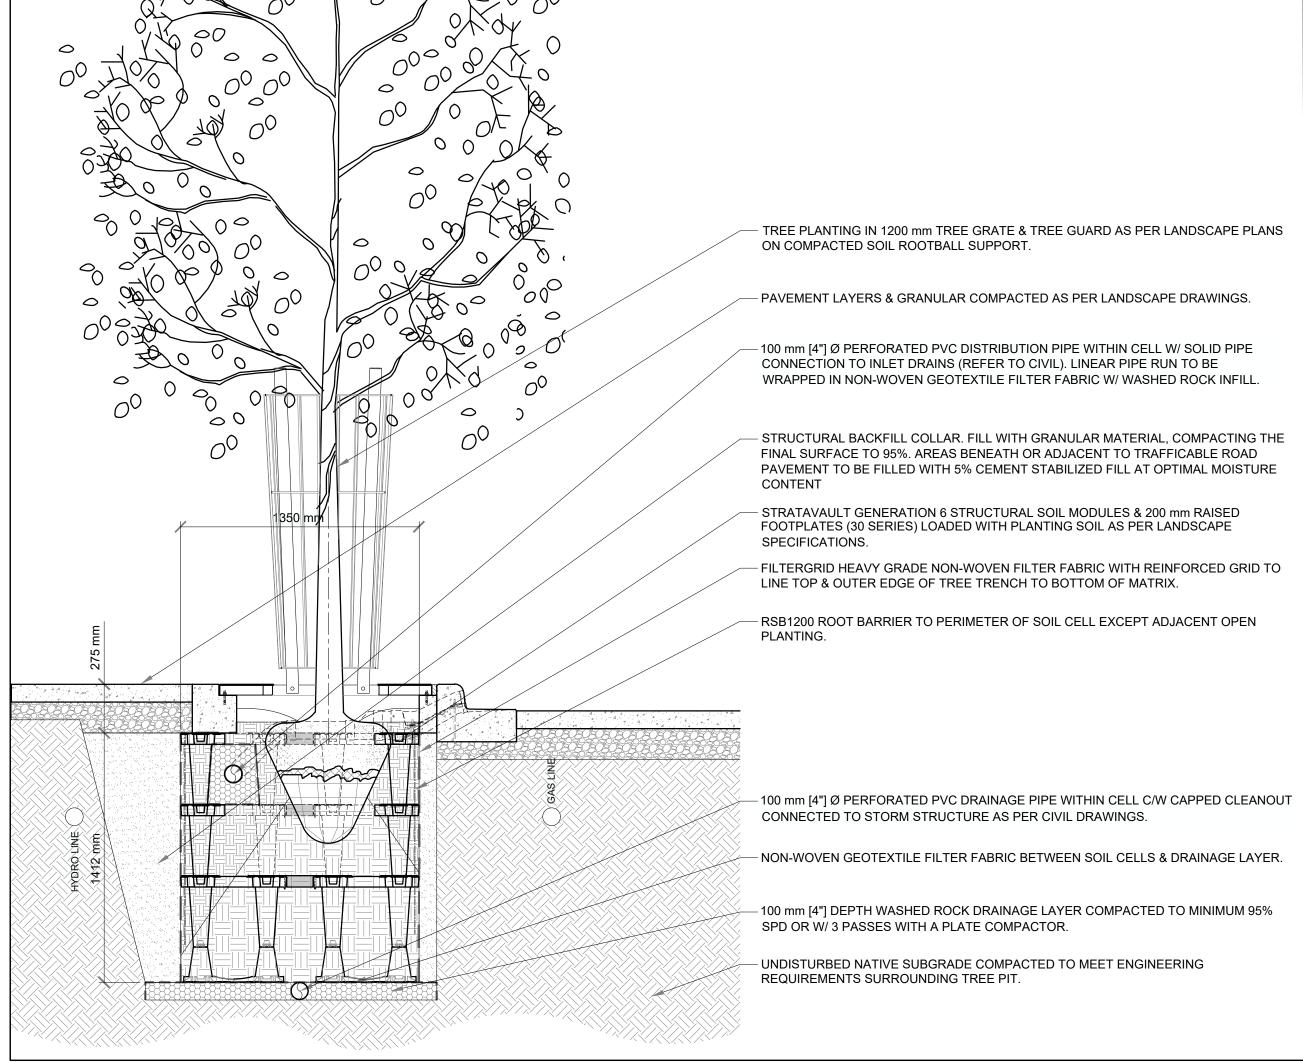

Consultant Drawings:

DS4557 Reference No: Sheet No. 1 of 1 Issue# 4

STRUCTURAL SOIL CELLS

DRAWING TITLE:

DWG NO:

DESIGNED BY: BIANCA BODLEY DRAWN BY: ELIZABETH BALDERSTON

ISSUED FOR

ADP MEETING

CIS PRESENTATION

DEVELOPMENT PERMIT

REVISED AND RE-ISSUED FOR DP

REVISED AND RE-ISSUED FOR DP REVISED AND RE-ISSUED FOR DP

ISSUED FOR BP RESUBMISSION

ISSUED FOR BP RESUBMISSION ISSUED FOR CONSTRUCTION

ISSUED FOR BP RESUBMISSION

3 RE-ISSUED FOR CONSTRUCTION

B ISSUED FOR TENDER

YY\MM\DD

04/13/2022

023/06/01

2024/04/30

2024/06/28

2024/12/18

2.Do not scale drawings.3.These drawings serve to illustrate specified products exclusively, and how they interface with other built elements within Phone: (+61) 1300 066-949 Phone: (+1) 888 999-3990 These drawings are to be read in conjunction with project specifications and consultant drawing packages.

 Citygreen drawings work off of information created and provided by the principal design lead (engineering or landscape architecture role). Whilst Citygreen makes every effort to maintain accuracy of provided documents and specifications, Citygreen bears no responsibility for design elements beyond defined scope, knowledge of unforeseen site conditions. 10 Herb Elliott Avenue. Sydney Olympic Park, NSW Vancouver, BC V5Z 1K5 5450 West 83rd Street Los Angeles, CA 90045

Drawn: A.R. Checked: H.L. 2025.06.12 REVISED AS PER COMMENTS Date: 2024.03.04 Approved: T.B. 2024.09.26 REVISED AS PER COMMENTS Scale 1:200, & 1:50 AS SHOWN 2024.07.29 REVISED AS PER COMMENTS 2024.04.29 REVISED AS PER COMMENTS 2024.04.17 ISSUED FOR PRELIMINARY REVIEW

TACMACK URBAN FORESTRY

1702 QUADRA STREET - VICTORIA W/ CITYGREEN STRATAVAULT GENERATION 6 Drawing Title:
SITE KEYPLAN, SOIL CELL LAYOUT, & SOIL CELL SECTION

SCO1 Scale: 1:20

transforming grey spaces into green

Email: info@citygreen.com

NOTES & DISCLAIMERS:
1.Installation to be completed in accordance with manufacturer's specifications. 6. Final details should be approved by the project design lead, and any deviations necessitate approval from both parties to ensure compliance and fully federated drawings across all levels.


7. Submittal drawings and one (1) set of revisions are provided by Citygreen. Costs for additional revisions are the

Issue Details

CITY OF VICTORIA DOWNTOWN REALM PLAN AND STREETSCAPE STANDARDS - NEW TOWN



Finish: Fine broom finish

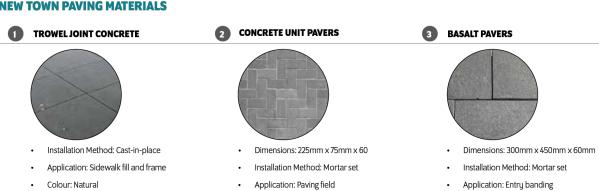


Colours: Natural greu

Finish: Unsealed

Colour: Charcoal grey

Finish: Flamed



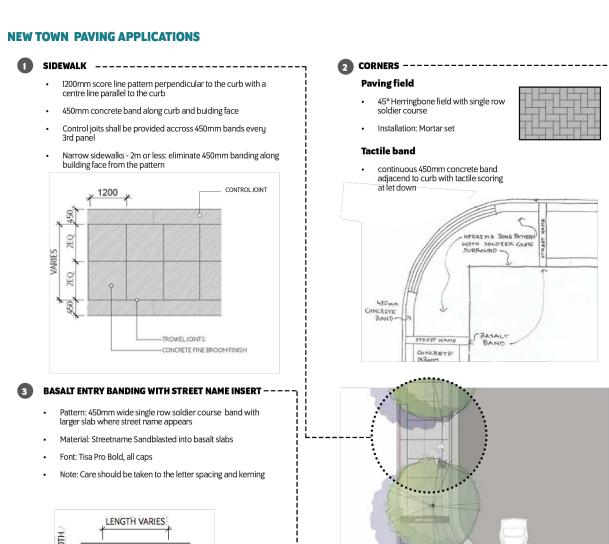

NEW TOWN PLANTING DETAILS APPLICATION For all sidewalks in New Town area there are be two types of trees-in-sidewalk condition:


Adaptation of existing tree locations to sidewalk improvements: Small modifications of proposed trowel joint pattern are recommended to best accommodate for existing tree locations. Detailed design and recommendations to be provided on a case-by-case basis for each improvement area.

Use of proposed poured-in-place resin bound material instead of tree grates is highly recommended to best accommodate heaving and overgrown tree routes and large tree trunks.

2. New development condition:

A street tree spacing of between 8 - 10 metres is desired

Tree grates should be set in a concrete band that runs across the sidewalk from curb to building face as illustrated on the diagram below with trowel joint defining the band always aligned with tree grates Street trees should be sited to correspond with architectural features of building

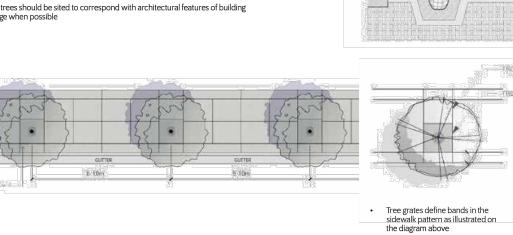

Concrete Sidewalk 2 Curb and Gutter

3 Growing Medium

Structural Growing Medium

5 Structural Soil Cell

38 | CITY OF VICTORIA

Fig. 12 Tree Pit Details

Typical Tree Pit Detai

Soil Cell Option

74 | CITY OF VICTORIA CITY OF VICTORIA NEW TOWN STANDARD DETAILS - SIDEWALKS









CONCRETE UNIT PAVER




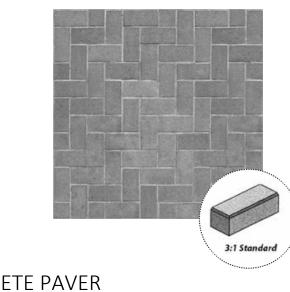


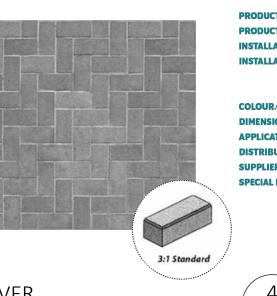



DOWNTOWN PUBLIC REALM PLAN STRATEGY + STREETSCAPE PLAN | 75

TROWEL JOINT CONCRETE

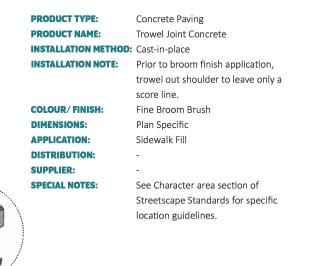

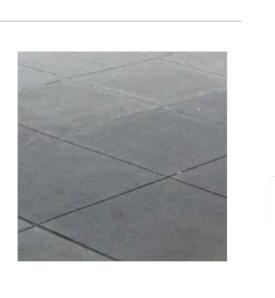

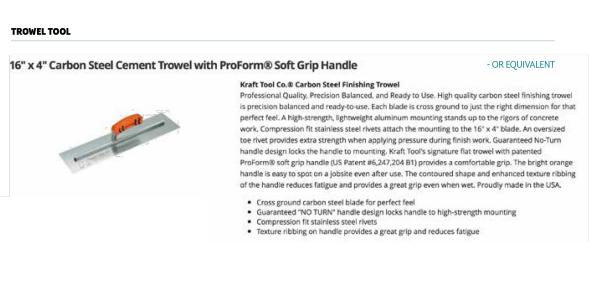

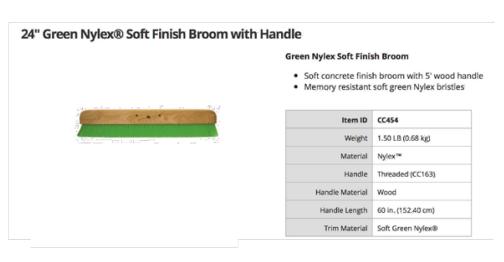



Basalt Banding- street name

Basalt Band

Natural Broom Finish

Bedrock Natural Stone

location guidelines.

See Character area section of

Entry Banding

or equivalent

PRODUCT NAME:

COLOUR/FINISH:

APPLICATION:

DISTRIBUTION:

SPECIAL NOTES:

SUPPLIER:


INSTALLATION METHOD: Mortar Set












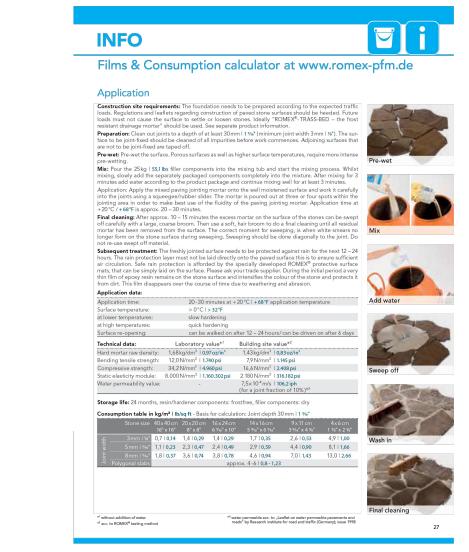



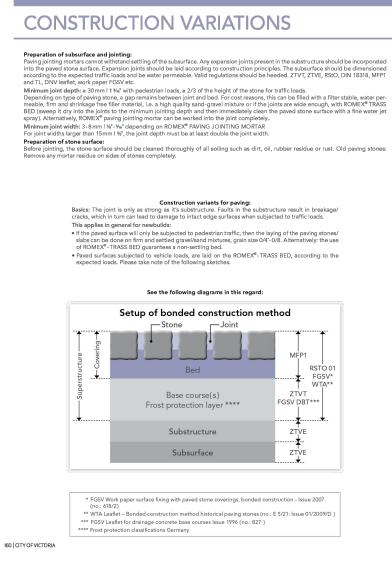

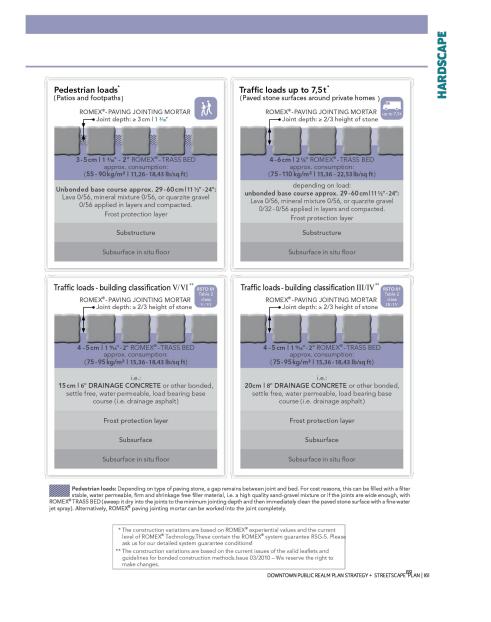

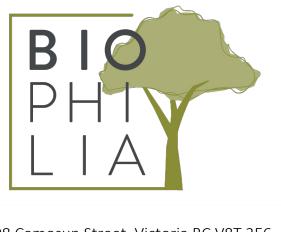

1608 Camosun Street, Victoria BC V8T 3E6 Info@biophiliacollective.ca 250 590 1156

PROJECT NAME:


THE ESTOYA

PROJECT ADDRESS:

1702 QUADRA STREET VICTORIA, BC

DESIGNED BY: BIANCA BODLEY DRAWN BY: ELIZABETH BALDERSTON

NO. **ISSUED FOR** TYY\MM\DD 1 CIS PRESENTATION 12/07/2021 2 DEVELOPMENT PERMIT 12/22/2021 3 ADP MEETING 04/13/2022 4 REVISED AND RE-ISSUED FOR DP 2023/06/01 5 REVISED AND RE-ISSUED FOR DP 6 REVISED AND RE-ISSUED FOR DP 2023/12/15 ISSUED FOR BP RESUBMISSION 2024/04/30 8 ISSUED FOR TENDER 2024/06/28 9 ISSUED FOR BP RESUBMISSION 2024/07/31 10 ISSUED FOR BP RESUBMISSION 2024/09/27 11 ISSUED FOR CONSTRUCTION 2024/10/25 12 ISSUED FOR BP RESUBMISSION 2024/12/18 13 RE-ISSUED FOR CONSTRUCTION 2025/01/22

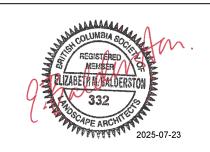

DRAWING TITLE:

MUNICIPAL HARDSCAPE DETAILS


DWG NO:

PELASTERFUGENMÖRTEL


1 NEW TOWN TREE GUARD


MODERN METAL BIN PRODUCT TYPE: Type A Litter Bin with Recycling Component Modern Metal Bin **PRODUCT NAME: DESIGN STYLE:** Modern Metal Frame Glossy Black (RAL 9017) Baked-on **COLOUR/FINISH:** Powder Coat 42" Height **DIMENSIONS: DISTRIBUTION:** Inner Harbour, Old Town, Rock Bay, New Town, Government Street, Douglas Street **MANUFACTURER:** City of Victoria **SPECIAL NOTES:** See Character area section of Streetscape Standards for specific location guidelines. NOTE: INSTALL AS PER MUNICIPAL SPECIFICATIONS




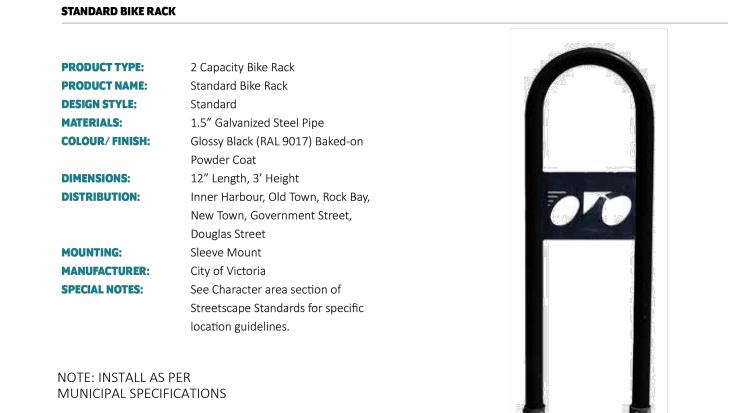


3 NEW TOWN BIKE RACK

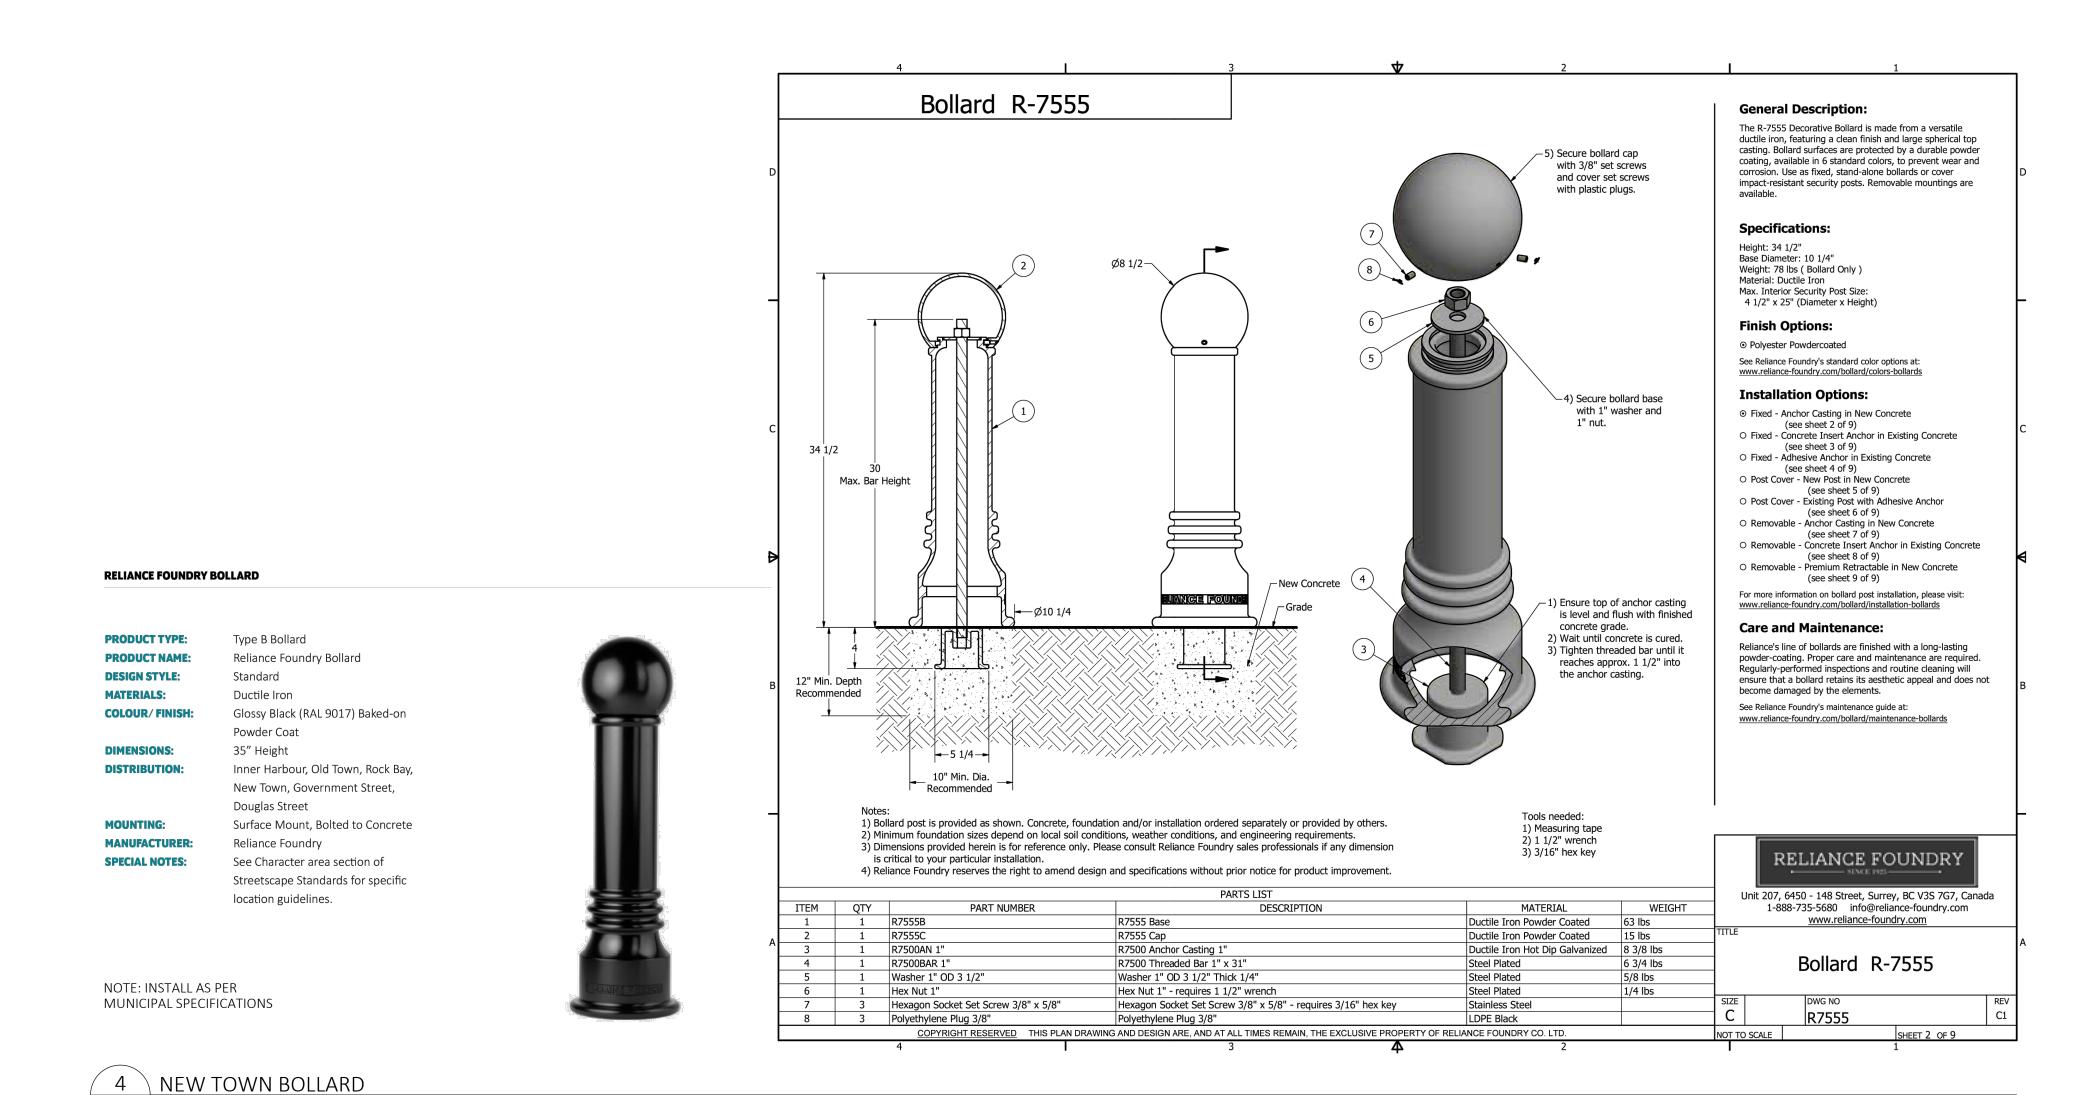

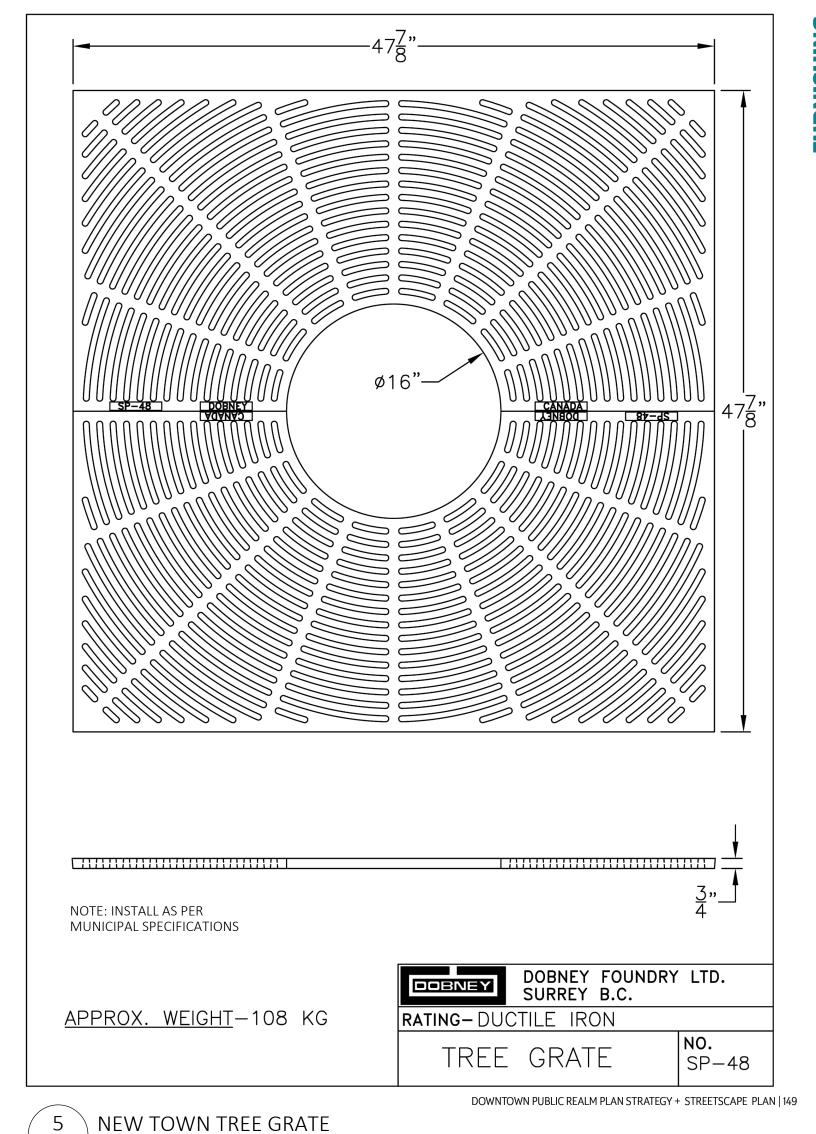


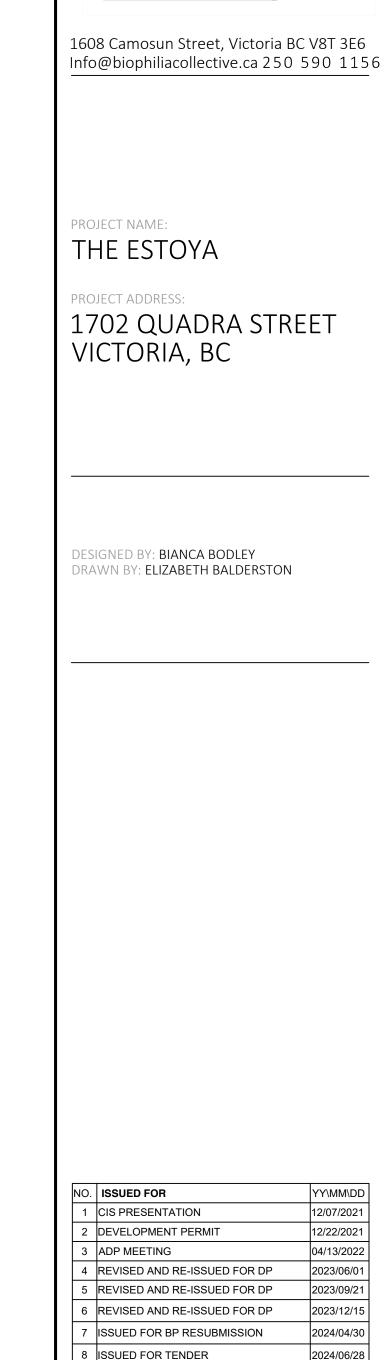


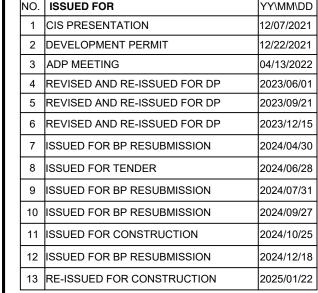






DRAWING TITLE: MUNICIPAL SITE **FURNITURE DETAILS**

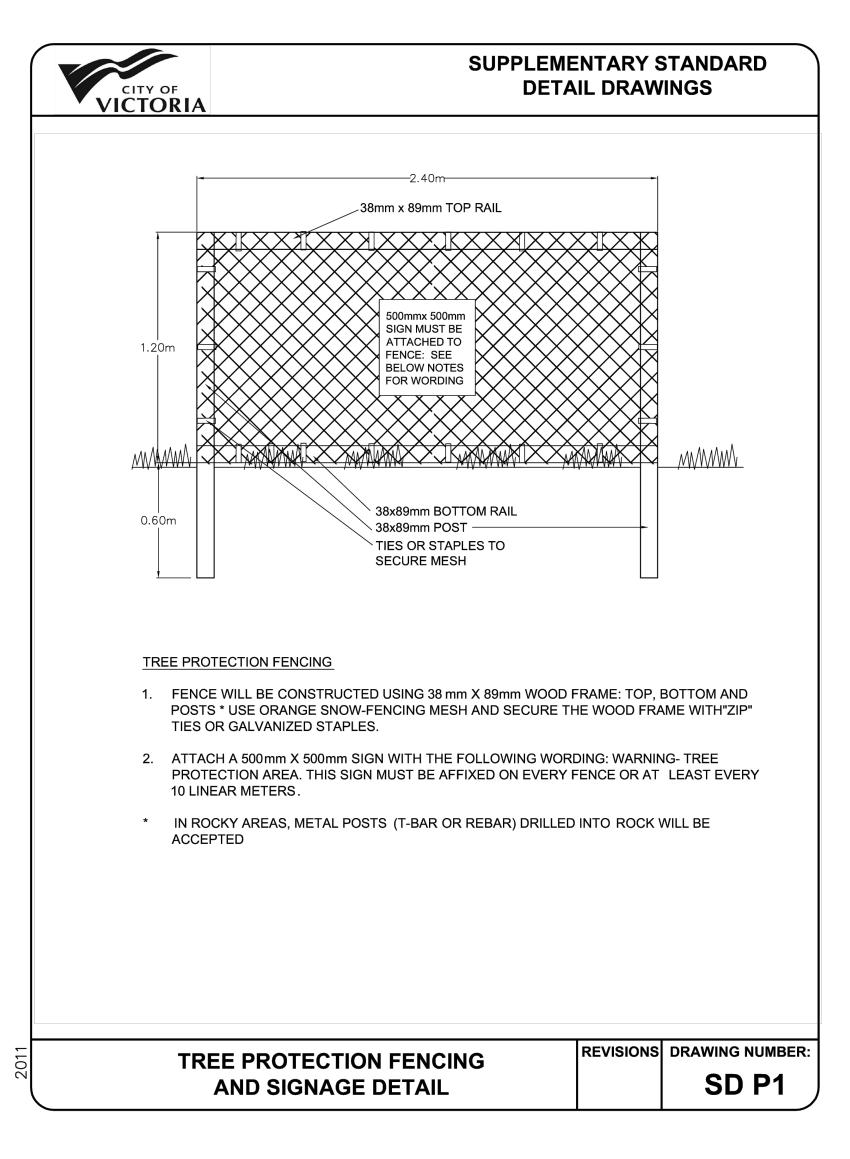

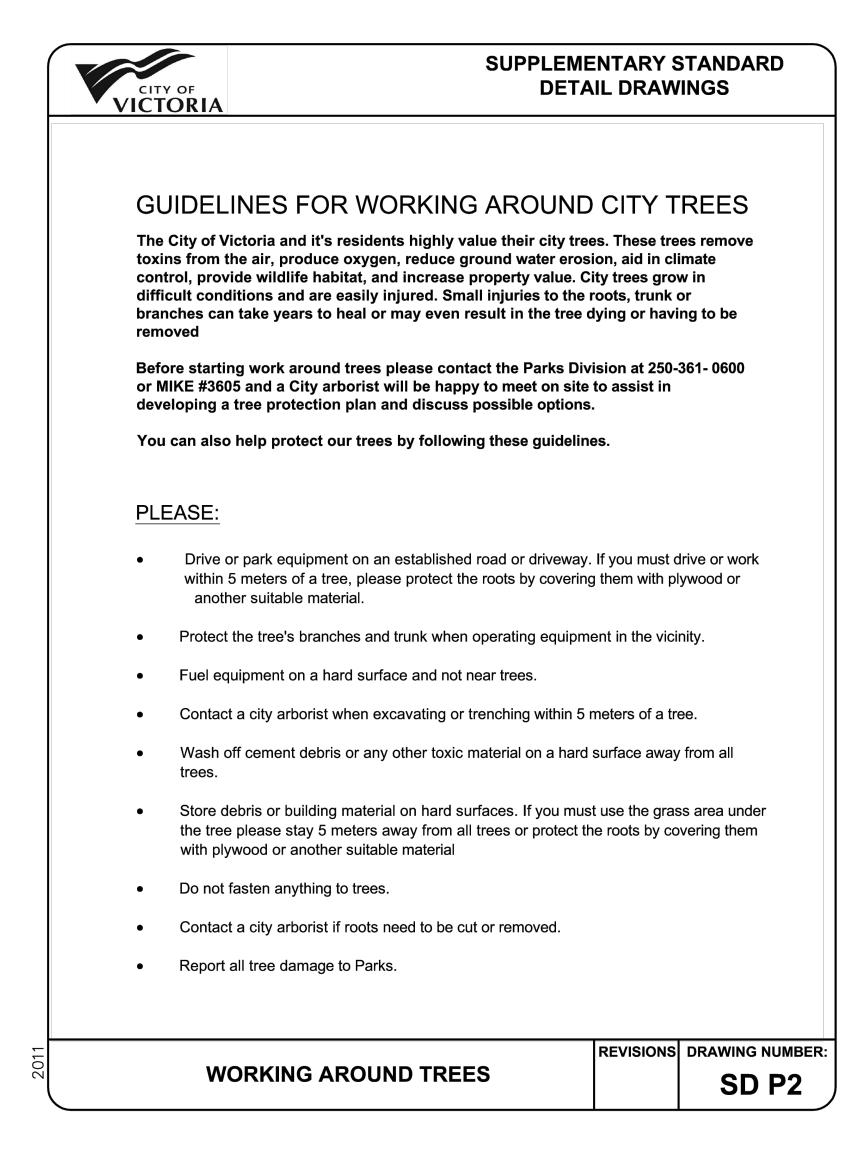


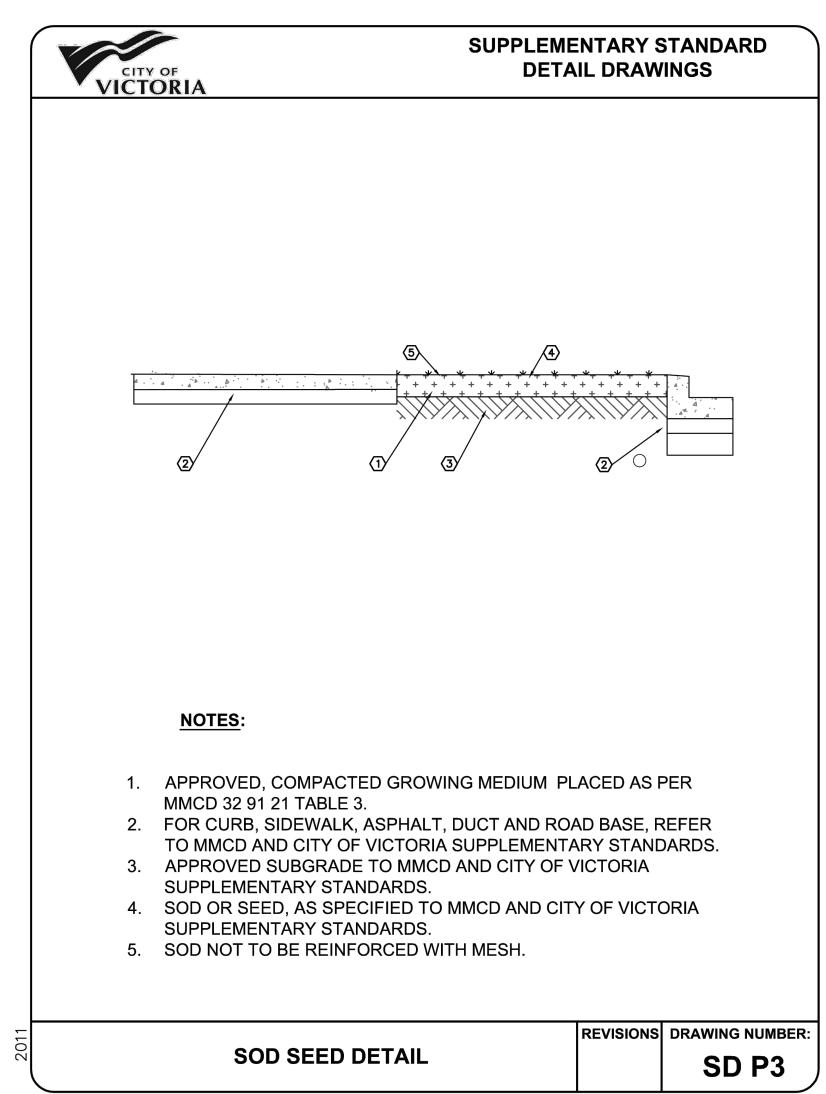

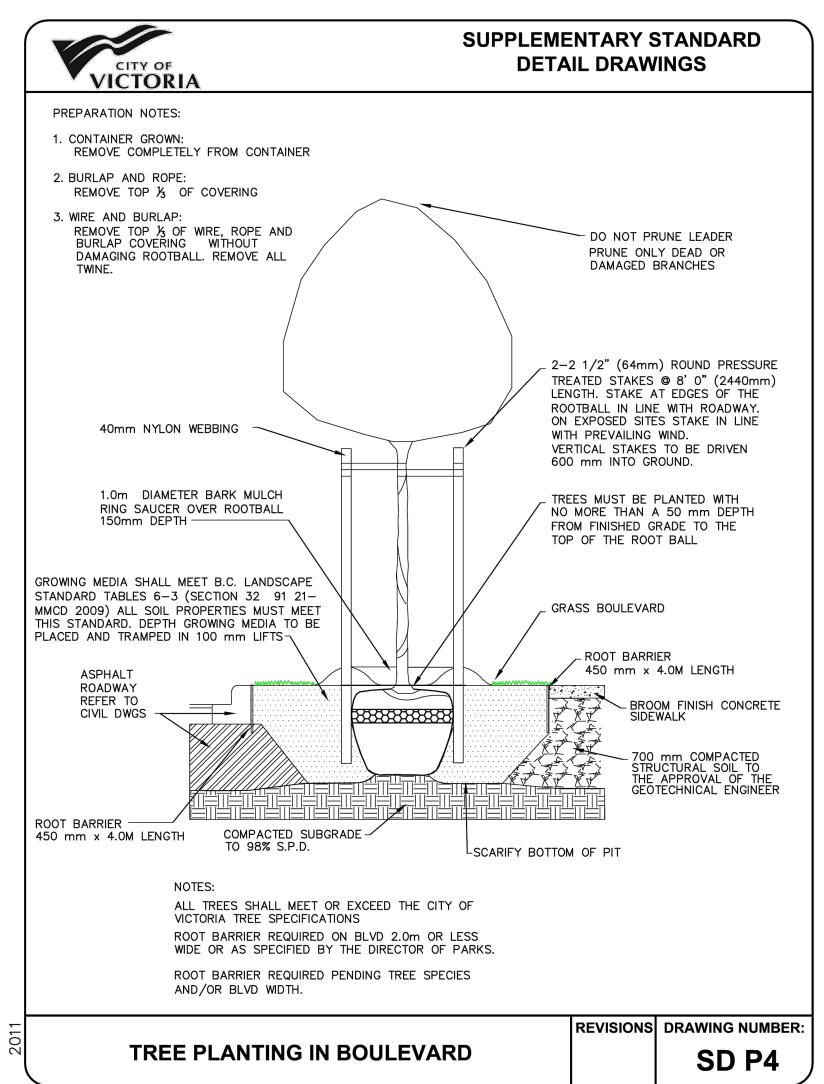

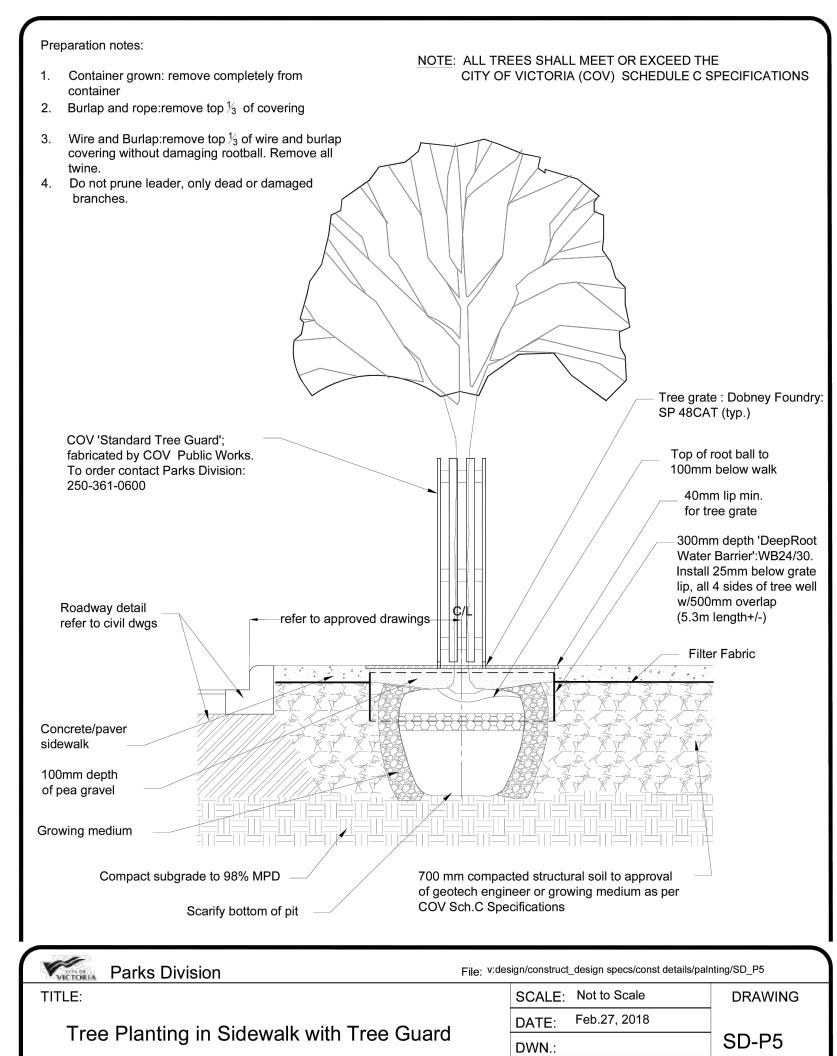

APP'D.:

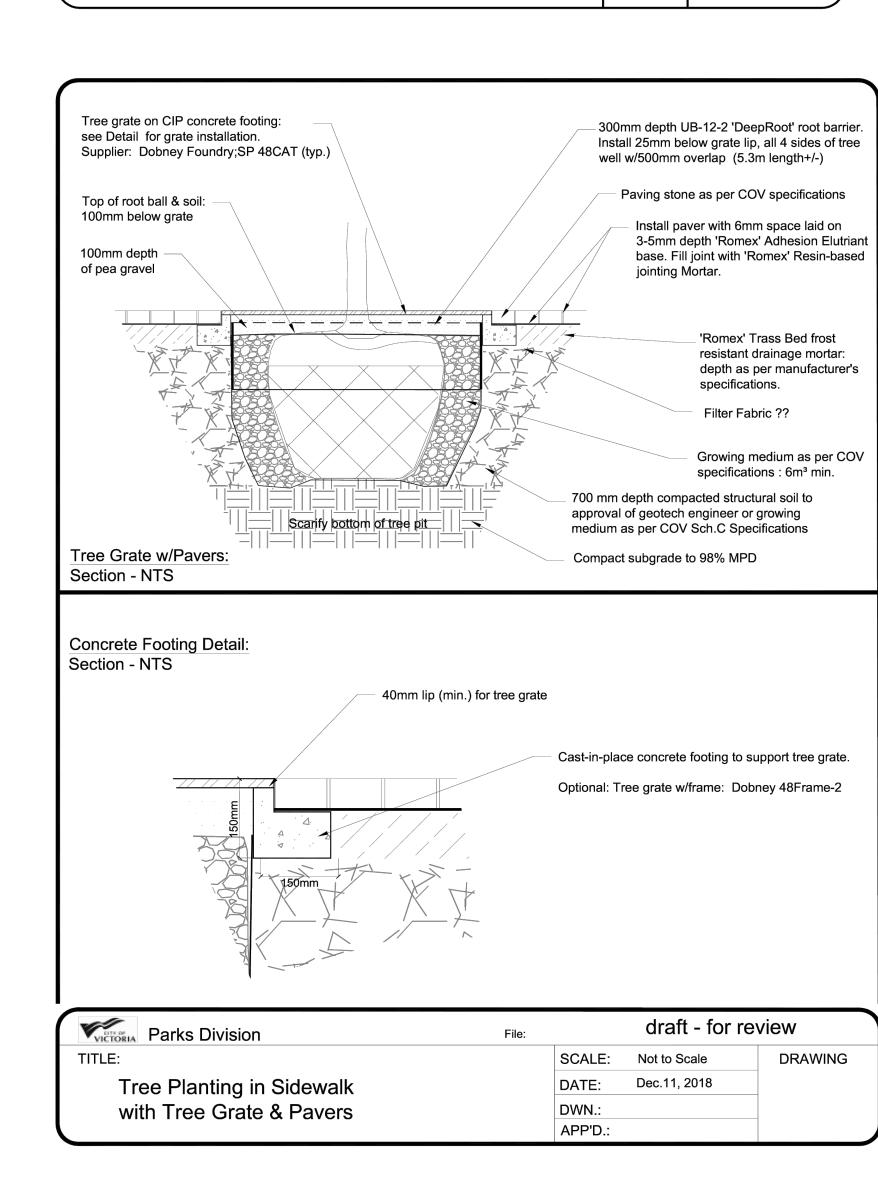



1608 Camosun Street, Victoria BC V8T 3E6 Info@biophiliacollective.ca 250 590 1156

PROJECT NAME:

THE ESTOYA

VICTORIA, BC

PROJECT ADDRESS:

1702 QUADRA STREET

DESIGNED BY: BIANCA BODLEY
DRAWN BY: ELIZABETH BALDERSTON

NO.	ISSUED FOR	YY\MM\D
1	CIS PRESENTATION	12/07/202
2	DEVELOPMENT PERMIT	12/22/202
3	ADP MEETING	04/13/202
4	REVISED AND RE-ISSUED FOR DP	2023/06/0
5	REVISED AND RE-ISSUED FOR DP	2023/09/2
6	REVISED AND RE-ISSUED FOR DP	2023/12/
7	ISSUED FOR BP RESUBMISSION	2024/04/3
8	ISSUED FOR TENDER	2024/06/2
9	ISSUED FOR BP RESUBMISSION	2024/07/3
10	ISSUED FOR BP RESUBMISSION	2024/09/2
11	ISSUED FOR CONSTRUCTION	2024/10/2
12	ISSUED FOR BP RESUBMISSION	2024/12/
13	RE-ISSUED FOR CONSTRUCTION	2025/01/2



DRAWING TITLE:

MUNICIPAL LANDSCAPE DETAILS

DWG NO:

SCALE: AS NOTED 6

1608 Camosun Street, Victoria BC V8T 3E6

PROJECT NAME:

THE ABBEY

PROJECT ADDRESS:


VICTORIA, BC

DESIGNED BY: BIANCA BODLEY

DRAWN BY: KIM TANG


1702 QUADRA STREET

Info@biophiliacollective.ca 250 590 1156

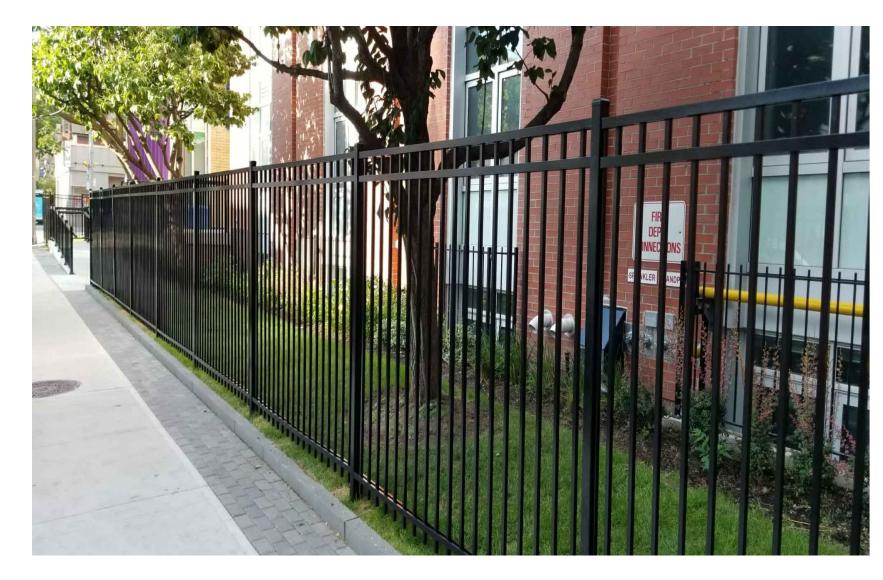

1 6' HT METAL PICKET FENCE

L3 NTS

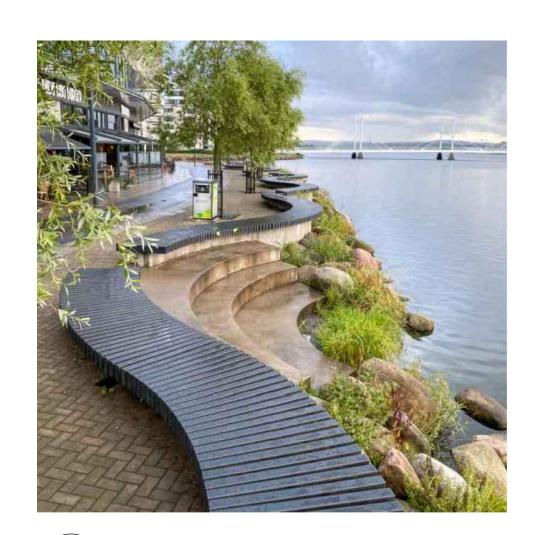

CUSTOM SEAT WALL BENCH

L3 NTS



BELGARD AQUALINE PERMEABLE PAVER

Type B Bollard

Ductile Iron

35" Height

Douglas Street

Reliance Foundry

Reliance Foundry Bollard

Glossy Black (RAL 9017) Baked-on

Inner Harbour, Old Town, Rock Bay,

Surface Mount, Bolted to Concrete

New Town, Government Street,

See Character area section of

Streetscape Standards for specific

L3 NTS

RELIANCE FOUNDRY BOLLARD

enhance wheelchair comfort Can be utilized to construct an **♦** AVAILABLE COLOURS ADA-compliant pavement

 Interlocking spacer bars for increased structural performance

Smooth surface with a microchamfer to minimize vibration and

True installed dimensions for

Can eliminate stormwater runoff

Meets the requirements of ASTM

and improve water quality

Chamfer Width: 3 mm

joint infill gradation) Surface Open Area: 10%

Spacer Bar Width: 10 mm

Surface Infiltration Rate: > 500 inches per hour (varies based on

Can be installed mechanically

design optimization Optimal joint openings for infiltration and maintenance







SHAPES & SIZES 45/16 x 83/4 x 31/8" 110 x 221.5 x 80mm

DURAFUSION™ Unmatched Durability

PRODUCT TYPE:

MODERN METAL BIN

PRODUCT NAME: DESIGN STYLE: MATERIALS: COLOUR/FINISH:

DIMENSIONS:

Douglas Street City of Victoria

location guidelines.

Component

Metal Frame

Powder Coat

42" Height

Modern


Modern Metal Bin

New Town, Government Street, See Character area section of Streetscape Standards for specific

Type A Litter Bin with Recycling

Glossy Black (RAL 9017) Baked-on

Inner Harbour, Old Town, Rock Bay,

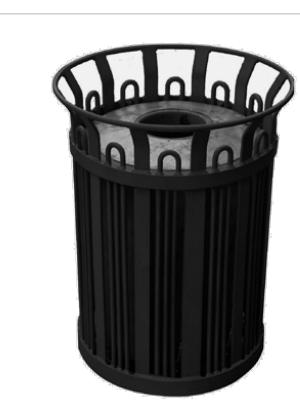

4 NEW TOWN BOLLARD

5 NEW TOWN LITTER RECEPTACLE


STANDARD BIKE RACK

1.5" Galvanized Steel Pipe Glossy Black (RAL 9017) Baked-on

Powder Coat 12" Length, 3' Height

location guidelines.


Inner Harbour, Old Town, Rock Bay, New Town, Government Street, Sleeve Mount See Character area section of Streetscape Standards for specific

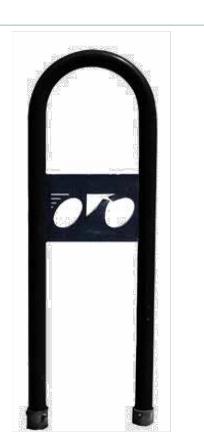


L3 NTS





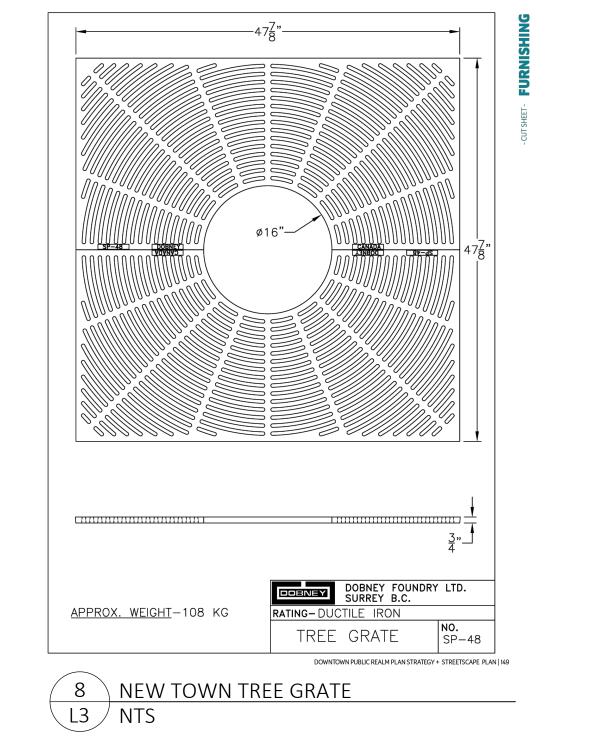

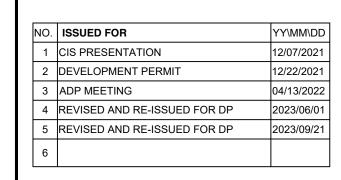




LANDSCAPE SITE PLAN

DRAWING TITLE:



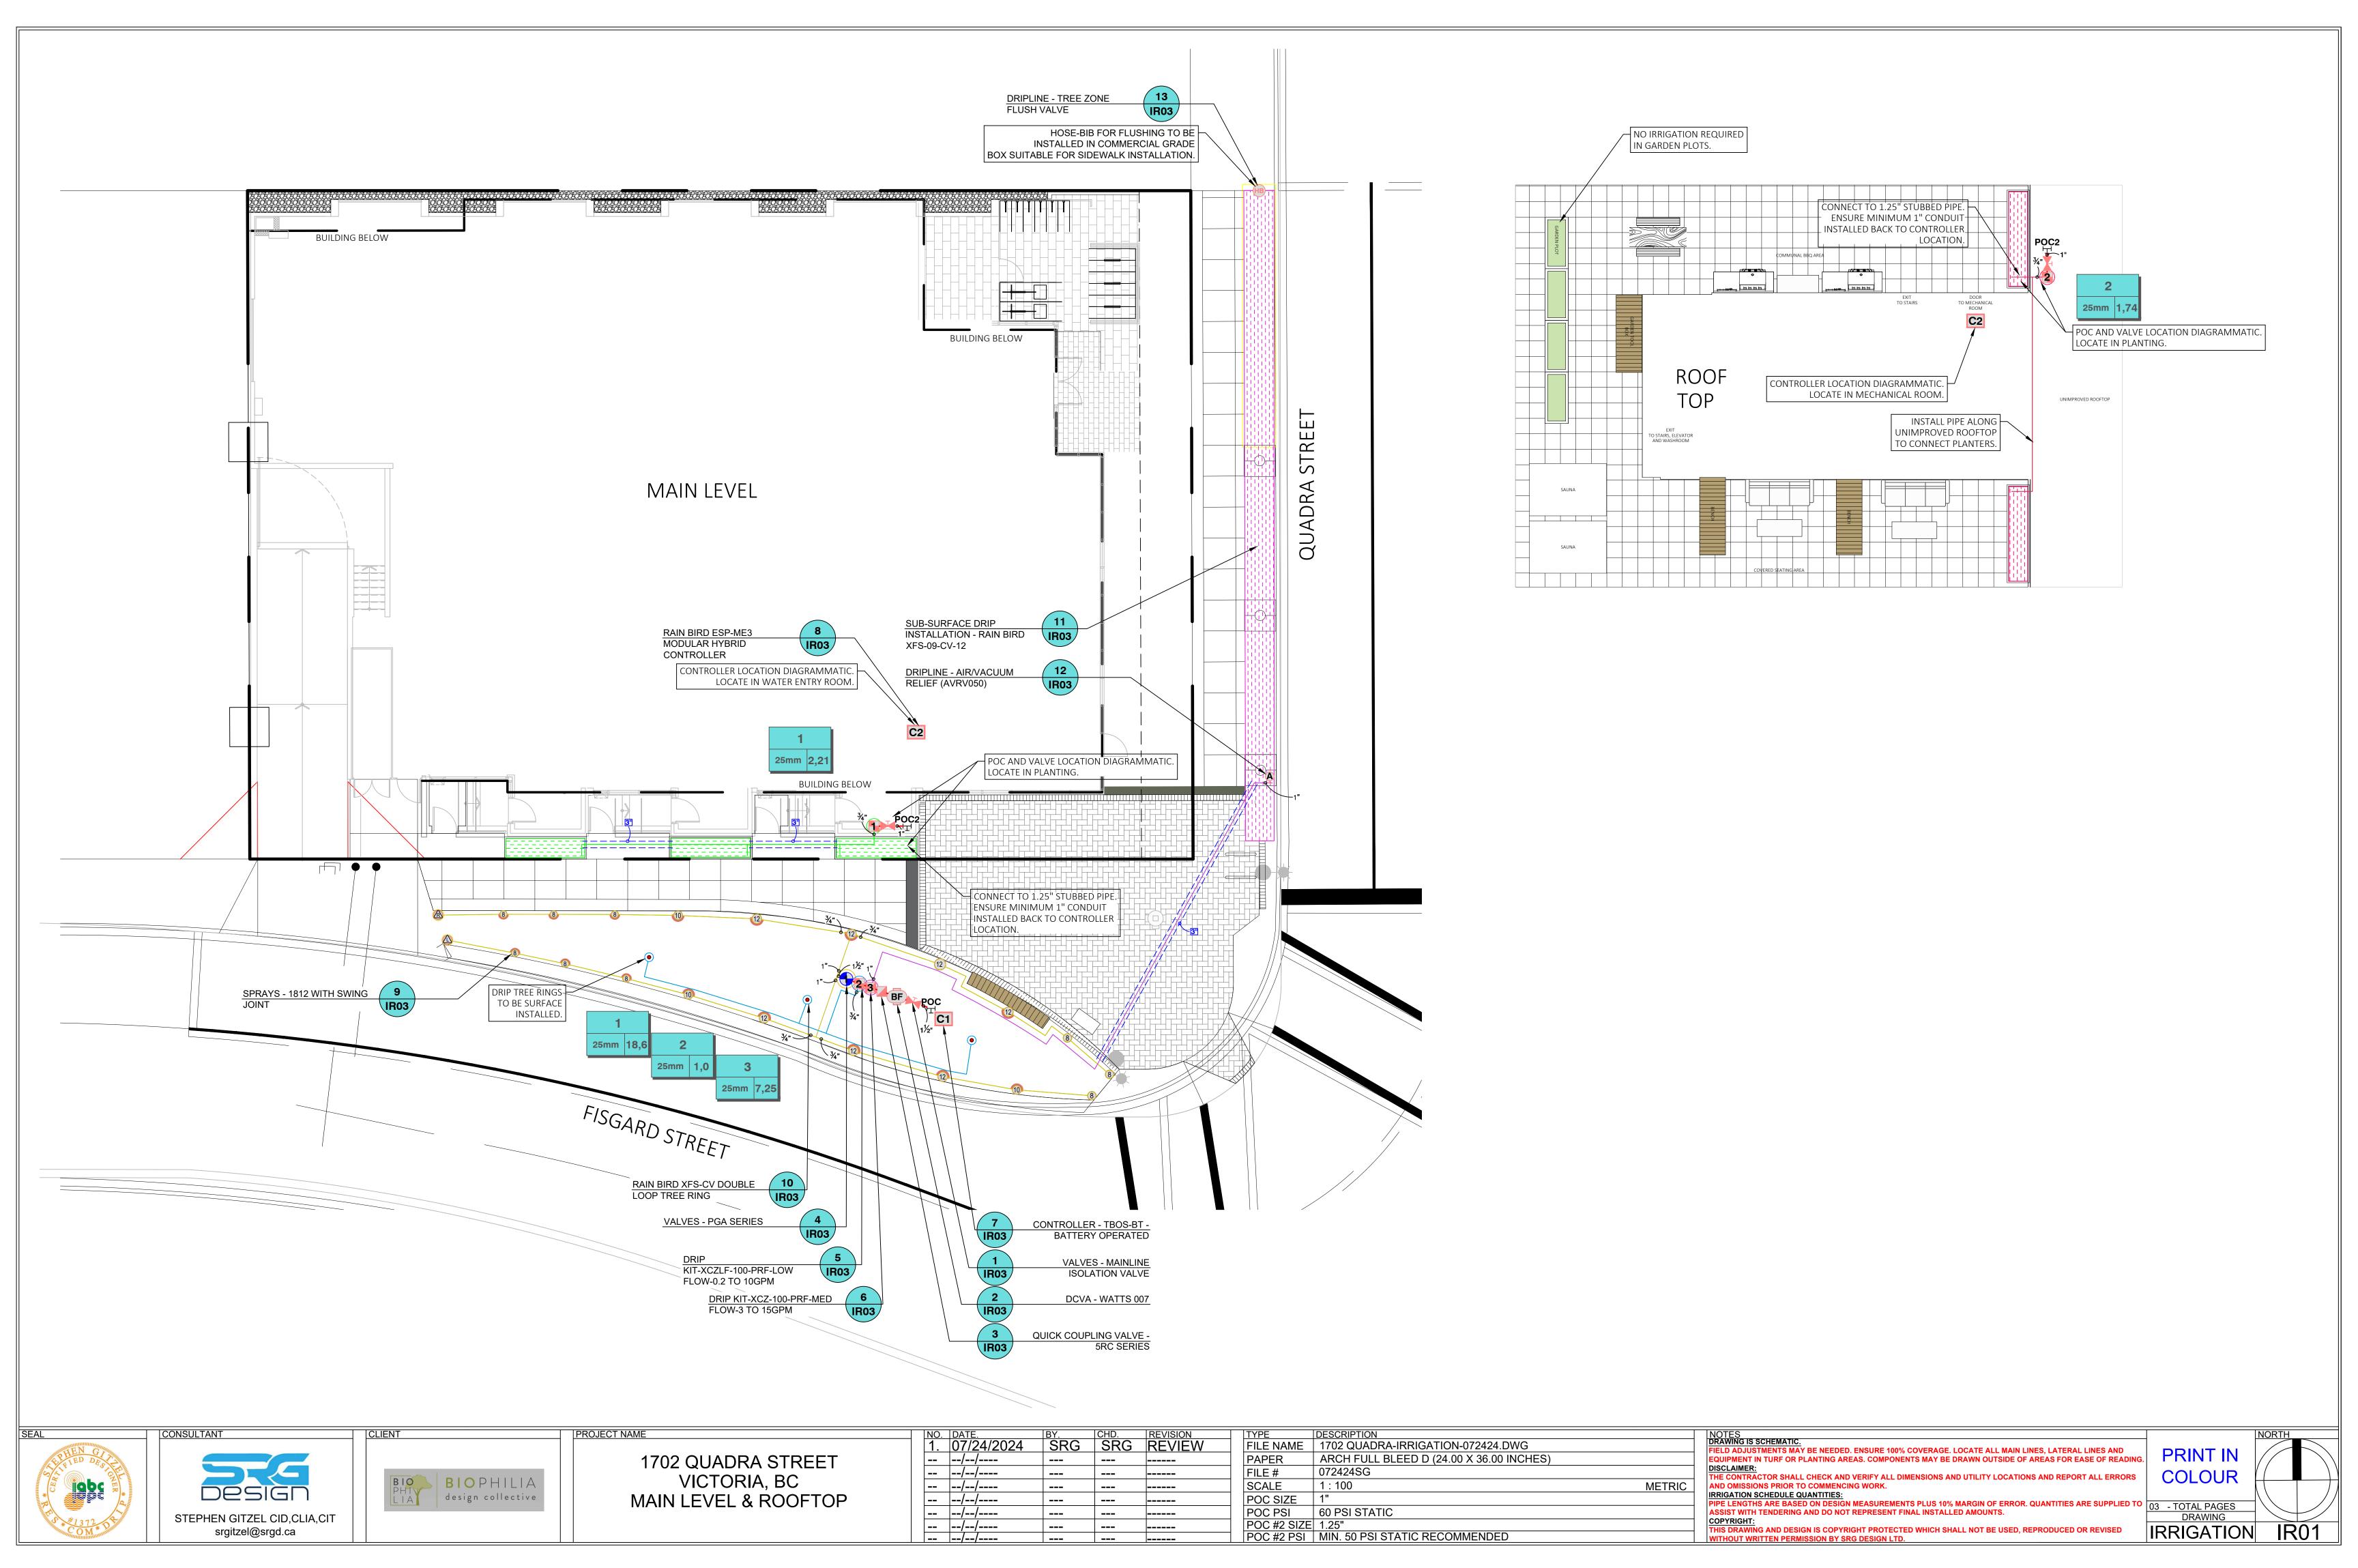

IRRIGATION	SCHEDULE OFF-SITE					
SYMBOL	MANUFACTURER/MODEL	QTY	ARC	PSI	GPM	RADIUS
	RAIN BIRD 1812 C/W MPR NOZZLE 15LCS	1	LCS	30	0,49	1,2x4,6
<u>@</u>	RAIN BIRD 1812 C/W MPR NOZZLE 15RCS	1	RCS	30	0,49	1,2x4,6
8	RAIN BIRD 1812 C/W MPR NOZZLE 08H	6	180	30	0,52	2,4 m
(1)	RAIN BIRD 1812 C/W MPR NOZZLE 10H	3	180	30	0,79	3,0 m
12	RAIN BIRD 1812 C/W MPR NOZZLE 12H	6	180	30	1,3	3,7 m
8	RAIN BIRD 1812 C/W MPR NOZZLE 08V	3	ADJ	30	≤ 2,88	2,4 m
(12)	RAIN BIRD 1812 C/W MPR NOZZLE 12V	1	ADJ	30	≤ 2,38	3,7 m
SYMBOL	MANUFACTURER/MODEL	QTY				
X	RAIN BIRD XCZ-100-PRF MEDIUM FLOW DRIP CONTROL KIT 25MM	1				
8	RAIN BIRD XCZLF-100-PRF LOW FLOW DRIP CONTROL KIT 25MM	1				
Ą	RAIN BIRD ARV050 13MM	1				
•	RAIN BIRD XFS-CV-09-12 DRIP TREE RING	3				
	AREA TO RECEIVE DRIPLINE RAIN BIRD XFS-CV-09-12 LANDSCAPE DRIPLINE	160 m				
SYMBOL	MANUFACTURER/MODEL	QTY				
•	RAIN BIRD PGA ELECTRIC REMOTE CONTROL VALVE 25MM	1				
	RAIN BIRD 5-RC QUICK-COUPLING VALVE 25MM	1				
НВ	HOSE-BIB FLUSH FOR TREE ZONE.	1				
	ISOLATION VALVE SIZED TO MAIN	1				
BF	WATTS 007 DCVA 25MM	1				
C1	RAIN BIRD TBOS-BT4 BATTERY OPERATED CONTROLLER	1				
POC	POINT OF CONNECTION 1"	1				
	- IRRIGATION LATERAL LINE: PVC CLASS 200 SDR 21 3/4"	80 m				
	IRRIGATION LATERAL LINE: PVC CLASS 200 SDR 21 1"	36 m				
	- IRRIGATION LATERAL LINE: PVC CLASS 200 SDR 21 1 1/2"	1 m				
	- IRRIGATION MAINLINE: PVC SCHEDULE 40 1 1/2"	6 m				
	PIPE SLEEVE: PVC SCHEDULE 40 - 2X DIAM. OF THE PIPE CARRYING 3"	12 m				

Valve Callout Valve Number #" # ● Valve Flow

VALVE SCHEDULE OFF-SITE							
NUMBER	MODEL	SIZE	TYPE	GPM			
1	RAIN BIRD PGA ELECTRIC REMOTE CONTROL VALVE	25mm	SHRUB SPRAY	18,59			
2	RAIN BIRD XCZLF-100-PRF LOW FLOW DRIP CONTROL KIT	25mm	DRIP EMITTER	1,0			
3	RAIN BIRD XCZ-100-PRF MEDIUM FLOW DRIP CONTROL KIT	25mm	AREA FOR DRIPLINE	7,25			

CRITICAL ANALYSIS OFF-SITE

2024-07-25


Generated:

P.O.C. NUMBER: 01 Water Source Information: 1" POC @ 60PSI FLOW AVAILABLE Point of Connection Size: 25mm Flow Available 19,88 GPM PRESSURE AVAILABLE 60 PSI 60 PSI Static Pressure at POC: Pressure Available: **DESIGN ANALYSIS** 18,59 GPM Maximum Station Flow: Flow Available at POC: 19,88 GPM 1,3 GPM Residual Flow Available: Critical Station: Design Pressure: 30 PSI 0,64 PSI Friction Loss: 0,06 PSI Fittings Loss: 0 PSI Elevation Loss: 7,25 PSI Loss through Valve: Pressure Req. at Critical Station: 37,9 PSI 0,0 PSI Loss for Fittings: Loss for Main Line: 0,01 PSI Loss for POC to Valve Elevation: Loss for Backflow: Critical Station Pressure at POC: 41,0 PSI Pressure Available: Residual Pressure Available: 19,0 PSI

REFERENCE NOTES SCHEDULE OFF-SITE DESCRIPTION ALL IRRIGATION WORK, INCLUDING REQUIRED INSPECTIONS, SHALL FOLLOW THE SUPPLEMENTARY SPECIFICATIONS FOR STREET TREES & IRRIGATION, SCHEDULE C TO THE VICTORIA SUBDIVISION & DEVELOPMENT SERVICING BYLAW 12-042, AND COMPLY WITH HABC STANDARDS. IRRIGATION INSPECTIONS ARE REQUIRED FOR ALL SLEEVING, OPEN TRENCH MAIN LINE AND LATERAL LINES, SYSTEM OPERATION, CONTROLLER AND BACKFLOW PREVENTER (INCL. INSPECTION TAG & TESTING REPORT). CALL PARKS AT 250-361-0600 AT LEAST 2 WORKING DAYS IN ADVANCE TO ARRANGE FOR IRRIGATION INSPECTIONS. IRRIGATION AS-BUILT SUBMITTALS (PDF AND .DWG FILES) COVERAGE ADJUSTMENTS AND DEFICIENCIES TO BE CORRECTED PRIOR TO ACCEPTANCE. 100MM SDR 28 PIPE BE USED FOR IRRIGATION SLEEVING UNDER HARD SURFACES. INSTALLATIONS WHERE A 90-DEGREE BEND IS REQUIRED SHOULD BE INSTALLED USING 100MM SDR 28 GSX (22.5 DEGREE) LONG SWEEPS. PLEASE INSTALL AT 400MM DEPTH.

"SLEEVES INSTALLED BY OTHERS" City of Victoria - Inspection instructions: IRRIGATION SYSTEMS - Tom Sherbo – tsherbo@victoria.ca Irrigation Systems on City property shall comply to City of Victoria Supplementary Specifications for Street Trees and Irrigation Schedule C, Bylaw 12-042, Subdivision Bylaw. Irrigation drawings must be submitted to Parks Division for review and approval 30 days prior to installation work. The following irrigation and sleeving inspections by Parks Staff are required by Schedule C. 1. Irrigation Sleeving prior to backfilling 2. Open trench Main Line and Pressure Test 3. Open trench Lateral Line 4. Irrigation system, Controller, Coverage test, Backflow Preventer Assembly Test Report required, Backflow Assembly is to have an inspection tag completed and attached.

PROJECT NAME

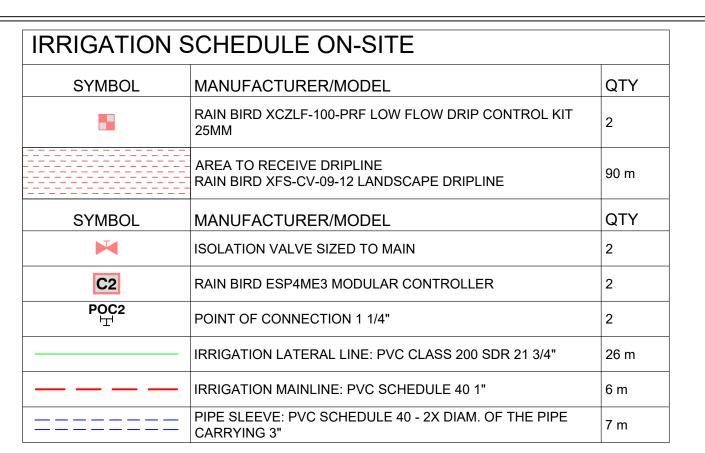


Valve Callout Valve Flow

VALVE SCHEDULE ON-SITE							
NUMBER	MODEL	SIZE	TYPE	GPM			
1	RAIN BIRD XCZLF-100-PRF LOW FLOW DRIP CONTROL KIT	25mm	AREA FOR DRIPLINE	2,21			
2	RAIN BIRD XCZLF-100-PRF LOW FLOW DRIP CONTROL KIT	25mm	AREA FOR DRIPLINE	1,74			

CRITICAL ANALYSIS MAIN LEVEL CRITICAL ANALYSIS ROOF TOP

OTTITION LE MINNET		ONTIONE ANALTOID NOOF TO			
Generated:	2024-07-25	Generated:	2024-07-25		
P.O.C. NUMBER: 02		P.O.C. NUMBER: 02			
Water Source Information:	1.25" POC @ 50PSI MIN.	Water Source Information:	1.25" POC @ 50PSI MI		
FLOW AVAILABLE		FLOW AVAILABLE			
Point of Connection Size:	32mm	Point of Connection Size:	32mm		
Flow Available	28,64 GPM	Flow Available	28,64 GPM		
PRESSURE AVAILABLE		PRESSURE AVAILABLE			
Static Pressure at POC:	50 PSI	Static Pressure at POC:	50 PSI		
Pressure Available:	50 PSI	Pressure Available:	50 PSI		
DESIGN ANALYSIS		DESIGN ANALYSIS			
Maximum Station Flow:	2,21 GPM	Maximum Station Flow:	1,74 GPM		
Flow Available at POC:	28,64 GPM	Flow Available at POC:	28,64 GPM		
Residual Flow Available:	26,43 GPM	Residual Flow Available:	26,9 GPM		
Critical Station:	1	Critical Station:	2		
Design Pressure:	30 PSI	Design Pressure:	30 PSI		
Friction Loss:	0,04 PSI	Friction Loss:	0,02 PSI		
Fittings Loss:	0 PSI	Fittings Loss:	0 PSI		
Elevation Loss:	0 PSI	Elevation Loss:	0 PSI		
Loss through Valve:	4,76 PSI	Loss through Valve:	4,62 PSI		
Pressure Req. at Critical Station:	34,8 PSI	Pressure Req. at Critical Station:	34,6 PSI		
Loss for Fittings:	0,0 PSI	Loss for Fittings:	0,0 PSI		
Loss for Main Line:	0,01 PSI	Loss for Main Line:	0,0 PSI		
Loss for POC to Valve Elevation:	0 PSI	Loss for POC to Valve Elevation:	0 PSI		
Loss for Backflow:	0 PSI	Loss for Backflow:	0 PSI		
Critical Station Pressure at POC:	34,8 PSI	Critical Station Pressure at POC:	34,6 PSI		
Pressure Available:	50 PSI	Pressure Available:	50 PSI		
Residual Pressure Available:	15,2 PSI	Residual Pressure Available:	15,4 PSI		

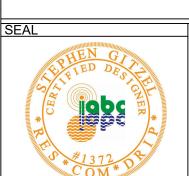



CONSULTANT



CLIENT

1702 QUADRA STREET VICTORIA, BC SCHEDULES

NO.	DATE.	BY.	CHD.	REVISION	TYPE	DESCRIPTION	
1.	07/24/2024	SRG	SRG	REVIEW	FILE NAME	1702 QUADRA-IRRIGATION-072424.DWG	
	//				PAPER	ARCH FULL BLEED D (24.00 X 36.00 INCHES)	
	//				FILE #	072424SG	<u>-</u>
	//				SCALE	1:100 MET	RIC
	//				POC SIZE	1"	
	//				POC PSI	60 PSI STATIC	
	//				POC #2 SIZE		
	//				POC #2 PSI	MIN. 50 PSI STATIC RECOMMENDED	1

FIELD ADJUSTMENTS MAY BE NEEDED. ENSURE 100% COVERAGE. LOCATE ALL MAIN LINES, LATERAL LINES AND EQUIPMENT IN TURF OR PLANTING AREAS. COMPONENTS MAY BE DRAWN OUTSIDE OF AREAS FOR EASE OF READING. DISCLAIMER:
THE CONTRACTOR SHALL CHECK AND VERIFY ALL DIMENSIONS AND UTILITY LOCATIONS AND REPORT ALL ERRORS AND OMISSIONS PRIOR TO COMMENCING WORK.

IRRIGATION SCHEDULE QUANTITIES:
PIPE LENGTHS ARE BASED ON DESIGN MEASUREMENTS PLUS 10% MARGIN OF ERROR. QUANTITIES ARE SUPPLIED TO

OBJECT WITH TENDERING AND DO NOT REPRESENT FINAL INSTALLED AMOUNTS.

DRAWING COPYRIGHT:
THIS DRAWING AND DESIGN IS COPYRIGHT PROTECTED WHICH SHALL NOT BE USED, REPRODUCED OR REVISED
WITHOUT WRITTEN PERMISSION BY SRG DESIGN LTD.

PRINT IN COLOUR

IRRIGATION IR02

NORTH

