



List of Architectural Drawings

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A1.4	Solar Study	(1:120) 1" = 10'-0"
A1.5	Sustainability Strategy	(1:120) 1" = 10'-0"
A1.6	Neighbouring Window Overlay	(1:120) 1" = 10'-0"
A2.0	Site Plan	1:120
A2.1	Graphical Floor Area Ratio	1:100
A2.2	Graphical No. of Stories	1:100
A2.3	Graphical Lot Coverage & Open Site Space	(1:120) 1" = 10'-0"
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A3.4	Unit B2 Floor Plans Unit 1	1:50
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A4.6	Block 01 & 02 Sections	1:65
A5.0	Building Assemblies	NTS
A6.0	Concept Renderings	NTS
A6.1	Concept Renderings	NTS
26	Sheets in Set	

Team of Consultants

Architect

Sèbastien Garon Architecture + Design Inc Project No. 19.015 1018 Deep Cove Rd North Vancouver BC Sébastien Garon, Architect, AIBC (604) 812-1869 sebastien@sgad.ca

Contractor

P. Cosgrave Construction Ltd. Paul Cosgrave, Principal (250) 886-1361 paul@cosgrave.ca

Landscape

BIOPHILIA design collective Itd

1501 Haultain St Victoria BC V8R 2K1 Bianca Bodley (250) 590-1156 bianca@biophiliacollective.ca

Arborist

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Geotechnical

Ryzuk Geotechnical Scott Currie, P. Eng. (250)-475-3131 scott@ryzuk.com

Surveyor

J.E.Anderson & Associates Project No. 31517 4212 Glanford Ave Victoria BC V8Z 4B7

(250) 727-2214 info@jeanderson.com

Civil Engineer

Westbrook Consulting Ltd. (250) 391-8592 ext. #235 IKvartuc@wbrook.ca

Structural

Skyline Engineering Wade Griffin (250)-590-4133 Ext. 103 wgriffi@seng.ca


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BC Vancouver 1018 Deep Cove Rd, North (604) 812-1869 info@ **www.SGAD.c**

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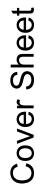
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REPORT INCONSISTENCIES AND OMISSIONS TO THE ARCHITECT FOR CLARIFICATION BEFORE COMMENCING WITH THE WORK



Issued 2019-06-19 2019-09-16 2019-10-21

Issued for DP Revised & Re-Issued for DP Revised & Re-Issued for DP 2019-12-12 Revised & Re-Issued for DP

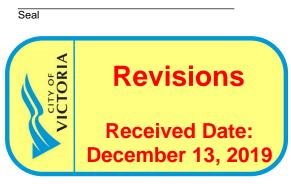


Project Name:

Fairfield-Kipling Development

Civic:	1400 Fairfield Rd & 349 Kipling St
Legal:	
PID:	
Project No:	19.015
Drawn By:	SG/TD
Plot Date:	Dec 12, 2019
Scale:	NTS
Sheet No:	





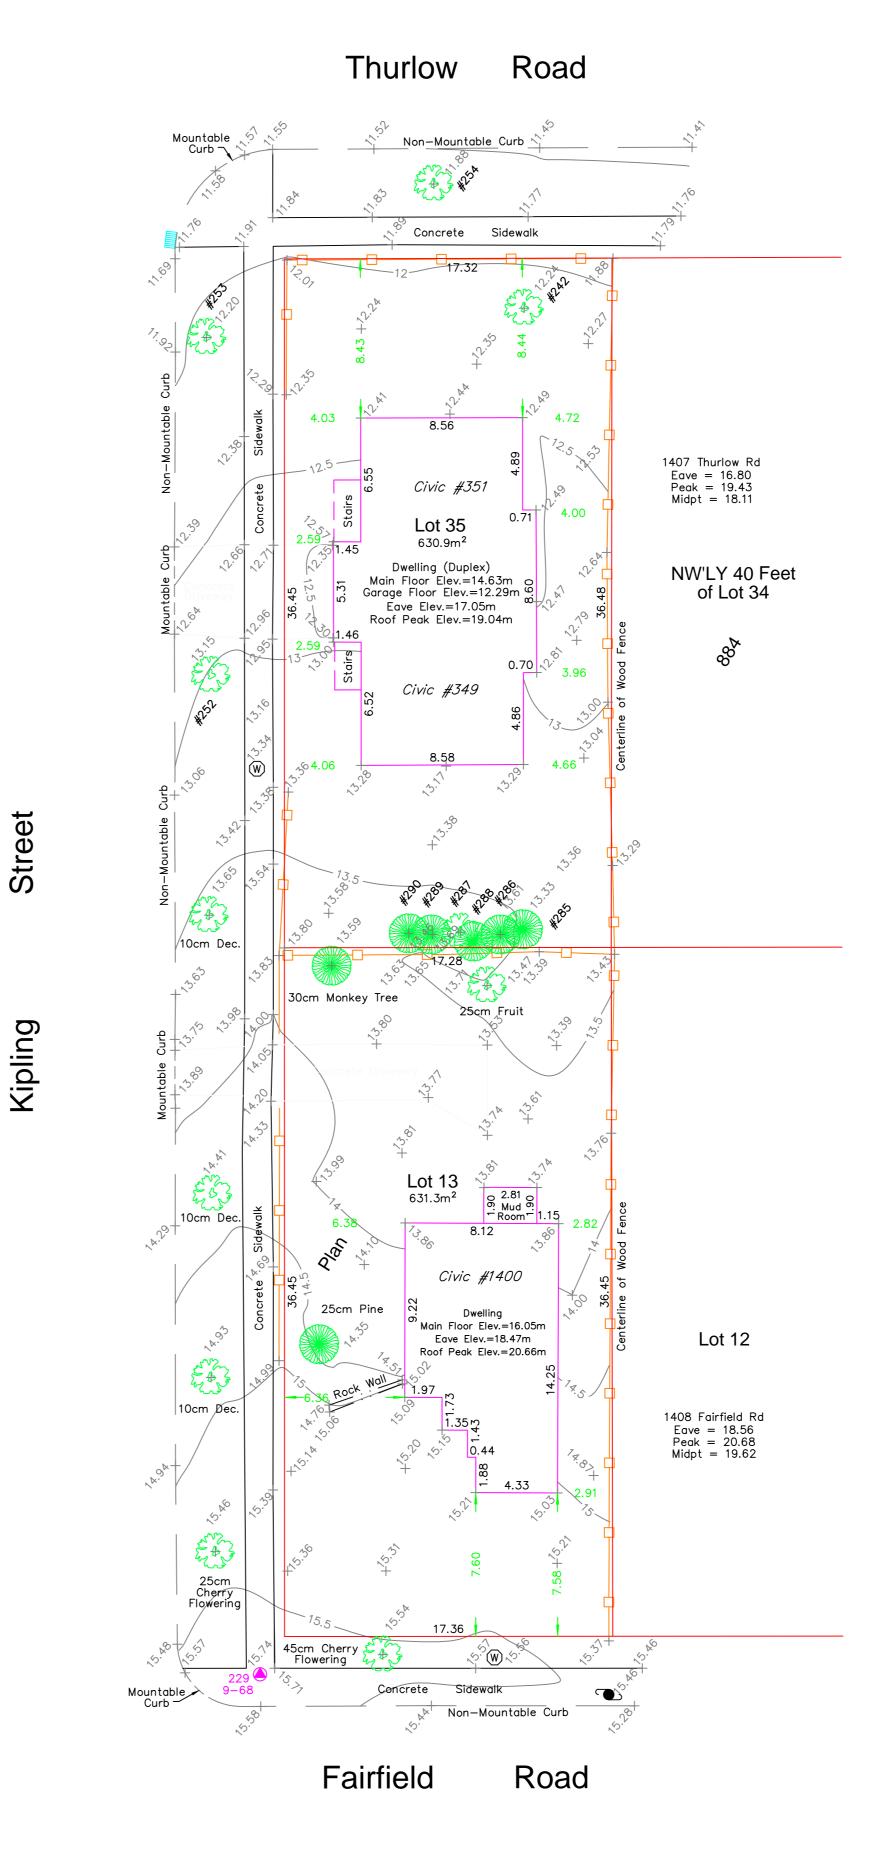

This sketch does not constitute a redefinition of the legal boundaries hereon described and is not to be used in any matter which would assume same. J.E. Anderson & Associates accepts no responsibility or liability for any damages that may be suffered by a third party as a result of any decision made, or actions taken based on this document. Subject to charges, legal notations, and interests shown on: Title No. ET59777 (P.I.D. 008-292-345) Lot 13 Title No. CA6094211 (P.I.D. 005-209-510) Lot 35



<u>LEGEND</u>


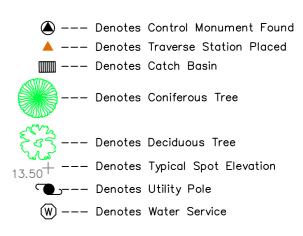


Table of Tree Descriptions

Tag #	Species	Diameter	
#242	Deciduous	60cm	
#252	Deciduous	45cm	
#253	Deciduous	50cm	
#254	Deciduous	30cm	
#285	Cedar	40cm	
#286	Cedar	40cm	
#287	Deciduous	30cm (Twin)	
#288	Cedar	30cm (Twin)	
#289	Cedar	30cm	
#290	Cedar	45cm (Twin)	
No tag	Monkey	30cm	
No tag	Fruit	25cm	
No tag	Deciduous	10cm	
No tag	Deciduous	10cm	
No tag	Cherry	25cm	
No tag	Cherry	45cm	
No tag	Pine	25cm	

Legal boundaries are derived from field survey Distances and elevations are in metres. Elevations are geodetic based on control monument 9-68. Elevations are at grade unless noted otherwise. Building dimensions and offsets to property lines are shown to exterior of building walls.

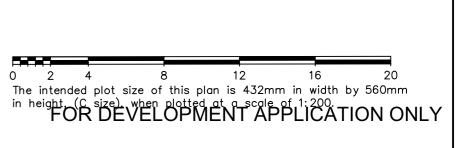


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Survey Plan	

Project Name:


Fairfield-Kipling Development

Civic:	1400 Fairfield Rd &
	349 Kipling St
Legal:	
PID:	
Project No:	19.015
Drawn By:	SG/TD
Plot Date:	Dec 12, 2019
Scale:	NTS
Sheet No:	


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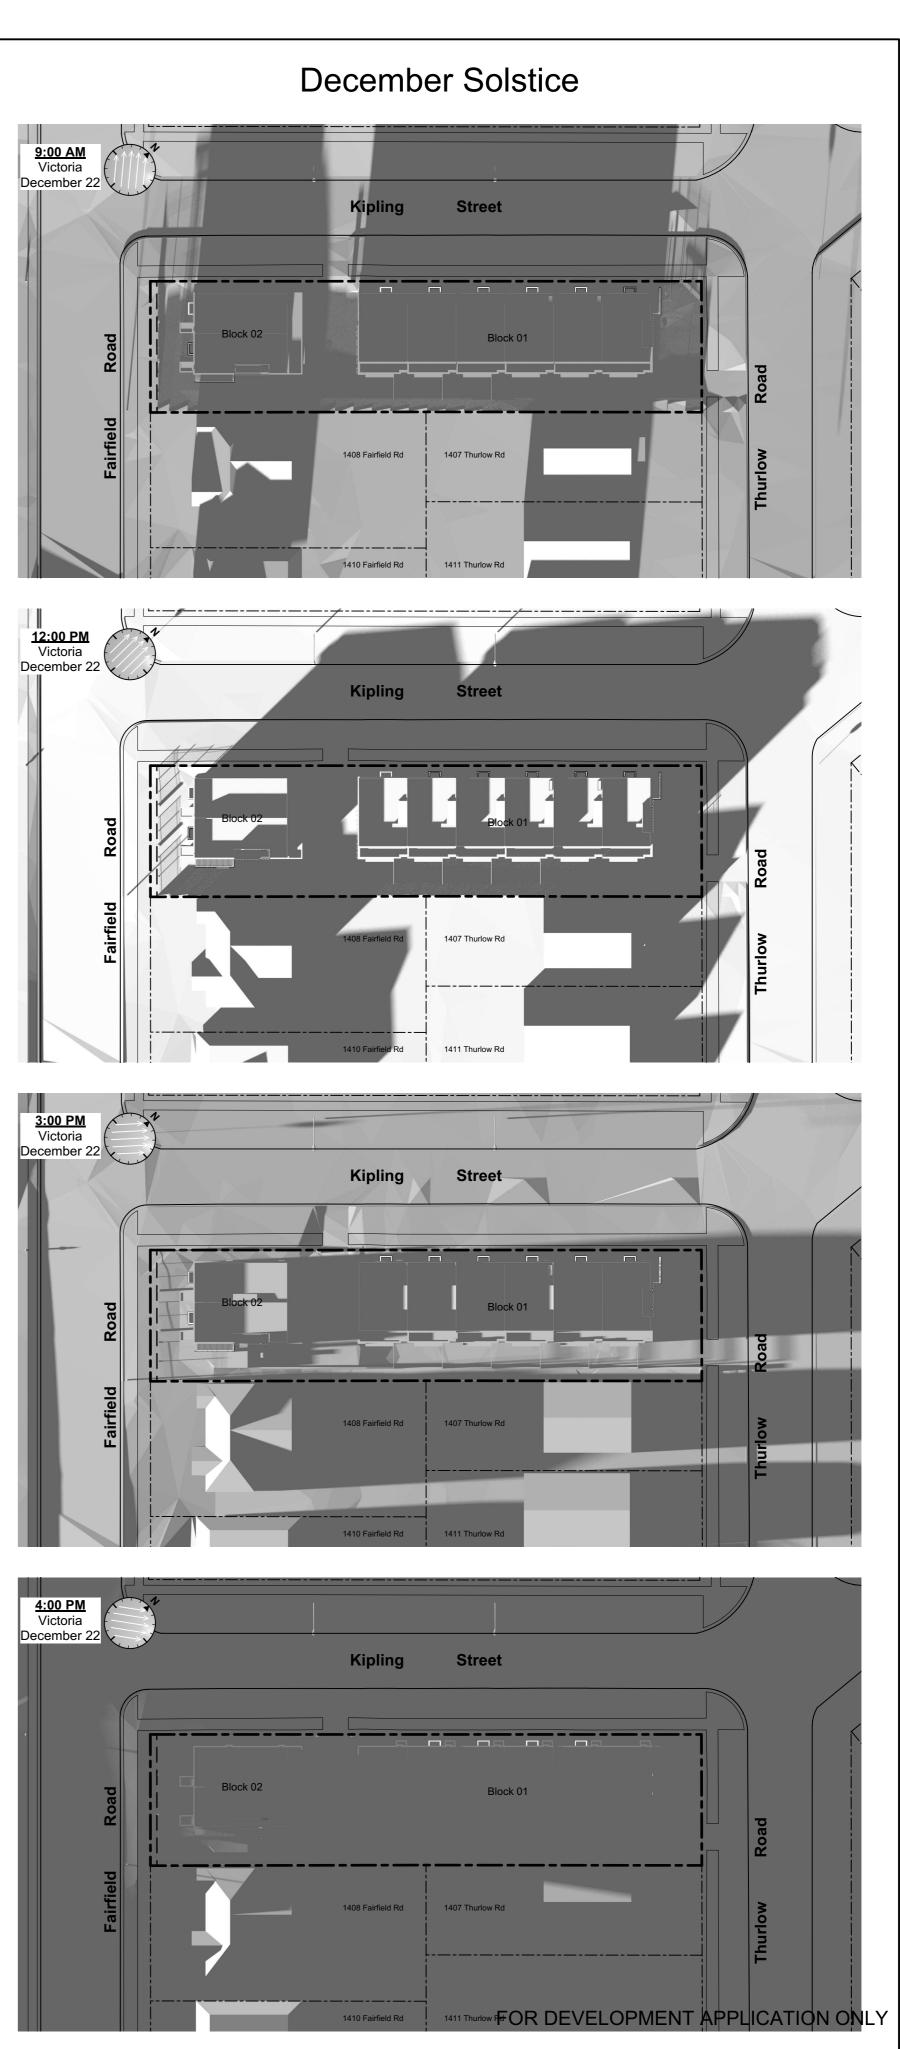


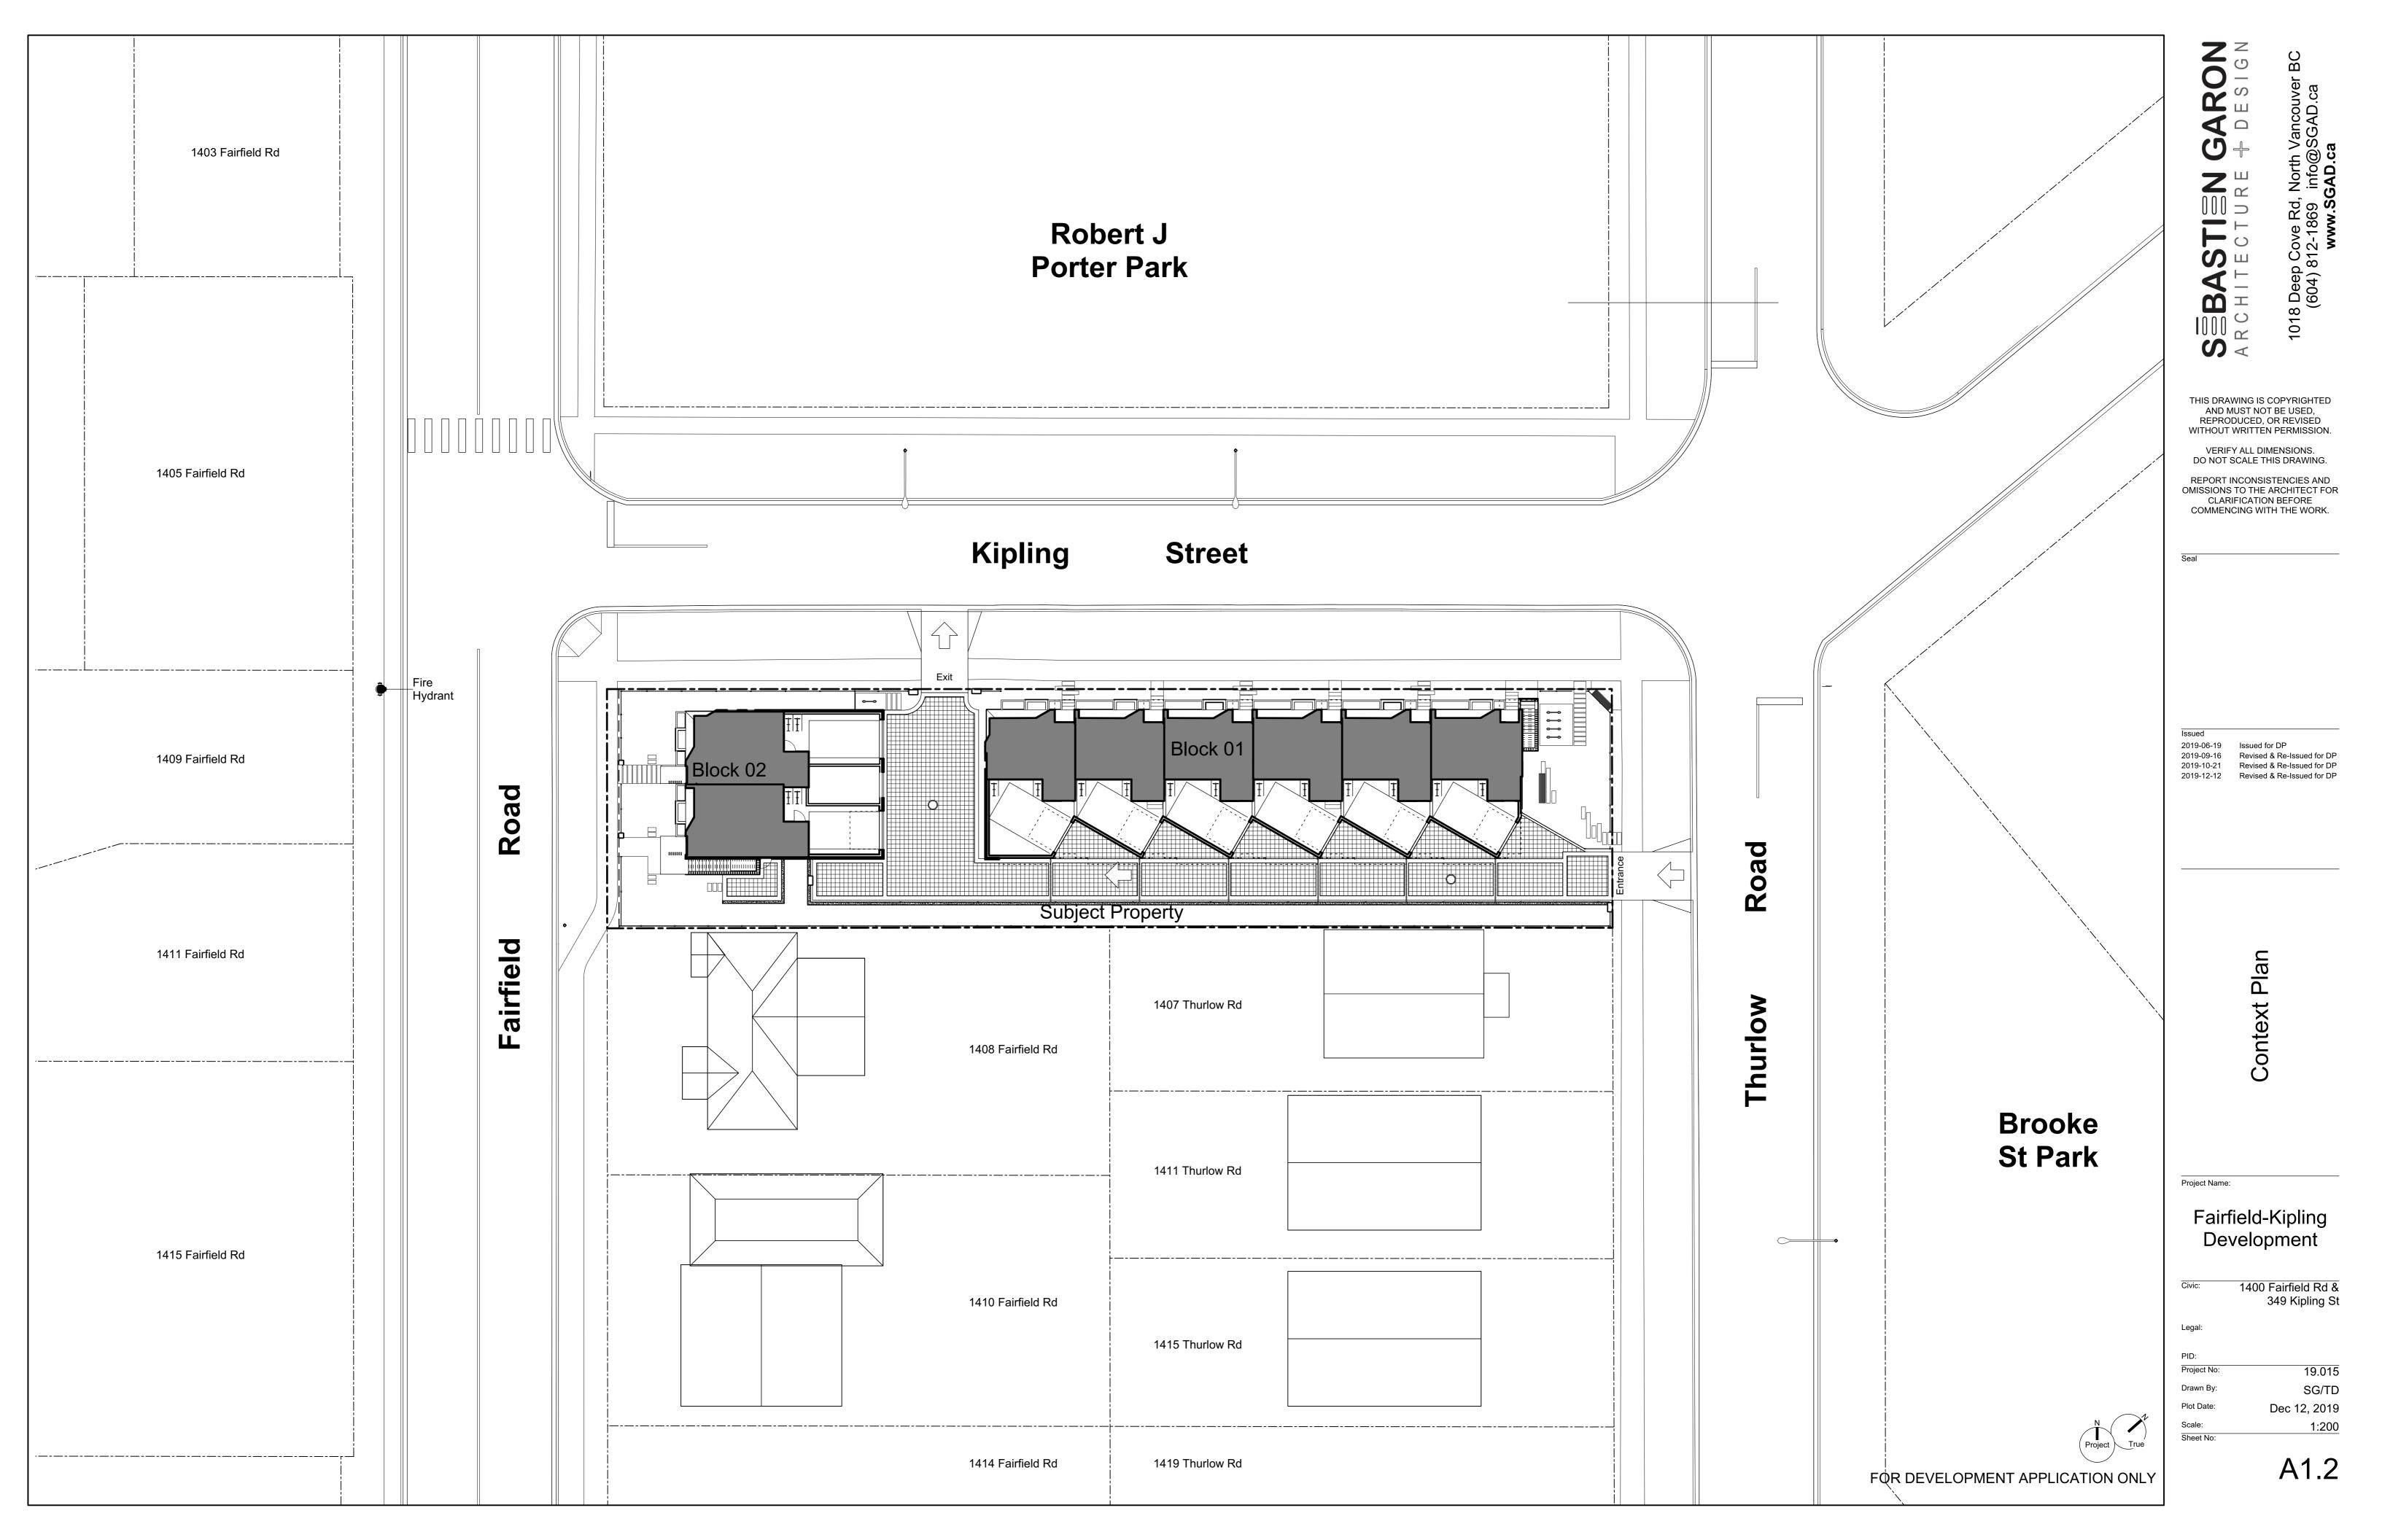


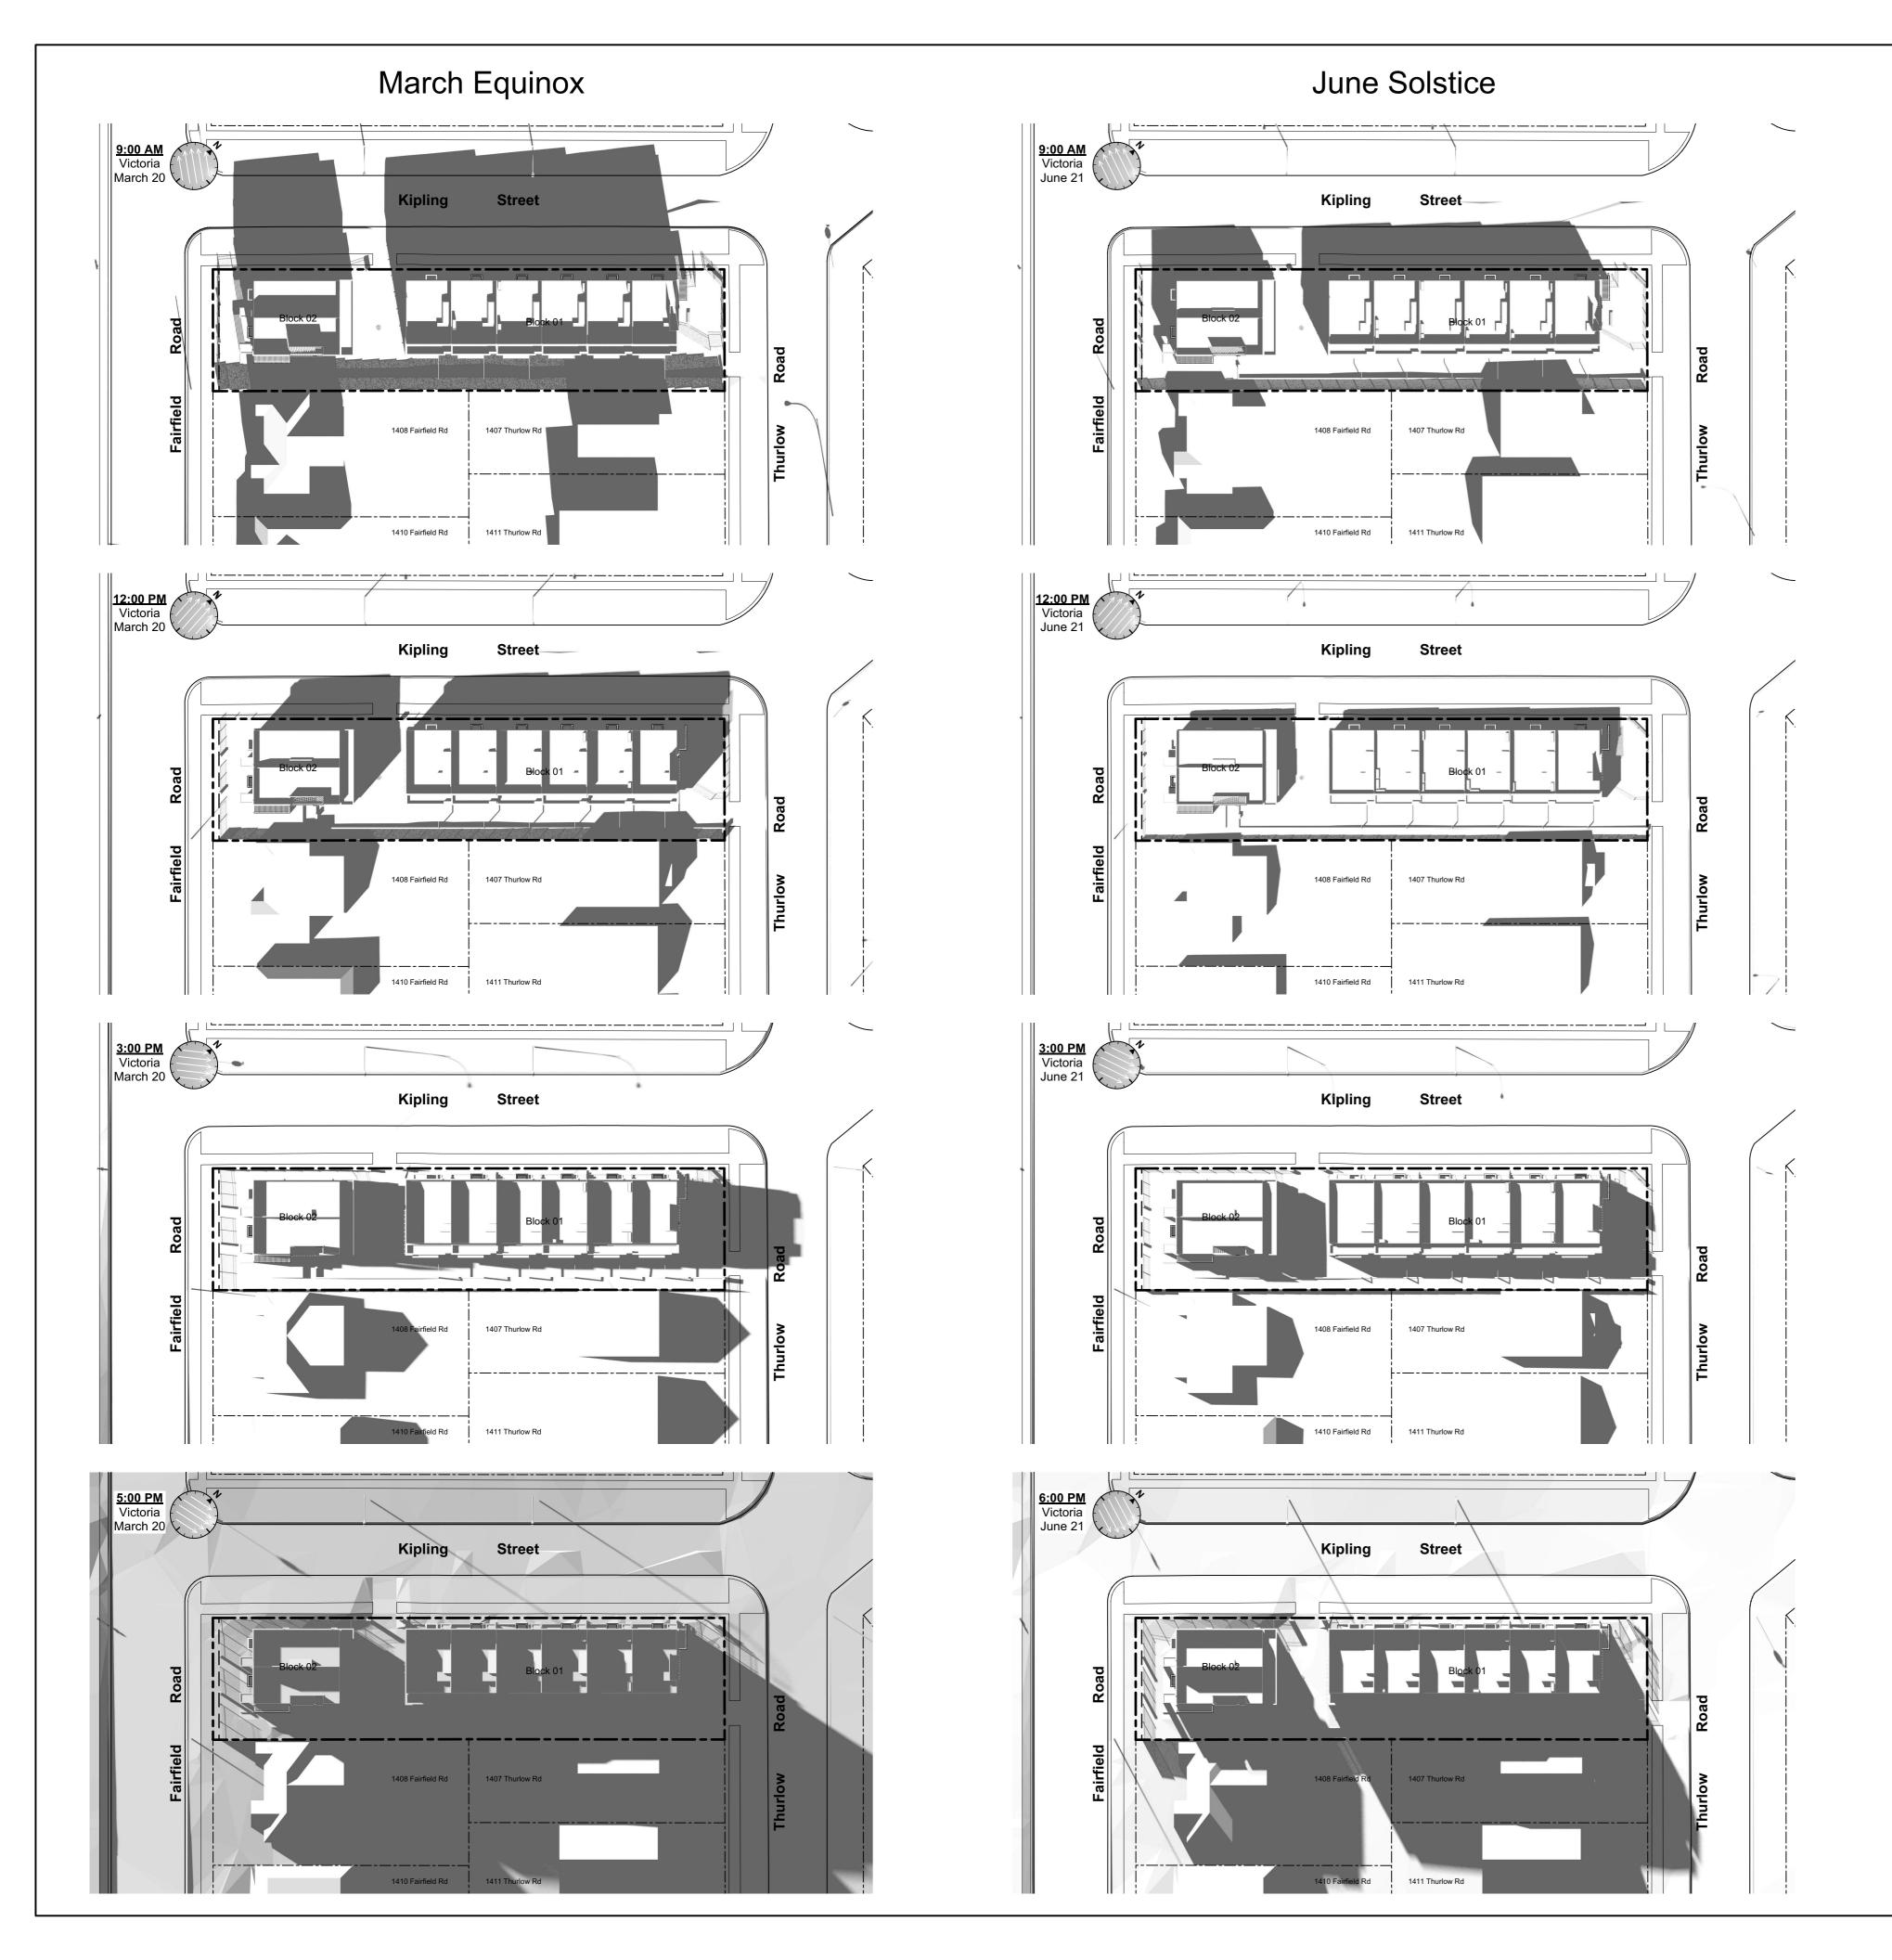

Block 02 _ _ _ _ _ | L----



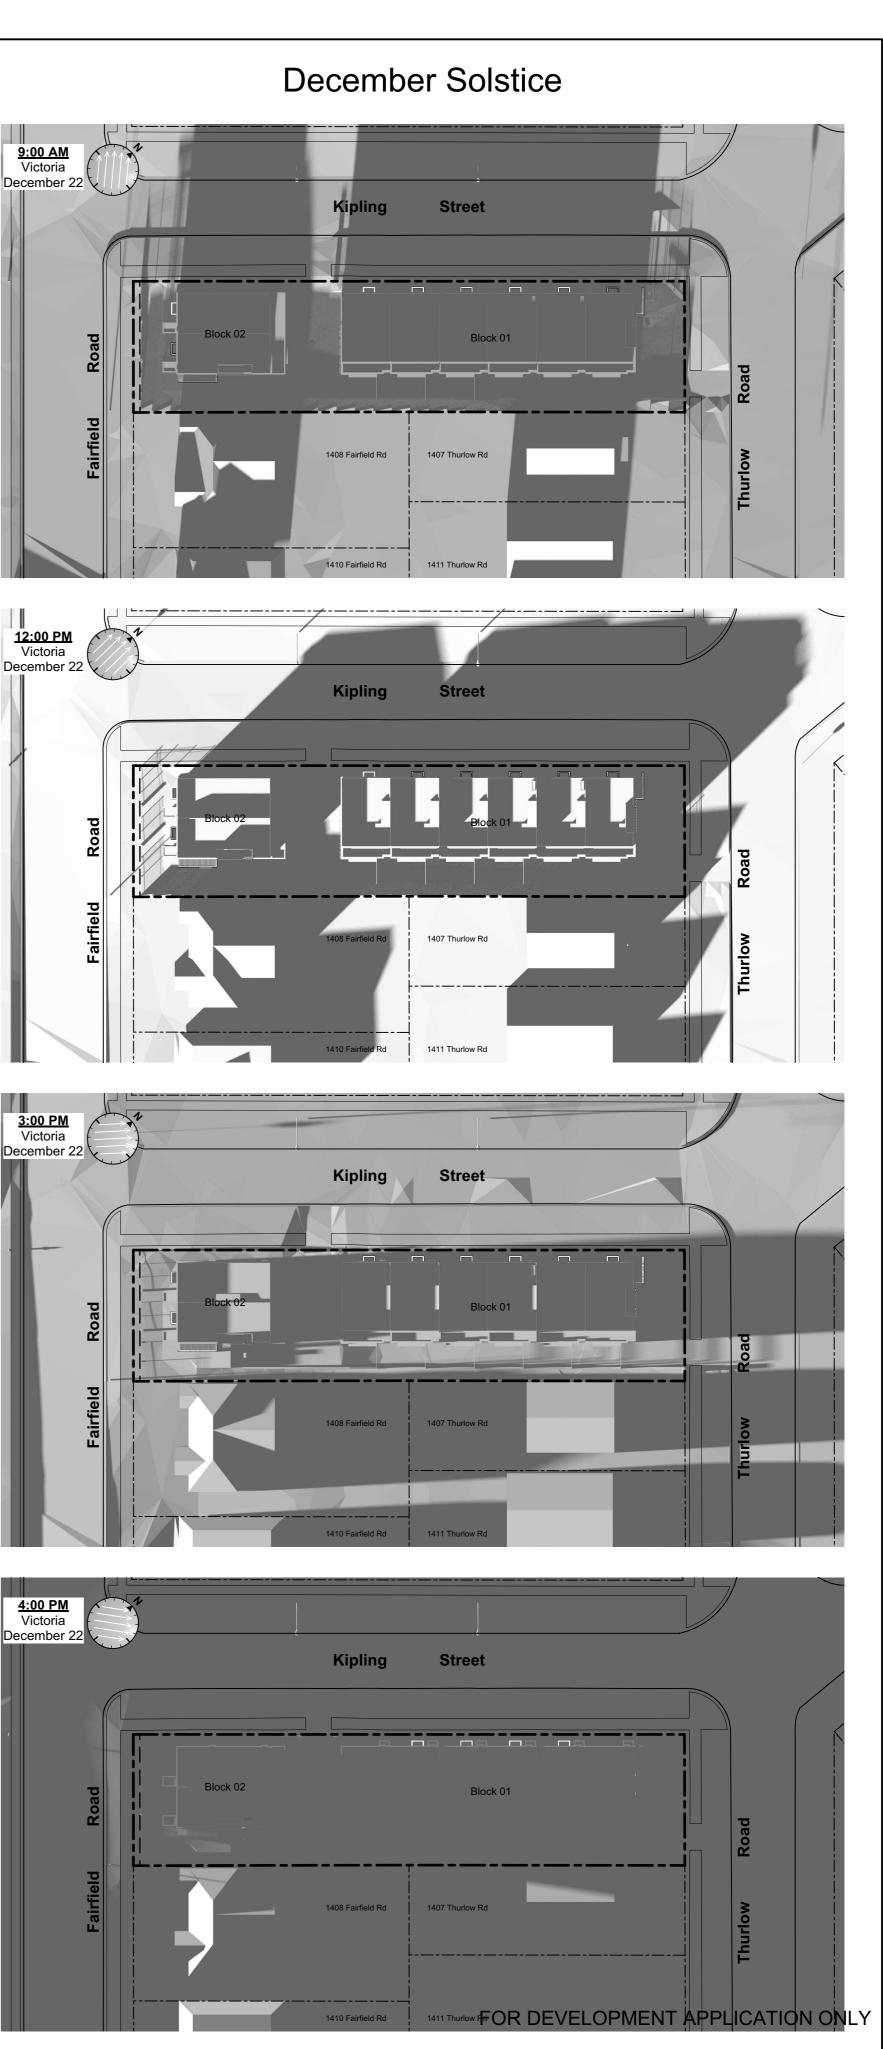

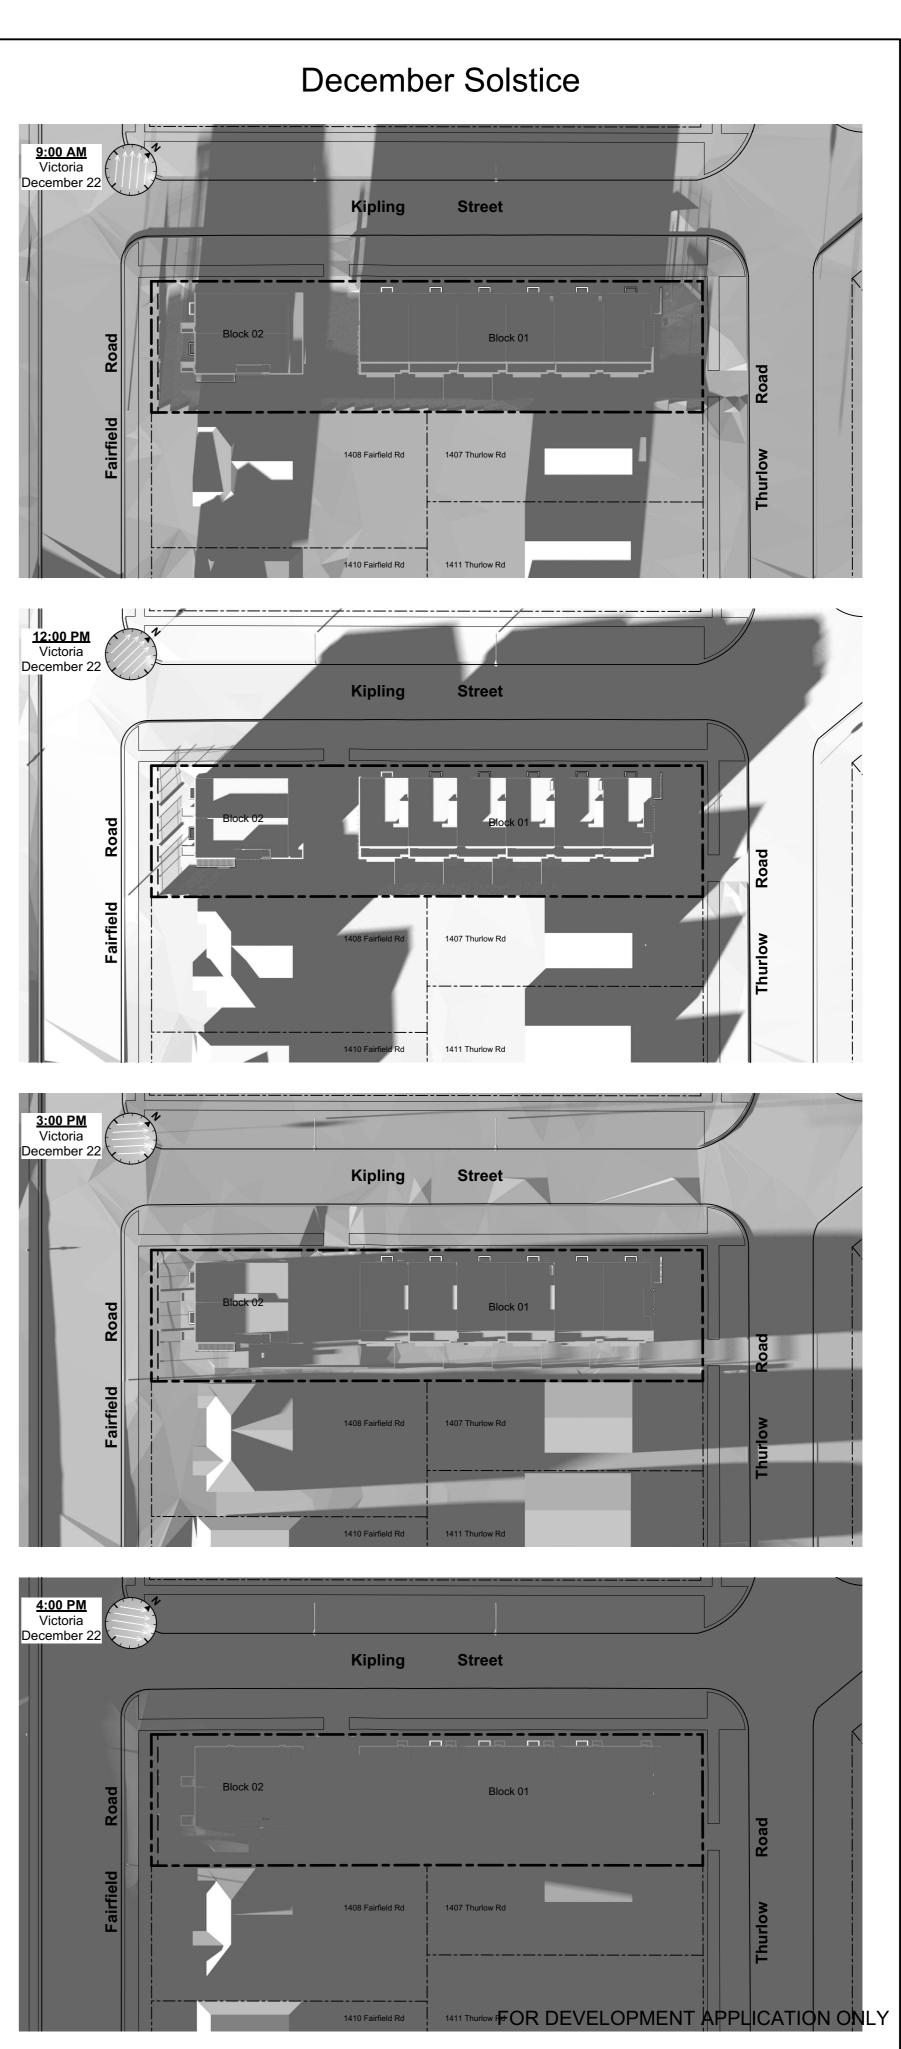

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	Solar Study
	ld-Kipling lopment
	400 Fairfield Rd & 349 Kipling St
Legal: PID:	-
Project No: Drawn By: Plot Date: Scale:	19.015 SG/TD Dec 12, 2019 (1:120) 1" = 10'-0"

A1.4

Sheet No:





Legend

- No. Description
- 1 Ready for solar panels (rough-in)
- 2 Ready for electric car charging outlets (rough-in)
- 3 Water efficient plumbing fixtures
- 4 Low-VOC interior finishes
- 5 Rooftop greenery
- 6 Water efficient landscaping
- 7 Bike parking
- 8 Enhanced natural light
- 9 Energy efficient light fixtures

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Seal	
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Sustainability Strategy	
Project Name: Fairfield-Ki Developm	
	field Rd & Kipling St
	19.015 SG/TD c 12, 2019 1" = 10'-0"

A1.5

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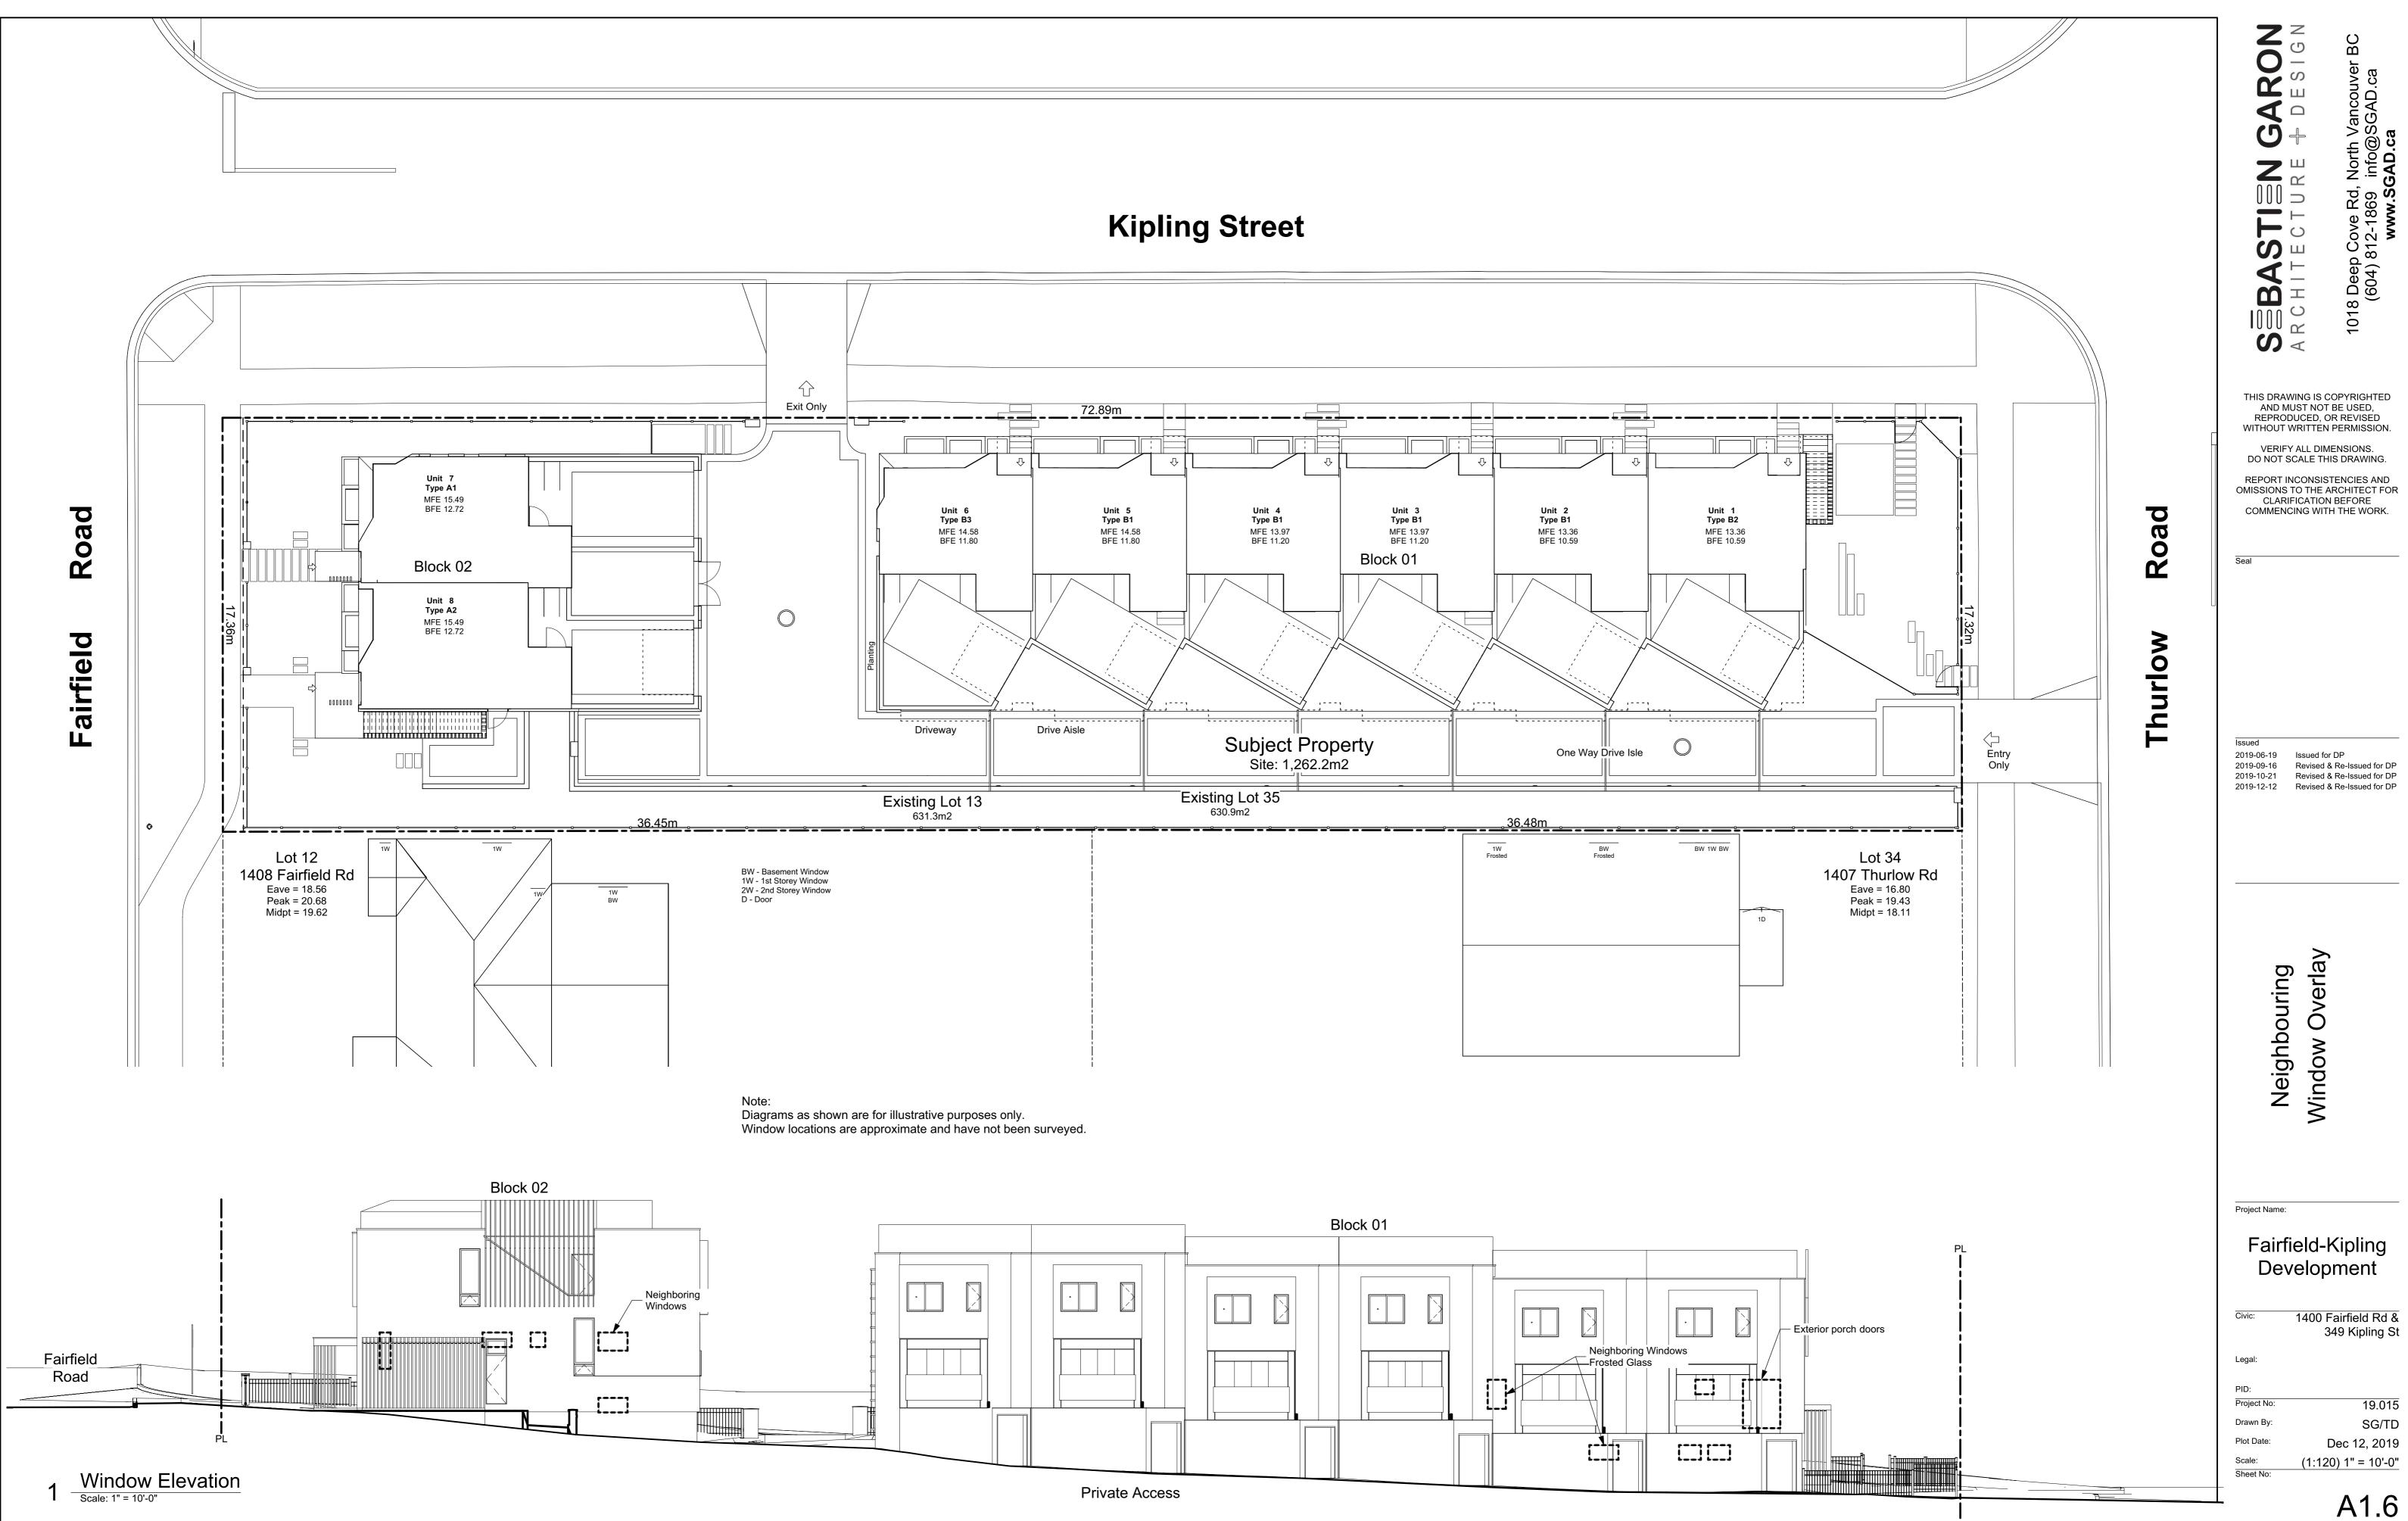
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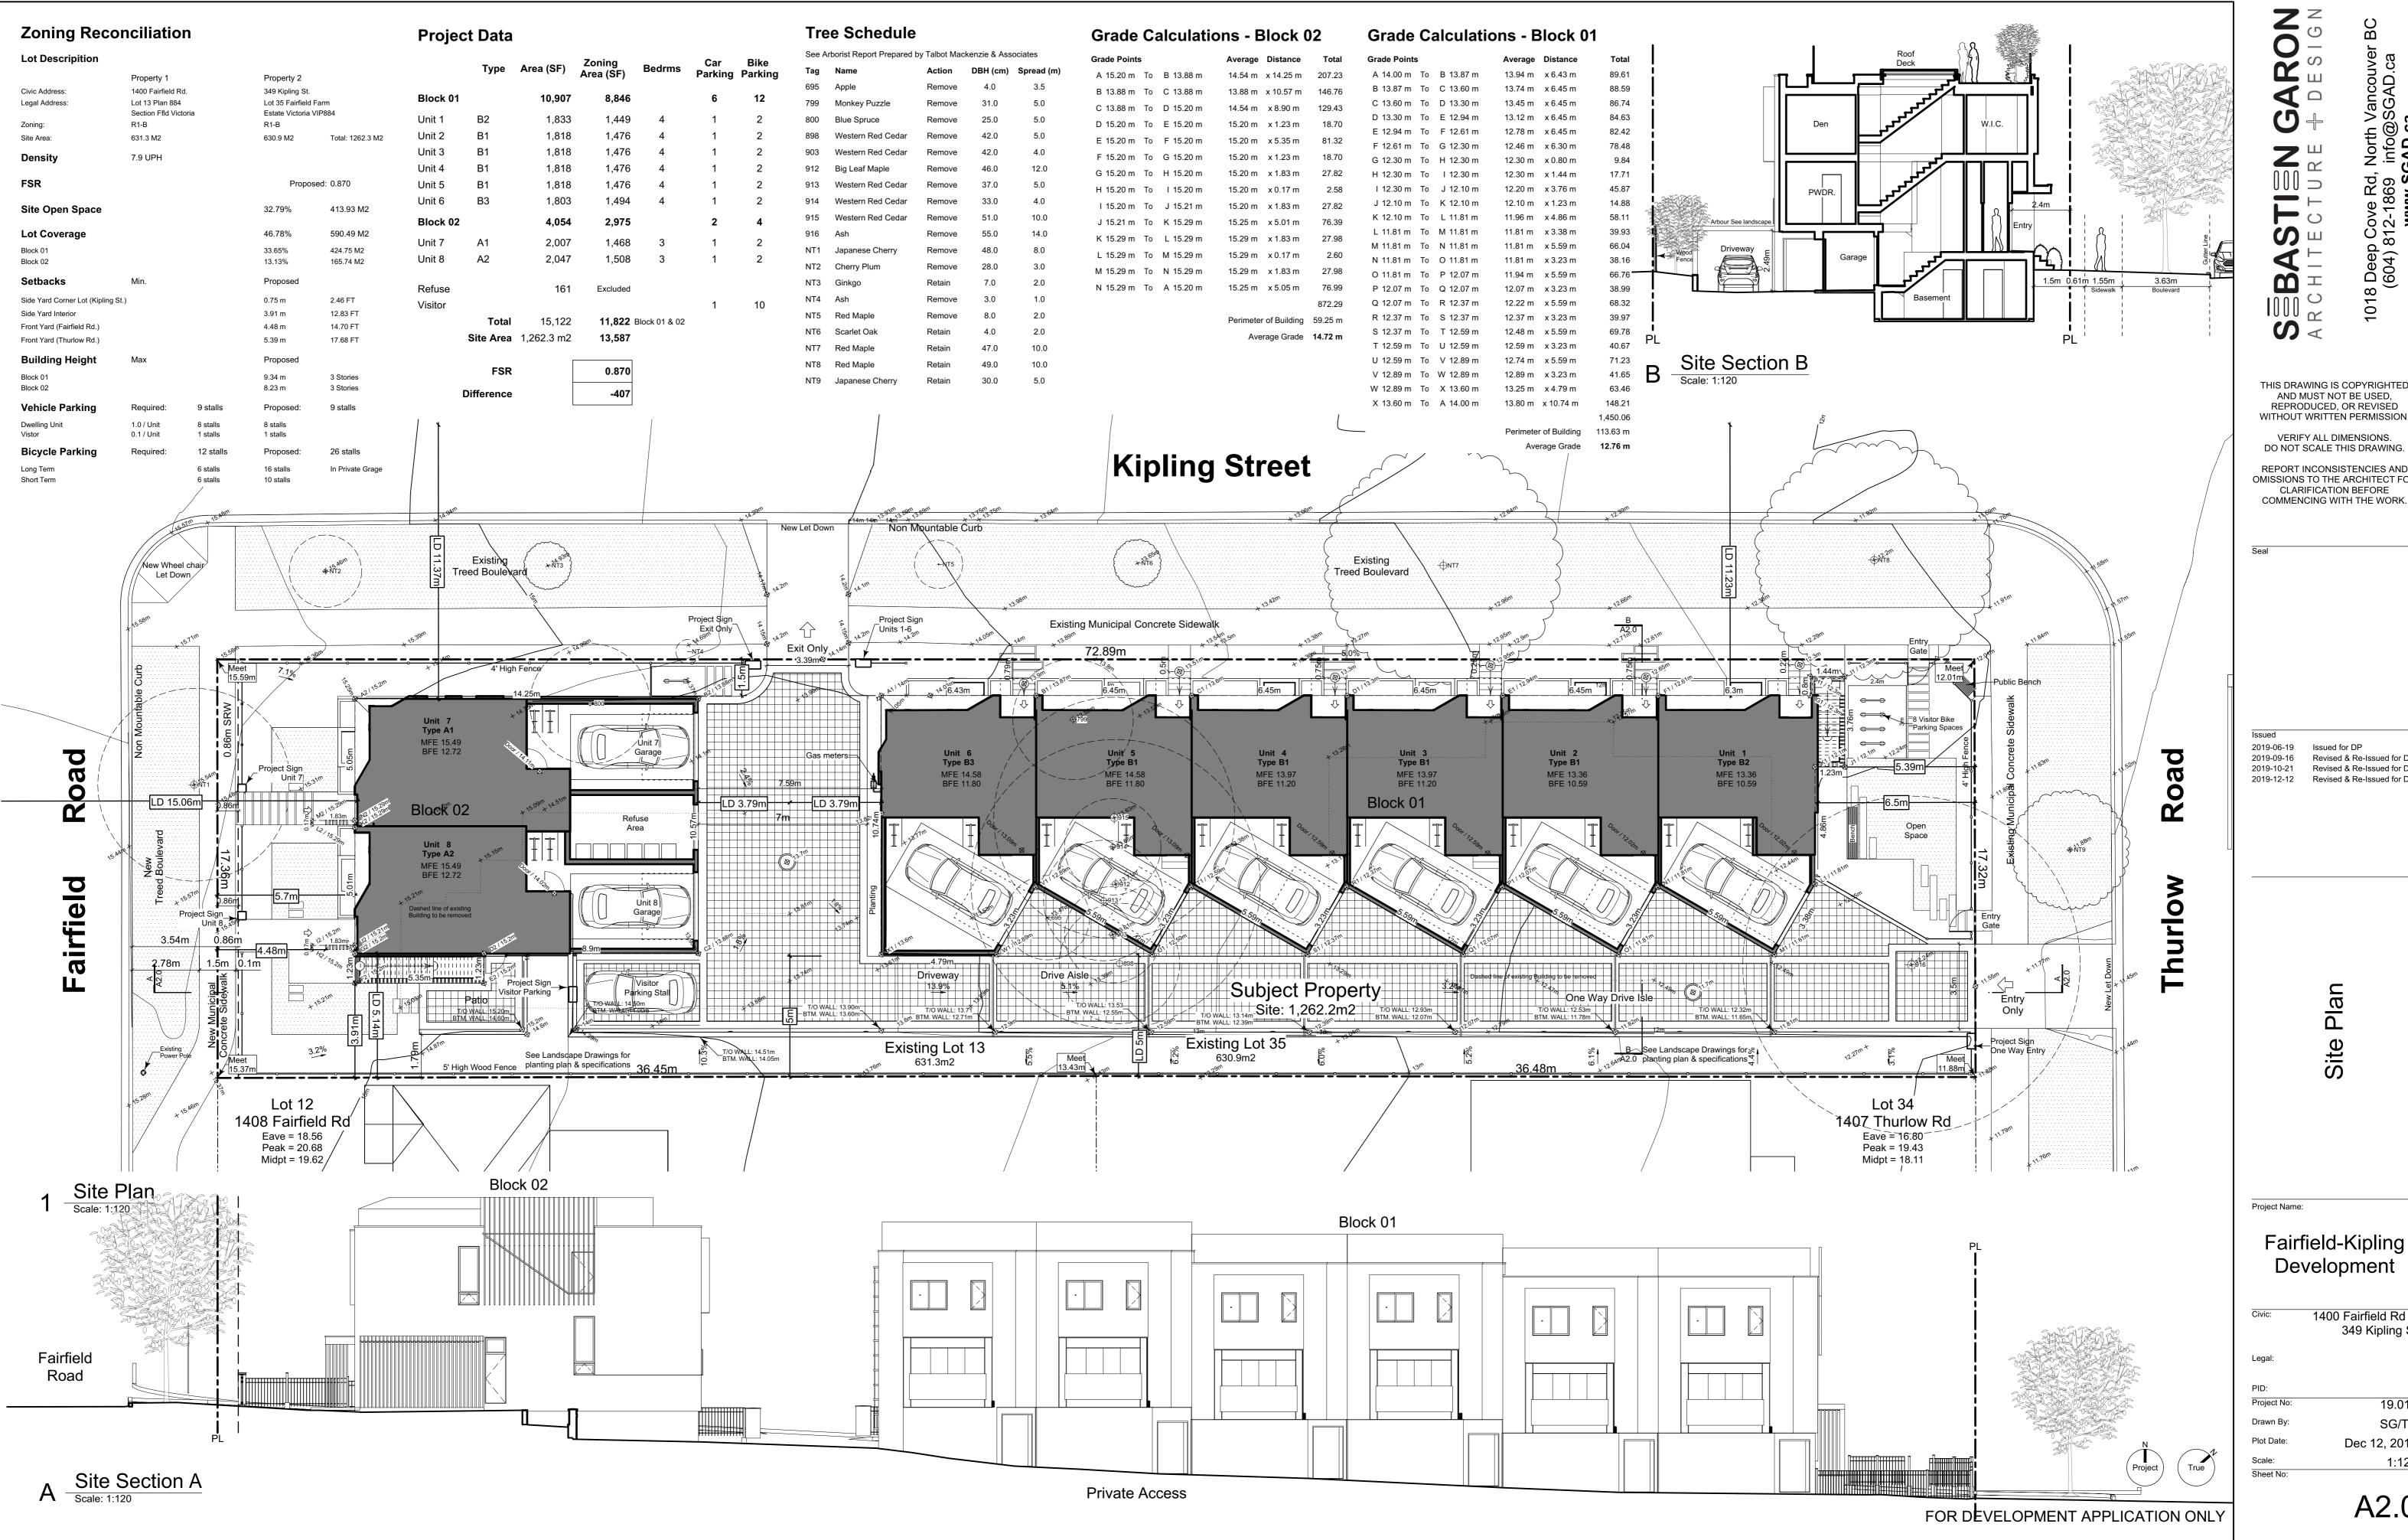
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6

7







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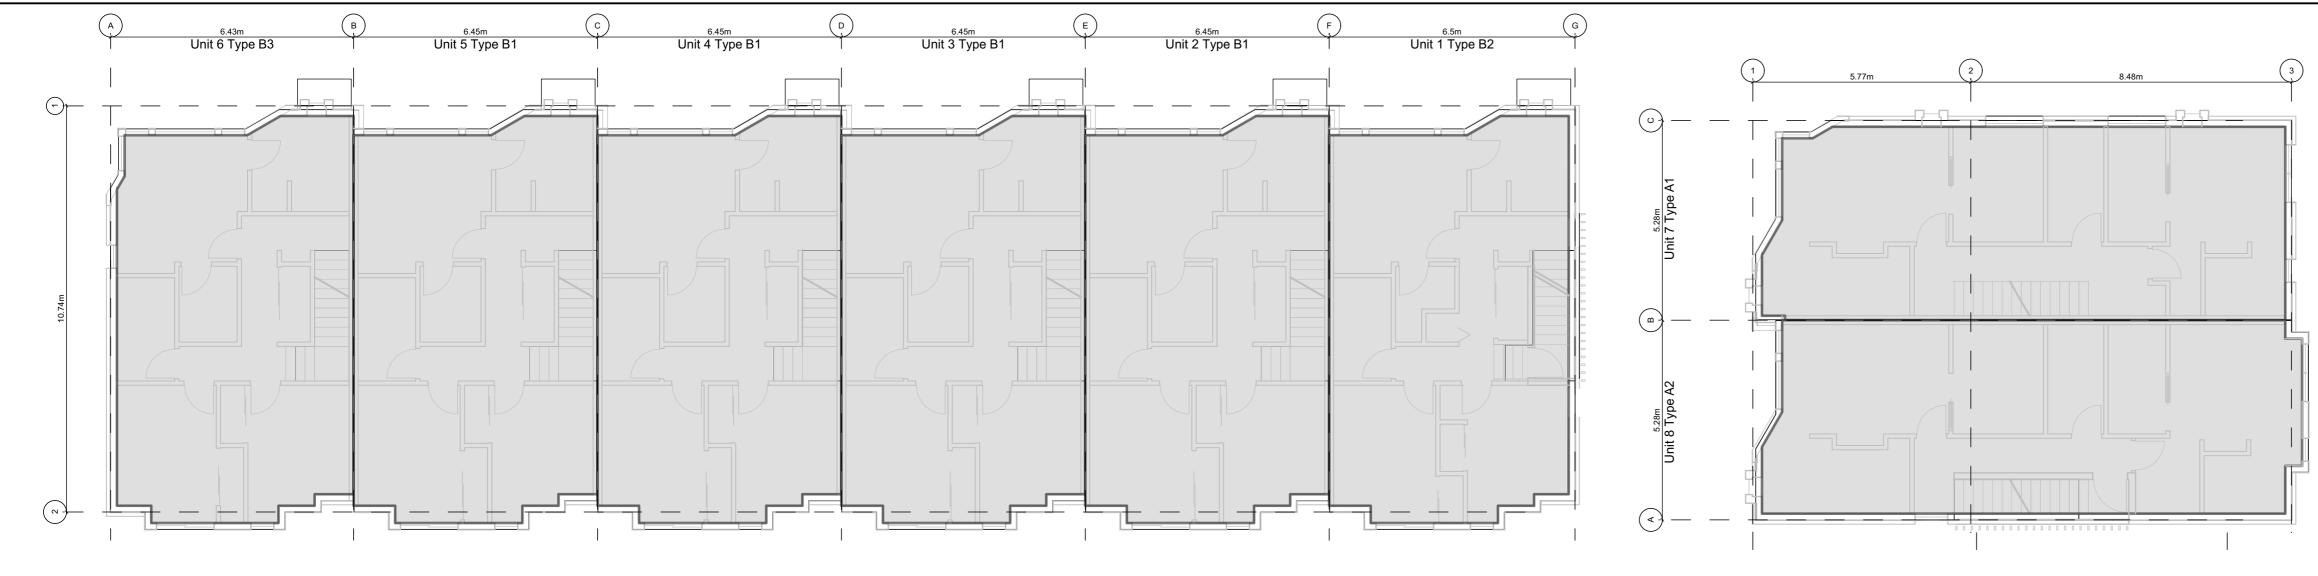
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Site Plan


Fairfield-Kipling Development

1400 Fairfield Rd & 349 Kipling St 19.015 SG/TD Dec 12, 2019 1:120


A2.0





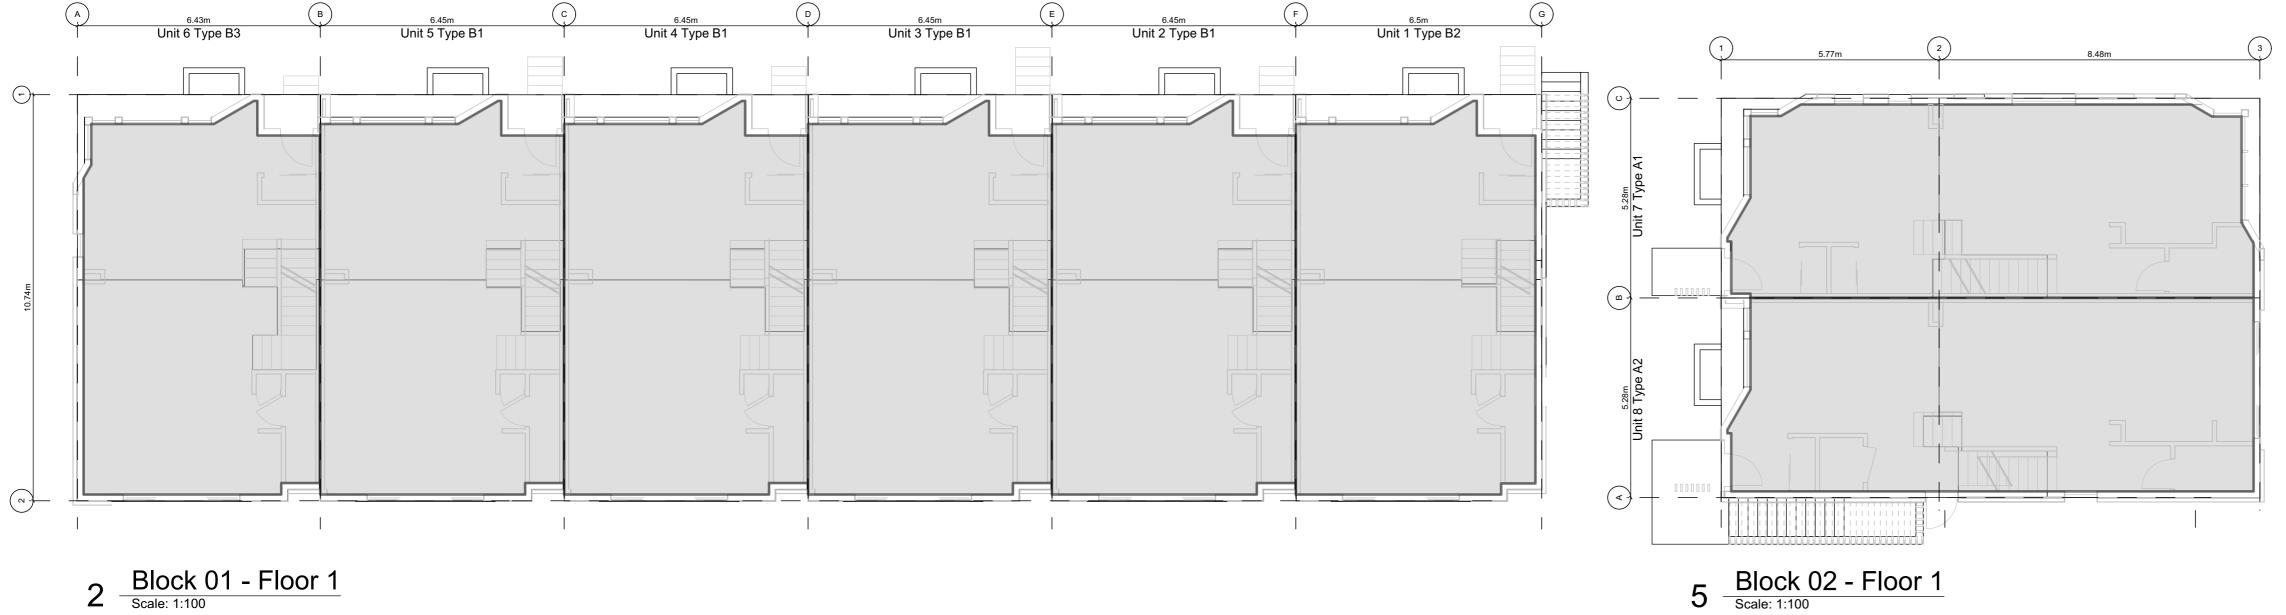

2 Block 01 - Floor 1 Scale: 1:100

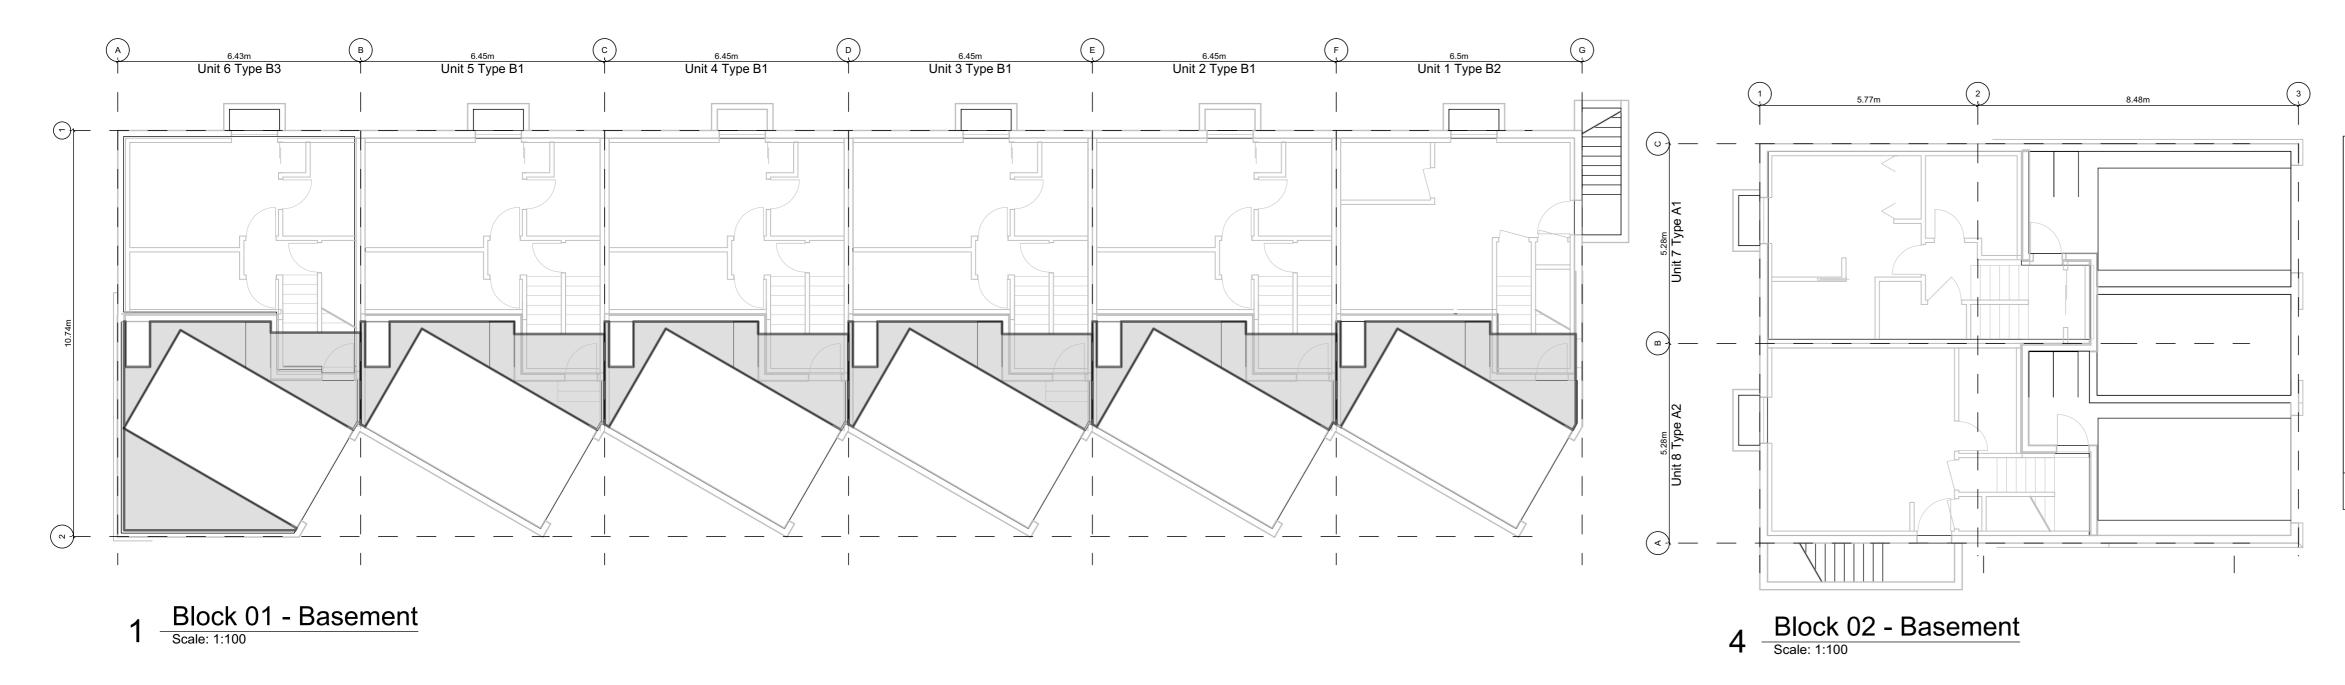

6 Block 02 - Floor 2 Scale: 1:100

Projec	ct Data					
	Туре	Area (SF)	Zoning Area (SF)	Bedrms	Car Parking	Bike Parkinç
Block 01		10,907	8,846		6	12
Unit 1	B2	1,833	1,449	4	1	2
Unit 2	B1	1,818	1,476	4	1	2
Unit 3	B1	1,818	1,476	4	1	2
Unit 4	B1	1,818	1,476	4	1	2
Unit 5	B1	1,818	1,476	4	1	2
Unit 6	B3	1,803	1,494	4	1	2
Block 02		4,054	2,975		2	4
Unit 7	A1	2,007	1,468	3	1	2
Unit 8	A2	2,047	1,508	3	1	2
Refuse		161	Excluded			
Visitor					1	10
	Total	15,122	11,822	Block 01 & 02		
	Site Area	1,262.3 m2	13,587			
	FSR	ſ	0.870			
Difference		-407				

Floor Space Ratio; The building area is measured to the interior side of the exterior wall and C/L of demising walls. Basements excluded.



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2019-09-16	R
2019-10-21	R
2019-12-12	R

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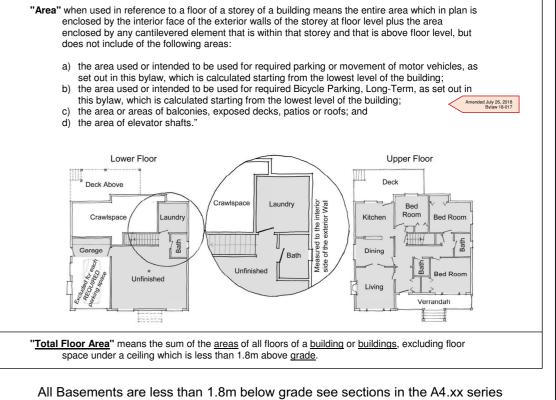


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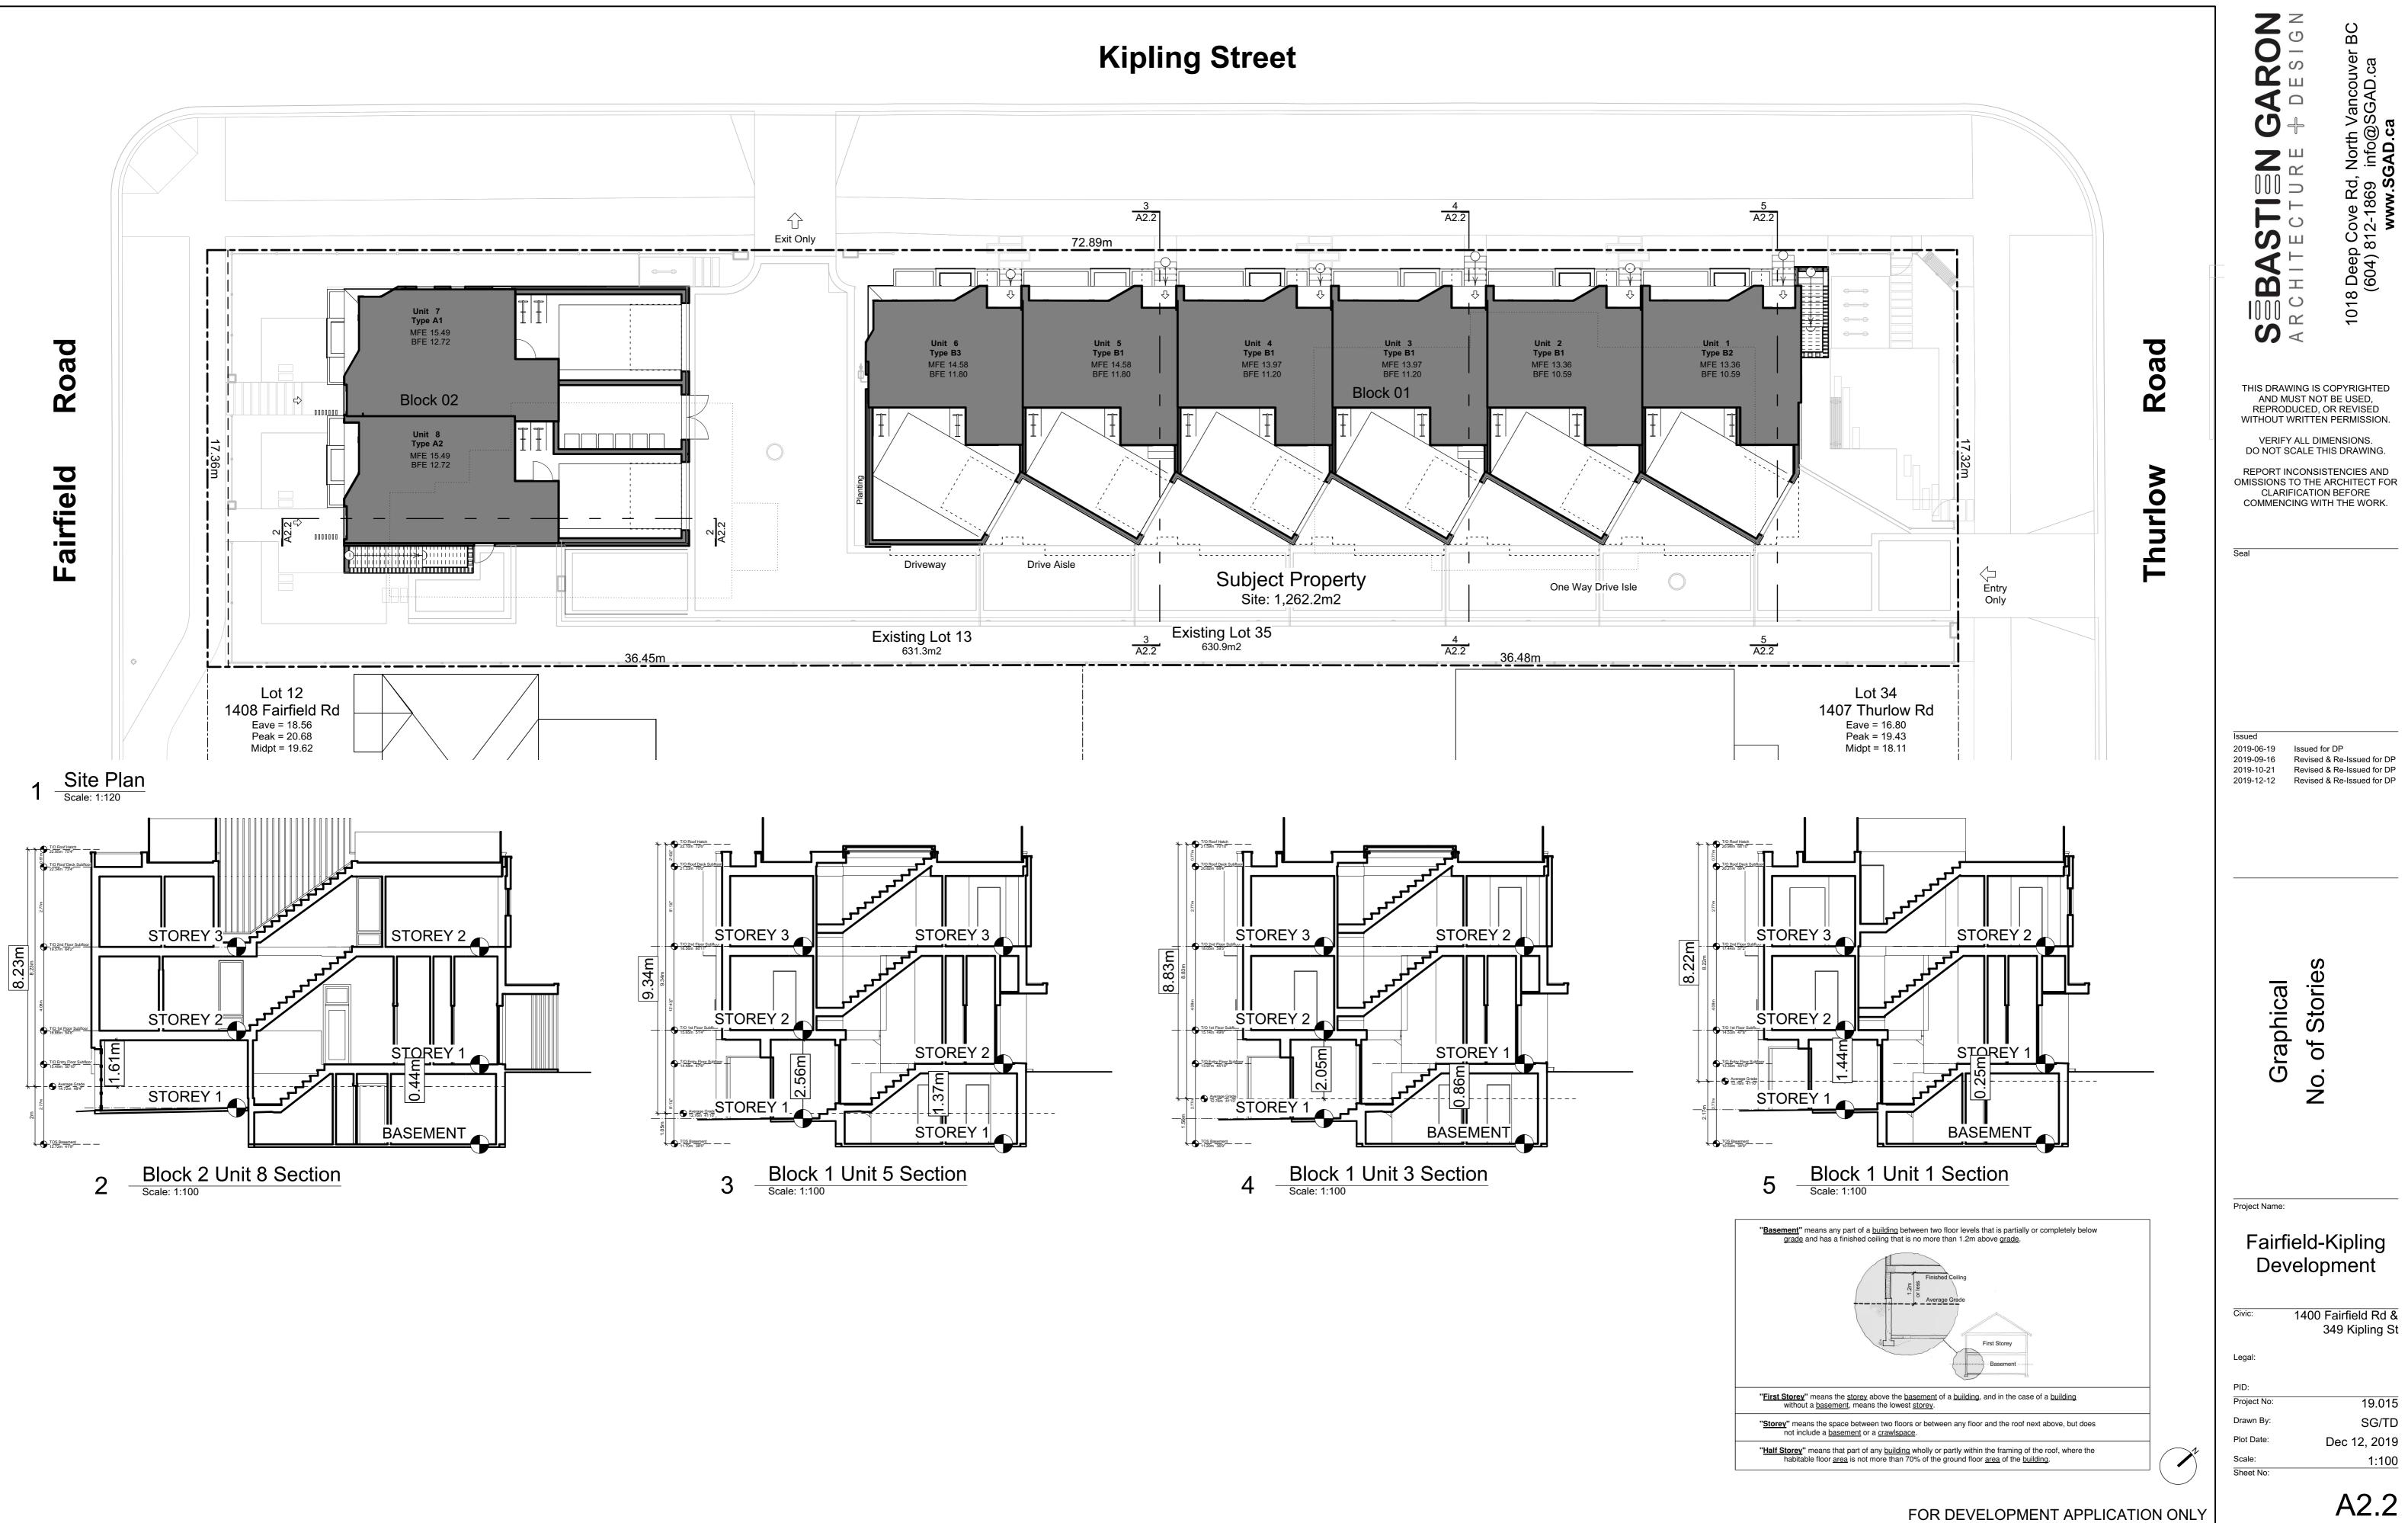
Fairfield-Kipling Development


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Scale:	1:100
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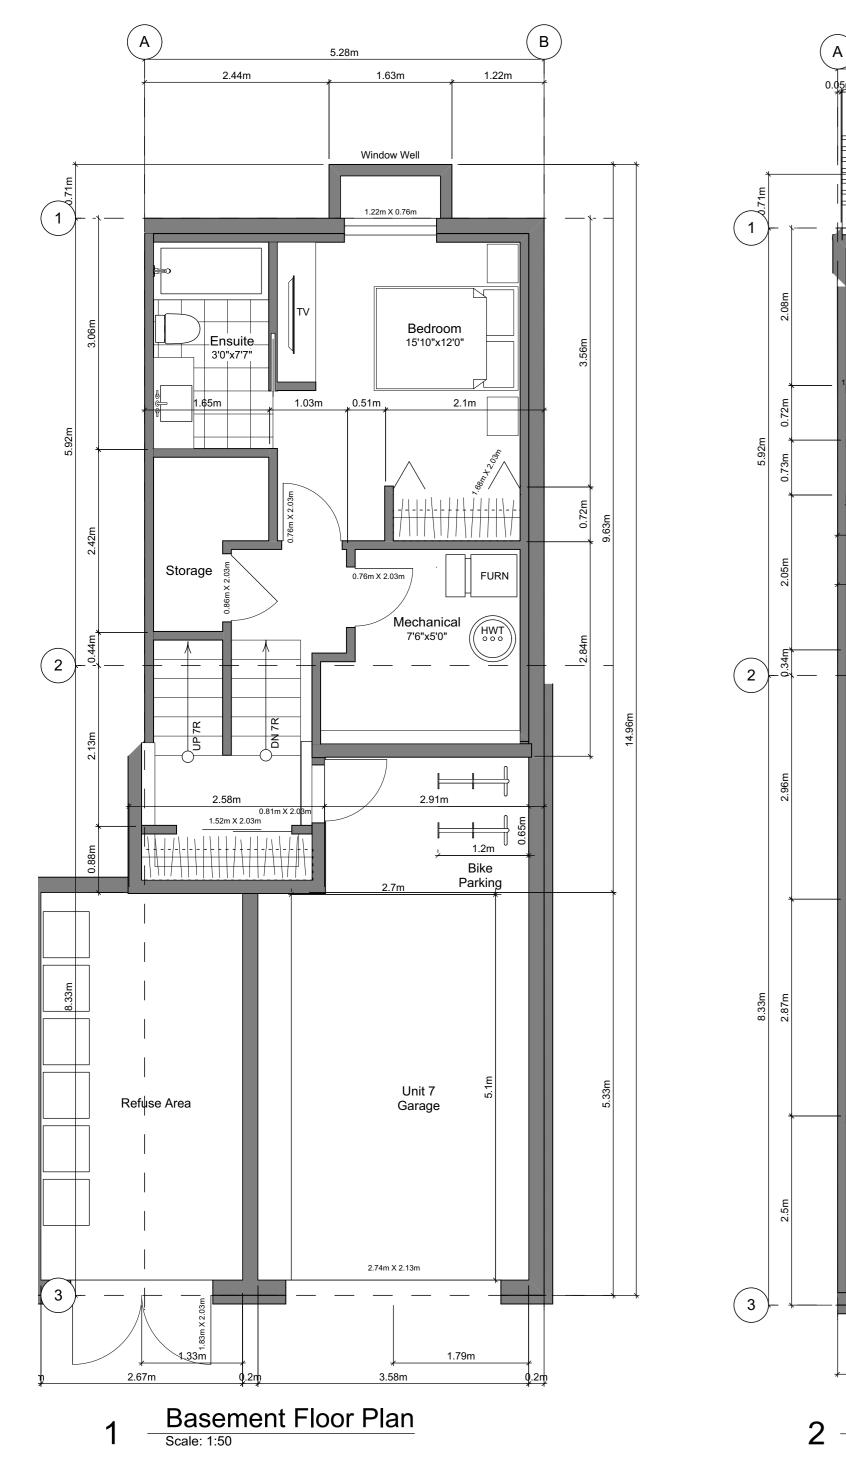
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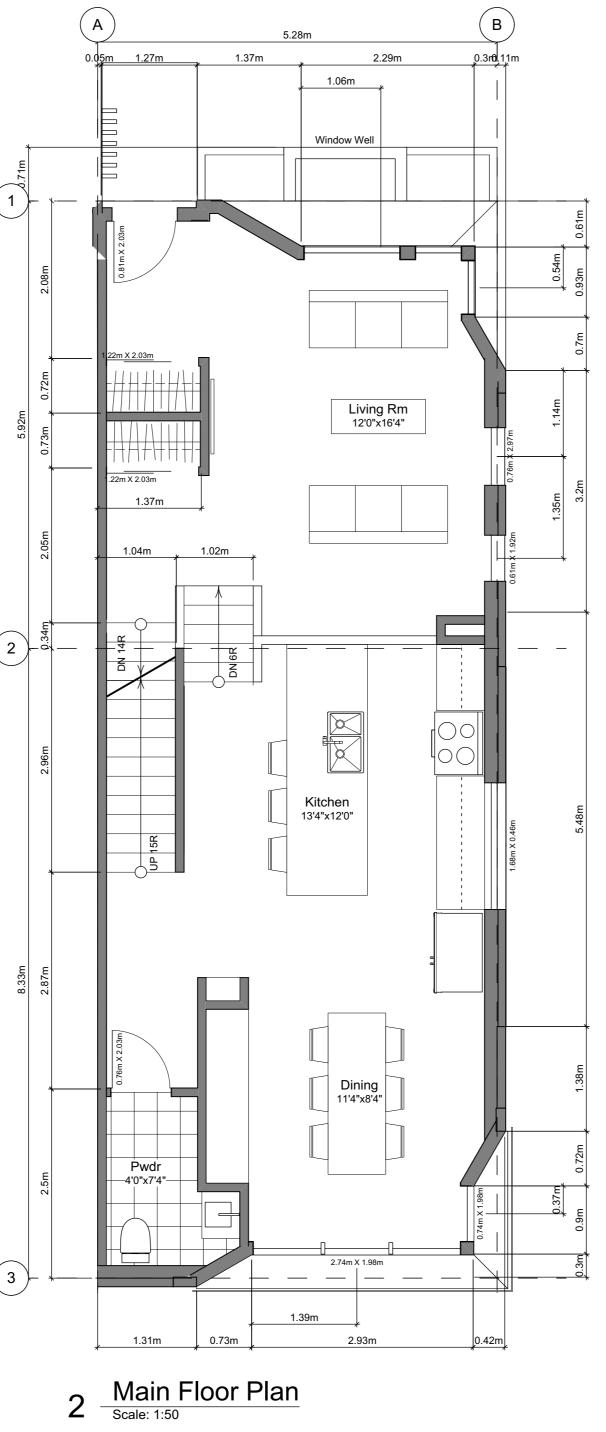



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3 Second Floor Plan Scale: 1:50


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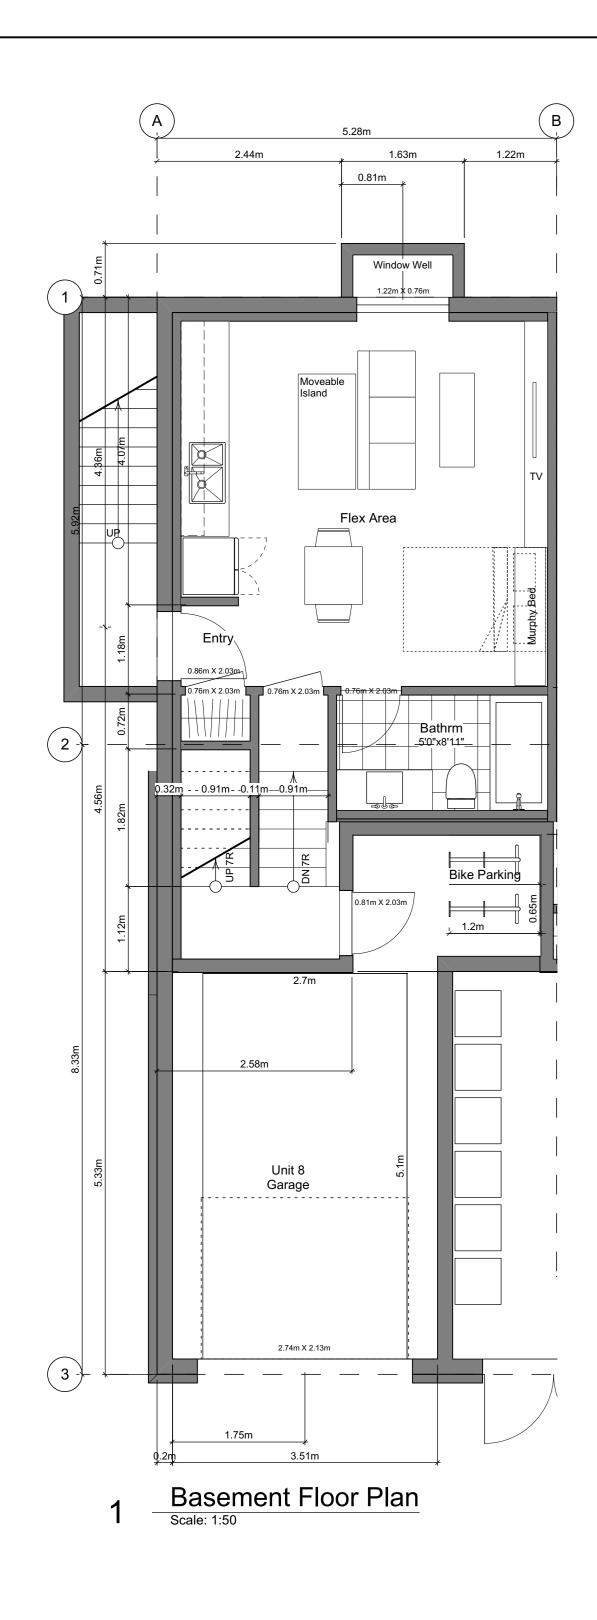
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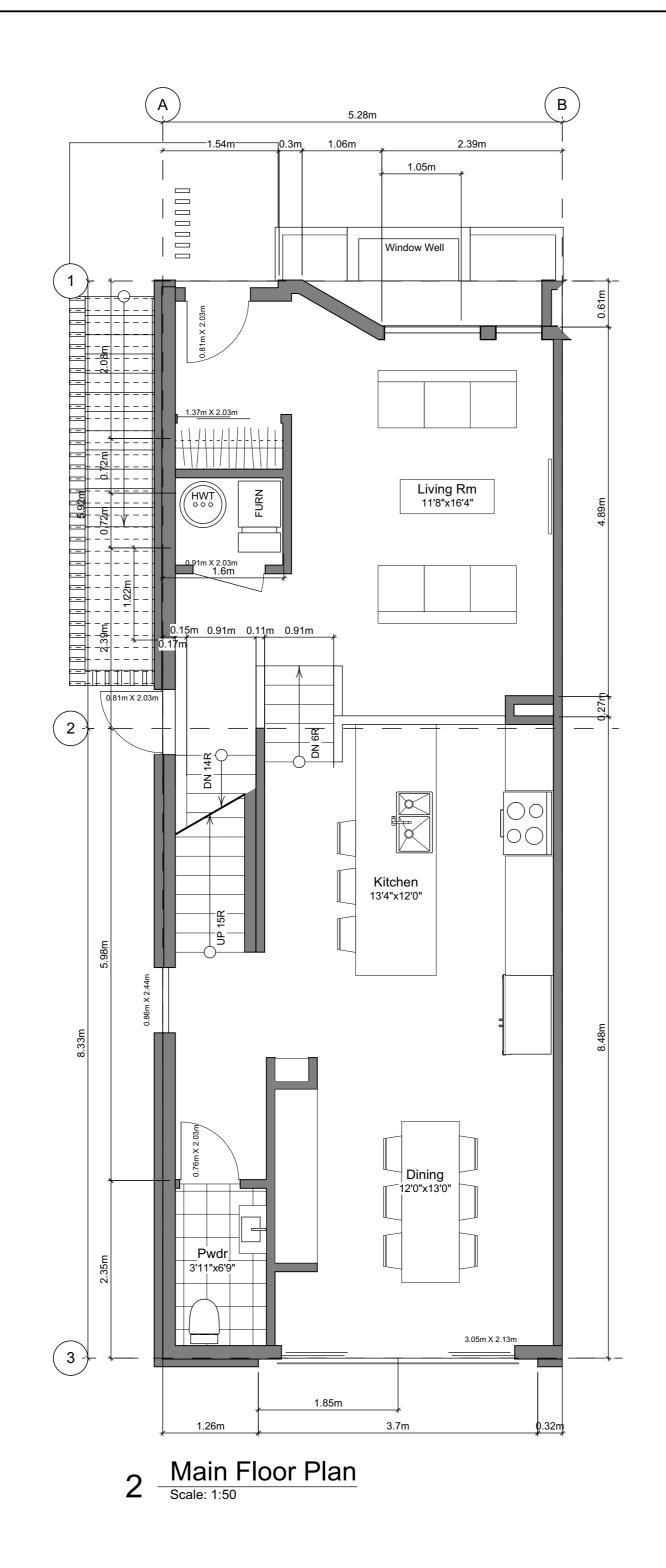
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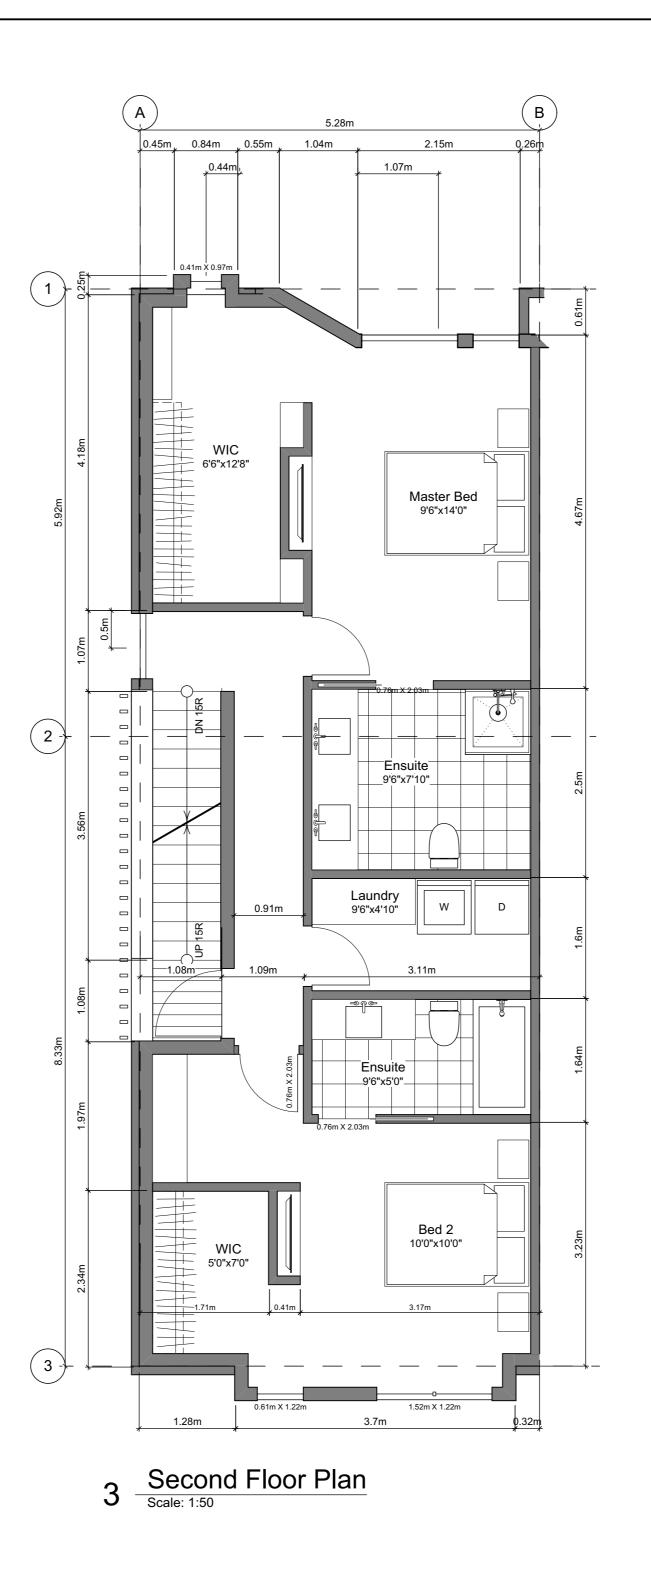
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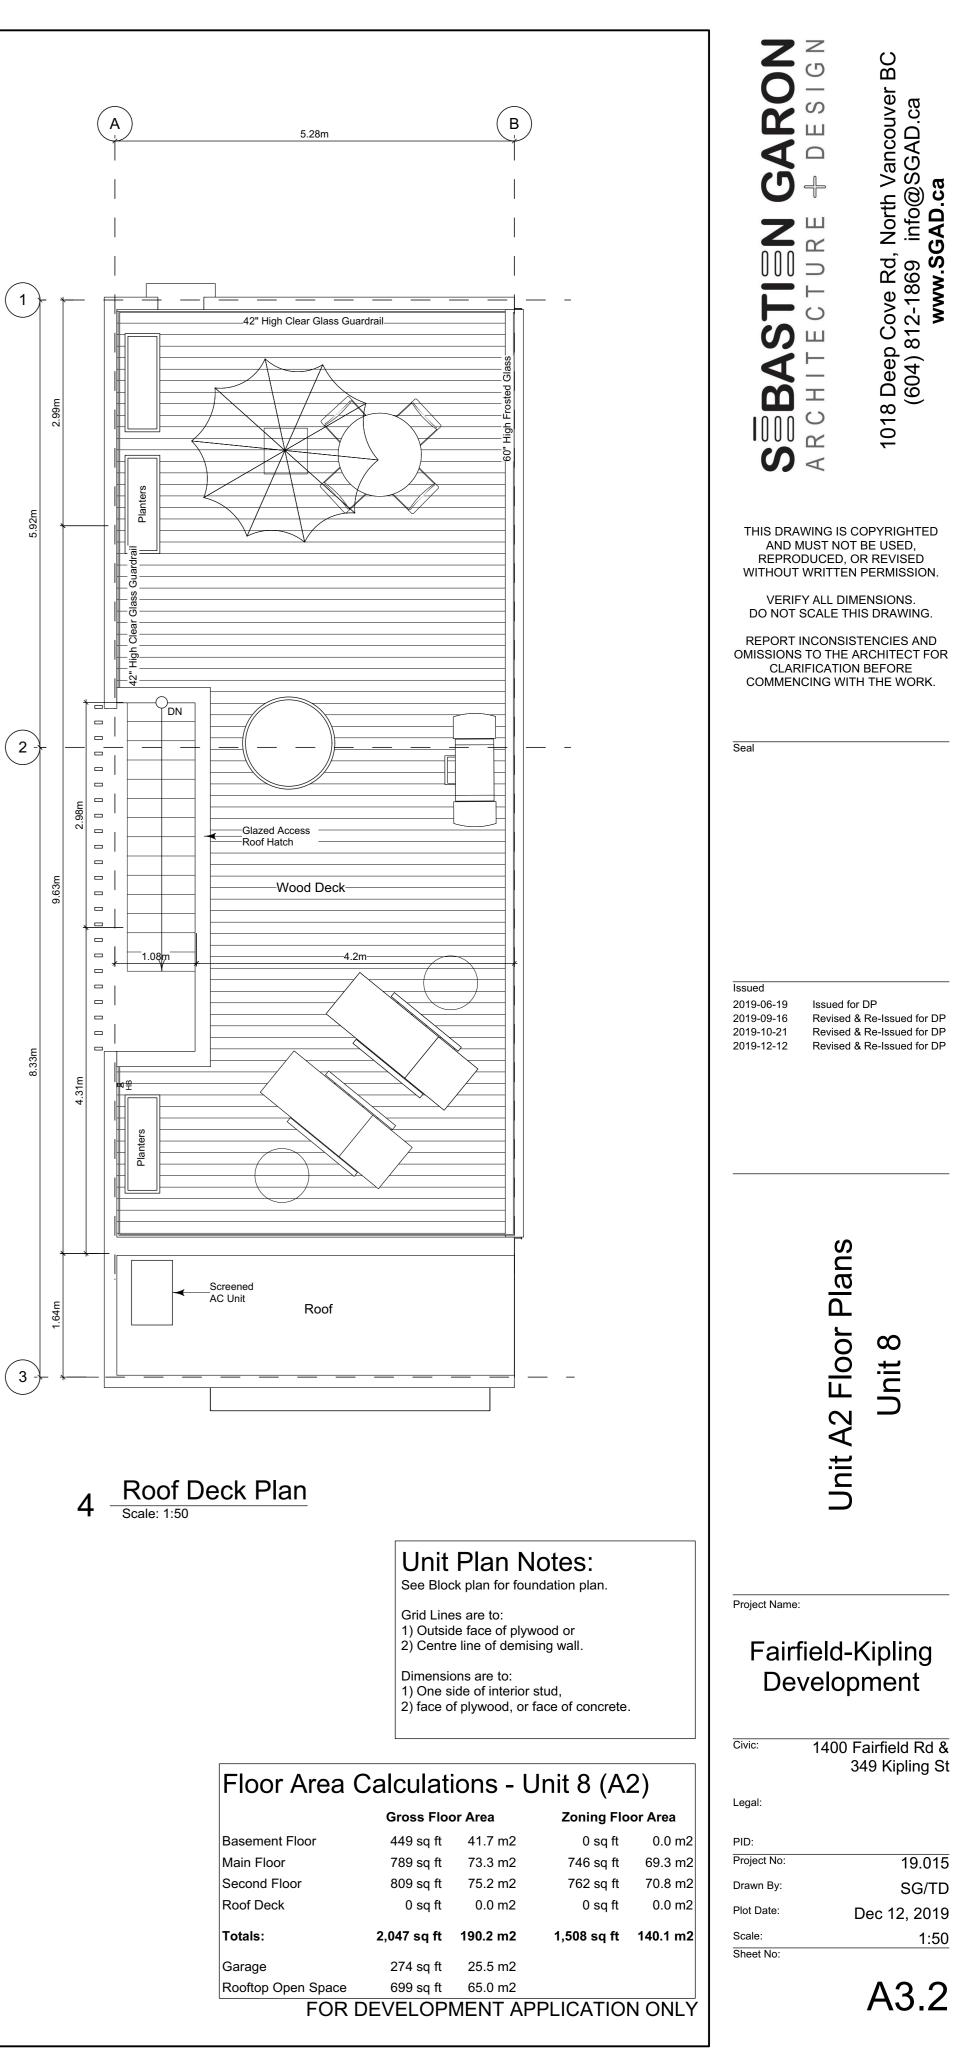
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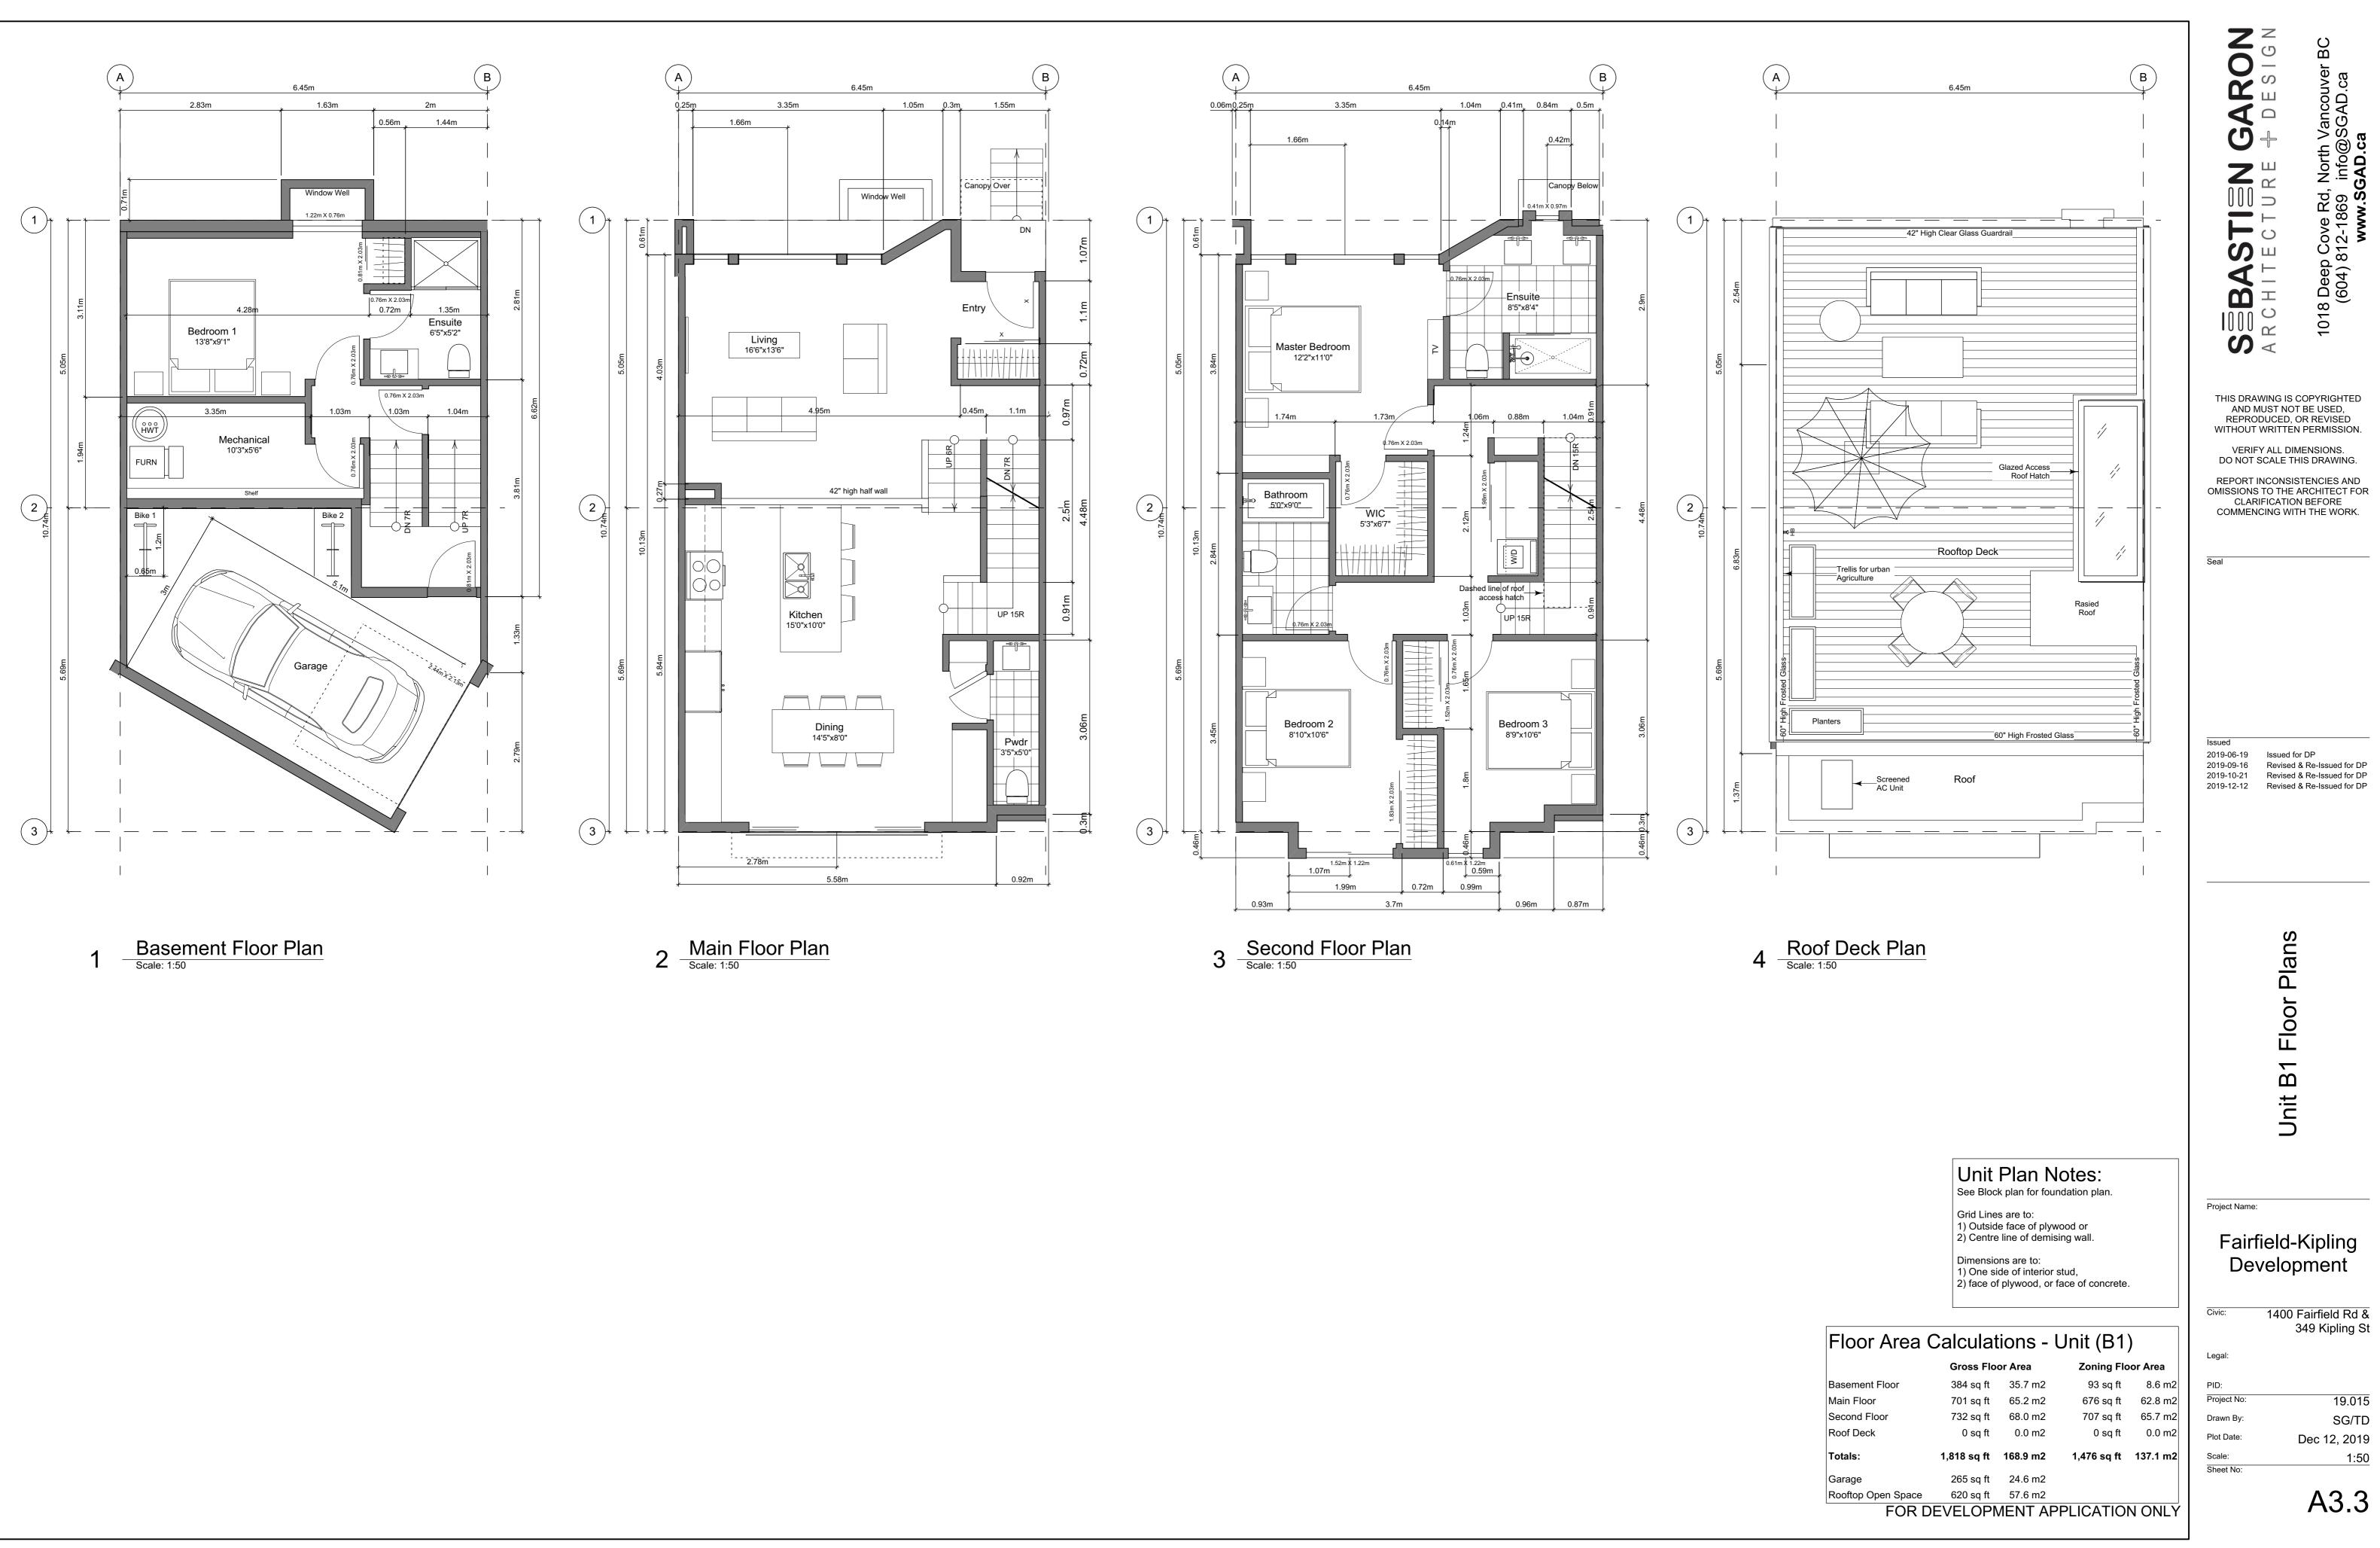








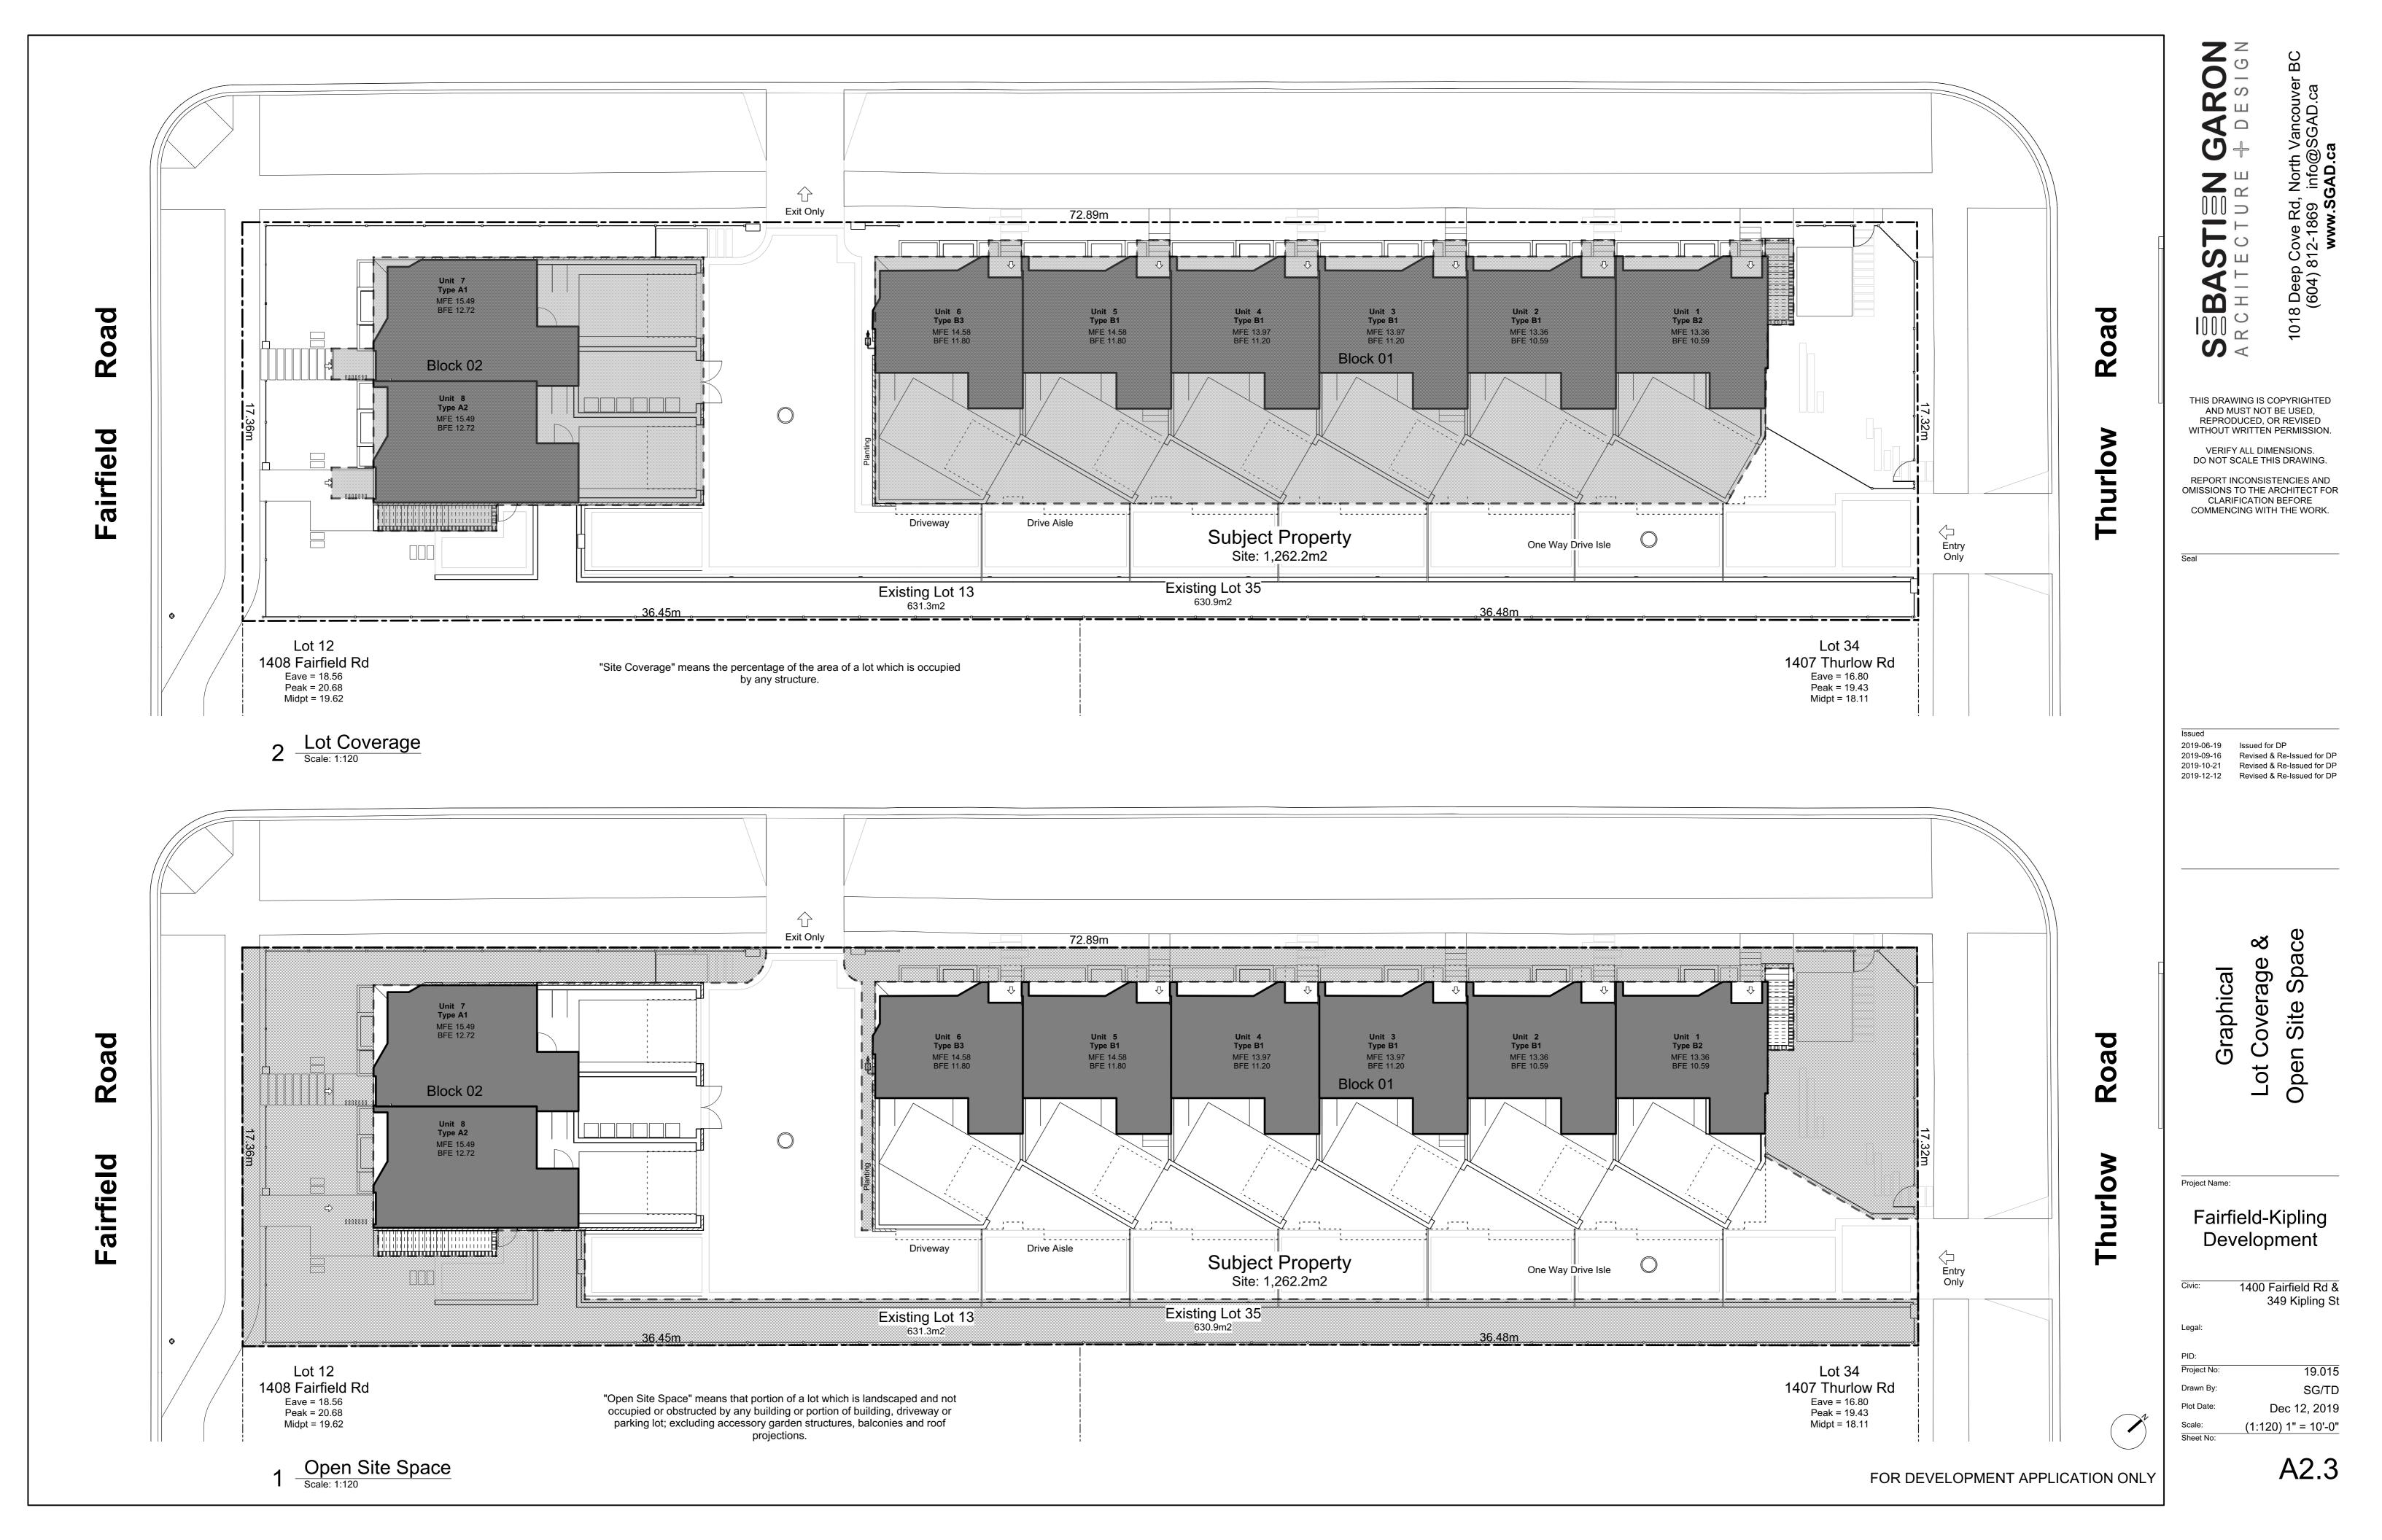

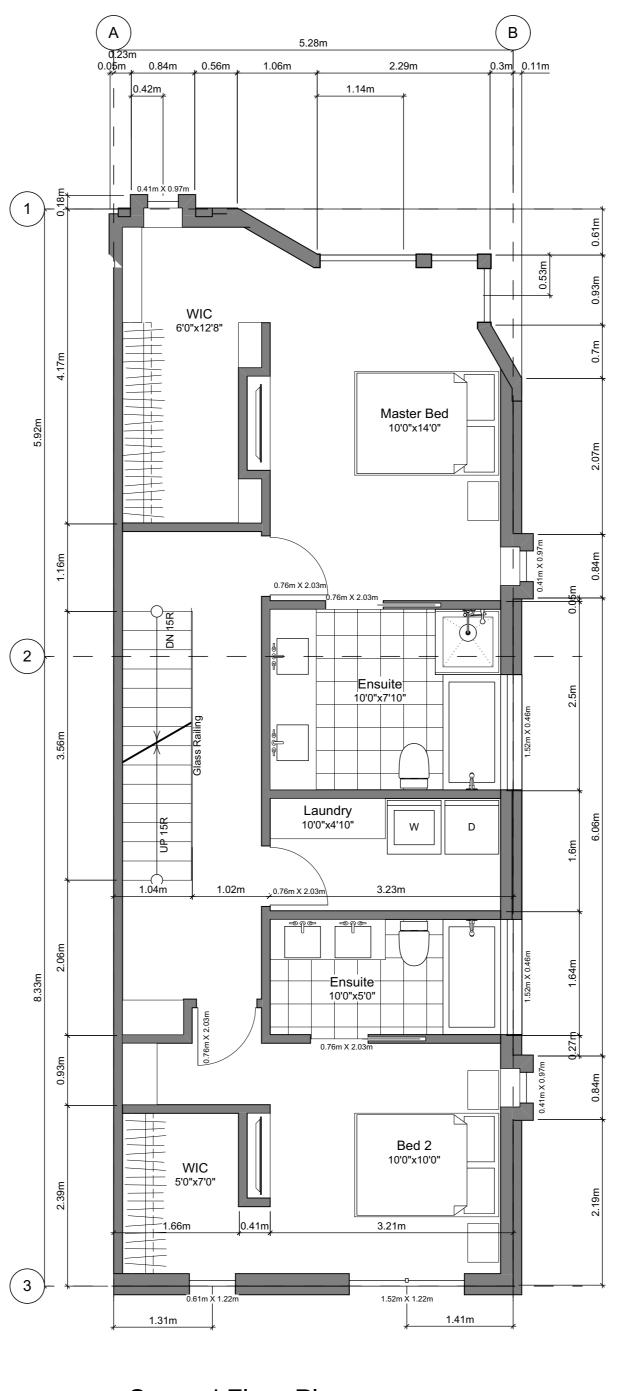

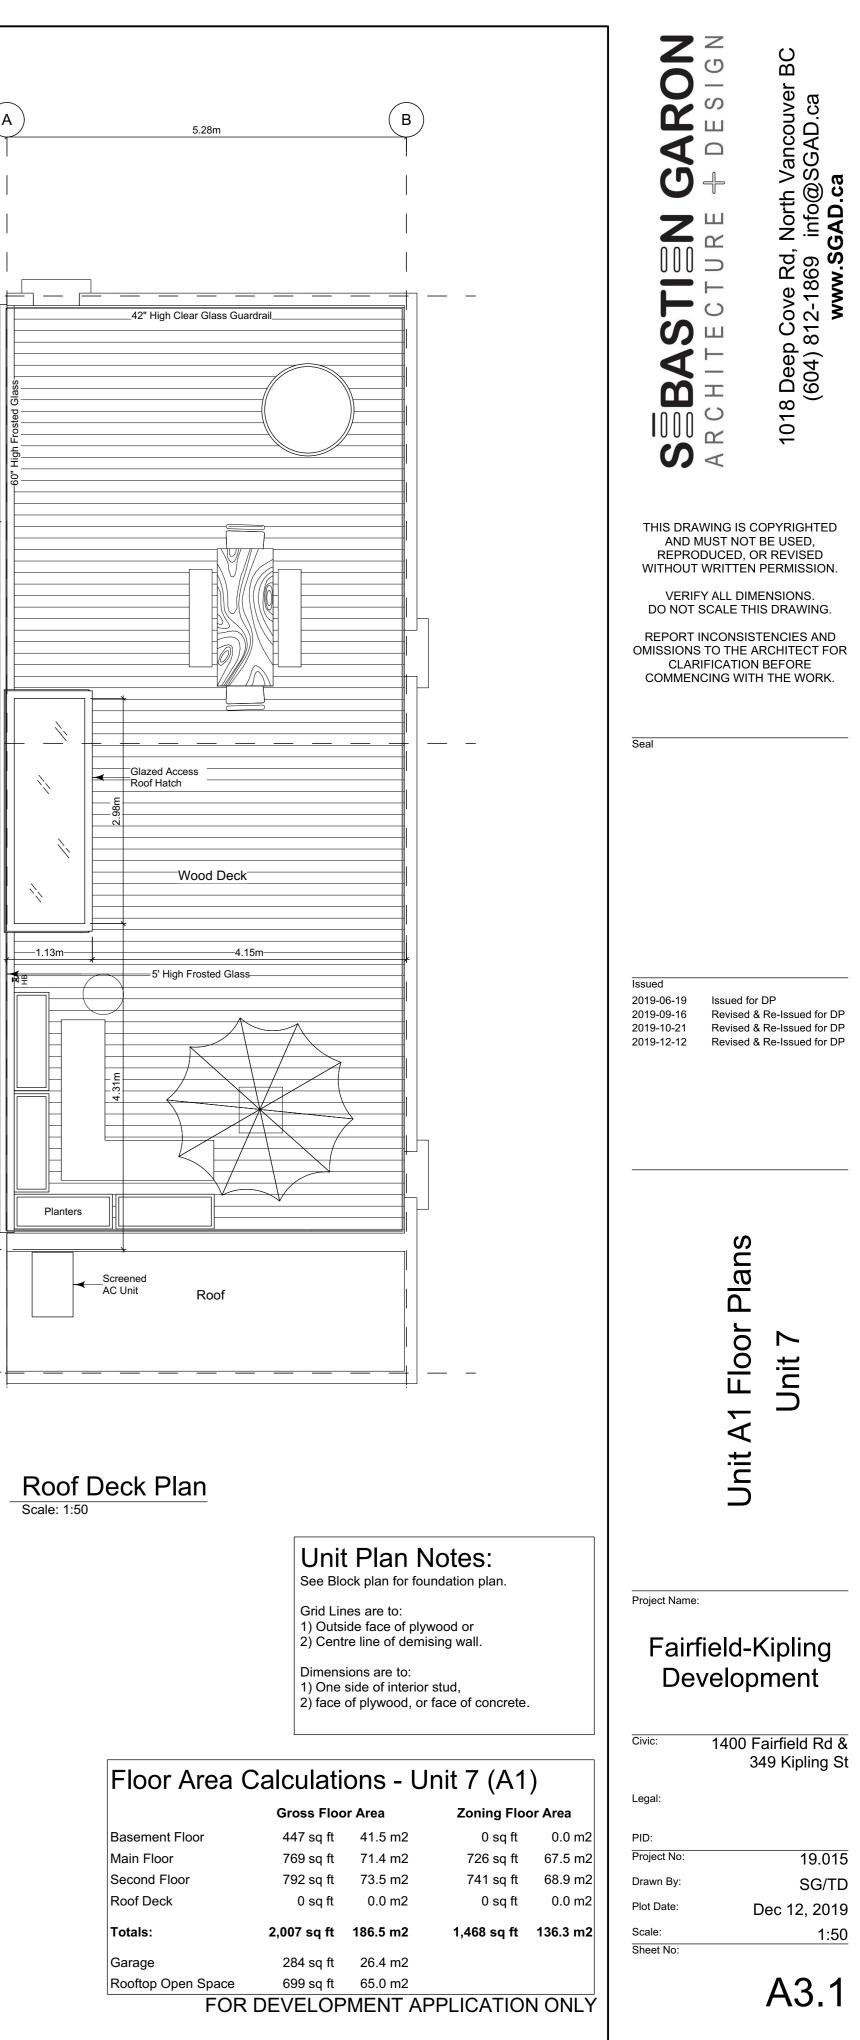

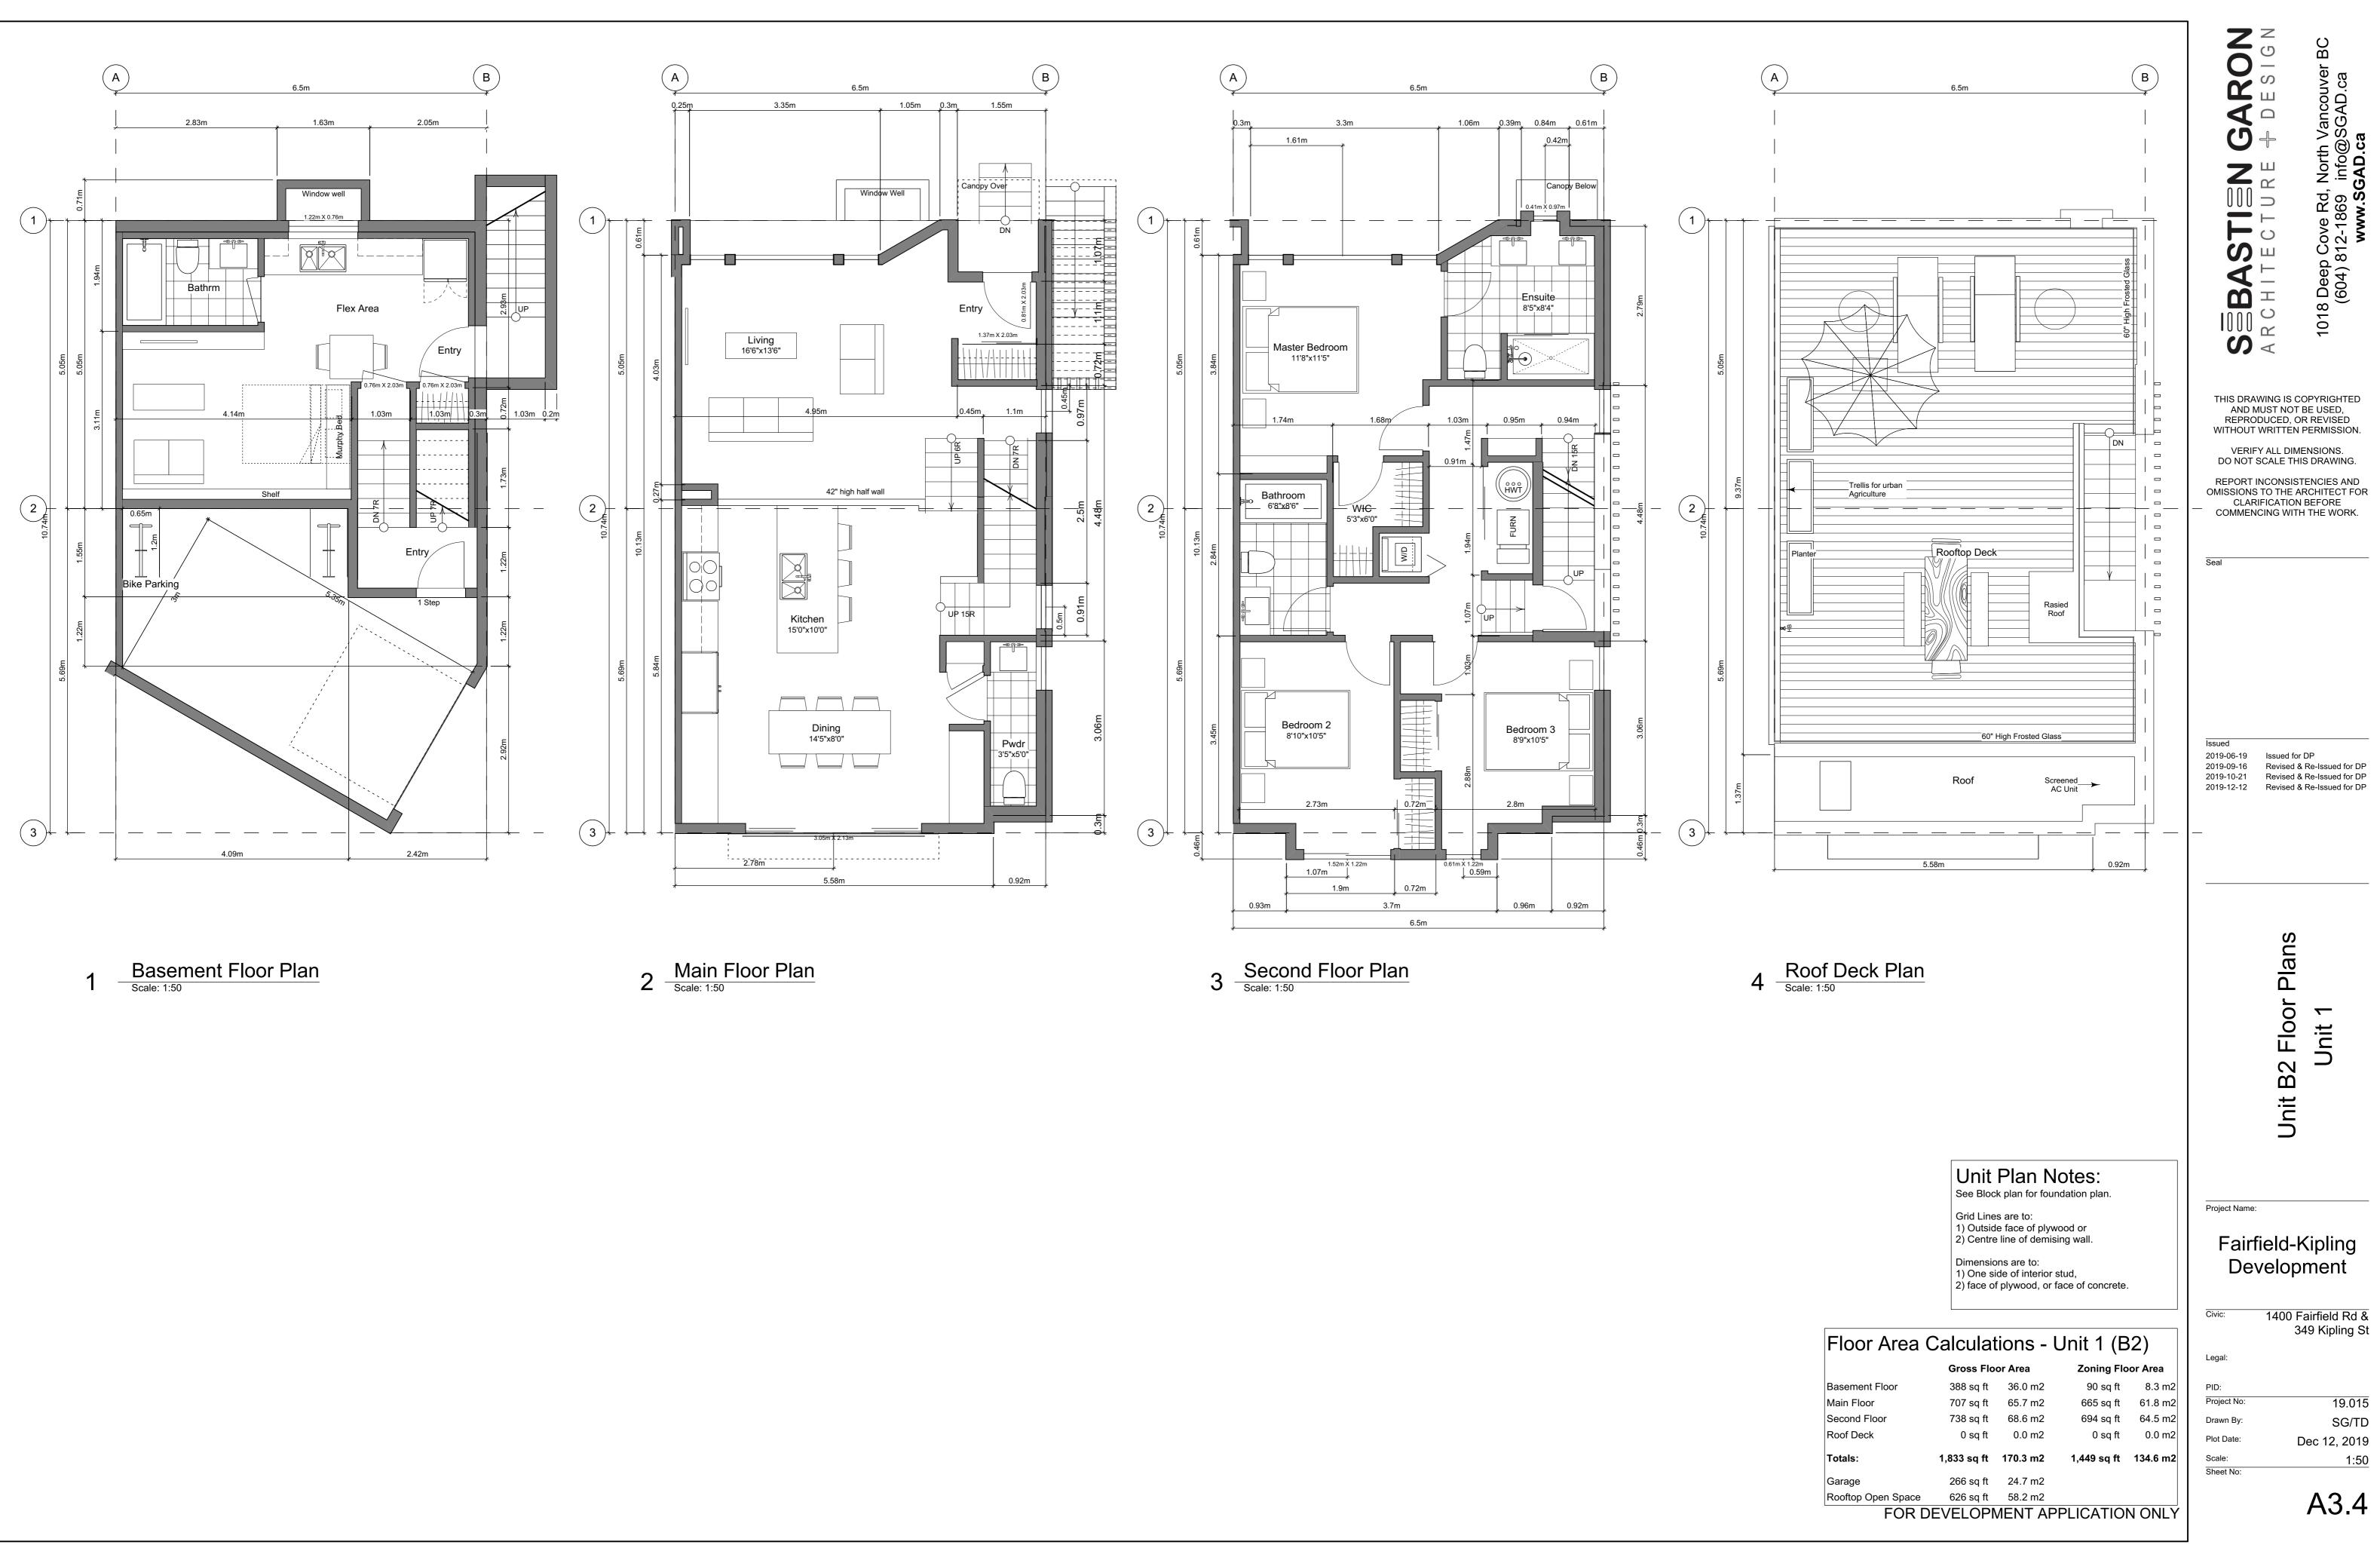

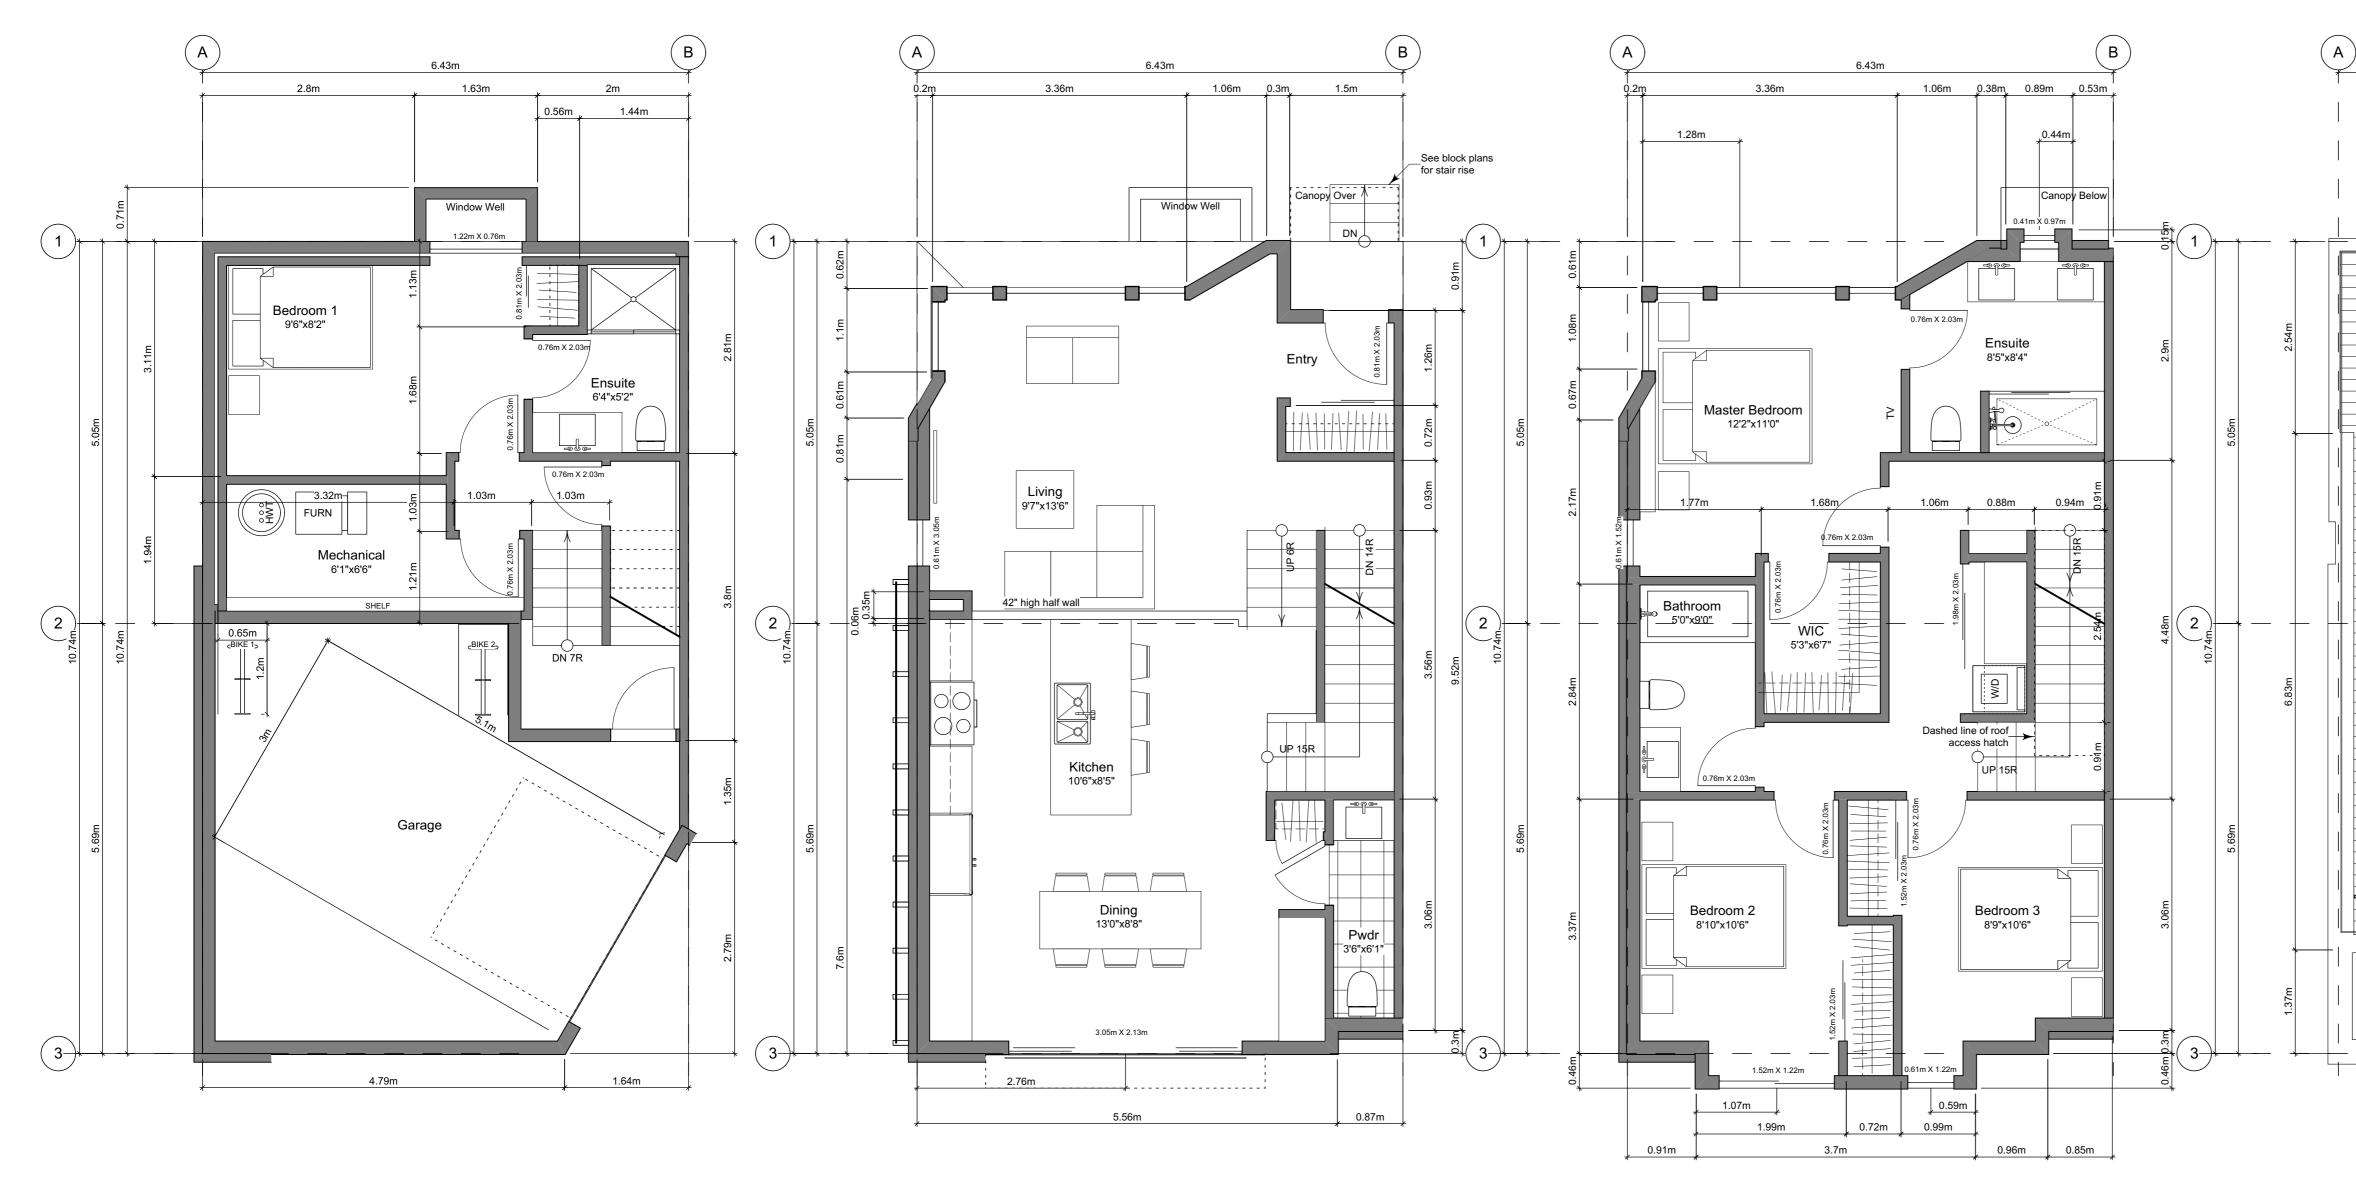



1 Basement Floor Plan Scale: 1:50

2 Main Floor Plan Scale: 1:50



2.54m		6.43m			SBASTION GARON	1018 Deep Cove Rd, North Vancouver BC (604) 812-1869 info@SGAD.ca www.SGAD.ca
6.83m		Rooftop Deck	Access of Hatch Rasied Roof ed Glass			T BE USED, OR REVISED N PERMISSION. MENSIONS. HIS DRAWING. STENCIES AND ARCHITECT FOR IN BEFORE TH THE WORK.
<u>wrst</u>		Pened Roof 				& Re-Issued for DP
		See Block Grid Lines 1) Outside 2) Centre Dimensior 1) One sid 2) face of Cor Area Calculati Gross Floo ent Floor 383 sq ft loor 694 sq ft d Floor 727 sq ft eck 0 sq ft	face of plywood or line of demising wall. hs are to: le of interior stud, plywood, or face of concret ONS - Unit 6 (I	B3) Ioor Area 14.7 m2 60.6 m2 63.6 m2 0.0 m2	Project Name: Fairfield- Develop	Kipling oment Fairfield Rd & 349 Kipling St 19.015 SG/TD Dec 12, 2019
	Garage	e 274 sq ft o Open Space 642 sq ft	25.5 m2 59.6 m2 IENT APPLICATIC		Sheet No:	1:50 A3.5

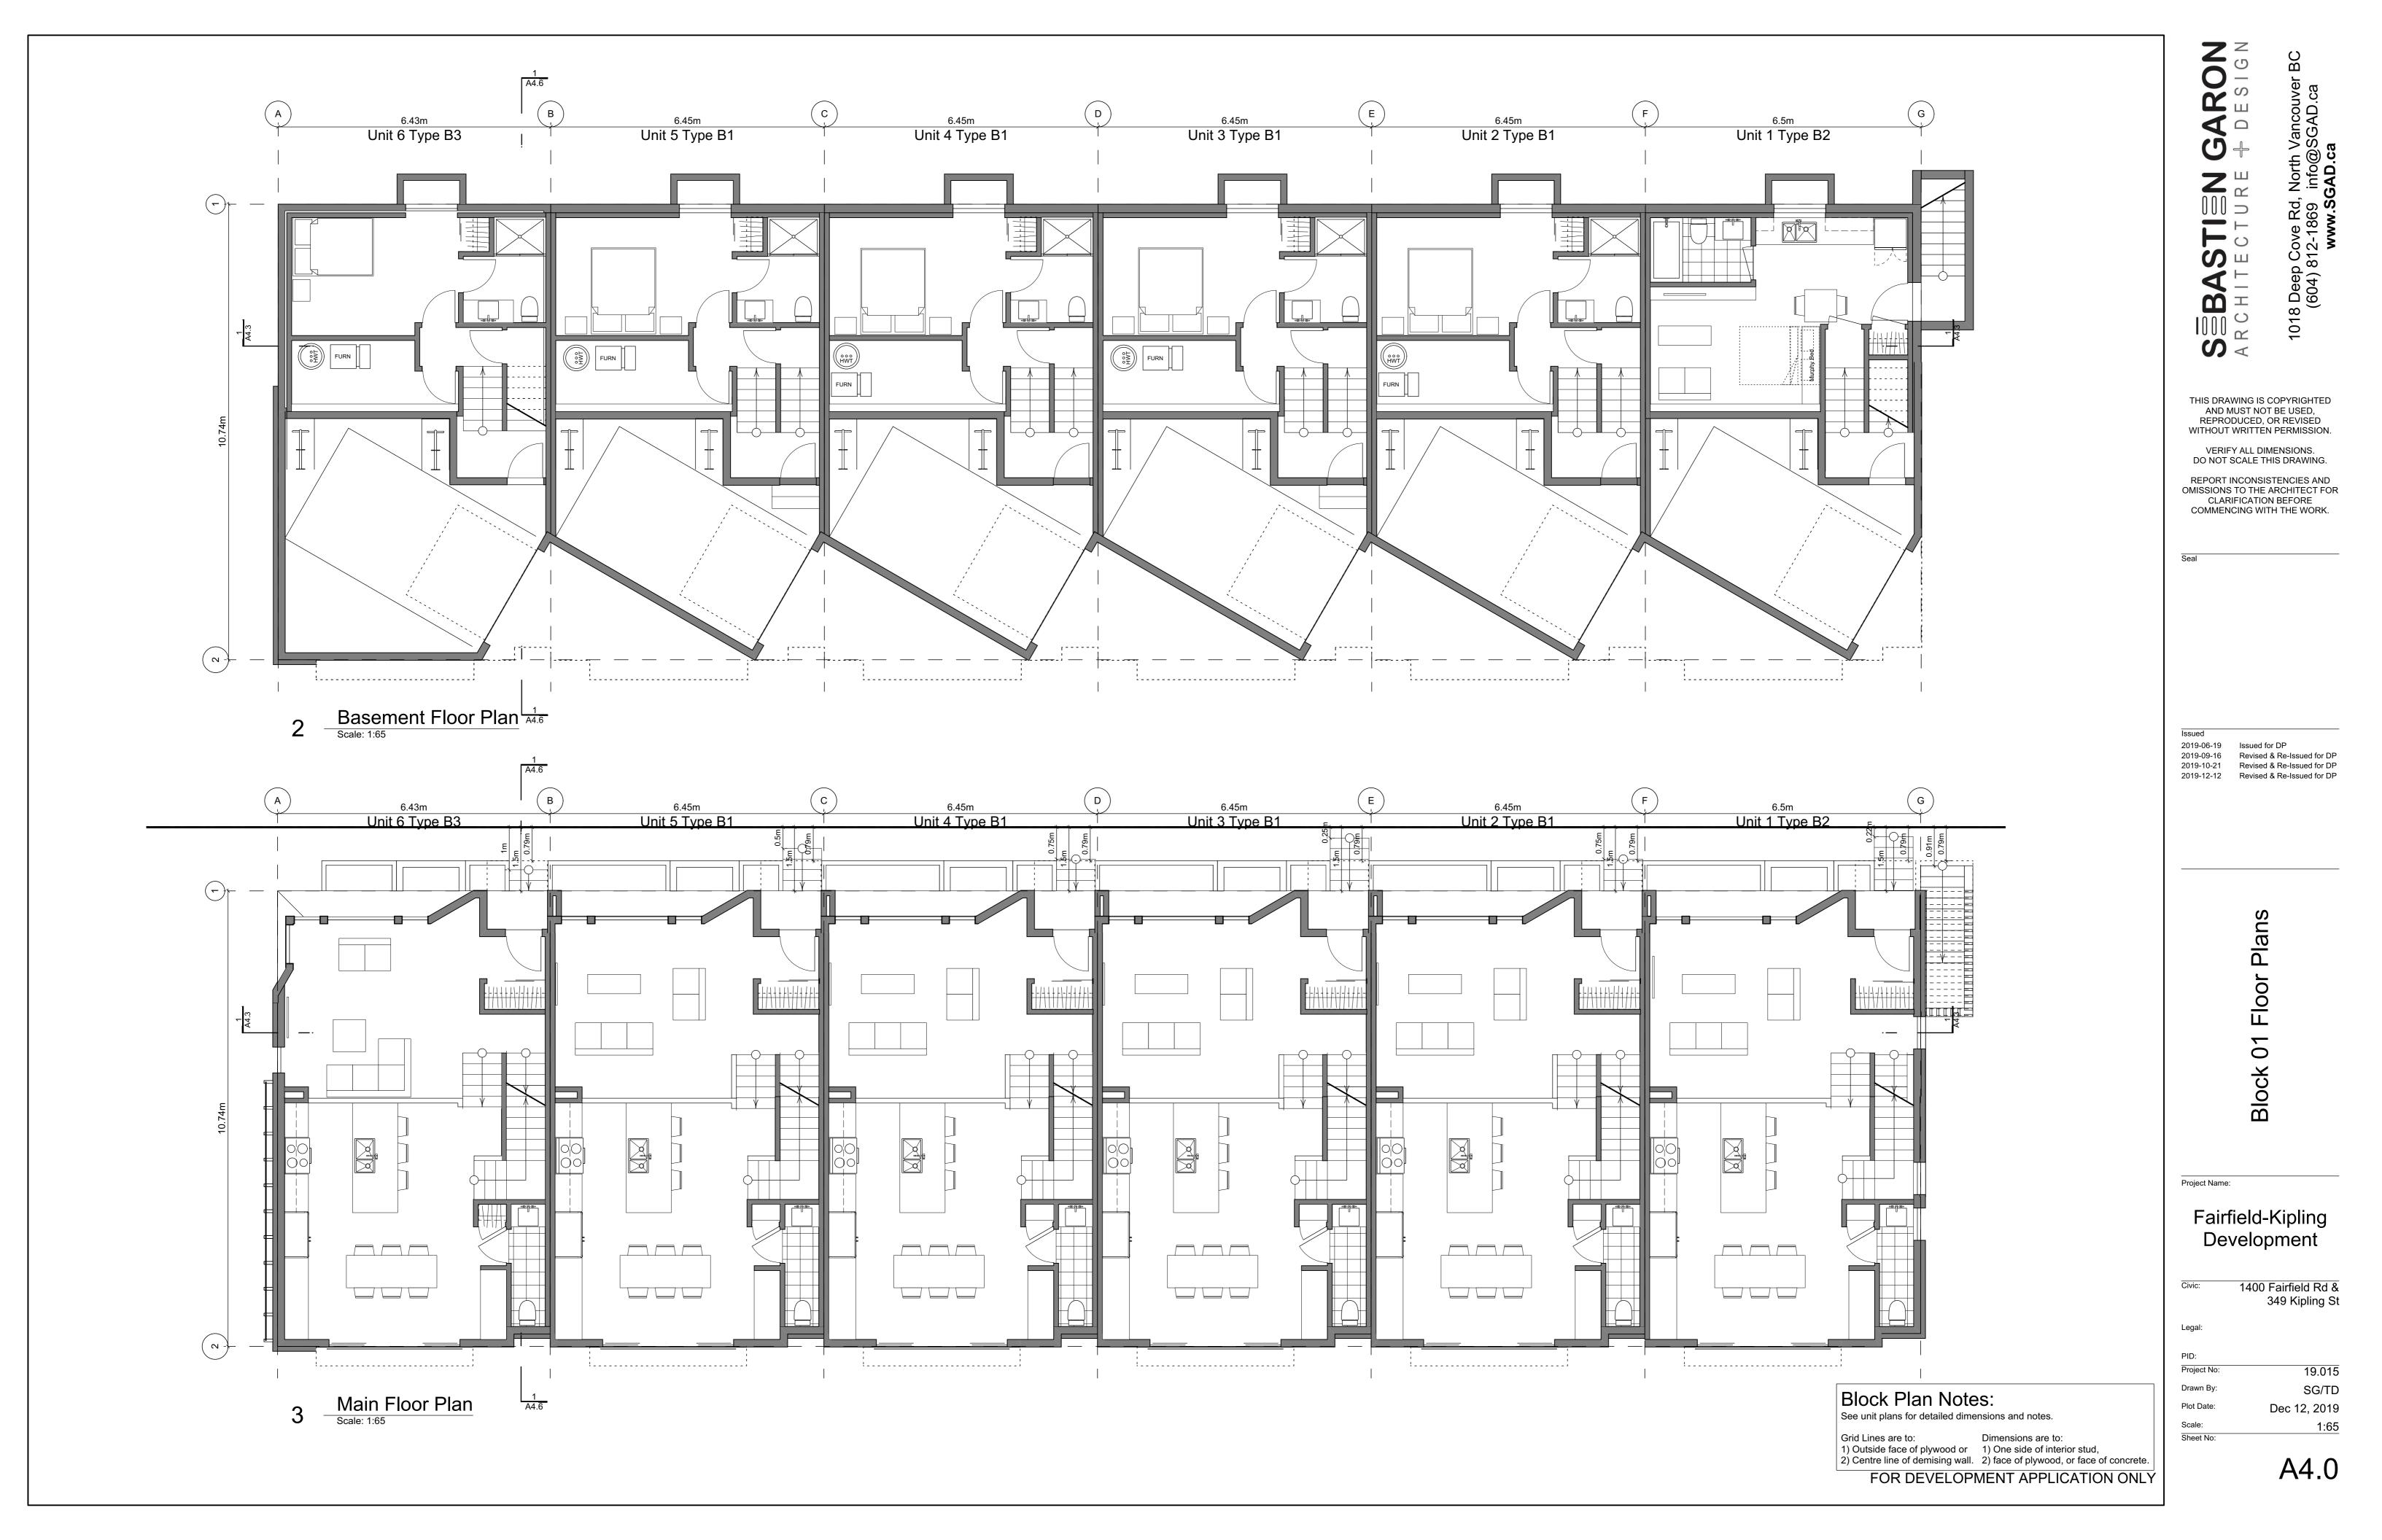

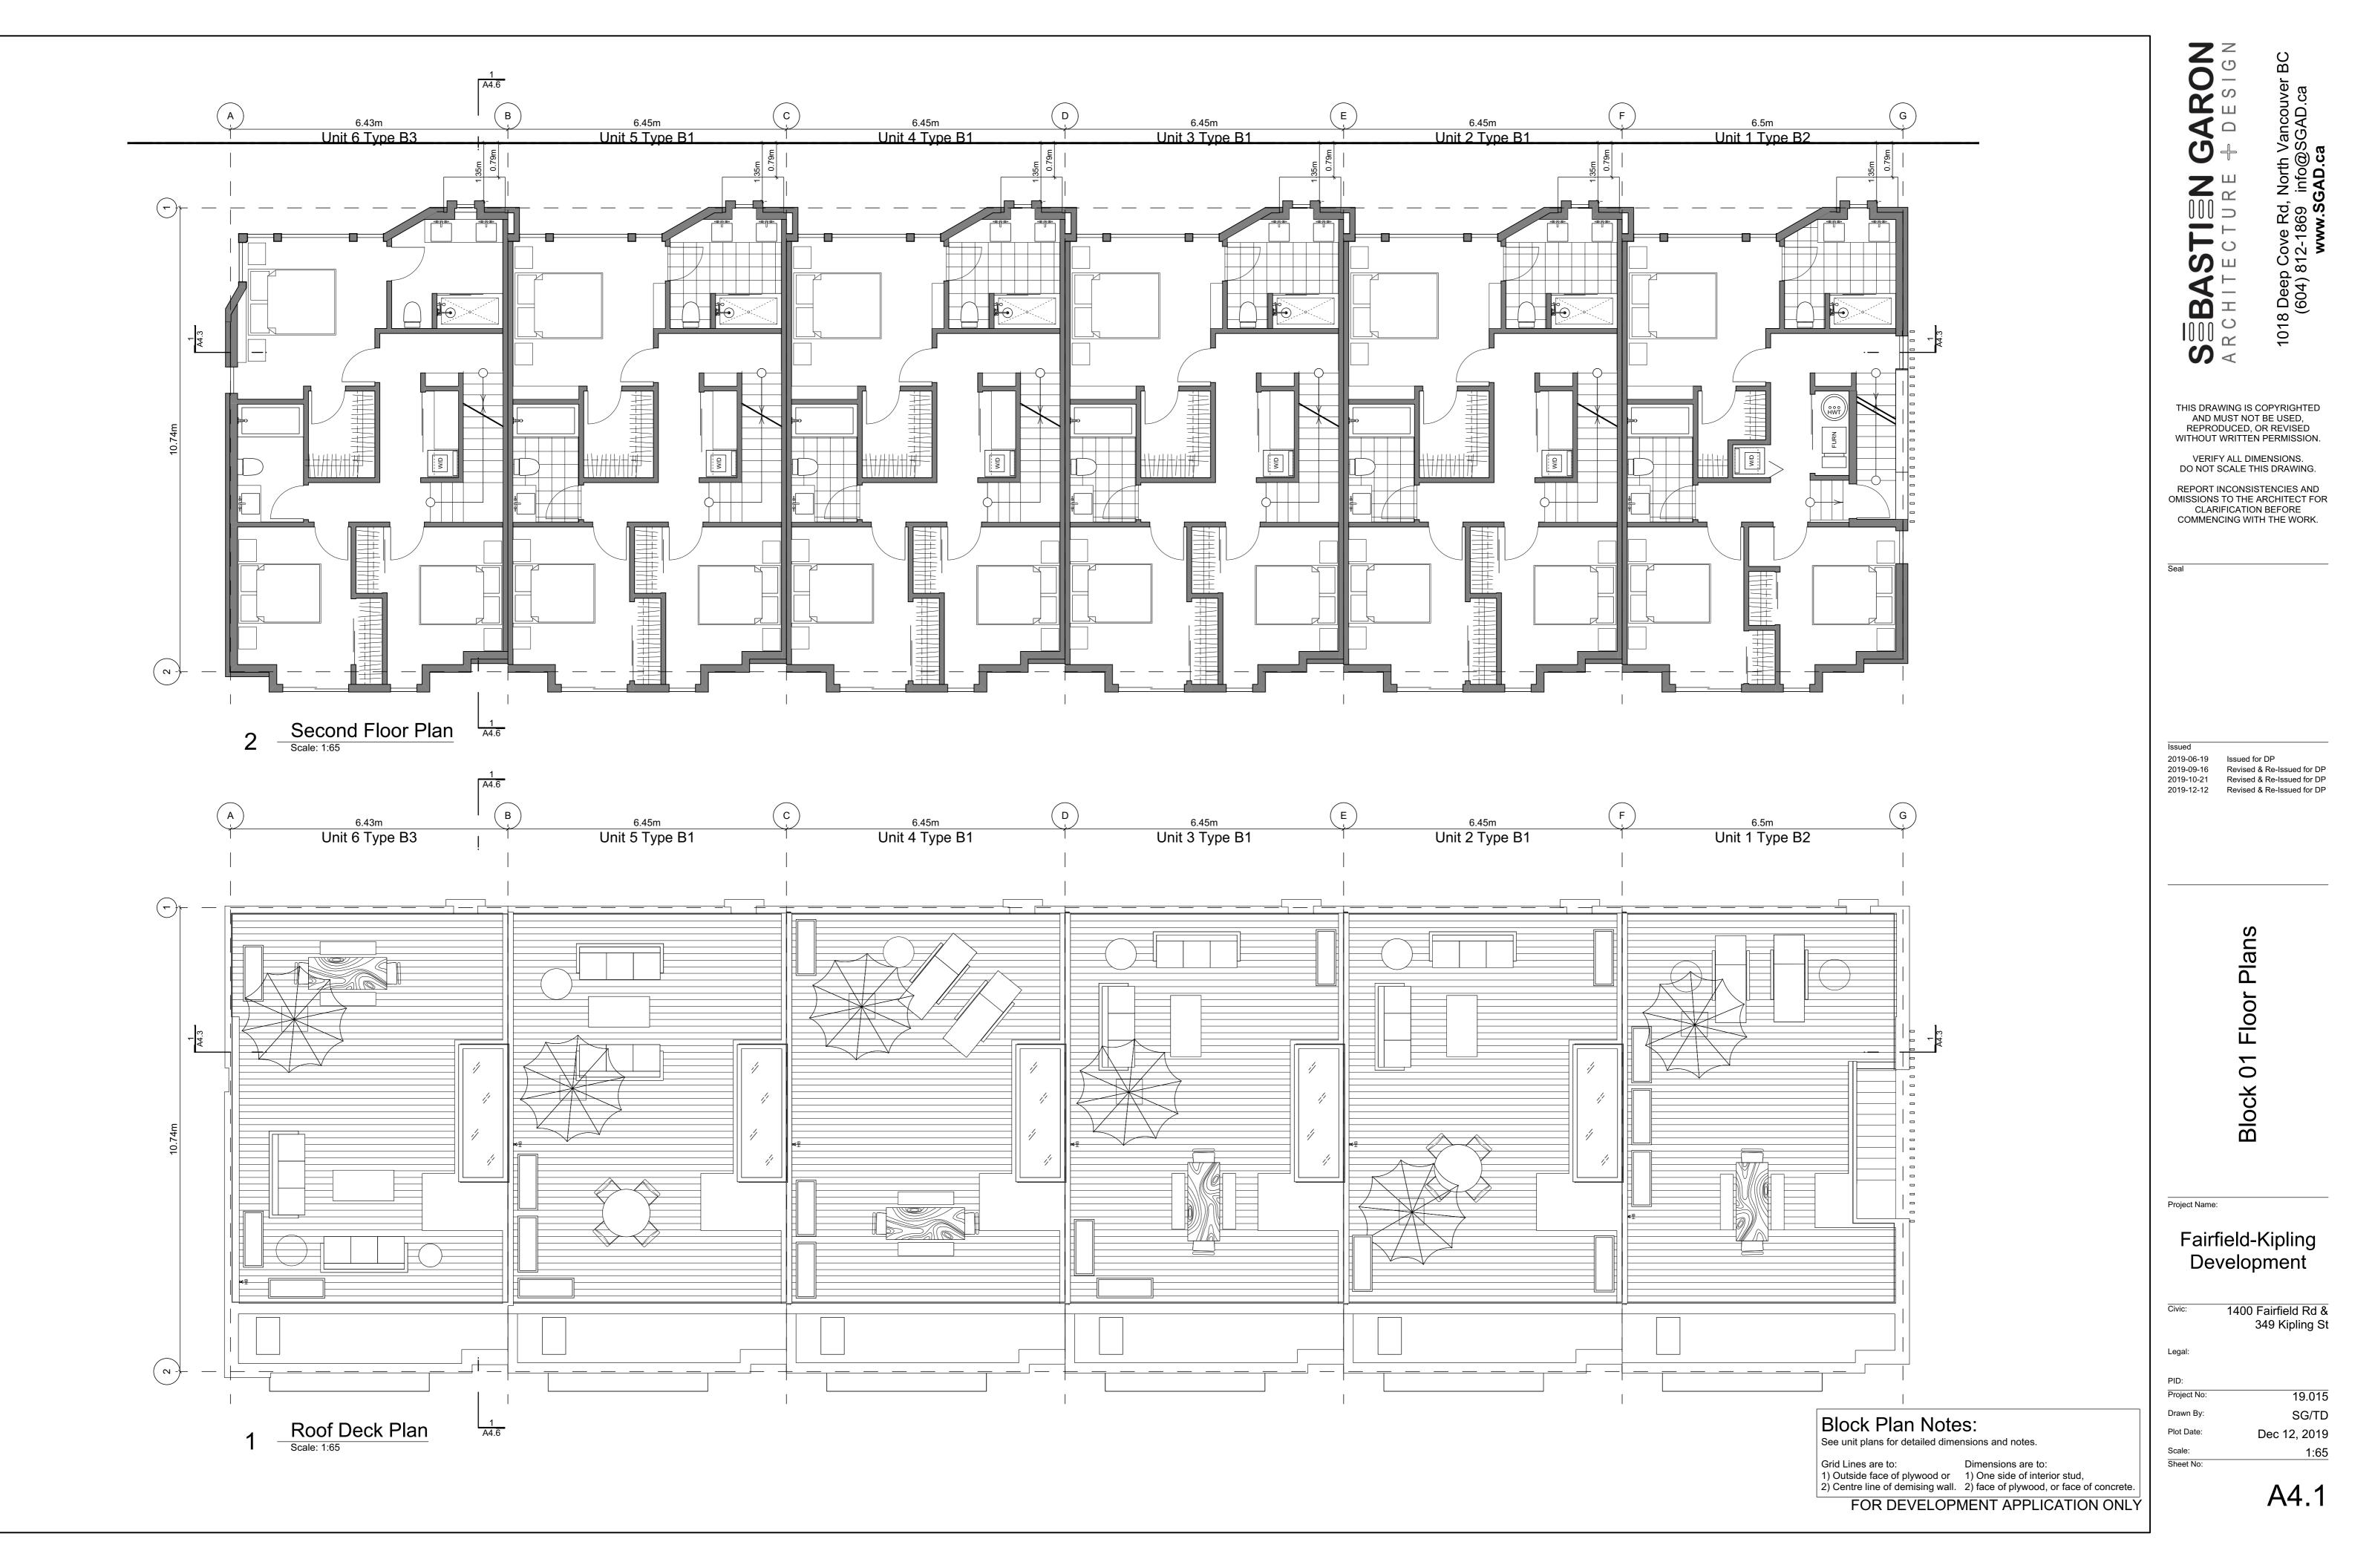

Building Exposure and Spatial Separation (9.10.15.4.)

Compartment	Area of Facade	Limiting Distance		Unprot Oper		Construction of Building Face	Cladding
				Allowed	Actual	-	
North Facade	48.8 m2	11.23 m	to C/L of Kipling St.	98.5 %	43 %	3/4hr, C	C or NC
East Facade	78.6 m2	18.03 m	to C/L of Thurlow Rd.	100.0 %	8.9 %	3/4hr, C	C or NC
South Facade	52.8 m2	5.00 m	to PL	52.0 %	22.7 %	3/4hr, C	C or NC
West Facade	80.7 m2	3.80 m	to C/L of Driveisle	36.6 %	9.1 %	3/4hr, C	NC


Exterior Materials


No.	Description	Colour / Finishes
1	Cable Trellis c/w Vines	See Landscape Drawings
2	Glass Railing	Glass Guardrail with White Aluminum Frame
3	Hardie Panels	Grey
4	I-XL Brick	Light Grey
5	Metal Cap Flashing	White
6	Metal Flashing	Silver or White
7	Metal Screen	
8	Parged Concrete	-
9	Stucco	White
10	Window Frame	Silver or white
11	Wood Grain Cladding	Wood Grain
All Mate	rials as noted or approved	equal









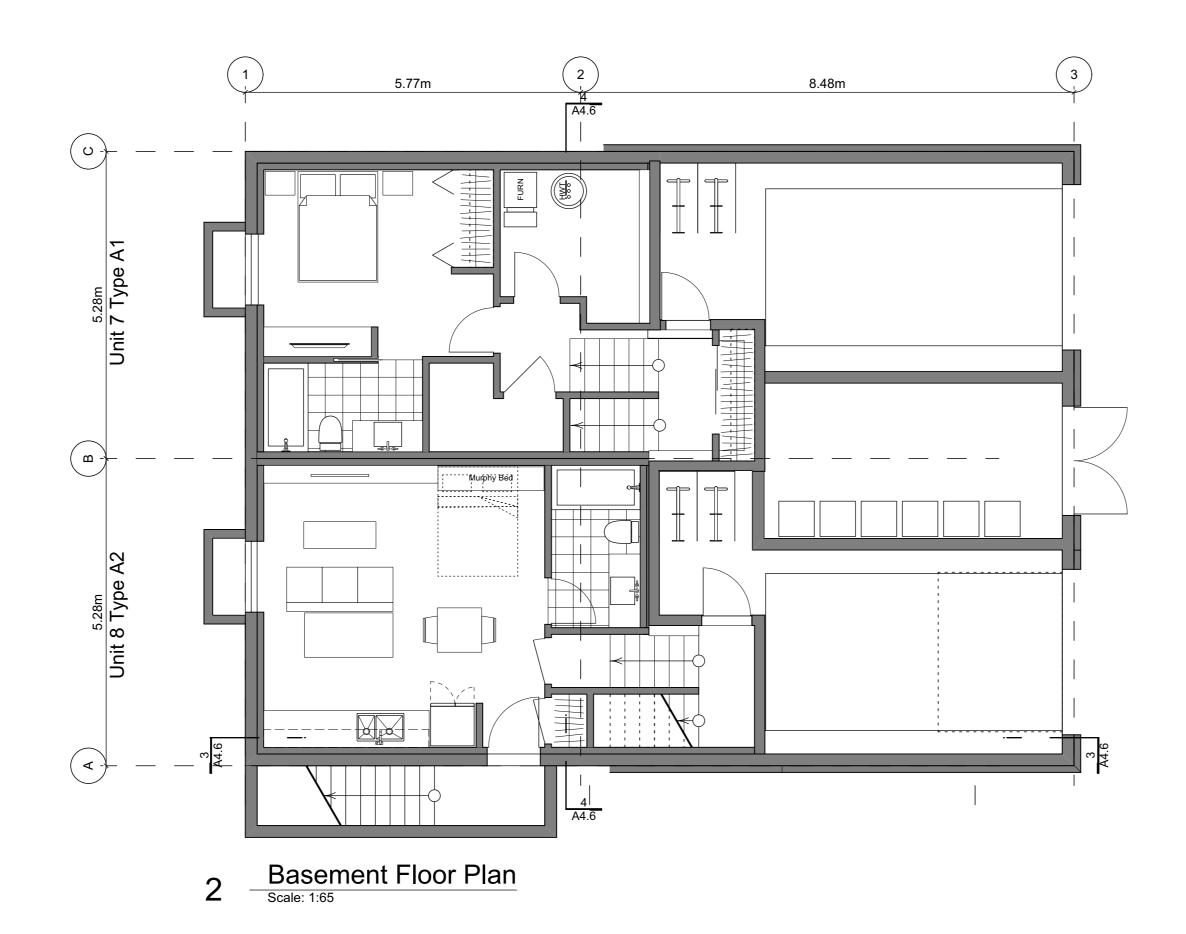

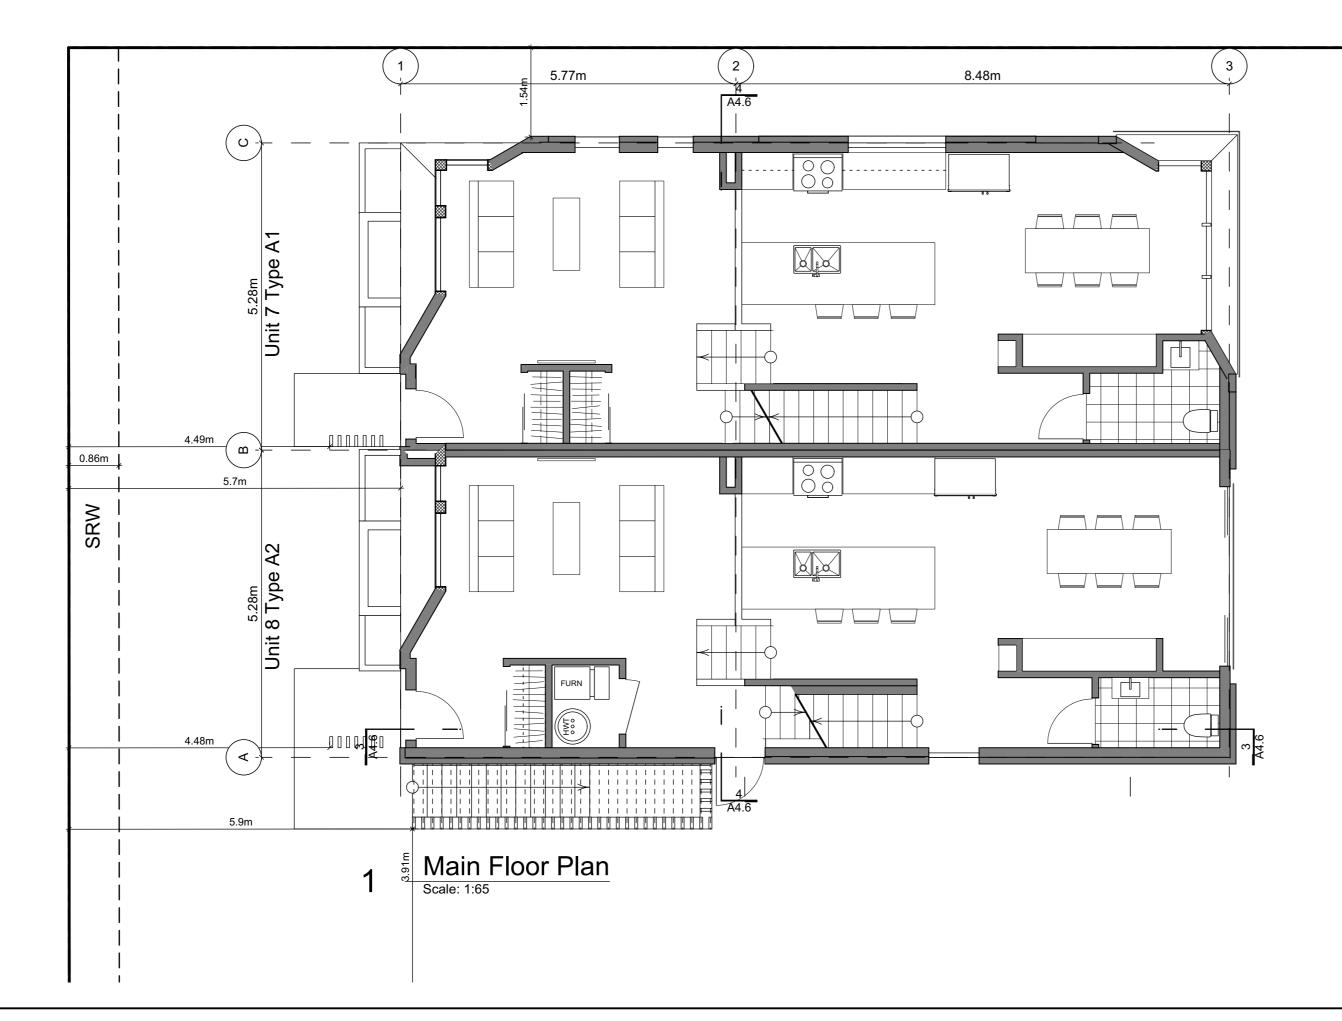

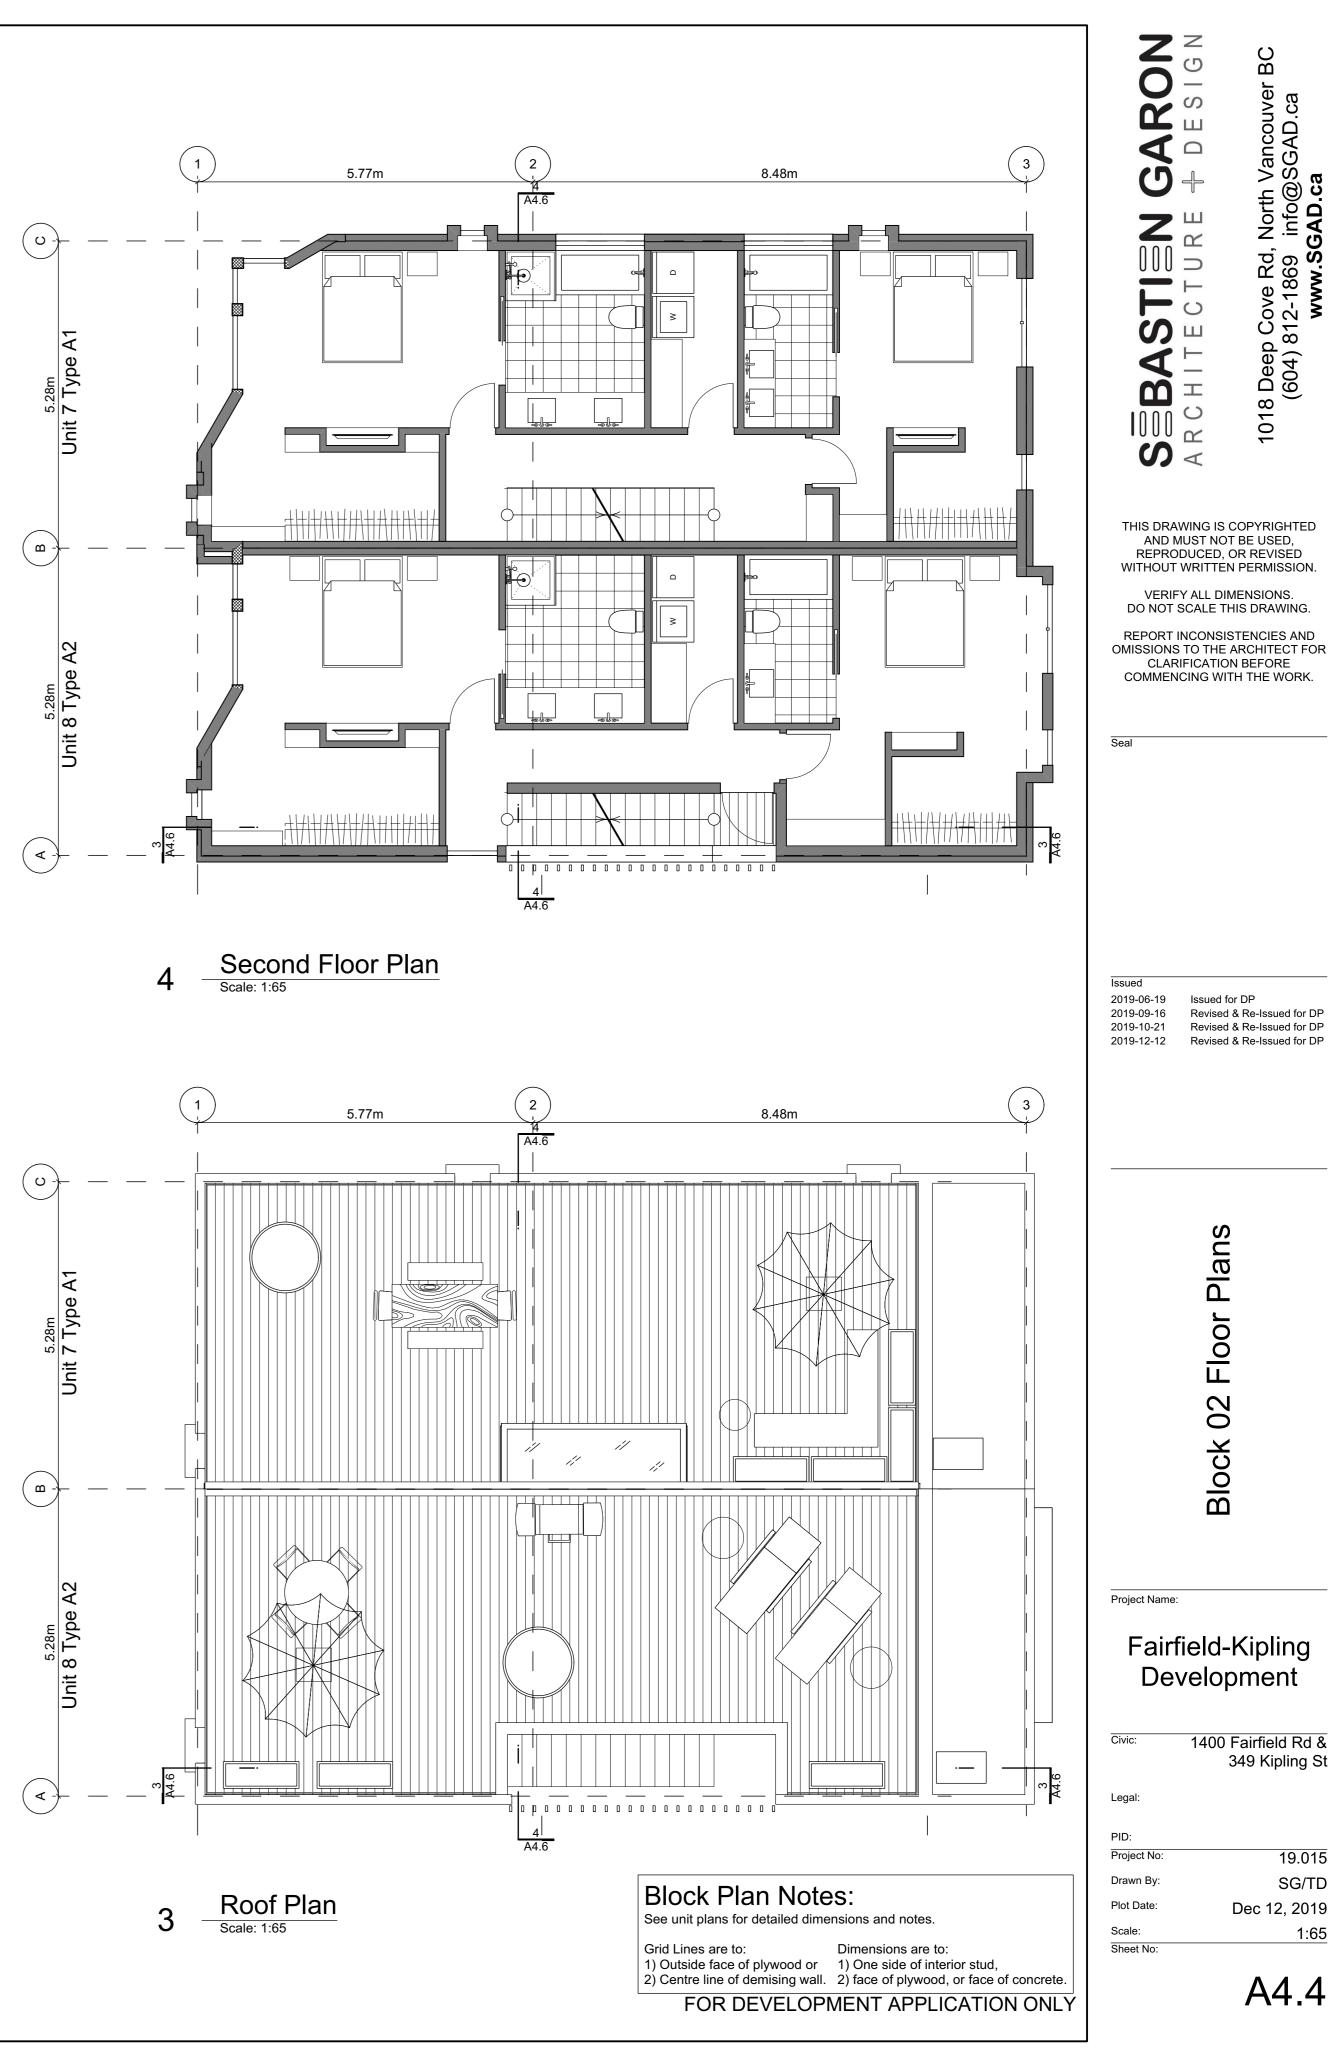

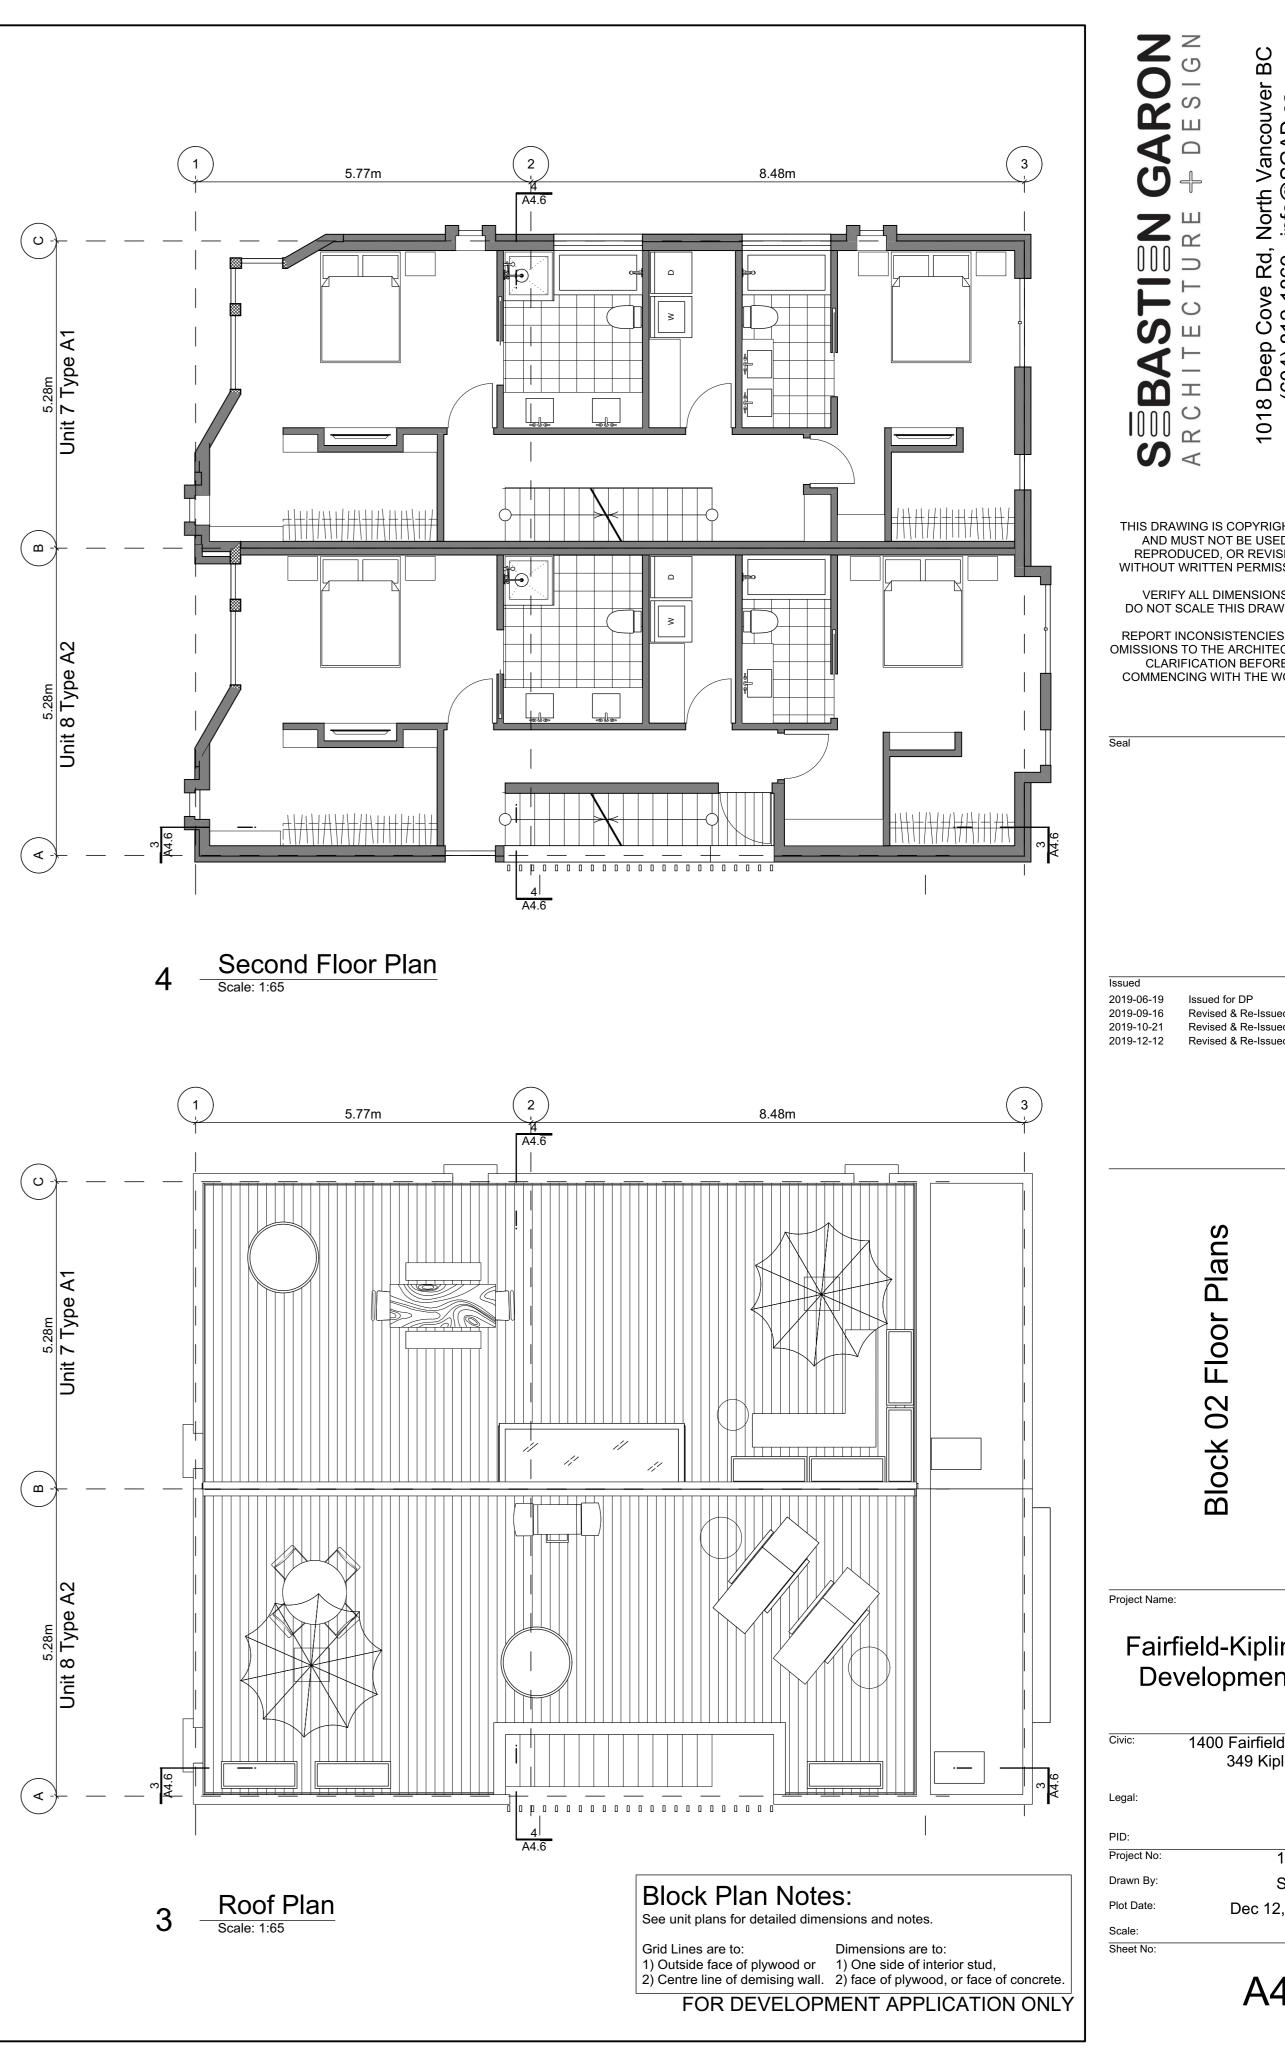

1:65

Building Exposure and Spatial Separation (9.10.15.4.)

Building Sprinklered to NFPA13

Compartment		Area of Facade	Lim	iting Distance	Unprot Oper		Construction of Building Face	Cladding
					Allowed	Actual		
North Facade		107.4 m2	11.37 m	to C/L Kipling St.	95.0 %	11.2 %	С	C or NC
East Facade	Α	39.1 m2	3.80 m	Halfway Block 2	26.2 %	14.0 %	С	C or NC
	в	7.2 m2	3.80 m	Halfway Block 2	36.3 %	50.7 %	С	C or NC
South Facade		106.4 m2	5.14 m	to PL	16.0 %	7.8 %	С	C or NC
West Facade		36.8 m2	15.06 m	to C/L Fairfield Rd.	100.0 %	37.4 %	С	C or NC

Exterior Materials


No.	Description	Colour / Finishes
1	Cable Trellis c/w Vines	See Landscape Drawings
2	Glass Railing	Glass Guardrail with White Aluminum Frame
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6	Metal Flashing	Silver or White
7	Metal Screen	
8	Parged Concrete	-
9	Stucco	White
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11	Wood Grain Cladding	Wood Grain
All Mate	rials as noted or approved	equal








A4.5

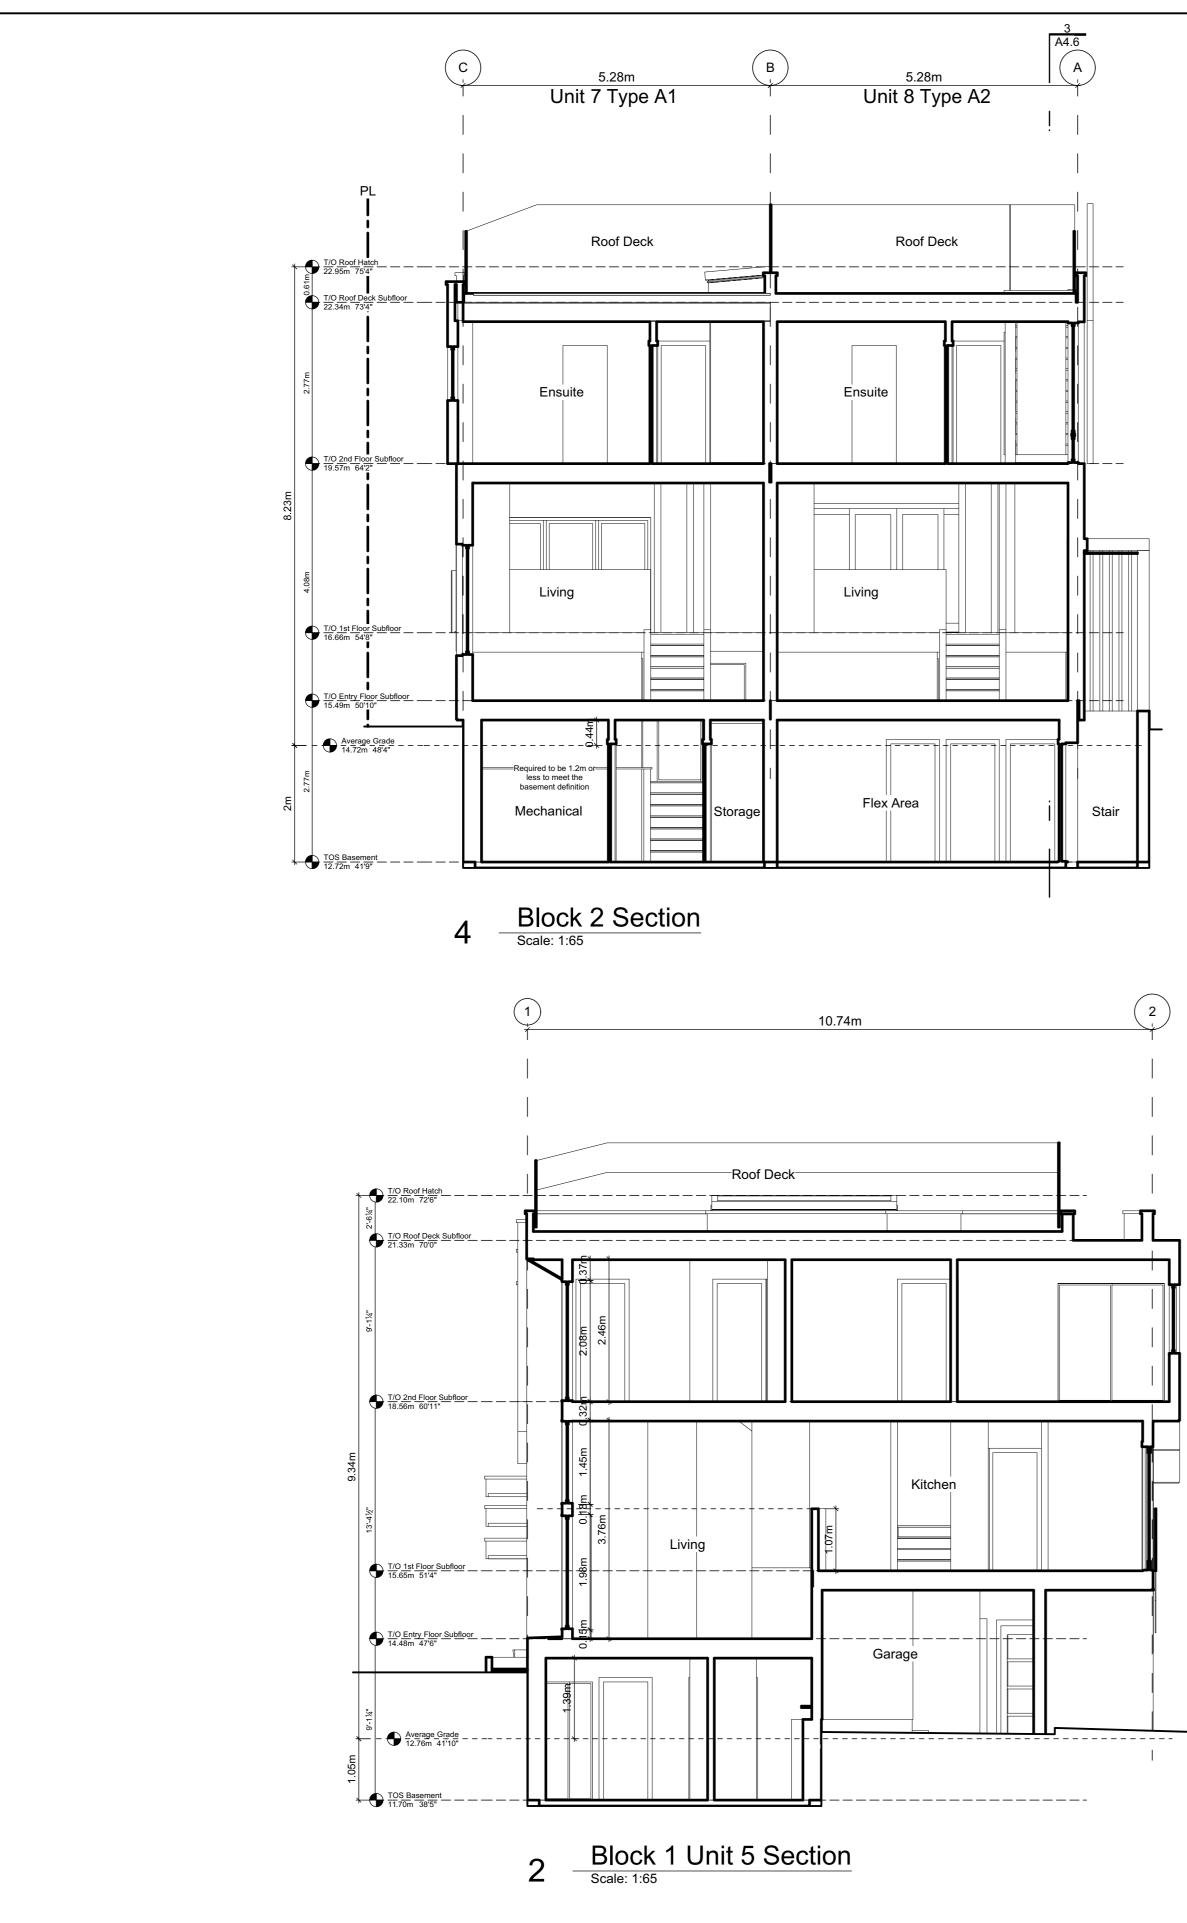

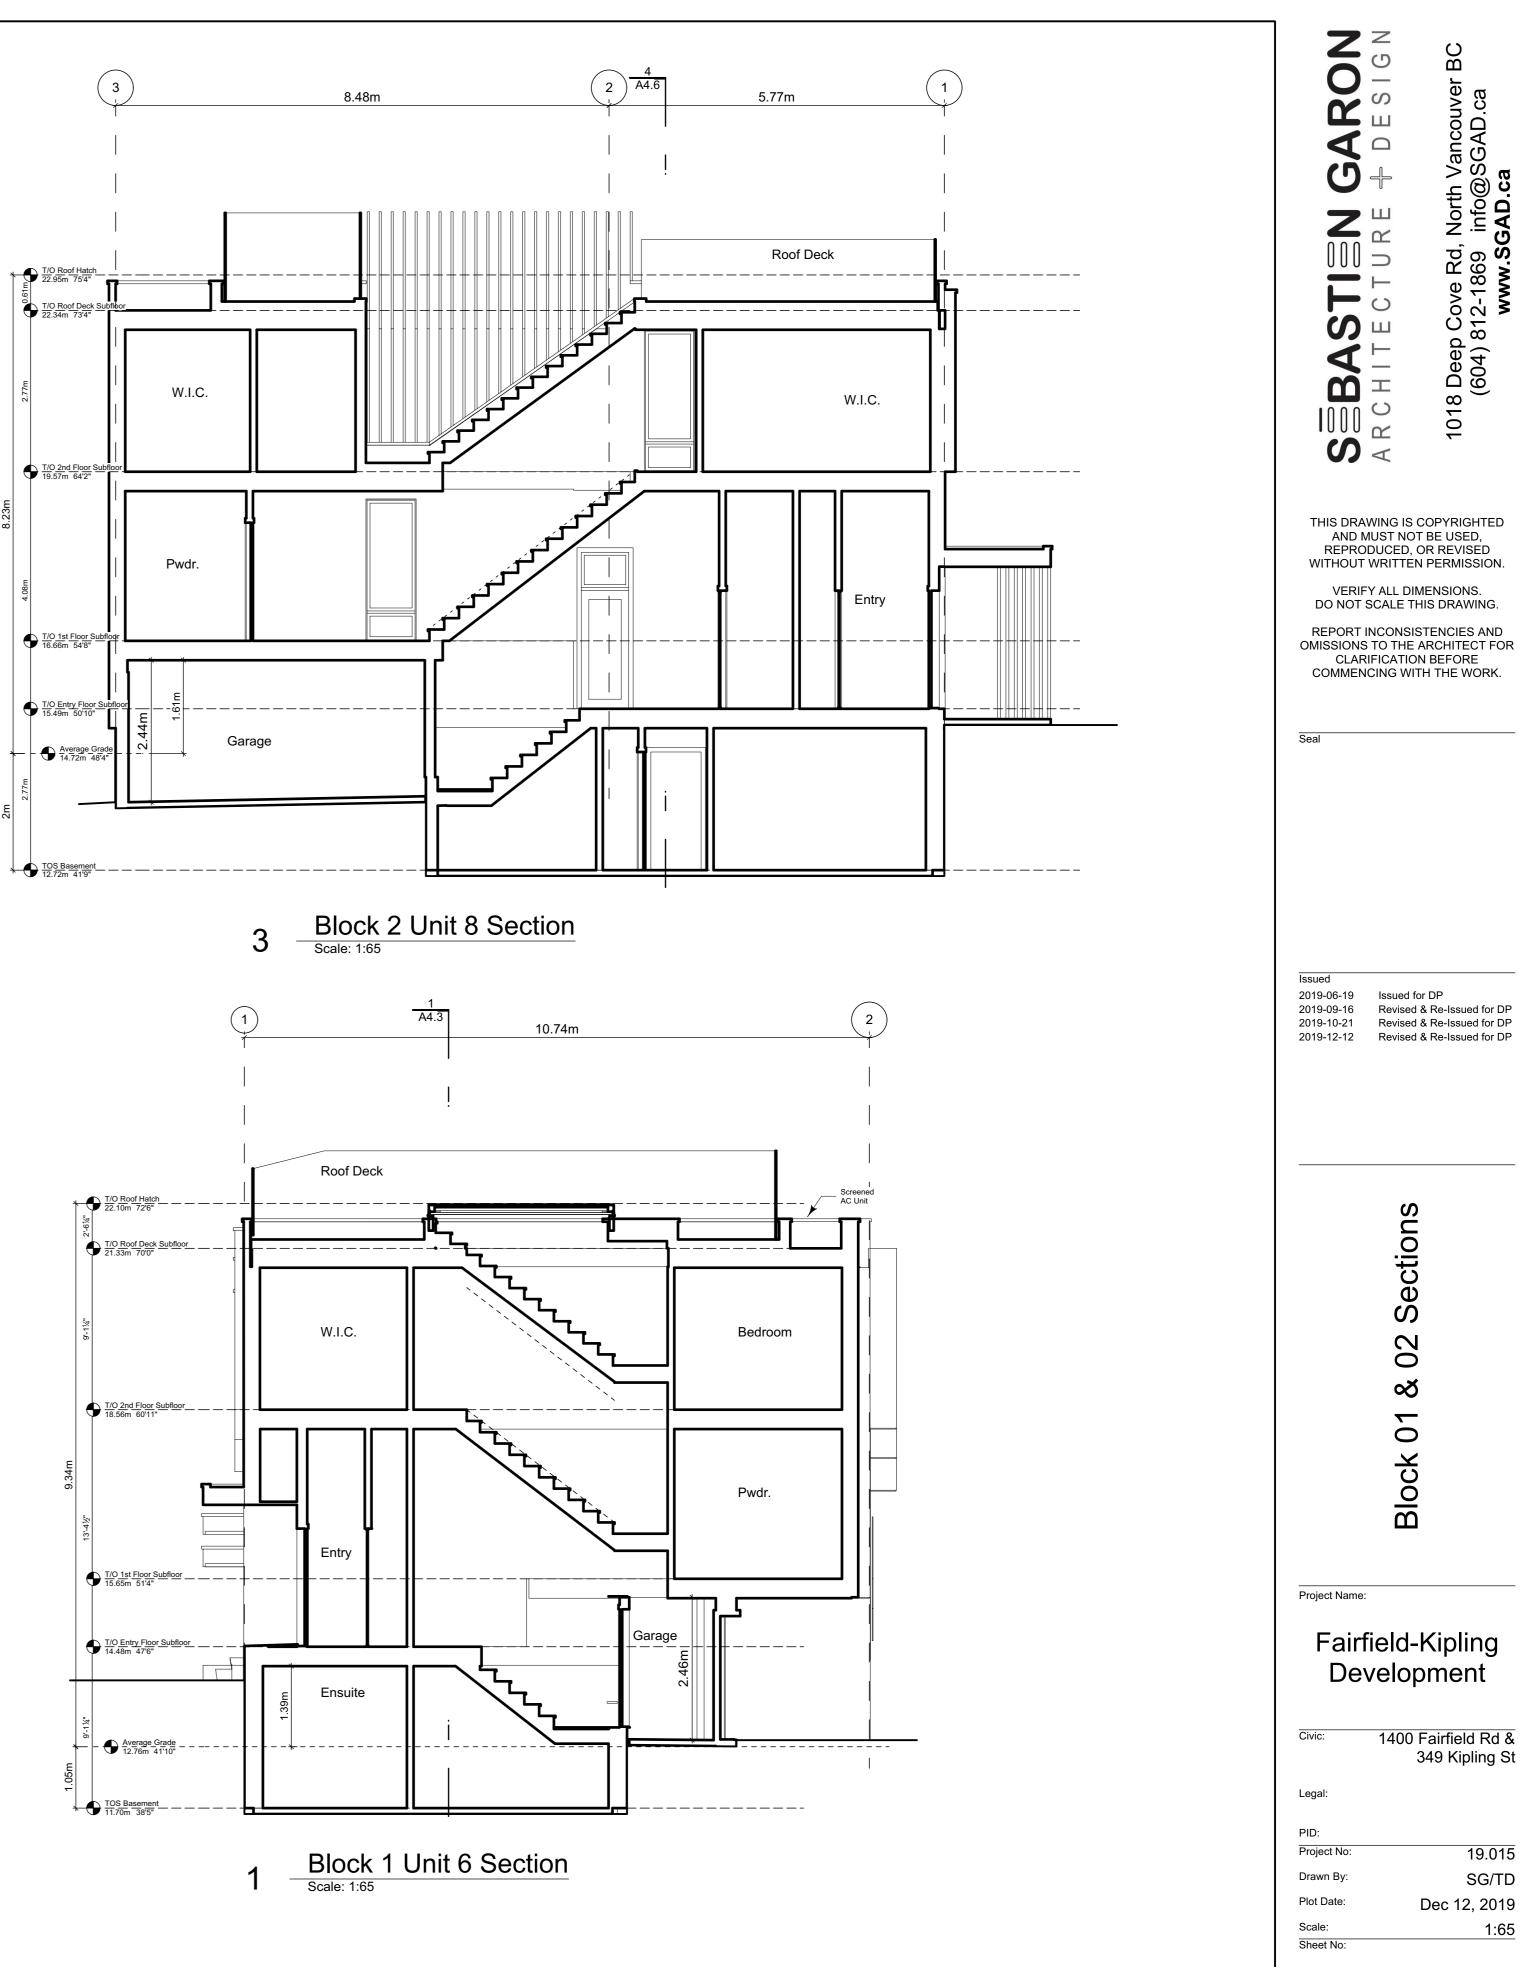

FOR DEVELOPMENT APPLICATION ONLY

A4.6

Climatic Data for the City of Victoria

December 10 2018 (BCBC 2018)

The following climatic data shall be used within the boundaries of the City of Victoria.

Deg		е	nperatur	sign Ter	De	
Bel	5%	y 2.5	Jul	у	Januar	,
	Vet °C	V	Dry °C	1% ℃	°C 1	2.5%
	17		24	-6		-4
Moist.	Ann.		ay Rain,	One Da	/lin.	15 I
Index	in, mm	Ra	, mm	1/50	Rain, mm	
0.98	800		91	g)	ç
ssures, l	Vind Pres	rly W	Hou	kPa 1/50	/ Load	Snov
1/50		/10	1	Sr		S₅
0.57).44	0	0.3		1.5
ismic Da	Se					
) S	Sa(2.0)	Sa(1.0	6a(0.5)	2) S	Sa(0.2
) 0	0.399	;	0.676	1.16		1.30

Alternatively site specific climatic data from Environment Canada can be used. Environment Canada can be emailed at <u>climate.services@ec.gc.ca</u> to obtain site specific climatic data. There is a user fee for providing site specific climatic data from Environment Canada.

Assemblies General Notes:

These assemblies have been selected in accordance with BCBC 2018 and in coordination with the project consultants. The contractor is to be compliant with all these requirements, any deviations will not be accepted without prior approval and coordination.

Abbreviations

FRR = Fire Resistance Ratin
VB = Vapour Barrier
FG = Fiber Glass
MB = Moisture Barrier
AB = Air Barrier
OC = On Centre

FRR = Fire Resistance Rating STC = Sound Transmission Class GWB = Gypsum Wall Board XPS = Extruded Polystyrene Rigid Insulation (Roxul CIS or equiv) RSI = Resistance Système International IIC = Impact Insulation Class UV = Ultraviolet ULC = Underwriters Laboratories of Canada

700				
82	5		220	
Pa				
a				
5.0)	Sa(10.0)	PGA	PGV
125	0.	044	0.580	0.834
	w 18°C 700 Ann. Ppn,	Ann. Tot. Ppn, mm 825 Pa 	w 18°C 700 Ann. Tot. Drivin Ppn, mm Press 825 Pa 5.0) Sa(10.0)	w 18°C 700 Ann. Tot. Driving Rain Wing Ppn, mm Pressure, Pa, 1/5 825 220 Pa

	ed with a Heat-Recovery Ventilator RSI values, BCBC Section 9.36. Energy Efficiency, Zone 4	4 <300	0 Deare	e Davs			
Assemb			Area %	DSI off	R-Value	FRR	STC
R1.0	Insulated Roof (Outboard Insulation)		UIRED: VIDED:		26.52 27.49	-	-
	All roofing work to RCABC five-year guarantee standards. Roof Covering to have a A, B, or C classification as per CAN/ULC-S107 Exterior Air Film			0.03	0.17		
MB	Torch On Built Up Membrane Protection Board			-	-		
AB, VB	5" Expanded polystyrene Type 2 Slope To drain 5/8" T&G Plywood sheathing (See structural)	0.035	/ mm	4.45 -	25.24 -		
	11 7/8" TJI joists (see structural)			0.16	0.91		
	1 layers 5/8" GWB			0.10	0.55		
	Interior Air Film Soffit - See elevations			0.11	0.62		
R1.1	Roof Cavity Fire Separation		UIRED:	-	-	1 HR	-
	11 7/8" TJI Rated RIm Board (see structural)	PRU	VIDED:	-	-	1 HR	-
R2.0	Insulated Roof (Spray Foam)		UIRED: VIDED:		26.52 29.60	-	-
	All roofing work to RCABC five-year guarantee standards. Roof Covering to have a A, B, or C classification as per CAN/ULC-S107 Exterior Air Film			0.03	0.17		
MB	Torch On Built Up Membrane			0.05	0.17		
	5/8" T&G Plywood sheathing (See structural) Cross Strapping slope to drain			-	-		
	11 7/8" TJI joists (see structural)	2.56	9.0%				
AB, VB	6" 2LB Medium Density/Closed Cell Spray Foam Insulation	5.49	91.0%	4.98	28.25		
	1 layers 5/8" GWB			0.10	0.55		
	Interior Air Film Soffit - See elevations			0.11	0.62		
R3.0	Un-Insulated Roof		UIRED:	-	-	-	-
	All reafing work to PCAPC five year guarantee standards	PRU	VIDED:	-	-	-	-
	All roofing work to RCABC five-year guarantee standards. Roof Covering to have a A, B, or C classification as per CAN/ULC-S107						
MB	Torch On Built Up Membrane						
	5/8" T&G Plywood sheathing (See structural)						
	11 7/8" TJI joists (see structural) Soffit - See elevations						
R4.0	Roof Deck		UIRED:		26.52	-	-
		PRO	VIDED:	5.21	29.60		
	Exterior Air Film			0.03	0.17		
	Floating Wood Deck Boards on 2X4 Sleepers DELTA MS - 5/16" dimpled membrane						
MB	Torch On Built Up Membrane 5/8" T&G plywood sheathing (see structural)			_	-		
	Cross Strapping slope to drain						
	11 7/8" TJI joists (see structural)	2.56	9.0%	4.00	25 07		
AB, VB	6 " 2LB Medium Density/Closed Cell Spray Foam Insulation	5.49	91.0%	4.98	26.87		
	Resilient metal channels @ 24" OC perpindicular to joists			-	-		
	1 layers 5/8" type X GWB			0.10	0.55		
	Interior Air Film						

	ed with a Heat-Recovery Ventilator e RSI values, BCBC Section 9.36. Energy Eff	icionov	Zono (~2000 F	lograa Day	~		
Assemb		iciency,		Area %	RSI eff.	R-Value	FRR	STC
10001110					(m2•K)/W			
W1.0	CIP Concrete Below Grade			UIRED: VIDED:	1.99 2.59	11.30 14.73	-	-
	Free drainage back fill (See geotechnical)				-	-		
	DELTA MS - 5/16" dimpled membrane				-	-		
lΒ	Waterproofing Install as per manufacturers recommend	dation			-	-		
	8" Reinforced Type S or N concrete wall (see structural	I)	0.0004/ı	mm	0.08	0.46		
B, VB	2.5" Continuous XPS Insulation		0.0336/ı	mm	2.13	12.12		
	2X2 Framing @ 24" OC (Service Cavity)				0.18	1.02		
	1 Layer 1/2" GWB				0.08	0.45		
	Interior Air Film				0.12	0.68		
W2.0	Wood Stud Wall		-	UIRED:	2.74	15.56	-	-
			PRO	VIDED:	3.04	17.24	-	-
	Exterior Air Film				0.03	0.17		
	Cladding (See Elevations)				-	-		
-	3/8" x 1 1/2" PT Strapping 16" OC				0.15	0.85		
1B	2 layers 30min building paper				-	-		
	1/2" Plywood Sheathing				0.10	0.57		
	o ()	framing	1.19	0.23	2.55	14.46		
		cavity	3.87	0.77				
B, VB	6 mil Poly UV				-	-		
	1 Layer 5/8" GWB Taped, Sanded, and ready for paint				0.09	0.51		
	Interior Air Film				0.12	0.68		
W3.0	Curtain Wall 6" Deep		-	UIRED: VIDED:	-	-	-	-
	1" insulating double pane exterior glazed							
	5" Extruded Aluminum Mullion							

Interior Wall

Assembly

W4.0 Suite to Suite BCBC 2018 Table A9. 1 layer 5/8" type 'X' UL 2X4 stud framing @ r 3 1/2" FG Batt Insulat 1" air space

2X4 stud framing @ 1 layer 5/8" type 'X' U

*Where noted as shea

W5.0 Non-Load Bea

1/2" GWB both sides 2X4 or 2X6 stud framir ** see plans for locatio ** 3 1/2" FG Batt Insu

W5.1 Load Bearing

** Refer to structural 1 layer 5/8" type 'X' UL 2x4 or 2x6 stud framin ** see plans for locati

** 3 1/2" FG Batt Insu

Floor Assemblies

Interior Air Film

Calculated with a Heat-Recovery Ventilator Effective RSI values, BCBC Section 9.36. Energy Efficiency, Zone 4 <3000 Degree Days

		,		0	,			
Assemb	bly		RSI	Area %	RSI eff. (m2•K)/W	R-Value	FRR	STC
E1 0	Wood Floor		REQ	UIRED:	-	-	-	-
F1.0	Wood Floor		PRO	VIDED:	-	-	-	-
	Finish Flooring to Owners spec							
	5/8" T&G plywood sheathing (see structural)							
	11 7/8" TJI joists (see structural)							
	1 layer 5/8" GWB							
F1.1	Insulated Wood Floor			UIRED:	4.67	26.52	-	-
			PRC	VIDED:	5.48	31.13	-	-
	Interior Air FIIm Finish Flooring to Owners spec				0.16	0.91		
	5/8" T&G plywood sheathing (see structural)				0.10	- 0.57		
	11 7/8" TJI joists (see structural)	framing	2.56	9.0%	0110	0101		
AB, VB	6.5" Rigid SM Foam Insulation Sealed in place.	cavity	5.78	91.0%	5.19	29.48		
//B, VB	Soffit - See elevations	ouvity	0.70	01.070	-	-		
	Exterior Air Film				0.03	0.17		
F2.0	Concrete Slab On Grade			UIRED:	-	-	-	-
			PRC	VIDED:	-	-	-	-
	4" Reinforced concrete slab (see structural)							
AB, VB	10 mil UV VB							
	6" compacted granular fill (see structural)							
	native soil							

0.11

0.62

RSI Area %	RSI eff. (m2•K)/W	R-Value	FRR	STC
		-	1 HR 1 HR	50 54
REQUIRED	-	-	-	-
PROVIDED	-	-	-	-
·				
REQUIRED	-	-	1 HR	-
PROVIDED	-	-	1 HR	-
Walls				
	REQUIRED PROVIDED REQUIRED PROVIDED	REQUIRED: PROVIDED: - PROVIDED: - - - - - - - - - - - - - - - - - - -	REQUIRED: PROVIDED: PROVIDED: PROVIDED: PROVIDED: PROVIDED: PROVIDED: PROVIDED: PROVIDED:	REQUIRED: - - 1 HR PROVIDED: - - - REQUIRED: - - - PROVIDED: - - - PROVIDED: - - - PROVIDED: - - - REQUIRED: - - - PROVIDED: - - - REQUIRED: - - - REQUIRED: - - - REQUIRED: - - 1 HR PROVIDED: - - 1 HR


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Issued	
2019-06-19	Issued for DP
2019-09-16	Revised & Re-Issued for DF
2019-10-21	Revised & Re-Issued for DF
2019-12-12	Revised & Re-Issued for DF




Project Name:

Fairfield-Kipling Development

Civic:	1400 Fairfield Rd &
	349 Kipling St
Legal:	
PID:	
Project No:	19.015
Drawn By:	SG/TD
Plot Date:	Dec 12, 2019
Scale:	NTS
Sheet No:	

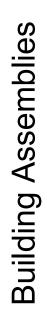



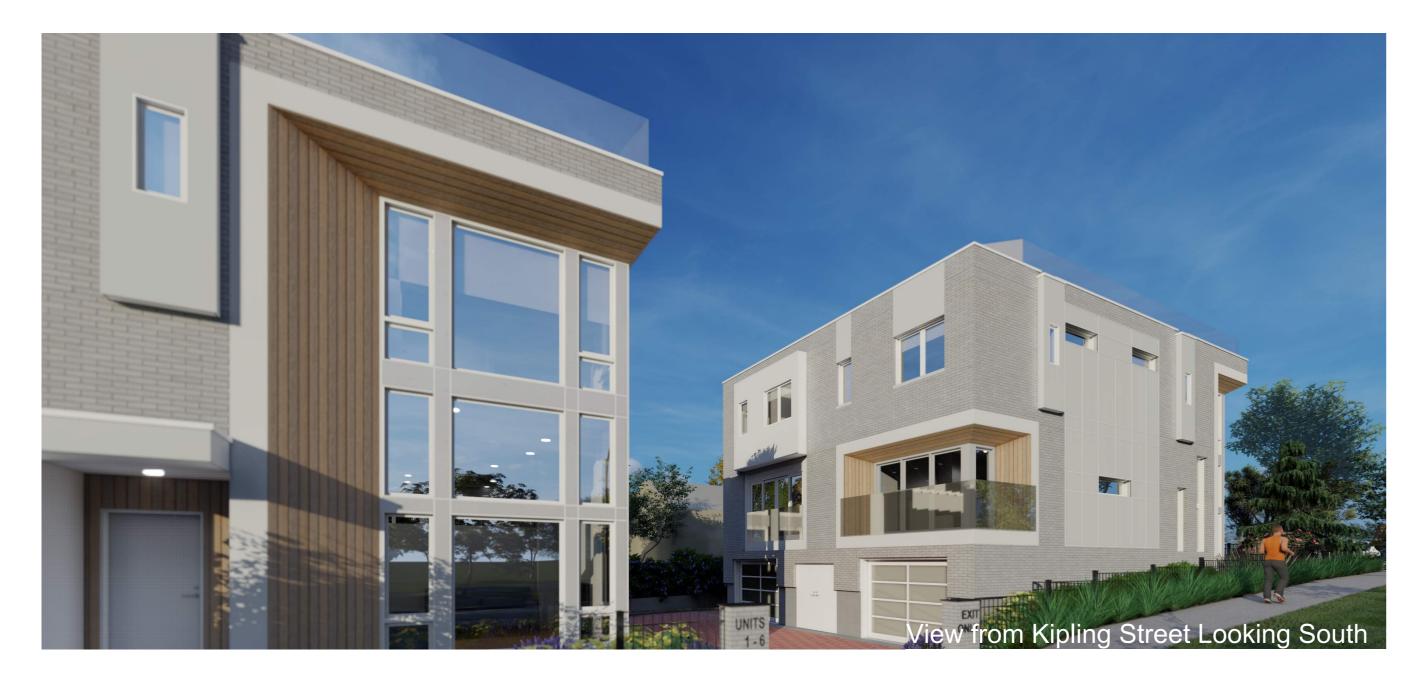



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Issued 2019-06-19 Issued for DP 2019-09-16 Revised & Re- 2019-10-21 Revised & Re- 2019-12-12 Revised & Re-	Issued for DP	
Concept Renderings		

PID:	
Project No:	19.015
Drawn By:	SG/TD
Plot Date:	Dec 12, 2019
Scale:	NTS
Sheet No:	

A6.0









View from Kipling Street South East FOR DEVELOPMENT APPLICATION ONLY



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Seal

Issued 2019-06-19 Issued for DP 2019-09-16Revised & Re-Issued for DP2019-10-21Revised & Re-Issued for DP2019-12-12Revised & Re-Issued for DP



Project Name:

Fairfield-Kipling Development

Civic:	1400 Fairfield Rd & 349 Kipling St
	040 Ripling Ot
Legal:	
PID:	
Project No:	19.015
Drawn By:	SG/TD
Plot Date:	Dec 12, 2019
Scale:	NTS
Sheet No:	

A6.1