

# 937 View Street

# **■LIST OF DRAWINGS**


#### ARCHITECTURAL Project Data Survey Site Plan Existing Site Plan Proposed Setback Plans Setback Sections Site Context - Shadow Analysis Site Context - Street Views Site Context - Street Elevations Site Context - Materials Site Context - Rendered Views Level 2 Plan Levels 3-4 Plan Levels 5-9 Plan Levels 10-11 Plan Levels 12-14 Plan Levels 15-18 Plan Level 19 Plan Roof Plan **Building Elevations Building Elevations** Building Sections Building Sections Area Plans

## LANDSCAPE

L1.01 Landscape Materials
L1.02 Stormwater Management
L3.01 Planting Plan - Level 1
L3.02 Planting Plan - Levels 2 and 19

### CIVIL

C100 General Notes
C200 Site Servicing Plan
C300 Grading Plan
C400 BC Hydro Information Plan

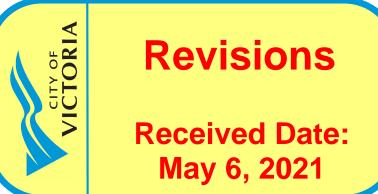

Issued for DP Revisions 3 20-08-12 Issued for DP Revisions 2 20-01-08 Issued for DP Revisions 1 19-10-02

21-05-04 Drawing File NOTE: All dimensions are shown in millimeters.

View St. Residential

937 View Street RED AR






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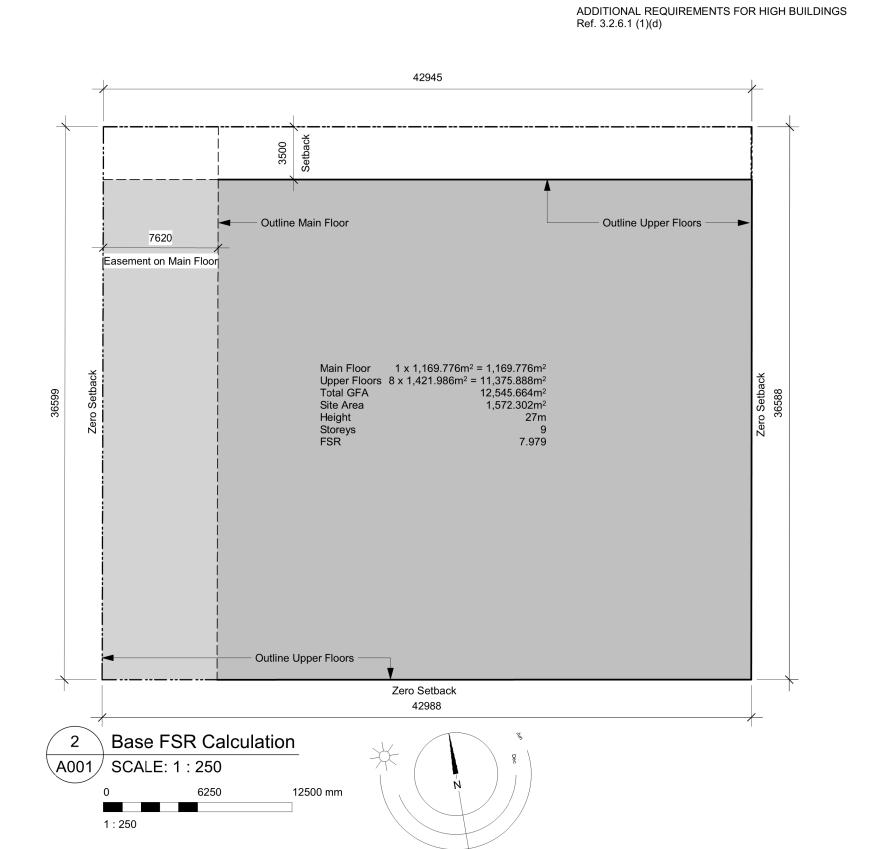
| architectural drawings and details.  ACST Acrylic Stucco H/C Handicap SPC Solid Particleboard Core ACT Acoustical Tile HM Hollow Metal ST Structure ACT Acoustical Tile HM Hollow Metal ST Structure AL ALWINDURY HS HOLLOW Steel Section STL Steel AL Aluminum HSS Hollow Steel Section STN Stained) AL ALWINDURY HSS HOLLOW Steel Section STN Stained) AC ALWINDURY HSS HOLLOW Steel Section STN Stained Steel S |   | F ABBREVIATIONS g abbreviations are used on door, window   | v. and finish schedule:  | s as well as on   |   |  | ANNOT  | ATIONS LEGEND  |
|--|---|--|--|---|---|--|--|--|
| ACT Acoustical Tile HM Hollow Metal ST Structure AFF Above Finished Floor HP High Point STL Steel  AL Aluminum HSS Hollow Steel Section STN Stain(ed) AC Auto-Opener H/W Hardware STNT Stone Tile AP Annunciator Panel INSUL Insulated SS Stainless Steel BG Building Grade LAM Laminated Glass SV Sheet Vinyl Flooring CEM Concrete MDFB Medium Density Fibreboard Base T/D Conc Concrete MDFB Medium Density Fibreboard Base T/D Conc Concrete Block MR Mirror TLAM Tempered Jouble Glazed CCL Centerline MP Metal Panel TGL Tempered Glass CPT Carpet Tile O/H Overhead TLGL Tempered Glass CPT Carpet Tile O/H Overhead TLGL Tempered Glass CPT Coramic Tile O/H Overhead TLGL Tempered Glass CPT Coramic Tile O/H Overhead TOD Top of Drain DD Deck Drain PLAM Plastic Laminate TOD Top of Parapet EDE Electric Bike Storage PLS Plaster TOP Top of Stab EV Export Polymer Coating PF Pressed Steel Frame TOP Top of Wall EV Exposed aggregate PTD Paper Towel Dispenser TD TOP Top of Wall EXP AGG Exposed aggregate PTD Paper Towel Dispenser TD TOP Top of Drain North Capture Towel Vision Glass EEC Fire Extinguisher Cabinet RB Rubber Base U/S Underside of. EFE Finished Floor Elevation RB Resilient Flooring VCT Vinyl Composition Tile GG Grab Bar RD-P Roof Drain Planter VIS Vision Glass GG Garb Bar RD-P Roof Drain Planter VIS Vinyl Tile GL Glass Block RWL Rain Water Leader VT Vinyl Tile GL Glass Block SAFI Spray Applied Florous Insulation VWC Water Closer GWB Gyesum Willboard SD Soap Dispenser WD Wood  AREA OF DROP CEILING GWB Gyesum Willboard SD Soap Dispenser WD Wood  AREA OF DROP CEILING STATUS Stain(ed) Total Tardware STM Total Tardware STM Towel Bar T |   |  | ,  |   |   |  |  |  |
| HC Hollow Core SL Sealer WPM Waterproof Membrane HCW Hollow Core Wood SP Spandrel Glass WRC Water Repellant Coating  1 KEYNOTE SYMBOL  | ACT AFF AL AO AP BG CEM CONC COBK C/L CPT CT C/W DD EB EL EPC EXP FEC FFE FG GBL GWG GWB HC | Acoustical Tile Above Finished Floor Aluminum Auto-Opener Annunciator Panel Building Grade Cementitious Backing Board Concrete Concrete Block Centerline Carpet Tile Ceramic Tile Complete With Deck Drain Electric Bike Storage Elevation Epoxy Polymer Coating Electric Vehicle Parking Exposed Aggregate Exterior Floor Drain Fire Extinguisher Cabinet Finished Floor Elevation Finished Grade Grab Bar Glass Block Glass Georgian Wire Glass Gypsum Wallboard Hollow Core | HM HP HSS H/W INSUL LAM LP MDFB MR MP O/H OW PF PLAM PLS PSF PT PTD/W PTW RA RB RES RD RD-P RWL SAFI SCW SD SL | Hollow Metal High Point Hollow Steel Section Hardware Insulated Laminated Glass Low Point Medium Density Fibreboard Base Mirror Metal Panel Overhead Operable Window Prefinished Plastic Laminate Plaster Pressed Steel Frame Paint Paper Towel Dispenser Paper Towel Dispenser Paper Towel Waste Roof Anchor Rubber Base Resilient Flooring Roof Drain Roof Drain - Planter Rain Water Leader Spray Applied Fibrous Insulation Solid Core Wood Soap Dispenser Sealer | ST<br>STL<br>STN<br>STNT<br>SS<br>SVF<br>TB<br>T/D<br>TLAM<br>TGL<br>TOD<br>TOI<br>TOP<br>TOS<br>TOW<br>TP<br>UNF<br>UNF<br>UNS<br>VCT<br>VI<br>VIS<br>VT<br>VWC<br>WD<br>WPM | Structure Steel Stain(ed) Stone Tile Stainless Steel Sheet Vinyl Flooring Towel Bar Tempered / Double Glazed Tempered Laminated Glass Tempered Glass Translucent Glass Top of Concrete Top of Drain Top of Insulation Top of Parapet Top of Slab Top of Wall Toilet Paper Unfinished (for GWB means taped and filled by not sanded to minimum ULC requirements where applicable) Unless Noted Otherwise Underside of Vinyl Composition Tile Vision Glass Vinyl Impact Sheet Vinyl Tile Vinyl Wall Covering Water Closet Wood Waterproof Membrane | 201<br>101a<br>W-10<br>W1<br>2.0 hr<br>00.00 | DOOR NUMBER See Door Schedule  WINDOW NUMBER See Window Schedule  WALL TYPE See Assemblies Schedule  RATED WALL DESIGNATION  ELEVATION DATUM  CEILING HEIGHT  AREA OF DROP CEILING |
| (12) MATERIAL TAG  |   |  |  |   |   |  | 1 A901                                       | INTERIOR ELEVATION REFERE  |

W1 C1 F1 B1 ROOM FINISHES

#### CIVIC ADDRESS: REGISTERED OWNER 937 VIEW STREET, VICTORIA, BC. Nelson Investments Inc. 595 Howe Street, 10th Floor Chris Nelson LEGAL DESCRIPTION: LOT A, OF LOTS 785, 786, and 787, VICTORIA CITY, tel: 604.318.6877 Vancouver, BC V6C 2T5 chris@nelsoninvestmentsinc.com PLAN 36505 **ZONING BYLAW SUMMARY ARCHITECT** Charles Kierulf dHKarchitects 977 Fort Street tel: 250.658.3367 BUILDING DESCRIPTION: fax: 250.658.3397 Victoria, B.C. 18 STOREY RESIDENTIAL BUILDING V8V 3K3 crk@dhk.ca RESIDENTIAL STRUCTURAL CONSULTANT **EXISTING ZONE:** R-48 HARRIS GREEN Suite #501 - 510 Burrard Street John Markulin Vancouver, BC tel: 604.685.9533 PROPOSED ZONE: jmarkulin@bmzse.com DEVELOPMENT PERMIT AREA: DPA 713 (HC) SITE AREA: 1 572.3 m<sup>2</sup> (16 924 s.f.) MECHANICAL Avalon Mechanical Consultants Ltd. 1245 Esquimalt Rd #300, FLOOR AREA: Jamie Clarke 621 m<sup>2</sup> (6 684 s.f.) tel: 250.384.4128 Victoria, BC 829 m<sup>2</sup> (8 923 s.f.) x 3 = 2 487 m<sup>2</sup> Level 2-4: V9A 3P2 jclarke@avalonmechanical.com Level 5-9: $804 \text{ m}^2 (8 654 \text{ s.f.}) \times 5 = 4 020 \text{ m}^2$ Level 10-11: 644 m<sup>2</sup> (6 932 s.f.) x 2 = 1 288 m<sup>2</sup> Level 12-14: 573 m<sup>2</sup> (6 168 s.f.) x 3 = 1 719 m<sup>2</sup> **ELECTRICAL CONSULTANT** Level 15-18: $502 \text{ m}^2 (5 403 \text{ s.f.}) \times 4 = 2 008 \text{ m}^2$ 396 m<sup>2</sup> (4 263 s.f.) Nemetz & Ass Ltd Level 19: Bijan Valagohar tel: 604.736.6562 2009 W 4th Ave TOTAL PROPOSED: 12 539 m<sup>2</sup> (135 019 s.f.) Vancouver, BC bijan@nemetz.com V6J 1N3 FLOOR SPACE RATIO: SITE COVERAGE: LANDSCAPE CONSULTANT Scott Murdoch Murdoch de Greeff Inc. **OPEN SITE SPACE:** 200-524 Culduthel Rd. tel: 250.412.2819 fax: 250.412.2892 Victoria, BC GREEN STORMWATER INFRASTRUCTURE: 83 m<sup>2</sup> (893 s.f.)\* V8Z 1G1 scott@mdidesign.ca \*Minimum 30% of paving area, refer to Landscape drawing L1.02 GRADE OF BUILDING: 17.7 m (GEODETIC AVG GRADE) **GEOTECHNICAL** See Site Plan for Grade Calculations Ryzuk Geotechnical Shane Moore 28 Crease Avenue tel: 250.475.3131 **HEIGHT OF BUILDING:** 60.2 m fax: 250.475.3611 Victoria, BC shane@ryzuk.com SETBACKS: V8Z 1S3 FRONT (View Street): REAR (S): SIDE (È): CIVIL CONSULTANT SIDE (W): Herold Engineering Sarah Campden tel: 250.590.4875 1051 Vancouver Street NUMBER OF STOREYS: 19 STOREYS Victoria, BC fax: 250.590.4392 SCampden@heroldengineering.com SUITE COMPOSITION: Studio $< 32m^2$ : 1 Bed / 1 Bath <45m<sup>2</sup>: 126 Suites 1 Bed / 1 Bath > 45m<sup>2</sup>: 33 Suites **ENVELOPE CONSULTANT** Chris Raudoy Morrison Hershfield 266 SUITES tel: 250.361.1215 x1142201 536 Broughton Street, 2nd Floor Victoria, BC fax: 250.361.1235 RESIDENTIAL PARKING: N/A V8W 1C6 craudoy@morrisonhershfield.com COMMERCIAL PARKING: **BICYCLE PARKING: BUILDING CODE SUMMARY** Required Long Term: Provided Long Term: 290 (25% EB) Required Short Term: Provided Short Term: BRITISH COLUMBIA BUILDING CODE 2018 - PART 3 CANADIAN STANDARDS ASSOCIATION B651-18 MAJOR OCCUPANCY CLASSIFICATION: GROUP C - RESIDENTIAL BUILDING AREA: 12 539 m<sup>2</sup> (135 019 s.f.) BUILDING HEIGHT: 19 STOREYS NUMBER OF STREETS FACING: ACCESSIBLE FACILITIES • ACCESSIBLE ENTRANCE CONSTRUCTION REQUIREMENTS: • 3.2.2.47 GROUP C, ANY HEIGHT, ANY AREA, SPRINKLERED NON-COMBUSTIBLE CONSTRUCTION WITH 2 HR MIN. FIRE RESISTANCE RATING TO FLOORS AND LOADBEARING

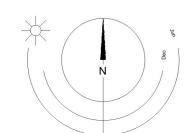PROJECT DIRECTORY

PROJECT DESCRIPTION





21-05-04

20-08-12

20-01-08

19-10-02

Issued for DP Revisions 3


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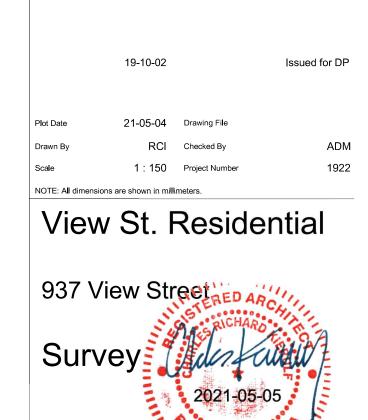
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Issued for DP



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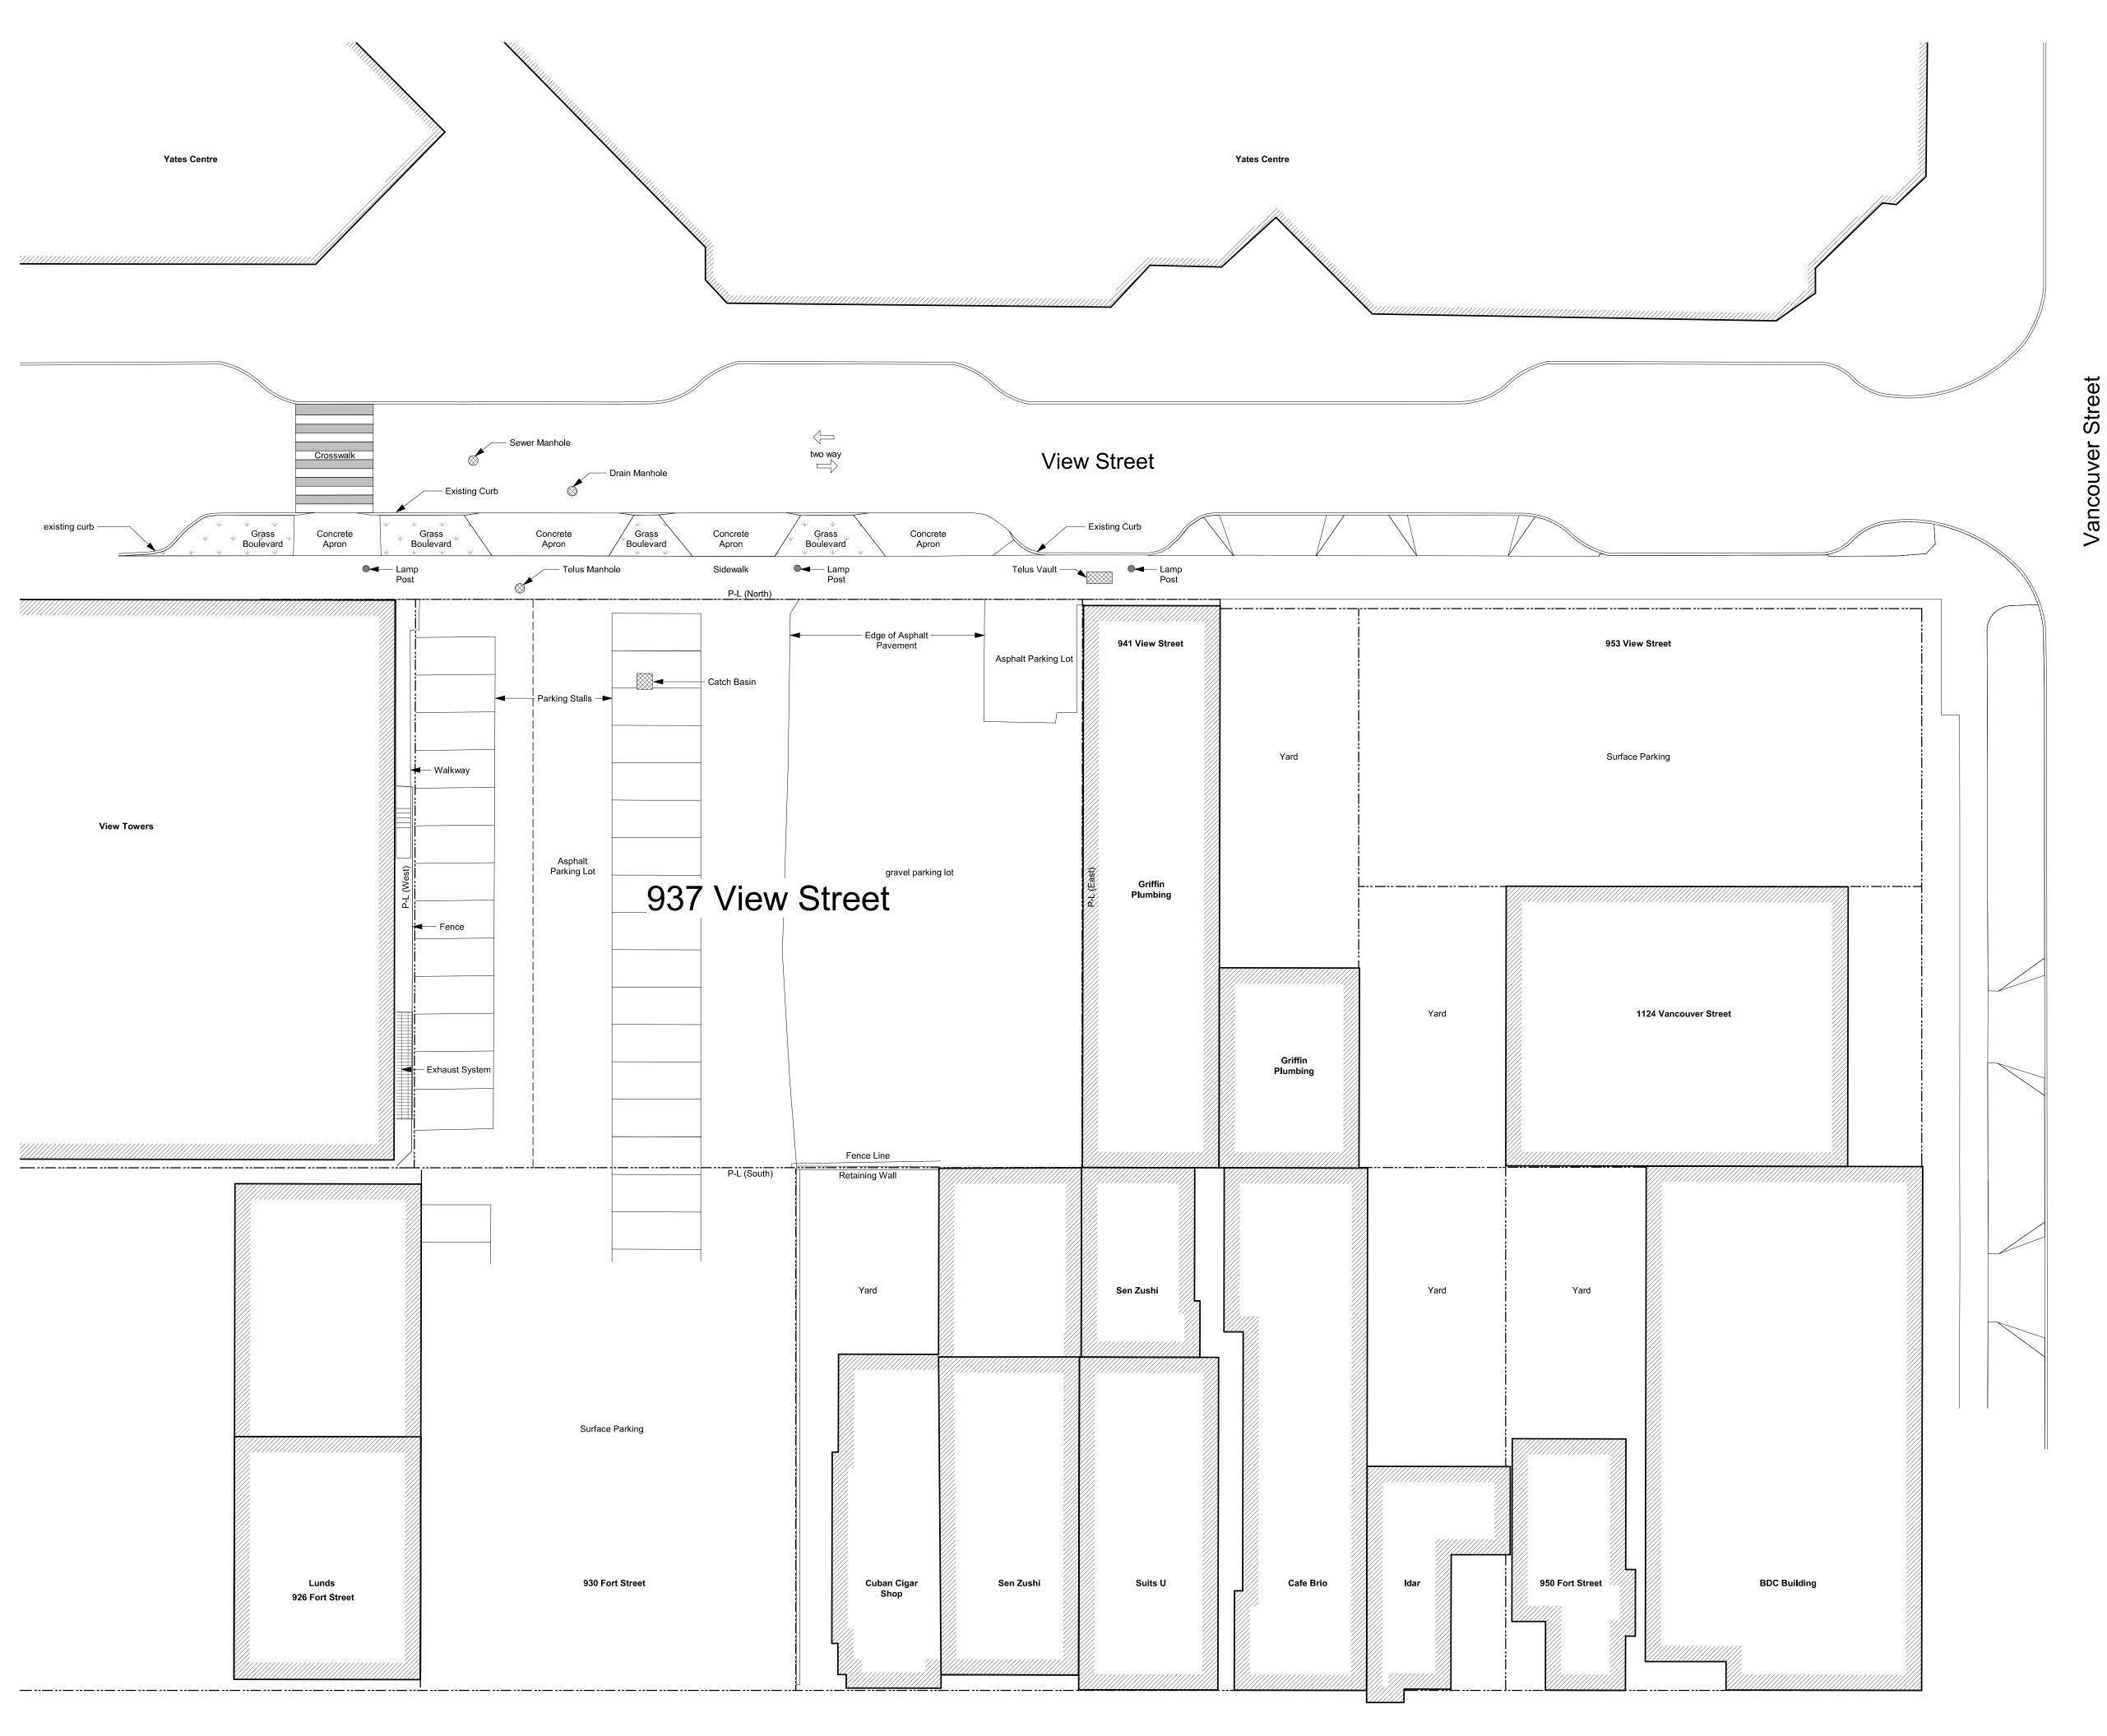




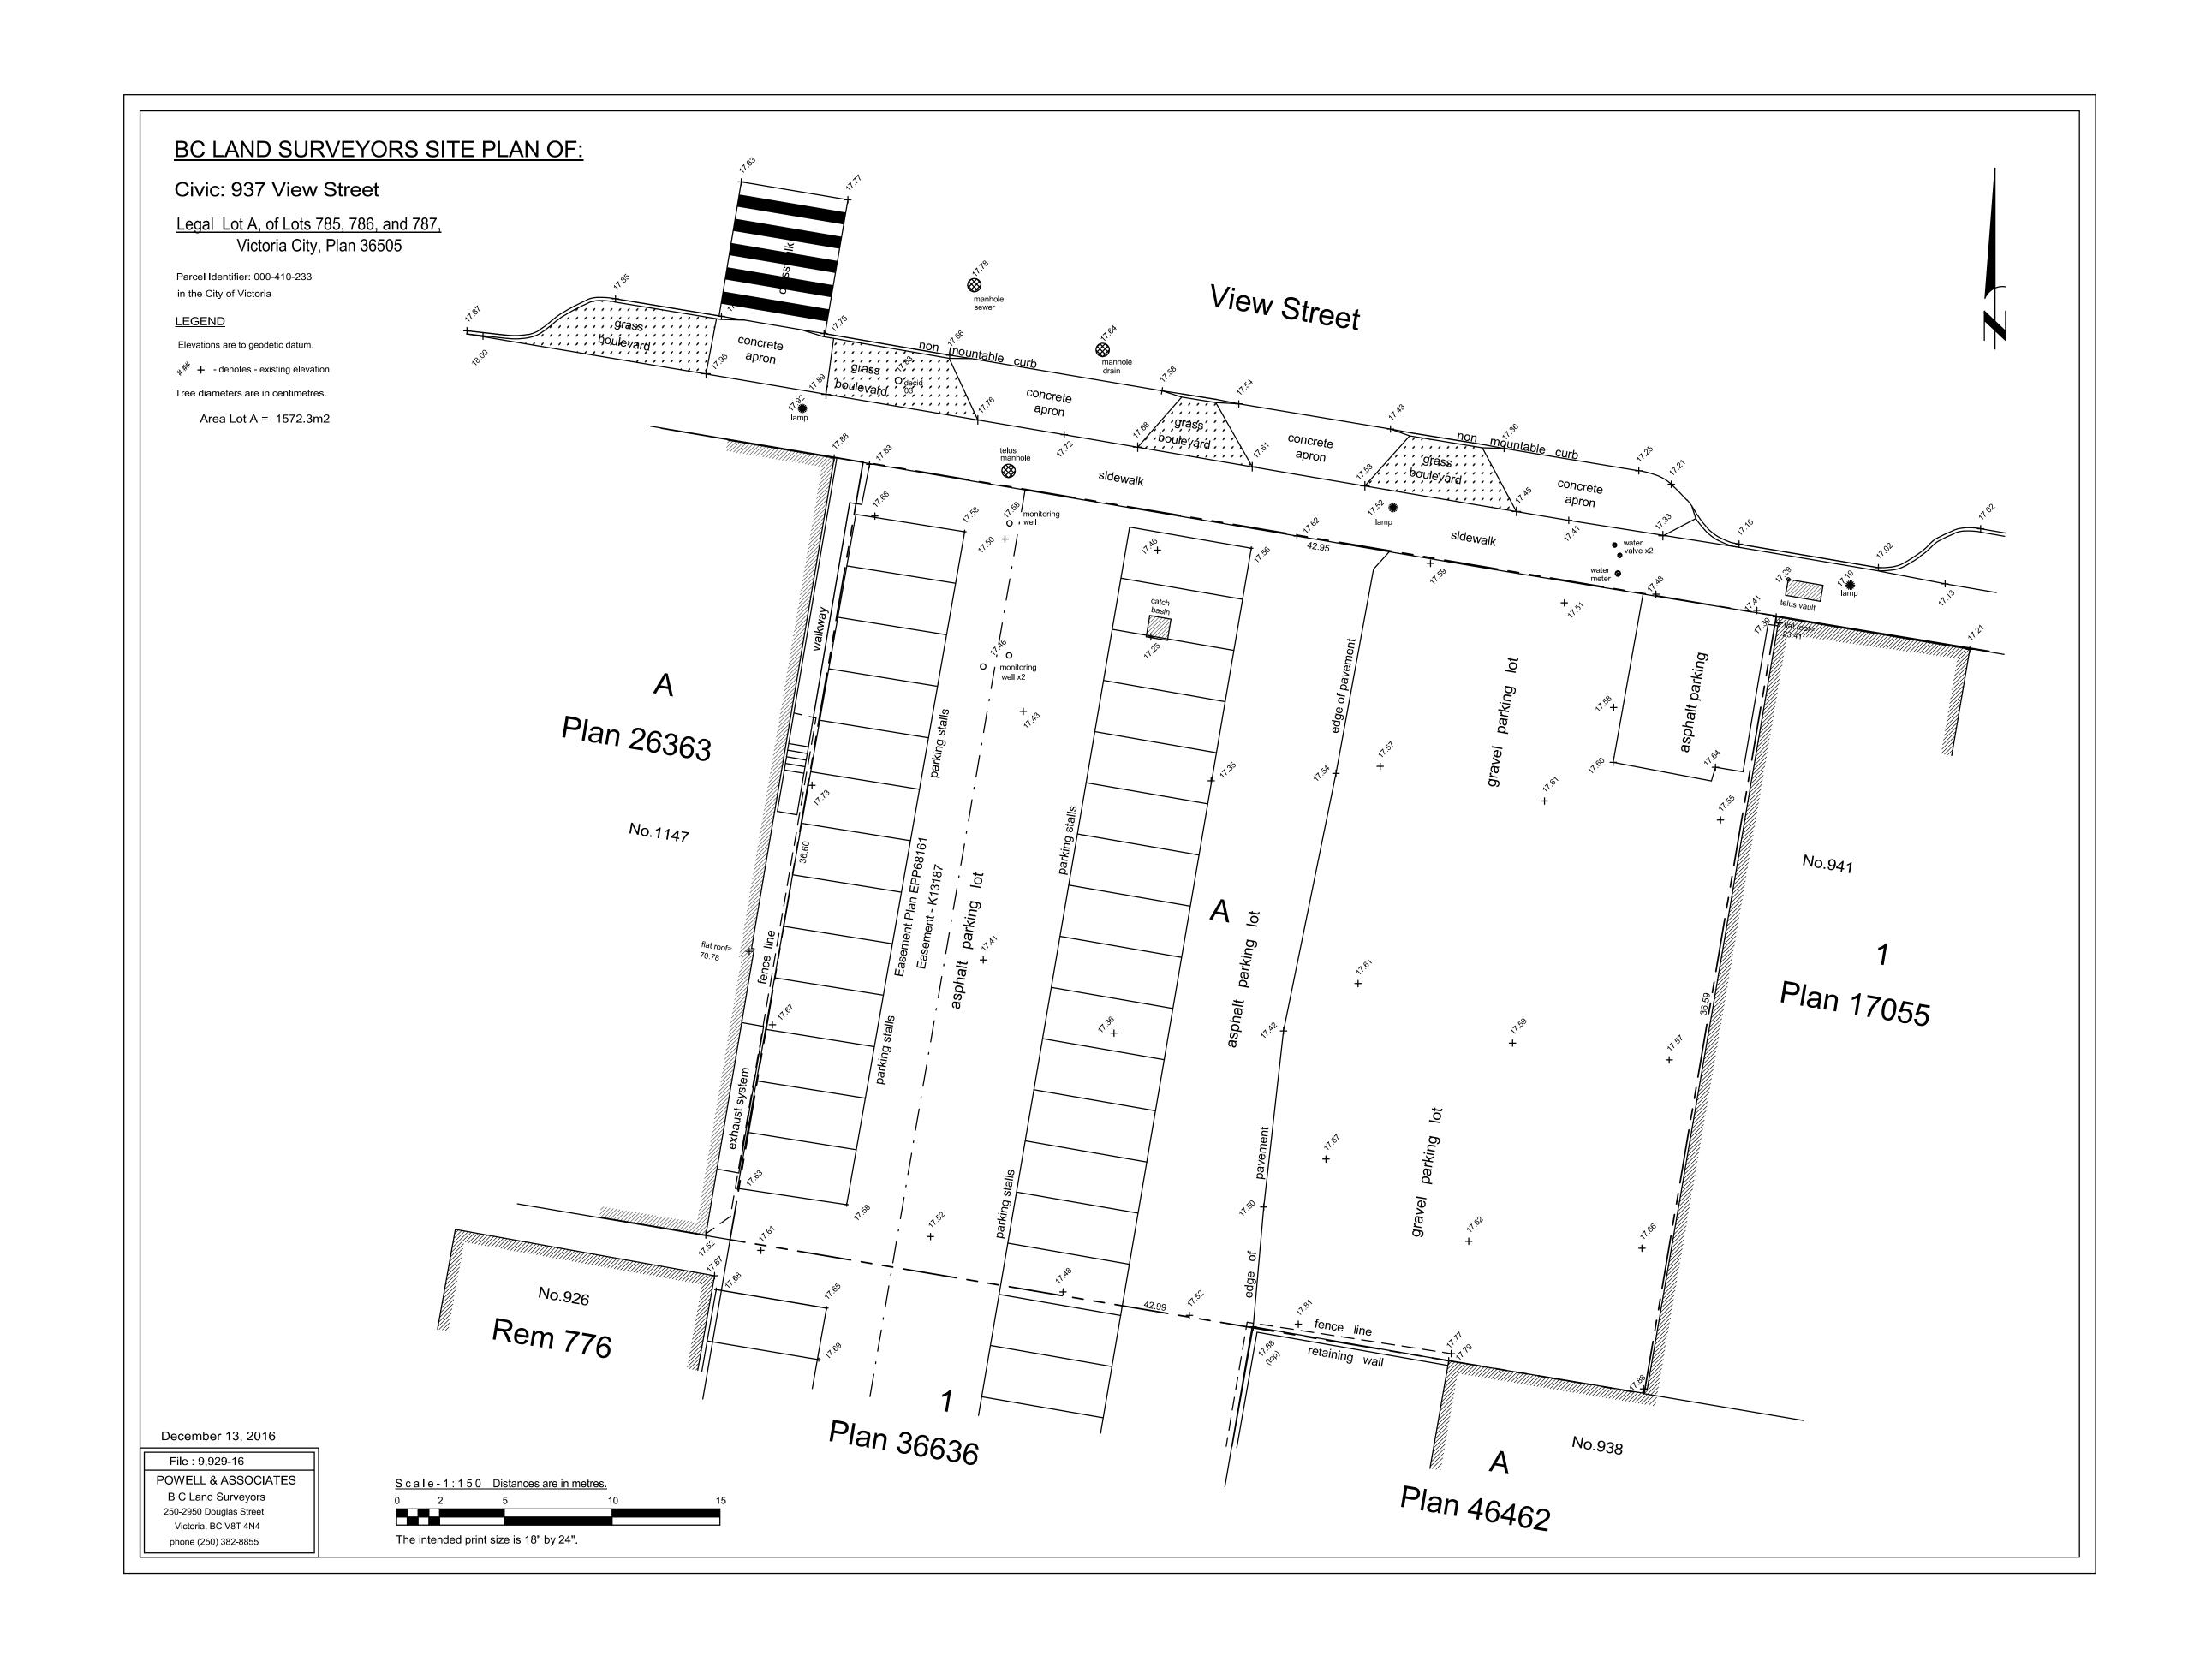

A100

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 Plot Date
 21-05-04
 Drawing File

 Drawn By
 RCI
 Checked By
 ADM

 Scale
 1 : 200
 Project Number
 1922

 NOTE: All dimensions are shown in millimeters.


Issued for DP

View St. Residential

19-10-02


937 View Street RED AR

Site Plan dasting

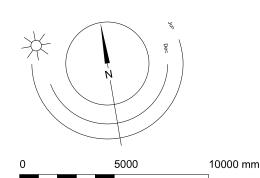



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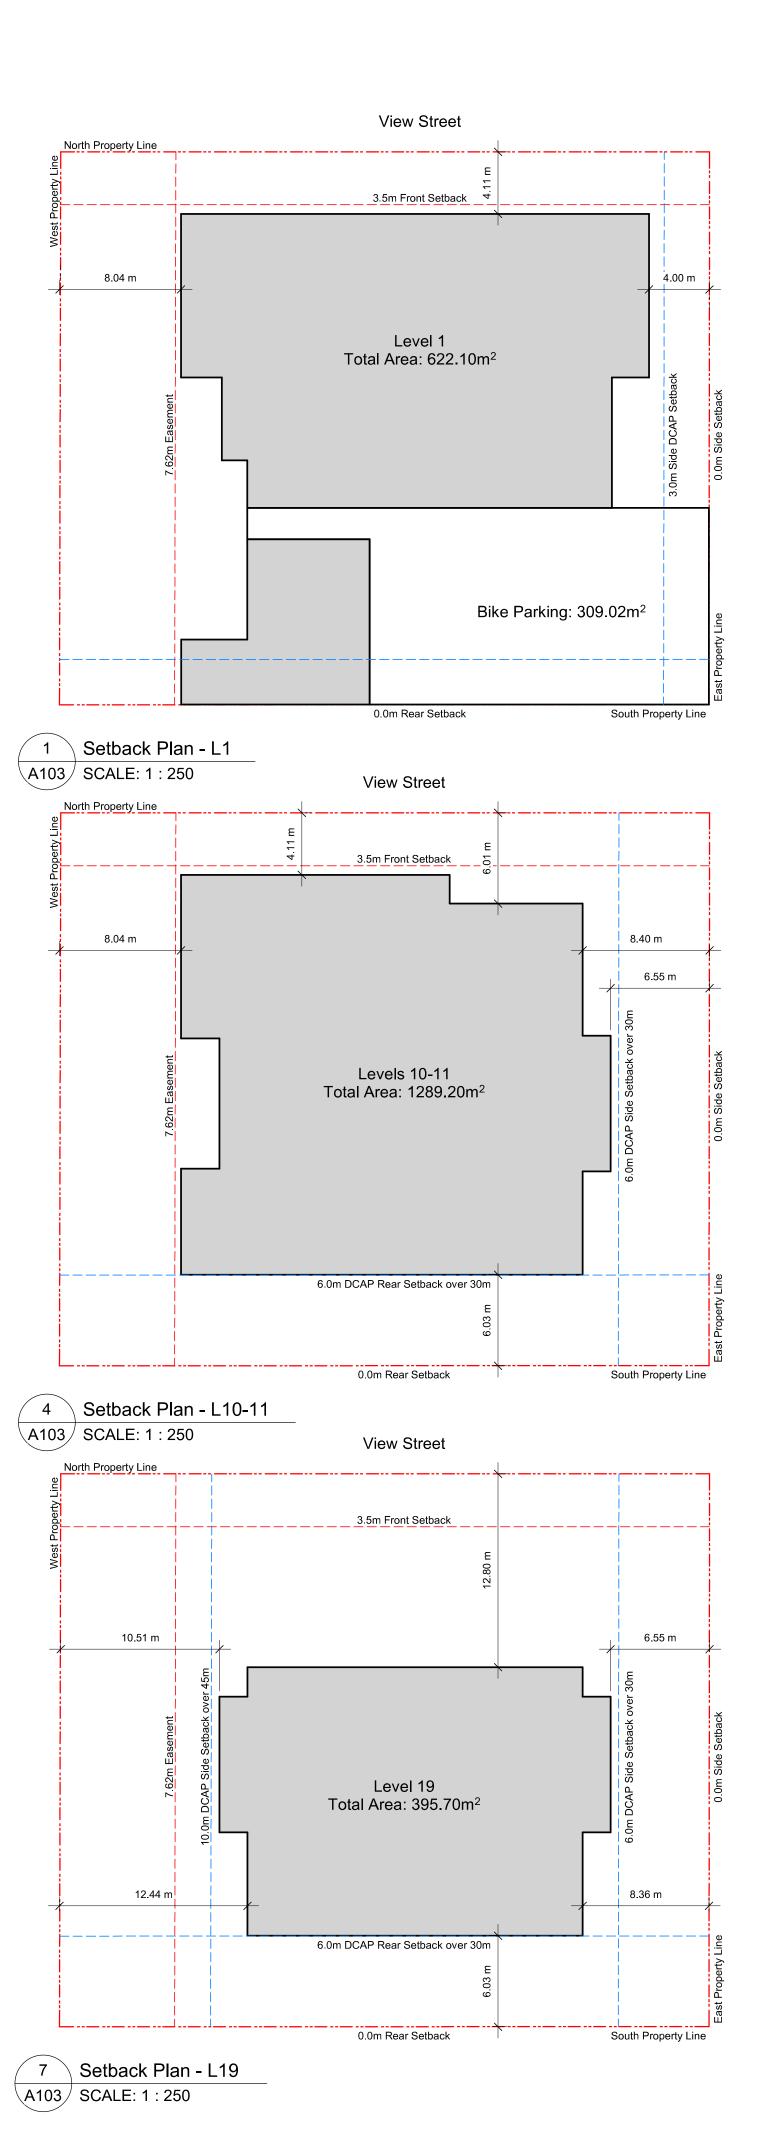
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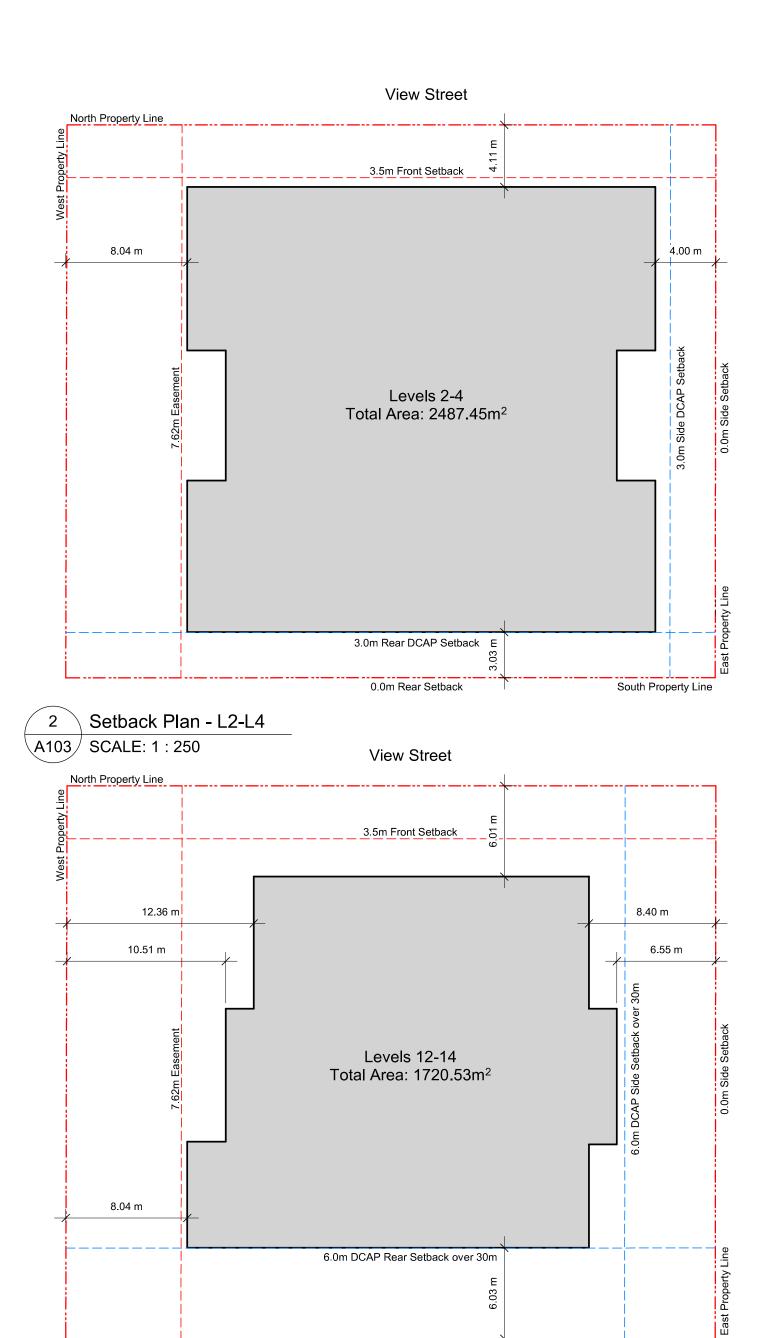
View St. Residential

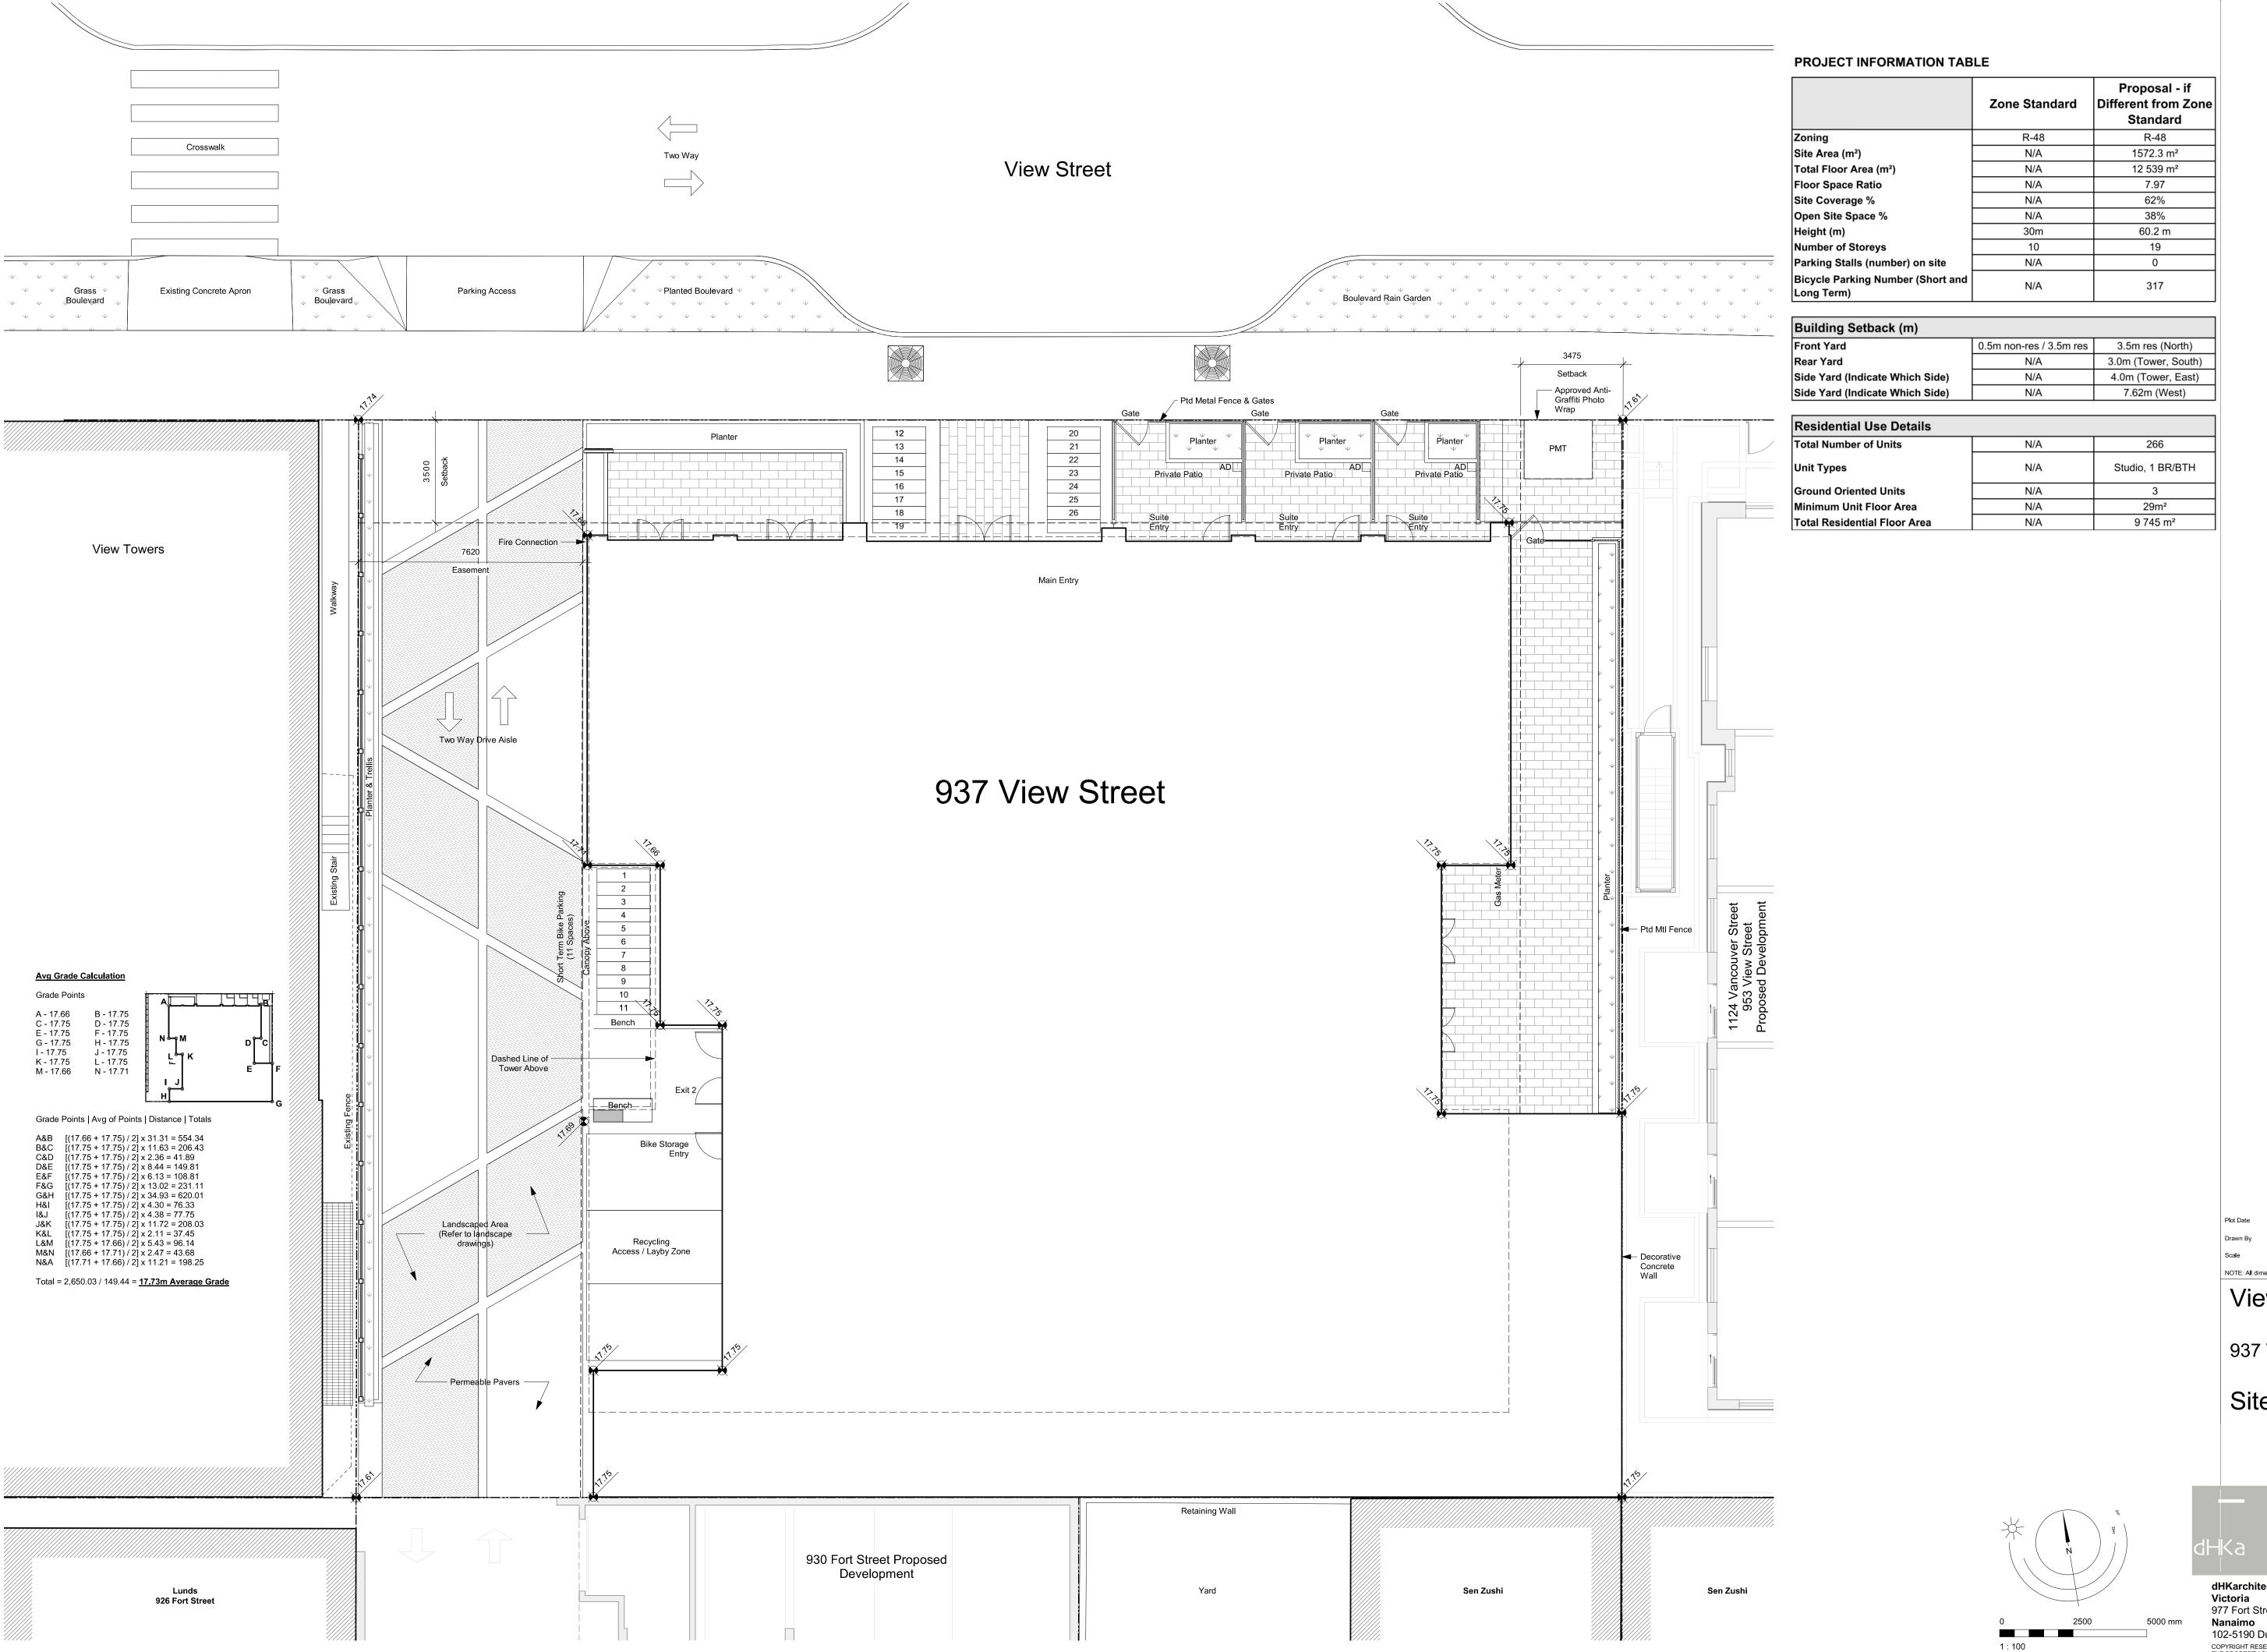937 View Street 40





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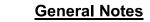






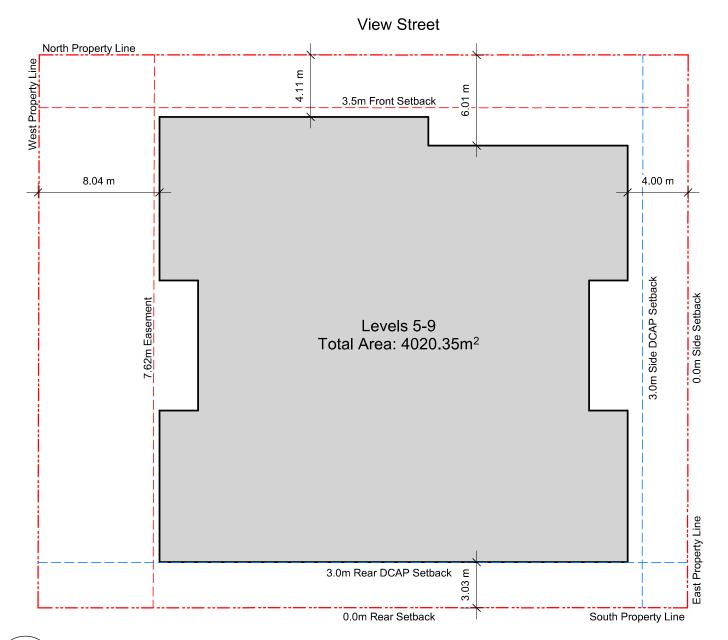

6 Setback Plan - L15-18 A103 SCALE: 1 : 250

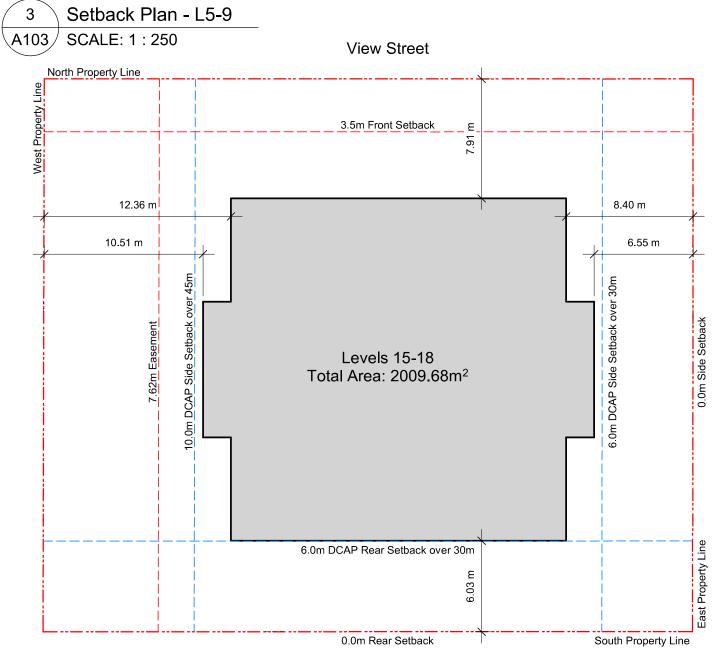

- 930 Fort Street outline based on Development Permit 5th Resubmission dated 2018-05-16.
- 1124 Vancouver Street, 953 View Street, 941 View Street outline based on Development Permit Submisison dated 2021-03-17.
- 937 View Street outline is to exterior face of sheathing, allowing for rainscreen and comice projections.

Issued for DP Revisions 3 20-08-12 Issued for DP Revisions 2

21-05-04 Drawing File


NOTE: All dimensions are shown in millimeters. View St. Residential

937 View Street





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2 Building Separation Section - West/East

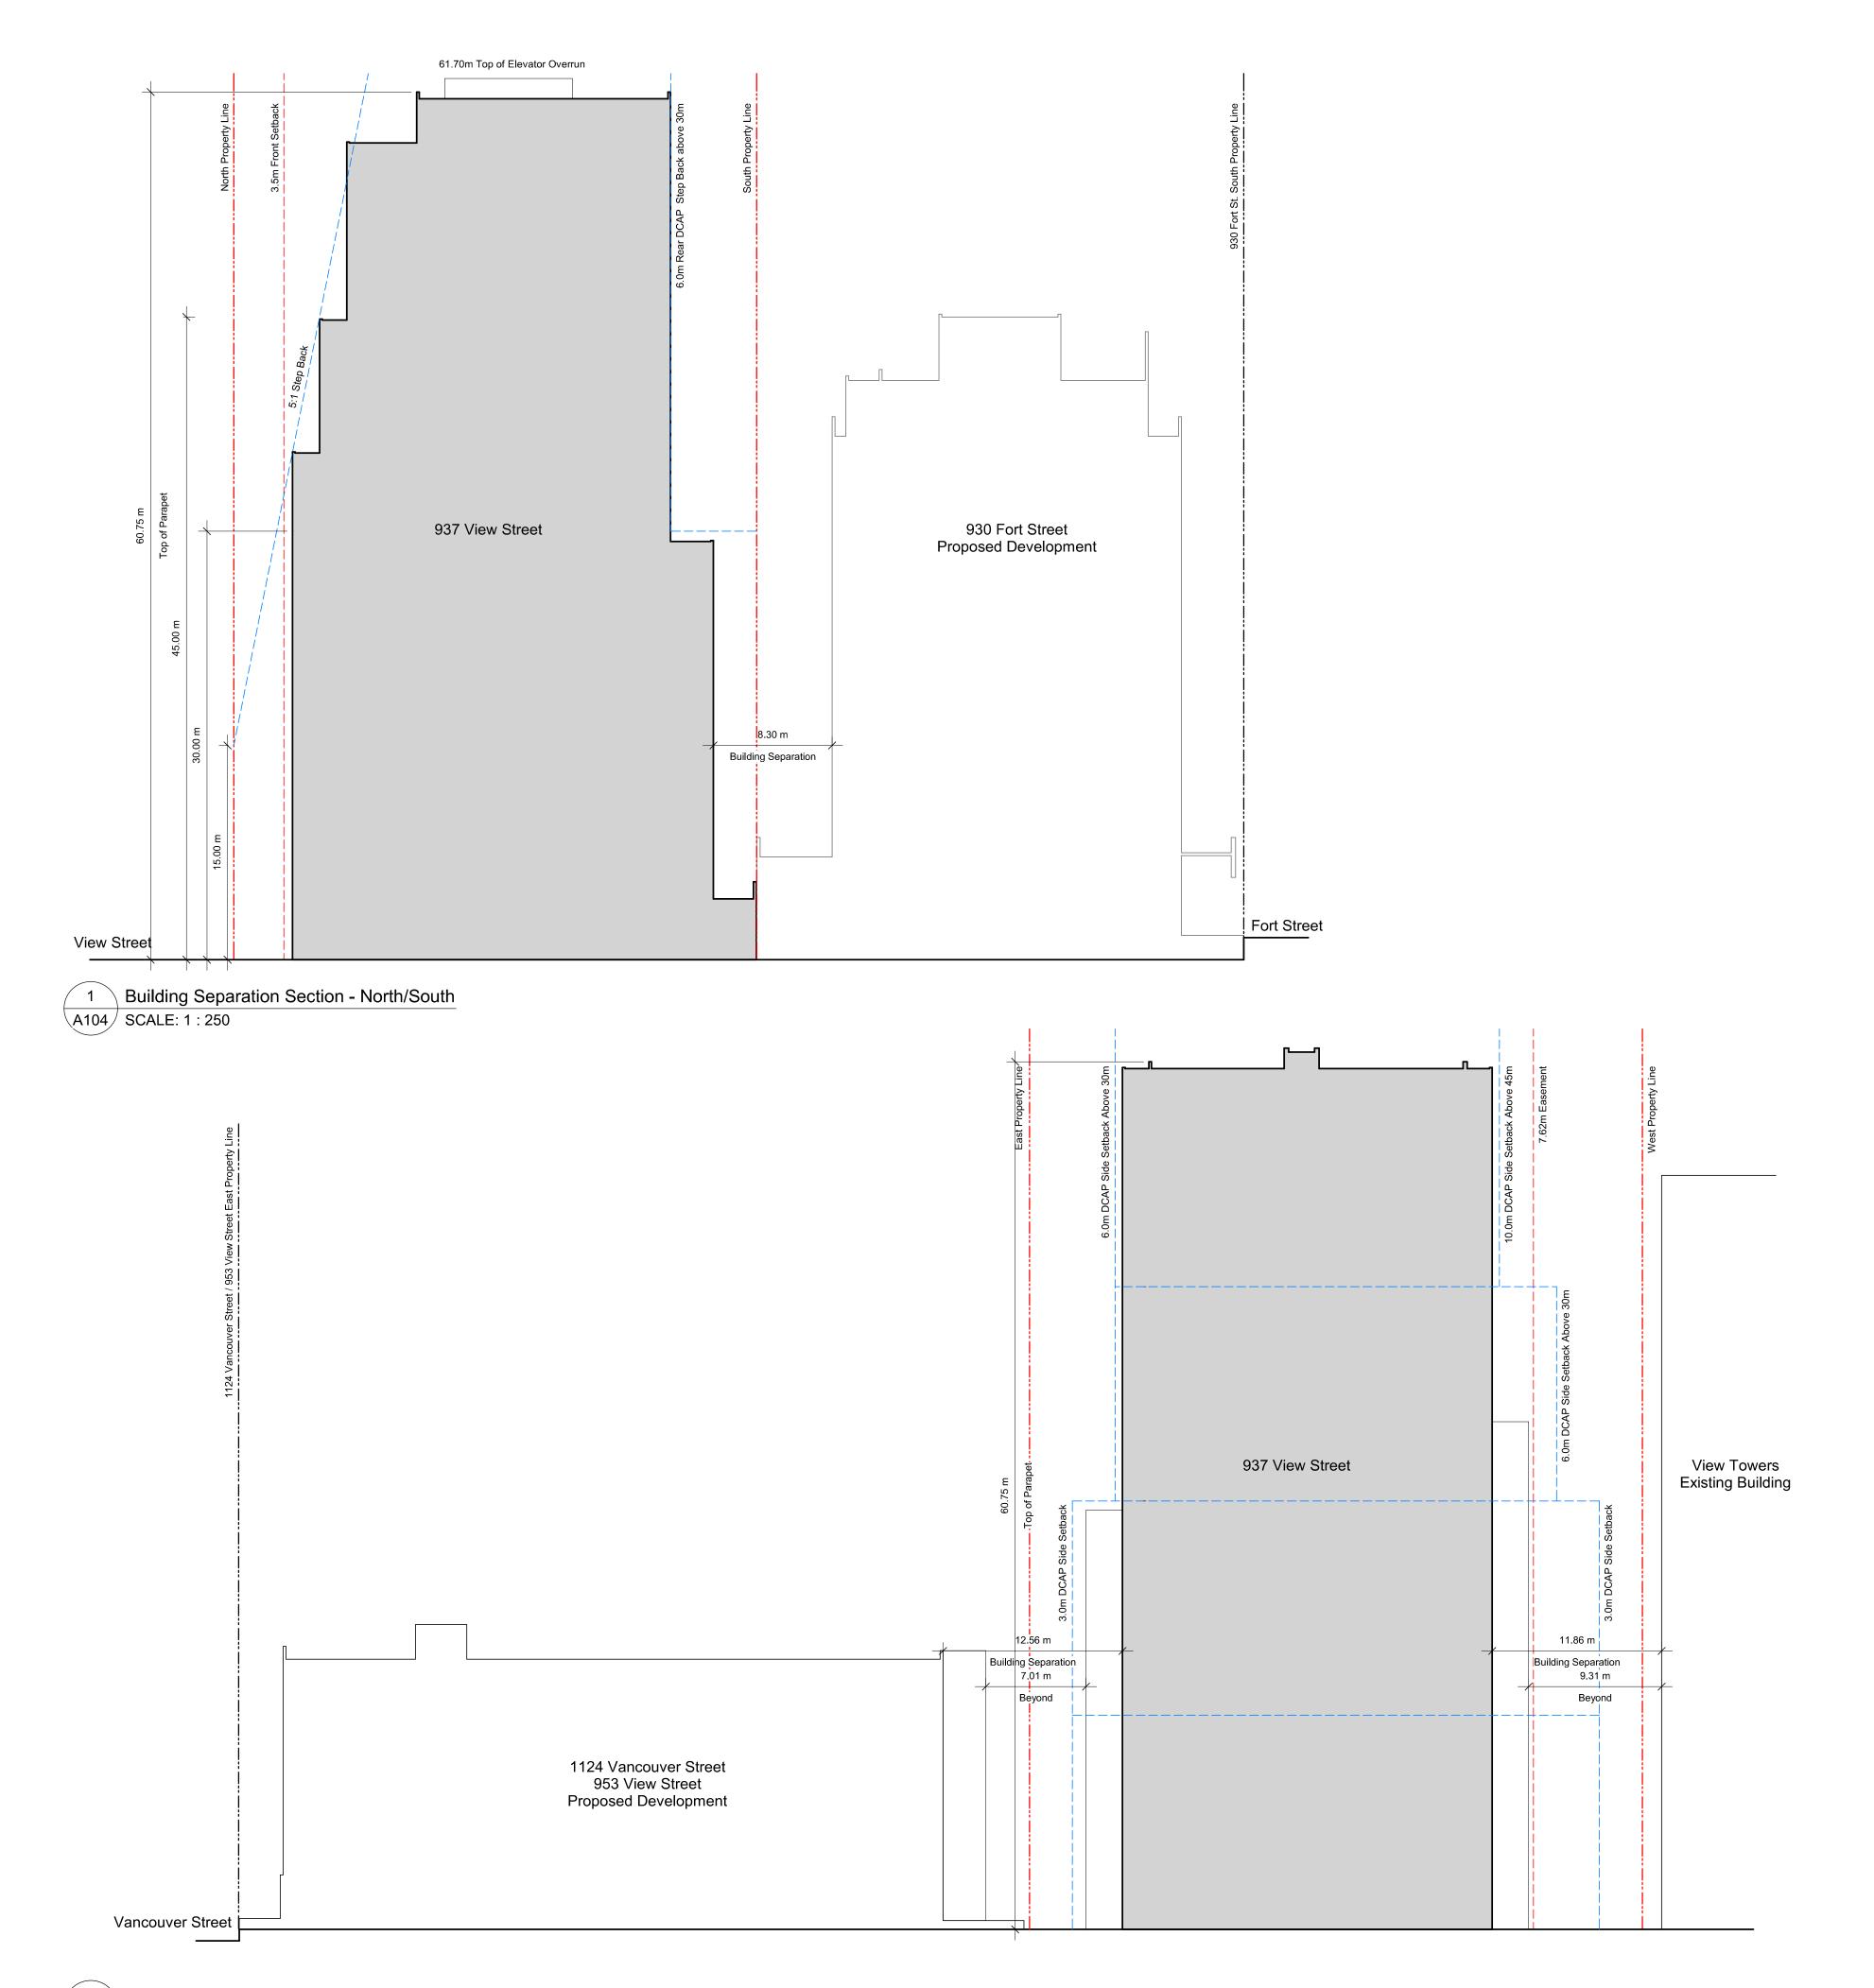A104 SCALE: 1 : 250

#### **General Notes**

- 930 Fort Street outline based on Development Permit 5th Resubmission dated 2018-05-16.
- 1124 Vancouver Street, 953 View Street, 941 View Street outline based on Development Permit Submisison dated 2021-03-17.
- 3. 937 View Street outline is to exterior face of sheathing, allowing for rainscreen and cornice projections.

Issued for DP Revisions 3 20-08-12 Issued for DP Revisions 2

21-05-04 Drawing File

NOTE: All dimensions are shown in millimeters.


View St. Residential


937 View Street AR








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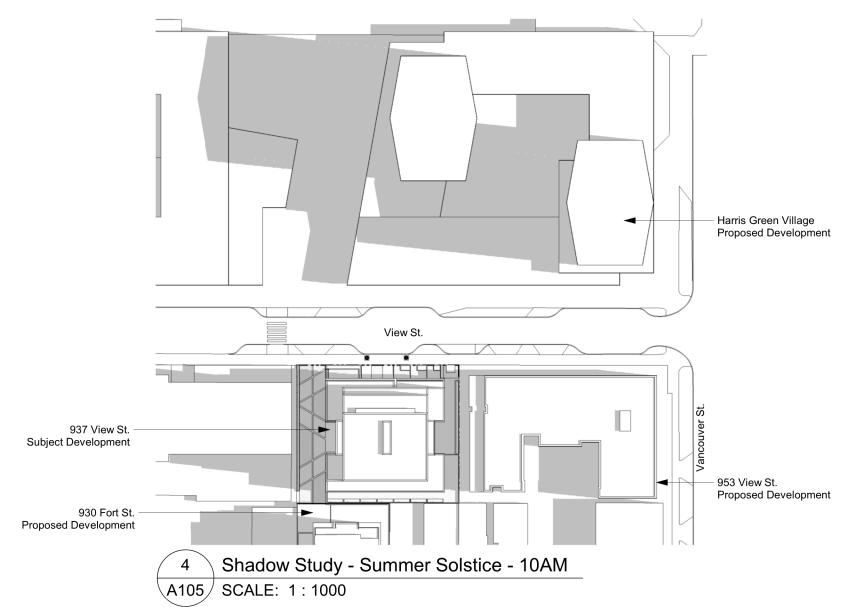


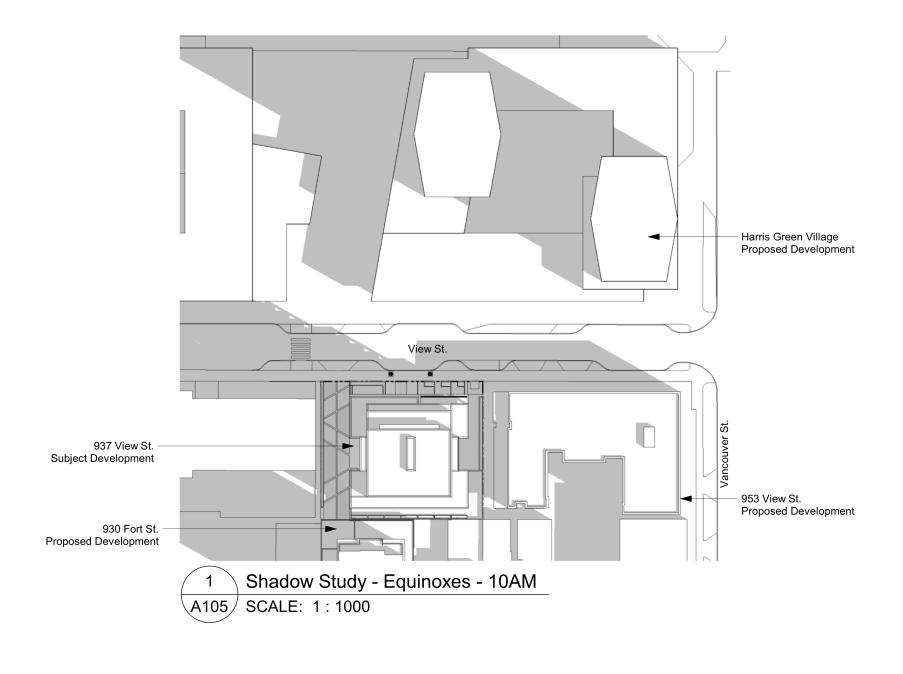


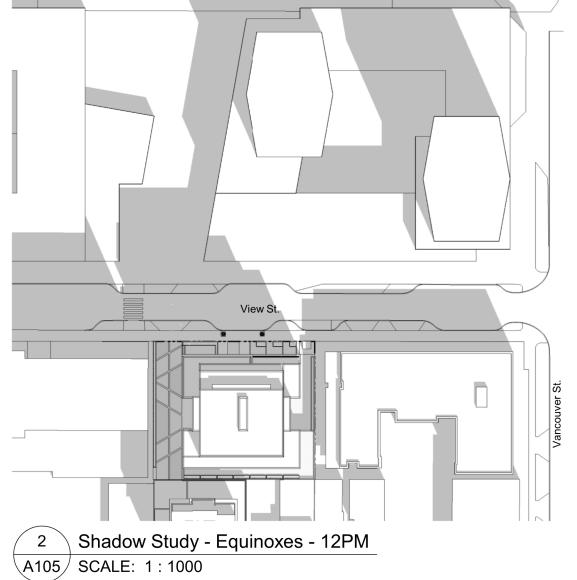


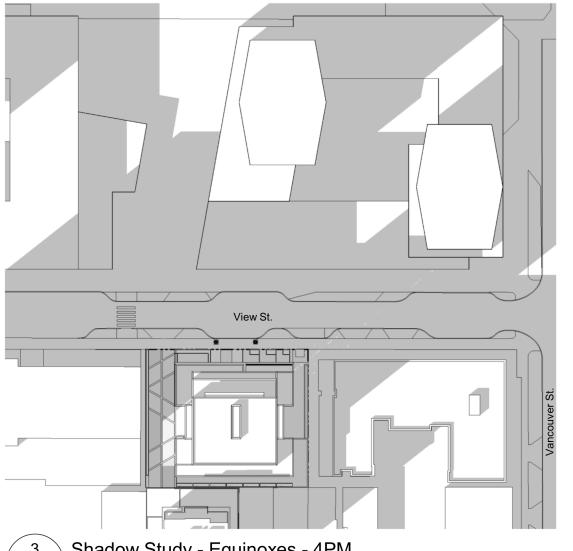


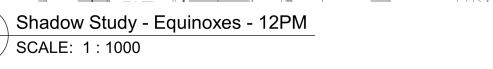


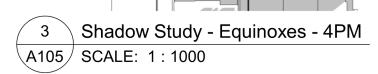


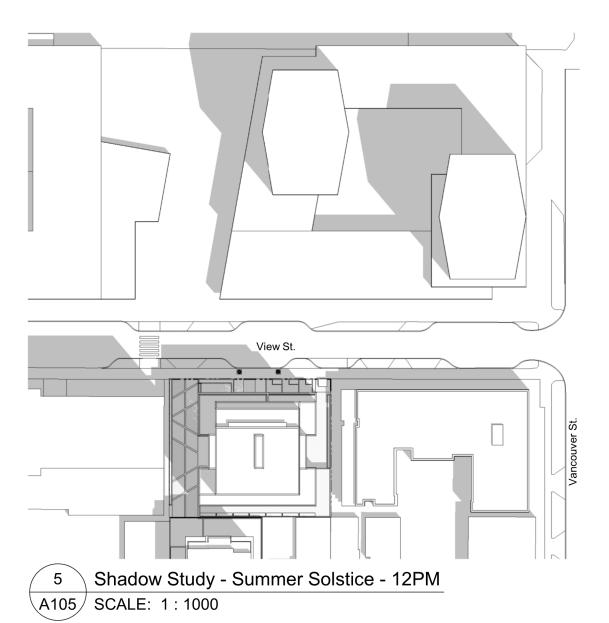

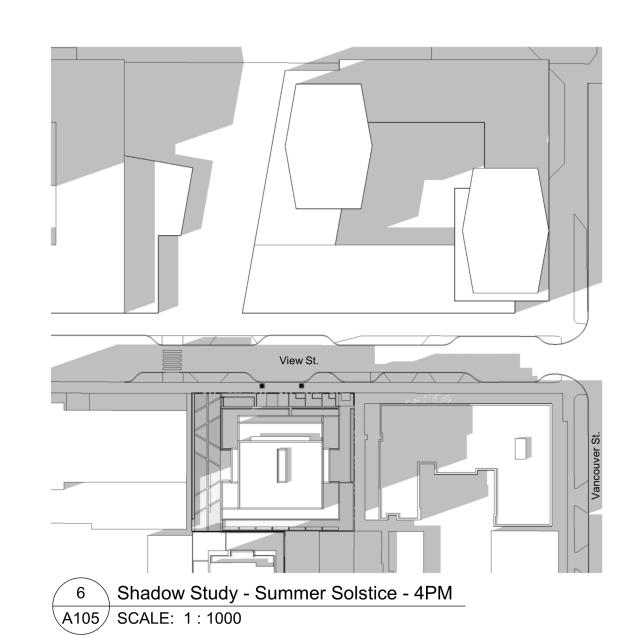


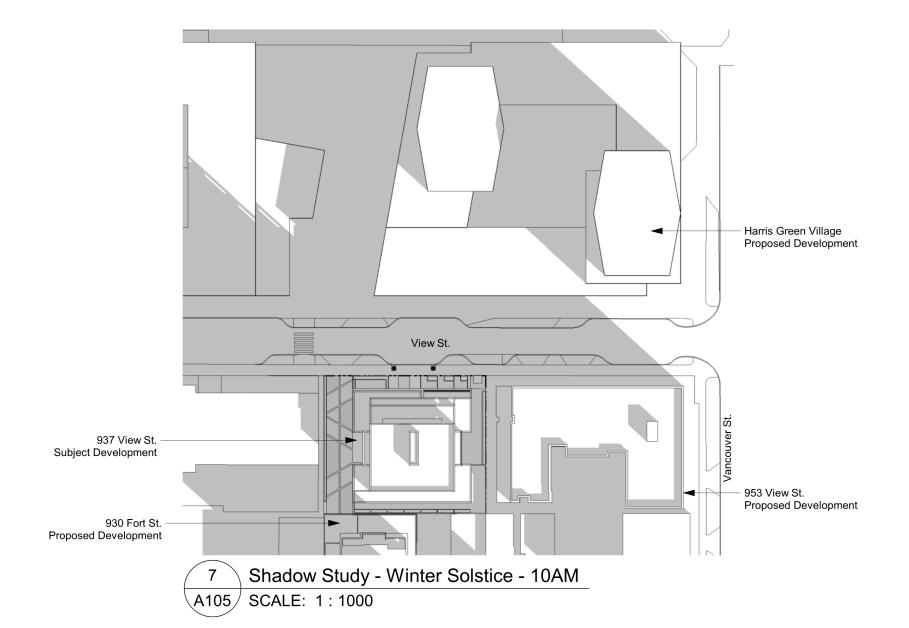

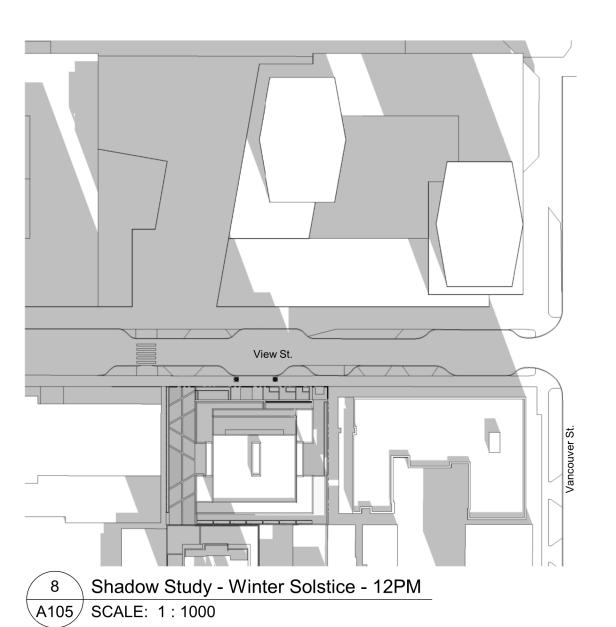

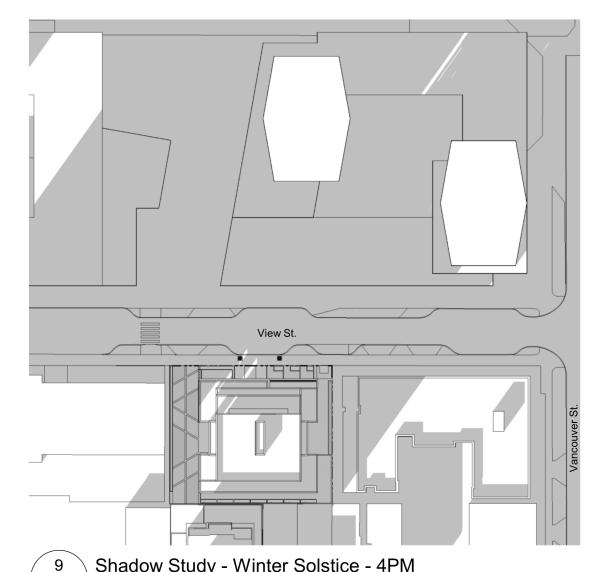

9 Shadow Study - Winter Solstice - 4PM A105 SCALE: 1:1000

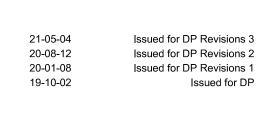


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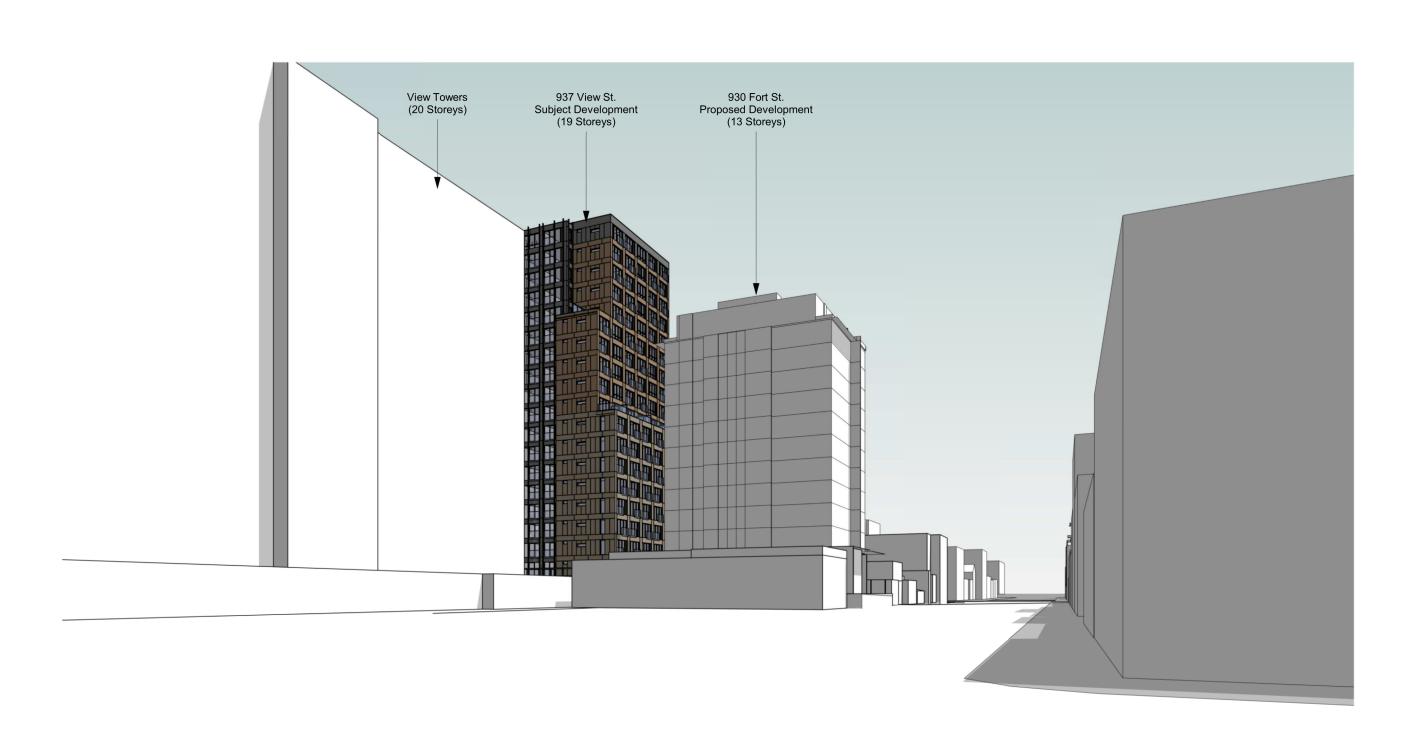
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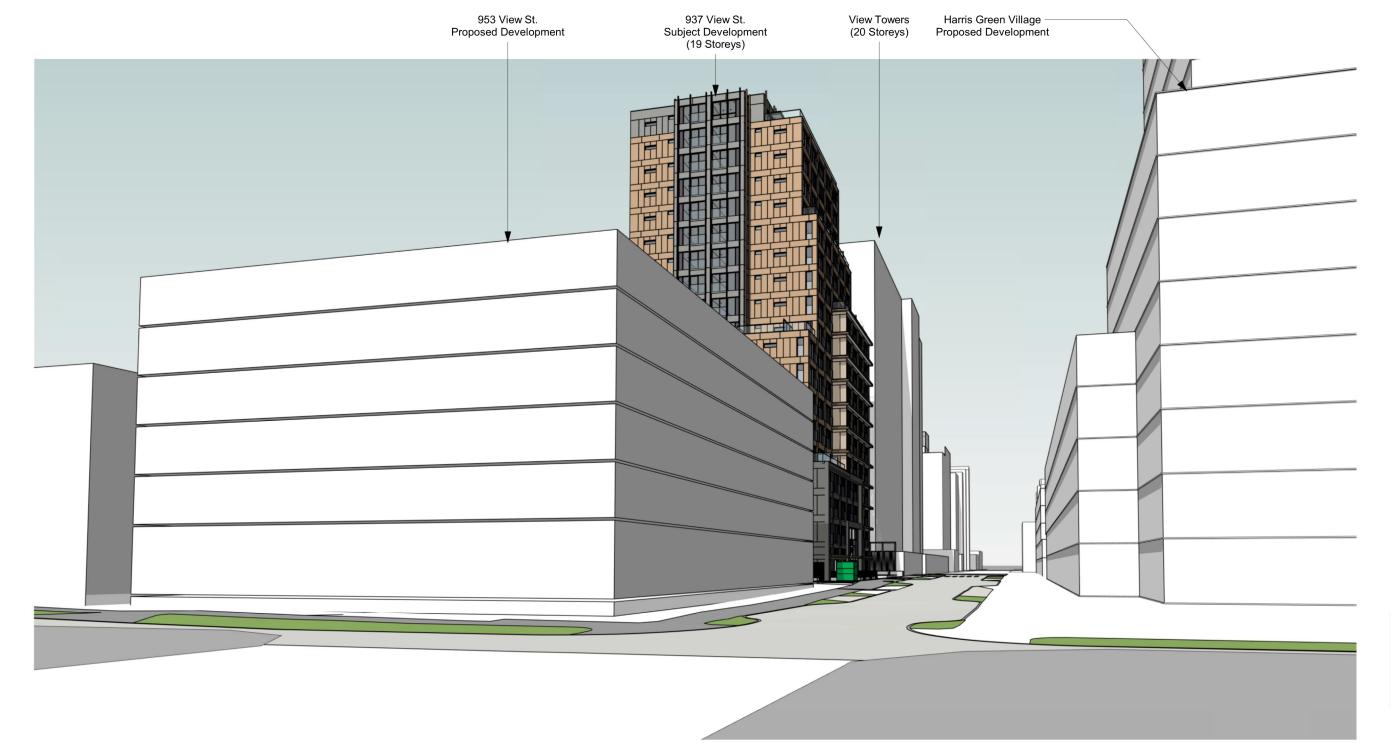
937 View Street AR

Site Contexter Cuit Shadow A 2021 visits






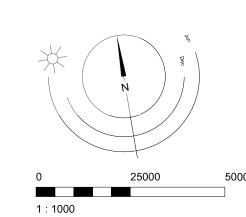






Street Perspective - Fort & Quadra - SW Corner
A107

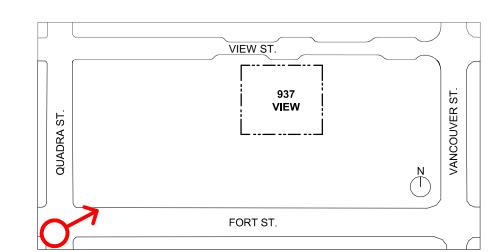


Street Perspective - View & Vancouver - NE Corner

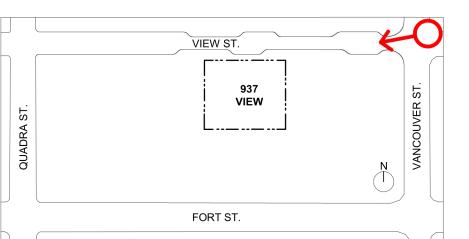

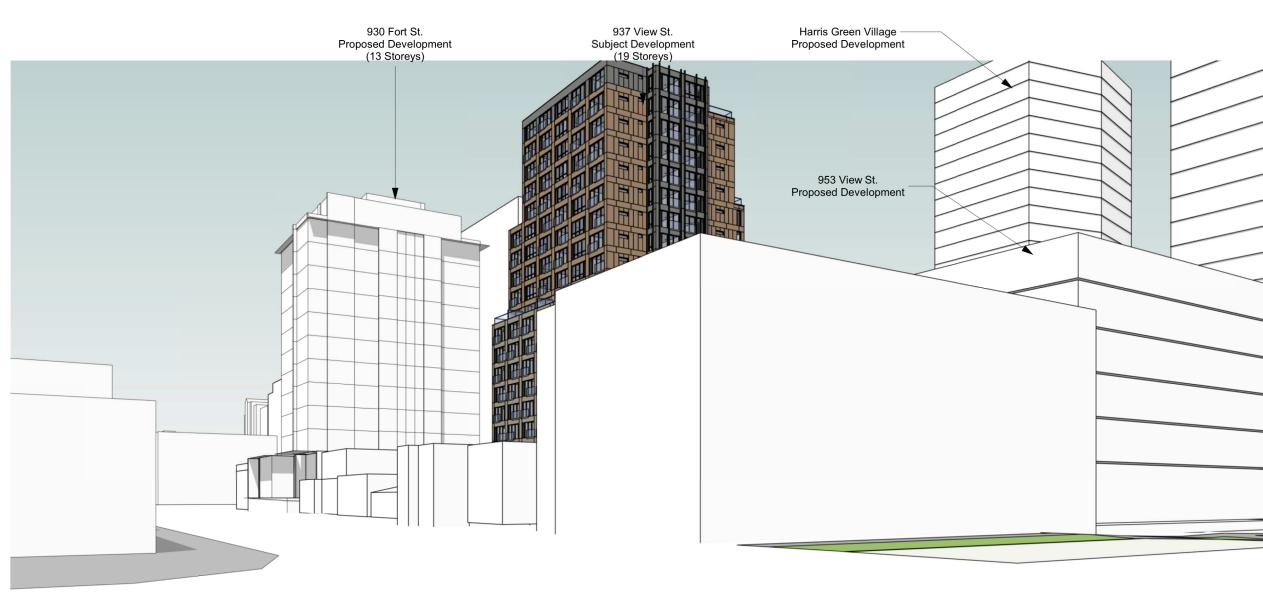


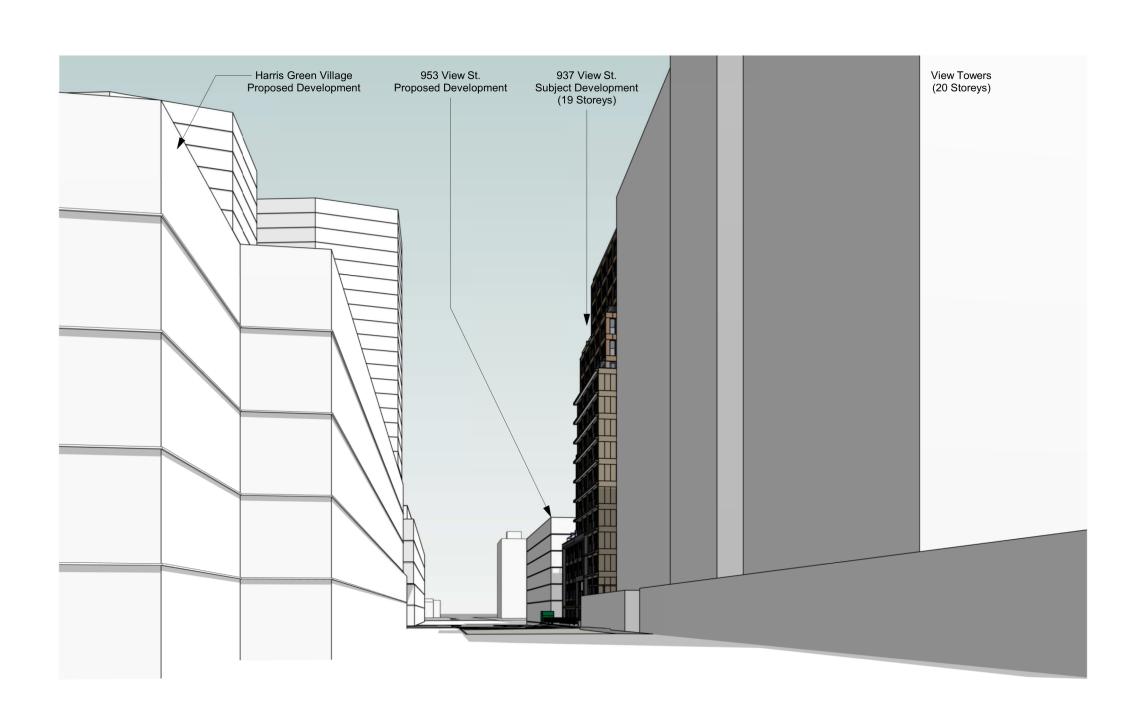

3 Street Perspective - Fort & Vancouver - SE Corner A107

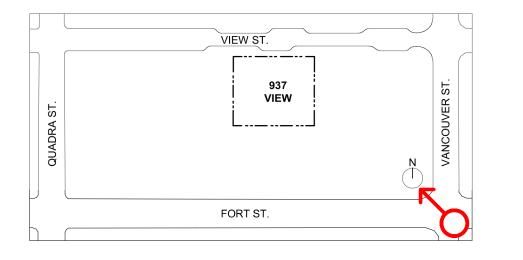

4 Street Perspective - View & Quadra - NW Corner

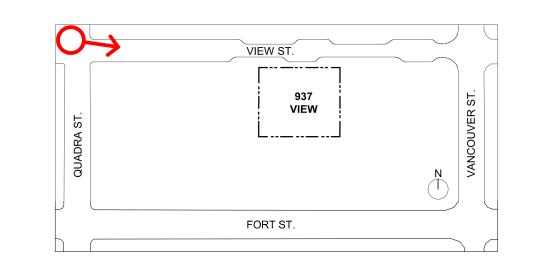

21-05-04 Issued for DP Revisions 3
20-08-12 Issued for DP Revisions 2
20-01-08 Issued for DP Revisions 1
19-10-02 Issued for DP

21-05-04 Drawing File

Drawn By RCI Checked By A
Scale 1:2000 Project Number 1

NOTE: All dimensions are shown in millimeters.

View St. Residential

Site Contest 2021-05-05



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✓ VANCOUVER STREET — ► ✓ 943 VIEW STREET 937 VIEW STREET → 941 VIEW STREET → ■ - 1147 QUADRA STREET

1 Street Elevation A108 SCALE: 1:300

Issued for DP Revisions 3 21-05-04 20-08-12 Issued for DP Revisions 2 20-01-08 Issued for DP Revisions 1 19-10-02 Issued for DP

21-05-04 Drawing File

NOTE: All dimensions are shown in millimeters.

View St. Residential

937 View Street ARC

Site Content 2021-05-05



A108

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Plot Date 21-05-04 Drawing File

Drawn By RCI Checked By AD

Scale As indicated Project Number 192

NOTE: All dimensions are shown in millimeters.

View St. Residential

937 View Street ARC








A109


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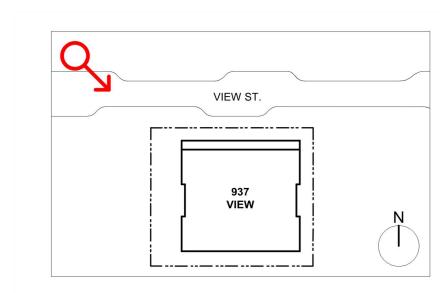




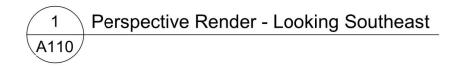

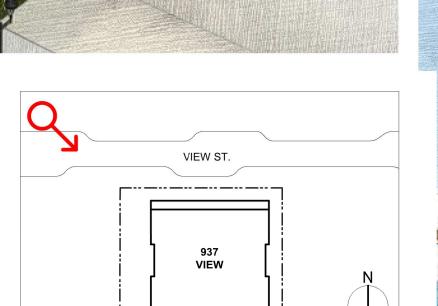

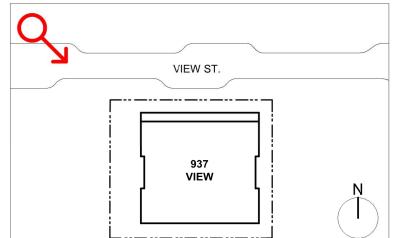Perspective Rendering - Crosswalk
A110

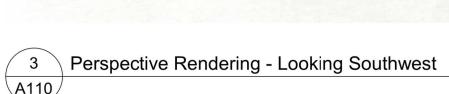

VIEW ST.



Issued for DP Revisions 3 20-08-12 Issued for DP Revisions 2 20-01-08 Issued for DP Revisions 1

View St. Residential


937 View Street RED 44







Victoria




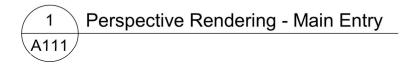


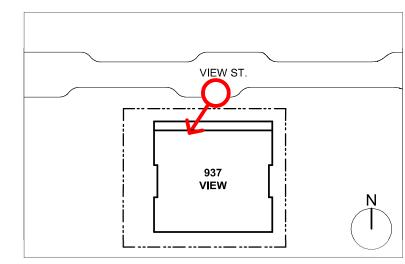

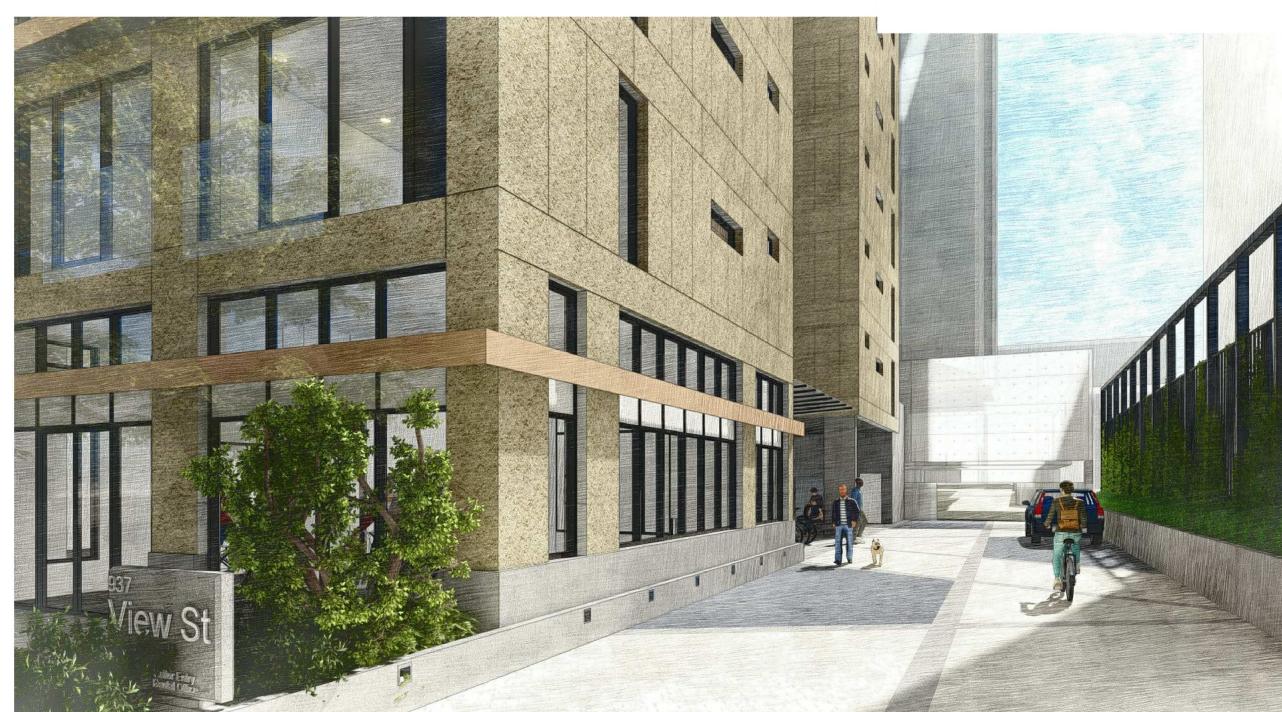


Perspective Rendering - Easement
A111

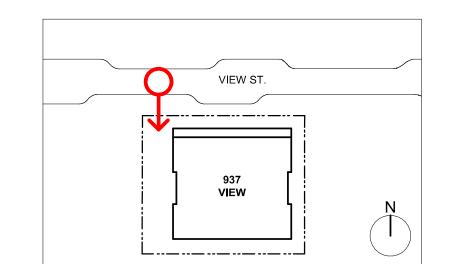


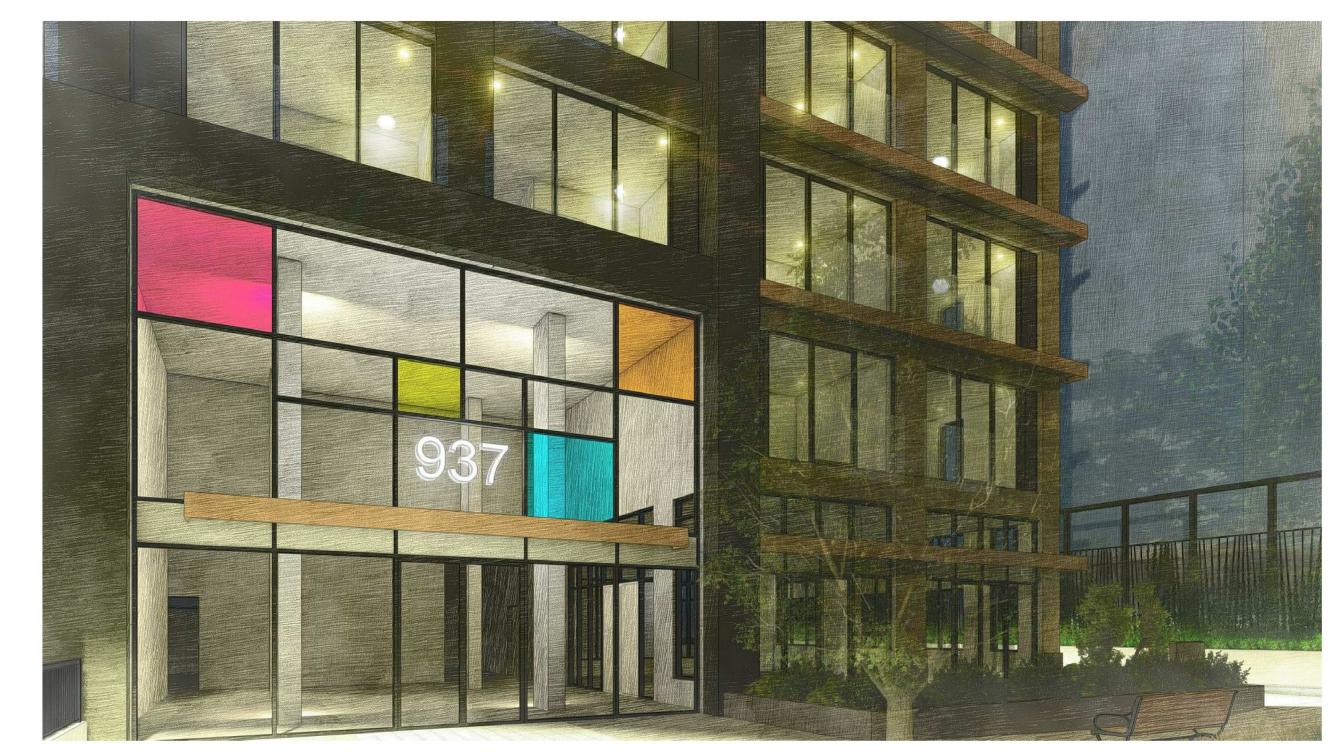


Perspective Rendering - Main Entry - Night

A111

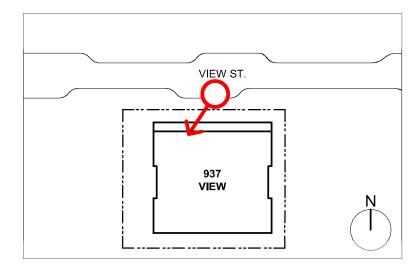

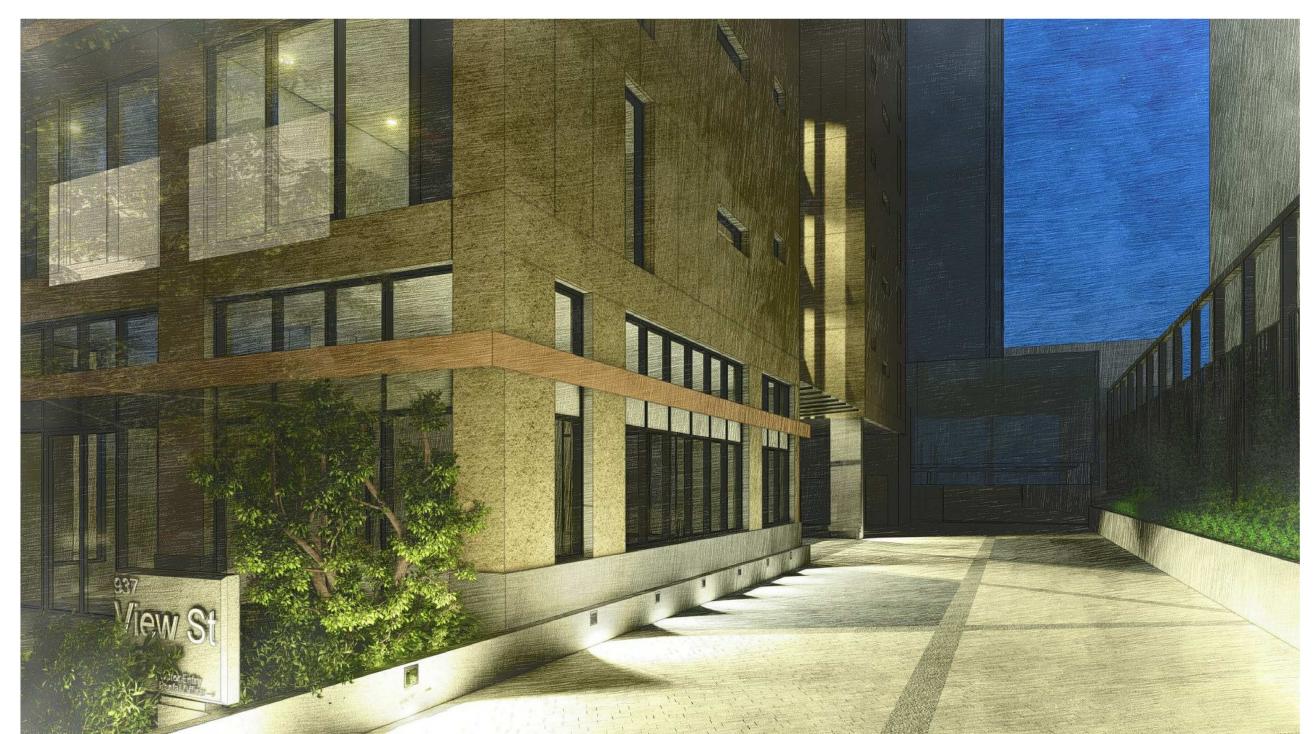

4 Perspective Rendering - Easement - Night
A111

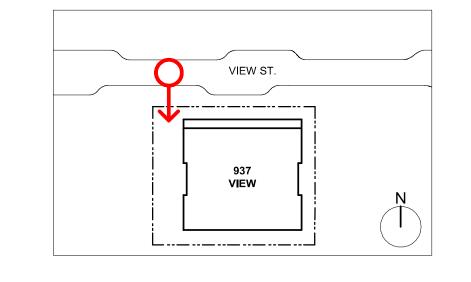

21-05-04 Issued for DP Revisions 3 20-08-12 Issued for DP Revisions 2 20-01-08 Issued for DP Revisions 1

Plot Date 21-05-04 Drawing File

Drawn By RCI Checked By A

Scale As indicated Project Number 1!

NOTE: All dimensions are shown in millimeters.

View St. Residential

937 View Street AA






dHKarchitects Victoria




1 Perspective Rendering - Townhouses at Easement
A112

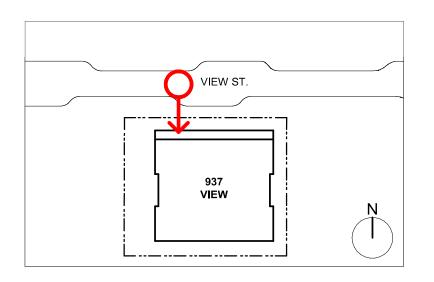



Perspective Rendering - Easement Looking at Bikes

A112

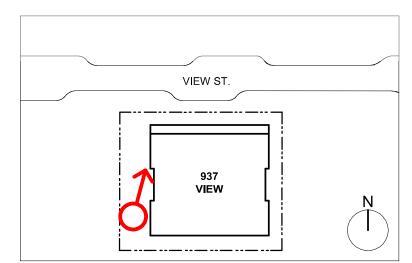

21-05-04 Issued for DP Revisions 3 20-08-12 Issued for DP Revisions 2 20-01-08 Issued for DP Revisions 1

Plot Date 21-05-04 Drawing File

Drawn By RCI Checked By

Scale As indicated Project Number

NOTE: All dimensions are shown in millimeters.

View St. Residential

937 View Street AR







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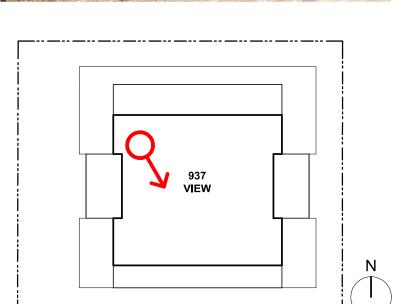
Perspective Rendering - L18 North Terrace
A113






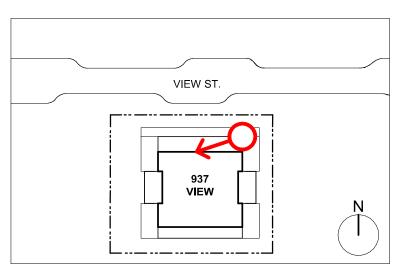


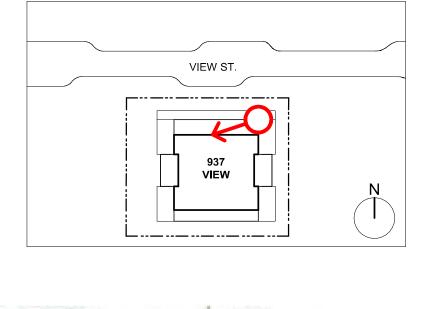3 Perspective Rendering - L18 Amenity
A113



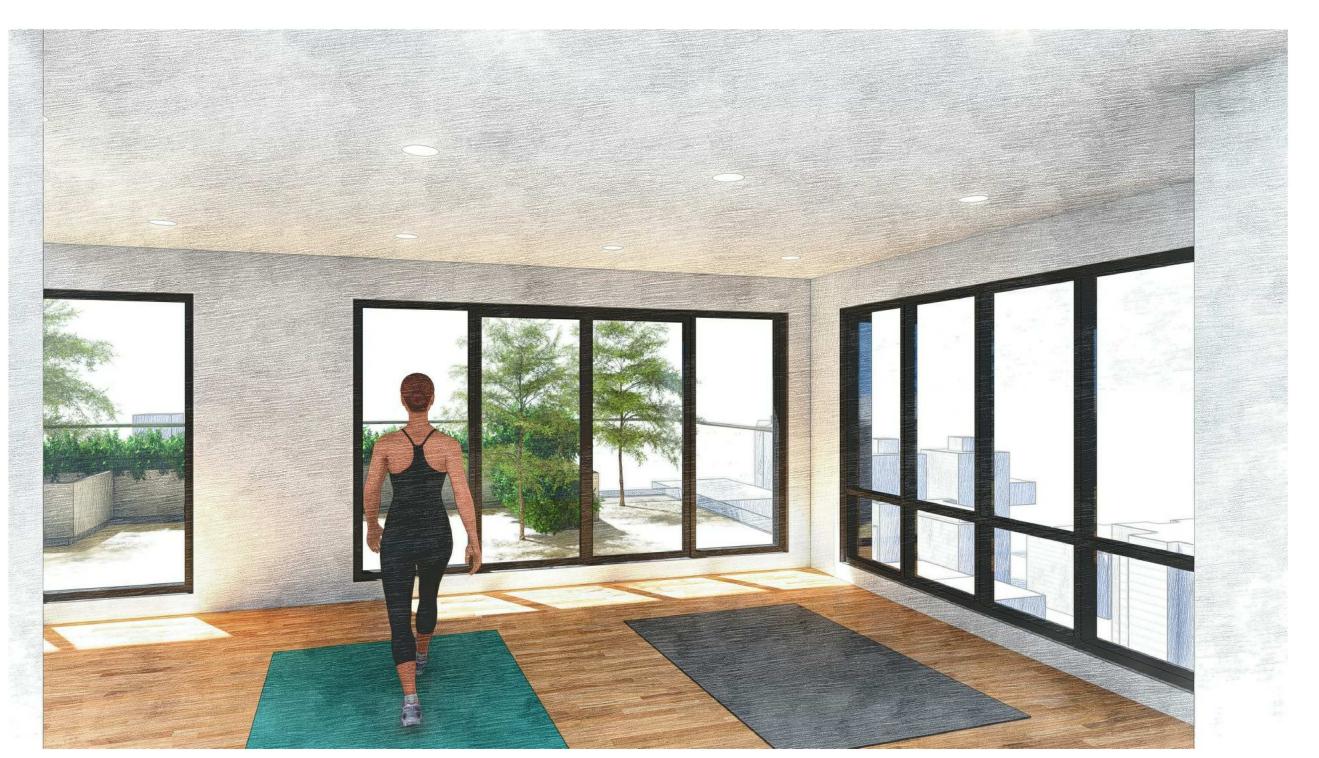


Perspective Rendering - L18 South Terrace
A113

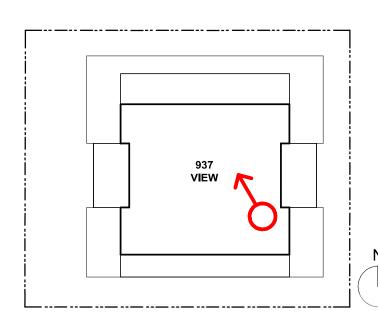



Perspective Rendering - L18 Fitness
A113

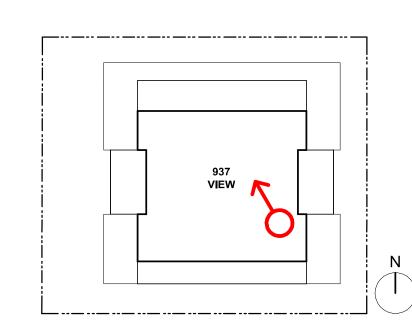

20-08-12 20-01-08 Issued for DP Revisions 2 Issued for DP Revisions 1

View St. Residential

937 View Street AR






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1 Perspective Rendering - Overall - Night A114



21-05-04 Issued for DP Revisions 3 20-08-12 Issued for DP Revisions 2 20-01-08 Issued for DP Revisions 1

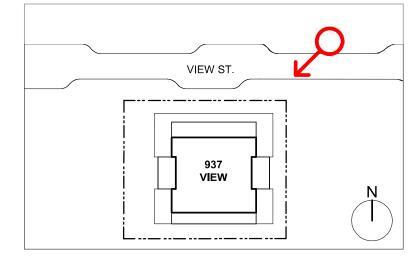Plot Date 21-05-04 Drawing File
Drawn By RCI Checked By
Scale As indicated Project Number

View St. Residential

937 View Street AR


NOTE: All dimensions are shown in millimeters.





A114

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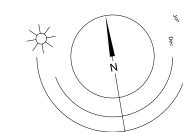


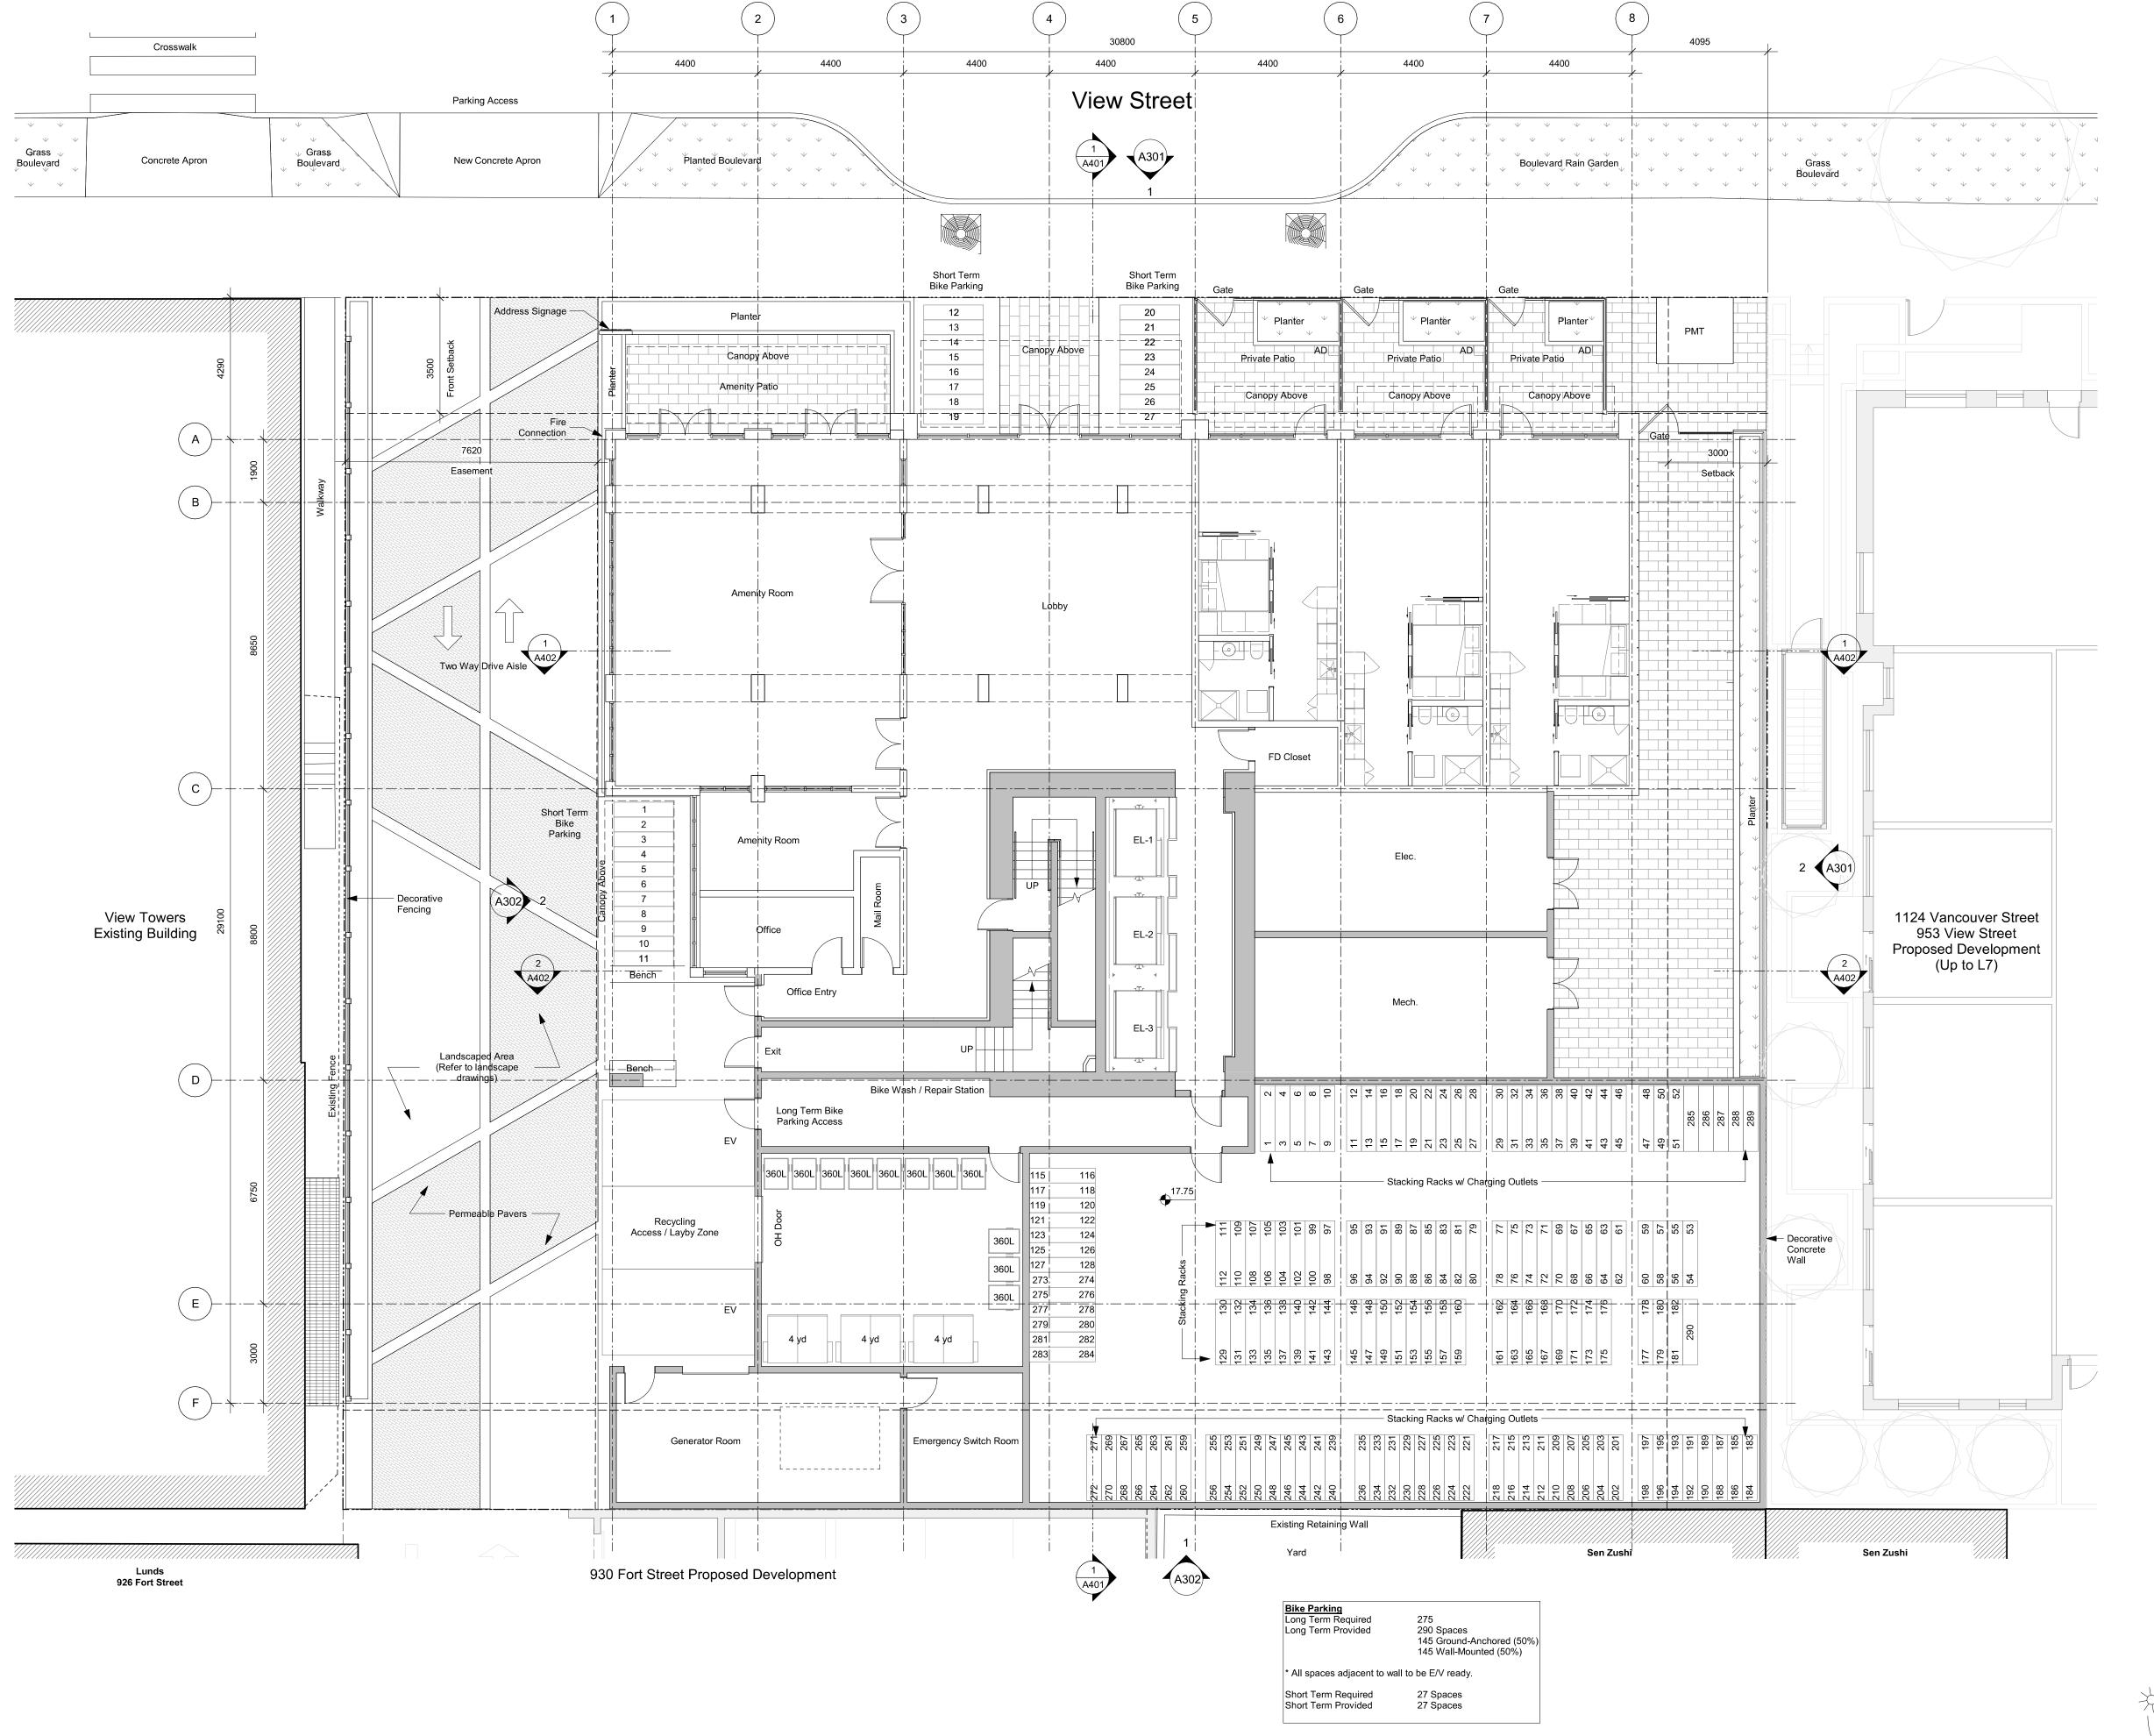21-05-04 Drawing File

View St. Residential


937 View Street

NOTE: All dimensions are shown in millimeters.





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 Plot Date
 21-05-04
 Drawing File

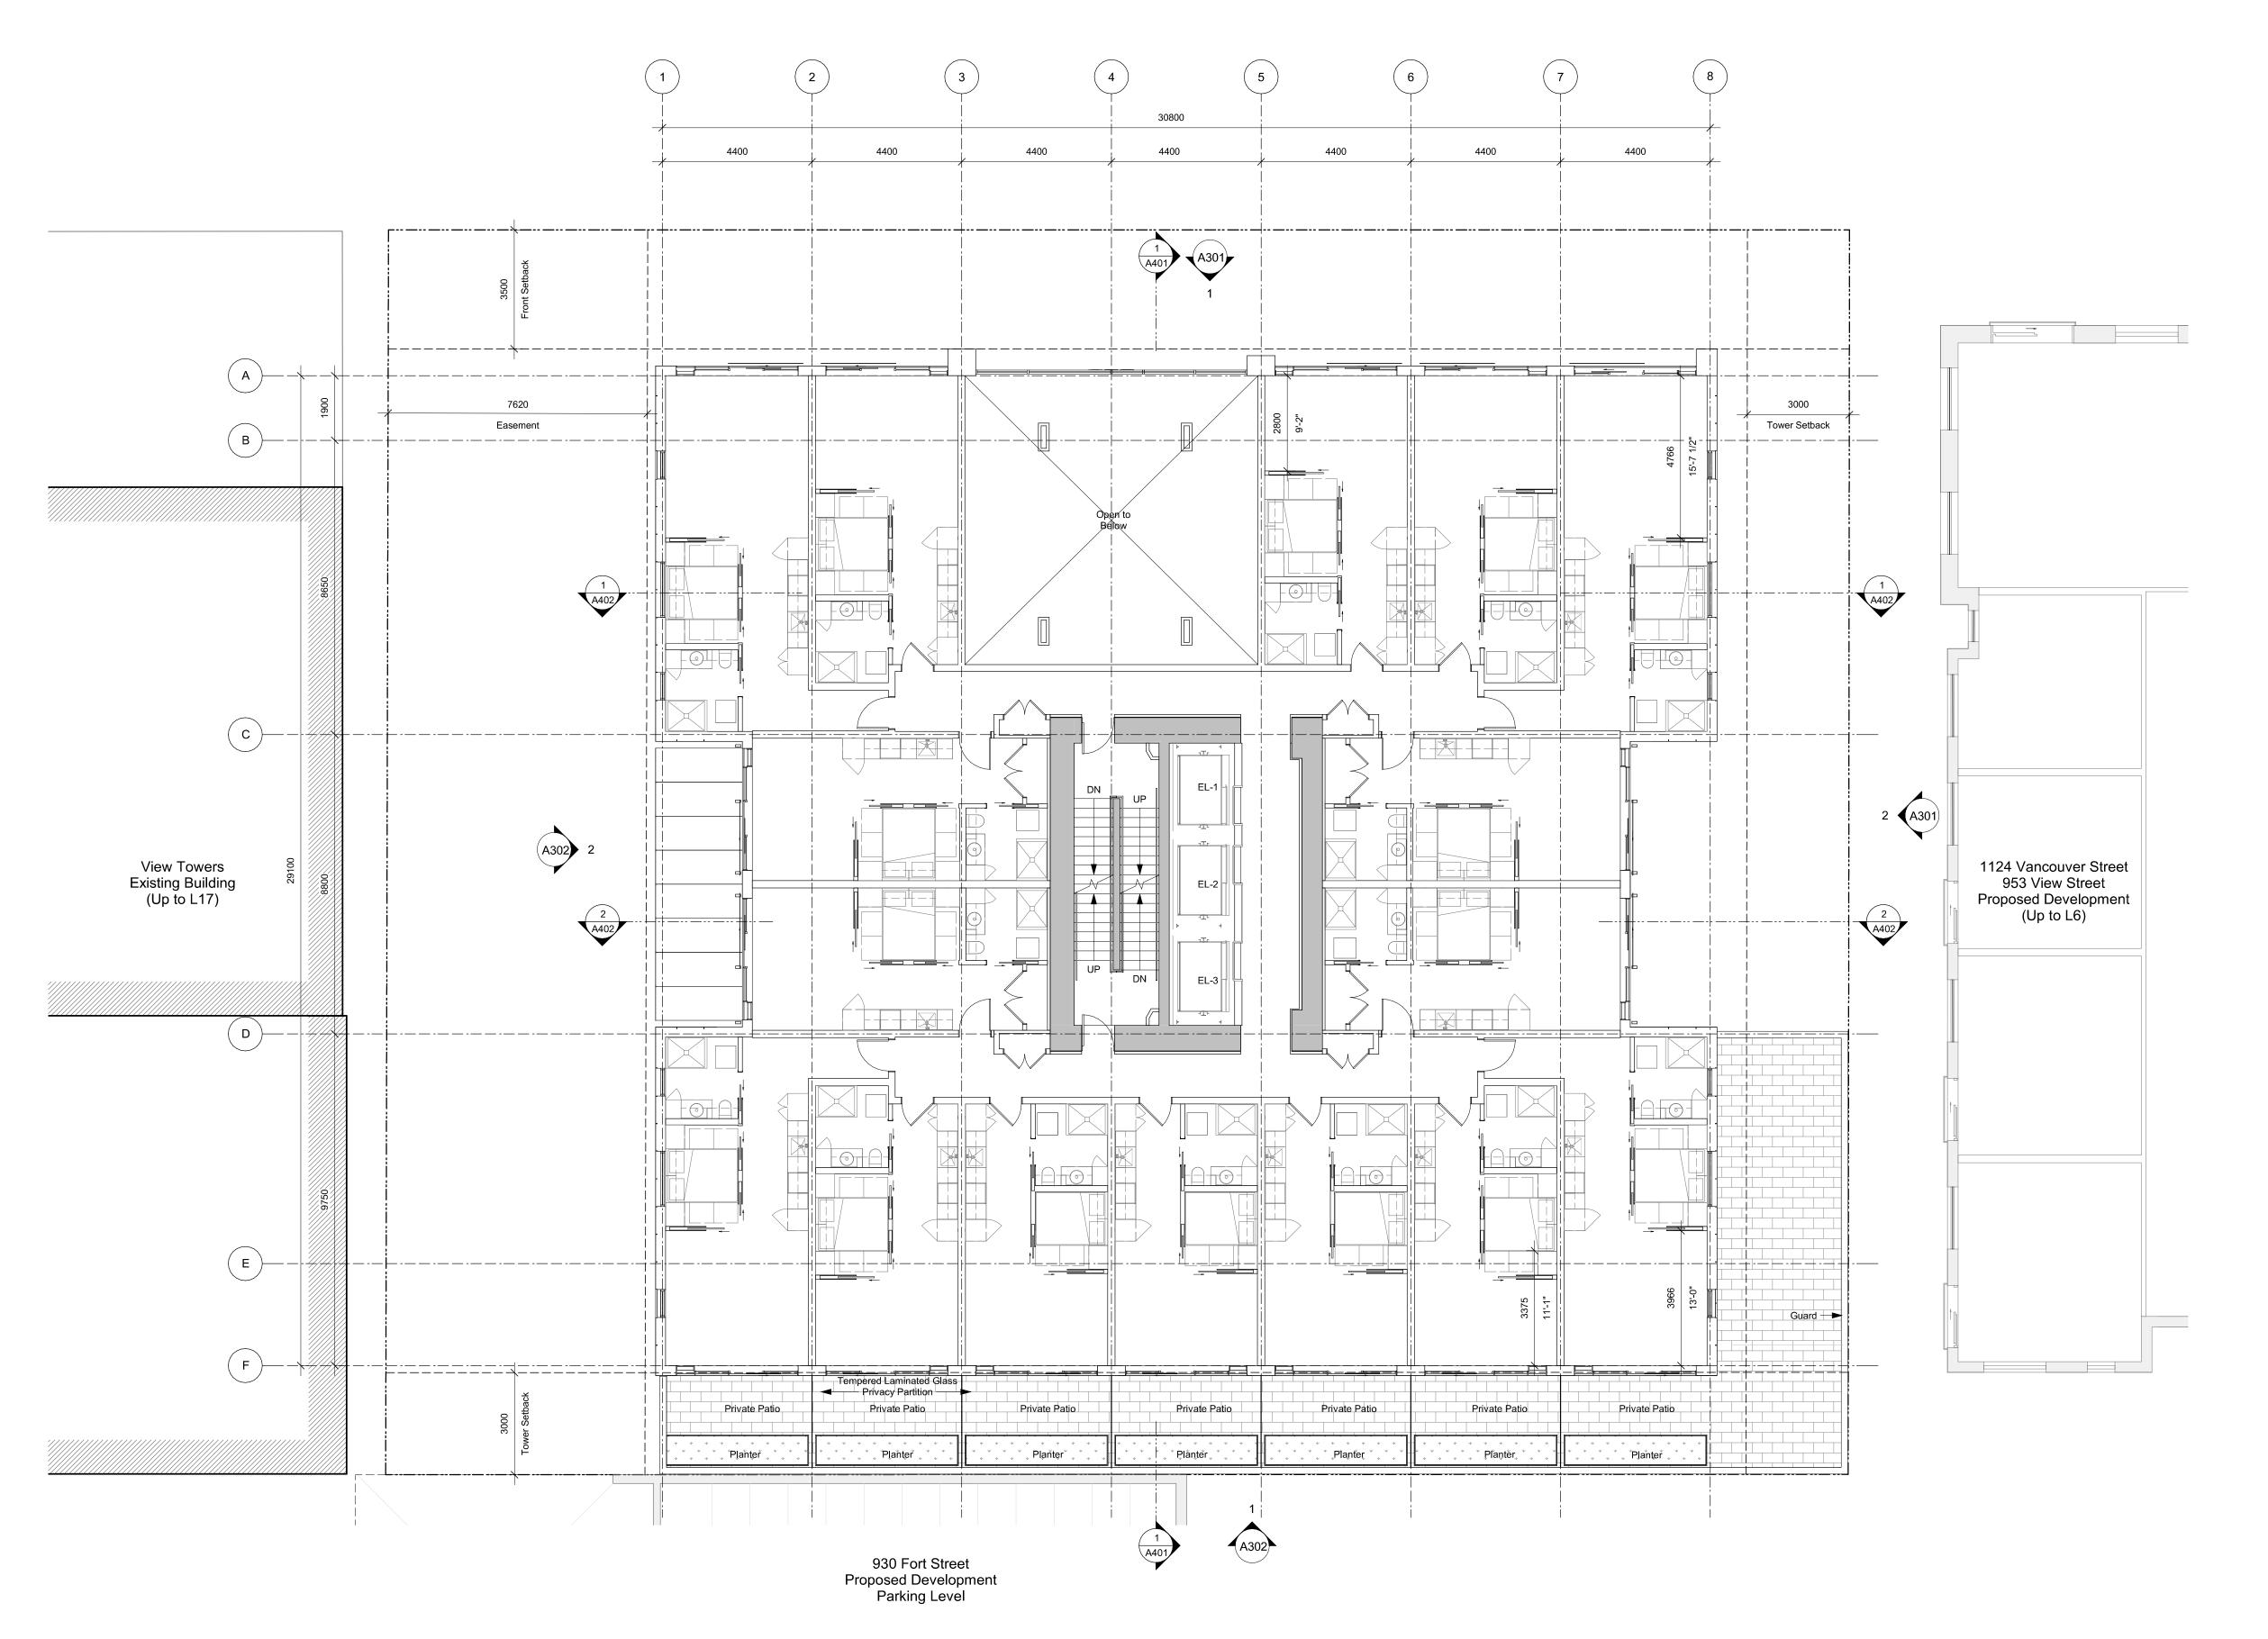 Drawn By
 RCI
 Checked By


 Scale
 1 : 100
 Project Number

View St. Residential

937 View Street AED A


NOTE: All dimensions are shown in millimeters.

Level 2 F 2021-05-05

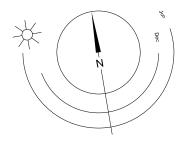



dHKarchi Victoria 977 Fort S

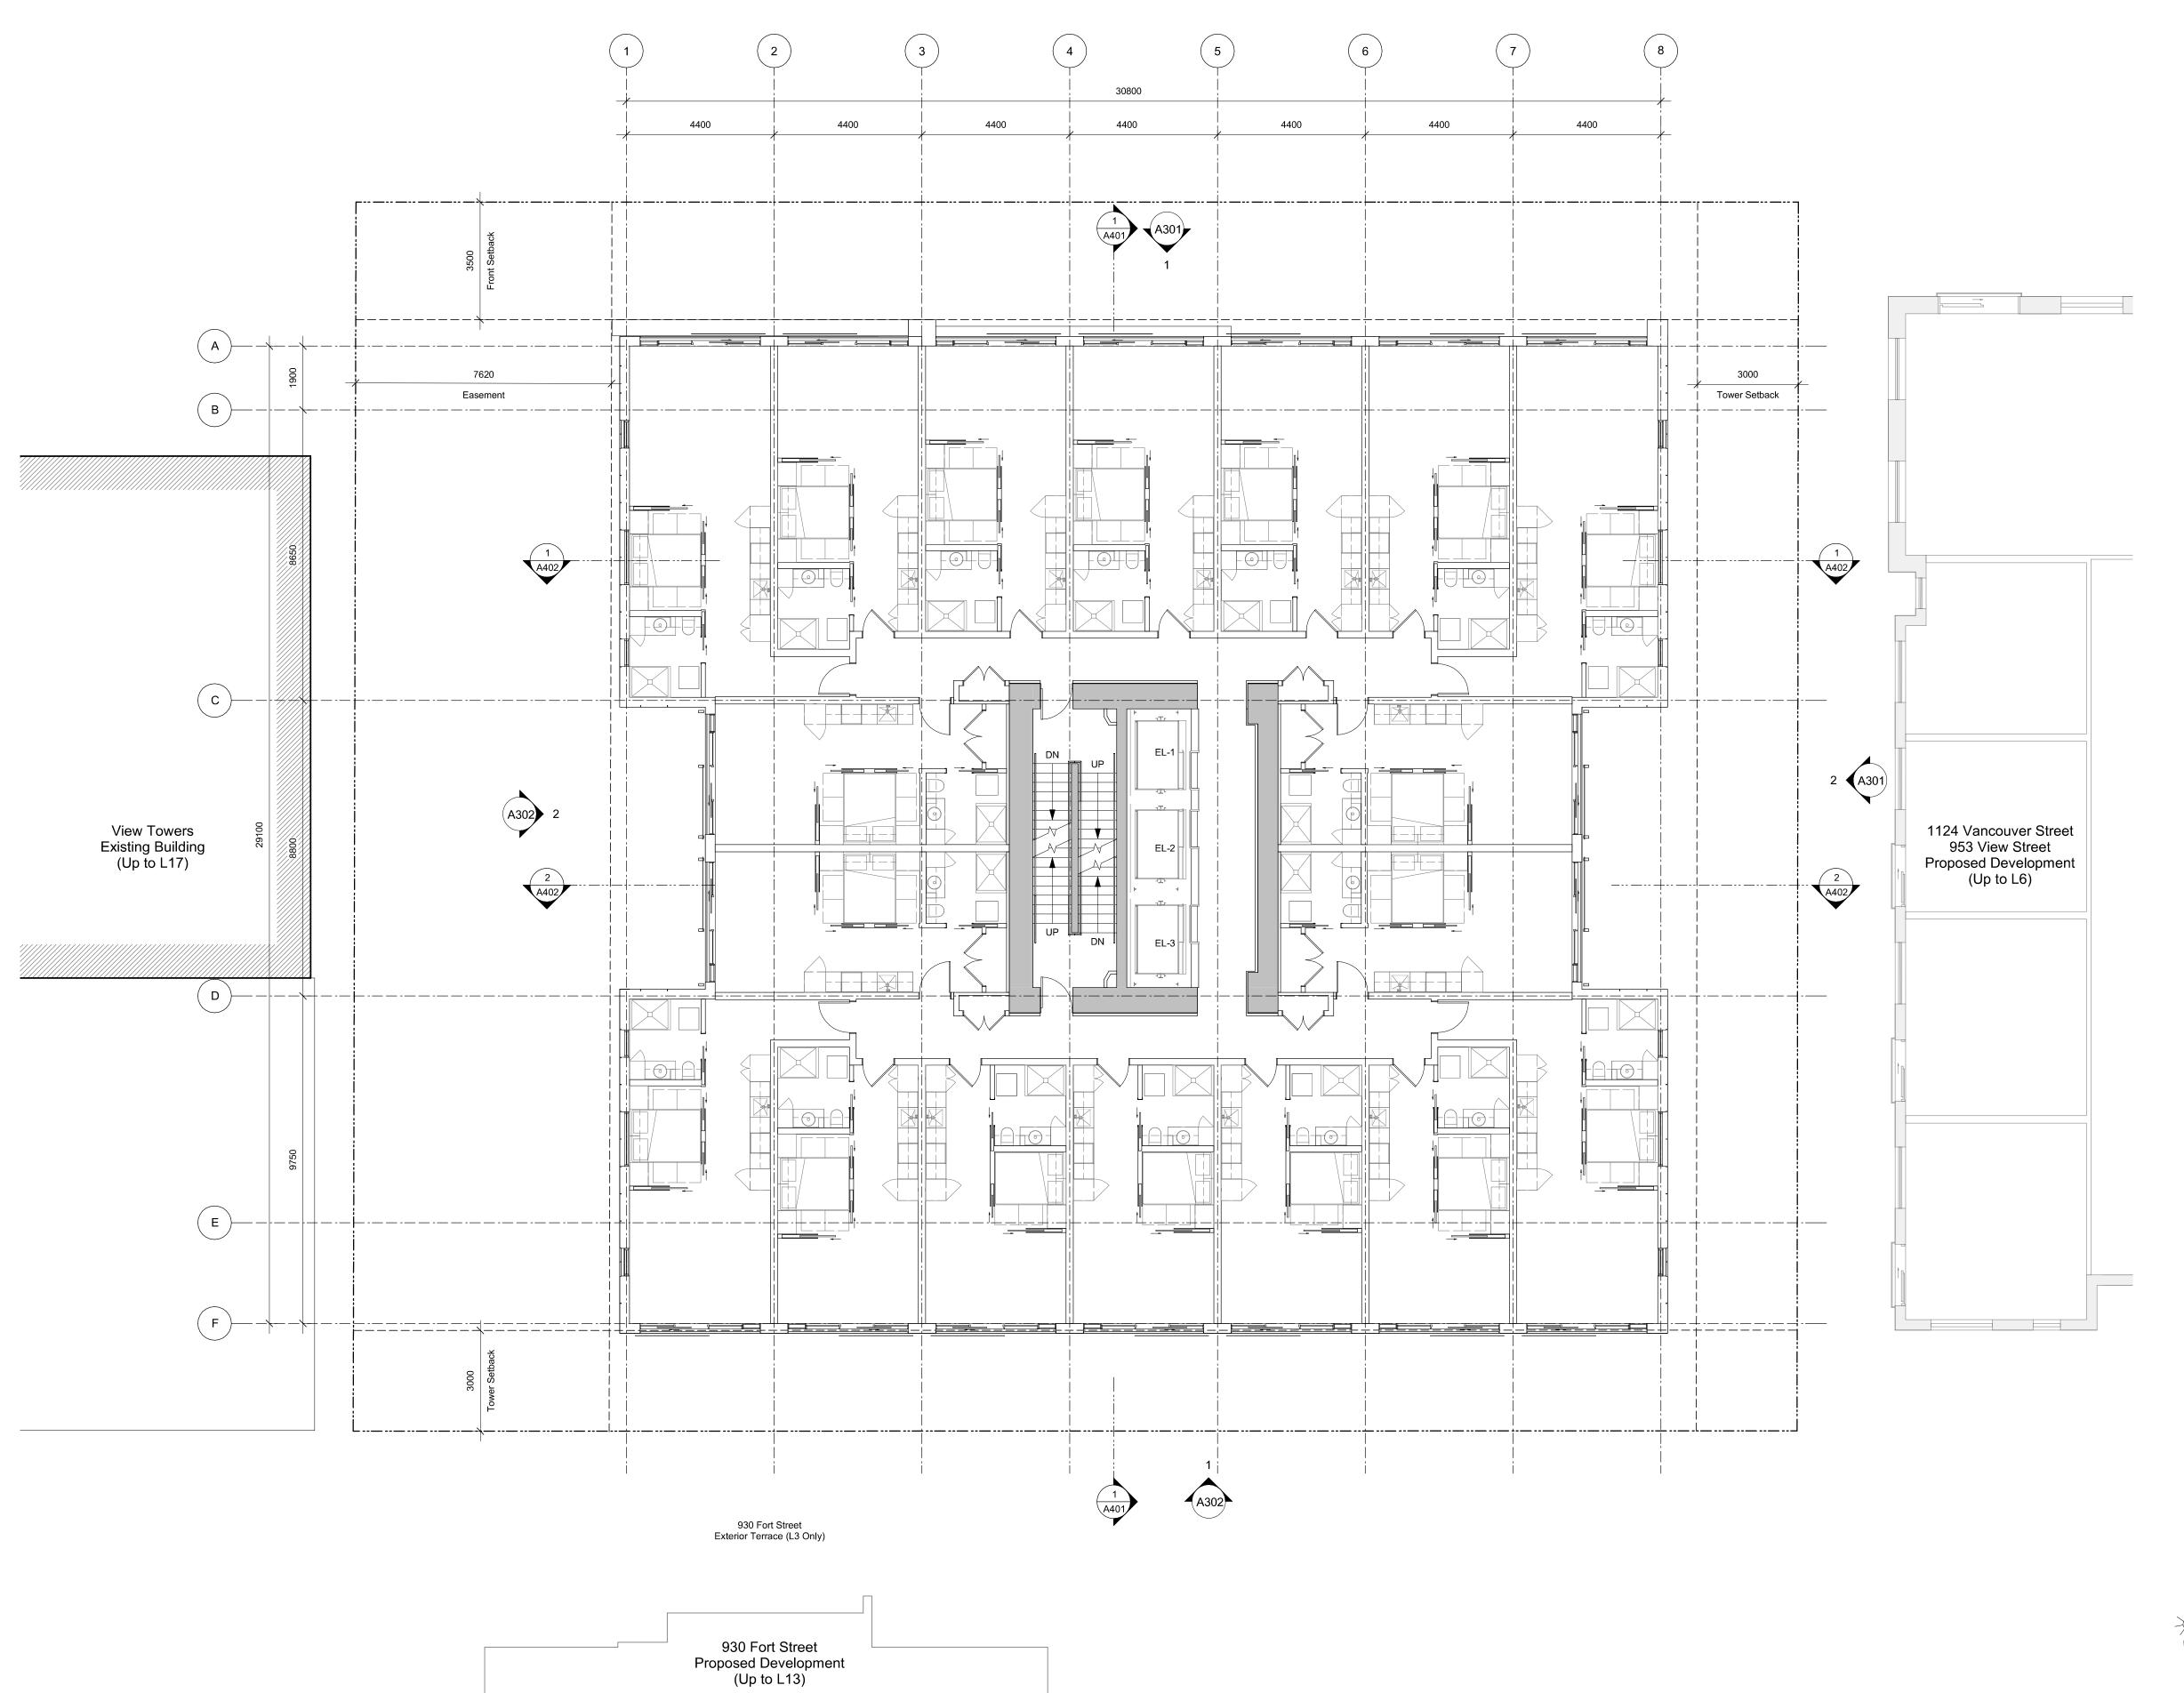

Plot Date 21-05-04 Drawing File

Drawn By RCI Checked By


Scale 1:100 Project Number

NOTE: All dimensions are shown in millimeters.

View St. Residential


937 View Street

Levels 3-4 Debarrons 2021-05-05

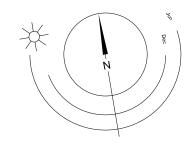



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Victoria
977 Fort Street

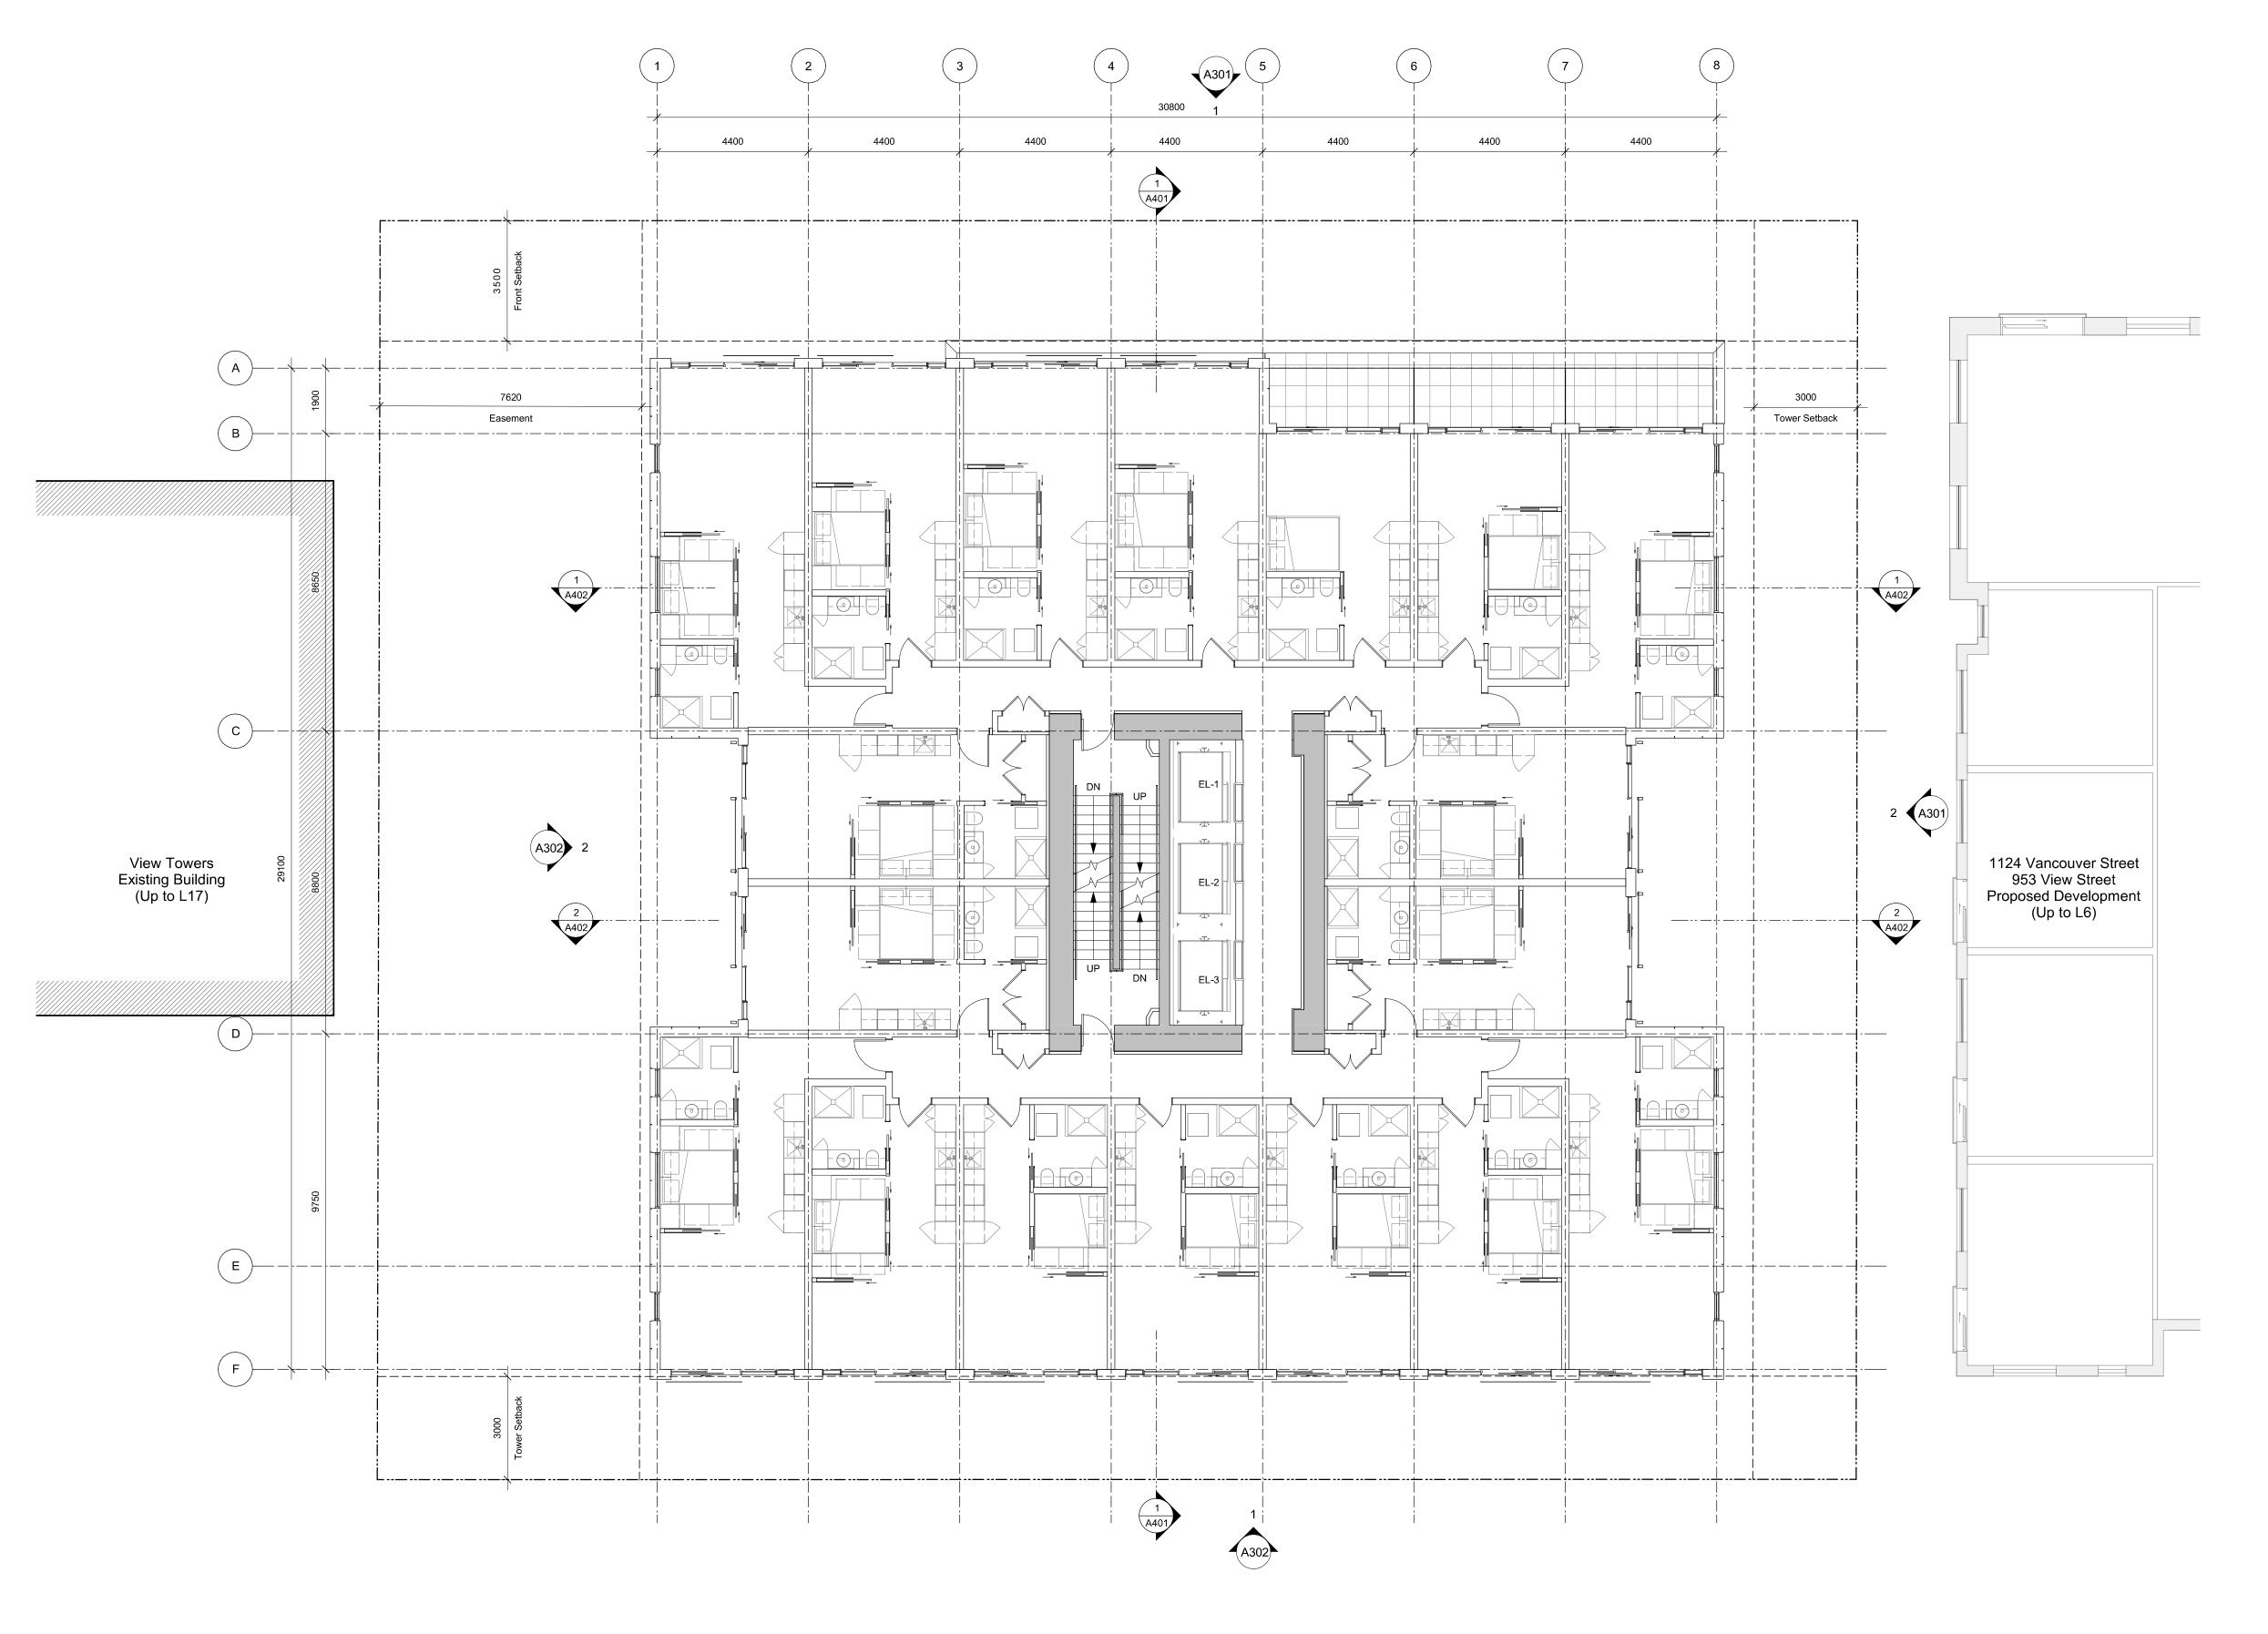

930 Fort Street Proposed Development (Up to L13) 21-05-04 Issued for DP Revisions 3 20-08-12 Issued for DP Revisions 2 20-01-08 Issued for DP Revisions 1 19-10-02 Issued for DP

Plot Date 21-05-04 Drawing File

Drawn By RCI Checked By


Scale 1:100 Project Number

NOTE: All dimensions are shown in millimeters.

View St. Residential


937 View Street

Levels 5-0 100 2021-05-05

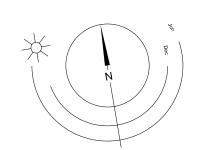



dHKarchitec Victoria 977 Fort Stre

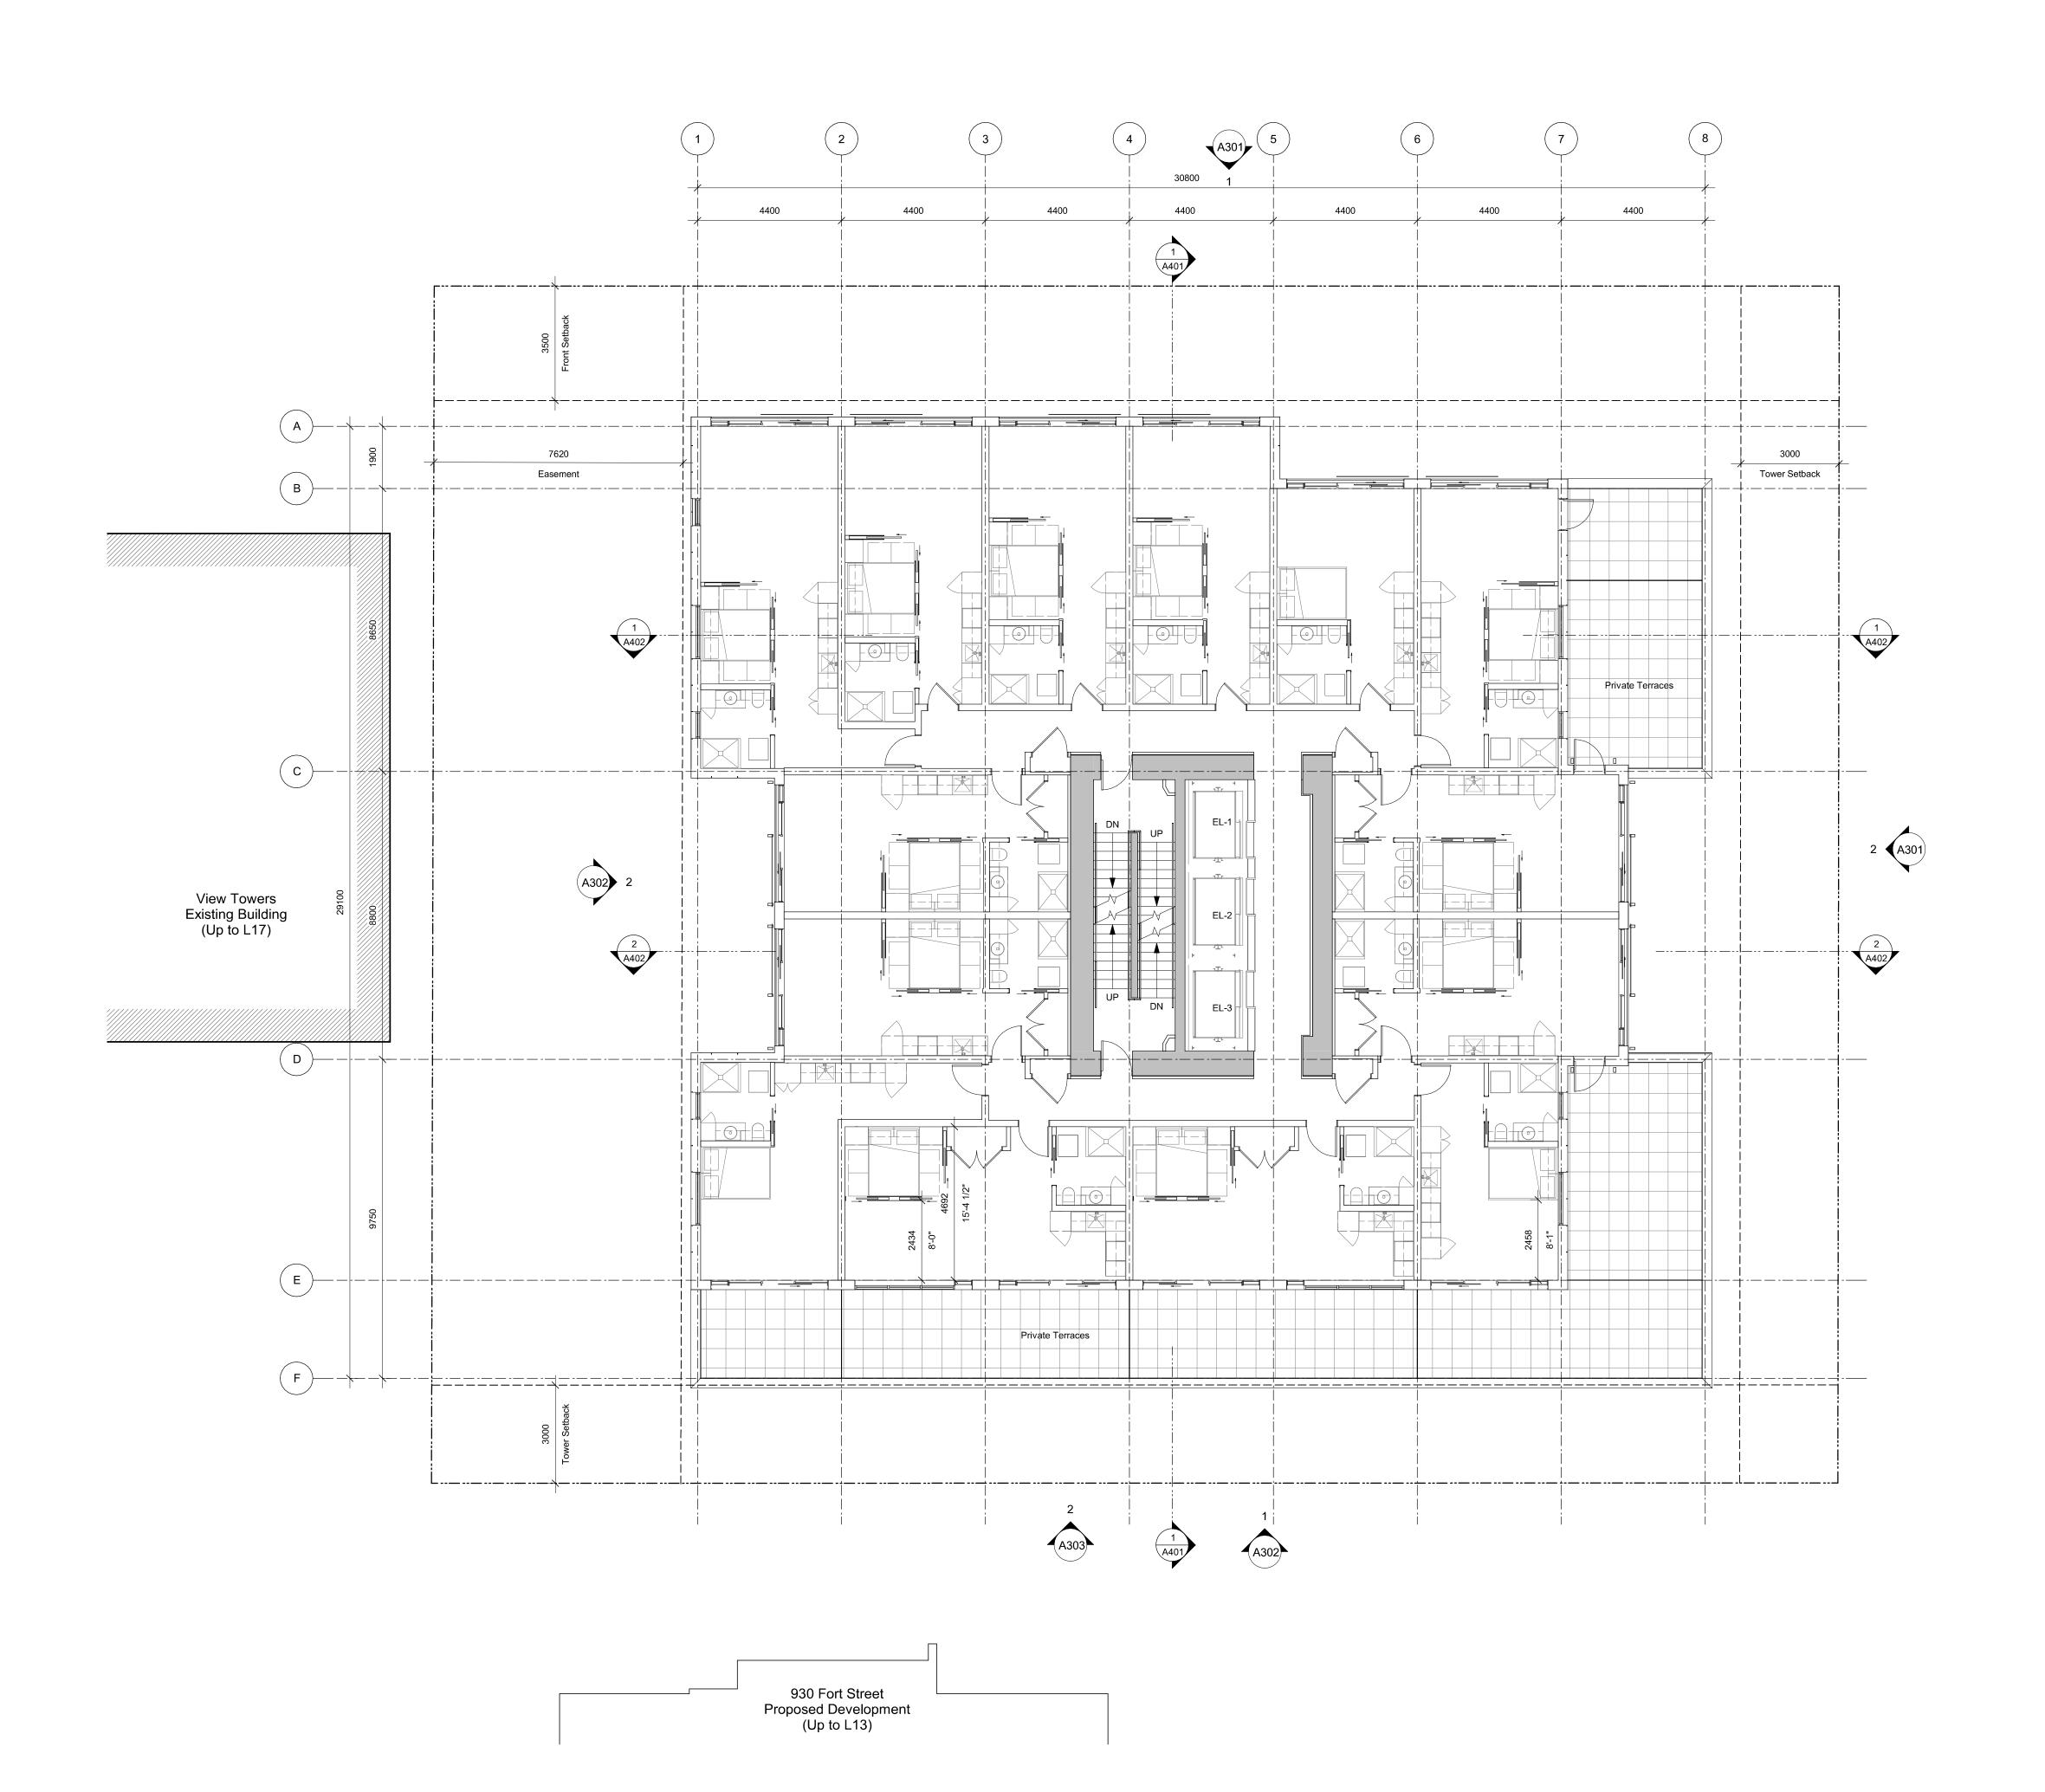

Plot Date 21-05-04 Drawing File

Drawn By RCI Checked By


Scale 1:100 Project Number

NOTE: All dimensions are shown in millimeters.

View St. Residential


937 View Street

Levels 10 Mar Pianu 2021-05-05

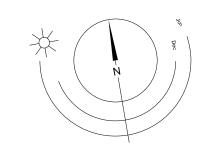



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930 Fort Street Proposed Development (Up to L13)

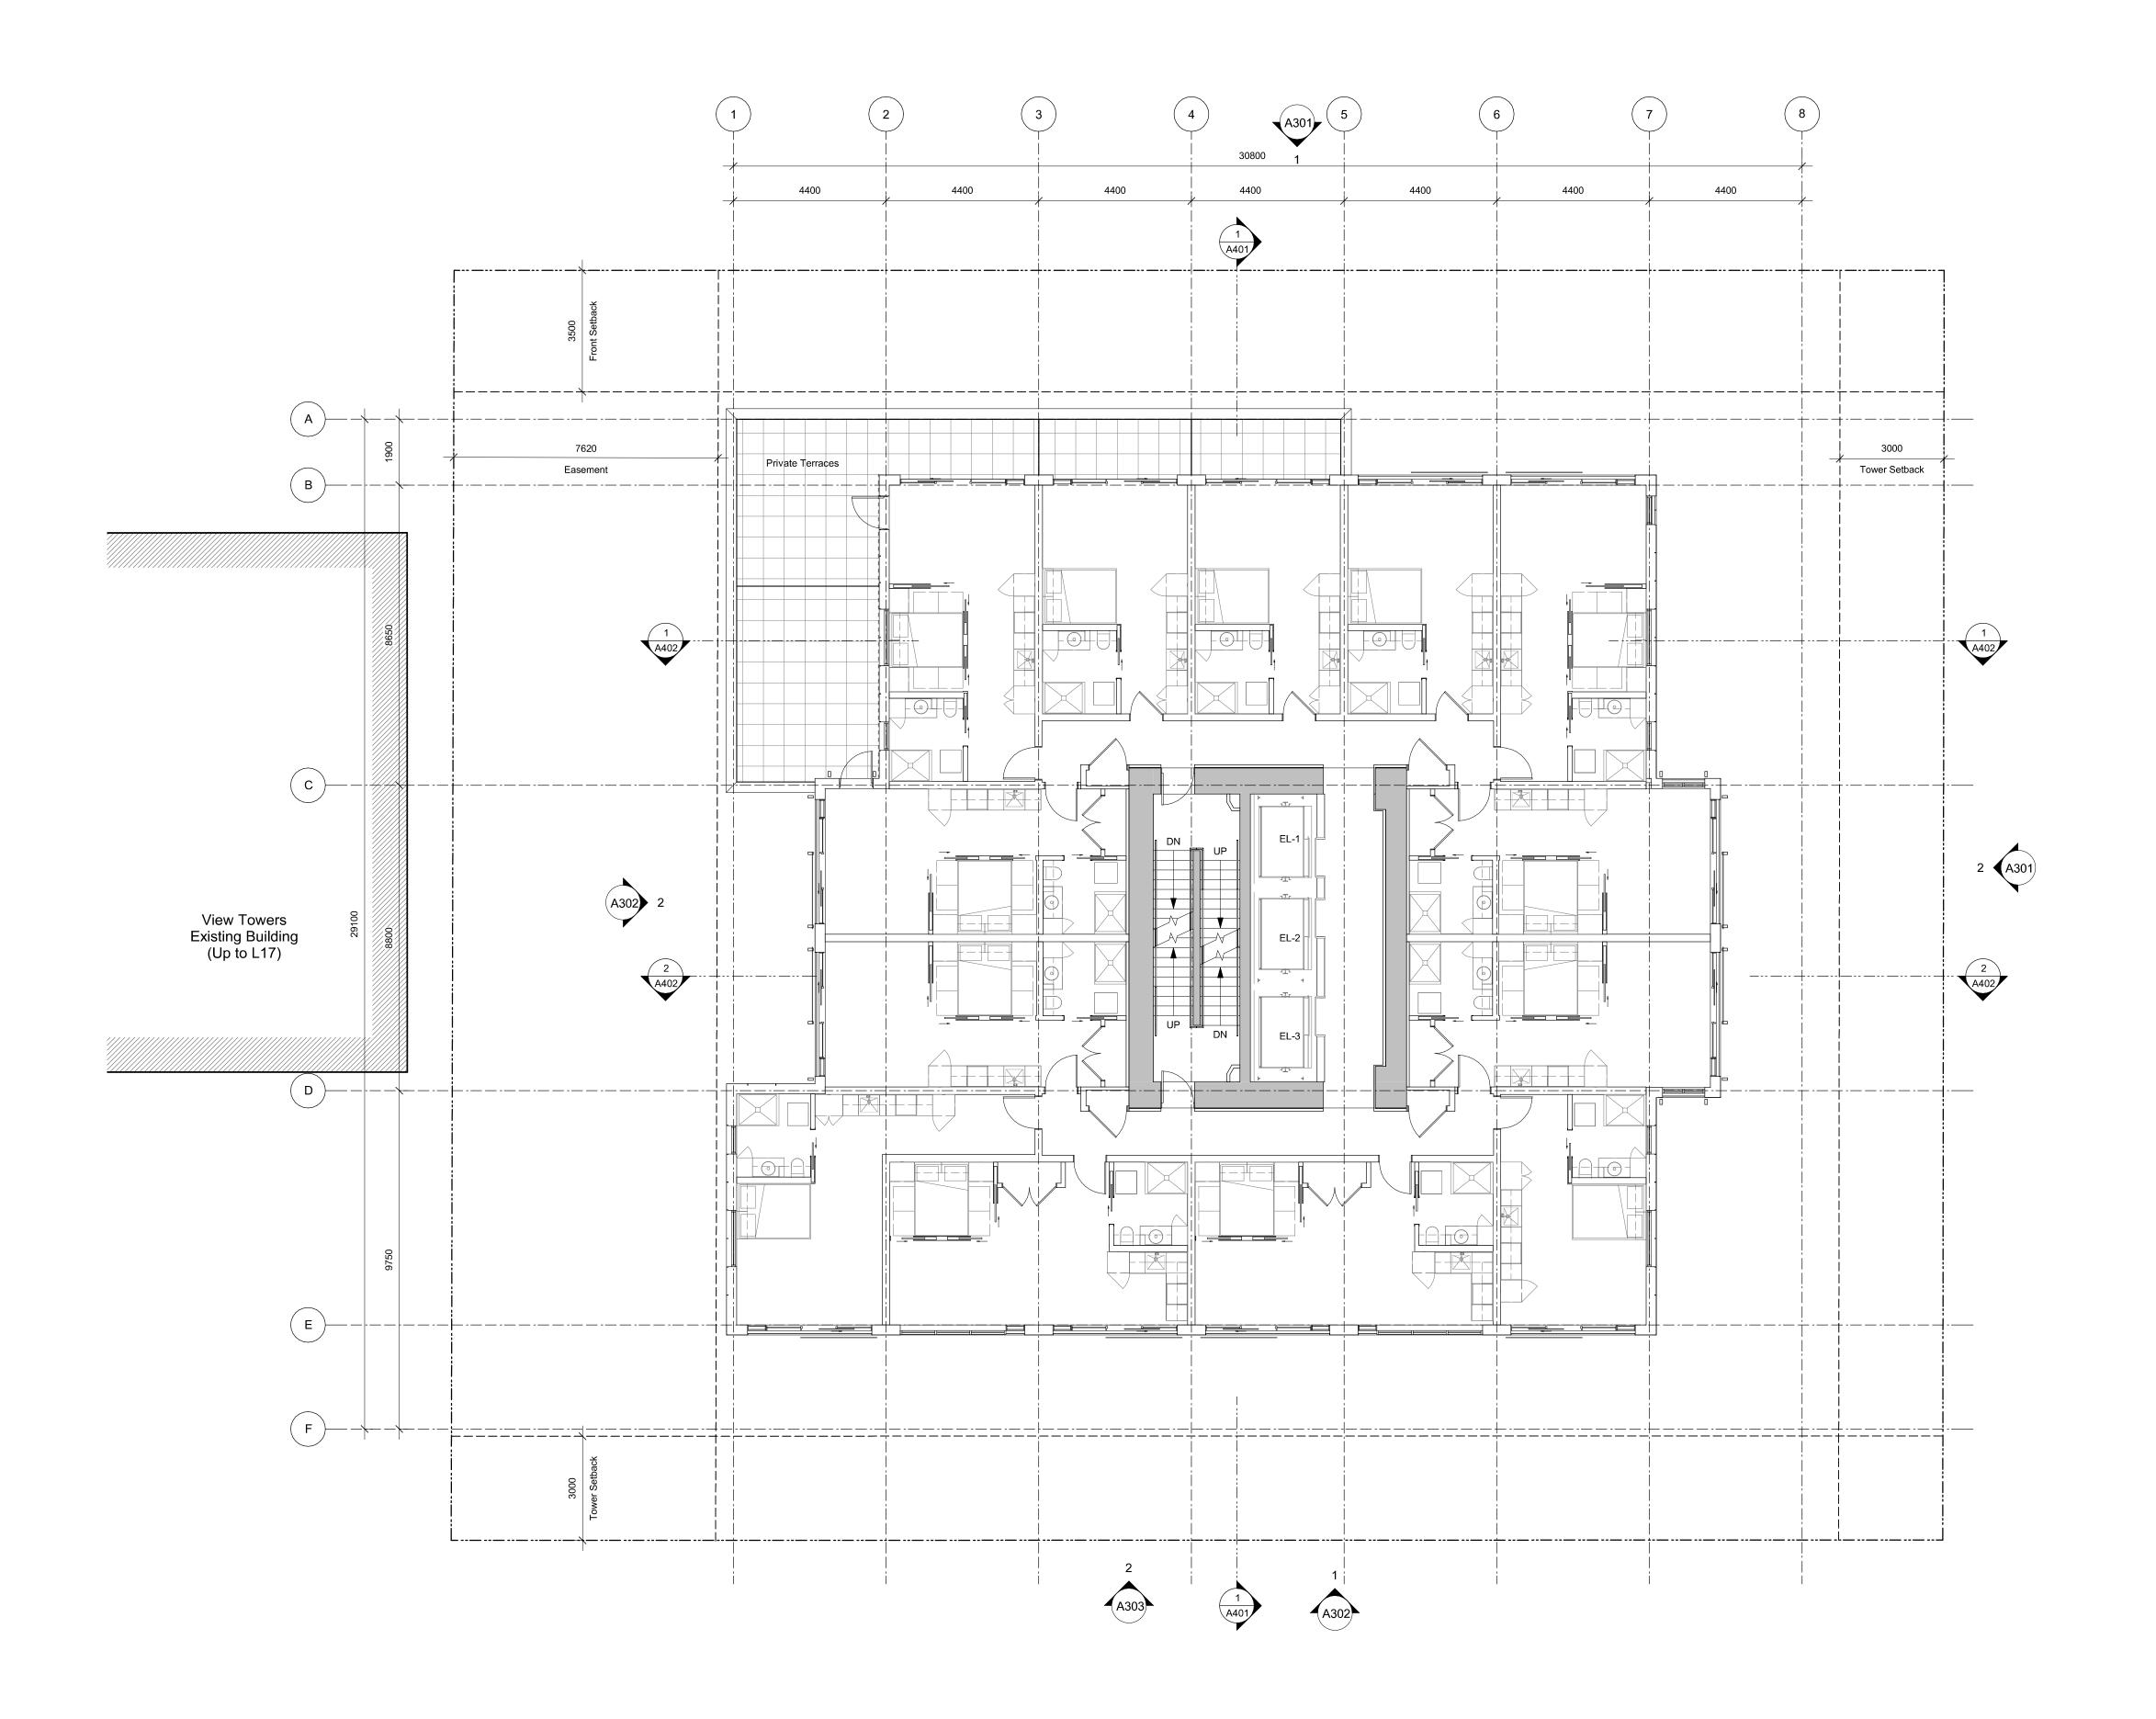
Issued for DP Revisions 3 20-08-12 Issued for DP Revisions 2 20-01-08 Issued for DP Revisions 1 19-10-02 Issued for DP

21-05-04 Drawing File


View St. Residential

NOTE: All dimensions are shown in millimeters.

937 View Street RED

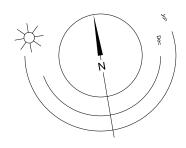



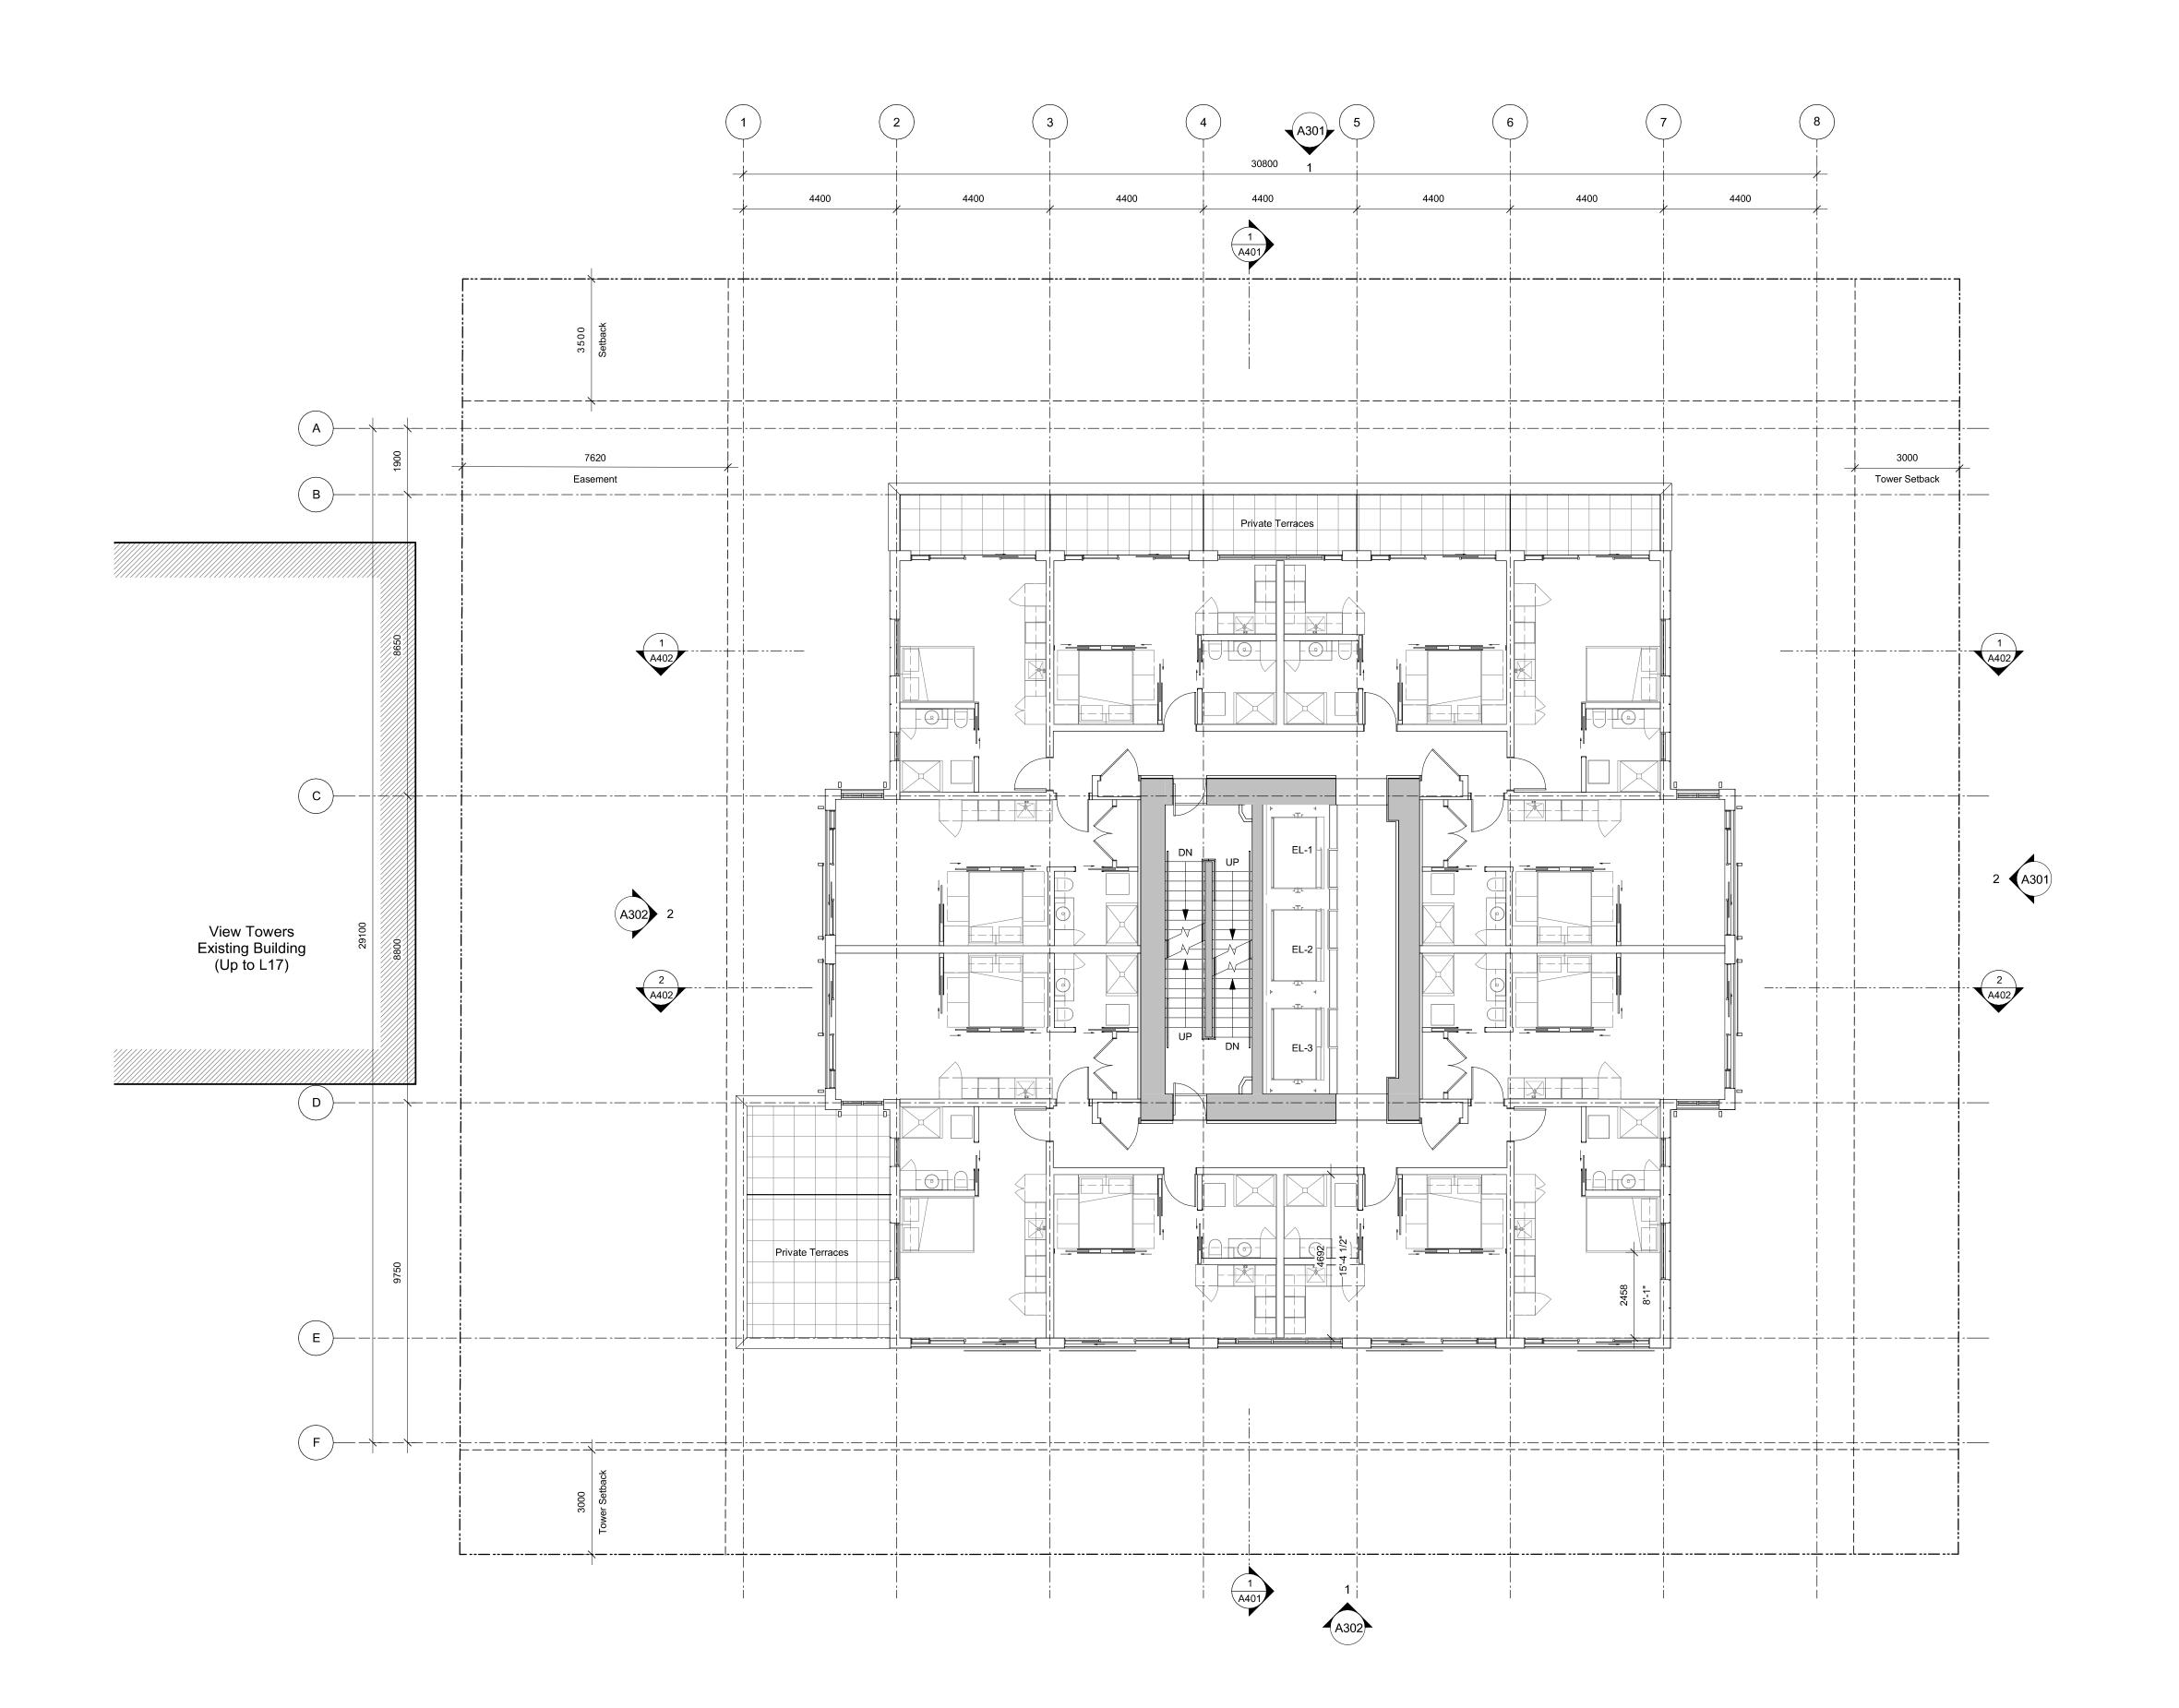

 Plot Date
 21-05-04
 Drawing File


 Drawn By
 RCI
 Checked By

 Scale
 1 : 100
 Project Number

View St. Residential


937 View Street

NOTE: All dimensions are shown in millimeters.

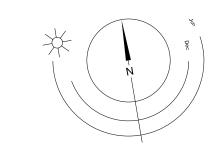



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 Plot Date
 21-05-04
 Drawing File

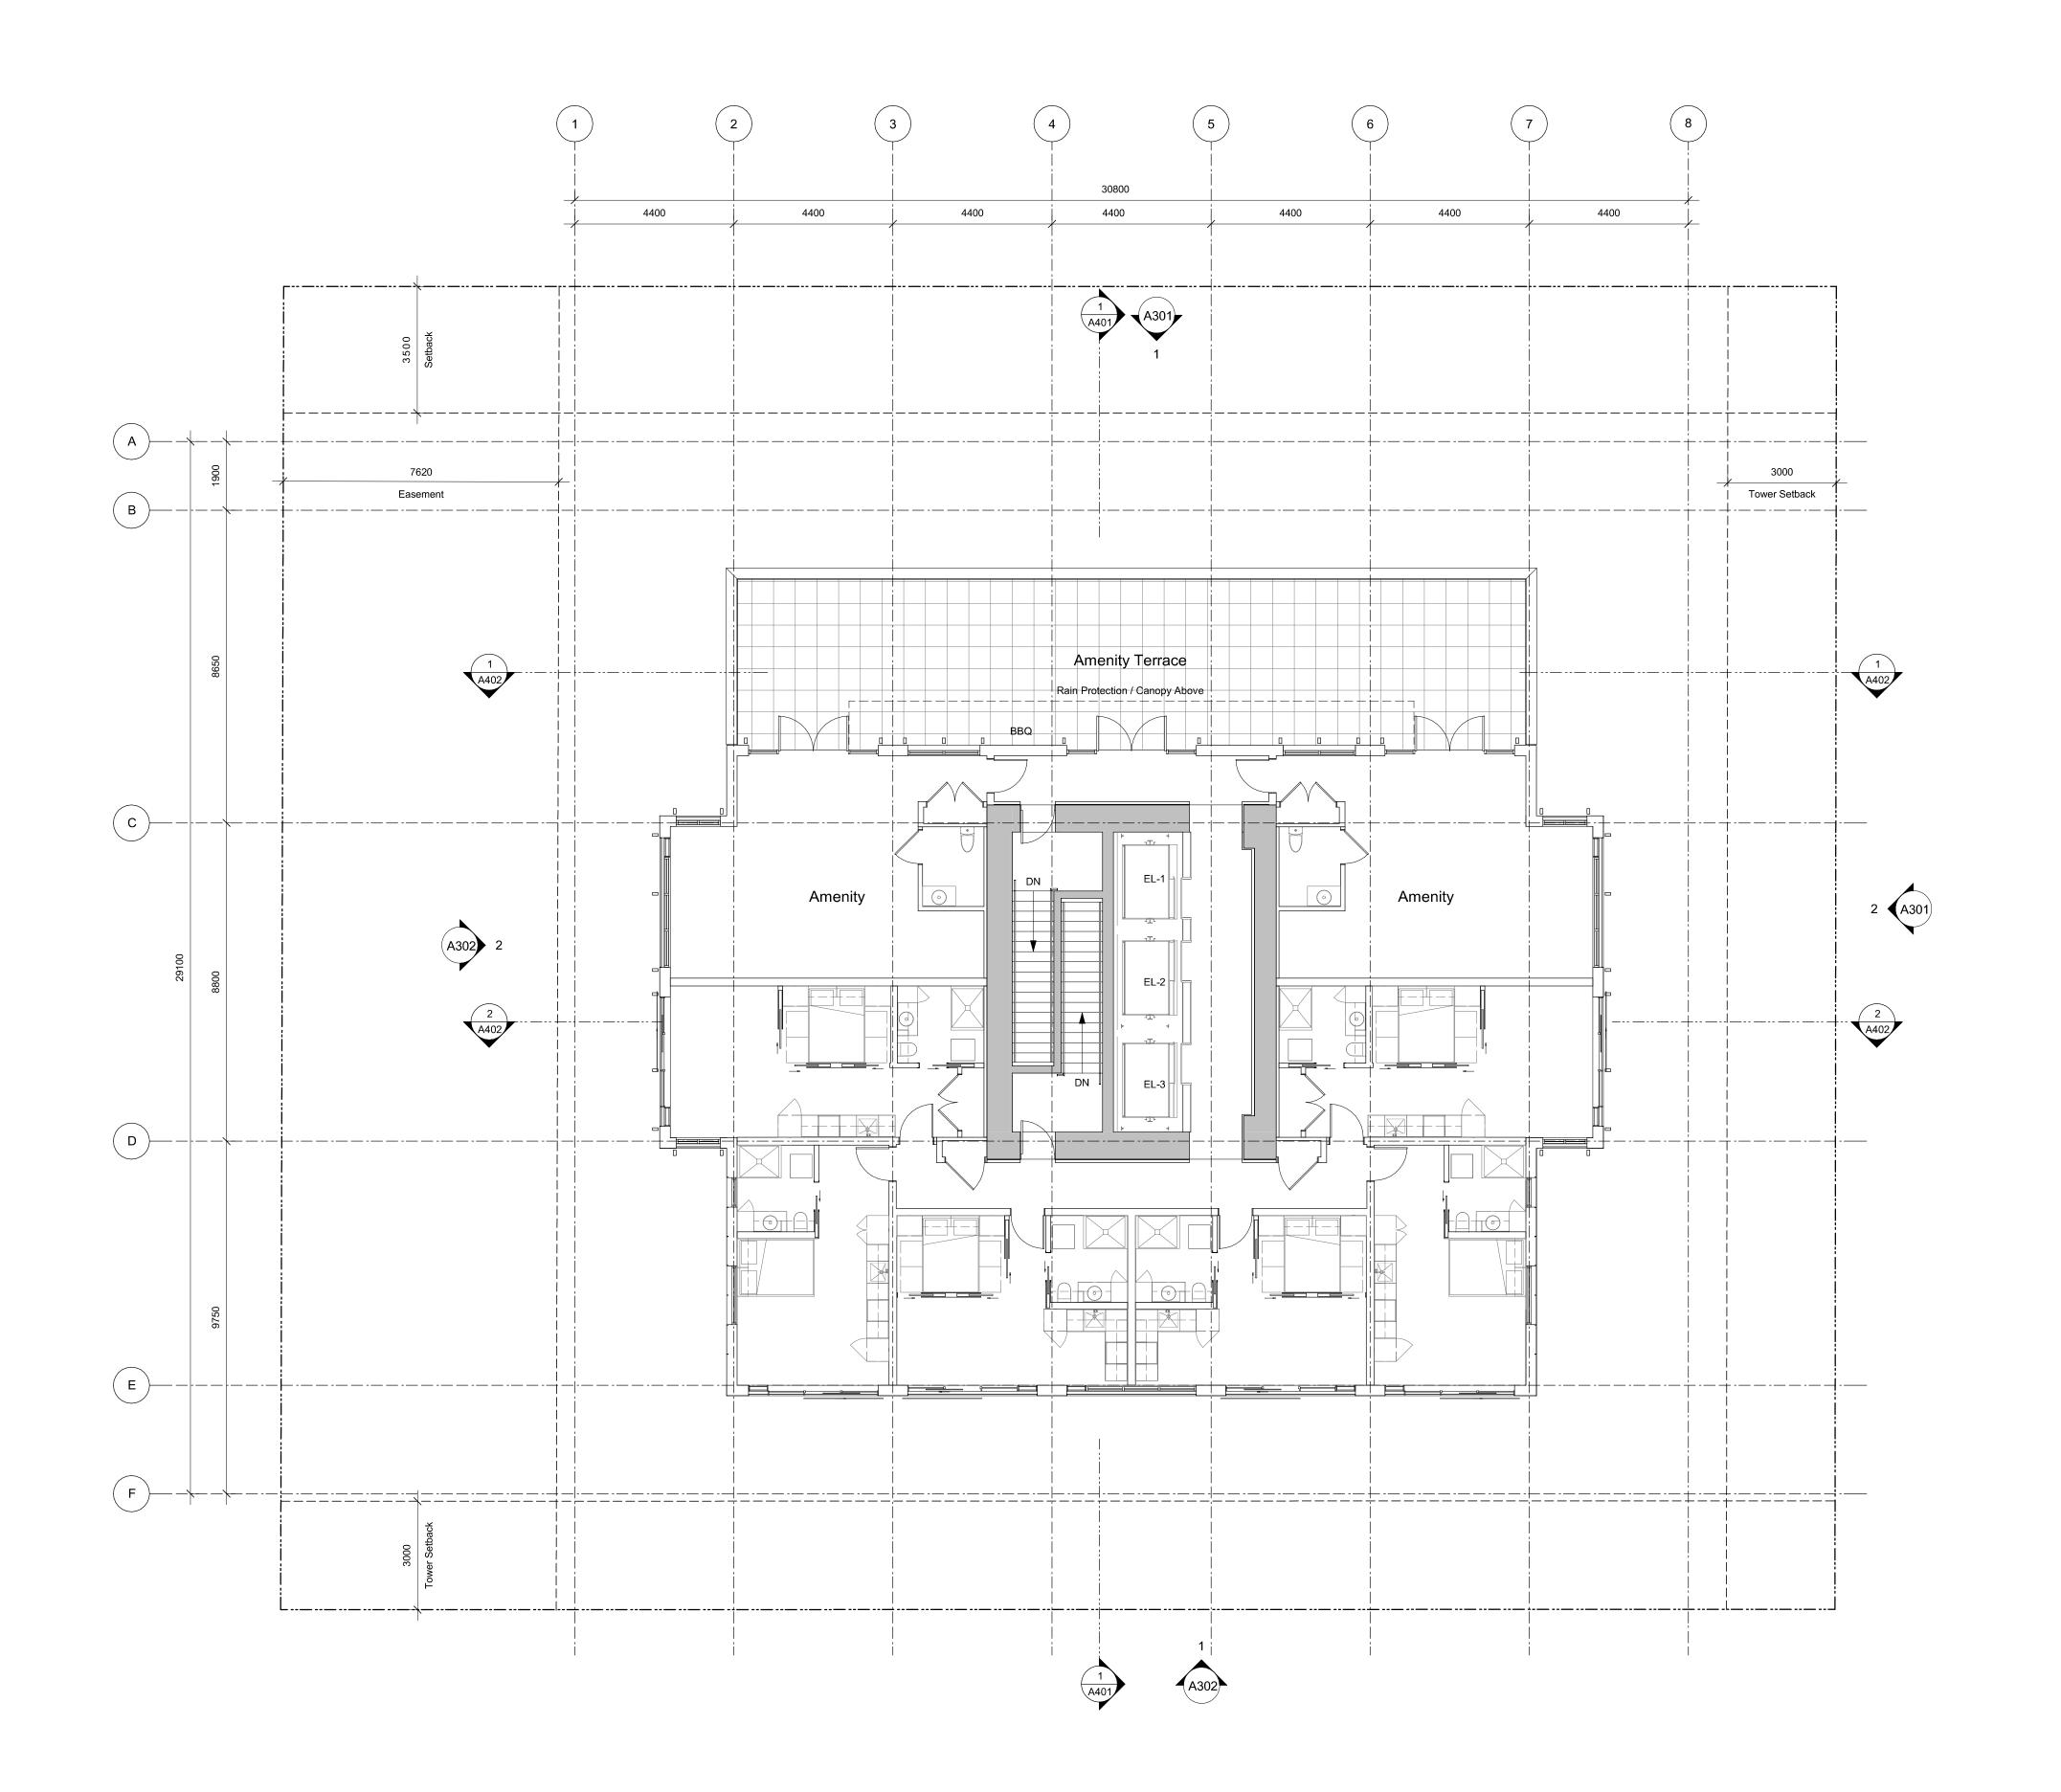 brawn By
 RCI
 Checked By


 6cale
 1:100
 Project Number

View St. Residential

937 View Street


NOTE: All dimensions are shown in millimeters.



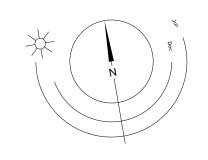



dHKarchitects Victoria

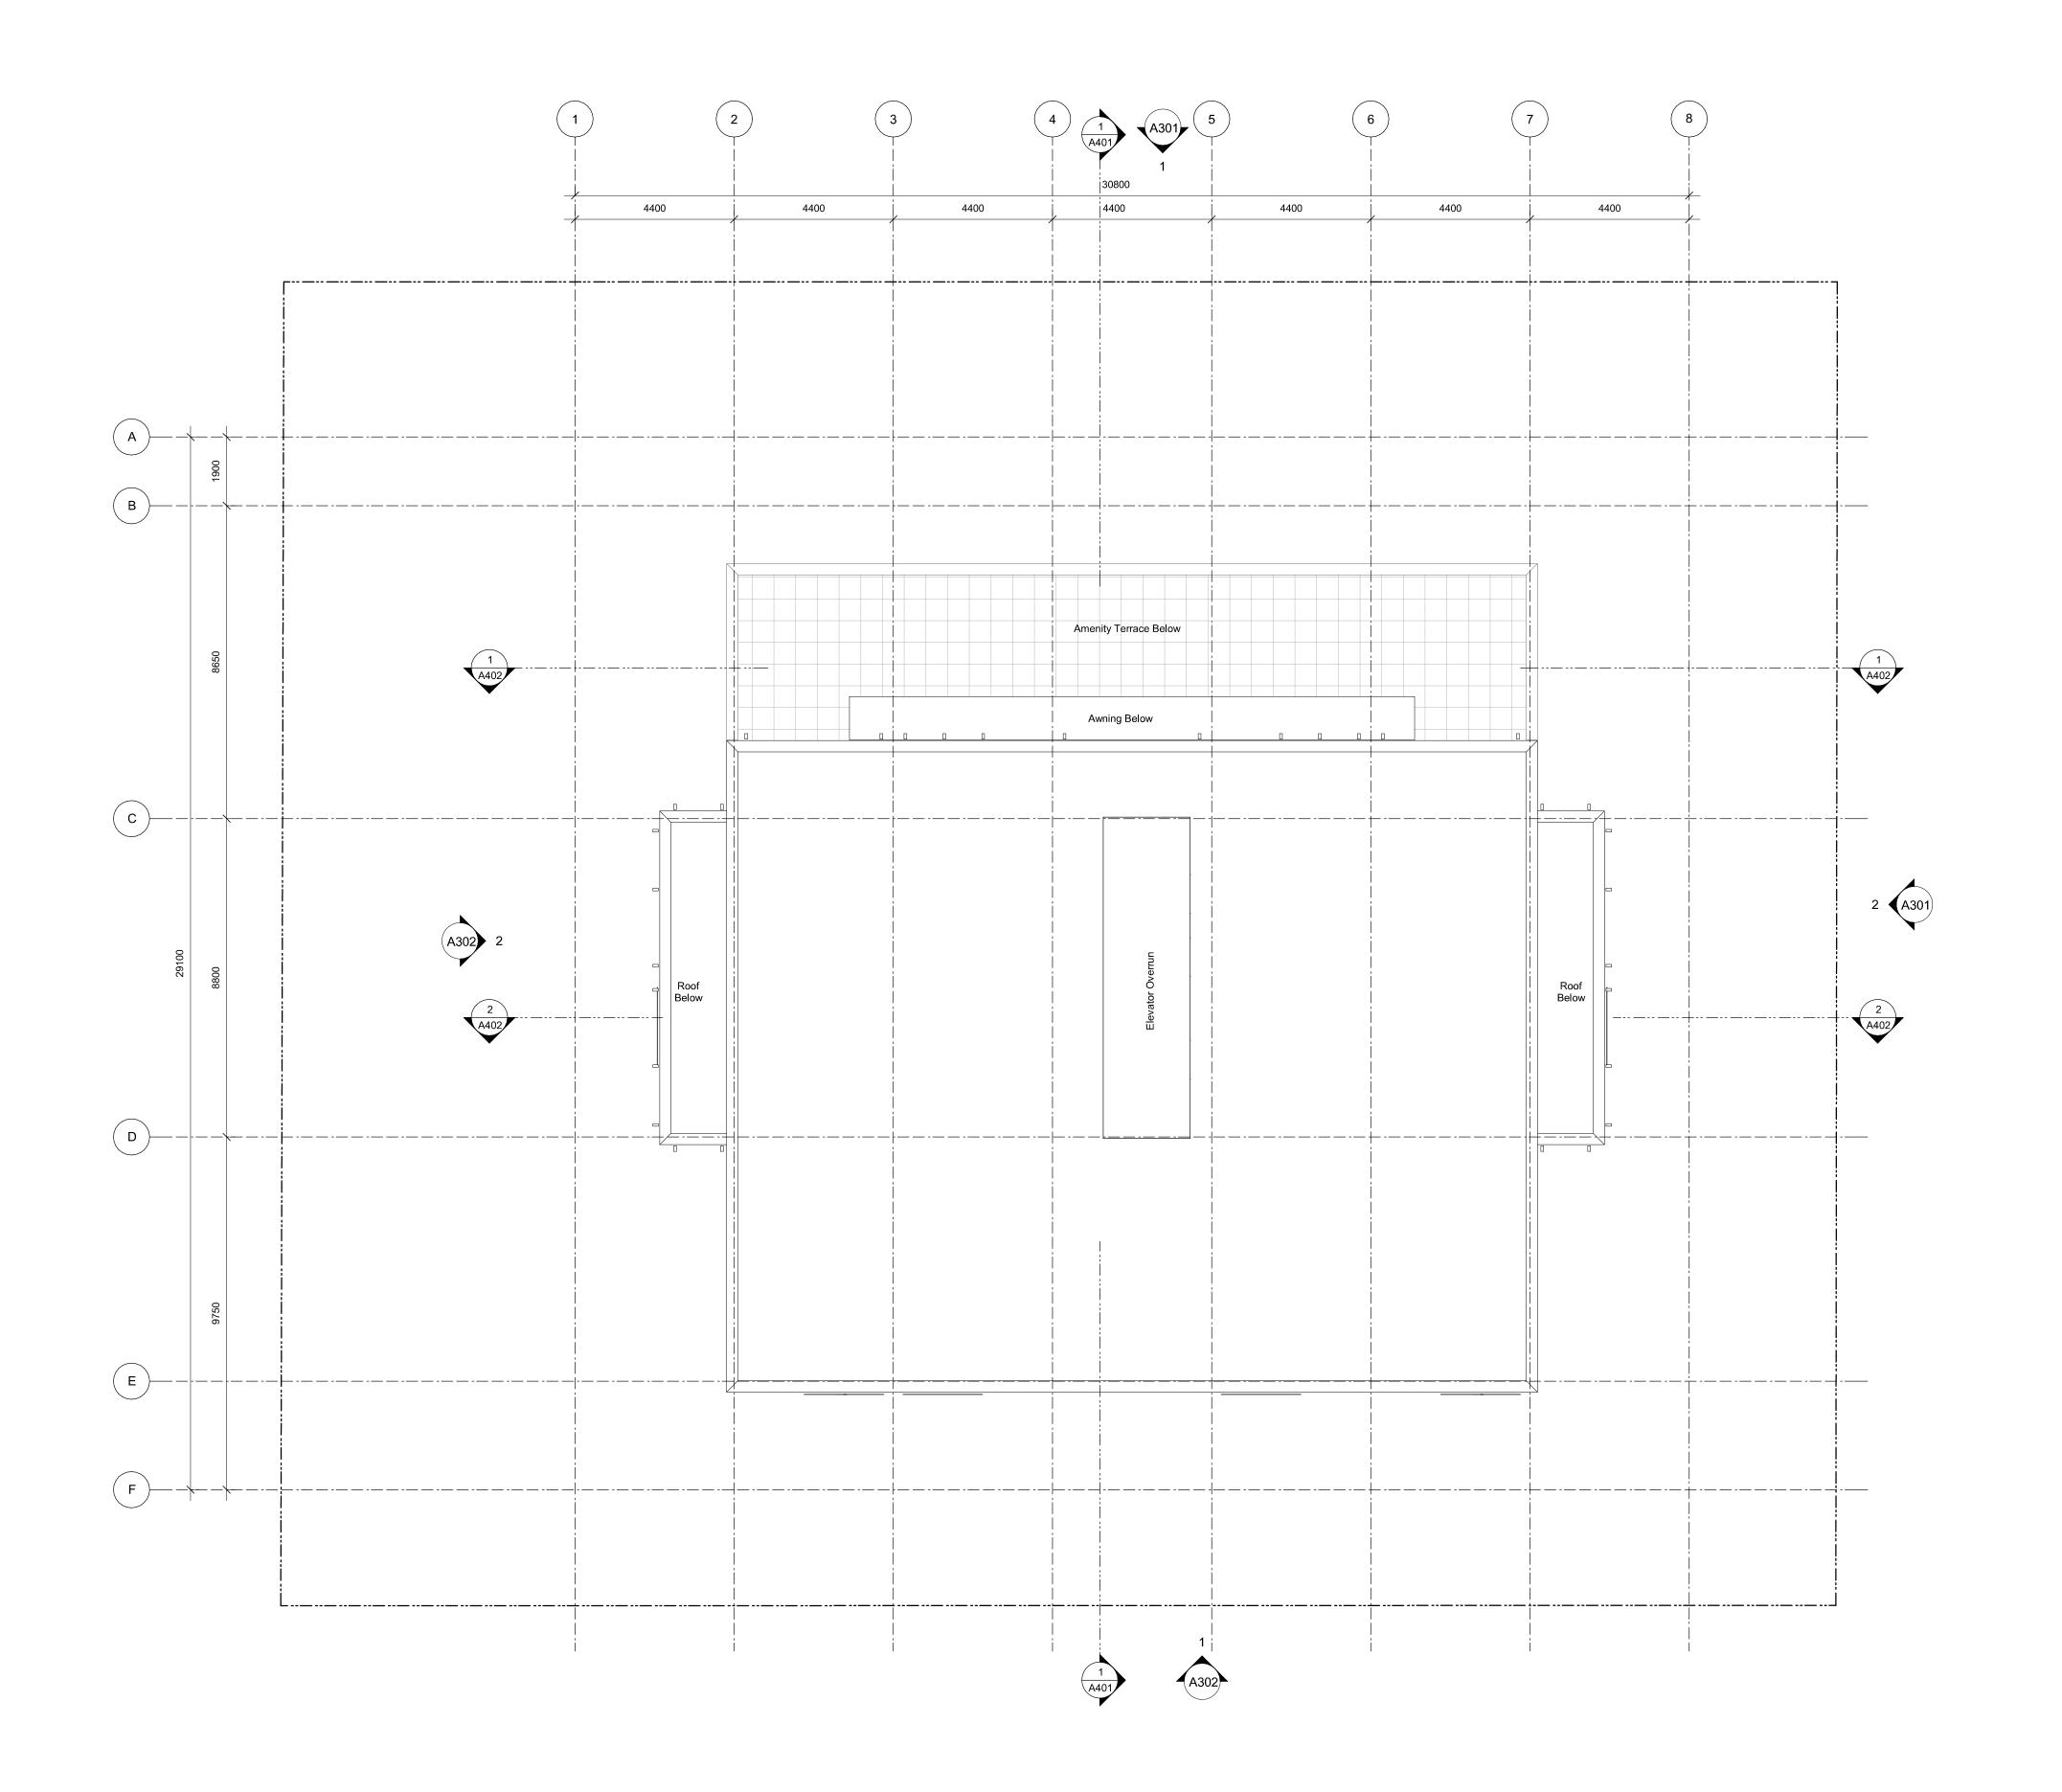

t Date 21-05-04 Drawing File

awn By RCI Checked By


1:100 Project Number

View St. Residential

937 View Street

NOTE: All dimensions are shown in millimeters.



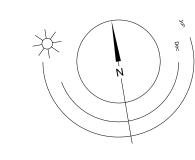



**dHKarch Victoria** 977 Fort



**Materials Schedule** 

1 Rainscreen Panel System - Gold

2 Rainscreen Panel System - Gray

3 Fibre Cement Panel - Beige

Fibre Cement Panel - Taupe

22ga. Prefinished Metal Flashing / Fascia to Match Siding

6 Solar Shading Device - Gold

7 Prefinished Metal Louvred Panel - Black

8 Juliette Balcony with Tempered Glass Guard

Tempered and Laminated Glass Guardrail with Anodized Aluminum Caprail

Low-e, Insulated Glass Anodized Aluminum Framed Window

Low-e, Insulated, Frosted Glass Anodized Aluminum Framed Window

Low-e, Insulated Glass with Safety Film Sliding Glass Door

Low-e, Insulated Glass with Coloured Film Tint Window Wall System - Colour to be Specified by Architect

14 Low-e, Insulated Glass Window Wall System

Tempered Translucent Glass Privacy Screen with Clear Anodized Aluminum Frame

16 Architectural Exposed Concrete

17 Decorative Concrete Wall

18) Wood Door with View Lite

19 Sectional Aluminum Overhead Garage Door

20 Painted Metal Fence

Issued for DP Revisions 3 21-05-04 20-08-12 Issued for DP Revisions 2 20-01-08 Issued for DP Revisions 1 19-10-02 Issued for DP

21-05-04 Drawing File

View St. Residential

NOTE: All dimensions are shown in millimeters





A301

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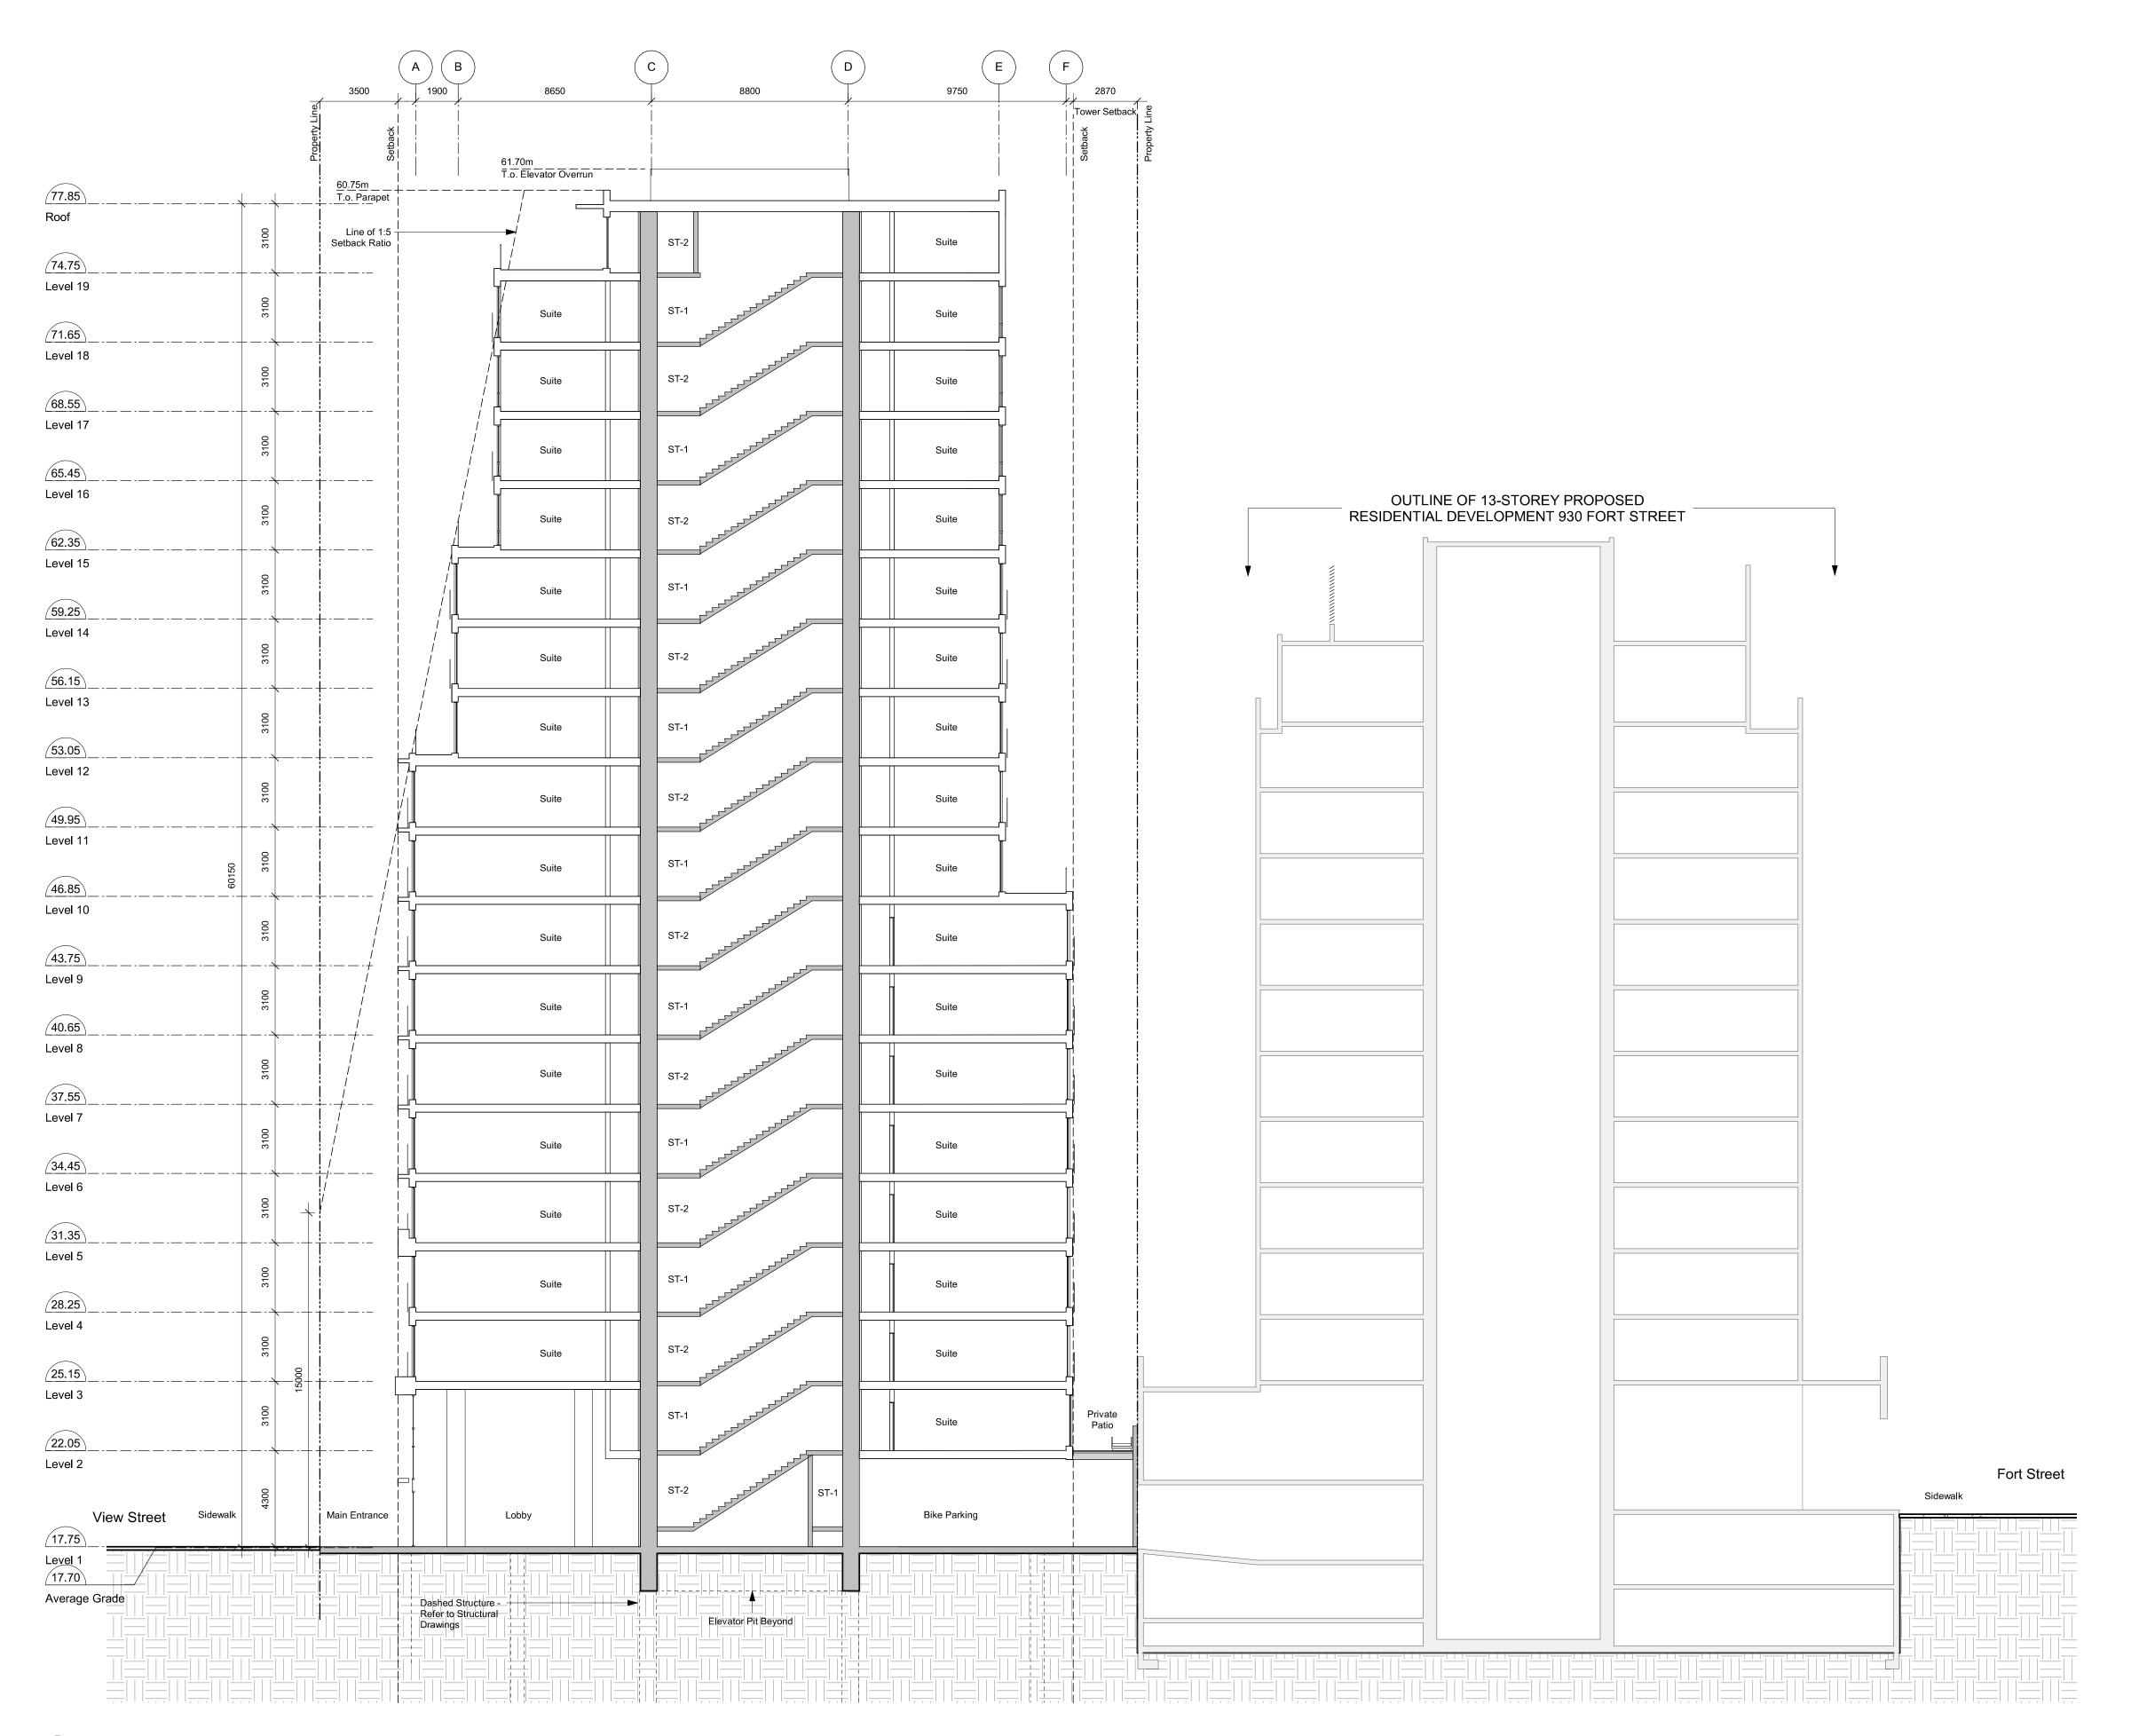
dHKa A302

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 Victoria
 977 Fort Street
 V8V 3K3
 T 1•250•658•3367

 Nanaimo
 102-5190 Dublin Way
 V9T 0H2
 T 1•250•585•5810

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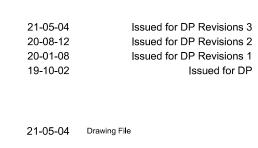


1 Building Section - North/South

A401 SCALE: 1 : 150

#### **General Notes**

- 930 Fort Street outline based on Development Permit 5th Resubmission dated 2018-05-16.
- 1124 Vancouver Street, 953 View Street, 941 View Street outline based on Development Permit Submisison dated 2021-03-17.
- 3. 937 View Street outline is to exterior face of sheathing, allowing for rainscreen and comice projections.



NOTE: All dimensions are shown in millimeters.

View St. Residential







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|                         |               | 8              | 4400  | 7 4400 | 4400  | 4400   | 4 4400 | 3 4400 | 2 1      | 7000  |
|-------------------------|---------------|----------------|-------|--------|-------|--|--------|--------|----------|---|
|                         | Property Line | - <del> </del> | _     |        |       |  |        |        |          | Fasement Page 1                                 |
| 77.85<br>oof<br>74.75   | 3100          | _              |       |        |       | Amenity Terrace                              |        |        |          | <u>57.50m</u><br>T.o. Parapet                   |
| evel 19<br>71.65        | 3100          | _              | I     | Suite  | Suite |  | Suite  | Suite  |          | Existing View Towers                            |
| vel 18                  | 3100          | _              |       | Suite  | Suite |  | Suite  | Suite  |          |   |
| vel 17                  | 3100          | _              | I     | Suite  | Suite |  | Suite  | Suite  |          |   |
| vel 16                  | 3100          | _              |       | Suite  | Suite |  | Suite  | Suite  |          |   |
| vel 15<br>9.25          | 3100          | _              | I     | Suite  | Suite | Suite  | Suite  | Suite  |          |   |
| 7el 14                  | 3100          | _              |       | Suite  | Suite | Suite  | Suite  | Suite  |          |   |
| .05<br>.el 12           | 3100          | _              |       | Suite  | Suite | Suite  | Suite  | Suite  |          |   |
| 95el 11                 | 3100          | _              |       | Suite  | Suite | Suite  | Suite  | Suite  | Suite    |   |
| .85<br>el 10            | 3100          | _              |       | Suite  | Suite | Suite  | Suite  | Suite  | Suite    |   |
| .75<br>el 9             | 3100          |                | Suite | Suite  | Suite | Suite  | Suite  | Suite  | Suite    |   |
| .65<br>el 8             | 3100          |                | Suite | Suite  | Suite | Suite  | Suite  | Suite  | Suite    |   |
| Proposed Building .55   | 3100          |                | Suite | Suite  | Suite | Suite  | Suite  | Suite  | Suite    |   |
| 1.45<br>vel 6           | 3100          |                | Suite | Suite  | Suite | Suite  | Suite  | Suite  | Suite    |   |
| .35<br>vel 5            | 3100          |                | Suite | Suite  | Suite | Suite  | Suite  | Suite  | Suite    |   |
| 3.25<br>vel 4           | 3100          | _ [            | Suite | Suite  | Suite | Suite  | Suite  | Suite  | Suite    |   |
| 5.15<br>vel 3           | 3100          |                | Suite | Suite  | Suite | Suite  | Suite  | Suite  | Suite    |   |
| 2.05 vel 2              | 3100          | _              | Suite | Suite  | Suite |  |        | Suite  | Suite    |   |
| 7.75                    | 4300          |                | Suite | Suite  | Suite | Lol  | oby    | Ame    | enity #F | Lane ROW  |
| vel 1 7.70 verage Grade |               |                |       |        |       | <u>'                                    </u> |        |        |          | Dashed Structure - Refer to Structural Drawings |

1 Building Section - East/West 1
A402 SCALE: 1:150

2 Building Section - East/West 2
A402 SCALE: 1: 150

#### **General Notes**

4400

4400

Suite

Elec. Comm

4400

74.75

Level 19

71.65

Level 18

68.55

Level 17

Level 16

62.35

Level 15

59.25

Level 14

56.15

Level 13

53.05

Level 12

49.95

Level 11

46.85

43.75

Level 9

40.65

Level 8

Proposed \_ Building \_

Level 7

34.45 Level 6

31.35 Level 5

28.25 Level 4

25.15

Level 3

22.05

Level 2

17.75

Level 1

17.70

Average Grade\_

4400

Suite

Bike Parking

Parking Access

Dashed Structure - Refer to Structural Drawings

Easement

Existing View Towers -

\_\_\_\_\_<u>60.60m</u> T.o. Parapet

- 930 Fort Street outline based on Development Permit 5th Resubmission dated 2018-05-16.
- 1124 Vancouver Street, 953 View Street, 941 View Street outline based on Development Permit Submisison dated 2021-03-17.
- 937 View Street outline is to exterior face of sheathing, allowing for rainscreen and cornice projections.

21-05-04 Issued for DP Revisions 3 20-08-12 Issued for DP Revisions 2 20-01-08 Issued for DP Revisions 1 19-10-02 Issued for DP

t Date 21-05-04 Drawing File awn By RCI Checked By

Scale As indicated Project Number

NOTE: All dimensions are shown in millimeters.

View St. Residential

937 View Street ARC







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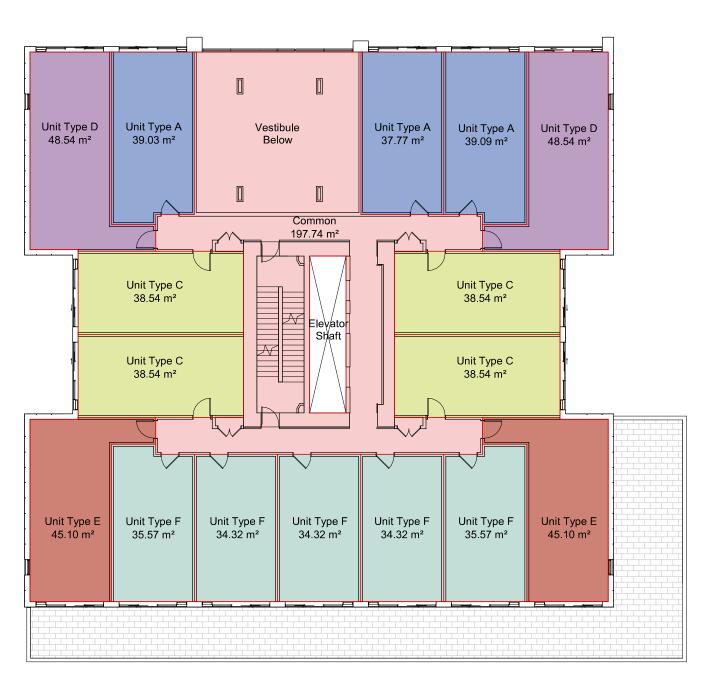
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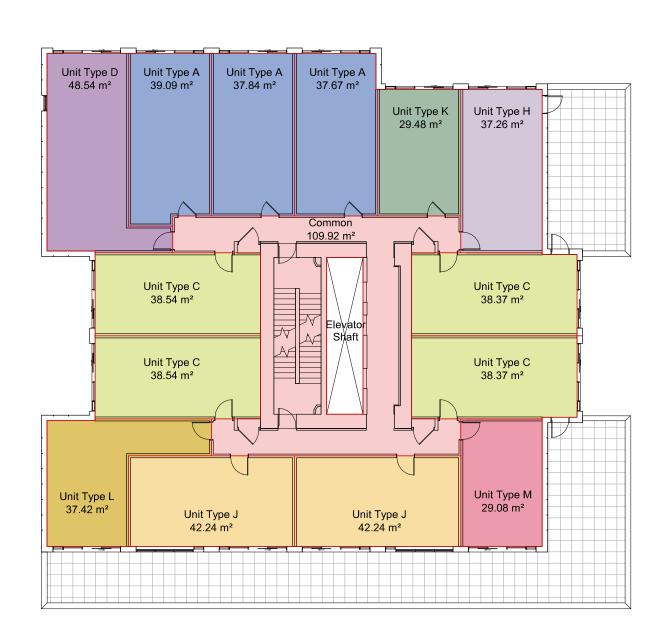
4 Level L5-L9 Area Plan A911 SCALE: 1:200




7 Level L15-L18 Area Plan A911 SCALE: 1:200

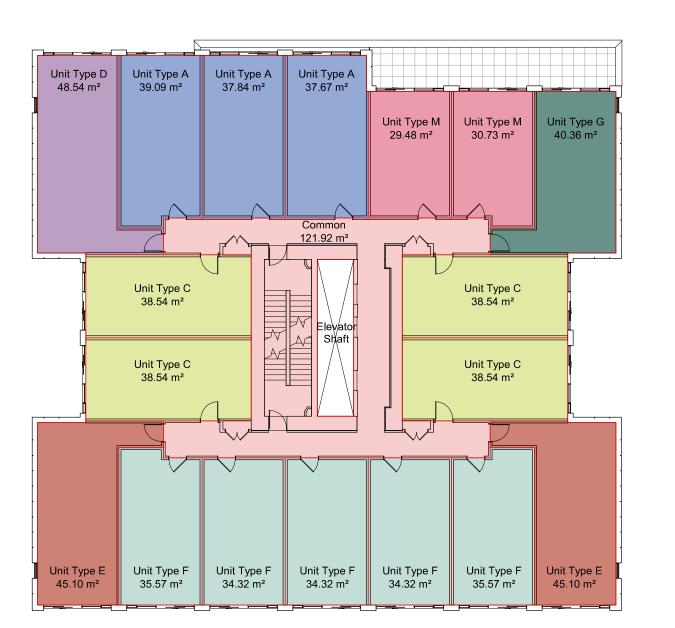


2 Level L2 Area Plan A911 SCALE: 1:200

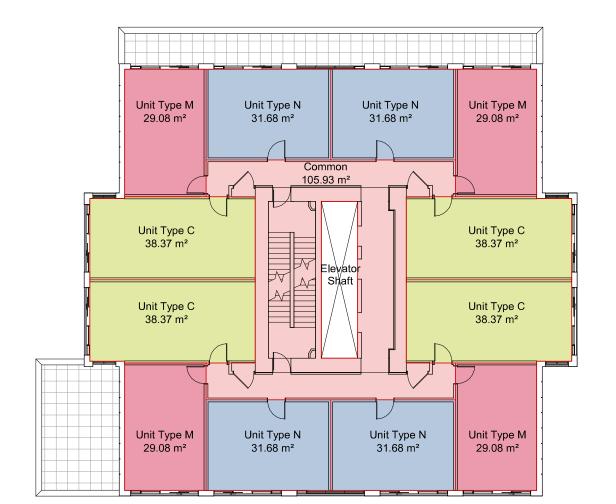


5 Level L10-L11 Area Plan A911 SCALE: 1:200

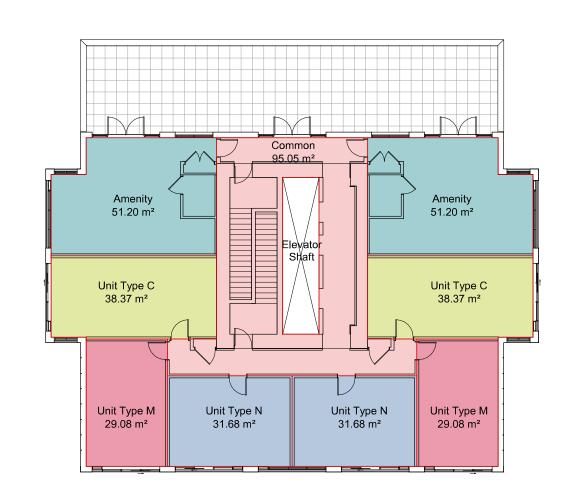

8 Level 19 Area Plan A911 SCALE: 1:200

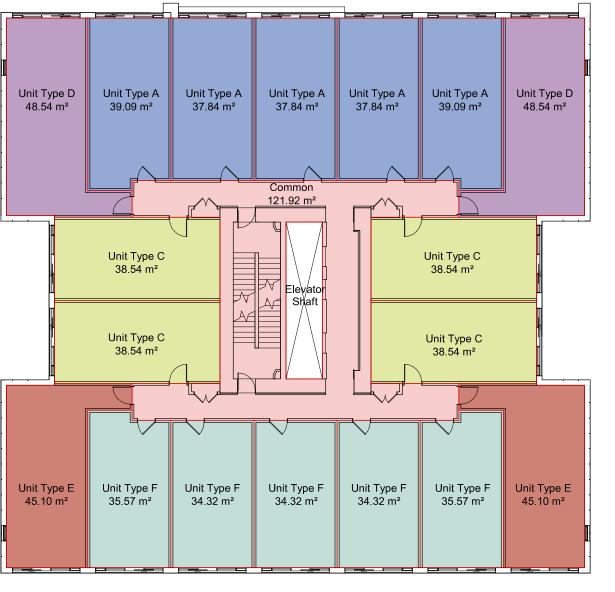

3 Level L3-L4 Area Plan A911 SCALE: 1:200

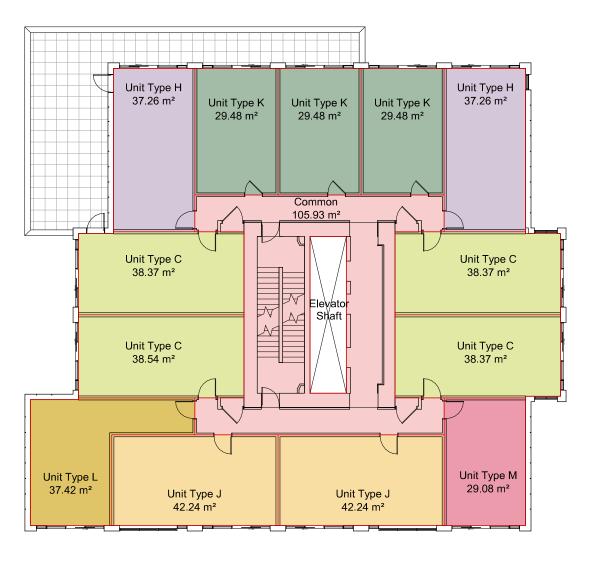

6 Level L12-L14 Area Plan A911 SCALE: 1:200

#### AREA SCHEDULE

City Zoning GFA

Ammenity

**Efficiency** 

Totals
Total GFA

Total Amenity

Efficiency

Total Commercial

Total Common & Core

Residential Strata

**Residential Common** 

| Description                      | Zoning (m <sup>2</sup> ) | Zoning (SF) | No. Suites |
|----------------------------------|--------------------------|-------------|------------|
| Level 1                          | •                        |             |            |
| City Zoning GFA                  | 621 m²                   | 6684 SF     |            |
| Residential Strata               | 74 m²                    | 795 SF      | 3          |
| Residential Common               | 547 m²                   | 5890 SF     |            |
| Efficiency                       | 11.9%                    |             |            |
| Level 2                          |                          |             |            |
| City Zoning GFA                  | 829 m²                   | 8923 SF     |            |
| Residential Strata               | 630 m²                   | 6777 SF     | 16         |
| Residential Common               | 199 m²                   | 2146 SF     |            |
| Efficiency                       | 75.9%                    | 75.95%      |            |
| Levels 3-4                       |                          |             |            |
| City Zoning GFA                  | 829 m²                   | 8923 SF     |            |
| Residential Strata               | 705 m²                   | 7593 SF     | 36         |
| Residential Common               | 124 m²                   | 1330 SF     |            |
| Efficiency                       | 85.1%                    | 85.09%      |            |
| Levels 5-9                       |                          |             |            |
| City Zoning GFA                  | 804 m²                   | 8654 SF     |            |
| Residential Strata               | 680 m²                   | 7324 SF     | 90         |
| Residential Common               | 124 m²                   | 1330 SF     |            |
| Efficiency                       | 84.6%                    | 84.63%      |            |
| Levels 10-11                     |                          |             |            |
| City Zoning GFA                  | 644 m²                   | 6932 SF     |            |
| Residential Strata               | 531 m²                   | 5717 SF     | 28         |
| Residential Common               | 113 m²                   |             |            |
| Efficiency                       | 82.5%                    |             |            |
| Levels 12-14                     |                          |             |            |
| City Zoning GFA                  | 573 m²                   | 6168 SF     |            |
| Residential Strata               | 464 m²                   |             |            |
| Residential Common               | 109 m²                   |             |            |
| Efficiency                       | 80.9%                    | 80.92%      |            |
| Levels 15-18                     |                          |             |            |
| City Zoning GFA                  | 502 m²                   | 5404 SF     |            |
| Residential Strata               | 393 m²                   |             | 48         |
|                                  | 109 m <sup>2</sup>       | 1176 SF     |            |
| Residential Common<br>Efficiency | 78.2%                    |             |            |

396 m<sup>2</sup>

205 m<sup>2</sup>

86 m²

105 m<sup>2</sup>

78.2%

12539 m²

1572 m²

7.975

9745 m²

105 m²

0 m²

2689 m²

78.56%

4263 SF

2203 SF

1129 SF

78.19%

134970 SF

104898 SF

1129 SF

28942 SF

78.56%

0 SF

16924 SF 7.975

930 SF

21-05-04 Issued for DP Revisions 3 20-08-12 Issued for DP Revisions 2 20-01-08 Issued for DP Revisions 1

Plot Date 21-05-04 Drawing File

Drawn By RCI Checked By AE

Scale As indicated Project Number 19

NOTE: All dimensions are shown in millimeters.

View St. Residential

General Notes

demising walls.

2. See A001 for required bike counts.

wall finish on all sides.


Plans and Area Schedule show areas measured to inside face of exterior walls, and centre of

Unit Schedule areas measured to inside face of





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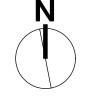
LEGEND — · · — Property line — .. — .. – Extent Of Underground Parking (indicative) **\_\_\_\_** Extent Of Roof / Canopy Line (indicative) ---- Rain garden TOP OF POOL Rain garden BOTTOM OF POOL <sup>2</sup> Architectural grade, provided for reference only e-17.62 Civil grade, provided for reference only • 17.75 Proposed landscape grade TV Top of Wall BV Bottom of Wall T( Top of Curb B( Rottom of Curb TF Top of Pool Bf Bottom of Pool T: Top of Stairs B: Bottom of Stairs UNDERGROUND UTILITIES **EXISTING** PROPOSED Storm drain Electrical LANDSCAPE MATERIALS Main Entry Paving Concrete Unit Paving Patio Pavine Concrete Unit Paving **Driveway Paving** Vehicular Concrete Unit Paving, natural/light colour Driveway Paving Vehicular Concrete Unit Paving, charcoal/dark colour Cast in place concrete paving Shrub/ Tree Planting Area on Grade Minimum 450 mm depth growing medium Rain Garden Area on Grade Raised Planting Area Growing medium depth vaires, minimum 450 mr. LANDSCAPE FURNISHINGS Type H Wood Bench with Backrest 2 total @ 5'11.25" Length x 2'7.19" Height Type A: Modern Metal Bin

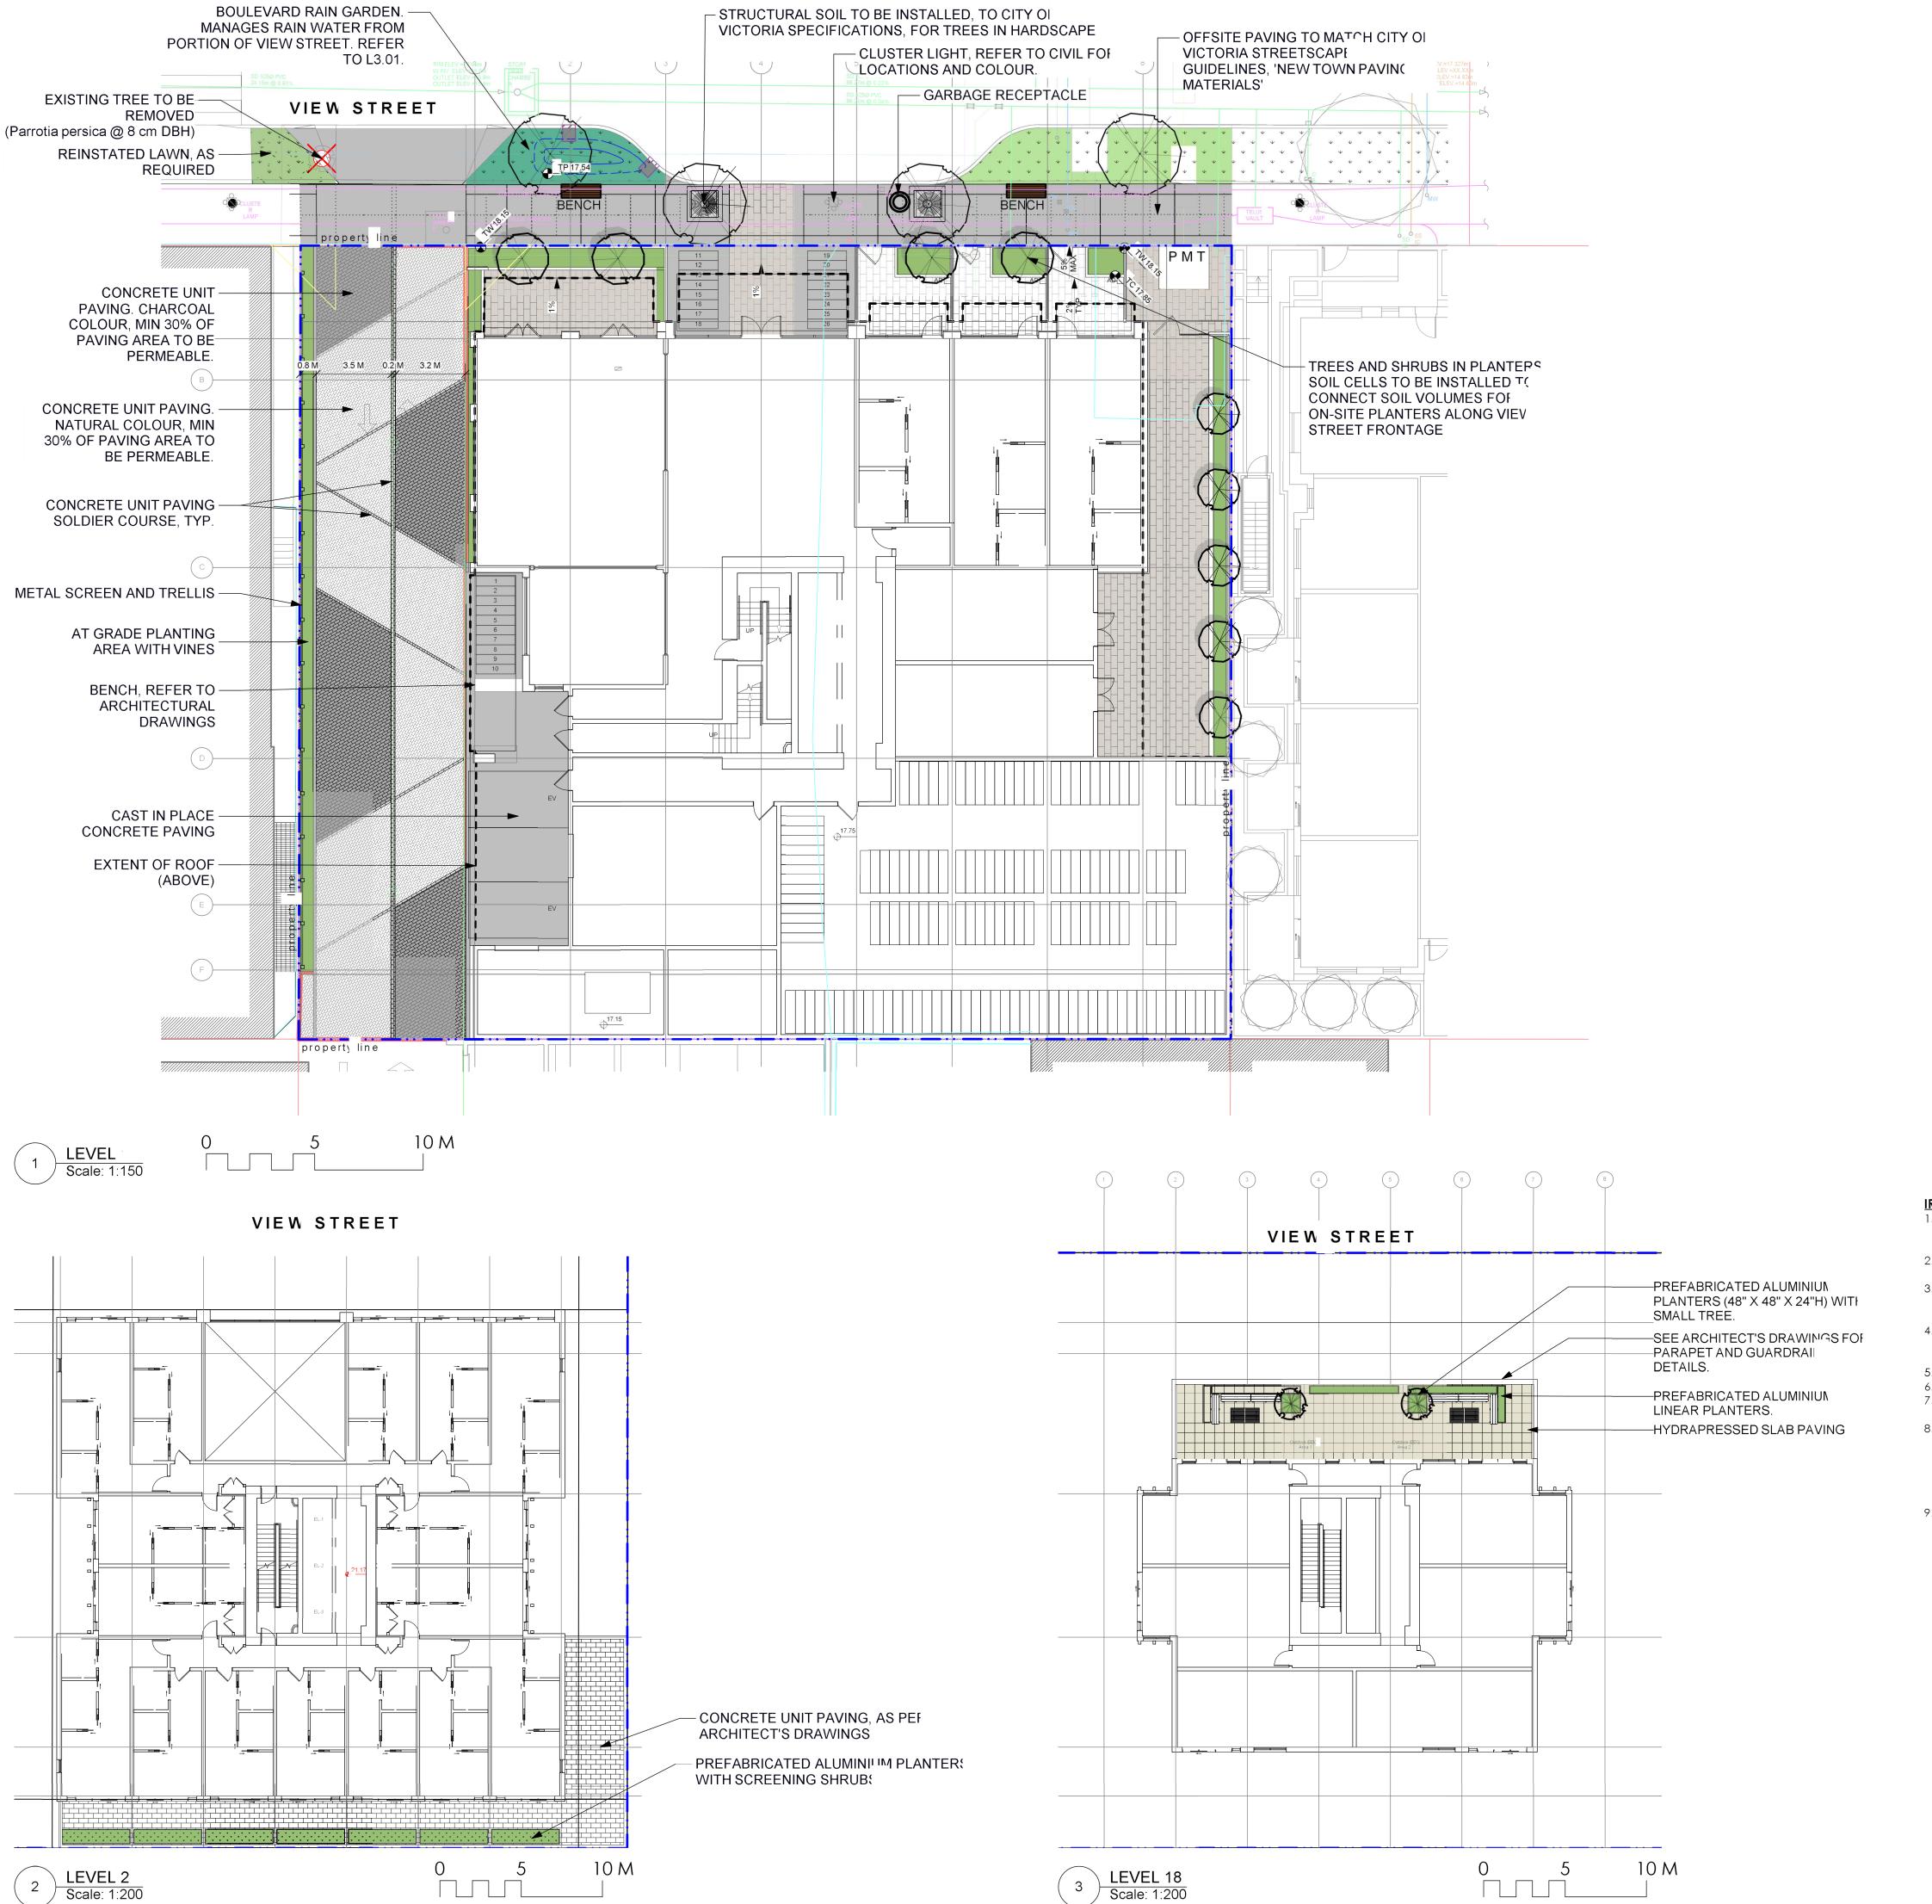**IRRIGATION NOTES** 


- 1. All specified work to meet the project specifications, and all standards or specification established in the lastest edition of the Canadian Landscape Standard and IIABC
- 2. Contractor to verify pressure and flow prior to installation of irrigation and notify owner representative in writing if such data adversely affects the operation of the system.
- 3. Sleeves shall be installed at the necessary depths, prior to pavement construction. Sleeving shall extend 300 mm from edge of paving into planting area, and shall have ends marked above grade unless otherwise shown.
- 4. Utilties Contractor to verify location of all on-site utilities, prior to construction. Resoration of damaged utilities shall be made at the contractor's expense, to the satisfaction of the owner's representatives.
- 5. Refer to mechanical drawings for irrigation point of connection.
- 6. Refer to electrical drawings for electrical service.
- 7. Contractor to field fit irrigation system around existing trees, to limit disturbance to roo
- 8. At various milestones during construction, inspection and testing of components will be required to ensure that the performance of irrigation system meets standards and specifications. Contractor to provide equipment and personnel necessary for performance of inspections and tests. Conduct all inspections and tests in the presence of the contract administrator. Keep work uncovered and accessible until successful completeition c inspection or test.
- 9. Trees within shrub or rain garden areas to be irrigated with spray heads.

## **DRAWING NOTES**

- 1. DO NOT SCALE DRAWING: Verify all property lines and existing
- structures/vegetation to remain, prior to commencing vark. 2. All plan dimensions in metres and all detail dimensions in millimetres.
- 3. Plant quantities on Plans shall take precedence over plant lis
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- services and utilities prior to start of construction.
- 5. Provide layout of all work for approval by Landscape Architec prior to proceeding with work.
- 6. Contractor to provide irrigation system for all planters to currer
- IIABC Standards and Contract Specifications. 7. Landscape installation to carry a 1 year warranty from date c
- 8. Plant material, installation and maintenance to conform to the
- current edition of the Canadian Landscape Standard. 9. General Contractor and/or sub-contractors are responsible for a costs related to production and submission to consultant of a landscape as-built information including irrigation.
- 10. Tree protection fencing, for existing trees, to be installed prior to commencement of all site work



| 1  | DP Rev                  | 21.04.30 |
|----|-------------------------|----------|
|    | Dev Permit Revisions    | 20.08.11 |
|    | Issued for DP revisions | 20.01.08 |
|    | DP REV                  | 19.10.17 |
|    | DEV PERMIT              | 17.07.07 |
| no | description             | date     |
|    |                         |          |

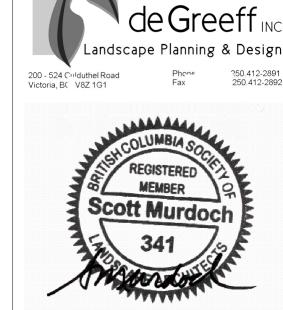

Murdoch

2021-04-30


NELSON INVESTMENTS, INC.


VIEW STREET RESIDENTIAL 937 VIEW STREET VICTORIA, BC

sheet title

Landscap **Materials** 

| project no. |           | 119.24   |
|-------------|-----------|----------|
| scale       | AS NOTED  | @ 24"x36 |
| drawn by    |           | ML       |
| checke by   |           | SM/PdG   |
| revison no. | sheet no. |          |
| <u>5</u>    | L         | 1.01     |

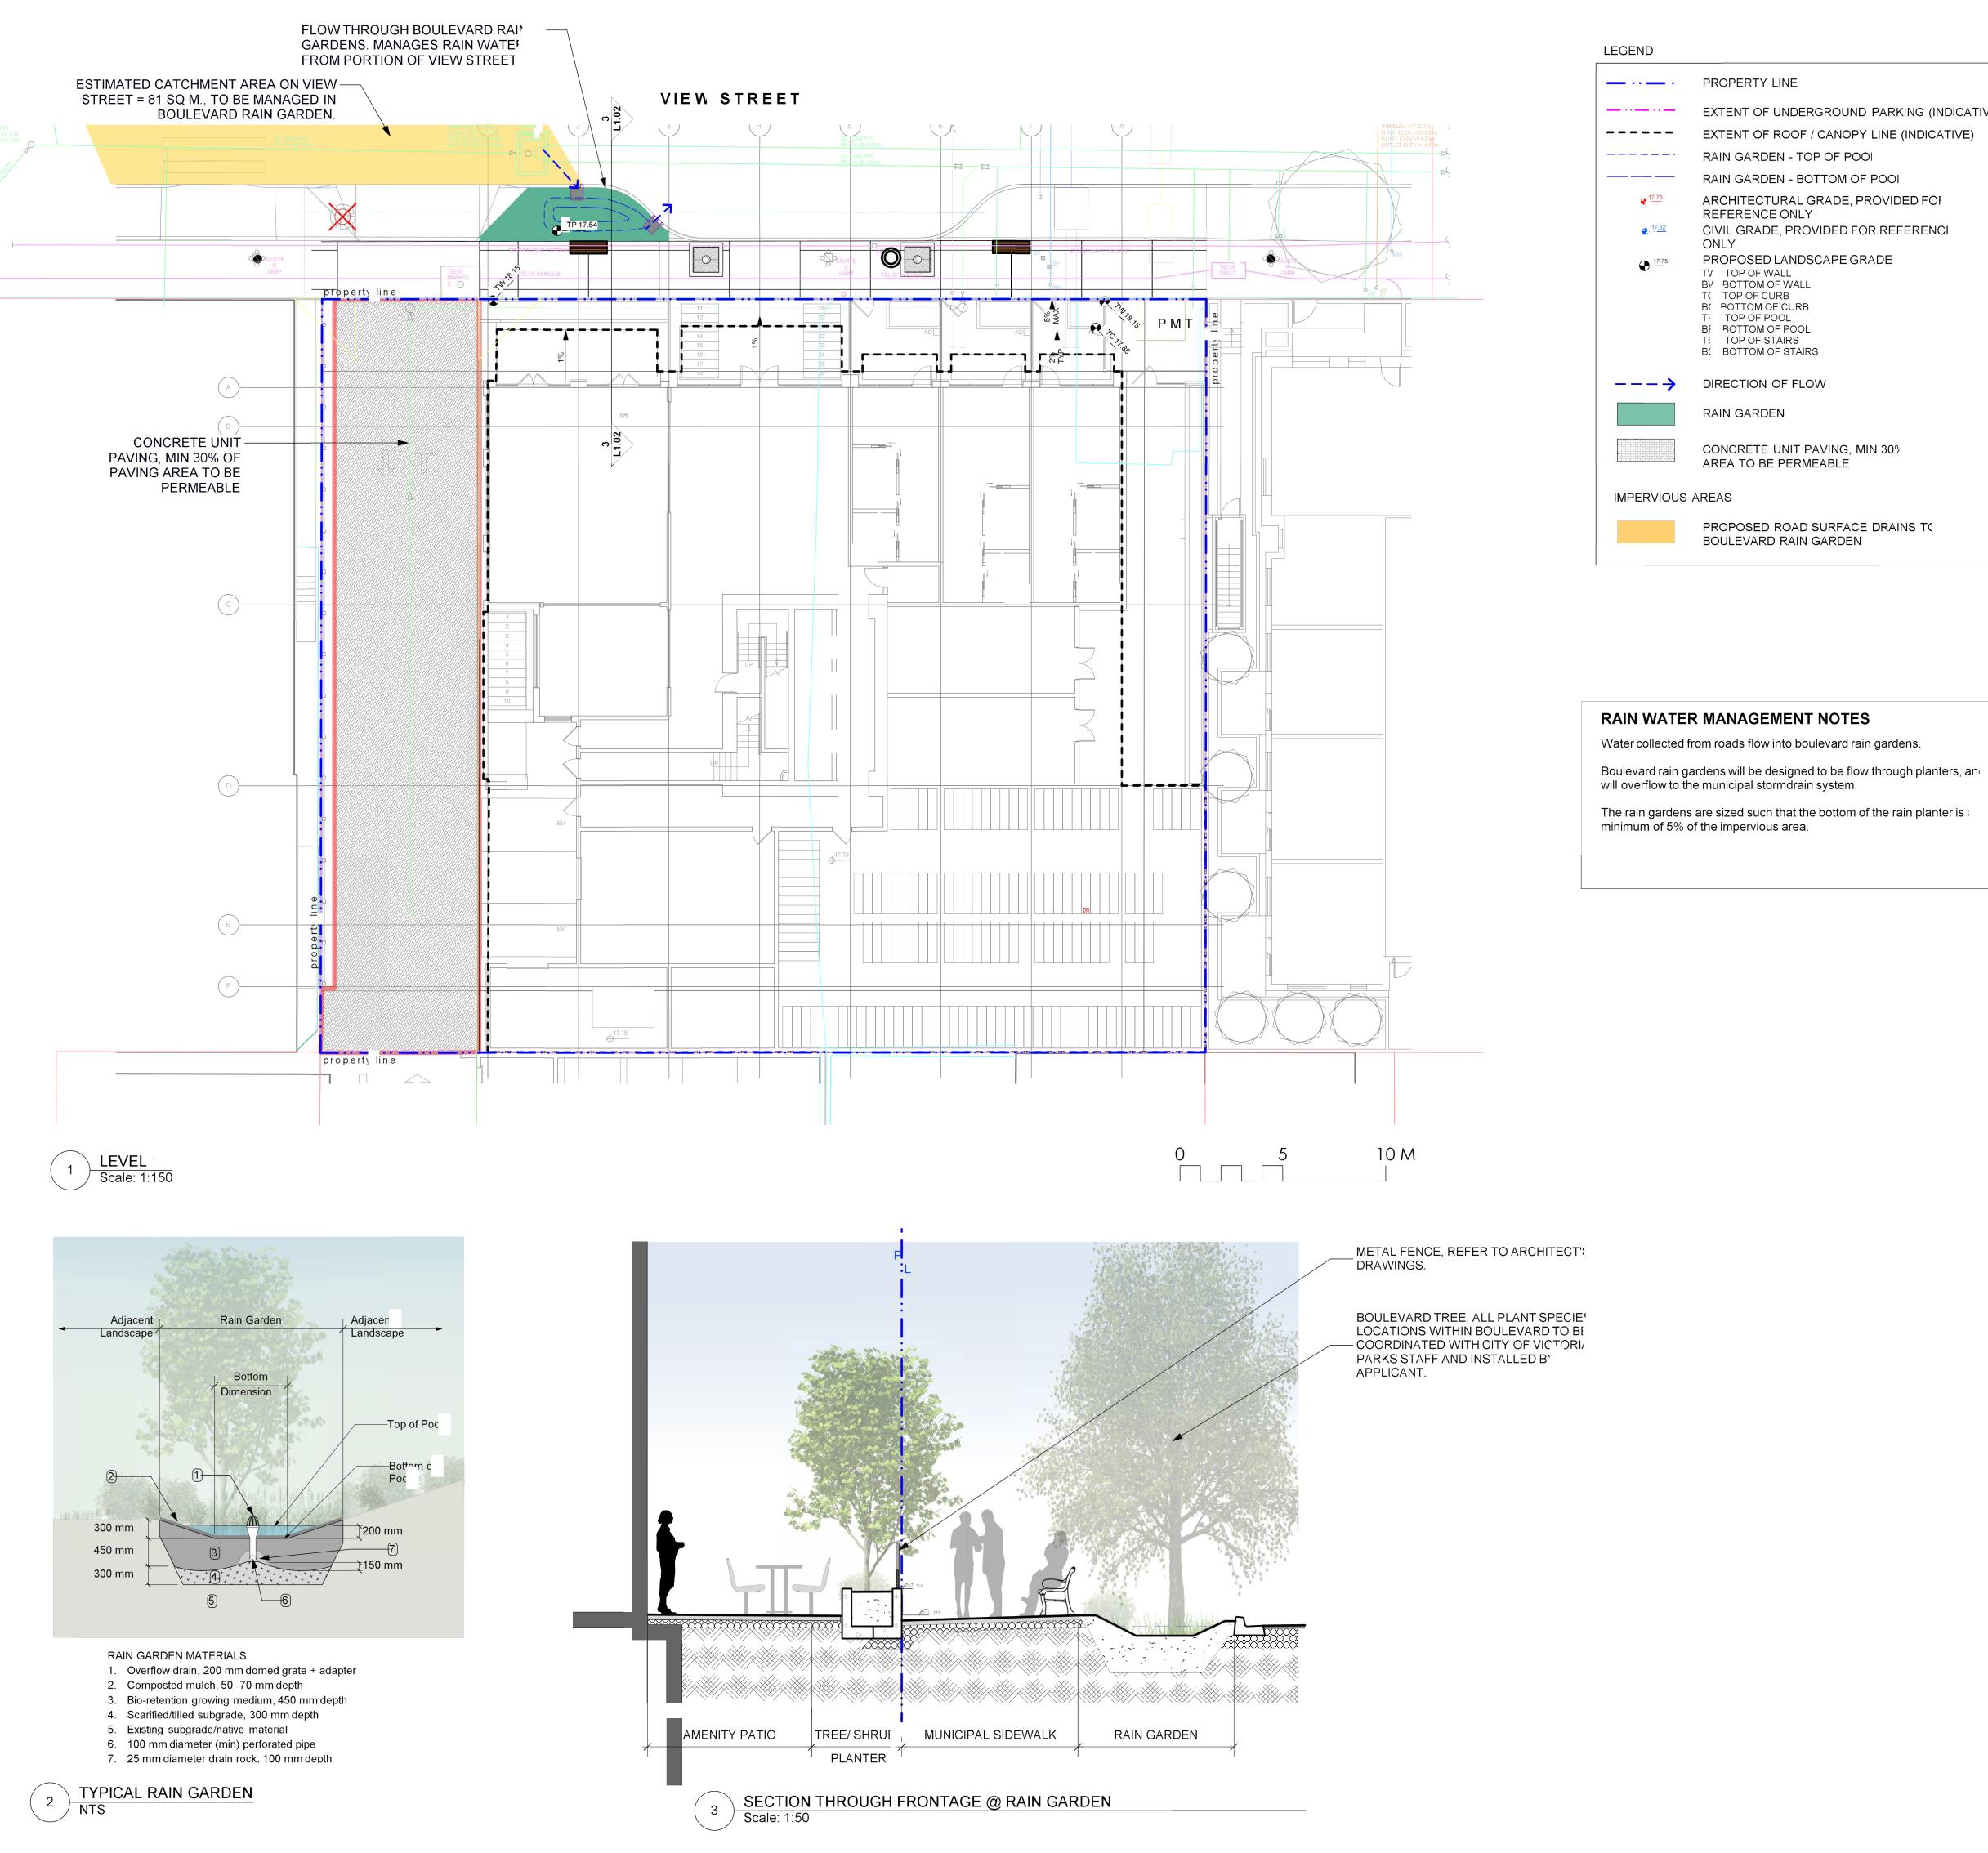

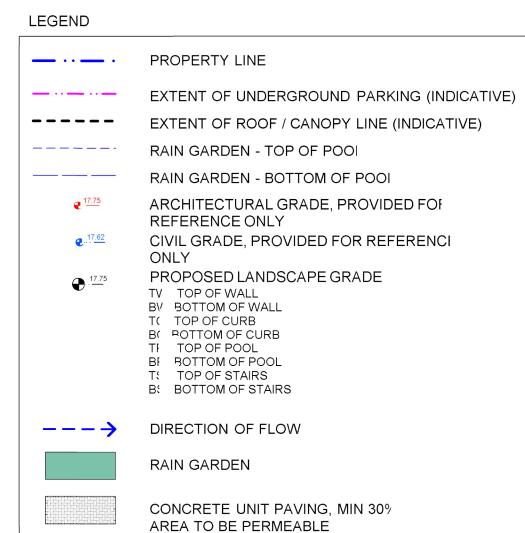


PROPOSED ROAD SURFACE DRAINS TO

BOULEVARD RAIN GARDEN

# **DRAWING NOTES**

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- landscape as-built information including irrigation. 10. Tree protection fencing, for existing trees, to be installed prior to commencement of all site work

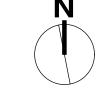

| 4     | Dev Permit Revisions    | 20.08.11 |
|-------|-------------------------|----------|
| 3     | Issued for DP revisions | 20.01.08 |
| 2     | DP REV                  | 19.10.17 |
| 1     | DEV PERMIT              | 17.07.07 |
| ev no | description             | date     |
|       |                         |          |





2021-04-30


NELSON INVESTMENTS, INC.

VIEW STREET RESIDENTIAL 937 VIEW STREET VICTORIA, BC

sheet title

Stormwate Management

| project no. |           | 119.24    |
|-------------|-----------|-----------|
| scale       | AS NOTED  | @ 24"x36" |
| drawn by    |           | ML        |
| checke by   |           | SM/PdG    |
| revison no. | sheet no. |           |
| 5           | L         | 1.02      |

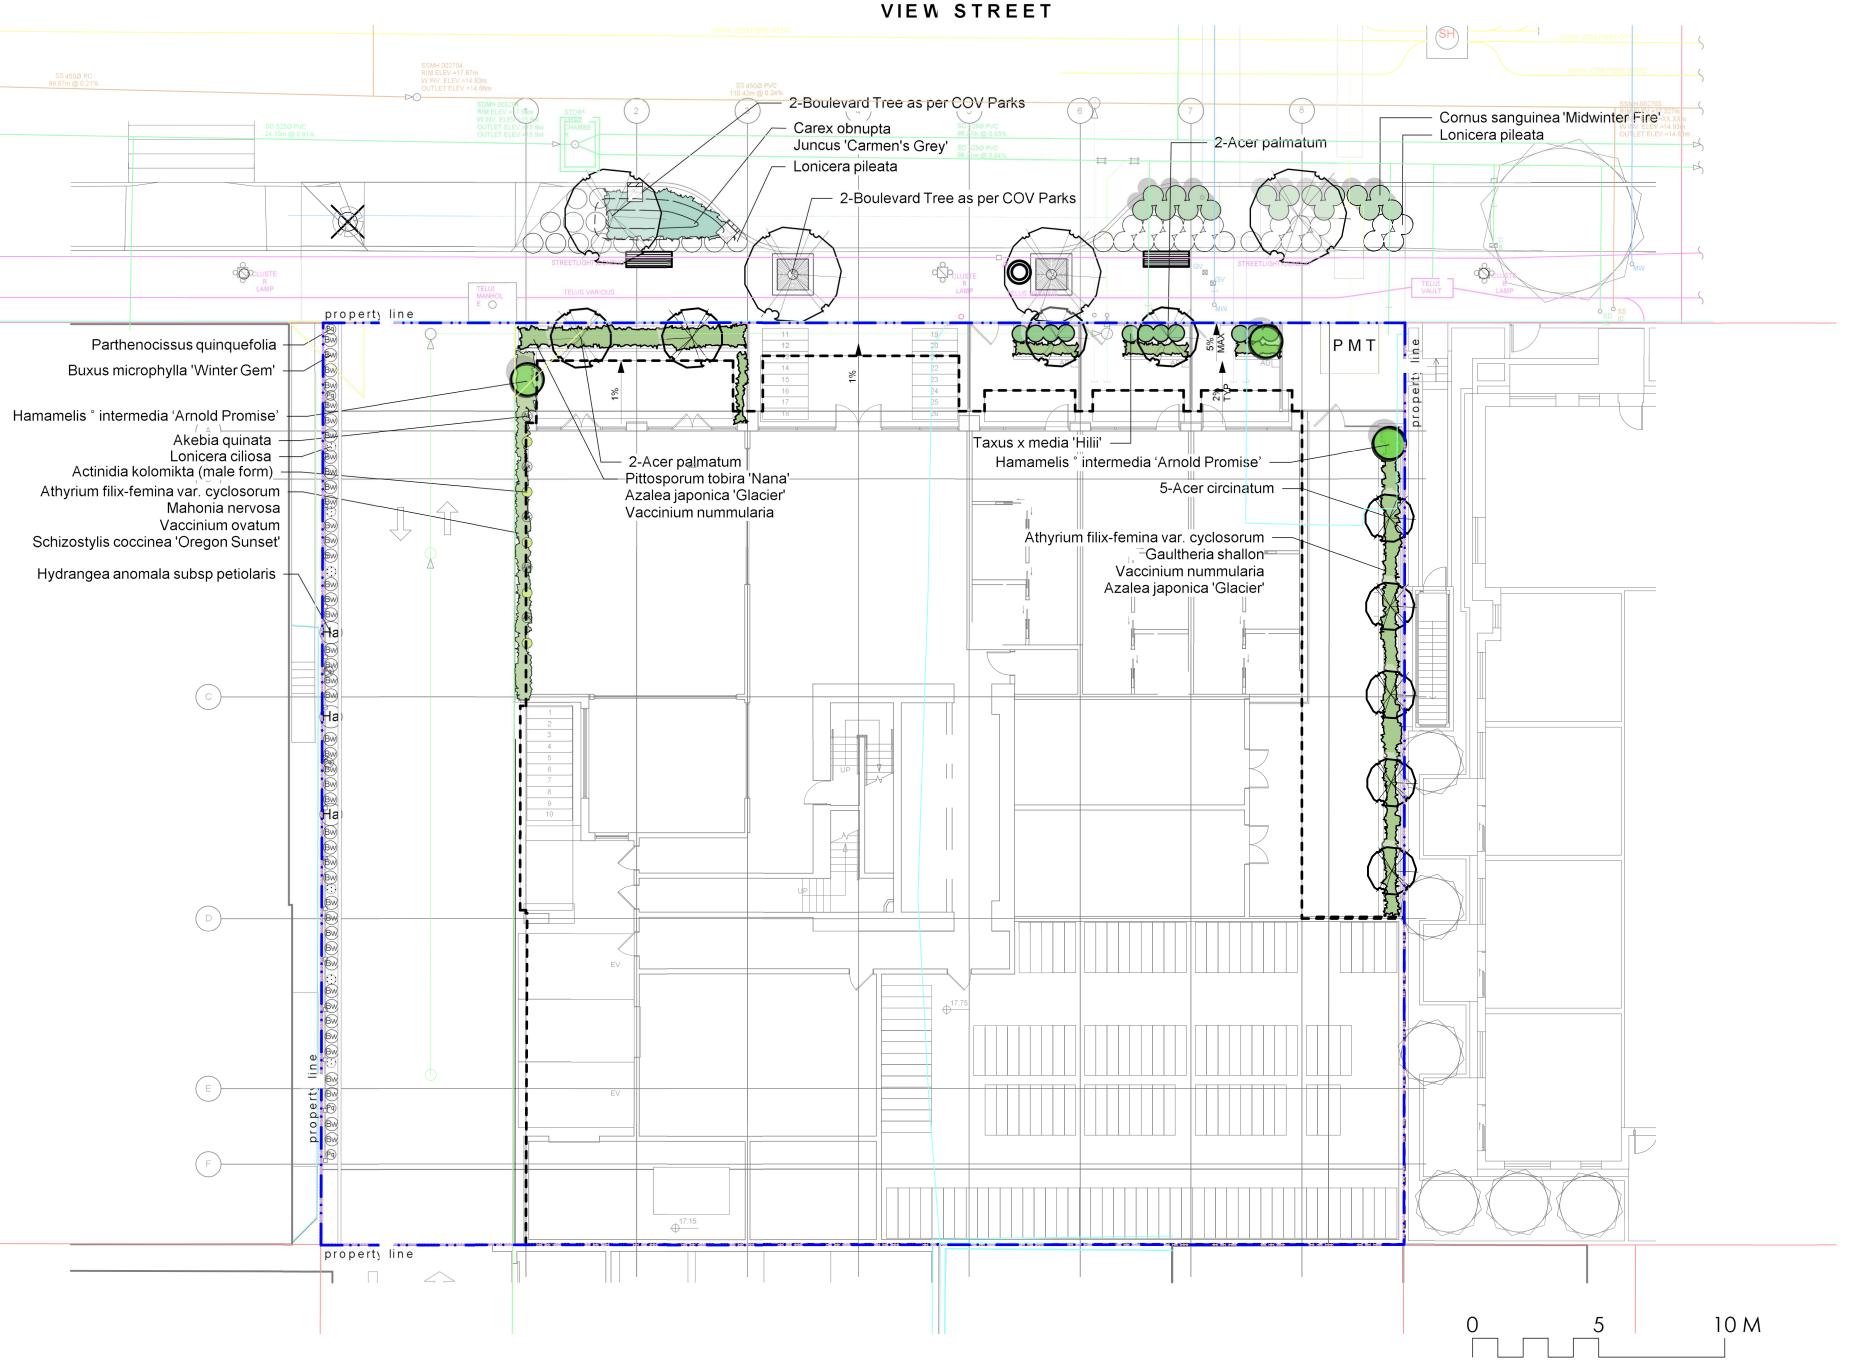


specifications → Prevailing wind 2. Trunk caliper shall meet Canadian Landscape Standard, current edition, for root ball size. 3. Max. depth of planting pit = rootball depth 4. Place stakes parallel to prevailing wind **PLAN VIEW** 5. Follow supply nursery's instructions on remova of rope, burlap, and wire baskets. Central leader. (Refer to Landscape— Specifications for prescribed quality). Non - abrasive tree ties. Arbour Tree Tie, or approved equivalent. Two (2) tree stakes, min 50 mm diameter stakes. Install approximately 50 mm away from the edge of the rootball. Stake location shall not interfere with permanent branches. Top of root ball shall be flush with— Mulch, 50 mm thickness. No more than— 25 mm of mulch on top of root ball. (Refer to Landscape Specifications for mulch). Round-topped soil berm 4" high x 8"-—Finished grade wide above root hall surface shall be constructed around the root ball. Berm shall begin at root ball periphery. Imported growing medium depth and type varies. Refer to Landscape Materials Plan. Loosened soil. Dig and turn the soil toreduce compaction to the area and depth -Scarify subsoil to a depth c 300mm before installing growing medium. Bottom of root ball rests on recompactedsoil. Tamp growing mediun below root Existing soil ball to prevent settling. TREE PLANTING DETAIL

—Tree stakes

Scale: 1:25

1. Trees shall be of quality prescribed in crowl

observations and root observations details and

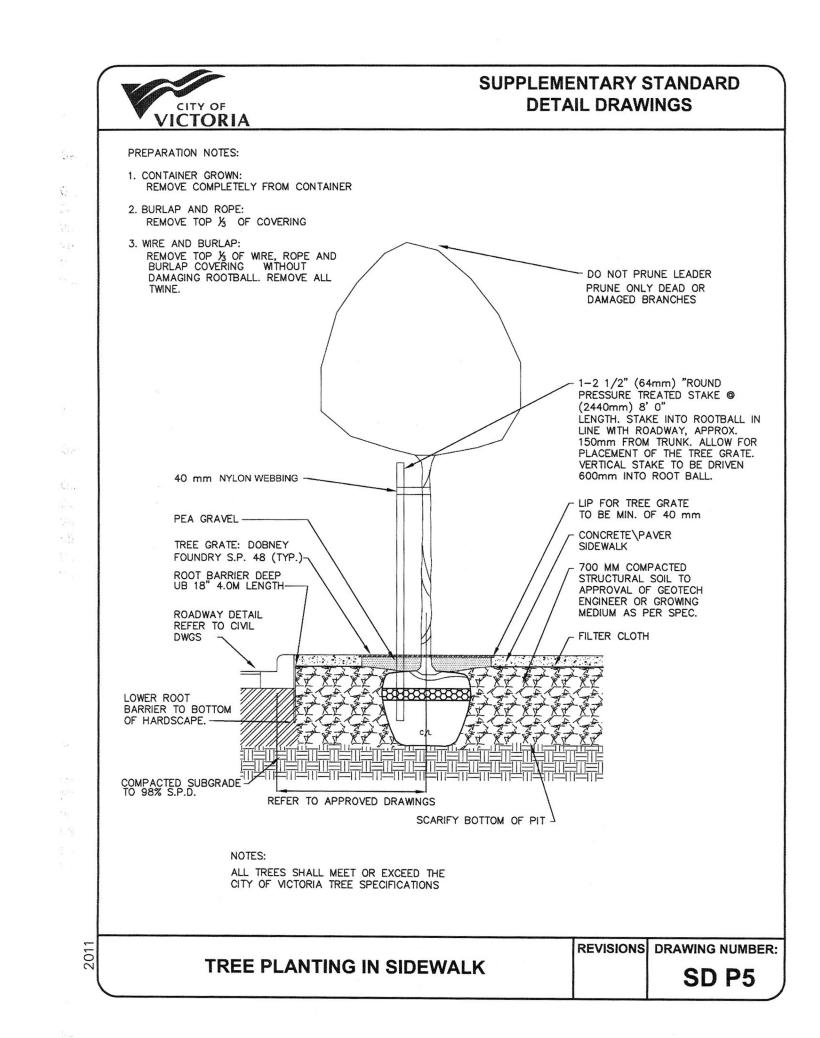



| Sym | Qty | Botanical Name                        | Common Name                   | Schd. Size / Plant Spacing    |
|-----|-----|---------------------------------------|-------------------------------|-------------------------------|
|     |     | TREES:                                |                               |                               |
|     | 5   | Acer circinatum                       | Vine Maple                    | 2.4 m ht, multi-stem (3 trunk |
|     | 4   | Acer palmatum                         | Japanese Maple                | 1.8 m height, specimen qualit |
|     | 4   | Boulevard Tree as per COV Parks       | Boulevard Tree as per COV Par | rl 6 cm cal, b+b              |
|     |     | SHRUBS:                               |                               |                               |
| Ack | 5   | Actinidia kolomikta (male form)       | Variegated Kiwi Vine          | #2 pot                        |
| Ak  | 5   | Akebia quinata                        | Chocolate vine                | #2 pot                        |
| Aff | 10  | Athyrium filix-femina var. cyclosorum | Northwestern Lady Fern        | #1 pot                        |
| Ag  | 22  | Azalea japonica 'Glacier'             | Glacier Azalea                | #1 pot                        |
| Bw  | 44  | Buxus microphylla 'Winter Gem'        | Littleleaf Boxwood            | #1 pot                        |
| Co  | 24  | Carex obnupta                         | Slough Sedge                  | #1 pot                        |
| Csm | 17  | Cornus sanguinea 'Midwinter Fire'     | Midwinter Fire Dogwood        | #1 pot                        |
| Gsh | 8   | Gaultheria shallon                    | Salal                         | #1 pot                        |
| Ha  | 3   | Hydrangea anomala subsp petiolaris    | Climbing Hydrangea            | #2 pot                        |
| Jcg | 8   | Juncus 'Carmen's Grey'                | Soft Common Rush              | Sp3                           |
| Loc | 6   | Lonicera ciliosa                      | Western Trumpet Honeysuckle   | #1 pot                        |
| Lp  | 38  | Lonicera pileata                      | Privet Honeysuckle            | #2 pot                        |
| Mn  | 5   | Mahonia nervosa                       | Oregon Grape Holly            | #1 pot                        |
| Pq  | 6   | Parthenocissus quinquefolia           | Virginia Creeper              | #2 pot                        |
| Ptn | 5   | Pittosporum tobira 'Nana'             | Dwarf Pittosporum             | #1 pot                        |
| Sco | 4   | Schizostylis coccinea 'Oregon Sunset' | Crimson Flag                  | #1 pot                        |
| Tmh | 11  | Taxus x media 'Hilii'                 | Hilii Yew                     | #3 pot, 2' max ht. male only  |
| Vnu | 22  | Vaccinium nummularia                  | Coin Whortleberry             | #1 pot                        |
| Vo  | 3   | Vaccinium ovatum                      | Evergreen Huckleberry         | #3 pot                        |

# PLANTING NOTES

1. Plant quantities and species may change between issuance of DP and Construction due to plant availabilit

2. Boulevard/Street Tree and planting locations and species to be coordinated with City of Victoria Parks Staf and installed by applicant.

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## <u>Tree Notes</u>

1. Tree planting inspection requirements 1st Inspection – Tree pits, structural soil and root barrier 2nd Inspection – Prior to planting, tree are inspected for pests

disease and structural defect 3rd Inspection – Completed planting, mulch, staking, tree grate

2. Two new tree guards will need to be purchased from the City c

Victoria at \$500 each.

3. The applicant will be required to pay the appraised value of the small boulevard tree proposed for removal. When the tree fee has been paid, the City will post the tree for [10] working day: after which it can be removed at the expense of the applican4 Dev Permit Revisions 20.08.11



DP REV

Issued for DP revisions 20.01.08

19.10.17



2021-04-30


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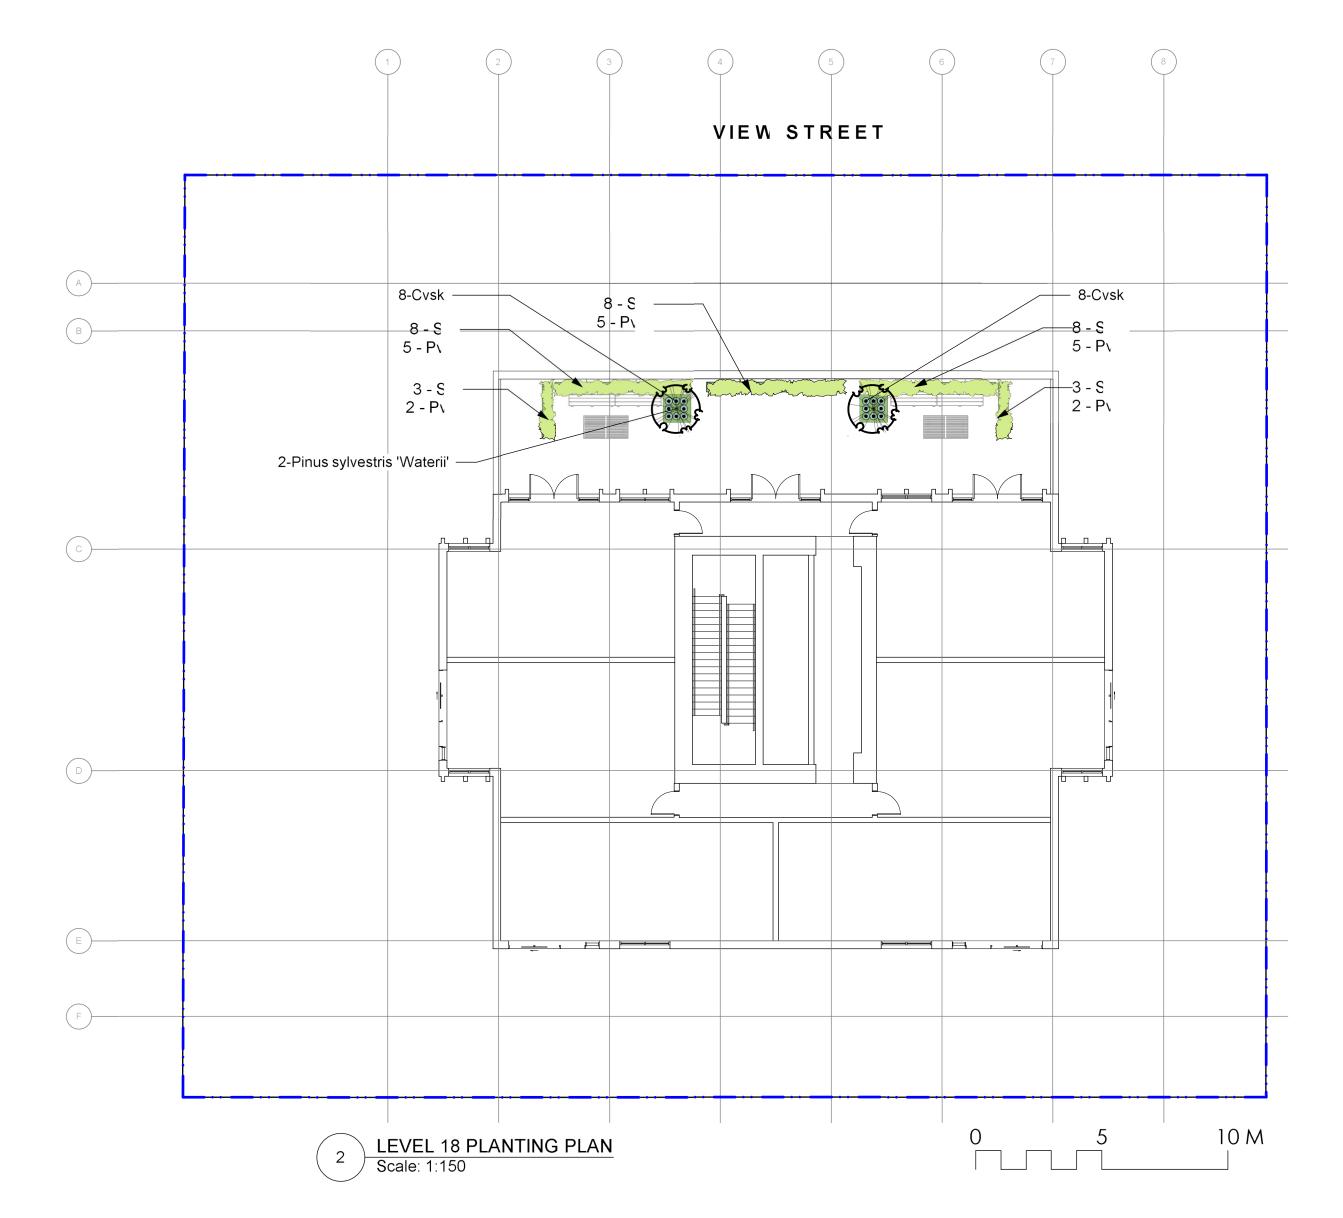
VIEW STREET RESIDENTIAL 937 VIEW STREET VICTORIA, BC

sheet title

Planting Plan Level 1

119.24 project no. AS NOTED @ 24"x36" scale drawn by SM/PdG checke by sheet no. revison no. L3.01 <u>/5</u>



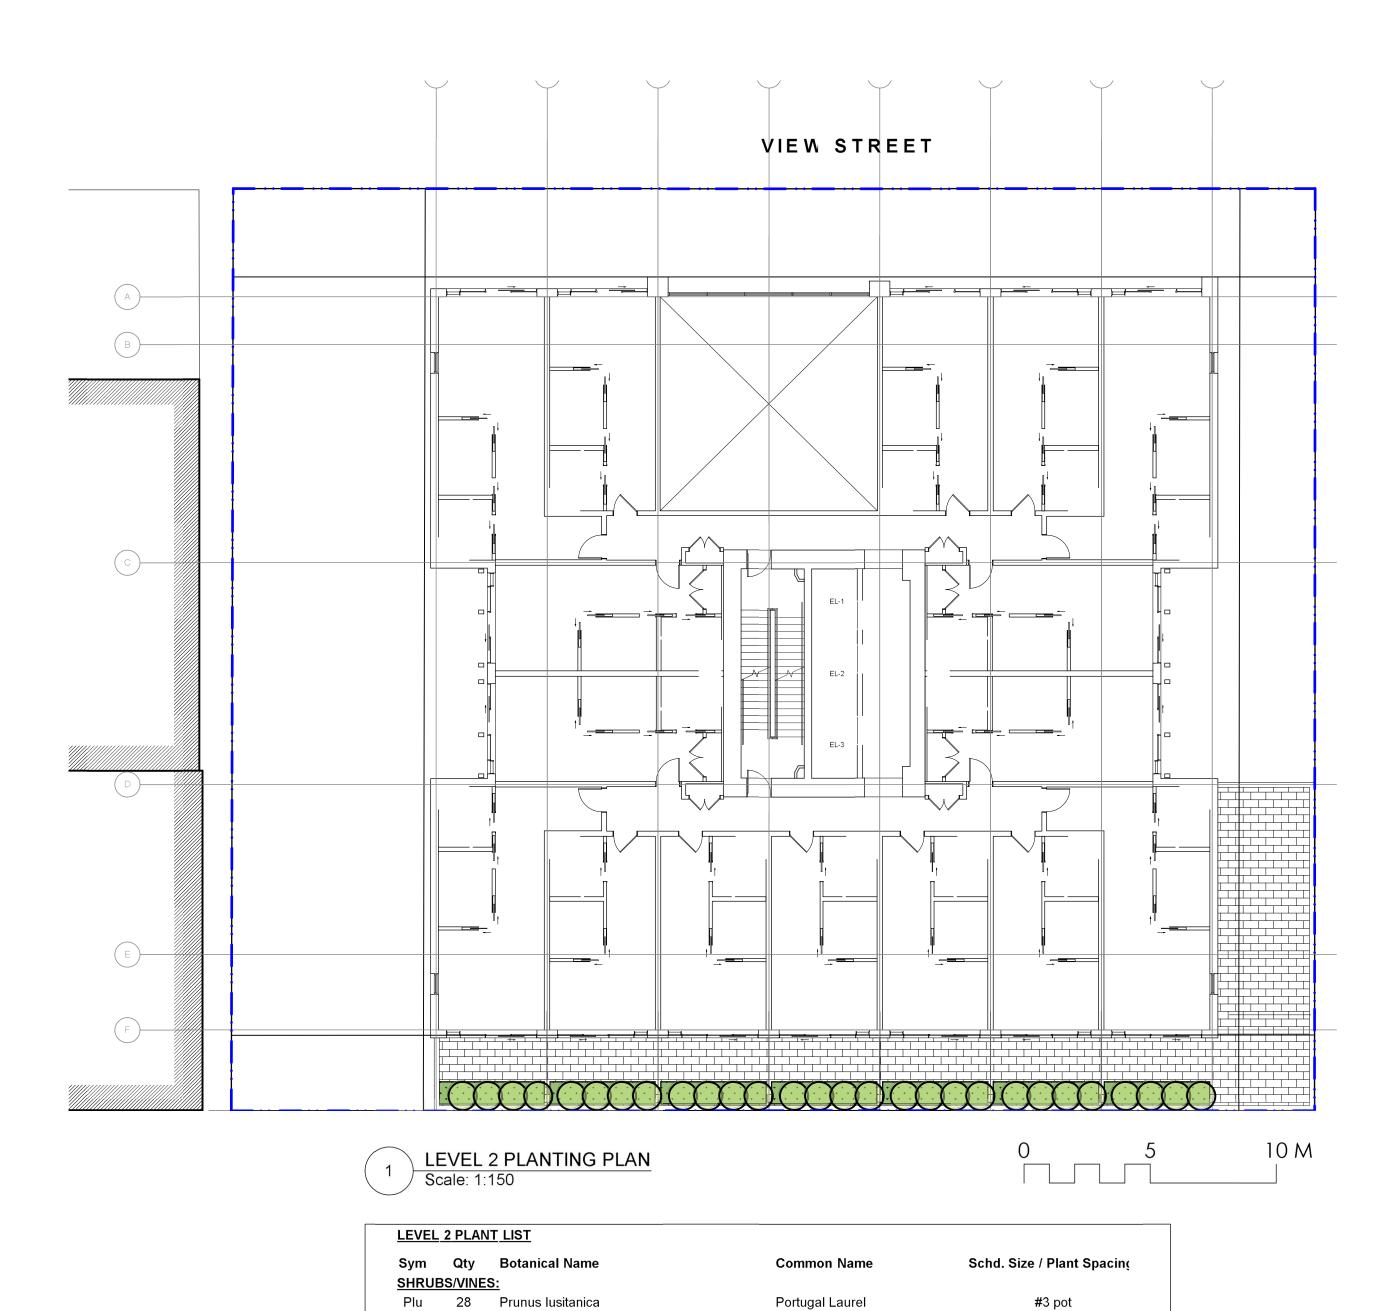

| Sym   | Qty       | Botanical Name                   | Common Name                  | Schd. Size / Plan<br>Spacinį          |
|-------|-----------|----------------------------------|------------------------------|---------------------------------------|
| TREES | <u>s:</u> |                                  |                              |                                       |
|       | 2         | Pinus sylvestris 'Waterii'       | Bonsai Pine                  | specimen, cloud pruned min 2 m height |
| SHRUE | 3S/VINE   | <u>:S:</u>                       |                              |                                       |
| Cvsk  | 16        | Calluna vulgaris 'Silver Knight' | Silver Knight Scotch Heather | #1 pot                                |
| Pvi   | 19        | Pennisetum villosum              | Feathertop Grass             | #1 pot                                |
|       |           | Stipa tenuissima                 | Mexican Feathergrass         | #1 pot                                |

#### **DRAWING NOTES**


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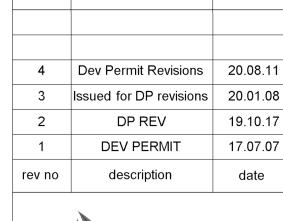
costs related to production and submission to consultant of a

landscape as-built information including irrigation. 10. Tree protection fencing, for existing trees, to be installed prior to commencement of all site work

#### PLANTING NOTES

- 1. Plant quantities and species may change between issuance of DI
- and Construction due to plant availability and design changes.
   Boulevard/Street Tree and planting locations and species to be coordinated with City of Victoria Parks Staff, and installed b applicant.



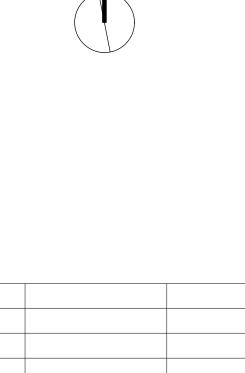



2021-04-30

2021-04-30

NELSON INVESTMENTS, INC.

VIEW STREET RESIDENTIAL 937 VIEW STREET VICTORIA, BC

sheet title


Planting Plan Levels 2 and 18

| 5           | L         | _3.02     |
|-------------|-----------|-----------|
| revison no. | sheet no. |           |
| checke by   |           | SM/PdG    |
| drawn by    |           | ML        |
| scale       | AS NOTED  | @ 24"x36' |
| project no. |           | 119.24    |
|             |           |           |

#### LEGEND

| EXISTING                              | PROPOSED  | DESCRIPTION   | EXISTING             | PROPOSED             | DESCRIPTION                               |
|---------------------------------------|-----------|---|----------------------|----------------------|---|
|                                       |           | EDGE OF PAVEMENT  | _ — → — — —          | +                    | REDUCER                                   |
| CURB                                  |           | CURB AND GUTTER   |                      | - <del>*</del> * * * | FENCE                                     |
|                                       |           | EDGE OF GRAVEL  |                      | ~                    | DITCH/SWALE                               |
| TB/BB                                 |           | TOP/BOTTOM OF BANK  | wm — — — —           | wm — — —             | WATERMAIN (SIZE AND MATERIAL NOTED)       |
| Св                                    |           | CATCH BASIN   | SS · ·               | SS — — —             | SANITARY SEWER (SIZE AND MATERIAL NOTED)  |
|                                       | <b> →</b> | WATER VALVE   | sp — · · · — · · · — | SD = =               | STORM DRAIN (SIZE AND MATERIAL NOTED)     |
| - <del>()</del> -FH                   | <b>*</b>  | FIRE HYDRANT  | UT                   | UT —                 | UNDERGROUND TELEPHONE                     |
| <b>- - - - ∃</b>                      |           | CAPPED END  | UH                   | UH                   | UNDERGROUND HYDRO                         |
| $\ominus$                             |           | UTILITY POLE AND STREET LIGHT (LABELLED PP,TP,PP/LS ETC.) |                      | IRR- — — — —         | IRRIGATION SLEEVES                        |
| <u></u>                               |           | MANHOLE   | $\odot$              |                      | MONUMENT                                  |
| — · · · —⊗ <sup>CO</sup>              |           | CLEANOUT  |                      |                      | PROPERTY LINE                             |
| SSIC/SDIC                             | SSIC/SDIC | SANITARY/STORM INSPECTION CHAMBER (2000 RISER)            |                      | 5+100 5+110          | CENTERLINE AND STATIONING                 |
| JB                                    |           | JUNCTION BOX  |                      |                      | SANITARY SEWER SERVICE CONNECTION AT MAIN |
| — — — — — — — — — — — — — — — — — — — |           | AIR VALVE   | +32.75               | 43.170)+             | ELEVATIONS                                |
| WM                                    | → wm      | WATER METER   |                      |                      | PAVEMENT REMOVAL                          |
|                                       |           |   |                      |                      | NEW ASPHALT                               |




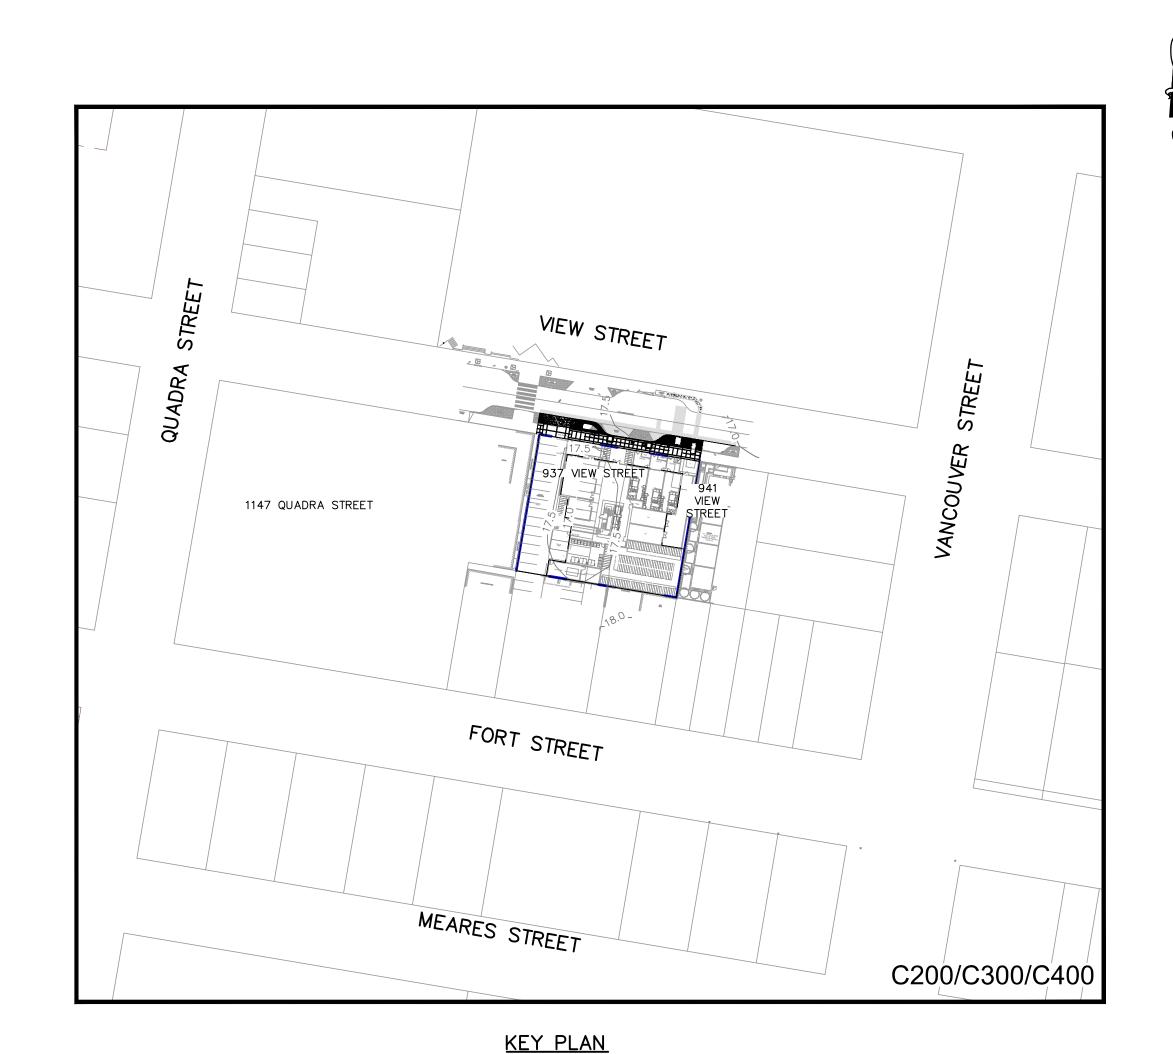

# LIST OF DRAWINGS

C100 GENERAL NOTES, LOCATION PLAN, KEY PLAN, DRAWINGS LIST & LEGEND

C200 C300 SITE SERVICING PLAN GRADING PLAN C400 BC HYDRO INFORMATION PLAN

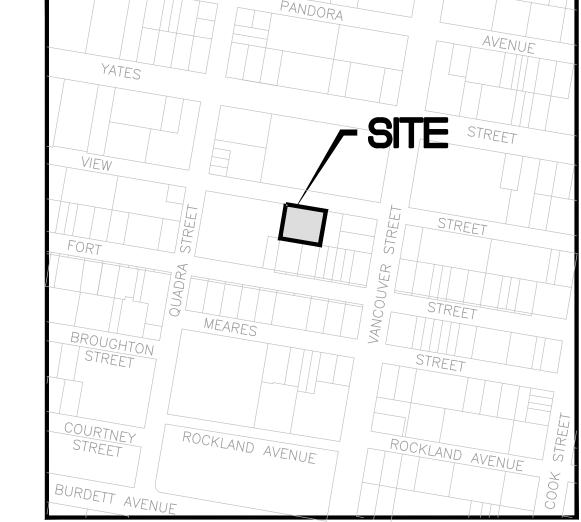

# **LOCATION PLAN**

937 VIEW STREET LOT A, OF LOTS 785, 786 AND 787, VICTORIA CITY, PLAN 36505. R-48, HARRIS GREEN RESIDENTIAL

LAND USE: 253 UNIT 15 STOREY RESIDENTIAL BUILDING PROPOSED: 1572m²

SITE AREA: DWELLING FOOTPRINT AREA: 725m<sup>2</sup> MAIN FLOOR ELEVATION: 17.60m

PLAN TO ACCOMPANY DEVELOPMENT PERMIT APPLICATION

#### **GENERAL NOTES:**

CIVIC ADDRESS:

LEGAL:

**ZONING:** 

- 1. ALL WORK AND MATERIALS ARE TO BE IN ACCORDANCE WITH THE CITY OF VICTORIA (CoV) SPECIFICATIONS, ITS SUPPLEMENTARY MASTER MUNICIPAL SPECIFICATIONS, STANDARD DETAIL DRAWINGS AND MMCD UNLESS OTHERWISE NOTED. IF A CONFLICT BETWEEN SPECIFICATIONS ARISES, THE MOST STRINGENT SHALL APPLY.
- 2. THE ENGINEER SHALL BE NOTIFIED 48 HOURS PRIOR TO COMMENCEMENT OF WORK.
- SIGNATURE BLOCK FOR SHALLOW UTILITIES TO BE SIGNED AND DATED PRIOR TO CONSTRUCTION. 4. PERMITS TO CONSTRUCT WORKS ON THE CoV RIGHT OF WAY MUST BE OBTAINED FROM THE CoV ENGINEERING DEPARTMENT PRIOR TO COMMENCING WORK. PERMITS MUST BE ON SITE FOR REVIEW AS
- 5. CONFIRM LOCATION AND ELEVATION OF ALL EXISTING UTILITIES AT ALL CROSSINGS AND CONNECTIONS
- AND REPORT ANY DISCREPANCIES TO THE ENGINEER PRIOR TO CONSTRUCTION. 6. CONFIRM THAT ELEVATION, LOCATION AND GRADIENT OF ASPHALT MATCH EXISTING PRIOR TO PLACEMENT
- OF ASPHALT OR CONCRETE.
- 7. ALL TREES NOT BEING REMOVED IN THE CONSTRUCTION AREA SHALL BE PROTECTED. CARE TO BE TAKEN TO RETAIN AS MANY TREES AS POSSIBLE.
- 8. ADJUST ALL MANHOLES, WATER VALVES, HYDRO VAULTS, ETC. TO MATCH NEW CONSTRUCTION. 9. ALL LOCATIONS AND ELEVATIONS OF EXISTING UTILITIES SHOWN ARE APPROXIMATE ONLY AND SHOULD BE CONFIRMED BY USE OF A PIPE LOCATOR AND MANUAL DIGGING. ALL OR ANY STRUCTURES NOT
- NECESSARILY SHOWN. 5. ALL EXCAVATED TRENCH AND SUBEXCAVATION MATERIALS TO BE DISPOSED OF OFFSITE.
- 6. ALL ELEVATIONS ARE TO GEODETIC DATUM.
- 7. DATA SOURCES: -TOPOGRAPHIC SURVEY COMPLETED BY POWELL & ASSOCIATES BC LAND SURVEYORS, DECEMBER 2016. -DIGITAL GIS PROVIDED BY CoV. -BC 1 CALL DATA FOR SHALLOW UTILITIES.

### **ROAD NOTES:**

- 1. CONSTRUCT ALL SIDEWALK AND DRIVEWAY CROSSINGS IN ACCORDANCE WITH COV AND MMCD STANDARDS AS NOTED ON DRAWINGS.
- 2. MAINTAIN VEHICULAR AND PEDESTRIAN ACCESS ALONG VIEW STREET DURING CONSTRUCTION.
- . ROAD RESTORATION FOR VIEW STREET TO COV SUPPLEMENTAL DWG. No. SD G5a AND G5b. 4. THE PROVISION OF APPROVED SIGNS AND CERTIFIED TRAFFIC CONTROL PERSONNEL IS THE
- 5. ALL PAVEMENT EXCAVATIONS TO BE SAWCUT. 6. PROJECT FRONTAGE TO BE RESTORED AS NOTED ON CIVIL, LANDSCAPE AND ARCHITECTURAL DRAWINGS
- AS PER CoV "NEW TOWN" SPECIFICATIONS.
- 7. PEDESTRIAN WALKING AREA TO BE DELINEATED DURING THE CONSTRUCTION OF THE WORKS AND MUST BE EASILY RECOGNIZABLE BY THE PUBLIC AND CONTAIN NO OBSTRUCTIONS TO MOBILITY SCOOTERS OR WHEELCHAIRS AND NO HAZARDOUS CONDITIONS. THE PUBLIC USING THESE AREAS MUST BE ADEQUATELY PROTECTED FROM TRAFFIC.

#### **WATER NOTES:**

- WATER SERVICE CONNECTION TO BE PER CoV STD. DWG. No. W2d SS.
- 2. CONTRACTOR TO CONFIRM THAT EXISTING WATER SERVICES HAVE BEEN CAPPED BY CONTRACTOR/DEVELOPER AND INSPECTED BY CoV PLUMBING DEPARTMENT AT DEVELOPER'S EXPENSE.


#### STORM DRAIN AND SANITARY SEWER NOTES:

CONTRACTOR'S SOLE RESPONSIBILITY.

- 1. CONTRACTOR TO CONFIRM THAT EXISTING SANITARY AND STORM DRAIN SERVICES HAVE BEEN CAPPED BY
- CONTACTOR/DEVELOPER AND INSPECTED BY CoV PLUMBING DEPARTMENT AT DEVELOPER'S EXPENSE. 2. STORM DRAIN AND SANITARY SEWER CONNECTIONS TO BE AS PER CoV STD. DWG. No. S7 SS. 3. STORM DRAIN CONNECTION TO BE 2000 PVC SDR28 AT A MINIMUM GRADE OF 2.00% UNLESS
- OTHERWISE NOTED. 4. SANITARY SEWER CONNECTION TO BE 2500 PVC SDR28 AT A MINIMUM GRADE OF 2.00% UNLESS
- 5. UNDERGROUND SERVICES TO BE LOCATED, EXPOSED AND ELEVATIONS CONFIRMED AT CROSSINGS PRIOR TO INSTALLATION OF CONNECTIONS.

# SHALLOW UTILITY AND STREET LIGHT NOTES:

- 1. EXISTING BC HYDRO, TELUS, SHAW CABLE AND FORTIS BC INFRASTRUCTURE INFORMATION SHOWN ON DRAWINGS IS SCHEMATIC AND FOR INFORMATION ONLY.
- 2. REFER TO UTILITY COMPANY DESIGN DRAWINGS FOR CONSTRUCTION DETAILS. CONSTRUCT UNDERGROUND UTILITIES AS SPECIFIED AND IN ACCORDANCE WITH BC HYDRO, TELUS, SHAW CABLE SPECIFICATIONS AND DRAWINGS.
- 3. CONFIRM AND COORDINATE WITH CoV FORCES REINSTATEMENT OF LAMP STANDARDS AS PER CoV SUPPLEMENTARY STANDARD DETAIL DRAWINGS, INCLUDING BASES, CONDUIT AND JUNCTION BOX. . CONTACT BC 1 CALL AT 1-800-474-6886 A MINIMUM OF 48 HOURS PRIOR TO CONSTRICTION.
- 5. CONTACT BC HYDRO, TELUS, SHAW CABLE AND FORTIS BC 48 HOURS PRIOR TO THE START OF ANY 6. BC HYDRO TO COORDINATE AND PROVIDE LIAISON WITH COV PRIOR TO AND DURING CONSTRUCTION.

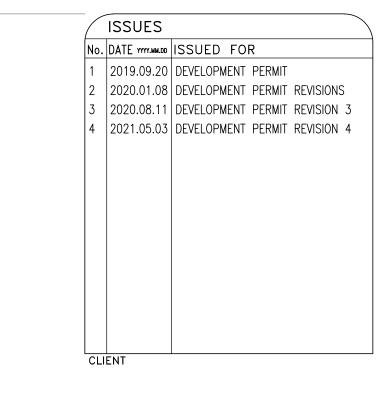

RE 937 VIE MARKE

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GENERAL NOTES, LOCATION PLAN,

KEY PLAN, DRAWINGS LIST & LEGEND

DESIGNED ENGINEER'S SEAL TDL DESIGN REVIEW LAM DRAFTING REVIEW 2021-05-04 PROJECT No. CLIENT DRAWING No.

5094-001 H: AS NOTED

HEL DRAWING No. C100 1 of 4

DESTROY ALL DRAWINGS SHOWING PREVIOUS REVISION

