

1702 QUADRA STREET + 862 FISGARD STREET


VICTORIA, BC

26.05.2025

ISSUED FOR DDP

ARYZE DEVELOPMENT
1839 Fairfield Road
Victoria, BC, V8S 169
P: 250.940.3568



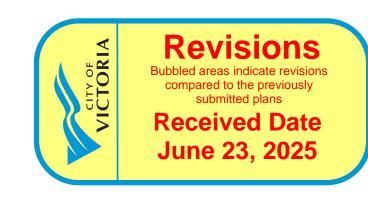

ARCHITECTURAL:

ARCHITECTURE INC

5468796 ARCHITECTURE INC. 266 McDermot Ave Winnipeg, MB. R3B 0S8 P: 204.480.8421

F: 204.480.8876

Sasa Radulovic | Principal Architect E: sasa@5468796.ca

Pablo Batista | Architect E: pablo@5468796.ca

COVER **GENERAL NOTES** RENDERINGS AG.2 AG.3 RENDERINGS AG.4 MATERIAL BOARD AG.5 SHADOW STUDIES AG.6 SITE CONTEXT ELEVATIONS AG.7 WINDOW + DOOR SCHEDULE AG.8 ZONING CALCULATIONS AG.9 SITE SURVEY

CONTEXT SITE PLAN EXISTING SITE PLAN + DEMOLITION PROPOSED SITE PLAN LEVEL 00 PLAN LEVEL 01 PLAN LEVEL 02 PLAN LEVEL 03 PLAN LEVEL 04/06/08/10/12 PLAN

LEVEL 05/07/09/11 PLAN

LEVEL 13 **ROOF PLAN** A1.8 BUILDING ELEVATION BUILDING ELEVATION A2.3 BUILDING ELEVATION

BUILDING ELEVATION BUILDING SECTION A3.2 BUILDING SECTION A3.3 **BUILDING SECTION BUILDING SECTION BUILDING SECTION** BUILDING SECTION

ENLARGED PLAN - BIKE ROOM

DEVELOPER:



1839 Fairfield Road Victoria, BC, V8S 1G9 P.250.940.3568 Vinit Jain E: vinit@aryze.ca

ARYZE DEVELOPMENTS INC.

CIVIL:



MCELHANNEY Suite 500 - 3960 Quadra Street Victoria, BC, V8X 4A3 P.778.746.7417

Nathan Dunlop E: ndunlop@mcelhanney.com

CONCEPTUAL SERVICING

ELECTRICAL:



e2 ENGINEERING 549 Herald Street Victoria, BC, V8W 1S5 P.778.433.9391

Peter Xu E: peter.xu@e3eng.ca

MECHANICAL:



AVALON MECHANICAL 300-1245 Esquimalt Road Victoria, BC, V9A 3P2 P.250.940.2976.

Kevin Jackson E: kjackson@avalonmechanical.com

ENVELOPE:



RDH BUILDING SCIENCE 602-740 Hillside Avenue Victoria, BC, V8T 1Z4 P.250.479.1110.

Byron Searle E: bsearle@rdh.com

LANDSCAPE:



BIOPHILIA Victoria, BC, V8T 3E6

P.250.590.1156 Bianca Bodley

E: bianca@biophiliacollective.ca Elizabeth Balderson E: elizabeth@biophiliacollective.ca

TREE REMOVAL AND PROTECTION PLAN LANDSCAPE SITE PLAN OFF-SITE PLANTING PLAN PRODUCTS AND SITE FURNITURE

ROOFTOP AMENITY AREA

SYMBOL LEGEND:



EXISTING DOOR NEW DOOR

F-1


FLOOR TYPE LABEL

FINIISH TYPE


LABEL **ROOF TYPE**

NOTES GRIDLINE MARKER


BUILDING SECTIONS:

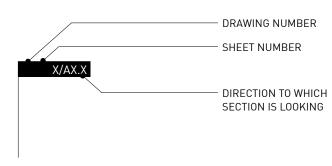


SECTIONS:

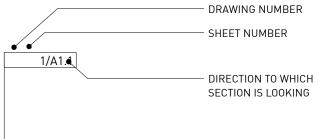

DETAILS:

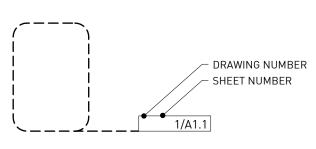


ROOM LABELS:

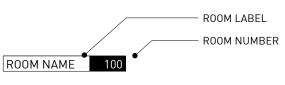



INTERIOR ELEVATIONS:



FLOOR CONSTRUCTION ELEVATIONS:

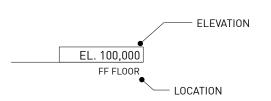

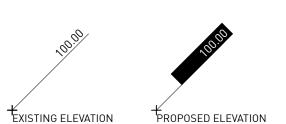

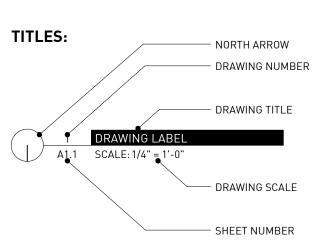

ABBREVIATIONS:	
& ABV AFF ALUM ANOD @ ARCH AT AVB	AND ABOVE ABOVE FINISHED FLOOR ALUMINUM ANODIZED AT ARCHITECTURAL ACOUSTIC TILE AIR/VAPOUR BARRIER
BLDG BLKG BRG BS B TO B	BUILDING BLOCKING BEARING BOTH SIDES BACK TO BACK
CB CF CG CJ CL CLG CLR COL CONC CONC CONN CONT CORR CT C/W	CATCH BASIN CLEAR FINISH CORNER GUARD CONTROL JOINT CENTRE LINE CEILING CLEAR COLUMN CONCRETE CONNECTION CONTINUOUS CORRIDOR CERAMIC TILE COMPLETE WITH
Ø DIM DN DRWG DTL	DIAMETER DIMENSION DOWN DRAWING DETAIL
EL EW EA ELEC EQ EXIST EJ EXT	ELEVATION EACH WAY EACH ELECTRICAL EQUAL EXISTING EXPANSION JOINT EXTERIOR
FDN FE FEJ FIN FD FFD FF FLEX FO FR FRR	FOUNDATION FIRE EXTINGUISHER FLOOR EXPANSION JOINT FINISHED FLOOR DRAIN FUNNEL DRAIN FINISHED FACE FLEXIBLE FACE OF FRIDGE FIRE RESISTANCE RATING
G GA GWB GCB GC	GRILL GAUGE GYPSUM WALL BOARD GYPSUM CEILING BOARD GENERAL CONTRACTOR GLASS
нм	HOLLOW METAL

HOLLOW METAL HOLLOW METAL INSULATED HORIZONTAL HOLLOW STEEL SECTION

HORIZ HERMETICALLY SEALED DOUBLE GLAZING HSS HSTG HERMETICALLY SEALED TRIPLE GLAZING HEATING, VENTILATING, AIR CONDITIONING INSIDE DIAMETER INSIDE FACE INSULATION INTERIOR LENGTH

METRE MILLIMETRE MOUNT MATERIAL MAX MAXIMUM MDF MEDIUM DENSITY FIBREBOARD MECH MECHANICAL MINIMUM MISCELLANEOUS MASONRY OPENING NOT IN CONTRACT NUMBER NOM NOMINAL NTS NOT TO SCALE

ON CENTRE **OUTSIDE DIAMETER** OVERHEAD 0PP OPPOSITE OPEN TO ABOVE OTB OPEN TO BELOW OVEN PLAM PLASTIC LAMINATE PLBG PLUMBING PAIR PREFINISHED

PAINTED FINISH PROPERTY LINE RADIUS **ROOF DRAIN** REINF REINFORCED REQ'D REQUIRED REV REVISION, REVISED, REVERSED ROUGH OPENING

PRESSED STEEL PRESSURE TREATED

SHEET FLOORING SIMILAR SPC'D SPECIFIED SQUARE STEEL STD STANDARD STAIN FINISH STRUCT STRUCTURAL SUSPENDED

SUSP TEMP TEMPERED TEMPERED GLASS TOP OF TYPICAL UNLESS OTHERWISE NOTED U/N UNDERSIDE VARNISHED FINISH VERTICAL

WHC

WIDE, WIDTH WASHER/DRYER WOOD HOLLOW CORE

WOOD SOLID CORE

4 Issued for DDP 3 Issued for TRG2 response 2 Issued for TRG1 response

Drawn By: Checked By: EA/MM/AR 23.05.2025 Printing Date:

26.05.2025

14.12.2023

21.09.2023

The Contractor shall verify all dimensions, datums and levels prior to commencement of work.


All errors and omissions to be reported to the Architect before proceeding.

This drawing must not be scaled.

This drawing is the property of the Architect; the copyright in same being reserved to him/her. It is

Any unauthorized alteration of the electronic data which constitute this document will void all responsibility for the altered document by the Architect.

This drawing is not to be used for building purposes until countersigned by:

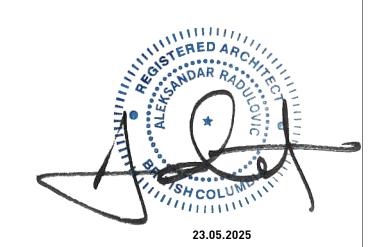

266 MCDERMOT AVE Winnipeg MB R3B 0S8 P: 204.480.8421 F: 204.480.8876


1702 QUADRA STREET + 862 FISGARD STREET

GENERAL NOTES

0650 Sheet

AG.1


Project

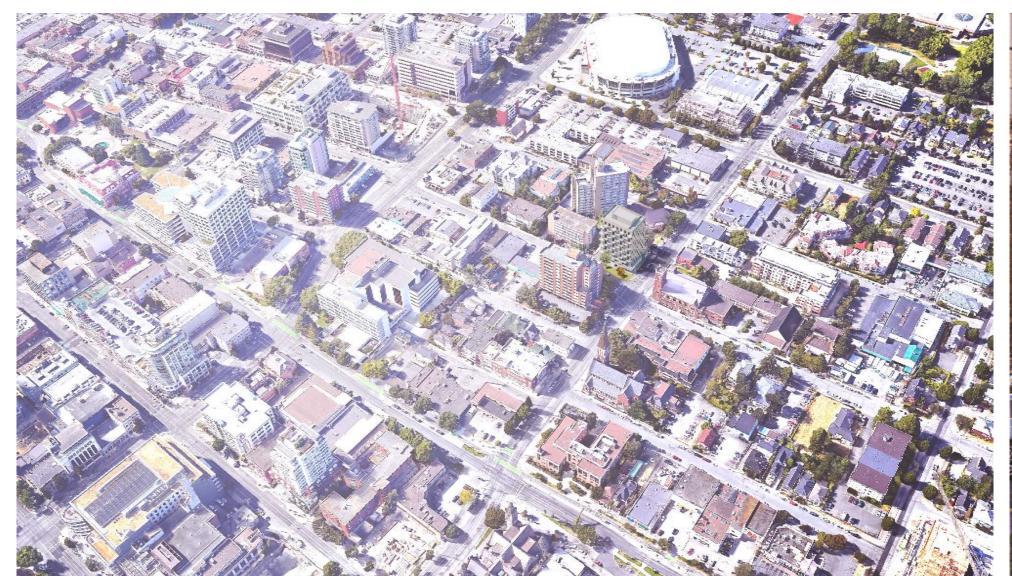



RENDER 5: AERIAL VIEW OF BUILDING

RENDER 3: STREETVIEW EXPERIENCE ALONG QUADRA

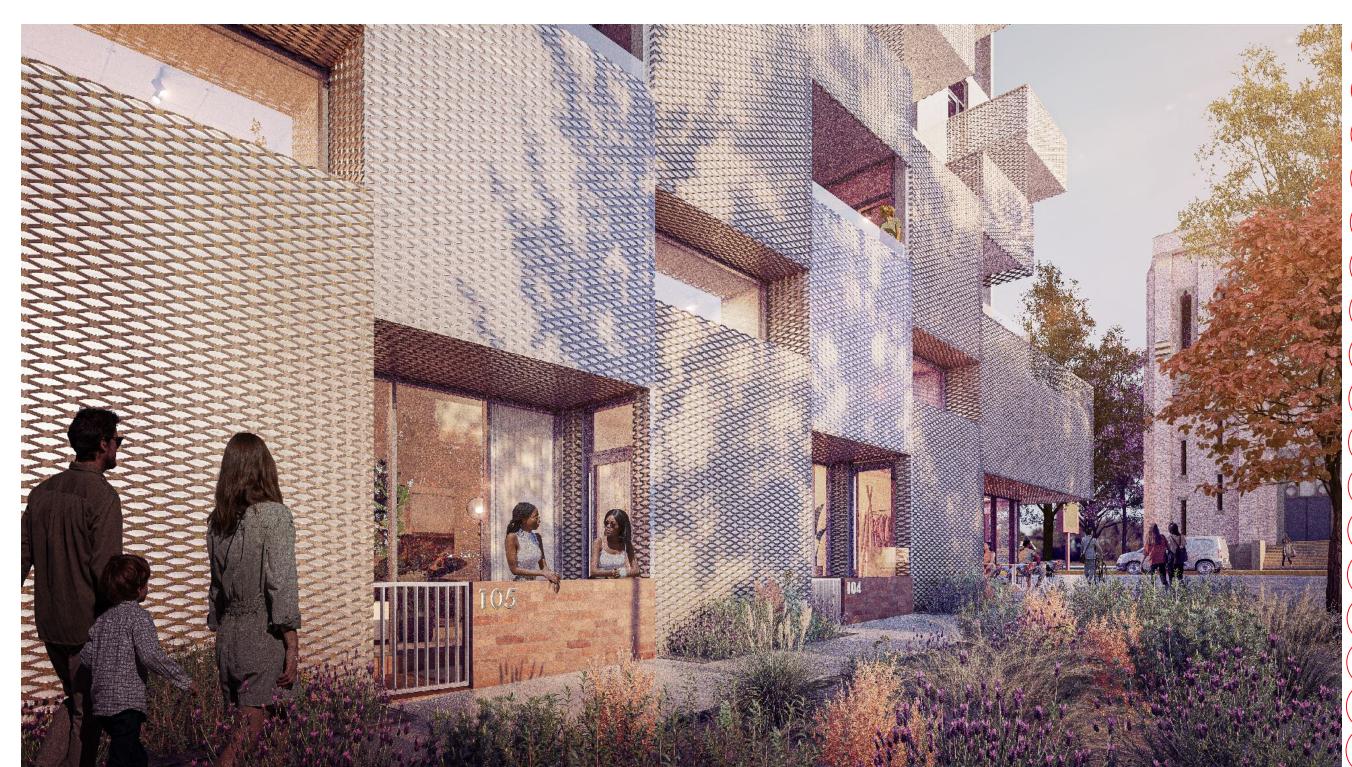

RENDER 4: STREET LEVEL VIEW OF THE BUILDING FROM FISGARD SIDEWALK

4 Issued for DDP 26.05.2025 3 Issued for TRG2 response 14.12.2023 2 Issued for TRG1 response 21.09.2023 1 Issued for DP 01.06.2023

Drawn By: Checked By: Printing Date: PB 23.05.2025

BG/RG

The Contractor shall verify all dimensions, datums and levels prior to commencement of work.

All errors and omissions to be reported to the Architect before proceeding.


This drawing must not be scaled.

This drawing is the property of the Architect; the copyright in same being reserved to him/her. It is

Any unauthorized alteration of the electronic data which constitute this document will void all responsibility for the altered document by the Architect.

This drawing is not to be used for building purposes until countersigned by:



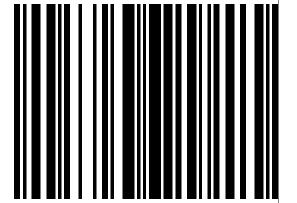

266 MCDERMOT AVE Winnipeg MB R3B 0S8 P: 204.480.8421 F: 204.480.8876

1702 QUADRA STREET + 862 FISGARD STREET

RENDERINGS

Project 0650 Sheet

AG.2

4 Issued for DDP 26.05.2025
3 Issued for TRG2 response 14.12.2023
2 Issued for TRG1 response 21.09.2023

Drawn By: BG / RG PB Checked By: Printing Date: 23.05.2025

The Contractor shall verify all dimensions, datums and levels prior to commencement of work.

All errors and omissions to be reported to the Architect before proceeding.


This drawing must not be scaled.


This drawing is the property of the Architect; the

copyright in same being reserved to him/her. It is not to be reproduced without his/her permission.

Any unauthorized alteration of the electronic data which constitute this document will void all responsibility for the altered document by the Architect.

This drawing is not to be used for building purposes until countersigned by:

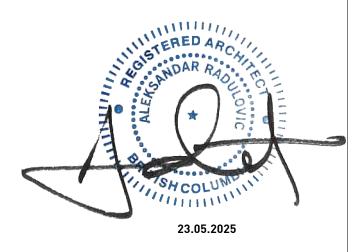

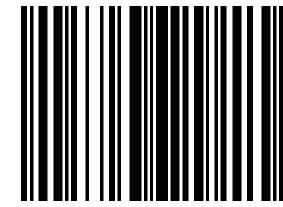

5 4 6 8 7 9 6 A R C H I T E C T U R E I N C 266 MCDERMOT AVE Winnipeg MB R3B 0S8 P: 204.480.8421 F: 204.480.8876

1702 QUADRA STREET + 862 FISGARD STREET

RENDERINGS

Project 0650 Sheet AG.3











ALUMINUM REFLECTIVE

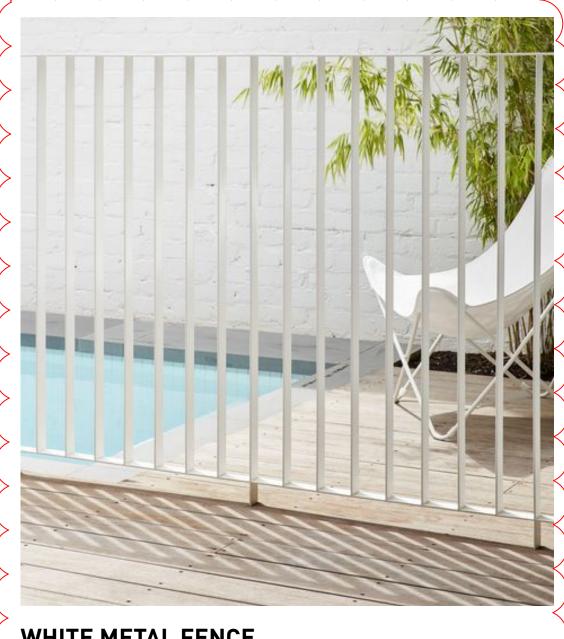

WHITE METAL FENCE



WHITE CEMENTITIOUS PANEL

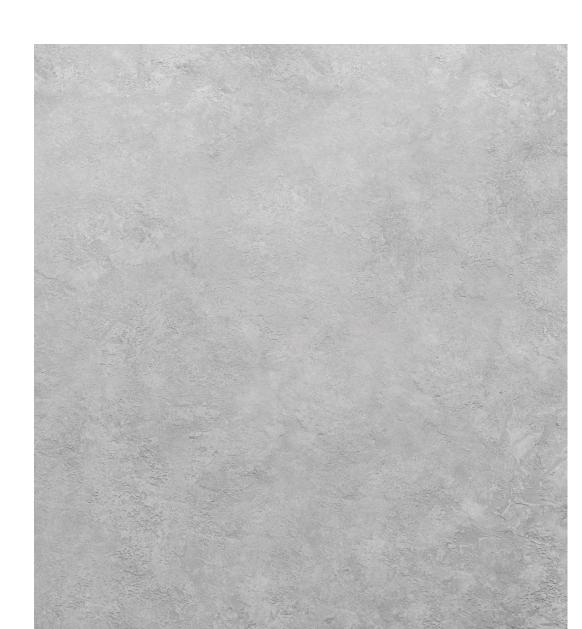

CONCRETE






GLASS - REFLECTIVE



GLASS - TRANSLUCEN

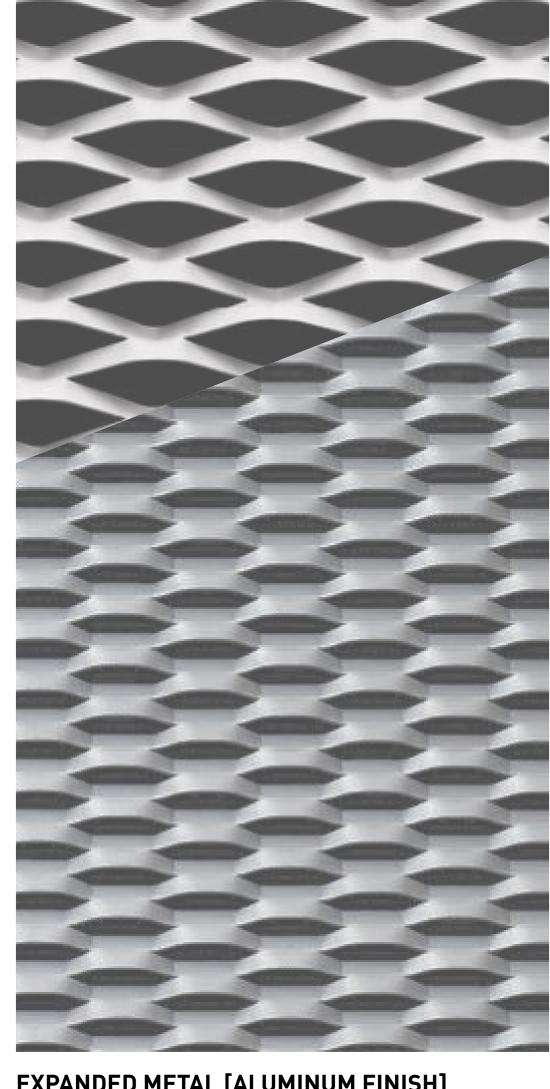

EXPANDED METAL [ALUMINUM FINISH]

4 Issued for DDP 26.05.2025 3 Issued for TRG2 response 14.12.2023 2 Issued for TRG1 response 21.09.2023 AR / RG PB 23.05.2025 The Contractor shall verify all dimensions, datums and levels prior to commencement of work.

All errors and omissions to be reported to the Architect before proceeding.

This drawing must not be scaled.

This drawing is the property of the Architect; the copyright in same being reserved to him/her. It is

Any unauthorized alteration of the electronic data which constitute this document will void all responsibility for the altered document by the Architect.

This drawing is not to be used for building purposes until countersigned by:



266 MCDERMOT AVE Winnipeg MB R3B 0S8 P: 204.480.8421 F: 204.480.8876

1702 QUADRA STREET + 862 FISGARD STREET

MATERIALS

Project 0650 Sheet AG.4



MARCH 20 9:00 AM



MARCH 20 12:00 PM



MARCH 20 4:00 PM





JUNE 21 9:00 AM



JUNE 21 12:00 PM



JUNE 21 4:00 PM



SEPTEMBER 22 9:00 AM



SEPTEMBER 22 12:00 PM



SEPTEMBER 22 4:00 PM




DECEMBER 21 9:00 AM



DECEMBER 21 12:00 PM



DECEMBER 21 4:00 PM

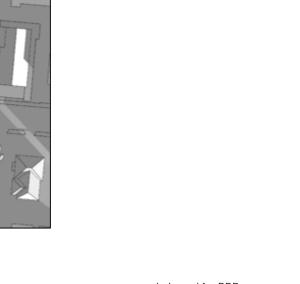

4 Issued for DDP 26.05.2025
3 Issued for TRG2 response 14.12.2023
2 Issued for TRG1 response 21.09.2023

Drawn By:
Checked By:
Printing Date:
PB
23.05.2025

The Contractor shall verify all dimensions, datums

and levels prior to commencement of work.


All errors and omissions to be reported to the Architect before proceeding.

This drawing must not be scaled.

This drawing is the property of the Architect; the copyright in same being reserved to him/her. It is not to be reproduced without his/her permission.

Any unauthorized alteration of the electronic data which constitute this document will void all responsibility for the altered document by the Architect.

This drawing is not to be used for building purposes until countersigned by:

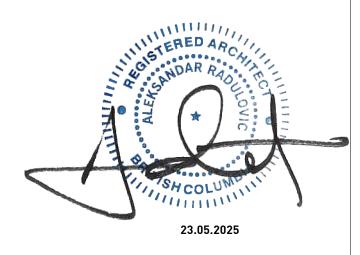


ARCHITECTURE INC 266 MCDERMOTAVE Winnipeg MB R3B 0S8 P: 204.480.8421 F: 204.480.8876

1702 QUADRA STREET + 862 FISGARD STREET

SHADOW STUDIES

Project 0650 Sheet AG.5 QUADRA ST ELEVATION [EAST FACADE]

FISGARD ST ELEVATION [SOUTH FACADE]

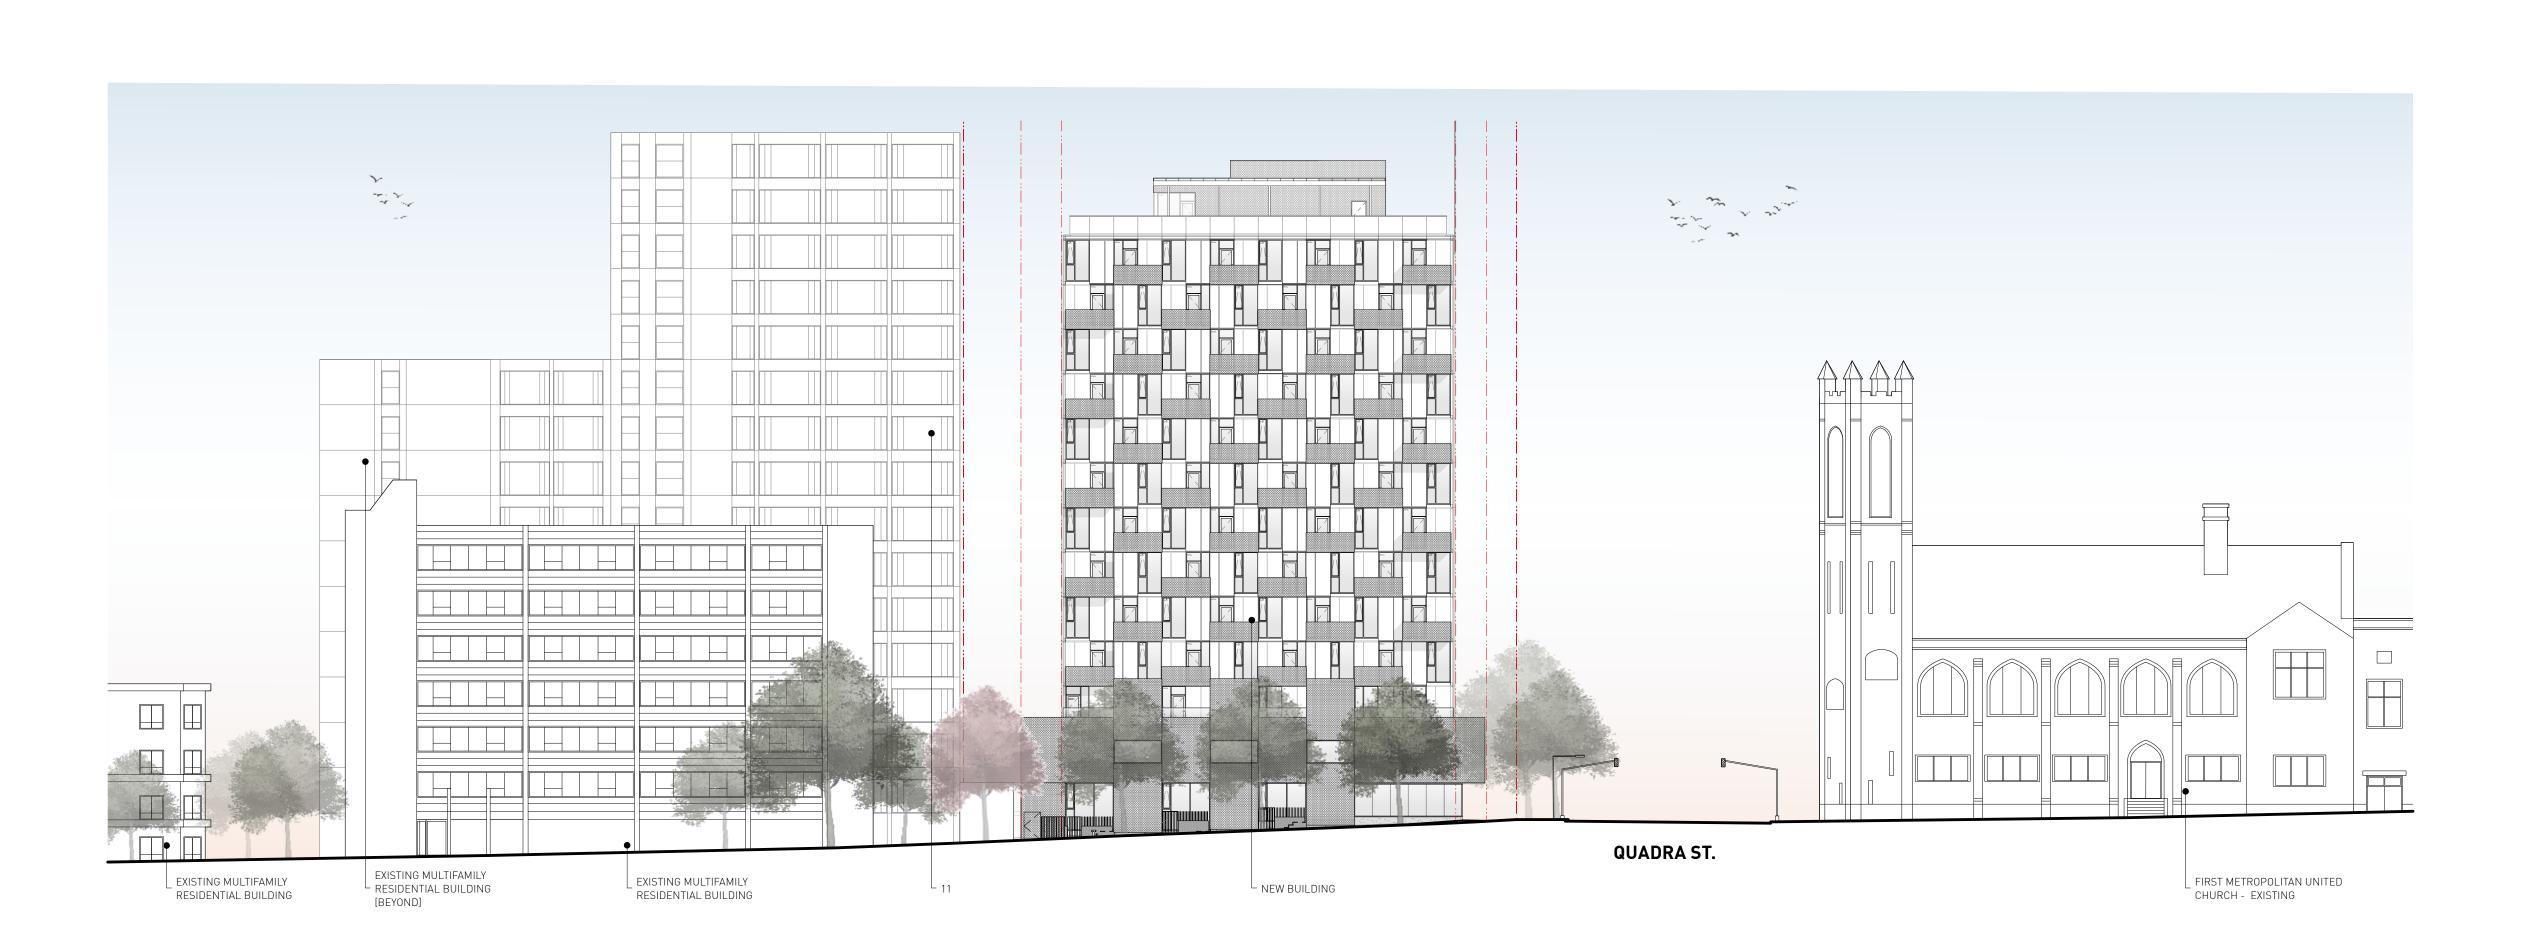

4 Issued for DDP

26.05.2025 3 Issued for TRG2 response 14.12.2023 2 Issued for TRG1 response 21.09.2023

EA / AR PB 23.05.2025 Printing Date:

The Contractor shall verify all dimensions, datums and levels prior to commencement of work.


All errors and omissions to be reported to the Architect before proceeding.


This drawing must not be scaled.

This drawing is the property of the Architect; the copyright in same being reserved to him/her. It is

Any unauthorized alteration of the electronic data which constitute this document will void all responsibility for the altered document by the

This drawing is not to be used for building purposes until countersigned by:

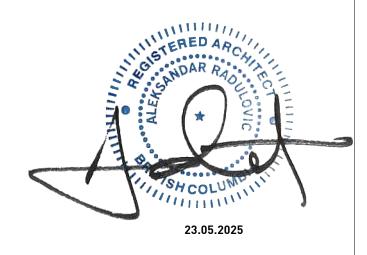

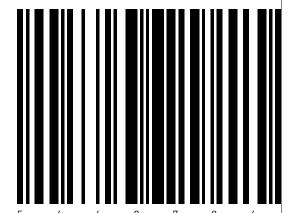

266 MCDERMOT AVE Winnipeg MB R3B 0S8 P: 204.480.8421 F: 204.480.8876

1702 QUADRA STREET + 862 FISGARD STREET

CONTEXT ELEVATIONS

Sheet

AG.6

RESIDENTIAL WINDOW SCHEDULE

• ALL GLAZING TO BE HSTG, LOW E ON SURFACE 2, ARGON-FILLED W/ SUPERSPACERS, LOW REFLECTIVITY COATING TO REDUCE INTERNAL GLARE

ALUMINUM WINDOW WALL SYSTEM

REFER TO WINDOW SUPPLIER CUT SHEETS FOR TEMPERING REQUIREMENTS
 PROVIDE PRE-FINISHED ALUMINUM FLASHING AT HEADS AND SILLS, COLOUR TO BE SELECTED BY ARCHITECT

• GLASS TO BE 3mm CLEAR [UNLESS OTHERWISE NOTED OR REQUIRED BY MANUFACTURING ENGINEER]

ALL INTERIOR CASINGS TO BE GYPSUM BOARD RETURN
ALL WINDOWS TO MEET NAFS-17 & CANADIAN TEST STANDARDS. ENVELOPE CONSULTANT TO REVIEW TESTING DATA.

ALL WINDOW SPECIFICATIONS MUST COMPLY OR SURPASS ENERGY CODE CONSULTANT'S ENERGY MODEL ASSUMPTIONS
 REFER TO ENVELOPE CONSULTANT WINDOW INSTALLATION GUIDELINES FOR SILL AND THREE SIDES MEMBRANE DETAILING FOR ALL RESIDENTIAL WINDOWS

ENVELOPE CONSULTANT TO REVIEW ALL RESIDENTIAL AND COMMERCIAL GLAZING SHOP DRAWINGS

COMMERCIAL WINDOW SCHEDULE

• ALUMICOR THERMALLY BROKEN STOREFRONT OR APPROVED EQUAL, SSG, ANTI-ROTATION BLOCKS TO BE ALUMINUM OR PVC
• ALL GLAZING TO BE HSTG, LOW E ON SURFACE 2, ARGON-FILLED W/ SUPERSPACERS, LOW REFLECTIVITY COATING TO REDUCE

INTERNAL GLARE


ALL EXTERIOR CURTAINWALL TO BE TEMPERED, BLACK FRAME

GLASS TO BE 6mm CLEAR & TEMPERED
 ALL WINDOW SPECIFICATIONS MUST COMPLY OR SURPASS ENERGY CODE CONSULTANT'S ENERGY MODEL ASSUMPTIONS


SUPPLY SPANDREL PANEL AS REQUIRED FOR MECHANICAL GRILLE PENETRATIONS OF CURTAIN WALL.


• ENVELOPE CONSULTANT TO REVIEW ALL RESIDENTIAL AND COMMERCIAL GLAZING SHOP DRAWINGS

RESIDENTIAL WINDOW WALL

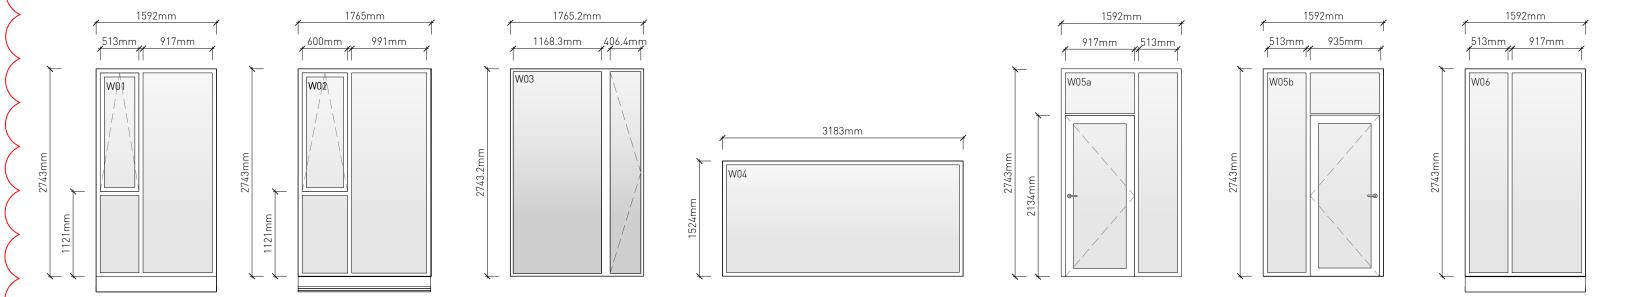



LIVE WORK STOREFRONT

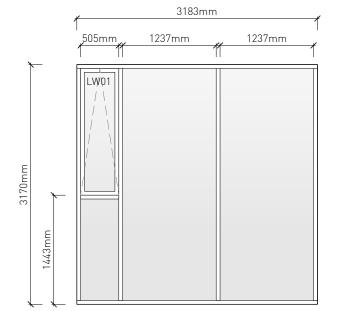


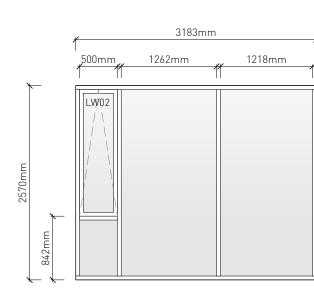


COMMERCIAL STOREFRONT

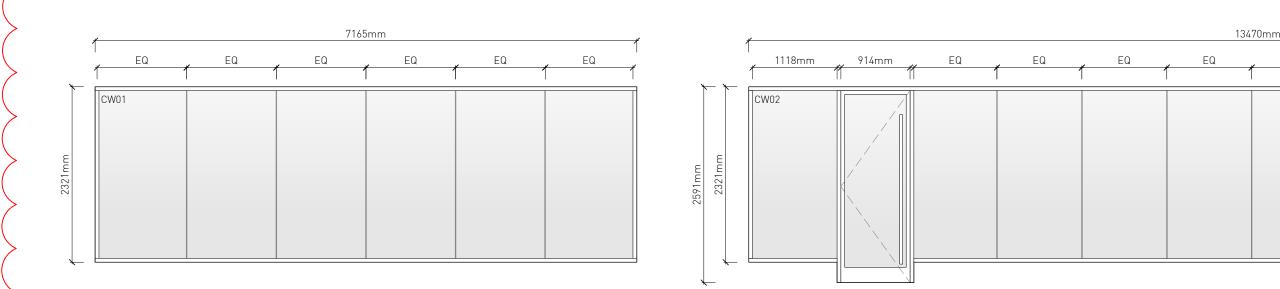


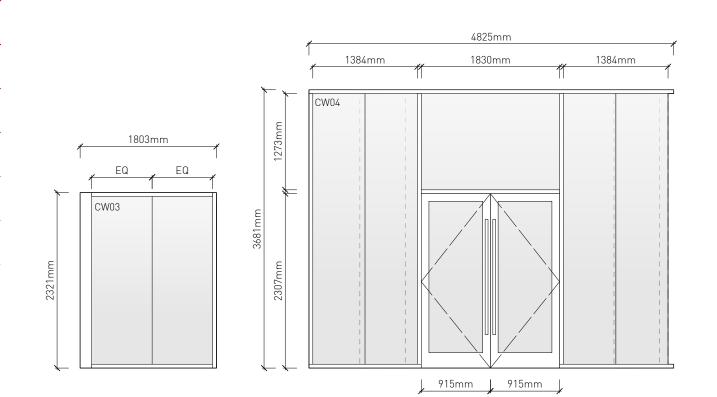


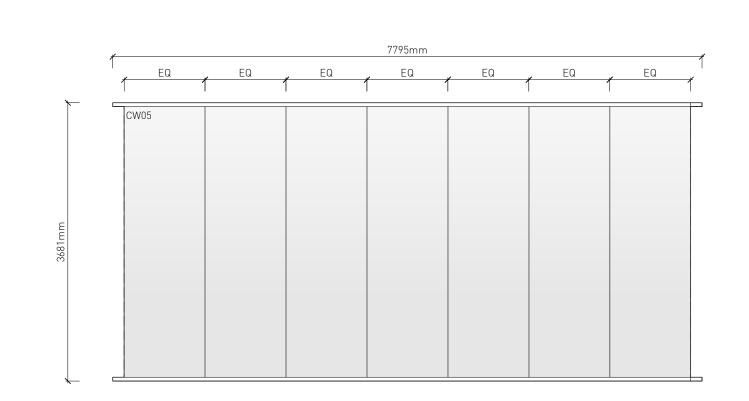

PENTHOUSE STOREFRONT

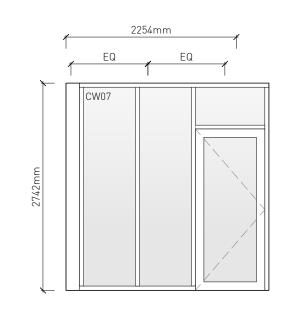

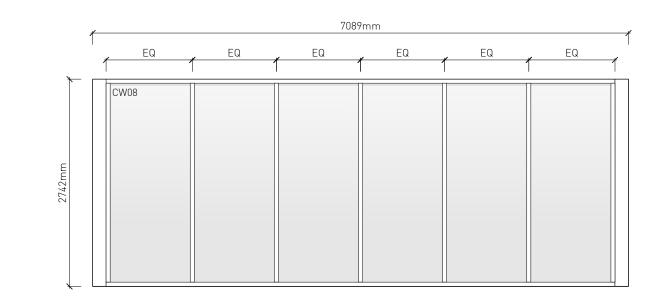

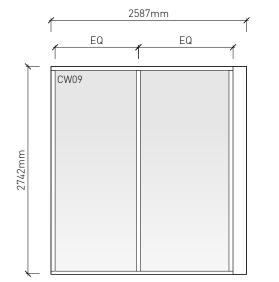



4 Issued for DDP
3 Issued for TRG2 response

2 Issued for TRG1 response

Drawn By: JK
Checked By: PB
Printing Date: 23.05.2025

26.05.2025

14.12.2023

21.09.2023

The Contractor shall verify all dimensions, datums and levels prior to commencement of work.

All errors and omissions to be reported to the Architect before proceeding.

This drawing must not be scaled.


This drawing is the property of the Architect; the copyright in same being reserved to him/her. It is not to be reproduced without his/her permission.

Any unauthorized alteration of the electronic data which constitute this document will void all responsibility for the altered document by the

This drawing is not to be used for building purposes until countersigned by:



23.05.2025

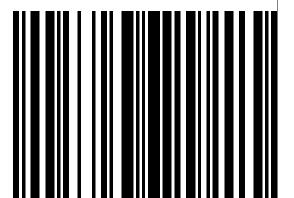

5 4 6 8 7 9 6 A R C H I T E C T U R E I N C 266 MCDERMOT AVE Winnipeg MB R3B 0S8 P: 204.480.8421 F: 204.480.8876

1702 QUADRA STREET + 862 FISGARD STREET


WINDOW & DOOR


SCHEDULE

AG.7


0650

Sheet

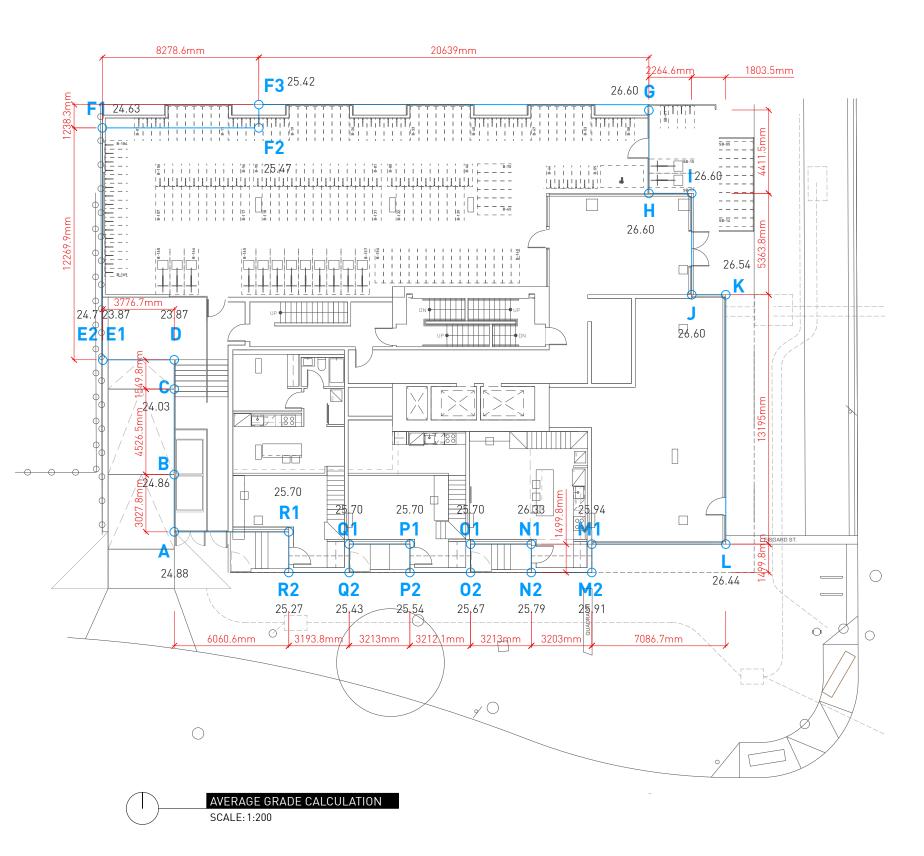

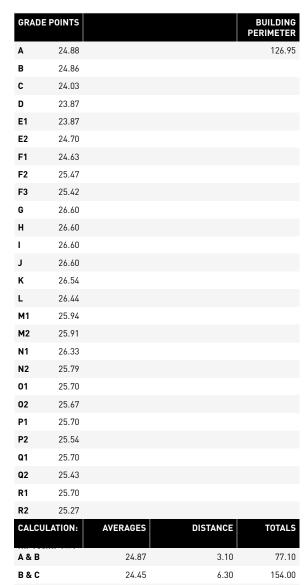


R1 25 R2 25 CALGULATIO A & B B & C C & D D & E1 E2 & F1 F1 & F2 F2 & F3 F3 & G G & H H & I I & J J & K K & L L & M1 M1 & M2 M2 & N2 N2 & N1 N1 & 01 01 & 02 02 & P2 P2 & P1 P1 & Q1 Q1 & Q2 Q2 & R2	24.87 24.45 23.95 23.87 24.67 25.05 25.45	3.10 6.30 5.40 3.77	77.10 154.00 129.33 89.99
CALCULATION A & B B & C C & D D & E1 E2 & F1 F1 & F2 F2 & F3 F3 & G G & H H & I I & J J & K K & L L & M1 M1 & M2 M2 & N2 N2 & N1 N1 & 01 O1 & 02 O2 & P2 P2 & P1 P1 & Q1 Q1 & Q2 Q2 & R2	24.87 24.45 23.95 23.87 24.67 25.05 25.45	3.10 6.30 5.40 3.77 13.2	77.10 154.00 129.33
A & B B & C C & D D & E1 E2 & F1 F1 & F2 F2 & F3 F3 & G G & H H & I I & J J & K K & L L & M1 M1 & M2 M2 & N2 N2 & N1 N1 & 01 01 & 02 02 & P2 P2 & P1 P1 & Q1 Q1 & Q2 Q2 & R2	24.87 24.45 23.95 23.87 24.67 25.05 25.45	3.10 6.30 5.40 3.77 13.2	77.10 154.00 129.33
B & C C & D D & E1 E2 & F1 F1 & F2 F2 & F3 F3 & G G & H H & I I & J J & K K & L L & M1 M1 & M2 M2 & N2 N2 & N1 N1 & 01 01 & 02 02 & P2 P2 & P1 P1 & Q1 Q1 & Q2 Q2 & R2	24.45 23.95 23.87 24.67 25.05 25.45	6.30 5.40 3.77 13.2	154.00 129.33
C & D D & E1 E2 & F1 F1 & F2 F2 & F3 F3 & G G & H H & I I & J J & K K & L L & M1 M1 & M2 M2 & N2 N2 & N1 N1 & 01 01 & 02 02 & P2 P2 & P1 P1 & Q1 Q1 & Q2 Q2 & R2	23.95 23.87 24.67 25.05 25.45	5.40 3.77 13.2	129.33
D & E1 E2 & F1 F1 & F2 F2 & F3 F3 & G G & H H & I I & J J & K K & L L & M1 M1 & M2 M2 & N2 N2 & N1 N1 & 01 O1 & 02 O2 & P2 P2 & P1 P1 & Q1 Q1 & Q2 Q2 & R2	23.87 24.67 25.05 25.45	3.77 13.2	
E2 & F1 F1 & F2 F2 & F3 F3 & G G & H H & I I & J J & K K & L L & M1 M1 & M2 M2 & N2 N2 & N1 N1 & 01 01 & 02 02 & P2 P2 & P1 P1 & Q1 Q1 & Q2 Q2 & R2	24.67 25.05 25.45	13.2	89.99
F1 & F2 F2 & F3 F3 & G G & H H & I I & J J & K K & L L & M1 M1 & M2 M2 & N2 N2 & N1 N1 & 01 01 & 02 02 & P2 P2 & P1 P1 & Q1 Q1 & Q2 Q2 & R2	25.05 25.45		
F2 & F3 F3 & G G & H H & I I & J J & K K & L L & M1 M1 & M2 M2 & N2 N2 & N1 N1 & 01 01 & 02 02 & P2 P2 & P1 P1 & Q1 Q1 & Q2 Q2 & R2	25.45		325.58
F3 & G G & H H & I I & J J & K K & L L & M1 M1 & M2 M2 & N2 N2 & N1 N1 & 01 01 & 02 02 & P2 P2 & P1 P1 & Q1 Q1 & Q2 Q2 & R2		8.3	207.92
G & H H & I I & J J & K K & L L & M1 M1 & M2 M2 & N2 N2 & N1 N1 & 01 01 & 02 02 & P2 P2 & P1 P1 & Q1 Q1 & Q2 Q2 & R2	01.04	1.2	30.53
H & I I & J J & K K & L L & M1 M1 & M2 M2 & N2 N2 & N1 N1 & 01 01 & 02 02 & P2 P2 & P1 P1 & Q1 Q1 & Q2 Q2 & R2	26.01	20.6	535.81
I & J J & K K & L L & M1 M1 & M2 M2 & N2 N2 & N1 N1 & 01 01 & 02 02 & P2 P2 & P1 P1 & Q1 Q1 & Q2 Q2 & R2	26.60	4.40	117.04
J & K K & L L & M1 M1 & M2 M2 & N2 N2 & N1 N1 & 01 01 & 02 02 & P2 P2 & P1 P1 & Q1 Q1 & Q2 Q2 & R2	26.60	2.26	60.12
K & L L & M1 M1 & M2 M2 & N2 N2 & N1 N1 & 01 01 & 02 02 & P2 P2 & P1 P1 & Q1 Q1 & Q2 Q2 & R2	26.60	5.36	142.58
L & M1 M1 & M2 M2 & N2 N2 & N1 N1 & 01 O1 & O2 O2 & P2 P2 & P1 P1 & Q1 Q1 & Q2 Q2 & R2	26.57	1.80	47.83
M1 & M2 M2 & N2 N2 & N1 N1 & O1 O1 & O2 O2 & P2 P2 & P1 P1 & Q1 Q1 & Q2 Q2 & R2	26.49	13.19	349.40
M2 & N2 N2 & N1 N1 & 01 O1 & O2 O2 & P2 P2 & P1 P1 & Q1 Q1 & Q2 Q2 & R2	26.19	7.01	183.59
N2 & N1 N1 & 01 O1 & O2 O2 & P2 P2 & P1 P1 & Q1 Q1 & Q2 Q2 & R2	25.93	1.5	38.89
N1 & 01 01 & 02 02 & P2 P2 & P1 P1 & Q1 Q1 & Q2 Q2 & R2	25.85	3.21	82.98
01 & 02 02 & P2 P2 & P1 P1 & Q1 Q1 & Q2 Q2 & R2	26.06	1.5	39.09
02 & P2 P2 & P1 P1 & Q1 Q1 & Q2 Q2 & R2	26.02	3.21	83.51
P2 & P1 P1 & Q1 Q1 & Q2 Q2 & R2	25.69	1.5	38.53
P1 & Q1 Q1 & Q2 Q2 & R2	25.61	3.21	82.19
Q1 & Q2 Q2 & R2	25.62	1.5	38.43
Q2 & R2	25.70	3.21	82.50
	25.57	1.5	38.35
	25.35	3.21	81.37
R2 & R1	25.49	1.5	38.23
R1 & A	25.29	6.01	151.99
		126.95	3246.86
AVERAGE			
25.58			

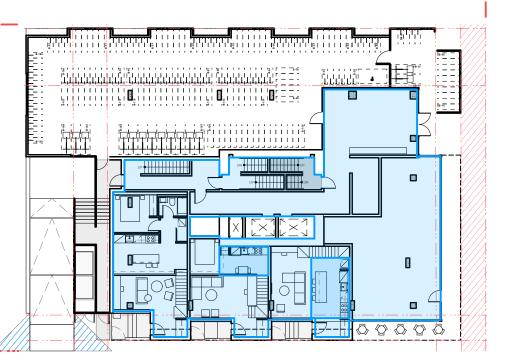


384.00 m²



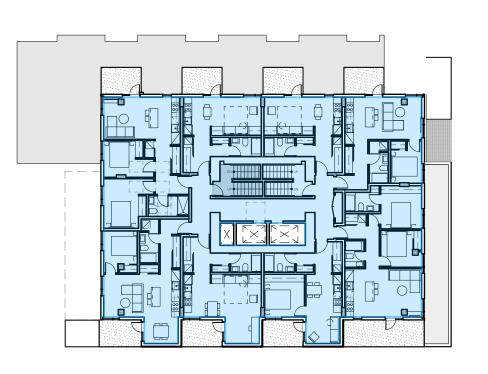


445.46 m²



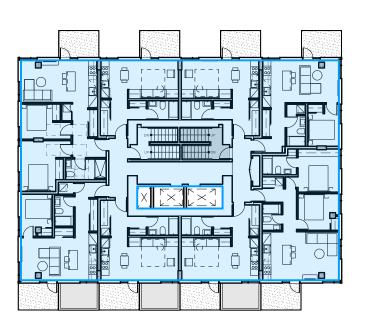

428.50 m²



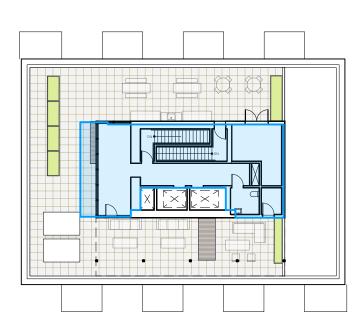

102.5 m²



PROJECT STATS:

REVISION NO.3				DECEMBER 14, 2023
SITE INFORMATION				
LEGAL DESCRIPTION	ZONING: R3-C	LOTS: A, 1, 2	SUBURBAN LOT: 4	PLAN: CITY 01516011
CIVIC ADDRESS	1702 QUADRA STE	REET, VICTORIA, BC		
ZONING	CURF [R-3C, RESIDE FAM	NTIAL MULTI-		1702 QUADRA PROJECT STATS
SITE AREA [m²]				947.78
GROSS FLOOR AREA [m²]				5217.01
FLOOR SPACE RATIO	3.	0		5.50
SITE COVERAGE (%)				76.5%
OPEN SITE SPACE (%)				23.5%
AVERAGE GRADE				24.59 m
BUILDING HEIGHT	NO BUILDING SH METRES I			13 STOREYS [42.88m]
SETBACKS				
NORTH [SIDE]	6.0	lm		4.85m [[EXCLUDING BIKE PARKING ENCLOSURE]
EAST [FRONT]	4.5	im		2.0m [BASE] 4.0m [TOWER]
SOUTH [FLANKING]	4.5	im		0.85m [BASE] 2.85m [TOWER]
WEST [REAR]	6.0	lm		3.8m [BASE - EXCLUDING BIKE PARKING ENCLOSURE] 6.5m [TOWER]

BUILDING DATA			
UNIT TYPES	AVERAGE AREA (M²)	UNIT COUNT	TOTAL AREA (M²)
RESIDENTIA	AL		
BACHELOR	34.72	43	1,492.85
1 BEDROOM UNIT	47.27	24	1,134.38
2 BEDROOM UNIT	65.19	21	1,368.95
ОТНЕ	ER		
COMMERCIAL UNIT [S]	86.43	1	86.43
WORK / LIVE	57.85	3	173.55
TOTAL		92	
TOTAL RENTABLE AREA			4,256.16

RESIDENTIAL UNIT MIX	UNIT COUNT	%
BACHELOR	43	47%
1 BEDROOM UNIT	24	26%
2 BEDROOM UNIT	21	23%

SITE DATA	
	AREA [m²]
EVEL 01	384.00
EVEL 02	445.46
EVEL 03	428.50
EVEL 04	428.50
EVEL 05	428.50
EVEL 06	428.50
EVEL 07	428.50
EVEL 08	428.50
EVEL 09	428.50
EVEL 10	428.50
EVEL 11	428.50
EVEL 12	428.50
EVEL 13	102.55
OTAL GROSS FLOOR AREA	5217.01
BUILDING FOOTPRINT	724.88

	UNIT COUNT	RATE	REQUIRED STALLS
RESIDENTIAL			
UNIT < 45 M ²	44	0.85 STALLS / UNIT	37
UNIT 45-70 M ²	46	1.0 STALLS / UNIT	46
UNIT > 70 M ²	0	1.45 STALLS / UNIT	0
VISITOR	91	0.1 STALLS / UNIT	9
COMMERCIAL			
RESTAURANT	86.43	1.0 STALLS / 20m ²	4
TOTAL REQUIRED		'	97

	UNIT COUNT	RATE	REQUIRED STALLS
LONG TERM			
UNIT < 45 M ²	44	1.0 STALLS / UNIT	44
UNIT => 45 M ²	47	1.25 STALLS / UNIT	59
RESTAURANT	86.43	1.0 STALLS / 400m ²	1
TOTAL REQUIRED			104

TOTAL PROPOSED				182
SHORT TERM				
	RESIDENTIAL	91	0.1 STALLS / UNIT	9.1
	RESTAURANT	86.43	1.0 STALLS / 100m ²	1
TOTAL REQUIRED				11

 4 Issued for DDP
 26.05.2025

 3 Issued for TRG2 response
 14.12.2023

2 Issued for TRG1 response

Drawn By: EA / PB
Checked By: PB
Printing Date: 23.05.2025

21.09.2023

The Contractor shall verify all dimensions, datums and levels prior to commencement of work.


All errors and omissions to be reported to the Architect before proceeding.


This drawing must not be scaled.

This drawing is the property of the Architect; the copyright in same being reserved to him/her. It is not to be reproduced without his/her permission

Any unauthorized alteration of the electronic data which constitute this document will void all responsibility for the altered document by the

This drawing is not to be used for building purposes until countersigned by:

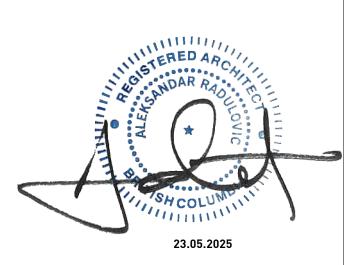

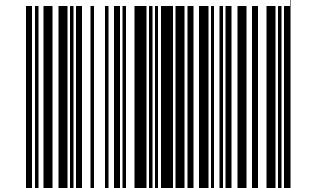


5 4 6 8 7 9 6 A R C H I T E C T U R E I N C 266 MCDERMOT AVE Winnipeg MB R3B 0S8 P: 204.480.8421 F: 204.480.8876

1702 QUADRA STREET + 862 FISGARD STREET

ZONING CALCULATIONS

Project
0650
Sheet

AG.8

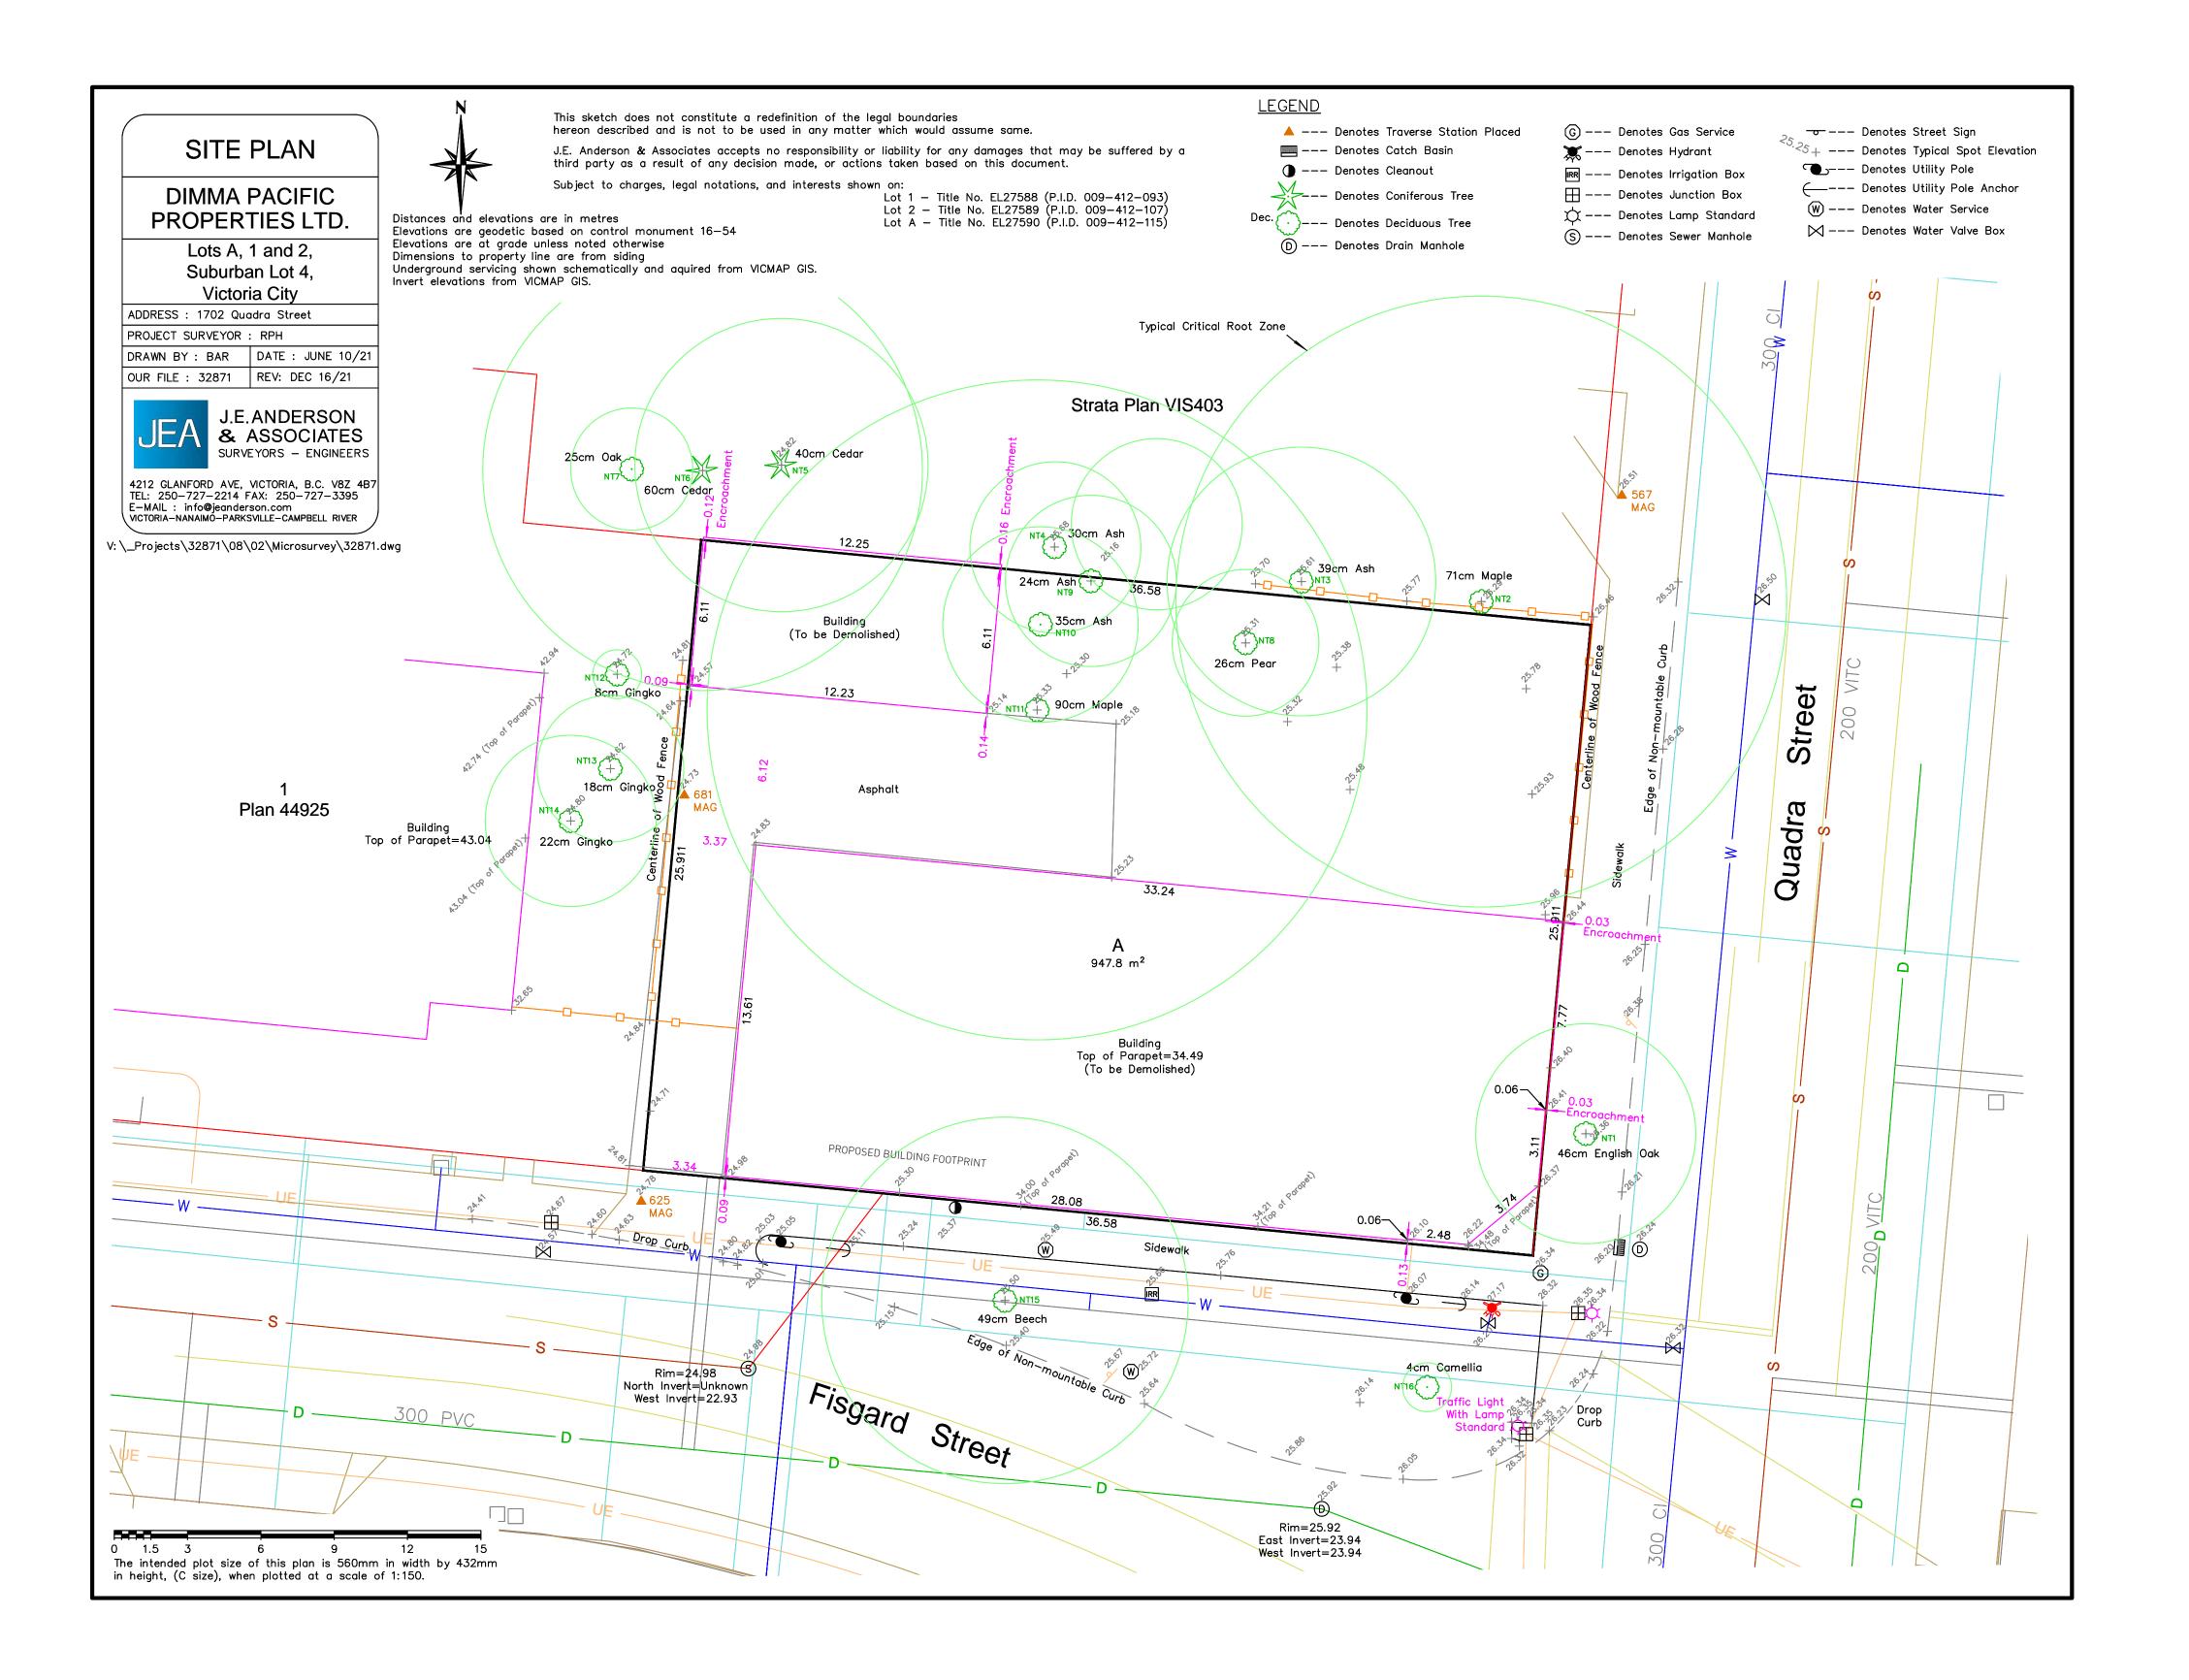

1 SITE SURVEY BY OTHERS
AG.5 SCALE: NTS

26.05.2025 4 Issued for DDP 3 Issued for TRG2 response 14.12.2023 2 Issued for TRG1 response 21.09.2023 1 Issued for DP 01.06.2023

PB 23.05.2025 Printing Date:

The Contractor shall verify all dimensions, datums

and levels prior to commencement of work. All errors and omissions to be reported to the

Architect before proceeding.

This drawing must not be scaled.


Drawn By: Checked By:


This drawing is the property of the Architect; the copyright in same being reserved to him/her. It is

Any unauthorized alteration of the electronic data which constitute this document will void all

responsibility for the altered document by the

This drawing is not to be used for building purposes until countersigned by:

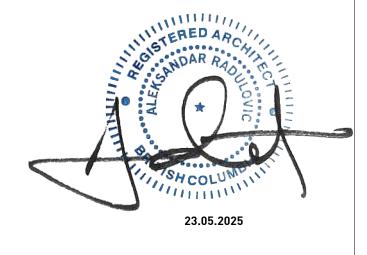

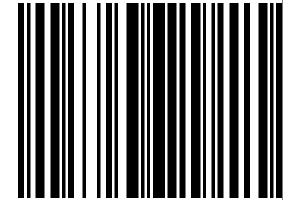


266 MCDERMOT AVE Winnipeg MB R3B 0S8 P: 204.480.8421 F: 204.480.8876

1702 QUADRA STREET + 862 FISGARD STREET

SITE SURVEY

0650 Sheet AG.9

Project

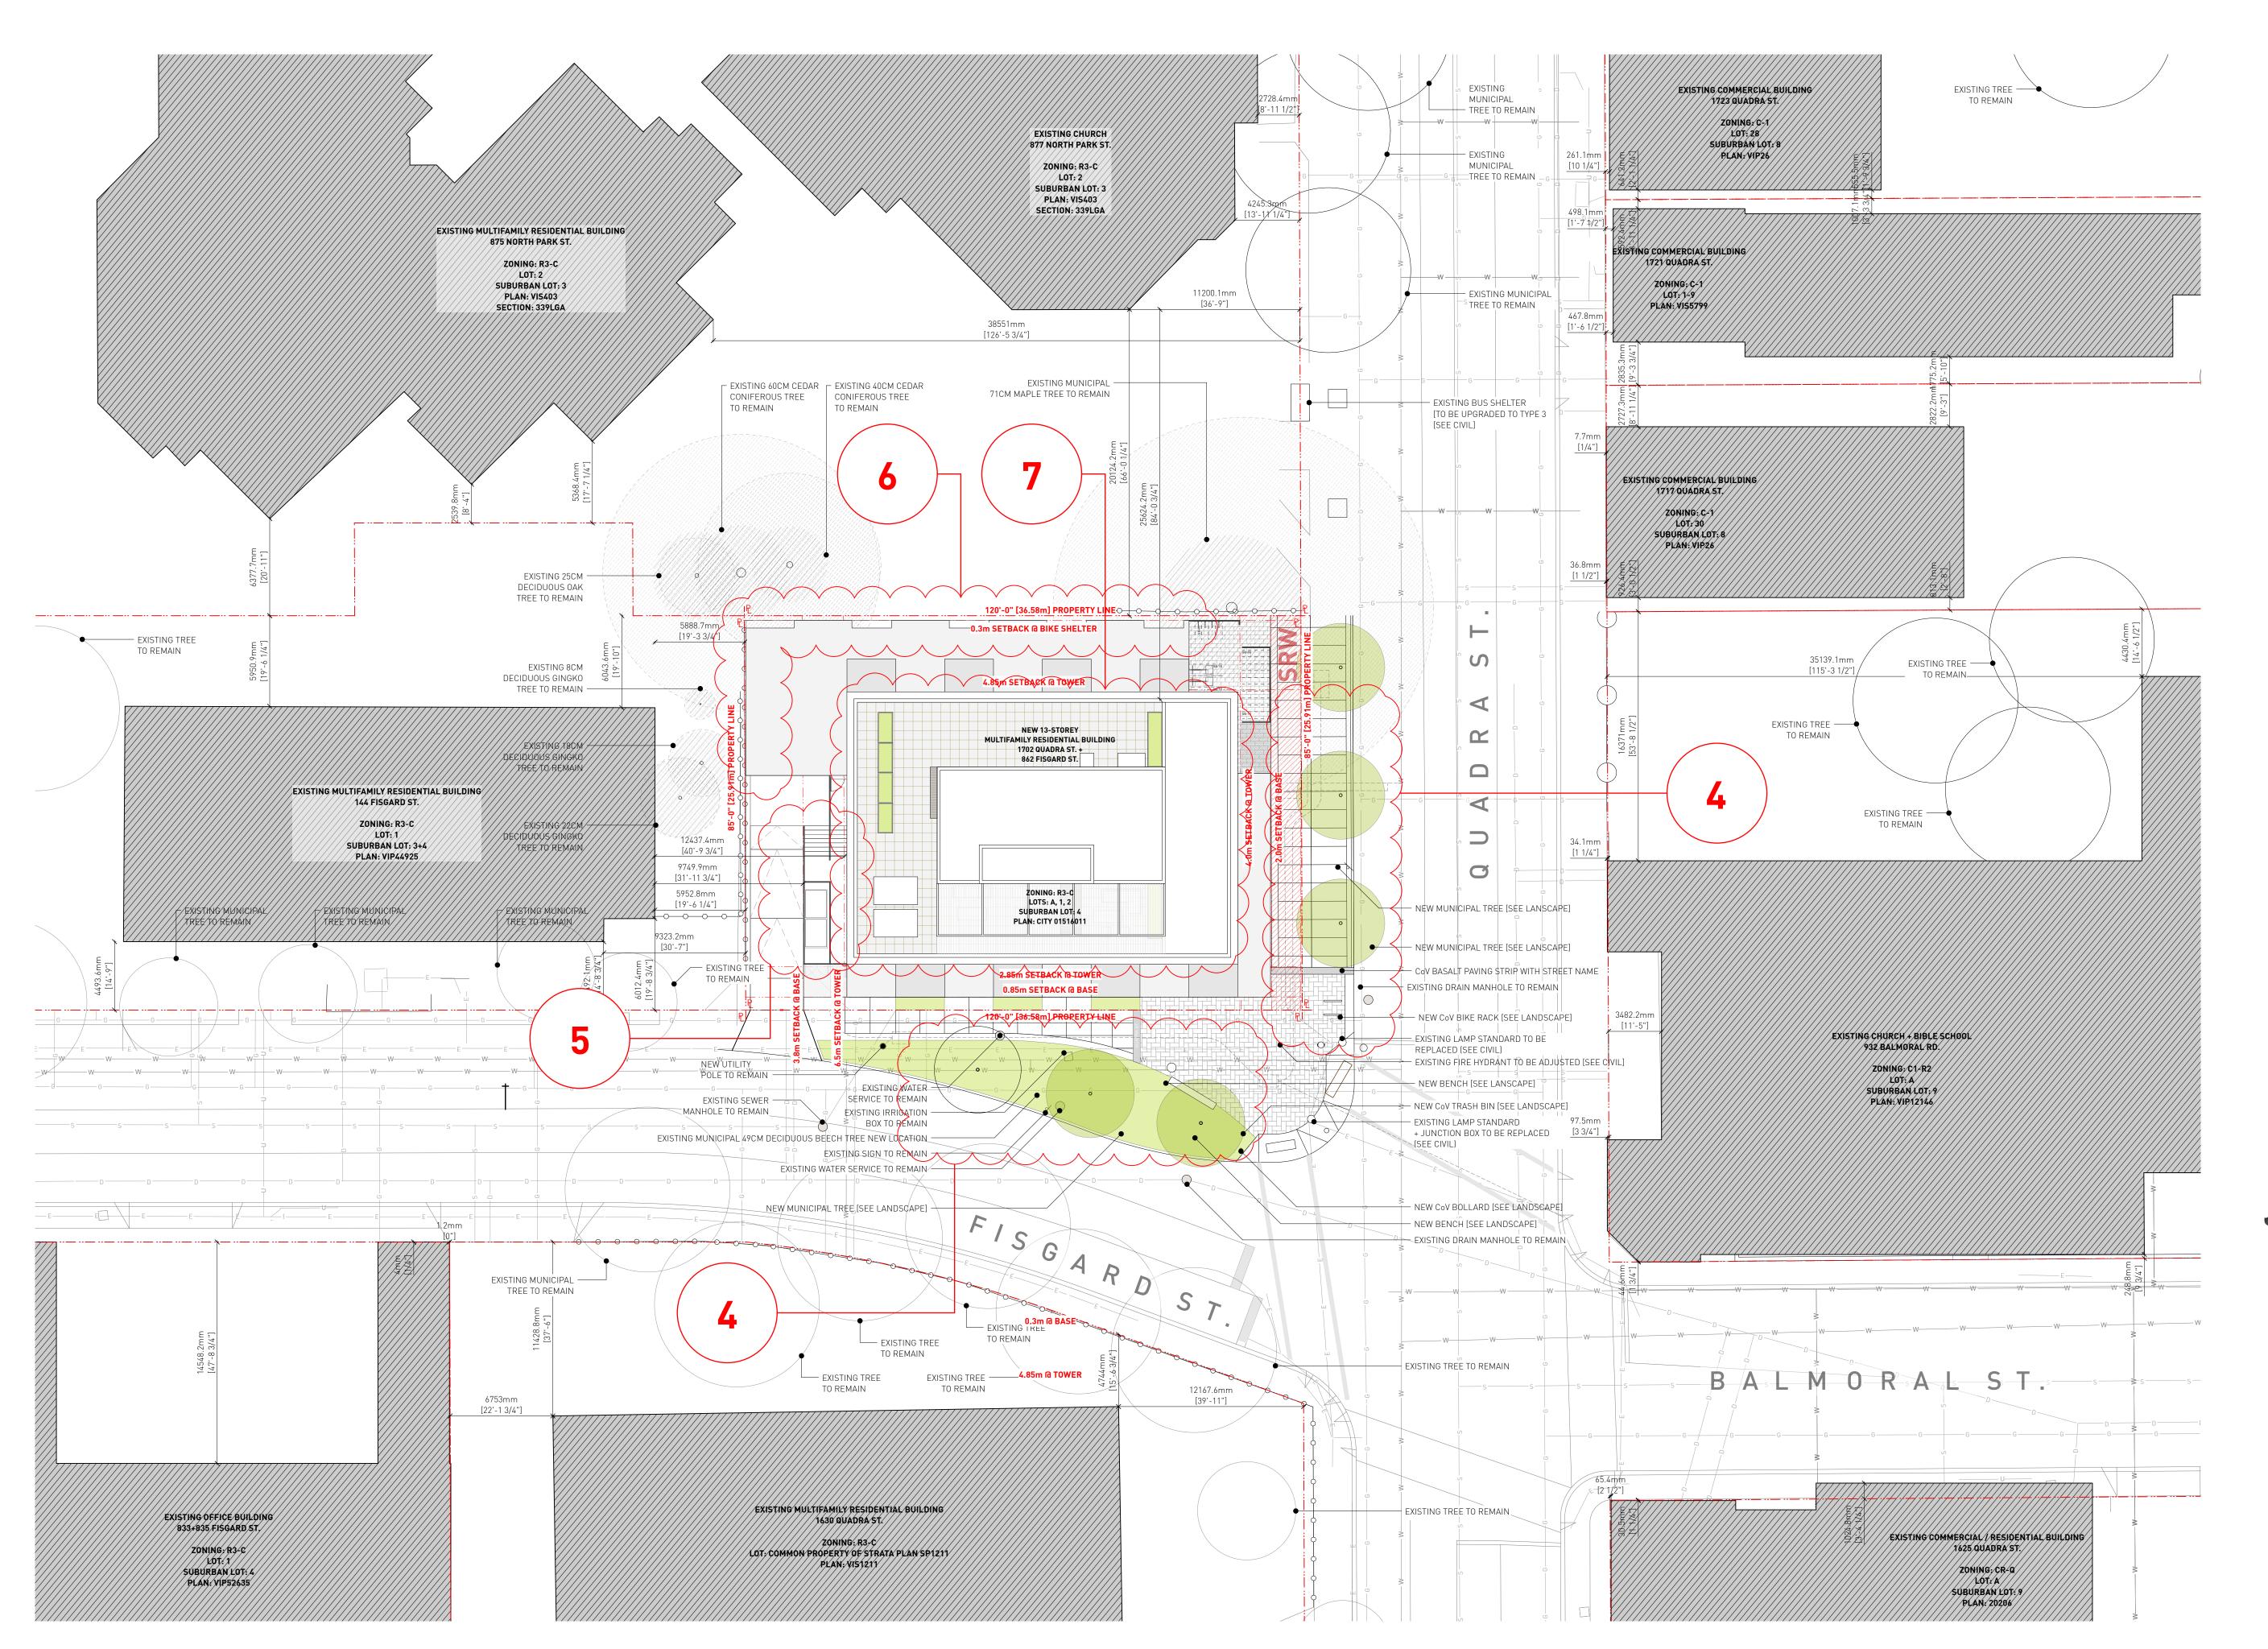

1 CONTEXT SITE PLAN
AG.6 SCALE: 1:200

LEGEND:

EXISTING BUILDING [TO BE DEMOLISHED]

EXISTING BUILDING

PROPOSED BUILDING
PROPERTY LINE
SETBACK LINE

EXISTING GAS LINE

EXISTING GAS LINE

EXISTING TREE [TO BE REMOVED]

EXISTING TREE

EXISTING TREE ROOT AREA

EXISTING TREE ROOT AREA [TO BE REMOVED]

EXISTING HYDRO POLE

EXISTING FIRE HYDRANT

4 Issued for DDP 26.05.2025
3 Issued for TRG2 response 14.12.2023
2 Issued for TRG1 response 21.09.2023

Drawn By: EA / MM / AR Checked By: PB Printing Date: 23.05.2025

The Contractor shall verify all dimensions, datums and levels prior to commencement of work.

All errors and omissions to be reported to the

Architect before proceeding.

This drawing must not be scaled.

This drawing is the property of the Architect; the copyright in same being reserved to him/her. It is not to be reproduced without his/her permission.

Any unauthorized alteration of the electronic data which constitute this document will void all responsibility for the altered document by the Architect.

This drawing is not to be used for building purposes until countersigned by:




266 MCDERMOT AVE Winnipeg MB R3B 0S8 P: 204.480.8421 F: 204.480.8876


1702 QUADRA STREET + 862 FISGARD STREET


CONTEXT SITE PLAN

0650 Sheet


Project

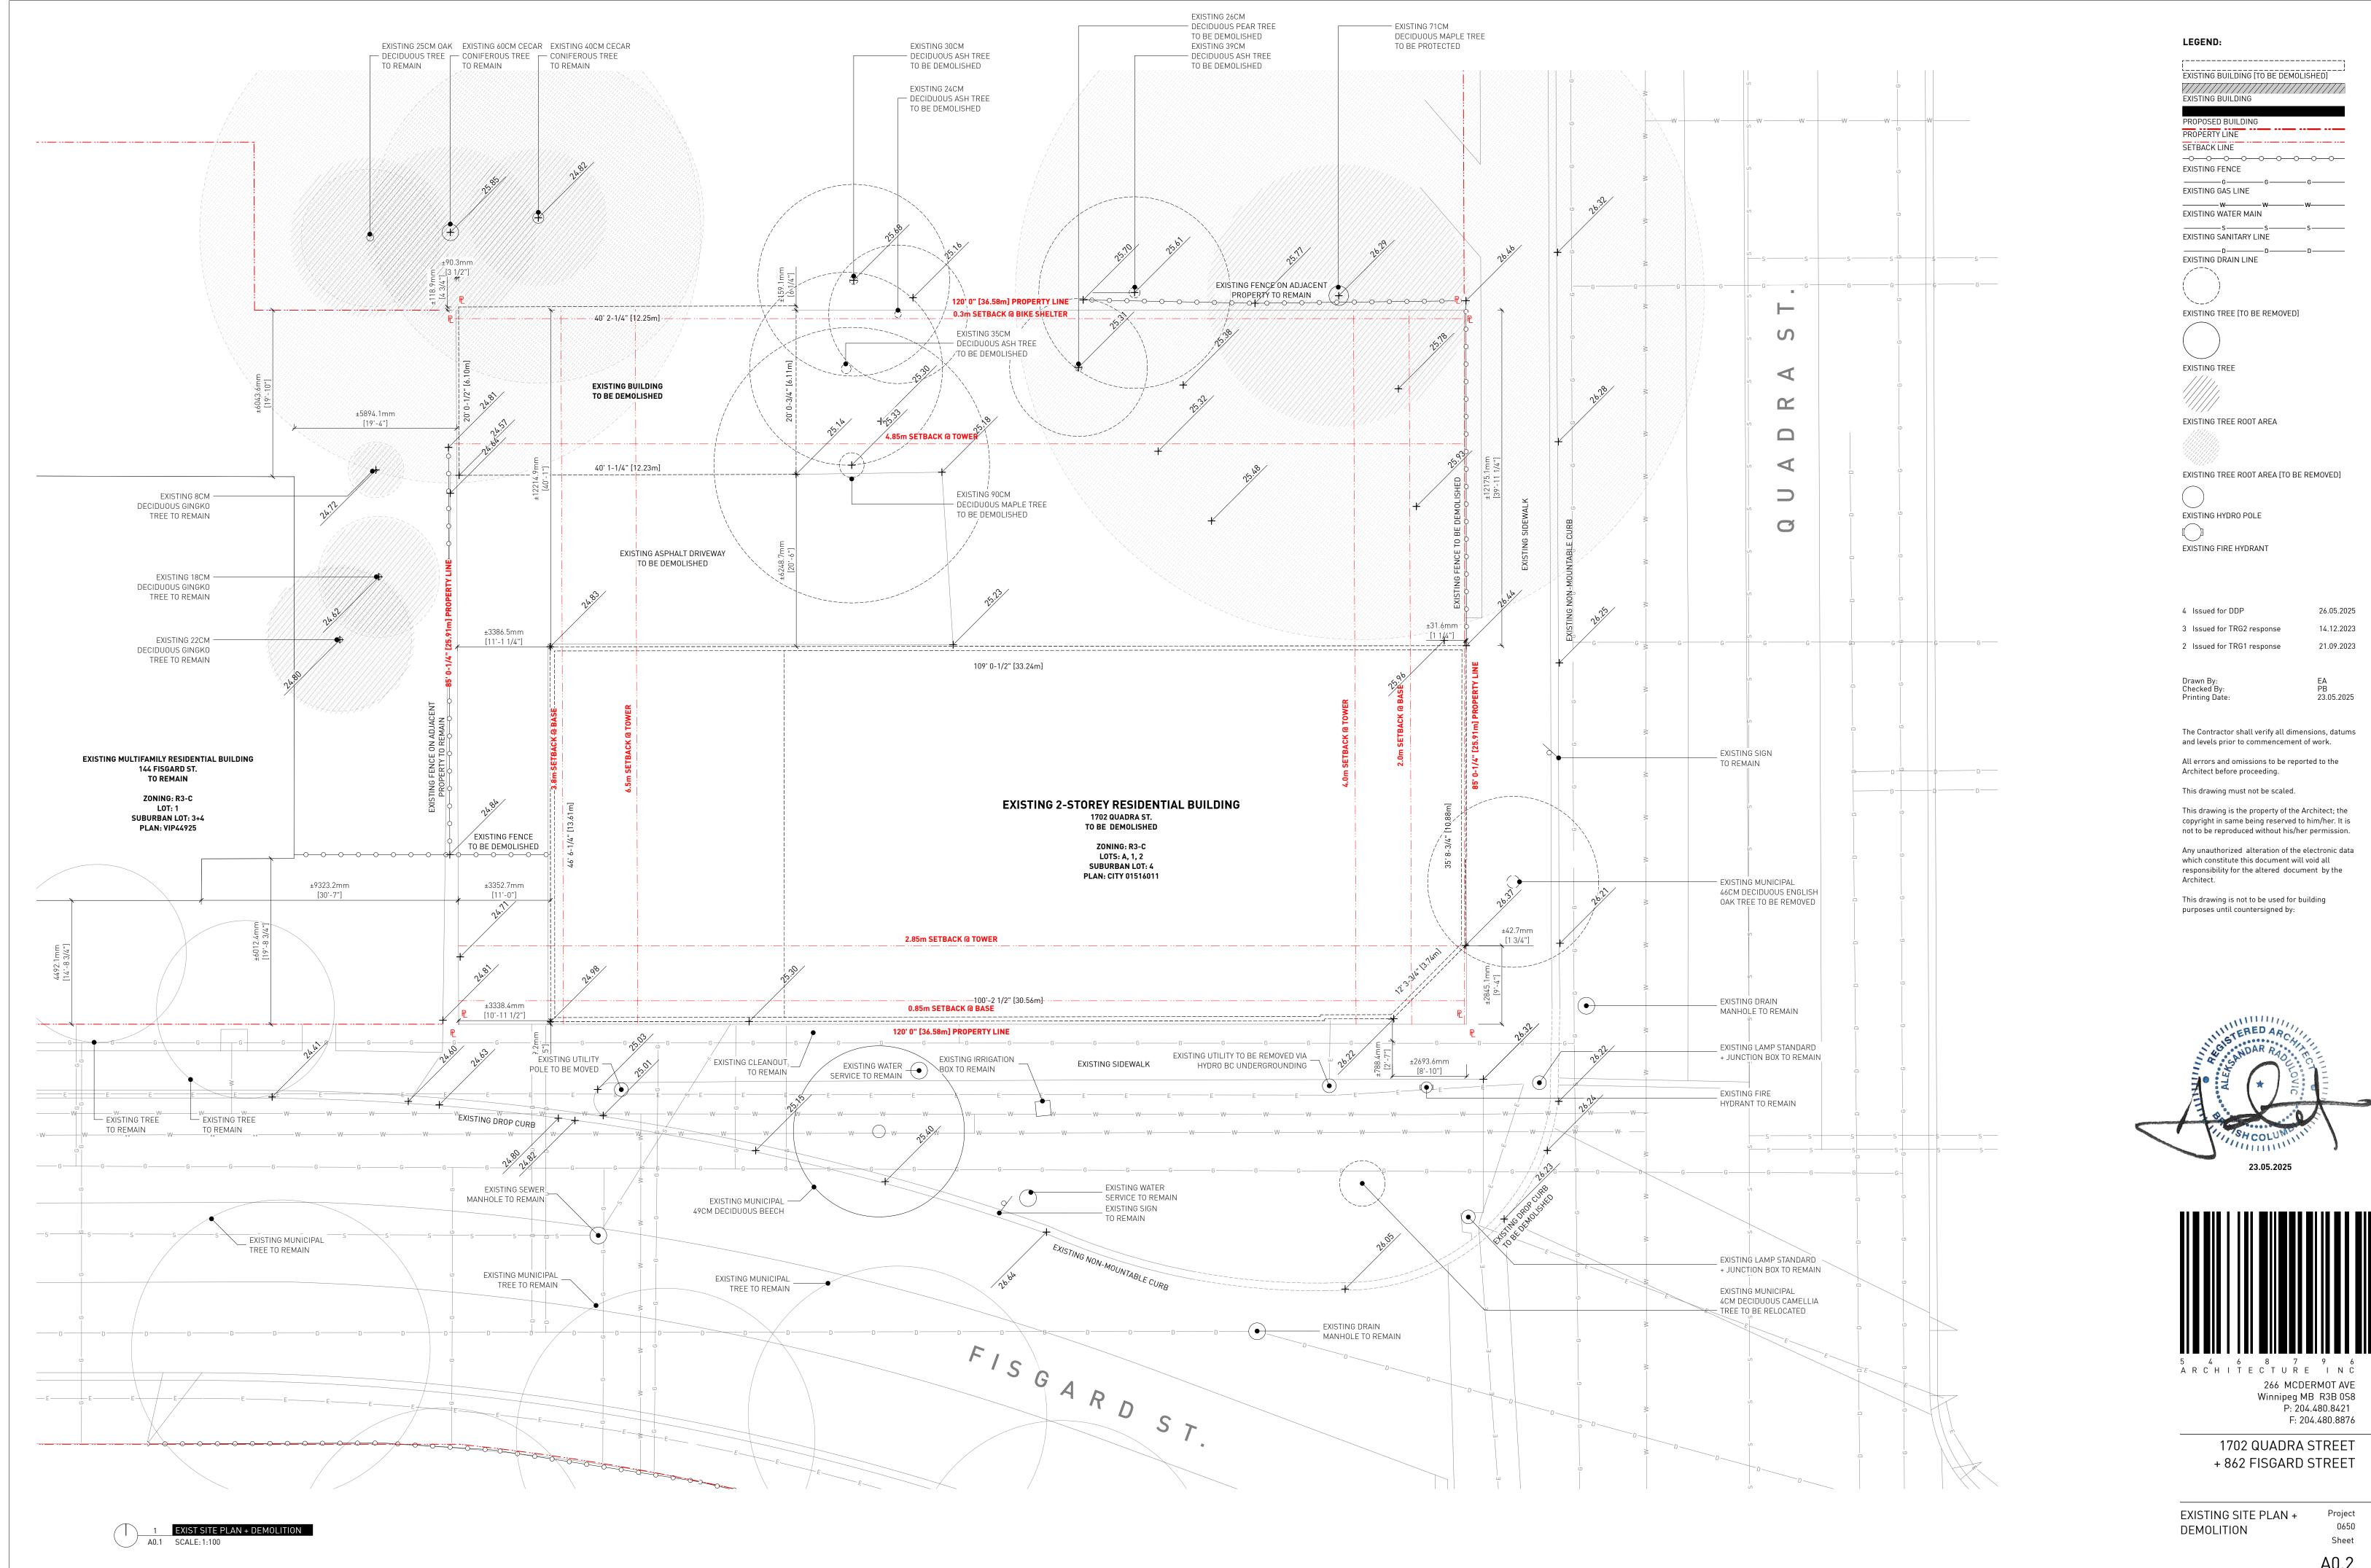


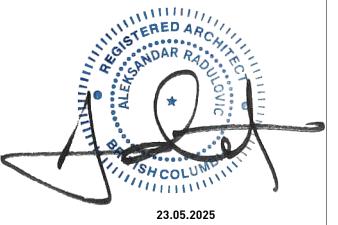

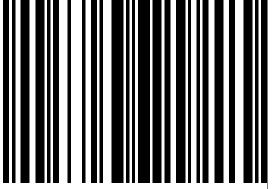

A0.2

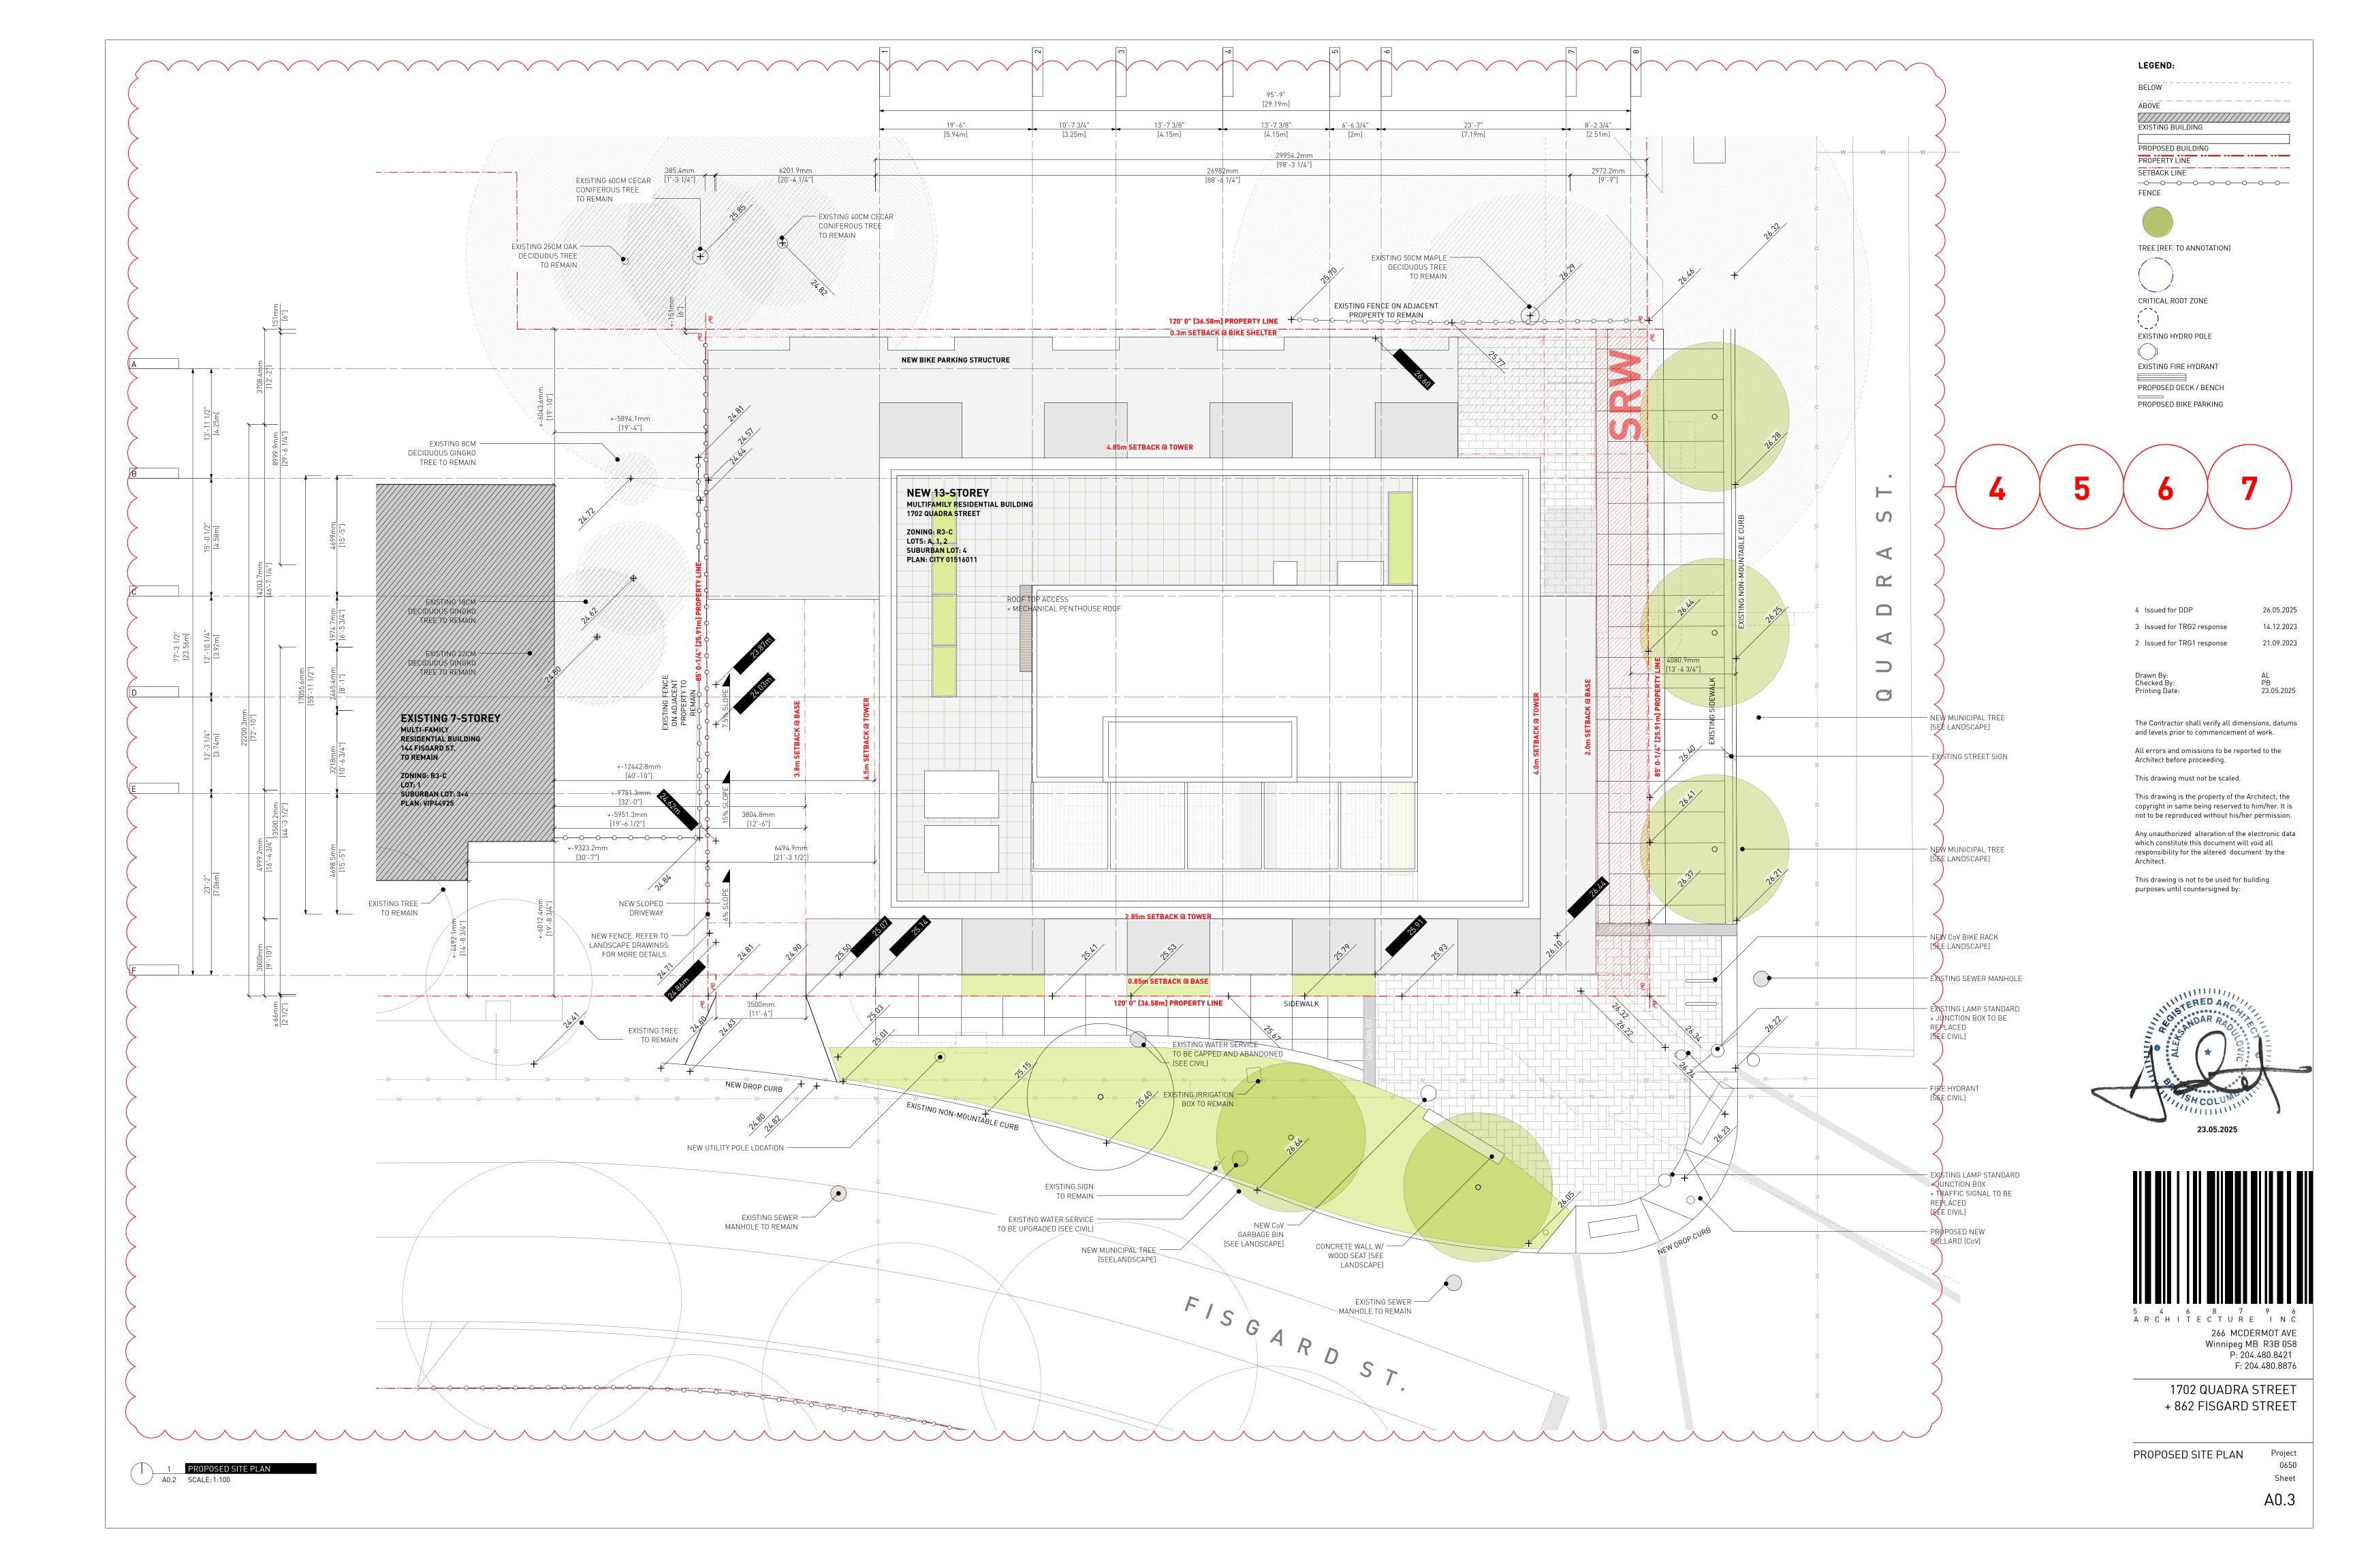

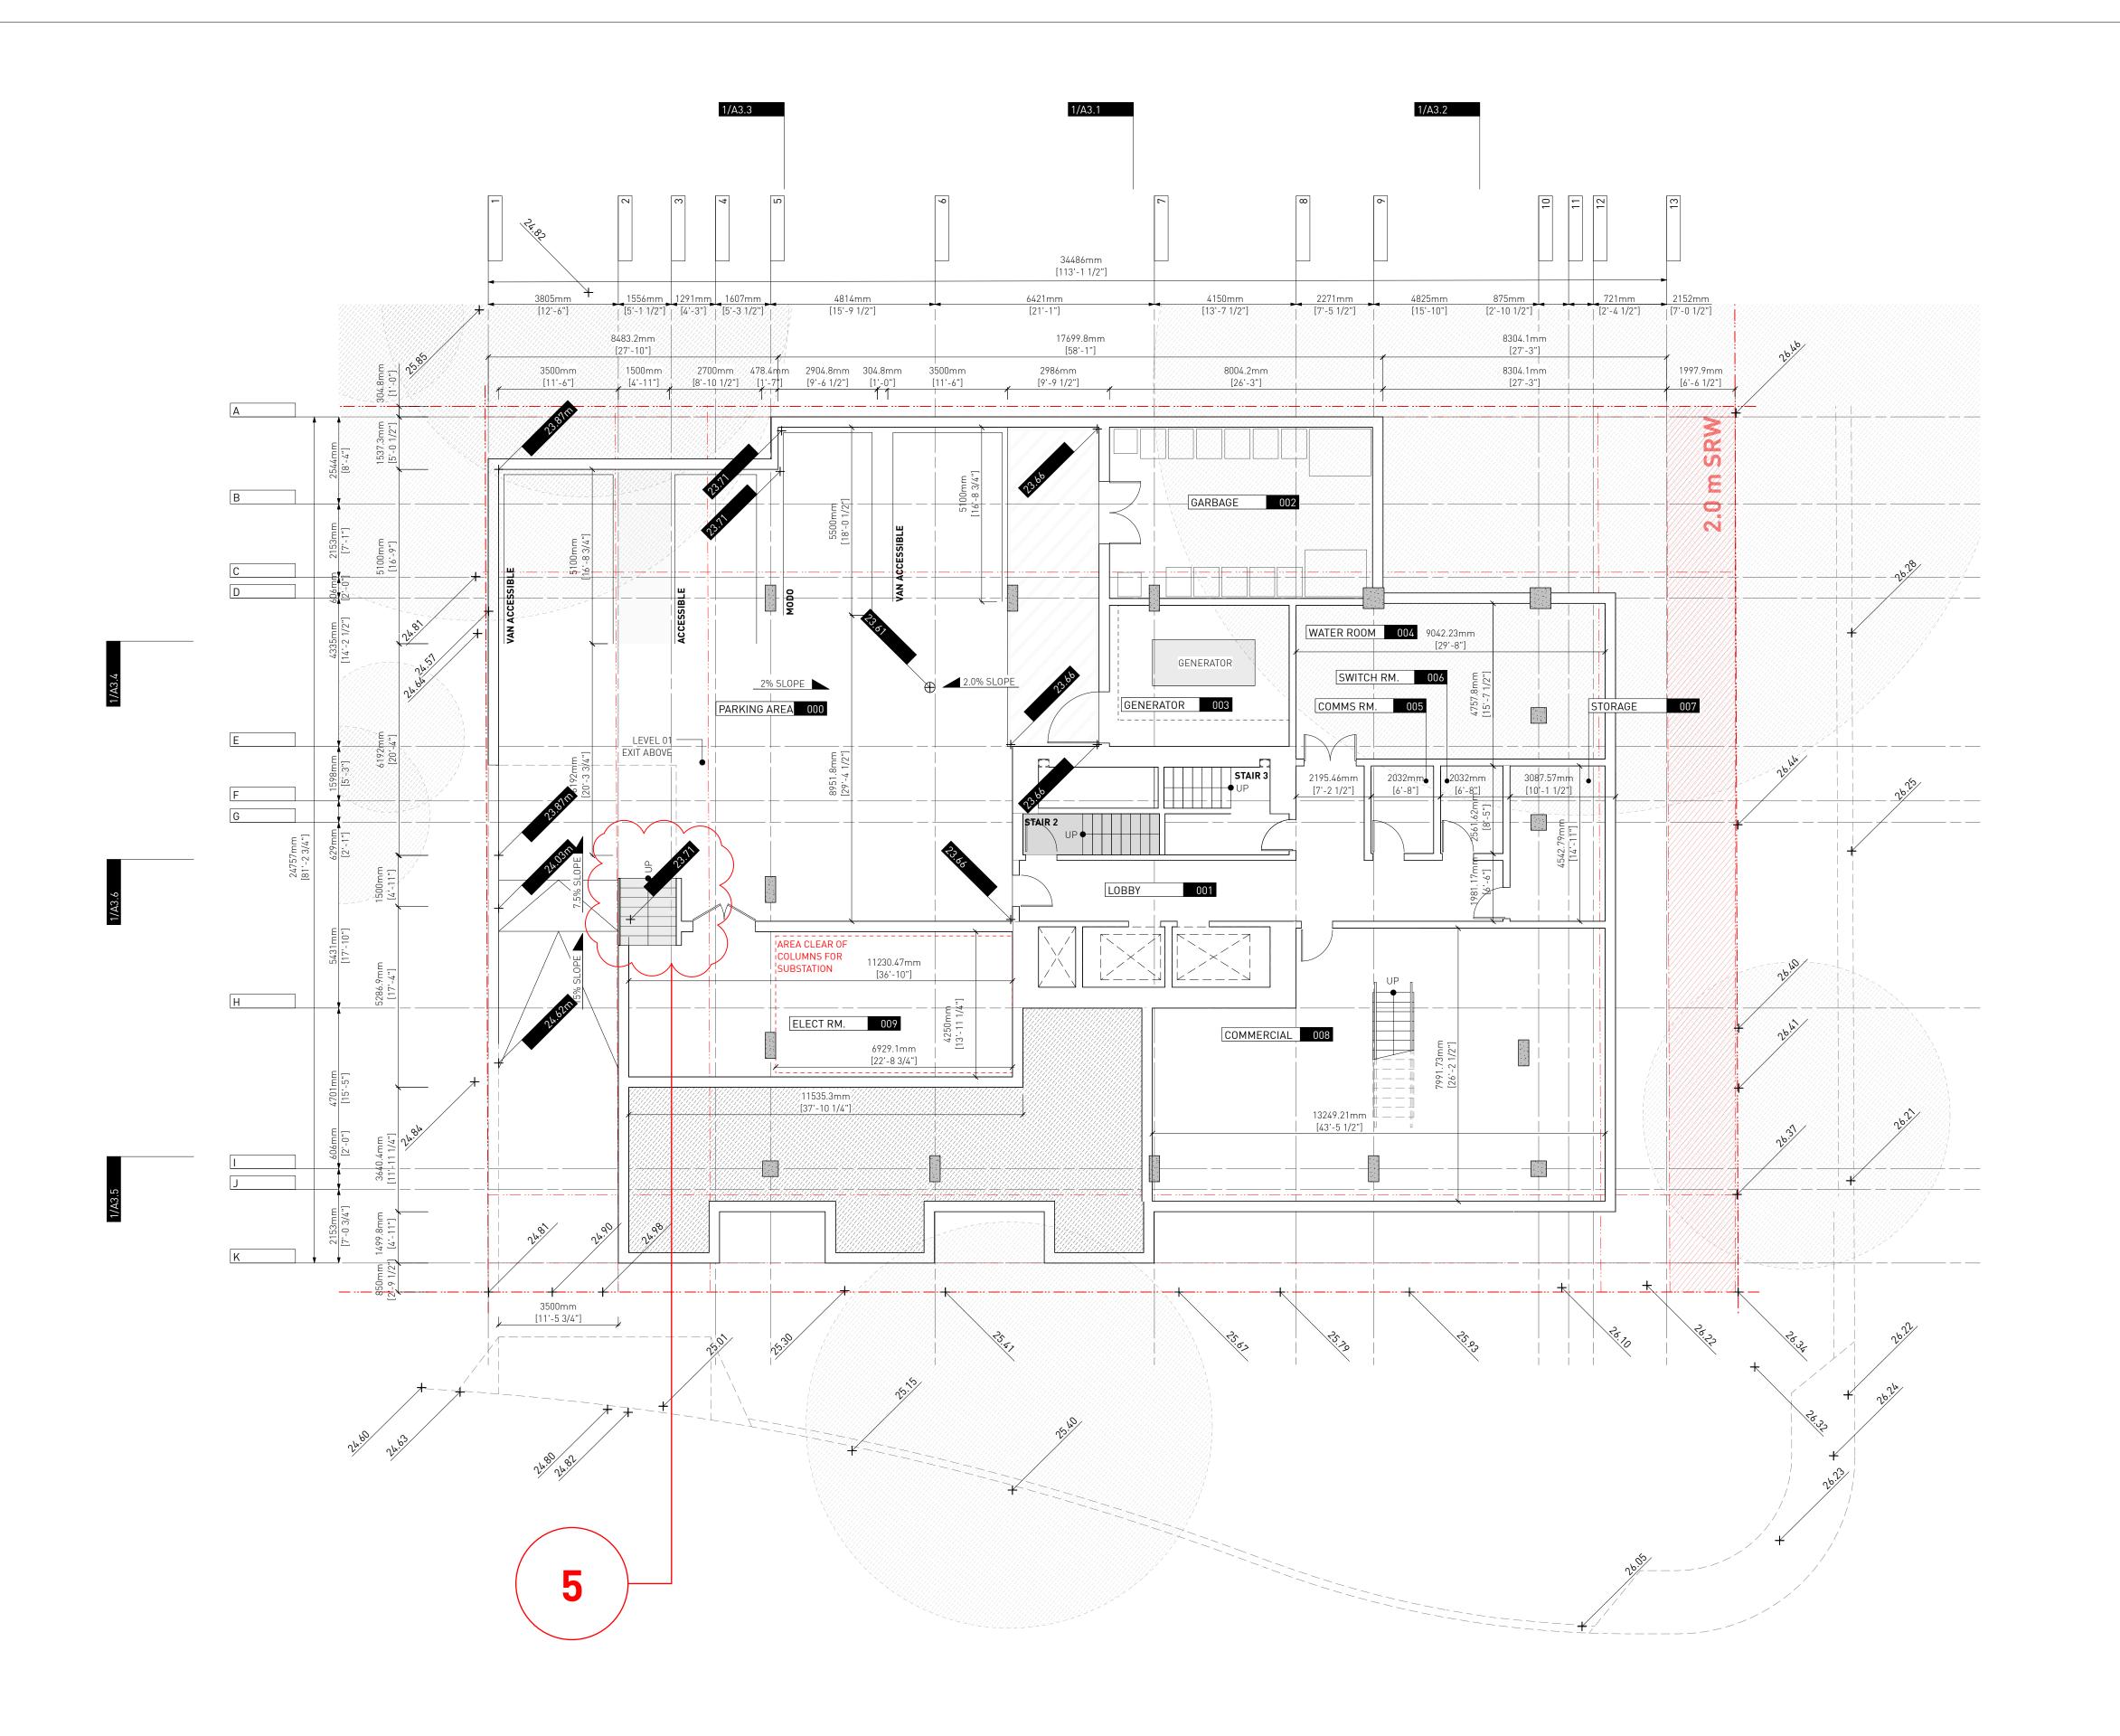


BELOW

ABOVE

EXISTING BUILDING

PROPOSED BUILDING
PROPERTY LINE
SETBACK LINE

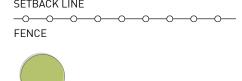



CRITICAL ROOT ZONE

EXISTING HYDRO POLE

EXISTING FIRE HYDRANT

EXISTING FIRE HYDRANT

PROPOSED DECK / BENCH
PROPOSED BIKE PARKING

4 Issued for DDP 26.05.2025
3 Issued for TRG2 response 14.12.2023

2 Issued for TRG1 response

Drawn By: EA / PB
Checked By: PB
Printing Date: 23.05.2025

21.09.2023

The Contractor shall verify all dimensions, datums and levels prior to commencement of work.


All errors and omissions to be reported to the Architect before proceeding.

This drawing must not be scaled.

This drawing is the property of the Architect; the copyright in same being reserved to him/her. It is not to be reproduced without his/her permission.

Any unauthorized alteration of the electronic data which constitute this document will void all responsibility for the altered document by the Architect.

This drawing is not to be used for building purposes until countersigned by:

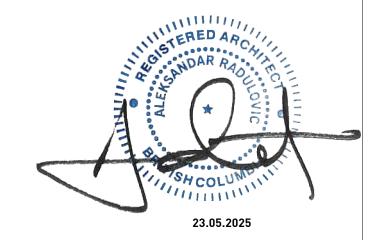




5 4 6 8 7 9 6 A R C H I T E C T U R E I N C 266 MCDERMOT AVE Winnipeg MB R3B 0S8 P: 204.480.8421 F: 204.480.8876

1702 QUADRA STREET + 862 FISGARD STREET

LEVEL 00 PLAN

Project 0650 Sheet A1.1

1 LEVEL 00 PLAN
A1.1 SCALE: 1:100

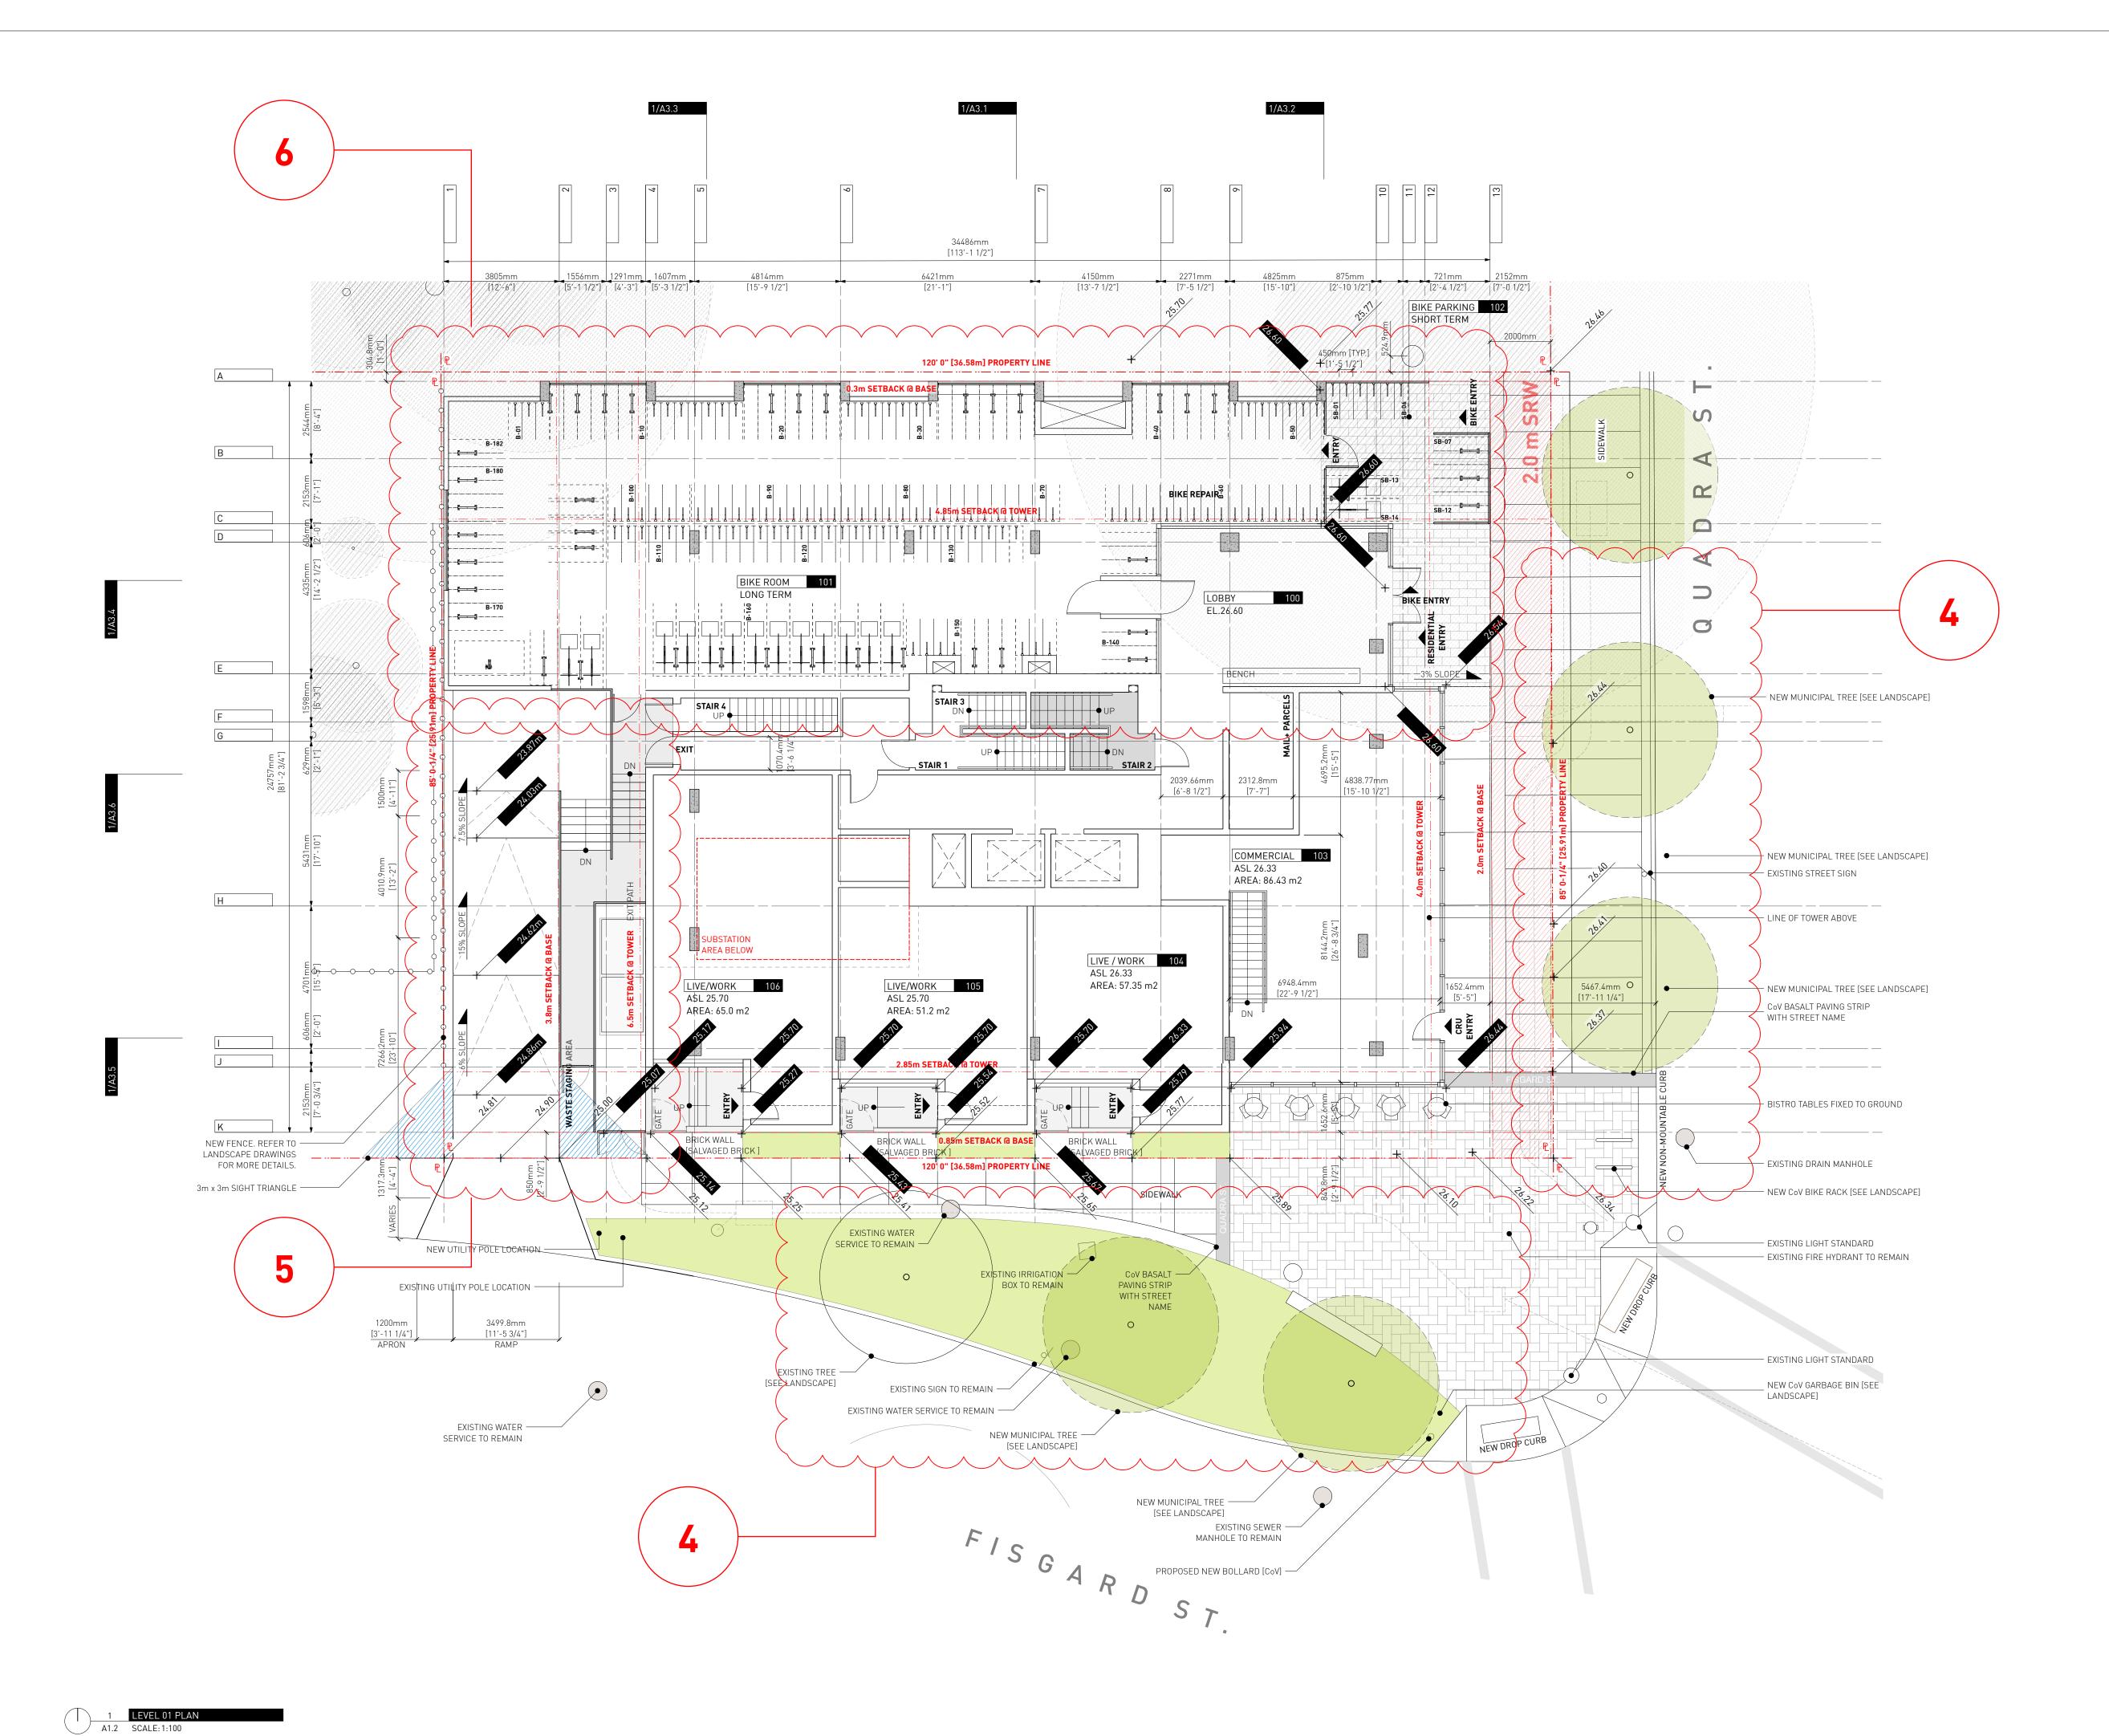

ELOW

EXISTING BUILDING

PROPOSED BUILDING
PROPERTY LINE

TREE [REF. TO ANNOTATION]

CRITICAL ROOT ZONE

EXISTING HYDRO POLE

EXISTING FIRE HYDRANT

PROPOSED DECK / BENCH

PROPOSED BIKE PARKING

 \wedge

 4 Issued for DDP
 26.05.2025

 3 Issued for TRG2 response
 14.12.2023

2 Issued for TRG1 response

Drawn By: EA / PB
Checked By: PB
Printing Date: 23.05.2025

21.09.2023

The Contractor shall verify all dimensions, datums and levels prior to commencement of work.


All errors and omissions to be reported to the Architect before proceeding.


This drawing must not be scaled.

This drawing is the property of the Architect; the copyright in same being reserved to him/her. It is not to be reproduced without his/her permission.

Any unauthorized alteration of the electronic data which constitute this document will void all responsibility for the altered document by the

This drawing is not to be used for building purposes until countersigned by:

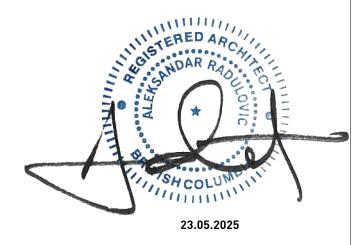

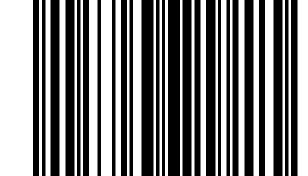


ARCHITECTURE INC 266 MCDERMOT AVE Winnipeg MB R3B 0S8 P: 204.480.8421 F: 204.480.8876

1702 QUADRA STREET + 862 FISGARD STREET

LEVEL 01 PLAN

Project 0650 Sheet

A1.2

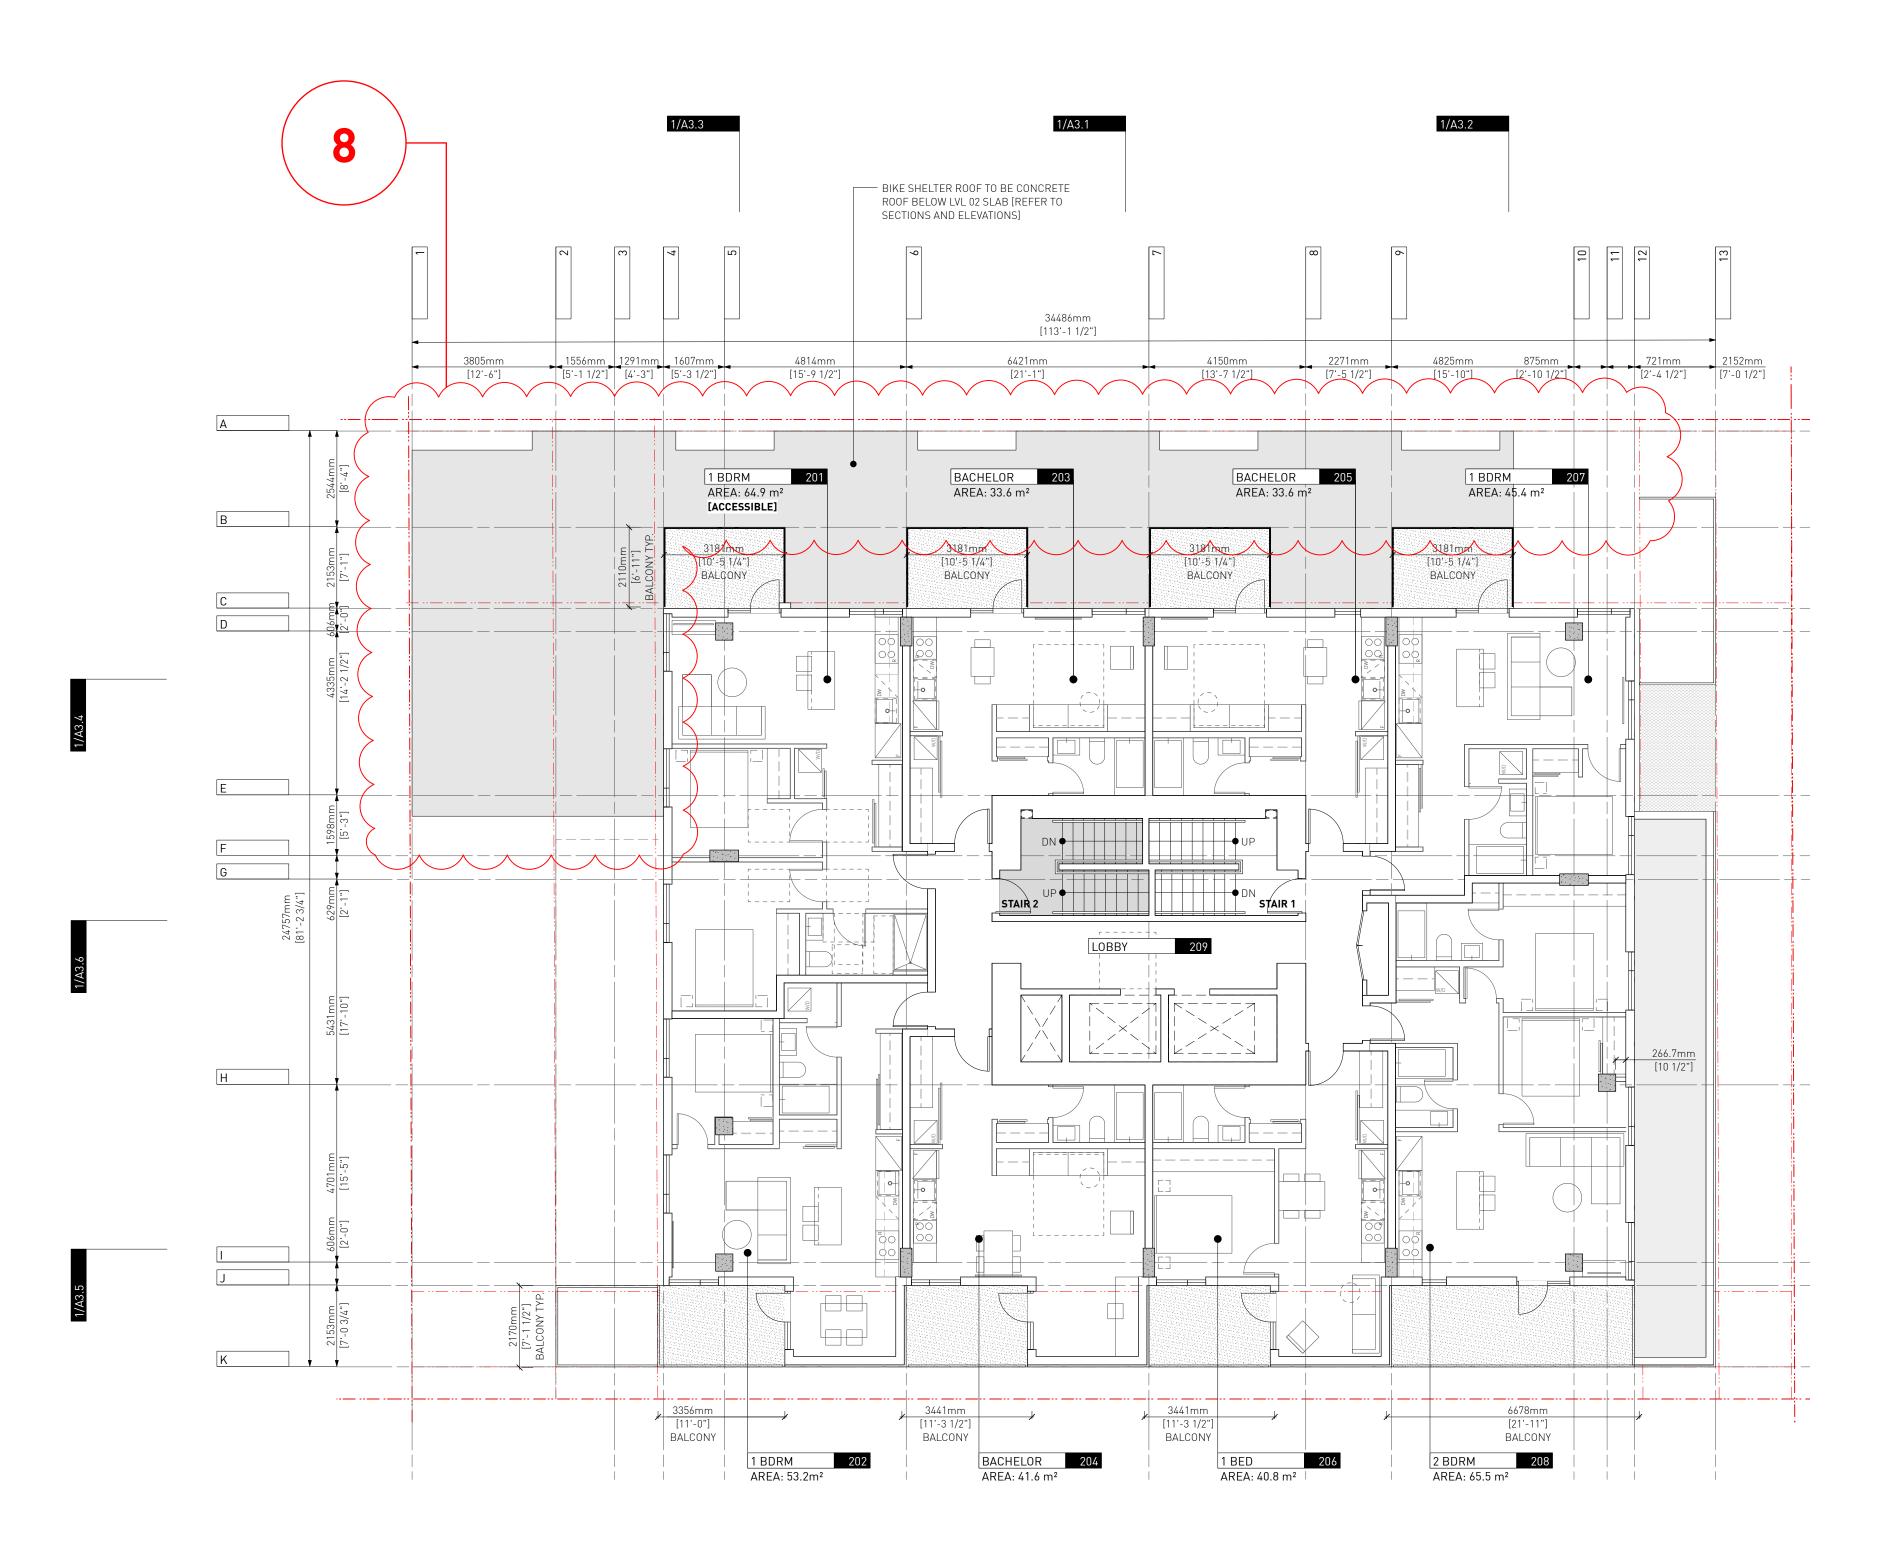

EXISTING BUILDING

PROPOSED BUILDING

PROPERTY LINE SETBACK LINE

4 Issued for DDP 26.05.2025 3 Issued for TRG2 response 14.12.2023 2 Issued for TRG1 response 21.09.2023

Drawn By: Checked By: Printing Date: PB 23.05.2025 The Contractor shall verify all dimensions, datums

EA / MM

All errors and omissions to be reported to the Architect before proceeding.

and levels prior to commencement of work.

This drawing must not be scaled.


This drawing is the property of the Architect; the copyright in same being reserved to him/her. It is

Any unauthorized alteration of the electronic data which constitute this document will void all responsibility for the altered document by the Architect.

This drawing is not to be used for building purposes until countersigned by:



23.05.2025

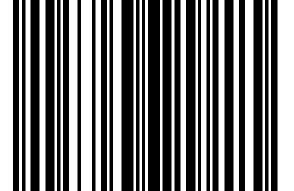



266 MCDERMOT AVE Winnipeg MB R3B 0S8 P: 204.480.8421 F: 204.480.8876

1702 QUADRA STREET + 862 FISGARD STREET

LEVEL 02 PLAN

Project 0650 Sheet A1.3

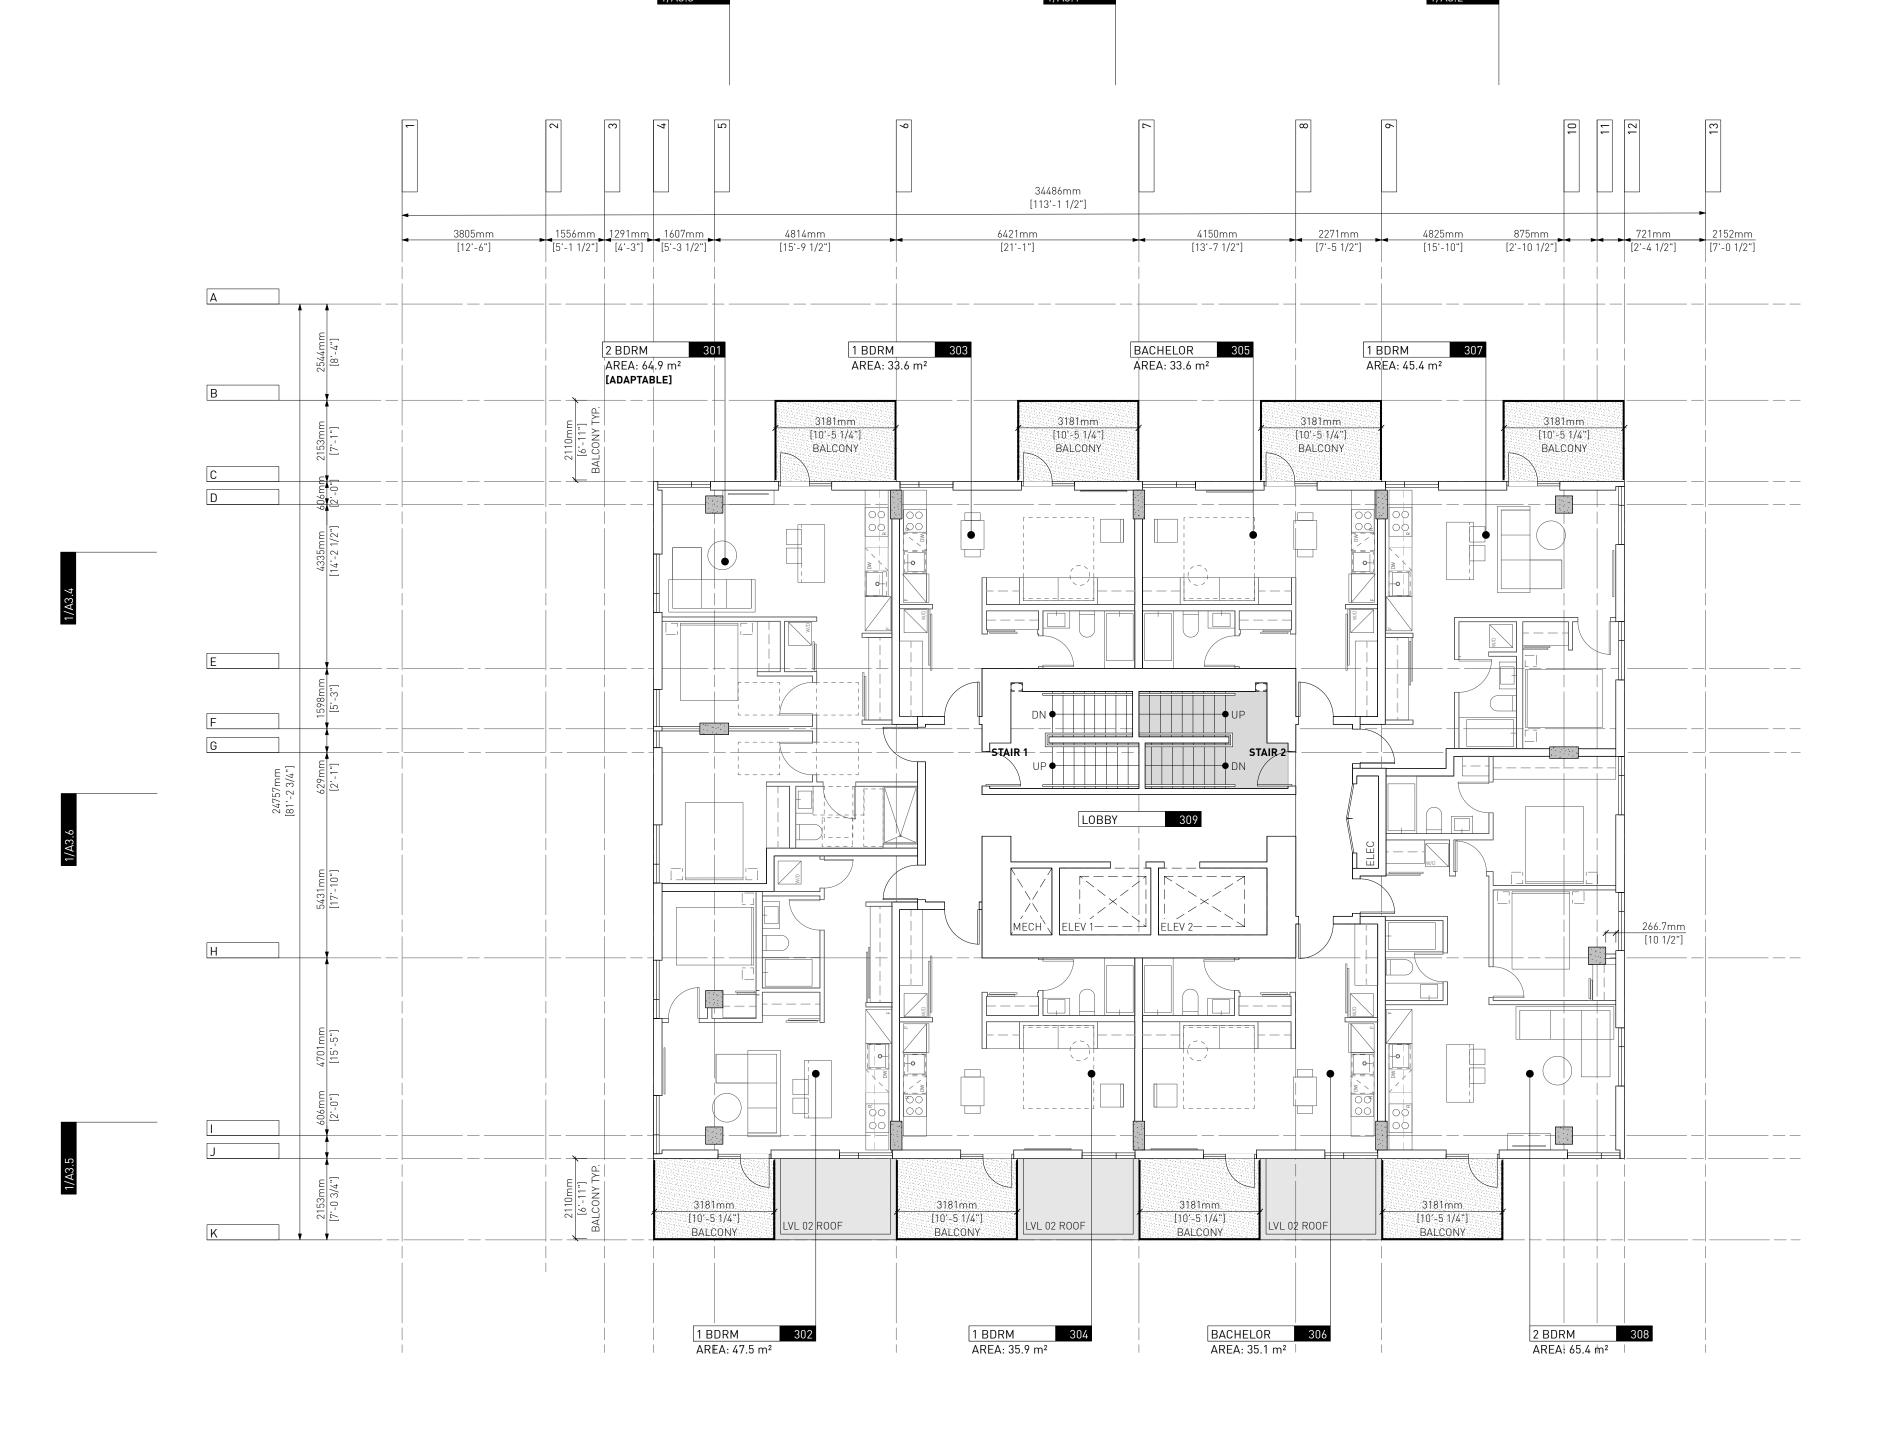

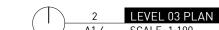

BELOW

EXISTING BUILDING

PROPOSED BUILDING

PROPERTY LINE SETBACK LINE

4 Issued for DDP 26.05.2025 3 Issued for TRG2 response 14.12.2023 2 Issued for TRG1 response 21.09.2023

Drawn By: Checked By: Printing Date: PB 23.05.2025 The Contractor shall verify all dimensions, datums

and levels prior to commencement of work.

EA / MM

All errors and omissions to be reported to the

Architect before proceeding. This drawing must not be scaled.

This drawing is the property of the Architect; the


copyright in same being reserved to him/her. It is

Any unauthorized alteration of the electronic data which constitute this document will void all responsibility for the altered document by the Architect.

This drawing is not to be used for building purposes until countersigned by:



23.05.2025

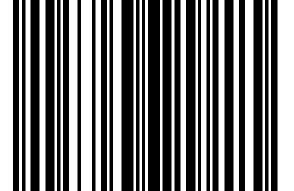


266 MCDERMOT AVE Winnipeg MB R3B 0S8 P: 204.480.8421 F: 204.480.8876

1702 QUADRA STREET + 862 FISGARD STREET

LEVEL 03 PLAN

Project 0650 Sheet A1.4

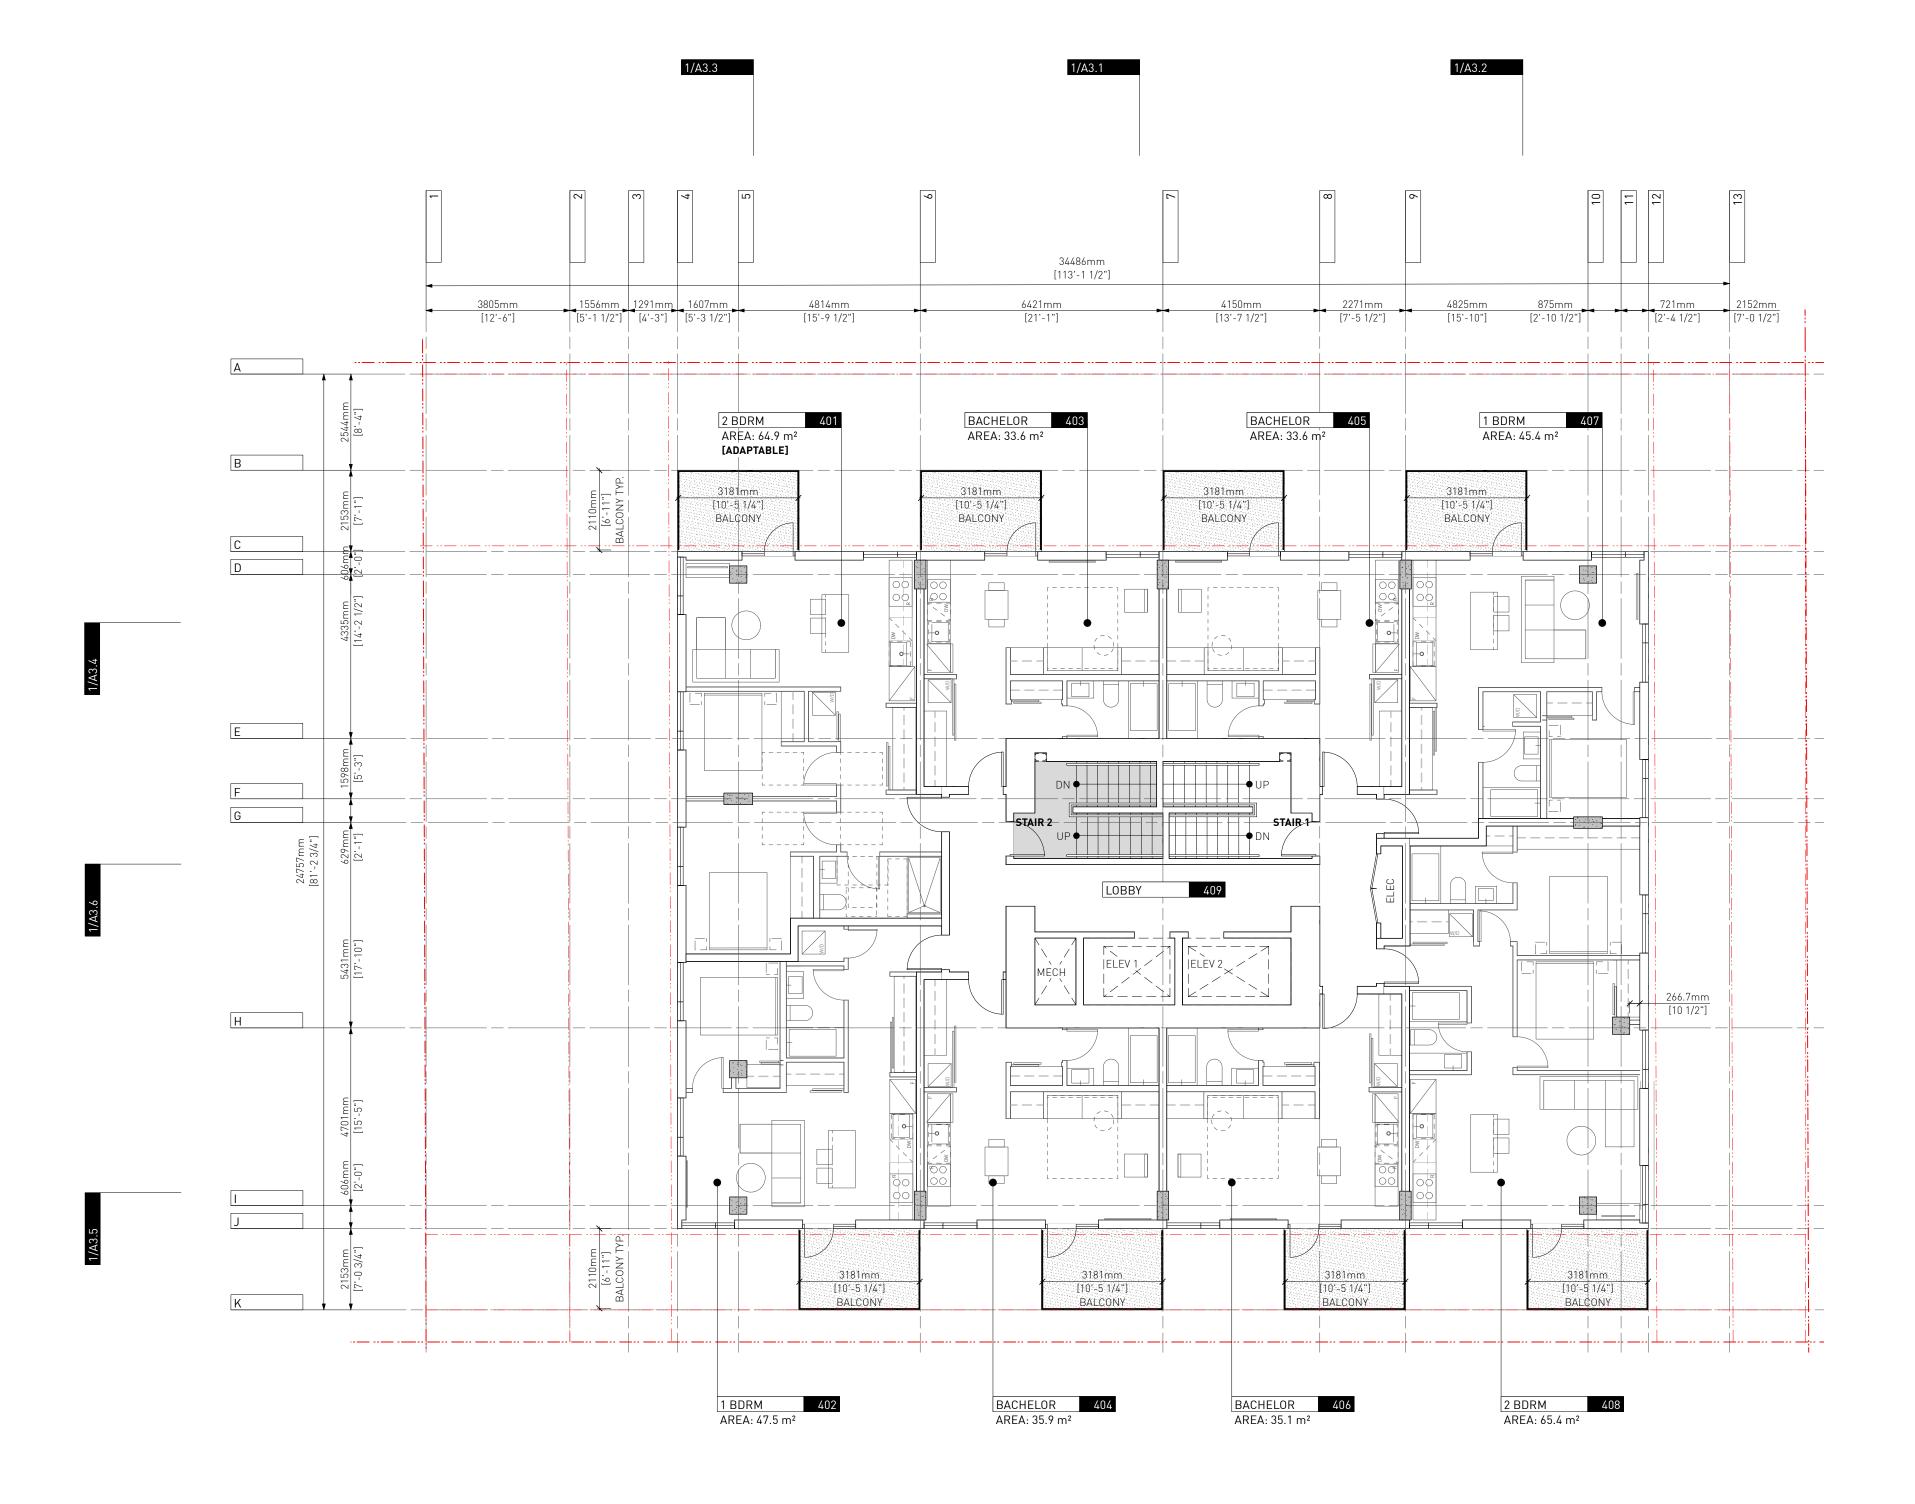

2 LEVEL 04 / 06 / 08 / 10 / 12 A1.5 SCALE: 1:100

LEGEND:

4 Issued for DDP

Drawn By: Checked By: Printing Date:

3 Issued for TRG2 response

2 Issued for TRG1 response

Architect before proceeding.

This drawing must not be scaled.

26.05.2025

14.12.2023

21.09.2023

EA / MM PB 23.05.2025

EXISTING BUILDING

PROPOSED BUILDING PROPERTY LINE

SETBACK LINE


responsibility for the altered document by the Architect. This drawing is not to be used for building purposes until countersigned by:

The Contractor shall verify all dimensions, datums and levels prior to commencement of work.

All errors and omissions to be reported to the

This drawing is the property of the Architect; the copyright in same being reserved to him/her. It is

Any unauthorized alteration of the electronic data which constitute this document will void all

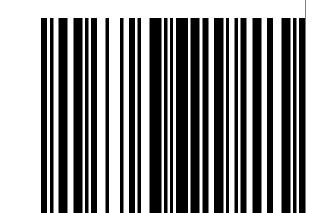

23.05.2025


266 MCDERMOT AVE Winnipeg MB R3B 0S8 P: 204.480.8421 F: 204.480.8876

1702 QUADRA STREET + 862 FISGARD STREET

LEVEL 04/06/08/10/12

Sheet A1.5

Project 0650

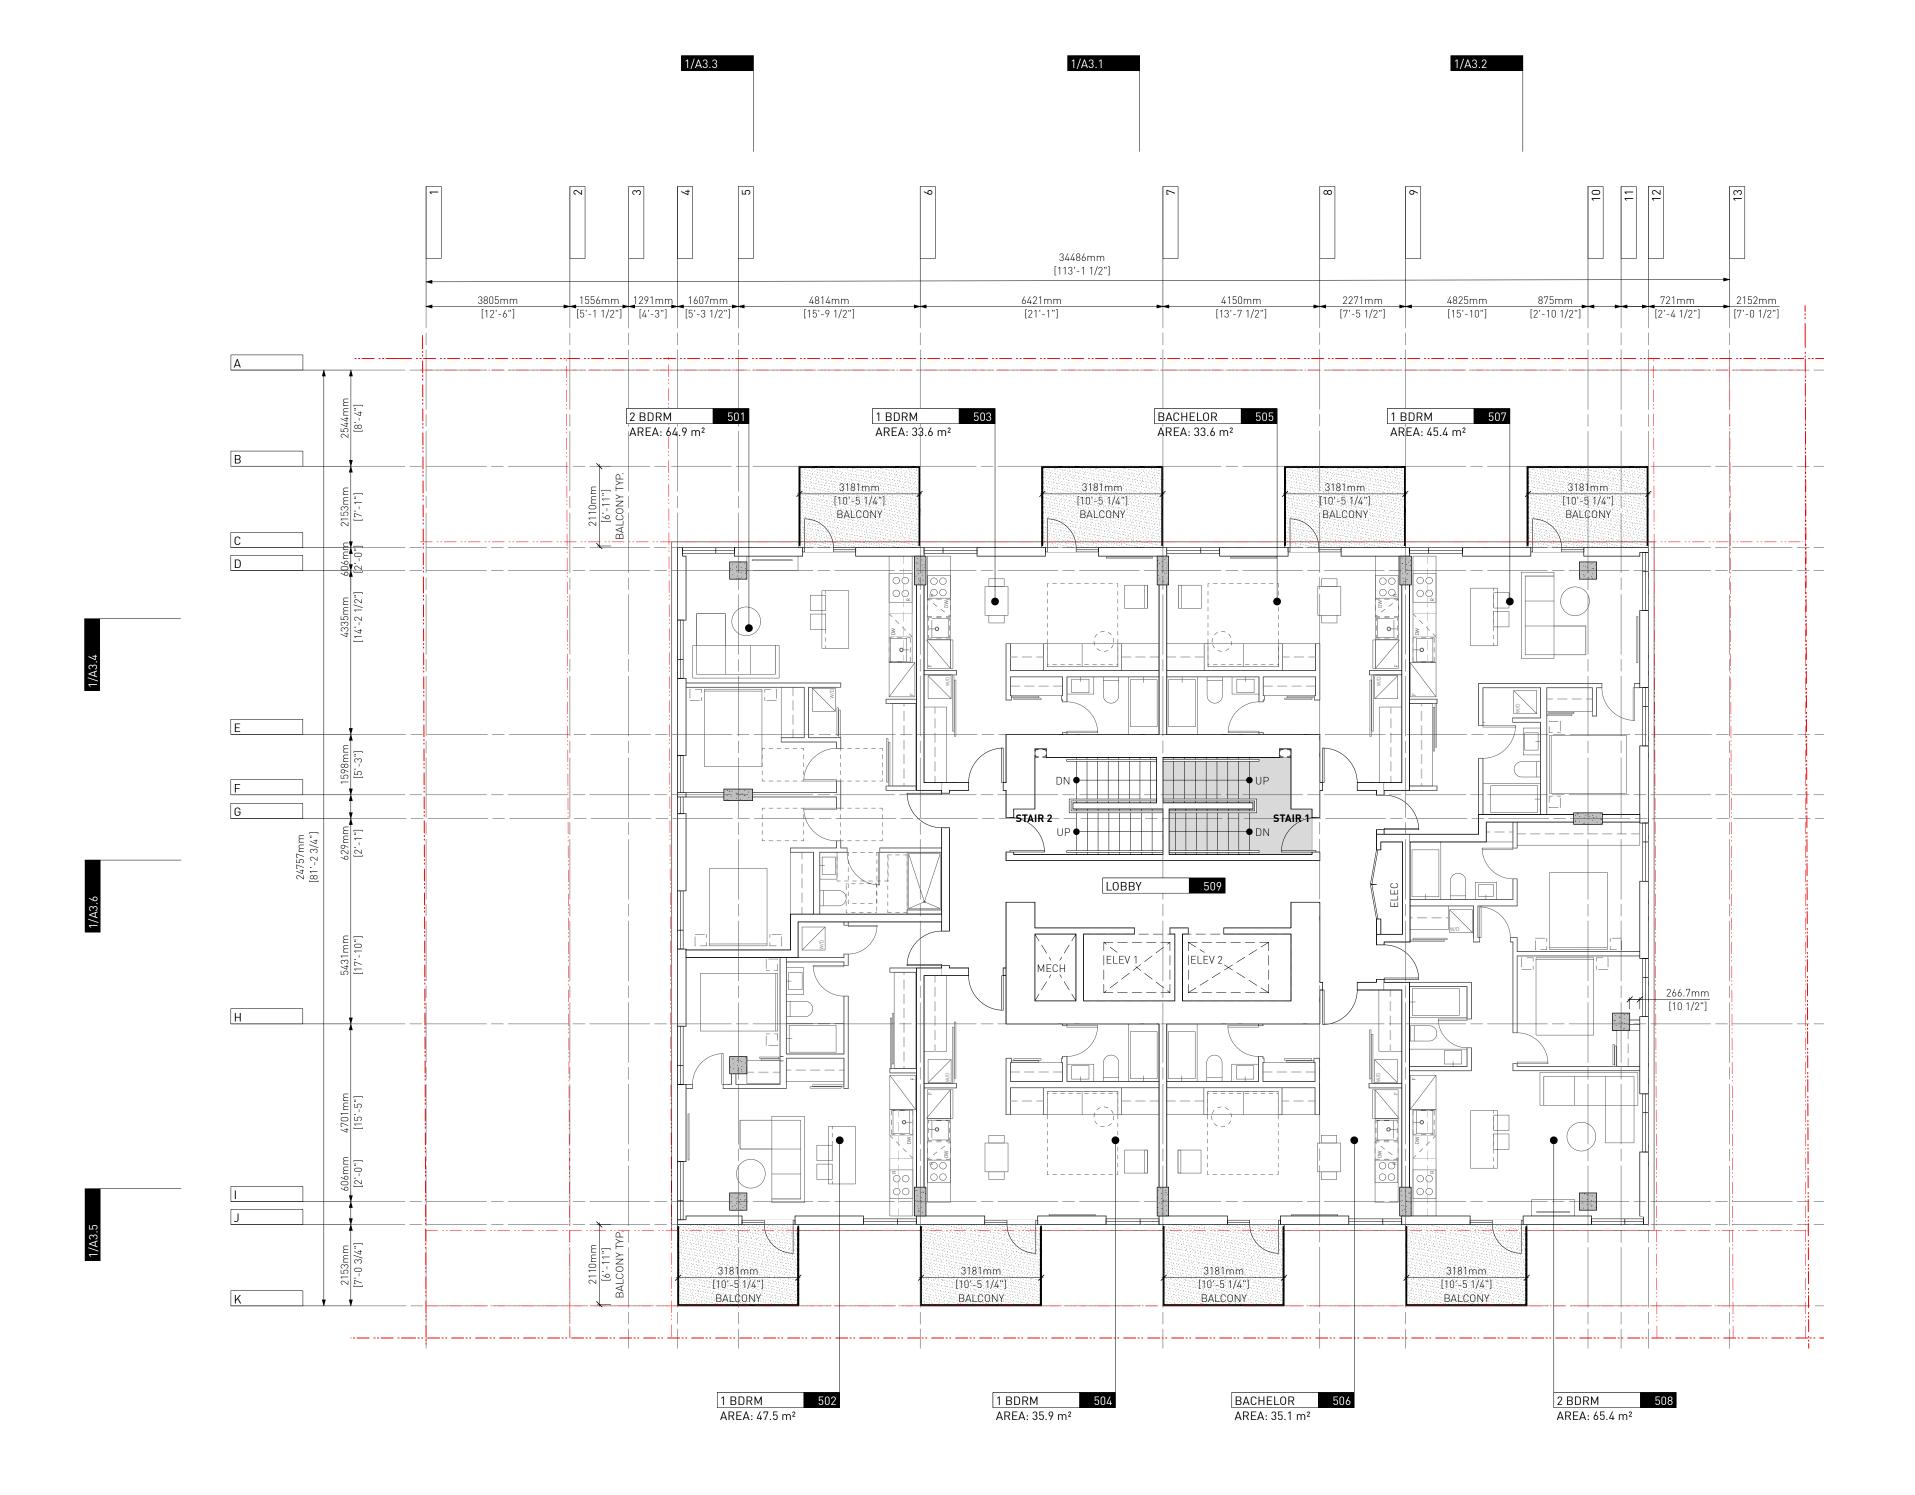

EXISTING BUILDING

PROPOSED BUILDING

PROPERTY LINE SETBACK LINE

4 Issued for DDP 26.05.2025 3 Issued for TRG2 response 14.12.2023

2 Issued for TRG1 response

The Contractor shall verify all dimensions, datums

and levels prior to commencement of work.

21.09.2023

EA / MM PB 23.05.2025

All errors and omissions to be reported to the

Architect before proceeding.

This drawing must not be scaled.

Drawn By: Checked By: Printing Date:


This drawing is the property of the Architect; the copyright in same being reserved to him/her. It is

Any unauthorized alteration of the electronic data which constitute this document will void all responsibility for the altered document by the Architect.

This drawing is not to be used for building purposes until countersigned by:



23.05.2025

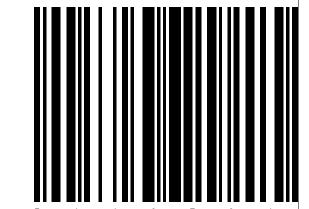


266 MCDERMOT AVE Winnipeg MB R3B 0S8 P: 204.480.8421 F: 204.480.8876

1702 QUADRA STREET + 862 FISGARD STREET

LEVEL 05/07/09/11

Project 0650 Sheet A1.6

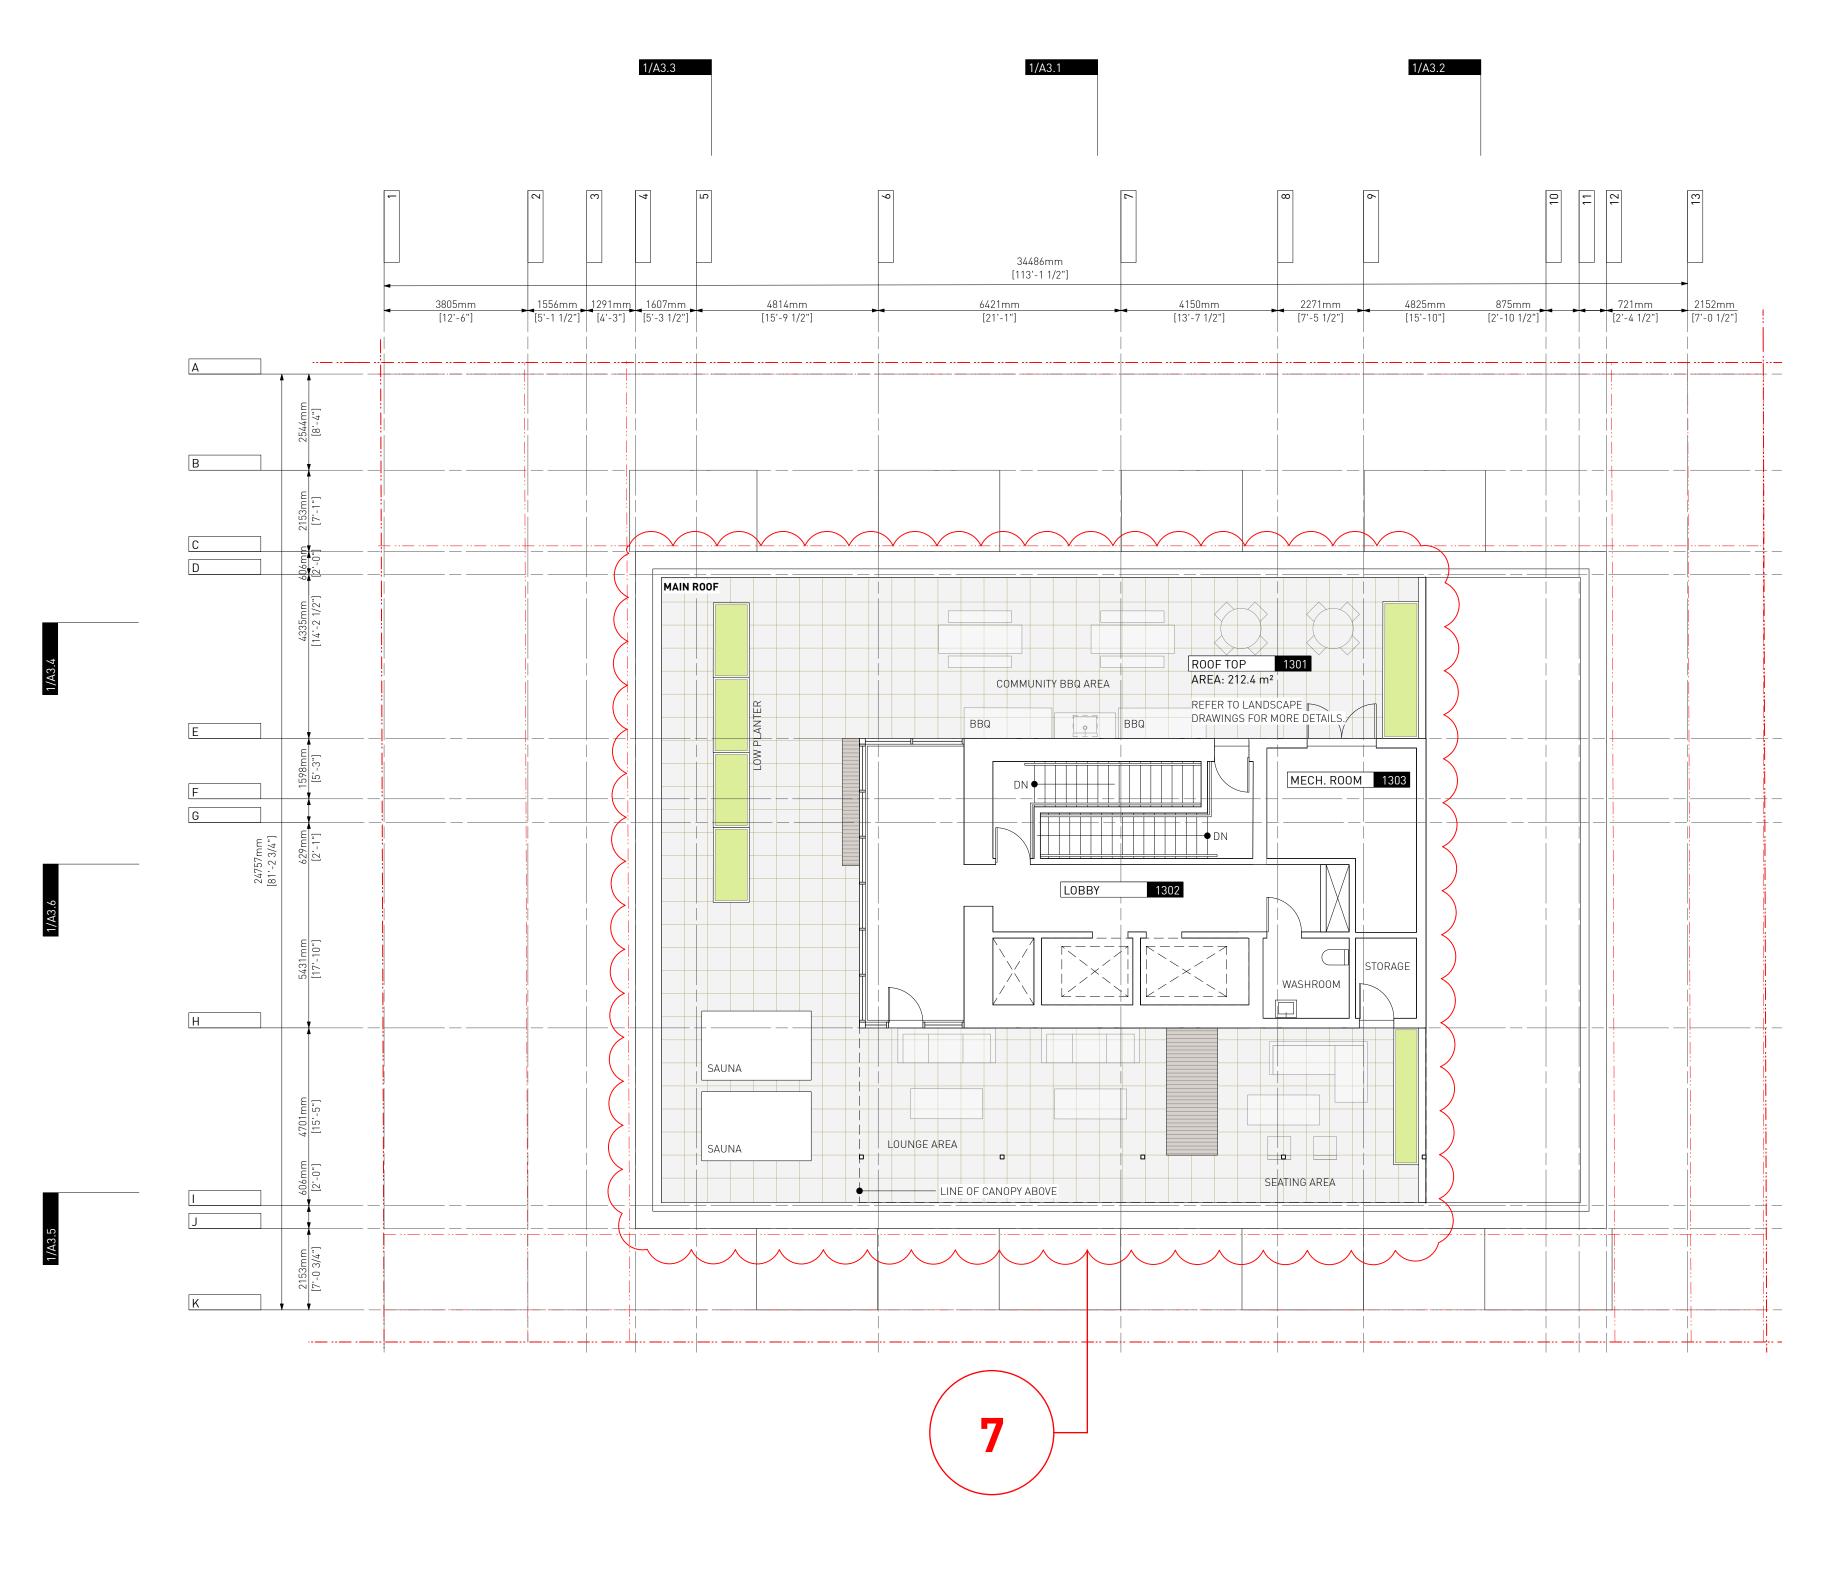

EXISTING BUILDING

PROPOSED BUILDING

PROPERTY LINE SETBACK LINE

4 Issued for DDP 26.05.2025 3 Issued for TRG2 response 14.12.2023 2 Issued for TRG1 response 21.09.2023

Drawn By: Checked By: Printing Date: PB 23.05.2025 The Contractor shall verify all dimensions, datums

and levels prior to commencement of work.

EA / MM

All errors and omissions to be reported to the Architect before proceeding.

This drawing must not be scaled.


This drawing is the property of the Architect; the copyright in same being reserved to him/her. It is

Any unauthorized alteration of the electronic data which constitute this document will void all responsibility for the altered document by the Architect.

This drawing is not to be used for building purposes until countersigned by:



23.05.2025

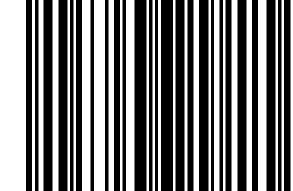


266 MCDERMOT AVE Winnipeg MB R3B 0S8 P: 204.480.8421 F: 204.480.8876

1702 QUADRA STREET + 862 FISGARD STREET

LEVEL 13

Project 0650 Sheet

A1.7

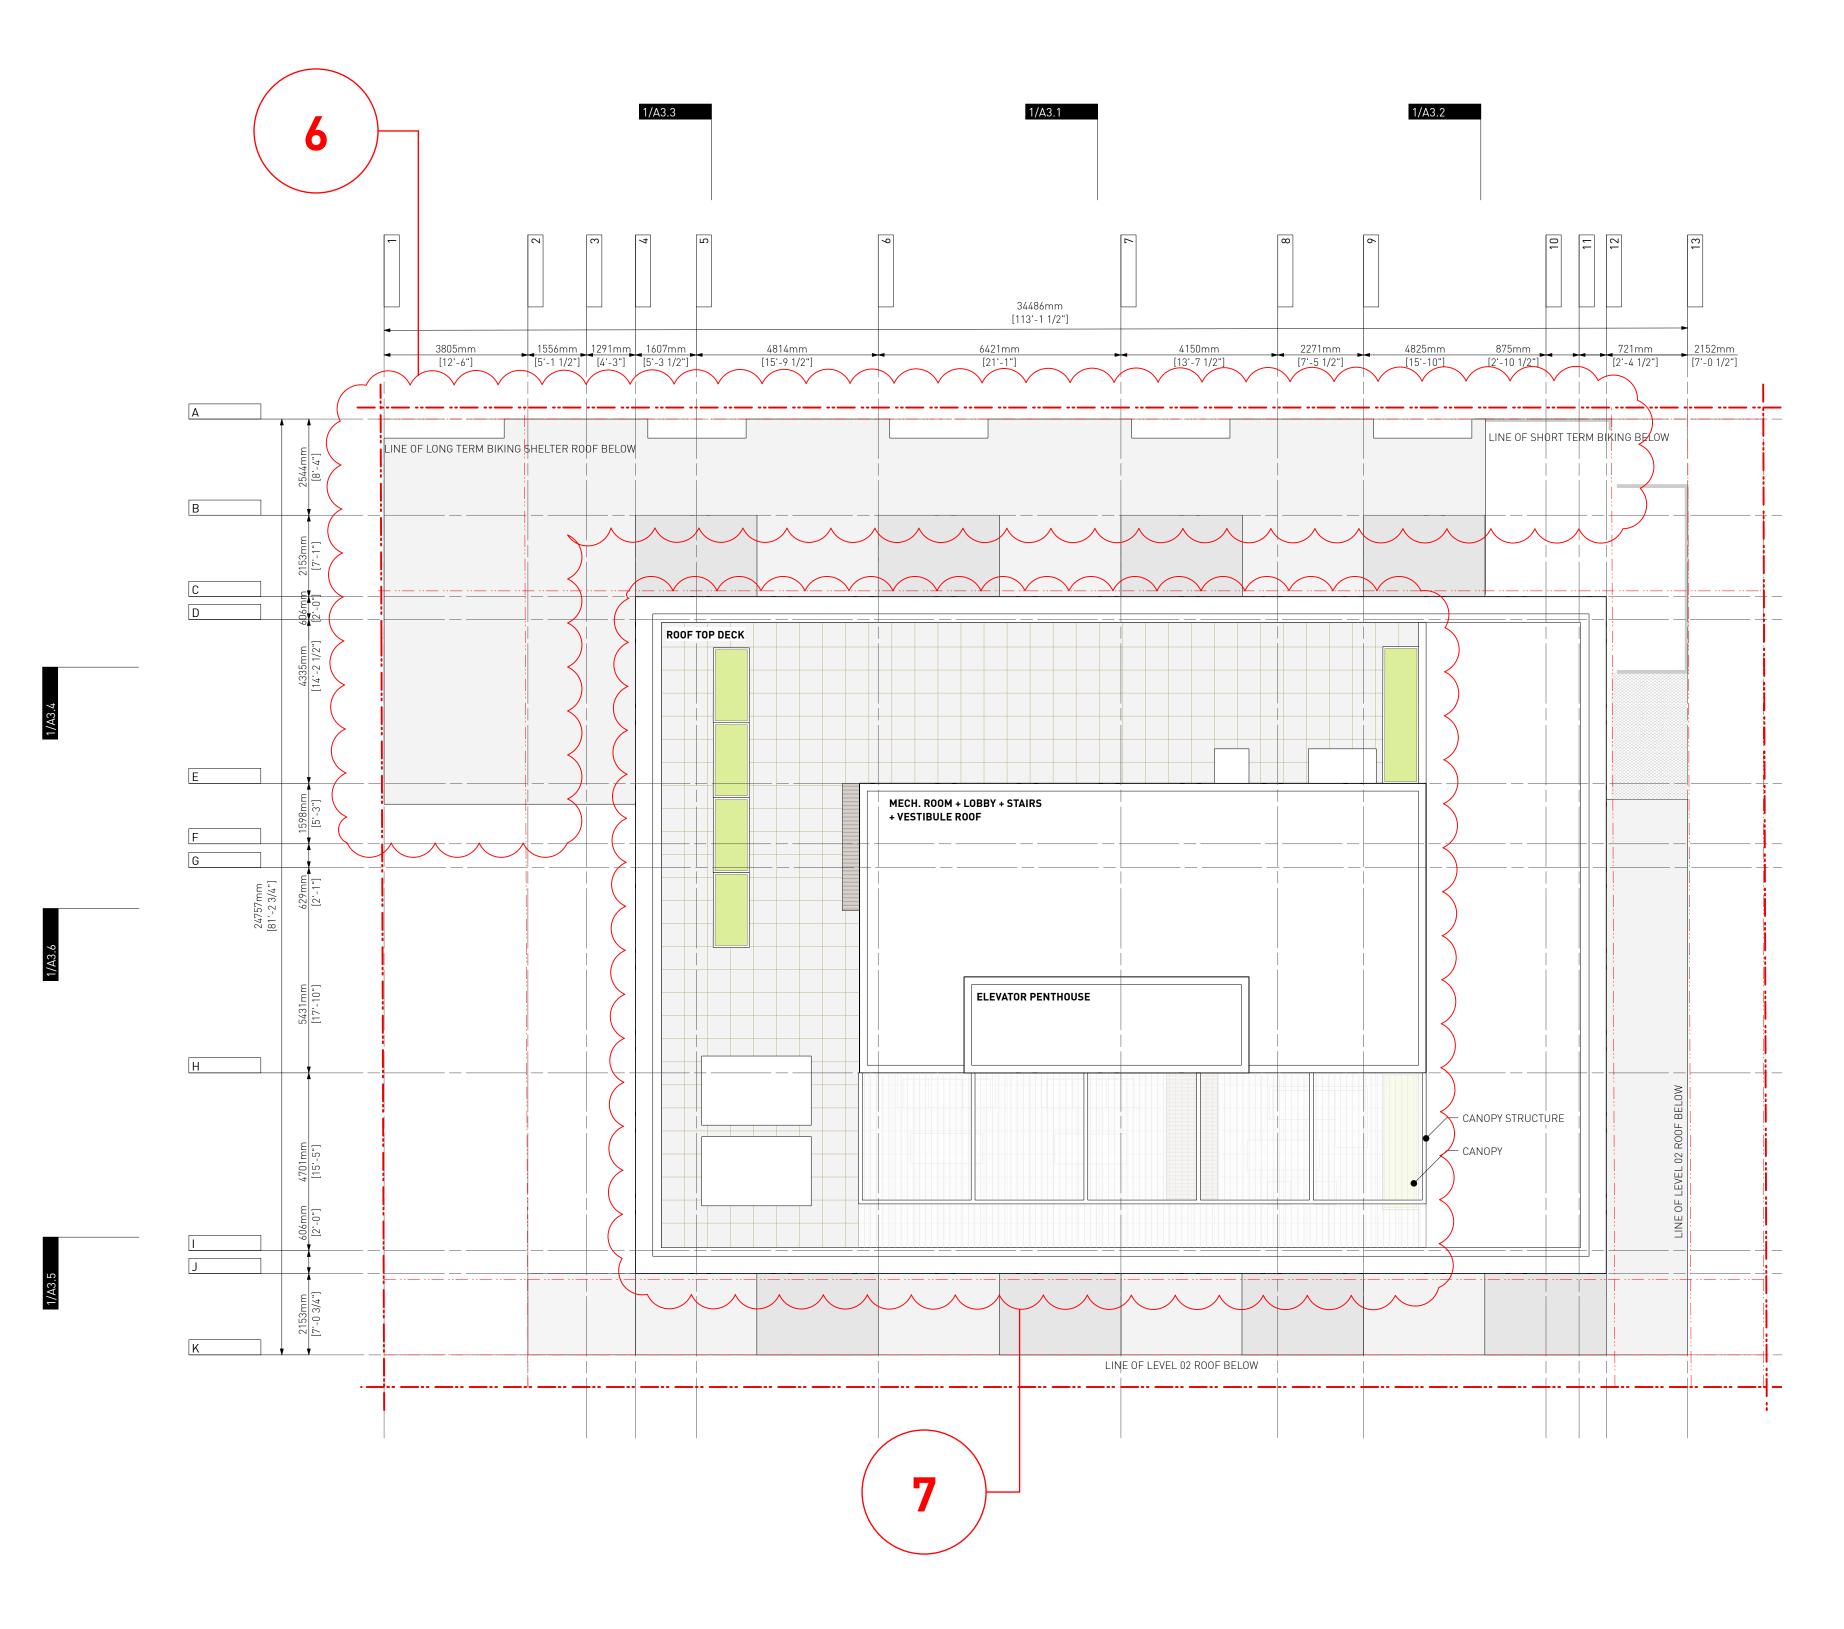

EXISTING BUILDING

PROPOSED BUILDING

PROPERTY LINE SETBACK LINE

4 Issued for DDP 26.05.2025 3 Issued for TRG2 response 14.12.2023 2 Issued for TRG1 response 21.09.2023

The Contractor shall verify all dimensions, datums

and levels prior to commencement of work.

EA / MM PB 23.05.2025

All errors and omissions to be reported to the Architect before proceeding.

This drawing must not be scaled.

This drawing is the property of the Architect; the

Drawn By: Checked By: Printing Date:


copyright in same being reserved to him/her. It is

Any unauthorized alteration of the electronic data which constitute this document will void all responsibility for the altered document by the Architect.

This drawing is not to be used for building purposes until countersigned by:



23.05.2025

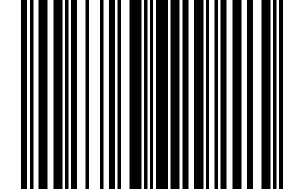


266 MCDERMOT AVE Winnipeg MB R3B 0S8 P: 204.480.8421 F: 204.480.8876


1702 QUADRA STREET + 862 FISGARD STREET

ROOF PLAN

Project 0650 Sheet

A1.8

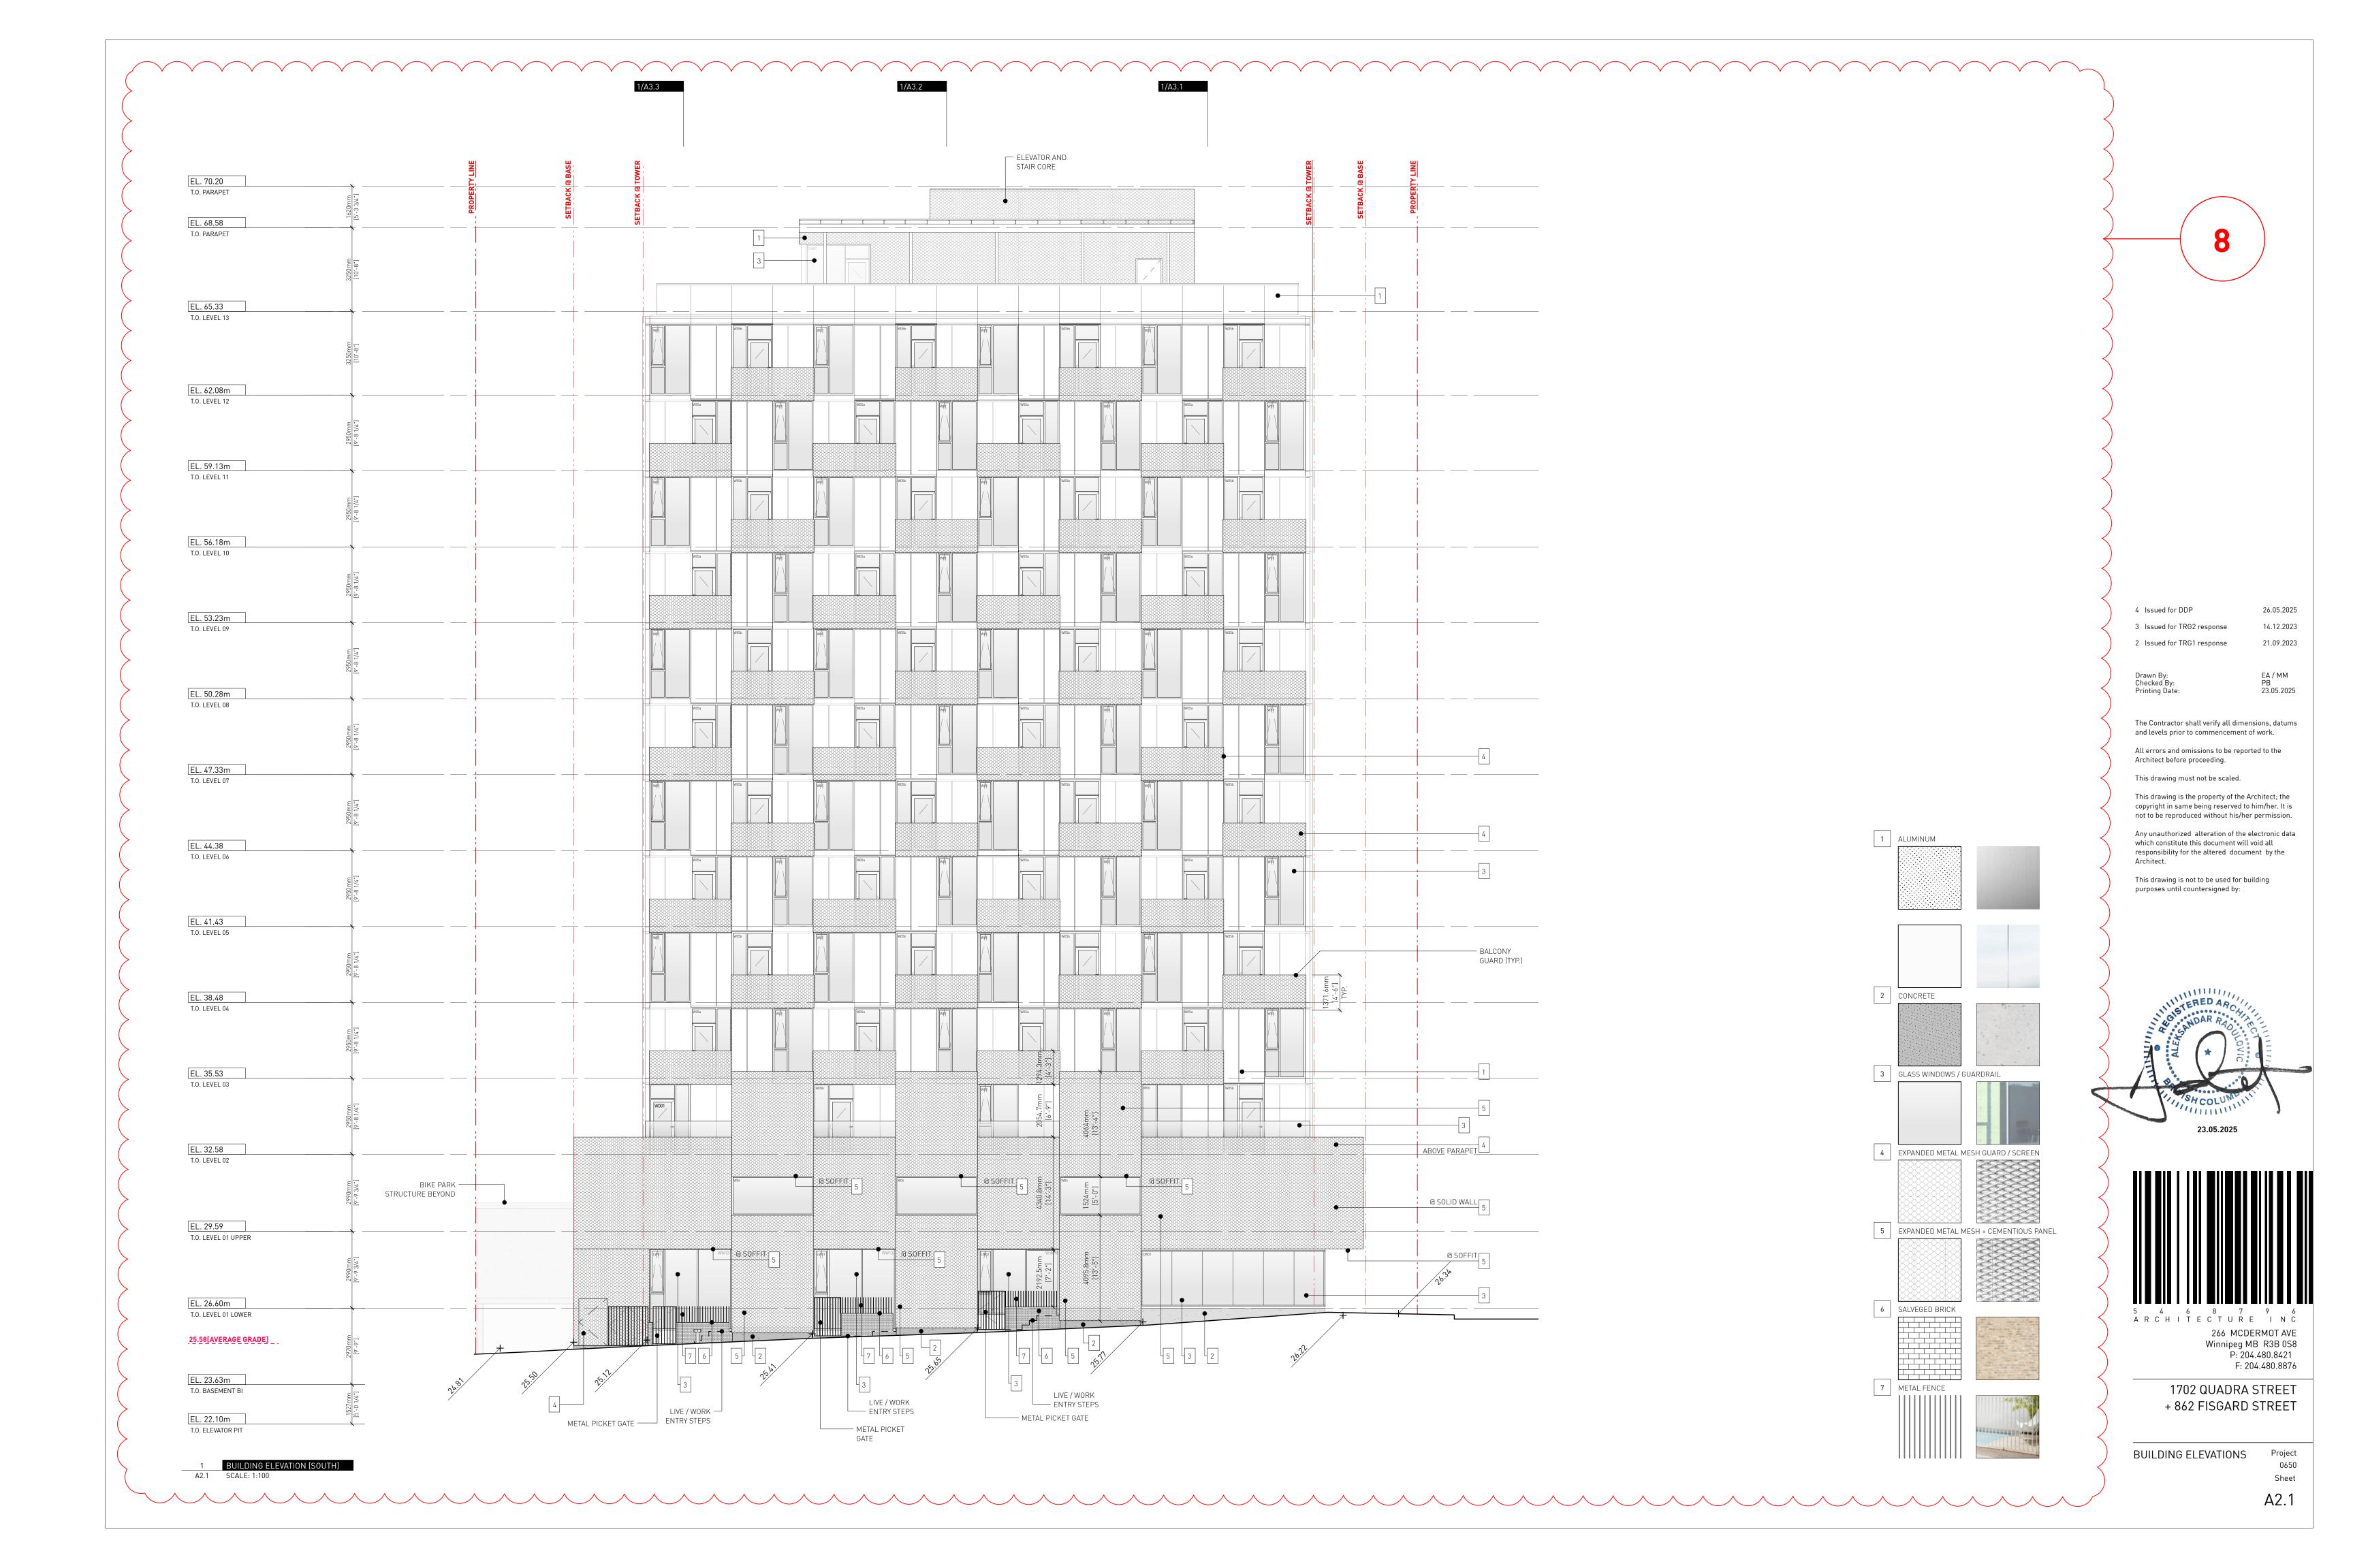

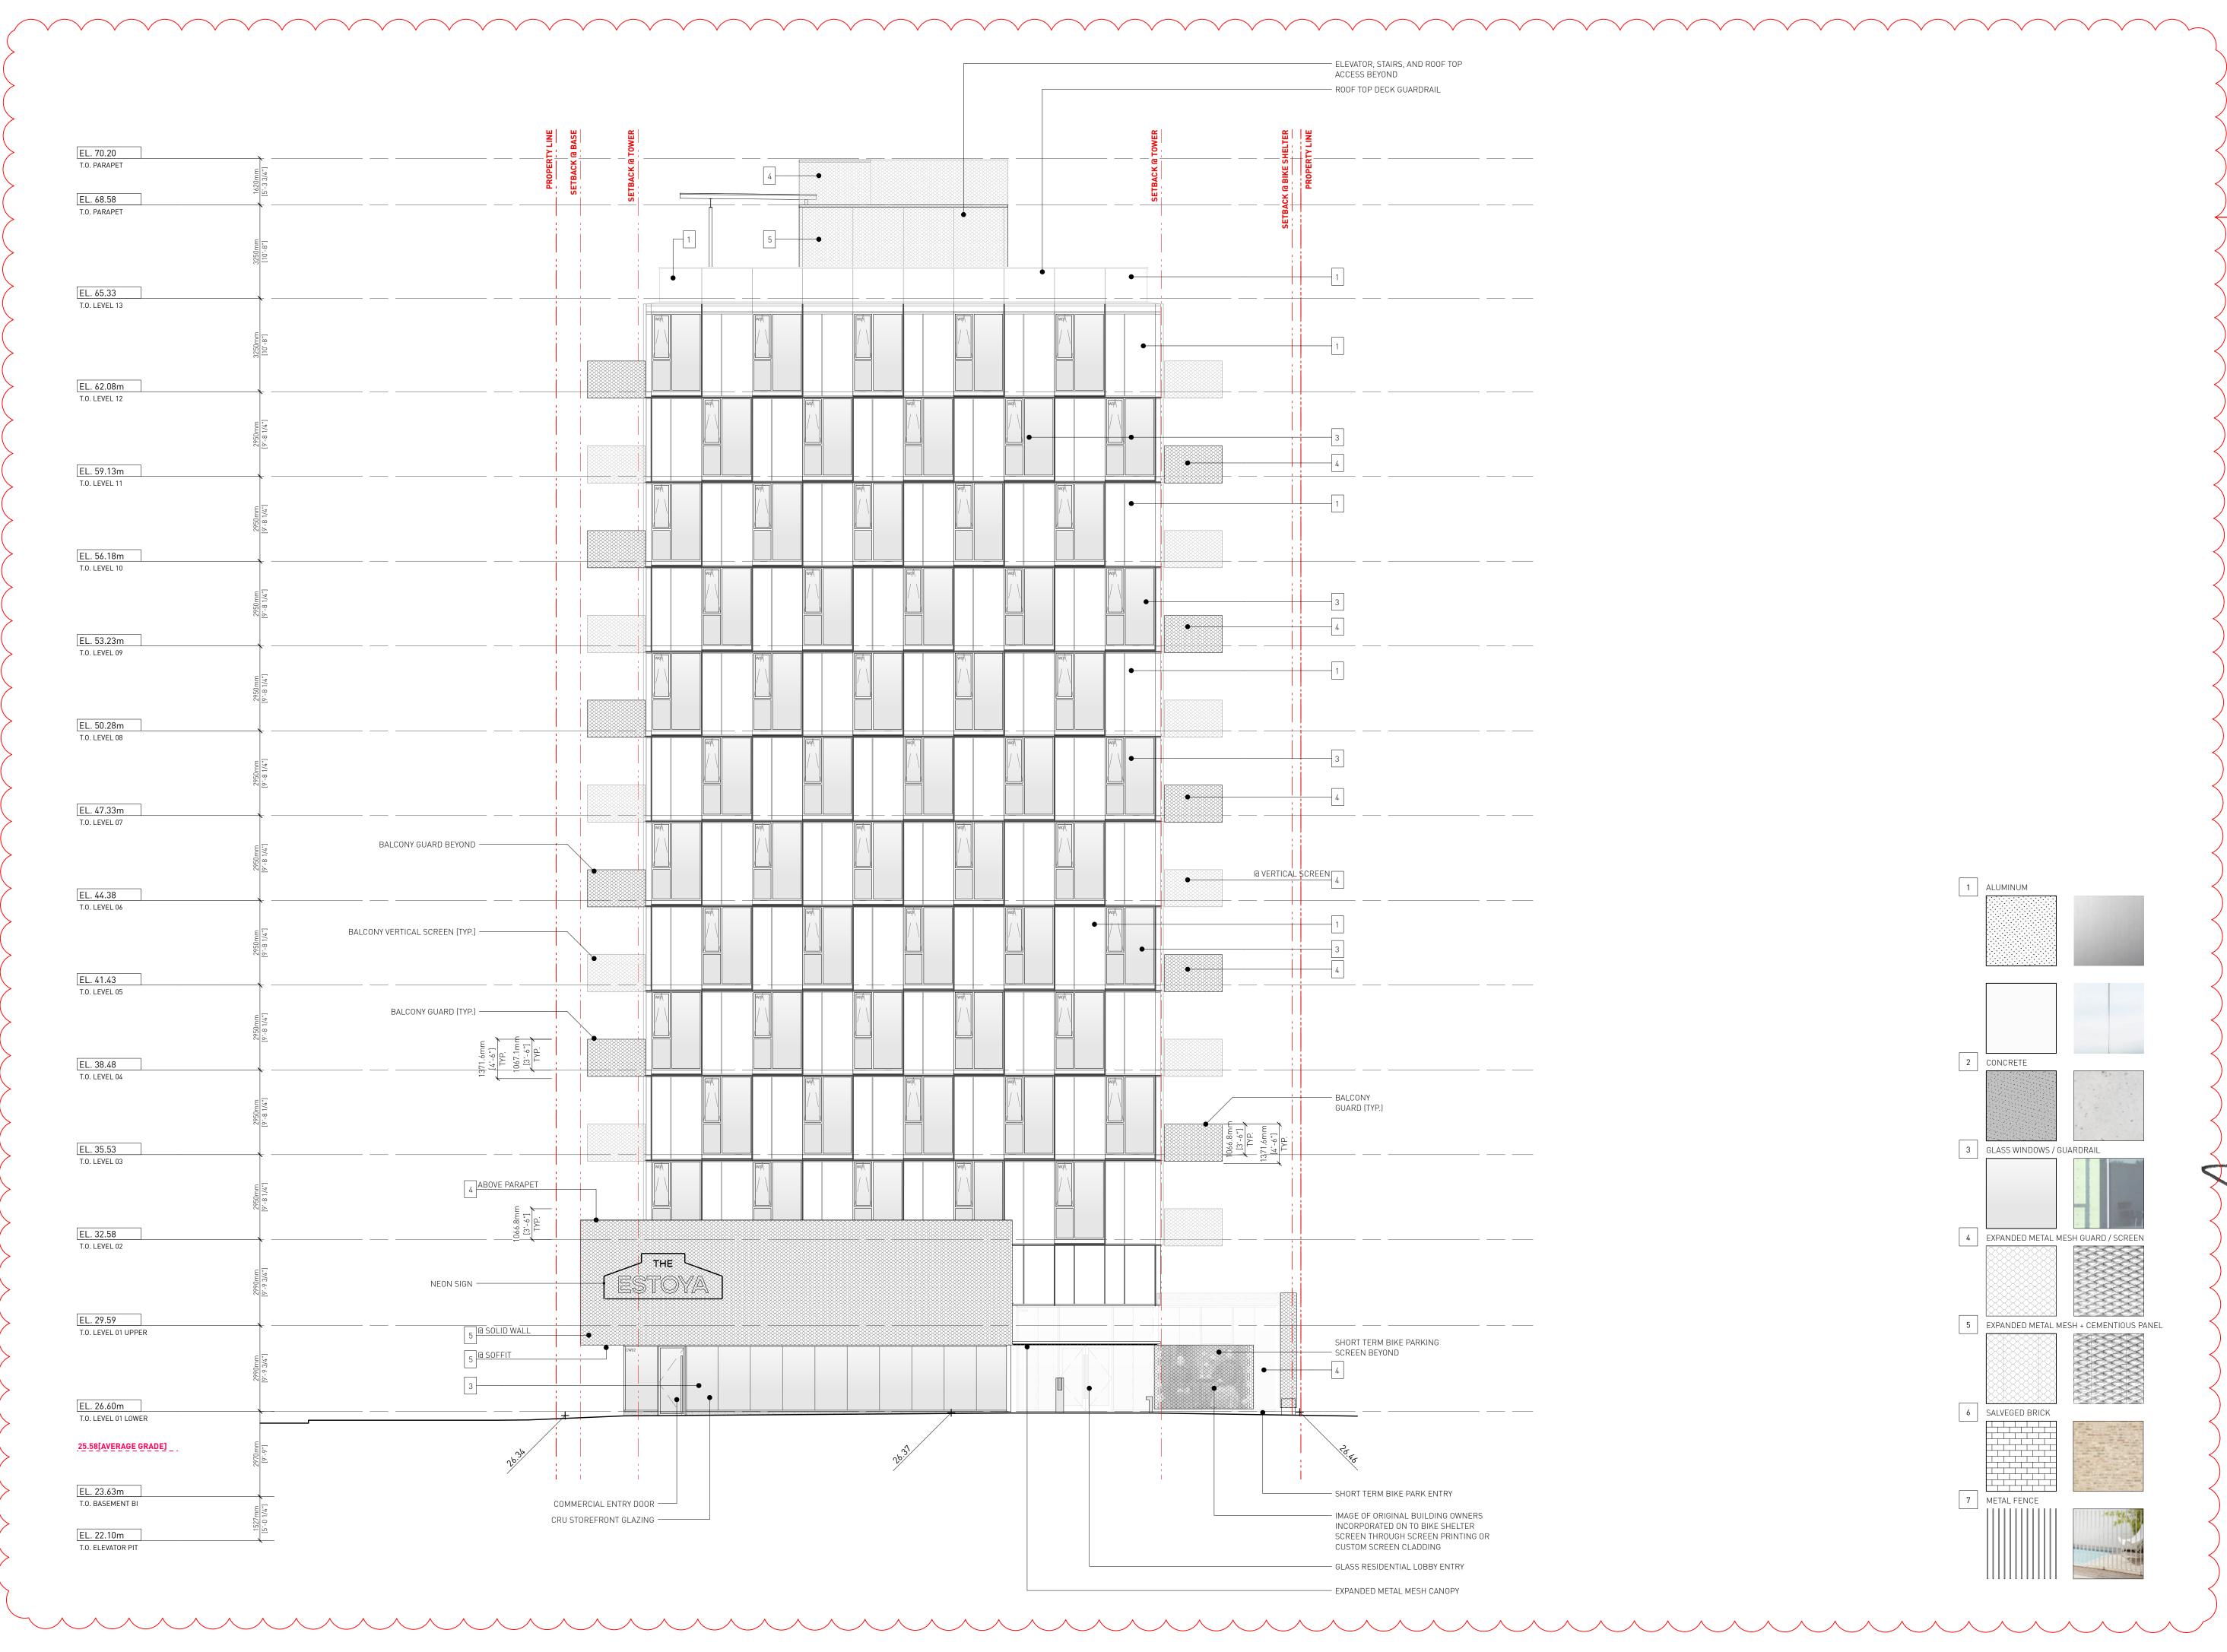

14.12.2023 21.09.2023 2 Issued for TRG1 response

26.05.2025

EA / MM

Drawn By: Checked By: Printing Date: PB 23.05.2025

The Contractor shall verify all dimensions, datums and levels prior to commencement of work.

All errors and omissions to be reported to the Architect before proceeding.

This drawing must not be scaled.


This drawing is the property of the Architect; the copyright in same being reserved to him/her. It is

Any unauthorized alteration of the electronic data which constitute this document will void all responsibility for the altered document by the

This drawing is not to be used for building purposes until countersigned by:



23.05.2025

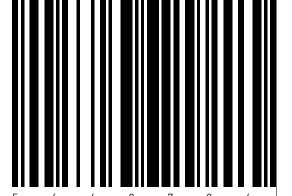


266 MCDERMOT AVE Winnipeg MB R3B 0S8 P: 204.480.8421 F: 204.480.8876

1702 QUADRA STREET + 862 FISGARD STREET

BUILDING ELEVATIONS

A2.2

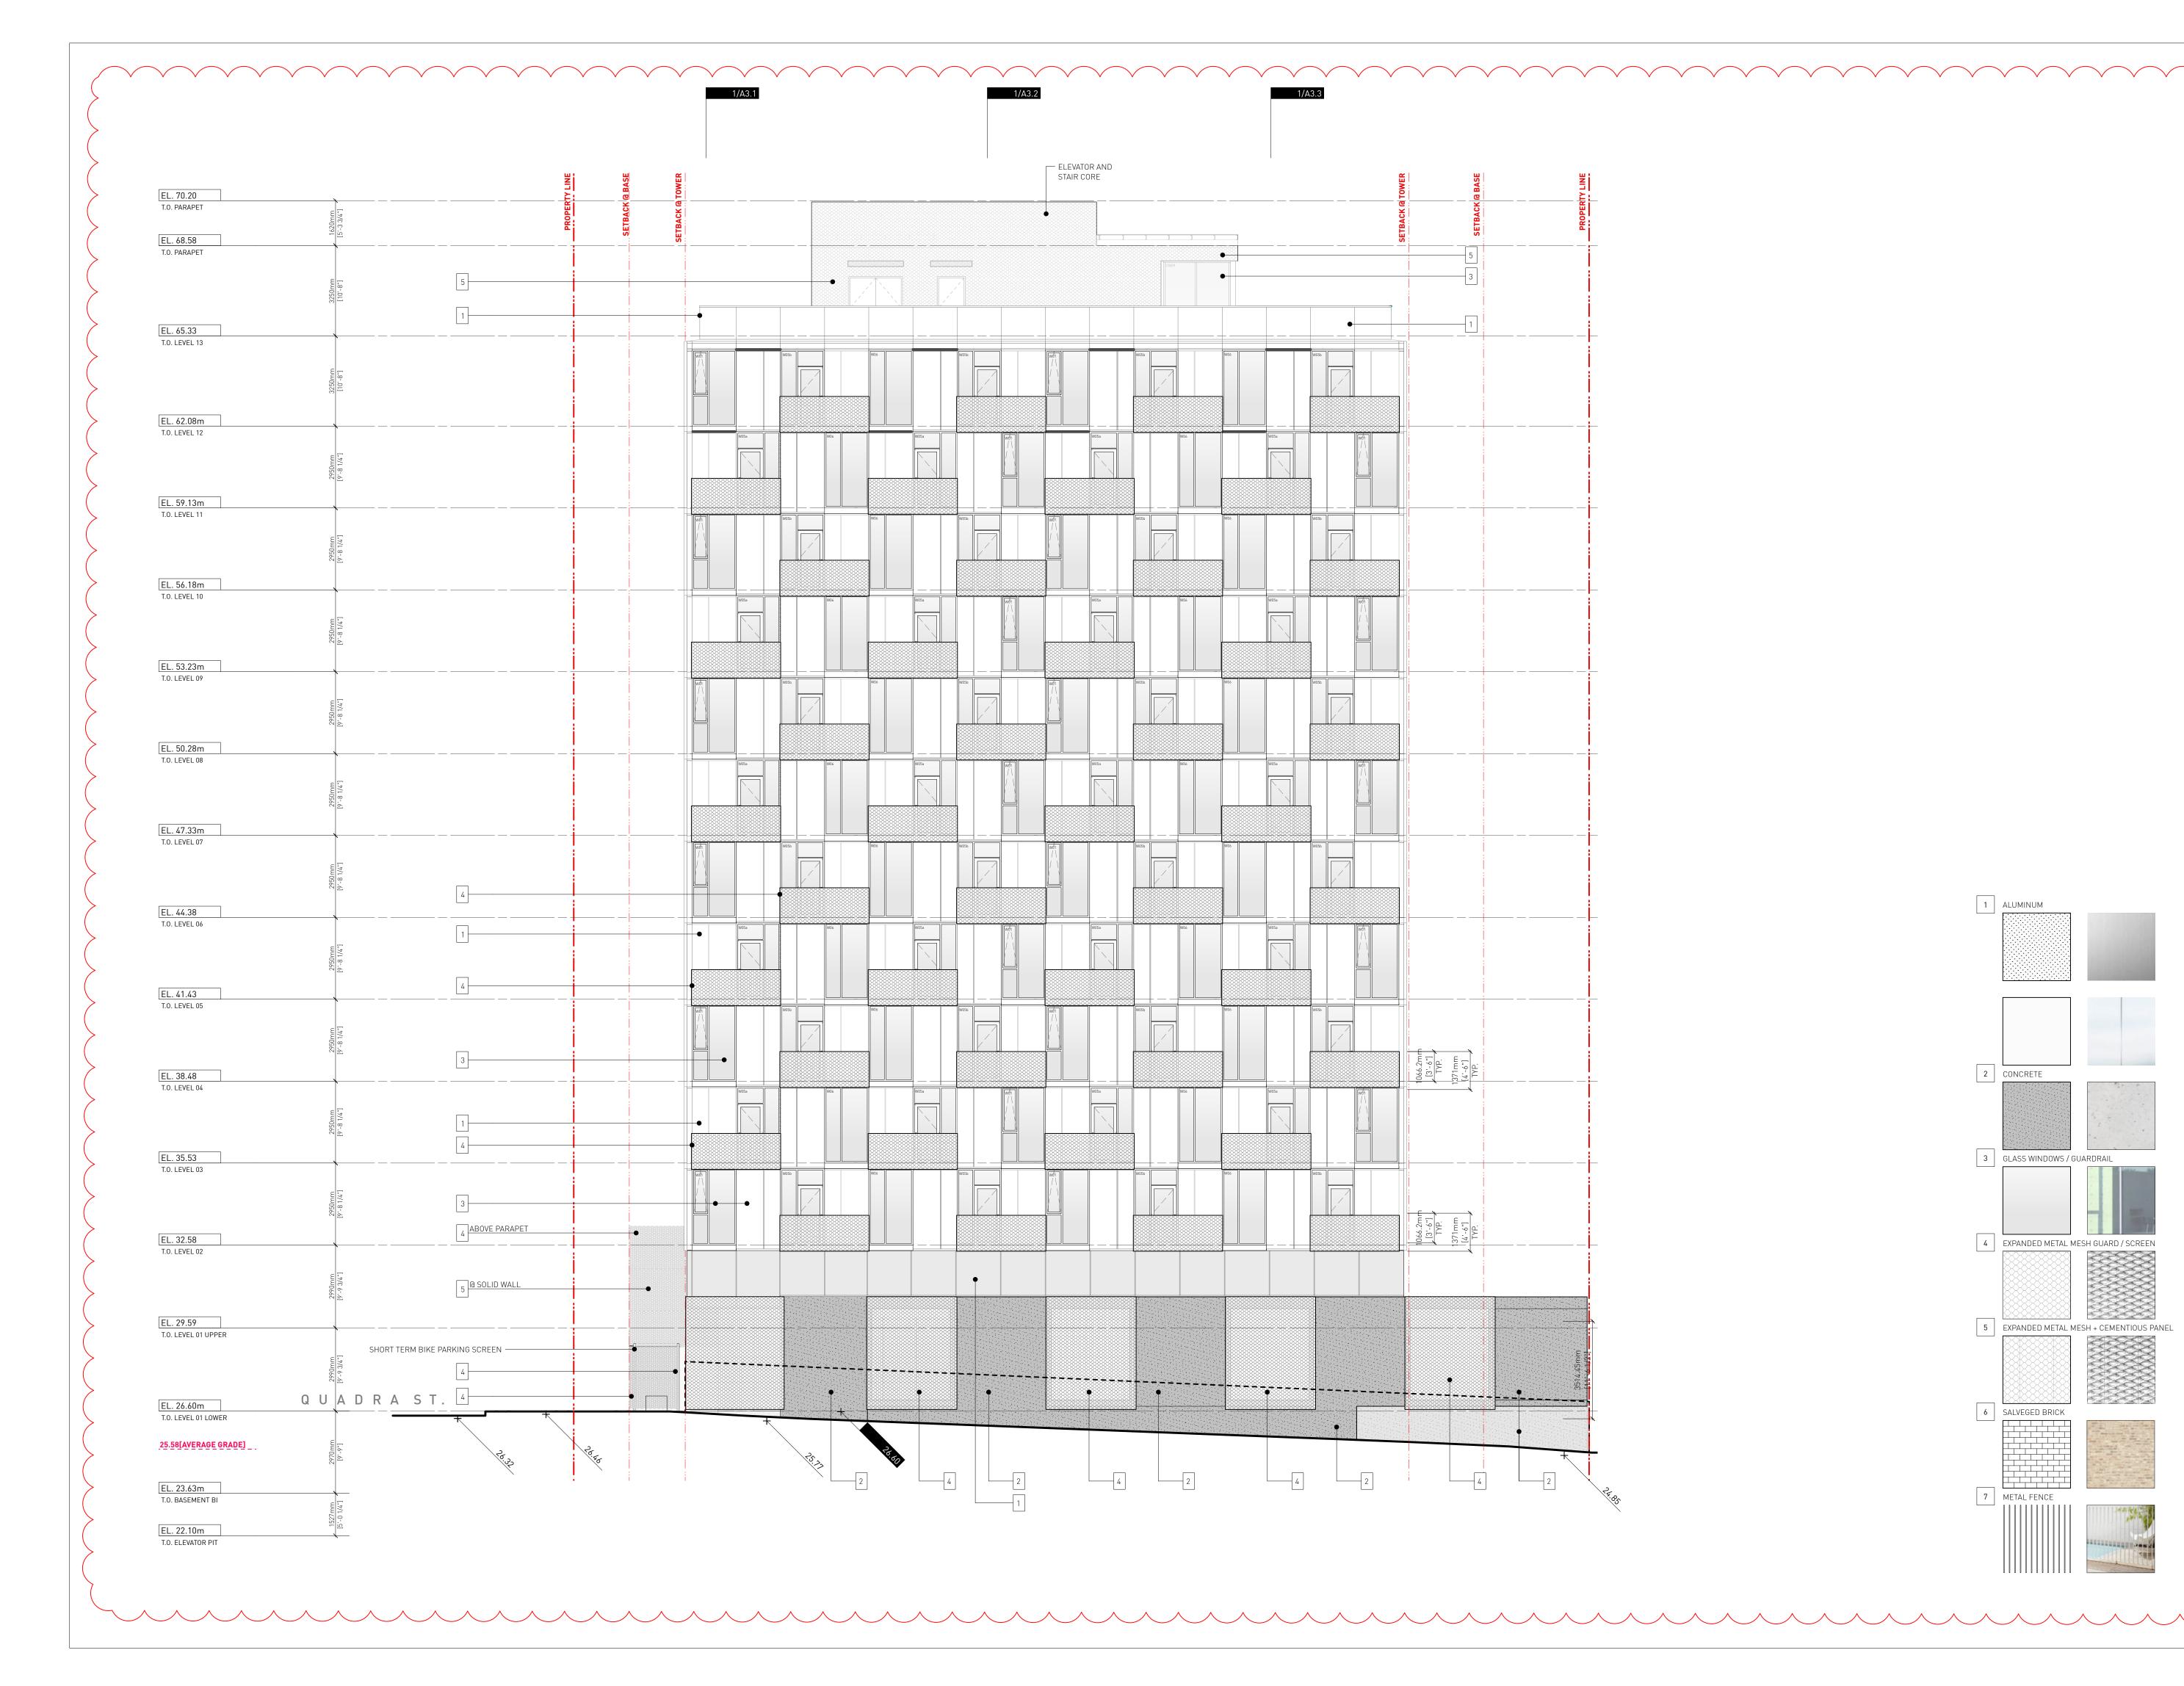



26.05.2025 14.12.2023 21.09.2023 2 Issued for TRG1 response

EA / MM

Drawn By: Checked By: Printing Date: PB 23.05.2025 The Contractor shall verify all dimensions, datums

All errors and omissions to be reported to the Architect before proceeding.

and levels prior to commencement of work.


This drawing must not be scaled.

This drawing is the property of the Architect; the


copyright in same being reserved to him/her. It is

Any unauthorized alteration of the electronic data which constitute this document will void all responsibility for the altered document by the

This drawing is not to be used for building purposes until countersigned by:

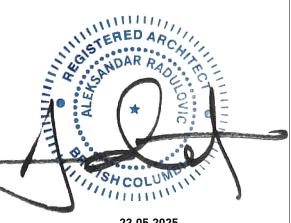

23.05.2025

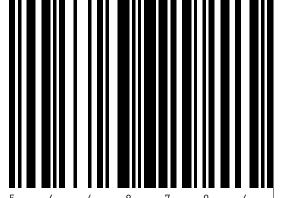


266 MCDERMOT AVE Winnipeg MB R3B 0S8 P: 204.480.8421 F: 204.480.8876

1702 QUADRA STREET + 862 FISGARD STREET

BUILDING ELEVATIONS

A2.3

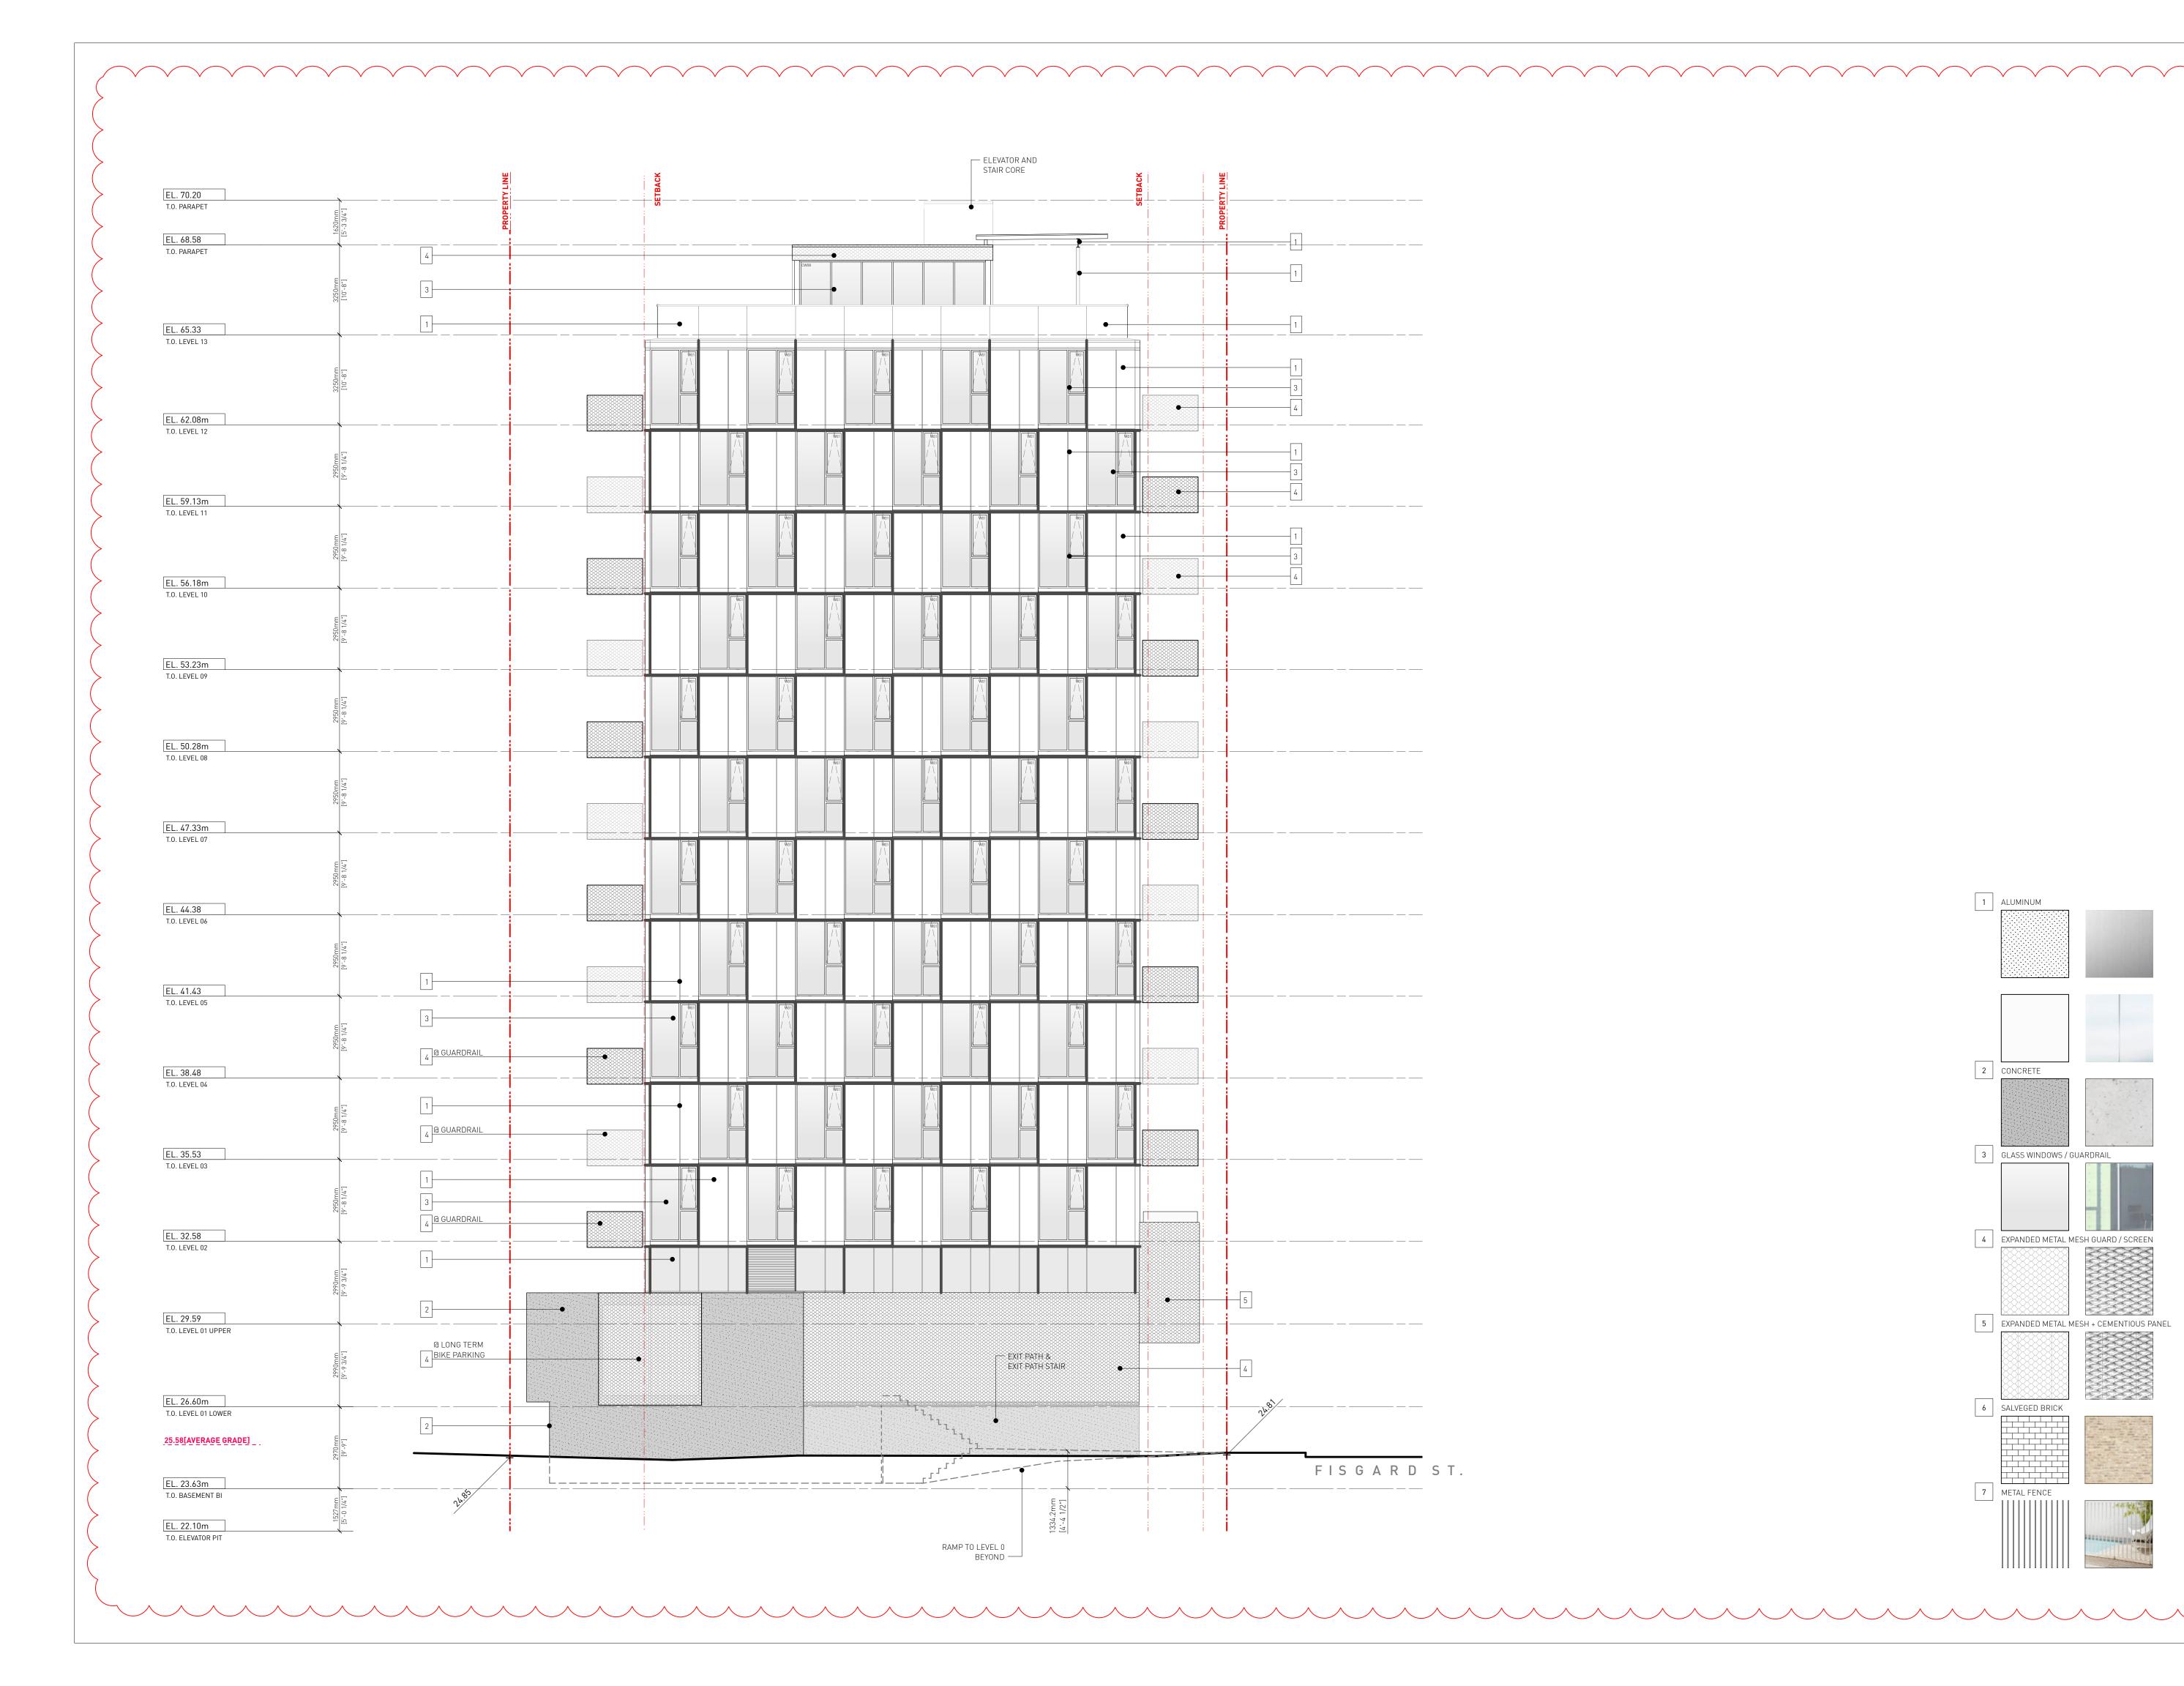



26.05.2025 14.12.2023 21.09.2023 2 Issued for TRG1 response

EA / MM

Drawn By: Checked By: Printing Date: PB 23.05.2025

The Contractor shall verify all dimensions, datums and levels prior to commencement of work. All errors and omissions to be reported to the


Architect before proceeding.

This drawing must not be scaled.


This drawing is the property of the Architect; the copyright in same being reserved to him/her. It is

Any unauthorized alteration of the electronic data which constitute this document will void all responsibility for the altered document by the

This drawing is not to be used for building purposes until countersigned by:

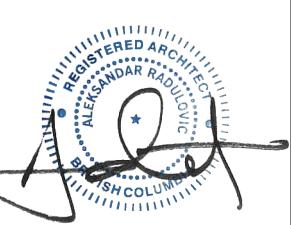

23.05.2025

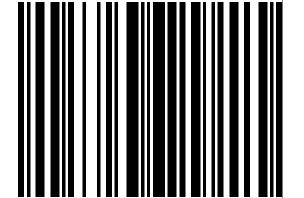


266 MCDERMOT AVE Winnipeg MB R3B 0S8 P: 204.480.8421 F: 204.480.8876

1702 QUADRA STREET + 862 FISGARD STREET

BUILDING ELEVATIONS Project

Sheet

A2.4

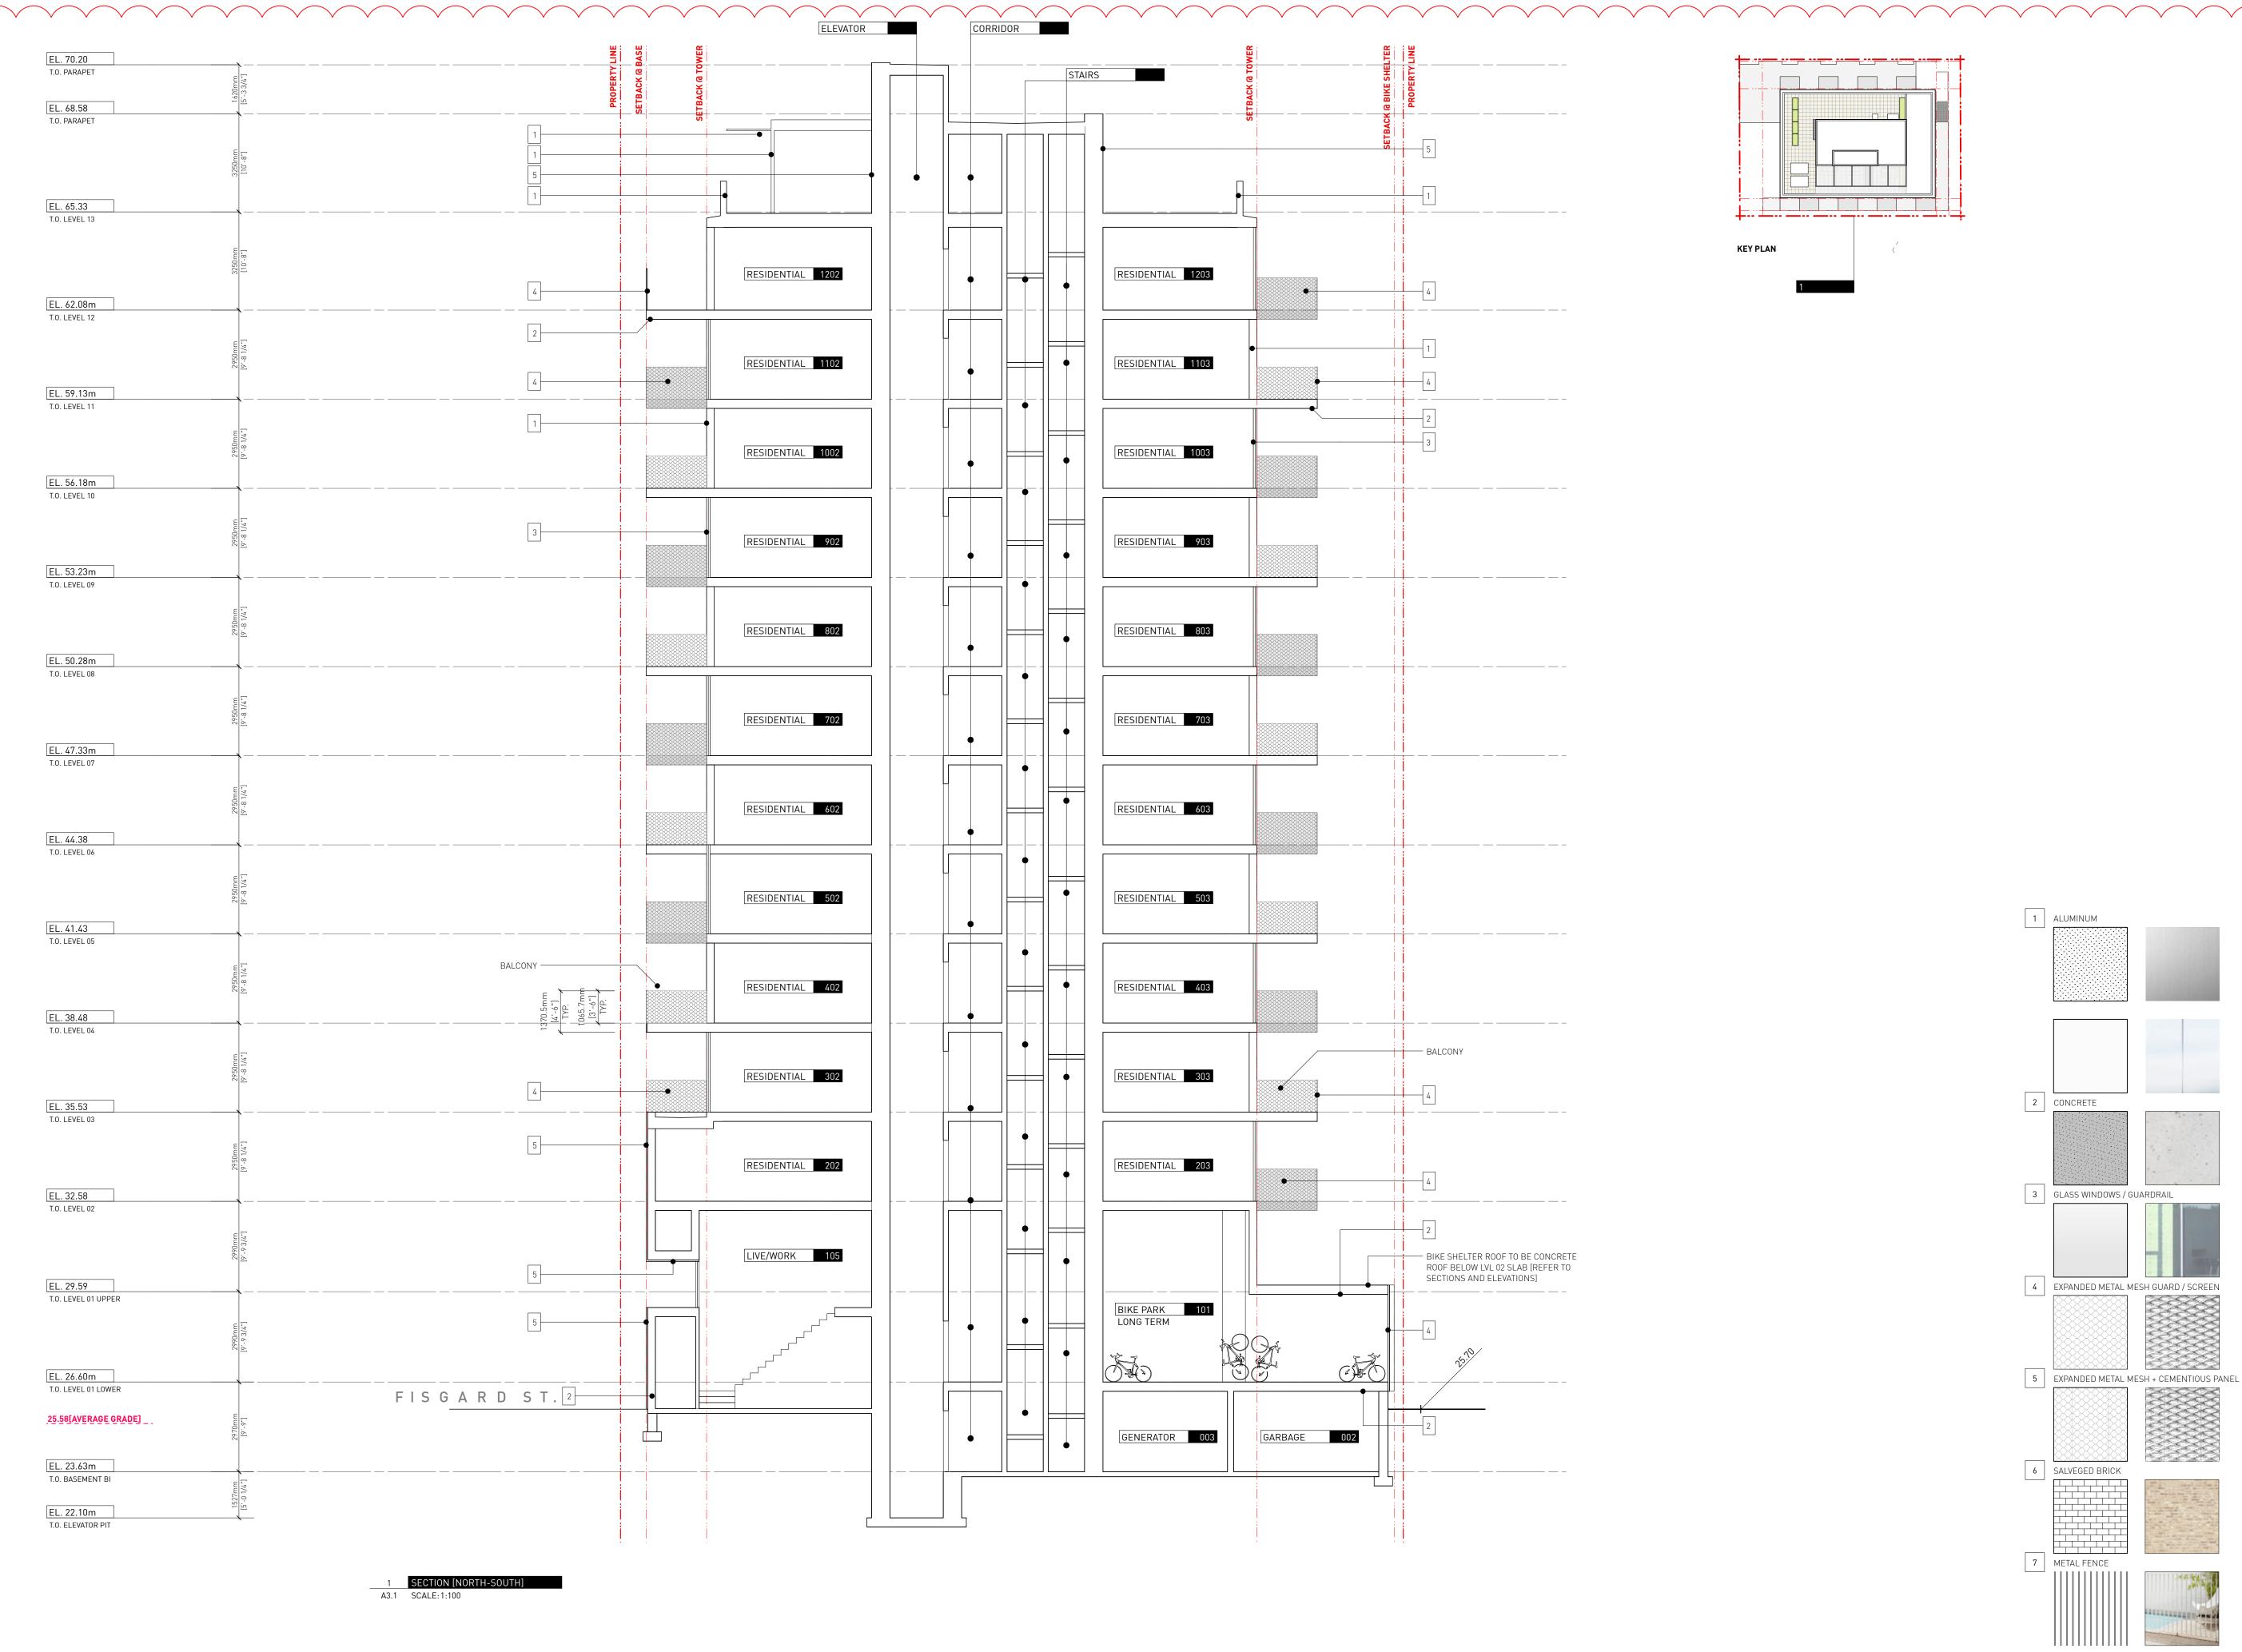



3 Issued for TRG2 response 2 Issued for TRG1 response

Drawn By: Checked By: Printing Date: PB 23.05.2025

26.05.2025

14.12.2023

21.09.2023

The Contractor shall verify all dimensions, datums and levels prior to commencement of work.

All errors and omissions to be reported to the Architect before proceeding.

This drawing must not be scaled.

1 ALUMINUM

2 CONCRETE

3 GLASS WINDOWS / GUARDRAIL

4 EXPANDED METAL MESH GUARD / SCREEN

5 EXPANDED METAL MESH + CEMENTIOUS PANEL

6 SALVEGED BRICK


7 METAL FENCE


This drawing is the property of the Architect; the

copyright in same being reserved to him/her. It is

Any unauthorized alteration of the electronic data which constitute this document will void all responsibility for the altered document by the

This drawing is not to be used for building purposes until countersigned by:

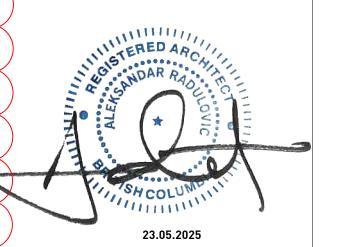

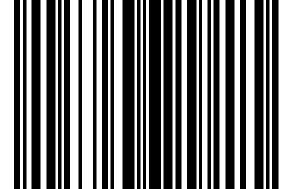

266 MCDERMOT AVE Winnipeg MB R3B 0S8 P: 204.480.8421 F: 204.480.8876


1702 QUADRA STREET + 862 FISGARD STREET


BUILDING SECTION

0650 Sheet

Project

A3.1

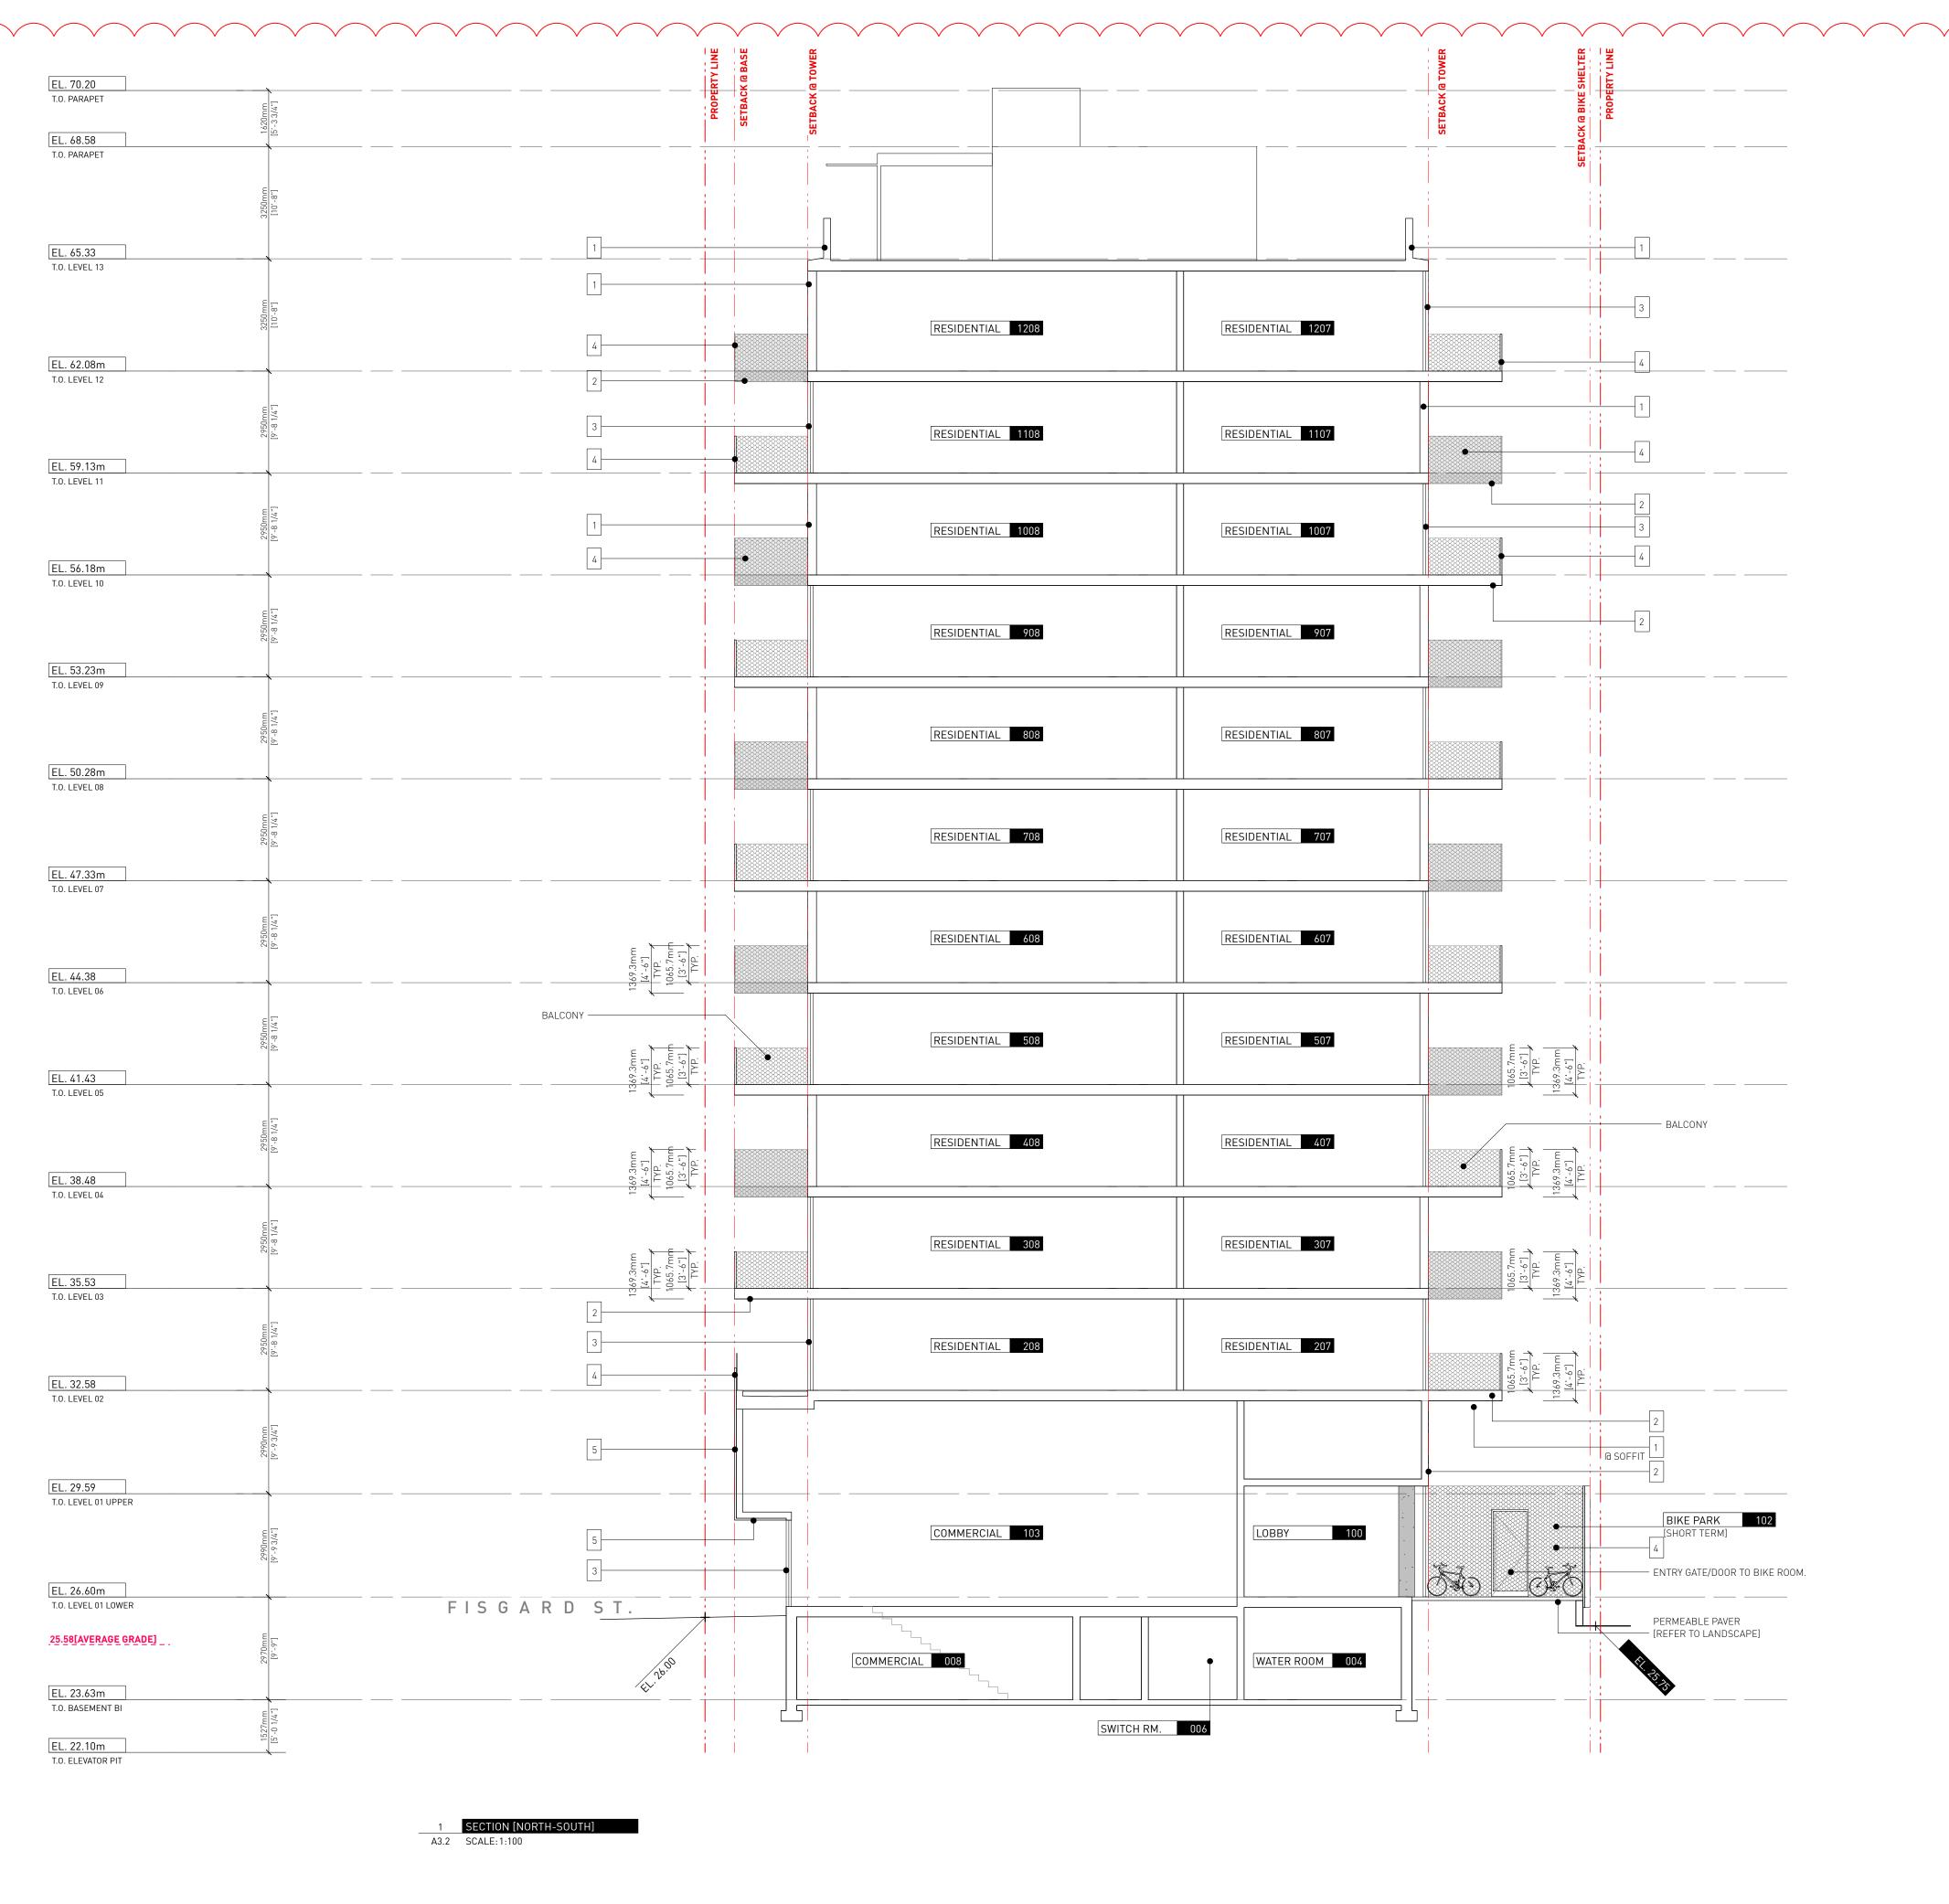

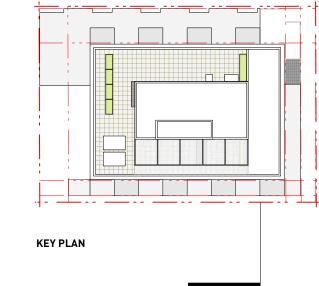

21.09.2023 2 Issued for TRG1 response Drawn By: Checked By: Printing Date:

26.05.2025

14.12.2023

PB 23.05.2025

The Contractor shall verify all dimensions, datums

and levels prior to commencement of work. All errors and omissions to be reported to the Architect before proceeding.

This drawing must not be scaled.

This drawing is the property of the Architect; the

1 ALUMINUM

2 CONCRETE

3 GLASS WINDOWS / GUARDRAIL

4 EXPANDED METAL MESH GUARD / SCREEN

5 EXPANDED METAL MESH + CEMENTIOUS PANEL


6 SALVEGED BRICK


7 METAL FENCE

copyright in same being reserved to him/her. It is

Any unauthorized alteration of the electronic data which constitute this document will void all responsibility for the altered document by the

This drawing is not to be used for building purposes until countersigned by:

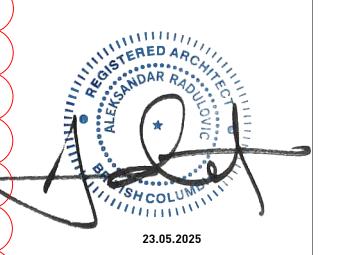

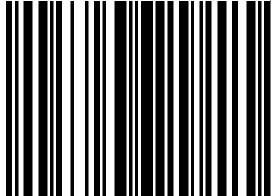


266 MCDERMOT AVE Winnipeg MB R3B 0S8 P: 204.480.8421 F: 204.480.8876

1702 QUADRA STREET + 862 FISGARD STREET

BUILDING SECTION

0650 Sheet A3.2

Project

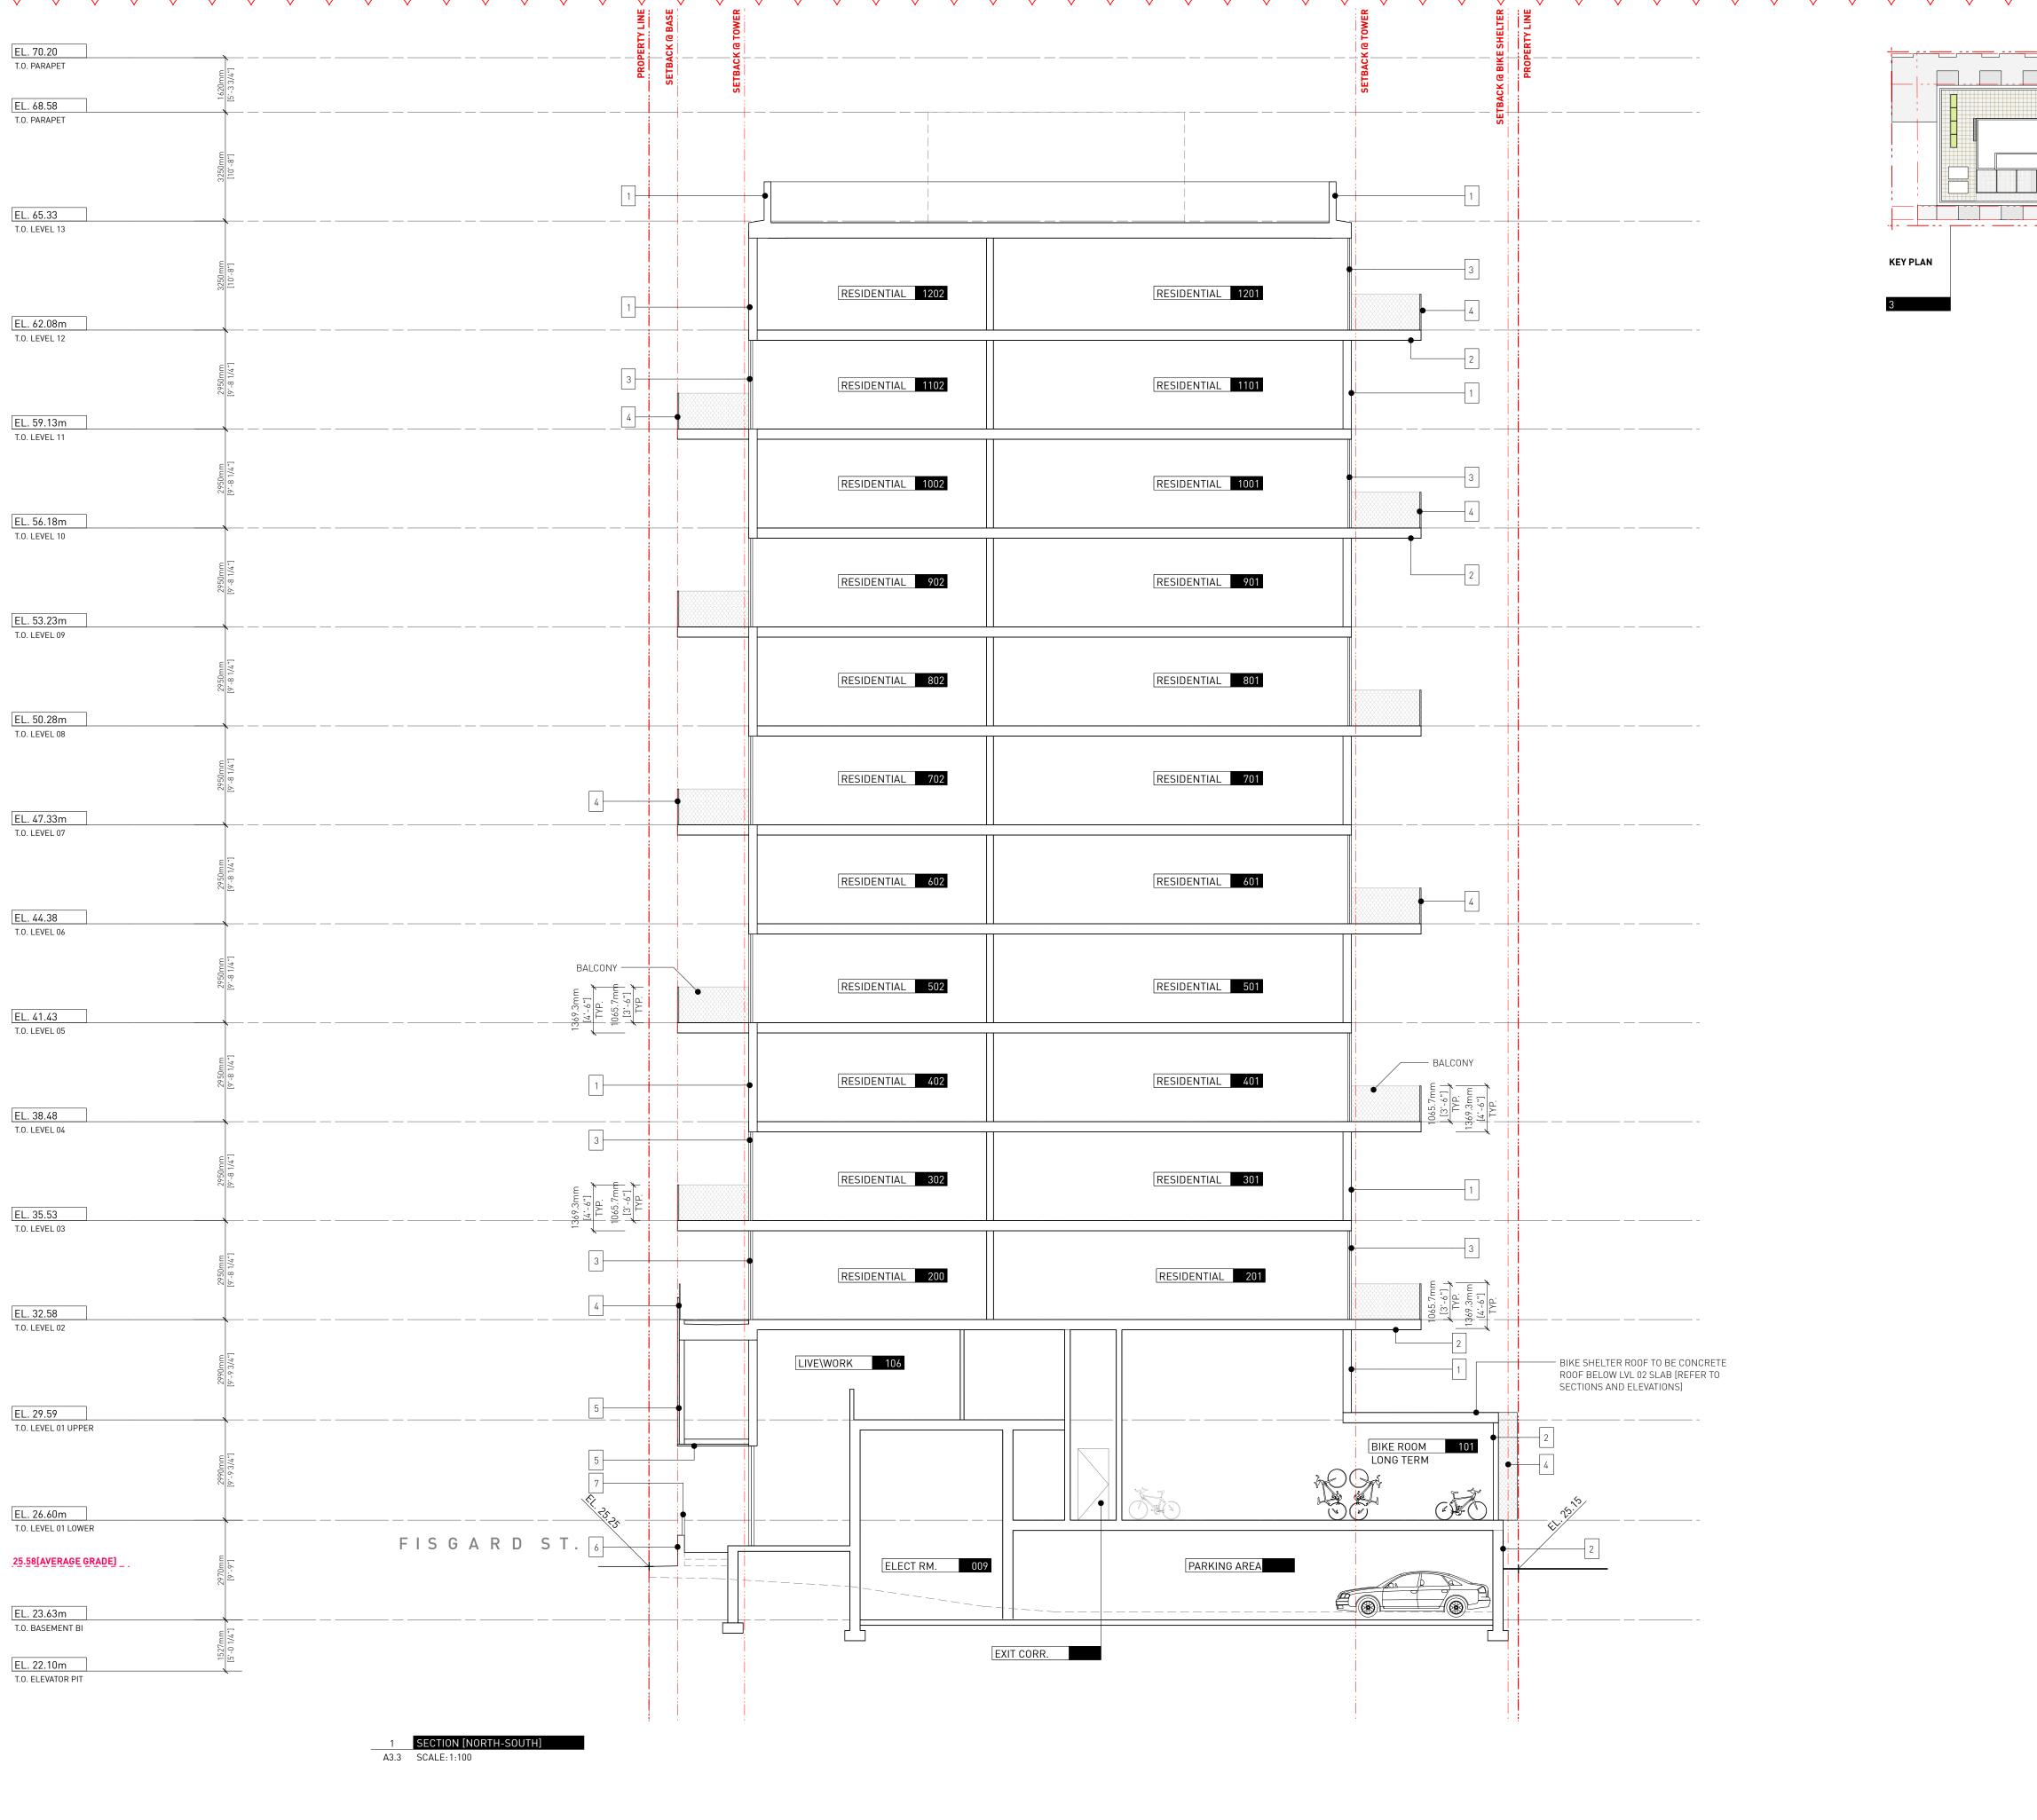



26.05.2025 3 Issued for TRG2 response 14.12.2023 21.09.2023 2 Issued for TRG1 response

PB 23.05.2025

Drawn By: Checked By: Printing Date: The Contractor shall verify all dimensions, datums

and levels prior to commencement of work. All errors and omissions to be reported to the Architect before proceeding.

This drawing must not be scaled.

1 ALUMINUM

2 CONCRETE

3 GLASS WINDOWS / GUARDRAIL

4 EXPANDED METAL MESH GUARD / SCREEN

5 EXPANDED METAL MESH + CEMENTIOUS PANEL


6 SALVEGED BRICK


7 METAL FENCE

This drawing is the property of the Architect; the copyright in same being reserved to him/her. It is

Any unauthorized alteration of the electronic data which constitute this document will void all responsibility for the altered document by the

This drawing is not to be used for building purposes until countersigned by:

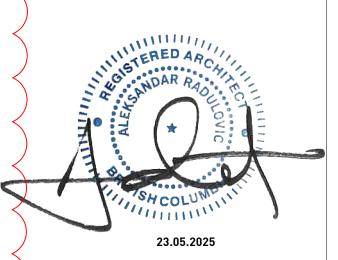

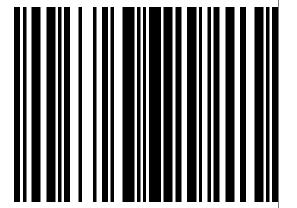

266 MCDERMOT AVE Winnipeg MB R3B 0S8 P: 204.480.8421 F: 204.480.8876


1702 QUADRA STREET + 862 FISGARD STREET


BUILDING SECTION

0650 Sheet

Project

A3.3

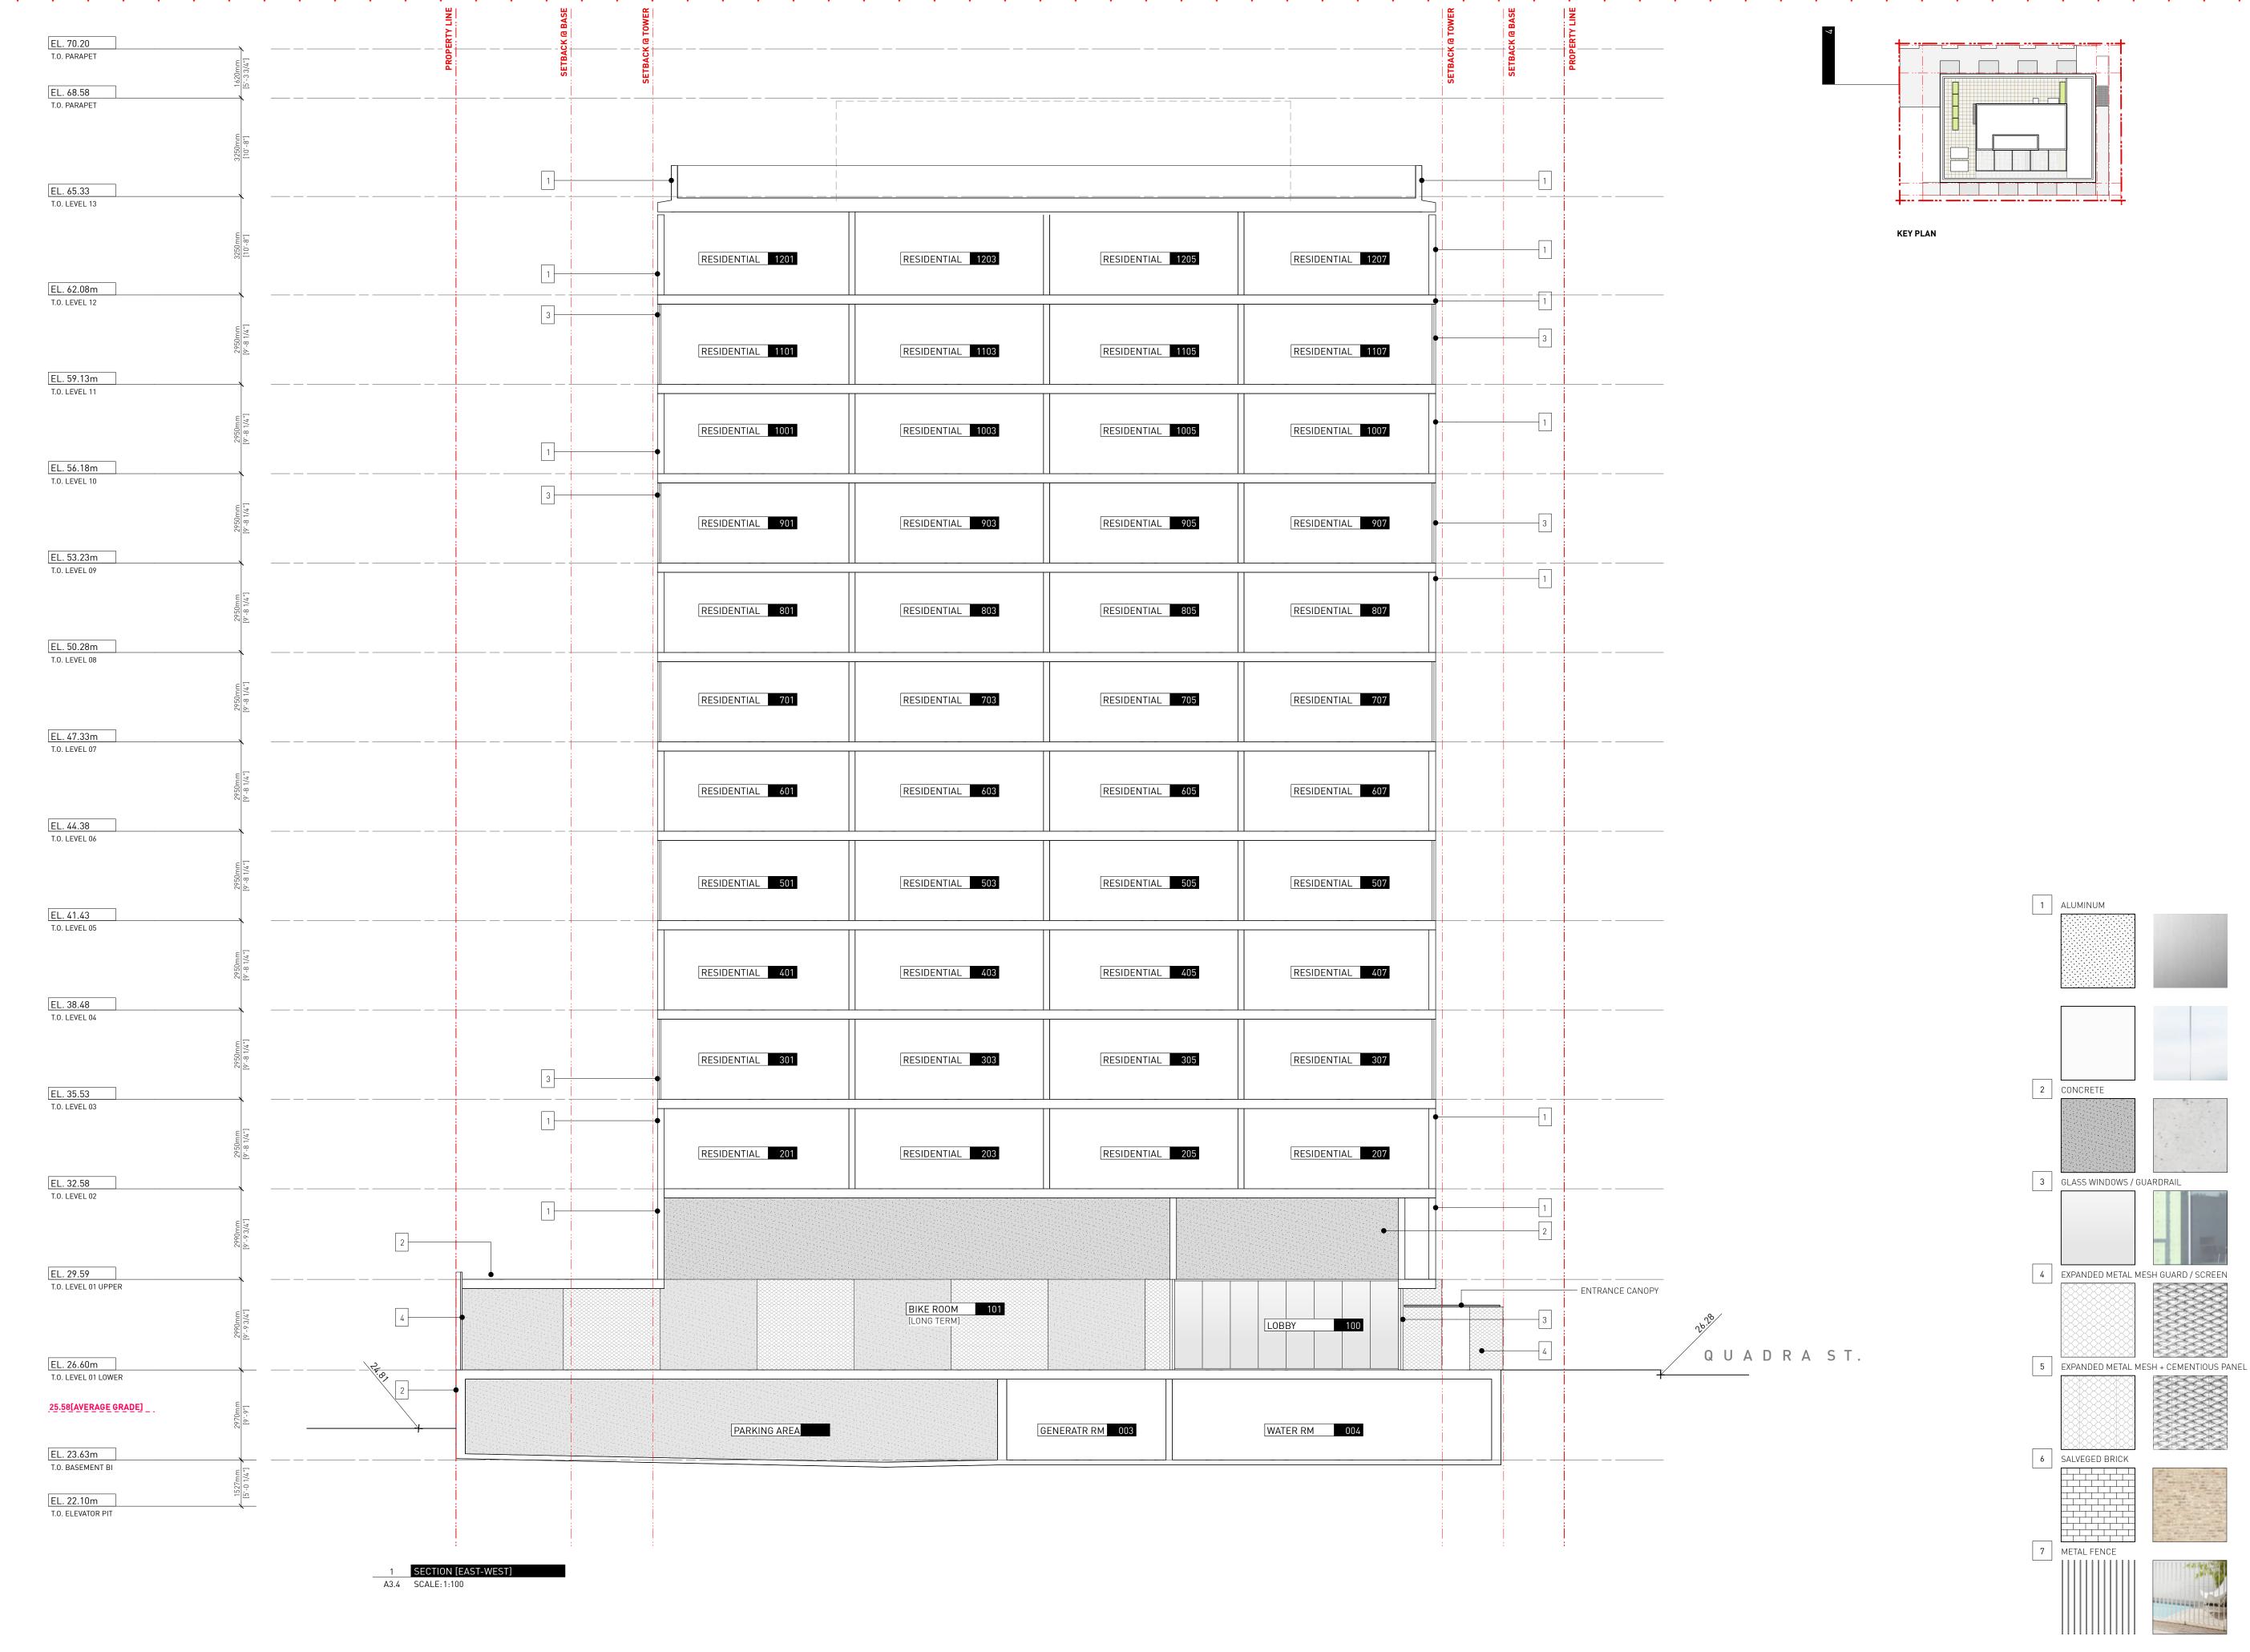

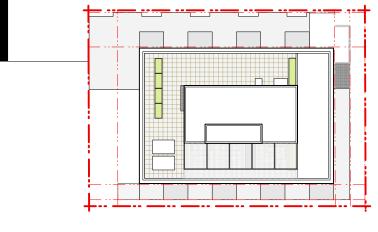

3 Issued for TRG2 response 14.12.2023 2 Issued for TRG1 response 21.09.2023

26.05.2025

Drawn By: Checked By: Printing Date: PB 23.05.2025

The Contractor shall verify all dimensions, datums

and levels prior to commencement of work. All errors and omissions to be reported to the Architect before proceeding.


This drawing must not be scaled.


This drawing is the property of the Architect; the

copyright in same being reserved to him/her. It is

Any unauthorized alteration of the electronic data which constitute this document will void all responsibility for the altered document by the

This drawing is not to be used for building purposes until countersigned by:

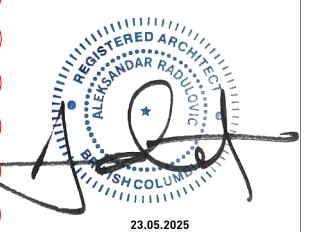

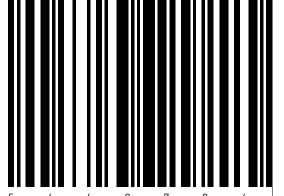

266 MCDERMOT AVE Winnipeg MB R3B 0S8 P: 204.480.8421 F: 204.480.8876

1702 QUADRA STREET + 862 FISGARD STREET

BUILDING SECTION

0650 Sheet A3.4

Project





26.05.2025 3 Issued for TRG2 response 14.12.2023 2 Issued for TRG1 response 21.09.2023

Drawn By: Checked By: Printing Date: PB 23.05.2025

The Contractor shall verify all dimensions, datums and levels prior to commencement of work. All errors and omissions to be reported to the

Architect before proceeding.

This drawing must not be scaled.

This drawing is the property of the Architect; the copyright in same being reserved to him/her. It is

Any unauthorized alteration of the electronic data which constitute this document will void all responsibility for the altered document by the

This drawing is not to be used for building purposes until countersigned by:



23.05.2025



266 MCDERMOT AVE Winnipeg MB R3B 0S8 P: 204.480.8421 F: 204.480.8876


1702 QUADRA STREET + 862 FISGARD STREET

BUILDING SECTION

0650 Sheet

Project

A3.5

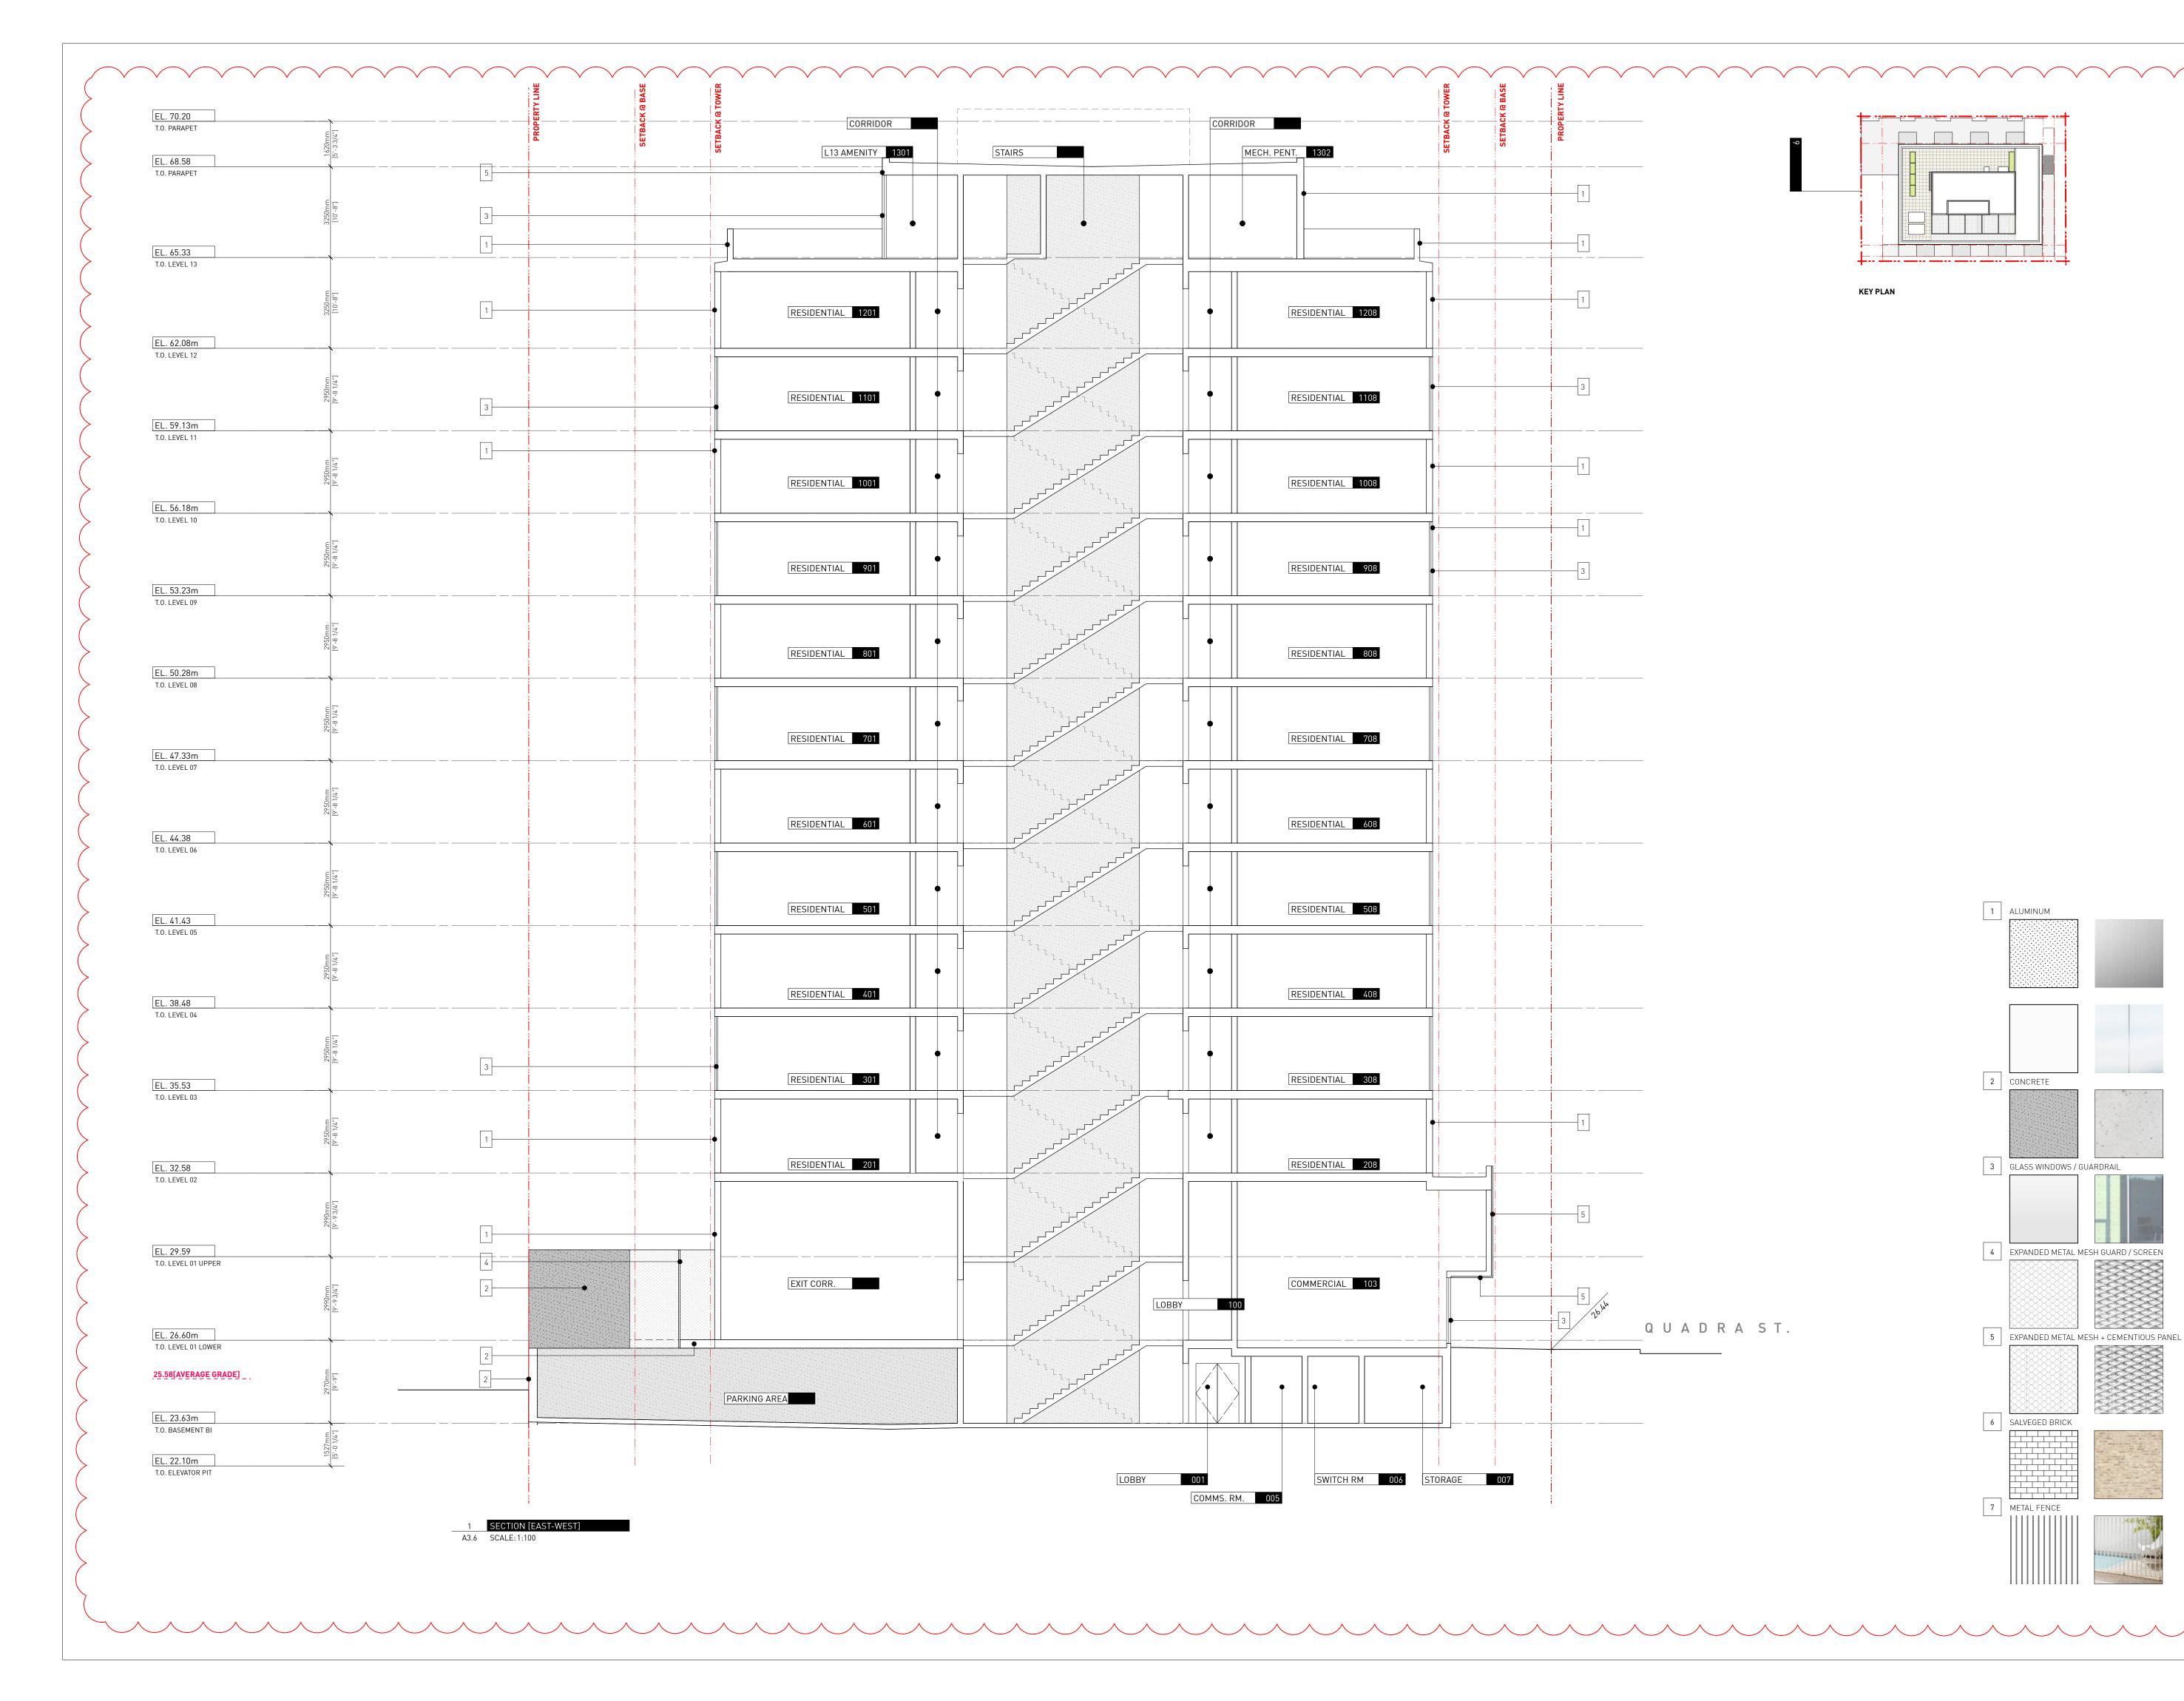

26.05.2025 14.12.2023 21.09.2023 2 Issued for TRG1 response

Drawn By: Checked By: Printing Date: PB 23.05.2025

The Contractor shall verify all dimensions, datums and levels prior to commencement of work. All errors and omissions to be reported to the

Architect before proceeding. This drawing must not be scaled.

This drawing is the property of the Architect; the

copyright in same being reserved to him/her. It is Any unauthorized alteration of the electronic data

which constitute this document will void all responsibility for the altered document by the

This drawing is not to be used for building purposes until countersigned by:



23.05.2025



266 MCDERMOT AVE Winnipeg MB R3B 0S8 P: 204.480.8421 F: 204.480.8876


1702 QUADRA STREET + 862 FISGARD STREET

BUILDING SECTION

0650 Sheet

Project

A3.6

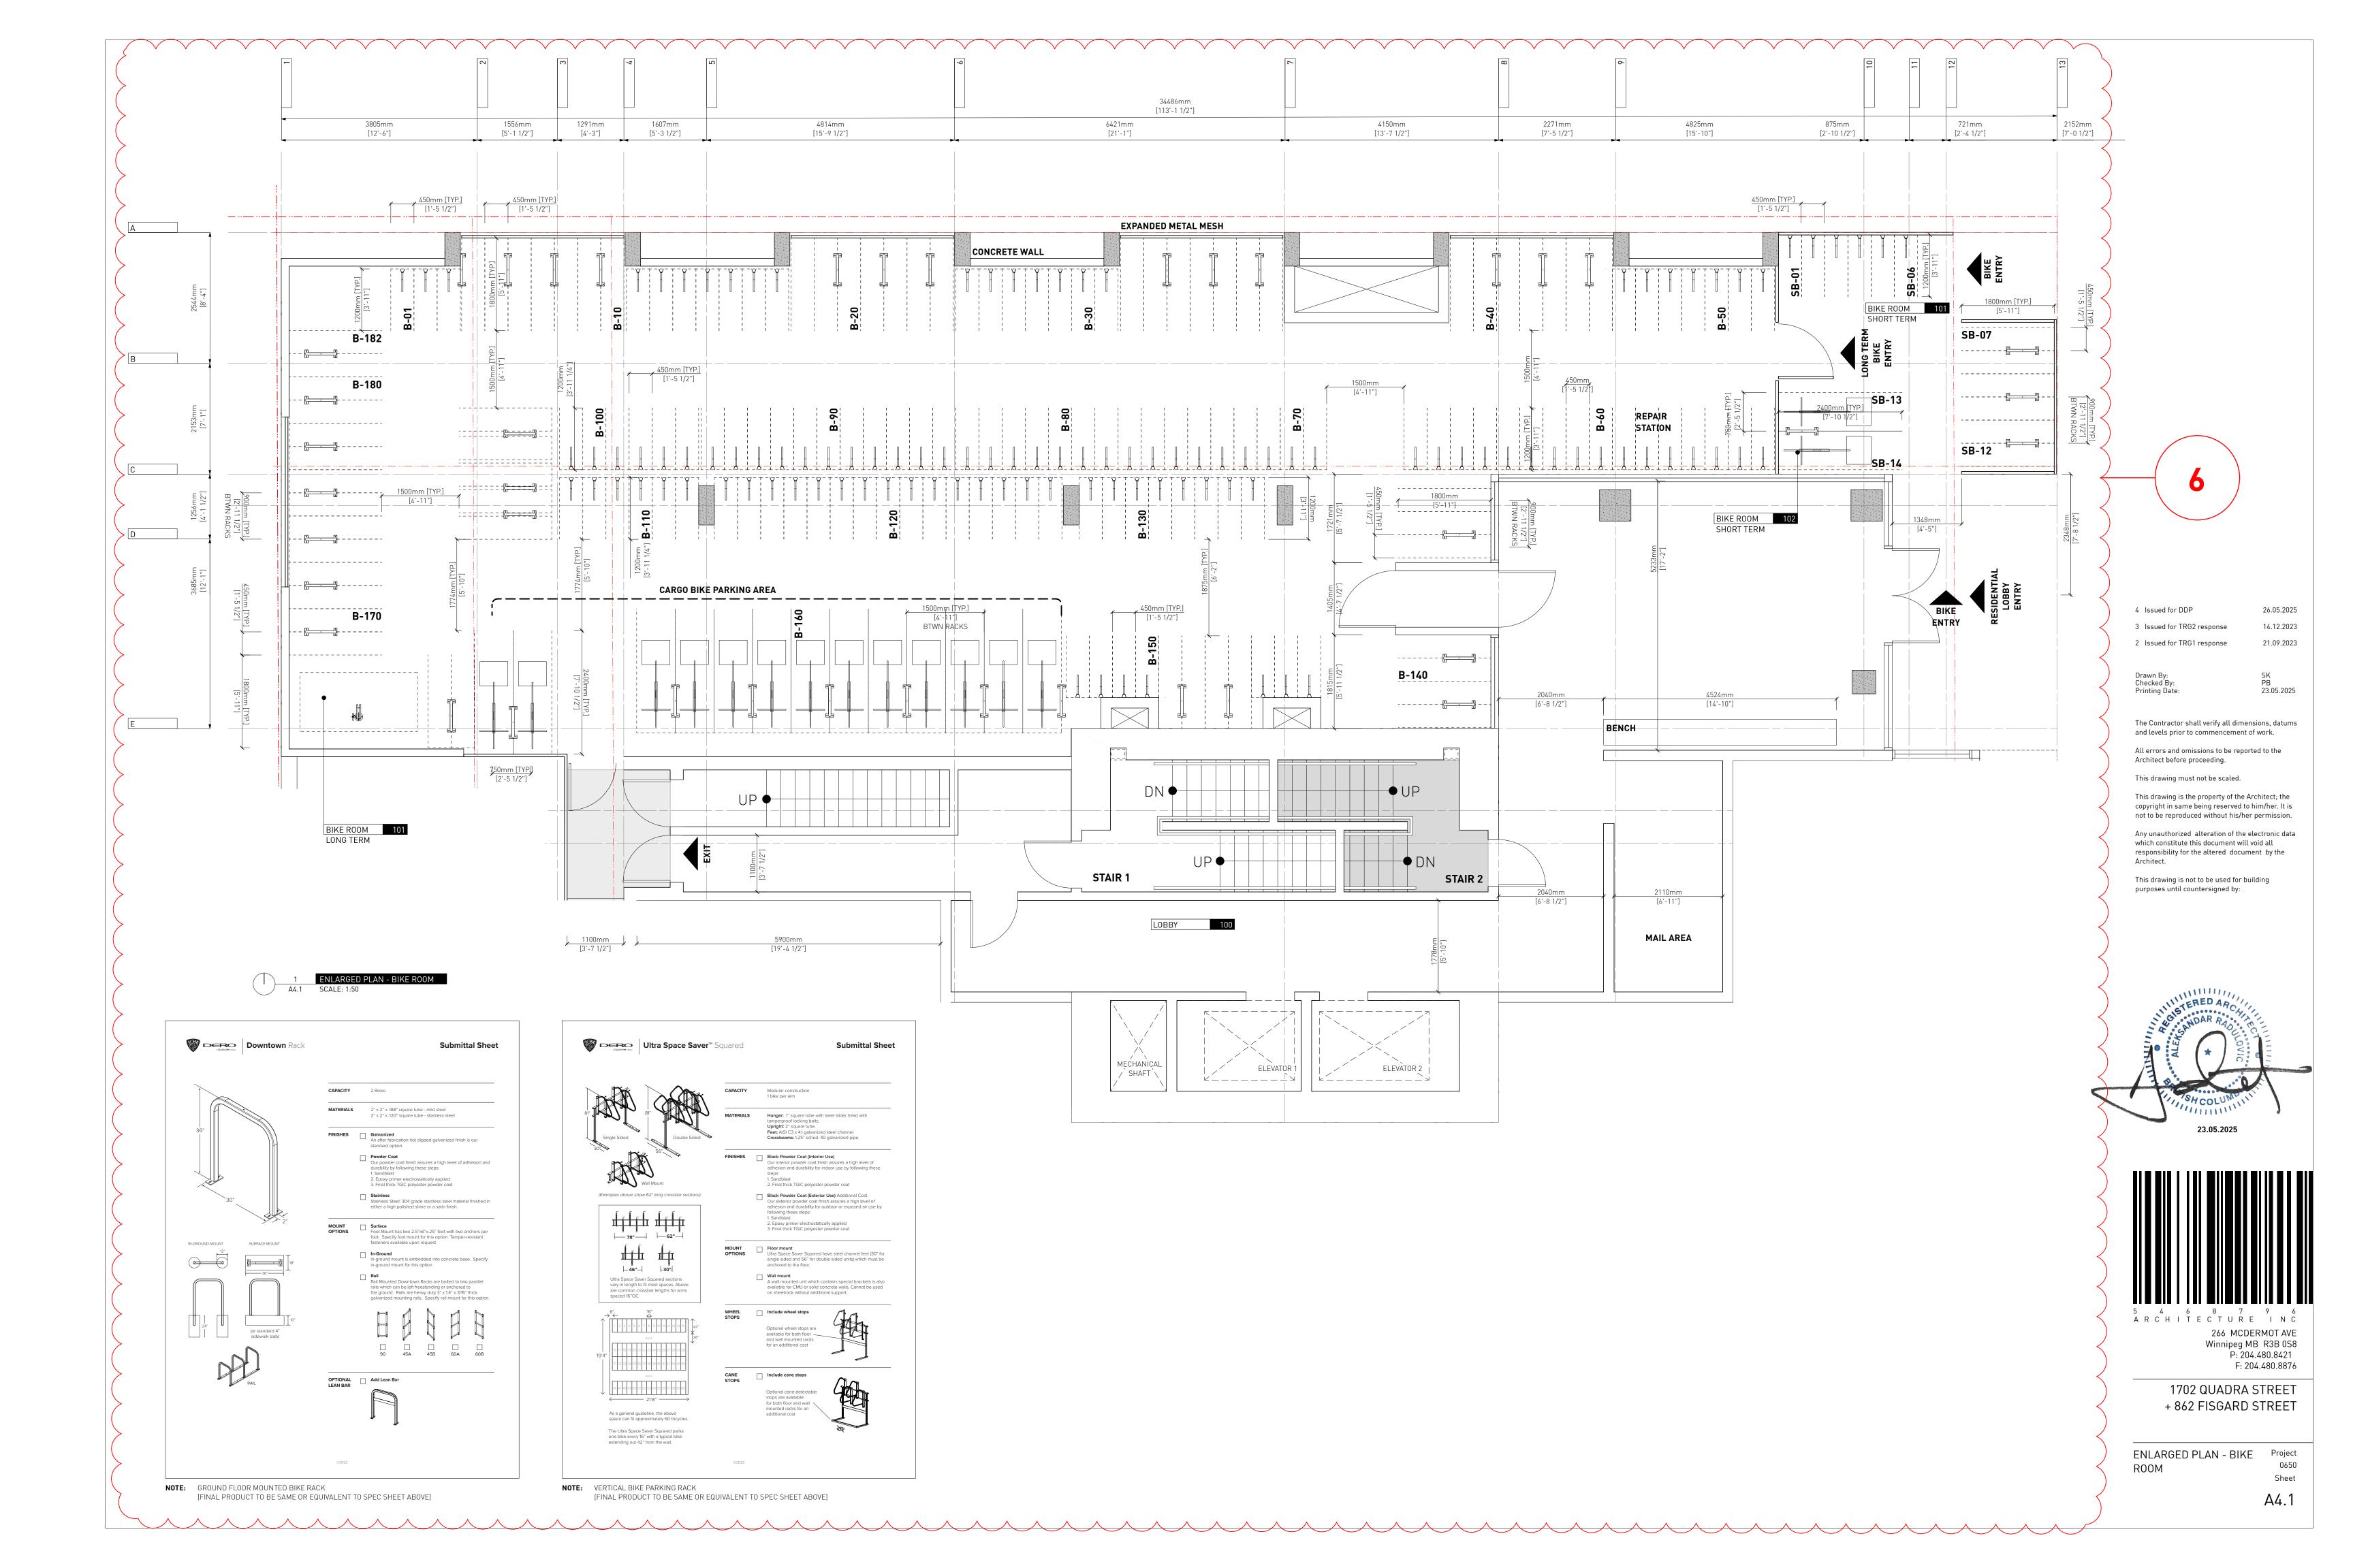

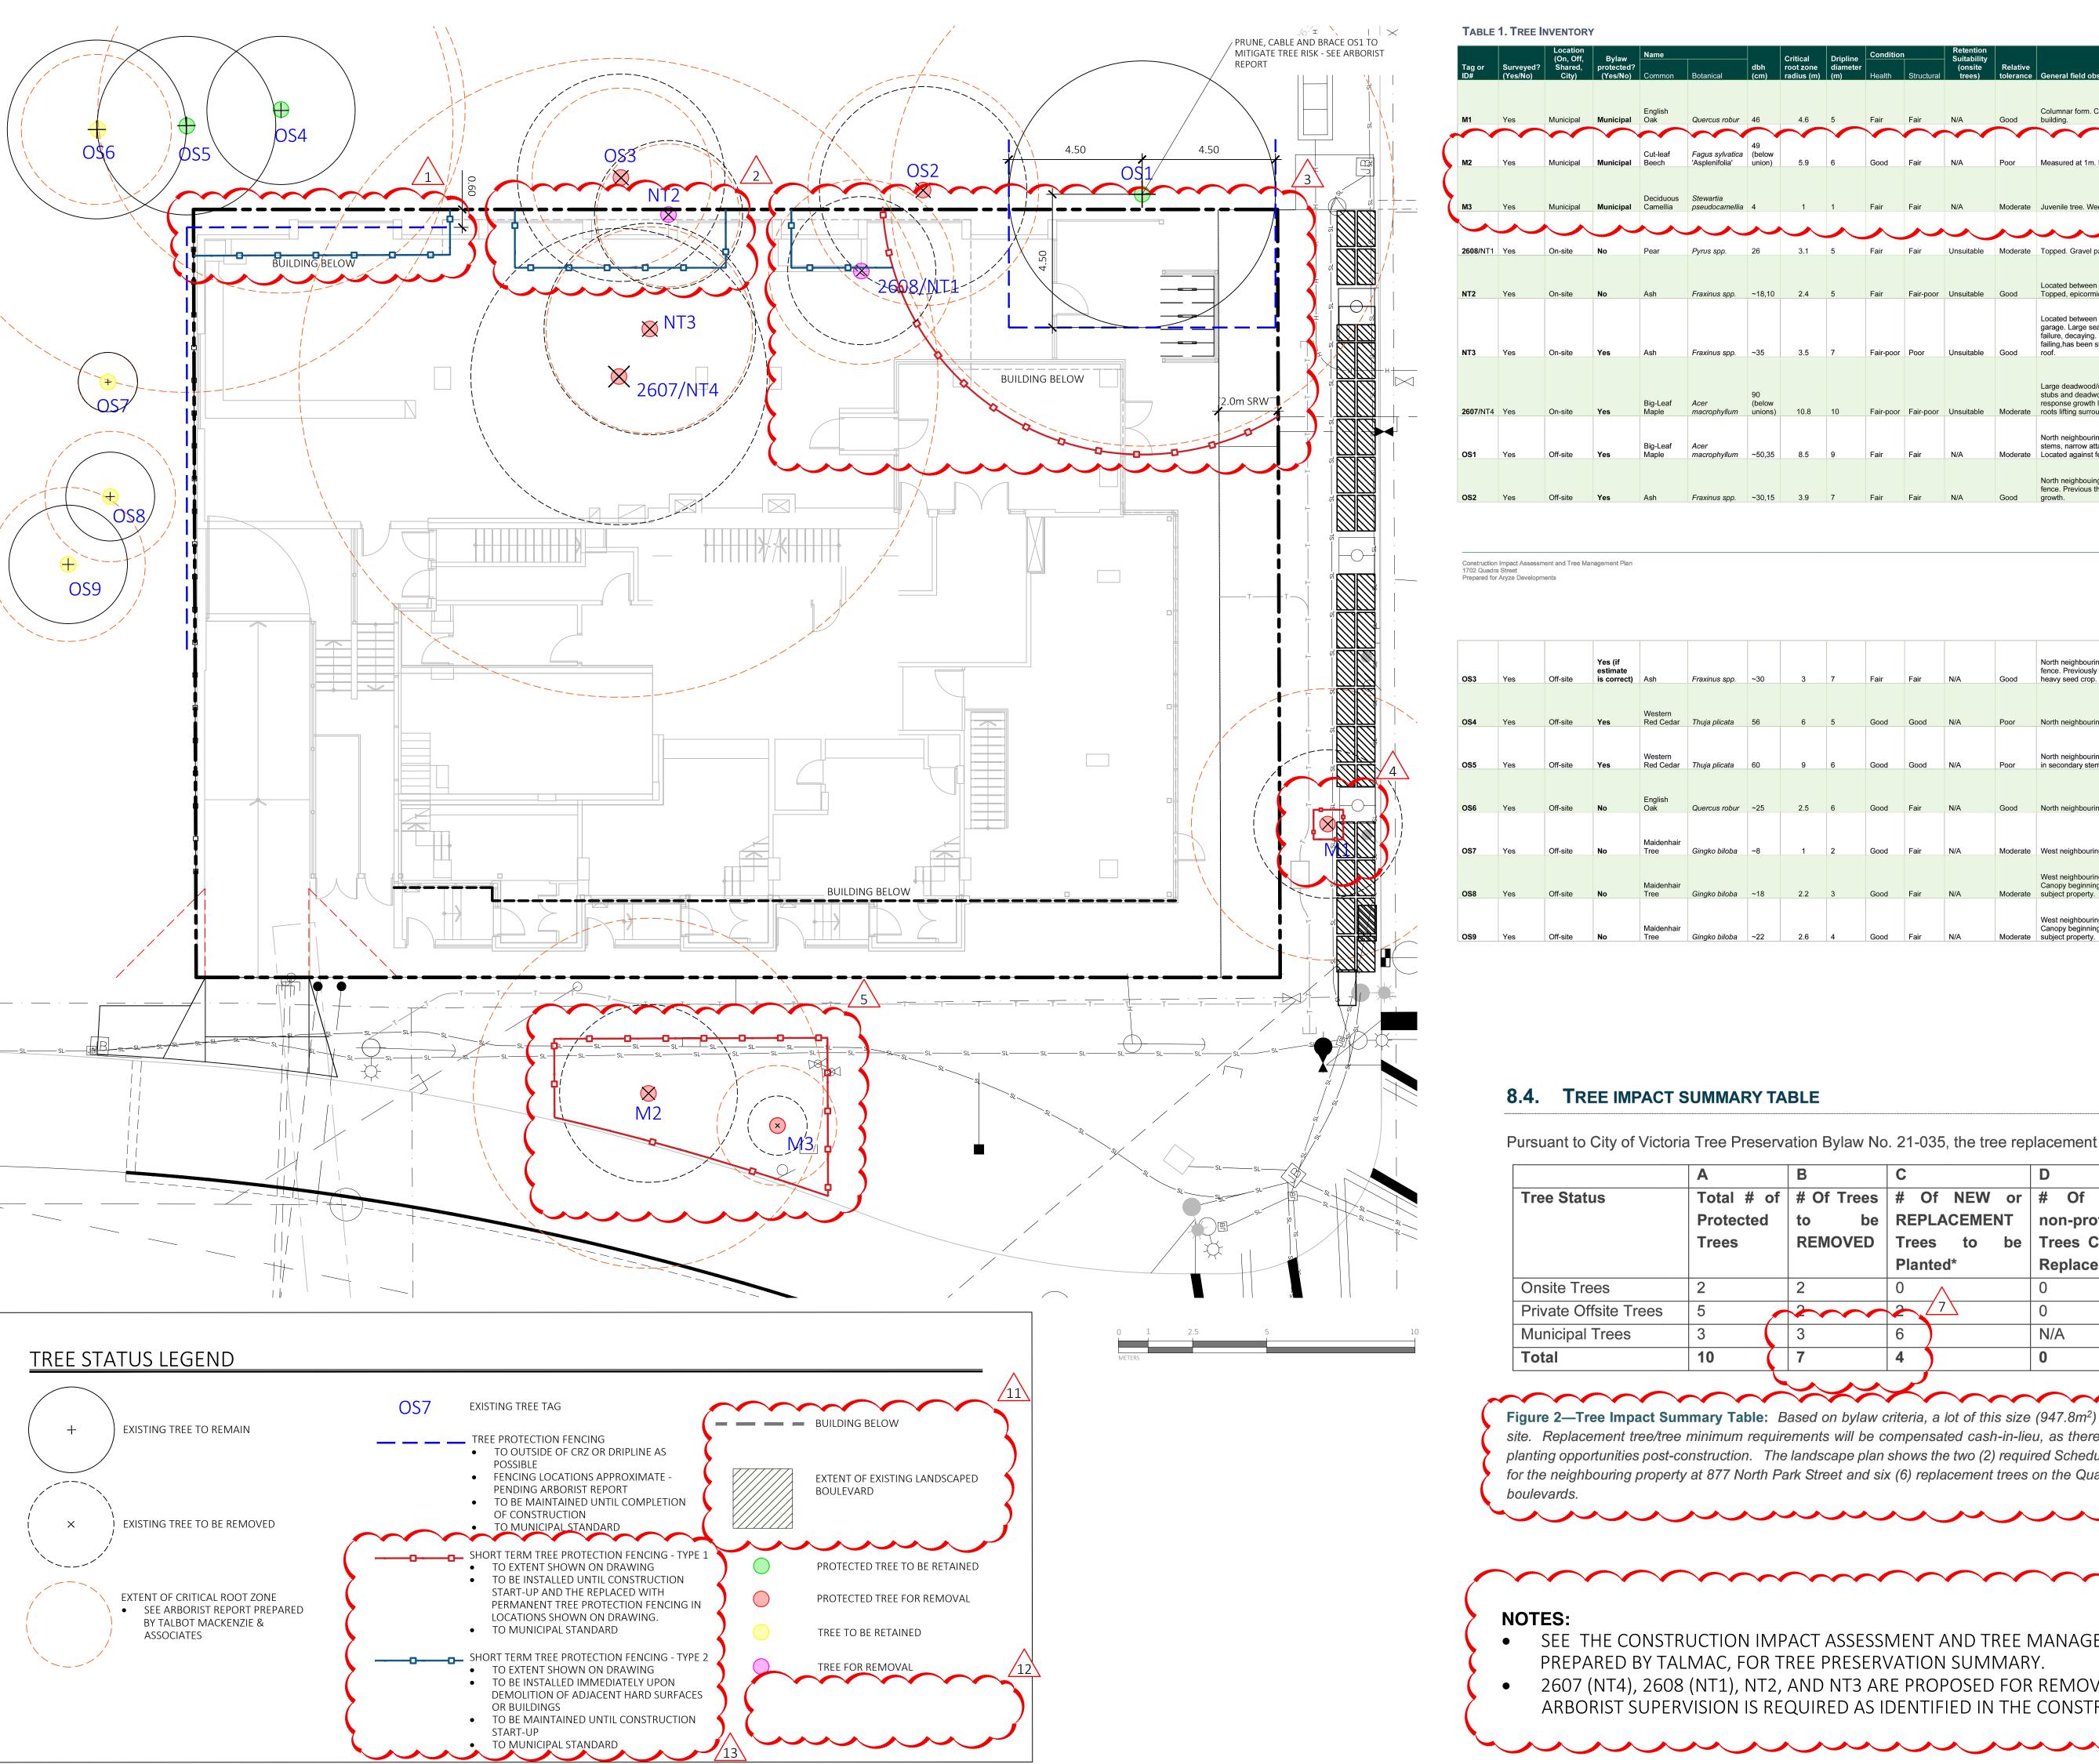


TABLE 1. TREE INVENTORY

(On, Off,		Location (On, Off, Bylaw			Bylaw	Name			Critical	Dripline	Condition	,	Retention Suitability				
Tag or ID#	Surveyed? (Yes/No)	Shared, City)	protected? (Yes/No)	Common	Botanical	dbh (cm)	root zone radius (m)	diameter (m)	Health	Structural	(onsite trees)	Relative tolerance	General field observations/remarks	Tree retention / location comments	Retention status		
M1	Yes	Municipal	Municipal	English Oak	Quercus robur	46	4.6	5	Fair	Fair	N/A	Good	Columnar form. Clearance pruned away from building.	Conflict with proposed underground hydro.	x _		
M2	Yes	Municipal	Municipal	Cut-leaf Beech	Fagus sylvatica 'Asplenifolia'	49 (below union)	5.9	6	Good	Fair	N/A	Poor	Measured at 1m. Hydro clearance pruned.	Conflict with proposed underground hydro.	х		
M3	Yes	Municipal	Municipal	Deciduous Camellia	Stewartia pseudocamellia	4	1	1	Fair	Fair	N/A	Moderate	Juvenile tree. Weedwacker damage.	Frontage improvements.	x		
2608 /NT1	Yes	On-site	No	Pear	Pyrus spp.	26	3.1	5	Fair	Fair	Unsuitable	Moderate	Topped. Gravel parking adjacent.	Within building footprint.	x		
NT2	Yes	On-site	No	Ash	Fraxinus spp.	~18,10	2.4	5	Fair	Fair-poor	Unsuitable	Good	Located between fence and storage shed. Topped, epicormic growth.	Within building footprint.	x		
NT3	Yes	On-site	Yes	Ash	Fraxinus spp.	~35	3.5	7	Fair-poor	Poor	Unsuitable	Good	Located between storage shed and brick garage. Large seam up trunk, likely from past failure, decaying. Lowest limb actively failing, has been shortened, will rest on garage roof.	Within building footprint.	x		
2607 /NT4	Yes	On-site	Yes	Big-Leaf Maple	Acer macrophyllum	90 (below unions)	10.8	10	Fair-poor	Fair-poor	Unsuitable	Moderate	Large deadwood/decay north canopy. Pruning stubs and deadwood in primary stem, response growth lower stem. Large surface roots lifting surrounding asphalt.	Within building footprint.	x		
OS1	Yes	Off-site	Yes	Big-Leaf Maple	Acer macrophyllum	~50,35	8.5	9	Fair	Fair	N/A	Moderate	North neighbouring property. Codominant stems, narrow attachments. Previous thinning. Located against fence.	Conflict with building footprint.	Retain*		
OS2	Yes	Off-site	Yes	Ash	Fraxinus spp.	~30,15	3.9	7	Fair	Fair	N/A	Good	North neighbouing property. Located against fence. Previous thinning and raising. Epicormic growth.	Conflict with building footprint.	x		

OS3	Yes	Off-site	Yes (if estimate is correct)	Ash	Fraxinus spp.	~30	3	7	Fair	Fair	N/A	Good	North neighbouring property. Located against fence. Previously topped, epicormic growth, heavy seed crop.	Conflict with building footprint.	x
033	165	Oll-Site	is correct)	ASII	τ ταλιτίας ορφ.	-30	3		T all	I all	IN/A	Good	neavy seed crop.	Commet with building lootprint.	^
)S4	Yes	Off-site	Yes	Western Red Cedar	Thuja plicata	56	6	5	Good	Good	N/A	Poor	North neighbouring property.	Potential impacts from building footprint.	Retain
OS 5	Yes	Off-site	Yes	Western Red Cedar	Thuja plicata	60	9	6	Good	Good	N/A	Poor	North neighbouring property, active inclusion in secondary stem attachment.	Potential impacts from building footprint.	Retain
OS6	Yes	Off-site	No	English Oak	Quercus robur	~25	2.5	6	Good	Fair	N/A	Good	North neighbouring property.	Possibly removed.	Retain
0 \$7	Yes	Off-site	No	Maidenhair Tree	Gingko biloba	~8	1	2	Good	Fair	N/A	Moderate	West neighbouring property.		Retain
OS8	Yes	Off-site	No	Maidenhair Tree	Gingko biloba	~18	2.2	3	Good	Fair	N/A	Moderate	West neighbouring property. Codominant top. Canopy beginning to encroach on driveway on		Retain
OSO	Voo	Officito	No	Maidenhair	Cingka bilaha	-22	2.6	4	Cood	Fair	NI/A	Madagete	West neighbouring property. Codominant top. Canopy beginning to encroach on driveway on a whice the property.		Potoin

8.4. TREE IMPACT SUMMARY TABLE

Pursuant to City of Victoria Tree Preservation Bylaw No. 21-035, the tree replacement calculations are as follows:

Α	В	С	D	
Total # of	# Of Trees	# Of NEW or	# Of EXISTING	NET
Protected	to be	REPLACEMENT	non-protected	CHANGE
Trees	REMOVED	Trees to be	Trees Counted as	(A-B+C+D)
		Planted*	Replacements	
2	2	0 ^	0	-2
5	2	2 7	0	0
3	3	6	N/A	3
10	7	4	0	1
	Total # of Protected Trees	Total # of # Of Trees Protected to be REMOVED 2 2 5 3	Total # of # Of Trees # Of NEW or REPLACEMENT Trees to be Planted* 2 2 0 7 3 6	Total # of # Of Trees # Of NEW or # Of EXISTING non-protected Trees to be Planted* 2 2 0 0 0 0 0 0 0 0 0 0 0 0 0 0 0 0 0

Figure 2—Tree Impact Summary Table: Based on bylaw criteria, a lot of this size (947.8m²) requires a 5-tree minimum onsite. Replacement tree/tree minimum requirements will be compensated cash-in-lieu, as there do not appear to be sufficient planting opportunities post-construction. The landscape plan shows the two (2) required Schedule E—Part 1 replacement trees for the neighbouring property at 877 North Park Street and six (6) replacement trees on the Quadra & Fisgard Street municipal boulevards.

NOTES:

- SEE THE CONSTRUCTION IMPACT ASSESSMENT AND TREE MANAGEMENT PLAN, APPENDIX B, PREPARED BY TALMAC, FOR TREE PRESERVATION SUMMARY.
- 2607 (NT4), 2608 (NT1), NT2, AND NT3 ARE PROPOSED FOR REMOVAL AT THE DEMOLITION PHASE. ARBORIST SUPERVISION IS REQUIRED AS IDENTIFIED IN THE CONSTRUCTION IMPACT ASSESSMENT



1608 Camosun Street, Victoria BC V8T 3E6 Info@biophiliacollective.ca 250 590 1156


PROJECT NAME:

THE ABBEY

PROJECT ADDRESS: 1702 QUADRA STREET VICTORIA, BC

DESIGNED BY: BIANCA BODLEY DRAWN BY: KIM TANG


NO.	ISSUED FOR	YY\MM\DD
1	CIS PRESENTATION	12/07/2021
2	DEVELOPMENT PERMIT	12/22/2021
3	ADP MEETING	04/13/2022
4	REVISED AND RE-ISSUED FOR DP	2023/06/01
5	REVISED AND RE-ISSUED FOR DP	2023/09/21
6	REVISED AND RE-ISSUED FOR DP	2023/12/15
7	ISSUED FOR BP RESUBMISSION	2024/04/30
8	ISSUED FOR TENDER	2024/06/28
9	ISSUED FOR BP RESUBMISSION	2024/07/31
10	ISSUED FOR BP RESUBMISSION	2024/09/27

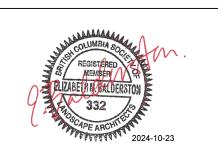



TREE REMOVAL & PROTECTION PLAN

DWG NO:

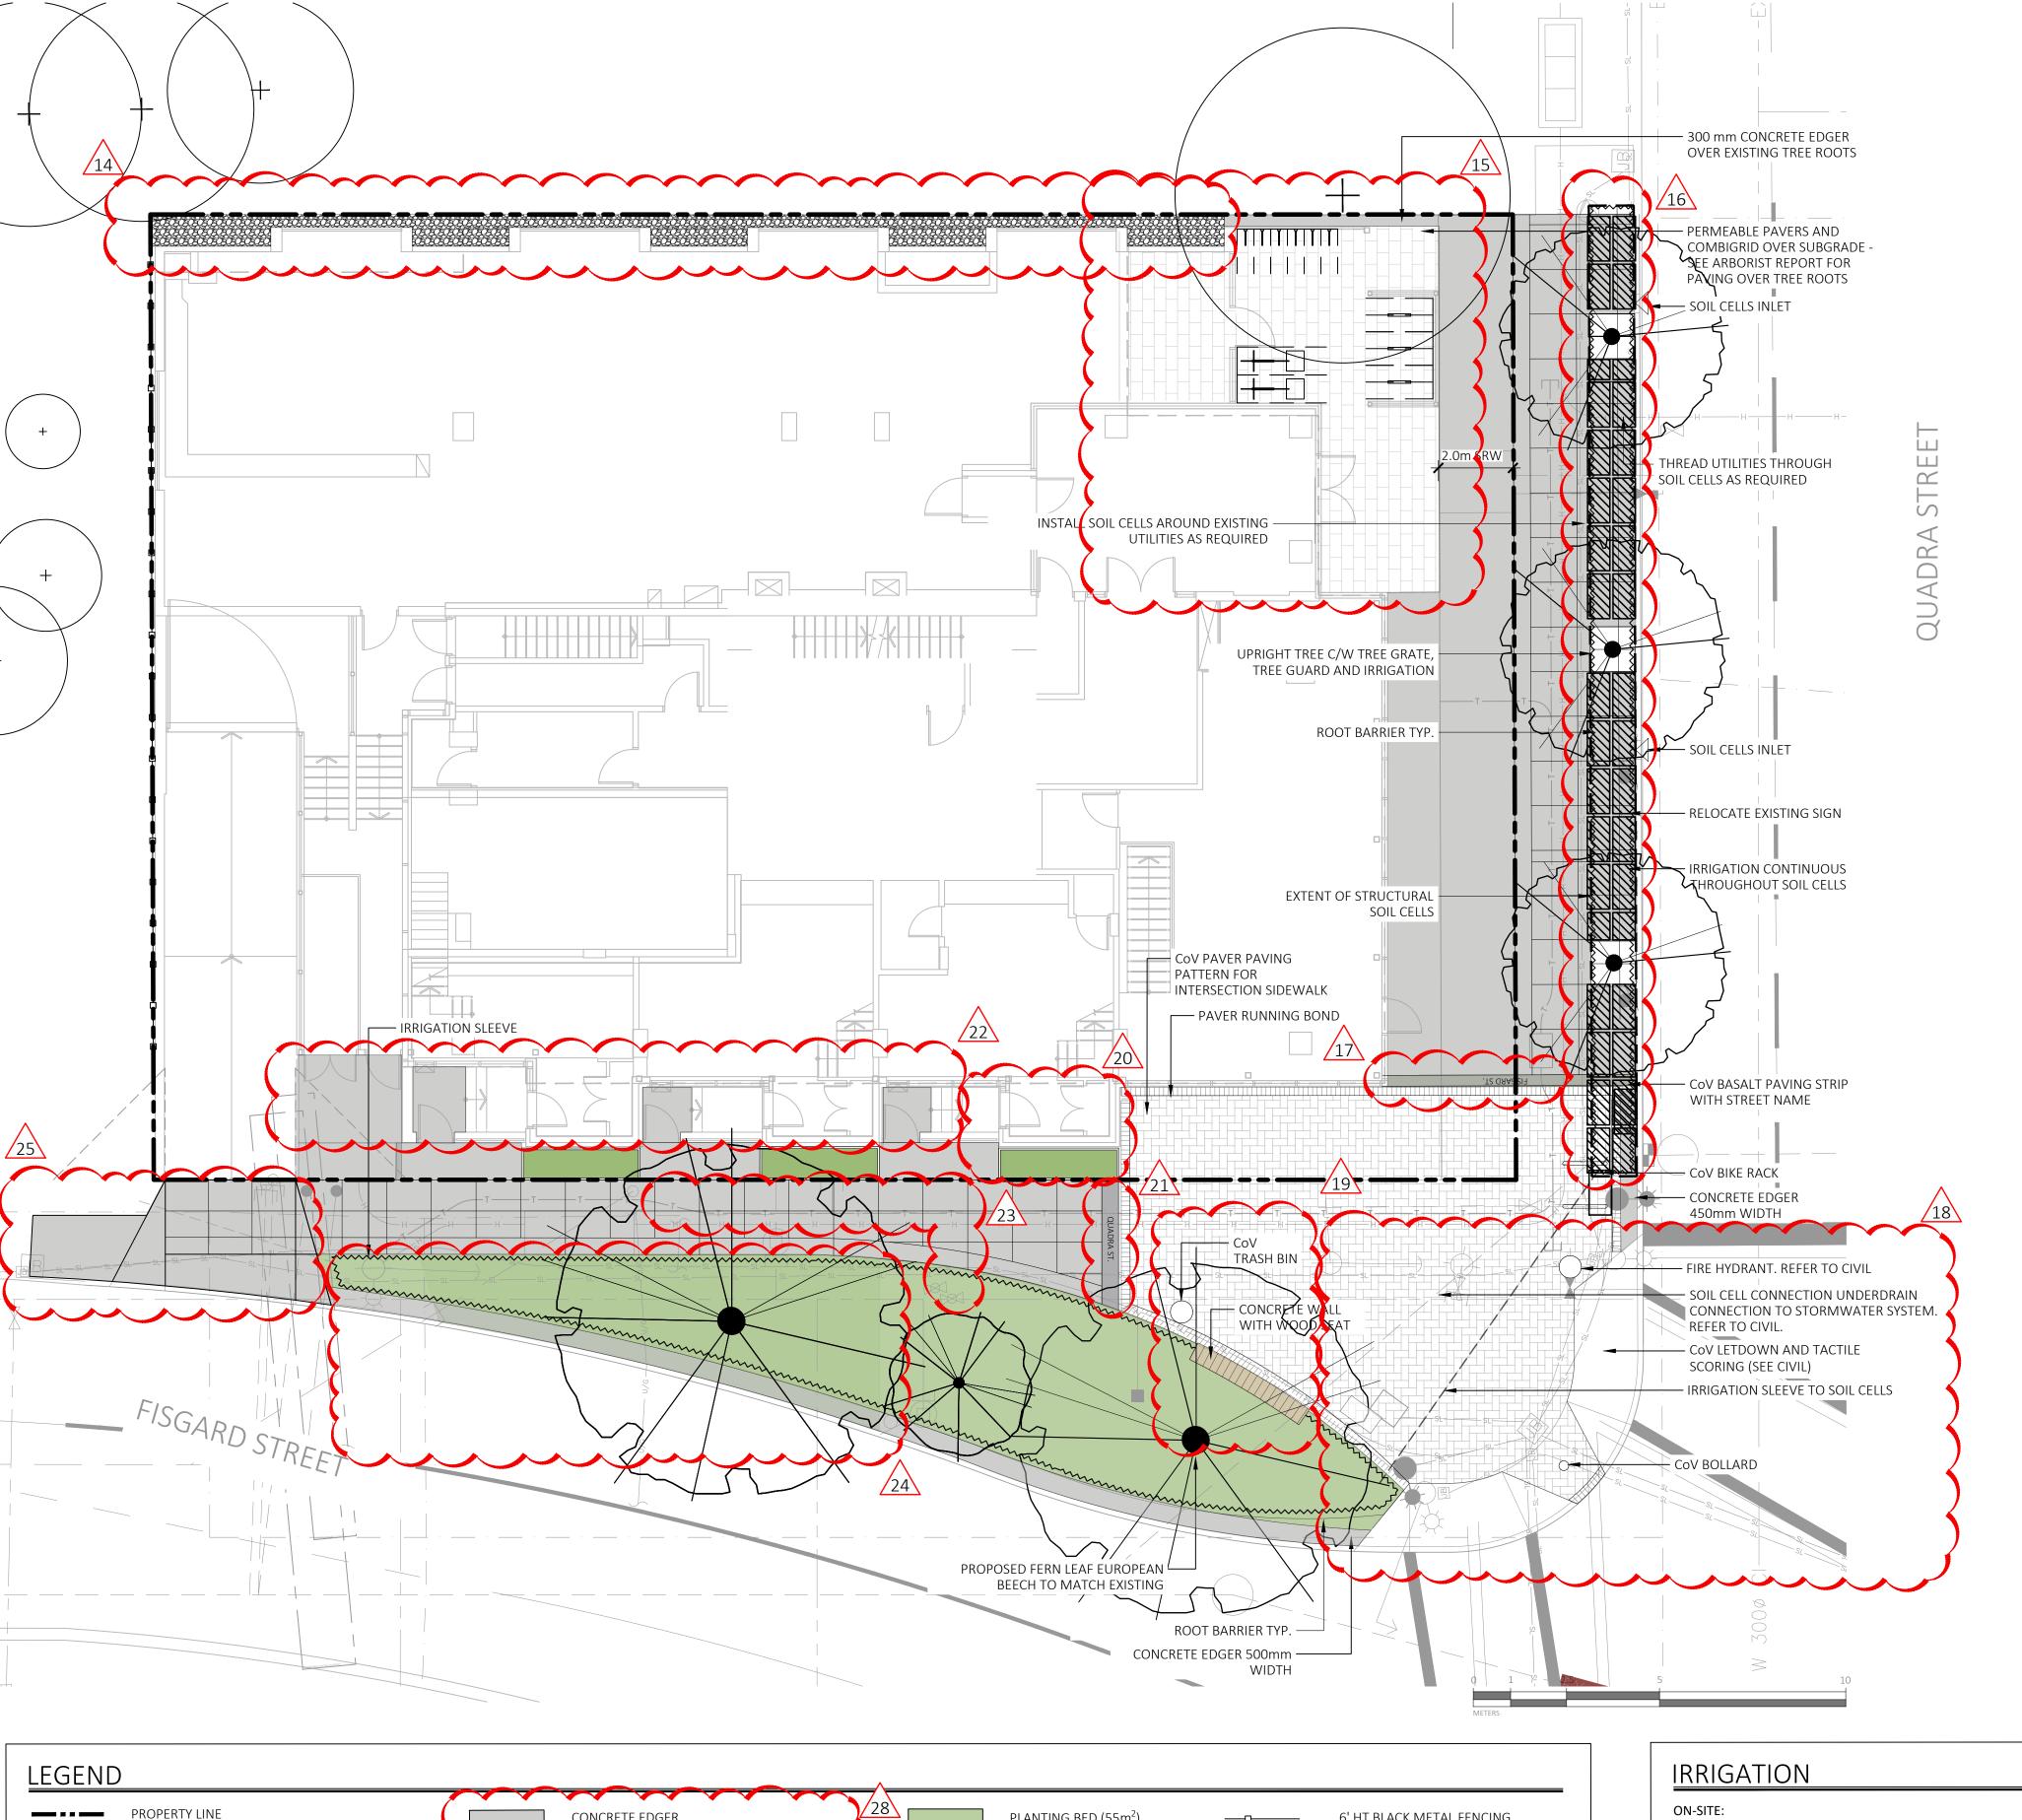

PLANTING BED (55m²)

MEDIUM (CLS)

ON-SITE PLANTING BED

MEDIUM (BCLS)

PROPOSED MUNICIPAL

STREET TREE

ROOT BARRIER

50 mm DEPTH MULCH

• 50 mm DEPTH MULCH

• 700mm DEPTH 1L GROWING

450mm DEPTH 1L GROWING

CONCRETE EDGER

MORTAR SET

SUBGRADE

GRAVEL MAINTENANCE STRIP

ALUMINIUM EDGER

MEDIUM

IRRIGATION

• 300mm DEPTH RIVER ROCK

STRUCTURAL SOIL CELLS (34.67m²)

1400mm DEPTH SOIL CELL GROWING

ACCENT PAVING

BASALT PAVER BANDING

• 2.0m WIDTH ON QUADRA STREET

GUIDELINE STANDARDS

SAW CUT JOINTING PATTERN

SIDEWALK INTERSECTION PAVING

GUIDELINE STANDARDS

POLYMERIC SAND JOINTS

SIDEWALK STREET NAME PAVING

GUIDELINE STANDARDS

PLACED ON SAND BED

MORTAR SET

TO CITY OF VICTORIA 'NEW TOWN' DESIGN

TO CITY OF VICTORIA 'NEW TOWN' DESIGN

ABBOTSFORD CONCRETE; NATURAL GREY

TO CITY OF VICTORIA 'NEW TOWN' DESIGN

BASALT PAVING STRIP WITH STREET NAME

___ LINE OF FOUNDATIONS

CONCRETE SIDEWALK

WIDTH AND DEPTH VARIES

SEE DRAWINGS AND DETAILS

450 - 500mm WIDTH - AS NOTED

PERMEABLE PAVER ON COMBIGRID OVER

BELGARD AQUALINE PERMEABLE PAVER

6' HT BLACK METAL FENCING

MUNICIPAL SITE FURNITURE

BOLLARD (2)

TRASH BIN (1)

BIKE RACK (2)

TREE GRATE (3)

• TREE GUARD (3)

SEAT WALL

ALONG WEST PROPERTY LINE

CONCRETE BASE, ARCHITECTURAL

CUSTOM WOOD SEAT TOP

- ALL AT-GRADE LANDSCAPE BEDS AND ROOFTOP PLANTERS TO BE IRRIGATED WITH AN
- DAYS PRIOR TO INSTALLATION.
- THE IRRIGATION INDUSTRY ASSOCIATION OF B.C. (IIABC).

OFF-SITE (MUNICIPAL)

- MUNICIPAL PLANTING BED AND STREET TREES TO BE IRRIGATED BY A SEPARATE SYSTEM SPECIFICATIONS FOR STREET TREES AND IRRIGATION SCHEDULE C TO BYLAW 12-042,
- SUBDIVISION BYLAW. • IRRIGATION DESIGN DRAWINGS MUST BE SENT TO PARKS FOR REVIEW 30 DAYS PRIOR TO INSTALLATION.
- DRAWINGS SHOULD INDICATE ALL COMPONENTS, MODELS AND MATERIALS FROM WATER
- THE CITY WILL REQUIRE 4 INSPECTIONS FOR IRRIGATION INSTALLATION:
- 1)SLEEVING,
- 3) OPEN TRENCH AND LATERAL LINE, 4) OPERATION AND COVERAGE, AND

CITY OF VICTORIA DOWNTOWN REALM PLAN AND STREETSCAPE STANDARDS - NEW TOWN

NEW TOWN PAVING MATERIALS

Installation Method: Cast-in-place

Colour: Natural

74 | CITY OF VICTORIA

NEW TOWN PAVING APPLICATIONS

SIDEWALK -----

Control joits shall be provided accross 450mm bands every 3rd panel

Narrow sidewalks - 2m or less: eliminate 450mm banding along

450mm concrete band along curb and building face

BASALT ENTRY BANDING WITH STREET NAME INSERT -

Material: Streetname Sandblasted into basalt slabs

larger slab where street name appears

Font: Tisa Pro Bold, all caps

NEW TOWN PLANTING DETAILS

and large tree trunks.

2. New development condition:

For all sidewalks in New Town area there are be two types of trees-in-sidewalk condition:

accommodate for existing tree locations. Detailed design and recommendations to be provided on a case-by-case basis for each improvement area.

Use of proposed poured-in-place resin bound material instead of tree grates is highly recommended to best accommodate heaving and overgrown tree routes

Tree grates should be set in a concrete band that runs across the sidewalk from curb to building face as illustrated on the diagram below with trowel joint defining the band always aligned with tree grates

Street trees should be sited to correspond with architectural features of building

1. Adaptation of existing tree locations to sidewalk improvements:

A street tree spacing of between 8 - 10 metres is desired

APPLICATION

Pattern: 450mm wide single row soldier course band with


Note: Care should be taken to the letter spacing and kerning

1200mm score line pattern perpendicular to the curb with a centre line parallel to the curb

Finish: Fine broom finish

Application: Sidewalk fill and frame



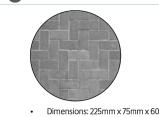

· Application: Paving field

Colours: Natural grey

Finish: Unsealed







Application: Entry banding

 Colour: Charcoal grey Finish: Flamed

45° Herringbone field with single row soldier course

continuous 450mm concrete band adjacend to curb with tactile scoring at let down

STREET NAME BAND CONCRETE

DOWNTOWN PUBLIC REALM PLAN STRATEGY + STREETSCAPE PLAN | 75

Tree grates define bands in the

the diagram above

sidewalk pattern as illustrated on

Installation: Mortar set

Tactile band

• Dimensions: 300mm x 450mm x 60mm 1608 Camosun Street, Victoria BC V8T 3E6 Installation Method: Mortar set Info@biophiliacollective.ca 250 590 1156


PROJECT NAME:


THE ABBEY

PROJECT ADDRESS:

1702 QUADRA STREET VICTORIA, BC

DESIGNED BY: BIANCA BODLEY DRAWN BY: KIM TANG

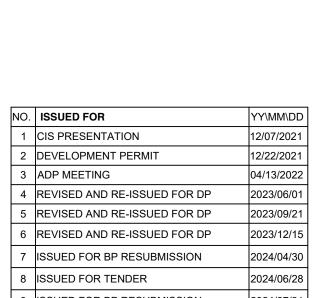

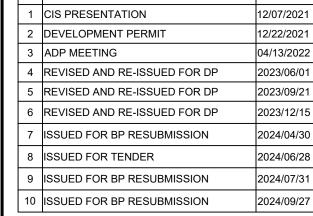








DRAWING TITLE:

LANDSCAPE SITE PLAN

DWG NO:

- AUTOMATIC IRRIGATION SYSTEM.
- DETAILED IRRIGATION PLAN TO BE SUBMITTED TO PARKS FOR REVIEW A MINIMUM OF 30
- ALL IRRIGATION DESIGNS AND INSTALLATIONS SHALL MEET THE MINIMUM STANDARDS OF

- FROM A SEPARATE CITY SOURCE CONFORMING TO THE CITY OF VICTORIA SUPPLEMENTARY
- SUPPLY TO IRRIGATION HEADS.
- 2) OPEN TRENCH MAINLINE AND PRESSURE TEST,
- 5) BACKFLOW PREVENTER ASSEMBLY TEST REPORT

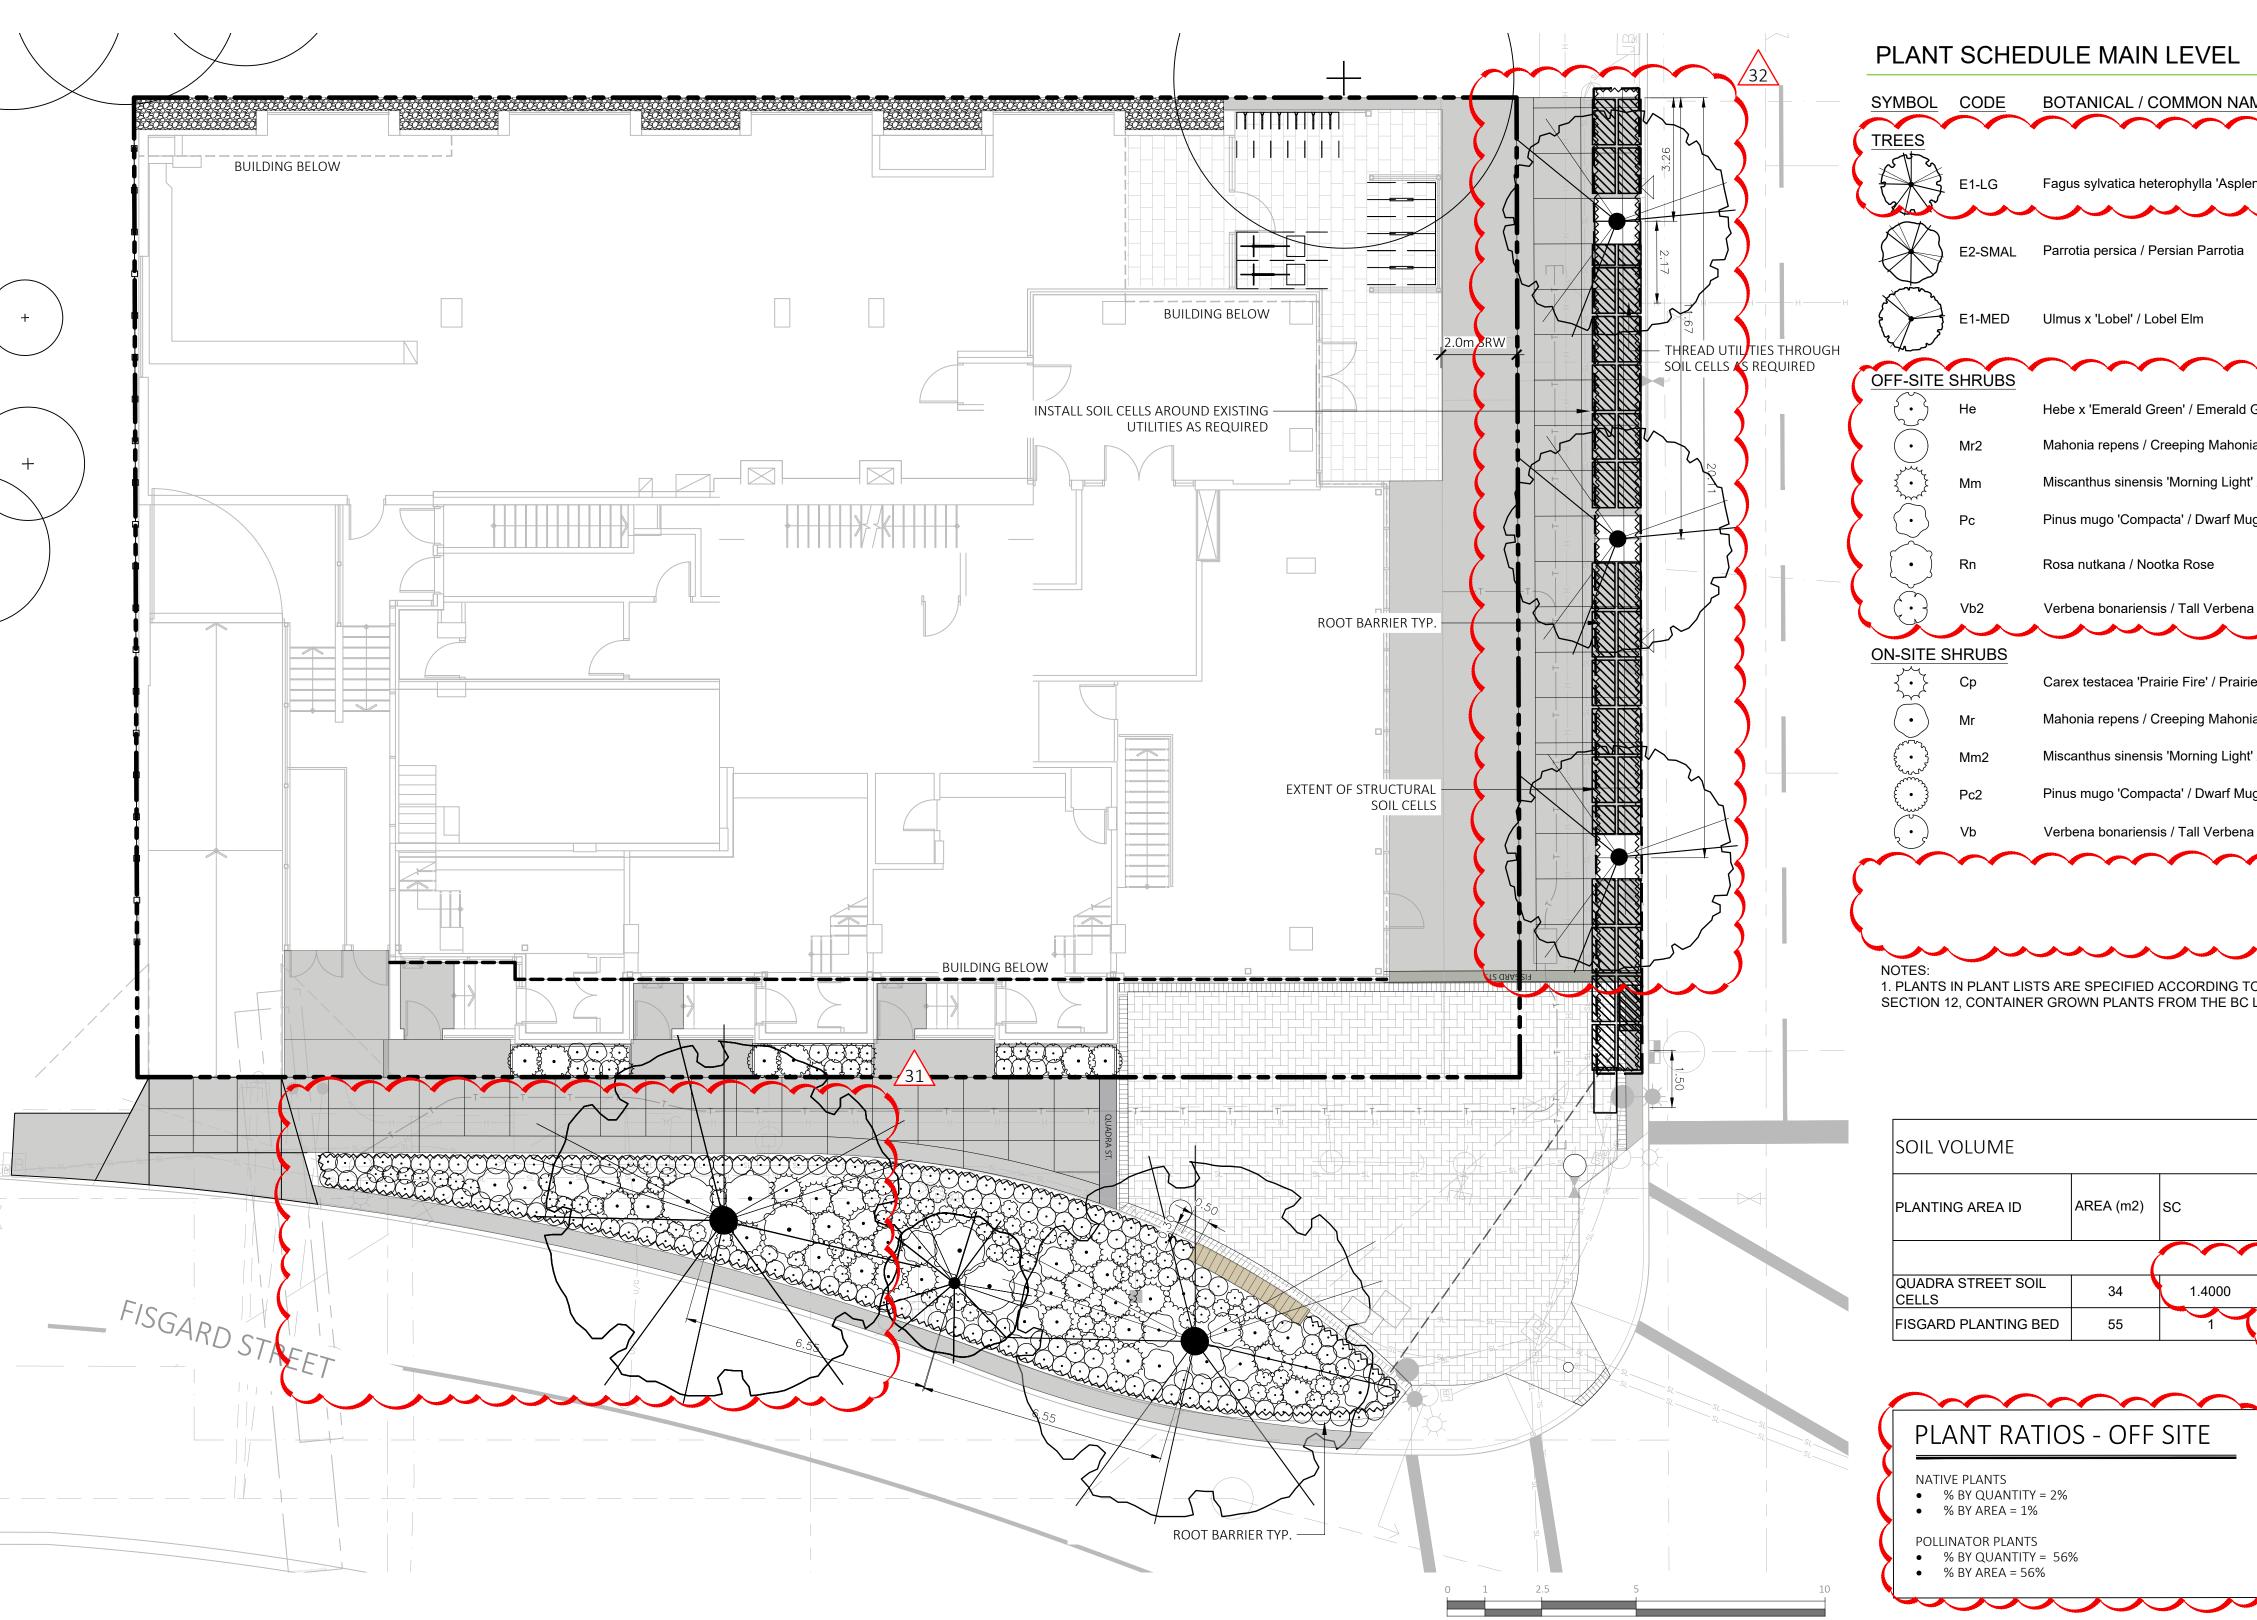

PLANT SCHEDULE MAIN LEVEL

	PLANT SCHEDULE MAIN LEVEL							
	SYMBOL	CODE	BOTANICAL / COMMON NAME	SIZE	SPACING	COMMENTS	QTY /	
1	TREES		\sim			$\sim\sim$	/33	
- (E1-LG	Fagus sylvatica heterophylla 'Aspleniifolia' / Fernleaf European Beech	70mm Cal.	As Shown	SPECIES T.B.D. BY PARKS AT BP STAGE	2	
		E2-SMAL	Parrotia persica / Persian Parrotia	70mm Cal.	As Shown	SPECIES T.B.D. BY PARKS AT BP STAGE	1	
– H - I		E1-MED	Ulmus x 'Lobel' / Lobel Elm	70mm Cal.	As Shown	SPECIES T.B.D. BY PARKS AT BP STAGE	3	
(OFF-SITE	SHRUBS	$\sim\sim\sim$			$\sim\sim$		
>		He	Hebe x 'Emerald Green' / Emerald Green Hebe	#2 POT	450mm	Full, Well Established	62	
>	$\overline{\bullet}$	Mr2	Mahonia repens / Creeping Mahonia	#2 POT	500mm	Full, Well Established	117	
>	•	Mm	Miscanthus sinensis 'Morning Light' / Morning Light Eulalia Grass	#3 POT	900mm	Full, Well Established	27	
>	$\widetilde{\bullet}$	Pc	Pinus mugo 'Compacta' / Dwarf Mugo Pine	#3 POT	900mm	Full, Well Established	16	
>		Rn	Rosa nutkana / Nootka Rose	#2 POT	1500mm	Full, Well Established	5	
1		Vb2	Verbena bonariensis / Tall Verbena	#1 POT	450mm	Full, Well Established	29	
,	ON-SITE S	LIDI IRQ						
	ON-SITE S		Carex testacea 'Prairie Fire' / Prairie Fire Orange Sedge	#4 DOT	F00	Full Well Fatablished		
	₹ • <i>≿</i>	Ср	Calex lestacea Fiallie File / Fiallie File Orallye Sedge	#1 POT	500mm	Full, Well Established	8	

1608 Camosun Street, Victoria BC V8T 3E6 Info@biophiliacollective.ca 250 590 1156

PROJECT NAME:

THE ABBEY

PROJECT ADDRESS:

1702 QUADRA STREET VICTORIA, BC

DESIGNED BY: BIANCA BODLEY DRAWN BY: KIM TANG

1. PLANTS IN PLANT LISTS ARE SPECIFIED ACCORDING TO THE CANADIAN NURSERY LANDSCAPE ASSOCIATION CANADIAN STANDARDS FOR NURSERY STOCK AND SECTION 12, CONTAINER GROWN PLANTS FROM THE BC LANDSCAPE STANDARD, CURRENT EDITION.

SOIL VOLUME			REPLACEMENT TREES PROPOSED			SOIL VOLUME REQUIRED (m3)					
PLANTING AREA ID	AREA (m2)	sc	A.ESTIMATED SOIL VOLUME	B.		C. # MEDIUM	D. # LARGE		F. MEDIUM	G. LARGE	TOTAL
ON-SITE ARF36											
QUADRA STREET SOIL CELLS	34	1.4000	45			3			15		45
FISGARD PLANTING BED	55	1	67	3	1		1	6		30	36

PLANT RATIOS - OFF SITE

Mahonia repens / Creeping Mahonia

Verbena bonariensis / Tall Verbena

Pinus mugo 'Compacta' / Dwarf Mugo Pine

Miscanthus sinensis 'Morning Light' / Morning Light Eulalia Grass

NATIVE PLANTS

- % BY QUANTITY = 2% • % BY AREA = 1%
- % BY QUANTITY = 56%
- POLLINATOR PLANTS

PLANT RATIOS - ON SITE

- NATIVE PLANTS
- % BY QUANTITY = 0% • % BY AREA = 0%

• % BY AREA = 50%

POLLINATOR PLANTS • % BY QUANTITY = 80%

MUNICIPAL BOULEVARD TREES

- TREES MUST HAVE ONE DOMINANT CENTRAL LEADER OR SINGLE STRAIGHT TRUNK, 5-8 cm DIAMETER, CALIPER MEASURED 15 cm ABOVE GROUND, WELL BALANCED CROWN WITH BRANCHING STARTING AT 1.8m-2.5m ABOVE GROUND
- TREES TO BE PLANTED AS PER PLANTIG OF TREES, SHRUBS AND GROUND COVERS (32 93 01 MMCD 2009 AND CITY OF VICTORIA SUPPLEMENTAL DRAWINGS SD P3 AND SD P4)

Full, Well Established

Full, Well Established

Full, Well Established

Full, Well Established

- PARKS WILL REQUIRE (3) INSPECTIONS FOR TREE PLANTING:
- 1) INSPECTION OF SOIL AND PLANTING AREA,
- 2) INSPECTION OF STOCK UPON DELIVERY, AND 3) INSPECTION OF INSTALLED TREE WITH MULCH AND STAKING. TRUNK FLARE MUST BE
- VISIBLE AND PLANTED AT OR SLIGHTLY ABOVE GRADE UPON INSPECTION • THE APPLICANT IS RESPONSIBLE FOR PROCURING AND PLANTING THE PROPOSED
- BOULEVARD TREES.
- THE APPLICANT MUST MAINTAIN THE TREE IN GOOD HEALTH AND STRUCTURAL CONDITION FOR 1 YEAR FROM THE SUBSTANTIAL COMPLETION TO BE ELIGIBLE FOR

PRE-CONSTRUCTION MEETING

PARKS REQUIRES A PRE-CONSTRUCTION MEETING TO BE HELD PRIOR TO

3 ADP MEETING 4 REVISED AND RE-ISSUED FOR DP 5 REVISED AND RE-ISSUED FOR DP 6 REVISED AND RE-ISSUED FOR DP ISSUED FOR BP RESUBMISSION ISSUED FOR TENDER ISSUED FOR BP RESUBMISSION 10 ISSUED FOR BP RESUBMISSION

YY\MM\DD



NO. **ISSUED FOR**

1 CIS PRESENTATION

2 DEVELOPMENT PERMIT



NORTH ARROW

DRAWING TITLE:

PLANTING PLAN -GROUND FLOOR

DWG NO:

SCALE: 1:100

COMMENCEMENT OF CONSTRUCTING THE FRONTAGE WORKS

SHRUBS + PERENNIALS

DWARF MUGO PINE







CREEPING MAHONIA




MISCANTHUS




VERBENA






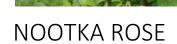

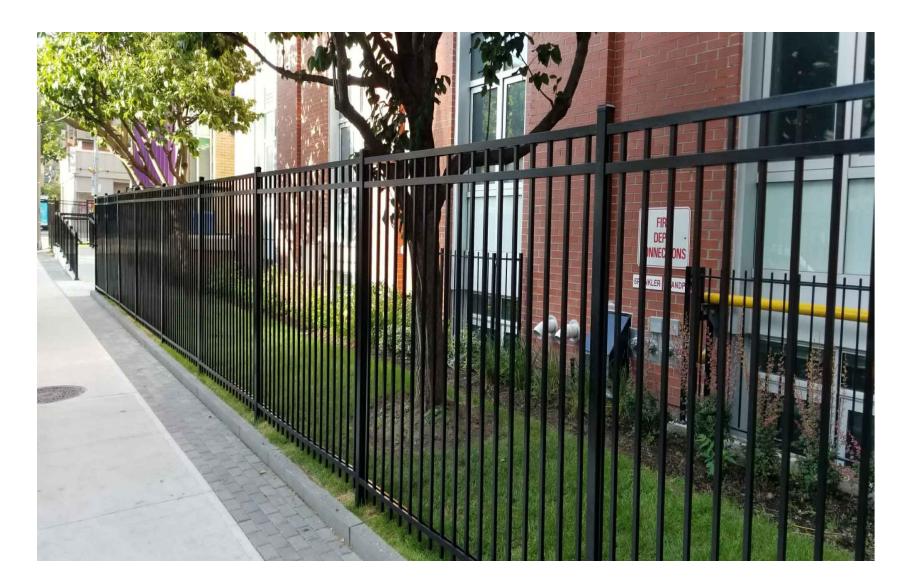

ig(1ig) 6' HT METAL PICKET FENCE

L3 NTS

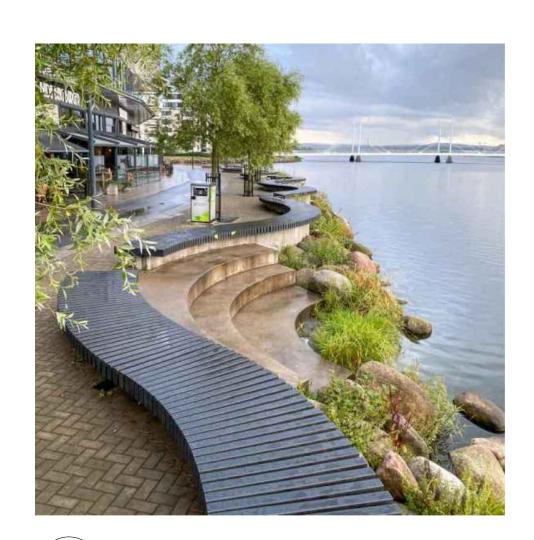

CUSTOM SEAT WALL BENCH

L3 NTS



BELGARD AQUALINE PERMEABLE PAVER

 Interlocking spacer bars for increased structural performance Smooth surface with a micro-

chamfer to minimize vibration and enhance wheelchair comfort Can be utilized to construct an

ADA-compliant pavement True installed dimensions for design optimization

Optimal joint openings for infiltration and maintenance Can eliminate stormwater runoff and improve water quality Meets the requirements of ASTM

Chamfer Width: 3 mm Spacer Bar Width: 10 mm Surface Infiltration Rate: > 500 inches per hour (varies based on joint infill gradation) Surface Open Area: 10%

Can be installed mechanically

MIDNIGHT

AVAILABLE COLOURS



™ NATURAL



SHADED GREY



45/16 x 83/4 x 31/8" 110 x 221.5 x 80mm

DURAFUSION™ Unmatched Durability

DESIGNED BY: BIANCA BODLEY DRAWN BY: KIM TANG

PROJECT NAME:

THE ABBEY

PROJECT ADDRESS:

VICTORIA, BC

1702 QUADRA STREET

1608 Camosun Street, Victoria BC V8T 3E6

Info@biophiliacollective.ca 250 590 1156

RELIANCE FOUNDRY BOLLARD

L3 / NTS

Standard Ductile Iron

Reliance Foundry Bollard Glossy Black (RAL 9017) Baked-on Powder Coat 35" Height

Inner Harbour, Old Town, Rock Bay,

Type B Bollard

New Town, Government Street, Douglas Street Surface Mount, Bolted to Concrete Reliance Foundry See Character area section of

Streetscape Standards for specific



MODERN METAL BIN

Type A Litter Bin with Recycling PRODUCT TYPE:

Component

Metal Frame

Powder Coat

42" Height

Modern

Modern Metal Bin

PRODUCT NAME: DESIGN STYLE: MATERIALS:

New Town, Government Street, Douglas Street

Glossy Black (RAL 9017) Baked-on

Inner Harbour, Old Town, Rock Bay,

City of Victoria See Character area section of Streetscape Standards for specific location guidelines.



4 NEW TOWN BOLLARD

L3 NTS

5 NEW TOWN LITTER RECEPTACLE

STANDARD BIKE RACK

1.5" Galvanized Steel Pipe Glossy Black (RAL 9017) Baked-on

Inner Harbour, Old Town, Rock Bay,

New Town, Government Street, Sleeve Mount See Character area section of Streetscape Standards for specific

location guidelines.


Powder Coat 12" Length, 3' Height



L3 NTS



7 NEW TOWN TREE GUARD

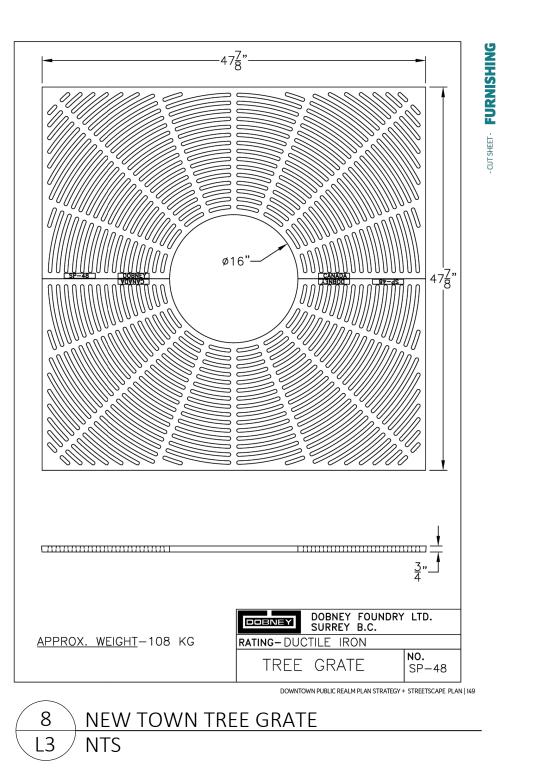


NO. **ISSUED FOR** YY\MM\DD 1 CIS PRESENTATION 12/07/2021 2 DEVELOPMENT PERMIT 3 ADP MEETING 4 REVISED AND RE-ISSUED FOR DP 5 REVISED AND RE-ISSUED FOR DP


DRAWING TITLE:


LANDSCAPE SITE PLAN



6 NEW TOWN BIKE RACK
L3 NTS

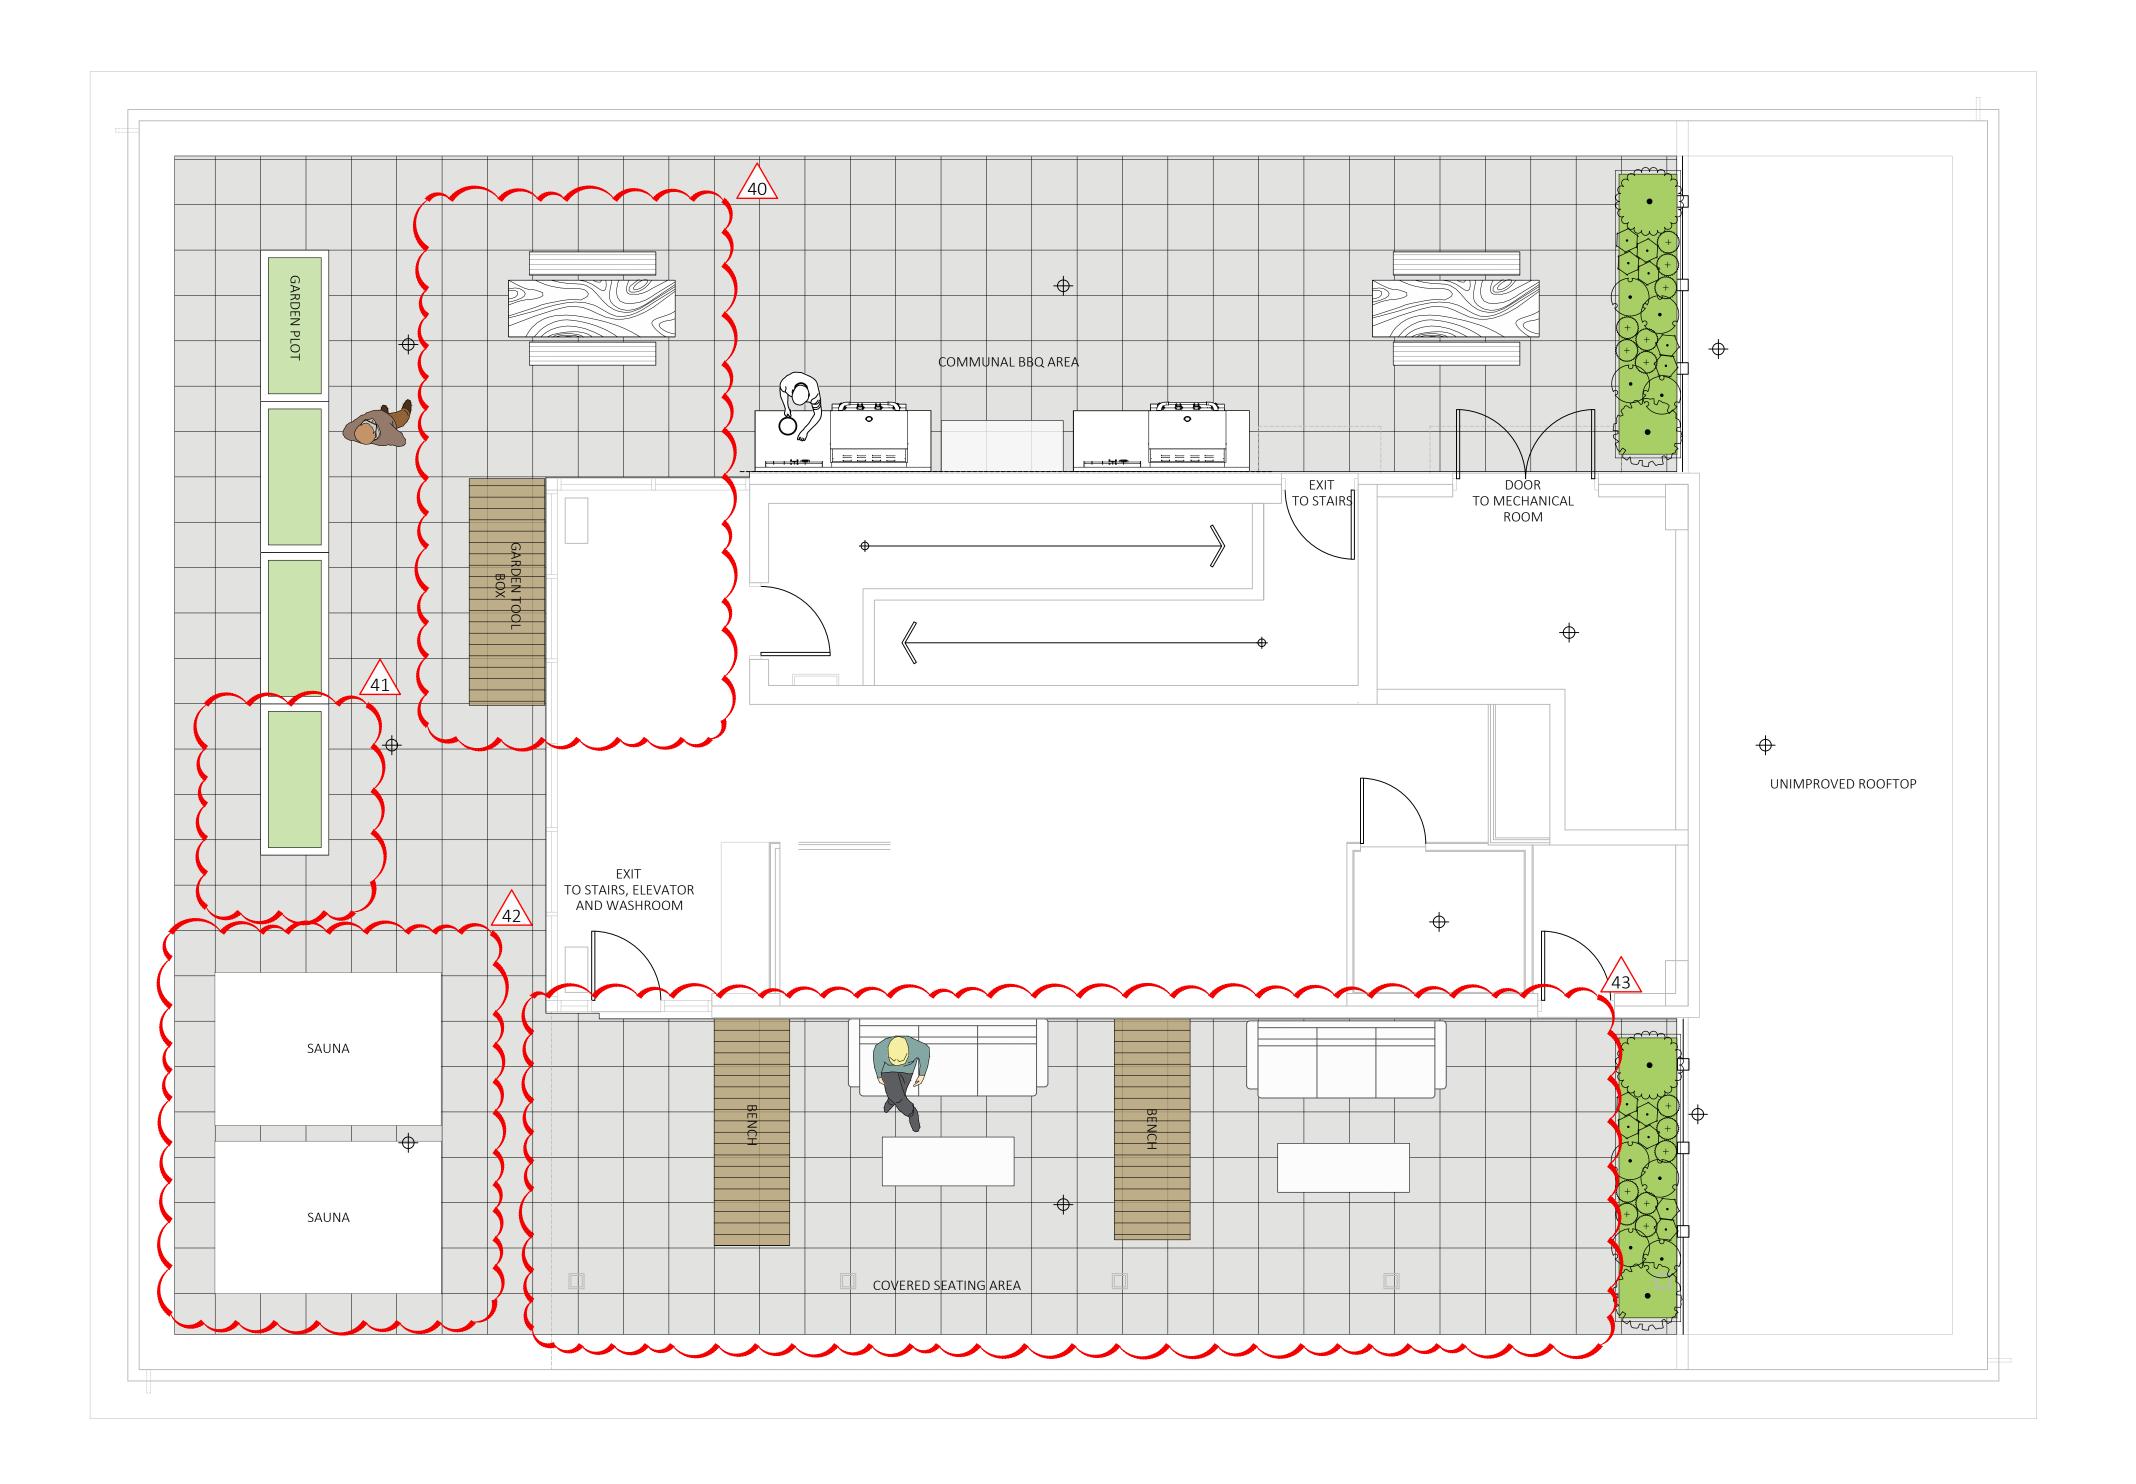

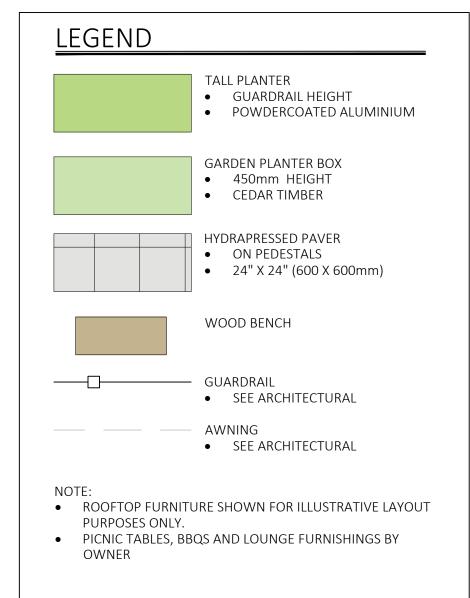

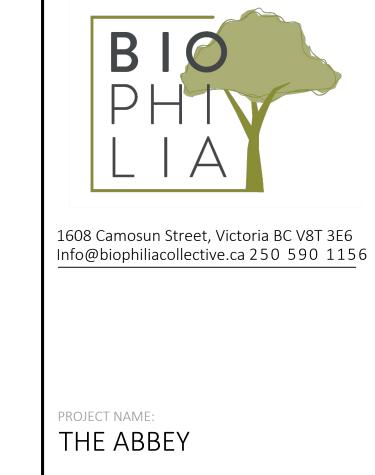

PROJECT ADDRESS:

1702 QUADRA STREET VICTORIA, BC

DESIGNED BY: BIANCA BODLEY DRAWN BY: KIM TANG

NO.	ISSUED FOR	YY\MM\DD
1	CIS PRESENTATION	12/07/2021
2	DEVELOPMENT PERMIT	12/22/2021
3	ADP MEETING	04/13/2022
4	REVISED AND RE-ISSUED FOR DP	2023/06/01
5	REVISED AND RE-ISSUED FOR DP	2023/09/21
6	REVISED AND RE-ISSUED FOR DP	2023/12/15
7	ISSUED FOR BP RESUBMISSION	2024/04/30
8	ISSUED FOR TENDER	2024/06/28
9	ISSUED FOR BP RESUBMISSION	2024/07/31
10	ISSUED FOR BP RESUBMISSION	2024/09/27






NORTH ARROW

DRAWING TITLE:

SITE PLAN - ROOFTOP **AMENITY**


DWG NO:

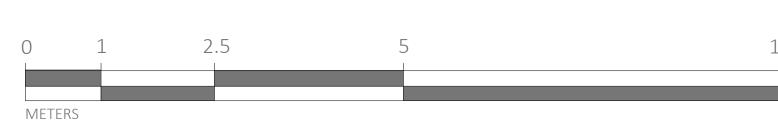








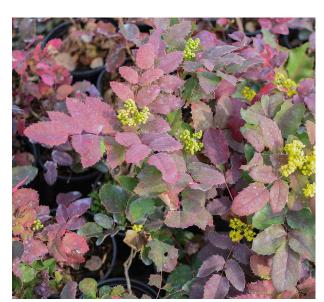





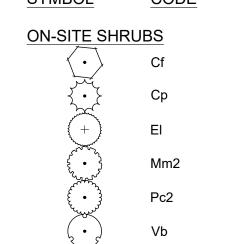

PLANT SCHEDULE ROOFTOP

BOTANICAL / COMMON NAME	SIZE	SPACING	COMMENTS	Q
Calluna vulgaris 'Firefly' / Firefly Heather	#1 POT	300mm	Full, Well Established	15
Carex testacea 'Prairie Fire' / Prairie Fire Orange Sedge	#1 POT	500mm	Full, Well Established	3
Eriophyllum lanatum / Woolly Sunflower	#1 POT	300mm	Full, Well Established	14
Miscanthus sinensis 'Morning Light' / Morning Light Eulalia Grass	#3 POT	900mm	Full, Well Established	1
Pinus mugo 'Compacta' / Dwarf Mugo Pine	#2 POT	900mm	Full, Well Established	2
Verbena bonariensis / Tall Verbena	#1 POT	450mm	Full. Well Established	6

FIREFLY HEATHER

PRAIRIE FIRE SEDGE

CREEPING MAHONIA