


1702 QUADRA STREET + 862 FISGARD STREET

VICTORIA, BC

26.05.2025 ISSUED FOR DDP





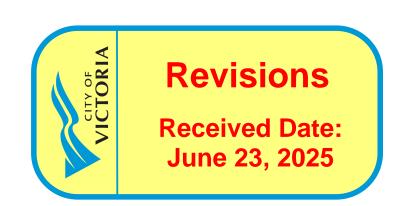

ARCHITECTURAL:

ARCHITECTURE INC

5468796 ARCHITECTURE INC. 266 McDermot Ave Winnipeg, MB. R3B 0S8 P: 204.480.8421

F: 204.480.8876

Sasa Radulovic | Principal Architect E: sasa@5468796.ca

Pablo Batista | Architect E: pablo@5468796.ca

COVER **GENERAL NOTES** RENDERINGS AG.2 AG.3 RENDERINGS AG.4 MATERIAL BOARD AG.5 SHADOW STUDIES AG.6 SITE CONTEXT ELEVATIONS AG.7 WINDOW + DOOR SCHEDULE AG.8 ZONING CALCULATIONS AG.9 SITE SURVEY

CONTEXT SITE PLAN EXISTING SITE PLAN + DEMOLITION PROPOSED SITE PLAN LEVEL 00 PLAN LEVEL 01 PLAN LEVEL 02 PLAN LEVEL 03 PLAN LEVEL 04/06/08/10/12 PLAN

LEVEL 05/07/09/11 PLAN

LEVEL 13 **ROOF PLAN** A1.8 BUILDING ELEVATION BUILDING ELEVATION A2.3 BUILDING ELEVATION

BUILDING ELEVATION BUILDING SECTION A3.2 BUILDING SECTION A3.3 **BUILDING SECTION BUILDING SECTION BUILDING SECTION** BUILDING SECTION

ENLARGED PLAN - BIKE ROOM

DEVELOPER:



1839 Fairfield Road Victoria, BC, V8S 1G9 P.250.940.3568 Vinit Jain E: vinit@aryze.ca

ARYZE DEVELOPMENTS INC.

CIVIL:



MCELHANNEY Suite 500 - 3960 Quadra Street Victoria, BC, V8X 4A3 P.778.746.7417

Nathan Dunlop E: ndunlop@mcelhanney.com

CONCEPTUAL SERVICING

ELECTRICAL:



e2 ENGINEERING 549 Herald Street Victoria, BC, V8W 1S5 P.778.433.9391

Peter Xu E: peter.xu@e3eng.ca

MECHANICAL:



AVALON MECHANICAL 300-1245 Esquimalt Road Victoria, BC, V9A 3P2 P.250.940.2976.

Kevin Jackson E: kjackson@avalonmechanical.com

ENVELOPE:



RDH BUILDING SCIENCE 602-740 Hillside Avenue Victoria, BC, V8T 1Z4 P.250.479.1110.

Byron Searle E: bsearle@rdh.com

LANDSCAPE:



BIOPHILIA Victoria, BC, V8T 3E6

P.250.590.1156 Bianca Bodley

E: bianca@biophiliacollective.ca Elizabeth Balderson E: elizabeth@biophiliacollective.ca

TREE REMOVAL AND PROTECTION PLAN LANDSCAPE SITE PLAN OFF-SITE PLANTING PLAN PRODUCTS AND SITE FURNITURE

ROOFTOP AMENITY AREA

SYMBOL LEGEND:



EXISTING DOOR NEW DOOR

F-1


FLOOR TYPE LABEL

FINIISH TYPE


LABEL **ROOF TYPE**

NOTES GRIDLINE MARKER


BUILDING SECTIONS:

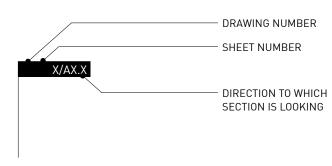


SECTIONS:

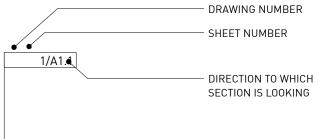

DETAILS:

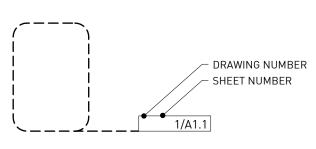


ROOM LABELS:

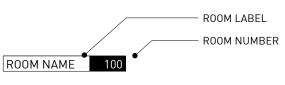



INTERIOR ELEVATIONS:



FLOOR CONSTRUCTION ELEVATIONS:

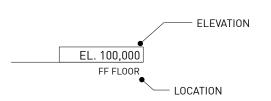

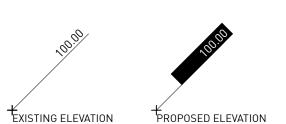

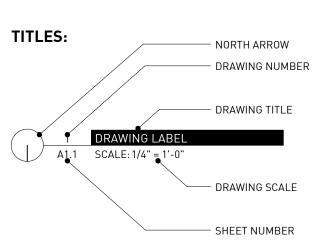

ABBREVIATIONS:	
& ABV AFF ALUM ANOD @ ARCH AT AVB	AND ABOVE ABOVE FINISHED FLOOR ALUMINUM ANODIZED AT ARCHITECTURAL ACOUSTIC TILE AIR/VAPOUR BARRIER
BLDG BLKG BRG BS B TO B	BUILDING BLOCKING BEARING BOTH SIDES BACK TO BACK
CB CF CG CJ CL CLG CLR COL CONC CONC CONN CONT CORR CT C/W	CATCH BASIN CLEAR FINISH CORNER GUARD CONTROL JOINT CENTRE LINE CEILING CLEAR COLUMN CONCRETE CONNECTION CONTINUOUS CORRIDOR CERAMIC TILE COMPLETE WITH
Ø DIM DN DRWG DTL	DIAMETER DIMENSION DOWN DRAWING DETAIL
EL EW EA ELEC EQ EXIST EJ EXT	ELEVATION EACH WAY EACH ELECTRICAL EQUAL EXISTING EXPANSION JOINT EXTERIOR
FDN FE FEJ FIN FD FFD FF FLEX FO FR FRR	FOUNDATION FIRE EXTINGUISHER FLOOR EXPANSION JOINT FINISHED FLOOR DRAIN FUNNEL DRAIN FINISHED FACE FLEXIBLE FACE OF FRIDGE FIRE RESISTANCE RATING
G GA GWB GCB GC	GRILL GAUGE GYPSUM WALL BOARD GYPSUM CEILING BOARD GENERAL CONTRACTOR GLASS
нм	HOLLOW METAL

HOLLOW METAL HOLLOW METAL INSULATED HORIZONTAL HOLLOW STEEL SECTION

HORIZ HERMETICALLY SEALED DOUBLE GLAZING HSS HSTG HERMETICALLY SEALED TRIPLE GLAZING HEATING, VENTILATING, AIR CONDITIONING INSIDE DIAMETER INSIDE FACE INSULATION INTERIOR LENGTH

METRE MILLIMETRE MOUNT MATERIAL MAX MAXIMUM MDF MEDIUM DENSITY FIBREBOARD MECH MECHANICAL MINIMUM MISCELLANEOUS MASONRY OPENING NOT IN CONTRACT NUMBER NOM NOMINAL NTS NOT TO SCALE

ON CENTRE **OUTSIDE DIAMETER** OVERHEAD 0PP OPPOSITE OPEN TO ABOVE OTB OPEN TO BELOW OVEN PLAM PLASTIC LAMINATE PLBG PLUMBING PAIR PREFINISHED

PAINTED FINISH PROPERTY LINE RADIUS **ROOF DRAIN** REINF REINFORCED REQ'D REQUIRED REV REVISION, REVISED, REVERSED ROUGH OPENING

PRESSED STEEL PRESSURE TREATED

SHEET FLOORING SIMILAR SPC'D SPECIFIED SQUARE STEEL STD STANDARD STAIN FINISH STRUCT STRUCTURAL SUSPENDED

SUSP TEMP TEMPERED TEMPERED GLASS TOP OF TYPICAL UNLESS OTHERWISE NOTED U/N UNDERSIDE VARNISHED FINISH VERTICAL

WHC

WIDE, WIDTH WASHER/DRYER WOOD HOLLOW CORE

WOOD SOLID CORE

4 Issued for DDP 3 Issued for TRG2 response 2 Issued for TRG1 response

Drawn By: Checked By: EA/MM/AR 23.05.2025 Printing Date:

26.05.2025

14.12.2023

21.09.2023

The Contractor shall verify all dimensions, datums and levels prior to commencement of work.


All errors and omissions to be reported to the Architect before proceeding.

This drawing must not be scaled.

This drawing is the property of the Architect; the copyright in same being reserved to him/her. It is

Any unauthorized alteration of the electronic data which constitute this document will void all responsibility for the altered document by the Architect.

This drawing is not to be used for building purposes until countersigned by:

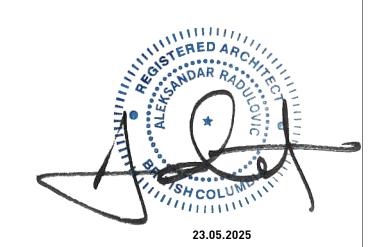


266 MCDERMOT AVE Winnipeg MB R3B 0S8 P: 204.480.8421 F: 204.480.8876

1702 QUADRA STREET + 862 FISGARD STREET

GENERAL NOTES

0650 Sheet

AG.1

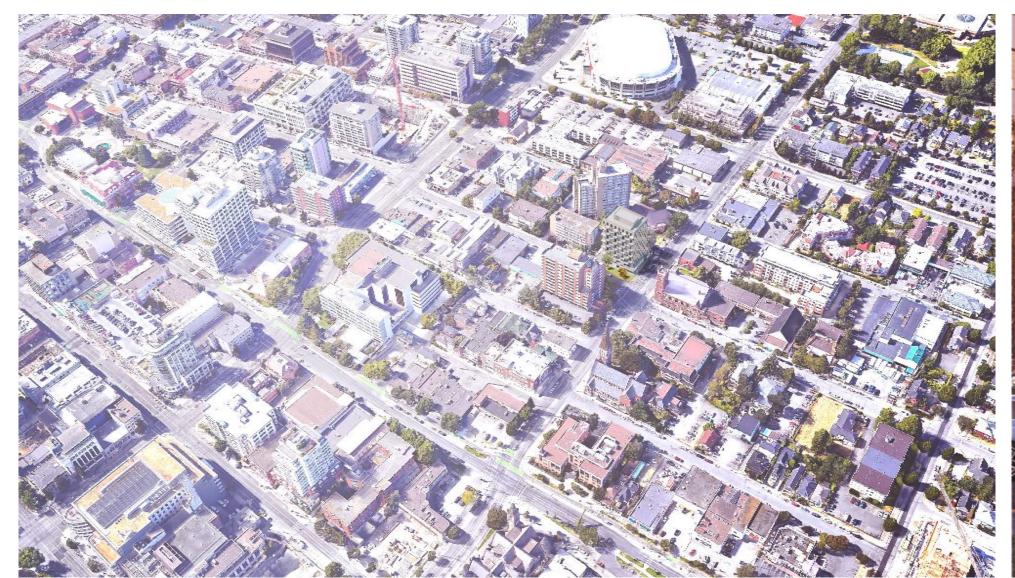



RENDER 5: AERIAL VIEW OF BUILDING

RENDER 3: STREETVIEW EXPERIENCE ALONG QUADRA



RENDER 4: STREET LEVEL VIEW OF THE BUILDING FROM FISGARD SIDEWALK



BG/RG

Drawn By: Checked By: Printing Date: PB 23.05.2025

The Contractor shall verify all dimensions, datums and levels prior to commencement of work.


All errors and omissions to be reported to the Architect before proceeding.

This drawing must not be scaled.

This drawing is the property of the Architect; the copyright in same being reserved to him/her. It is not to be reproduced without his/her permission.

Any unauthorized alteration of the electronic data which constitute this document will void all responsibility for the altered document by the Architect.

This drawing is not to be used for building purposes until countersigned by:

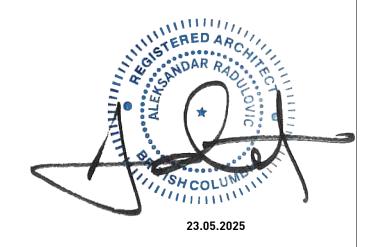

266 MCDERMOT AVE Winnipeg MB R3B 0S8 P: 204.480.8421 F: 204.480.8876

1702 QUADRA STREET + 862 FISGARD STREET

RENDERINGS

0650 Sheet AG.2

2 Issued for TRG1 response 21.09.2023 Drawn By: Checked By: Printing Date: BG/RG

PB 23.05.2025

The Contractor shall verify all dimensions, datums and levels prior to commencement of work.

All errors and omissions to be reported to the Architect before proceeding.


This drawing must not be scaled.


This drawing is the property of the Architect; the

copyright in same being reserved to him/her. It is

Any unauthorized alteration of the electronic data which constitute this document will void all responsibility for the altered document by the Architect.

This drawing is not to be used for building purposes until countersigned by:

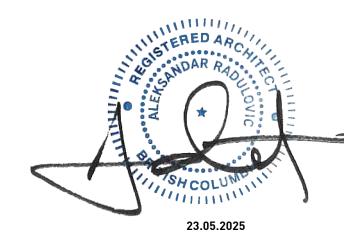

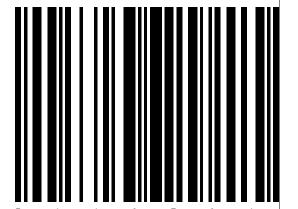


266 MCDERMOT AVE Winnipeg MB R3B 0S8 P: 204.480.8421 F: 204.480.8876

1702 QUADRA STREET + 862 FISGARD STREET


RENDERINGS

Project 0650 Sheet


AG.3

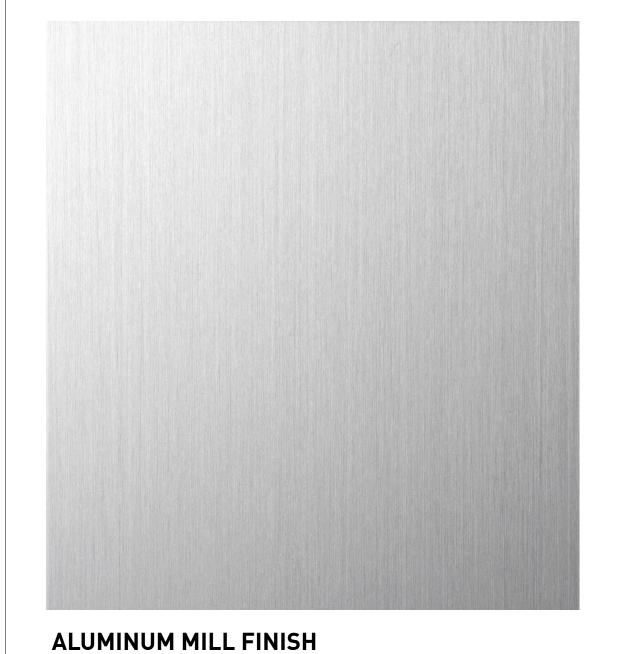




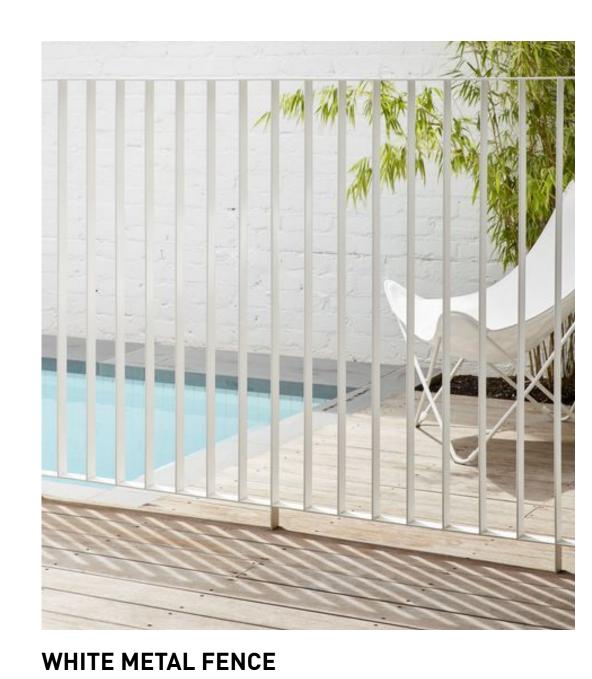



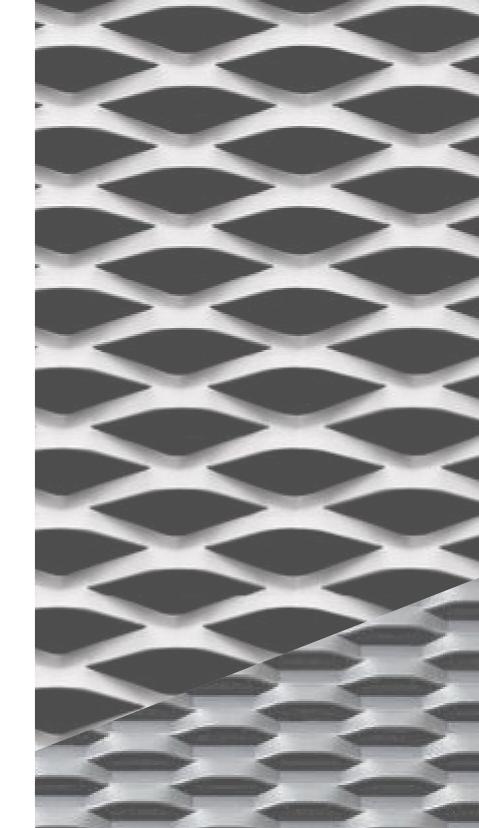

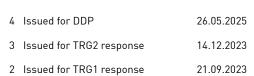

n By: AR / RG ked By: PB ing Date: 23.05.2025

The Contractor shall verify all dimensions, datums and levels prior to commencement of work.

All errors and omissions to be reported to the Architect before proceeding.

This drawing must not be scaled.


This drawing is the property of the Architect; the copyright in same being reserved to him/her. It is

Any unauthorized alteration of the electronic data which constitute this document will void all responsibility for the altered document by the Architect.

This drawing is not to be used for building purposes until countersigned by:





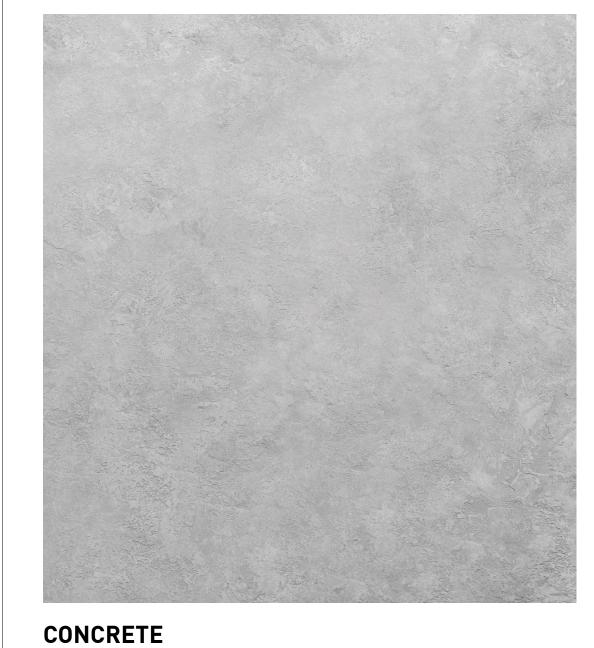





GLASS - REFLECTIVE GLASS - TRANSLUCEN



5 4 6 8 7 9 6 A R C H I T E C T U R E I N C

5 4 6 8 7 9 6 A R C H I T E C T U R E I N C 266 MCDERMOT AVE Winnipeg MB R3B 0S8 P: 204.480.8421 F: 204.480.8876

1702 QUADRA STREET + 862 FISGARD STREET

MATERIALS

Project 0650 Sheet AG.4



MARCH 20 9:00 AM



MARCH 20 12:00 PM



MARCH 20 4:00 PM





JUNE 21 9:00 AM



JUNE 21 12:00 PM



JUNE 21 4:00 PM



SEPTEMBER 22 9:00 AM



SEPTEMBER 22 12:00 PM



SEPTEMBER 22 4:00 PM




DECEMBER 21 9:00 AM



DECEMBER 21 12:00 PM



DECEMBER 21 4:00 PM

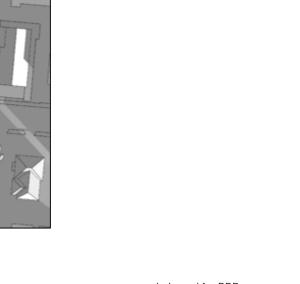

4 Issued for DDP 26.05.2025
3 Issued for TRG2 response 14.12.2023
2 Issued for TRG1 response 21.09.2023

Drawn By:
Checked By:
Printing Date:
PB
23.05.2025

The Contractor shall verify all dimensions, datums

and levels prior to commencement of work.


All errors and omissions to be reported to the Architect before proceeding.

This drawing must not be scaled.

This drawing is the property of the Architect; the copyright in same being reserved to him/her. It is not to be reproduced without his/her permission.

Any unauthorized alteration of the electronic data which constitute this document will void all responsibility for the altered document by the Architect.

This drawing is not to be used for building purposes until countersigned by:

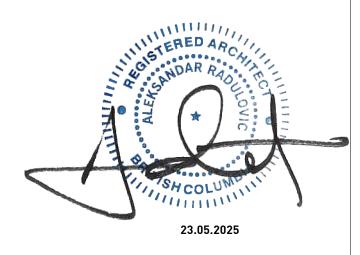



ARCHITECTURE INC 266 MCDERMOTAVE Winnipeg MB R3B 0S8 P: 204.480.8421 F: 204.480.8876

1702 QUADRA STREET + 862 FISGARD STREET

SHADOW STUDIES

Project 0650 Sheet AG.5

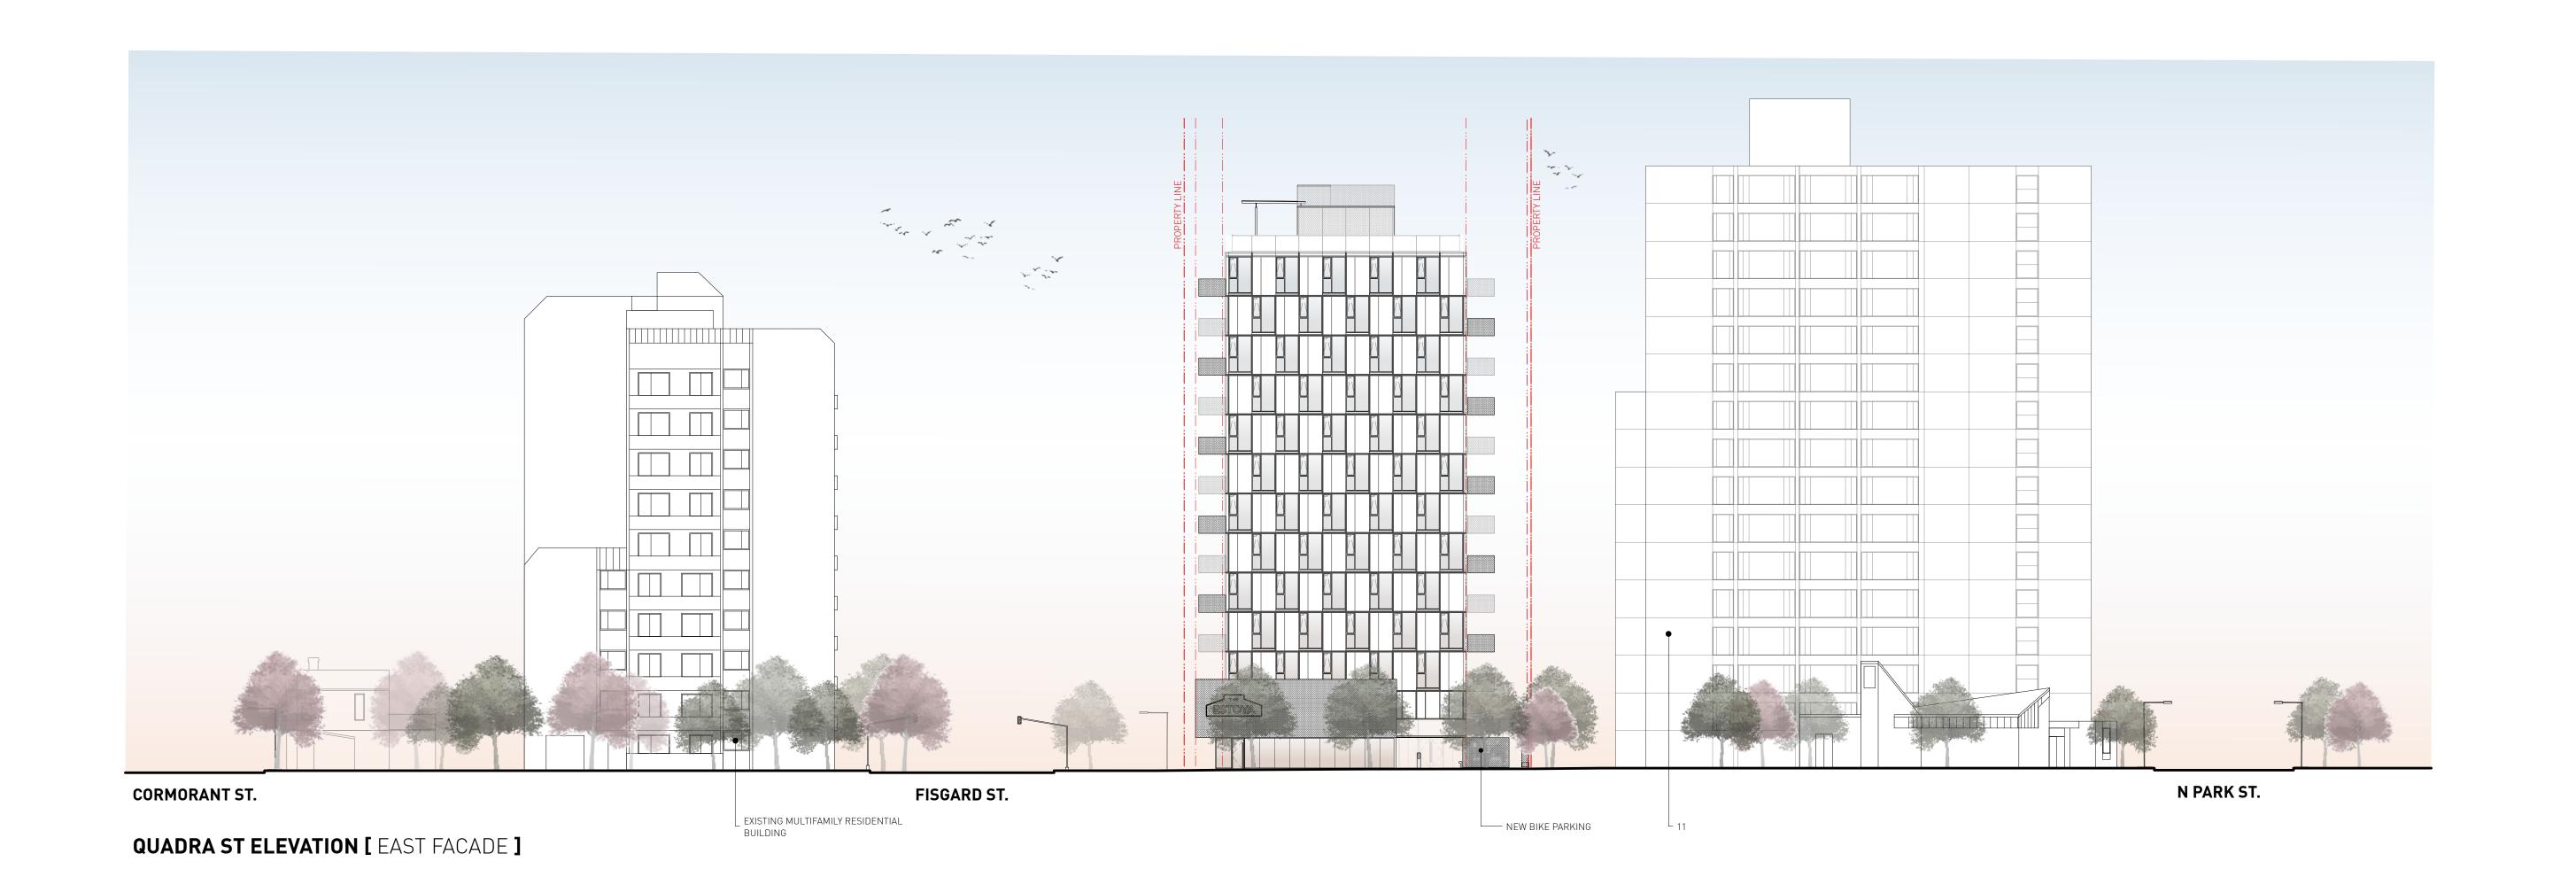

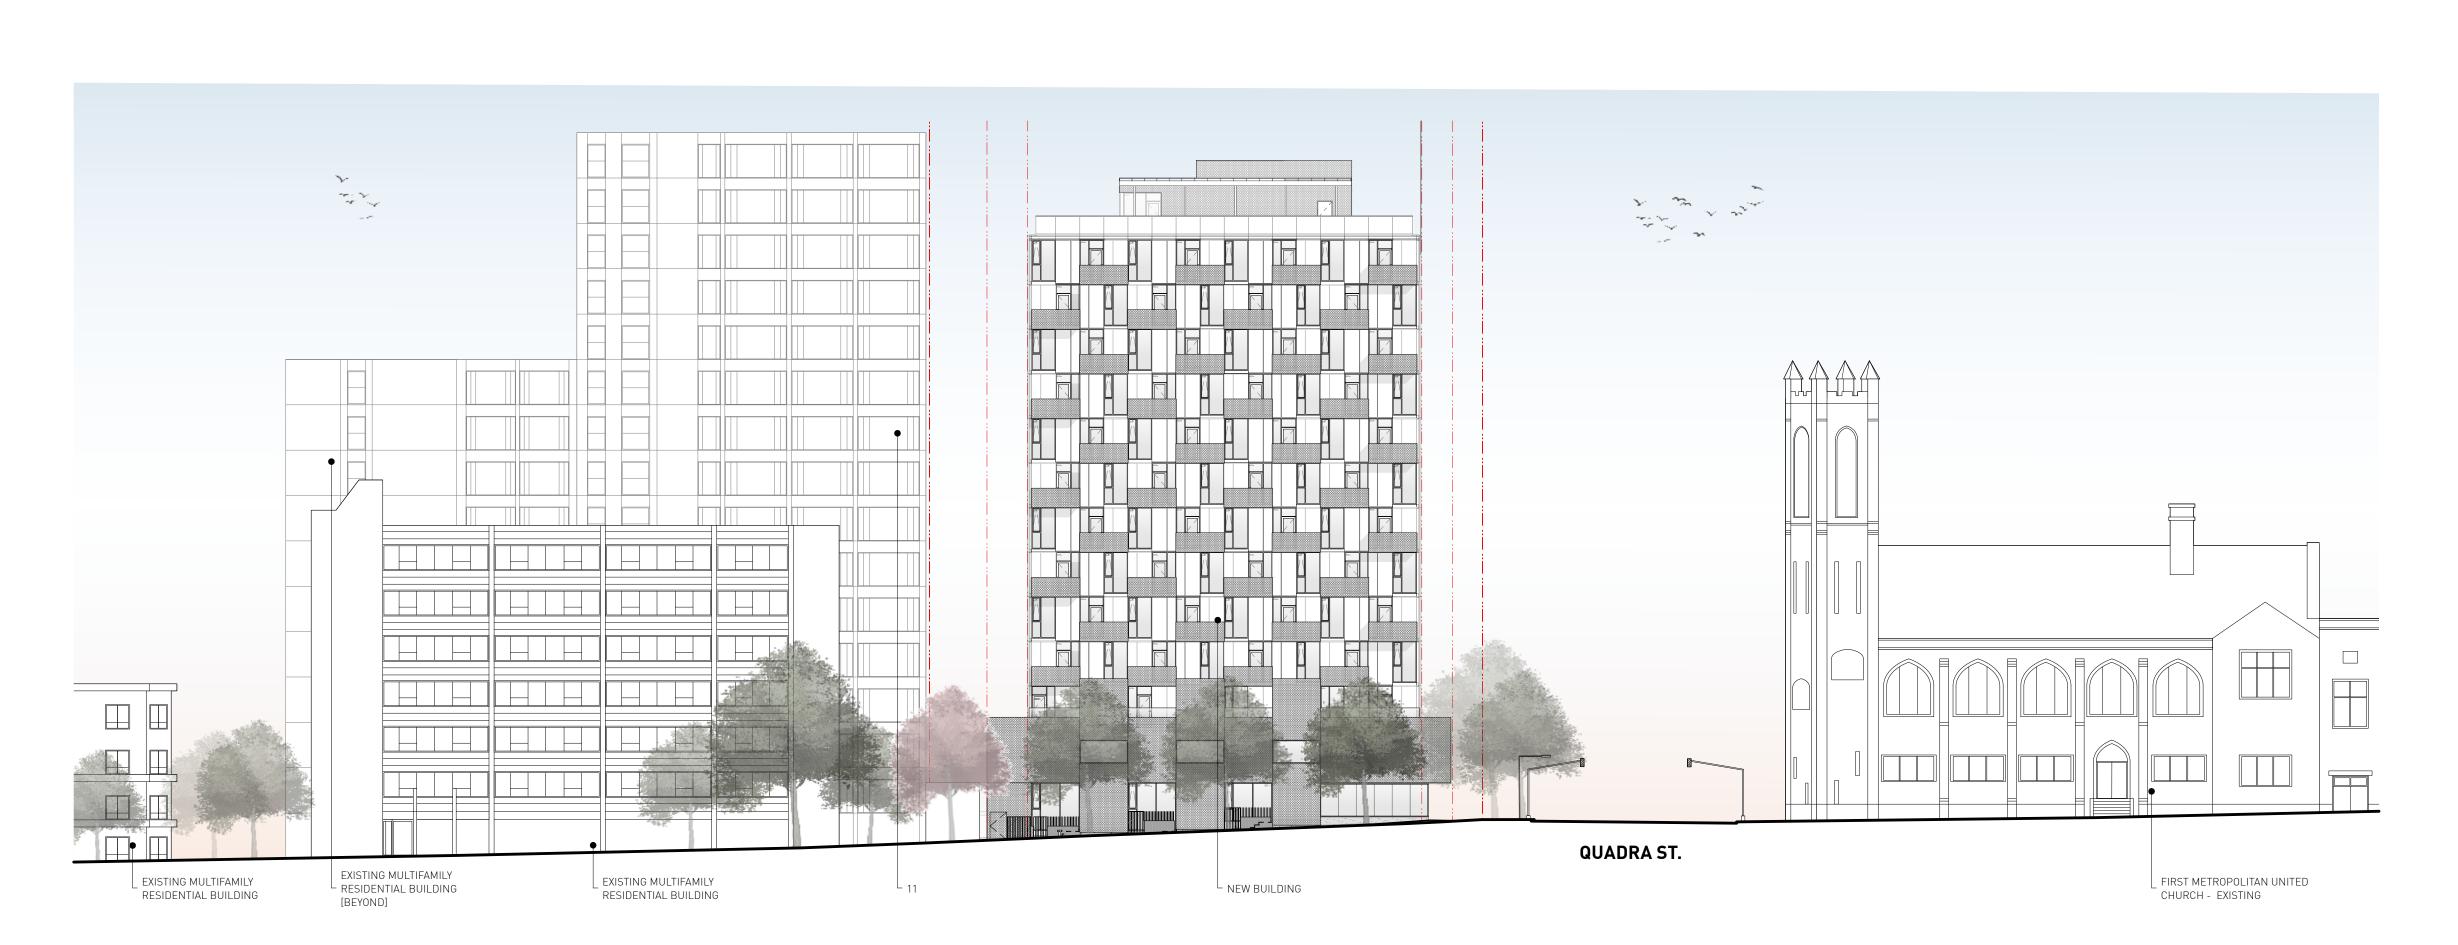

FISGARD ST ELEVATION [SOUTH FACADE]

4 Issued for DDP 26.05.2025
3 Issued for TRG2 response 14.12.2023

21.09.2023

Drawn By: EA / AR
Checked By: PB
Printing Date: 23.05.2025

The Contractor shall verify all dimensions, datums and levels prior to commencement of work.

All errors and omissions to be reported to the Architect before proceeding.


2 Issued for TRG1 response


This drawing must not be scaled.

This drawing is the property of the Architect; the copyright in same being reserved to him/her. It is

Any unauthorized alteration of the electronic data which constitute this document will void all responsibility for the altered document by the

This drawing is not to be used for building purposes until countersigned by:

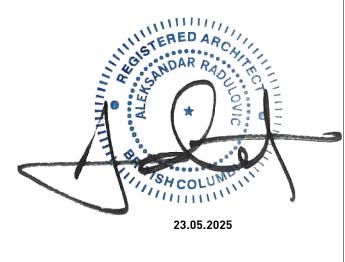

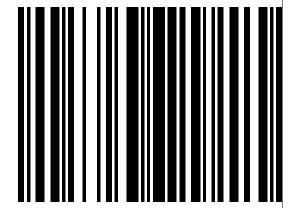

ARCHITECTURE INC 266 MCDERMOT AVE Winnipeg MB R3B 0S8 P: 204.480.8421 F: 204.480.8876

1702 QUADRA STREET + 862 FISGARD STREET

CONTEXT ELEVATIONS

O650 Sheet

RESIDENTIAL WINDOW SCHEDULE

• ALL GLAZING TO BE HSTG, LOW E ON SURFACE 2, ARGON-FILLED W/ SUPERSPACERS, LOW REFLECTIVITY COATING TO REDUCE INTERNAL GLARE

ALUMINUM WINDOW WALL SYSTEM

• REFER TO WINDOW SUPPLIER CUT SHEETS FOR TEMPERING REQUIREMENTS

• PROVIDE PRE-FINISHED ALUMINUM FLASHING AT HEADS AND SILLS, COLOUR TO BE SELECTED BY ARCHITECT • GLASS TO BE 3mm CLEAR [UNLESS OTHERWISE NOTED OR REQUIRED BY MANUFACTURING ENGINEER]

ENVELOPE CONSULTANT TO REVIEW ALL RESIDENTIAL AND COMMERCIAL GLAZING SHOP DRAWINGS

ALL INTERIOR CASINGS TO BE GYPSUM BOARD RETURN

• ALL WINDOWS TO MEET NAFS-17 & CANADIAN TEST STANDARDS. ENVELOPE CONSULTANT TO REVIEW TESTING DATA. • ALL WINDOW SPECIFICATIONS MUST COMPLY OR SURPASS ENERGY CODE CONSULTANT'S ENERGY MODEL ASSUMPTIONS

• REFER TO ENVELOPE CONSULTANT WINDOW INSTALLATION GUIDELINES FOR SILL AND THREE SIDES MEMBRANE DETAILING FOR ALL RESIDENTIAL WINDOWS

• ALUMICOR THERMALLY BROKEN STOREFRONT OR APPROVED EQUAL, SSG, ANTI-ROTATION BLOCKS TO BE ALUMINUM OR PVC

• ALL GLAZING TO BE HSTG, LOW E ON SURFACE 2, ARGON-FILLED W/ SUPERSPACERS, LOW REFLECTIVITY COATING TO REDUCE INTERNAL GLARE

• ALL EXTERIOR CURTAINWALL TO BE TEMPERED, BLACK FRAME GLASS TO BE 6mm CLEAR & TEMPERED


COMMERCIAL WINDOW SCHEDULE

• ALL WINDOW SPECIFICATIONS MUST COMPLY OR SURPASS ENERGY CODE CONSULTANT'S ENERGY MODEL ASSUMPTIONS


• SUPPLY SPANDREL PANEL AS REQUIRED FOR MECHANICAL GRILLE PENETRATIONS OF CURTAIN WALL.


• ENVELOPE CONSULTANT TO REVIEW ALL RESIDENTIAL AND COMMERCIAL GLAZING SHOP DRAWINGS


RESIDENTIAL WINDOW WALL

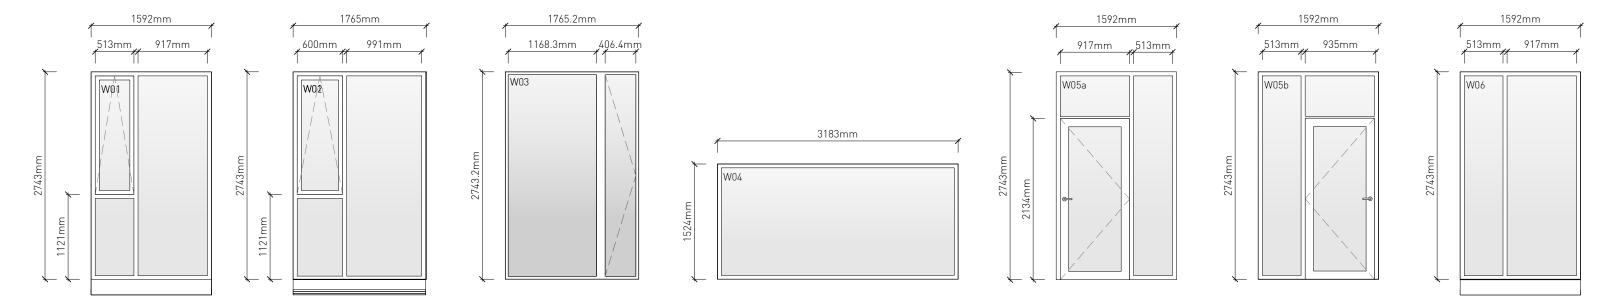


COMMERCIAL STOREFRONT

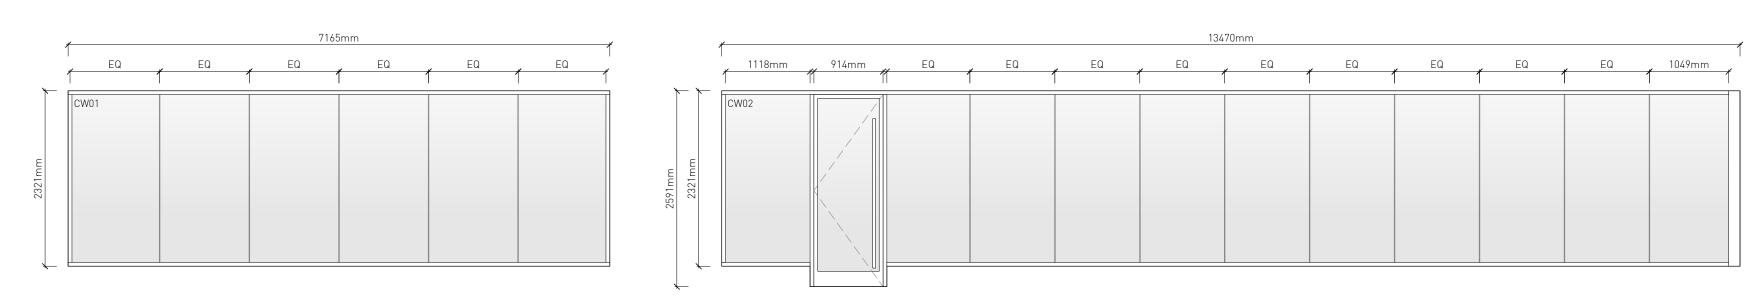

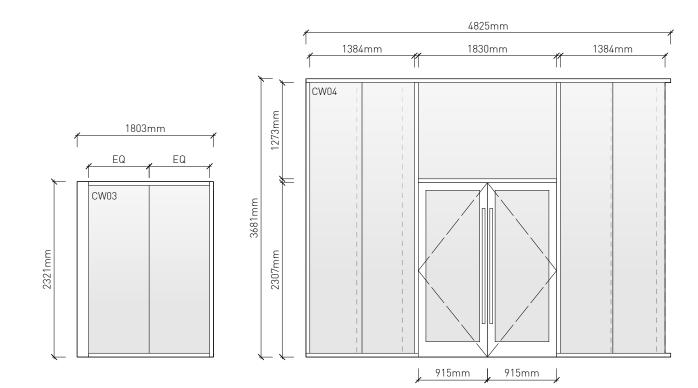


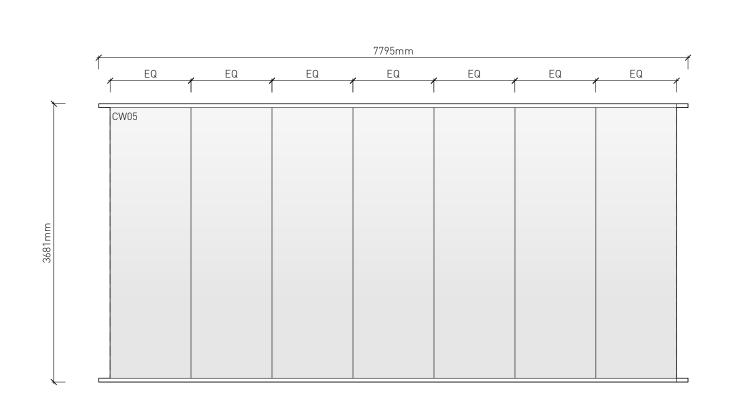



LIVE WORK STOREFRONT

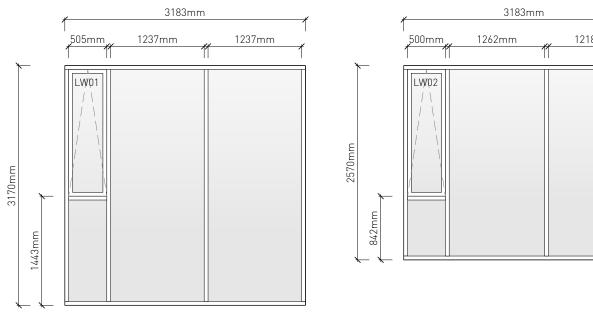

PENTHOUSE STOREFRONT

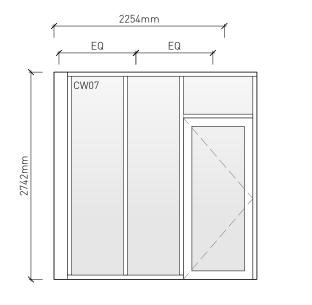

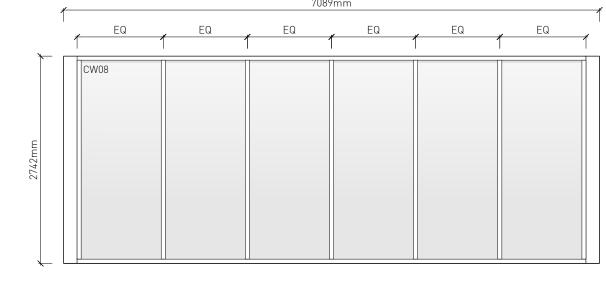

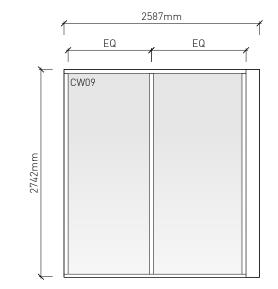

26.05.2025 4 Issued for DDP 3 Issued for TRG2 response 14.12.2023 2 Issued for TRG1 response 21.09.2023

Drawn By: Checked By: PB 23.05.2025 Printing Date:

The Contractor shall verify all dimensions, datums and levels prior to commencement of work.


All errors and omissions to be reported to the Architect before proceeding.


This drawing must not be scaled.

This drawing is the property of the Architect; the copyright in same being reserved to him/her. It is

Any unauthorized alteration of the electronic data which constitute this document will void all responsibility for the altered document by the

This drawing is not to be used for building purposes until countersigned by:

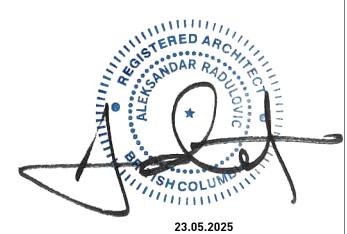

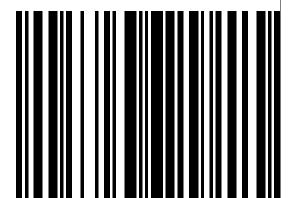



266 MCDERMOT AVE Winnipeg MB R3B 0S8 P: 204.480.8421 F: 204.480.8876

1702 QUADRA STREET + 862 FISGARD STREET


WINDOW & DOOR SCHEDULE

0650 Sheet AG.7

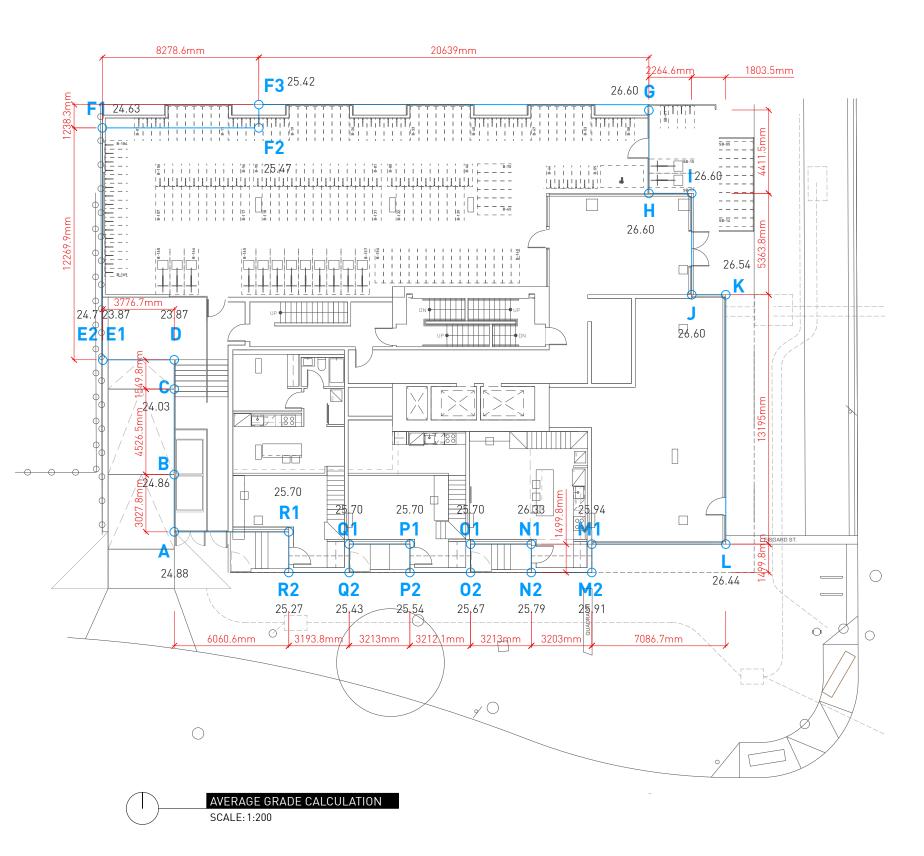

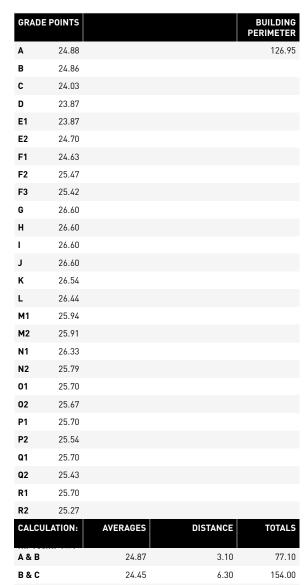


R1 25 R2 25 CALGULATIO A & B B & C C & D D & E1 E2 & F1 F1 & F2 F2 & F3 F3 & G G & H H & I I & J J & K K & L L & M1 M1 & M2 M2 & N2 N2 & N1 N1 & 01 01 & 02 02 & P2 P2 & P1 P1 & Q1 Q1 & Q2 Q2 & R2	24.87 24.45 23.95 23.87 24.67 25.05 25.45	3.10 6.30 5.40 3.77	77.10 154.00 129.33 89.99
CALCULATION A & B B & C C & D D & E1 E2 & F1 F1 & F2 F2 & F3 F3 & G G & H H & I I & J J & K K & L L & M1 M1 & M2 M2 & N2 N2 & N1 N1 & 01 O1 & 02 O2 & P2 P2 & P1 P1 & Q1 Q1 & Q2 Q2 & R2	24.87 24.45 23.95 23.87 24.67 25.05 25.45	3.10 6.30 5.40 3.77 13.2	77.10 154.00 129.33
A & B B & C C & D D & E1 E2 & F1 F1 & F2 F2 & F3 F3 & G G & H H & I I & J J & K K & L L & M1 M1 & M2 M2 & N2 N2 & N1 N1 & 01 01 & 02 02 & P2 P2 & P1 P1 & Q1 Q1 & Q2 Q2 & R2	24.87 24.45 23.95 23.87 24.67 25.05 25.45	3.10 6.30 5.40 3.77 13.2	77.10 154.00 129.33
B & C C & D D & E1 E2 & F1 F1 & F2 F2 & F3 F3 & G G & H H & I I & J J & K K & L L & M1 M1 & M2 M2 & N2 N2 & N1 N1 & 01 01 & 02 02 & P2 P2 & P1 P1 & Q1 Q1 & Q2 Q2 & R2	24.45 23.95 23.87 24.67 25.05 25.45	6.30 5.40 3.77 13.2	154.00 129.33
C & D D & E1 E2 & F1 F1 & F2 F2 & F3 F3 & G G & H H & I I & J J & K K & L L & M1 M1 & M2 M2 & N2 N2 & N1 N1 & 01 01 & 02 02 & P2 P2 & P1 P1 & Q1 Q1 & Q2 Q2 & R2	23.95 23.87 24.67 25.05 25.45	5.40 3.77 13.2	129.33
D & E1 E2 & F1 F1 & F2 F2 & F3 F3 & G G & H H & I I & J J & K K & L L & M1 M1 & M2 M2 & N2 N2 & N1 N1 & 01 O1 & 02 O2 & P2 P2 & P1 P1 & Q1 Q1 & Q2 Q2 & R2	23.87 24.67 25.05 25.45	3.77 13.2	
E2 & F1 F1 & F2 F2 & F3 F3 & G G & H H & I I & J J & K K & L L & M1 M1 & M2 M2 & N2 N2 & N1 N1 & 01 01 & 02 02 & P2 P2 & P1 P1 & Q1 Q1 & Q2 Q2 & R2	24.67 25.05 25.45	13.2	89.99
F1 & F2 F2 & F3 F3 & G G & H H & I I & J J & K K & L L & M1 M1 & M2 M2 & N2 N2 & N1 N1 & 01 01 & 02 02 & P2 P2 & P1 P1 & Q1 Q1 & Q2 Q2 & R2	25.05 25.45		
F2 & F3 F3 & G G & H H & I I & J J & K K & L L & M1 M1 & M2 M2 & N2 N2 & N1 N1 & 01 01 & 02 02 & P2 P2 & P1 P1 & Q1 Q1 & Q2 Q2 & R2	25.45		325.58
F3 & G G & H H & I I & J J & K K & L L & M1 M1 & M2 M2 & N2 N2 & N1 N1 & 01 01 & 02 02 & P2 P2 & P1 P1 & Q1 Q1 & Q2 Q2 & R2		8.3	207.92
G & H H & I I & J J & K K & L L & M1 M1 & M2 M2 & N2 N2 & N1 N1 & 01 01 & 02 02 & P2 P2 & P1 P1 & Q1 Q1 & Q2 Q2 & R2	01.04	1.2	30.53
H & I I & J J & K K & L L & M1 M1 & M2 M2 & N2 N2 & N1 N1 & 01 01 & 02 02 & P2 P2 & P1 P1 & Q1 Q1 & Q2 Q2 & R2	26.01	20.6	535.81
I & J J & K K & L L & M1 M1 & M2 M2 & N2 N2 & N1 N1 & 01 01 & 02 02 & P2 P2 & P1 P1 & Q1 Q1 & Q2 Q2 & R2	26.60	4.40	117.04
J & K K & L L & M1 M1 & M2 M2 & N2 N2 & N1 N1 & 01 01 & 02 02 & P2 P2 & P1 P1 & Q1 Q1 & Q2 Q2 & R2	26.60	2.26	60.12
K & L L & M1 M1 & M2 M2 & N2 N2 & N1 N1 & 01 01 & 02 02 & P2 P2 & P1 P1 & Q1 Q1 & Q2 Q2 & R2	26.60	5.36	142.58
L & M1 M1 & M2 M2 & N2 N2 & N1 N1 & 01 O1 & O2 O2 & P2 P2 & P1 P1 & Q1 Q1 & Q2 Q2 & R2	26.57	1.80	47.83
M1 & M2 M2 & N2 N2 & N1 N1 & O1 O1 & O2 O2 & P2 P2 & P1 P1 & Q1 Q1 & Q2 Q2 & R2	26.49	13.19	349.40
M2 & N2 N2 & N1 N1 & 01 O1 & O2 O2 & P2 P2 & P1 P1 & Q1 Q1 & Q2 Q2 & R2	26.19	7.01	183.59
N2 & N1 N1 & 01 O1 & O2 O2 & P2 P2 & P1 P1 & Q1 Q1 & Q2 Q2 & R2	25.93	1.5	38.89
N1 & 01 01 & 02 02 & P2 P2 & P1 P1 & Q1 Q1 & Q2 Q2 & R2	25.85	3.21	82.98
01 & 02 02 & P2 P2 & P1 P1 & Q1 Q1 & Q2 Q2 & R2	26.06	1.5	39.09
02 & P2 P2 & P1 P1 & Q1 Q1 & Q2 Q2 & R2	26.02	3.21	83.51
P2 & P1 P1 & Q1 Q1 & Q2 Q2 & R2	25.69	1.5	38.53
P1 & Q1 Q1 & Q2 Q2 & R2	25.61	3.21	82.19
Q1 & Q2 Q2 & R2	25.62	1.5	38.43
Q2 & R2	25.70	3.21	82.50
	25.57	1.5	38.35
	25.35	3.21	81.37
R2 & R1	25.49	1.5	38.23
R1 & A	25.29	6.01	151.99
		126.95	3246.86
AVERAGE			
25.58			

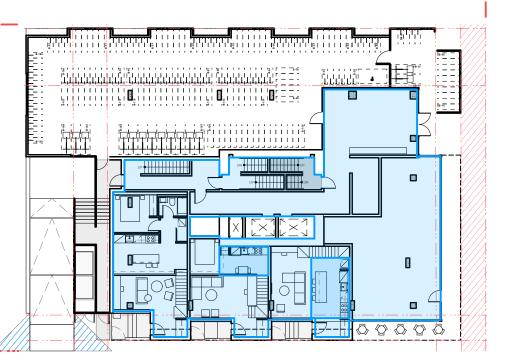


384.00 m²



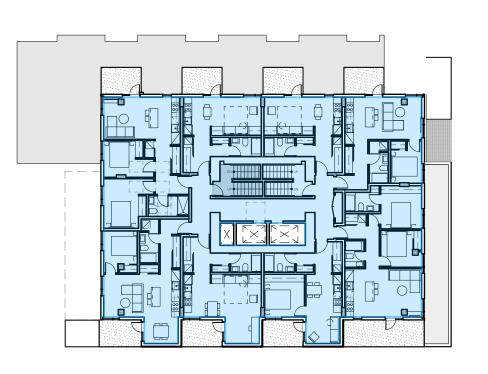


445.46 m²



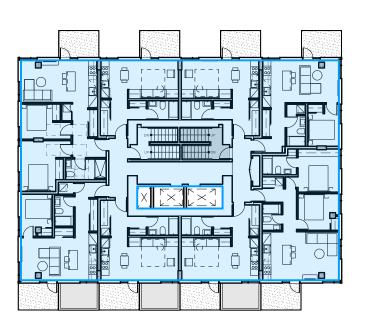

428.50 m²



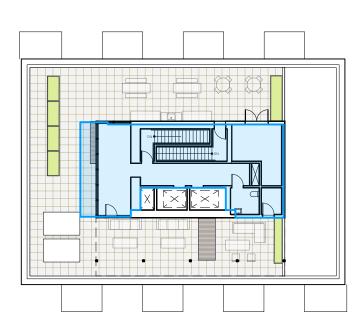

102.5 m²



PROJECT STATS:

REVISION NO.3				DECEMBER 14, 2023
SITE INFORMATION				
LEGAL DESCRIPTION	ZONING: R3-C	LOTS: A, 1, 2	SUBURBAN LOT: 4	PLAN: CITY 01516011
CIVIC ADDRESS	1702 QUADRA STE	REET, VICTORIA, BC		
ZONING	CURF [R-3C, RESIDE FAM	NTIAL MULTI-		1702 QUADRA PROJECT STATS
SITE AREA [m²]				947.78
GROSS FLOOR AREA [m²]				5217.01
FLOOR SPACE RATIO	3.	0		5.50
SITE COVERAGE (%)				76.5%
OPEN SITE SPACE (%)				23.5%
AVERAGE GRADE				24.59 m
BUILDING HEIGHT	NO BUILDING SH METRES I			13 STOREYS [42.88m]
SETBACKS				
NORTH [SIDE]	6.0	lm		4.85m [[EXCLUDING BIKE PARKING ENCLOSURE]
EAST [FRONT]	4.5	im		2.0m [BASE] 4.0m [TOWER]
SOUTH [FLANKING]	4.5	im		0.85m [BASE] 2.85m [TOWER]
WEST [REAR]	6.0	lm		3.8m [BASE - EXCLUDING BIKE PARKING ENCLOSURE] 6.5m [TOWER]

BUILDING DATA			
UNIT TYPES	AVERAGE AREA (M²)	UNIT COUNT	TOTAL AREA (M²)
RESIDENTIA	AL		
BACHELOR	34.72	43	1,492.85
1 BEDROOM UNIT	47.27	24	1,134.38
2 BEDROOM UNIT	65.19	21	1,368.95
ОТНЕ	ER		
COMMERCIAL UNIT [S]	86.43	1	86.43
WORK / LIVE	57.85	3	173.55
TOTAL		92	
TOTAL RENTABLE AREA			4,256.16

RESIDENTIAL UNIT MIX	UNIT COUNT	%
BACHELOR	43	47%
1 BEDROOM UNIT	24	26%
2 BEDROOM UNIT	21	23%

SITE DATA	
	AREA [m²]
EVEL 01	384.00
EVEL 02	445.46
EVEL 03	428.50
EVEL 04	428.50
EVEL 05	428.50
EVEL 06	428.50
EVEL 07	428.50
EVEL 08	428.50
EVEL 09	428.50
EVEL 10	428.50
EVEL 11	428.50
EVEL 12	428.50
EVEL 13	102.55
OTAL GROSS FLOOR AREA	5217.01
BUILDING FOOTPRINT	724.88

	UNIT COUNT	RATE	REQUIRED STALLS
RESIDENTIAL			
UNIT < 45 M ²	44	0.85 STALLS / UNIT	37
UNIT 45-70 M ²	46	1.0 STALLS / UNIT	46
UNIT > 70 M ²	0	1.45 STALLS / UNIT	0
VISITOR	91	0.1 STALLS / UNIT	9
COMMERCIAL			
RESTAURANT	86.43	1.0 STALLS / 20m ²	4
TOTAL REQUIRED		'	97

	UNIT COUNT	RATE	REQUIRED STALLS
LONG TERM			
UNIT < 45 M ²	44	1.0 STALLS / UNIT	44
UNIT => 45 M ²	47	1.25 STALLS / UNIT	59
RESTAURANT	86.43	1.0 STALLS / 400m ²	1
TOTAL REQUIRED			104

TOTAL PROPOSED				182
SHORT TERM				
	RESIDENTIAL	91	0.1 STALLS / UNIT	9.1
	RESTAURANT	86.43	1.0 STALLS / 100m ²	1
TOTAL REQUIRED				11

 4 Issued for DDP
 26.05.2025

 3 Issued for TRG2 response
 14.12.2023

2 Issued for TRG1 response

Drawn By: EA / PB
Checked By: PB
Printing Date: 23.05.2025

21.09.2023

The Contractor shall verify all dimensions, datums and levels prior to commencement of work.


All errors and omissions to be reported to the Architect before proceeding.


This drawing must not be scaled.

This drawing is the property of the Architect; the copyright in same being reserved to him/her. It is not to be reproduced without his/her permission

Any unauthorized alteration of the electronic data which constitute this document will void all responsibility for the altered document by the

This drawing is not to be used for building purposes until countersigned by:

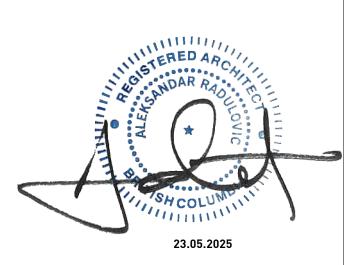

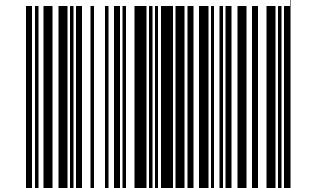


5 4 6 8 7 9 6 A R C H I T E C T U R E I N C 266 MCDERMOT AVE Winnipeg MB R3B 0S8 P: 204.480.8421 F: 204.480.8876

1702 QUADRA STREET + 862 FISGARD STREET

ZONING CALCULATIONS

Project
0650
Sheet

AG.8

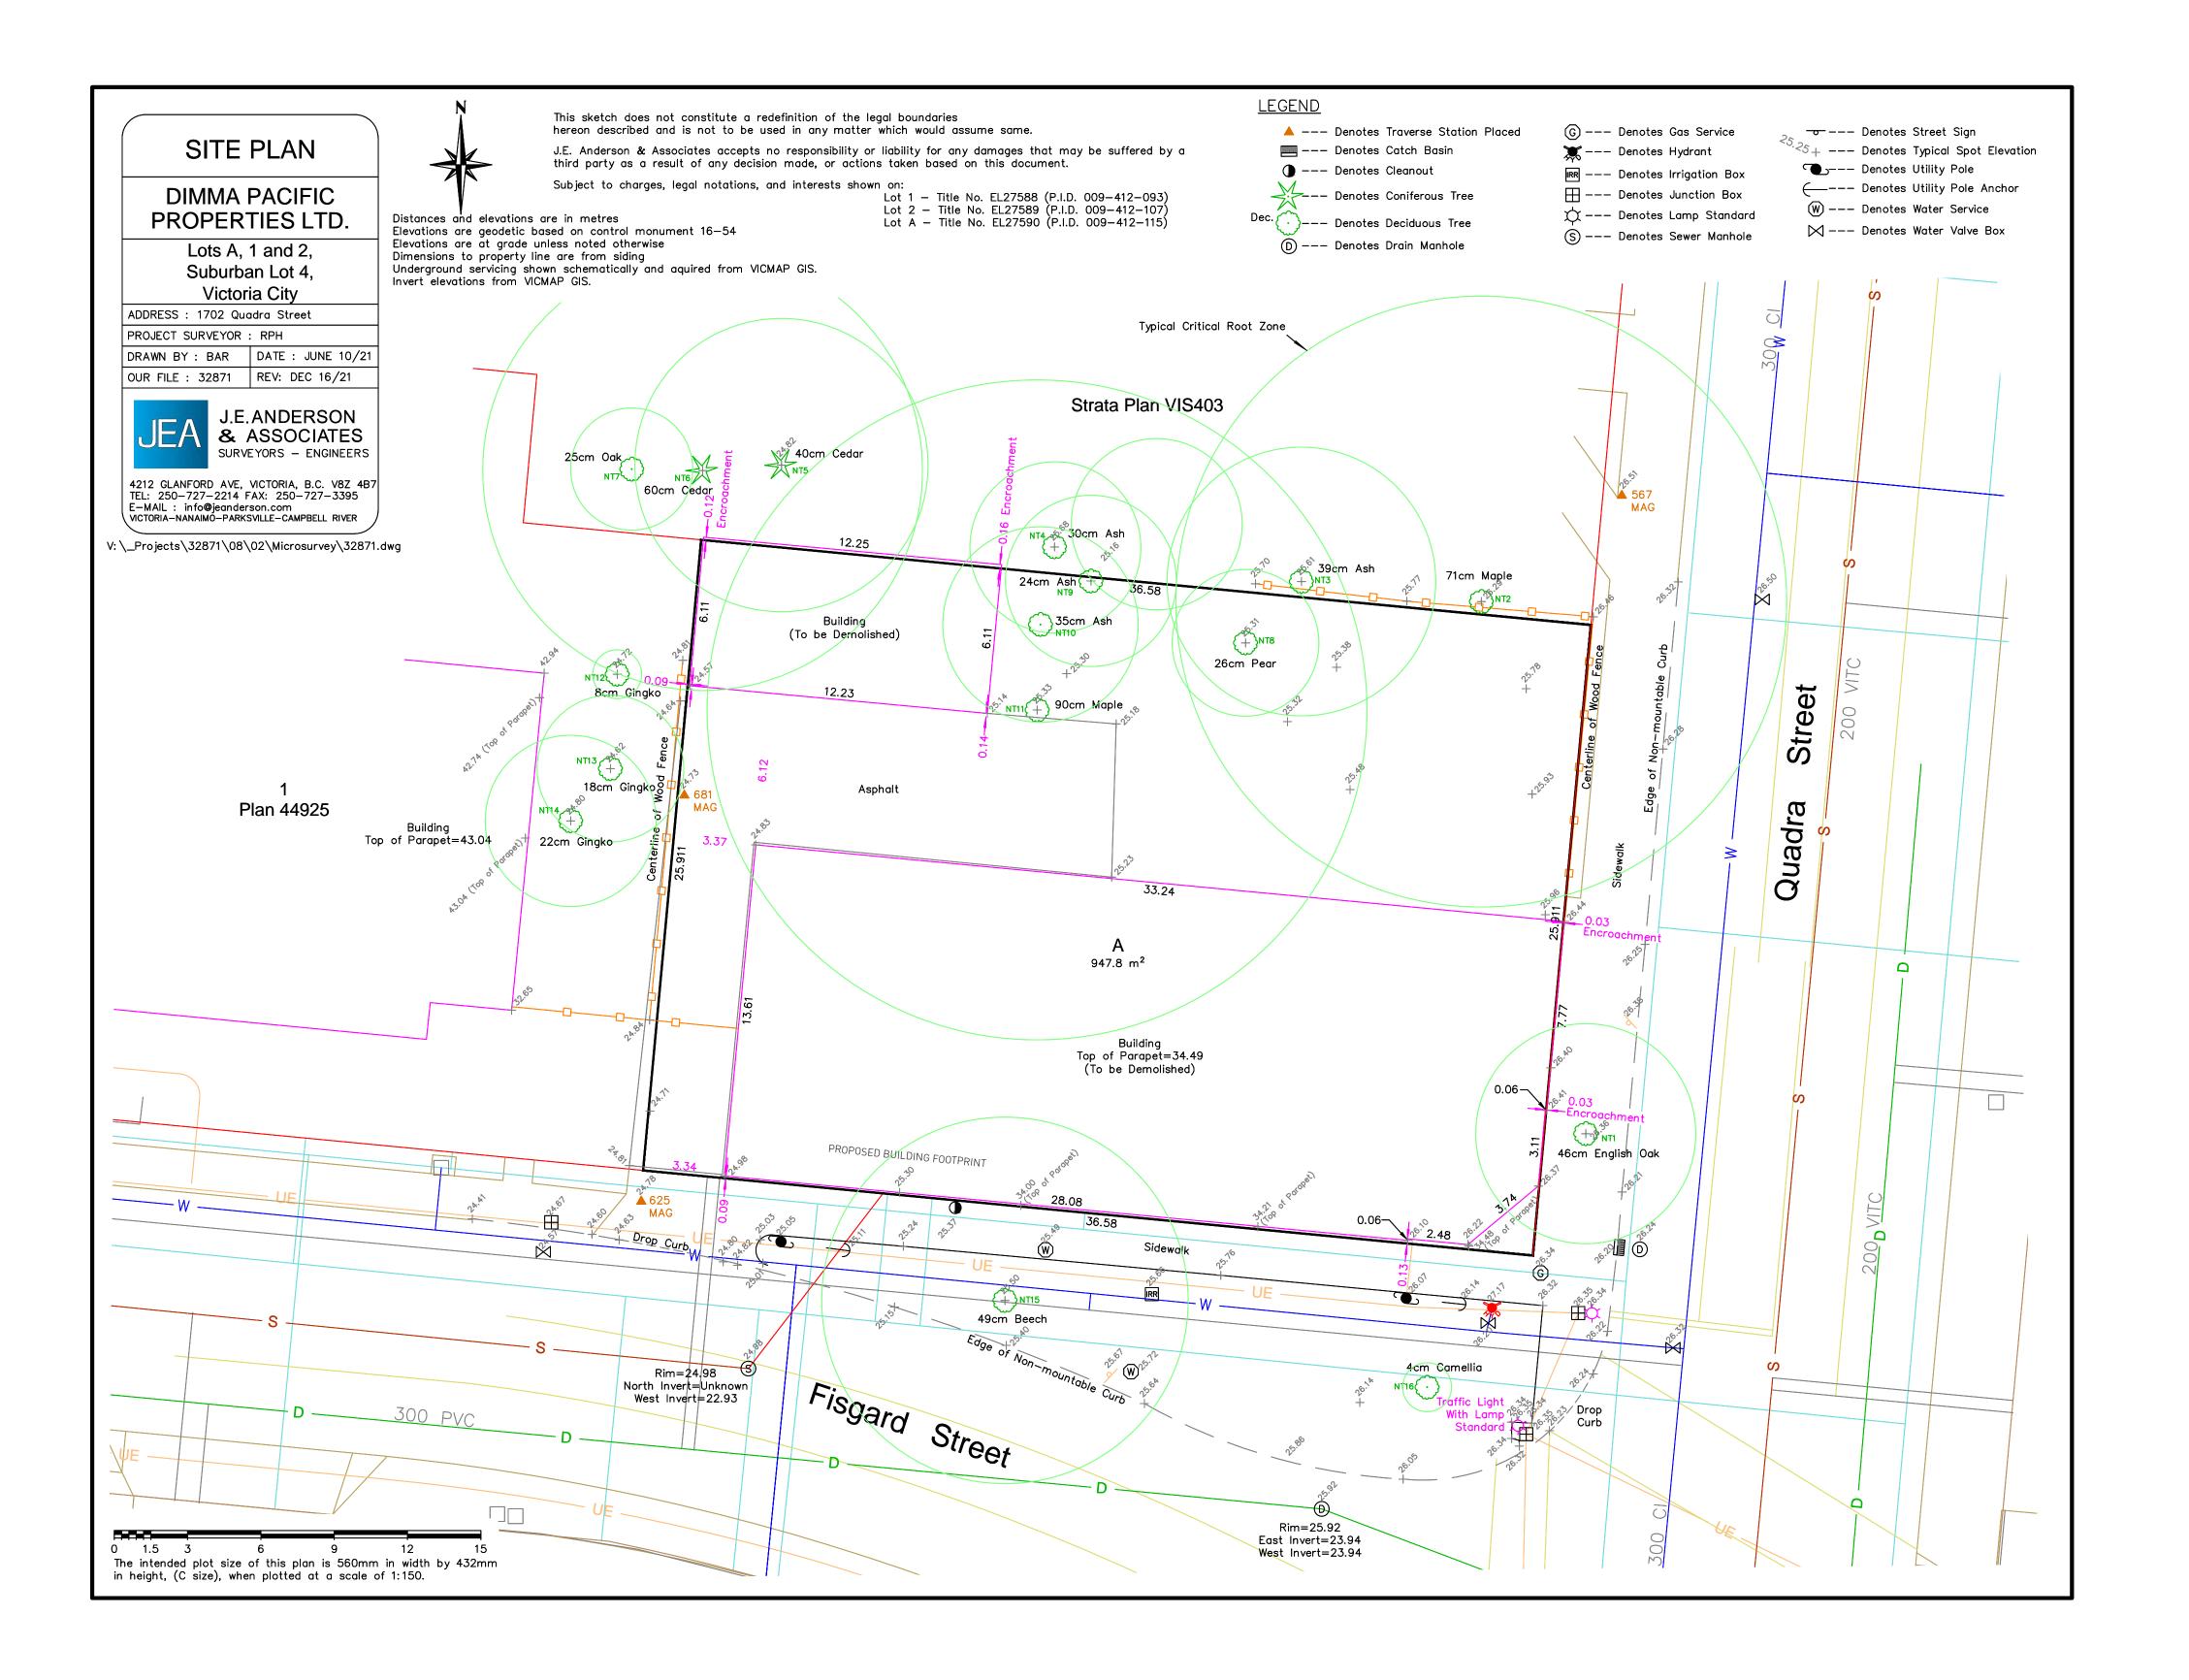

1 SITE SURVEY BY OTHERS
AG.5 SCALE: NTS

26.05.2025 4 Issued for DDP 3 Issued for TRG2 response 14.12.2023 2 Issued for TRG1 response 21.09.2023 1 Issued for DP 01.06.2023

PB 23.05.2025 Printing Date:

The Contractor shall verify all dimensions, datums

and levels prior to commencement of work. All errors and omissions to be reported to the

Architect before proceeding.

This drawing must not be scaled.


Drawn By: Checked By:


This drawing is the property of the Architect; the copyright in same being reserved to him/her. It is

Any unauthorized alteration of the electronic data which constitute this document will void all

responsibility for the altered document by the

This drawing is not to be used for building purposes until countersigned by:

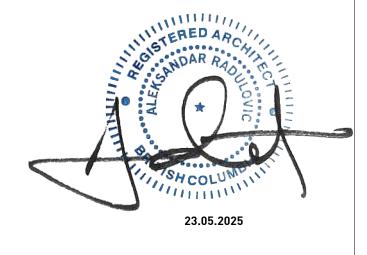

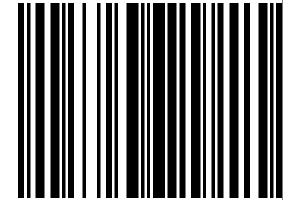


266 MCDERMOT AVE Winnipeg MB R3B 0S8 P: 204.480.8421 F: 204.480.8876

1702 QUADRA STREET + 862 FISGARD STREET

SITE SURVEY

0650 Sheet AG.9

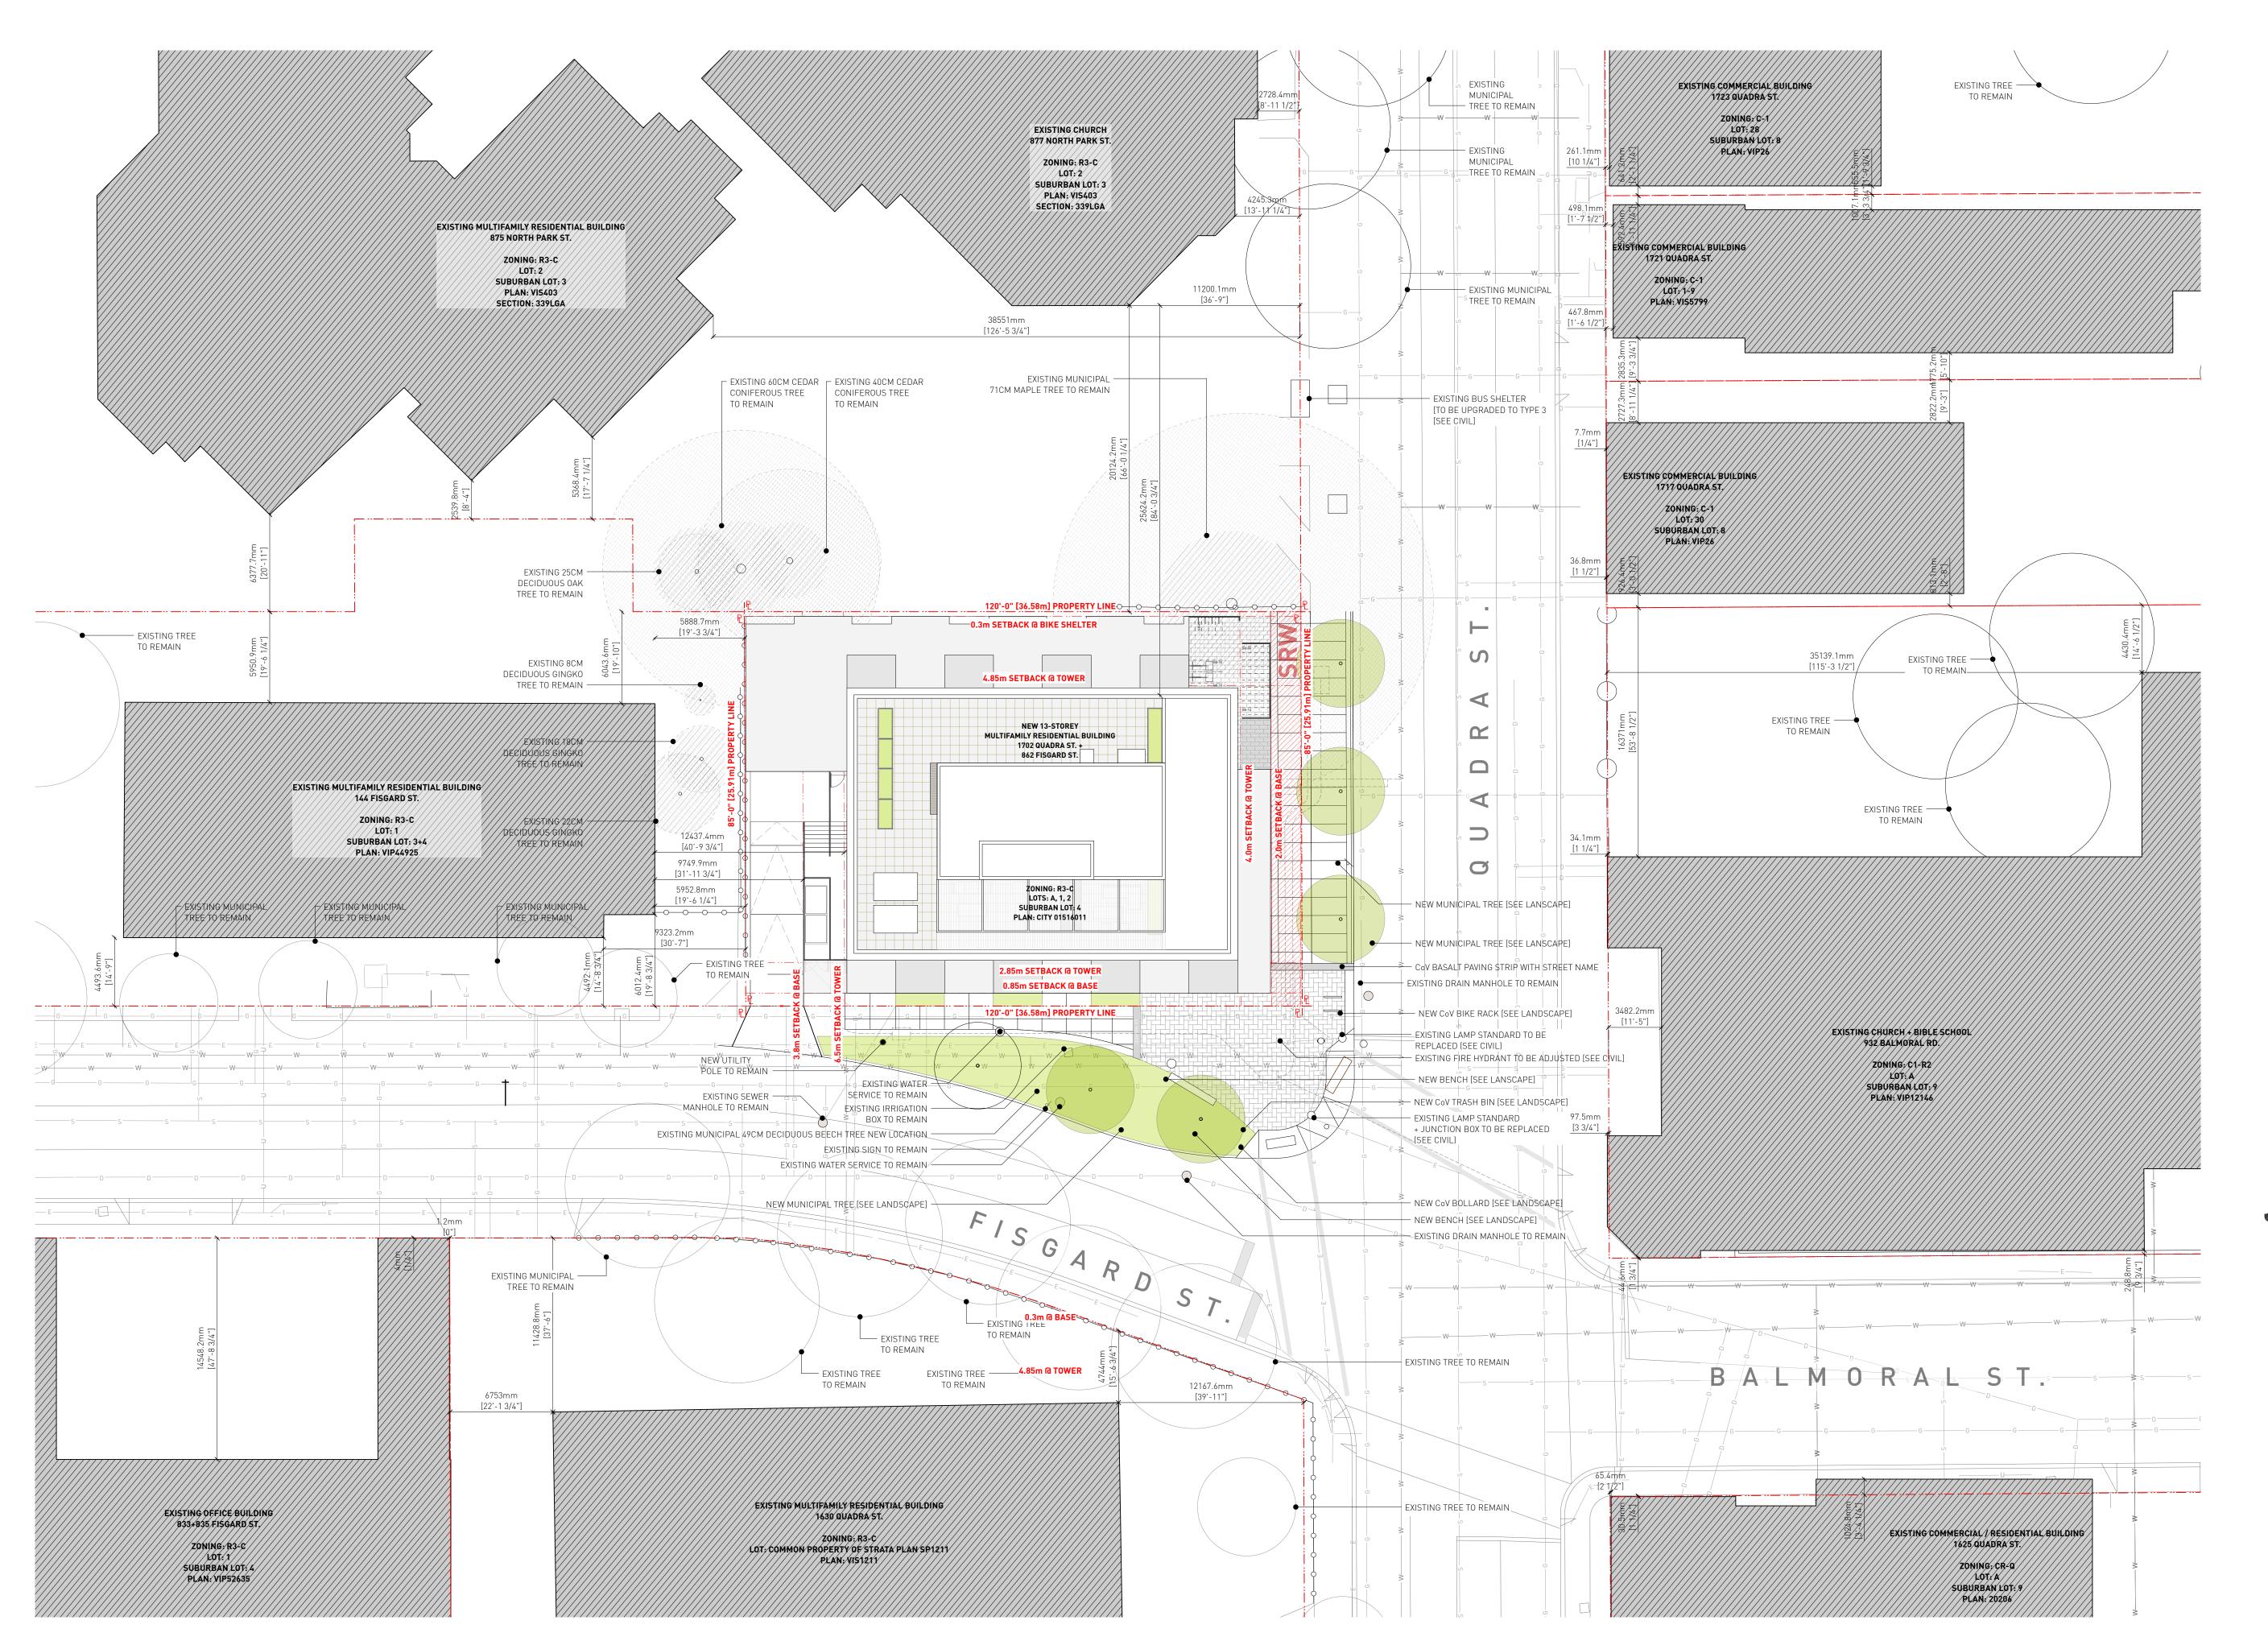

EXISTING BUILDING [TO BE DEMOLISHED]

EXISTING BUILDING

PROPOSED BUILDING PROPERTY LINE SETBACK LINE EXISTING FENCE _____G_____G_____

EXISTING WATER MAIN _____s___s___s____s EXISTING SANITARY LINE _____D____D_____ EXISTING DRAIN LINE

EXISTING TREE [TO BE REMOVED]

EXISTING GAS LINE

EXISTING TREE

EXISTING TREE ROOT AREA

EXISTING TREE ROOT AREA [TO BE REMOVED]

EXISTING HYDRO POLE EXISTING FIRE HYDRANT

4 Issued for DDP 26.05.2025 3 Issued for TRG2 response 14.12.2023 2 Issued for TRG1 response 21.09.2023

EA/MM/AR Checked By: 23.05.2025 Printing Date:

The Contractor shall verify all dimensions, datums and levels prior to commencement of work. All errors and omissions to be reported to the

Architect before proceeding. This drawing must not be scaled.

This drawing is the property of the Architect; the copyright in same being reserved to him/her. It is

Any unauthorized alteration of the electronic data which constitute this document will void all responsibility for the altered document by the Architect.

This drawing is not to be used for building purposes until countersigned by:





266 MCDERMOT AVE Winnipeg MB R3B 0S8 P: 204.480.8421 F: 204.480.8876


1702 QUADRA STREET + 862 FISGARD STREET

CONTEXT SITE PLAN


Project 0650 Sheet

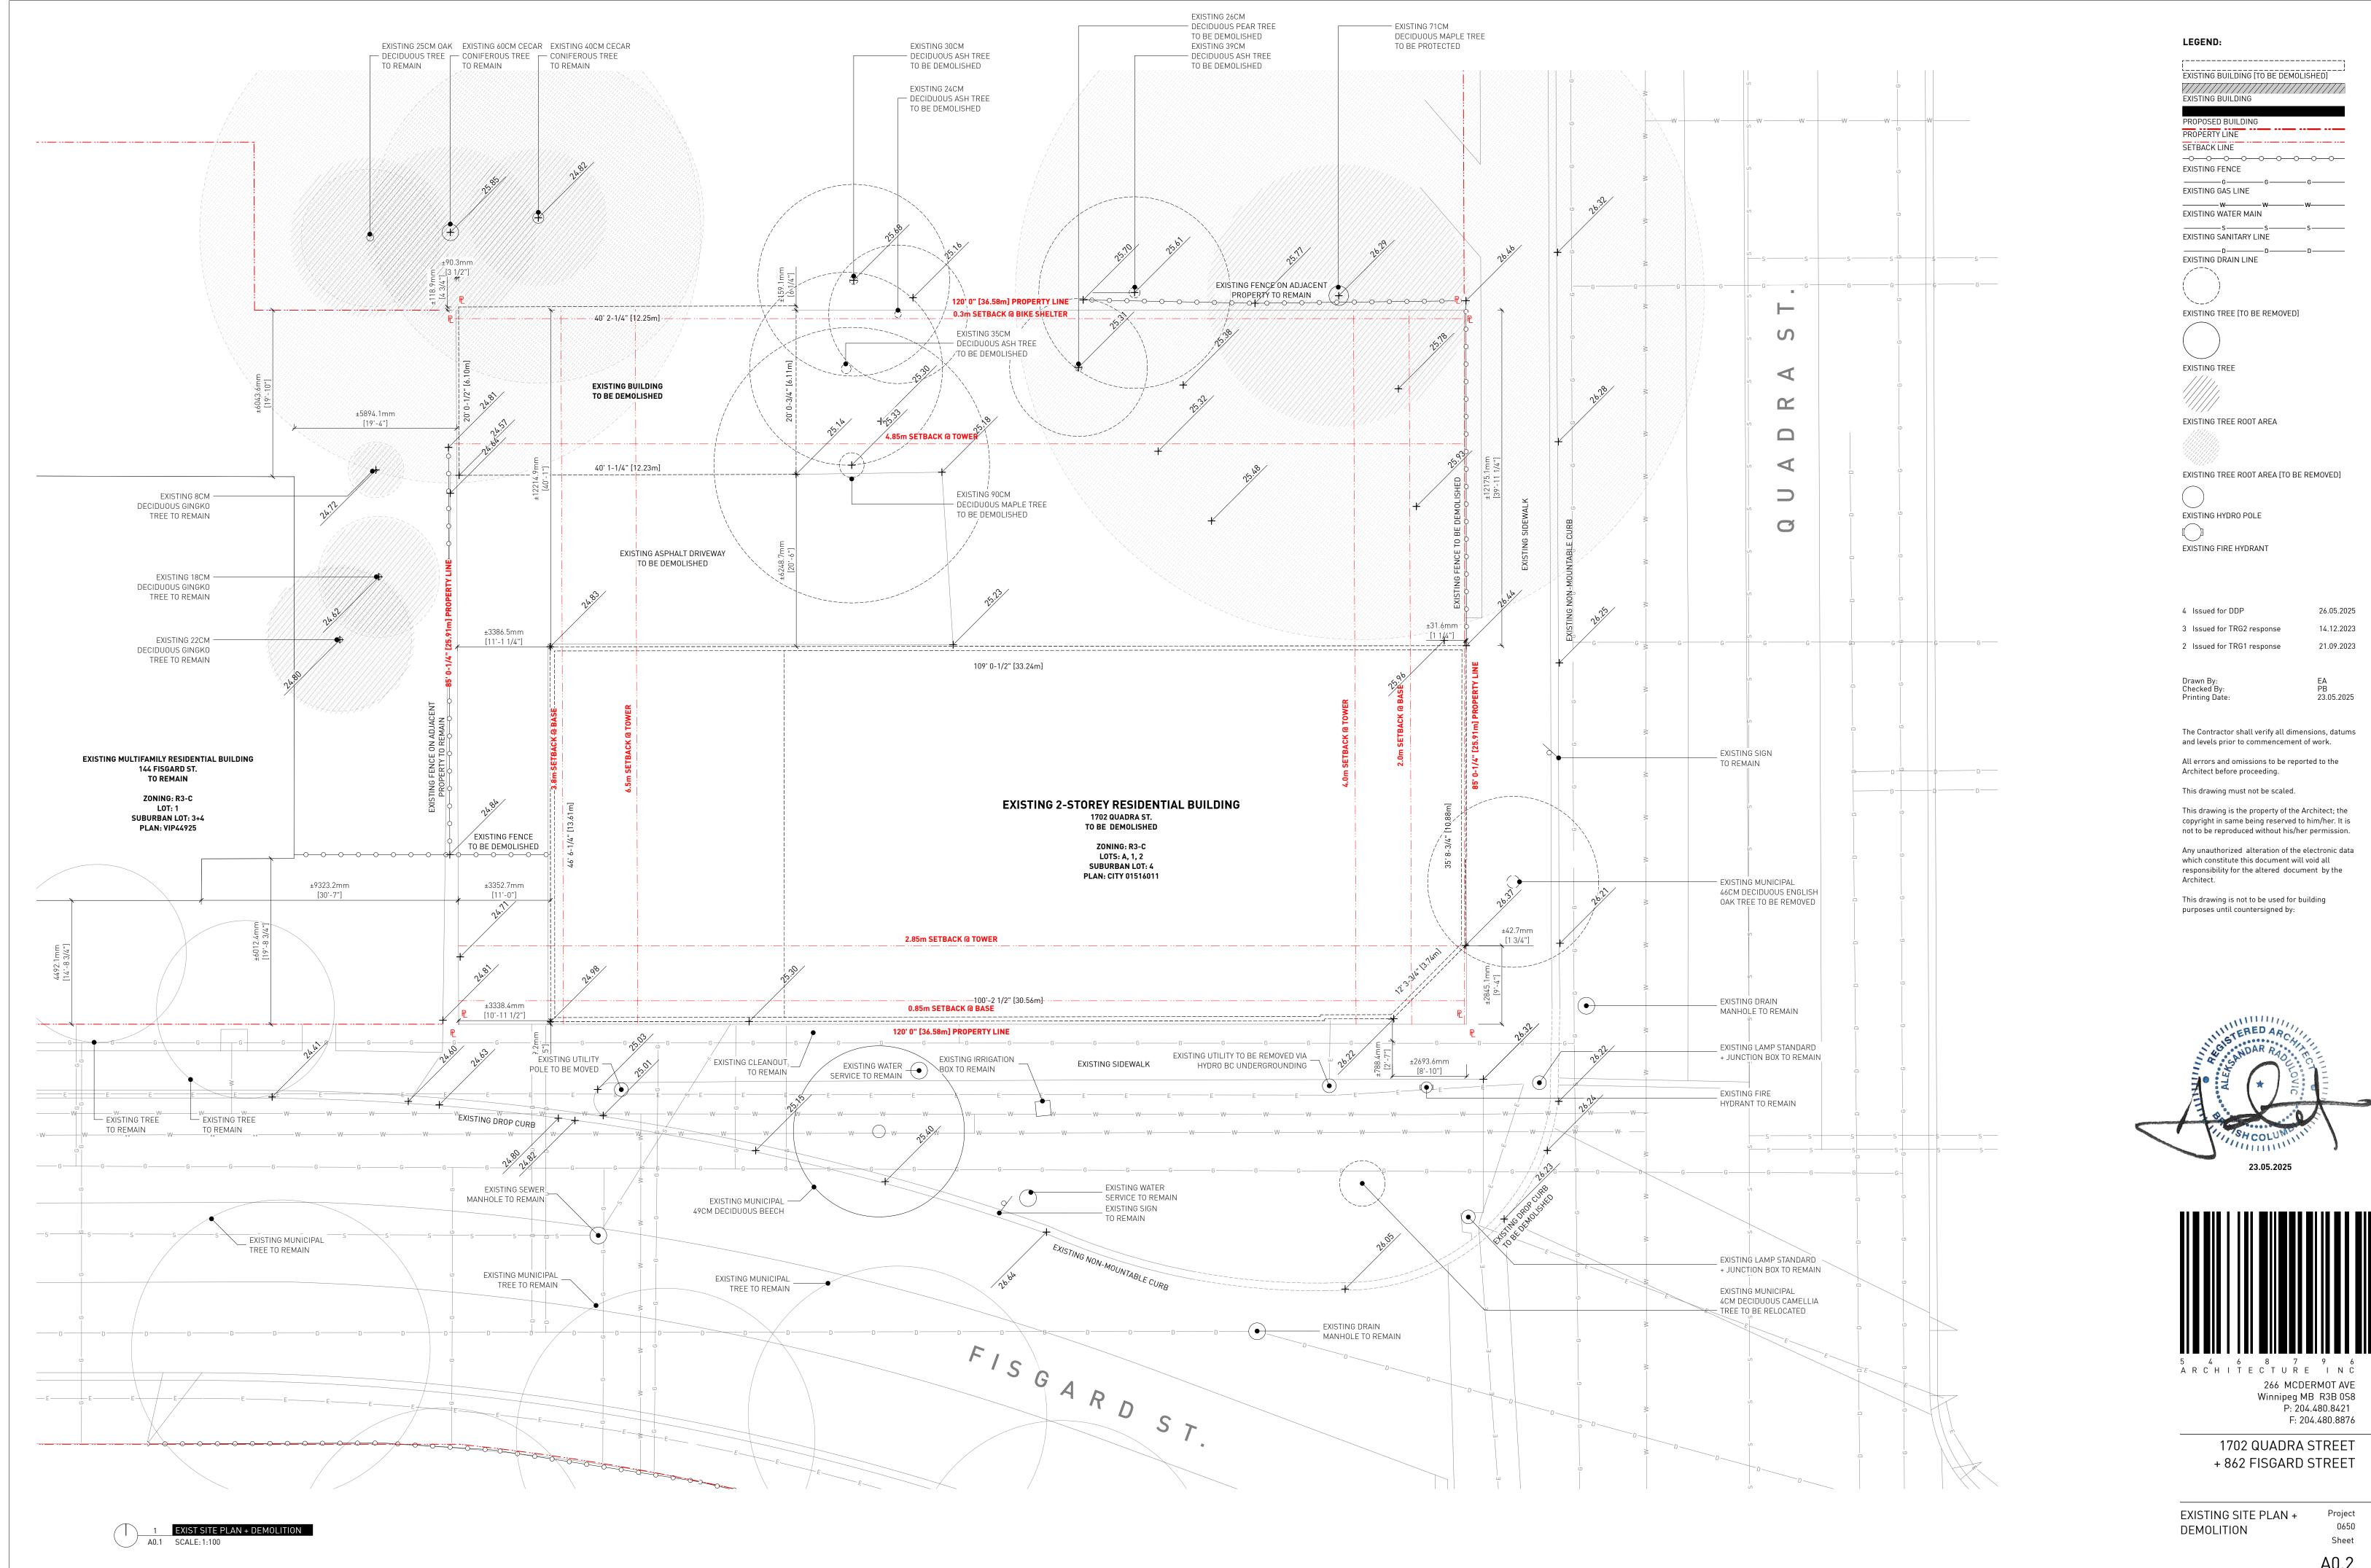

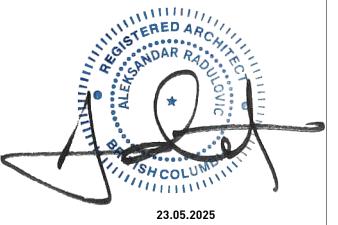


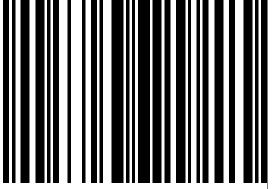

A0.2

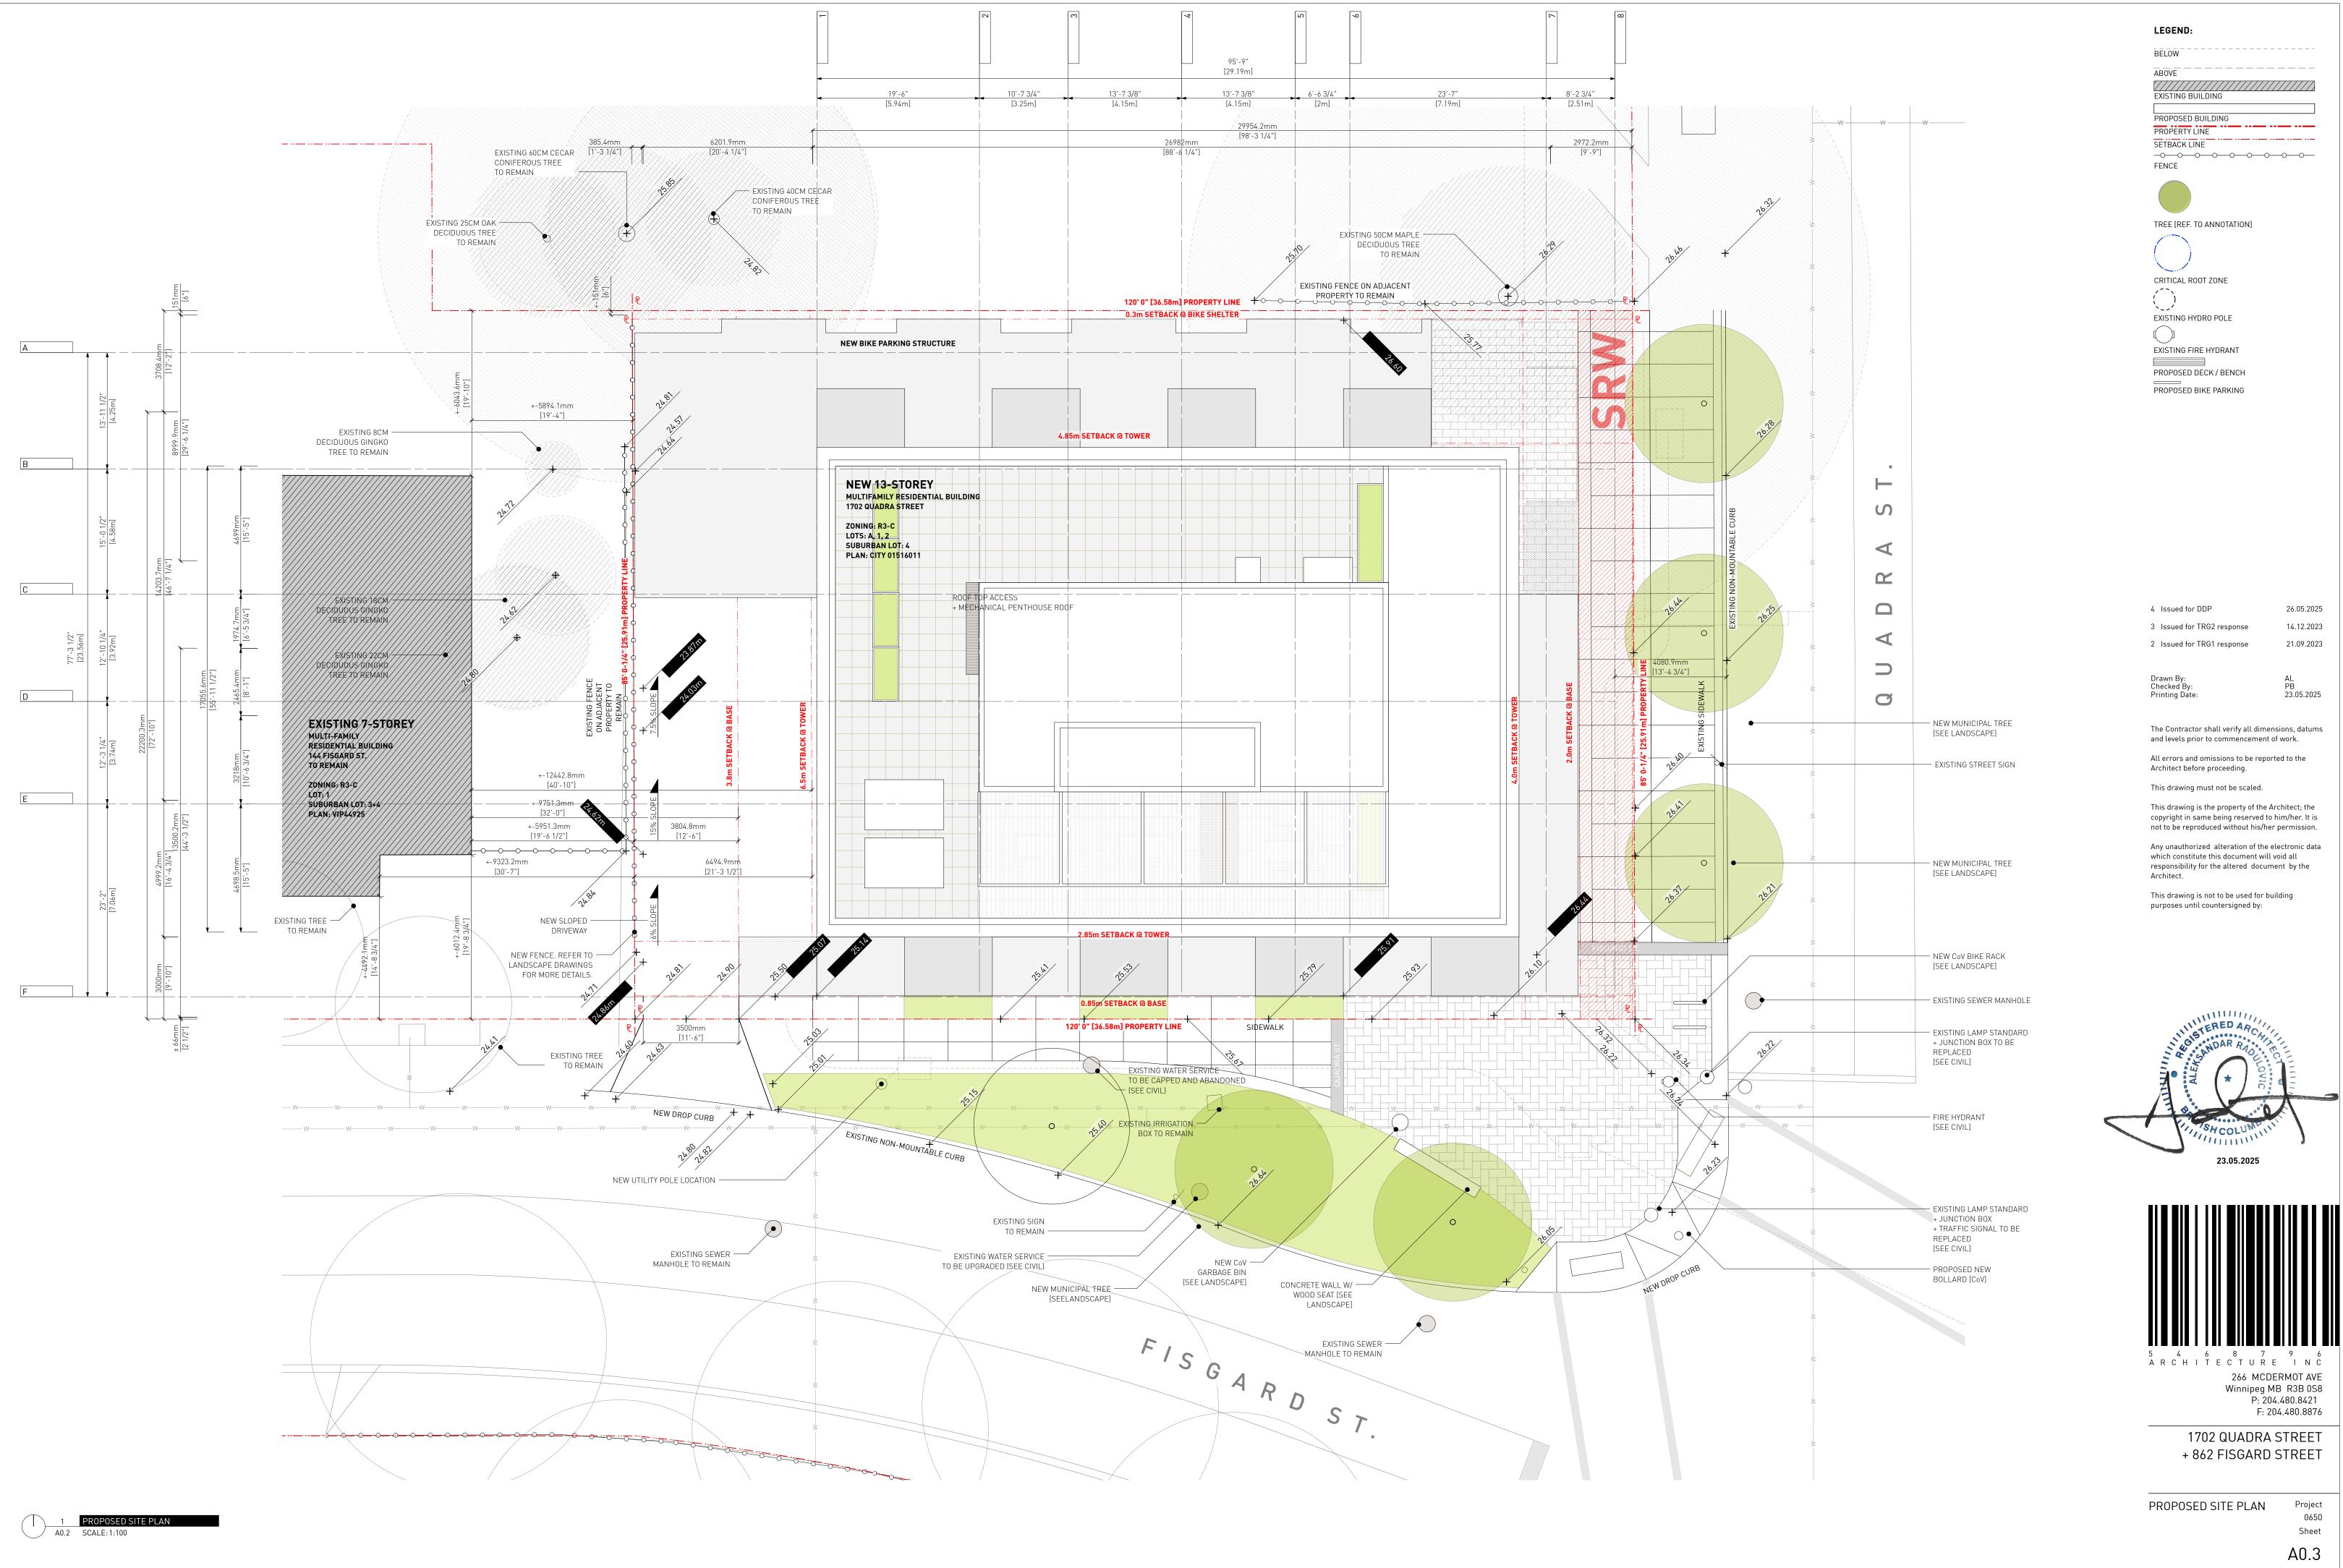



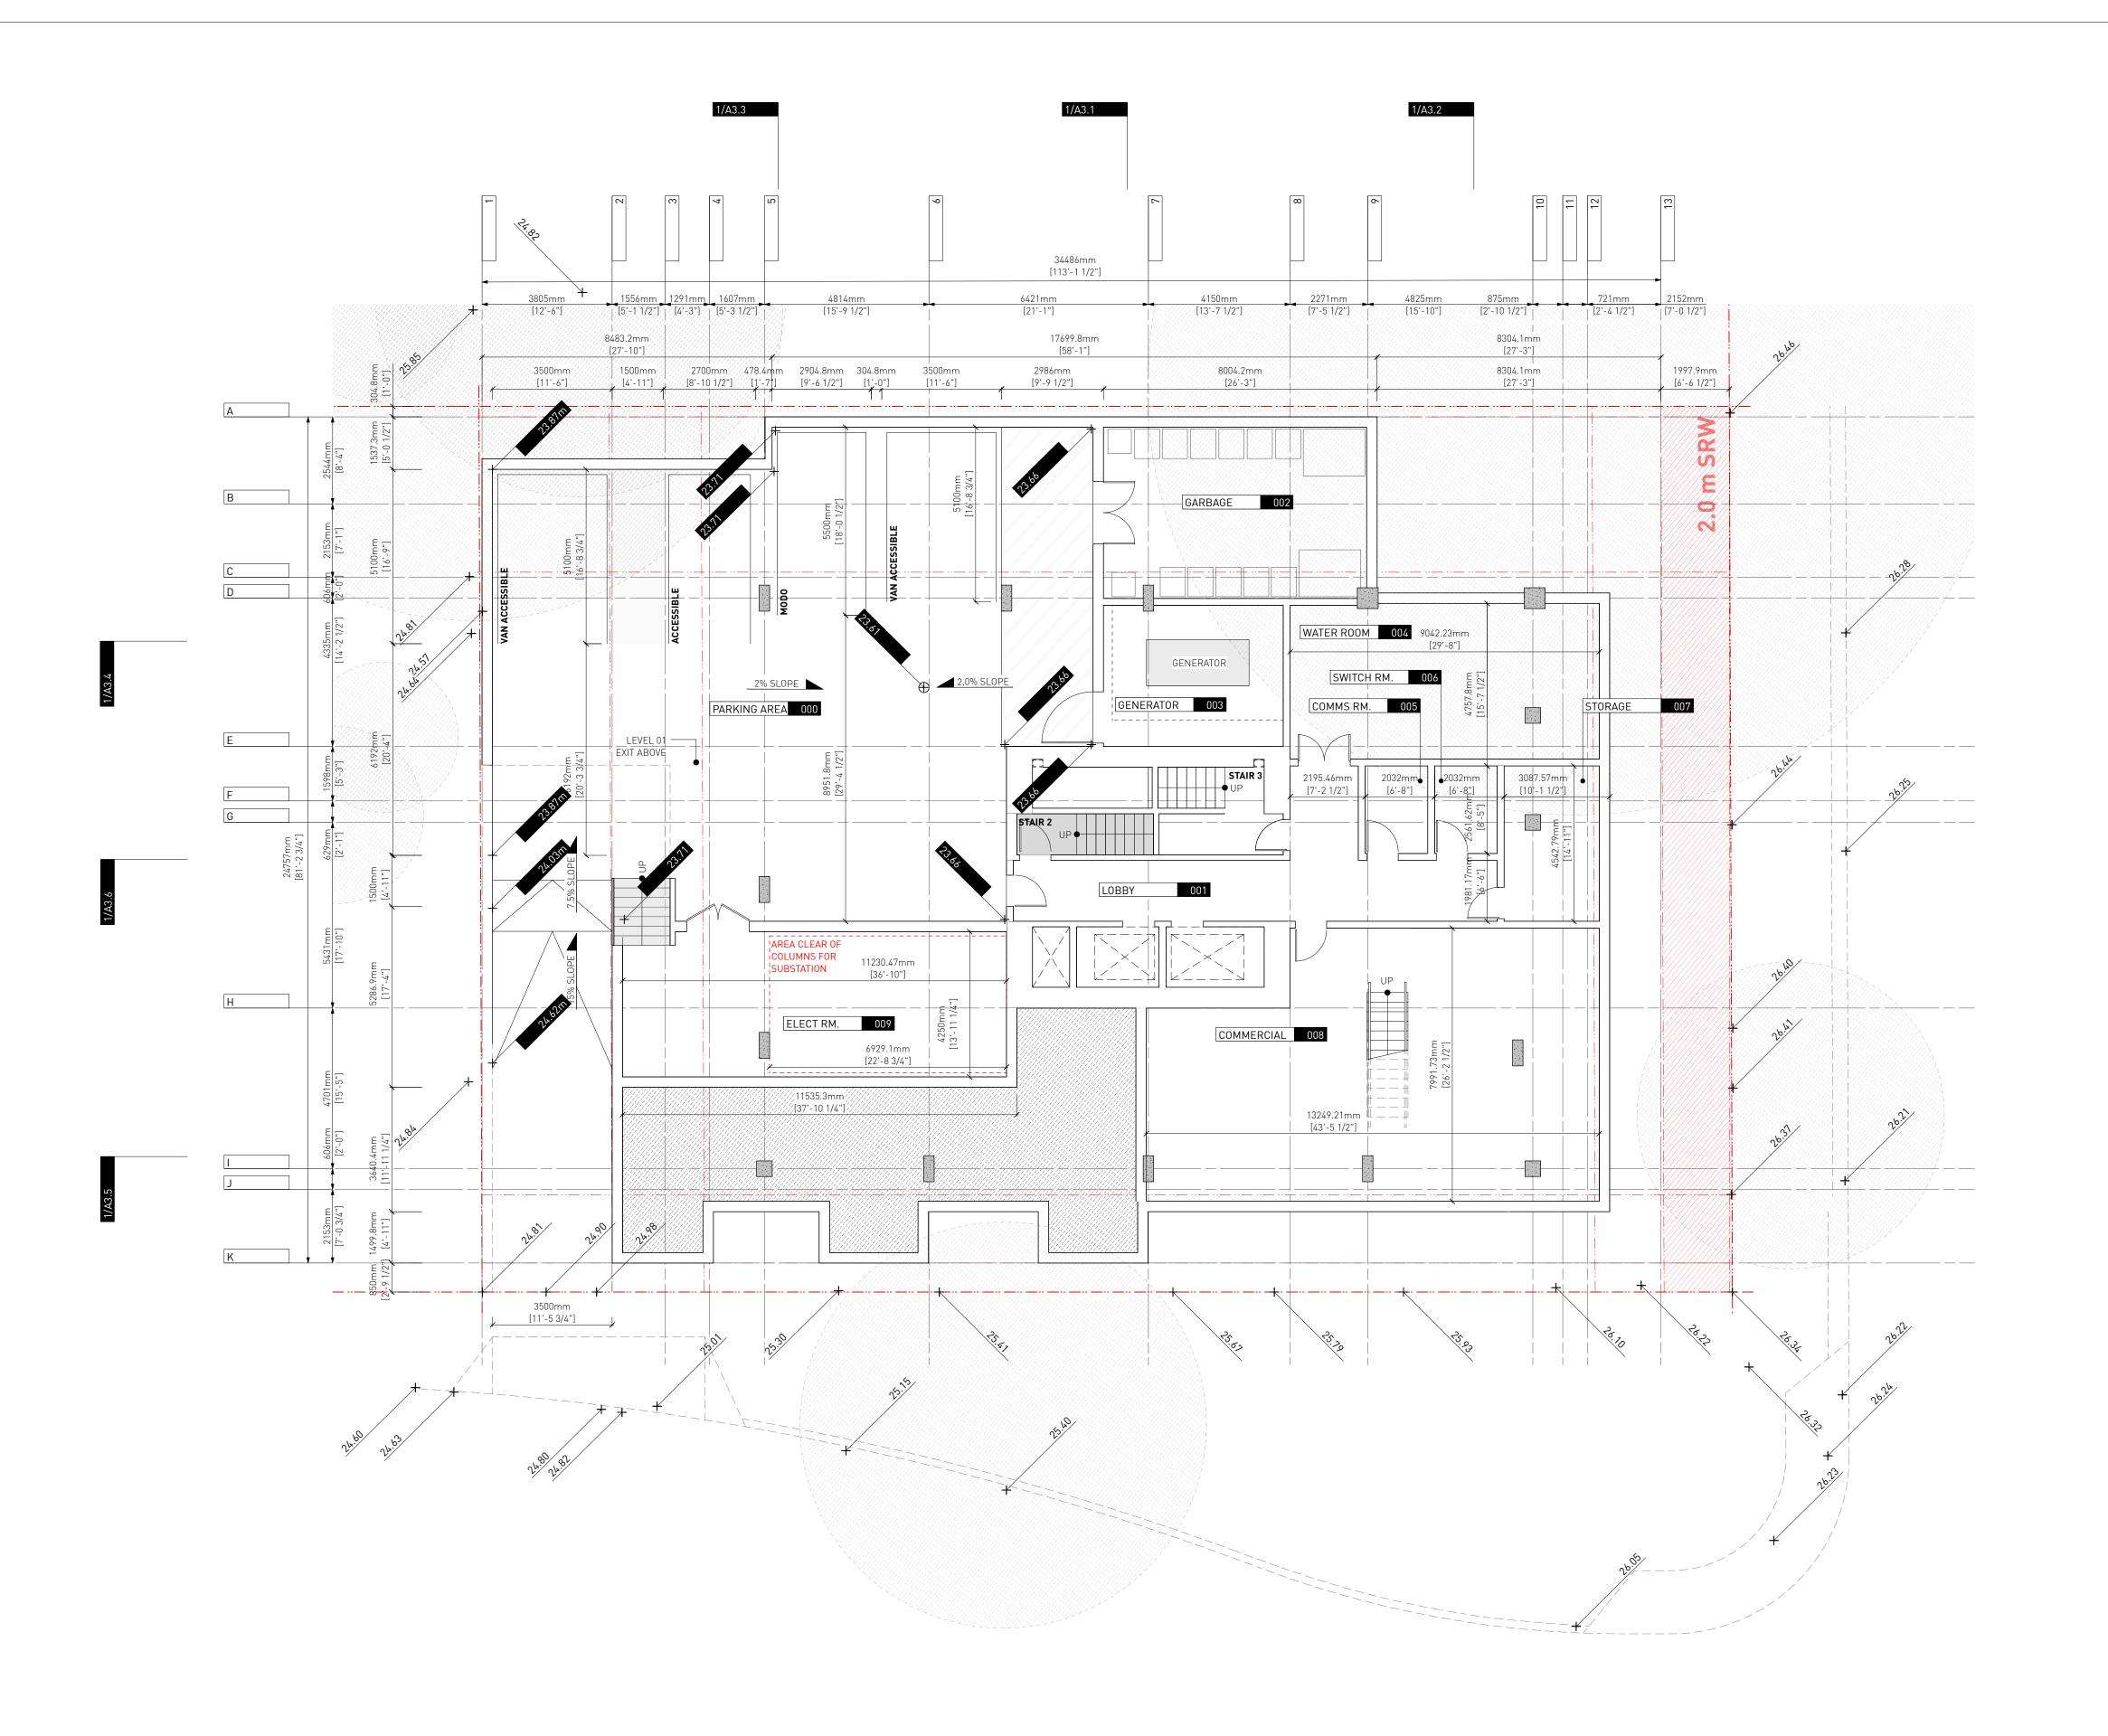


BELOW

ABOVE

EXISTING BUILDING

PROPOSED BUILDING
PROPERTY LINE
SETBACK LINE

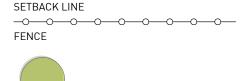

TREE [REF. TO ANNOTATION]

CRITICAL ROOT ZONE

EXISTING HYDRO POLE

EXISTING FIRE HYDRANT

PROPOSED DECK / BENCH
PROPOSED BIKE PARKING

4 Issued for DDP 26.05.2025
3 Issued for TRG2 response 14.12.2023

2 Issued for TRG1 response

Drawn By: EA / PB
Checked By: PB
Printing Date: 23.05.2025

21.09.2023

The Contractor shall verify all dimensions, datums and levels prior to commencement of work.

All errors and omissions to be reported to the Architect before proceeding.

This drawing must not be scaled.

This drawing is the property of the Architect; the


copyright in same being reserved to him/her. It is not to be reproduced without his/her permission.

Any unauthorized alteration of the electronic data which constitute this document will void all responsibility for the altered document by the Architect.

This drawing is not to be used for building purposes until countersigned by:



23.05.2025

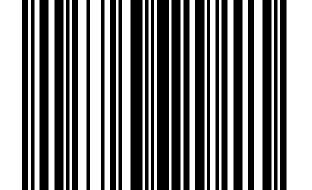


5 4 6 8 7 9 6 A R C H I T E C T U R E I N C 266 MCDERMOT AVE Winnipeg MB R3B 0S8 P: 204.480.8421 F: 204.480.8876

1702 QUADRA STREET + 862 FISGARD STREET

LEVEL 00 PLAN

Project 0650 Sheet A1.1

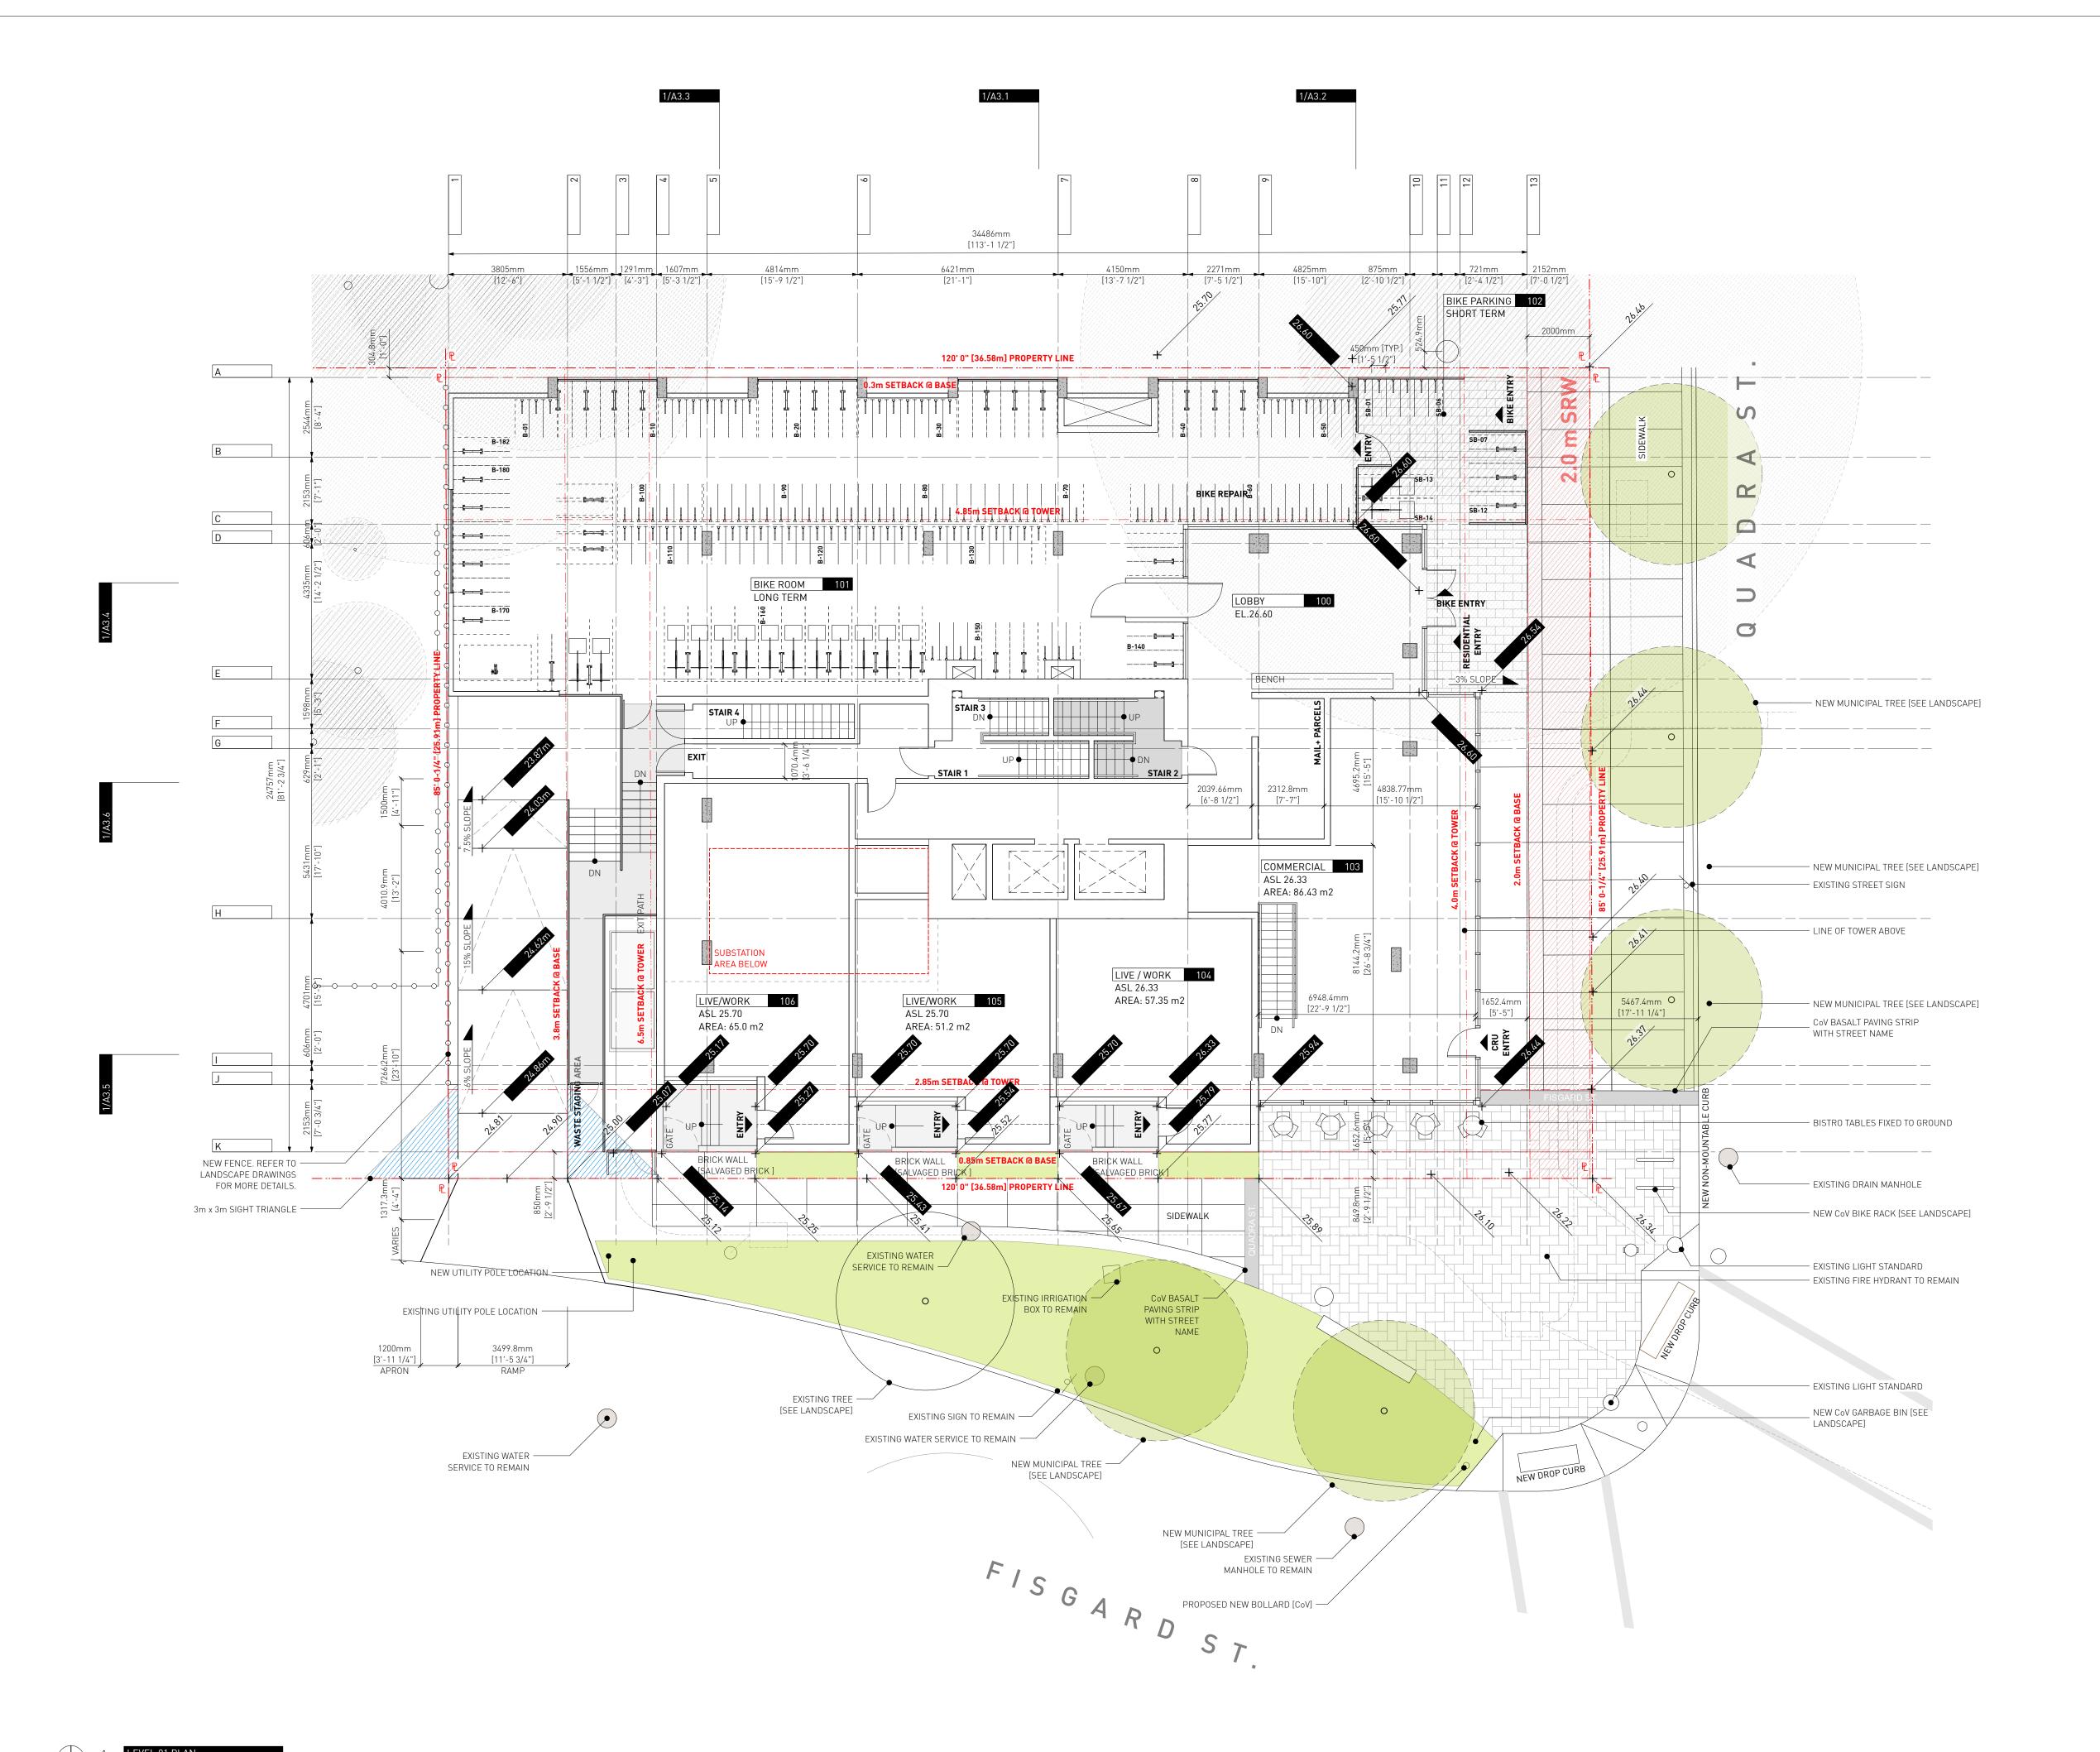

EXISTING BUILDING

PROPOSED BUILDING PROPERTY LINE SETBACK LINE

-

TREE [REF. TO ANNOTATION]

CRITICAL ROOT ZONE

EXISTING HYDRO POLE

EXISTING FIRE HYDRANT

PROPOSED DECK / BENCH

PROPOSED BIKE PARKING

4 Issued for DDP 3 Issued for TRG2 response

2 Issued for TRG1 response

Drawn By: Checked By: 23.05.2025 Printing Date:

26.05.2025

14.12.2023

21.09.2023

EA / PB

The Contractor shall verify all dimensions, datums and levels prior to commencement of work. All errors and omissions to be reported to the


Architect before proceeding. This drawing must not be scaled.


This drawing is the property of the Architect; the

copyright in same being reserved to him/her. It is Any unauthorized alteration of the electronic data

which constitute this document will void all responsibility for the altered document by the

This drawing is not to be used for building purposes until countersigned by:

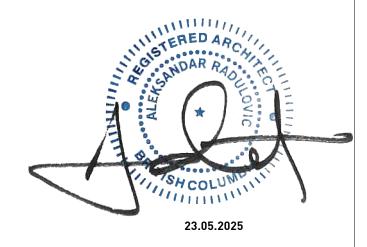

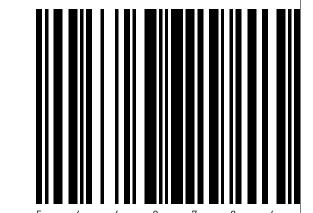


266 MCDERMOT AVE Winnipeg MB R3B 0S8 P: 204.480.8421 F: 204.480.8876

1702 QUADRA STREET + 862 FISGARD STREET

LEVEL 01 PLAN

Project 0650 Sheet

A1.2

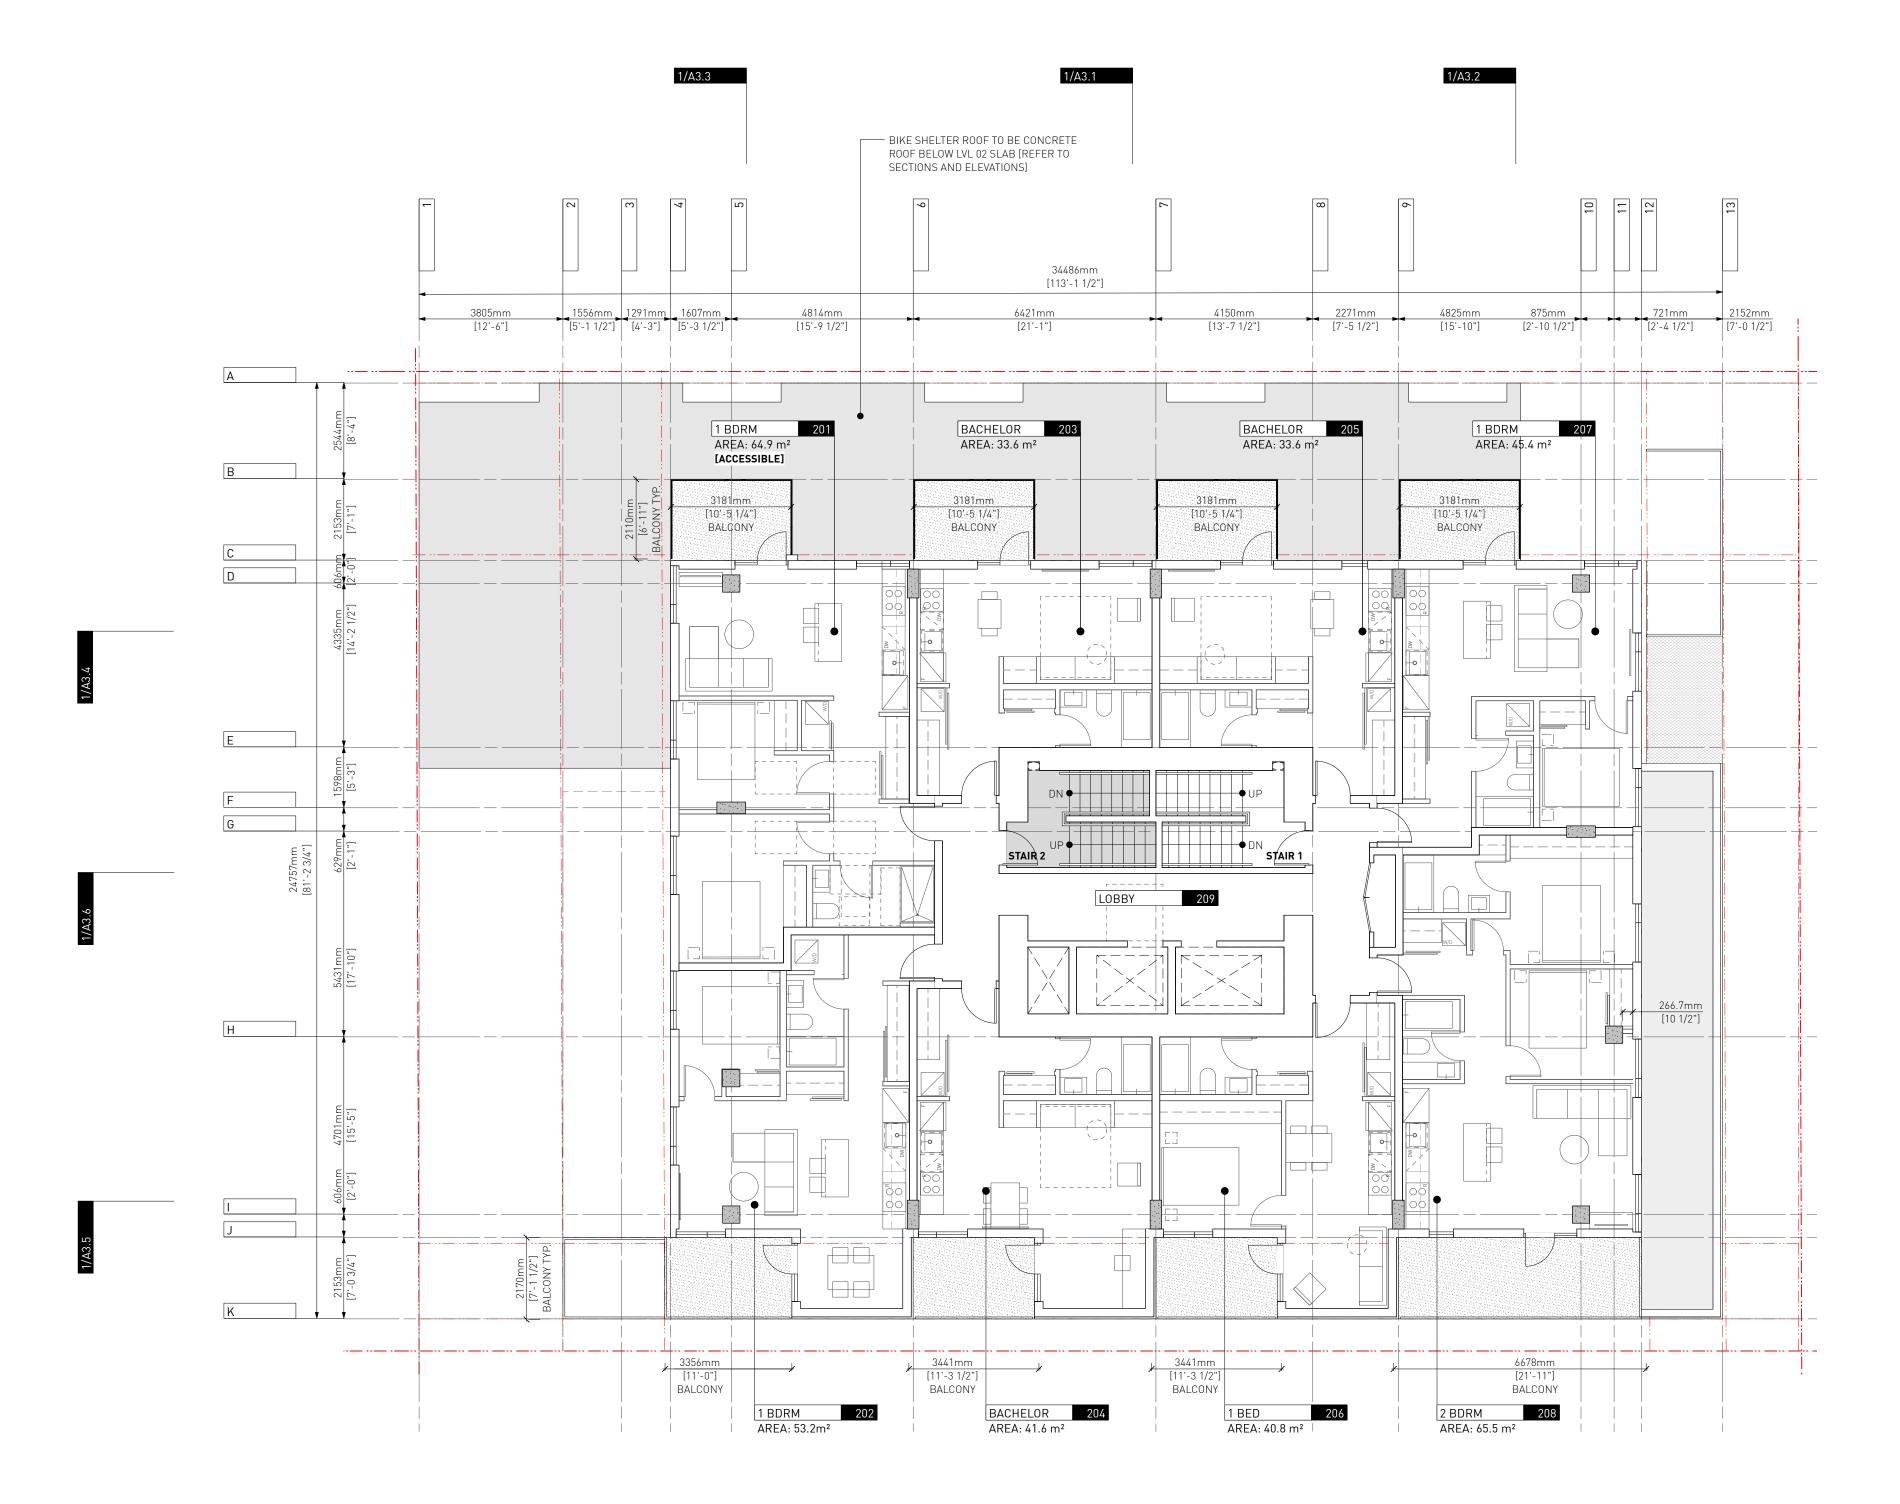

EXISTING BUILDING

PROPOSED BUILDING

PROPERTY LINE SETBACK LINE

4 Issued for DDP 3 Issued for TRG2 response

2 Issued for TRG1 response

Drawn By: Checked By: Printing Date: PB 23.05.2025

The Contractor shall verify all dimensions, datums

26.05.2025

14.12.2023

21.09.2023

EA / MM

and levels prior to commencement of work. All errors and omissions to be reported to the

Architect before proceeding.

This drawing must not be scaled.


This drawing is the property of the Architect; the copyright in same being reserved to him/her. It is

Any unauthorized alteration of the electronic data which constitute this document will void all responsibility for the altered document by the Architect.

This drawing is not to be used for building purposes until countersigned by:



23.05.2025

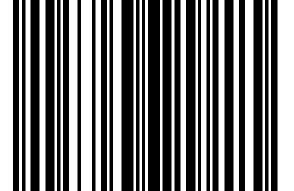



266 MCDERMOT AVE Winnipeg MB R3B 0S8 P: 204.480.8421 F: 204.480.8876

1702 QUADRA STREET + 862 FISGARD STREET

LEVEL 02 PLAN

Project 0650 Sheet A1.3

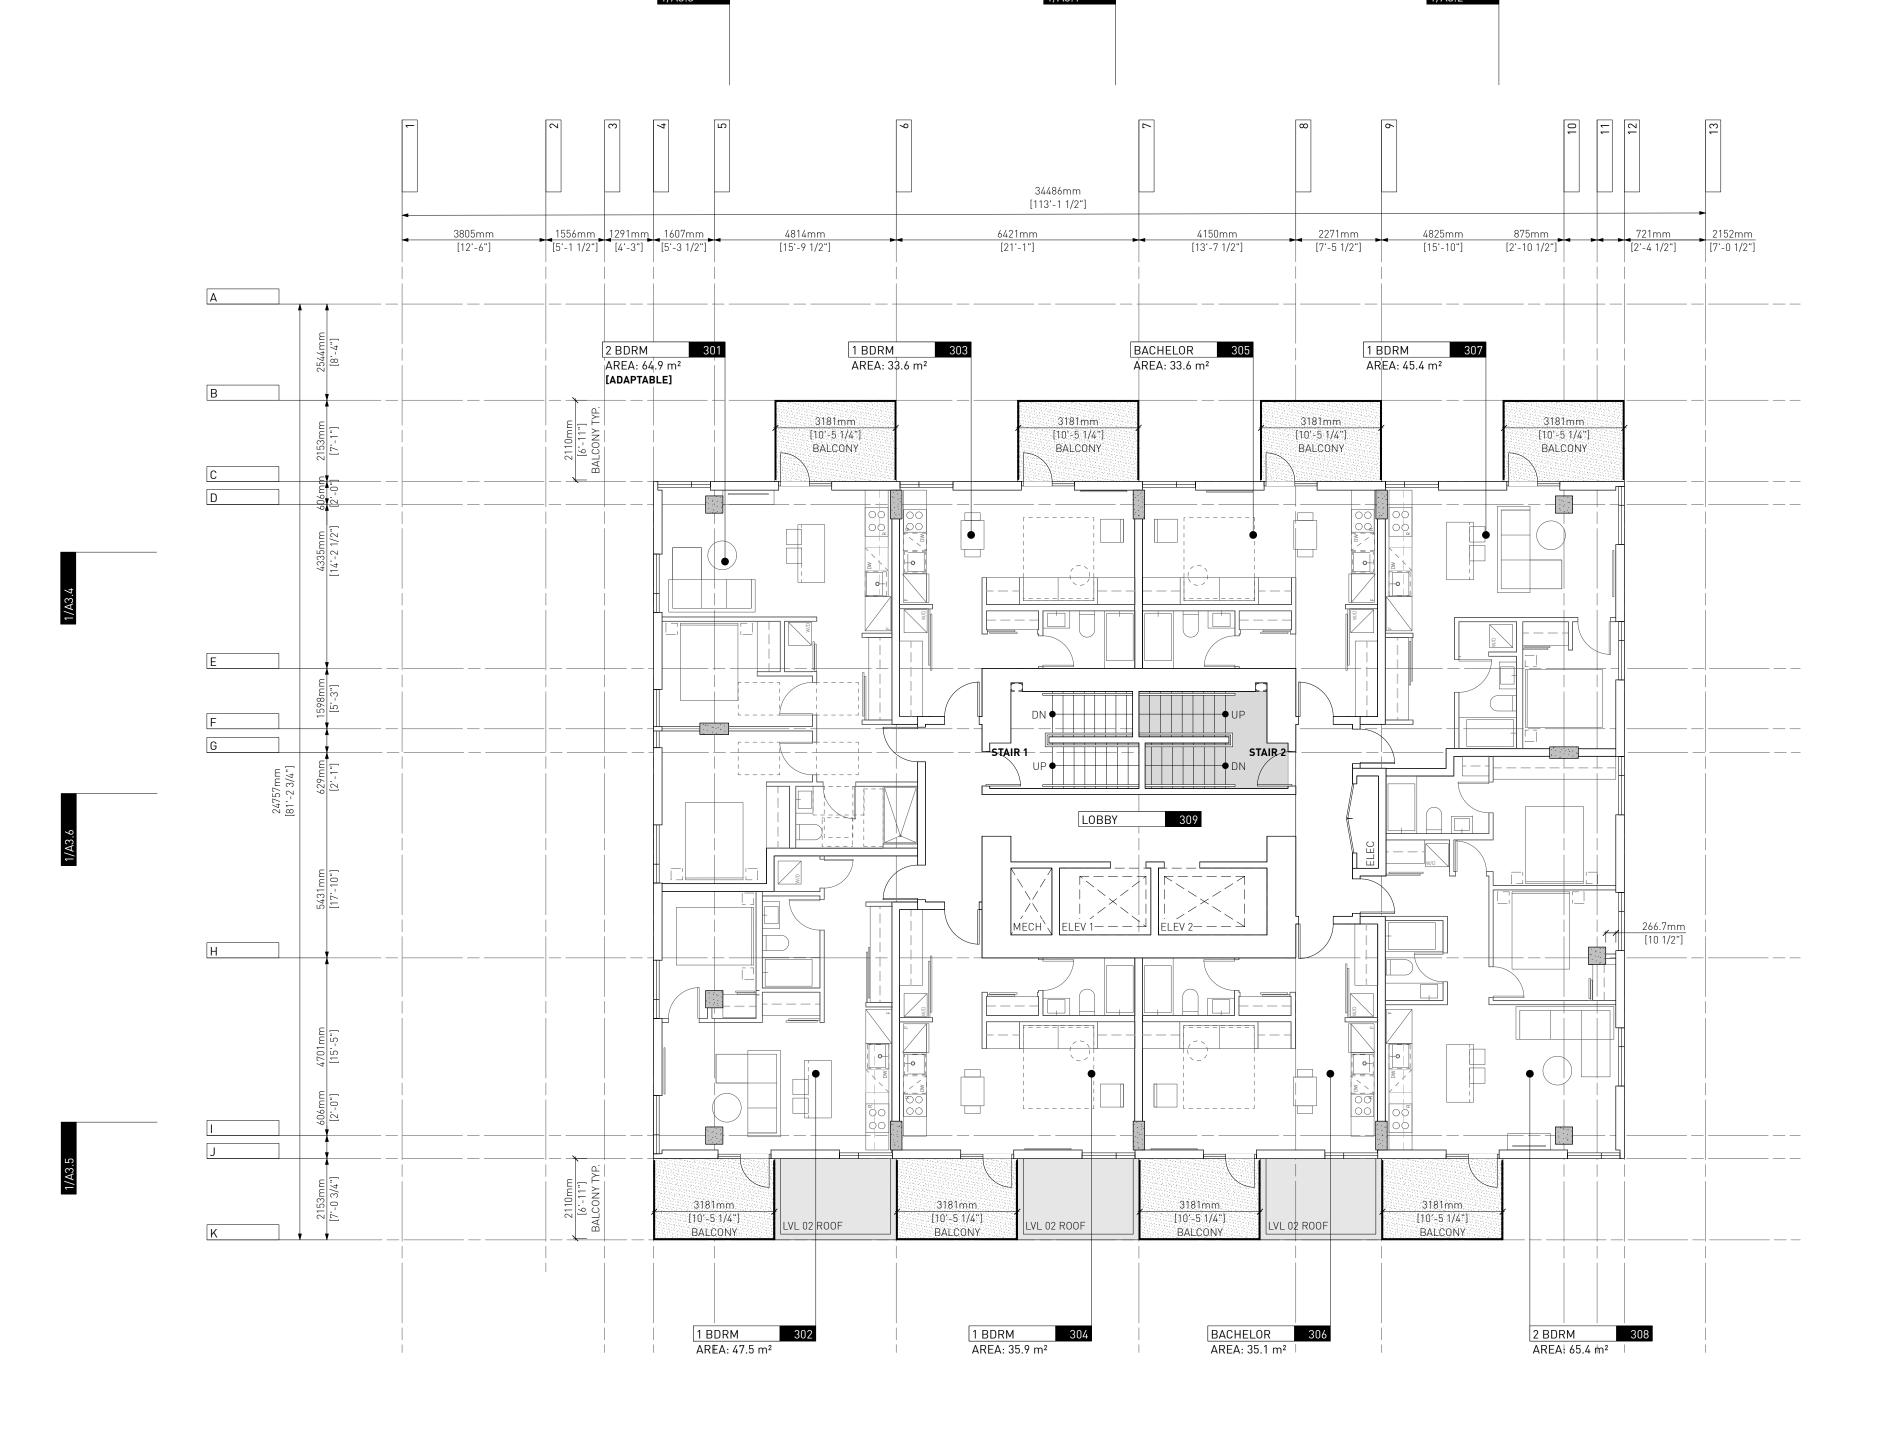

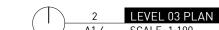

BELOW

EXISTING BUILDING

PROPOSED BUILDING

PROPERTY LINE SETBACK LINE

4 Issued for DDP 26.05.2025 3 Issued for TRG2 response 14.12.2023 2 Issued for TRG1 response 21.09.2023

Drawn By: Checked By: Printing Date: PB 23.05.2025 The Contractor shall verify all dimensions, datums

and levels prior to commencement of work.

EA / MM

All errors and omissions to be reported to the

Architect before proceeding. This drawing must not be scaled.

This drawing is the property of the Architect; the


copyright in same being reserved to him/her. It is

Any unauthorized alteration of the electronic data which constitute this document will void all responsibility for the altered document by the Architect.

This drawing is not to be used for building purposes until countersigned by:



23.05.2025

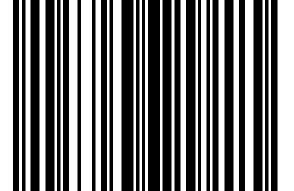


266 MCDERMOT AVE Winnipeg MB R3B 0S8 P: 204.480.8421 F: 204.480.8876

1702 QUADRA STREET + 862 FISGARD STREET

LEVEL 03 PLAN

Project 0650 Sheet A1.4

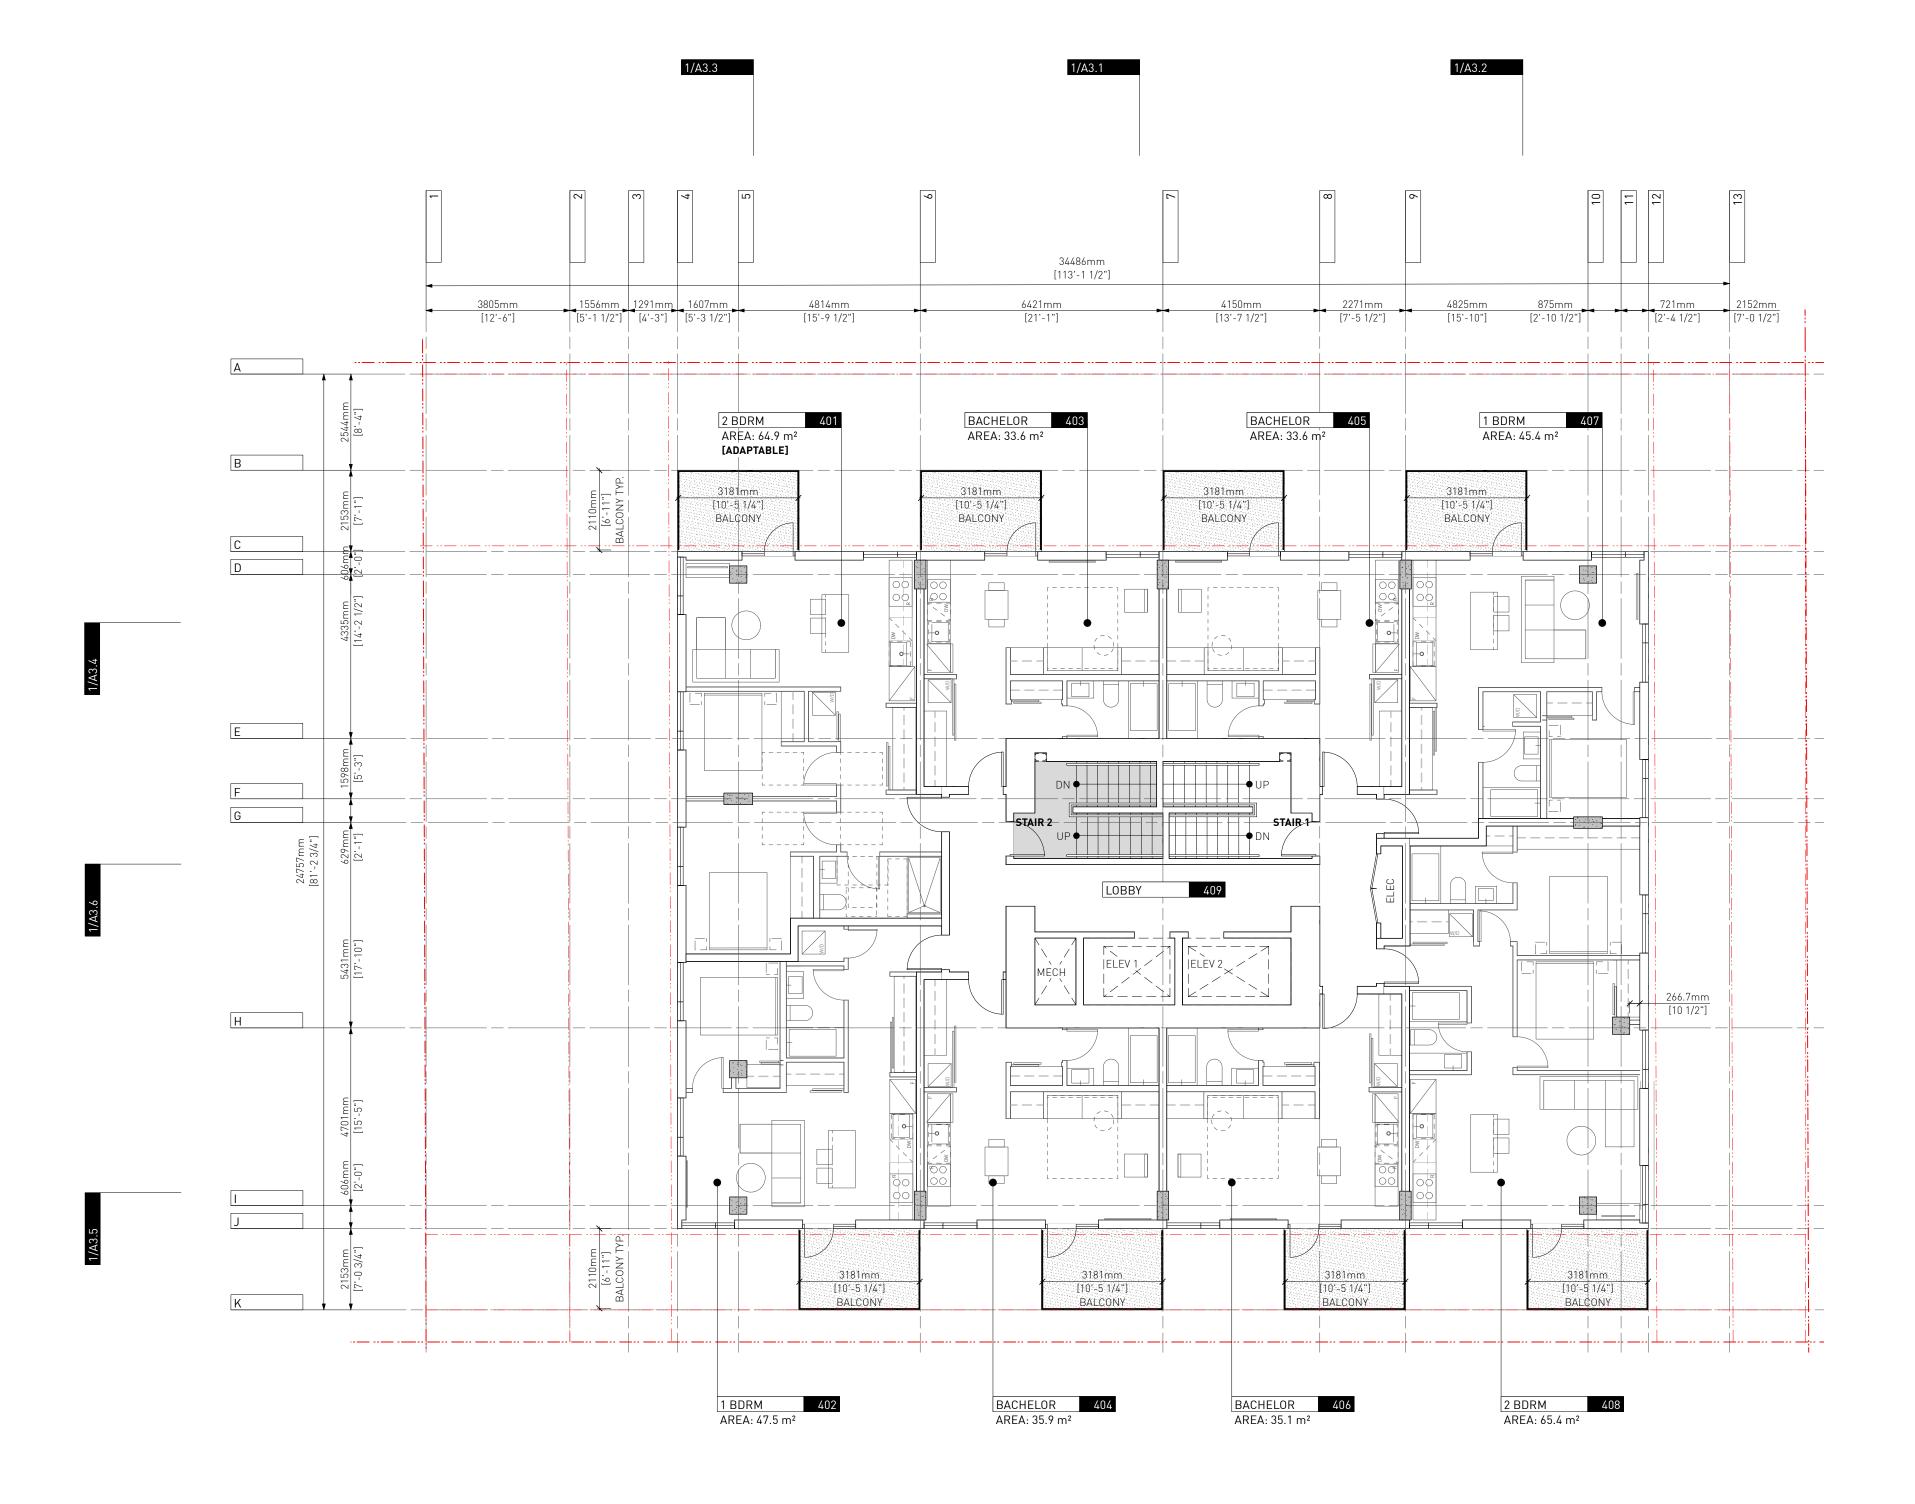

2 LEVEL 04 / 06 / 08 / 10 / 12 A1.5 SCALE: 1:100

LEGEND:

4 Issued for DDP

Drawn By: Checked By: Printing Date:

3 Issued for TRG2 response

2 Issued for TRG1 response

Architect before proceeding.

This drawing must not be scaled.

26.05.2025

14.12.2023

21.09.2023

EA / MM PB 23.05.2025

EXISTING BUILDING

PROPOSED BUILDING PROPERTY LINE

SETBACK LINE


responsibility for the altered document by the Architect. This drawing is not to be used for building purposes until countersigned by:

The Contractor shall verify all dimensions, datums and levels prior to commencement of work.

All errors and omissions to be reported to the

This drawing is the property of the Architect; the copyright in same being reserved to him/her. It is

Any unauthorized alteration of the electronic data which constitute this document will void all

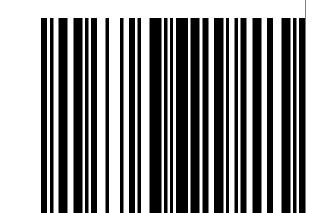


23.05.2025

266 MCDERMOT AVE Winnipeg MB R3B 0S8 P: 204.480.8421 F: 204.480.8876

1702 QUADRA STREET + 862 FISGARD STREET

LEVEL 04/06/08/10/12

Sheet A1.5

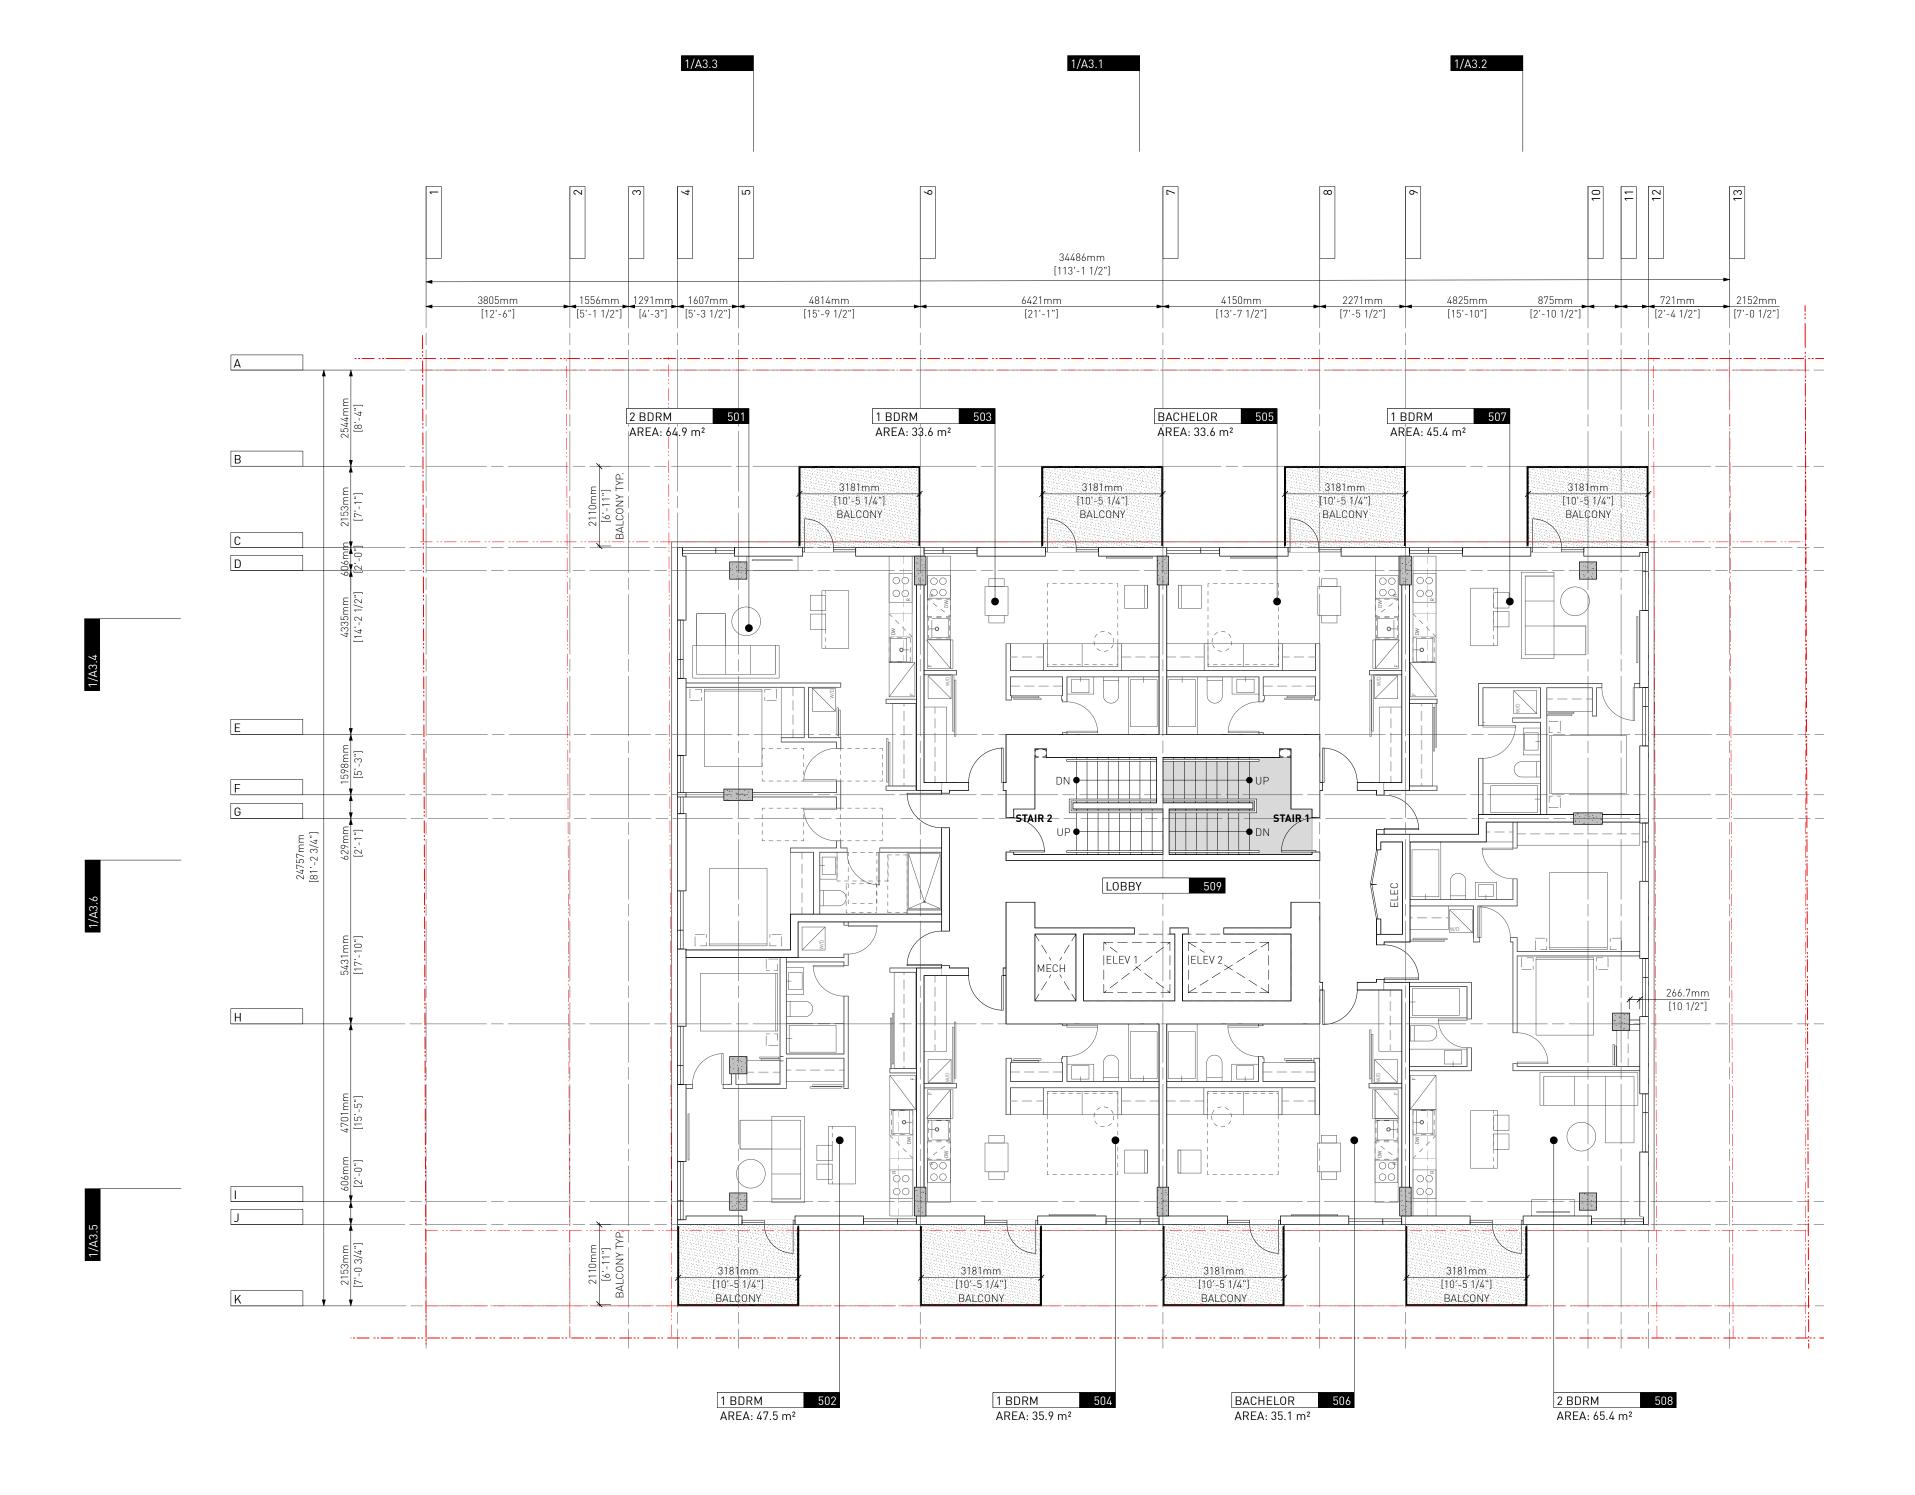

EXISTING BUILDING

PROPOSED BUILDING

PROPERTY LINE SETBACK LINE

4 Issued for DDP 26.05.2025 3 Issued for TRG2 response 14.12.2023

2 Issued for TRG1 response

The Contractor shall verify all dimensions, datums

and levels prior to commencement of work.

21.09.2023

EA / MM PB 23.05.2025

All errors and omissions to be reported to the

Architect before proceeding.

This drawing must not be scaled.

Drawn By: Checked By: Printing Date:


This drawing is the property of the Architect; the copyright in same being reserved to him/her. It is

Any unauthorized alteration of the electronic data which constitute this document will void all responsibility for the altered document by the Architect.

This drawing is not to be used for building purposes until countersigned by:



23.05.2025

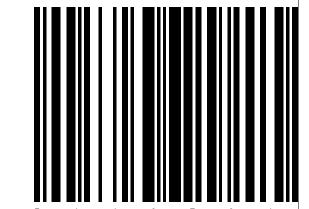


266 MCDERMOT AVE Winnipeg MB R3B 0S8 P: 204.480.8421 F: 204.480.8876

1702 QUADRA STREET + 862 FISGARD STREET

LEVEL 05/07/09/11

Project 0650 Sheet A1.6

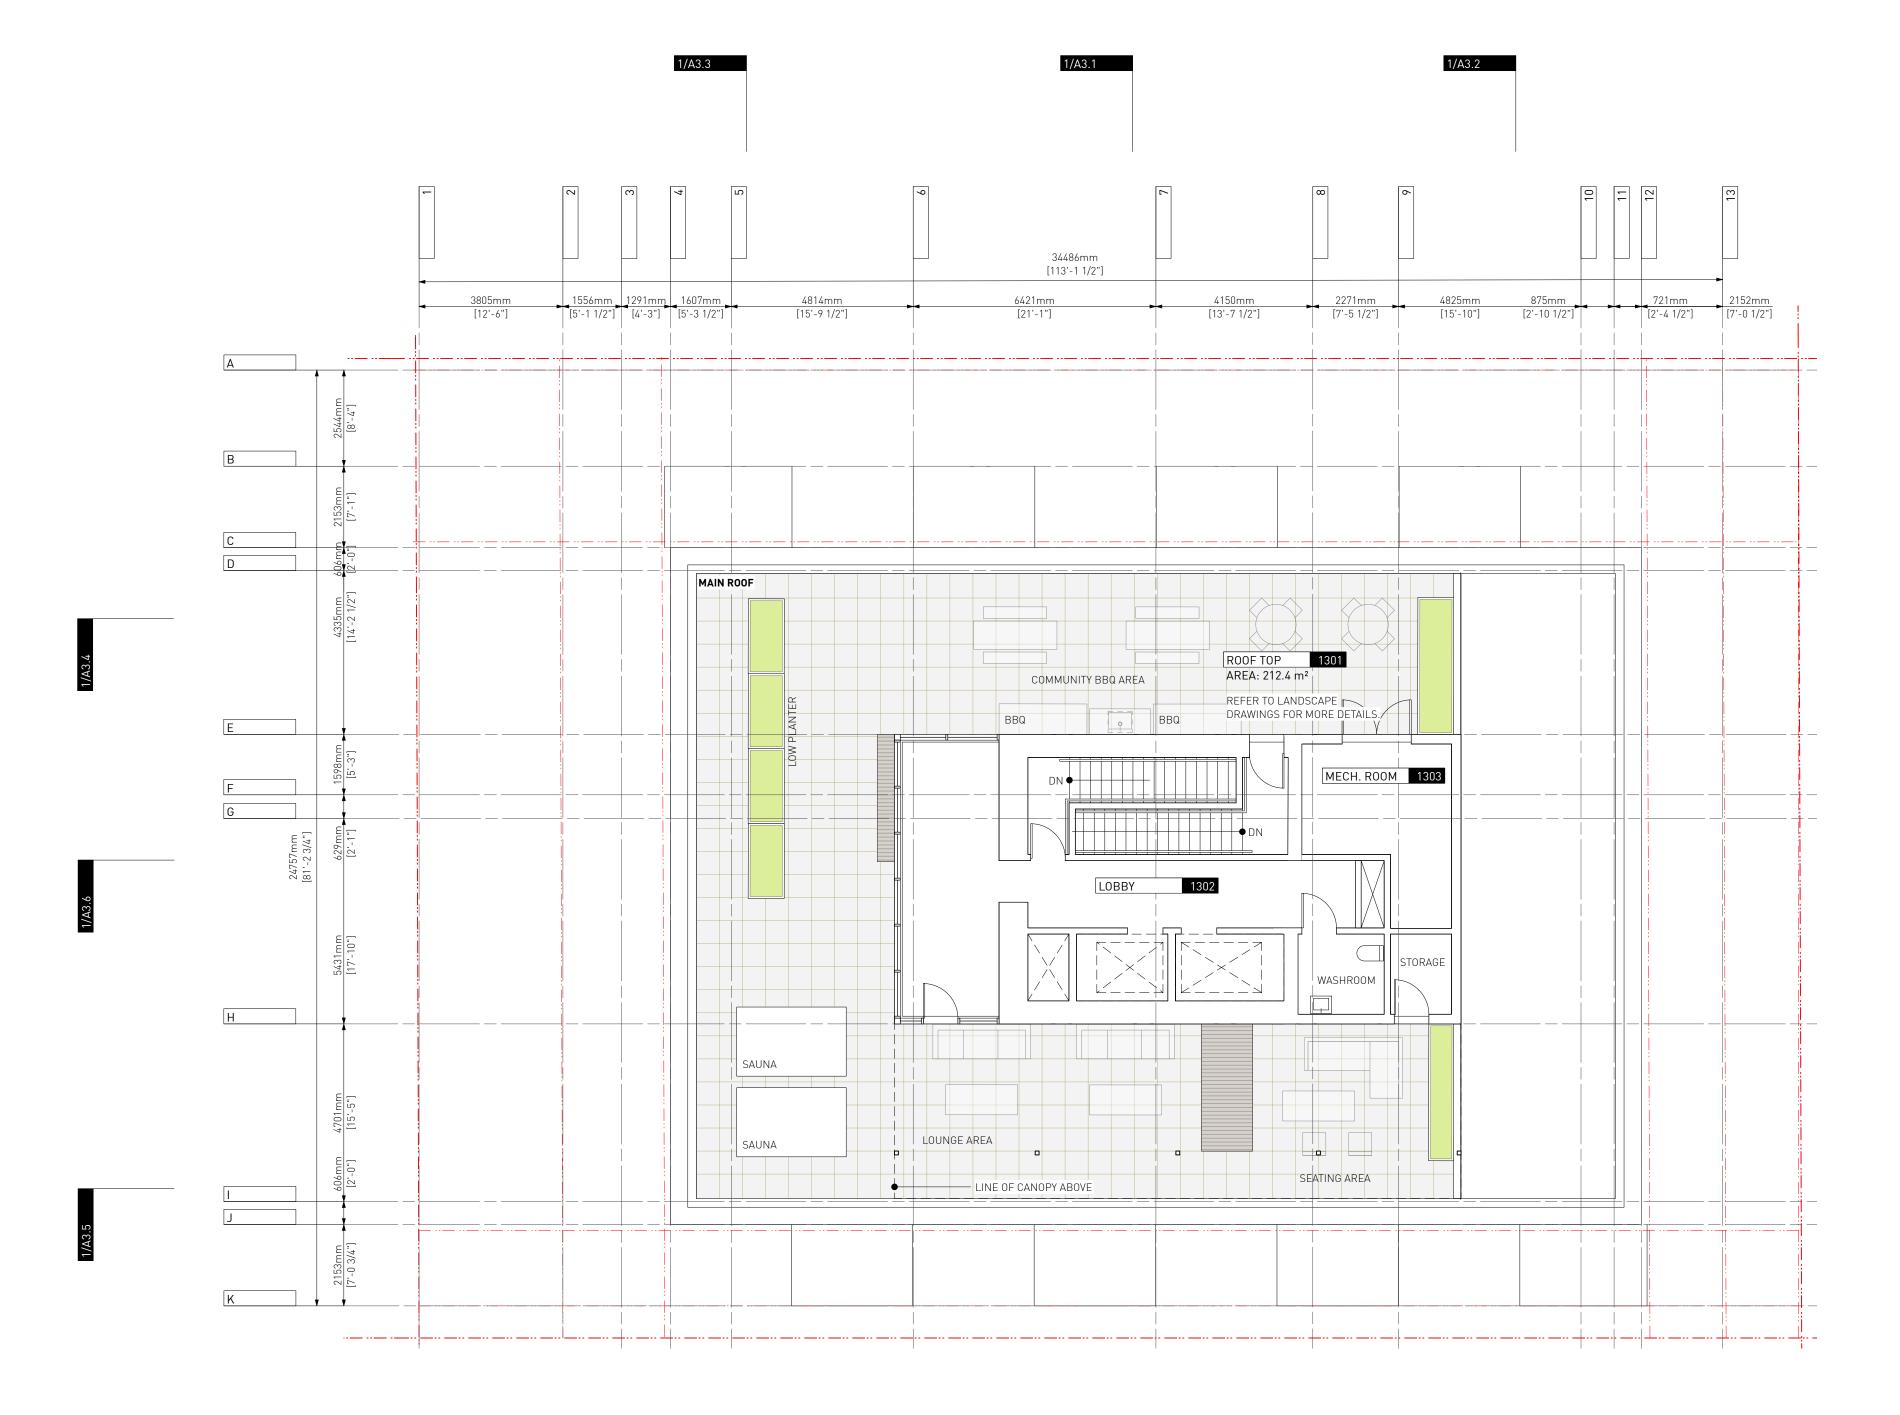

2 LEVEL 05 / 07 / 09 / 11

LEGEND:

N

30VE

EXISTING BUILDING

4 Issued for DDP

Drawn By: Checked By: Printing Date:

3 Issued for TRG2 response

2 Issued for TRG1 response

Architect before proceeding.

This drawing must not be scaled.

26.05.2025

14.12.2023

21.09.2023

EA / MM PB 23.05.2025

PROPOSED BUILDING
PROPERTY LINE

responsibility for the altered document by the Architect.


This drawing is not to be used for building purposes until countersigned by:

The Contractor shall verify all dimensions, datums and levels prior to commencement of work.

All errors and omissions to be reported to the

This drawing is the property of the Architect; the copyright in same being reserved to him/her. It is

Any unauthorized alteration of the electronic data which constitute this document will void all

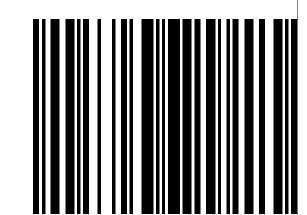


23.05.2025

5 4 6 8 7 9 6 A R C H I T E C T U R E I N C 266 MCDERMOT AVE Winnipeg MB R3B 0S8 P: 204.480.8421 F: 204.480.8876

1702 QUADRA STREET + 862 FISGARD STREET

LEVEL 13

Project 0650 Sheet A1.7

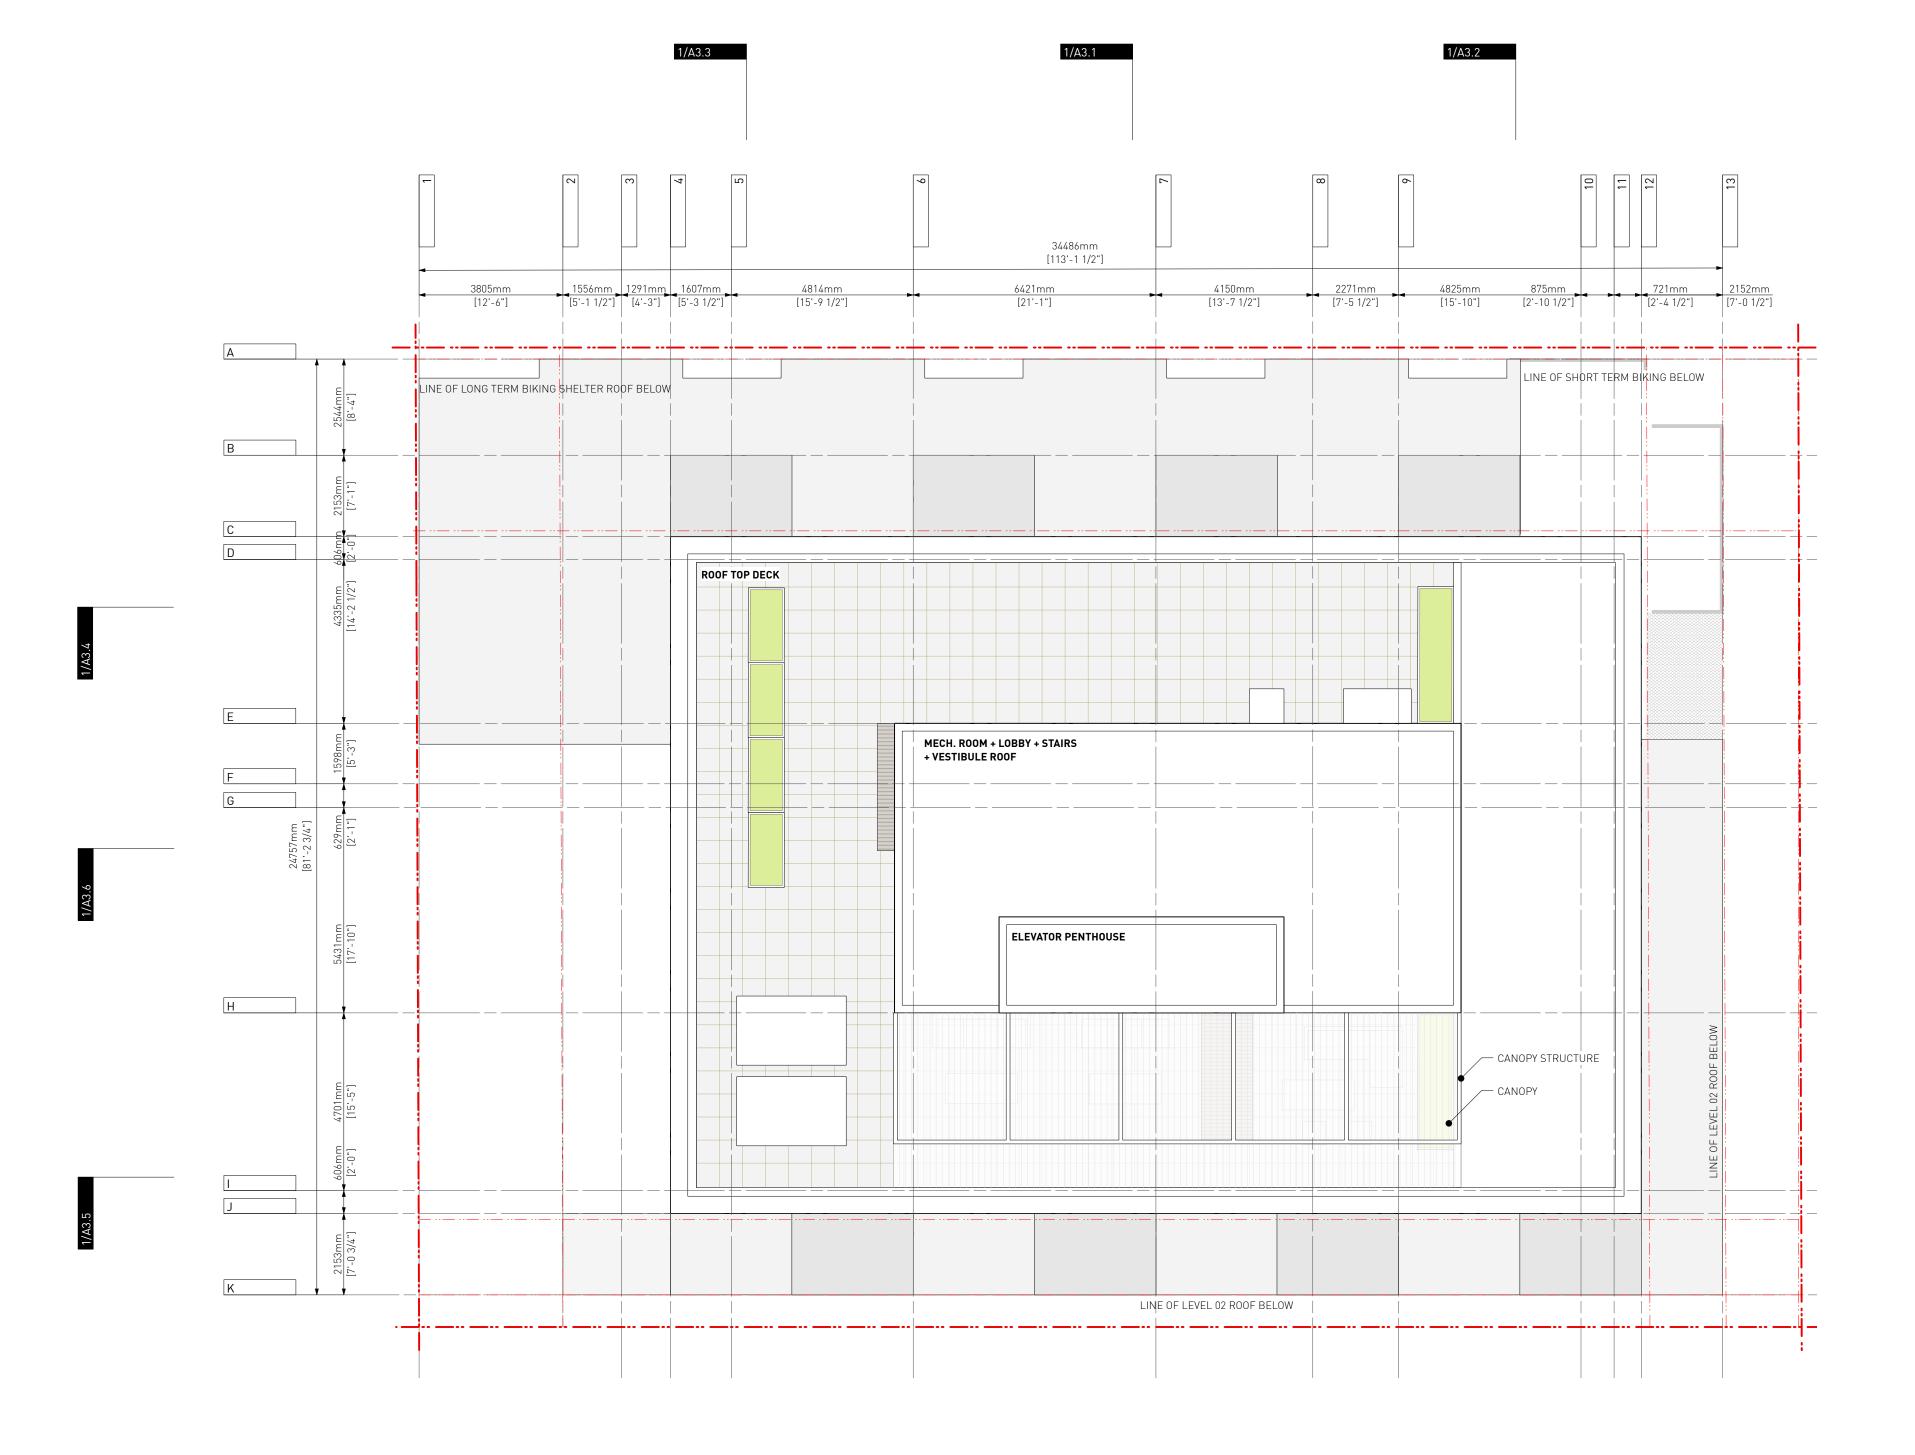

EXISTING BUILDING

PROPOSED BUILDING PROPERTY LINE SETBACK LINE

4 Issued for DDP 26.05.2025 3 Issued for TRG2 response 14.12.2023 2 Issued for TRG1 response 21.09.2023

The Contractor shall verify all dimensions, datums

and levels prior to commencement of work.

EA / MM PB 23.05.2025

All errors and omissions to be reported to the Architect before proceeding.


This drawing must not be scaled.

Drawn By: Checked By: Printing Date:


This drawing is the property of the Architect; the copyright in same being reserved to him/her. It is

Any unauthorized alteration of the electronic data which constitute this document will void all responsibility for the altered document by the Architect.

This drawing is not to be used for building purposes until countersigned by:

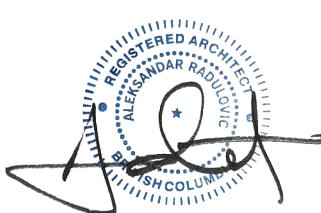

23.05.2025

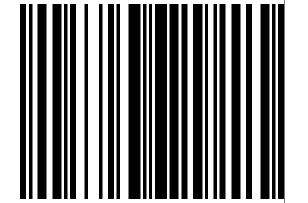


266 MCDERMOT AVE Winnipeg MB R3B 0S8 P: 204.480.8421 F: 204.480.8876

1702 QUADRA STREET + 862 FISGARD STREET

ROOF PLAN

0650 Sheet A1.8

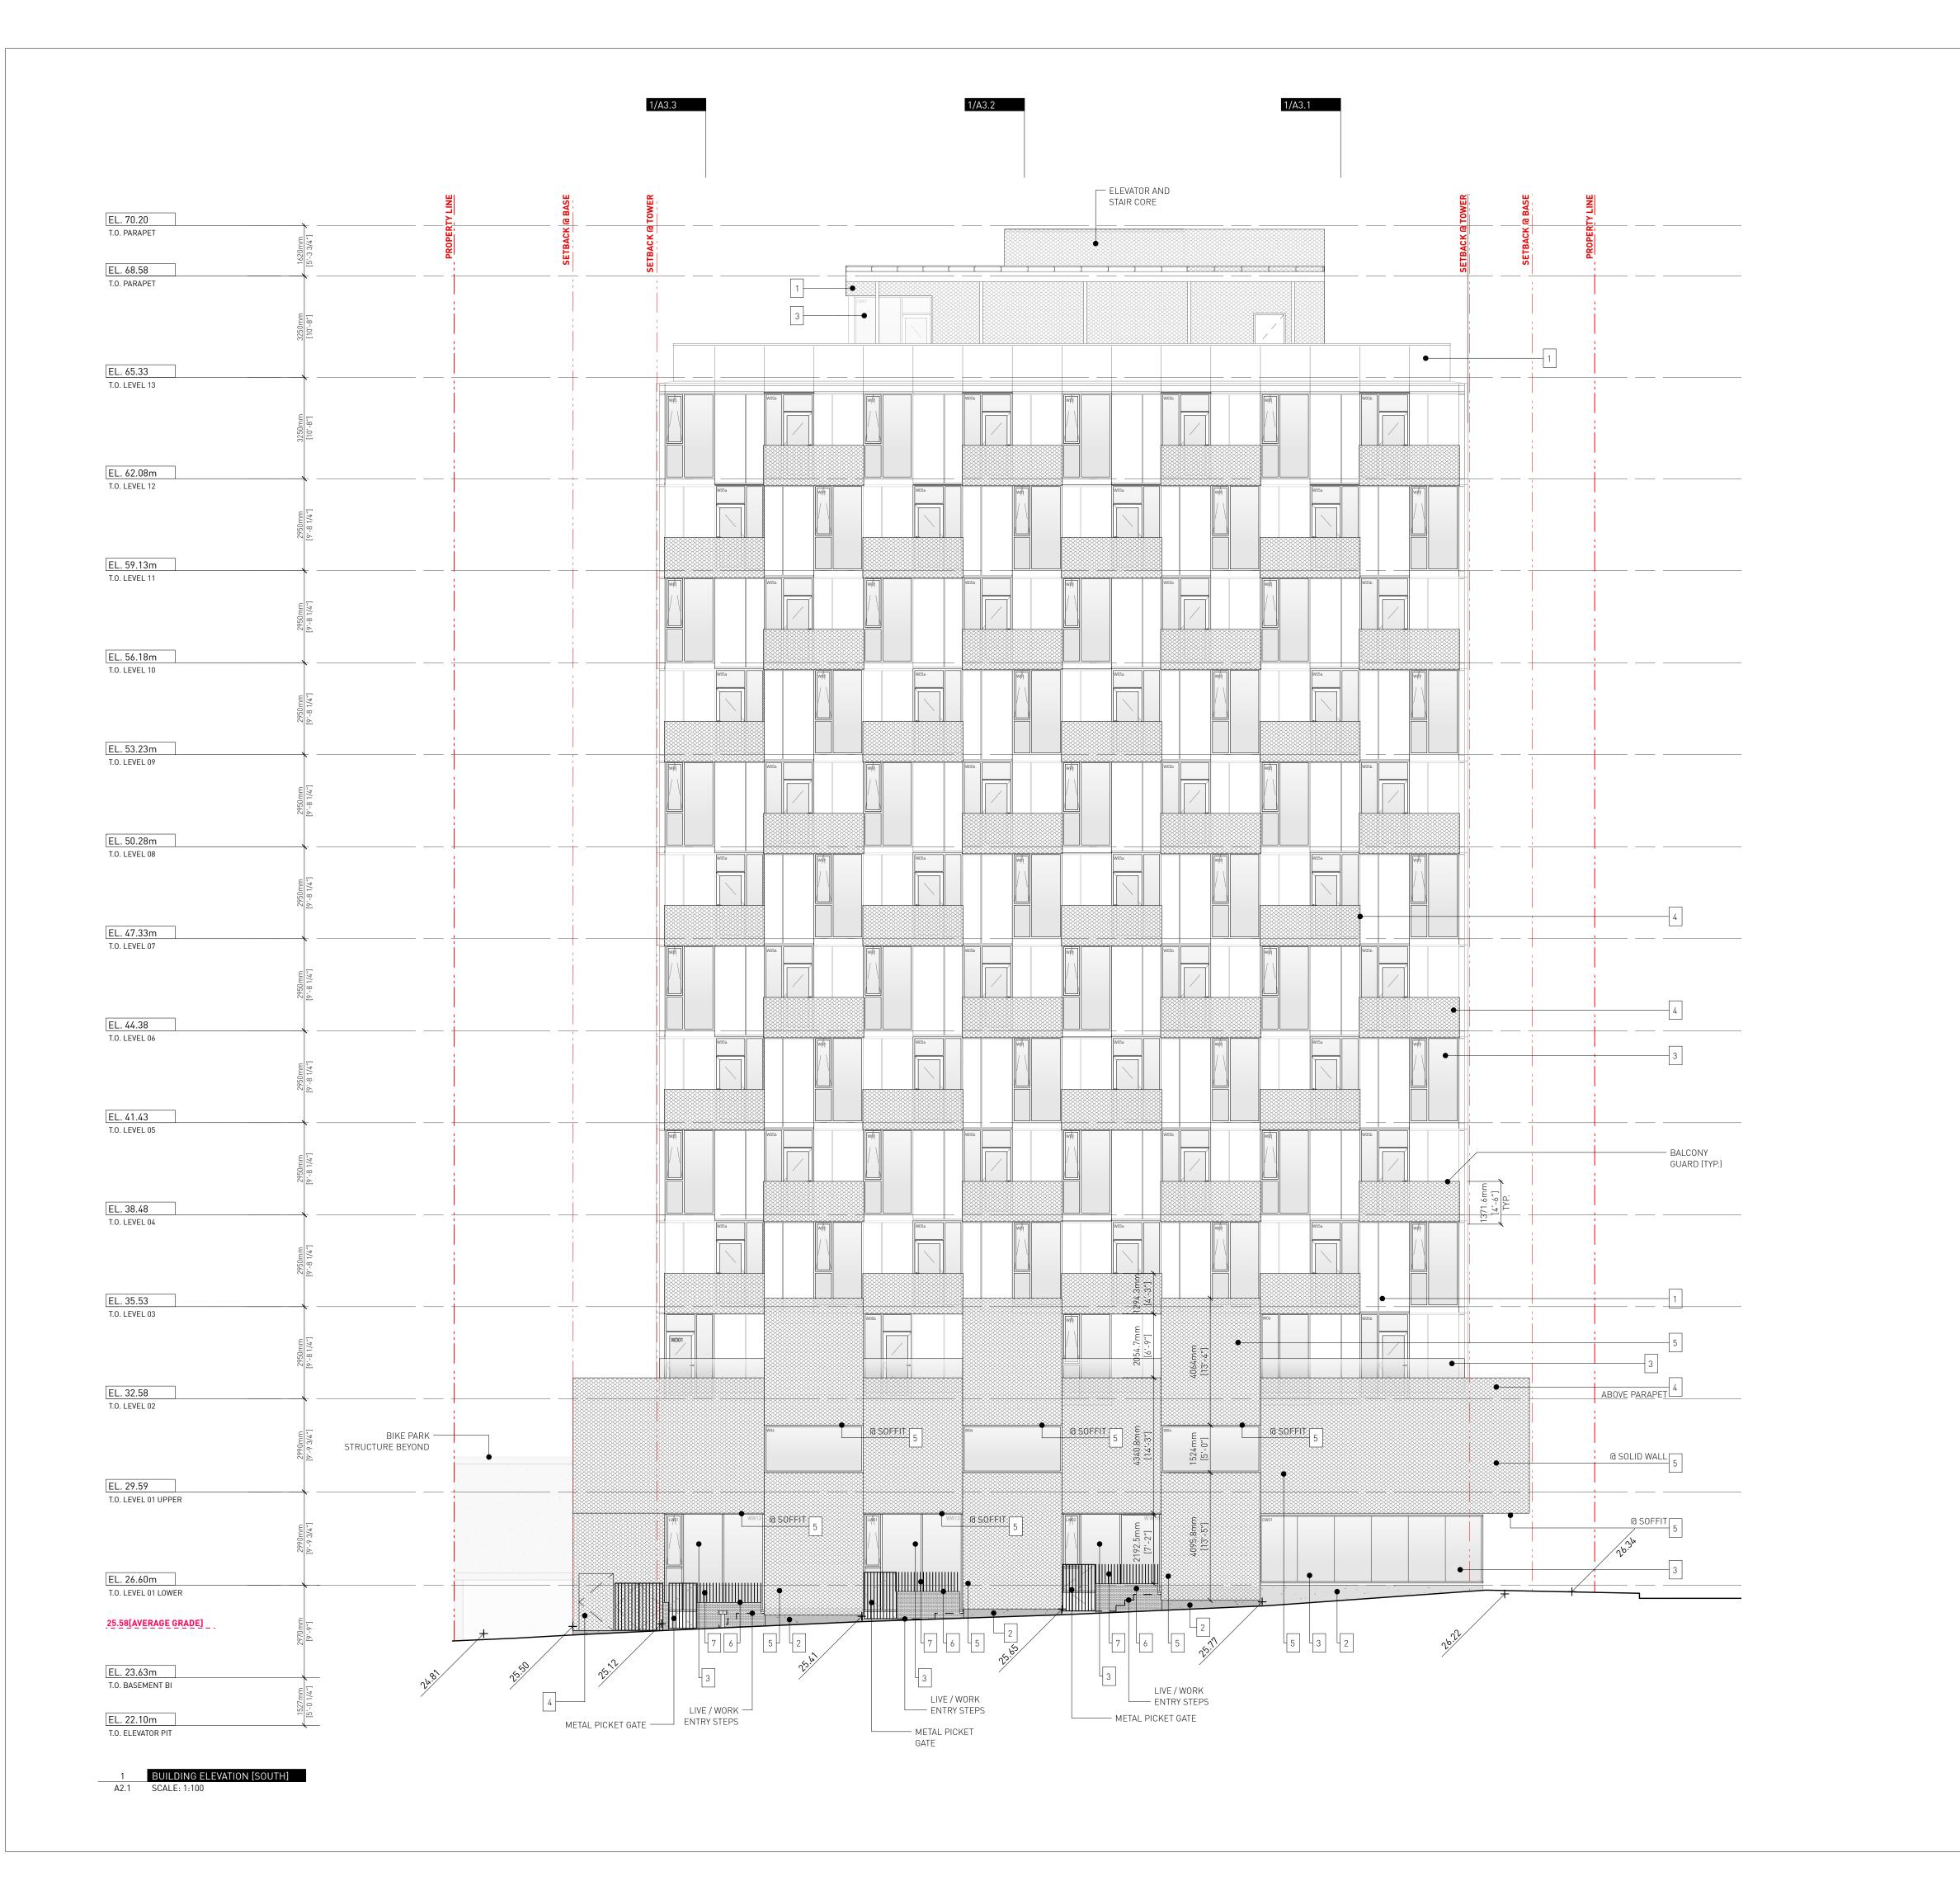

2 Issued for TRG1 response

Drawn By: Checked By: Printing Date: EA / MM PB 23.05.2025

21.09.2023

The Contractor shall verify all dimensions, datums and levels prior to commencement of work.

All errors and omissions to be reported to the

Architect before proceeding.

This drawing must not be scaled.

1 ALUMINUM

2 CONCRETE

3 GLASS WINDOWS / GUARDRAIL

4 EXPANDED METAL MESH GUARD / SCREEN

5 EXPANDED METAL MESH + CEMENTIOUS PANEL

6 SALVEGED BRICK


7 METAL FENCE

This drawing is the property of the Architect; the copyright in same being reserved to him/her. It is

Any unauthorized alteration of the electronic data which constitute this document will void all responsibility for the altered document by the Architect.

This drawing is not to be used for building purposes until countersigned by:



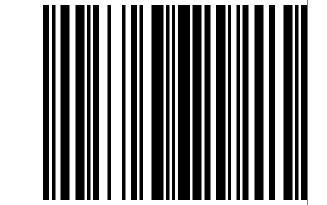


266 MCDERMOT AVE Winnipeg MB R3B 0S8 P: 204.480.8421 F: 204.480.8876

1702 QUADRA STREET + 862 FISGARD STREET

BUILDING ELEVATIONS

Sheet A2.1

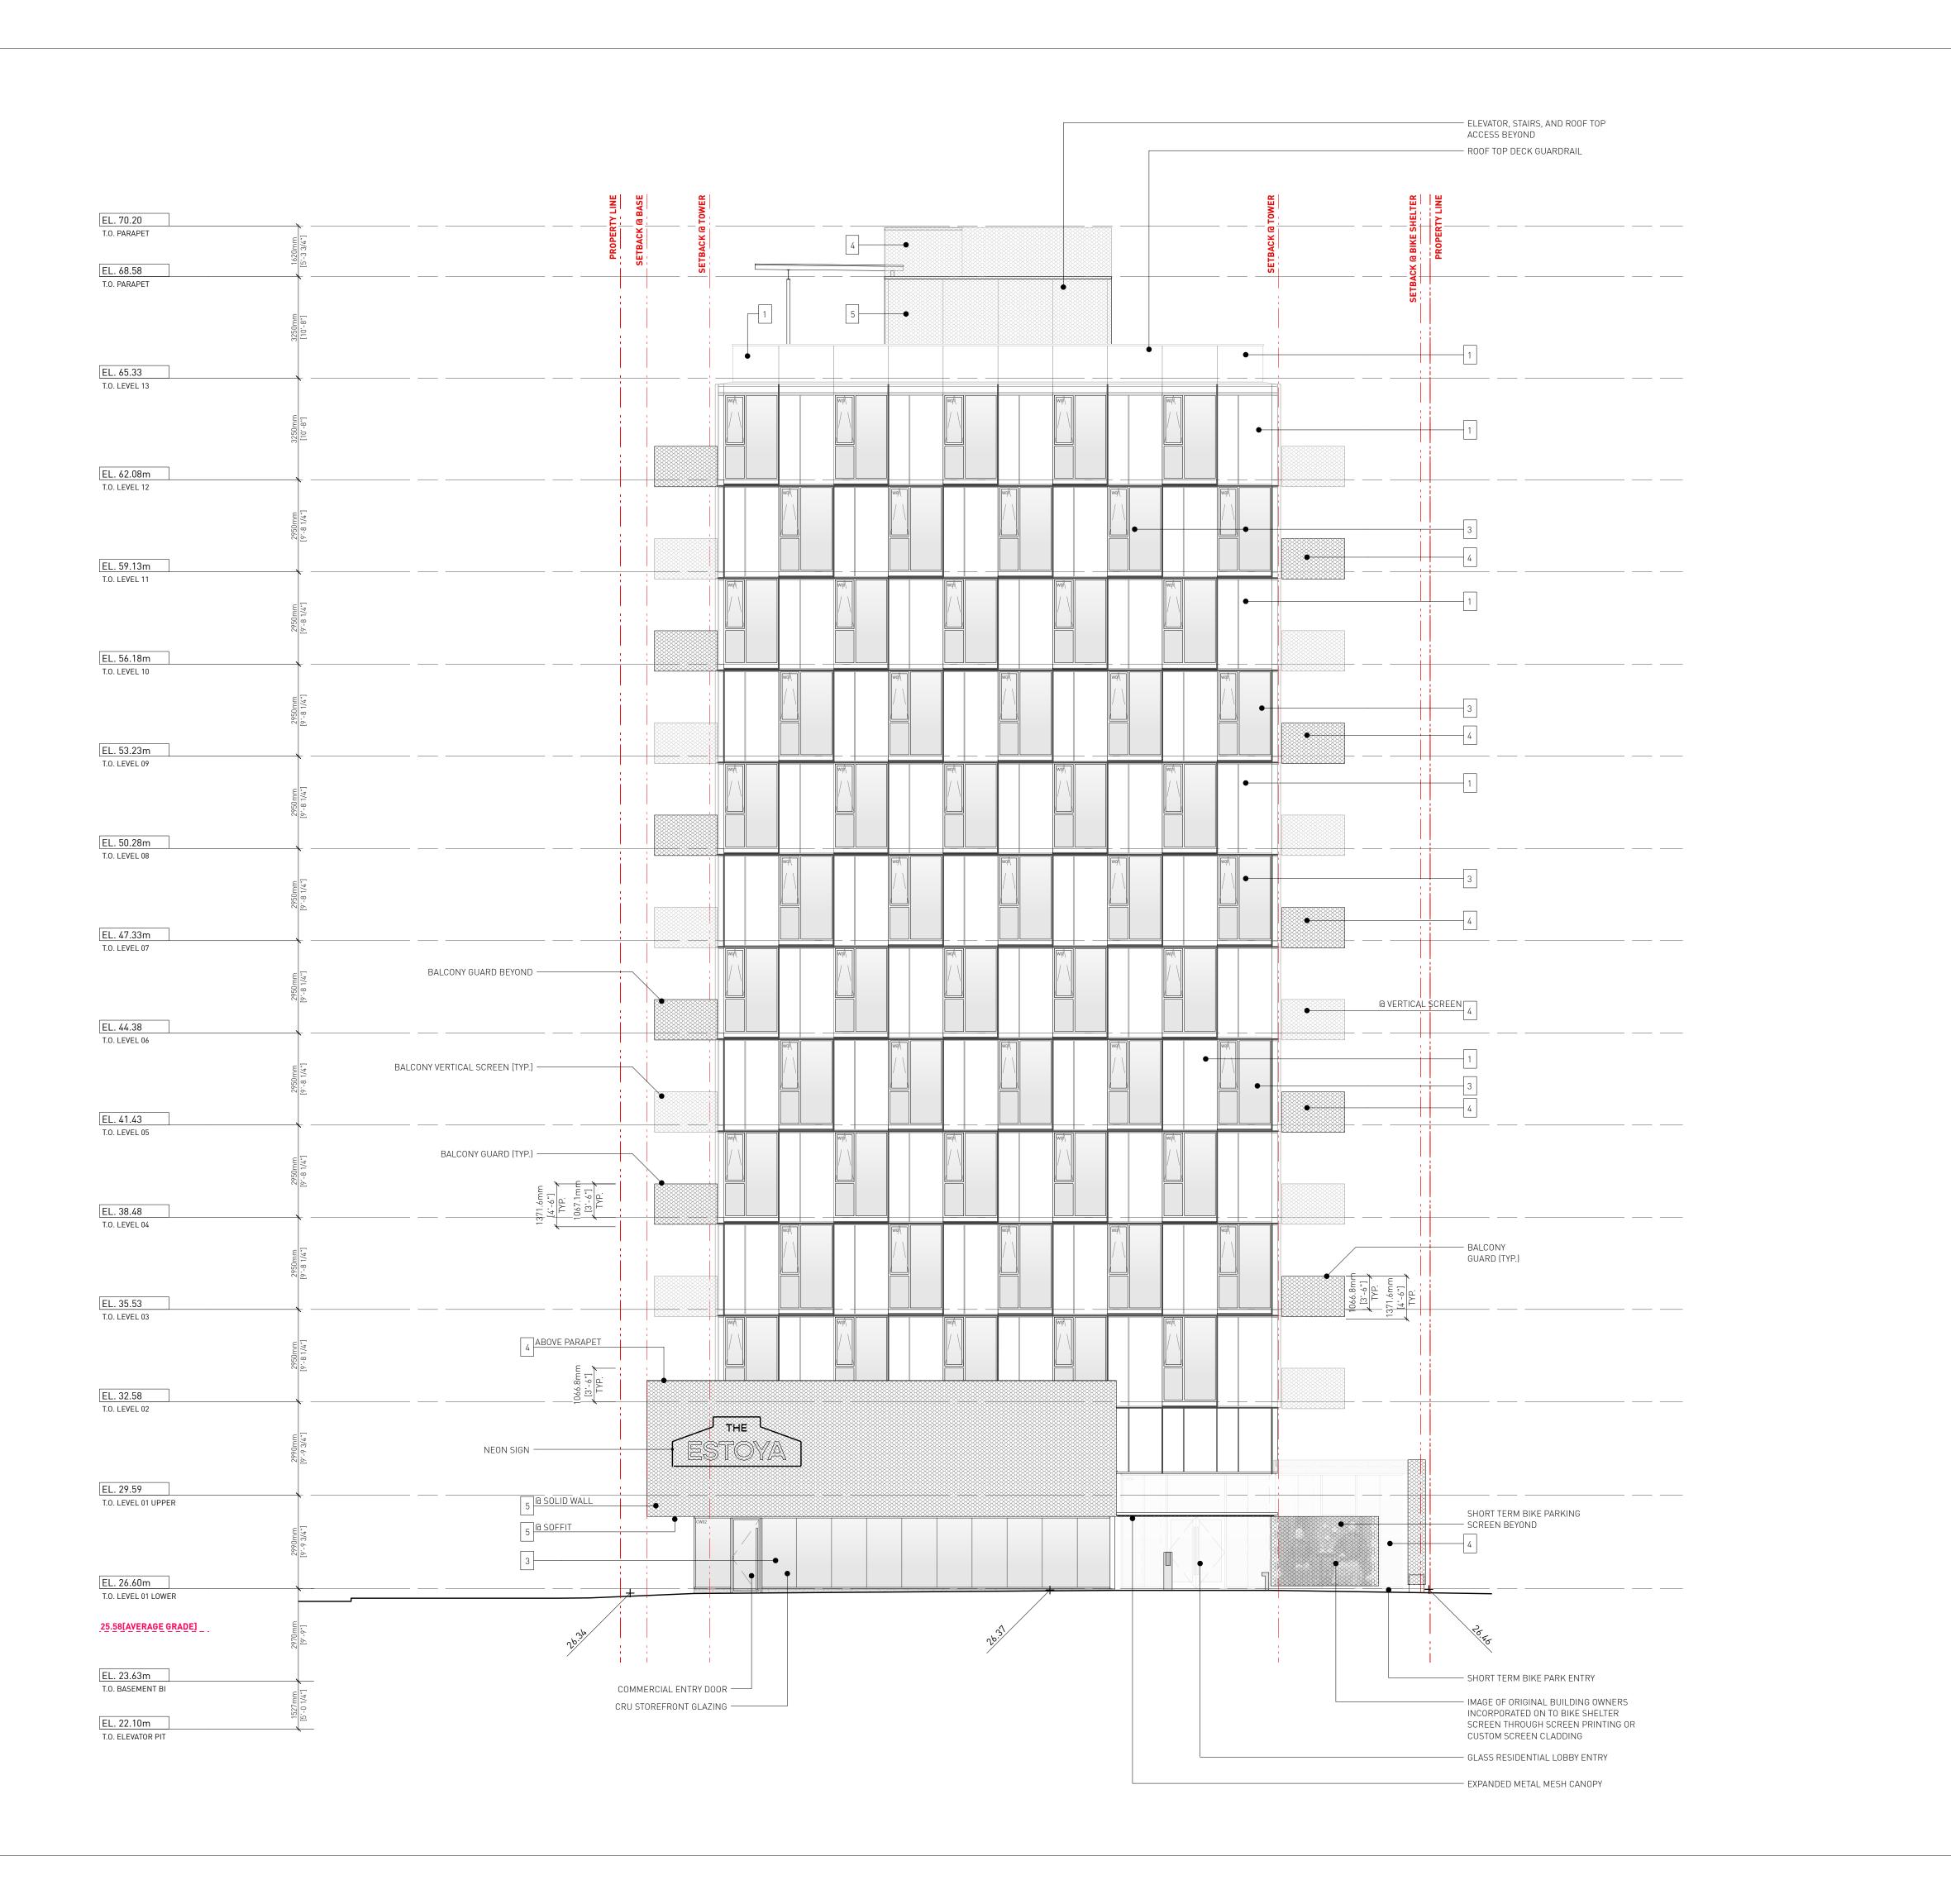

3 Issued for TRG2 response 14.12.2023
2 Issued for TRG1 response 21.09.2023

EA / MM PB 23.05.2025

The Contractor shall verify all dimensions, datums

All errors and omissions to be reported to the

and levels prior to commencement of work.

Architect before proceeding.

This drawing must not be scaled.

1 ALUMINUM

2 CONCRETE

3 GLASS WINDOWS / GUARDRAIL

4 EXPANDED METAL MESH GUARD / SCREEN

5 EXPANDED METAL MESH + CEMENTIOUS PANEL

6 SALVEGED BRICK


7 METAL FENCE

Drawn By: Checked By: Printing Date:

This drawing is the property of the Architect; the copyright in same being reserved to him/her. It is not to be reproduced without his/her permission.

Any unauthorized alteration of the electronic data which constitute this document will void all responsibility for the altered document by the Architect.

This drawing is not to be used for building purposes until countersigned by:

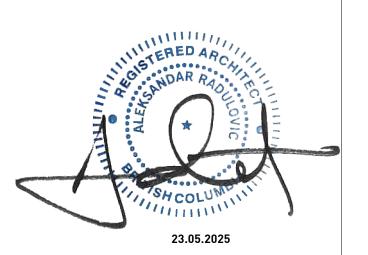


5 4 6 8 7 9 6 A R C H I T E C T U R E I N C 266 MCDERMOT AVE Winnipeg MB R3B 0S8 P: 204.480.8421 F: 204.480.8876

1702 QUADRA STREET + 862 FISGARD STREET

BUILDING ELEVATIONS

0650 Sheet

A2.2

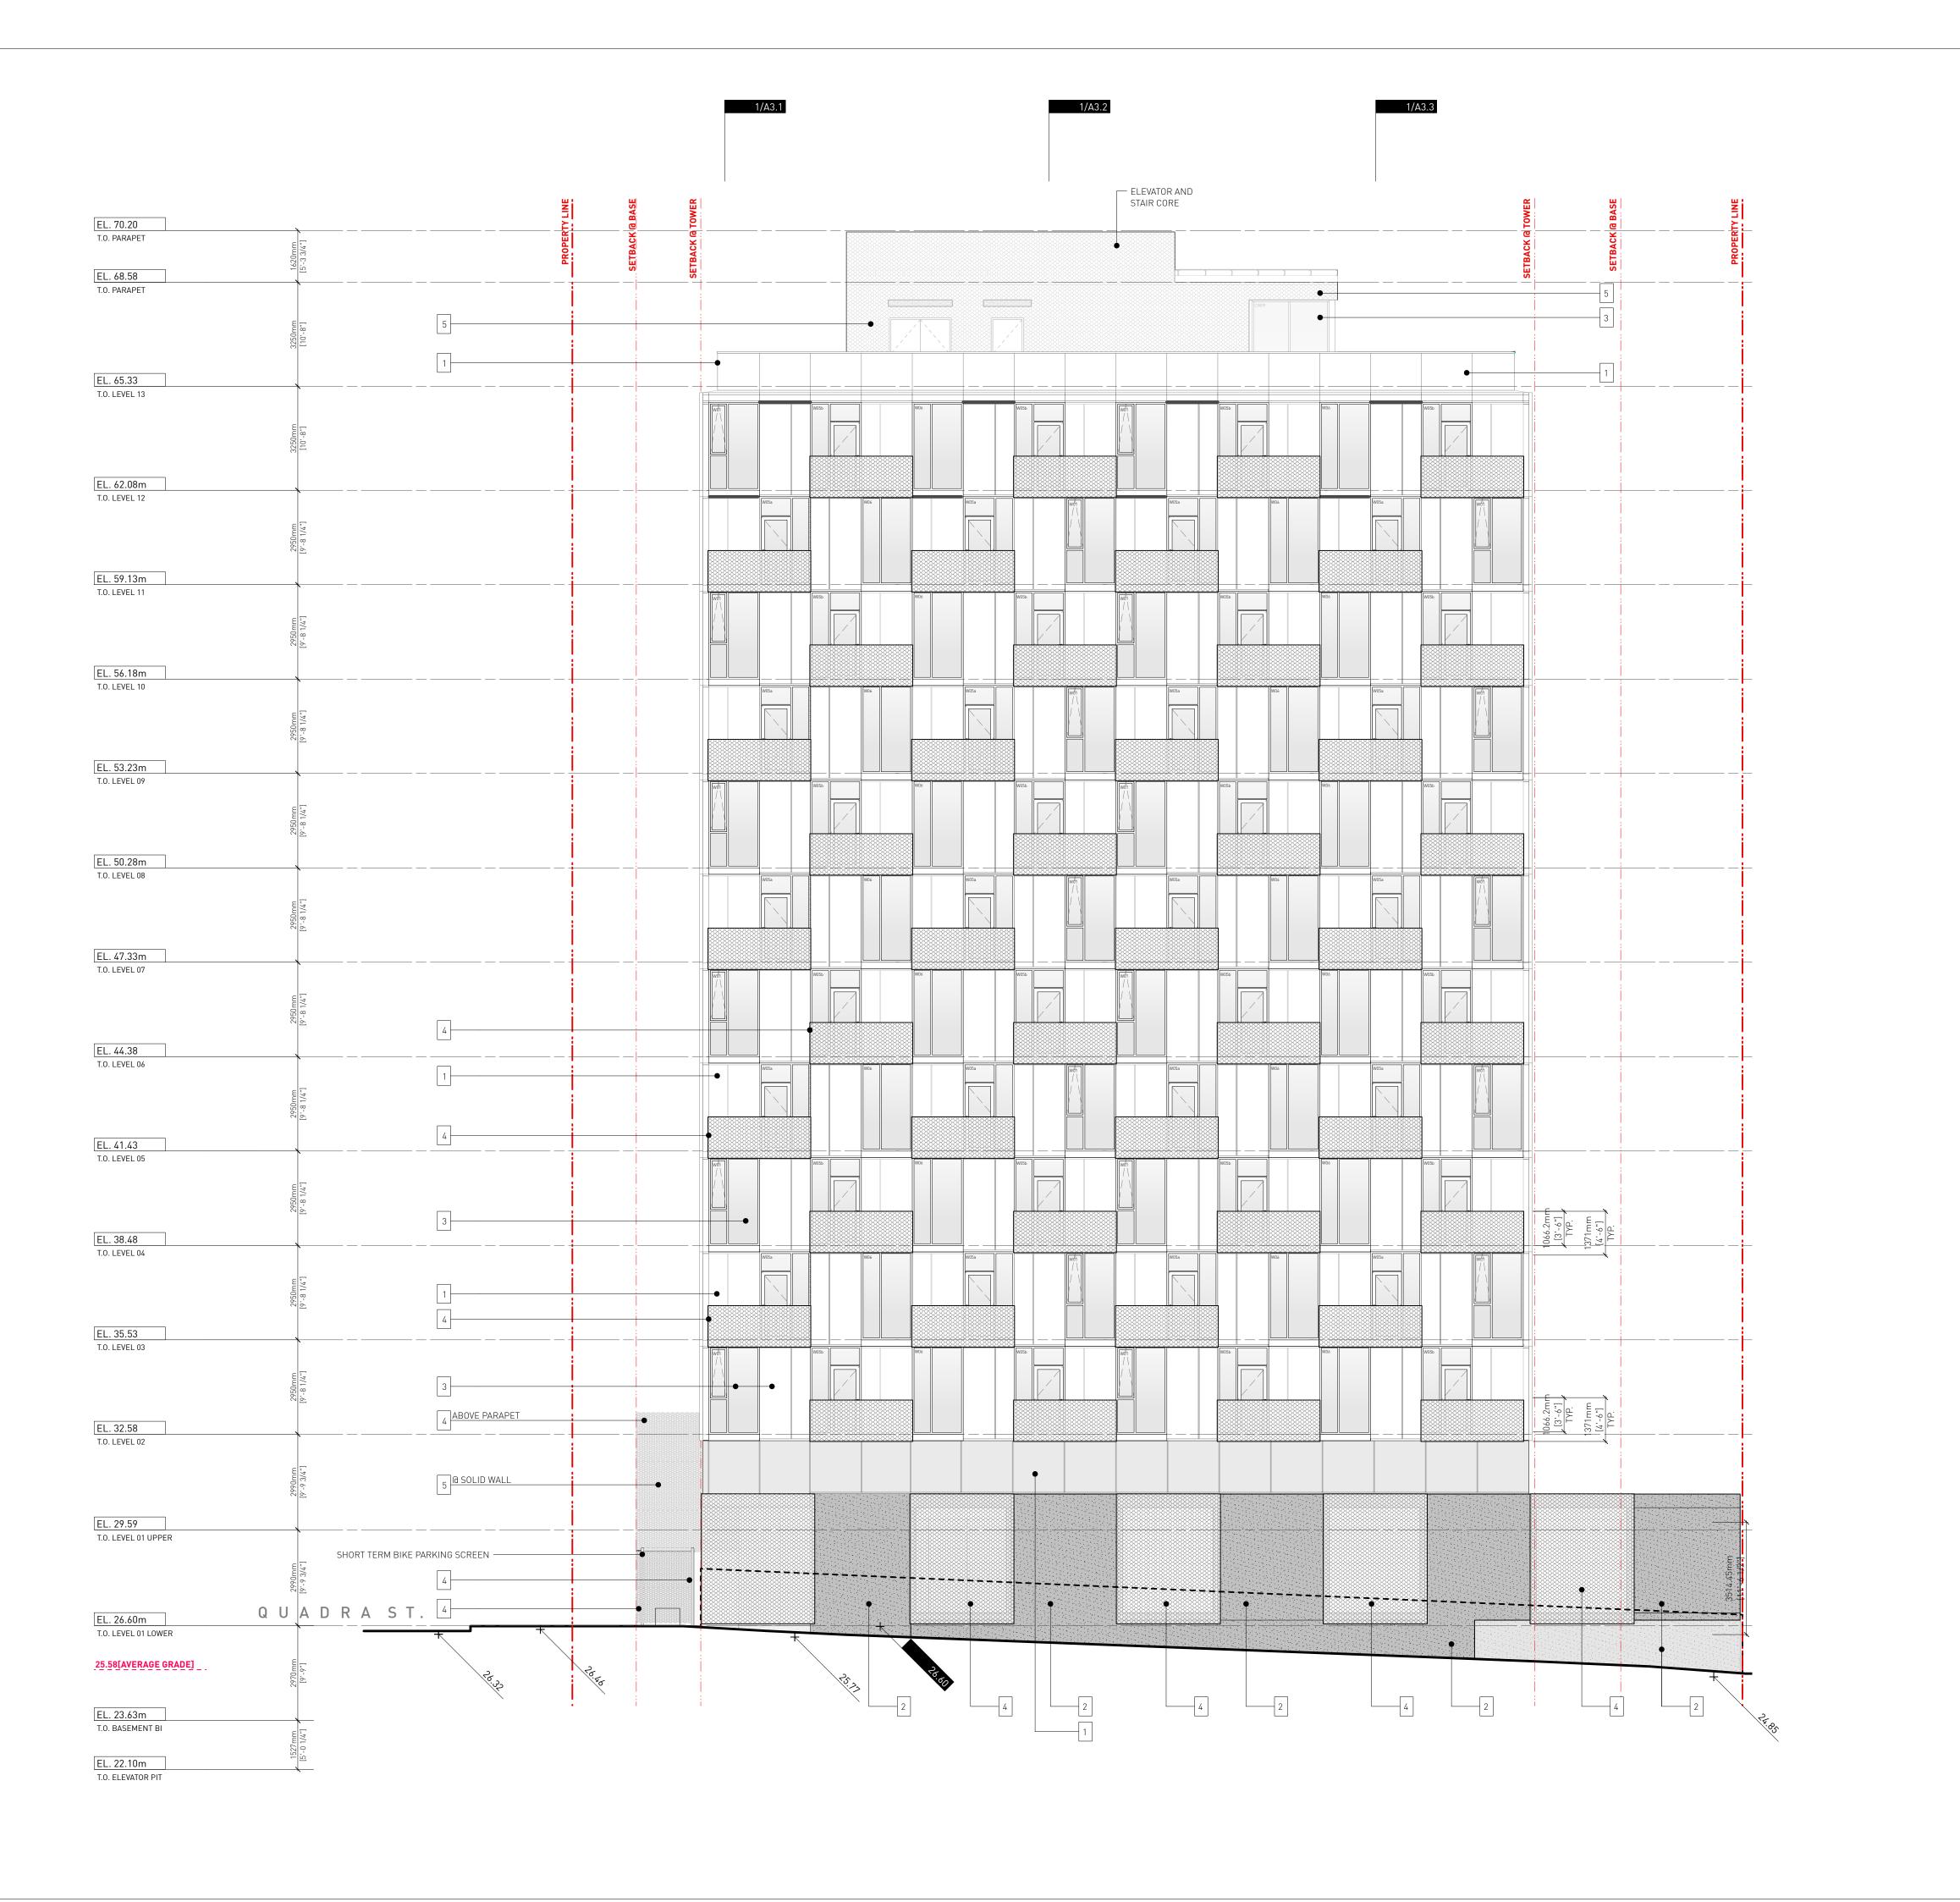

2 Issued for TRG1 response 21.09.2023 Drawn By: Checked By: Printing Date: EA / MM

PB 23.05.2025

The Contractor shall verify all dimensions, datums and levels prior to commencement of work.

All errors and omissions to be reported to the Architect before proceeding.

This drawing must not be scaled.

This drawing is the property of the Architect; the

1 ALUMINUM

2 CONCRETE

3 GLASS WINDOWS / GUARDRAIL

4 EXPANDED METAL MESH GUARD / SCREEN

5 EXPANDED METAL MESH + CEMENTIOUS PANEL


6 SALVEGED BRICK

7 METAL FENCE

copyright in same being reserved to him/her. It is

Any unauthorized alteration of the electronic data which constitute this document will void all responsibility for the altered document by the

This drawing is not to be used for building purposes until countersigned by:

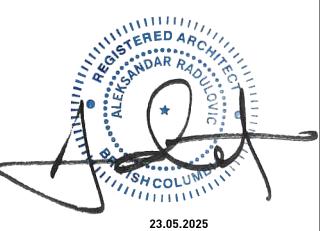




266 MCDERMOT AVE Winnipeg MB R3B 0S8 P: 204.480.8421 F: 204.480.8876

1702 QUADRA STREET + 862 FISGARD STREET

BUILDING ELEVATIONS

Sheet

A2.3

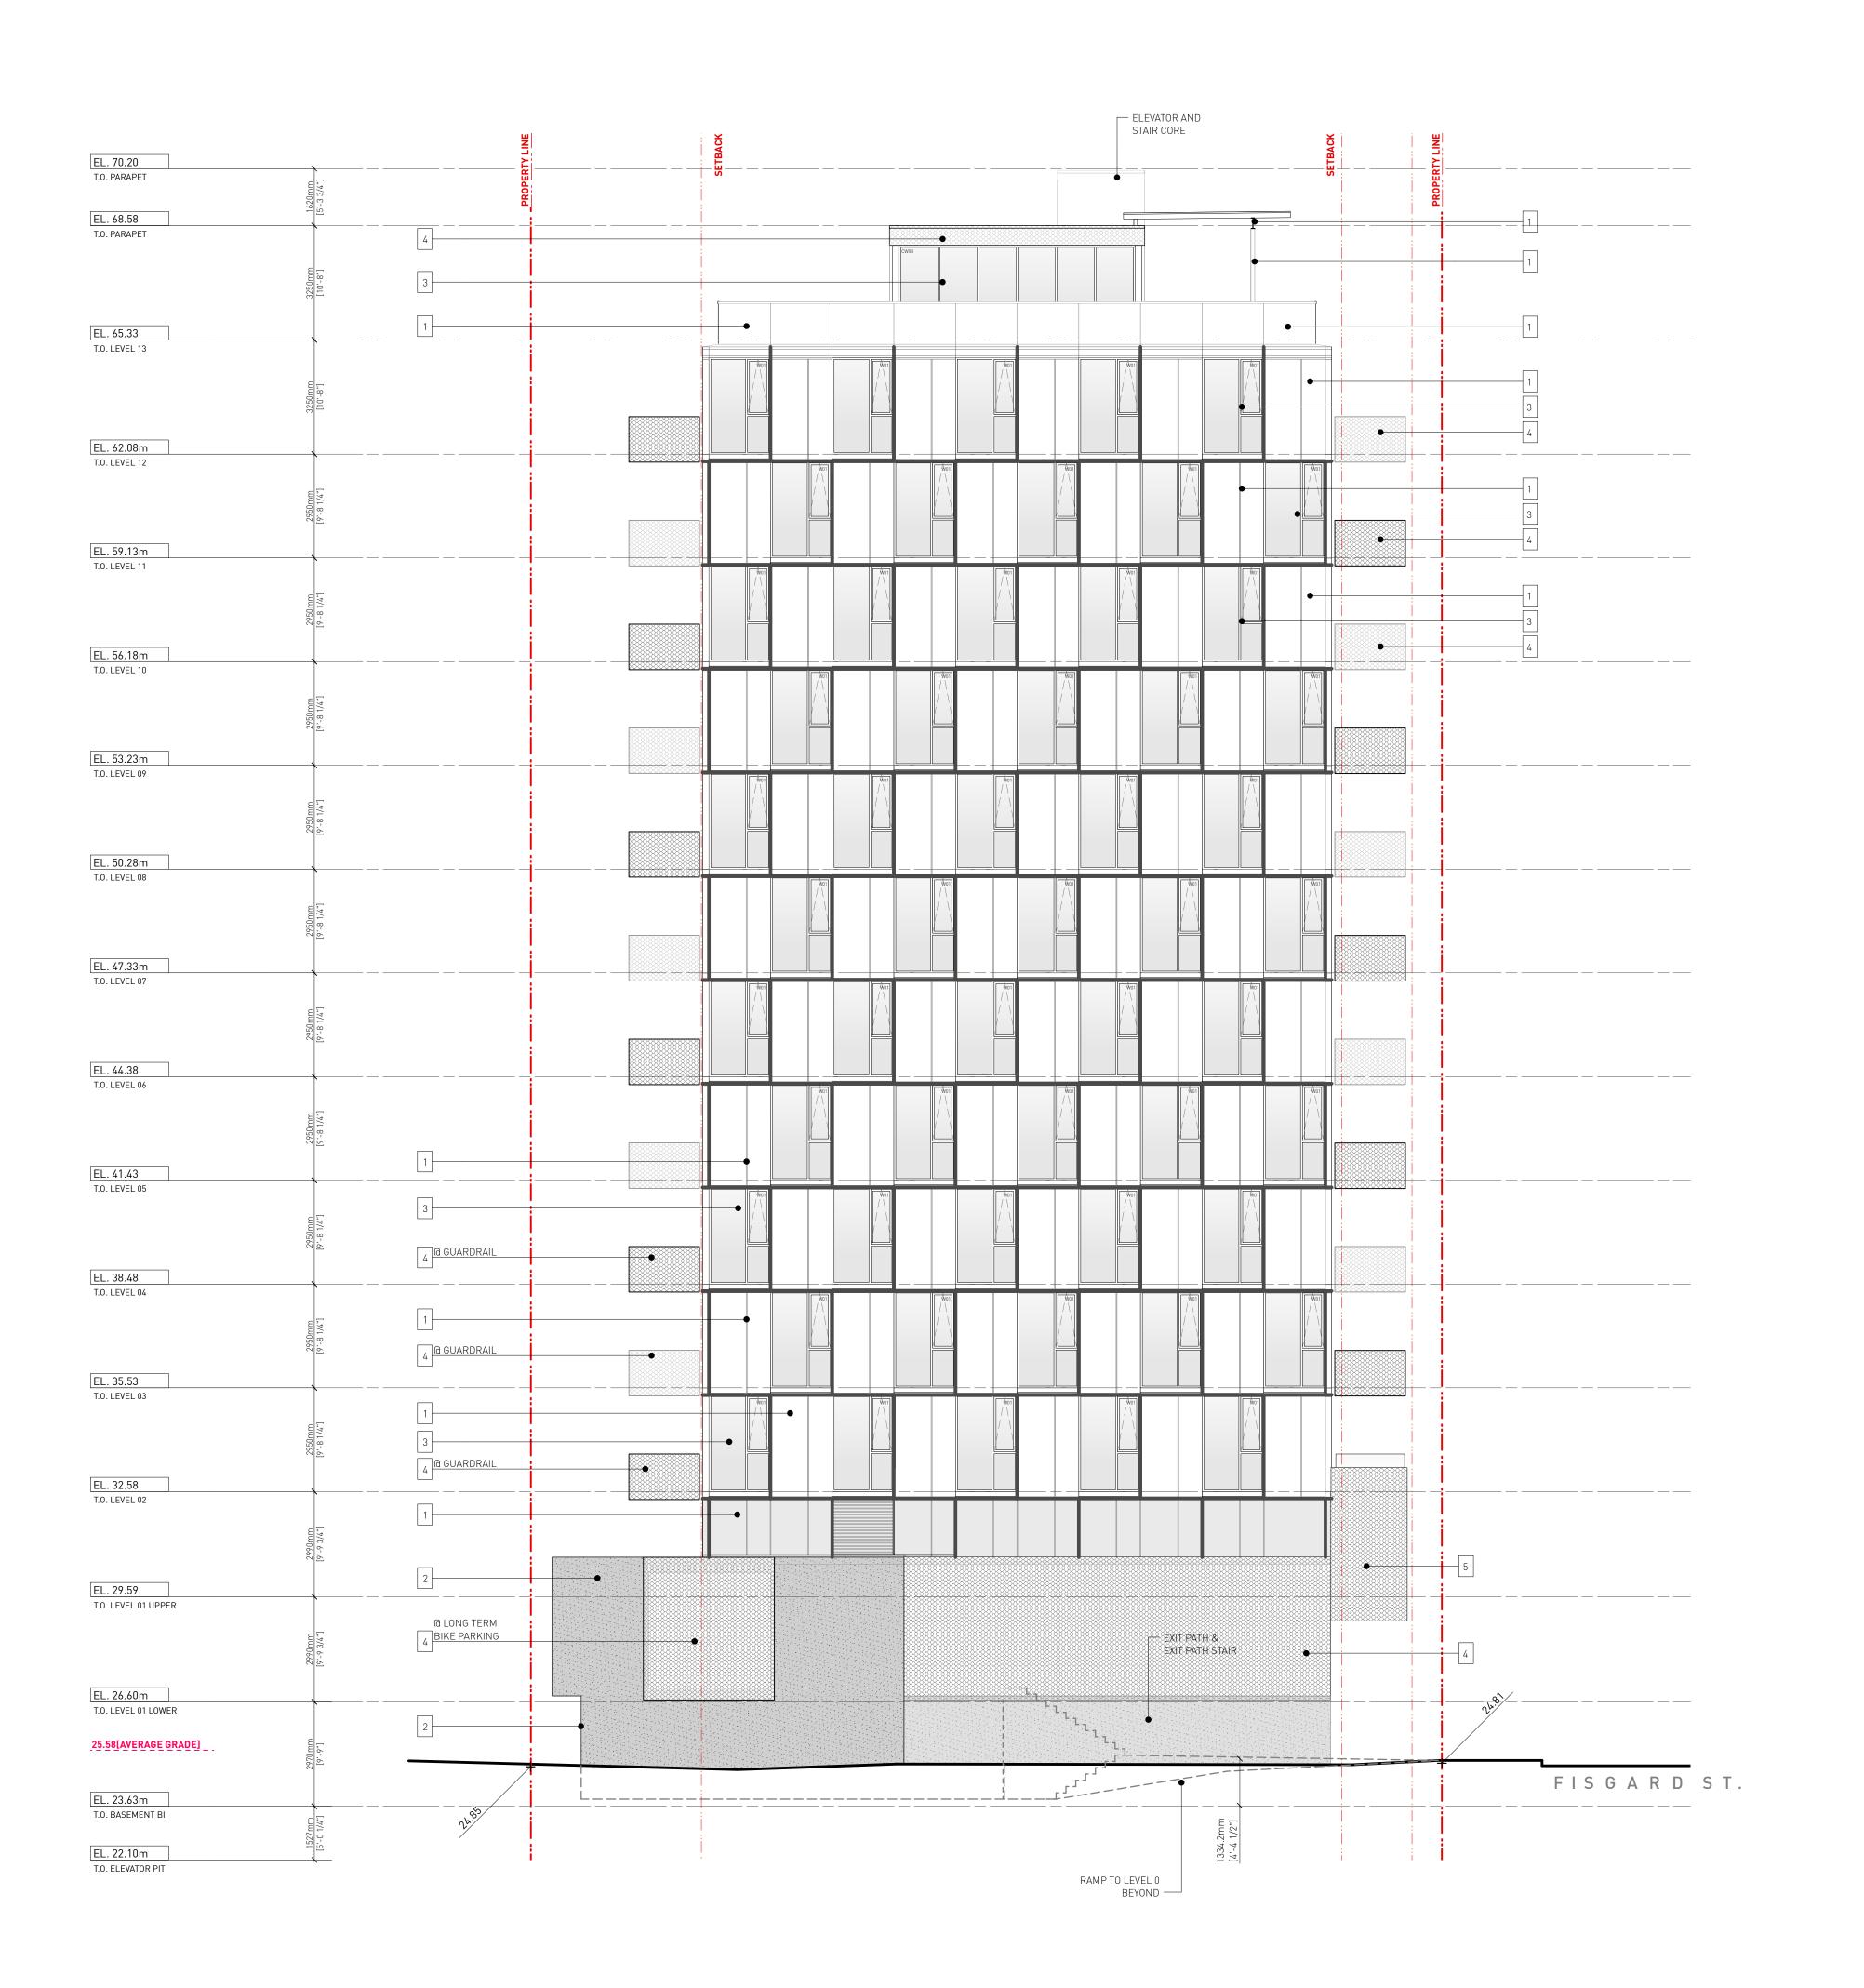

2 Issued for TRG1 response

Drawn By: Checked By: Printing Date: EA / MM PB 23.05.2025

21.09.2023

The Contractor shall verify all dimensions, datums and levels prior to commencement of work.

All errors and omissions to be reported to the Architect before proceeding.

This drawing must not be scaled.

1 ALUMINUM

2 CONCRETE

3 GLASS WINDOWS / GUARDRAIL

4 EXPANDED METAL MESH GUARD / SCREEN

5 EXPANDED METAL MESH + CEMENTIOUS PANEL


6 SALVEGED BRICK


7 METAL FENCE

This drawing is the property of the Architect; the copyright in same being reserved to him/her. It is

Any unauthorized alteration of the electronic data which constitute this document will void all responsibility for the altered document by the Architect.

This drawing is not to be used for building purposes until countersigned by:

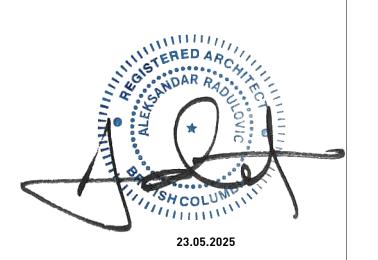

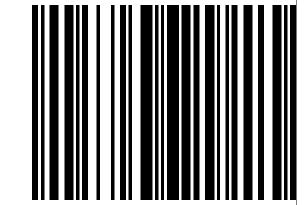



266 MCDERMOT AVE Winnipeg MB R3B 0S8 P: 204.480.8421 F: 204.480.8876

1702 QUADRA STREET + 862 FISGARD STREET

BUILDING ELEVATIONS

Sheet A2.4

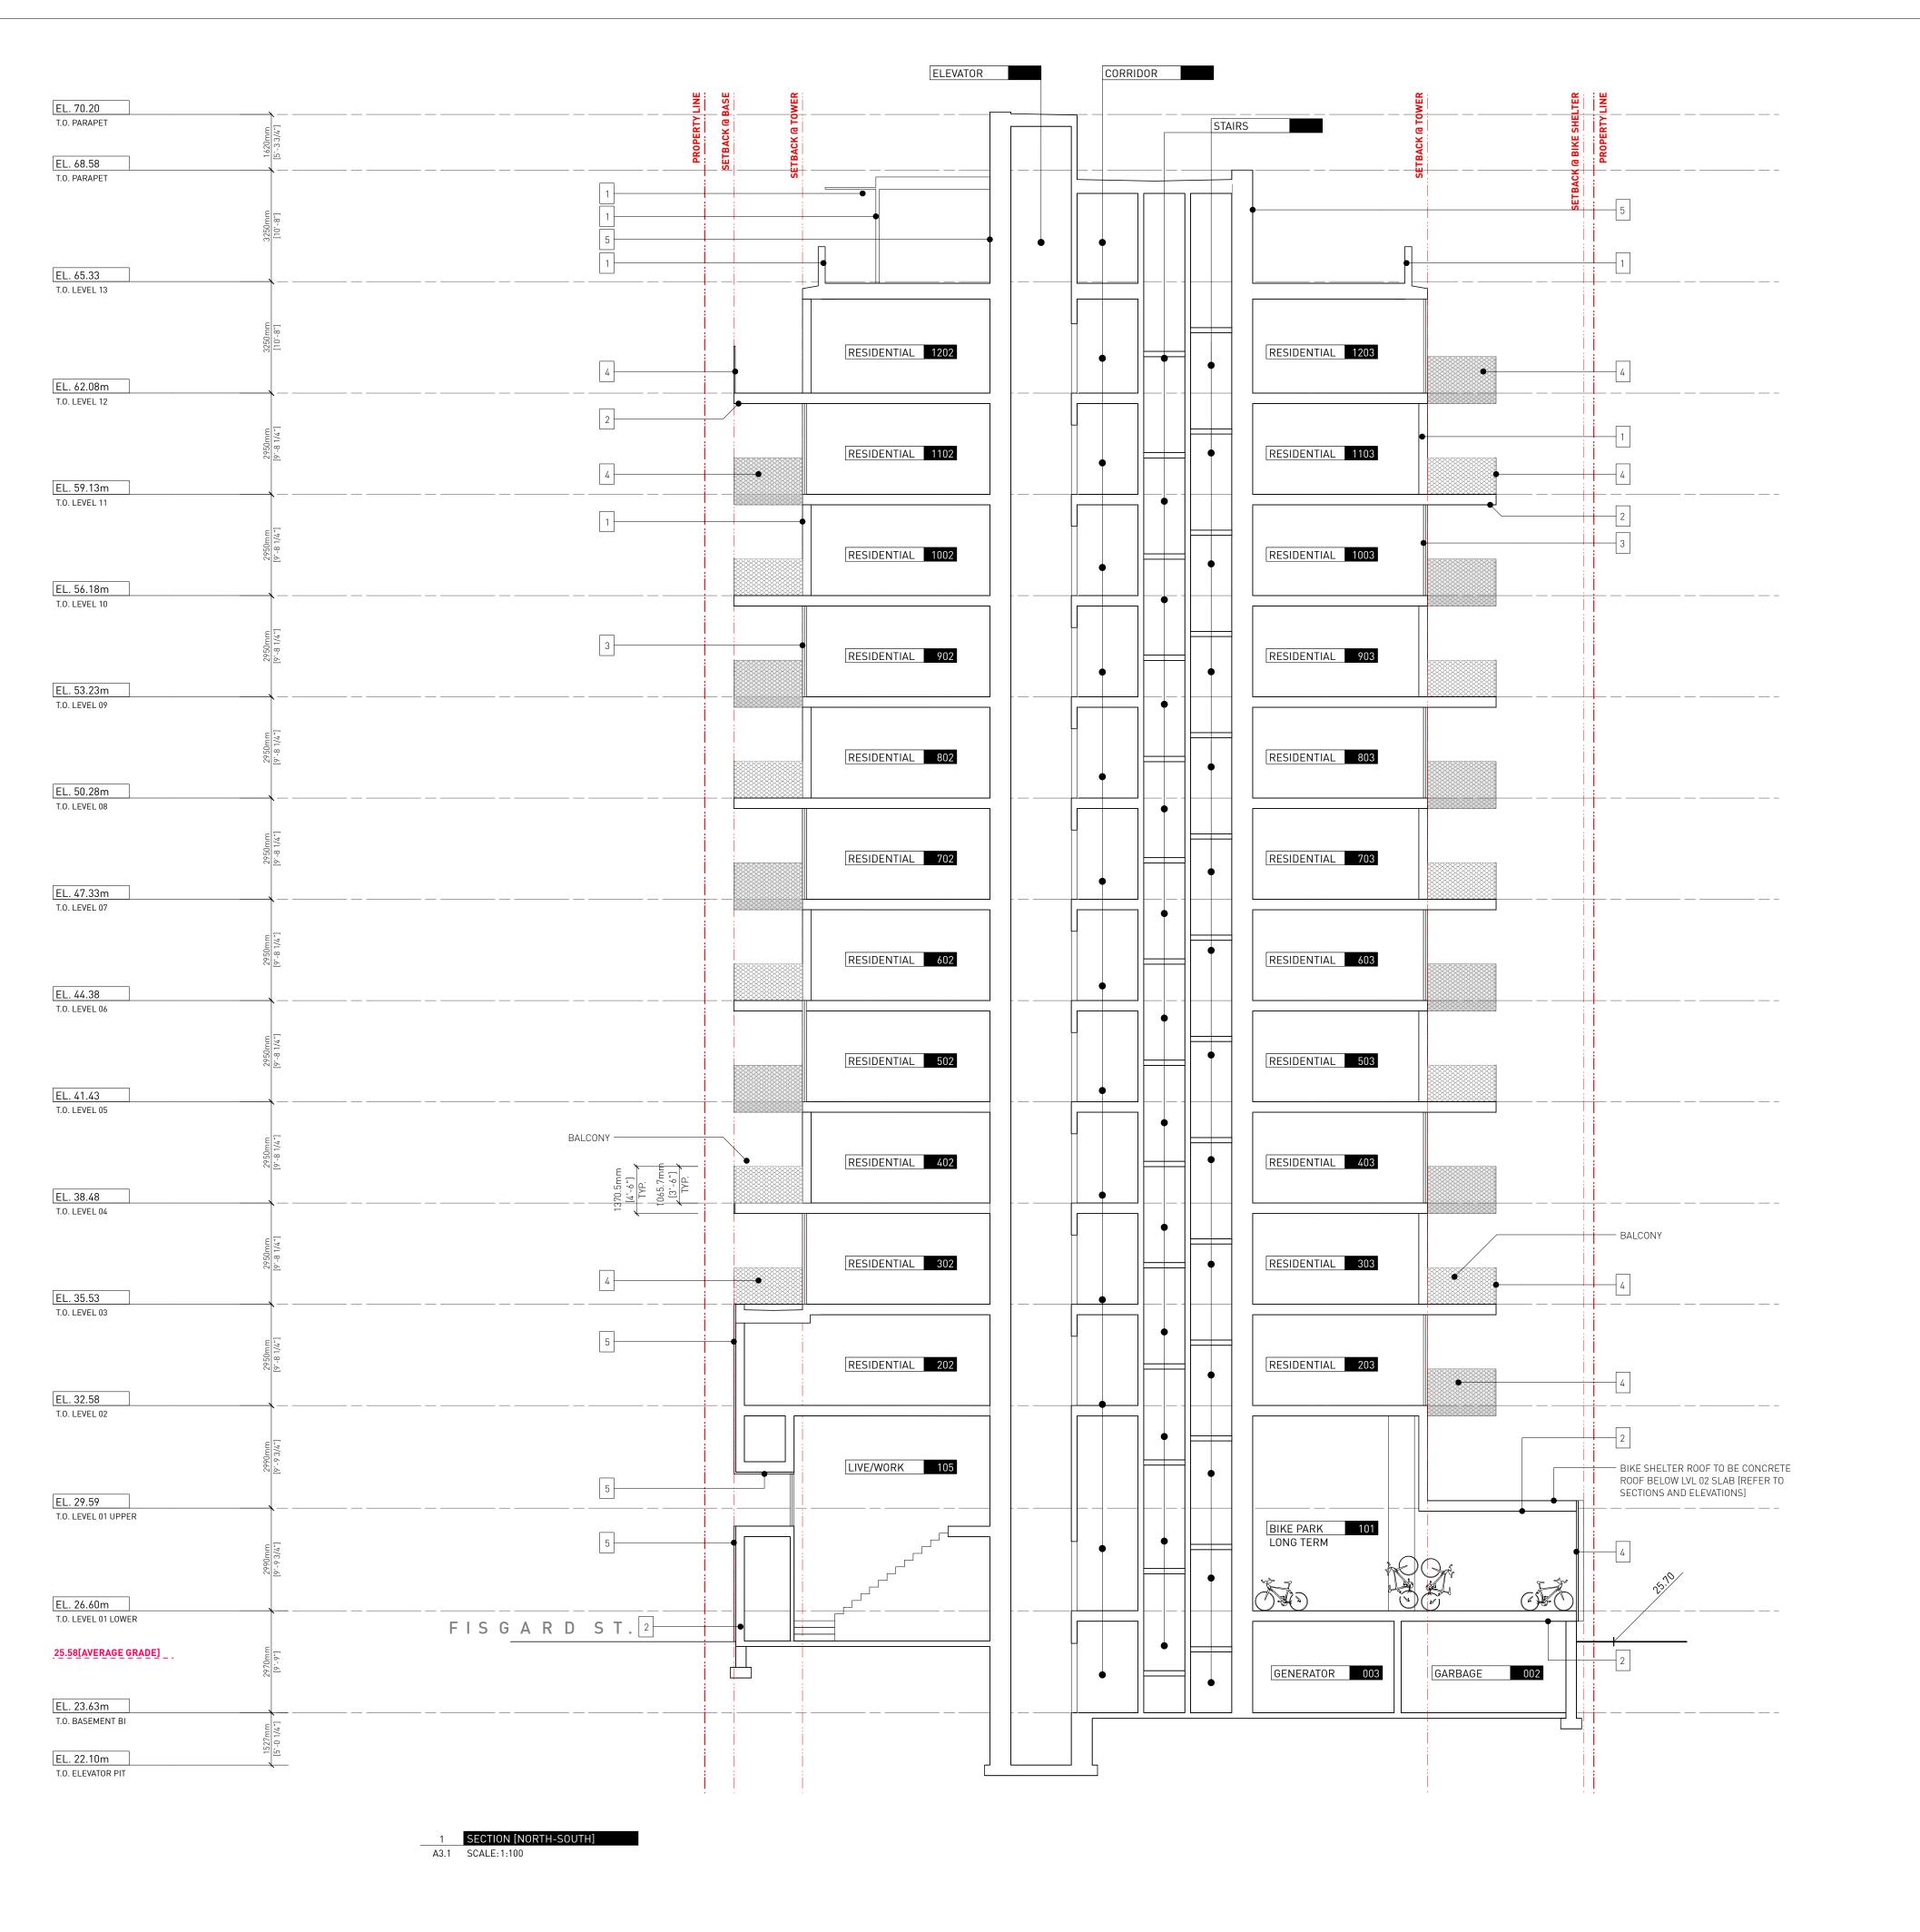

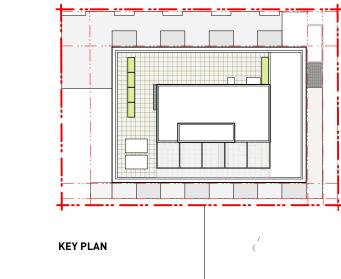

2 Issued for TRG1 response

Drawn By: Checked By: Printing Date: PB 23.05.2025

21.09.2023

The Contractor shall verify all dimensions, datums and levels prior to commencement of work.

All errors and omissions to be reported to the

Architect before proceeding. This drawing must not be scaled.

This drawing is the property of the Architect; the

1 ALUMINUM

2 CONCRETE

3 GLASS WINDOWS / GUARDRAIL

4 EXPANDED METAL MESH GUARD / SCREEN

5 EXPANDED METAL MESH + CEMENTIOUS PANEL


6 SALVEGED BRICK

7 METAL FENCE

copyright in same being reserved to him/her. It is

Any unauthorized alteration of the electronic data which constitute this document will void all responsibility for the altered document by the Architect.

This drawing is not to be used for building purposes until countersigned by:

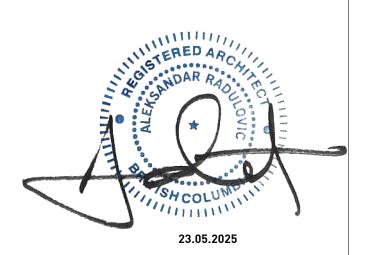




266 MCDERMOT AVE Winnipeg MB R3B 0S8 P: 204.480.8421 F: 204.480.8876


1702 QUADRA STREET + 862 FISGARD STREET

BUILDING SECTION

Project 0650 Sheet

A3.1

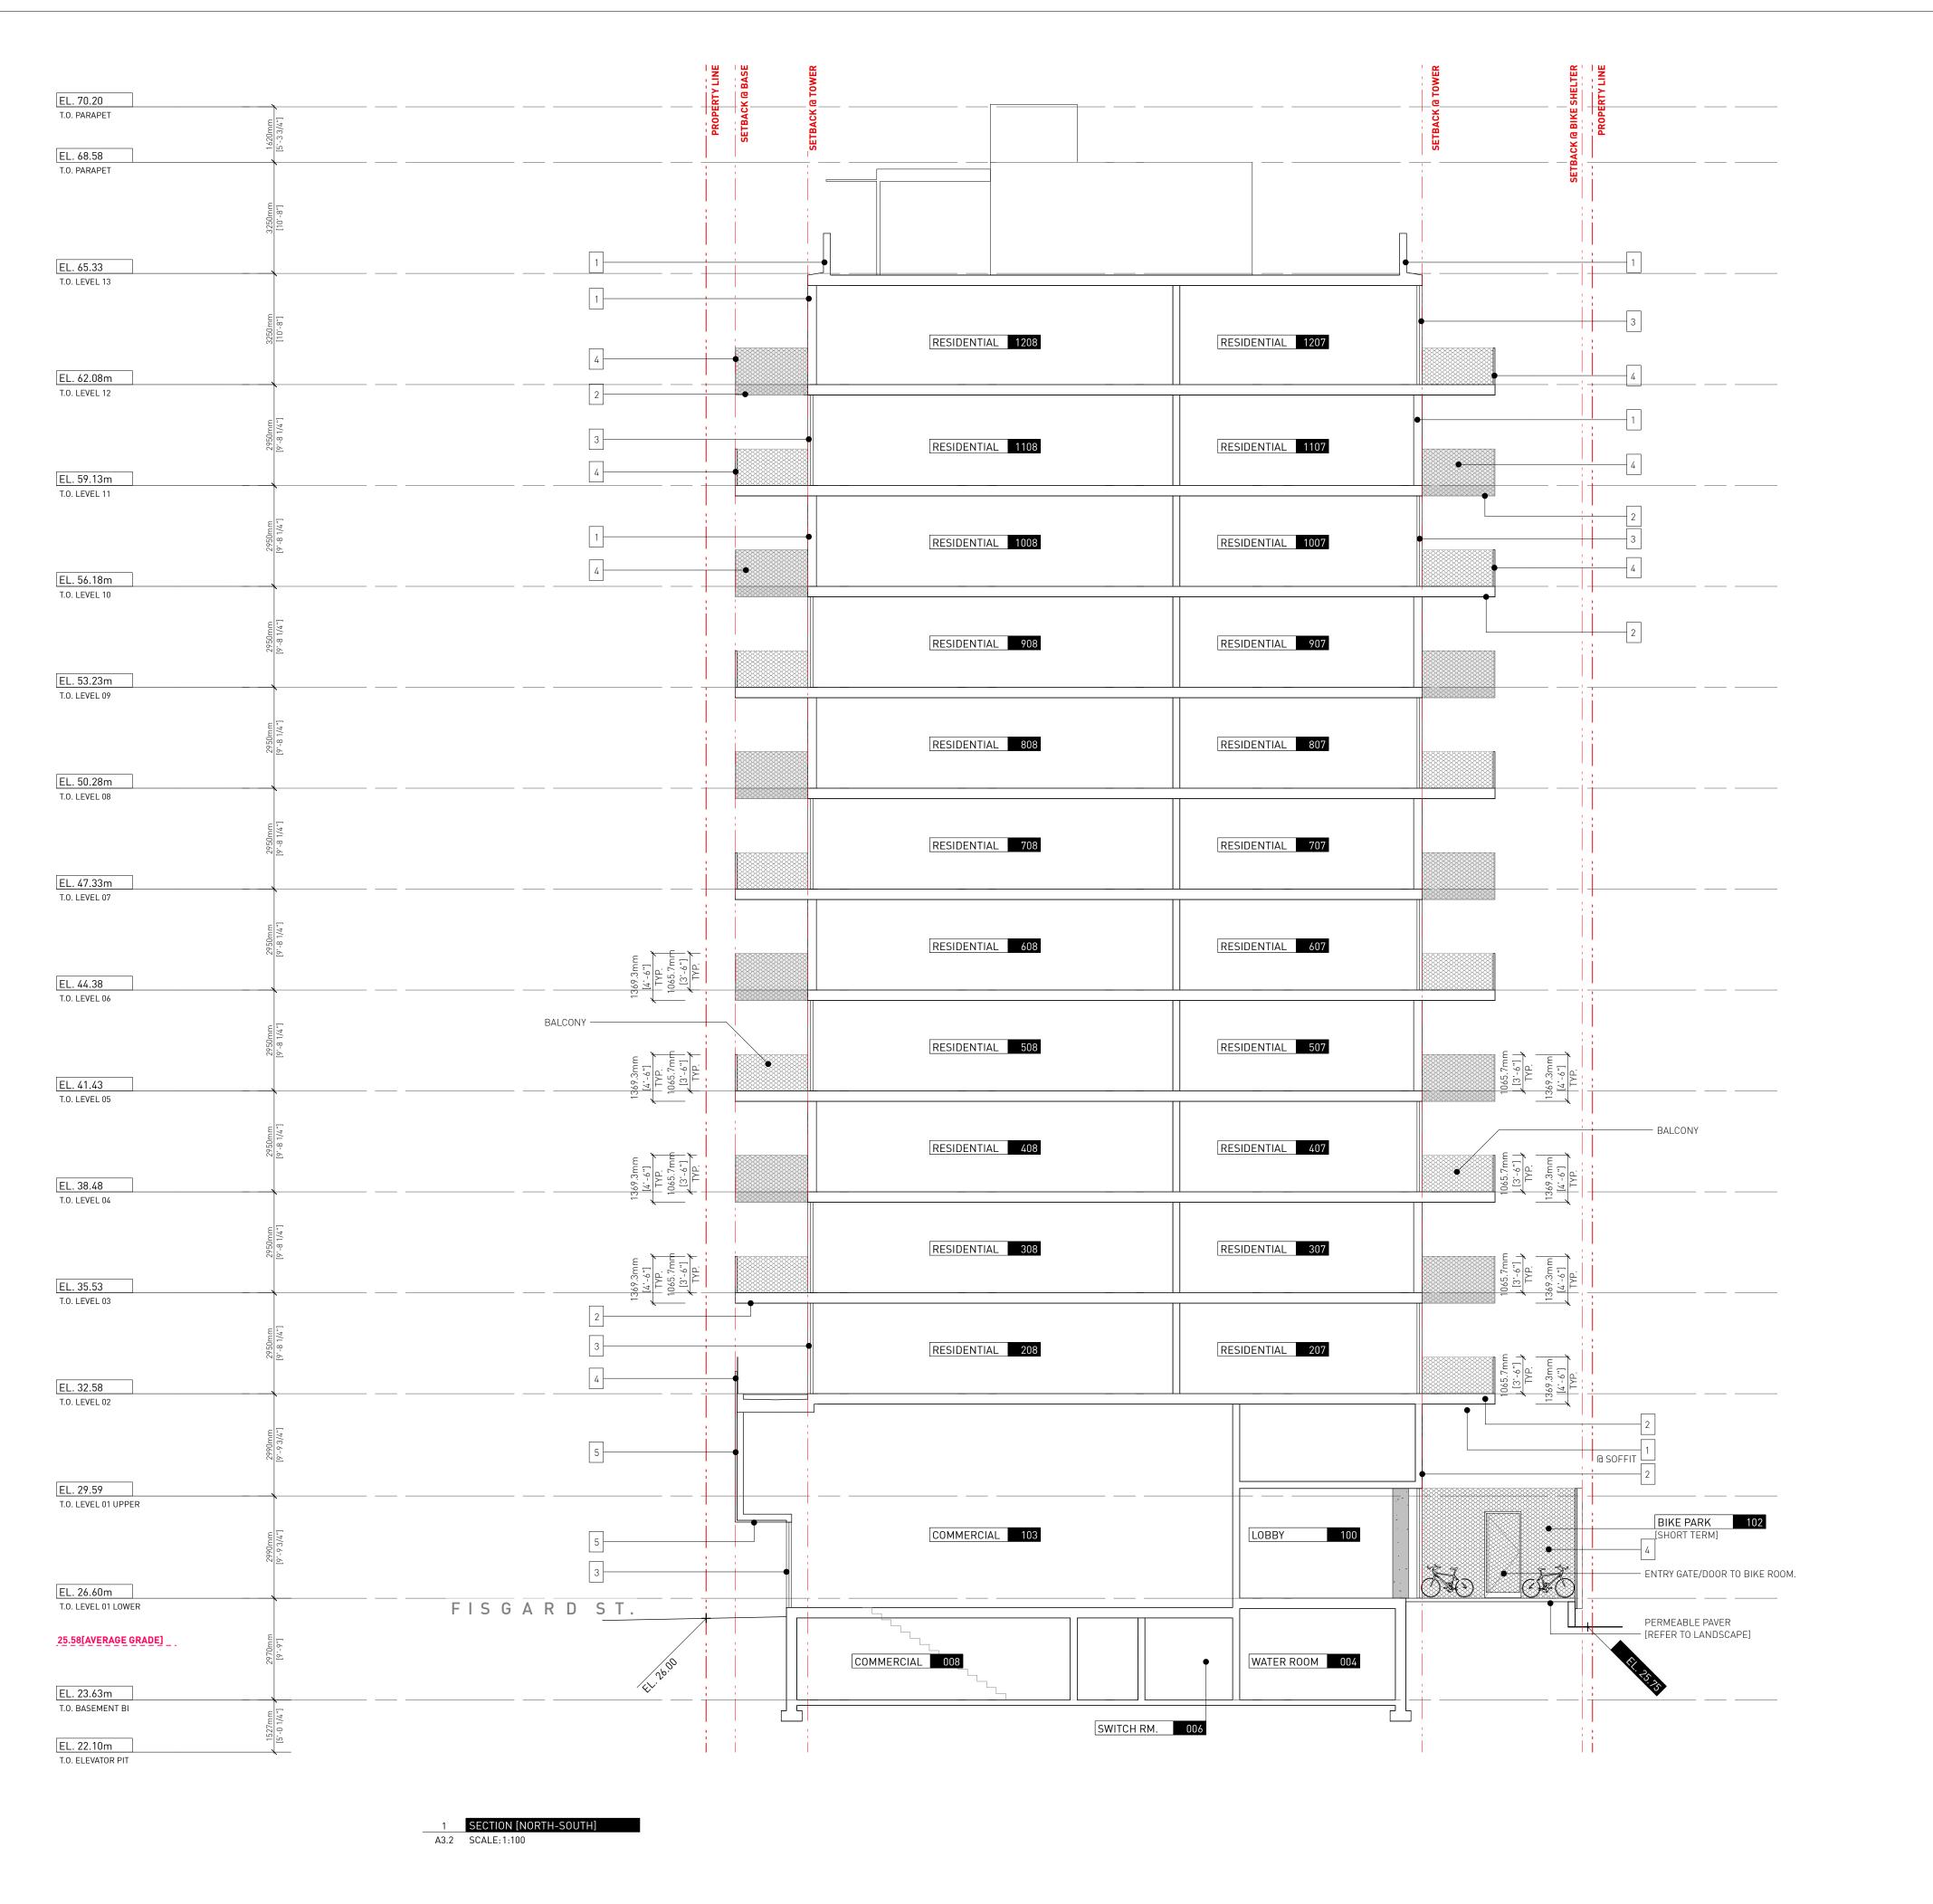

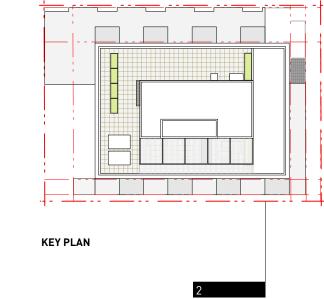

2 Issued for TRG1 response

Drawn By: Checked By: Printing Date: PB 23.05.2025

21.09.2023

The Contractor shall verify all dimensions, datums and levels prior to commencement of work.

All errors and omissions to be reported to the Architect before proceeding.

This drawing must not be scaled.

1 ALUMINUM

2 CONCRETE

3 GLASS WINDOWS / GUARDRAIL

4 EXPANDED METAL MESH GUARD / SCREEN

5 EXPANDED METAL MESH + CEMENTIOUS PANEL


6 SALVEGED BRICK


7 METAL FENCE

This drawing is the property of the Architect; the copyright in same being reserved to him/her. It is

Any unauthorized alteration of the electronic data which constitute this document will void all responsibility for the altered document by the Architect.

This drawing is not to be used for building purposes until countersigned by:

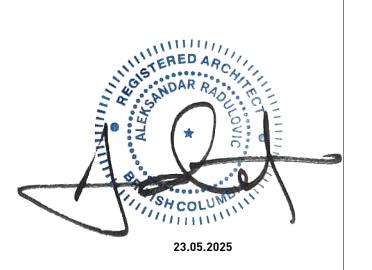

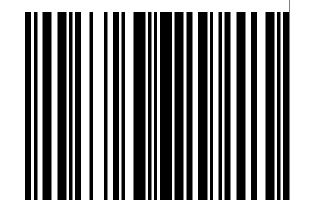



266 MCDERMOT AVE Winnipeg MB R3B 0S8 P: 204.480.8421 F: 204.480.8876

1702 QUADRA STREET + 862 FISGARD STREET

BUILDING SECTION

Project 0650 Sheet A3.2

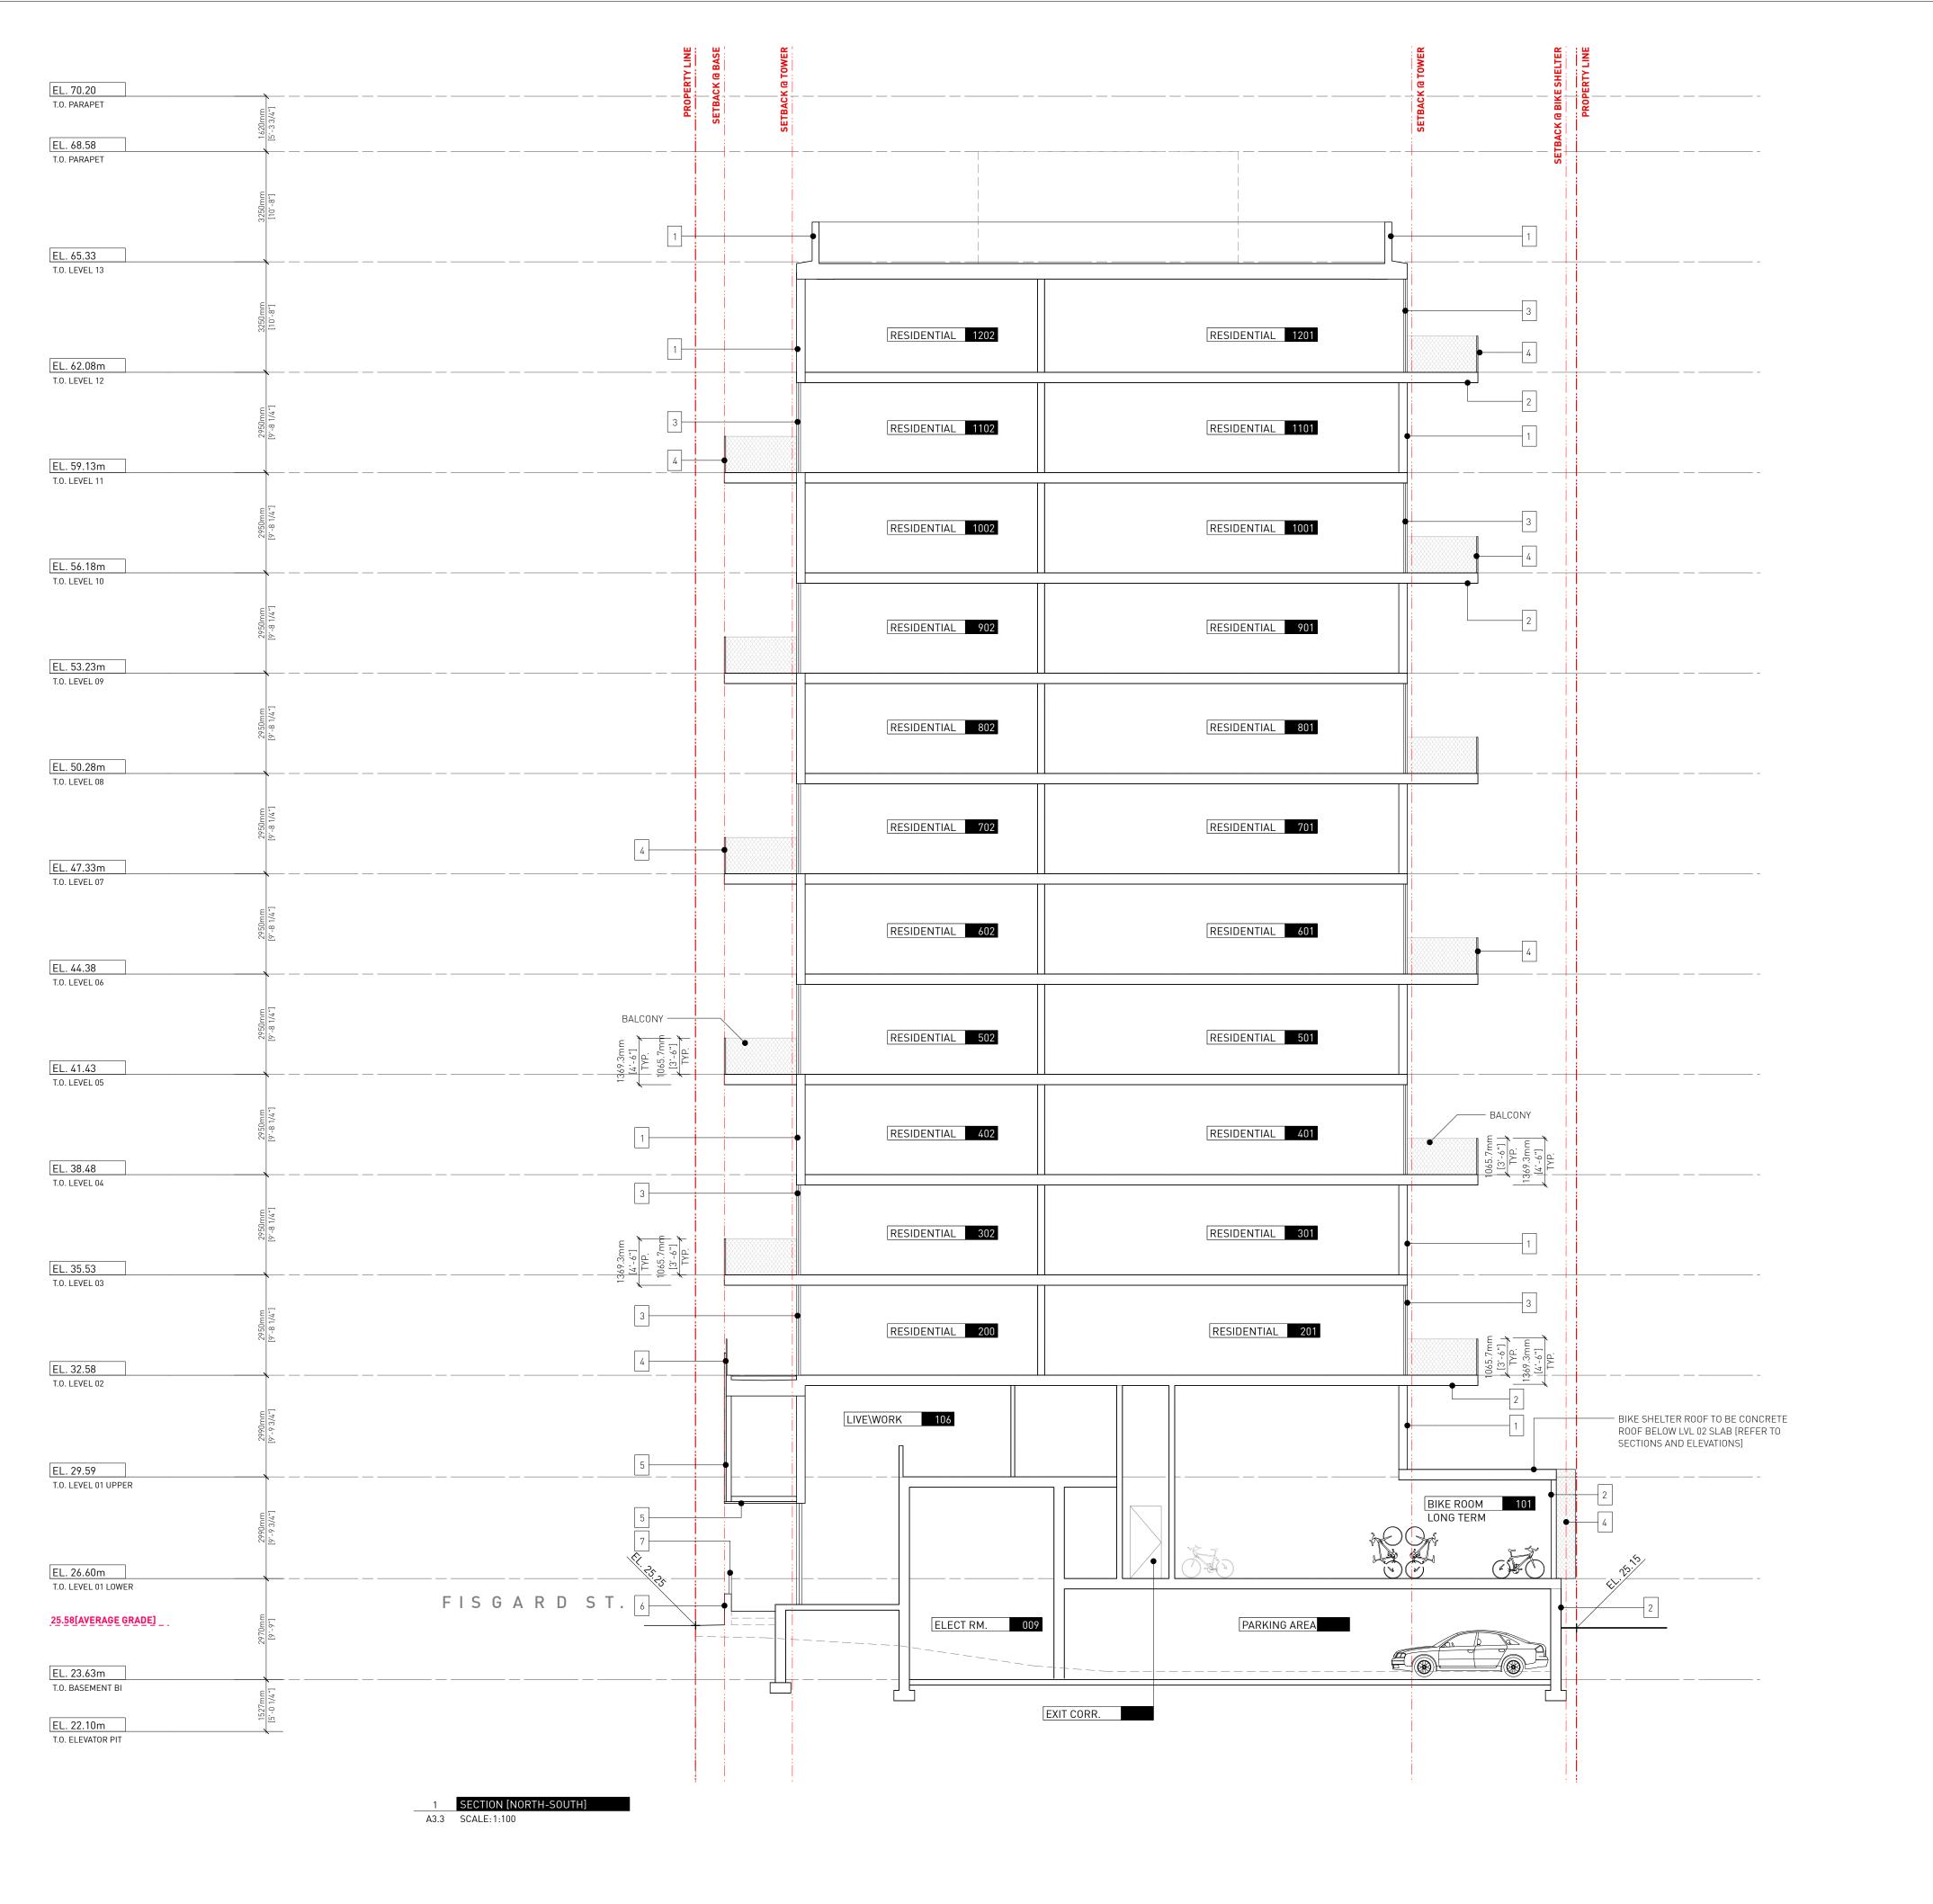

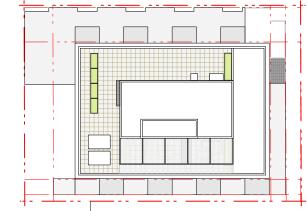

KEY PLAN

4 Issued for DDP 26.05.2025
3 Issued for TRG2 response 14.12.2023

2 Issued for TRG1 response

Drawn By:
Checked By:
Printing Date:
PB
23.05.2025

21.09.2023

The Contractor shall verify all dimensions, datums and levels prior to commencement of work.

All errors and omissions to be reported to the Architect before proceeding.

This drawing must not be scaled.

This drawing is the property of the Architect; the

1 ALUMINUM

2 CONCRETE

3 GLASS WINDOWS / GUARDRAIL

4 EXPANDED METAL MESH GUARD / SCREEN

5 EXPANDED METAL MESH + CEMENTIOUS PANEL


6 SALVEGED BRICK

7 METAL FENCE

copyright in same being reserved to him/her. It is not to be reproduced without his/her permission.

Any unauthorized alteration of the electronic data which constitute this document will void all responsibility for the altered document by the

This drawing is not to be used for building purposes until countersigned by:

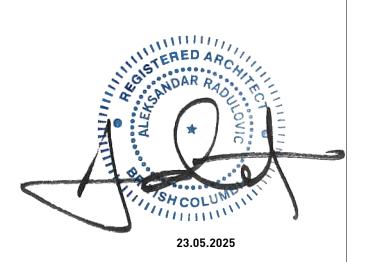





5 4 6 8 7 9 6 A R C H I T E C T U R E I N C 266 MCDERMOT AVE Winnipeg MB R3B 0S8 P: 204.480.8421 F: 204.480.8876

1702 QUADRA STREET + 862 FISGARD STREET

BUILDING SECTION

0650 Sheet

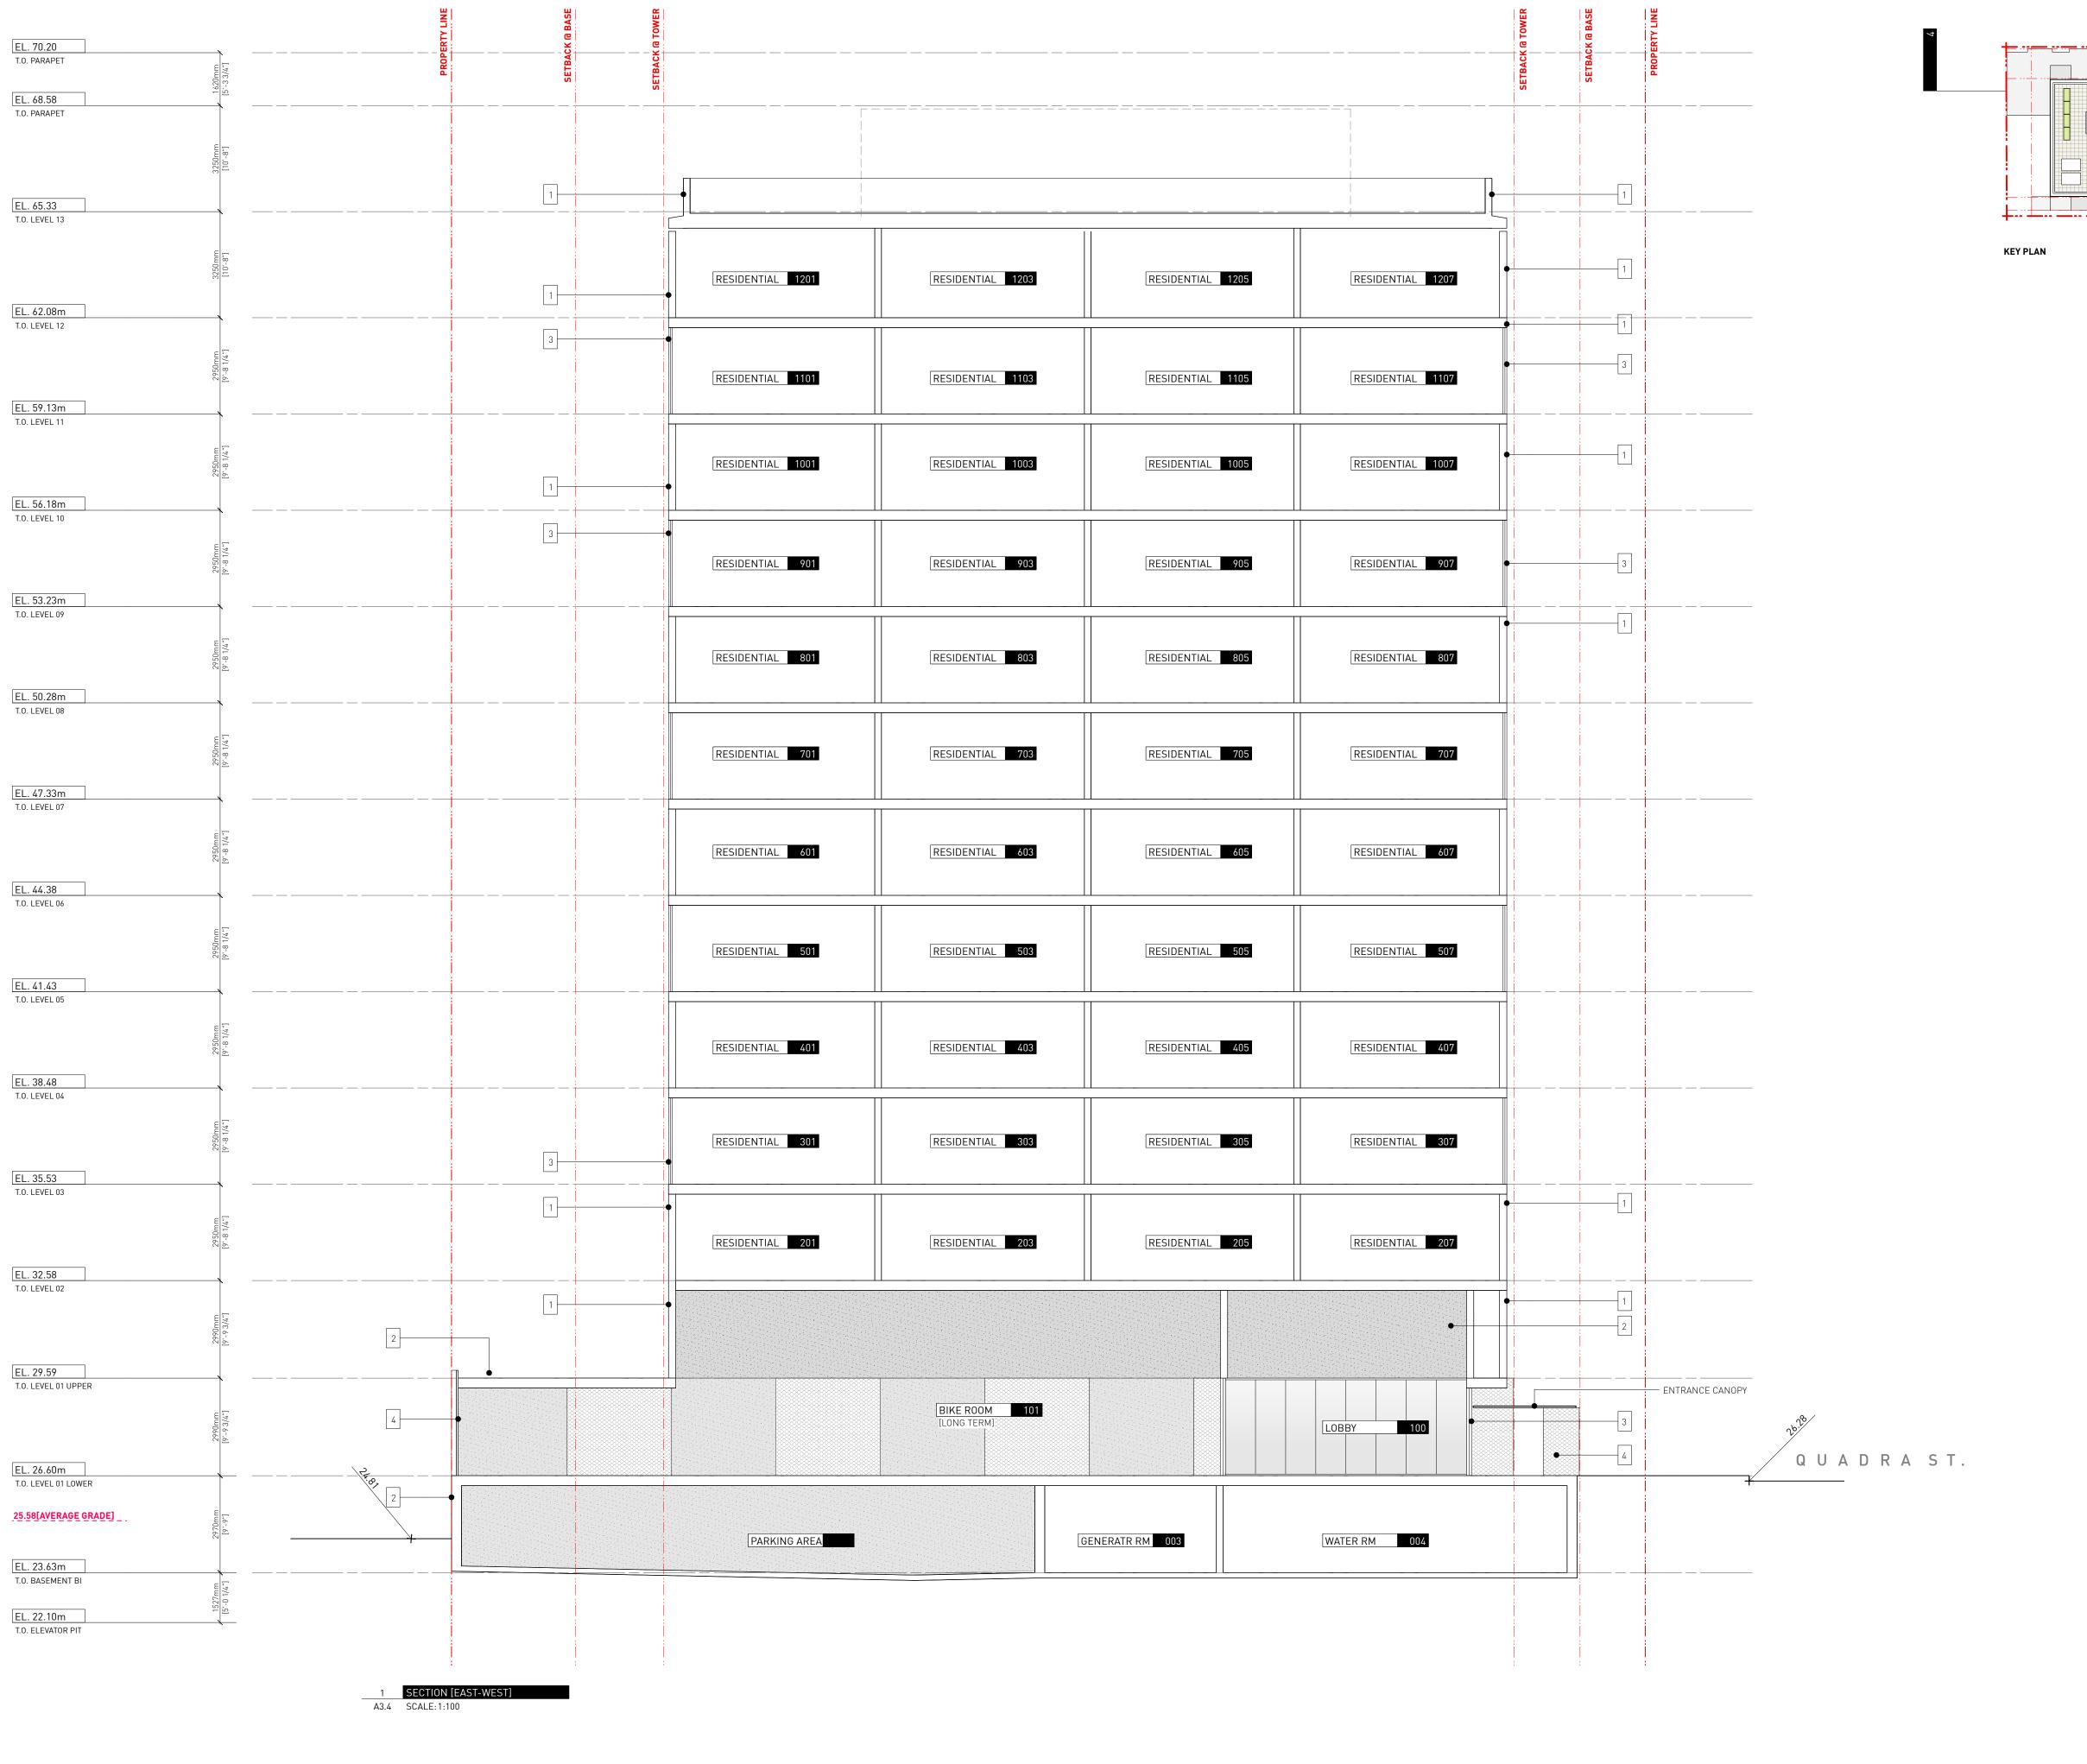

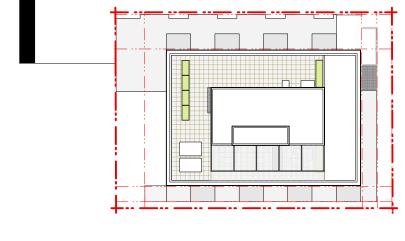

1 ALUMINUM

2 CONCRETE

3 GLASS WINDOWS / GUARDRAIL

4 EXPANDED METAL MESH GUARD / SCREEN

5 EXPANDED METAL MESH + CEMENTIOUS PANEL

6 SALVEGED BRICK

7 METAL FENCE

4 Issued for DDP 26.05.2025 3 Issued for TRG2 response 14.12.2023

2 Issued for TRG1 response 21.09.2023

Drawn By: Checked By: Printing Date: PB 23.05.2025

The Contractor shall verify all dimensions, datums

and levels prior to commencement of work. All errors and omissions to be reported to the

Architect before proceeding.

This drawing must not be scaled.

This drawing is the property of the Architect; the copyright in same being reserved to him/her. It is

Any unauthorized alteration of the electronic data

which constitute this document will void all responsibility for the altered document by the Architect.

This drawing is not to be used for building purposes until countersigned by:



23.05.2025





266 MCDERMOT AVE Winnipeg MB R3B 0S8 P: 204.480.8421 F: 204.480.8876

1702 QUADRA STREET + 862 FISGARD STREET

BUILDING SECTION

0650 Sheet A3.4

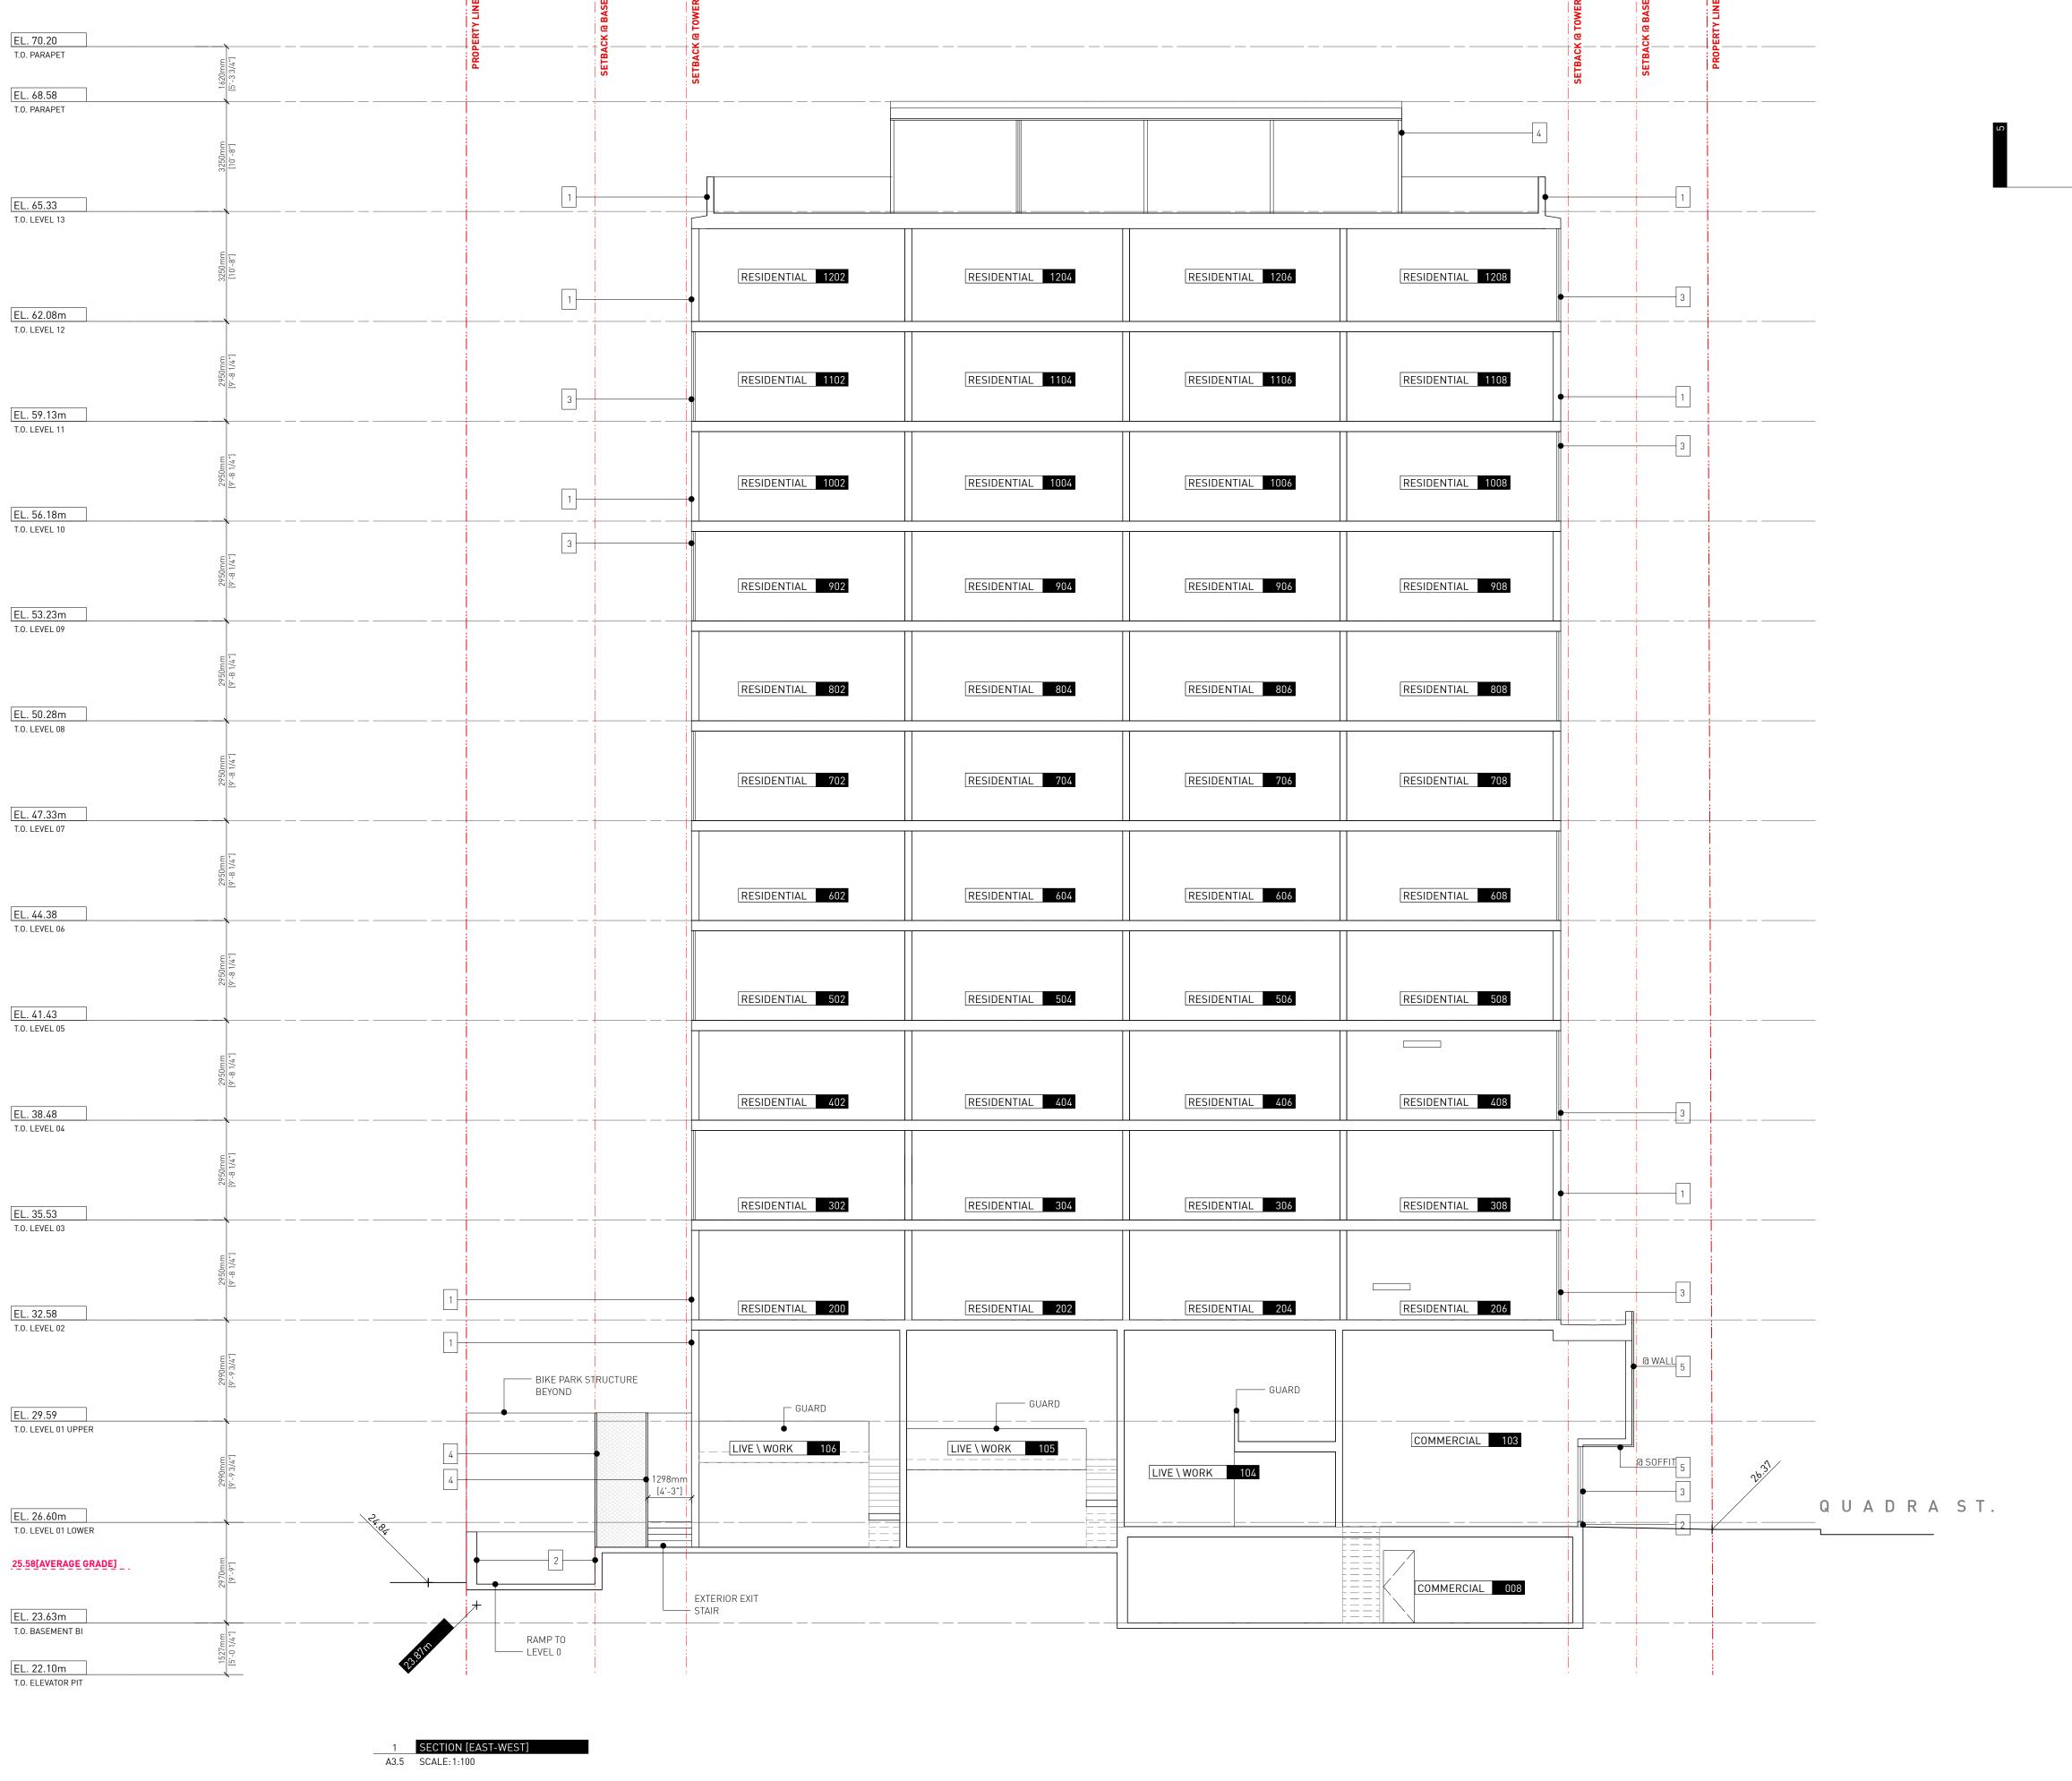

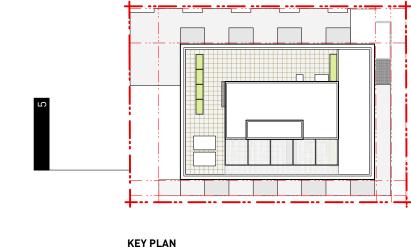

1 ALUMINUM

2 CONCRETE

3 GLASS WINDOWS / GUARDRAIL

4 EXPANDED METAL MESH GUARD / SCREEN

5 EXPANDED METAL MESH + CEMENTIOUS PANEL

6 SALVEGED BRICK

7 METAL FENCE

4 Issued for DDP 26.05.2025 3 Issued for TRG2 response 14.12.2023

2 Issued for TRG1 response 21.09.2023 Drawn By: Checked By: Printing Date:

PB 23.05.2025

The Contractor shall verify all dimensions, datums and levels prior to commencement of work.

All errors and omissions to be reported to the Architect before proceeding.

This drawing must not be scaled.

This drawing is the property of the Architect; the

copyright in same being reserved to him/her. It is

Any unauthorized alteration of the electronic data which constitute this document will void all responsibility for the altered document by the Architect.

This drawing is not to be used for building purposes until countersigned by:






266 MCDERMOT AVE Winnipeg MB R3B 0S8 P: 204.480.8421 F: 204.480.8876


1702 QUADRA STREET + 862 FISGARD STREET

BUILDING SECTION

Project 0650 Sheet

A3.5

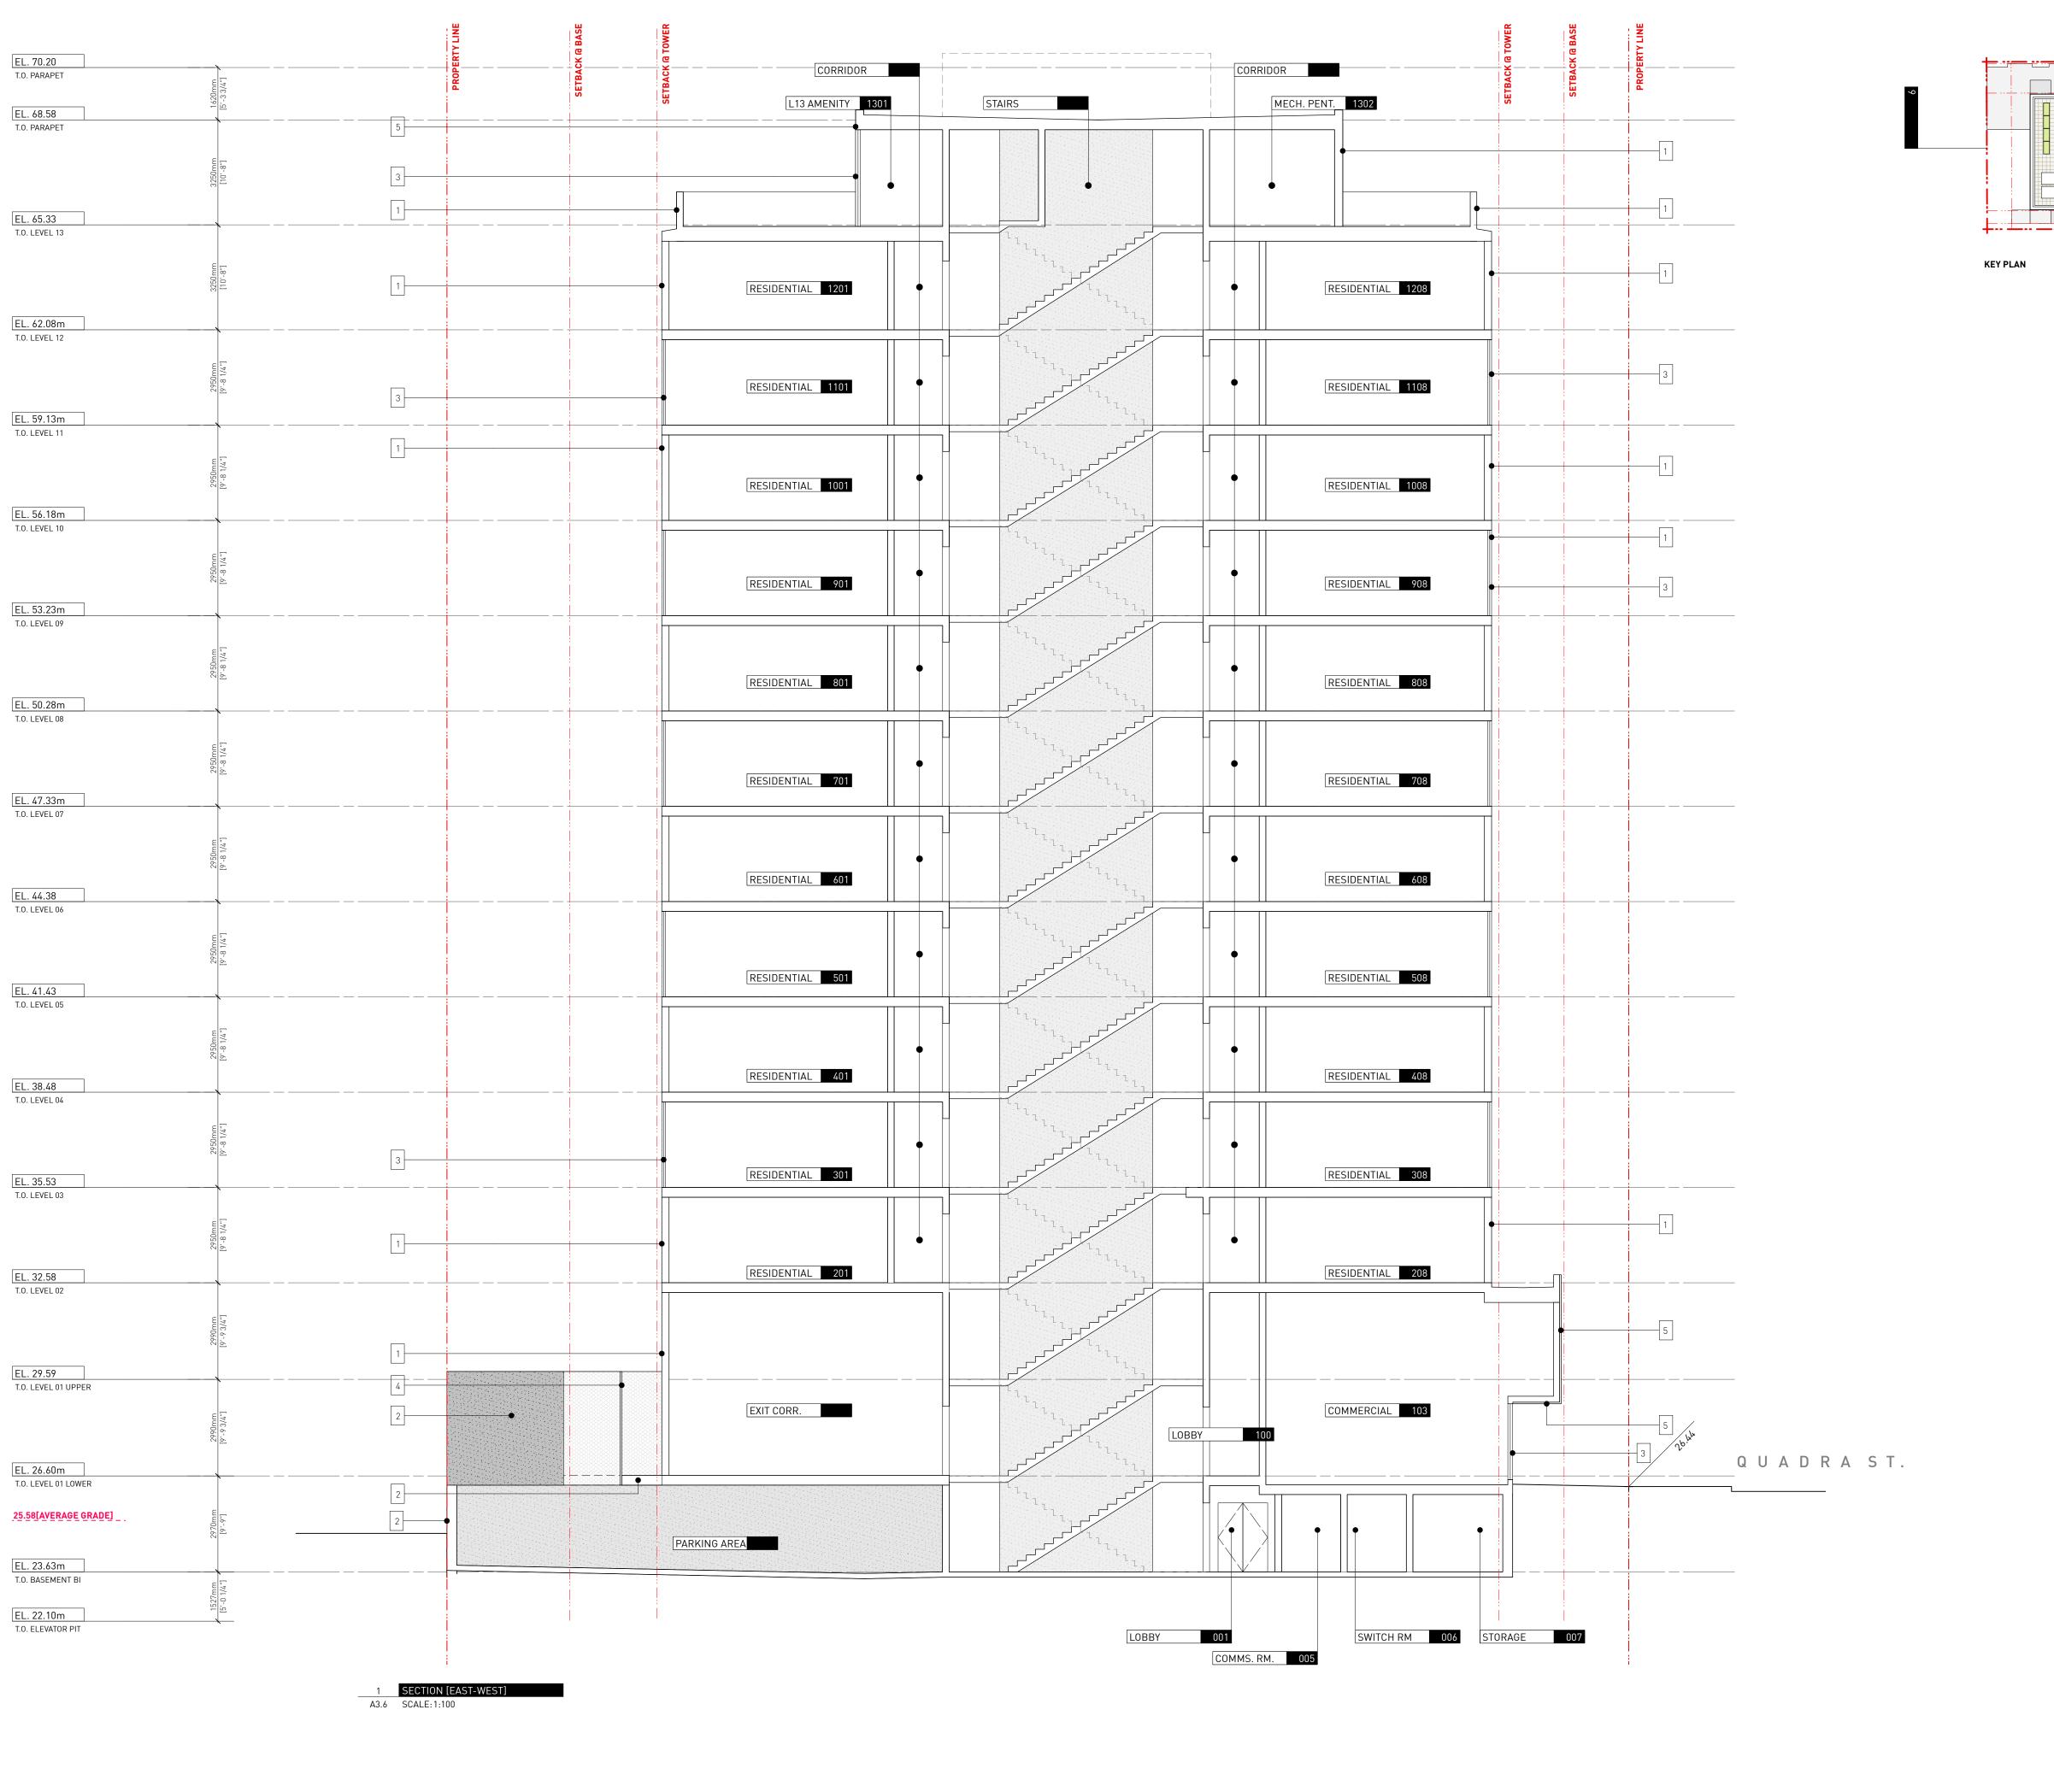

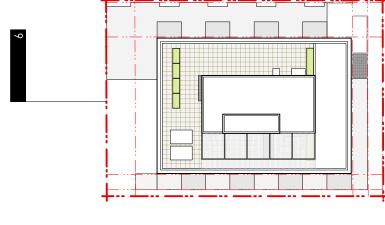

1 ALUMINUM

2 CONCRETE

3 GLASS WINDOWS / GUARDRAIL

4 EXPANDED METAL MESH GUARD / SCREEN

5 EXPANDED METAL MESH + CEMENTIOUS PANEL

6 SALVEGED BRICK

7 METAL FENCE

4 Issued for DDP 26.05.2025
3 Issued for TRG2 response 14.12.2023

2 Issued for TRG1 response

Drawn By:
Checked By:
Printing Date:
PB
23.05.2025

21.09.2023

The Contractor shall verify all dimensions, datums and levels prior to commencement of work.

All errors and omissions to be reported to the Architect before proceeding.

This drawing must not be scaled.

This drawing is the property of the Architect; the copyright in same being reserved to him/her. It is not to be reproduced without his/her permission.

Any unauthorized alteration of the electronic data which constitute this document will void all responsibility for the altered document by the Architect.

This drawing is not to be used for building purposes until countersigned by:






ARCHITECTURE INC 266 MCDERMOT AVE Winnipeg MB R3B 0S8 P: 204.480.8421 F: 204.480.8876

1702 QUADRA STREET + 862 FISGARD STREET

BUILDING SECTION

Project 0650 Sheet A3.6

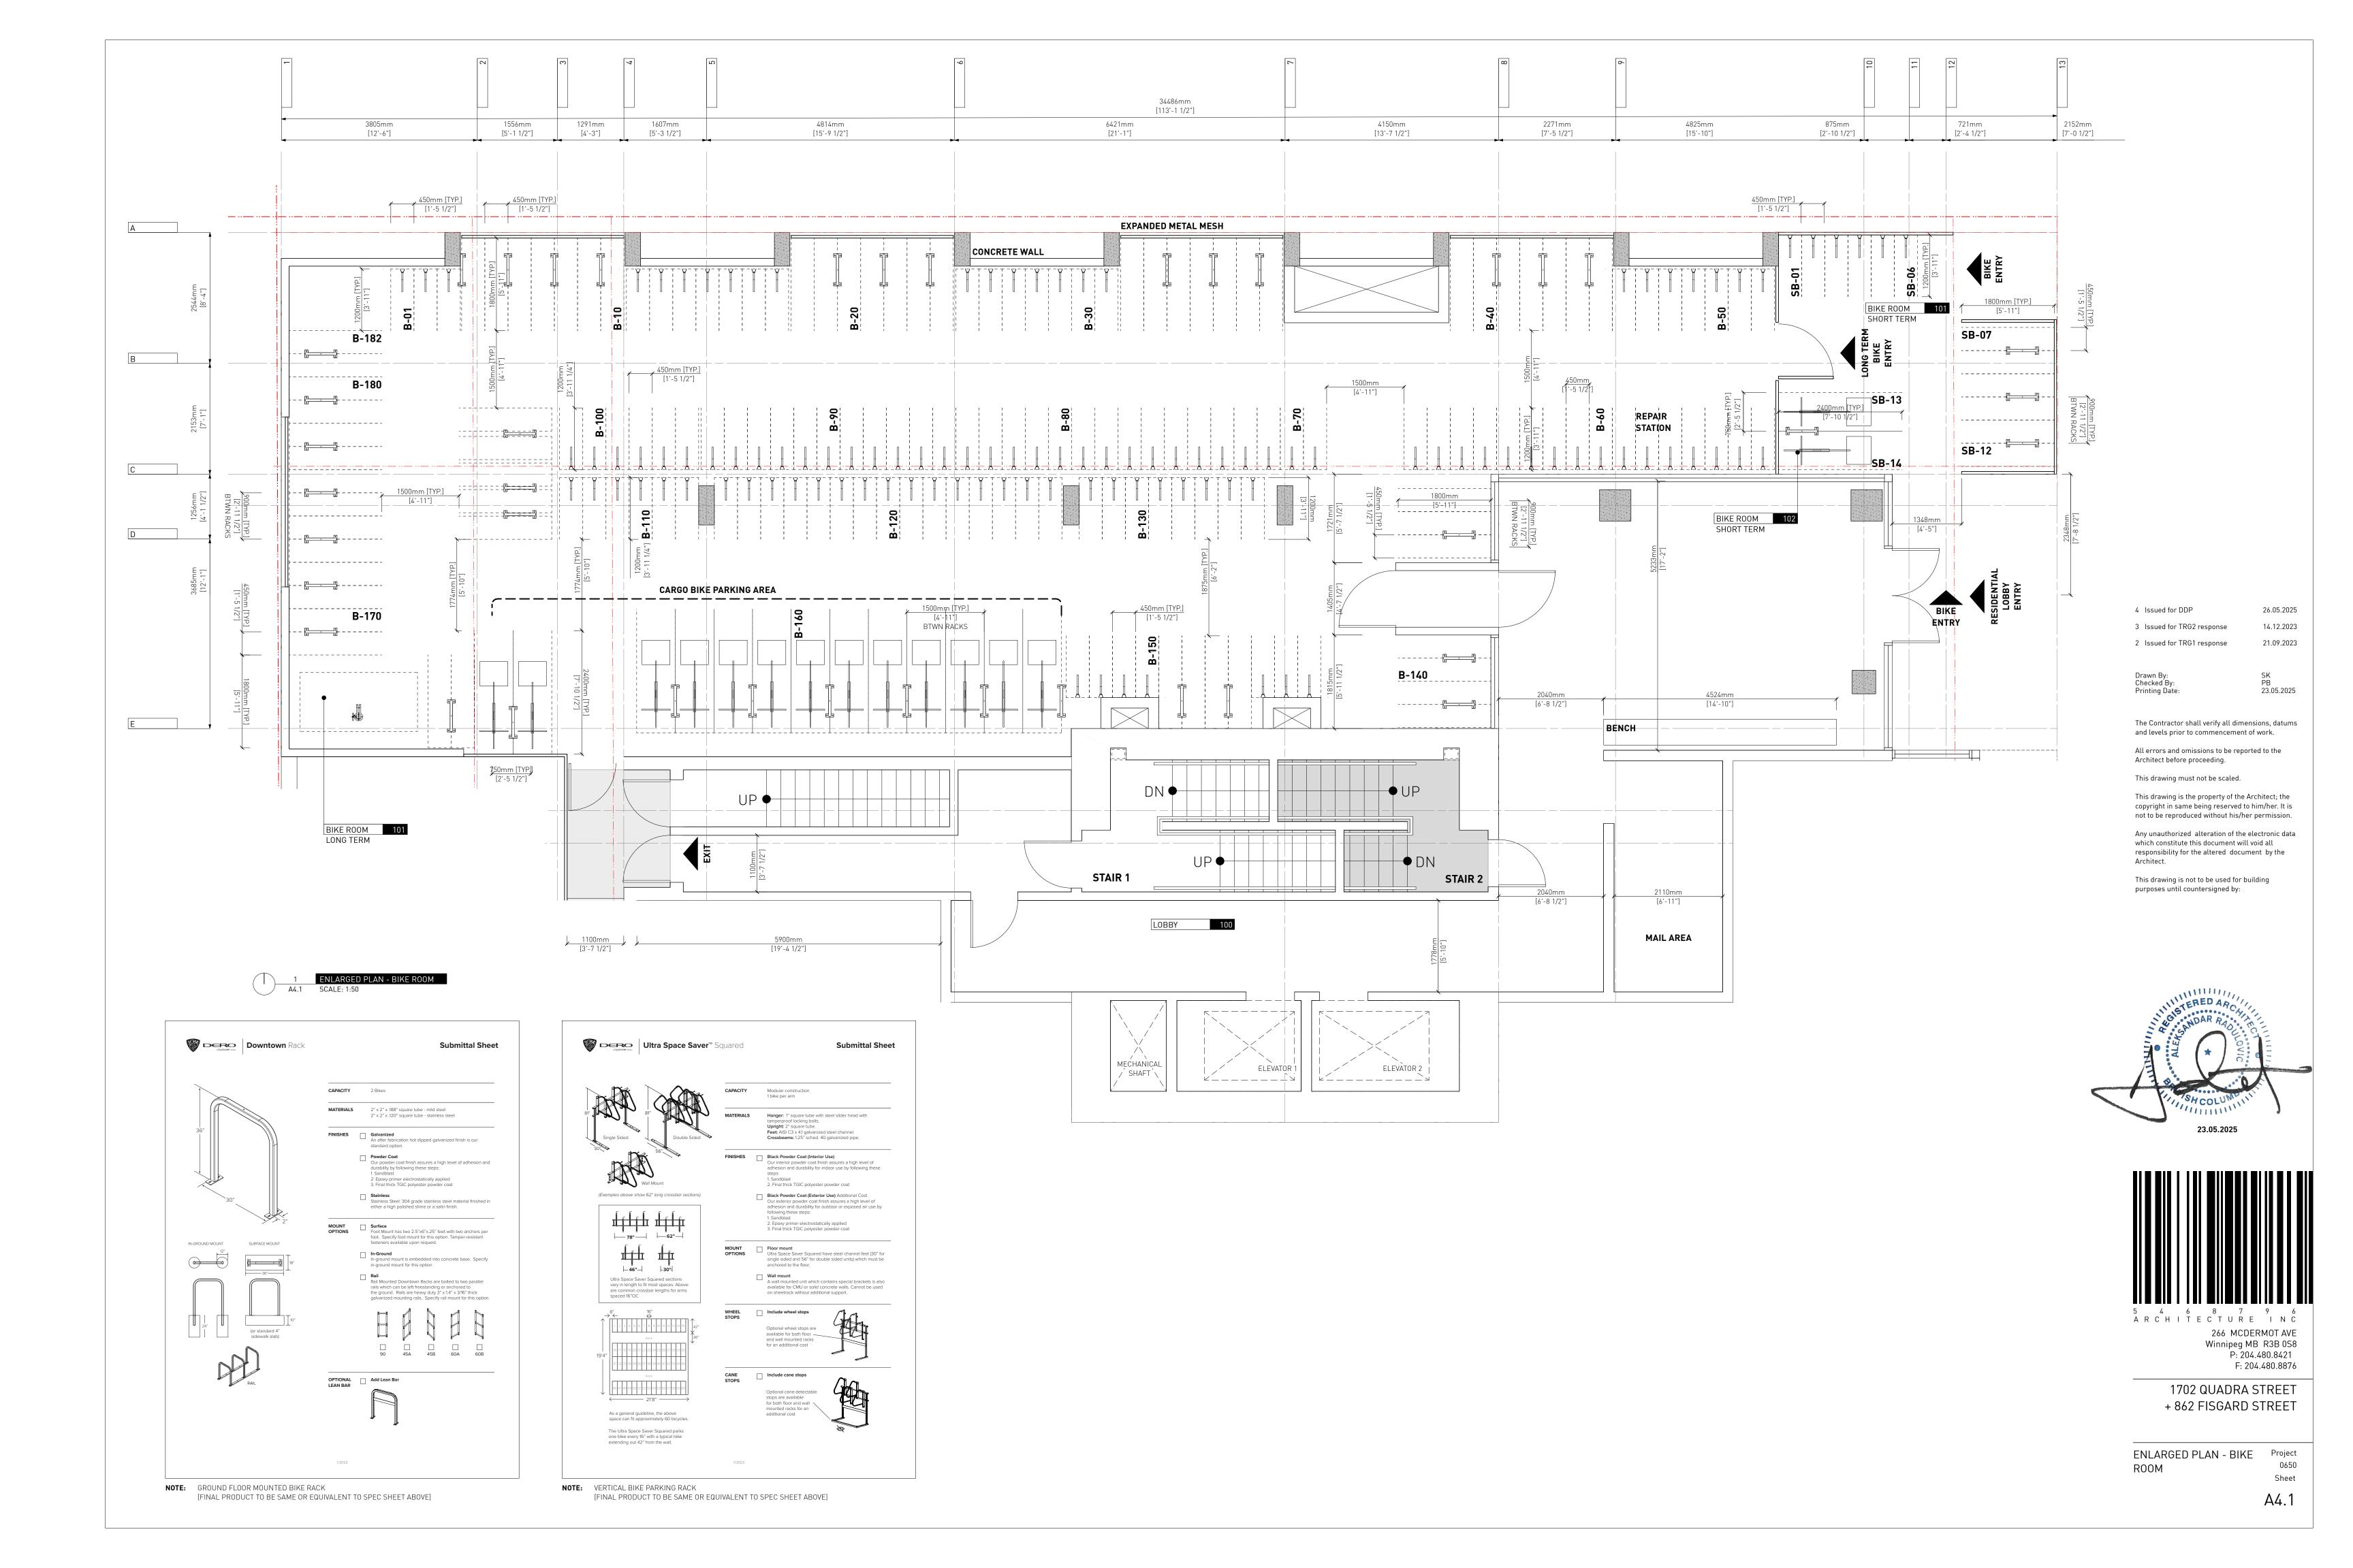

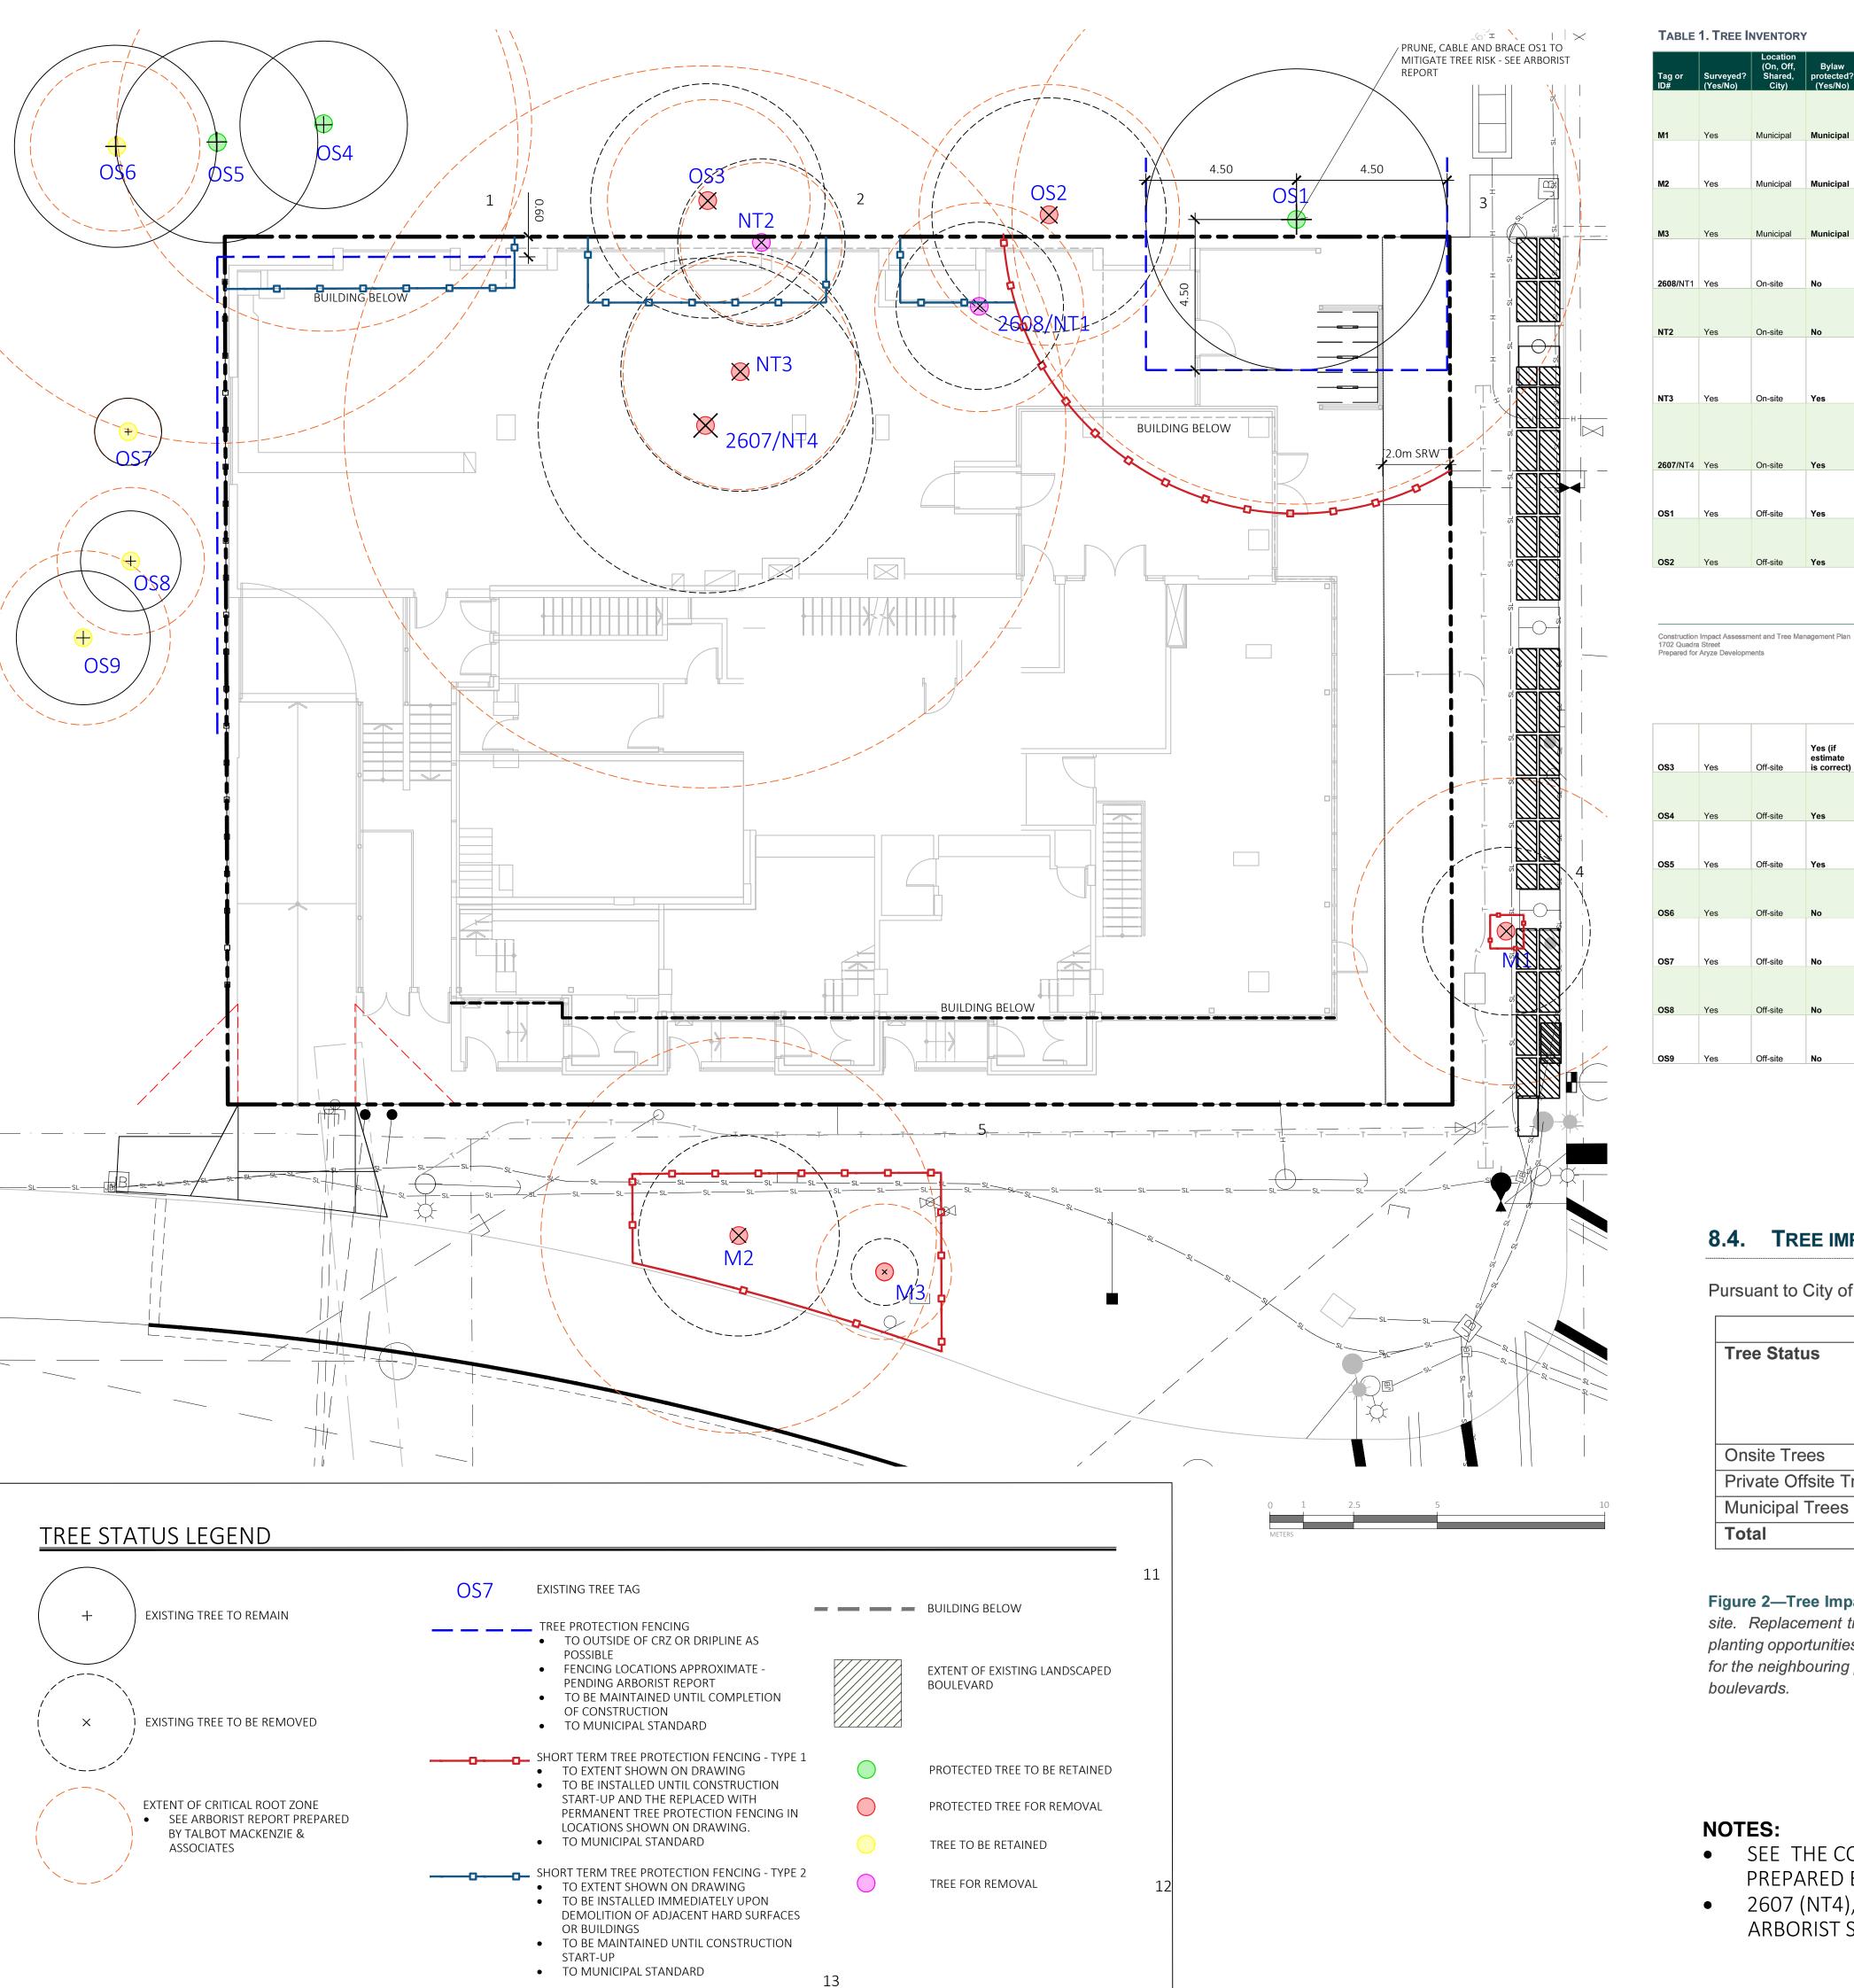


TABLE 1. TREE INVENTORY

		Location (On, Off,	Bylaw	Name			Critical	Dripline	Condition	ļ	Retention Suitability				
ag or #	Surveyed? (Yes/No)	Shared, City)	protected? (Yes/No)	Common	Botanical	dbh (cm)	root zone radius (m)	diameter (m)	Health	Structural	(onsite trees)	Relative tolerance	General field observations/remarks	Tree retention / location comments	Retent status
11	Yes	Municipal	Municipal	English Oak	Quercus robur	46	4.6	5	Fair	Fair	N/A	Good	Columnar form. Clearance pruned away from building.	Conflict with proposed underground hydro.	x
						49									
12	Yes	Municipal	Municipal	Cut-leaf Beech	Fagus sylvatica 'Asplenifolia'	(below union)	5.9	6	Good	Fair	N/A	Poor	Measured at 1m. Hydro clearance pruned.	Conflict with proposed underground hydro.	x
				2555	, iopioimona		5.5		0000				praise.	ya.a.	
				Deciduous	Stewartia										
/ 13	Yes	Municipal	Municipal	Camellia	pseudocamellia	4	1	1	Fair	Fair	N/A	Moderate	Juvenile tree. Weedwacker damage.	Frontage improvements.	X
:608/ NT1	Yes	On-site	No	Pear	Pyrus spp.	26	3.1	5	Fair	Fair	Unsuitable	Moderate	Topped. Gravel parking adjacent.	Within building footprint.	x
	.,				_	40.40							Located between fence and storage shed.		
IT2	Yes	On-site	No	Ash	Fraxinus spp.	~18,10	2.4	5	Fair	Fair-poor	Unsuitable	Good	Topped, epicormic growth.	Within building footprint.	X
													Located between storage shed and brick garage. Large seam up trunk, likely from past		
													failure, decaying. Lowest limb actively failing,has been shortened, will rest on garage		
NT3	Yes	On-site	Yes	Ash	Fraxinus spp.	~35	3.5	7	Fair-poor	Poor	Unsuitable	Good	roof.	Within building footprint.	X
						90							Large deadwood/decay north canopy. Pruning stubs and deadwood in primary stem,		
:607 /NT4	Yes	On-site	Yes	Big-Leaf Maple	Acer macrophyllum	(below unions)	10.8	10	Fair-poor	Fair-poor	Unsuitable	Moderate	response growth lower stem. Large surface roots lifting surrounding asphalt.	Within building footprint.	х
	W	011-11-		Big-Leaf	Acer	50.05	0.5		F.:-		N/A	N 4 - 4 4 -	North neighbouring property. Codominant stems, narrow attachments. Previous thinning.	Open Mind with the Malling for the dark	D. 4-1-
S1	Yes	Off-site	Yes	Maple	macrophyllum	~50,35	8.5	9	Fair	Fair	N/A	Moderate	Located against fence.	Conflict with building footprint.	Retain
													North neighbouing property. Located against fence. Previous thinning and raising. Epicormic		
)S2	Yes	Off-site	Yes	Ash	Fraxinus spp.	~30,15	3.9	7	Fair	Fair	N/A	Good	growth.	Conflict with building footprint.	Х

North neighbouring property. Located against Potential impacts from building North neighbouring property, active inclusion Potential impacts from building Possibly removed. West neighbouring property. Codominant top. Off-site No Tree Gingko biloba ~18 2.2 3 Good Fair N/A Moderate subject property.

> West neighbouring property. Codominant top Canopy beginning to encroach on driveway on

8.4. TREE IMPACT SUMMARY TABLE

Pursuant to City of Victoria Tree Preservation Bylaw No. 21-035, the tree replacement calculations are as follows:

	Α	В	С	D	
Tree Status	Total # of	# Of Trees	# Of NEW or	# Of EXISTING	NET
	Protected	to be	REPLACEMENT	non-protected	CHANGE
	Trees	REMOVED	Trees to be	Trees Counted as	(A-B+C+D)
			Planted*	Replacements	
Onsite Trees	2	2	0	0	-2
Private Offsite Trees	5	2	2 7	0	0
Municipal Trees	3	3	6	N/A	3
Total	10	7	4	0	1

Figure 2—Tree Impact Summary Table: Based on bylaw criteria, a lot of this size (947.8m²) requires a 5-tree minimum onsite. Replacement tree/tree minimum requirements will be compensated cash-in-lieu, as there do not appear to be sufficient planting opportunities post-construction. The landscape plan shows the two (2) required Schedule E—Part 1 replacement trees for the neighbouring property at 877 North Park Street and six (6) replacement trees on the Quadra & Fisgard Street municipal boulevards.

NOTES:

- SEE THE CONSTRUCTION IMPACT ASSESSMENT AND TREE MANAGEMENT PLAN, APPENDIX B, PREPARED BY TALMAC, FOR TREE PRESERVATION SUMMARY.
- 2607 (NT4), 2608 (NT1), NT2, AND NT3 ARE PROPOSED FOR REMOVAL AT THE DEMOLITION PHASE. ARBORIST SUPERVISION IS REQUIRED AS IDENTIFIED IN THE CONSTRUCTION IMPACT ASSESSMENT



1608 Camosun Street, Victoria BC V8T 3E6 Info@biophiliacollective.ca 250 590 1156

PROJECT NAME:

THE ABBEY

PROJECT ADDRESS:

1702 QUADRA STREET VICTORIA, BC

DESIGNED BY: BIANCA BODLEY DRAWN BY: KIM TANG

NO.	ISSUED FOR	YY\MM\DD
1	CIS PRESENTATION	12/07/2021
2	DEVELOPMENT PERMIT	12/22/2021
3	ADP MEETING	04/13/2022
4	REVISED AND RE-ISSUED FOR DP	2023/06/01
5	REVISED AND RE-ISSUED FOR DP	2023/09/21
6	REVISED AND RE-ISSUED FOR DP	2023/12/15
7	ISSUED FOR BP RESUBMISSION	2024/04/30
8	ISSUED FOR TENDER	2024/06/28
9	ISSUED FOR BP RESUBMISSION	2024/07/31
10	ISSUED FOR BP RESUBMISSION	2024/09/27
		•






DRAWING TITLE:

TREE REMOVAL & PROTECTION PLAN

DWG NO:

SCALE: 1:100



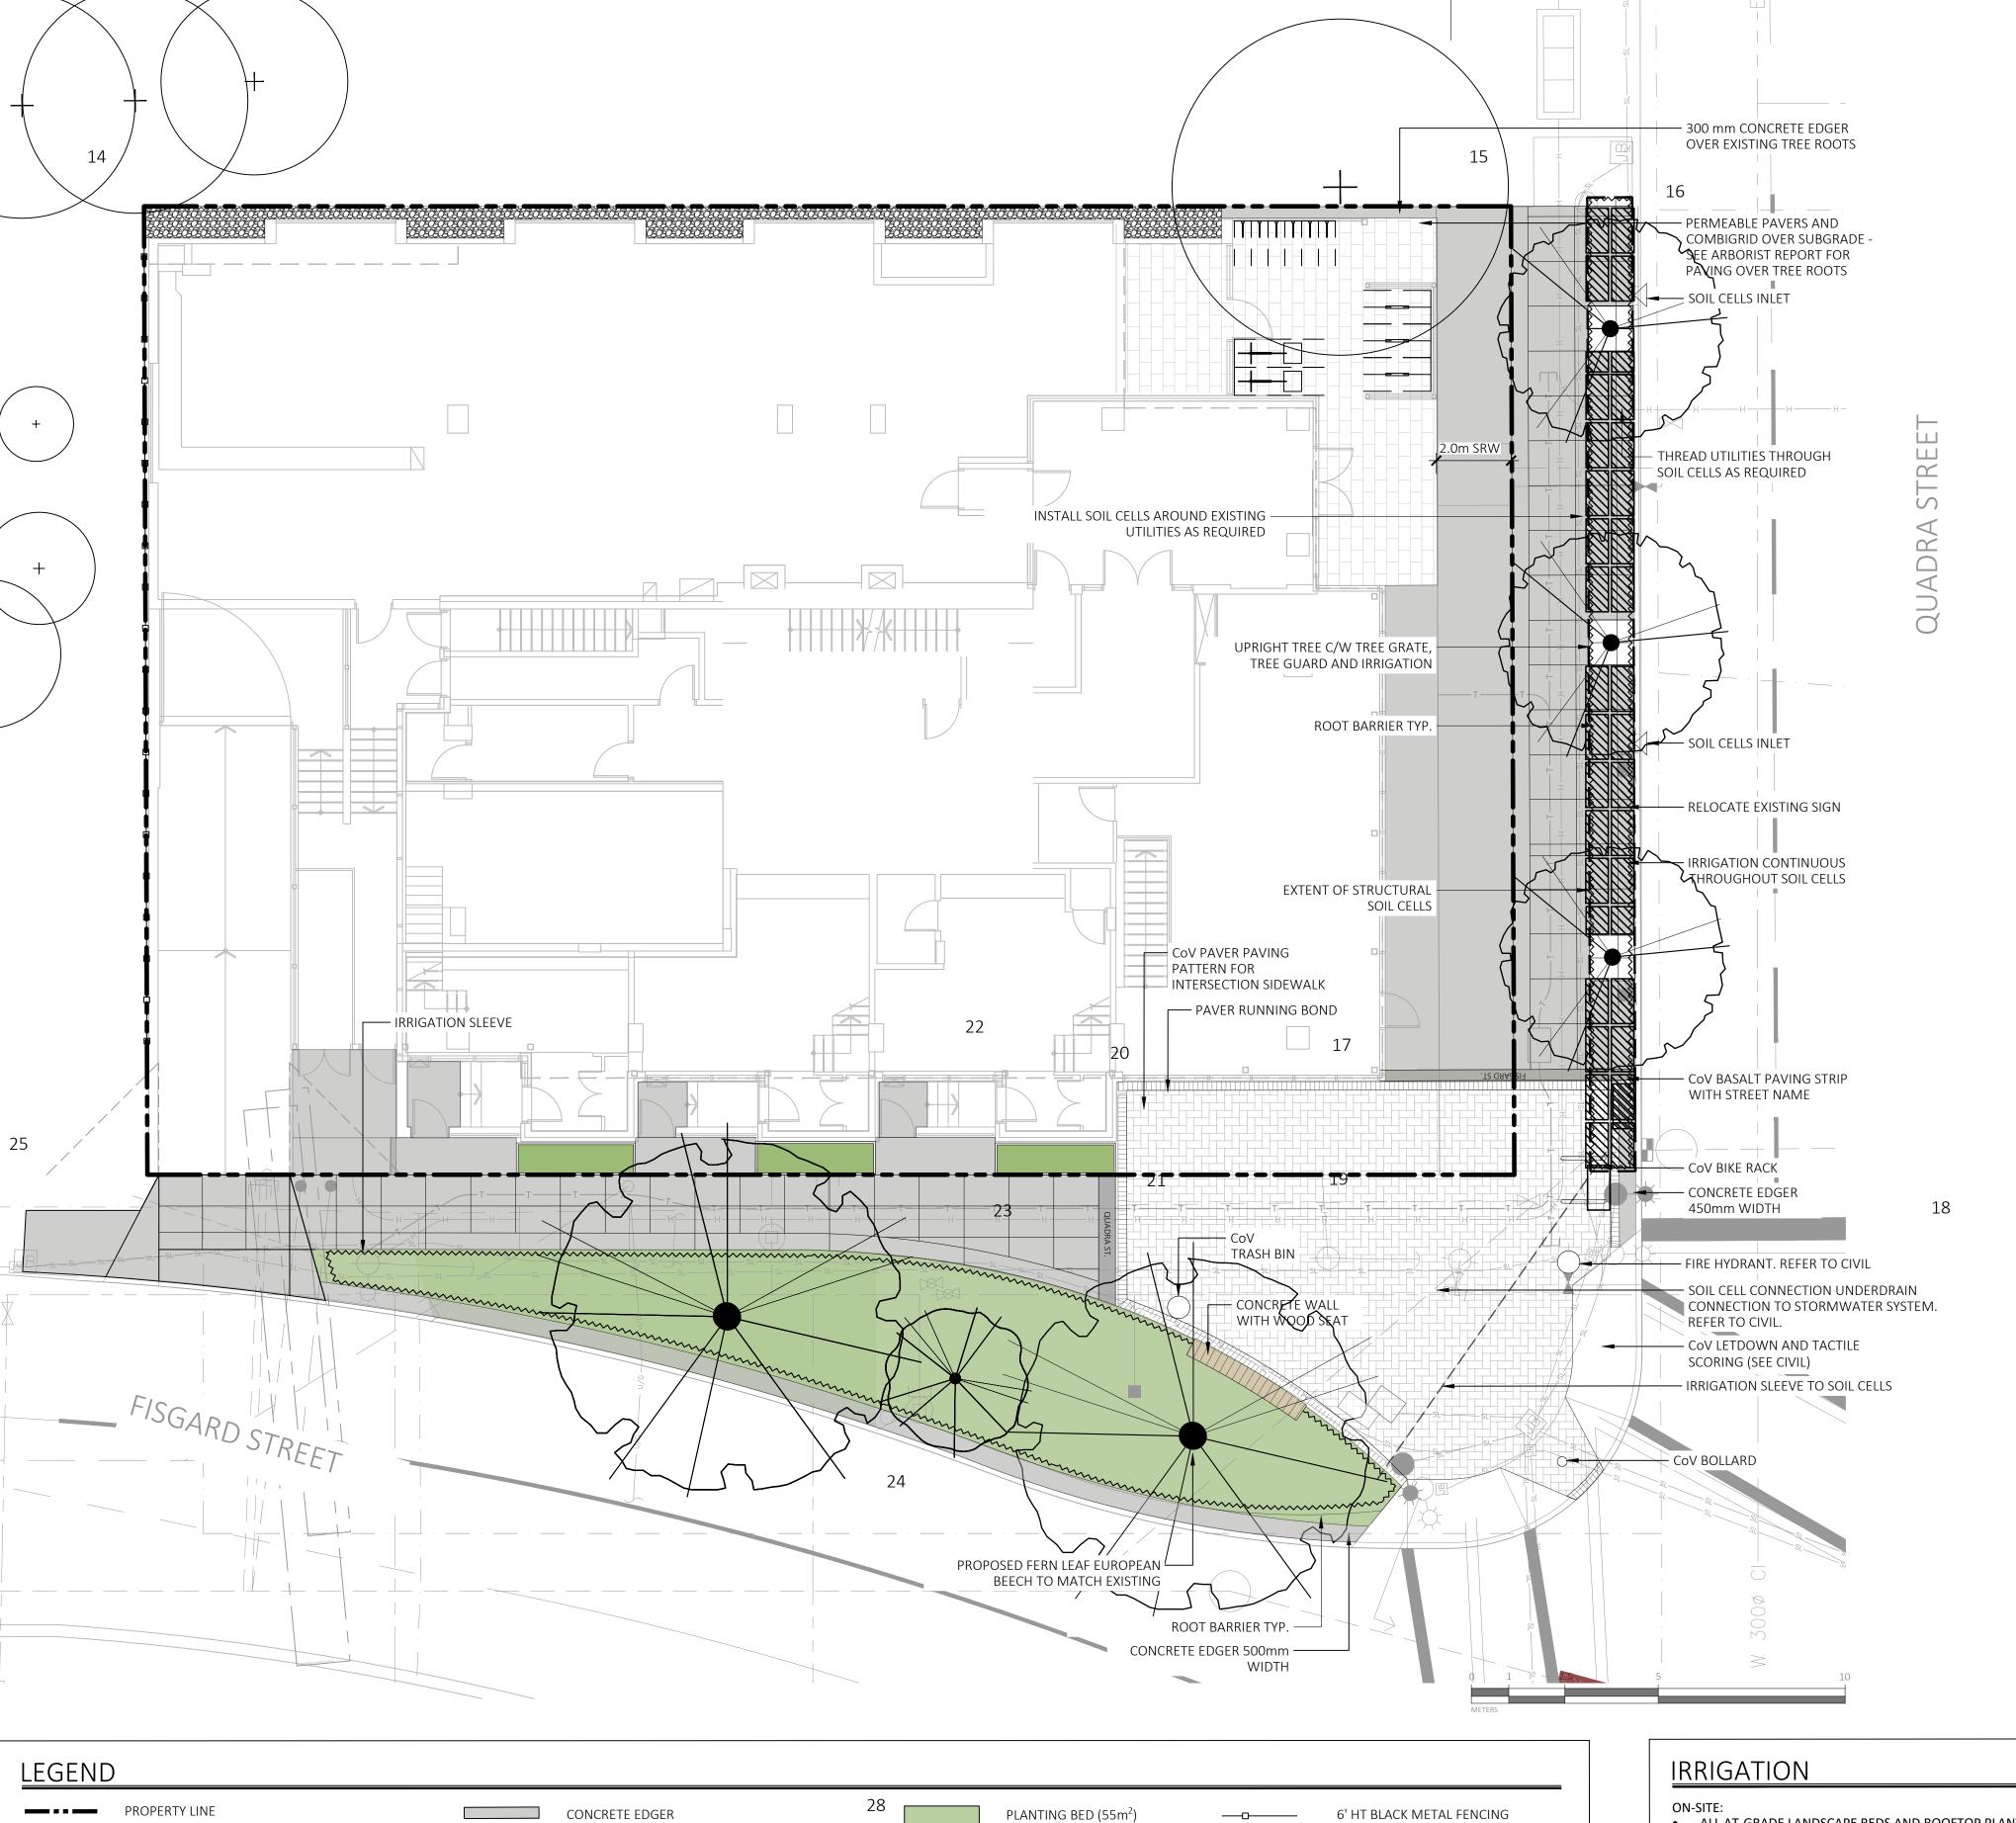

• 700mm DEPTH 1L GROWING

450mm DEPTH 1L GROWING

50 mm DEPTH MULCH

MEDIUM (CLS)

ON-SITE PLANTING BED

MEDIUM (BCLS)

PROPOSED MUNICIPAL

STREET TREE

ROOT BARRIER

• 50 mm DEPTH MULCH

WIDTH AND DEPTH VARIES

BASALT PAVER BANDING

MORTAR SET

SUBGRADE

COLOUR: NATURAL

ALUMINIUM EDGER

MEDIUM

IRRIGATION

GRAVEL MAINTENANCE STRIP

300mm DEPTH RIVER ROCK

STRUCTURAL SOIL CELLS (34.67m²)

• 1400mm DEPTH SOIL CELL GROWING

ACCENT PAVING

SEE DRAWINGS AND DETAILS

450 - 500mm WIDTH - AS NOTED

PERMEABLE PAVER ON COMBIGRID OVER

BELGARD AQUALINE PERMEABLE PAVER

— — — SRW

2.0m WIDTH ON QUADRA STREET

GUIDELINE STANDARDS

SAW CUT JOINTING PATTERN

SIDEWALK INTERSECTION PAVING

GUIDELINE STANDARDS

SIDEWALK STREET NAME PAVING

GUIDELINE STANDARDS

TO CITY OF VICTORIA 'NEW TOWN' DESIGN

TO CITY OF VICTORIA 'NEW TOWN' DESIGN

ABBOTSFORD CONCRETE; NATURAL GREY

TO CITY OF VICTORIA 'NEW TOWN' DESIGN

BASALT PAVING STRIP WITH STREET NAME

LINE OF FOUNDATIONS

CONCRETE SIDEWALK

LIGHT BROOM FINISH

PLACED ON SAND BED

MORTAR SET

POLYMERIC SAND JOINTS

ALONG WEST PROPERTY LINE

MUNICIPAL SITE FURNITURE

BOLLARD (2)

TRASH BIN (1)

BIKE RACK (2)

SEAT WALL

TREE GRATE (3)

TREE GUARD (3)

CONCRETE BASE, ARCHITECTURAL

CUSTOM WOOD SEAT TOP

- ALL AT-GRADE LANDSCAPE BEDS AND ROOFTOP PLANTERS TO BE IRRIGATED WITH AN AUTOMATIC IRRIGATION SYSTEM.
- DETAILED IRRIGATION PLAN TO BE SUBMITTED TO PARKS FOR REVIEW A MINIMUM OF 30
- DAYS PRIOR TO INSTALLATION.
- ALL IRRIGATION DESIGNS AND INSTALLATIONS SHALL MEET THE MINIMUM STANDARDS OF THE IRRIGATION INDUSTRY ASSOCIATION OF B.C. (IIABC).

OFF-SITE (MUNICIPAL)

- MUNICIPAL PLANTING BED AND STREET TREES TO BE IRRIGATED BY A SEPARATE SYSTEM FROM A SEPARATE CITY SOURCE CONFORMING TO THE CITY OF VICTORIA SUPPLEMENTARY SPECIFICATIONS FOR STREET TREES AND IRRIGATION SCHEDULE C TO BYLAW 12-042,
- SUBDIVISION BYLAW. IRRIGATION DESIGN DRAWINGS MUST BE SENT TO PARKS FOR REVIEW 30 DAYS PRIOR TO
- INSTALLATION. DRAWINGS SHOULD INDICATE ALL COMPONENTS, MODELS AND MATERIALS FROM WATER
- SUPPLY TO IRRIGATION HEADS.
- THE CITY WILL REQUIRE 4 INSPECTIONS FOR IRRIGATION INSTALLATION: 1)SLEEVING, 2) OPEN TRENCH MAINLINE AND PRESSURE TEST,

3) OPEN TRENCH AND LATERAL LINE, 4) OPERATION AND COVERAGE, AND 5) BACKFLOW PREVENTER ASSEMBLY TEST REPORT

CITY OF VICTORIA DOWNTOWN REALM PLAN AND STREETSCAPE STANDARDS - NEW TOWN

NEW TOWN PAVING MATERIALS

Installation Method: Cast-in-place

Colour: Natural

Finish: Fine broom finish

Application: Sidewalk fill and frame






• Dimensions: 225mm x 75mm x 60

Application: Paving field

Colours: Natural grey

• Finish: Unsealed

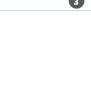





Colour: Charcoal grey

Finish: Flamed



• Dimensions: 300mm x 450mm x 60mm 1608 Camosun Street, Victoria BC V8T 3E6 Installation Method: Mortar set Info@biophiliacollective.ca 250 590 1156 Application: Entry banding


PROJECT NAME:

THE ABBEY

PROJECT ADDRESS:

1702 QUADRA STREET VICTORIA, BC

DESIGNED BY: BIANCA BODLEY DRAWN BY: KIM TANG

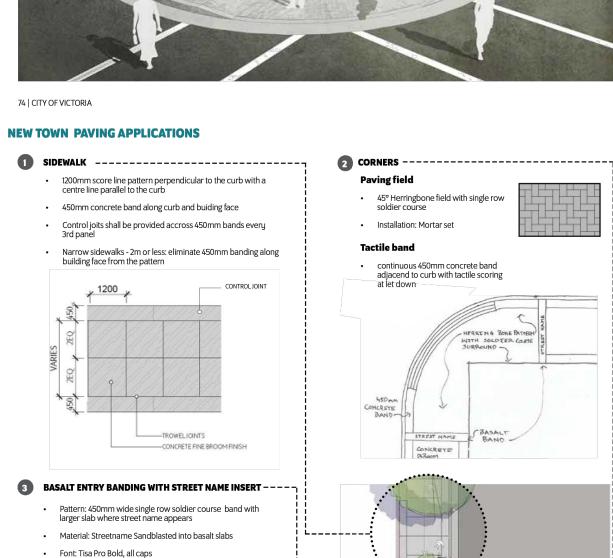

Note: Care should be taken to the letter spacing and kerning

DOWNTOWN PUBLIC REALM PLAN STRATEGY + STREETSCAPE PLAN | 75


NEW TOWN PLANTING DETAILS


APPLICATION For all sidewalks in New Town area there are be two types of trees-in-sidewalk condition:


1. Adaptation of existing tree locations to sidewalk improvements: accommodate for existing tree locations. Detailed design and recommendations to be provided on a case-by-case basis for each improvement area. Use of proposed poured-in-place resin bound material instead of tree grates is highly recommended to best accommodate heaving and overgrown tree routes and large tree trunks.

2. New development condition:

 A street tree spacing of between 8 - 10 metres is desired Tree grates should be set in a concrete band that runs across the sidewalk from curb to building face as illustrated on the diagram below with trowel joint defining the band always aligned with tree grates Street trees should be sited to correspond with architectural features of building

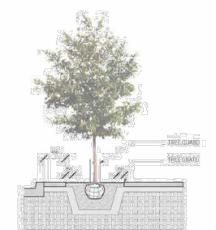

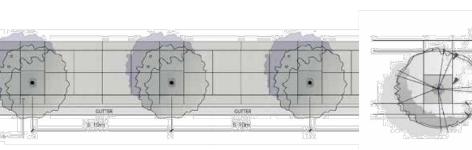


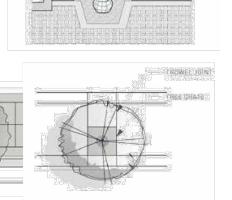

Tree grates define bands in the

the diagram above

sidewalk pattern as illustrated on

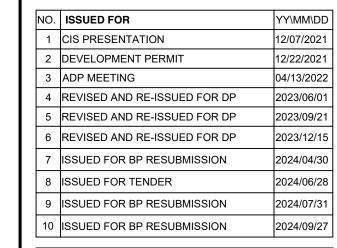








DRAWING TITLE:

LANDSCAPE SITE PLAN

DWG NO:



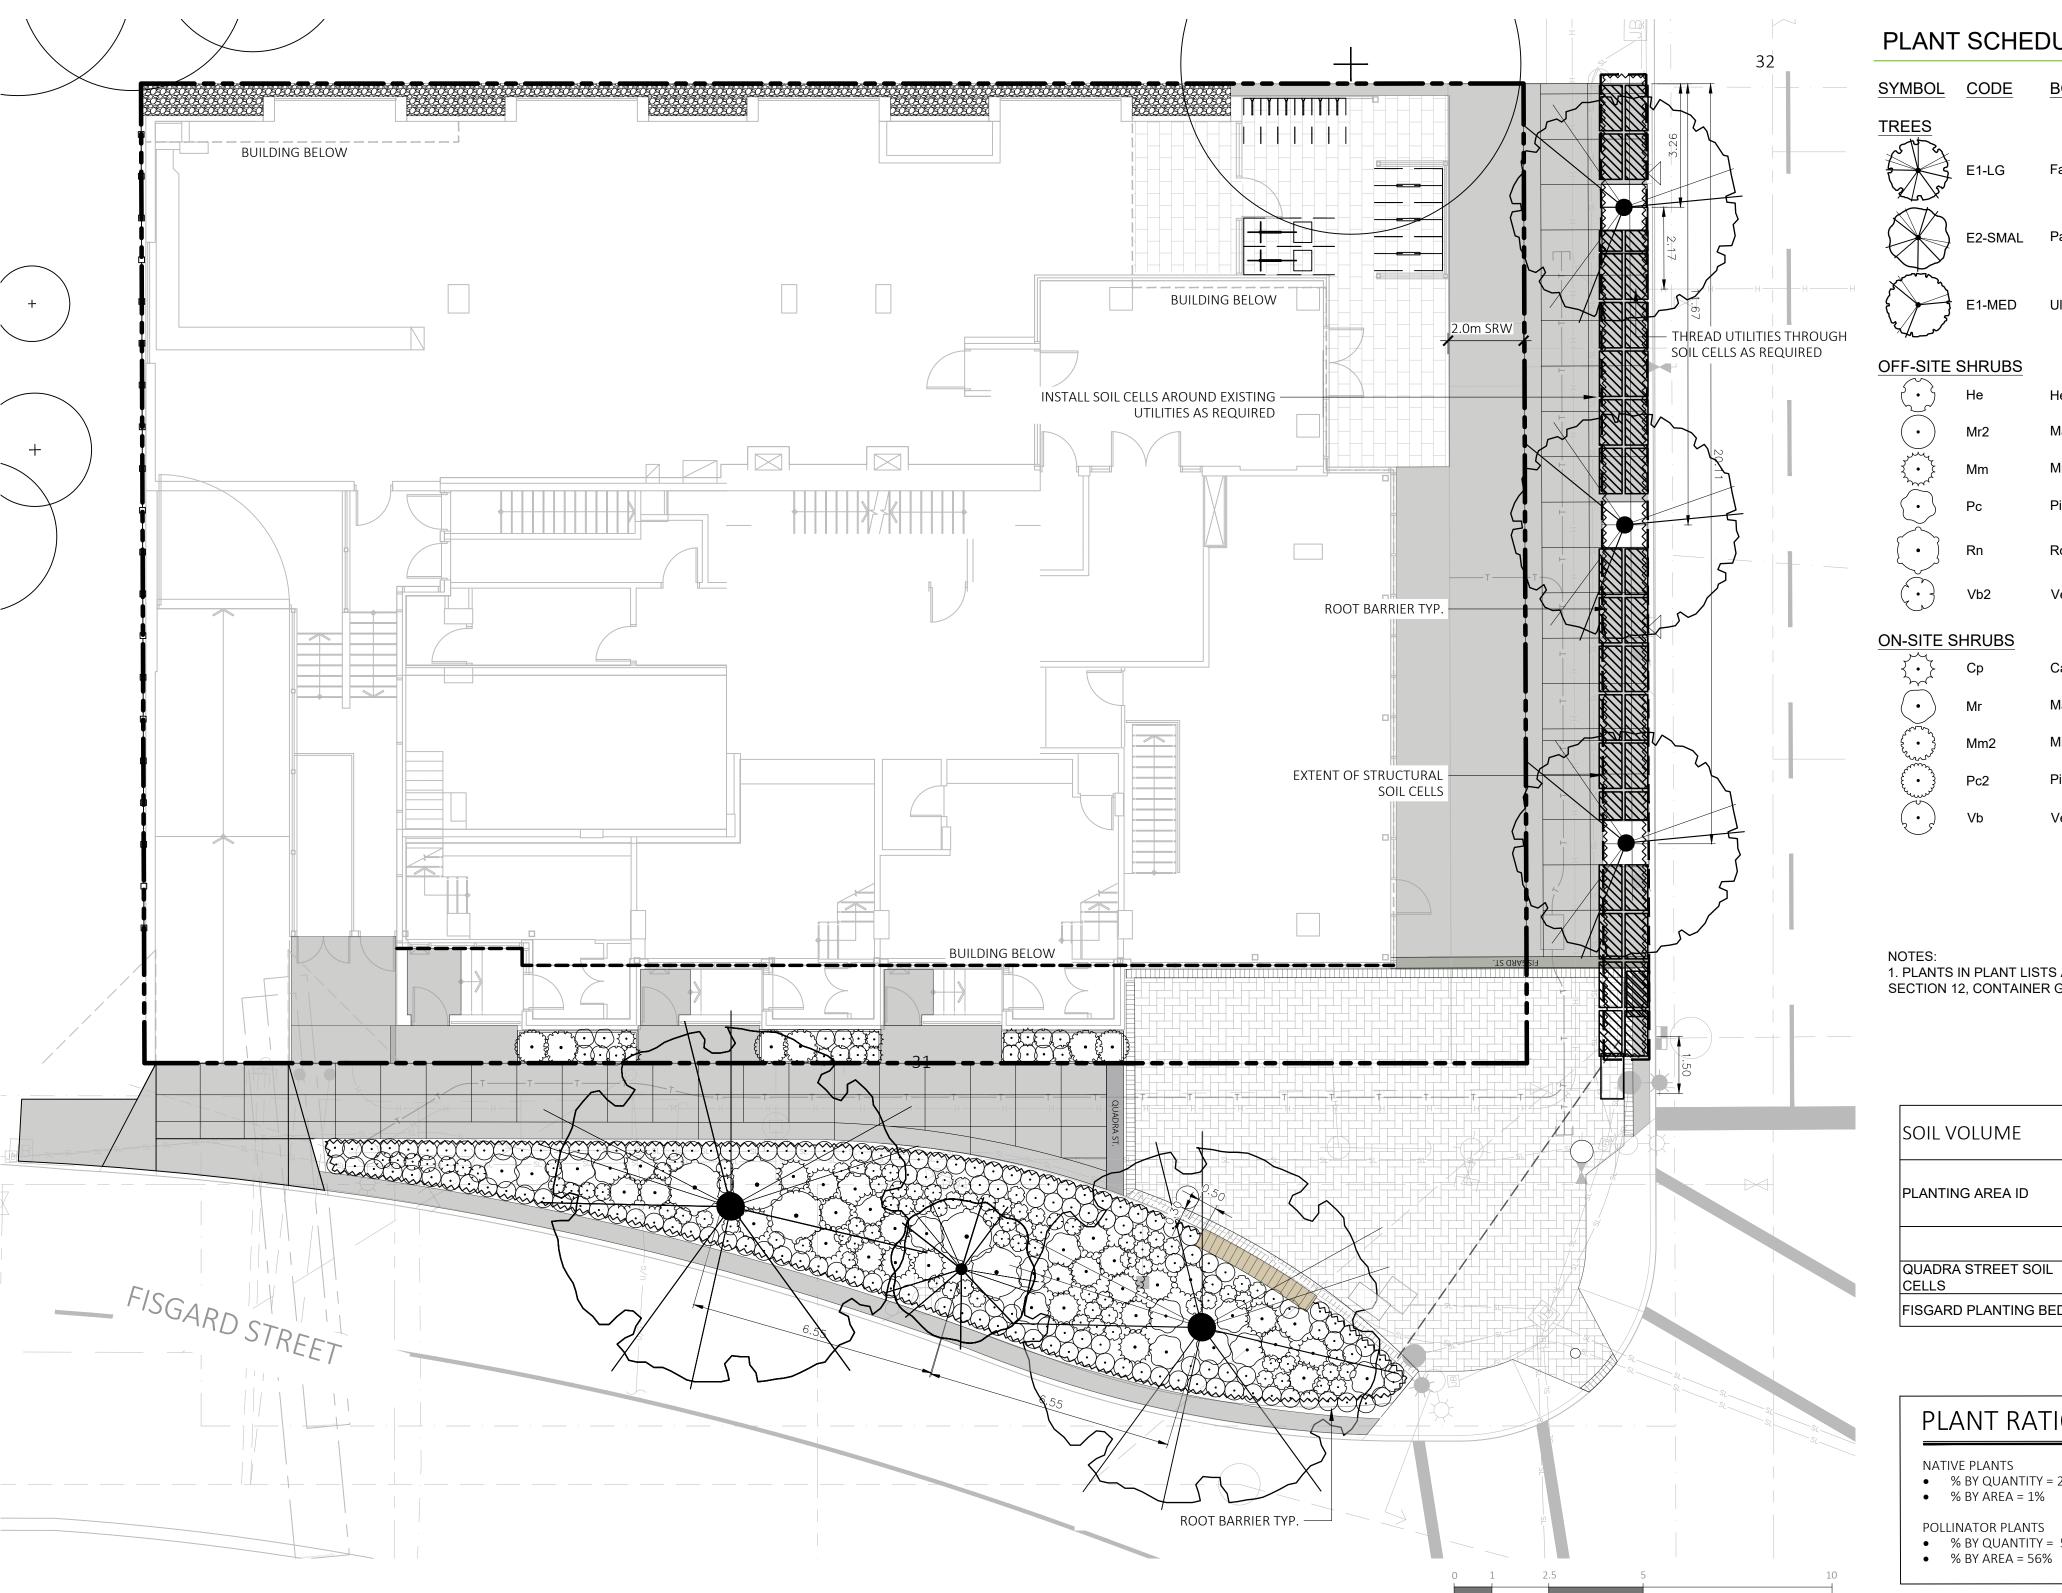

PLANT SCHEDULE MAIN LEVEL

	SYMBOL	L CODE BOTANICAL / COMMON NAME		SIZE SPACING		COMMENTS	QTY	3	
	TREES								
	3	E1-LG	Fagus sylvatica heterophylla 'Aspleniifolia' / Fernleaf European Beech	70mm Cal.	As Shown	SPECIES T.B.D. BY PARKS AT BP STAGE	2		
		E2-SMAL	Parrotia persica / Persian Parrotia	70mm Cal.	As Shown	SPECIES T.B.D. BY PARKS AT BP STAGE	1		
- H		E1-MED	Ulmus x 'Lobel' / Lobel Elm	70mm Cal.	As Shown	SPECIES T.B.D. BY PARKS AT BP STAGE	3	3	
	OFF-SITE	SHRUBS							
		He	Hebe x 'Emerald Green' / Emerald Green Hebe	#2 POT	450mm	Full, Well Established	62		
	•	Mr2	Mahonia repens / Creeping Mahonia	#2 POT	500mm	Full, Well Established	117		
) •	Mm	Miscanthus sinensis 'Morning Light' / Morning Light Eulalia Grass	#3 POT	900mm	Full, Well Established	27		
		Pc	Pinus mugo 'Compacta' / Dwarf Mugo Pine	#3 POT	900mm	Full, Well Established	16		
		Rn	Rosa nutkana / Nootka Rose	#2 POT	1500mm	Full, Well Established	5		
		Vb2	Verbena bonariensis / Tall Verbena	#1 POT	450mm	Full, Well Established	29		
	ON-SITE SHRUBS								
		Ср	Carex testacea 'Prairie Fire' / Prairie Fire Orange Sedge	#1 POT	500mm	Full, Well Established	8		
	•	Mr	Mahonia repens / Creeping Mahonia	#2 POT	500mm	Full, Well Established	8		
	~~~~~~~~~~~~~~~~~~~~~~~~~~~~~~~~~~~~~~	Mm2	Miscanthus sinensis 'Morning Light' / Morning Light Eulalia Grass	#3 POT	900mm	Full, Well Established	3		
	£ • 33	Pc2	Pinus mugo 'Compacta' / Dwarf Mugo Pine	#2 POT	900mm	Full, Well Established	3		
	( · )	Vb	Verbena bonariensis / Tall Verbena	#1 POT	450mm	Full, Well Established	7	3.	

1. PLANTS IN PLANT LISTS ARE SPECIFIED ACCORDING TO THE CANADIAN NURSERY LANDSCAPE ASSOCIATION CANADIAN STANDARDS FOR NURSERY STOCK AND SECTION 12, CONTAINER GROWN PLANTS FROM THE BC LANDSCAPE STANDARD, CURRENT EDITION.

SOIL VOLUME	IL VOLUME			REPLACEMENT TREES PROPOSED			SOIL VOLUME REQUIRED (m3)			
PLANTING AREA ID	AREA (m2)	sc	A.ESTIMATED SOIL VOLUME	B. # SMALL	C. # MEDIUM	D. # LARGE	E. SMALL	F. MEDIUM	G. LARGE	TOTAL
ON-SITE AREA										
QUADRA STREET SOIL CELLS	34	1.4000	45		3			15		45
FISGARD PLANTING BED	55	1	67	1		1	6		30	36

## PLANT RATIOS - OFF SITE

- NATIVE PLANTS
- % BY QUANTITY = 2%% BY AREA = 1%
- POLLINATOR PLANTS
- % BY QUANTITY = 56%

## PLANT RATIOS - ON SITE

MUNICIPAL BOULEVARD TREES

WITH BRANCHING STARTING AT 1.8m-2.5m ABOVE GROUND

• PARKS WILL REQUIRE (3) INSPECTIONS FOR TREE PLANTING:

1) INSPECTION OF SOIL AND PLANTING AREA,

2) INSPECTION OF STOCK UPON DELIVERY, AND

• TREES MUST HAVE ONE DOMINANT CENTRAL LEADER OR SINGLE STRAIGHT TRUNK, 5-8 cm DIAMETER, CALIPER MEASURED 15 cm ABOVE GROUND, WELL BALANCED CROWN

• TREES TO BE PLANTED AS PER PLANTIG OF TREES, SHRUBS AND GROUND COVERS (32 93 01 MMCD 2009 AND CITY OF VICTORIA SUPPLEMENTAL DRAWINGS SD P3 AND SD P4)

3) INSPECTION OF INSTALLED TREE WITH MULCH AND STAKING. TRUNK FLARE MUST BE

VISIBLE AND PLANTED AT OR SLIGHTLY ABOVE GRADE UPON INSPECTION • THE APPLICANT IS RESPONSIBLE FOR PROCURING AND PLANTING THE PROPOSED

CONDITION FOR 1 YEAR FROM THE SUBSTANTIAL COMPLETION TO BE ELIGIBLE FOR


THE APPLICANT MUST MAINTAIN THE TREE IN GOOD HEALTH AND STRUCTURAL

- NATIVE PLANTS
- % BY QUANTITY = 0%% BY AREA = 0%
- POLLINATOR PLANTS

BOULEVARD TREES.

• % BY QUANTITY = 80% % BY AREA = 50%

## SHRUBS + PERENNIALS

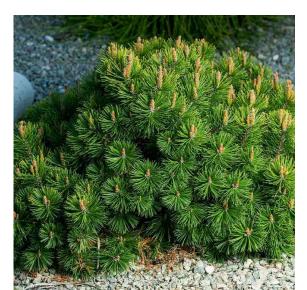

DWARF MUGO PINE

EMERALD GREEN HEBE





CREEPING MAHONIA



MISCANTHUS





PRAIRIE FIRE SEDGE



NOOTKA ROSE

# DEPOSIT RETURN.

## PRE-CONSTRUCTION MEETING

 PARKS REQUIRES A PRE-CONSTRUCTION MEETING TO BE HELD PRIOR TO COMMENCEMENT OF CONSTRUCTING THE FRONTAGE WORKS



1608 Camosun Street, Victoria BC V8T 3E6 Info@biophiliacollective.ca 250 590 1156

PROJECT NAME:

THE ABBEY

PROJECT ADDRESS:

1702 QUADRA STREET VICTORIA, BC

DESIGNED BY: BIANCA BODLEY DRAWN BY: KIM TANG

NO. **ISSUED FOR** YY\MM\DD 1 CIS PRESENTATION 2 DEVELOPMENT PERMIT 3 ADP MEETING 4 REVISED AND RE-ISSUED FOR DP 5 REVISED AND RE-ISSUED FOR DP 6 REVISED AND RE-ISSUED FOR DP ISSUED FOR BP RESUBMISSION ISSUED FOR TENDER 9 ISSUED FOR BP RESUBMISSION 10 ISSUED FOR BP RESUBMISSION



NORTH ARROW

DRAWING TITLE:

PLANTING PLAN -**GROUND FLOOR** 

DWG NO:

1608 Camosun Street, Victoria BC V8T 3E6

PROJECT NAME:

THE ABBEY

PROJECT ADDRESS:


VICTORIA, BC

DESIGNED BY: BIANCA BODLEY

DRAWN BY: KIM TANG


1702 QUADRA STREET

Info@biophiliacollective.ca 250 590 1156

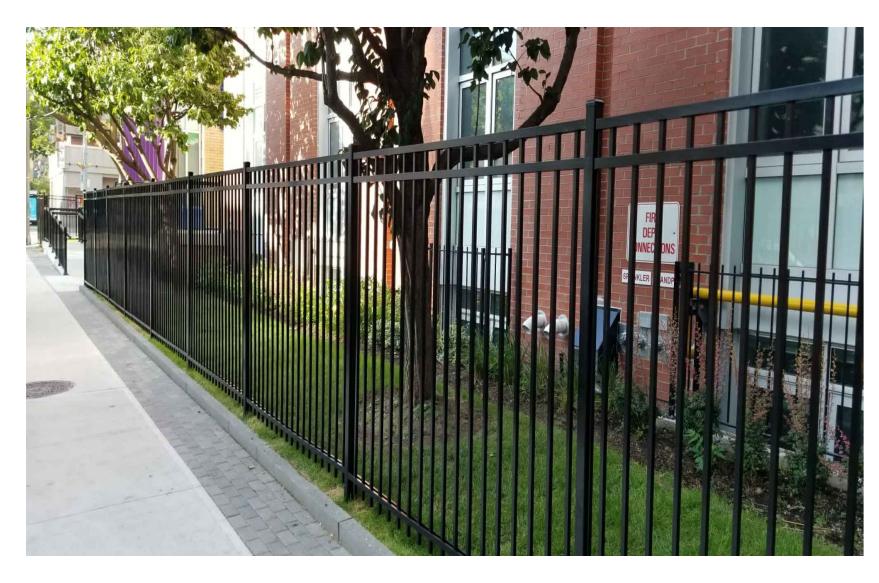

1 6' HT METAL PICKET FENCE

L3 NTS

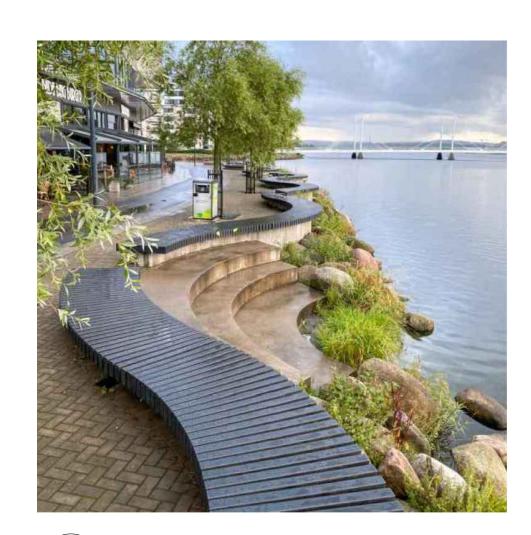

CUSTOM SEAT WALL BENCH

L3 NTS



BELGARD AQUALINE PERMEABLE PAVER

## enhance wheelchair comfort

Smooth surface with a microchamfer to minimize vibration and

 Interlocking spacer bars for increased structural performance

- Can be utilized to construct an ADA-compliant pavement True installed dimensions for
- design optimization Optimal joint openings for infiltration and maintenance Can eliminate stormwater runoff and improve water quality
- Meets the requirements of ASTM Chamfer Width: 3 mm Spacer Bar Width: 10 mm Surface Infiltration Rate: > 500 inches per hour (varies based on
- joint infill gradation) Surface Open Area: 10% Can be installed mechanically

## **♦** AVAILABLE COLOURS







SHAPES & SIZES

45/16 x 83/4 x 31/8" 110 x 221.5 x 80mm

DURAFUSION™ Unmatched Durability

#### RELIANCE FOUNDRY BOLLARD

L3 NTS

Glossy Black (RAL 9017) Baked-on

Type B Bollard Reliance Foundry Bollard Ductile Iron

35" Height Inner Harbour, Old Town, Rock Bay, New Town, Government Street, Douglas Street

Surface Mount, Bolted to Concrete Reliance Foundry See Character area section of Streetscape Standards for specific



## **MODERN METAL BIN**

PRODUCT TYPE:

**PRODUCT NAME: DESIGN STYLE: MATERIALS: COLOUR/FINISH:** 


City of Victoria

Type A Litter Bin with Recycling

Component Modern Metal Bin Modern Metal Frame Glossy Black (RAL 9017) Baked-on Powder Coat

42" Height Inner Harbour, Old Town, Rock Bay, New Town, Government Street,

Douglas Street See Character area section of Streetscape Standards for specific location guidelines.

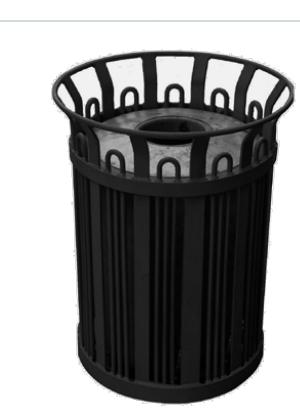

TREE GUARD FABRICATED BY

TO ORDER CONTACT PARKS DIVISION: 250-361-0600

COV PUBLIC WORKS

4 NEW TOWN BOLLARD
L3 NTS

5 NEW TOWN LITTER RECEPTACLE

## STANDARD BIKE RACK

1.5" Galvanized Steel Pipe Glossy Black (RAL 9017) Baked-on Powder Coat


12" Length, 3' Height

location guidelines.

Inner Harbour, Old Town, Rock Bay,

Streetscape Standards for specific

New Town, Government Street, Douglas Street Sleeve Mount See Character area section of

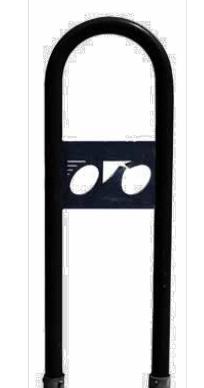



6 NEW TOWN BIKE RACK
L3 NTS



7 NEW TOWN TREE GUARD

L3 NTS

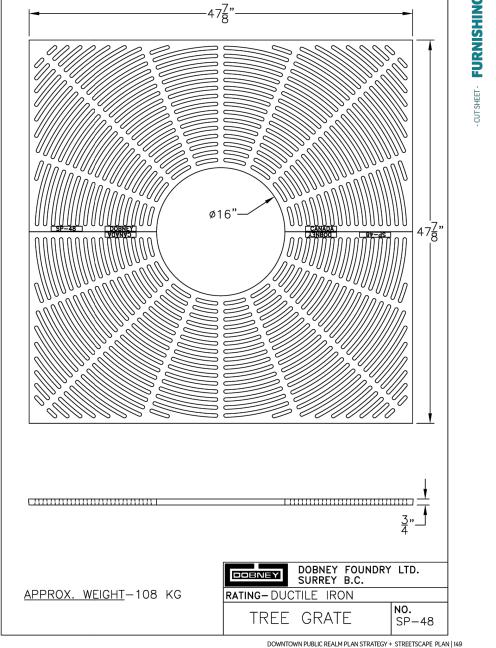

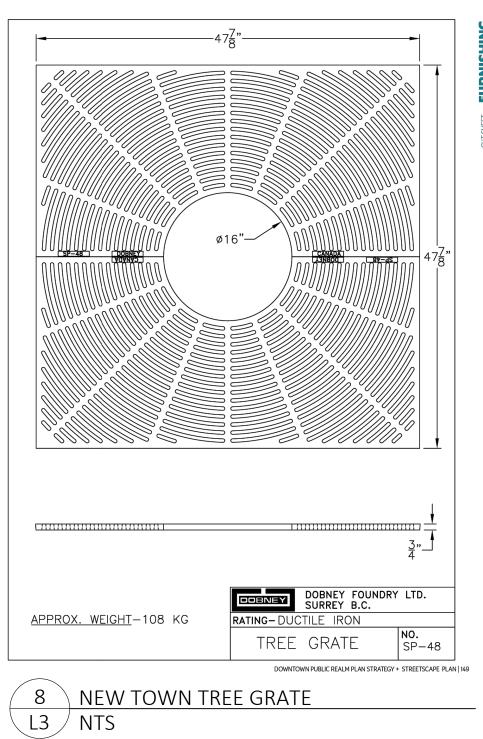

NO. **ISSUED FOR** 

3 ADP MEETING


1 CIS PRESENTATION 2 DEVELOPMENT PERMIT


4 REVISED AND RE-ISSUED FOR DP

5 REVISED AND RE-ISSUED FOR DP

YY\MM\DD 12/07/2021

DRAWING TITLE: LANDSCAPE SITE PLAN

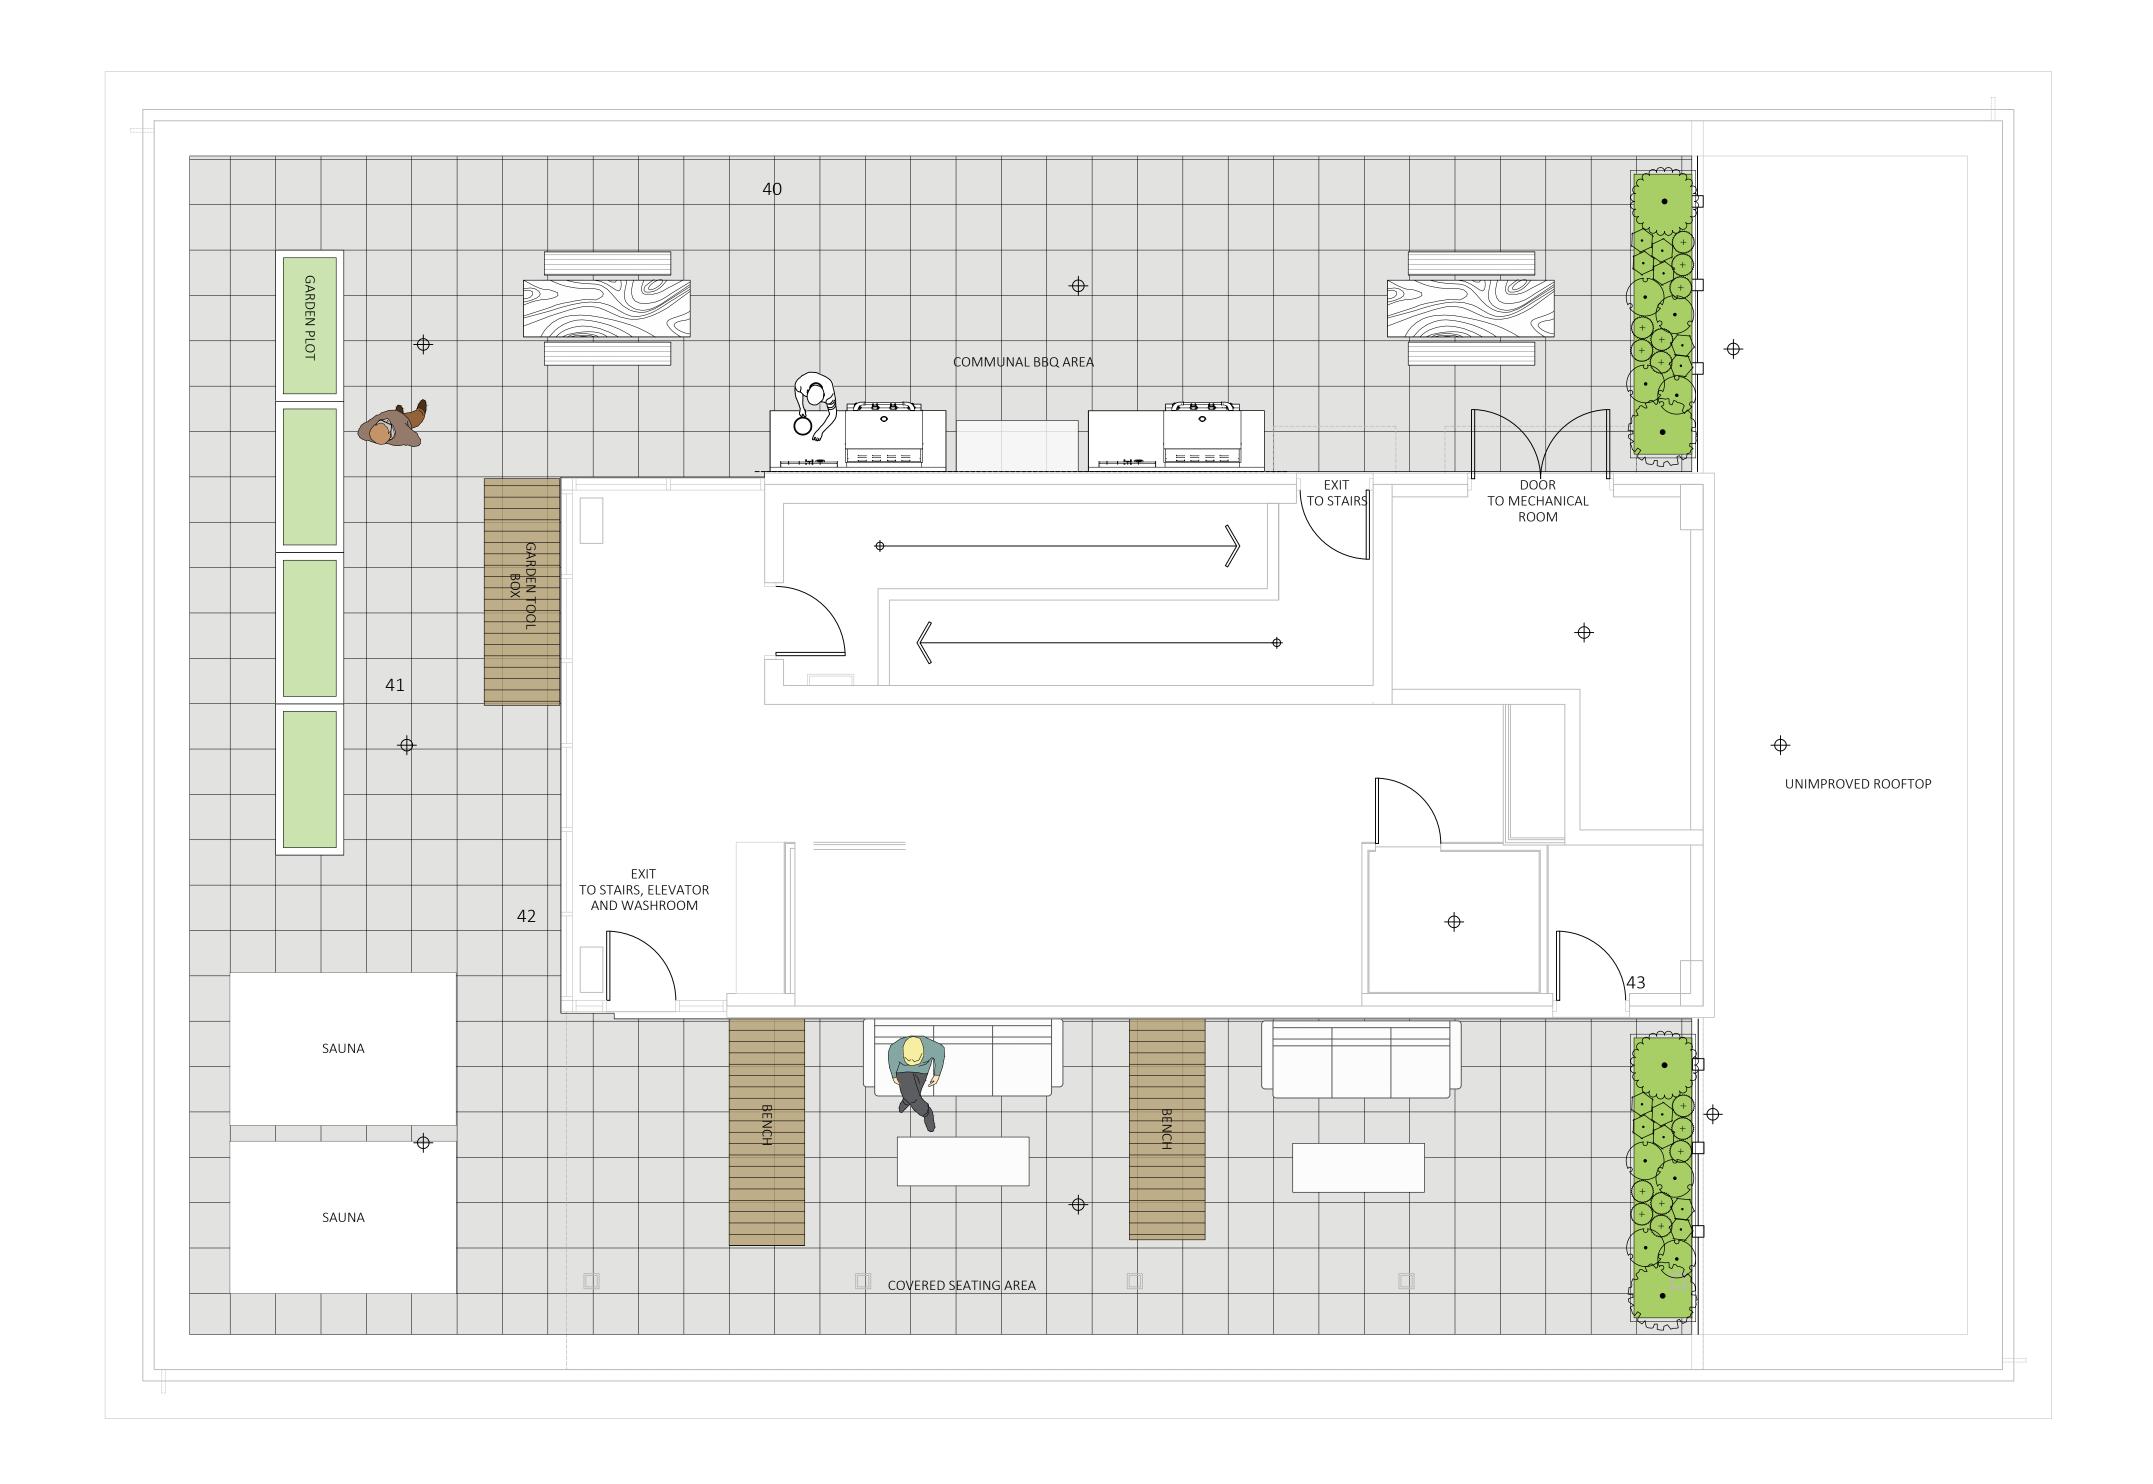

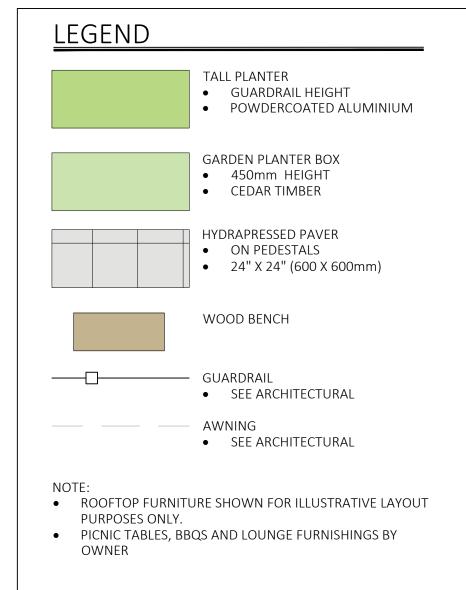



PROJECT NAME:

THE ABBEY

PROJECT ADDRESS:

1702 QUADRA STREET VICTORIA, BC

DESIGNED BY: BIANCA BODLEY DRAWN BY: KIM TANG

NO.	ISSUED FOR	YY\MM\DD
1	CIS PRESENTATION	12/07/2021
2	DEVELOPMENT PERMIT	12/22/2021
3	ADP MEETING	04/13/2022
4	REVISED AND RE-ISSUED FOR DP	2023/06/01
5	REVISED AND RE-ISSUED FOR DP	2023/09/21
6	REVISED AND RE-ISSUED FOR DP	2023/12/15
7	ISSUED FOR BP RESUBMISSION	2024/04/30
8	ISSUED FOR TENDER	2024/06/28
9	ISSUED FOR BP RESUBMISSION	2024/07/31
10	ISSUED FOR BP RESUBMISSION	2024/09/27









SITE PLAN - ROOFTOP

DWG NO:

SCALE: **1:50** 





DRAWING TITLE:

**AMENITY** 



VERBENA








CREEPING MAHONIA



MISCANTHUS



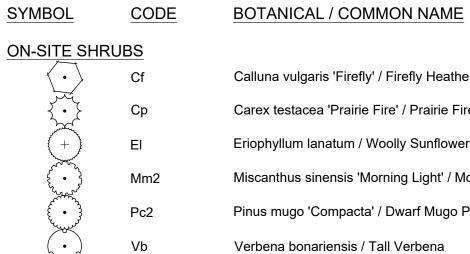

PLANT SCHEDULE ROOFTOP

ITE S	HRUBS					
$\overline{\langle \cdot \rangle}$	Cf	Calluna vulgaris 'Firefly' / Firefly Heather	#1 POT	300mm	Full, Well Established	15
}**	Ср	Carex testacea 'Prairie Fire' / Prairie Fire Orange Sedge	#1 POT	500mm	Full, Well Established	3
+	El	Eriophyllum lanatum / Woolly Sunflower	#1 POT	300mm	Full, Well Established	14
**************************************	Mm2	Miscanthus sinensis 'Morning Light' / Morning Light Eulalia Grass	#3 POT	900mm	Full, Well Established	1
£.	Pc2	Pinus mugo 'Compacta' / Dwarf Mugo Pine	#2 POT	900mm	Full, Well Established	2
(3.5)	Vb	Verbena bonariensis / Tall Verbena	#1 POT	450mm	Full, Well Established	6

FIREFLY HEATHER

PRAIRIE FIRE SEDGE