TENANT IMPROVEMENT CRU 4, 1555 VANCOUVER STREET VICTORIA, BC,

1555 Vancouver Street, Victoria BC, V8V 0C8 Civic Address:

Legal Description: Plan EPP89897, Suburban Lot 15, Victoria land district

Airspace PL, Airspace Parcel 4

PID: 030-997-241

ARCHITECTURAL DRAWINGS:

COVER SHEET

BUILDING CODE ANALYSIS

SITE PLAN, GENERAL NOTES

FLOOR PLAN - P1 FLOOR PLAN - LEVEL 1

FLOORPLAN

WASHROOM ELEVATIONS/DOOR FRAME DETAIL

SECTIONS/ELEVATIONS

Owner: Warmland Cannabis Corporation

6-4715 Trans Canada Hwy Duncan, BC V9L 6E1 778-455-4367 contact: Chris Clay

e: admin@warmlandcannabis.com

Consultant Team:

ARCHITECT: Carolynn Wilson Architect Inc.

924b Richmond Ave Victoria, BC V8S3Z3 250-514-7578

contact: Carolynn Wilson e: carolynnwilson@me.com

MECHANICAL ENGINEER: Avalon Mechanical Consultants Ltd.

1245 Esquimalt Road, #300 Victoria, BC V9A 3P2 250-384-4128 contact: Jamie Clarke e: jclarke@avalonmechanical.com

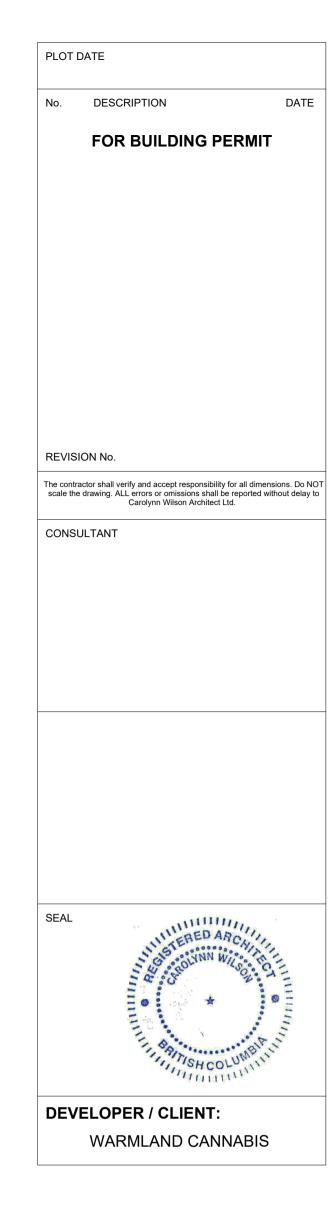
ELECTRICAL ENGINEER: AES Engineering

> Victoria, BC V8Z 6T8 250-381-6121 contact: Bal Klear

3785 Carey Rd #500, e: bal.klear@aesengr.com

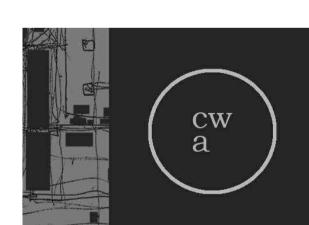




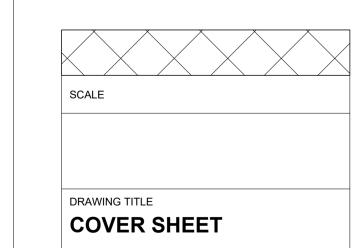




1555 VANCOUVER STREET VICTORIA, BC. V8V 0C8



carolynn wilson architect ltd. 924 b richmond ave. v8s 3z3 204.514.7578



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LIST OF ABBREVIATIONS ACOUSTIC PANEL CEILING DOUBLE ACOUSTIC TILE DOUBLE GLAZED(ING) AIR CONDITIONING DEGREES ADD ADDENDUM ##° ##' ##" DEGREES, MINUTES, SECONDS ADJ AFF ADJACENT DEGREES FAHRENHEIT ABOVE FINISHED FLOOR **DEGREES CELSIUS** AGGREGATE DEMOLITION AHU AIR HANDLING UNIT ALUM / AL ALUMINUM DETAIL(S) DRINKING FOUNTAIN APPROXIMATE / APPROXIMATELY APPROX ACCESS PANEL DOOR GRILLE ASPHALT PAVING DIA or Ø DIAMETER ARCHITECTURAL DIFFUSER DIM ASSY **ASSEMBLY** DIMENSION AVG DARK re:COLOUR SHADING **AVERAGE** BASEBOARD HEATER DWG **BUILDING INFORMATION MODEL** BRITISH COLUMBIA BUILDING CODE EA **BCBC** BOARD **ETCETERA** BARRIER FREE EXTERIOR INSULATION FINISH BLVD BOULEVARD SYSTEM BLDG BUILDING ELEC ELEV BUILDING PERMIT **ELEVATION** BPV BRICK PAVING **ELECTRICAL PANEL** BASEMENT **EXPANSION JOINT** BULKHD BULKHEAD EQ EQMT **EQUIPMENT** CENTER TO CENTER C/C FACH SIDE COMPLETE WITH EXIST. or EX EXISTING c/w CAB. CB CABINET(S) FXTFRIOR EXPOSED / EXPOSED STRUCTURE CATCH BASIN CBD CEM CEMENT BOARD **CEMENT / CEMENTITIOUS** FIRE ALARM / ANNUNCIATOR PANEL CUBIC FEET FINISHED FLOOR **CORNER GUARD** FINISHED FLOOR LEVEL CHBD CHALK BOARD FINISHED GRADE COAT HOOK FLOOR DRAIN CAST IN PLACE LAM FIRE DEPARTMENT CONNECTION CONTROL JOINT FOUNDATION **CONSTRUCTION JOINT** FIRE HOSE CABINET CO COL CONC CONT **CLEAN OUT** FINISHED/FINISH COLUMN FLOOR / FLOOR LEVEL CONCRETE LTG **FIREPROOFING** CONTINUOUS FIREPLACE CENTRE LINE REFRIGERATOR CLOSET FIBREGLASS REINFORCED PANEL CLG CEILING FIRE RESISTENCE RATING cm CMU CORR CPT CPV CT CENTIMETRE(S) FIRESTOP(PING) CONCRETE MASONRY UNIT SQUARÈ FOOT / FEET CORRIDOR FOOTING CARPET FURN FUR. FURNITURE / FURNISHED CONCRETE PAVER FURRING CERAMIC TILE FIRE EXTINGUISHER CABINET CW COLD WATER CWALL CURTAIN WALL

KD

LEED

MDF

MECH

MEMB

MFR

KILD DRIED

LAMINATE

LAVATORY

LIGHTING

METRE(S)

MAXIMUM

MECHANICAL

MIRROR(ED)

MINIMUM

METAL

MANUFACTURER

MISCELLANEOUS

MICROWAVE OVEN

MILLIMETRES

MEMBRANE

METRES SQUARED

LEADERSHIP IN ENERGY AND

ENVIRONMENTAL DESIGN

LIGHT re: COLOUR SHADING

MEDIUM DENSITY FIBREBOARD

GALV GALV GB1 GB2 GB3 120° GF GL	GALVANIZED GAUGE VERTICAL GRAB BAR HORIZONTAL GRAB BAR GRAB BAR GROUND FAULT GLASS / GLAZING GRIDI INF	N/A ND NIC No. or # NOM NTS NOT	NOT APPLICABLE SANITARY NAPKIN DISPOSAL NOT IN CONTRACT NUMBER NOMINAL TO SCALE	SA SAN SAM SC SCHED SD SECT SF	SUPPLY AIR (GRILLE) SANITARY SELF-ADHERING MEMBRANE SOLID CORE SCHEDULE SOAP DISPENSER SECTION SQUARE FOOR
GWB GWG	GYPSUM WALLBOARD GEORGIAN WIRED GLASS	OD OFF	ON CENTRE OUTSIDE DIAMETER OFFICE	SGL SH SI SIM	SEALED GLAZING UNIT SHELF INTERNATIONAL SYSTEM OF UNITS - METRIC SIMILAR
ha HB HD H/C	HECTARES HOSE BIBB HAND DRYER HANDICAPPED ACCESSIBLE	OPP OSB OWSJ	OPPOSITE ORIENTED STRAND BOARD OPEN WEB STEEL JOIST	SND SOG SPEC S/S	SANITARY NAPKIN DISPENSER SLAB ON GRADE SPECIFICATION(S) STAINLESS STEEL
HC HM HORZ	HOLLOW CORE HOLLOW METAL HORIZONTAL HOUR	PC PED PL PLAM	PRECAST CONCRETE PEDESTRIAN PLASTER PLASTIC LAMINATE	SSM ST STC	SOLID SURFACE MATERIAL STREET SOUND TRANSMISSION CLASS (RATING)
hr HSS HT. or H HVAC	HOLLOW STRUCTURAL SECTION HEIGHT HEATING VENTILATION & AIR	PLY PM POLY	PLYWOOD PERFORATED METAL POLYETHYLENE SHEET	STD STL STN STRUCT	STANDARD STEEL STAIN STRUCTURAL
HW HWT HWD	CONDITIONING HOT WATER HOT WATER TANK HARDWOOD	PMR PMC PREFAB PREFIN	REFINISHED METAL ROOFING PREFINISHED METAL CLADDING PREFABRICATED PREFINISHED	T&B T&G	TOP AND BOTTOM TOUNGUE AND GROOVE
ICF ID	INSULATED CONCRETE FORMS(S) INSIDE DIAMETER	PREV PT PSF PNT	PREVIOUS PRESSURE TREATED PRESSED STEEL FRAME PAINT(ED)	TB TBD TD TEMP	TOWEL BAR TACKBOARD TRENCH DRAIN TEMPORARY
IHM IMP INFO INSUL INT	INSULATED HOLLOW METAL IMPERIAL INFORMATION INSULATION INTERIOR	PTD PTN PVC	PAPER TOWEL DISPENSER PARTITION POLY VINYL CHLORIDE	TEMP TGL THK THRU TOC	TEMPERED GLASS THICK THROUGH TOP OF CONCRETE
IMP.	INVERT KILD DRIED	QT	QUARRY TILE	TOF TOP	TOP OF FOOTING TOP OF PARAPET TOPOGRAPHICAL

ft2-°F-hr/Btu

RD

RCP

REF

RES

RADIUS or RESISTANCE VALUE IMP

ROD & SHELF, IN CLOSETS

RETURN AIR (GRILLE)

RESILIENT FLOORING

REINFORCE(D)(MENT)

REFLECTED CEILING PLAN

RAINWATER LEADER

RESISTANCE VALUE SI, m2-Kelvins/W

RESILIENT BASE

ROOF DRAIN

REQUIRED

REFERENCE

RESIDENTIAL

RIGHT OF WAY

ROUGH OPENING

RAINWATER PIPE

ROAD

W w/ w/o WBD WC WD WDB WP WPC WS WVN WWM	WIDTH WITH WITHOUT WHITEBOARD WATER CLOSET WOOD WOOD BASE WATER PROOF(ING) WALL PAPER COVERING WOOD SIDING WOOD VENEER WELDED WIRE MESH
YD	YARD(S)
0 hr 20 MIN 3/4 hr 1 hr 1.5 hr 2 hr 4 hr	0 HOUR FIRE RATED 20 MINUTE FIRE RATED 45 MINUTE FIRE SEPARATION ONE HOUR FIRE SEPARATION 90 MINUTE FIRE SEPARATION TWO HOUR FIRE SEPARATION FOUR HOUR FIRE SEPARATION

TOPOGRAPHICAL

TOILET PAPER DISPENSER

UNLESS NOTED OTHERWISE

TOP OF STEEL

UNDERGROUND

VAPOUR BARRIER

VINYL COMPOSITE TILE

VINYL WALL COVERING

UNDERSIDE

VERTICAL

TOP OF WALL

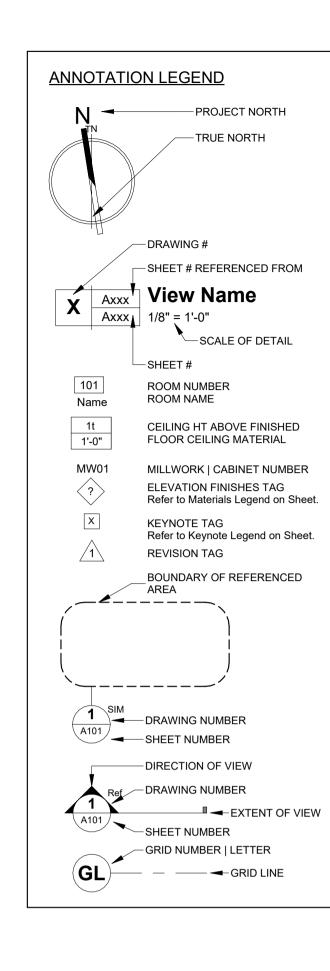
TERRAZZO

TYPICAL

TOPO

TOS TOW TPD TRZ TYP

VWC





LEGEND:

(1) Proposed Warmland Cannabis

Panaga Pizza Quesada Burritos & Tacos

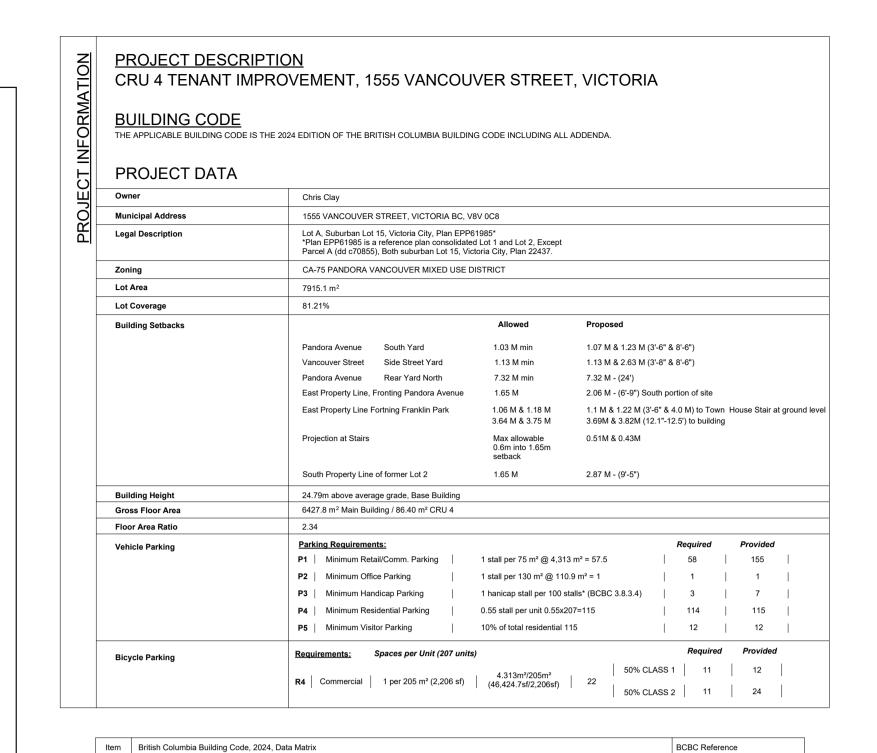
(4) Pandora by Bosa Properties

Save On Foods

Affirmative Tax and Accounting McDonald's

Mason Street Playground

Entrance Locations to Buildings



New Additon Alteration Tenant Improvement

Part 3

Part 9

Acceptable Solutions & Prescriptive Requirements

Type of Project

2 Basis of Code Analysis

3	Building Area (m²))	86.4 m ² (² CRU 4 / 1, 082m ² 1.4.1.2. Defined Terms
4	Major Occupancy	(s)	Group 'E	'E' for CRU 4 / Group 'C' - Residential Occupancy for Base Building Table 3.1.2.1
5	Multiple Occupand	cy Fire Separations	yes	es no EXISTING IN BASE BUILDING Table 3.1.3.1.
6	Foamed Plastics F	Protection	yes	es no EXISTING IN BASE BUILDING 3.1.4.2.(1)
7	Fire-Protection Ra	ating of Closures	SEE TAB	ABLE BELOW Table 3.1.8.4.
8		ating of Closure Doors	SEE TAB	ABLE BELOW Table 3.1.8.4. & 3.1.8.19.(1)
9	Firewall(s)		yes	es no 3.1.10.2.(1)
10	Occupant Load Ca	alculations:	CRU 4: <	<10 persons Table 3.1.17.1.
11	Number of Storey	s	6 Storeys	ys EXISTING IN BASE BUILDING / 1 Storey for CRU 4 3.2.1.1.
12		s / Fire Fighter Access Routes		is EXISTING IN BASE BUILDING 3.2.2.10. & 3.2.5.4
13	Building Classifica	ation	Group 'C'	C', up to 6 Storeys, Sprinklered 3.2.2.51
14	Permitted Constru			mbustible Non-Combustible Both 3.2.2.51.(2)
15	Floor & Structure			blies of Combustible Construction: N/A to CRU
15	Fire Resistance Ratings (FRR) - E	vieting		
	realings (Fritt) - E	AN) - EXISTING		· · · · · · · · · · · · · · · · · · ·
			Other Flo	iools. PAR III, File separations (3.2.2.31.(2)
			Mozza	nines:
			Mezzanin	
			Roofs:	N/A to CRU 3.2.2.51.(2)
16	Spatial Separation	and Exposure protection	see Base	se Building Documents 3.2.3.1.
17	Construction of Ex	posing Building Walls Submitted	d with Base B	Building, Info for Tenant Improvement walls only
	Facade	Assemblies		
	North	Wall Construction Permitted		Combustible Noncombustible N/A
	.,,,,,,,,,,,,,,,,,,,,,,,,,,,,,,,,,,,,,,	Cladding Construction Permitte	ed	Combustible Noncombustible N/A
	East	Wall Construction Permitted		Combustible Noncombustible N/A
	EdSt	Cladding Construction Permitte	ed	Combustible Noncombustible N/A 3.2.3.7. & 3.2.2.51
	South	Wall Construction Permitted		Combustible Noncombustible N/A
	South	Cladding Construction Permitte	ed	Combustible Noncombustible N/A
	West	Wall Construction Permitted		Combustible Noncombustible
	vvest.	Cladding Construction Permitte	ed	Combustible Noncombustible
18	Fire Alarm require	d (Refer to Electrical)		yes no 3.2.4.1
19	Access Route Des	<u> </u>		Yes - previously provided for the Base Building 3.2.5.6.(1)
20	Standpipe Require	ed		yes no 3.2.5.8.(1)
21	Automatic Sprinkle	er System Required		yes no 3.2.5.12.
22	Additional Require	ements for High Buildings		yes no 3.2.6.
23	Lighting & Emerae	ency Power Systems (Refer to Elec	ctrical)	yes no 3.2.7.
24	0 0	enings through Floor assemblies	-	yes no N/A 3.2.8.
25	Separation of Suite	es / Fire Compartments		yes no 3.3.1.1.
26	Hazardous Substa	ances		yes no 3.3.1.2.(1)
27	Means of Egress f	rom Contained Open Spaces, Roc	ofs and	yes no 3.3.1.3.
28	Service Rms. Public Corridors			yes no 3.3.1.4.
29	Two Egress Doorv	vavs Provided		yes no 3.3.1.5.
30		/ithin a Room or Suite		40m - Business and Personal Services Occupancy 3.3.1.6. & 3.4.2.5.
31	Janitor's Room Fir			N/A 3.3.1.22
				<u> </u>
32	Storage Garage S	eparation		0.0.0.0
33	Vestibules	At a m		N/A 3.3.5.7.
34	Exit Width Calculation: CRU 4			Based on max allowable occupant load of 10 persons 10 persons x 6.1 mm = 610mm width x2 exits required 850mm width x2 exits provided
35	Fire Resistance Rating of Exit Separations Exits Through Lobbies Elevator Shaft & Machine Room Fire Separation			N/A to CRU, 1hr FRR to Base Building 3.4.4.1.(1).
36				yes no 3.4.4.2.
37				1 hour FRR 3.5.3.1 & 3.5.3.3.
38	Dumbwaiter Fire S	Separation		N/A 3.5.3.2.
39	Service Room Fire	e Separations		Rooms w/ Fuel-Fired Appliances 1 hour FRR 3.6.2.1.
				Electrical Rooms 2 hour FRR 3.6.2.1.
40	Water Closets for Business and Personal Services Occupancy based on Occupant Load			1 Accessible Wahsroom / Occupancy <10 Persons Table 3.7.2.2.A
41	Accessibility:			3.8.2
	Access	to all Storeys Required		yes no 3.8.2.3.
		al Washroom Required		yes no CRU 4 3.8.2.8.
		ble Public Washrooms Required		yes no 3.8.2.8.
	Path of	Travel		Provided to Main Entrance 3.8.3.2.
		ble Parking		4 Parking Spaces Provided 3.8.3.4.
				g spasse
		ble Entrance		Provided at Main Entrance 3.8.3.6
42		ble Entrance		Provided at Main Entrance 3.8.3.6. N/A Part 5 & Part 10

PROJECT LOCATION PLAN

SCALE 1:1

DRAWING TITLE **BUILDING CODE ANALYSIS**

carolynn wilson architect ltd. 924 b richmond ave.

victoria, bc v8s 3z3 204.514.7578

SHEET No.

PLOT DATE

REVISION No.

CONSULTANT

DEVELOPER / CLIENT:

WARMLAND CANNABIS

TENANT

IMPROVEMENT

1555 VANCOUVER STREET

VICTORIA, BC. V8V 0C8

DESCRIPTION

FOR BUILDING PERMIT

The contractor shall verify and accept responsibility for all dimensions. Do NOT scale the drawing. ALL errors or omissions shall be reported without delay to Carolynn Wilson Architect Ltd.

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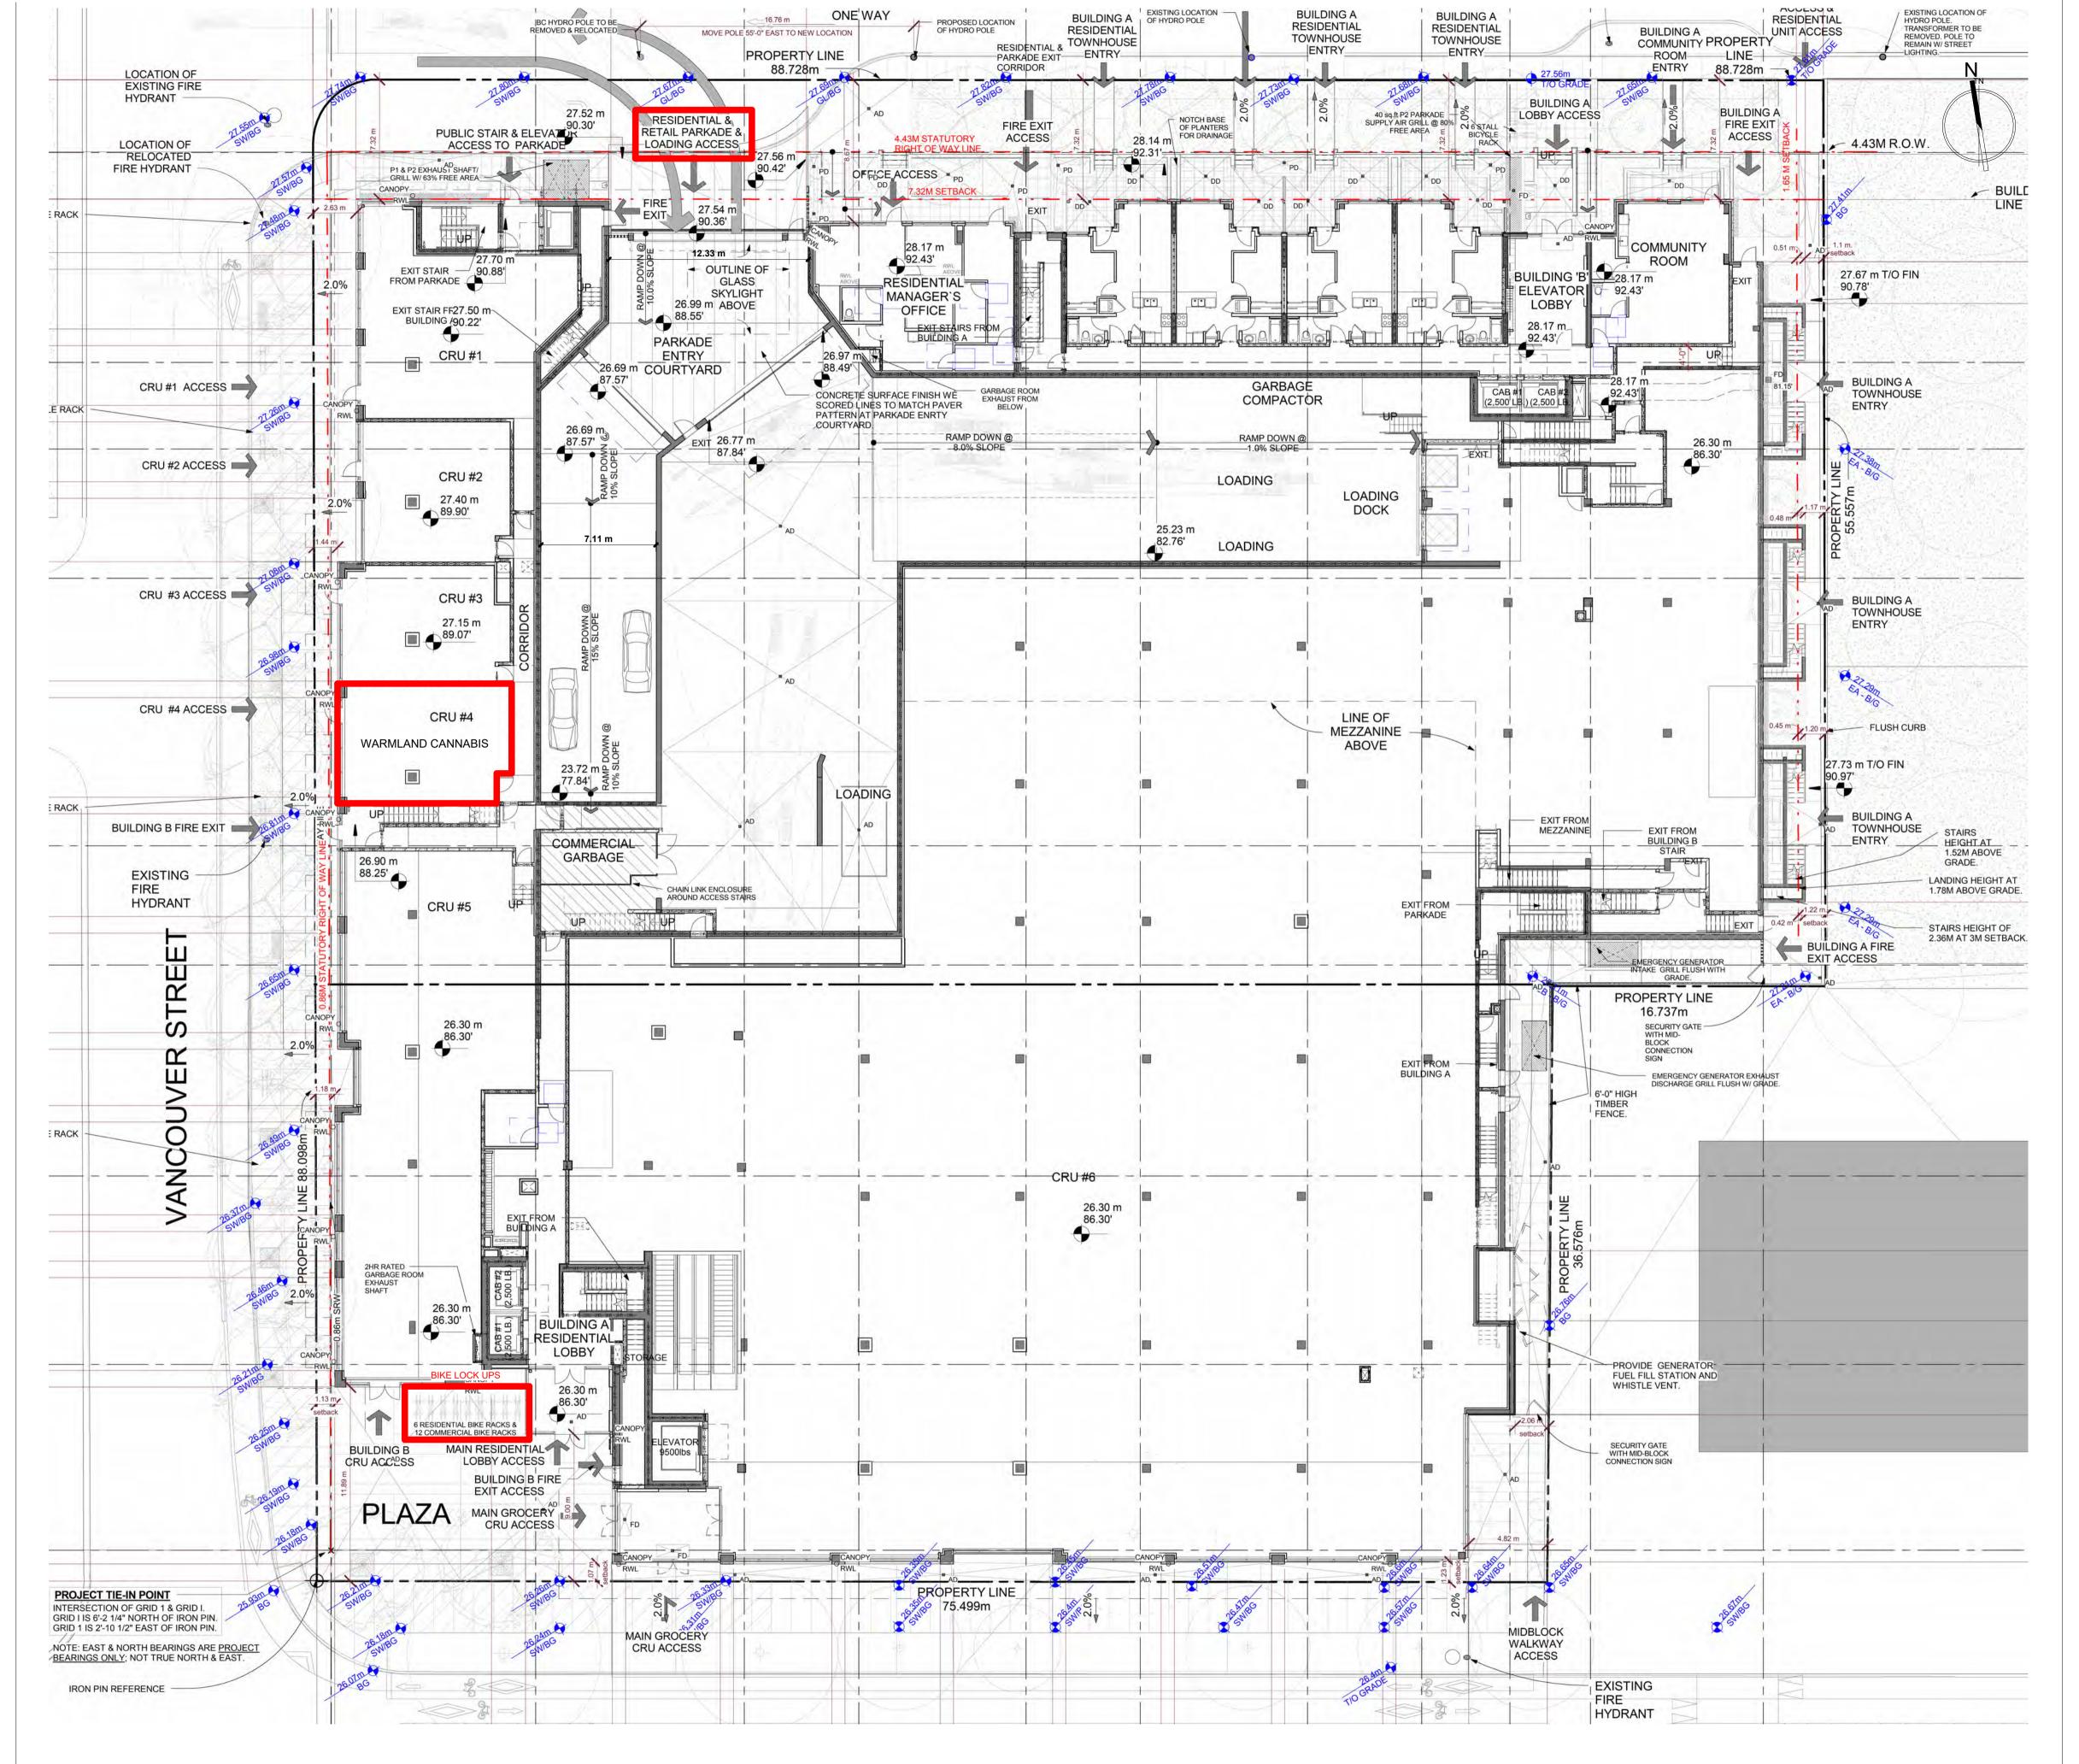
GENERAL NOTES

- 1. THE WORK INDICATED IN THESE DOCUMENTS IS INTENDED TO BE A COMPLETE WORK IN EVERY RESPECT. THE CONTRACTOR SHALL ABIDE BY AND COMPLY WITH THE TRUE INTENT AND MEANING OF ALL THE CONTRACT DOCUMENTS TAKEN AS WHOLE. ANY WORK SHOWN ON THE DRAWINGS EVEN IF NOT PARTICULARLY DESCRIBED IN THE SPECIFICATIONS, OR VICE VERSA, IS TO BE DONE BY THE CONTRACTOR AS IF IT WERE BOTH SHOWN ON DRAWINGS AND SPECIFIED.
- 2. EXAMINE SITE. REVIEW ALL SITE CONDITIONS PERTINENT TO WORK OF THE CONTRACT. THE CONSULTANT DOES NOT GUARANTEE EXISTING SITE INFORMATION INDICATED IN THE CONTRACT DOCUMENTS AND THE CONTRACTOR MUST ANTICIPATE MINOR VARIANCES IN SUCH INFORMATION RELATIVE TO ACTUAL CONDITIONS PRIOR TO BID CLOSE. REPORT ANY MAJOR DISCREPANCIES TO THE CONSULTANT.
- PERFORM WORK IN ACCORDANCE WITH B.C. BUILDING CODE (BCBC) LATEST EDITION AND ANY OTHER CODE OF PROVINCIAL OR LOCAL APPLICATION PROVIDED THAT IN ANY CASE OF CONFLICT OR DISCREPANCY, THE MORE STRINGENT REQUIREMENTS OR AUTHORITY HAVING JURISDICTION SHALL APPLY.
- 4. MEET OR EXCEED REQUIREMENTS OF CONTRACT DOCUMENTS, SPECIFIED STANDARDS AND CODES, AND REFERENCED DOCUMENTS.
- 5. CONFLICT IN TERMINOLOGY UTILIZED WITHIN THE CONTRACT DOCUMENTS WILL BE DECIDED AS THE MORE EXPENSIVE ALTERNATIVE.
- 6. WHERE SITE WORK INVOLVES BREAKING INTO OR CONNECTING TO EXISTING SERVICES, CARRY OUT WORK IN ACCORDANCE WITH MUNICIPAL AND OR UTILITY COMPANY REQUIREMENTS. COORDINATE SERVICE INTERUPTIONS WITH *OWNER* AND AUTHORITY HAVING JURISDICTION.
- 7. FIT WORK AIRTIGHT TO PIPES, SLEEVES, DUCTS AND CONDUITS AND CONFORM TO FIRE STOPPING AND FIRE SEPARATION REQUIREMENTS. CONCEAL ALL PIPES, DUCTS, CONDUITS AND WIRING IN FLOOR, WALL AND ROOF AND CEILING CONSTRUCTION OF FINISHED AREAS.
- 8. RECORD EXACT LOCATIONS OF NEW, MAINTAINED, RE-ROUTED AND ABANDONED SERVICE LINES ON AS-BUILT DRAWINGS.
- 9. THE LOCATION OF EXISTING FEATURES, BOTH ABOVE GRADE AND UNDERGROUND, HAS BEEN DETERMINED FROM AVAILABLE RECORDS BUT IS NOT GUARANTEED. THE LOCATION OF ALL SUCH FEATURES SHALL BE VERIFIED IN THE FIELD BY THE CONTRACTOR. NOTIFY CONSULTANT OF DISCREPANCIES PRIOR TO START OF THE WORK.
- 10. DEMOLITION IN THE VICINITY OF EXISTING STRUCTURES AND UTILITIES SHALL BE CAREFULLY PERFORMED. THE *CONTRACTOR* SHALL BE HELD RESPONSIBLE FOR DAMAGE TO AND FOR PROTECTION OF, EXISTING STRUCTURES AND UTILITIES. DAMAGE TO EXISTING STRUCTURES AND UTILITIES IS TO BE MADE GOOD TO THE SATISFACTION OF THE CONSULTANT AT NO COST TO THE *OWNER*.
- 11. ALL THE VARIOUS WORKS SHALL BE EXECUTED IN A WORKMANLIKE MANNER AND OF THE BEST MATERIALS AND WORKMANSHIP IN ACCORDANCE WITH THE CONTRACT DOCUMENTS. NONE BUT SKILLED, EXPERIENCED WORKMEN AND THEIR APPRENTICES SHALL BE EMPLOYED ON THE WORK.
- 12. ALL THE MATERIALS USED IN THE EXECUTION OF THE WORK OF THIS CONTRACT SHALL BE NEW AND/OR BEST QUALITY UNLESS OTHERWISE SHOWN.
- 13. READ ALL DRAWINGS IN CONJUCTION WITH ALL PROJECT SPECIFICATION SECTIONS.
- 14. CONTAIN SITE WORK AREA TO LIMITS AS SHOWN ON SITE PLAN. DECONSTRUCTED AND WASTE MATERIALS TO BE REMOVED FROM SITE AND TRANSPORTED TO RECYCLING FACILITIES AUTHOURIZED TO HANDLE AND DISPOSE OF THE MATERIALS.
- 15. CONTRACTORS STORAGE AND LAY-DOWN AREA IS TO BE CONTAINED WITHIN SITE WORK AREA LIMITS UNLESS OTHERWISE NOTED.
- 16. LIMIT SITE ACCESS TO ROUTES INDICATED ON THE SITE PLAN. COORDINATE ALL ACCESS WITH AUTHORITY HAVING JURISDICTION AND THE OWNER'S RESTRICTIONS PRIOR TO COMMENCEMENT OF WORK. ABIDE BY ALL MUNICIPAL REQUIREMENTS, OWNER RESTRICTIONS AND CONTRACT DOCUMENTS
- 17. SITE AND TOPOGRAPHICAL INFORMATION HAS BEEN OBTAINED FROM SURVEY DRAWINGS OBTAINED FROM THE *OWNER*. LOCATIONS OF ALL SITE COMPONENTS AND ELEVATION DATUMS PRIOR TO COMMENCEMENT OF THE WORK. NOTIFY CONSULTANT OF DISCREPANCIES PRIOR TO START OF THE WORK.
- 18. RE-GRADE ALL AREAS DISTURBED DURING CONSTRUCTION TO FINISHED GRADES AS INDICATED ON *DRAWINGS* AND BLEND INTO EXISTING NATURAL GRADE AS REQUIRED.
- 19. UNLESS OTHERWISE INDICATED EXTERIOR DIMENSIONS ARE TO FACE OF FOUNDATION WALL OR FACE OF EXTERIOR SHEATHING.
- 20. UNLESS OTHERWISE INDICATED INTERIOR DIMENSIONS ARE TO FACE OF WALL FINISH. REFER TO ARCHITECTURAL ASSEMBLY DRAWINGS FOR WALL AND PARTITION CONSTRUCTION. READ ALL DIMENSIONS ON ARCHITECTURAL IN CONJUNCTION WITH STRUCTURAL LAYOUT DRAWINGS. NOTIFY CONSULTANT OF DISCREPANCIES PRIOR TO START OF THE WORK.
- 21. ALL WALL PENETRATIONS TO BE SEALED USING APPROVED BUILDING ENVELOPE PRODUCTS AND METHODS.
- 22. NEW & EXISTING GRADES SHOWN IN ELEVATION ARE APPROXIMATE. CONTRACTOR TO FIELD VERIFY ALL DATUM POINTS WITH EXISTING SITE CONDITIONS AND MAKE NECESSARY ADJUSTMENT OF FOOTING HEIGHTS, COLUMN LENGTHS, STAIR TERMINATIONS AND FINAL FINISH CLADDING TERMINATIONS. MAKE ADJUSTMENTS TO MATERIAL LENGTHS AND QUANTITIES AS NECESSARY TO SUIT EXISTING & ADJUSTED GRADE CONDITIONSAS NECESSARY. REPORT ANY DISCREPANCIES TO CONSULTANT PRIOR TO START OF WORK.
- 23. THROUGH BOLT ALL CABINETS, SHELVING AND WALL MOUNTED FIXTURESTO SOLID WOOD BLOCKING TO ACHIEVE SEISMIC RESTRAINT.
- 24. ALL SHELVES TO BE ADJUSTABLE U.N.O.
- 25. CONFIRM CLEARANCES REQUIRED FOR ALL *OWNER* SUPPLIED EQUIPMENT PRIOR TO FABRICATION OF MILLWORK OR WORK TO BE BUILT IN.
- 26. PRIOR TO INSTALLATION COORDINATE PLACEMENT OF ALL SERVICES FIXTURES AND FITTING WITHIN CEILING SPACES TO AVOID CONFLICTS THAT RESULT IN DESIGN ELEVATION CHANGES TO CEILINGS. PREPARE COORDINATION DRAWING FOR REVIEW FOR COMPLEX CONDITIONS. CONTRACTOR TO INCORPORATE NECESSARY CHANGES IF CONSULTANT AGREES TO ADJUST DEISN LEVEL OF FINISHED CEILINGS.

CONSTRUCTION ASSEMBLY NOTES

- 1. REFER TO STRUCTURAL DRAWING FOR ALL INFORMATION REGARDING CONCRETE STRUTURAL, SIZES & SPACING & CONNECTIONS OF LOADBEARING WALL STUDS, FLOOR JOISTS, ROOF JOISTS AND SHEAR WALLS.
- 2. PLYWOOD SHEATHING SPECIFIED ON STRUCTURAL DRAWINGS FOR SHEARWALLS IS SEPARATE AND AN ADDITIONAL TO MATERIAL COMPONENTS FOR CONSTRUCTION ASSEMBLIES LISTED ON ARCHITECTURAL DRAWINGS. DRYWALL LISTED IN ASSEMBLIES TO BE APPLIED OVER TOP OF PLYWOOD SHEARWALLS REQUIRED BY
- 3. FILL ALL INDIVIDUAL STUD SPACES ACCOMODATING SUPPLY OR WASTE WATER PIPING OR RAINWATER LEADERS WITH MINERAL FIBRE BATT INSULATION.
- 4. FILL VOIDS BETWEEN PREFAB SHOWER UNITS AND FLOOR BELOW WITH MINERAL FIBRE BATT INSULATION.
- 5. PROVIDE 90mm FIBREGLASS BATT INSULATION IN VOID SPACE ABOVE DROPPED CEILING IN ALL SUITE BATHROOMS TO COVER MINIMUN OF 50% CEILING AREA IN PLAN.
- 6. PROVIDE FIRESTOPPING AT ALL CONCEALED SPACES AND OTHER LOCATIONS IN ACCORDANCE WITH BC. BUILDING CODE (BCBC) LATEST EDITION.
- 7. PROVIDE FIRESTOPPING OF SERVICE PENETRATIONS AT ALL REQUIRED FIRE SEPARATIONS IN CONFORMANCE WITH BC. BUILDING CODE (BCBC) LATEST EDITION.
- 8. PROVIDE CONTINUOUS FOAM GASKET BETWEEN WALL PLATES AND CONCRETE FOUNDATION WALL OR SLAB ON GRADE.
- 9. BEHIND 3 SIDES OF ALL PREFAB SHOWER UNITS IN SUITES, SUBTITUTE 5/8" TYPE 'X' WATER RESISTANT TILE BACKER BOARD FOR 5/8" GYPSUM BOARD SPECIFIED IN WALL ASSEMBLY.
- 10. PROVIDE MINIMUM 2x6" SOLID WOOD BLOCKING BETWEEN STUDS FOR MOUNTING OF ALL HANDRAILS AND GRAB BARS.
- 11. DROP CEILING BELOW FLOOR ASSEMBLIES LISTED SHALL CONSIST OF 1 LAYER 5/8" GYPSUM BOARD ON METAL SUSPENSION SYSTEM.
- 12. ALL LOAD BEARING WALLS, POSTS & BEAMS SUPPORTING RATED FLOOR ASSEMBLIES TO HAVE FIRE REISTANCE EQUAL TO FLOOR RATING.
- 13. SHEATHING MEMBRANE SPECIFIED AT ALL EXTERIOR WALL ASSEMBLIES TO HAVE TAPED VERTICAL JOINTS AND CAULKED HORIZONTAL JOINTS TO CREATE CONTINUOUS
- 14. COORDINATE ALL ACCESS PANEL LOCATIONS IN WALLS & CEILING WITH MECHANICAL

AND ELECTRICAL REQUIRMENTS.





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CONSULTANT

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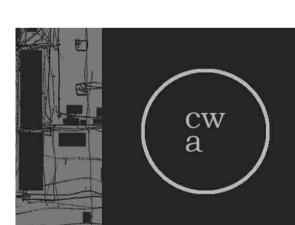
WARMLAND CANNABIS

TENANT

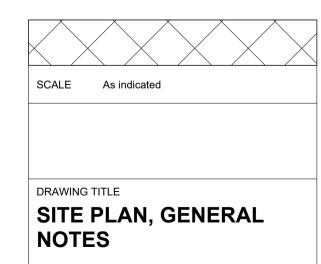
IMPROVEMENT

1555 VANCOUVER STREET VICTORIA, BC. V8V 0C8

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carolynn wilson architect ltd 924 b richmond ave. victoria, bc v8s 3z3 204.514.7578

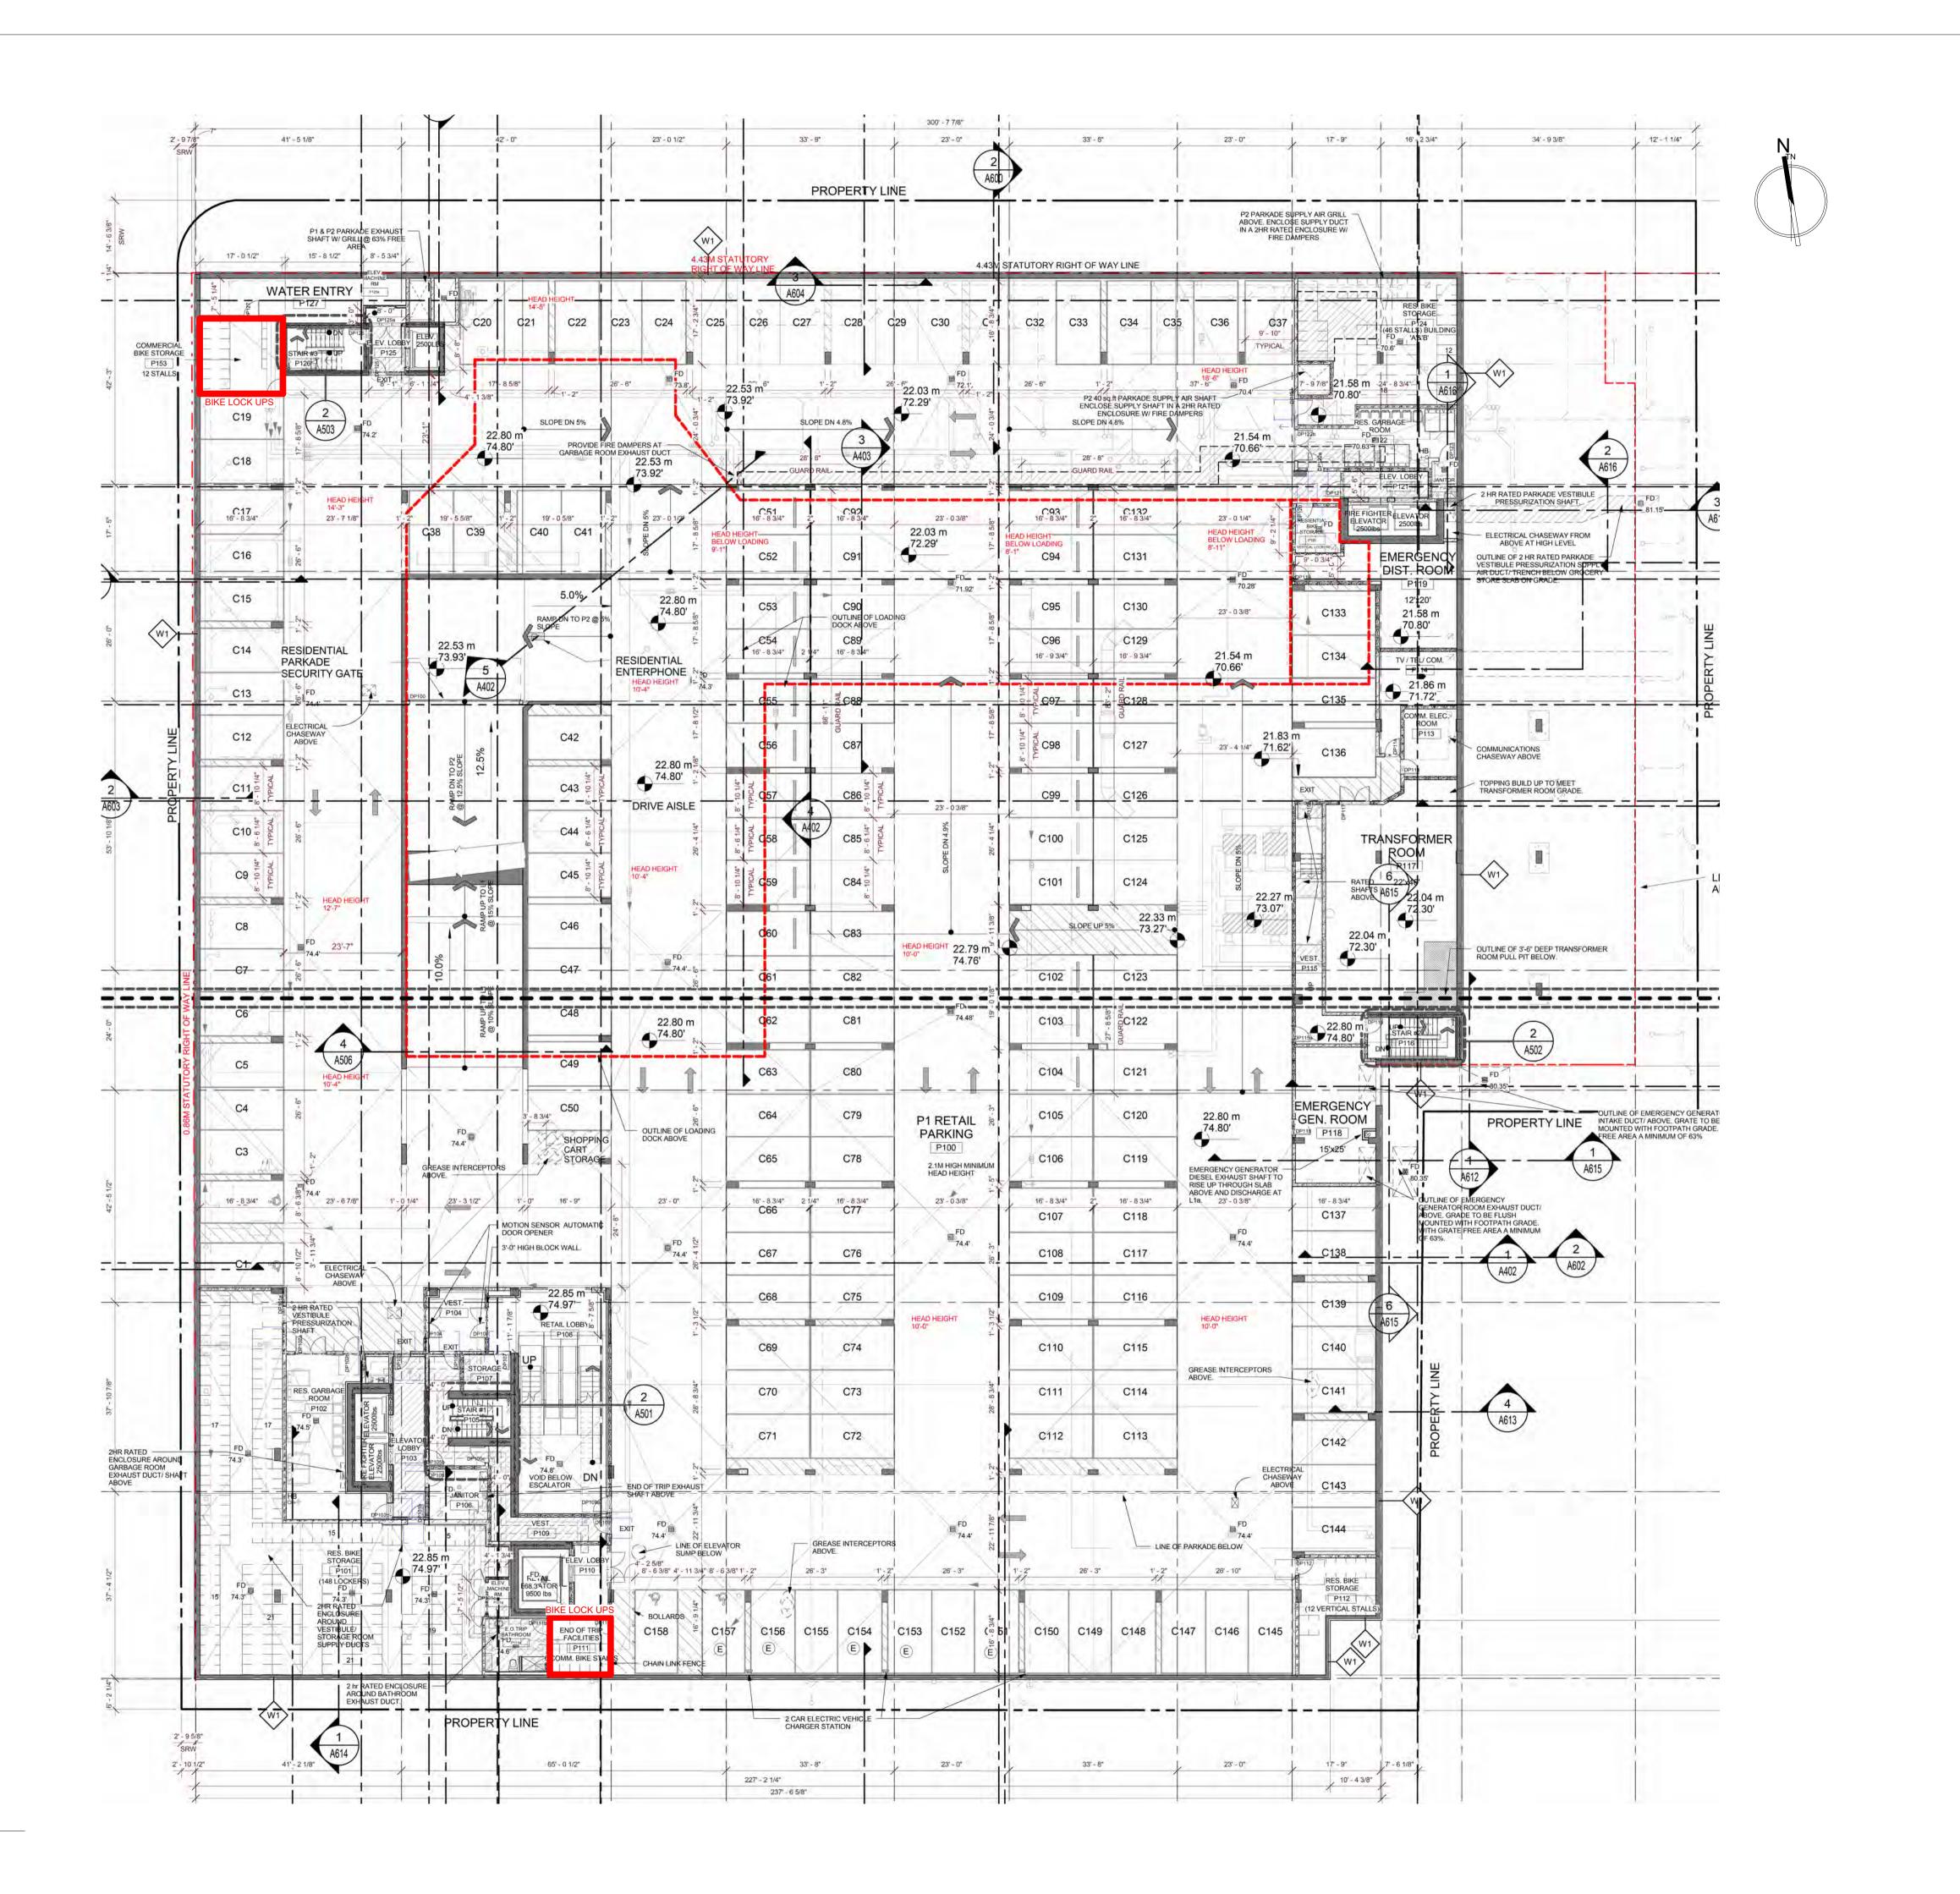


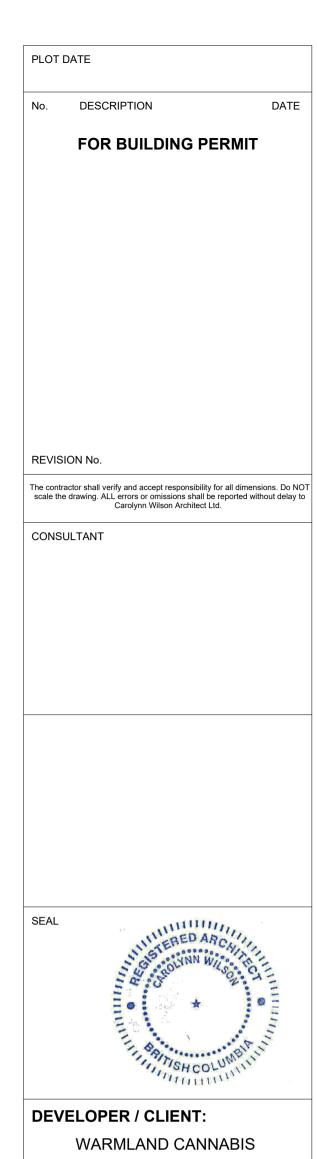
SHEET No.

A1.2

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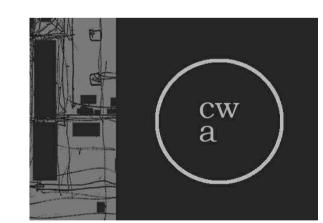
Wilson Architect Ltd.





TENANT IMPROVEMENT

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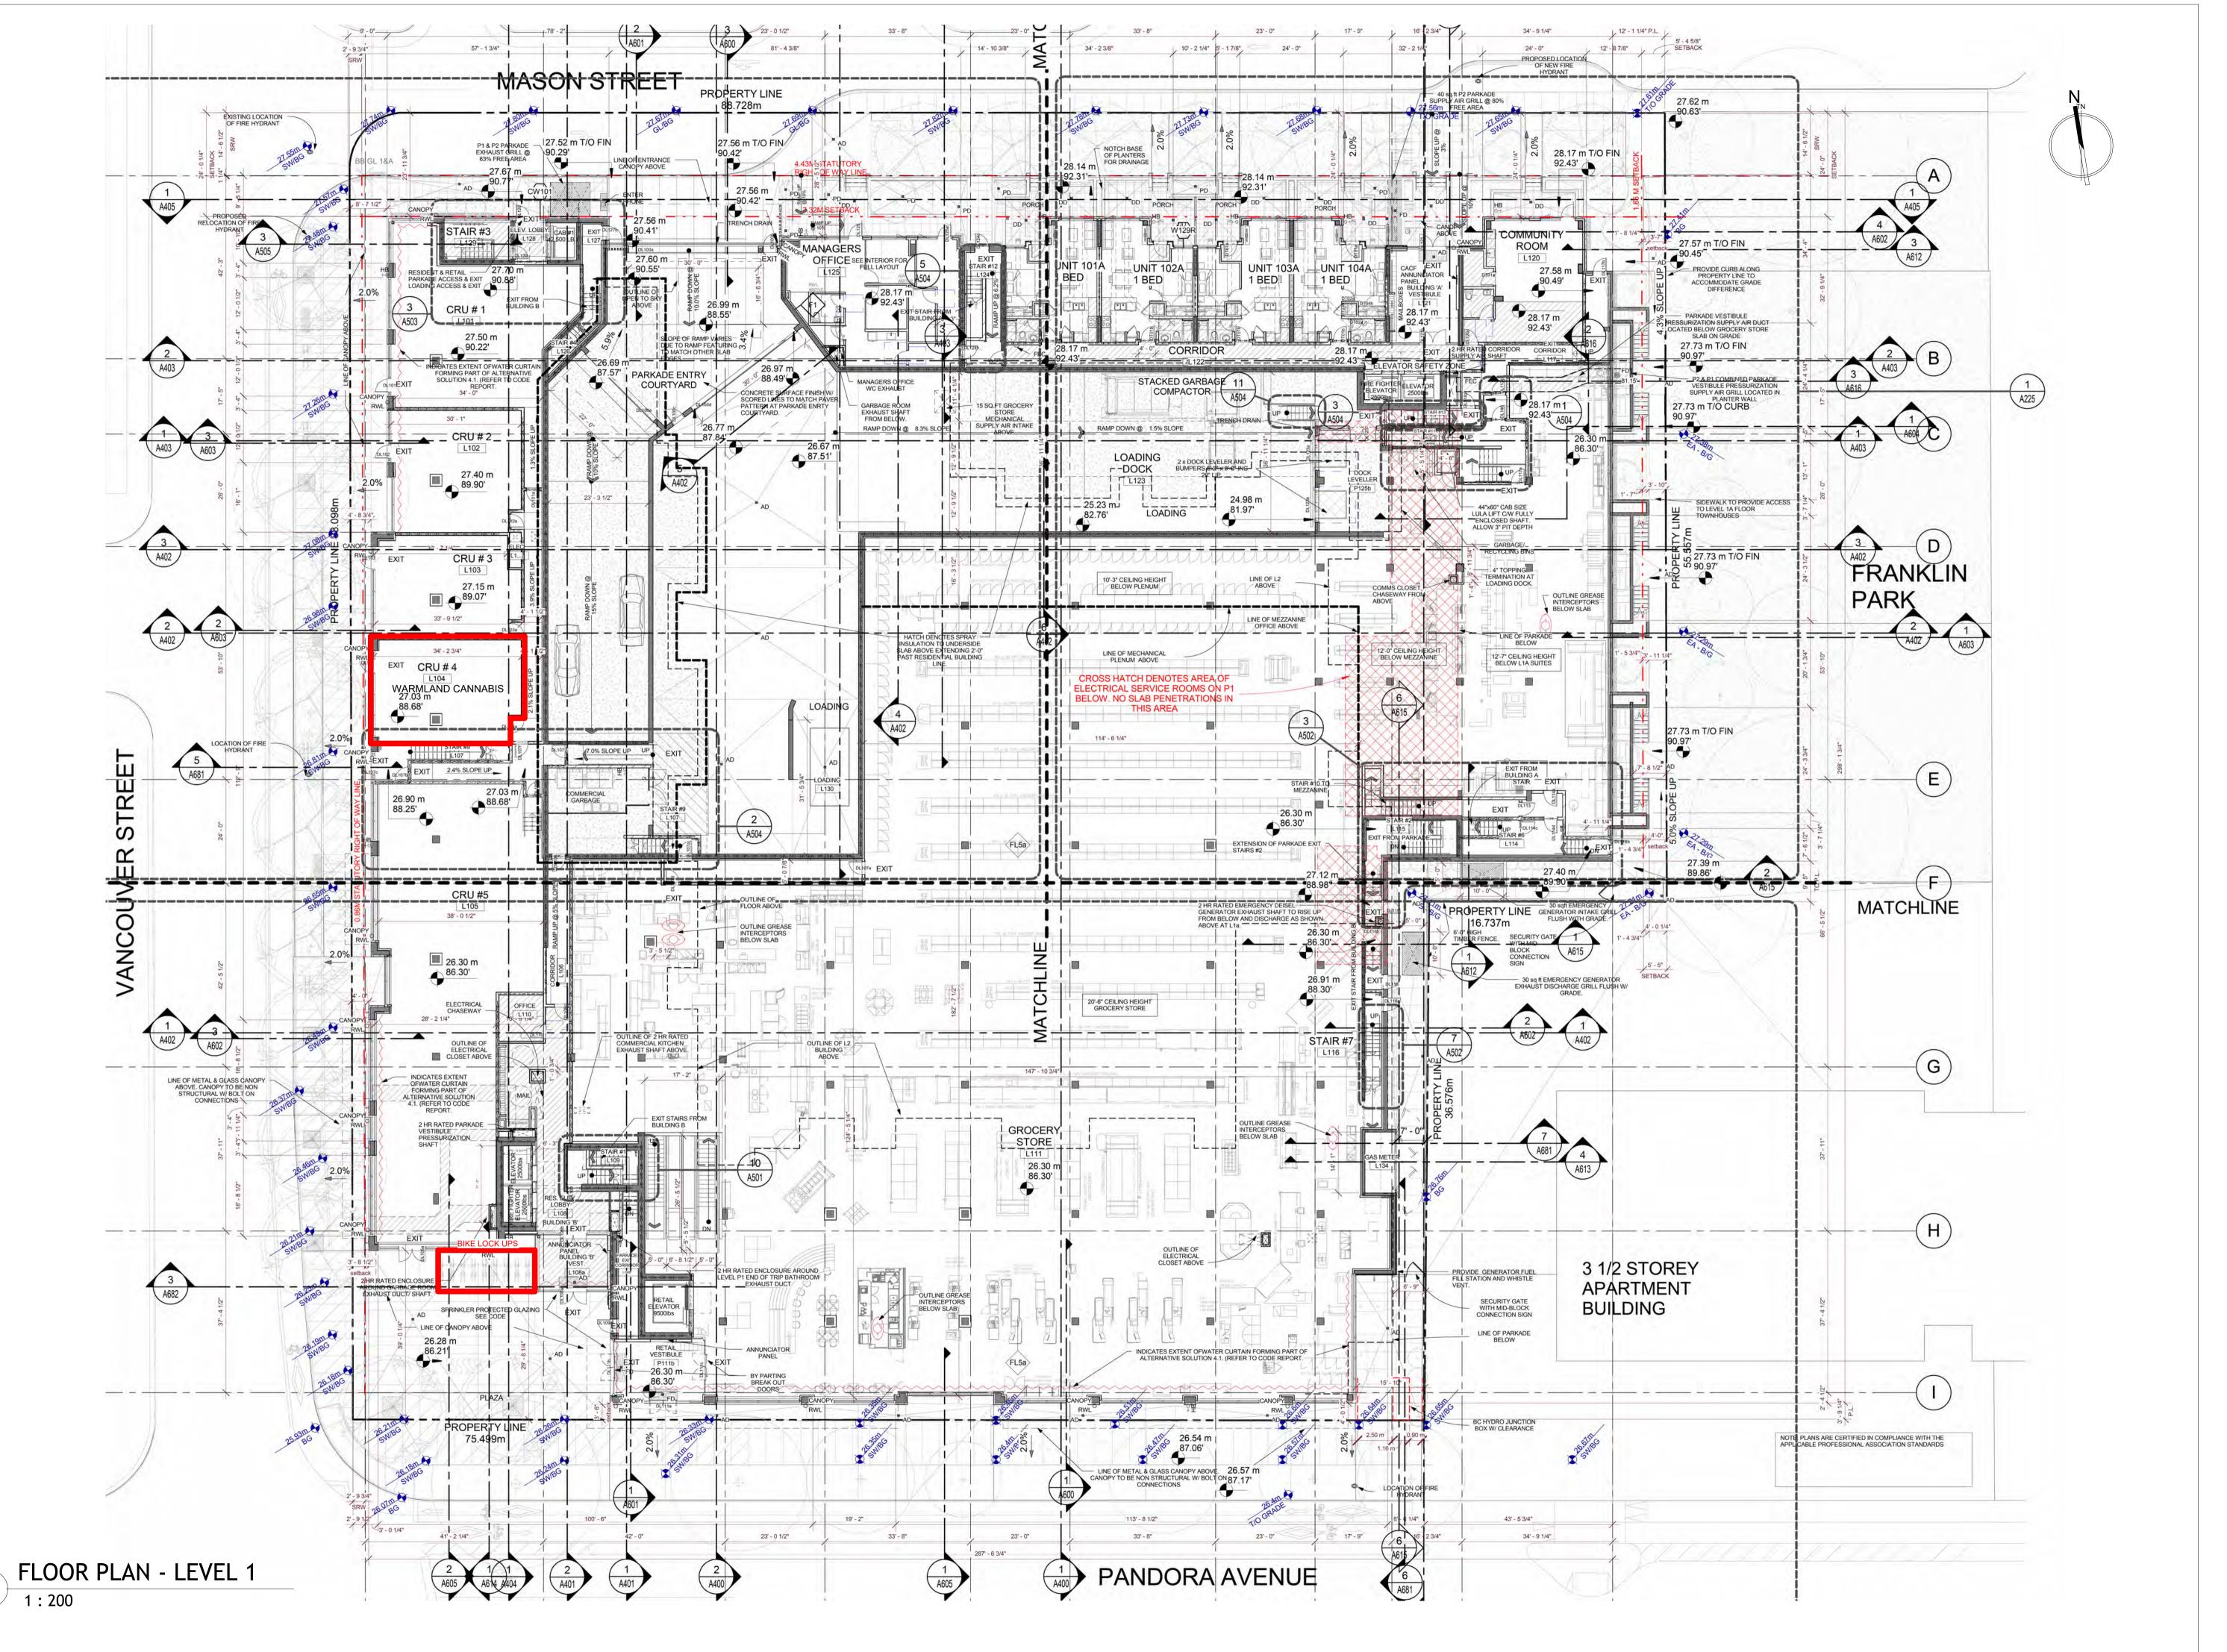


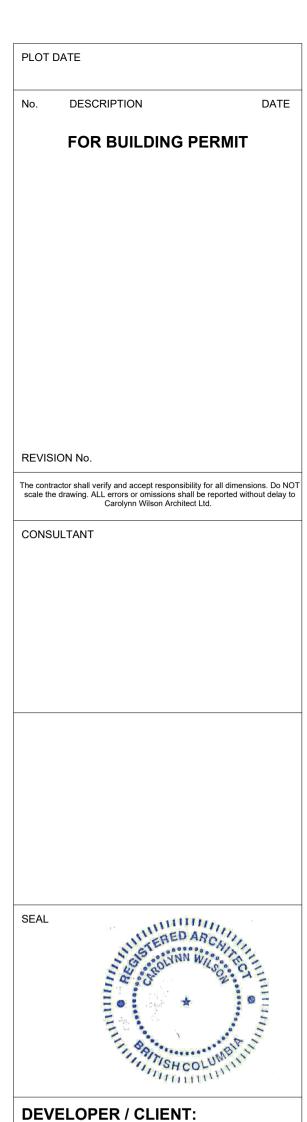
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SCALE 1:200
DRAWING TITLE
FLOOR PLAN - P1
SHEET No.

A1.3

7 1 1 1 0

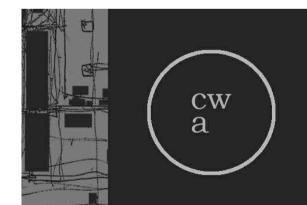




TENANT IMPROVEMENT

WARMLAND CANNABIS

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PARTITION LEGEND EXISTING STEEL STUD PARTITION W/ GWB FINISH EXISTING CONCRETE MASONRY BLOCK PARTITION

EXISTING EXTERIOR WALL WITH GWB FINISH - MAKE SMOOTH AS NEEDED FOR PRIME/FINISH PAINT AS PER OWNER

EXISTING FURRED-OUT WALL - MAKE SMOOTH AS NEEDED FOR PRIME/FINISH PAINT AS PER OWNER

EXISTING 6" STUD FURRED-OUT WALL - MAKE SMOOTH AS NEEDED FOR PRIME/FINISH PAINT AS PER OWNER

140mm STEEL STUD WALL TO U/S OF CONCRETE FLOOR ABOVE - SEISMIC BRACE WALL 13mm PLYWOOD SHEATHING - ON FOH SIDE

ACOUSTIC BATT INSULATION 12.7mm GWB ON BOTH SIDES TO 100mm ABOVE ACT

89mm STEEL STUD WALL TO U/S OF CONCRETE FLOOR ABOVE - SEISMIC BRACE WALL

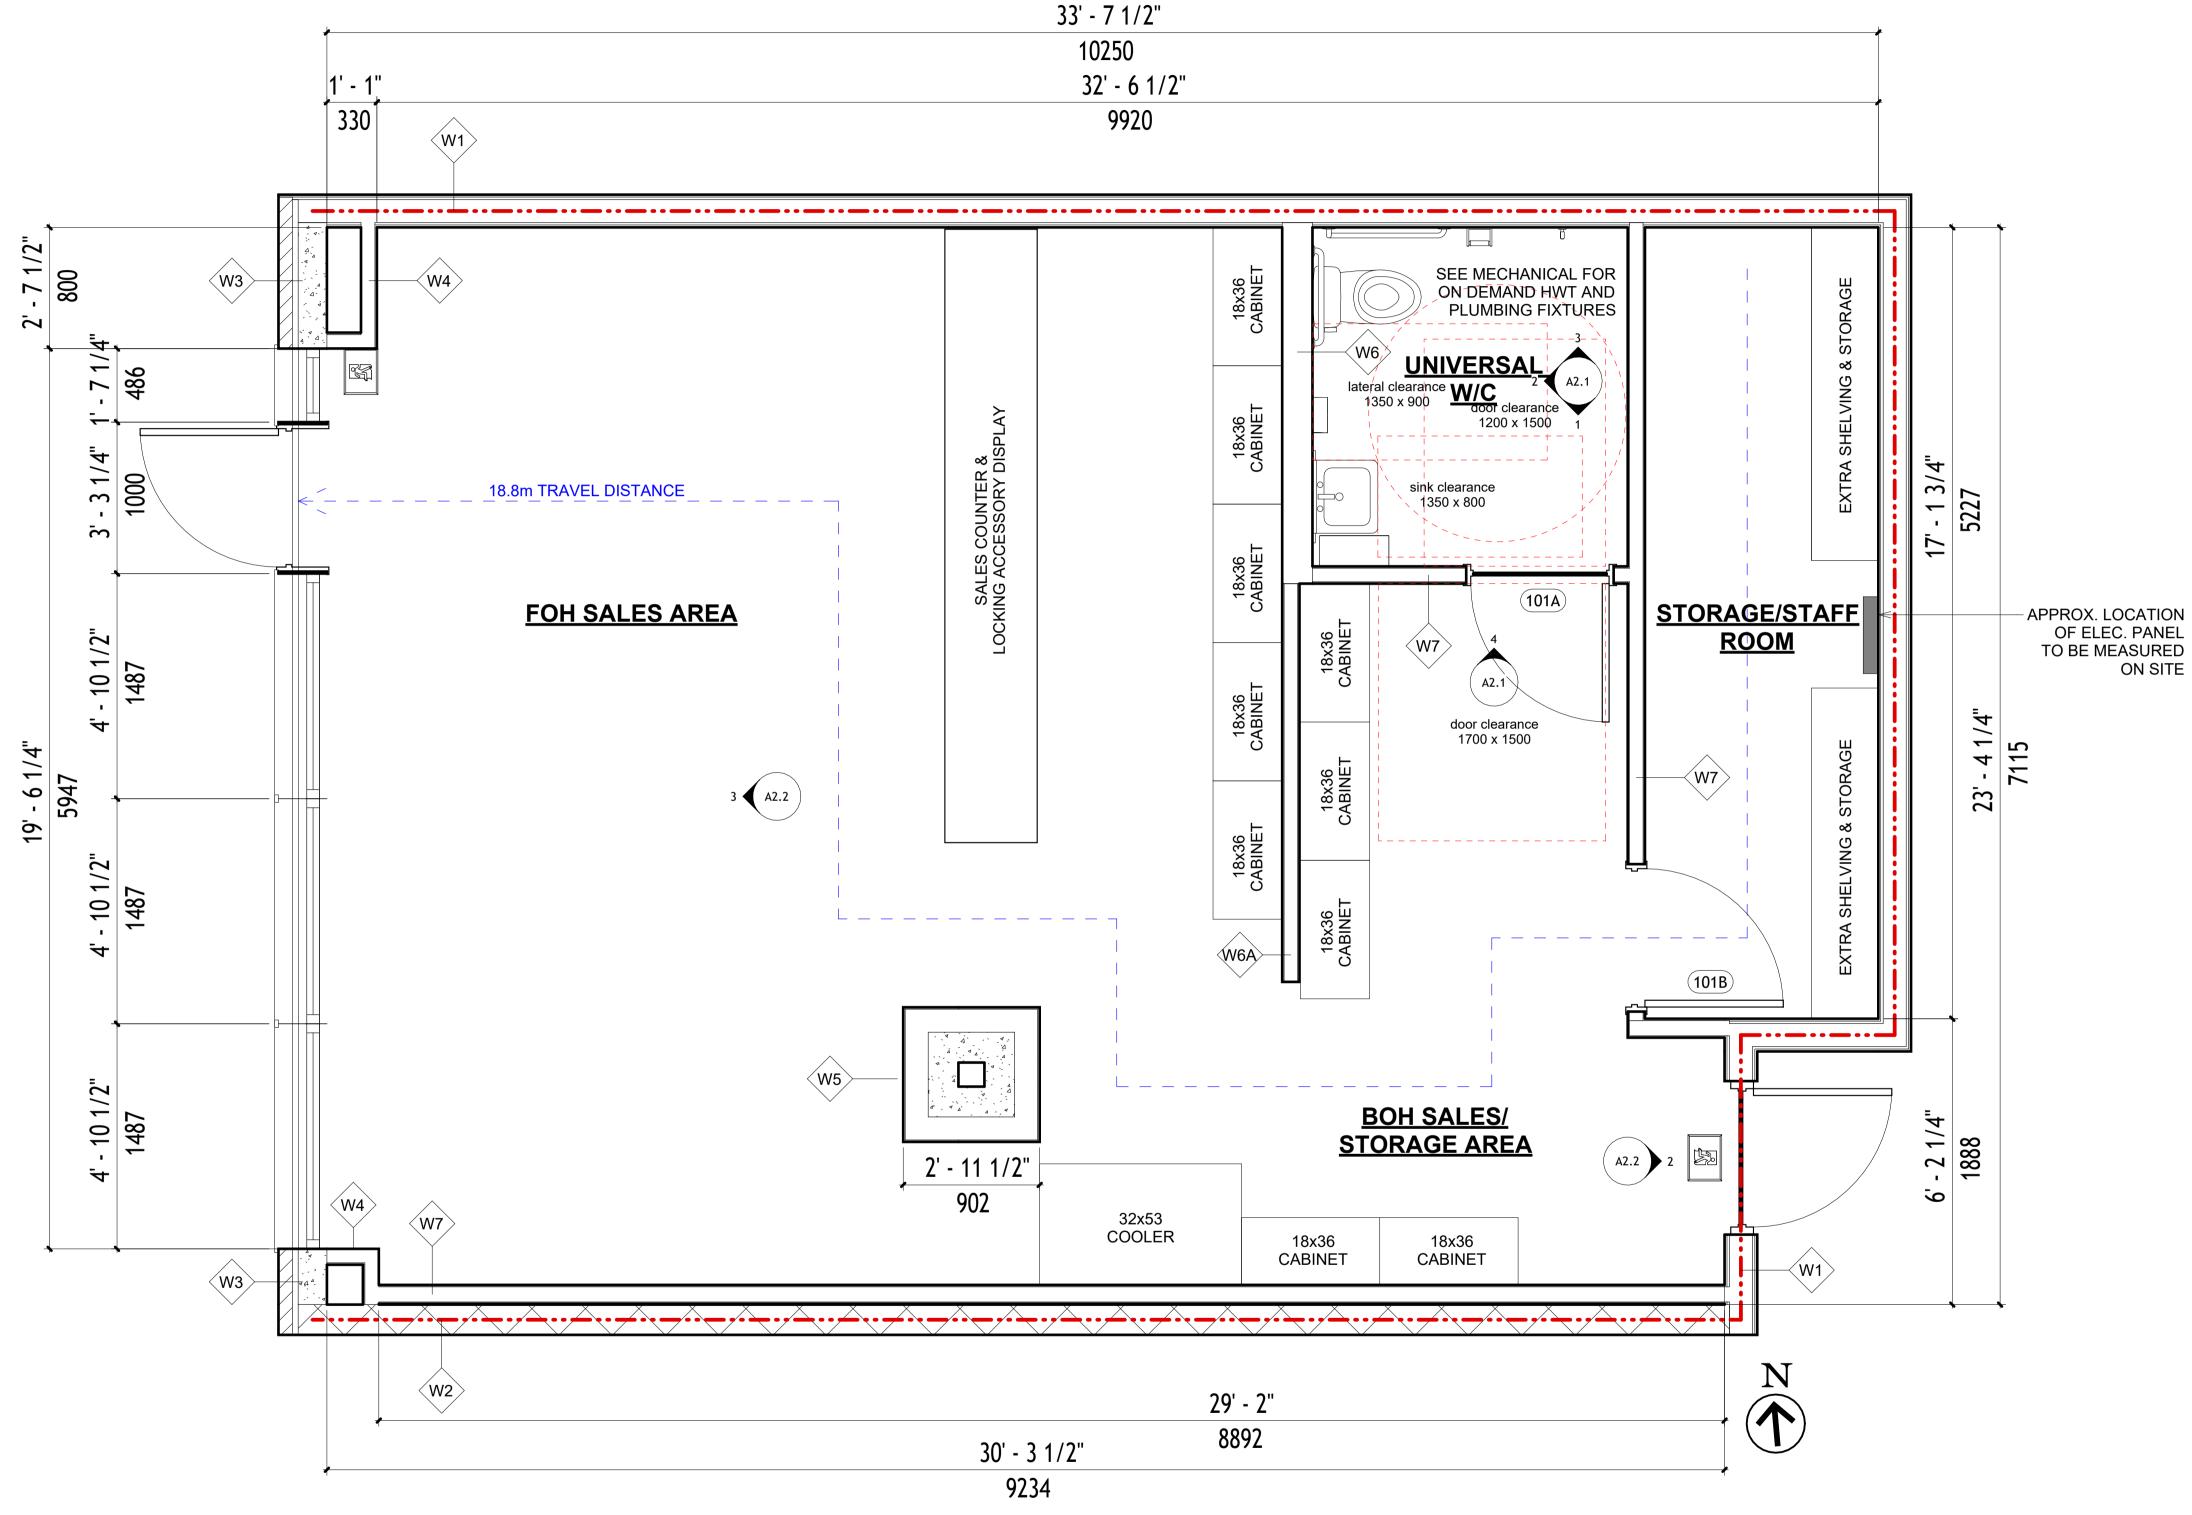
13mm PLYWOOD SHEATHING ON FOH SIDE 12.7mm GWB ON BOTH SIDES TO 100mm ABOVE ACT

89mm STEEL STUD WALL TO U/S OF CONCRETE FLOOR ABOVE - SEISMIC BRACE WALL ACOUSTIC BATT INSULATION

12.7mm GWB ON BOTH SIDES TO 100mm ABOVE ACT

2HR FIRE SEPARATION

W7



PROPOSED FLOOR PLAN

PLOT DATE

No. DESCRIPTION

FOR BUILDING PERMIT

REVISION No.

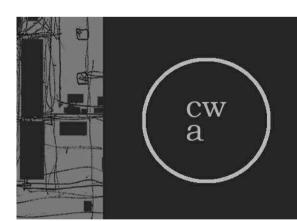
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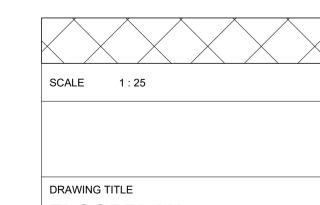
DEVELOPER / CLIENT: WARMLAND CANNABIS

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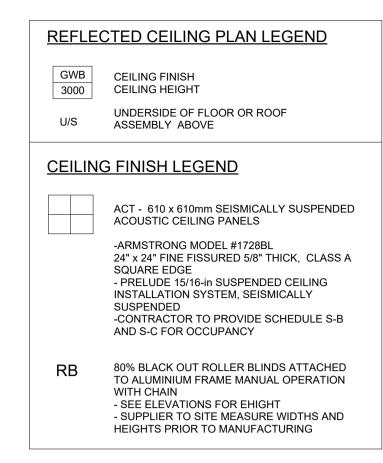
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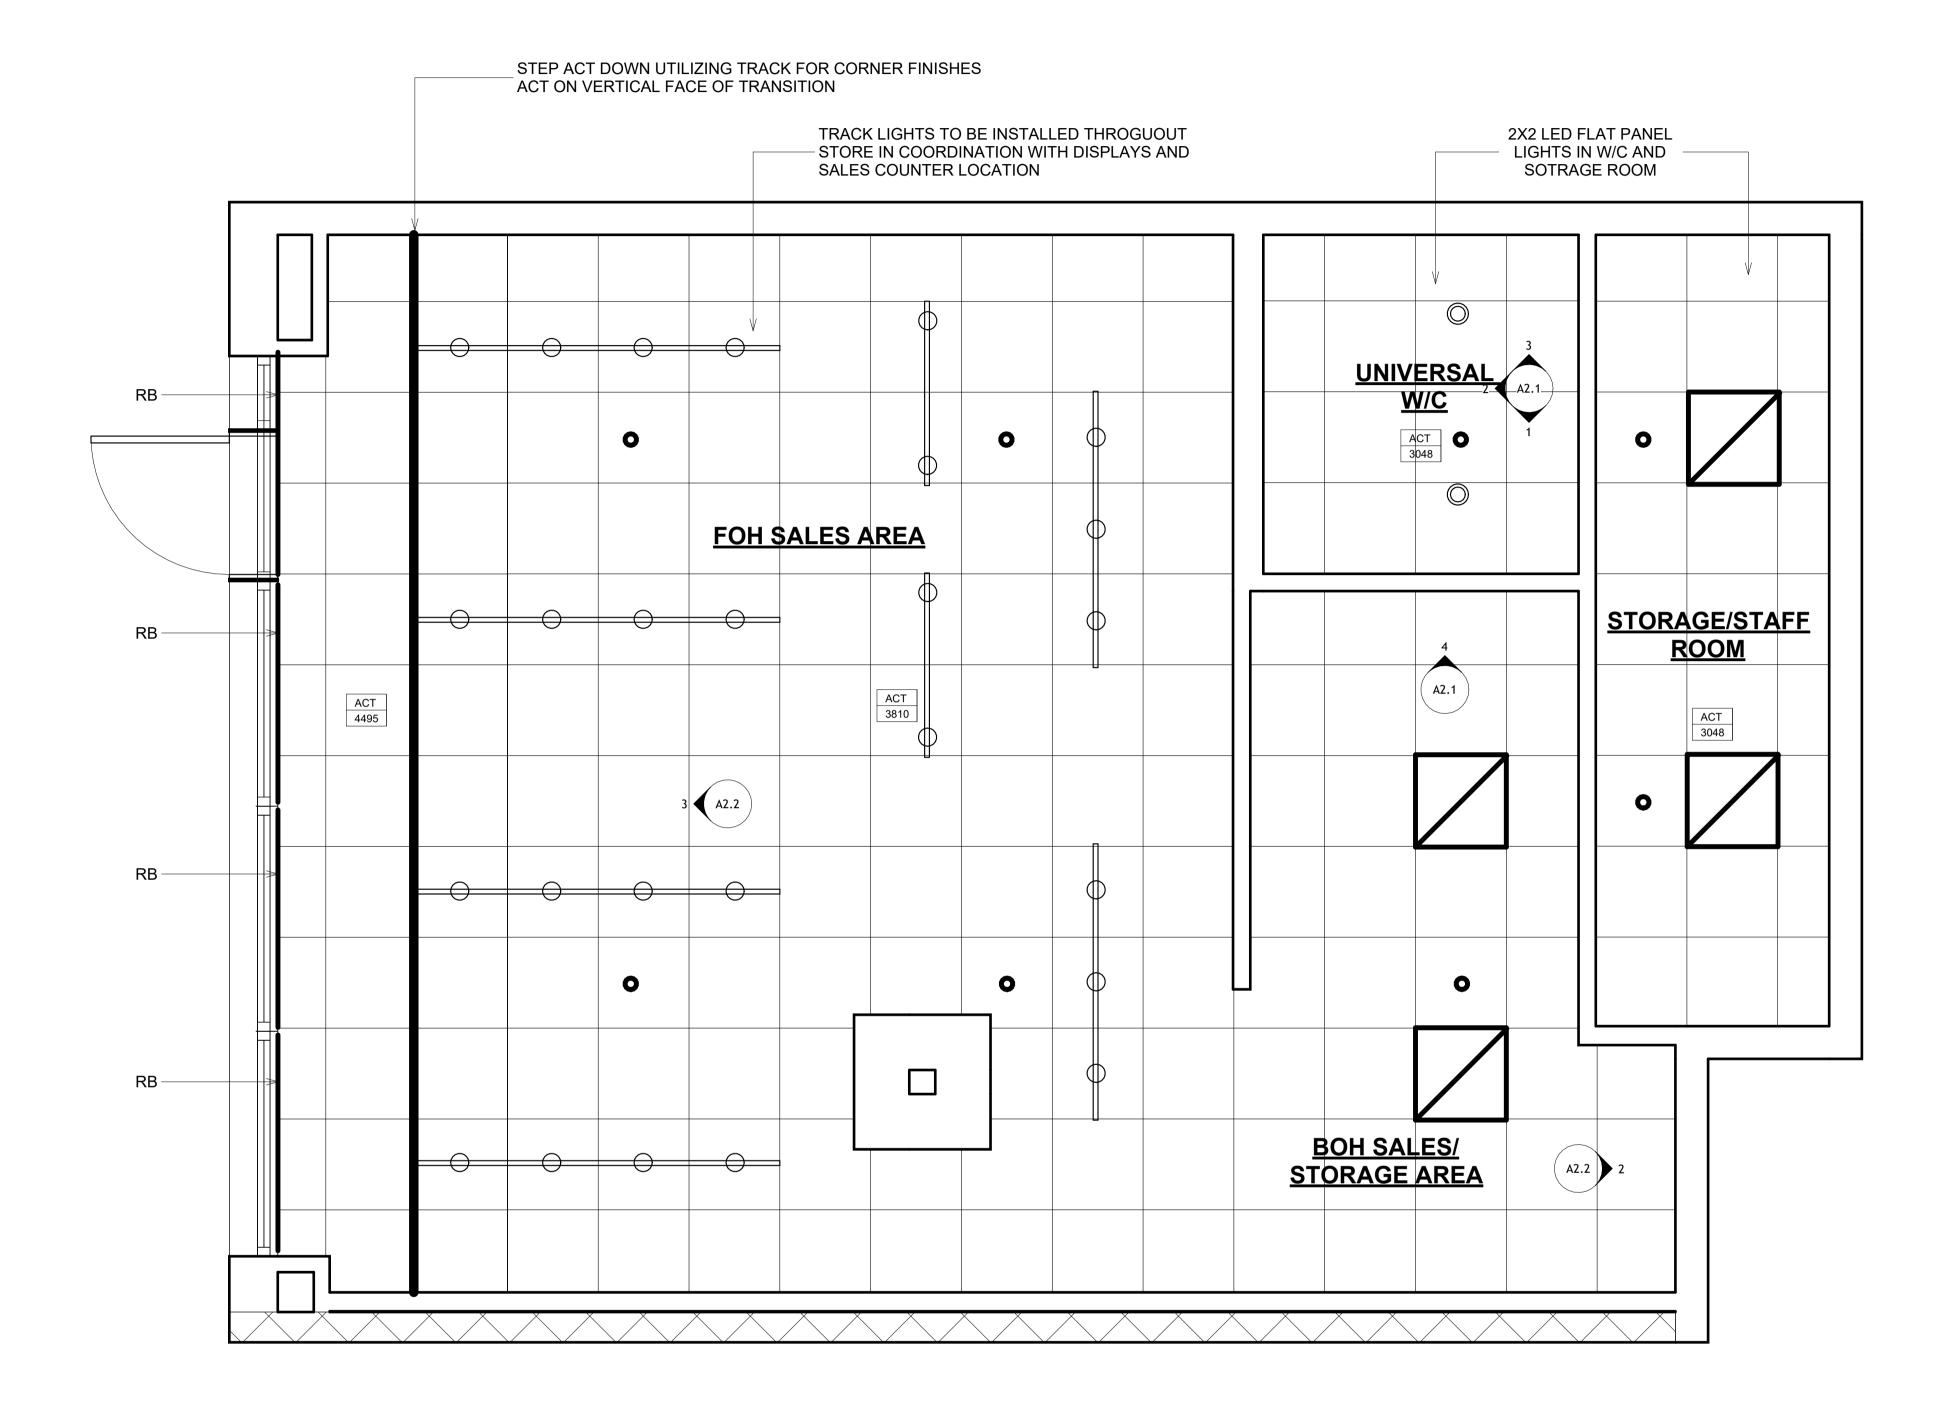


FLOORPLAN

SHEET No.

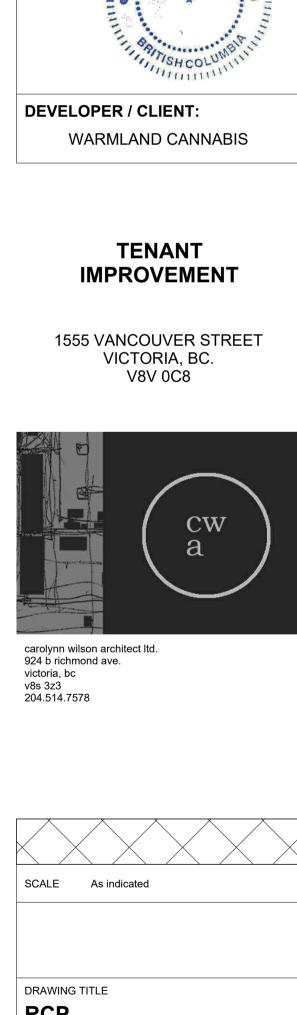
A1.5





COORDINATION NOTES

- -TILES AND TRACK TO BE BLACK
- -FINAL CEILING HEIGHT TBD, TO BE MEASURED AND DETERMINED ON SITE
- -MAINTAIN MAXIMUM ALLOWABLE HEIGHT IN THE FRONT SALES AREA
- -EXISTING HVAC/SPRINKLERS TO BE MEASURED AND CONFIRMED ON SITE



A1.6

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PROPOSED REFLECTED CEILING PLAN

No. DESCRIPTION

FOR BUILDING PERMIT

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REVISION No.

CONSULTANT

GENERAL FINISHES NOTES:

- ALL WALLS TO BE MUDDED, SANDED, AND **PAINTED**
- BENJAMIN MOORE OC26 (WHITE) POSSIBLE INSTALLATION OF POWER
- BLINDS AT FRONT WINDOWS, TO REFERENCE NEIBHGOURING BUSINESSES.
- MENU SCREEN REQUIREMENTS
 - A/C RECEPTACLE
 - ETHERNET
- TELUS CUSTOM SECURITY TO BE INSTALLED. KEYPAD ON WALL NEAR FRONT ENTRANCE WILL REQUIRE A/C RECEPTACLE
- PROVIDE PLYWOOD BACKING IN ALL WALLS WHERE SHELVING AND CABINETS ARE TO BE ATTACHED FOR SEISMIC BRACING
- CONTRACTOR TO SCRAPE, CLEAN, AND LEVEL THE EXISTING FLOOR

ROOM FINISHES LEGEND:

FLOORING:

F1 - CARBONIZED BAMBOO FLOORING

F2 - VINYL PLANK FLOORING

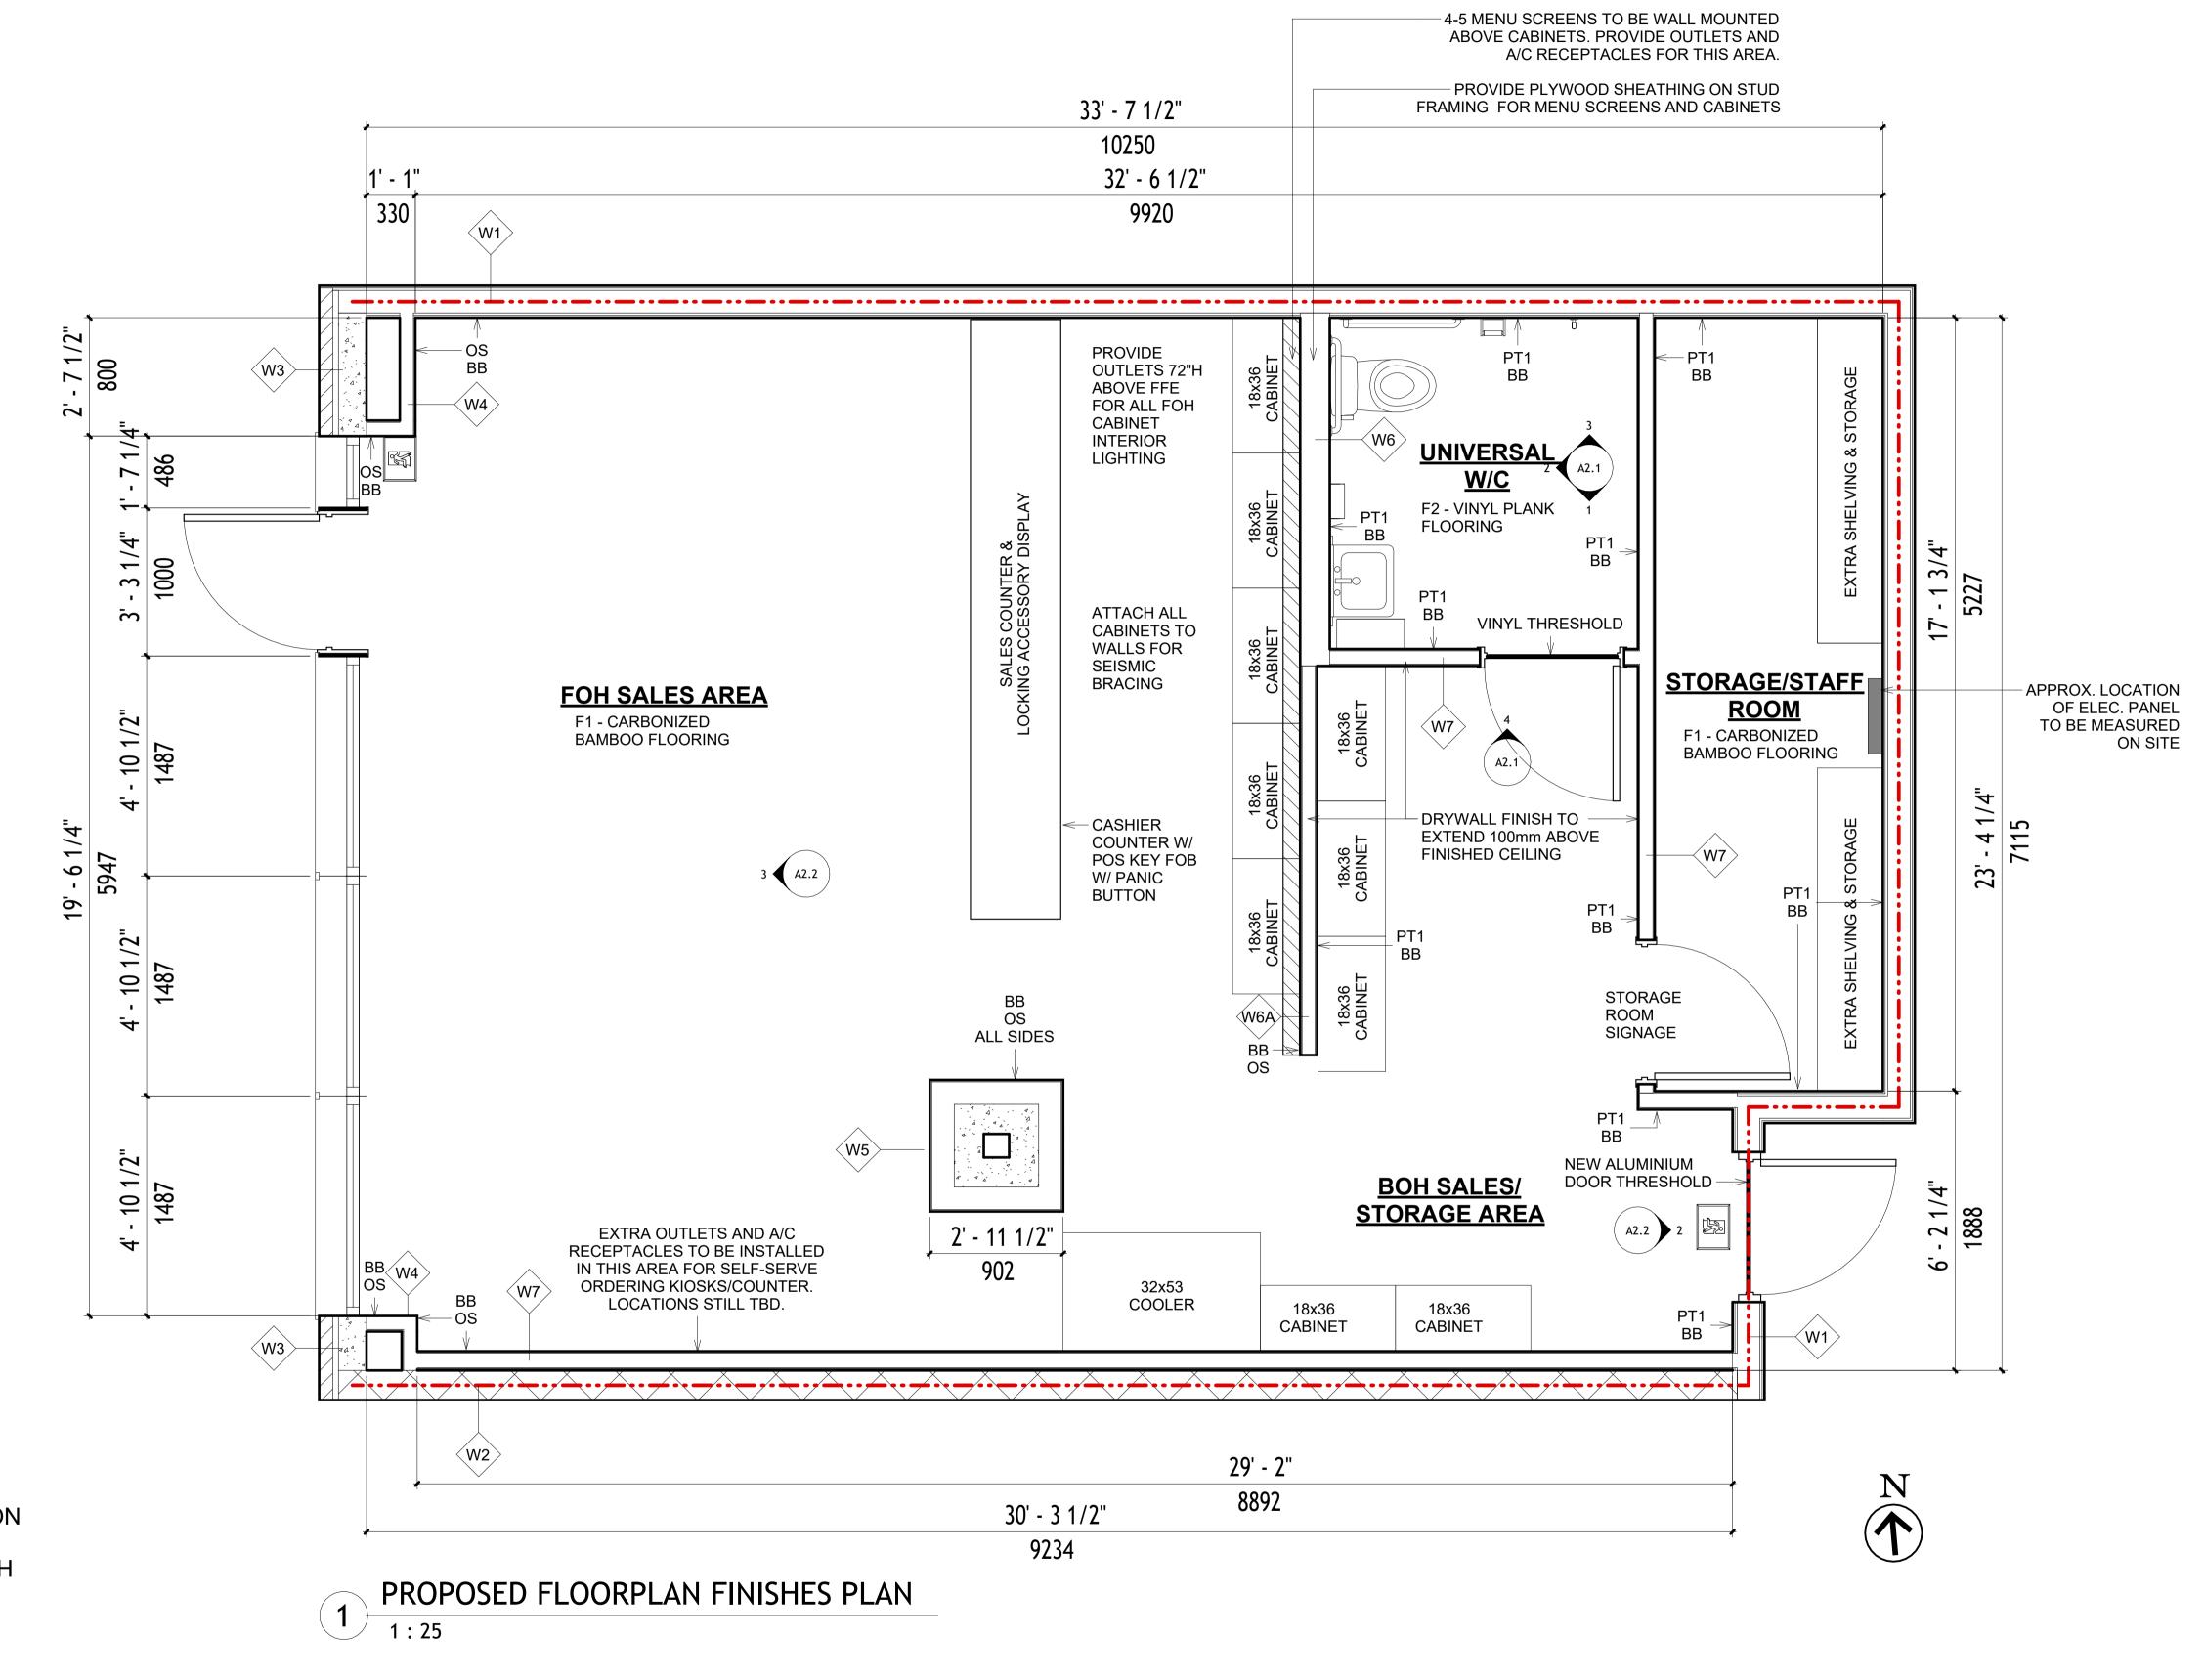
BASE BOARD:

BB - WOOD BASE BOARD PAINTED WHITE FINISH

PAINT:

PT1- BENJAMIN MOORE OC26 (WHITE) Silver Satin OC-26 | Benjamin Moore

OS - FINISH WALL AS PER OWNERS SPECIFICATION - ELECTRICAL TRADE TO COORDINATE THE FLUSH FACE OF THE DATA AND OUTLETS WITH THE OWNERS INTERIOR FINISHES



PLOT DATE DESCRIPTION FOR BUILDING PERMIT

REVISION No.

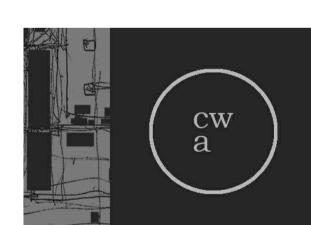
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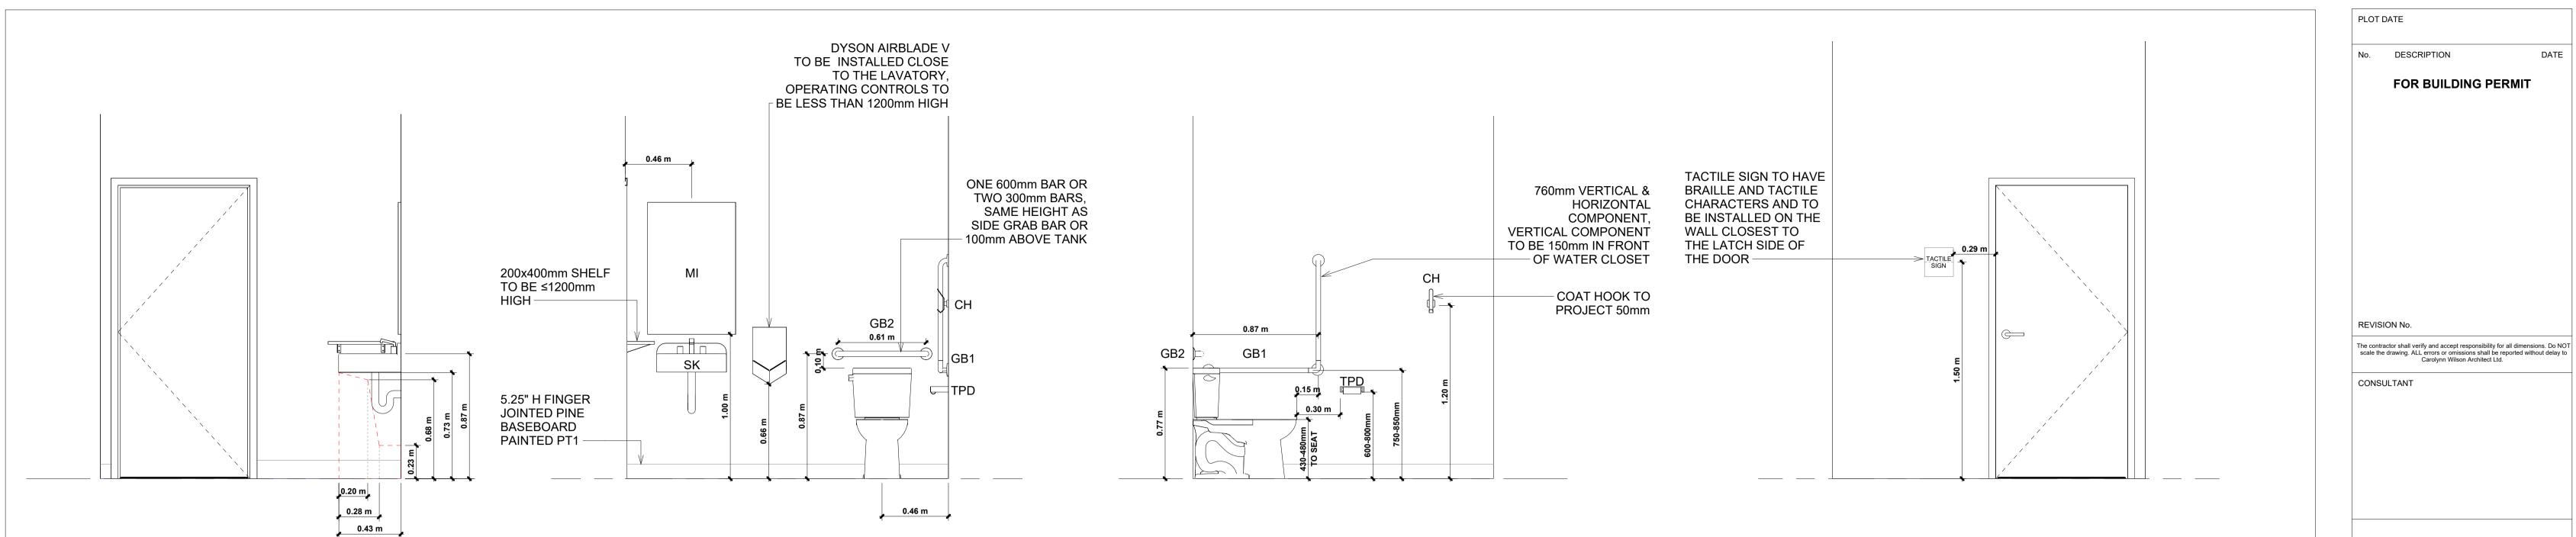
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DRAWING TITLE

FLOORPLAN INTERIOR **FINISHES**

SHEET No.

A1.7



WASHROOM ELEVATION 1

WASHROOM ELEVATION 2

WASHROOM ELEVATION 3

WASHROOM DOOR ELEVATION

LETTERS AND NUMERALS SHALL BE

1.5mm ABOVE THE SURFACE;

NEAR THE BOTTOM EDGE OF

AND COLOUR-CONTRASTED

WITH THEIR BACKGROUND.

RAISED BETWEEN 0.8 AND

ACCOMPANIED BY BRAILLE

16 TO 50mm IN HEIGHT;

TACTILE CHARACTERS

SANS SERIF;

THE SIGN;

DOOR SCHEDULE															
	Door Panel									Frame					
	Size														
Mark	Location	Width	Height	Thickness	Type	Material	Finish	FRR	Hardware	Signage Type	Signage Label	Type	Material	Finish	Comments
101A	WASHROOM	914	2032	45	Α	WD SC	WD		PRIVACY	12"X3" BRUSHED	UNIVERSAL	1	WD	PT	
							VENEER		SET	ALUM ALUPANEL	W/C +				
							ST			+ WHEELCHAIR	WHEELCHAIR				
										SYMBOL	SYMBOL				
101B	STORAGE	914	2032	45	В	WD HC	PT1	NO	TBD	TBD	STORAGE	1	WD	PT	

ABBREVIATIONS

WD - WOOD PT - PAINTED AL - ALUMINUM AN - ANODIZED HC - HOLLOW CORE M/WD - METAL FACE / SOLID WOOD CORE PRE - PREFINISHED BY MANUFACTURER WD SC- WOOD SOLID CORE N/A - NOT APPLICABLE

WASHROOM ACCESSORY LEGEND

TPD - TOILET PAPER DISPENSER

CH - COAT HOOK, SEE SPEC.

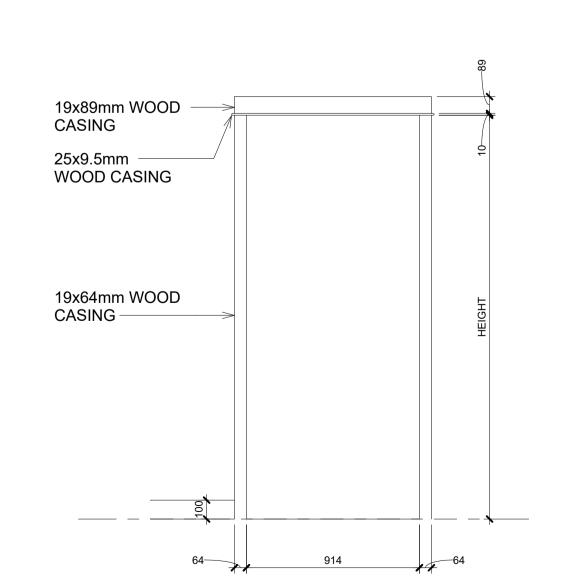
GB1 - 32mm DIA. STAINLESS STEEL L-SHAPED GRAB BAR, SLIP RESISTANT, PROVIDE PLYWOOD BACKING IN WALL, SEE SPEC.

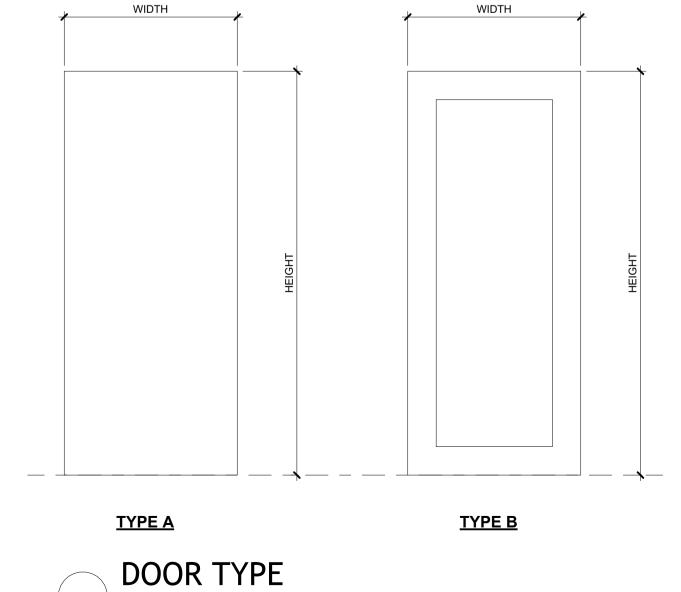
GB2 - 38mm DIA. STAINLESS STEEL GRAB BAR 610mm LONG, SLIP RESISTANT, PROVIDE PLYWOOD BACKING IN WALL, SEE SPEC.

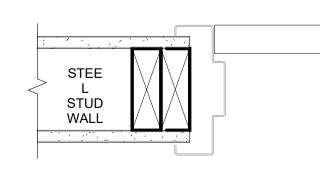
MI - BOBRICK SS CHANNEL MIRROR WITH FRAME - B-165 1836 - 18" X 36"

FT - FAUCET, SEE MECHANICAL

SK - WALL MOUNTED SINK, SEE MECHANICAL







DOOR TRIM TYPE 1 DETAIL

DOOR FRAME DETAIL





TENANT

IMPROVEMENT

WARMLAND CANNABIS

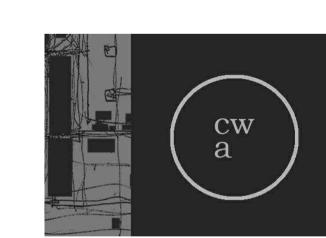
DEVELOPER / CLIENT:

DESCRIPTION

REVISION No.

FOR BUILDING PERMIT

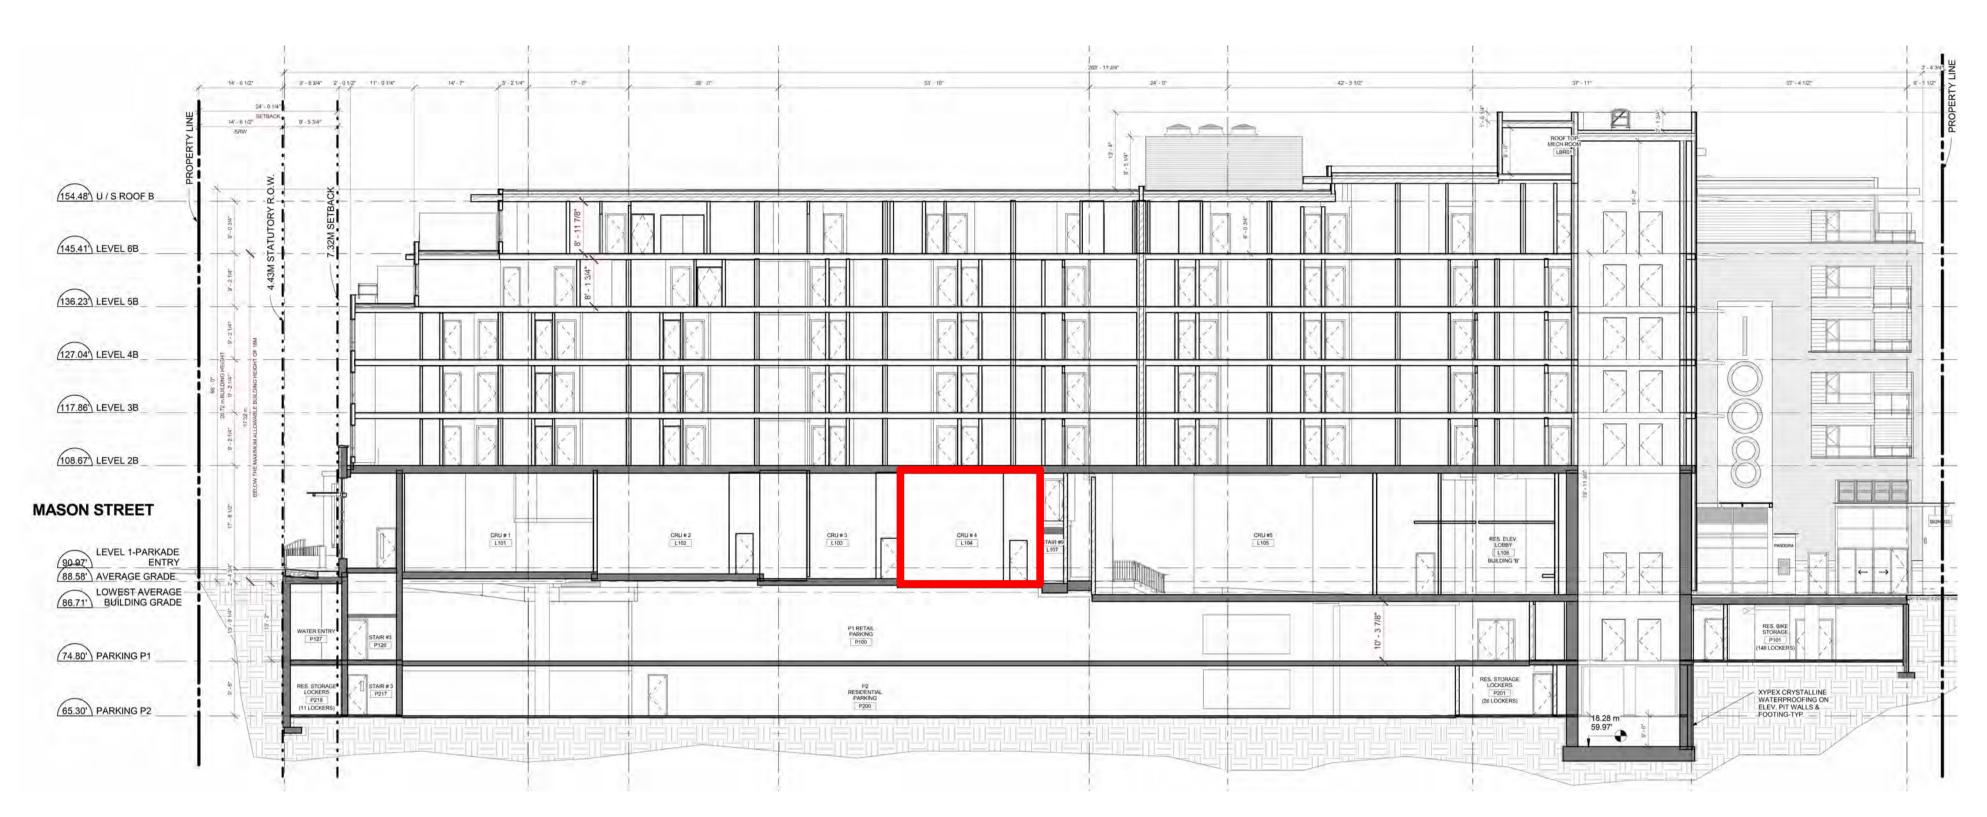
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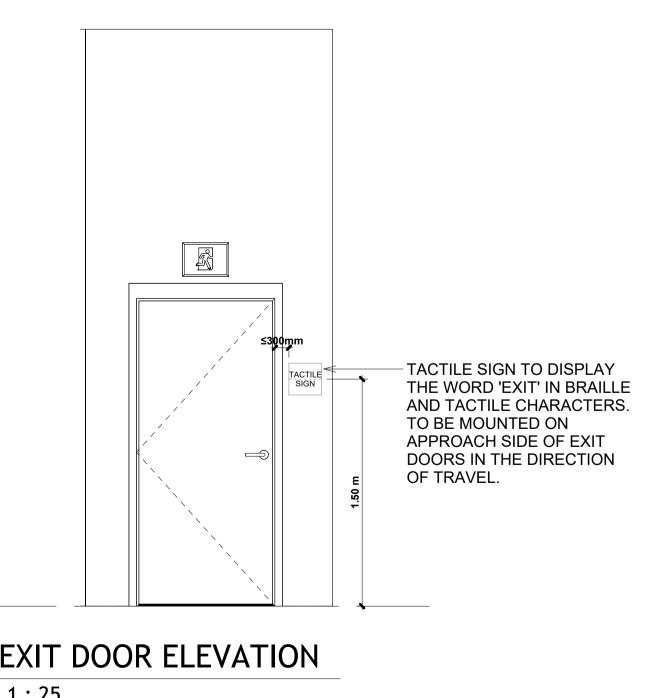


SHEET No. **A2.1**



1 EXISTING BUILDING SECTION
1:200

3 INTERIOR STORE FRONT ELEVATION
1:25



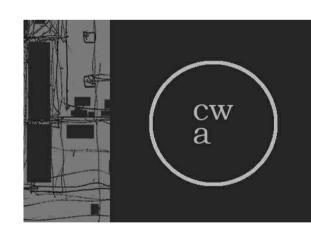
2 EXIT DOOR ELEVATION
1:25

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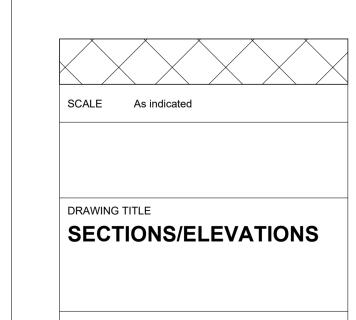
DEVELOPER / CLIENT: WARMLAND CANNABIS

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A2.2