



List of Architectural Drawings

No.	Title	Scale
A1.0	Cover Sheet	NTS
A1.1	Survey Plan	NTS
A1.2	Context Plan	1:200
A1.3	Context Streetscape	(1:120) 1" = 10'-0"
A1.4	Solar Study	(1:120) 1" = 10'-0"
A1.5	Sustainability Strategy	(1:120) 1" = 10'-0"
A1.6	Neighbouring Window Overlay	(1:120) 1" = 10'-0"
A2.0	Site Plan	1:120
A2.1	Graphical Floor Area Ratio	1:100
A2.2	Graphical Site Coverage & Open Site Space	(1:120) 1" = 10'-0"
A2.3	Graphical Average Grade Calculation	1:100
A3.1	Unit 1 Floor Plans	1:50
A3.2	Unit 2 & 3 Floor Plans	1:50
A3.3	Unit 4 Floor Plans	1:50
A3.4	Unit 5 Floor Plans	1:50
A3.5	Unit 6 Floor Plans	1:50
A3.6	Unit 7 Floor Plans	1:50
A3.7	Unit 8 & 9 Floor Plans & Refuse Plans	1:50
A3.8	Unit 8 & 9 Floor Plans	1:50
A4.0	Block 01 Floor Plans	1:100
A4.1	Block 01 Elevations	1:65
A4.2	Block 01 Elevations & Sections	1:65
A4.3	Block 02 Floor Plans	1:100
A4.4	Block 02 Elevations	1:65
A4.5	Block 02 Elevations & Sections	1:65
A4.6	Roof Plans	1:100
A5.0	Concept Renderings	NTS
A5.1	Concept Renderings	NTS
28	Sheets in Set	

Team of Consultants

Architect

Sèbastien Garon Architecture + Design Inc Project No. 19.015 1018 Deep Cove Rd North Vancouver BC Sébastien Garon, Architect, AIBC (604) 812-1869 sebastien@sgad.ca

Contractor

P. Cosgrave Construction Ltd. Paul Cosgrave, Principal (250) 886-1361 paul@cosgrave.ca

Landscape

BIOPHILIA design collective Itd

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Geotechnical

Ryzuk Geotechnical Scott Currie, P. Eng. (250)-475-3131 scott@ryzuk.com

Surveyor

J.E.Anderson & Associates Project No. 31517 4212 Glanford Ave Victoria BC V8Z 4B7

(250) 727-2214 info@jeanderson.com

Civil Engineer

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Structural

Skyline Engineering Wade Griffin (250)-590-4133 Ext. 103 wgriffi@seng.ca


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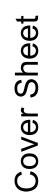
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Issued	
2020-09-21	Revised & Re-Issued for DP
2021-07-20	Revised & Re-Issued for DP
2021-11-21	Revised & Re-Issued for DP
2021-12-16	Revised & Re-Issued for DP
2022-03-30	Revised & Re-Issued for DP
2022-04-11	Revised & Re-Issued for DP
2022-05-10	Revised & Re-Issued for DP
2022-10-06	Revised & Re-Issued for DP
2022-11-04	Revised & Re-Issued for DP
2022-11-14	Revised & Re-Issued for DP



Project Name:


Fairfield-Kipling Development


Civic:	1400 Fairfield Rd &
	349 Kipling St
egal:	

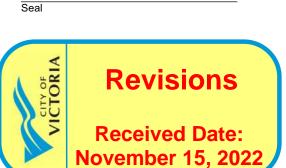PID:	
Project No:	19.015
Drawn By:	SG/TD
Plot Date:	Nov 4, 2022
Scale:	NTS
Sheet No:	


A1.0

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This sketch does not constitute a redefinition of the legal boundaries hereon described and is not to be used in any matter which would assume same. J.E. Anderson & Associates accepts no responsibility or liability for any damages that may be suffered by a third party as a result of any decision made, or actions taken based on this document. Subject to charges, legal notations, and interests shown on: Title No. ET59777 (P.I.D. 008-292-345) Lot 13 Title No. CA6094211 (P.I.D. 005-209-510) Lot 35

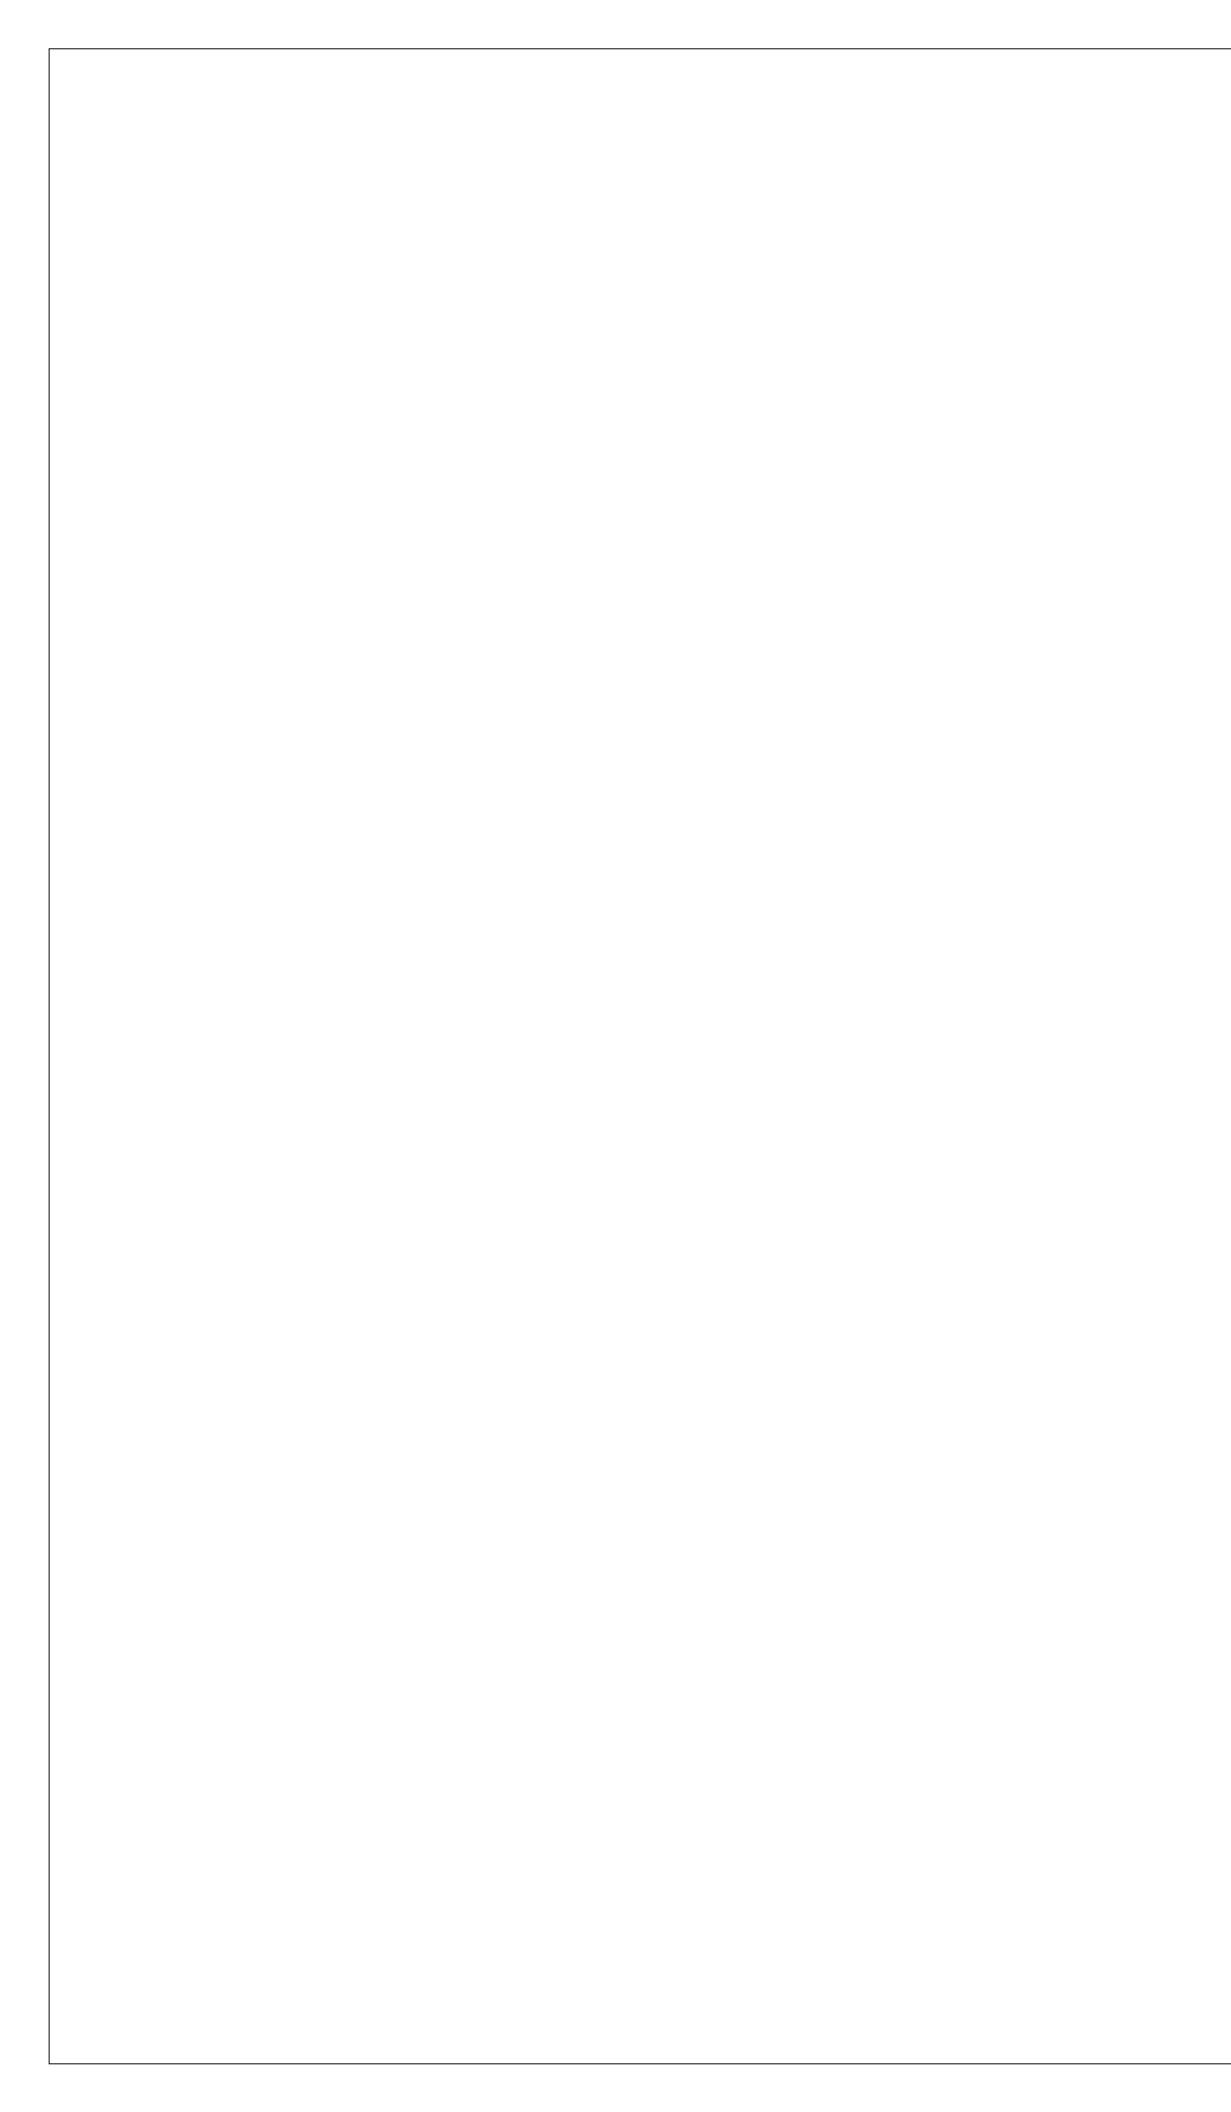
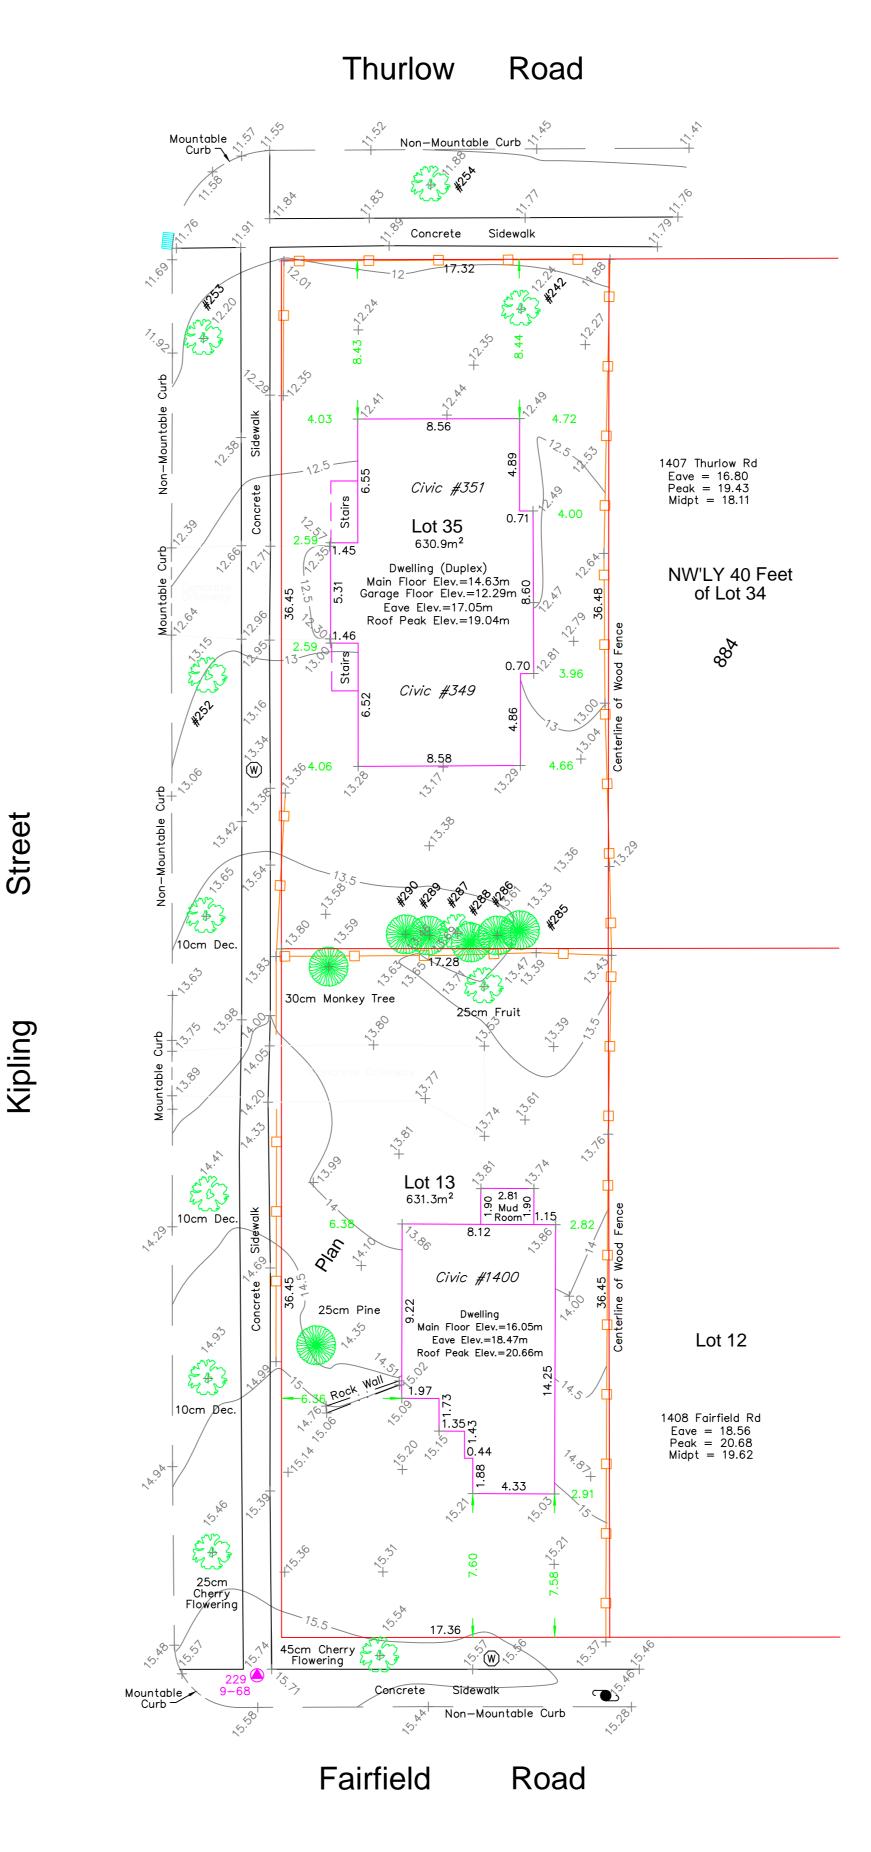
<u>LEGEND</u>


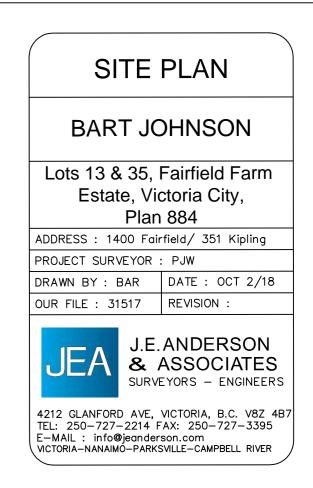


Table of Tree Descriptions

Tag #	Species	Diameter
#242	Deciduous	60cm
#252	Deciduous	45cm
#253	Deciduous	50cm
#254	Deciduous	30cm
#285	Cedar	40cm
#286	Cedar	40cm
#287	Deciduous	30cm (Twin)
#288	Cedar	30cm (Twin)
#289	Cedar	30cm
#290	Cedar	45cm (Twin)
No tag	Monkey	30cm
No tag	Fruit	25cm
No tag	Deciduous	10cm
No tag	Deciduous	10cm
No tag	Cherry	25cm
No tag	Cherry	45cm
No tag	Pine	25cm

Legal boundaries are derived from field survey Distances and elevations are in metres. Elevations are geodetic based on control monument 9-68. Elevations are at grade unless noted otherwise. Building dimensions and offsets to property lines are shown to exterior of building walls.

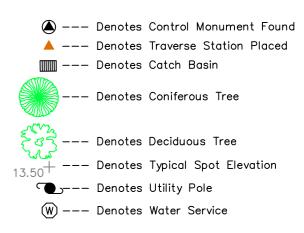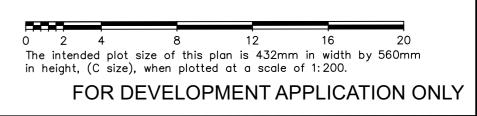

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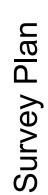
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2020-09-21	Revised & Re-Issued for DP
2021-07-20	Revised & Re-Issued for DP
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2021-12-16	Revised & Re-Issued for DP
2022-03-30	Revised & Re-Issued for DP
2022-04-11	Revised & Re-Issued for DP
2022-05-10	Revised & Re-Issued for DP
2022-10-06	Revised & Re-Issued for DP
2022-11-04	Revised & Re-Issued for DP
2022-11-14	Revised & Re-Issued for DP




Project Name:

Fairfield-Kipling Development

Civic:	1400 Fairfield Rd &
	349 Kipling St
Legal:	
PID:	
Project No:	19 015

Project No:	19.015
Drawn By:	SG/TD
, ,	30/10
Plot Date:	Nov 4, 2022
Scale:	NTS
Sheet No:	

A1.1

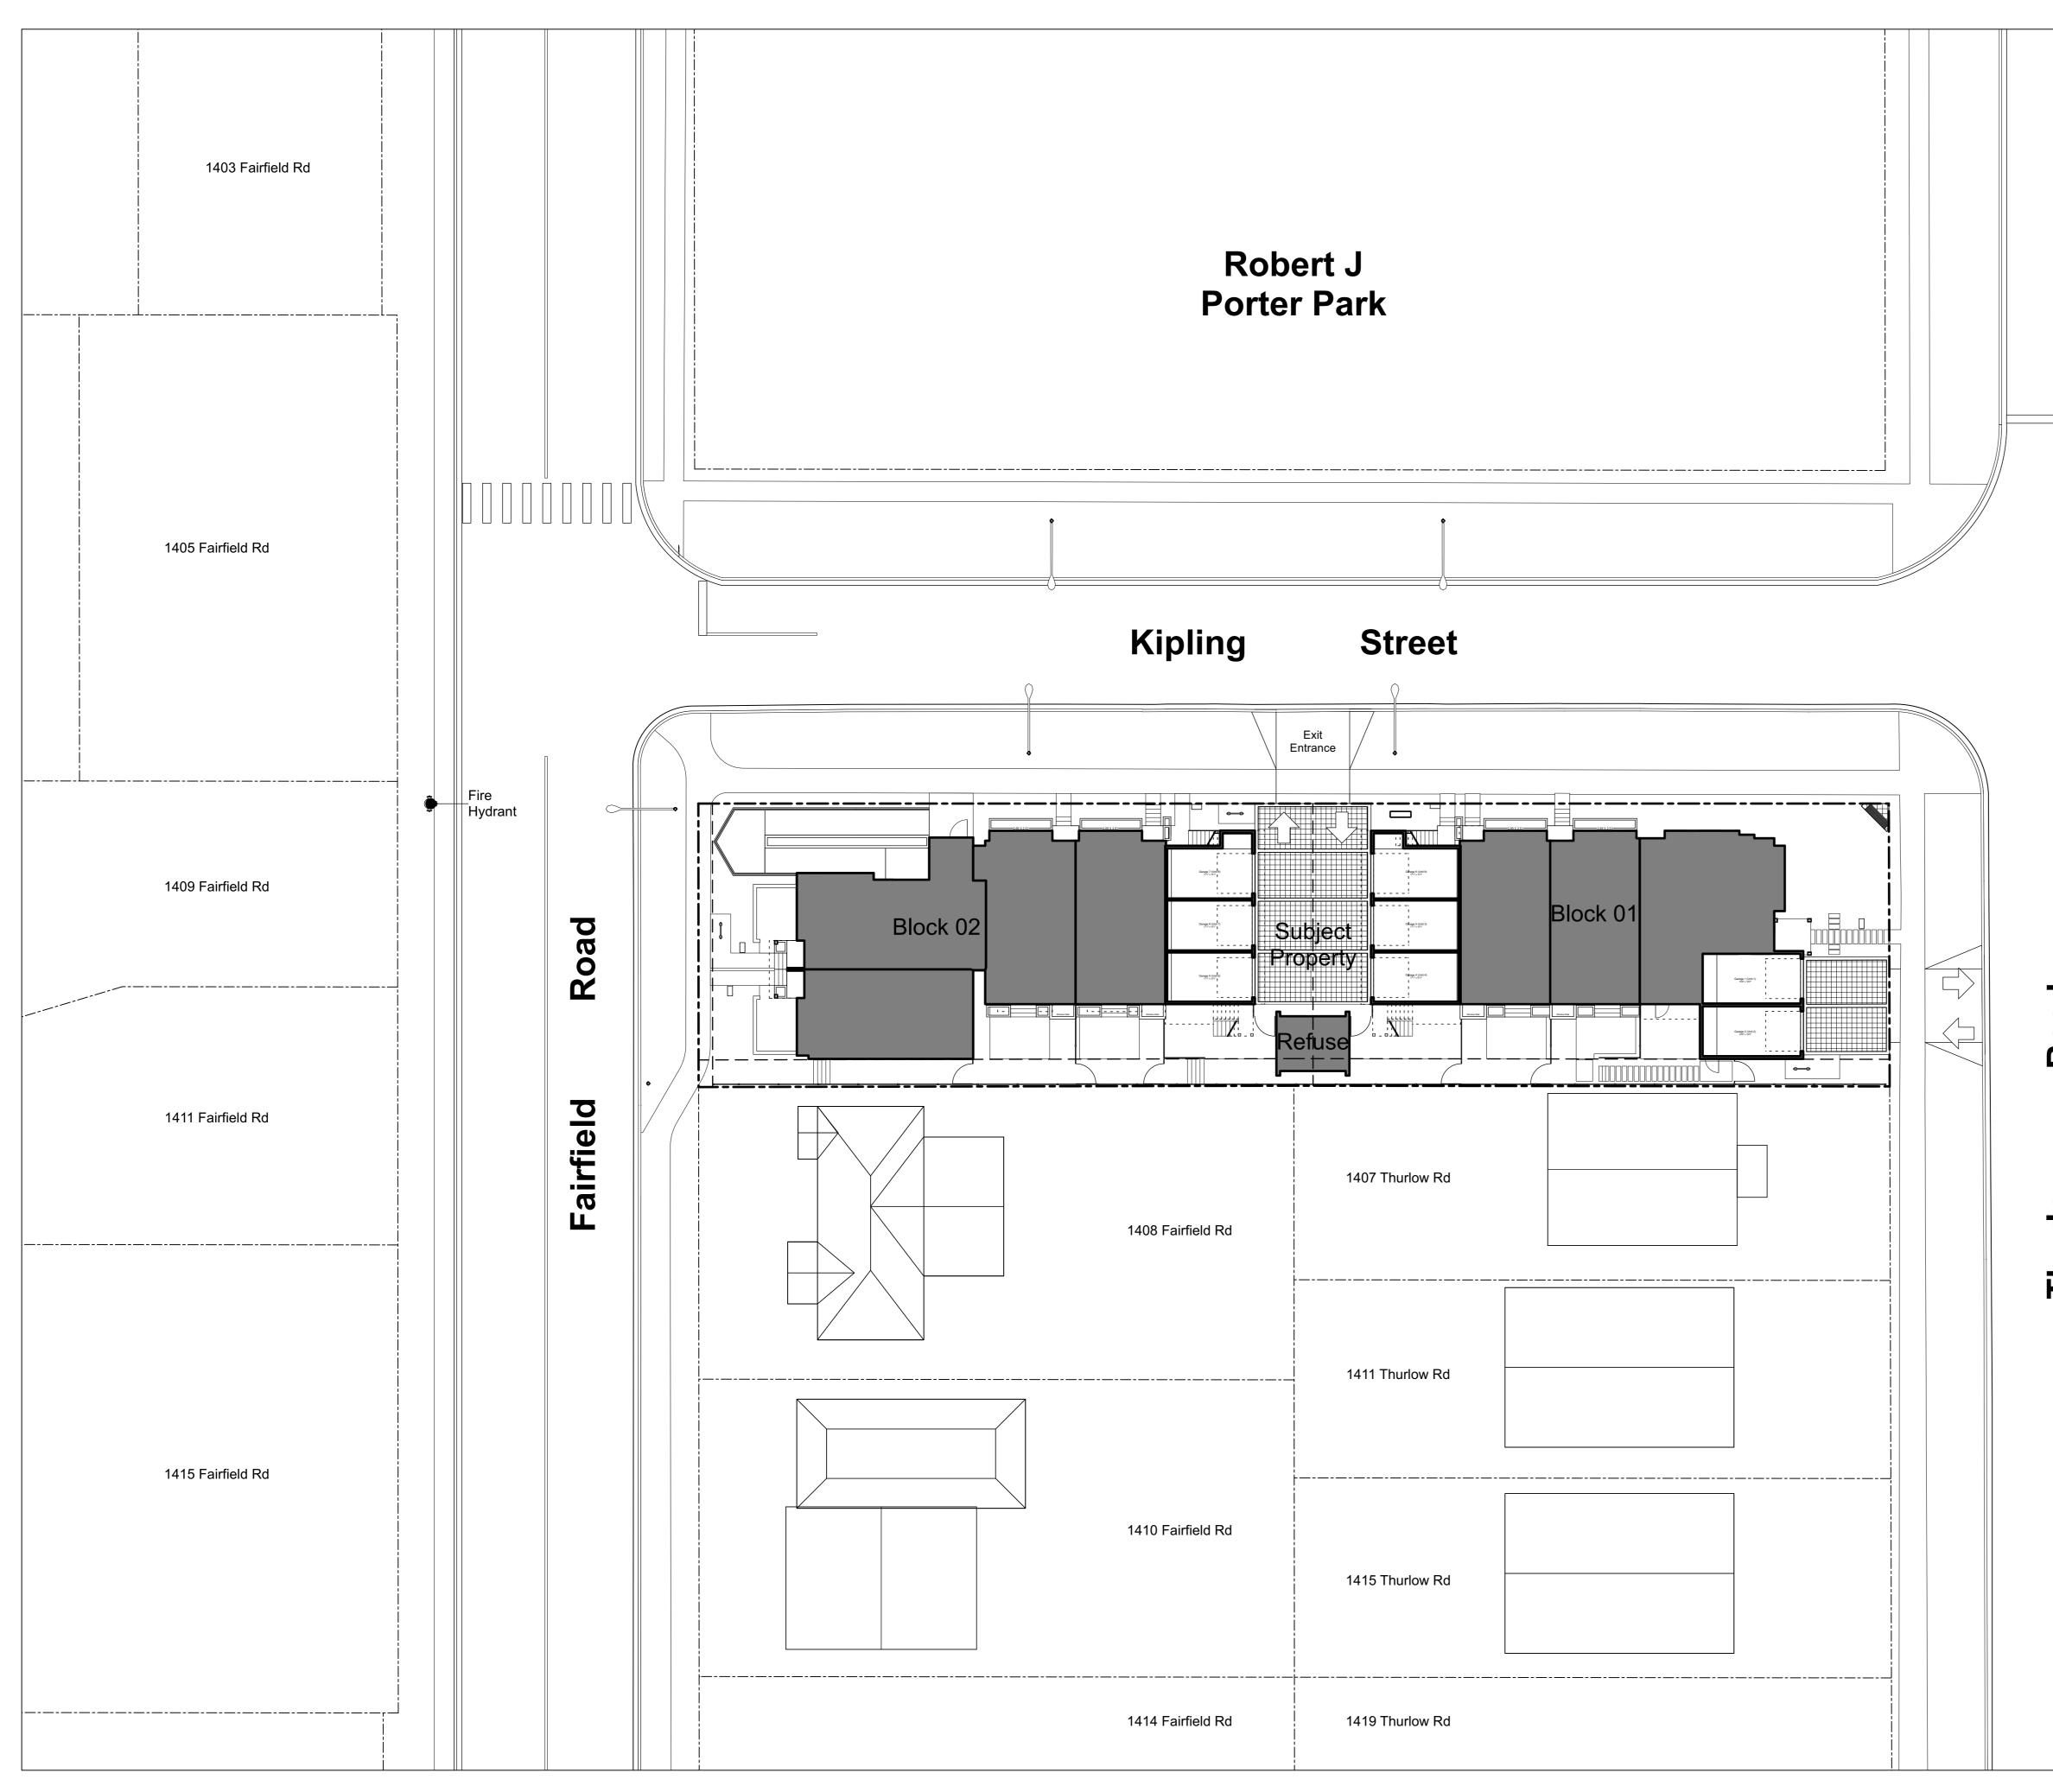


		Sabastian carson Architecture + design 1018 Deep Cove Rd, North Vancouver BC (604) 812-1869 info@SGAD.ca www.SGAD.ca
		<text><text><text><text></text></text></text></text>
Road		Issued2020-09-21Revised & Re-Issued for DP2021-07-20Revised & Re-Issued for DP2021-11-21Revised & Re-Issued for DP2021-12-16Revised & Re-Issued for DP2022-03-30Revised & Re-Issued for DP2022-04-11Revised & Re-Issued for DP2022-05-10Revised & Re-Issued for DP2022-10-06Revised & Re-Issued for DP2022-11-04Revised & Re-Issued for DP2022-11-14Revised & Re-Issued for DP
Thurlow	Brooke	Context Plan
	St Park	<section-header> Project Name: Staffieldf-Kipling Developendendendendendendendendendendendendende</section-header>



Streetscape Kipling Street




Streetscape Fairfield Road 2

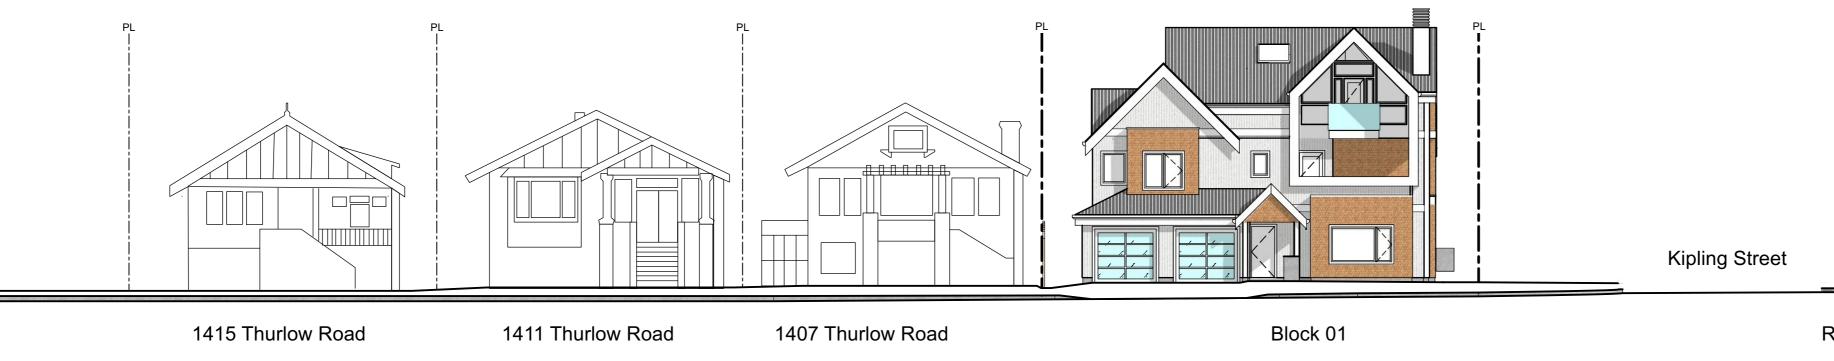


Block 02


1408 Fairfield Road


1410 Fairfield Road

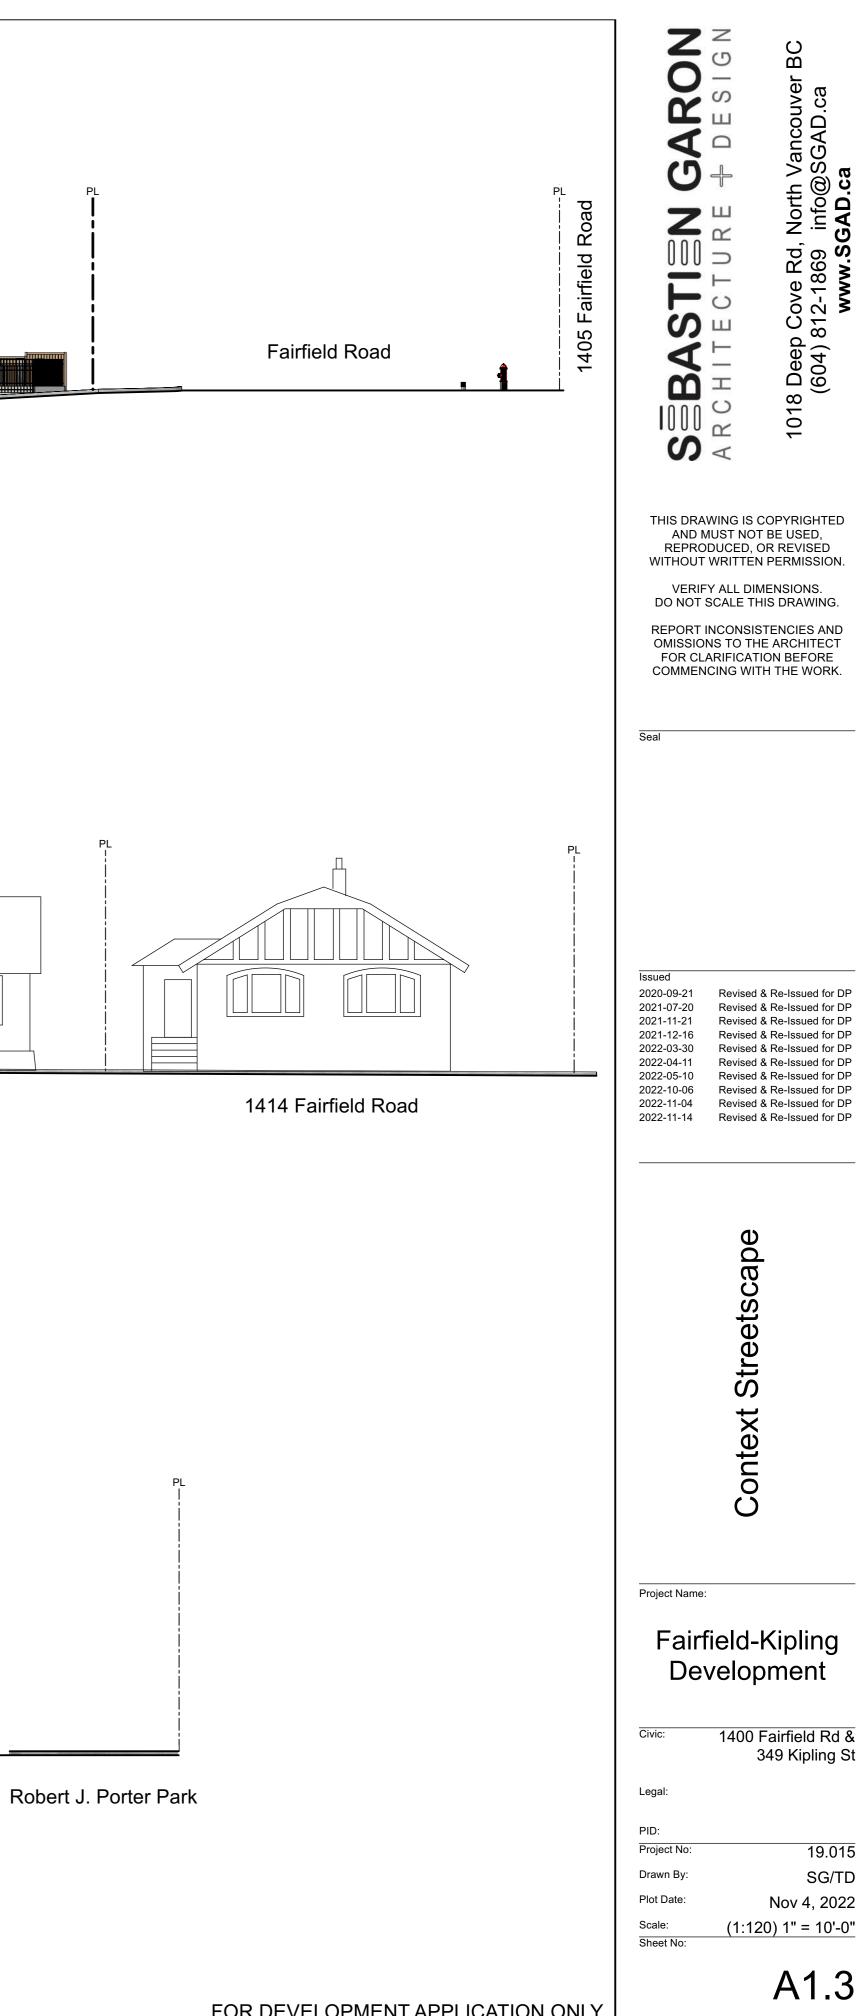



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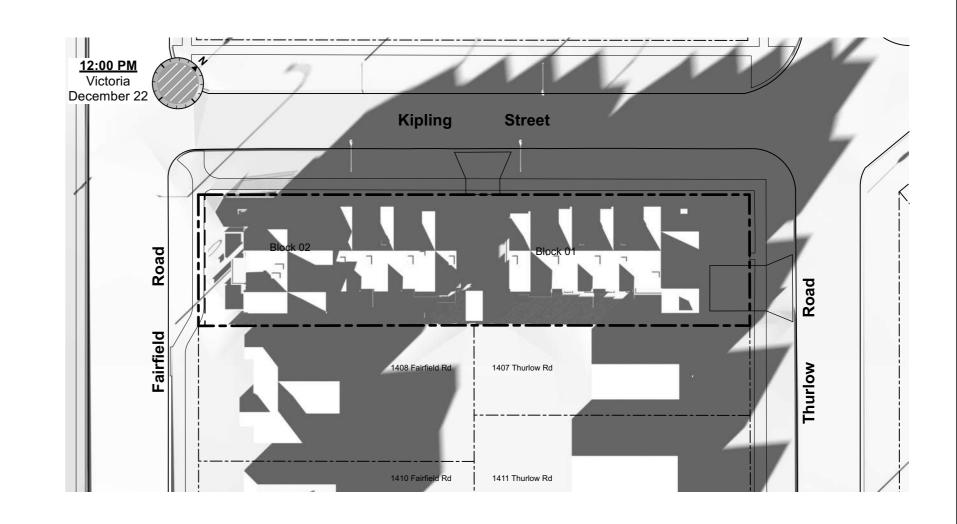


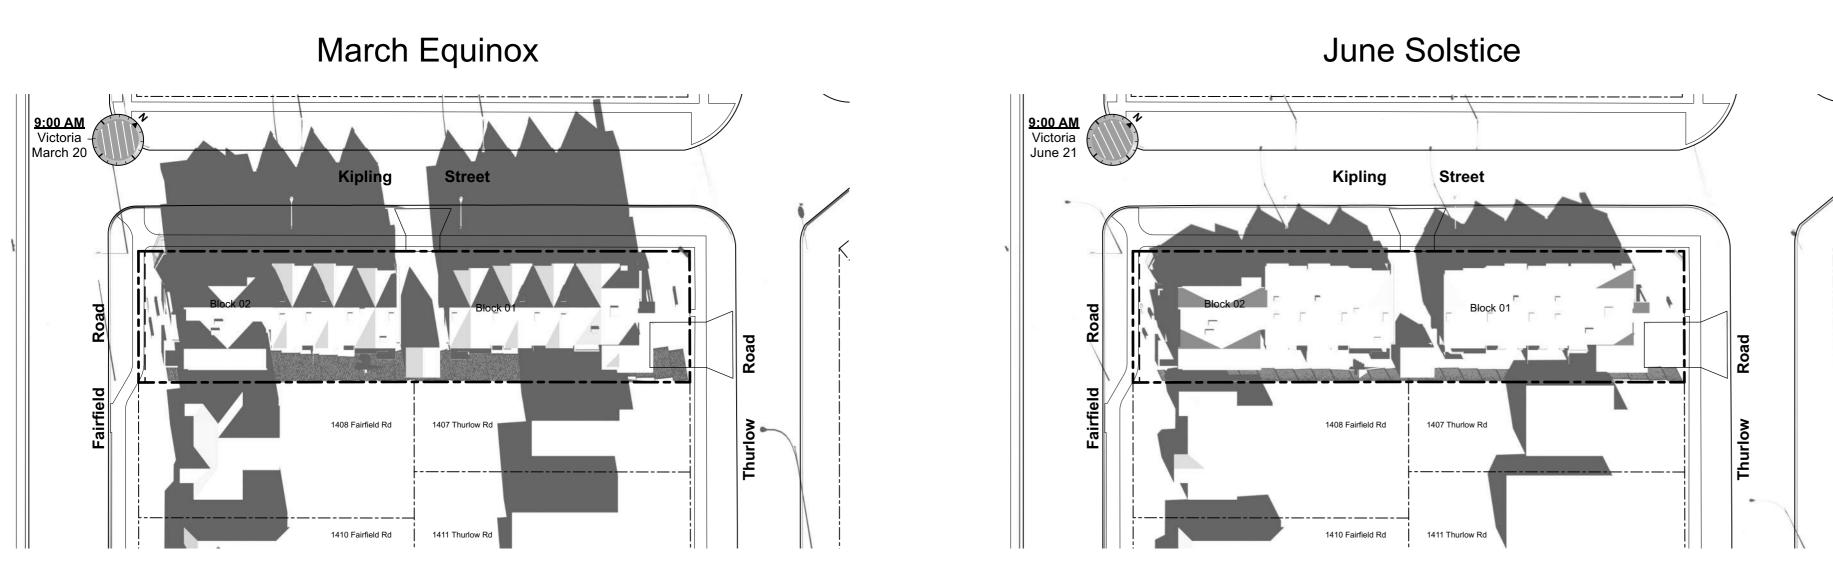


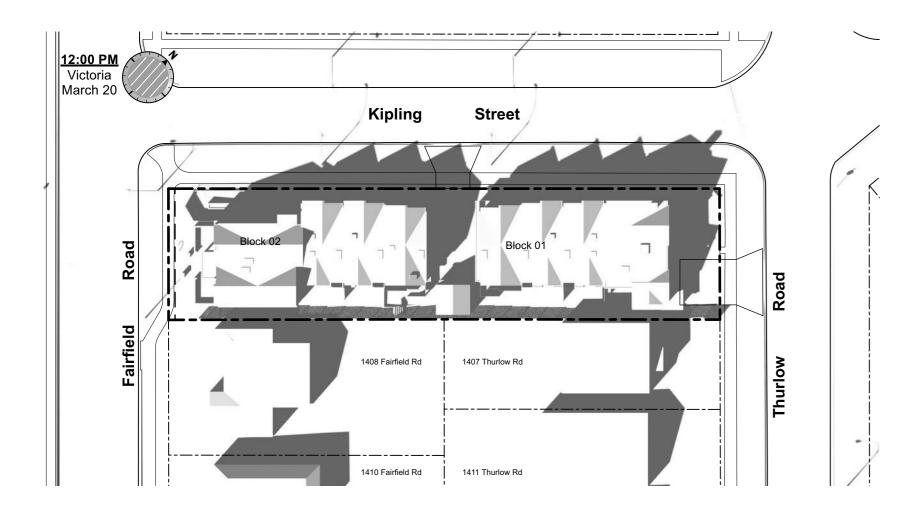

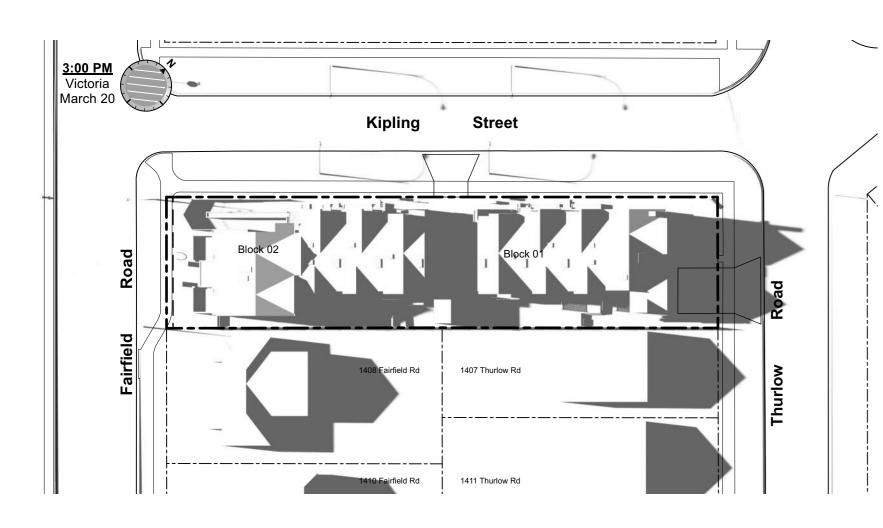

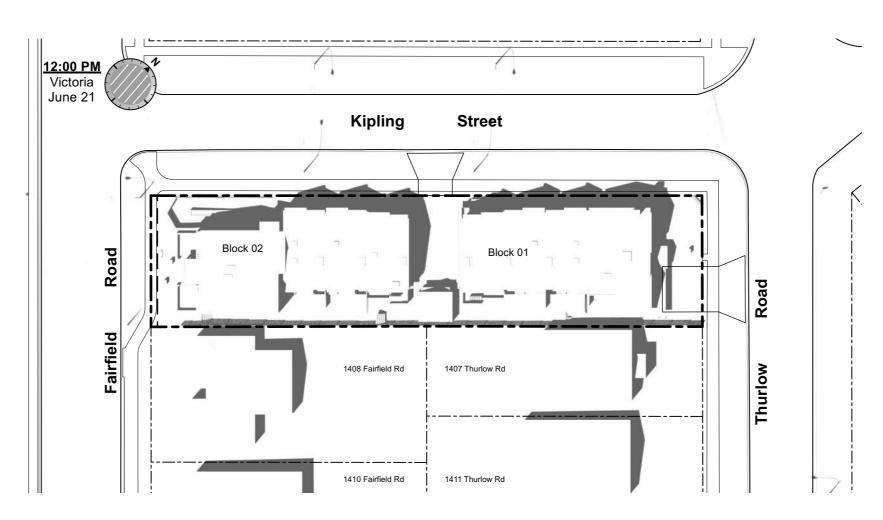

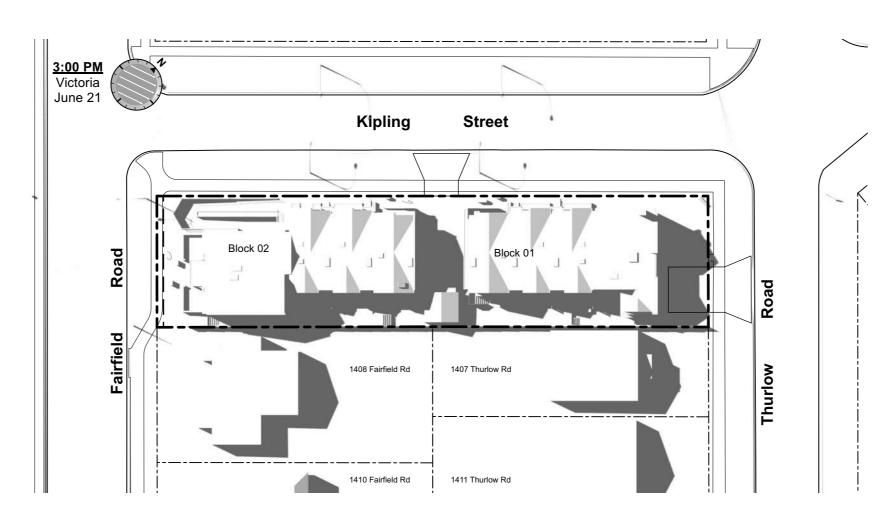

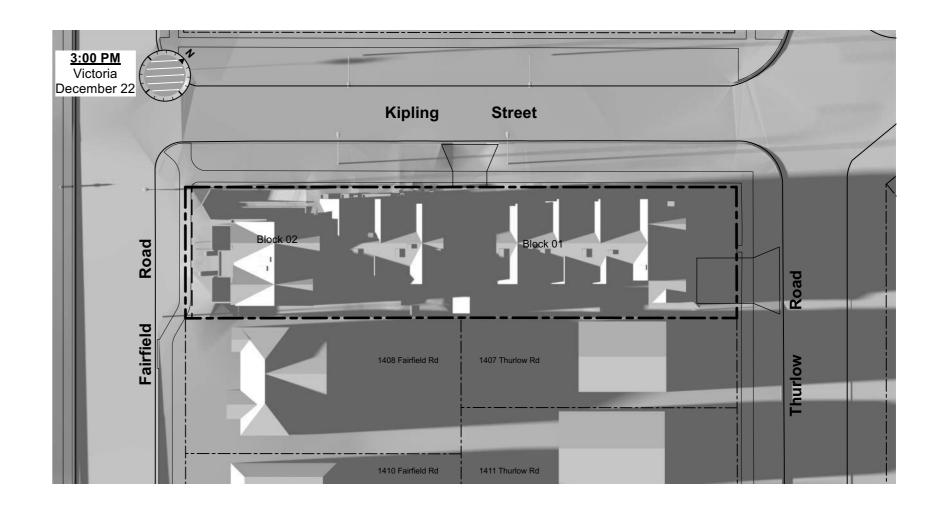

December Solstice

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	Solar Study	•	

Project Name:

Fairfield-Kipling Development

Civic:	1400 Fairfield Rd &
	349 Kipling St
Legal:	
PID:	
Project No:	19.015
Drawn By:	SG/TD
Plot Date:	Nov 4, 2022
Scale:	(1:120) 1" = 10'-0"
Sheet No:	

(1:120) 1" = 10'-0" A1.4






Legend

- No. Description
- 1 Ready for solar panels (rough-in)
- 2 Ready for electric car charging outlets (rough-in)
- 3 Water efficient landscaping
- 4 Enhanced Bike Parking
- 5 Enhanced natural light
- 6 Energy efficient light fixtures
- 7 Water efficient plumbing fixtures
- 8 Low-VOC interior finishes


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2020-09-21 Revised & Re-Issued for DP 2021-07-20 Revised & Re-Issued for DP 2021-11-21 Revised & Re-Issued for DP 2021-12-16 Revised & Re-Issued for DP 2022-03-30 Revised & Re-Issued for DP 2022-04-11 Revised & Re-Issued for DP 2022-05-10 Revised & Re-Issued for DP 2022-11-04 Revised & Re-Issued for DP 2022-11-14 Revised & Re-Issued for DP 2022-11-14 Revised & Re-Issued for DP	2020-09-21 Revised & Re-Issued for DP 2021-07-20 Revised & Re-Issued for DP 2021-11-21 Revised & Re-Issued for DP 2022-03-30 Revised & Re-Issued for DP 2022-03-30 Revised & Re-Issued for DP 2022-03-10 Revised & Re-Issued for DP 2022-05-10 Revised & Re-Issued for DP 2022-11-04 Revised & Re-Issued for DP 2022-11-14 Revised & Re-Issued for DP 2022-15-15 Revised & Re-Issued for DP 2022-16-16 <td>2020-09-21 2021-07-20 2021-07-20 2021-11-21 Revised & Re-Issued for DP 2022-03-30 Revised & Re-Issued for DP 2022-05-10 Revised & Re-Issued for DP 2022-01-06 Revised & Re-Issued for DP 2022-11-04 Revised & Re-Issued for DP 2022-11-14 Revised & Revised & Revised</td> <td>AND M REPRO WITHOUT DO NOT REPORT I OMISSIOI FOR CL COMMEN</td> <td>AUST NOT DUCED, OI WRITTEN Y ALL DIMI SCALE THI INCONSIST NS TO THE ARIFICATIO</td> <td>BE USED, R REVISED PERMISSION. ENSIONS. S DRAWING. ENCIES AND ARCHITECT ON BEFORE</td>	2020-09-21 2021-07-20 2021-07-20 2021-11-21 Revised & Re-Issued for DP 2022-03-30 Revised & Re-Issued for DP 2022-05-10 Revised & Re-Issued for DP 2022-01-06 Revised & Re-Issued for DP 2022-11-04 Revised & Re-Issued for DP 2022-11-14 Revised & Revised	AND M REPRO WITHOUT DO NOT REPORT I OMISSIOI FOR CL COMMEN	AUST NOT DUCED, OI WRITTEN Y ALL DIMI SCALE THI INCONSIST NS TO THE ARIFICATIO	BE USED, R REVISED PERMISSION. ENSIONS. S DRAWING. ENCIES AND ARCHITECT ON BEFORE
ility	Project Name: Fairfield-Kipling Development	Project Name: Fairfield-Kipling Development Civic: 1400 Fairfield Rd & 349 Kipling St Legal: PID: Project No: 19.015	2020-09-21 2021-07-20 2021-11-21 2021-12-16 2022-03-30 2022-04-11 2022-05-10 2022-10-06 2022-11-04	Revised & Revised & Revised & Revised & Revised & Revised & Revised &	Re-Issued for DP Re-Issued for DP
	Fairfield-Kipling Development	Fairfield-Kipling Development Civic: 1400 Fairfield Rd & 349 Kipling St Legal: PID: Project No: 19.015		ility	

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A1.5



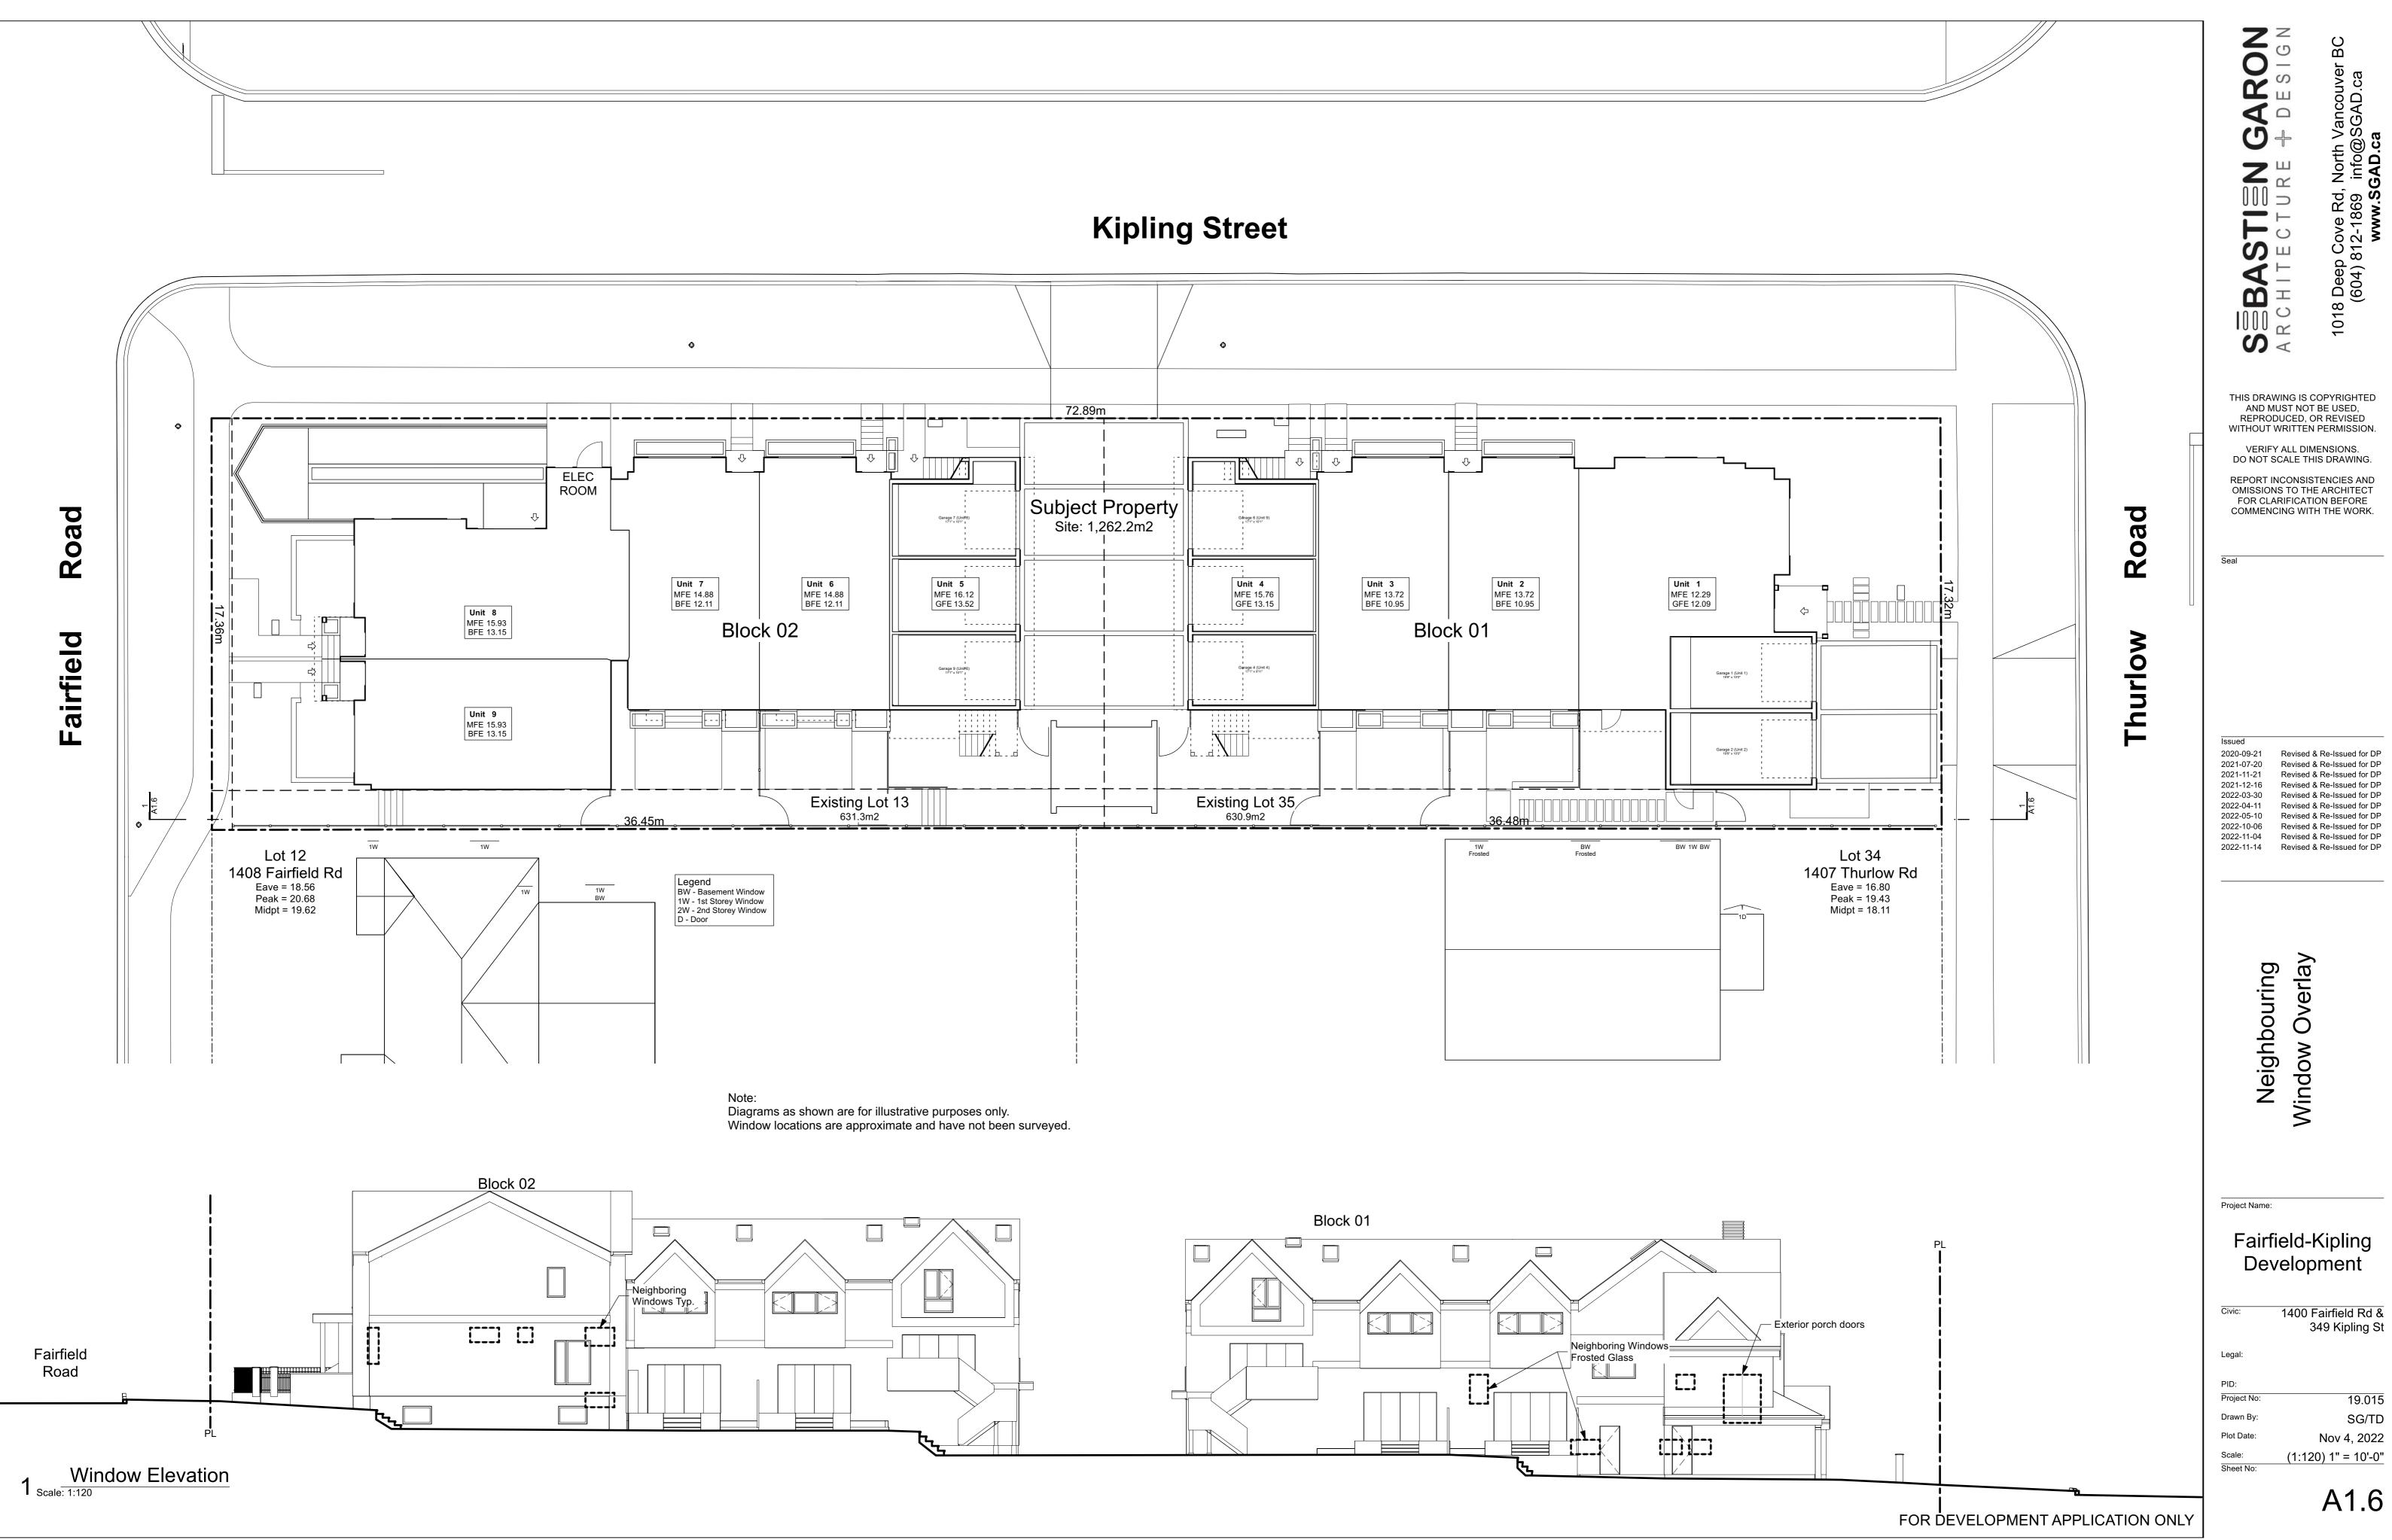

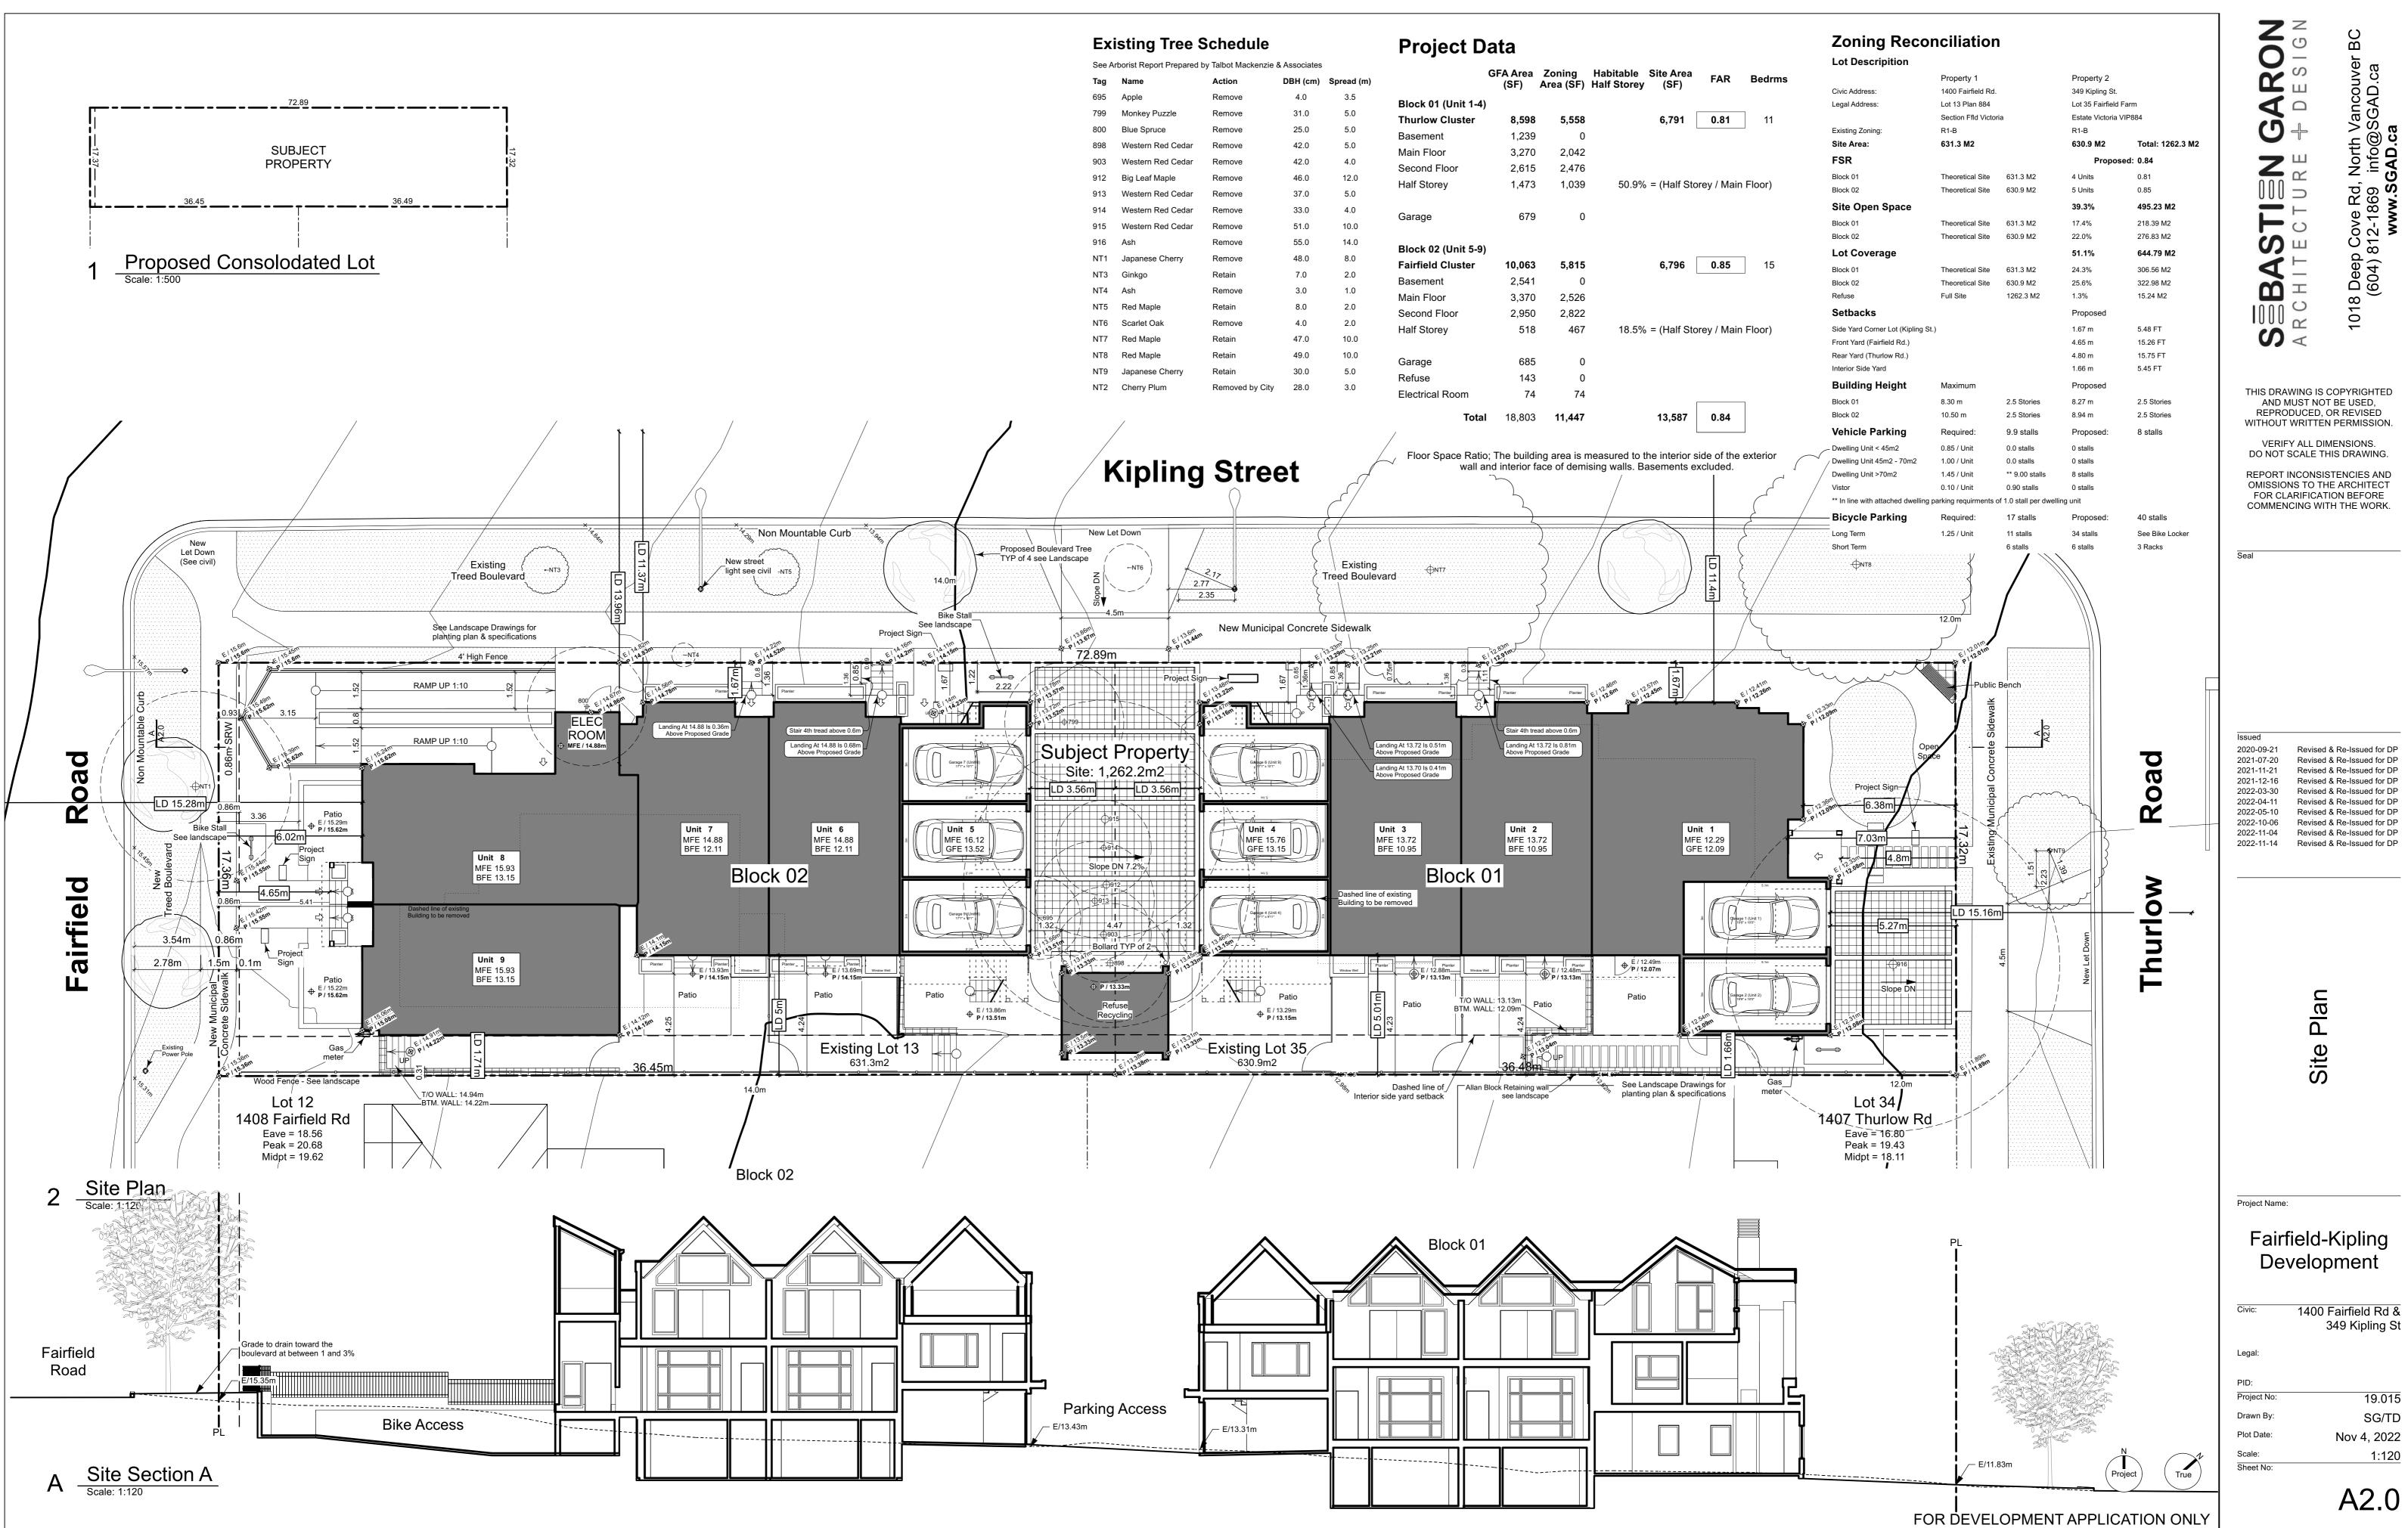


See Ar	borist Report Prepared by	Talbot Mackenzie 8	& Associates	
Tag	Name	Action	DBH (cm)	Spread (m)
695	Apple	Remove	4.0	3.5
799	Monkey Puzzle	Remove	31.0	5.0
800	Blue Spruce	Remove	25.0	5.0
898	Western Red Cedar	Remove	42.0	5.0
903	Western Red Cedar	Remove	42.0	4.0
912	Big Leaf Maple	Remove	46.0	12.0
913	Western Red Cedar	Remove	37.0	5.0
914	Western Red Cedar	Remove	33.0	4.0
915	Western Red Cedar	Remove	51.0	10.0
916	Ash	Remove	55.0	14.0
NT1	Japanese Cherry	Remove	48.0	8.0
NT3	Ginkgo	Retain	7.0	2.0
NT4	Ash	Remove	3.0	1.0
NT5	Red Maple	Retain	8.0	2.0
NT6	Scarlet Oak	Remove	4.0	2.0
NT7	Red Maple	Retain	47.0	10.0
NT8	Red Maple	Retain	49.0	10.0
NT9	Japanese Cherry	Retain	30.0	5.0
NT2	Cherry Plum	Removed by City	28.0	3.0

	GFA Area (SF)		Habitable Half Storey		FAR	Bedrn
Block 01 (Unit 1-4)					
Thurlow Cluster	8,598	5,558		6,791	0.81	11
Basement	1,239	0				2
Main Floor	3,270	2,042				
Second Floor	2,615	2,476				
Half Storey	1,473	1,039	50.9%	= (Half Sto	orey / Main	Floor)
Garage	679	0				
Block 02 (Unit 5-9)					
Fairfield Cluster	10,063	5,815		6,796	0.85	15
Basement	2,541	0				2
Main Floor	3,370	2,526				
Second Floor	2,950	2,822				
Half Storey	518	467	18.5%	= (Half Sto	orey / Main	Floor)
Garage	685	0				
Refuse	143	0				
Electrical Room	74	74				1
Tota	l 18,803	11,447		13,587	0.84	



	Calculations			Unit 1	
	Gross Flo	or Area	Zoning Flo	oor Area	Bedrm
Basement Floor		No Baseme	ent as per zonir	ng definition	
Main Floor	1,243 sq ft	115.5 m2	801 sq ft		
Second Floor Half Storey	•	81.1 m2 88.8 m2	•	75.5 m2 53.8 m2	
-					•
Totals:	3,072 sq ft		2,193 sq ft	203.7 mz	3
Garage	168 sq ft	15.7 m2			
Floor Area	Calculations			Unit 2	
	Gross Flo	or Area	Zoning Flo	oor Area	Bedrm
Basement Floor		57.8 m2	0 sq ft		
Main Floor	-	57.3 m2	•	58.5 m2	
Second Floor Half Storey	509 SQ II	54.8 m2	11 p2 00C	52.8 m2	
Totals:	1,828 sq ft	169.9 m2	1,198 sq ft	111.3 m2	3
Garage	168 sq ft	15.7 m2			
Floor Area	Calculations			Unit 3	
	Gross Flo	or Aroa			Bedrm
Basement Floor		57.3 m2	0 sq ft	oor Area 0.0 m2	Dearm
Main Floor	616 sq ft		605 sq ft		
Second Floor Half Storey	589 sq ft		568 sq ft		
Totals:	1,823 sq ft	169.3 m2	1,173 sq ft	109.0 m2	3
Garage	172 sq ft	16.0 m2	, 4 '		-
	Calculations			Unit 4	
10017400	Gross Flo	or Area	Zoning Flo		Bedrm
Basement Floor	0.0001.0		ent as per zonir		200
Main Floor	794 sq ft	73.8 m2	7 sq ft	-	
Second Floor	-	52.3 m2	-	48.9 m2	
Half Storey	518 sq ft	48.1 m2	460 sq ft	42.8 m2	
Totals:	1,875 sq ft	174.2 m2	994 sq ft	92.3 m2	2
Garage	170 sq ft	15.8 m2			
Floor Area	Calculations		l	Unit 5	
	Gross Flo	or Area	Zoning Flo	oor Area	Bedrm
Basement Floor			ent as per zonir		
Main Floor	794 sq ft	73.7 m2	0 sq ft	0.0 m2	
Second Floor	563 sq ft	52.3 m2	527 sq ft	48.9 m2	
Half Storey	518 sq ft	48.1 m2	467 sq ft	43.4 m2	
Totals:	1,875 sq ft	174.2 m2	994 sq ft	92.4 m2	2
Garage	0 sq ft	0.0 m2			
Floor Area	Calculations			Unit 6	
		o # A #o o			D a duna
Basement Floor	Gross Flo	58.3 m2	2011119 Fic 0 sq ft	oor Area 0.0 m2	Bedrm
Main Floor	•	56.3 m2	•	55.9 m2	
Second Floor	•	54.8 m2	•	53.9 m2	
Half Storey					
Totals:	1,833 sq ft	170.3 m2	1,182 sq ft	109.8 m2	4
Garage	169 sq ft	15.7 m2			
Floor Area	Calculations			Unit 7	
	Gross Flo		Zoning Flo		Bedrm
_	619 sq ft		0 sq ft		
	600 f		-	L	
Main Floor Second Floor		57.5 m2 59.1 m2 54.8 m2	621 sq ft	57.7 m2 53.2 m2	
Main Floor Second Floor Half Storey	589 sq ft	59.1 m2 54.8 m2	621 sq ft 572 sq ft	53.2 m2	
Main Floor Second Floor Half Storey Totals:	589 sq ft 1,844 sq ft	59.1 m2 54.8 m2 171.4 m2	621 sq ft	53.2 m2	
Main Floor Second Floor Half Storey Totals: Garage	589 sq ft 1,844 sq ft 172 sq ft	59.1 m2 54.8 m2	621 sq ft 572 sq ft 1,193 sq ft	53.2 m2 110.8 m2	
Main Floor Second Floor Half Storey Totals: Garage	589 sq ft 1,844 sq ft 172 sq ft Calculations	59.1 m2 54.8 m2 171.4 m2 16.0 m2	621 sq ft 572 sq ft 1,193 sq ft	53.2 m2 110.8 m2 Unit 8	4
Main Floor Second Floor Half Storey Totals: Garage Floor Area	589 sq ft 1,844 sq ft 172 sq ft Calculations Gross Flo	59.1 m2 54.8 m2 171.4 m2 16.0 m2	621 sq ft 572 sq ft 1,193 sq ft Zoning Flo	53.2 m2 110.8 m2 Unit 8 por Area	4
Main Floor Second Floor Half Storey Totals: Garage Floor Area Basement Floor	589 sq ft 1,844 sq ft <u>172 sq ft</u> Calculations Gross Flo 678 sq ft	59.1 m2 54.8 m2 171.4 m2 16.0 m2 or Area 63.0 m2	621 sq ft 572 sq ft 1,193 sq ft Zoning Flo 0 sq ft	53.2 m2 110.8 m2 Unit 8 por Area 0.0 m2	4
Main Floor Second Floor Half Storey Totals: Garage Floor Area Basement Floor Main Floor Second Floor	589 sq ft 1,844 sq ft <u>172 sq ft</u> Calculations Gross Flo 678 sq ft 696 sq ft	59.1 m2 54.8 m2 171.4 m2 16.0 m2	621 sq ft 572 sq ft 1,193 sq ft Zoning Flo 0 sq ft 691 sq ft	53.2 m2 110.8 m2 Unit 8 por Area	4 Bedrm
Main Floor Second Floor Half Storey Totals: Garage Floor Area Basement Floor Main Floor Second Floor Half Storey	589 sq ft 1,844 sq ft 172 sq ft Calculations Gross Flo 678 sq ft 696 sq ft 626 sq ft	59.1 m2 54.8 m2 171.4 m2 16.0 m2 or Area 63.0 m2 64.7 m2 58.2 m2	621 sq ft 572 sq ft 1,193 sq ft Zoning Flo 0 sq ft 691 sq ft 598 sq ft	53.2 m2 110.8 m2 Unit 8 00 Area 0.0 m2 64.2 m2 55.6 m2	4 Bedrm
Main Floor Second Floor Half Storey Totals: Garage Floor Area Basement Floor Main Floor Second Floor Half Storey Totals:	589 sq ft 1,844 sq ft 172 sq ft Calculations Gross Flo 678 sq ft 696 sq ft 626 sq ft 2,001 sq ft	59.1 m2 54.8 m2 171.4 m2 16.0 m2 or Area 63.0 m2 64.7 m2 58.2 m2 185.9 m2	621 sq ft 572 sq ft 1,193 sq ft Zoning Flo 0 sq ft 691 sq ft	53.2 m2 110.8 m2 Unit 8 00 Area 0.0 m2 64.2 m2 55.6 m2	4 Bedrm
Main Floor Second Floor Half Storey Totals: Garage Floor Area Basement Floor Main Floor Second Floor Half Storey Totals: Garage	589 sq ft 1,844 sq ft 172 sq ft Calculations Gross Flo 678 sq ft 696 sq ft 626 sq ft 626 sq ft 172 sq ft	59.1 m2 54.8 m2 171.4 m2 16.0 m2 or Area 63.0 m2 64.7 m2 58.2 m2	621 sq ft 572 sq ft 1,193 sq ft Zoning Fla 0 sq ft 691 sq ft 598 sq ft 1,289 sq ft	53.2 m2 110.8 m2 Unit 8 oor Area 0.0 m2 64.2 m2 55.6 m2 119.8 m2	4 Bedrm
Main Floor Second Floor Half Storey Totals: Garage Floor Area Basement Floor Main Floor Second Floor Half Storey Totals: Garage	589 sq ft 1,844 sq ft 172 sq ft Calculations Gross Flo 678 sq ft 696 sq ft 626 sq ft 2,001 sq ft	59.1 m2 54.8 m2 171.4 m2 16.0 m2 or Area 63.0 m2 64.7 m2 58.2 m2 185.9 m2	621 sq ft 572 sq ft 1,193 sq ft Zoning Fla 0 sq ft 691 sq ft 598 sq ft 1,289 sq ft	53.2 m2 110.8 m2 Unit 8 00 Area 0.0 m2 64.2 m2 55.6 m2	4 Bedrm
Main Floor Second Floor Half Storey Totals: Garage Floor Area Basement Floor Main Floor Second Floor Half Storey Totals: Garage	589 sq ft 1,844 sq ft 172 sq ft Calculations Gross Flo 678 sq ft 696 sq ft 626 sq ft 626 sq ft 172 sq ft	59.1 m2 54.8 m2 171.4 m2 16.0 m2 or Area 63.0 m2 64.7 m2 58.2 m2 185.9 m2 16.0 m2 or Area	621 sq ft 572 sq ft 1,193 sq ft Zoning Fla 0 sq ft 691 sq ft 598 sq ft 1,289 sq ft	53.2 m2 110.8 m2 Unit 8 oor Area 0.0 m2 64.2 m2 55.6 m2 119.8 m2 Unit 9	4 Bedrm
Main Floor Second Floor Half Storey Totals: Garage Floor Area Basement Floor Main Floor Second Floor Half Storey Totals: Garage Floor Area Basement Floor	589 sq ft 1,844 sq ft 172 sq ft Calculations Gross Flo 678 sq ft 696 sq ft 626 sq ft 172 sq ft 172 sq ft Calculations Gross Flo 616 sq ft	59.1 m2 54.8 m2 171.4 m2 16.0 m2 or Area 63.0 m2 64.7 m2 58.2 m2 185.9 m2 16.0 m2 or Area 57.2 m2	621 sq ft 572 sq ft 1,193 sq ft Zoning Fla 0 sq ft 691 sq ft 598 sq ft 1,289 sq ft Zoning Fla 0 sq ft	53.2 m2 110.8 m2 Unit 8 por Area 0.0 m2 64.2 m2 55.6 m2 119.8 m2 Unit 9 por Area 0.0 m2	4 Bedrm
Main Floor Second Floor Half Storey Totals: Garage Floor Area Basement Floor Main Floor Second Floor Half Storey Totals: Garage Floor Area Basement Floor Main Floor	589 sq ft 1,844 sq ft 172 sq ft Calculations Gross Flo 678 sq ft 696 sq ft 626 sq ft 172 sq ft 172 sq ft Calculations Gross Flo 616 sq ft 627 sq ft	59.1 m2 54.8 m2 171.4 m2 16.0 m2 or Area 63.0 m2 64.7 m2 58.2 m2 185.9 m2 16.0 m2 or Area 57.2 m2 58.3 m2	621 sq ft 572 sq ft 1,193 sq ft Zoning Fla 0 sq ft 691 sq ft 598 sq ft 1,289 sq ft 1,289 sq ft Coning Fla 0 sq ft 613 sq ft	53.2 m2 110.8 m2 Unit 8 oor Area 0.0 m2 64.2 m2 55.6 m2 119.8 m2 Unit 9 oor Area 0.0 m2 56.9 m2	4 Bedrm
Basement Floor Main Floor Second Floor Half Storey Totals: Garage	589 sq ft 1,844 sq ft 172 sq ft Calculations Gross Flo 678 sq ft 696 sq ft 626 sq ft 172 sq ft 172 sq ft Calculations Gross Flo 616 sq ft	59.1 m2 54.8 m2 171.4 m2 16.0 m2 or Area 63.0 m2 64.7 m2 58.2 m2 185.9 m2 16.0 m2 or Area 57.2 m2 58.3 m2	621 sq ft 572 sq ft 1,193 sq ft Zoning Fla 0 sq ft 691 sq ft 598 sq ft 1,289 sq ft Zoning Fla 0 sq ft	53.2 m2 110.8 m2 Unit 8 oor Area 0.0 m2 64.2 m2 55.6 m2 119.8 m2 Unit 9 oor Area 0.0 m2 56.9 m2	4 Bedrm
Main Floor Second Floor Half Storey Totals: Garage Floor Area Basement Floor Main Floor Second Floor Half Storey Totals: Garage Floor Area Basement Floor Main Floor Second Floor	589 sq ft 1,844 sq ft 172 sq ft Calculations Gross Flo 678 sq ft 696 sq ft 626 sq ft 172 sq ft 172 sq ft Calculations Gross Flo 616 sq ft 627 sq ft	59.1 m2 54.8 m2 171.4 m2 16.0 m2 or Area 63.0 m2 64.7 m2 58.2 m2 185.9 m2 16.0 m2 or Area 57.2 m2 58.3 m2	621 sq ft 572 sq ft 1,193 sq ft Zoning Fla 0 sq ft 691 sq ft 598 sq ft 1,289 sq ft 1,289 sq ft 0 sq ft 613 sq ft 613 sq ft 544 sq ft	53.2 m2 110.8 m2 Unit 8 oor Area 0.0 m2 64.2 m2 55.6 m2 119.8 m2 Unit 9 oor Area 0.0 m2 56.9 m2 50.6 m2	4 Bedrm 2 Bedrm

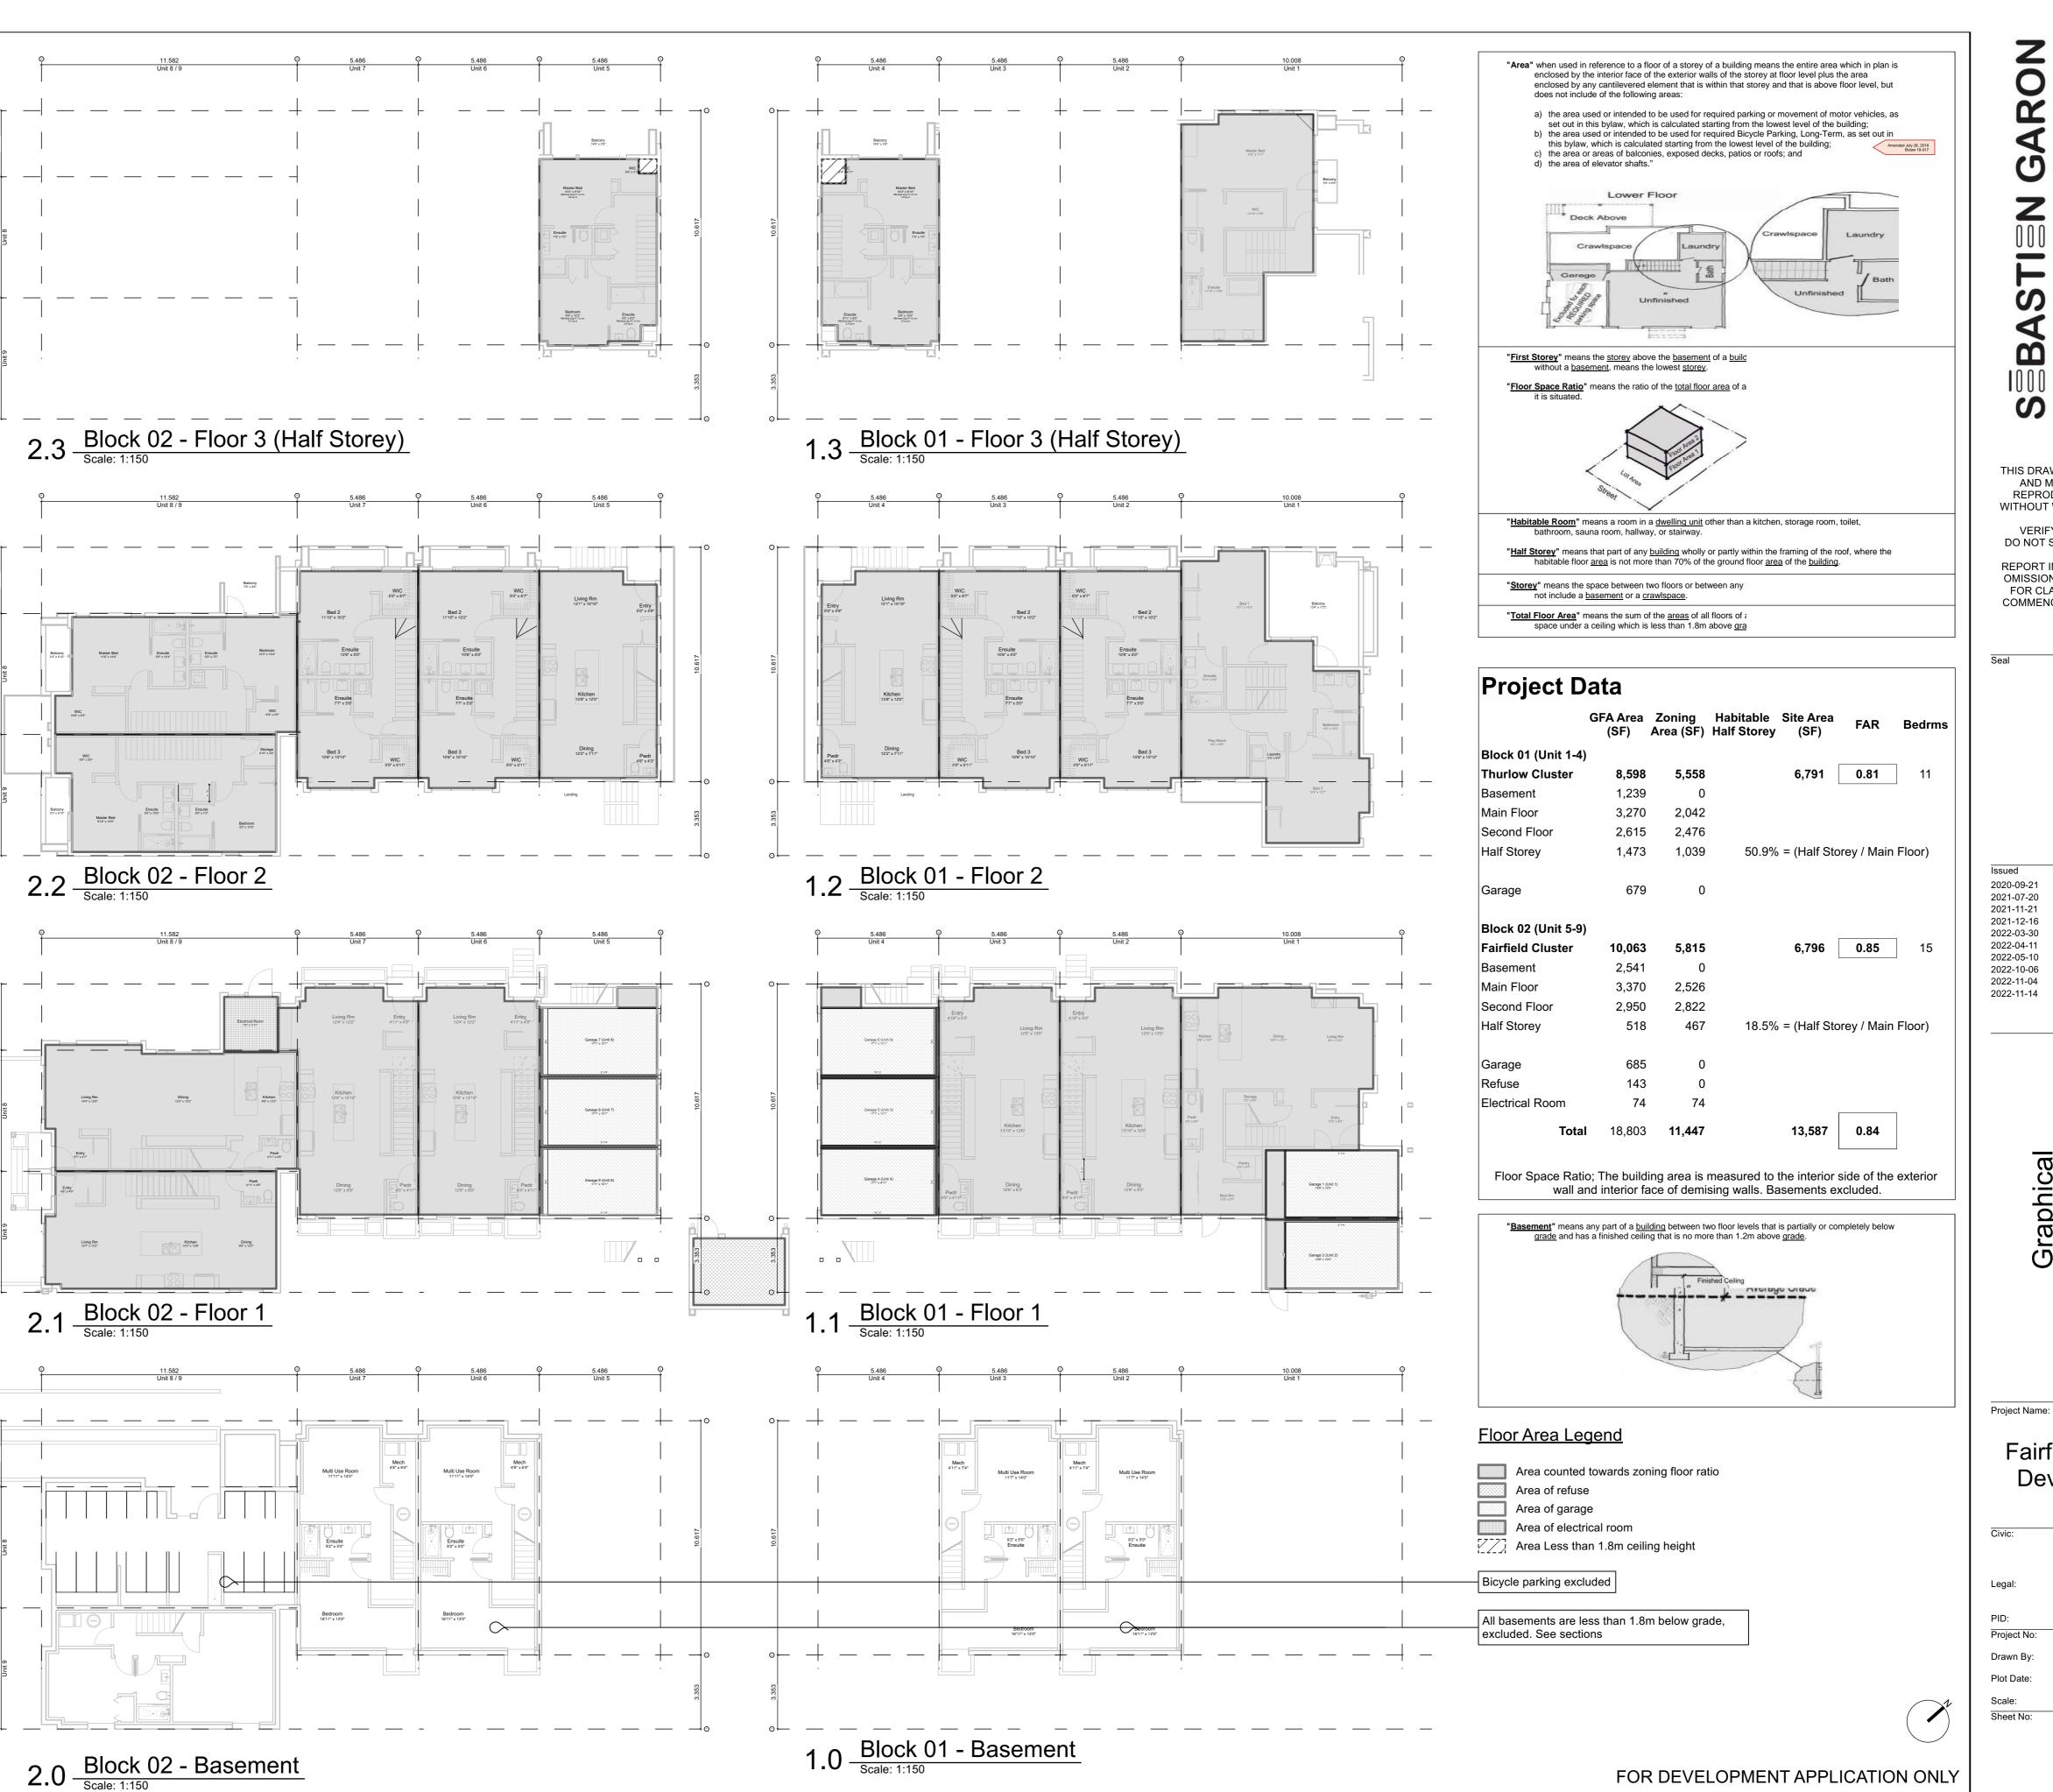

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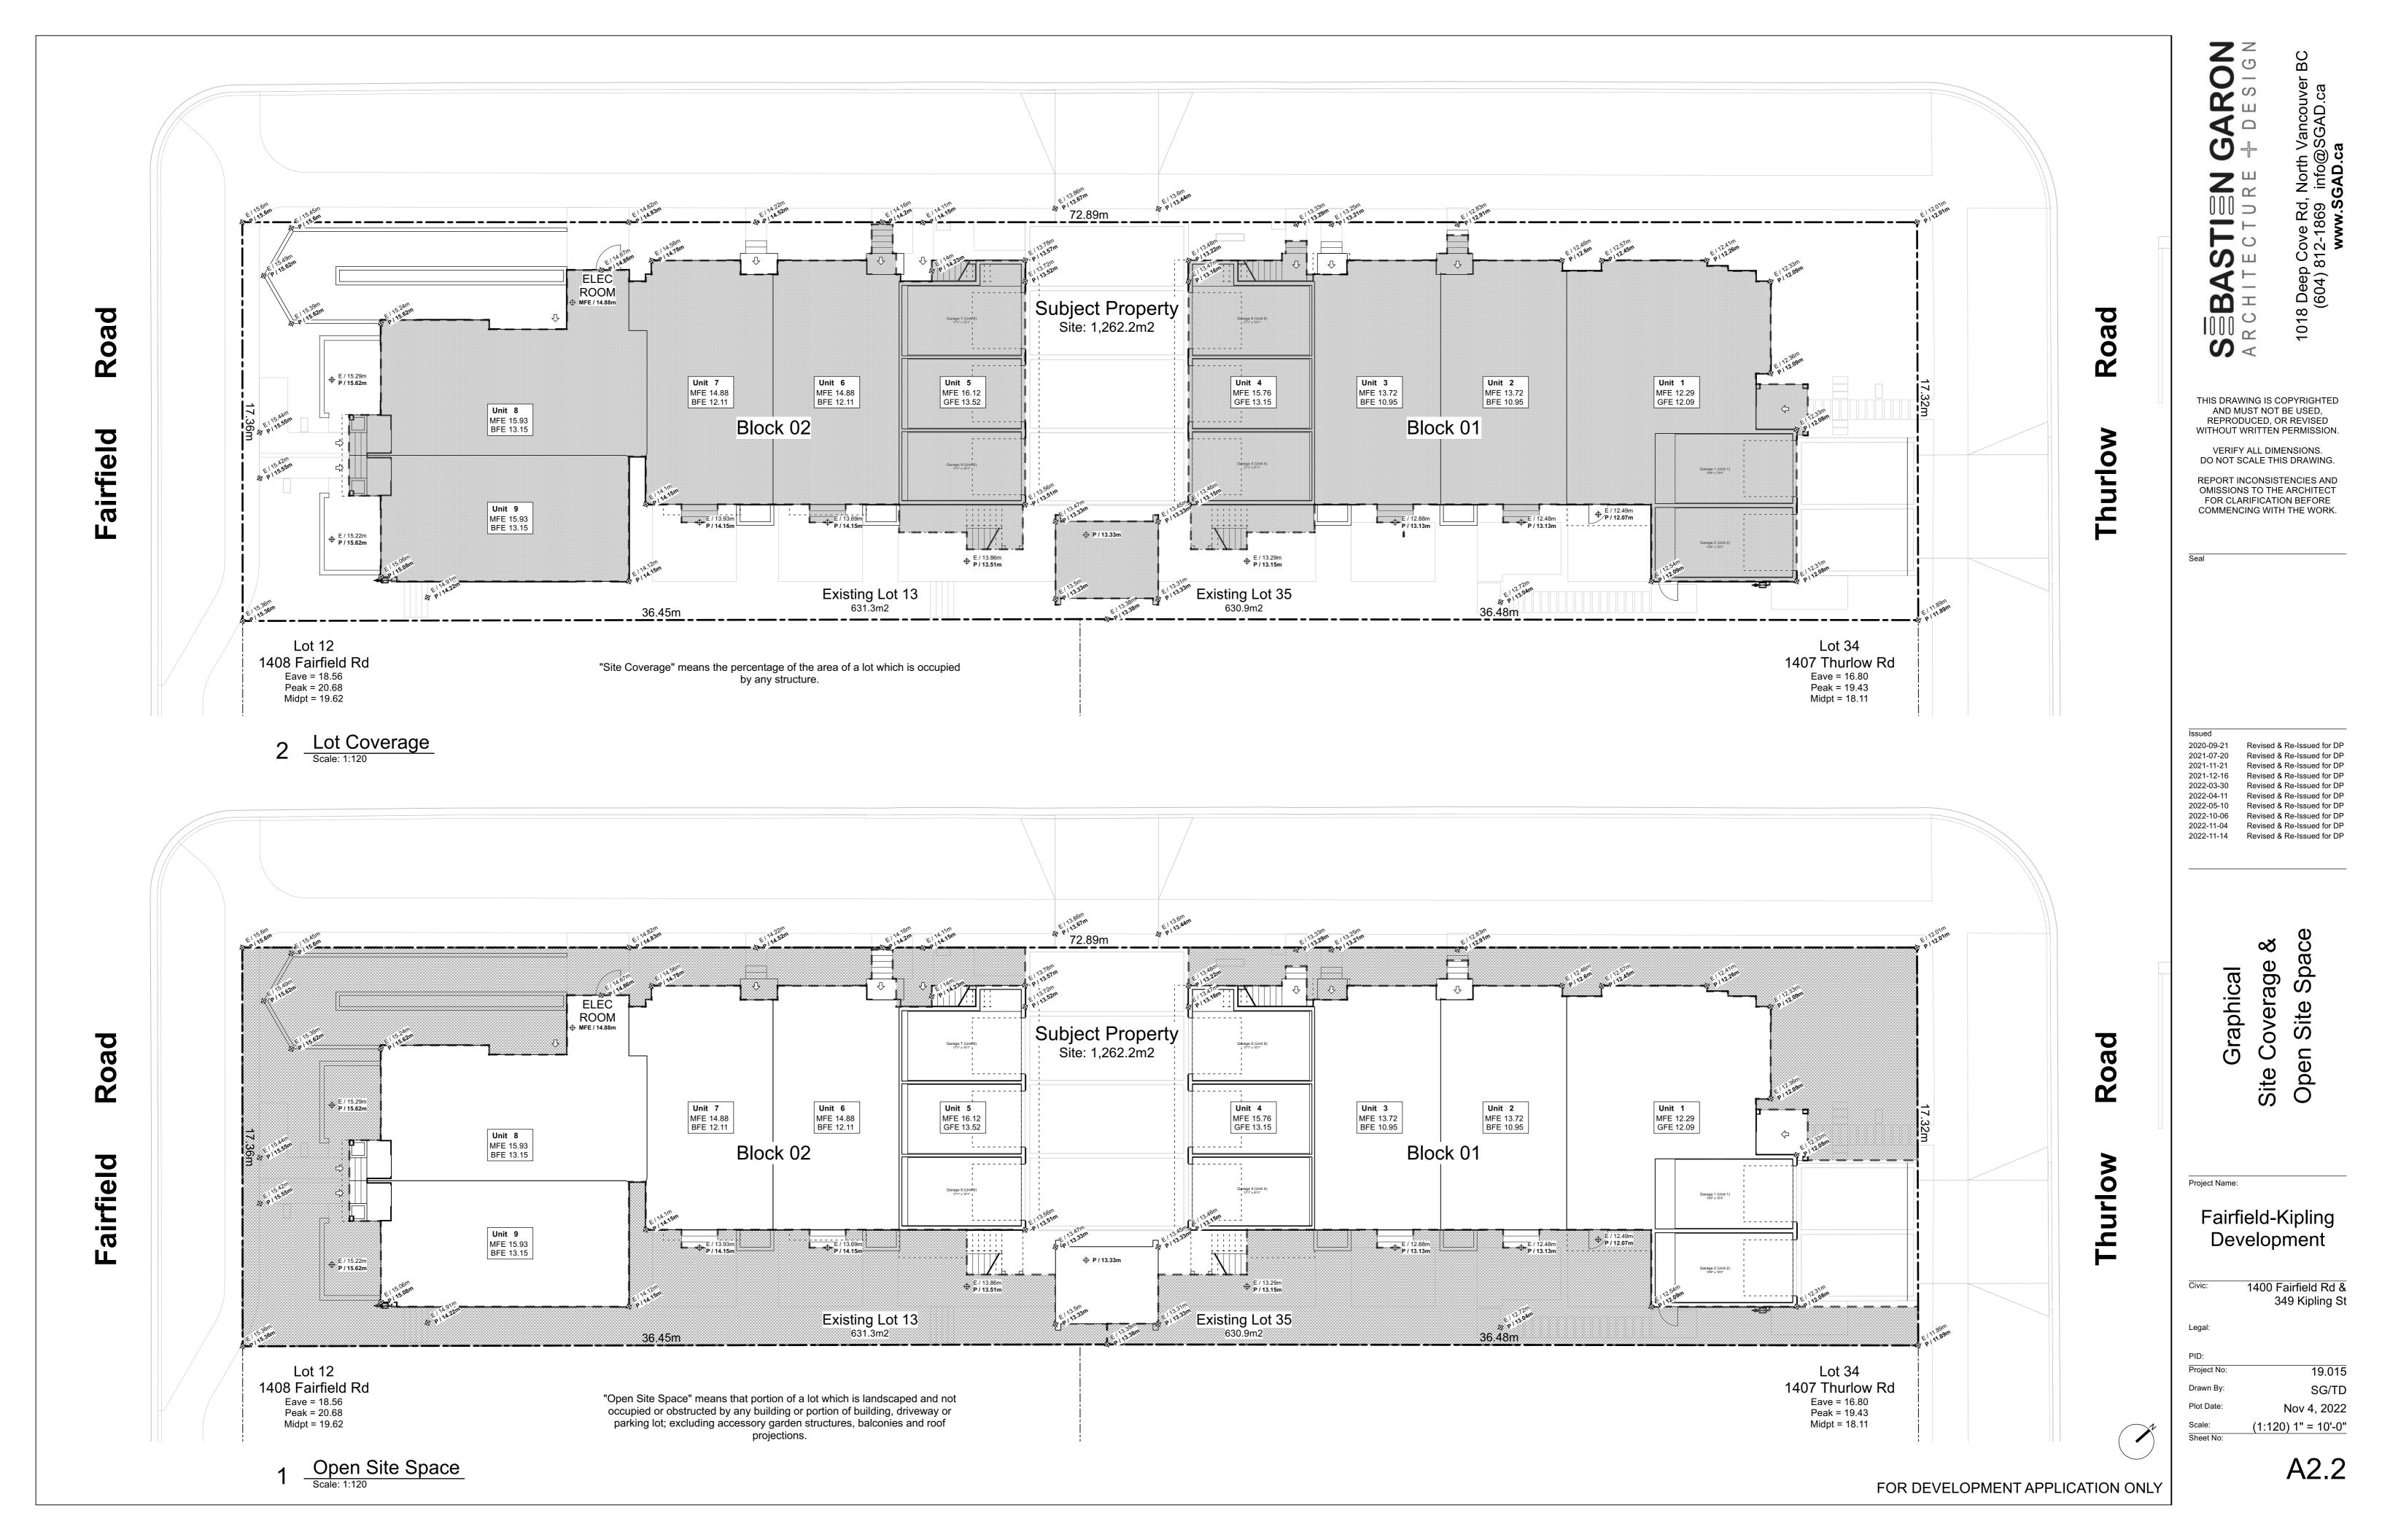
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2020-09-21	Revised & Re-Issued for DP
2021-07-20	Revised & Re-Issued for DP
2021-11-21	Revised & Re-Issued for DP
2021-12-16	Revised & Re-Issued for DP
2022-03-30	Revised & Re-Issued for DP
2022-04-11	Revised & Re-Issued for DP
2022-05-10	Revised & Re-Issued for DP
2022-10-06	Revised & Re-Issued for DP
2022-11-04	Revised & Re-Issued for DP
2022-11-14	Revised & Re-Issued for DP




Fairfield-Kipling Development


Civic:	1400 Fairfield Rd
	349 Kipling S
Legal:	
PID:	
Project No:	19.01
Drawn By:	SG/TI
Plot Date:	Nov 4, 202
Scale:	1:10
Sheet No:	

A2.1



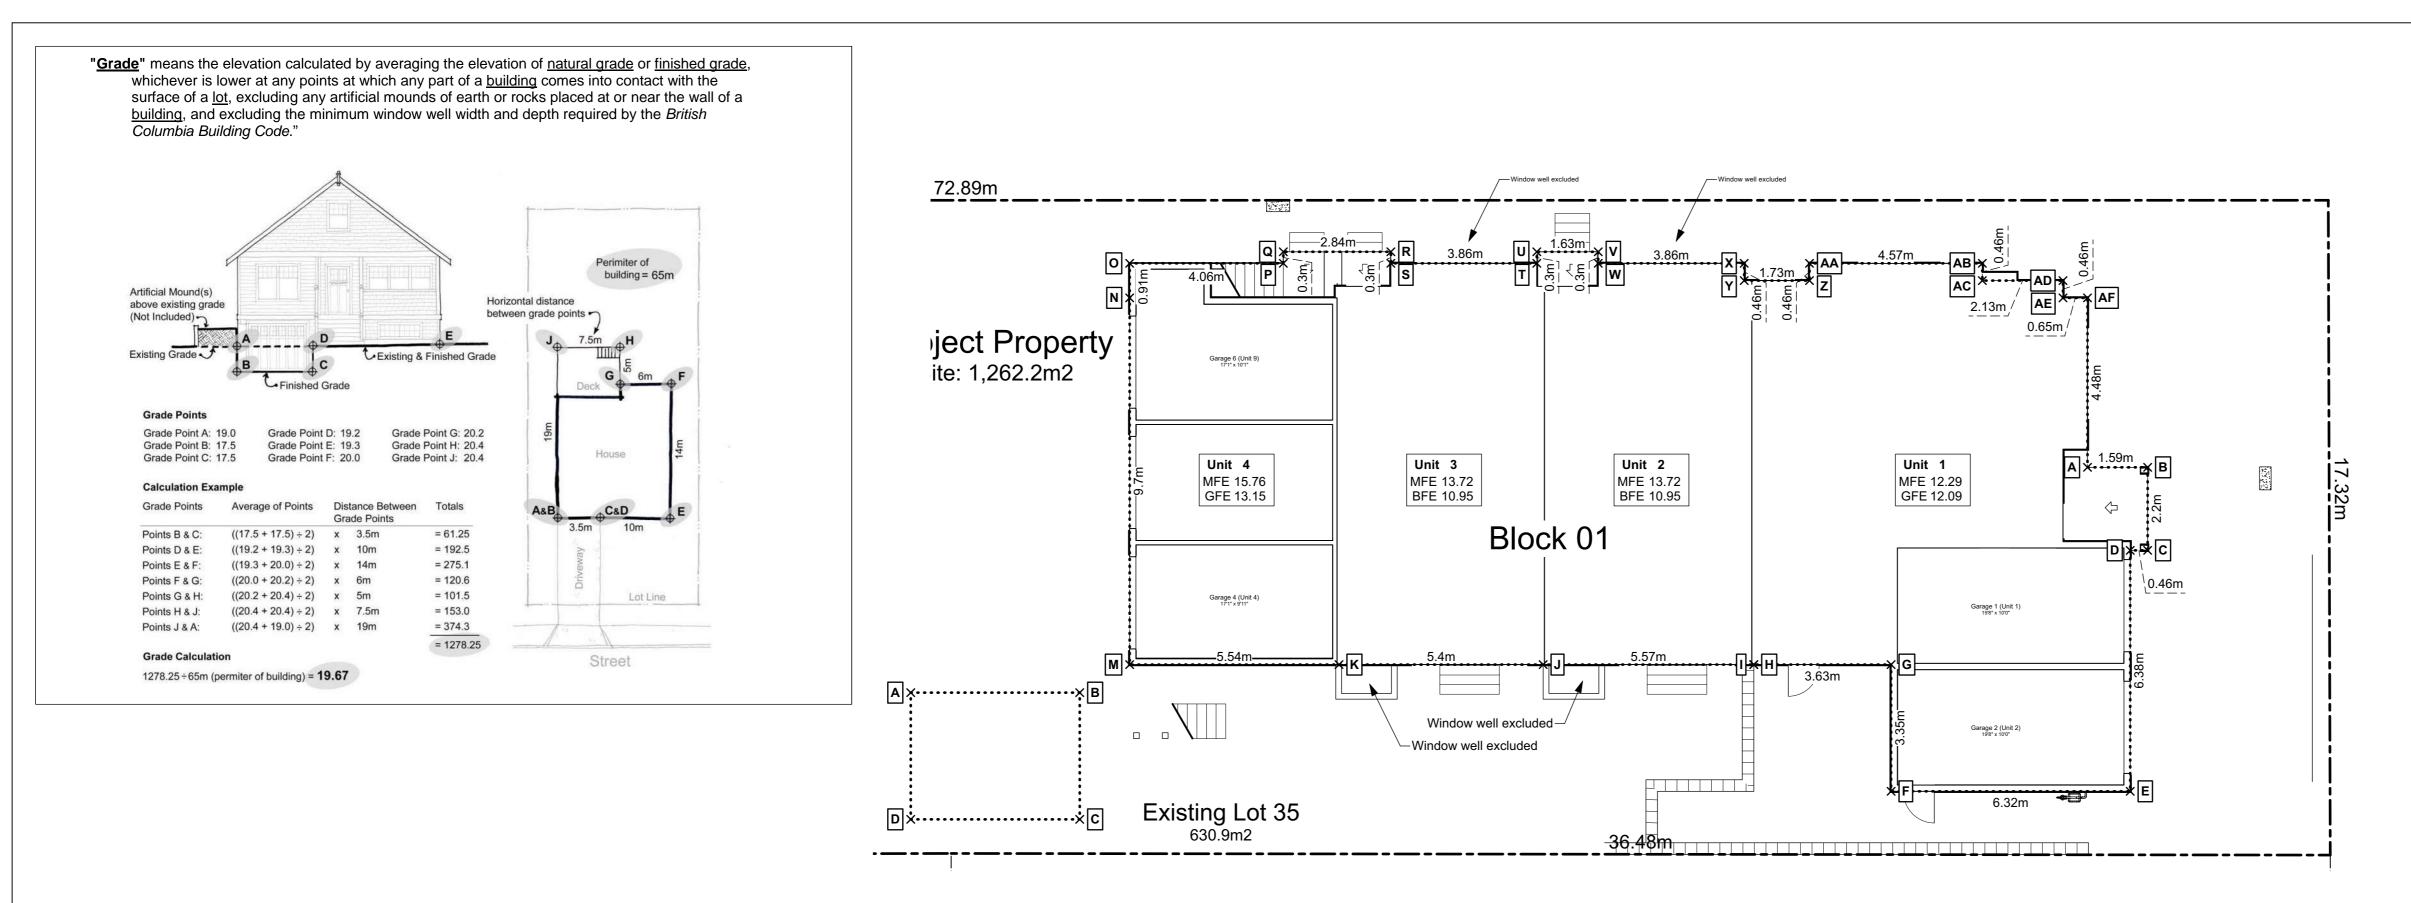

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Block 01 Average Grade

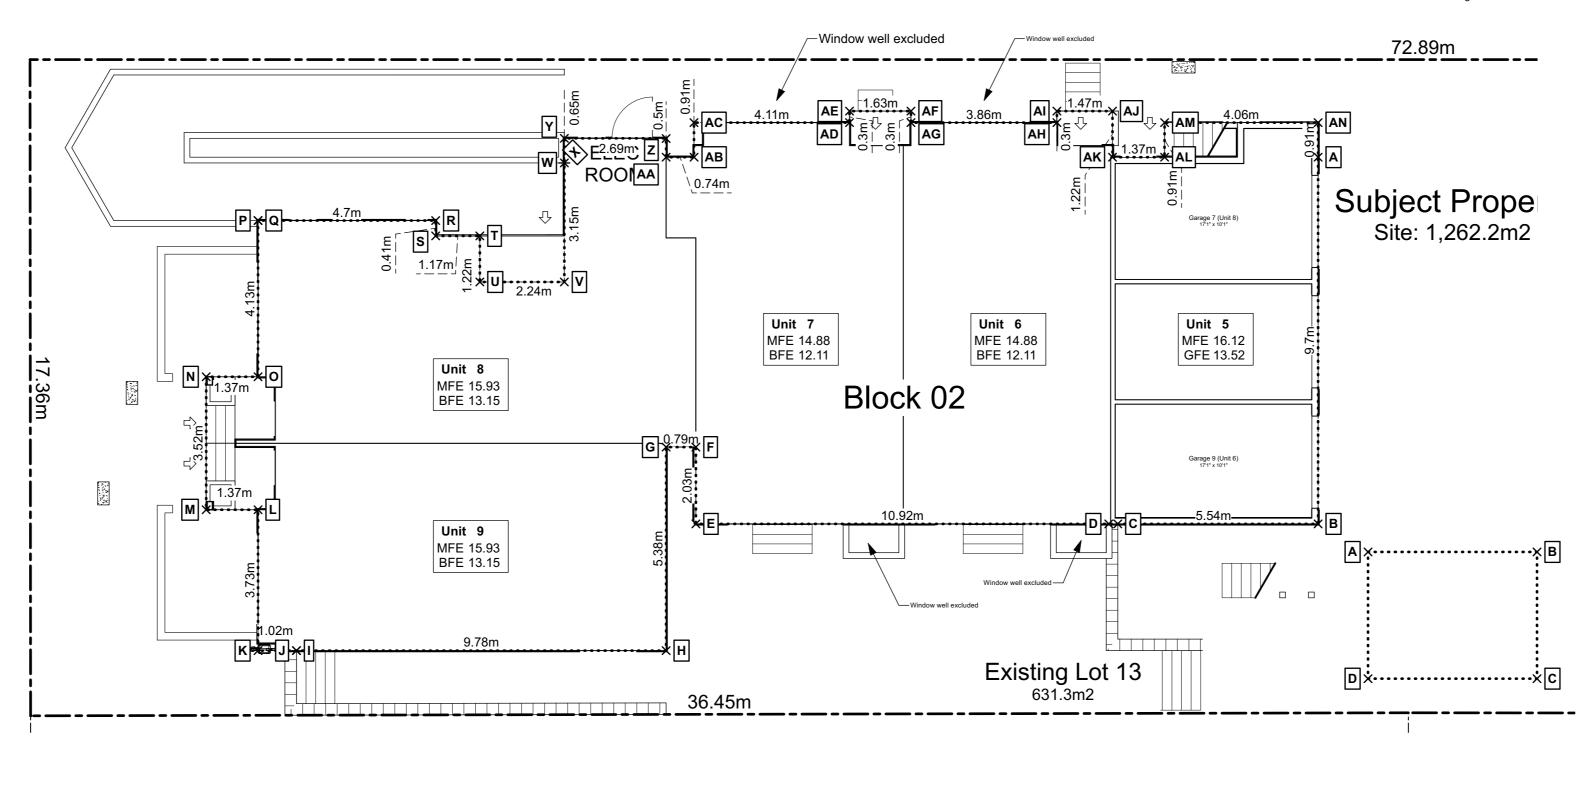Grade Calculations - Accessory Refuse

PT	Natural Grade	Finished Grade	Lowest Grade	PT Lowest Grade	Average	Distance	Total
Α	13.47 m	13.33 m	13.33 m —>	B 13.33 m	13.33 m	x 4.47 m	59.59
В	13.45 m	13.33 m	13.33 m —>	C 13.31 m	13.32 m	x 3.35 m	44.63
С	13.31 m	13.33 m	13.31 m —>	D 13.33 m	13.32 m	x 4.47 m	59.55
D	13.50 m	13.33 m	13.33 m —>	A 13.33 m	13.33 m	x 3.35 m	44.66
Α	13.47 m	13.33 m	13.33 m				
						Out Tatal	000 44

Sub-Total: 208.41 Perimeter of Building 15.64 m Average Grade 13.33 m

2 Block 02 Average Grade

РТ	Natural Grade	Finished Grade	Lowest Grade	РТ	Lowest Grade	Average	Distance	Total
А	12.36 m	12.09 m	12.09 m —>	в	12.09 m	12.09 m	x 1.59 m	19.22
в	12.30 m	12.09 m	12.09 m —>	с	12.06 m	12.08 m	x 2.20 m	26.57
С	12.30 m	12.06 m	12.06 m —>	D	12.09 m	12.08 m	x 0.46 m	5.55
D	12.33 m	12.09 m	12.09 m —>	Е	12.09 m	12.09 m	x 6.38 m	77.13
Е	12.30 m	12.09 m	12.09 m —>	F	12.09 m	12.09 m	x 6.32 m	76.41
F	12.52 m	12.09 m	12.09 m —>	G	12.09 m	12.09 m	x 3.35 m	40.50
G	12.49 m	12.09 m	12.09 m —>	н	12.09 m	12.09 m	x 3.63 m	43.89
н	12.49 m	12.09 m	12.09 m —>	I	12.49 m	Step Up		
I	12.49 m	13.13 m	12.49 m —>	J	12.73 m	12.61 m	x 5.57 m	70.22
J	12.73 m	13.13 m	12.73 m —>	к	13.13 m	12.93 m	x 5.40 m	69.81
κ	13.23 m	13.13 m	13.13 m —>	М	13.15 m	13.14 m	x 3.35 m	44.02
м	13.44 m	13.15 m	13.15 m —>	Ν	13.16 m	13.15 m	x 13.06 m	171.79
Ν	13.47 m	13.16 m	13.16 m —>	0	13.22 m	13.19 m	x 0.91 m	12.00
ο	13.48 m	13.22 m	13.22 m —>	Ρ	13.27 m	13.25 m	x 4.06 m	53.78
Р	13.33 m	13.27 m	13.27 m>	Q	13.28 m	13.27 m	x 0.30 m	3.98
Q	13.35 m	13.28 m	13.28 m —>	R	13.16 m	13.22 m	x 2.84 m	37.54
R	13.21 m	13.16 m	13.16 m —>	S	13.15 m	13.15 m	x 0.30 m	3.95
S	13.21 m	13.15 m	13.15 m —>	т	12.95 m	13.05 m	x 3.86 m	50.38
т	13.03 m	12.95 m	12.95 m —>	U	12.95 m	12.95 m	x 0.30 m	3.88
U	13.01 m	12.95 m	12.95 m —>	v	12.60 m	12.77 m	x 1.63 m	20.82
v	12.60 m	12.90 m	12.60 m —>	w	12.36 m	12.48 m	x 0.30 m	3.74
w	12.36 m	12.90 m	12.36 m —>	Х	12.50 m	12.43 m	x 3.86 m	47.98
х	12.50 m	12.60 m	12.50 m —>	Y	12.35 m	12.42 m	x 0.46 m	5.72
Y	12.35 m	12.60 m	12.35 m —>	z	12.52 m	12.43 m	x 1.73 m	21.51
z	12.54 m	12.52 m	12.52 m —>	AA	12.52 m	12.52 m	x 0.46 m	5.76
AA	12.57 m	12.52 m	12.52 m —>	AB	12.27 m	12.40 m	x 4.57 m	56.65
AB	12.40 m	12.27 m	12.27 m —>	AC	12.27 m	12.27 m	x 0.46 m	5.64
AC	12.42 m	12.27 m	12.27 m —>	AD	12.09 m	12.18 m	x 2.13 m	25.94
AD	12.35 m	12.09 m	12.09 m —>	AE	12.09 m	12.09 m	x 0.46 m	5.56
AE	12.36 m	12.09 m	12.09 m —>	AF	12.09 m	12.09 m	x 0.65 m	7.86
AF	12.33 m	12.09 m	12.09 m					
							Sub-Total	1 017 82

Sub-Total: 1,017.82 Perimeter of Building 80.59 m Average Grade 12.63 m

Grade Calculations - Block 02

PT	Natural Grade	Finished Grade	Lowest Grade	РТ	Lowest Grade	J	Average	Distance	Total
Α	13.68 m	13.52 m	13.52 m —>	в	13.52 m		13.52 m	x 13.06 m	176.55
в	13.57 m	13.52 m	13.52 m —>	С	13.52 m		13.52 m	x 5.54 m	74.89
С	13.59 m	13.52 m	13.52 m —>	D	13.60 m		13.56 m	x 3.35 m	45.43
D	13.60 m	14.15 m	13.60 m —>	Е	14.08 m		13.84 m	x 10.92 m	151.15
Е	14.08 m	14.15 m	14.08 m —>	F	14.12 m		14.10 m	x 2.03 m	28.62
F	14.12 m	14.15 m	14.12 m —>	G	14.15 m		14.13 m	x 0.79 m	11.16
G	14.18 m	14.15 m	14.15 m —>	н	14.13 m		14.14 m	x 5.38 m	76.06
н	14.13 m	14.15 m	14.13 m —>	I	14.22 m		14.18 m	x 9.78 m	138.64
I	14.96 m	14.22 m	14.22 m —>	J	14.96 m	S	Step Up		
J	14.96 m	15.01 m	14.96 m —>	к	15.02 m		14.99 m	x 1.02 m	15.29
к	15.02 m	15.09 m	15.02 m —>	L	15.22 m		15.12 m	x 3.73 m	56.39
L	15.22 m	15.62 m	15.22 m —>	М	15.23 m		15.22 m	x 1.37 m	20.86
м	15.23 m	15.62 m	15.23 m —>	Ν	15.27 m		15.25 m	x 3.52 m	53.68
Ν	15.27 m	15.62 m	15.27 m —>	0	15.25 m		15.26 m	x 1.37 m	20.90
0	15.25 m	15.62 m	15.25 m —>	Ρ	15.24 m		15.24 m	x 4.13 m	62.96
Ρ	15.24 m	15.62 m	15.24 m —>	Q	13.75 m	S	Step Dow	n	
Q	15.24 m	13.75 m	13.75 m —>	R	13.27 m		13.51 m	x 4.70 m	63.50
R	15.11 m	13.27 m	13.27 m —>	S	13.27 m		13.27 m	x 0.41 m	5.44
s	15.13 m	13.27 m	13.27 m —>	т	13.15 m		13.21 m	x 1.17 m	15.46
т	15.08 m	13.15 m	13.15 m —>	U	13.15 m		13.15 m	x 1.22 m	16.04
U	15.11 m	13.15 m	13.15 m —>	v	13.15 m		13.15 m	x 2.24 m	29.46
v	14.46 m	13.15 m	13.15 m —>	w	13.15 m		13.15 m	x 3.15 m	41.42
w	14.64 m	13.15 m	13.15 m —>	Х	14.47 m	S	Step Up		
х	14.47 m	14.86 m	14.47 m —>	Y	14.47 m		14.47 m	x 0.65 m	9.41
Y	14.47 m	14.86 m	14.47 m —>	z	14.38 m		14.42 m	x 2.69 m	38.80
z	14.38 m	14.80 m	14.38 m —>	AA	14.29 m		14.33 m	x 0.50 m	7.17
AA	14.29 m	14.80 m	14.29 m —>	AB	14.29 m		14.29 m	x 0.74 m	10.57
AB	14.29 m	14.80 m	14.29 m —>	AC	14.61 m		14.45 m	x 0.91 m	13.15
AC	14.61 m	14.78 m	14.61 m —>	AD	14.11 m		14.36 m	x 4.11 m	59.01
AD	14.11 m	14.49 m	14.11 m —>	AE	14.19 m		14.15 m	x 0.30 m	4.24
AE	14.19 m	14.50 m	14.19 m —>	AF	14.09 m		14.14 m	x 1.63 m	23.04
AF	14.09 m	14.49 m	14.09 m —>	AG	14.01 m		14.05 m	x 0.30 m	4.21
AG	14.01 m	14.49 m	14.01 m —>	AH	14.04 m		14.02 m	x 3.86 m	54.14
AH	14.04 m	14.30 m	14.04 m —>	AI	14.10 m		14.07 m	x 0.30 m	4.22
AI	14.10 m	14.28 m	14.10 m —>	AJ	14.09 m		14.10 m	x 1.47 m	20.72
AJ	14.09 m	14.26 m	14.09 m —>	AK	13.96 m		14.03 m	x 1.22 m	17.11
AK	13.96 m	14.30 m	13.96 m —>	AL	13.94 m		13.95 m	x 1.37 m	19.11
AL	13.94 m	14.25 m	13.94 m —>	AM	14.03 m		13.98 m	x 0.91 m	12.73
АМ	14.03 m	14.21 m	14.03 m —>	AN	13.58 m		13.81 m	x 4.06 m	56.06
AN	13.79 m	13.58 m	13.58 m						
								Sub-Total:	1,457.59
							Perimete	r of Building	103.90 m

Issued 2020-09-21 Revised & Re-Issued for DP Revised & Re-Issued for DP 2021-07-20 2021-11-21 Revised & Re-Issued for DP 2021-12-16 Revised & Re-Issued for DP 2022-03-30 Revised & Re-Issued for DP 2022-04-11 Revised & Re-Issued for DP 2022-05-10 Revised & Re-Issued for DP 2022-10-06 Revised & Re-Issued for DP 2022-11-04 Revised & Re-Issued for DP 2022-11-14 Revised & Re-Issued for DP



Project Name:

Legal:

Scale: Sheet No:

Fairfield-Kipling Development

1400 Fairfield Rd & 349 Kipling St Civic:

PID: Project No: 19.015 SG/TD Drawn By: Nov 4, 2022 Plot Date:

FOR DEVELOPMENT APPLICATION ONLY

Average Grade 14.03 m

A2.3

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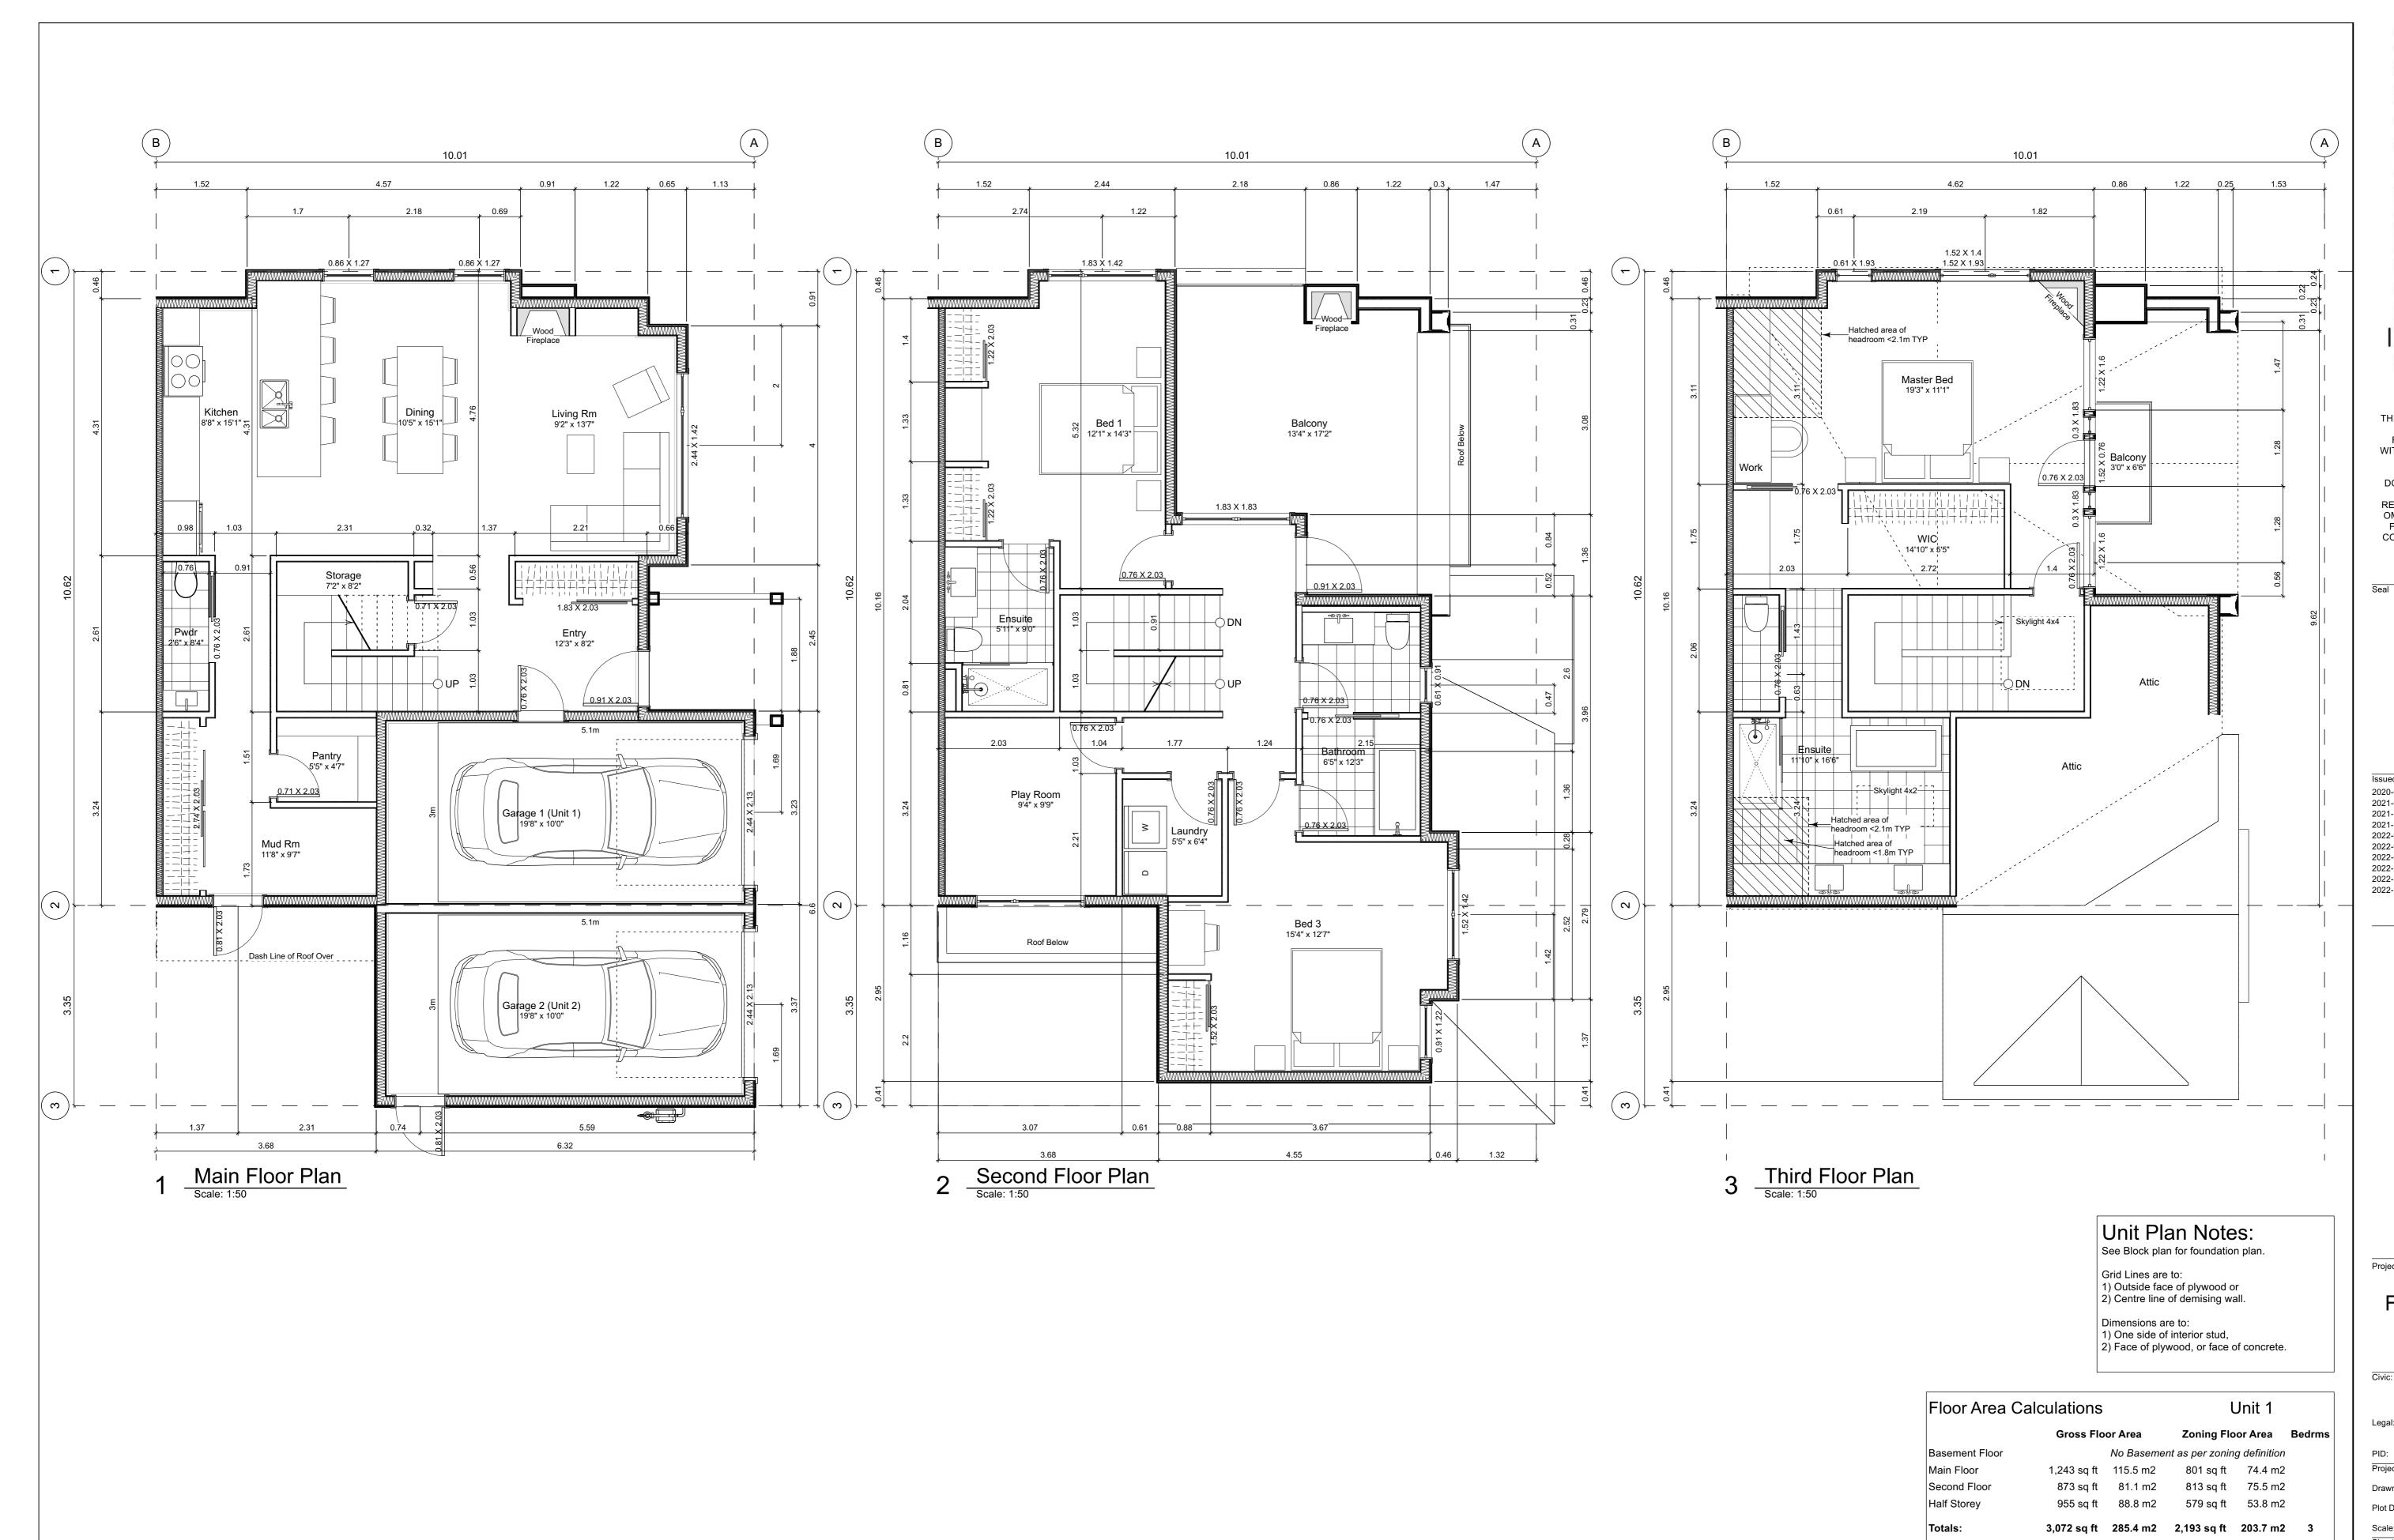
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2020-09-21	Revised & Re-Issued for DP
2021-07-20	Revised & Re-Issued for DP
2021-11-21	Revised & Re-Issued for DP
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2022-03-30	Revised & Re-Issued for DP
2022-04-11	Revised & Re-Issued for DP
2022-05-10	Revised & Re-Issued for DP
2022-10-06	Revised & Re-Issued for DP
2022-11-04	Revised & Re-Issued for DP
2022-11-14	Revised & Re-Issued for DP



Project Name:

Fairfield-Kipling Development

Civic:	1400 Fairfield Rd &
	349 Kipling St
_egal:	
PID:	
	40.045


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Drawn By:	SG/TD
Plot Date:	Nov 4, 2022
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Sheet No:	

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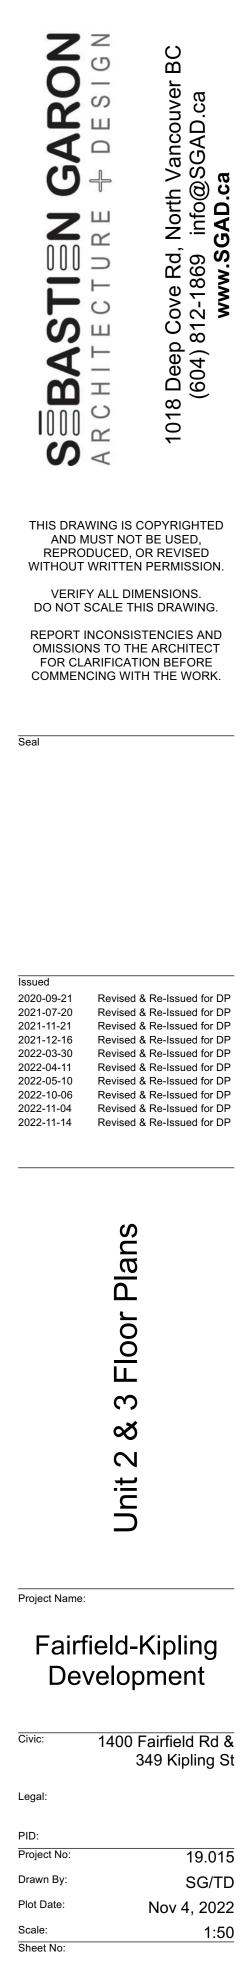
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168 sq ft 15.7 m2


Garage





Floor Area C	alculations		I	Jnit 3	
	Gross Flo	or Area	Zoning Flo	oor Area	Bedrm
Basement Floor	617 sq ft	57.3 m2	0 sq ft	0.0 m2	
Main Floor	616 sq ft	57.3 m2	605 sq ft	56.2 m2	
Second Floor	589 sq ft	54.8 m2	568 sq ft	52.8 m2	
Half Storey					
Totals:	1,823 sq ft	169.3 m2	1,173 sq ft	109.0 m2	3
Garage	172 sq ft	16.0 m2			

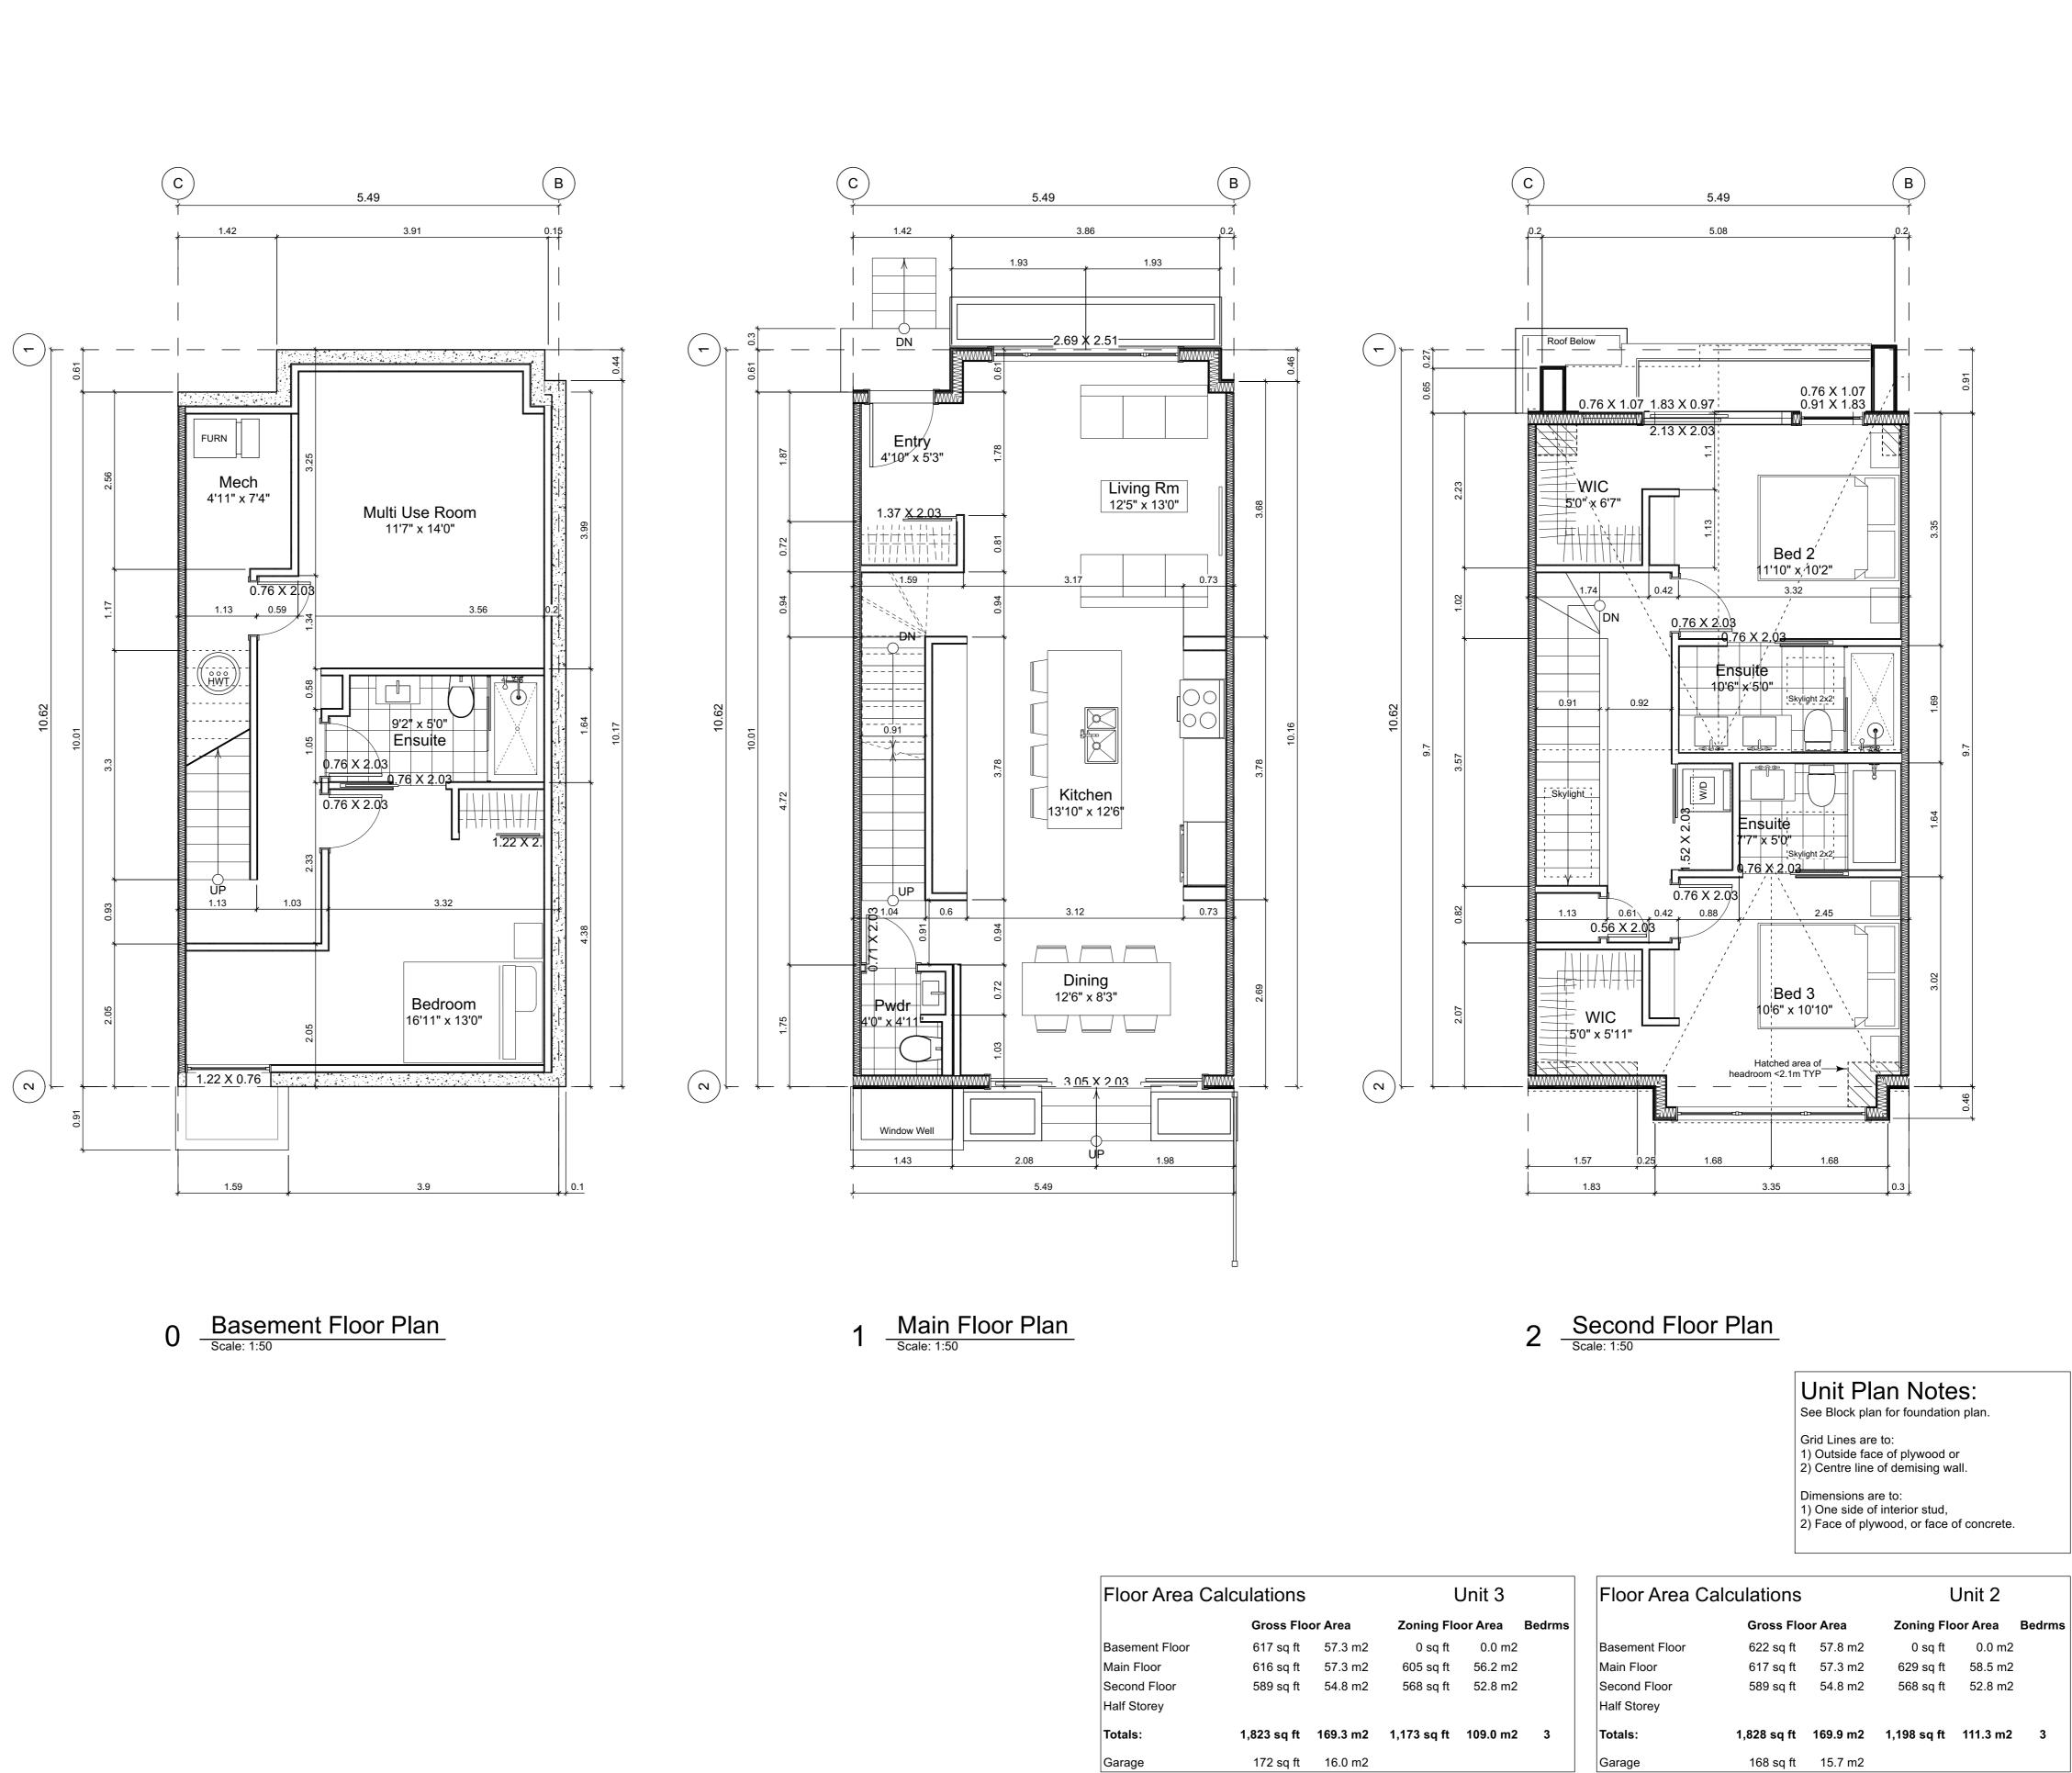

A3.2

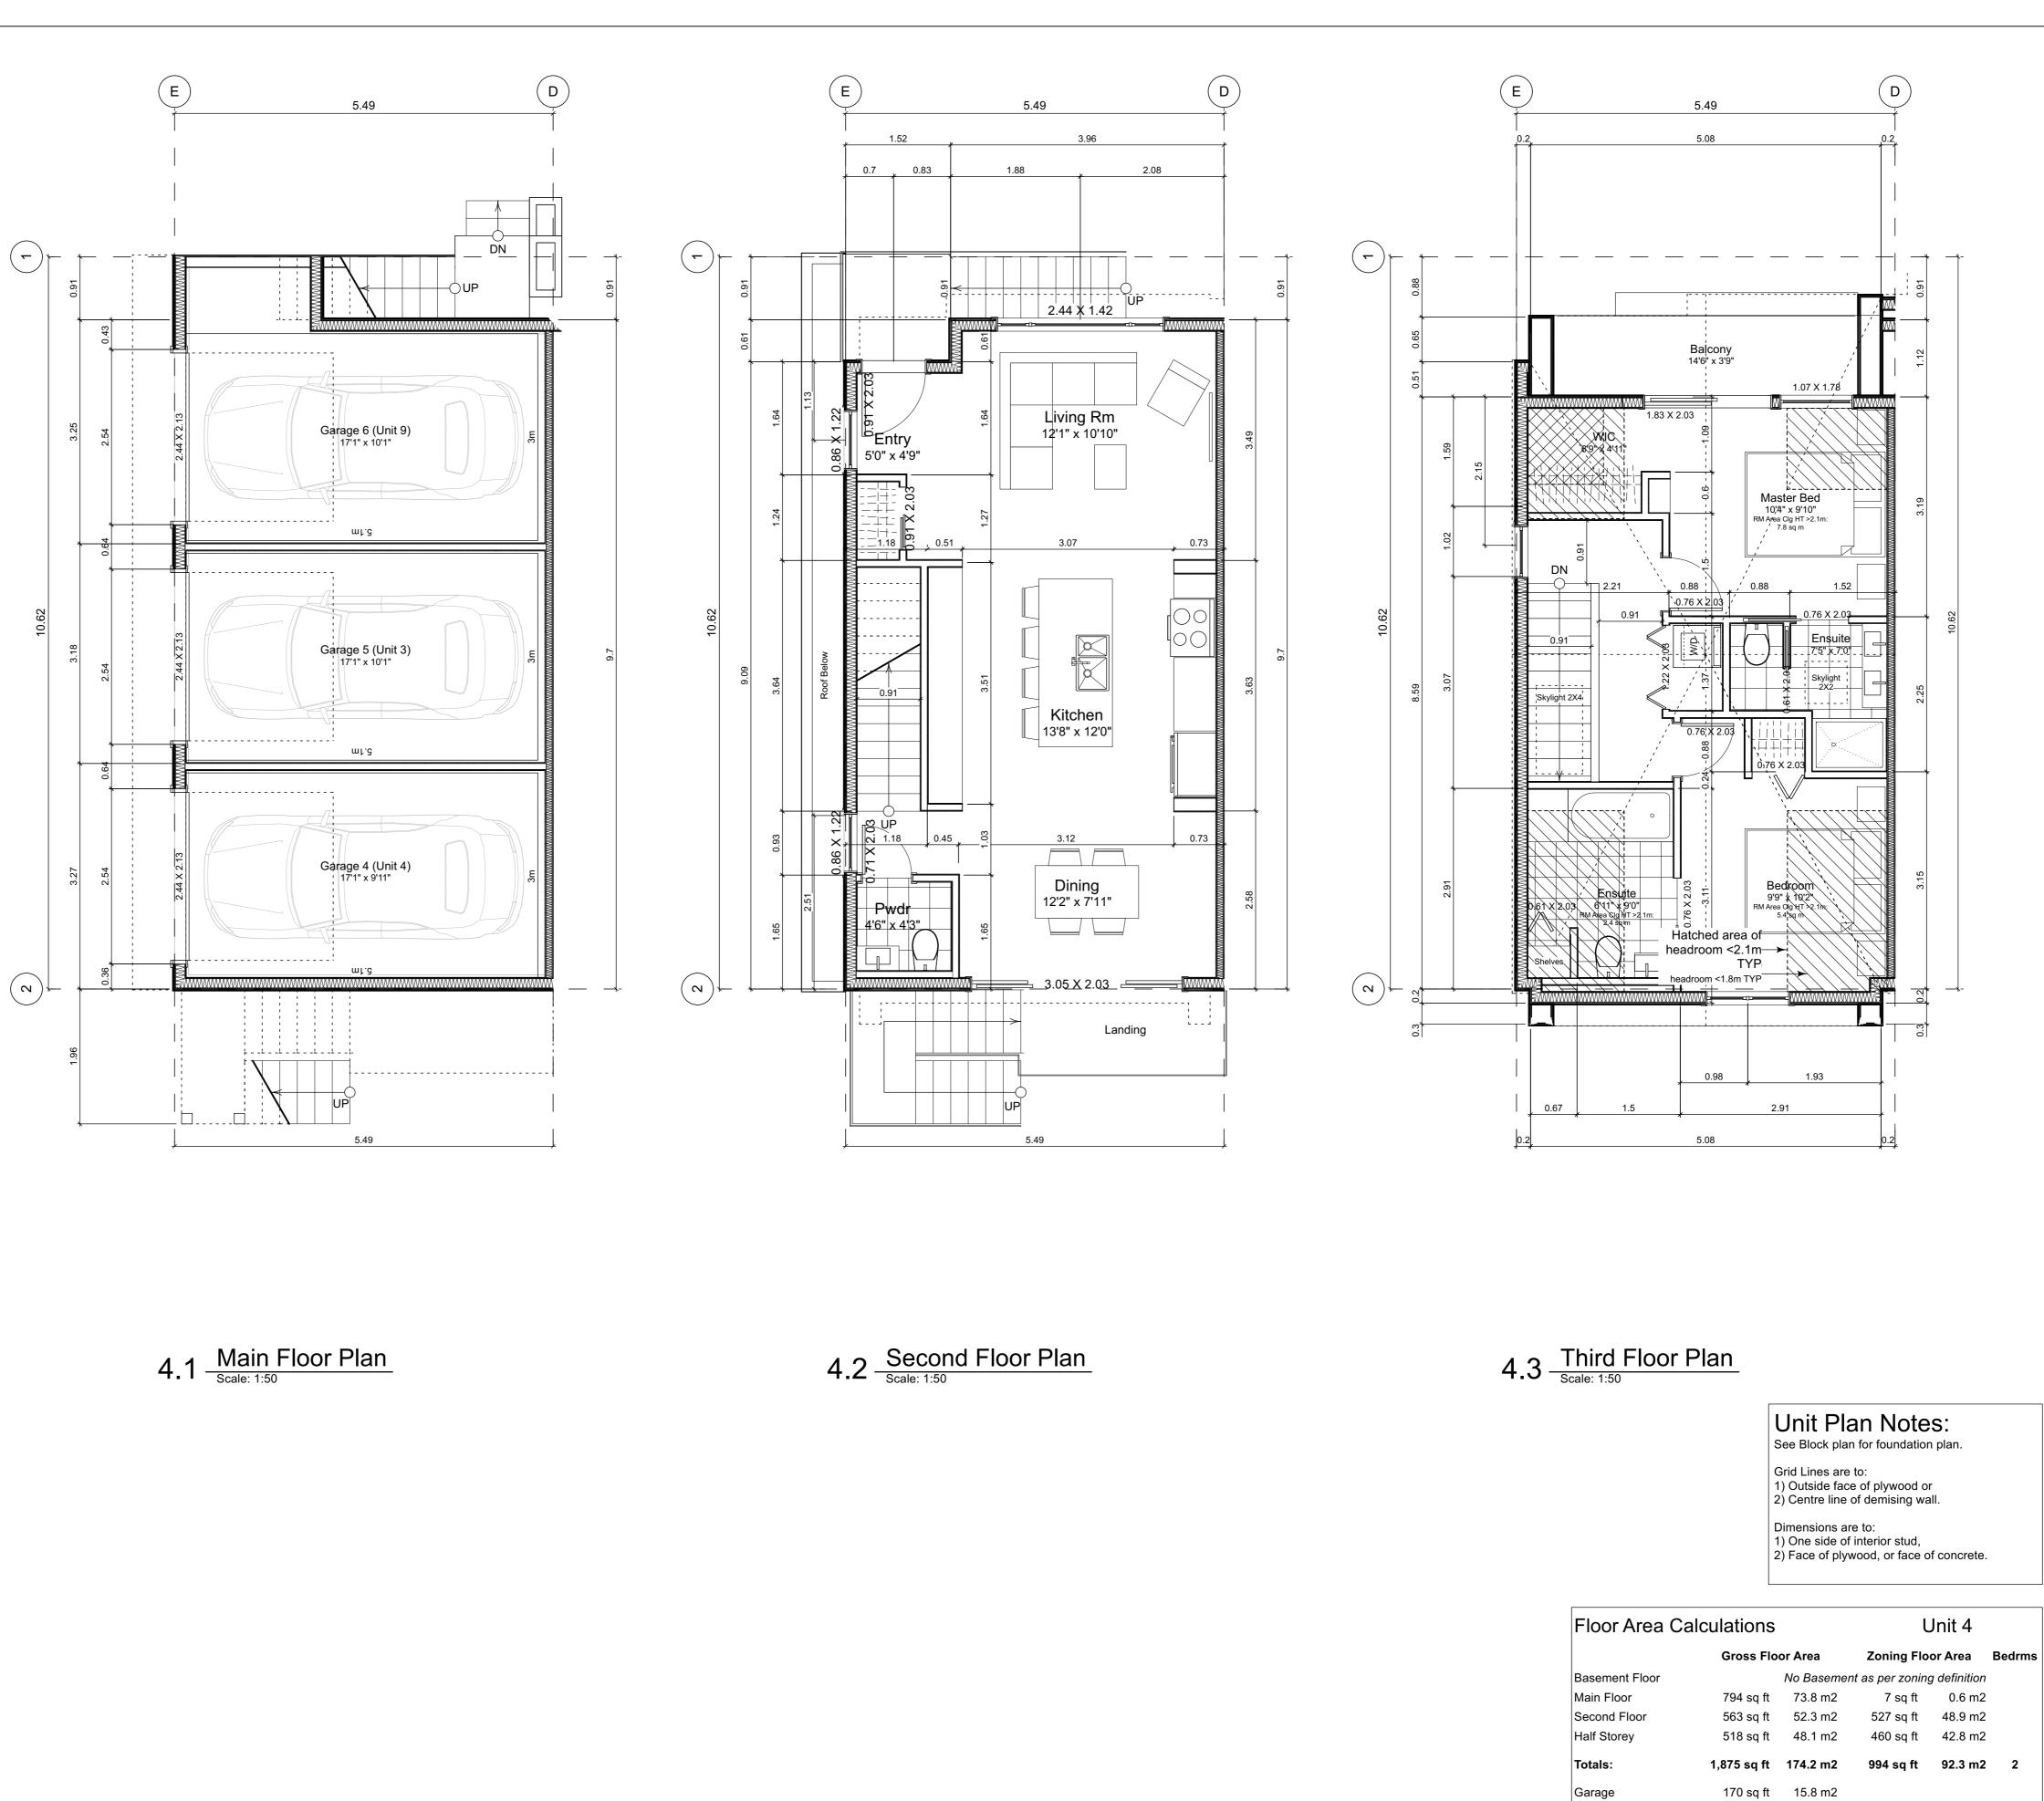

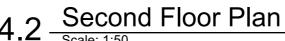

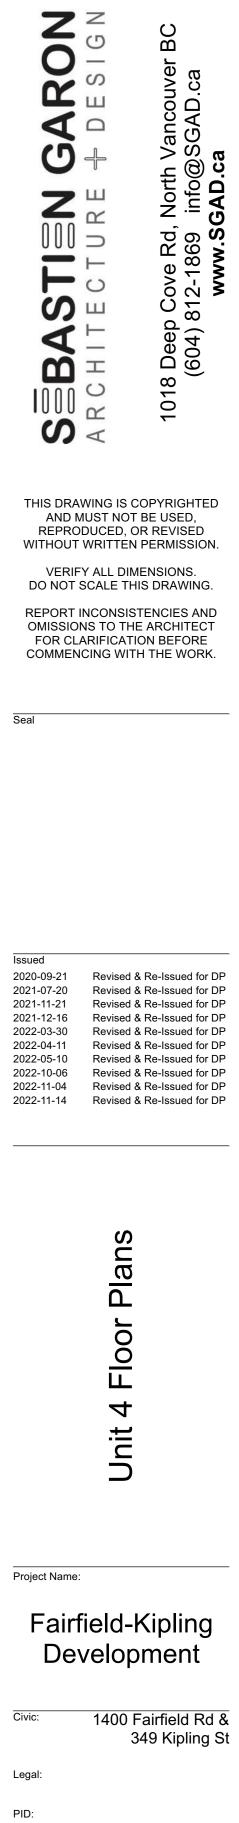


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PID:	
Project No:	19.015
Drawn By:	SG/TD
Plot Date:	Nov 4, 2022
Scale:	1:50
Sheet No:	

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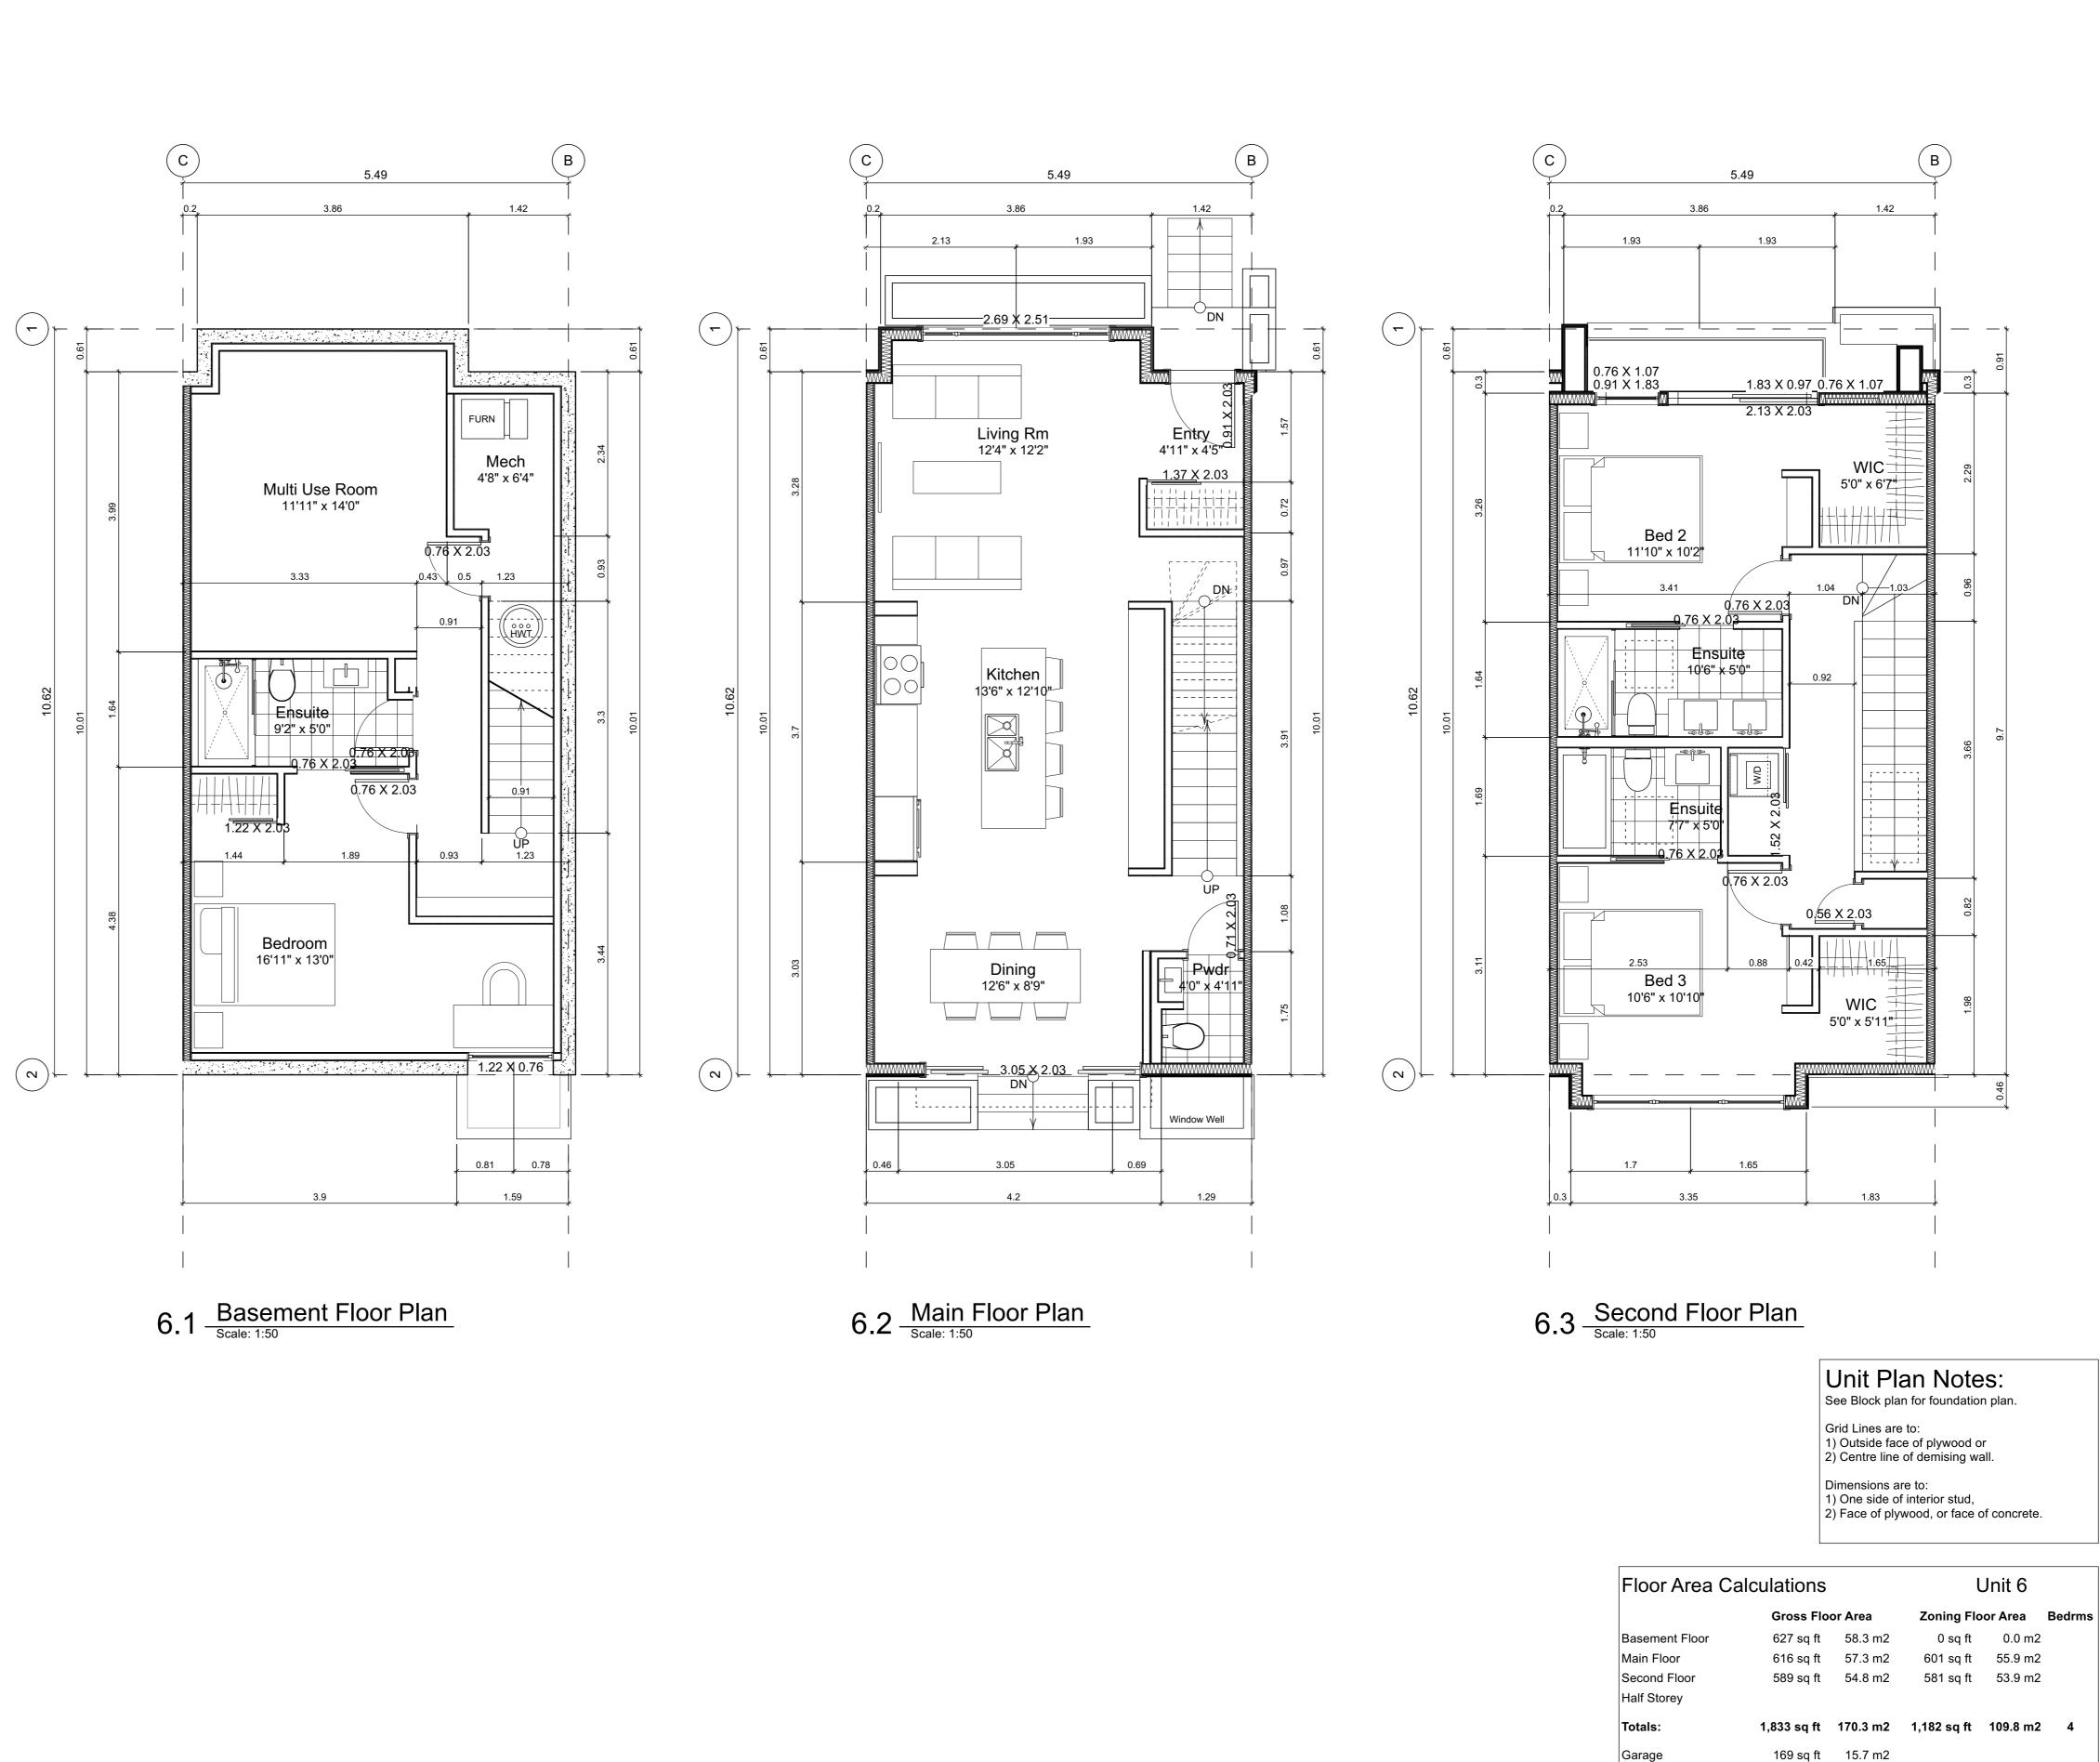
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Project No:	19.01
Drawn By:	SG/TI
Plot Date:	Nov 4, 202
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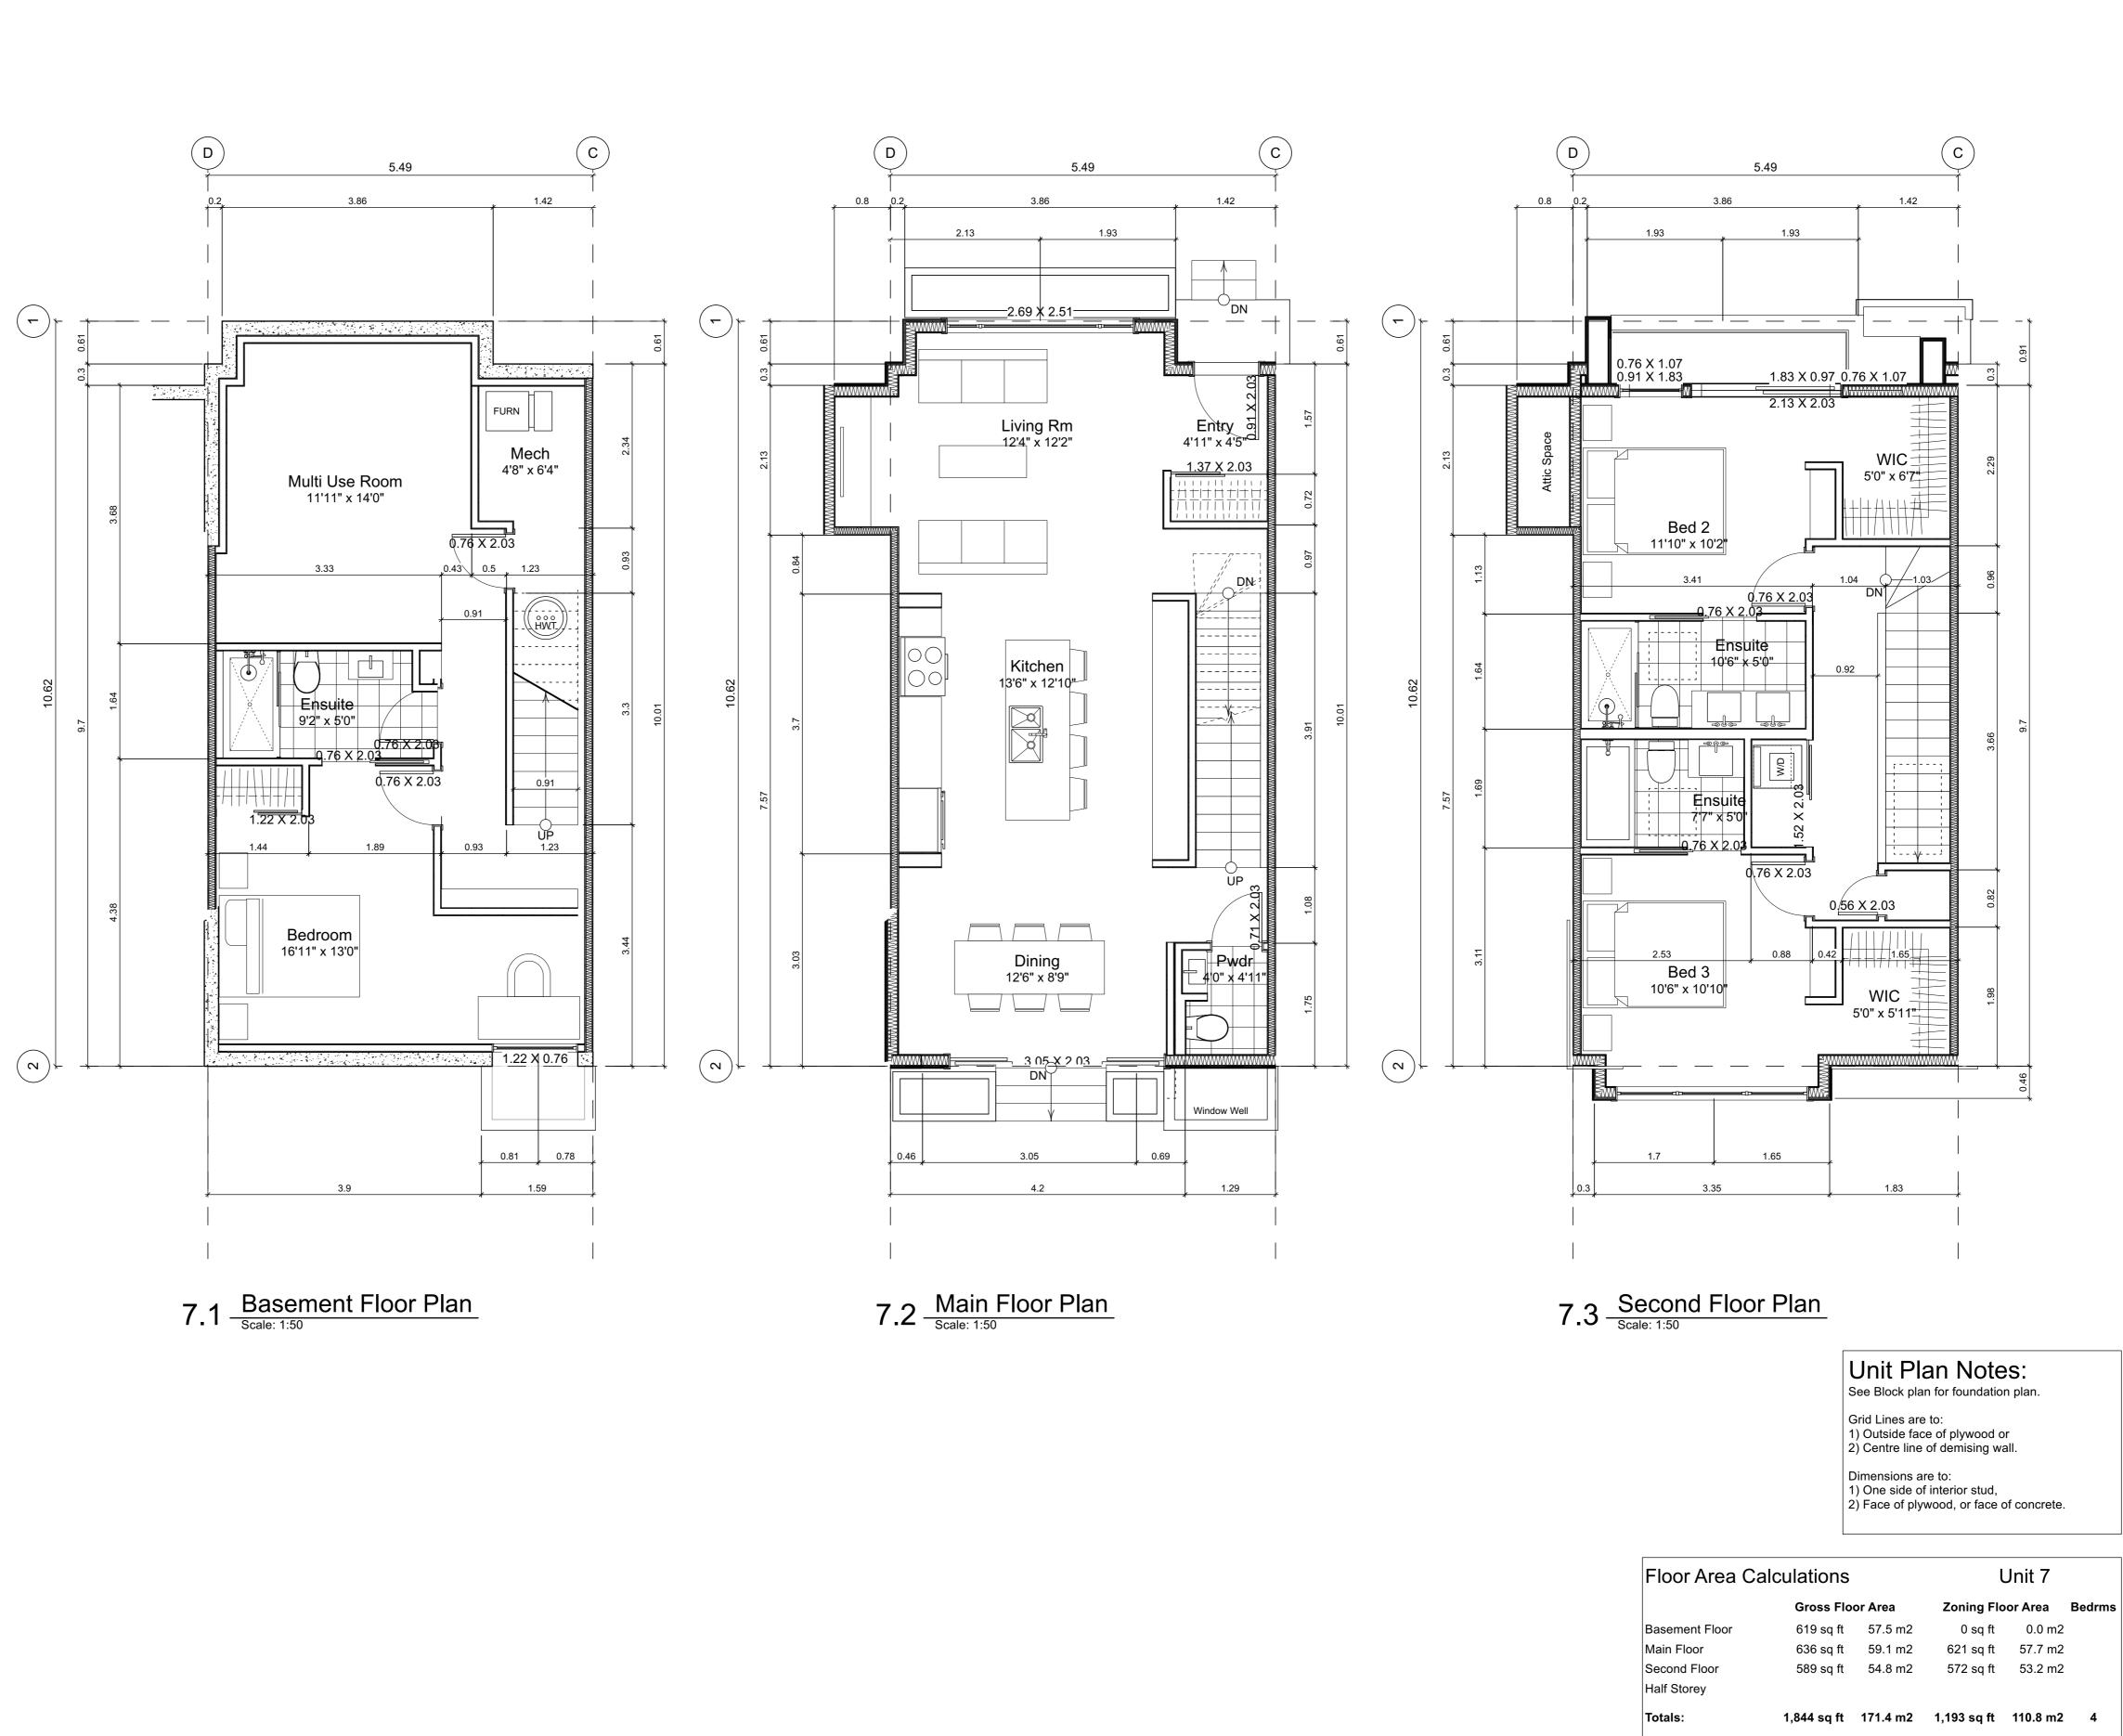
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	Unit 6 Floor Plans	
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Legal:		rfield Rd &) Kipling St
PID: Project No: Drawn By: Plot Date: Scale:	N	19.015 SG/TD ov 4, 2022
Sheet No:		<u>1:50</u>

Garage

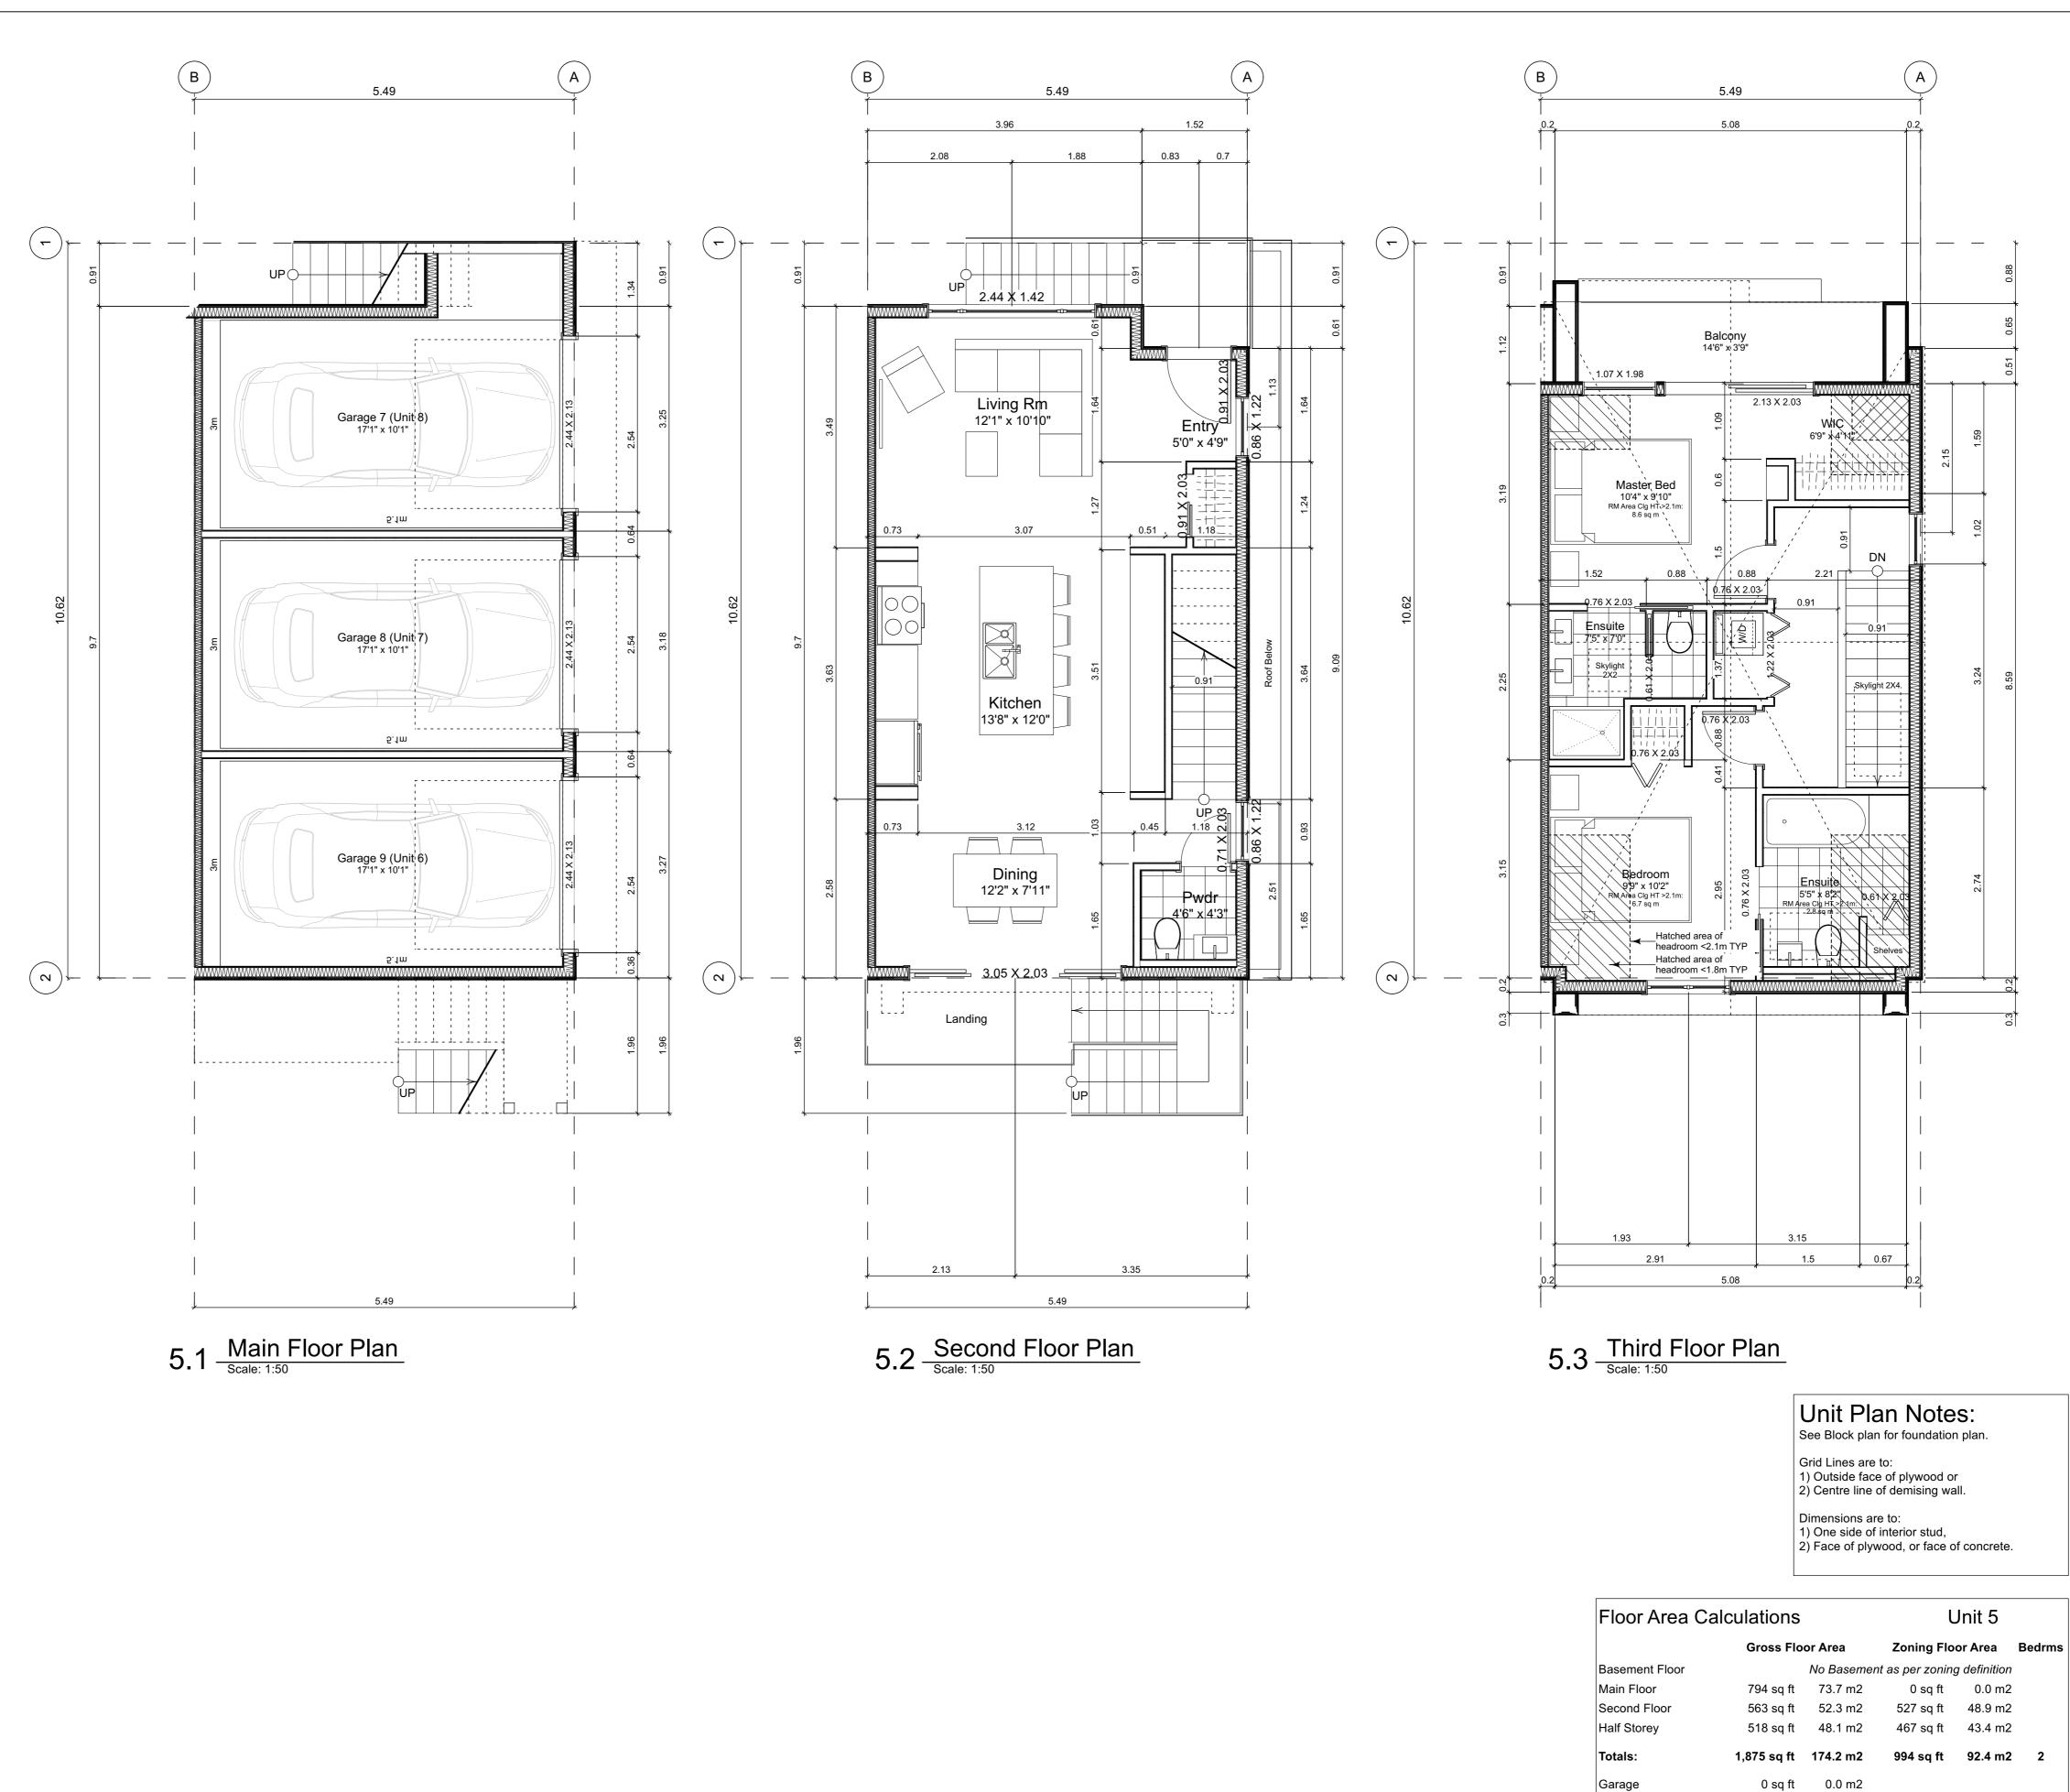


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	Unit 7 Floor Plans	
		Kipling oment
ivic: egal:		Fairfield Rd & 349 Kipling St
ID: roject No: rawn By: lot Date: cale: heet No:		19.015 SG/TD Nov 4, 2022 1:50

172 sq ft 16.0 m2

Garage

A2.0

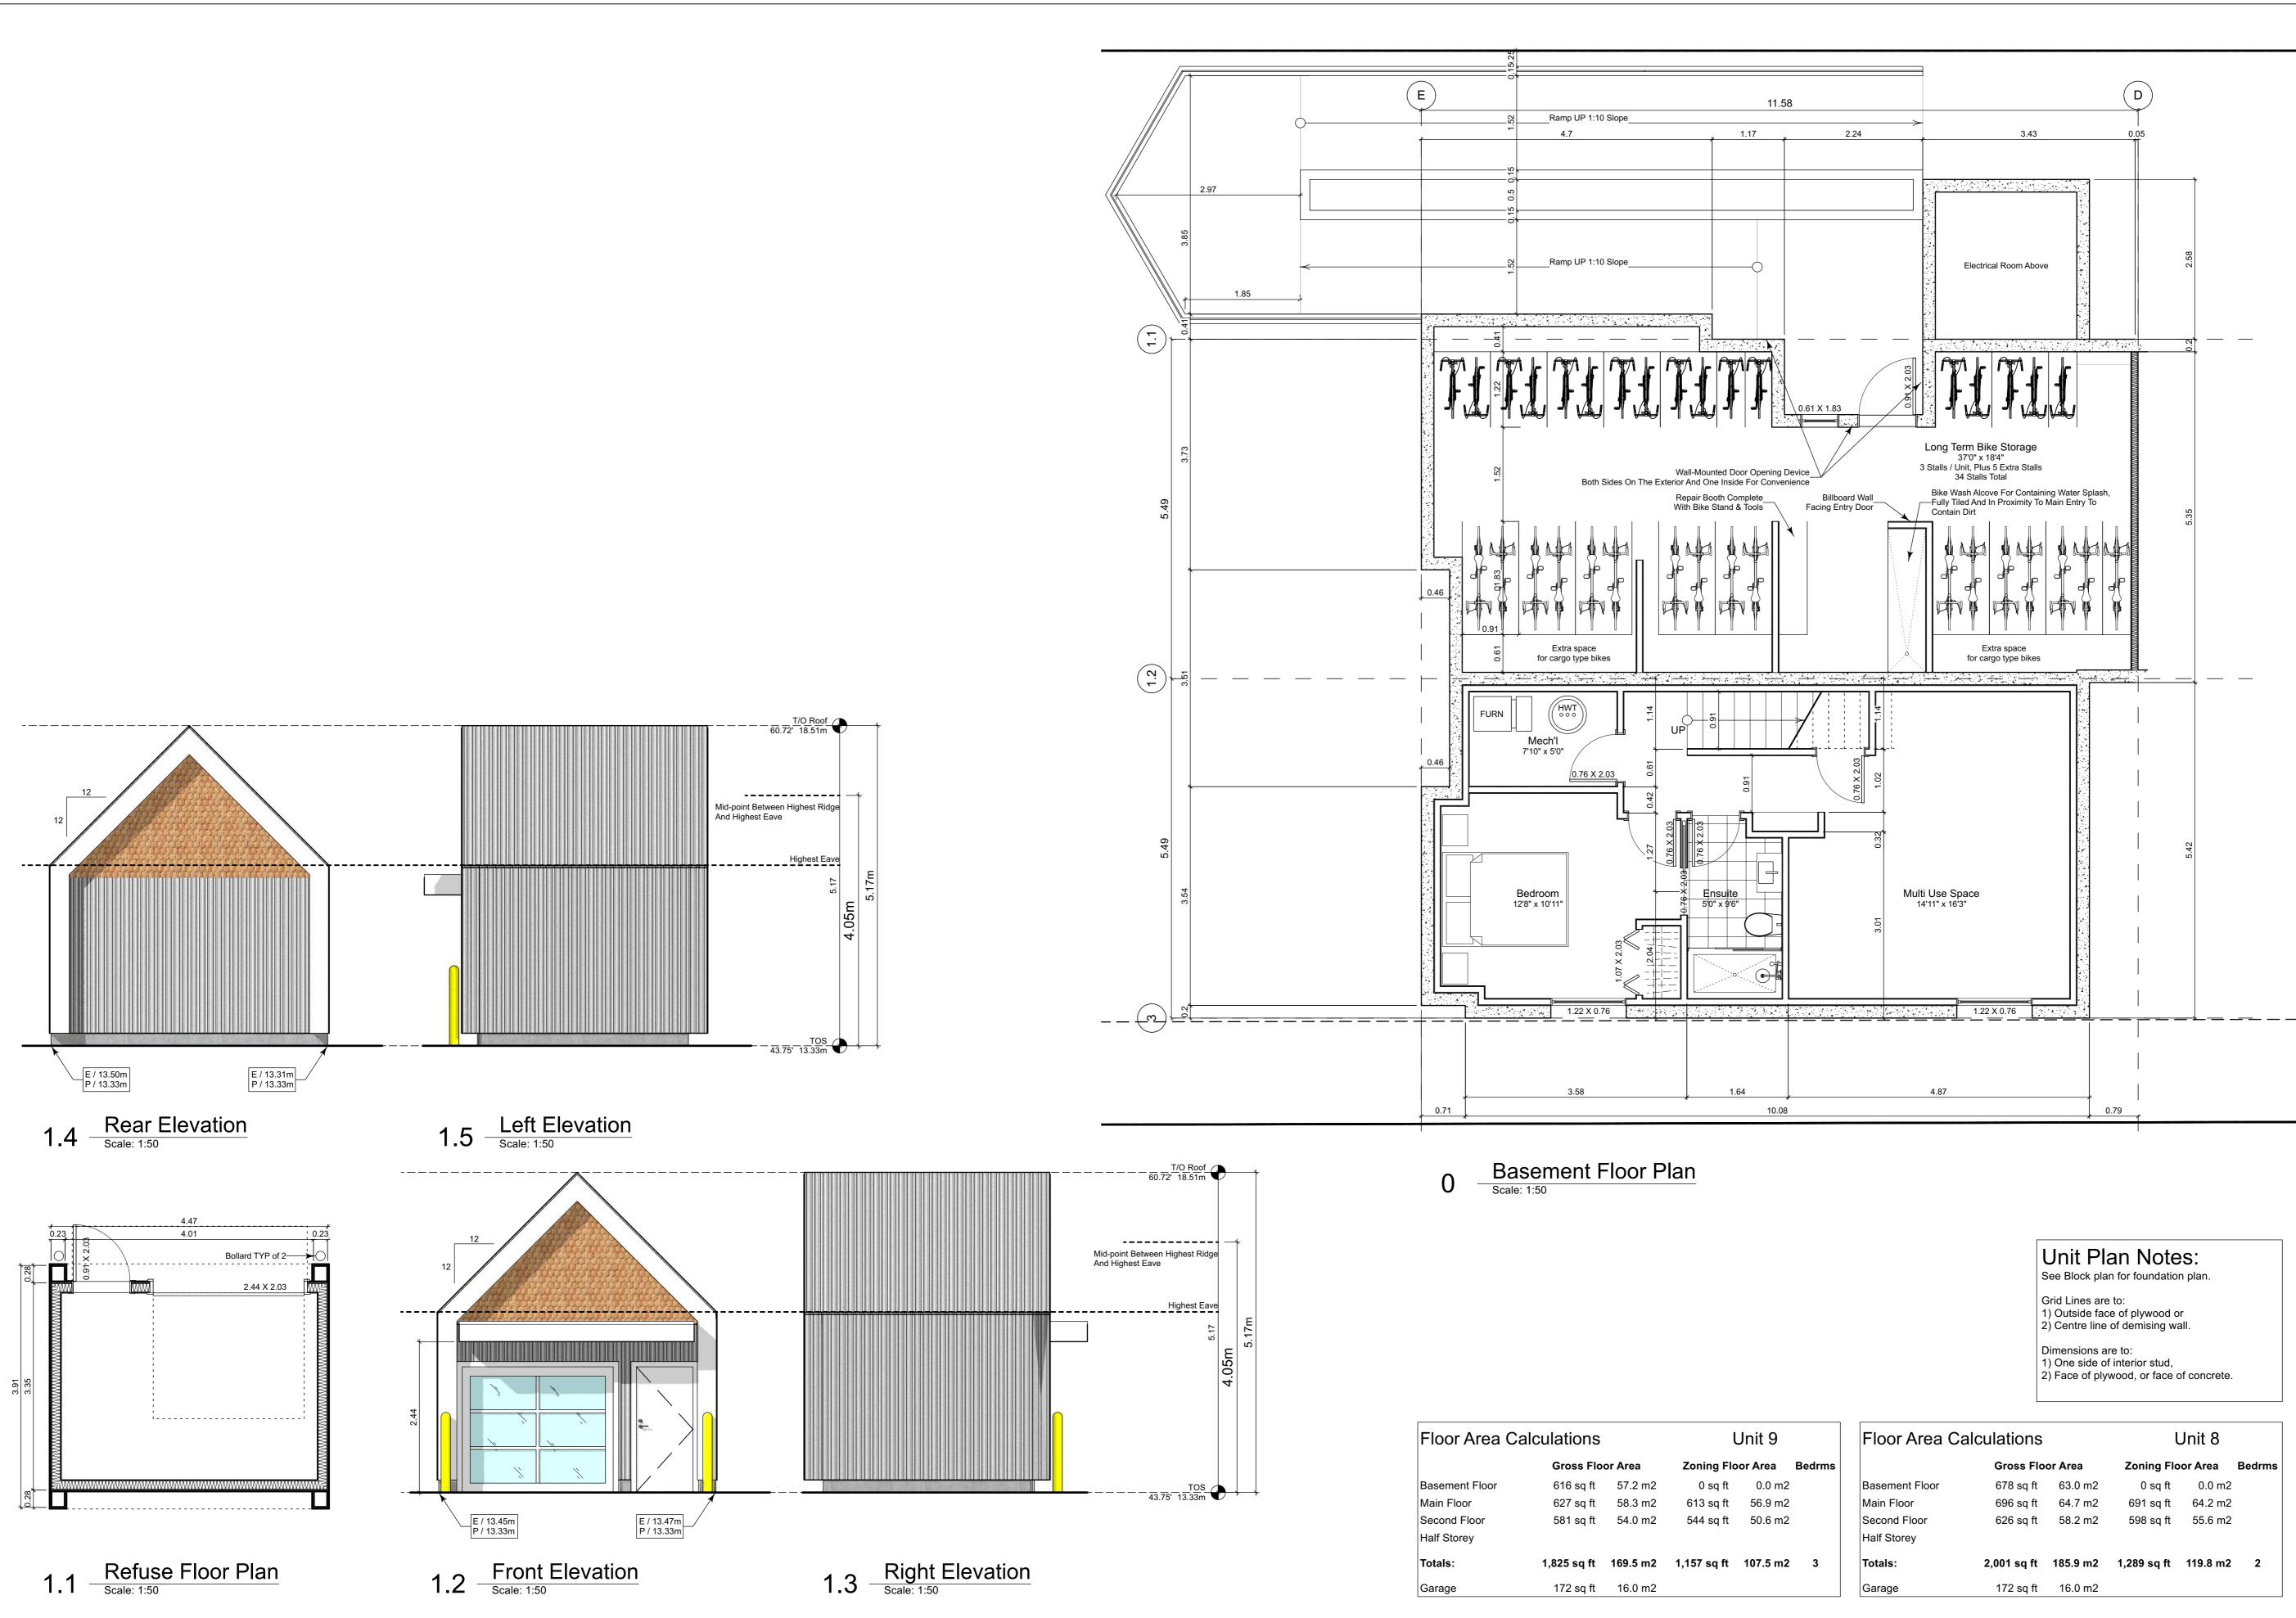


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	Unit 8 & 9 Floor Plans & Refuse Plans	
	īeld-K velopr	
Civic: Legal:	1400 Fa	irfield Rd & 9 Kipling St
PID: Project No: Drawn By: Plot Date: Scale:	N	19.015 SG/TD Nov 4, 2022 1:50

FOR DEVELOPMENT APPLICATION ONLY

A3.7

Scale: Sheet No:

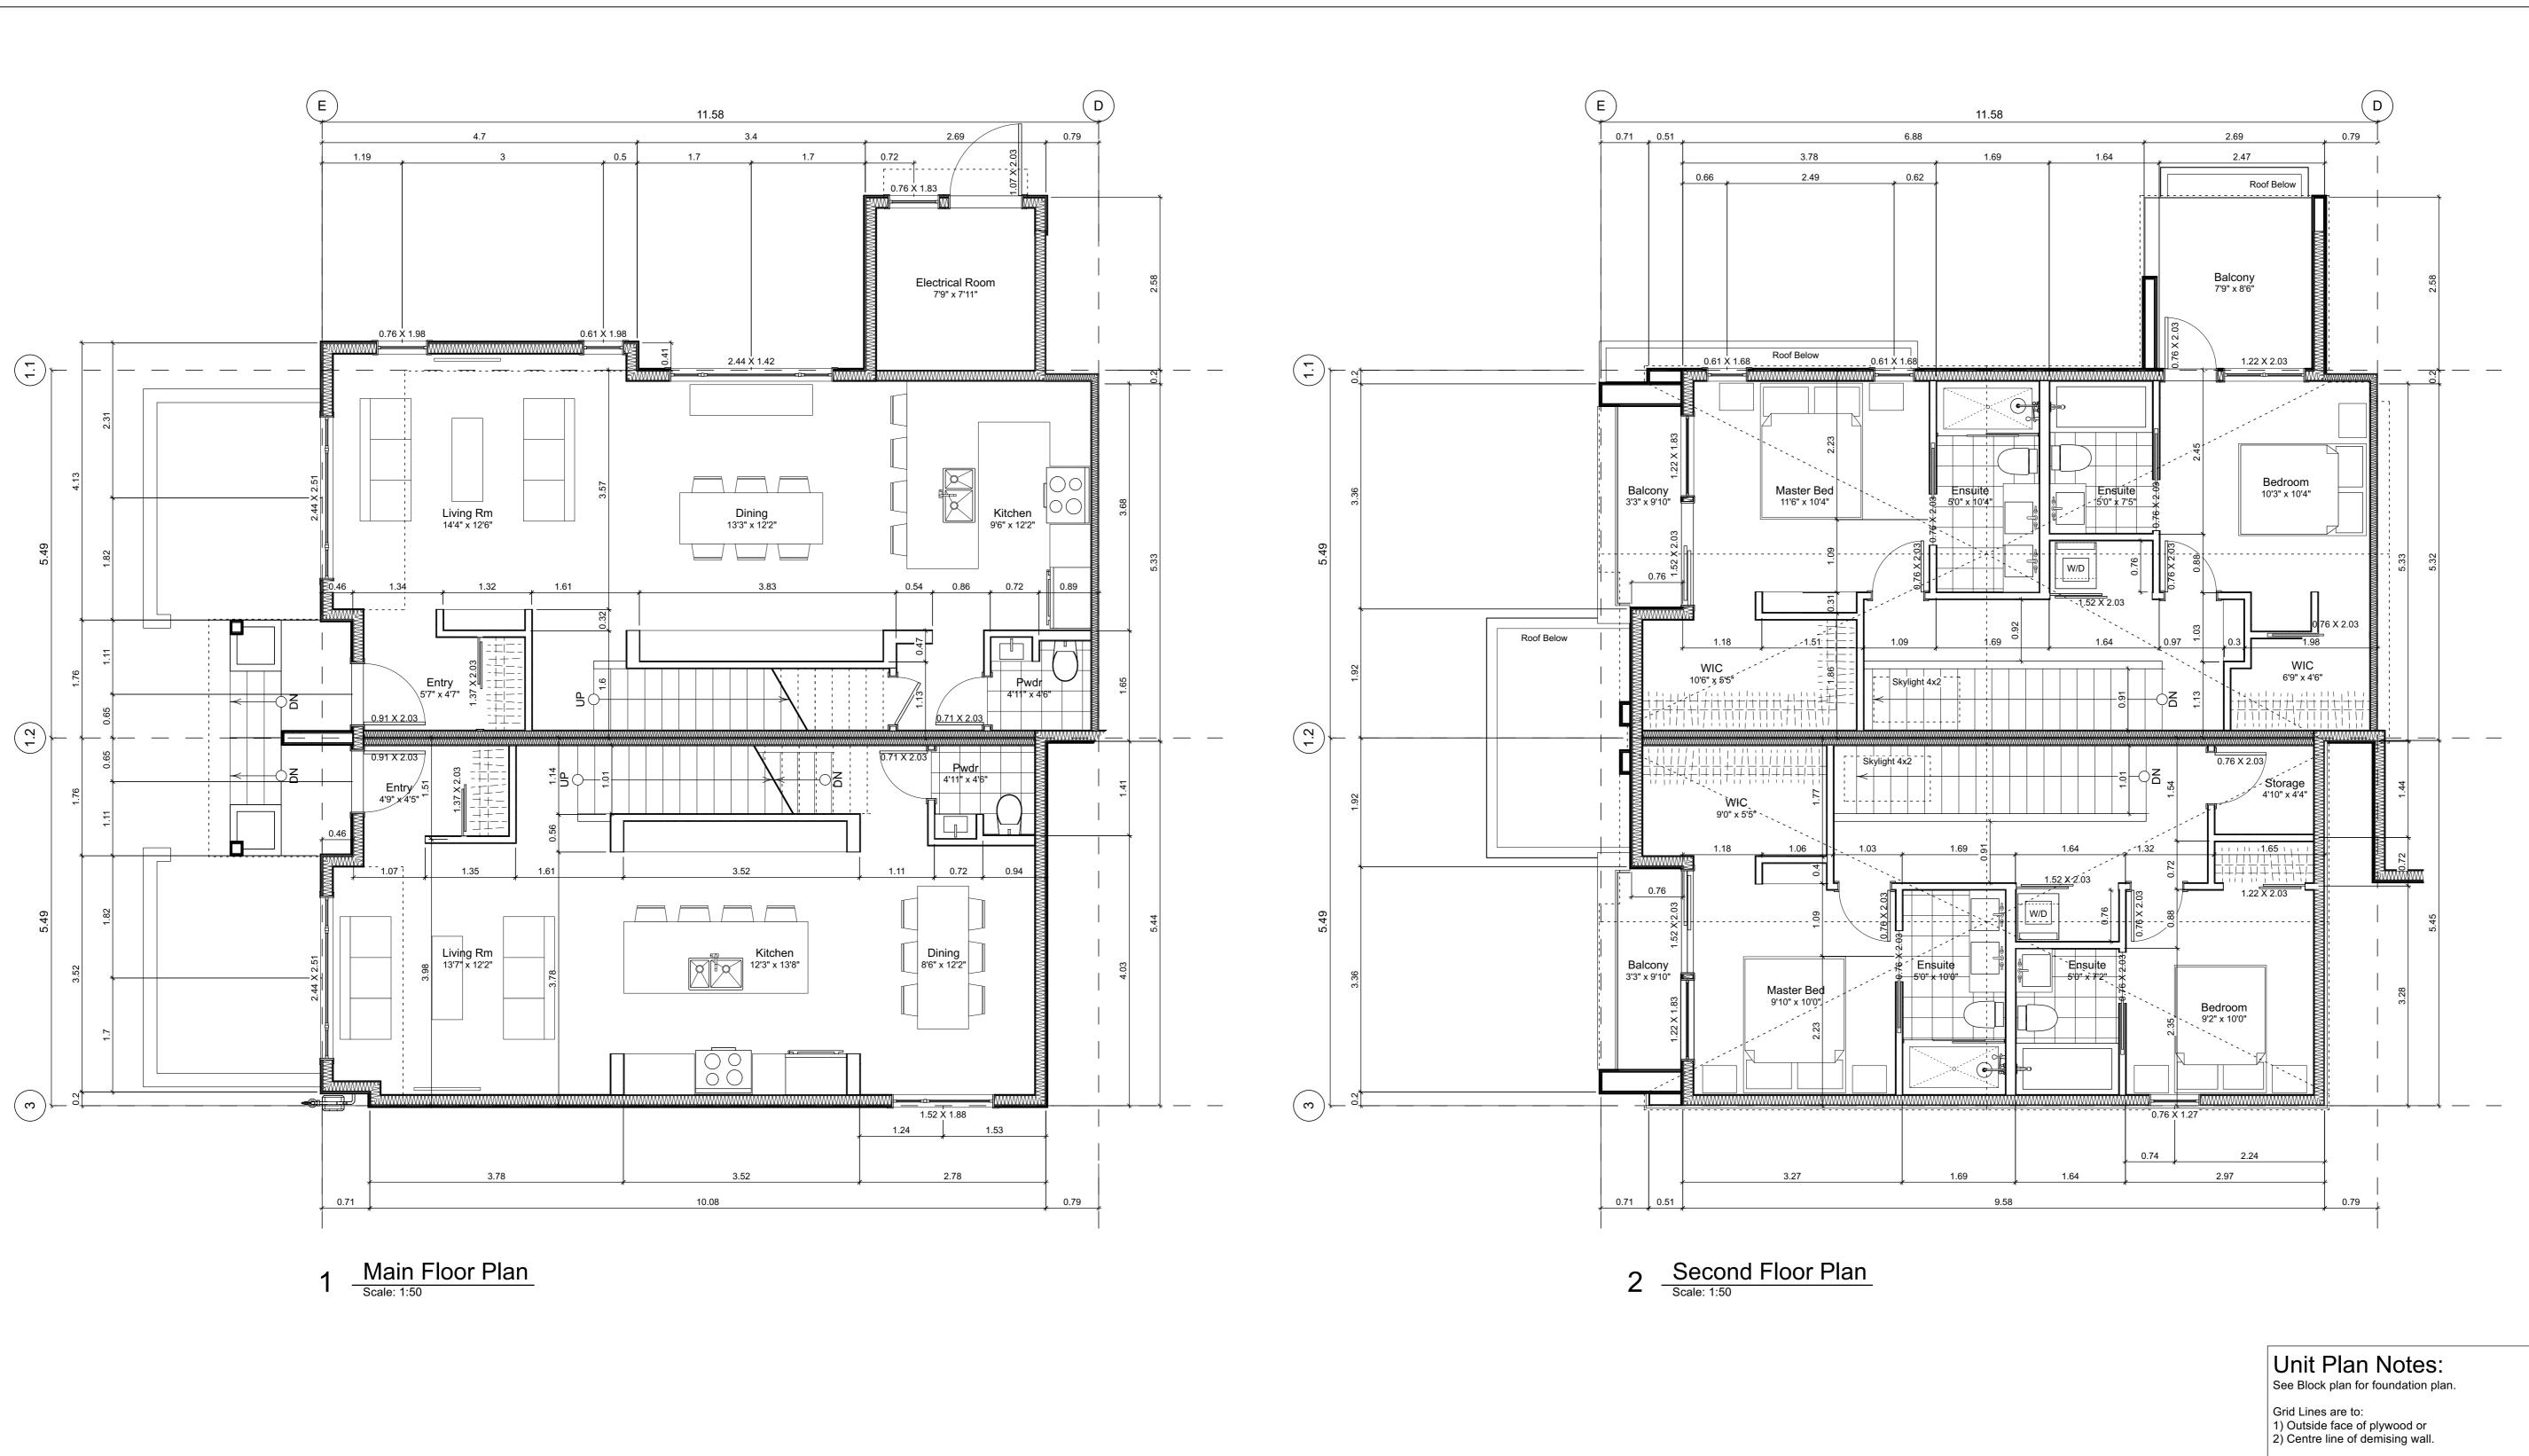

Floor Area Calculations			Unit 9			Floor Area Calculations			Unit 8		
	Gross Flo	or Area	Zoning Flo	oor Area	Bedrms		Gross Flo	or Area	Zoning Flo	oor Area	Bedrms
Basement Floor	616 sq ft	57.2 m2	0 sq ft	0.0 m2		Basement Floor	678 sq ft	63.0 m2	0 sq ft	0.0 m2	
Main Floor	627 sq ft	58.3 m2	613 sq ft	56.9 m2		Main Floor	696 sq ft	64.7 m2	691 sq ft	64.2 m2	
Second Floor	581 sq ft	54.0 m2	544 sq ft	50.6 m2		Second Floor	626 sq ft	58.2 m2	598 sq ft	55.6 m2	
Half Storey						Half Storey					
Totals:	1,825 sq ft	169.5 m2	1,157 sq ft	107.5 m2	3	Totals:	2,001 sq ft	185.9 m2	1,289 sq ft	119.8 m2	2
Garage	172 sq ft	16.0 m2				Garage	172 sq ft	16.0 m2			

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Unit 8 & 9 Floor Plans	
Fairfield-K	• •
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egal: ID: roject No:	19.015
rawn By:	SG/TD Nov 4, 2022

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A3.8

Scale: Sheet No: 1:50

Dimensions are to: 1) One side of interior stud, 2) Face of plywood, or face of concrete.



A4.0

Spatial Separation (9.10.14.4.) - Block 01 (Not Sprinklered)

Compartment	Area of	Limiting Distance (LD)		Unprotected	Openings	Construction of	Cladding
	Facade			Permitted	Actual	Building Face	
North Facade							
(N) Unit 1	51.5 m2	11.40 m	to C/L Kipling St.	95.2 % 49.0 m2	19.9 % 10.3 m2	C, 45 MIN	C or NC
(N) Unit 2	41.2 m2	11.40 m	to C/L Kipling St.	LD Exceeds 8.0m, UPO	Allowed > 100%	C, 45 MIN	C or NC
(N) Unit 3	39.6 m2	11.40 m	to C/L Kipling St.	LD Exceeds 8.0m, UPO	Allowed > 100%	C, 45 MIN	C or NC
(N) Unit 4	38.9 m2	11.40 m	to C/L Kipling St.	LD Exceeds 8.0m, UPO	Allowed > 100%	C, 45 MIN	C or NC
East Facade							
(E) Unit 1	88.9 m2	15.16 m	to Thurlow Rd	LD Exceeds 12.0m, UPC	Allowed > 100%	C, 45 MIN	C or NC
South Facade							
(S) Unit 1A	14.1 m2	1.66 m	to PL	19.5 % **2.8 m2	0.0 % 0.0 m2	C, 60 MIN	NC
(S) Unit 1B	30.6 m2	5.00 m	to PL	42.5 % 13.0 m2	10.5 % 3.2 m2	C, 45 MIN	C or NC
(S) Garage 2	17.9 m2	1.66 m	to PL	15.4 % **2.8 m2	9.2 % 1.7 m2	C, 60 MIN	NC
(S) Unit 2	35.9 m2	5.00 m	to PL	42.5 % 15.2 m2	23.9 % 8.6 m2	C, 45 MIN	C or NC
(S) Unit 3	35.9 m2	5.00 m	to PL	42.5 % 15.2 m2	23.9 % 8.6 m2	C, 45 MIN	C or NC
(S) Unit 4	24.9 m2	5.00 m	to PL	42.5 % 10.6 m2	33.6 % 8.4 m2	C, 45 MIN	C or NC
(S) Garage 3	12.6 m2	1.66 m	to PL	21.9 % **2.8 m2	0.0 % 0.0 m2	C, 60 MIN	NC
West Facade							
(W) Unit 4	43.1 m2	3.56 m	to Midway	29.4 % **12.7 m2	6.5 % 2.8 m2	C, 45 MIN	C or NC
(W) Garage 4	7.2 m2	3.56 m	to Midway	175.7 % **12.7 m2	72.1 % 5.2 m2	C, 45 MIN	C or NC
(W) Garage 5	7.3 m2	3.56 m	to Midway	174.1 % **12.7 m2	71.5 % 5.2 m2	C, 45 MIN	C or NC
(W) Garage 6	9.7 m2	3.56 m	to Midway	130.9 % **12.7 m2	53.7 % 5.2 m2	C, 45 MIN	C or NC
9.10.14.2.(2) Fire	Compartme	ents are to	be a min. of 45min F	-RR ** Limiting Di	stance Squared		


9.10.14.2.(2) Fire Compartments are to be a min. of 45min FRR


9.10.14.3. Assumes Fire department response time is < 10min

Exterior Materials


No.	Description	
1	Wood Shingles	Cedar
2	Vertical Siding	Light Grey
3	Stucco	Acrylic, White
4	Cementious Trims & Panels	White
5	Horizontal Cladding	Wood Grain
6	Window Frame	White
7	Glass Railing	Glass Guardrail with White Aluminum Frame
8	Metal Cap Flashing	White
9	Metal Cladding	Standing Seam, White
10	Metal Roof	Standing Seam, White
11	Soffit	Wood Grain
12	Exposed Concrete	-
13	Skylight	
14	Pergola	
15	Gutter & Downspout	White

All Materials as noted or approved equal

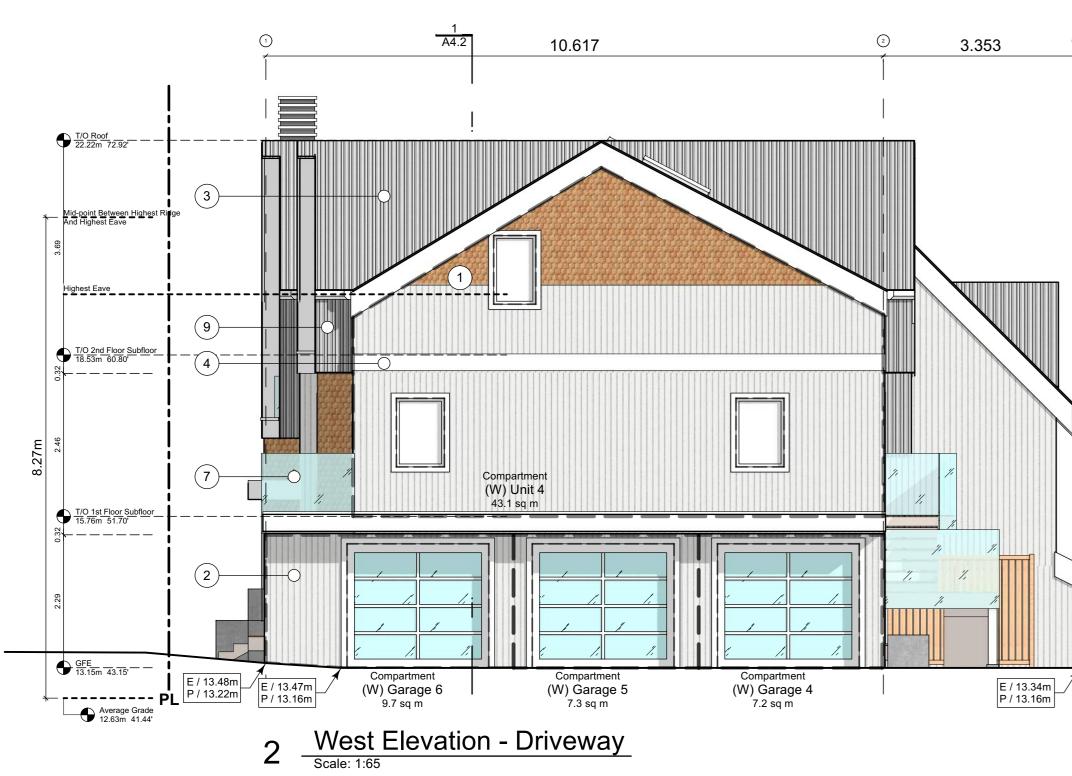

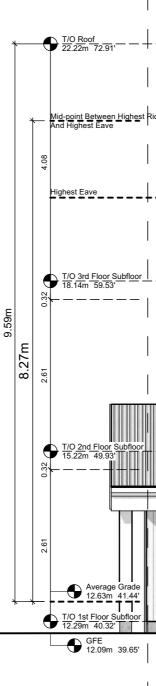



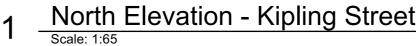



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2022-04-11	Revised & Re-Issued for DP
2022-05-10	Revised & Re-Issued for DP
2022-10-06	Revised & Re-Issued for DP
2022-11-04	Revised & Re-Issued for DP
2022-11-14	Revised & Re-Issued for DP

Elevations
Block 01

Sheet No:

Fairfield-Kipling Development

1400 Fairfield Rd & 349 Kipling St 19.015 SG/TD Nov 4, 2022

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Cedar Light Grey Acrylic, White White Horizontal Cladding Wood Grain White Glass Guardrail with White Aluminum Frame White Standing Seam, White Standing Seam, White Wood Grain -






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Block 01 Elevations & Sections	
Project Name: Fairfield-K	íiplina
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Fairfield-Kipling Development

1400 Fairfield Rd & 349 Kipling St

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wn By:	SG/TD
Date:	Nov 4, 2022
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Spatial Separation (9.10.14.4.) - Block 02 (Not Sprinklered)

Compartment	Area of Facade	Limiti	imiting Distance (LD) Unprotected Openings Constru Buildin		Unprotected Openings		Cladding
	I acade			Permitted	Permitted Actual		
North Facade							
(N) Unit 5	38.5 m2	11.37 m	to C/L Kipling St.	LD Exceeds 8.0m, UPO	Allowed > 100%	C, 45 MIN	C or NC
(N) Unit 6	39.1 m2	11.37 m	to C/L Kipling St.	95.0 % 37.1 m2	35.4 % 13.8 m2	C, 45 MIN	C or NC
(N) Unit 7	36.8 m2	11.37 m	to C/L Kipling St.	95.0 % 34.9 m2	50.3 % 18.5 m2	C, 45 MIN	C or NC
(N) Unit 8	79.2 m2	13.96 m	to C/L Kipling St.	LD Exceeds 12.0m, UPC	Allowed > 100%	C, 45 MIN	C or NC
East Facade							
(E) Unit 5	47.6 m2	3.56 m	to Midway	26.6 % **12.7 m2	5.9 % 2.8 m2	C, 60 MIN	C or NC
(E) Garage 7	9.6 m2	3.56 m	to Midway	132.1 % **12.7 m2	54.2 % 5.2 m2	C, 45 MIN	C or NC
(E) Garage 8	7.3 m2	3.56 m	to Midway	174.1 % **12.7 m2	71.5 % 5.2 m2	C, 45 MIN	C or NC
(E) Garage 9	7.4 m2	3.56 m	to Midway	170.5 % **12.7 m2	70.0 % 5.2 m2	C, 45 MIN	C or NC
(E) Refuse	0.0 m2	3.56 m	to Midway	#DIV 0! **12.7 m2	#DIV 0! 0.0 m2	C, 45 MIN	C or NC
South Facade							
(S) Unit 5	41.6 m2	5.00 m	to PL	63.5 % 26.4 m2	20.1 % 8.4 m2	C, 45 MIN	C or NC
(S) Unit 6	35.0 m2	5.00 m	to PL	71.4 % **25.0 m2	30.7 % 10.7 m2	C, 45 MIN	C or NC
(S) Unit 7	35.0 m2	5.00 m	to PL	71.4 % **25.0 m2	30.7 % 10.7 m2	C, 45 MIN	C or NC
(S) Unit 9	90.2 m2	1.71 m	to PL	8.4 % 7.6 m2	5.9 % 5.3 m2	NC, 60 MIN	NC
West Facade							
(W) Unit 8	38.6 m2	15.28 m	to C/L Fairfield Rd.	LD Exceeds 8.0m, UPO	Allowed > 100%	C, 45 MIN	C or NC
(W) Unit 9	38.2 m2	15.28 m	to C/L Fairfield Rd.	LD Exceeds 8.0m, UPO Allowed > 100%		C, 45 MIN	C or NC

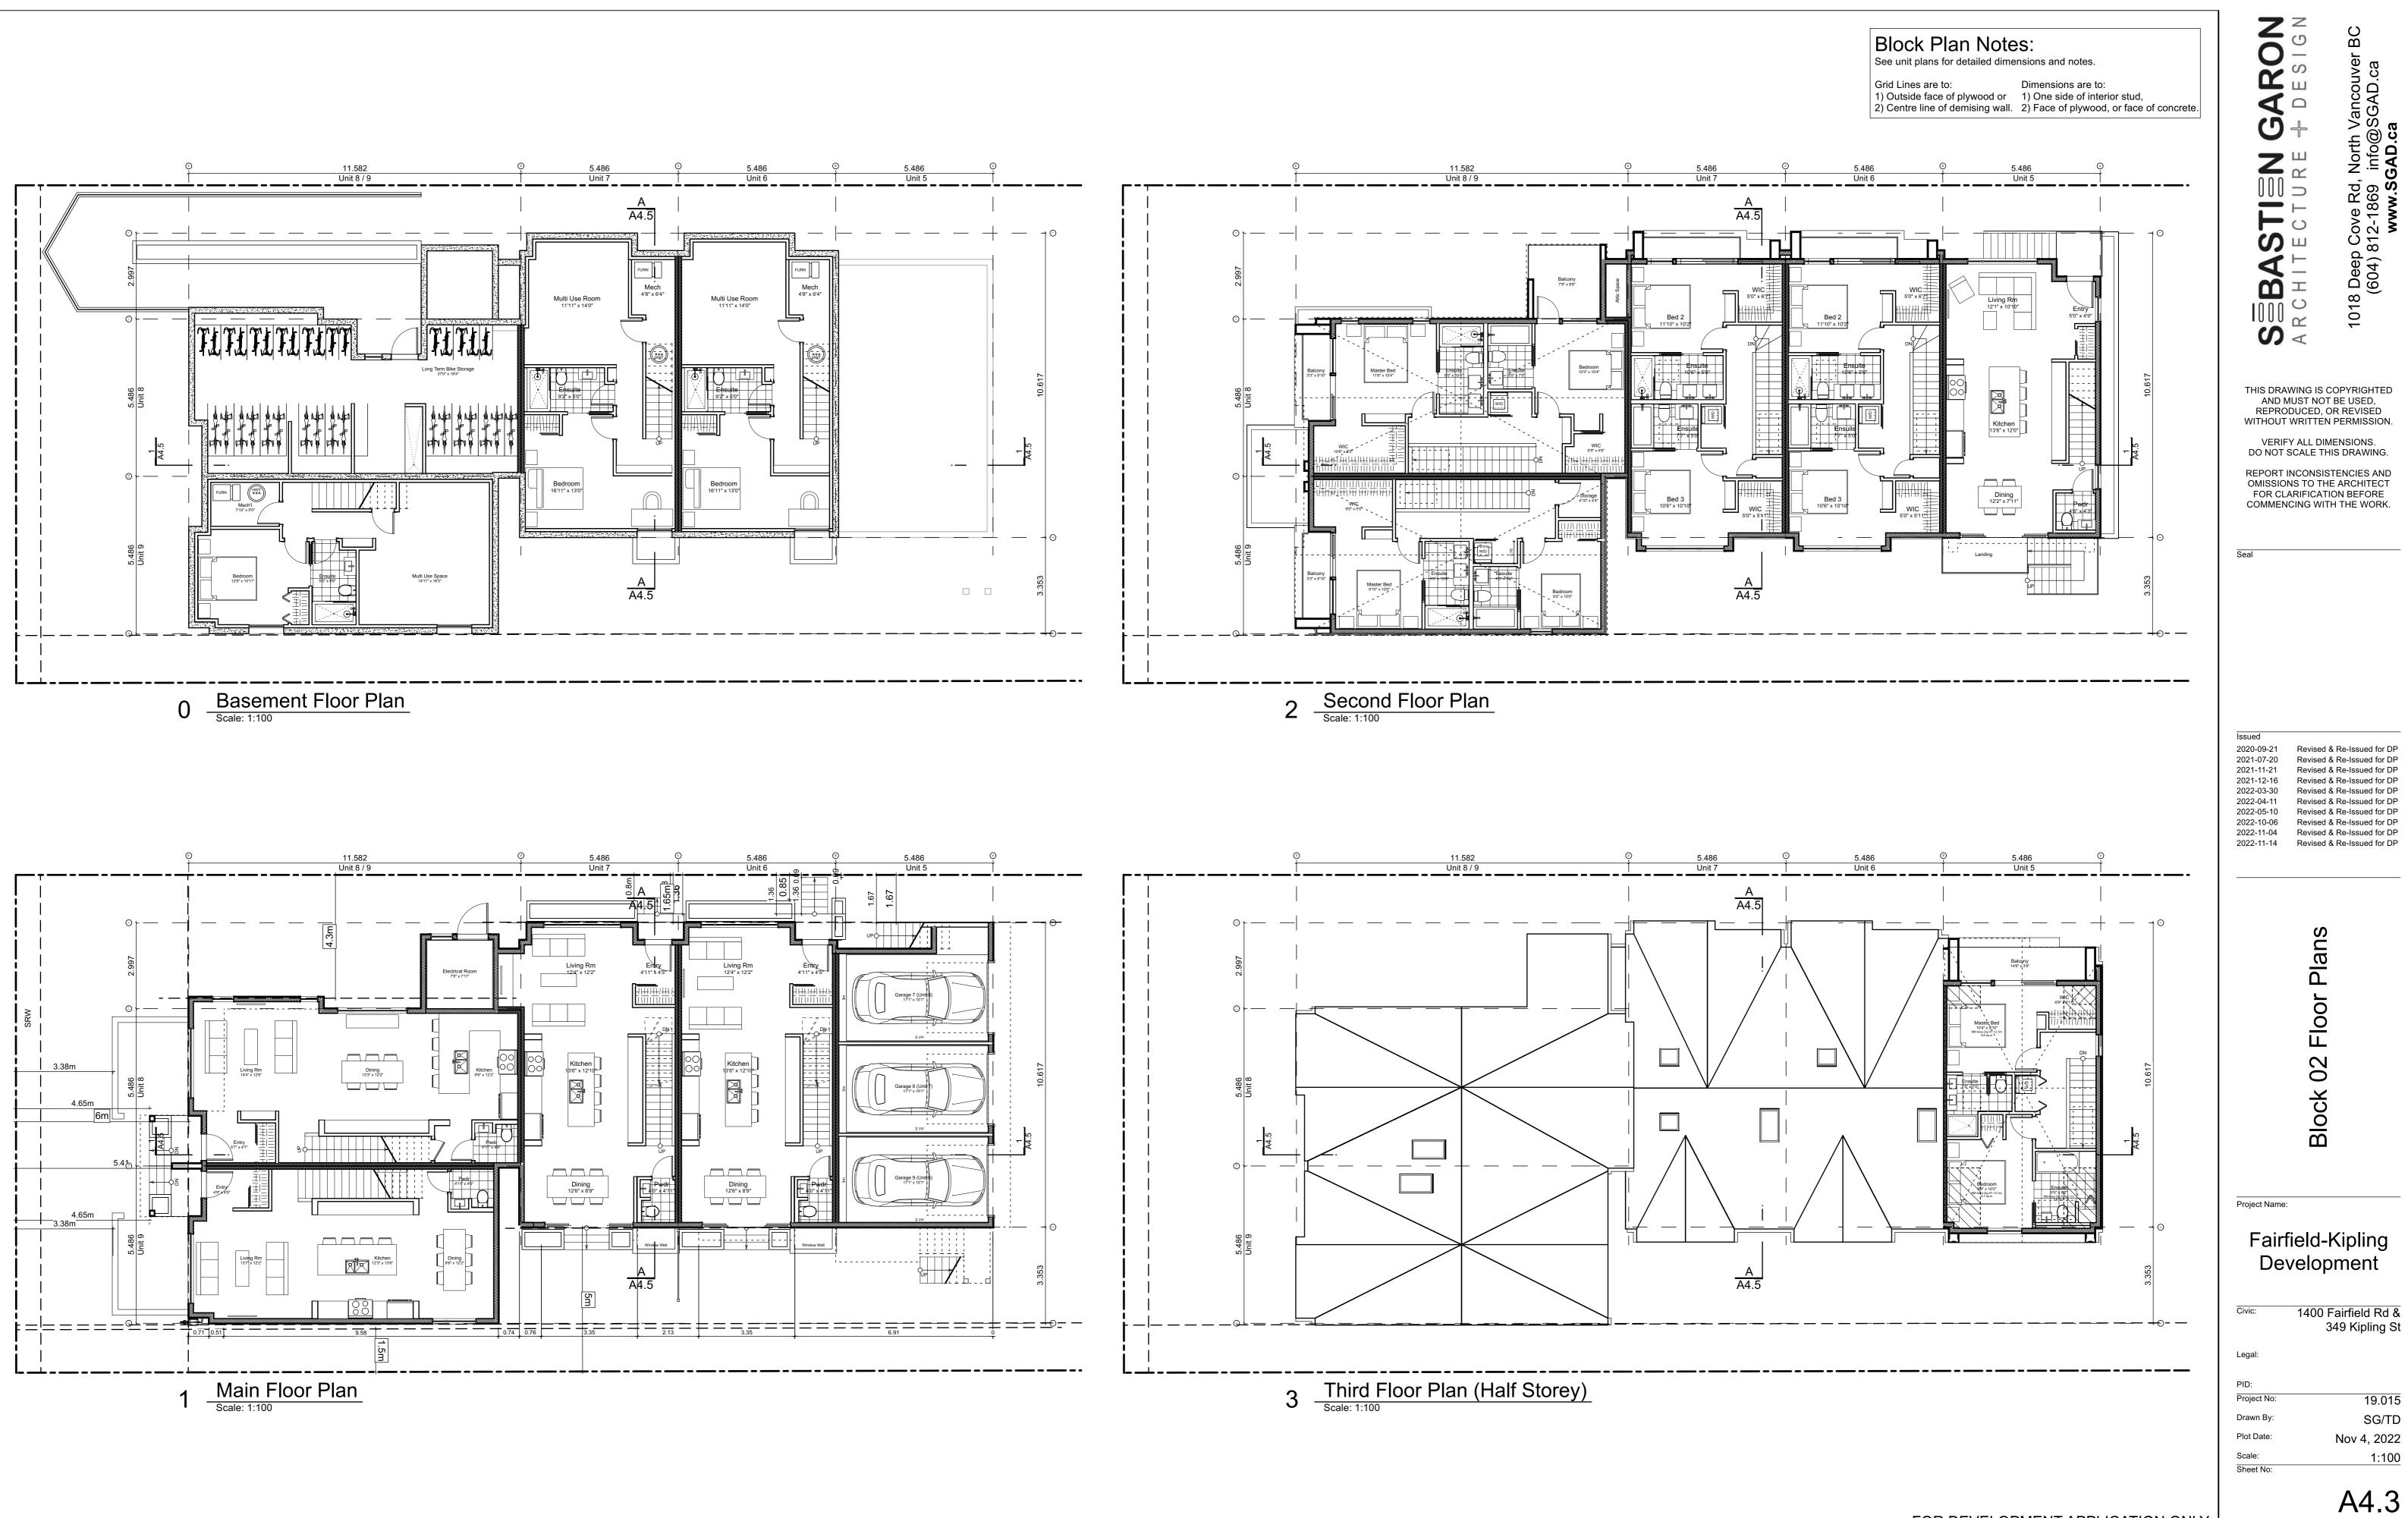** Limiting Distance Squared 9.10.14.2.(2) Fire Compartments are to be a min. of 45min FRR

9.10.14.3. Assumes Fire department response time is < 10min


Exterior Materials

No.	Description	
1	Wood Shingles	Cedar
2	Vertical Siding	Light Grey
3	Stucco	Acrylic, White
4	Cementious Trims & Panels	White
5	Horizontal Cladding	Wood Grain
6	Window Frame	White
7	Glass Railing	Glass Guardrail with
8	Metal Cap Flashing	White
9	Metal Cladding	Standing Seam, Whi
10	Metal Roof	Standing Seam, Whi
11	Soffit	Wood Grain
12	Exposed Concrete	-
13	Skylight	
14	Pergola	
15	Gutter & Downspout	White

All Materials as noted or approved equal

Mid-point Between Highest F And Highest Eave 10-Highest Eave (3) (2)<u>T/O 3rd Floor Subfloor</u> 18.90m 62.01' ⊾____ (1)-_(T/O 1st Floor Subfloor -----____ (5)-Average Grade 14.03m 46.03' E / 13.78m P / 13.57m




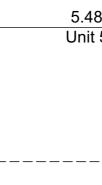



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2022-05-10	Revised & Re-Issued for DP
2022-10-06	Revised & Re-Issued for DP
2022-11-04	Revised & Re-Issued for DP
2022-11-14	Revised & Re-Issued for DP

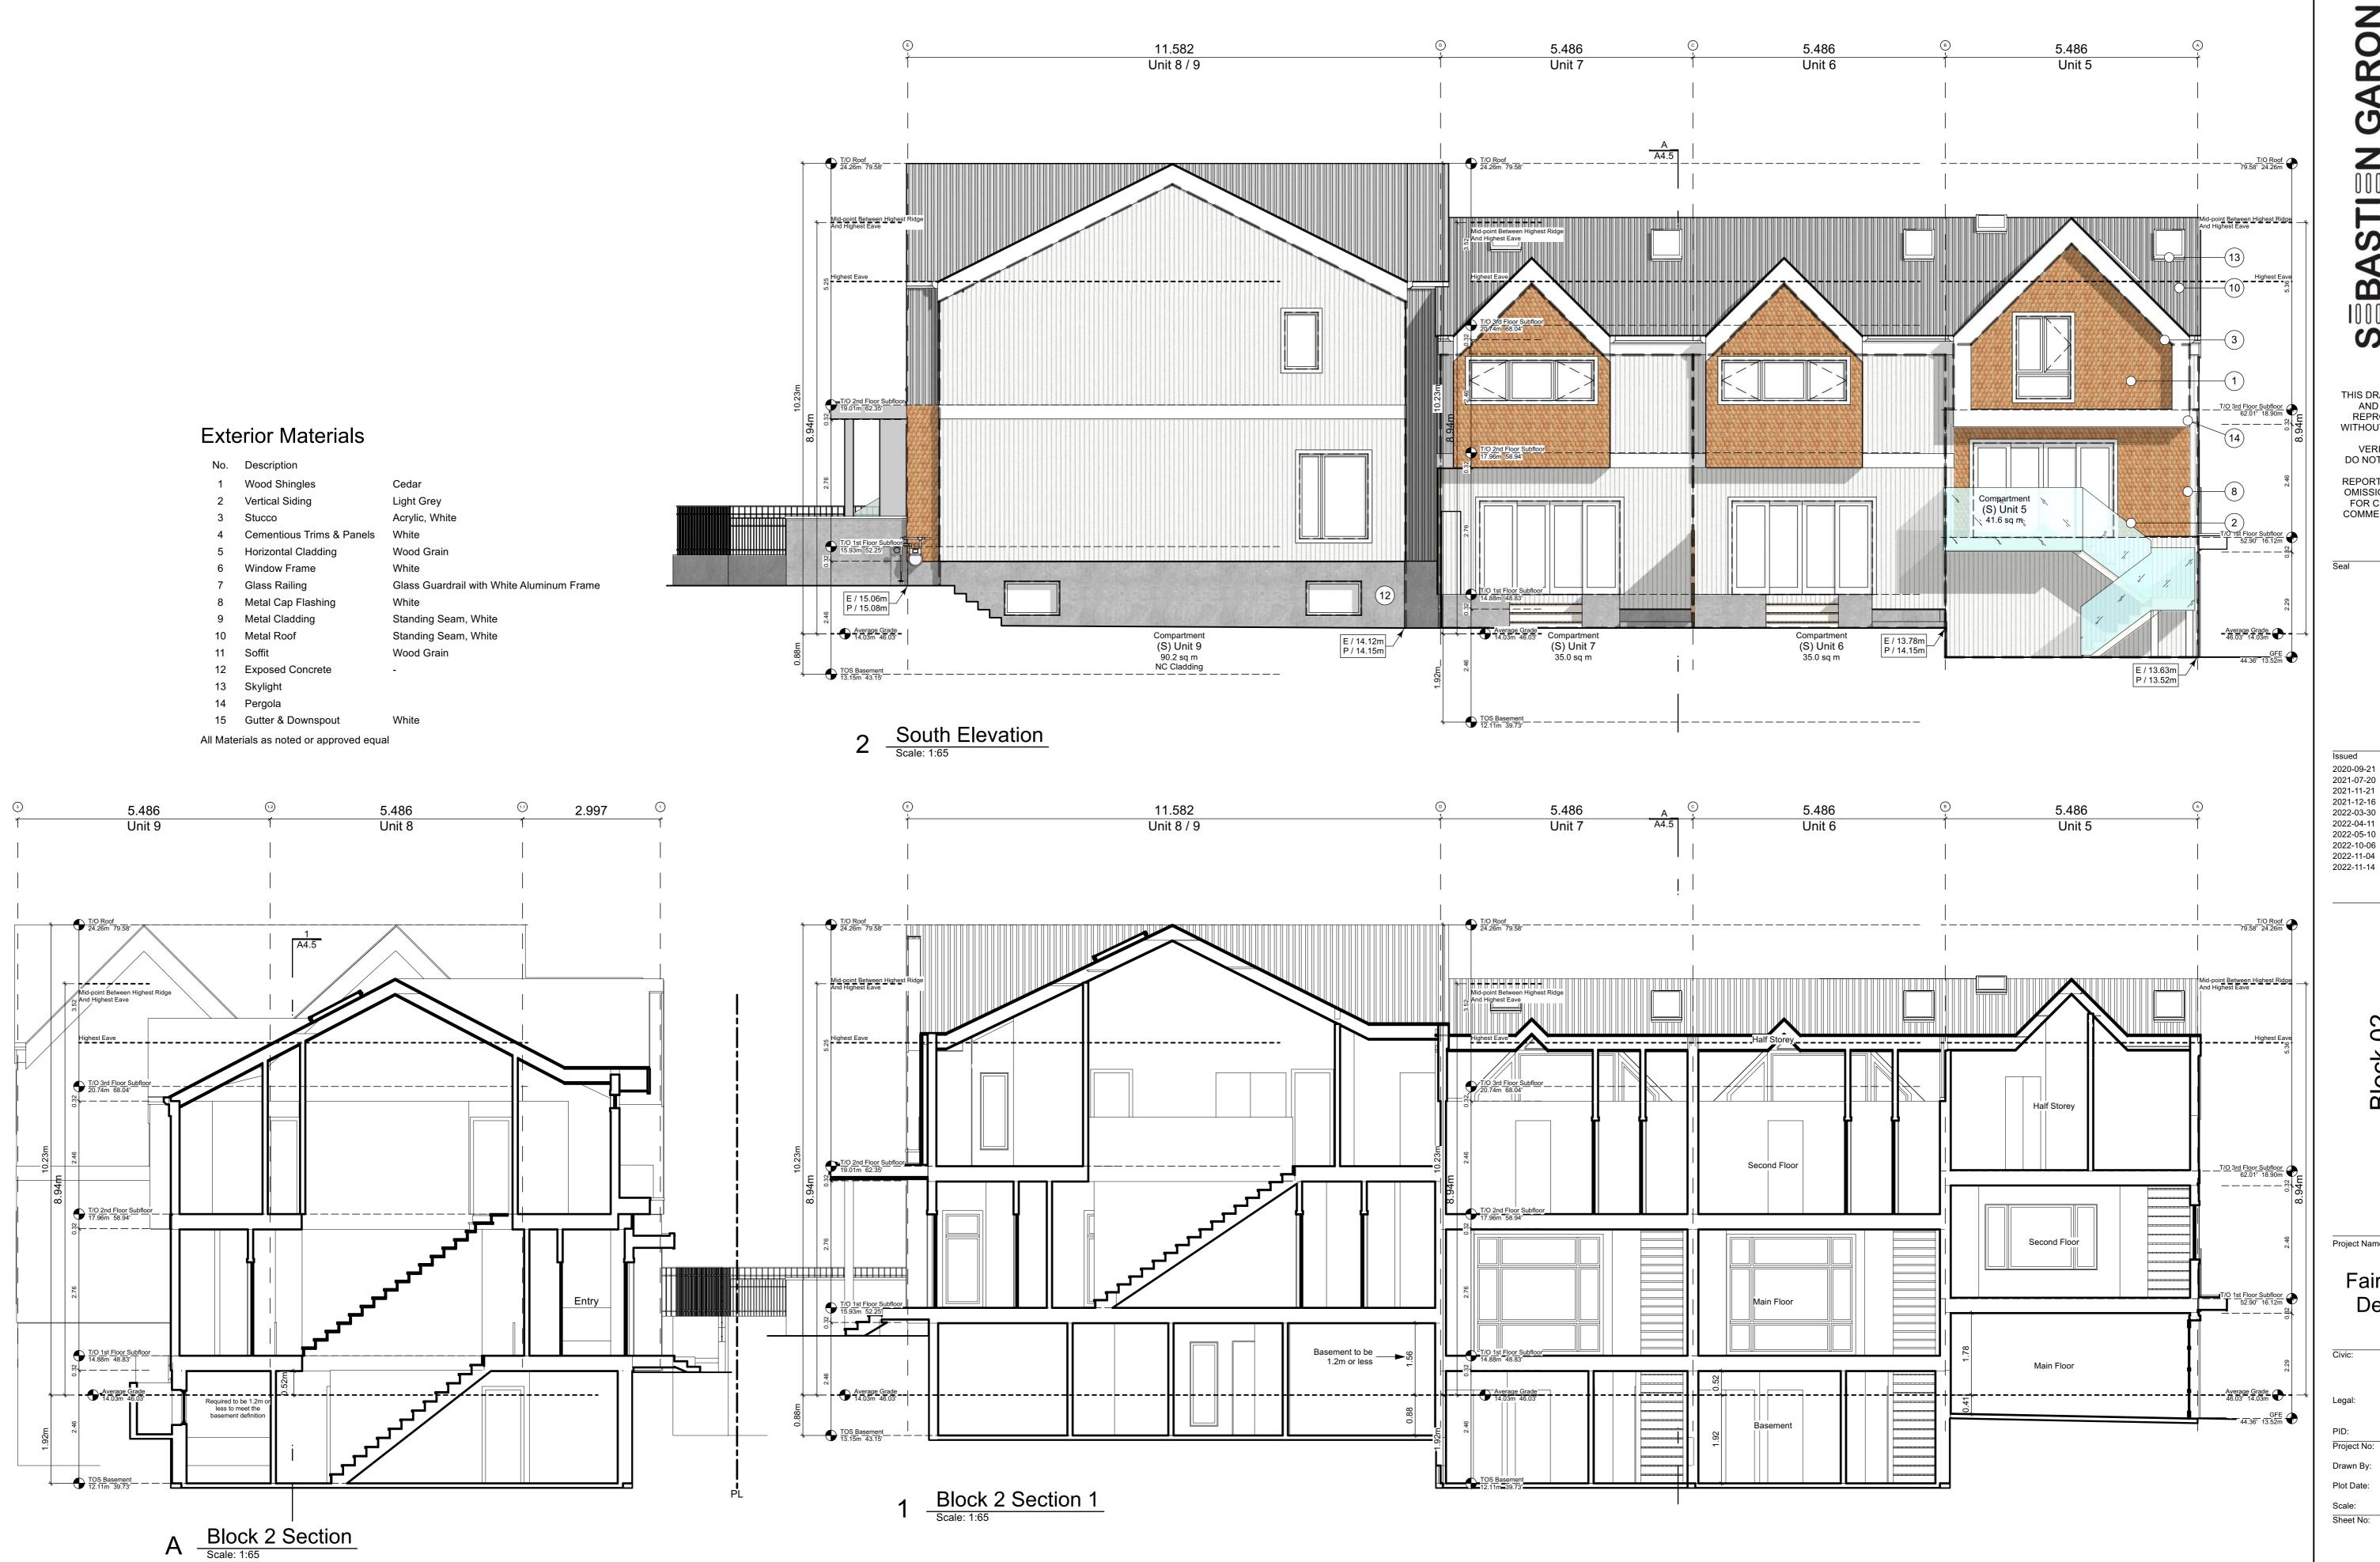

Project Name:


Fairfield-Kipling Development

1400 Fairfield Rd & 349 Kipling St

No:	19.015
By:	SG/TD
ite:	Nov 4, 2022
	1:65
No:	

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Roof Plans
Project Name: Fairfield-Kipling Development Civic: 1400 Fairfield Rd & 349 Kipling St Legal: PID: Project No: 19.015 Drawn By: SG/TD Plot Date: Nov 4, 2022 Scale: 1:100
Scale: 1:100 Sheet No:

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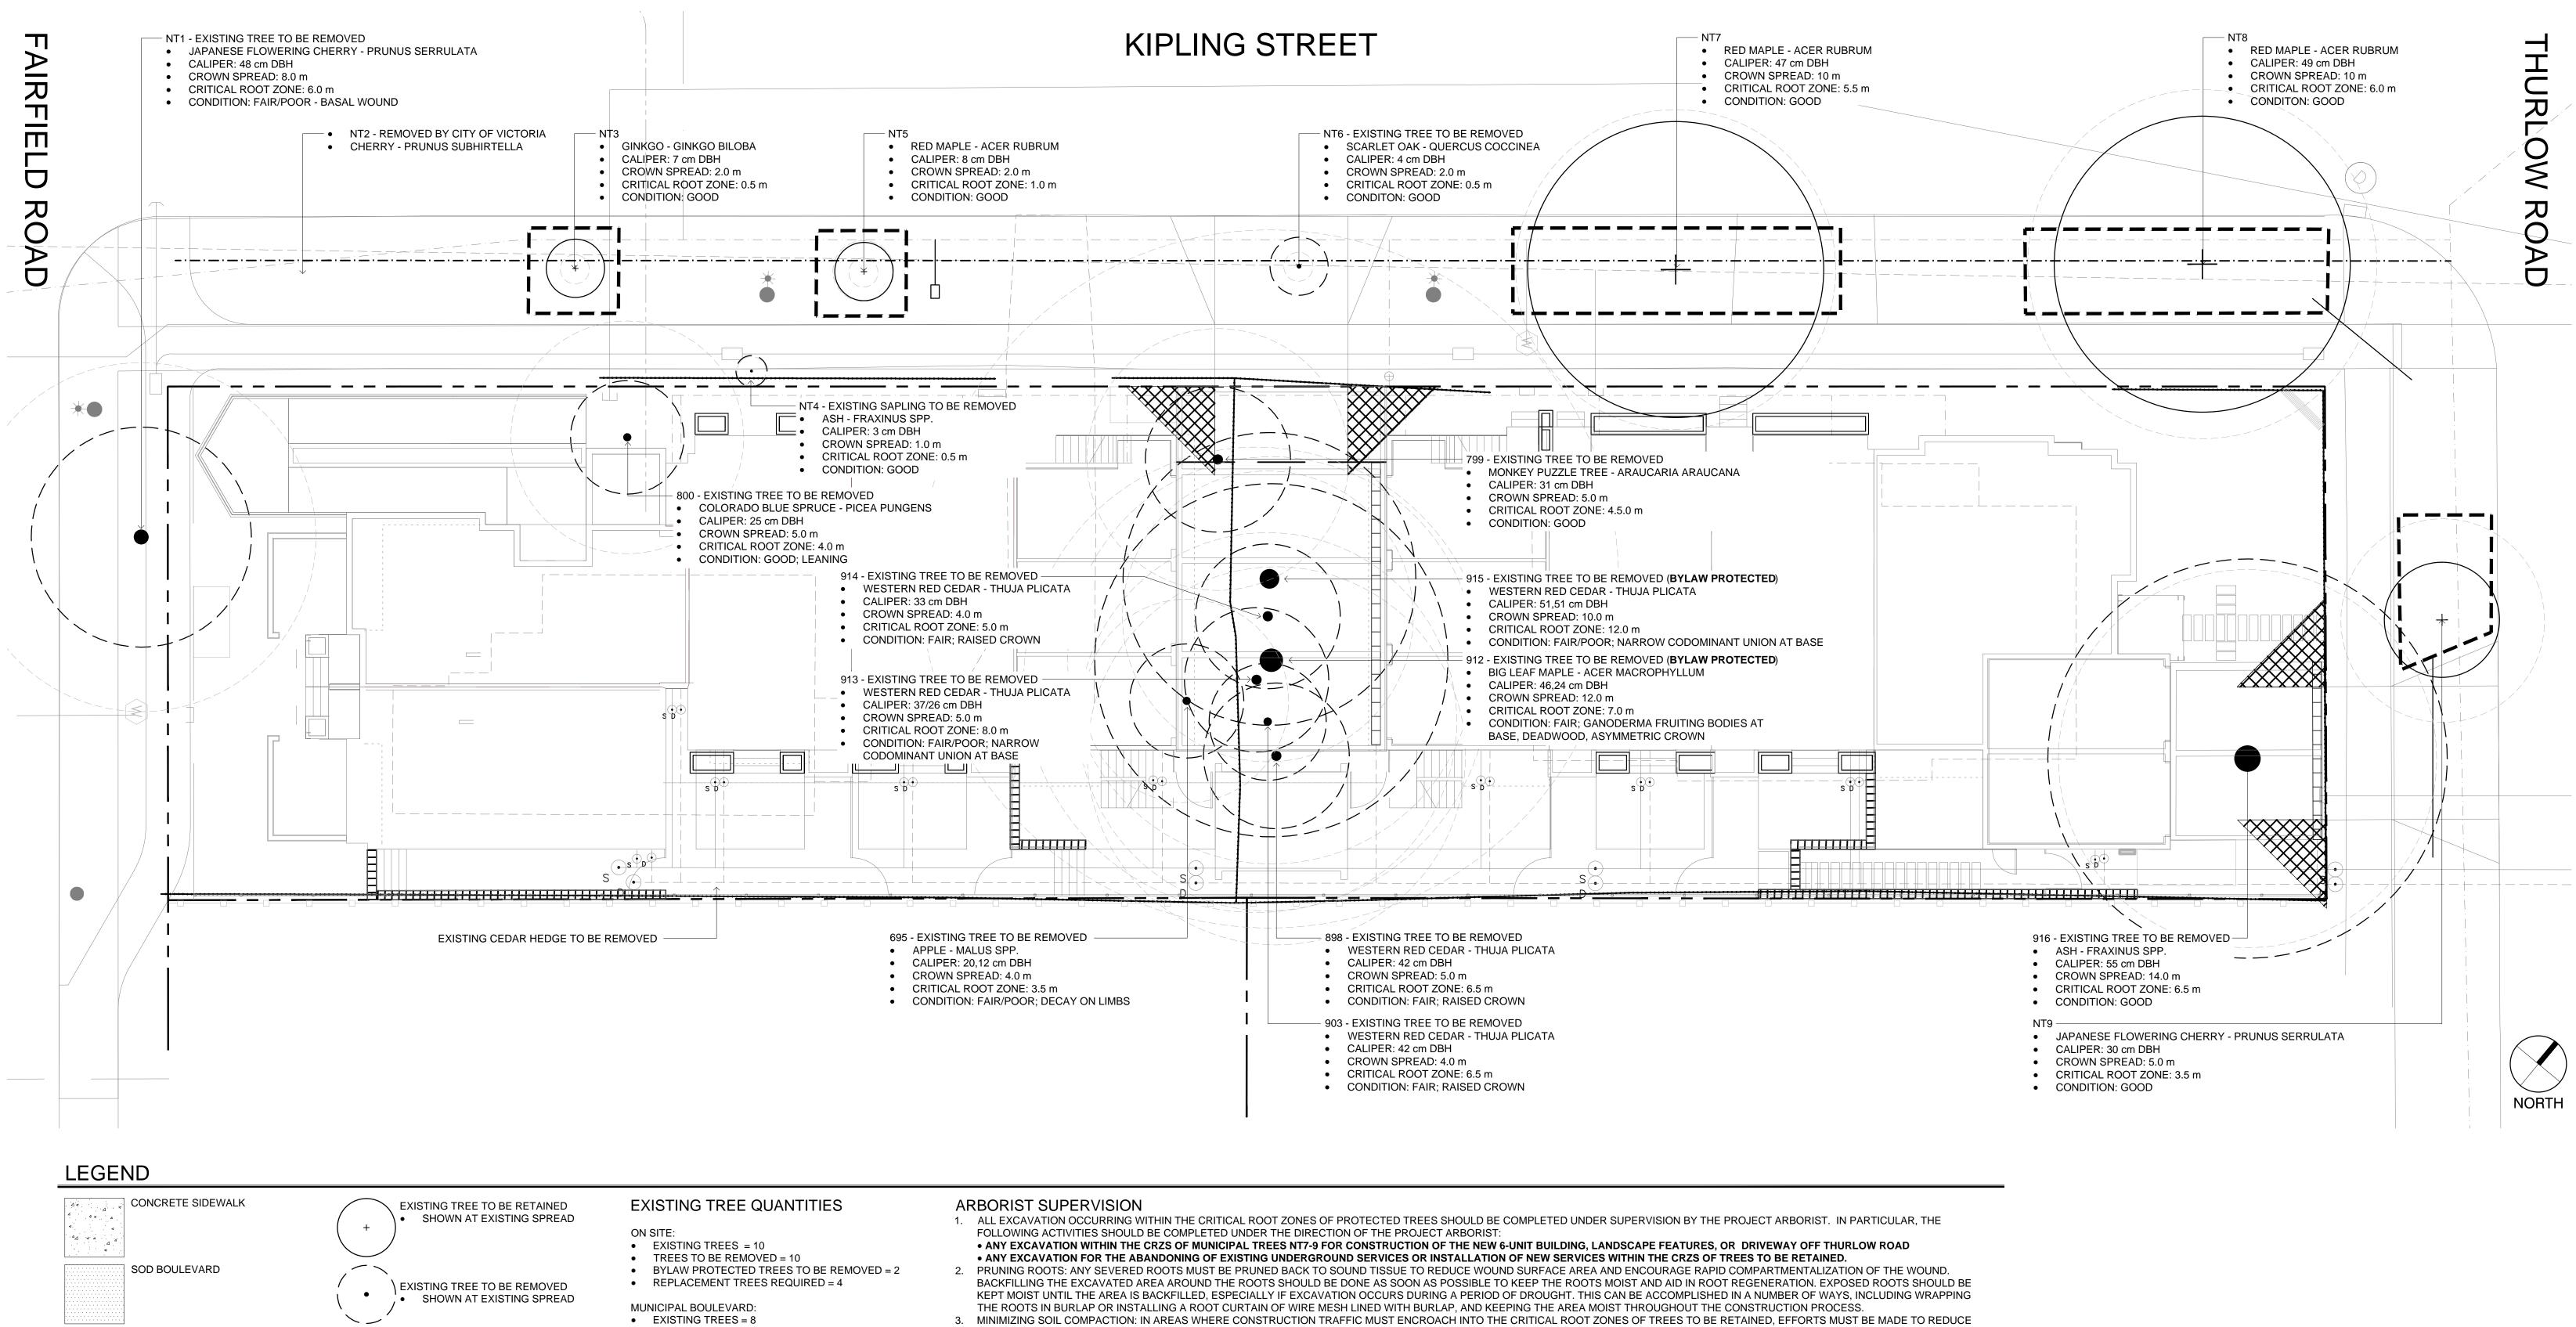

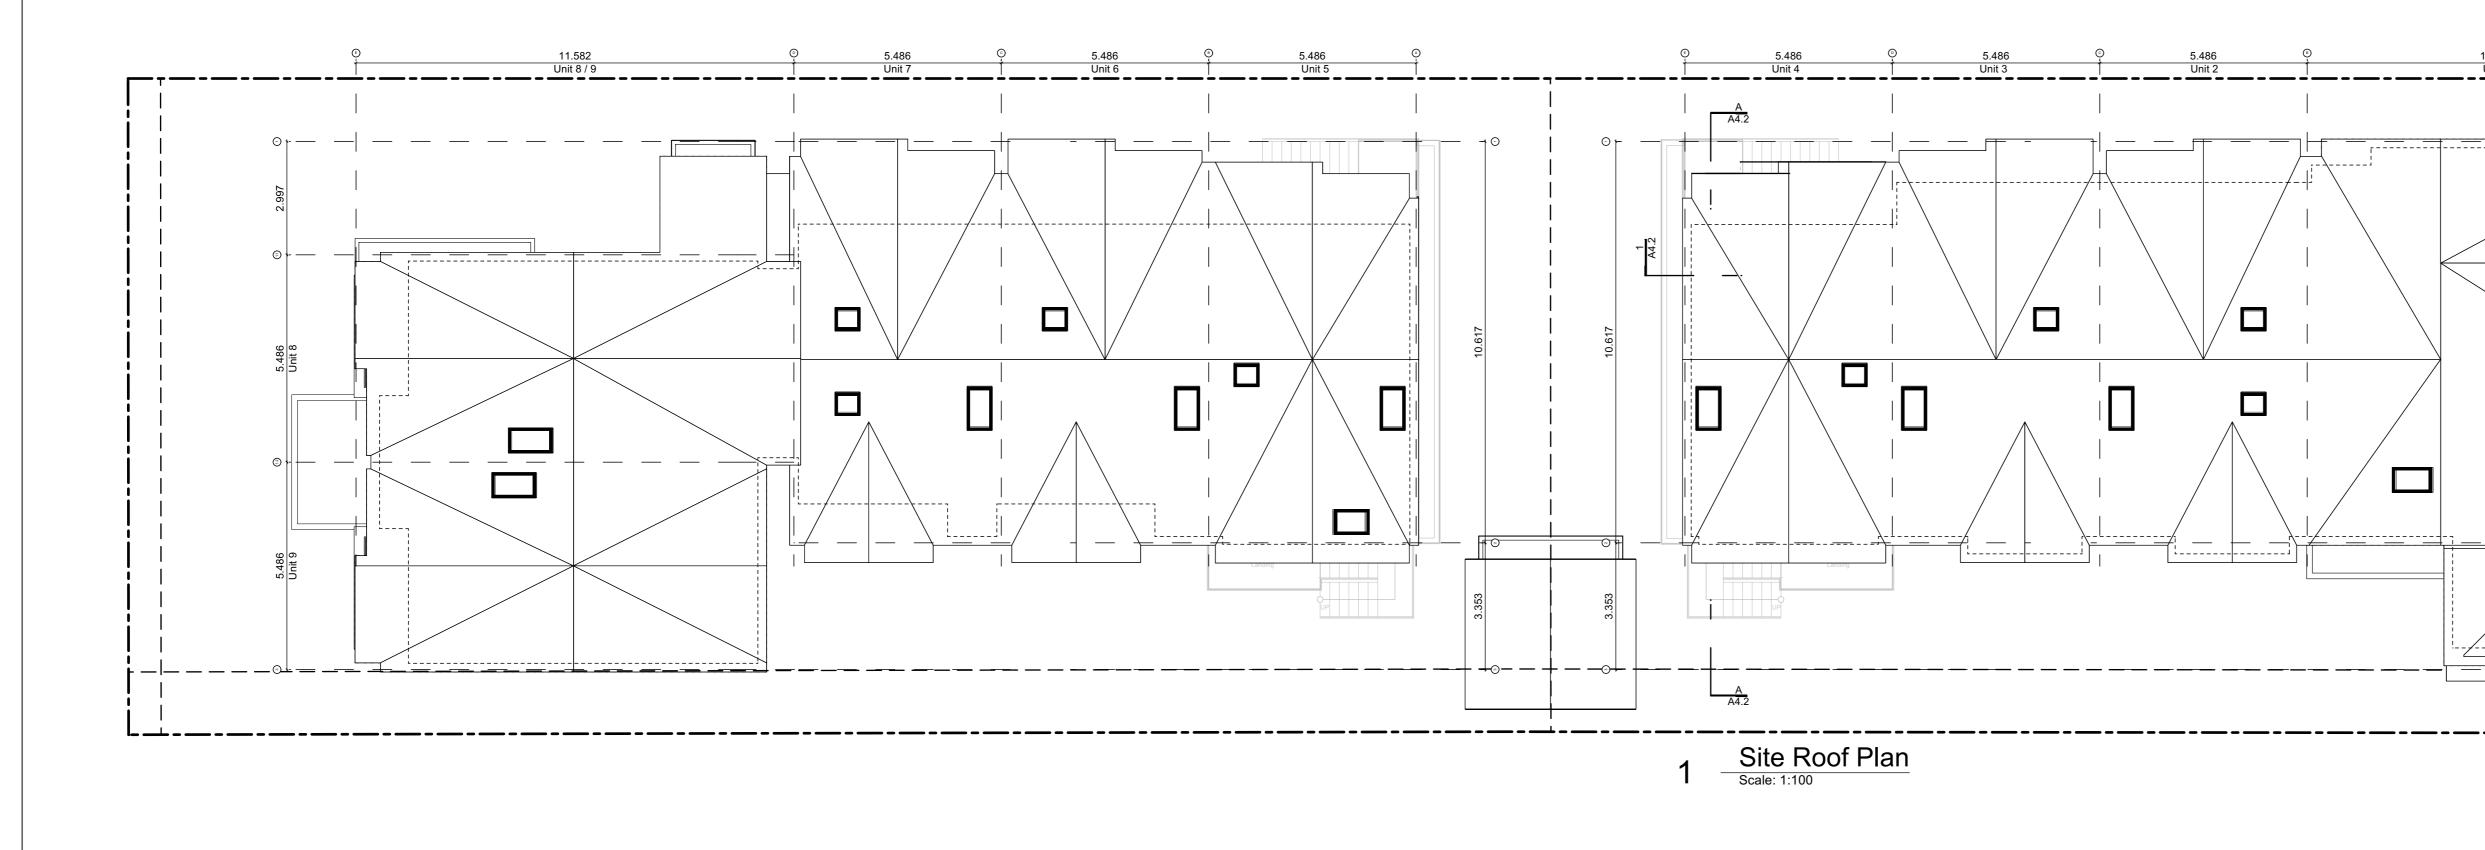
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PID: Project No: Drawn By: Plot Date: Scale:	19.015 SG/TD Nov 4, 2022 NTS

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Plot Date:

Scale: Sheet No:



- ------ PROPERTY LINE TREE PROTECTION FENCING
 - TO OUTSIDE OF DRIPLINE WHERE POSSIBLE (AS SHOWN)
 - TO BE MAINTAINED UNTIL COMPLETION OF CONSTRUCTION
 - TO CITY OF VICTORIA STANDARD

• TREES TO BE REMOVED = 3 (NT1, NT4, NT6)

NOTES: 1. SEE ARBORIST REPORT FOR ADDITIONAL INFORMATION, REQUIREMENTS AND RECOMMENDATIONS


CRITICAL ROOT ZONE






- SOIL COMPACTION WHERE POSSIBLE BY DISPLACING THE WEIGHT OF MACHINERY AND FOOT TRAFFIC. THIS CAN BE ACHIEVED BY ONE OF THE FOLLOWING METHODS: • INSTALLING A LAYER OF HOG FUEL OR COARSE WOOD CHIPS AT LEAST 20 CM IN DEPTH AND MAINTAINING IT IN GOOD CONDITION UNTIL CONSTRUCTION IS COMPLETE. • PLACING MEDIUM WEIGHT GEOTEXTILE CLOTH OVER THE AREA TO BE USED AND INSTALLING A LAYER OF CRUSHED ROCK TO A DEPTH OF 15 CM OVER TOP. • PLACING TWO LAYERS OF 19MM PLYWOOD. • PLACING STEEL PLATES.
- LANDSCAPING AND IRRIGATION SYSTEMS: THE PLANTING OF NEW TREES AND SHRUBS SHOULD NOT DAMAGE THE ROOTS OF RETAINED TREES. THE INSTALLATION OF ANY IN-GROUND IRRIGATION SYSTEM MUST TAKE INTO ACCOUNT THE CRITICAL ROOT ZONES OF THE TREES TO BE RETAINED. PRIOR TO INSTALLATION, WE RECOMMEND THE IRRIGATION TECHNICIAN CONSULT WITH THE PROJECT ARBORIST ABOUT THE MOST SUITABLE LOCATIONS FOR THE IRRIGATION LINES AND HOW BEST TO MITIGATE THE IMPACTS ON THE TREES TO BE RETAINED. THIS MAY REQUIRE THE PROJECT ARBORIST SUPERVISE THE EXCAVATIONS ASSOCIATED WITH INSTALLING THE IRRIGATION SYSTEM. EXCESSIVE FREQUENT IRRIGATION AND IRRIGATION WHICH WETS THE TRUNKS OF TREES CAN HAVE A DETRIMENTAL IMPACT ON TREE HEALTH AND CAN LEAD TO ROOT AND TRUNK DECAY.
- ARBORIST ROLE: IT IS THE RESPONSIBILITY OF THE CLIENT OR HIS/HER REPRESENTATIVE TO CONTACT THE PROJECT ARBORIST FOR THE PURPOSE OF: • LOCATING THE BARRIER FENCING
- REVIEWING THE REPORT WITH THE PROJECT FOREMAN OR SITE SUPERVISOR
- LOCATING WORK ZONES, WHERE REQUIRED
- SUPERVISING ANY EXCAVATION WITHIN THE CRITICAL ROOT ZONES OF TREES TO BE RETAINED • REVIEWING AND ADVISING OF ANY PRUNING REQUIREMENTS FOR MACHINE CLEARANCES
- REVIEW AND SITE MEETING: ONCE THE PROJECT RECEIVES APPROVAL, IT IS IMPORTANT THAT THE PROJECT ARBORIST MEET WITH THE PRINCIPALS INVOLVED IN THE PROJECT TO REVIEW THE INFORMATION CONTAINED HEREIN. IT IS ALSO IMPORTANT THAT THE ARBORIST MEET WITH THE SITE FOREMAN OR SUPERVISOR BEFORE ANY SITE CLEARING, TREE REMOVAL, DEMOLITION, OR OTHER CONSTRUCTION ACTIVITY OCCURS AND TO CONFIRM THE LOCATIONS OF THE TREE PROTECTION BARRIER FENCING.


LE PARC - RESIDENCES 1400 Fairfield Rd and 349 Kipling St

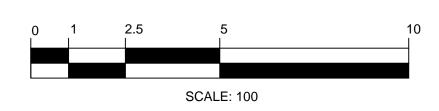

TREE REMOVAL AND PROTECTION PLAN Date: May 5, 2022 Scale 1:100 Revised and Re-Issued for DP

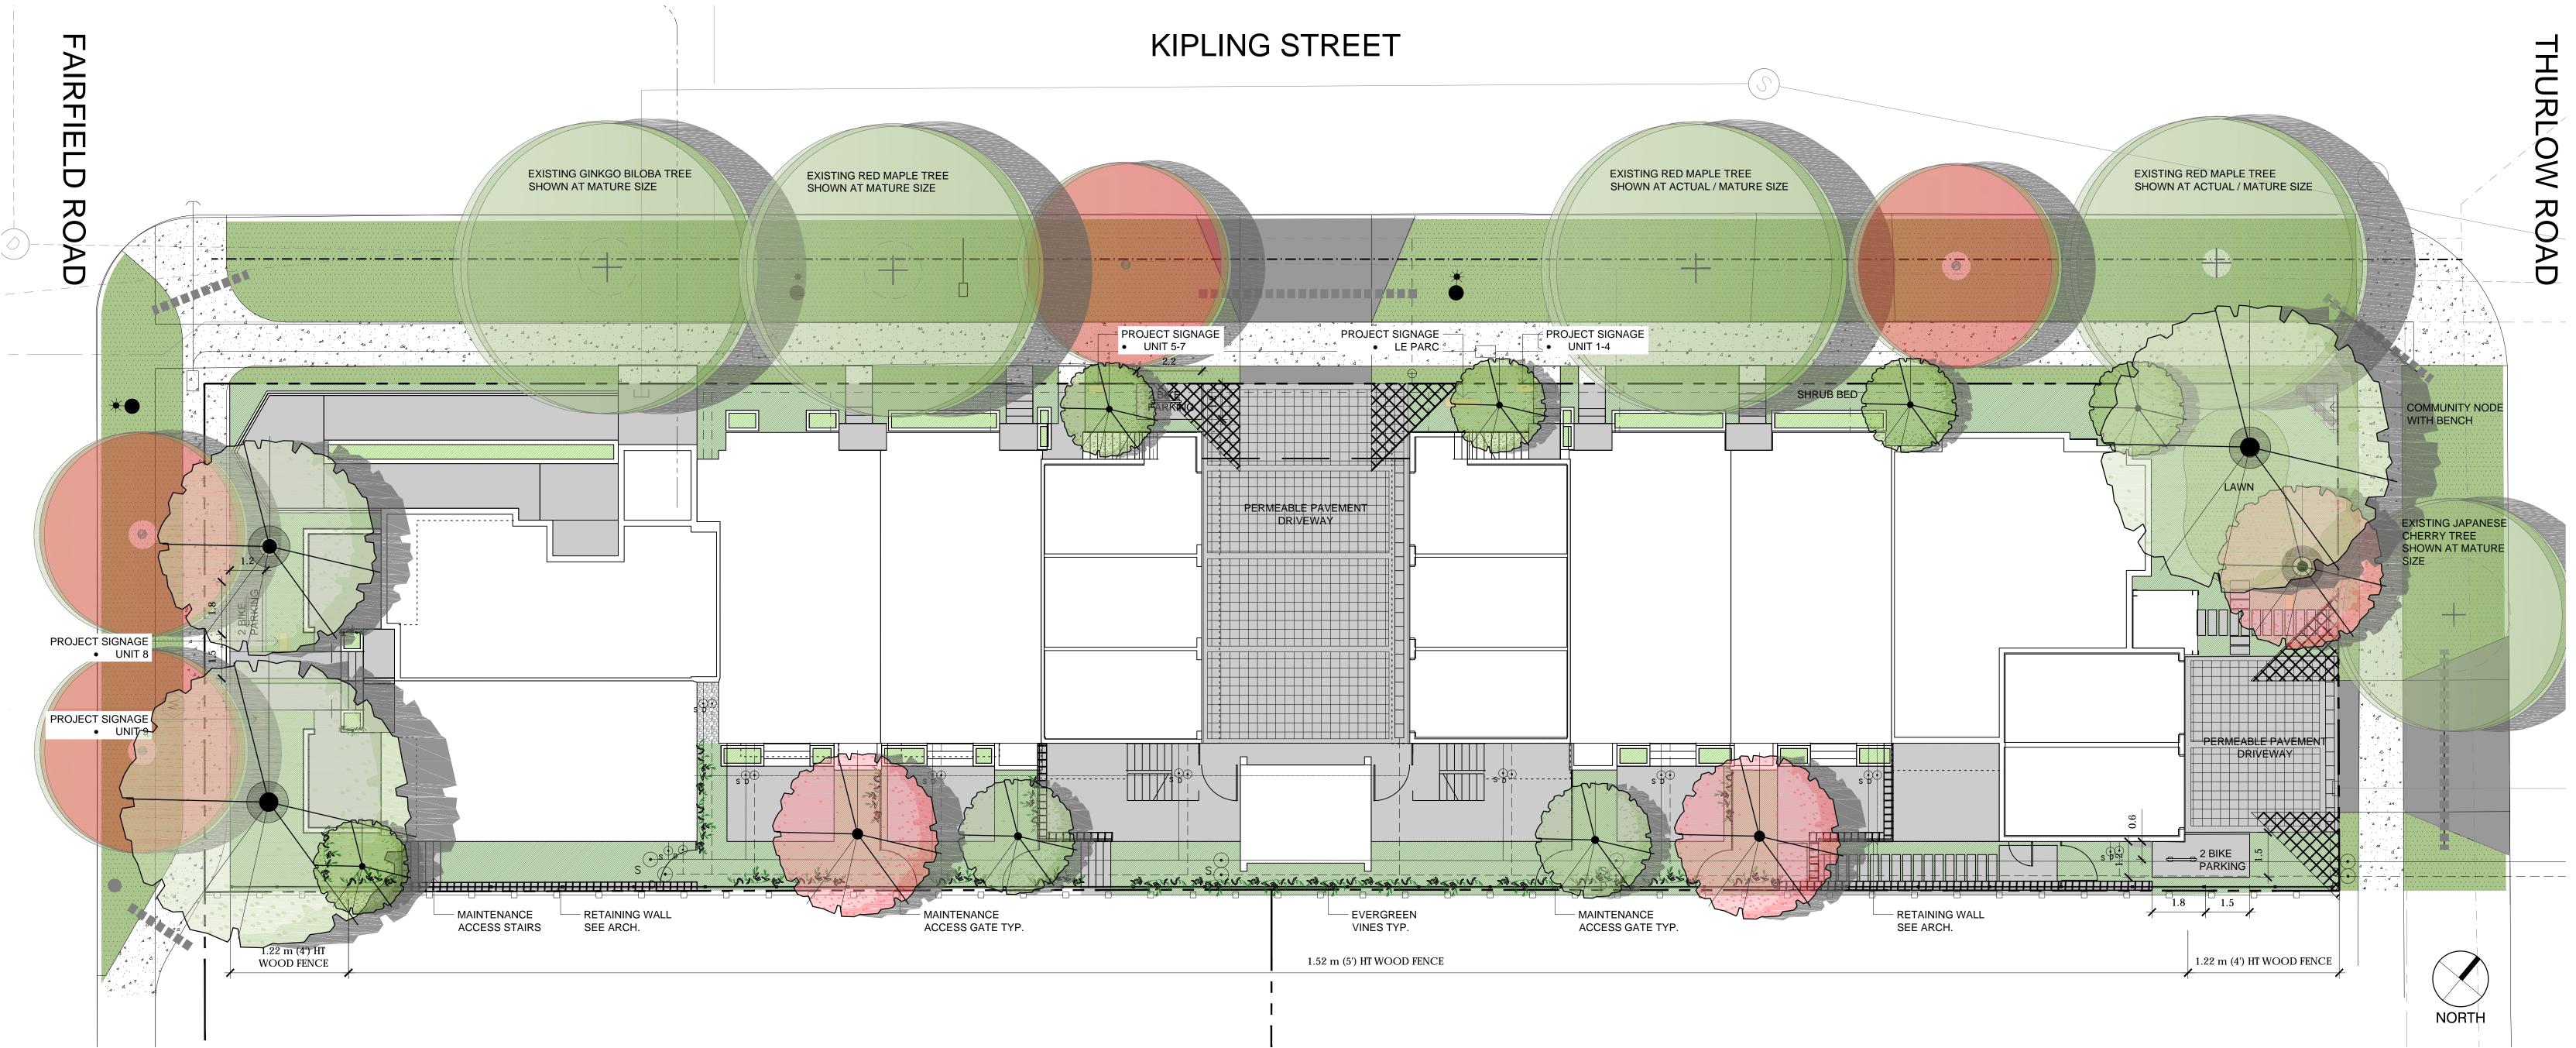

LEGEND

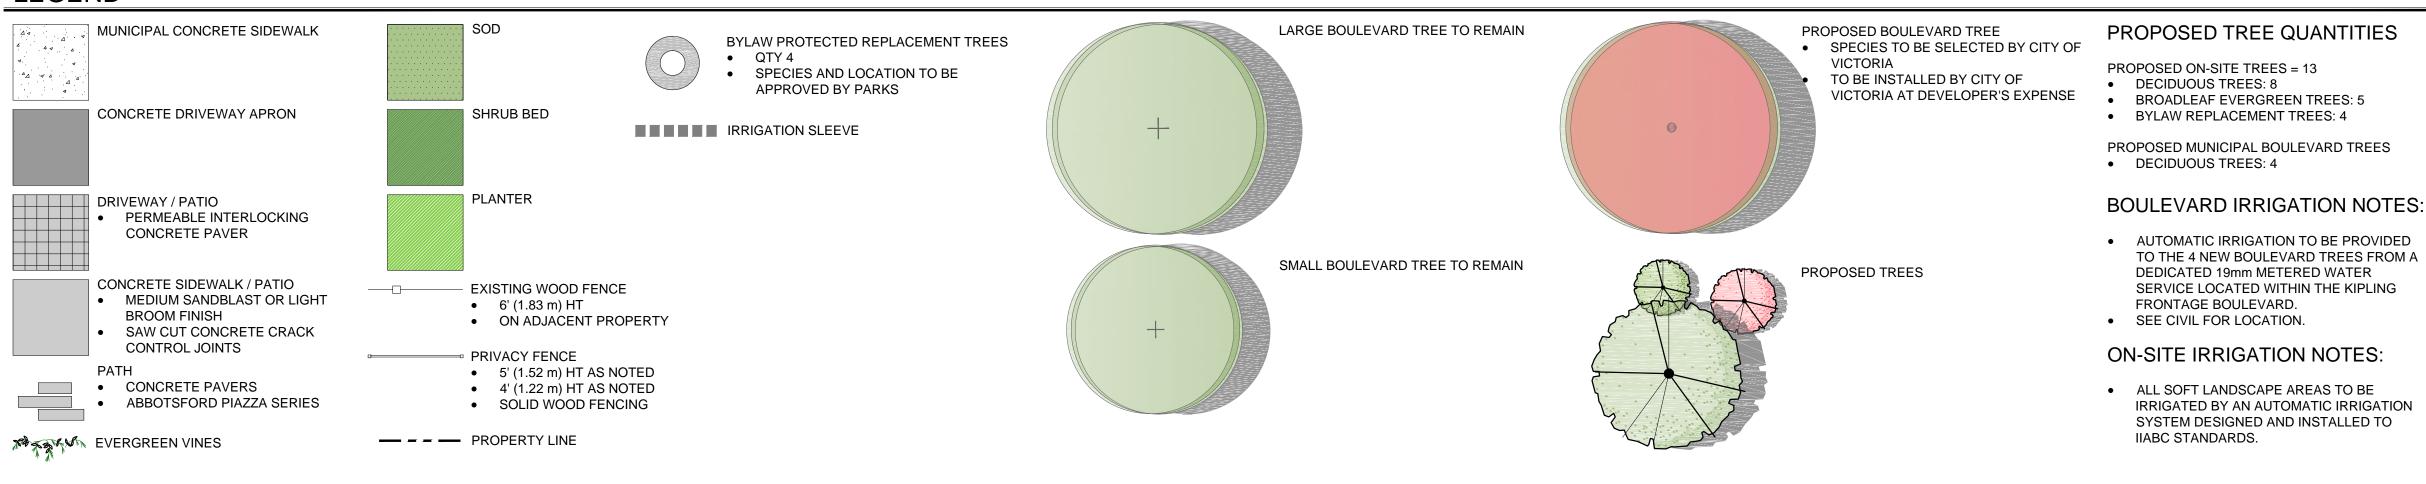







Le Parc - Residences 1400 Fairfield Rd and 349 Kipling St



LANDSCAPE SITE PLAN Date: May 5, 2022 Scale 1:100 Revised and Re-Issued for DP

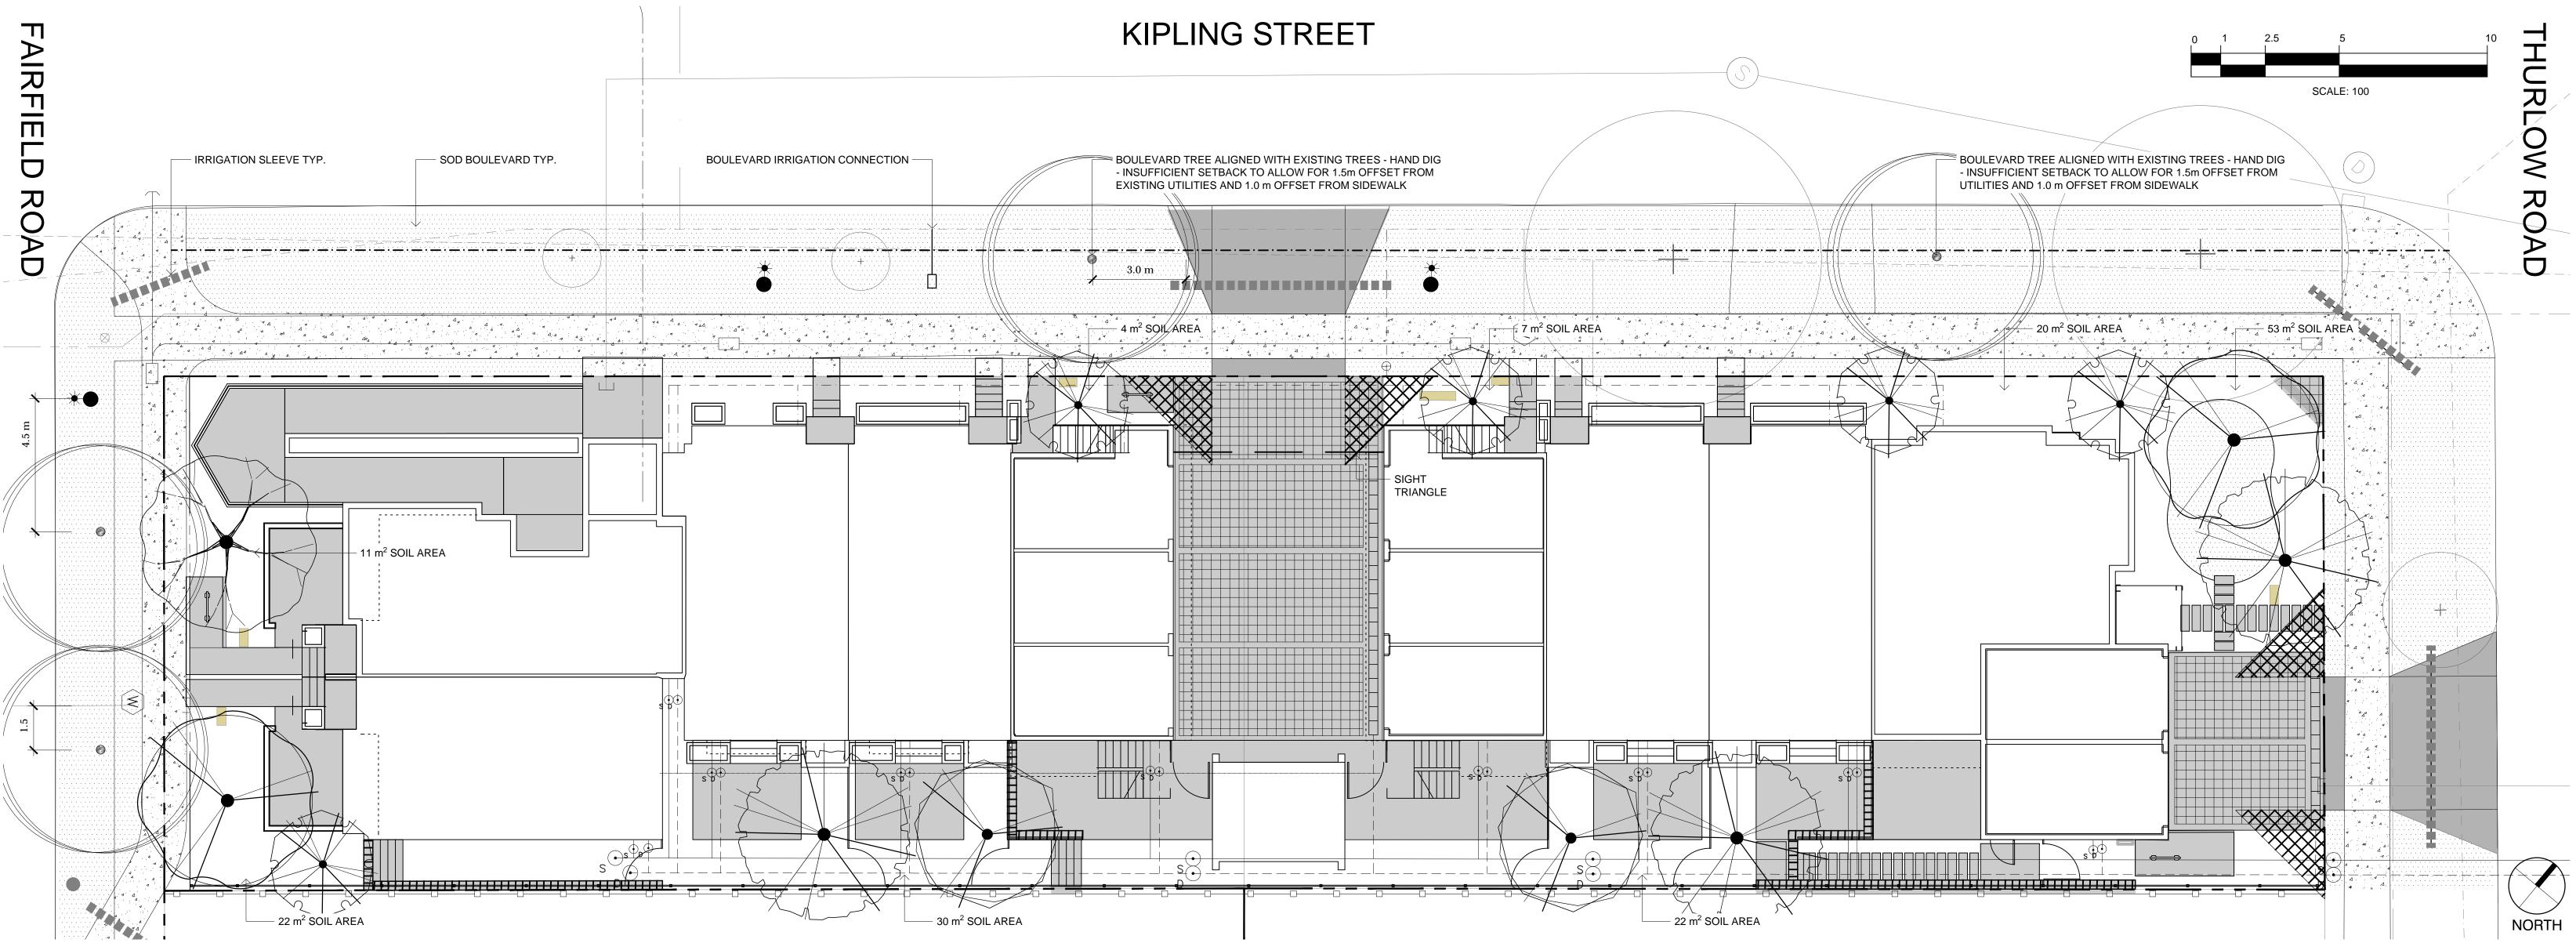

LEGEND

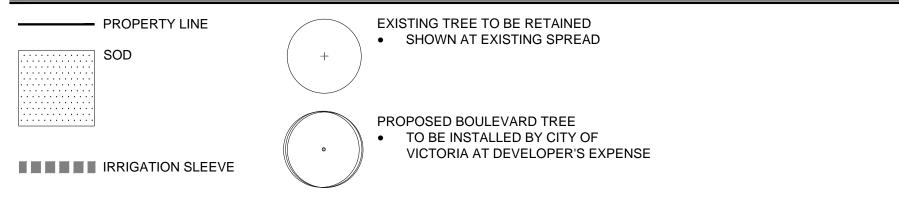

TREES	QTY	BOTANICAL / COMMON NAME	CONT	CAL	REMARKS
	3	CORNUS NUTTALLII / PACIFIC DOGWOOD	CONT	60 MM	NATIVE; 10 M HT X 10 M W
A A A A A A A A A A A A A A A A A A A	5	MAGNOLIA GRANDIFLORA `LITTLE GEM` / LITTLE GEM DWARF SOUTHERN MAGNOLIA	CONT	40 MM	EVERGREEN; 5 M HT X 3 M W
	1	PARROTIA PERSICA / PERSIAN PARROTIA	B@B	60 MM	DECIDUOUS; 8 M HT X 5 M W
\bigcirc	2	QUERCUS GARRYANA / GARRY OAK	CONT	AS AVAILABLE	NATIVE; 20 M HT X 20 M W
\bigcirc	2	STYRAX JAPONICUS / JAPANESE SNOWBELL	CONT	50 MM	ORNAMENTAL; 5 M H X 5 M V

NOTES: 1. PLANTS IN PLANT LISTS ARE SPECIFIED ACCORDING TO THE CANADIAN NURSERY LANDSCAPE ASSOCIATION CANADIAN STANDARDS FOR NURSERY STOCK AND SECTION 12, CONTAINER GROWN PLANTS FROM THE BC LANDSCAPE STANDARD, CURRENT EDITION.

2. ALL LANDSCAPE AREAS TO BE IRRIGATED WITH AN AUTOMATIC IRRIGATION SYSTEM DESIGNED TO IIABC STANDARDS.

3. ALL PROPOSED BOULEVARD TREES TO HAVE 10m³ MIN. GROWING MEDIUM.

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PACIFIC DOGWOOD



LITTLE GEM DWARF MAGNOLIA



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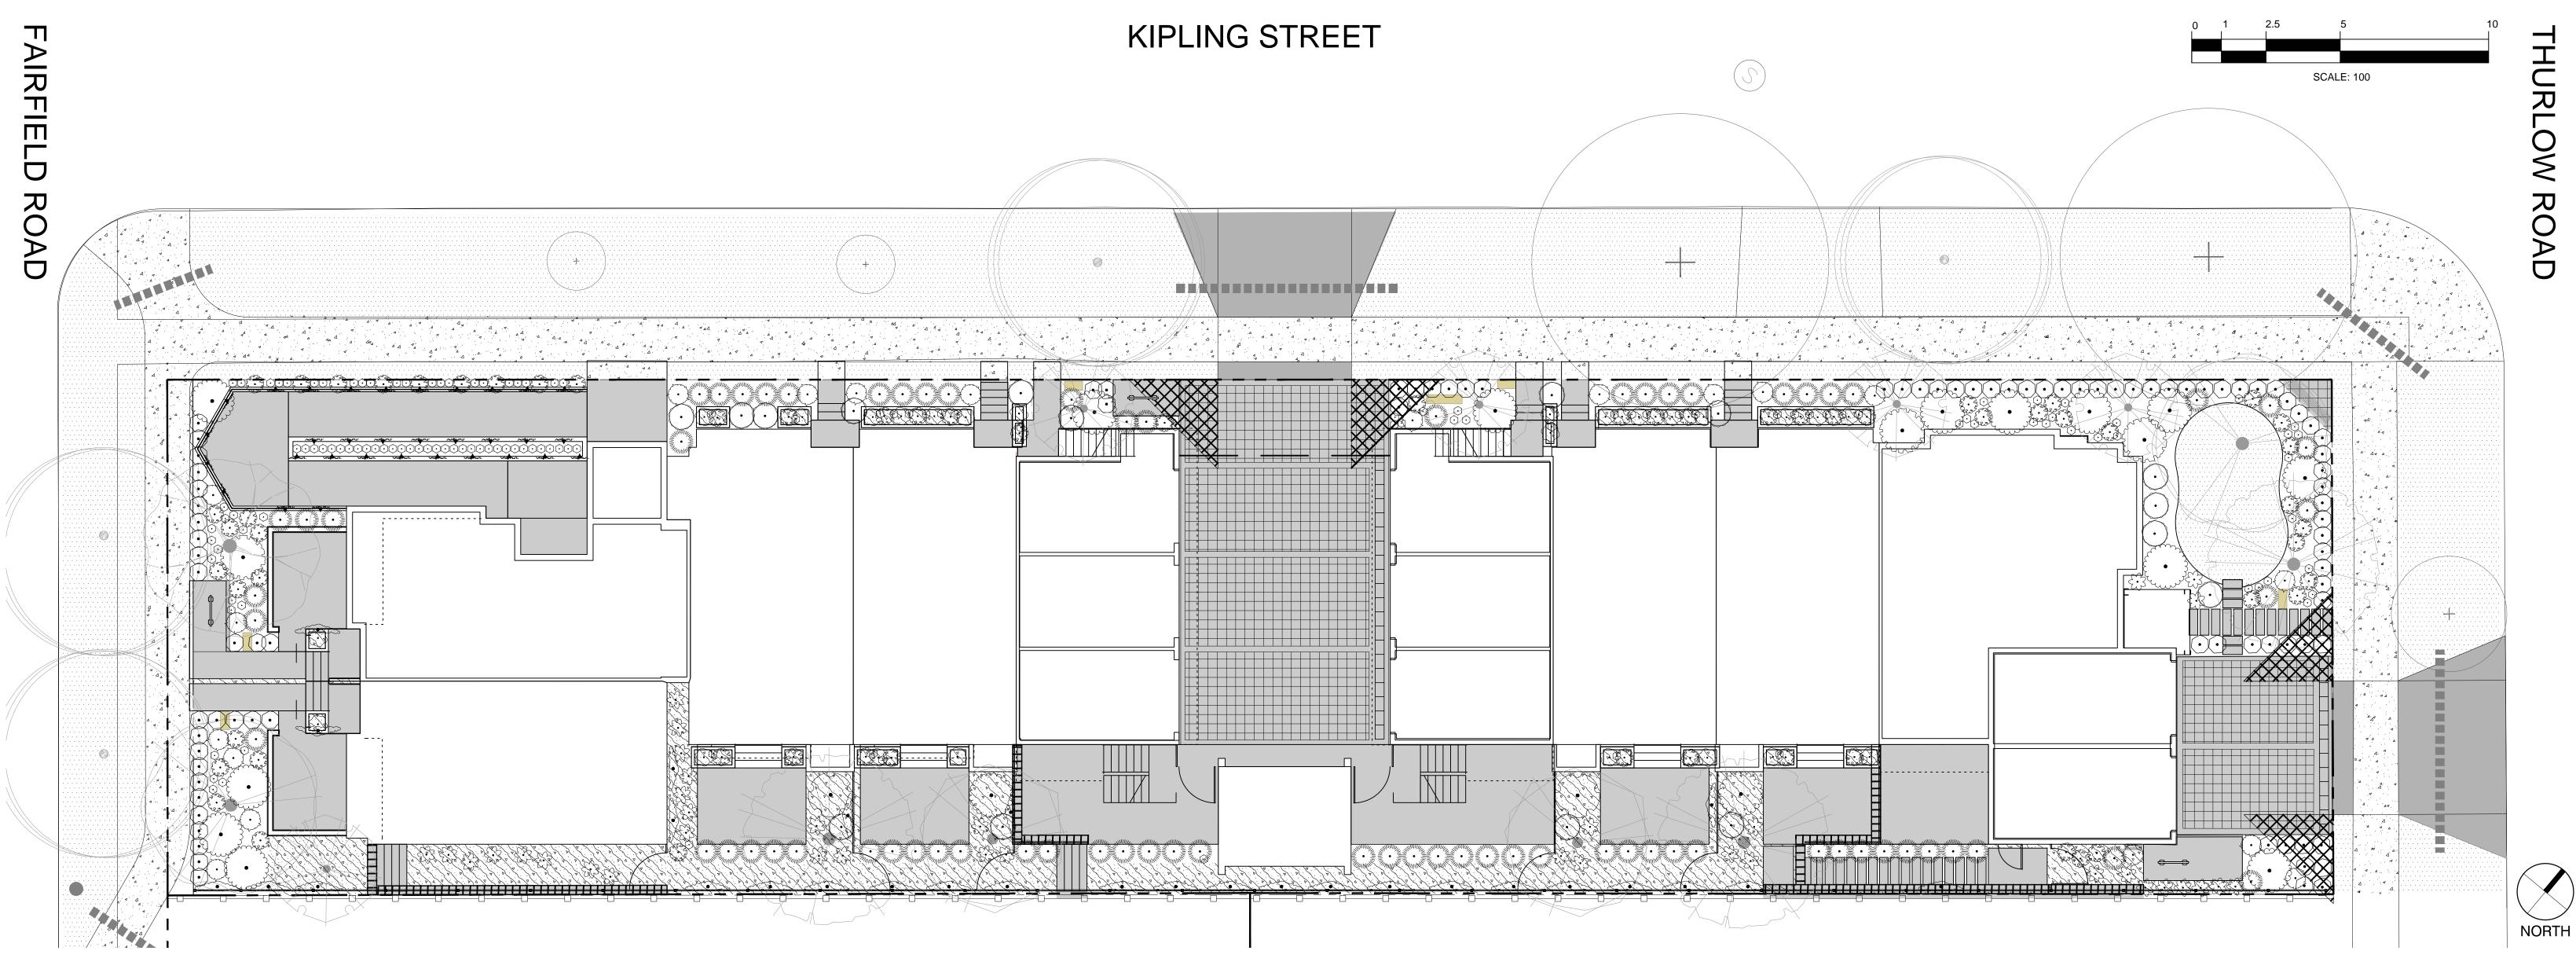




JAPANESE SNOWBELL


TREE PLANTING PLAN Date: May 5, 2022 Scale 1:100 Revised and Re-Isued for DP





PLANT SCHEDULE - SHRUBS

SHRUBS	QTY	BOTANICAL / COMMON NAME	CONT	SPACING
- and the second	32	ARCTOSTAPHYLOS UVA-URSI `MASSACHUSETTS` / MASSACHUSETTS KINNIKINNICK	#1 CONT	0.6m
$\overline{\mathbf{\cdot}}$	24	BRACHYGLOTTIS GREYI / DAISY BUSH	#2 CONT	0.6m
\bullet	90	BUXUS X `GREEN MOUNTAIN` / GREEN MOUNTAIN BOXWOOD	#2 CONT	0.6m
	3	CHOISYA TERNATA / MEXICAN ORANGE	#3 CONT	1.5m
•	2	HYDRANGEA PANICULATA `PHANTOM` / PANICLED HYDRANGEA	#3 CONT	1.5m
~~ • ~	29	JASMINUM POLYANTHUM / PINK JASMINE TRELLIS	#1 CONT	1.5m
\odot	139	LAVANDULA ANGUSTIFOLIA `AROMATICO BLUE` / ENGLISH LAVENDER `AROMATICO BLUE`	#2 CONT	0.3m
	73	MISCANTHUS SINENSIS `GRAZIELLA` / GRAZIELLA MAIDEN GRASS	#2 CONT	0.8m
$\langle \cdot \rangle$	19	PENNISETUM ORIENTALE `KARLEY ROSE` / KARLEY ROSE FOUNTAIN GRASS	#1 CONT	0.75m
÷	38	POLYSTICHUM MUNITUM / WESTERN SWORD FERN	#1 CONT	0.6m
	15	RHODODENDRON X `CHRISTMAS CHEER` / CHRISTMAS CHEER RHODODENDRON	#5 CONT	1.5m
50 0 00 00 00 00 00 00 00 00 00 00 00 00	64	SANTOLINA VIRENS / GREEN LAVENDER COTTON	#1 CONT	0.6m
\bigcirc	16	SARCOCOCCA CONFUSA / SWEETBOX	#1 CONT	0.9m

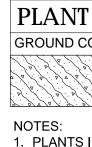



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HYDRANGEA

JASMINE VINE



BUILT-IN PLANTER



COMMUNITY BENCH

SCHEDULE - GROUNDCOVER								
OVERS	QTY	BOTANICAL / COMMON NAME	CONT	SPACING	REMARKS			
8 8 8 8 8 8 8 8 8 8 8 8 8 8	1,177	SAGINA SUBULATA / IRISH MOSS	PLUG	300mm				

1. PLANTS IN PLANT LISTS ARE SPECIFIED ACCORDING TO THE CANADIAN NURSERY LANDSCAPE ASSOCIATION CANADIAN STANDARDS FOR NURSERY STOCK AND SECTION 12, CONTAINER GROWN PLANTS FROM THE BC LANDSCAPE STANDARD, CURRENT EDITION.

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MEXICAN ORANGE



IRISH MOSS





MAIDEN GRASS

SHRUB PLANTING PLAN Date: May 5, 2022 Scale 1:100 Revised and Re-Isued for DP

L3

