937 VIEW STREET



Project Rendering - Main Entry Streetscape at View Street

■LIST OF DRAWINGS

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LANDSCAPE

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24-06-26 Issued for DP Revisions 9
24-04-10 Issued for DP Revisions 8
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23-08-15 Issued for DP Revisions 6
23-05-09 Issued for DP Revisions 5
21-12-20 Issued for DP Revisions 4
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20-08-12 Issued for DP Revisions 2
20-01-08 Issued for DP Revisions 1
19-10-02 Issued for DP

 Plot Date
 23-12-12
 Drawing File

 Drawn By
 RCI
 Checked By
 ADI

 Scale
 1 : 1
 Project Number
 192

View St. Residential

937 View Street

Cover

Received Date:
July 3, 2024
Deemed Date:
September 27, 2023



937 VIEW STREET



Vinyl Composition Tile

Vinyl Impact Sheet

Vinyl Wall Covering

Waterproof Membrane

Water Repellant Coating

Water Closet

Wood

Underside of...



LIST OF ABBREVIATIONS

GBL

Finished Grade

Glass Block

Hollow Core Hollow Core Wood

Fire Extinguisher Cabinet

Finished Floor Elevation

Georgian Wire Glass

Gypsum Wallboard

The following abbreviations are used on door, window, and finish schedules as well as on architectural drawings and details.

RB RES RD

RD-P

RWL SAFI SCW

Rubber Base

Roof Drain

Resilient Flooring

Roof Drain - Planter


Rain Water Leader

Solid Core Wood

Soap Dispenser

Spandrel Glass

Spray Applied Fibrous Insulation

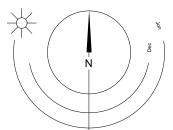

BUILDING CODE SUMMARY

MAJOR OCCUPANCY CLASSIFICATION:

BRITISH COLUMBIA BUILDING CODE 2024 - PART 3

ADDITIONAL REQUIREMENTS FOR HIGH BUILDINGS
• Ref. 3.2.6.1 (1)(d)

RESISTANCE RATING TO FLOORS AND LOADBEARING

CANADIAN STANDARDS ASSOCIATION B651-18

REFERENCED DOCUMENTS:

GROUP C - RESIDENTIAL

NUMBER OF STREETS FACING:

ACCESSIBLE ENTRANCE

CONSTRUCTION REQUIREMENTS:

ACCESSIBLE FACILITIES

BUILDING HEIGHT: 23 STOREYS

	ACST	Acrylic Stucco	H/C	Handicap	SPC	Solid Particleboard Core	
	ACT	Acoustical Tile	HM	Hollow Metal	ST	Structure	
	AFF	Above Finished Floor	HP	High Point	STL	Steel	
	AL	Aluminum	HSS	Hollow Steel Section	STN	Stain(ed)	
	AO	Auto-Opener	H/W	Hardware	STNT	Stone Tile	
	AP	Annunciator Panel	INSUL	Insulated	SS	Stainless Steel	
	BG	Building Grade	LAM	Laminated Glass	SVF	Sheet Vinyl Flooring	
	CEM	Cementitious Backing Board	LP	Low Point	TB	Towel Bar	
	Conc	Concrete	MDFB	Medium Density Fibreboard Base	T/D	Tempered / Double Glazed	
	CBK	Concrete Block	MR	Mirror	TLAM	Tempered Laminated Glass	
	C/L	Centerline	MP	Metal Panel	TGL	Tempered Glass	
	CPT	Carpet Tile	O/H	Overhead	TLGL	Translucent Glass	
	CT	Ceramic Tile	OW	Operable Window	TOC	Top of Concrete	
	C/W	Complete With	PF	Prefinished	TOD	Top of Drain	
	DD	Deck Drain	PLAM	Plastic Laminate	TOI	Top of Insulation	
	EB	Electric Bike Storage	PLS	Plaster	TOP	Top of Parapet	
	EL	Elevation	PSF	Pressed Steel Frame	TOS	Top of Slab	
	EPC	Epoxy Polymer Coating	PT	Paint	TOW	Top of Wall	
	EV	Electric Vehicle Parking	PTD	Paper Towel Dispenser	TP	Toilet Paper	
	EXP AGG	Exposed Aggregate	PTD/W	Paper Towel Dispenser / Waste	UNF	Unfinished (for GWB means taped and filled by not sanded to	
	EXT	Exterior	PTW	Paper Towel Waste		minimum ULC requirements where applicable)	
	FD	Floor Drain	RA	Roof Anchor	UNO	Unless Noted Otherwise	
1	FFO	Fine Frationarie Inc. October 4	DD.	Dode been Deepe	11/0	Uniderated as A	

The following annotations are used on architectural drawings and details: BEDROOM ROOM NAME & ROOM NUMBER 201 (101a) DOOR NUMBER See Door Schedule WINDOW NUMBER See Window Schedule W1 WALL TYPE See Assemblies Schedule 2.0 hr RATED WALL DESIGNATION 00.00 ELEVATION DATUM CEILING HEIGHT AREA OF DROP CEILING

KEYNOTE SYMBOL

MATERIAL TAG

W1 C1 F1 B1 ROOM FINISHES

INTERIOR ELEVATION REFERENCE

ANNOTATIONS LEGEND

Level 23: TOTAL PROPOSED: 12 325 m² (132 665 s.f.) FLOOR SPACE RATIO: SITE COVERAGE: OPEN SITE SPACE: **GREEN STORMWATER INFRASTRUCTURE:** Landscape drawing L1.01 GRADE OF BUILDING: HEIGHT OF BUILDING: SETBACKS: FRONT (View Street): REAR (S): SIDE (È): SIDE (W): NUMBER OF STOREYS: 23 STOREYS SUITE COMPOSITION: 1 Bed / 1 Bath <45m²: 3 Bed / 1 Bath > 45m²: 3 Bed / 2 Bath > 45m²: 8 Suites TOTAL: 266 SUITES RESIDENTIAL PARKING:

271 (25% EB)

28 (27 Res / 1 CRU)

COMMERCIAL PARKING:

Required Long Term: Provided Long Term:

Required Short Term:

Provided Short Term:

PROJECT DESCRIPTION

REGISTERED OWNER 937 VIEW STREET, VICTORIA, BC. Nelson Investments Inc. 595 Howe Street, 10th Floor Chris Nelson LEGAL DESCRIPTION: tel: 604.318.6877 Vancouver, BC LOT A, OF LOTS 785, 786, and 787, VICTORIA CITY, V6C 2T5 chris@nelsoninvestmentsinc.com PLAN 36505 **ZONING BYLAW SUMMARY ARCHITECT** dHKarchitects Charles Kierulf 977 Fort Street tel: 250.658.3367 **BUILDING DESCRIPTION:** Victoria, B.C. fax: 250.658.3397 23 STOREY RESIDENTIAL BUILDING crk@dhk.ca RESIDENTIAL RENTAL STRUCTURAL R-48 HARRIS GREEN 3600 Uptown Blvd Chris Jaques Building 15, Suite 301 DEVELOPMENT PERMIT AREA: DPA 713 (HC) tel: 778.834.2331 Victoria, BC V8Z 0B9 Chris.Jaques@wsp.com 1 572.3 m² (16 924 s.f.) SITE AREA: FLOOR AREA: 676 m² (7 276 s.f.) Level 1: MECHANICAL 801 m² (7 622 s.f.) Level 2: Avalon Mechanical Consultants Ltd. 801 m² (8 622 s.f.) x 3 = 2 403 m² Level 3-5: 1245 Esquimalt Rd #300, Jamie Clarke $477.5 \text{ m}^2 (5 140 \text{ s.f.}) \times 17 = 8 118 \text{ m}^2$ Level 6-22: tel: 250.384.4128 Victoria, BC 327 m² (6 168 s.f.) V9A 3P2 jclarke@avalonmechanical.com **ELECTRICAL CONSULTANT** Nemetz & Ass Ltd 2009 W 4th Ave Bijan Valagohar tel: 604.736.6562 Vancouver, BC V6J 1N3 bijan@nemetz.com LANDSCAPE CONSULTANT *Minimum 30% of paving area, refer to Murdoch de Greeff Inc. Scott Murdoch 200-524 Culduthel Rd. tel: 250.412.2819 fax: 250.412.2892 Victoria, BC 17.7 m (GEODETIC AVG GRADE) V8Z 1G1 scott@mdidesign.ca See Site Plan for Grade Calculations **GEOTECHNICAL** Shane Moore Ryzuk Geotechnical 28 Crease Avenue tel: 250.475.3131 Victoria, BC fax: 250.475.3611 shane@ryzuk.com CIVIL CONSULTANT Tim Lutic Herold Engineering tel: 250.590.4875 1051 Vancouver Street Victoria, BC fax: 250.590.4392 Tlutic@heroldengineering.com V8V 4T6 **ENVELOPE CONSULTANT** Morrison Hershfield tel: 250.361.1215 x1142201 536 Broughton Street, 2nd Floor


Victoria, BC


V8W 1C6


fax: 250.361.1235

craudoy@morrisonhershfield.com

PROJECT DIRECTORY

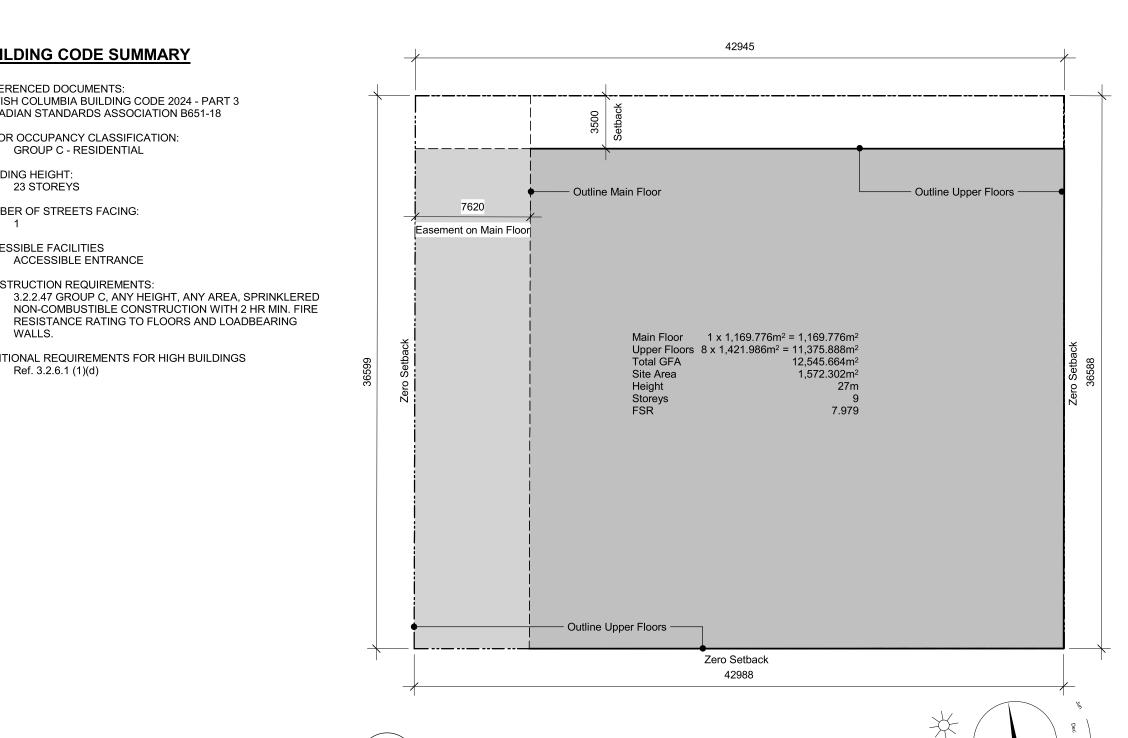

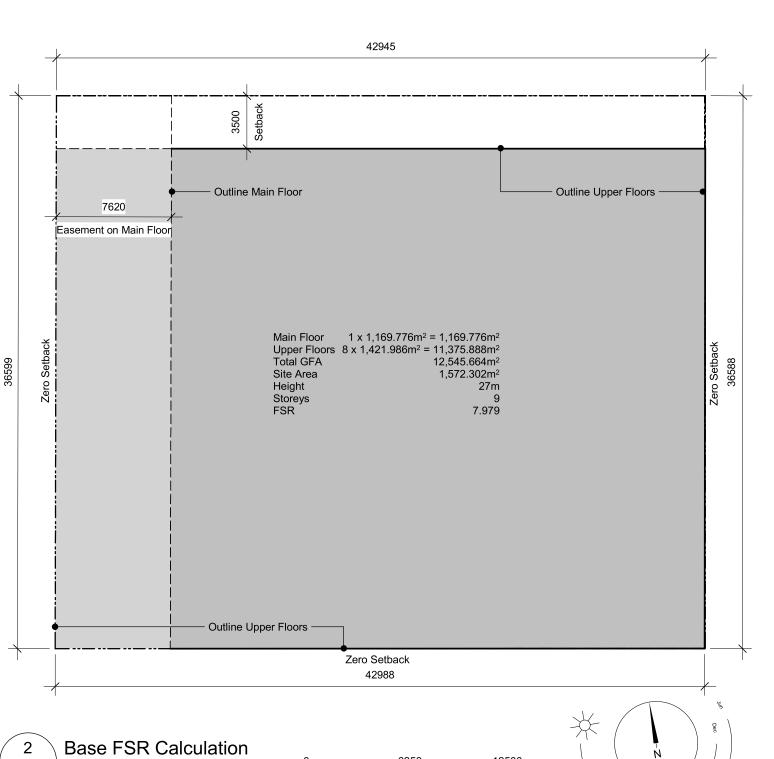

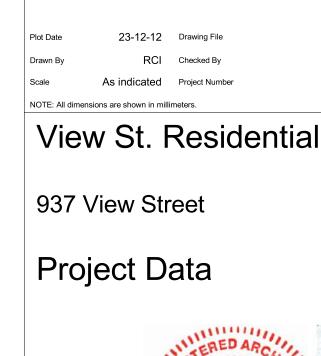

24-04-10

23-08-15

23-05-09

21-05-04

20-08-12

20-01-08

19-10-02

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Issued for DP Revisions 6

Issued for DP Revisions 5


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Issued for DP Revisions 1

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19-10-02 Issued for DP


View St. Residential


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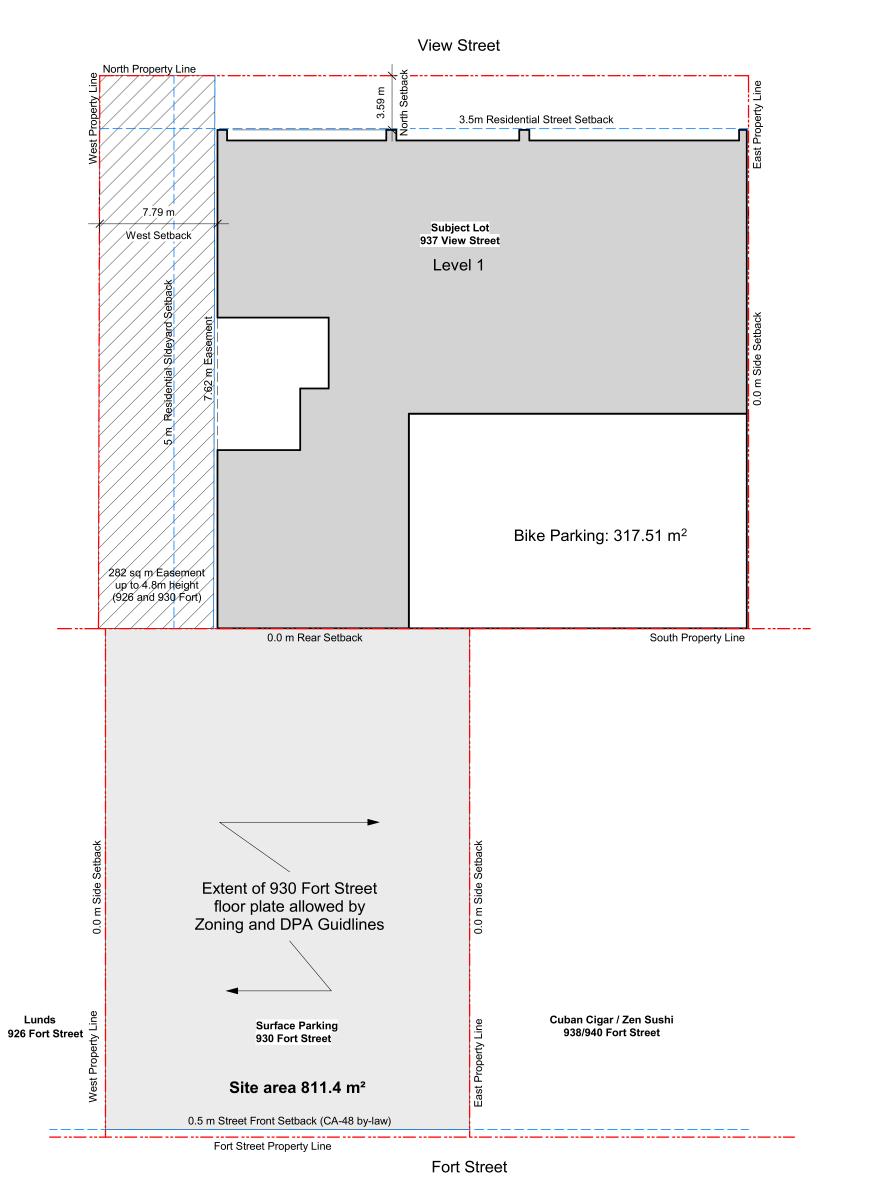
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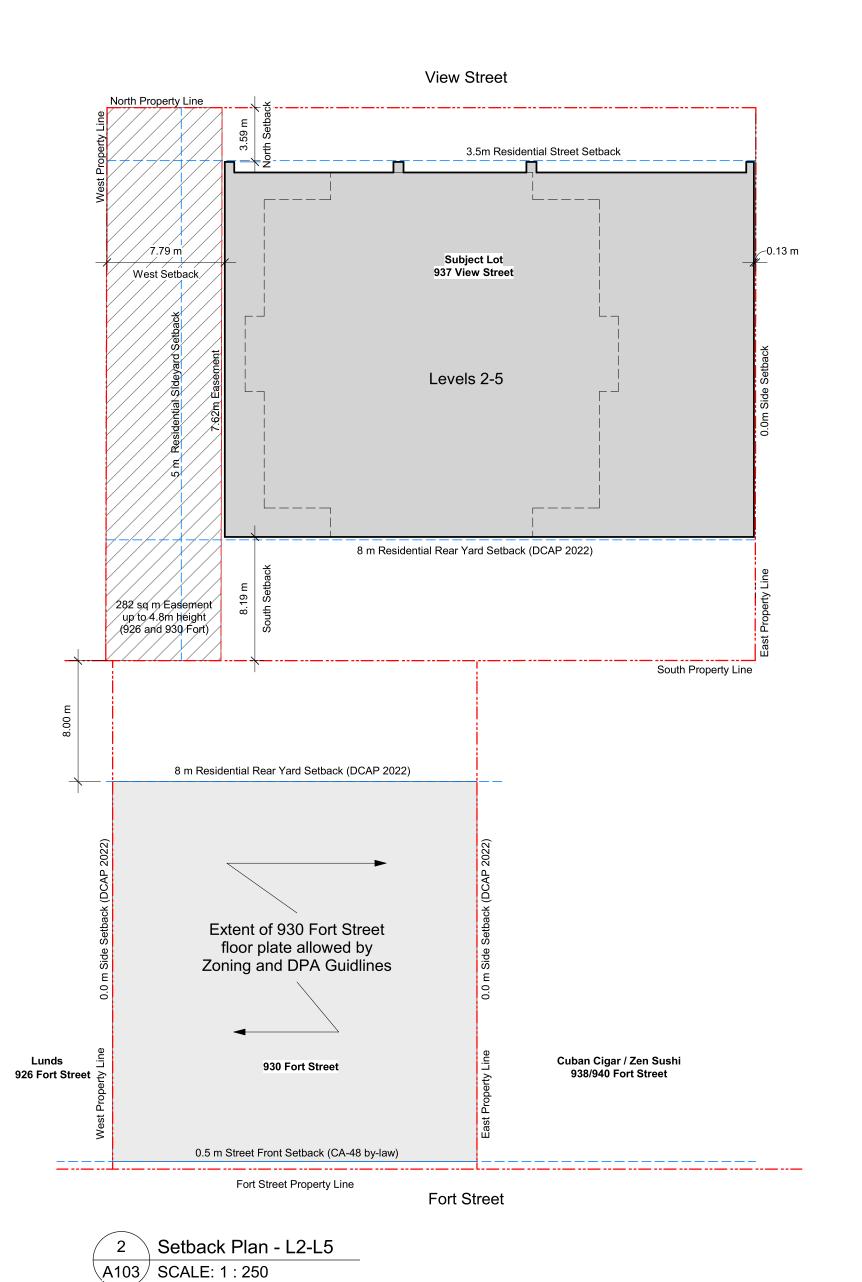



Victoria 977 Fort Street

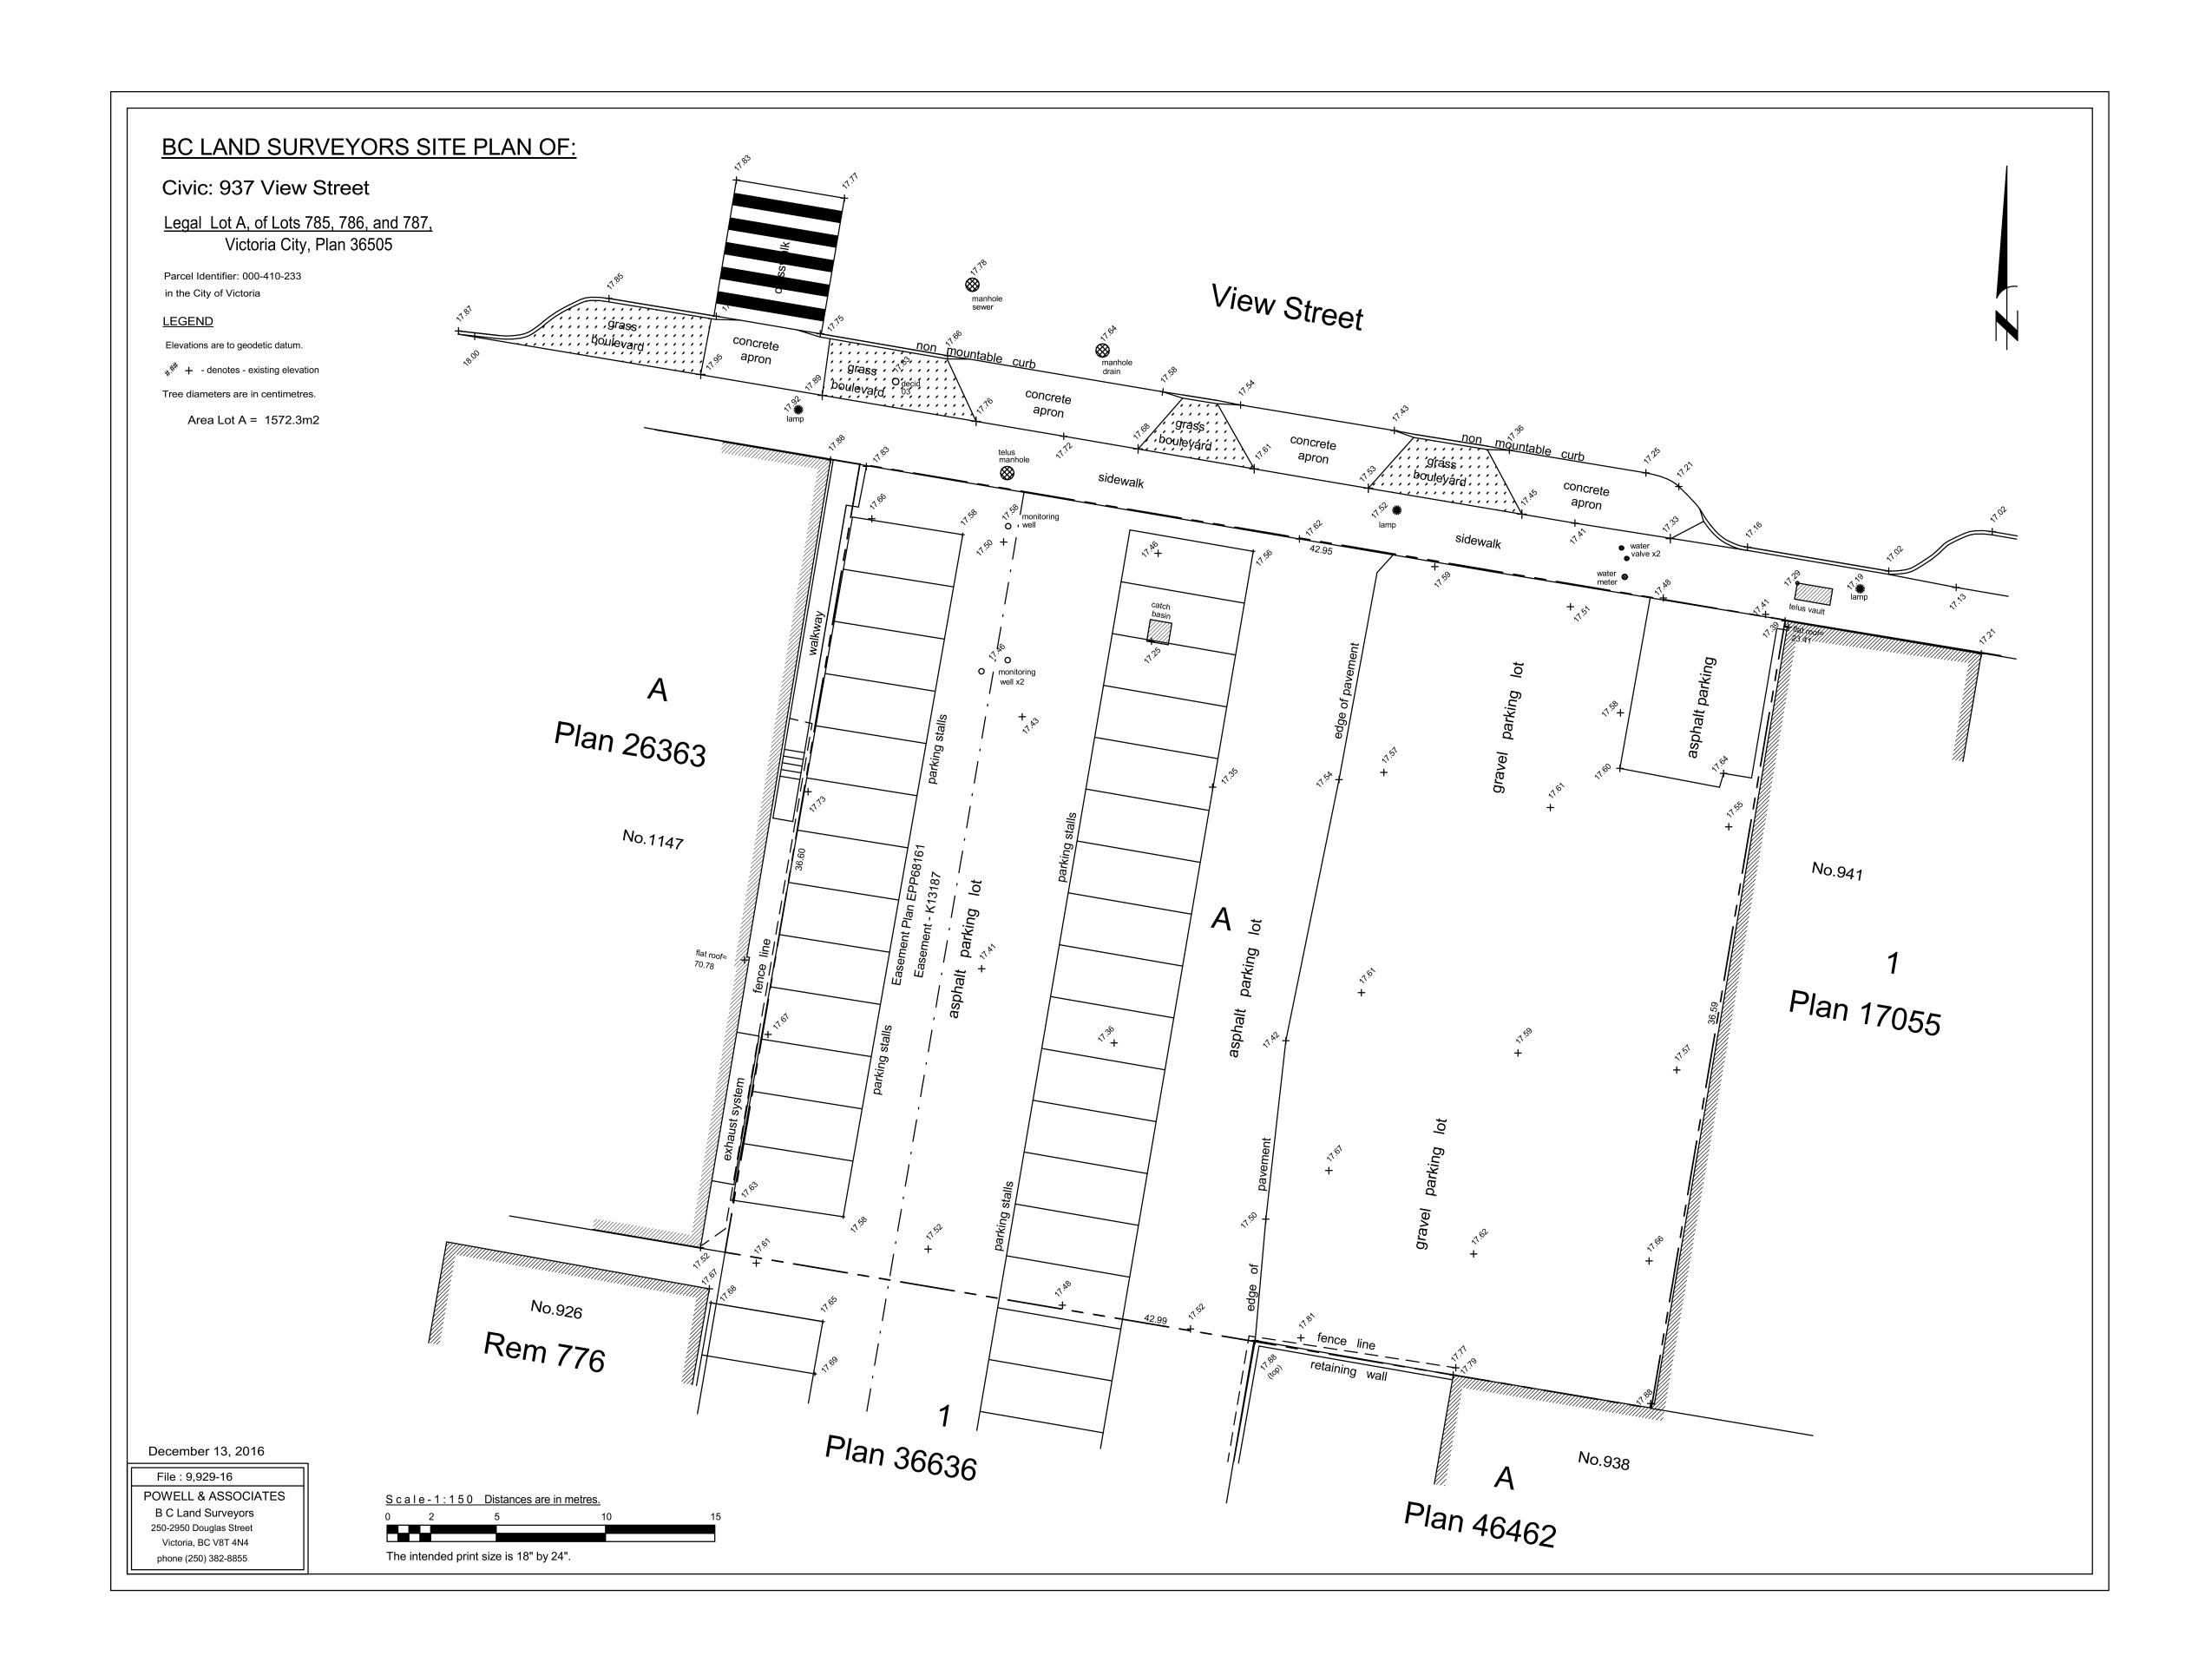



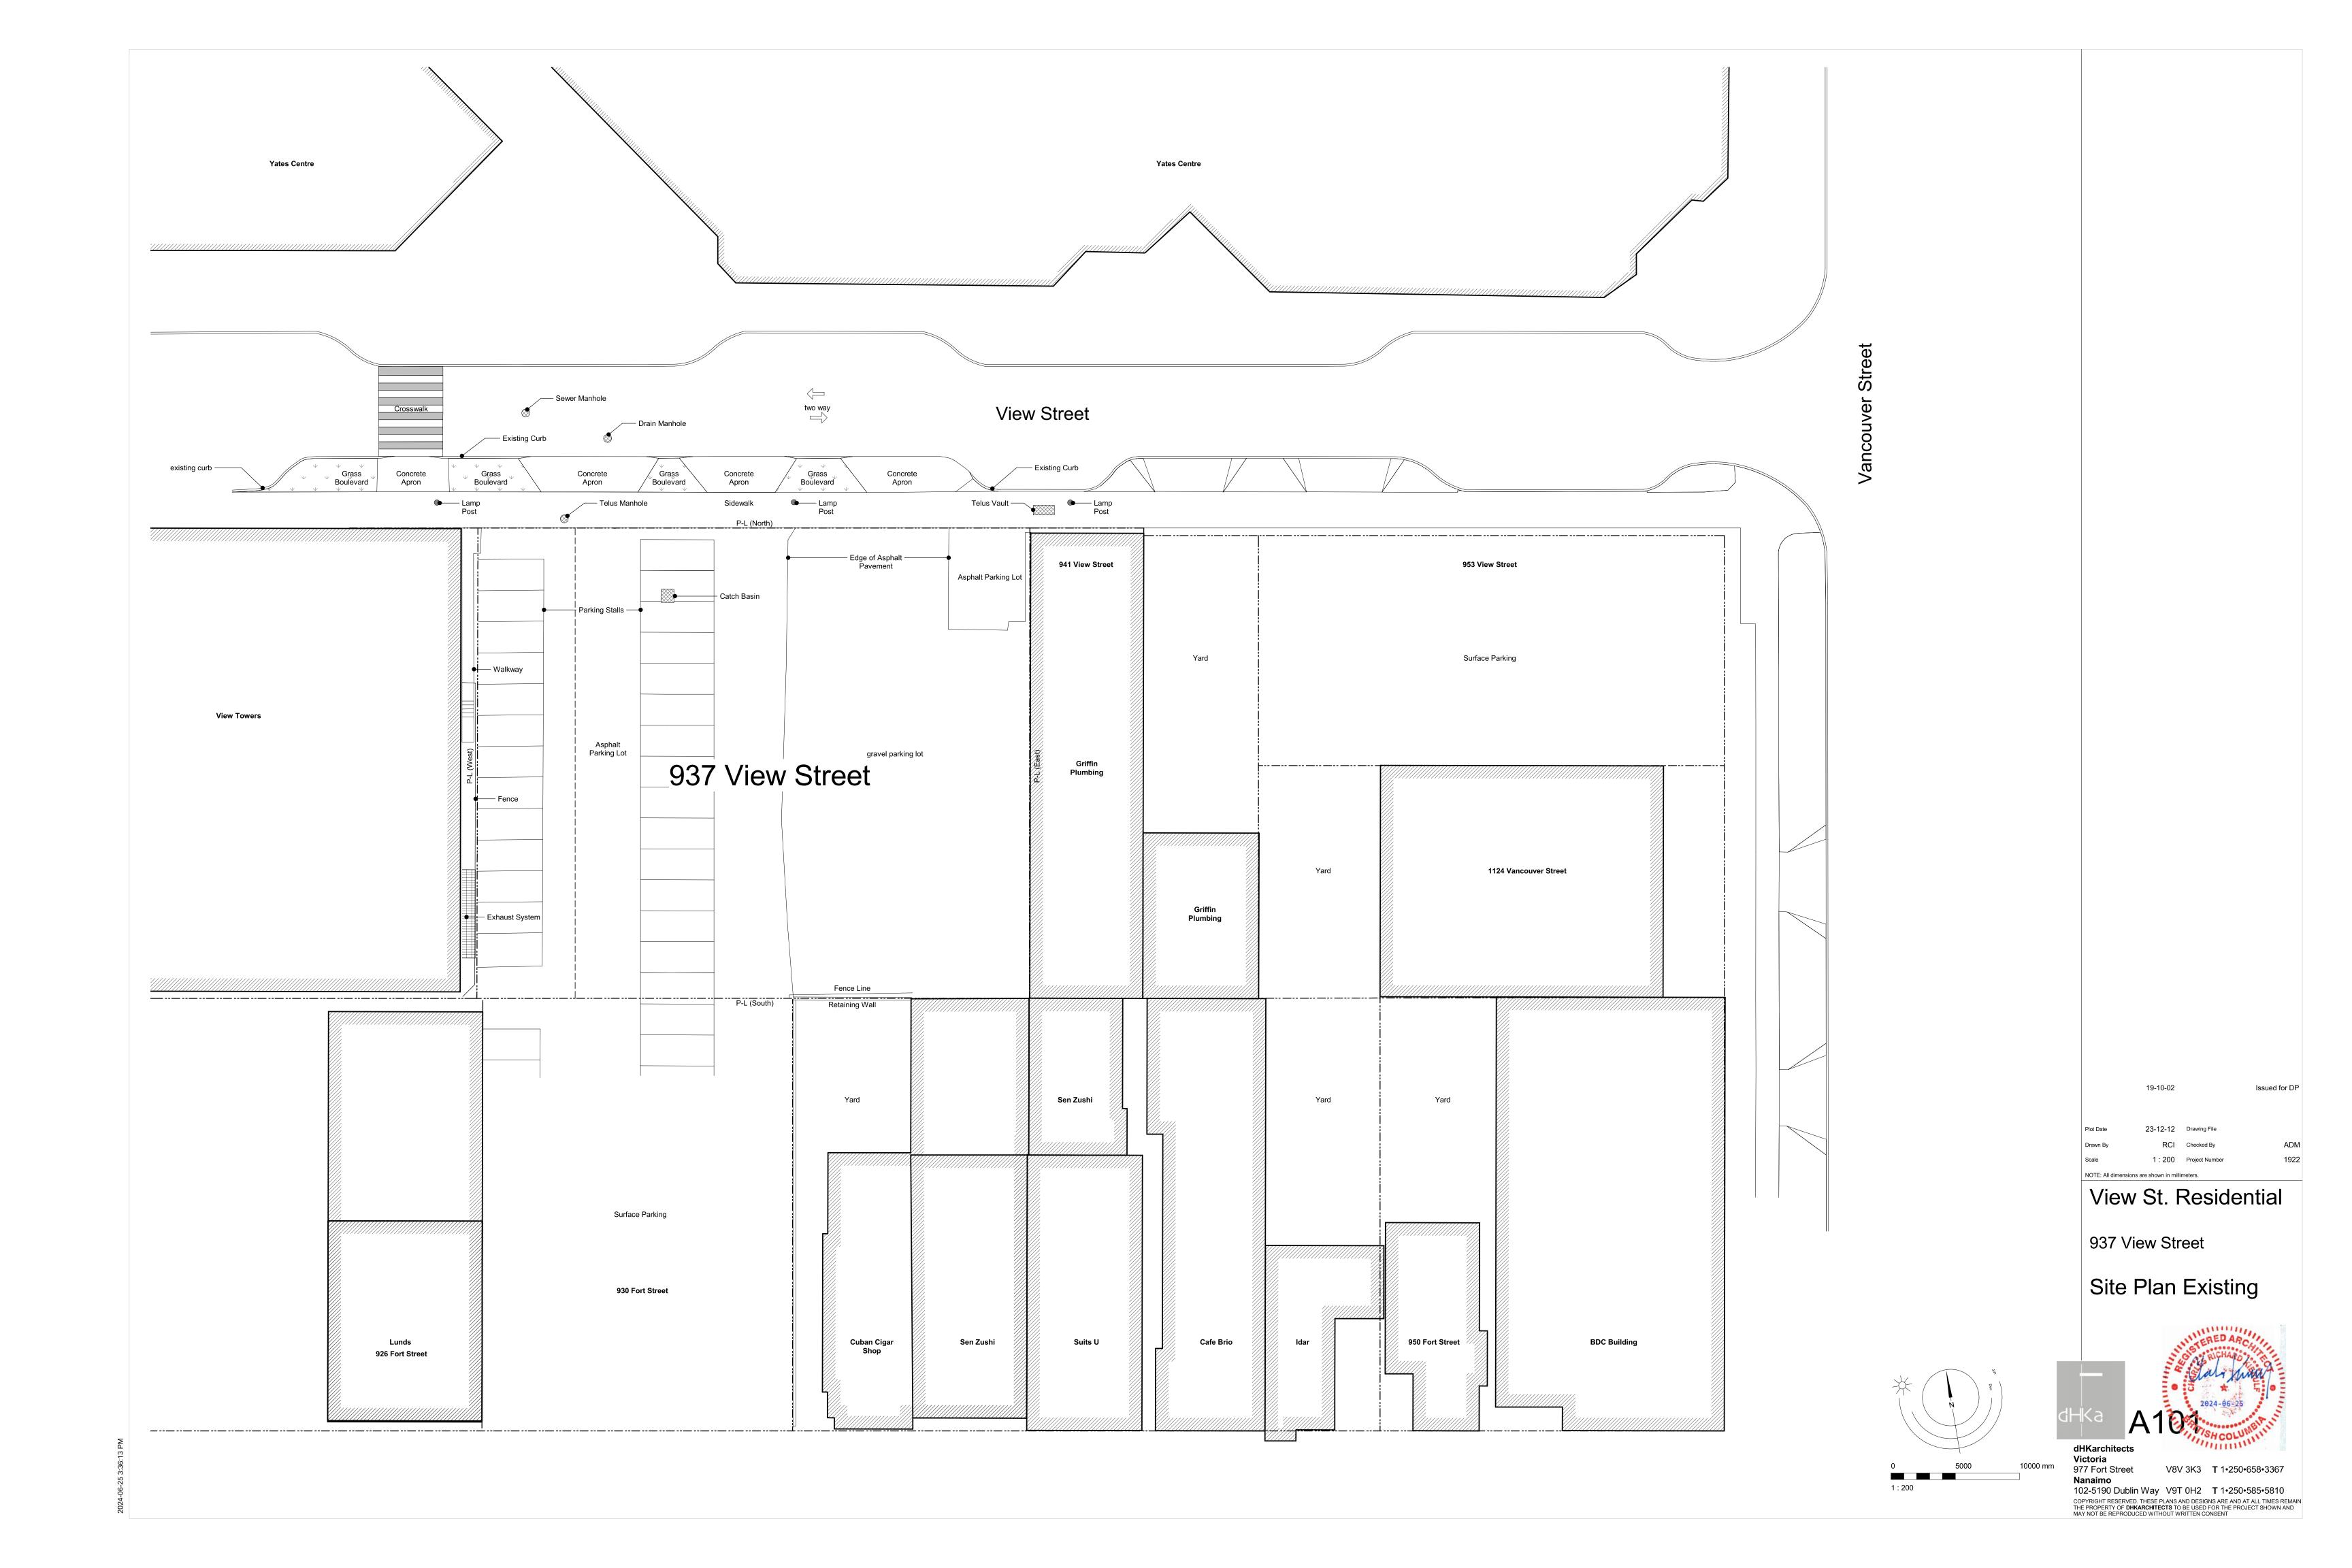

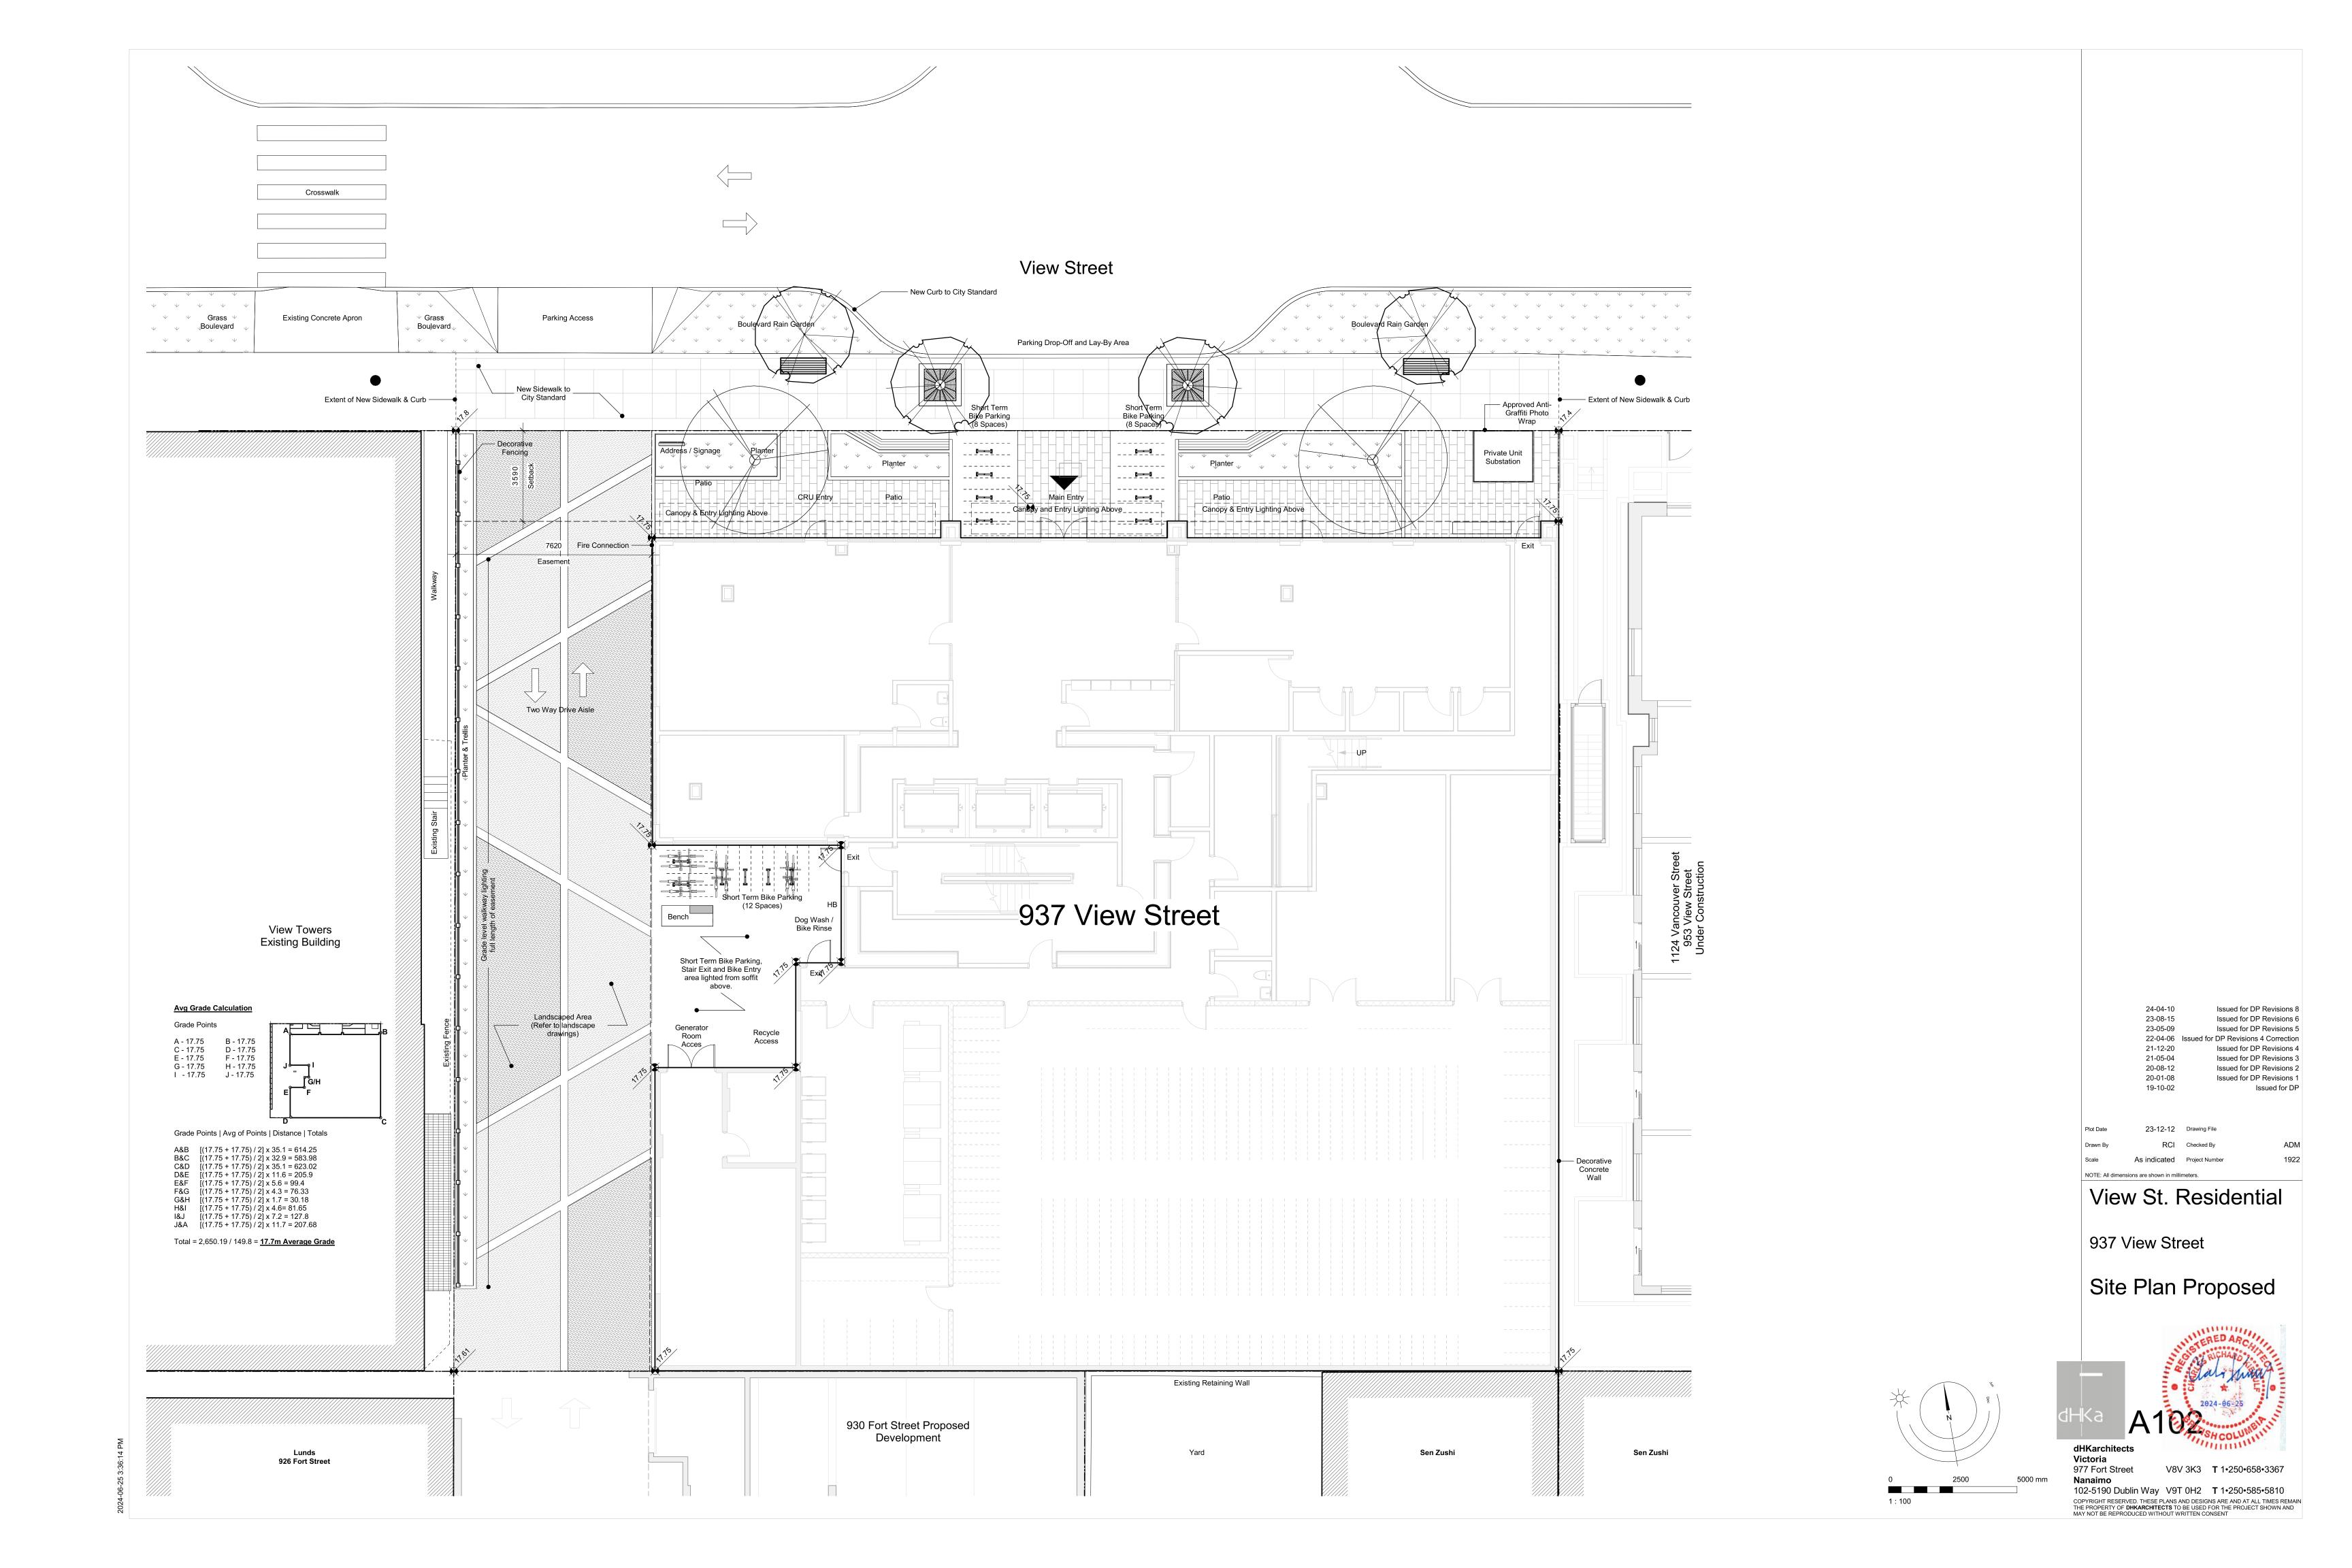

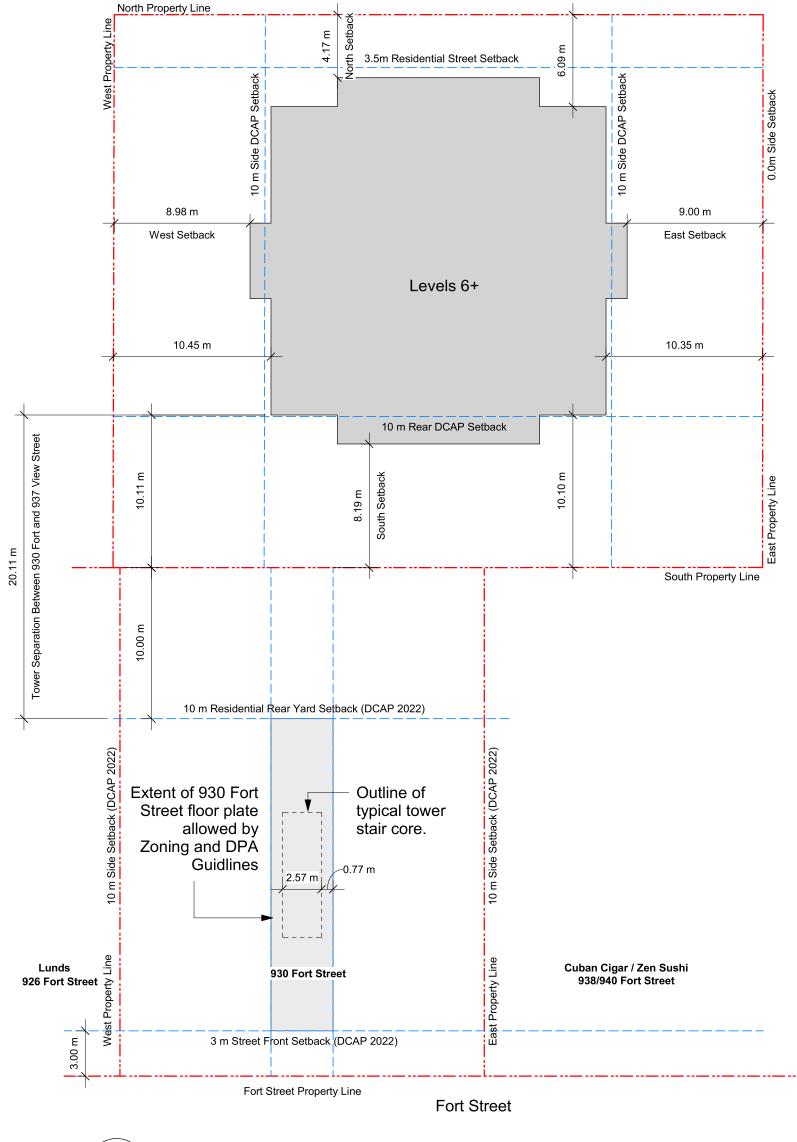

View Street

√ 3 \ Setback Plan - L6+

 1 \ Setback Plan - L1 A103 | SCALE: 1 : 250

930 Fort Site and Zoning Info

1. CA-84 ZONE, HARRIS GREEN (930 FORT STREET) DISTRICT CA-04 ZONE, HARRING GREEN (930 FORT STREET) DISTRICT
 DPA 7B (HC) - Corridors Heritage
 DPA 16 - General Form and Character
 Downtown Core area (DCAP 2022), Residential MixedUse District

Site Area: FAR maximum:

5.5:1 (4462.7 m² max area) Height maximum: 45m (restricted by DCAP requirements)
Storeys maximum 13 (restricted by DCAP requirements) 45m (restricted by DCAP requirements) Notes on 930 Fort Street Setback analysis:

1. This analysis assumes development for 930 Fort Street would be for a residential use.

2. Drawings 1-2/A103 Levels 1 to 5 are unrestricted by adjacent property setbacks.

The existing width of 930 Fort Street and combined design guidelines do not allow for a functional tower floor plates. 4. Tower separation between the proposed development at 937 View Street and the theoretical massing overlap of a tower on 930 Fort Street is <u>20.11m.</u> This distance exceeds DCAP building separation guidelines for tall buildings.

5. Development above 5 storeys for 930 Fort Street is fundamentally restricted by the lot width and not restricted by the location of buildings on adjacent sites.

21-05-04 Issued for DP Revisions 3 Issued for DP Revisions 2 20-08-12 23-12-12 Drawing File

Issued for DP Revisions 8

Issued for DP Revisions 5

24-04-10


23-05-09

RCI Checked By 1:250 Project Number NOTE: All dimensions are shown in millimeters.


View St. Residential


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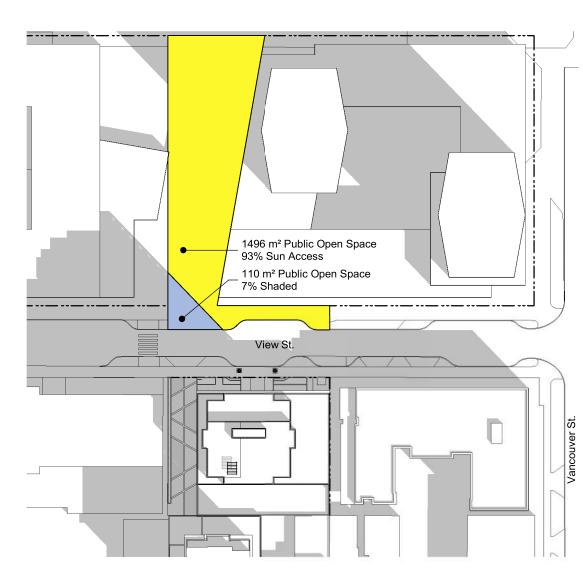
Setback Plans

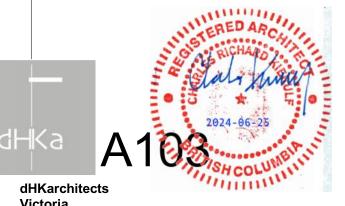


Victoria V8V 3K3 **T** 1•250•658•3367 977 Fort Street 102-5190 Dublin Way V9T 0H2 **T** 1•250•585•5810 COPYRIGHT RESERVED. THESE PLANS AND DESIGNS ARE AND AT ALL TIMES REMAIN THE PROPERTY OF **DHKARCHITECTS** TO BE USED FOR THE PROJECT SHOWN AND MAY NOT BE REPRODUCED WITHOUT WRITTEN CONSENT




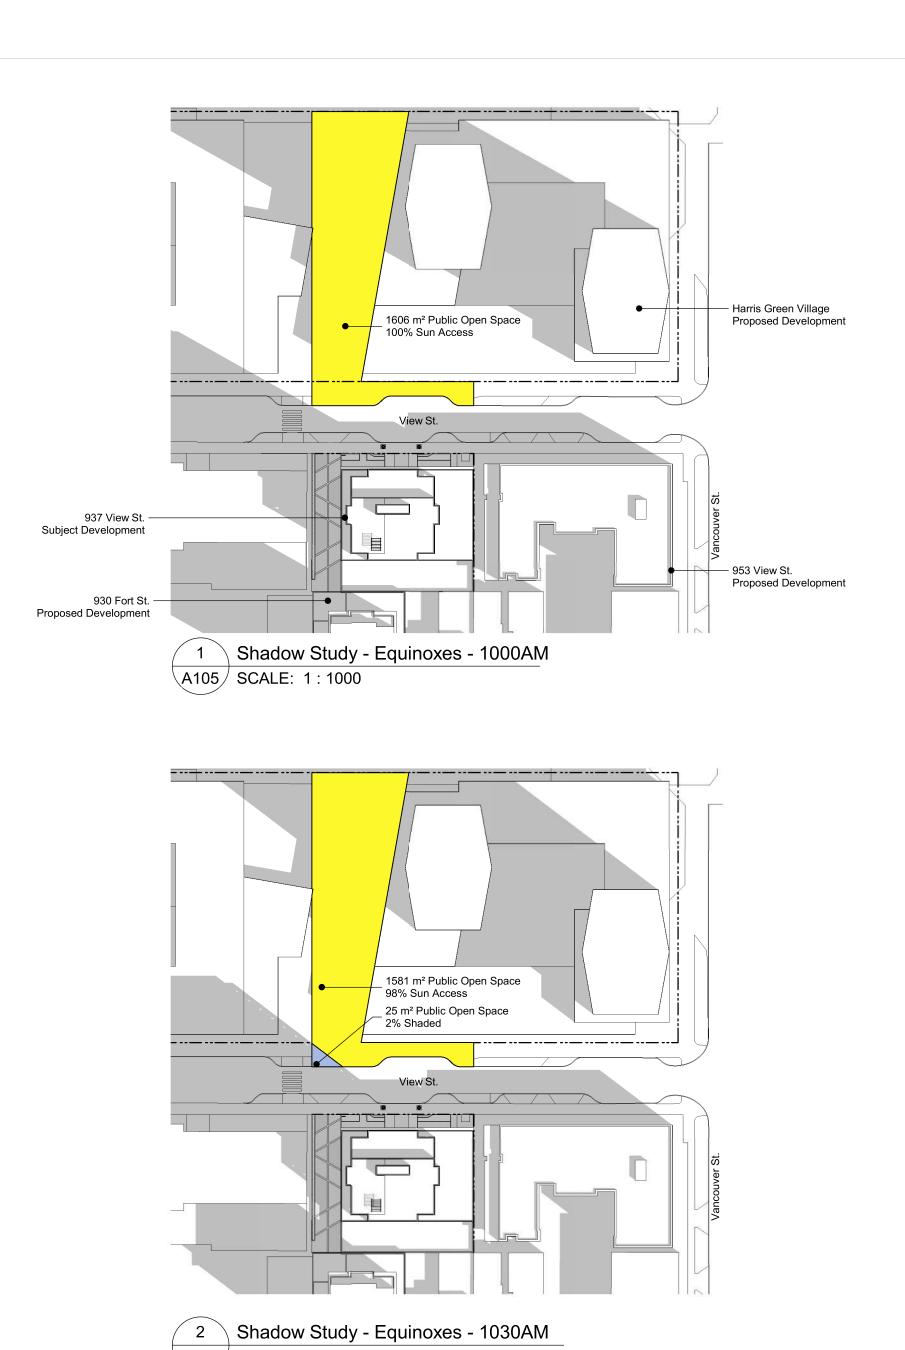


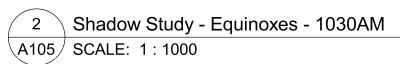



3 Shadow Study - Equinoxes - 1100AM A105 SCALE: 1:1000

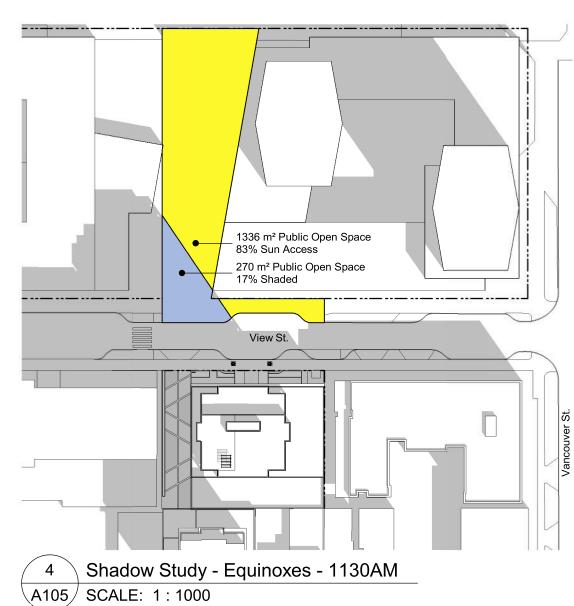


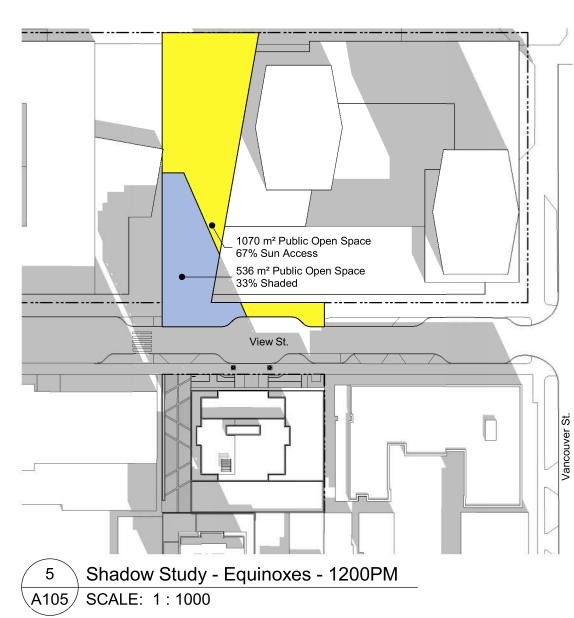


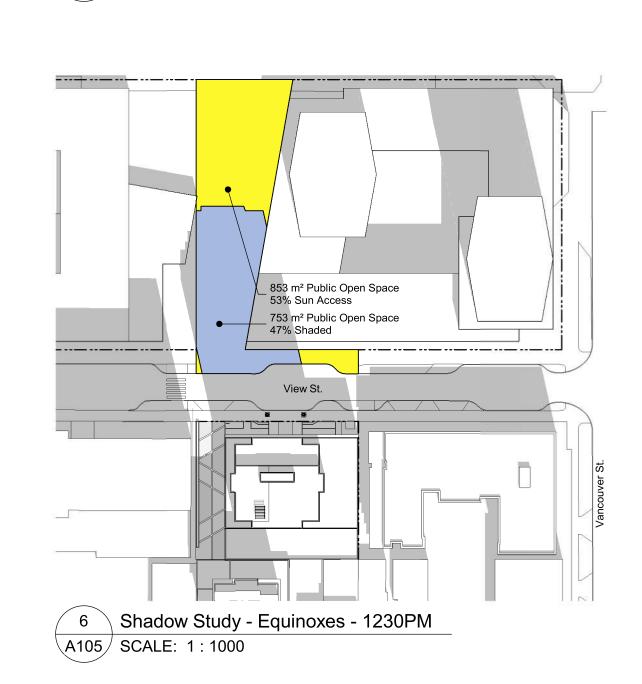

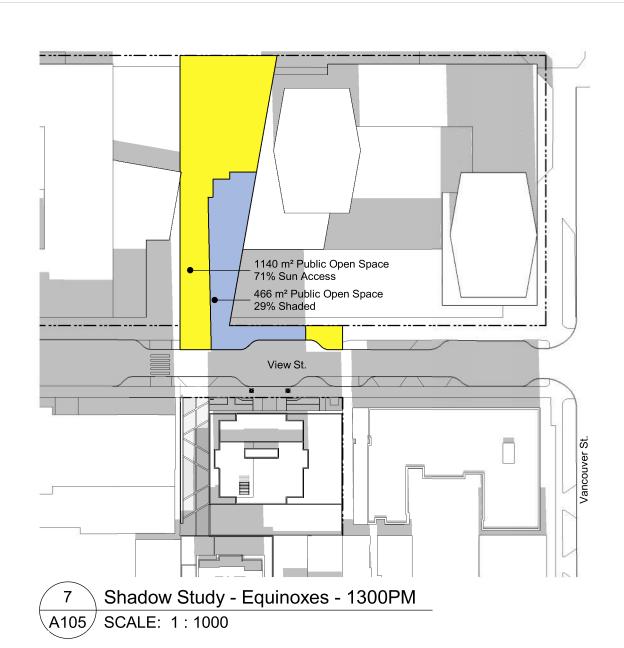


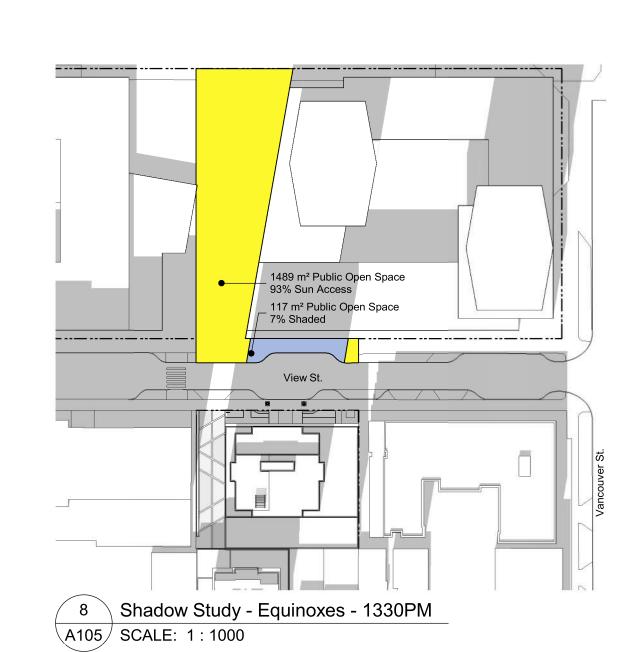

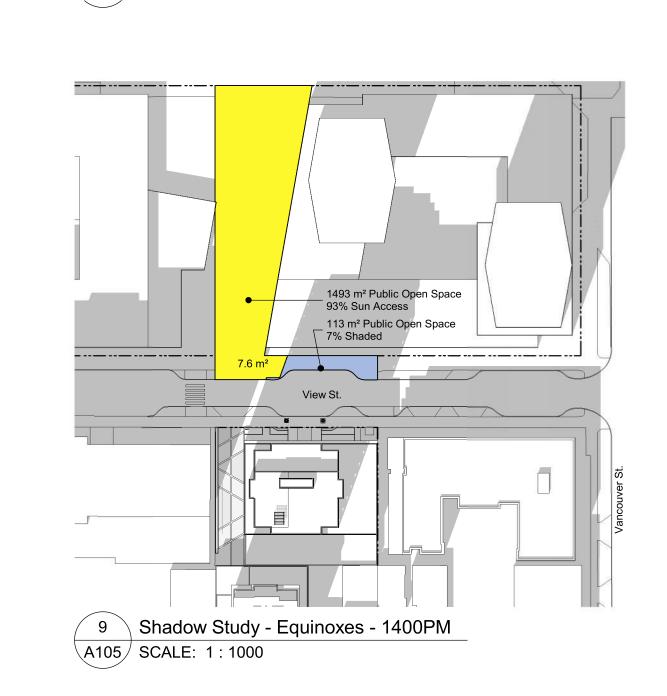


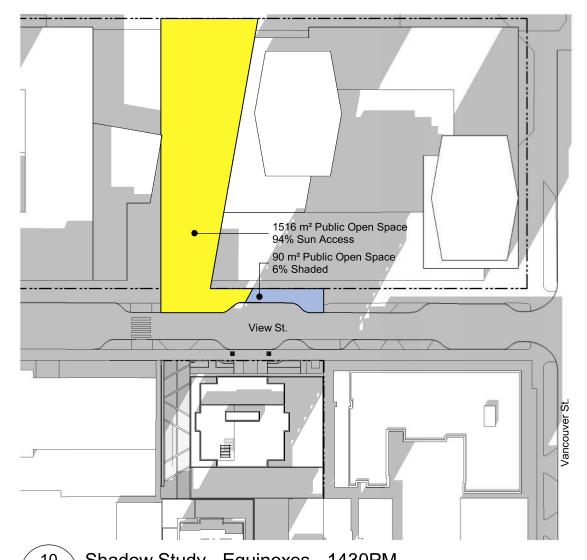

10 Shadow Study - Equinoxes - 1430PM A105 SCALE: 1:1000

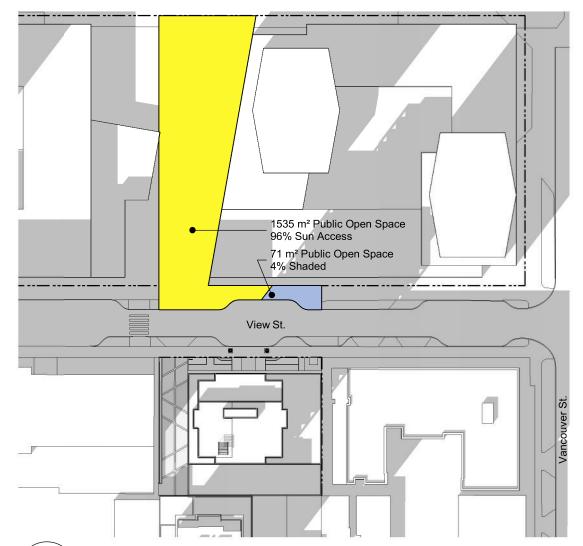

Shadow Study - Equinoxes - 1500PM
A105 SCALE: 1:1000

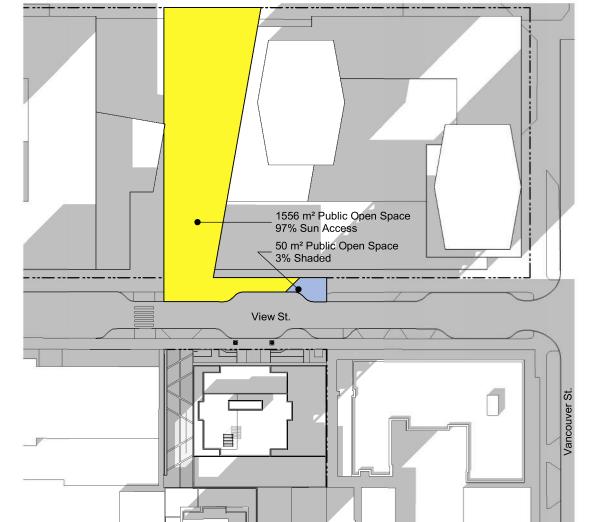

Shadow Study - Equinoxes - 1530PM
A105 SCALE: 1:1000

1:1000

View St. Residential					
NOTE: All dimensions are shown in millimeters.					
Scale	1 : 1000	Project Number			
Drawn By	RCI	Checked By			
Plot Date	23-12-12	Drawing File			

21-05-04 20-08-12

20-01-08

19-10-02

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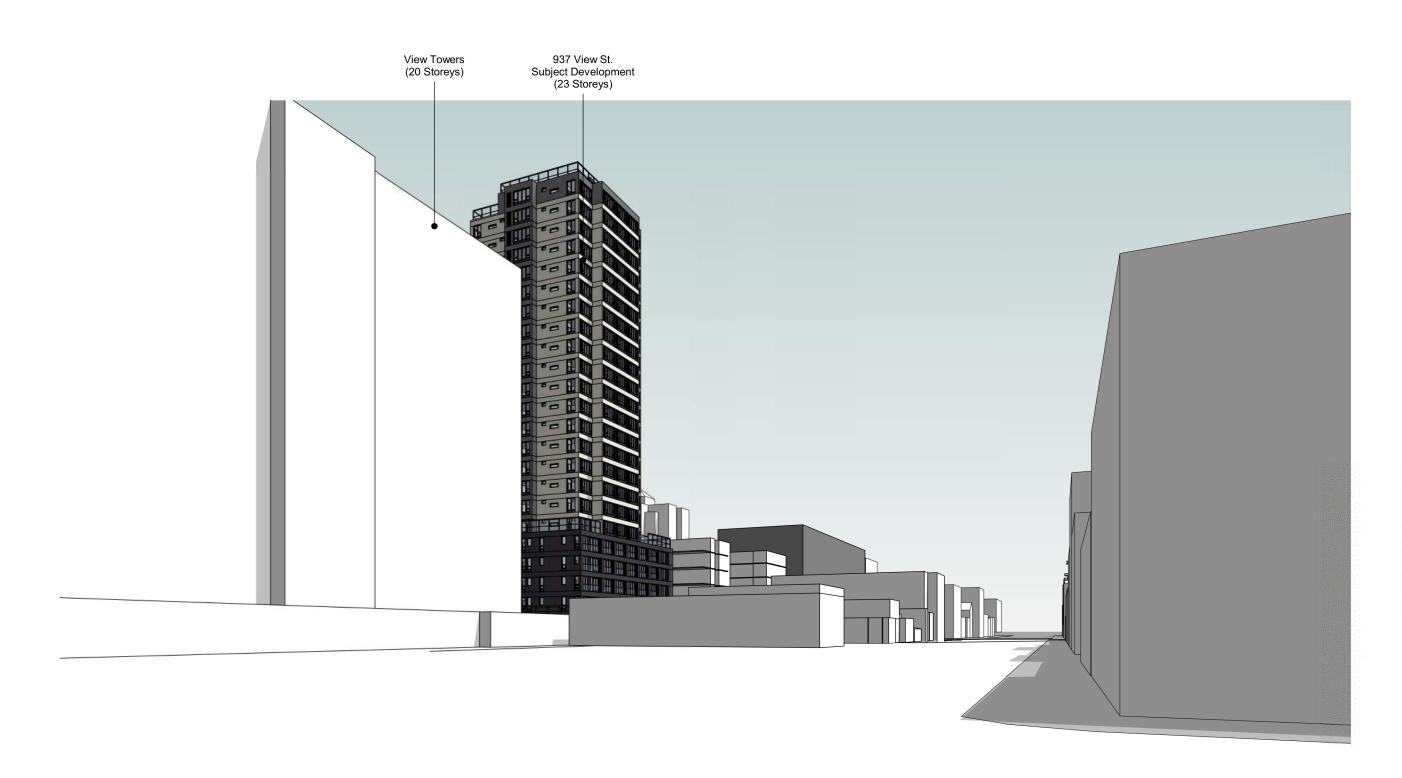
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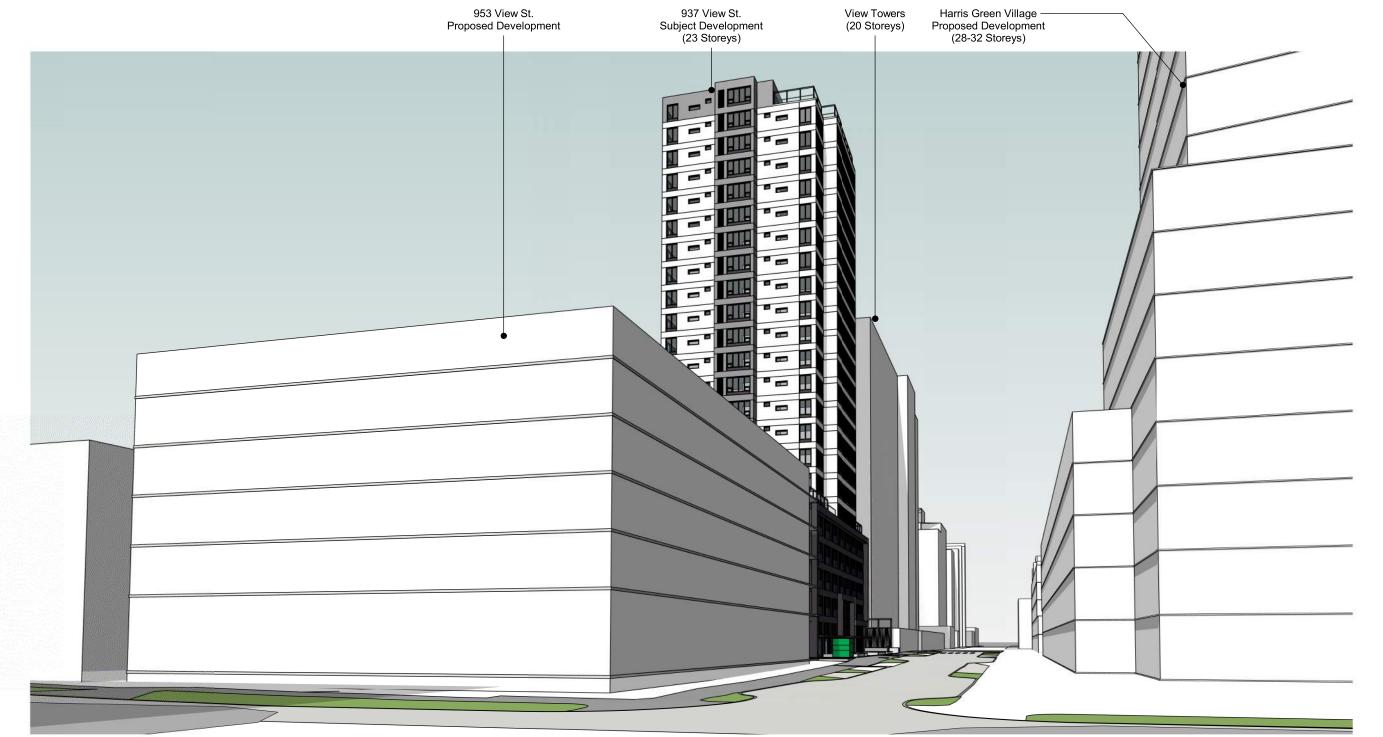
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937 View Street


Site Context -Shadow Analysis










1 Street Perspective - Fort & Quadra - SW Corner A107

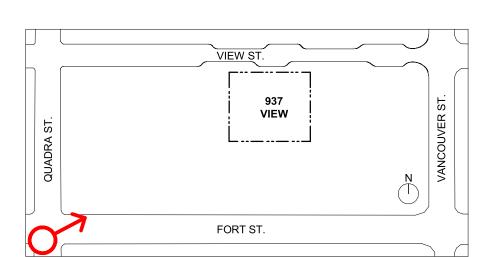


Street Perspective - View & Vancouver - NE Corner

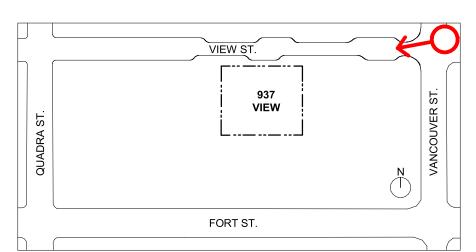

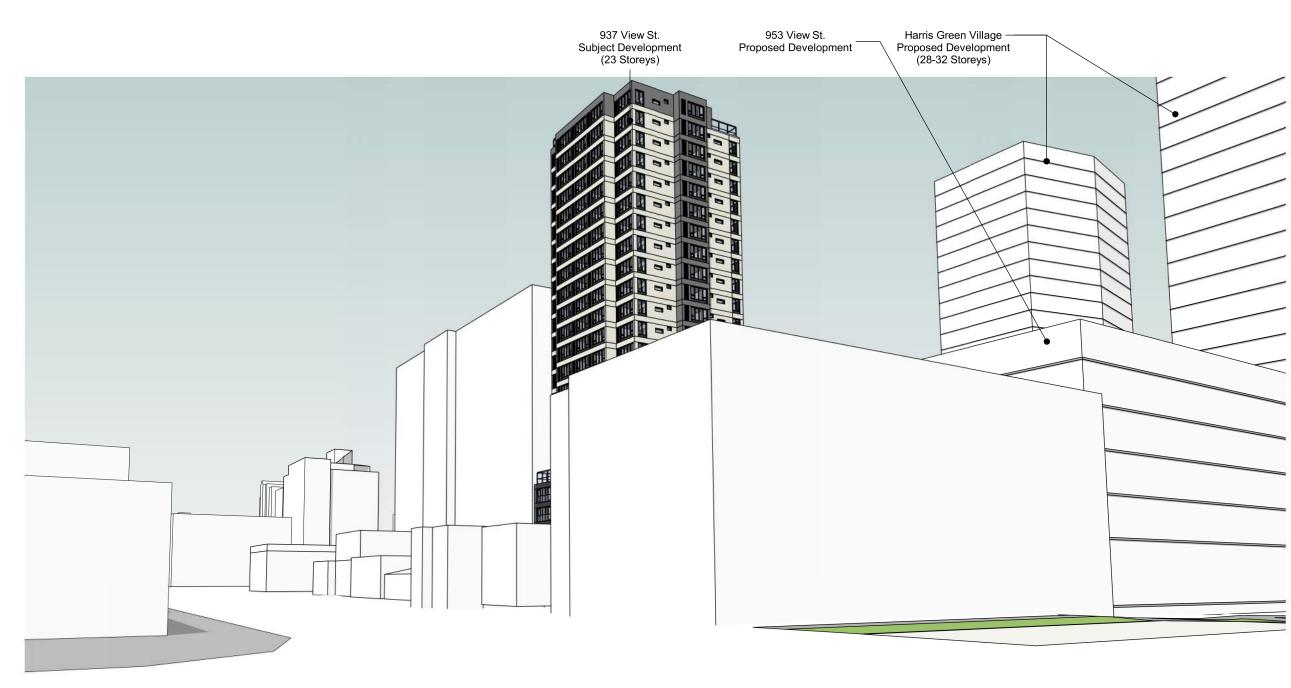


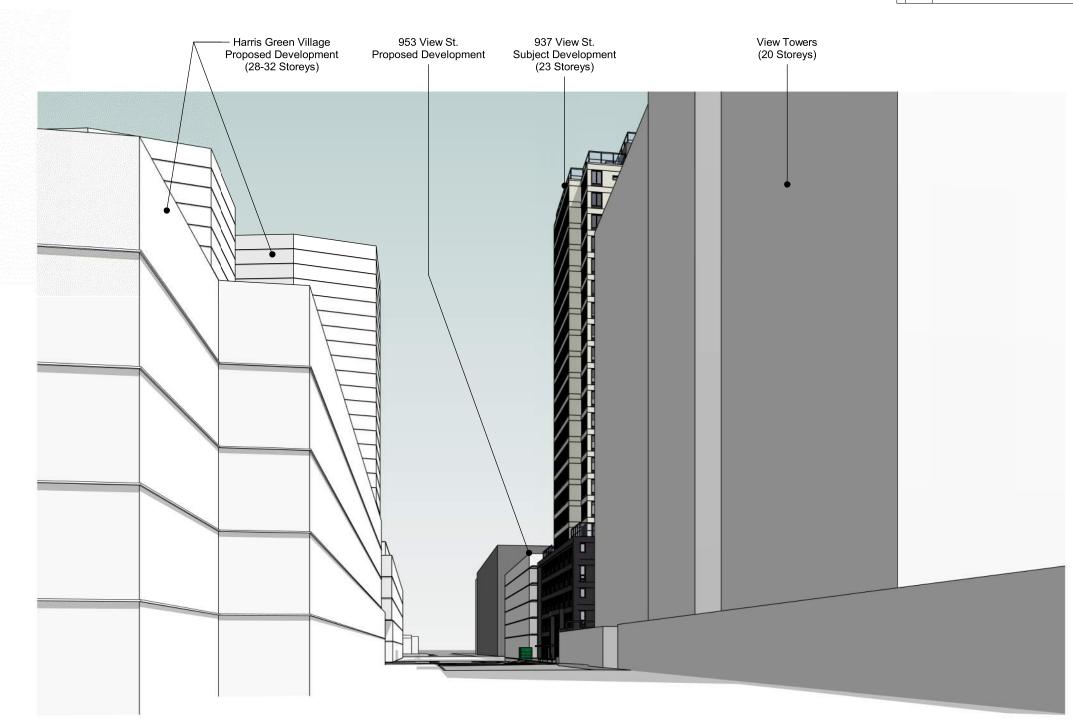

3 Street Perspective - Fort & Vancouver - SE Corner A107

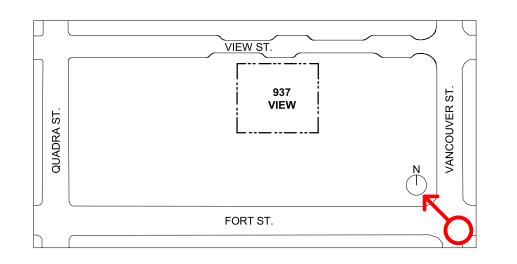

Street Perspective - View & Quadra - NW Corner

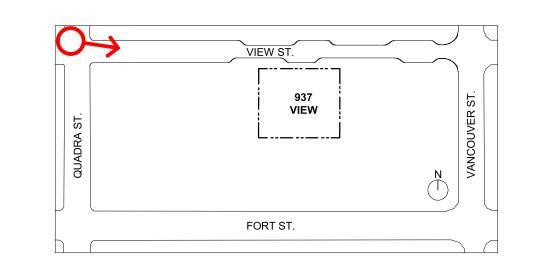


View St. Residential

937 View Street


Site Context - Street Views




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Street Perspective - View St Looking East From Blanshard
St SCALE:

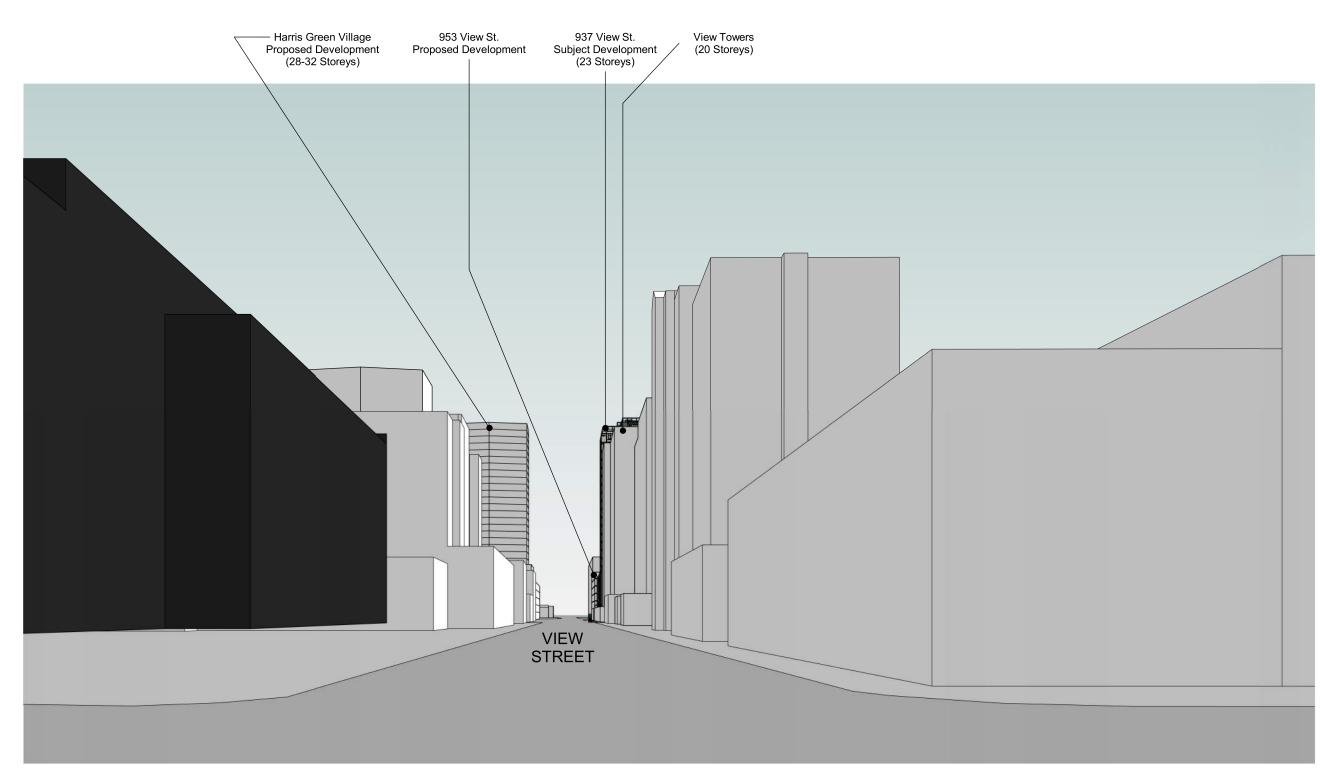


3 Street Perspective - View St Looking West From Cook St A107a SCALE:

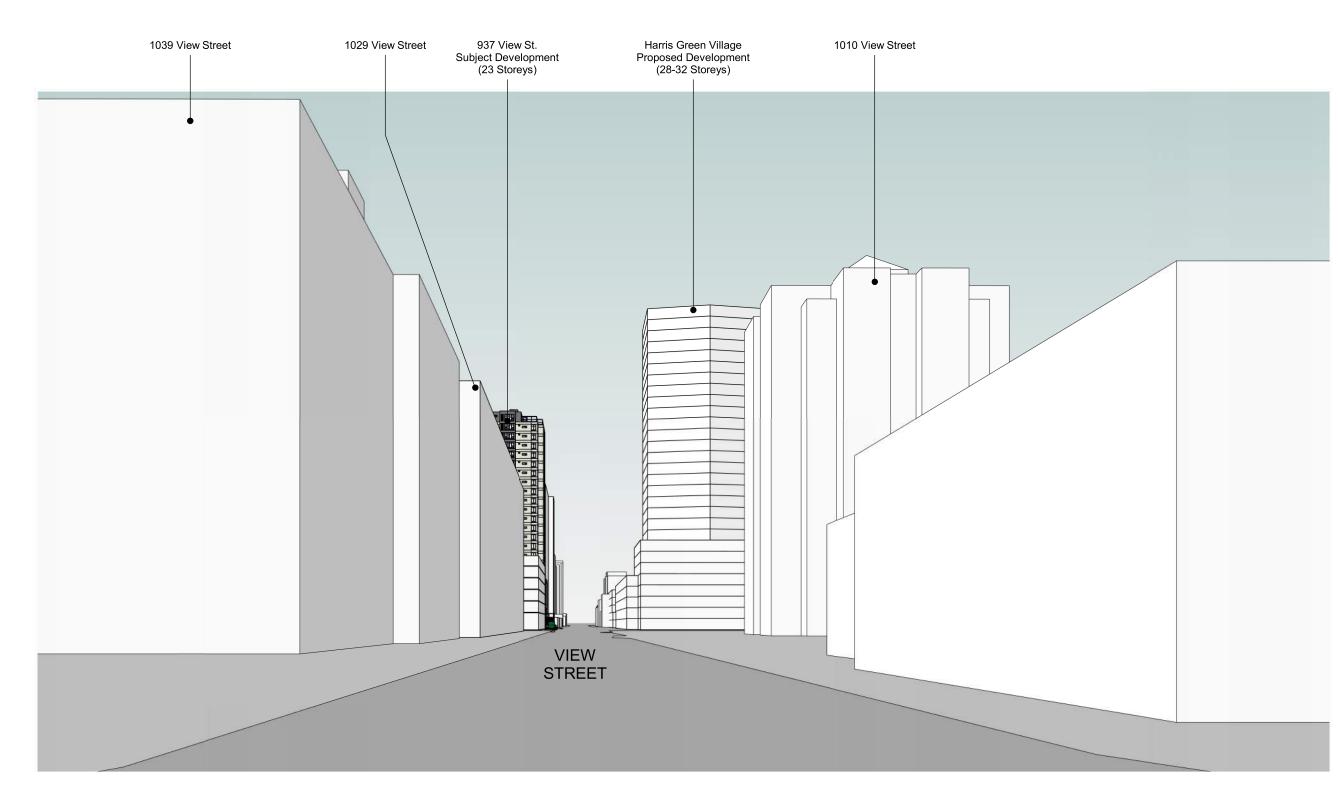

Street Perspective - Vancouver St Looking South From Yates St SCALE:

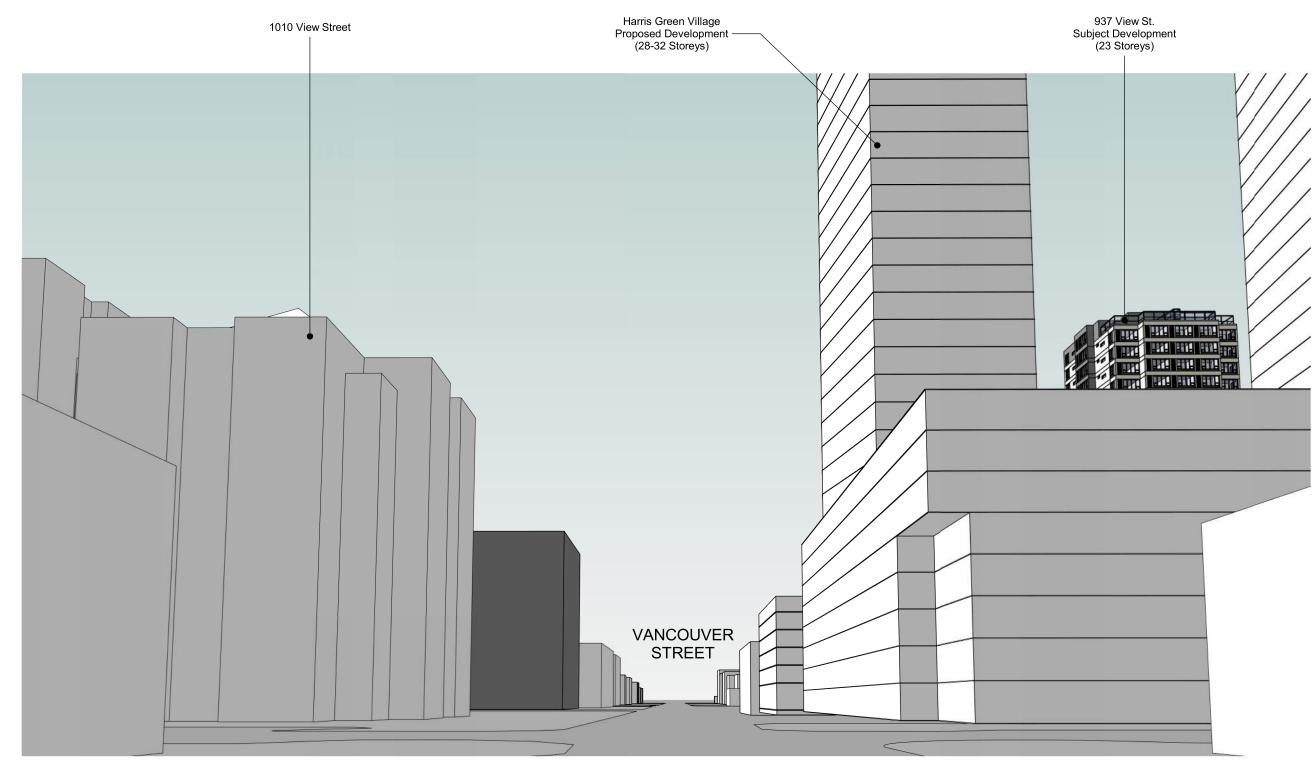


Existing View of Downtown From Laurel Pt.

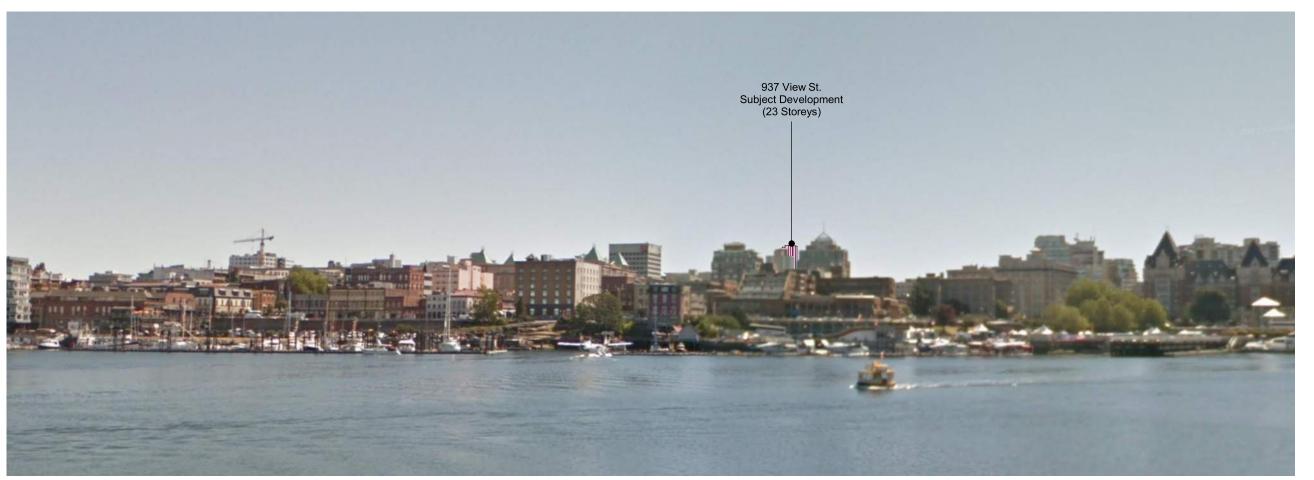

Modeled View of Downtown From Laurel Pt. With Proposed Development

4 DCAP View Cone From Laurel Pt

A107a SCALE: 1:100

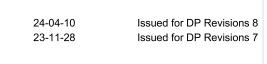

Plot Date 23-12-12 Drawing File

Drawn By Author Checked By Ch

Scale 1:100 Project Number

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937 View Street

Site Context - Street Views



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937 View Street

23-05-09

21-12-20

21-05-04

20-08-12

Site Context - Street Elevations


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1 Street Elevation - North

A108 | SCALE: 1:300



Tempered and Laminated

Structural Glass Guardrail w/

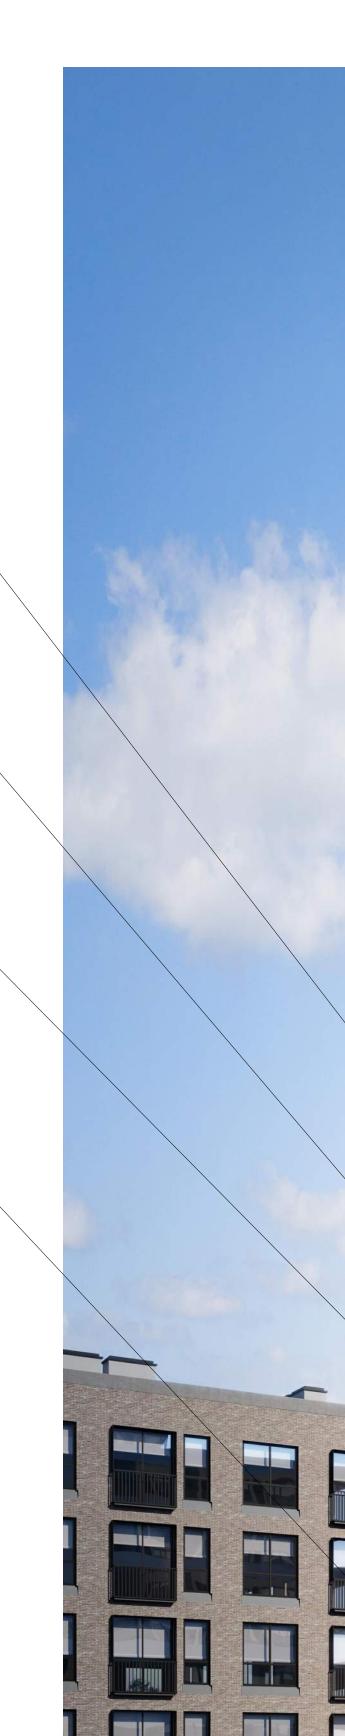Aluminum Cap Rail

Anodized

Three

Signage

Dimensional Backlit Address

Window Wall -System w/ Low E

Insulated Glass & LED Coloured

Painted Metal — Gates, Trellis, Guards & Fencing

Backlit Feature



Issued for DP Revisions 5 Issued for DP Revisions 3 21-05-04 20-08-12 Issued for DP Revisions 2 20-01-08 Issued for DP Revisions 1 19-10-02

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937 View Street

Site Context -Materials



Victoria 977 Fort Street

Architectural Exposed
 Concrete
 Benches/Planters




1. Rendered Interior Concept Plan of L1 Amenity Room Library, Work Lounge and Meeting Rooms


Terrace Lounge Outdoor Cooking Area Outdoor Fitness Area Living Room Fitness Room

937 VIEW STREET
LEVEL 23 AMENITY ROOMS

3. Rendered Interior Concept Plan of L23 Amenity
Rooms and Outdoor Terrace Area

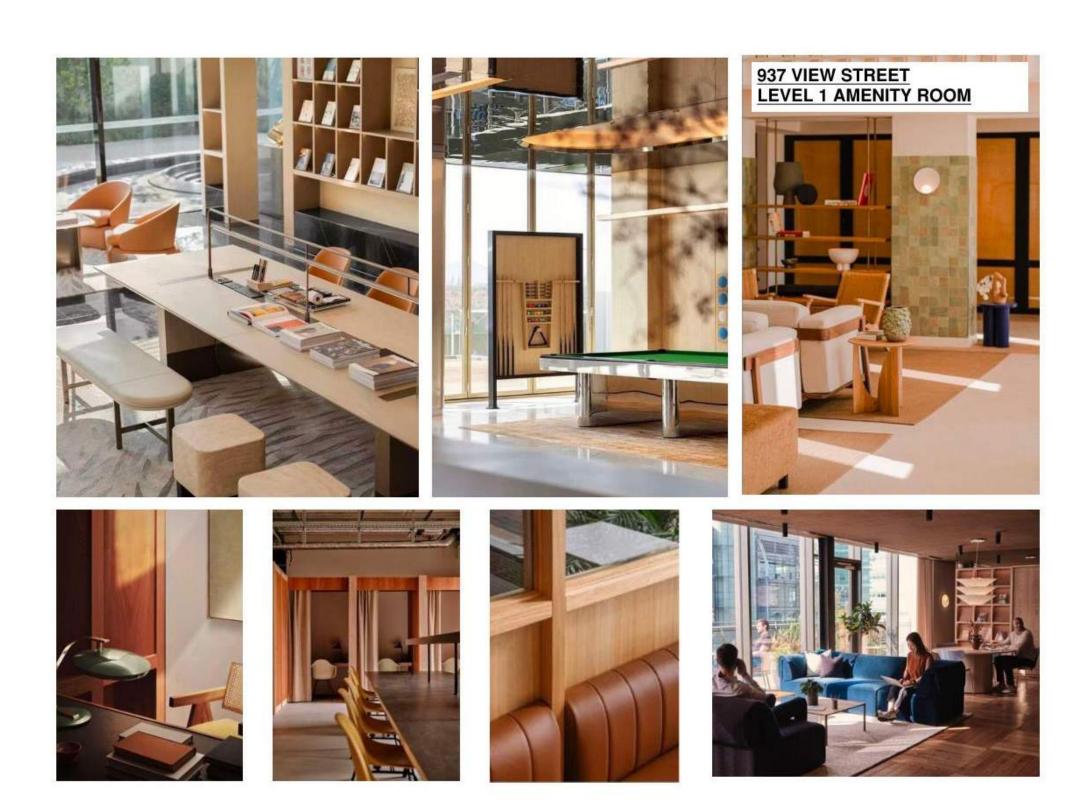

2. Material Character Concept Images of L1 Amenity Room Library, Work Lounge and Meeting Rooms

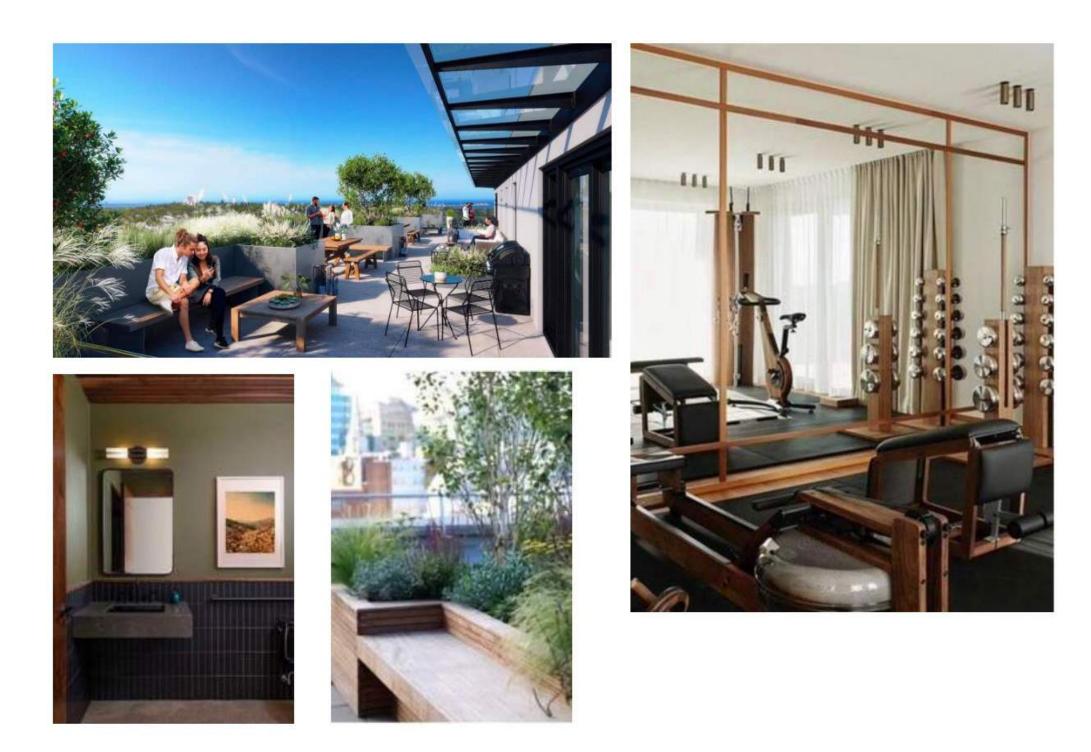

4. Material Character Concept Images of L23 Amenity
Rooms and Outdoor Terrace Area



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23-08-15

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1 Interior Design Concept Plans
A117 SCALE: 1:2

1 3 6 5

Rendered Plan View of Unit Type C (NTS)



Rendered View of Living Area

TYPICAL UNIT TYPE C

LIVABILITY NOTES

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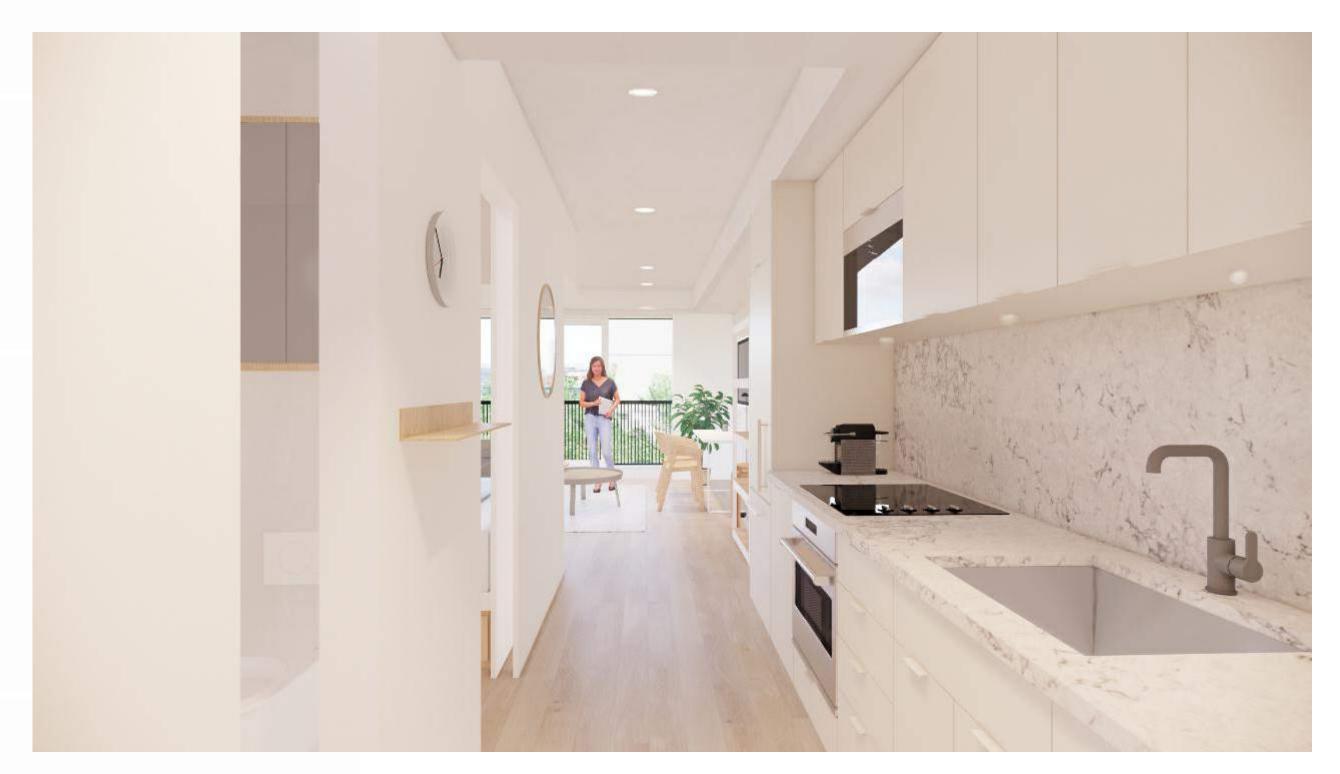
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8


- 33 m sq average size (min 32.16 max 33.09 m sq)
 Juliette Balcony and full height windows on primary elevation for light and air access.
 Built in storage and bedroom furniture.
- 4. W/D in every unit.
- 5. Three piece bathrooms with built in linen storage and medicine cabinets.
 6. Full featured galley style kitchen and cabinets including tub style stailess steel sink, microwave, electric induction range and electric oven.
 7. Living area sized for flexibility with prewired for high speed data / cable.
 8. High ceilings with high performance LED lighting.



Rendered View of Kitchen Area



Rendered View of Living and Bedroom Area

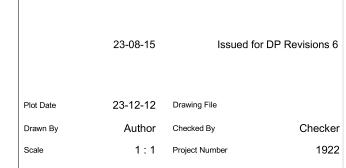


View St. Residential


937 View Street

Livability - Rendered Interior Views



Victoria 977 Fort Street

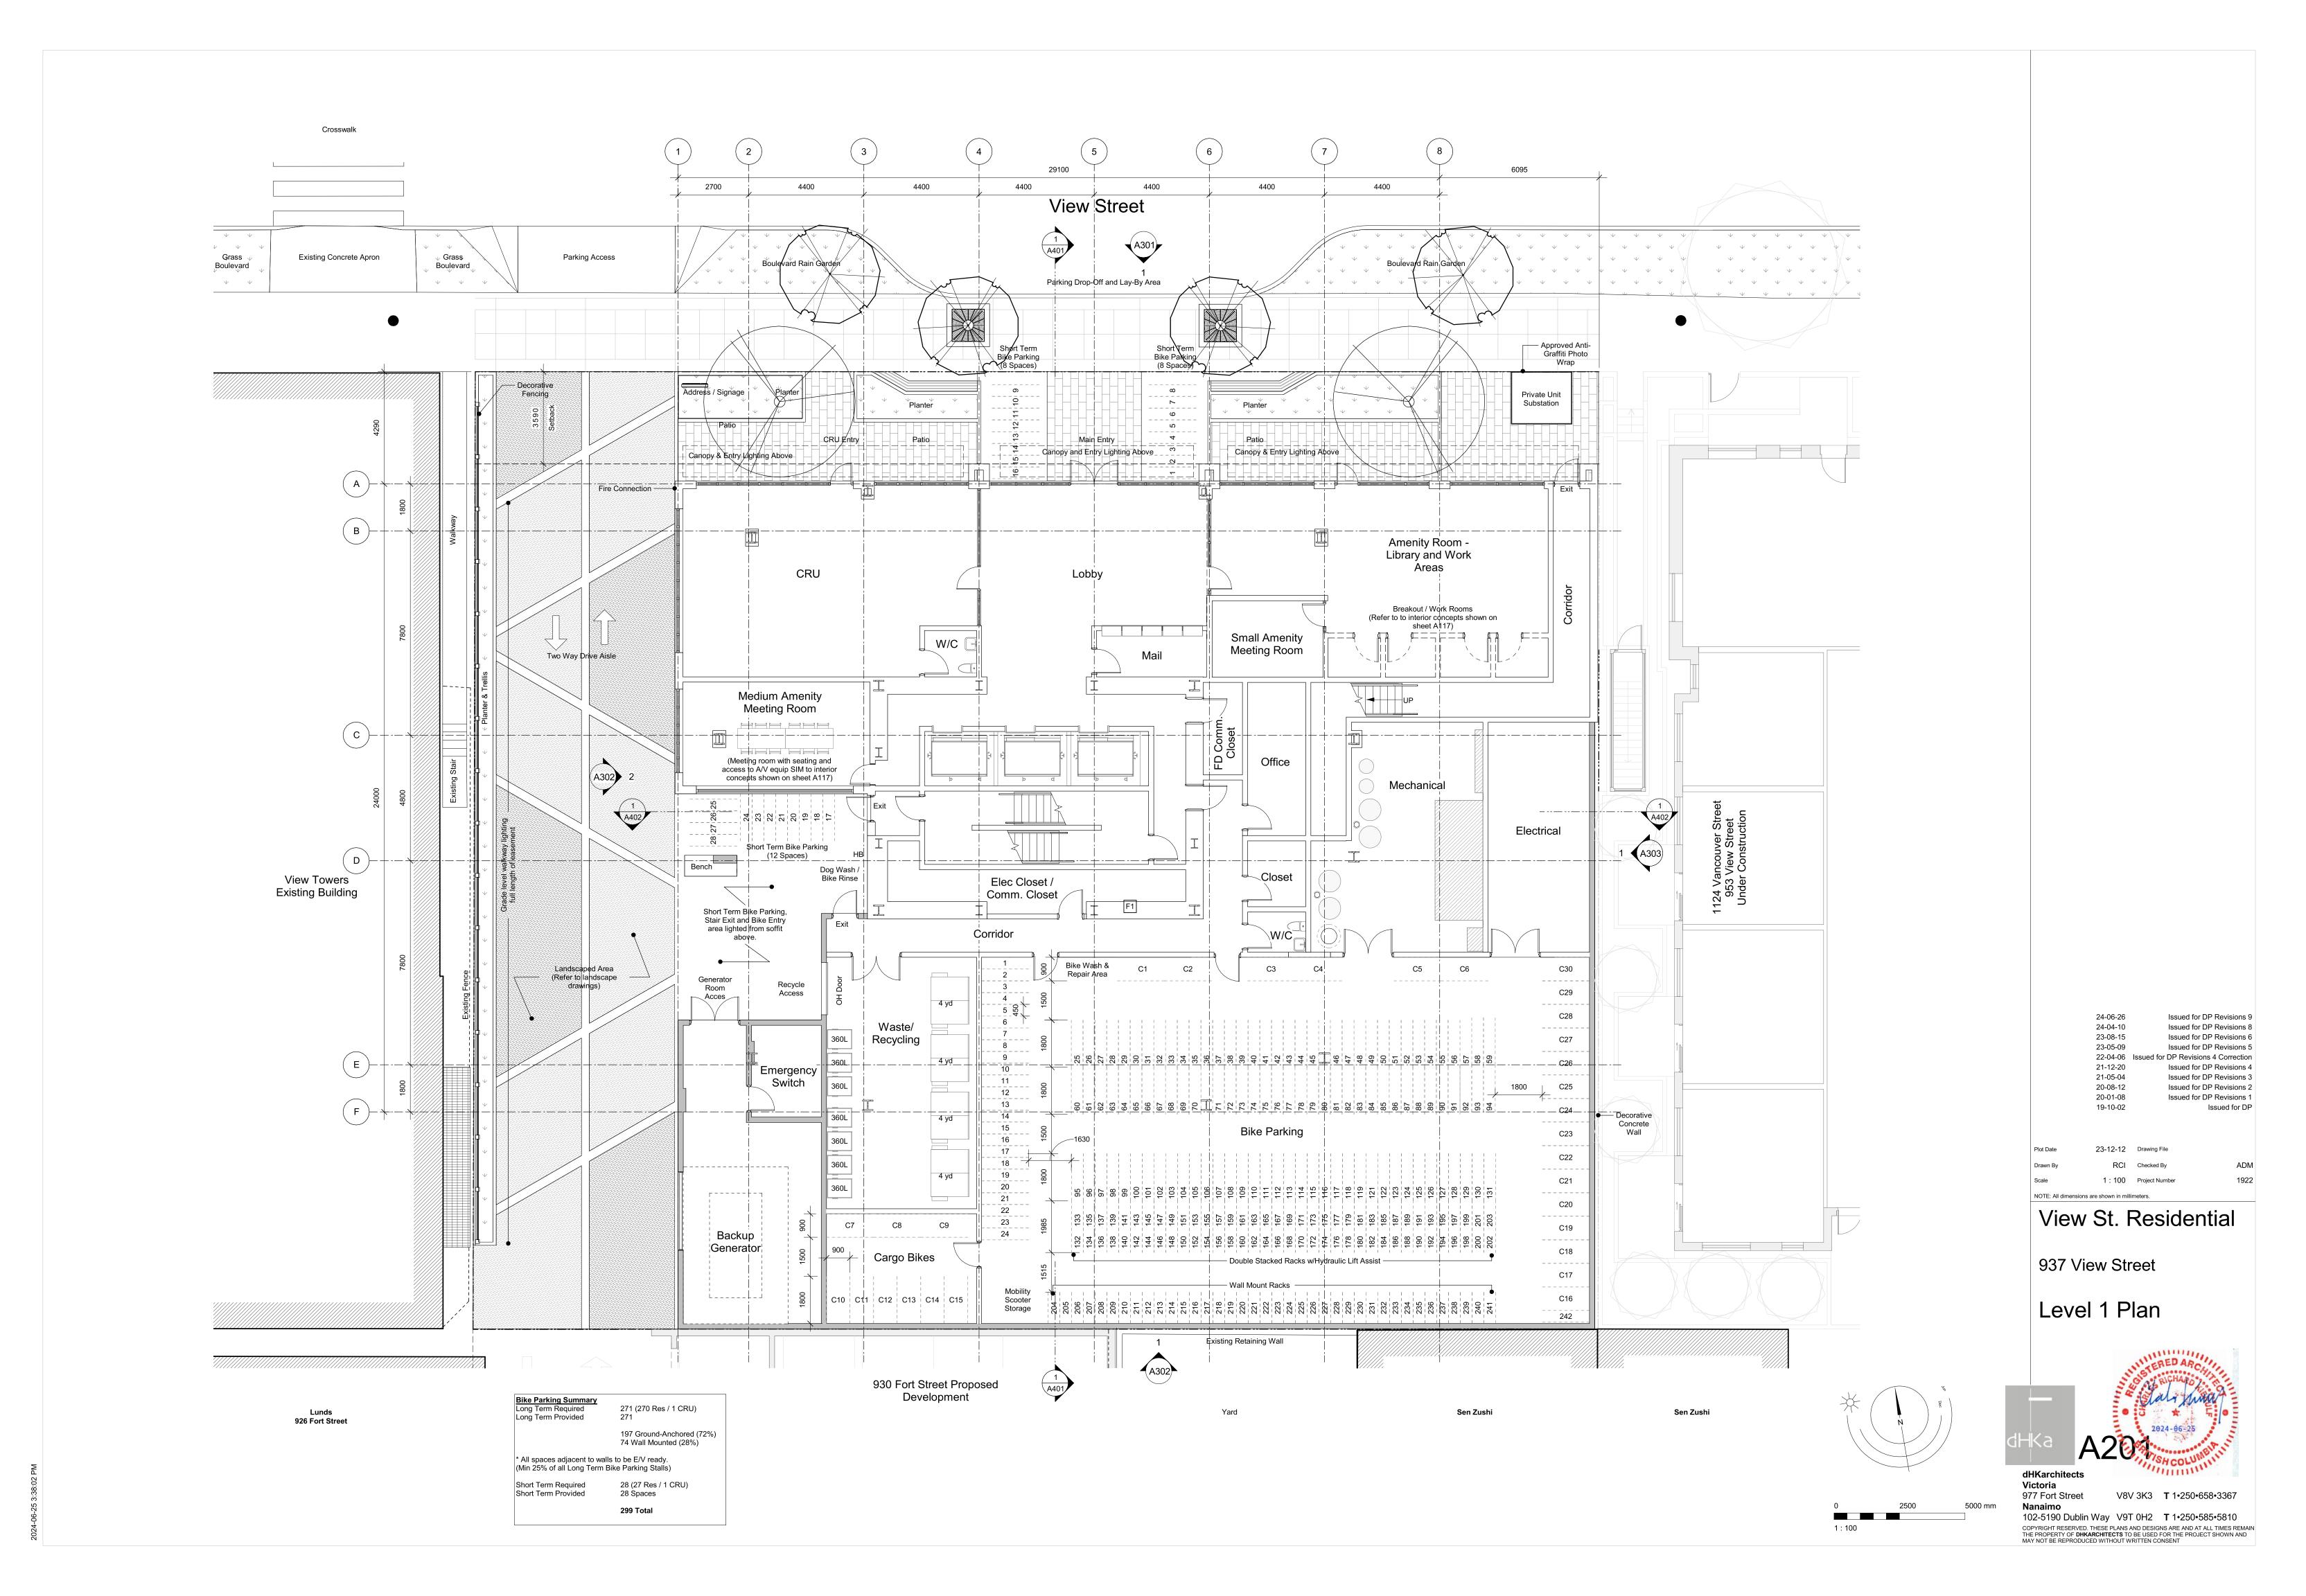

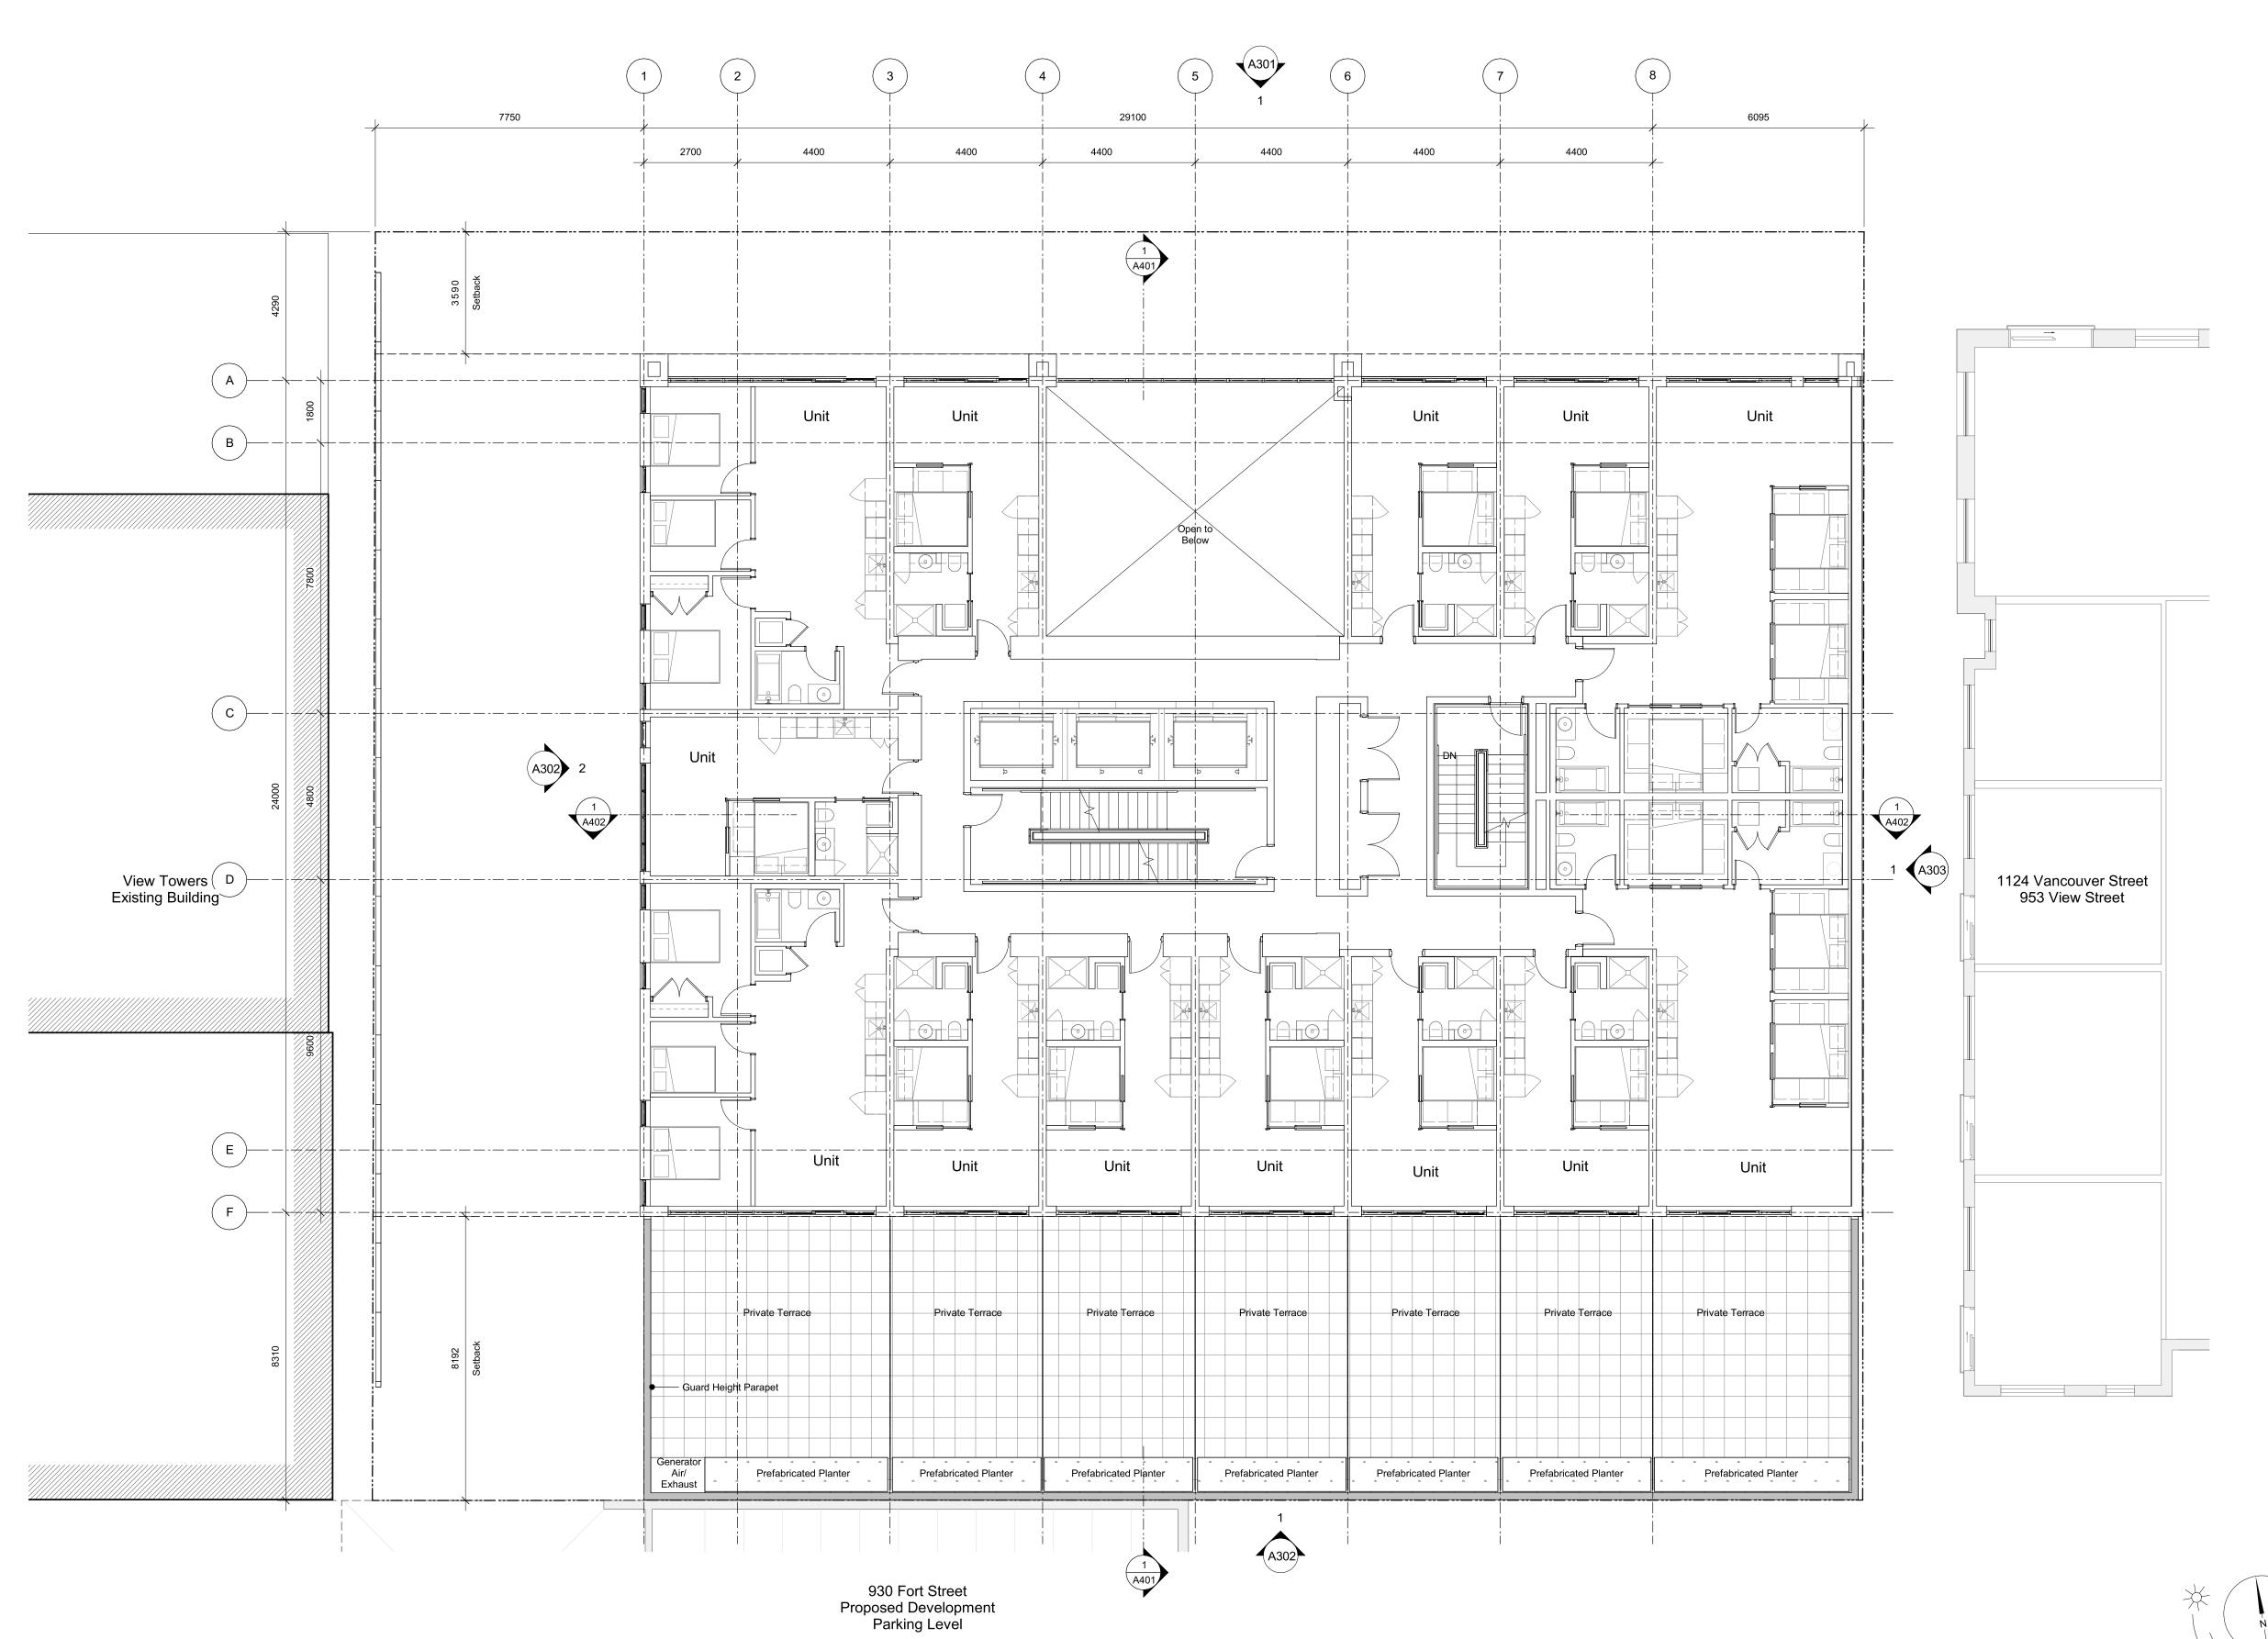

23-08-15 Issued for DP Revisions 6 23-05-09 Issued for DP Revisions 5 Issued for DP Revisions 3 21-05-04 20-08-12 20-01-08 Issued for DP Revisions 2
Issued for DP Revisions 1 19-10-02 Issued for DP


23-12-12 Drawing File

View St. Residential

937 View Street


Level 2 Plan

NOTE: All dimensions are shown in millimeters.

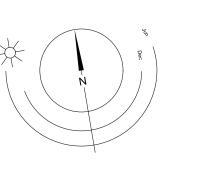



Victoria 977 Fort Street

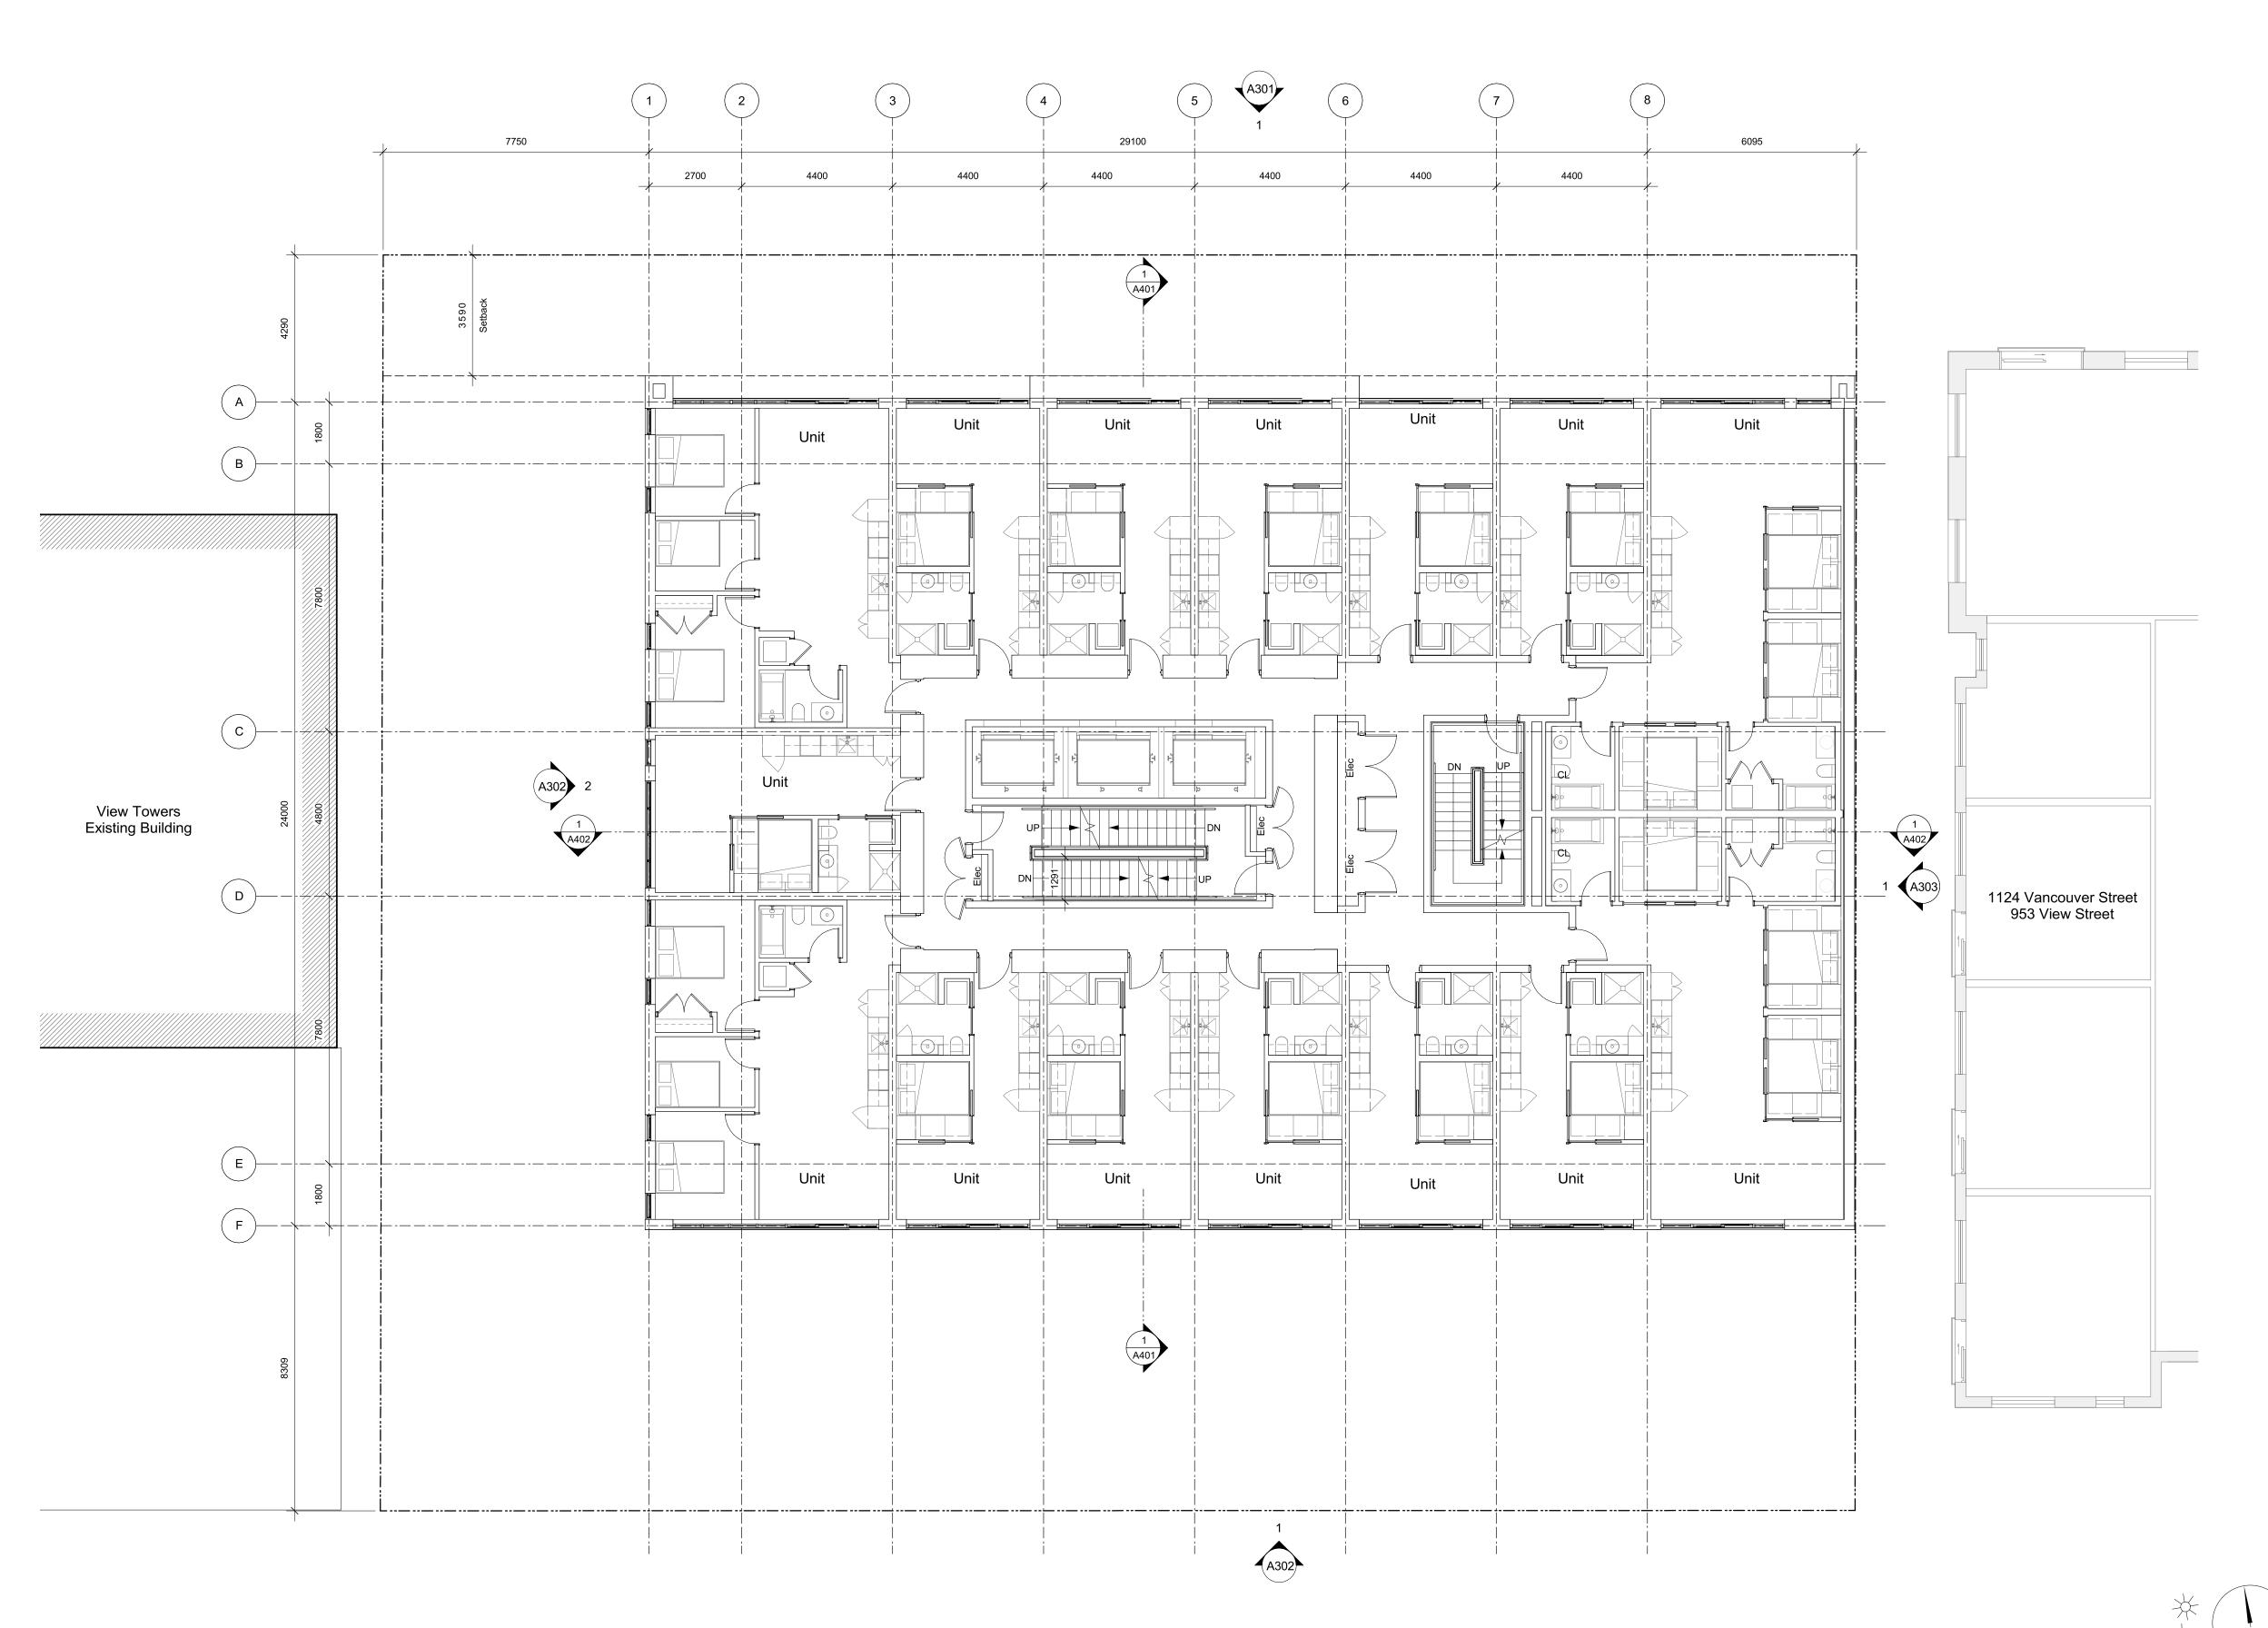

930 Fort Street Proposed Development (Up to L13)


Issued for DP Revisions 6 23-05-09 Issued for DP Revisions 5 Issued for DP Revisions 3 21-05-04 20-08-12 20-01-08 Issued for DP Revisions 2
Issued for DP Revisions 1 19-10-02

23-12-12 Drawing File


View St. Residential

937 View Street

Levels 3-5 Plan

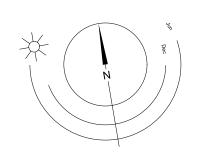

Victoria 977 Fort Street

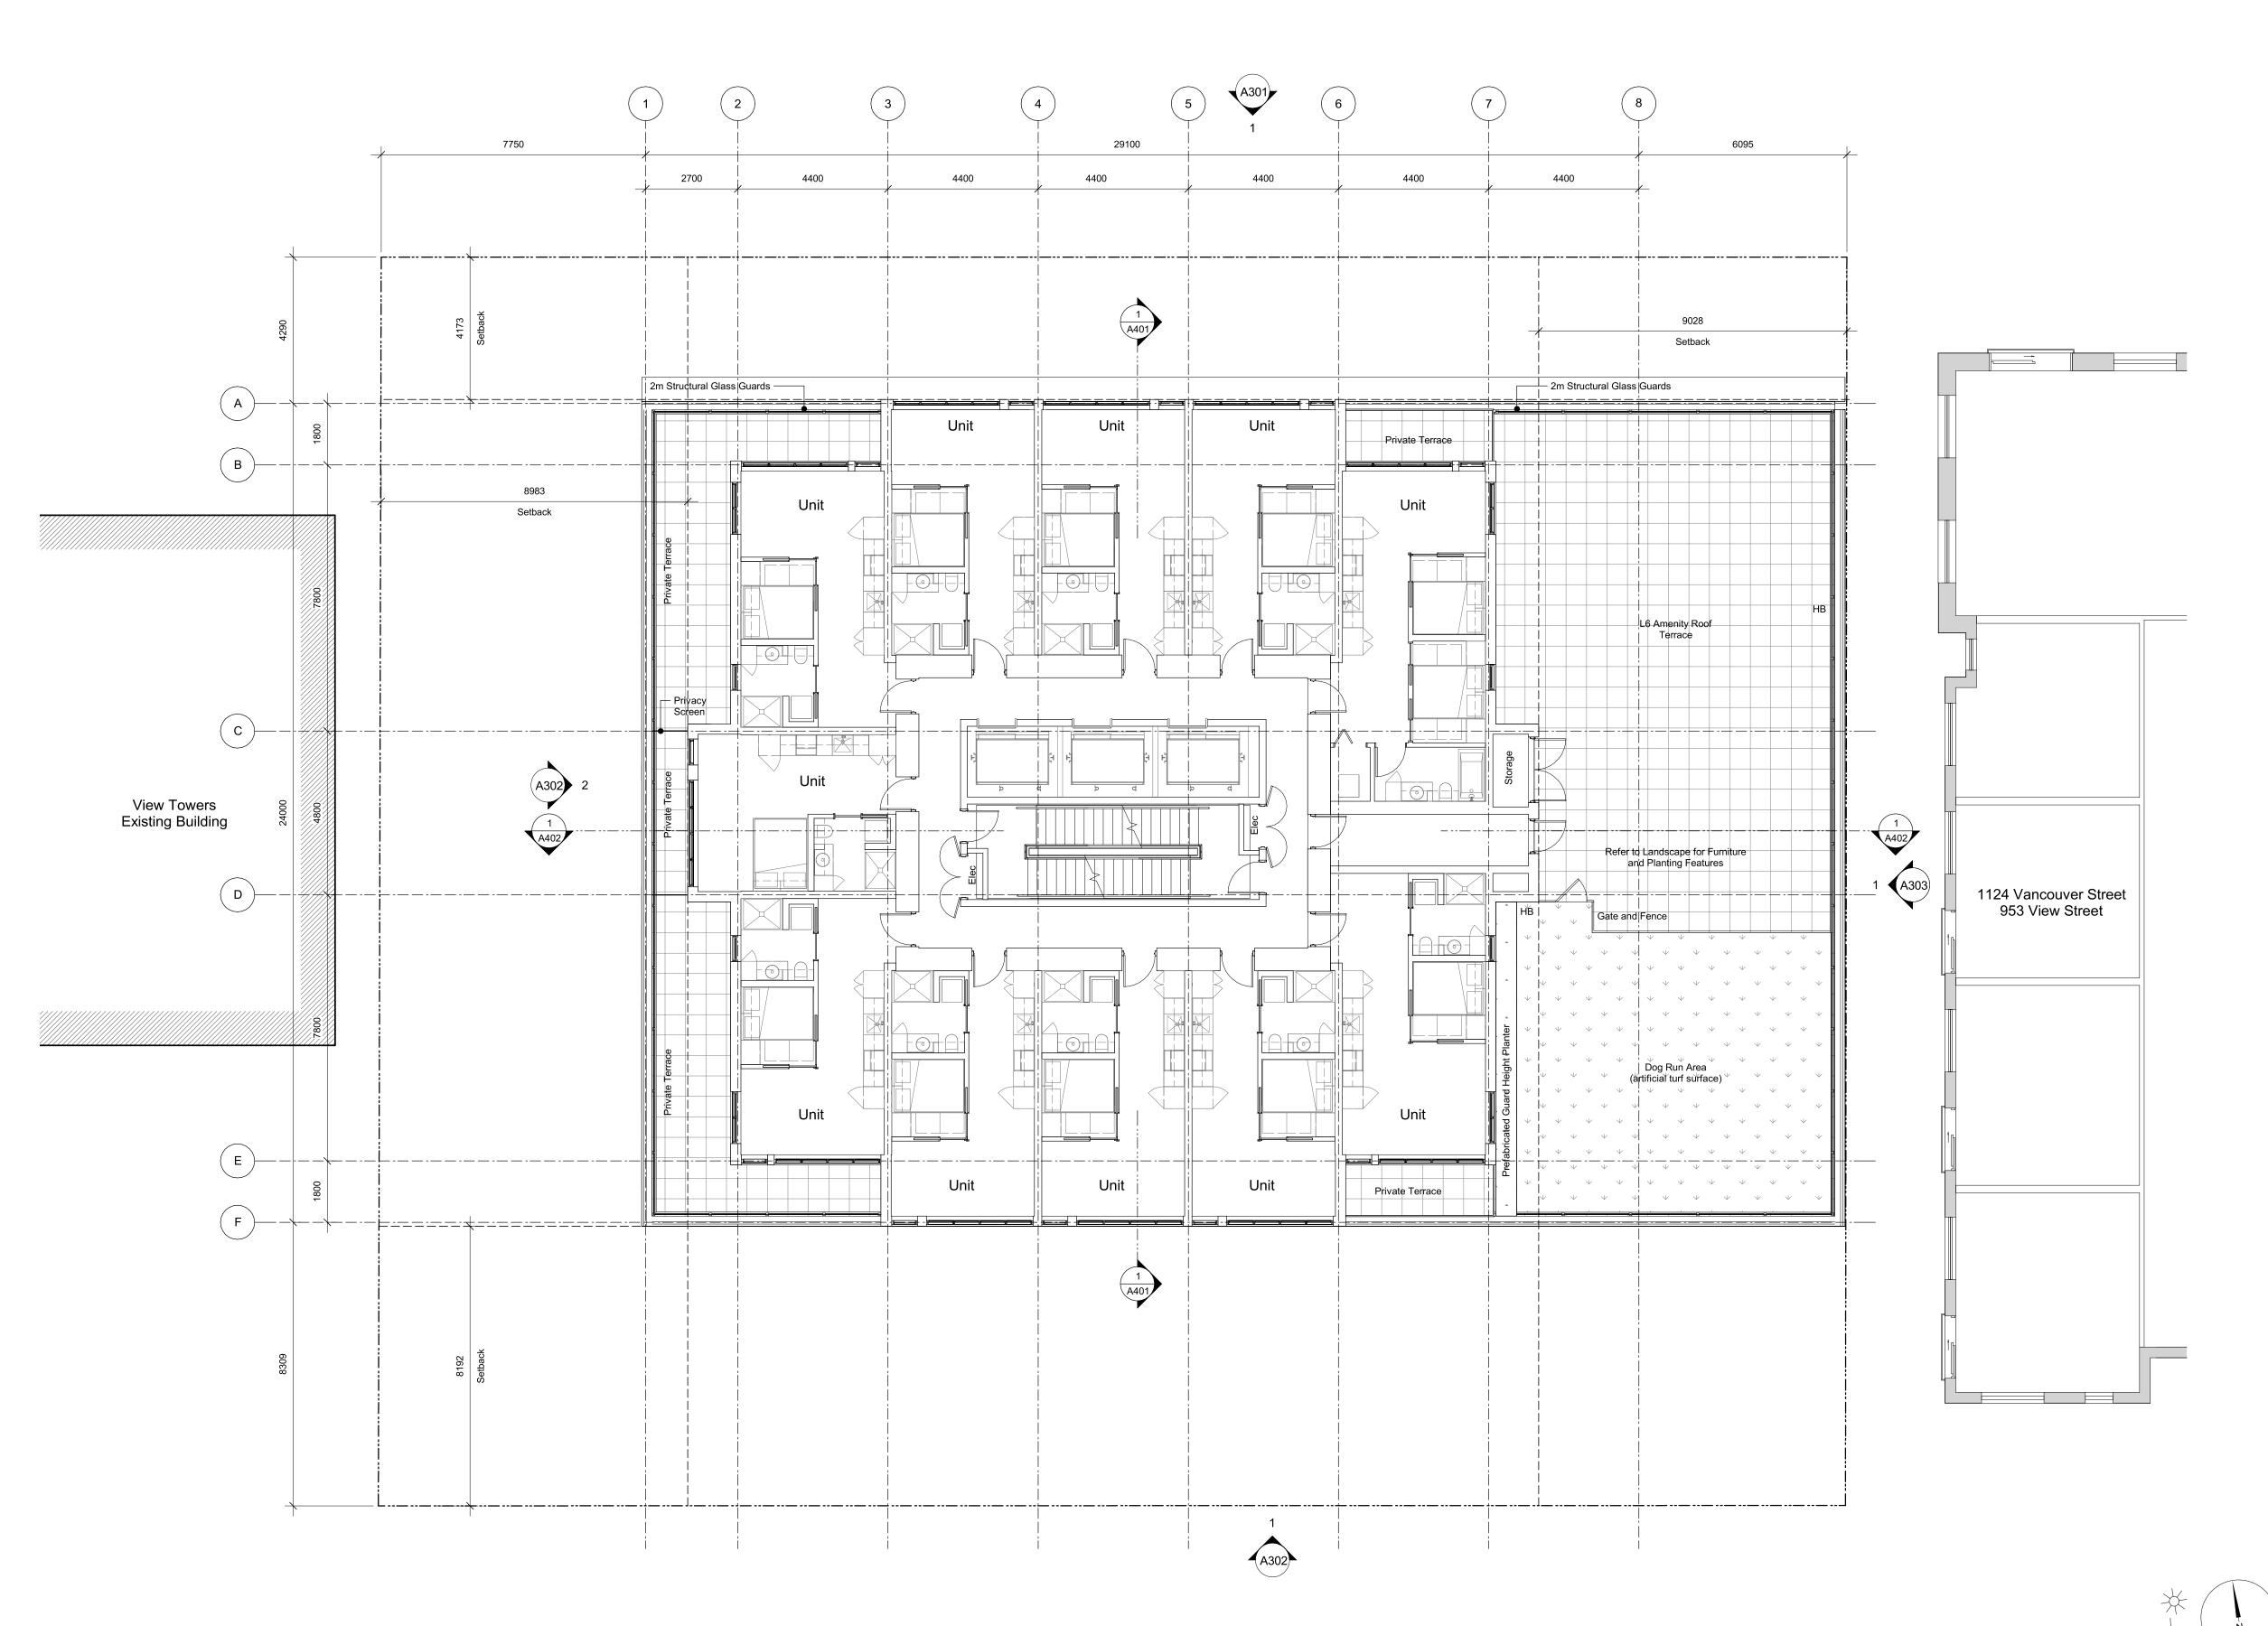


930 Fort Street Proposed Development (Up to L13)

Issued for DP Revisions 8 23-08-15 Issued for DP Revisions 6 23-05-09 Issued for DP Revisions 5 Issued for DP Revisions 3 21-05-04 20-08-12 20-01-08 Issued for DP Revisions 2 Issued for DP Revisions 1 19-10-02

View St. Residential


937 View Street

Levels 6 Plan

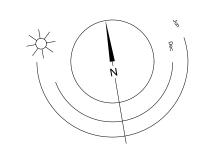



Victoria 977 Fort Street

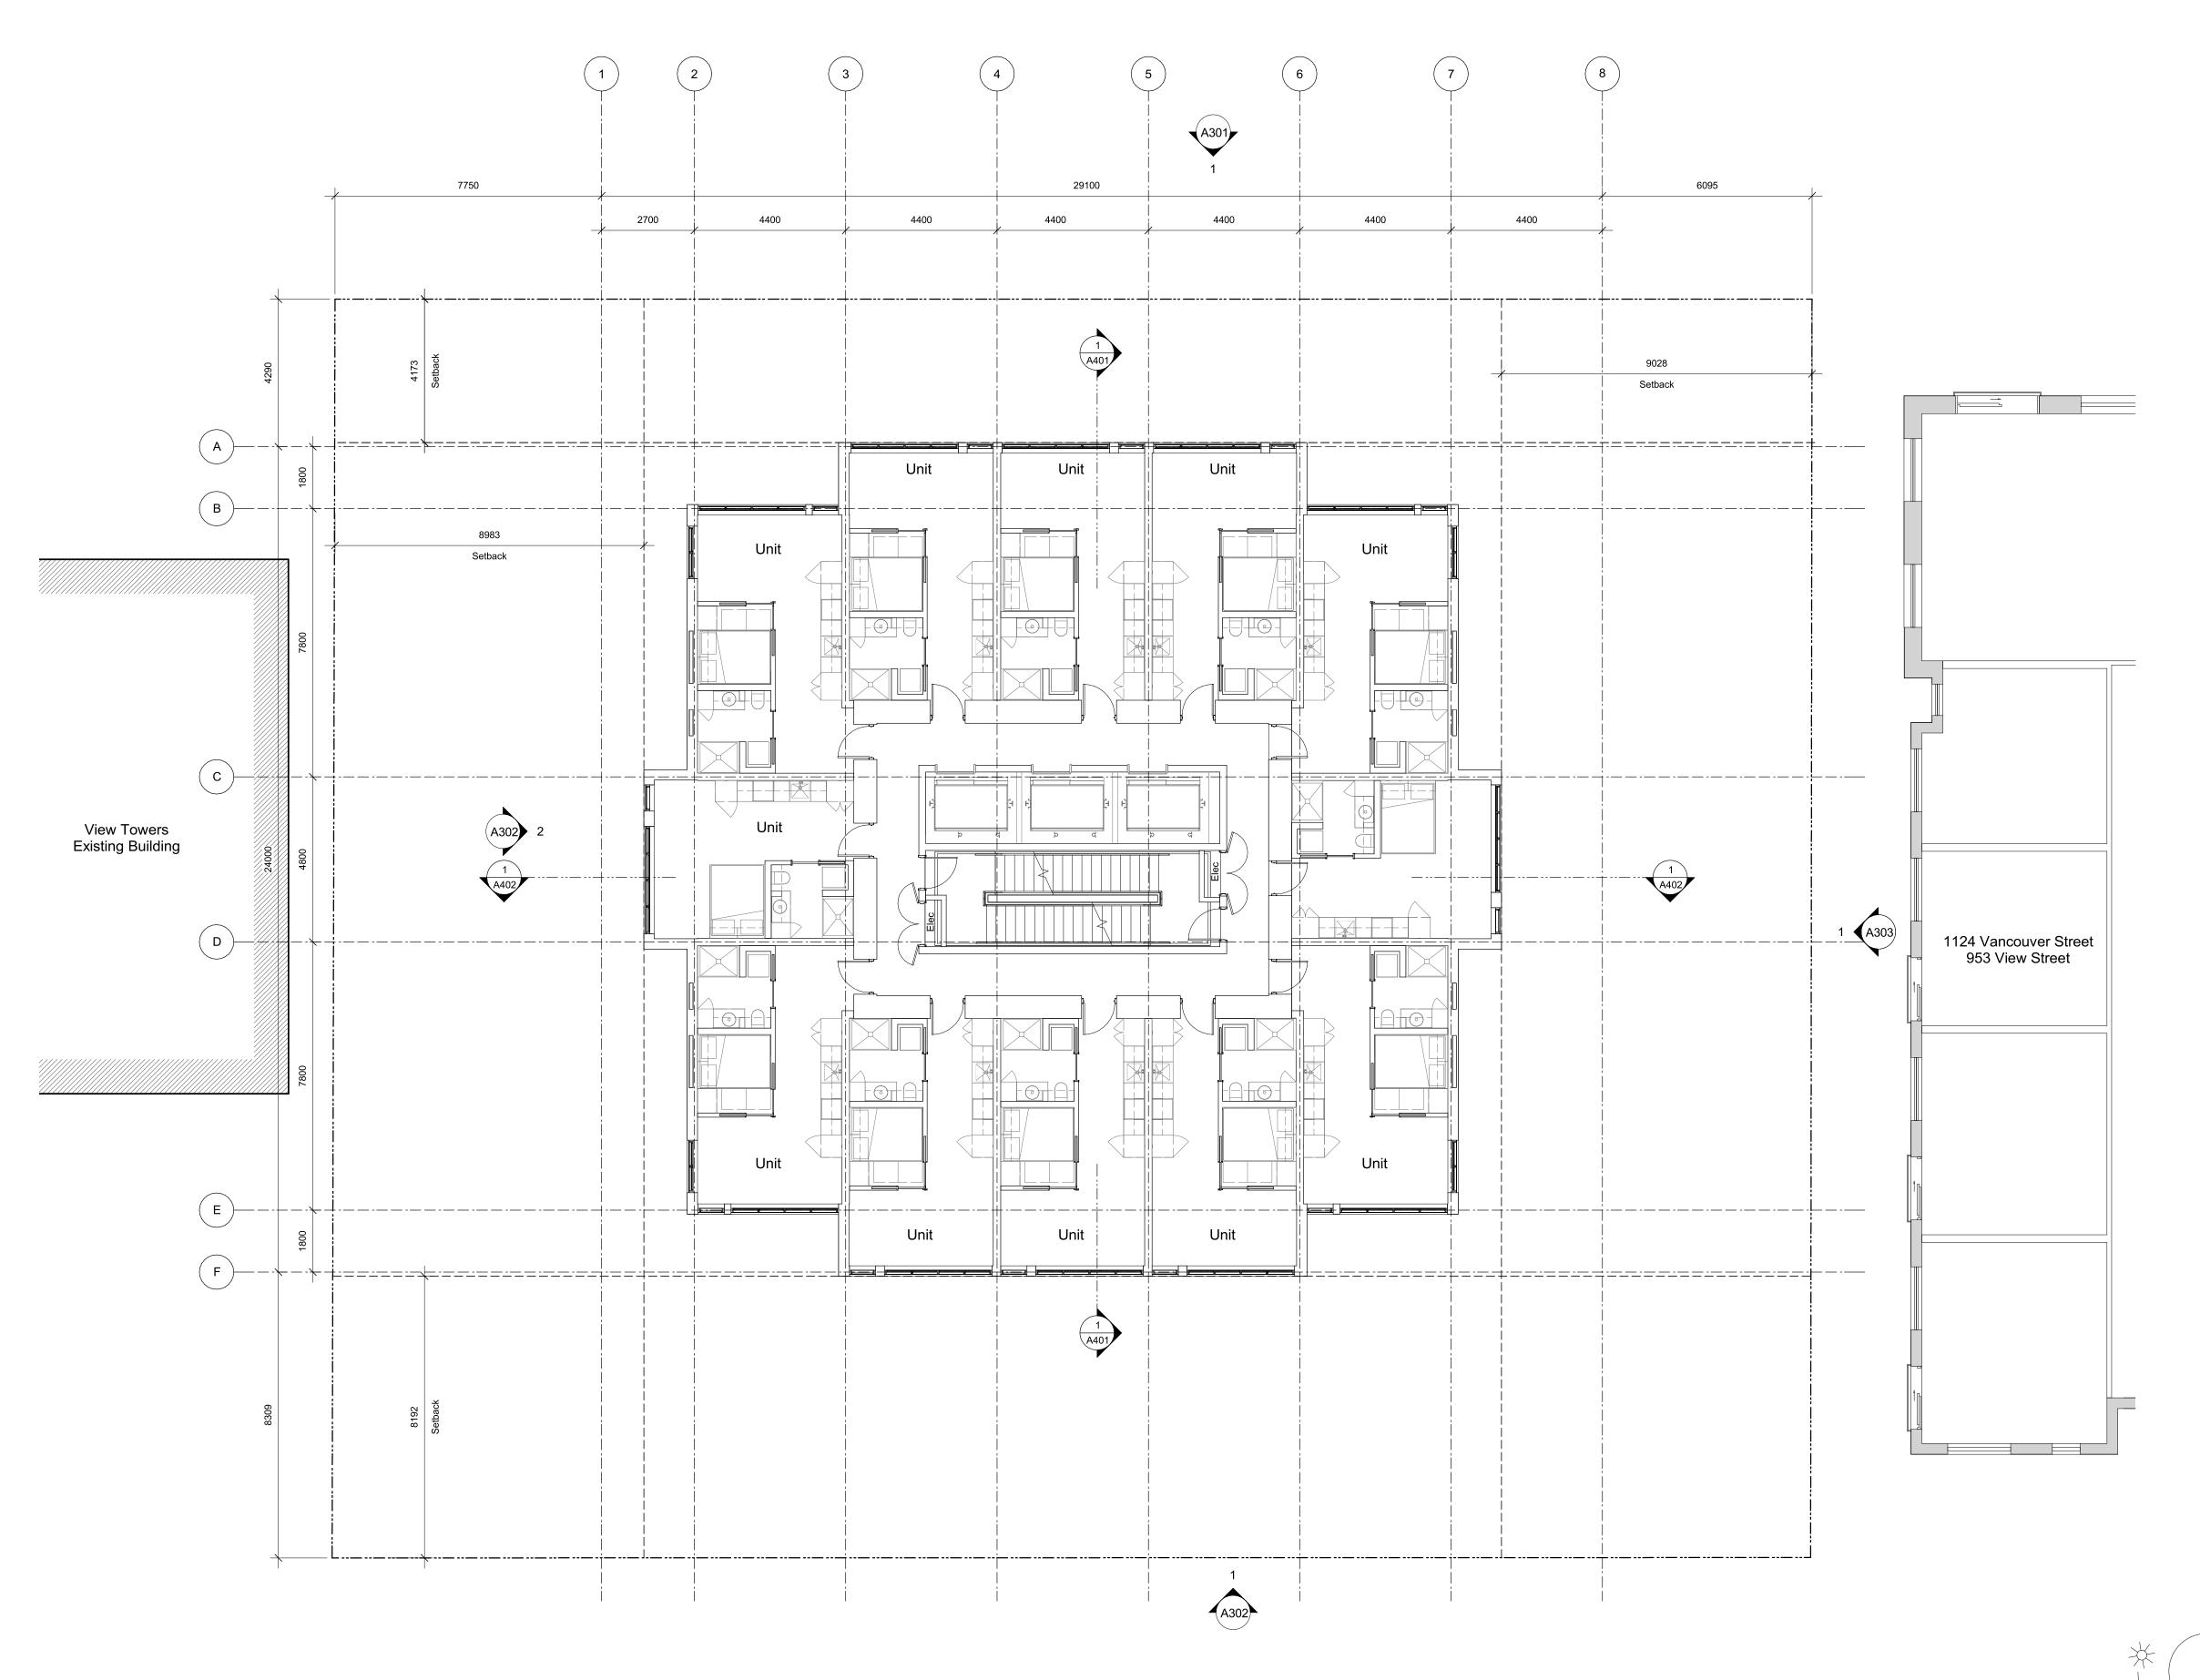

21-05-04 20-08-12 20-01-08 19-10-02

Issued for DP Revisions 1


Issued for DP Revisions 5 Issued for DP Revisions 3

Issued for DP Revisions 2

View St. Residential

937 View Street


Levels 7-22 Plan

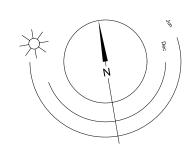

Victoria 977 Fort Street

102-5190 Dublin Way V9T 0H2 **T** 1•250•585•5810 COPYRIGHT RESERVED. THESE PLANS AND DESIGNS ARE AND AT ALL TIMES REMAIN THE PROPERTY OF **DHKARCHITECTS** TO BE USED FOR THE PROJECT SHOWN AND MAY NOT BE REPRODUCED WITHOUT WRITTEN CONSENT

930 Fort Street Proposed Development (Up to L13)

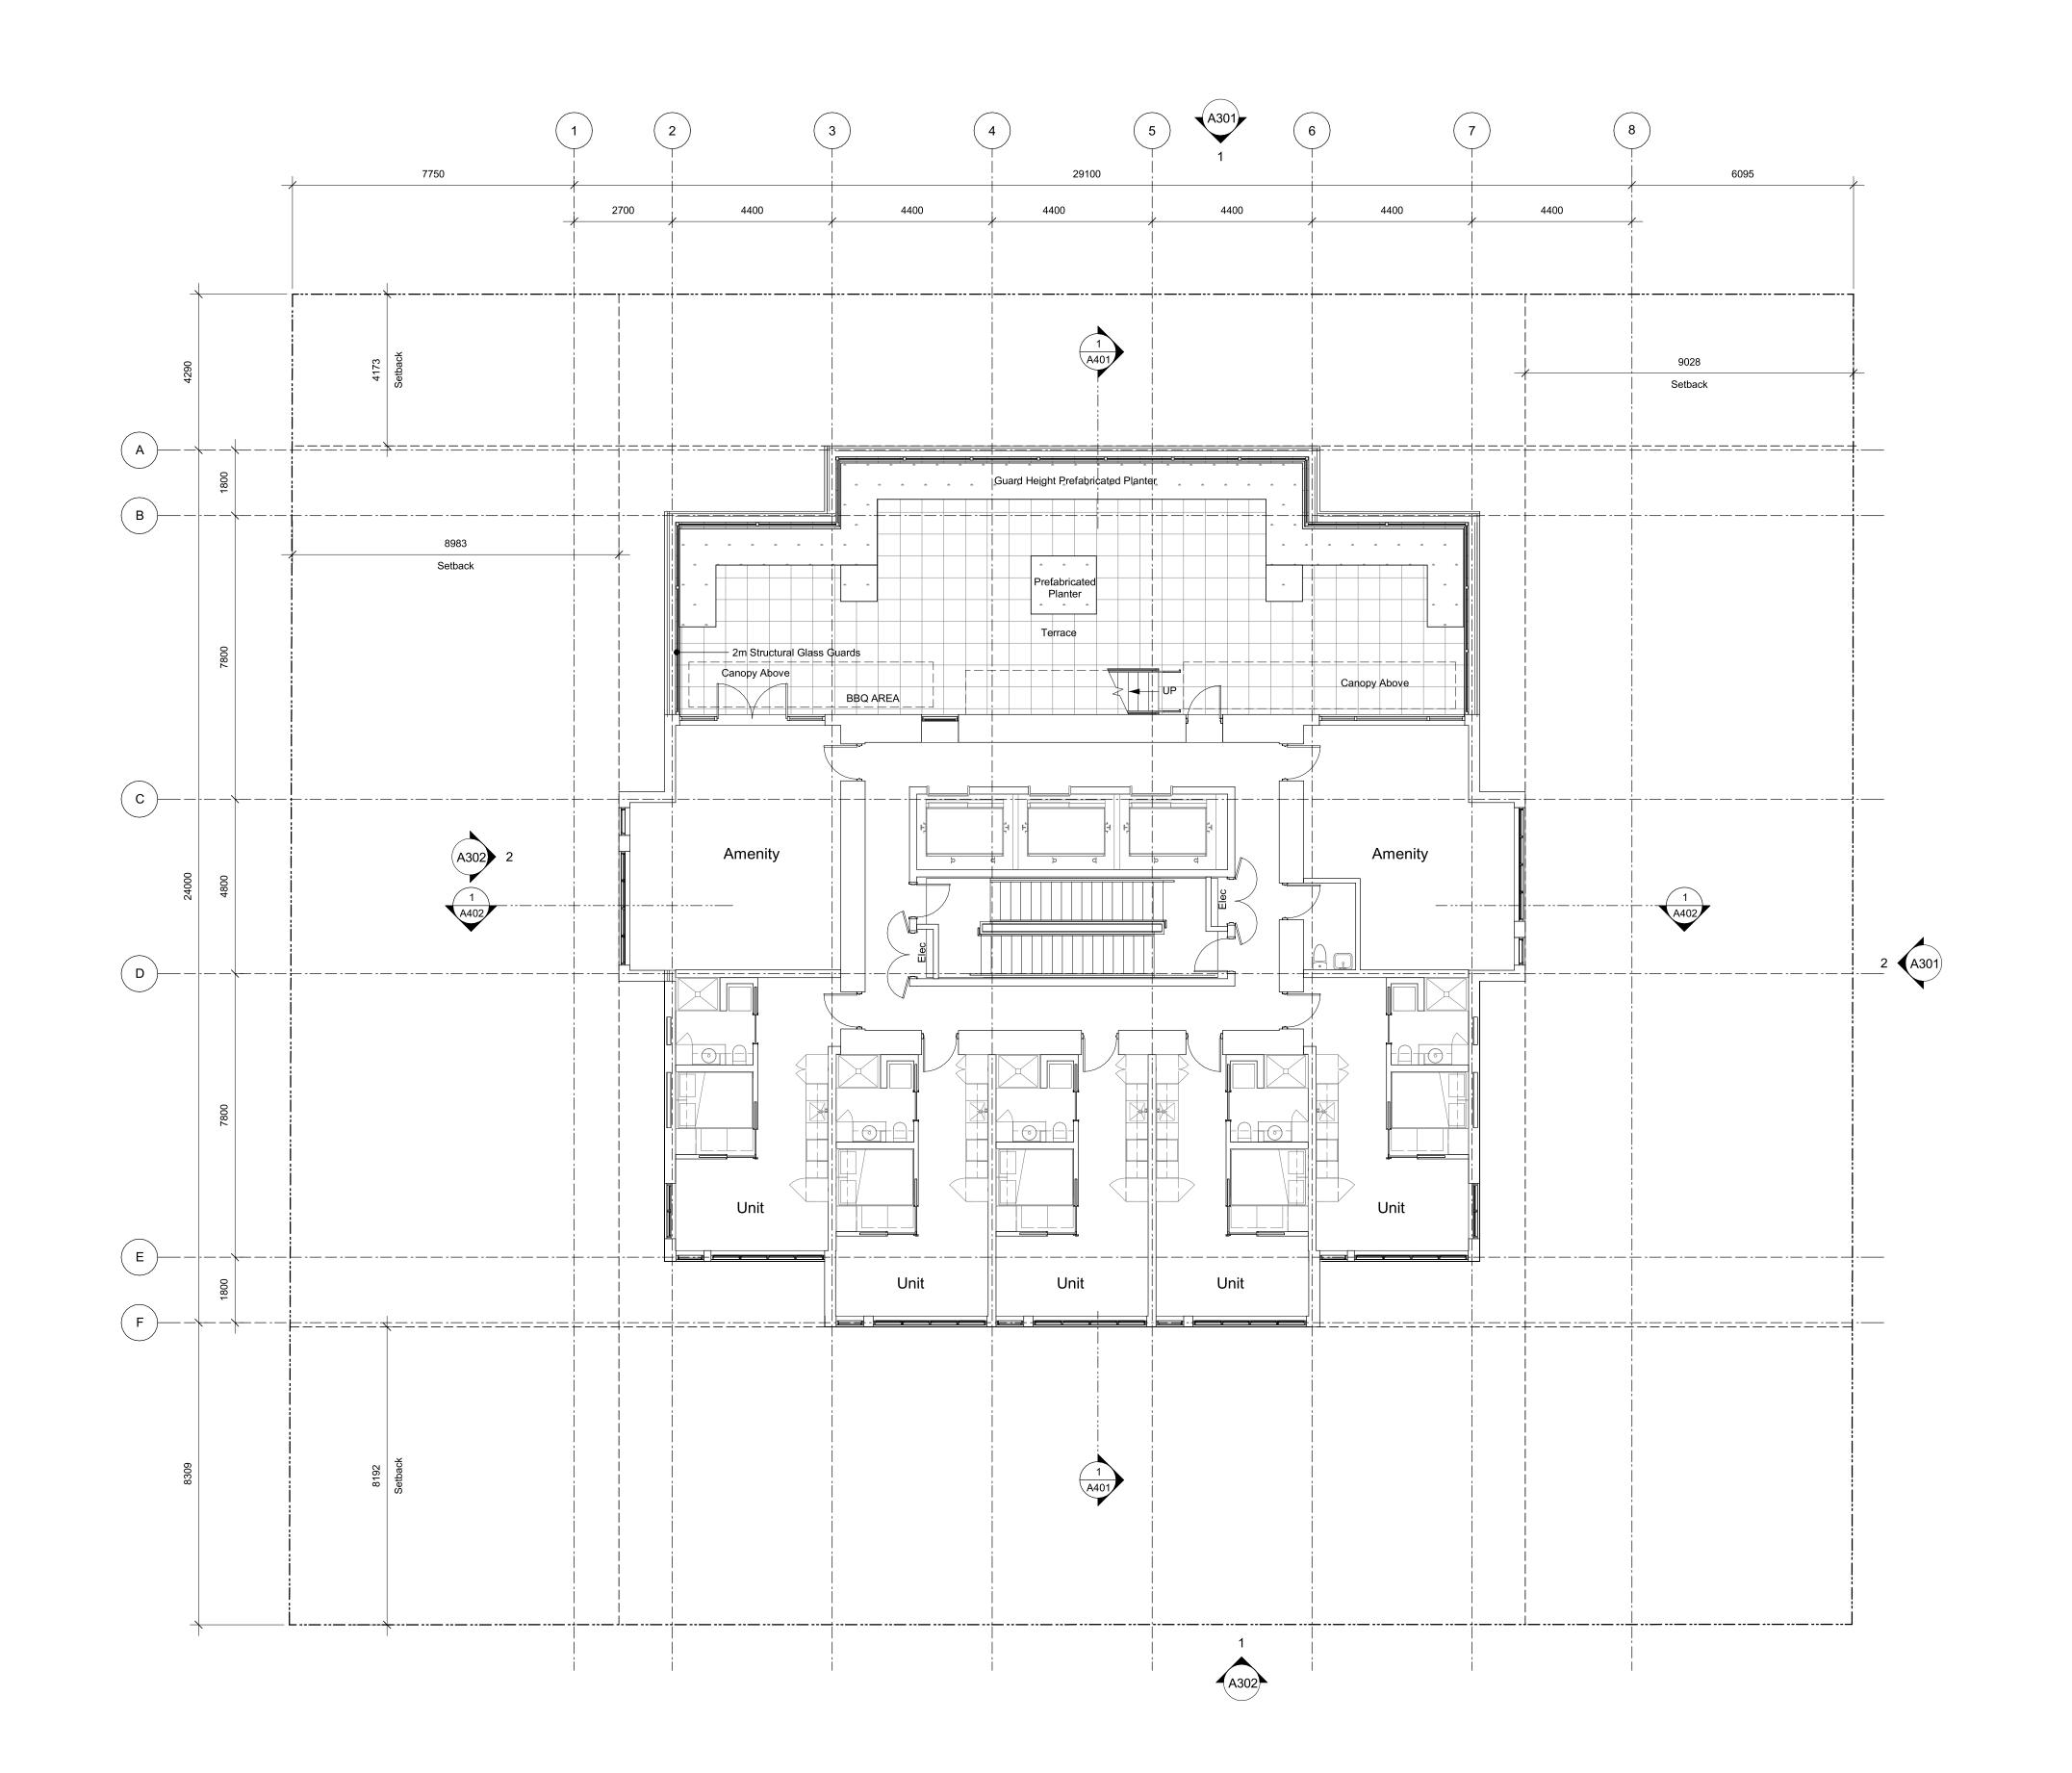


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View St. Residential


937 View Street

Level 23 Plan



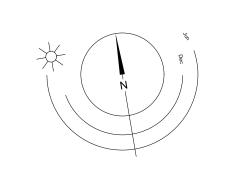

Victoria 977 Fort Street

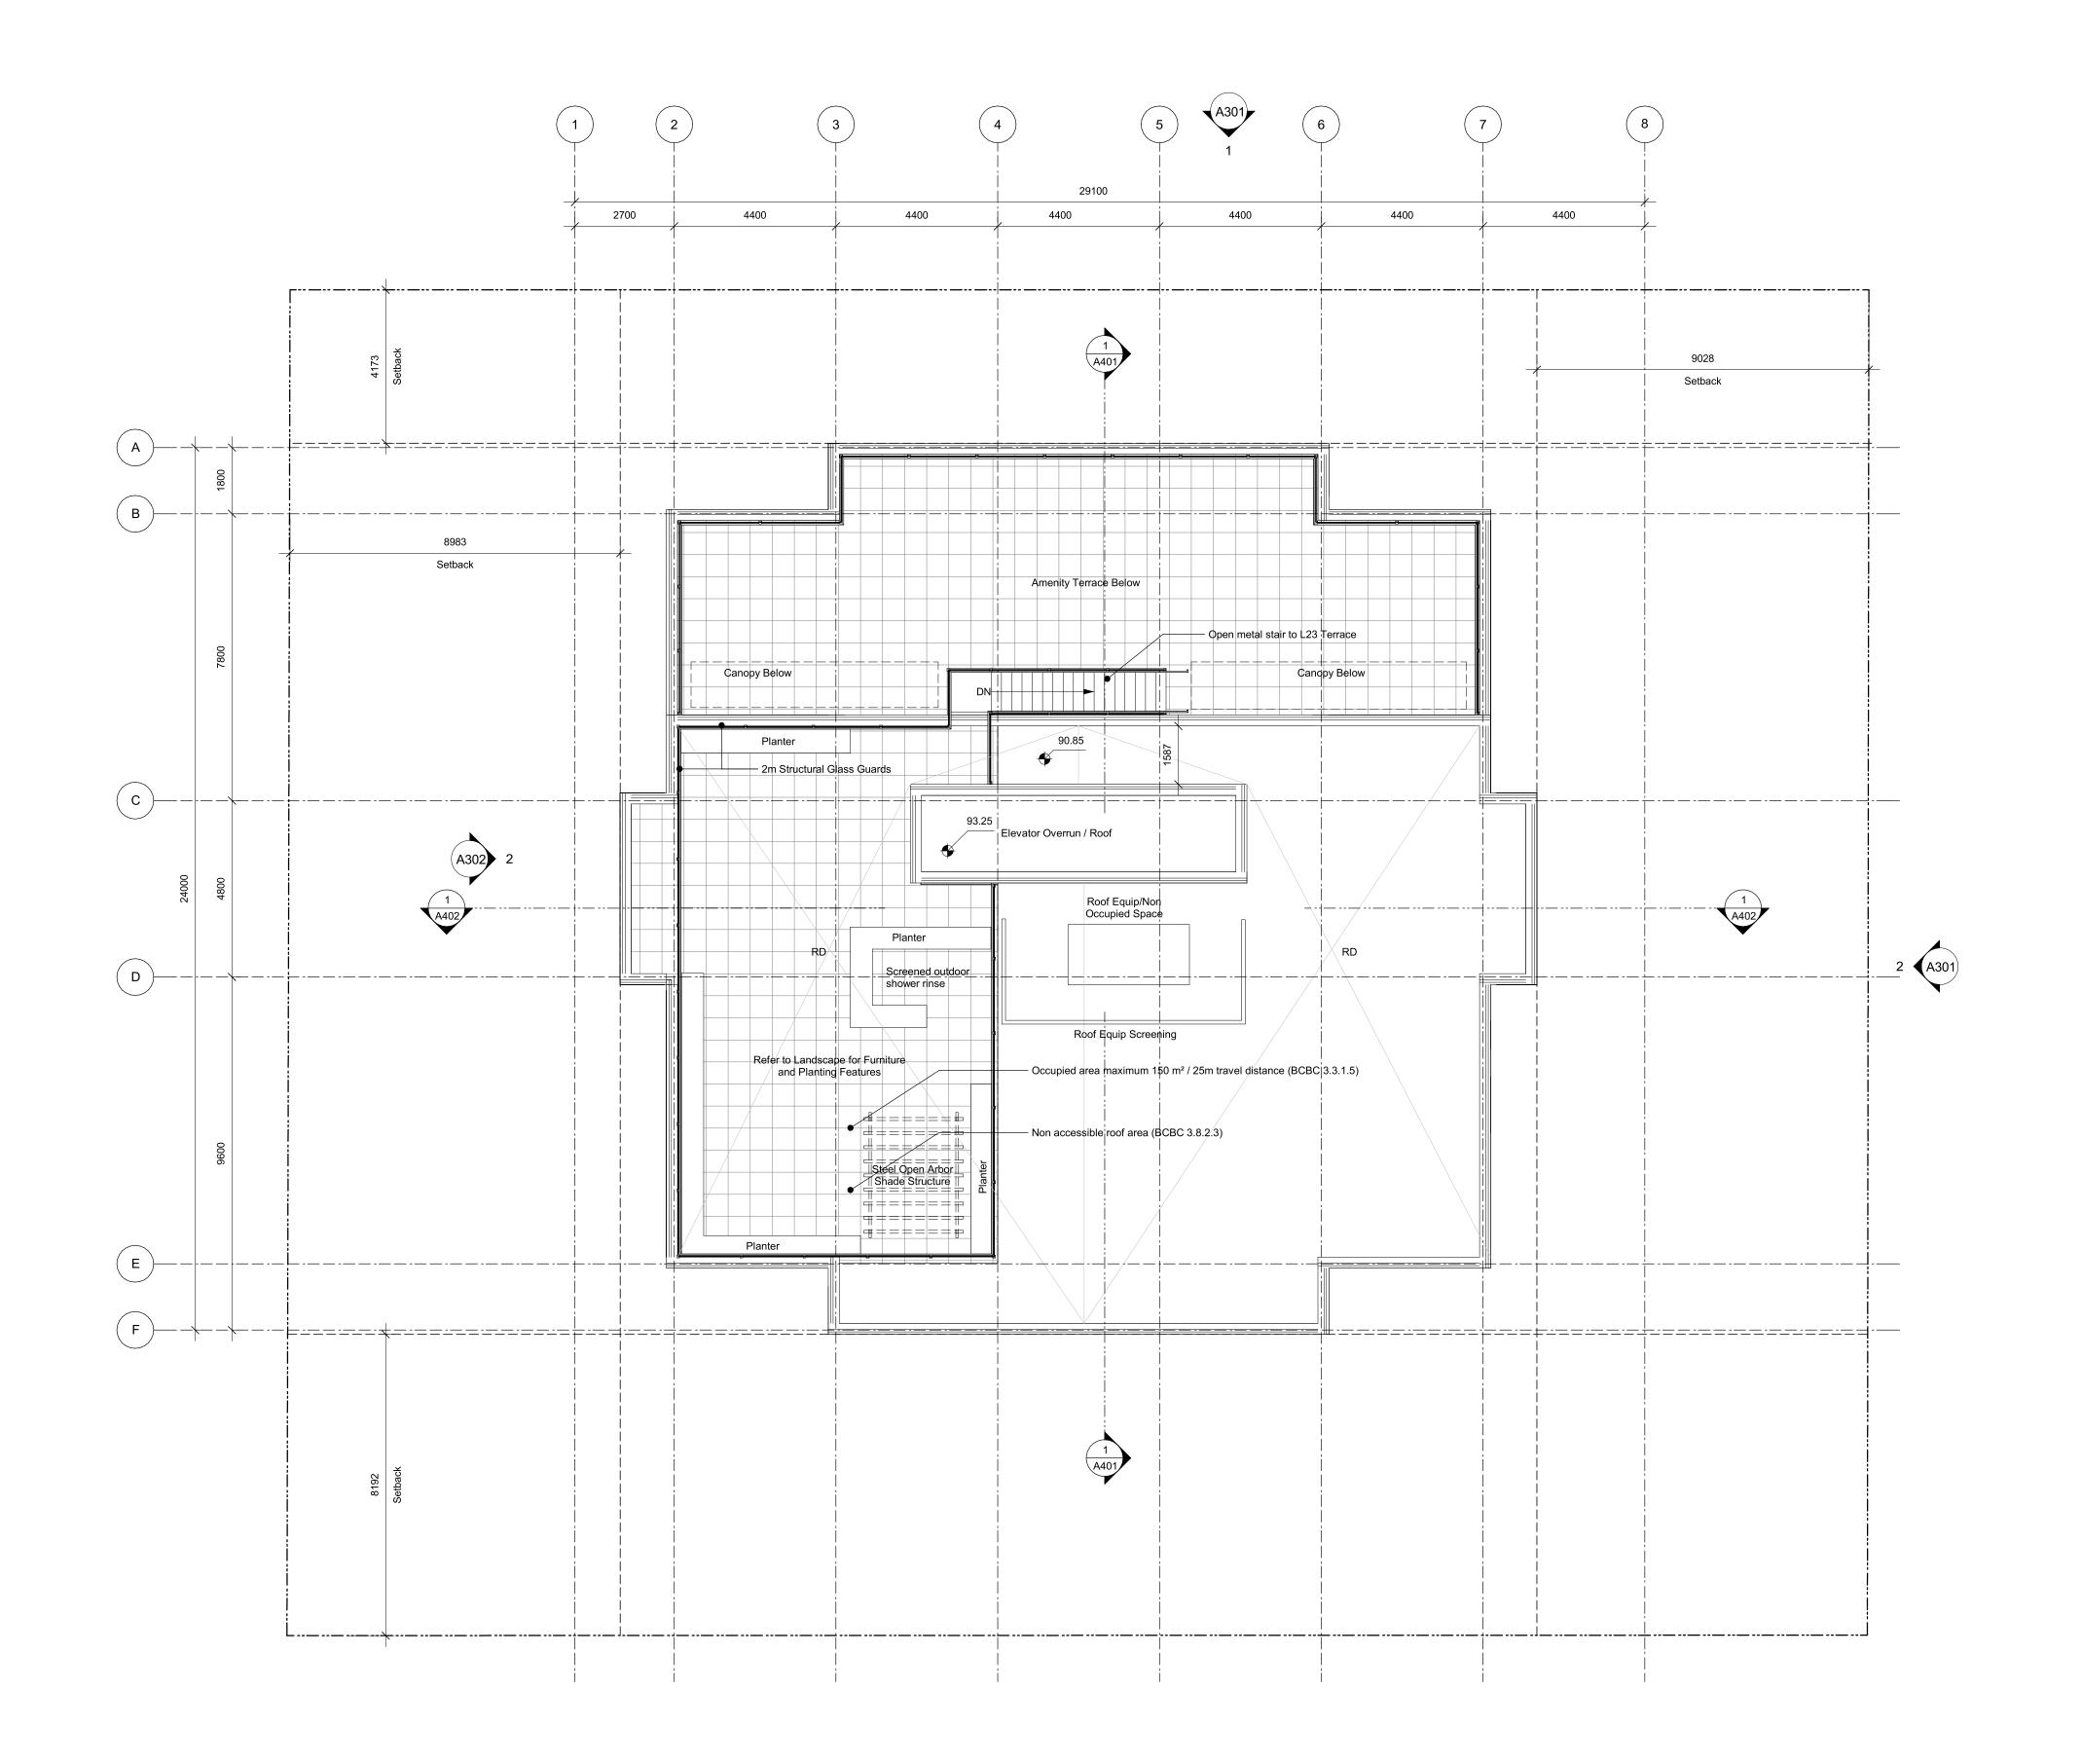


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23-12-12 Drawing File NOTE: All dimensions are shown in millimeters.

View St. Residential

937 View Street

Roof Plan



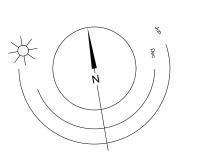









1 Building Elevation - East - Adjacent Window Overlay A303 SCALE: 1:100

24-04-10 Issued for DP Revisions 8 23-08-15 Issued for DP Revisions 6 Issued for DP Revisions 2 20-08-12

Area of Window on Adjacent Building


23-12-12 Drawing File NOTE: All dimensions are shown in millimeters.


View St. Residential

937 View Street


Adjacent Buildings Analysis




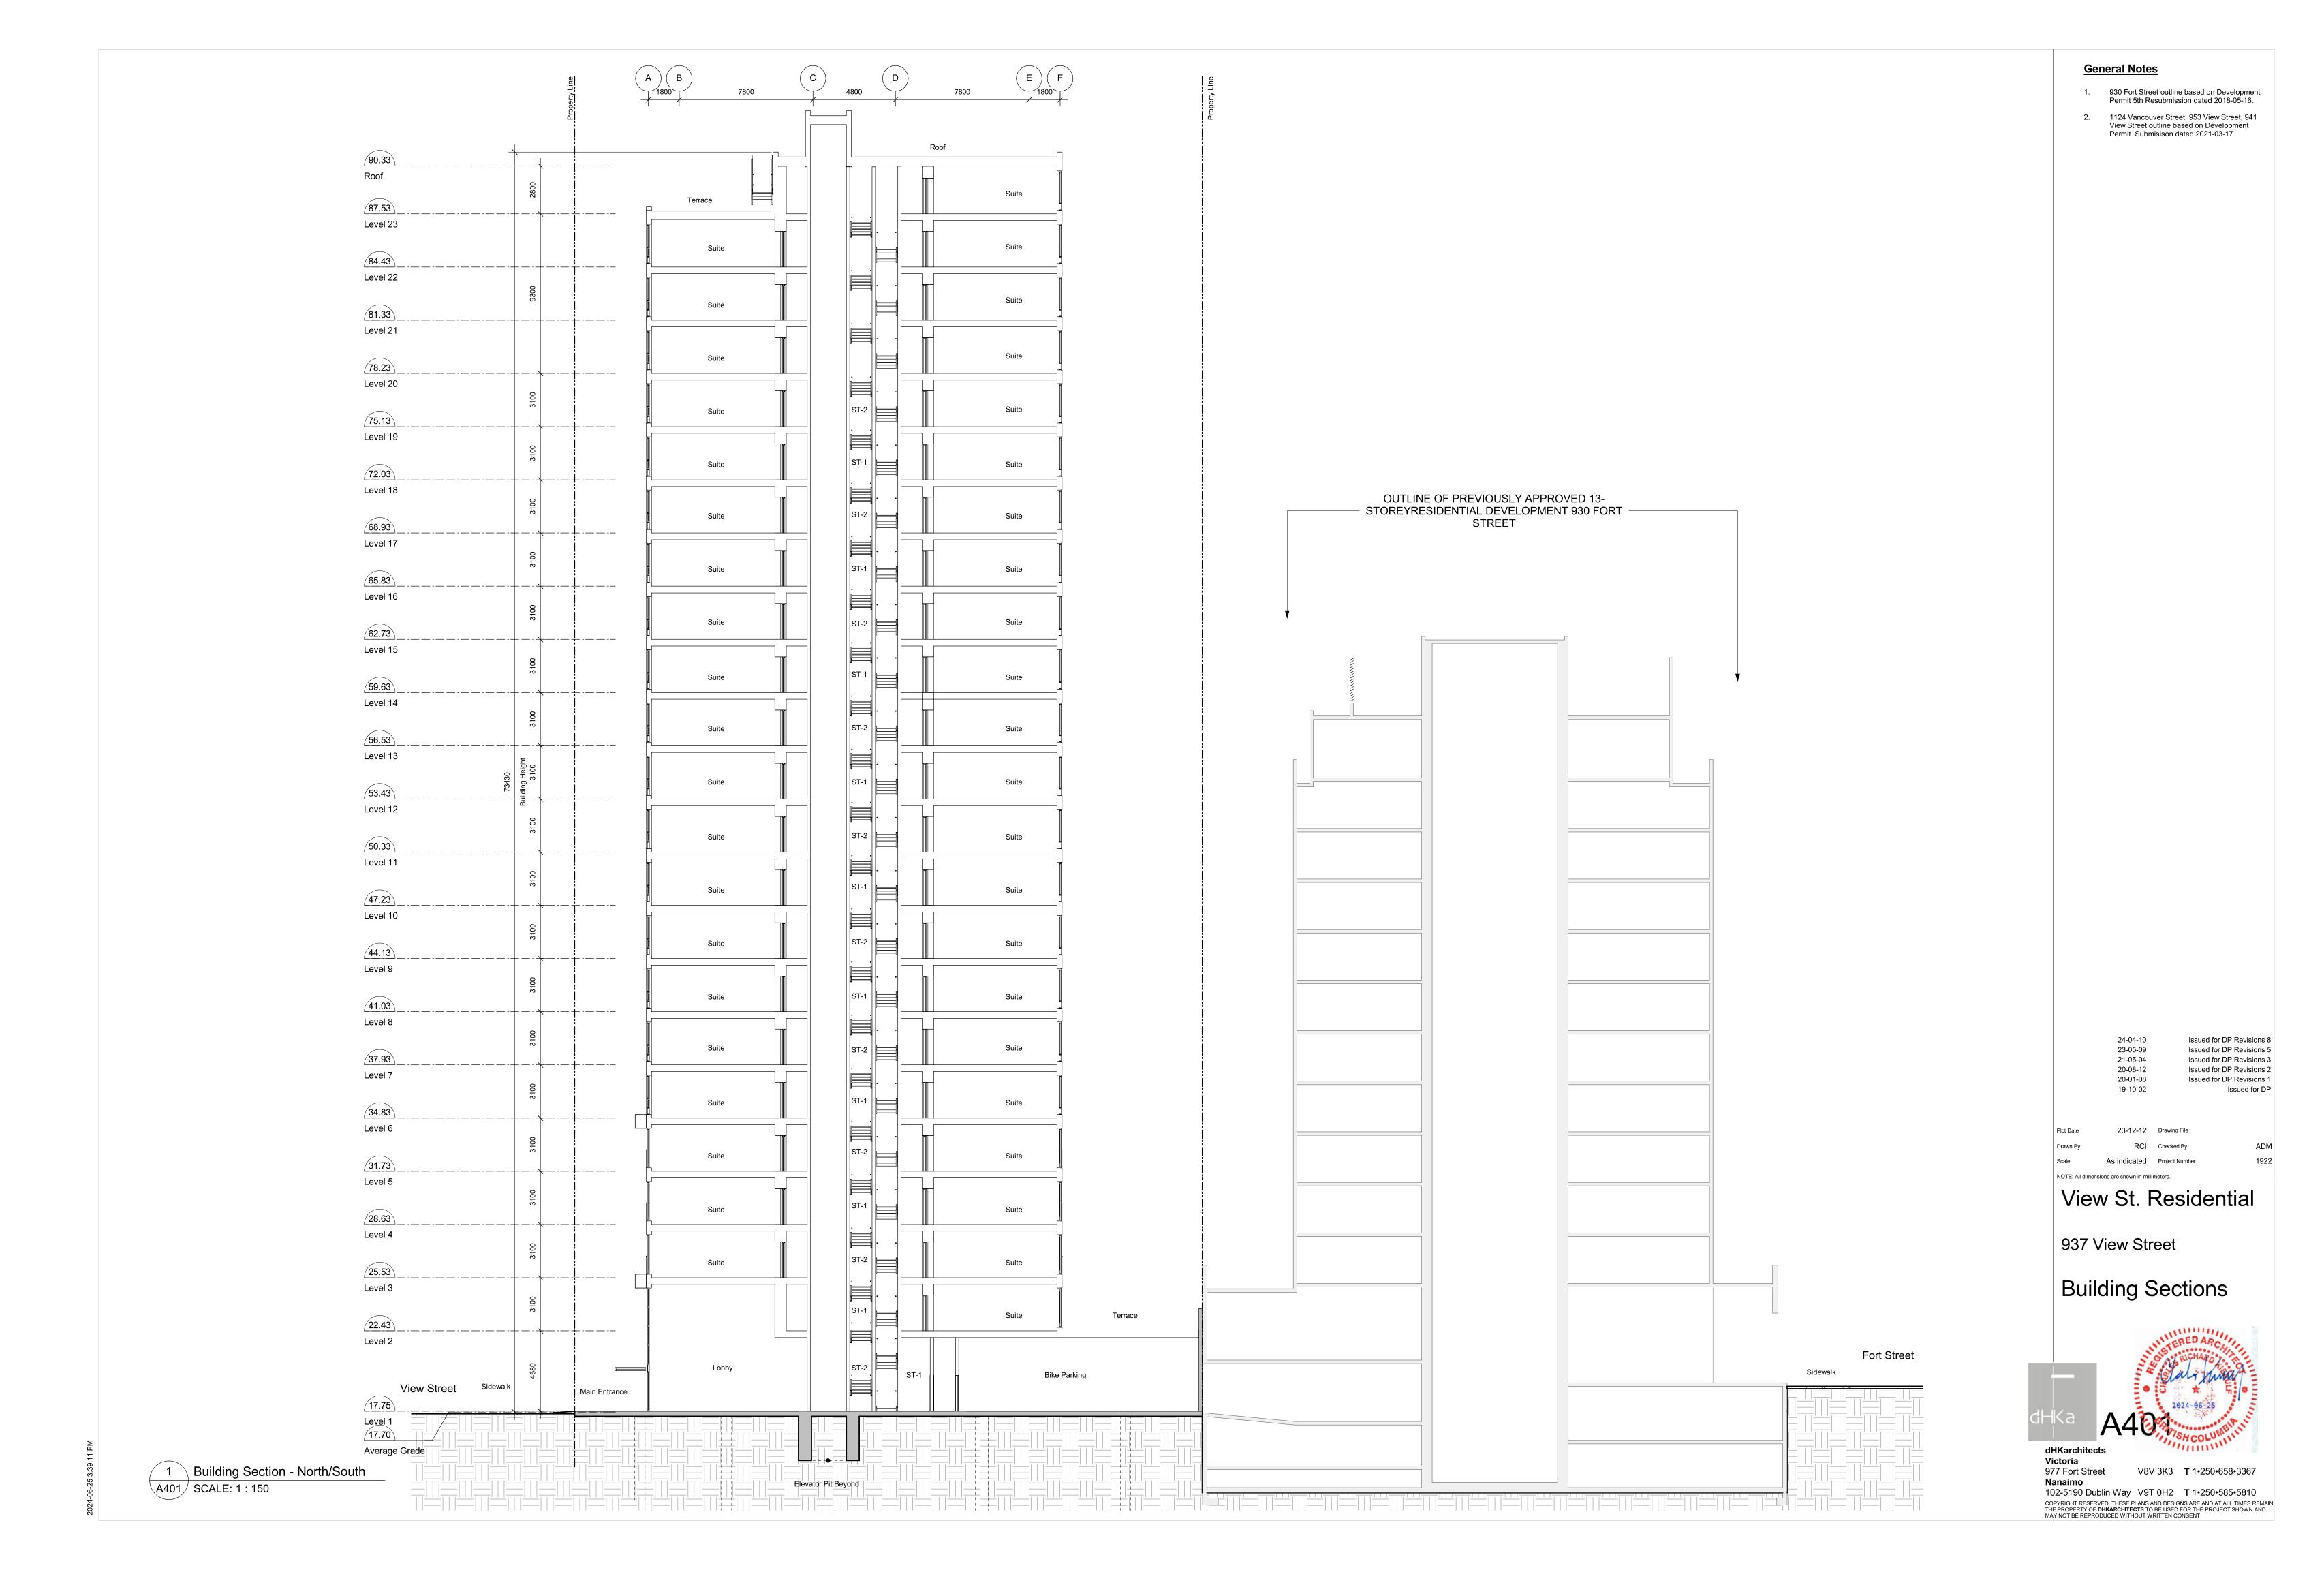


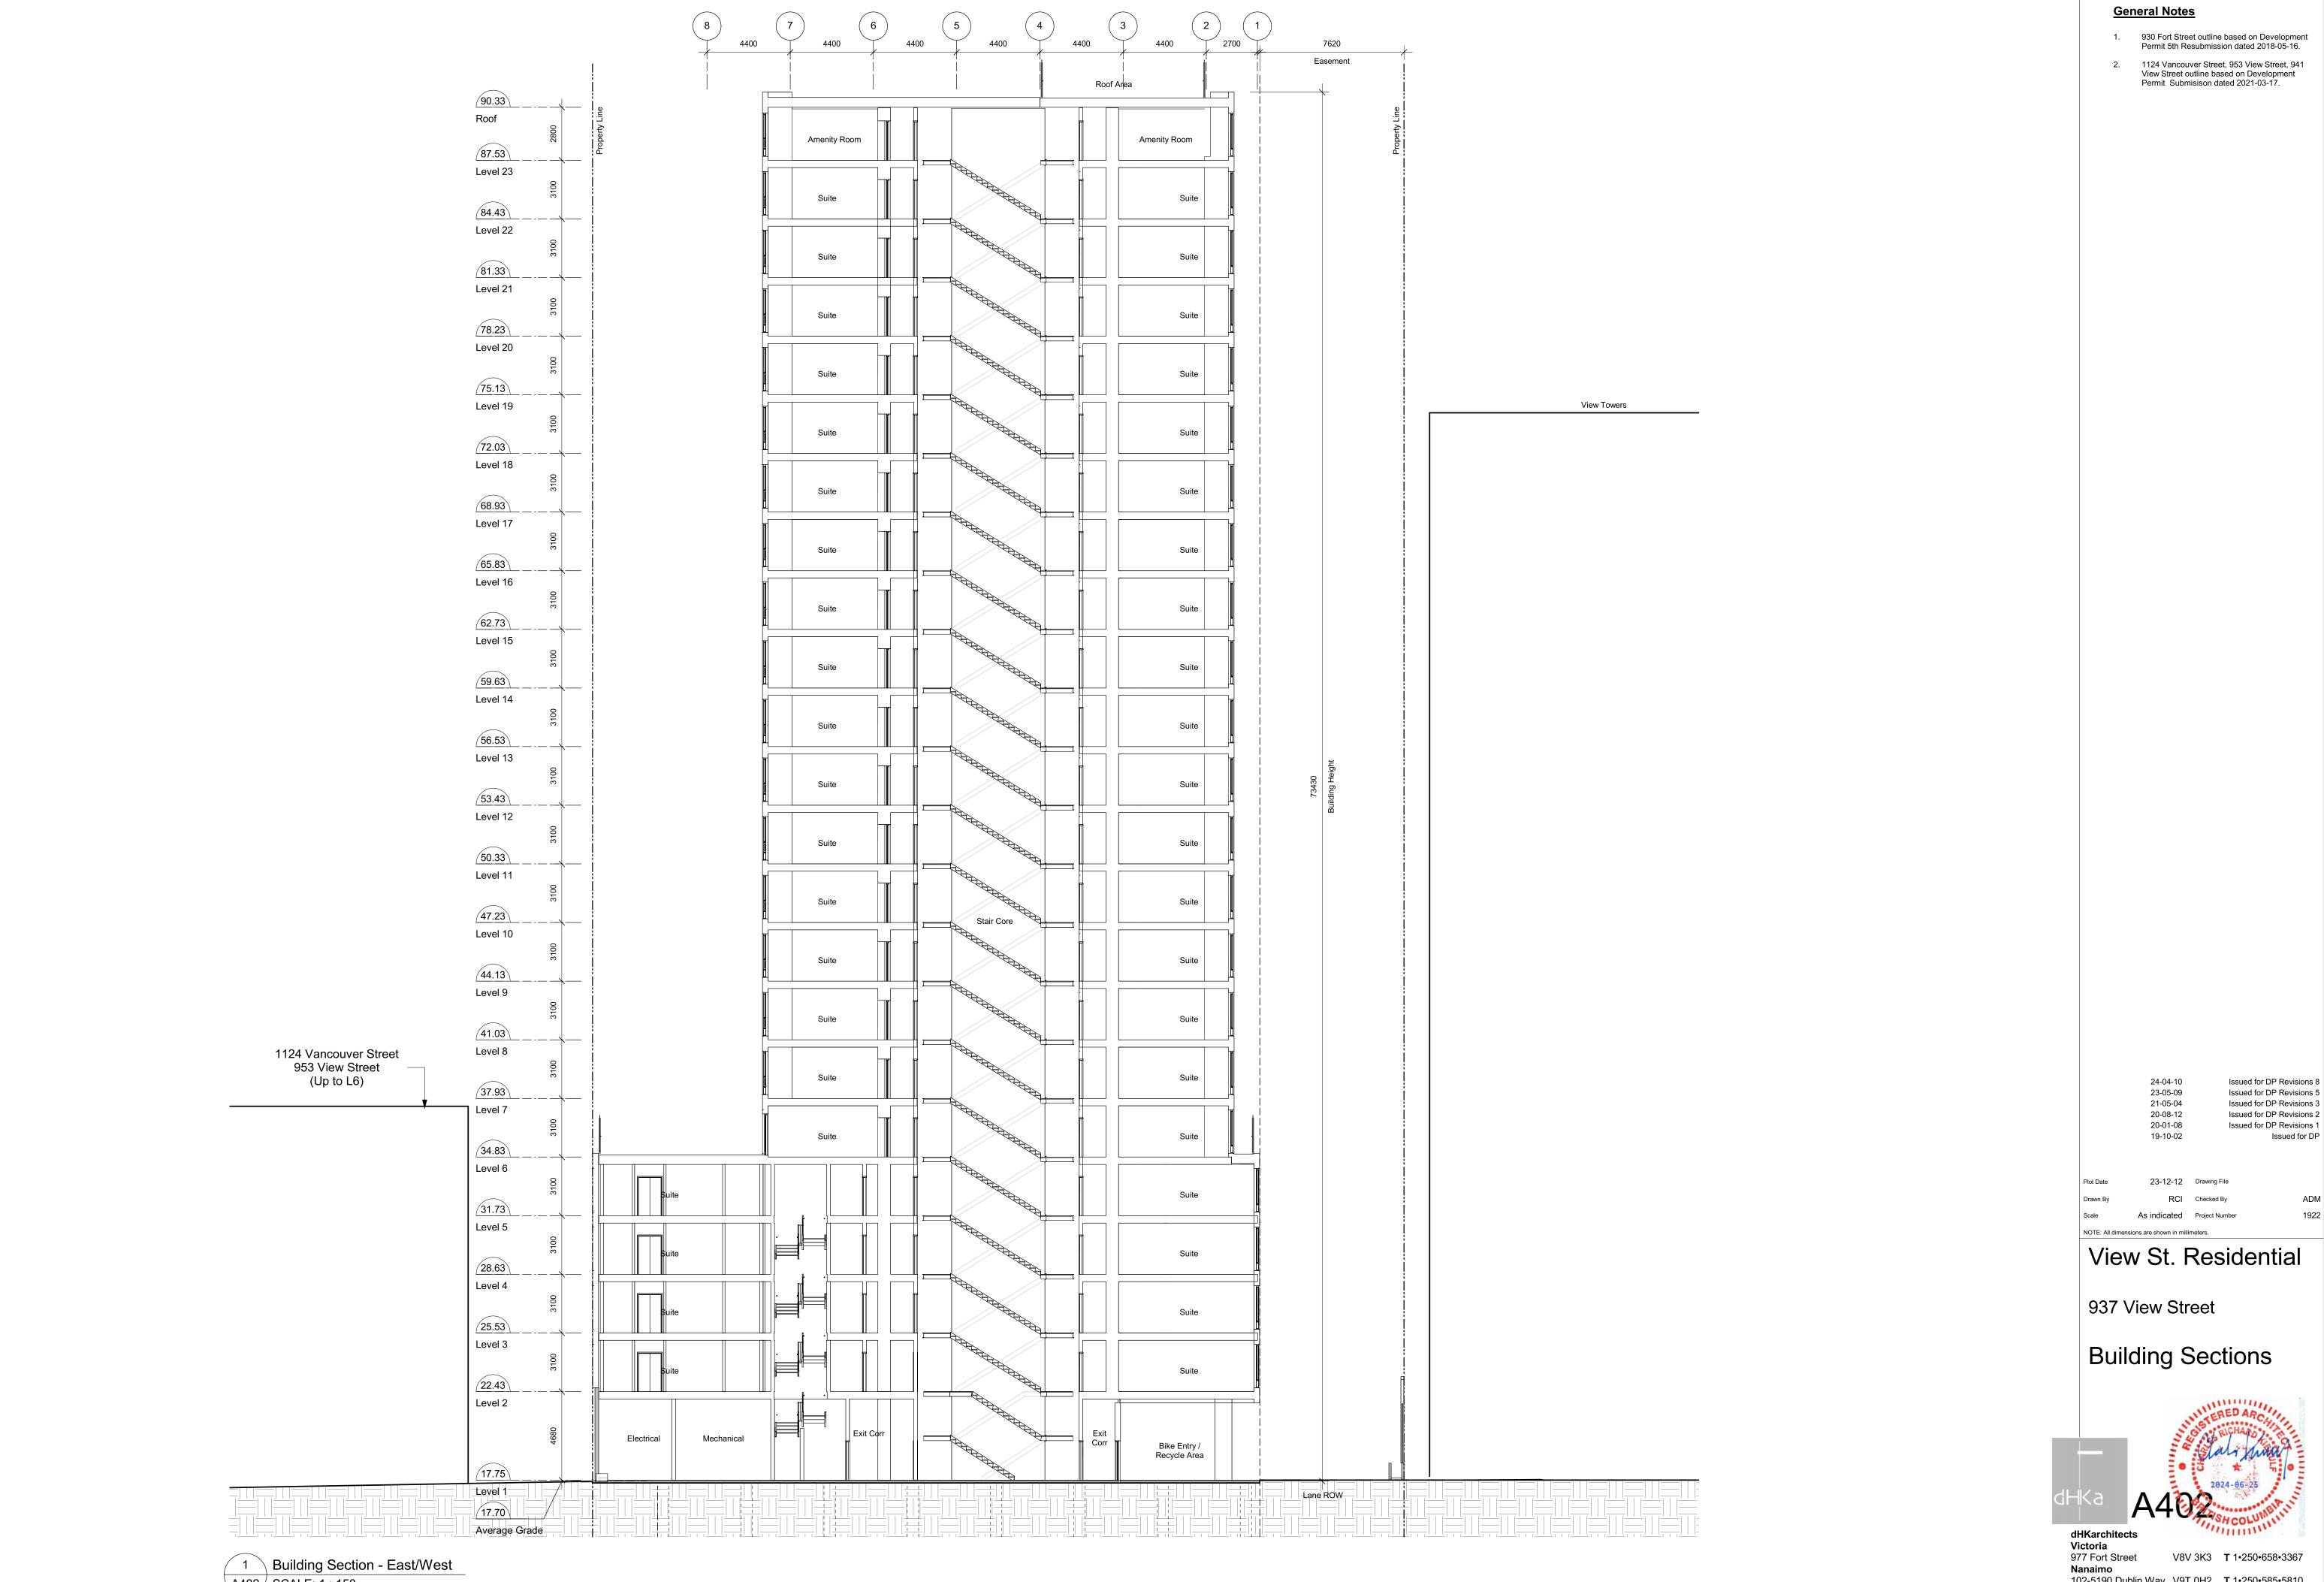


1 Building Section - East/West
A402 SCALE: 1: 150

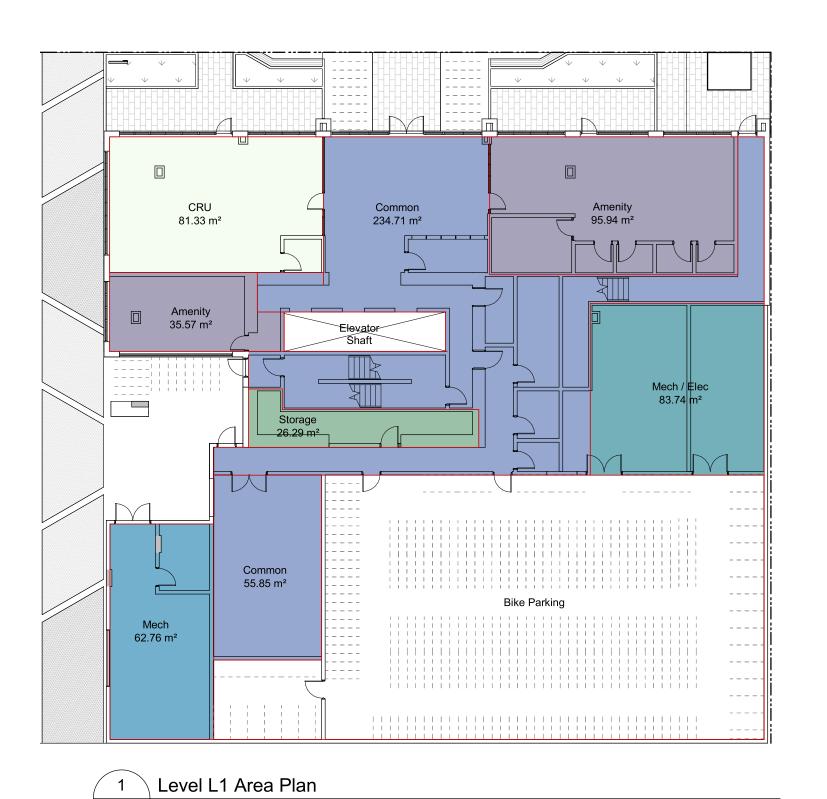

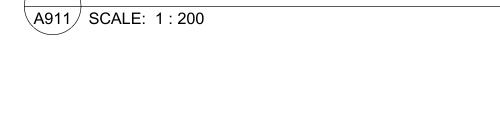

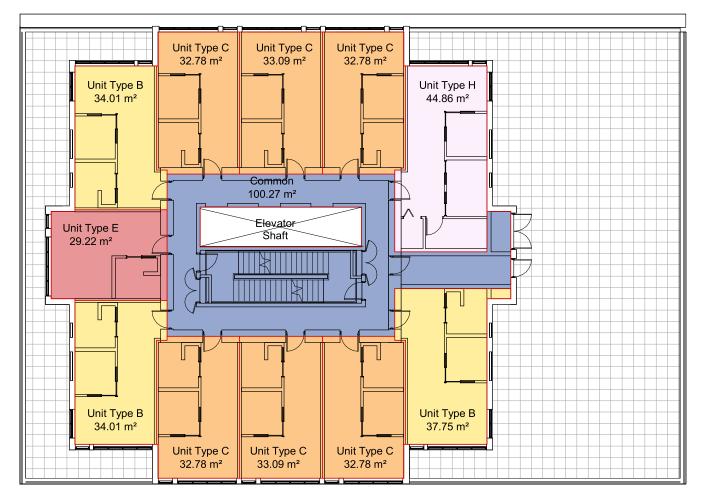

5 Level L6 Area Plan A911 SCALE: 1:200

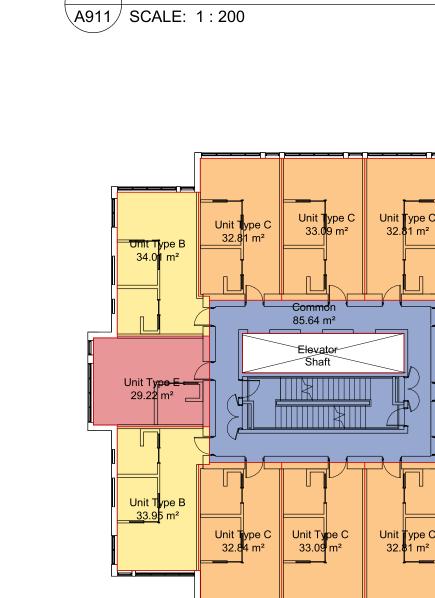

2 Level L2 Area Plan

Unit Type C 32.97 m²

Unit Type D 66.32 m²


Unit Type F 35.93 m²

6 Levels L7-L22 Area Plan A911 | SCALE: 1:200


Floor Areas

Level	Area
Level 1	676 m²
Level 2	801 m²
Level 3	801 m²
Level 4	801 m²
Level 5	801 m²
Level 6	477 m²
Level 7	478 m²
Level 8	477 m²
Level 9	478 m²
Level 10	478 m²
Level 11	478 m²
Level 12	478 m²
Level 13	478 m²
Level 14	477 m²
Level 15	478 m²
Level 16	478 m²
Level 17	478 m²
Level 18	478 m²
Level 19	478 m²
Level 20	478 m²
Level 21	478 m²
Level 22	478 m²
Level 23	327 m ²

Area Summary		Unit Type and Count Sur	<u>mmary</u>
Site Area Total FAR Areas	1,572 m ² 12,325 m ²	Studio (Types E) 1BR (Types A, B, C, F)	33 216
FAR	7.84	2BR (Type H) 3BR (Types D, G)	1 16
		Total Units	266

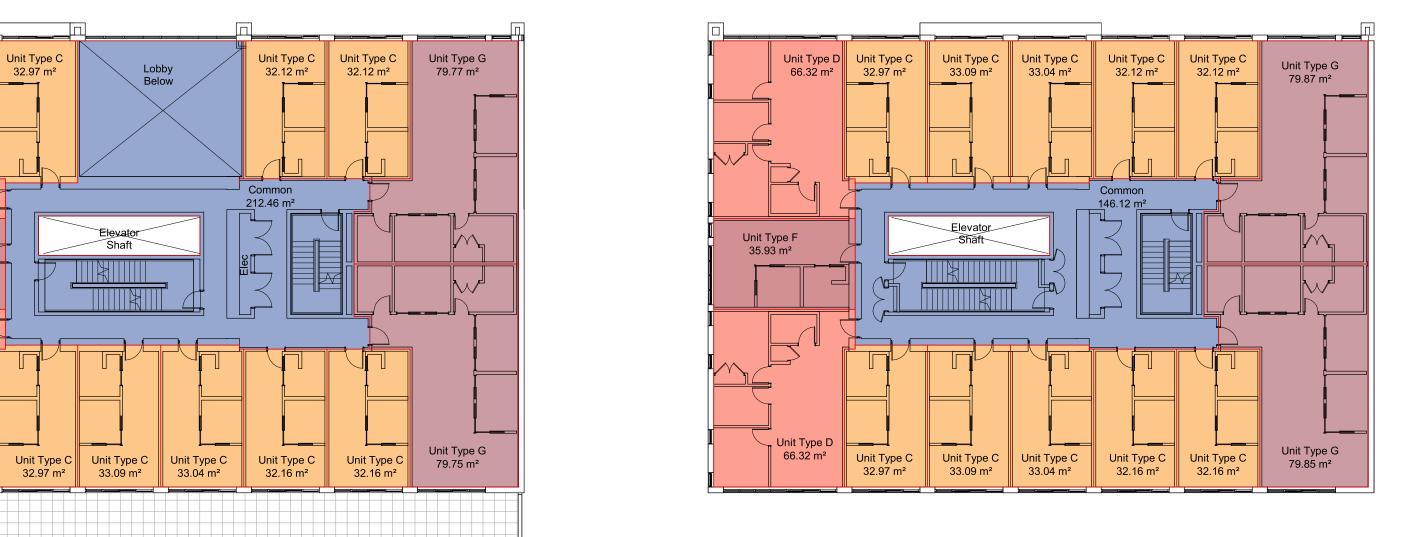


3 Levels L3-L5 Area Plan A911 SCALE: 1:200

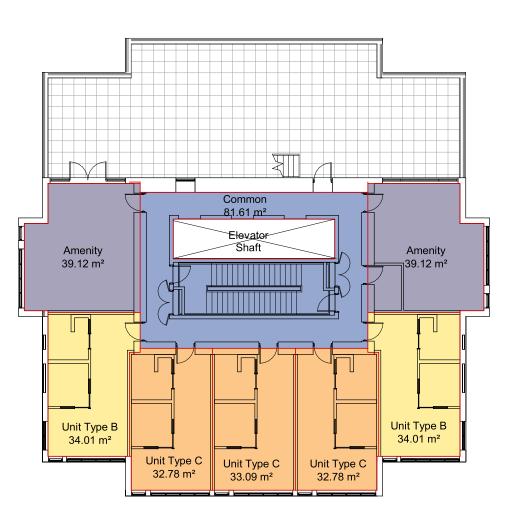

4 Level L23 Area Plan A911 | SCALE: 1:200

General Notes

- 1. Plans and Area Schedule show areas measured to inside face of exterior walls, and centre of demising walls.
- 2. See A001 for required bike counts.
- Unit Schedule areas measured to inside face of wall finish on all sides.

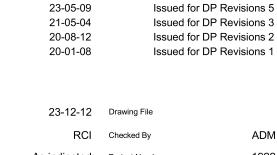

Issued for DP Revisions 8

Issued for DP Revisions 6


View St. Residential


23-08-15

937 View Street

NOTE: All dimensions are shown in millimeters.

Area Plans

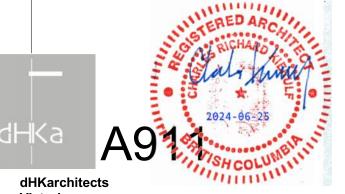

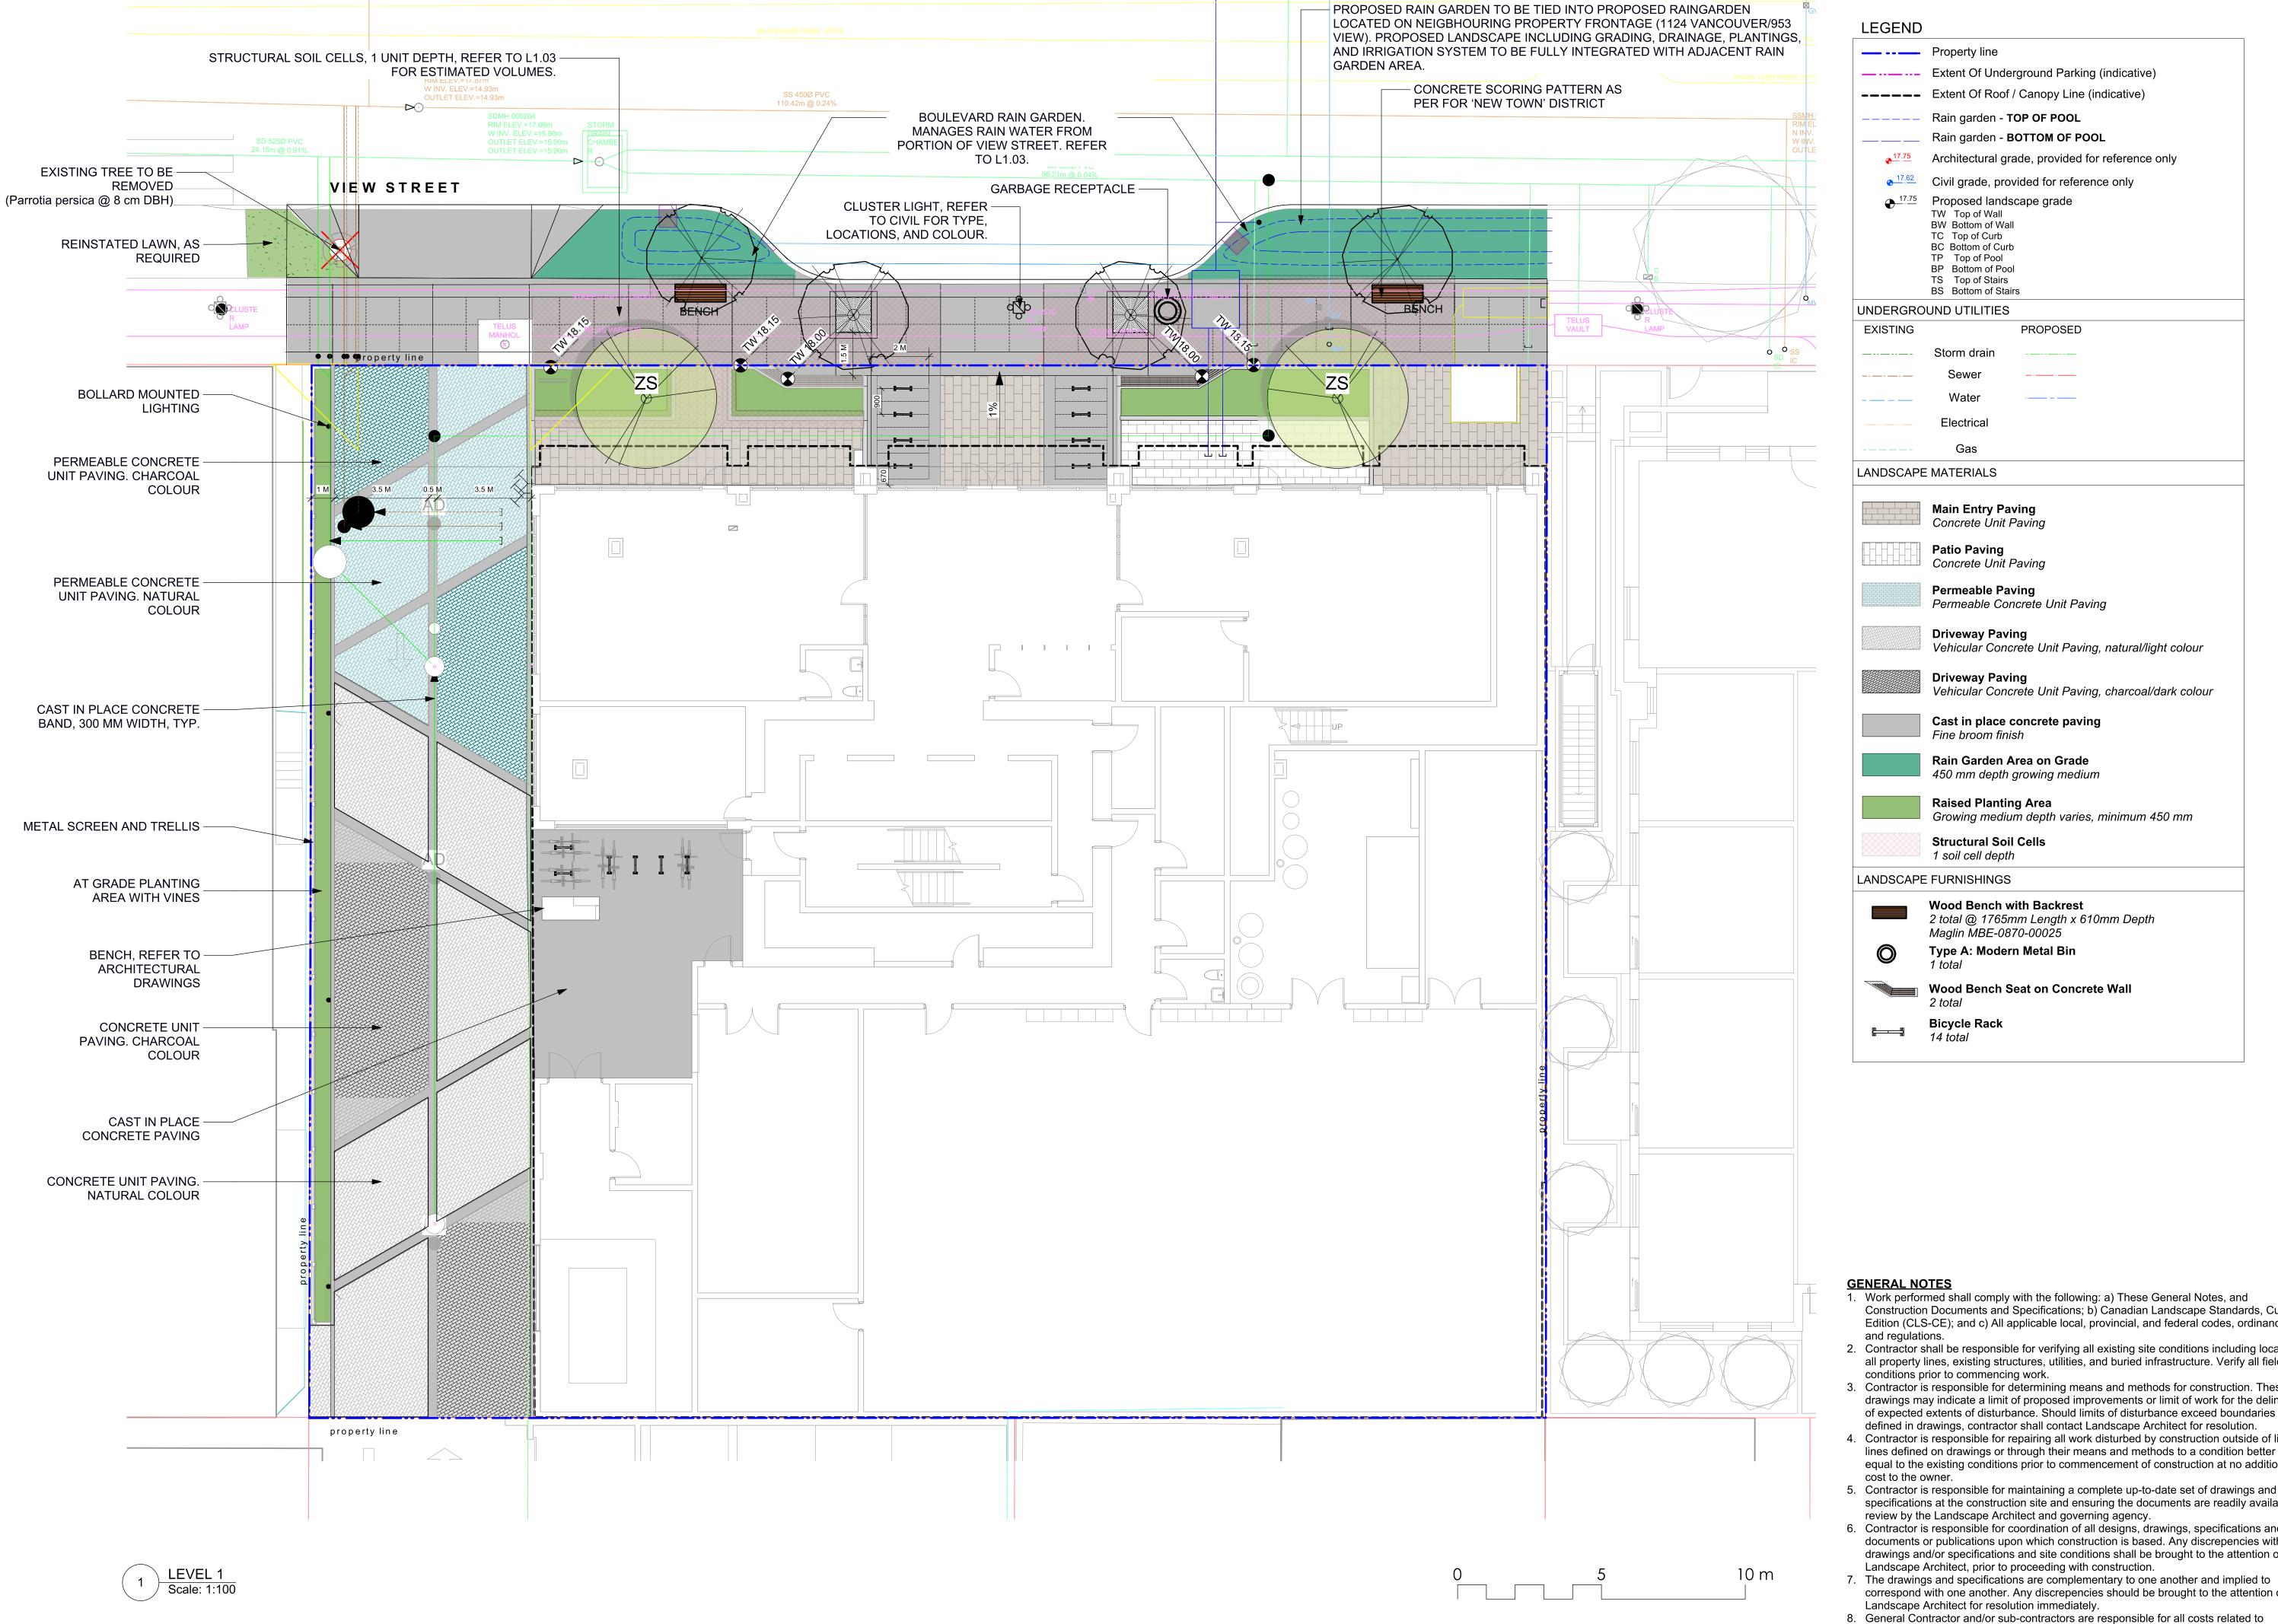




	Property line
	Extent Of Underground Parking (indicative)
	Extent Of Roof / Canopy Line (indicative)
	Rain garden - TOP OF POOL
	Rain garden - BOTTOM OF POOL
<u>◆17.75</u>	Architectural grade, provided for reference only
1 7.62	Civil grade, provided for reference only
17.75	Proposed landscape grade TW Top of Wall BW Bottom of Wall TC Top of Curb BC Bottom of Curb TP Top of Pool BP Bottom of Pool TS Top of Stairs BS Bottom of Stairs
	17.62

UNDERGROUND UTILITIES EXISTING PROPOSED

LXIOTINO		THOI OOLD
	Storm drain	
	Sewer	
	Water	
	Electrical	
	Gas	

LANDSCAPE MATERIALS

Patio Paving Concrete Unit Paving

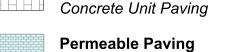

Main Entry Paving Concrete Unit Paving

Permeable Concrete Unit Paving

Driveway Paving Vehicular Concrete Unit Paving, natural/light colour

Driveway Paving Vehicular Concrete Unit Paving, charcoal/dark colour

Cast in place concrete paving Fine broom finish

Rain Garden Area on Grade 450 mm depth growing medium

Raised Planting Area Growing medium depth varies, minimum 450 mm

Structural Soil Cells 1 soil cell depth

LANDSCAPE FURNISHINGS

Wood Bench with Backrest 2 total @ 1765mm Length x 610mm Depth Maglin MBE-0870-00025

Type A: Modern Metal Bin

Wood Bench Seat on Concrete Wall

Bicycle Rack

GENERAL NOTES

irrigation.

1. Work performed shall comply with the following: a) These General Notes, and Construction Documents and Specifications; b) Canadian Landscape Standards, Current Edition (CLS-CE); and c) All applicable local, provincial, and federal codes, ordinances, and regulations.

2. Contractor shall be responsible for verifying all existing site conditions including location of all property lines, existing structures, utilities, and buried infrastructure. Verify all field conditions prior to commencing work.


3. Contractor is responsible for determining means and methods for construction. These drawings may indicate a limit of proposed improvements or limit of work for the delineation of expected extents of disturbance. Should limits of disturbance exceed boundaries defined in drawings, contractor shall contact Landscape Architect for resolution.

4. Contractor is responsible for repairing all work disturbed by construction outside of limit lines defined on drawings or through their means and methods to a condition better than or equal to the existing conditions prior to commencement of construction at no additional cost to the owner.

5. Contractor is responsible for maintaining a complete up-to-date set of drawings and specifications at the construction site and ensuring the documents are readily available for review by the Landscape Architect and governing agency.

6. Contractor is responsible for coordination of all designs, drawings, specifications and other documents or publications upon which construction is based. Any discrepencies with the drawings and/or specifications and site conditions shall be brought to the attention of the Landscape Architect, prior to proceeding with construction.

correspond with one another. Any discrepencies should be brought to the attention of the Landscape Architect for resolution immediately. 8. General Contractor and/or sub-contractors are responsible for all costs related to production and submission to consultant of all landscape as-built information including

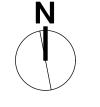

DP REV	24.06.24
DP REV	24.04.15
DP REV	23.09.15
DP REV	23.05.10
DP REV	21.04.30
Dev Permit Revisions	20.08.11
Issued for DP revisions	20.01.08
DP REV	19.10.17
DEV PERMIT	17.07.07
description	date
	DP REV DP REV DP REV DP REV Dev Permit Revisions Issued for DP revisions DP REV DEV PERMIT





NELSON INVESTMENTS, INC.

VIEW STREET RESIDENTIAL 937 VIEW STREET VICTORIA, BC

sheet title


Landscape **Materials: Ground** Level

project no.		119.24
scale	AS NOTED	@ 24"x3
drawn by		ML
checked by		SM/PdG
revison no.	sheet no.	



L1.01



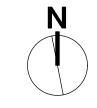

9	DP REV	24.06.24
8	DP REV	24.04.15
7	DP REV	23.09.15
6	DP REV	23.05.10
5	DP REV	21.04.30
4	Dev Permit Revisions	20.08.11
3	Issued for DP revisions	20.01.08
2	DP REV	19.10.17
1	DEV PERMIT	17.07.07
rev no	description	date
074		





NELSON INVESTMENTS, INC.


VIEW STREET RESIDENTIAL 937 VIEW STREET VICTORIA, BC


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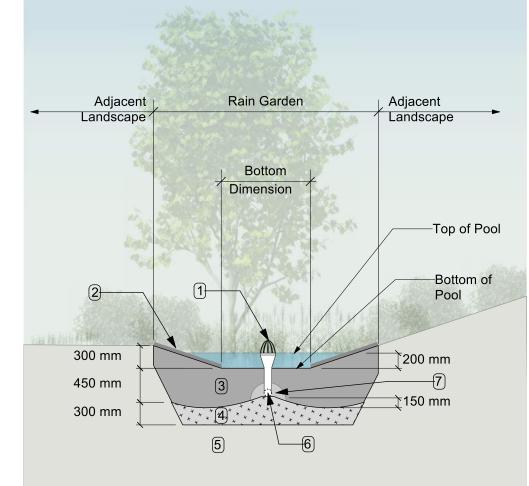
Landscape Materials: Upper Levels

project no.		119.24
scale	AS NOTED	@ 24"x36"
drawn by		ML
checked by		SM/PdG
revison no.	sheet no.	
	_	

L1.02 9



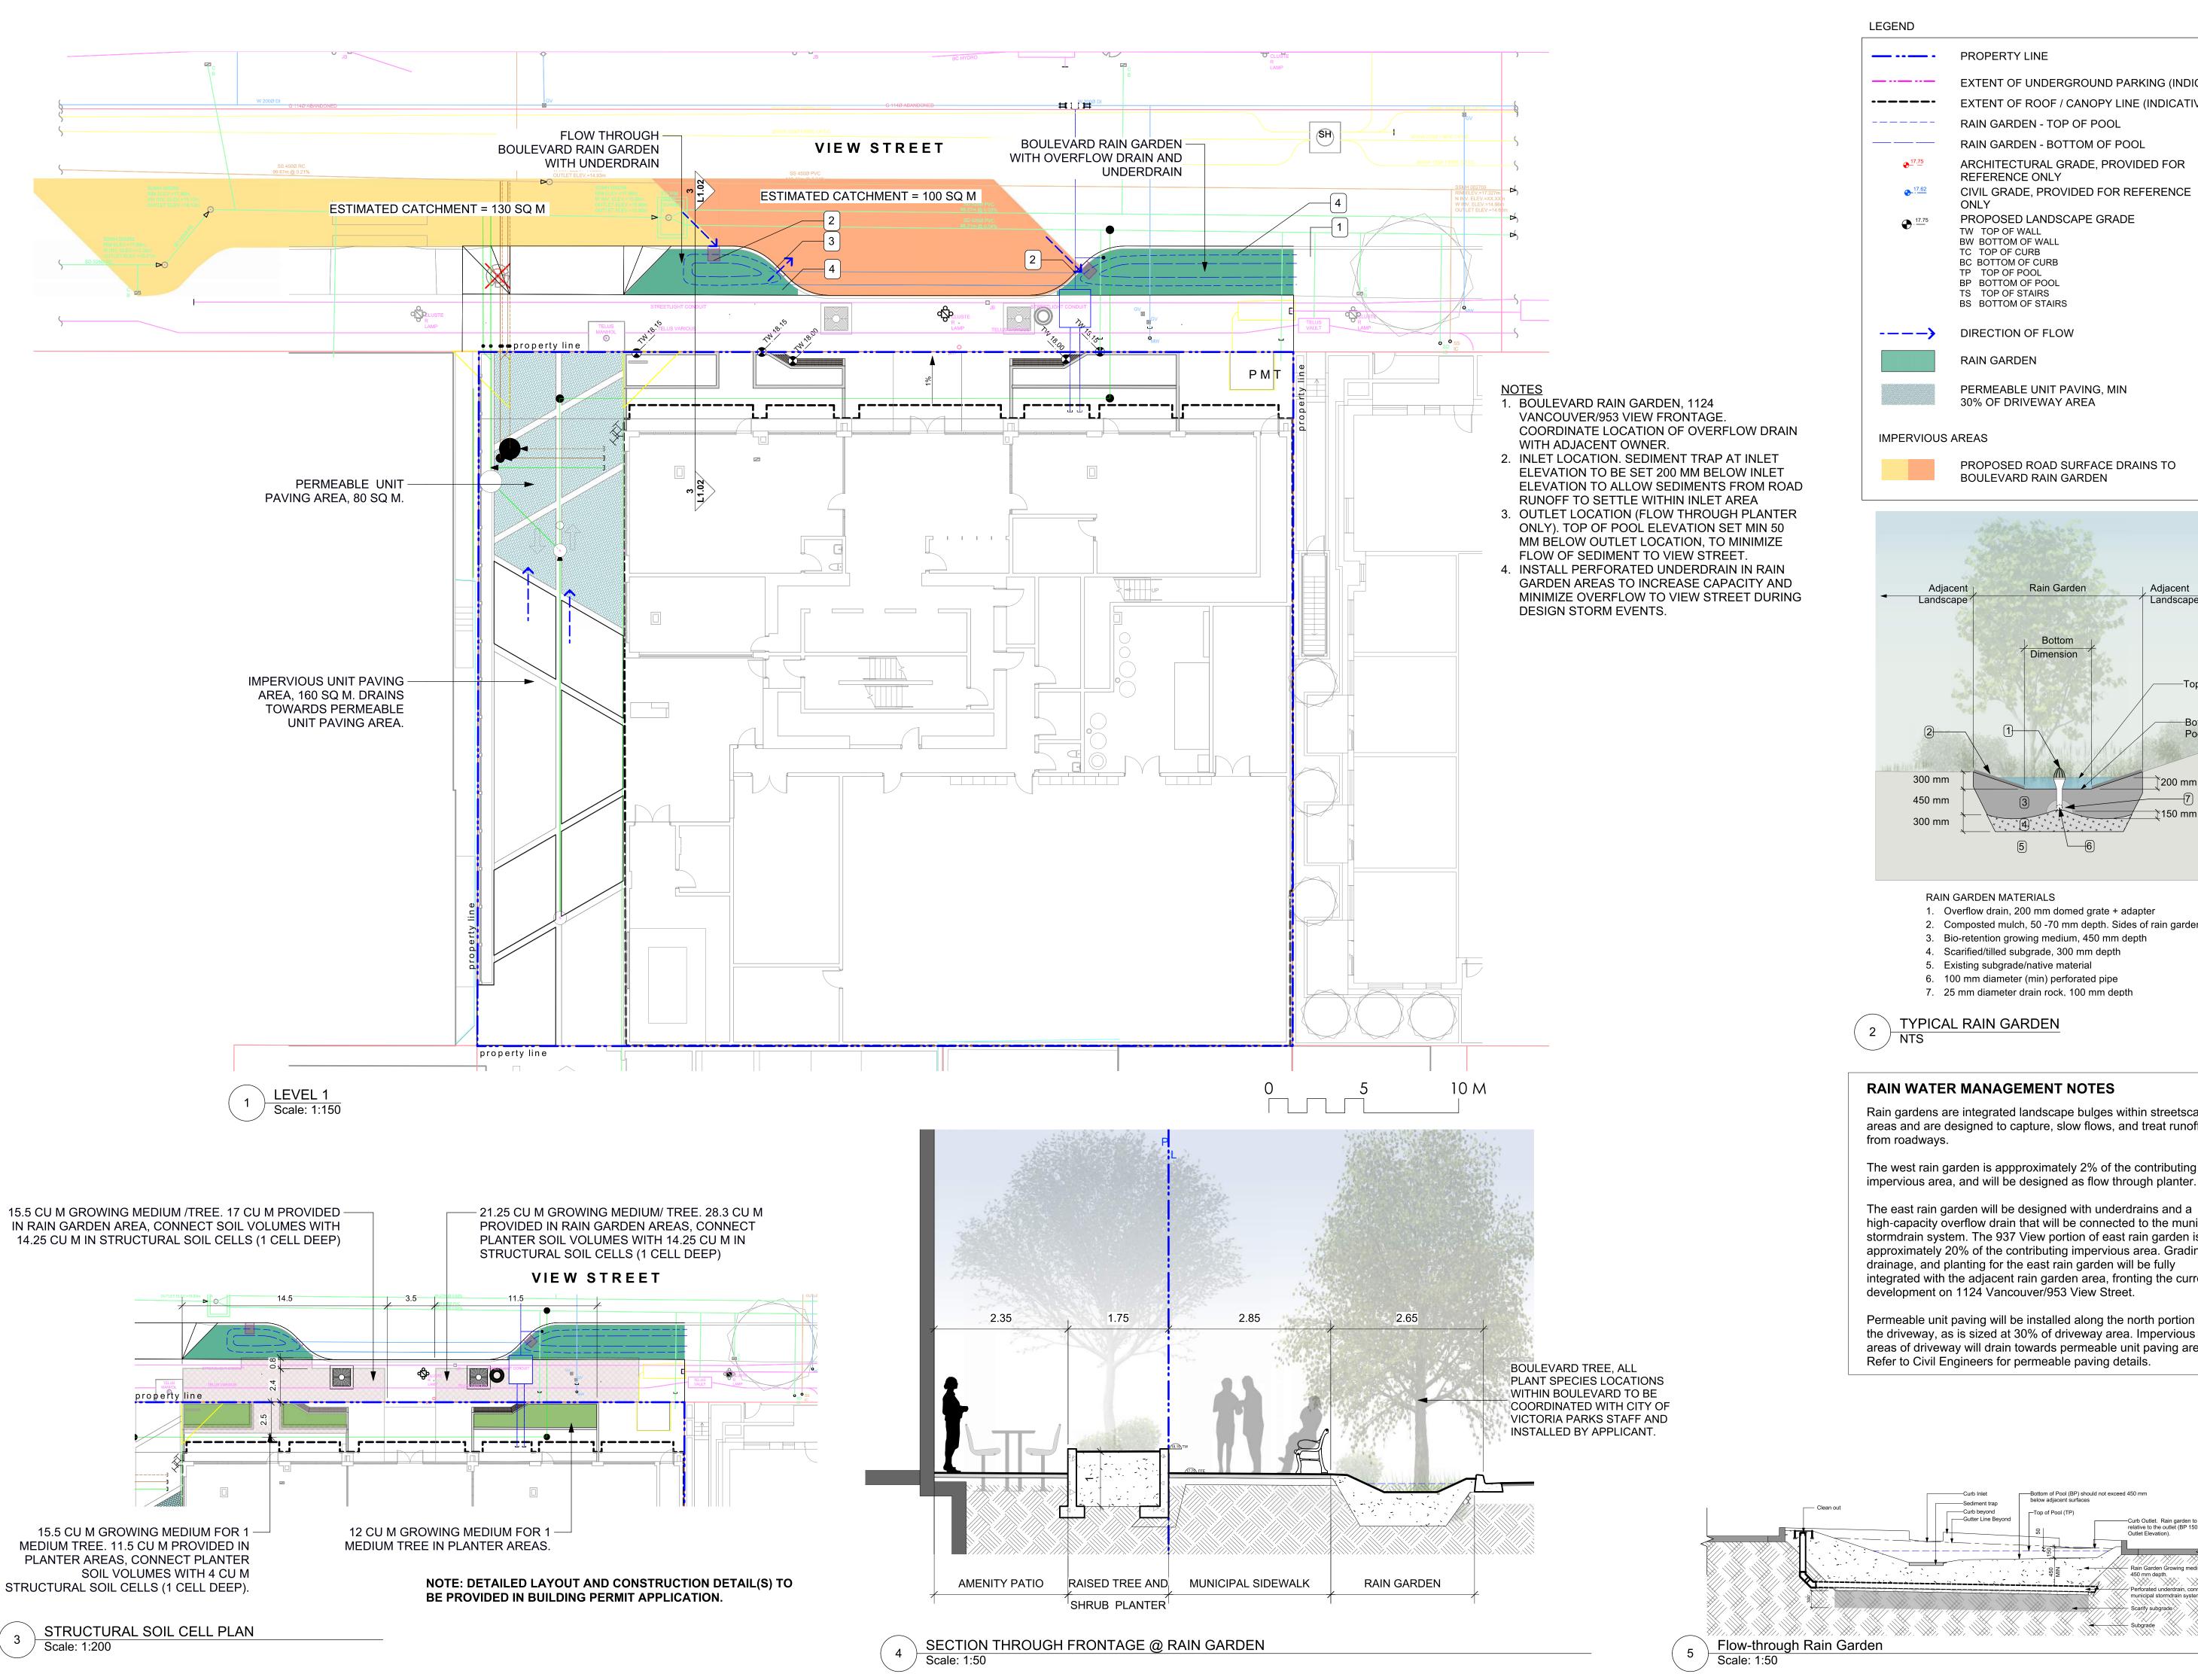

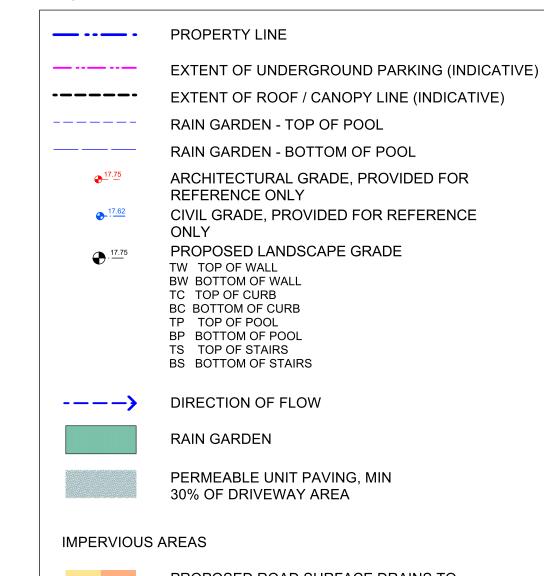

1. Overflow drain, 200 mm domed grate + adapter


2. Composted mulch, 50 -70 mm depth. Sides of rain garden only.


Rain gardens are integrated landscape bulges within streetscape areas and are designed to capture, slow flows, and treat runoff

The west rain garden is appproximately 2% of the contributing impervious area, and will be designed as flow through planter.

high-capacity overflow drain that will be connected to the municipal stormdrain system. The 937 View portion of east rain garden is approximately 20% of the contributing impervious area. Grading, drainage, and planting for the east rain garden will be fully integrated with the adjacent rain garden area, fronting the current

Permeable unit paving will be installed along the north portion of the driveway, as is sized at 30% of driveway area. Impervious areas of driveway will drain towards permeable unit paving area.

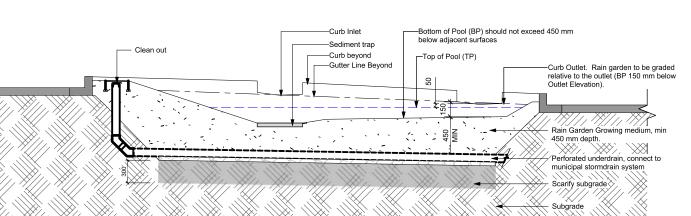

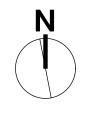

9	DP REV	24.06.24
8	DP REV	24.04.15
7	DP REV	23.09.15
6	DP REV	23.05.10
5	DP REV	21.04.30
4	Dev Permit Revisions	20.08.11
3	Issued for DP revisions	20.01.08
2	DP REV	19.10.17
1	DEV PERMIT	17.07.07
v no	description	date
04		






NELSON INVESTMENTS, INC.

VIEW STREET RESIDENTIAL 937 VIEW STREET VICTORIA, BC

sheet title

Stormwater Management

project no.		119.24
scale	AS NOTED	@ 24"x36"
drawn by		ML
checked by		SM/PdG
revison no.	sheet no.	
9		1.03

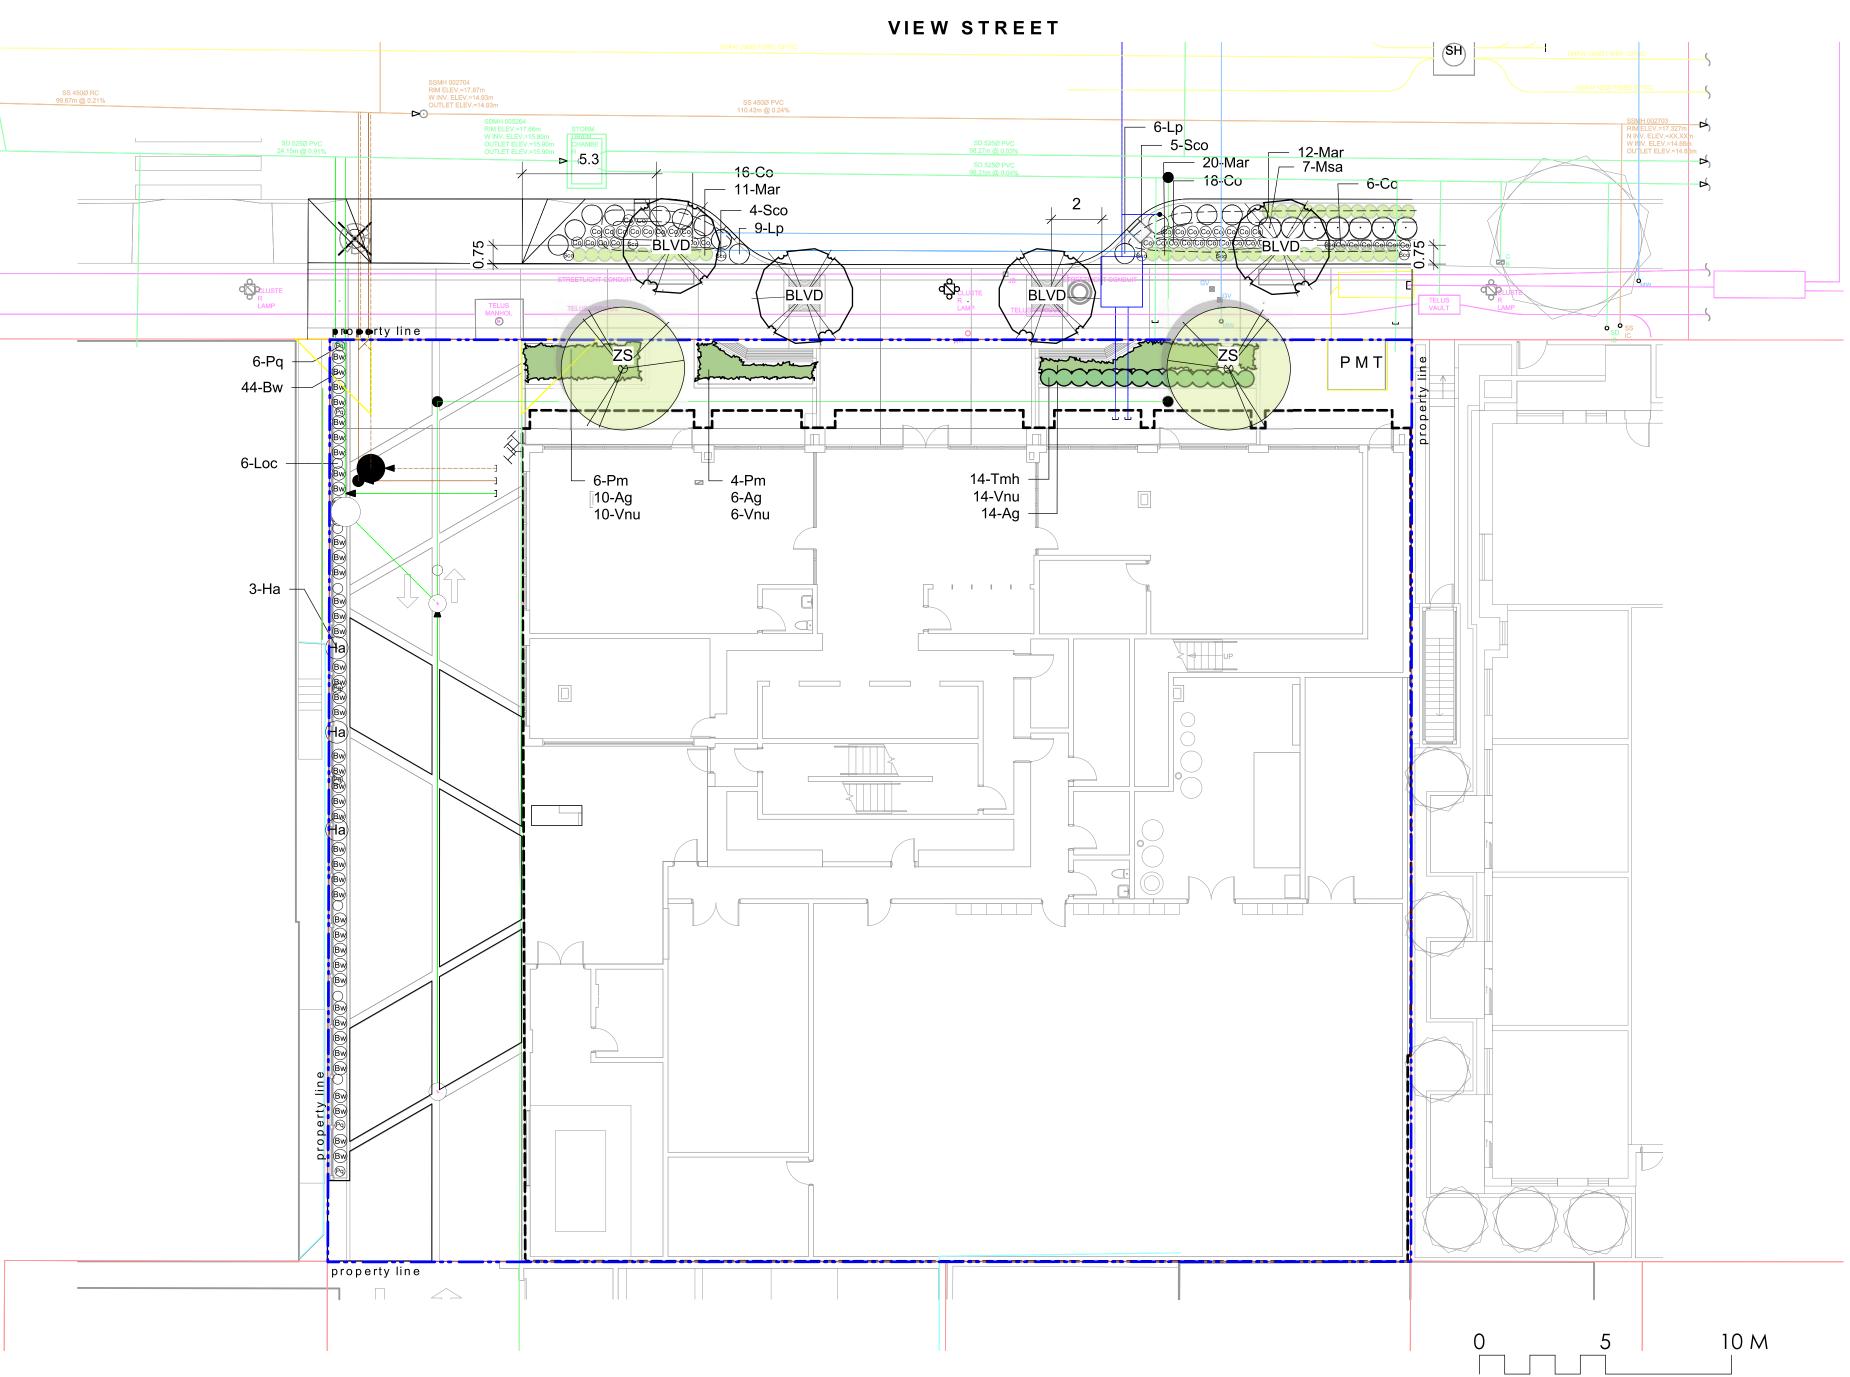



Sym	Qty	Botanical Name	Common Name	Schd. Size / Plant Spacing
		TREES:		
BLVD	4	Boulevard Tree as per COV Parks	Boulevard Tree as per COV Parks	6.0 cm cal, b+b
ZS	2	Zelkova serrata 'Green Vase'	Gren Vase Japanese Zelkova	6.0cm cal, b&b
		SHRUBS:		
Ag	30	Azalea japonica 'Glacier'	Glacier Azalea	#1 pot
Bw	44	Buxus microphylla 'Winter Gem'	Littleleaf Boxwood	#1 pot
Co	40	Carex obnupta	Slough Sedge	#1 pot
На	3	Hydrangea anomala subsp petiolaris	Climbing Hydrangea	#1 pot
Loc	6	Lonicera ciliosa	Western Trumpet Honeysuckle	#1 pot
Lp	15	Lonicera pileata	Privet Honeysuckle	#2 pot
Mar	43	Mahonia repens	Prostrate Oregon Grape	#1 pot
Msa	7	Miscanthus sinensis 'Adagio'	Adagio Maiden Grass	#1 pot
Pq	6	Parthenocissus quinquefolia	Virginia Creeper	#1 pot
Pm	10	Polystichum munitum	Sword Fern	#1 pot
Sco	9	Schizostylis coccinea 'Oregon Sunset'	Crimson Flag	#1 pot
Tmh	14	Taxus x media 'Hilii'	Hilii Yew	#3 pot, 0.6 m ht. male only
Vnu	30	Vaccinium nummularia	Coin Whortleberry	#1 pot

GENERAL PLANTING NOTES

- 1. Plant quantities on Plans shall take precedence over plant list quantities.
- 2. Provide layout of all work for approval by Contract Administrator prior to proceeding with work.
- 3. Plant material, installation and maintenance to conform to the current edition of the Canadian Landscape Standard.
- 4. Plant quantities and species may change between issuance of DP and Construction due to plant availability and design changes. Substitutions to be approved by Landscape Architect.

BOULEVARD & GREENWAY PLANTING NOTES

contact Tom Sherbo, tsherbo@victoria.ca


- 1. Final selection and placement of boulevard trees to be determined through consultation with
- 2. Boulevard trees have been placed to avoid existing and proposed infrastructure. Trees planted within 1m of an existing underground municipal service will have a root barrier installed between the root ball and the existing infrastructure
- 3. Boulevard trees will be place a minimum of 1.5 m from an above ground municipal service such as fire hydrant, streetlight or driveway.
- 4. Proposed Street Trees must comply to City of Victoria Supplementary Specifications for Street Trees and Irrigation Schedule C, Bylaw 12-042, Subdivision Bylaw and the current version of the Canadian Landscape Standard. Planting details can be found in Schedule B3-4 or on the approved landscape plan. The following tree inspections by Parks Staff are required by Schedule C. To schedule an inspection please contact Rob Hughes, rhughes@victoria.ca and
- also copy treepermits@victoria.ca 48 hours prior to the required inspection time. 5. Trees must have one dominant central leader or single straight trunk, 5-8 cm diameter, caliper measured 15 cm above ground, well balanced crown with branching starting at 1.8 m-2.5 m above ground, as per the City of Victoria Supplemental Drawings SD P4 and must comply with the current version of the Canadian Landscape Standard
- 6. Parks will require [3] inspections for tree planting: 1) Inspection of excavated tree pits, soil cells, root barriers. 2) Inspection of trees prior to planting. (Parks staff can inspect trees prior to shipping at local nurseries. Photos can be provided from up-island and mainland nurseries. Tree must meet the spec upon delivery.) 3) Inspection of installed tree with mulch and staking. Contact treepermits@victoria.ca to arrange for inspections, allow for 48 hrs notice.
- 7. The finished grade for boulevards must be firm against footprints, loose textured, free of all stones, roots, and branches. Parks inspection is required to turf installation. Email gstaniforth@victoria.ca to arrange for inspections, allow 48 hrs notice.
- 8. Final inspection of turf shall be conducted once the turf has knit, mowed at least twice to a height of 2.5 inches and no surface soil is visible.
- 9. Plant material and installation must meet or exceed the current edition of the Canadian Landscape Standard and specifications for planted landscapes as required in the MMCD.
- 10. Planted Landscape Inspections: 1) Excavated and scarified subgrade prior placement of the growing media 2) Installed and prepared Growing media prior to planting 3) Plant material onsite prior to planting (Parks staff can inspect plants prior to shipping at local nurseries. Photos can be provided from up-island and mainland nurseries.) 4) Planted landscape prior to the installation of mulch. 5) Inspection when the planted and mulched landscaping meets the conditions for total performance as required in the MMCD. To schedule an inspection please
- and also copy treepermits@victoria.ca 48 hours prior to the required inspection time. 11. The applicant will be required to pay the appraised value of the small boulevard tree proposed for removal. When the tree fee has been paid, the City will post the tree for [10] working days, after which it can be removed at the expense of the applicant.

IRRIGATION NOTES


- 1. Contractor to provide irrigation system for all planting areas to current IIABC Standards and Contract Specifications.
- 2. All specified work to meet the project specifications, and all standards or specifications established in the lastest edition of the Canadian Landscape Standard and IIABC standards
- Design/build drawings for detailed irrigation plan to be submitted to Contract Administrator in PDF and .dwg formats at least two weeks prior to commencement of irrigation installation
- 4. Utilties Contractor to verify location of all on-site utilities, prior to construction. Restoration of damaged utilities shall be made at the contractor's expense, to the satisfaction of the owner's representatives. 5. Refer to electrical drawings for electrical service.
- 6. Controller and backflow prevention device to be located in Mechanical Room, unless otherwise noted. Refer to Mechanical drawings for size and location of irrigation

7. Contractor to verify pressure and flow prior to installation of irrigation and notify

- owner's representative in writing if such data adversely affects the operation of the 8. Sleeves shall be installed at the necessary depths, prior to pavement construction. Sleeving shall extend 300 mm from edge of paving into planting area, and shall have
- ends marked above grade unless otherwise shown. 9. Contractor to field fit irrigation system around existing trees, to limit disturbance to
- 10. At various milestones during construction, inspection and testing of components will be required to ensure that the performance of irrigation system meets standards and specifications. Contractor to provide equipment and personnel necessary for performance of inspections and tests. Conduct all inspections and tests in the presence of the contract administrator. Keep work uncovered and accessible until successful completeition of inspection or test.
- 11. Over spray onto hardscape areas to be minimized. Use drip irrigation within small planting areas to avoid overspray.
- 12. Trees within shrub or rain garden areas to be irrigated with spray heads. 13. Trees in Plaza in hard pavement (soil cells below) to recieve temporary irrigation system around root collar and permanent drip irrigation system
- 14. Irrigation Systems on City property shall comply to City of Victoria Supplementary Specifications for Street Trees and Irrigation Schedule C, Bylaw 12-042, SubdivisionBylaw. Irrigation drawings must be submitted to Parks Division for review and approval 30 days prior to installation work. The following irrigation and sleeving inspections by Parks Staff are required by Schedule C. To schedule an inspection please contac Tom Sherbo, tsherbo@victoria.ca and also copy treepermits@victoria.ca 48 hours prior to the required inspection time.

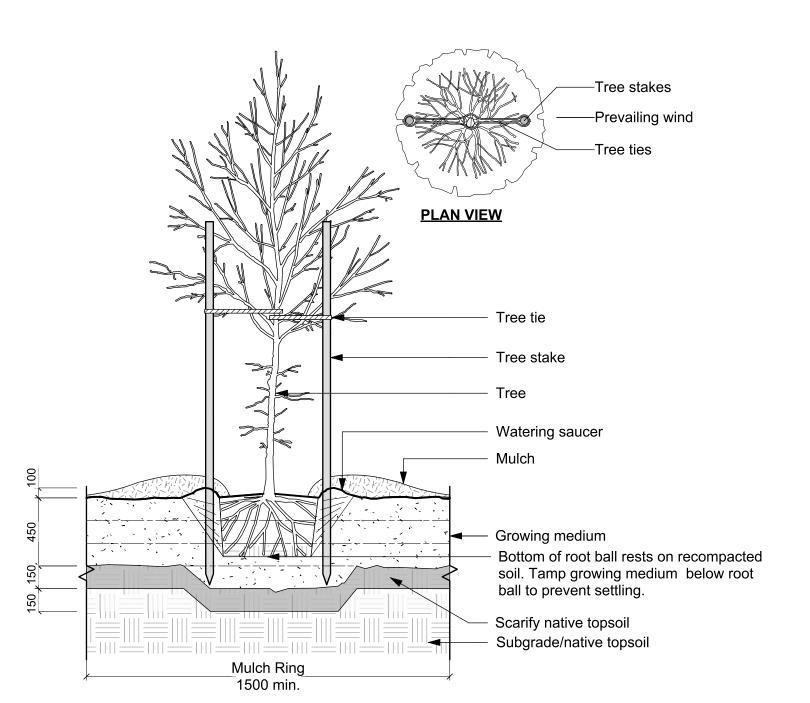



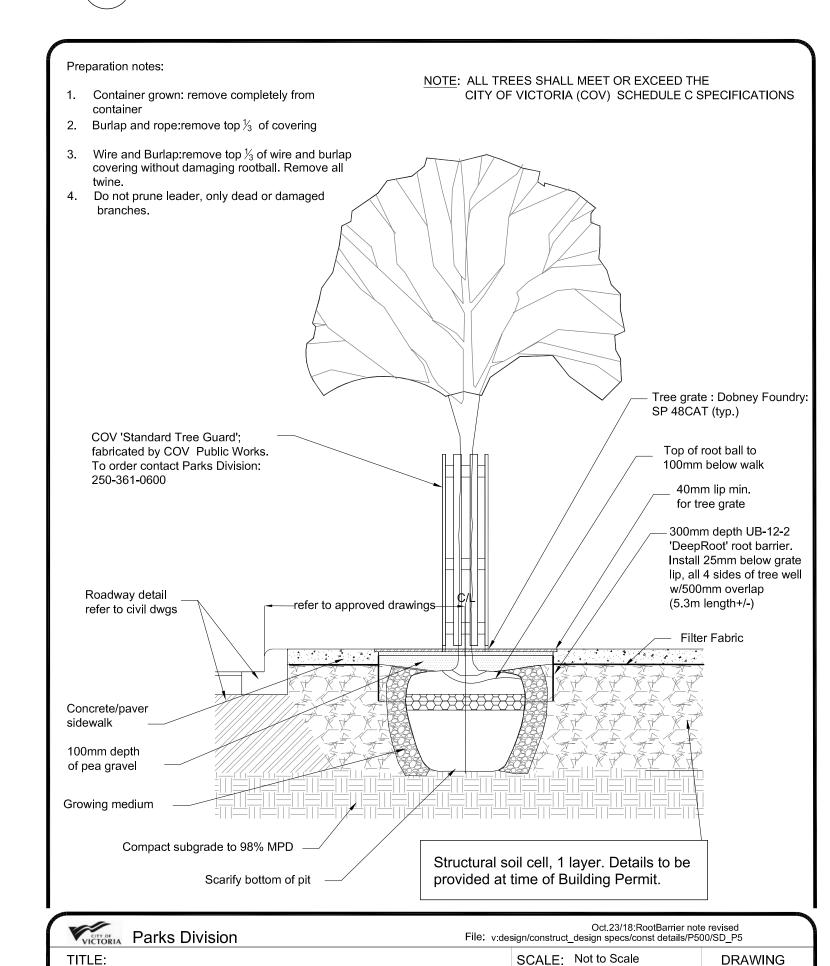

DWN.: APP'D.:


Tree Planting in Sidewalk with Tree Guard

1. Work performed shall comply with the following: a) These General Notes, and Construction Documents and Specifications; b) Canadian Landscape Standards, Current Edition (CLS-CE), and c) All applicable local, provincial, and federal codes, ordinances, and regulations.

DATE: Feb.27, 2018

SD-P5

- 2. Contractor shall be responsible for verifying all existing site conditions including location of all property lines, existing structures, utilities, and buried infrastructure. Verify all field conditions prior to commencing work.
- 3. Contractor is responsible for determining means and methods for construction. These drawings may indicate a limit of proposed improvements or limit of work for the delineation of expected extents of disturbance. Should limits of disturbance
- exceed boundaries defined in drawings, contractor shall contact Landscape Architect for resolution. 4. Contractor is responsible for repairing all work disturbed by construction outside of limit lines defined on drawings or through their means and methods to a condition better than or equal to the existing conditions prior to commencement of construction at no additional cost to the owner.
- 5. Contractor is responsible for maintaining a complete up-to-date set of drawings and specifications at the construction site
- and ensuring the documents are readily available for review by the Landscape Architect and governing agency. 6. Contractor is responsible for coordination of all designs, drawings, specifications and other documents or publications upon which construction is based. Any discrepencies with the drawings and/or specifications and site conditions shall be brought to the attention of the Landscape Architect, prior to proceeding with construction.
- 7. The drawings and specifications are complementary to one another and implied to correspond with one another. Any discrepencies should be brought to the attention of the Landscape Architect for resolution immediately.
- 8. General Contractor and/or sub-contractors are responsible for all costs related to production and submission to consultant of all landscape as-built information including irrigation.

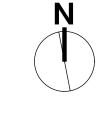

9	DP REV	24.06.24
8	DP REV	24.04.15
7	DP REV	23.09.15
6	DP REV	23.05.10
5	DP REV	21.04.30
4	Dev Permit Revisions	20.08.11
3	Issued for DP revisions	20.01.08
2	DP REV	19.10.17
1	DEV PERMIT	17.07.07
rev no	description	date





NELSON INVESTMENTS, INC.

VIEW STREET RESIDENTIAL

sheet title

Planting Plan: Ground Level

937 VIEW STREET


VICTORIA, BC

roject no.		119.24
cale	AS NOTED	@ 24"x36"
rawn by		ML
necked by		SM/PdG

revison no. sheet no.

L3.01



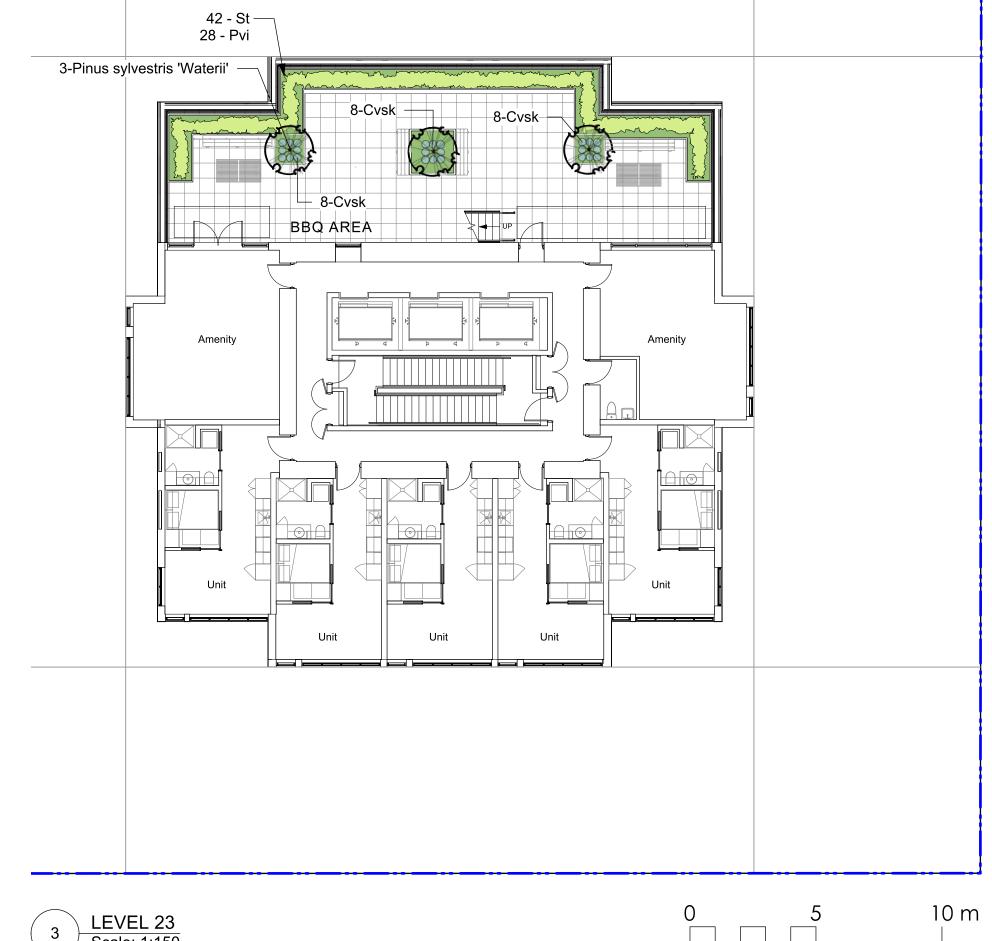


Plu 32 Prunus lusitanica Portugal Laurel #3 pot LEVEL 6 SHRUBS/PERENNIALS: 15 Azalea japonica 'Glacier' Glacier Azalea #1 pot 5 Lavandula angustifolia 'Hidcote' Hidcote English Lavender #1 pot 66 Pittosporum tobira 'Nana' Dwarf Pittosporum #1 pot Evergreen Huckleberry 15 Vaccinium ovatum #3 pot LEVEL 23 TREES: specimen, cloud pruned, 3 Pinus sylvestris 'Waterii' Bonsai Pine min 2 m height, SHRUBS/PERENNIALS: Silver Knight Scotch Heather #1 pot 24 Calluna vulgaris 'Silver Knight' Pvi 28 Pennisetum villosum Feathertop Grass #1 pot Mexican Feathergrass 42 Stipa tenuissima #1 pot **ROOF LEVEL** SHRUBS/PERENNIALS: 20 Nandina domestica 'Lemon Lime' Lemon Lime Heavenly Bamboo #2 pot 13 Phyllostachys aurea 'Koi' Koi Bamboo #5 pot 6 Rosmarinus officinalis #2 pot Rosemary

Common Name

PLANT LIST - UPPER LEVELS

Sym Qty Botanical Name

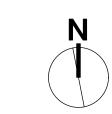

9	DP REV	24.06.24
8	DP REV	24.04.15
7	DP REV	23.09.15
6	DP REV	23.05.10
5	DP REV	21.04.30
4	Dev Permit Revisions	20.08.11
3	Issued for DP revisions	20.01.08
2	DP REV	19.10.17
1	DEV PERMIT	17.07.07
ev no	description	date
04		





NELSON INVESTMENTS, INC.

VIEW STREET RESIDENTIAL 937 VIEW STREET

sheet title

Planting Plan: Upper Levels

project no.		119.24
scale	AS NOTED	@ 24"x36"
drawn by		ML
checked by		SM/PdG

L3.02

revison no. sheet no.

VICTORIA, BC 1. Work performed shall comply with the following: a) These General Notes, and Construction Documents and Specifications; b) Canadian Landscape Standards, Current

Schd. Size / Plant

Spacing

2. Contractor shall be responsible for verifying all existing site conditions including location of all property lines, existing structures, utilities, and buried infrastructure. Verify all field

Edition (CLS-CE); and c) All applicable local, provincial, and federal codes, ordinances,

GENERAL NOTES

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defined in drawings, contractor shall contact Landscape Architect for resolution. 4. Contractor is responsible for repairing all work disturbed by construction outside of limit lines defined on drawings or through their means and methods to a condition better than or equal to the existing conditions prior to commencement of construction at no additional


cost to the owner. 5. Contractor is responsible for maintaining a complete up-to-date set of drawings and specifications at the construction site and ensuring the documents are readily available for review by the Landscape Architect and governing agency.

6. Contractor is responsible for coordination of all designs, drawings, specifications and other

drawings and/or specifications and site conditions shall be brought to the attention of the Landscape Architect, prior to proceeding with construction. 7. The drawings and specifications are complementary to one another and implied to correspond with one another. Any discrepencies should be brought to the attention of the

documents or publications upon which construction is based. Any discrepencies with the

Landscape Architect for resolution immediately. 8. General Contractor and/or sub-contractors are responsible for all costs related to production and submission to consultant of all landscape as-built information including irrigation.

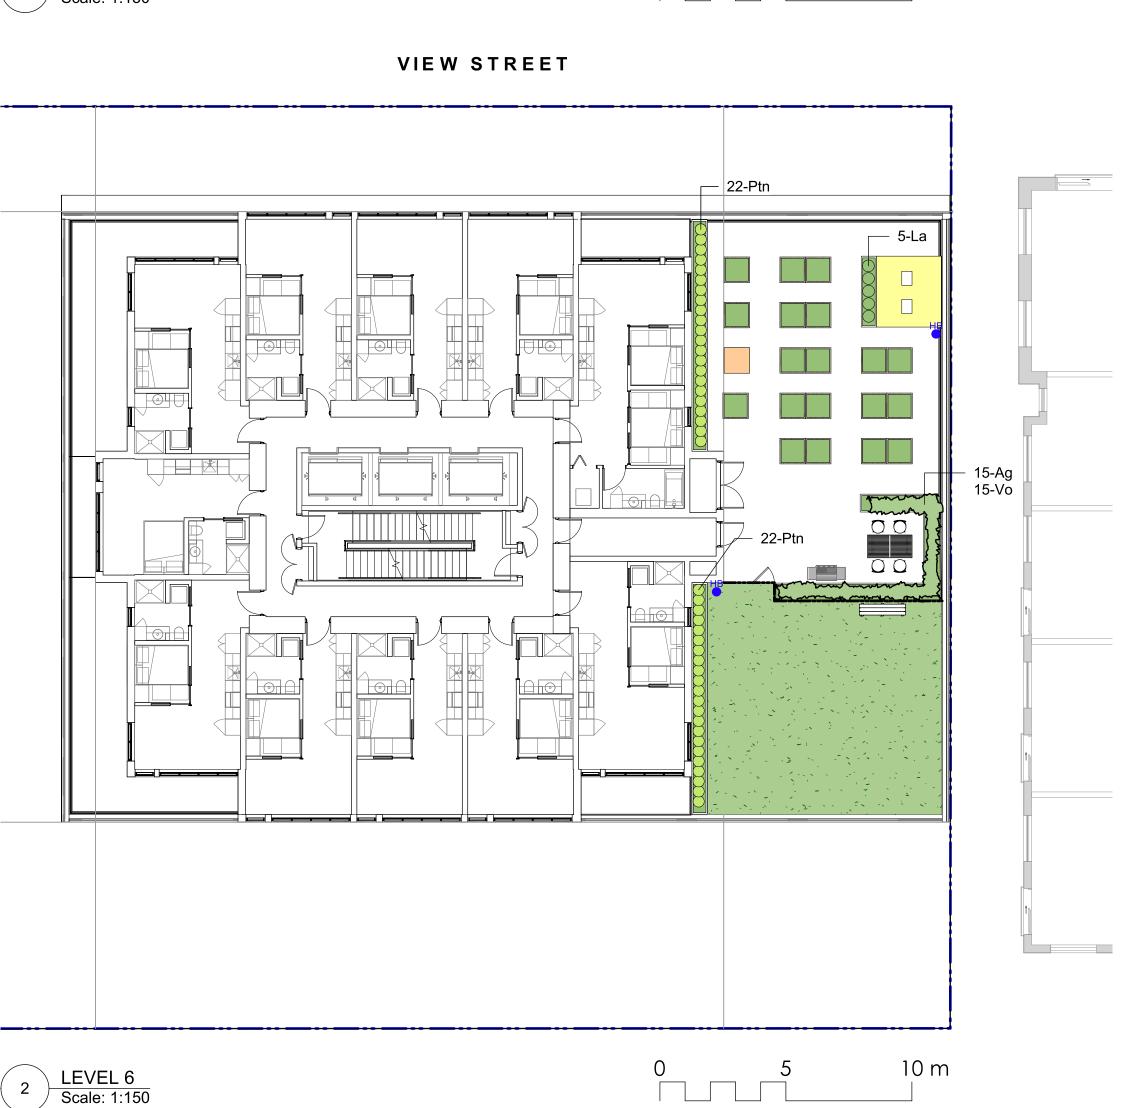




LEGEND

EVICTING	DDODOCED	DESCRIPTION	EVICTING	DDODOSED	DECORIDATION
EXISTING	PROPOSED	DESCRIPTION	EXISTING	PROPOSED	DESCRIPTION
///		EDGE OF PAVEMENT			REDUCER
CURB		CURB AND GUTTER			FENCE
		EDGE OF GRAVEL		~ ~ ~	DITCH/SWALE
ТВ/ВВ		TOP/BOTTOM OF BANK			WATERMAIN (SIZE AND MATERIAL NOTED)
		CATCH BASIN	s	s	SANITARY SEWER (SIZE AND MATERIAL NOTED)
WV_		WATER VALVE	D	D	STORM DRAIN (SIZE AND MATERIAL NOTED)
- -FH	+	FIRE HYDRANT	т_	т——т	UNDERGROUND TELEPHONE
		CAPPED END	———Н———	——н——	UNDERGROUND HYDRO
\ominus		UTILITY POLE AND STREET LIGHT (LABELED PP,TP,PP/LS ETC.)	· ·		MONUMENT
· MH	-	MANHOLE			PROPERTY LINE
⊗ co		CLEANOUT		5+100 5+110	CENTERLINE AND STATIONING
SSIC/SDIC	SSIC/SDIC	SANITARY/STORM INSPECTION CHAMBER (2000 RISER)			SANITARY SEWER SERVICE CONNECTION AT MAI
JB		JUNCTION BOX	+32.75	43.170)+	ELEVATIONS
(AR)		AIR VALVE			PAVEMENT REMOVAL
WM	WM	WATER METER			ASPHALT MILL AND OVERLAY



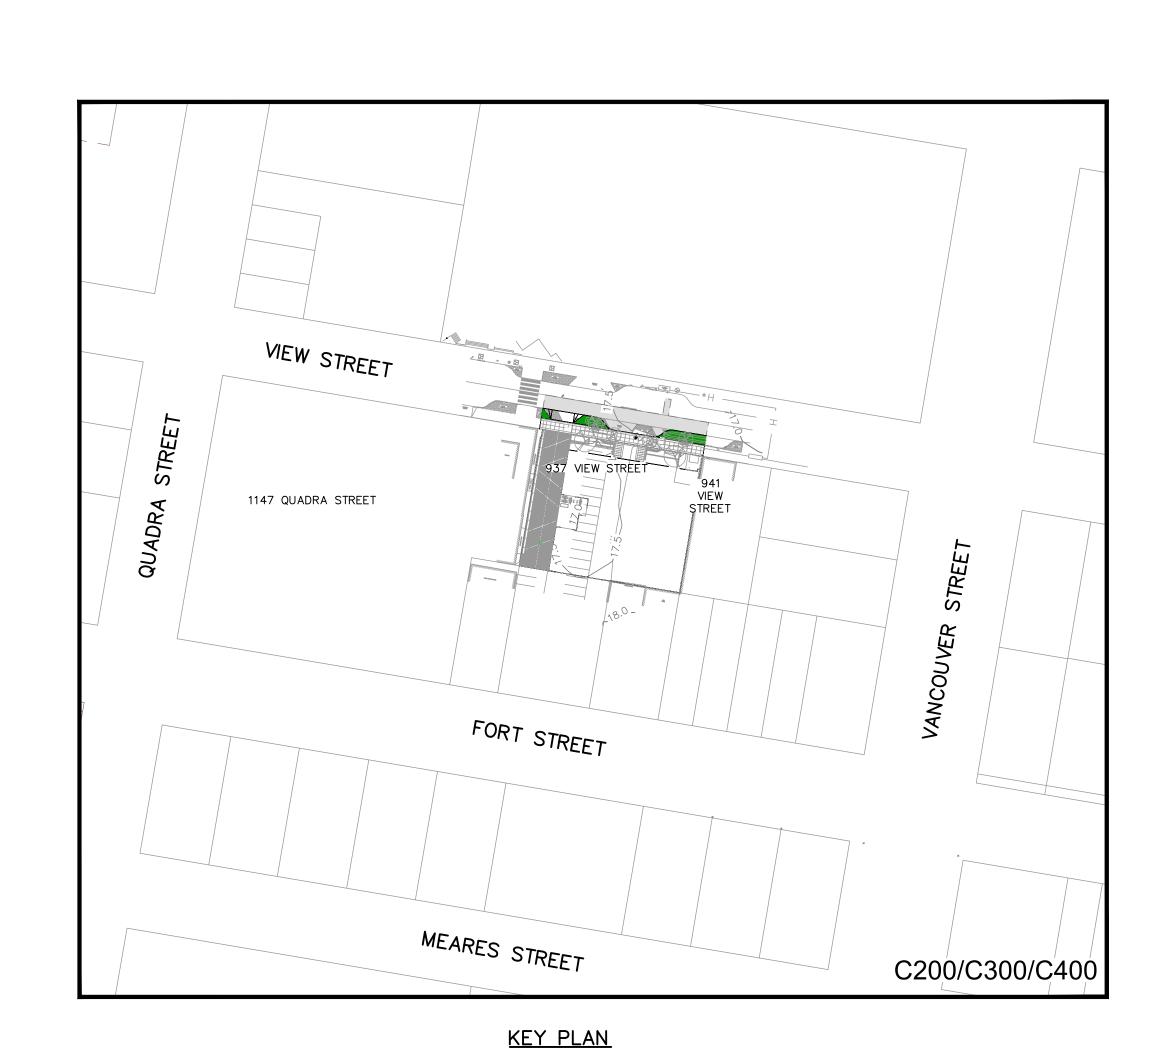




DWG No.	DESCRIPTION

C100 GENERAL NOTES, LOCATION PLAN, KEY PLAN, DRAWINGS LIST & LEGEND

C200 C300 C400 SITE SERVICING PLAN GRADING PLAN

BC HYDRO INFORMATION PLAN

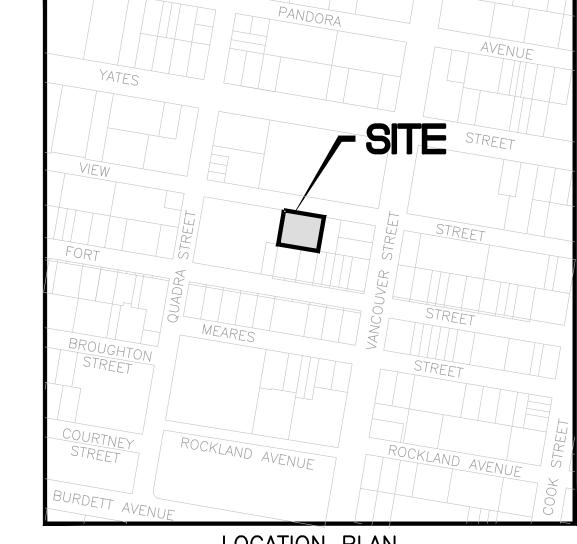

LOCATION PLAN

937 VIEW STREET LOT A, OF LOTS 785, 786 AND 787, VICTORIA CITY, PLAN 36505. R-48, HARRIS GREEN

LAND USE: RESIDENTIAL 253 UNIT 15 STOREY RESIDENTIAL BUILDING PROPOSED:

SITE AREA: 1572m² DWELLING FOOTPRINT AREA: 725m² 17.60m MAIN FLOOR ELEVATION:

PLAN TO ACCOMPANY DEVELOPMENT PERMIT APPLICATION

GENERAL NOTES:

CIVIC ADDRESS:

LEGAL:

ZONING:

- 1. ALL WORK AND MATERIALS ARE TO BE IN ACCORDANCE WITH THE CITY OF VICTORIA (CoV) SPECIFICATIONS, ITS SUPPLEMENTARY MASTER MUNICIPAL SPECIFICATIONS, STANDARD DETAIL DRAWINGS AND MMCD UNLESS OTHERWISE NOTED. IF A CONFLICT BETWEEN SPECIFICATIONS ARISES, THE MOST STRINGENT SHALL APPLY.
- 2. THE ENGINEER SHALL BE NOTIFIED 48 HOURS PRIOR TO COMMENCEMENT OF WORK.
- SIGNATURE BLOCK FOR SHALLOW UTILITIES TO BE SIGNED AND DATED PRIOR TO CONSTRUCTION. 4. PERMITS TO CONSTRUCT WORKS ON THE CoV RIGHT OF WAY MUST BE OBTAINED FROM THE CoV ENGINEERING DEPARTMENT PRIOR TO COMMENCING WORK. PERMITS MUST BE ON SITE FOR REVIEW AS
- 5. CONFIRM LOCATION AND ELEVATION OF ALL EXISTING UTILITIES AT ALL CROSSINGS AND CONNECTIONS
- AND REPORT ANY DISCREPANCIES TO THE ENGINEER PRIOR TO CONSTRUCTION. 6. CONFIRM THAT ELEVATION, LOCATION AND GRADIENT OF ASPHALT MATCH EXISTING PRIOR TO PLACEMENT
- OF ASPHALT OR CONCRETE.
- 7. ALL TREES NOT BEING REMOVED IN THE CONSTRUCTION AREA SHALL BE PROTECTED. CARE TO BE TAKEN TO RETAIN AS MANY TREES AS POSSIBLE.
- 8. ADJUST ALL MANHOLES, WATER VALVES, HYDRO VAULTS, ETC. TO MATCH NEW CONSTRUCTION. 9. ALL LOCATIONS AND ELEVATIONS OF EXISTING UTILITIES SHOWN ARE APPROXIMATE ONLY AND SHOULD BE CONFIRMED BY USE OF A PIPE LOCATOR AND MANUAL DIGGING. ALL OR ANY STRUCTURES NOT
- NECESSARILY SHOWN. 5. ALL EXCAVATED TRENCH AND SUBEXCAVATION MATERIALS TO BE DISPOSED OF OFFSITE.
- 6. ALL ELEVATIONS ARE TO GEODETIC DATUM.
- 7. DATA SOURCES: -TOPOGRAPHIC SURVEY COMPLETED BY POWELL & ASSOCIATES BC LAND SURVEYORS, DECEMBER 2016.
- -DIGITAL GIS PROVIDED BY CoV. -BC 1 CALL DATA FOR SHALLOW UTILITIES.

ROAD NOTES:

- 1. CONSTRUCT ALL SIDEWALK AND DRIVEWAY CROSSINGS IN ACCORDANCE WITH CoV AND MMCD STANDARDS AS NOTED ON DRAWINGS.
- . MAINTAIN VEHICULAR AND PEDESTRIAN ACCESS ALONG VIEW STREET DURING CONSTRUCTION.
- ROAD RESTORATION FOR VIEW STREET TO COV SUPPLEMENTAL DWG. No. SD G5a AND G5b. 4. THE PROVISION OF APPROVED SIGNS AND CERTIFIED TRAFFIC CONTROL PERSONNEL IS THE
- CONTRACTOR'S SOLE RESPONSIBILITY.
- 5. ALL PAVEMENT EXCAVATIONS TO BE SAWCUT. 6. PROJECT FRONTAGE TO BE RESTORED AS NOTED ON CIVIL, LANDSCAPE AND ARCHITECTURAL DRAWINGS
- AS PER CoV "NEW TOWN" SPECIFICATIONS.
- 7. PEDESTRIAN WALKING AREA TO BE DELINEATED DURING THE CONSTRUCTION OF THE WORKS AND MUST BE EASILY RECOGNIZABLE BY THE PUBLIC AND CONTAIN NO OBSTRUCTIONS TO MOBILITY SCOOTERS OR WHEELCHAIRS AND NO HAZARDOUS CONDITIONS. THE PUBLIC USING THESE AREAS MUST BE ADEQUATELY PROTECTED FROM TRAFFIC.

WATER NOTES:


- WATER SERVICE CONNECTION TO BE PER CoV STD. DWG. No. W2d SS.
- 2. CONTRACTOR TO CONFIRM THAT EXISTING WATER SERVICES HAVE BEEN CAPPED BY CONTRACTOR/DEVELOPER AND INSPECTED BY CoV PLUMBING DEPARTMENT AT DEVELOPER'S EXPENSE.

STORM DRAIN AND SANITARY SEWER NOTES:

- 1. CONTRACTOR TO CONFIRM THAT EXISTING SANITARY AND STORM DRAIN SERVICES HAVE BEEN CAPPED BY CONTACTOR/DEVELOPER AND INSPECTED BY CoV PLUMBING DEPARTMENT AT DEVELOPER'S EXPENSE.
- 2. STORM DRAIN AND SANITARY SEWER CONNECTIONS TO BE AS PER CoV STD. DWG. No. S7 SS. 3. STORM DRAIN CONNECTION TO BE 2000 PVC SDR28 AT A MINIMUM GRADE OF 2.00% UNLESS
- OTHERWISE NOTED. 4. SANITARY SEWER CONNECTION TO BE 2500 PVC SDR28 AT A MINIMUM GRADE OF 2.00% UNLESS
- 5. UNDERGROUND SERVICES TO BE LOCATED, EXPOSED AND ELEVATIONS CONFIRMED AT CROSSINGS PRIOR TO INSTALLATION OF CONNECTIONS.

SHALLOW UTILITY AND STREET LIGHT NOTES:

- 1. EXISTING BC HYDRO, TELUS, SHAW CABLE AND FORTIS BC INFRASTRUCTURE INFORMATION SHOWN ON DRAWINGS IS SCHEMATIC AND FOR INFORMATION ONLY.
- 2. REFER TO UTILITY COMPANY DESIGN DRAWINGS FOR CONSTRUCTION DETAILS. CONSTRUCT UNDERGROUND UTILITIES AS SPECIFIED AND IN ACCORDANCE WITH BC HYDRO, TELUS, SHAW CABLE SPECIFICATIONS AND DRAWINGS.
- 3. CONFIRM AND COORDINATE WITH CoV FORCES REINSTATEMENT OF LAMP STANDARDS AS PER CoV SUPPLEMENTARY STANDARD DETAIL DRAWINGS, INCLUDING BASES, CONDUIT AND JUNCTION BOX.
- CONTACT BC 1 CALL AT 1-800-474-6886 A MINIMUM OF 48 HOURS PRIOR TO CONSTRICTION. 5. CONTACT BC HYDRO, TELUS, SHAW CABLE AND FORTIS BC 48 HOURS PRIOR TO THE START OF ANY
- 6. BC HYDRO TO COORDINATE AND PROVIDE LIAISON WITH CoV PRIOR TO AND DURING CONSTRUCTION.

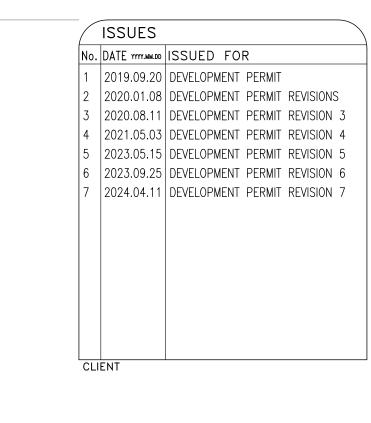

Щ 937 VIE MARKE

Tel: 250-590-4875 Fax: 250-590-4392 Email: mail@heroldengineering.com

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GENERAL NOTES, LOCATION PLAN, KEY PLAN, **DRAWINGS LIST**

& LEGEND DESIGNED ENGINEER'S SEAL HEL PERMIT NO: 1000201 DESIGN REVIEW DRAFTED LAM DRAFTING REVIEW PROJECT No. CLIENT DRAWING No.

5094-001 H: AS NOTED

HEL DRAWING No. C100 1 of 4

DESTROY ALL DRAWINGS SHOWING PREVIOUS REVISION

