

ADDRESS: 1905 LEE AVE. LOT 4 PLAN 5969 SECTION 76 VICTORIA

DRAWING NAME:
LANDSCAPE PLAN, F
AND GRADE PLANS DRAWING SCALE:


SEE DRAWINGS

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SHEET NUMBER






Principal Exhaust fan:

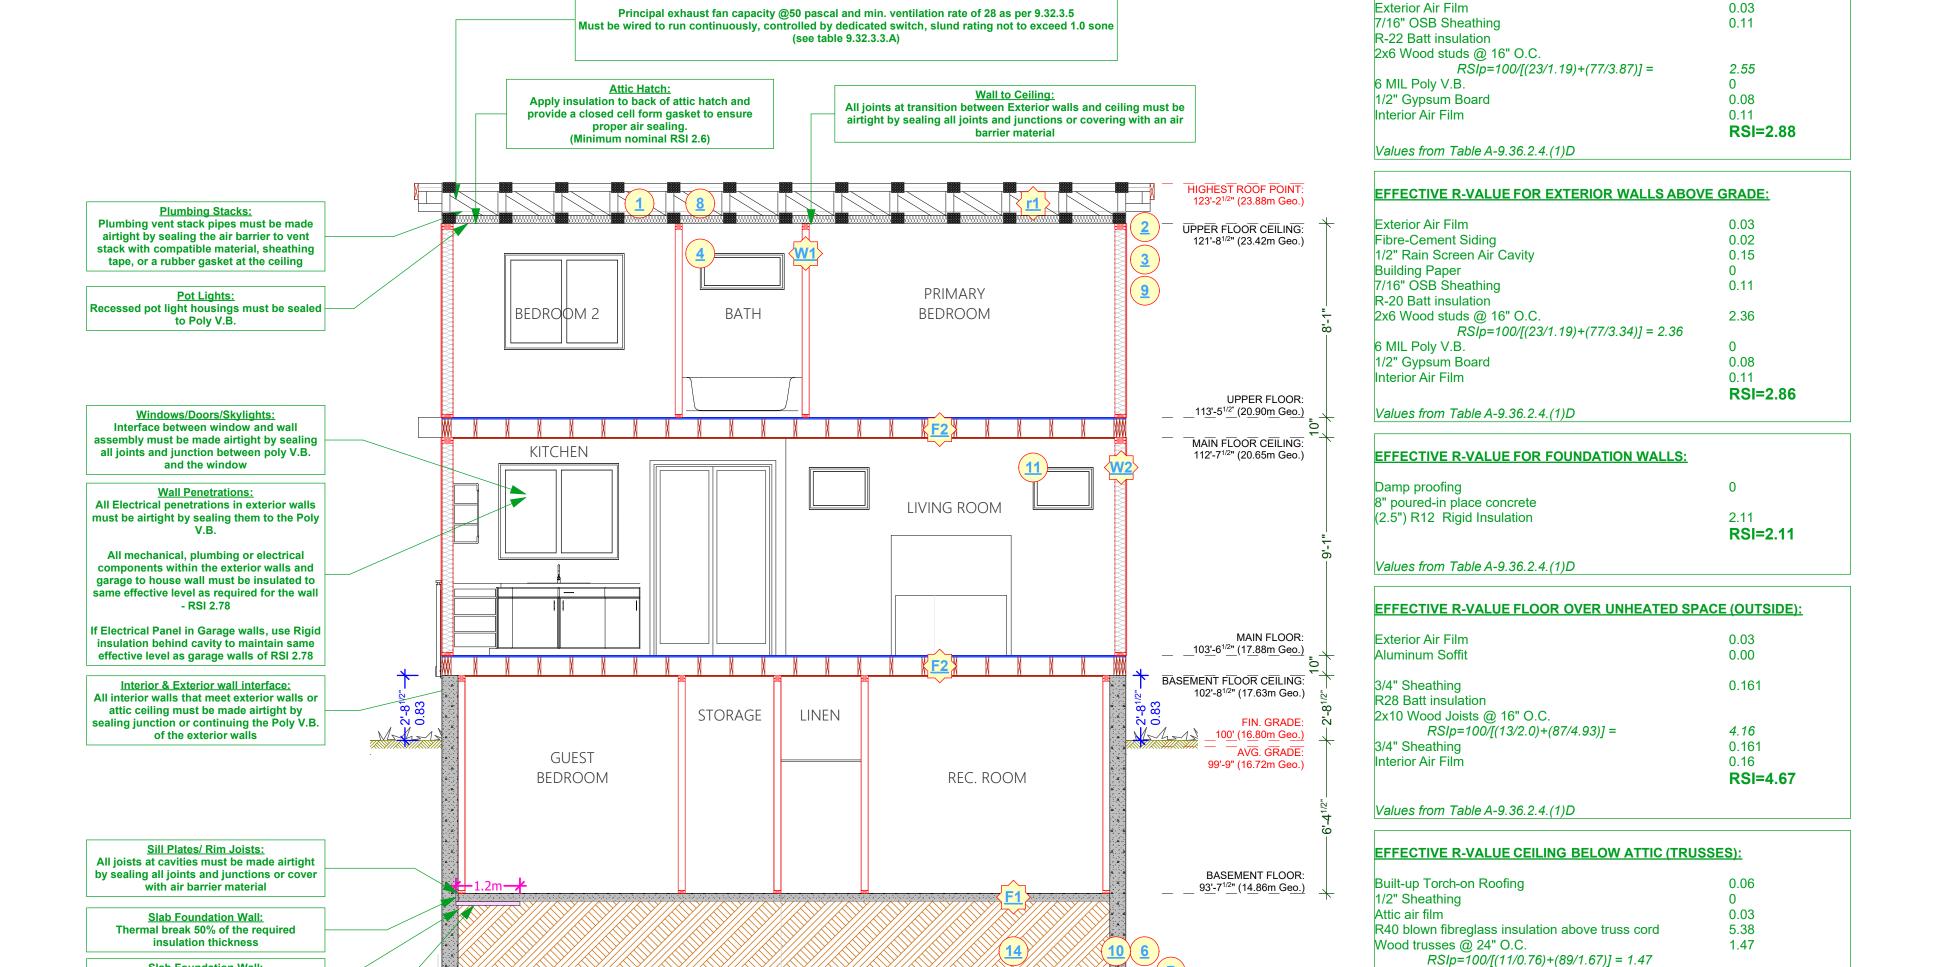

CROSS SECTION A-1

SCALE: 1/4" = 1' - 0"

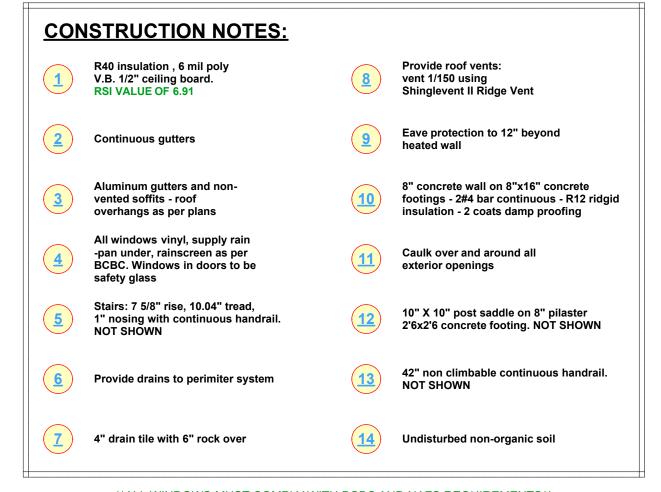

Slab Foundation Wall:
Slab air barrier must be made airtight

by sealing the floor to foundation wall

(2.5") R12 Rigid Insulation to be 1.2m in

Ensure continuity of insulation as per BCBC 9.36.2.5(2)

2x4 strapping to allow for cross ventilation

POLYETHYLENE (V.B. & A.B.)

CONTINUOUS SOFFIT VENT

EXTERIOR FINISH
19mm (3/4") AIR SPACE /
P.T. WOOD STRAPPING
SHEATHING PAPER (M.B.)
SHEATHING
WOOD FRAMING
BATT INSULATION
POLYETHYLENE (A.B. & V.B.)
GYPSUM BOARD

SOFFIT DETAIL

SCALE: 1" = 1' - 0"

SEE "FLASHING - BEST PRACTICE GUIDE" FOR ADDITIONAL ROOF FLASHING DETAILS


ROUFING SHINGLES (M.B.)
WATERPROOF ROOF MEMBRANE (M.B.) FOR
EAVE PROTECTION
ROOF SHEATHING
WOOD ROOF FRAMING

CONTINUE EAVE PROTECTION 300mm (12") BEYOND INSIDE FACE OF WALL

WATER SHEDDING ROOF / WALL

SEALED POLYETHYLENE APPROACH

ALL WINDOWS MUST COMPLY WITH BCBC AND NAFS REQUIREMENTS
MUST BE CLEARLY LABELED ON ALL WINDOW UNITS UPON INSTALLATION FOR INSPECTION. -ONE
EXTERIOR DOOR IS PERMITTED TO HAVE A HIGHER U-VALUE OF 2.6, ALL OTHERS MUST HAVE
U-VALUE LESS THEN 1.80 (AS PER TABLE 9.36.2.7.A) -GARAGE VEHICULAR DOORS MUST BE MINIMUM
NOMINAL RSI OF 1.1

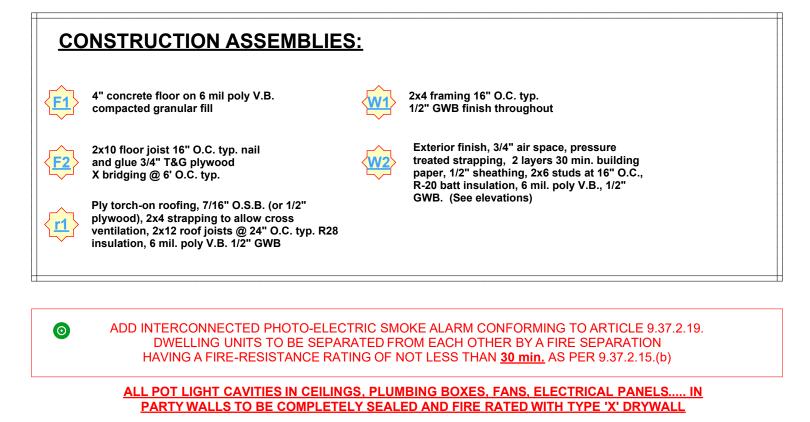

6 MIL Poly V.B.

Interior Air Film

1/2" Gypsum Board

Values from Table A-9.36.2.4.(1)D

0.08

0.12

RSI=7.14

EFFECTIVE R-VALUE FOR EXTERIOR WALLS AGAINST LOWER ROOF:

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CROSS SECTION A-1 AND
SOFFIT DETAIL
DRAWING SCALE:
1/4"=1'-0"


ISSUE DATE:
AUG 24, 2022


DRAWN BY:
KYLE LEGGETT

SON PAPER BECOME WALLS ON SITE 8 FX 250.590.4577 www.javadesigns.ca

SHEET NUMBER



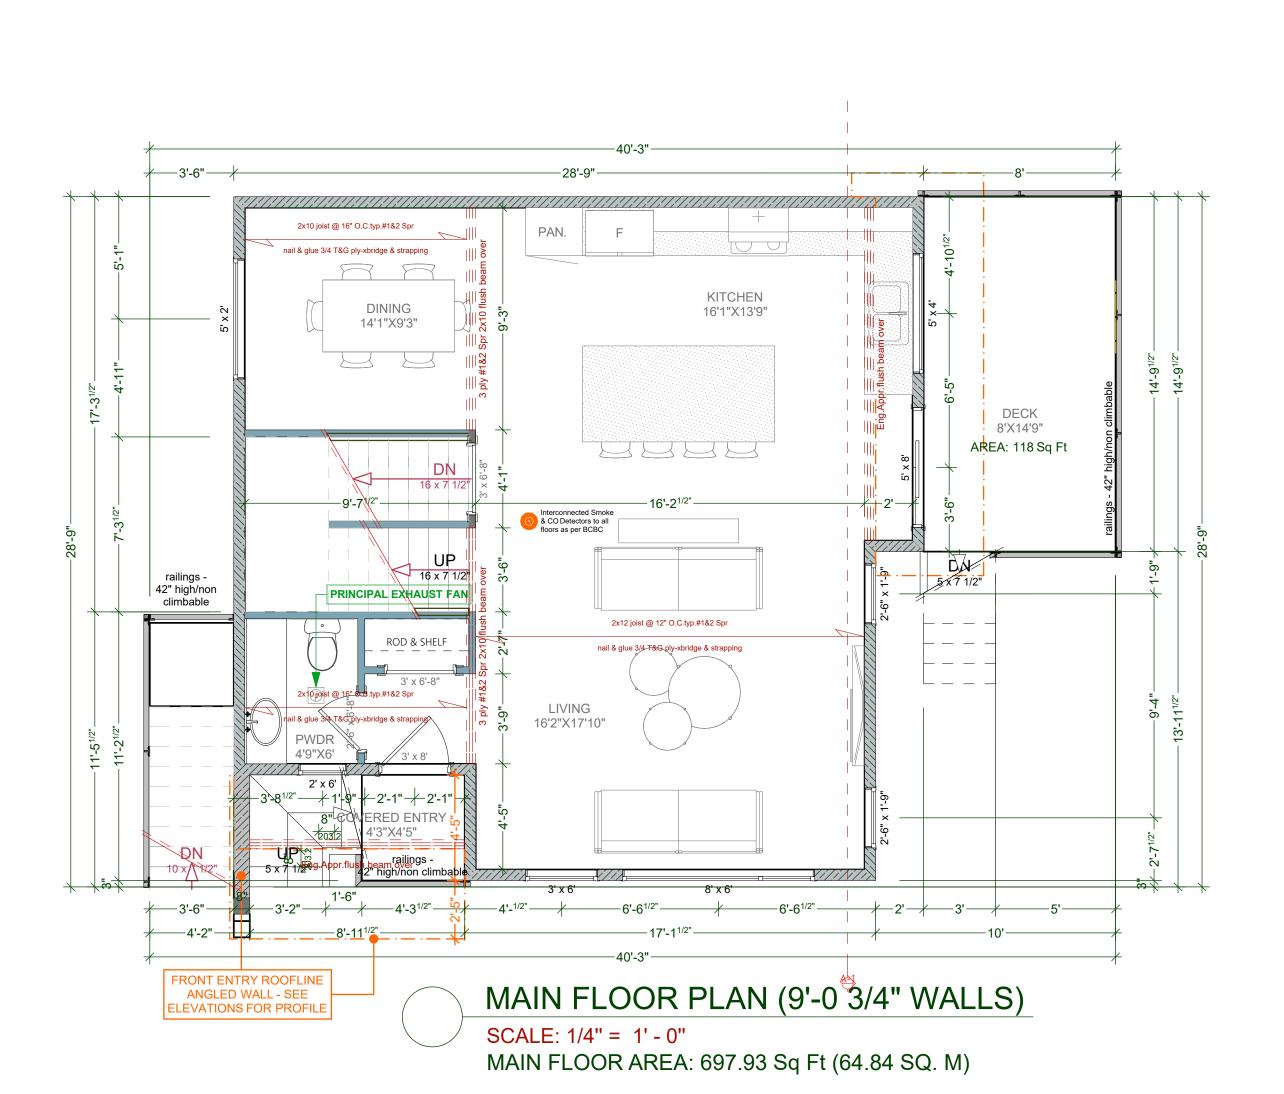


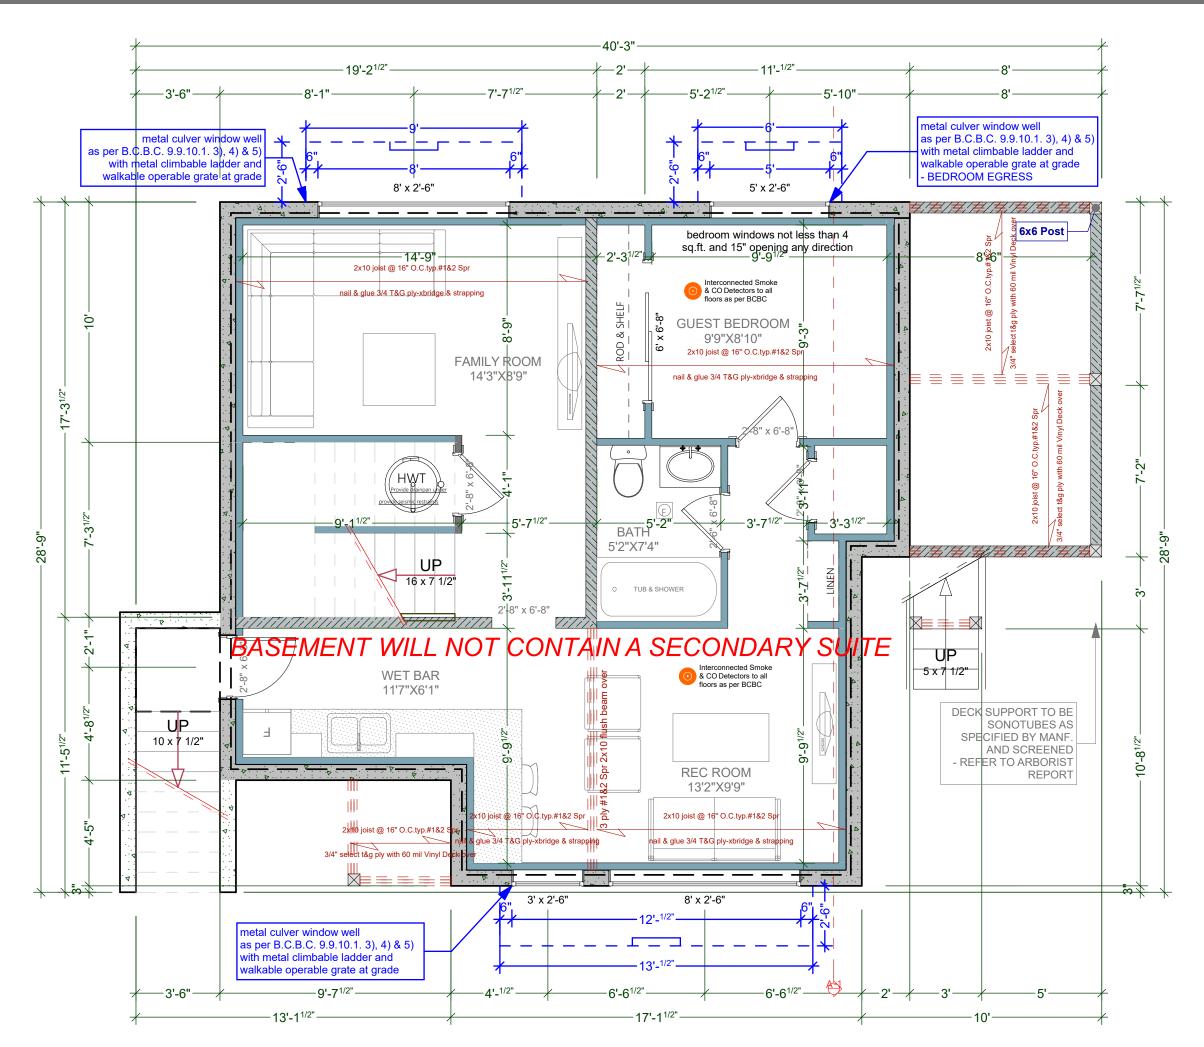

BASEMENT FLOOR PLAN (9'-0 3/4" WALLS)

SCALE: 1/4" = 1' - 0"

BASEMENT FLOOR AREA: 608.48 Sq Ft (56.53 SQ. M)

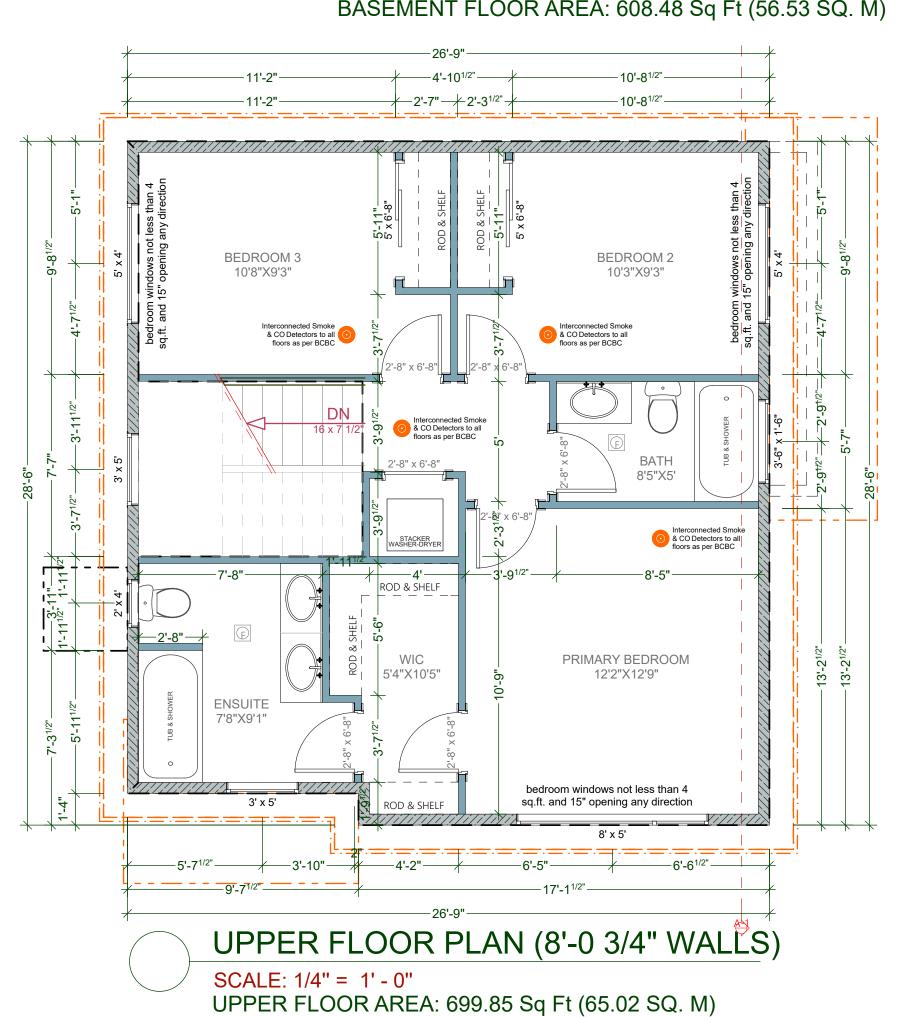

WHERE LINES ON PAPER BECOME WALLS ON SITE PH 250.590.2468 FX 250.590.4577 www.javadesigns.ca


DRA


DRAWING NAME:
FOUNDATION, BASEMENT, MAIN
AND UPPER FLOOR PLANS

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SHEET NUMBER

A4



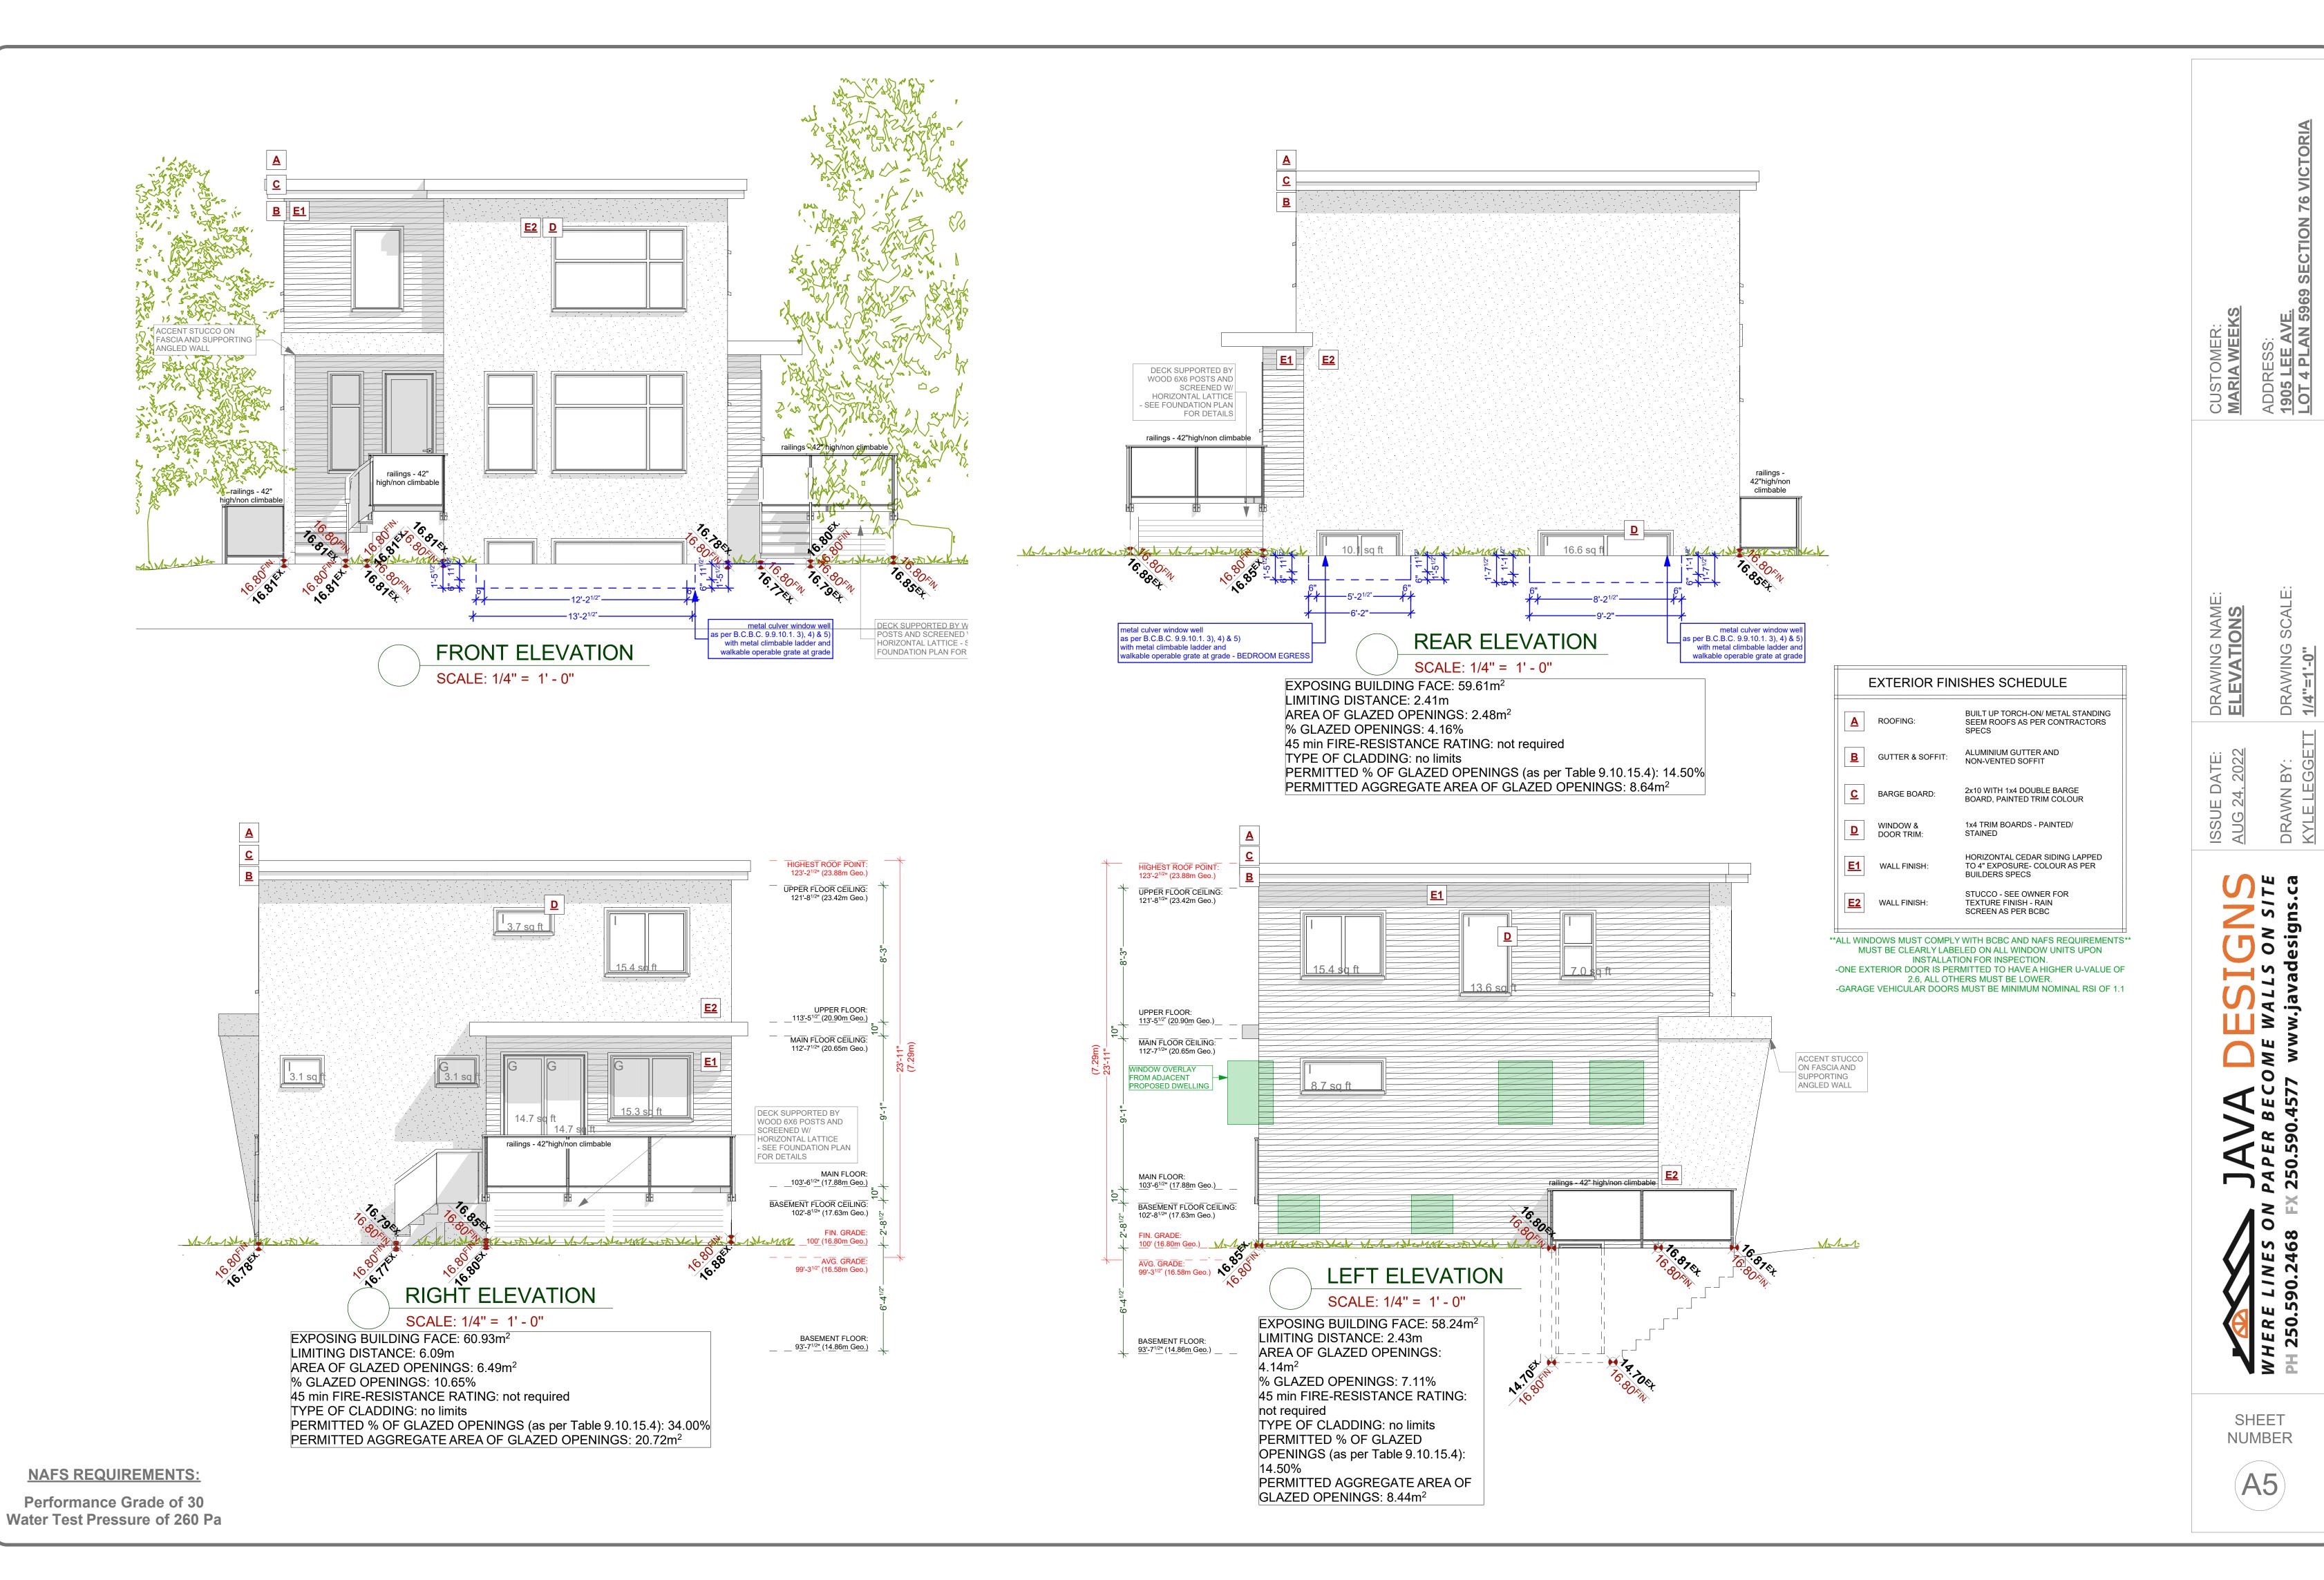
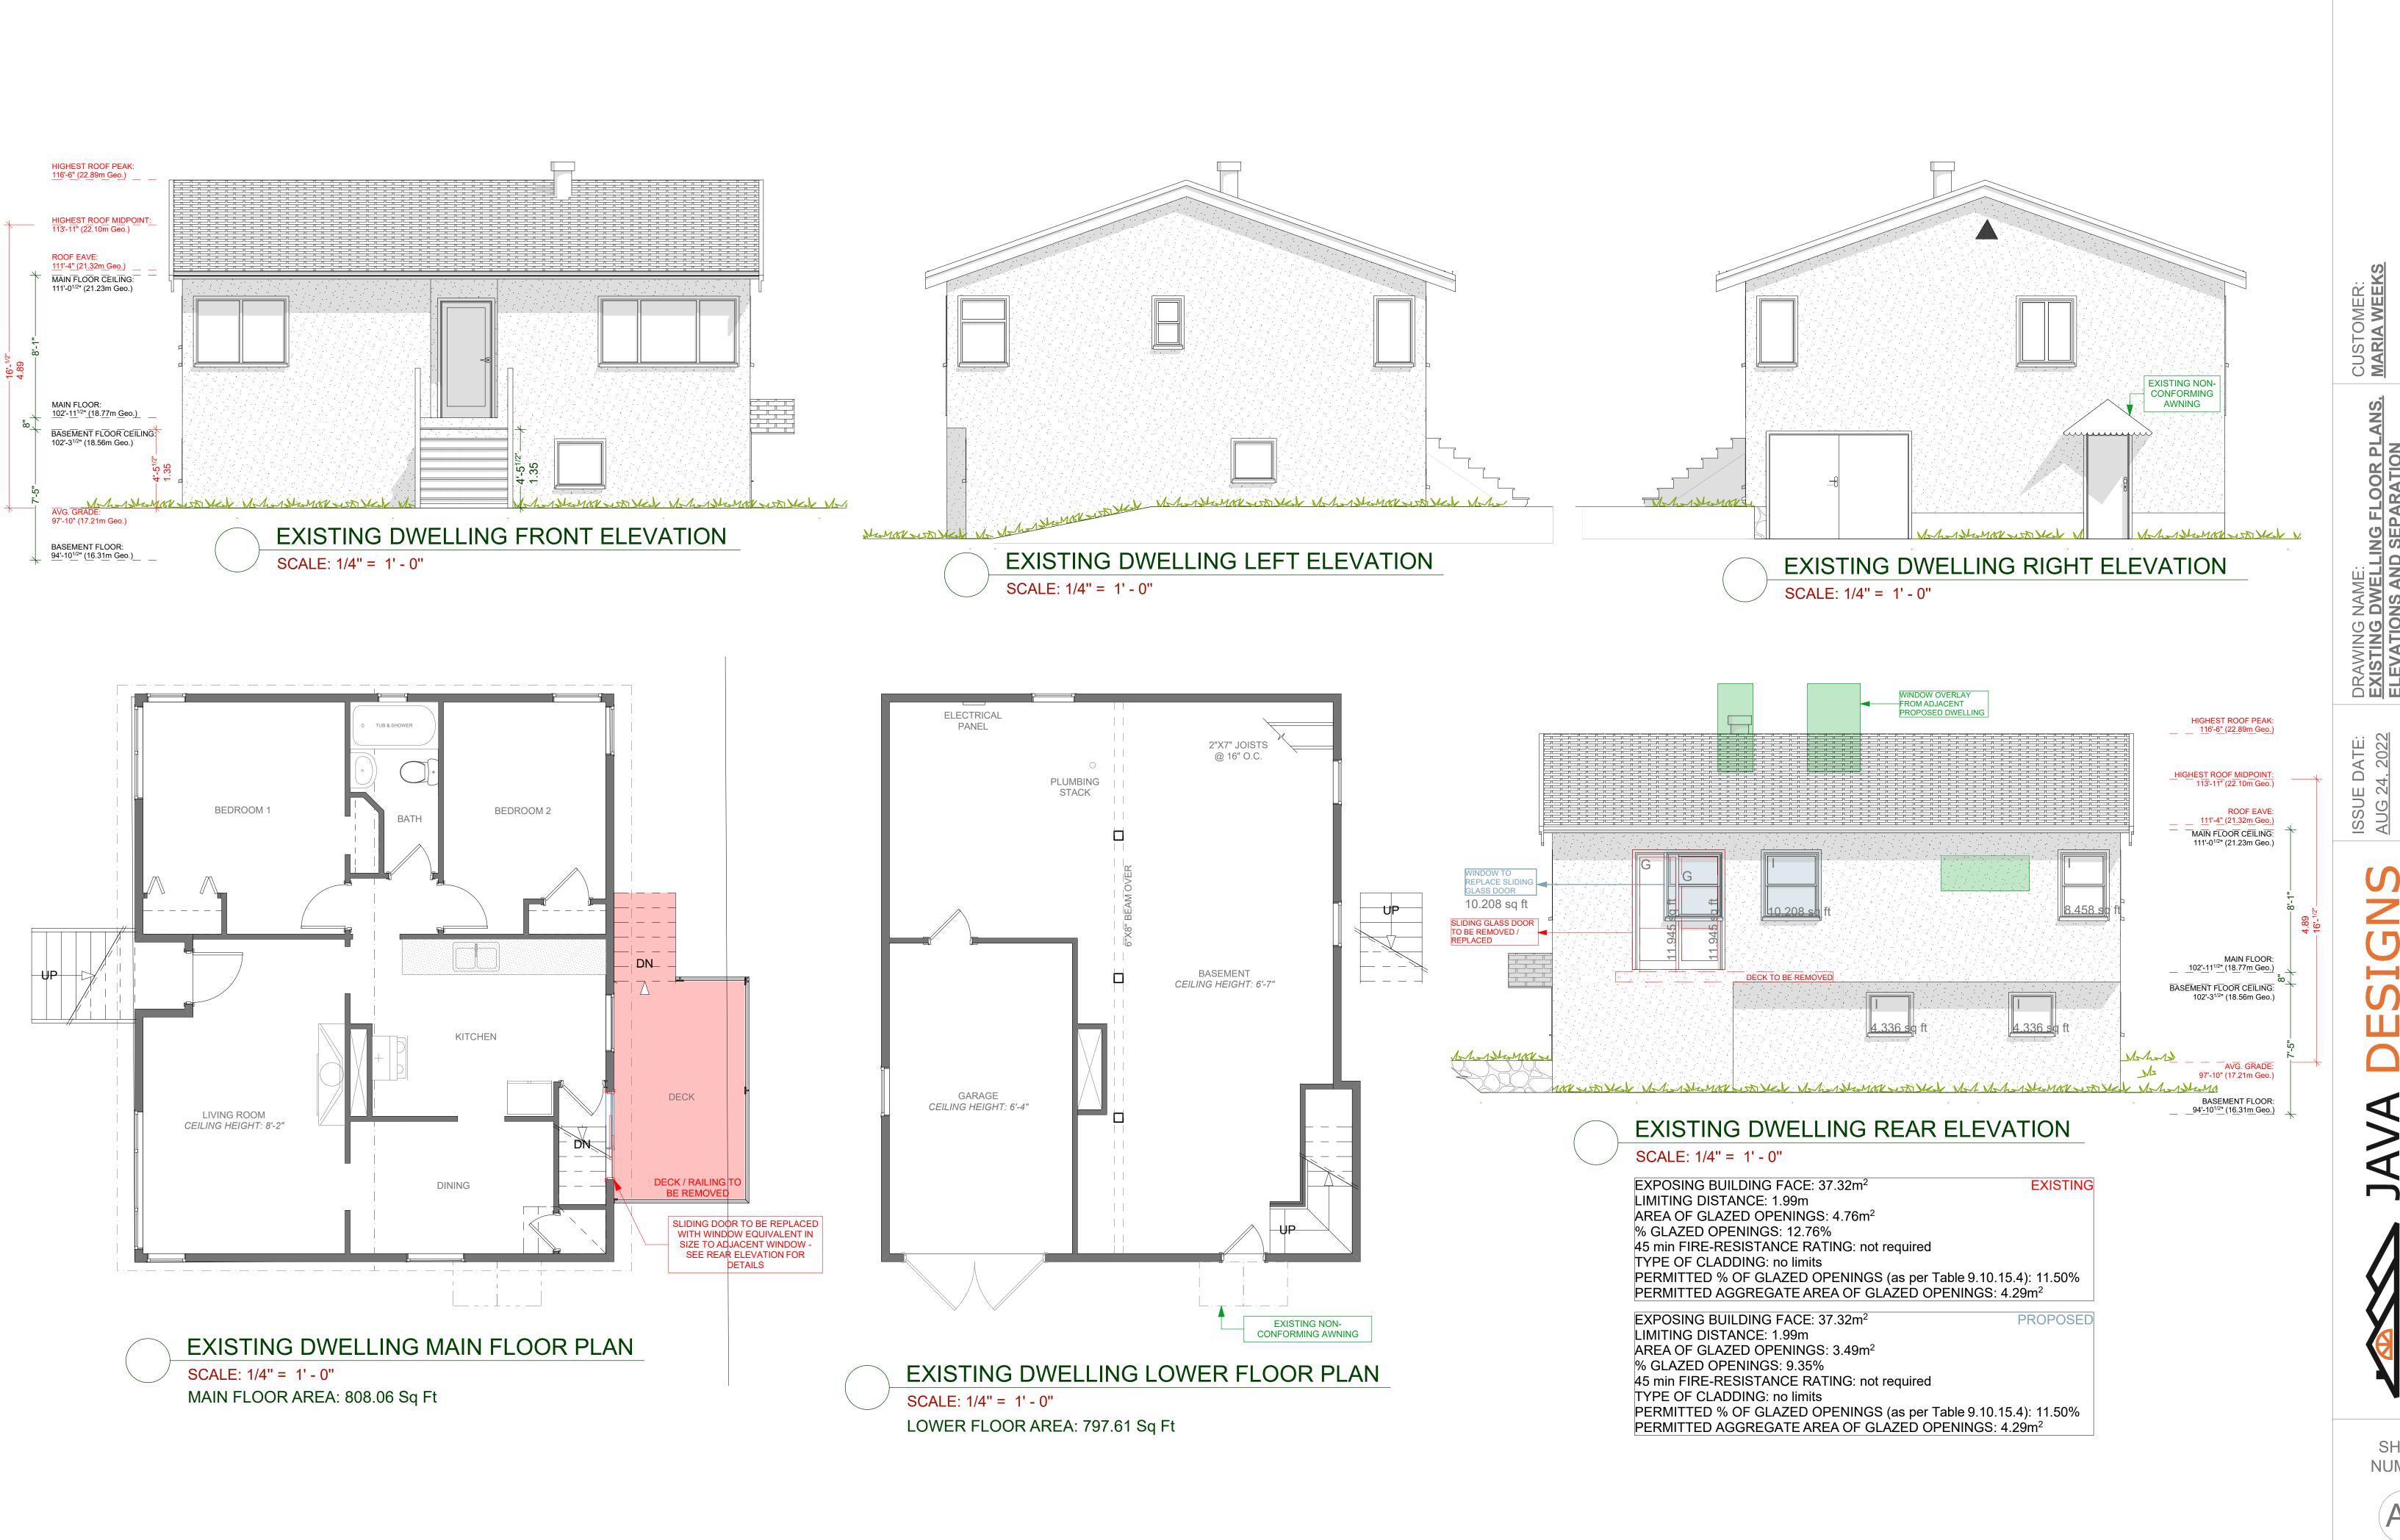
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(A6)