A100. Site Plan A105 Site Sections

A106 Context Elevations

A120 Parkade Floor Plan

A121 Ground Floor Plan

A122 Level 2 Floor Plan A123 Level 3 Floor Plan

A124 Level 4 Floor Plan

A125 Level 5 Floor Plan

A126 Roof Plan A200 Elevations

A201 Elevations

A900 Renderings

A901 Sun Study

A902 Renderings A903 Diagrams

C1 Site Plan

Pandora Avenue - Plan & Profile Camosun Street - Plan & Profile

Site Grading

Road Markings & Signage

Standard Details

E000 Offsite Electrical Details

E100 Site Plan, Details and Legend

L0.00 Cover Page

L0.01 Tree Management Plan

L0.02 Tree Management Plan L3.11 Soil Depth Plan - L1

L3.12 Soil Depth Plan - L4 & L5

L4.01. Lighting Plan - L1


L4.02. Lighting Plan - L4 & L5

L5.01. Sections L6.11 Details





Revisions

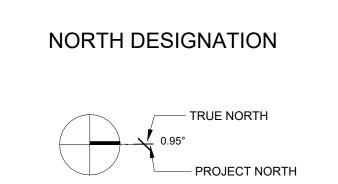

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PROJECT LOCATION PLAN

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January 21, 2025

2025-01-21

Parking - Code Plan SCALE = 1:400

LEVEL P1

DIAGONAL DISTANCE = 57m

Min. Separation of Exits: 28.5m Max. Travel: 45m

Min. Exit Width 6.1mm/person x 29 = 177mm

Occupant Load Net Area: 1375 m² Storage Garage: 46 sq.m/person 1375/46 = 29 people

Occupancy: F, Div. 3 - Storage Garage

Ramps, Corridors, Passageways 8mm/person x 29 = 232mm



3 Level 2&3 - Code Plan SCALE = 1:400

SECOND & THIRD FLOOR


= 32 people

Occupancy: Group C Occupant Load

16 Bedrooms x 2 people/bedroom

Min. Exit Width Ramps, Corridors, Passageways 6.1mm/person x 32 = 195mm 8mm/person x 32 = 256mm

Occupancy: Group C Occupant Load 13 Bedrooms x 2 people/bedroom = 26 people

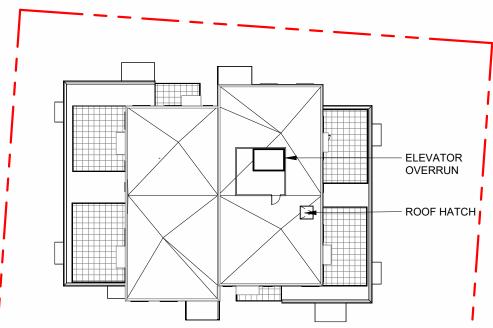

5 Level 5 - Code Plan SCALE = 1:400

FIFTH FLOOR

Occupancy: Group C

Occupant Load 9 Bedrooms x 2 people/bedroom

Min. Exit Width Ramps, Corridors, Passageways
6.1mm/person x 9 = 54.9mm Stairs
8mm/person x 9 = 72mm

	= 18 people		
	*	TABLE 3.2.3.1 L	<u>D</u>
		BUILDING COMPARTMENT	LIMITING DISTANCE (m)
		A B	3.697 7.74
		C D E	6.12 8.69 6.96
		F <u>TABLE 3.2.3.7</u>	9.24
		BUILDING COMPARTMENT	LIMITING DISTANCE (m)
		A B C	3.697 7.74 6.12
1		D	8.69

EXTERIOR -EXIT PATH — EXTERIOR

2 Level 1 - Code Plan SCALE = 1:400


GROUND FLOOR

Occupancy: Group C Occupant Load

11 Bedrooms x 2 people/bedroom = 22 people

Common Area (Suite 105) Area=47.3m² 0.96m²/person for Space with tables and seating (BCBC 3.1.17.1) Load= 47.3m² / 0.96= 50 people


Total Occ. Load = 60+22=82 people Min. Exit Width Ramps, Corridors, Passageways 6.1mm/person x 82 =500mm 8mm/person x 82 = 656mm

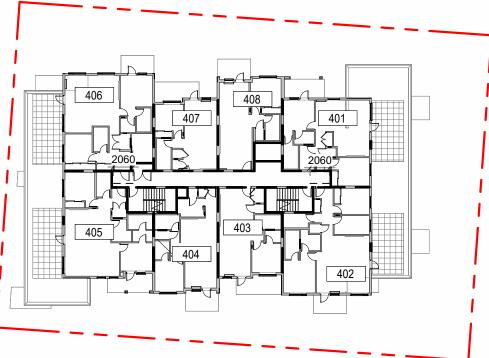

Level 4 - Code Plan

FOURTH FLOOR

Min. Exit Width Ramps, Corridors, Passageways 6.1mm/person x 26 = 159mm 8mm/person x 26 = 208mm

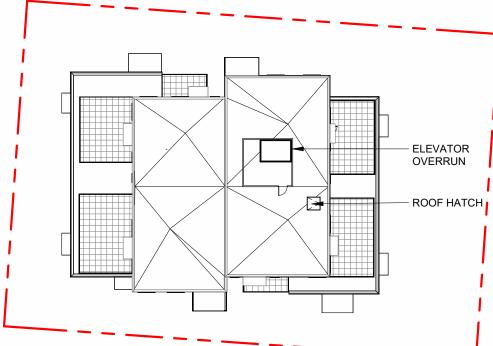

Roof - Code Plan

ROOF

Occupancy: Service Occupant Load

Roof Hatch

TABLE 3.2.3.1 L	<u>D</u>					
BUILDING COMPARTMENT	LIMITING DISTANCE (m)	ALLOWABLE OPENINGS (%)	AREA OF E BUILDING (sq.r	FACE	PROPOSED OPENINGS (sq.m)	PROPOSED OPENINGS (%)
A B C D E F	3.697 7.74 6.12 8.69 6.96 9.24	42.26 100 98.97 100 100	66.7 39.2 178. 115. 123. 38.7	25 55 34 50	22.85 9.58 55.88 41.59 45.19 11.04	34.23 24.4 31.297 36.06 36.59 28.52
TABLE 3.2.3.7						
BUILDING COMPARTMENT	LIMITING DISTANCE (m)	ALLOWABLE OPENINGS (%)	REQUIRED FRR		O TYPE OF RUCTION	REQUIRED TYPE OF CLADDING
A B C D E F	3.697 7.74 6.12 8.69 6.96 9.24	42.26 100 98.97 100 100	1h N/A 45 min N/A N/A N/A	A A A	AII AII AII AII AII	Non-combustible Non-combustible Non-combustible Non-combustible Non-combustible Non-combustible


ıı

ZONING DATA		
ZONE	R3-2	
USE	RESIDENTIAL	
REGULATORY CONDITIONS	ALLOWABLE	PROVIDED
SITE AREA	- m²	1725 m²
GROSS FLOOR AREA	- m ²	3439 m²
COMMERCIAL FLOOR AREA	- m ²	0 m ²
FLOOR AREA RATIO (FAR)	1.6	2
SITE COVERAGE	32 %	56.7 %
OPEN SITE SPACE	60 %	40 %
BUILDING HEIGHT (from Natural Grade)	18.5 m	17.4 m
NUMBER OF STOREYS	6+	5
PARKING	REQUIRED BY SCHEDULE 'C'	PROVIDED
VEHICLES	47	35 RESIDENTIAL (1 ACCESSIBLE) 5 GUEST (1 ACCESSIBLE VAN)
BICYCLES		
CLASS 1 @ GRADE	57	58
CLASS 2 @ LOBBY ENTRANCE	6	6
SETBACKS NORTH (REAR)	3.0 m	4.8 m
EAST (FLANKING STREET)	7.5 m	2.1 m
SOUTH (FRONT STREET)	12 m	1.1 m
WEST (INTERNAL BOUNDARY)	3 m	3.6 m
RESIDENTIAL USE DETAILS		
TOTAL NUMBER OF UNITS	47	7
UNITS TYPES	STUDIO, 1 ,2 ,3 BEDROOMS, INCLUDING GROUND ORIENTED (SEE UNIT TABLES)	
GROUND ORIENTED UNITS	1	1
MINIMUM UNIT AREA	41.	15 m ²

RESIDENTIAL USE DETAILS	
TOTAL NUMBER OF UNITS	47
UNITS TYPES	STUDIO, 1 ,2 ,3 BEDROOMS, INCLUDING GROUND ORIENTED (SEE UNIT TABLES)
GROUND ORIENTED UNITS	11
MINIMUM UNIT AREA	41.15 m ²
TOTAL RESIDENTIAL AREA	2869.01 m ²

BICYCLE PARKING SUMMARY	
LONG-TERM 22 TWO TIER	SHORT-TERM
33 GROUND ORIENTED 3 GROUND ORIENTED CARGO 58 LONG-TERM STALLS	2 WEATHER PROTECTED 4 NON-WEATHER PROTECTED 6 SHORT-TERM STALLS



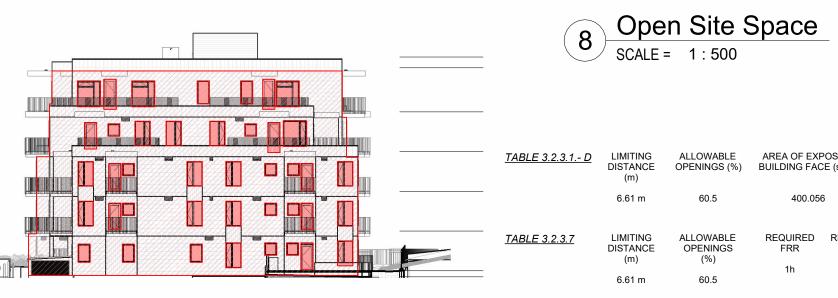

North Building Elevation - Limiting Distance


SCALE = 1:300

PROJECT TYPE	NEW CONSTRUCTION RENOVATION ADDITION	
GOVERNING BUILDING CODE	2018 BC BUILDING CODE PART 3	REFER TO NOTES
MAJOR OCCUPANCIES	A1 A2 A3 A4 B1 B2 C D E F1 F2 F3	3.1.2.1.
BUILDING AREA	920 m² (Outside face of Exterior Walls)	1.4.1.2.
GRADE	33.94 m	1.4.1.2.
BUILDING HEIGHT (STOREYS, m)	5 STOREYS ABOVE GRADE 13.5 m 1 STOREYS BELOW GRADE	1.4.1.2.

CLASSIFICATION	GROUP C, UP TO 6 STOREYS, SPRINKLERED	3.2.2.50.
	GROUP F3, ANY HEIGHT, ANY AREA, SPRINKLERED (PARKING GARAGE)	3.2.2.80.
MAXIMUM BUILDING AREA	1800 m ²	3.2.2.50.(1)(0
NUMBER OF STREETS FACING	2	3.2.2.10
CONSTRUCTION TYPES PERMITTED	COMBUSTIBLE NON - COMBUSTIBLE	
INTERCONNECTED FLOOR SPACE	YES N	3.2.8.

EXITS FROM FLOOR AREAS		
NUMBER OF EXITS REQUIRED	2	3.4.2.1.
SEPERATION OF EXITS (MIN.)	ONE HALF MAXIMUM FLOOR AREA DIAGONAL, OR 9 m, WHICH EVER IS GREATER	3.4.2.3
MAX. TRAVEL DISTANCE ALLOWED	GROUP C 45 m GROUP F3 45 m	3.4.2.5.
MEZZANINE	YES NO 🗸	3.2.8.

VERTICAL FIRE SEPARATIONS (USING HORIZONTAL ASSEMBLIES)	C F3 TO C 1 hr 2 hrs FT FLOORS 1 hr MEZZANINE 1hr ROOF LOADBEARING STRUCTURE IMMEDIATELY BELOW A FLOOR OR ROOF ASSEMBLY SHALL HAVE A FIRE RESISTANCE RATING NOT LESS THAN THAT REQUIRED FOR THE SUPPORTED FLOOR OR ROOF.	Group F3 Parking Garage to have 1.5 hr FT separation from all other occupancies
EXITS	1hr	

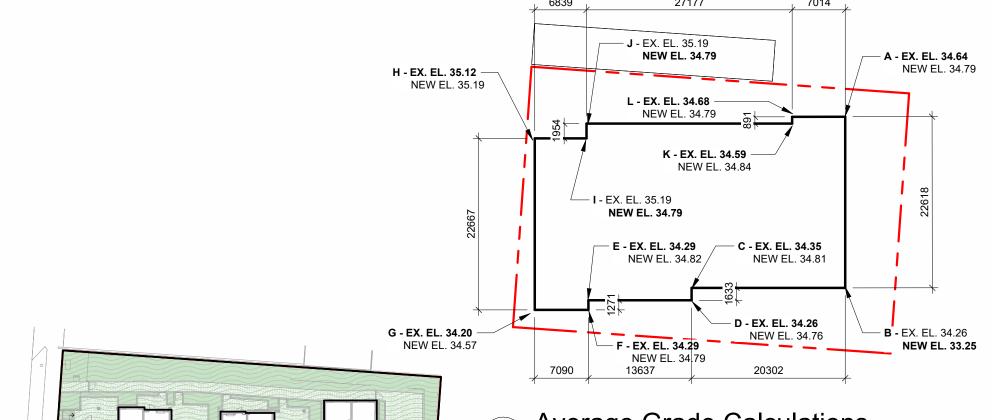

PROPOSED OPENINGS (%)

CLADDING


AREA OF EXPOSING PROPOSED


REQUIRED TYPE OF REQUIRED TYPE OF

CONSTRUCTION

ALLOWABLE

OPENINGS

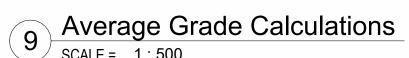


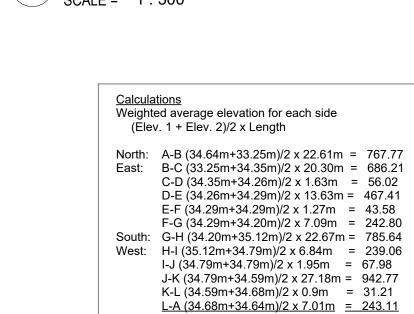

TOTAL = 4573.54 Divided by perimeter 4573.54 / 133.10 = 34.36m Average grade = 34.36 NOTE: There is no proposed change to the average grade of the

BC Building Code *Grade* is determined as the lowest average grade at an exterior wall. This occurs at the project's North side: (34.64m+33.25m) / 2 = 33.94m

BCBC Grade = 33.94m

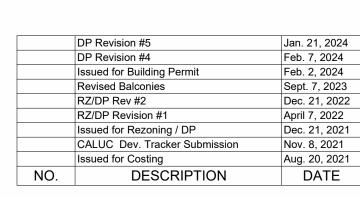




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Date	January 21, 2025
Scale	Project #
As indicated	2106
ALERED APPLY	Revision



2025-01-21

1/21/2025 1:44:17 PM

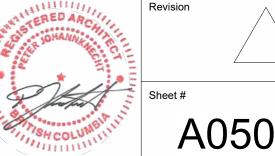Number	Area
Studio - A1	
107	41.15 m ² 41.15 m ²
Jr. 1 BD - B1	
109	42.28 m ² 42.28 m ²
Jr. 1 BD - B2	
108	43.61 m ² 43.61 m ²
Jr. 1 BD - B3	40.442
407 211	46.44 m² 46.44 m²
112 311	46.44 m ² 46.44 m ²
4	185.77 m ²
Jr. 1 BD - B4 110	47.34 m²
1	47.34 m²
Jr. 1 BD - B5 301	47.77 m²
101	47.77 m²
201 3	47.77 m² 143.30 m²
1 BD - C1 207	50.99 m²
307	50.99 m²
2 1 BD - C2	101.97 m²
113	52.48 m²
212 408	52.48 m ² 52.48 m ²
312	52.48 m ²
4 1 BD - C3	209.92 m²
305 105	53.99 m ² 53.89 m ²
205	53.99 m²
403 4	53.99 m ² 215.84 m ²
1 BD+D - D1	
310 210	60.35 m ² 60.35 m ²
111	60.35 m ² 181.06 m ²
3 1 BD+D - D2	101.00111-
106 206	62.28 m ² 62.28 m ²
404	62.28 m²
306 4	62.28 m ² 249.12 m ²
1 BD+D - D3 304	62 75 m ²
204	62.75 m ² 62.75 m ²
2 2 BD - E1	125.50 m ²
308	66.74 m ²
208 2	66.74 m ² 133.49 m ²
2 BD - E2 303	67.47 m²
203	67.47 m²
2 2 BD - E3	134.93 m²
209	67.73 m²
309 2	67.73 m ² 135.46 m ²
2 BD - E4	
302 102	70.92 m ² 70.92 m ²
202	70.92 m²
3 2 BD - E5	212.76 m²
401 1	72.45 m ² 72.45 m ²
2 BD - Penthous	se - F1
504 1	79.06 m ² 79.06 m ²
2 Bed - Penthoւ	ıse - F2
501 1	81.29 m ² 81.29 m ²
2 BD - Penthous	
502 1	81.53 m ² 81.53 m ²
2 BD - Penthous 503	se F4 87.87 m²
1	87.87 m²
2 BD+D - G1 405	79.76 m²
1	79.76 m²
2 BD+D - G2 406	90.35 m²
1	90.35 m ²
2 BD+D - G3 402	92.38 m²
1 Grand total: 47	92.38 m² 2868.19 m²

Name	Number	Area
evel 1		
BD - C2	113	52.48 m²
BD - C3	105	53.89 m ²
BD+D - D1	111	60.35 m²
BD+D - D2	106	62.28 m²
2 BD - E4	102	70.92 m²
r. 1 BD - B1	109	42.28 m²
r. 1 BD - B2	108	43.61 m²
r. 1 BD - B3	112	46.44 m²
r. 1 BD - B4	110	47.34 m²
r. 1 BD - B5	101	47.77 m²
Studio - A1	107	41.15 m ²
evel 1: 11	1	568.51 m²
evel 2		
BD - C1	207	50.99 m²
BD - C2	212	52.48 m²
BD - C3	205	53.99 m²
BD+D - D1	210	60.35 m ²
BD+D - D2	206	62.28 m ²
BD+D - D3	204	62.75 m²
BD - E1	208	66.74 m²
BD - E2	203	67.47 m²
BD - E3	209	67.73 m²
BD - E4	202	70.92 m²
r. 1 BD - B3	211	46.44 m²
r. 1 BD - B5	201	47.77 m²
evel 2: 12	ı -	709.90 m²
evel 3		
BD - C1	307	50.99 m²
BD - C2	312	52.48 m²
BD - C3	305	53.99 m²
BD+D - D1	310	60.35 m ²
BD+D - D2	306	62.28 m²
BD+D - D3	304	62.75 m²
BD - E1	308	66.74 m²
BD - E2	303	67.47 m²
BD - E3	309	67.73 m²
BD - E4	302	70.92 m²
r. 1 BD - B3	311	46.44 m²
r. 1 BD - B5	301	47.77 m ²
evel 3: 12		709.90 m ²
evel 4		. 55.55 111
BD - C2	408	52.48 m²
BD - C3	403	53.99 m²
BD+D - D2	404	62.28 m²
BD - E5	401	72.45 m²
BD+D - G1	405	79.76 m ²
BD+D - G2	406	90.35 m ²
BD+D - G3	402	92.38 m ²
r. 1 BD - B3	407	46.44 m ²
evel 4: 8	701	550.12 m ²
evel 4: 8 evel 5		JJU. 12 III
BD - Penthouse -	504	79.06 m²
DD - Peninouse - 1		7 3.00 111
BD - Penthouse -	502	81.53 m ²
3	302	01.00111
BD - Penthouse	503	87.87 m²
4		
Bed - Penthouse -	501	81.29 m²
2		
evel 5: 4		329.75 m²
		2868.19 m ²

Name	Number	Area
1 BD - C1		
1 BD - C1	207	50.99 m²
1 BD - C1 2	307	50.99 m ² 101.97 m ²
1 BD - C2	T	
1 BD - C2 1 BD - C2	113 212	52.48 m ² 52.48 m ²
1 BD - C2	312	52.48 m²
1 BD - C2 4	408	52.48 m ² 209.92 m ²
† 1 BD - C3		209.92 111
1 BD - C3	105	53.89 m²
1 BD - C3 1 BD - C3	205 305	53.99 m ² 53.99 m ²
1 BD - C3	403	53.99 m²
1 1 BD+D - D1		215.84 m²
1 BD+D - D1	111	60.35 m²
1 BD+D - D1 1 BD+D - D1	310	60.35 m ²
3	010	181.06 m²
1 BD+D - D2 1 BD+D - D2	106	62.28 m²
1 BD+D - D2 1 BD+D - D2	206	62.28 m²
1 BD+D - D2	306	62.28 m ²
1 BD+D - D2 4	404	62.28 m ² 249.12 m ²
1 BD+D - D3	loo :	
1 BD+D - D3 1 BD+D - D3	304	62.75 m ²
2	1	125.50 m ²
2 BD - E1 2 BD - E1	208	66.74 m²
2 BD - E1	308	66.74 m²
2 2 BD - E2		133.49 m²
2 BD - E2 2 BD - E2	203	67.47 m²
2 BD - E2	303	67.47 m²
2 2 BD - E3		134.93 m²
2 BD - E3	209	67.73 m²
2 BD - E3	309	67.73 m ² 135.46 m ²
2 2 BD - E4		135.46 MF
2 BD - E4	102	70.92 m²
2 BD - E4 2 BD - E4	302	70.92 m ² 70.92 m ²
3	002	212.76 m ²
2 BD - E5 2 BD - E5	404	70 45 m²
2 BD - E3 1	401	72.45 m ² 72.45 m ²
2 BD - Penthous		
2 BD - Penthouse - F1	504	79.06 m²
1		79.06 m²
2 BD - Penthous 2 BD -	e - F3 502	81.53 m²
Penthouse - F3	002	
1 2 BD - Penthous	e F4	81.53 m²
2 BD -	503	87.87 m²
Penthouse F4 1		87.87 m²
2 BD+D - G1		JO. III
2 BD+D - G1	405	79.76 m²
1 2 BD+D - G2		79.76 m²
2 BD+D - G2	406	90.35 m²
1 2 BD+D - G3		90.35 m ²
2 BD+D - G3 2 BD+D - G3	402	92.38 m²
1 2 Rod - Ponthous		92.38 m²
2 Bed - Penthous 2 Bed -	se - F2 501	81.29 m²
Penthouse - F2		
1 Jr. 1 BD - B1		81.29 m²
Jr. 1 BD - B1	109	42.28 m²
1 Jr. 1 BD - B2		42.28 m²
Jr. 1 BD - B2 Jr. 1 BD - B2	108	43.61 m²
1		43.61 m²
Jr. 1 BD - B3 Jr. 1 BD - B3	112	46.44 m²
Jr. 1 BD - B3	211	46.44 m²
Jr. 1 BD - B3	311 407	46.44 m² 46.44 m²
Jr. 1 BD - B3 4	401	185.77 m ²
Jr. 1 BD - B4	440	
Jr. 1 BD - B4 1	110	47.34 m ² 47.34 m ²
Jr. 1 BD - B5		77.U T III
Jr. 1 BD - B5	101	47.77 m²
Jr. 1 BD - B5 Jr. 1 BD - B5	301	47.77 m ² 47.77 m ²
3	1	143.30 m ²
Studio - A1	1.0=	41.15 m²
Studio A1	107	- 10 m
Studio - A1 1	107	41.15 m ²

Level	Name	Number	Department	Area
D4				
P1 Circulation				
P1	Elevator	001	Circulation	19.69 m²
	Vestibule			
P1	Vest.	005	Circulation	3.39 m²
P1 P1	Stair 1 Stair 2	S1-0 S2-0	Circulation Circulation	11.25 m ² 11.82 m ²
<u>4</u>	Stair 2	52-0	Circulation	46.14 m ²
Common				40.14 111
P1	Garbage Room	002	Common	17.43 m²
1	1		'	17.43 m²
Parking				
P1	Parking Area	P100	Parking	1291.90 m
1 Camilaa				1291.90 m
Service P1	Gas Room	004	Service	12.68 m²
<u>F1</u> P1	DHW Room	004	Service	9.03 m ²
<u>' '</u> P1	Water Entry	008	Service	20.96 m ²
P1	Elev. Ctrl.	009	Service	2.10 m ²
P1	Electrical Closet	E-0.1	Service	7.68 m²
	1			
P1	Electrical Closet	E-0.2	Service	4.35 m ²
6	<u> </u>	1		56.80 m²
o Storage				50.60 111
P1	Storage	003	Storage	42.01 m²
P1	Storage	006	Storage	5.63 m ²
2	1			47.64 m²
P1: 14				1459.91 m
Level 1				
Circulation		100	- I ::	40.44.3
Level 1	Corridor	100	Circulation	49.44 m²
Level 1 Level 1	Stair 1 Stair 2	S1-1 S2-1	Circulation Circulation	21.04 m ² 11.53 m ²
3	Otali Z	02-1	Circulation	82.00 m ²
Common				02.00 III
Level 1	Bike Rm	103	Common	67.96 m²
Level 1	Lobby	104	Common	12.77 m²
2				80.73 m ²
Residential Unit		Leave	I	
Level 1	Jr. 1 BD - B5	101	Residential Unit	47.77 m²
Level 1	2 BD - E4	102	Residential Unit	70.92 m ²
Level 1 Level 1	1 BD - C3 1 BD+D - D2	105	Residential Unit Residential Unit	53.89 m ² 62.28 m ²
Level 1	Studio - A1	107	Residential Unit	41.15 m ²
Level 1	Jr. 1 BD - B2	107	Residential Unit	43.61 m ²
Level 1	Jr. 1 BD - B1	109	Residential Unit	42.28 m ²
Level 1	Jr. 1 BD - B4	110	Residential Unit	47.34 m²
Level 1	1 BD+D - D1	111	Residential Unit	60.35 m ²
Level 1	Jr. 1 BD - B3	112	Residential Unit	46.44 m²
Level 1	1 BD - C2	113	Residential Unit	52.48 m²
11				568.51 m ²
Service	ГІос	120	Convice	4.00 2
Level 1	Elec.	120	Service	1.36 m ² 1.36 m ²
ı Level 1: 17				732.59 m ²
Level 1. 17				7 52.00 111
Circulation				
Level 2	Corridor	200	Circulation	49.44 m²
Level 2	Stair 1	S1-2	Circulation	11.85 m²
Level 2	Stair 2	S2-2	Circulation	11.53 m²
3				72.82 m²
Residential Unit	I. 4 DD D	004	Deside e 111.9	4
Level 2	Jr. 1 BD - B5	201	Residential Unit	47.77 m²
Level 2 Level 2	2 BD - E4 2 BD - E2	202	Residential Unit Residential Unit	70.92 m ² 67.47 m ²
Level 2	1 BD+D - D3	203	Residential Unit	62.75 m ²
Level 2	1 BD - C3	205	Residential Unit	53.99 m ²
Level 2	1 BD+D - D2	206	Residential Unit	62.28 m ²
Level 2	1 BD - C1	207	Residential Unit	50.99 m²
Level 2	2 BD - E1	208	Residential Unit	66.74 m²
Level 2	2 BD - E3	209	Residential Unit	67.73 m²
Level 2	1 BD+D - D1	210	Residential Unit	60.35 m²
Level 2	Jr. 1 BD - B3	211	Residential Unit	46.44 m²
Level 2	1 BD - C2	212	Residential Unit	52.48 m ²

Level	Name	Number	Department	Area
Service				
Level 2	Elec.	E-2	Service	1.36 m²
1	2.00.		0011100	1.36 m ²
Level 2: 16				784.08 m²
Level 3				704.00 111
Circulation				
Level 3	Corridor	300	Circulation	49.44 m²
Level 3	Stair 1	S1-3	Circulation	11.85 m ²
Level 3	Stair 2	S2-3	Circulation	11.53 m²
3	Stall 2	32-3	Circulation	72.82 m ²
ડ Residential Unit				12.02 111
Level 3	Jr. 1 BD - B5	301	Residential Unit	47.77 m²
Level 3	2 BD - E4	302	Residential Unit	70.92 m ²
Level 3	2 BD - E2 1 BD+D - D3	303	Residential Unit Residential Unit	67.47 m² 62.75 m²
Level 3				
Level 3	1 BD - C3	305	Residential Unit	53.99 m²
Level 3	1 BD+D - D2	306	Residential Unit	62.28 m ²
Level 3	1 BD - C1	307	Residential Unit	50.99 m ²
Level 3	2 BD - E1	308	Residential Unit	66.74 m²
Level 3	2 BD - E3	309	Residential Unit	67.73 m²
Level 3	1 BD+D - D1	310	Residential Unit	60.35 m ²
Level 3	Jr. 1 BD - B3	311	Residential Unit	46.44 m²
Level 3	1 BD - C2	312	Residential Unit	52.48 m²
12				709.90 m ²
Service	1	I= a		
Level 3	Elec.	E-3	Service	1.36 m²
1				1.36 m ²
Level 3: 16				784.08 m ²
Level 4				
Circulation	1	1	Tax	
Level 4	Corridor	400	Circulation	38.07 m ²
Level 4	Stair 1	S1-4	Circulation	11.85 m²
Level 4	Stair 2	S2-4	Circulation	11.53 m²
3				61.45 m²
Residential Unit	T	1	T=	
Level 4	2 BD - E5	401	Residential Unit	72.45 m²
Level 4	2 BD+D - G3	402	Residential Unit	92.38 m²
Level 4	1 BD - C3	403	Residential Unit	53.99 m²
Level 4	1 BD+D - D2	404	Residential Unit	62.28 m²
Level 4	2 BD+D - G1	405	Residential Unit	79.76 m²
Level 4	2 BD+D - G2	406	Residential Unit	90.35 m ²
Level 4	Jr. 1 BD - B3	407	Residential Unit	46.44 m²
Level 4	1 BD - C2	408	Residential Unit	52.48 m ²
8				550.12 m ²
Service				
Level 4	Elec.	E-4	Service	1.32 m²
1				1.32 m ²
Level 4: 12				612.89 m ²
Level 5				
Circulation				
Level 5	Corridor	500	Circulation	34.13 m ²
Level 5	Stair 1	S1-5	Circulation	12.08 m²
Level 5	Stair 2	S2-5	Circulation	13.43 m²
LCVCI O				59.63 m²
3			Residential Unit	81.29 m²
3 Residential Unit	2 Bed -	501		i i
3 Residential Unit	2 Bed - Penthouse - F2	501		
3 Residential Unit Level 5		501	Residential Unit	81.53 m²
3 Residential Unit Level 5 Level 5	Penthouse - F2		-	
3 Residential Unit Level 5 Level 5	Penthouse - F2 2 BD - Penthouse - F3 2 BD -		Residential Unit Residential Unit	81.53 m ² 87.87 m ²
3 Residential Unit Level 5 Level 5 Level 5	Penthouse - F2 2 BD - Penthouse - F3 2 BD - Penthouse F4	502	Residential Unit	87.87 m²
3 Residential Unit Level 5 Level 5 Level 5 Level 5	Penthouse - F2 2 BD - Penthouse - F3 2 BD - Penthouse F4 2 BD -	502	-	
3 Residential Unit Level 5 Level 5 Level 5 Level 5	Penthouse - F2 2 BD - Penthouse - F3 2 BD - Penthouse F4	502	Residential Unit	87.87 m ² 79.06 m ²
3 Residential Unit Level 5 Level 5 Level 5	Penthouse - F2 2 BD - Penthouse - F3 2 BD - Penthouse F4 2 BD -	502	Residential Unit	87.87 m²

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The Hive - 1516 Camosun H Development

1516 Camosun St. 1270 & 1286 Pandora Ave.

Sheet Name


January 21, 2025


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Unit Data

FSR AREA				
Level	Name	Area		
vel 1	Floor 1	707.23 m ²		
vel 2	Floor 2	833.81 m ²		
vel 3	Floor 3	833.86 m ²		
vel 4	Floor 4	651.12 m ²		
vel 5	Floor 5	413.33 m²		
rand total: 5 3439.35 m²				





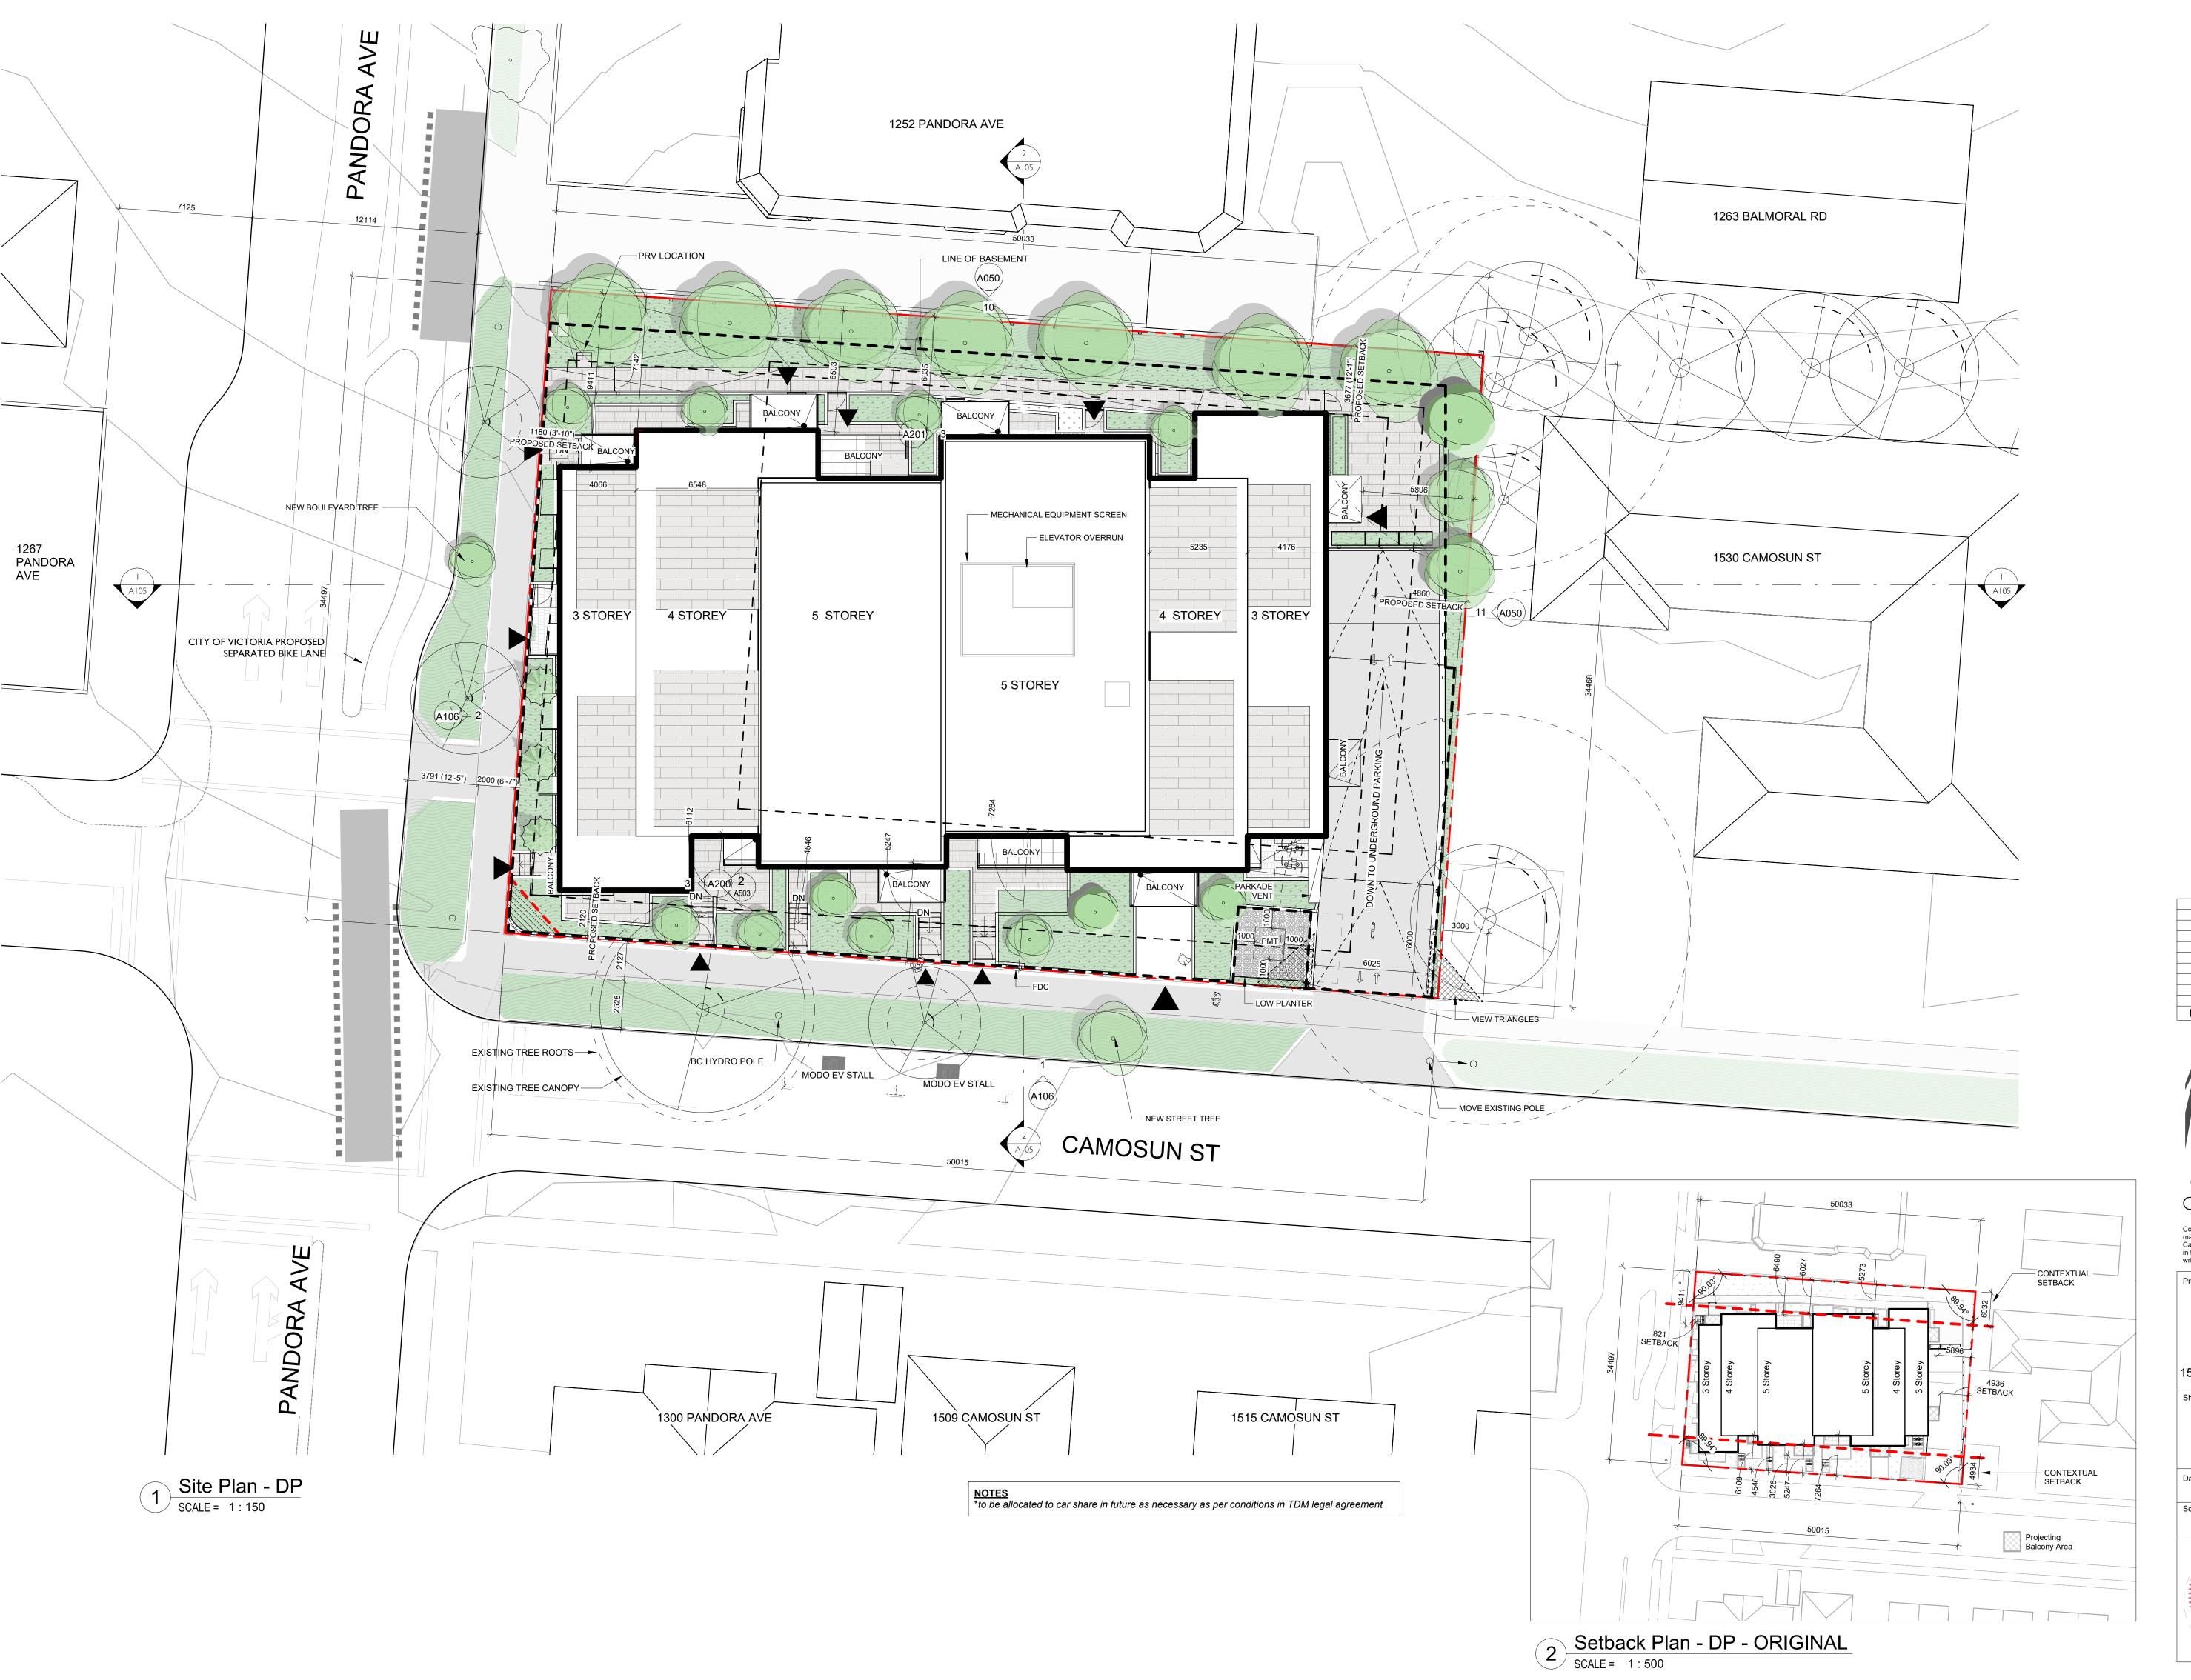
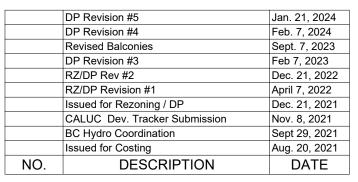
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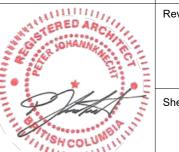
H Development

1516 Camosun St. 1270 & 1286 Pandora Ave.

Sheet Name
Site Plan

Scale January 21, 2025


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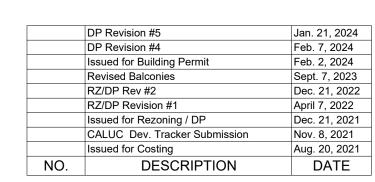


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Level 5 47440

Level 4 44290

Level 3 41140

Level 2 37990

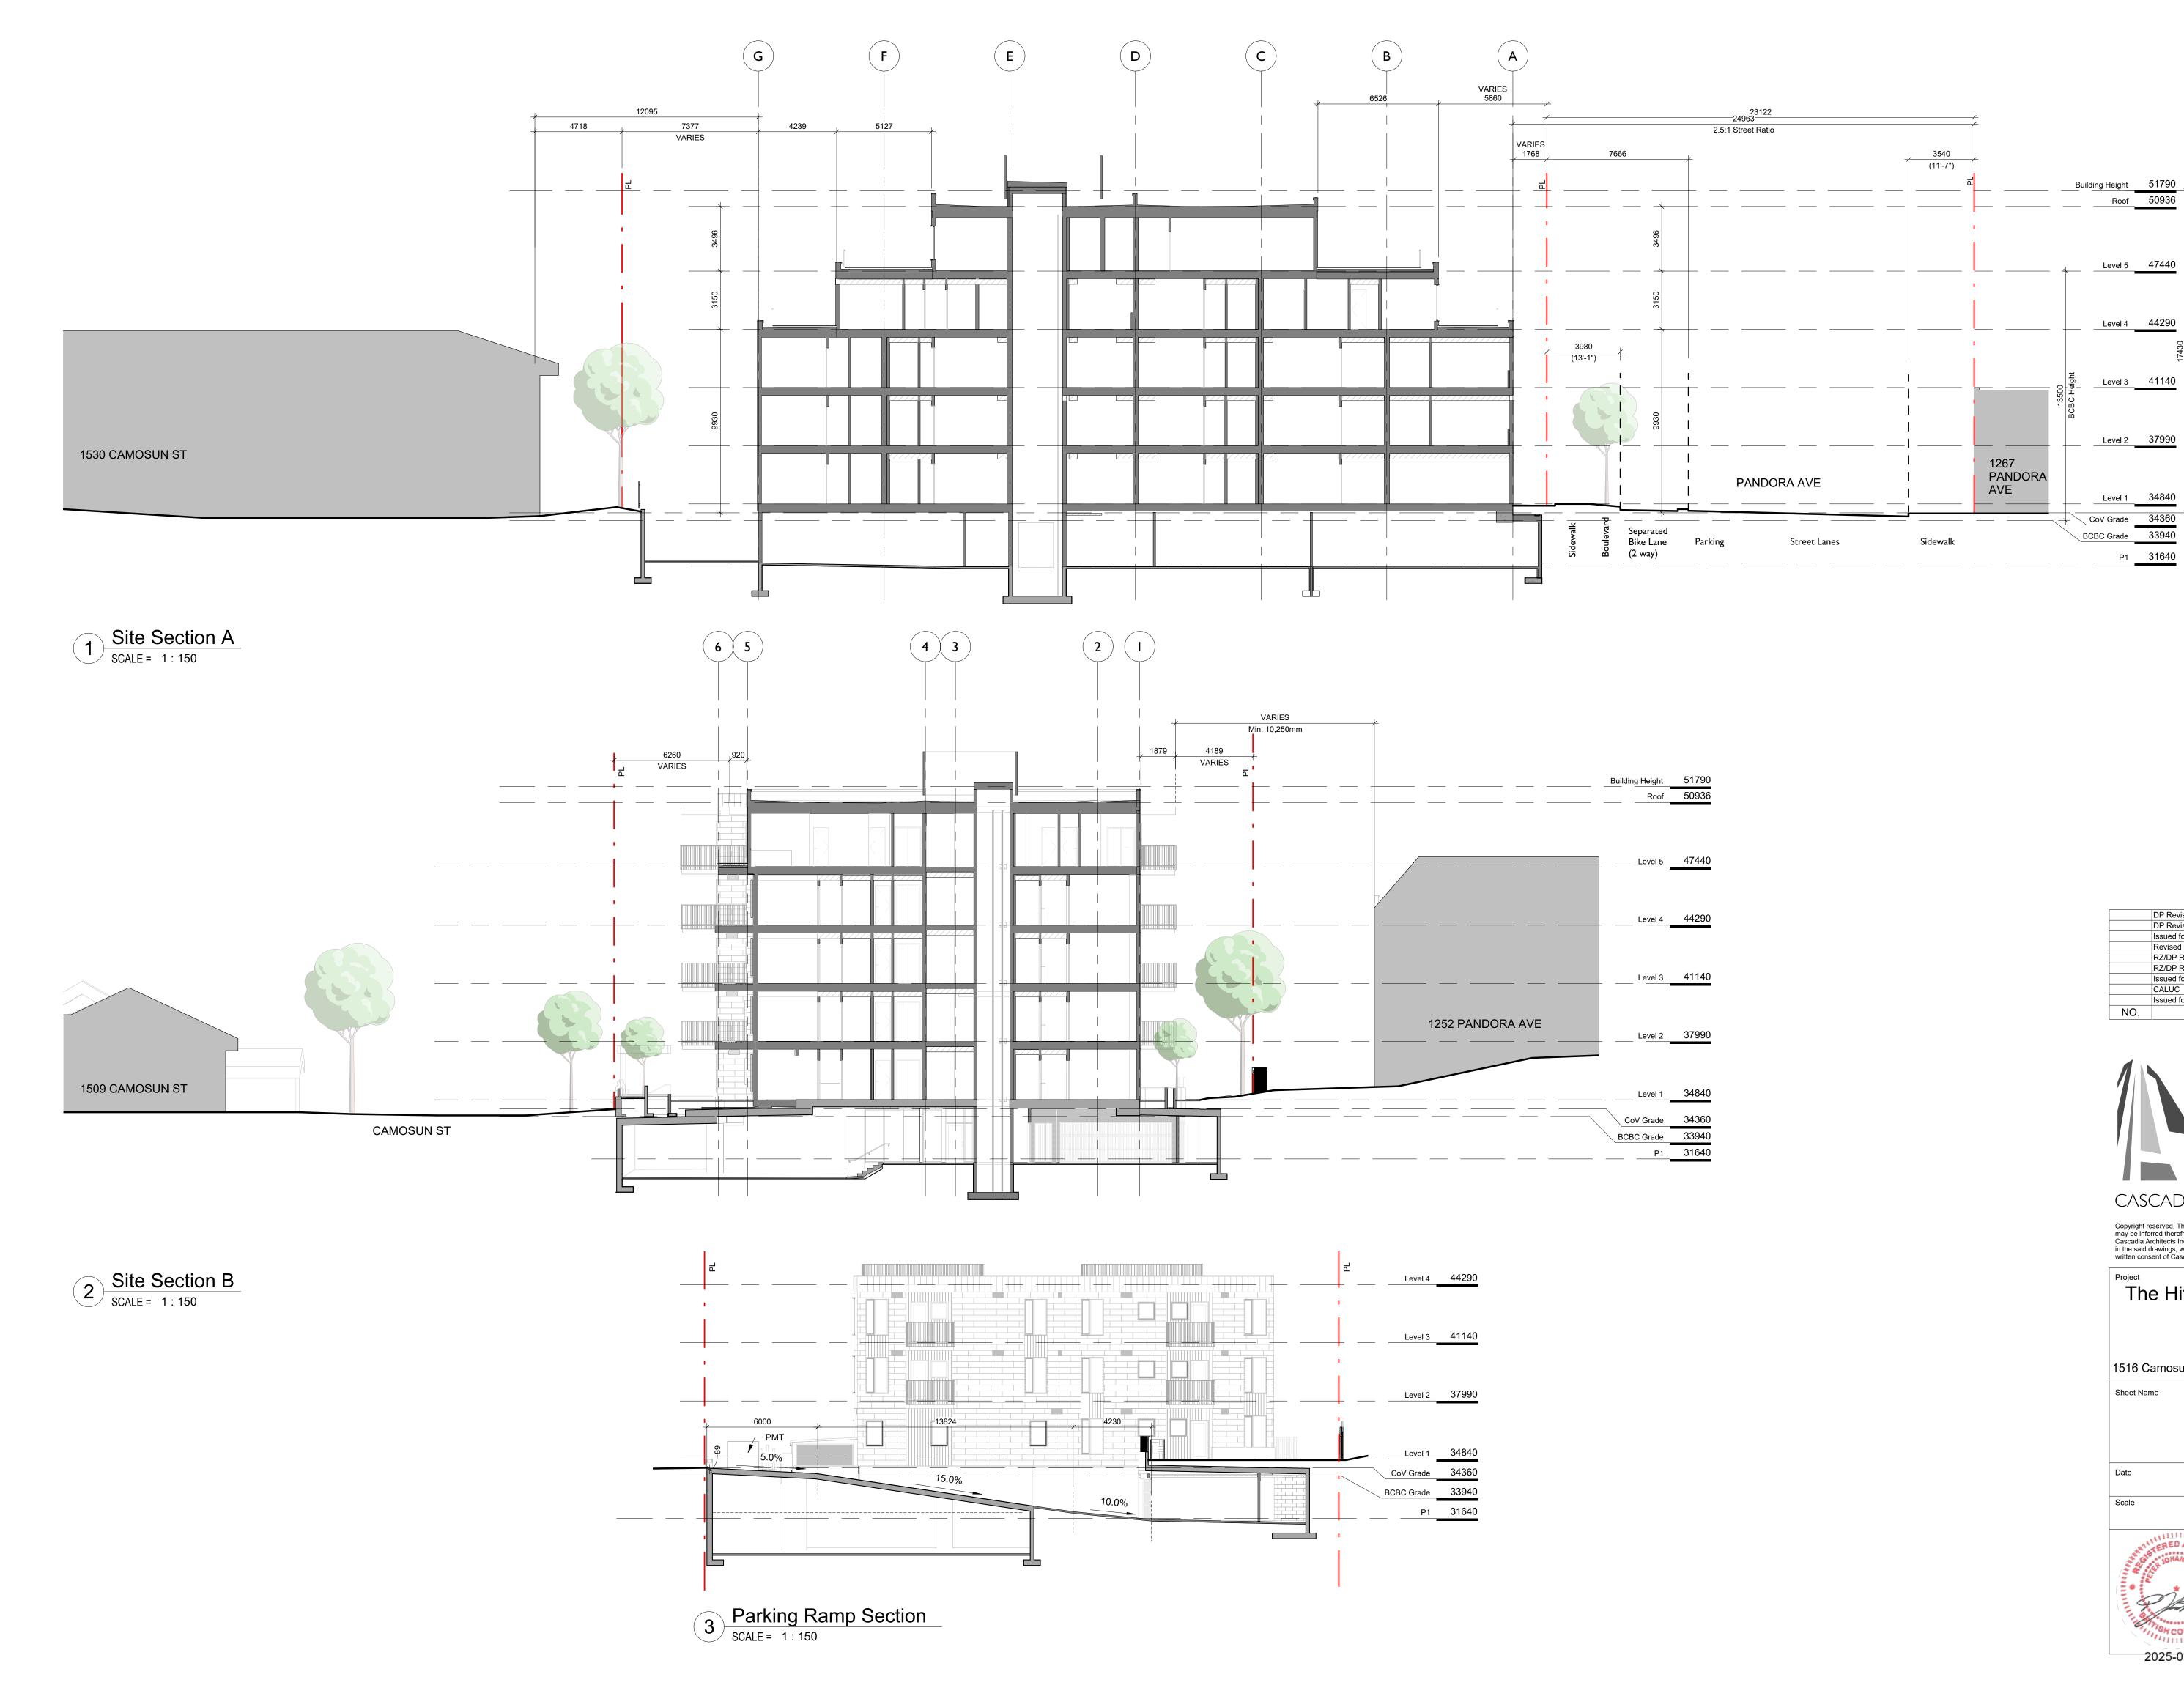P1 31640



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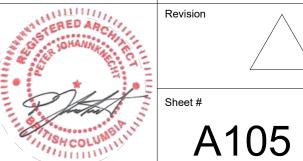
The Hive - 1516 Camosun

1516 Camosun St. 1270 & 1286 Pandora Ave.

Site Sections

January 21, 2025

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H Development










Birdseye view from the East

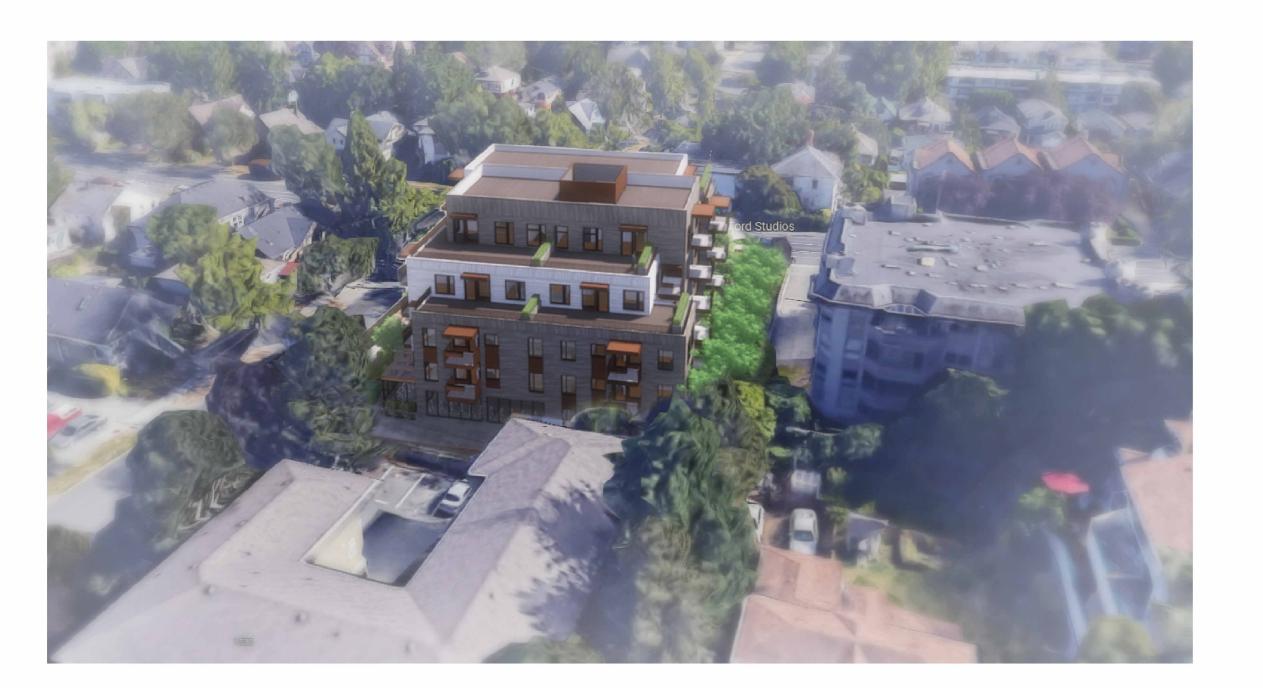

Birdseye view from the North West

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1516 Camosun St. 1270 & 1286 Pandora Ave.

Context Elevations

Date
January 21, 2025

Scale Project #


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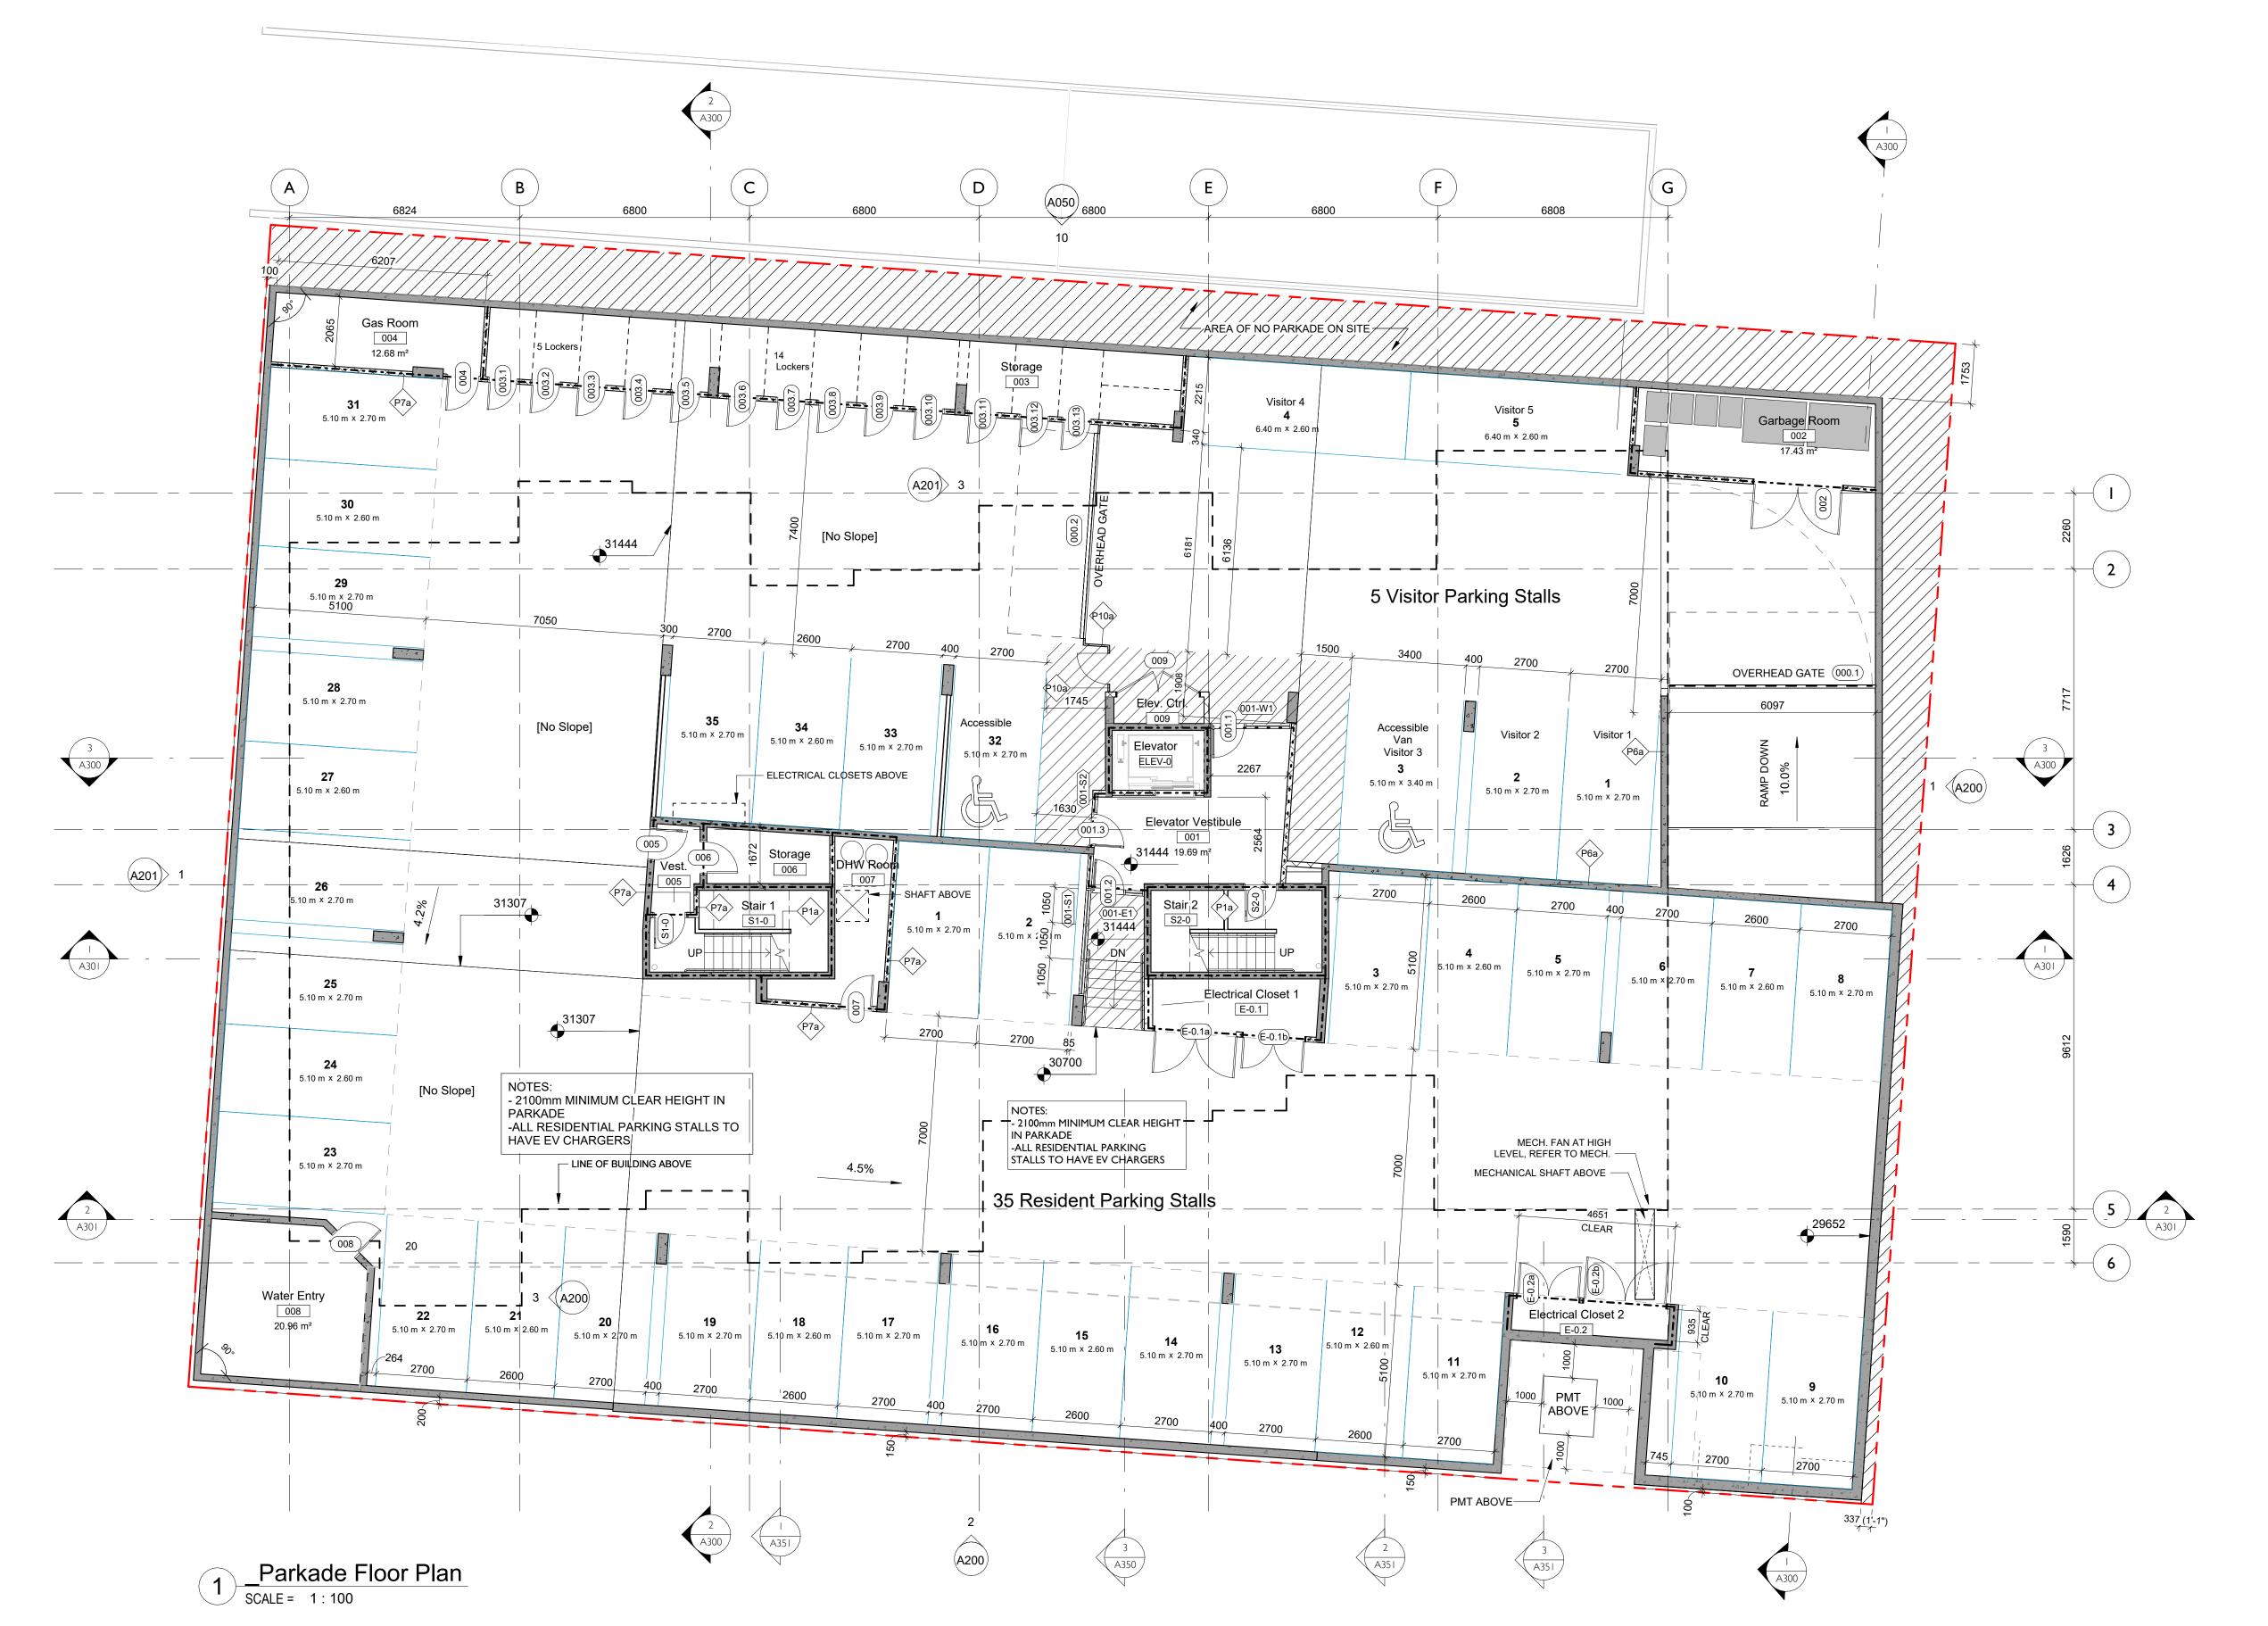
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H Development





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	DP Revision #3	Feb 7, 2023
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	Draft BC Hydro Coordination	Feb. 3, 2022
	Issued for Rezoning / DP	Dec. 21, 2021
	CALUC Dev. Tracker Submission	Nov. 8, 2021
	BC Hydro Coordination	Sept 29, 2021
	Issued for Costing	Aug. 20, 2021
NO.	DESCRIPTION	DATE

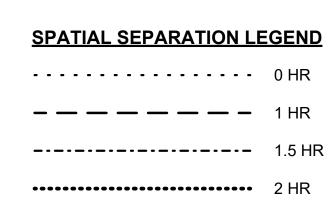


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Parkade Floor Plan


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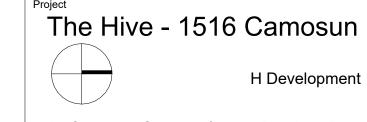




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NO.	DESCRIPTION	DATE

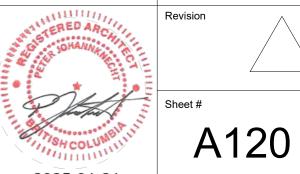


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1516 Camosun St. 1270 & 1286 Pandora Ave.

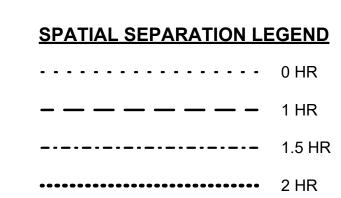Ground Floor Plan


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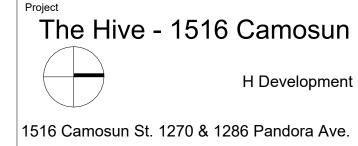




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NO.	DESCRIPTION	DATE

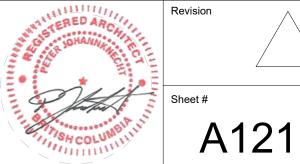


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Level 2 Floor Plan

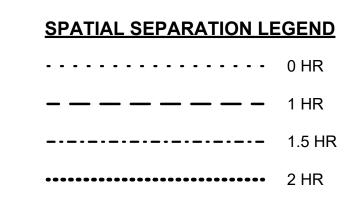Date		J 04 000
		January 21, 202
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	1 : 100	2106




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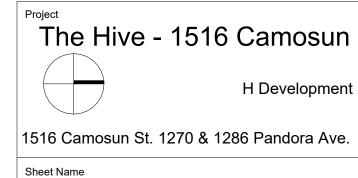


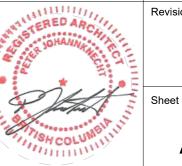

	DP Revision #5	Jan. 21, 202
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	CALUC Dev. Tracker Submission	Nov. 8, 2021
	Issued for Costing	Aug. 20, 202
NO.	DESCRIPTION	DATE

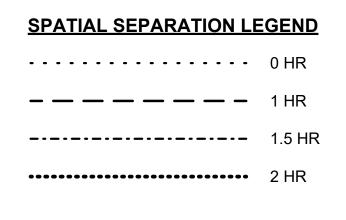


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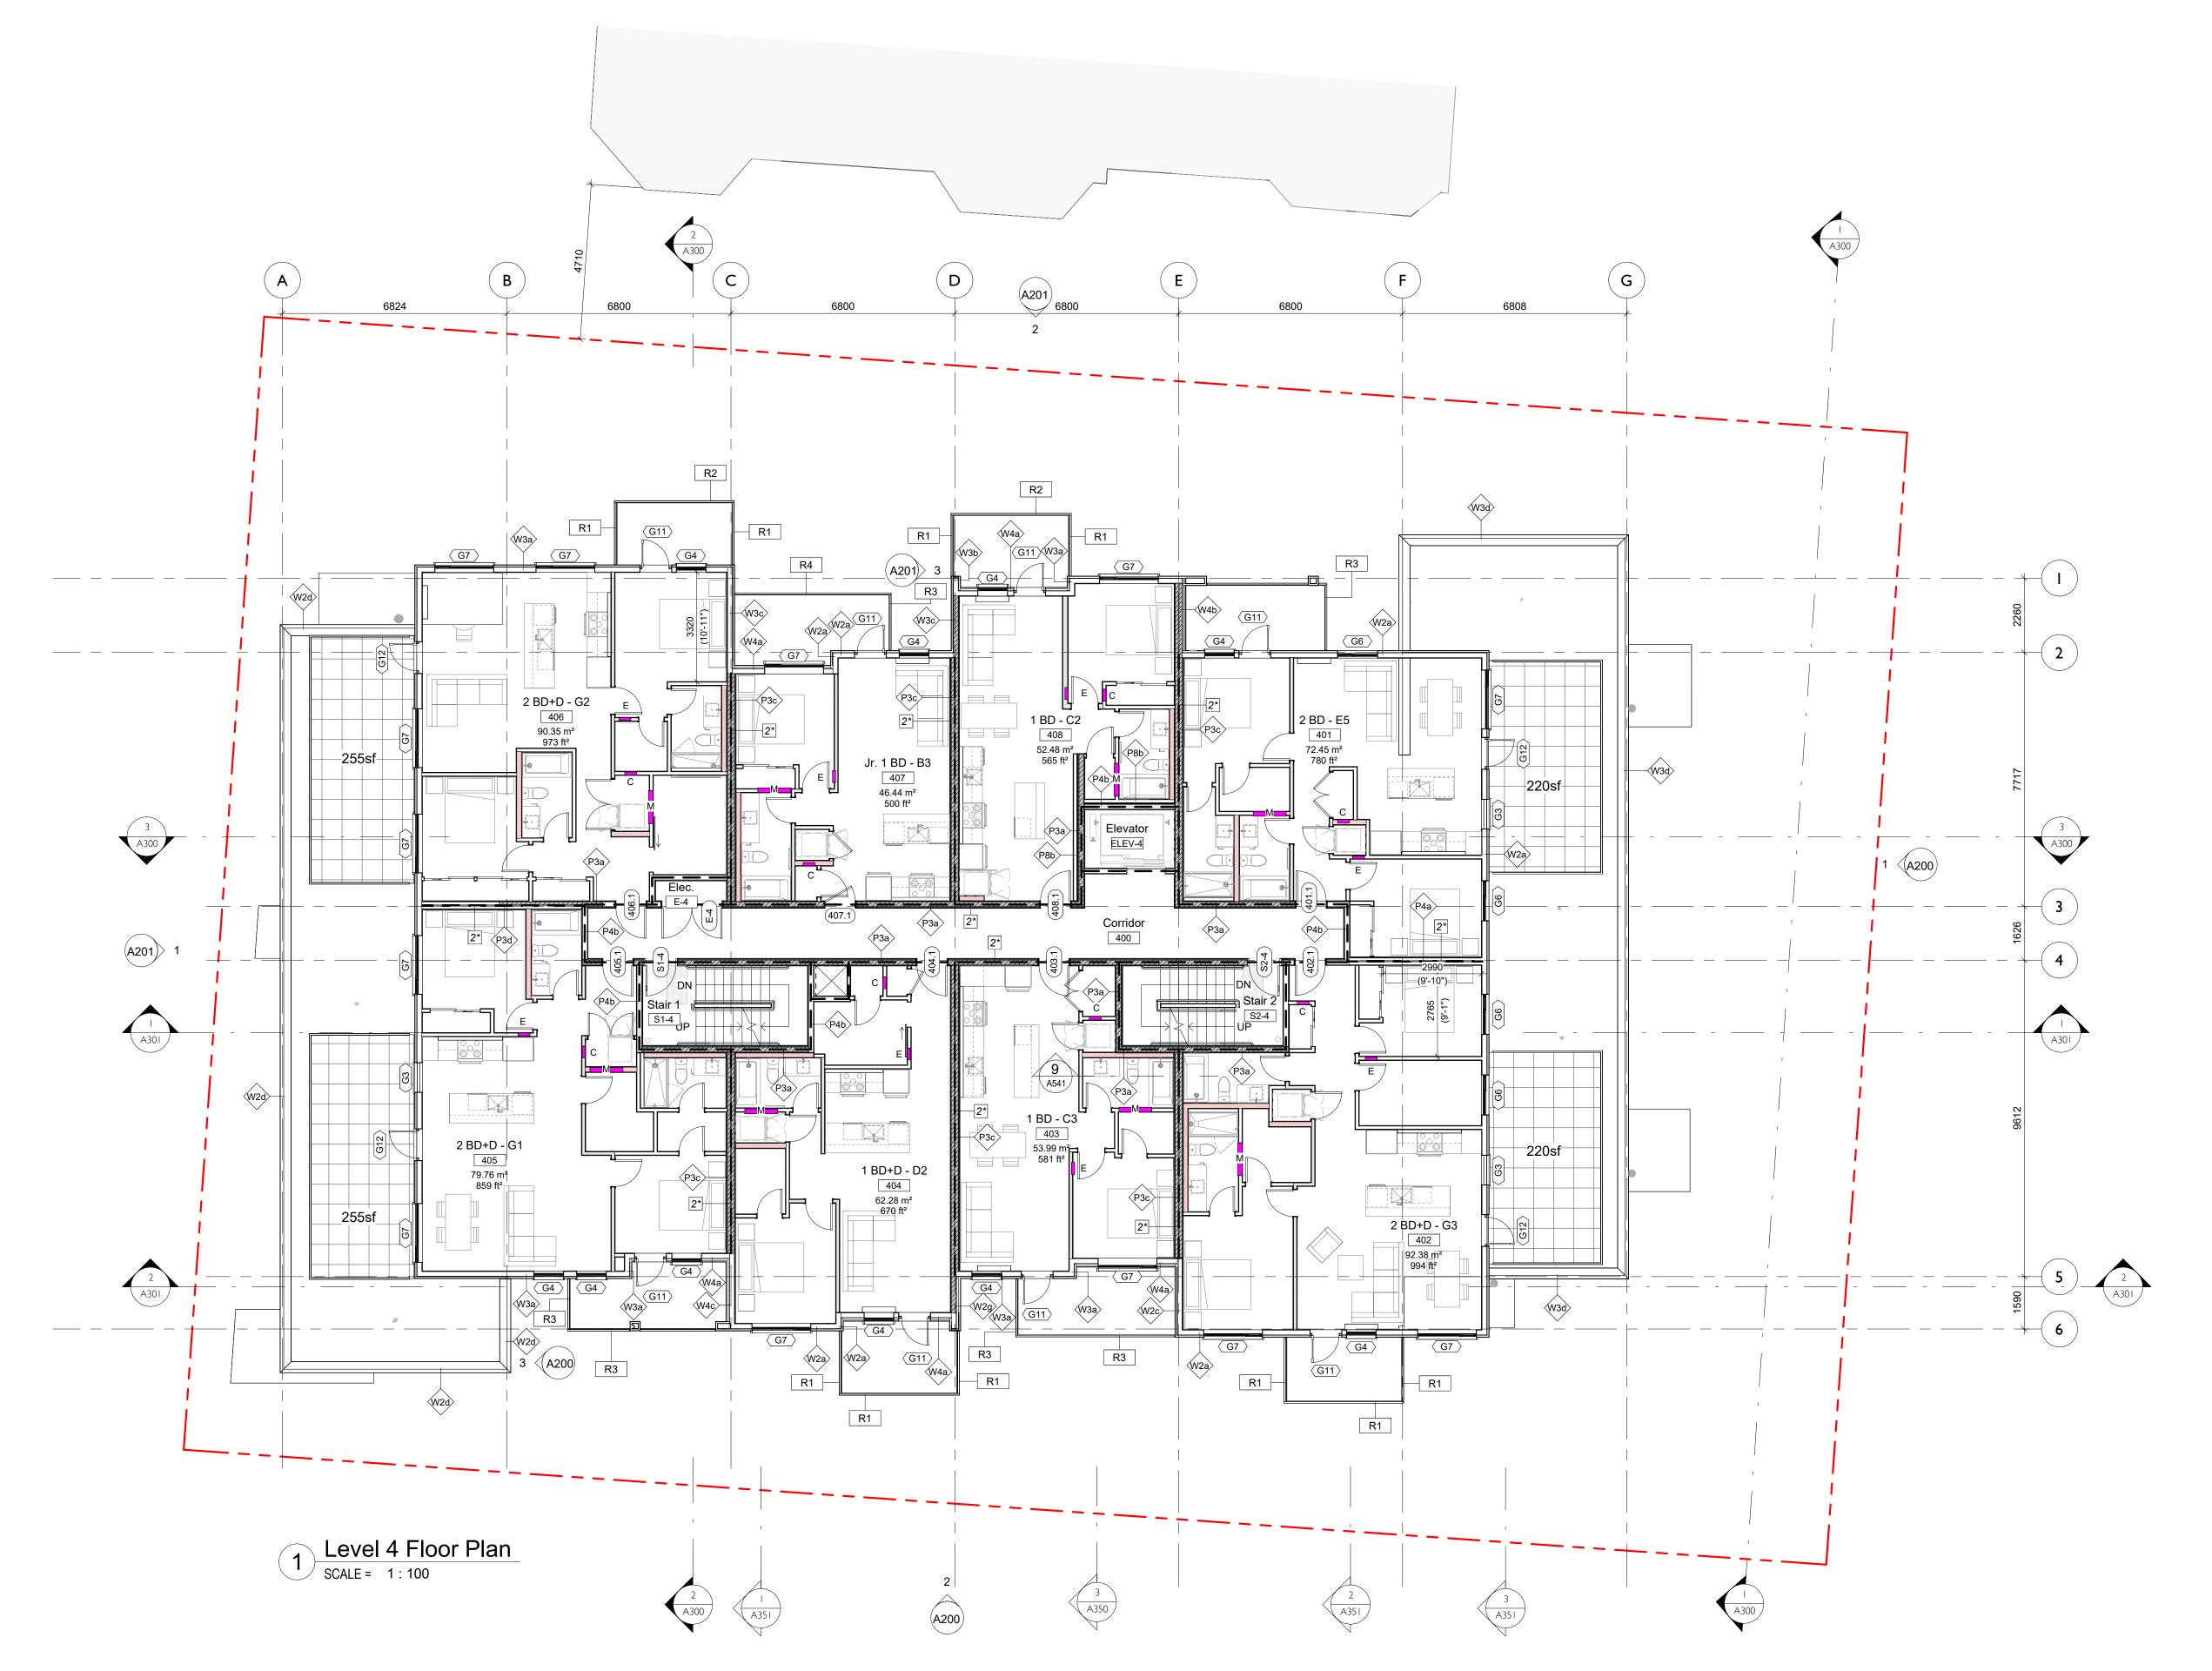



Level 3 Floor Plan

Date	January 21, 2025
Scale	Project #
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	DP Revision #5	Jan. 21, 2024
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	CALUC Dev. Tracker Submission	Nov. 8, 2021
	Issued for Costing	Aug. 20, 2021
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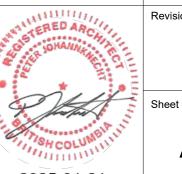


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Level 4 Floor Plan

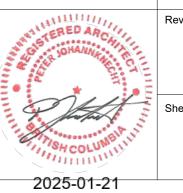
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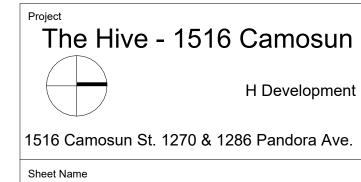


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	Issued for Costing	Aug. 20, 2021
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Level 5 Floor Plan

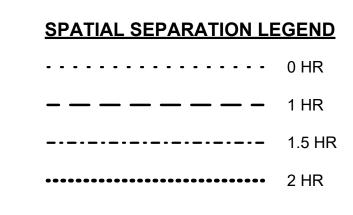
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The Hive - 1516 Camosun

H Development

1516 Camosun St. 1270 & 1286 Pandora Ave.

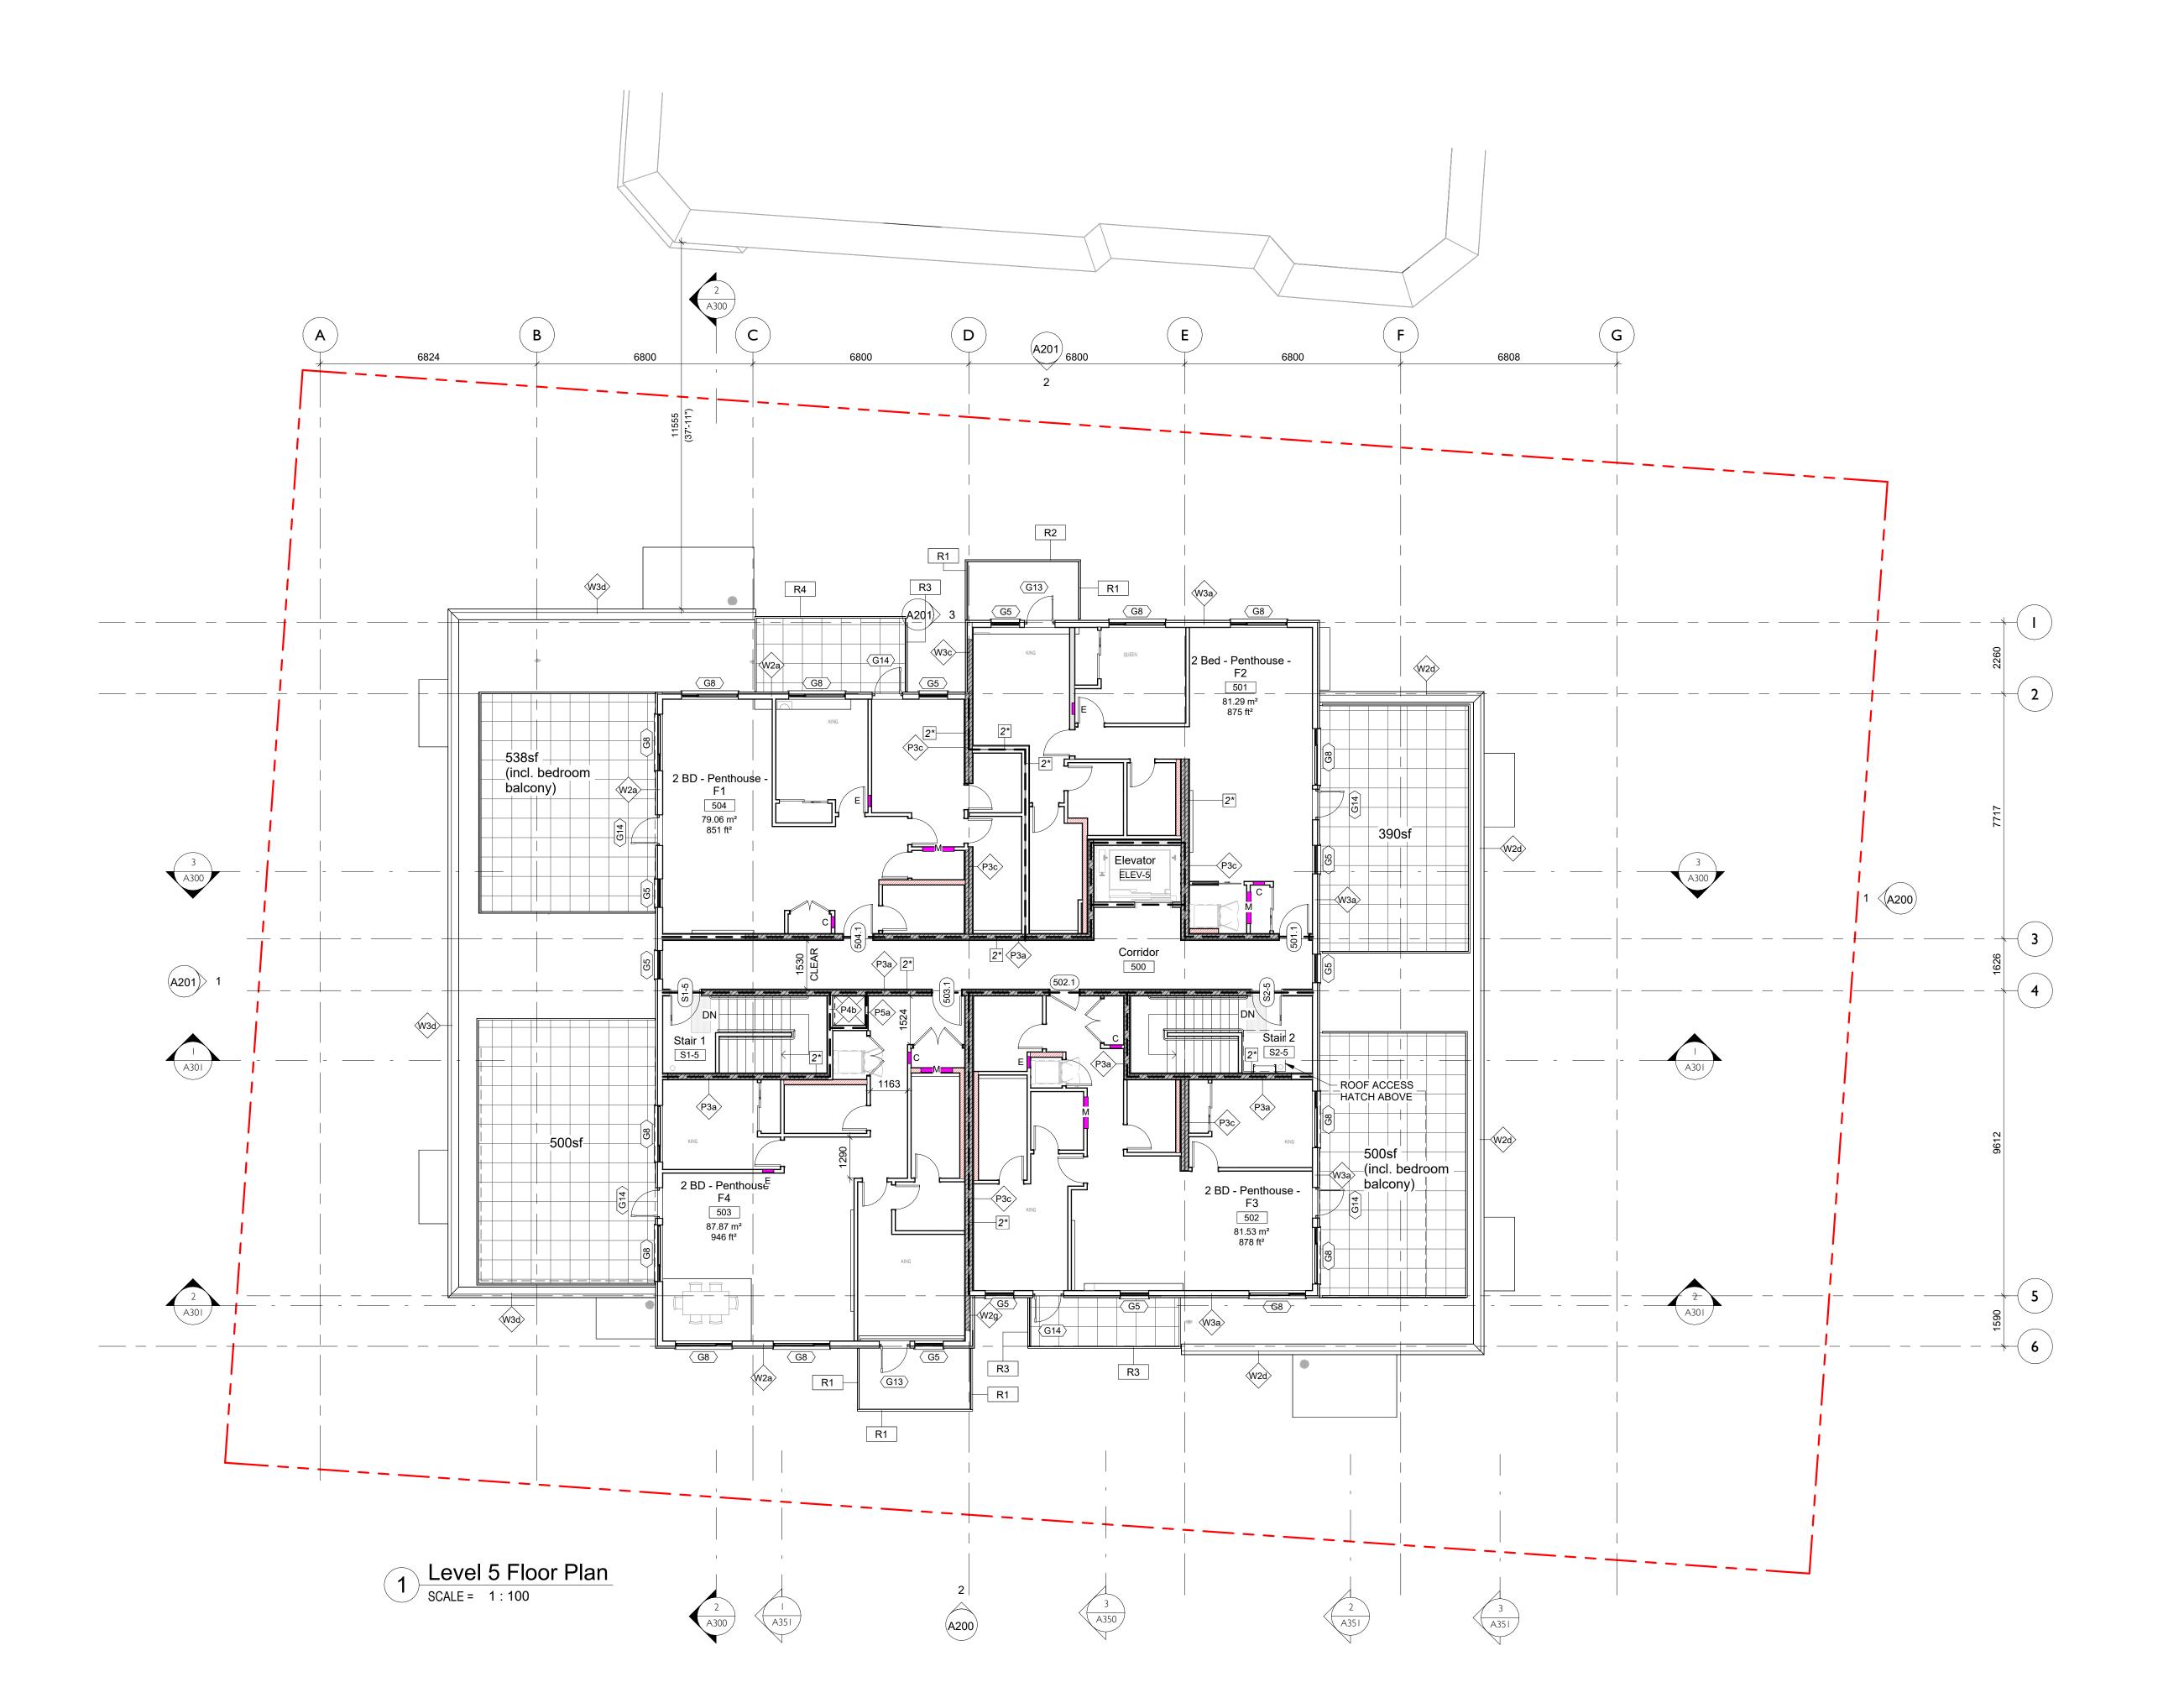Roof Plan

January 21, 2025
Scale Project #

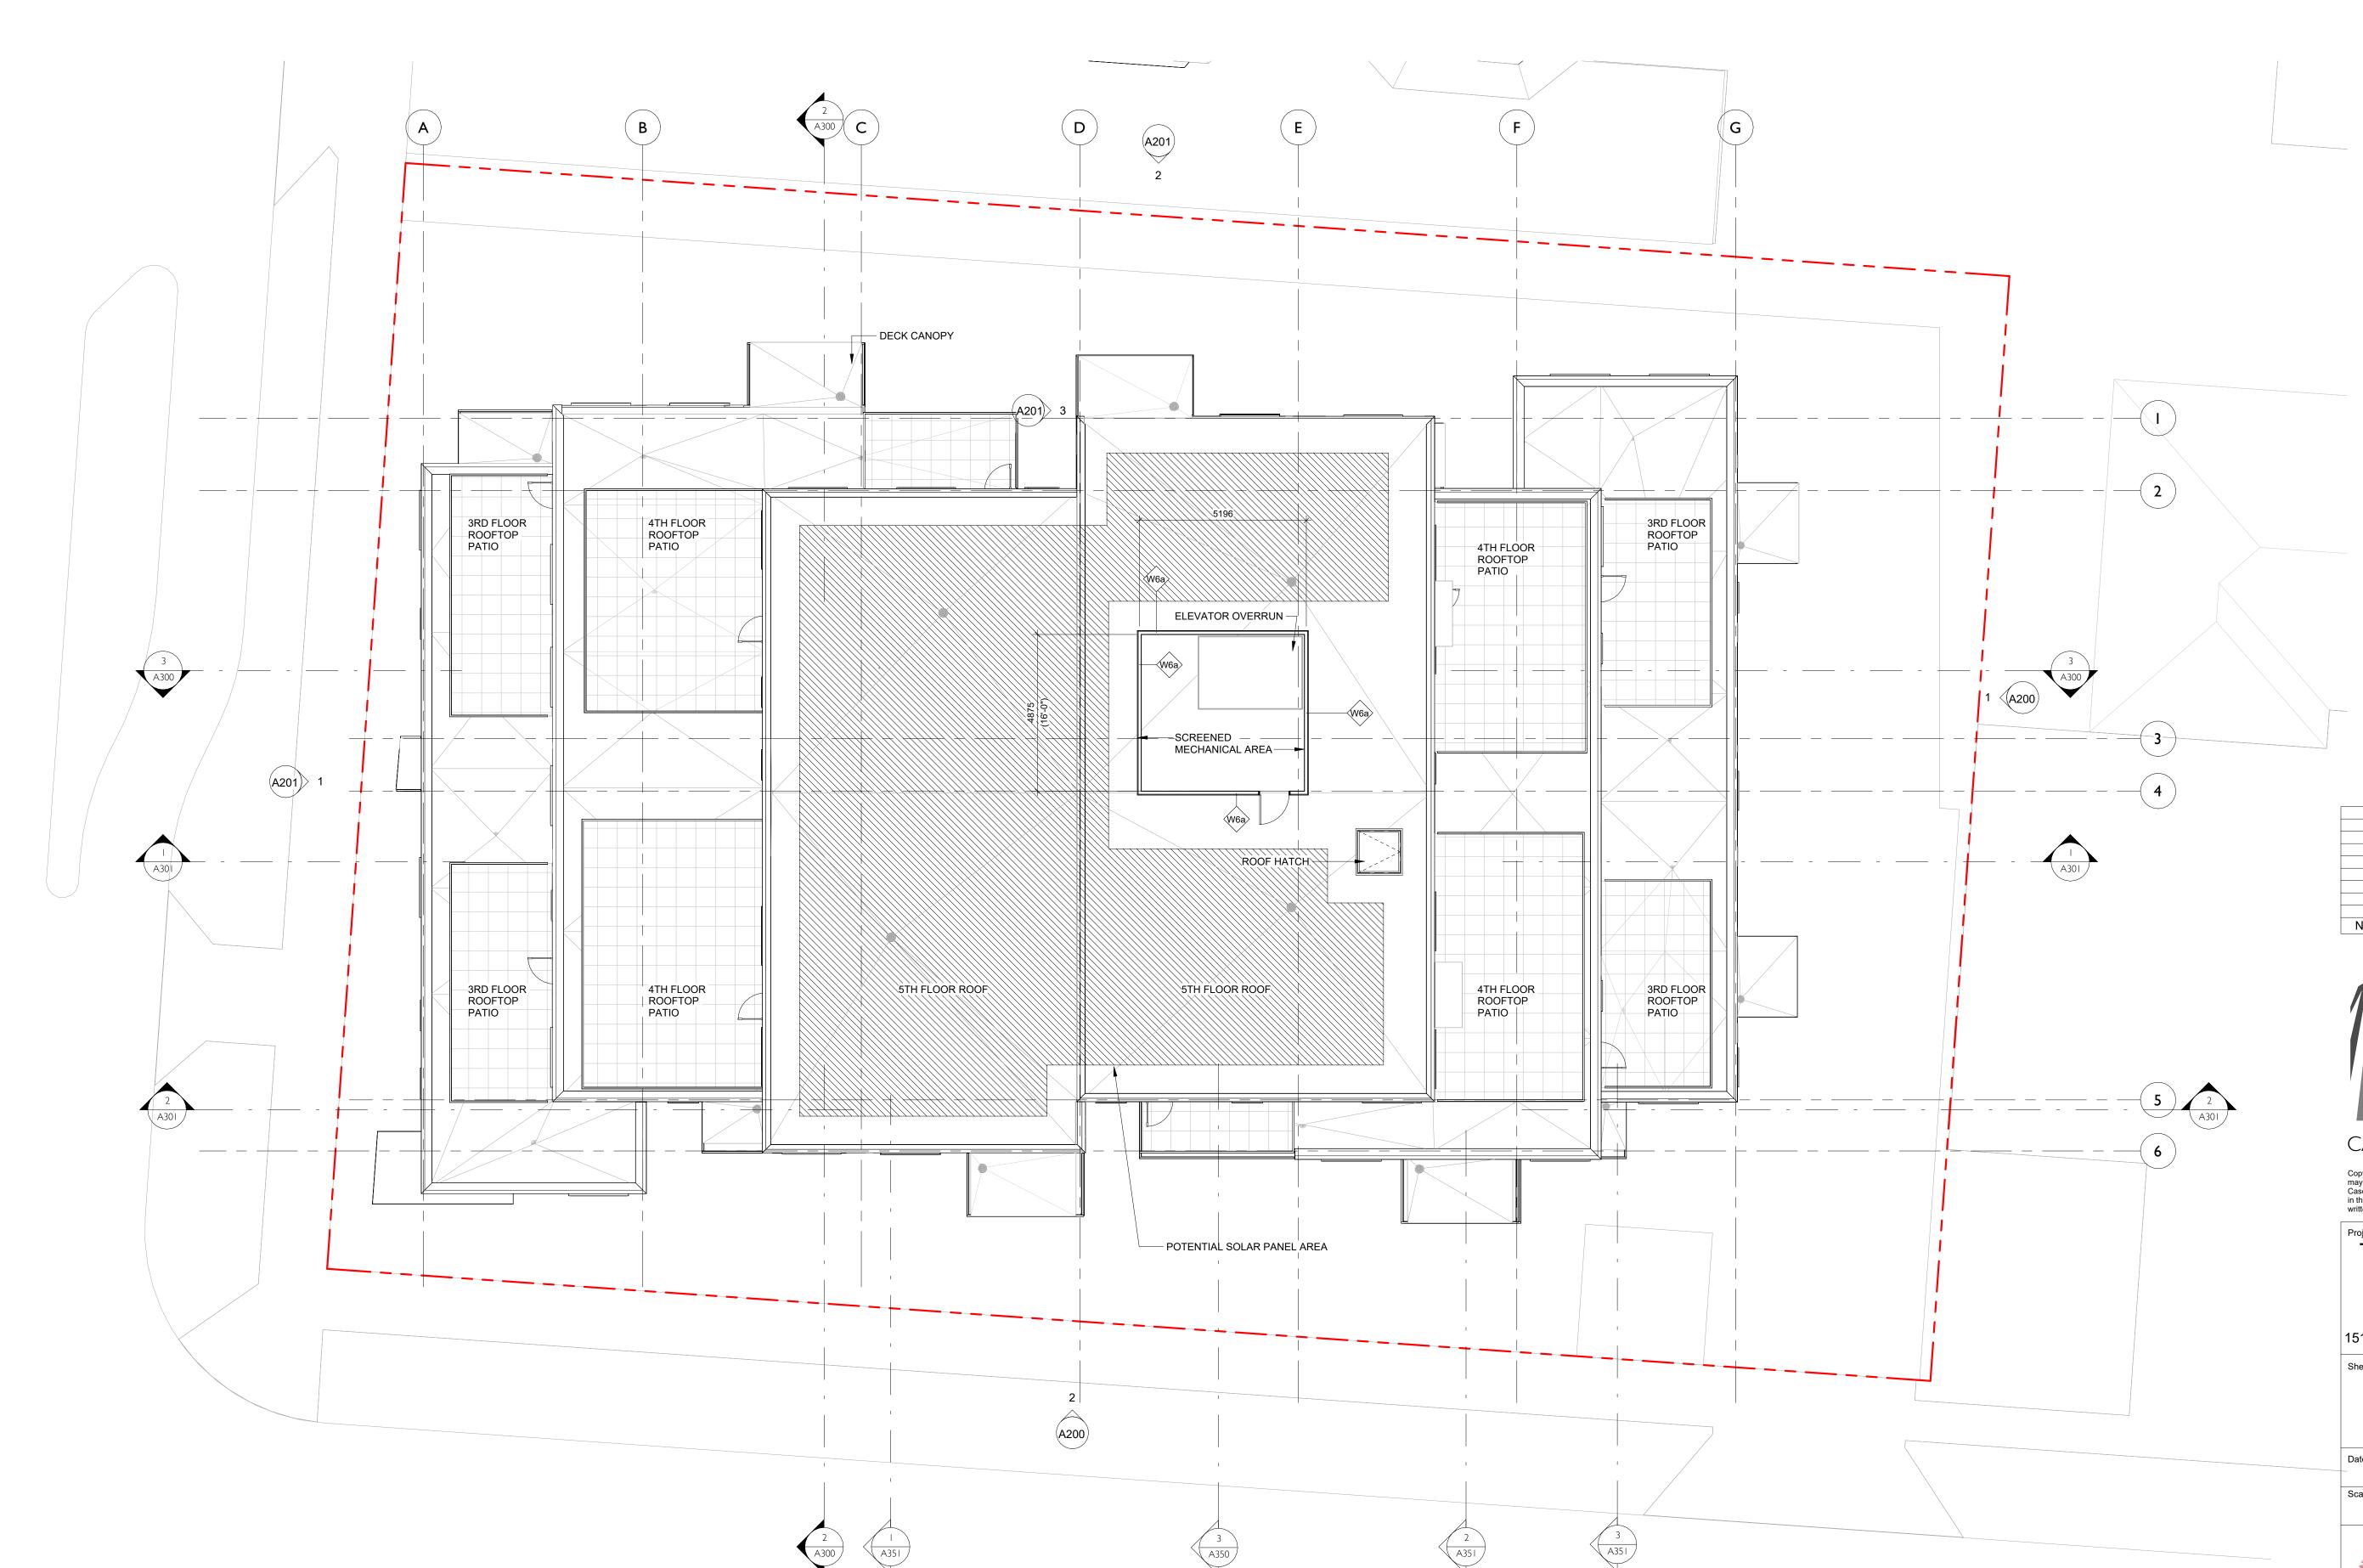

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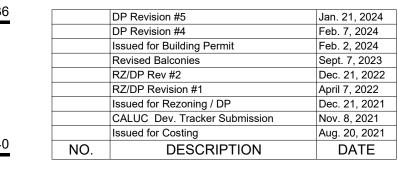


North Building Elevation

SCALE = 1:100









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The Hive - 1516 Camosun

H Development

1516 Camosun St. 1270 & 1286 Pandora Ave.

Elevations

Scale As indicated

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January 21, 2025





Exterior Materials

1. Single Skin Running Bond Metal Panel - Colour 1 (Light)
2. Single Skin Running Bond Metal Panel - Colour 2 (Dark)
3. Metal panel - Bronze finish
4. Aluminum railing - Bronze and dark brown finish
5. Not used
6. Window/door with deep frame - Dark finish
7. Storefront system - Dark bronze finish
8. Architectural concrete
9. Not Used
10. Exposed wood
11. Painted metal columns - dark finish

1 2

3 4


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	DP Revision #5	Jan. 21, 2024
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1516 Camosun St. 1270 & 1286 Pandora Ave.

Sheet Name	Elevations

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View from Camosun and Pandora



View from Northeast of Site

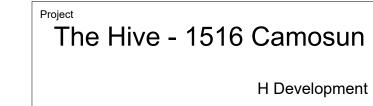

View from of lane from Pandora at West side of site



View of main	building ont	y from cidowalk
view oi main	bullaing enti	y from sidewalk

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The Hive - 1516 Camosun

H Development

1516 Camosun St. 1270 & 1286 Pandora Ave.


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January 21, 2025




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DP Revision #5
RZ/DP Rev #2
RZ/DP Revision #1
Issued for Rezoning / DP

NO.

DESCRIPTION

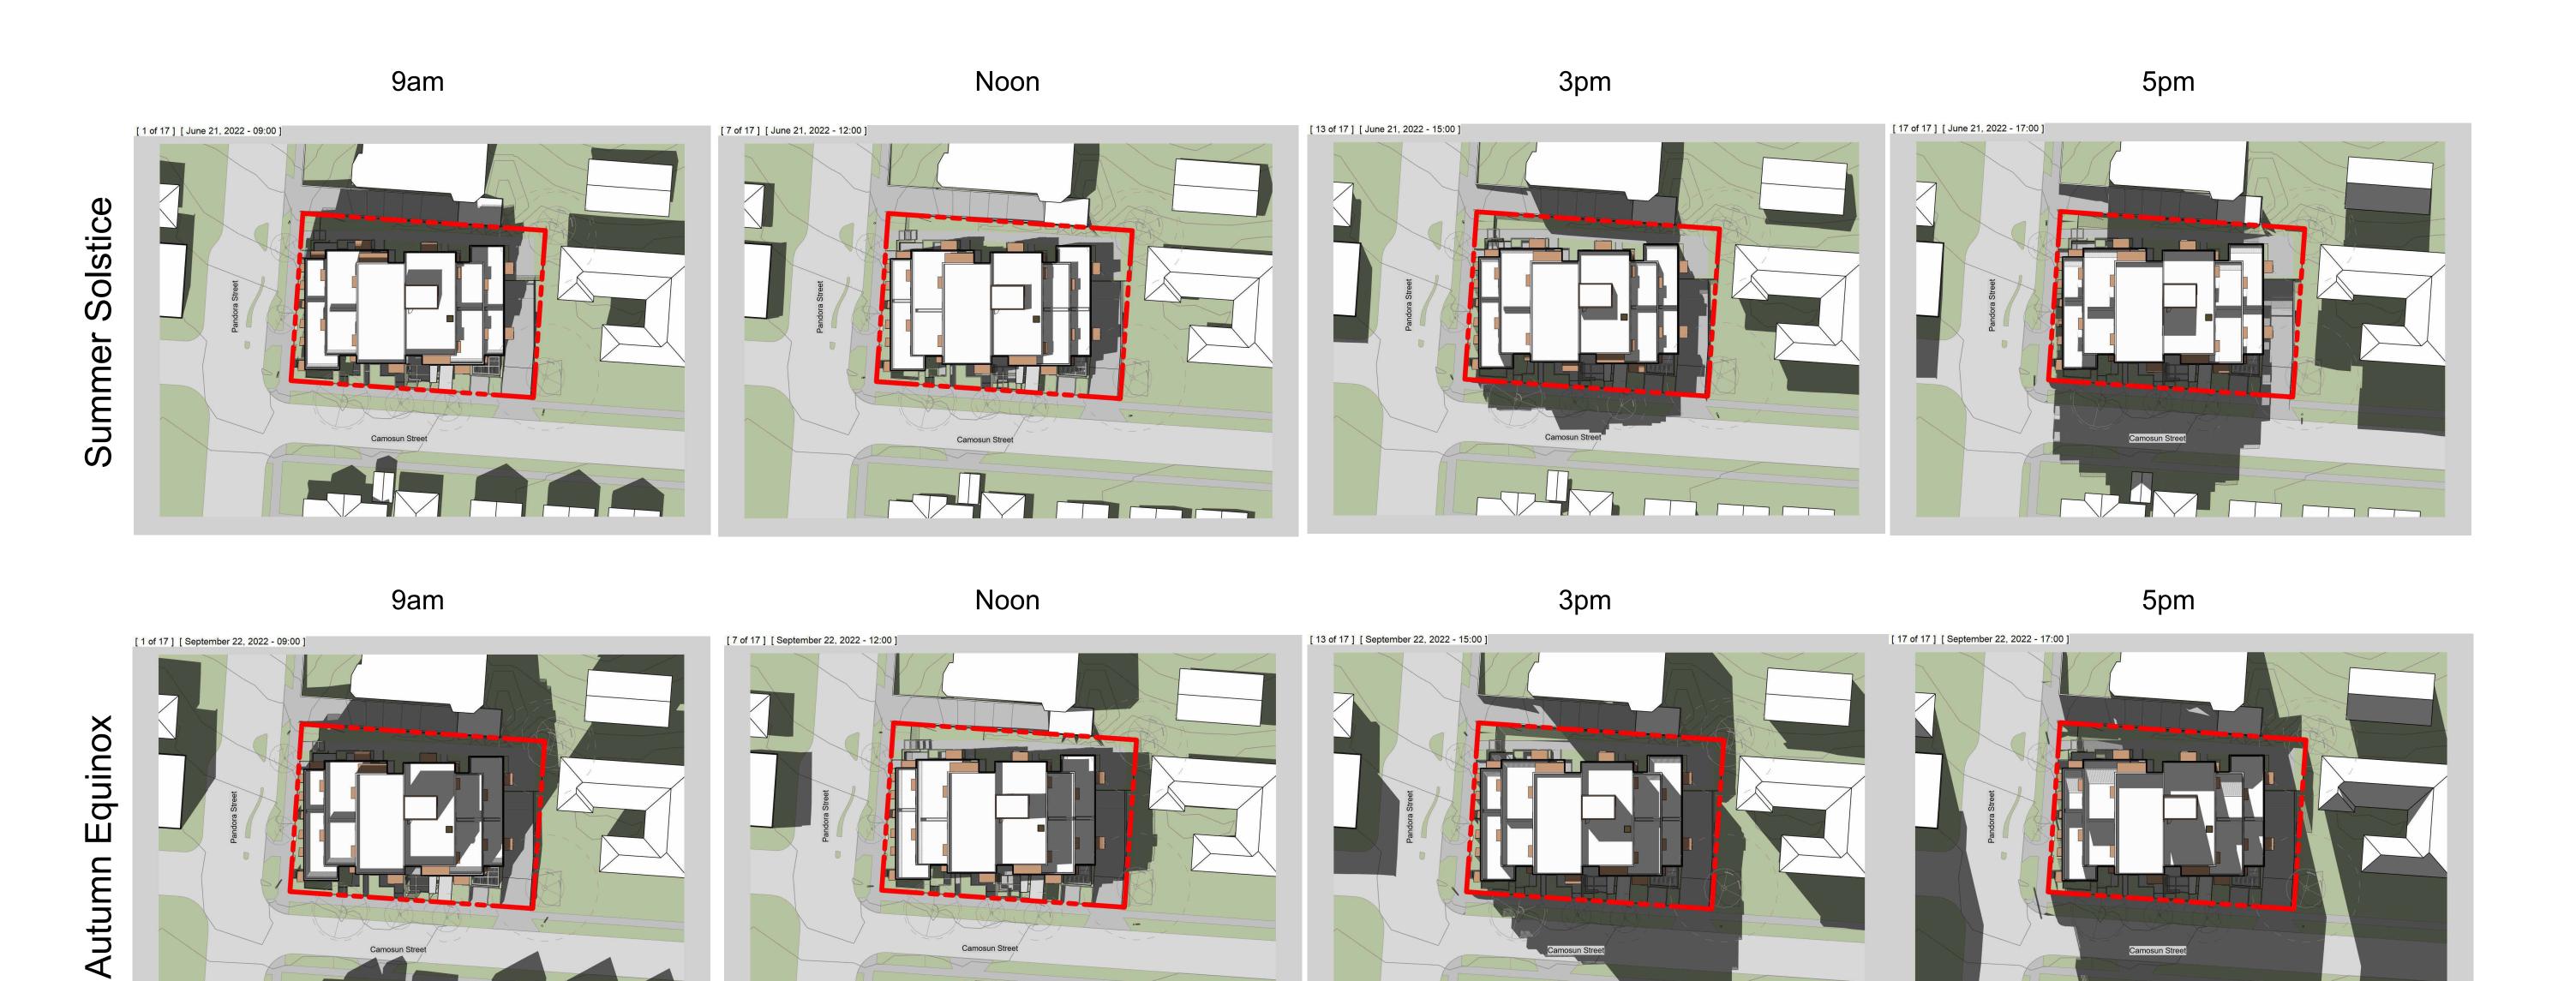Jan. 21, 2024
Dec. 21, 2022
April 7, 2022
Dec. 21, 2021
DATE

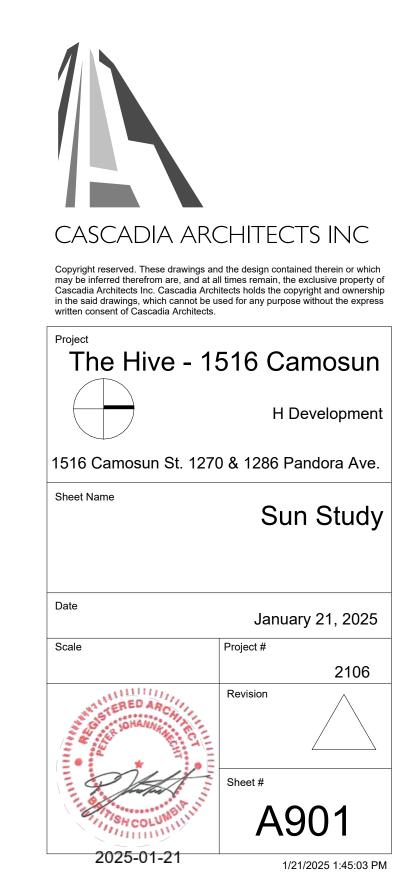C:\Users\andy\Documents\2106 - 1516 Camosun - CD - Central_2024_andy@cascadiaarchitects.ca.rvt



View from Pandora and Camosun looking Northwest (Not updated)



View from neighbouring top floor balcony showing privary provided by angled guardrail pickets



View looking West over Camosun Street (Not Updated)



View from Pandora Street at neighbouring property showing angled guardrail pickets



View from top floor balcony showing privacy provided by angled guardrail pickets

	DP Revision #5	Jan. 21, 2024
	DP Revision #4	Feb. 7, 2024
	RZ/DP Rev #2	Dec. 21, 2022
	RZ/DP Revision #1	April 7, 2022
	Issued for Rezoning / DP	Dec. 21, 2021
	CALUC Dev. Tracker Submission	Nov. 8, 2021
NO.	DESCRIPTION	DATE



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The Hive - 1516 Camosun

1516 Camosun St. 1270 & 1286 Pandora Ave.

Renderings

January 21, 2025

ale Project #

RED ARCOLUMNIA SH

2011115 2025 01 21 ____

H Development





















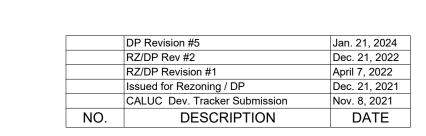

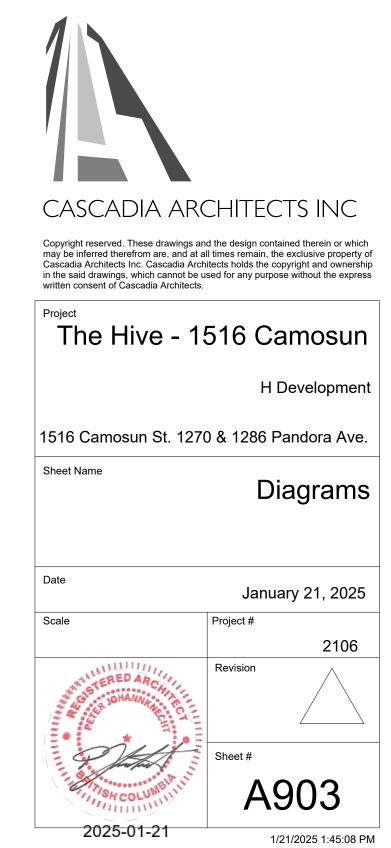

GENERAL LANDSCAPE NOTES

GENERAL:

DO NOT PROCEED IN UNCERTAINTY.

- 2. DO NOT SCALE DRAWINGS.
- 3. DRAWINGS AND SPECIFICATIONS ARE TO BE READ IN CONJUNCTION WITH ALL OTHER DRAWINGS/SPECIFICATIONS IN THIS PROJECT SET. ANY DISCREPANCIES AMONG DRAWINGS,
- SPECIFICATIONS AND INDUSTRY BEST PRACTICES TO BE REPORTED TO THE PROJECT / CONSTRUCTION MANAGER AND THE LANDSCAPE CONSULTANT FOR DIRECTION.
- 4. ALL LANDSCAPE SPECIFICATION SECTIONS AND DRAWINGS ARE AFFECTED BY REQUIREMENTS OF DIVISION 01 SECTIONS (PROVIDED IN THE PROJECT MANUAL). 5. CONTRACTOR TO FAMILIARIZE THEMSELVES WITH ALL SITE CONDITIONS, INCLUDING THE LIMITS OF WORK AND EXISTING FEATURES TO BE PROTECTED, PRIOR TO SUBMITTING
- BIDS/QUOTES.
- 6. CONTRACTOR TO CONFIRM LOCATION AND ELEVATION OF ALL UNDERGROUND UTILITIES/FEATURES PRIOR TO COMMENCING WORK.
- 7. CONTRACTOR TO TAKE NECESSARY PRECAUTIONS TO PROTECT SITE FEATURES / CONDITIONS, WITHIN AND BEYOND THE LIMITS OF WORK EXISTING AT THE TIME OF CONSTRUCTION. ALL DISTURBED SURFACES, AREAS, STRUCTURES, VEGETATION, HABITAT ETC. ON PUBLIC / PRIVATE PROPERTY TO PROMPTLY BE RESTORED TO EQUAL OR BETTER CONDITION THAN EXISTING AND TO THE SATISFACTION OF THE MUNICIPALITY HAVING JURISDICTION / PROPERTY OWNER.
- 8. CONTRACTOR TO MAINTAIN THE SITE IN A SAFE AND TIDY CONDITION AT ALL TIMES. DO NOT OBSTRUCT PEDESTRIAN OR VEHICULAR CIRCULATION. DO NOT LEAVE UNPROTECTED HOLES / PITS / OPENINGS OVERNIGHT. ALL EXCESS MATERIALS AND REFUSE TO BE REMOVED FROM THE SITE DAILY UNLESS OTHERWISE DIRECTED BY THE CONSTRUCTION MANAGER.

STANDARDS:

1.1. ALL WORK ON MUNICIPAL PROPERTY TO CONFORM TO THE CITY OF VICTORIA DEVELOPMENT STANDARDS (AUTHORITY HAVING JURISDICTION) INCLUDING BUT NOT LIMITED TO:

- 1.1.1. CITY OF VICTORIA SUPPLEMENTARY SPECIFICATIONS SCHEDULE 'B' TO THE SUBDIVISION AND DEVELOPMENT SERVICING BYLAW NO. 12-042
- 1.1.2. CITY OF VICTORIA SUPPLEMENTAL DRAWINGS 1.1.3. CITY OF VICTORIA SUPPLEMENTARY SPECIFICATIONS FOR STREET TREES AND IRRIGATION, SCHEDULE C.
- 2. ALL LANDSCAPE WORK ON THE DEVELOPMENT SITE TO CONFORM TO THE Canadian Landscape Standard (CLS), UNLESS SPECIFICALLY STATED OTHERWISE IN WRITTEN SPECIFICATIONS AND ON DRAWINGS.
- 3. ALL HARD SURFACE (INCLUDING BUT NOT LIMITED TO PAVING, CONCRETE RETAINING WALLS AND CONCRETE PLANTERS) TO CONFORM TO THE Master Municipal Construction Documents Association PLATINUM EDITION (MMCD) AND MMCD SUPPLEMENTAL DRAWINGS AND SPECIFICATIONS, UNLESS SPECIFICALLY STATED OTHERWISE IN WRITTEN
- SPECIFICATIONS AND ON DRAWINGS. 4. IN CASES OF CONFLICT BETWEEN THE CLS AND THE MMCD, THE MORE STRINGENT REQUIREMENT WILL TAKE PRECEDENCE.
- 5. LANDSCAPE CONTRACTOR TO BE FAMILIAR WITH MUNICIPAL DEVELOPMENT STANDARDS AND BE IN POSSESSION OF THE CLS AND MMCD MANUALS AND SUPPLEMENTAL DRAWINGS
- AND SPECIFICATIONS. 6. GROWING MEDIUM AND GROWING MEDIUM TESTING TO CLS Section 6.
- 7. IRRIGATION DESIGN AND INSTALLATION TO IIABC STANDARDS AND CLS Section 5.

1. CONTRACTOR TO COORDINATE INSTALLATION OF IRRIGATION AND ELECTRICAL SLEEVES WITH ARCHITECTURAL, MECHANICAL, ELECTRICAL AND CIVIL WORKS.

1. CONTRACTOR TO PROVIDE SAMPLES, TEST RESULTS AND SHOP DRAWINGS TO LANDSCAPE CONSULTANT FOR REVIEW AND APPROVAL 45 DAYS PRIOR TO INSTALLATION.

2. SEE ALSO SUBMITTALS TABLE BELOW FOR ADDITIONAL INFORMATION.

GROWING MEDIUM TESTING: 1. GROWING MEDIUM TEST RESULTS ARE MANDATORY.

- 2. TEST RESULTS TO INCLUDE ANALYSIS OF ALL GROWING MEDIUM NUTRIENTS NOTED IN CLS 6.2.7 AND ARE TO BE REPORTED IN THE SAME UNITS AS NOTED IN THAT SECTION.
- 3. TEST RESULTS TO INCLUDE ANALYSIS OF SOIL TEXTURE, ORGANIC CONTENT AND ACIDITY AS PER CLS 6.3.5 AND BE REPORTED IN THE SAME UNITS AS NOTED IN THAT SECTION.
- 4. TEST RESULTS TO INCLUDE RECOMMENDATIONS FOR AMENDMENTS TO MEET THE REQUIREMENTS FOR EACH GROWING MEDIUM TYPE.

COMPACTION TESTING: 1. COMPACTION TESTS FOR HARD SURFACE SUBGRADE, GRANULAR SUB-BASE, AND GRANULAR BASE ARE MANDATORY.

5. RECOMMENDED GROWING MEDIUM TESTING FACILITY: Pacific Soil Analysis Inc. 11720 Voyageur Way, Richmond, BC V6X 3G9.

1. CONTRACTOR TO ALERT THE LANDSCAPE CONSULTANT A MINIMUM OF 3 WORKING DAYS PRIOR TO REQUIRED LANDSCAPE INSPECTIONS.

1. REQUESTS FOR SUBSTITUTIONS TO CONFORM TO THE DIVISION 01 SECTION AND BE SUBMITTED TO THE LANDSCAPE CONSULTANT, THROUGH THE PROJECT ADMINISTRATOR, A MINIMUM OF 45 DAYS PRIOR TO SCHEDULED WORK.

2. PLEASE NOTE THAT SOME SUBSTITUTIONS MAY REQUIRE MUNICIPAL APPROVAL.

1. CONTRACTOR SHALL WARRANTY ALL WORKMANSHIP AND MATERIALS FOR 1 FULL YEAR FOLLOWING THE DATE OF TOTAL PERFORMANCE AS PER MMCD UNLESS SPECIFICALLY NOTED OTHERWISE. FAULTY MATERIALS AND WORKMANSHIP SHALL BE PROMPTLY REPAIRED / REPLACED TO THE SATISFACTION OF THE LANDSCAPE CONSULTANT.

1. CONTRACTOR TO INSTALL AND MAINTAIN SEDIMENTATION FILTRATION MEASURES AS REQUIRED FOR LANDSCAPE WORKS TO PREVENT MATERIALS FROM LEAVING THE SITE AND / OR ENTERING STORM DRAINS; STOCKPILED LANDSCAPE MATERIALS ARE TO BE KEPT TARPED.

ELECTRICAL - DESIGN BUILD

LANDSCAPE LIGHTING:

- 1. IT IS THE INTENTION OF THE PROJECT THAT THE LANDSCAPE CONTRACTOR FURNISH A FUNCTIONAL LIGHTING SYSTEM AS DESCRIBED ON THE DRAWINGS AND IN THIS SECTION.
- 2. THE SCOPE OF WORK INCLUDES SUPPLY AND INSTALLATION OF LOW VOLTAGE LIGHTING PRODUCTS, CABLING, TRANSFORMER(S) / POWER SUPPLIES / DRIVERS AND ELECTRICAL
- 3. ELECTRICAL CONTRACTOR IS TO INCLUDE POWER (CONDUIT AND CONDUCTORS) TO LOW VOLTAGE TRANSFORMERS/DRIVERS IN SUPPORT OF THE LANDSCAPE LIGHTING PLAN. THE NUMBER OF CONNECTION POINTS IS NOT DETERMINED - THIS DEPENDS ON HOW THE LANDSCAPE CONTRACTOR LAYS OUT THE SYSTEM, BUT WILL NOT EXCEED 5. REFER TO THE LANDSCAPE LIGHTING PLAN FOR GENERAL INFORMATION.
- 4. 15A 1P CIRCUIT FROM HOUSE PANEL, SWITCHED BY A PROGRAMMABLE TIMER INSTALLED IN THE ELECTRICAL ROOM.
- 5. TRANSFORMER TO BE ADEQUATELY SIZED FOR THE LOAD PLUS 40% RESERVE CAPACITY. TRANSFORMERS TO BE ARRANGED SUCH THAT NO LOAD REQUIRES WIRING IN EXCESS OF
- 6. TIMER FUNCTION ON TRANSFORMER TO BE DISABLED IF PROVIDED.
- TRANSFORMERS, DRIVERS AND POWER SUPPLIES ARE TO BE INSTALLED IN GROUND JUNCTION BOXES, SUPPLIED AND INSTALLED BY THIS DIVISION.
- 8. THE LANDSCAPE CONTRACTOR SHALL COORDINATE WITH THE ELECTRICAL CONTRACTOR FOR AC CIRCUIT TO EACH JUNCTION BOX LOCATION AND WITH THE GENERAL CONTRACTOR FOR THE INSTALLATION OF ELECTRICAL SLEEVES.
- 9. THE USE OF GEL FILLED WIRE NUTS IS REQUIRED.

IRRIGATION COORDINATION:

1. ELECTRICAL CONTRACTOR TO COORDINATE WITH CONSTRUCTION MANAGER AND IRRIGATION DESIGNER/INSTALLER TO PROVIDE ELECTRICAL FOR THE OPERATION OF AN AUTOMATIC IRRIGATION SYSTEM AND CONTROLLER.


IRRIGATION

IRRIGATION: 1. SEE IRRIGATION PLANS AND DETAILS.

- 2. THE SCOPE OF WORK INCLUDES SUPPLY AND INSTALLATION OF BACKFLOW PREVENTER, CONTROLLER, ALL IRRIGATION COMPONENTS, IRRIGATION SLEEVES, 1 YEAR
- MAINTENANCE/WARRANTY (SEE WRITTEN SPECIFICATIONS AND REQUIREMENTS BELOW) AND AN OPERATION MANUAL. 3. THE IRRIGATION CONTRACTOR SHALL COORDINATE WITH THE GENERAL CONTRACTOR AND ELECTRICAL CONTRACTOR FOR THE INSTALLATION OF IRRIGATION SLEEVES.

MAINTENANCE

- 4. UPON COMPLETION OF IRRIGATION INSTALLATION, CONTRACTOR TO SUBMIT AS-CONSTRUCTED DRAWINGS, OPERATION AND MAINTENANCE MANUAL, TOOLS PROVIDED BY THE MANUFACTURER AND BASE IRRIGATION SCHEDULE TO IIABC STANDARDS (SECTION 5 OF BCLS).
- INSPECT AND CALIBRATE IRRIGATION SYSTEM AS PER SEASONAL REQUIREMENTS. 6. INSPECT GROWING MEDIUM FREQUENTLY (MINIMUM MONTHLY AND WEEKLY DURING PERIODS OF DROUGHT AND HIGH HEAT) FOR MOISTURE CONTENT AND ADJUST IRRIGATION SCHEDULE AS OFTEN AS REQUIRED TO MAINTAIN THE HEALTH OF THE PLANT MATERIAL DUE TO: RAPID DRAINAGE IN THE GROWING MEDIUM, ABSENCE OF A WATER TABLE, FINITE AMOUNT OF GROWING MEDIUM, AND EXPOSURE TO CLIMATIC CONDITIONS.
- 7. CONTRACTOR TO COORDINATE WITH THE OWNER'S MAINTENANCE REPRESENTATIVE AND TOGETHER PERFORM ONE WINTERIZATION AND ONE SPRING START-UP DURING THE ONE YEAR WARRANTY PERIOD.

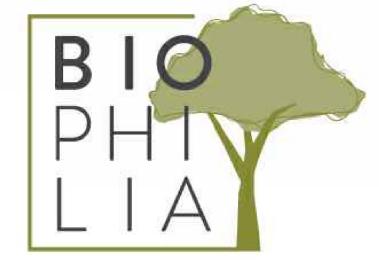



1516 CAMOSUN ST.

1516 Camosun St. Victoria, BC.

SHEET LIST

L0.00 COVER PAGE

L0.01 TREE MANAGEMENT PLAN

L1.02 MATERIALS PLAN - L4 & L5

L0.02 TREE MANAGEMENT PLAN

L1.01 MATERIALS PLAN - L1

L2.00 PLANTING SCHEDULE L1

L2.01 TREE PLANTING PLAN - L1

L2.02 PLANTING PLAN - L1

L3.11 SOIL DEPTH PLAN - L1


L4.01 LIGHTING PLAN - L1

L5.01 SECTIONS

L6.11 DETAILS

SUBMITTALS

SUBMITTALS									
SPECIFICATION SECTION	TITLE	SHOP DRAWINGS	MOCK-UP	SUBMITTALS	FOR APPROVAL				
MMCD 03 30 20	CONCRETE WALKS, CURBS AND GUTTERS								
MMCD 03 30 53	CAST IN PLACE CONCRETE								
MMCD 31 02 17	AGGREGATES AND GRANULAR MATERIALS								
MMCD 31 22 01	SITE GRADING								
MMCD 31 24 13	ROADWAY EXCAVATION, EMBANKMENT AND COMPACTION								
MMCD 32 11 23	GRANULAR BASE								
MMCD 32 14 01	UNIT PAVING		yes	yes	product cut sheets, mockup 3.0m paved area on site				
CLS 4	GRADING AND DRAINAGE								
CLS 5	IRRIGATION			yes	as-constructed drawings, submissions				
CLS 6	GROWING MEDIUM			yes	supplier name, growing medium test results				
CLS 7	LAWNS AND GRASS (HYDRAULIC SEEDING)			yes	supplier name, product information				
CLS 8	TURFGRASS SOD			yes	supplier name, product information				
CLS 9	PLANTS AND PLANTING		yes	yes	nursery name, tree and shrub layout on site prior to planting				
CLS 10	MULCHING			yes	supplier name, product information				
CLS 11	LANDSCAPE OVER STRUCTURES - GREEN ROOFS								
CLS 12	CONTAINER GROWN PLANTS								
	CUSTOM SITE FURNITURE	yes		yes	shop drawings, colour samples				

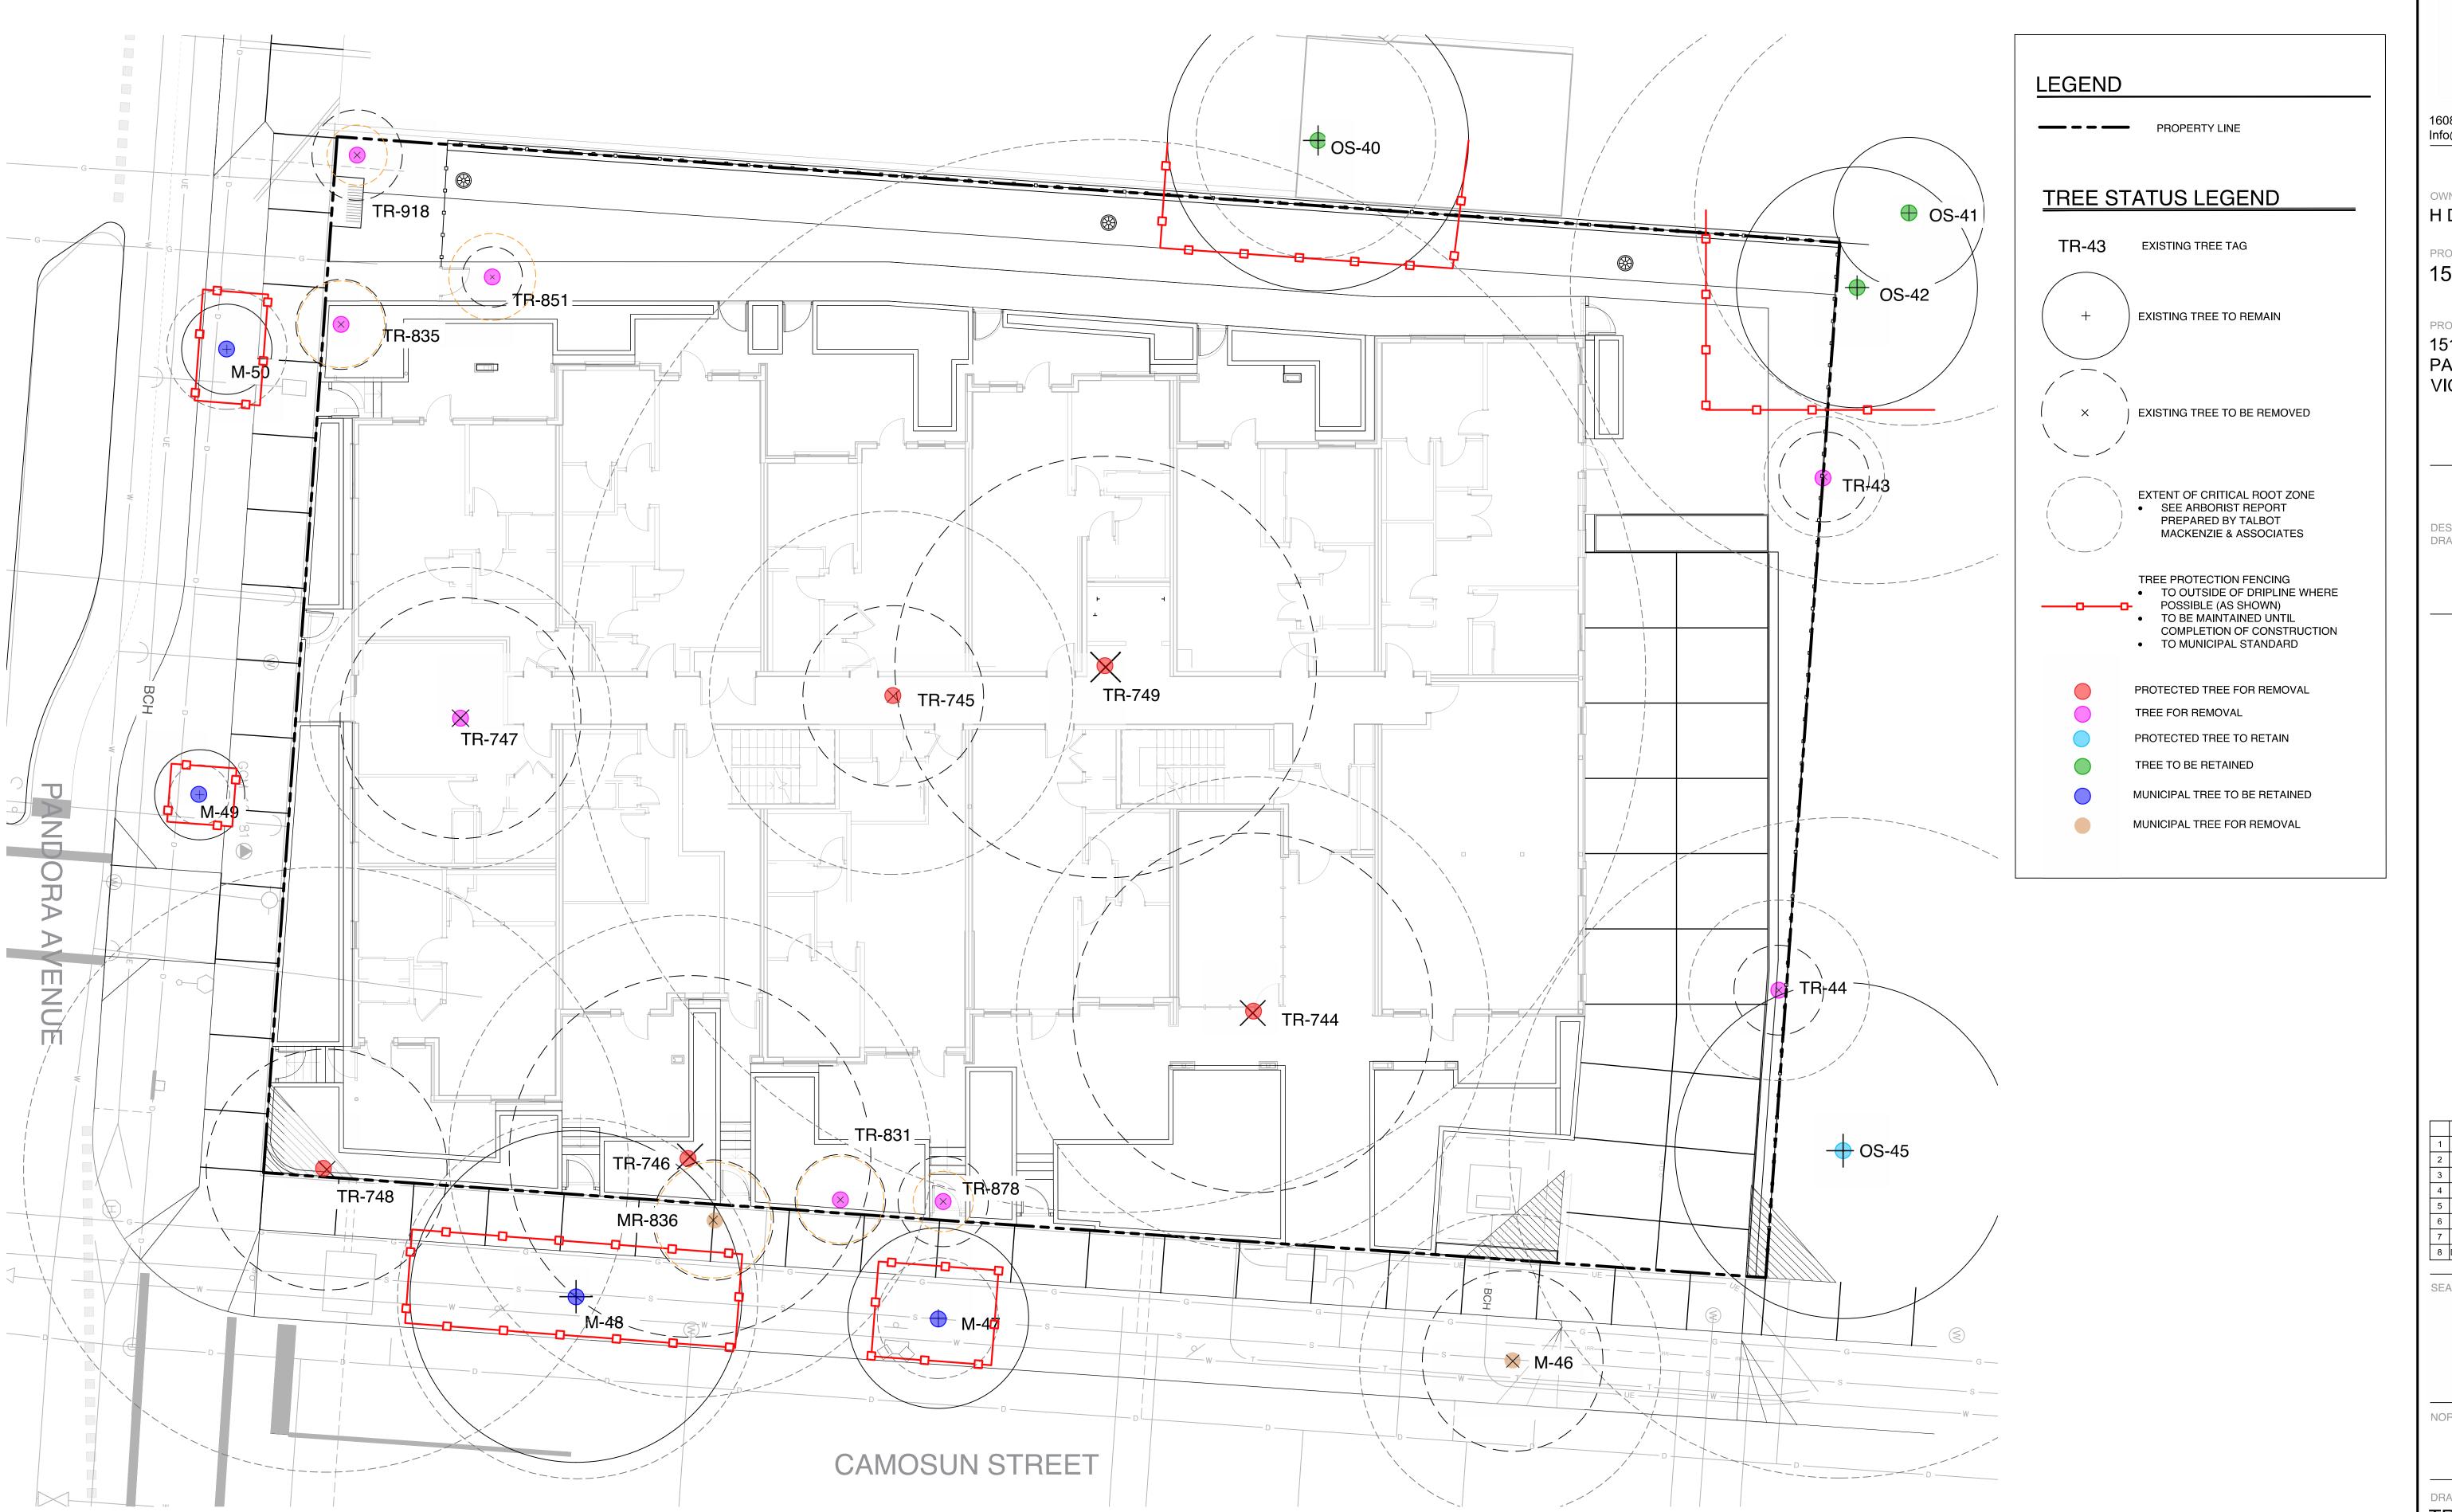



1608 Camosun Street, Victoria BC V8T 3E6 Info@biophiliacollective.ca 250 590 1156

OWNER/CLIENT:

H DEVELOPMENTS

PROJECT NAME:

1516 CAMOSUN ST.

PROJECT ADDRESS:

1516 CAMOSUN ST. 1270 & 1286 PANDORA AVE. VICTORIA, BC

DESIGNED BY: BIANCA BODLEY

DRAWN BY: GM

DEVELOPMENT PERMIT DEVELOPMENT PERMIT RESUBMISSION 23/02/08 DEVELOPMENT PERMIT RESUBMISSION 24/02/09 8 DEVELOPMENT PERMIT RESUBMISSION 25/01/22



DRAWING TITLE:

TREE MANAGEMENT PLAN LEVEL 1

SCALE: 1:100 LO.01

TREE INVENTORY TARLES

G&A Tree ID	Common Name	DBH (cm)	PRZr (m)	Crown Diameter (m)	Health	Structural Condition	Location	Retention Suitability	Species to lerance of disturbance	Comments	Action
OS-40	Cedar hedge	20	4	10	GOOD	GOOD	Off-site Non-Bylaw	SUITABLE	GOOD	Located above and behind ex. retaining wall	Retain
OS-41	Flowering cherry	49	7	5	COOD	POOR	Off-site Non-Bylaw	SUITABLE	POOR	Overmature	Retain
OS-42	Black pine	53	10	13	FAIR	GOOD	Off-site Non-Bylaw	SUITABLE	GCOD	:	Retain
43	American ash	22	4	3	FAIR	GOOD	Boundary Non-Bylaw	SUITABLE	MCDERATE	Conflicts with proposed parkade	Remove
44	White birch	16	3	3	Poor	FAIR	On-site Non-Bylaw	SUITABLE	POOR	Conflicts with proposed parkade	Remove
OS-45	Black pine	59	11	11	FAIR	GOOD	Off-site Bylaw	SUITABLE	GOOD		Retain
M-46	English hawthorn	27	5	6	GOOD	FAIR	Municipal Tree	SUITABLE	GCOD		Remove
M-47	Crablapple	10	2	6	GOOD	FAIR	Municipal Tree	SUITABLE	GCOD		Retain
M-48	English hawthorn	35	6	11	GOOD	FAIR	Municipal Tree	SUITABLE	GCOD		Retain
M-49	Deciduous sp.	8	1	3	©CD	GOOD	Municipal Tree	SUITABLE	MCDERATE		Retain
831	Lawson cypress	17	3	3	GOOD	GOOD	On-site Non-Bylaw	SUITABLE	GCOD		Remove
835	Flowering plum	16	3	3	GOOD	FAIR	On-site Non-Bylaw	SUITABLE	MODERATE	Recent crown reduction with heading cuts	Remove
851	Flowering plum	13	2	3	COOD	FAIR	On-site Non-Bylaw	SUITABLE	MODERATE	Recent crown reduction with heading cuts	Remove
878	Japanese cedar	16	3	2	GOOD	FAIR	On-site Non-Bylaw	SUITABLE	MODERATE		Remove
918	Flowering plum	15	3	2	GOOD	FAIR	On-site Non-Bylaw	SUITABLE	MCDERATE	Recent crown reduction with heading cuts	Remove
M-50	Deciduous sp.	12	2	3	GOOD	GOOD	Municipal Tree	SUITABLE	MCDERATE		Retain
744	Ash sp.	47	8	12	GOOD	FAIR	On-site Bylaw	UNSUITABLE	MODERATE	Located within proposed building footprint	Remove
745	Red cedar	32	6	6	GOOD	GOOD	On-site Bylaw	SUITABLE	GCOD	Located within proposed building footprint	Remove
746	Flowering plum	45	8	12	FAIR	POOR	On-site Bylaw	UNSUITABLE	POOR	Located within proposed building footprint. Significant decay within main stem.	Remove - Hazard Tree
M-836	English yew	20	4	4	Poor	POOR	Municipal Tree	SUITABLE	GCOD	Co-dependent with Tree 746. Conflicts with proposed parkadle.	Remove
747	Apple sp.	27	5	8	FAIR	FAIR	On-site Non-Bylaw	SUITABLE	GCOD	Located within proposed building footprint	Remove
748	Laburnum sp.	55	10	8	GOOD	FAIR	On-site Bylaw	UNSUITABLE	GCOD	Located within proposed building footprint	Remove
749	Red cedar	99	18	14	GOOD	GOOD	On-site Bylaw	SUITABLE	MCDERATE	Located within proposed building footprint	Remove

1	PROTECTED TREE IMPACT SUMMARY TABLE (focus on Replacement trees)									
1	A	В	С	0	E	F				
Tree Status	Total # of Bylaw Protected Trees	Total # of Bylaw Protected Trees to be REMOVED	Total # of Replacement and Landscape Trees to be Planted*	# of EXISTING Non-Protected Trees Nominated as Replacement Trees	RESIDUAL (POST-CONSTRUCTION) TREE TOTAL (A-B+C+D)	NET CHANGE (C+D)-E				
Onsite trees	5	5	24	0	24	19				
Offsite trees	4	0	0	0	4	0				
Municipal trees	6	2	2	0	6	0				
Tota	15	7	26	0	34	19				

volume is insufficient, replacement trees will not be permitted.

SUPPLEMENTARY STANDARD DETAIL DRAWINGS 38mm x 89mm TOP RAIL SIGN MUST BE ATTACHED TO FENCE; SEE BELOW NOTES FOR WORDING 38x89mm BOTTOM RAIL N 38x89mm POST —— TIES OR STAPLES TO SECURE MESH TREE PROTECTION FENCING FENCE WILL BE CONSTRUCTED USING 38 mm X 89mm WOOD FRAME; TOP, BOTTOM AND POSTS * USE ORANGE SNOW-FENCING MESH AND SECURE THE WOOD FRAME WITH ZIP* TIES OR GALVANIZED STAPLES 2. ATTACH A 500mm X 500mm SIGN WITH THE FOLLOWING WORDING: WARNING-TREE PROTECTION AREA THIS SIGN WUST BE AFFIXED ON EVERY FENCE OR AT LEAST EVERY 10 LINEAR METERS IN ROCKY AREAS, METAL POSTS (T-BAR OR REBAR) DRILLED INTO ROCK WILL BE ACCEPTED REVISIONS DRAWING NUMBER: TREE PROTECTION FENCING SD P1 AND SIGNAGE DETAIL



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DESIGNED BY: BIANCA BODLEY DRAWN BY: GM

ISSUED FOR DEVELOPMENT PERMIT DEVELOPMENT PERMIT RESUBMISSION 22/04/04 3 DEVELOPMENT PERMIT RESUBMISSION 22/12/19 4 DEVELOPMENT PERMIT RESUBMISSION 23/02/08 5 ISSUED FOR BUILDING PERMIT 6 DEVELOPMENT PERMIT RESUBMISSION 24/02/09 7 DEVELOPMENT PERMIT RESUBMISSION 24/12/17 8 DEVELOPMENT PERMIT RESUBMISSION 25/01/22





NORTH ARROW



TREE MANAGEMENT PLAN



1 \ MATERIALS PLAN FOR LEVEL 1

1:100

LEGEND

UNDERGROUND PARKING SLAB FENCE LINE

MATERIALS SCHEDULE LEVEL

SYMBOL DESCRIPTION <u>QTY</u> PAVING TYPE 1: CIP CONCRETE 52.6 m² -PEDESTRIAN GRADE -NATURAL COLOR -SMOOTH FINISH -SAWCUT PATTERN TO MATERIALS PLAN PAVING TYPE 2: CONCRETE UNIT PAVERS 175.4 m² -NEWSTONE COASTAL SLATE PAVERS -COLOR: BIRCHWOOD PAVING TYPE 3: CONCRETE UNIT PAVERS 114.6 m² -NEWSTONE COASTAL SLATE PAVERS -COLOR: WINTER SKY 259.5 m² PLANTED AREAS -REFER TO PLANTING PLAN RAINGARDEN 79.5 m² -STORMWATER MANAGEMENT AREA -REFER TO SECTIONS AND DETAILS 12.2 m² MAINTAINANCE STRIP -PEBBLE MULCH

-COLOR SALT AND PEPPER

SOD - MUNICIPAL BOULEVARD AREA

-TO CITYOF VICTORIA STANDARD

SPECIFICATIONS AND DETAILS

238.6 m²

222.9 m²

MUNICIPAL SIDEWALK

-CIP CONCRETE -SEE CIVIL

TREE SCHEDULE



MATERIALS PLAN NOTES

1. REFER TO CIVIL FOR WORKS ON MUNICIPAL SIDEWALKS 2. REFER TO SECTIONS AND DETAILS FOR LANDSCAPE

LANDSCAPE NOTES

IRRIGATION

- SEE IRRIGATION PLANS, DETAILS AND WRITTEN
- **SPECIFICATIONS**
- ALL ON-SITE PLANTED BEDS AND TREES TO BE IRRIGATED BY AN AUTOMATIC IRRIGATION SYSTEM.

PROPOSED BOULEVARD TREES

- TREE SPECIES TO BE COORDINATED WITH PARKS PRIOR TO
- TREES MUST HAVE ONE DOMINANT CENTRAL LEADER OR SINGLE STRAIGHT TRUNK, 5-8 cm DIAMETER, CALIPER MEASURED 15 cm ABOVE GROUND, WELL BALANCED CROWN WITH BRANCHING STARTING AT 1.8m-2.5m ABOVE GROUND
- TREES TO BE PLANTED AS PER PLANTIG OF TREES, SHRUBS AND GROUND COVERS (32 93 01 MMCD 2009 AND CITY OF VICTORIA SUPPLEMENTAL DRAWINGS SD P3 AND SD P4)
- PROPOSED STREET TREES MUST COMPLY TO CITY OF VICTORIA SUPPLEMENTARY SPECIFICATIONS FOR STREET TREES AND IRRIGATION SCHEDULE C, BYLAW 12-042, SUBDIVISION BYLAW AND THE CURRENT VERSION OF THE CANADIAN LANDSCAPE STANDARD. PLANTING DETAILS CAN BE FOUND IN SCHEDULE B3-4 OR ON THE APPROVED LANDSCAPE PLAN. THE FOLLOWING TREE INSPECTIONS BY PARKS STAFF ARE REQUIRED BY SCHEDULE C. TO SCHEDULE AN INSPECTION PLEASE CONTACT ROB HUGHES, RHUGHES@VICTORIA.CA AND ALSO COPY
- TREEPERMITS@VICTORIA.CA 48 HOURS PRIOR TO THE REQUIRED INSPECTION TIME. TREE PLANTING INSPECTIONS
- 1. EXCAVATED TREE PITS, SOIL CELLS, ROOT BARRIERS 2. TREES PRIOR TO PLANTING. (PARKS STAFF CAN INSPECT TREES PRIOR TO SHIPPING AT LOCAL NURSERIES. PHOTOS CAN BE PROVIDED FROM UP-ISLAND AND MAINLAND NURSERIES. TREE

MUST MEET THE SPEC UPON DELIVERY.) 3. COMPLETED PLANTING - TREE PLANTING GRATE/GUARD, STAKES ETC.

- THE APPLICANT IS RESPONSIBLE FOR PROCURING AND PLANTING THE PROPOSED BOULEVARD TREES.
- THE APPLICANT MUST MAINTAIN THE TREE IN GOOD HEALTH AND STRUCTURAL CONDITION FOR 1 YEAR FROM THE SUBSTANTIAL COMPLETION TO BE ELIGIBLE FOR DEPOSIT

RETURN. BOULEVARD IRRIGATION

- SEE IRRIGATION PLAN
- MUNICIPAL BOULEVARD TO BE IRRIGATED BY A SEPARATE SYSTEM FROM A SEPARATE CITY SOURCE CONFORMING TO THE CITY OF VICTORIA SUPPLEMENTARY
- SPECIFICATIONS FOR STREET TREES AND IRRIGATION SCHEDULE C TO BYLAW 12-042, SUBDIVISION BYLAW. • IRRIGATION DESIGN DRAWINGS MUST BE SENT TO PARKS
- FOR REVIEW 30 DAYS PRIOR TO INSTALLATION. • DRAWINGS SHOULD INDICATE ALL COMPONENTS, MODELS AND MATERIALS FROM WATER SUPPLY TO IRRIGATION
- THE CITY WILL REQUIRE 4 INSPECTIONS FOR IRRIGATION INSTALLATION: 1)SLEEVING, 2) OPEN TRENCH MAINLINE AND PRESSURE TEST, 3) OPEN TRENCH AND LATERAL LINE, 4) OPERATION AND COVERAGE, AND BACKFLOW PREVENTER ASSEMBLY TEST REPORT.



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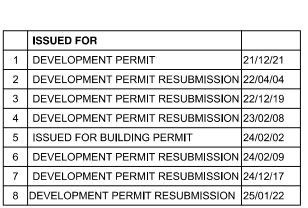
1516 CAMOSUN ST

PROJECT ADDRESS:

1516 CAMOSUN ST. 1270 & 1286 PANDORA AVE. VICTORIA, BC

DESIGNED BY: BIANCA BODLEY

DRAWN BY: GM







DRAWING TITLE:

MATERIALS PLAN LEVEL 1

DWG NO:

MATERIALS SCHEDULE LEVEL 4

SYMBOL DESCRIPTION


PAVING TYPE 4: CONCRETE SLABS ON PEDESTAL
-BELGARD TEXADA PAVER
-COLOR: NATURAL
-SCREWJACK PEDESTAL SYSTEM

PAVING TYPE 5: PEA GRAVEL

92.9


CONCRETE CURB

PRIVACY SCREEN

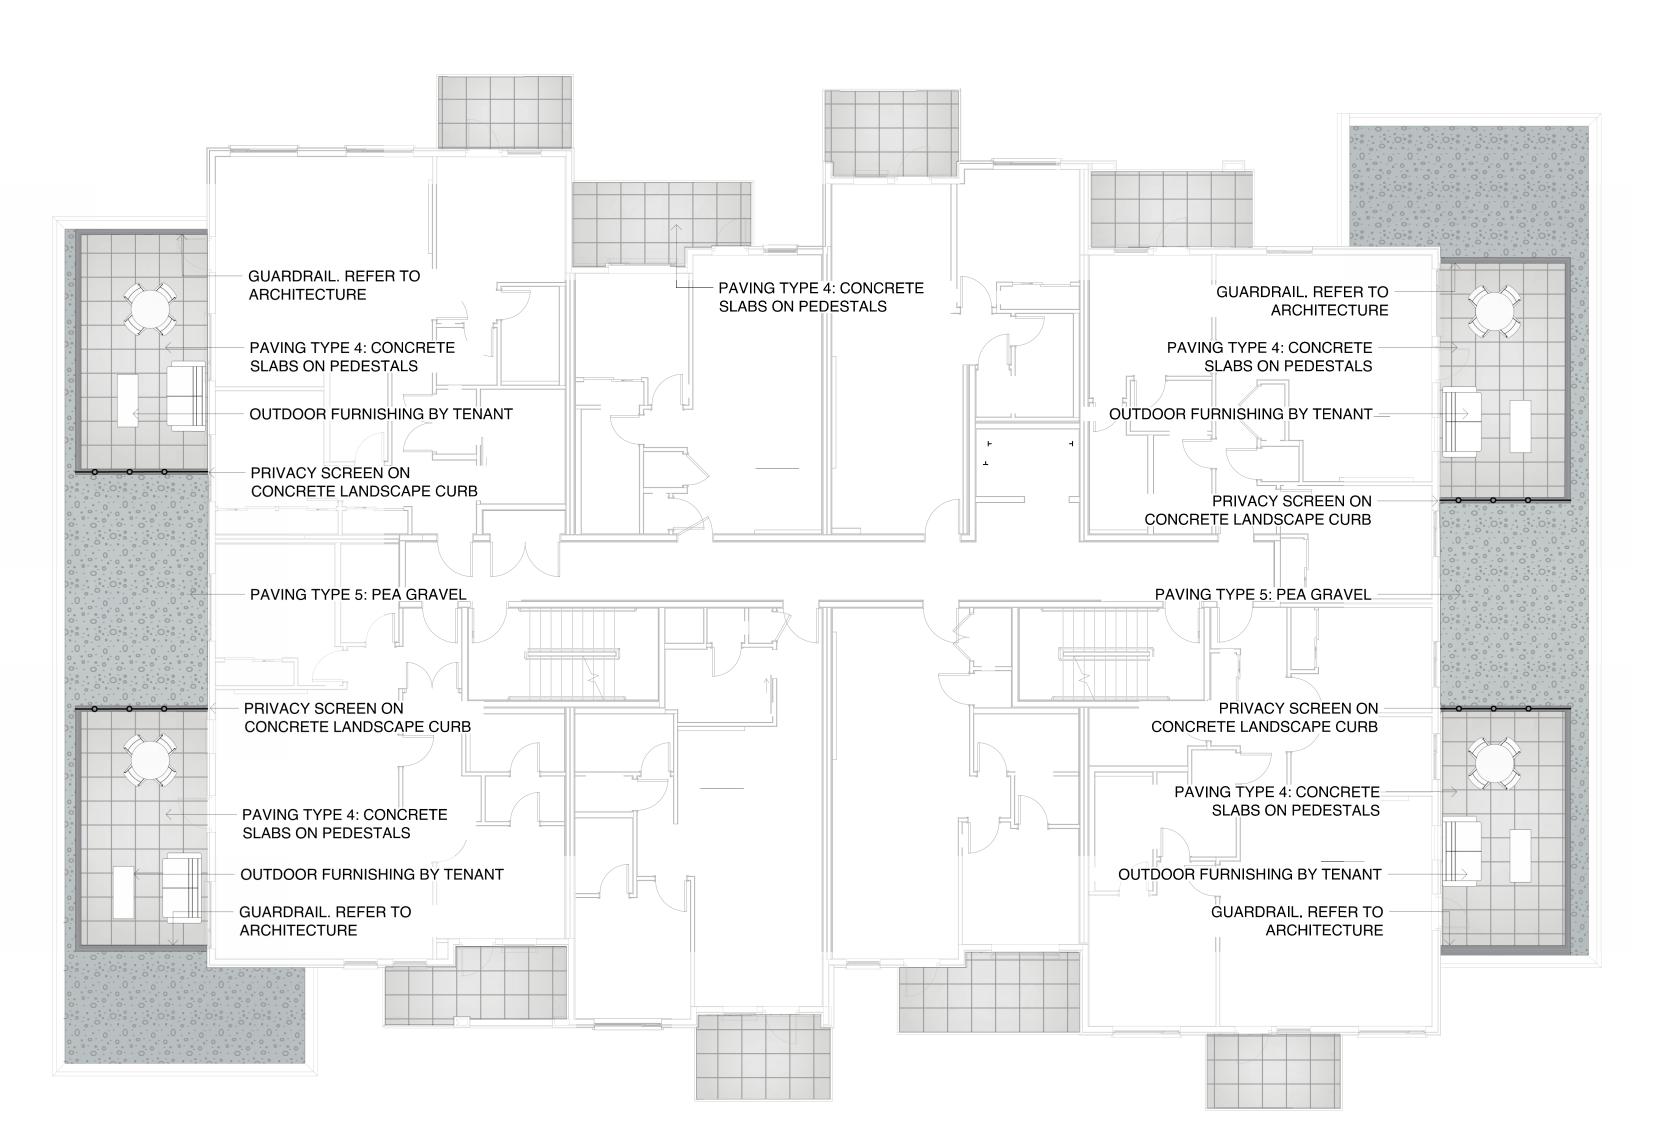

1 MATERIALS PLAN - LEVEL 4



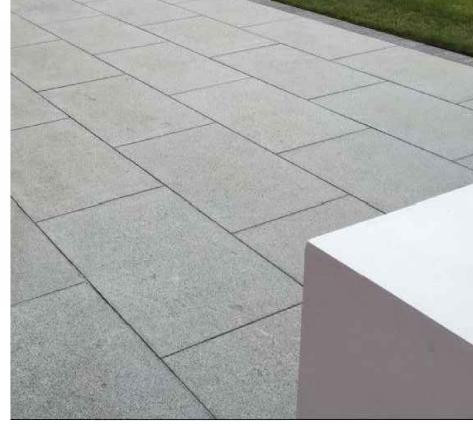

MATERIALS SCHEDULE LEVEL 5

SYMBOL DESCRIPTION


PAVING TYPE 4: CONCRETE SLABS ON PEDESTAL
-BELGARD TEXADA PAVER
-COLOR: NATURAL
-SCREWJACK PEDESTAL SYSTEM

PAVING TYPE 5: PEA GRAVEL

86.6 m²

CONCRETE CURB

PRIVACY SCREEN

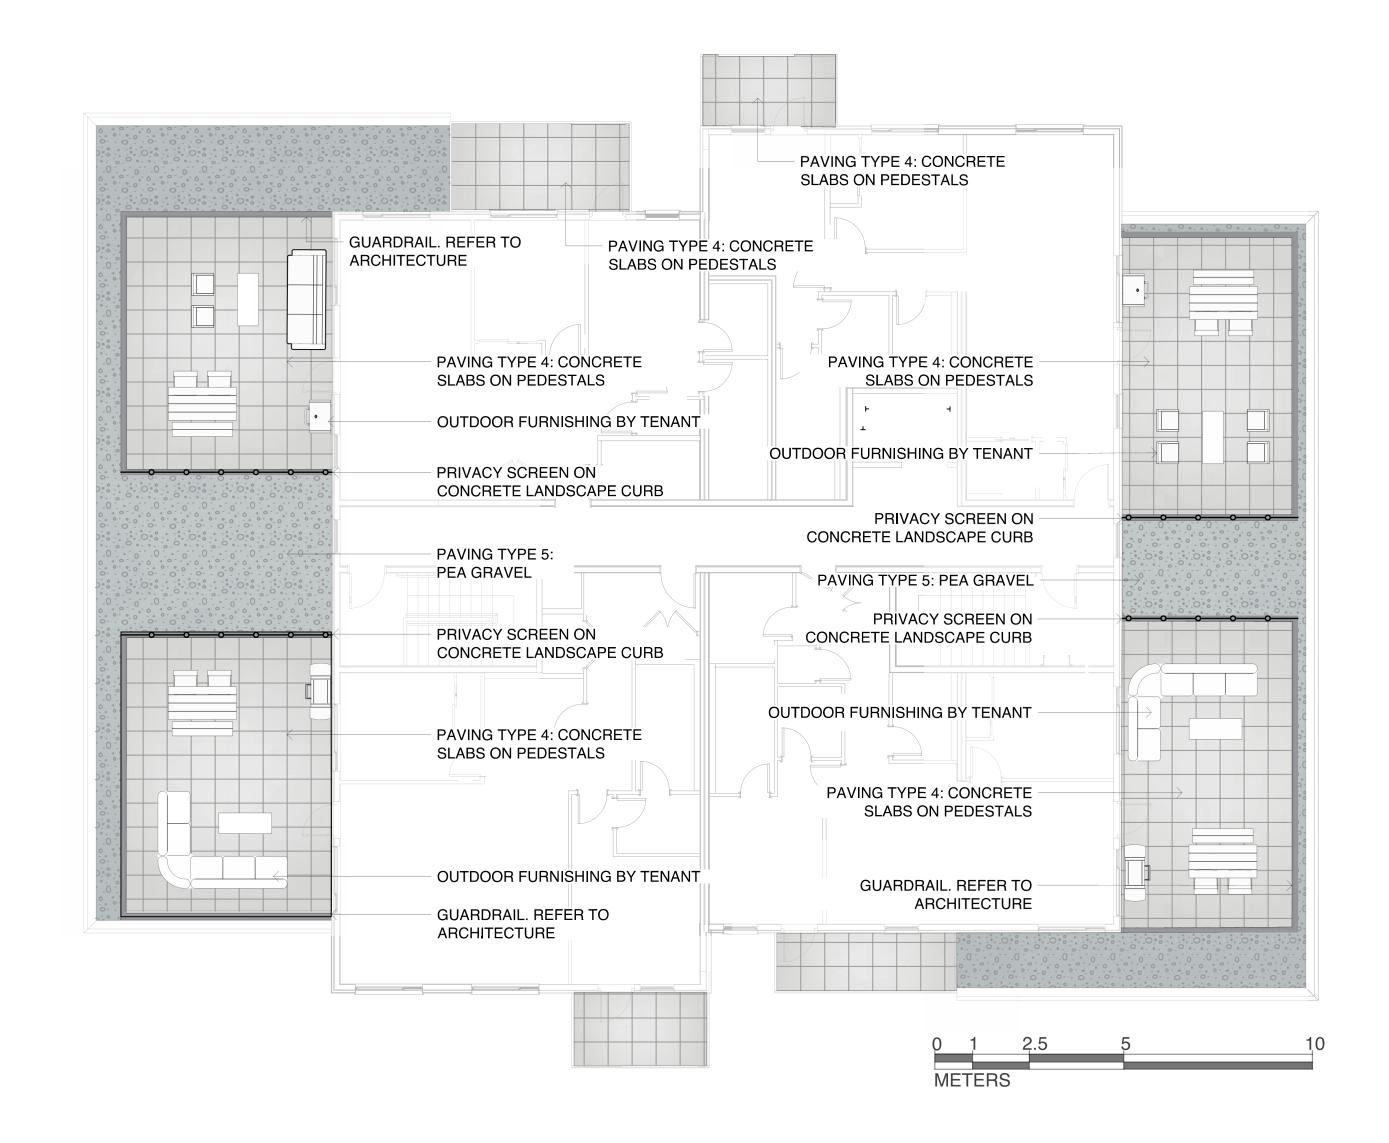

2 MATERIALS PLAN - LEVEL 5 1:100

MATERIALS PLAN NOTES

 REFER TO SECTIONS AND DETAILS FOR LANDSCAPE IMPROVEMENTS



1608 Camosun Street, Victoria BC V8T 3E6 Info@biophiliacollective.ca 250 590 1156

OWNER/CLIENT:

H DEVELOPMENTS

PROJECT NAME:

1516 CAMOSUN ST.


PROJECT ADDRESS:

1516 CAMOSUN ST. 1270 & 1286 PANDORA AVE. VICTORIA, BC

DESIGNED BY: BIANCA BODLEY DRAWN BY: GM

ISSUED FOR

1 DEVELOPMENT PERMIT 21/12/21
2 DEVELOPMENT PERMIT RESUBMISSION 22/04/04
3 DEVELOPMENT PERMIT RESUBMISSION 22/12/19
4 DEVELOPMENT PERMIT RESUBMISSION 23/02/08
5 ISSUED FOR BUILDING PERMIT 24/02/02
6 DEVELOPMENT PERMIT RESUBMISSION 24/02/09
7 DEVELOPMENT PERMIT RESUBMISSION 24/12/17
8 DEVELOPMENT PERMIT RESUBMISSION 25/01/22

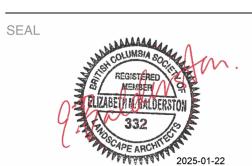

NORTH ARROW

LEVEL 4&5

DRAWING TITLE:


MATERIALS PLAN

DWG NO:

SCALE: 1:100 L1.02

LEGEND

PROPERTY LINE

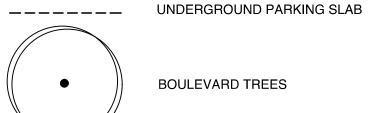

BOULEVARD TREES

PLANT SCHEDULE LEVEL 1

. —,	• • • • • • • • • • • • • • • • • • • •					
SYMBOL	CODE	BOTANICAL / COMMON NAME	SIZE	SPACING	<u>QTY</u>	REMARKS
TREES						
	AC2	Acer circinatum / Vine Maple	60mm Cal.	As Shown	3	B&B, Well Established
(·)	AG	Acer griseum / Paperbark Maple	60mm Cal.	As Shown	8	B&B, Well Established
	AA2	Acer rubrum `Armstrong` / Armstrong Red Maple	60mm Cal.	As Shown	5	B&B, Well Established
	CJ	Cercidiphyllum japonicum / Katsura Tree	60mm Cal.	As Shown	3	B&B, Well Established
777 • C.C.C.C.C.C.C.C.C.C.C.C.C.C.C.C.C.C.C	CG	Chamaecyparis nootkatensis 'Green Arrow' / Green Arrow Nootka Cypress	150cm Ht.	As Shown	3	B&B, Well Established
£	QG	Quercus garryana / Oregon White Oak	60mm Cal.	As Shown	2	B&B, Well Established
SYMBOL	CODE	BOTANICAL / COMMON NAME	<u>SIZE</u>	SPACING	<u>QTY</u>	<u>REMARKS</u>
SHRUBS						
	Am	Arctostaphylos uva-ursi 'Massachusetts' / Massachusetts Kinnikinnick	#2	1200 mm.	28	Well Established
£ • }	Ct	Choisya ternata / Mexican Orange	#3	1500 mm.	12	Well Established
	Cf	Cornus sericea 'Farrow' / Arctic Fire® Red Twig Dogwood	#2	1200 mm.	20	Well Established
(0)	Gs	Gaultheria shallon / Salal	#2	750 mm	40	Well Established
$\widetilde{\bigcirc}$	Рр	Pinus mugo 'Pumilio' / Dwarf Mugo Pine	#2	1000 mm	37	Well Established
WWWWWWWWWWWWWWWWWWWWWWWWWWWWWWWWWWWWWW	Pc	Prostanthera cuneata / Alpine Mint Bush	#2	1200 mm.	43	Well Established
(+)	Rs	Ribes sanguineum / Red Flowering Currant	#2	1500 mm.	10	Well Established
+	Sd	Spiraea douglasii / Western Spirea	#2	600 mm.	91	Well Established
$\widetilde{\langle \cdot \rangle}$	Th	Taxus x media 'Hicksii' / Hicks Anglo-Japanese Yew	#2	750 mm	9	Well Established
Ö	Vo	Vaccinium ovatum / Evergreen Huckleberry	#2	1200 mm.	42	Well Established
EEDNIC						
FERNS	Aa	Adiantum aleuticum / Western Maidenhair Fern	#2	600 mm.	31	Well Established
	Pm	Polystichum munitum / Western Sword Fern	#2	750 mm	121	Well Established
	Pp2	Polystichum polyblepharum / Japanese Tassel Fern	#2	750 mm	36	Well Established
W	•					
<u>GRASSES</u> پىر	-					
4 + E	MI	Miscanthus sinensis 'Little Kitten' / Little Kitten Eulalia Grass	#2	450 mm.	37	Well Established
PERENNIA	<u>ALS</u>					
\odot	Ac	Asarum caudatum / Wild Ginger	#1	300 mm	56	Well Established
\bigcirc	Ec	Erica carnea / Winter Heath	#1	450 mm.	90	Well Established
•	Or	Oxalis oregana / Redwood Sorrel	#1	300 mm	107	Well Established
$\overline{(\cdot)}$	Rh	Rudbeckia hirta / Black-eyed Susan	#1	450 mm.	36	Well Established
$\overline{\bigcirc}$	Тр	Thymus pseudolanuginosus / Woolly Thyme	#1	300 mm	38	Well Established
VINE/ESP	ALIER					
·	Hc	Hydrangea anomala / Climbing Hydrangea	#1	750 mm	7	Well Established

PLANTING PLAN NOTES

- ALL PLANT MATERIAL TO BCSLA STANDARDS.
- 2. THE SEARCH AREA FOR PLANT MATERIAL IS THE PACIFIC NORTHWEST INCLUDING WASHINGTON, OREGON AND BRITISH COLUMBIA.
- 3. CONFIRM PLANTING LAYOUT WITH LANDSCAPE ARCHITECT ON SITE.
- 4. ALL SOIL VOLUMES TO MEET THE STANDARDS OF THE CITY OF VICTORIA. REFER TO
- SOIL DEPTH PLANS FOR SOIL DEPTH REQUIREMENTS.
- THE APPLICANT IS RESPONSIBLE FOR PROCURING AND PLANTING THE PROPOSED BOULEVARD TREES.



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PROJECT ADDRESS:

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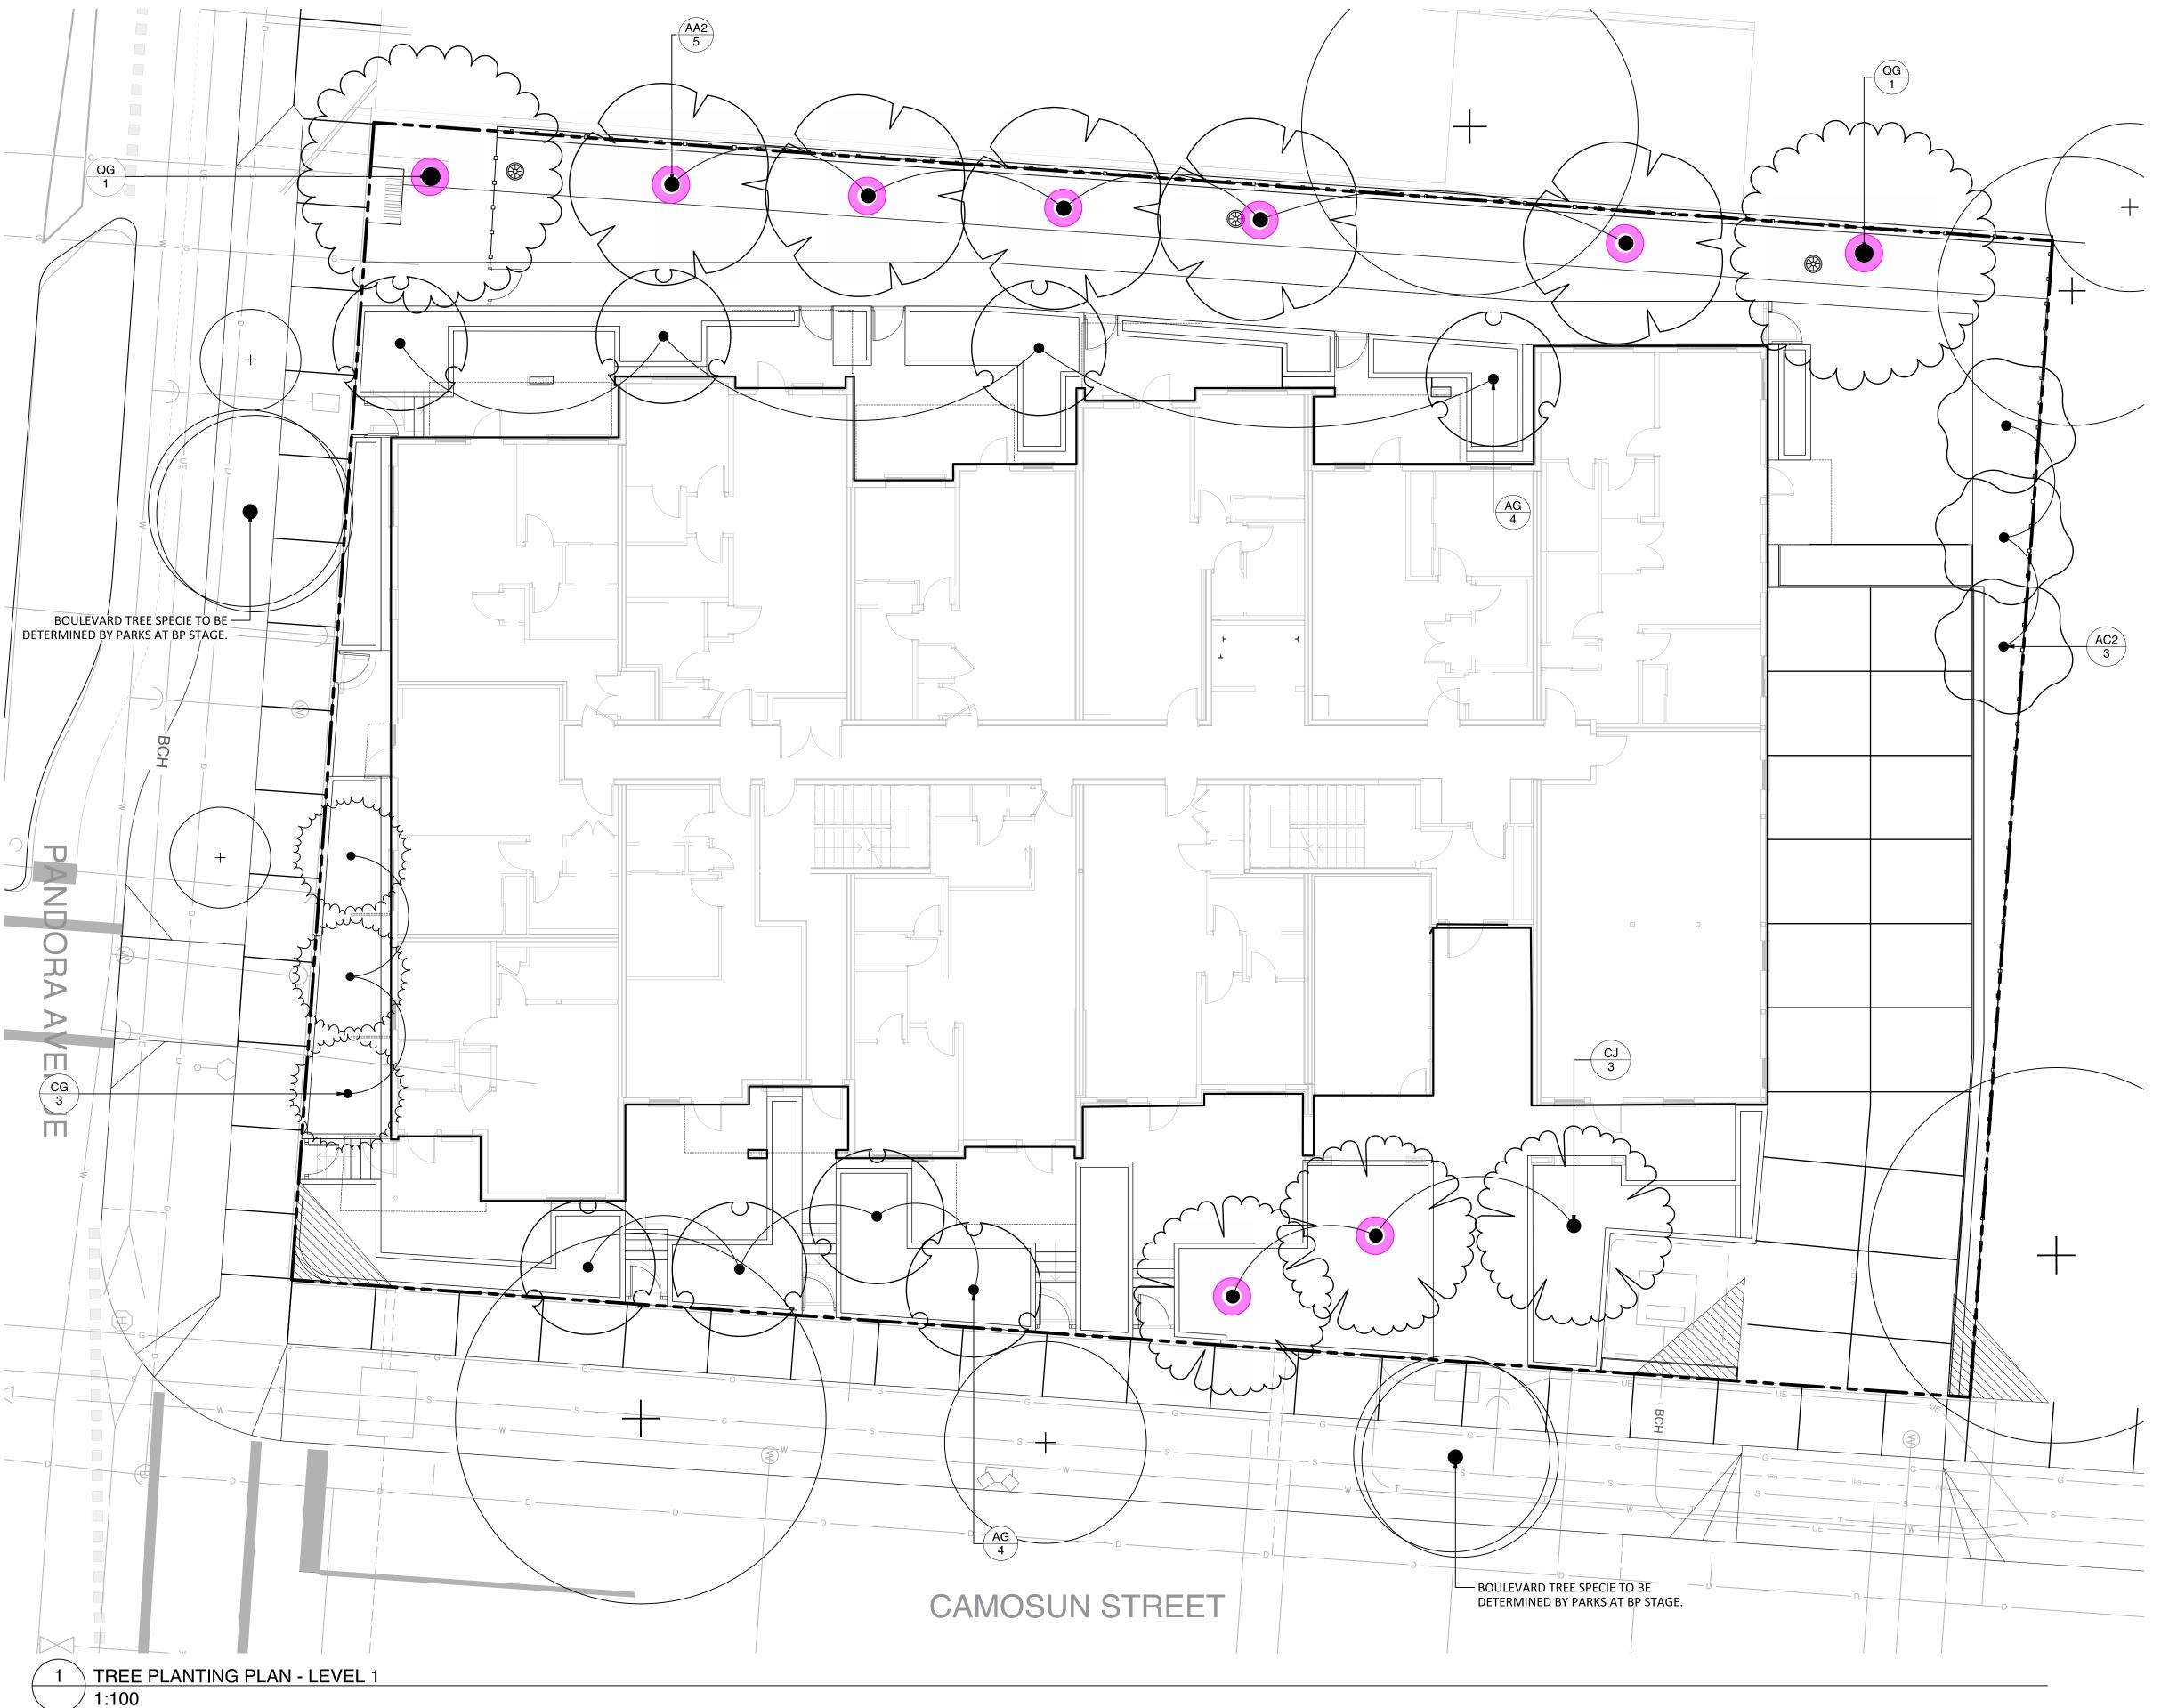
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		-

NORTH ARROW

DRAWING TITLE:

PLANTING SCHEDULE LEVEL 1

DWG NO:



PLANTING PLAN NOTES


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- ARCHITECT ON SITE. 4. ALL SOIL VOLUMES TO MEET THE STANDARDS OF THE CITY OF VICTORIA. REFER TO SOIL DEPTH PLANS FOR
- SOIL DEPTH REQUIREMENTS. 5. THE APPLICANT IS RESPONSIBLE FOR PROCURING AND PLANTING PROPOSED BOULEVARD TREES.

LEGEND

PROPERTY LINE

UNDERGROUND PARKING SLAB

REPLACEMENT TREE

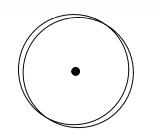

BOULEVARD TREES

PLANT SCHEDULE LEVEL 1

SYMBOL CODE BOTANICAL / COMMON NAME

Acer circinatum / Vine Maple

Acer rubrum `Armstrong` / Armstrong Red Ma

Acer griseum / Paperbark Maple

Chamaecyparis nootkatensis 'Green Arrow' / (

Cercidiphyllum japonicum / Katsura Tree

Quercus garryana / Oregon White Oak

LANDSCAPE NOTES

IRRIGATION

• SEE IRRIGATION PLANS, DETAILS AND WRITTEN

SPECIFICATIONS ALL ON-SITE PLANTED BEDS AND TREES TO BE IRRIGATED BY AN AUTOMATIC IRRIGATION SYSTEM.

PROPOSED BOULEVARD TREES

TREE SPECIES TO BE COORDINATED WITH PARKS PRIOR TO

- PLANTING TREES MUST HAVE ONE DOMINANT CENTRAL LEADER OR SINGLE STRAIGHT TRUNK, 5-8 cm DIAMETER, CALIPER MEASURED 15 cm ABOVE GROUND, WELL BALANCED CROWN
- WITH BRANCHING STARTING AT 1.8m-2.5m ABOVE GROUND TREES TO BE PLANTED AS PER PLANTIG OF TREES, SHRUBS AND GROUND COVERS (32 93 01 MMCD 2009 AND CITY OF VICTORIA SUPPLEMENTAL DRAWINGS SD P3 AND SD P4)
- PROPOSED STREET TREES MUST COMPLY TO CITY OF VICTORIA SUPPLEMENTARY SPECIFICATIONS FOR STREET TREES AND IRRIGATION SCHEDULE C, BYLAW 12-042, SUBDIVISION BYLAW AND THE CURRENT VERSION OF THE CANADIAN LANDSCAPE STANDARD. PLANTING DETAILS CAN BE FOUND IN SCHEDULE B3-4 OR ON THE APPROVED LANDSCAPE PLAN. THE FOLLOWING TREE INSPECTIONS BY PARKS STAFF ARE REQUIRED BY SCHEDULE C. TO SCHEDULE AN INSPECTION PLEASE CONTACT ROB HUGHES, RHUGHES@VICTORIA.CA AND ALSO COPY TREEPERMITS@VICTORIA.CA 48 HOURS PRIOR TO THE

REQUIRED INSPECTION TIME. TREE PLANTING INSPECTIONS 1. EXCAVATED TREE PITS, SOIL CELLS, ROOT BARRIERS

2. TREES PRIOR TO PLANTING. (PARKS STAFF CAN

NURSERIES. PHOTOS CAN BE PROVIDED FROM UP-ISLAND AND MAINLAND NURSERIES. TREE MUST MEET THE SPEC UPON DELIVERY.) 3. COMPLETED PLANTING - TREE PLANTING

INSPECT TREES PRIOR TO SHIPPING AT LOCAL

THE APPLICANT IS RESPONSIBLE FOR PROCURING AND

GRATE/GUARD, STAKES ETC.

PLANTING THE PROPOSED BOULEVARD TREES. THE APPLICANT MUST MAINTAIN THE TREE IN GOOD HEALTH AND STRUCTURAL CONDITION FOR 1 YEAR FROM THE SUBSTANTIAL COMPLETION TO BE ELIGIBLE FOR DEPOSIT RETURN.

- BOULEVARD IRRIGATION
- SEE IRRIGATION PLAN MUNICIPAL BOULEVARD TO BE IRRIGATED BY A SEPARATE SYSTEM FROM A SEPARATE CITY SOURCE CONFORMING TO THE CITY OF VICTORIA SUPPLEMENTARY SPECIFICATIONS FOR STREET TREES AND IRRIGATION SCHEDULE C TO BYLAW 12-042, SUBDIVISION BYLAW.
- IRRIGATION DESIGN DRAWINGS MUST BE SENT TO PARKS FOR REVIEW 30 DAYS PRIOR TO INSTALLATION. DRAWINGS SHOULD INDICATE ALL COMPONENTS, MODELS AND MATERIALS FROM WATER SUPPLY TO IRRIGATION
- HEADS. THE CITY WILL REQUIRE 4 INSPECTIONS FOR IRRIGATION INSTALLATION: 1)SLEEVING, 2) OPEN TRENCH MAINLINE AND PRESSURE TEST, 3) OPEN TRENCH AND LATERAL LINE, 4) OPERATION AND COVERAGE, AND BACKFLOW PREVENTER ASSEMBLY TEST REPORT.



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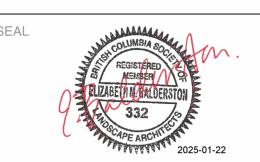
1516 CAMOSUN ST

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DESIGNED BY: BIANCA BODLEY DRAWN BY: GM

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NORTH ARROW

DRAWING TITLE:

TREE PLANTING PLAN LEVEL 1




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LEGEND

PROPERTY LINE

UNDERGROUND PARKING SLAB

REPLACEMENT TREE

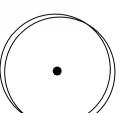

BOULEVARD TREES

PLANT SCHEDULE LEVEL 1

SYMBOL CODE BOTANICAL / COMMON NAME

AC2 Acer circinatum / Vine Maple

Acer griseum / Paperbark Maple

Acer rubrum 'Armstrong' / Armstrong Red Maple

Cercidiphyllum japonicum / Katsura Tree

Chamaecyparis nootkatensis 'Green Arrow' / Green Arrow Nootka Cypress

Quercus garryana / Oregon White Oak

SYMBOL CODE BOTANICAL / COMMON NAME

Arctostaphylos uva-ursi 'Massachusetts' / Massachusetts Kinnikinnick

Choisya ternata / Mexican Orange

Cornus sericea 'Farrow' / Arctic Fire® Red Twig Dogwood

Gaultheria shallon / Salal

Pinus mugo 'Pumilio' / Dwarf Mugo Pine

Prostanthera cuneata / Alpine Mint Bush

Ribes sanguineum / Red Flowering Currant

Spiraea douglasii / Western Spirea

Taxus x media 'Hicksii' / Hicks Anglo-Japanese Yew

Vaccinium ovatum / Evergreen Huckleberry

Adiantum aleuticum / Western Maidenhair Fern

Polystichum polyblepharum / Japanese Tassel Fern

GRASSES

Miscanthus sinensis 'Little Kitten' / Little Kitten Eulalia Grass

Polystichum munitum / Western Sword Fern

Asarum caudatum / Wild Ginger

Erica carnea / Winter Heath

Oxalis oregana / Redwood Sorrel

Rudbeckia hirta / Black-eyed Susan

Thymus pseudolanuginosus / Woolly Thyme

Hydrangea anomala / Climbing Hydrangea

PLANTING PLAN NOTES

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- 2. THE SEARCH AREA FOR PLANT MATERIAL IS THE PACIFIC NORTHWEST INCLUDING
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- 4. ALL SOIL VOLUMES TO MEET THE STANDARDS OF THE CITY OF VICTORIA. REFER TO SOIL DEPTH PLANS FOR SOIL DEPTH REQUIREMENTS.

IRRIGATION NOTES:

- SEE IRRIGATION PLANS, DETAILS AND WRITTEN
- SPECIFICATIONS
- ALL ON-SITE PLANTED BEDS AND TREES TO BE IRRIGATED BY AN AUTOMATIC IRRIGATION SYSTEM.



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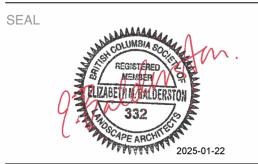
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DRAWING TITLE: PLANTING PLAN LEVEL 1

DWG NO:



1 SOIL DEPTH PLAN - LEVEL 1

1:100

LEGEND

PROPERTY LINE

UNDERGROUND PARKING SLAB

REPLACEMENT TREE (1:1)

146.8 m²

SOIL DEPTH SCHEDULE LEVEL 1

SYMBOL DESCRIPTION <u>QTY</u> 1000 MM MIN SOIL DEPTH 366.1 m² 450 MM MIN SOIL DEPTH 38.0 m²

150 MM MIN SOIL DEPTH

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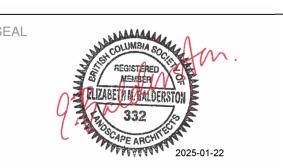
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NORTH ARROW




DRAWING TITLE:

SOIL DEPTH PLAN

LEVEL 1

DWG NO:

SCALE: 1:100 L3.11

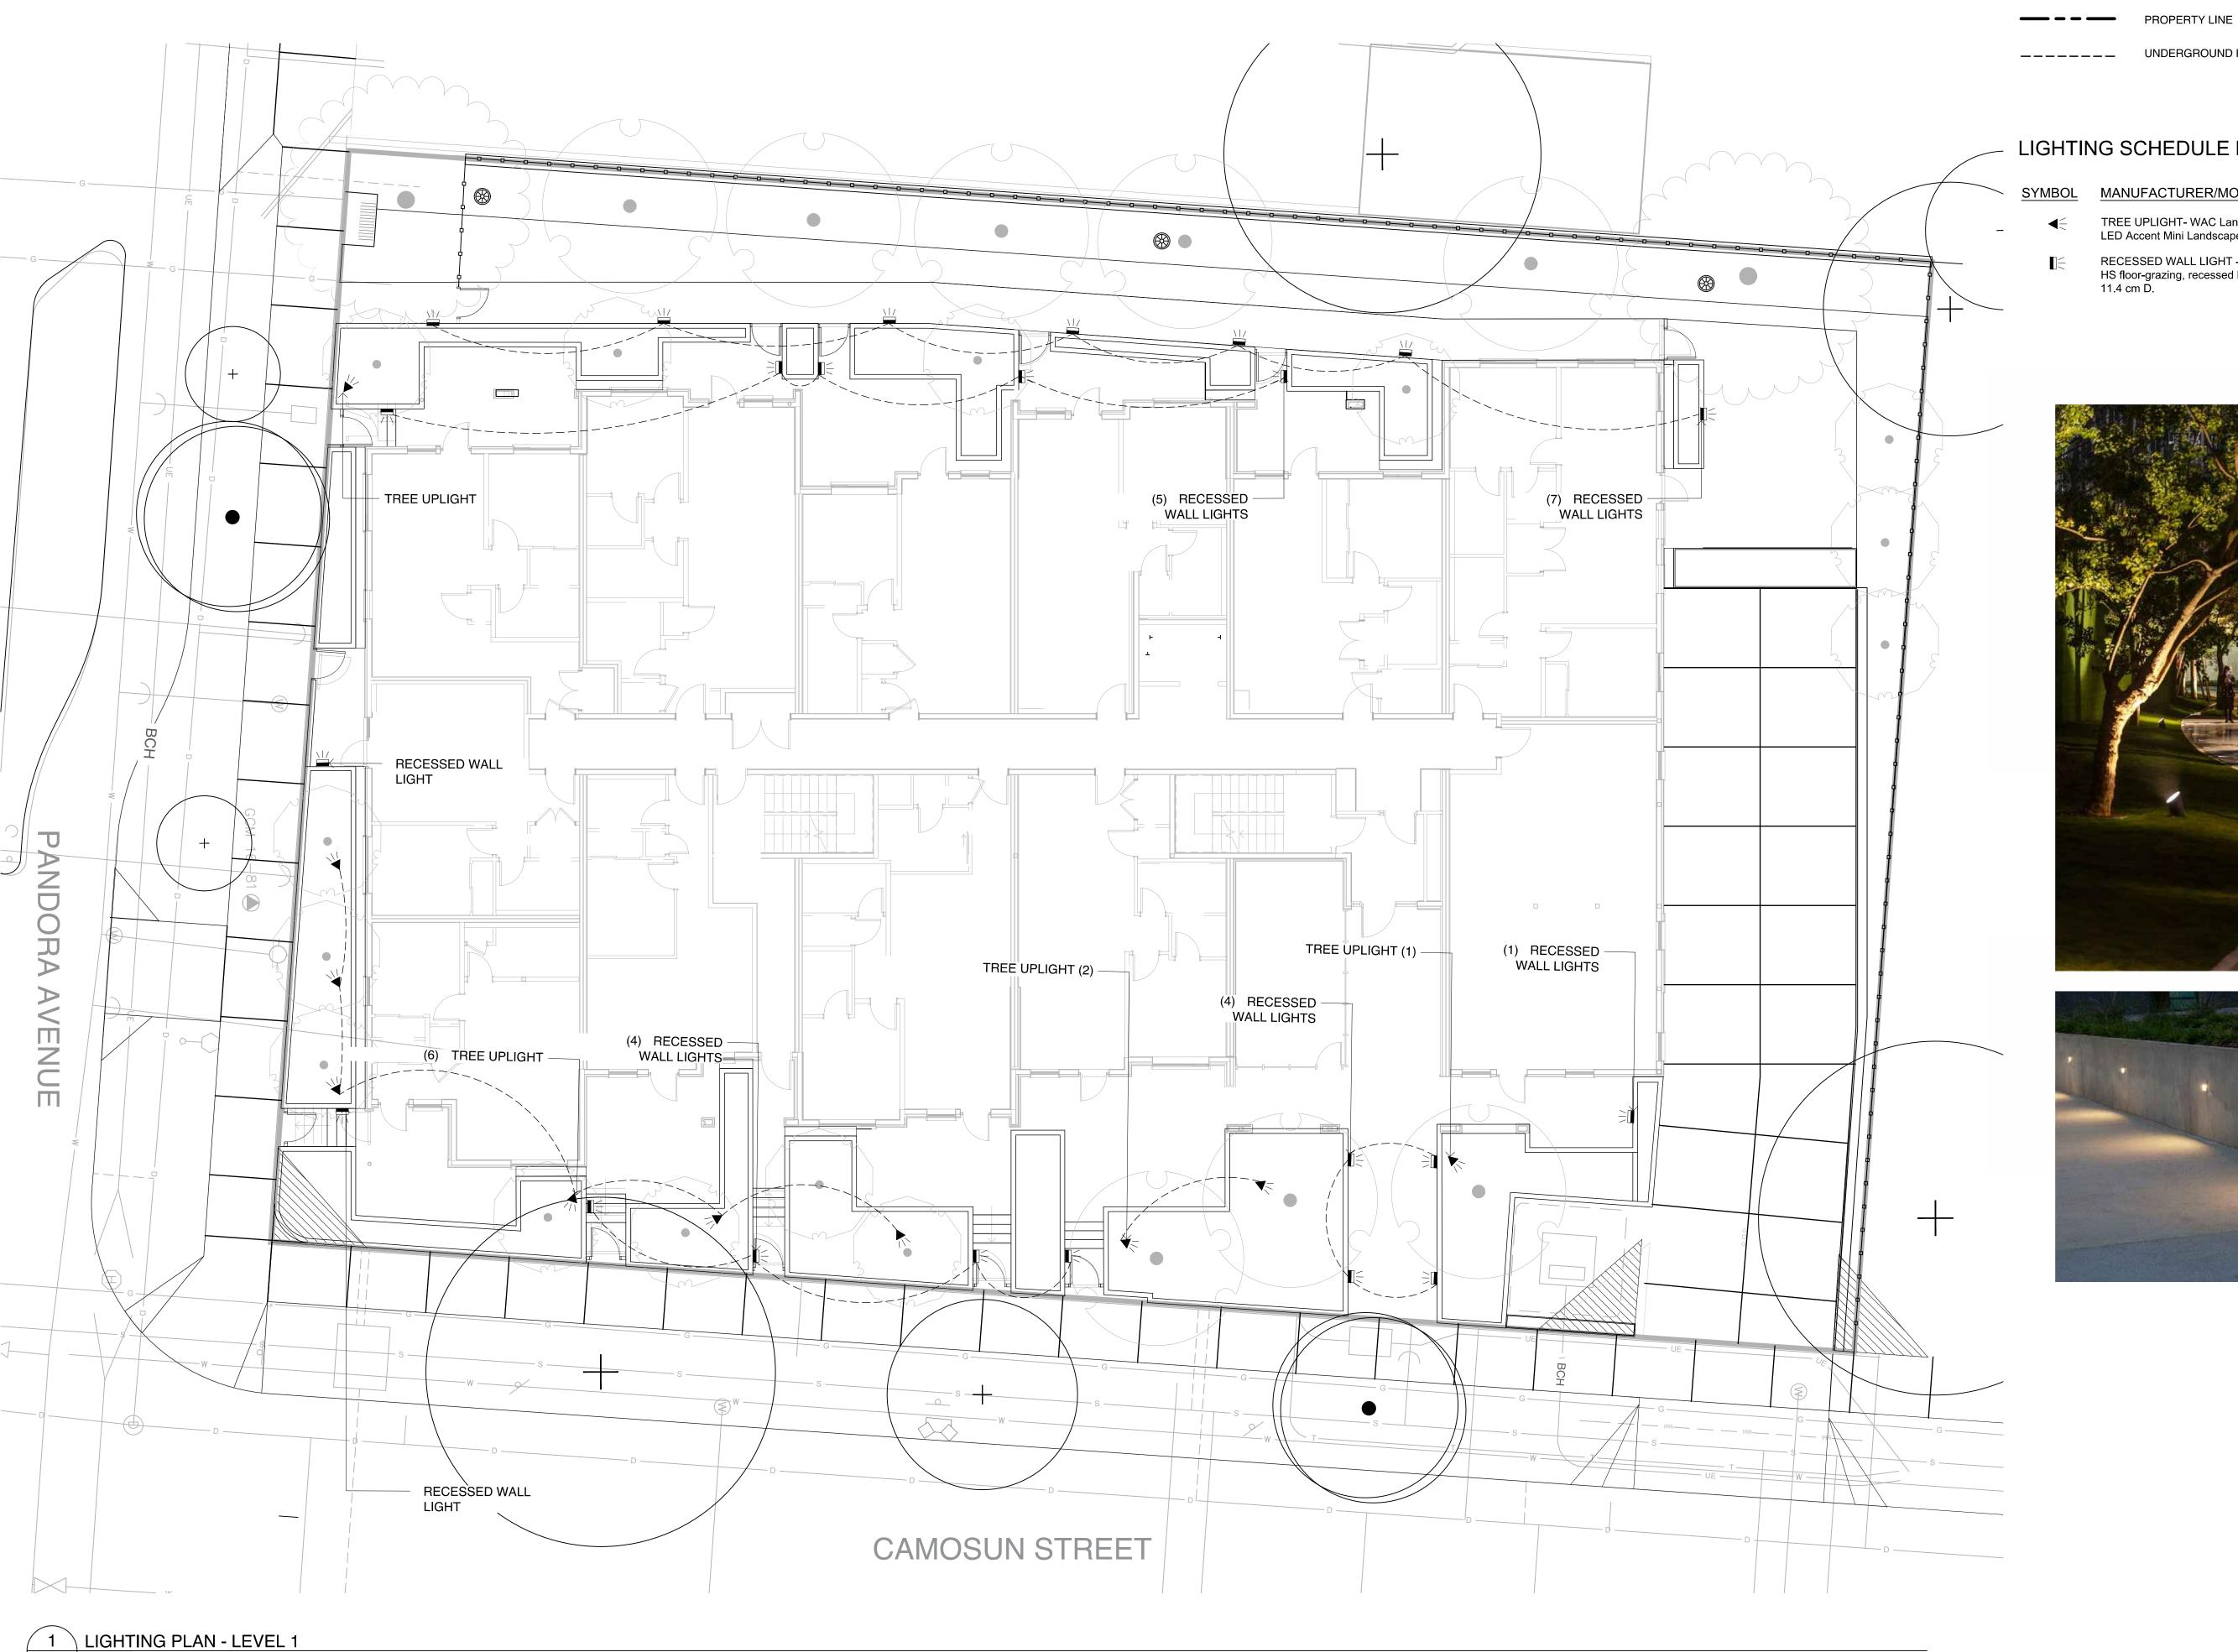

/ 1:100

LEGEND

_____ UNDERGROUND PARKING SLAB

LIGHTING SCHEDULE LEVEL 1

SYMBOL MANUFACTURER/MODEL/DESCRIPTION

TREE UPLIGHT- WAC Landscape Lighting 5111 LED Accent Mini Landscape Spotlight

RECESSED WALL LIGHT - FX Luminaire HS HS floor-grazing, recessed hardscape light. 20.3 cm W x 5.8 cm H x 11.4 cm D.





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OWNER/CLIENT:

<u>QTY</u>

10

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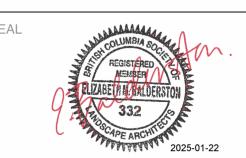
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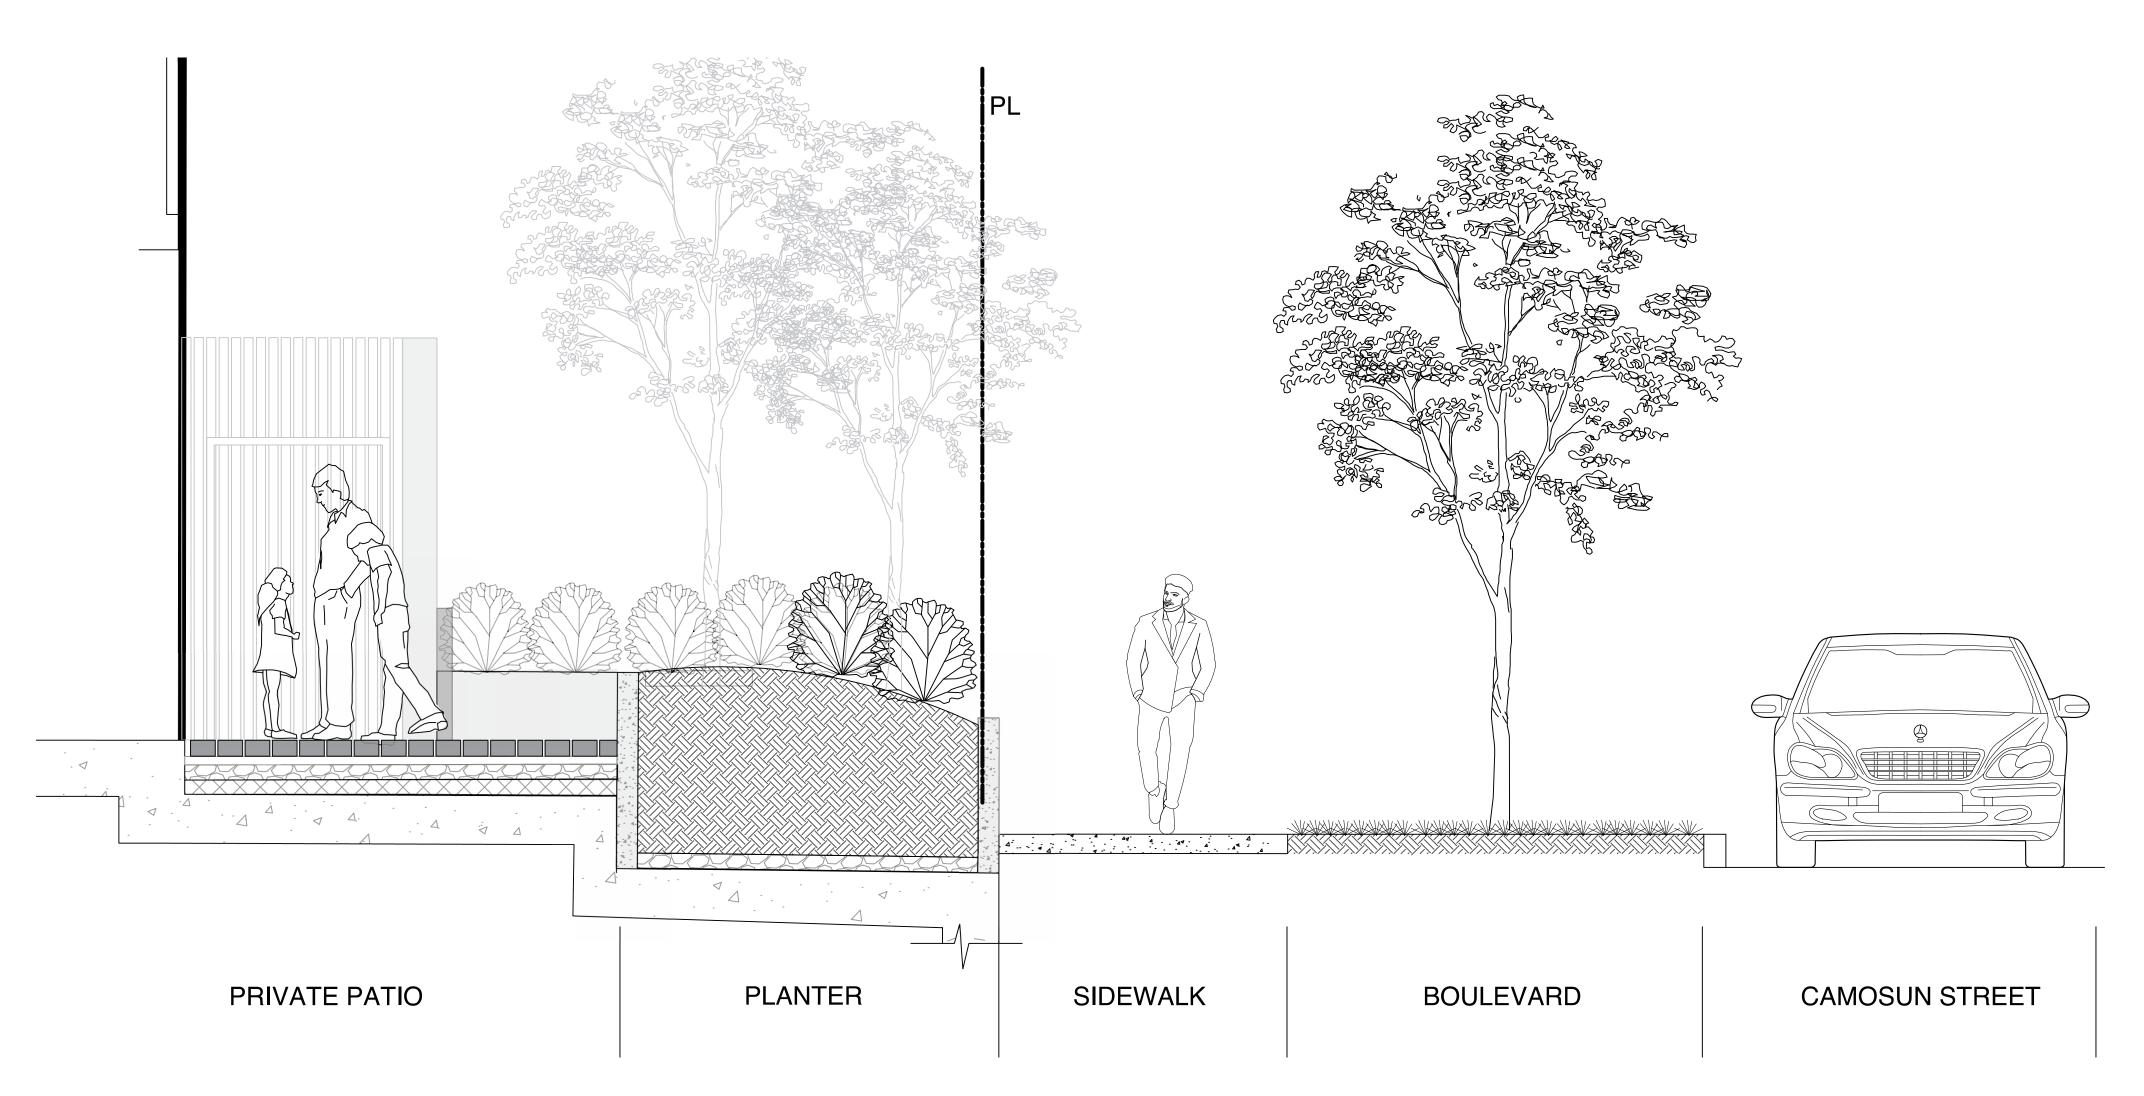
NORTH ARROW

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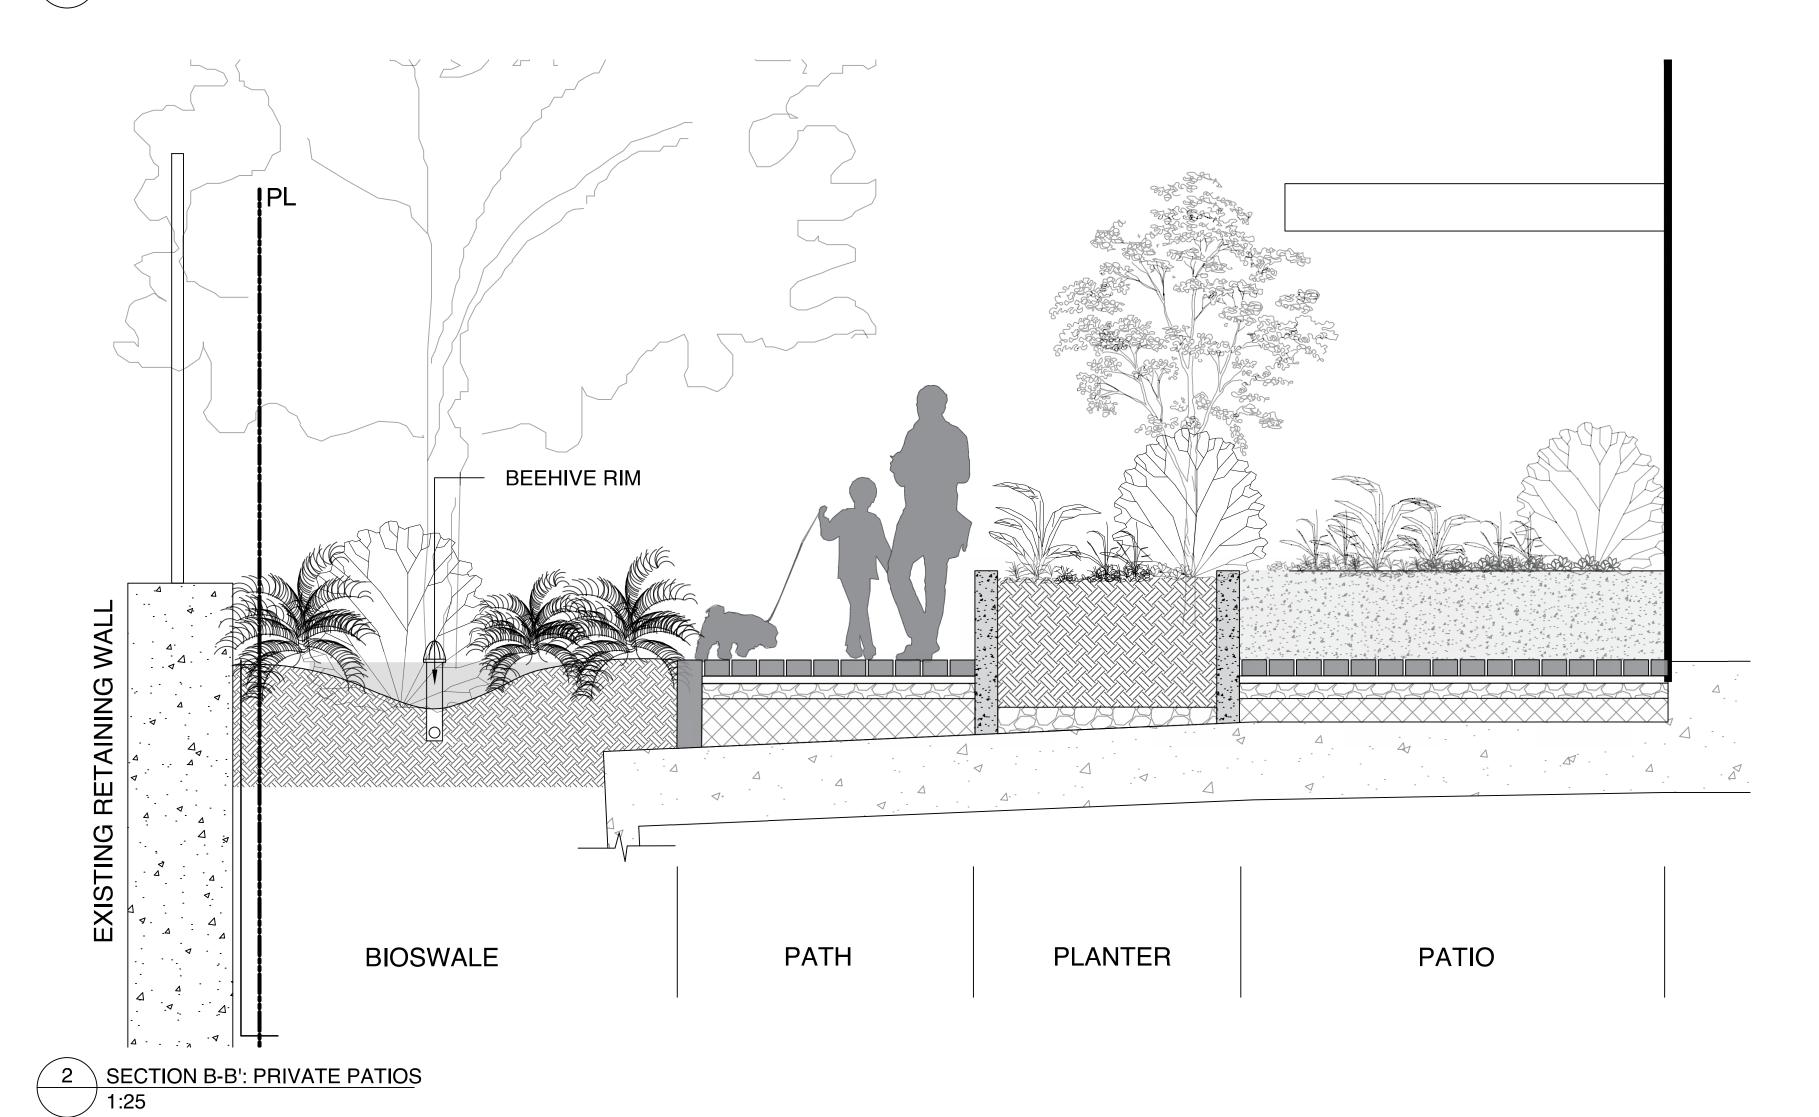
LEVEL 1

LIGHTING PLAN

SCALE: 1:100 L4.01



1 SECTION A-A': FRONT PATIO





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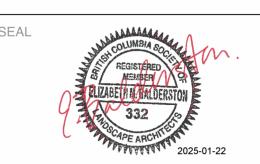
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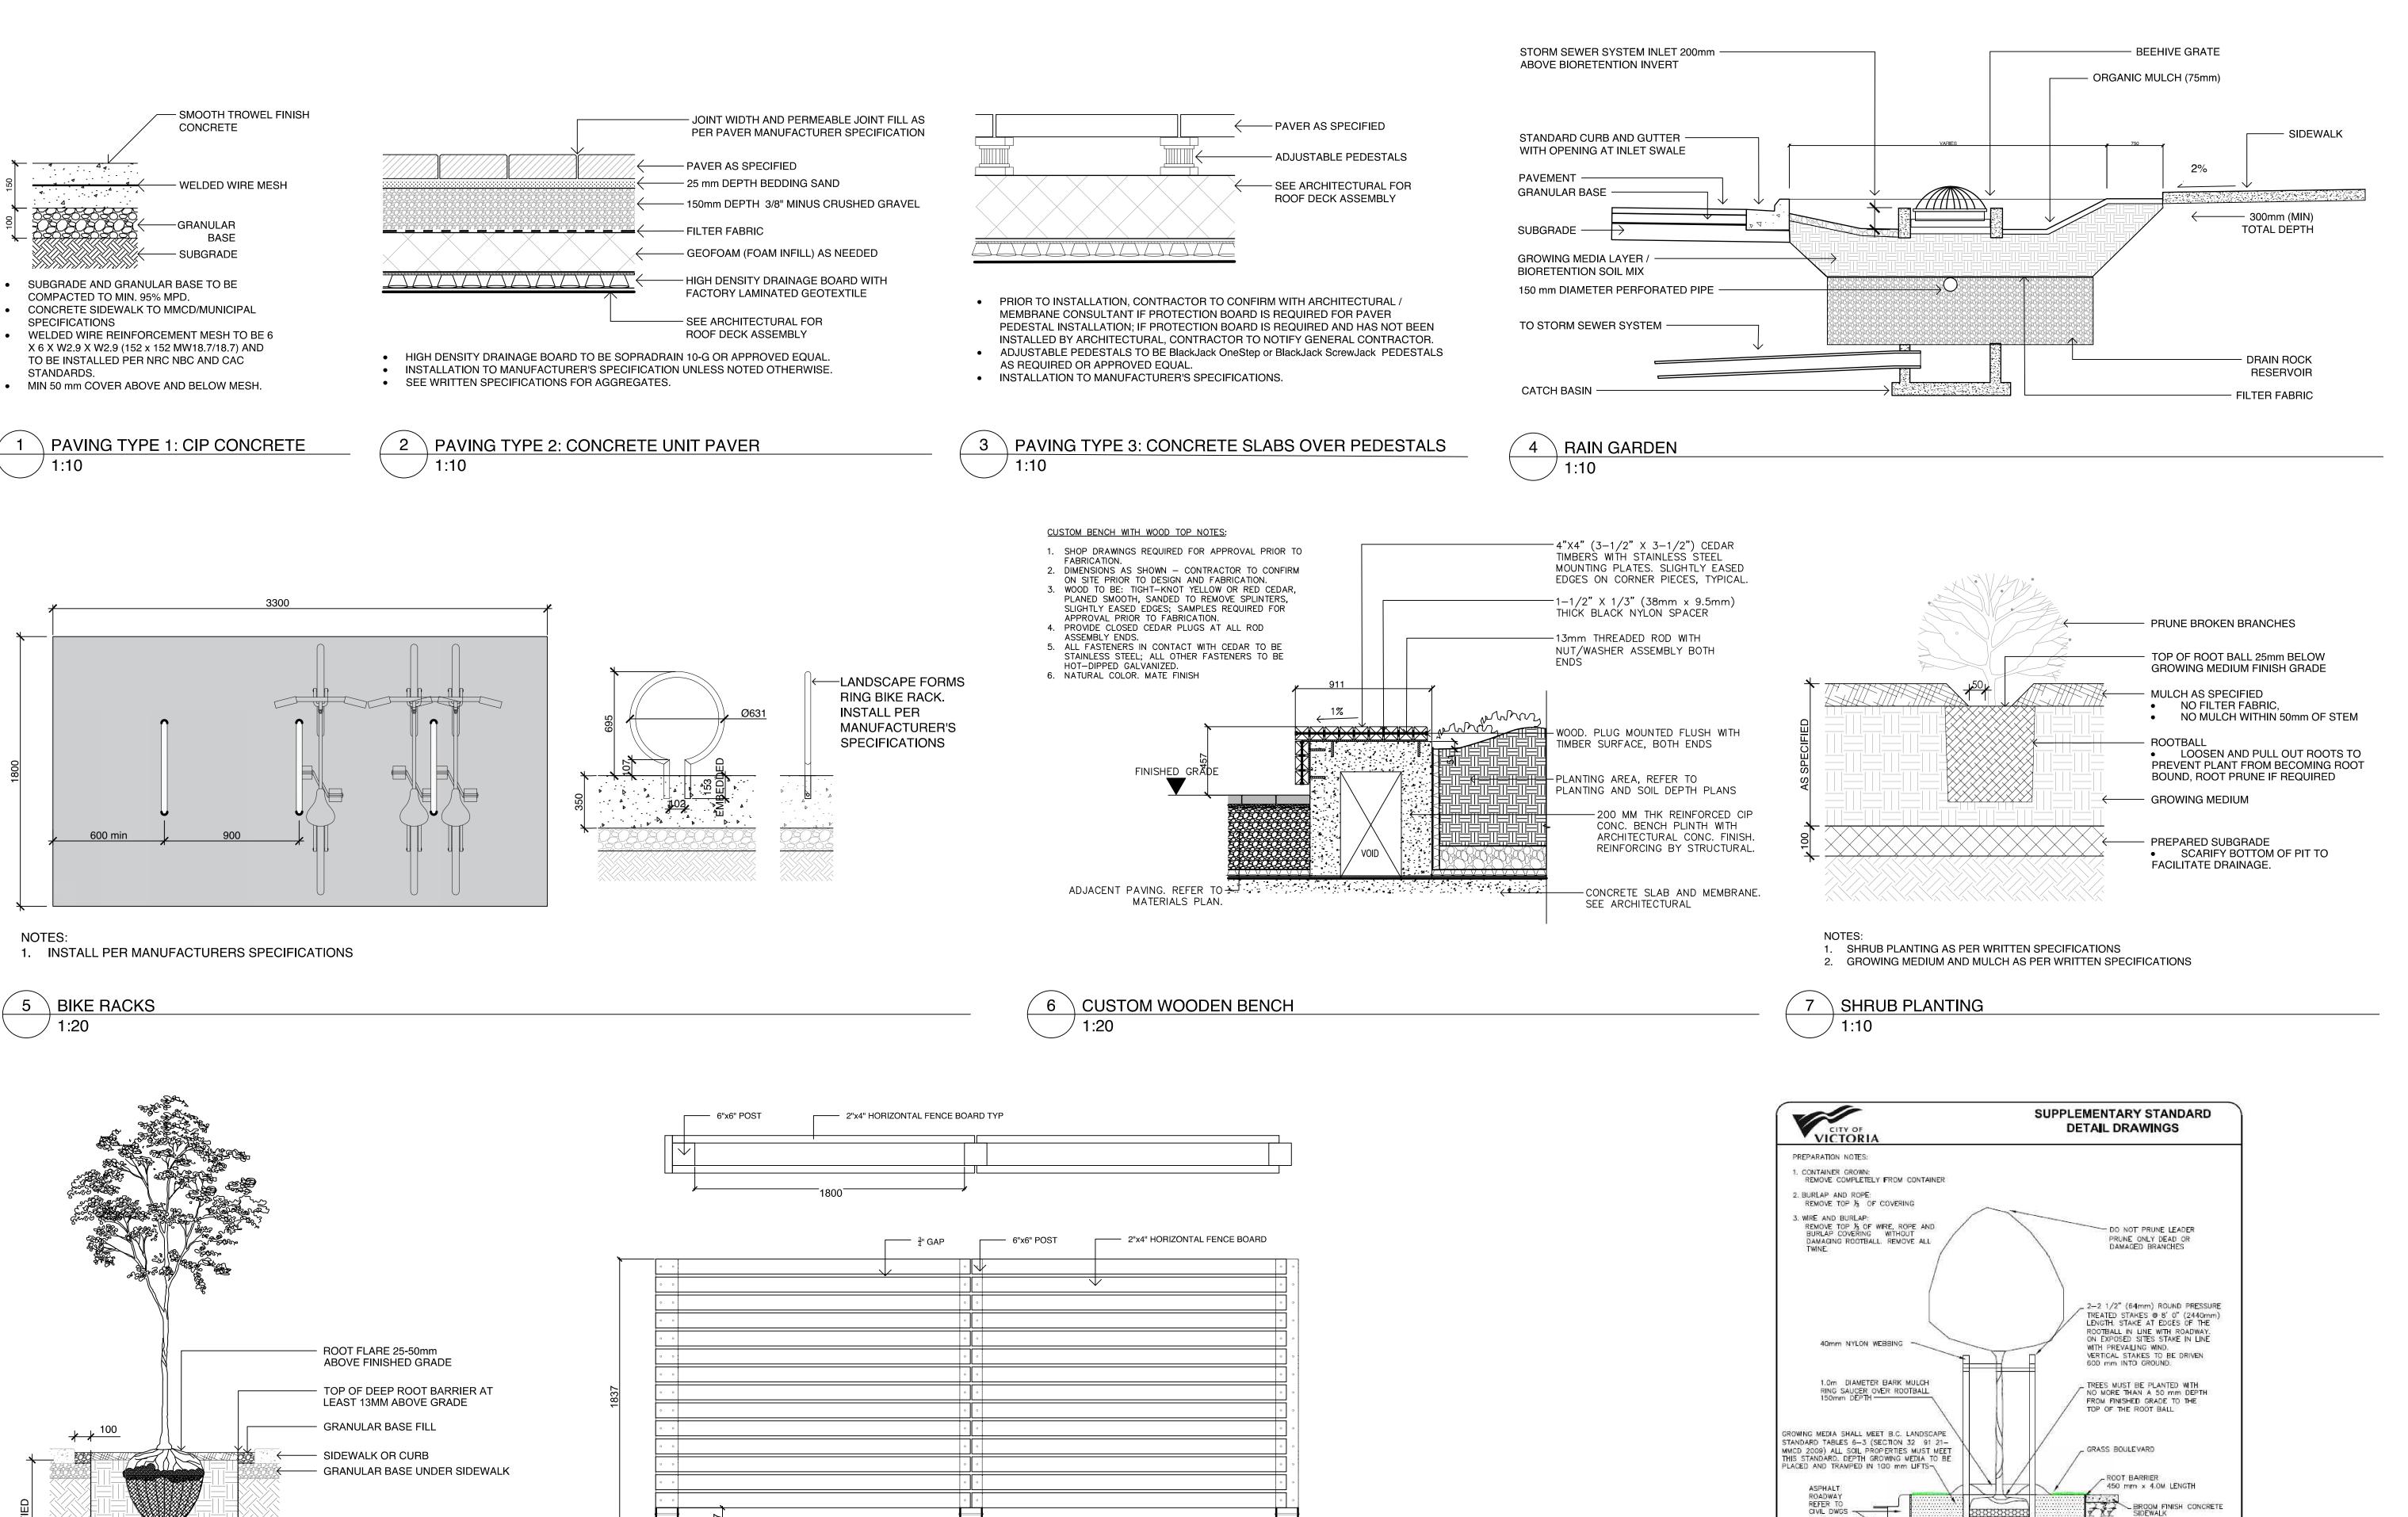


DRAWING TITLE:

SECTIONS

DWG NO:

NOTES: 1. SECTIONS FOR ILLUSTRATION PURPOSES ONLY



1. ALL LUMBER TO BE SMOOTH,

2. ALL SCREWS TO BE POLYMER

FINISHED 4 SIDES, CLEAR GRADE

SEASONED CEDAR - ALL RIPPED

BOARDS TO BE PLANED SMOOTH

ALL NUTS AND WASHERS TO BE SELF

LOCKING STAINLESS STEEL 4. POST BASE ANCHOR TO BE BLACK

POWDERCOATED STEEL

COATED EXTERIOR WOOD SCREWS

ROOT BARRIER 450 mm x 4.0M LENGTH

COMPACTED SUBGRADE -/ TO 98% S.P.D.

AND/OR BLVD WIDTH.

ALL TREES SHALL MEET OR EXCEED THE CITY OF VICTORIA TREE SPECIFICATIONS

ROOT BARRIER REQUIRED ON BLVD 2.0m OR LESS WIDE OR AS SPECIFIED BY THE DIRECTOR OF PARKS

ROOT BARRIER REQUIRED PENDING TREE SPECIES

TREE PLANTING IN BOULEVARD

BACKFILL WITH GROWING MEDIUM DEPTH AS NOTED

UNDISTURBED OR COMPACTED

⊁-223**-**⊁


PERIMETER FENCE

MATERIAL UNDER ROOT BALL

EXISTING SUBGRADE

1. ROOT BARRIER TO BE DEEP ROOT UB-24 OR APPROVED EQUAL

\ ROOT BARRIERS

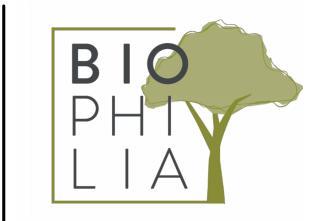

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NORTH ARROW

DRAWING TITLE:

DETAILS

DWG NO:

10 TREE PLANTING IN BOULEVARD

REVISIONS DRAWING NUMBER

SD P4

