




POINT	EXISTING	PROPOSED	DISTANCE BE	TWEEN POINTS	AVE. OF POINTS
Α	20.235	20.146	POINT A-B	31.724	639.98
В	20.138	20.192	POINT B-C	1.908	38.45
С	20.162	20.200	POINT C-D	2.295	46.28
D	20.173	20.200	POINT D-I	10.905	220.08
Е	REMOVED				
F	REMOVED				
G	REMOVED				
Н	REMOVED				
ı	20.280	20.190	POINT I-J	1.077	21.75
J	20.258	20.200	POINT J-K	1.397	28.22
K	20.269	20.200	POINT K-L	4.651	93.78
L	20.312	20.127	POINT L-M	9.464	191.97
M	20.442	20.127	POINT M-N	22.600	462.36
N	20.475	20.127	POINT N-O	11.483	233.54
0	20.369	20.200	POINT O-A	19.115	385.61
			TOTAL	116.62	2362.02
AVERAGE GRADE = 2362.02 / 116.62 = 20.25					

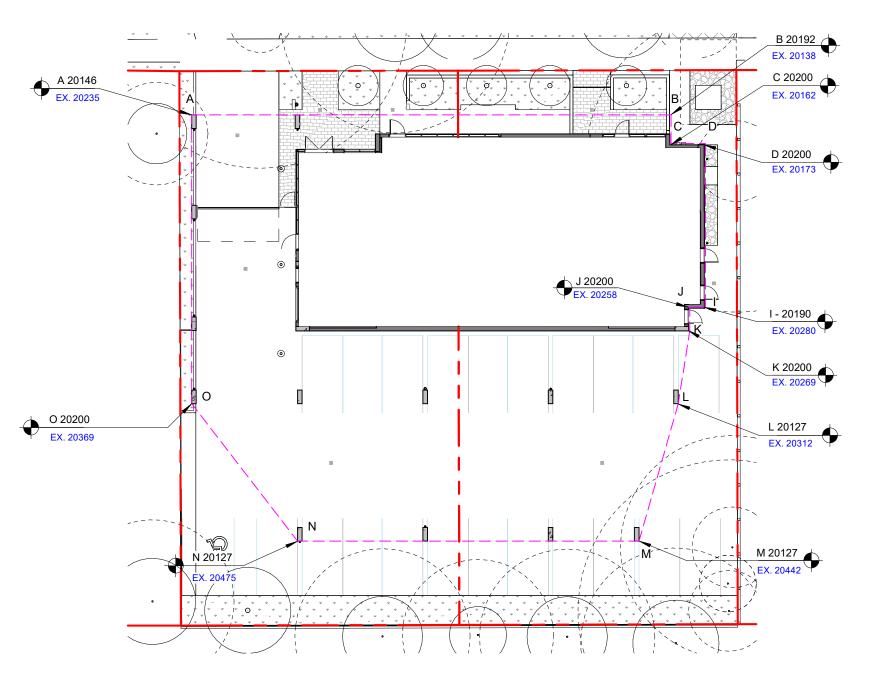

2 Average Grade Points Key Plan SCALE = 1:250

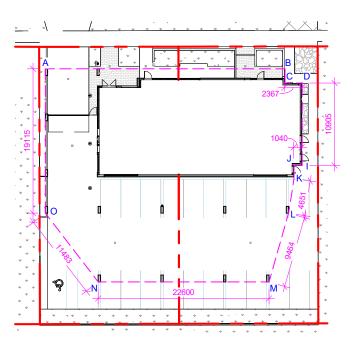


3 Distance Between Points Key Plan
SCALE = 1:500

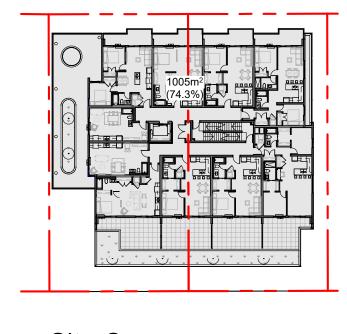


Site Coverage

SCALE = 1:500

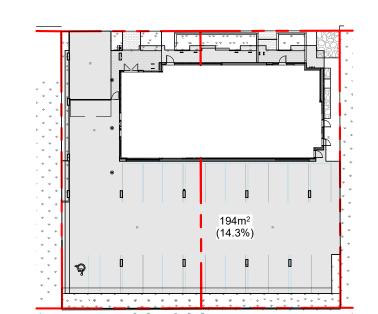

Open Site Space

SCALE = 1:500

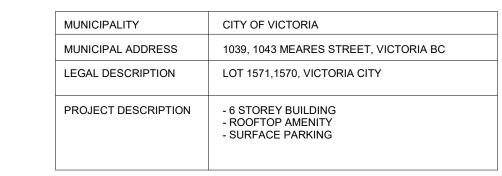

PROJECT INFORMATION

ZONE (EXISTING)	R3-1			
PROPOSED ZONE	UNKNOWN	UNKNOWN		
SITE AREA (m²)	1,352m²			
TOTAL FLOOR AREA (m²)	3,365m²			
FLOOR SPACE RATIO	2.49 : 1			
SITE COVERAGE (%)	74.3%			
OPEN SITE SPACE (%)	14.3%			
HEIGHT (m)	21.94m	21.94m		
NUMBER OF STOREYS	6			
	REQUIRED	PROVIDED		
PARKING STALLS (#) ON SITE	46	22 (2 Accessible)		
BICYCLE PARKING (#) SHORT TERM	6	8		
BICYCLE PARKING (#) LONG TERM	60	82		

BUILDING SETBACKS (m)	ALLOWED	PROVIDED
FRONT YARD	1.950m	1.969m
REAR YARD (TO LEVEL 2 DECK)	3.215m	3.309m
REAR YARD (TO BUILDING FACE LVL 2-6)	9.630m	9.811m
SIDE YARD (W-TO COLUMN FACE)	0.810m (W/ 0.300m ALLOWABLE PROJECTION)	0.810m (W/ 0.296m PROJECTION)
SIDE YARD (W-TO BUILDING FACE LVL 2-6)	5.090m	5.168m
SIDE YARD (E)	1.805m	1.897m

RESIDENTIAL USE DETAILS				
TOTAL NUMBER OF UNITS	50			
UNIT TYPE	1 BD (24), STUDIO (9)			
	2 BD (16), LIVE/WORK (1)			
GROUND-ORIENTATED UNITS	1			
MINIMUM UNIT FLOOR AREA (m²)	30.12m ²			
TOTAL RESIDENTIAL FLOOR AREA (m²)	2,753.21m ²			



ļ.	ISSUED FOR DDP	Feb. 20, 2025
2	ISSUED FOR TENDER	Sept. 27, 2024
	Issued for BP Resubmission	May 16, 2024
	Issued for Building Permit	Feb. 09, 2024
	Rezoning/DP Rev1	Mar 1, 2023
	Rezoning/DP	July 7, 2022
NO.	DESCRIPTION	DATE




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1039-1043 Meares Street


Jawl Residential Ltd.


Survey & Project Data

February 20, 2025 As indicated 2124

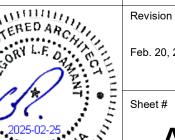

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GENERAL NOTES

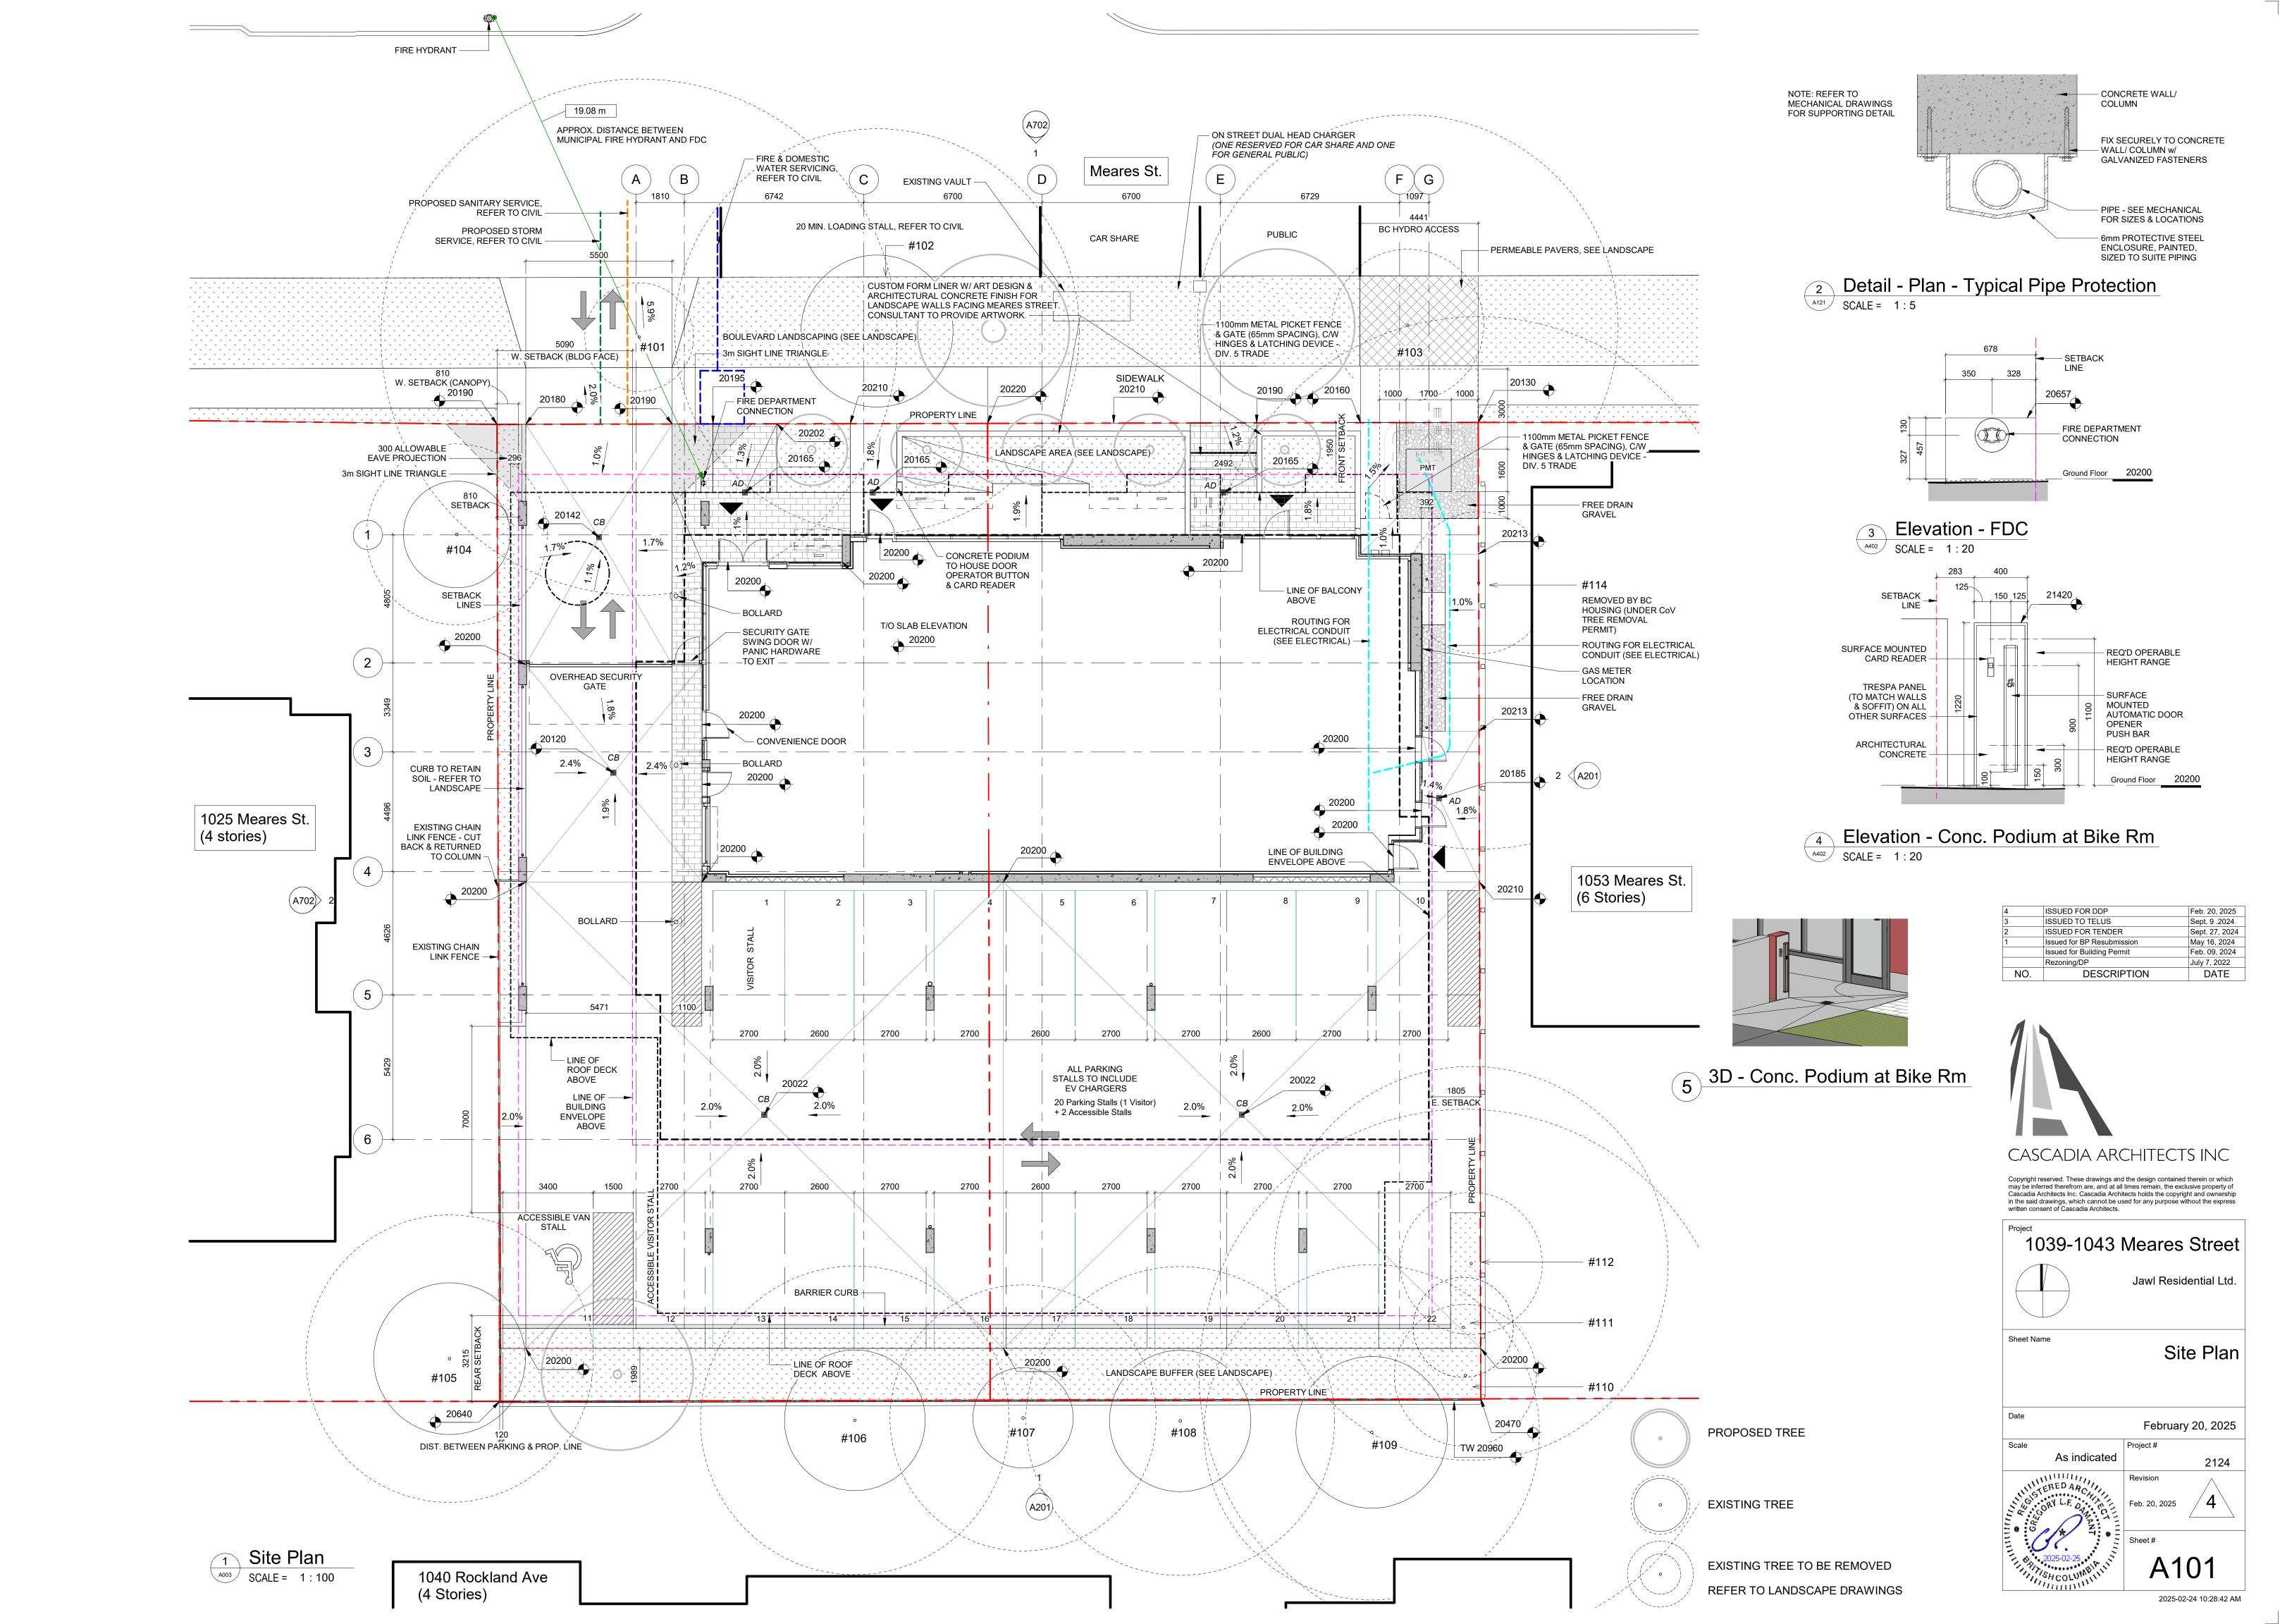- 1. ALL DIMENSIONS ARE TO GRIDLINES, FACE OF CONCRETE, FACE OF EXTERIOR SHEATHING, FACE OF FRAMING, UNLESS NOTED OTHERWISE
- 2. ALL OPENING DIMENSIONS, WHEN SHOWN, ARE TO HEEL DEPTH OF FRAME, OR CENTER OF UNIT.
- REFER GLAZING SCHEDULE.
 3. DOOR DIMENSIONS GIVEN ARE CLEAR SLAB WIDTHS, EXCLUSIVE OF FRAMES. REFER DOOR SCHEDULE.

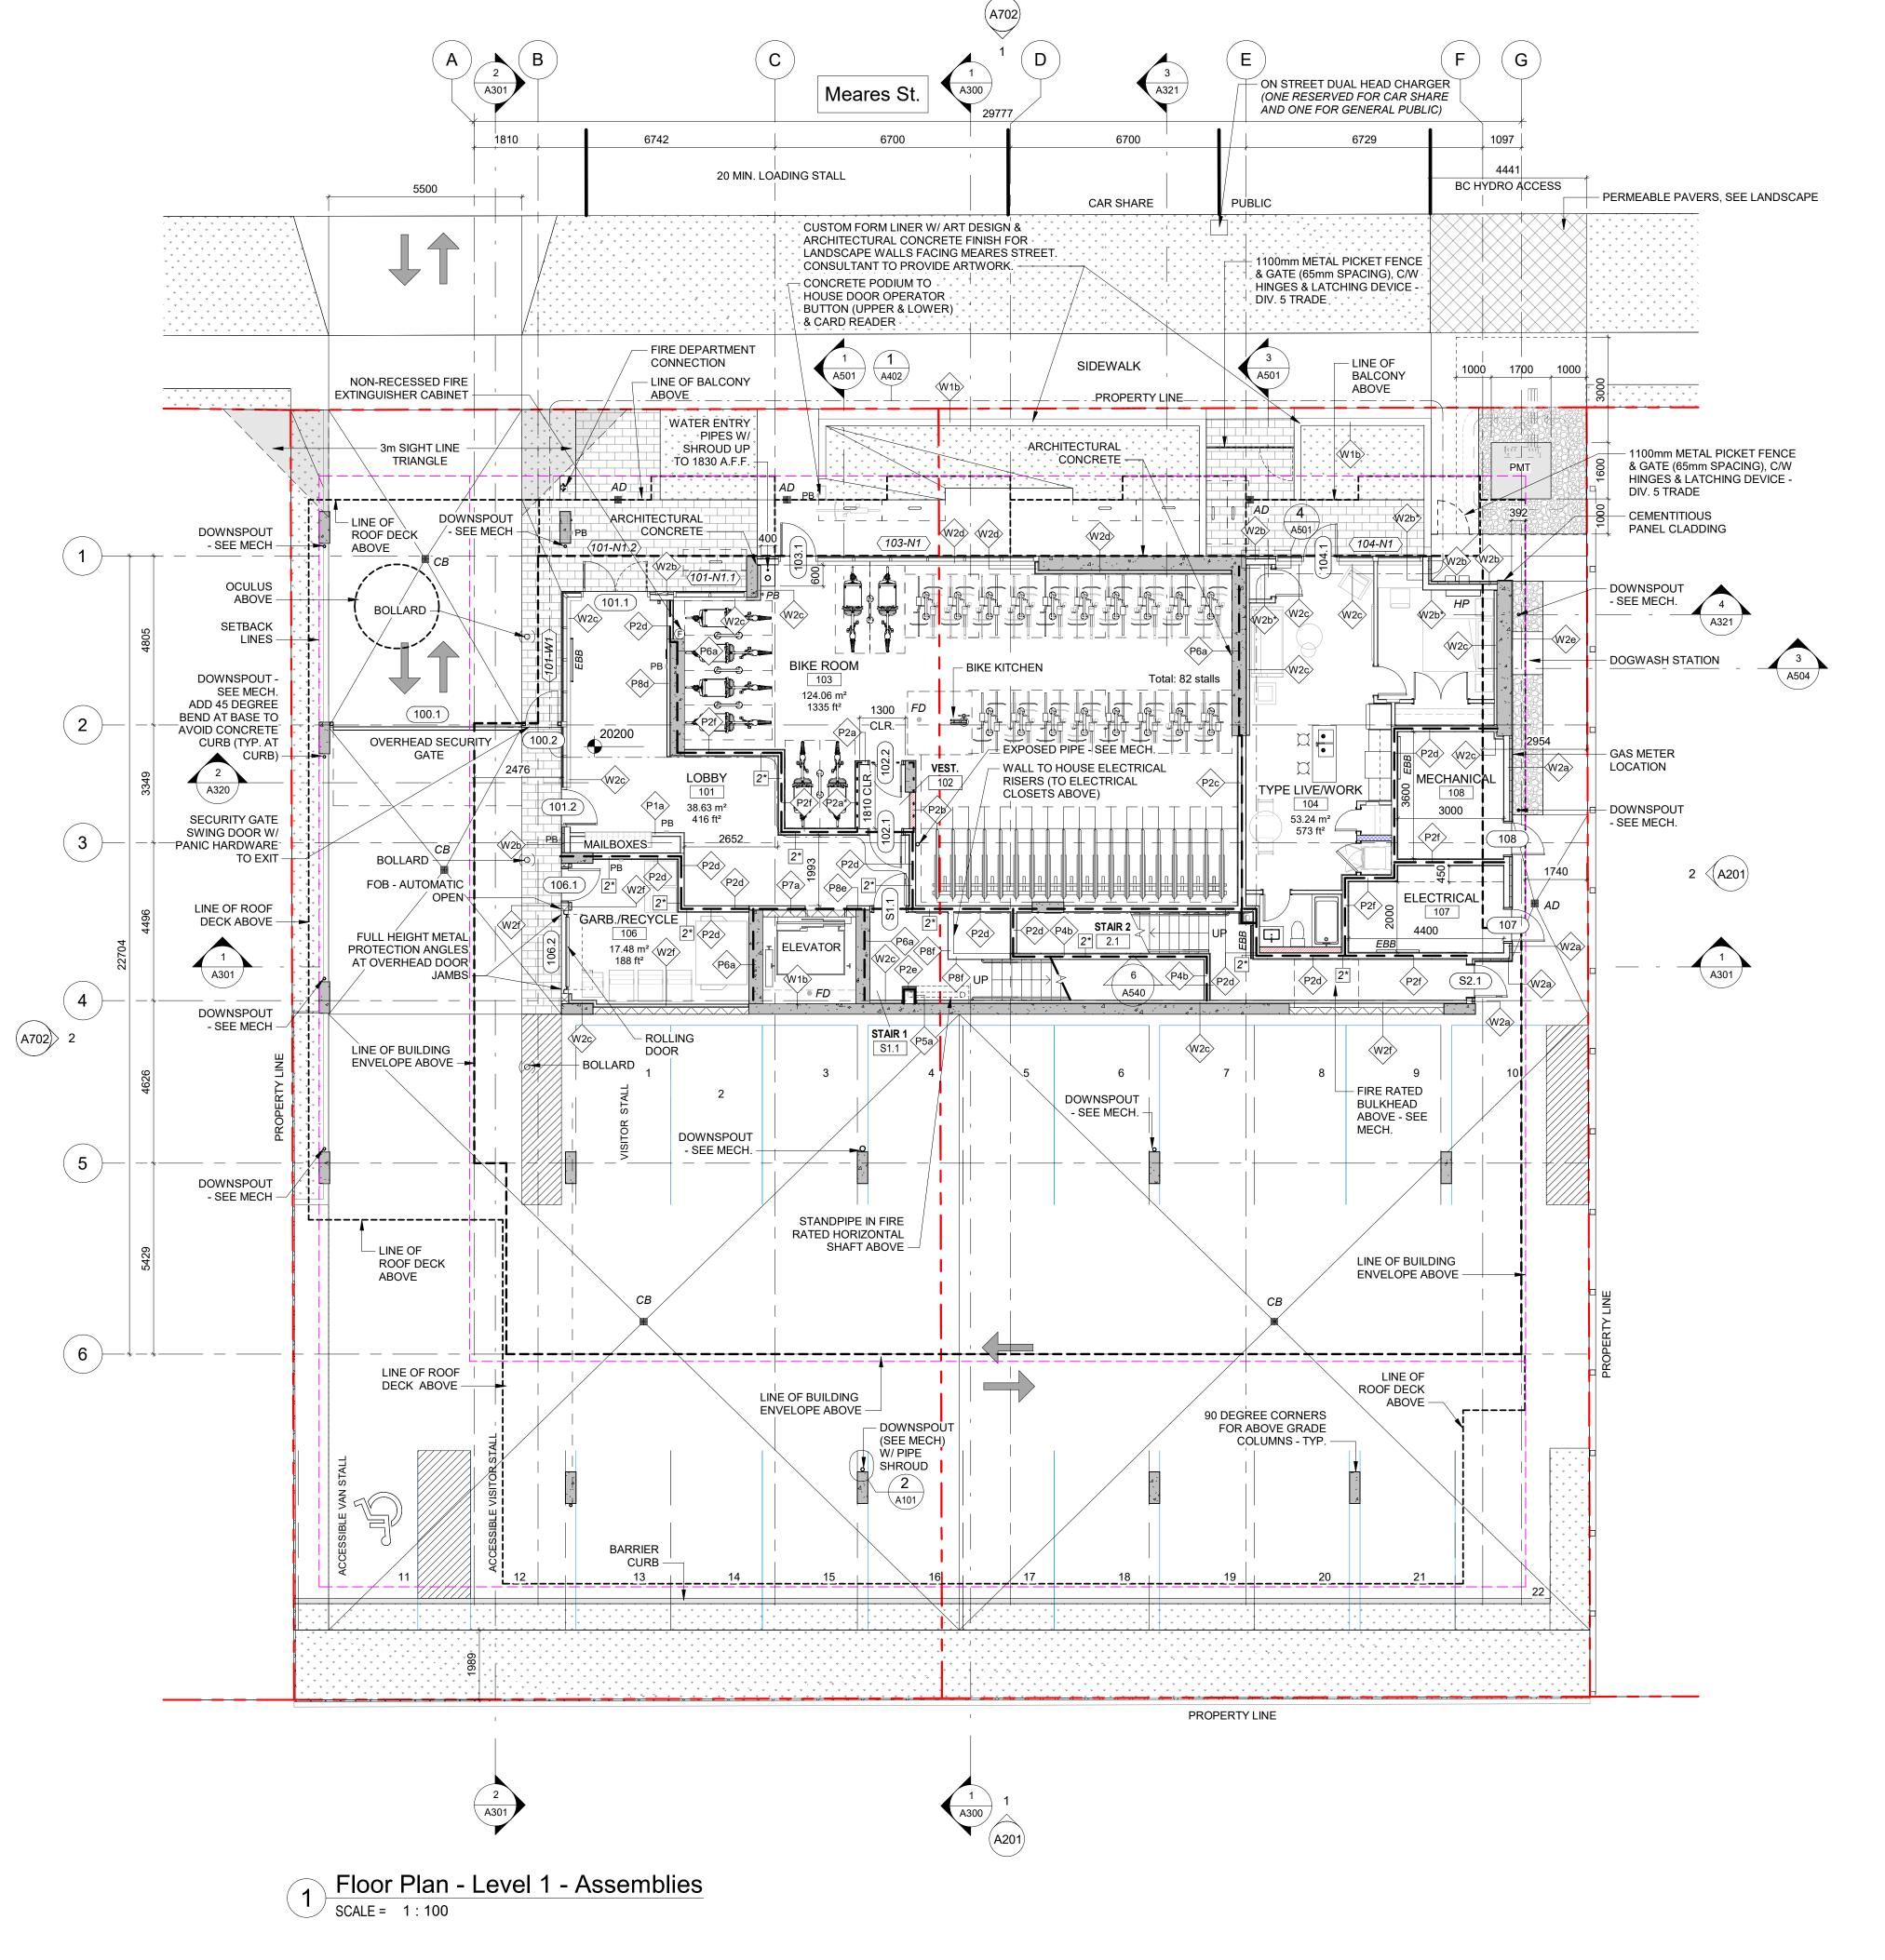Area Schedule (Gross Building)		
Level Area		
Ground Floor	165.35 m²	
Level 2	626.95 m ²	
Level 3	626.95 m²	
Level 4	626.95 m²	
Level 5	626.95 m²	
Level 6	626.96 m ²	
Roof level	37.51 m ²	
Grand total: 7	3337.60 m ²	

Parking Calculation Breakdown

Bike Parking Calculation
Residential Long Term
1 space per unit > 45m2
10 units x 1 = 10 spaces

TOTAL = 66 spaces Required

82 Spaces Provided

(74 Long-term, 8 Short-term)

6 spaces

0.65 space per unit > 45m2 10 units x 0.65 = 6.5 spaces

Parking Calculation
Core Area Residential

 1.25 space per unit < 45m2</td>
 0.80 space per unit < 45m2, > 70m2

 40 units x 1.25 = 50 spaces
 35 units x 0.80 = 28 spaces

 Commercial Long Term
 1.2 space per unit < 70m2</td>

Visitor 0.1 space per unit

50 units x 0.1 = 5 spaces

Commercial Personal Servic

Commercial Personal Service 1 space per 50sqm Floor Area 33.61 / 50 = 0.67

TOTAL = 46 spaces Required
22 Spaces Provided
(2 Accessible Stalls
1 Visitor stall)

NOTATION LEGEND

WOOD FRAME WALL

WOOD FRAME BEARING WALL: 1hr FRR

WOOD FRAME SANITARY CHASE

WOOD FRAME SHEAR / BEARING WALL: 1

WOOD FRAME WATER RISER / MI

CONCRETE MASONRY UNIT

REINFORCED CONCRETE: SEE STRUCTUI

ASSEMBLY TAG

(1-W01) GLAZING TAG (UNIT TYPE, ELEVATION, #)

H20 HOSE BIBB

F FIRE ALARM PULL STATION

PB ADO PUSH BAR

PD PLANTER DRAIN

BD BI-LEVEL DRAIN

RD ROOF DRAIN

CB CATCH BASIN

TD TRENCH DRAIN

DOUBLE GWB THIS SIDE

EBB ELECTRIC BASEBOARD HEATER

			1 HR
1hr FRR			1.5 HR
	••••	•••••	2 HR
IDAI	4	ISSUED FOR DDP	Feb. 20, 2025
JRAL	2	ISSUED FOR TENDER	Sept. 27, 2024

Issued for BP Resubmission


Issued for Building Permi

Rezoning/DP Rev3

Rezoning/DP Rev1

SPATIAL SEPARATION LEGEND


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Project 1039-1043 Meares Street

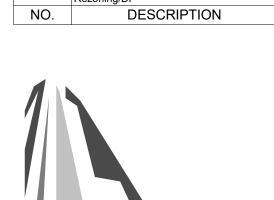

Jawl Residential Ltd.

May 16, 2024 Feb. 09, 2024

August 3, 2023

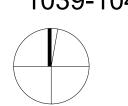Mar 1, 2023

July 7, 2022

DATE

Floor Plan - Level 1 -

Assemblies

Scale Project #
As indicated Project #
2124



2124


Revision

Feb. 20, 2025

Sheet #

1/2/

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Roof Plan - Lower - Finished

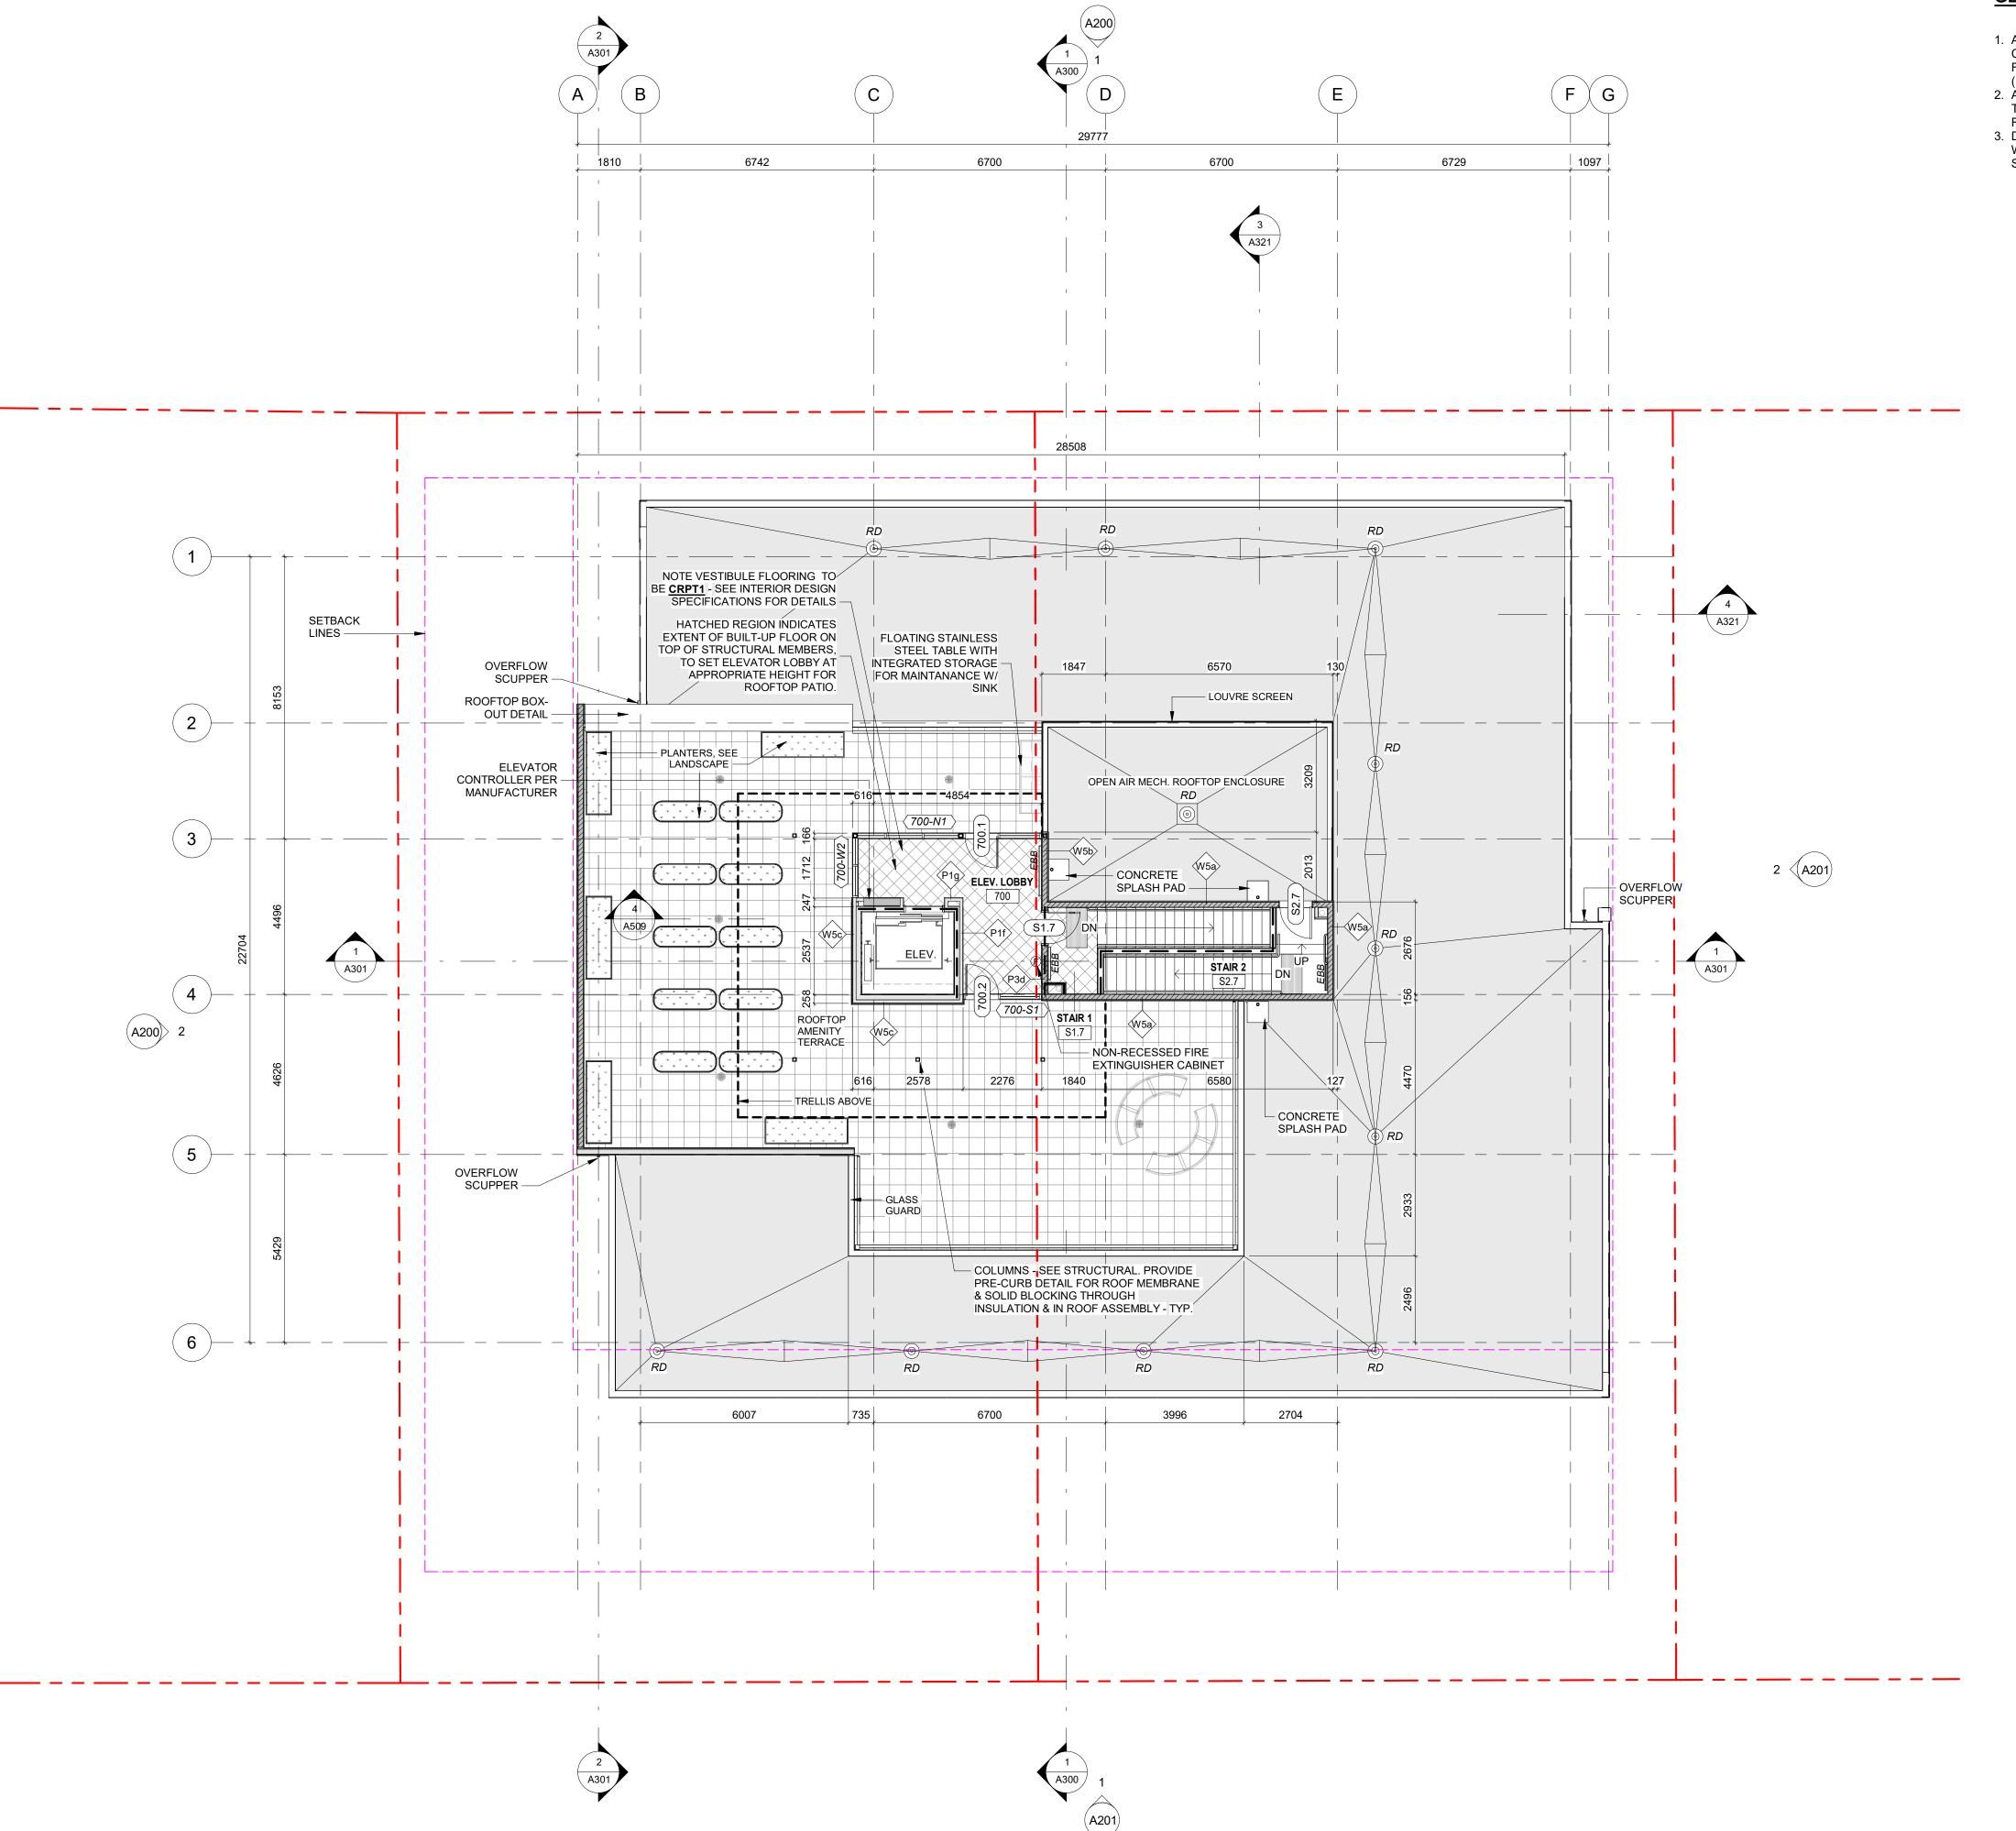SCALE = 1:100

GENERAL NOTES

- 1. ALL DIMENSIONS ARE TO GRIDLINES, FACE OF CONCRETE, FACE OF EXTERIOR SHEATHING, FACE OF FRAMING, UNLESS NOTED OTHERWISE
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- 3. DOOR DIMENSIONS GIVEN ARE CLEAR SLAB WIDTHS, EXCLUSIVE OF FRAMES. REFER DOOR SCHEDULE.
- SPATIAL SEPARATION LEGEND

2 HR

NOTATION LEGEND

WOOD FRAME WALL

WOOD FRAME BEARING WALL: 1hr FRR

WOOD FRAME SHEAR / BEARING WALL: 1hr FRR

REINFORCED CONCRETE: SEE STRUCTURAL

WOOD FRAME SANITARY CHASE

WOOD FRAME WATER RISER / METER

CONCRETE MASONRY UNIT

301.3 DOOR TAG

ASSEMBLY TAG

(1-W01) GLAZING TAG (UNIT TYPE, ELEVATION, #)

H20 HOSE BIBB

F FIRE ALARM PULL STATION

PB ADO PUSH BARPD PLANTER DRAIN

BD BI-LEVEL DRAIN

RD ROOF DRAIN

CB CATCH BASIN

TD TRENCH DRAIN

DOUBLE GWB THIS SIDE

EBB ELECTRIC BASEBOARD HEATER

 4
 ISSUED FOR DDP
 Feb. 20, 2025

 2
 ISSUED FOR TENDER
 Sept. 27, 2024

 Rezoning/DP
 July 7, 2022

 NO.
 DESCRIPTION
 DATE



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1039-1043 Meares Street


Jawl Residential Ltd.

Roof Plan - Lower -

Finished

Feb. 20, 2025

February 20, 2025

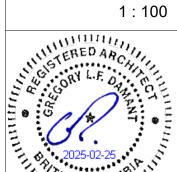

128


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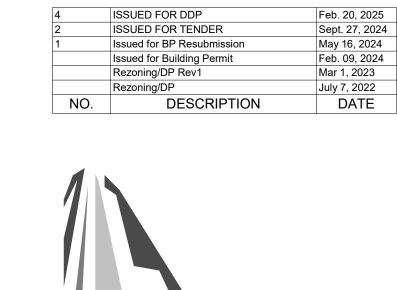


FINISH MATERIALS

USED

- 01. INTEGRATED LOUVRE
- 02. CUSTOM PATTERN GLASS SEE DETAILS BELOW
- 03. POWDER COATED ALUMINUM PANEL
- 04. CURTAIN WALL/ STOREFRONT GLAZING
- 05. GLAZING
- 06. VERTICAL FENCING (CHARCOAL)
- 07. CEMENTITIOUS PANEL (COLOUR 1) (CERACLAD ELEMENTS)
- 08. CEMENTITIOUS PANEL (COLOUR 2) (CERACLAD CASHMERE SMOOTH)
- 09. NOT USED
- 10. FIBER CEMENT PANEL CLADDING (COLOUR TO BE CONFIRMED)
- 11. ARCHITECTURAL CONCRETE FINISH
- 12. ALUM. VERTICAL/ HORIZONTAL SUNSHADE (LIGHT GREY)
- 13. CONCRETE MASONRY BLOCK
- 14. LANDSCAPE CONC. WALL (1100mm High) WITH CUSTOM PATTERN
- 15. SOLID PHENOLIC CLADDING PANEL (COLOUR TO BE CONFIRMED)



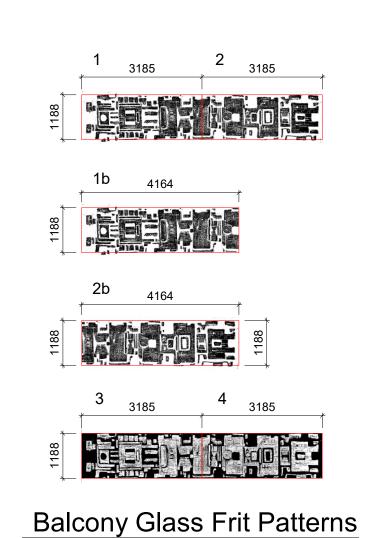

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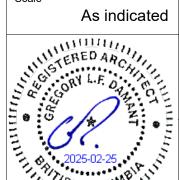
Project

1039-1043 Meares Street

Jawl Residential Ltd.

Elevations

February 20, 2025



Project #

2124

Revision

Feb. 20, 2025

Sheet #

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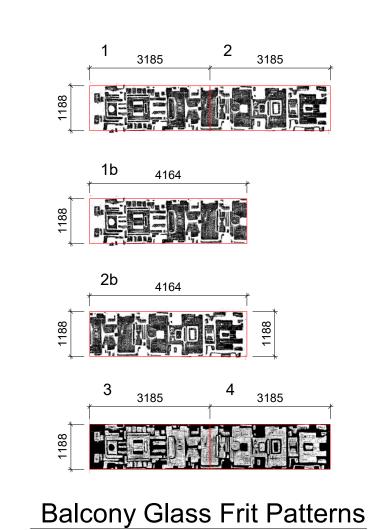
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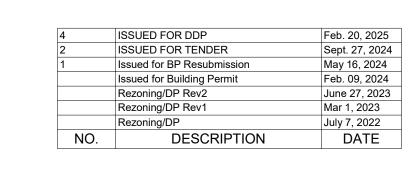


FINISH MATERIALS

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- 02. CUSTOM PATTERN GLASS SEE DETAILS BELOW
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1039-1043 Meares Street

Jawl Residential Ltd.

Elevations

February 20, 2025

As indicated

2124 Feb. 20, 2025


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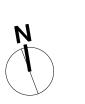
JAWL RESIDENTIAL

MEARES DEVELOPMENT

Victoria, BC

Landscape Sheets				
Sheet No.	Sheet Title			
L0.00	Cover			
L0.01	General Information Sheet			
L1.01	Landscape Materials			
L1.02	Landscape Materials L2 & Roof			
L2.01	Landscape Grading and Drainage			
L2.02	Landscape Grading and Drainage L2 & Roof			
L3.01	Planting Plan			
L3.02	Planting Plan - L2 & Roof			
L4.01	Landscape Details: Paving			
L4.02	Landscape Details: Planting & Planters			



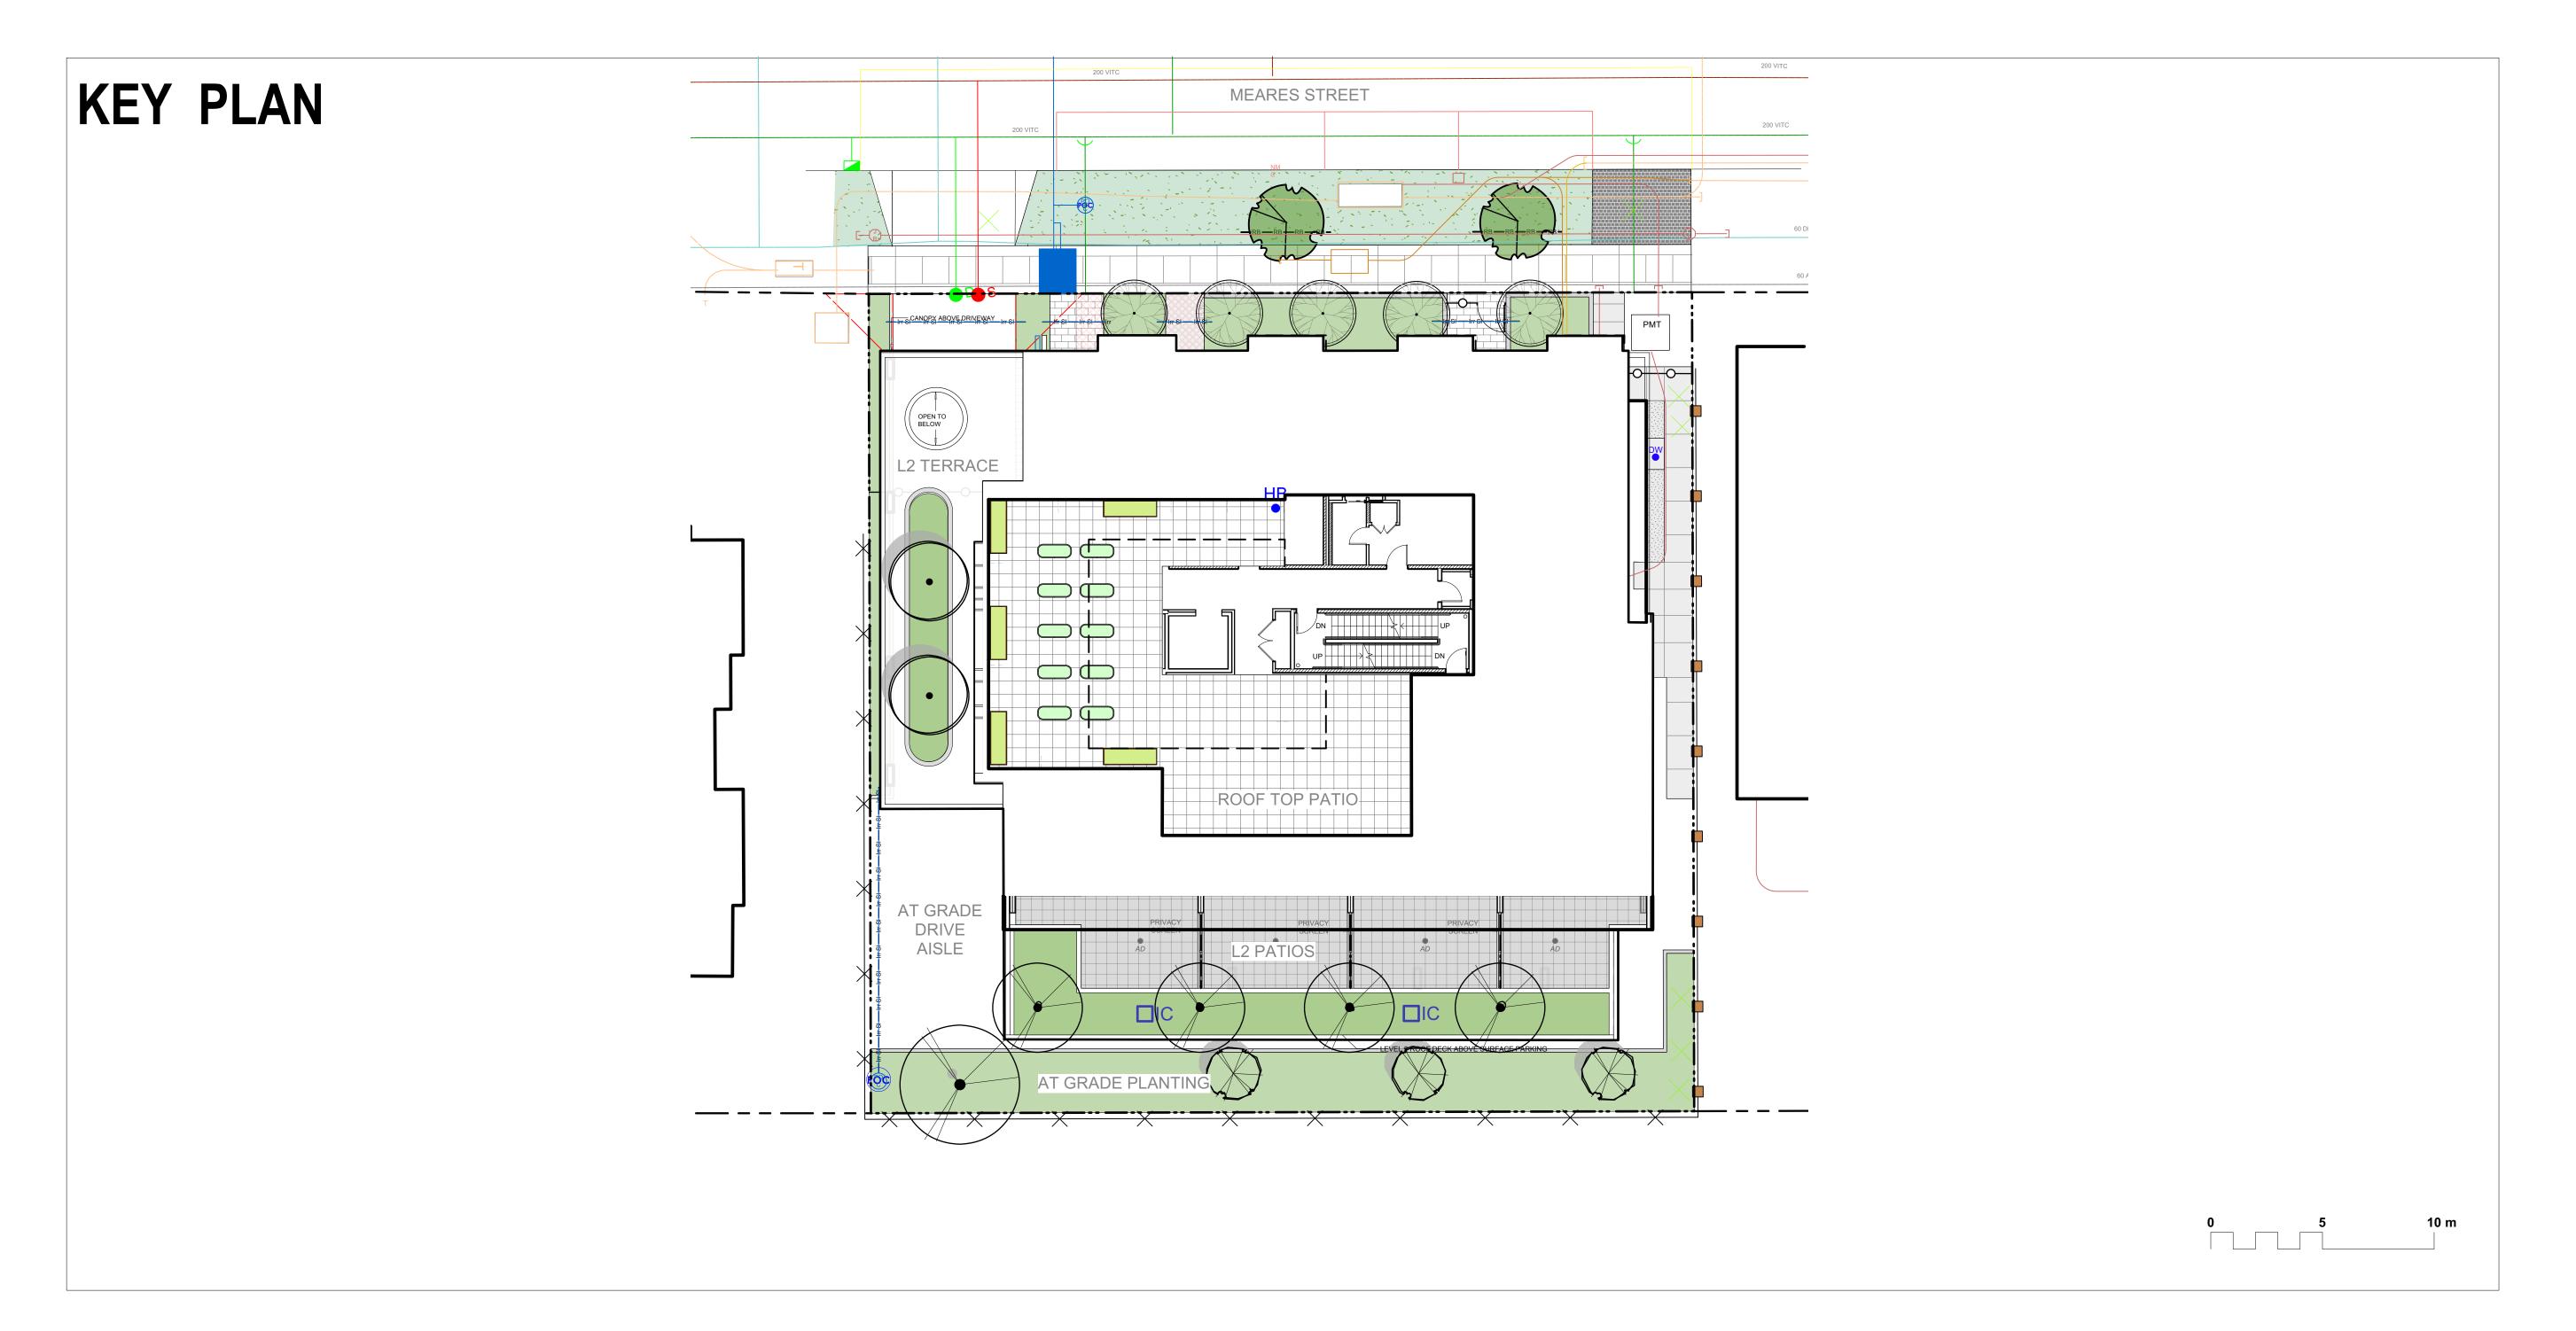

NOTFORCONSTRUCTION

12	Issued for DDP	2025-02-18
11	Issued for BP Resub 2	2025-02-18
10	Issued for Tender	2024-09-13
9	IFT 99%	2024-09-13
8	BP Resubmission	2024-05-16
7	BP	2023-12-01
6	BP Draft/Coord.	2023-10-24
5	REZ / DP	2023-03-15
4	REZ / DP	2022-10-21
rev no	description	date





Jawl Residential 3374 Tennyson Ave

3374 Tennyson Ave. Victoria, BC

1039-1043 Meares St 1039-1043 Meares St

Victoria, BC

sheet title

Cover

project no.	122.11
scale	1: 150 @ 24"x36"
drawn by	MDI
checked by	SM/JD
revision no.	sheet no.
12	L0.00

GENERAL NOTES

Documents and Specifications; b) Canadian Landscape Standards, Current Edition (CLS-CE); and c) All applicable local, provincial, and federal codes, ordinances, and regulations.

1. Work performed shall comply with the following: a) These General Notes, and Construction

- 2. Contractor shall be responsible for verifying all existing site conditions including location of all property lines, existing structures, utilities, and buried infrastructure. Verify all field conditions prior to
- 3. Contractor is responsible for determining means and methods for construction. These drawings may indicate a limit of proposed improvements or limit of work for the delineation of expected extents of disturbance. Should limits of disturbance exceed boundaries defined in drawings, contractor shall contact Landscape Architect for resolution.
- 4. Contractor is responsible for repairing all work disturbed by construction outside of limit lines defined on drawings or through their means and methods to a condition better than or equal to the existing conditions prior to commencement of construction at no additional cost to the owner.
- 5. Contractor is responsible for maintaining a complete up-to-date set of drawings and specifications at the construction site and ensuring the documents are readily available for review by the Landscape Architect and governing agency.
- 6. Contractor is responsible for coordination of all designs, drawings, specifications and other documents or publications upon which construction is based. Any discrepencies with the drawings and/or specifications and site conditions shall be brought to the attention of the Landscape Architect, prior to
- 7. The drawings and specifications are complementary to one another and implied to correspond with one another. Any discrepencies should be brought to the attention of the Landscape Architect for resolution immediately
- 8. General Contractor and/or sub-contractors are responsible for all costs related to production and submission to consultant of all landscape as-built information including irrigation.

TREE RETENTION AND REMOVAL NOTES

- 1. Tree protection fencing, for existing trees, to be installed prior to commencement of all site work. Refer to Arborist's plans for location of tree protection fencing, and protection fencing detail.
- 2. Refer to arborist's report for detailed information for existing tree resources.

SITE GRADING AND DRAINAGE NOTES

- 1. All elevations are in meters.
- 2. Refer to Architectural plans, sections and elevations for top of slab elevations. Slab elevations indicated on Landscape drawings are for reference only. Report any discrepancies to consultant for
- 3. All road, public walkway and vehicular drive aisles and parking area elevations indicated on the Landscape drawings are for reference only. Refer to Civil Engineering drawings. Report any discrepancies to consultant for review and response.
- 4. Confirm all existing grades prior to contruction. Report any discrepancies to consultant for review and
- 5. Unless otherwise noted provide a minimum slope of 2% on all hard and soft Landscape areas to ensure positive drainage away from buildings, to rain gardens, or to drainage devices.
- 6. All landscape areas shall not exceed a maximum slope of 3:1 in all instances.
- 7. Upon discovery, contractor to refrain from blasting rock to meet landscape subgrades. Contractor to contact Landscape Architect on how to proceed in each instance.
- <u>IRRIGATION NOTES</u>

- 1. Contractor to provide irrigation system for all planters to current IIABC Standards and Contract
- 2. All specified work to meet the project specifications, and all standards or specifications established in the lastest edition of the Canadian Landscape Standard and IIABC standards.
- 3. Design/build drawings for detailed irrigation plan to be submitted to Contract Administrator in PDF and .dwg formats at least two weeks prior to commencement of irrigation installation
- 4. Utilities Contractor to verify location of all on-site utilities, prior to construction. Restoration of damaged utilities shall be made at the contractor's expense, to the satisfaction of the owner's representatives.
- 5. Refer to electrical drawings for electrical service.
- Controller and backflow prevention device to be located in Mechanical Room, unless otherwise noted.
- Refer to Mechanical drawings for size and location of irrigation service. 7. Contractor to verify pressure and flow prior to installation of irrigation and notify owner's representative in writing if such data adversely affects the operation of the system.
- 8. Sleeves shall be installed at the necessary depths, prior to pavement construction. Sleeving shall extend 300 mm from edge of paving into planting area, and shall have ends marked above grade unless otherwise shown.
- Contractor to field fit irrigation system around existing trees, to limit disturbance to root systems. 10. At various milestones during construction, inspection and testing of components will be required to ensure that the performance of irrigation system meets standards and specifications. Contractor to provide equipment and personnel necessary for performance of inspections and tests. Conduct all inspections and tests in the presence of the contract administrator. Keep work uncovered and accessible until successful completeition of inspection or test.
- 11. Over spray onto hardscape areas to be minimized. Use drip irrigation within small planting areas to avoid overspray.

GROWING MEDIUM NOTES

- . Refer to Landscape Specifications for growing medium properties by soil type. 2. Advise Contract Administrator of sources of growing medium to be utilized 14 days in advance of
- Growing medium properties and handling shall meet CLS-CE (see Section 6 CLS-CE).
- 4. Contractor is responsible for soil analysis and amendment requirements to supply suitable growing medium, as specified by testing agency. Soil analysis and amendment costs shall be included in the price for the work.
- 5. Submit to the Landscape Architect a copy of the soil analysis report from Pacific Soil Analysis Inc. 5-11720 Voyageur Way, Richmond, BC, V6X 3G9. p. 604- 273-8226. The analysis shall be of tests done on the proposed growing medium from stratified samples taken from the supply source. Costs of the initial and all subsequent tests to ensure compliance with the specifications shall be borne by the Contractor.
- 6. Contract Administrator will collect sample of growing medium in place and determine acceptance of material, depth of growing medium and finish grading. Approval of growing medium material subject to soil testing and analysis. Planting is not to occur until finished grades have been approved by Contract Administrator.

SITE LAYOUT NOTES

- 1. Provide layout of all work for approval by Contract Administrator prior to proceeding with work. Requests for site review as required 48 hours in advance of performing any work, unless otherwise
- 2. Layout and verify dimensions prior to construction. Bring discrepancies to the attention of the Contract
- Administrator. 3. Written dimensions take precedence over scale. Do not scale drawings.
- 4. All plan dimensions in metres and all detail dimensions in millimetres, unless otherwise noted.
- 5. Where dimensions are called as 'equal' or 'eq', space referenced items equally, measured to centre

GENERAL PLANTING NOTES

1. Plant quantities on Plans shall take precedence over plant list quantities.

- 2. Provide layout of all work for approval by Contract Administrator prior to proceeding with work. 3. Plant material, installation and maintenance to conform to the current edition of the Canadian
- Landscape Standard.
- 4. Plant quantities and species may change between issuance of DP and Construction due to plant availability and design changes. Substitutions to be approved by Landscape Architect.

ON-SLAB TREE PLANTING NOTES

- 1. For on-slab landscape, a root barrier will be installed to protect exposed water proof membranes. A dimple board (drain mat) will be installed over the root barrier.
- 2. Parkade walls and foundation walls will be protected with a dimple board (drain mat) to convey water
- to the perimeter drain and protect wall from roots.
- 3. A root barrier will be installed between the tree roots and perimeter drain, to minimize tree root interference with the drain, where the follow conditions exist in on-grade planting areas: a)where trees less than 8m tall are located closer than 2m from a parkade or foundation wall; b) where trees more than 8m tall are located closer than 3m from a parkade or foundation wall; and c) where perimeter drains are less than 2m deep.

BOULEVARD PLANTING NOTES

- 1. Boulevard trees have been placed to avoid existing and proposed infrastructure. Trees planted within 1m of an existing underground municipal service will have a root barrier installed between the root ball and the existing infrastructure.
- 2. Boulevard trees will be place a minimum of 1.5m from an above ground municipal service such as fire hydrant, streetlight or driveway.
- 3. Final selection of boulevard trees to be determined through consultation with municipal parks staff. The proposed boulevard trees must comply with the City of Victoria Supplementary Specifications for
- Street Trees and Irrigation Schedule C, Bylaw 12-042, Subdivision Bylaw. 4. Soil volume for boulevard trees to be as follows: 8 cu. m. for small trees, 12 cu. m. for medium trees,
- and 16 cu. m. for large trees. 5. The following tree inspections by City of Victoria Parks staff are required by Schedule C: (1)
- Excavation for tree pits, soil cells and root barrier; (2);Trees prior to planting (parks staff can inspect trees prior to shipping at local nursuries. Photos can be provided from up-island and mainland nursuries. Tree must meet the spec upon delivery); (3) Completed tree planting, installed tree grates, guards, stakes, etc.
- To schedule an inspection please contact Rob Hughes, rhughes@victoria.ca and also copy treepermits@victoria.ca 48 hours prior to the required inspection time.

PAVING NOTES

- 1. Final concrete control joint layout to be confirmed by Landscape Architect prior to installation. Control joints to logically align with edges, corners, and intersections of Landscape and Architectural elements and/or as indicated on plan. Contractor to obtain layout approval by Landscape Architect prior to installation. Contractor to pour concrete pavement in alternating panels as required to achieve control joint design and to prevent cracking.
- Cast in place concrete areas that are subject to vechicular loading shall be structurally reinforced for applicable vehicular loading requirements. See Structural Engineering drawings.

WARRANTY AND MAINTENANCE NOTES

- 1. Contractor is responsible for Maintenance from installation to Acceptance of the work by the Contract Administrator
- 2. Refer to Landscape Specifications for Maintenance Period following Acceptance.
- 3. Landscape installation to carry a 1-year warranty from date of acceptance. This warranty is based on adequate maintenance by the Owner after Acceptance, as determined by the Landscape Architect. The Contractor will not be responsible for plant loss or damage to other products by causes out of the Contractor's control, such as vandalism, "acts of God", "excessive wear and tear", or abuse.
- 4. Contractor is responsible for plant damage, failure and death due to poor delivery, storage and handling, and all other installation related aspects up until the End of Warranty period.
- 5. Plant material, installation and maintenance to conform with the current edition of the Canadian Landscape Standards, and the Contract Specifications

MUNICIPAL IRRIGATION NOTES


- 1. Irrigation systems on City property to conform to City of Victoria Supplementary Specifications for Street Trees and Irrigation Schedule C, Bylaw 12-042, Subdivision Bylaw.
- 2. Irrigation drawings must be submitted to the City of Victoria Parks Division for review and approval 30
- days prior to installation work.
- 3. The following irrigation and sleeving inspections by City of Victoria Parks staff are required by Schedule c: (1) Irrigation sleeving prior to backfilling; (2) Open trench main line and pressure Test; (3) Open trench lateral line; and (4) Irrigation system, controller, coverage test, backflow preventer
- assembly test report required, backflow assembly to have an inspection tag completed and attached. 4. Boulevard tree irrigation system will be maintained and operated by municipality, after it is inspected and approved by municipal staff.
- 5. Irrigation to be installed as per Municipal Specifications, for all boulevard planting areas (unless
- 6. Design/build drawings for boulevard irrigation to be submitted to Contract Administrator in PDF and dwg formats, at least two weeks prior to commencement of irrigation installation and will be reviewed.
- by municipal staff. Refer to Civil drawings for location of boulevard irrigation point of connection. Separate water meter and timer/controller, to be provided at point of connection. Timer/controller for boulevard areas must
- be readily accessible to municipal staff. Irrigation will only be required for tree drip loops, not for boulevard grass.
- 9. Please schedule all inspections by contacting Chuck Bass at cbass@victoria.ca and also copy treepermits@victoria.ca and tsherbo@victoria.ca 48 hours prior to the required inspection time.

LINE TYPE LEGEND

details and management strategies).

Property line 3m Site Line Triangle Extent of Roof, above _____

EXISTING PLANT LEGEND (Refer to Arborist Report and Tree Retention & Removal Plan for full

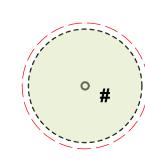


Existing Tree to be retained Onsite qty = 0Offsite (neighbour property) qty = 7



Existing Tree to be removed

Onsite qty = 3 Municipal (boulevard) qty = 2 Removed by adjacent development = 1 Total Removed = 5

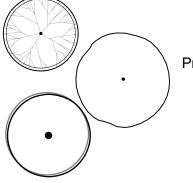

Proposed Trees Onsite qty = 12 (Level one: 8. Level two: 6) Municipal (boulevard) qty = 2 Total = 14

GRADING LEGEND

Existing Landscape Grade Civil Grade, provided for reference only




Architectural grade, provided for reference

Proposed Landscape Grade

TOW Top of Wall BW Bottom of Wall TS Top of Stairs TOC Top of Curb BS Bottom of Stairs BC Bottom of Curb TP Top of Pool LP Low Point

DRAINAGE LEGEND

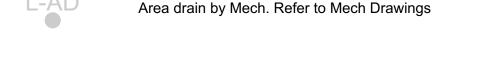


Inspection Chamber

IRRIGATION LEGEND



Irrigation Point of Connection Proposed Irrigation Point of Connection. Provide water service and electrical conduit to this location. Refer to Mech & Elec Drawings.

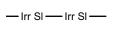

Irrigation Sleeve Schedule 40 PVC, dia. shall be min 3x main line diameter, or 2x lateral line diameter. Install irrigation wiring in separate 2" electrical conduit. Extend sleeve 300 mm past edge of hard surface or walls.

6-L4.02



Hose Bib See Mech.

(1.0) PAVEMENTS, RAMPS, CURBS Cast in place concrete, broom finish with sawcut 3-L4.01 "New Town" paying. Landscape shows control

See Arch.

See Mech.

2-L4.02

3-L4.02

5-L4.02

1.2	Concrete - Type 2	"New Town" paving. Landscape shows control joints, only - refer to civil.	See Civil.
1.3	Unit Paving - On Grade	Belgard Canada, Classic Standard (225mm x 112.5mm x 60mm). Charcoal, running bond pattern.	1-L4.01
1.4	Turfstone	Belgard Canada, c/w structural soil base.	See Civil.
1.5	Gravel Maintenance Edge		5-L4.01
1.6	Structural Soil Cells	Two layers deep. Contractor to provide Shop Drawings	7-L4.01
1.7	Unit Paver on Pedestal - Type 1	610 mm x 610 mm x 20 mm porcelain tile. Supplier: Enmon North Amercia, or approved equivalent. Stack bond on pedestal. Colour: Project Silver	2-L4.01
1.8	Unit Paver on Pedestal - Type 2	Belgard Canada (or approved equivalent) - 'Texada' in color Natural. Stack Bond on pedestal. 610mm x 610mm x 50mm	2-L4.01
1.9	CIP Concrete Curb Edge	Concrete Curb Edge to retain soil. 150 or 200 height. See L2.01.	6-L4.01

Urbanscape Serpentine Bike Rack (model

Hose Bib c/w concrete pad and drain.

Growing medium - refer to spec. 450mm depth.

Sod over growing medium - refer to spec. 600mm

depth or as permitted by Project Arborist within

protected root zone

BRK538S), suface mount. Supplier: Sudden Fun

2.0 SITE WALLS / EMBANKMENTS					
2.1	Cast in Place Concrete Entry Wall		Concrete wall. Refer to Arch.	See Arch.	

PROPOSED

UNDERGROUND UTILITIES

Concrete - Type 1

(3.0) SITE FURNISHINGS

3.1 Standard Bike Rack,

3.6 Dogwash Station

Shrub and Tree Planting Area -

Lawn Area (Sod)

(Shown for reference only - refer to Civil Engineer's drawings).

Storm drain

Electrical

Hydro Tel

	Capacity. 1	 Recreation.	
3.2	Double Bike Rack, Capacity: 2	Urbanscape Serpentine Bike Rack (model BRK538S), suface mount. Supplier: Sudden Fun Recreation.	See Mfr.
3.3	Raised Bed Planter	SproutBox metal raised garden bed. Series: 17" Tall Modular 9 in 1 kit, 'V7' 5ft x 2ft configuration. Finish: Slate Grey - or approved equivalent. C/w engineered light weight growing medium. Foam voiding to limit soil depth to 400 depth max.	See Mfr.
3.4	Aluminium Planter	Aluminium Planter. Supplier: Green Theory Designs, or approved equivalent. C/w engineered light weight growing medium - refer to spec. Foam Voiding to limit soil depth to 900 depth max.	7-L4.02
3.5	Bollard	See Arch.	See Arch

4.0	RAILINGS, BARRIERS, F	ENCING		
4.1	Security Gate and Fence	~~~	See Arch.	See Arch.
4.2	Screening		See Arch.	See Arch.
4.3	Cedar Fencing by Neighbour		Offset from property line for clarity. Protect and retain.	By Others.
4.4	Existing Chain Link Fence	* × ×	Offset from property line for clarity. Protect and retain unless otherwise noted.	N/A
4.5	Root Barrier	—RB — RB — RI	Deep Root Tree Root Barrier (UB-24) or approved equivalent.	See Mfr.
5.0	PLANTING AND LANDSO	CAPE		
5.1	Shrub and Tree Planting Area - On Grade		Growing medium - refer to spec. 450mm depth unless otherwise noted. See Plan.	4-L4.02



NOTFORCONSTRUCTION

12	Issued for DDP	2025-02-1
11	Issued for BP Resub 2	2025-02-1
10	Issued for Tender	2024-09-1
9	IFT 99%	2024-09-1
8	BP Resubmission	2024-05-1
7	BP	2023-12-0
6	BP Draft/Coord.	2023-10-2
5	REZ / DP	2023-03-1
4	REZ / DP	2022-10-2
rev no	description	date
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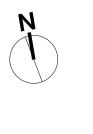
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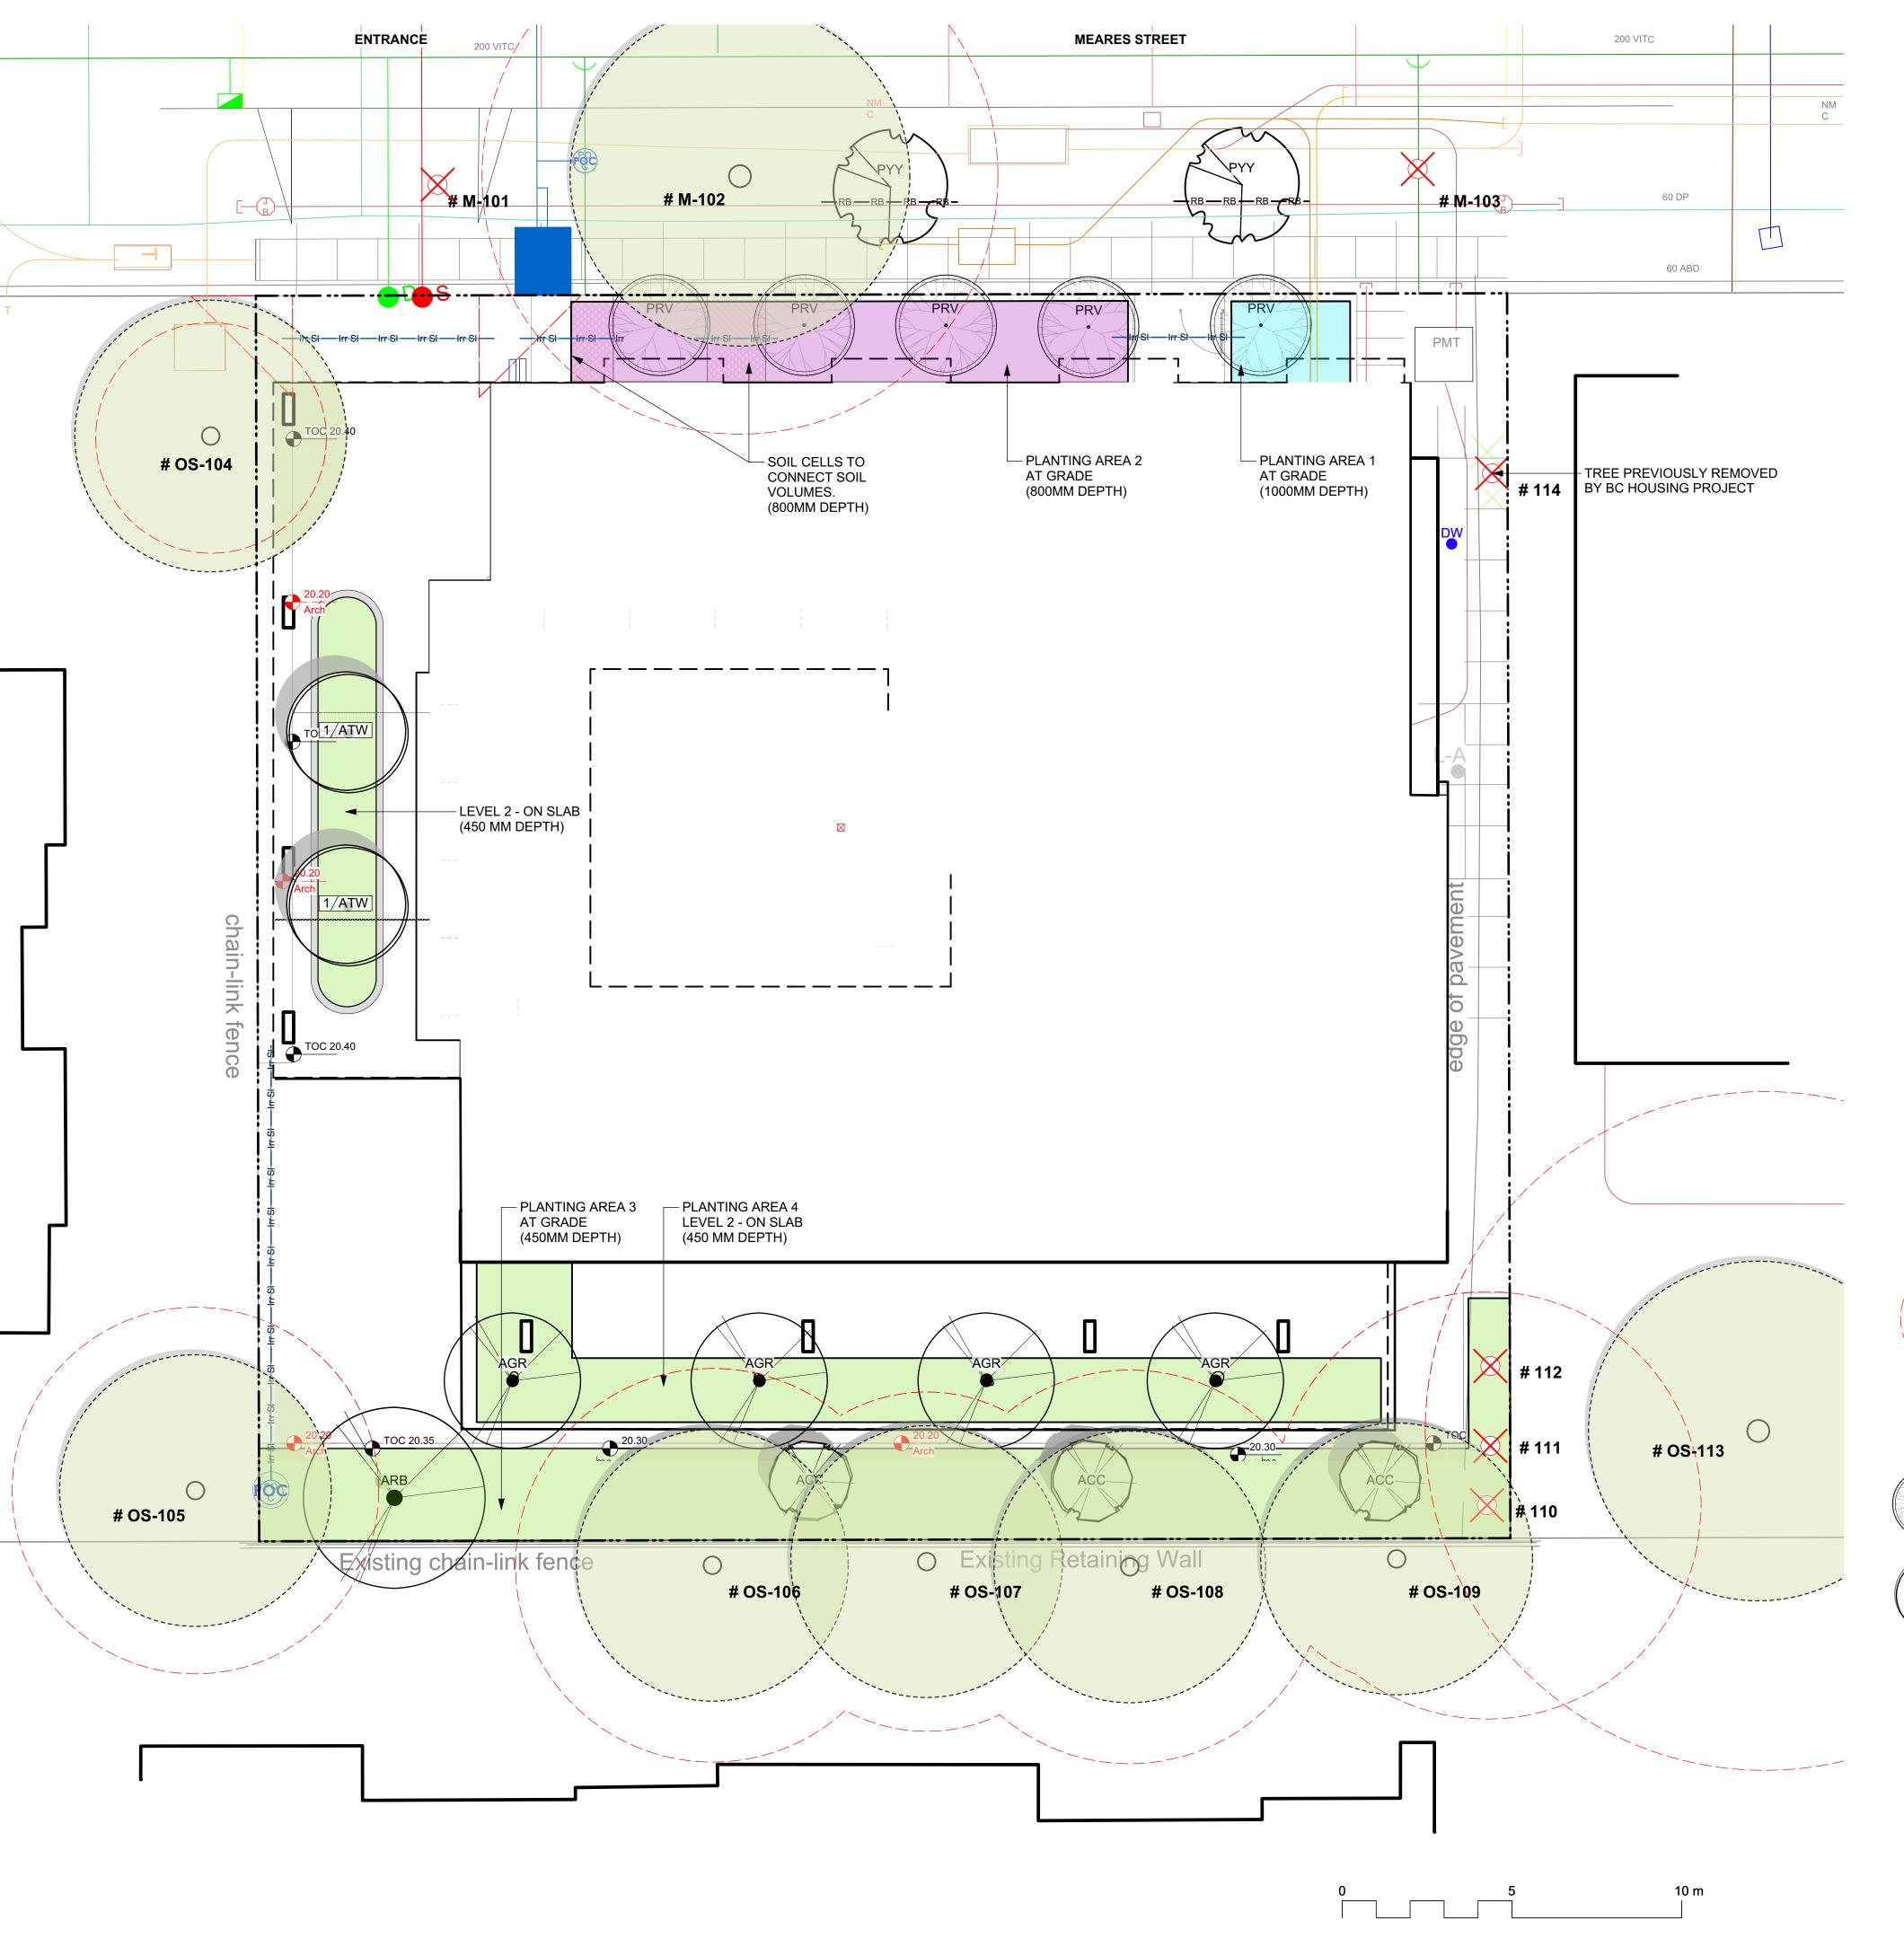
1039-1043 Meares St 1039-1043 Meares St Victoria, BC


sheet title

General Information Sheet

122.11 project no. 1: 100 @ 24"x36" scale drawn by SM/JD checked by revision no. sheet no. 12





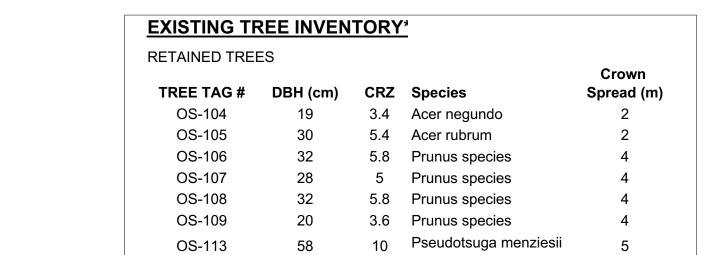

TOTAL TREES TO BE RETAINED: 8

REMOVED TREES

INCIVIO VED TINEI	_0			_
TREE TAG #	DBH (cm)	CRZ	Species	Crown Spread (
M-101	54	9.7	Prunus yedoensis	3.5
M-103	44	7.9	Prunus species	6.5
110	35, 35	6.3	Acer rubrum	4.5
111	20	3.6	Acer rubrum	3.5
112	41	7.4	Acer rubrum	4.5

7.6 Prunus yedoensis

TOTAL TREES TO BE REMOVED: 5

* Based on Arborist's Report recieved from Arborist, 06/09/2022. Refer to Arborist report for details on tree conditions and Arborist recommendations.

** Tree 114 previously removed by BC Housing project.

REPLACEMENT TREE SOIL VOLUME TABLE

					CEMENT PROPOSEI		SOIL VOLUME REQUIRED (m3)			
Planting Area ID	Area (m2)	Soil Volume Multiplier	A. Estimated Soil Volume (m3)	B. Small	C. Medium	D. Large	E. Small	F. Medium	G. Large	Total
ONSITE	I.		l							
1	8.5	1	8.5	1			8			8
2	39.1	0.8	31.3	4			24			24
3	104.5	0.45	47.0	3	1		18	20		38
4	58.3	0.45	26.2	4			24			24

TREES:				
ACC	3	Acer circinatum	Vine Maple	3 m ht, 1.8 width, multi-stem
ARB	1	Acer rubrum 'Bowhall'	Autumn Flame Tm Scarlet Maple	6.0cm cal, b&b
PRV	5	Parrotia persica 'Ruby Vase'	Ruby Vase Persian Ironwood	6.0cm cal, b&b, 1.8m standard mir
PYY	2	Prunus yedoensis 'Yoshino'	Yoshino Cherry Blossom	5.0cm cal. with min. 6' standard

EXISTING PLANT LEGEND

(Refer to Arborist Report and Tree Retention & Removal Plan for full

details and management strategies).

ATW 2 Acer tegmentosum "White Tigres White Tigress Maple

Existing Tree to be retained Onsite qty = 0Offsite (neighbour property) qty = 7 Total = 7

Existing Tree to be removed Onsite qty = 3Municipal (boulevard) qty = 2 Removed by adjacent development = 1 Total = 6 Total Removed = 5

Proposed Trees Onsite qty = 12 (Level one: 8. Level two: 6)

<u>Municipal (boulevard) qty = 2</u>

Total = 14

REPLACEMENT TREE SUMMARY Refer to Tree Protection Plan for Full Replacement Tree Table


REQUIRED (as per Tree Protection Bylaw)


1352.3 sq m Lot Area: Minimum # of Trees for Lot Area: PROPOSED DESIGN Proposed 1:1 Replacement Trees Proposed 2:1 Replacement Trees 12 Total Replacement Trees Proposed

4.0cm cal, b&b, multi-stem

Proposed Municipal Trees

SOIL DEPTH LEGEND

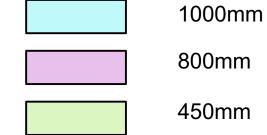

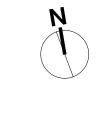

NOTFORCONSTRUCTION

12 Issued for DDP 2025-02-18 11 Issued for BP Resub 2 2025-02-18 10 Issued for Tender 2024-09-13 9 IFT 99% 2024-09-13 8 BP Resubmission 2024-05-16 7 BP 2023-12-01 6 BP Draft/Coord. 2023-10-24 5 REZ / DP 2023-03-15 4 REZ / DP 2022-10-21 v no description date			
10 Issued for Tender 2024-09-13 9 IFT 99% 2024-09-13 8 BP Resubmission 2024-05-16 7 BP 2023-12-01 6 BP Draft/Coord. 2023-10-24 5 REZ / DP 2023-03-15 4 REZ / DP 2022-10-21	12	Issued for DDP	2025-02-18
9 IFT 99% 2024-09-13 8 BP Resubmission 2024-05-16 7 BP 2023-12-01 6 BP Draft/Coord. 2023-10-24 5 REZ / DP 2023-03-15 4 REZ / DP 2022-10-21	11	Issued for BP Resub 2	2025-02-18
8 BP Resubmission 2024-05-16 7 BP 2023-12-01 6 BP Draft/Coord. 2023-10-24 5 REZ / DP 2023-03-15 4 REZ / DP 2022-10-21	10	Issued for Tender	2024-09-13
7 BP 2023-12-01 6 BP Draft/Coord. 2023-10-24 5 REZ / DP 2023-03-15 4 REZ / DP 2022-10-21	9	IFT 99%	2024-09-13
6 BP Draft/Coord. 2023-10-24 5 REZ / DP 2023-03-15 4 REZ / DP 2022-10-21	8	BP Resubmission	2024-05-16
5 REZ / DP 2023-03-15 4 REZ / DP 2022-10-21	7	BP	2023-12-01
4 REZ / DP 2022-10-21	6	BP Draft/Coord.	2023-10-24
	5	REZ / DP	2023-03-15
v no description date	4	REZ / DP	2022-10-21
	v no	description	date





Jawl Residential 3374 Tennyson Ave.

Victoria, BC


1039-1043 Meares St

1039-1043 Meares St Victoria, BC

sheet title

Tree Removal, Retention & Replacement Plan

project no.	122.11
scale	1: 100 @ 24"x36"
drawn by	MDI
checked by	SM/JD
revision no.	sheet no.
12	L0.02

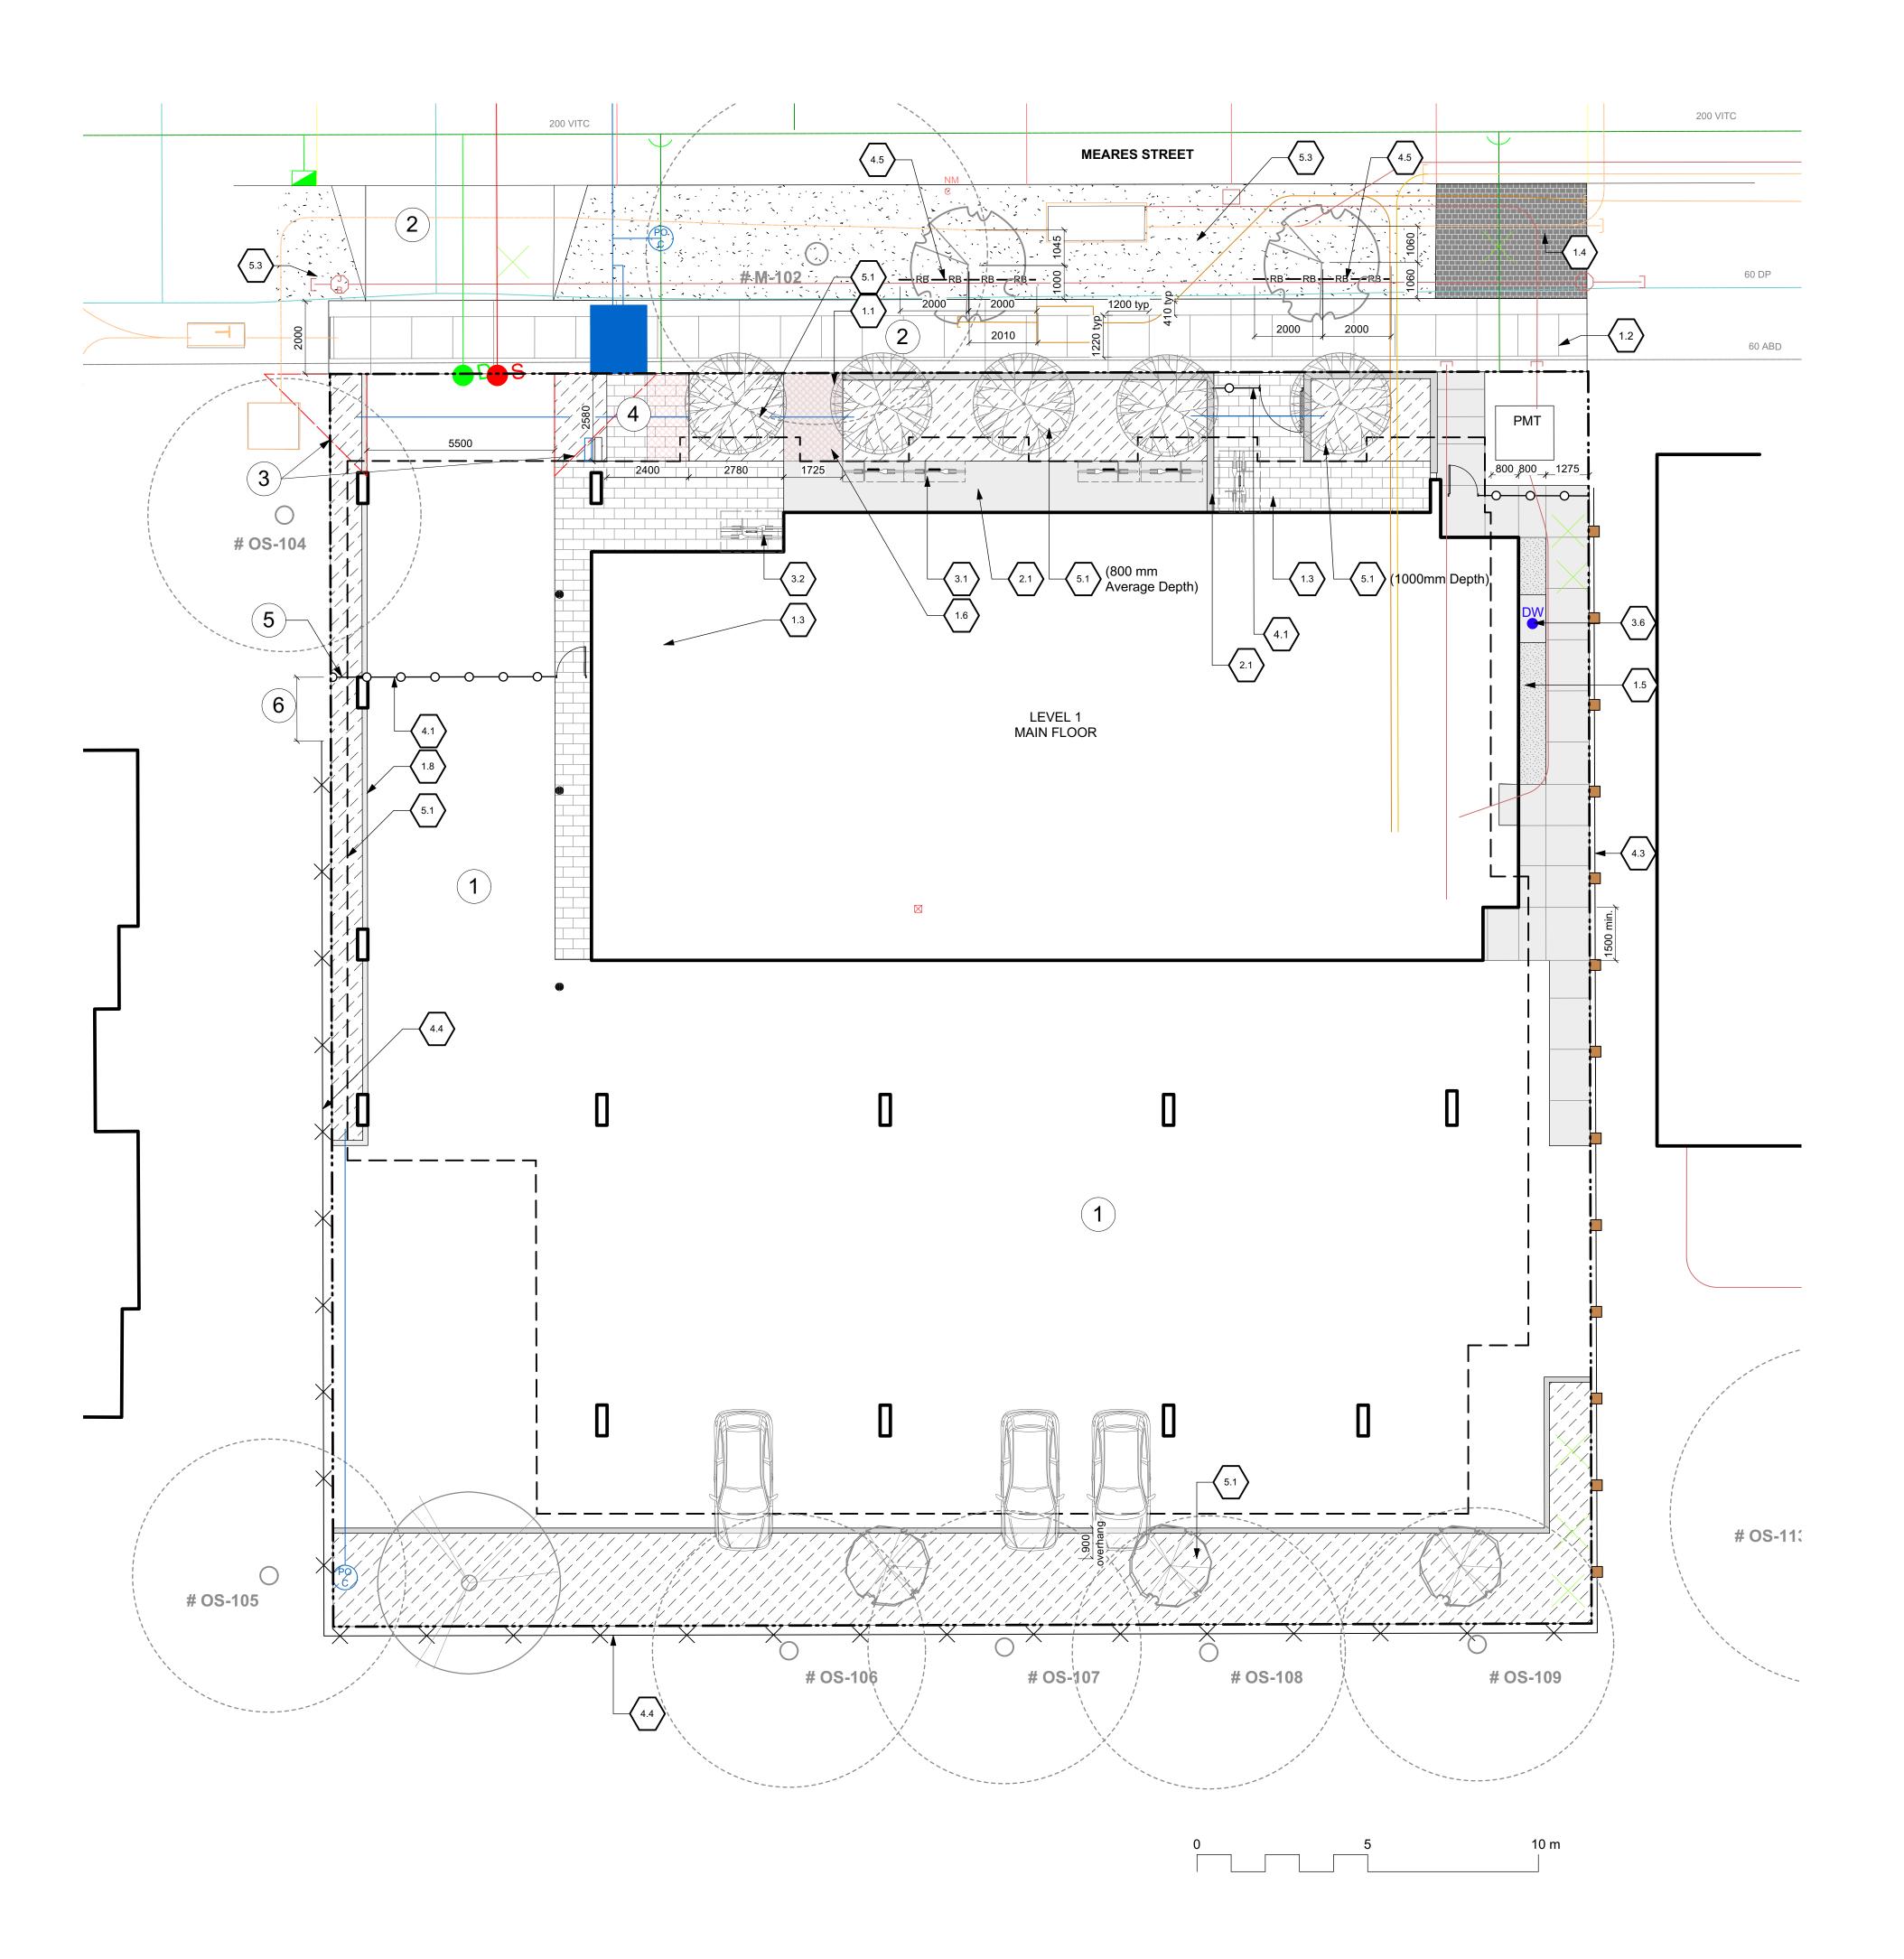

	Concrete - Type 1		Cast in place concrete, broom finish with sawcut	3-L4.
			joints.	J-L4.
1.2	Concrete - Type 2		"New Town" paving. Landscape shows control joints, only - refer to civil.	See C
1.3	Unit Paving - On Grade		Belgard Canada, Classic Standard (225mm x 112.5mm x 60mm). Charcoal, running bond pattern.	1-L4.
1.4	Turfstone		Belgard Canada, c/w structural soil base.	See C
1.5	Gravel Maintenance Edge			5-L4.
1.6	Structural Soil Cells		Two layers deep. Contractor to provide Shop Drawings	7-L4.
1.7	Unit Paver on Pedestal - Type 1		610 mm x 610 mm x 20 mm porcelain tile. Supplier: Enmon North Amercia, or approved equivalent. Stack bond on pedestal. Colour: Project Silver	2-L4.
1.8	Unit Paver on Pedestal - Type 2		Belgard Canada (or approved equivalent) - 'Texada' in color Natural. Stack Bond on pedestal. 610mm x 610mm x 50mm	2-L4.
1.9	CIP Concrete Curb Edge		Concrete Curb Edge to retain soil. 150 or 200 height. See L2.01.	6-L4.
2.0	SITE WALLS / EMBANKI	MENTS		
2.1	Cast in Place Concrete Entry Wall		Concrete wall. Refer to Arch.	See A
3.0	SITE FURNISHINGS			
3.1	Standard Bike Rack, Capacity: 1		Urbanscape Serpentine Bike Rack (model BRK538S), suface mount. Supplier: Sudden Fun Recreation.	See M
3.2	Double Bike Rack, Capacity: 2		Urbanscape Serpentine Bike Rack (model BRK538S), suface mount. Supplier: Sudden Fun Recreation.	See M
3.3	Raised Bed Planter		SproutBox metal raised garden bed. Series: 17" Tall Modular 9 in 1 kit, 'V7' 5ft x 2ft configuration. Finish: Slate Grey - or approved equivalent. C/w engineered light weight growing medium. Foam voiding to limit soil depth to 400 depth max.	See M
3.4	Aluminium Planter		Aluminium Planter. Supplier: Green Theory Designs, or approved equivalent. C/w engineered light weight growing medium - refer to spec. Foam Voiding to limit soil depth to 900 depth max.	7-L4.
3.5	Bollard	•	See Arch.	See A
3.6	Dogwash Station	DW	Hose Bib c/w concrete pad and drain.	See M
4.0	RAILINGS, BARRIERS, F	ENCING		
4.1	Security Gate and Fence	00	See Arch.	See A
4.2	Screening		See Arch.	See A
4.3	Cedar Fencing by Neighbour		Offset from property line for clarity. Protect and retain.	By Oth
	Existing Chain Link Fence	* × ×	Offset from property line for clarity. Protect and retain unless otherwise noted.	N/A
4.4				
4.4	Root Barrier	—RB—RB—RI	Deep Root Tree Root Barrier (UB-24) or approved equivalent.	See M
	Root Barrier PLANTING AND LANDS			See M
4.5				
4.5	PLANTING AND LANDSO		equivalent. Growing medium - refer to spec. 450mm depth	4-L4. 2-L4. 3-L4.

REFERENCE NOTES


- Refer to Architects drawings for parking lot details.
- Refer to Civil Eng. drawings for driveway crossing and sidewalk details.
- 3.0m sight triangle.
- Final structural soil cell design to be coorinated with underground services in this area. Depth of services to be verified prior to shop drawing production.
- Add section of chainlink fence to close gap between property line and security gate.
- Extend existing chainlink fene on property line to close off access to meet new security gate.



NOTFORCONSTRUCTION

12	Issued for DDP	2025-02-18
11	Issued for BP Resub 2	2025-02-18
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9	IFT 99%	2024-09-13
8	BP Resubmission	2024-05-16
7	BP	2023-12-01
6	BP Draft/Coord.	2023-10-24
5	REZ / DP	2023-03-15
4	REZ / DP	2022-10-21
rev no	description	date



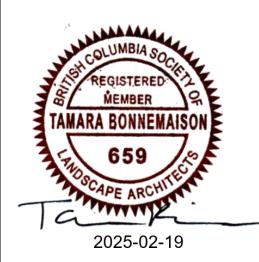

Jawl Residential
3374 Tennyson Ave.
Victoria, BC


project 1039-1043 Meares St 1039-1043 Meares St Victoria, BC

sheet title


Landscape Materials

project no.		122.11
scale	1: 100	@ 24"x36"
drawn by		MDI
checked by		SM/JD
revision no.	sheet no.	
12	L	1.01

MEARES STREET

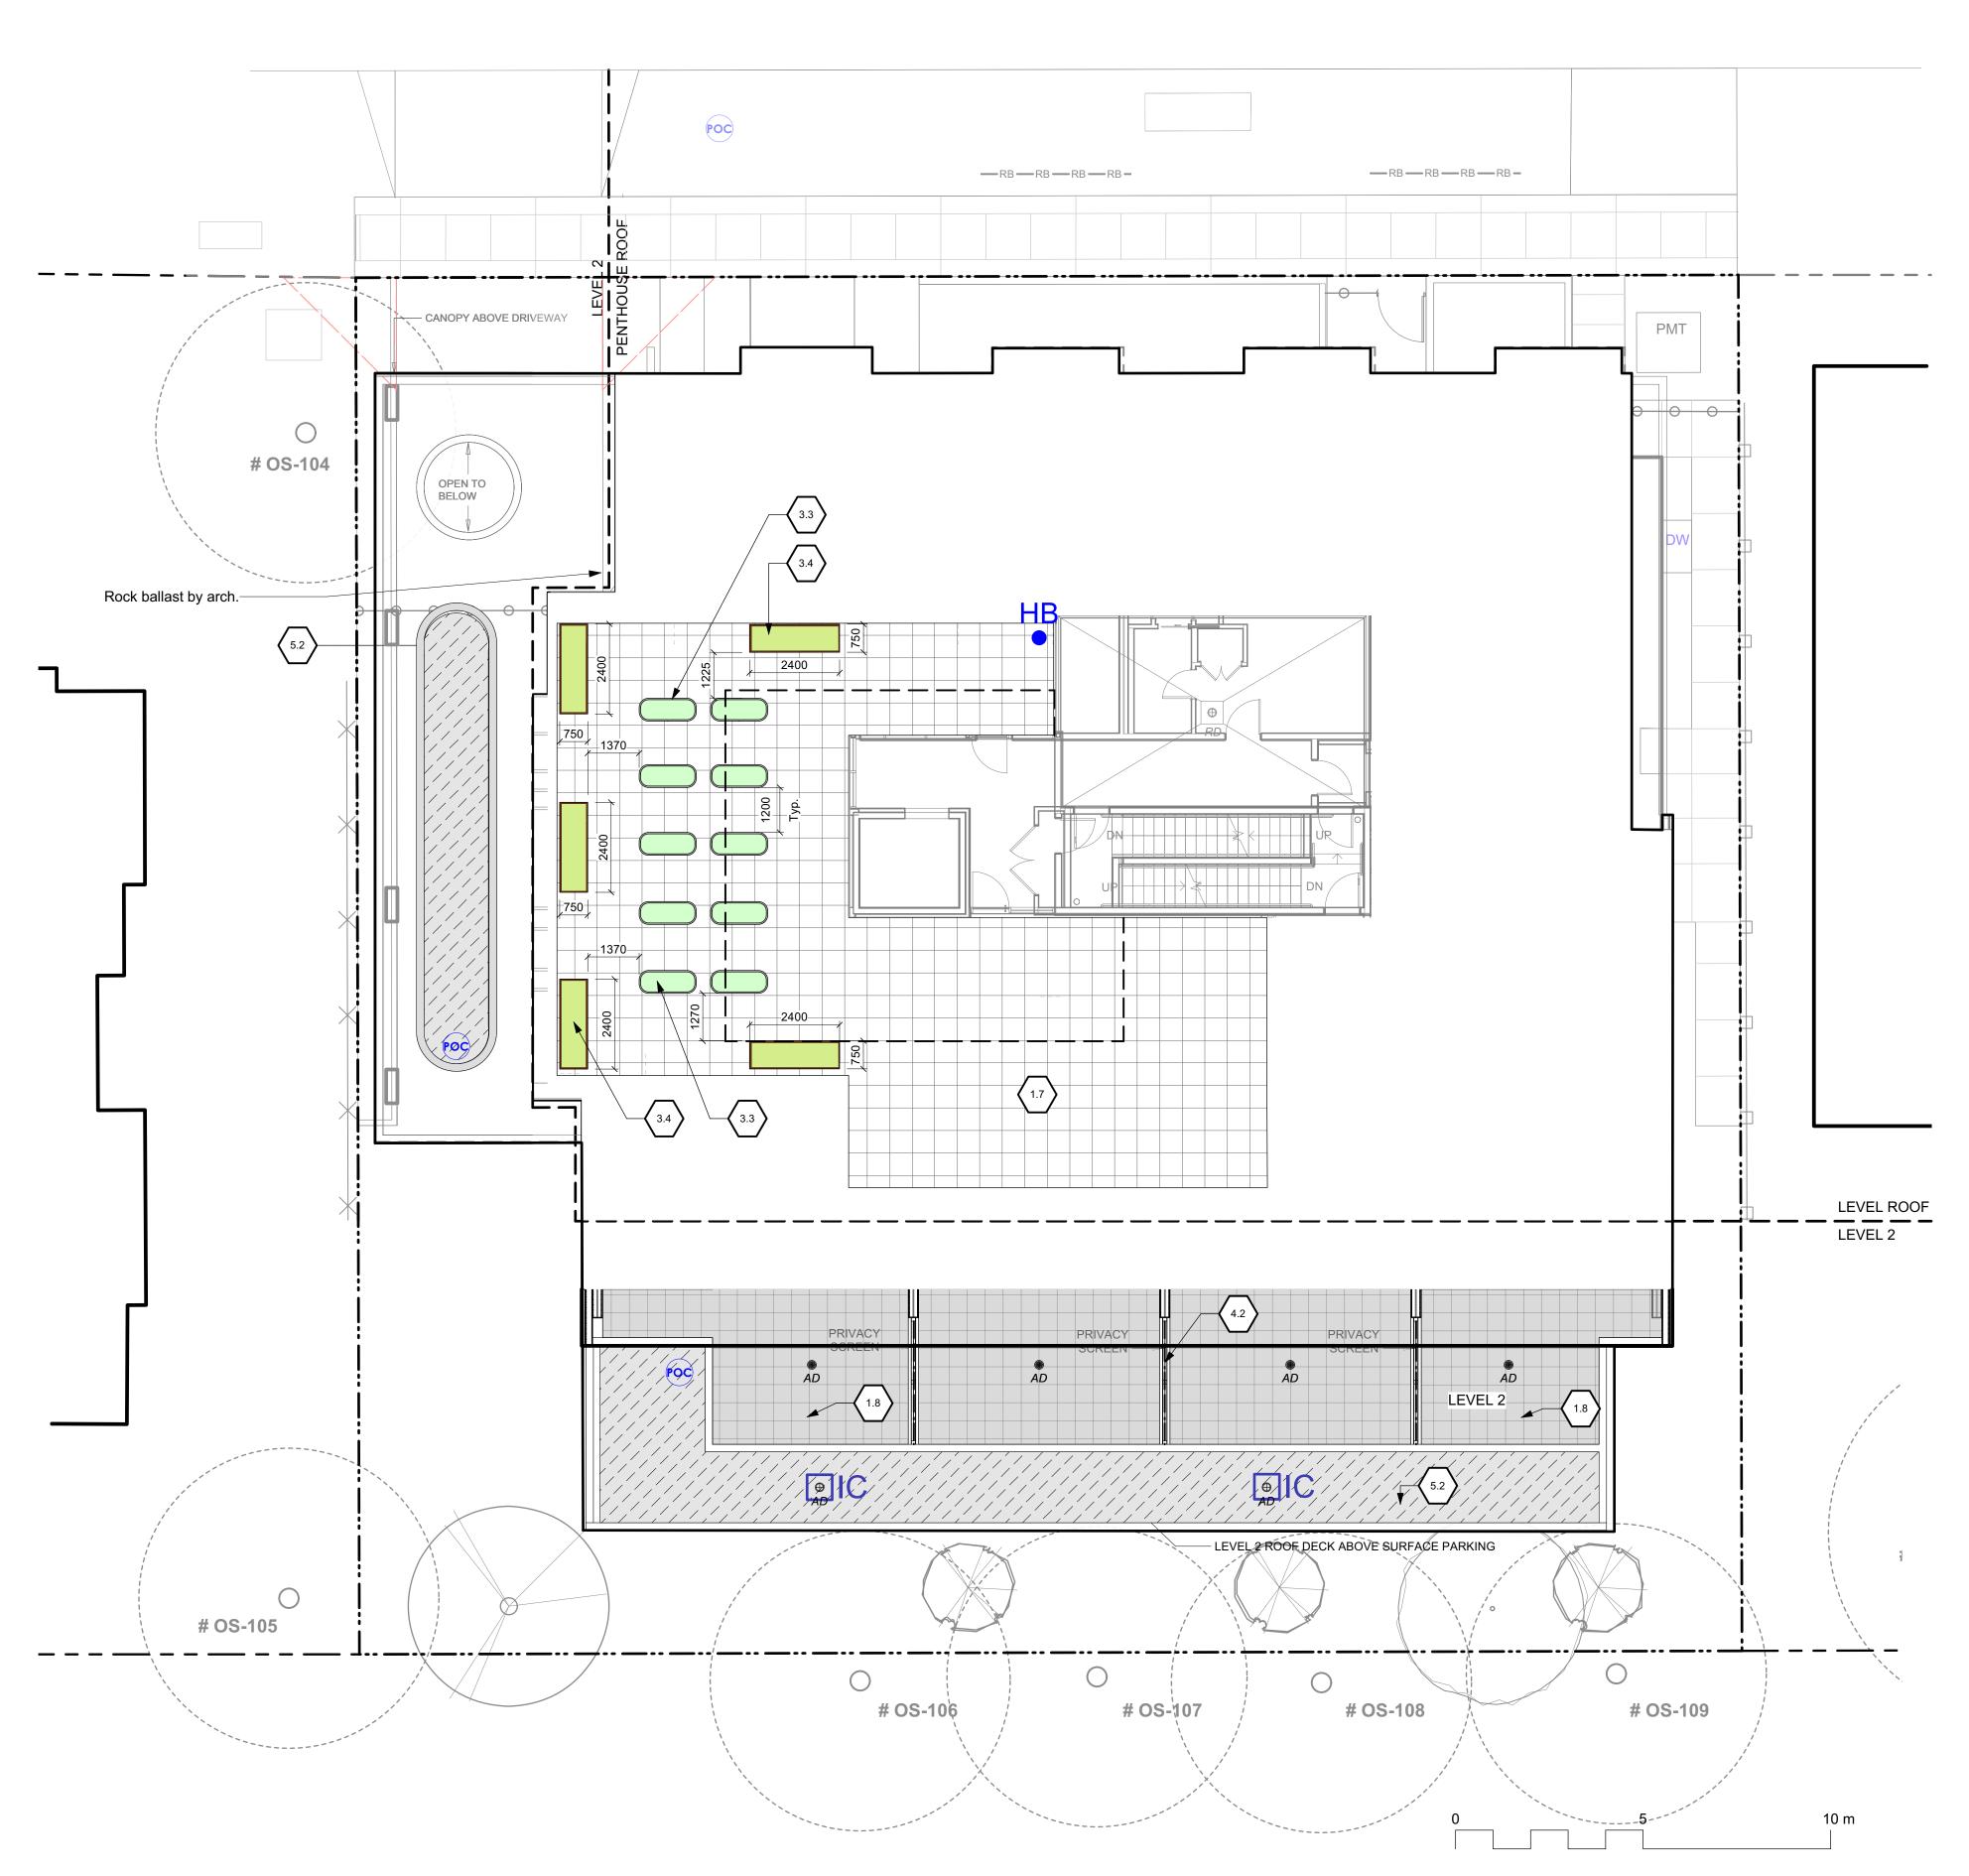

	PAVEMENTS, RAMPS, C	CILEO		
1.1	Concrete - Type 1		Cast in place concrete, broom finish with sawcut joints.	3-L4.01
1.2	Concrete - Type 2		"New Town" paving. Landscape shows control joints, only - refer to civil.	See Civil
1.3	Unit Paving - On Grade		Belgard Canada, Classic Standard (225mm x 112.5mm x 60mm). Charcoal, running bond pattern.	1-L4.01
1.4	Turfstone		Belgard Canada, c/w structural soil base.	See Civil
1.5	Gravel Maintenance Edge			5-L4.01
1.6	Structural Soil Cells		Two layers deep. Contractor to provide Shop Drawings	7-L4.01
1.7	Unit Paver on Pedestal - Type 1		610 mm x 610 mm x 20 mm porcelain tile. Supplier: Enmon North Amercia, or approved equivalent. Stack bond on pedestal. Colour: Project Silver	2-L4.01
1.8	Unit Paver on Pedestal - Type 2		Belgard Canada (or approved equivalent) - 'Texada' in color Natural. Stack Bond on pedestal. 610mm x 610mm x 50mm	2-L4.01
1.9	CIP Concrete Curb Edge		Concrete Curb Edge to retain soil. 150 or 200 height. See L2.01.	6-L4.01
2.0	SITE WALLS / EMBANK	MENTS	·	
2.1	Cast in Place Concrete Entry Wall		Concrete wall. Refer to Arch.	See Arch
3.0	SITE FURNISHINGS			
3.1	Standard Bike Rack, Capacity: 1		Urbanscape Serpentine Bike Rack (model BRK538S), suface mount. Supplier: Sudden Fun Recreation.	See Mfr
3.2	Double Bike Rack, Capacity: 2		Urbanscape Serpentine Bike Rack (model BRK538S), suface mount. Supplier: Sudden Fun Recreation.	See Mfr
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3.4	Aluminium Planter		Aluminium Planter. Supplier: Green Theory Designs, or approved equivalent. C/w engineered light weight growing medium - refer to spec. Foam Voiding to limit soil depth to 900 depth max.	7-L4.02
3.5	Bollard	•	See Arch.	See Arch
3.6	Dogwash Station	DW	Hose Bib c/w concrete pad and drain.	See Mech
4.0	RAILINGS, BARRIERS, F	ENCING		
4.1	Security Gate and Fence	0-0-0-	See Arch.	See Arch
4.2	Screening		See Arch.	See Arch
4.3	Cedar Fencing by Neighbour		Offset from property line for clarity. Protect and retain.	By Others
4.4	Existing Chain Link Fence	*	Offset from property line for clarity. Protect and retain unless otherwise noted.	N/A
4.5	Root Barrier	—RB —RB —RI	Deep Root Tree Root Barrier (UB-24) or approved equivalent.	See Mfr.
5.0	PLANTING AND LANDS	CAPE		
5.1	Shrub and Tree Planting Area - On Grade		Growing medium - refer to spec. 450mm depth unless otherwise noted. See Plan.	4-L4.02
5.2	Shrub and Tree Planting Area - On Slab		Growing medium - refer to spec. 450mm depth.	2-L4.02 3-L4.02
	and the second s			

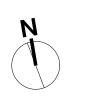

NOTFORCONSTRUCTION

12	Issued for DDP	2025-02-18
11	Issued for BP Resub 2	2025-02-18
10	Issued for Tender	2024-09-13
9	IFT 99%	2024-09-13
8	BP Resubmission	2024-05-16
7	ВР	2023-12-01
6	BP Draft/Coord.	2023-10-24
5	REZ / DP	2023-03-15
4	REZ / DP	2022-10-21
rev no	description	date





client

Jawl Residential


3374 Tennyson Ave. Victoria, BC

project
1039-1043 Meares St

1039-1043 Meares St Victoria, BC


Landscape Materials L2 & Roof

project no.		122.11
scale	1: 100	@ 24"x36"
drawn by		MDI
checked by		SM/JD
revision no.	sheet no.	
12	L	1.02

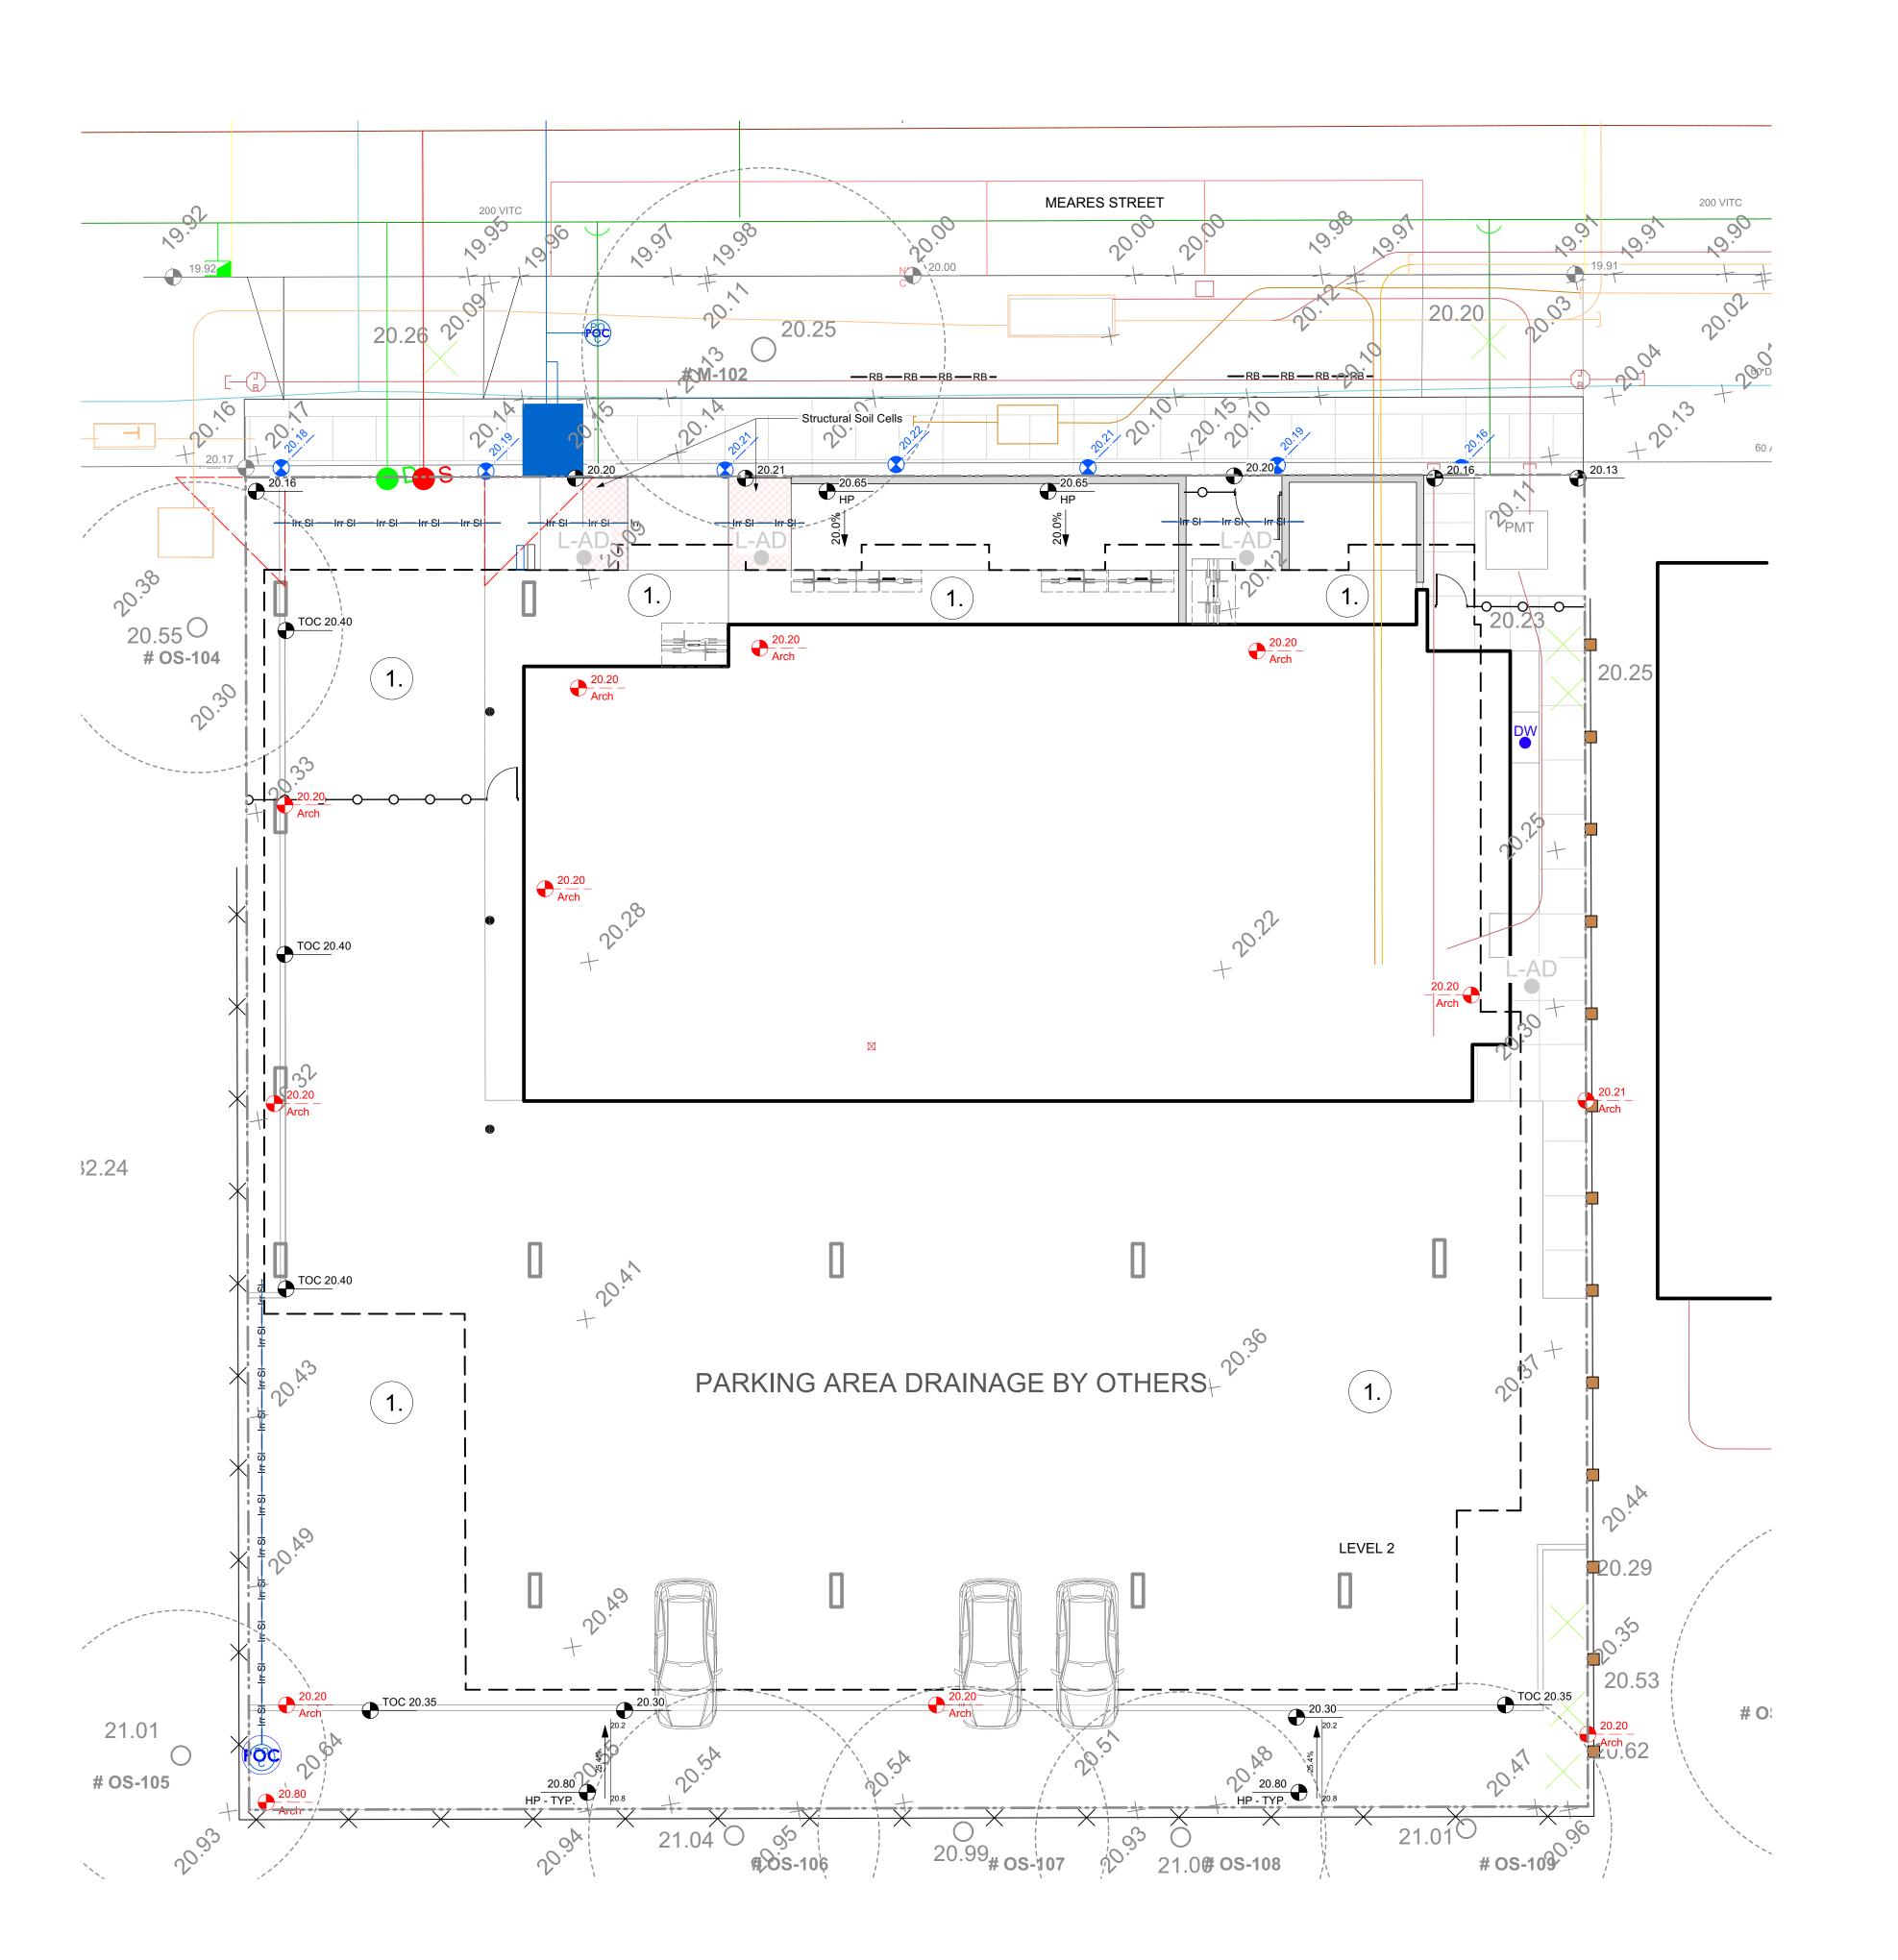

GRADING LEGEND

+ 20.15 Existing Landscape Grade

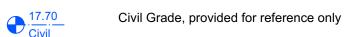

Architectural grade, provided for reference

Proposed Landscape Grade

TOW Top of Wall BP Bottom of Pool
BW Bottom of Wall TS Top of Stairs
TOC Top of Curb BS Bottom of Stairs

1. Refer to Architects DWG's for onsite grading.

BC Bottom of Curb
TP Top of Pool

DRAINAGE LEGEND

L-AD

Area drain by Mech. Refer to Mech Drawings


Inspection Chamber

6-L4.02

IRRIGATION LEGEND



Irrigation Point of Connection
Proposed Irrigation Point of Connection.
Provide water service and electrical conduit to this location. Refer to Mech & Elec Drawings.

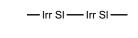

Irrigation Sleeve
Schedule 40 PVC, dia. shall be min 3x main line

diameter, or 2x lateral line diameter. Install irrigation wiring in separate 2" electrical conduit. Extend sleeve 300 mm past edge of hard surface or walls.



Hose Bib See Mech.

NOTFORCONSTRUCTION

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5	REZ / DP	2023-03-15
4	REZ / DP	2022-10-21
rev no	description	date





2025-02-19

Jawl Residential 3374 Tennyson Ave. Victoria, BC

project 1039-1043 Meares St


1039-1043 Meares St Victoria, BC

sheet title

Landscape Grading and Drainage

12	L2.01
revision no.	sheet no.
checked by	SM/JD
drawn by	MDI
scale	1: 100 @ 24"x36"
project no.	122.11

MEARES STREET

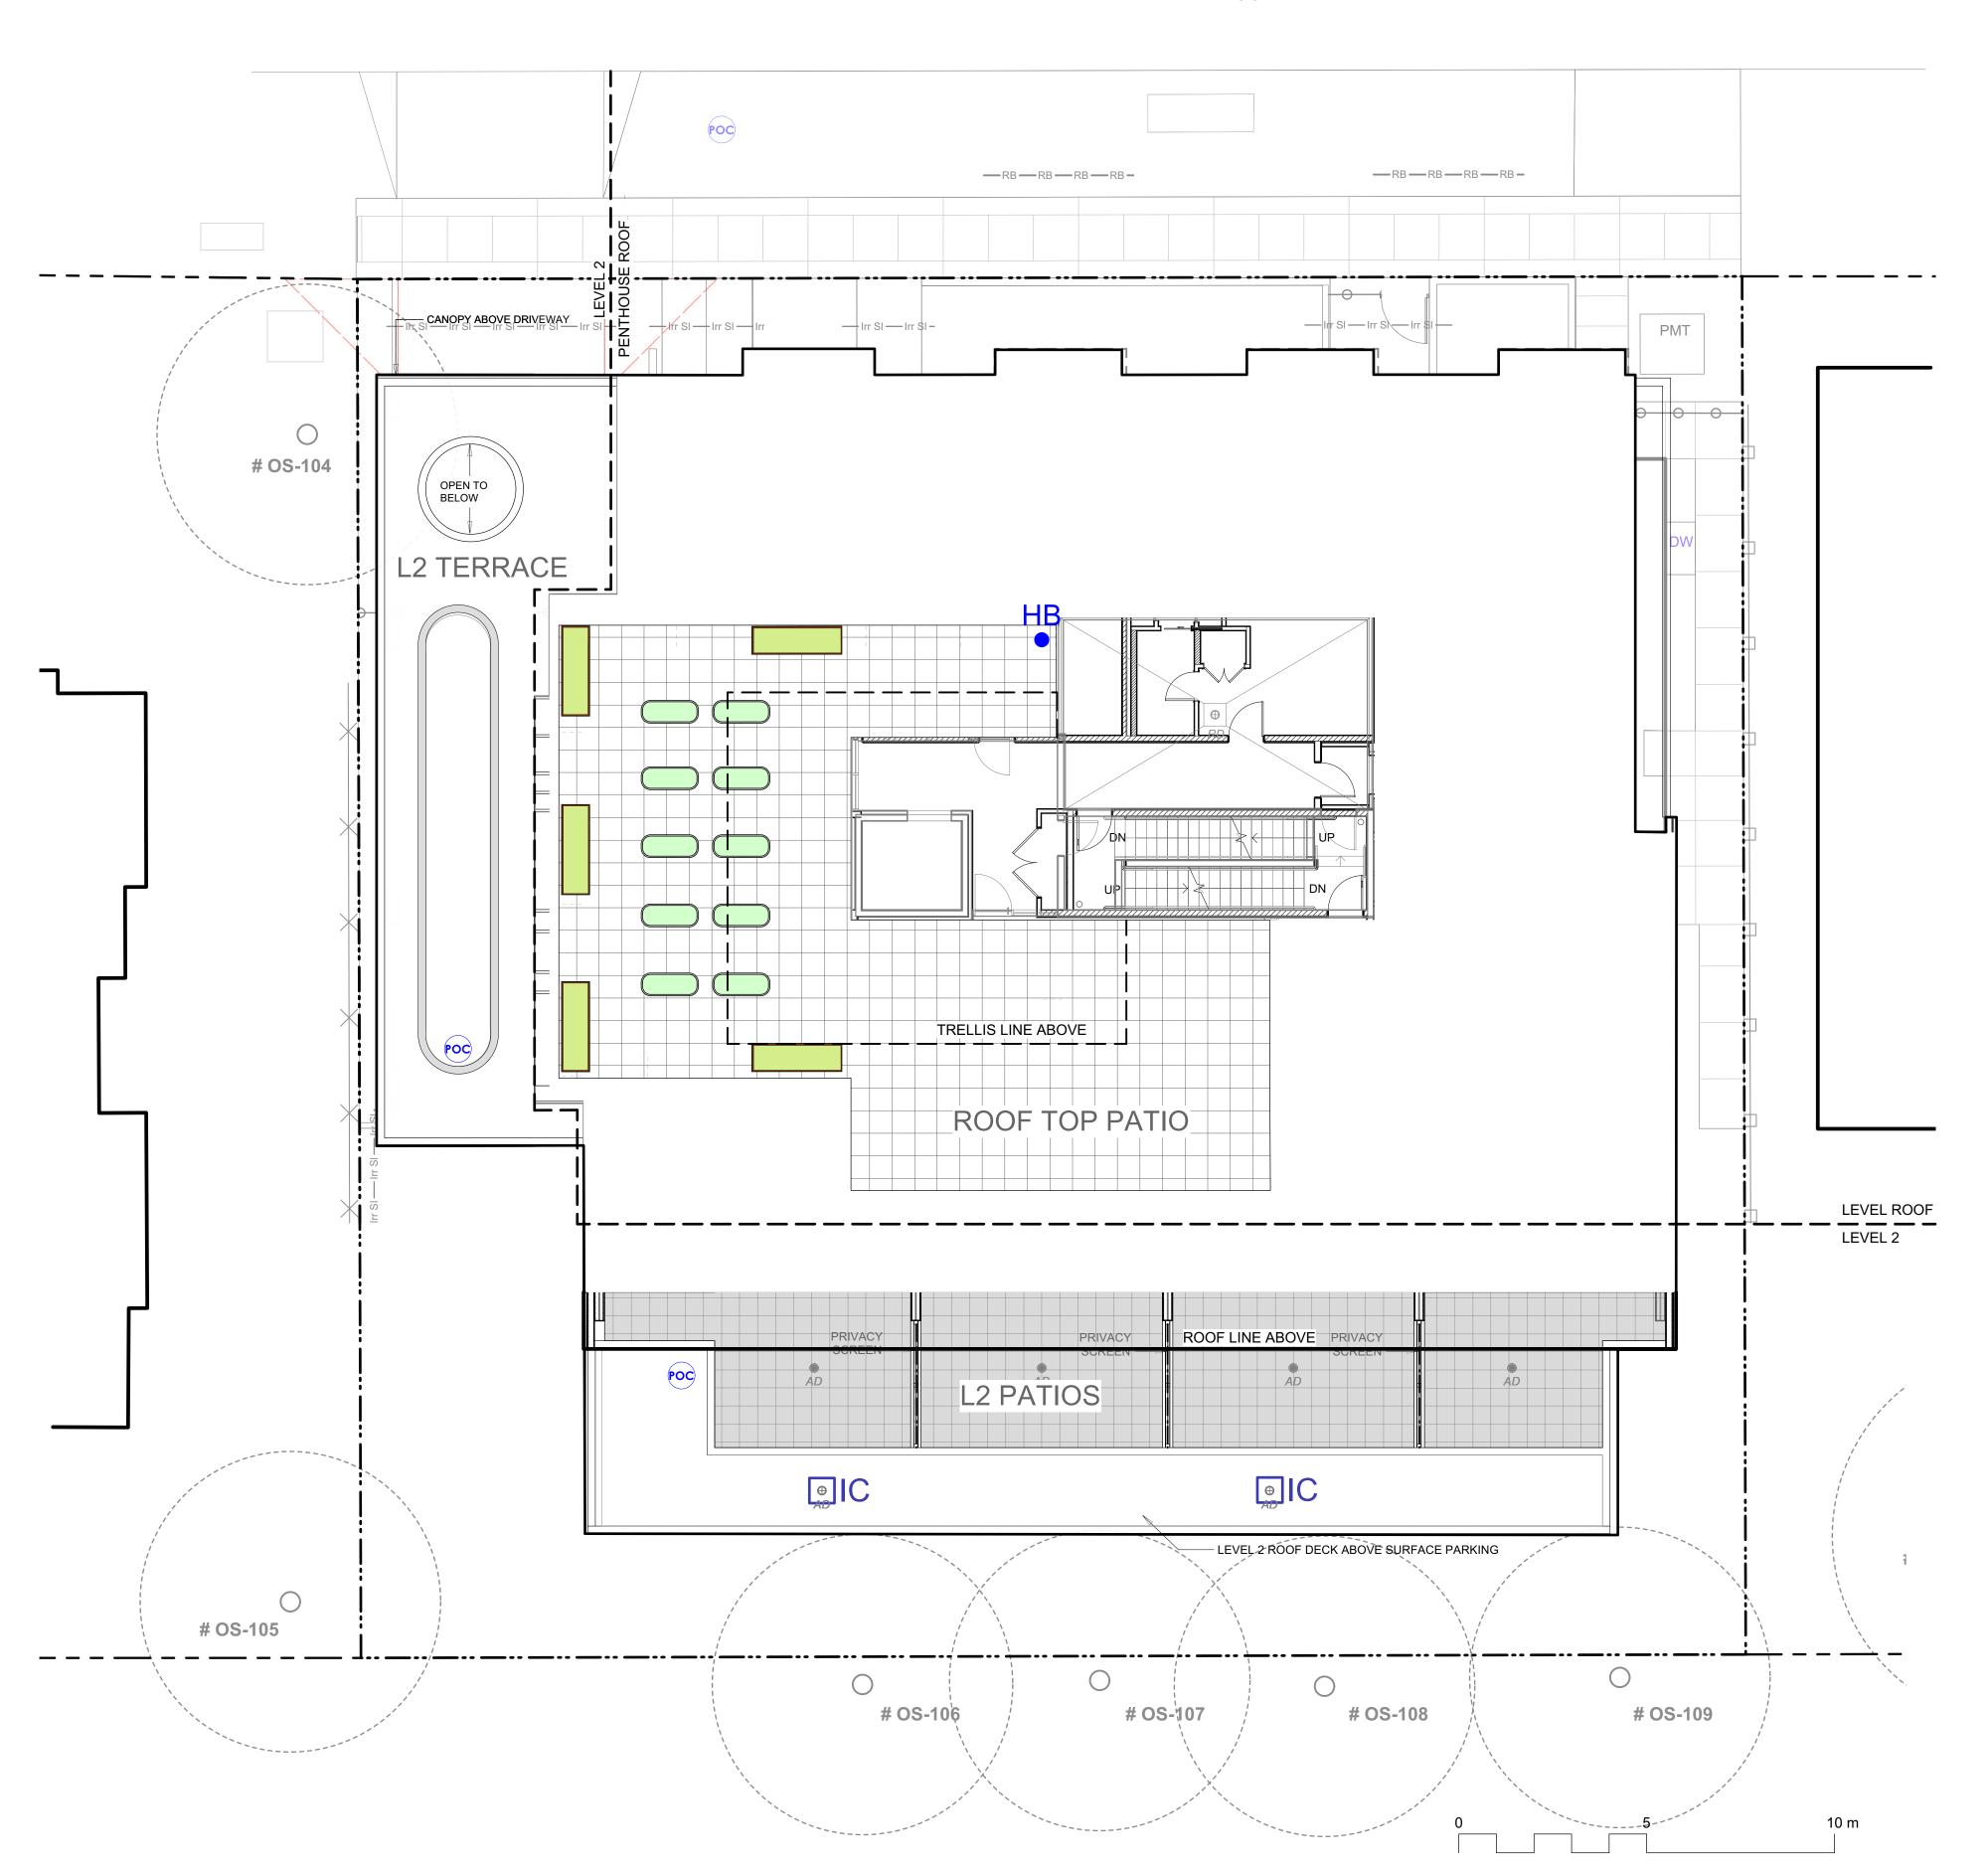

GRADING LEGEND

+ 20.15 Existing Landscape Grade



Civil Grade, provided for reference only



Architectural grade, provided for reference



Proposed Landscape Grade

TOW Top of Wall BP Bottom of Pool
BW Bottom of Wall TS Top of Stairs
TOC Top of Curb BS Bottom of Stairs
BC Bottom of Curb HP High Point
TP Top of Pool LP Low Point

DRAINAGE LEGEND



Area drain by Mech. Refer to Mech Drawings




Inspection Chamber

6-L4.02

IRRIGATION LEGEND



Irrigation Point of Connection
Proposed Irrigation Point of Connection.
Provide water service and electrical conduit to this location. Refer to Mech & Elec Drawings.

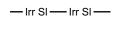

Irrigation Sleeve
Schedule 40 PVC, dia. shall be min 3x main line diameter, or 2x lateral line diameter. Install irrigation wiring in separate 2" electrical conduit. Extend sleeve 300 mm past edge of hard surface or walls.



Hose Bib See Mech.

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ev no	description	date





client

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3374 Tennyson Ave. Victoria, BC


1039-1043 Meares St 1039-1043 Meares St

sheet title

Victoria, BC

Landscape Grading and Drainage L2 & Roof


project no.	122.11
scale	1: 100 @ 24"x36"
drawn by	MDI
checked by	SM/JD
revision no.	sheet no.
12	L2.02

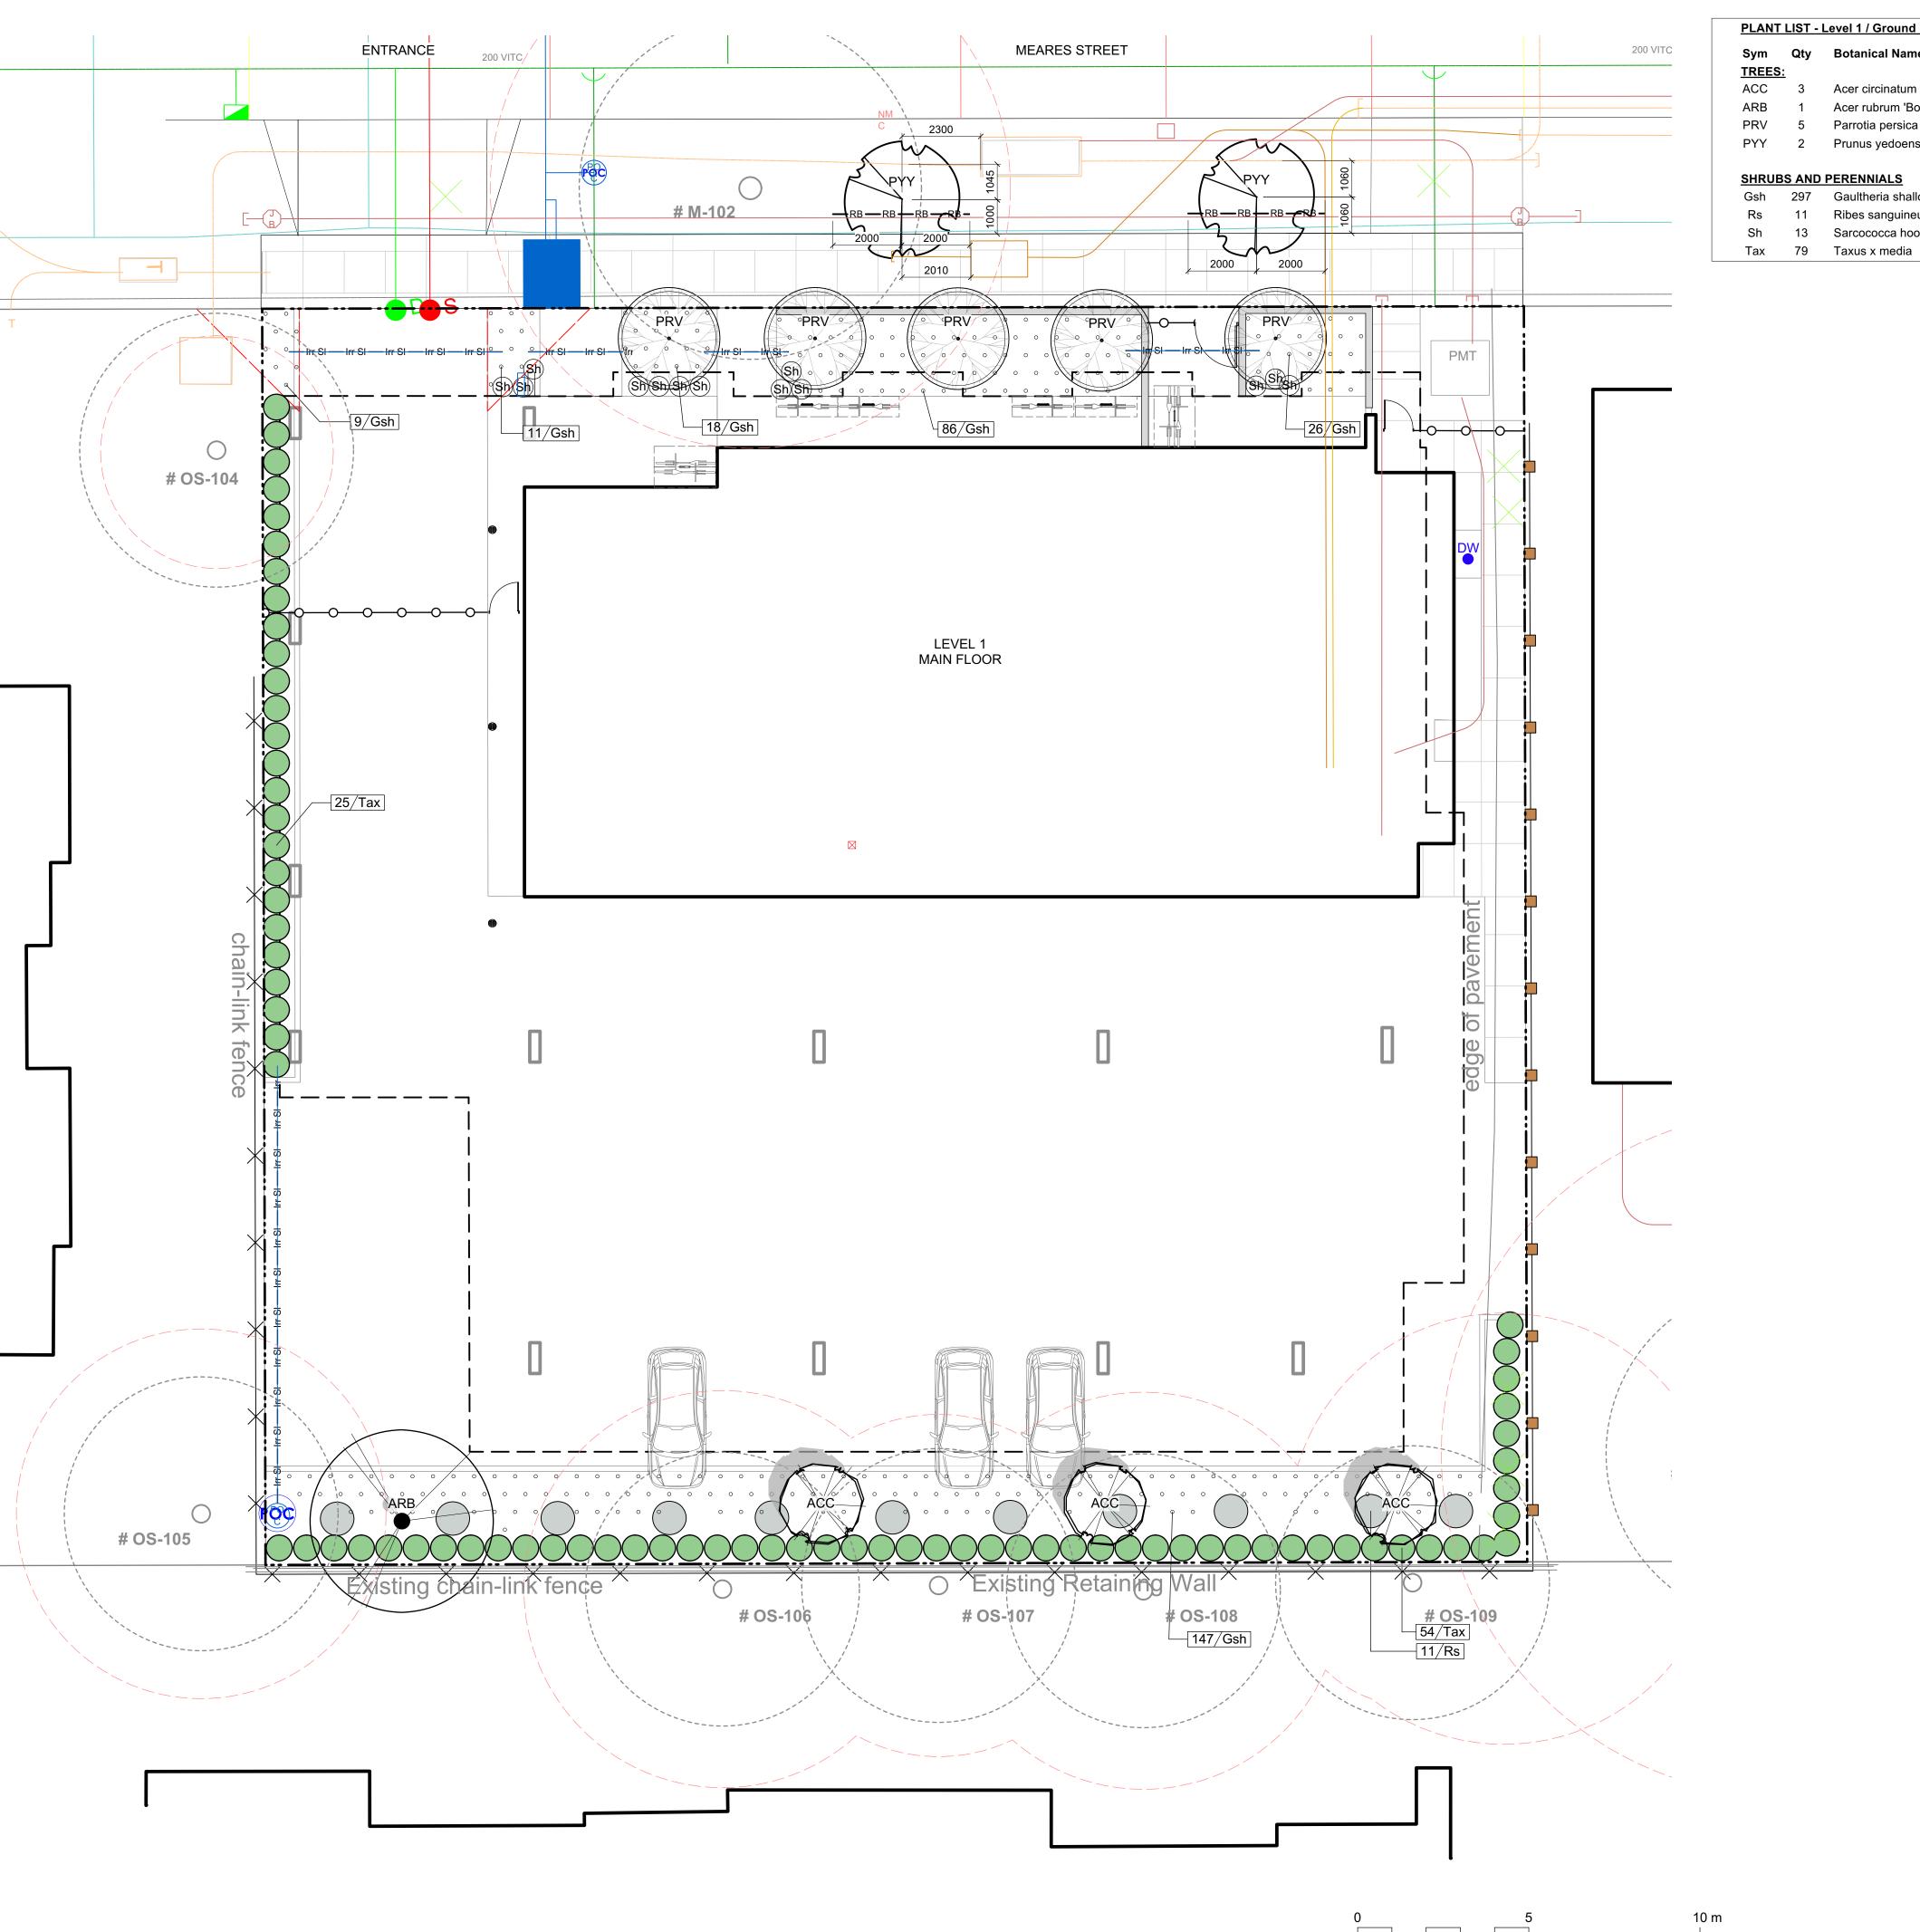

PLANT LIST - Level 1 / Ground Level List Schd. Size / Plant Spacing Sym Qty Botanical Name **Common Name** TREES: ACC 3 Acer circinatum Vine Maple 3 m ht, 1.8 width, multi-stem Autumn Flame Tm Scarlet Maple 6.0cm cal, b&b Acer rubrum 'Bowhall' PRV 5 Parrotia persica 'Ruby Vase' Ruby Vase Persian Ironwood 6.0cm cal, b&b, 1.8m standard min. PYY 2 Prunus yedoensis 'Yoshino' 5.0cm cal. with min. 6' standard Yoshino Cherry Blossom Gsh 297 Gaultheria shallon #1 pot Red Flowering Currant 11 Ribes sanguineum #3 pot 13 Sarcococca hookeriana var humilis Himilayan Sweet Box #1 pot

Hybrid Yew

#10 pot, 5' high

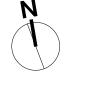

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5	REZ / DP	2023-03-15
4	REZ / DP	2022-10-21
rev no	description	date
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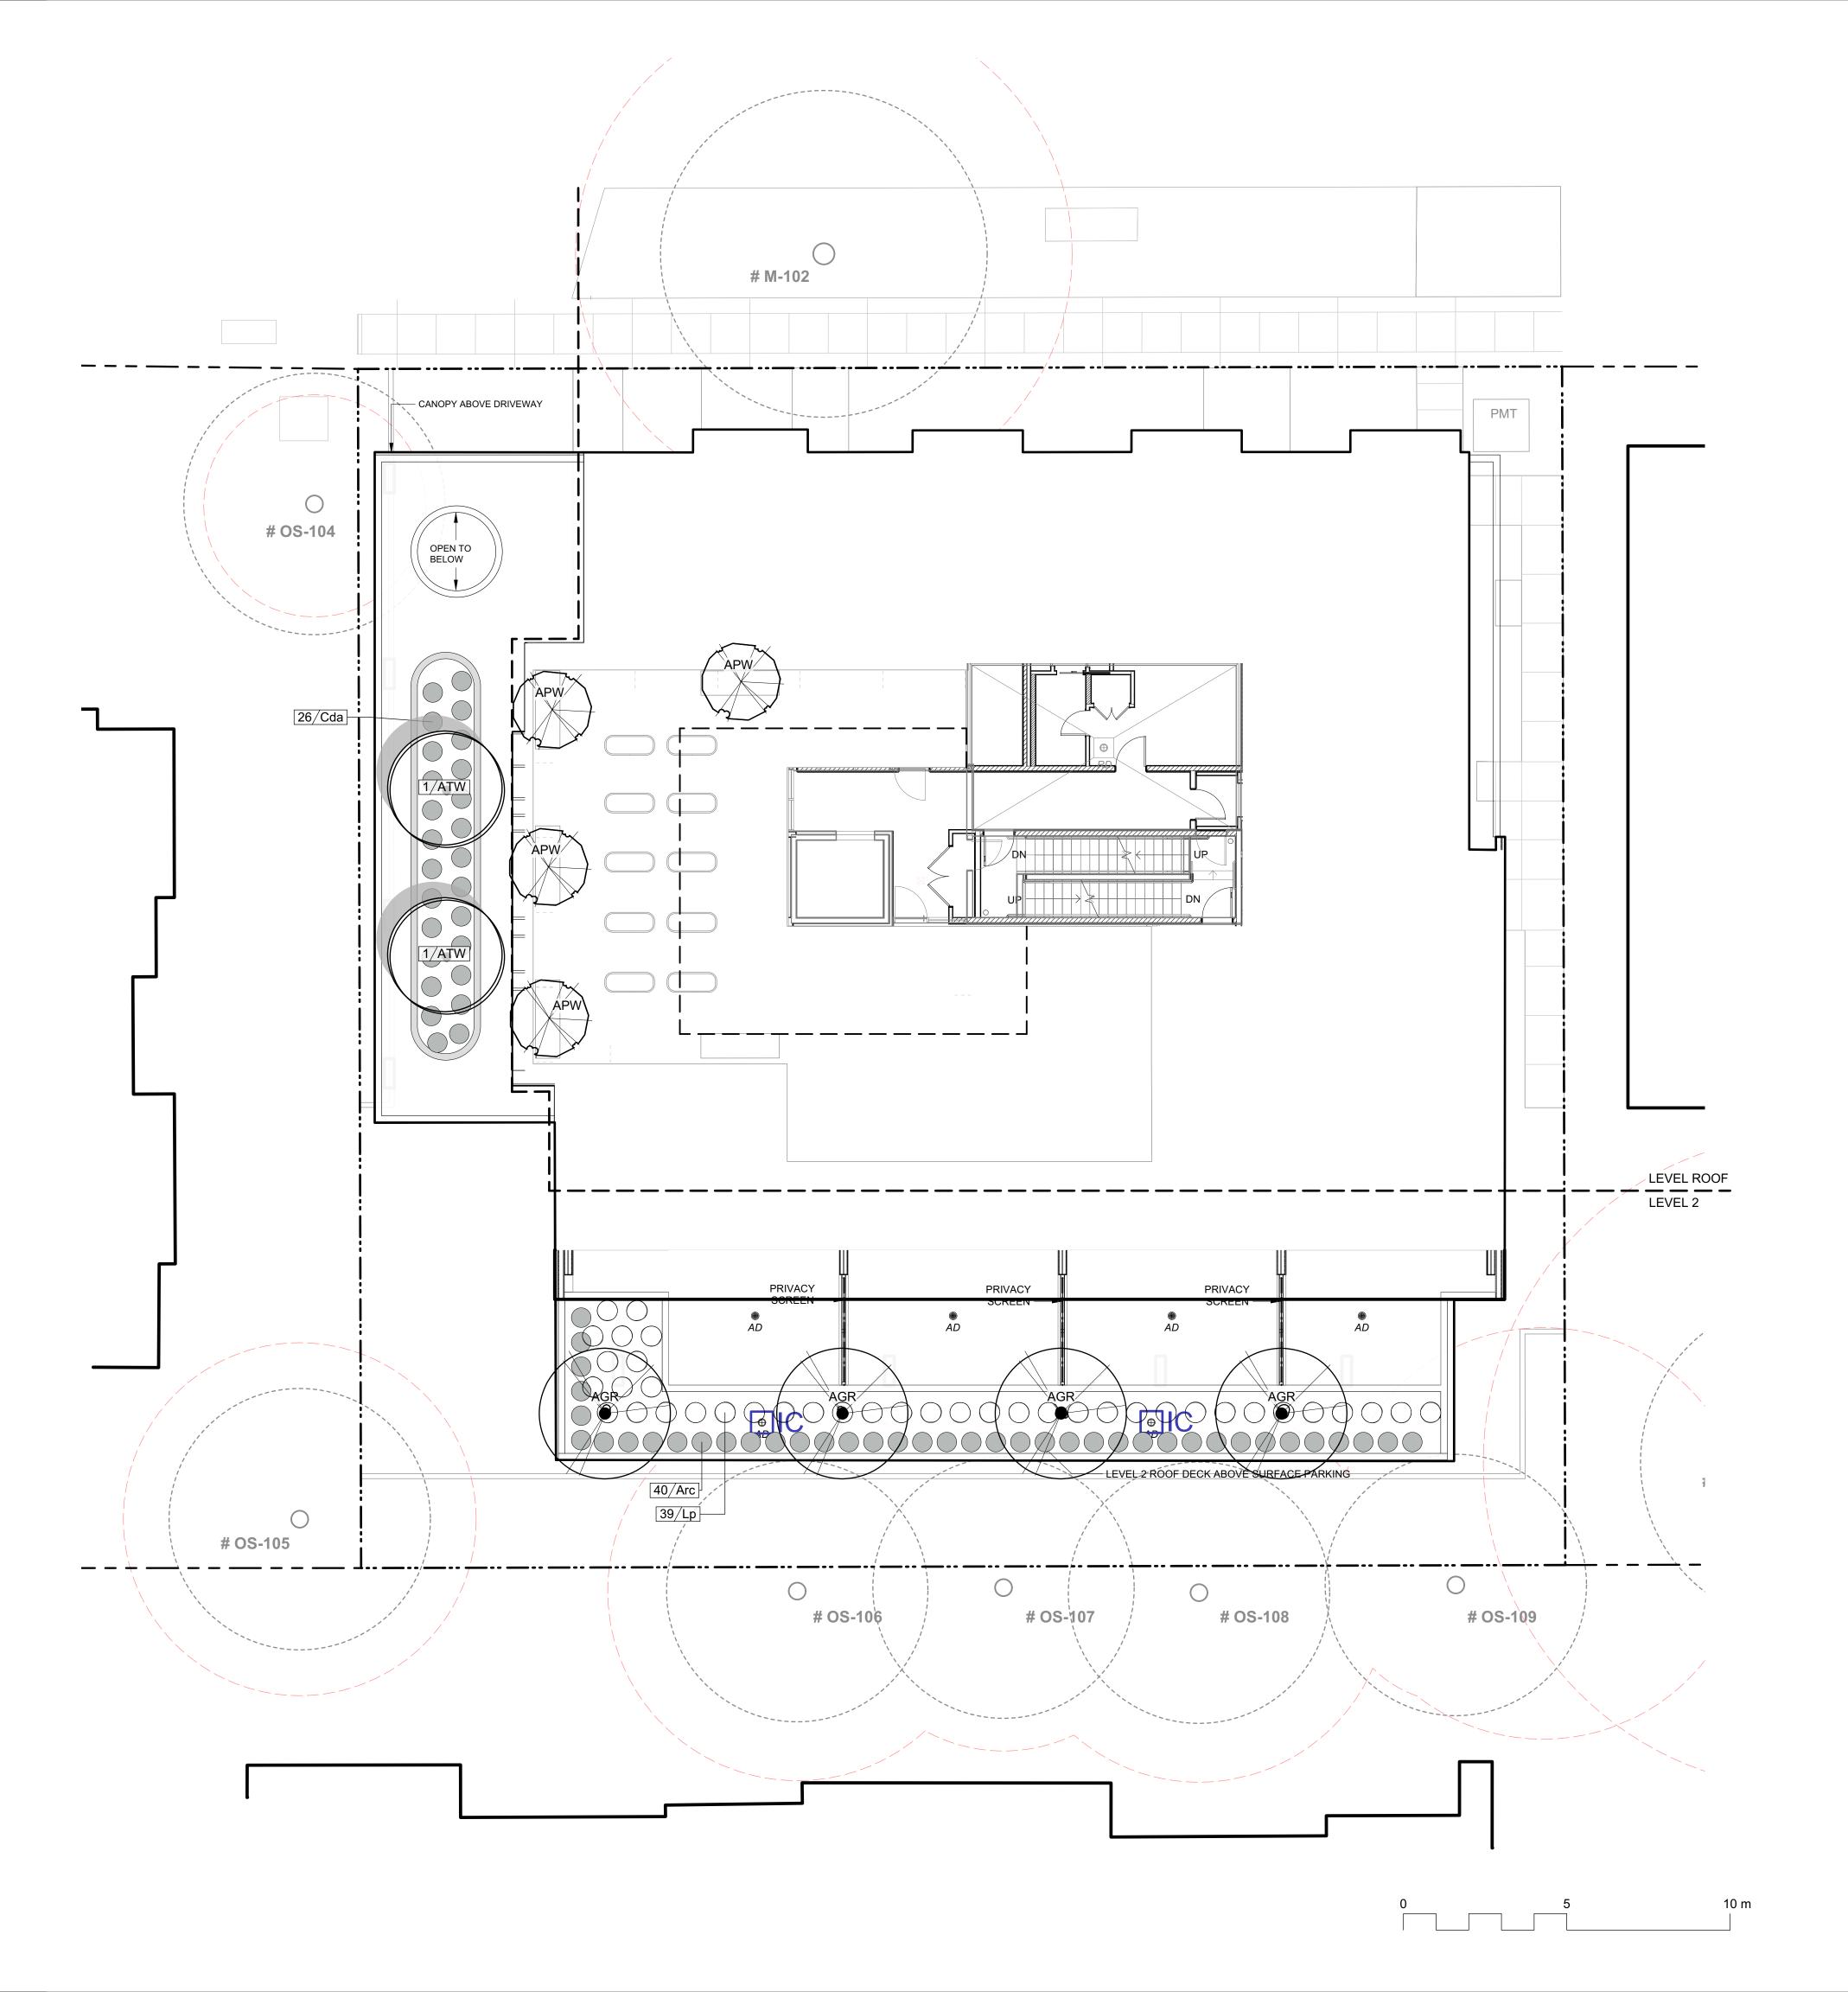
project 1039-1043 Meares St

1039-1043 Meares St Victoria, BC

sheet title

Planting Plan

project no.	122.11
scale	1:100 @ 24"x36"
drawn by	MDI
checked by	SM/JD
revision no.	sheet no.
12	L3.01





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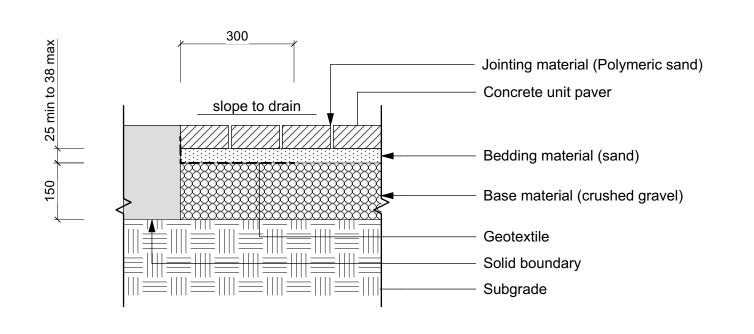
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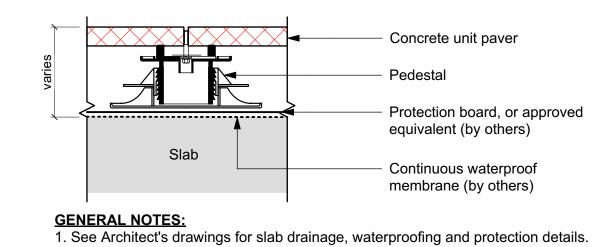
1039-1043 Meares St 1039-1043 Meares St Victoria, BC


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Planting Plan - L2 & Roof

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revision no.	sheet no.
checked by	SM/JD
drawn by	MDI
scale	1:100 @ 24"x36"
project no.	122.11






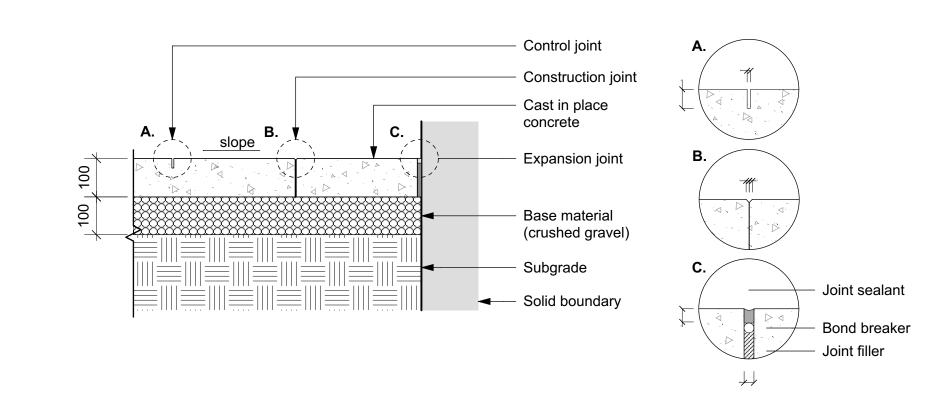



Concrete Unit Paving on Grade
Scale: 1:10

2 Concrete Unit Paving on Pedestal
Scale: 1:10

3 CIP Concrete Paving on Grade Scale: 1:10

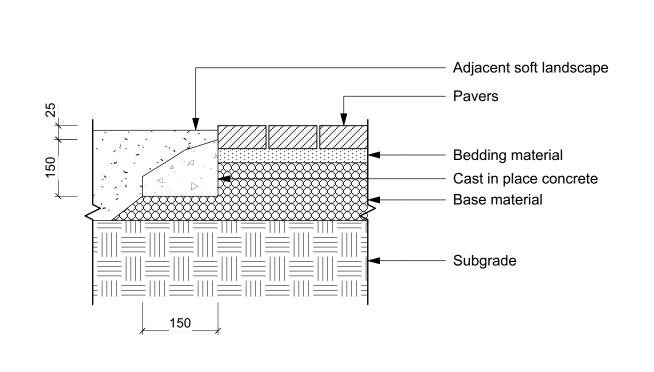

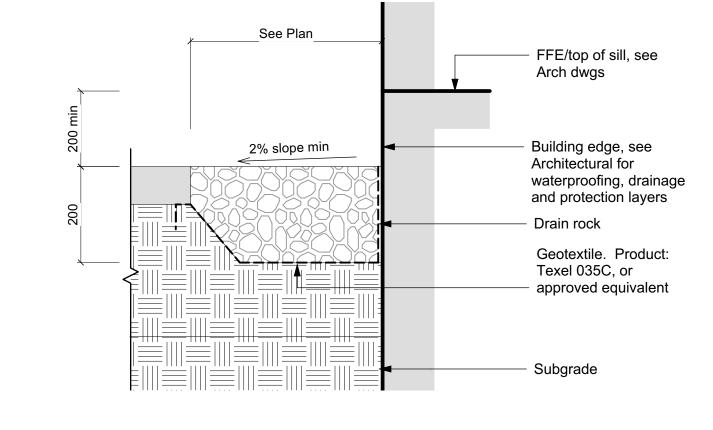


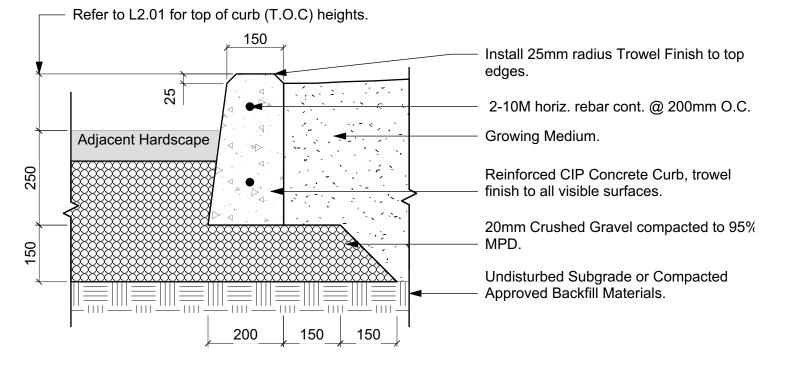


GENERAL NOTES

1. All CIP concrete to be 32 Mpa, Class C-2.
2. All rebar to have 50mm cover min., all edges.

6 CIP Concrete Curb Edge
Scale: 1:10

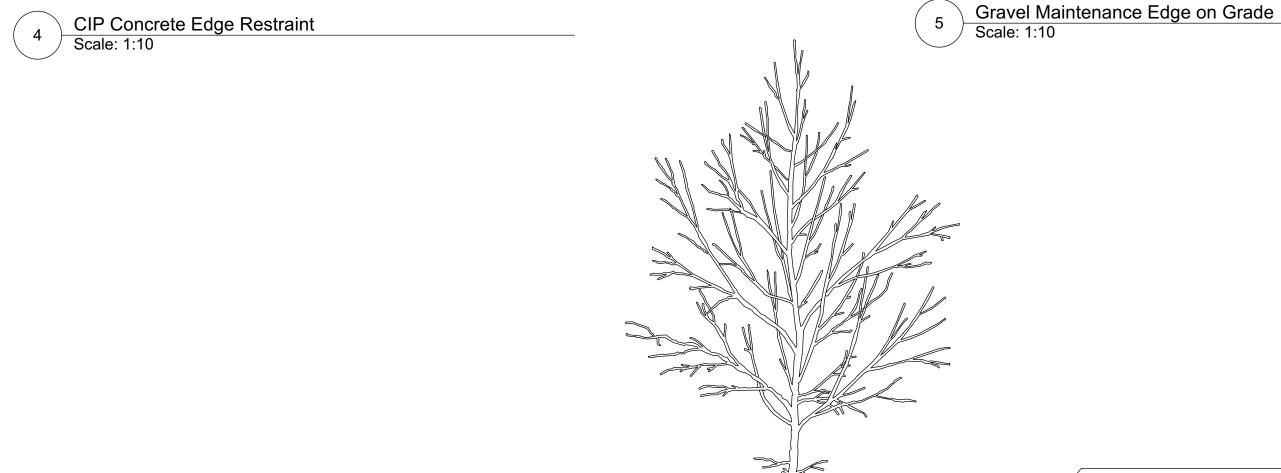

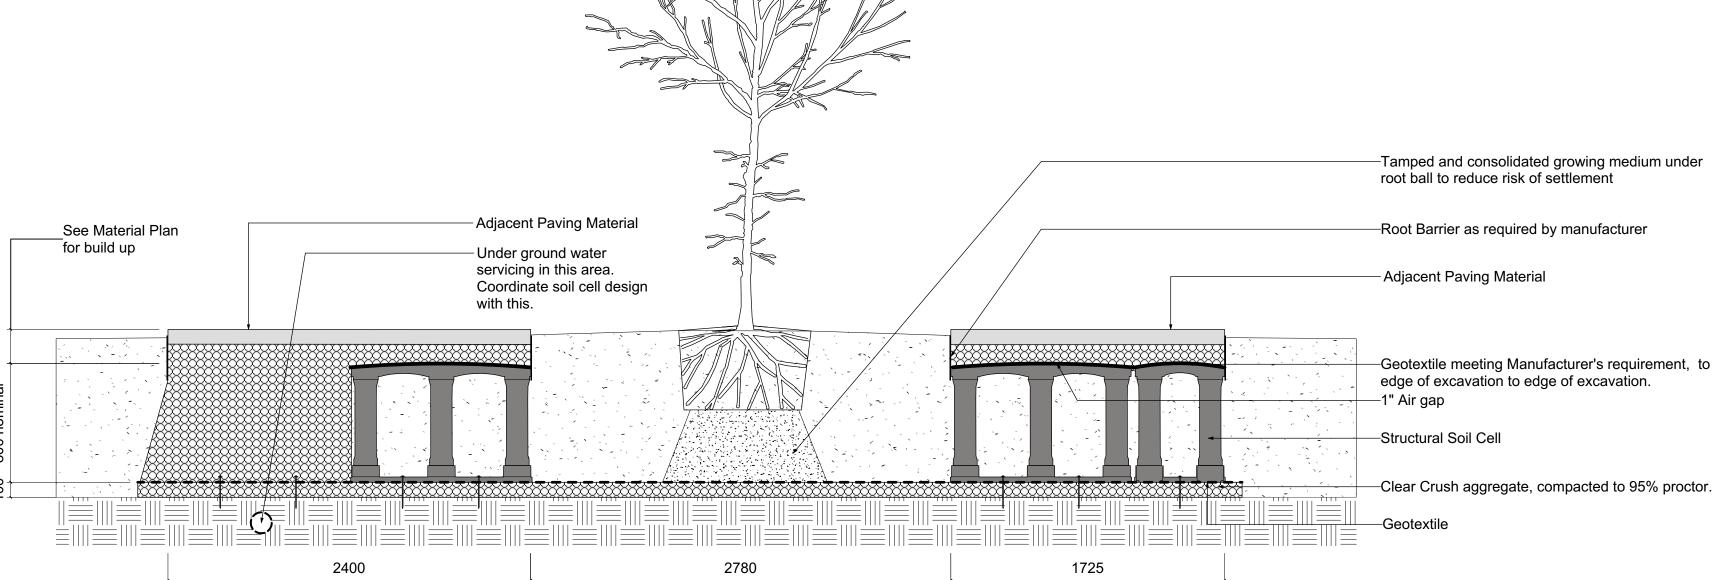

GENERAL NOTES:

1. Contractor to provide Shop Drawings from manufacturer showing all materials and layout.

project no. 122.11
scale 1: 100 @ 24"x36"
drawn by MDI
checked by SM/JD
revision no. sheet no.

L4.01

7 Structural Tree Cells
Scale: 1:25



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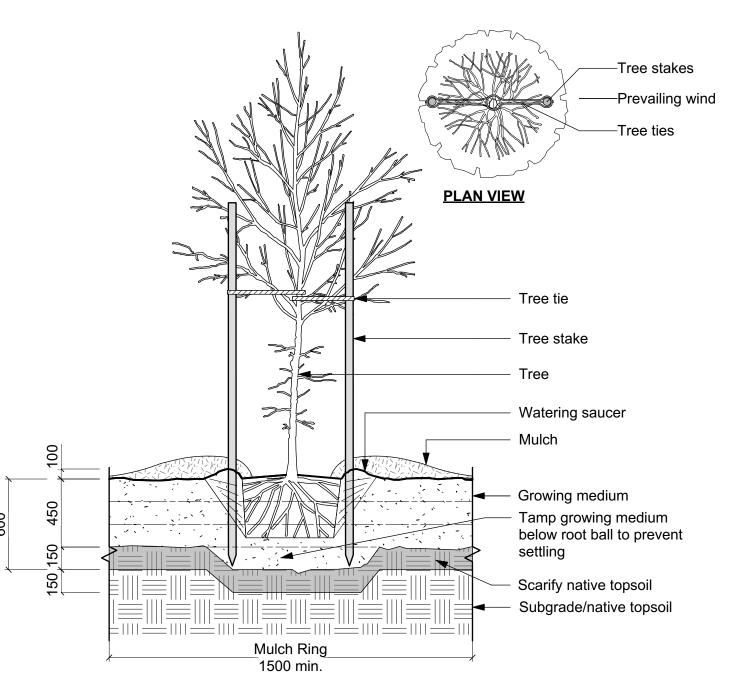
Victoria, BC

project 1039-1043 Meares St


1039-1043 Meares St Victoria, BC

sheet title

Landscape Details: Paving



Tree Planting Detail on Grade Scale: 1:25

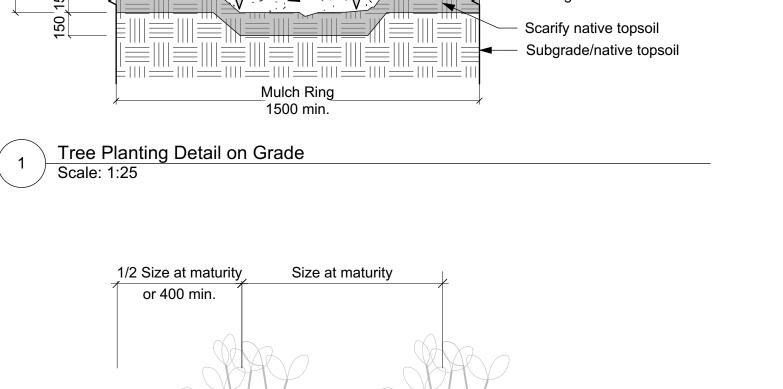



— Shrub Size at maturity Mulch Adjacent landscape, condition varies Max. 1:1 slope typical Scarify subgrade Subgrade/native topsoil

Shrub Planting Area on Grade
Scale: 1:25


Inspection Port

Scale: 1:10

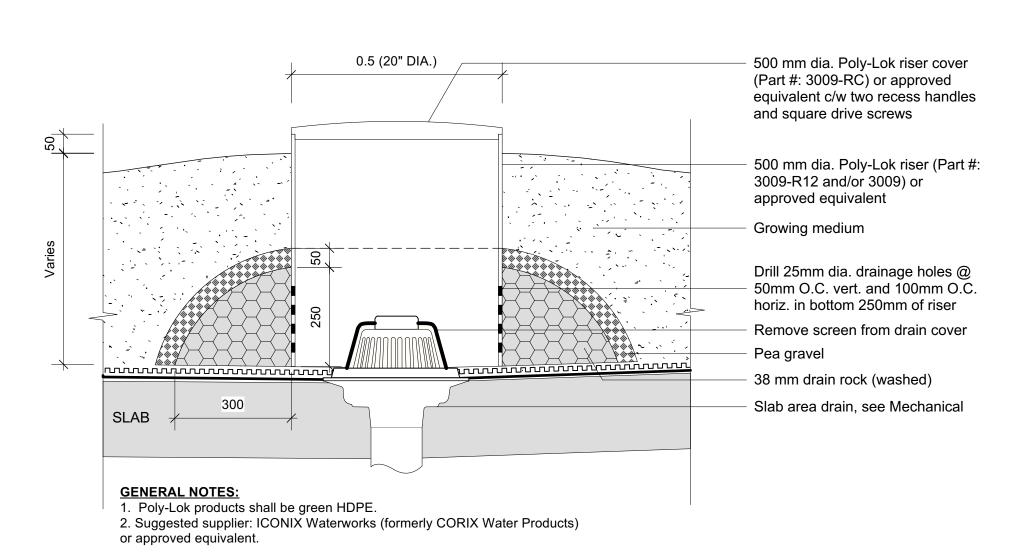


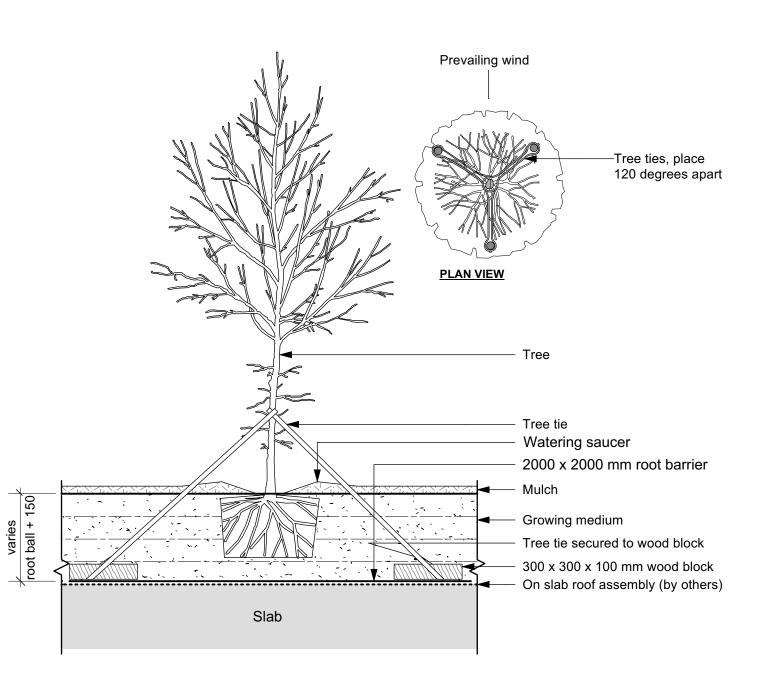


Tree Planting Detail on Slab Scale: 1:25

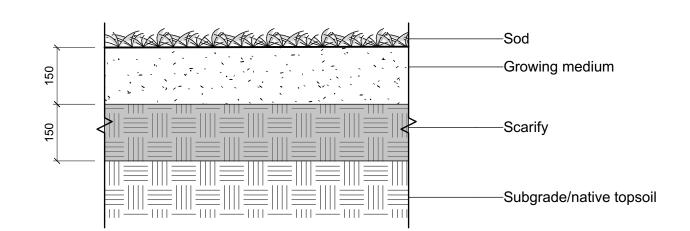



Lawn Area SOD

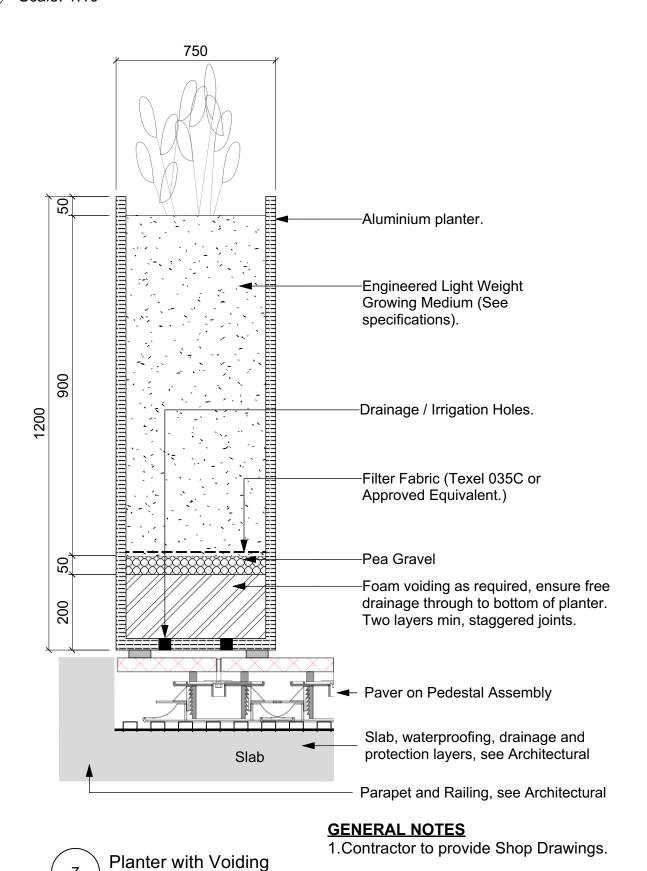

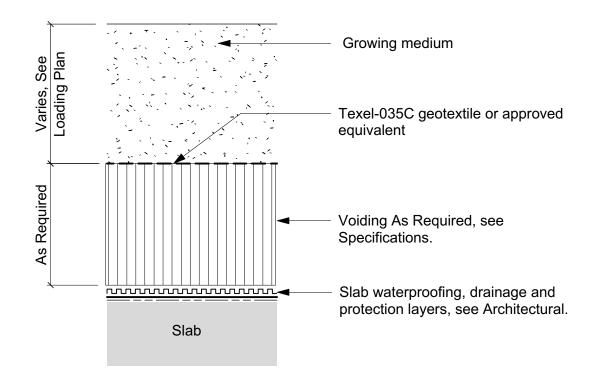

ON SLAB

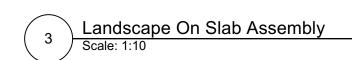

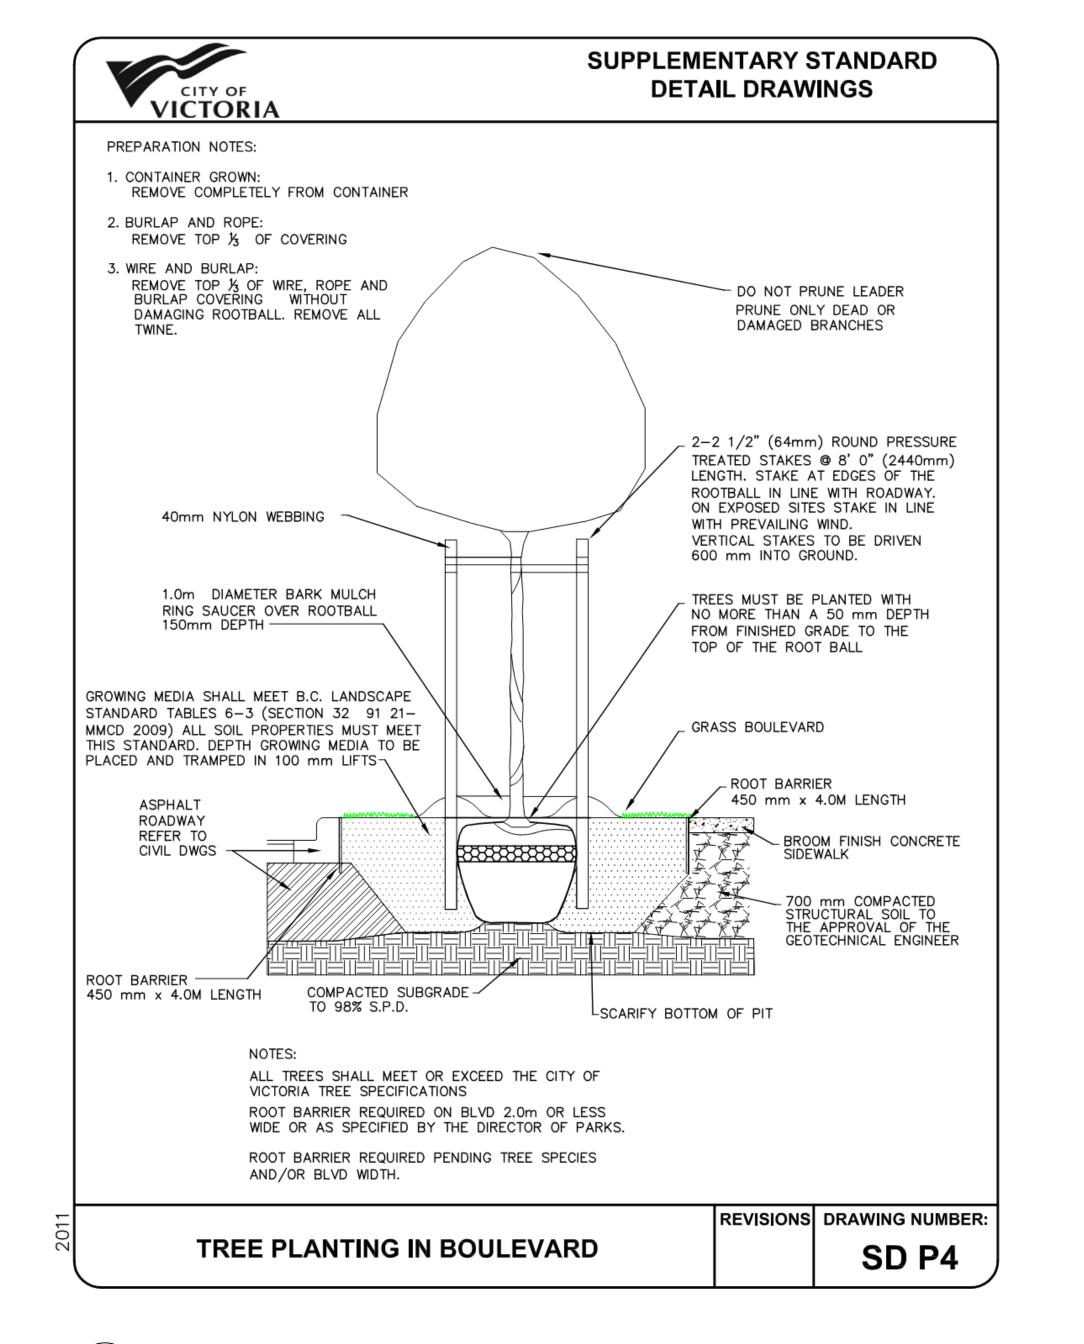



Tree Planting in Boulevard Detail Scale: 1:25

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rev no	description	date





Victoria, BC V8Z 3P6 E: admin@mdidesign.ca

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3374 Tennyson Ave. Victoria, BC

project 1039-1043 Meares St 1039-1043


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Meares St

Victoria, BC


Landscape Details: Planting & Planters

drawn by		MDI
checked by		SM/JD
revision no.	sheet no.	
12	L	4.02

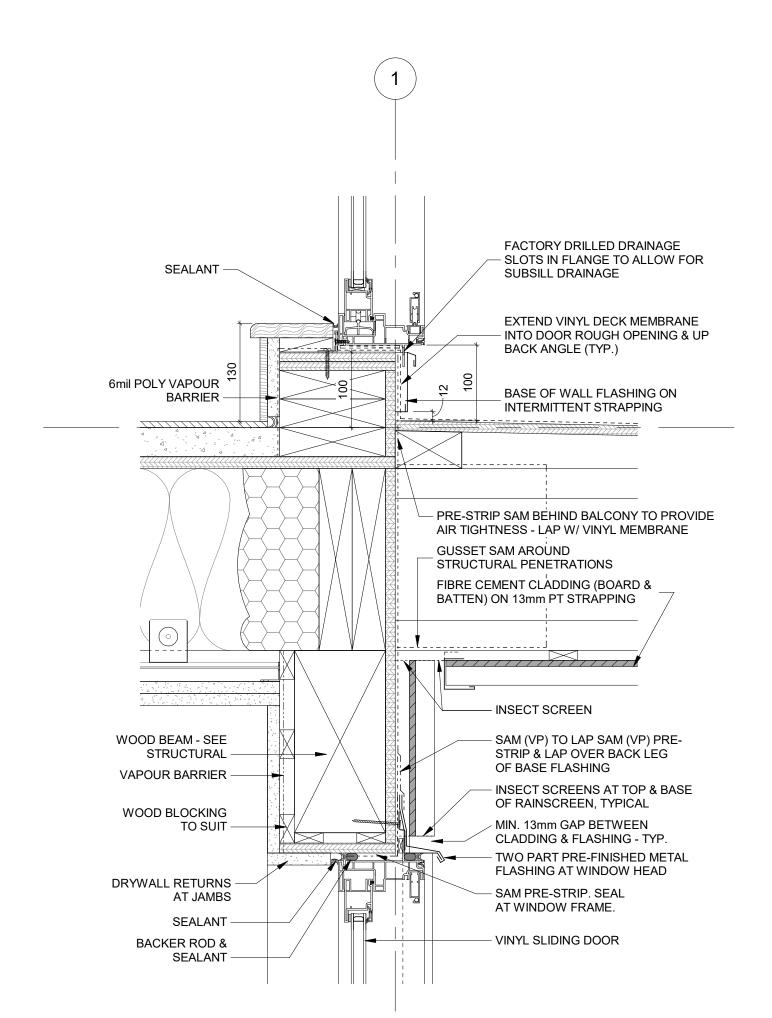


Detail - Section - Balcony Door Sill

SCALE = 1:5

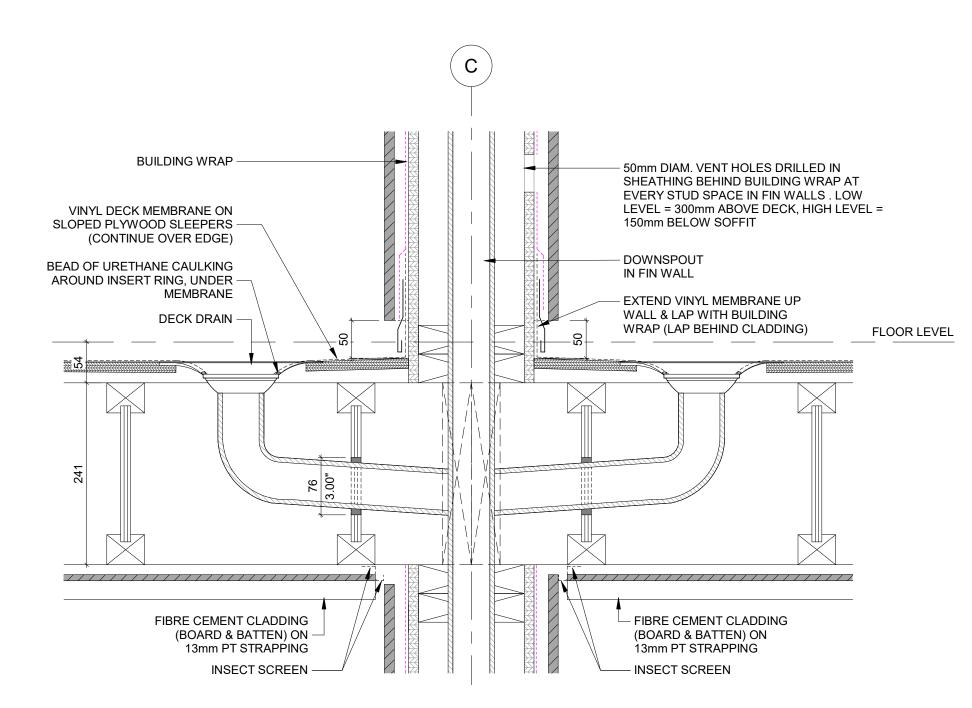


Detail - Section - L5-L6 Balcony Drains

SCALE = 1:5

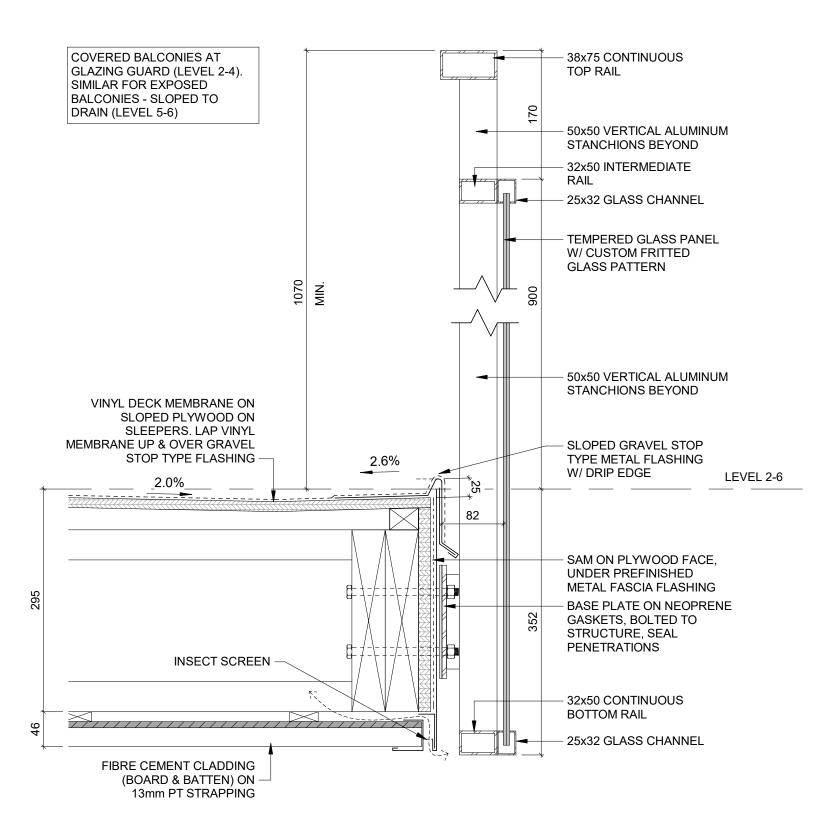


6 Detail - Section - Balcony Guard - Glazing
SCALE = 1:5

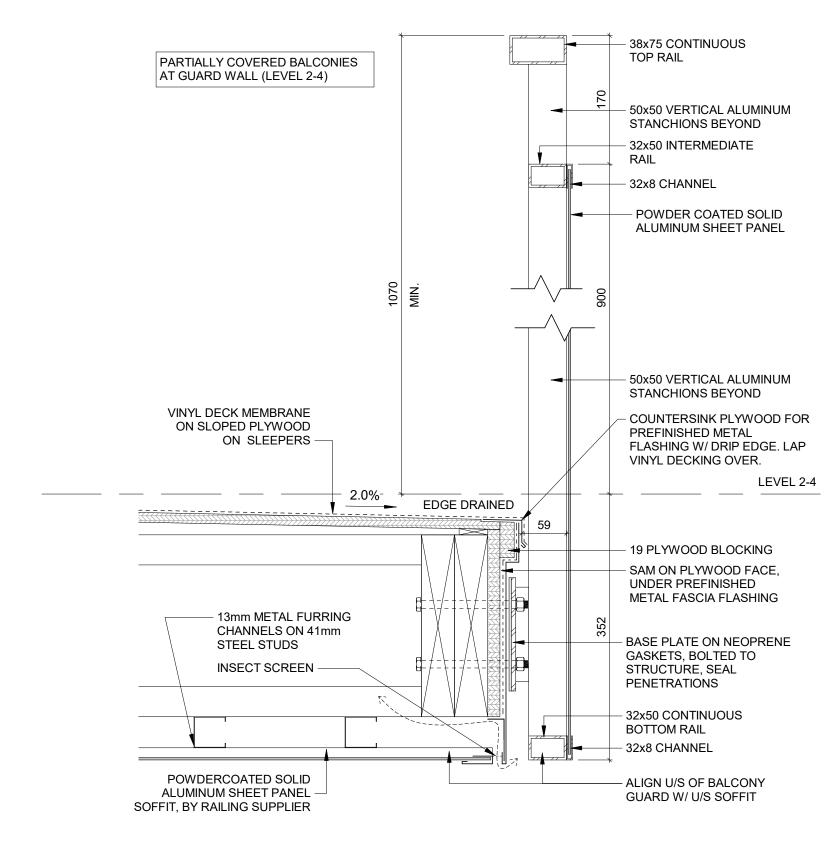

Detail - Section - Balcony Guard Wall

SCALE = 1:5

MEMBRANE LEGEND		
 SAM:	SELF-ADHERED MEMBRANE AIR/ MOISTURE BARRIER/ THRU-WALL FLASHING	
 SAM (VP):	SELF-ADHERED MEMBRANE/ VAPOUR PERMEABLE (AIR/ MOISTURE BARRIER)	
 SAM (HT):	SELF-ADHERED MEMBRANE - HIGH TEMPERATURE	
 BUILDING WRAP		
 COLD FLUID APPLIED WATERPROOFING		
 VAPOUR BARRIER		
 2 PLY SBS MEMBRANE (INDICATED W/ 2 LINES UNLESS NOTED)		

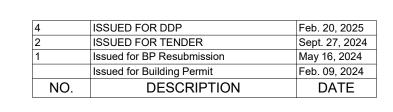



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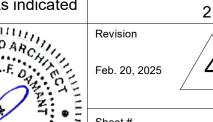
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Details - Level-3-6 -Envelope - Balcony

Scale Project #

As indicated Project #

Revision



A506

2025-02-24 10:29:37 AM