







	DENT : CONTEXT
	DENT + CONTEXT
DP0.00.02	STREETSCAPES
DP0.00.03	POLICY FRAMEWORK
DP0.00.04	SITE CONSTRAINTS
DP0.00.05	SITE CONSTRAINTS
DP0.00.06	DESIGN RATIONALE
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DP0.00.08	DESIGN RATIONALE
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DP0.00.11	MASSING EVOLUTION
DP0.00.12	MASSING + HEIGHT
DP0.05.01	MEANDERING PATHWAY PEDESTRIAN EXPERIENCE
DP0.05.02	MEANDERING PATHWAY PEDESTRIAN EXPERIENCE
DP0.05.03	MEANDERING PATHWAY PEDESTRIAN EXPERIENCE
DP0.05.04	MEANDERING PATHWAY PEDESTRIAN EXPERIENCE
DP0.05.05	MEANDERING PATHWAY PEDESTRIAN EXPERIENCE
DP0.05.06	MEANDERING PATHWAY PEDESTRIAN EXPERIENCE
DP0.05.07	MEANDERING PATHWAY PEDESTRIAN EXPERIENCE
DP0.06.00	BUILDING 1A VIEW
DP0.06.01	BUILDING 1A VIEW
DP0.06.02	BUILDING 1A CLOSE-UP
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DP0.06.07	BUILDING 2A VIEW
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DP0.06.09	BUILDING 2B VIEW
DP0.06.10	BUILDING 2B VIEW
DP0.06.11	BUILDING 2B CLOSE-UP
DP0.07.01	OVERALL AERIAL VIEW

ARCHITECTURAL

SHEET NAME

SHEET NUMBER

OVERALL SITE	
DP0.10.0	PROJECT INFORMATION + STATISTICS
DP0.10.00	PROJECT INFORMATION + STATISTICS
DP0.10.01	SITE SURVEY
DP0.10.02	CONTEXT PLAN
DP0.10.03	OVERALL SITE PLAN
DP0.10.05	PHASING PLAN
DP0.10.06	AVERAGE GRADE PLAN
DP0.10.07	MULTI-DISCIPLINARY COORDINATION SITE PLAN
DP0.10.08	OVERALL PHASE 2 SITE PLAN
DP0.11.01	SHADOW STUDY DIAGRAMS
DP0.12.01	FIRE ACCESS PLAN PHASE I + II
DP0.13.01	SITE SECTIONS

CITY OF VICTORIA DESIGN GUIDELINES

ARCHITECTURAL			
SHEET NUMBER SHEET NAME			

BUILDING 1a + 1b				
DP1.20.00	OVERALL FLOOR PLAN BLDG 1A/1B - LEVEL P2			
DP1.20.01	OVERALL FLOOR PLAN BLDG 1A/1B - LEVEL P1			
DP1.20.02	OVERALL FLOOR PLAN BLDG 1A/1B - LEVEL 01			
DP1.20.03	OVERALL FLOOR PLAN BLDG 1A/1B - LEVEL 02			
DP1.20.04	OVERALL FLOOR PLAN BLDG 1A/1B - LEVEL 03			
DP1.20.05	OVERALL FLOOR PLAN BLDG 1A/1B - LEVEL 04			
DP1.20.06	OVERALL FLOOR PLAN BLDG 1A/1B - LEVEL 05			
DP1.20.07	OVERALL FLOOR PLAN BLDG 1A/1B - LEVEL 06			
DP1.20.08	OVERALL FLOOR PLAN BLDG 1A/1B - ROOF			
DP1.30.01	BLDG 1A/1B NORTHEAST + SOUTHEAST ELEVATIONS			
DP1.30.02	BLDG 1A EAST + WEST ELEVATIONS			
DP1.30.03	BLDG 1B SOUTHWEST + WEST ELEVATIONS			
DP1.32.00	BLDG 1A SECTIONS			
DP1.32.01	BLDG 1B SECTIONS			
DP1.40.01	ENLARGED BIKE PLANS BLDG 1A/1B			

BUILDING 2a + 2b	
DP2.20.00	OVERALL FLOOR PLAN BLDG 2A/2B - LEVEL P1
DP2.20.01	OVERALL FLOOR PLAN BLDG 2A/2B - LEVEL 01
DP2.20.02	OVERALL FLOOR PLAN BLDG 2A/2B - LEVEL 02
DP2.20.03	OVERALL FLOOR PLAN BLDG 2A/2B - LEVEL 03
DP2.20.04	OVERALL FLOOR PLAN BLDG 2A/2B - LEVEL 04
DP2.20.05	OVERALL FLOOR PLAN BLDG 2A/2B - LEVEL 05
DP2.20.06	OVERALL FLOOR PLAN BLDG 2A/2B - LEVEL 06
DP2.20.07	OVERALL FLOOR PLAN BLDG 2A/2B - ROOF
DP2.30.01	BLDG 2A/2B NORTHWEST + SOUTHEAST ELEVATIONS
DP2.30.02	BLDG 2A EAST + WEST ELEVATIONS
DP2.30.03	BLDG 2B NORTHEAST + WEST ELEVATIONS
DP2.32.01	BLDG 2A/2B OVERALL SECTION
DP2.32.02	BLDG 2A/2B SECTIONS
DP2.40.01	ENLARGED BIKE PLANS BLDG 2A/2B
DP2.40.02	ENLARGED BIKE PLANS BLDG 2A/2B

<u>LANDSCAPE</u>		
SHEET NUMBER	SHEET NAME	

L0.00	COVER SHEET
L0.01	DESIGN VISION AND PRINCIPLES
L0.02	DIAGRAMS
L0.03	TREE MANAGEMENT PLAN
L1.00	OVERALL SITE PLAN
L1.01	ENLARGEMENT PLAN (WEST)
L1.02	ENLARGEMENT PLAN (EAST)
L1.03	ROOF LEVEL PLAN
L2.00	LIGHTING PLAN
L3.00	PLANTING PALETTE
L3.01	PLANTING PLAN
L4.00	LANDSCAPE SECTIONS
L5.00	DETAILS - HARDSCAPE
L5.01	DETAILS - FURNISHING
L5.02	DETAILS - SOFTSCAPE

CIVIL			
SHEET NUMBER SHEET NAME			
C101	GENERAL NOTES & SITE PLAN		
C102	EXISTING SITE SERVICING		
C103	PROPOSED SITE SERVICING		

CLIENT INTRACORP HOMES INTRACORP

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BURNSIDE PHASE II

133-135 GORGE ROAD E, VICTORIA, BC

PROJECT NO: 138914

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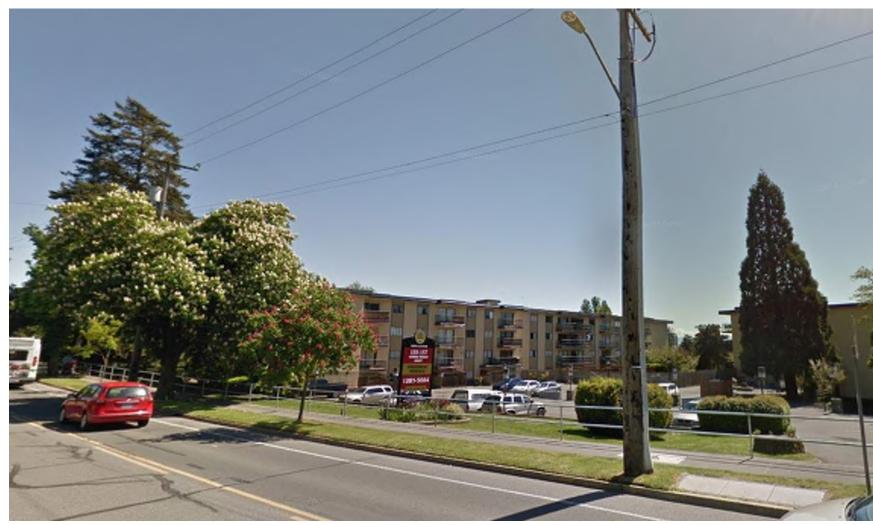
SHEET TITLE DRAWING LIST + CONTACTS

SHEET NUMBER

DP0.00.01

DP0.08.01

1. View of the Oxford hotel from Gorge road.



2. View of neighboring Gorge apartments from Gorge road.



3. Intersection of Balfour Ave and Gorge road facing Southeast.



4. Intersection of Balfour Ave and Gorge road facing North.





5. Gorge road facing West (East of subject site).



6. View South on Albany St (Facing the subject site).



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PROJECT

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STREETSCAPES

SHEET NUMBER DP0.00.02

ISSUE

CITY OF VICTORIA POLICY FRAMEWORK


Aligning with the OCP and BGNP

Throughout the design process, the City of Victoria's policy documentation has been used as a framework. A thorough review of the Official Community Plan (OCP), Burnside Gorge Neighbourhood Plan, Design Guidelines for Multi-Unit Residential, Commercial and Industrial, and Land Use Bylaw has been undertaken and considered, including, but not limited to, the following.

OFFICIAL COMMUNITY PLAN (2012)

The Burnside Gorge neighbourhood and the subject site is subject to the policies within the City of Victoria's Official Community Plan (OCP), which sets out the City's vision, values and goals for the future of the city. Along with high level land use and growth management objectives the OCP also defines objectives for transportation and mobility, parks and recreation, infrastructure, the economy, and sustainability, amongst other topics. While most growth is expected to occur in the downtown core and urban villages, residential and employment growth will also be directed to other neighbourhoods, particularly along transit routes.

The site is within Development Permit Area 7A Corridors, which requires consideration of the City's Design Guidelines for Multi-Unit Residential, Commercial and Industrial (2012), revised 2019 and Revitalization Guidelines for Corridors, Villages and Town Centres (2017). DPA 8: Victoria Arm - Gorge Waterway also applies to establish guidelines for the protection of the natural environment, ecosystems and biological diversity of this sensitive area. Other city-wide policies that align with the OCP such as Go Victoria the City's Sustainable Mobility Strategy, Parks Master Plan, Housing Strategy, Inclusionary Housing and Community Amenity Policy, and Tenant Assistance Policy have been considered in crafting the proposal.

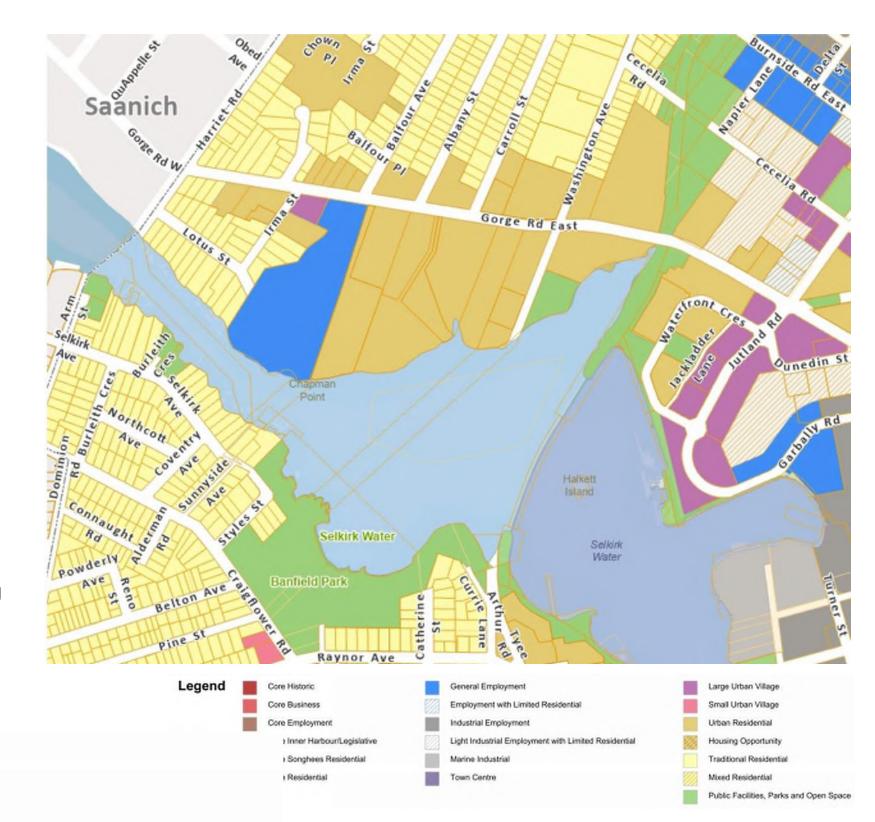




Burnside Gorge Neighbourhood Plan Goals


BURNSIDE GORGE NEIGHBOURHOOD PLAN (2017)

The BGNP outlines several "big moves" that will help achieve the plan vision and goals. Particularly relevant to the development of the subject site are:


- Reconnect with the waterfront: The waterfront is a great but under utilized asset due to limited accessibility. The plan advocates for improved public spaces along the waterfront including new and improved parks and a waterfront trail.
- Create better pedestrian and cycling connections: The area needs safe bike routes to connect destinations within the community and to the broader cycling network, as well as improved pedestrian access. Key roadways are identified for substantial short and long-term improvements.
- Encourage housing diversity: A balance of housing types are needed to diversify the neighbourhood and support improvements and amenities.
- Calm busy arterial streets: Improvements to major roads including development of the All Ages and Abilities route on Gorge Road will make it safer and more comfortable for all users to bike and walk.
- Green the neighbourhood: Tree retention and replacement, enhancement of waterfront ecosystems, and new parks and open spaces will "green" the neighbourhood and provide more opportunities for recreation and public enjoyment.



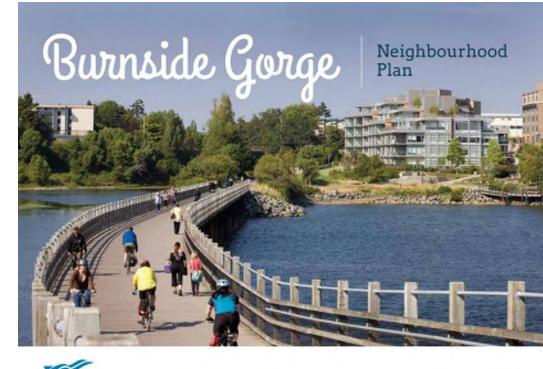

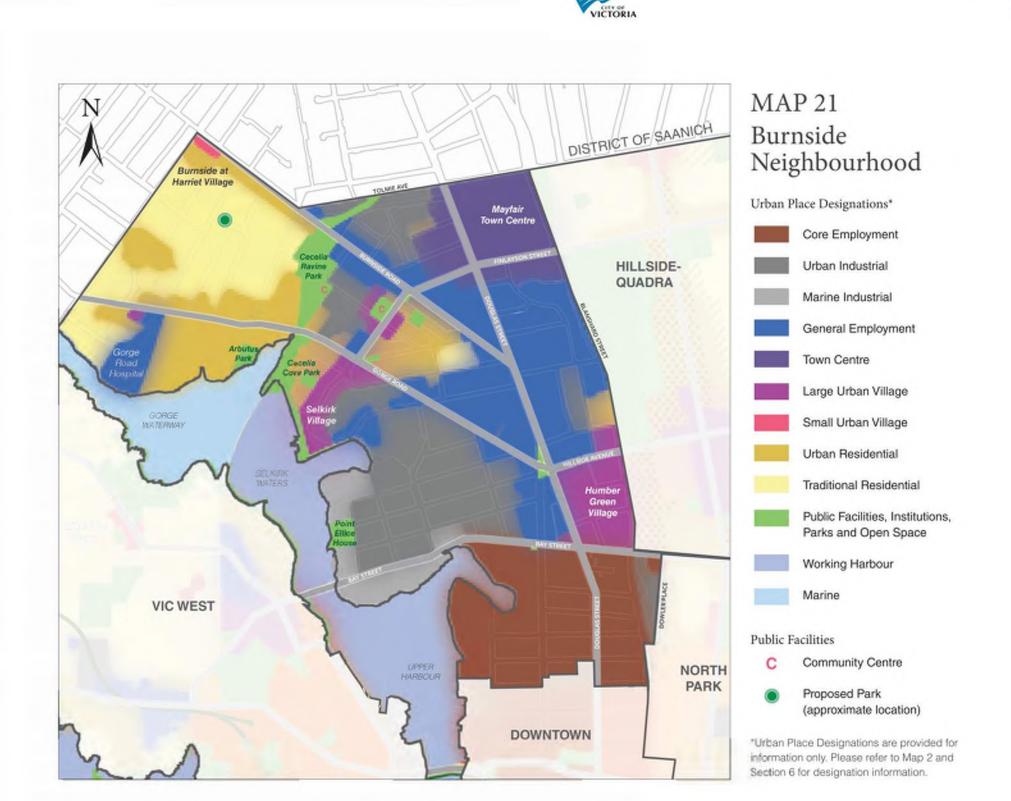



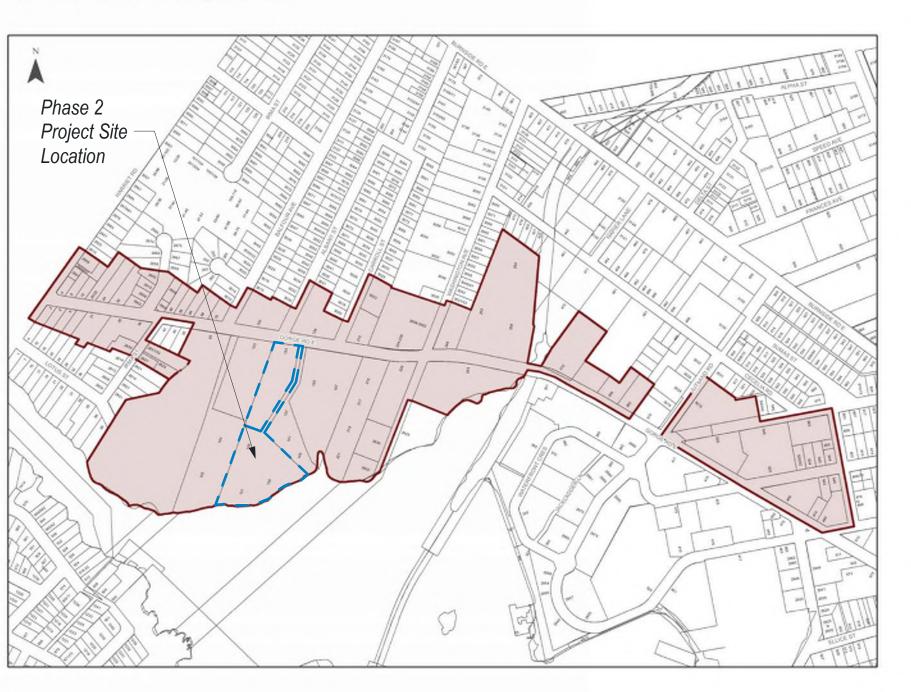

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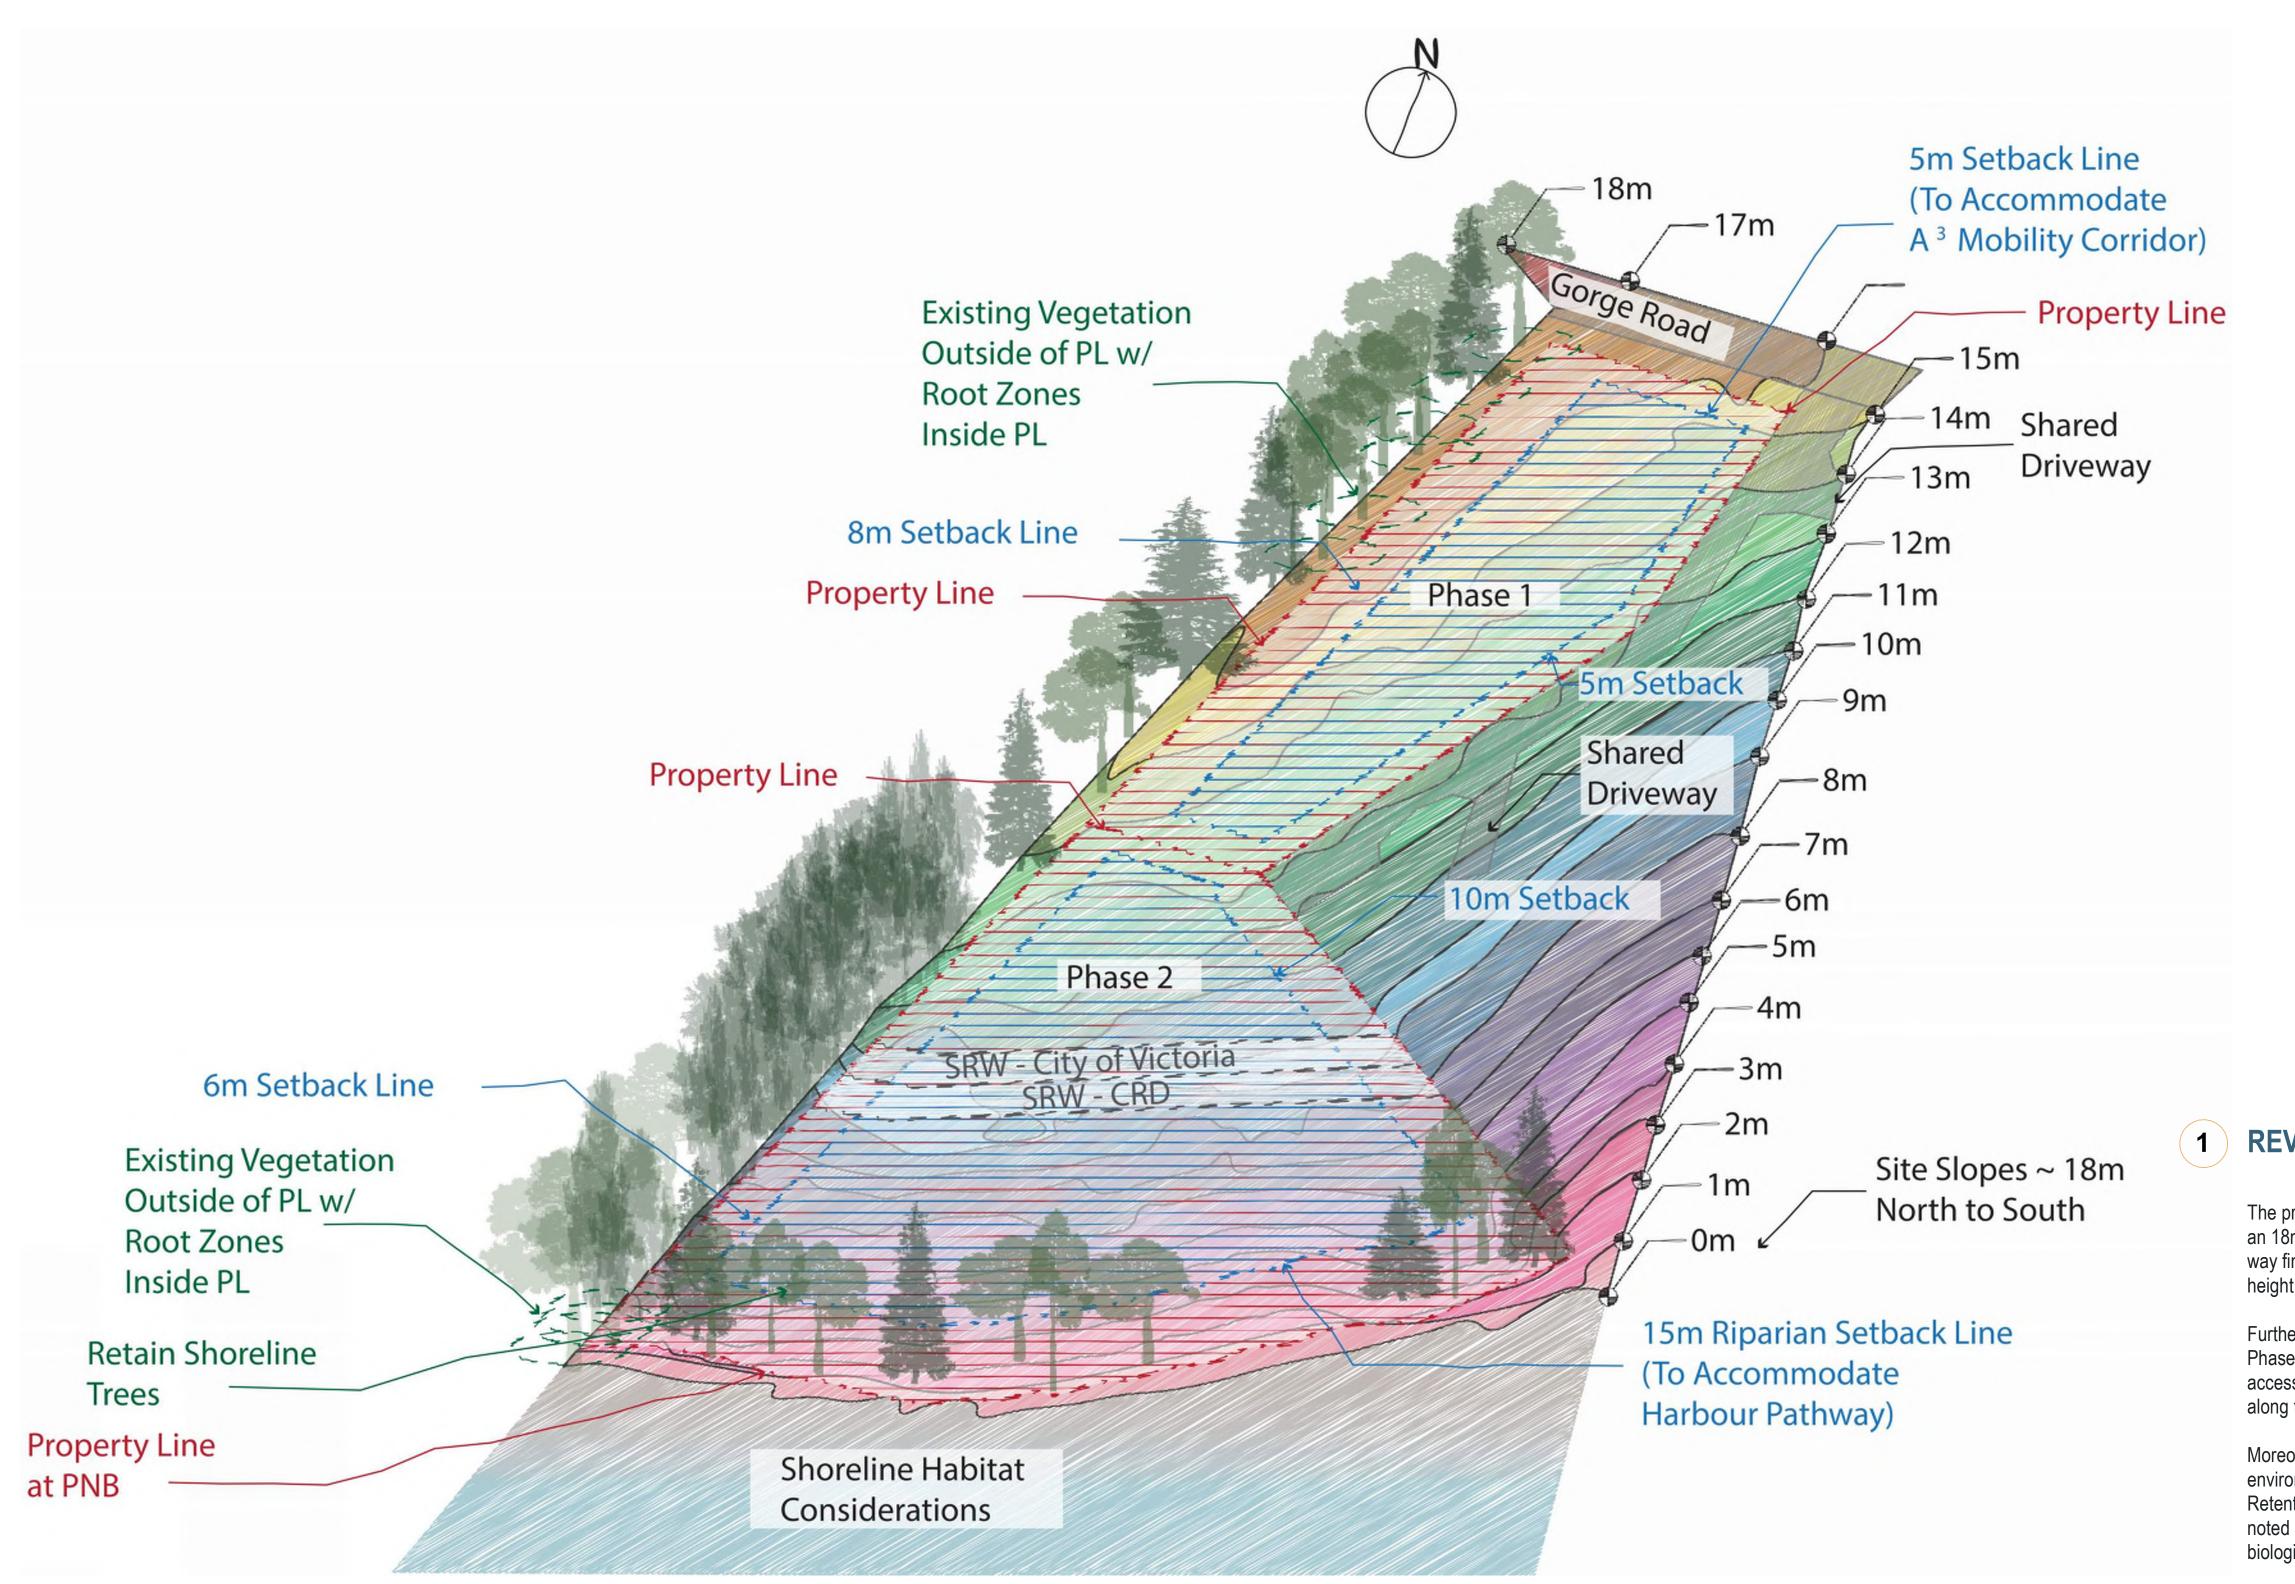
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POLICY FRAMEWORK

PROJECT SITE ASSESSMENT

Understanding Opportunities and Constraints

During the initial design process, the site was examined with consideration for its physical constraints and assets, City policy objectives, and placemaking opportunities.



1 REVIEW SITE CONSTRAINTS

The project site offers both unique shape and slope conditions. With nearly an 18m fall from North to South, key considerations included lobby sighting, way finding and pedestrian circulation, vehicular access and overall building

Further site constraints that would impact building form were noted on the Phase 2 site where it is bisected by two SRWs. Additional easement and access considerations were required for the shared driveway conditions along the eastern property line.

Moreover, the shoreline created particular constraints when considering environmental impacts to the sensitive ecosystem in the mudflat area. Retention of existing non-invasive site vegetation wherever possible was also noted as imperative to both soil retention and maintenance of the area's biological diversity.

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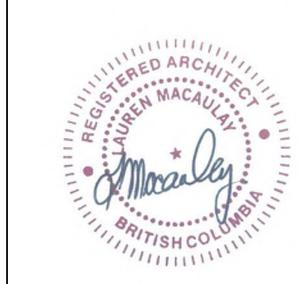
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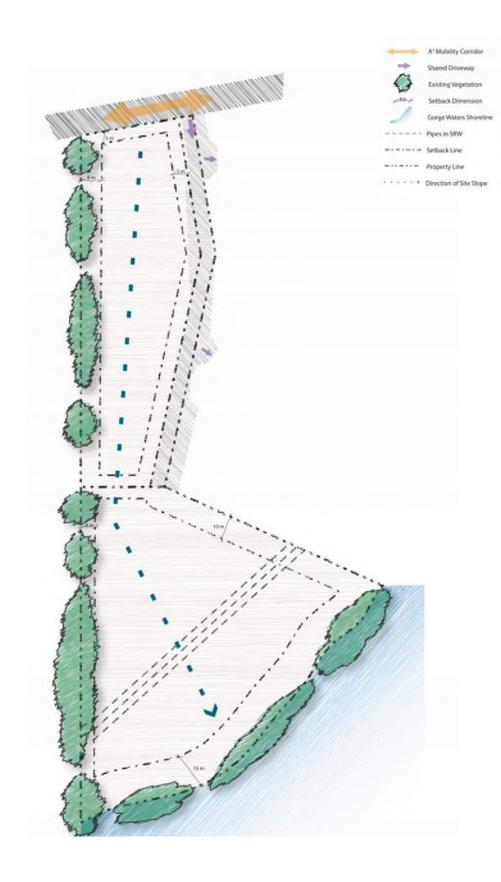
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PROJECT SITE ASSESSMENT


Understanding Opportunities and Constraints

ASSESS ASSETS + OPPORTUNITIES




A decision was made early on to lean into the site slope and design was directed towards stepping the buildings with the natural topography. Considerations were made to retain as much of the original vegetation as possible, particularly on the western property line where the trees and shrubs create a natural buffer to neighbouring properties.

3 IDENTIFY FOCAL POINTS

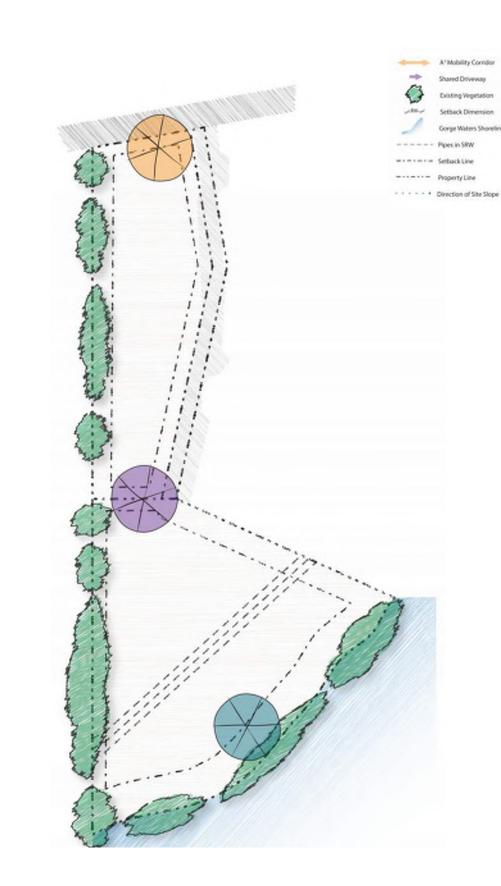


Due to the unique shape of the project site, clear opportunities for place making presented themselves as locations for placemaking hubs. The northern most border in Phase 1 is a natural location for a commercial interface, providing additional retail opportunities for the neighbourhood. The centre pinch point is an ideal location for a public plaza allowing for passive wayfinding and creating an open space between phases. Lastly, the shoreline was identified as a key site amenity that presented opportunities for both enhancement and preservation.

4 CONNECT HUBS

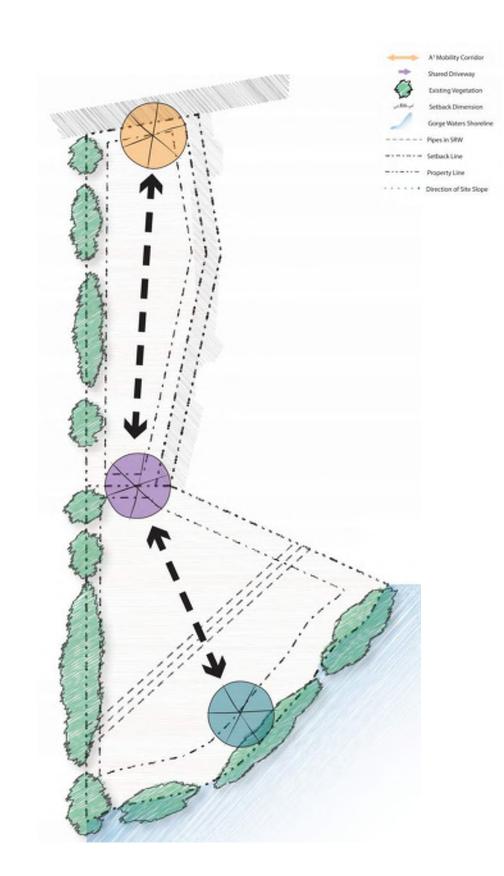

Once key focal points were identified, a pedestrian route was designed to encourage use of each of these locations. The path has been designed as an open, visible, naturalized pathway that helps users passively move from urban to natural environments.

5 SHAPE THE BUILDINGS

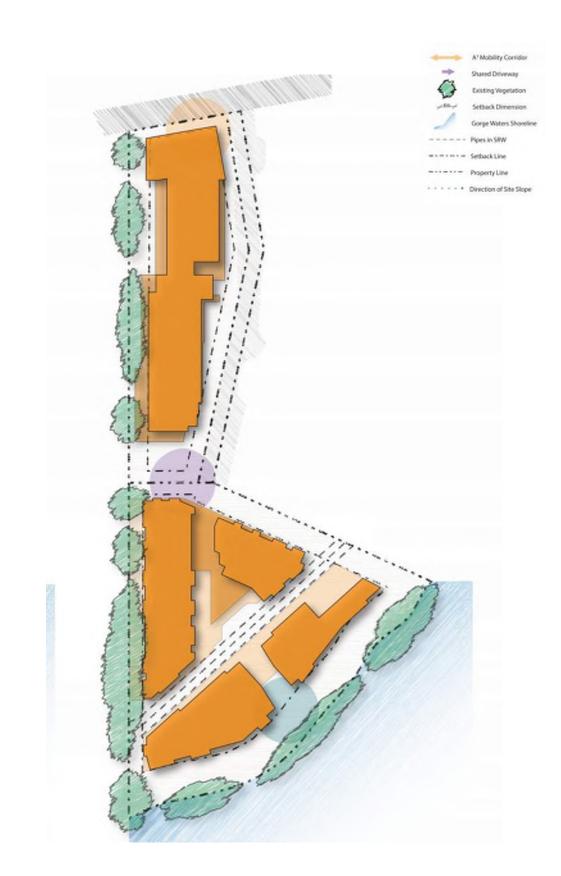

Lastly, the buildings were formed from extruding up basic blocks around site setbacks and service right of ways. Those blocks were then articulated to create open, central plaza spaces to encourage public circulation and use. In addition, balconies and patios were designed to face the central plazas to create eyes on the street, but are still slightly screened from the path by using strategic landscape planting to ensure privacy for residential units.

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SHEET TITLE

SITE CONSTRAINTS

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SEASIDE VILLAGE

Bridging Urban and Nature



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BURNSIDE PHASE II

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DESIGN RATIONALE


A Series of Plazas Connecting Urban to Coastal

The design of this waterfront series transforms the area into a vibrant public space that seamlessly bridges the urban environment with the coastal edge. A sequence of interconnected plazas, courtyards, transitional paths, and a waterfront boardwalk invites pedestrians to immerse themselves in the Gorge's natural landscape and community.

Four key nodes serve as focal points along a publicly accessible path stretching from Gorge Rd down to the water. These nodes are more than just waypoints; they are dynamic plazas that create an engaging public corridor, encouraging exploration and interaction with the waterfront.

Each plaza is designed to seamlessly transition from urban to natural settings, offering unique experiences that celebrate both community and nature.


- 1. The Urban Plaza: Starting near Gorge Rd, this lively gateway features retail spaces, cafes, and seating areas, encouraging social interaction and welcoming residents and visitors.
- 2. Residential Plaza: Further along, this tranquil oasis offers lush landscaping and shaded seating, providing a peaceful retreat from urban
- 3. Gorge Waterway View Plaza: As you proceed further, the path gently slopes downward leading you to the third plaza, where you meet Gorge's Waterway view for the first time.
- 4. Waterfront Plaza: At the water's edge, this dynamic space includes multiple gathering areas and walking paths.

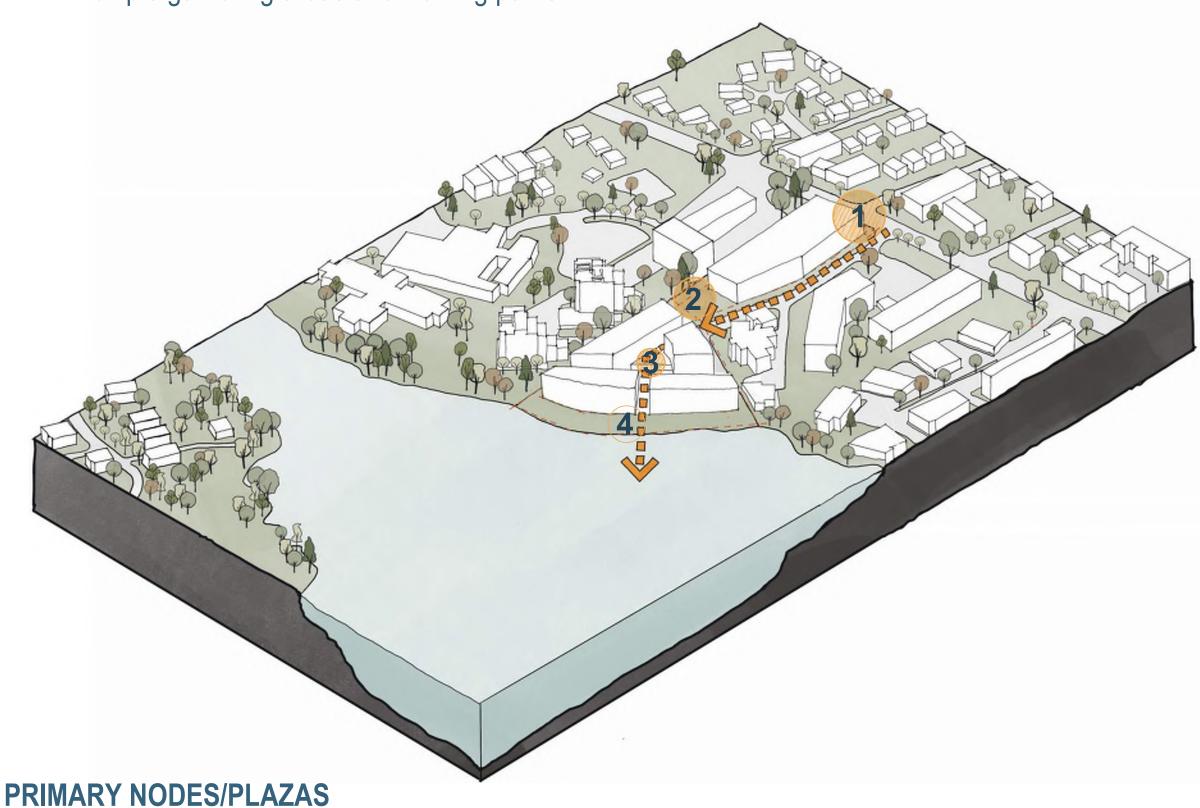



The Urban Plaza

Phase 1 includes retail units and a urban plaza that provides the initial public crossroad for the waterfront access with Gorge Rd.

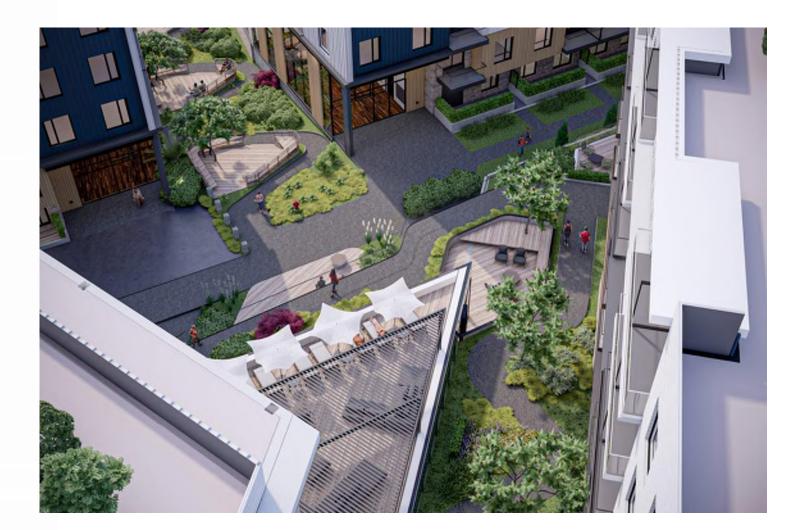

Gorge's Waterway Plaza

A terracing landscape and considered separation of waterfront buildings allows for multiple platforms to view out towards the Gorge waterway from within the



Residential Plaza

A lush central plaza bridging Phase 1 and 2, serving as a residential yard with spaces for relaxation and recreation. Creating an interconnected village with public connectivity at the heart of the site.



Waterfront Plaza

The path ends at a spacious waterfront plaza, perfect for enjoying the views, having a meal, or watching the boats. This area embodies the project's vision of seamlessly connecting urban and natural environments, providing a unique and enriching experience.

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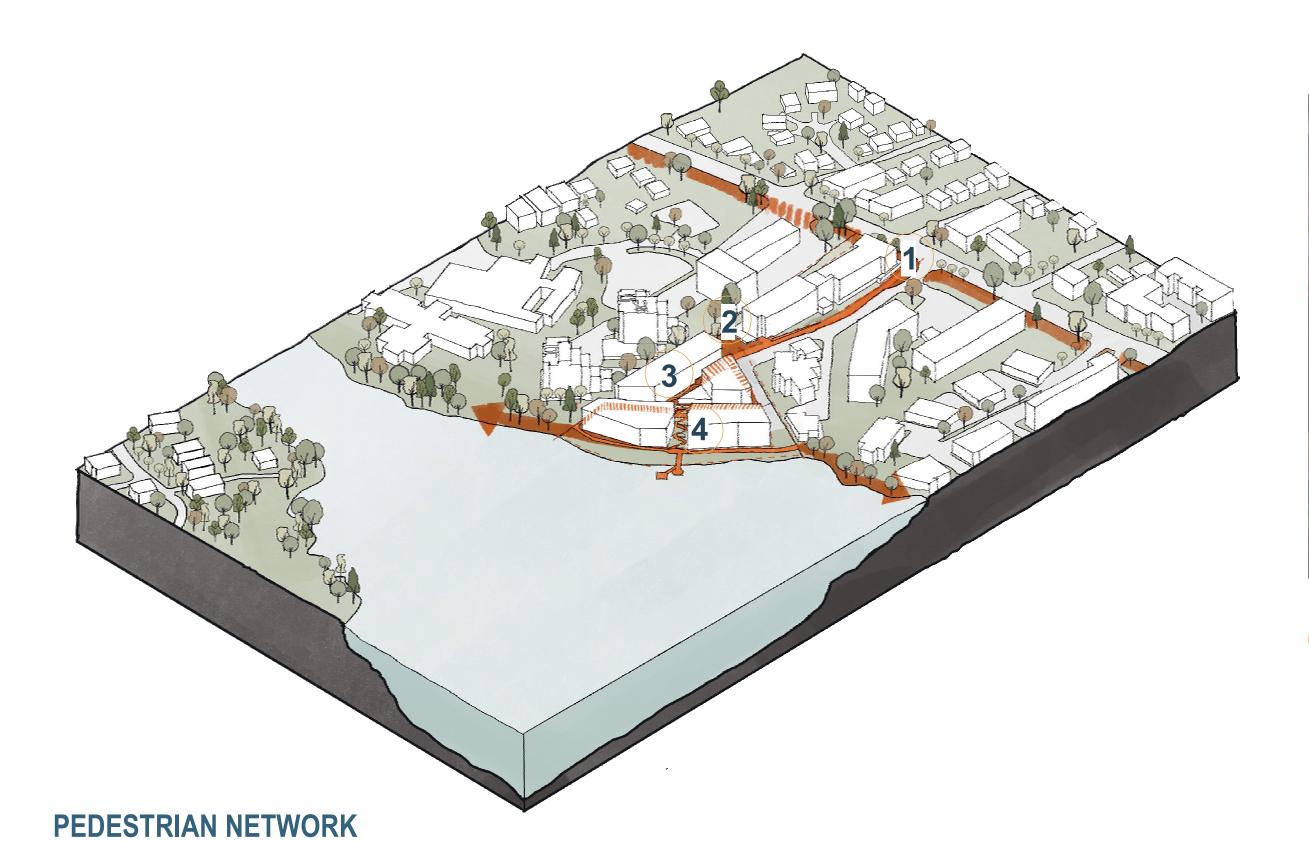
An Accessible Pedestrian Network

The proposed public pedestrian network that connects the city with the waterfront is a fantastic addition for both the project and the city. This accessible network creates a seamless transition from the urban environment to the natural beauty of the Gorge Waterway, encouraging residents and visitors of all abilities to explore and enjoy the area.

It enhances accessibility, promotes healthy lifestyles by encouraging outdoor activities and exercise, and fosters a stronger sense of community.

By linking key urban areas with the waterfront, the pedestrian network not only enriches the daily lives of those who live and work in the area but also boosts local businesses, making it a valuable asset for the entire neighborhood.

Each portion of the pedestrian network is designed to seamlessly transition from urban to natural settings, connecting the series of plazas that act as gathering places.





The Urban Realm - Pedestrian Access Point

A vibrant entry point at the northern edge, framed by retail spaces, which draws pedestrians from Gorge Rd into the site.



3 Meandering Pathway

A meandering path with dense planting, transitioning from residential to naturalized environment, offering seating and informal gathering spaces with initial views of the



Residential Pathway

The Residential Pathway winds through the heart of the community, offering a peaceful escape from the urban bustle. As you stroll along, you'll pass beautifully landscaped gardens and charming courtyards, each designed to foster a sense of tranquility and connection to nature.



4 Boardwalk Access

The significant elevation drop of phase II is made fully accessible by providing a meandering pathway through a naturalized landscape that blends the urban and coastal environments. A public boardwalk along the water's edge, establish a point of future connectivity to the Harbour Pathway.

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BURNSIDE PHASE II

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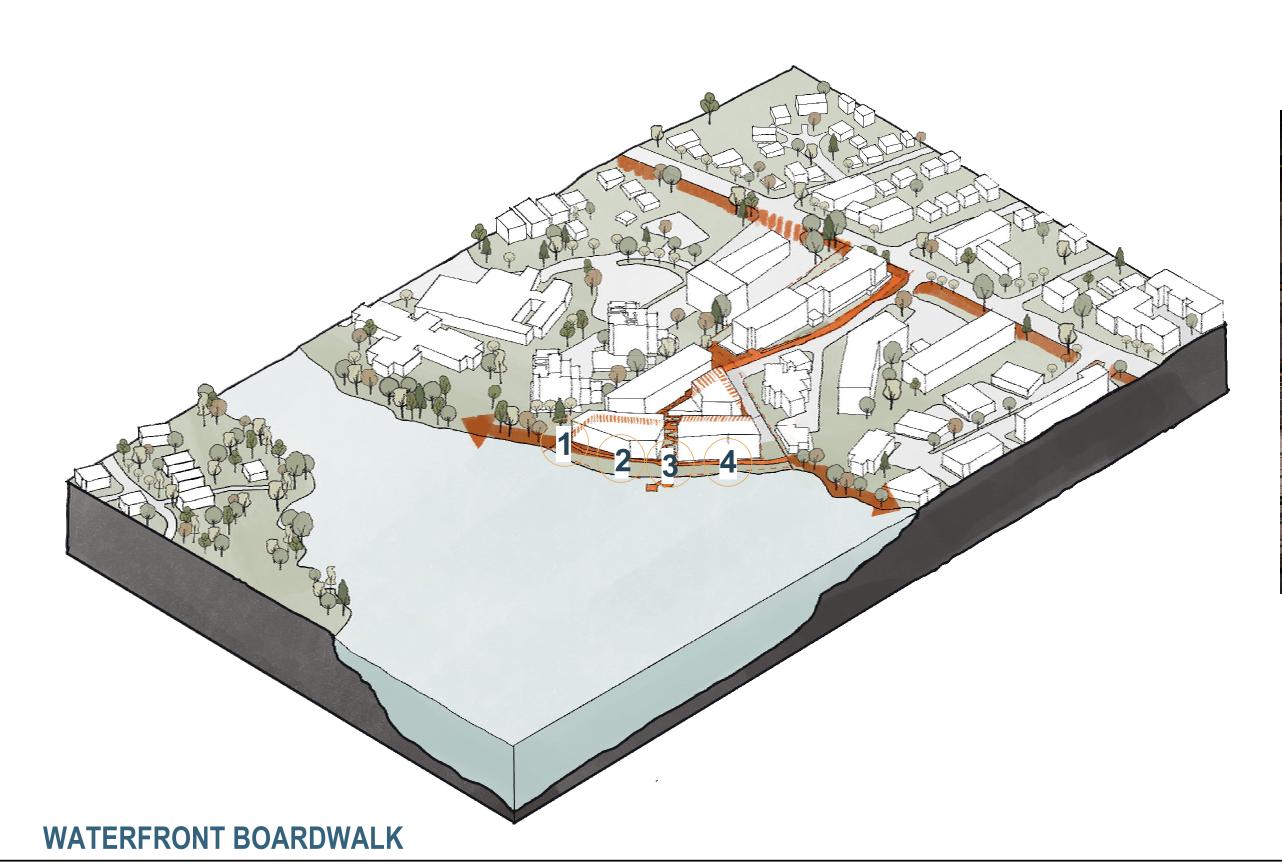
DESIGN RATIONALE

Waterfront Boardwalk

A publicly accessible boardwalk along the water's edge, establishing a future connection to the Harbour Pathway, is a fantastic addition to the neighborhood. This boardwalk not only enhances the scenic beauty of the waterfront but also provides a safe and accessible space for residents and visitors to enjoy leisurely strolls, exercise, and social activities.

By linking the neighborhood to the future Harbour Pathway, it creates a continuous, inviting route that encourages exploration and connectivity within the community.

This addition promotes a healthier, more active lifestyle and strengthens the sense of community, making the neighborhood more vibrant and attractive to both locals and visitors.





Recreational Activities

The boardwalk is designed to accommodate various recreational activities such as walking, jogging, and cycling. It provides a safe and enjoyable space for people of all ages to engage in outdoor exercise while taking in the natural surroundings.



3 Community Spaces

Where the boardwalk meets the meandering pedestrian pathway, there are thoughtfully placed seating areas and viewing spots where people can gather, relax, and socialize. These spaces foster a sense of community and provide opportunities for social interaction and leisure.



2 Scenic Views

The boardwalk offers breathtaking panoramic views of the Gorge Waterway, allowing residents and visitors to enjoy the serene beauty of the water and surrounding landscapes.



4 Ecological Integration

The design of the boardwalk incorporates native plants and sustainable materials, enhancing the natural habitat and acknowledging the importance of preserving the waterway's natural beauty

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BURNSIDE PHASE II

133-135 GORGE ROAD E, VICTORIA, BC

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DESIGN RATIONALE

Phase I Design Cues to Inform Phase II

Phase II aims to create a harmonious urban/coastal village by emphasizing a unified color palette and overarching theme, fostering a sense of local cohesion. However, within this cohesive framework, each building is designed to interpret the theme in its own unique and visually diverse way. To ensure continuity between both phases, Phase II builds upon the design language established in Phase I in three key areas:

- A. Character
- **B.** Form
- **C.** Materiality

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A. ARCHITECTURAL CHARACTER:

Bridging the urban environment with the coastal edge.

- 1. Urban Character
- 2. Residential Character
- **Coastal Character**



Linear Facade Patterns Fibre Cement Shingle Volumes

Non Linear Facade Patterns

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BURNSIDE PHASE II

133-135 GORGE ROAD E, VICTORIA, BC

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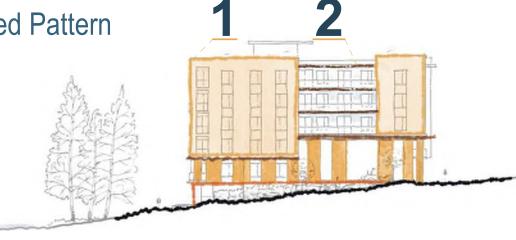
DESIGN RATIONALE

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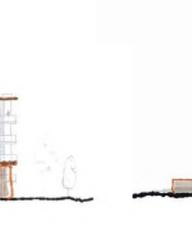
B. ARCHITECTURAL FORM/ LANGUAGE:

- Boxes / Cubes
- 2. Horizontal Lines

Staggered Pattern







C. MATERIALITY


- **Brick Base**
- 2. Fiber Cement Wood Look
- 3. White Colour
- 4. Fiber Cement Accent Colour (Blue-Green)







MASSING EVOLUTION

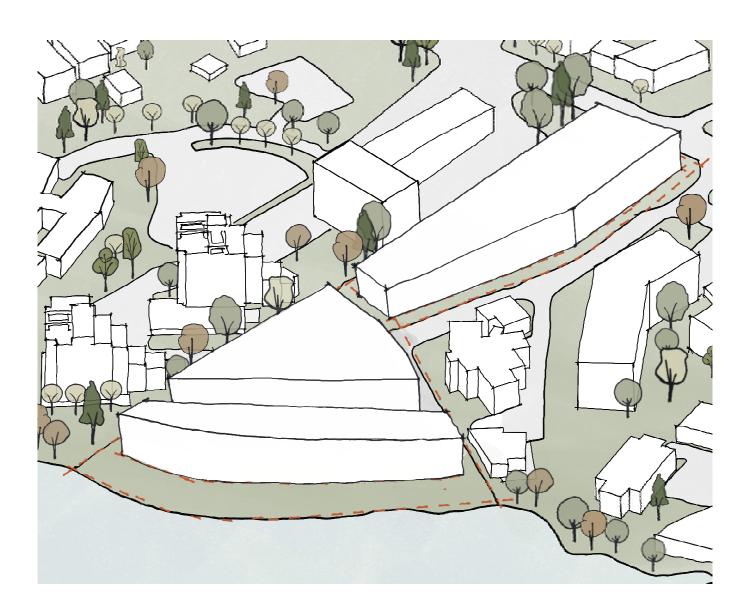


1. EXTRUDED SITE MASSING

The maximum buildable form is defined by site setbacks, SRW's, a coastal riparian setback, and maximum building height.



2. GROUNDED

In key locations around the buildings, strong brick elements are located to increase the impact and presence of ground oriented units and lobbies. This provides visual reinforcement of the walk up unit and a ground orient scale that is separate from the rest of the building above.

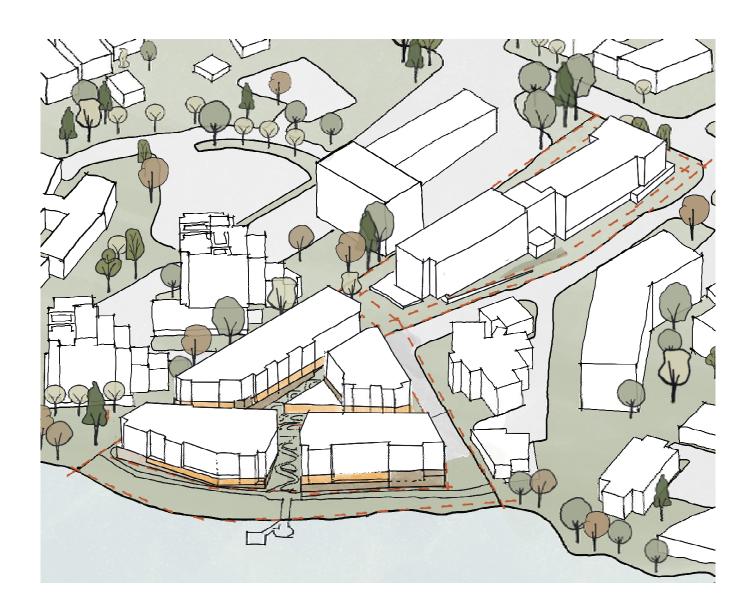

3. HORIZONTAL MASSING BREAK-UP

Additional horizontal datum's are created along the building facades to create a transitional facade from grounded elements of brick and saturated colors near the ground to lighter more reflective materials at the upper floors.



4. VERTICAL MASSING BREAK-UP | CARVING

To further reduce the scale of architectural elements, each building is carved in a vertical rhythm with balconies being partially inset to provide varying depths along the facade. This breaks up the longer block forms and reintroduces a residential scale and rhythm to the buildings.



5. VILLAGE: COHESIVE DIVERSITY

Each building's design fits within the overall village style but is unique in its application. This produces various architectural expressions across the site and allows each building to respond to its unique site conditions.



6. PROPOSED BUILDING FORM

The design of the buildings focuses on a simplified form that act as a background and boundary to the central courtyard and meandering pedestrian path.

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PROJECT

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BURNSIDE PHASE II

133-135 GORGE ROAD E, VICTORIA, BC

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MASSING EVOLUTION

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MASSING + HEIGHT

Rooftop Views of the Gorge Waterway

Each building is strategically positioned to step down the slope, creating a terraced effect. This design approach ensures that every building, regardless of its position on the slope, has unobstructed views of the Gorge Waterway from the rooftop.

The terracing not only enhances the visual appeal, but also allows for efficient use of the sloped terrain, minimizing the need for extensive excavation and retaining walls.

Each building's rooftop is designed as a communal space, featuring green roofs and outdoor amenities that encourage social interaction and provide a serene environment for residents to enjoy the panoramic views.

By stepping the buildings with the terrain, we create a cohesive and aesthetically pleasing development that respects the natural topography and offers a unique living experience.









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BURNSIDE PHASE II

133-135 GORGE ROAD E, VICTORIA, BC

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MASSING + HEIGHT

MEANDERING **PATHWAY** ENTRANCE

As you begin your journey down the meandering path, you are greeted by the first plaza (Phase I at Gorge Rd.), a vibrant urban corner bustling with activity. This node serves as a lively gathering spot, where residents and visitors can socialize and enjoy the urban atmosphere.

Continuing along the path, you gradually leave the urban hustle behind and enter a more tranquil

The residential plaza, nestled among lush greenery, offers a peaceful retreat with shaded benches and a playground. This area articulates both phases of the project and is designed to provide a moment of respite, where you can pause and appreciate the natural beauty around you.

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MEANDERING PATHWAY PEDESTRIAN EXPERIENCE

DP0.05.01

Building 1A-B North Facade - Residential Plaza - Public Path into Phase II

PHASE 2



The meandering path with dense planting transitions seamlessly from the residential area to a naturalized environment, creating a harmonious blend of urban and natural landscapes.

This pathway is designed to offer a serene and immersive experience, providing initial glimpses of the water, enhancing the journey with moments of scenic beauty, and fostering a deeper connection with the natural surroundings.

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MEANDERING PATHWAY PEDESTRIAN EXPERIENCE

DP0.05.02



PHASE 2



The pathway reaches the third plaza, which serves as a communal space that encourages social interaction due to its location in the center of Phase II courtyard.

The plaza serves as a central hub between all four Phase II Buildings. The programming leans into passive CPTED principles, locating opportunities for patios and balconies to overlook the lobbies and central pedestrian circulation of all four buildings.

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MEANDERING PATHWAY PEDESTRIAN EXPERIENCE

DP0.05.03

Building 1A-B - Gorge's Waterway Plaza

GORGE'S WATERWAY PLAZA

The design of the plaza allows for multiple elevated platforms, each offering unique vantage points to view the stunning Gorge Waterway. Residents and visitors can enjoy unobstructed views of the water, thanks to the strategic placement of buildings and terraces.

These platforms not only enhance the aesthetic appeal of the area but also provide inviting spaces for relaxation and social interaction

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MEANDERING PATHWAY PEDESTRIAN EXPERIENCE

DP0.05.04

Building 2A-B - Gorge's Waterway Plaza

MEANDERING **PATHWAY**

As you are near the end of the path, the transition from the urban realm to the natural setting becomes more pronounced. The final stretch of the journey offers a framed view of the Gorge Waterway, with the path lined by native vegetation and gentle slopes.

The design ensures accessibility for all, with smooth surfaces and gentle gradients that accommodate strollers, wheelchairs, and bicycles. INTRACORP HOMES

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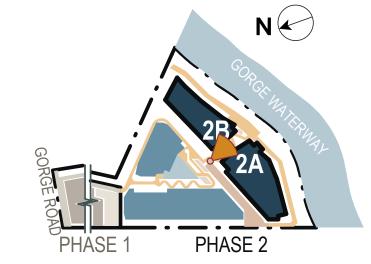
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MEANDERING PATHWAY PEDESTRIAN EXPERIENCE

DP0.05.05



PATHWAY

The path continues to wind its way down, bringing you closer to the water. A space that encourages active engagement with the environment.

The proximity to the water provides a refreshing breeze and a sense of openness, making it a popular spot for families and outdoor enthusiasts.

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PHASE 2

MEANDERING PATHWAY PEDESTRIAN EXPERIENCE

DP0.05.06



Building 2B SW Corner - Meandering Pathway

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BURNSIDE PHASE II

133-135 GORGE ROAD E, VICTORIA, BC

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MEANDERING PATHWAY PEDESTRIAN EXPERIENCE

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Building 2B SW Corner - Waterfront Plaza

WATERFRONT PLAZA

The path culminates in a spacious waterfront plaza, where you can sit and take in the views, enjoy a meal, or simply watch the boats go by. This final gathering area embodies the project's vision of creating a seamless connection between the urban and natural environments, offering a unique and enriching pedestrian experience.

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PHASE 2

BURNSIDE PHASE II

133-135 GORGE ROAD E, VICTORIA, BC

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BUILDING 1A VIEW





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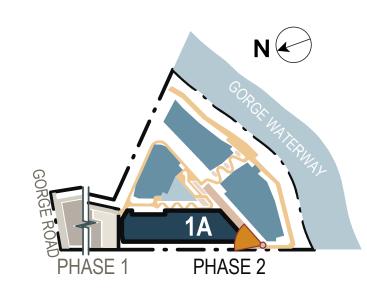
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BUILDING 1A VIEW

SHEET NUMBER DP0.06.01









Building 1B East Facade Detail View

The material palette is based on the natural environment of the west coast. Warm wood tones give reference to the local cedar trees, which are contrasted against a deep blue used to reflect the Gorge Waterway.

Brick elements have been used as a nod to the rocky shores along the southern most property line and white and charcoal notes have been added to help frame and define the palette.




Building 1B East Facade Detail View



Building 1B East Facade Detail View



Building 1A East Facade Detail View

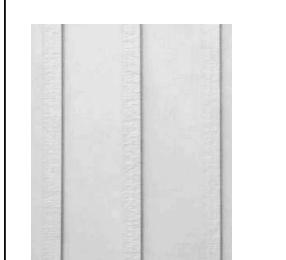

CEMENT BOARD SIDING PANEL

Product: Vertical Siding | Board & Batten
Colour: Arctic White

Product: Shingle
Colour: Arctic White



CEMENT BOARD SIDING PANEL



CEMENT SIDING PANEL

Product: Vertical Siding Colour: Desert Beach



CEMENT BOARD SOFFIT PANEL

Product: Soffit Panel Cedarmill Colour: Desert Beach



CEMENT BOARD SIDING PANEL

Product: Vertical Siding | Board & Batten Colour: Deep Ocean




CEMENT BOARD SIDING PANEL

Product: Vertical Siding



BRICK

Product: Standard Brick

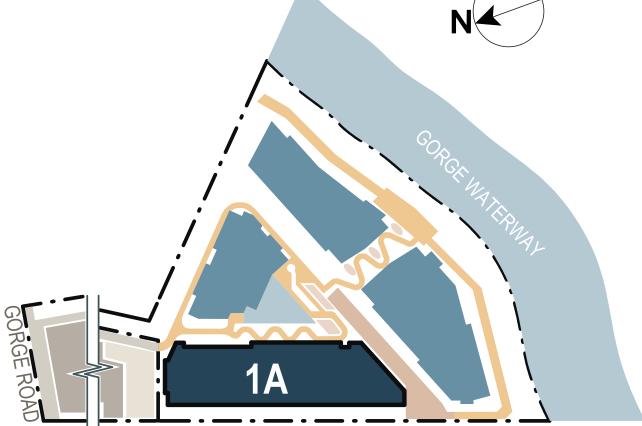

PHASE 1

PHASE 2



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SHEET TITLE **BUILDING 1A CLOSE-UP**

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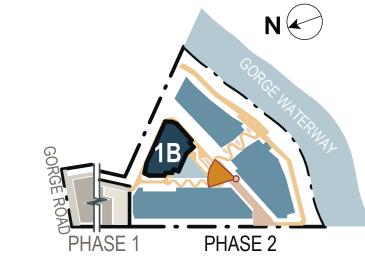
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BUILDING 1B VIEW

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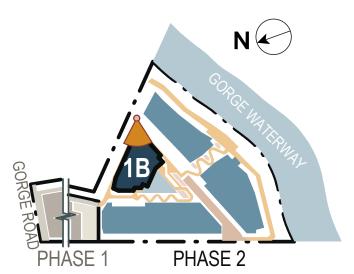
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BUILDING 1B VIEW

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Building 1B - Lobby Detail View



Building 1B - SW Facade Detail View



Building 1B - West Facade Detail View




Building 1B - Lobby Detail View



Building 1B - SE Corner Detail View



Building 1B - East Facade Detail View

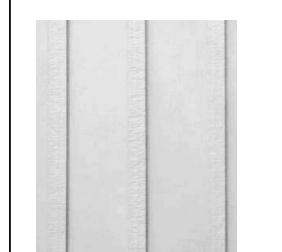

CEMENT BOARD SIDING PANEL

Product: Vertical Siding | Board & Batten
Colour: Arctic White

Product: Shingle
Colour: Arctic White



CEMENT BOARD SIDING PANEL



CEMENT SIDING PANEL

Product: Vertical Siding Colour: Desert Beach




CEMENT BOARD SOFFIT PANEL

Product: Soffit Panel Cedarmill Colour: Desert Beach



CEMENT BOARD SIDING PANEL

Product: Vertical Siding | Board & Batten Colour: Deep Ocean

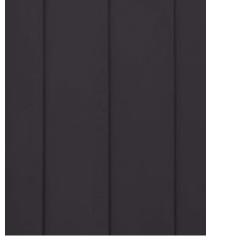


CEMENT BOARD SIDING PANEL

Product: Vertical Siding | Board & Batten Colour: Midnight Black



BRICK

Product: Standard Brick Colour: Warm Grey

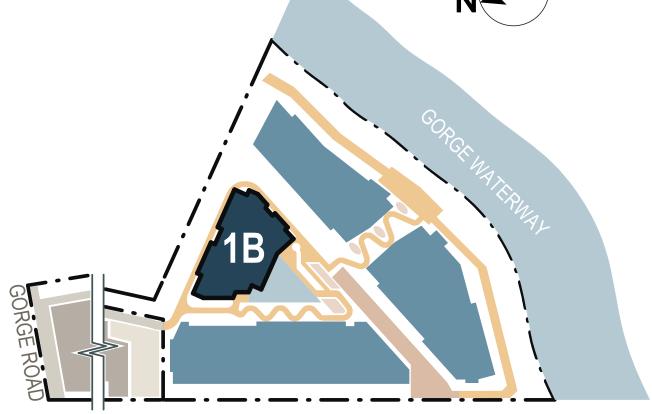

PHASE 1

PHASE 2



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PROJECT **BURNSIDE PHASE II**

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BUILDING 1B CLOSE-UP

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2024-11-28



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PHASE 2

Building 2A NE Corner - Gorge's Waterway Plaza

BURNSIDE PHASE II

133-135 GORGE ROAD E, VICTORIA, BC

PROJECT NO: 138914 DRAWN BY: ARCADIS CHECKED BY: ARCADIS APPROVED BY: ARCADIS PROJECT MGR: ARCADIS

SHEET TITLE **BUILDING 2A VIEW**

DP0.06.06



The intent was to make the waterfront buildings blend seamlessly with the natural shoreline by following the terrain's contours. By incorporating brick as a base, we provide these buildings with a sense of permanence and stability, blending well with the natural surroundings. Its earthy tones and textures complement the coastal landscape, creating a cohesive and timeless aesthetic that anchors the structure to its site.

Large windows and balconies offer views of the Gorge Waterway, while planters in roofs and native plantings enhance the connection to the environment. This design respects and enhances the shoreline's beauty, creating a unique living experience that celebrates the natural surroundings.

INTRACORP HOMES

INTRACORP Building the Extraordinary

Suite 600 Burrard Street Vancouver, Canada, V6C 2B5

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BURNSIDE PHASE II

133-135 GORGE ROAD E, VICTORIA, BC

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ARCADIS **ARCADIS**

BUILDING 2A VIEW

DP0.06.07

PHASE 2

Building 2A South Facade - Waterfront Plaza





Building 2A - East Facade Detail View





DESCRIPTION A DEVELOPMENT PERMIT 2024-11-28



Building 2A - South Facade Detail View



Building 2A South Facade Detail View



Building 2A South Facade Balconies + Soffit Detail



Building 2A South Facade Balcony Detail



Building 2A - Lobby Detail View



CEMENT BOARD SIDING PANEL

Product: Vertical Siding | Board & Batten Colour: Arctic White Colour: Arctic White



CEMENT BOARD SIDING PANEL



CEMENT SIDING PANEL

Product: Vertical Siding Colour: Desert Beach Colour: Desert Beach



CEMENT BOARD SOFFIT PANEL Product: Soffit Panel Cedarmill



CEMENT BOARD SIDING PANEL


Product: Vertical Siding | Board & Batten Colour: Deep Ocean



CEMENT BOARD SIDING PANEL Product: Vertical Siding | Board & Batten Colour: Midnight Black




Product: Standard Brick Colour: Warm Grey

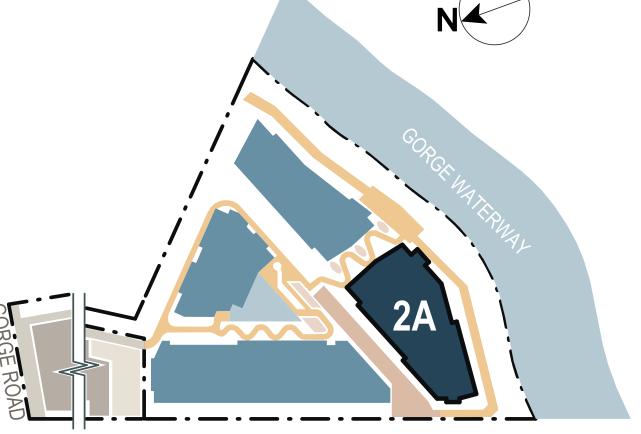

PHASE 1

PHASE 2

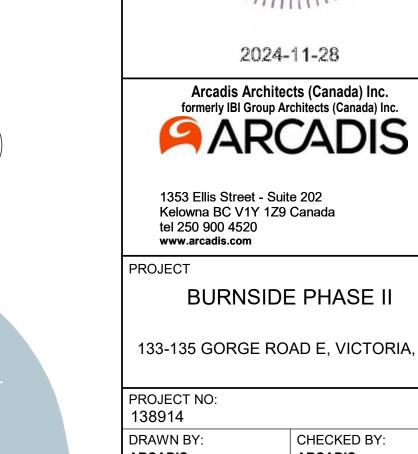

BURNSIDE PHASE II

133-135 GORGE ROAD E, VICTORIA, BC

2024-11-28

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SEAL

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PROJECT NO: 138914	
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SHEET TITLE **BUILDING 2A CLOSE-UP**

DP0.06.08

CLIENT INTRACORP HOMES

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BURNSIDE PHASE II

133-135 GORGE ROAD E, VICTORIA, BC

PROJECT NO: 138914	
DRAWN BY: ARCADIS	CHECKED BY: ARCADIS
PROJECT MGR:	APPROVED BY:

APPROVED BY: ARCADIS ARCADIS

SHEET TITLE **BUILDING 2B VIEW**

DP0.06.09

PHASE 2



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BURNSIDE PHASE II


133-135 GORGE ROAD E, VICTORIA, BC

DRAWN BY: CHECKED BY: ARCADIS ARCADIS PROJECT MGR: APPROVED BY: ARCADIS ARCADIS

SHEET TITLE

BUILDING 2B VIEW

DP0.06.10

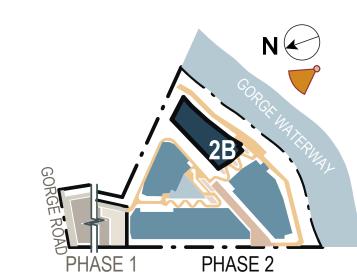

Building 2B - North Facade Detail View



Building 2B - West Facade Detail View



Building 2B - Lobby Detail View





Building 2B - South Facade Detail View




Building 2B - South Facade Detail View



Building 2B - South Facade Detail View



Building 2B - South Facade Detail View

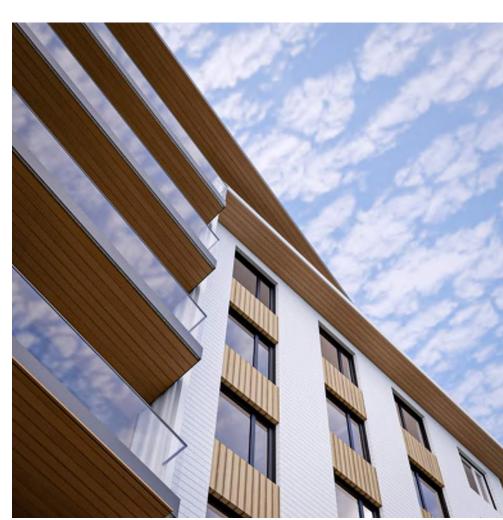

Building 2B - South Facade Detail View



CEMENT BOARD SIDING PANEL

Product: Vertical Siding | Board & Batten
Colour: Arctic White

Product: Shingle
Colour: Arctic White



CEMENT SIDING PANEL CEMENT BOARD SIDING PANEL

Product: Vertical Siding Colour: Desert Beach



CEMENT BOARD SOFFIT PANEL Product: Soffit Panel Cedarmill

Colour: Desert Beach




Product: Vertical Siding | Board & Batten

Colour: Deep Ocean




CEMENT BOARD SIDING PANEL Product: Vertical Siding | Board & Batten Colour: Midnight Black

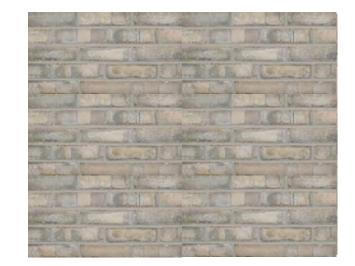


BRICK

Product: Standard Brick Colour: Warm Grey

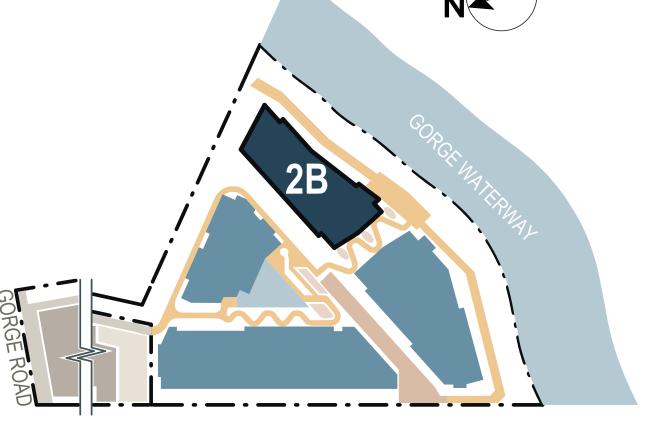

PHASE 1

PHASE 2

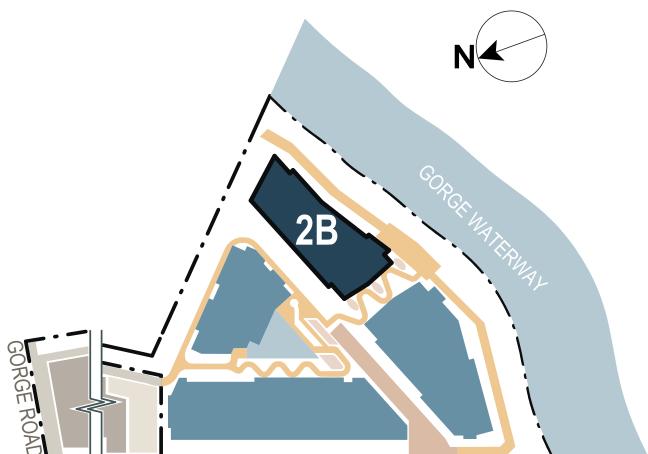

PROJECT NO: 138914 DRAWN BY:

PROJECT

CHECKED BY: ARCADIS ARCADIS APPROVED BY: ARCADIS PROJECT MGR: ARCADIS SHEET TITLE

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BURNSIDE PHASE II

133-135 GORGE ROAD E, VICTORIA, BC

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INTRACORP HOMES

INTRACORP

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2024-11-28

DESCRIPTION

A DEVELOPMENT PERMIT

BUILDING 2B CLOSE-UP

DP0.06.11

A



2024-11-28

2024-11-28

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PHASE 2

BURNSIDE PHASE II

133-135 GORGE ROAD E, VICTORIA, BC

PROJECT NO: 138914	
DRAWN BY: ARCADIS	CHECKED BY: ARCADIS
PROJECT MGR: ARCADIS	APPROVED BY: ARCADIS

SHEET TITLE OVERALL AERIAL VIEW

DP0.07.01

Overall Site View from the Gorge Waterway

RESPONSE TO DPA7A

Urban Design Guidelines

City of Victoria - Design Guidelines for Multi-Unit Residential, Commercial and Industrial (2019)

Ref No	Document Ref No	Description
01	2.1	New development should contribute to cohesion, visual identity and the quality of streetscapes, particularly when adjacent and nearby buildings are similar in scale, proportion, rhythm and pattern:
02	2.1.1	New development should incorporate building elements that are complementary, such as street walls, façade rhythm and horizontal cornice lines
03	2.1.2	New development is encouraged to add interest to the streetscape through variations in building height, rooflines and massing
	2.2.	New development should avoid long unvaried stretches of frontages in ways that include, but are not limited to:
04		
	2.2.1	Massing that gives the impression of small blocks
05	2.3	New development is encouraged to have a strong relationship to the street, particularly when public uses are allowed along street level
06	2.3.1	Buildings should be oriented towards public streets, walkways and amenities (Parks, harbour and coastline, etc.)
09	2.3.3	Where possible, buildings should frame public streets and open spaces to create a sense of enclosure, street vitality and safety.
12	2.3.4	Building facades should be modulated at grade level to enable street activity such as browsing, outdoor cafes and street entertainment, as well as to enable placement of seating where appropriate.
05	2.3.5	Visual and physical connections between the public street and buildings should be developed (e.g. patios and spill-out activity, views to and from interior spaces, awnings and canopies).
	2.4	Residential use at street level should have strong entry features and building designs that encourage interaction with the street.
19		
	2.4.1	Individual entrances with direct connections to the public sidewalk are encouraged.

3.0 Hun	nan Scale	, Massing, Height and Architectural Features
Drawing Ref No	Document Ref No	Description
07	3.1	Larger and longer buildings should be visually broken into human-scaled proportions. This could be achieved in a number of ways, including breaks in form projections, balconies, bay windows, surface treatments, and building articulation.
	3.1.1	Building bases should be well-designed and articulated, especially along facades that are adjacent to a street
14	3.1.2	Large, blank windowless and featureless walls that are visible from the public realm are strongly discouraged
15	3.1.3	Building facades should be designed so that entrances for pedestrians are legible and prominent, an that vehicular entrances and doors and subordinated features
13	3.3	Perceived building mass should be mitigated through the use of architectural elements, visually interesting rooflines, stepping back of upper floors, detailing tha creates rhythm and visual interest, or other design solutions.
03	3.3.2	Roof forms should complement the character of the buildings in the immediate context
10	3.3.3	The visual impact and perceive massing of any enclosed elevator shafts and oth mechanical equipment should be reduced with architectural treatments
07	3.6	Porches, steps, alcoves or other design features are encouraged to make transition from the public realm of the street and sidewalk, to the private realm of residences
12	3.7	The use of building elements such as raised terraces, forecourts or landscaping should be considered to enhance residential entrances.

4.0 Exter	rior Finis	shes
Drawing Ref No	Document Ref No	Description
16	4.1	Exterior building materials should be high quality, durable and capable of weathering gracefully
	4.1.1	Higher quality materials used on the principal façade should be continued around any building corner or edge which is visible from the public realm.
18	4.2	Rich and varied architectural materials are encouraged to enhance and articulate street frontages.
17	4.4	The exposed undersides of balconies and porches that are visible from a street or public walkway should be clad with exterior materials that result in a finished appearance and which complement the palette of exterior materials used on the rest of the building.

Drawing Ref No	Document Ref No	Description
09	5.1	Open space should be usable, attractive, and well-integrated with the design of the building.
12	5.2	Public and semi-public spaces should be distinguished from private spaces through design elements, including, but not limited to:
	5.2.2	Changes in paving or grading
13	5.2.3	Architectural Features
05	5.2.4	Changes in landscape, raised planters or other landscaping features
08	5.5	Landscape design should preserve existing native vegetation where possible.
20	5.7	Landscape should be designed to allow clear, unobstructed views of surrounding areas through the placement of living features and other elements.
10	5.10	Consideration should be given to the inclusion of private open space in residential developments in the form of courtyards, recessed balconies, terraced balconies or rooftop gardens.

_	7.0 01110	CIOUI ACI	cessible Design and Safety
	Drawing Ref No	Document Ref No	Description
ne	11	7.1	A high standard of accessibility in site, building and landscape design is encourage to address the needs of all users, including people who have disabilities.
gh	12	7.1.1	Disabled access should be appropriately designed and clearly visible form the main entrance, not relegated to a secondary building frontage for the sake of architectural convenience.
	09	7.1.2	When provided, access ramps and related elements should be visually integrated with the overall building design and site plan so as to not appear disjointed form the building façade
	10	7.1.3	Smooth Routes should be provided. Vertical disruptions along pedestrian routes should be avoided for ease of use by people with wheeled mobility devices, strollers and bicycles.
	20	7.1.4	Landscaping should be accessible for people with varying levels of ability and mobility.
	09	7.2	The following factors should be taken into account to design environment s that people feel safe to use:
	01	7.2.1	Visibility by others (design for seeing and being seen)
	02	7.2.4	Sightlines (Ability to see route ahead and open spaces form buildings)
	05	7.2.5	Activity generators (Design places for uses that attract people and that provide opportunities for casual surveillance)
	17	7.3	New development should be design to maximize opportunities for causal surveillance and 'eyes on the street' through placement of windows, balconies and street-level uses.
	03	7.3.1	Blank, windowless walls should be avoided, which do not permit occupants to observe the street in the course of everyday activities.
	01	7.3.2	Window features with transparent glazing should be placed to overlook streets, pathways, open spaces and parking areas to increase neighbourhood security.



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BURNSIDE PHASE II

133-135 GORGE ROAD E, VICTORIA, BC

138914 DRAWN BY: CHECKED BY: ARCADIS **ARCADIS** PROJECT MGR: APPROVED BY: **ARCADIS**

SHEET TITLE CITY OF VICTORIA DESIGN

GUIDELINES



November 28, 2024

PROJECT DESCRIPTION

PROJECT NAME	BURNSIDE GORGE - PHASE 2	
PROJECT ADDRESS	135 GORGE ROAD E.	
PID	002-608-421	
CURRENT ZONING	T1	
PROPOSED ZONING	CD	
ALLOWABLE FSR	2.00	
PROPOSED FSR	2.00	

SITE AREA

PHASE 2 SITE AREA AND FSR	AREA Ha	AREA ft²	AREA m²
SITE AREA - PHASE 2	1.249	134,409	12,487
ALLOWABLE FSR	2.00	2.00	2.00
TOTA	L ALLOWABLE FSR	268,818	24,974

INTERNAL SITE BREAKDOWN	AREA Ha	AREA ft²	AREA m²	
PHASE 2 - B1A+1B	0.620	66,787	6,205	
PHASE 2 - B2A + 2B	0.628	67,622	6,282	
TOTAL PARCEL AREA	1.249	134,409	12,487	

SITE COVERAGE + OPEN SPACE

SITE COVERAGE	46 %	OPEN SPACE	37.10 %
TOTAL BHASE 2 SITE COVEDACE	61,983.06 ft²	TOTAL PHASE 2 OPEN SPACE	49,862.53 ft²
E COVERAGE TAL PHASE 2 SITE COVERAGE	5,758.41 m²	TOTAL PHASE 2 OPEN SPACE	4,632.38 m²

	HEIGHT IN m ALLOWABLE	HEIGHT IN m PROPOSED	HEIGHT IN ft PROPOSED	No. OF STOREYS	
BUILDING 1A	22 m	20.4m	66' - 11 1/8"	6	
BUILDING 1B	22 m	21.3m	69' - 9 3/8"	6	
BUILDING 2A	22 m	20.6m	67' - 8 1/4"	6	
BUILDING 2B	22 m	20.7m	67' - 11"	6	

SETBACKS

DESCRIPTION	REQUIRED DIST. in	DISTANCES PROVIDED			
DESCRIPTION	m	DIST. in m	DIST. in ft		
PHASE 2 - NORTH PL	5m	5m	16' - 4 7/8		
PHASE 2 - EAST PL	6m	10m	32' - 9 3/4		
HASE 2 - SOUTH PL (RIPARIAN SRW)	15m	15m	49' - 2 1/2		
PHASE 2 - WEST PL	6m	6m	19' - 8 1/4		

Unit Location	Total Area (ft²)	Average			Count l	y Leve			T	% of Type	% of Total Mix
		Area (ft²)	01	02	03	04	05	06	Total Count	Mix	

Jr 1 Bed											
B1a	15,514	443	0	7	7	7	7	7	35	66%	11%
B1b	6,717	448	0	3	3	3	3	3	15	28%	5%
B2a	1,482	494	0	0	0	1	1	1	3	6%	1%
B2b	0	0	0	0	0	0	0	0	0	0%	0%
	23,712	447	0	10	10	11	11	11	53		16%

Bed												
	B1a	3,101	443	1	2	1	1	1	1	7	13%	2%
	B1b	9,678	509	0	3	4	4	4	4	19	36%	6%
	B2a	3,069	512	1	1	1	1	1	1	6	11%	2%
	B2b	9,243	486	1	2	4	4	4	4	19	36%	6%
		25,091	492	3	8	10	10	10	10	51		16%

Jr 2 Bed											
B1a	35,733	596	0	12	12	12	12	12	60	58%	18%
B1b	2,868	574	0	1	1	1	1	1	5	5%	2%
B2a	17,053	588	0	5	6	6	6	6	29	28%	9%
B2b	5,386	539	1	1	2	2	2	2	10	10%	3%
	61,039	587	1	19	21	21	21	21	104		32%

18,950	758	3	3	4	o o	5	o o	20	26%	8%
			^	-	E	6	E	25	200/	0.07
a 20,598	792	3	4	4	5	5	5	26	27%	8%
13,395	670	0	4	4	4	4	4	20	21%	6%
a 16,776	671	1	4	5	5	5	5	25	26%	8%
t	b 13,395	b 13,395 670	b 13,395 670 0	b 13,395 670 0 4	b 13,395 670 0 4 4	b 13,395 670 0 4 4 4	b 13,395 670 0 4 4 4 4	b 13,395 670 0 4 4 4 4 4	b 13,395 670 0 4 4 4 4 4 20	b 13,395 670 0 4 4 4 4 4 20 21%

	20,724	987	1	4	4	4	4	4	21		6%
B2b	9,276	928	0	2	2	2	2	2	10	48%	3%
B2a	11,448	1,041	1	2	2	2	2	2	11	11%	3%
B1b	0	0	0	0	0	0	0	0	0	0%	0%
B1a	0	0	0	0	0	0	0	0	0	0%	0%

616 12 56 62 65 65 65 325

B1a	71,123	127
B1b	32,657	59
B2a	53,649	75

Total 200,284

B2b 42,854 Total 200,284

UNITS BY BUILDING AND LEVEL AREA ft² AREA m² B01 - LEVEL 06 14,020 ft² 1,303 m² B01 - LEVEL 05 14,020 ft² 1,303 m² B01 - LEVEL 04 14,020 ft² 1,303 m² B01 - LEVEL 03 1,303 m² 25 14,020 ft² 1,295 m² B01 - LEVEL 02 12 13,936 ft² B01 - LEVEL 01 1,106 ft² 103 m² B01 - LEVEL 06 6,637 ft² 617 m² B01 - LEVEL 05 6,637 ft² 617 m² 6,637 ft² 617 m² B01 - LEVEL 04 617 m² B01 - LEVEL 03 6,637 ft² B01 - LEVEL 02 6,111 ft² 568 m² 9,642 m² B02 - LEVEL 06 10,664 ft² 991 m² B02 - LEVEL 05 10,664 ft² 991 m² B02 - LEVEL 04 10,664 ft² 991 m² B02 - LEVEL 03 13 9,482 ft² 881 m² 8,696 ft² B02 - LEVEL 02 808 m² B02 - LEVEL 01 3,480 ft² 323 m² B02 - LEVEL 06 8,702 ft² 808 m² B02 - LEVEL 05 8,702 ft² 808 m² B02 - LEVEL 04 8,702 ft² 808 m² B02 - LEVEL 03 8,003 ft² 743 m²

3 25 39 51 21 139

53 51 104 96 21 325 200,284 ft²

B02 - LEVEL 02

B02 - LEVEL 01

CLIENT INTRACORP HOMES INTRACORP

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5,817 ft²

2,927 ft²

96,503 ft²

540 m²

272 m²

8,965 m²

18,607 m²

		FLOOR TO		ļ		GRO	SS BUILDING AREA	(ft²)					EXCLUSIONS (ft²)		
PHASE 2 BUILDING AREAS COMBINED	ELEVATION (ft)	FLOOR(ft)	UNIT COUNT	PARKING COMMON	RETAIL	AMENITY	LOBBY	CIRCULATION	RESIDENTIAL	SUBTOTAL	PARKING	ELEVATOR	LONG TERM BIKES	SUBTOTAL	FSR AREA
LEVEL															
ROOF			0	0	0	0	0	2,077	0	2,077	0	403	0	403	1,674
LEVEL 06	The state of the s		65	1,687	0	0	0	6,732	40,023	48,442	0	567	0	567	47,875
LEVEL 05			65	1,687	0	0	0	6,732	40,023	48,442	0	567	0	567	47,875
LEVEL 04			65	1,687	0	0	0	6,732	40,023	48,442	0	567	0	567	47,875
LEVEL 03			62	845	0	0	0	6,712	38,142	45,698	0	567	0	567	45,132
LEVEL 02			56	1,511	0	882	1,537	7,329	34,561	45,820	0	567	0	567	45,253
LEVEL 01			12	35,680	0	7,969	451	9,149	7,513	60,763	30,605	567	0	31,172	29,591
LEVEL P1			0	66,700	0	0	0	3,202	0	69,902	55,290	566	7,445	63,301	*
LEVEL P2			0	3,182	0	0	0	312	0	3,494	3,182	149	0	3,331	-
(****															
			325	112,979	-	8,851	1,988	48,977	200,284	373,079	89,077	4,518	7,445	101,040	265,275
	METRIC CO	NVERSION TO m ²		10,496		822	185	4,550	18,607	34,660	8,276	420	692	9,387	24,645

SALEABLE AREA - TYPICAL FLOOR	38,142 ft²	TOTAL COMMON AND CIRCULATION AREA	72,879 ft²	the standard of the	
EFFICIENCY	83%	TOTAL RESIDENTIAL AREA	200,284 ft ²	FSR AREA PERMITTED	268,818
		TOTAL COMMERCIAL AREA	•		
TOTAL SALEABLE AREA	200,284 ft ²	PROPOSED TOTAL AREA	373,079 ft²	FSR AREA ACHIEVED	265,275
EFFICIENCY	54%	TOTAL COMMERCIAL % OF PROJECT	N/A	DIFFERENCE	3,543
		RESIDENTIAL EFFICIENCY EXCL COMMERCIAL AND PARKADE	71%	FSR ACHIEVED	1.9
				tted is 2.00. It is anticipated that the additional process as part of design development and c	

		UNIT TYPE										
LEVEL	JR ·	1 BR	1	BR	JR:	2 BR	21	BR	3	BR	NOMBER	OF UNITS
	B1a + 1b	B2a + 2b	B1a + 1b	B2a + 2b	B1a + 1b	B2a + 2b	B1a + 1b	B2a + 2b	B1a + 1b	B2a + 2b	B1a + 1b	B2a + 2b
6	10	1	5	5	13	8	9	10	0	4	37	28
5	10	1	5	5	13	8	9	10	0	4	37	28
4	10	1	5	5	13	8	9	10	0	4	37	28
3	10	0	5	5	13	8	9	8	0	4	37	25
2	10	0	5	3	13	6	8	7	0	4	36	20
1	0	0	1	2	0	1	1	6	0	1	2	10
TOTAL PER BUILDING	50	3	26	25	65	39	45	51	0	21	186	139
COMBINED TOTAL	ţ	53		51	1	04	9	06	2	21	3	25
UNIT MIX	16	6%	10	6%	32	2%	30	0%	6	%	10	0%

	GROSS BUILDING	AREA	
LEVEL	LOCATION	AREA ft²	AREA m²
B01 - LEVEL P2	PARKADE	3,586 ft²	333 m²
B01 - LEVEL P1	PARKADE	41,088 ft ²	3,817 m ²
B01 - LEVEL 01	B1 + PARKADE	32,502 ft²	3,020 m²
B1		77,176 ft²	7,170 m²
B01 - LEVEL 06	B1a SOUTH	12,544 ft²	1,165 m²
B01 - LEVEL 06	B1a NORTH	4,335 ft ²	403 m²
B01 - LEVEL 05	B1a SOUTH	12,544 ft²	1,165 m²
B01 - LEVEL 05	B1a NORTH	4,335 ft²	403 m²
B01 - LEVEL 04	B1a SOUTH	12,544 ft²	1,165 m²
B01 - LEVEL 04	B1a NORTH	4,335 ft²	403 m²
B01 - LEVEL 03	B1a SOUTH	12,544 ft²	1,165 m²
B01 - LEVEL 03	B1a NORTH	4,335 ft²	403 m²
B01 - LEVEL 02	B1a SOUTH	12,544 ft²	1,165 m²
B01 - LEVEL 02	B1a NORTH	4,335 ft ²	403 m²
B1a		84,391 ft²	7,840 m²
B01 - LEVEL 06	B1b	8,408 ft ²	781 m²

DUI - LEVEL 03	סוט	0,400 IL	701111
B01 - LEVEL 04	B1b	8,408 ft ²	781 m²
B01 - LEVEL 03	B1b	8,408 ft ²	781 m²
B01 - LEVEL 02	B1b	8,408 ft ²	781 m²
B1b		42,041 ft ²	3,906 m ²
B1		203,608 ft ²	18,916 m²
B02 - LEVEL P1	PARKADE	31,678 ft²	2,943 m ²
B02 - LEVEL 01	PARKADE + B2	29,886 ft²	2,777 m ²
B2		61,564 ft ²	5,720 m ²
B02 - LEVEL 06	B2a	13,500 ft²	1,254 m ²
B02 - LEVEL 05	B2a	13,500 ft²	1,254 m²
B02 - LEVEL 04	B2a	13,500 ft²	1,254 m²
B02 - LEVEL 03	B2a	13,550 ft²	1,259 m ²
B02 - LEVEL 02	B2a	13,292 ft²	1,235 m ²
B2a		67,341 ft ²	6,256 m ²

B02 - LEVEL 06	B2b	10,914 ft²	1,014 m²
B02 - LEVEL 05	B2b	10,914 ft²	1,014 m ²
B02 - LEVEL 04	B2b	10,914 ft²	1,014 m ²
B02 - LEVEL 03	B2b	10,882 ft²	1,011 m²
B02 - LEVEL 02	B2b	8,644 ft²	803 m²
B2b		52,267 ft ²	4,856 m²
B2		181,172 ft²	16,831 m²



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BURNSIDE PHASE II

133-135 GORGE ROAD E, VICTORIA, BC

PROJECT NO: 138914 DRAWN BY: CHECKED BY: ARCADIS **ARCADIS** PROJECT MGR:

APPROVED BY:

ARCADIS

ARCADIS SHEET TITLE

PROJECT INFORMATION + STATISTICS

DP0.10.0

PARKING COUNT


A CONTRACTOR OF THE CONTRACTOR	BYL	AW REQUIREMEN	NT		CLIENT REQUIREMENT			
TYPE OF PARKING	RULE	BUILDIN	IG STATS	REQUIRED PARKING	RULE	BUILDING STATS	REQUIRED PARKING	
RESIDENTIAL	0.75 PER UNIT < 45 m 0.9 PER UNIT ≥ 45 m² BUT ≤ 70 m² 1.3 PER UNIT ≥ 70 m²	1	COUNT 67 88 70	51 170 91	0.50 PER UNIT	UNIT COUNT 325	163	
COMMERCIAL RETAIL	1 SPACES PER 37.5 m² OF GROSS FLOOR AREA	ft² 0	REA m² 0	0	SAME AS BYLAW		0	
VISITOR PARKING	0.1 PER UNIT		COUNT 25	33	SAME A	S BYLAW	33	
TOTAL REQUIRED BY I	BYLAW 345				TOTAL REQUIRED BY CLIENT		196	
TOTAL PROVIDED (INCL. ACCES	SIBLE) 265	RES RA	TIO PROVIDED/UNIT	0.71	1 DIFFERENCE		69	


TYPE OF BIKE PARKING		BYLAW REQUIREMEN	NT	BUILDIN	IG STATS	CITY REQUIRED		
RESIDENTIAL	LONG TERM: 1 PE	R UNIT > 45 m² AND 1.25 PER UNIT < 70 m	2	< 45 m ²	> 45 m ²	LONG TERM	SHORT TERM	
RESIDENTIAL	SHORT TERM: GR	EAT OF 6 PER BUILDING OR 0.1 PER UNIT	67	258	390	33		
COMMERCIAL	LONG TERM CLAS	S A: 1 PER 200 m ²		ft²	m²	LONG TERM	SHORT TERM	
COMMERCIAL	SHORT TERM CLA	SS B: 1 PER 200 m²	0	0	0	0		
TOTAL REQUIRED	SHORT TERM	33						
TOTAL REQUIRED	LONG TERM	390	SURPLUS (DEFICIENCY)		D BY TYPE			
PROVIDED	SHORT TERM	36	3	LTG	LTC	LTW	STG	
1 KOVIDED	LONG TERM	398	8	198	40	160	36	

LEVEL	STALL TYPE	TOTAL	STALL TYPE
	<u> </u>		<u> </u>
1			B1
01 - LEVEL 01	RESIDENTIAL	54	RESIDENTIAL
		54	RESIDENTIAL - ACCESSIBLE
01 - LEVEL P1	RESIDENTIAL	69	RESIDENTIAL - ACCESSIBLE VAN
01 - LEVEL P1	RESIDENTIAL - ACCESSIBLE	4	VISITOR
01 - LEVEL P1	RESIDENTIAL - ACCESSIBLE VAN	2	VISITOR - ACCESSIBLE VAN
01 - LEVEL P1	VISITOR	19	
01 - LEVEL P1	VISITOR - ACCESSIBLE VAN	1	B2
		95	RESIDENTIAL
01 - LEVEL P2	RESIDENTIAL	7	RESIDENTIAL - ACCESSIBLE
01 - LEVEL P2	RESIDENTIAL - ACCESSIBLE	2	RESIDENTIAL - ACCESSIBLE VAN
		9	VISITOR
		158	VISITOR - ACCESSIBLE VAN
2			
02 - LEVEL 01	RESIDENTIAL	23	TOTAL
02 - LEVEL 01	RESIDENTIAL - ACCESSIBLE	4	
02 - LEVEL 01	VISITOR	14	
02 - LEVEL 01	VISITOR - ACCESSIBLE VAN	1	
		42	
02 - LEVEL P1	RESIDENTIAL	60	
02 - LEVEL P1	RESIDENTIAL - ACCESSIBLE	3	
02 - LEVEL P1	RESIDENTIAL - ACCESSIBLE VAN	2	

RULE	BUILDING	REQUIRED	PROVIDED
101 OR MORE RESIDENTIAL = 1 ACCESSIBLE / 25 SPACES	B1a + B1b	6	6
6-25 VISITOR = 0 ACCESSIBLE	B1a + B1b	0	0
7-12 ACCESSIBLE RESIDENTIAL = 2 ACCESSIBLE VAN	B1a + B1b	2	2
6-25 VISITOR = 1 ACCESSIBLE VAN	B1a + B1b	1	1
BUI	LDING 1 SUBTOTAL	9	9
101 OR MORE RESIDENTIAL = 1 ACCESSIBLE / 25 SPACES	B2a + B2b	6	7
6-25 VISITOR = 0 ACCESSIBLE	B2a + B2b	0	0
2-6 ACCESSIBLE RESIDENTIAL = 1 ACCESSIBLE VAN	B2a + B2b	1	2
6-25 VISITOR = 1 ACCESSIBLE VAN	B2a + B2b	1	1
BUI	LDING 2 SUBTOTAL	8	10
	TOTAL	17	19

	BICYCLE	PARKING STALLS PROVID	<u>ED</u>	
LEVEL	LEVEL PARKING TYPE STALL TYPE		TOTAL	% MIX
B1				
B01 - LEVEL P1	CLASS A	LONG TERM WALL ANCHORED	44	11%
B01 - LEVEL P1	CLASS A	LONG TERM GROUND ANCHORED	58	15%
B01 - LEVEL P1	CLASS A	LONG TERM CARGO GROUND ANCHORED	2	1%
B2			104	
B02 - LEVEL P1	CLASS A	LONG TERM WALL ANCHORED	116	29%
B02 - LEVEL P1	CLASS A	LONG TERM GROUND ANCHORED	140	35%
B02 - LEVEL P1	CLASS A	LONG TERM CARGO GROUND ANCHORED	38	10%
			294	
TOTAL			398	

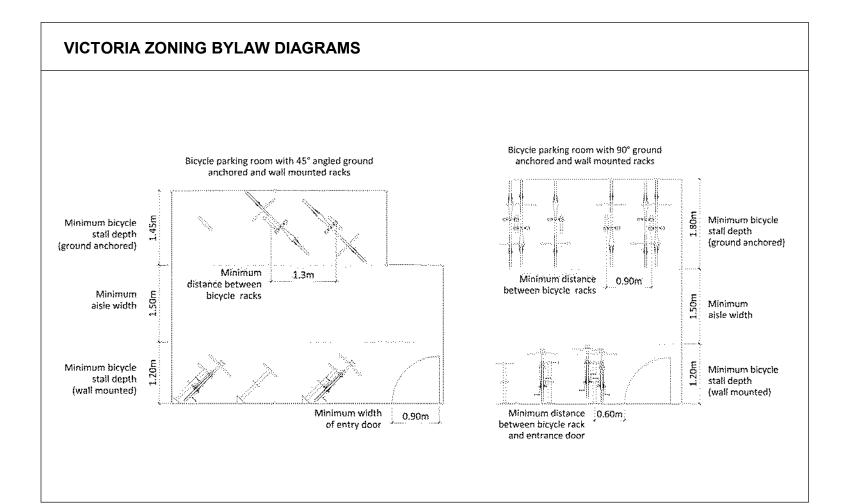

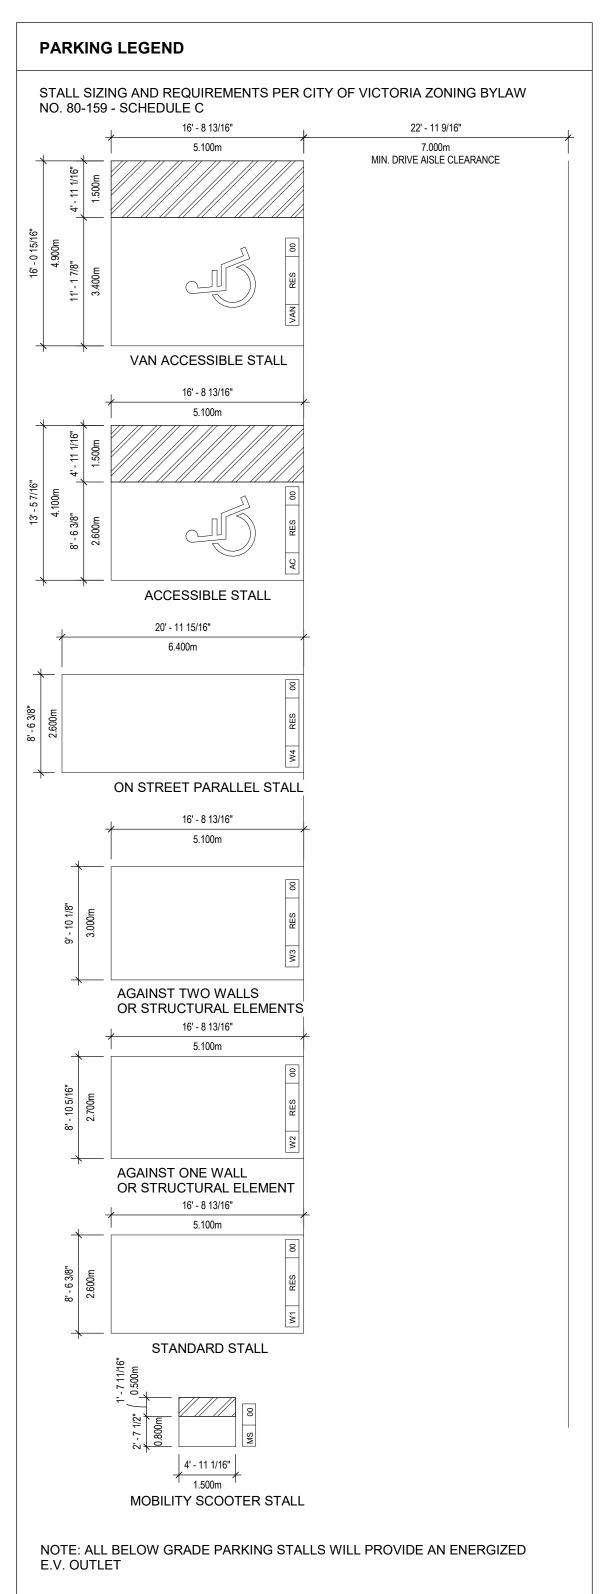



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BURNSIDE PHASE II

133-135 GORGE ROAD E, VICTORIA, BC

CHECKED BY:

ARCADIS

PROJECT NO: 138914 DRAWN BY: ARCADIS


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SHEET TITLE PROJECT INFORMATION + STATISTICS

SHEET NUMBER

DP0.10.00

TOTAL

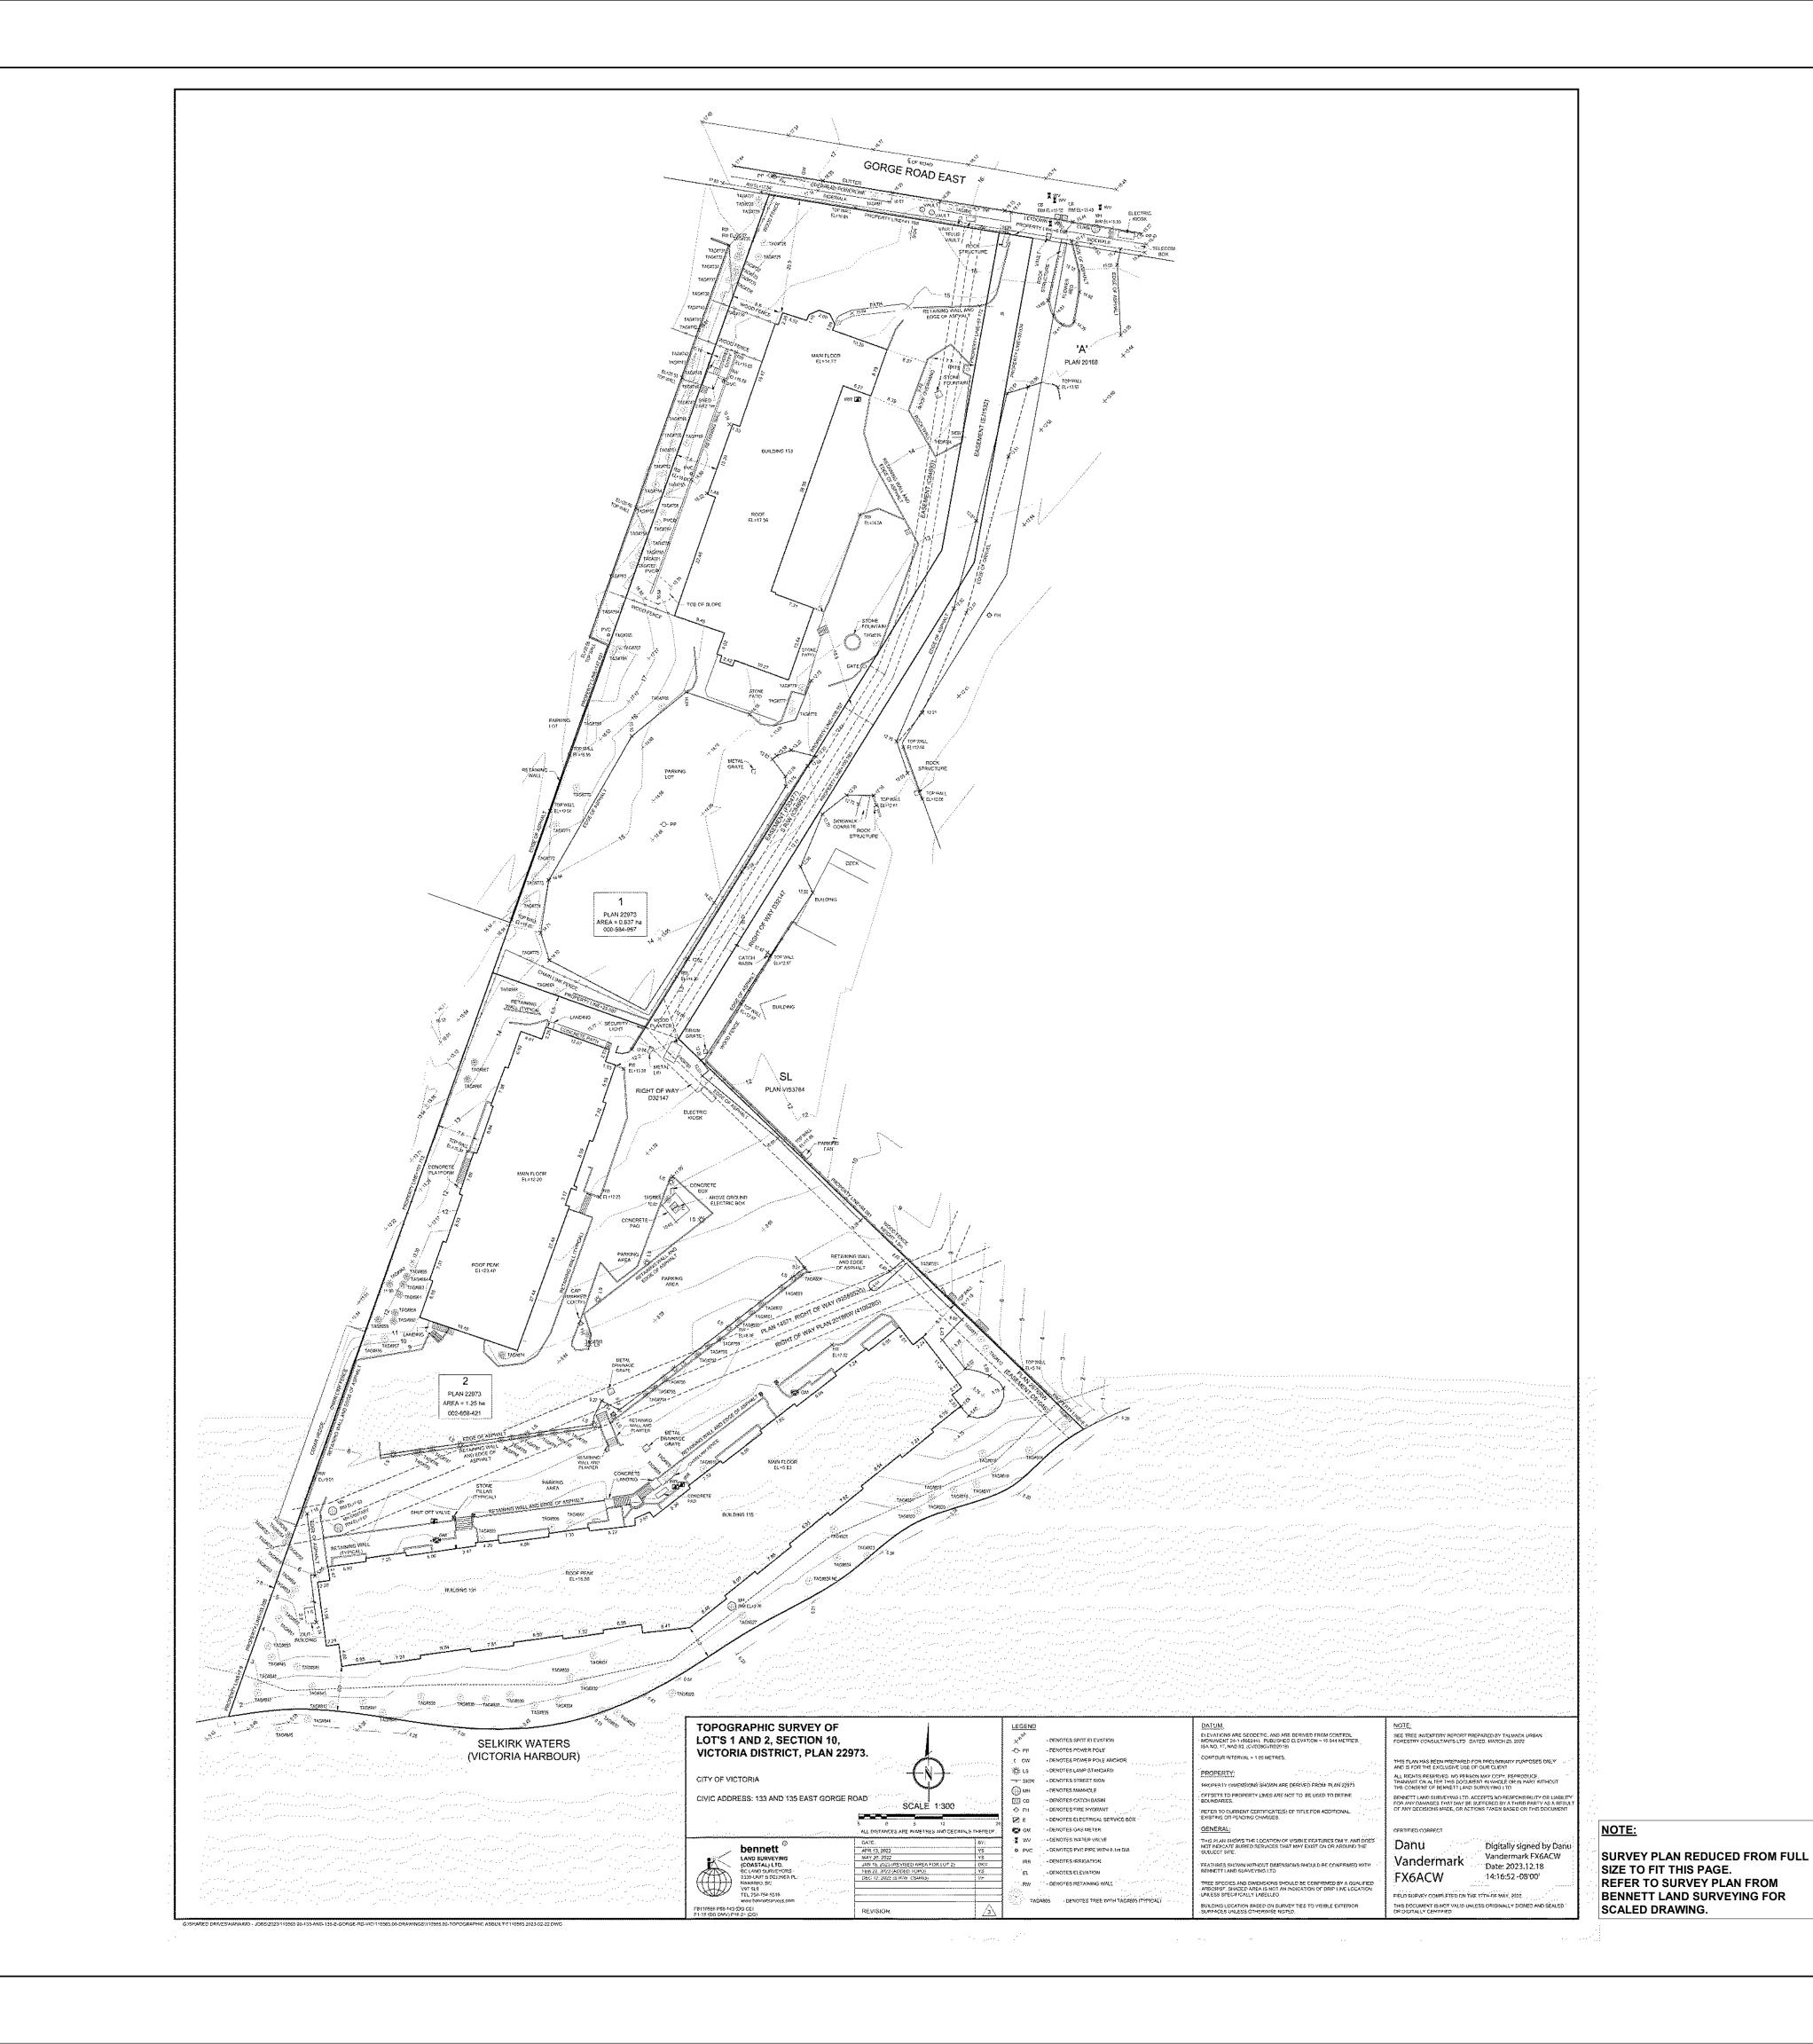

CLIENT INTRACORP HOMES

> INTRACORP Building the Extraordinary

Suite 600 Burrard Street Vancouver, Canada, V6C 2B5

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PROJECT

BURNSIDE PHASE II

133-135 GORGE ROAD E, VICTORIA, BC

PROJECT NO:	
138914	
DRAWN BY:	CHECKED BY:
ARCADIS	ARCADIS
PROJECT MGR:	APPROVED BY:
ARCADIS	ARCADIS

SHEET TITLE

SITE SURVEY

DP0.10.01



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INTRACORP

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PROJECT

BURNSIDE PHASE II


133-135 GORGE ROAD E, VICTORIA, BC

PROJECT NO: 138914 DRAWN BY: ARCADIS CHECKED BY: ARCADIS PROJECT MGR:

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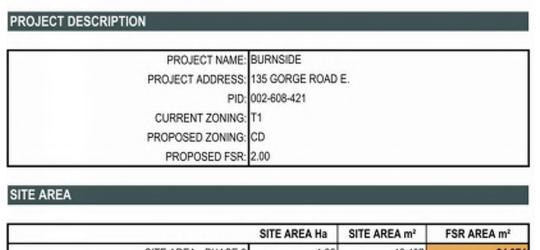
CONTEXT PLAN

SHEET NUMBER
DP0.10.02

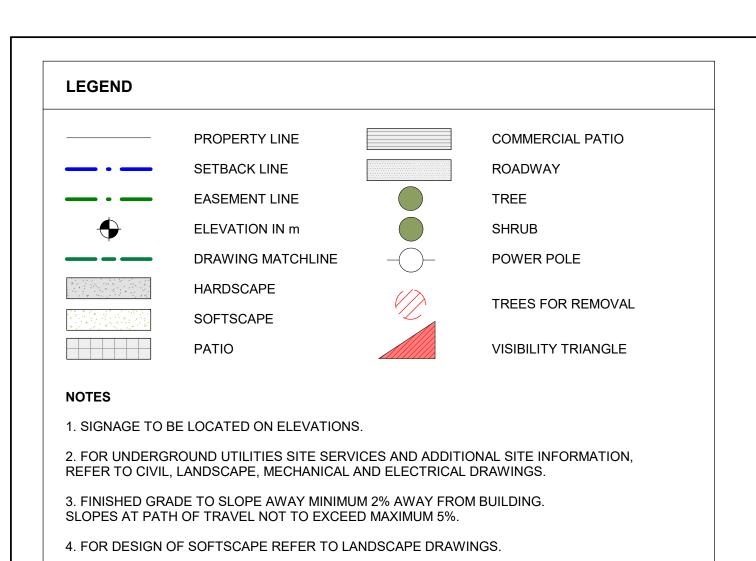

5. FOR ADDITIONAL GRADES REFER TO SHEETS DP0.10.04, DP0.10.06, LANDSCAPE AND CIVIL

DRAWINGS.



BURNSIDE STATISTICS - PHASE 2

	SITE AREA Ha	SITE AREA m ²	FSR AREA m²	PHASE 2 - NORTH PL
SITE AREA - PHASE 2	1.25	12,487	24,974	PHASE 2 - EAST PL
ALLOWABLE FSR MULTIPLIER		2.00		PHASE 2 - SOUTH PL (RIPARIAN SRW)
TOTAL ALLOWABLE FSR (m²)	2.00	2.00	24,974	PHASE 2 - WEST PL

INTERNAL SITE BREAKDOWN	AREA Ha	AREA m²	AREA ft ²
PHASE 2 - B1A+1B	0.620	6,205	66,787
PHASE 2 - B2A+2B	0.628	6,282	67,622
TOTAL PARCEL AREA	1.249	12,487	134,409
SITE COVERAGE + OPEN SPACE			
SITE COVERAGE + OPEN SPACE	DHASE 2		
	PHASE 2		
TOTAL SITE COVERAGE %	PHASE 2		

TOTAL SITE OPEN SPACE 9 TOTAL SITE OPEN SPACE (m2)

4 STOREY

4 STOREY

GORGE APARTMENTS -REDWOOD PARK

-IT				FSR AREAS	6 - B1A+1B - RESIDENTIAL
		HEIGHT IN m	No. OF STOREYS		OVERALL m²
	PHASE 2 - B1A	20.4m	6		ROOF 96
	PHASE 2 - B1B	21.3m		LE	VEL 06 2,288
	PHASE 2 - B2A	20.6m		LE	VEL 05 2,288
	PHASE 2 - B2B	20.7m		LE	VEL 04 2,288
			-	LE	VEL 03 2,288
ACKS				LE	VEL 02 2,267
				LE	VEL 01 2,967
		DISTANCE IN m	DISTANCE IN ft	LEV	/EL P1 3,639
	PHASE 2 - NORTH PL	5m	16" - 4 7/8"	15)	/EL DO 20E

15m

32' - 9 3/4

49' - 2 1/2

19" - 8 1/4

3 STOREY

VEHICLE STALLS	REQUIRED	PROVIDED
COMMERCIAL	0	0
COMMERCIAL ACCESSIBLE	0	0
VISITOR	19	33
VISITOR ACCESSIBLE	0	0
VISITOR ACCESSIBLE VAN	2	2
RESIDENTIAL	128	213
RESIDENTIAL ACCESSIBLE	12	13
RESIDENTIAL ACCESSIBLE VAN	3	4
LOADING STALLS	0	0
PHASE 2 TOTAL	164	265
BIKE STALLS	REQUIRED	PROVIDED
SHORT TERM RESIDENTIAL	33	36
LONG TERM RES. GROUND ANCHORED	199	198
LONG TERM RESIDENTIAL CARGO	40	40
LONG TERM RES. WALL ANCHORED	159	160
PHASE 2 TOTAL	431	434

CHAPMAN POINT

VICTORIA HERITAGE

FOUNDATION

UNIT COUNT	FSR m ²	OVERALL m ²	
0	74	96	ROOF
37	2,257	2,288	LEVEL 06
37	2,257	2,288	LEVEL 05
37	2,257	2,288	LEVEL 04
37	2,257	2,288	LEVEL 03
36	2,235	2,267	LEVEL 02
2	1,446	2,967	LEVEL 01
0	0	3,639	LEVEL P1
0	0	325	LEVEL P2
186	12,782	18,445	TOTAL

	OVERALL m²	FSR m²	UNIT COUNT
ROOF	97	82	0
LEVEL 06	2,212	2,191	28
LEVEL 05	2,212	2,191	28
LEVEL 04	2,212	2,191	28
LEVEL 03	1,957	1,936	25
LEVEL 02	1,990	1,969	20
LEVEL 01	2,678	1,303	10
LEVEL P1	2,855	0	0
TOTAL	16,215	11,862	139

01	/ERALL m²	FSR m²	UNIT COUNT
B1A + 1B	18,445	12,782	186
B2A + 2B	16,215	11,862	139
TOTAL	34,660	14,973	325

PHASE 2 - B1A + 1B

PHASE 2 - B2A + 2B

GORGE WATERWAY

35.12

20 41.55

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Building the Extraordinary
Suite 600 Burrard Street Vancouver, Canada, V6C 2B5

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PROJECT

BURNSIDE PHASE II

133-135 GORGE ROAD E, VICTORIA, BC

PROJECT NO: 138914 DRAWN BY:

CHECKED BY: ARCADIS ARCADIS PROJECT MGR: APPROVED BY: **ARCADIS** ARCADIS

SHEET TITLE


OVERALL SITE PLAN

DP0.10.03

1 OVERALL SITE PLAN DP0.10.03 SCALE: 1:500

GORGE **BUILDING 01 - RESIDENTIAL** MF (L00) - 13.5m ROAD **BUILDING 1A - RESIDENTIAL** 06 STOREYS PROPOSED LOBBY (L01) - 9.20m 06 STOREYS 10.50 m TOW 12.00 m TOW 19.00 m TOW 15.50 m TOW 14.00 m TOW EXISTING RETAINING WALL - EXISTING FIRE HYDRANT

EXISTING RETAINING WALL

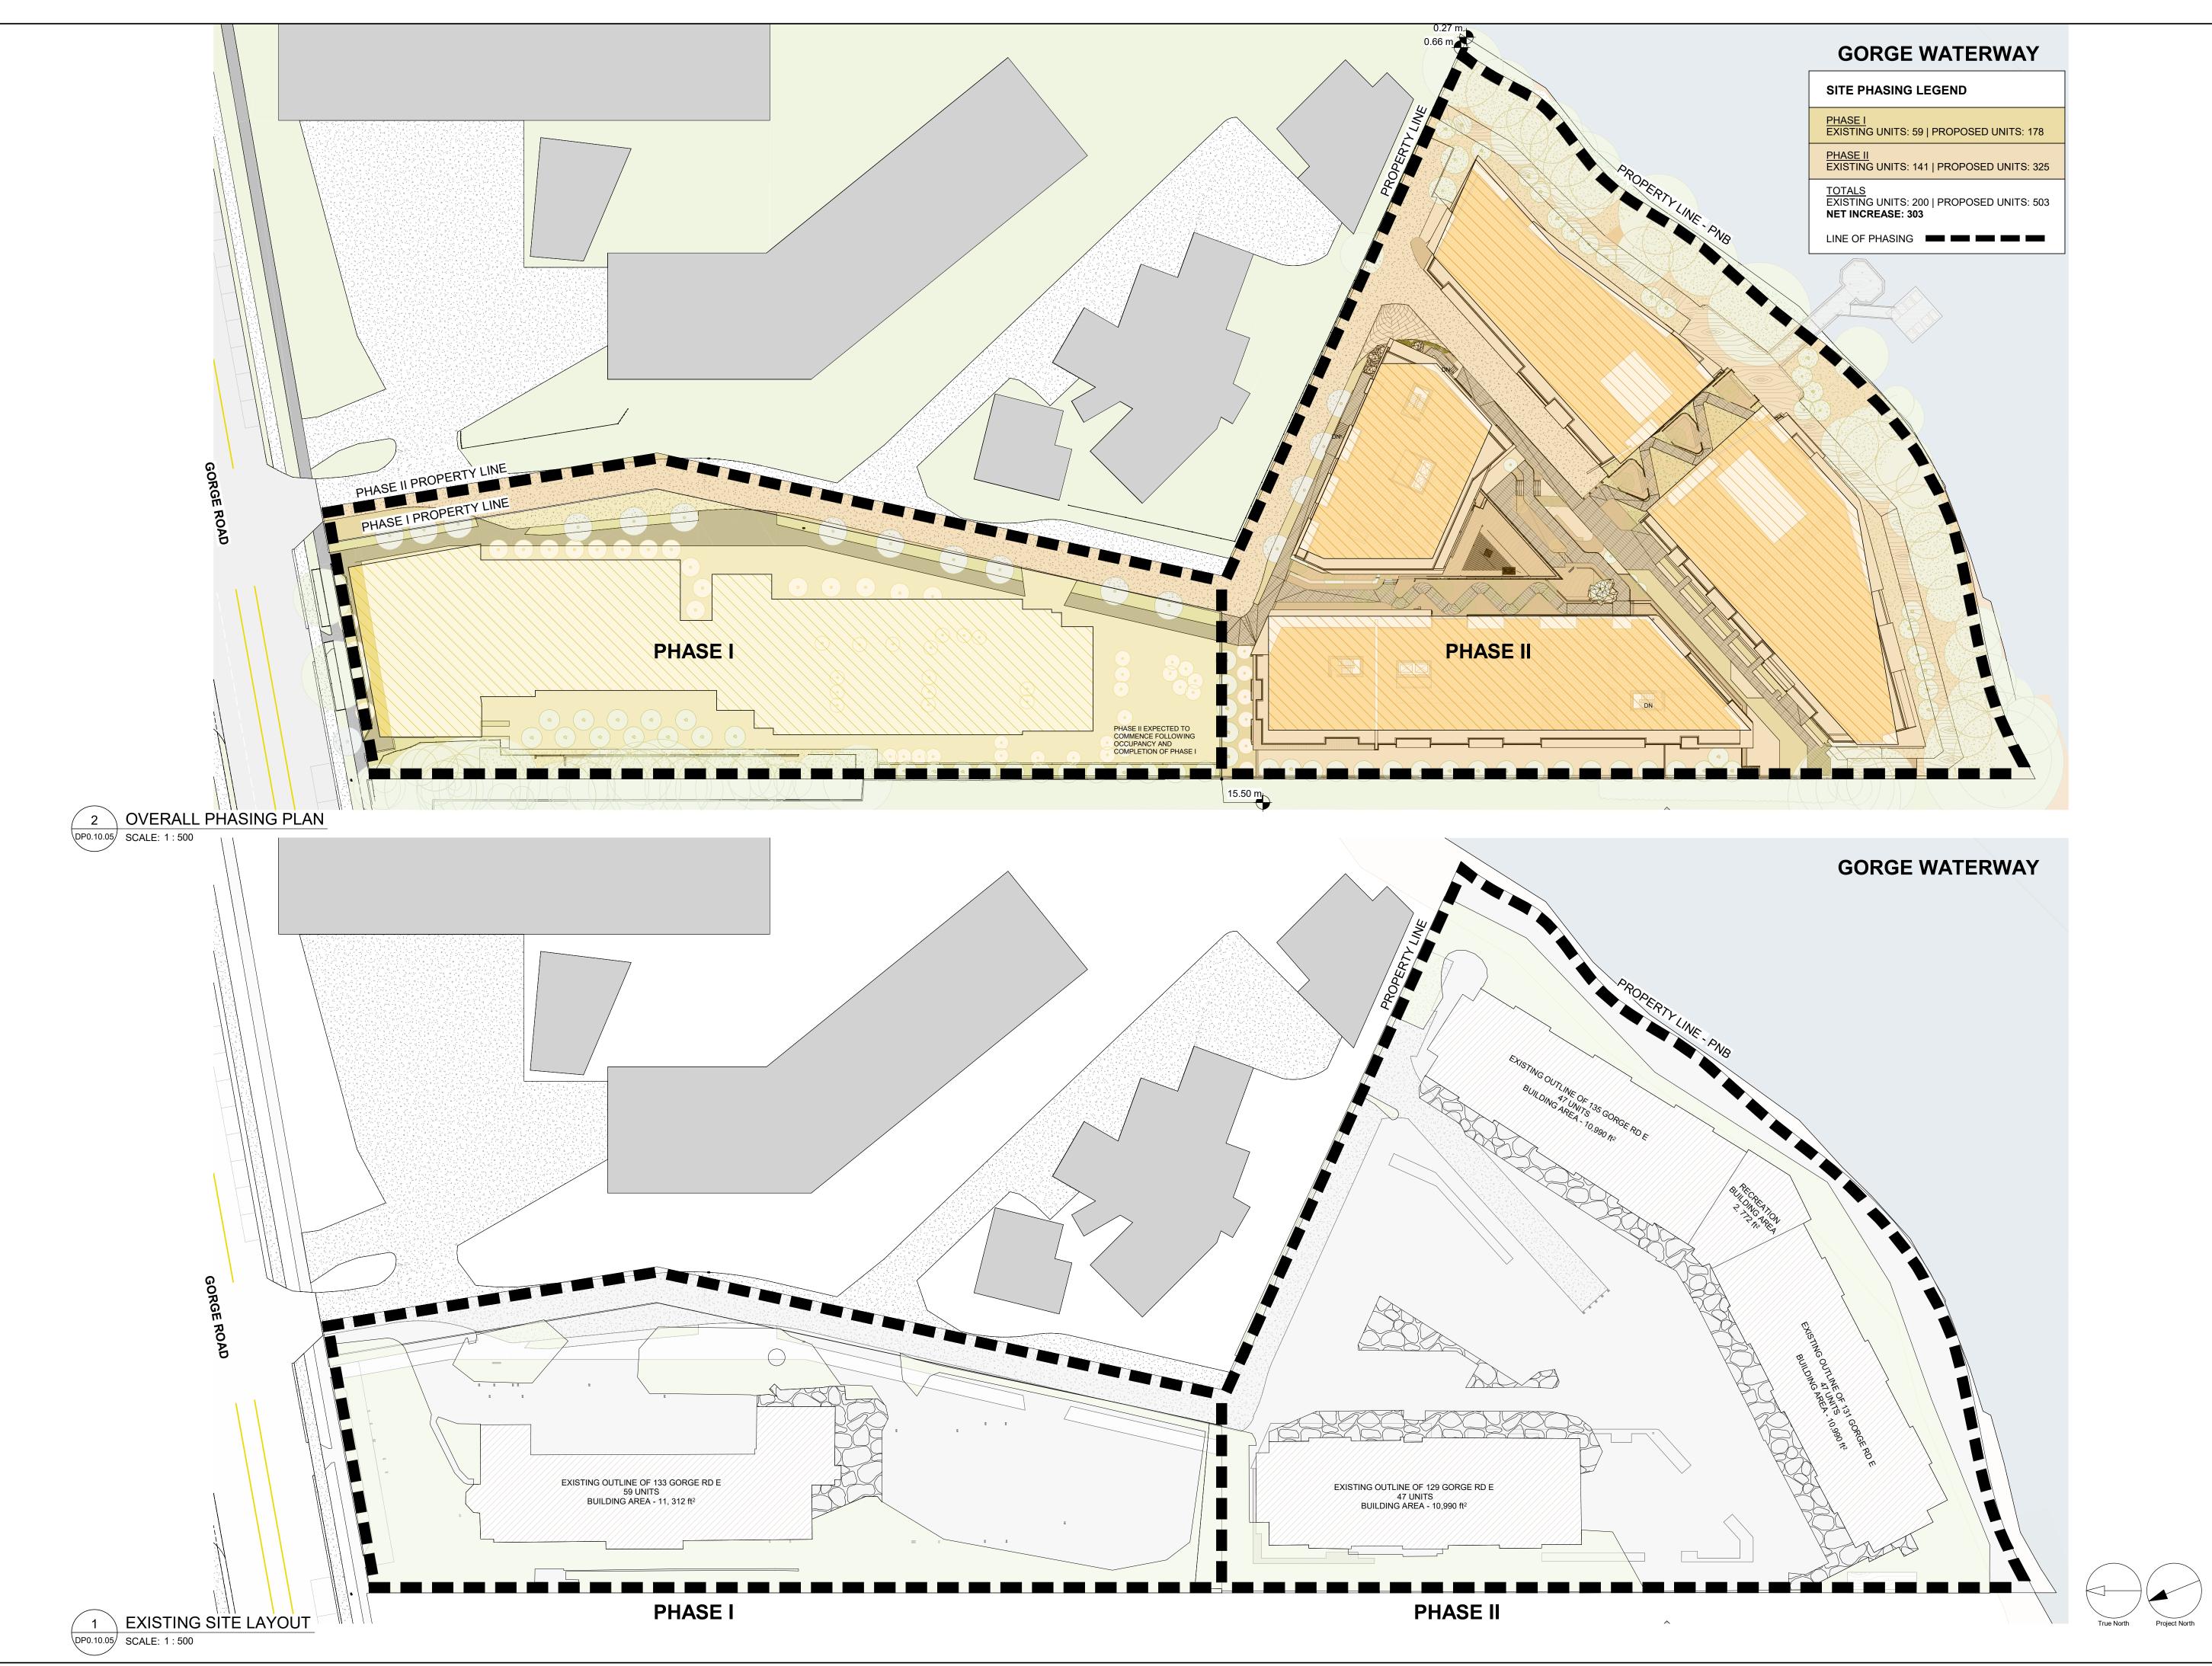

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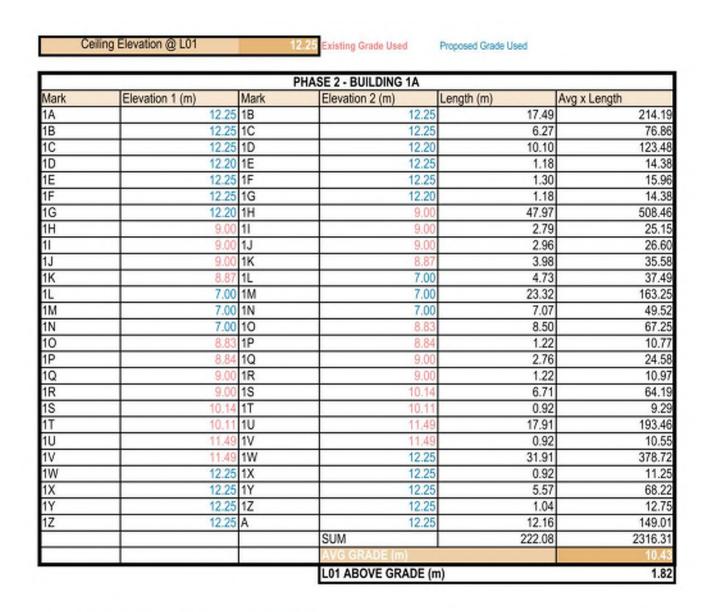
BURNSIDE PHASE II

133-135 GORGE ROAD E, VICTORIA, BC

138914	
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PROJECT MGR: ARCADIS	APPROVED BY: ARCADIS

SHEET TITLE PHASING PLAN

DP0.10.05



PHASE 2 - BUILDING 1B					
Mark	Elevation 1 (m)	Mark	Elevation 2 (m)	Length (m)	Avg x Length
2A	12.19	2B	8.48	41.94	433.46
2B	8.48	2C	7.86	4.79	39.13
2C	7.86	2D	7.69	1.83	14.22
2D	7.69	2E	7.79	3.39	26.2
2E	7.79	2F	7.79	15.79	123.00
2F	7.79	2G	7.76	2.82	21.9
2G	7.76	2H	8.00	4.37	34.4
2H	8.00	21	8.76	6.17	51.71
21	8.76	2J	8.90	23.41	206.67
2J	8.90	2K	11.95	43.88	457.44
2K	11.95	A	12 19	4 21	50.85

L01 ABOVE GRADE (m)

isting Grade Used Proposed Grade Used


Ceiling Elevation @ 01 xisting Grade Used Proposed Grade Used


Ceiling Elevation @ L01

		PHAS	SE 2 - BUILDING 2A - LEVEL	01	
Mark	Elevation 1 (m)	Mark	Elevation 2 (m)	Length (m)	Avg x Length
3A	7.00	3B	4.65	14.03	81.7
3B	4.65	3C	2.98	11.01	42.0
3C	2.98	3D	2.85	25.48	74.2
3D	2.85	3E	3.62	37.90	122.5
3E	3.62	3F	6.22	11.28	55.4
3F	6.22	3G	6.17	1.29	8.0
3G	6.17	3H	7.00	3.31	21.8
3H	7.00	31	7.06	18.03	126.7
31	7.06	3J	7.00	1.26	8.8
3J	7.00	3K	7.08	25.22	177.5
3K	7.08	3L	6.90	1.05	7.3
3L	6.90	3A	7.00	7.19	49.9
			SUM	157.03	776.2
			AVG GRADE (m)		4.9
			LEVEL 01 ABOVE GRA	ADE (m)	2.0


Ceiling Elevation @ 01	6 49 Existing Grade Used	Pronneed Grade Head


Mark	Elevation 1 (m)	Mark	Elevation 2 (m)	Length (m)	Avg x Length
4A	6.39	4B	6.24	6.92	43.70
4B	6.24	4C	6.50	1.38	8.77
4C	6.50	4D	6.41	19.05	122.99
4D	6.41	4E	6.12	1.54	9.65
4E	6.12	4F	6.69	22.44	143.70
4F	6.69	4G	3.80	17.90	93.88
4G	3.80	4H	3.77	20.33	76.96
4H	3.77	41	2.87	29.59	98.22
41	2.87	4J	3.04	1.19	3.50
4J	3.04	4K	3.02	6.80	20.60
4K	3.02	4L	5.00	13.02	52.20
4L	5.00	4A	6.39	10.11	57.57
			SUM	150.25	731.73
			AVG GRADE (m)		4.87
			LEVEL 01 ABOVE GRA	ADE (m)	2.12

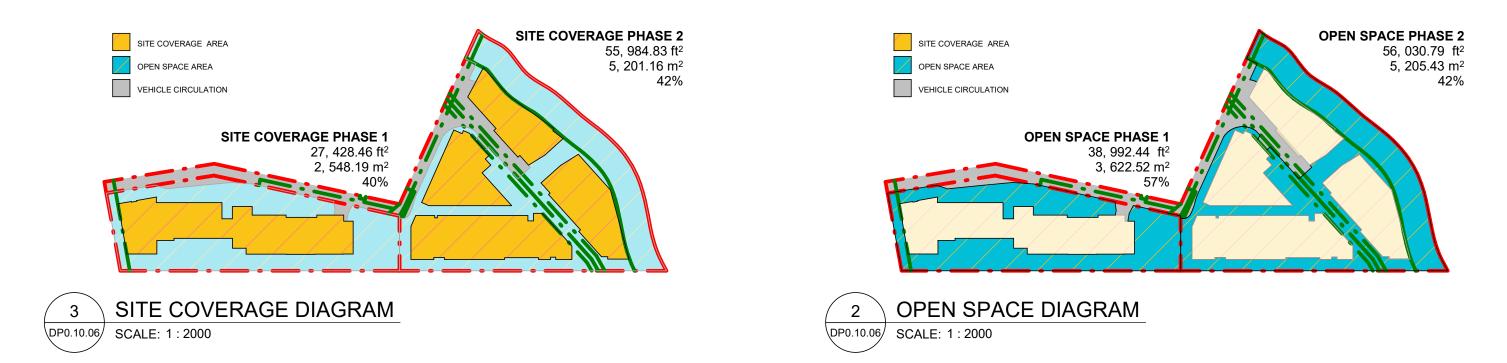

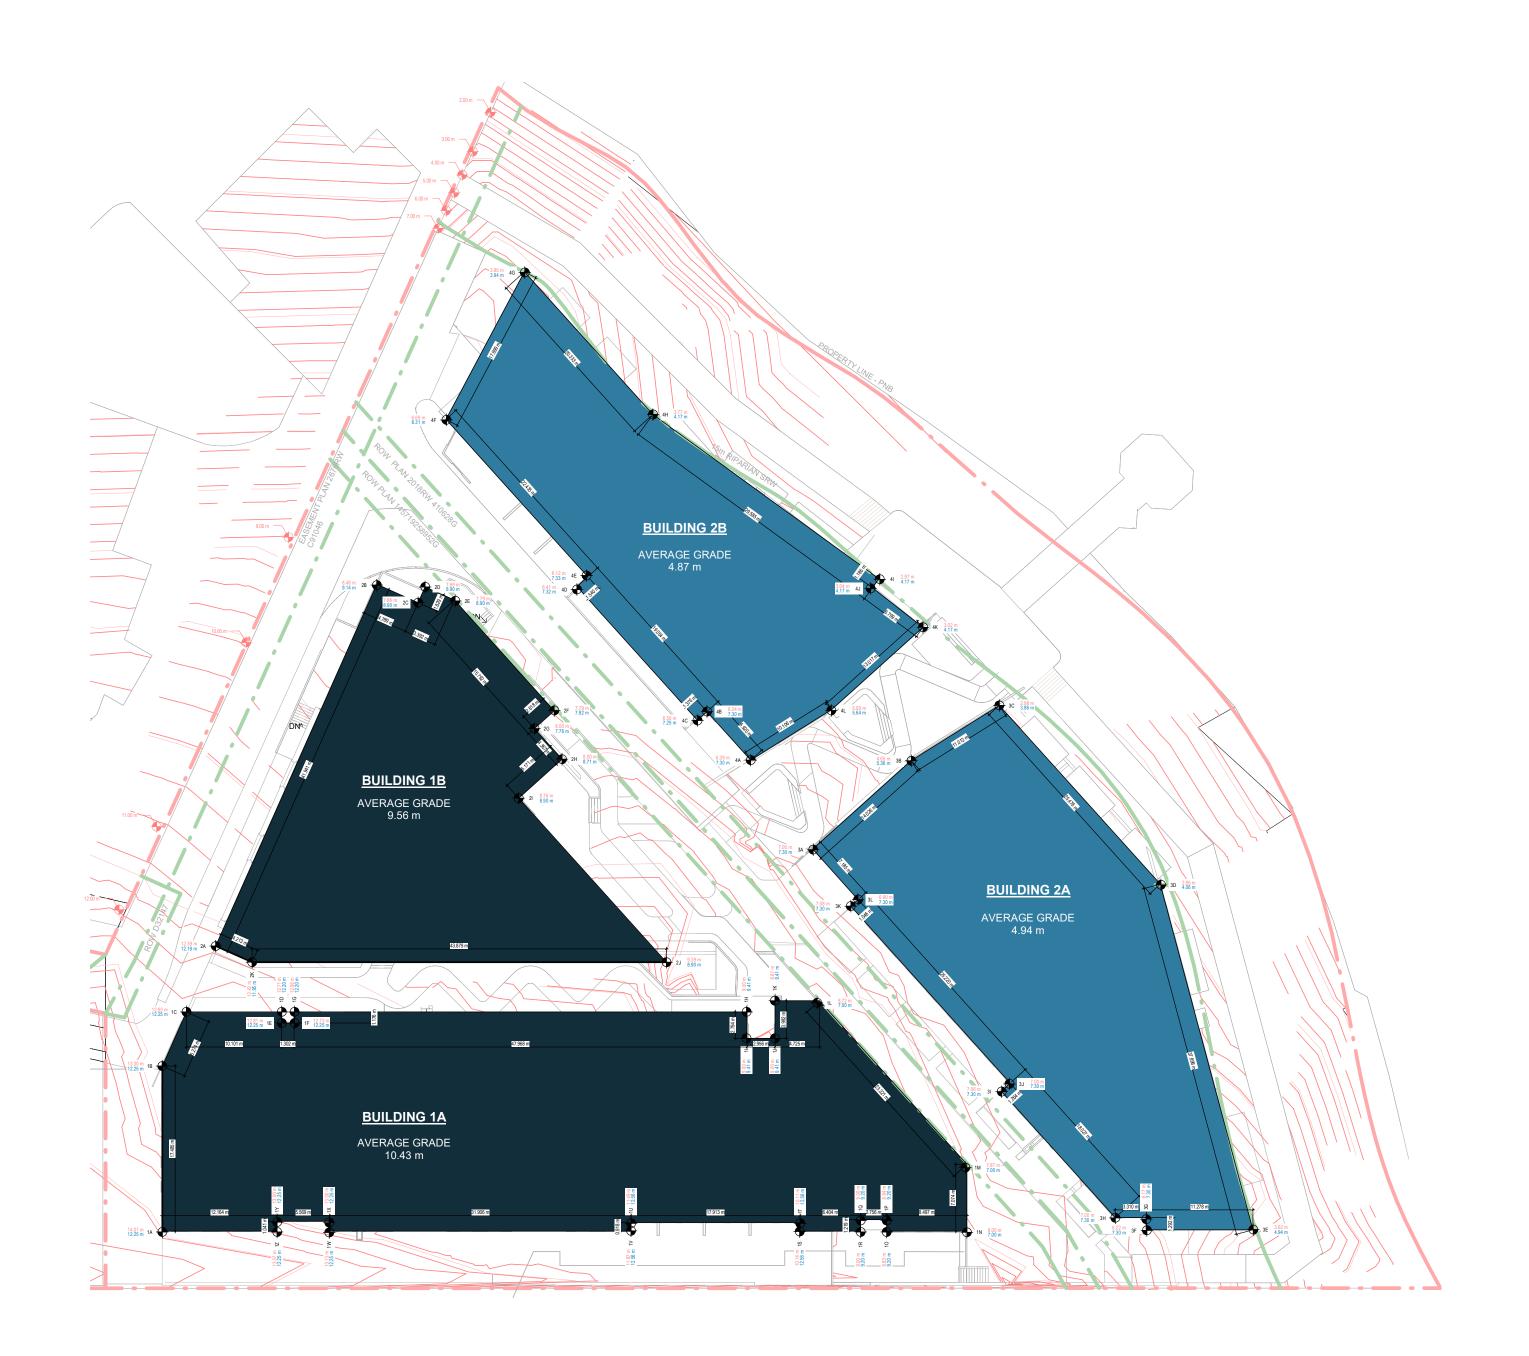



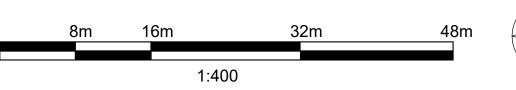

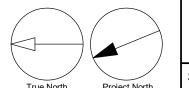

CLIENT INTRACORP HOMES INTRACORP

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No.	DESCRIPTION	DATE
Α	DEVELOPMENT PERMIT	2024-11-2

CONSULTANTS



2024-11-28



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PROJECT

BURNSIDE PHASE II

133-135 GORGE ROAD E, VICTORIA, BC

PROJECT NO: 138914

DRAWN BY: CHECKED BY: ARCADIS **ARCADIS** PROJECT MGR: APPROVED BY: ARCADIS **ARCADIS**

SHEET TITLE AVERAGE GRADE PLAN

SHEET NUMBER DP0.10.06



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ISSUES		
No.	DESCRIPTION	DATE
Α	DEVELOPMENT PERMIT	2024-11-2

CONSULTANTS



2024-11-28



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PROJECT

BURNSIDE PHASE II

133-135 GORGE ROAD E, VICTORIA, BC


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SHEET TITLE

MULTI-DISCIPLINARY COORDINATION SITE PLAN

SHEET NUMBER
DP0.10.07



Autodesk Docs://138914-135E-GorgeRd_R2022/7
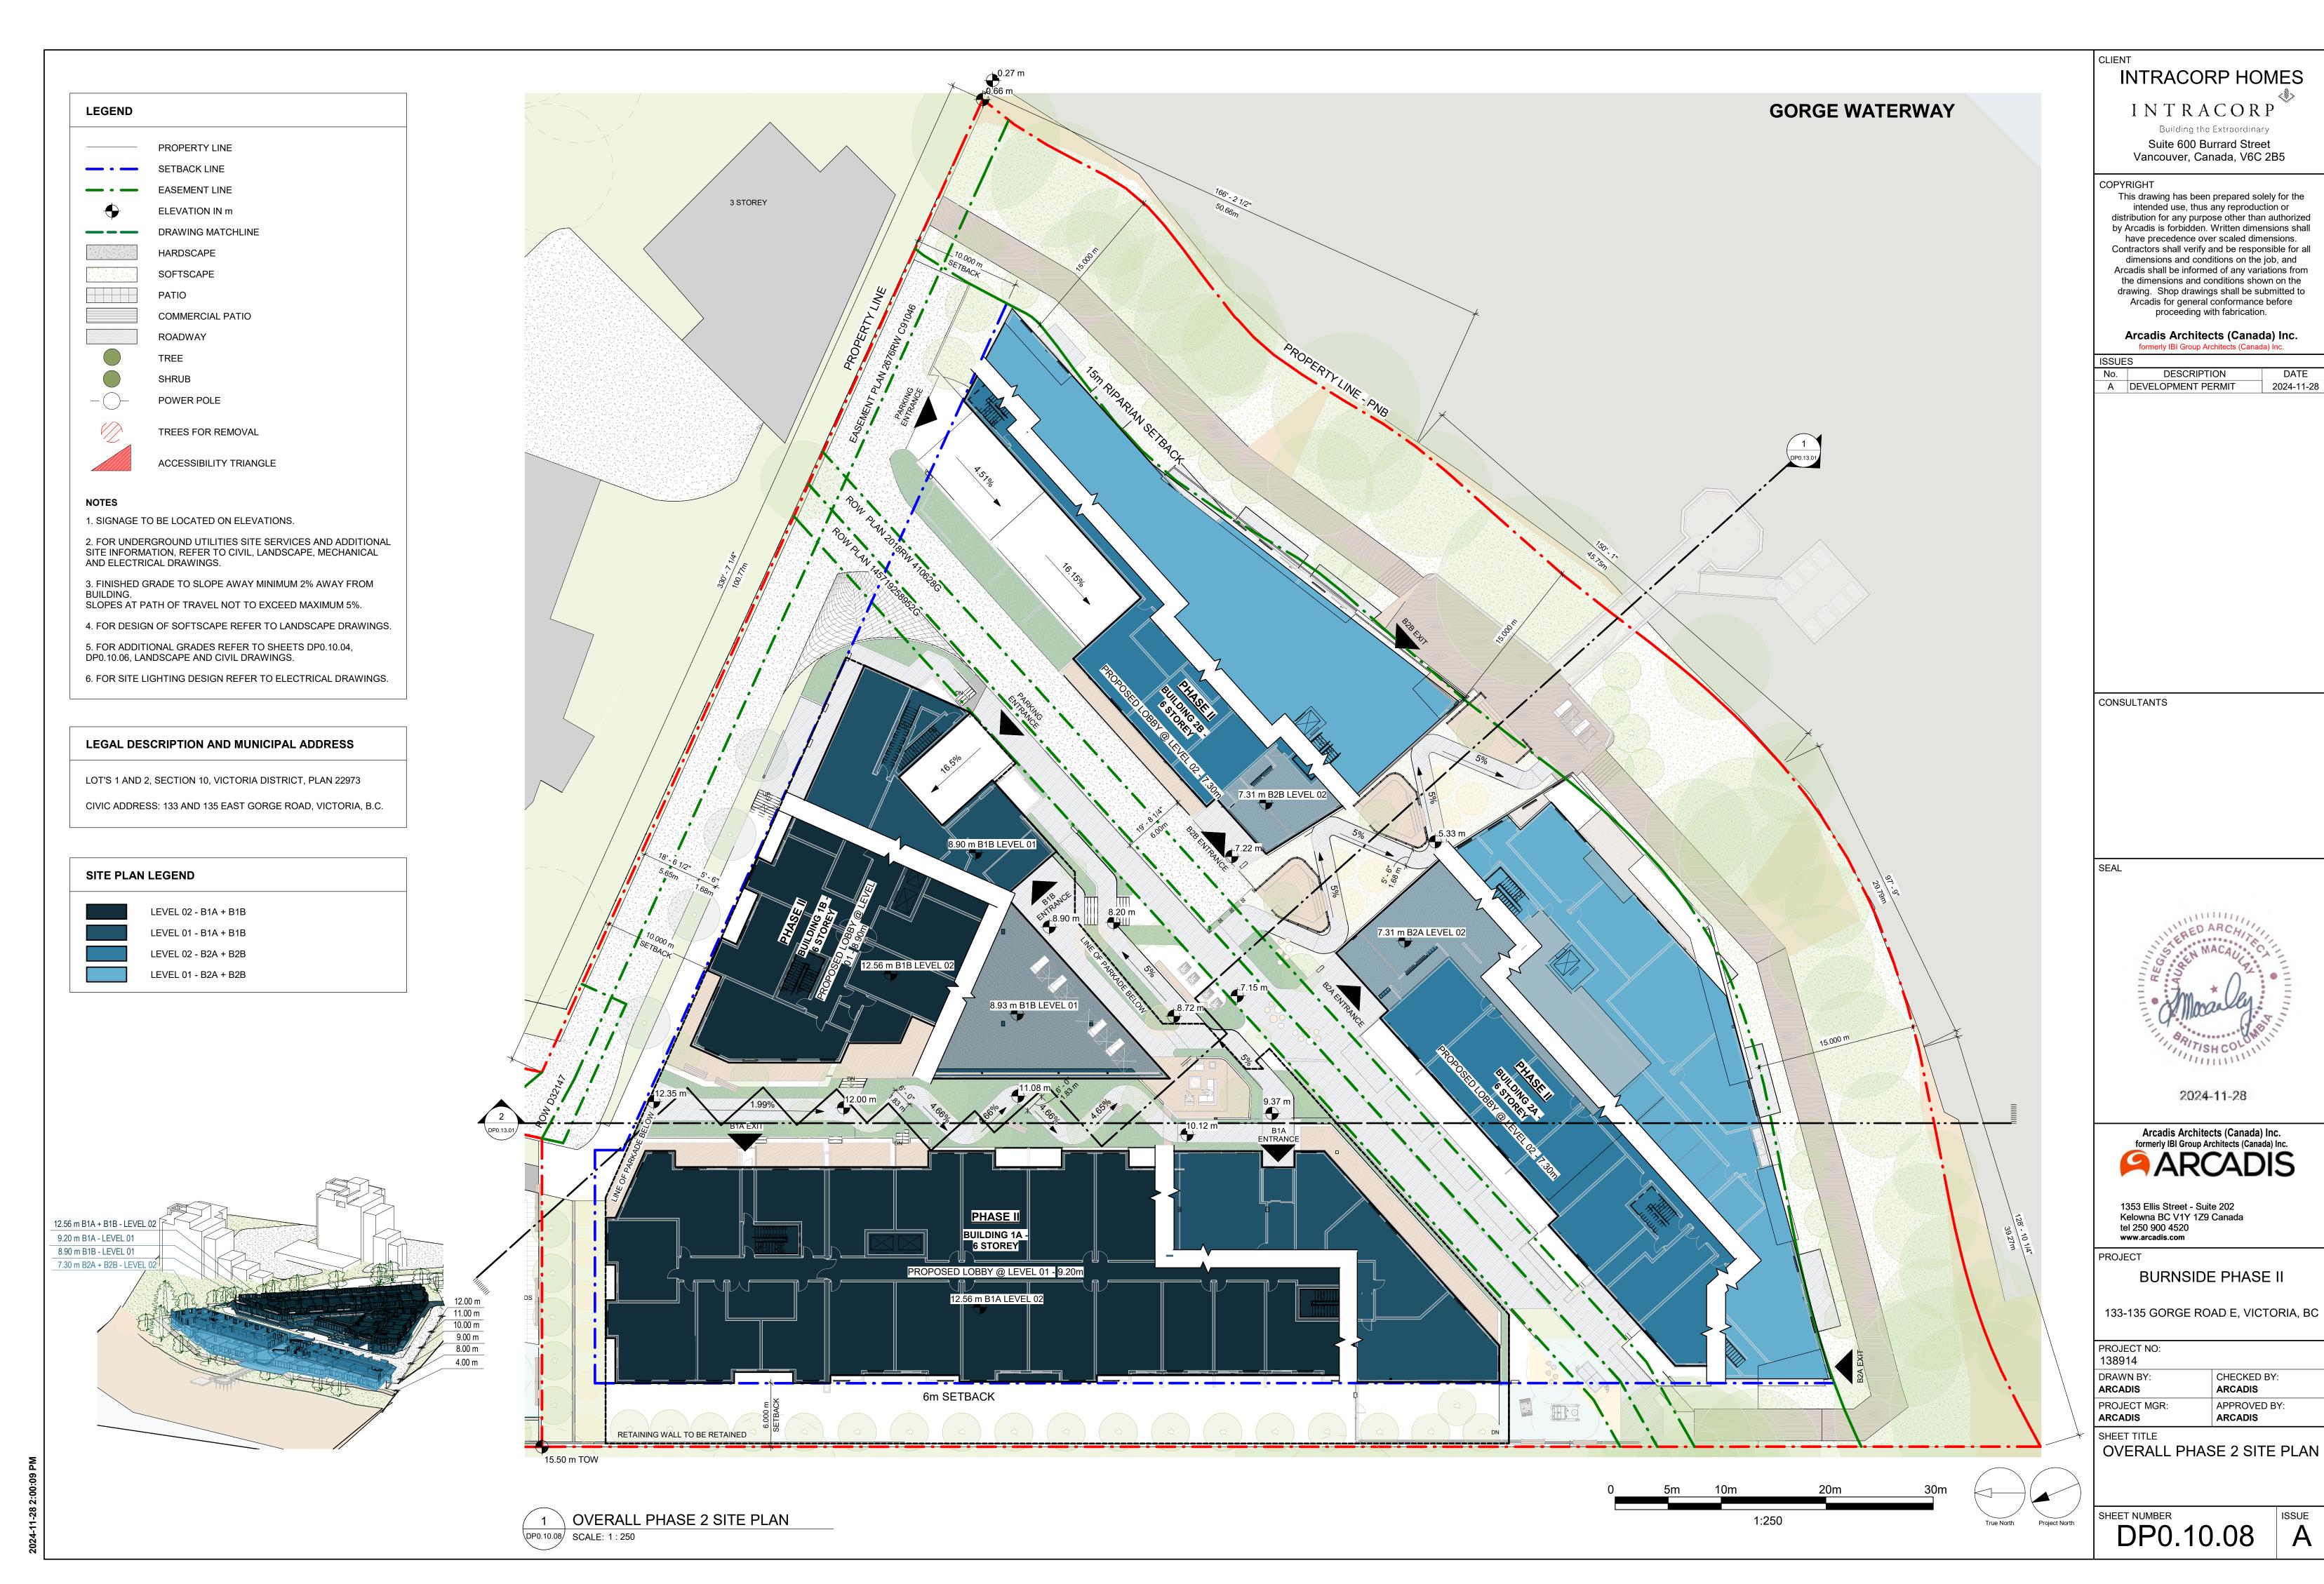
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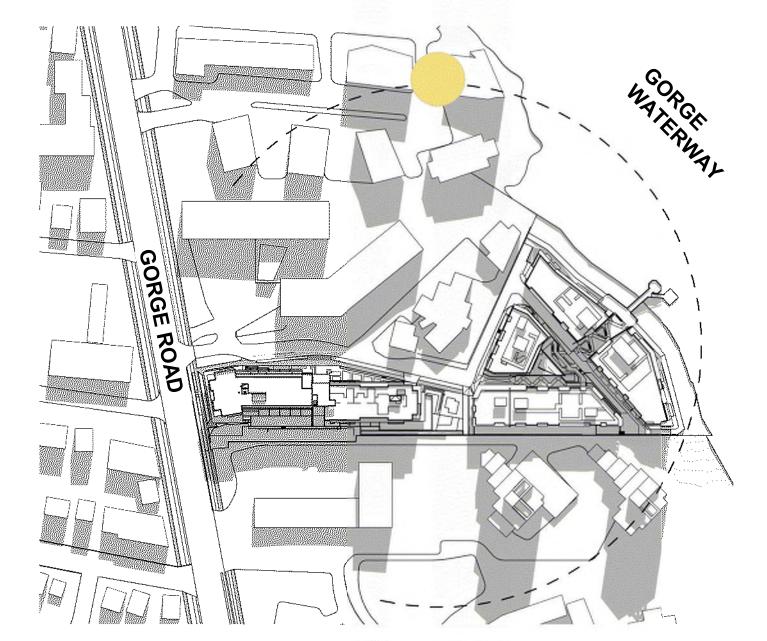
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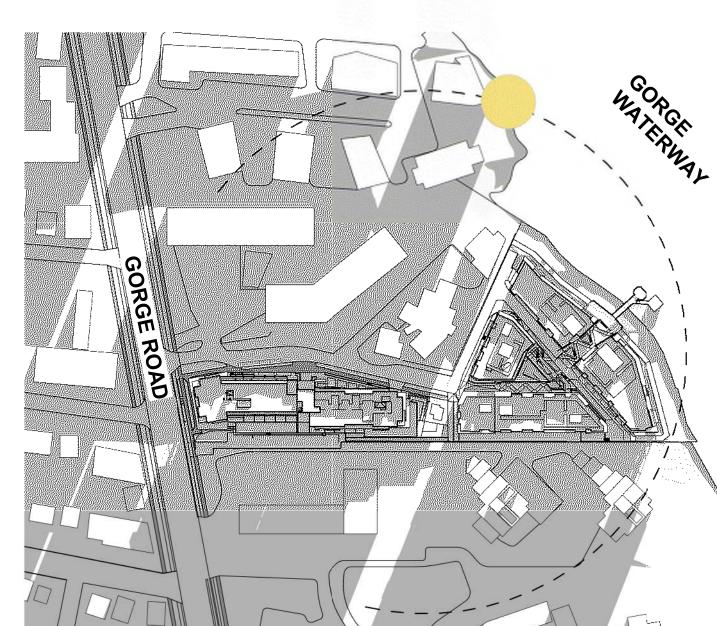
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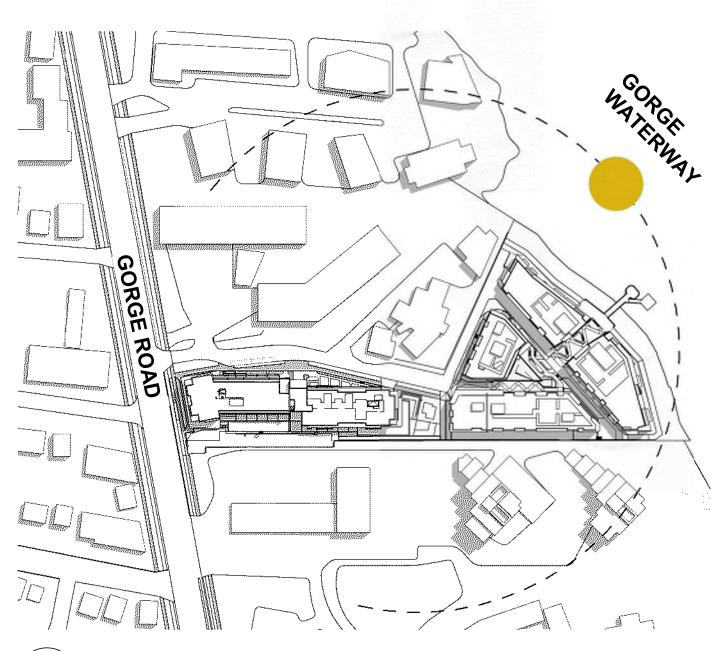
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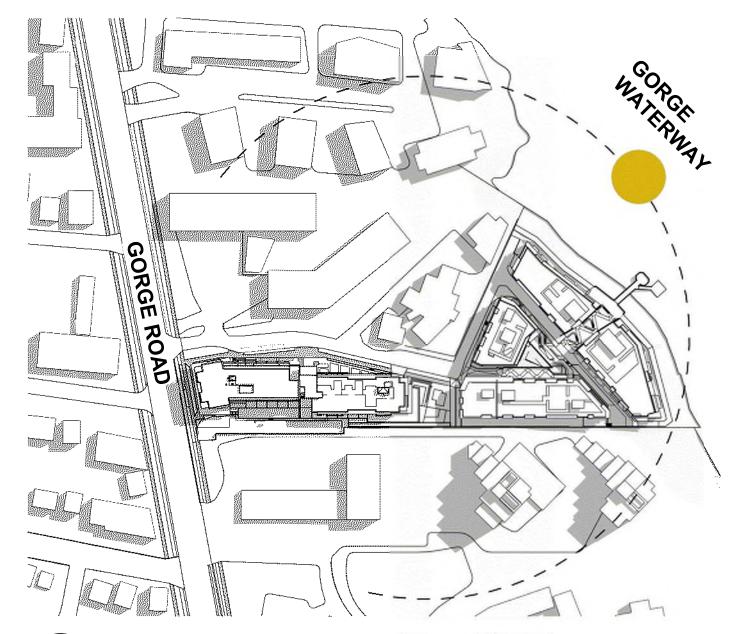
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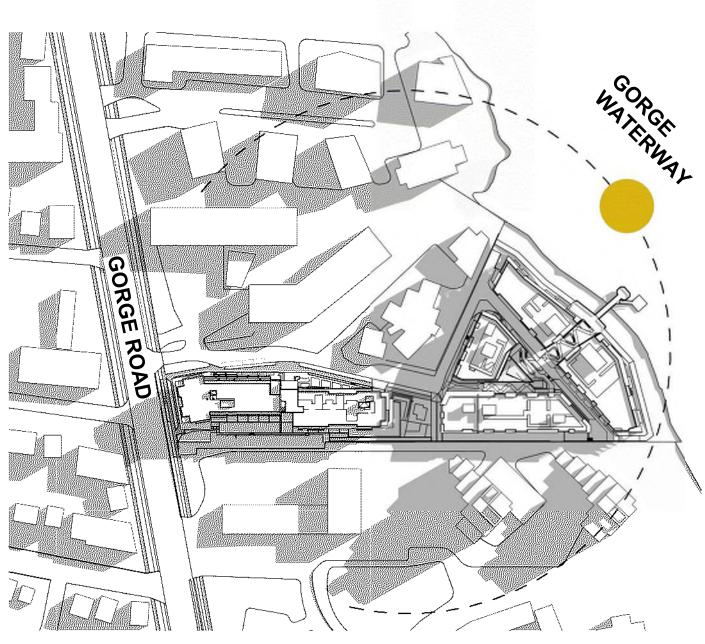
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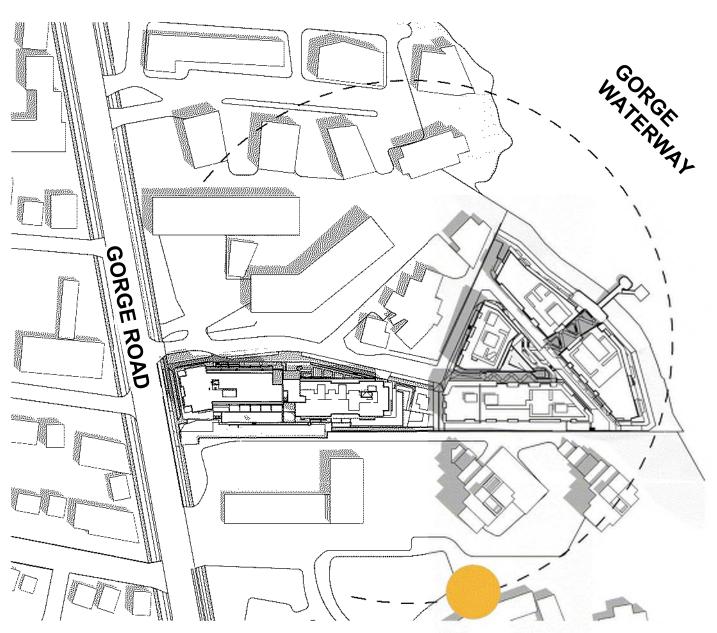
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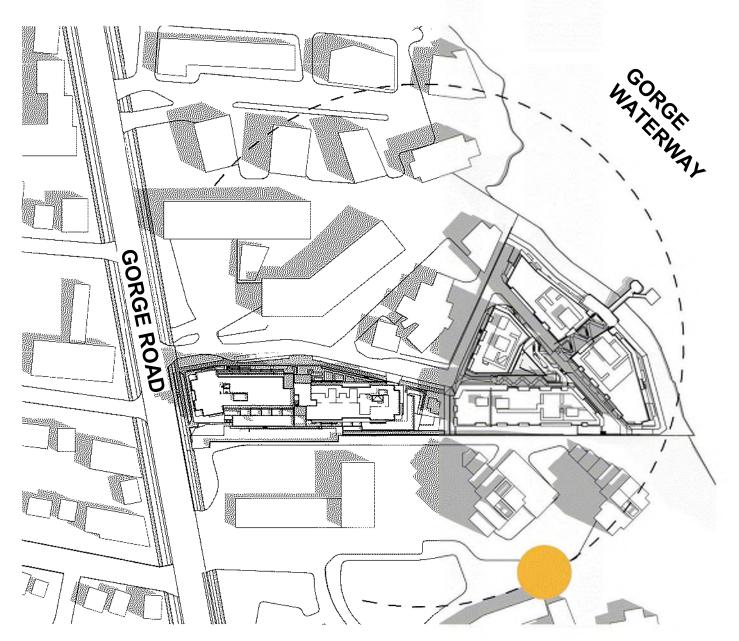
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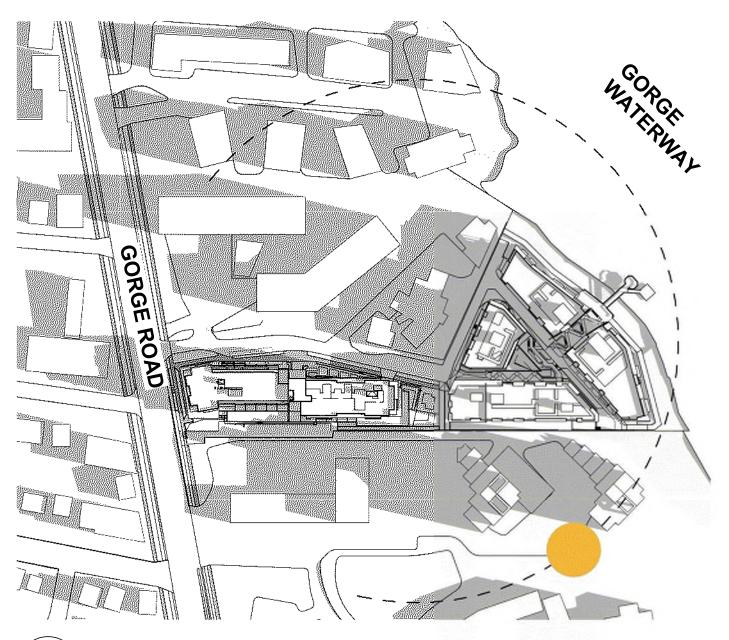
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6 FALL EQUINOX 3:30 PM
DP0.11.01 SCALE: NTS



WINTER SOLSTICE 3:30 PM

DP0.11.01 SCALE: NTS

SHEET TITLE SHADOW STUDY DIAGRAMS

PROJECT NO: 138914

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BURNSIDE PHASE II

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