



CONTACTS

OWNER

1030 Fort Street Holdings Ltd. Care of Jawl Properties Ltd. 1515 Douglas St Suite 200 Victoria, BC V8W 2G4

ARCHITECT

Cascadia Architects 101 - 804 Broughton Street Victoria, BC V8W 1E4

LANDSCAPE DESIGNER

Murdoch de Greeff 200 - 524 Culduthel Road Victoria, BC V8Z 1G1

CIVIL ENGINEER

301-3600 Uptown Blvd. Victoria, BC V8Z 089

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Gregory Damant, Architect AIBC greg@cascadiaarchitects.ca 250.590.3223

Scott Murdoch, Landscape Architect, R.P. Bio. scott@mdidesign.ca 250.412.2891

> Ben Harms, P. Eng. Ben.Harms@wsp.com 250.384.5510

LIST OF DRAWINGS

ARCHITECTURAL


A000	Cover
A010	Perspectives
A050	Spatial Separation
A051	Code Analysis
A100	Site Plan and Project Data
A101	Proposed Floor Plans
A102	Roof Plan
A200	Building Elevations S-W
A201	Building Elevations N-E
A300	Building Sections
A500	Context Elevation & Shadow Study
A300	Context Lievation & Shadow Study

LANDSCAPE


L1.01 Landscape Materials


CIVIL

Conceptual Site Servicing Plan

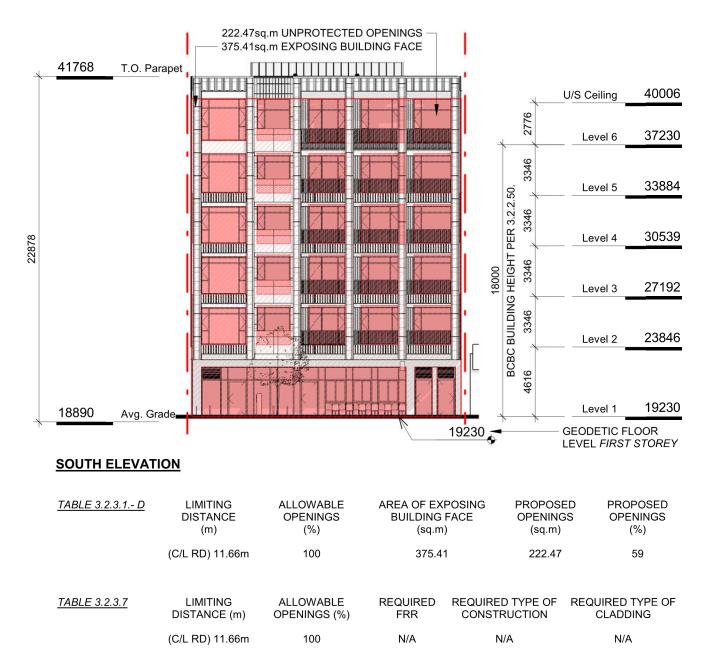

South Elevation - LD Key

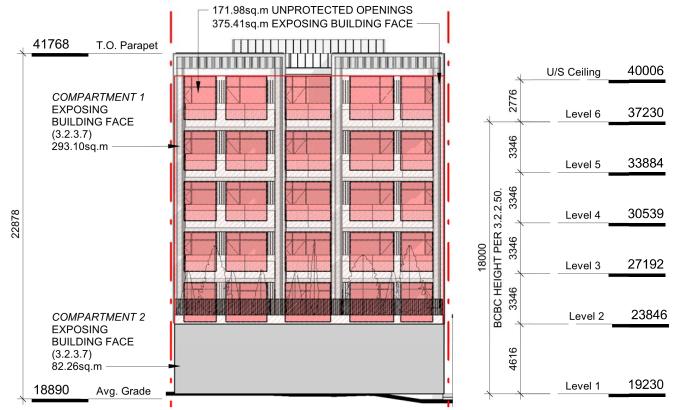

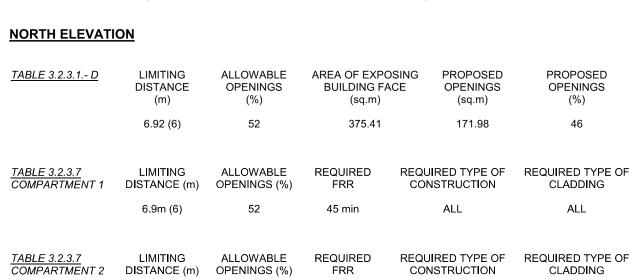

1 hr


Noncombustible

Noncombustible


North Elevation - LD Key

SCALE = 1:250

0.1m (0)

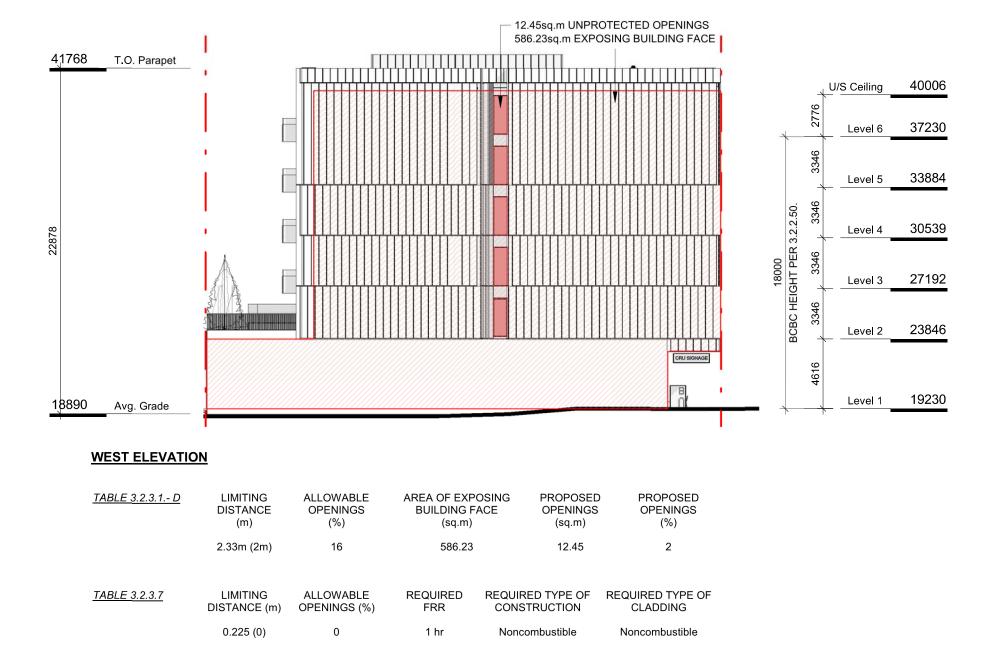


6 West Elevation - LD Key
SCALE = 1:250

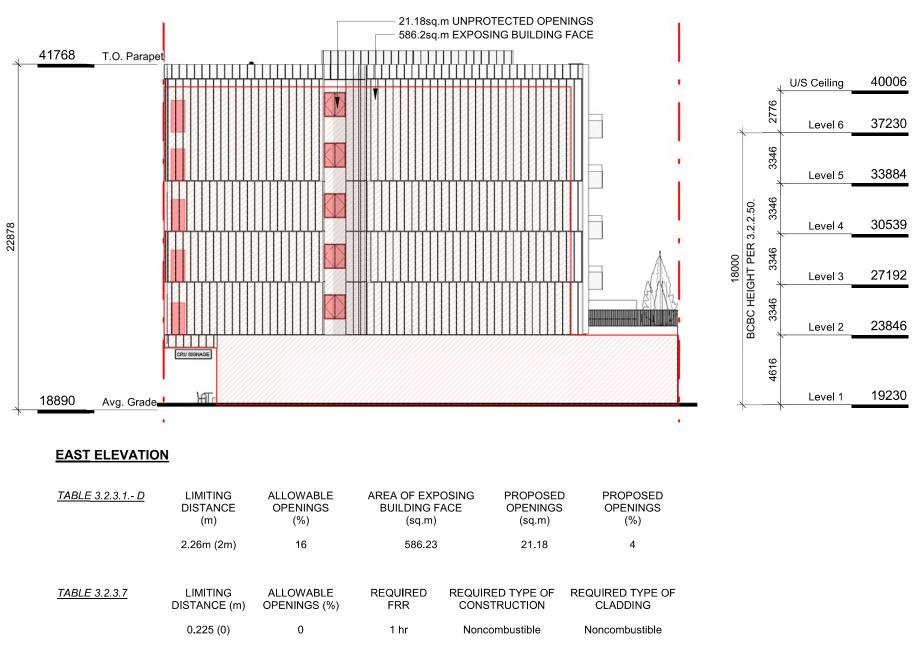

East Elevation - LD Key

SCALE = 1:250

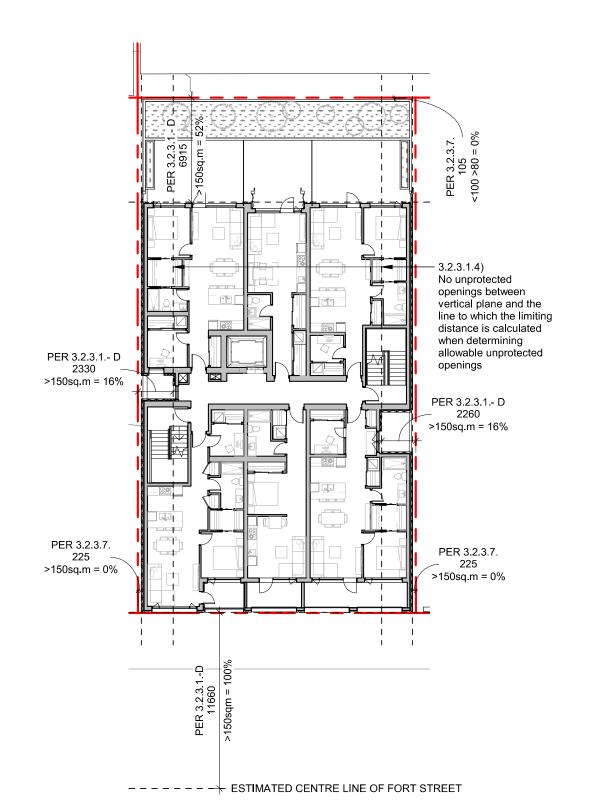

9 Spatial Separation Keyplan SCALE = 1:250





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Project

1030 FORT STREET

JAWL PROPERTIES

1030 Fort Street, Victoria BC

Spatial Separation

SEPT 15, 2021


1: 250 Project #

2112

Revision
SEPT 15, 2021
Sheet #


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1 Level 1 Code Plan
SCALE = 1:250

2 Level 2-6 Typ. Code Plan
SCALE = 1:250

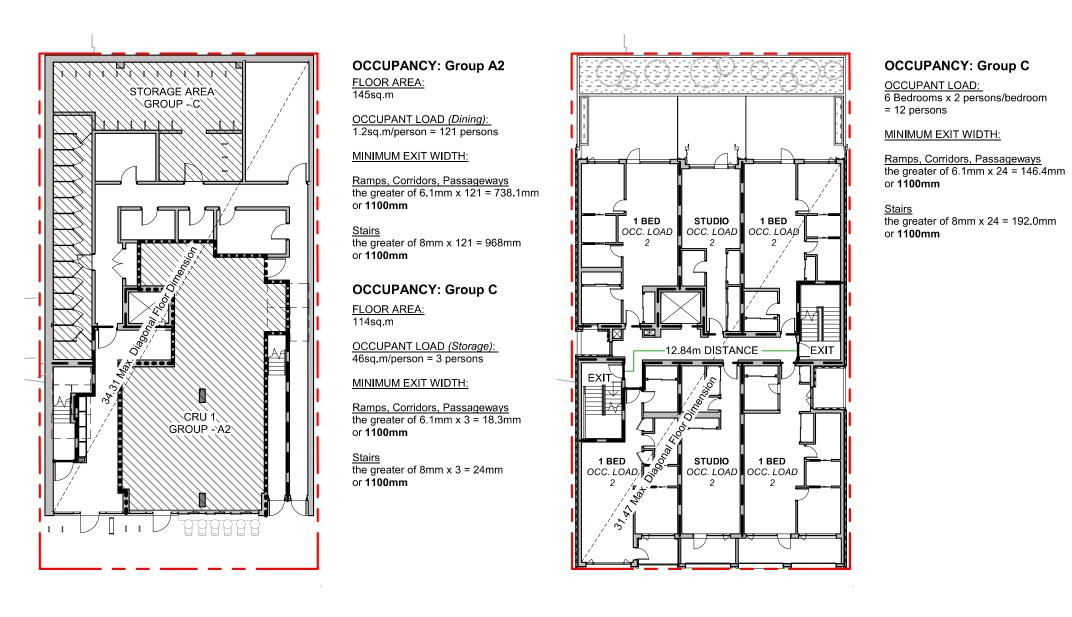

F.R.R. Separations - Key Section

SCALE = 1:250

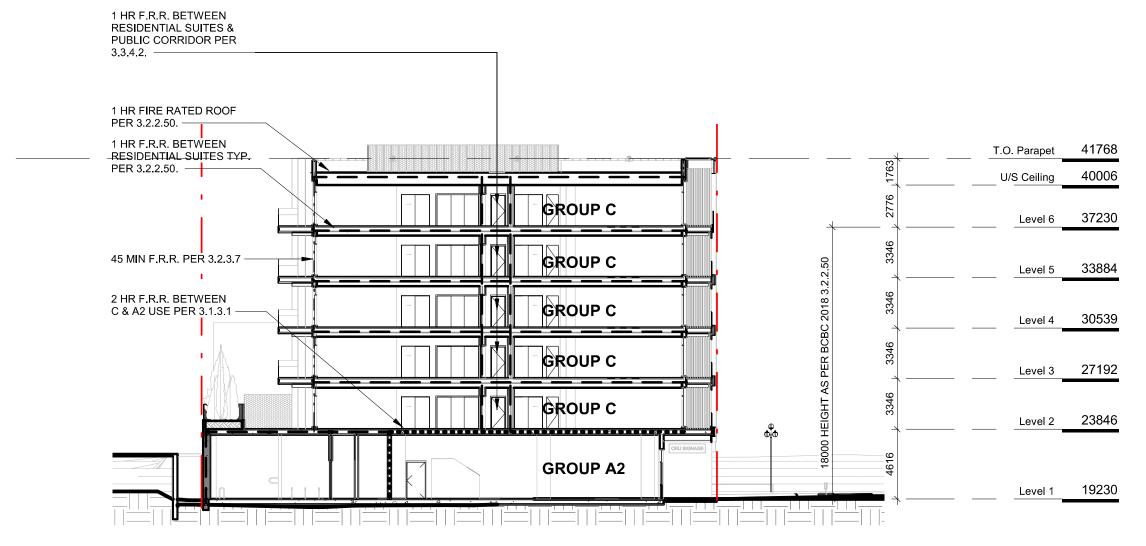BUILDING CODE ANALYSIS

PROJECT TYPE	NEW CONSTRUCTION RENOVATION ADDITION	N
GOVERNING BUILDING CODE	2018 BC BUILDING CODE	
MAJOR OCCUPANCY	A1 A2 A3 A4 B1 B2 B3 C D E F1 F2 F3	3.1.2.1
SUPERIMPOSED OCCUPANCY	A1 A2 A3 A4 B1 B2 B3 C D E F1 F2 F3	3.2.2.7
BUILDING AREA	576 m ²	1.4.1.2
GRADE	18.75 m geodetic	1.4.1.2
BUILDING HEIGHT (STOREYS, m)	6 STOREYS ABOVE GRADE 18 m, LEVEL 1 TO LEVEL 6 0 STOREYS BELOW GRADE	1.4.1.2, 3.2.2.50

BUILDING FIRE SAFETY & CONSTRUCTION CLASSIFICATION

CLASSIFICATION	GROUP C, UP TO 6 STOREYS, SPRINKLERED	3.2.2.50 , 3.2.2.24
No. OF STREETS FACING	1	3.2.2.10
CONSTRUCTION TYPES PERMITTED	✓ COMBUSTIBLE NON-COMBUSTIBLE	3.2.2.50
FIRE ALARM SYSTEM	YES NO	3.2.4.1
STANDPIPE SYSTEM	YES NO	3.2.5.8
HIGH BUILDING	YES NO	3.2.6.1
INTERCONNECTED FLOOR SPACE	YES NO	3.2.8

FIRE RESISTANCE RATINGS

HORIZONTAL SEPARATIONS	1 hr FLOORS 1 hr MEZZANINE 1 hr ROOF	3.2.2.50, 3.2.2.24
LOADBEARING WALLS, COLUMNS & ARCHES	1 hr (NOT LESS THAN THAT REQUIRED FOR SUPPORTED STRUCTURE)	3.2.2.50, 3.2.2.24
EXITS	1 hr	3.4.4.1
MAJOR OCCUPANCY SEPARATION	2 hr C to A2	3.1.3.1

EXITS FROM FLOOR AREAS

NUMBER OF EXITS REQUIRED	2	3.4.2.1
SEPARATION OF EXITS (MIN.)	1/2 MAX. DIAGONAL FLOOR AREA, BUT NEED NOT BE > 9 m	3.4.2.3
MAX. TRAVEL DISTANCE ALLOWED	45 m, GROUP C 45 m, GROUP A2	3.4.2.5
MEZZANINE	YES NO	3.2.8

OCCUPIED FLOOR AREAS & OCCUPANT LOAD

LEVEL 1	145	sq.m, A2 (Dining)	114	sq.m, C (Storage)	0 bds	C (Residential)	1.4.1.2, 3.1.17.1
LEVEL 2 - 6	0	sq.m, A2 (Dining)	0	sq.m, C (Storage)	6 bds	C (Residential)	1.4.1.2, 3.1.17.1
TOTAL	145	sq.m, A2 (Dining)	114	sq.m, C (Storage)	30 bds	C (Residential)	1.4.1.2, 3.1.17.1
OCCUPANT LOAD	121	1.2sq.m./person	3	46sq.m./person	60	2 persons*bdrm	3.1.17.1

WATER CLOSETS	OCCUPANT LOAD	REQUIRED	PROVIDED	
LEVEL 1(A2)	121 PERSONS	2 M 3 F	T.B.D. AT T.I.	3.7.2.2- A

ACCESSIBILITY		
UNIVERSAL WASHROOM	REQUIRED AT LEVEL 1	3.8.2.8.3

FIRE RESISTANCE RATING - KEY

2 HOUR

—---- 1.5 HOUR

SEPT 15, 2021 **DATE** NO. DESCRIPTION



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1030 FORT STREET


JAWL PROPERTIES

1030 Fort Street, Victoria BC


Code Analysis

SEPT 15, 2021 Project # As indicated

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EXISTING SITE SURVEY SCALE = 1:200

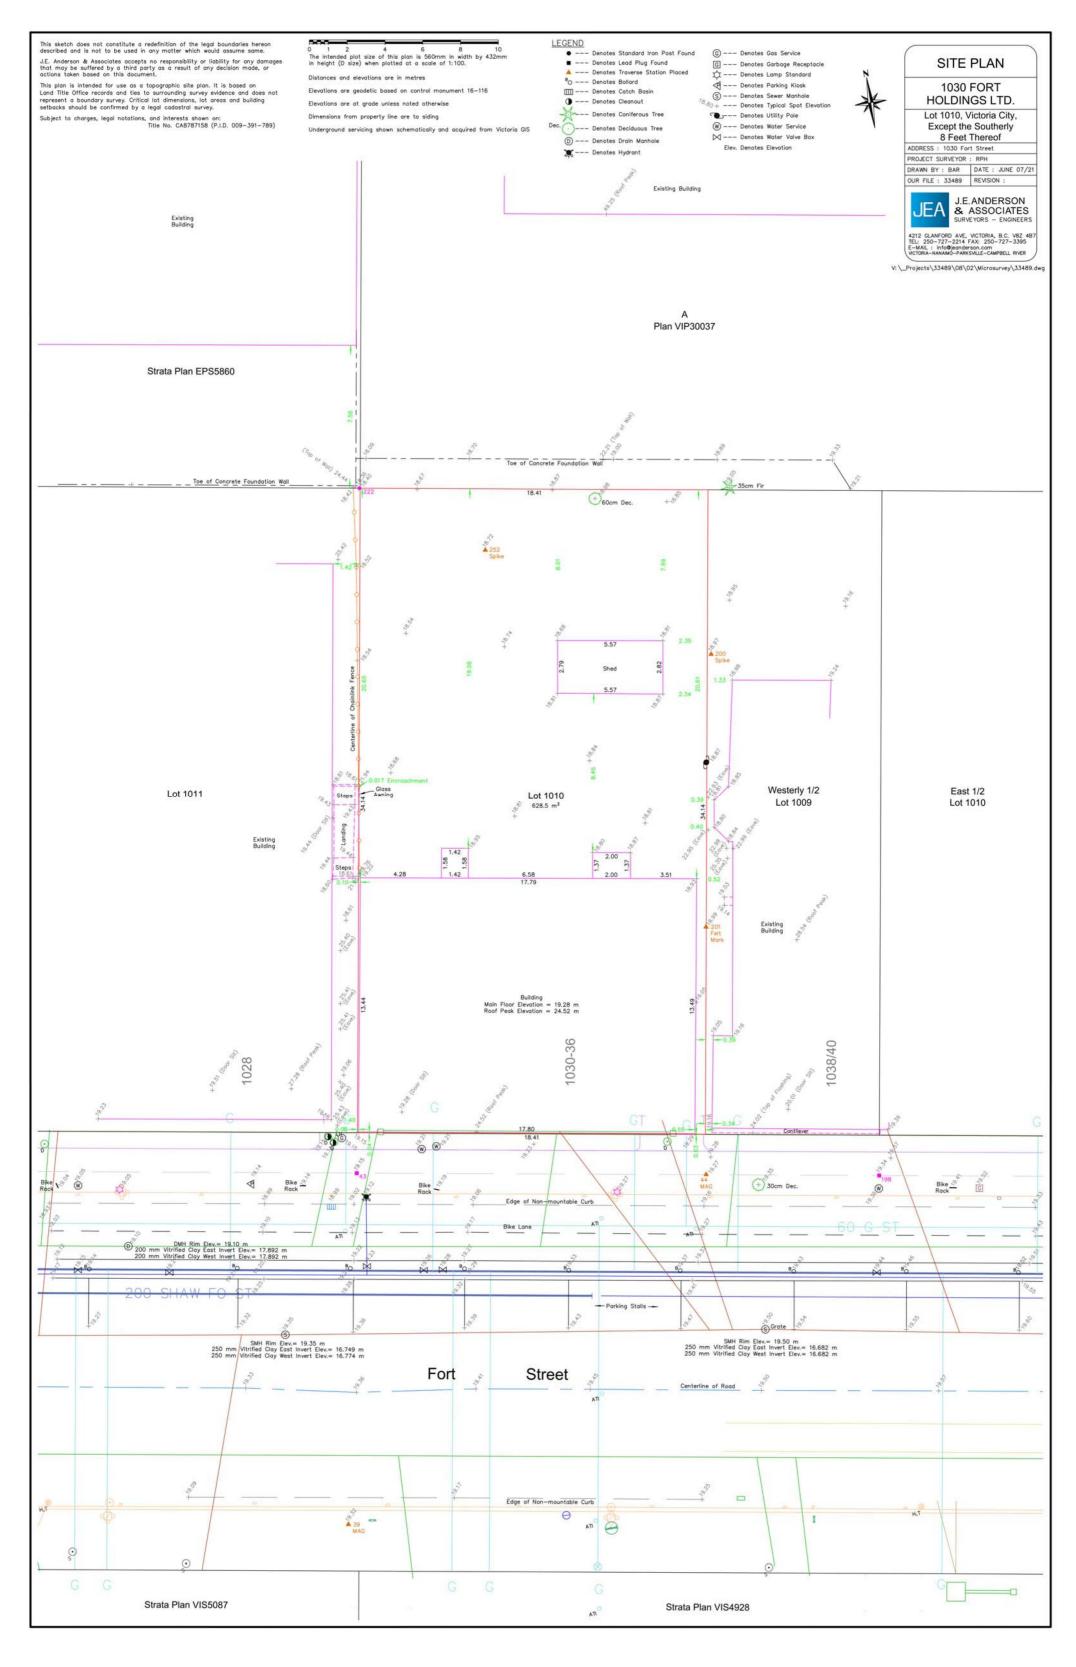

DATA

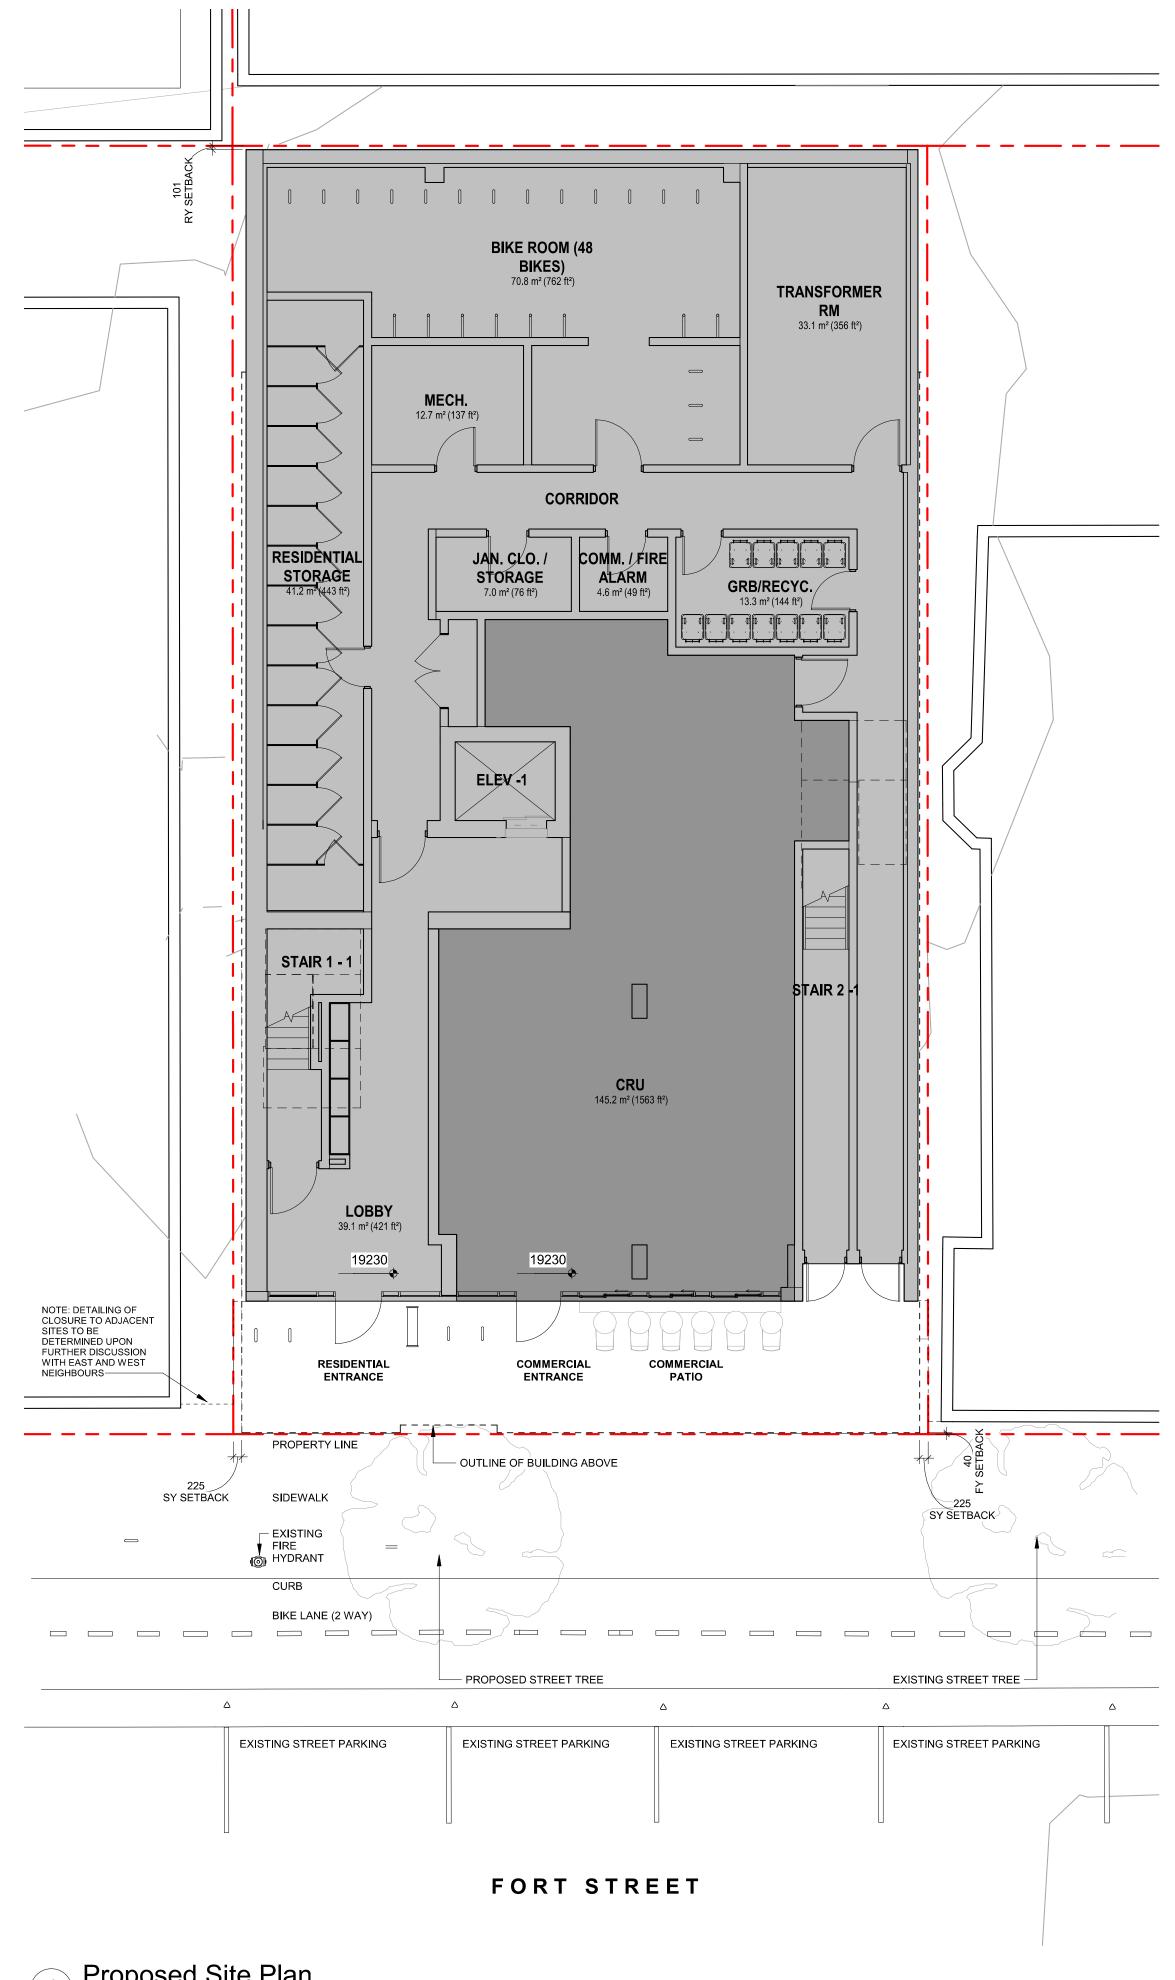MUNICIPALITY	CITY OF VICTORIA
MUNICIPAL ADDRESS	1030 FORT STREET, VICTORIA BC
LEGAL DESCRIPTION	LOT 1010, VICTORIA CITY, EXCEPT THE SOUTHERLY 8 FEET THEREOF
PROJECT DESCRIPTION	6 STOREY BUILDING 5 STOREYS RESIDENTIAL OVER 1 STOREY COMMERCIAL

PROJECT INFORMATION

ZONE (EXISTING)	CA-42		
PROPOSED ZONE	ONE UNKNOWN		
SITE AREA (m²)	628.5m ²		
TOTAL FLOOR AREA (m²)	2,480m²		
COMMERCIAL FLOOR AREA (m²)	146m²		
FLOOR SPACE RATIO	OR SPACE RATIO 4:1		
SITE COVERAGE (%)	97.5%		
OPEN SITE SPACE (%)	14%		
HEIGHT (m)	22.28m		
NUMBER OF STOREYS	6		
	REQUIRED	PROVIDED	
PARKING STALLS (#) ON SITE	24	0	
BICYCLE PARKING (#) SHORT TERM	8	8	
BICYCLE PARKING (#) LONG TERM	36	48	

BUILDING SETBACKS (m)

, ,	
FRONT YARD	0.04m
REAR YARD (LEVEL 1)	0.10m
REAR YARD (TO BUILDING FACE LEVEL 2-6)	7.0m
SIDE YARD (W)	0.23m
SIDE YARD (E)	0.23m
COMBINED SIDE YARDS	0.46m

RESIDENTIAL USE DETAILS
TOTAL NUMBER OF UNITS

TOTAL NUMBER OF UNITS	30
UNIT TYPE	1 BD+ DEN (20), STUDIO (10)
GROUND-ORIENTATED UNITS	0
MINIMUM UNIT FLOOR AREA (m²)	36.7m ²
TOTAL RESIDENTIAL FLOOR AREA (m²)	1,651m²

SUPPORTING CALCULATIONS

ZONING FLOOR AREAS

445.36 m² Level 1 Level 2 406.64 m² Level 3 406.67 m² Level 4 406.67 m²

Level 5 406.67 m² Level 6 406.67 m² Grand total: 6 2478.68 m²

FLOOR SPACE RATIO $2480m^2 / 628.5m^2 = 4:1$

SITE COVERAGE $608.5 \text{m}^2 / 628.5 \text{m}^2 = 0.97 (97\%)$

 $85.6\text{m}^2 / 628.5\text{m}^2 = 0.14 (14\%)$

AVERAGE GRADE

OPEN SITE SPACE

GRADE POINTS: GRADE POINTS: (PROPOSED) (NATURAL) 18.450 18.450 18.960 **19.090 19.070**

NATURAL GRADE POINTS (EXISTING)

18.960 19.200 19.200

GRADE POINTS:

((18.450 + 18.960)/2) x 17.8 = 332.95 ((18.960 + 19.090)/2) x 30.5 = 580.26 ((19.090 + 19.070)/2) x 17.8 = 339.62 ((19.070 + 18.450)/2) x 30.5 = 572.18

1,825.01 AVERAGE GRADE = 1825.01/96.6 = **18.89**

A 18450 _____ B 18959 [€] ₄ B 18959 C 19087 D 19200

D 19074

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GRADE POINTS (PROPOSED)

Site Plan and Project Data SEPT 15, 2021

Issued for RZ/DP

NO.

Issued for Development Tracker

DESCRIPTION

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1030 FORT STREET

1030 Fort Street, Victoria BC

JAWL PROPERTIES

Project # As indicated SEPT 15, 2021


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DATE


Proposed Site Plan

SCALE = 1:100



LEVEL 1 - ZONING FLOOR AREA: 445sq.m (measured to inside face of exterior wall, excluding elevator shaft & required bike parking)

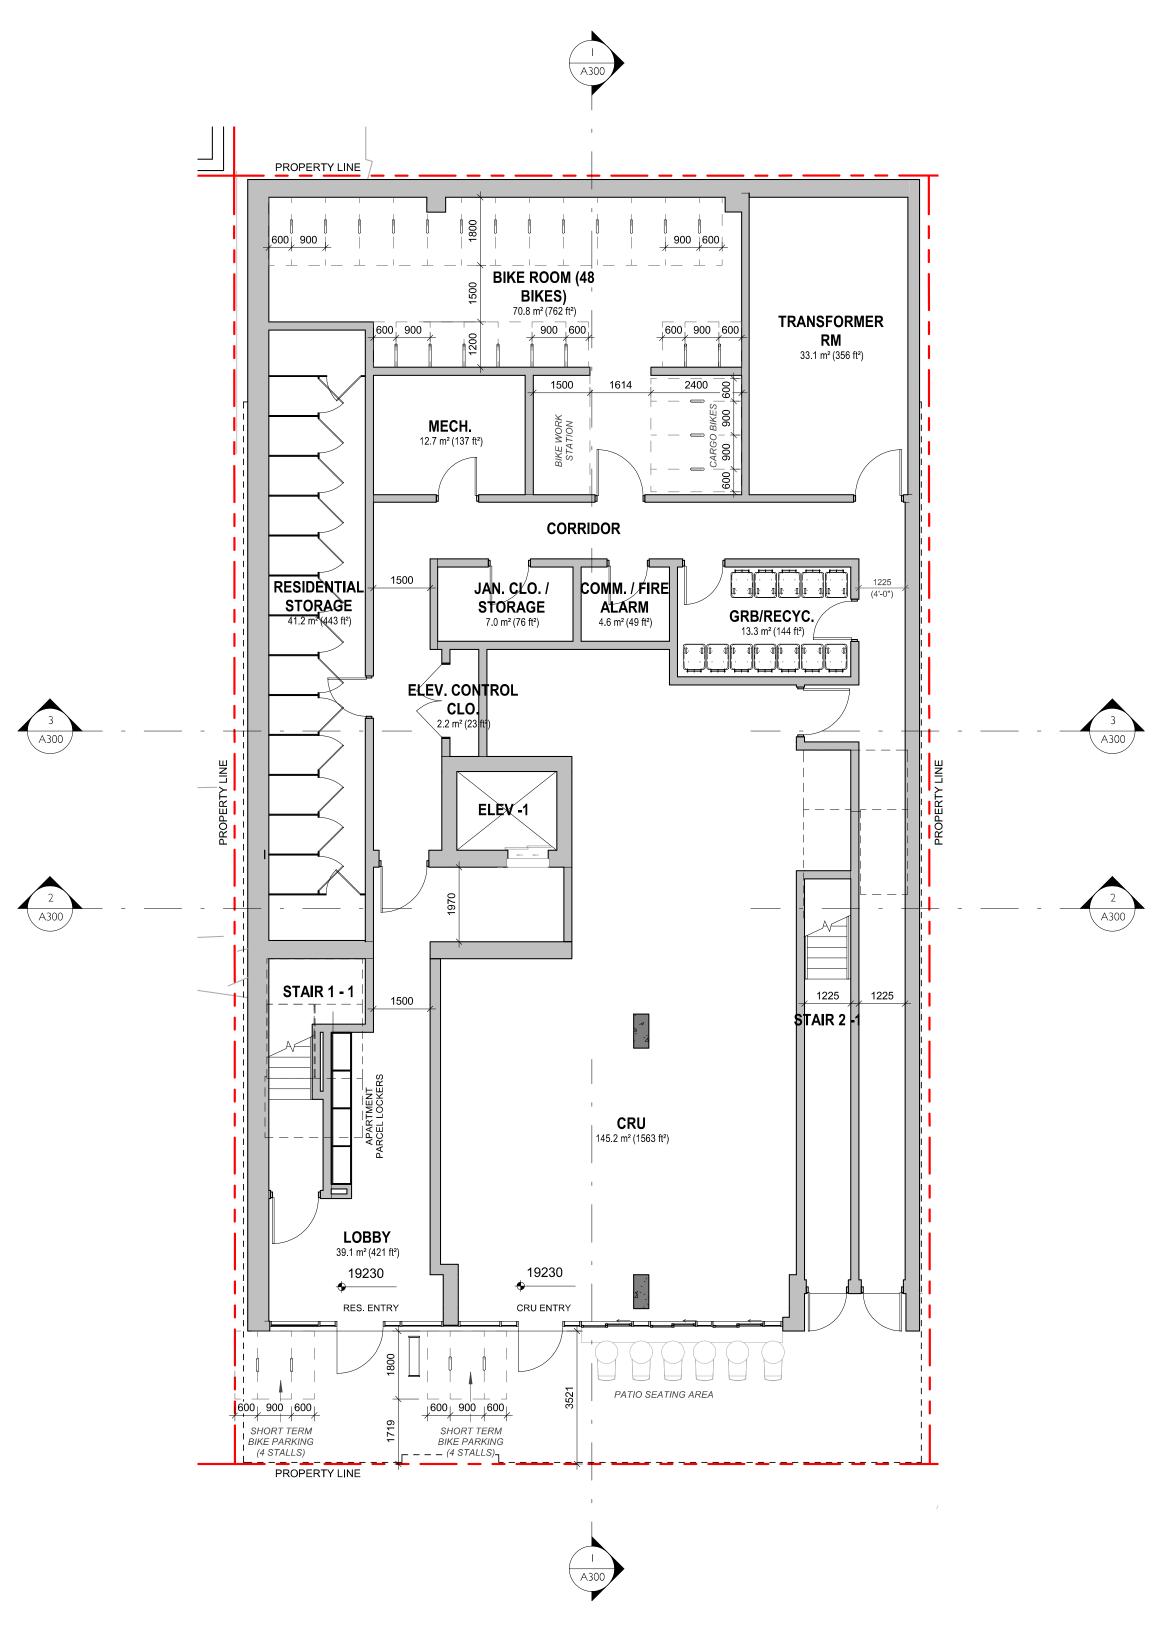1 Level 1 Proposed Plan
SCALE = 1:100

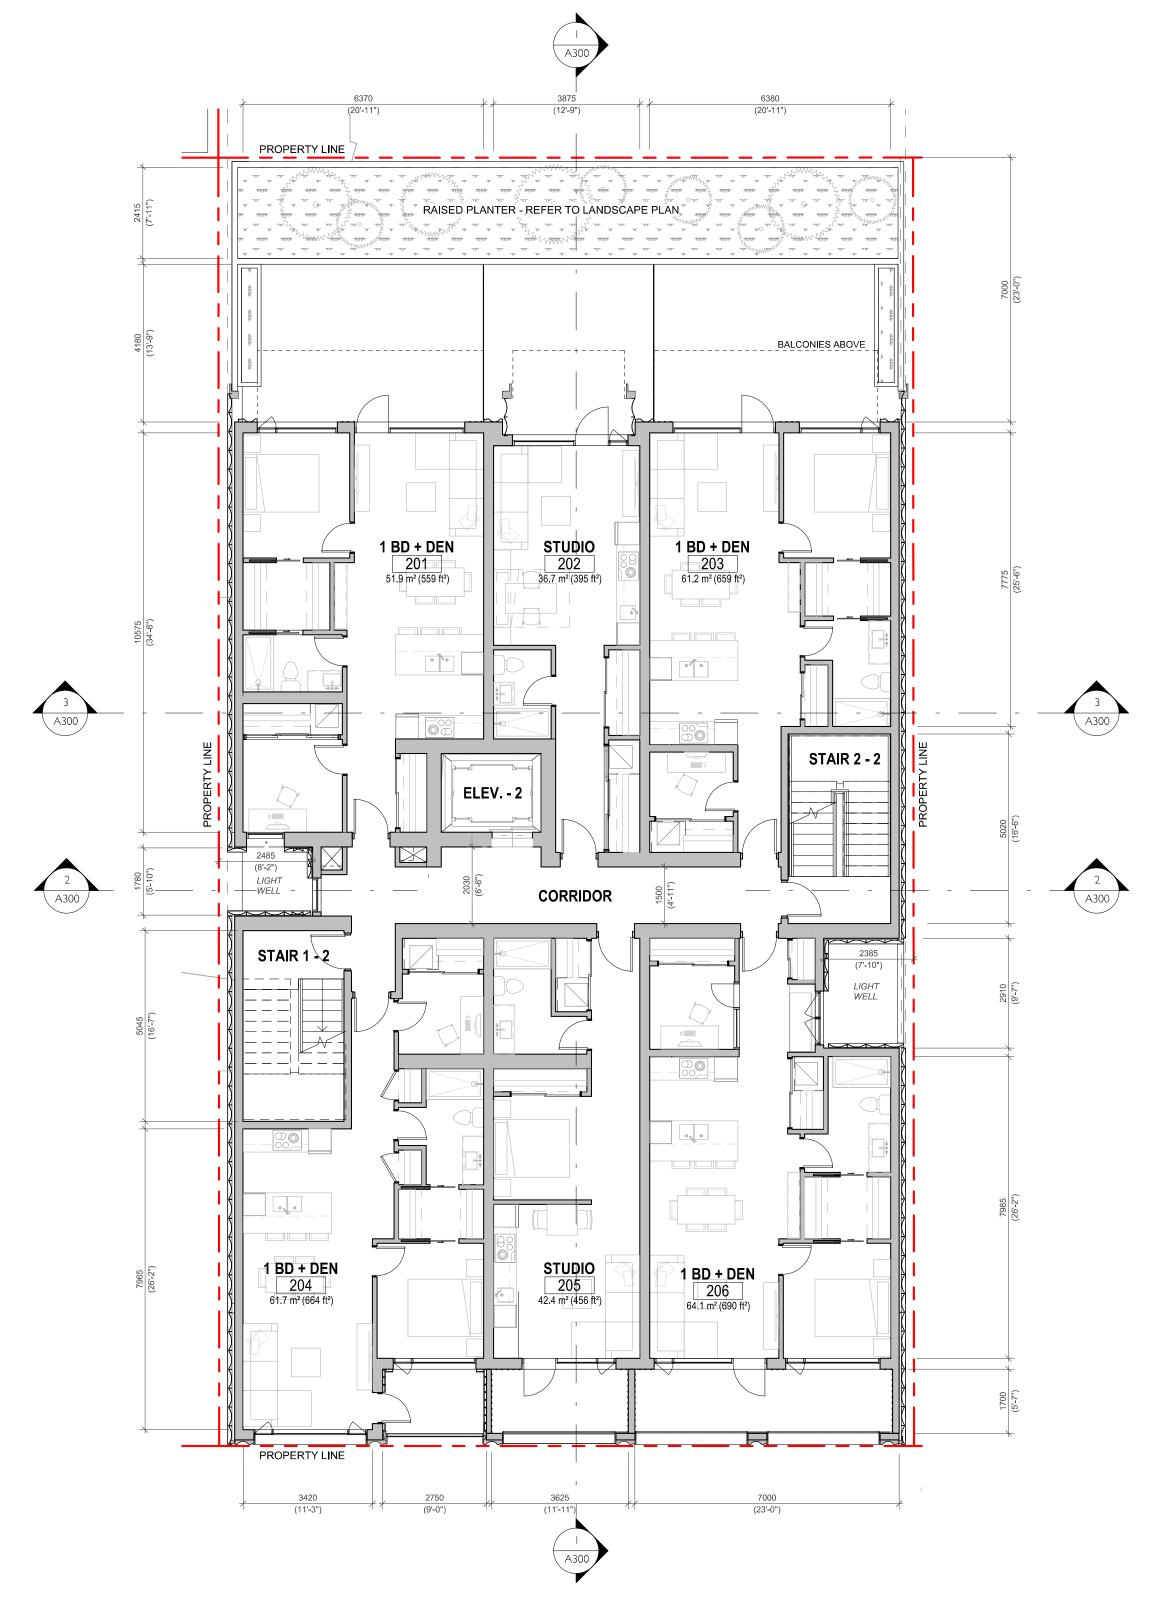

LEVEL 2-6 - ZONING FLOOR AREA: 407sq.m (measured to inside face of exterior wall, excluding elevator shaft & required bike parking)

2 Levels 2-6 Typical Proposed Plan

SCALE = 1:100





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1030 FORT STREET

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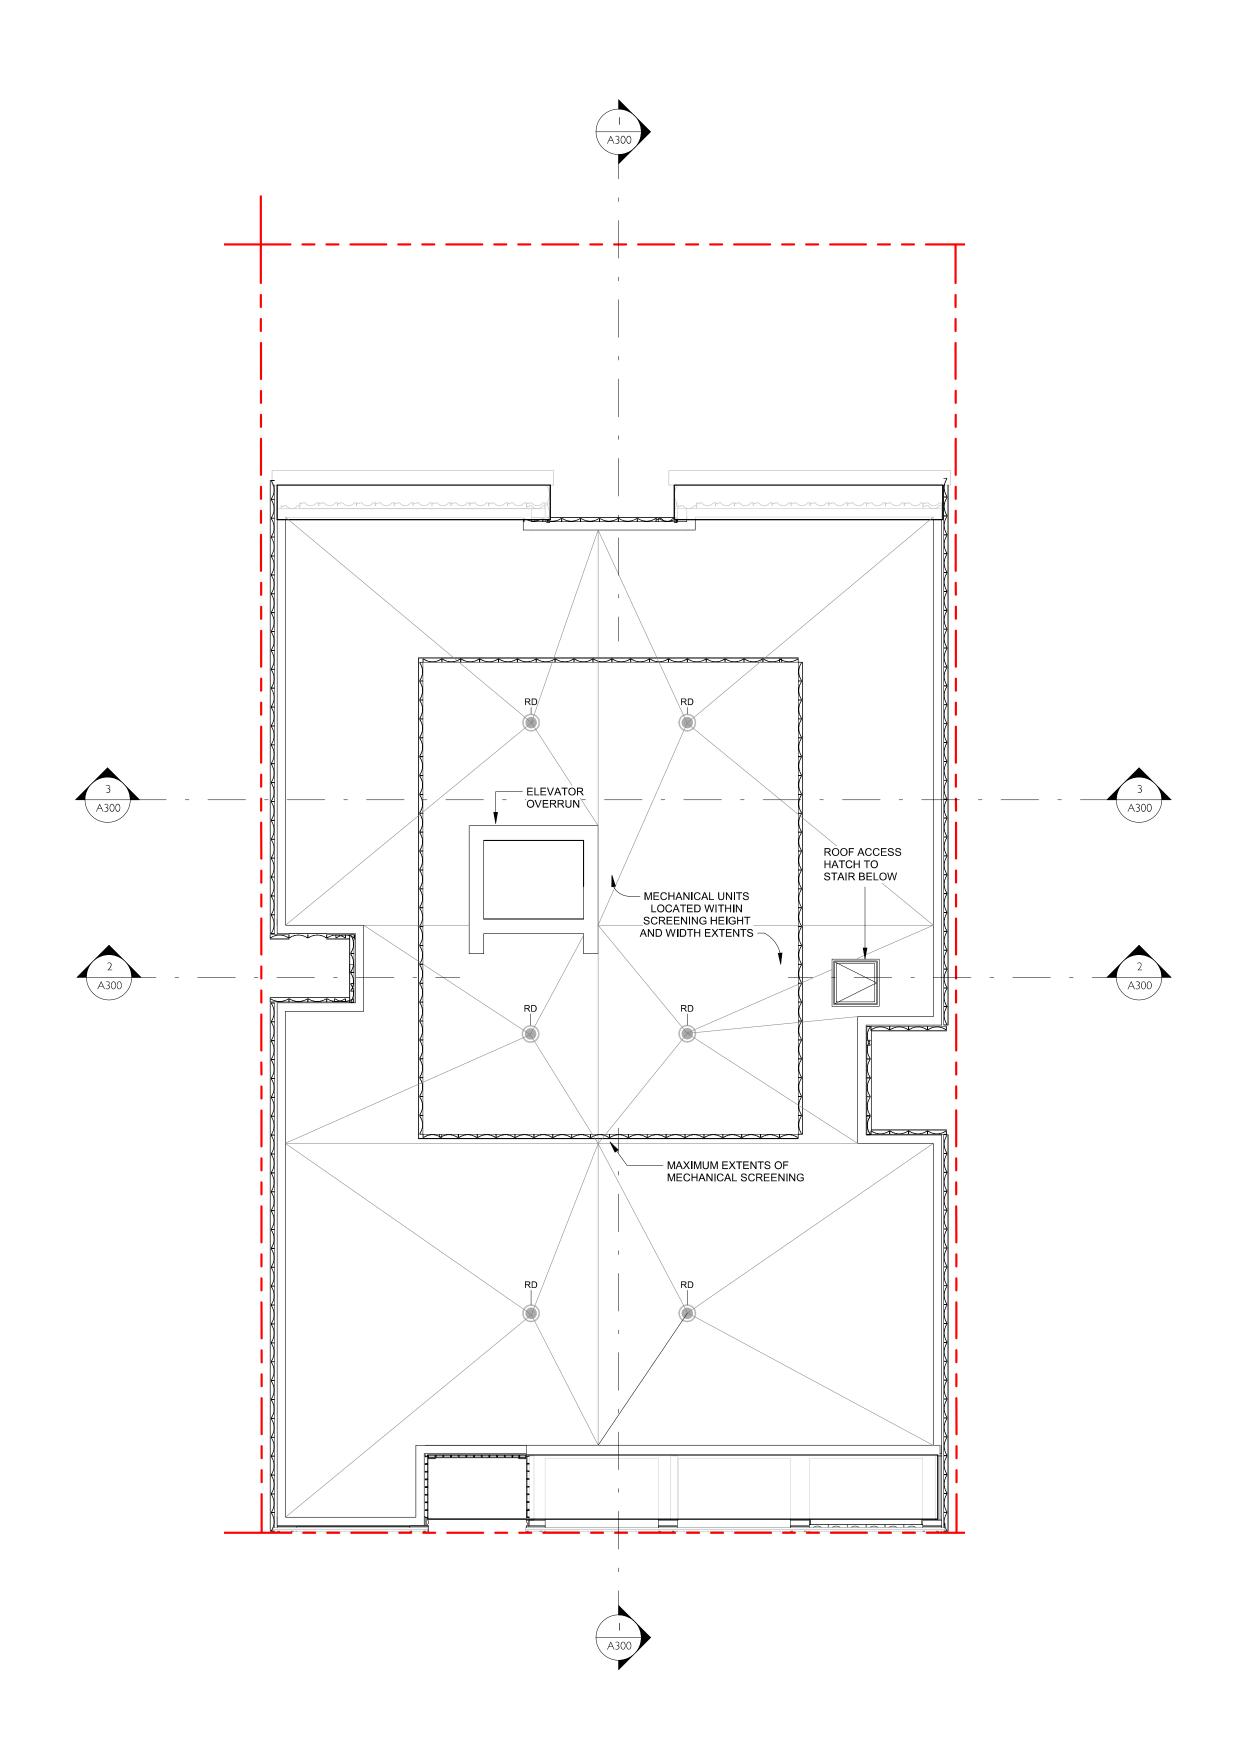
1030 Fort Street, Victoria BC

Proposed Floor Plans

SEPT 15, 2021 2

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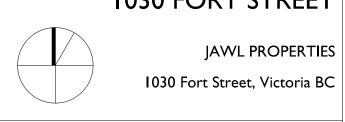


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Project

1030 FORT STREET



Sheet Name

Roof Plan

Scale		
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FINISH MATERIALS

01. TERRA COTTA


03., 05.

04., 10.

06., 07.

- 02. TRANSPARENT GLAZING
- 03. FRITTED GLASS
- 04. PRE-FINISHED METAL
- 05. PRE-FINISHED PERFORATED METAL
- 06. WOOD GRAIN TEXTURED FINISH
- 07. CEMENTITIOUS PANEL
- 08. ARCHITECTURAL CONCRETE
- 09. CONCRETE
- 10. MECHANICAL LOUVRE



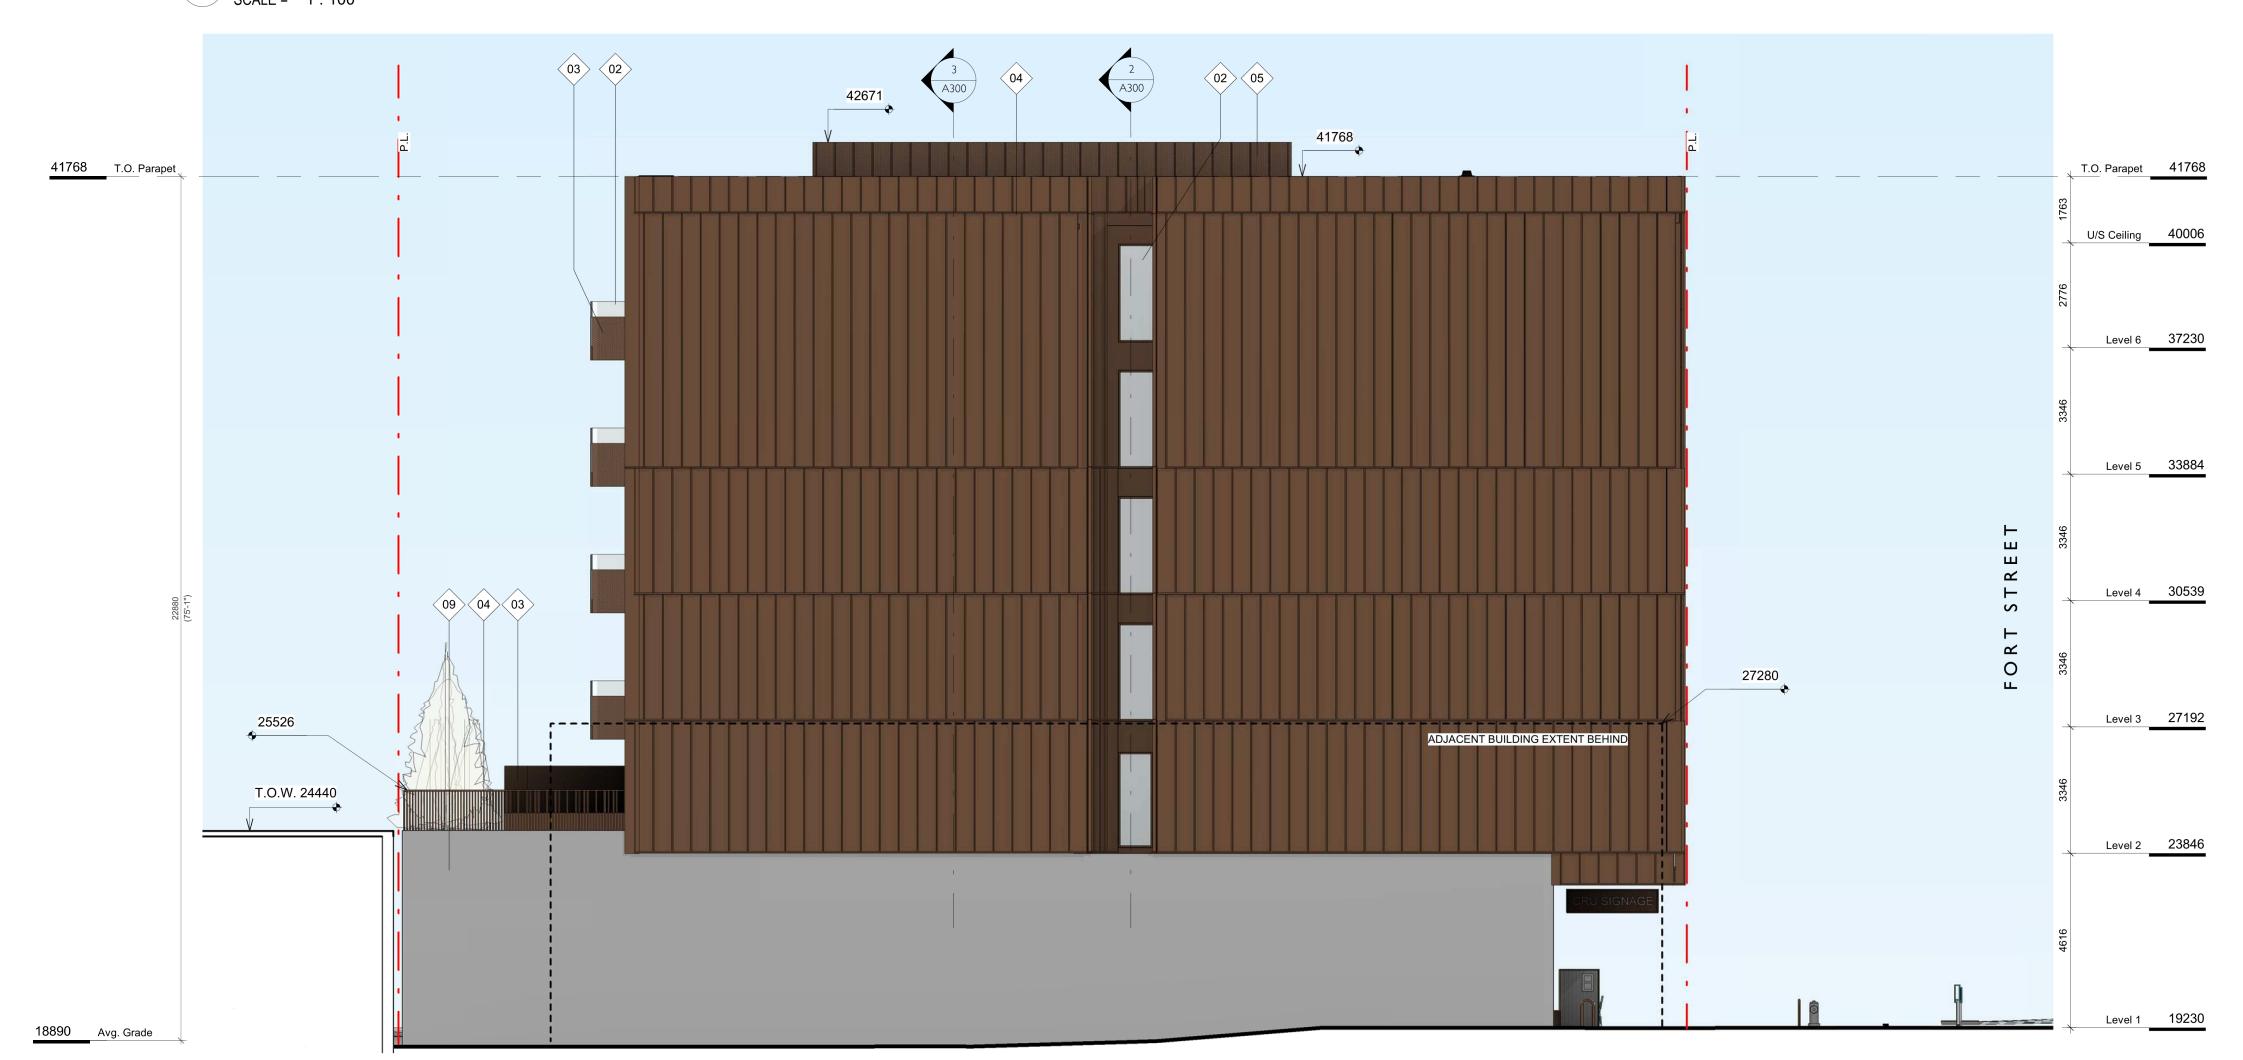

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Project

IO30 FORT STREET

JAWL PROPERTIES

1030 Fort Street, Victoria BC

Sheet Name

Building Elevations S-W

Date

SEPT 15, 2021

Scale

As indicated

Project #

2112

Revision

SEPT 15, 2021

Sheet #

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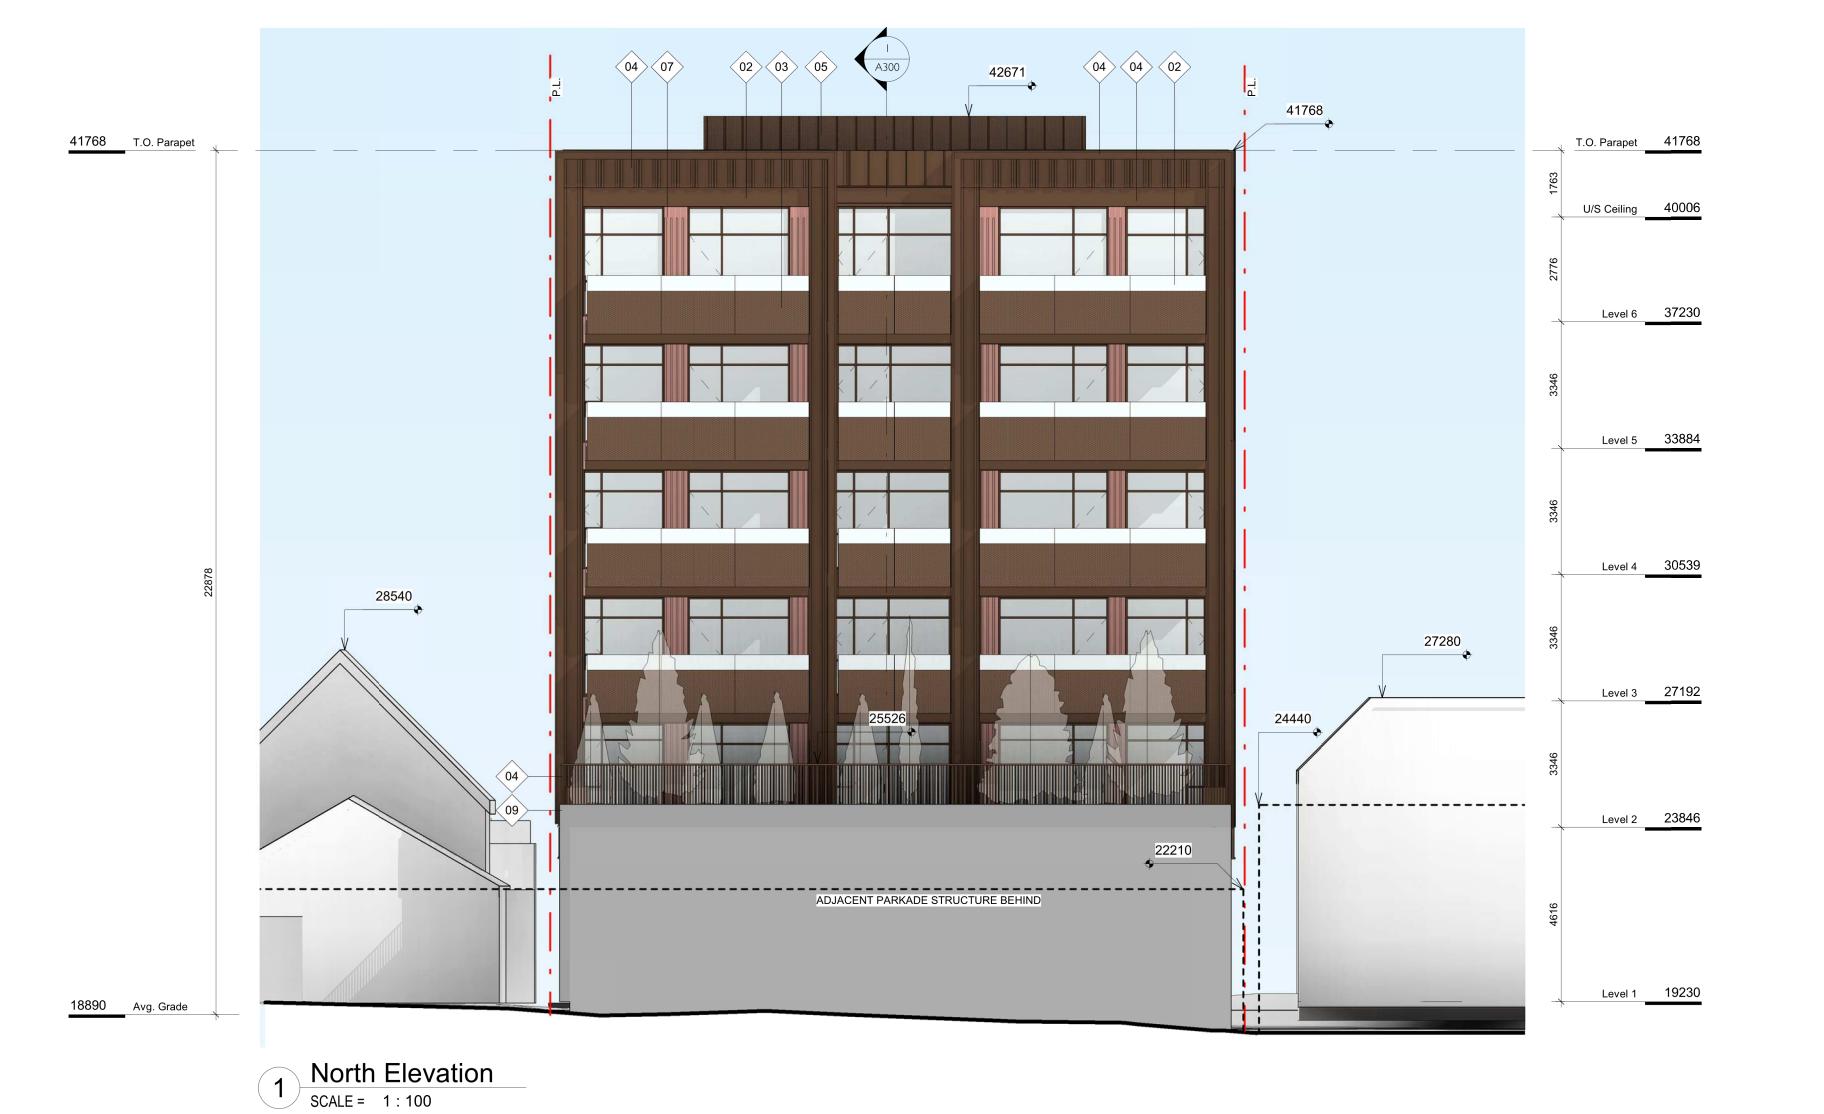
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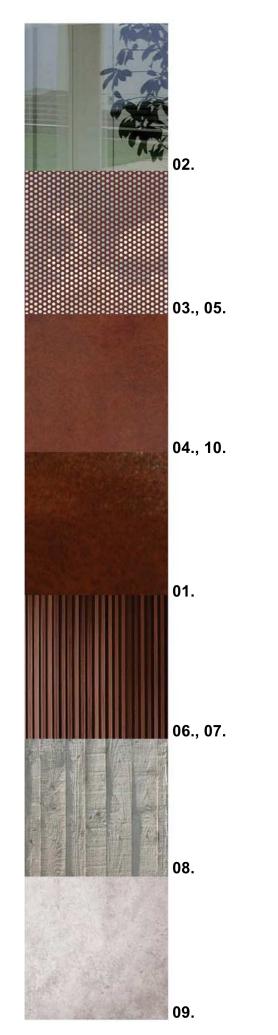
DESCRIPTION

SEPT 15, 2021 AUG 03, 2021 DATE

West Elevation


SCALE = 1:100





FINISH MATERIALS

- 01. TERRA COTTA
- 02. TRANSPARENT GLAZING
- 03. FRITTED GLASS
- 04. PRE-FINISHED METAL
- 05. PRE-FINISHED PERFORATED METAL
- 06. WOOD GRAIN TEXTURED FINISH
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Project

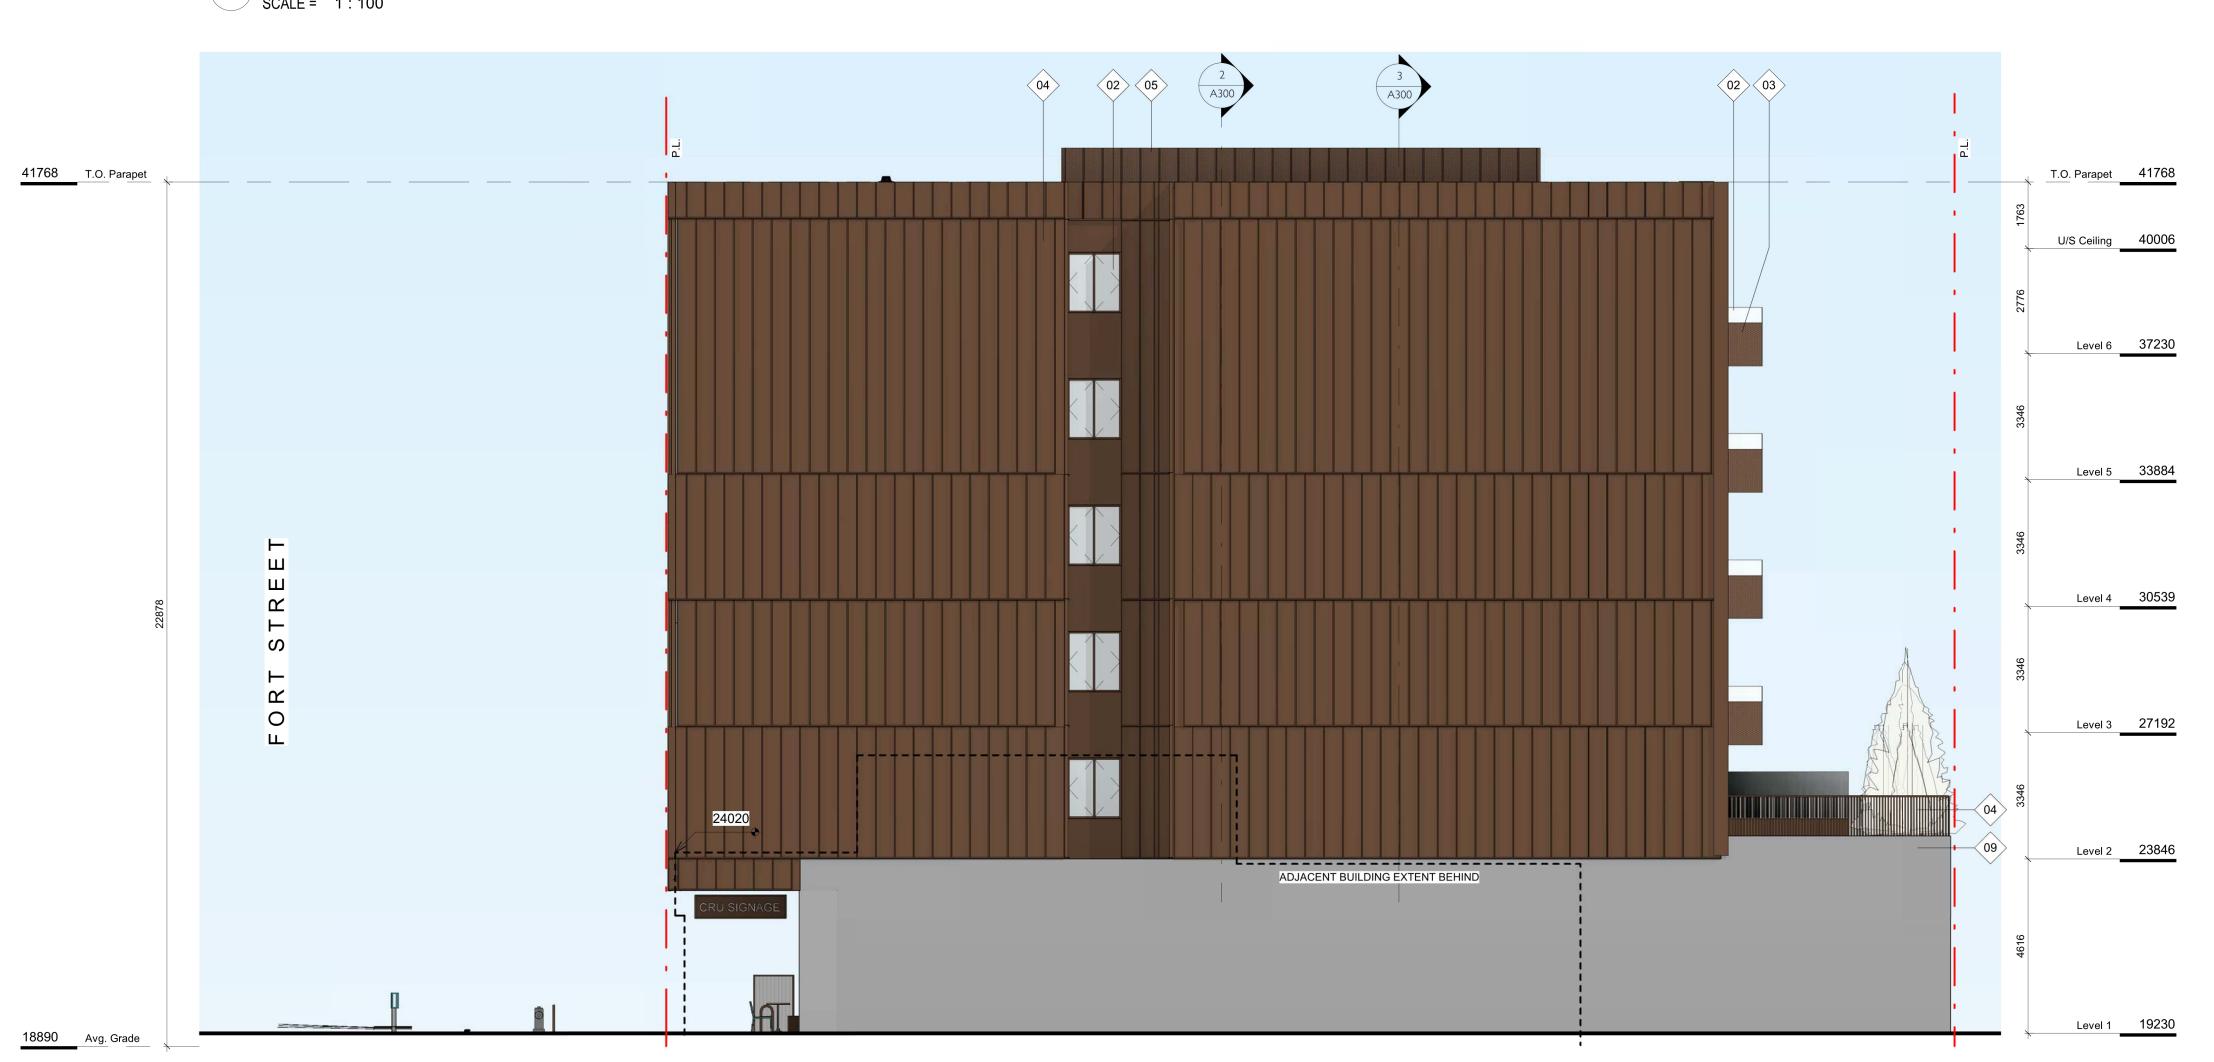I 030 FORT STREET

JAWL PROPERTIES

1030 Fort Street, Victoria BC

Sheet Name

Building Elevations N-E

Date

SEPT 15, 2021

Scale

As indicated

Project #

2112

Revision

SEPT 15, 2021

Sheet #

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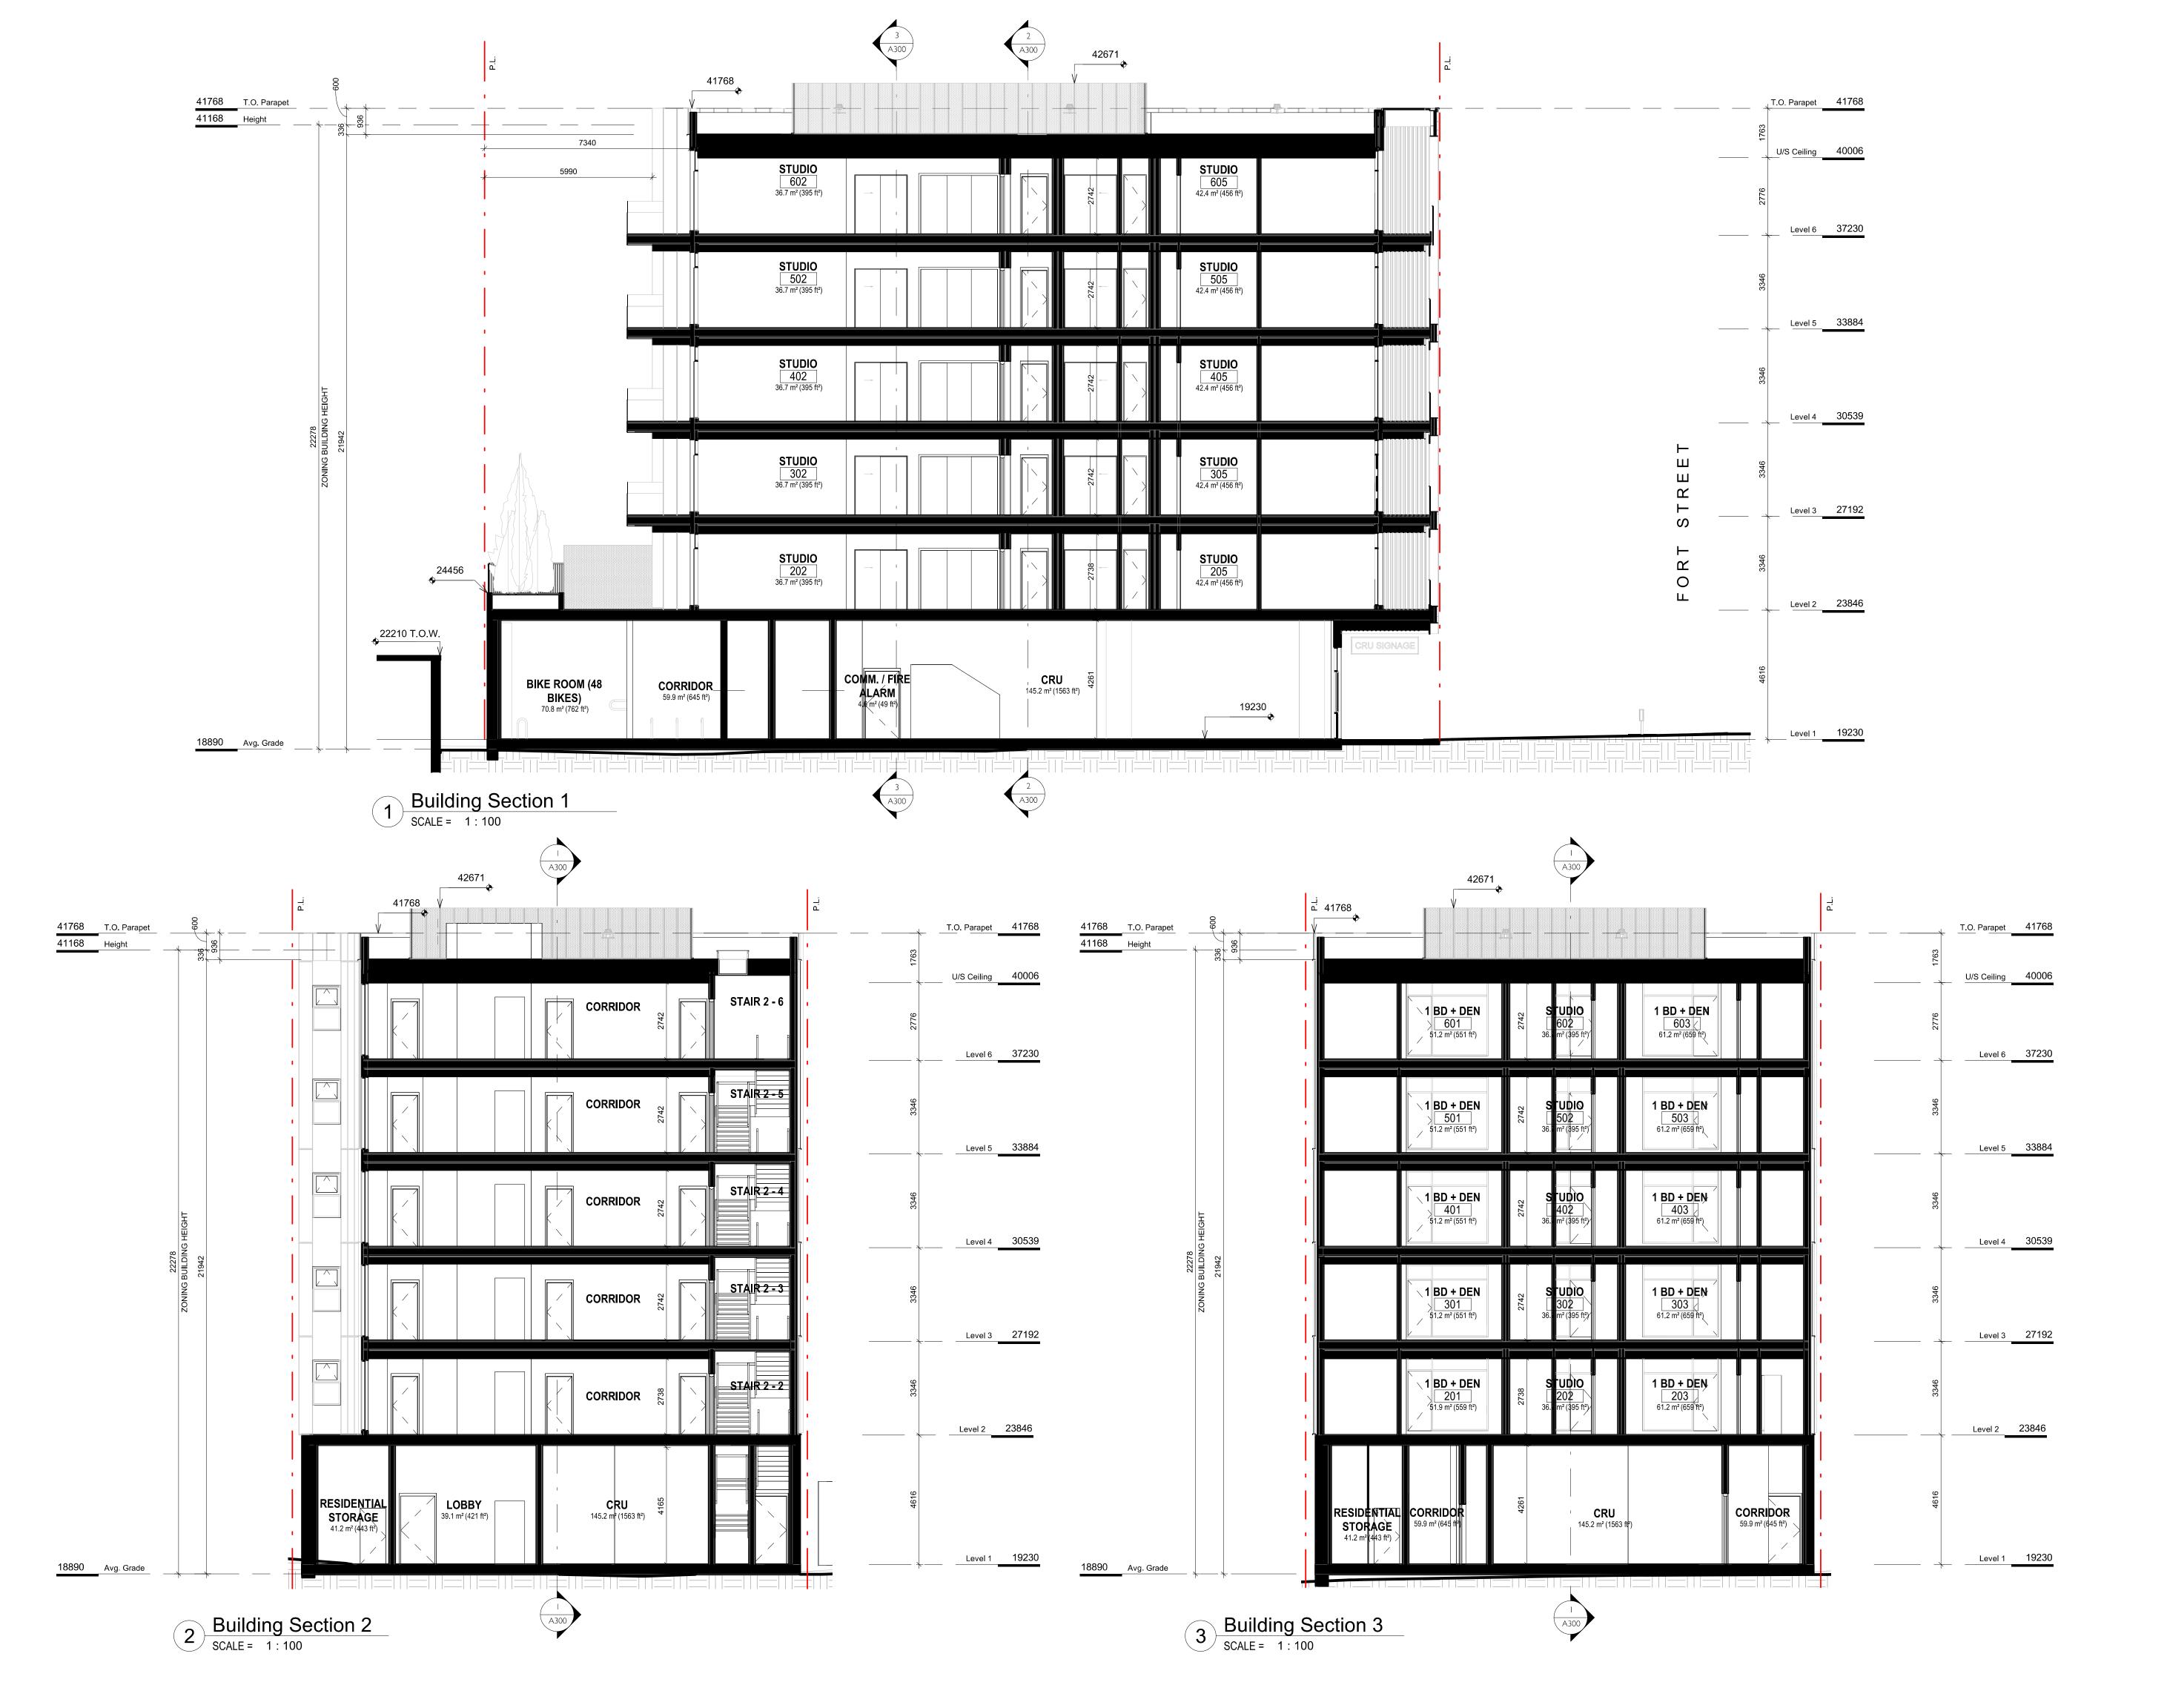
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DESCRIPTION

AUG 03, 2021 **DATE**

2 East Elevation
SCALE = 1:100







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JAWL PROPERTIES


1030 Fort Street, Victoria BC

Building Sections


Date

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1030 Fort Street, Victoria BC

Context Elevation & Shadow Study Level 4 30539
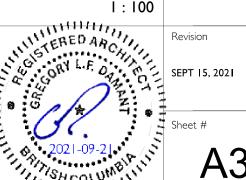
> SEPT 15, 2021 Project #


U/S Ceiling 40006

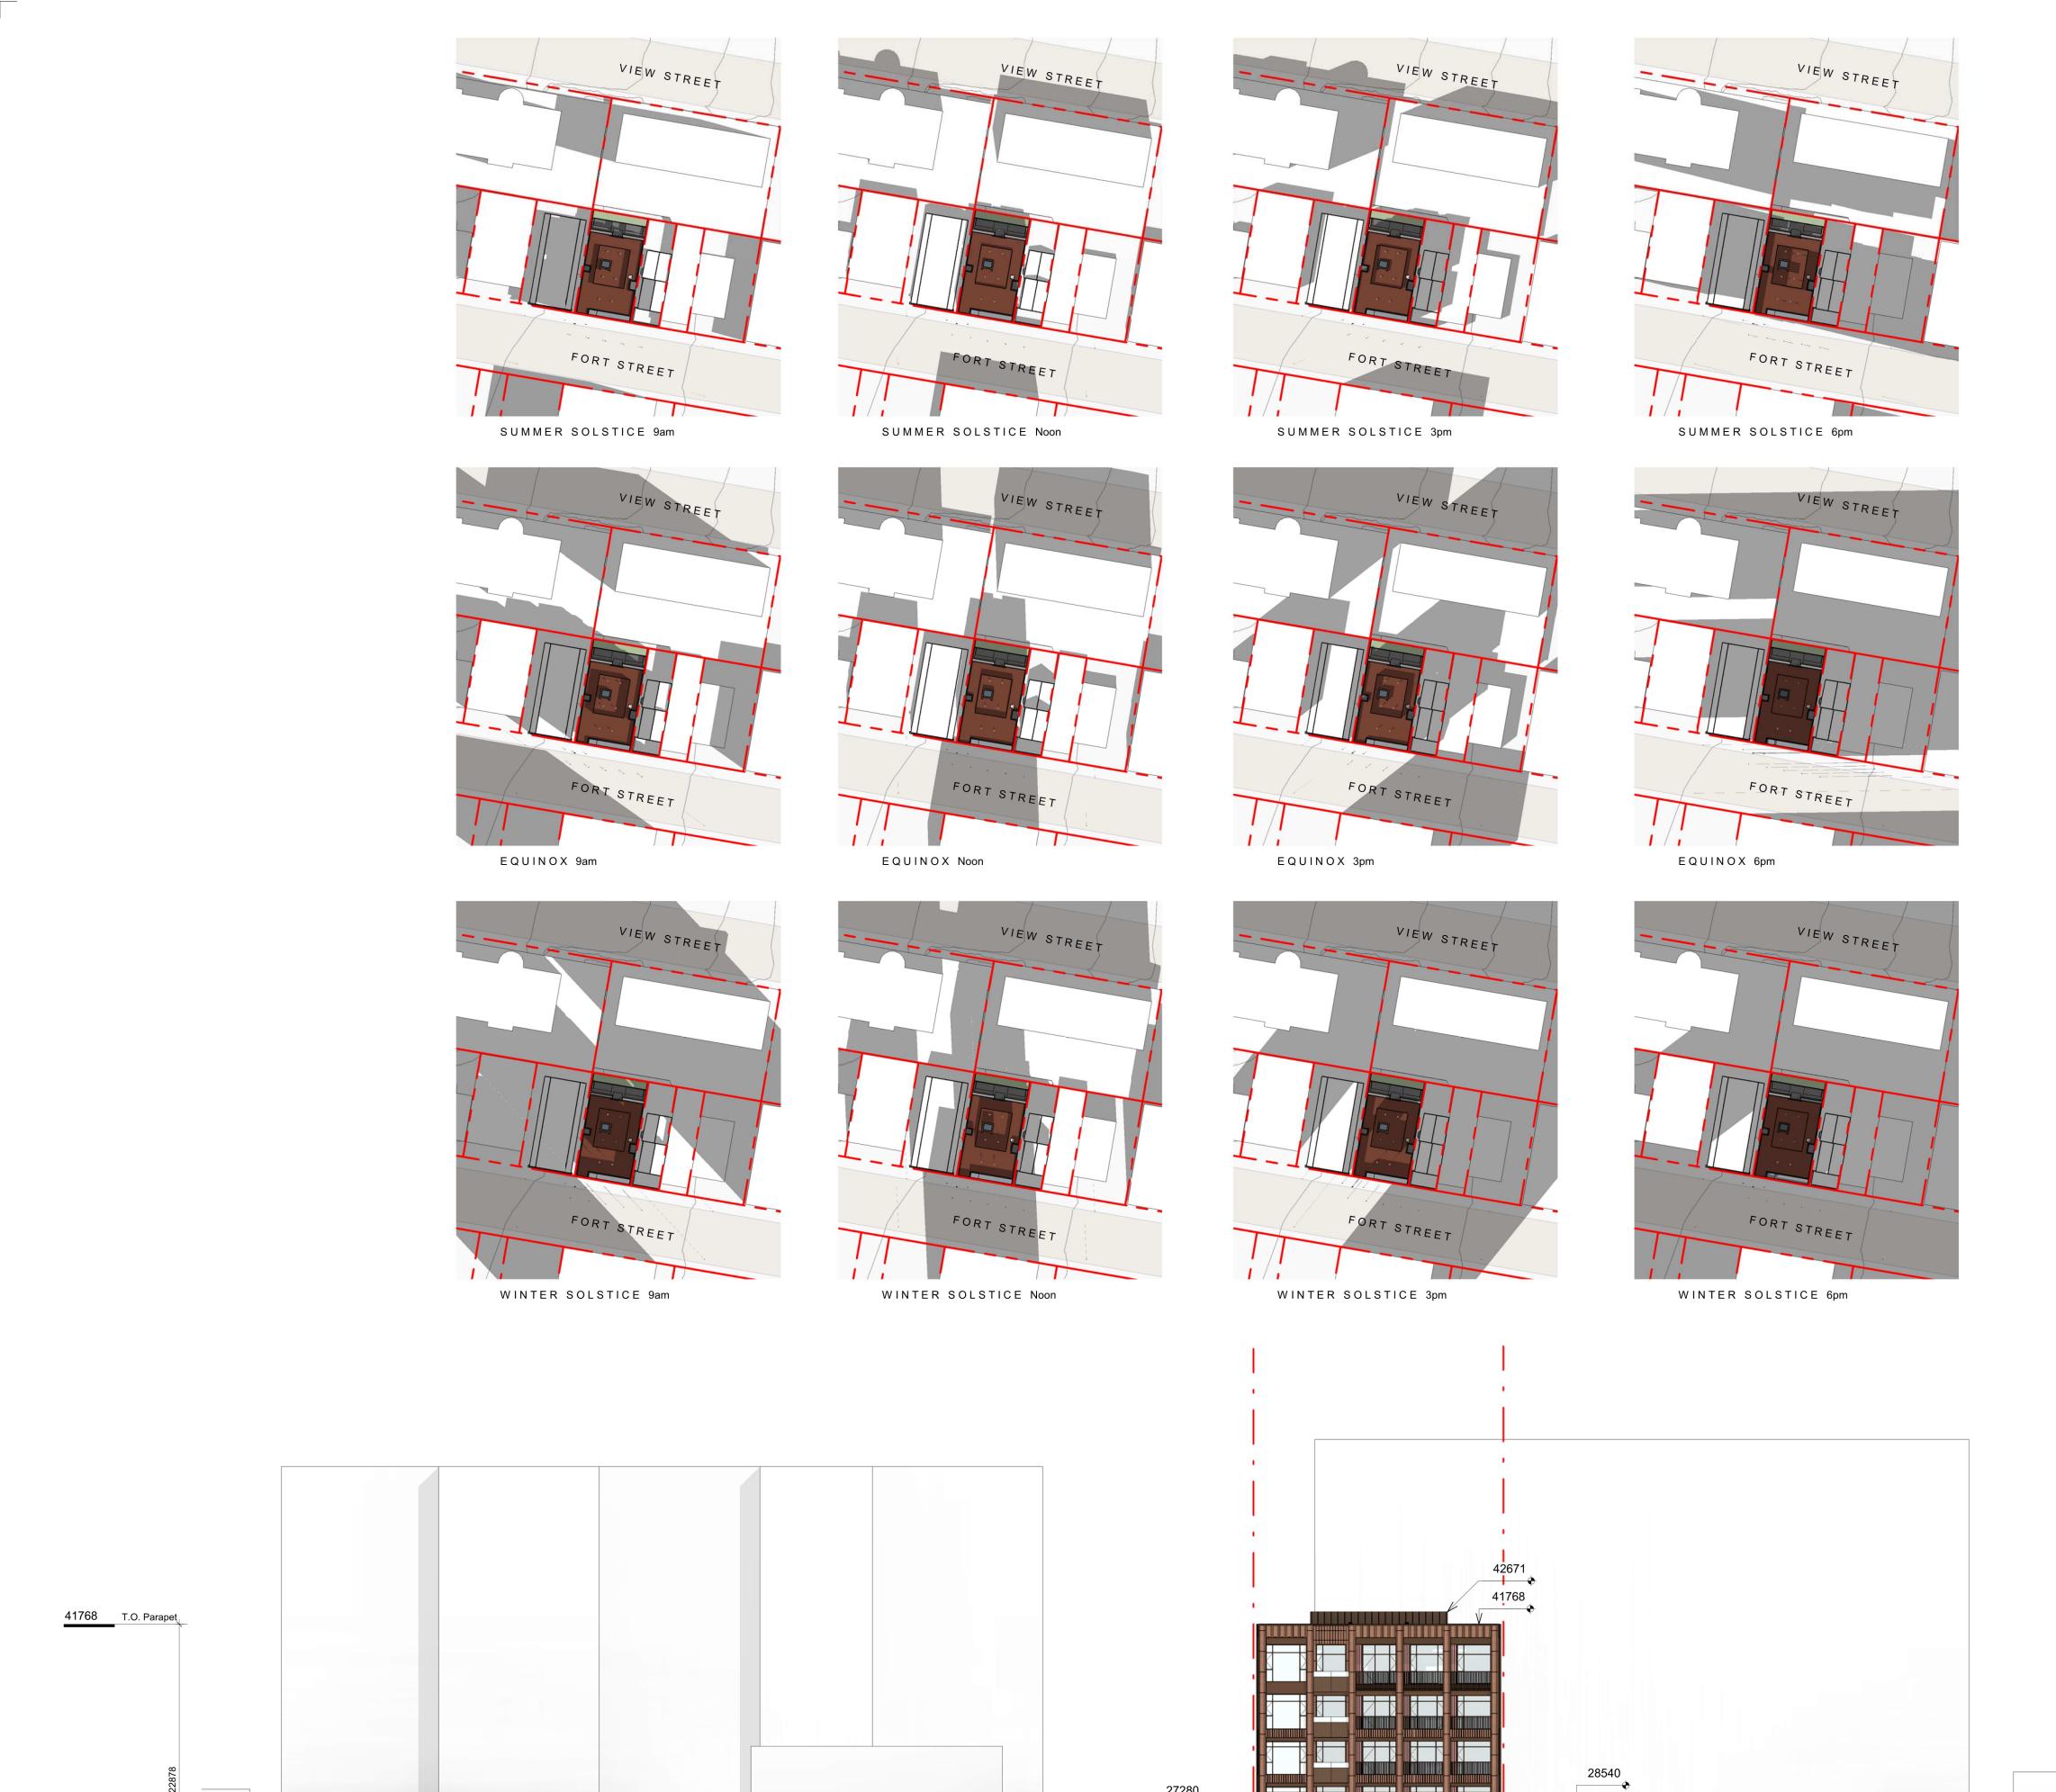Level 6 37230


Level 3 27192



PLANT LIST **Botanical Name** Schd. Size / Plant Spacing **Common Name** TREES: Cnp 5 Chamaecyparis nootkatensis 'Pendula' Nootka False Cypress 2.5 m ht Gleditsia triacanthos inermis 'Skyline' Skyline Honeylocust 5.0 cm cal, b+b Hamamelis ° intermedia 'Diane' Hybrid Witch Hazel #15 pot SHRUBS/FERNS/GRASSES/VINES: #1 pot Azalea PJM 5 Azalea japonica 'Pjm' #1 pot / 500 cm O.C. 22 Cotoneaster dammeri Bearberry 6 Oxalis oregana Redwood Sorrel Sp3, 30cm o.c. 6 Pachysandra terminalis Japanese Spurge

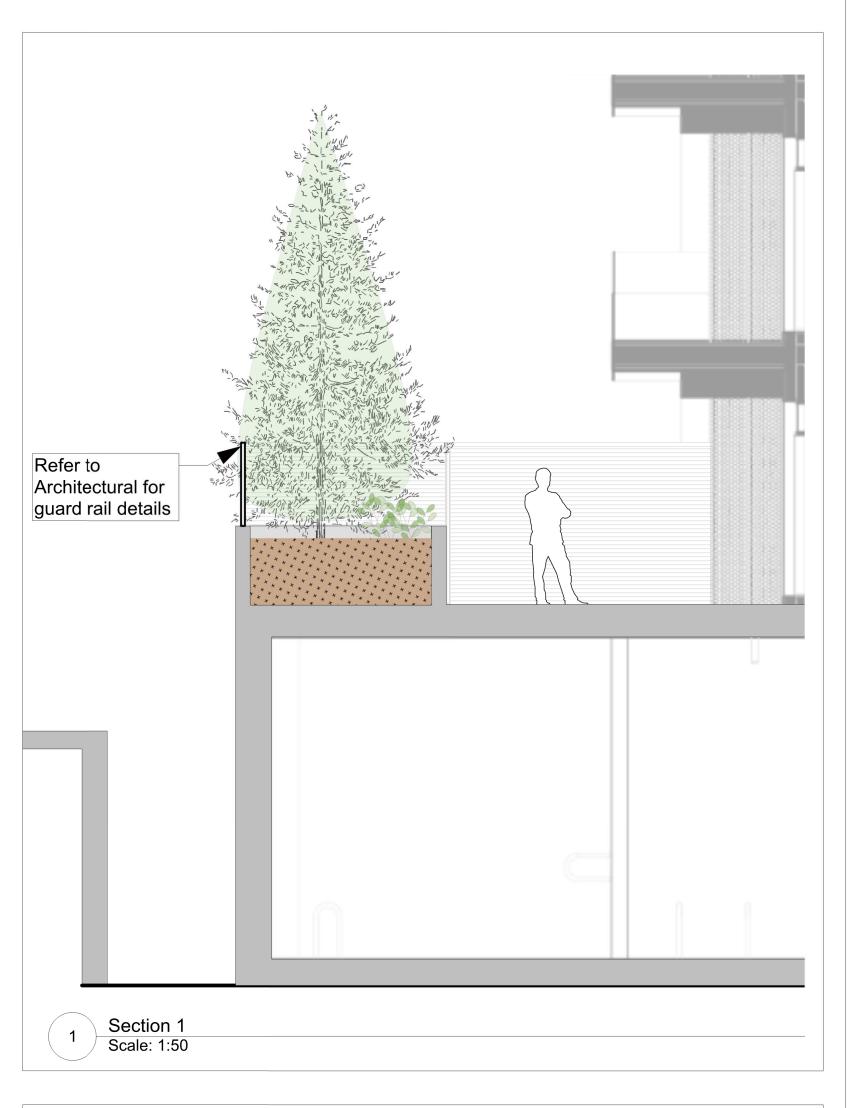

PLANKING PAVER EXAMPLES

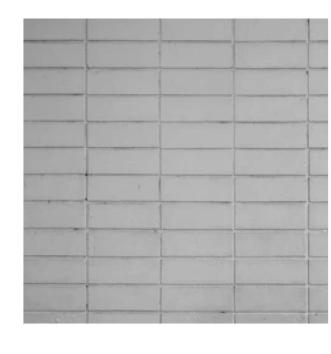

CONIFER PRIVACY



PLANTING APPROACH



SHADE PERENNIALS




LINE TYPE LEGEND

Property line
Right of Way
SPEA
RAR Setback
Extent of Existing Treeline
Extent of Roof, above
Extent of Parkade, below
Rain garden - TOP OF POOL
Rain garden - BOTTOM OF POOL
Proposed Contour Line, 0.5m interval
Existing Contour Line, 0.5m interval

EXISTING PLANT LEGEND

(Refer to Arborist Report and Tree Retention & Removal Plan for full details and management strategies).

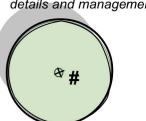

Existing Tree to be retained

MATERIALS LEGEND



Concrete Unit Paving.
Belgarde-Moduline Series Plank
Pavers, Colour: Grey.
Pattern: Stacked Bond

Planting Area 600mm Depth

----- Privacy Screening

Soil Medium

—O—O— Guard Rail

Concrete Retaining Wall - On Grade


New Town- City of Victoria Standard Trowel Joint Concrete; Cast in Place, Side Walk Fill & Frame Natural Colour, Fine Broom Finish,

1200mm Scoreline pattern
perpendicular to curb
(Pattern to be adjusted to fit with tree
grate layout)
450mm concrete band along curb and
back side of sidewalk (Property line)
Control joints every 3rd planel of
450mm bands

Tree Grate

Fire Hydrant

Proposed Trees

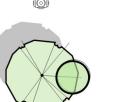

SITE FURNISHINGS LEGEND



Planters @ Guard Rail Height

Bike Racks

Victoria, B.C. sheet title Landscape Materials

1030 Fort Street

1030 Fort Street,

project

Jawl Properties Ltd,

1515 Douglas St Suite 200, Victoria, BC

DP

description


Murdoch

2021-08-03

rev no

03/Aug/2021

project no.		121.29
scale	1: 100	@ 24"x36"
drawn by		EB
checked by		SM/PdG
revison no.	sheet no.	
1		1.01

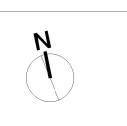

ENGINEERING NOTES:

- 1. ALL CONSTRUCTION AND MATERIALS TO BE IN ACCORDANCE WITH THE LATEST VERSION OF THE CITY OF VICTORIA SPECIFICATIONS, MASTER MUNICIPAL CONSTRUCTION DOCUMENT (MMCD) PLATINUM EDITION, AND THESE DRAWINGS.
- 2. ALL CONSTRUCTION SURVEY LAYOUT TO BE PROVIDED BY THE CONTRACTOR.
- 3. PERMIT TO CONSTRUCT WORKS ON CITY RIGHT-OF-WAY MUST BE OBTAINED FROM THE CITY ENGINEERING DEPARTMENT BEFORE WORKS COMMENCE. NOTIFY CITY OF VICTORIA 48 HOURS PRIOR TO CONSTRUCTION.
- 4. ALL SERVICE LOCATIONS AND CROSSINGS ARE NOT GUARANTEED AS TO THEIR ACCURACY. LOCATIONS OF ALL EXISTING SERVICES, FEATURES AND APPURTENANCES SHOWN ON THE DRAWINGS ARE TO BE CONSIDERED APPROXIMATE ONLY. VERIFY ALL LOCATIONS IN THE FIELD PRIOR TO CONSTRUCTION.
- 5. CONTACT BC-1 (1-800-474-6886), BC HYDRO, TELUS, SHAW CABLE, AND FORTIS BC FOR
- UNDERGROUND UTILITY LOCATIONS 72 HOURS PRIOR TO CONSTRUCTION.


 6. CONTRACTOR TO VIDEO INSPECT EXISTING 200mm STORM DRAIN BETWEEN EAST AND WEST PROPERTY LINES ALONG PROJECT FRONTAGE PRE AND POST CONSTRUCTION TO
- CONFIRM PIPE CONDITION.


 7. EXISTING SERVICES MUST BE EXPOSED AT CROSSING POINTS PRIOR TO CONSTRUCTION.
- 8. ANY CONFLICT BETWEEN EXISTING INFRASTRUCTURE AND THE DESIGN TO BE RELAYED TO ENGINEER AND CITY TECHNICIAN IMMEDIATELY.
- ADJUST ALL PROPOSED AND EXISTING APPURTENANCES TO MEET FINAL DESIGN GRADES.
 CITY CREWS TO INSTALL ALL SEWER AND DRAIN CONNECTIONS AND SERVICES UP TO THE PROPERTY LINE, AT THE DEVELOPER'S EXPENSE.
- 11. WATER SERVICE CONNECTIONS ARE TO BE INSTALLED TO NEW METER AT THE PROPERTY LINE BY THE CITY OF VICTORIA MUNICIPAL CREW, AT THE DEVELOPER'S EXPENSE. THE CONTRACTOR SHALL NOT OPERATE ANY WATERMAIN OR SERVICE VALVES.
- 12. CONTRACTOR IS RESPONSIBLE FOR COORDINATION WITH ALL PARTIES REQUIRED FOR SERVICING TO PROPERTY LINE, INCLUDING ABANDONMENT OF EXISTING SERVICES. CAP ABANDONED HYDRO/TEL/SHAW CONDUIT 300mm OUTSIDE PROPERTY LINE.
- 13. UNDERGROUND WIRING TO BE CONSTRUCTED IN ACCORDANCE WITH BC ELECTRICAL
- CODE, BC HYDRO/TEL DRAWINGS AND SPECIFICATIONS.


 14. OVERHEAD WIRING IS NOT SHOWN ON CONTRACT DRAWINGS.
- 15. STREETS SHALL BE SWEPT CLEAN ON A REGULAR BASIS TO REMOVE ANY CONSTRUCTION
- 16. ALL CONSTRUCTION TO BE IN ACCORDANCE WITH CITY OF VICTORIA STORMWATER BYLAW.
- 17. DISPOSE OF ALL UNSUITABLE EXCAVATED MATERIAL AS PER SPECIFICATIONS, IN ACCORDANCE WITH ALL APPLICABLE REGULATIONS.
- 18. ALL TRAFFIC CONTROL TO CONFORM TO THE MOST CURRENT WORKSAFE BC, MMCD AND MINISTRY OF TRANSPORTATION SPECIFICATIONS (TRAFFIC CONTROL MANUAL FOR WORK ON ROADWAYS).
- 19. PROVIDE TRAFFIC CONTROL, SIGNAGE, BARRICADES, ILLUMINATION, AND DETOUR ROUTING AS REQUIRED TO MAINTAIN TRAFFIC FLOW AND EMERGENCY VEHICLE ACCESS. OUTBOUND ARTERIAL ROAD TRAVEL LANES TO BE OPEN AFTER 3:00 PM.

 THE CONTRACTOR WILL BE HELD DESPONSIBLE FOR THE BERNIN OF ANY DAMAGE.
- 20. THE CONTRACTOR WILL BE HELD RESPONSIBLE FOR THE REPAIR OF ANY DAMAGE CAUSED TO EXISTING STREETS OR SERVICES BY CONSTRUCTION EQUIPMENT AND/OR TRUCKS HAULING MATERIALS TO THE SITE. THIS WILL INCLUDE DAILY CLEANING OR SWEEPING ALL EXISTING ROADS OF DIRT AND DEBRIS CAUSED BY CONSTRUCTION ACTIVITY.
- 21. ALL ASPHALT AND CONCRETE CUTS TO BE SQUARE CUT WITH SAW.
- 22. COORDINATE CONSTRUCTION OF ALL WORKS WITHIN ROADWAYS WITH CITY OF VICTORIA WORKS CREWS.
- 23. REFER TO ELECTRICAL AND MECHANICAL DRAWINGS FOR BC HYDRO, TELUS, SHAW CABLE AND FORTIS BC UTILITY CONSTRUCTION DETAILS.
- 24. FIELD SURVEY COMPLETED BY GEOVERRA 2020/2021.
- 25. CONTRACTOR IS TO PROVIDE AS-CONSTRUCTED DRAWING MARKUPS TO ENGINEER UPON CONSTRUCTION COMPLETION.


YYYY-MM-DD

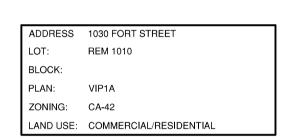

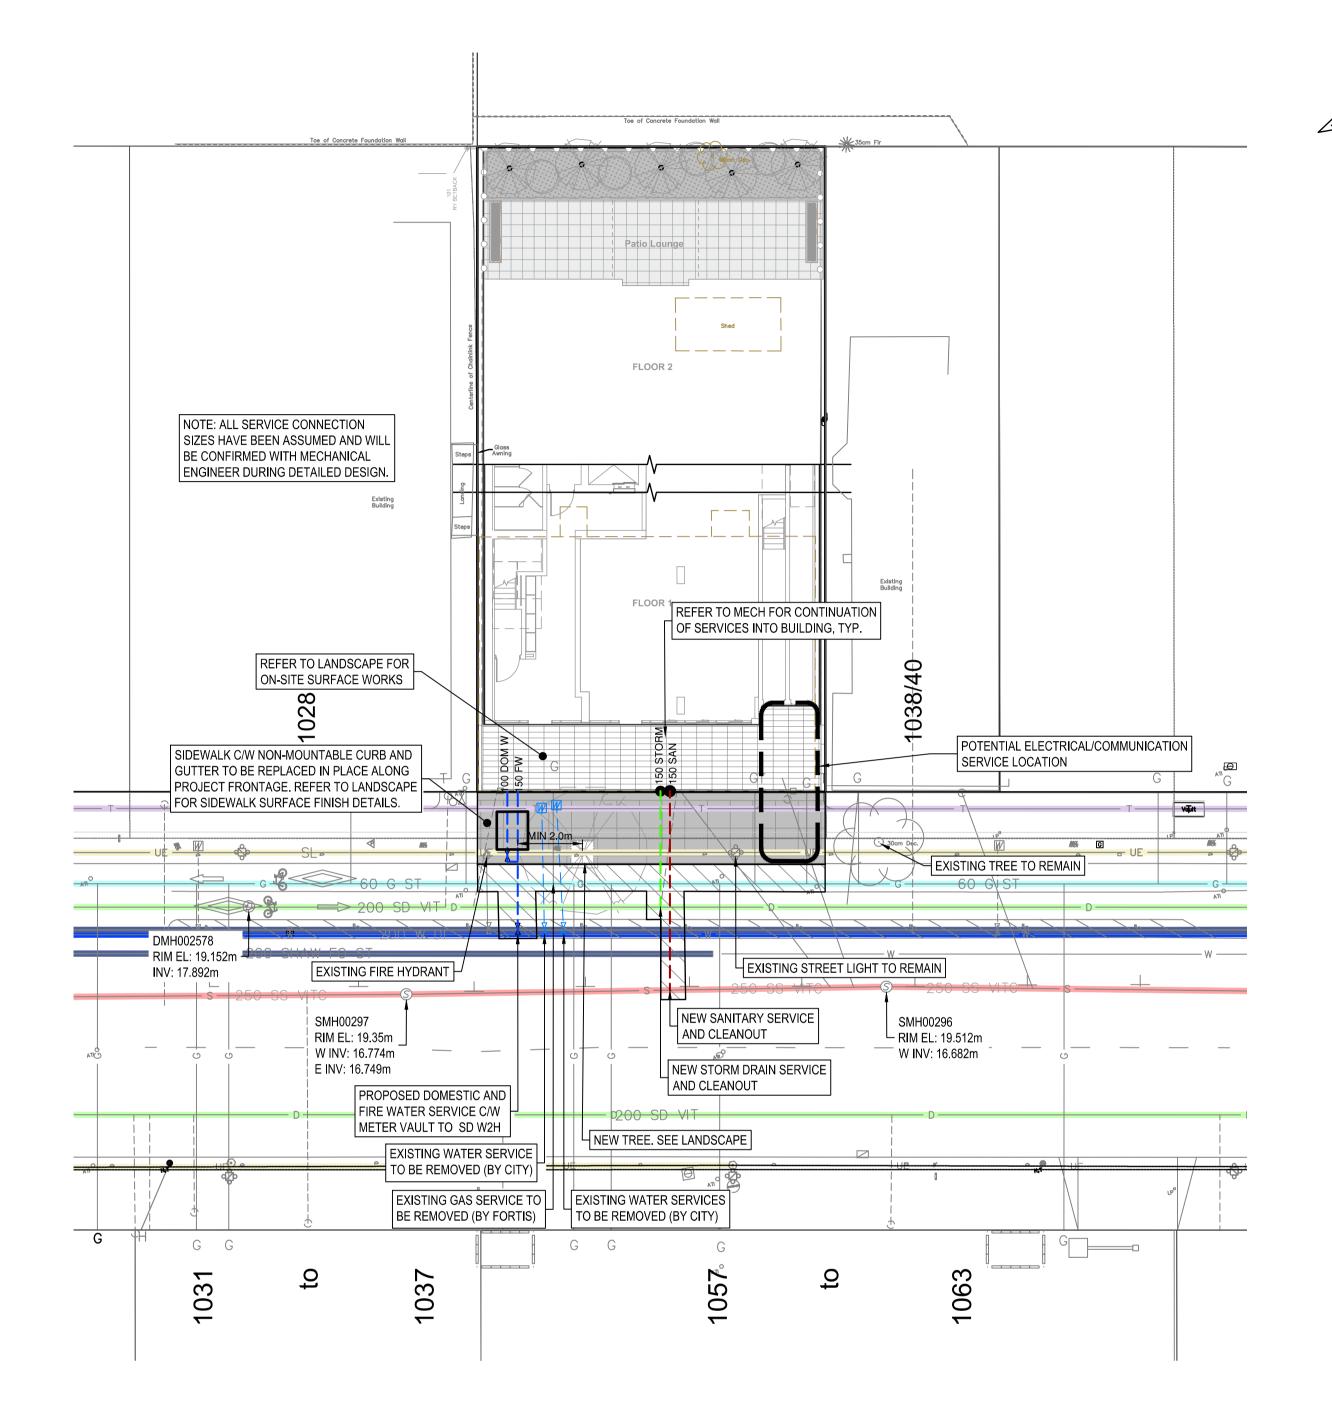

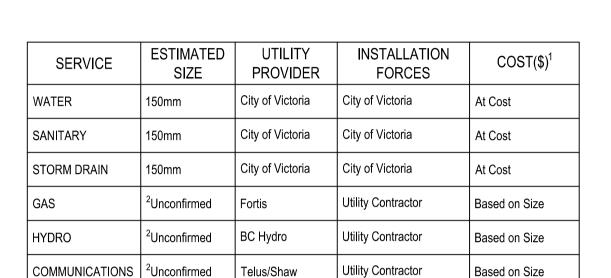

¹ City of Victoria Schedule of fees for Service Connections Provided in Appendix A
² Design loads and service size to be confirmed by mechanical and Electrical consultants during detailed design stage.

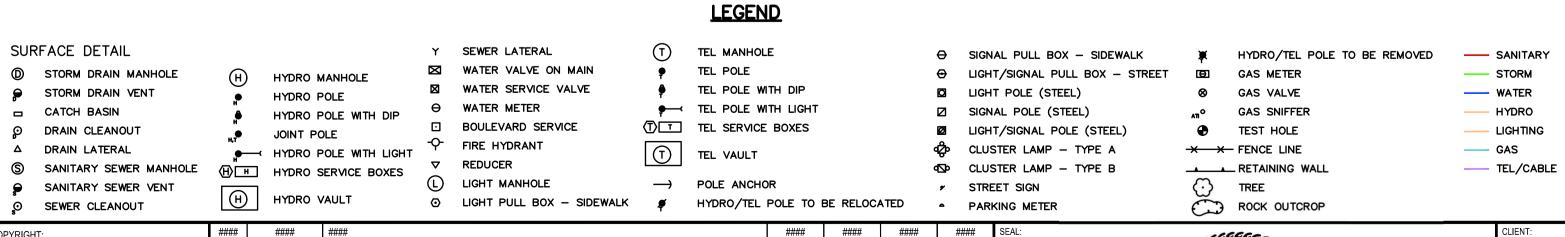

DES

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THIS DRAWING AND DESIGN IS COPYRIGHT #### | #### #### #### PROTECTED WHICH SHALL NOT BE USED, REPRODUCED OR REVISED WITHOUT #### | #### #### #### #### #### WRITTEN PERMISSION BY WSP CANADA INC. #### #### #### #### #### #### #### #### THE CONTRACTOR SHALL CHECK AND VERIFY ALL DIMENSIONS AND UTILITY LOCATIONS AND REPORT ALL ERRORS AND OMISSIONS PRIOR TO COMMENCING WORK. 2021/09/15 ISSUED FOR DEVELOPMENT PERMIT/RE-ZONING CD JCS THIS DRAWING IS NOT TO BE SCALED.

DESCRIPTION

B. W. HARMS
49278

OF ESS / ON TO SERVICE SE

JAWL PROPERTIES LTD. 1515 Douglas St Suite 200, Victoria, BC

CLIENT REF. NO:



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	T+ 1 250-384-5510 F+ 1 250-386-2844 wsp.com

	1:200	
PROJECT: 1030 FORT STREET MIXED-USE DEVELOPMENT	CONCEPTUAL SITE SERVICING PLAN	
PROJECT NO: 211-06978-00	DRAWING NO: C01 SHEET NO: 1 OF 1	
SCALE: 1:200 DISCIPLINE: CIVIL	FOR DEVELOPMENT PERMIT/RE-ZONING 2021/08/	ISS/REV: