

OWNER

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ARCHITECT

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LANDSCAPE DESIGNER


Biophilia 1608 Camosun Street Victoria, BC V8T 3E6

Bianca Bodley bianca@biophiliacollective.ca 250.590.1156

CIVIL ENGINEER

McElhanney 500 - 3960 Quadra Street Victoria, BC V8X 4A3

Nathan Dunlop ndunlop@mcelhanney.com 778.746.7417

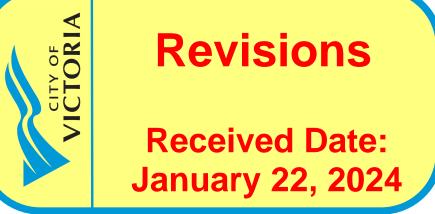



ARCHITECTURAL

A-000	COVER
A-009	PERSPECTIVES

PERSPECTIVE & WINDOW OVERLAY

CONTEXT ELEVATIONS & PERSPECTIVES

A-012 SHADOW STUDIES SITE PLAN & PROJECT DATA

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CODE REVIEW

SPATIAL SEPARATION A-101 LEVEL 1 PROPOSED PLAN

LEVEL 2 PROPOSED PLAN

LEVEL 3 PROPOSED PLAN

LEVEL 4 PROPOSED PLAN

EXTERIOR ELEVATIONS EXTERIOR ELEVATIONS

BUILDING SECTIONS

CIVIL

PRELIMINARY CIVIL PLAN

LANDSCAPE


LANDSCAPE SITE PLAN PAVEMENT SPECIFICATIONS UPPER LEVEL LANDSCAPE PLAN


TREE REMOVAL PLAN

TREE PLANTING PLAN SOIL VOLUME ANALYSIS

GROUND FLOOR PLANTING PLAN UPPER LEVELS PLANTING PLAN

DETAILS

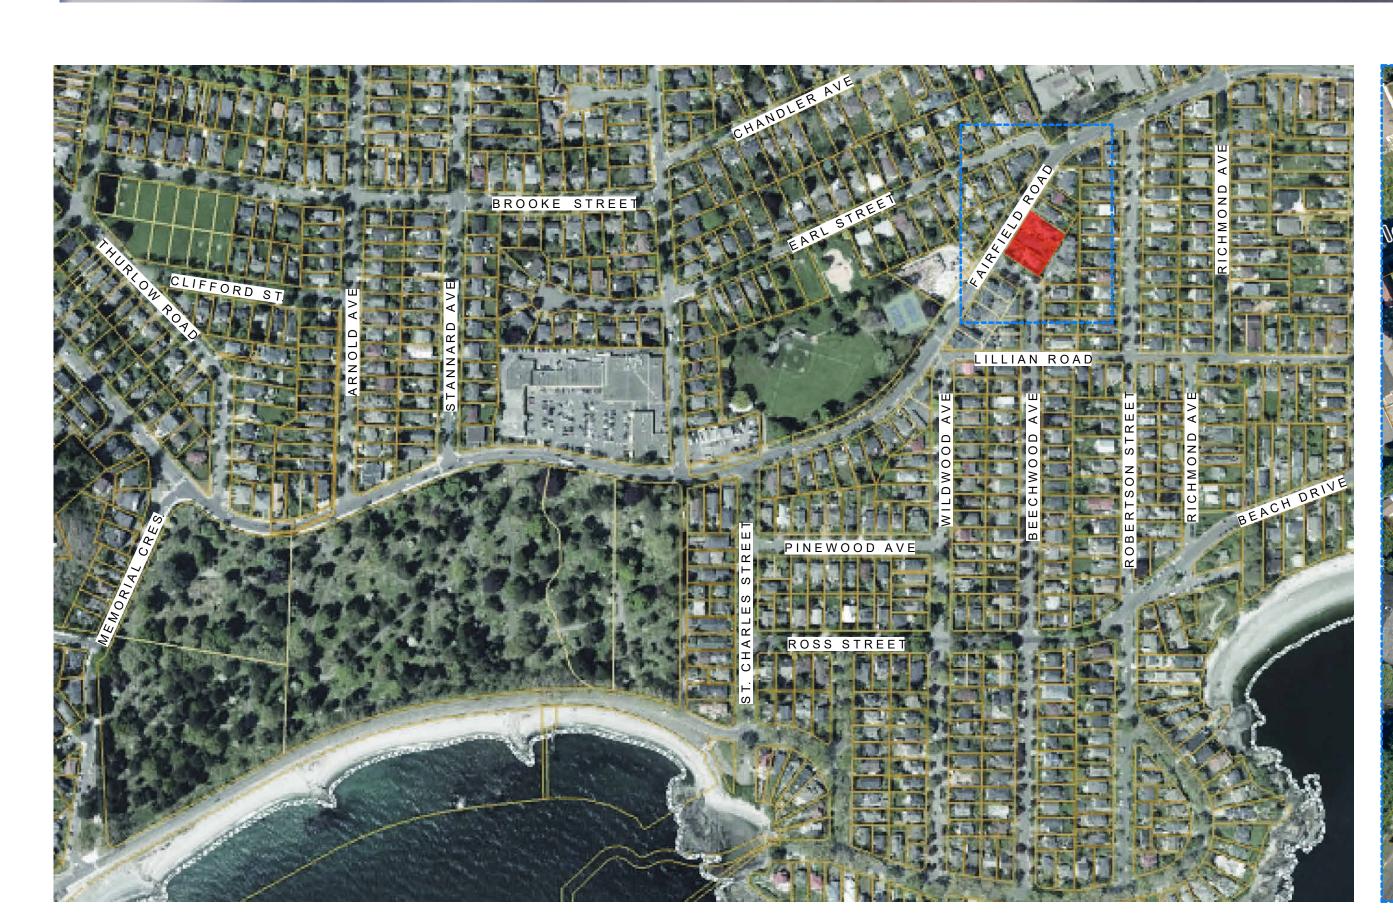

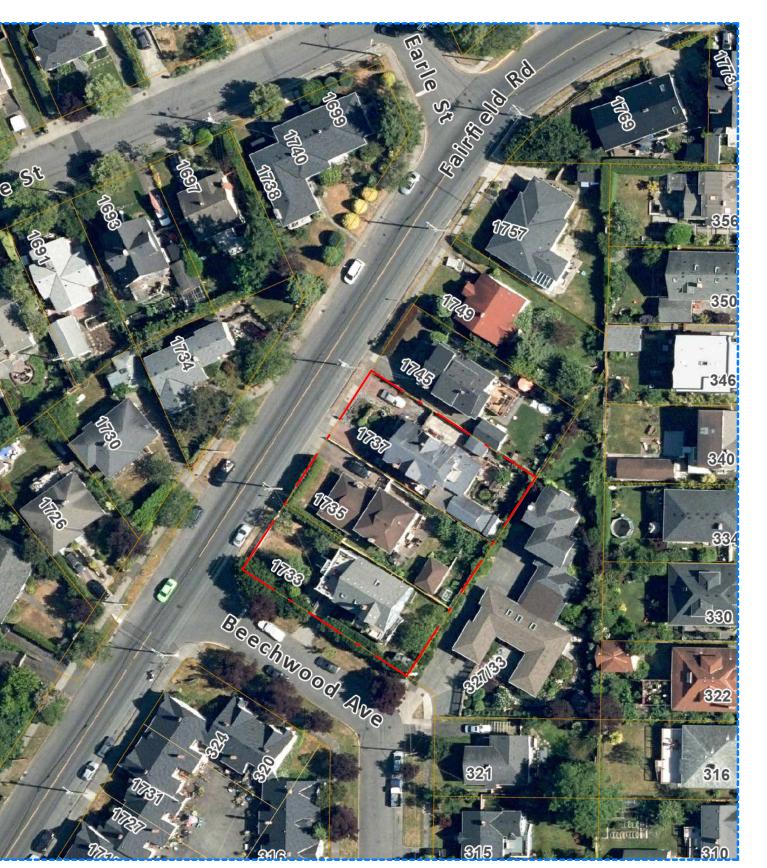

PROJECT SITE (NTS)

PROJECT LOCATION PLAN (NTS)





1 BEECHWOOD ELEVATION PERSPECTIVE
SCALE = 1:100





13	DP/RZ Rev4	Jan 18, 2024
4	DP/RZ Rev2	Jan 26, 2023
3	DP/RZ Rev1	July 20, 2022
2	DP/RZ Submission	April 29, 2022
1	Development Tracker Application	March 7, 2022
NO.	DESCRIPTION	DATE
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1733-1737 Fairfield Rd

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PERSPECTIVES

JANUARY 18, 2024

Project #
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Revision


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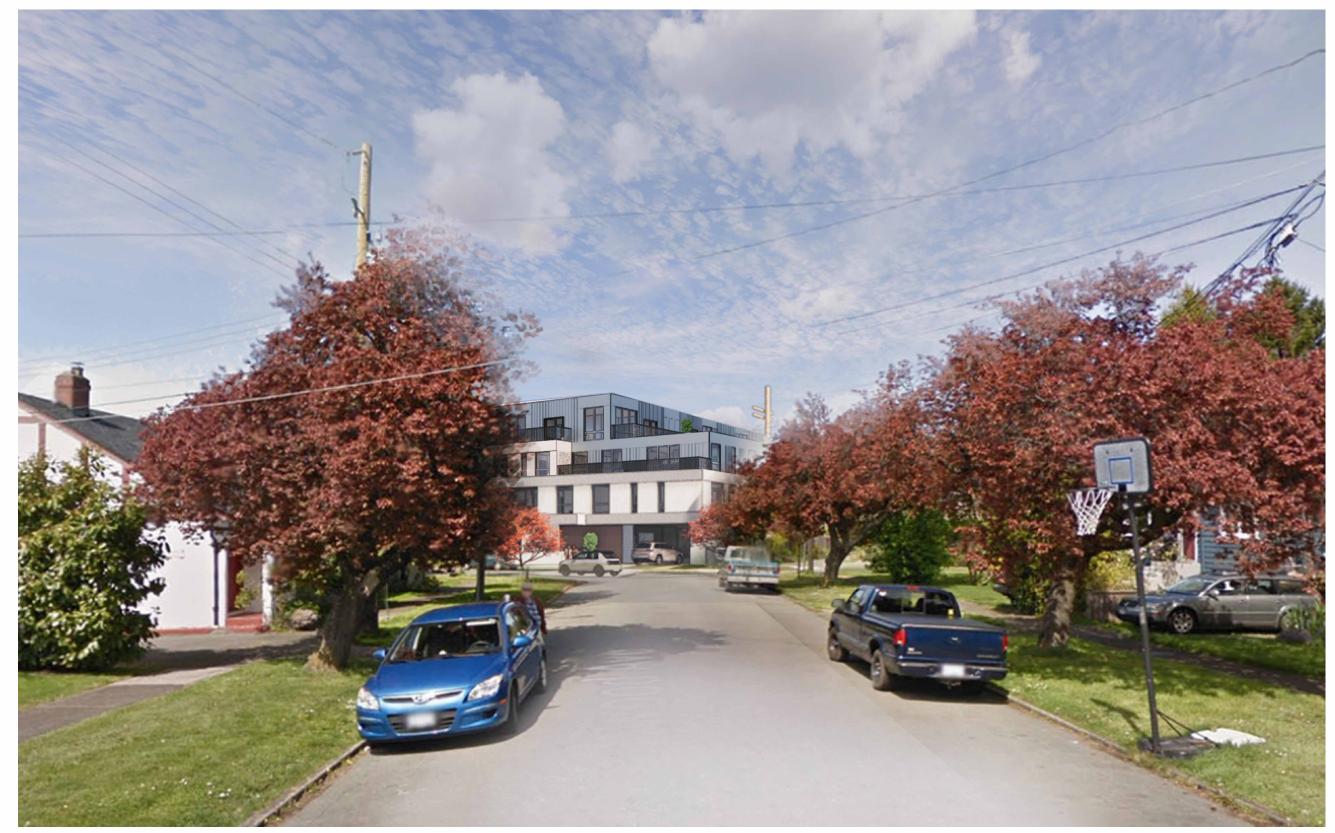







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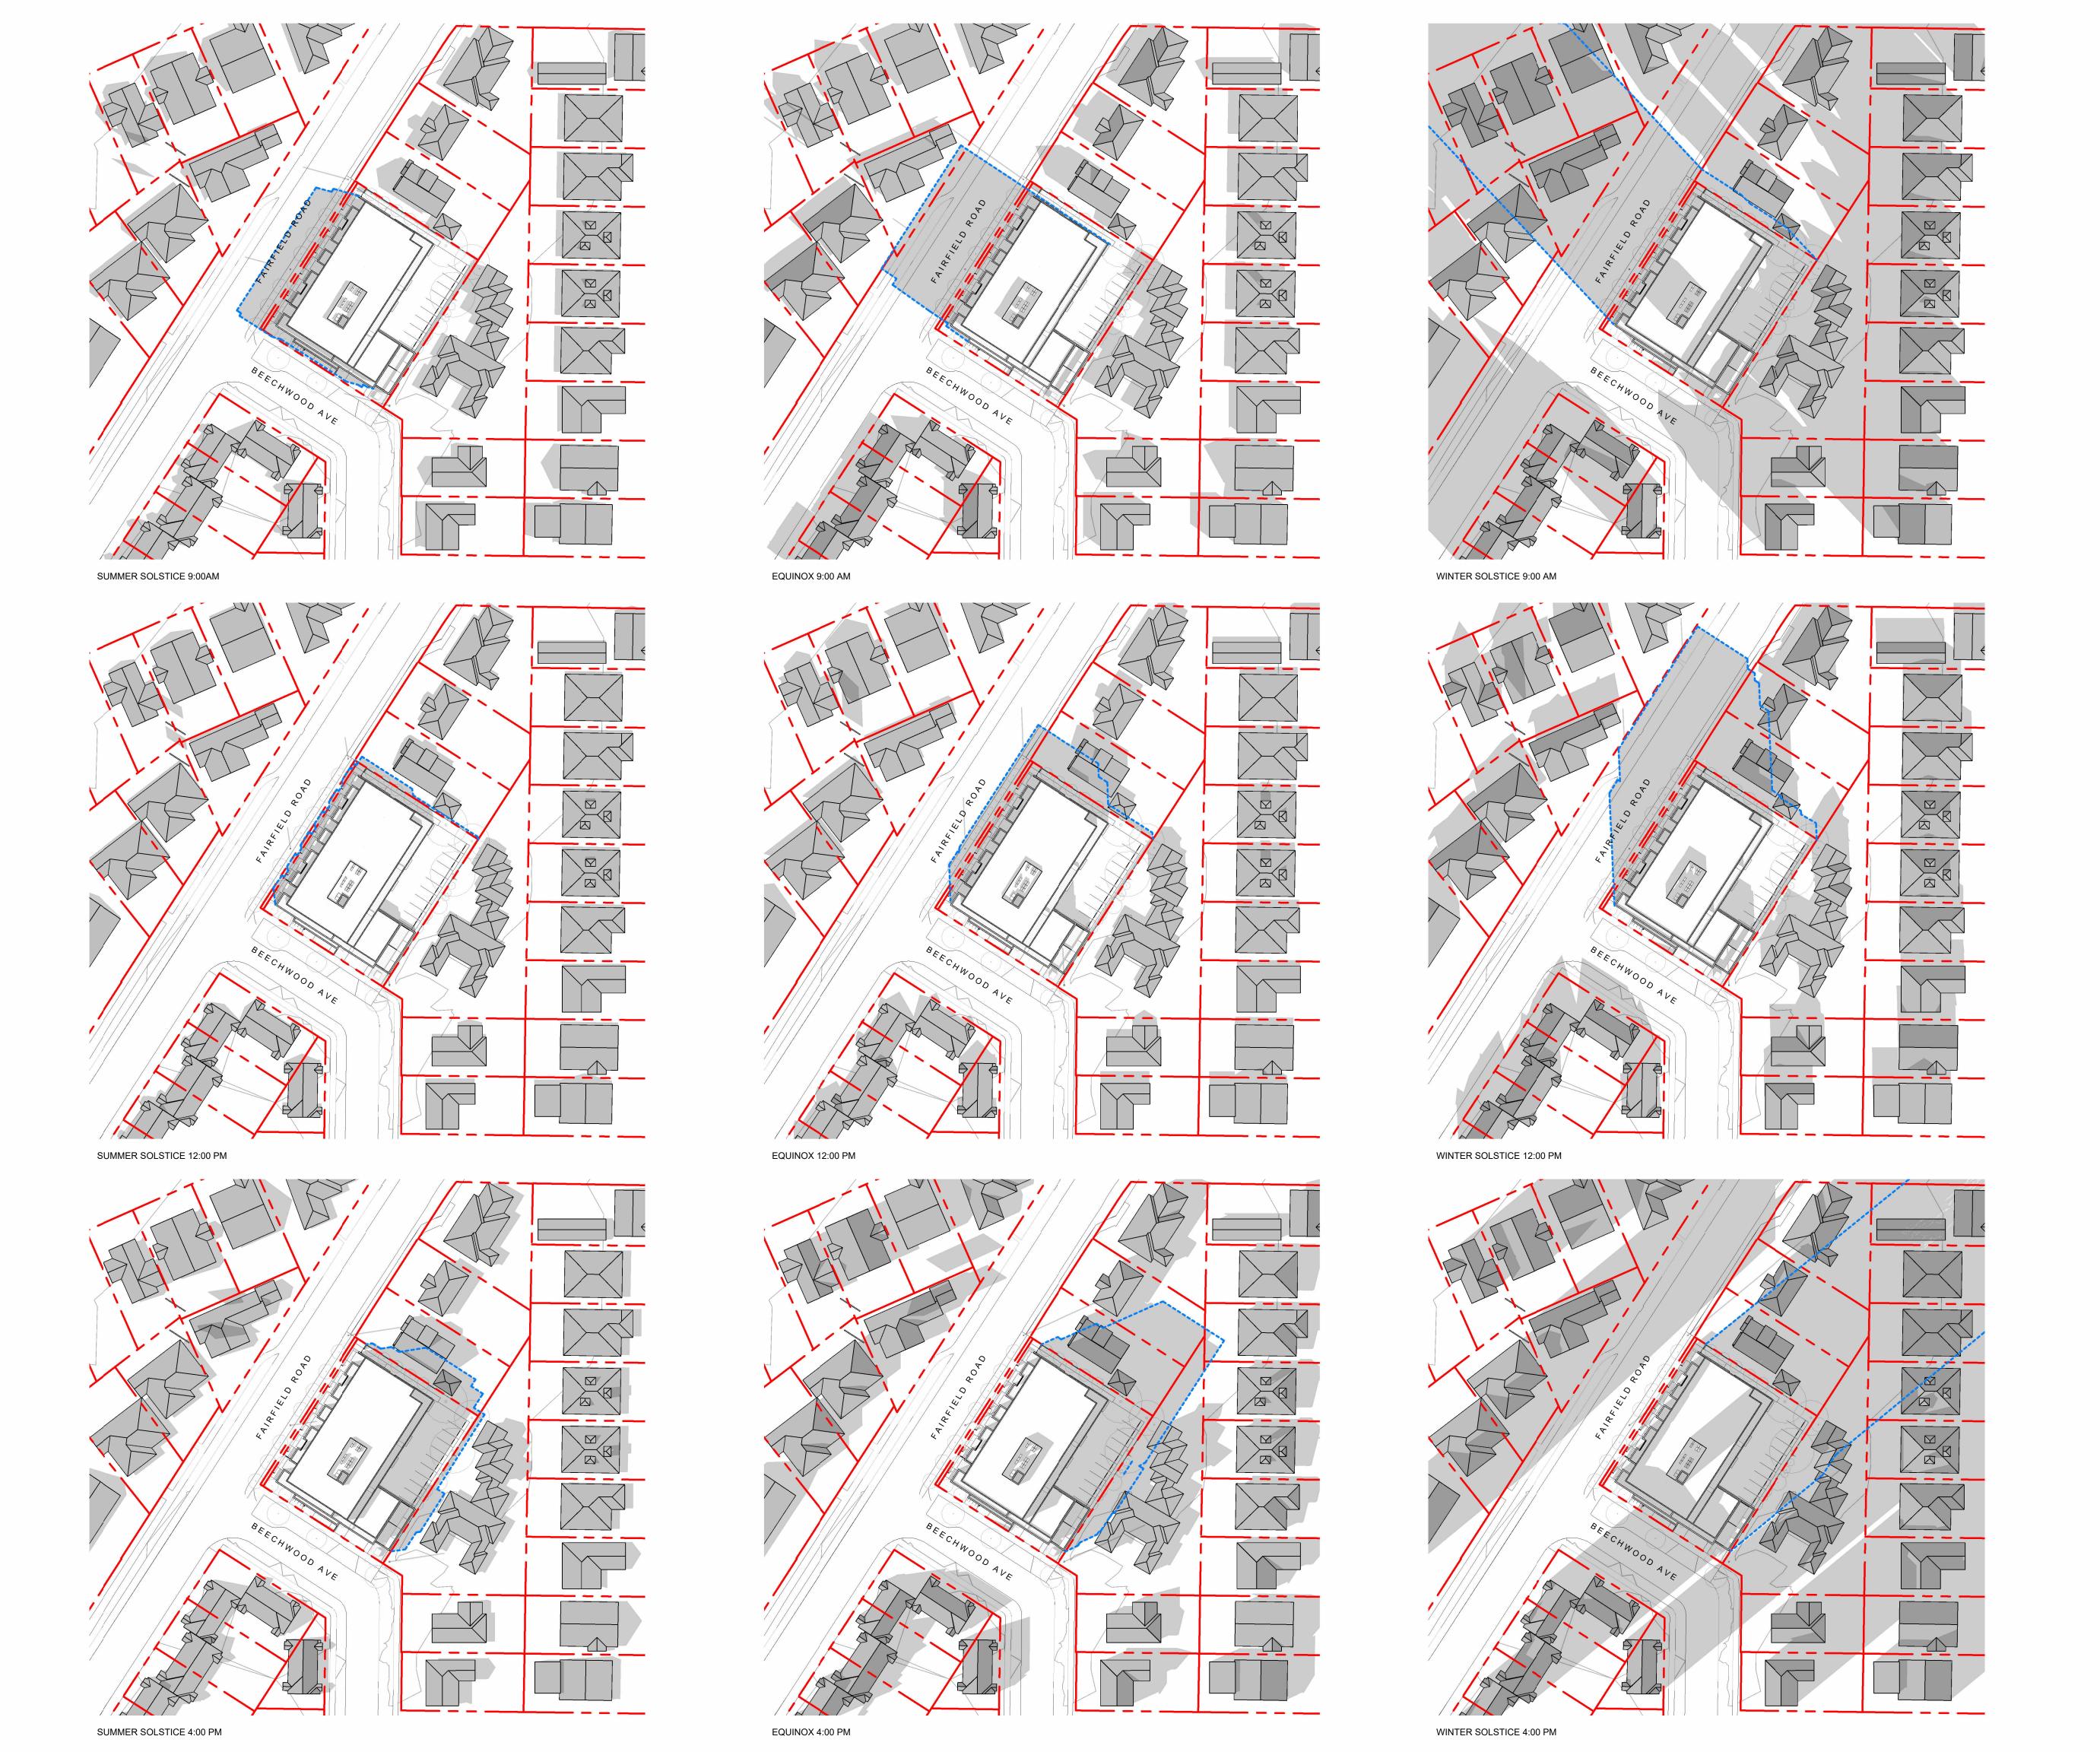


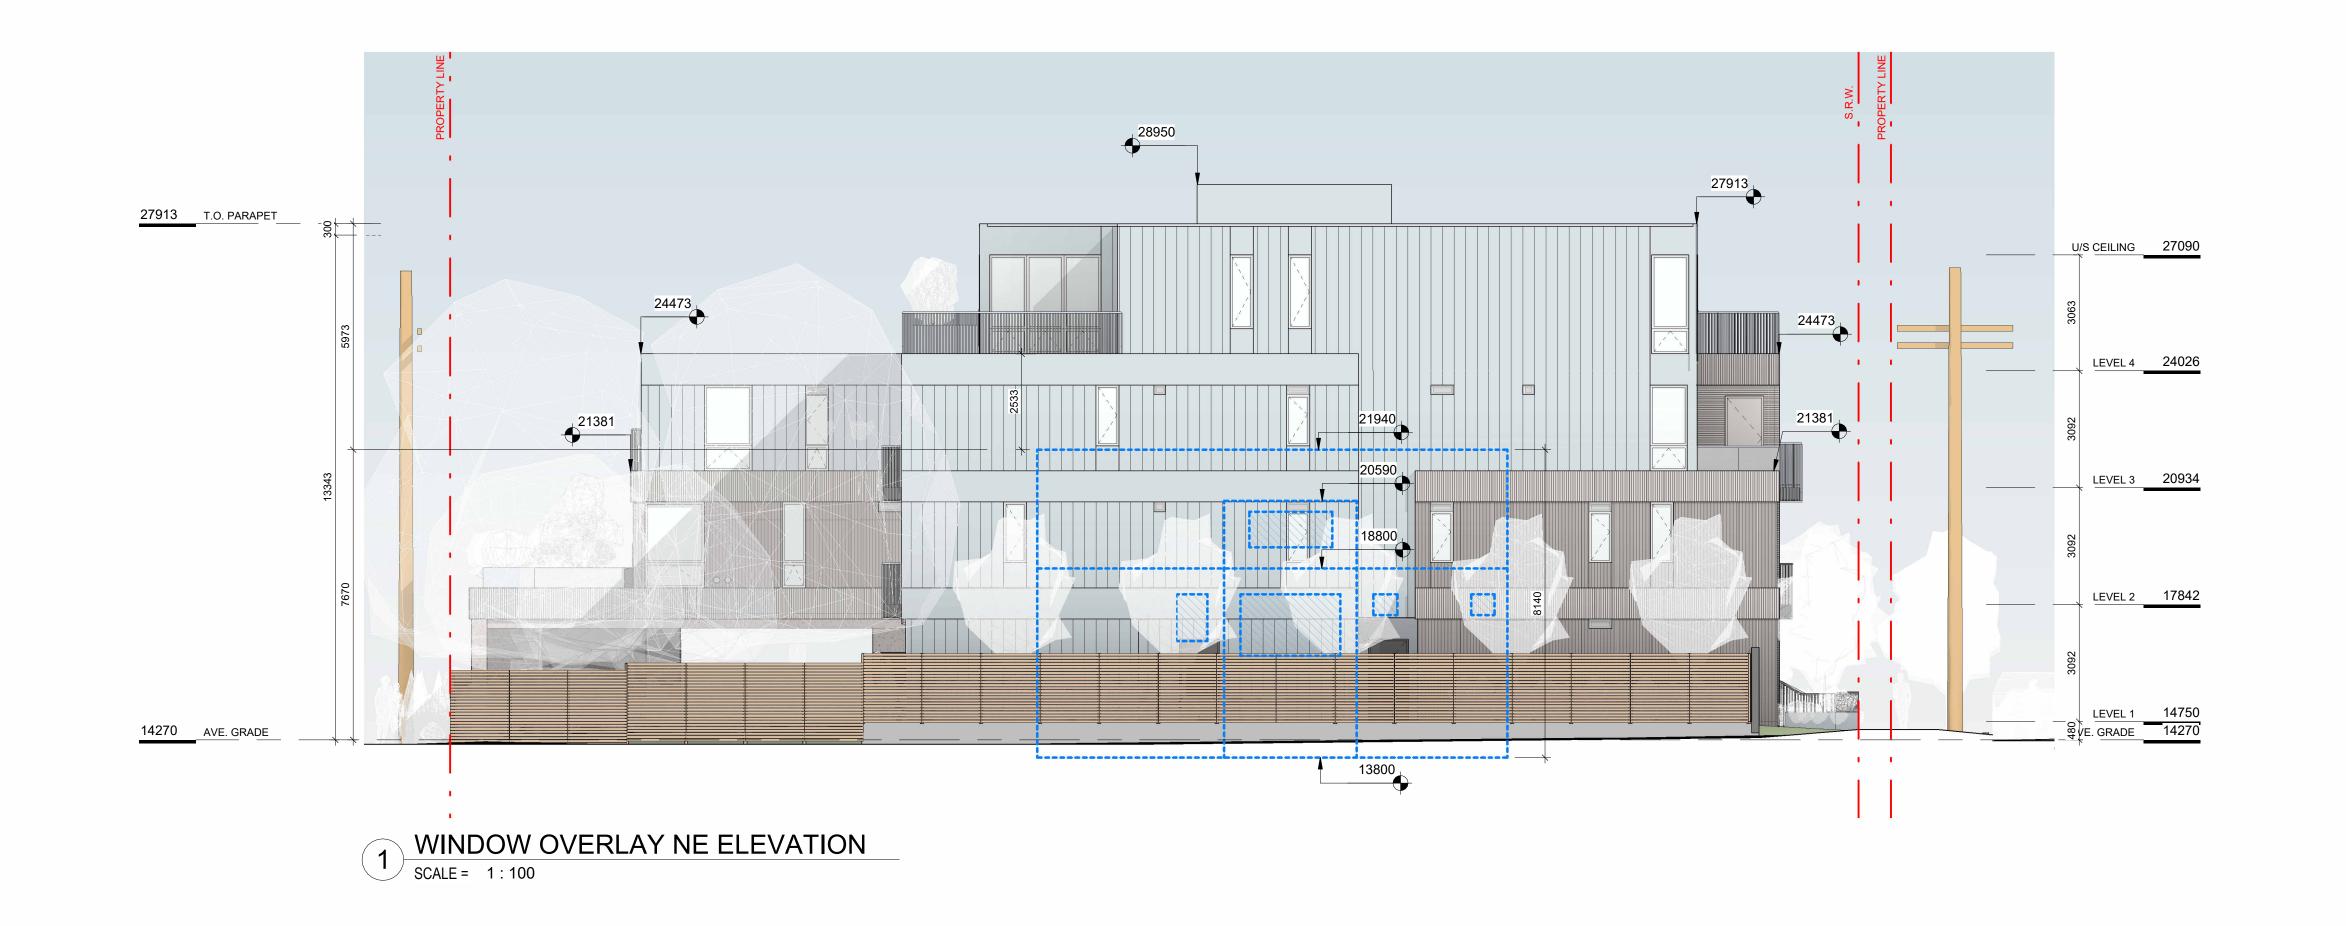



1 CONTEXT PERSPECTIVE FAIRFIELD ROAD
SCALE = 1:100

2 CONTEXT PERSPECTIVE BEECHWOOD AVE SCALE = 1:100



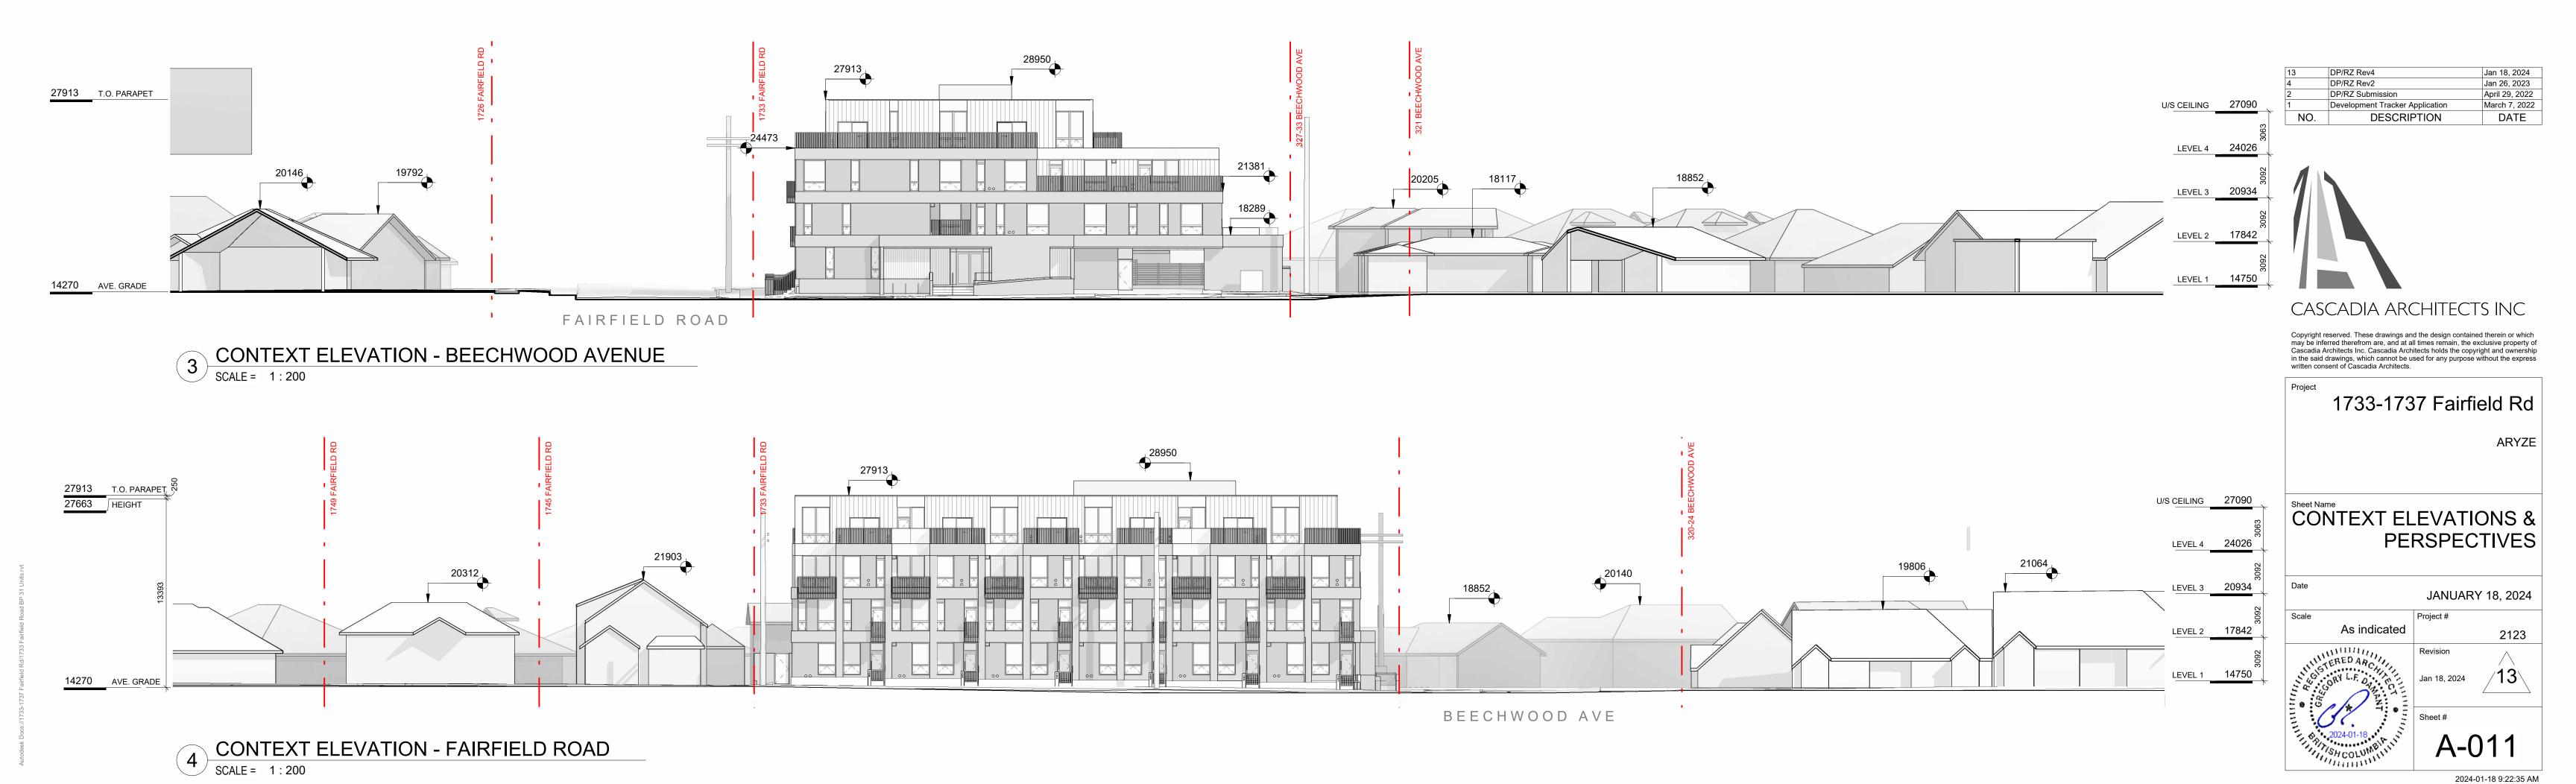

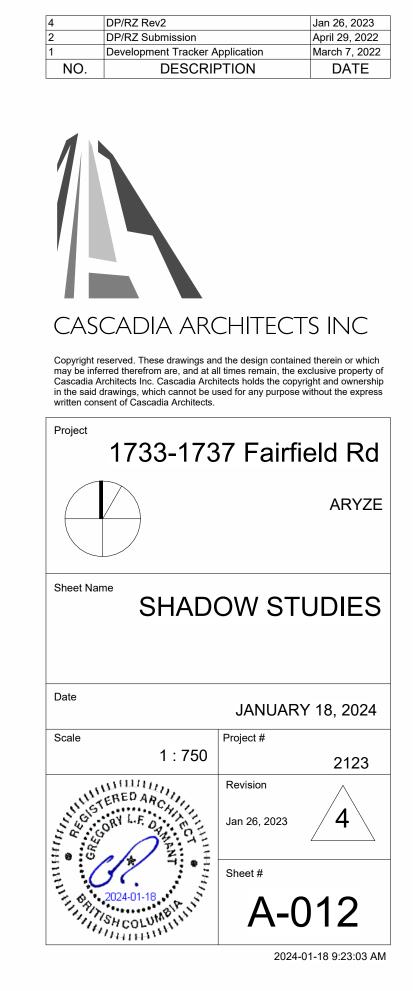

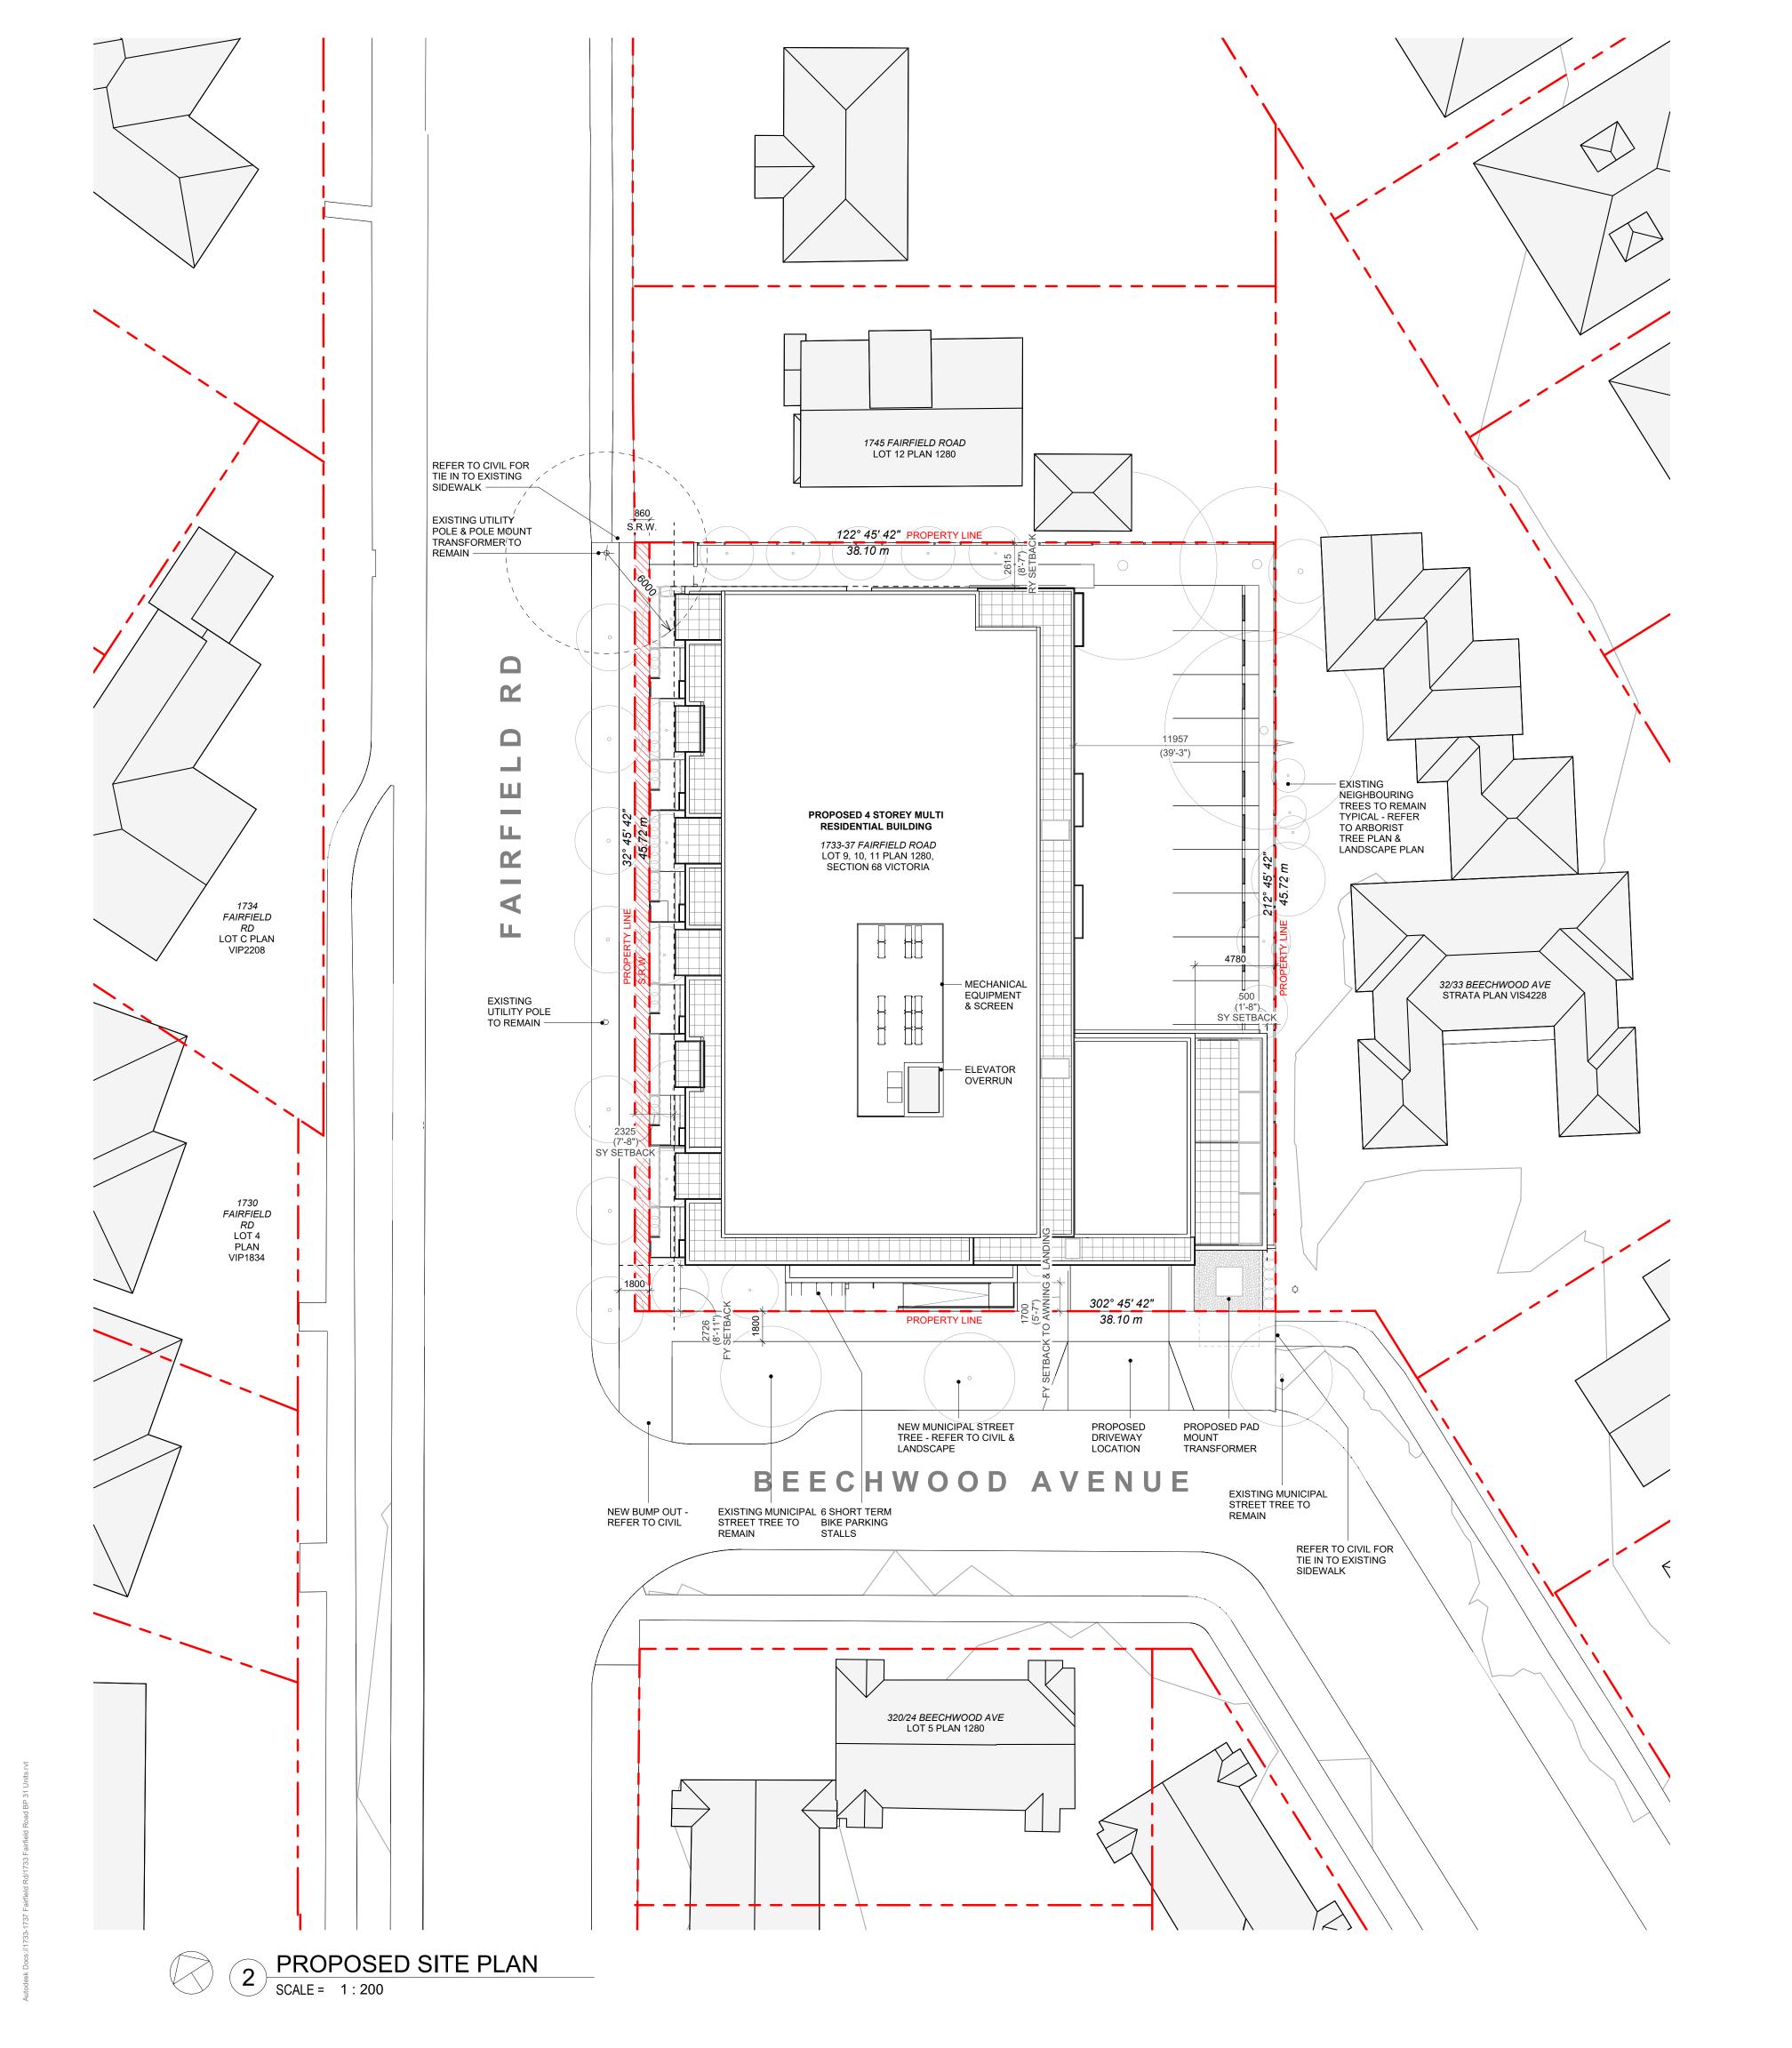

DATA

MUNICIPALITY	CITY OF VICTORIA
MUNICIPAL ADDRESS	1733-37 FAIRFIELD ROAD, VICTORIA BC
LEGAL DESCRIPTION	LOT 9, 10, 11, PLAN 1280, SECTION 68 VICTORIA
PROJECT DESCRIPTION	4 STOREY MULTI UNIT RESIDENTIAL BUILDING

PROJECT INFORMATION

ZONE (EXISTING)	R1-G	
PROPOSED ZONE	UNKNOWN	
SITE AREA (m²)	1,741.93m²	
TOTAL FLOOR AREA (m²)	3118.36m²	
COMMERCIAL FLOOR AREA (m²)	0	
FLOOR SPACE RATIO	1.79:1	
SITE COVERAGE (%)	65%	
OPEN SITE SPACE (%)	23%	
HEIGHT (m)	13.39m	
NUMBER OF STOREYS	4	
	REQUIRED	PROVIDED
PARKING STALLS (#) TOTAL ON SITE		23 (+1sml)
PARKING STALLS - VISITOR (#) ON SITE	3	2
BICYCLE PARKING (#) SHORT TERM	6	6
BICYCLE PARKING (#) LONG TERM	37	51

BUILDING SETBACKS (m)

	PROPOSED
FRONT YARD (BEECHWOOD AVE)	2.73m
FRONT YARD (TO AWNING/LANDING)	1.70m
INTERNAL SIDE YARD (TO BALCONY)	0.50m
INTERNAL SIDE YARD (TO BUILDING FACE)	4.78m
SIDE YARD (FAIRFIELD RD)	2.33m
REAR YARD	2.62m
COMBINED SIDE YARDS	2.83m

RESIDENTIAL USE DETAILS

TOTAL NUMBER OF UNITS	29
UNIT TYPE	TOWNHOMES (6), 1 BEDS (10), 2 BEDS (13),
GROUND-ORIENTATED UNITS	6
MINIMUM UNIT FLOOR AREA (m²)	51m²

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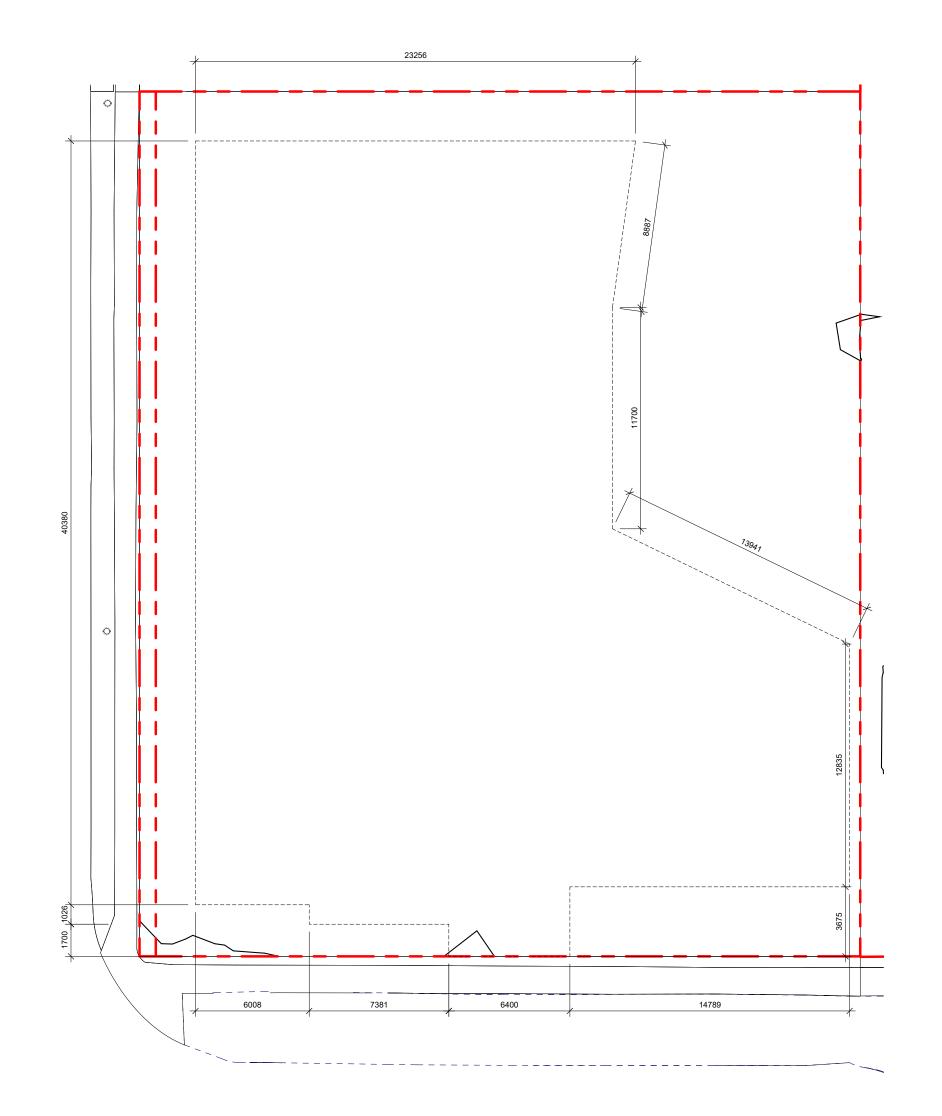
SITE PLAN & PROJECT DATA

Scale As indicated Project #

Jan 18, 2024

Sheet #

[#] **A-050**



1 DISTANCE BTWN POINTS KEY PLAN SCALE = 1:200


					T
POINT NAME	NATURAL	PROPOSED	DISTANCE B	etween points	AVE. OF POINTS
Α	14.209	14.42	Point A & B	6.008	85.20
В	14.332	14.15	Point B & C	1.026	14.50
С	14.208	14.12	Point C & D	7.381	103.92
D	14.04	14.11	Point D & E	1.7	23.83
E	13.997	14.10	Point E & F	6.4	89.96
F	14.75	14.11	Point F & G	3.63	51.72
G	14.38	14.44	Point G & H	13.35	191.33
Н	14.346	14.28	Point H & I	12.88	183.90
I	14.273	14.41	Point I & J	12.663	181.52
J	14.397	14.69	Point J & K	11.7	167.72
K	14.273	14.64	Point K & L	8.887	126.40
L	14.172	14.62	Point L & M	23.256	332.30
M	14.406	14.64	Point M & N	40.38	577.74

Total 2130.03 149.26 **Average Grade** 14.27

*NOTE: Lowest grade point governs per Schedule A definition

_ 5804.5<u>1 ft²</u> L1 AREA 2

6 L1 FLOOR AREA SCALE = 1:500

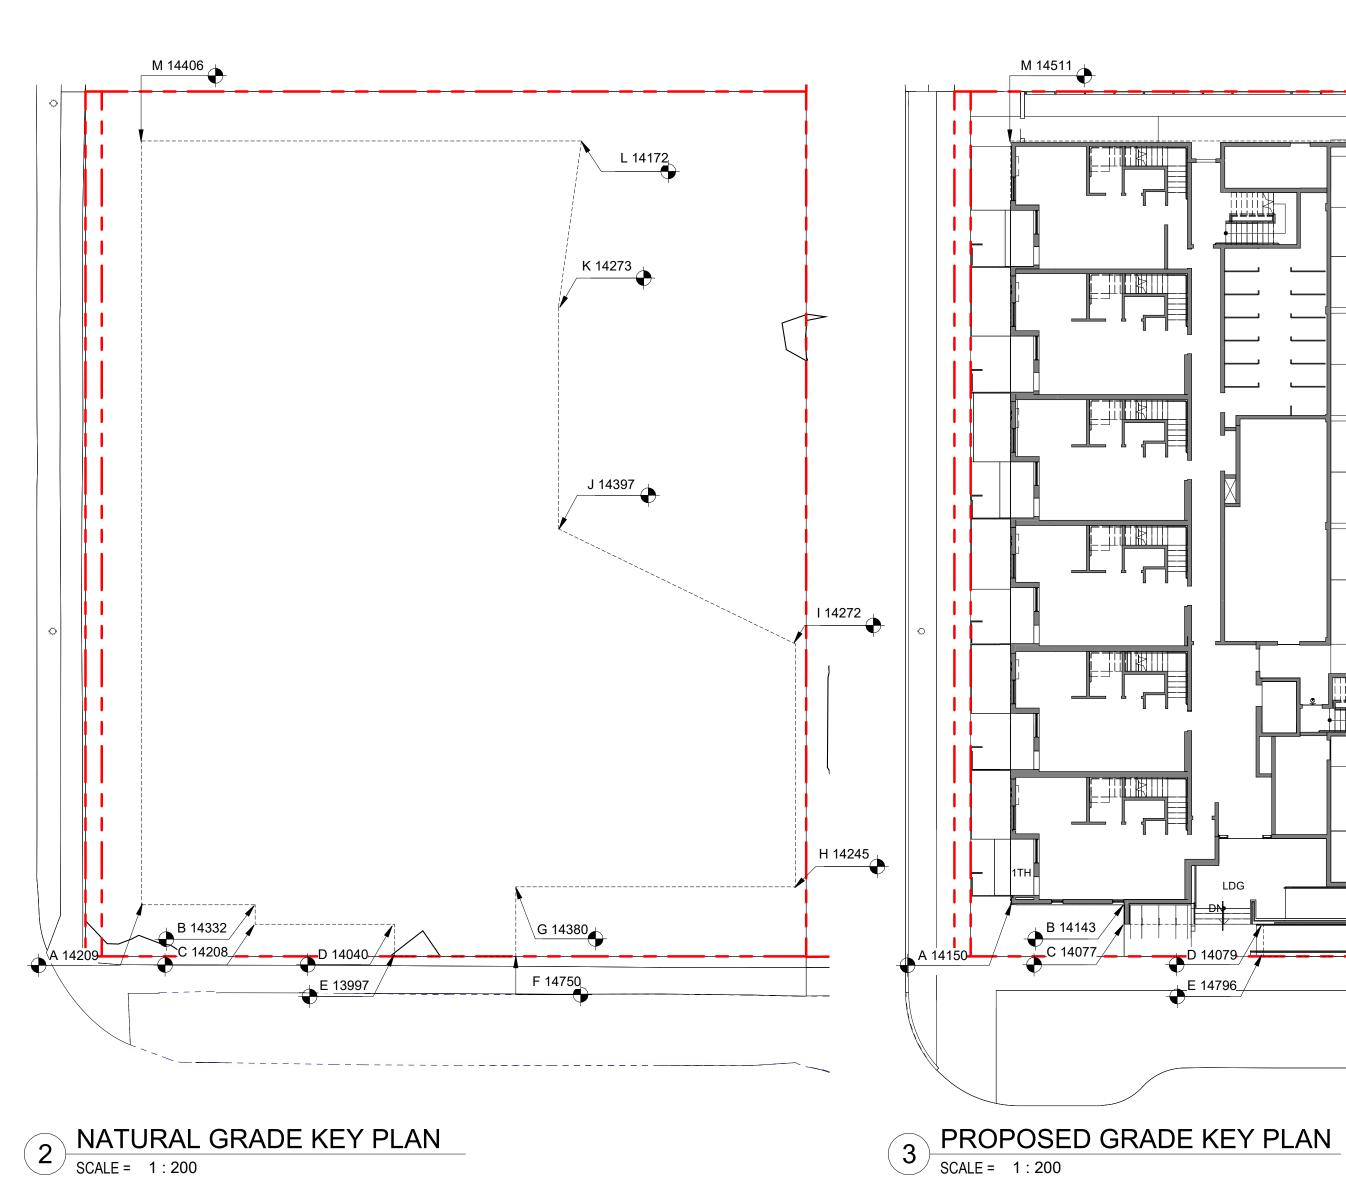


2 NATURAL GRADE KEY PLAN
SCALE = 1:200

374.01 m²-


OPEN SITE SPACE

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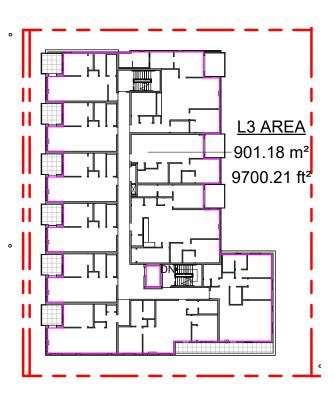


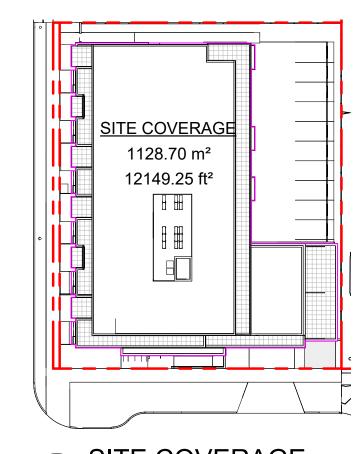SITE COVERAGE


SCALE = 1:500

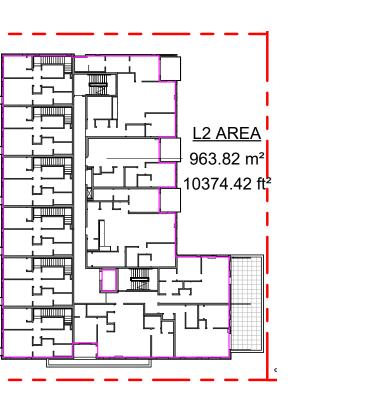

7 L2 FLOOR AREA SCALE = 1:500



8 L3 FLOOR AREA
SCALE = 1:500

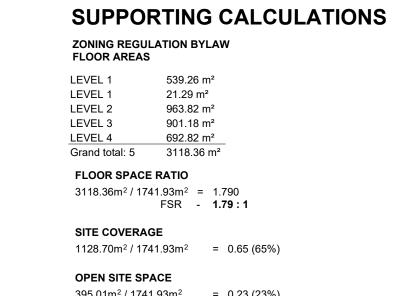


M 14511

14750 - 14200*(PROPOSED)* = 550mm 14750 - 14171*(EXISTING)* = 579mm LDG (LANDING AT PRIMARY ENTRANCE) 14750 - 14114*(PROPOSED)* = 636mm 14750 - 14040 *(EXISTING)* = 710mm RMP (INTERMEDIARY RAMP LANDING) 14507 - 14114*(PROPOSED)* = 393mm 14507 - 14280 *(EXISTING)* = 227mm $395.01m^2 / 1741.93m^2 = 0.23 (23\%)$

HEIGHT OF PATIOS, STAIRS, & RAMP TO

1TH PATIO (WORST CASE GRADING ALONG FAIRFIELD RD - THEREFORE ALL <600mm)

EXISTING & PROPOSED GRADE REFER TO GRADE KEY PLANS

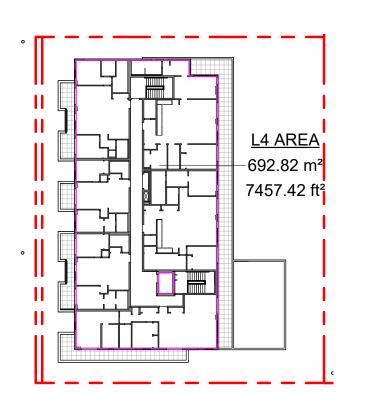

9 L4 FLOOR AREA

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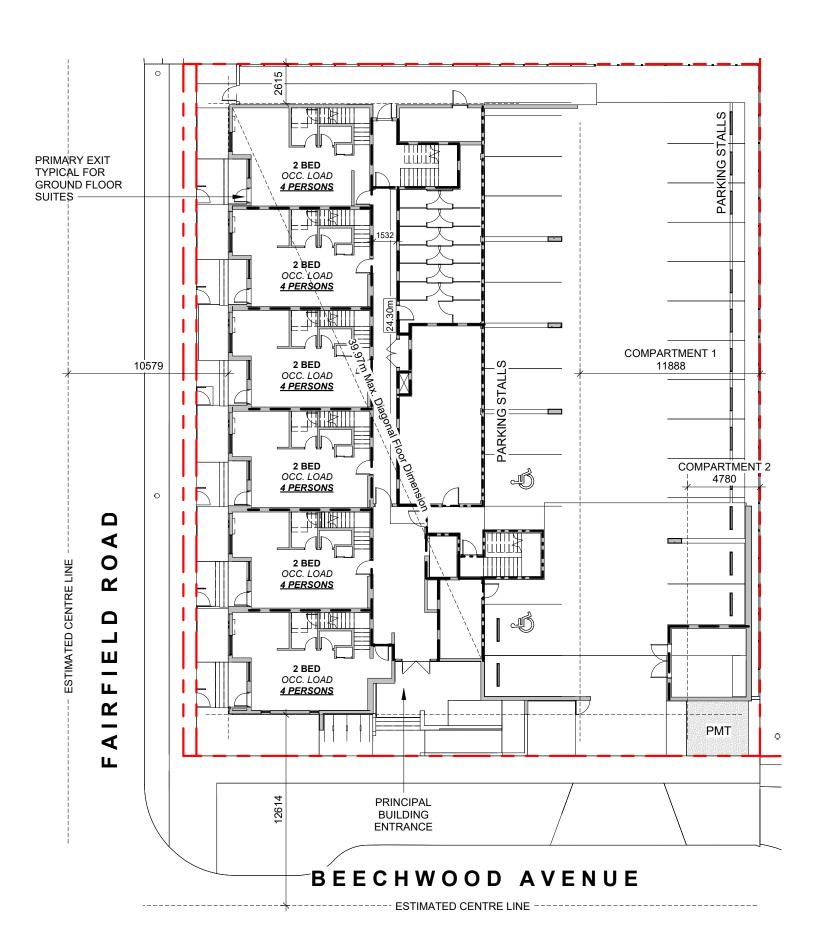
written consent of Cascadia Architects. 1733-1737 Fairfield Rd

ZONING CALCULATIONS

Date	JANUARY 18, 202
Scale	Project #
As indicated	2123
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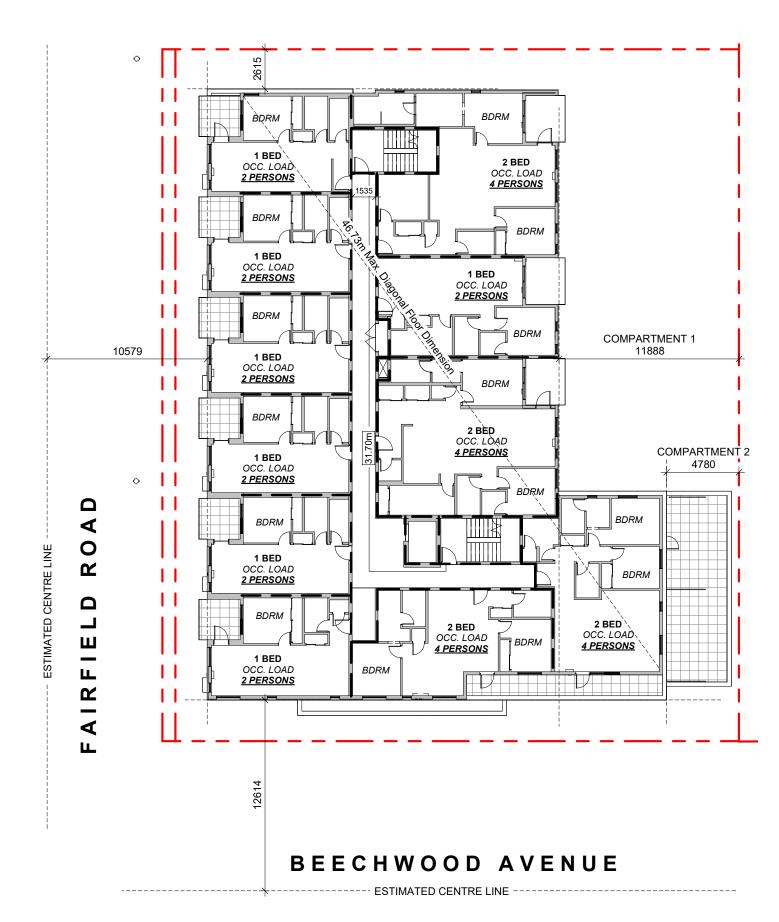
OCCUPANT LOAD: Occupancy: Group C
12 Bedrooms x 2 persons/bedroom

= 24 persons

MINIMUM EXIT WIDTH:

Ramps, Corridors, Passageways
the greater of 6.1mm x 24 = 146.4mm
or 1100mm (minimum 1500mm for or 1100mm accessible path of travel)


1 L1 CODE REVIEW KEY PLAN
SCALE = 1:250



OCCUPANT LOAD: MINIMUM EXIT WIDTH: Occupancy: Group C 15 Bedrooms x 2 persons/bedroom = 30 persons

Ramps, Corridors, Passageways
the greater of 6.1mm x 30 = 183mm
the greater of 8mm x 30 = 240mm or 1100mm (minimum 1500mm for or 1100mm accessible path of travel)

3 L3 CODE REVIEW KEY PLAN
SCALE = 1:250

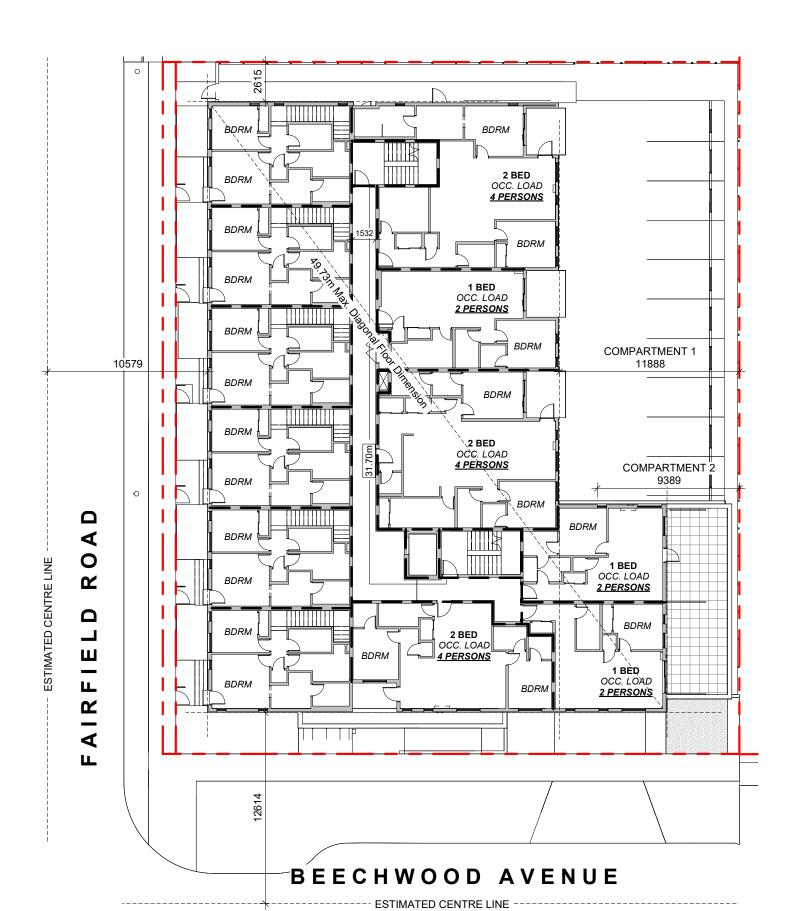

OCCUPANT LOAD: Occupancy: Group C 9 Bedrooms x 2 persons/bedroom


= 18 persons

MINIMUM EXIT WIDTH:

accessible path of travel)

Ramps, Corridors, Passageways
the greater of 6.1mm x 18 = 109.8mm
the greater of 8mm x 18 = 144.0mm or 1100mm (minimum 1500mm for or 1100mm

L2 CODE REVIEW KEY PLAN

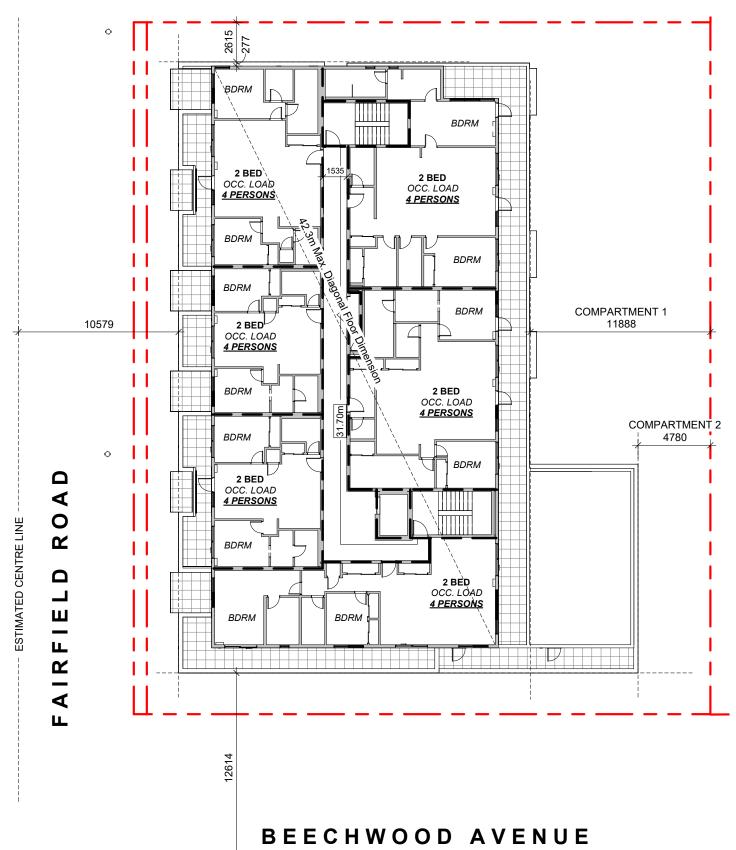

- ESTIMATED CENTRE LINE -

OCCUPANT LOAD: Occupancy: Group C 12 Bedrooms x 2 persons/bedroom

MINIMUM EXIT WIDTH: or 1100mm (minimum 1500mm for accessible path of travel)

Ramps, Corridors, Passageways
the greater of 6.1mm x 24 = 146.4mm
the greater of 8mm x 24 = 184mm

L4 CODE REVIEW KEY PLAN SCALE = 1:250

BUILDING CODE ANALYSIS

NEW CONSTRUCTION RENOVATION ADDITIO	N
2018 BC BUILDING CODE PART 3 PART 9	
A1 A2 A3 A4 B1 B2 B3 C D E F1 F2 F3	3.1.2.1
1116 m² (approx)	1.4.1.2
18.75 m geodetic	1.4.1.2
4 STOREYS ABOVE GRADE 0 STOREYS BELOW GRADE	1.4.1.2
	2018 BC BUILDING CODE

BUILDING FIRE SAFETY & CONSTRUCTION CLASSIFICATION

CLASSIFICATION	GROUP C, UP TO 4 STOREYS, SPRINKLERED	3.2.2.51
MAXIMUM BUILDING AREA	1800 m ²	3.2.2.51
No. OF STREETS FACING	1 (BEECHWOOD AVE UNDER 9M MINIMUM STREET WIDTH)	3.2.2.10
CONSTRUCTION TYPES PERMITTED	✓ COMBUSTIBLE NON-COMBUSTIBLE	3.2.2.51
FIRE ALARM SYSTEM	YES NO	3.2.4.1
STANDPIPE SYSTEM	YES NO	3.2.5.8
HIGH BUILDING	YES NO	3.2.6.1
INTERCONNECTED FLOOR SPACE	YES NO EXCEPT WITHIN AT GRADE RESIDENTIAL UNITS	3.2.8


FIRE RESISTANCE RATINGS

HORIZONTAL SEPARATIONS	1 hr FLOORS 1 hr MEZZANINE Unrated ROOF	3.2.2.51
LOADBEARING WALLS, COLUMNS & ARCHES	1 hr (NOT LESS THAN THAT REQUIRED FOR SUPPORTED STRUCTURE)	3.2.2.51
EXITS	1 hr	3.4.4.1

EXITS FROM FLOOR AREAS

NUMBER OF EXITS REQUIRED	2	3.4.2.1
SEPARATION OF EXITS (MIN.)	1/2 MAX. DIAGONAL FLOOR AREA, BUT NEED NOT BE > 9 m	3.4.2.3
MAX. TRAVEL DISTANCE ALLOWED	45 m, GROUP C	3.4.2.5
MEZZANINE	YES NO	3.2.8

FIRE RESISTANCE RATING - KEY - - - - - - UNRATED FIRE SEPERATIONS 1.5 HOUR _----2 HOUR

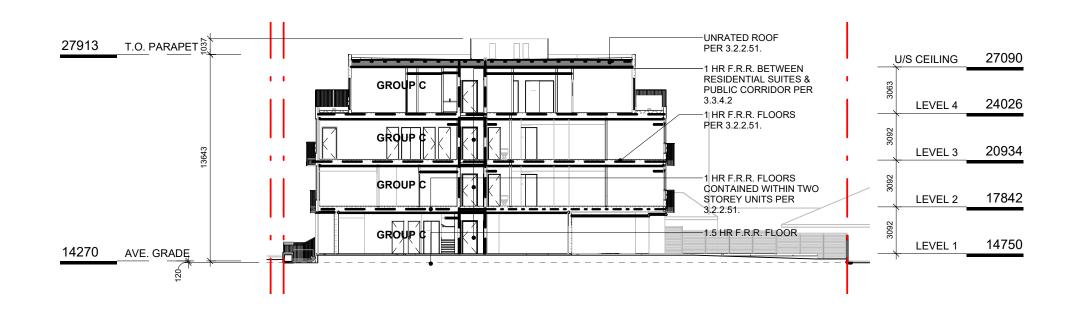

5 CODE REVIEW KEY SECTION
SCALE = 1:250





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CODE REVIEW

As indicated


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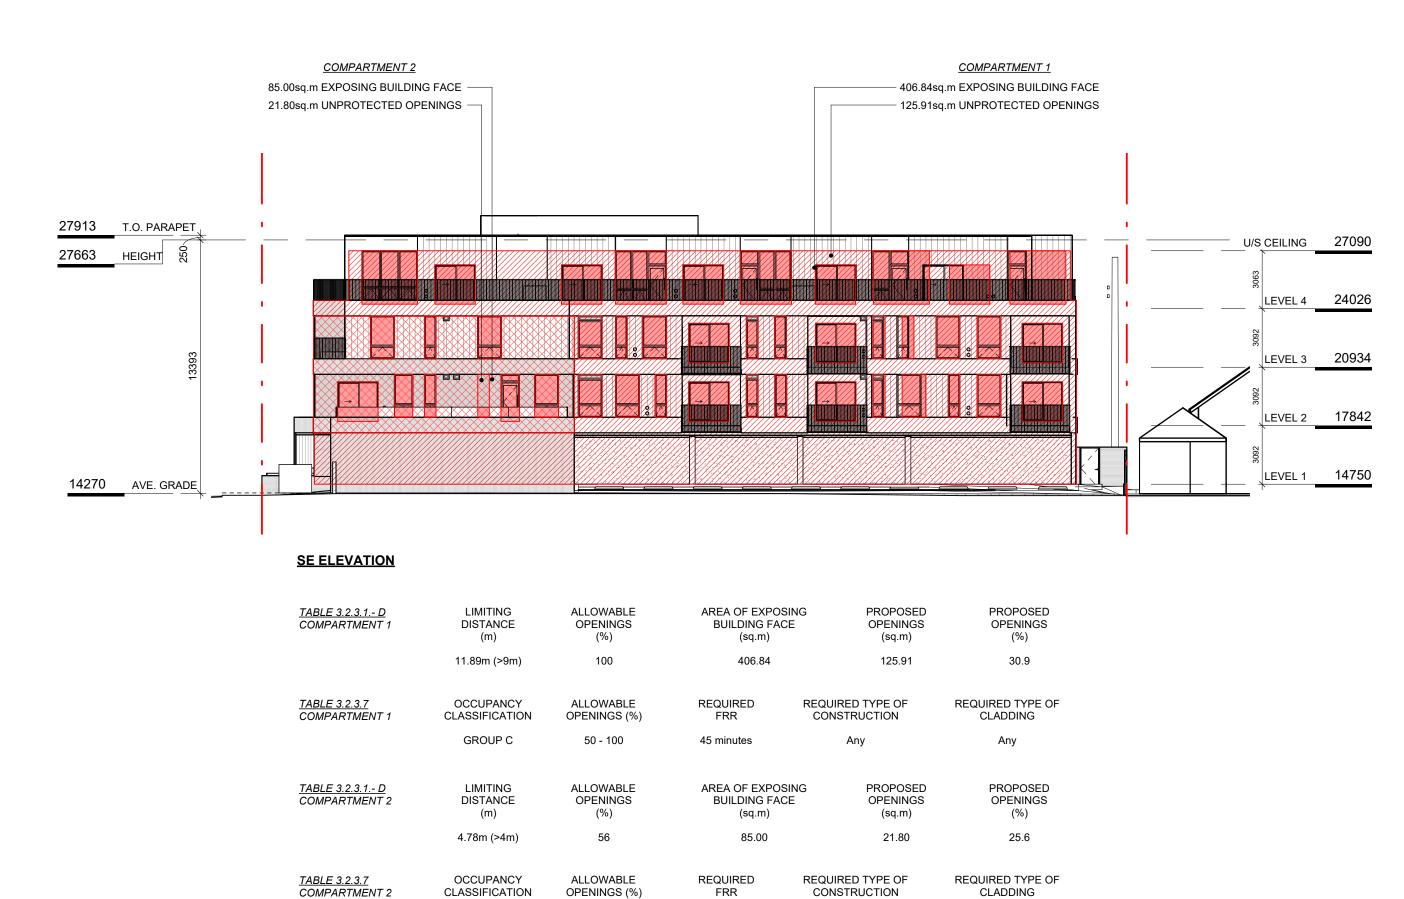
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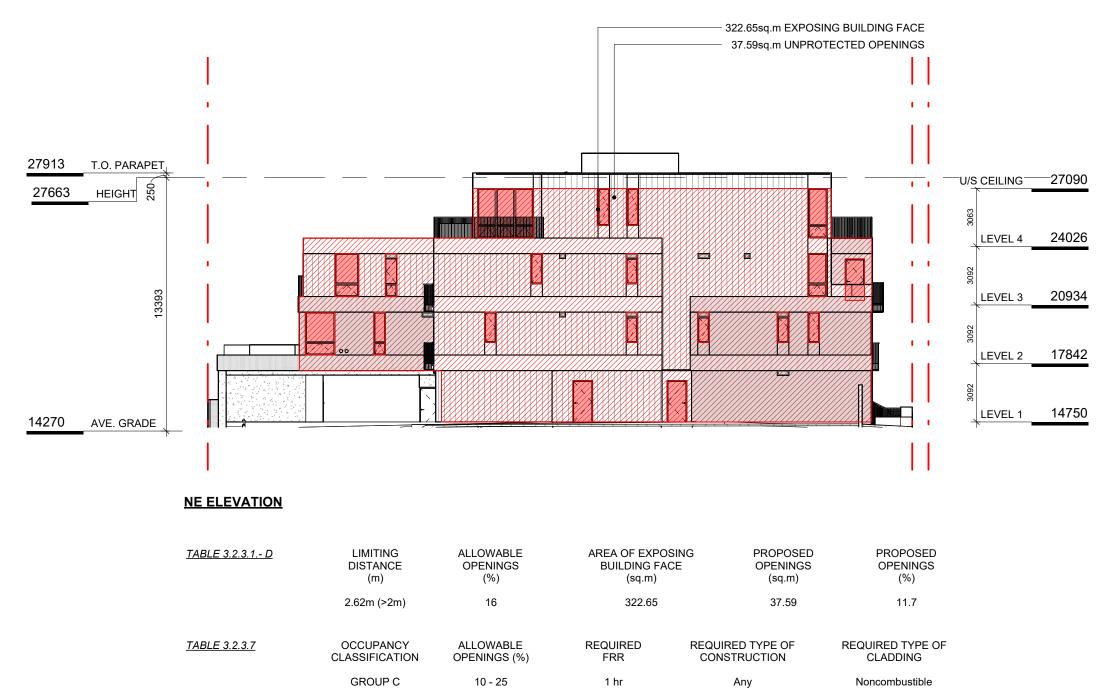


NW ELEVATION - LD KEY SCALE = 1:200




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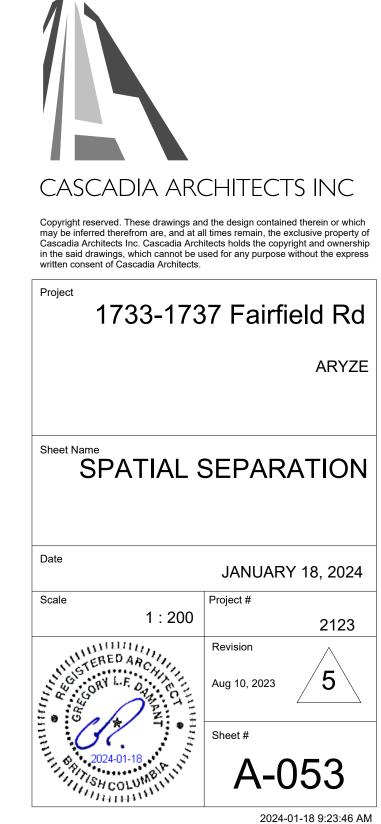
GROUP C

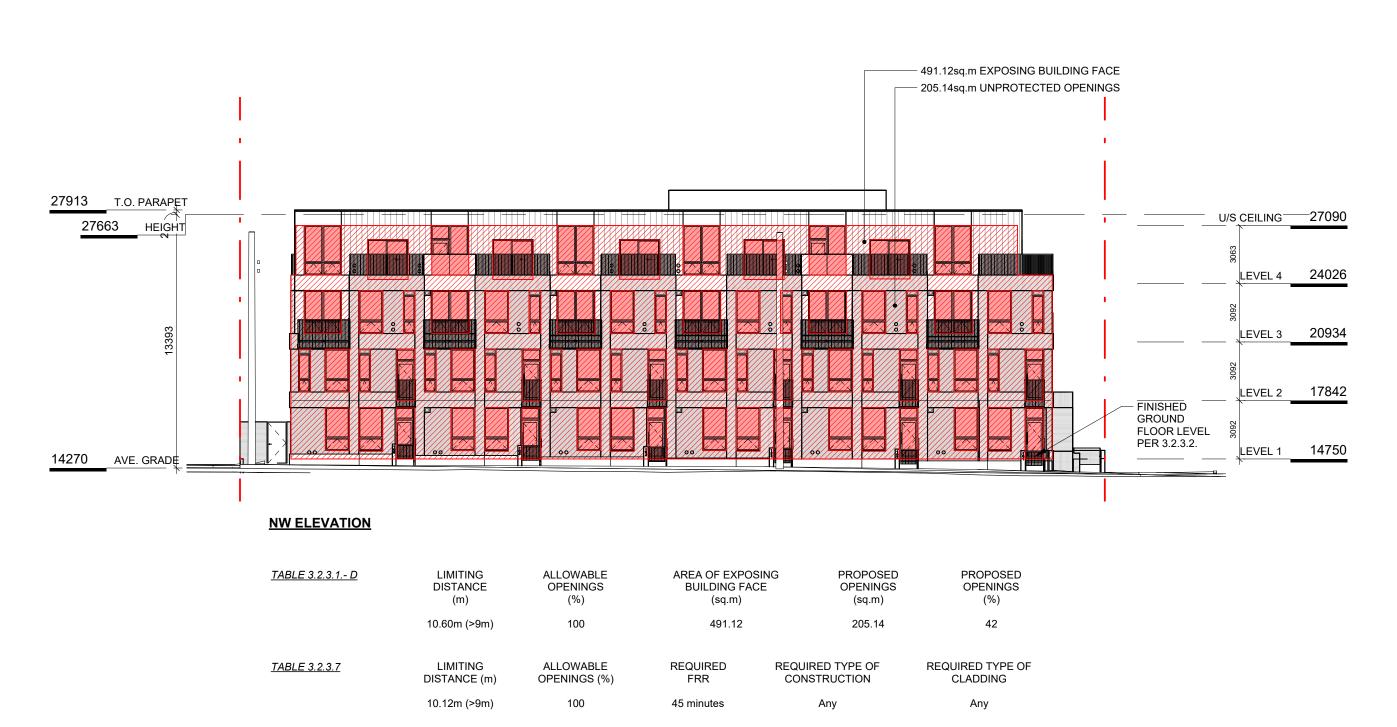

2 NE ELEVATION - LD KEY SCALE = 1:200

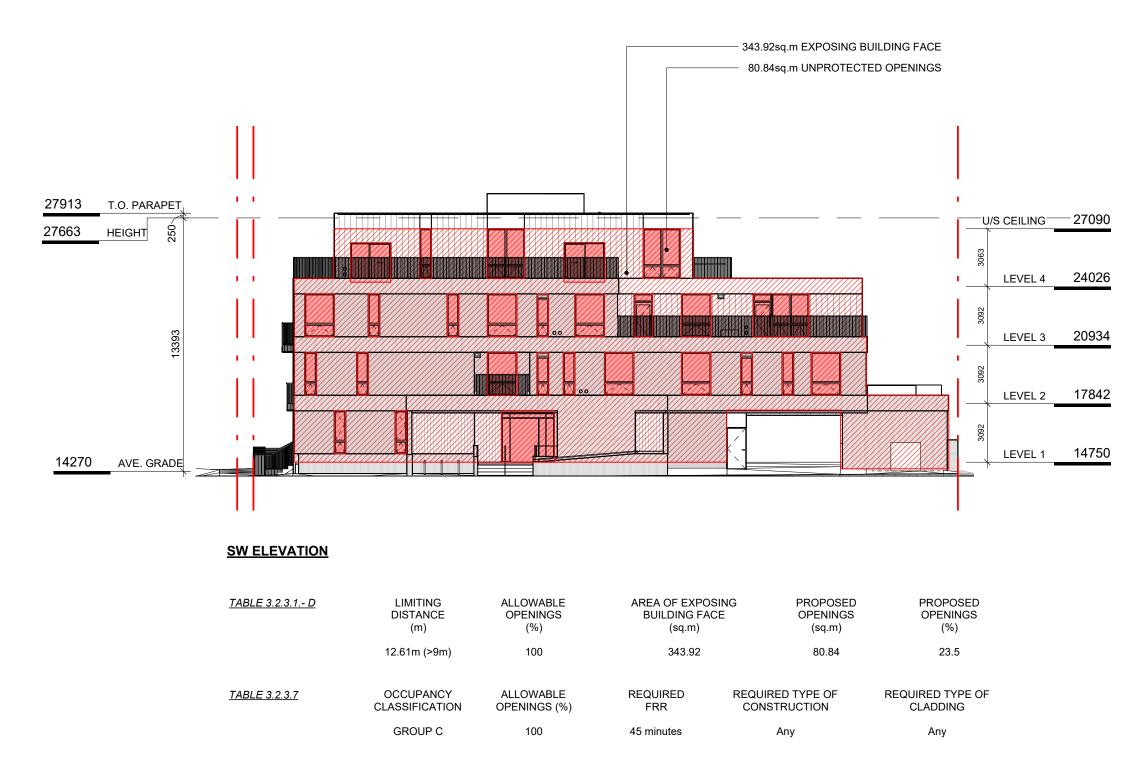

3 SW ELEVATION - LD KEY



DP/RZ Rev2 DP/RZ Rev1

NO.

DP/RZ Submission

DESCRIPTION

Aug 10, 2023 Jan 26, 2023

July 20, 2022 April 29, 2022 DATE



NO.	DESCRIPTION	DATE
1	Development Tracker Application	March 7, 2022
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13	DP/RZ Rev4	Jan 18, 2024



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LEVEL 1 PROPOSED PLAN

JANUARY 18, 2024


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1 L2 PROPOSED PLAN
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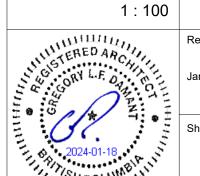
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LEVEL 2 PROPOSED

PLAN

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LEVEL 3 PROPOSED PLAN

JANUARY 18, 2024


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LEVEL 4 PROPOSED PLAN

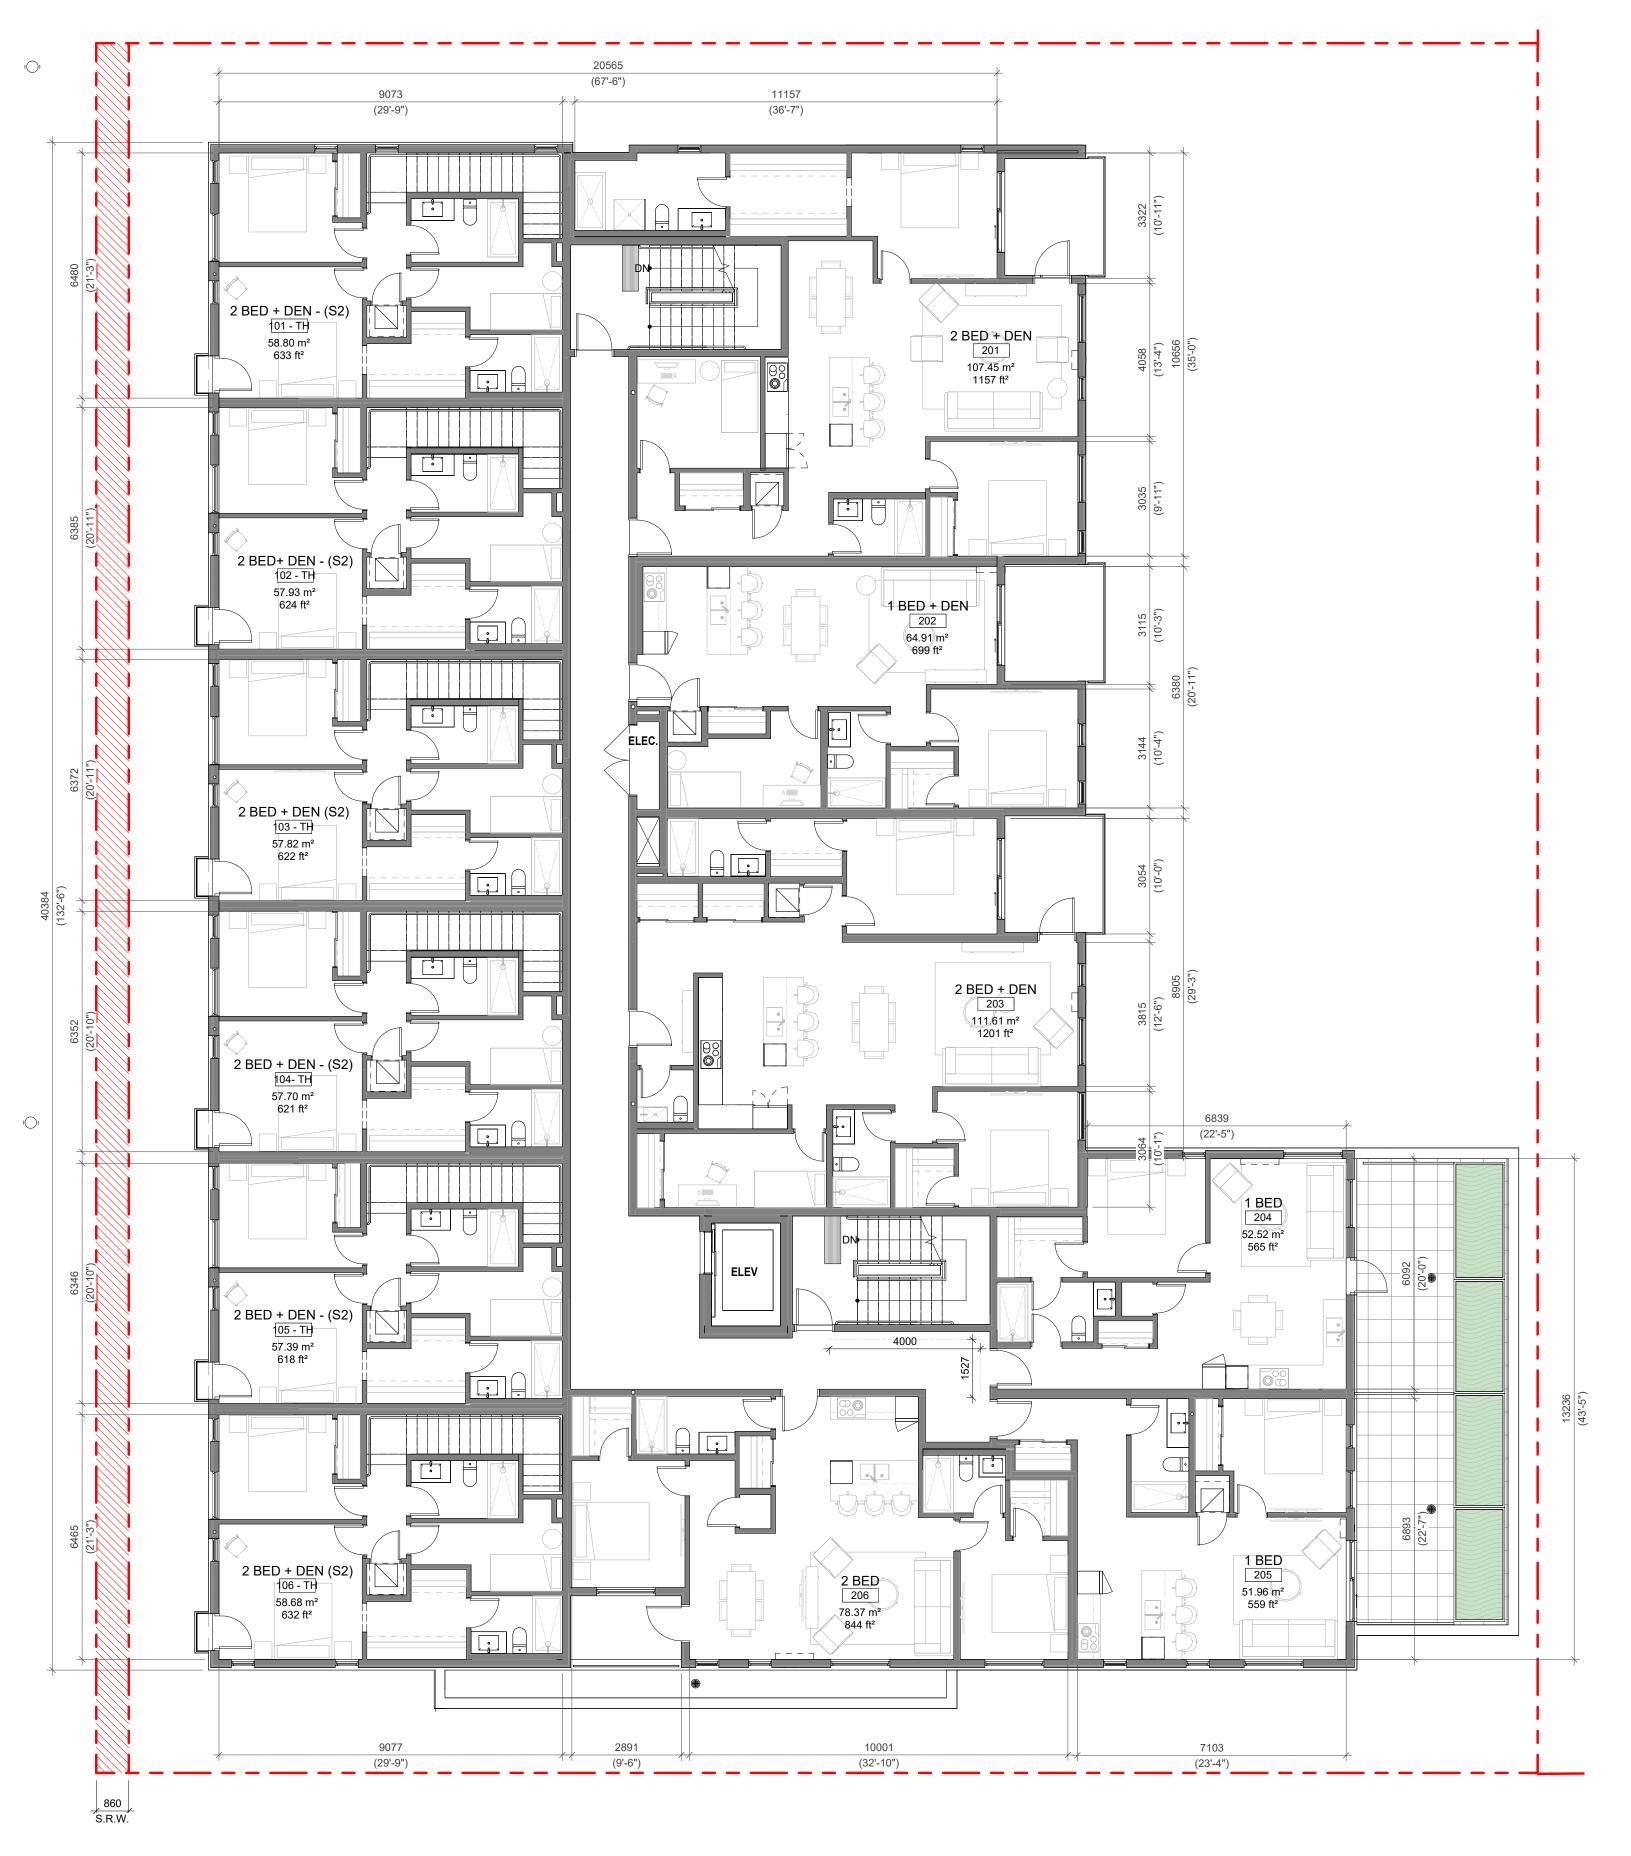JANUARY 18, 2024

Scale 1:100 F

Revision

Jan 18, 2024

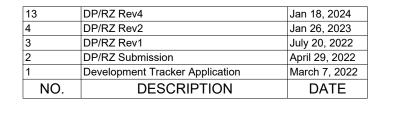Sheet #

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1 L4 PROPOSED PLAN
SCALE = 1:100









SW ELEVATION

SCALE = 1:100

FINISH SCHEDULE

- 01. PANELIZED CEMENTITIOUS CLADDING LIGHT FINISH
- 02. PREFINISHED METAL **FLAT PANEL**
- 03. PREFINISHED METAL STANDING SEAM
- 04. METAL PICKET GUARD
- 05. GLAZING
- 06. WOOD GRAIN FINISH
- 07. HORIZONTAL WOOD FENCE

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	5 4 3 2 1	5 DP/RZ Rev3 4 DP/RZ Rev2 3 DP/RZ Rev1 2 DP/RZ Submission 1 Development Tracker Application



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EXTERIOR ELEVATIONS

As indicated

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Jan 18, 2024

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SE ELEVATION SCALE = 1:100



- 01. PANELIZED CEMENTITIOUS CLADDING
- 03. PREFINISHED METAL
- 04. METAL PICKET GUARD
- 06. WOOD GRAIN FINISH

2	DP/RZ Submission Development Tracker Application	April 29, 2022 March 7, 2022
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EXTERIOR ELEVATIONS

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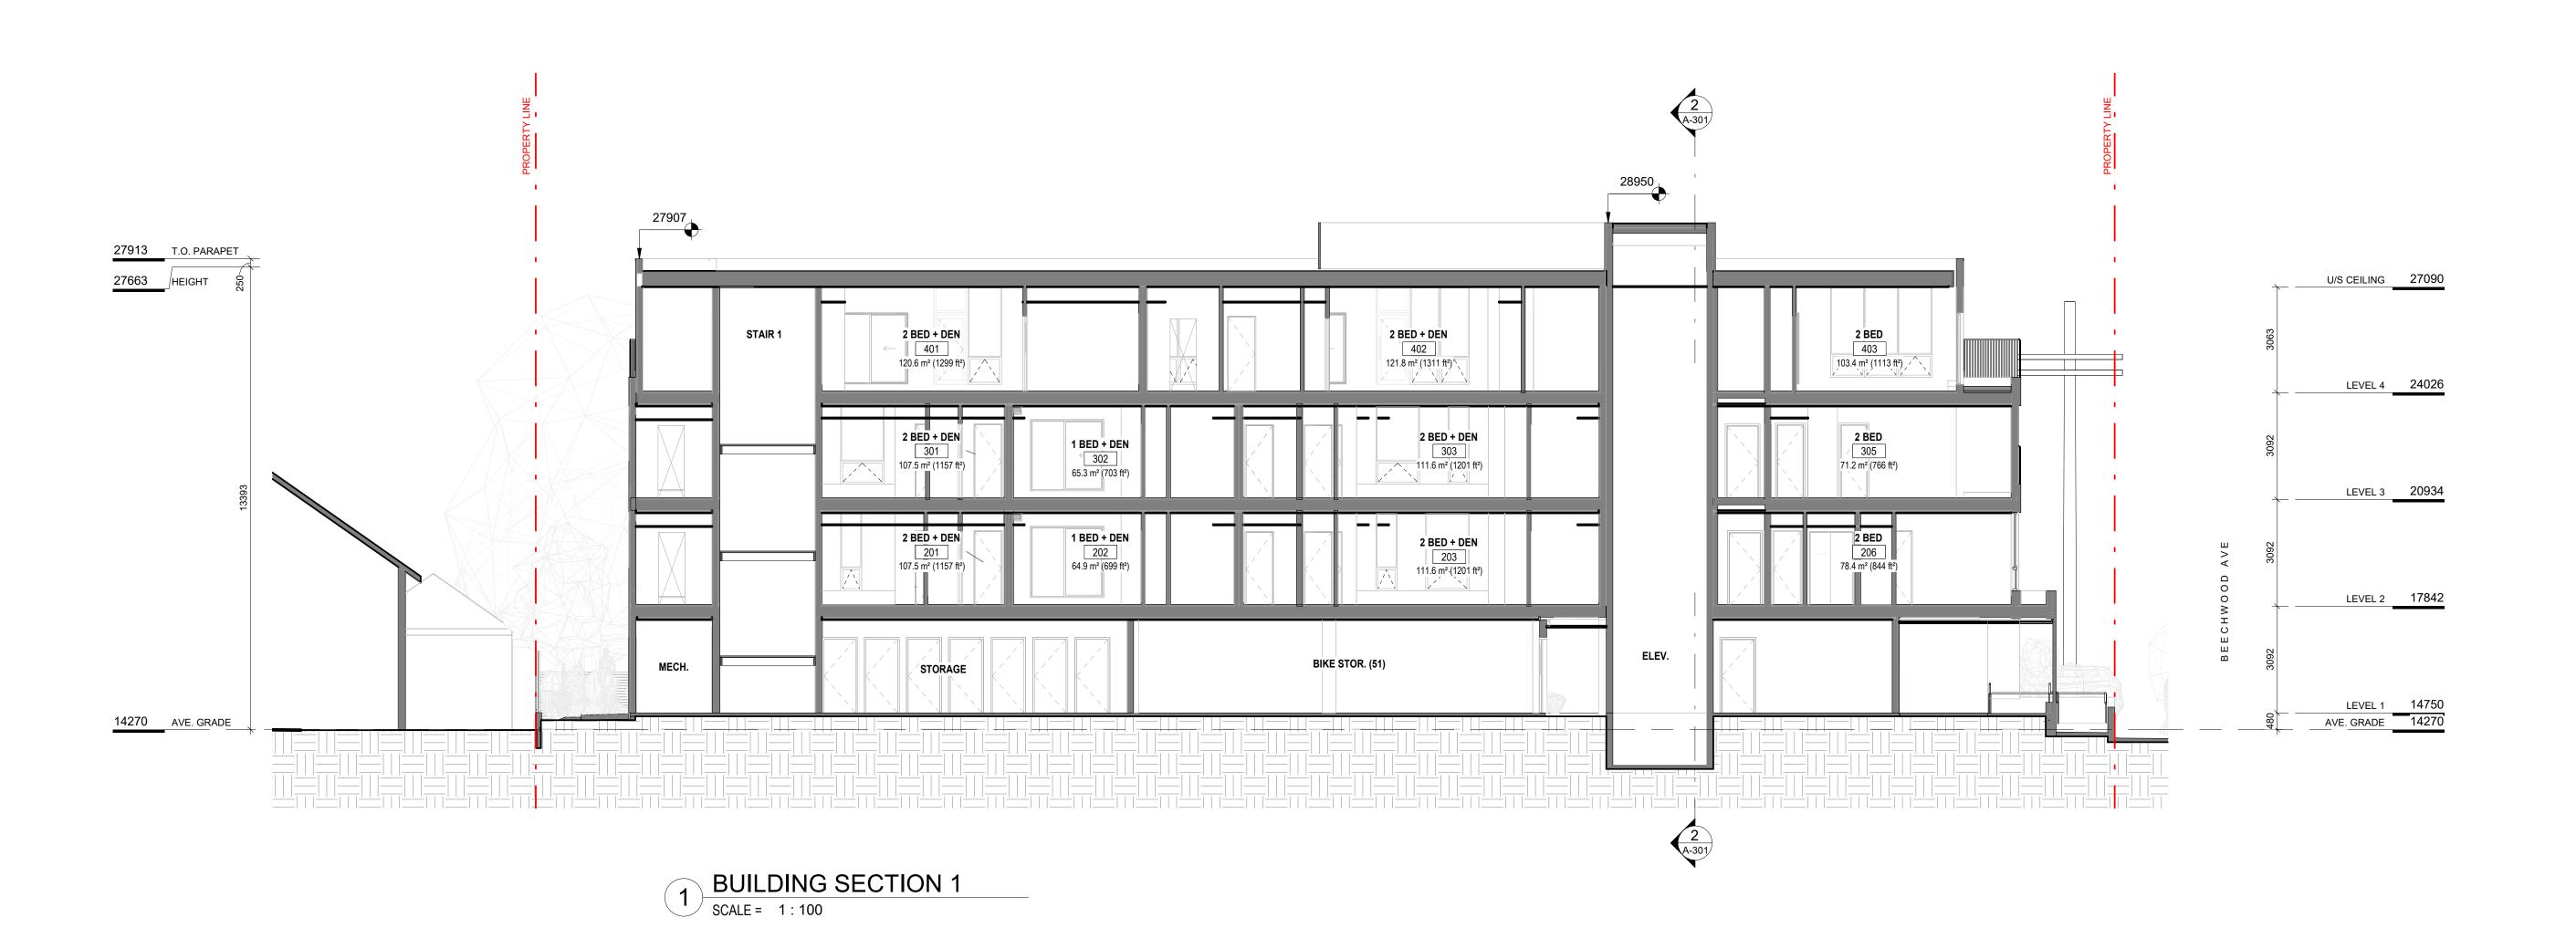
Jan 18, 2024


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SCALE = 1:100

2123





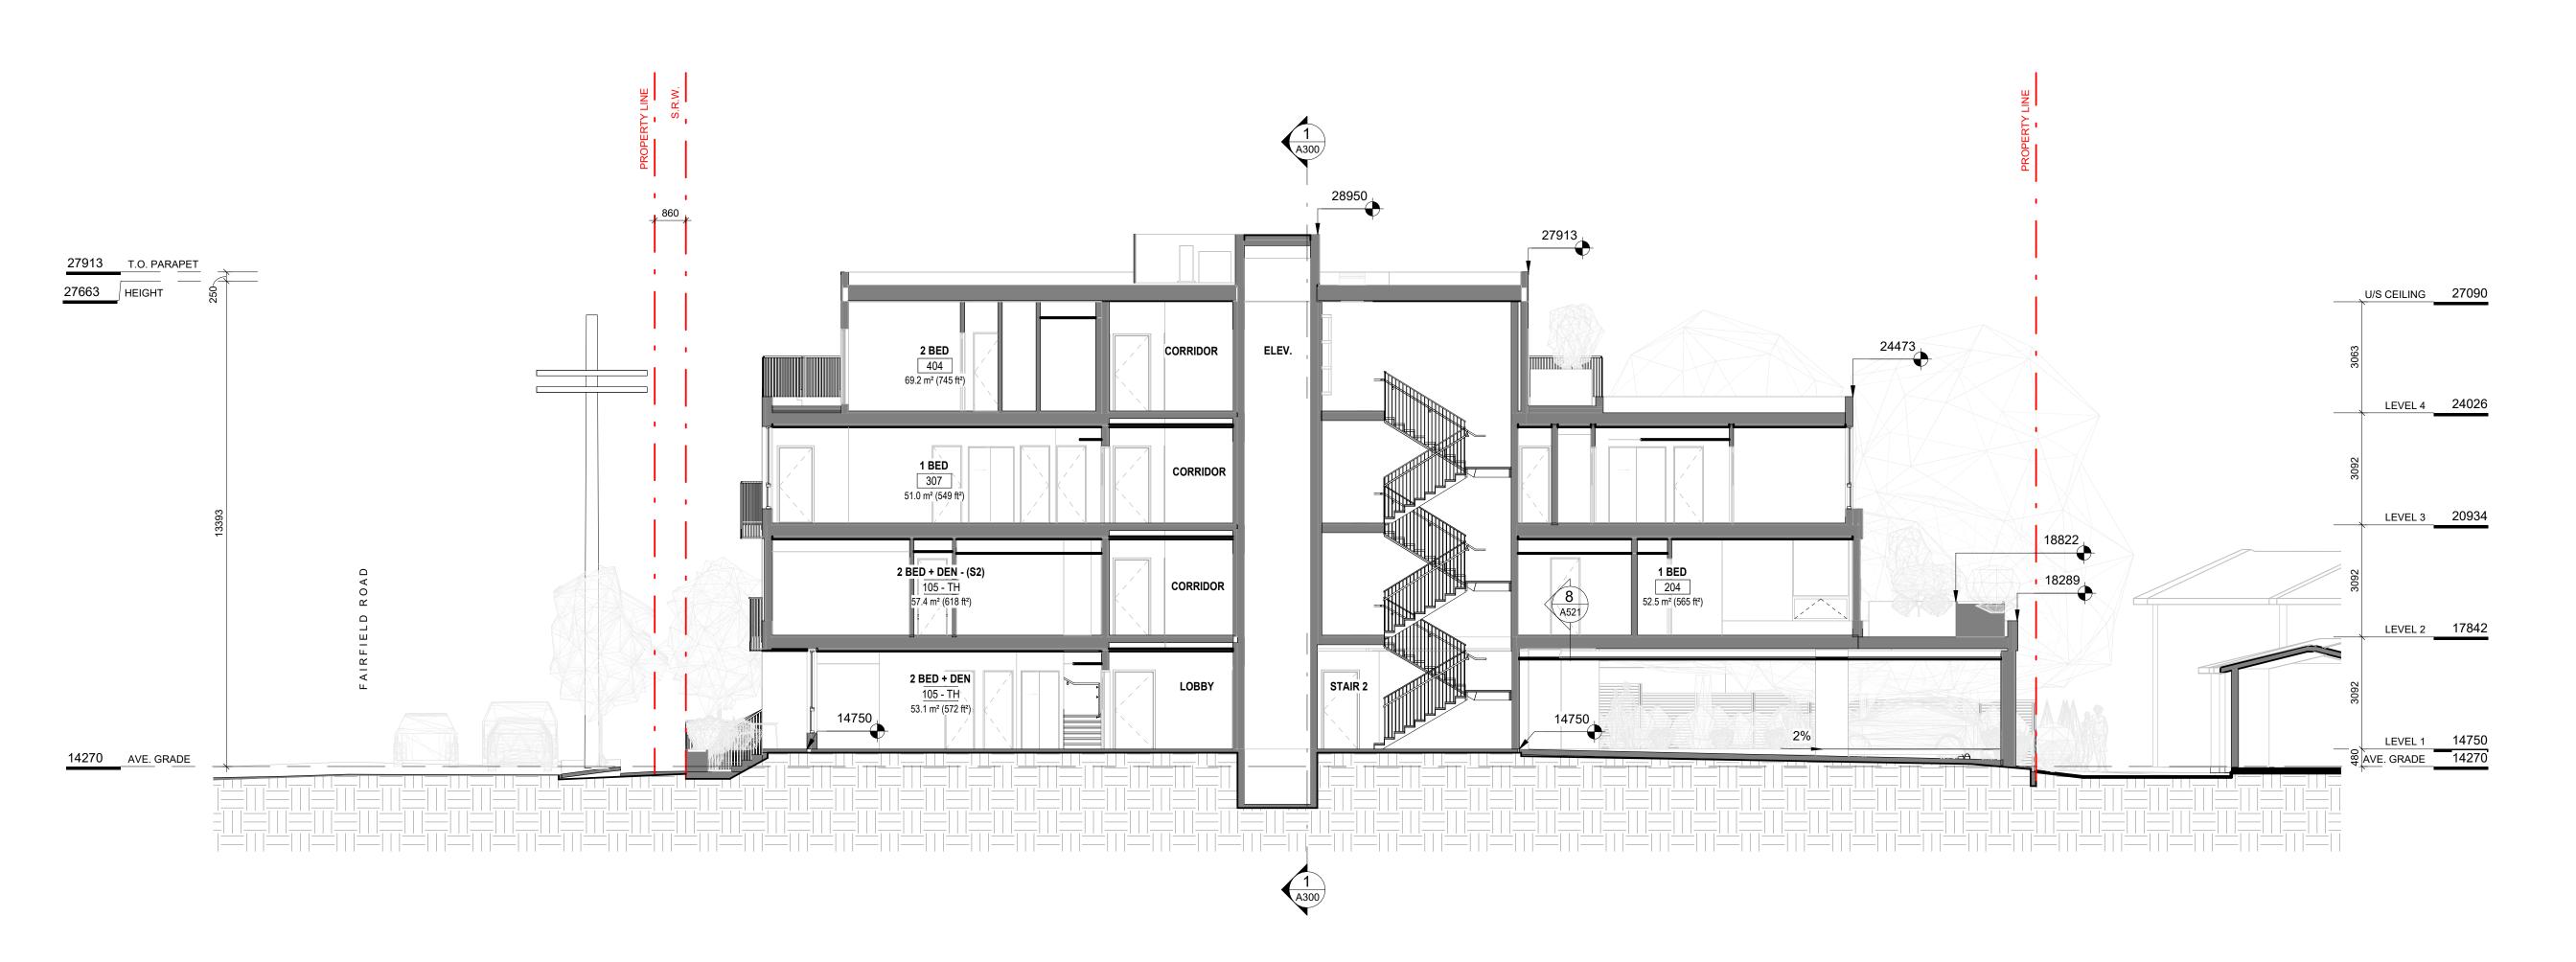

DP/RZ Rev2 DP/RZ Rev1 DP/RZ Submission

NO.

Development Tracker Application

DESCRIPTION

Jan 18, 2024 Jan 26, 2023 July 20, 2022 April 29, 2022 March 7, 2022 DATE

ARYZE

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1733-1737 Fairfield Rd

BUILDING SECTIONS

JANUARY 18, 2024


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2123 Jan 18, 2024

A-301

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2 BUILDING SECTION 2
SCALE = 1:100



MATERIAL SPECIFICATIONS

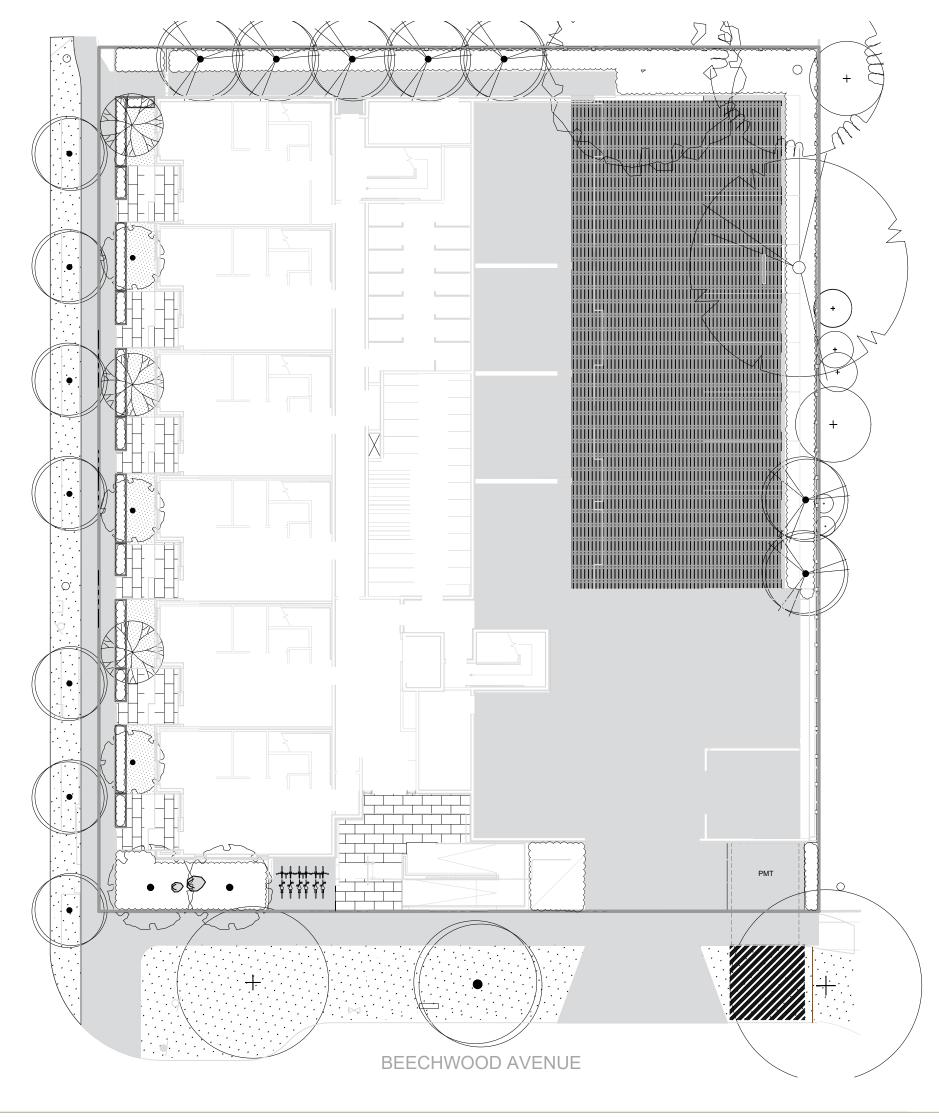- GROWING MEDIUM TESTING. MIXING. HANDLING AND PLACEMENT TO CLS SECTION 6.
- 2. ON SITE GROWING MEDIUM TYPE TO BE: AS PER DRAWING LEGEND. 3. PLANTER GROWING MEDIUM TO BE:
 - 50% BY VOLUME 1H HIGH TRAFFIC LAWN GROWING MEDIUM 50% BY VOLUME Pro-Mix HP Mychorrizae OR APPROVED EQUAL

- OFF-SITE GROWING MEDIUM: BOULEVARD GROWING MEDIUM TO BE:
 - MMCD Planting Areas Growing Medium to City of Victoria Supplementary Specifications Schedule 'B', Table 2. AS PER MUNICIPAL STANDARD.
 - IF NO MUNICIPAL STANDARD, GROWING MEDIUM TO CLS SECTION 6 2L LOW TRAFFIC LAWN AREAS.

1. MULCH IN ALL OTHER AREAS TO BE: Mitchell Excavating Ltd. Fine Bark Mulch - fir/hemlock OR APPROVED EQUAL.

2. HANDLING AND PLACEMENT TO CLS Section 10 - Mulching/Mulch

- 1. MUNICIPAL SOD TO BE: No. 1 Premium Grade Nursery Turfgrass.
- 2. HANDLING AND PLACEMENT TO BCLS Section 8 Turfgrass Sod. 3. SHALL BE SUITED TO THE LOCALITY, SITE CONDITIONS AND INTENDED FUNCTION OF THE PROJECT AREA.

1. ROOT BARRIER TO BE: Deeproot 18" Universal Guide OR APPROVED EQUAL.

1. FILTER FABRIC TO BE: Soprema Soprafiltre non-woven geotextile OR APPROVED EQUAL. 2. INSTALL AS PER MANUFACTURER'S SPECIFICATIONS AND LANDSCAPE DETAILS.

AGGREGATE:

- 1. PLANTER DRAIN ROCK TO BE: 19 mm MINUS GRANULAR BASE (TO MMCD SPECIFICATION) 2. GREEN ROOF DRAIN ROCK TO BE: 6 mm WASHED DRAIN ROCK
 - SUBMITTALS

- ALL PRODUCTS AND WORKMANSHIP, INCLUDING: PLANT MATERIAL, TRANSPORTATION, HANDLING AND PROTECTION. SCHEDULING AND STORAGE, WATERING AND IRRIGATION, TIME OF PLANTING, PLANTING, CONDITIONS FOR ACCEPTANCE AND INSECTS PESTS AND DISEASE CONTROL, TO BCLS SECTION 9 - PLANTS AND PLANTING, WRITTEN SPECIFICATIONS AND
- 2. CONDITIONS FOR TOTAL PERFORMANCE TO MMCD SECTION PLANTING OF TREES, SHRUBS AND GROUNDCOVERS. 3. IN THE EVENT OF A DISCREPANCY BETWEEN QUANTITIES LISTED ON THE PLANTING PLAN AND IN THE PLANT LIST. THE PLANTING PLAN QUANTITIES TO TAKE PRECEDENCE.

CAST IN PLACE CONCRETE:

1. ALL CAST IN PLACE CONCRETE AND ASSOCIATED WORK AND MATERIALS TO CONFORM TO MMCD SPECIFICATIONS; ASSOCIATED WORK INCLUDES GRADING, SUBGRADE COMPACTION, GRANULAR BASE MATERIALS AND COMPACTION.

IRRIGATION - DESIGN BUILD

IRRIGATION:

- 1. IT IS THE INTENTION OF THE PROJECT THAT THE LANDSCAPE CONTRACTOR FURNISH A FUNCTIONAL AUTOMATIC IRRIGATION SYSTEM TO ALL ON-SITE AND OFF SITE LANDSCAPE AREAS AS DESCRIBED ON THE LANDSCAPE DRAWINGS AND IN THIS SECTION.
- 2. THE SCOPE OF WORK INCLUDES SUPPLY AND INSTALLATION OF BACKFLOW PREVENTER, CONTROLLER, ALL IRRIGATION COMPONENTS, IRRIGATION SLEEVES YEAR MAINTENANCE/WARRANTY (SEE WRITTEN SPECIFICATIONS AND REQUIREMENTS BELOW) AND AN OPERATION MANUAL.
- 3. THE IRRIGATION CONTRACTOR SHALL COORDINATE WITH THE GENERAL CONTRACTOR AND ELECTRICAL CONTRACTOR FOR THE INSTALLATION OF IRRIGATION SLEEVES.

MAINTENANCE

- 4. UPON COMPLETION OF IRRIGATION INSTALLATION, CONTRACTOR TO SUBMIT AS-CONSTRUCTED DRAWINGS, OPERATION AND MAINTENANCE MANUAL, TOOLS PROVIDED BY THE MANUFACTURER AND BASE IRRIGATION SCHEDULE TO IIABC STANDARDS (SECTION 5 OF BCLS).
- 5. INSPECT AND CALIBRATE IRRIGATION SYSTEM AS PER SEASONAL REQUIREMENTS.
- INSPECT GROWING MEDIUM FREQUENTLYMINIMUM MONTHLY AND WEEKLY DURING PERIODS OF DROUGHT AND HIGH HEAT) FOR MOISTURE CONTENT AND ADJUST IRRIGATION SCHEDULE AS OFTEN AS REQUIRED TO MAINTAIN THE HEALTH OF THE PLANT MATERIAL DUE TO: RAPID DRAINAGE IN THE GROWING MEDIUM, ABSENCE OF A WATER TABLE, FINITE AMOUNT OF GROWING MEDIUM, AND EXPOSURE TO CLIMATIC CONDITIONS.
- 7. CONTRACTOR TO COORDINATE WITH THE OWNER'S MAINTENANCE REPRESENTATIVE AND TOGETHER PERFORM ONE WINTERIZATION AND ONE SPRING START-UP DURING THE ONE YEAR WARRANTY PERIOD.

SUBMITTALS					
SPECIFICATION SECTION	TITLE	SHOP DRAWINGS	MOCK-UP	SUBMITTALS	FOR APPROVAL
MMCD 03 30 20	CONCRETE WALKS, CURBS AND GUTTERS				
MMCD 03 30 53	CAST IN PLACE CONCRETE				
MMCD 31 02 17	AGGREGATES AND GRANULAR MATERIALS				
MMCD 31 22 01	SITE GRADING				
MMCD 31 24 13	ROADWAY EXCAVATION, EMBANKMENT AND COMPACTION				
MMCD 32 11 23	GRANULAR BASE				
MMCD 32 14 01	UNIT PAVING		yes	yes	product cut sheets, mockup 3.0m paved area on site
CLS 4	GRADING AND DRAINAGE				
CLS 5	IRRIGATION	yes			irrigation design for approval
CLS 6	GROWING MEDIUM			yes	supplier name, growing medium test results
CLS 7	LAWNS AND GRASS (HYDRAULIC SEEDING)			yes	supplier name, product information
CLS 8	TURFGRASS SOD			yes	supplier name, product information
CLS 9	PLANTS AND PLANTING		yes	yes	nursery name, tree and shrub layout on site prior to planting
CLS 10	MULCHING			yes	
CLS 11	LANDSCAPE OVER STRUCTURES - GREEN ROOFS				
CLS 12	CONTAINER GROWN PLANTS				



1733 FAIRFIELD

1733 FAIRFIELD ROAD, VICTORIA, BC

SHEET LIST

L0.1 TREE MANAGEMENT & REMOVAL PLAN

L1.1 MATERIALS PLAN - LEVEL 1

L1.2 MATERIALS PLAN - UPPER LEVELS

L2.1 LAYOUT PLAN

L3.1 GRADING PLAN

L4.1 SOIL VOLUME PLAN

L4.2 TREE PLANTING PLAN

L4.3 PLANTING PLAN - LEVEL 1

L4.4 PLANTING PLAN - UPPER LEVELS

L5.1 LIGHTING PLAN

L6.1 IRRIGATION PLAN - LEVEL 1

L6.2 IRRIGATION PLAN - UPPER LEVELS

L7.1 PAVING DETAILS

L7.2 SITE FURNISHINGS DETAILS

L7.3 PLANTING DETAILS

GENERAL LANDSCAPE NOTES

GENERAL

- 1. DO NOT PROCEED IN UNCERTAINTY. DO NOT SCALE DRAWINGS.
 - DRAWINGS AND SPECIFICATIONS ARE TO BE READ IN CONJUNCTION WITH ALL OTHER DRAWINGS/SPECIFICATIONS IN THIS PROJECT SET. ANY DISCREPANCIES AMONG DRAWINGS,
- SPECIFICATIONS AND INDUSTRY BEST PRACTICES TO BE REPORTED TO THE PROJECT / CONSTRUCTION MANAGER AND THE LANDSCAPE CONSULTANT FOR DIRECTION.
- ALL LANDSCAPE SPECIFICATION SECTIONS AND DRAWINGS ARE AFFECTED BY REQUIREMENTS OF DIVISION 01 SECTIONS (PROVIDED IN THE PROJECT MANUAL). CONTRACTOR TO FAMILIARIZE THEMSELVES WITH ALL SITE CONDITIONS, INCLUDING THE LIMITS OF WORK AND EXISTING FEATURES TO BE PROTECTED, PRIOR TO SUBMITTING
- CONTRACTOR TO CONFIRM LOCATION AND ELEVATION OF ALL UNDERGROUND UTILITIES/FEATURES PRIOR TO COMMENCING WORK.
- CONTRACTOR TO TAKE NECESSARY PRECAUTIONS TO PROTECT SITE FEATURES / CONDITIONS, WITHIN AND BEYOND THE LIMITS OF WORK EXISTING AT THE TIME OF CONSTRUCTION. ALL DISTURBED SURFACES, AREAS, STRUCTURES, VEGETATION, HABITAT ETC. ON PUBLIC / PRIVATE PROPERTY TO PROMPTLY BE RESTORED TO EQUAL OR BETTER CONDITION THAN EXISTING
- AND TO THE SATISFACTION OF THE MUNICIPALITY HAVING JURISDICTION / PROPERTY OWNER. CONTRACTOR TO MAINTAIN THE SITE IN A SAFE AND TIDY CONDITION AT ALL TIMES. DO NOT OBSTRUCT PEDESTRIAN OR VEHICULAR CIRCULATION. DO NOT LEAVE UNPROTECTED HOLES / PITS / OPENINGS OVERNIGHT. ALL EXCESS MATERIALS AND REFUSE TO BE REMOVED FROM THE SITE DAILY UNLESS OTHERWISE DIRECTED BY THE CONSTRUCTION MANAGER.

- ALL WORK ON MUNICIPAL PROPERTY TO CONFORM TO THE CITY OF VICTORIBEVELOPMENT STANDARDS (AUTHORITY HAVING JURISDICTIONINCLUDING BUT NOT LIMITED TO:
- 1.1. CITY OF VICTORIA SUPPLEMENTARY SPECIFICATIONS SCHEDULE 'B' TO THE SUBDIVISION AND DEVELOPMENT SERVICING BYLAW NO. 12-042
- 1.2. CITY OF VICTORIA SUPPLEMENTAL DRAWINGS 2. CITY OF VICTORIA SUPPLEMENTARY SPECIFICATIONS FOR STREET TREES AND IRRIGATION, SCHEDULE C.ALL LANDSCAPE WORK ON THE DEVELOPMENT SITE TO CONFORM TO THE
- CURRENT EDITION OF THECanadian Landscape Standard (CLS), UNLESS SPECIFICALLY STATED OTHERWISE IN WRITTEN SPECIFICATIONS AND ON DRAWINGS. ALL HARD SURFACE (INCLUDING BUT NOT LIMITED TO PAVING, CONCRETE RETAINING WALLS AND CONCRETE PLANTERS) TO CONFORM TO TWASter Municipal Construction Documents Association PLATINUM EDITION (MMCD) AND MMCD SUPPLEMENTAL DRAWINGS AND SPECIFICATIONS. UNLESS SPECIFICALLY STATED OTHERWISE IN WRITTEN SPECIFICATIONS AND ON
- 4. IN CASES OF CONFLICT BETWEEN THE CLS AND THE MMCD, THE MORE STRINGENT REQUIREMENT WILL TAKE PRECEDENCE.
- LANDSCAPE CONTRACTOR TO BE FAMILIAR WITH MUNICIPAL DEVELOPMENT STANDARDS AND BE IN POSSESSION OF THE CLS AND MMCD MANUALS AND SUPPLEMENTAL DRAWINGS AND
- 6. GROWING MEDIUM AND GROWING MEDIUM TESTING TO CLS Section 6.
- 7. IRRIGATION DESIGN AND INSTALLATION TO IIABC STANDARDS AND CLS Section 5.

1. CONTRACTOR TO COORDINATE INSTALLATION OF IRRIGATION AND ELECTRICAL SLEEVES WITH ARCHITECTURAL, MECHANICAL, ELECTRICAL AND CIVIL WORKS.

SUBMITTALS:

1. CONTRACTOR TO PROVIDE SAMPLES, TEST RESULTS AND SHOP DRAWINGS TO LANDSCAPE CONSULTANT FOR REVIEW AND APPROVAL 45 DAYS PRIOR TO INSTALLATION. 2. SEE ALSO SUBMITTALS TABLE BELOW FOR ADDITIONAL INFORMATION.

- GROWING MEDIUM TESTING: 1. GROWING MEDIUM TEST RESULTS ARE MANDATORY.
- TEST RESULTS TO INCLUDE ANALYSIS OF ALL GROWING MEDIUM NUTRIENTS NOTED IN CLS 6.2.7 AND ARE TO BE REPORTED IN THE SAME UNITS AS NOTED IN THAT SECTION.
- TEST RESULTS TO INCLUDE ANALYSIS OF SOIL TEXTURE, ORGANIC CONTENT AND ACIDITY AS PER CLS 6.3.5 AND BE REPORTED IN THE SAME UNITS AS NOTED IN THAT SECTION. TEST RESULTS TO INCLUDE RECOMMENDATIONS FOR AMENDMENTS TO MEET THE REQUIREMENTS FOR EACH GROWING MEDIUM TYPE.
- RECOMMENDED GROWING MEDIUM TESTING FACILITY: Pacific Soil Analysis Inc. 11720 Voyageur Way, Richmond, BC V6X 3G9.

1. COMPACTION TESTS FOR HARD SURFACE SUBGRADE, GRANULAR SUB-BASE, AND GRANULAR BASE ARE MANDATORY.

1. CONTRACTOR TO ALERT THE LANDSCAPE CONSULTANT A MINIMUM OF 3 WORKING DAYS PRIOR TO REQUIRED LANDSCAPE INSPECTIONS.

WARRANTY:

1. REQUESTS FOR SUBSTITUTIONS TO CONFORM TO THE DIVISION 01 SECTION AND BE SUBMITTED TO THE LANDSCAPE CONSULTANT, THROUGH THE PROJECT ADMINISTRATOR, A MINIMUM OF 45 DAYS PRIOR TO SCHEDULED WORK. 2. PLEASE NOTE THAT SOME SUBSTITUTIONS MAY REQUIRE MUNICIPAL APPROVAL.

OTHERWISE. FAULTY MATERIALS AND WORKMANSHIP SHALL BE PROMPTLY REPAIRED / REPLACED TO THE SATISFACTION OF THE LANDSCAPE CONSULTANT.

ENVIRONMENTAL PROTECTION: 1. CONTRACTOR TO INSTALL AND MAINTAIN SEDIMENTATION FILTRATION MEASURES AS REQUIRED FOR LANDSCAPE WORKS TO PREVENT MATERIALS FROM LEAVING THE SITE AND / OR

1. CONTRACTOR SHALL WARRANTY ALL WORKMANSHIP AND MATERIALS FOR 1 FULL YEAR FOLLOWING THE DATE OF TOTAL PERFORMANCE AS PER MMCD UNLESS SPECIFICALLY NOTED

ENTERING STORM DRAINS; STOCKPILED LANDSCAPE MATERIALS ARE TO BE KEPT TARPED.

ELECTRICAL - DESIGN BUILD

9. THE USE OF GEL FILLED WIRE NUTS IS REQUIRED.

LANDSCAPE LIGHTING:

- 1. IT IS THE INTENTION OF THE PROJECT THAT THE LANDSCAPE CONTRACTOR FURNISH A FUNCTIONAL LIGHTING SYSTEM AS DESCRIBED ON THE DRAWINGS AND IN THIS SECTION.
- THE SCOPE OF WORK INCLUDES SUPPLY AND INSTALLATION OF LOW VOLTAGE LIGHTING PRODUCTS, CABLING, TRANSFORMER(S) / POWER SUPPLIES / DRIVERS AND ELECTRICAL SLEEVES. 3. ELECTRICAL CONTRACTOR IS TO INCLUDE POWER (CONDUIT AND CONDUCTORS) TO LOW VOLTAGE TRANSFORMERS/DRIVERS IN SUPPORT OF THE LANDSCAPE LIGHTING PLAN. THE NUMBER OF CONNECTION POINTS IS NOT DETERMINED - THIS DEPENDS ON HOW THE LANDSCAPE CONTRACTOR LAYS OUT THE SYSTEM, BUT WILL NOT EXCEED 5. REFER TO THE LANDSCAPE LIGHTING PLAN FOR GENERAL INFORMATION.
- 4. 15A 1P CIRCUIT FROM HOUSE PANEL, SWITCHED BY A PROGRAMMABLE TIMER INSTALLED IN THE ELECTRICAL ROOM.
- TRANSFORMER TO BE ADEQUATELY SIZED FOR THE LOAD PLUS 40% RESERVE CAPACITY. TRANSFORMERS TO BE ARRANGED SUCH THAT NO LOAD REQUIRES WIRING IN EXCESS OF 75'. TIMER FUNCTION ON TRANSFORMER TO BE DISABLED IF PROVIDED.
- TRANSFORMERS, DRIVERS AND POWER SUPPLIES ARE TO BE INSTALLED IN GROUND JUNCTION BOXES, SUPPLIED AND INSTALLED BY THIS DIVISION.
- 8. THE LANDSCAPE CONTRACTOR SHALL COORDINATE WITH THE ELECTRICAL CONTRACTOR FOR AC CIRCUIT TO EACH JUNCTION BOX LOCATION AND WITH THE GENERAL CONTRACTOR FOR THE INSTALLATION OF ELECTRICAL SLEEVES.

IRRIGATION COORDINATION:

1. ELECTRICAL CONTRACTOR TO COORDINATE WITH CONSTRUCTION MANAGER AND IRRIGATION DESIGNER/INSTALLER TO PROVIDE ELECTRICAL FOR THE OPERATION OF AN AUTOMATIC IRRIGATION SYSTEM AND CONTROLLER.

Table 1. Tree Inventory Multiple stems form at 3m above grade - included bark at main stem Project arborist to union with active response growth, supervise all excavation M1 Yes City City cherry plum cerasifera 47 10 5.9 5 Good Fair/good Moderate associated surface decay. critical root zone. installation of the Recently planted - still staked, 'Pacific sunset' 5 6 0.6 Moderate included bark at stem unions. *Possible for transplant. Remove grade - no major weaknesses Project arborist to Purple leaf Prunus pruning wounds with associated required within the critical root zone. Retain cherry plum cerasifera 26 6 3.3 4 Good Fair/good Moderate surface decay.


Codomimant stems form at .3m above grade - included bark - not Located within the active, historic pruning wounds footprint of the Moderate existing building.

Multiple stems form at 1m above proposed building grade - narrow angles of Located within the ittachment, stems topped and Fair/poor Unsuitable Moderate decayed with sloughing bark. proposed building. grade for overhead utilities Laburnum sp. 21, 28 7 6.3 4 Fair Poor Unsuitable Poor sloughing bark. proposed building. opped historically at 5m above grade - multiple regrowth leaders footprint of the form at topping locations. proposed building. Will be heavily impacted by excavation required form at 2m above grade - narrow proposed building. Also topped historically at 4m above footprint of the Prunus sp. 55 5 6.9 4 Fair Fair/poor Unsuitable Moderate grade - large topping wound. Will be heavily impacted to construct the Flowering cherry, codominant proposed building. Will .5m above grade, large heading excavation for the 19, 25 5 4.6 proposed parking stall. Remove Will be heavily impacted by excavation required yew trees spaced less than 1m foundation of the English yew Taxus baccata 8, 6 5 2.5 1 Fair Fair/poor Unsuitable Moderate Will be heavily impacted by excavation required Growing within a hedge row of 5 to construct the yew trees spaced less than 1m English yew Taxus baccata 5, 5, 5 5 1.4 1 proposed building. Will be heavily impacted by excavation required Growing within a hedge row of 5 yew trees spaced less than 1m foundation of the English yew Taxus baccata 9 5 2.5 1 Fair Fair/poor Unsuitable Moderate Will be heavily impacted by excavation required Growing within a hedge row of 5 to construct the yew trees spaced less than 1m proposed building. by excavation required yew trees spaced less than 1m foundation of the English yew Taxus baccata 9, 4 5 2.6 1 Fair Fair/poor Unsuitable Moderate Will be heavily impacted by excavation required Growing within a hedge row of 13 to construct the yew trees spaced less than 1m English yew Taxus baccata 11,16 5 2.8 proposed building. by excavation required yew trees spaced less than 1m foundation of the English yew Taxus baccata 18 5 2.3 1 Fair Fair/poor Unsuitable Moderate Will be heavily impacted Growing within a hedge row of 13 to construct the yew trees spaced less than 1m Taxus baccata 12, 8 5 2.1 proposed building. by excavation required Growing within a hedge row of 13 to construct the yew trees spaced less than 1m foundation of the English yew Taxus baccata 8, 8 5 2.6 1 Fair Fair/poor Unsuitable Moderate Will be heavily impacted Growing within a hedge row of 13 to construct the yew trees spaced less than 1m Taxus baccata 14, 8 5 2.4 proposed building. by excavation required Growing within a hedge row of 13 yew trees spaced less than 1m foundation of the English yew Taxus baccata 12, 5 5 1.9 1 Fair Fair/poor Unsuitable Moderate Will be heavily impacted Growing within a hedge row of 13 to construct the yew trees spaced less than 1m Fair Fair/poor Unsuitable Moderate apart. proposed building. by excavation required Growing within a hedge row of 13 to construct the yew trees spaced less than 1m foundation of the English yew Taxus baccata 5, 4 5 2 1 Fair Fair/poor Unsuitable Moderate apart. by excavation required Growing within a hedge row of 13 to construct the yew trees spaced less than 1m English yew Taxus baccata , 4 5 1.8 1 proposed building. Will be heavily impacted by excavation required yew trees spaced less than 1m foundation of the English yew Taxus baccata 5, 4 5 2.2 1 Fair Fair/poor Unsuitable Moderate apart. proposed building. Will be heavily impacted by excavation required Growing within a hedge row of 13 to construct the yew trees spaced less than 1m proposed building. by excavation required yew trees spaced less than 1m foundation of the English yew Taxus baccata 16 5 2 1 Fair Fair/poor Unsuitable Moderate apart. Will be heavily impacted by excavation required Growing within a hedge row of 13 to construct the yew trees spaced less than 1m English yew Taxus baccata 5, 5, 5 5 2.4 proposed building. by excavation required Growing within a hedge row of 7 yew trees spaced less than 1.25m foundation of the English yew Taxus baccata 5, 5 5 2.3 1 Fair Fair/poor Unsuitable Moderate proposed building. Remove Will be heavily impacted by excavation required Growing within a hedge row of 7 to construct the yew trees spaced less than 1.25m foundation of the English yew Taxus baccata 8, 4 5 1.3 1 Fair Fair/poor Unsuitable Moderate proposed building. by excavation required Growing within a hedge row of 7 to construct the yew trees spaced less than 1.25m foundation of the English yew Taxus baccata 4, 4, 4 5 1.3 1 Fair Fair/poor Unsuitable Moderate Will be heavily impacted by excavation required Growing within a hedge row of 7 to construct the yew trees spaced less than 1.25m foundation of the Fair Fair/poor Unsuitable Moderate proposed building.
Will be heavily impacted by excavation required Growing within a hedge row of 7 yew trees spaced less than 1.25m foundation of the English yew Taxus baccata 8, 8, 8 5 2.2 1 Fair Fair/poor Unsuitable Moderate proposed building.
Will be heavily impacted Growing within a hedge row of 7 to construct the yew trees spaced less than 1.25m foundation of the English yew Taxus baccata 12, 5 5 1.9 proposed building. Will be heavily impacted by excavation required Growing within a hedge row of 7 to construct the yew trees spaced less than 1.25m foundation of the proposed building.
Will be heavily impacted English yew Taxus baccata 5, 5, 5 5 2.6 1 Fair Fair/poor Unsuitable Moderate apart. Growing within a hedge row of 5 yew trees spaced less than 1m by excavation required to construct the apart. *1 Bylaw size stem within foundation of the Taxus baccata 11, 33 5 5 proposed building. Will be heavily impacted Growing within a hedge row of 5 by excavation required yew trees spaced less than 1m apart. *1 Bylaw size stem within to construct the foundation of the proposed building.
Will be heavily impacted English yew Taxus baccata 22 5 2.8 1 Fair Fair/poor Unsuitable Moderate Growing within a hedge row of 5 yew trees spaced less than 1m by excavation required to construct the apart. *1 Bylaw size stem within foundation of the proposed building. Will be heavily impacted Growing within a hedge row of 5 by excavation required yew trees spaced less than 1m apart. *1 Bylaw size stem within to construct the foundation of the foundation of the proposed building. Remove
Will be heavily impacted English yew Taxus baccata 13 5 1.6 1 Fair Fair/poor Unsuitable Moderate hedge. Growing within a hedge row of 5 yew trees spaced less than 1m by excavation required to construct the apart. *1 Bylaw size stem within foundation of the proposed building. Will be heavily impacted by excavation required Hedge row consisting of to construct the approximately 30 individual stems - foundation of the proposed building. Codominant stems form at .3m above grade - no major Located within the weaknesses visible at stem union, footprint of the Moderate ivy covered trunk. proposed parking stall. Remove Topped historically at 5m above grade - multiple regrowth leaders footprint of the *Parking stall proposed arborist to supervise all

Moderate narrow planting strip.

within the crz.

WINDMILL PALM REQUESTED TO BETRANSPLANTED / REMOVED BY LANDSCAPE TO ALLOW FOR PLANTING OF LARGE CANOPY TREE

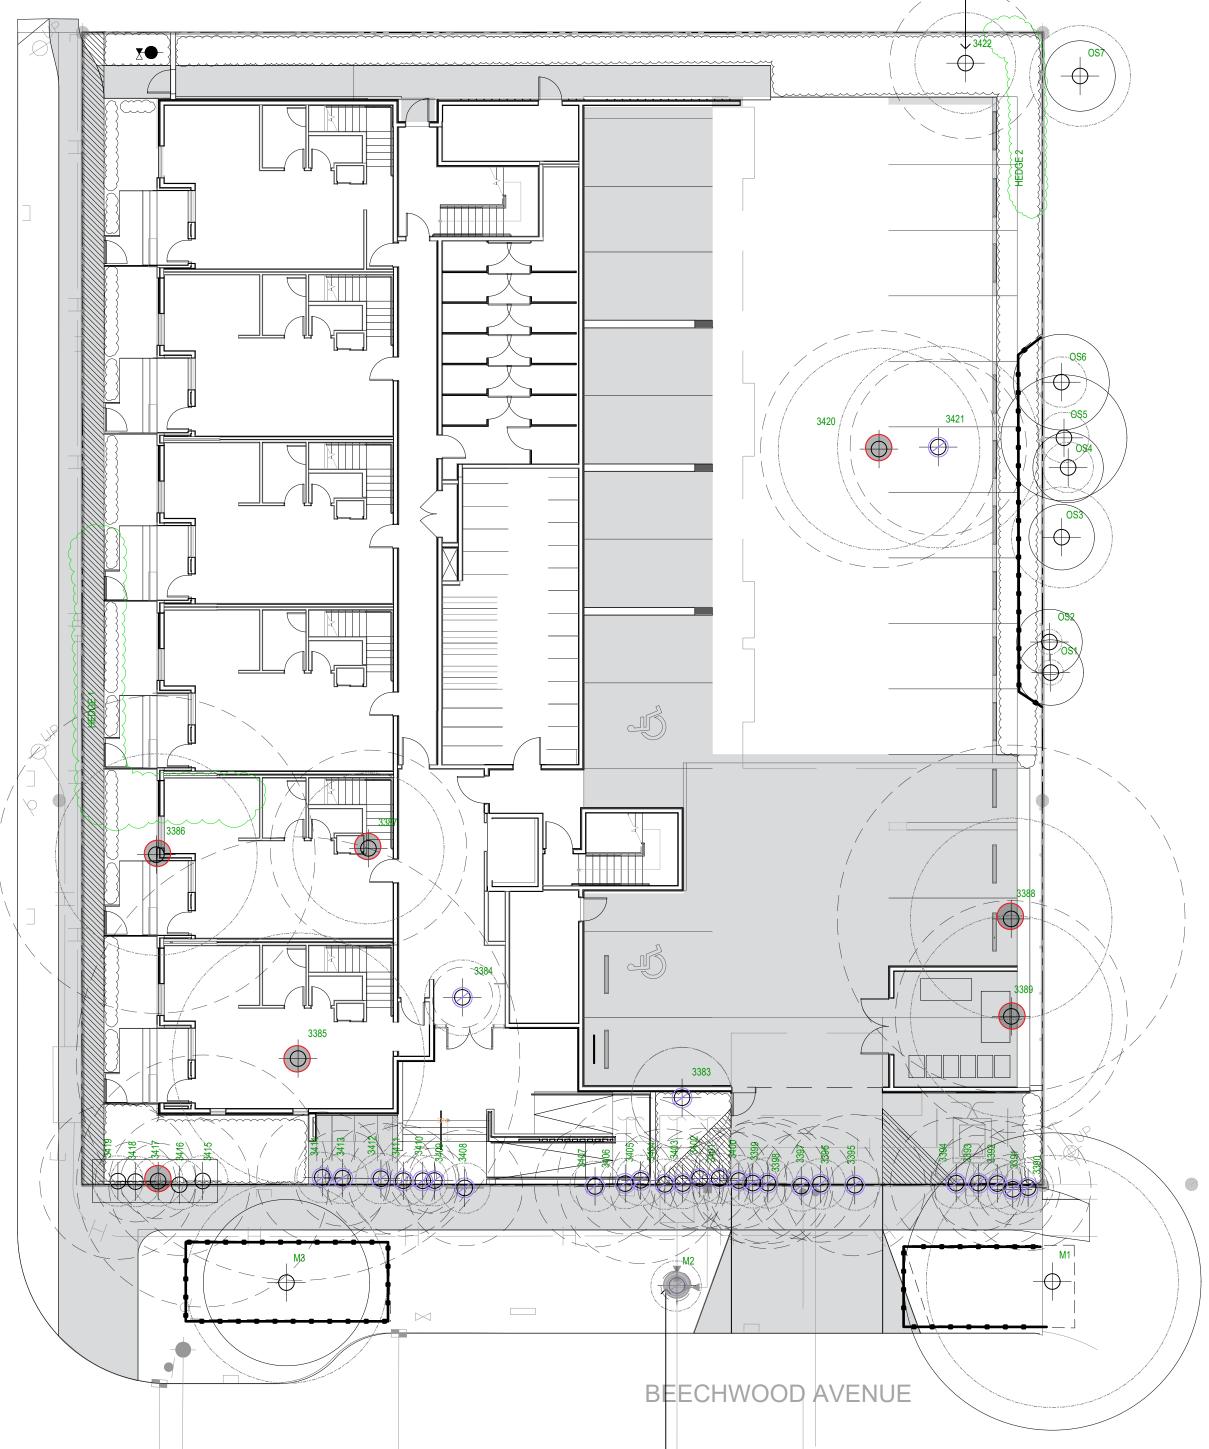




NOTE: SEE ORIGINAL TREE INVENTORY AND TABLES IN REPORT PREPARED BY TALBOT & MACKENZIE

BOULEVARD TREE M2 TO BE REMOVED AND RELOCATED BY CITY OF

CIVIL). REMOVAL TO BE PAID FOR BY DEVELOPER.

VICTORIA FOR INSTALLATION OF PROPOSED WATER CONNECTION (SEE



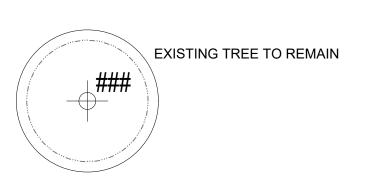



TREE PROTECTION FENCING

TO OUTSIDE OF DRIPLINE WHERE POSSIBLE (AS SHOWN)

 TO BE MAINTAINED UNTIL COMPLETION OF CONSTRUCTION
 TO MUNICIPAL STANDARD

PROTECTED TREE AND SHRUB FOR REMOVAL

MUNICIPAL TREE FOR REMOVAL



1608 Camosun Street, Victoria BC V8T 3E6 Info@biophiliacollective.ca 250 590 1156

OWNER/CLIENT:

ARYZE DEVELOPMENTS

PROJECT ADDRESS:

1733 FAIRFIELD, VICTORIA, BC

DESIGNED BY:BIANCA BODLEY DRAWN BY:TYLER YESTAL

NO.	ISSUE	YY\MM\DD
1	ISSUED FOR DEVELOPMENT TRACKER	22\03\04
2	ISSUED FOR RZ/DP	22\05\02
3	ISSUED FOR COORDINATION	22\07\18
4	ISSUED FOR RZ/ DP	22\07\20
5	ISSUED FOR RZ/ DP RESUBMISSION	23\01\24
6	ISSUED FOR RZ/ DP RESUBMISSION	2023\08\18
7	25% BUILDING PERMIT	2023\10\10
8	ISSUED FOR BP COORDINATION	2023/11/24
9	DP/RZ REV 4	2024/01/12

SEAL


NORTH ARROW

DRAWING TITLE:

TREE REMOVAL & PROTECTION PLAN

DWG NO:

L0.1

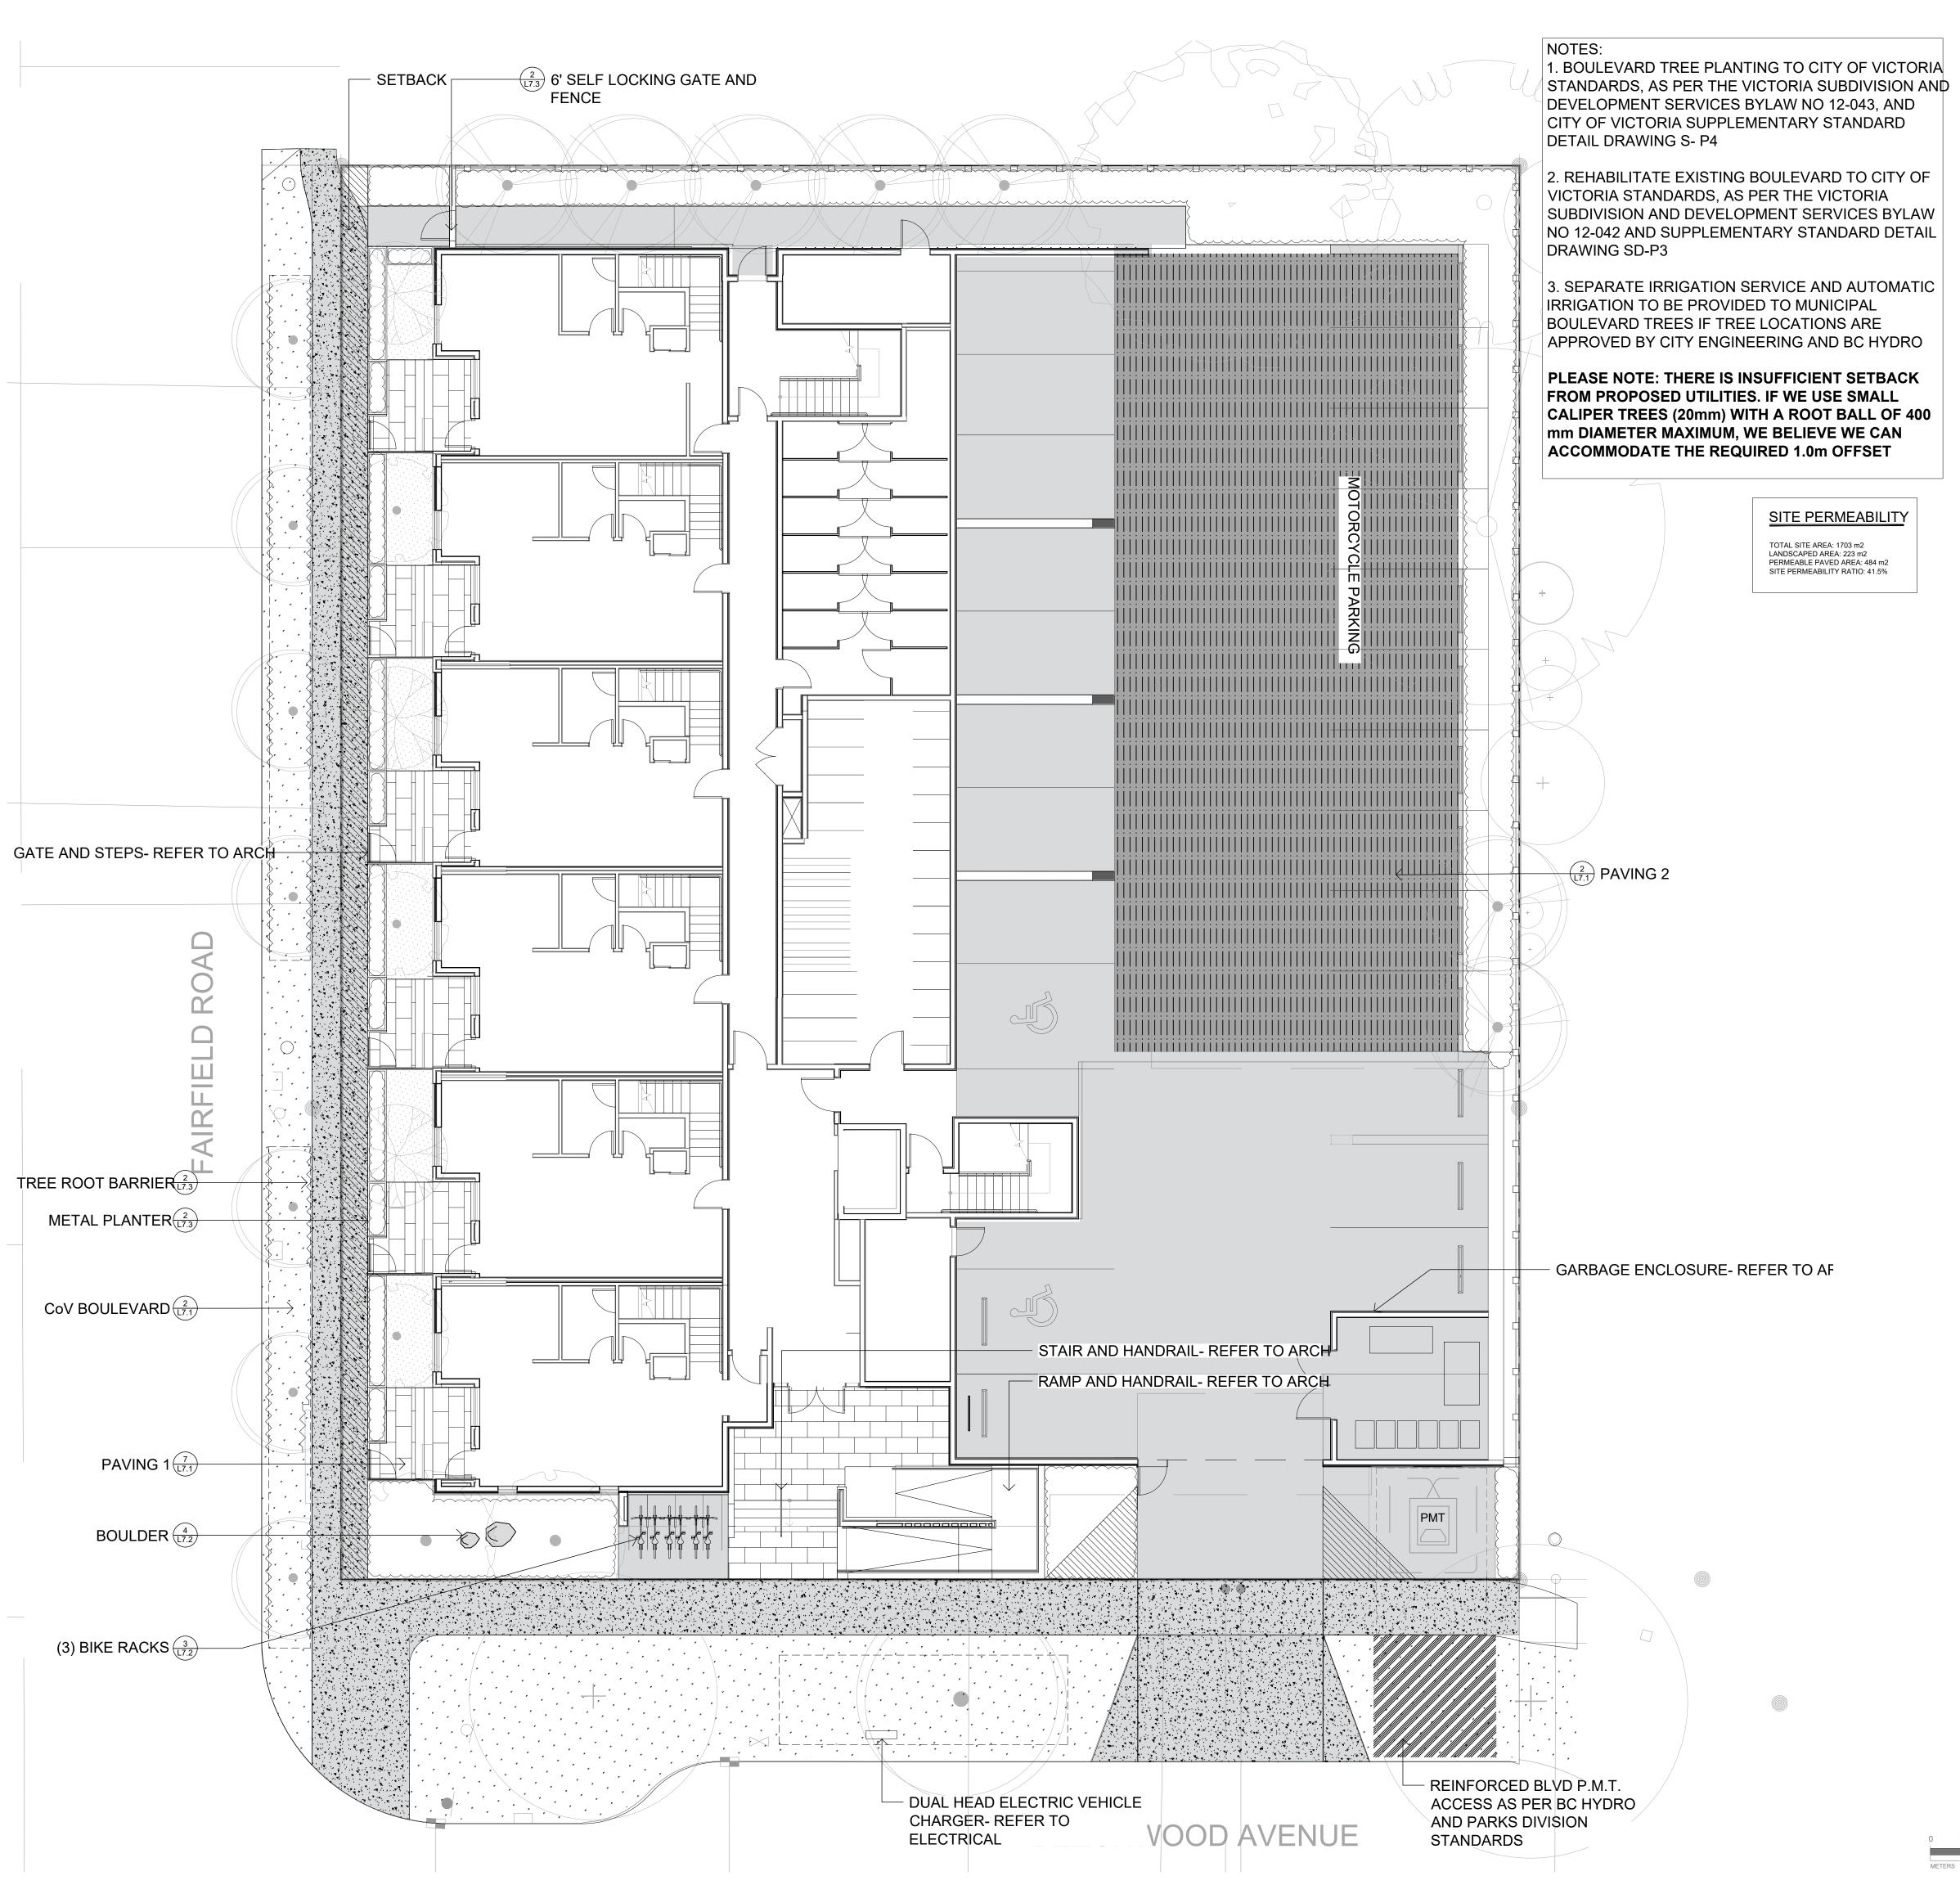

LEGEND

_____ _____

PROPERTY LINE



ROOF OVERHANG



ON-SITE LANDSCAPE AREA 1000 mm DEPTH GROWING MEDIUM




50 mm DEPTH MULCH



RAISED PLANTER 450 mm DEPTH PLANTER GROWING MEDIUM



• 50 mm DEPTH MULCH

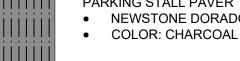

PARKING STALL PAVER NEWSTONE DORADO DRAIN PAVERS


PATIO AND BALCONY PAVER ARISTOKRAT™ SERIES COLOR: CASCADE GRANITE



SOD MUNICIPAL BOULEVARD AREA 150 mm DEPTH HIGH TRAFFIC LAWN GROWING MEDIUM SOD



 150mm DEPTH HIGH TRAFFIC LAWN GROWING MEDIUM 850 mm DEPTH GROWING MEDIUM FOR TREE PIT

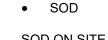

 1000 mm DEPTH PLANTING AREAS GROWING MEDIUM (MMCD) FOR LAWN AREA WITH TREES + SOD

 150 mm DEPTH HIGH TRAFFIC LAWN GROWING MEDIUM (MMCD) FOR AREA WITHOUT TREES + SOD

MUNICIPAL SIDEWALK

 CIP CONCRETE WITH BROOM FINISH TO CITY OF VICTORIA MUNICIPAL STANDARDS

CONCRETE PATH AND DRIVEWAY



TREE PIT WITH 1000mm DEPTH GROWING MEDIUM FOR BOULEVARD TREES






VANCOUVER ISLAND GRANITE OR



FENCE • 6' HT SOLID CEDAR WOOD FENCE

STAIN: HEMLOCK GREY


LANDSCAPE BOULDER

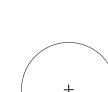


EXISTING BOULEVARD TREE TO BE RETAINED




PROPOSED BOULEVARD TREE TO BE SPECIFIED BY CITY OF VICTORIA PARKS

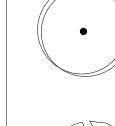

PROPOSED TREES

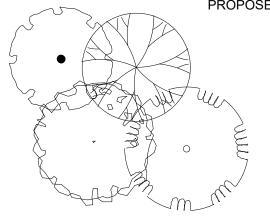

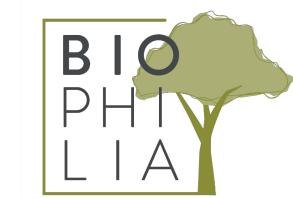

1608 Camosun Street, Victoria BC V8T 3E6 Info@biophiliacollective.ca 250 590 1156

OWNER/CLIENT:

ARYZE DEVELOPMENTS

PROJECT ADDRESS:

1733 FAIRFIELD, VICTORIA, BC

DESIGNED BY:BIANCA BODLEY DRAWN BY: TYLER YESTAL

NO. ISSUE YY\MM\DD ISSUED FOR DEVELOPMENT TRACKER | 22\03\04 ISSUED FOR RZ/DP 22\05\02 ISSUED FOR COORDINATION 22\07\18

ISSUED FOR RZ/ DP 22\07\20 ISSUED FOR RZ/ DP RESUBMISSION 23\01\24 ISSUED FOR RZ/ DP RESUBMISSION 2023\08\18 2023\10\10 25% BUILDING PERMIT 2023/11/24 2024/01/12 9 DP/RZ REV 4


SEAL

NORTH ARROW

DRAWING TITLE:

LANDSCAPE SITE PLAN LEVEL 1

DWG NO:

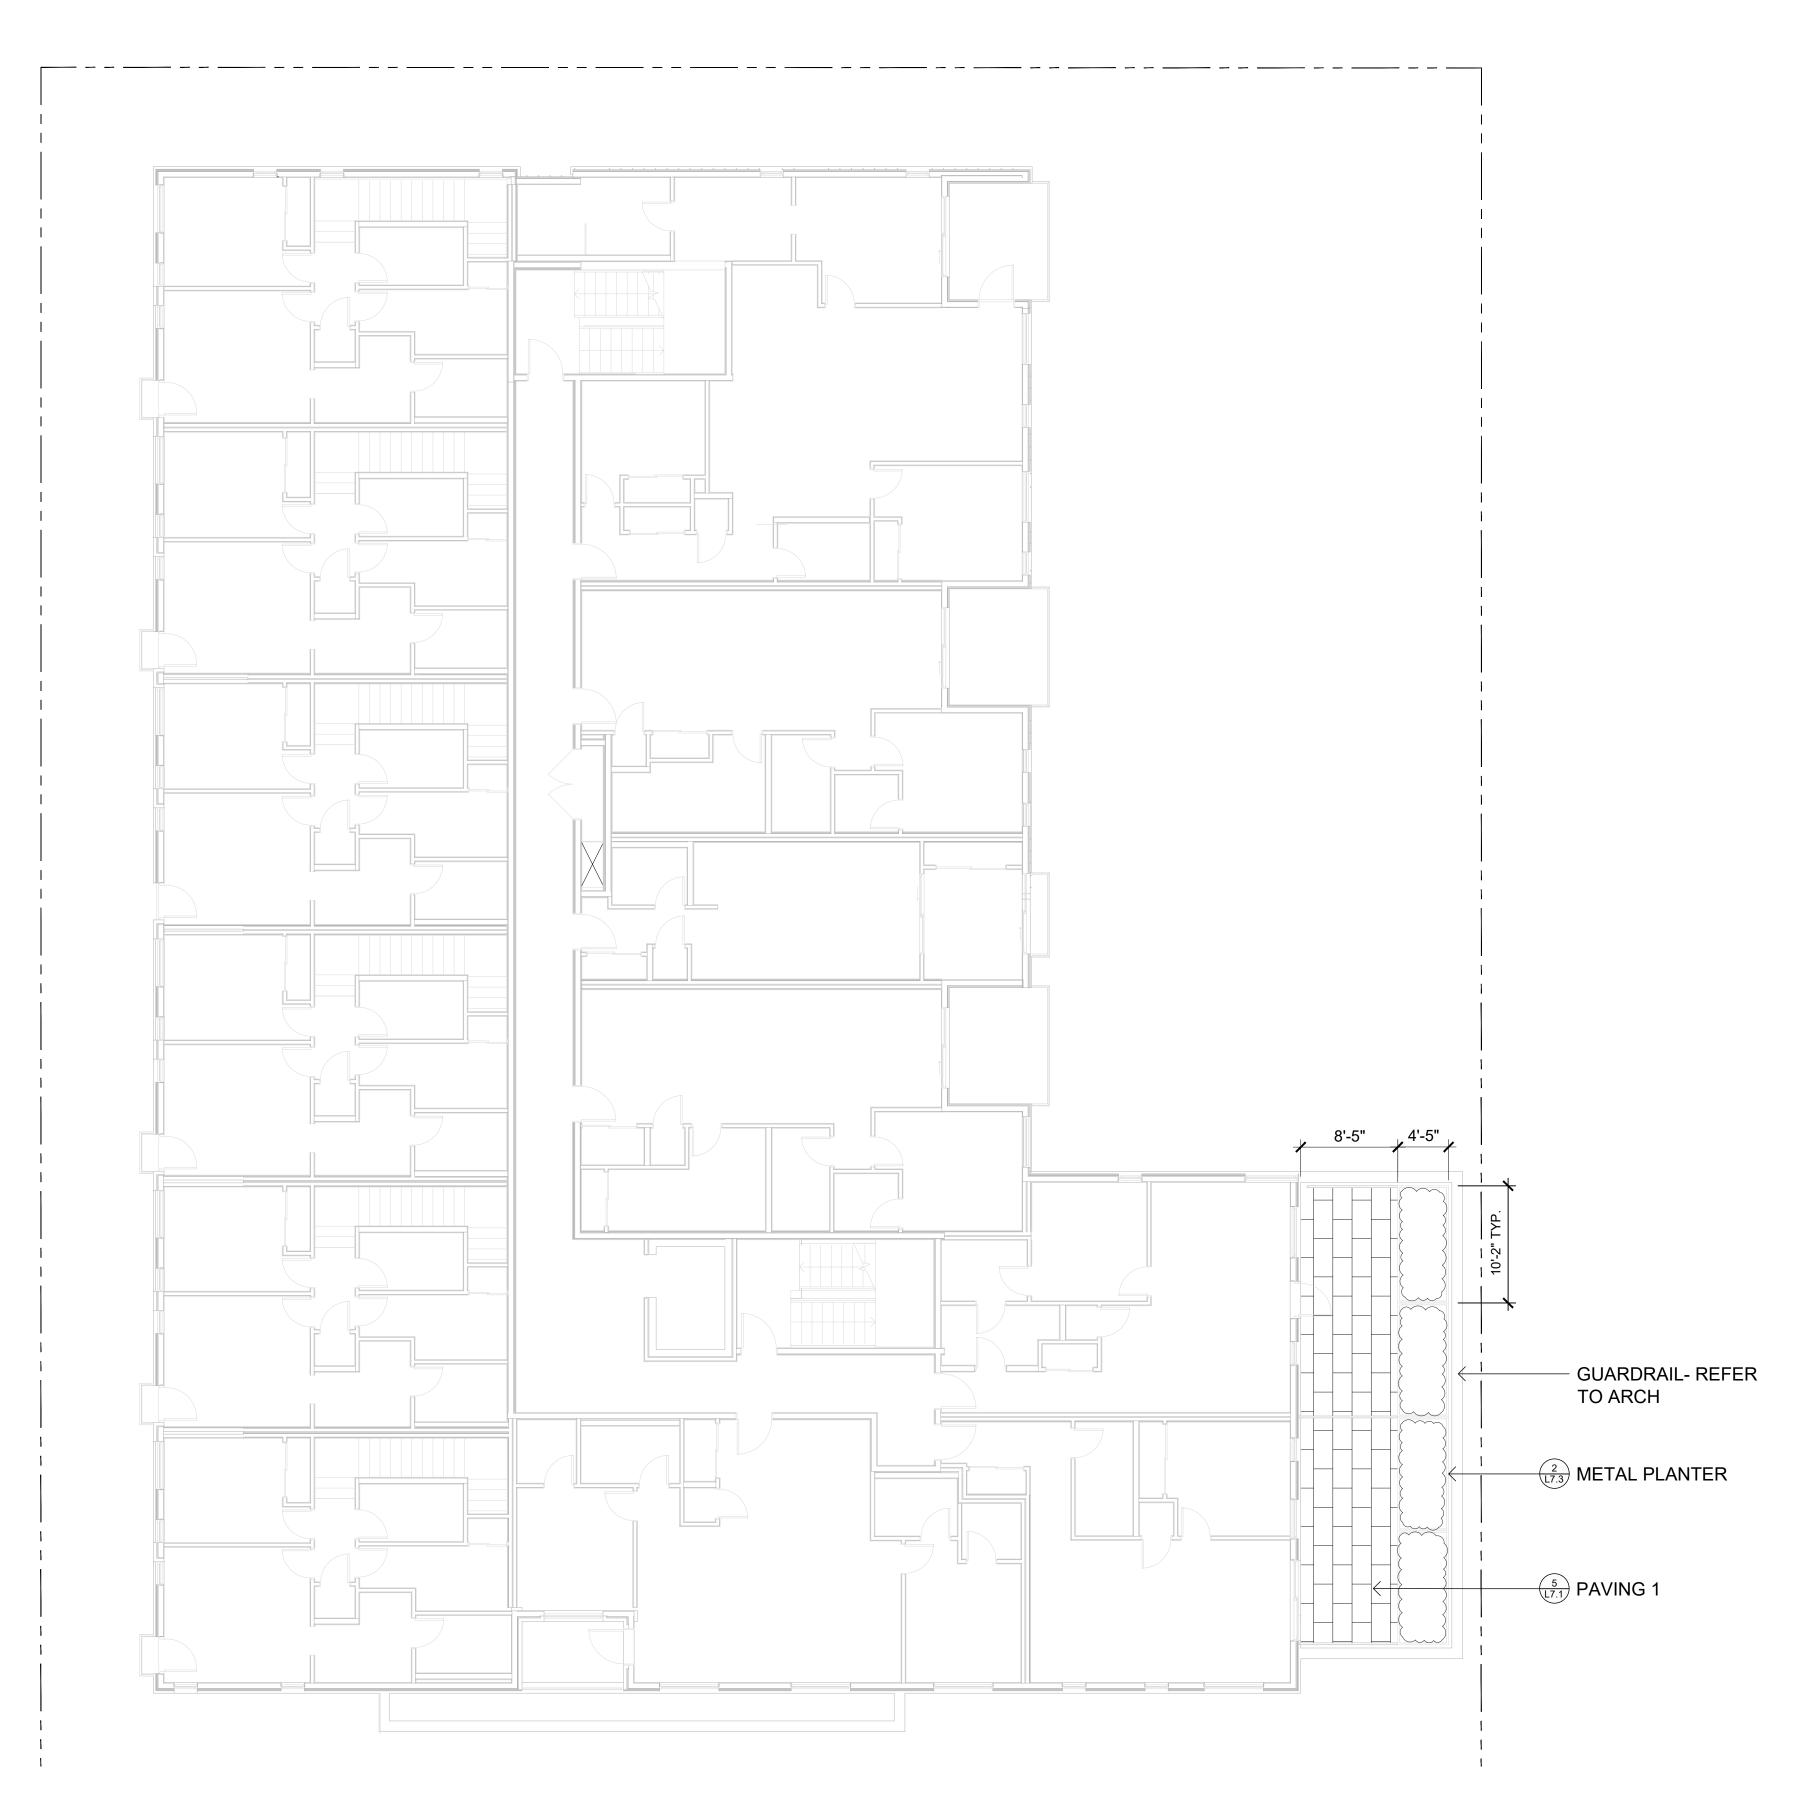





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2024/01/12


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SEAL


NORTH ARROW

LANDSCAPE MATERIALS AND LAYOUT PLAN LEVELS 2, 3, & 4

DWG NO:



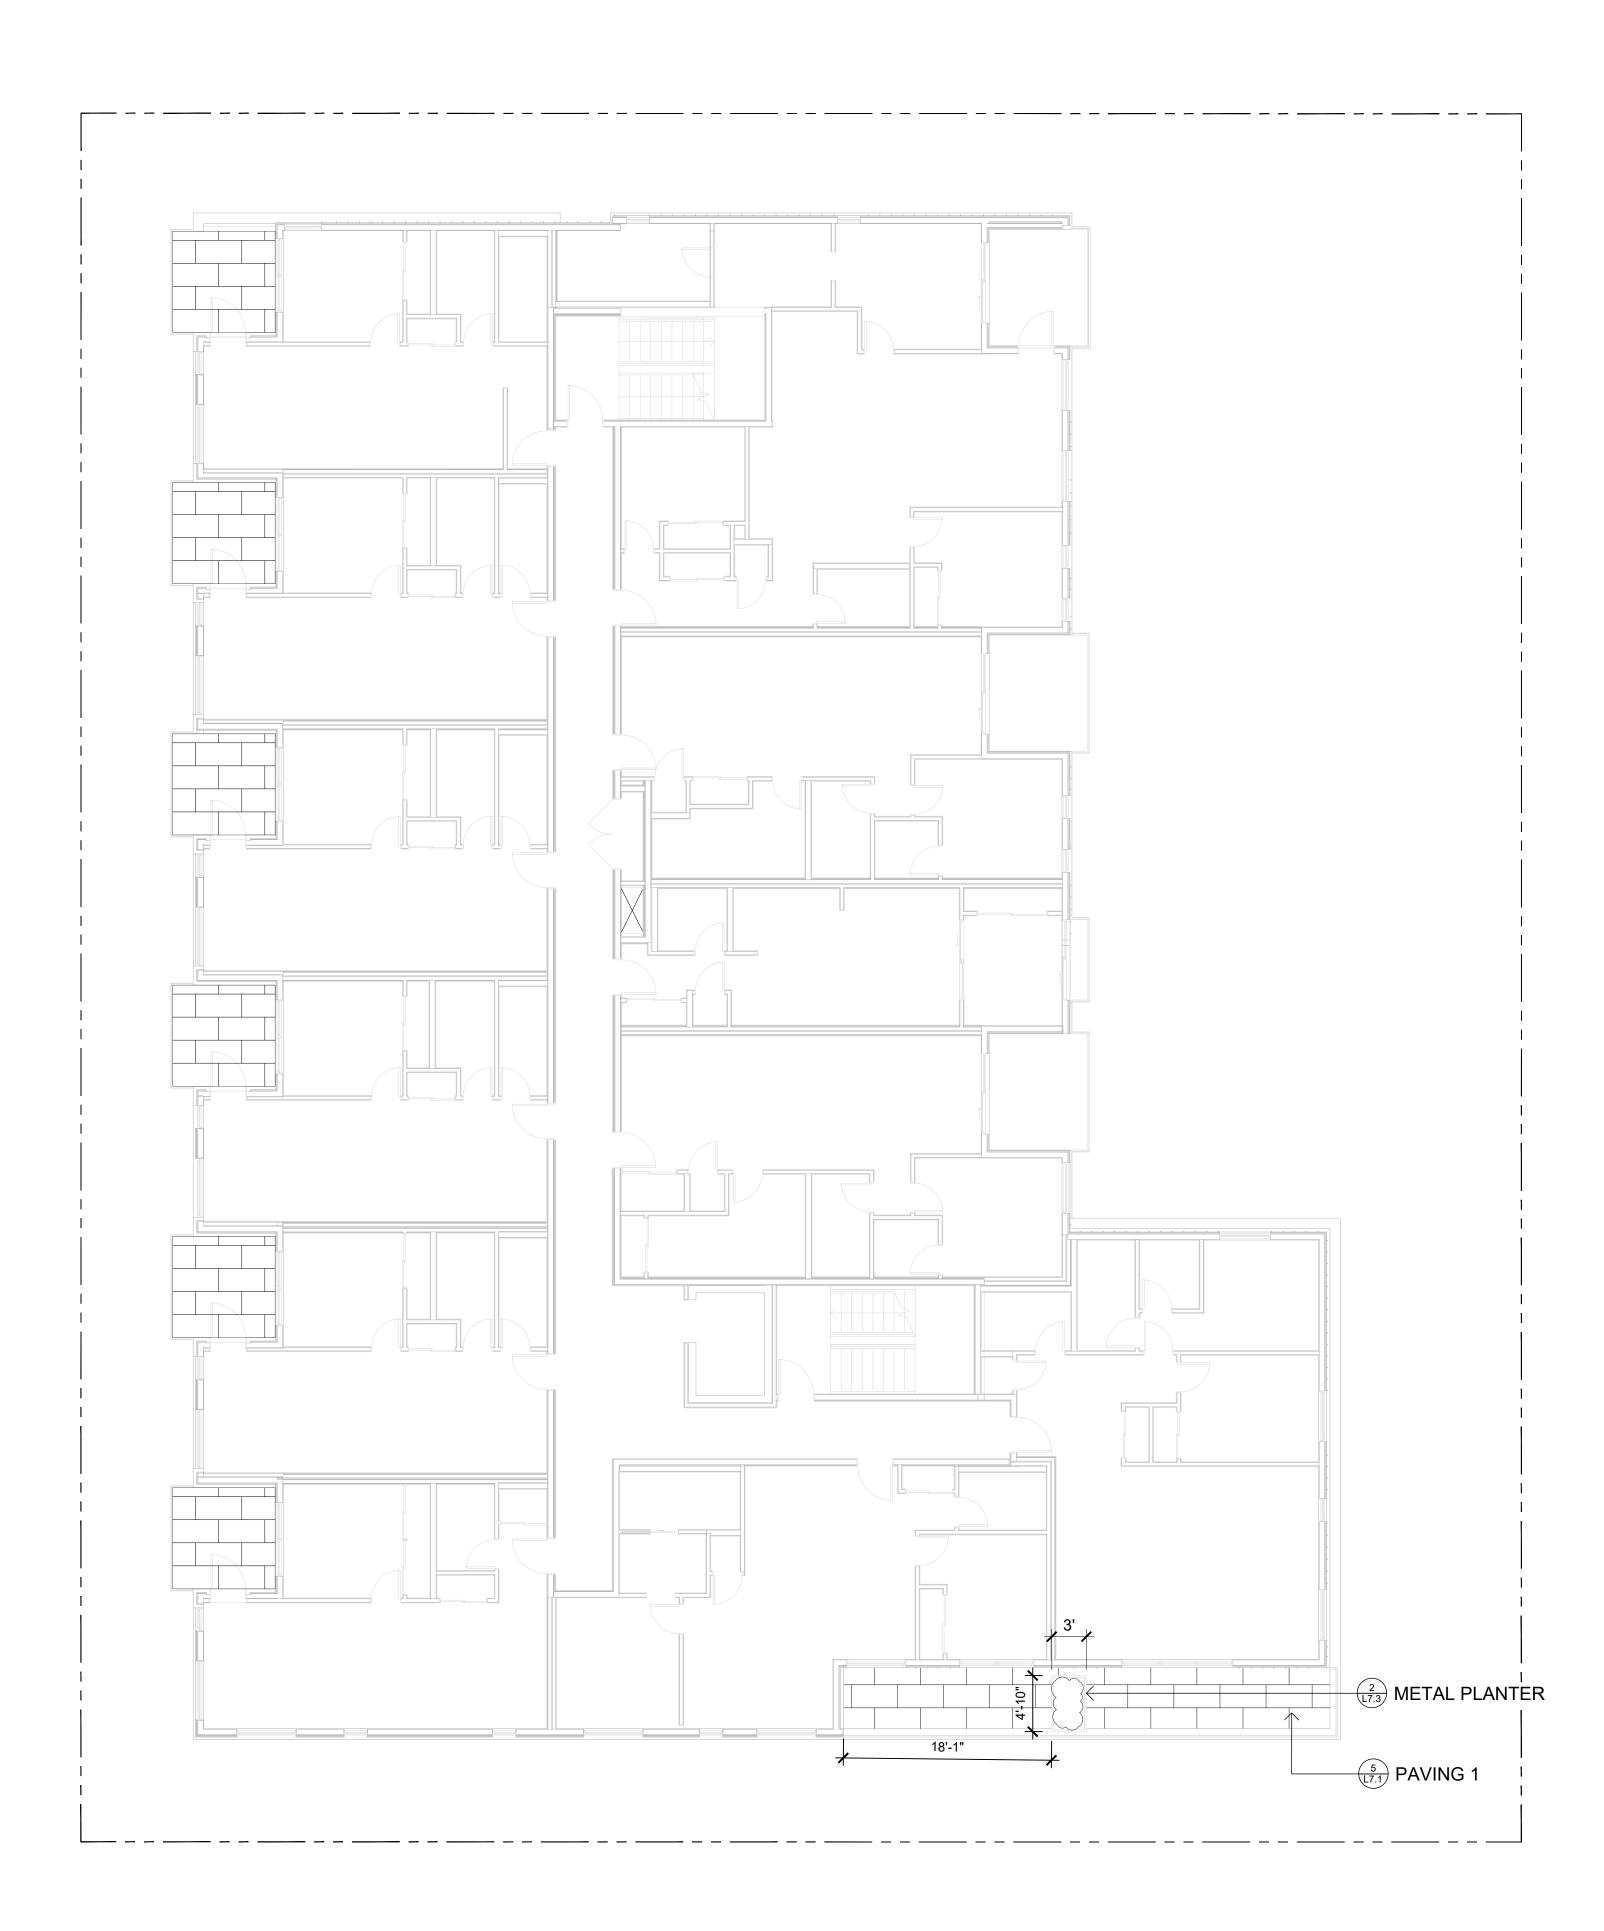

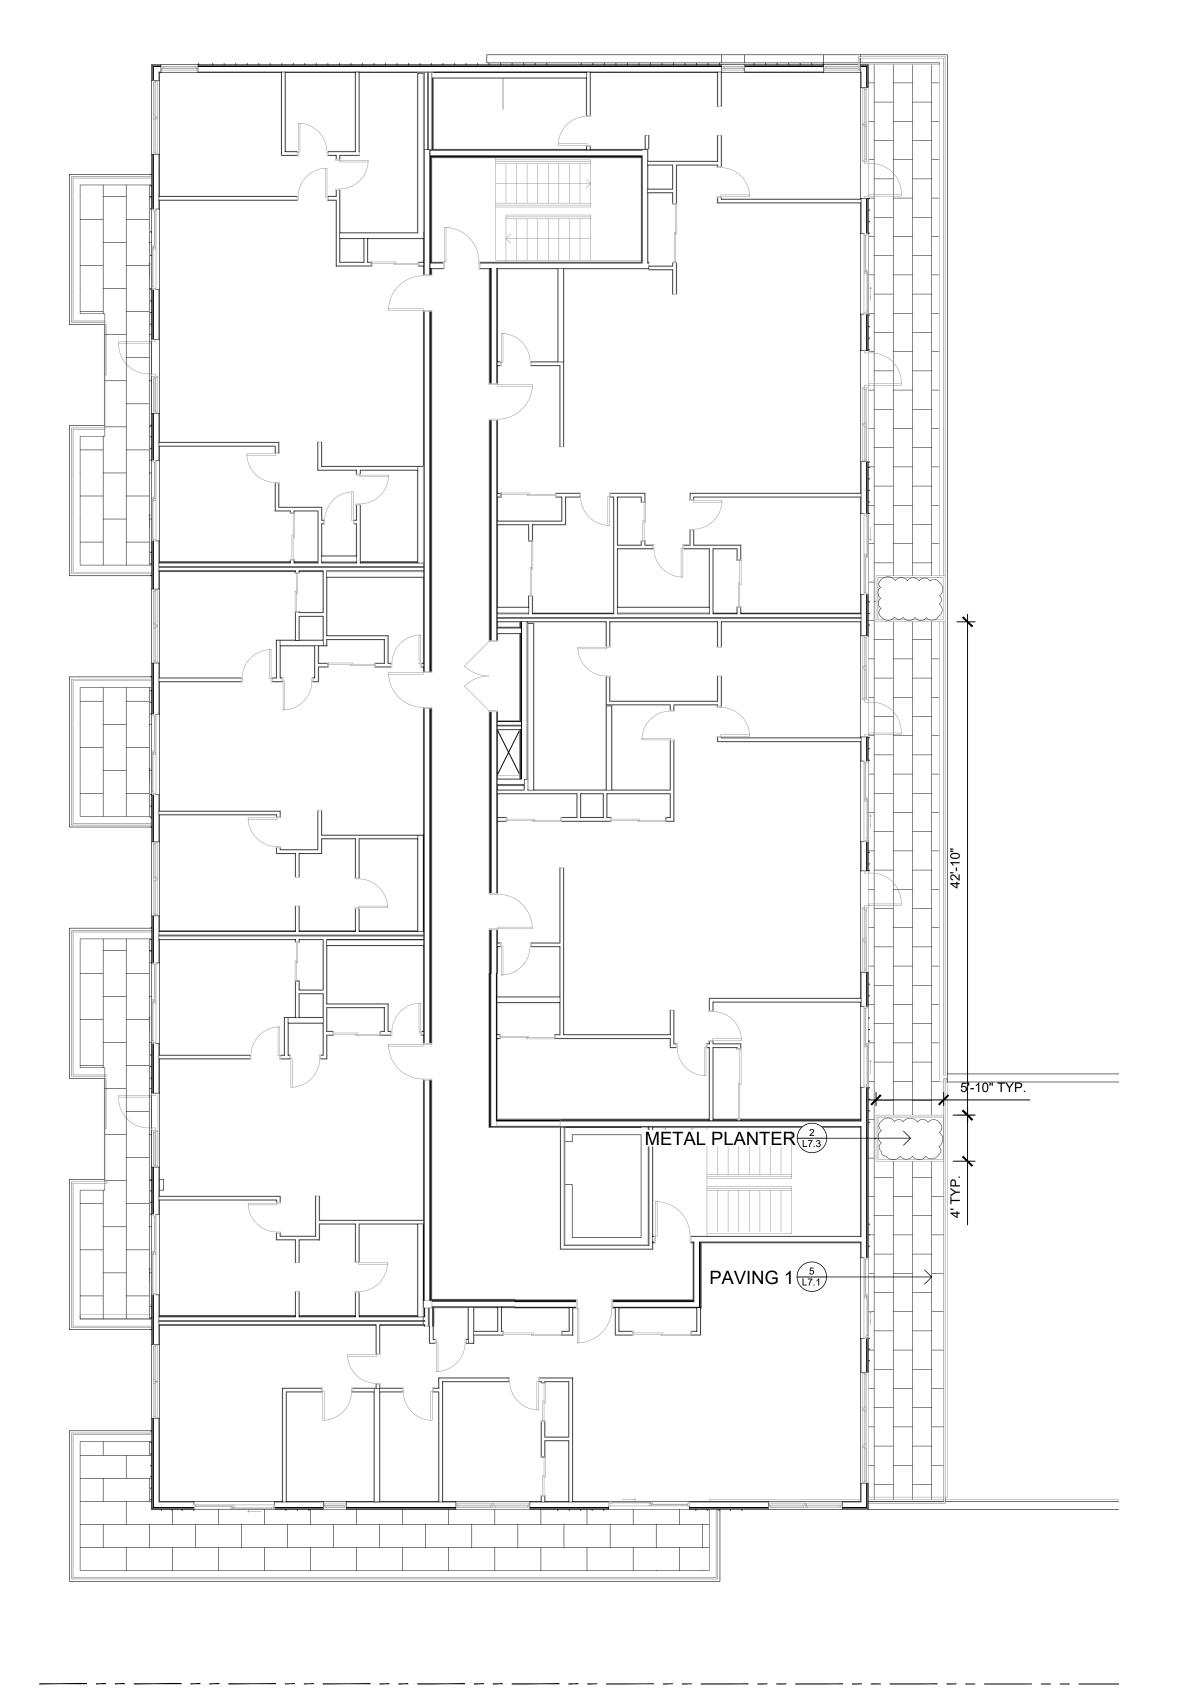

2 LEVEL 4 BALCONY & PLANTER L1.3 1:100





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9 DP/RZ REV 4

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 2023\10\10

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 2023/11/24

SEAL


NORTH ARROW

DRAWING TITI

LANDSCAPE MATERIALS
AND LAYOUT PLAN
LEVELS 2, 3, & 4

DWG NO:

SCALE: AS NOTED

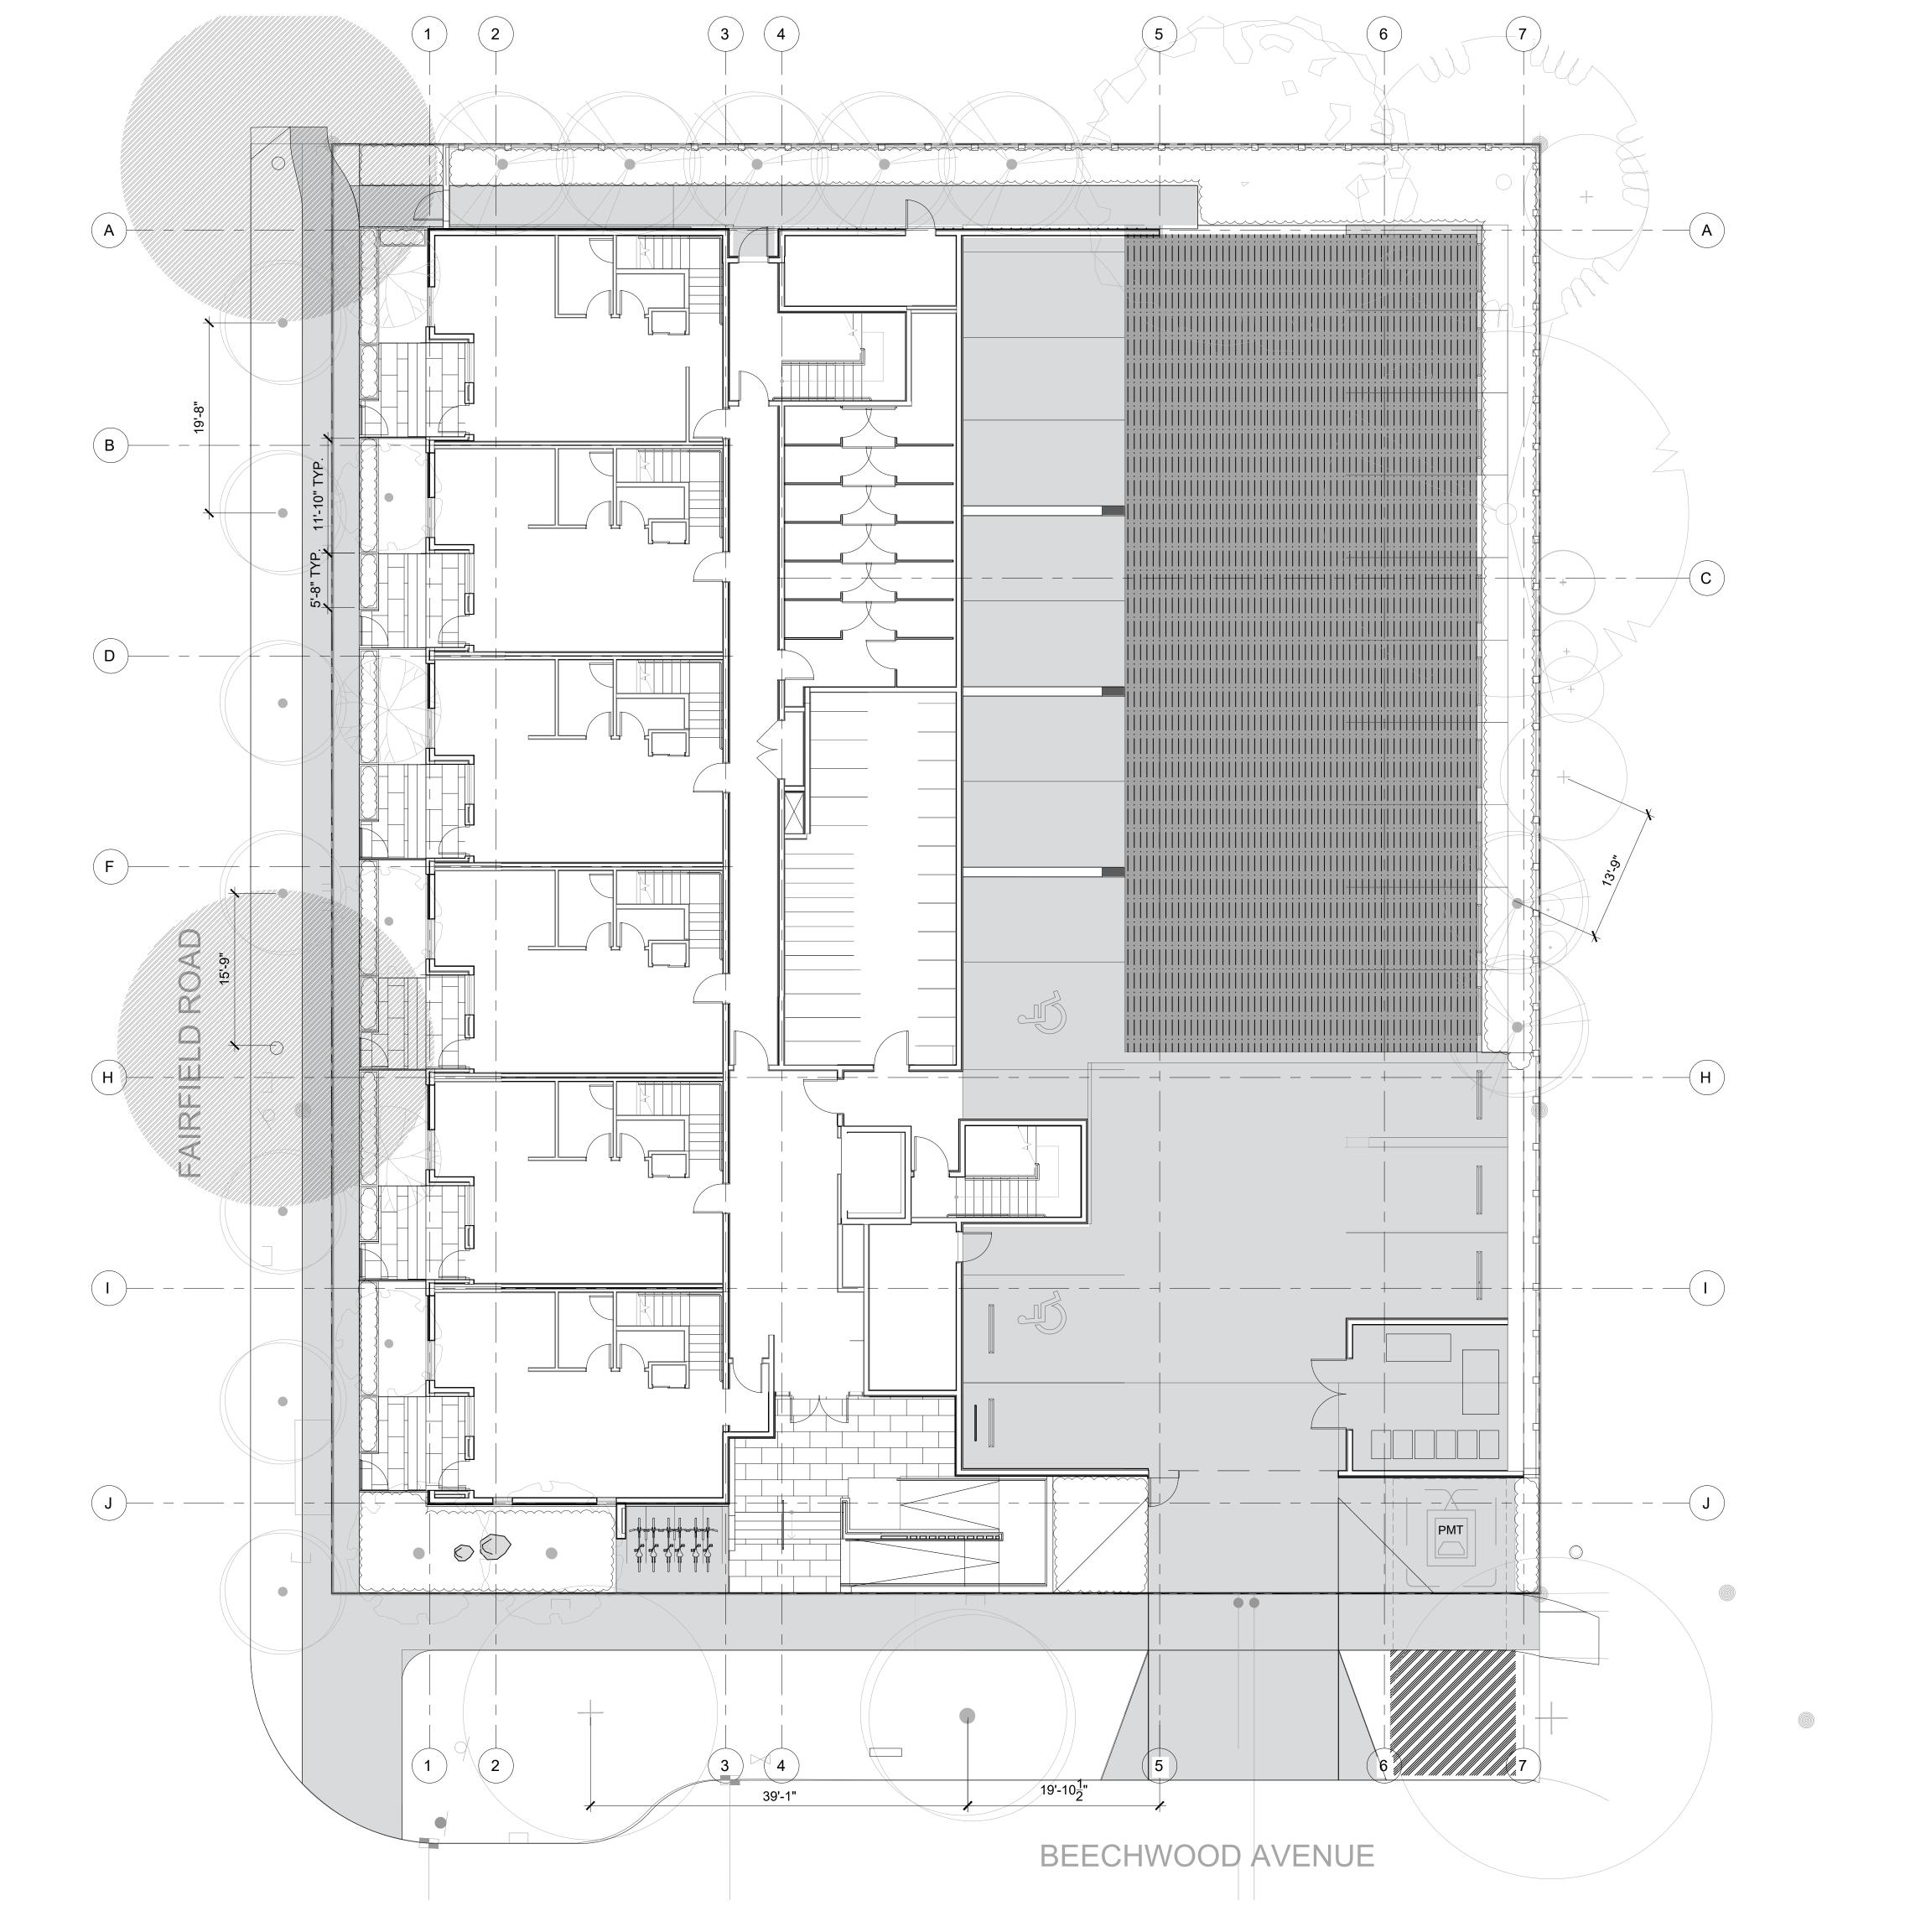



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2024/01/12

9 DP/RZ REV 4

SEAL

NORTH ARROW

DRAWING TITLE:

LAYOUT PLAN


DWG NO:

LAYOUT PLAN NOTES

ALL DIMENSIONS ARE NOMINAL
 REFER TO GRADING PLAN FOR ELEVATIONS

3. ALL SITE FURNISHINGS TO BE CONFIRMED WITH LANDSCAPE ARCHITECT PRIOR TO INSTALLATION

L2.1

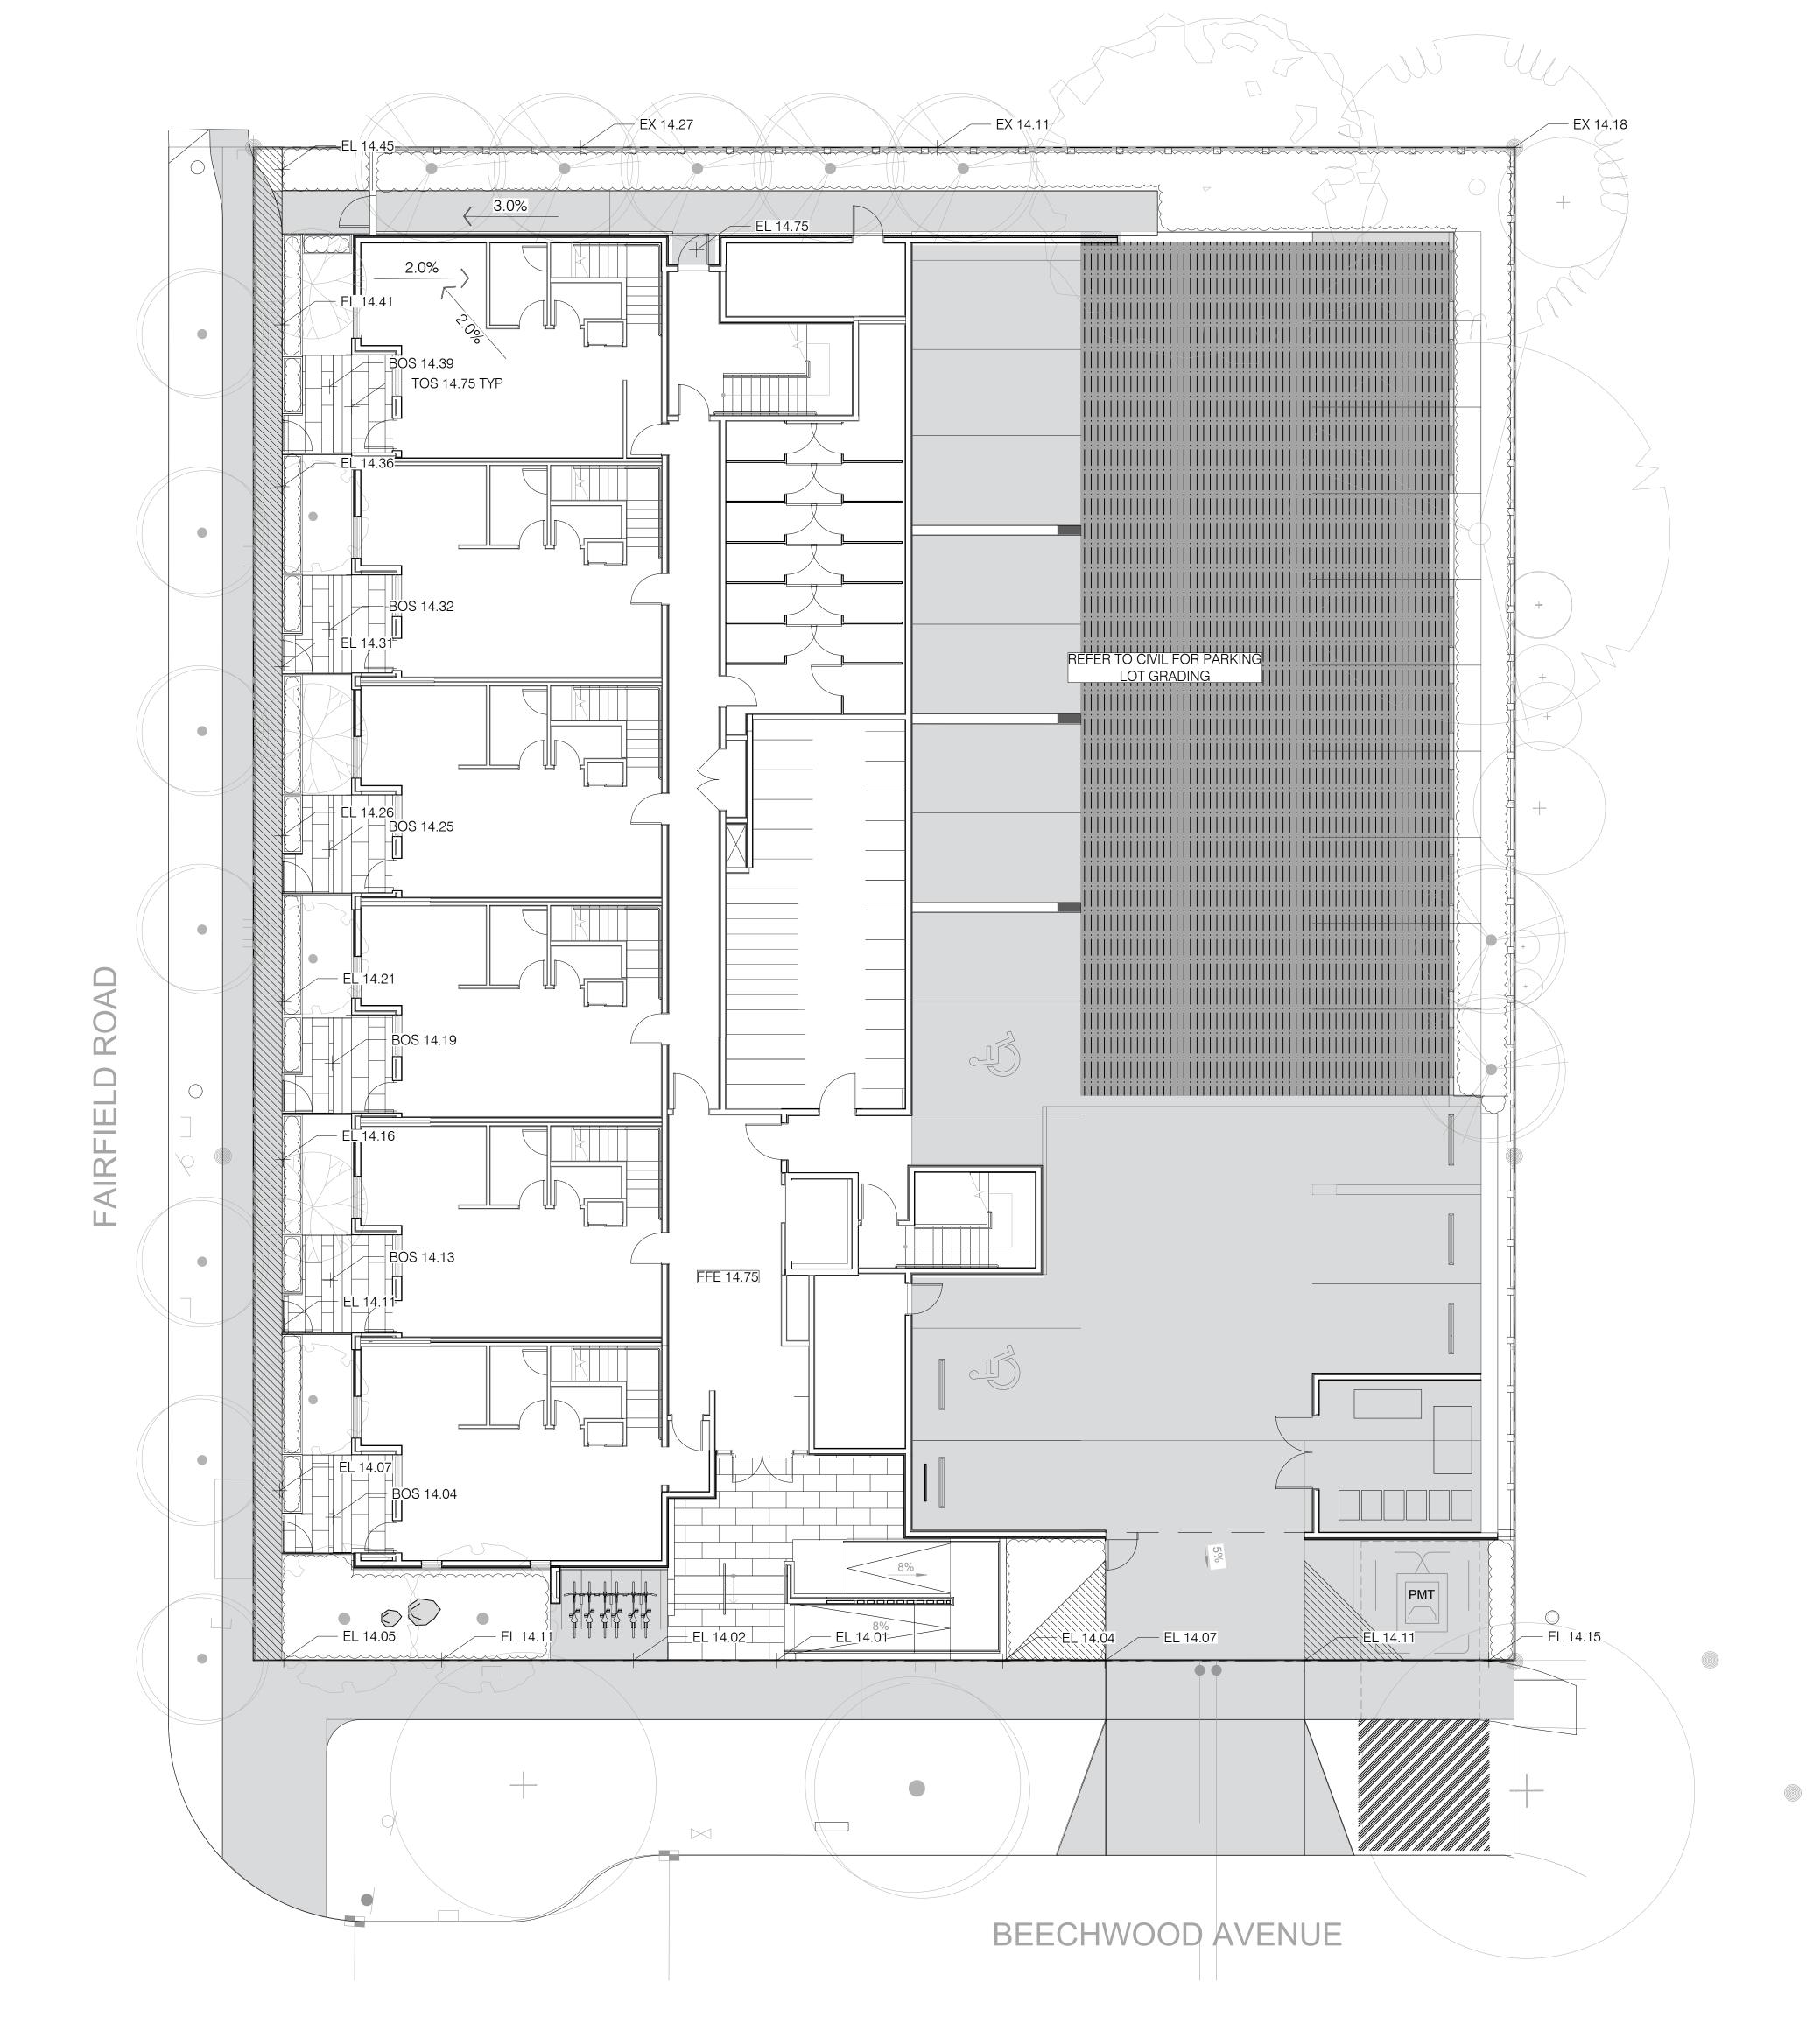



1608 Camosun Street, Victoria BC V8T 3E6 Info@biophiliacollective.ca 250 590 1156

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2024/01/12

9 DP/RZ REV 4

SEAL

GRADING PLAN NOTES


ALL ELEVATIONS ARE NOMINAL. CONTRACTOR TO VERIFY SPOT ELEVATION PRIOR THE START OF CONSTRUCTION.
 ALL ELEVATIONS ARE TO TOP OF FINISHED GRADE UNLESS

REFER TO CIVIL FOR ALL OFFISITE AND PARKING LOT GRADING.
 REFER TO ARCH FOR ONSITE PATIO GRADING.

NORTH ARROW

DRAWING TITLE:

GRADING PLAN

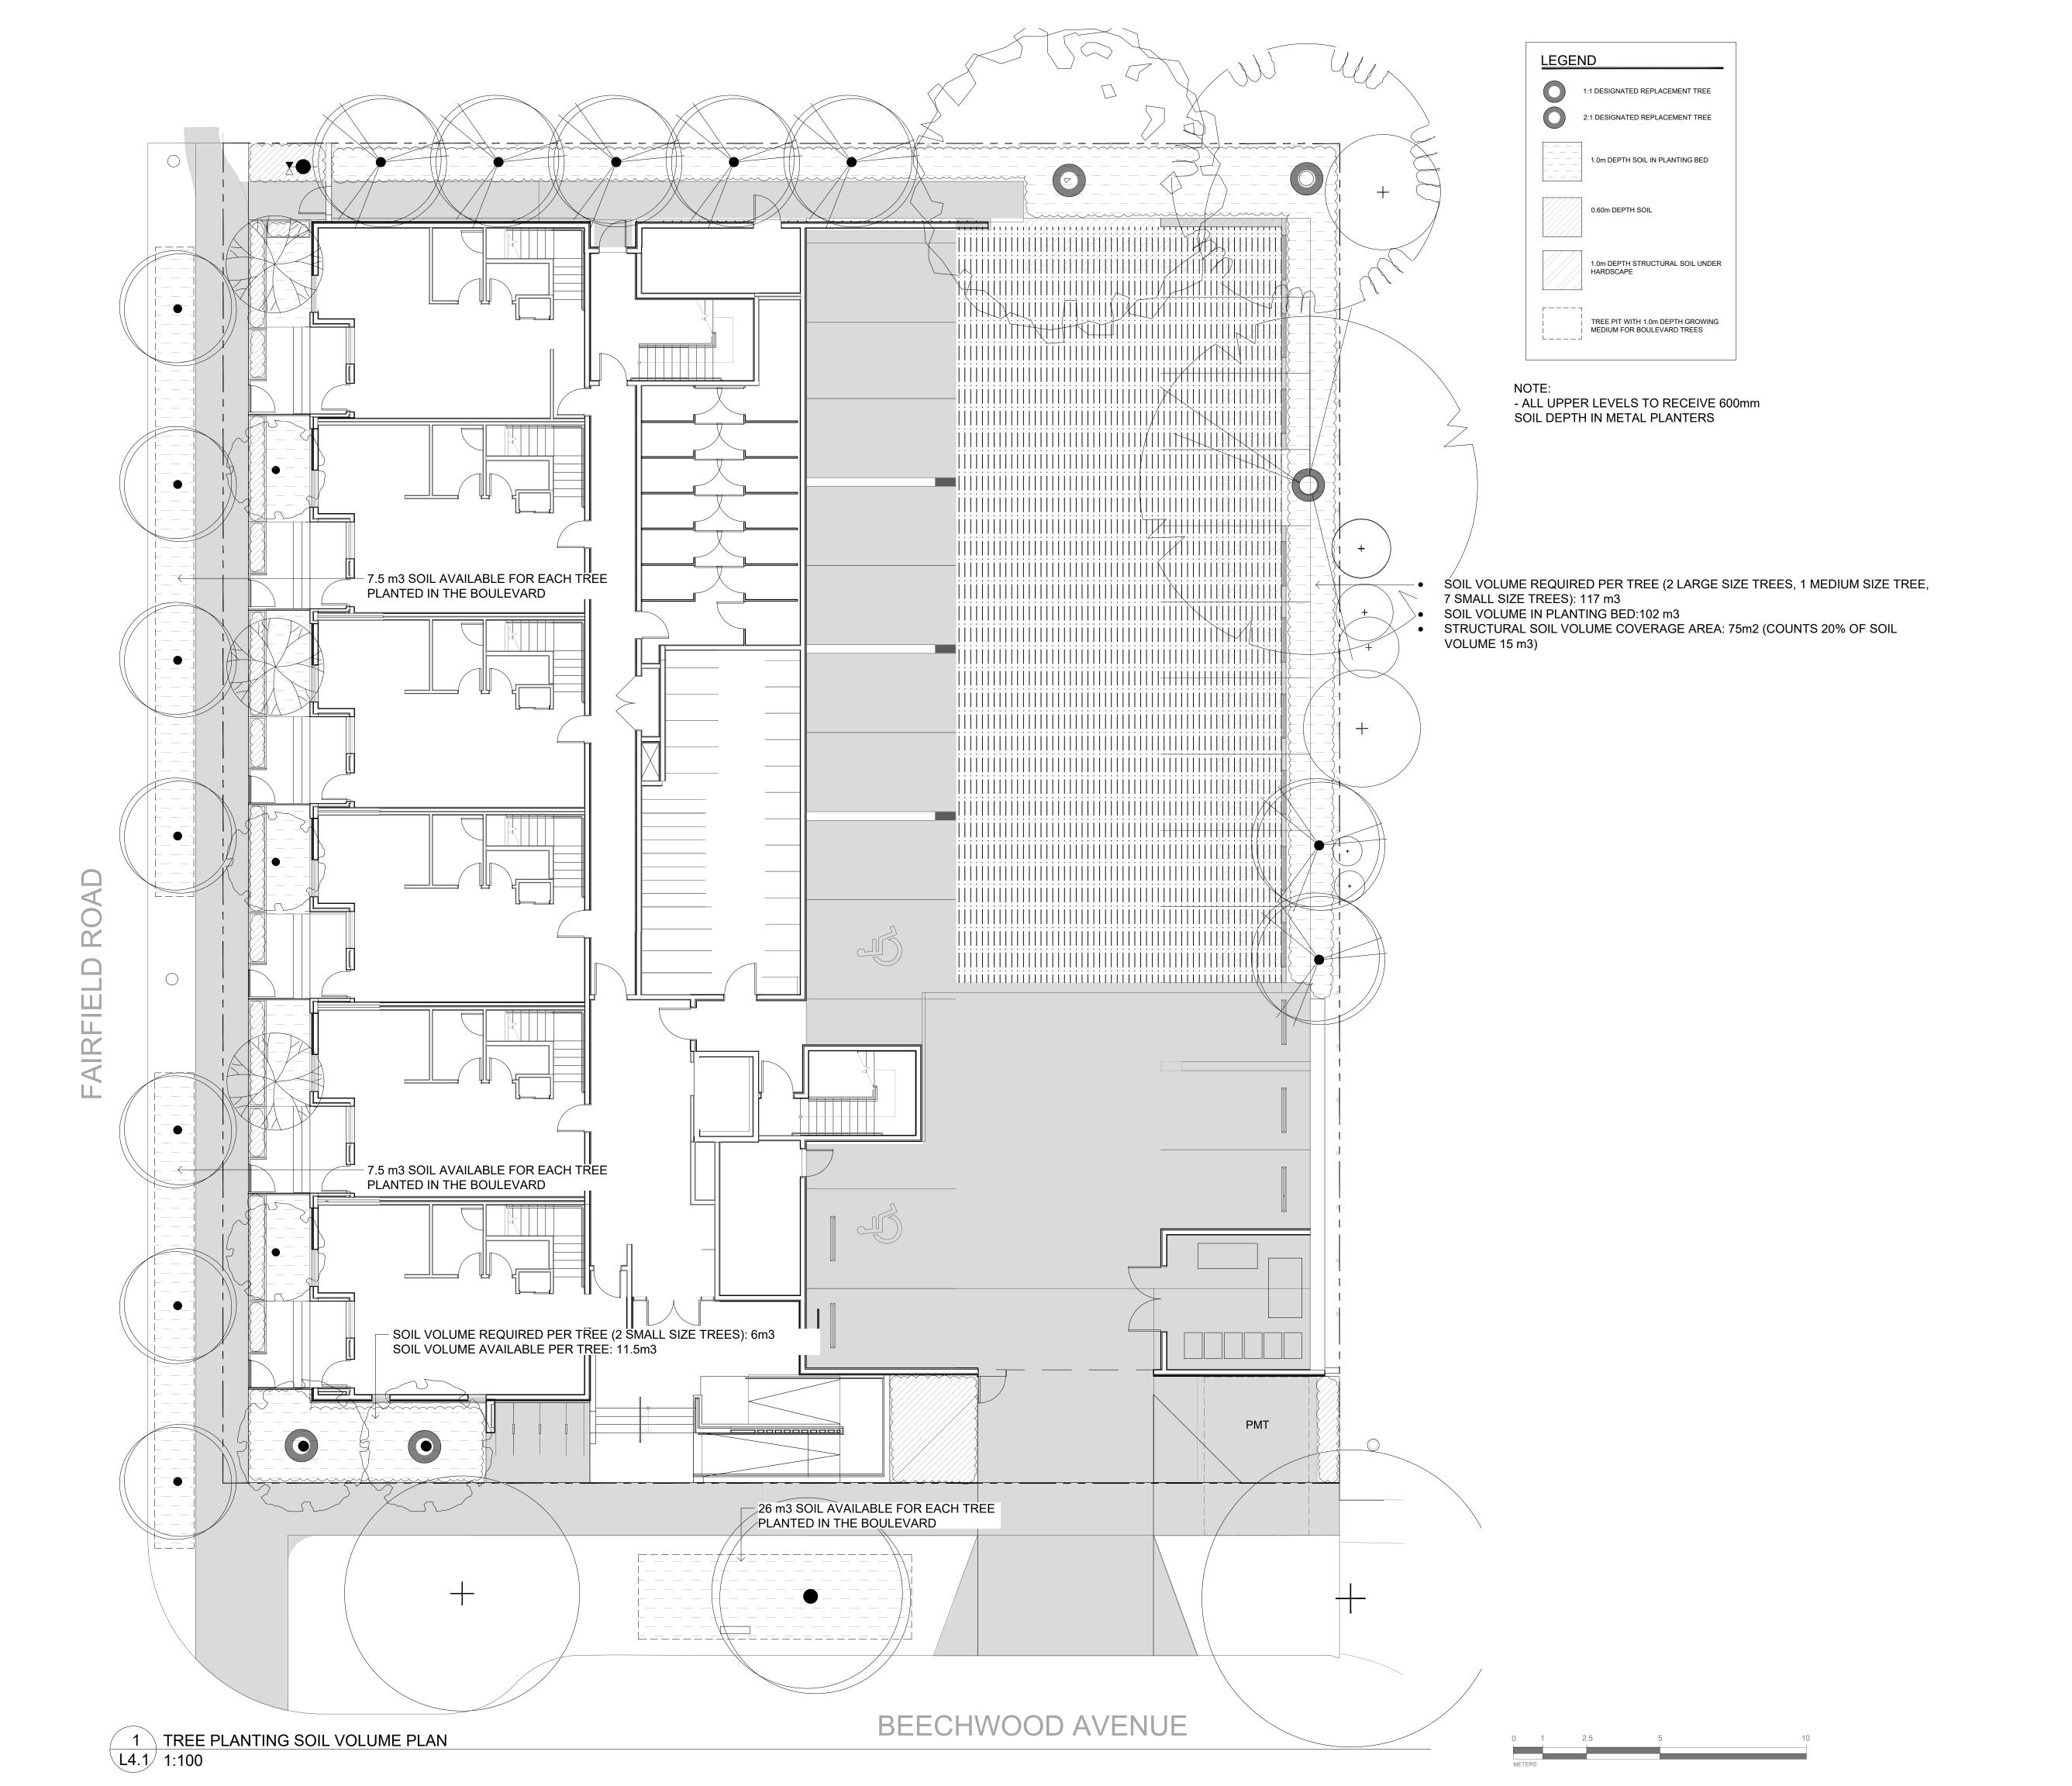



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SEAL


NORTH ARROW


DRAWING TITLE:

SOIL VOLUME PLAN

DWG NO:

LE: AS NOTED

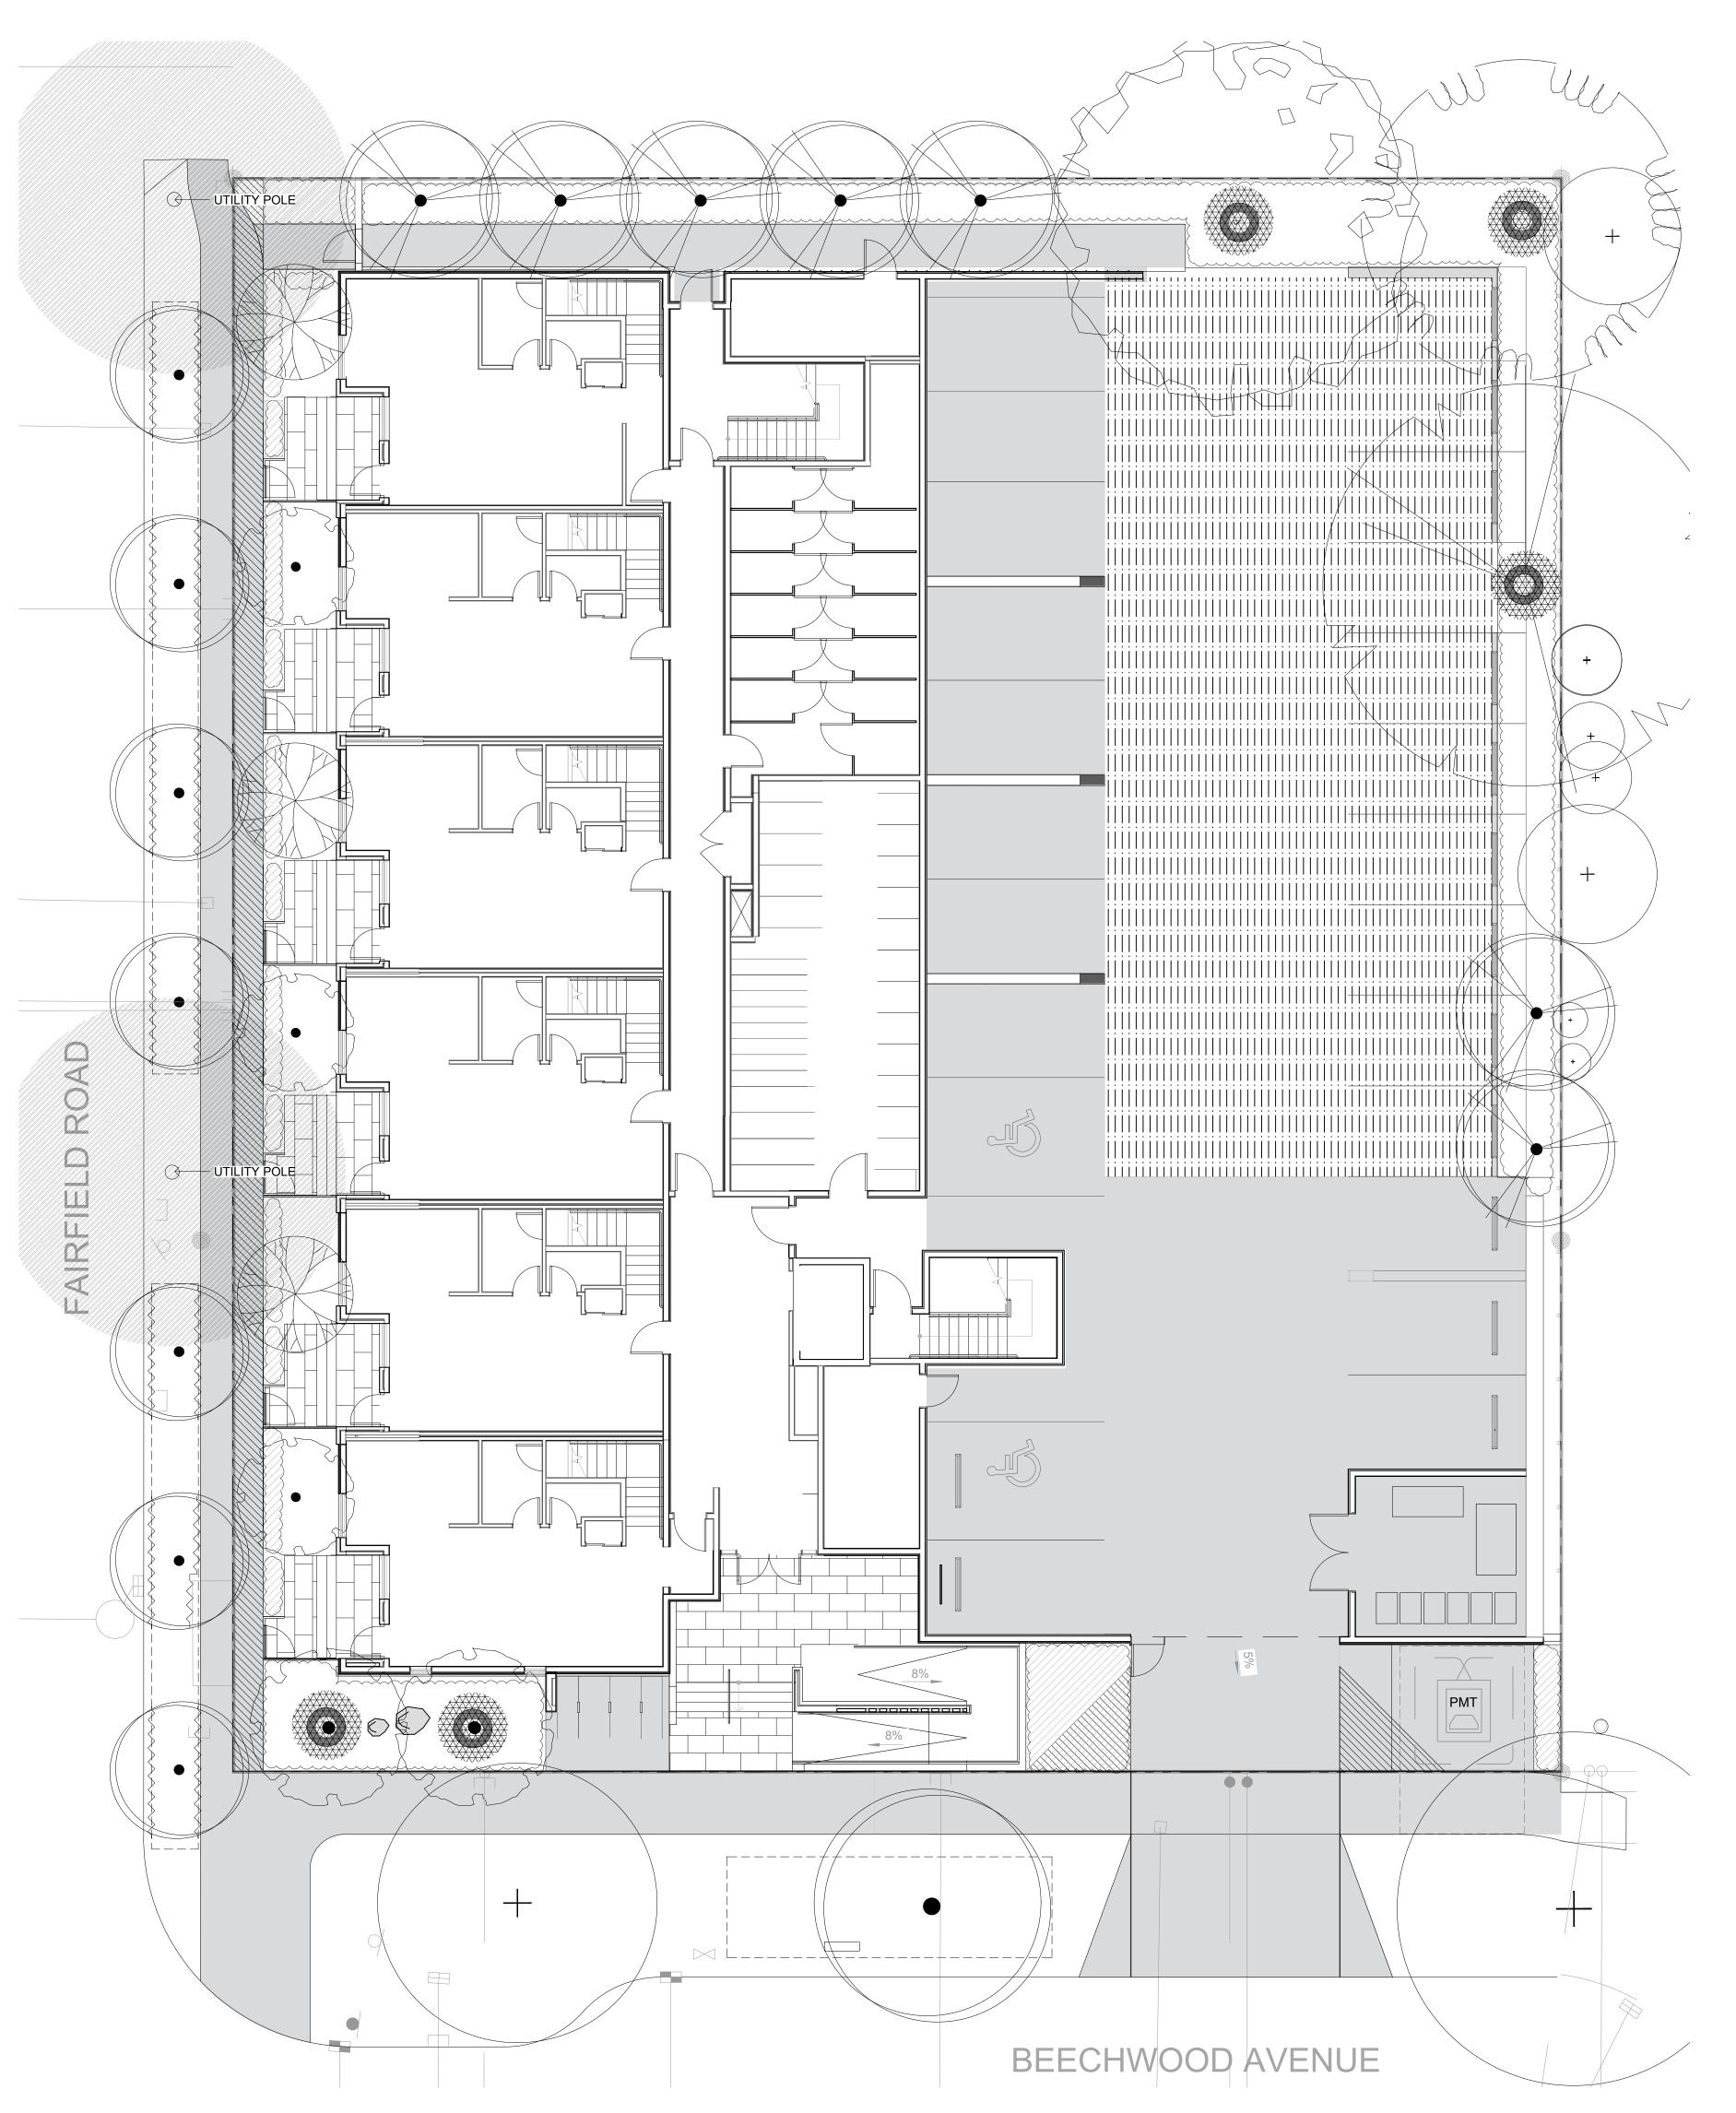

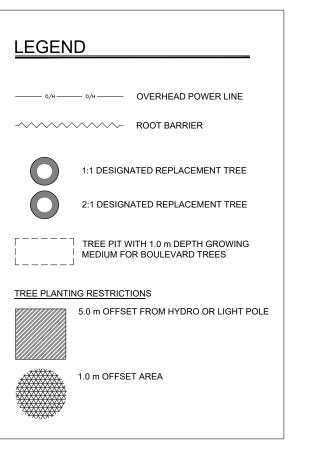

Quantity	Symbol	Latin Name	Common Name	Container	Caliper	Size	Native
5		Acer griseum	griseum Paperbark Maple		6 cm	>2 m	
1	A CONTRACTOR OF THE CONTRACTOR	Fraxinus americana 'Autumn Applause'	Autumn Applause white ash	B&B	6 cm	>2 m	
1		Liriodendron tulipifera	Tulip tree	B&B	6 cm	>2 m	
7		Parrotia persica 'Ruby Vase'	Ruby Vase Parrotia	B&B	6 cm	>2 m	
3		Styrax japonicus	Japanese snowbell	B&B	6 cm	>2 m	
1		Quercus palustris	Pin Oak	B&B	6 cm	>2 m	
8		BOULEVARD TREE TO BE DETERMINED BY PARKS AT BP		B&B	TBD		

TREE STATUS	TOTAL	TO BE RETAINED	TO BE REMOVED	REPLACEMENTS REQUIRED	MINIMUM REQUIRED FOR LOT SIZE	PROPOSED
ON-SITE TREES AND SHRUBS BYLAW PROTECTED	7	0	7	7	9	4
MUNICIPAL TREES	3	2	1	1		8
NEIGHBORING TREES, BYLAW PROTECTED	0	0	0	0		0

REPLACEMENT TREES TO BE PLANTED ON SITE	4	
REPLACEMENT TREE SHORTFALL	3	
TOTAL PROPOSED TREES ON SITE (REPLACEMENT (ACTUAL) + OTHER)	18	

NOTES:

- IRRIGATION SYSTEM ON CITY PROPERTY SHALL COMPLY TO CITY OF VICTORIA SUPPLEMENTARY SPECIFICATIONS FOR STREET TREES AND IRRIGATION SCHEDULE C, BYLAW 12-042, SUBDIVISION BYLAW. IRRIGATION DRAWINGS MUST BE SUBMITTED TO PARKS DIVISION FOR REVIEW AND APPROVAL 30 DAYS PRIOR TO INSTALLATION WORK. THE FOLLOWING IRRIGATION AND SLEEVING INSPECTIONS BY PARKS STAFF ARE REQUIRED BY SCHEDULE C.
- IRRIGATION INSPECTION REQUIREMENTS:
- a. THE IRRIGATION SYSTEM AND SLEEVING INSPECTION REQUIREMENTS CAN BE FOUND IN SCHEDULE C OF THE VICTORIA SUBDIVISION AND DEVELOPMENT SERVICING BYLAW NO. 12-042.
- b. IRRIGATION SLEEVING PRIOR TO BACKFILLING*
- c. OPEN TRENCH MAIN LINE AND PRESSURE TEST
- d. OPEN TRENCH LATERAL LINE
- e. IRRIGATION SYSTEM, CONTROLLER, COVERAGE TEST, BACKFLOW PREVENTER ASSEMBLY TEST REPORT
- REQUIRED, BACKFLOW ASSEMBLY IS TO HAVE AN INSPECTION TAG COMPLETED AND ATTACHED. • 100MM SDR 28 PIPE WILL BE USED FOR IRRIGATION SLEEVING UNDER HARD SURFACES. INSTALLATIONS WHERE A 90-DEGREE BEND IS REQUIRED SHOULD BE INSTALLED USING 100MM SDR 28 GSX (22.5 DEGREE) LONG



SWEEPS. INSTALL WILL BE AT 400MM DEPTH.



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6	ISSUED FOR RZ/ DP RESUBMISSION	2023\08\1
7	25% BUILDING PERMIT	2023\10\1
8	ISSUED FOR BP COORDINATION	2023/11/2
9	DP/RZ REV 4	2024/01/12


SEAL

ACTUAL NUMBER : 5 2 x LARGE TREE (1:1) 1 x MEDIUM TREE (1:1) 2 x SMALL TREE (2:1)

NORTH ARROW

DRAWING TITLE:

TREE PLANTING PLAN

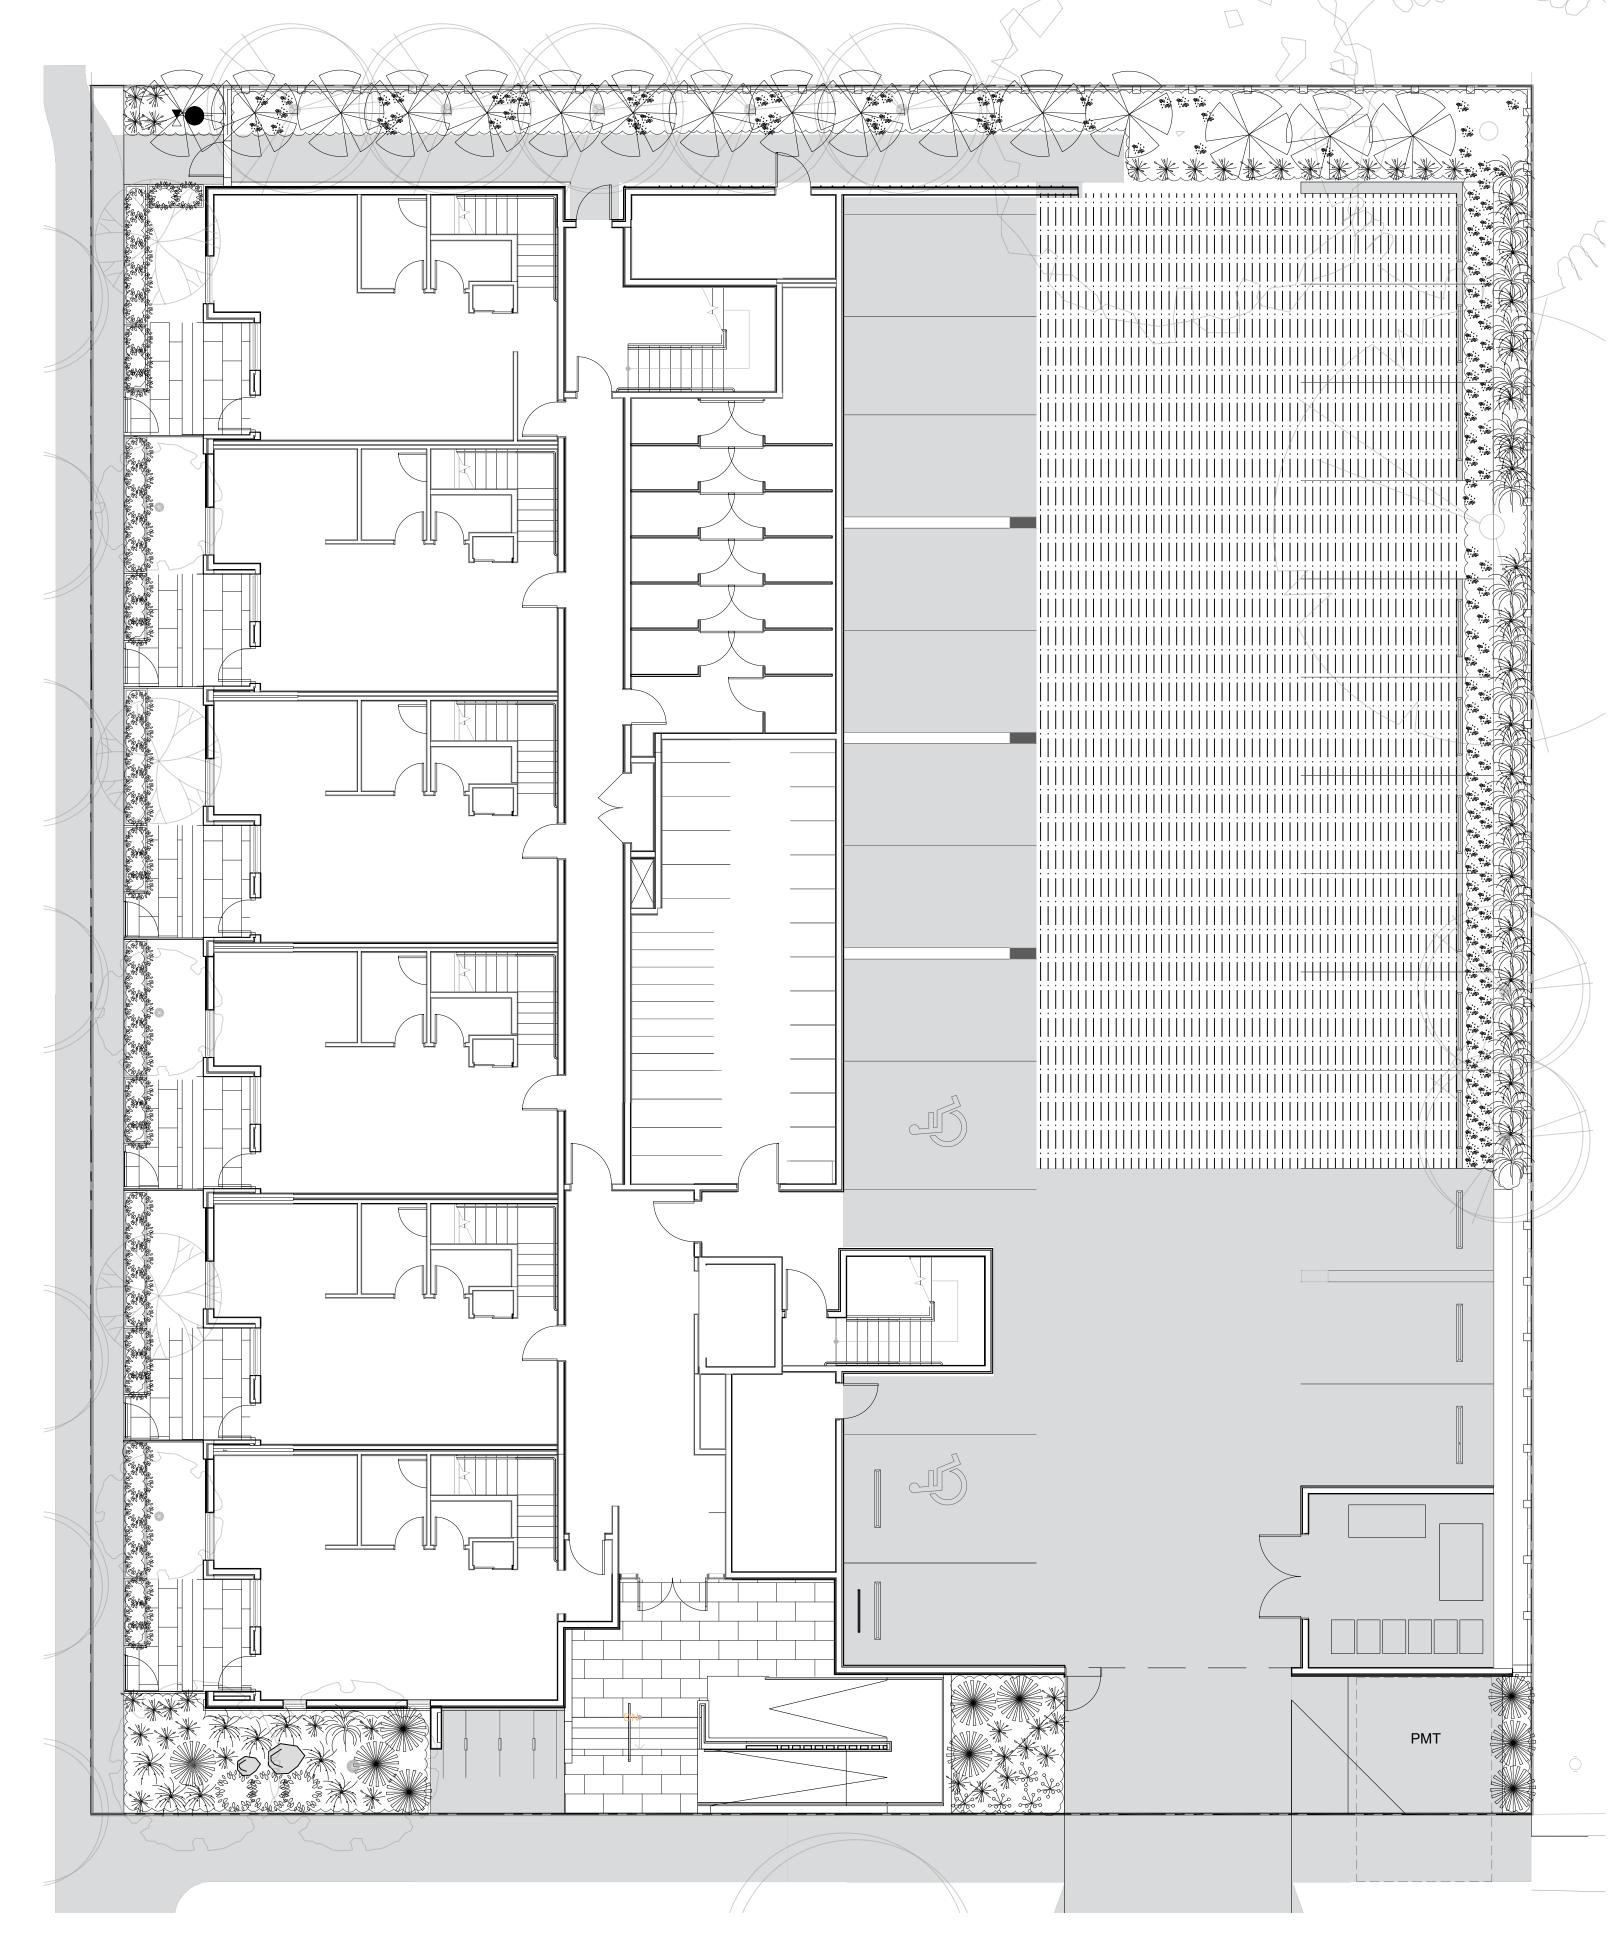

PLANT SCHEDULE Common Name | Container | Native | Pollinator Symbol Quantity Latin Name ***** 12 Armeria maritima White-flowered Thrift 10cm Arctostaphylos 90. OP 60 Uva-Ursi Kinnikinnick 10cm 'Massachusetts' New Zealand hair Carex testacea 30 #1 'Prairie Fire' Cephalotaxus Spreading Japanese 10 #2 harringtonia plum yew 'Prostrata' 16 Choisya ternata Mexican mock orange Hebe pinguifolia 50 Hebe Sutherlandii #1 'Sutherlandii' Miscanthus sinensis Huron Light maiden 30 'Huron Light' Miscanthus sinensis | Chinese silver grass 25 #1 Morning Light 'Morning Light'

1. PLANTS IN PLANT LISTS ARE SPECIFIED ACCORDING TO THE CANADIAN NURSERY LANDSCAPE ASSOCIATION CANADIAN STANDARDS FOR NURSERY STOCK AND SECTION 12, CONTAINER GROWN PLANTS FROM THE BC LANDSCAPE STANDARD, CURRENT EDITION.

Dwarf purpletop

#1


Verbena bonariensis

'Lollipop'

PLANTING PLAN NOTES

- ALL PLANT MATERIAL TO BCSLA STANDARDS.
- 2. THE SEARCH ARE FOR PLANT MATERIAL IS THE PACIFIC NORTHWEST INCLUDING WASHINGTON, OREGON AND BRITISH COLUMBIA.
- 3. CONFIRM PLANTING LAYOUT WITH LANDSCAPE ARCHITECT ON SITE.
- 4. ALL SOIL VOLUMES TO MEET THE STANDARDS OF THE CITY OF VICTORIA. REFER TO SOIL DEPTH PLANS FOR SOIL DEPTH REQUIREMENTS.
- 5. ALL GROWING MEDIUM PROVISION AND INSTALLATION TO BE IN LINE WITH CANADIAN LANDSCAPE
- 6. REFER TO CIVIL AND MECHANICAL FOR DRAINS.
- 7. ALL ONSITE AND OFF-SITE LANDSCAPE AREAS TO BE IRRIGATED BY AN UNDERGROUND AUTOMATIC IRRIGATION SYSTEM. IRRIGATION TO BE SUPPLIED BY CONTRACTOR
- 8. PLANTING AROUND EXISTING CRITICAL TREE ROOT ZONES TO BE INSTALLED UNDER THE SUPERVISION OF A CERTIFIED ARBORIST.

0 1 2.5 5 1 METERS

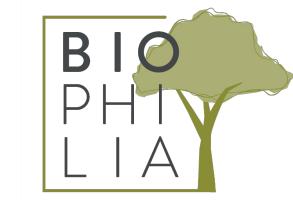

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8	ISSUED FOR BP COORDINATION	2023/11/24

2024/01/12

9 DP/RZ REV 4

SEAL

NORTH ARROW

DRAWING TITLE:


SHRUB PLANTING PLAN
LEVEL 1


DWG NO:

L4.3


1 GROUND FLOOR PLANTING PLAN

L3 1:100

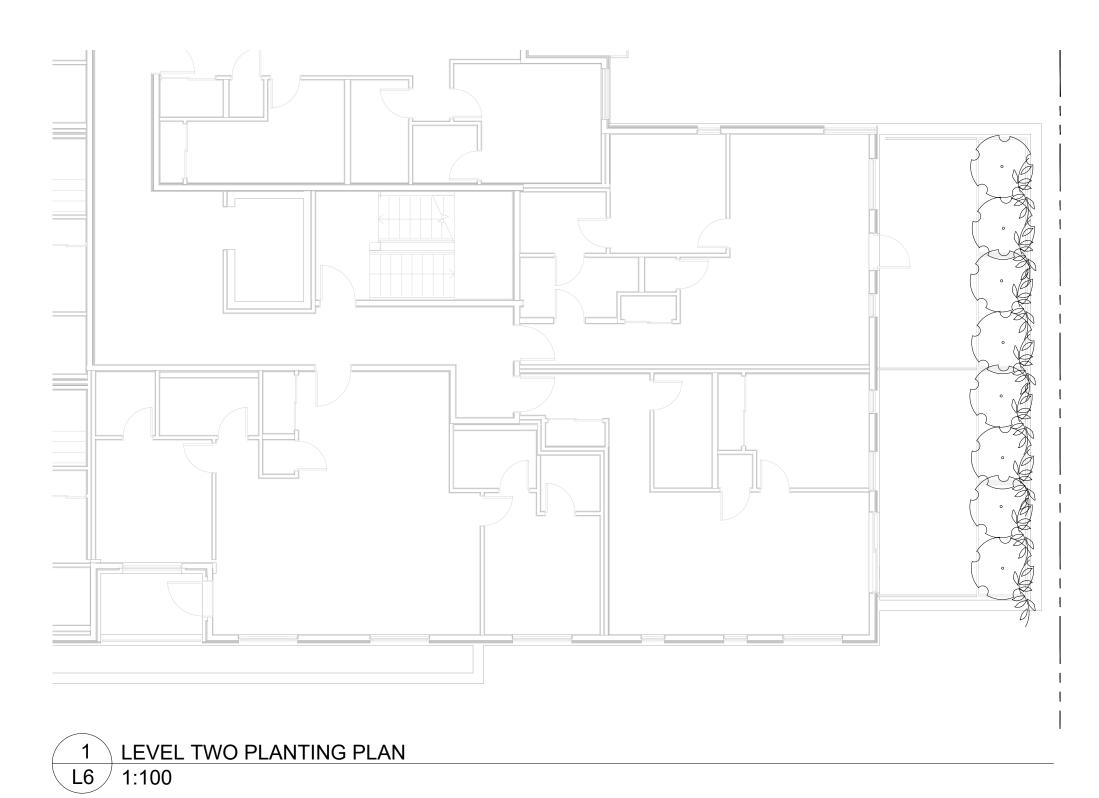

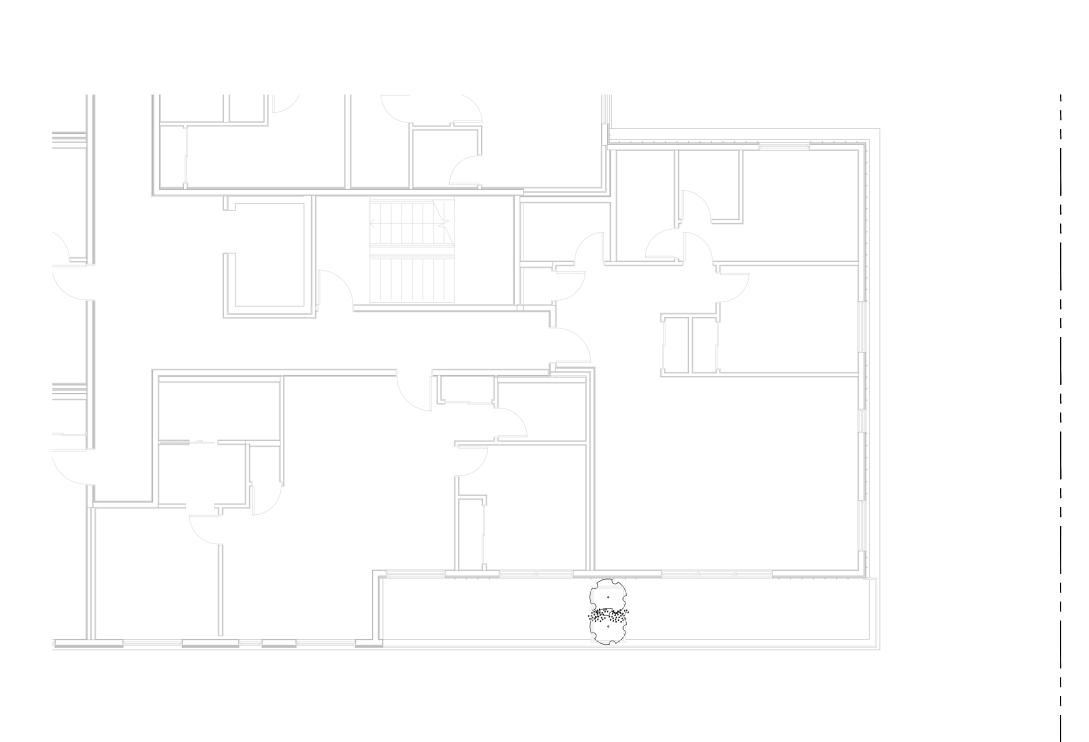



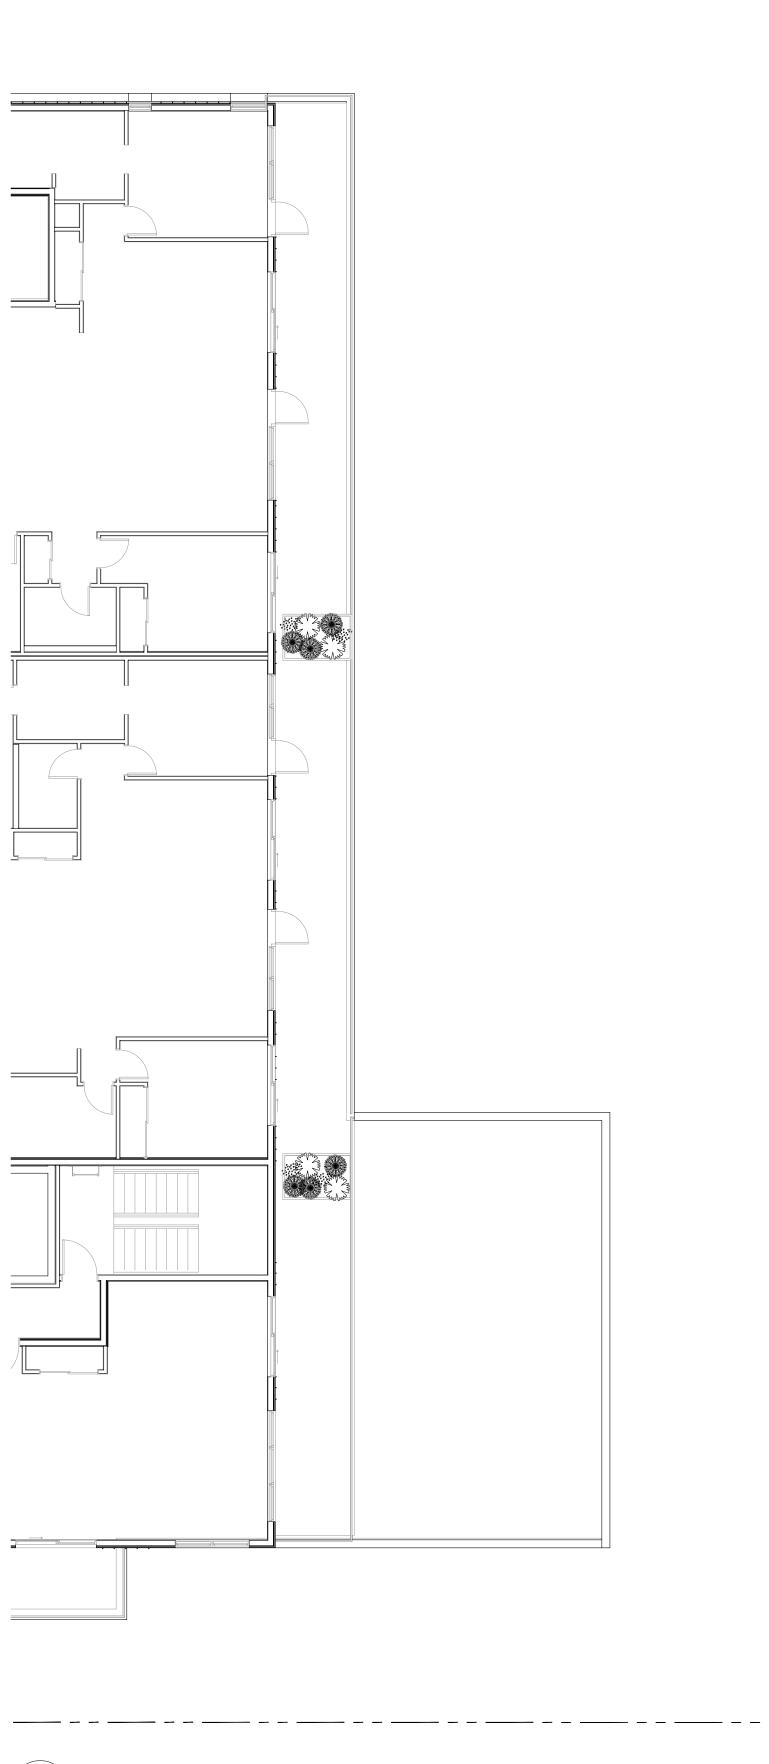

3 LEVEL FOUR PLANTING PLAN L6 1:100

PLANT S	SCHEDULE			T	I	Γ
Quantity	Symbol	Latin Name	Common Name	Container	Native	Pollinato
6		Armeria maritima 'Alba'	White-flowered Thrift	10cm		у
10		Choisya ternata	Mexican Orange Blossom	#3		У
6		Pinus strobus 'Horsford Dwarf'	Horsford Dwarf Eastern white pine	#2		
	an/m		Place A Thore White			

Reblooming Azalea

Virginia Creeper

#2

1. PLANTS IN PLANT LISTS ARE SPECIFIED ACCORDING TO THE CANADIAN NURSERY LANDSCAPE ASSOCIATION CANADIAN STANDARDS FOR NURSERY STOCK AND SECTION 12, CONTAINER GROWN PLANTS FROM THE BC LANDSCAPE STANDARD, CURRENT EDITION.

Parthenocussus

quinquefolia

PLANTING PLAN NOTES

ALL PLANT MATERIAL TO BCSLA STANDARDS.
 THE SEARCH ARE FOR PLANT MATERIAL IS THE PACIFIC NORTHWEST INCLUDING WASHINGTON,

OREGON AND BRITISH COLUMBIA.

CONFIRM PLANTING LAYOUT WITH LANDSCAPE ARCHITECT ON SITE.
 ALL SOIL VOLUMES TO MEET THE STANDARDS OF THE CITY OF VICTORIA. REFER TO SOIL DEPTH

PLANS FOR SOIL DEPTH REQUIREMENTS.

STANDARDS

6. REFER TO CIVIL AND MECHANICAL FOR DRAINS.
7. ALL ONSITE AND OFF-SITE LANDSCAPE AREAS TO BE IRRIGATED BY AN UNDERGROUND AUTOMATIC

5. ALL GROWING MEDIUM PROVISION AND INSTALLATION TO BE IN LINE WITH CANADIAN LANDSCAPE

IRRIGATION SYSTEM. IRRIGATION TO BE SUPPLIED BY CONTRACTOR

8. PLANTING AROUND EXISTING CRITICAL TREE ROOT ZONES TO BE INSTALLED UNDER THE SUPERVISION OF A CERTIFIED ARBORIST.



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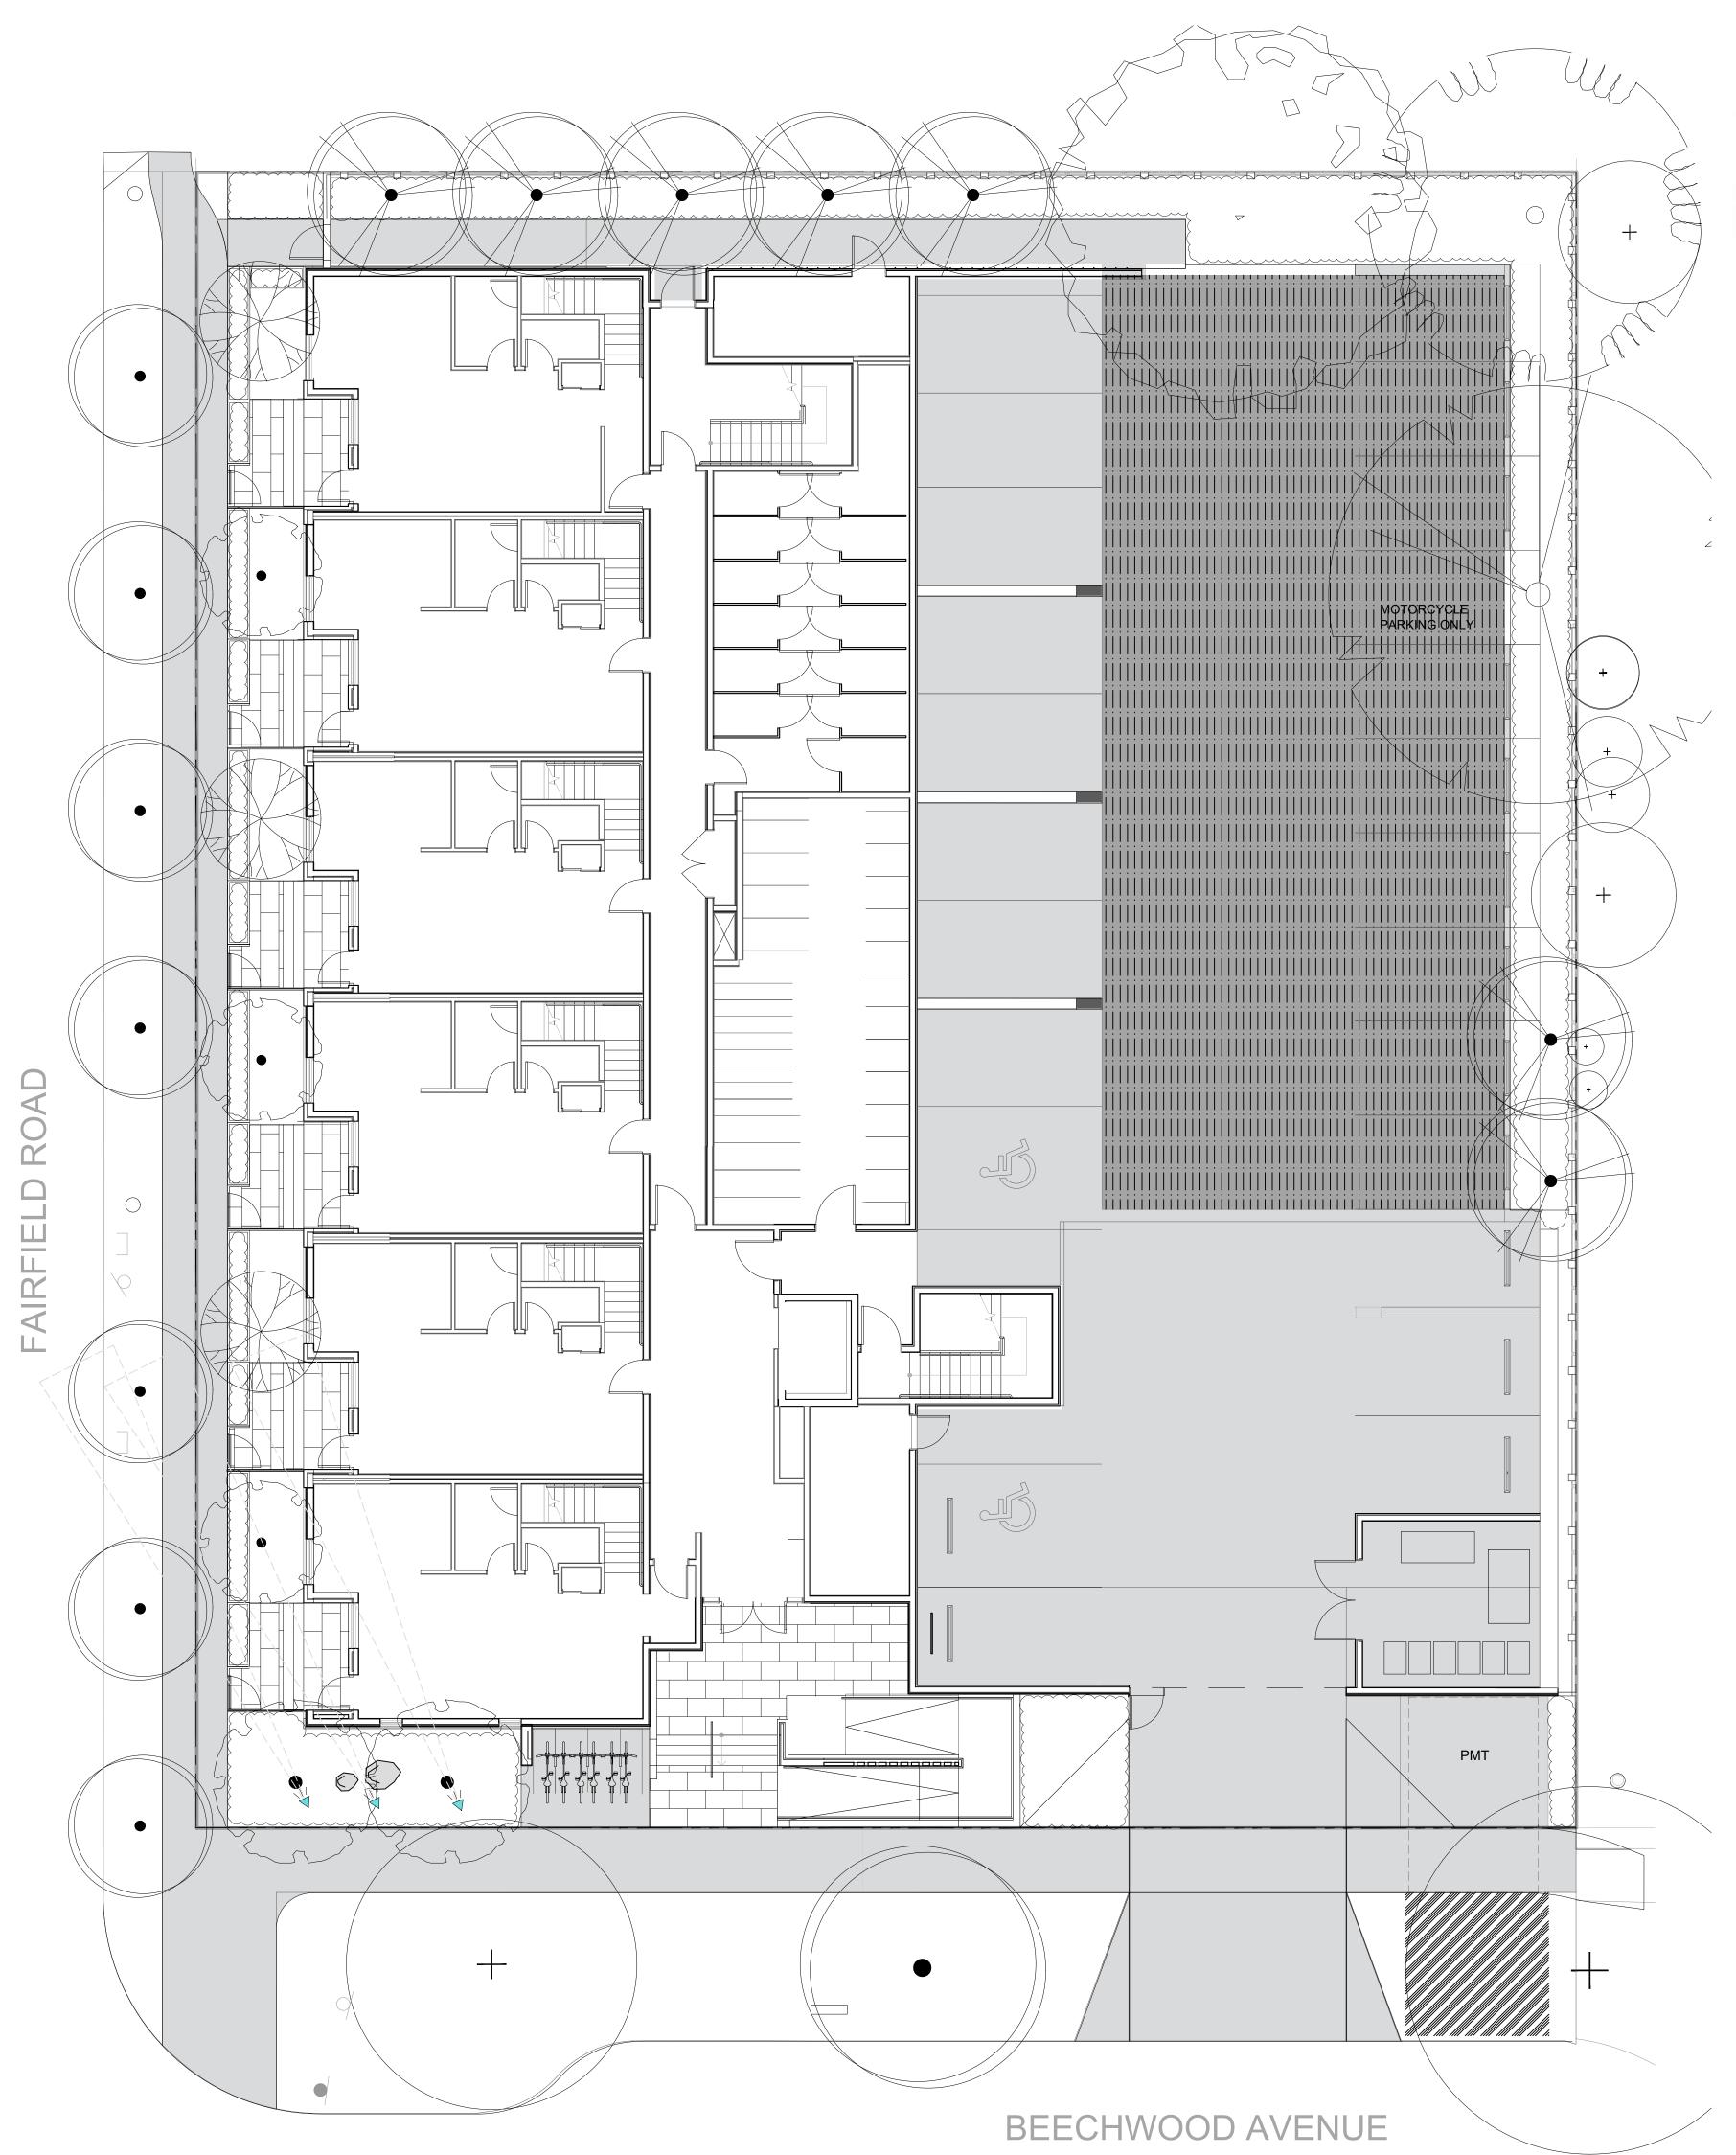
SEAL

NORTH ARROW

DRAWING TITLE:

SHRUB PLANTING PLAN LEVELS 2, 3, & 4





LIGHTING SCHEDULE

<u>SYMBOL</u> MANUFACTURER/MODEL/DESCRIPTION

WAC Landscape Lighting 5111

LED Accent Mini Landscape Spotlight Order code: 5111, Aluminum Alloy, (BK) Black on Aluminum, Mounting

Lamp: 5111 Integrated LED, 18W|23VA, 2700K, Beamspread: Narrow Accessories: Additional Mounting Stake

<u>QTY</u>

<u>DETAIL</u>



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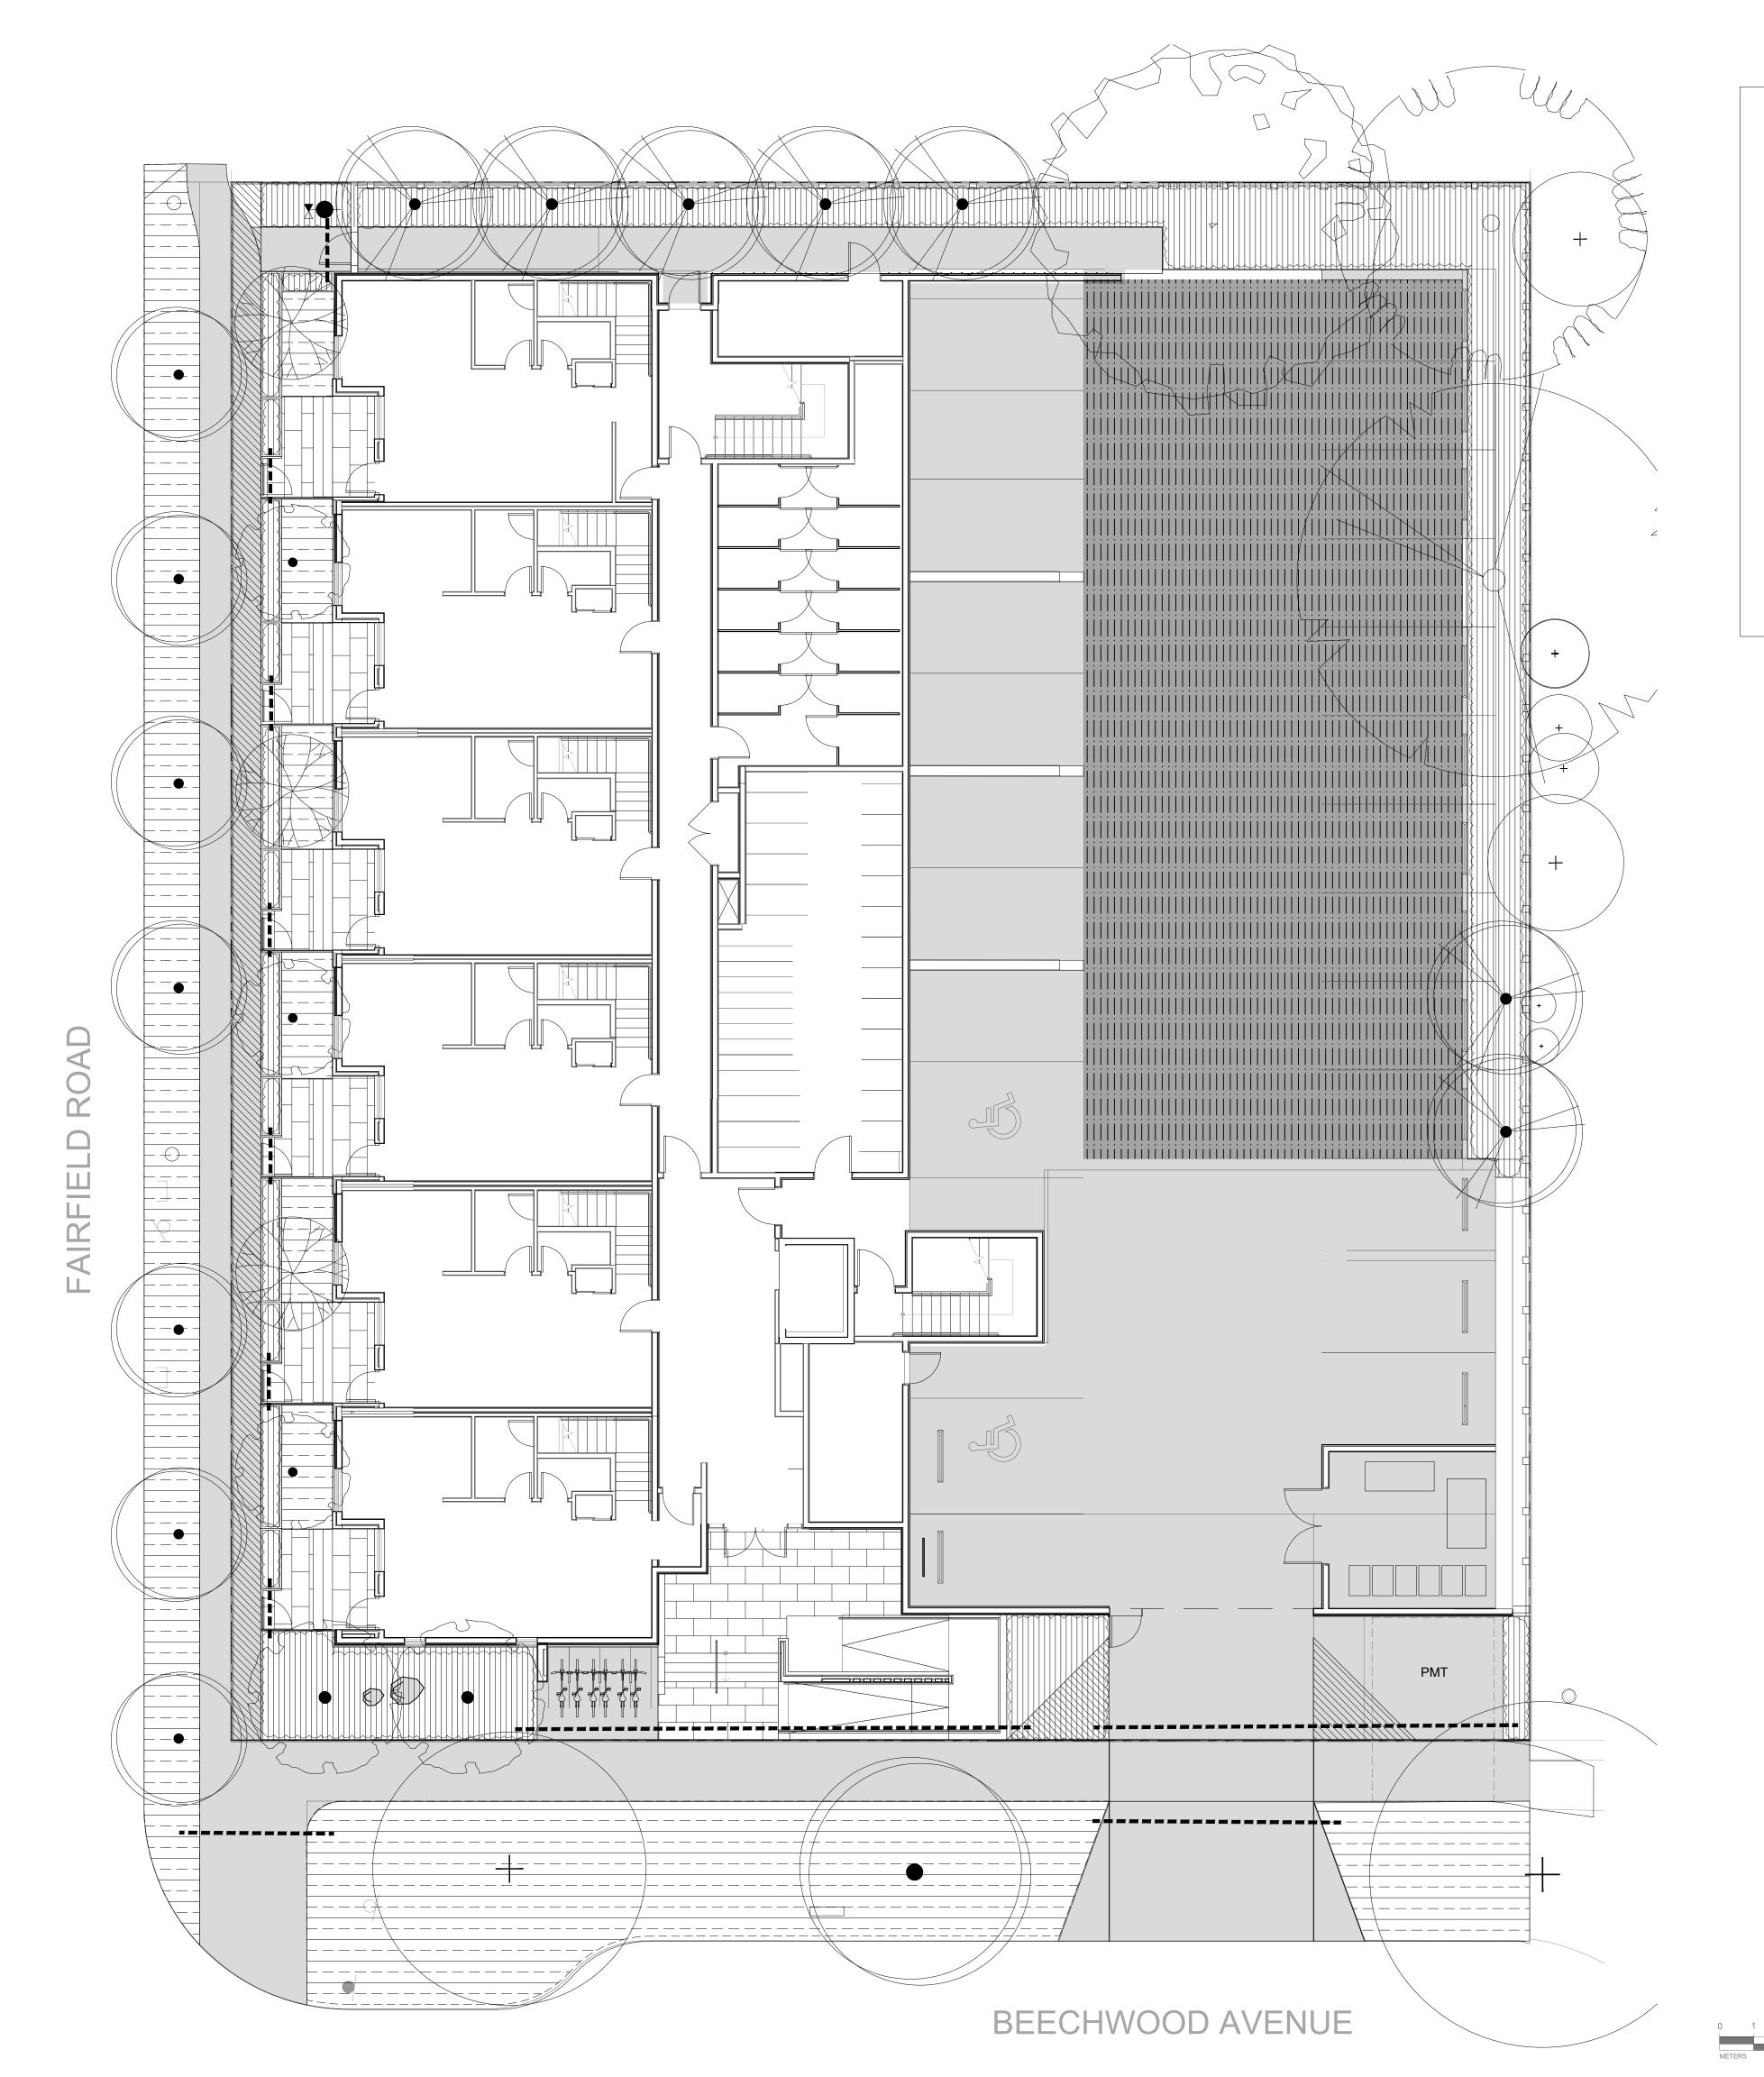
SEAL

NORTH ARROW

DRAWING TITLE:

LANDSCAPE LIGHTING PLAN LEVEL 1

DWG NO:



LEGEND

PIPE SLEEVE: PVC SCHEDULE 40 TWICE THE SIZE OF THE INTERIOR PIPE OF MIN. 50MM DIA.

HOSE BIB

SHUT OFF VALVE

2" PVC POINT OF CONNECTION

AREA TO RECEIVE DRIPLINE- RAIN BIRD XFS-CV-09-12 SUB-SURFACE LANDSCAPE DRIPLINE WITH A HEAVY-DUTY .3 BAR CHECK VALVE. 3.41 LPH EMITTERS AT 30CM O.C. DRIPLINE LATERALS SPACED AT 30CM APART, WITH EMITTERS OFFSET FOR TRIANGULAR PATTERMN. SPECIFY XF INSERT **FITTINGS**

TREES IN THIS AREA TO RECEIVE IRRIGATION

NOTES

- IRRIGATION PLANS TO BE SUBMITTED A BUILDING PERMIT SUBMISSION. - OFFSITE TREES TO BE IRRIGATED BY SEPARATE IRRIGATION SYSTEM. - ALL OFFSITE IRRIGATION TO FOLLOW THE CITY OF VICTORIA STANDARDS - IRRIGATION DRIPLINE TO BE INSTALLED SUB-SURFACE AND SLEEVED UNDER METAL PLANTERS REFER TO MECHANICAL FOR HOSEBIB LOCATIONS



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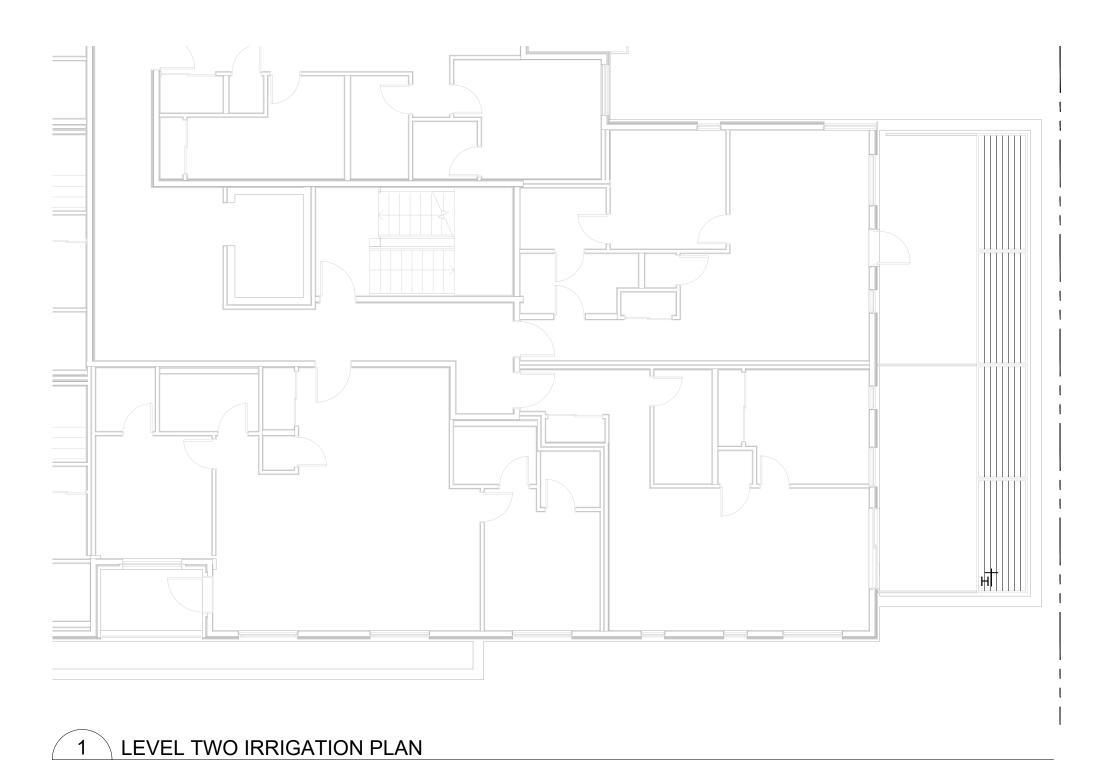
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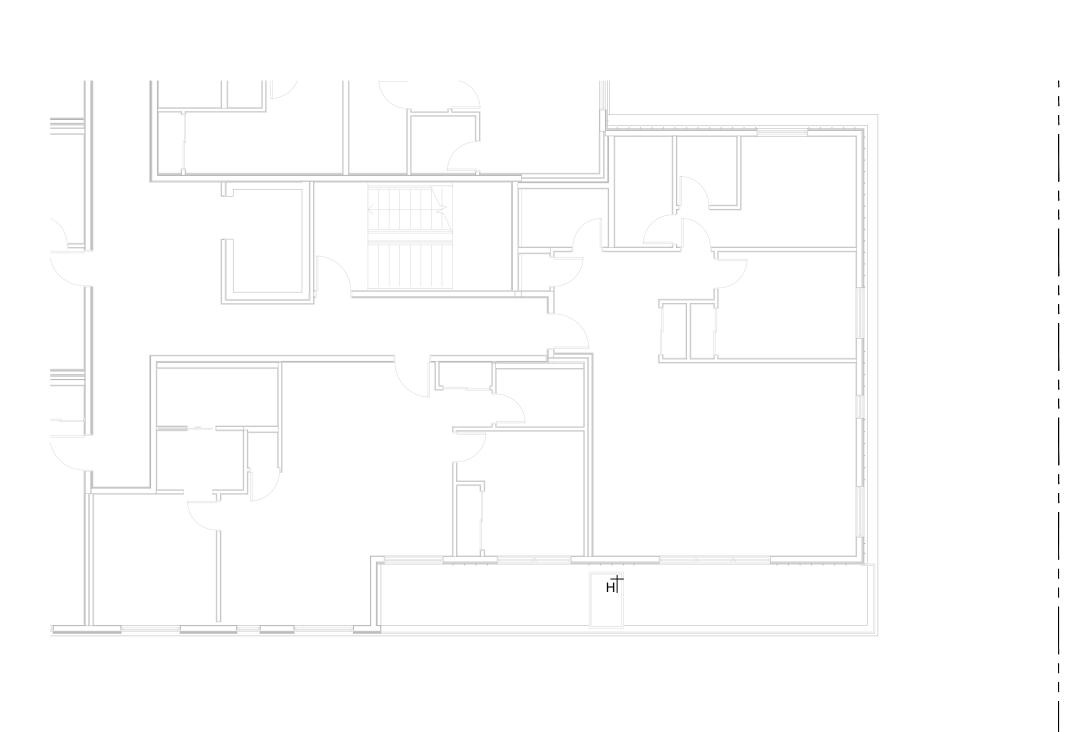
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DRAWING TITLE:

IRRIGATED AREAS PLAN LEVEL 1


DWG NO:





2 LEVEL THREE IRRIGATION PLAN 1:100

L6.2 1:100

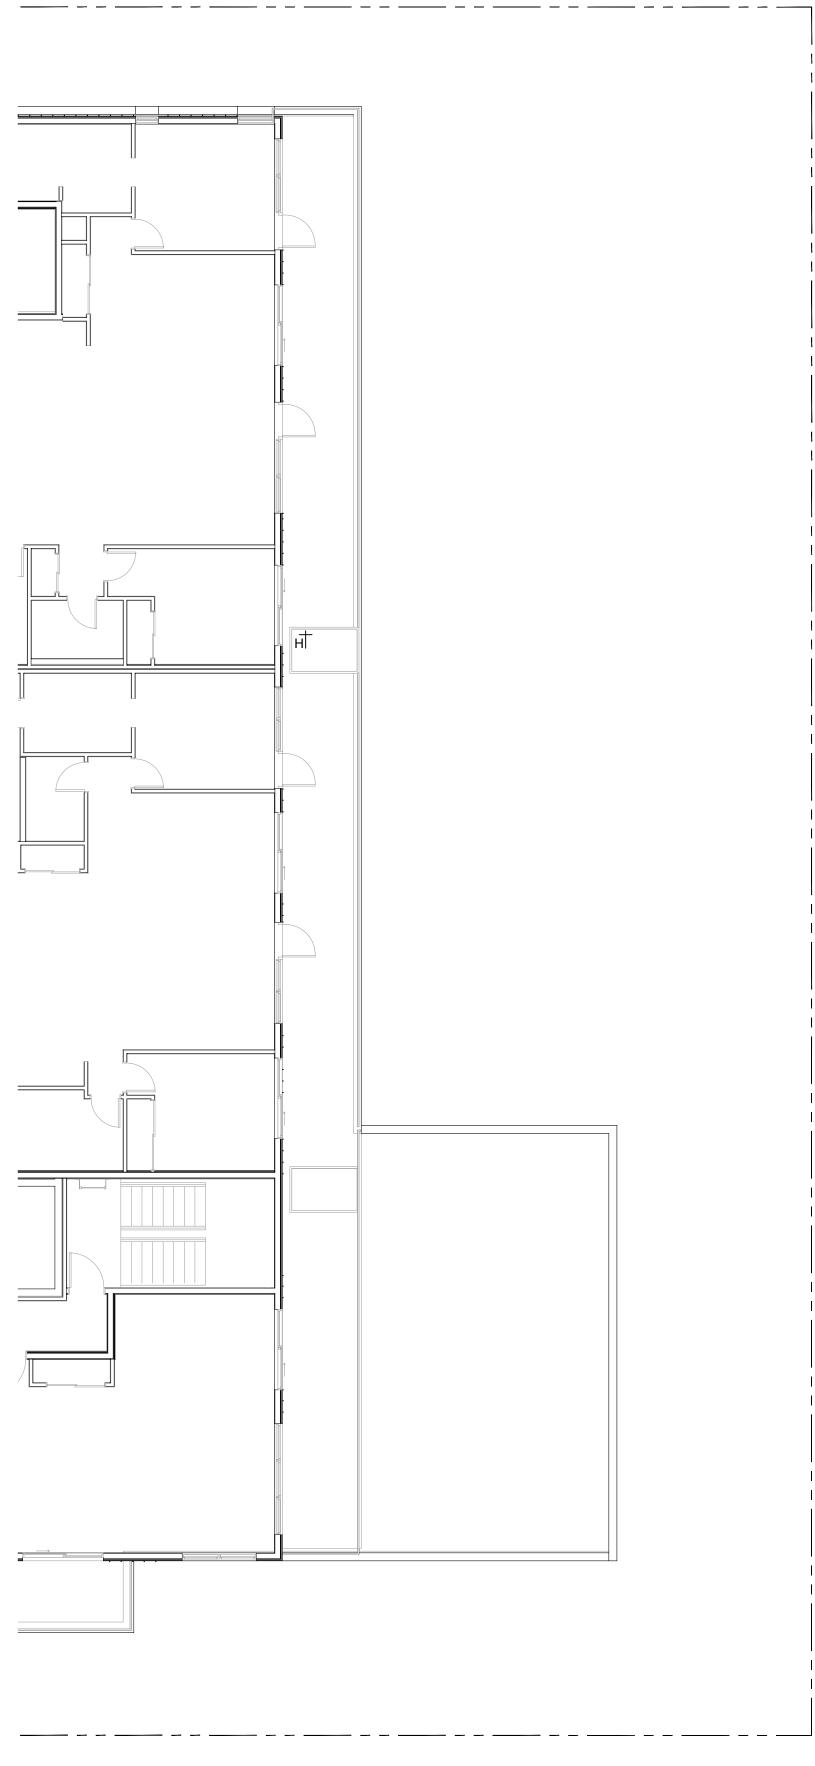

3 LEVEL FOUR IRRIGATION PLAN L6.2 1:100

LEGEND

---- PIPE SLEEVE: PVC SCHEDULE 40 TWICE THE SIZE OF THE INTERIOR PIPE OF MIN. 50MM DIA.

2" PVC POINT OF CONNECTION

HOSE BIB

SHUT OFF VALVE

AREA TO RECEIVE DRIPLINE- RAIN BIRD XFS-CV-09-12 SUB-SURFACE LANDSCAPE DRIPLINE WITH A HEAVY-DUTY .3 BAR CHECK VALVE. 3.41 LPH EMITTERS AT 30CM O.C. DRIPLINE LATERALS SPACED AT 30CM APART, WITH EMITTERS OFFSET FOR TRIANGULAR PATTERMN. SPECIFY XF INSERT **FITTINGS**

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LOCATIONS

OWNER/CLIENT: ARYZE DEVELOPMENTS

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1733 FAIRFIELD, VICTORIA, BC

DESIGNED BY:BIANCA BODLEY DRAWN BY: TYLER YESTAL


NO. ISSUE YY\MM\DD 1 ISSUED FOR DEVELOPMENT TRACKER 22\03\04 2 ISSUED FOR RZ/DP 22\05\02 3 ISSUED FOR COORDINATION 22\07\18 4 ISSUED FOR RZ/ DP 22\07\20 5 ISSUED FOR RZ/ DP RESUBMISSION 23\01\24 6 ISSUED FOR RZ/ DP RESUBMISSION 2023\08\18 7 25% BUILDING PERMIT 2023\10\10 8 ISSUED FOR BP COORDINATION 2023/11/24 9 DP/RZ REV 4 2024/01/12

NORTH ARROW


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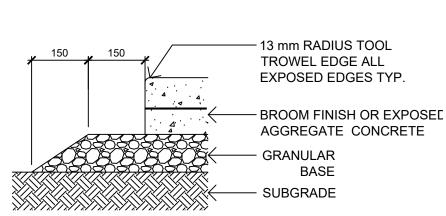
IRRIGATED AREAS PLAN LEVELS 2, 3, & 4



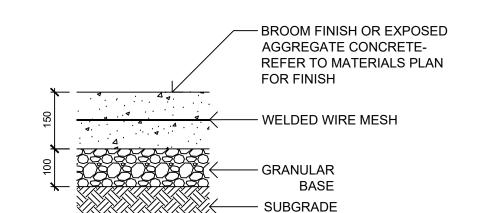


- SUBGRADE AND GRANULAR BASE TO BE
- COMPACTED TO MIN. 95% MPD. CONCRETE SIDEWALK TO MMCD/MUNICIPAL
- SPECIFICATIONS • WELDED WIRE REINFORCEMENT MESH TO BE 6 X 6 X W2.9 X W2.9 (152 x 152 MW18.7/18.7) AND TO BE INSTALLED PER NRC NBC AND CAC
- STANDARDS. MIN 50 mm COVER ABOVE AND BELOW MESH.



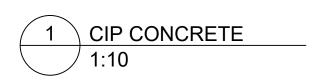

 EXTEND GRANULAR BASE 300 mm PAST EDGE OF SIDEWALK




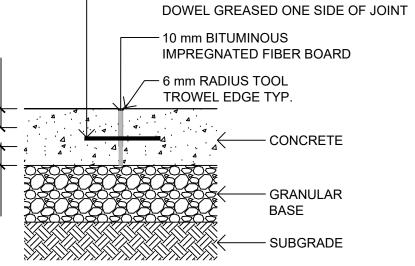

10 mm DIA X 200 mm LONG SMOOTH BAR

- BAR DOWELS @ 450 mm O.C. AND STARTING 300 mm FROM OUTSIDE EDGE OF CONCRETE - CENTER IN CONCRETE SLAB (MIN. 50 mm COVER)
- ISOLATION JOINT MAXIMUM SPACING 9.0 m JOINTING AS PER LAYOUT PLAN AND AT ALL ABUTTING CONCRETE STRUCTURES



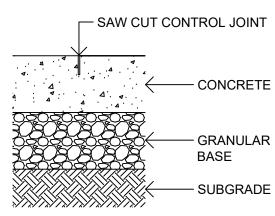


JOINT DEPTH 1/3 SLAB THICKNESS

REFER TO PAVER MANUFACTURER FOR

INSTALLATION

 CONTROL JOINT MAXIMUM SPACING 3.0 m JOINTING PATTERN AS PER LAYOUT PLAN



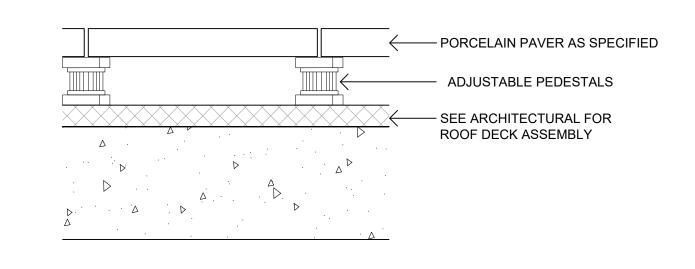


- PRIOR TO INSTALLATION, CONTRACTOR TO CONFIRM WITH ARCHITECTURAL / MEMBRANE CONSULTANT IF PROTECTION BOARD IS REQUIRED FOR PAVER PEDESTAL INSTALLATION; IF PROTECTION BOARD IS REQUIRED AND HAS NOT BEEN INSTALLED BY ARCHITECTURAL, CONTRACTOR TO NOTIFY GENERAL CONTRACTOR.
- ADJUSTABLE PEDESTALS TO BE BlackJack OneStep or BlackJack ScrewJack PEDESTALS AS REQUIRED OR APPROVED EQUAL.
- INSTALLATION TO MANUFACTURER'S SPECIFICATIONS.

Available At


View Gallery



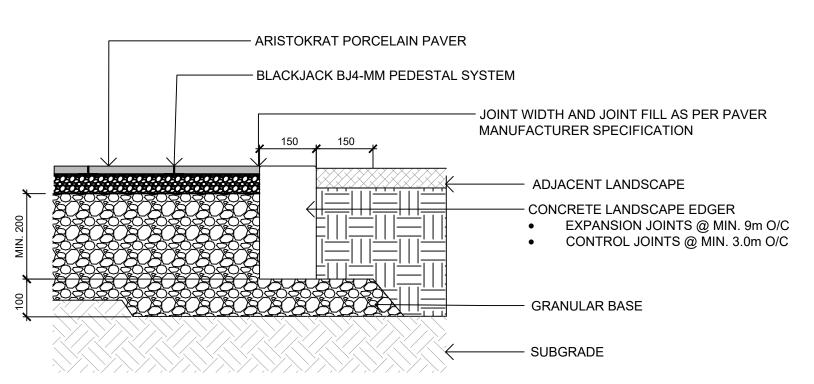


- SUBGRADE AND GRANULAR BASE TO BE COMPACTED TO MIN.
- 95% MPD. CONCRETE TO MMCD SPECIFICATION UNLESS NOTED OTHERWISE.



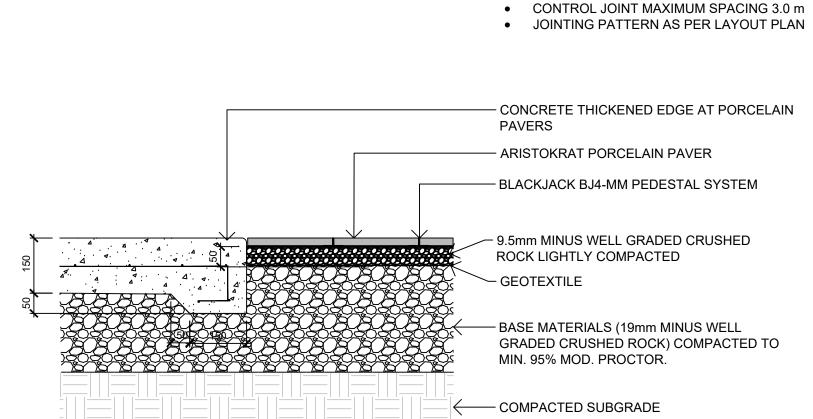



Aristokrat® Series

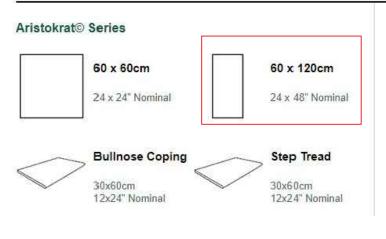











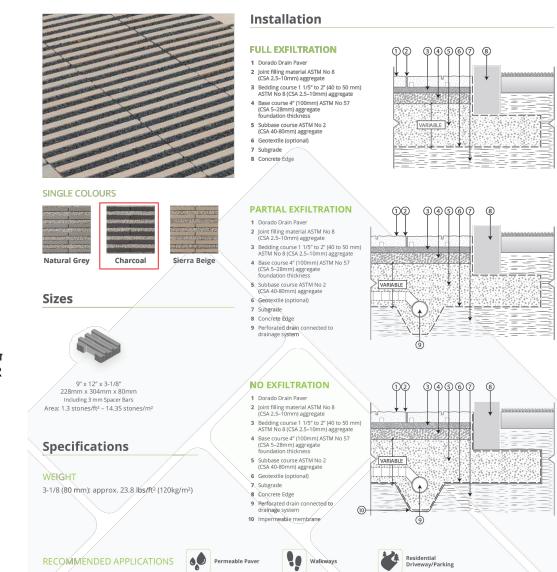

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- LANDSCAPE EDGER TO BE: PERMALOC CleanLine Commercial Grade Landscape Edging OR APPROVED EQUAL 4.8mm (3/16") THICKNESS; 102mm (4") HEIGHT; 4.8m (16') LENGTH; NATURAL MILL FINISH; 305mm (12") STAKE.
- INSTALL EDGER AS PER MANUFACTURER'S INSTRUCTIONS
- 1 X 4 WOOD SUPPORT TO BE STAKED IN PLACE AND USED TO ENSURE EDGER IS INSTALLED IN A STRAIGHT LINE AND MAINTAINS A STRAIGHT ALIGNMENT DURING THE INSTALLATION OF GROWING MEDIUM AND RIVER ROCK. MAY BE SCRAP WOOD AS LONG AS IT IS STRAIGHT.
- FILTER FABRIC TO BE POLYPROPYLENE FIBRE NONWOVEN GEOTEXTILE, SUCH AS NILEX 4551 OR APPROVED EQUAL

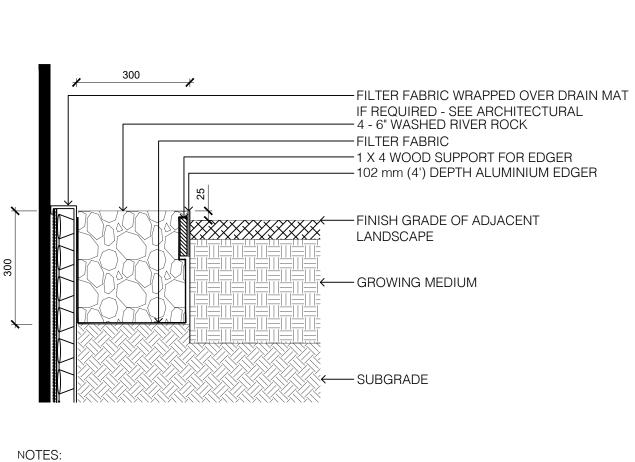



1608 Camosun Street, Victoria BC V8T 3E6 Info@biophiliacollective.ca 250 590 1156

OWNER/CLIENT:

ARYZE DEVELOPMENTS

PROJECT ADDRESS:

1733 FAIRFIELD VICTORIA, BC

DESIGNED BY: BIANCA BODLEY


DRAWN BY: TYLER YESTAL

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6	ISSUED FOR RZ/ DP RESUBMISSION	2023\08\18
7	25% BUILDING PERMIT	2023\10\10

NORTH ARROW

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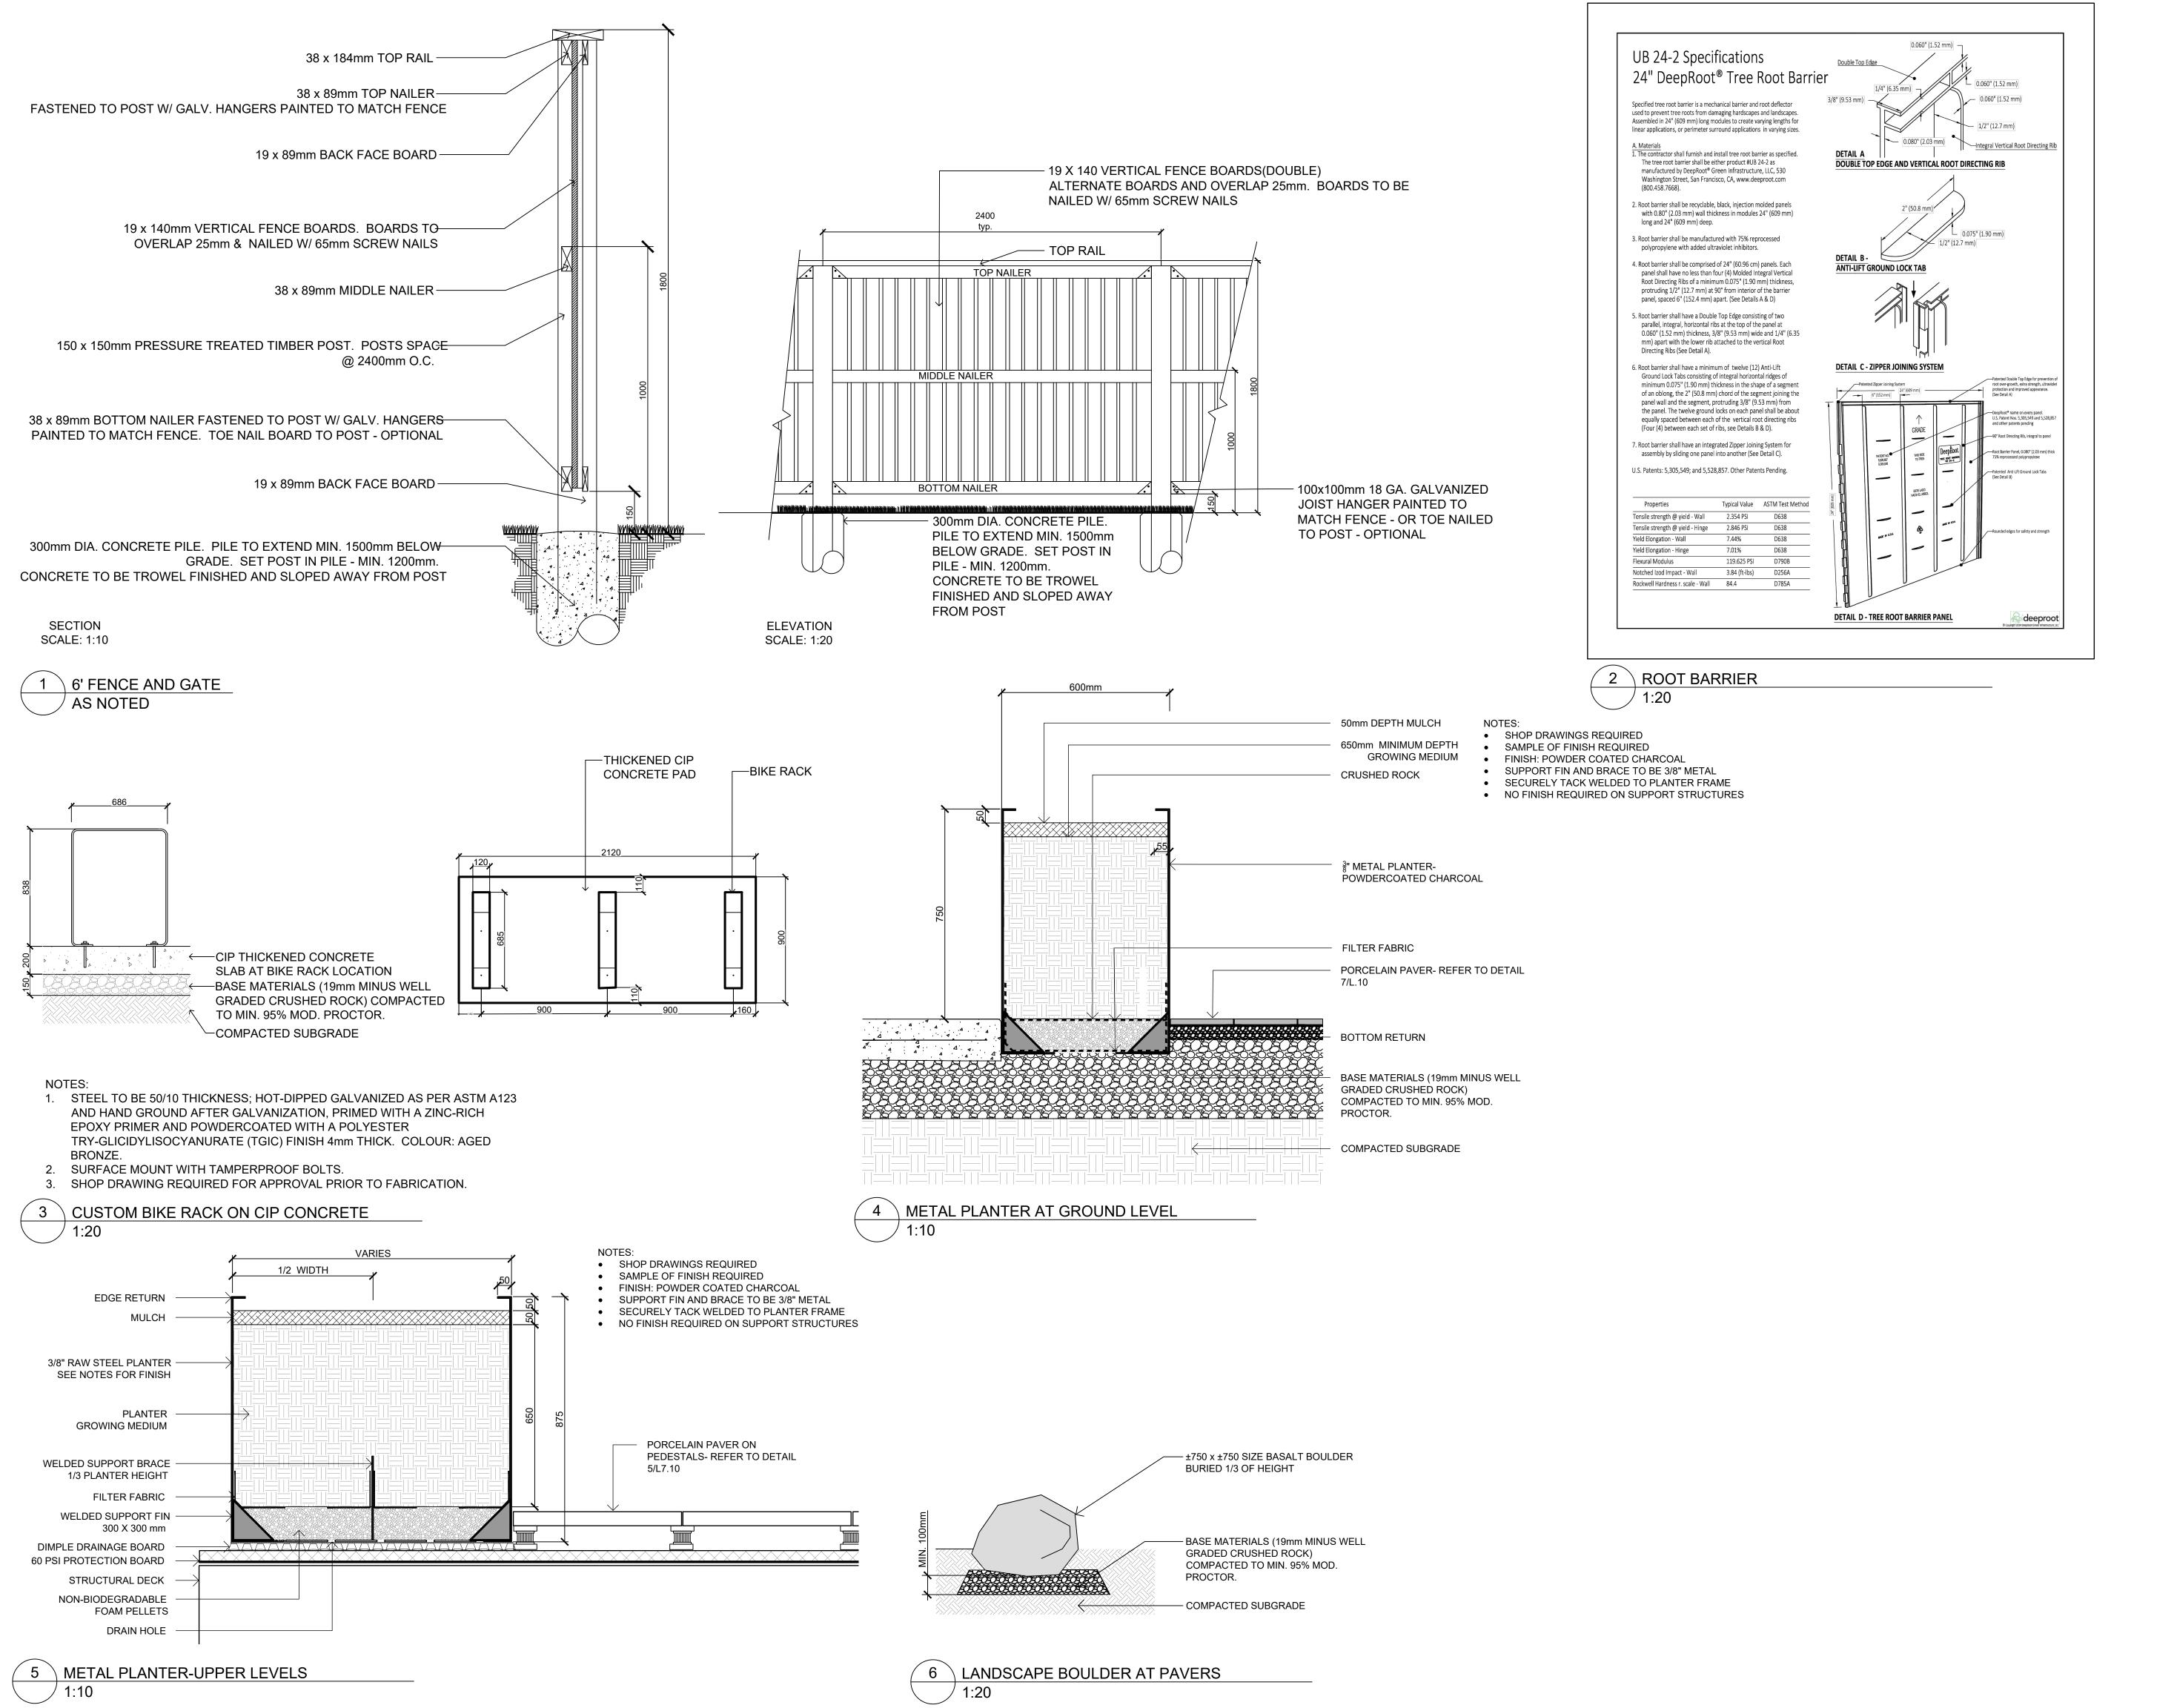
PAVING DETAILS

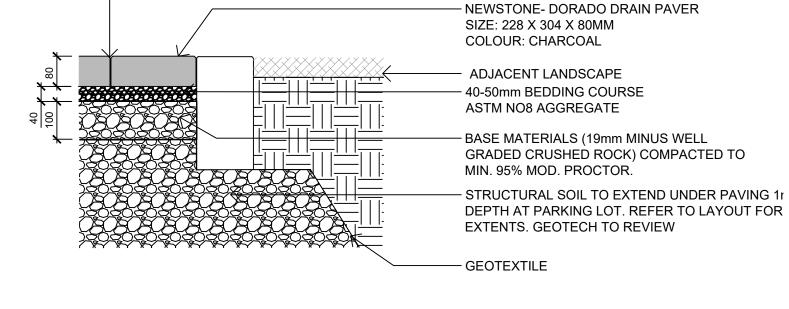

- JOINT WIDTH AND JOINT FILL AS PER

PAVER MANUFACTURER SPECIFICATION

- SUBGRADE AND GRANULAR BASE TO BE COMPACTED TO MIN. 95% MPD. GRANULAR BASE TO BE COMPACED IN MAX. 100mm LIFTS.
- PAVER AND PAVER INSTALLATION TO MMCD AND MANUFACTURER'S
- SPECIFICATION UNLESS NOTED OTHERWISE.
- GEOTECH TO REVIEW PRIOR TO INSTALLATION.
- 8 \ PAVER 2





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SEAL


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DRAWING TITLE:

SITE FURNISHINGS DETAILS

DWG NO:


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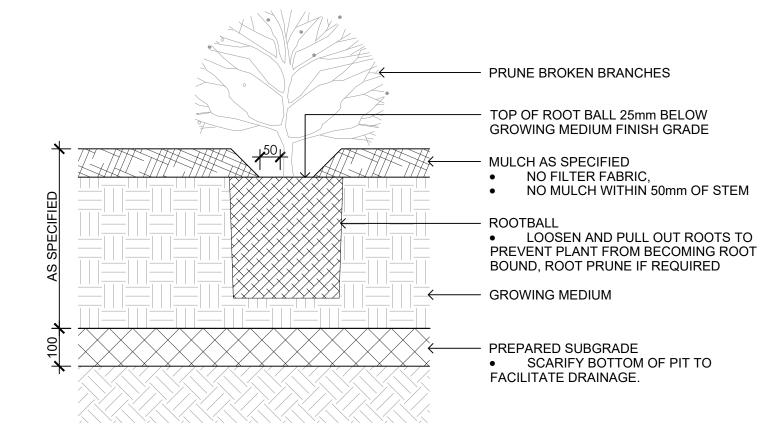
NOTES

- CONTRACTOR SHALL INSURE PERCOLATION OF ALL PLANTING PITS PRIOR TO INSTALLATION
- 2. FOR B&B: REMOVE TOP 1/3 OF BURLAP AND CAGE PRIOR TO BACKFILLING WITH GROWING MEDIUM
- FOR CONTAINERS: LOOSEN ROOT STRUCTURE AND ENSURE NO CIRCLING ROOTS BY LIGHT ROOT PRUNING
 INSTALL TREE TIE AT APPROX. 50% OF TREE HT. FOR CONIFERS LESS THAN 3m HT. AND 100mm BELOW LOWEST BRANCH
- FOR DECIDUOUS LESS THAN 100mm CAL. DO NOT REMOVE OR CONSTRAIN ANY BRANCHES.
- 5. STANDARD TREE PLANTING DETAILS TO BE APPLIED ACCORDINGLY TO TREES PLANTED IN PLANTERS
- 6. TREE PLANTING ON MUNICIPAL PROPERTY TO MUNICIPAL STANDARD DETAIL

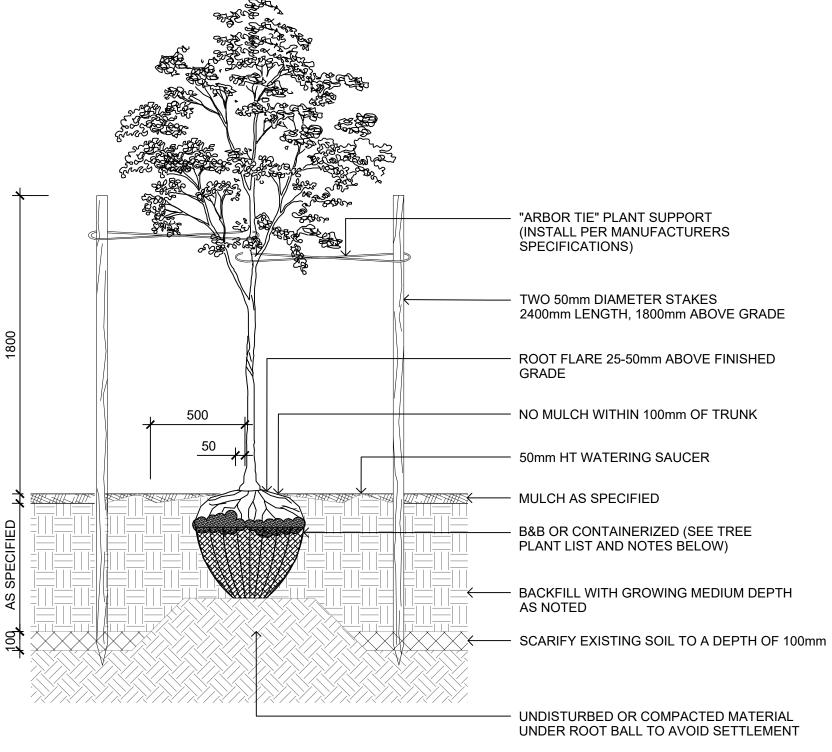






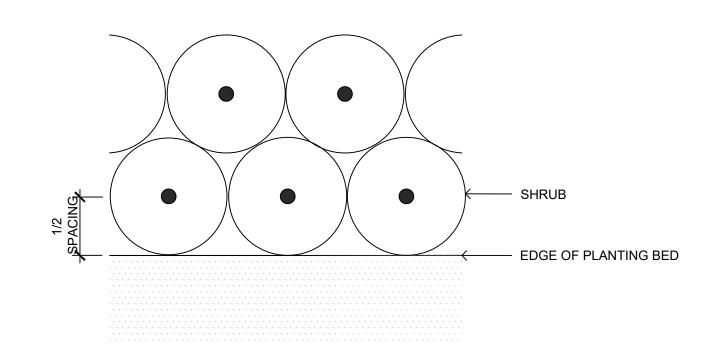


NOTES:
1. SHRUB PLANTING AS PER WRITTEN SPECIFICATIONS
2. GROWING MEDIUM AND MULCH AS PER WRITTEN SPECIFICATIONS



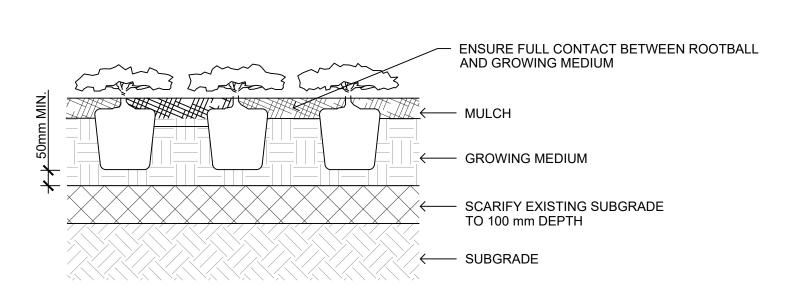

NOTES:

- PLACE AND COMPACT SUBGRADE AS PER WRITTEN SPECIFICATIONS
- SUBGRADE TO BE COMPACTED TO A CONSISTENT 80% M.P.D
 GROWING MEDIUM AND MULCH AS PER WRITTEN SPECIFICATIONS
- 3 GROUNDCOVER PLANTING

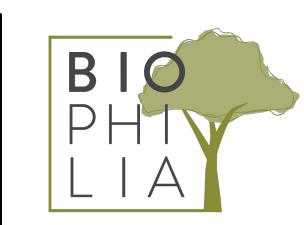

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SEAL

NORTH ARROW

DRAWING TITLE:

PLANTING DETAILS

G NO:

SCALE: AS NOTED

