

2540 - 2542 SHELBOURNE STREET



Project Rendering - North Looking View @ Shelbourne Street



Project Rendering - North Looking View @ Amenity and Play Area

PROJECT DESCRIPTION

CIVIC ADDRESS:
2540 - 2542 SHELBOURNE STREET
VICTORIA, BC
LEGAL DESCRIPTION:
LOT 9 AND AMENDED LOT 10 (DD141161)
BLOCK 6, SECTION 8A VICTORIA DISTRICT PLAN 881A

ZONING BYLAW SUMMARY

BUILDING DESCRIPTION:
Group C, 3 Storey Wood Construction
USES:
Residential Townhomes
EXISTING ZONE:
R1-B
PROPOSED ZONE:
TBD
SITE AREA:
1,526m² (16,426 s.f.)
FLOOR AREAS
TOTAL PROPOSED:
1,552.5 m² (16,711 s.f.)
FLOOR SPACE RATIO:
1.02 : 1 FSR
SITE COVERAGE
42%
OPEN SITE SPACE
33%
GRADE OF BUILDING:
North Bldg 20.3m
South Bldg 20.2m
(See Site Plan for Avg
Grade Calculation)

HEIGHT OF BUILDING:
North Bldg 10.7m
South Bldg 10.8m
NUMBER OF STOREYS:
3 STOREYS
RESIDENTIAL PARKING:
13 stalls (EV Ready)
BICYCLE PARKING:
15 Class 1/EV Ready (in suite)
12 Short term (rack)
SETBACKS:
North Bldg South Bldg
FRONT (Street): 8.11m 8.08m
REAR: 7.22m 3.02m
SIDE (North): 2.44m 19.19m
SIDE (South): 19.19m 2.44m
COMBINED SIDE: 4.88m 4.88m

SUITE COMPOSITION:
TOTAL: 15 SUITES
3 Bedroom 1
2 Bedroom 14
Ground-Orientated Units
Minimum Unit Floor Area 107.5m²

BUILDING CODE SUMMARY:
BCBC Part 9, Group C, 3 Storey Wood Construction
North Building: 303.8 m² Building Area
South Building: 336.5 m² Building Area

All material specifications, details and construction methods to conform to local by-laws and British Columbia Building Code (BCBC).

PROJECT DIRECTORY

DEVELOPER
Shelbourne Project Limited Partnership
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LANDSCAPE CONSULTANT
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Victoria, BC, V8T 1M5
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ARBORIST
Talmack Urban Forestry Consultants Ltd.
Noah Talbot, BA
P. 250.895.3492


DRAWING LIST

A000 COVER SHEET / PROJECT DATA
A001 SURVEY
A002 SHADOW STUDY
A003 PERSPECTIVE VIEWS
A004 PERSPECTIVE VIEWS
A101 SITE PLAN
A201 L1 PLAN
A202 L2 PLAN
A203 L3 PLAN
A204 ROOF PLAN
A301 ELEVATIONS
A302 ELEVATIONS
A303 STREET ELEVATION
A401 SECTIONS
A900 AREA PLANS

ANNOTATIONS LEGEND

The following annotations are used on architectural drawings and details:

BEDROOM ROOM NAME & ROOM NUMBER
[201]
DOOR NUMBER
101a
See Door Schedule
WINDOW NUMBER
W-10
See Window Schedule
WALL TYPE
W1
See Assemblies Schedule
RATED WALL DESIGNATION
2.0 R
ELEVATION DATUM
00.00
CEILING HEIGHT
2440
AREA OF DROP CEILING
KEYNOTE SYMBOL
1
MATERIAL TAG
12
INTERIOR ELEVATION REFERENCE
A901
ROOM FINISHES
W1 C1 F1 B1

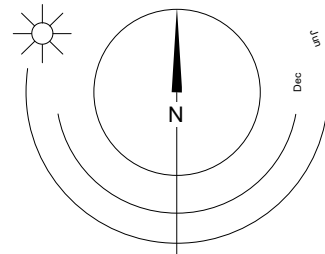

LIST OF ABBREVIATIONS

The following abbreviations are used on door, window, and finish schedules as well as on architectural drawings and details.


ACST	Acrylic Stucco	HP	High Point	ST	Structure
ACT	Acoustical Tile	HSS	Hollow Steel Section	STL	Steel
AFF	Above Finished Floor	HW	Hardware	STN	Stain(ed)
AL	Aluminum	INSUL	Insulated	STNT	Stone Tile
BG	Building Grade	LAM	Laminated Glass	SV	Stainless Steel
CEM	Cementitious Backing Board	LP	Low Point	SVF	Sheet Vinyl Flooring
Conc	Concrete	MDFB	Medium Density Fibreboard Base	TB	Towel Bar
CBK	Concrete Block	MR	Mirror	T/D	Tempered / Double Glazed
Centerline	Centerline	MP	Metal Panel	TLAM	Tempered Laminated Glass
CPT	Carpet Tile	O/H	Overhead	TGL	Tempered Glass
CT	Ceramic Tile	OW	Operable Window	TLGL	Translucent Glass
CW	Complete With	PF	Prefinished	TOC	Top of Concrete
DD	Deck Drain	PLAM	Plastic Laminate	TOD	Top of Drain
EL	Elevation	PLS	Plaster	TOI	Top of Insulation
EPC	Epoxy Polymer Coating	PSF	Pressed Steel Frame	TOP	Top of Parapet
EXP AGG	Exposed Aggregate	PT	Paint	TOS	Top of Slab
EXT	Exterior	PTD	Paper Towel Dispenser	TOW	Top of Wall
FD	Floor Drain	PTDW	Paper Towel Dispenser / Waste	TP	Toilet Paper
FEC	Fire Extinguisher Cabinet	RA	Roof Anchor	UNF	Unfinished (for GWB means taped and filled by not sanded to minimum ULC requirements where applicable)
FFE	Finished Floor Elevation	RB	Rubber Base	UNO	Unless Noted Otherwise
FG	Finished Grade	RES	Resilient Flooring	U/S	Underside of
GB	Grab Bar	RD	Roof Drain	VCT	Vinyl Composition Tile
GBL	Glass Block	RD-P	Roof Drain - Planter	VI	Vision Glass
GL	Glass	RWL	Rain Water Leader	VIS	Vinyl Impact Sheet
GWG	Georgian Wire Glass	SAFI	Spray Applied Fibrous Insulation	VT	Vinyl Tile
GWB	Gypsum Wallboard	SCW	Solid Core Wood	VWC	Vinyl Wall Covering
HC	Hollow Core	SD	Soap Dispenser	WC	Water Closet
HCW	Handicap	SL	Sealer	WD	Wood
H/C	Hollow Metal	SP	Spandrel Glass	WPM	Waterproof Membrane
HM	Hollow Metal	SPC	Solid Particleboard Core	WRC	Water Repellent Coating

Revisions
Bubbled areas indicate revisions compared to the previously submitted plans
Received Date:
November 20, 2023

23/09/01 ISSUED FOR DP AMENDMENTS
23/07/27 ISSUED FOR DP AMENDMENTS
23/04/20 ISSUED FOR DP AMENDMENTS
22/10/04 ISSUED FOR DP AMENDMENTS
22/10/24 ISSUED FOR ADP
22/07/18 ISSUED FOR REZONING

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TOWNHOMES
2540 & 2542 Shelbourne
Street, Victoria, BC
Project Data

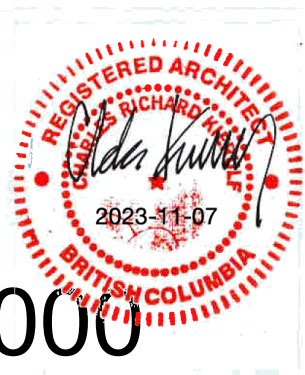

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977 Fort Street
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**B.C. LAND SURVEYOR'S SITE PLAN OF:
LOT 9 AND AMENDED LOT 10 (DD1481161), BLOCK 6, SECTION 8A,
VICTORIA DISTRICT, PLAN 881A**

LEGEND

Elevations are geodetic based on integrated survey monument 26-43 in Victoria at elevation 17.768m.
Note: Only trees with Trunk greater than 0.20m are identified. Consult Arborist to verify tree species
Grade shots are taken at the point marked X.
Contours are descriptive, and only accurate to +/- 0.5m interval

- - denotes Lead Plug found
- - denotes Utility Pole
- - denotes Water meter
- ⊕ - denotes Sign
- - denotes catch basin
- MFE - denotes Main Floor Elevation (Doorsill)
- ⊕ - denotes retaining wall (T=Top)
- * - denotes irrigation

Refer to arborist report for tree info.

Parcel Identification Number (PID)
000-040-339 (LOT 9) AND 002-618-541 (AMD LOT 10)
TOTAL SITE AREA
1526 m²
MUNICIPALITY
VICTORIA
CIVIC ADDRESS
2540 AND 2542 SHELBOURNE STREET
VICTORIA, BC
ZONING
R1-B

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This document was prepared for the exclusive use of our client, FRAME PROPERTIES

*This document is intended for use as a topographic plan. It is based on Land Title Office records, and does not represent a boundary survey. Critical lot dimensions and areas must be confirmed by a proper cadastral survey.


Undersurface charges and covenant will not be shown on this survey unless such documents are provided and can be shown in two dimensional view.

Explorer Land Surveying Inc., accepts no responsibility or liability for any damages that may be suffered by a third party as a result of any decisions made or actions taken based on this document.



SCALE

0 1:200 10
All distances are in metres.
The intended plot size of this plan is 610mm in width by 457mm in height (C size) when plotted at a scale of 1:200

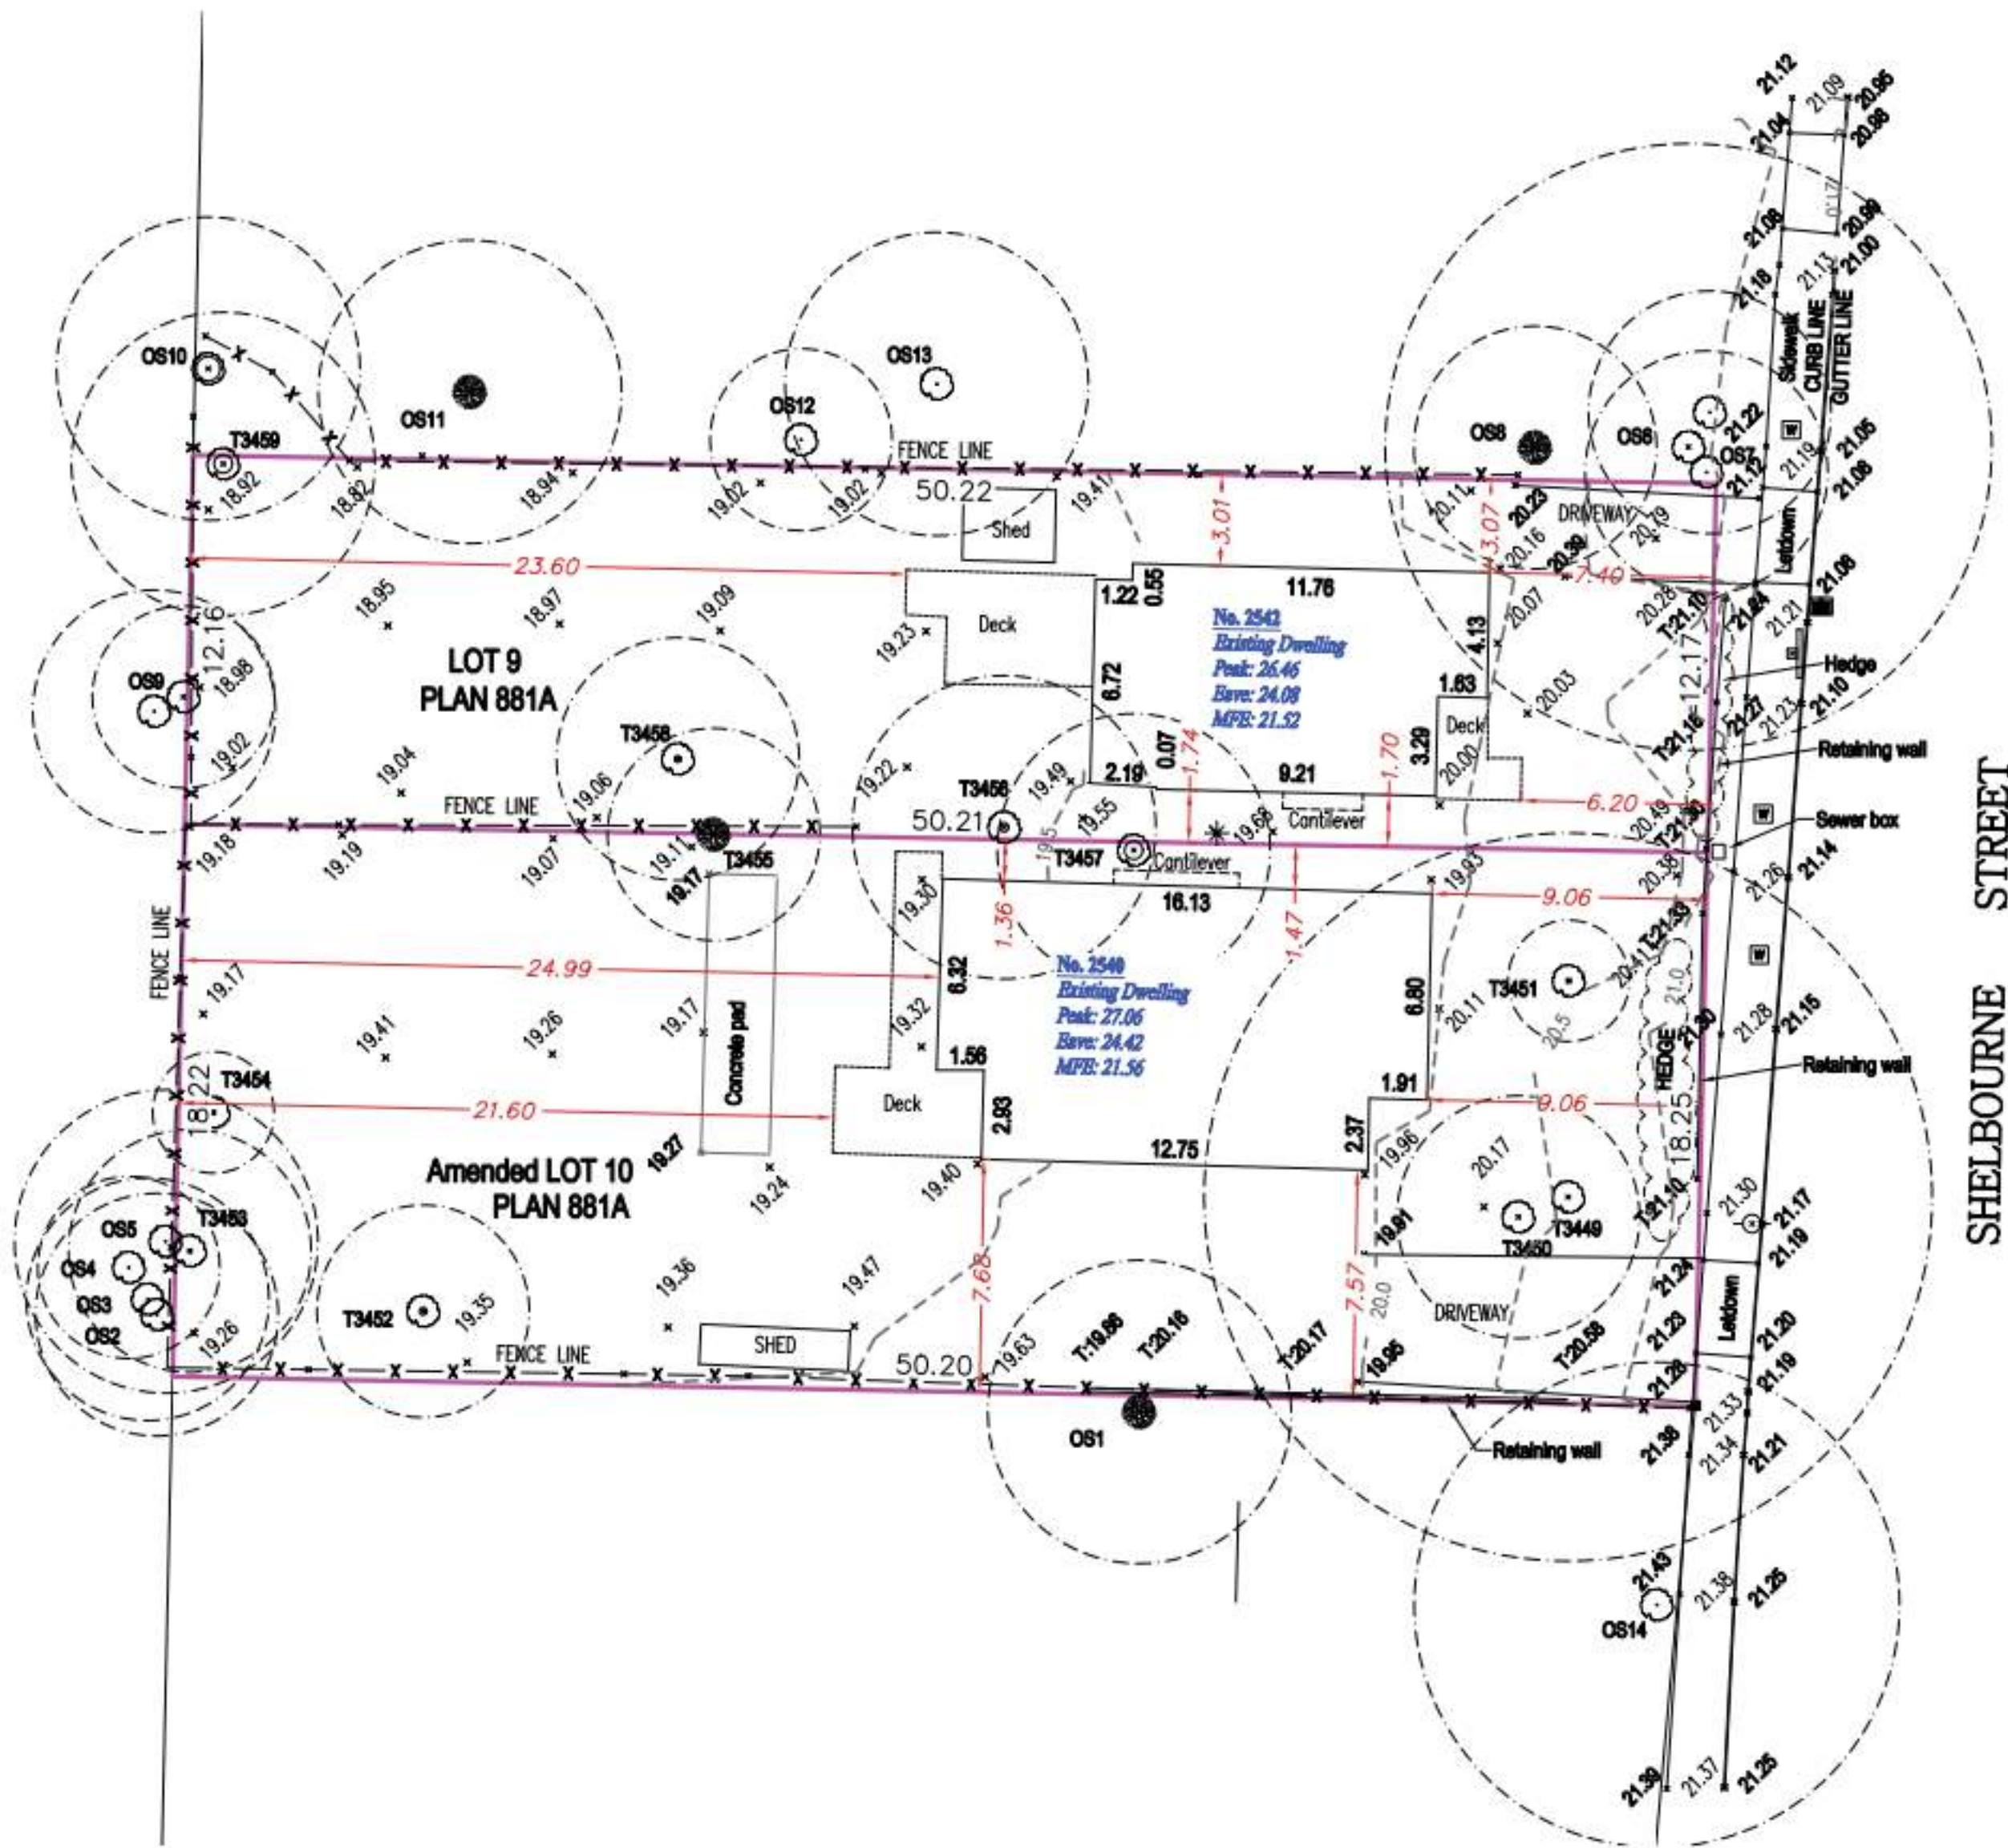

CERTIFIED CORRECT

Lot dimensions are correct according to Land Title Office records.
Kenneth
Ng
F8NUM8

Kenneth KC Ng, BCLS
Field Survey - 8 March, 2022
Dated this 17th of March, 2022.

This document is not valid unless originally signed and sealed or digitally signed with Arbolist digital signature.
Info: <https://www.arbolist.com>

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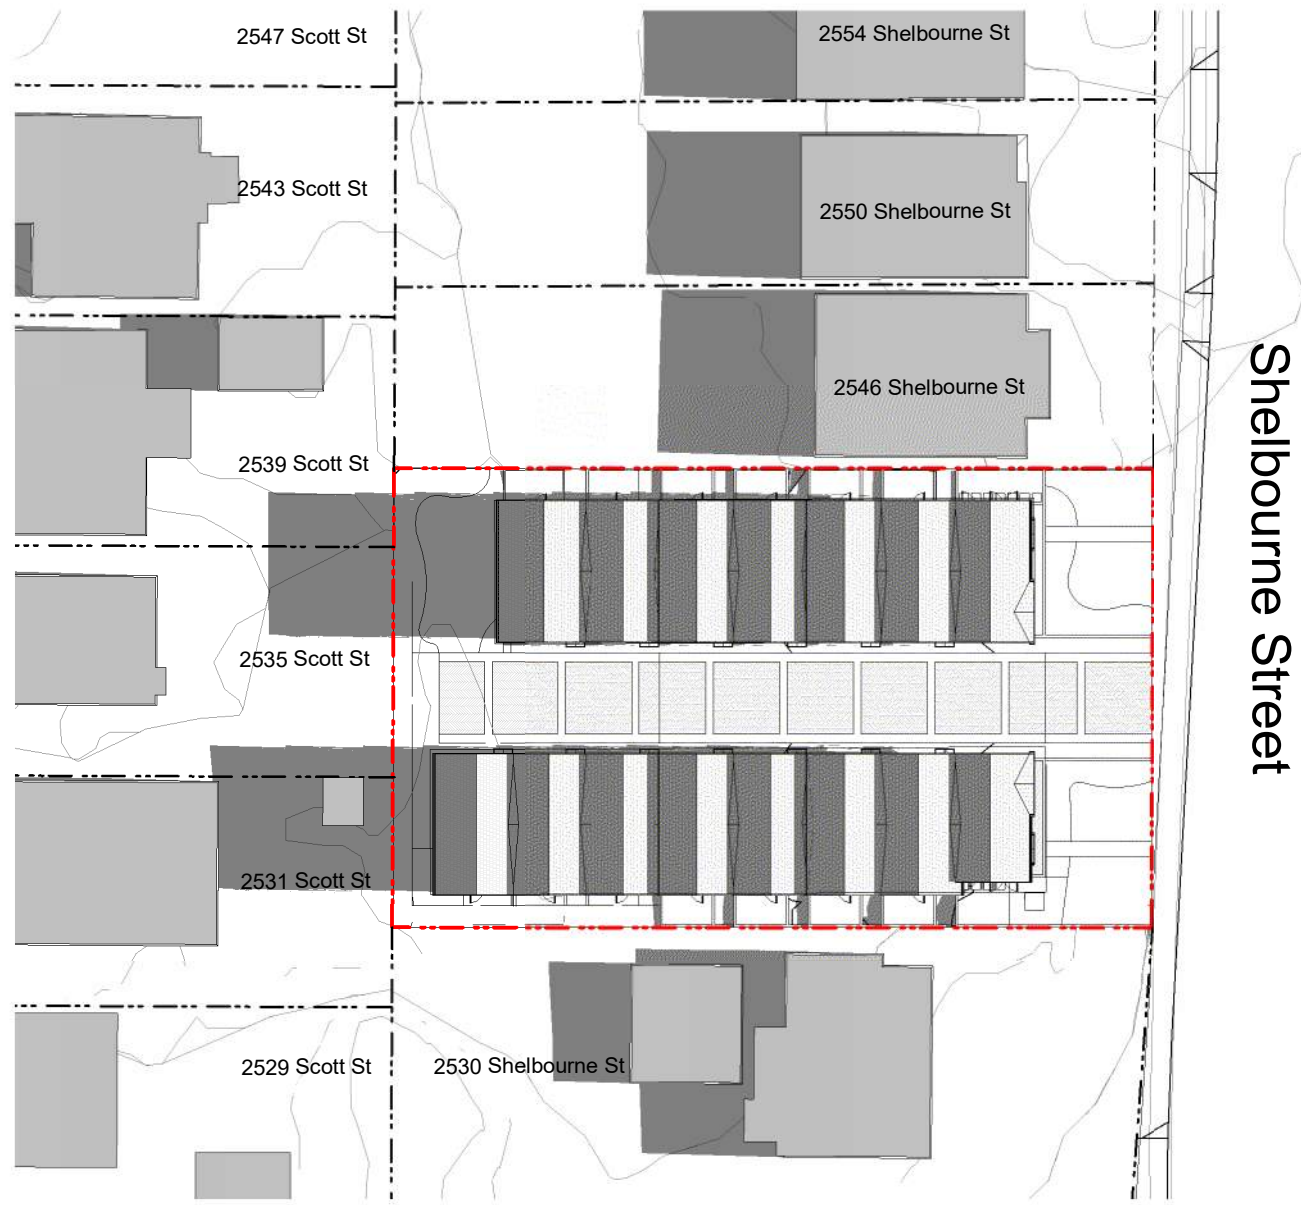
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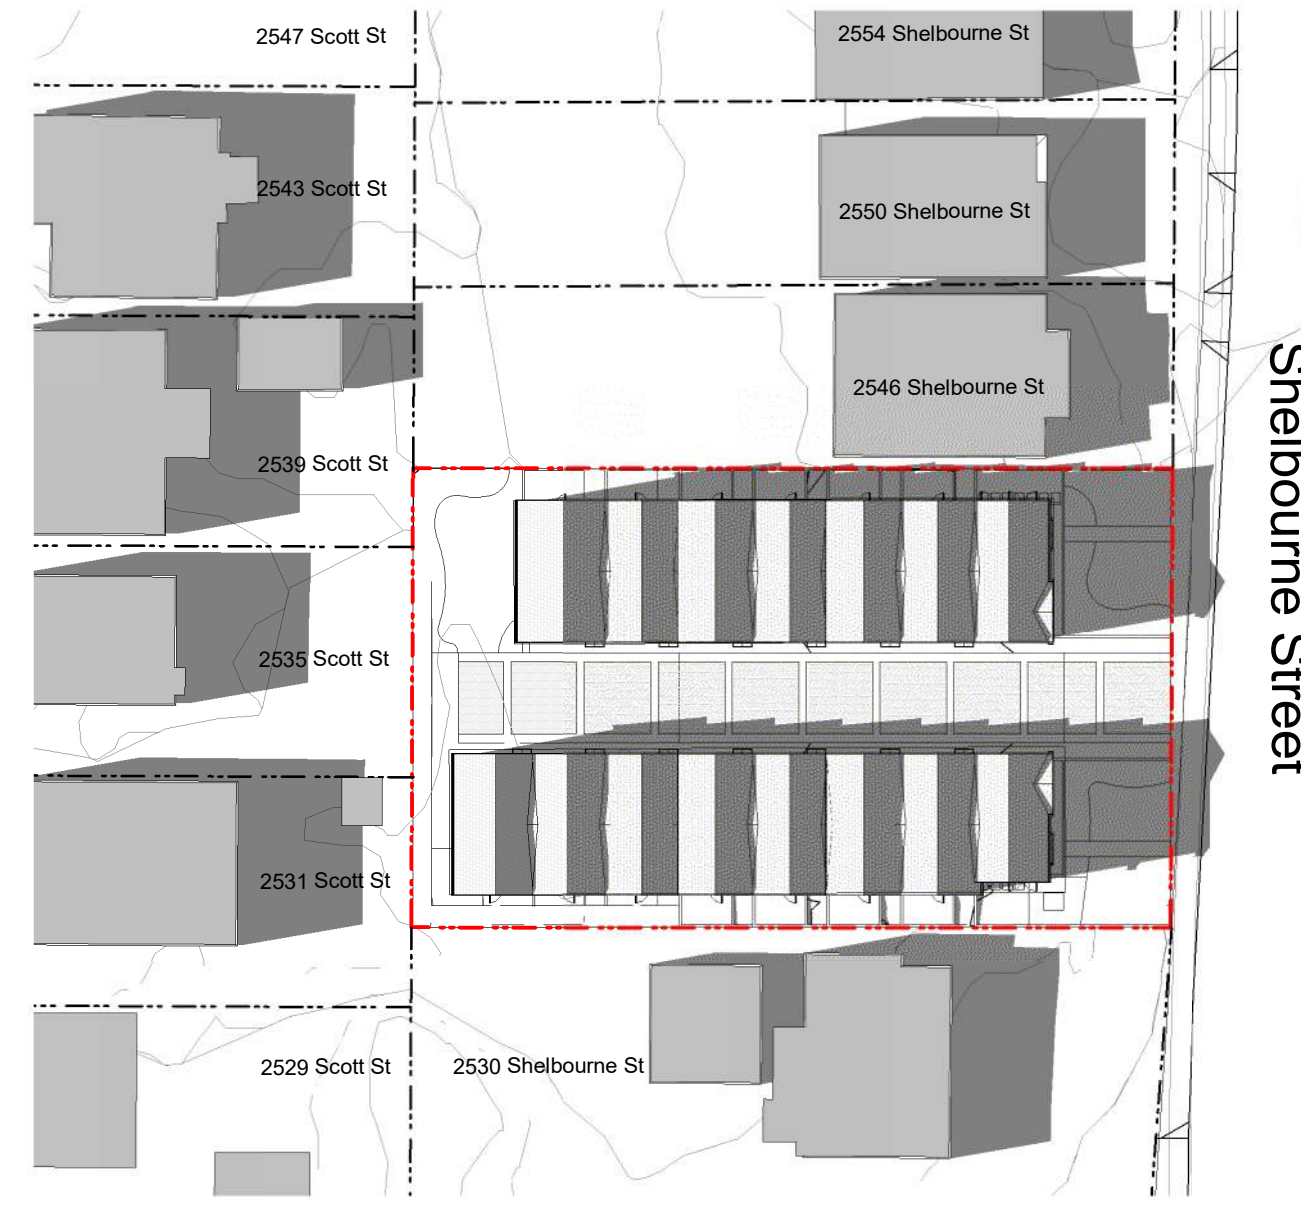
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1 Shadow Study - Summer Solstice (Jun 21) 8AM
A002 SCALE: 1 : 500



2 Shadow Study - Summer Solstice (Jun 21) 12PM
A002 SCALE: 1 : 500



3 Shadow Study - Summer Solstice (Jun 21) 4PM
A002 SCALE: 1 : 500




4 Shadow Study - Spring Equinox (Mar 21) 8AM
A002 SCALE: 1 : 500




5 Shadow Study - Spring Equinox (Mar 21) 12PM
A002 SCALE: 1 : 500



6 Shadow Study - Spring Equinox (Mar 21) 4PM
A002 SCALE: 1 : 500

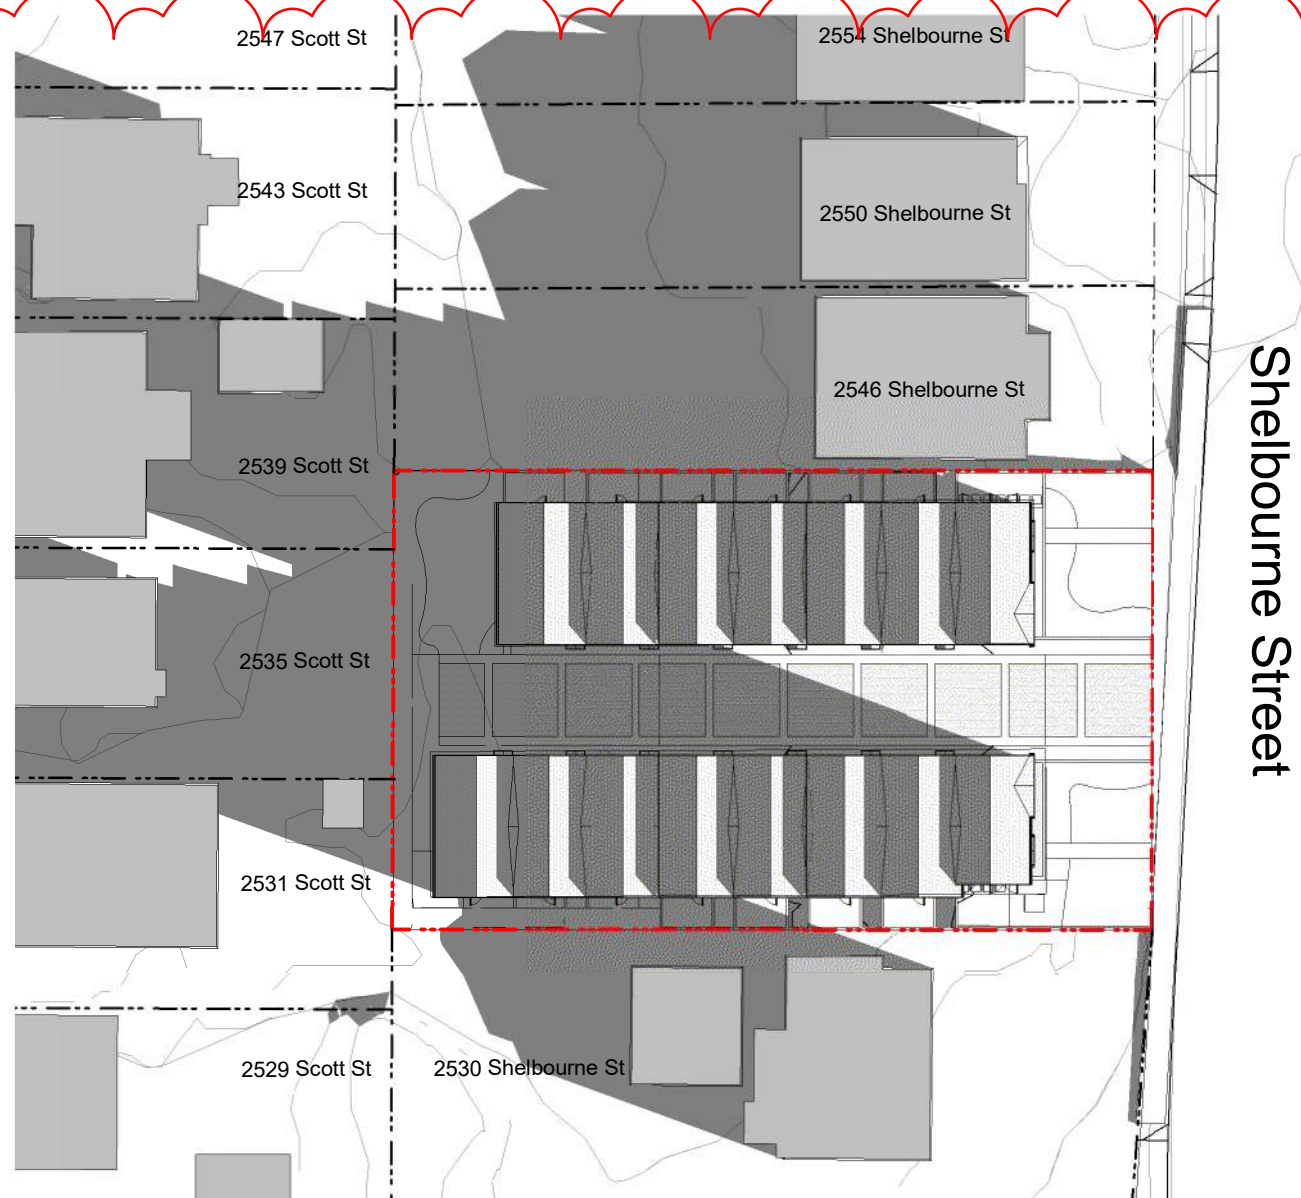


7 Shadow Study - Fall Equinox (Sep 21) 8AM
A002 SCALE: 1 : 500

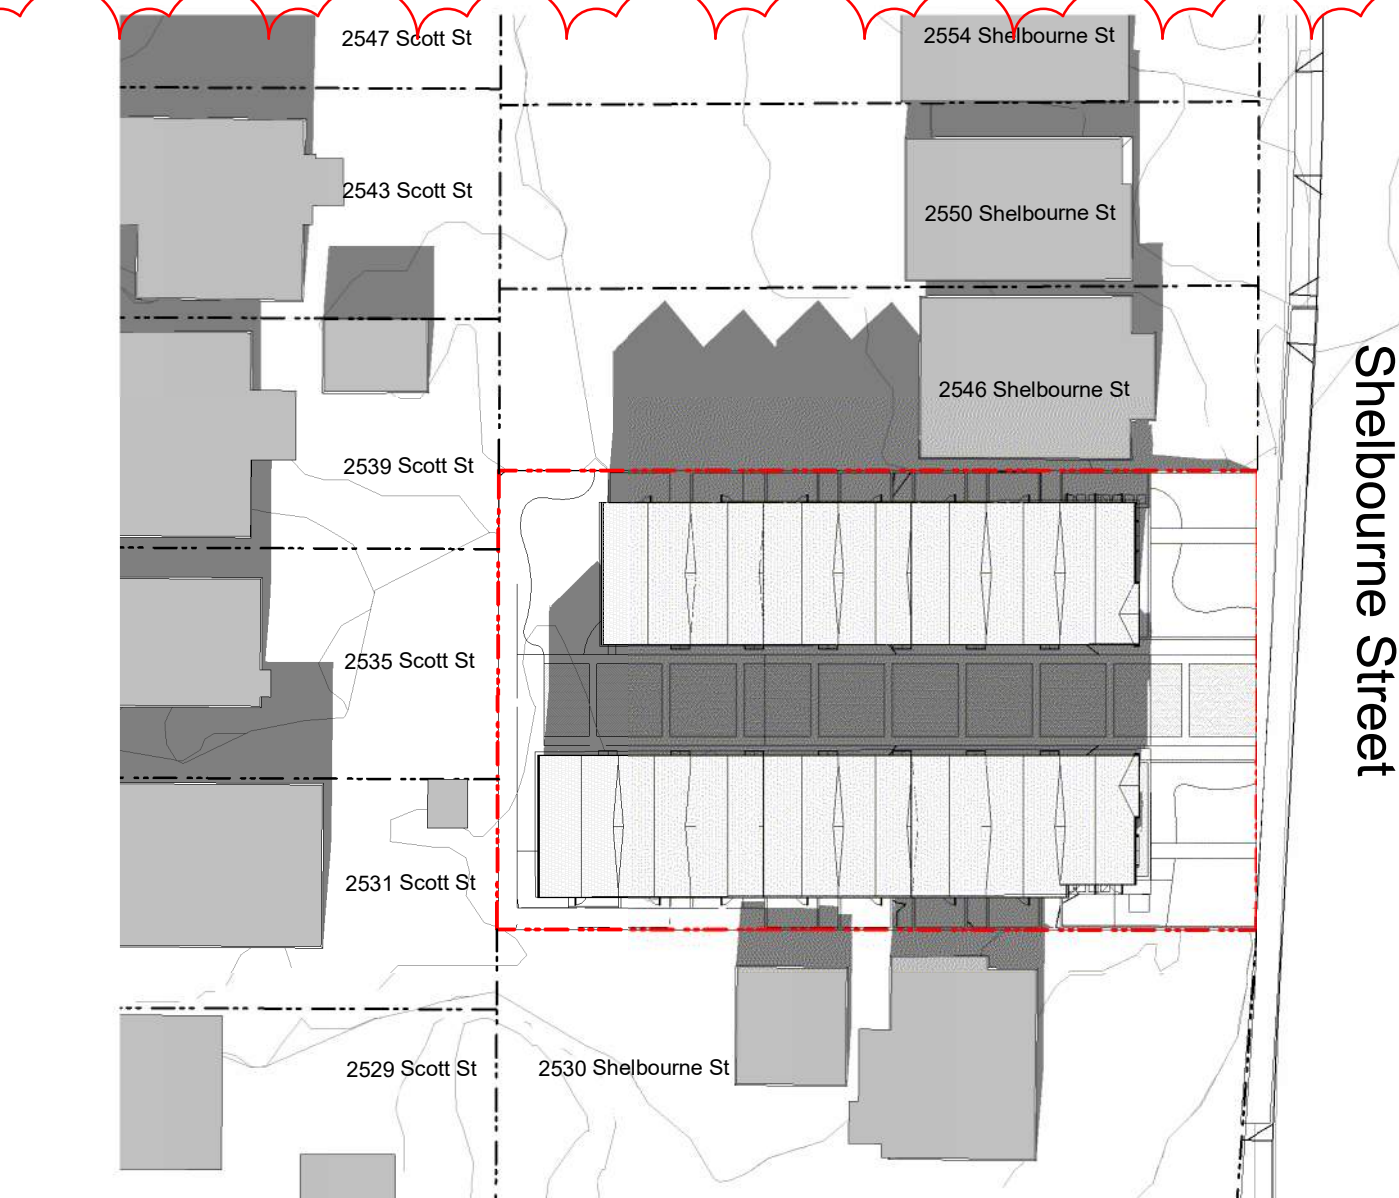

8 Shadow Study - Fall Equinox (Sep 21) 12PM
A002 SCALE: 1 : 500



9 Shadow Study - Fall Equinox (Sep 21) 4PM
A002 SCALE: 1 : 500

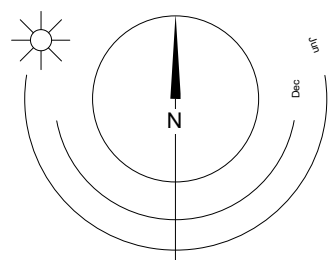

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Street, Victoria, BC
Shadow Study




A002

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1. Project Rendering - North Looking View @ Shelbourne Street



2. Project Rendering - Typical Side Yard Patio

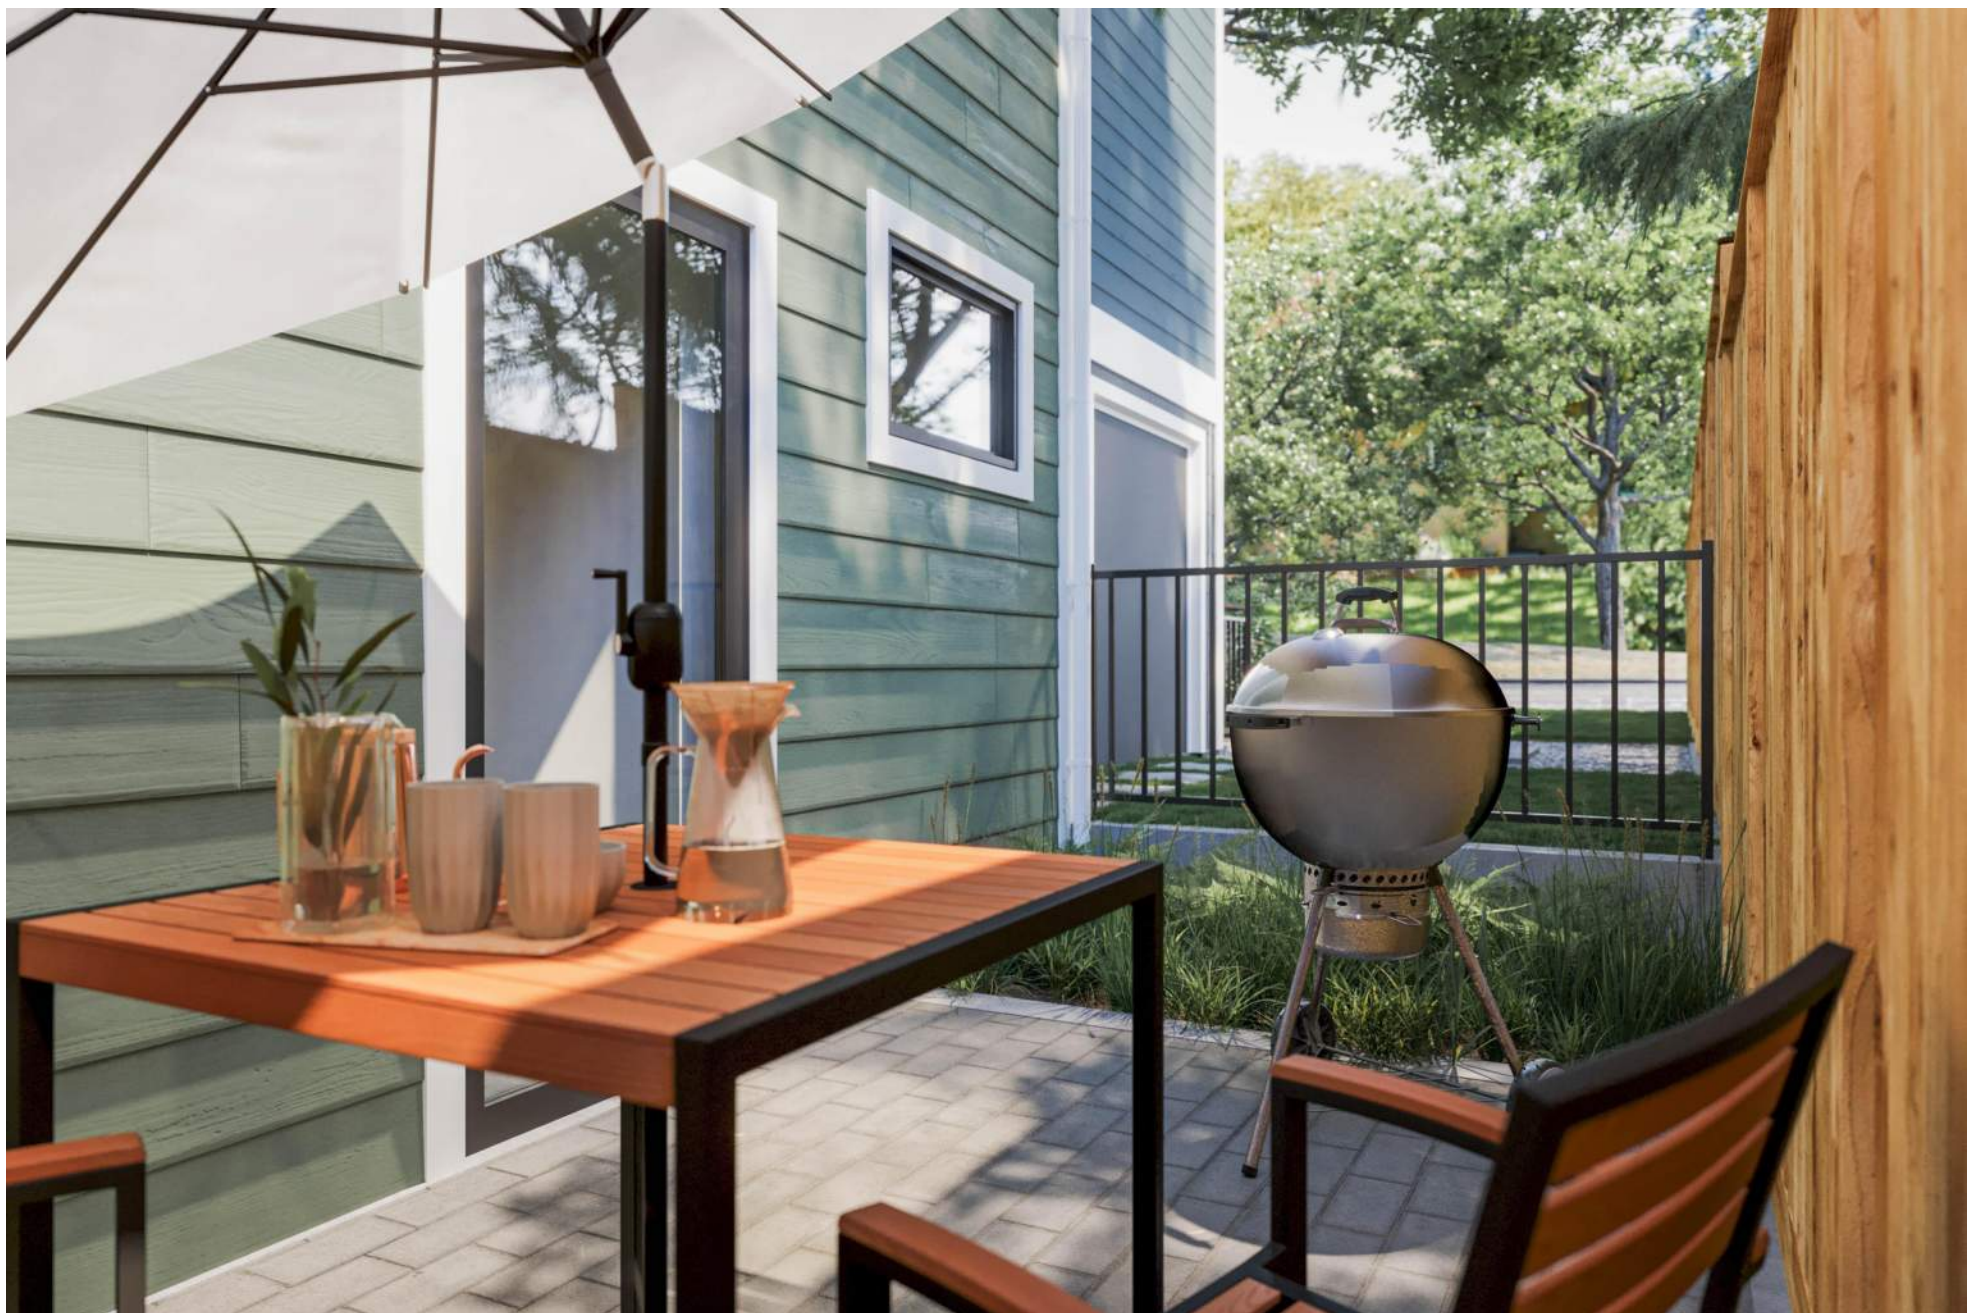

3. Project Rendering - South Looking View @ Shelbourne Street

23/04/20
22/10/24

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Plot Date	23/09/01	Drawing File	
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**FERNWOOD
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Perspective Views



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1. Project Rendering - North Looking View @ Amenity and Play Area

23/04/20
22/10/24

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Perspective Views


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A004


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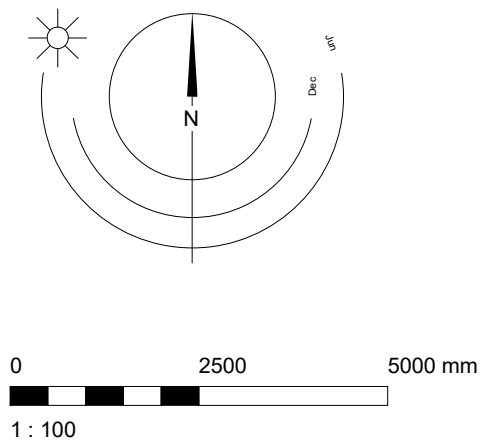


SITE AREA AND COVERAGE	
SITE AREA:	1,526 m ²
SITE COVERAGE:	640 m ² / 42%
OPEN SITE SPACE:	504 m ² / 33%

Average Grade Calculations

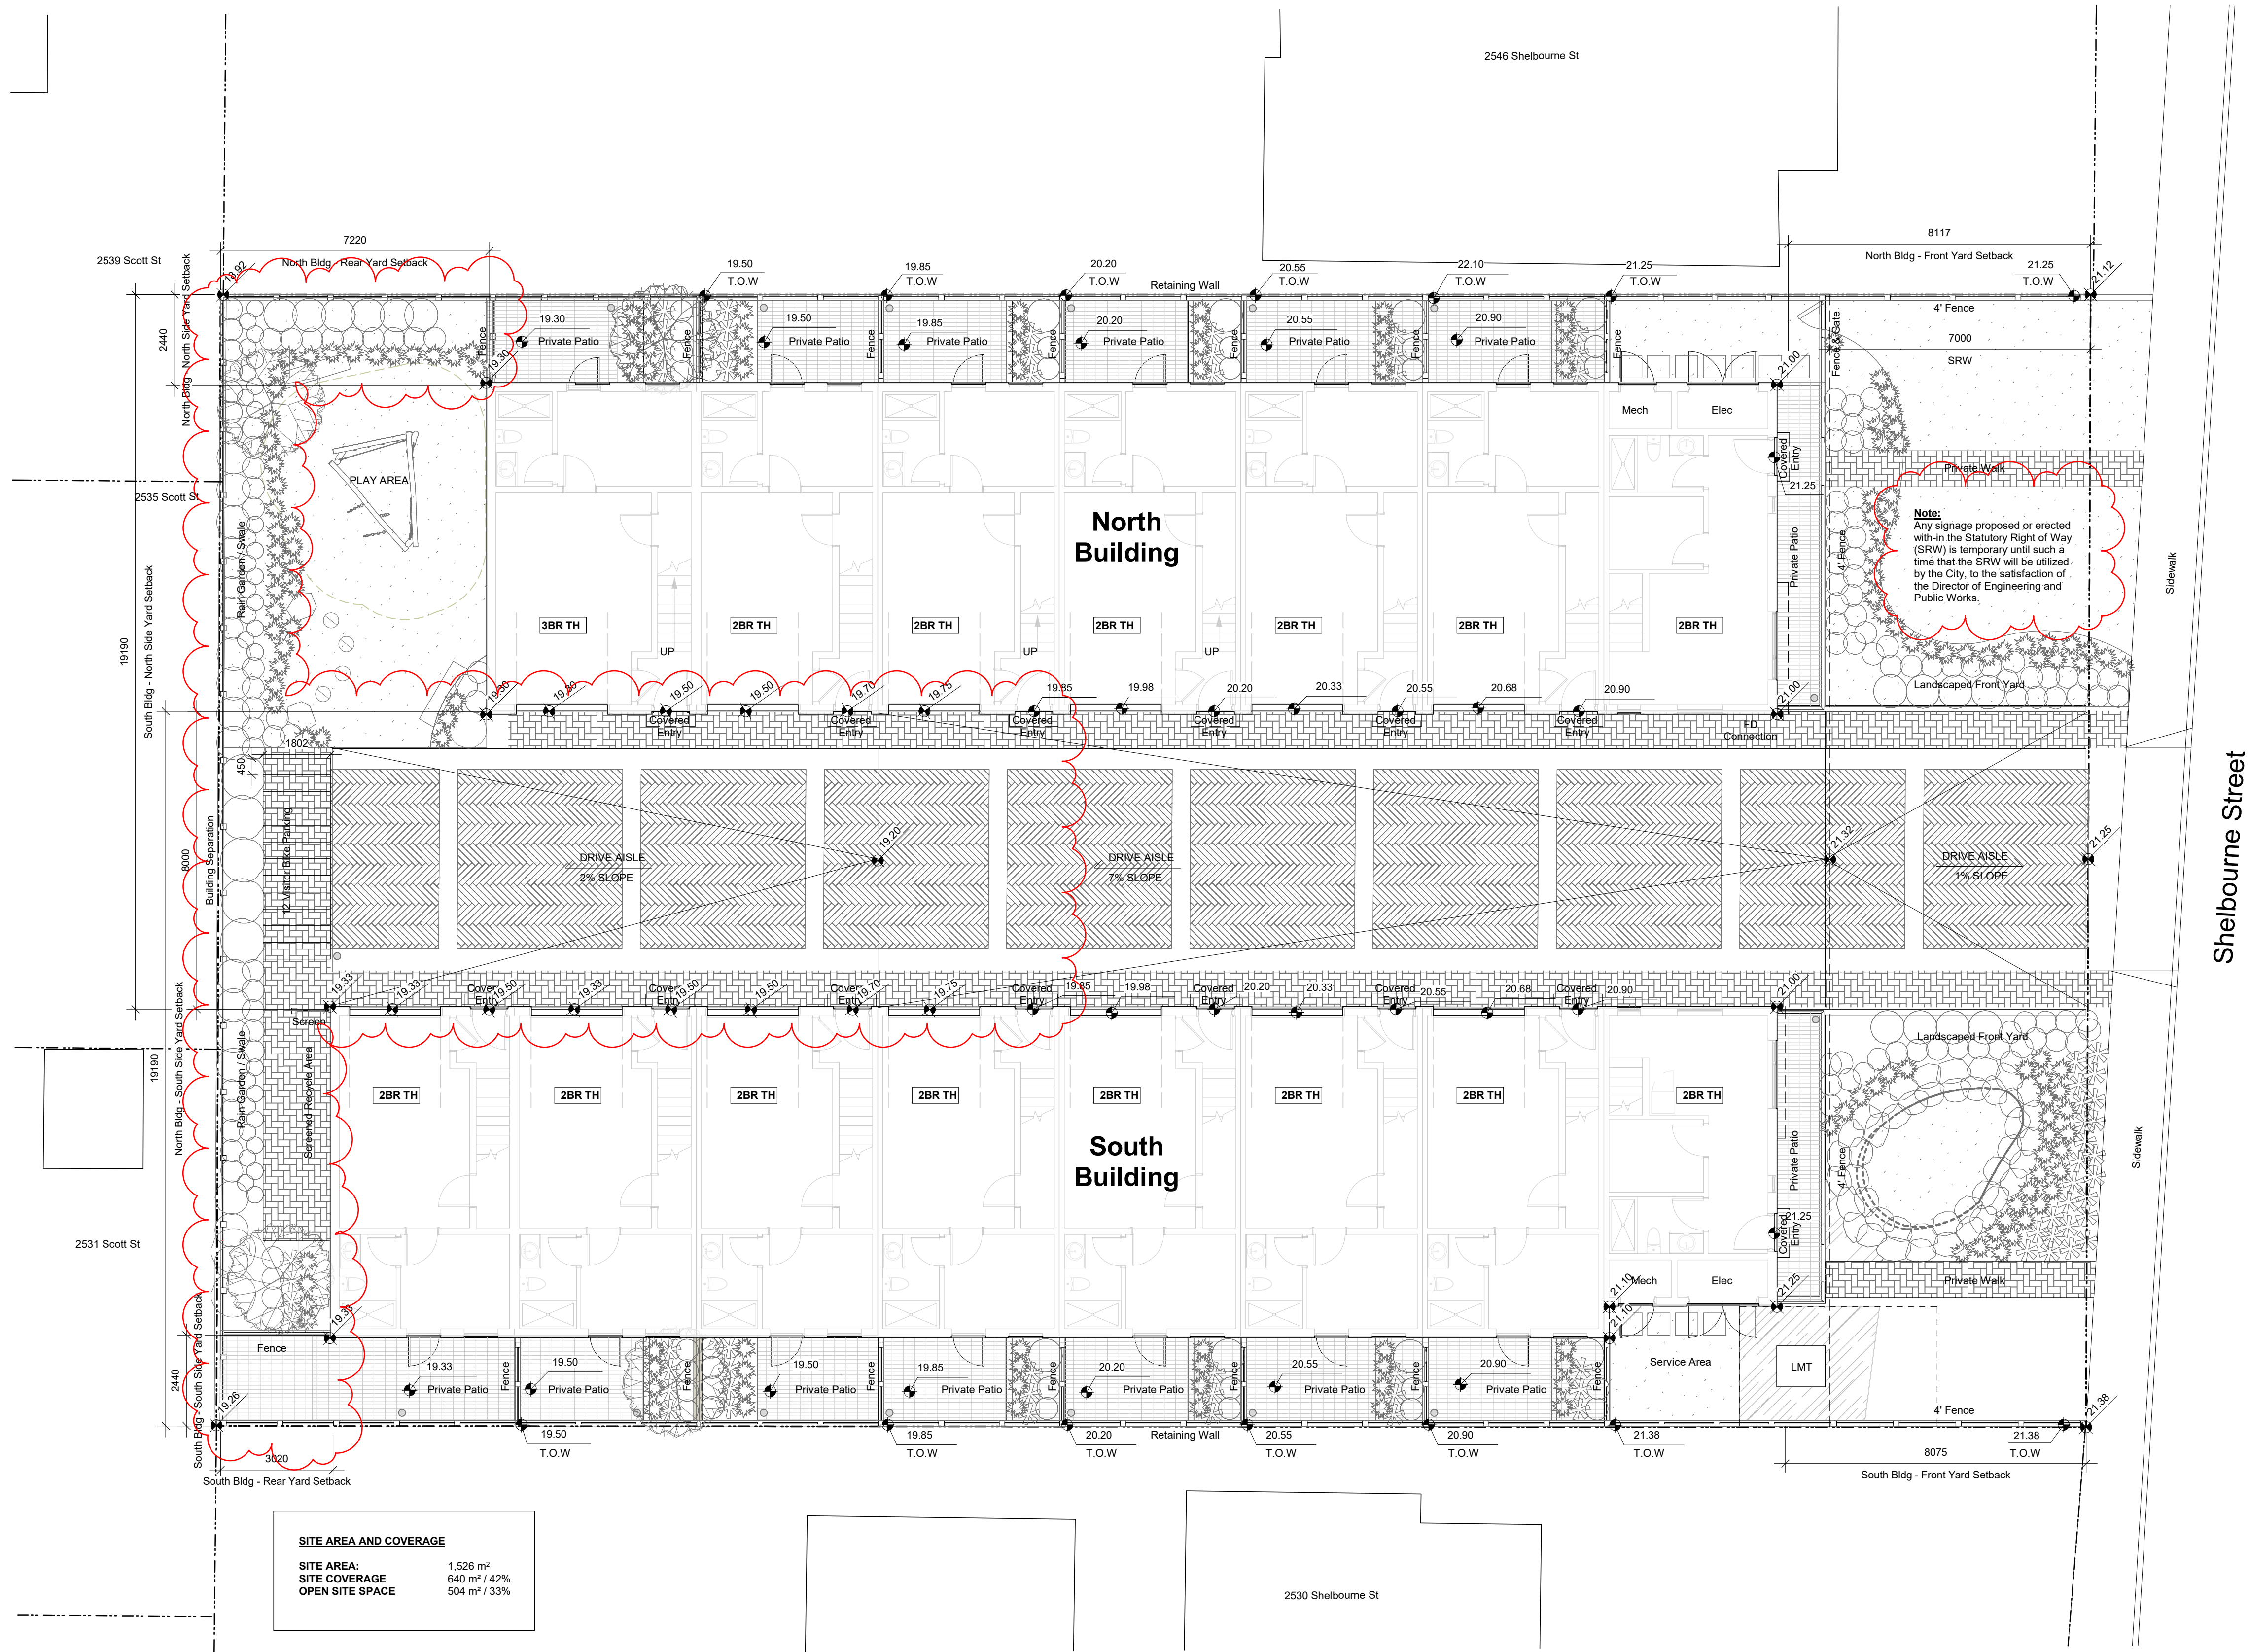

North Bldg	Grade Points	Avg of Points	x	Distance	Totals
Grade Point A - 19.3	Points A - B	((19.3+21.2)/2)=20.15	x	34.65	= 698.2
Grade Point B - 21	Points B - C	((21+21.2)/2)=21	x	8.9	= 186.9
Grade Point C - 21	Points C - D	((21+19.3)/2)=20.15	x	34.65	= 698.2
Grade Point D - 19.3	Points D - A	((21+21)/2)=21	x	8.9	= 186.9
North Bldg Grade Calculation					1770.2
1770.2/87.1 (Perimeter) = 20.3m					
South Bldg	Grade Points	Avg of Points	x	Distance	Totals
Grade Point E - 19.3	Points E - F	((19.3+21.2)/2)=20.15	x	34.65	= 698.2
Grade Point F - 21	Points F - G	((21+21.25)/2)=21.13	x	8.07	= 170.52
Grade Point G - 21.25	Points G - H	((21.25+21.1)/2)=21.18	x	4.5	= 95.3
Grade Point H - 21.1	Points H - I	((21.1+21.1)/2)=21.1	x	0.85	= 17.94
Grade Point I - 21.1	Points I - J	((21.1+19.3)/2)=20.2	x	34.3	= 692.86
Grade Point J - 19.3	Points J - E	((19.3+19.3)/2)=19.3	x	8.9	= 171.77
South Bldg Grade Calculation					1846.59
1846.59/91.27 (Perimeter) = 20.2m					

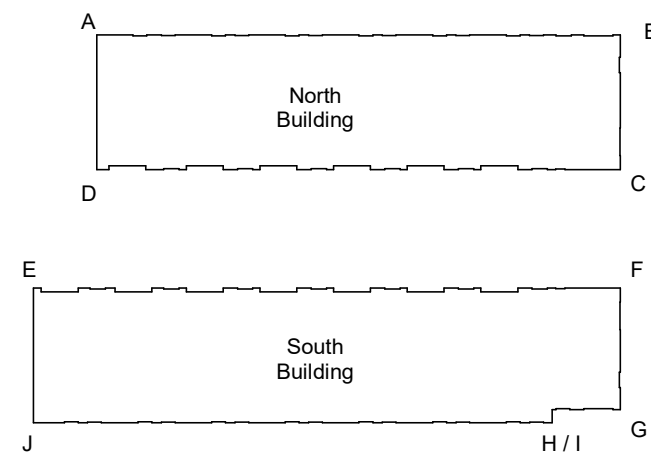


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FERNWOOD TOWNHOMES


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Site Plan



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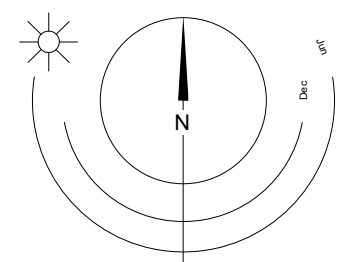


1 Level 1 - Overall Plan
A201 SCALE: 1 : 100
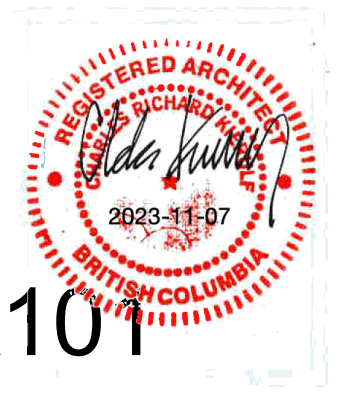
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Street, Victoria, BC
L1 Plan

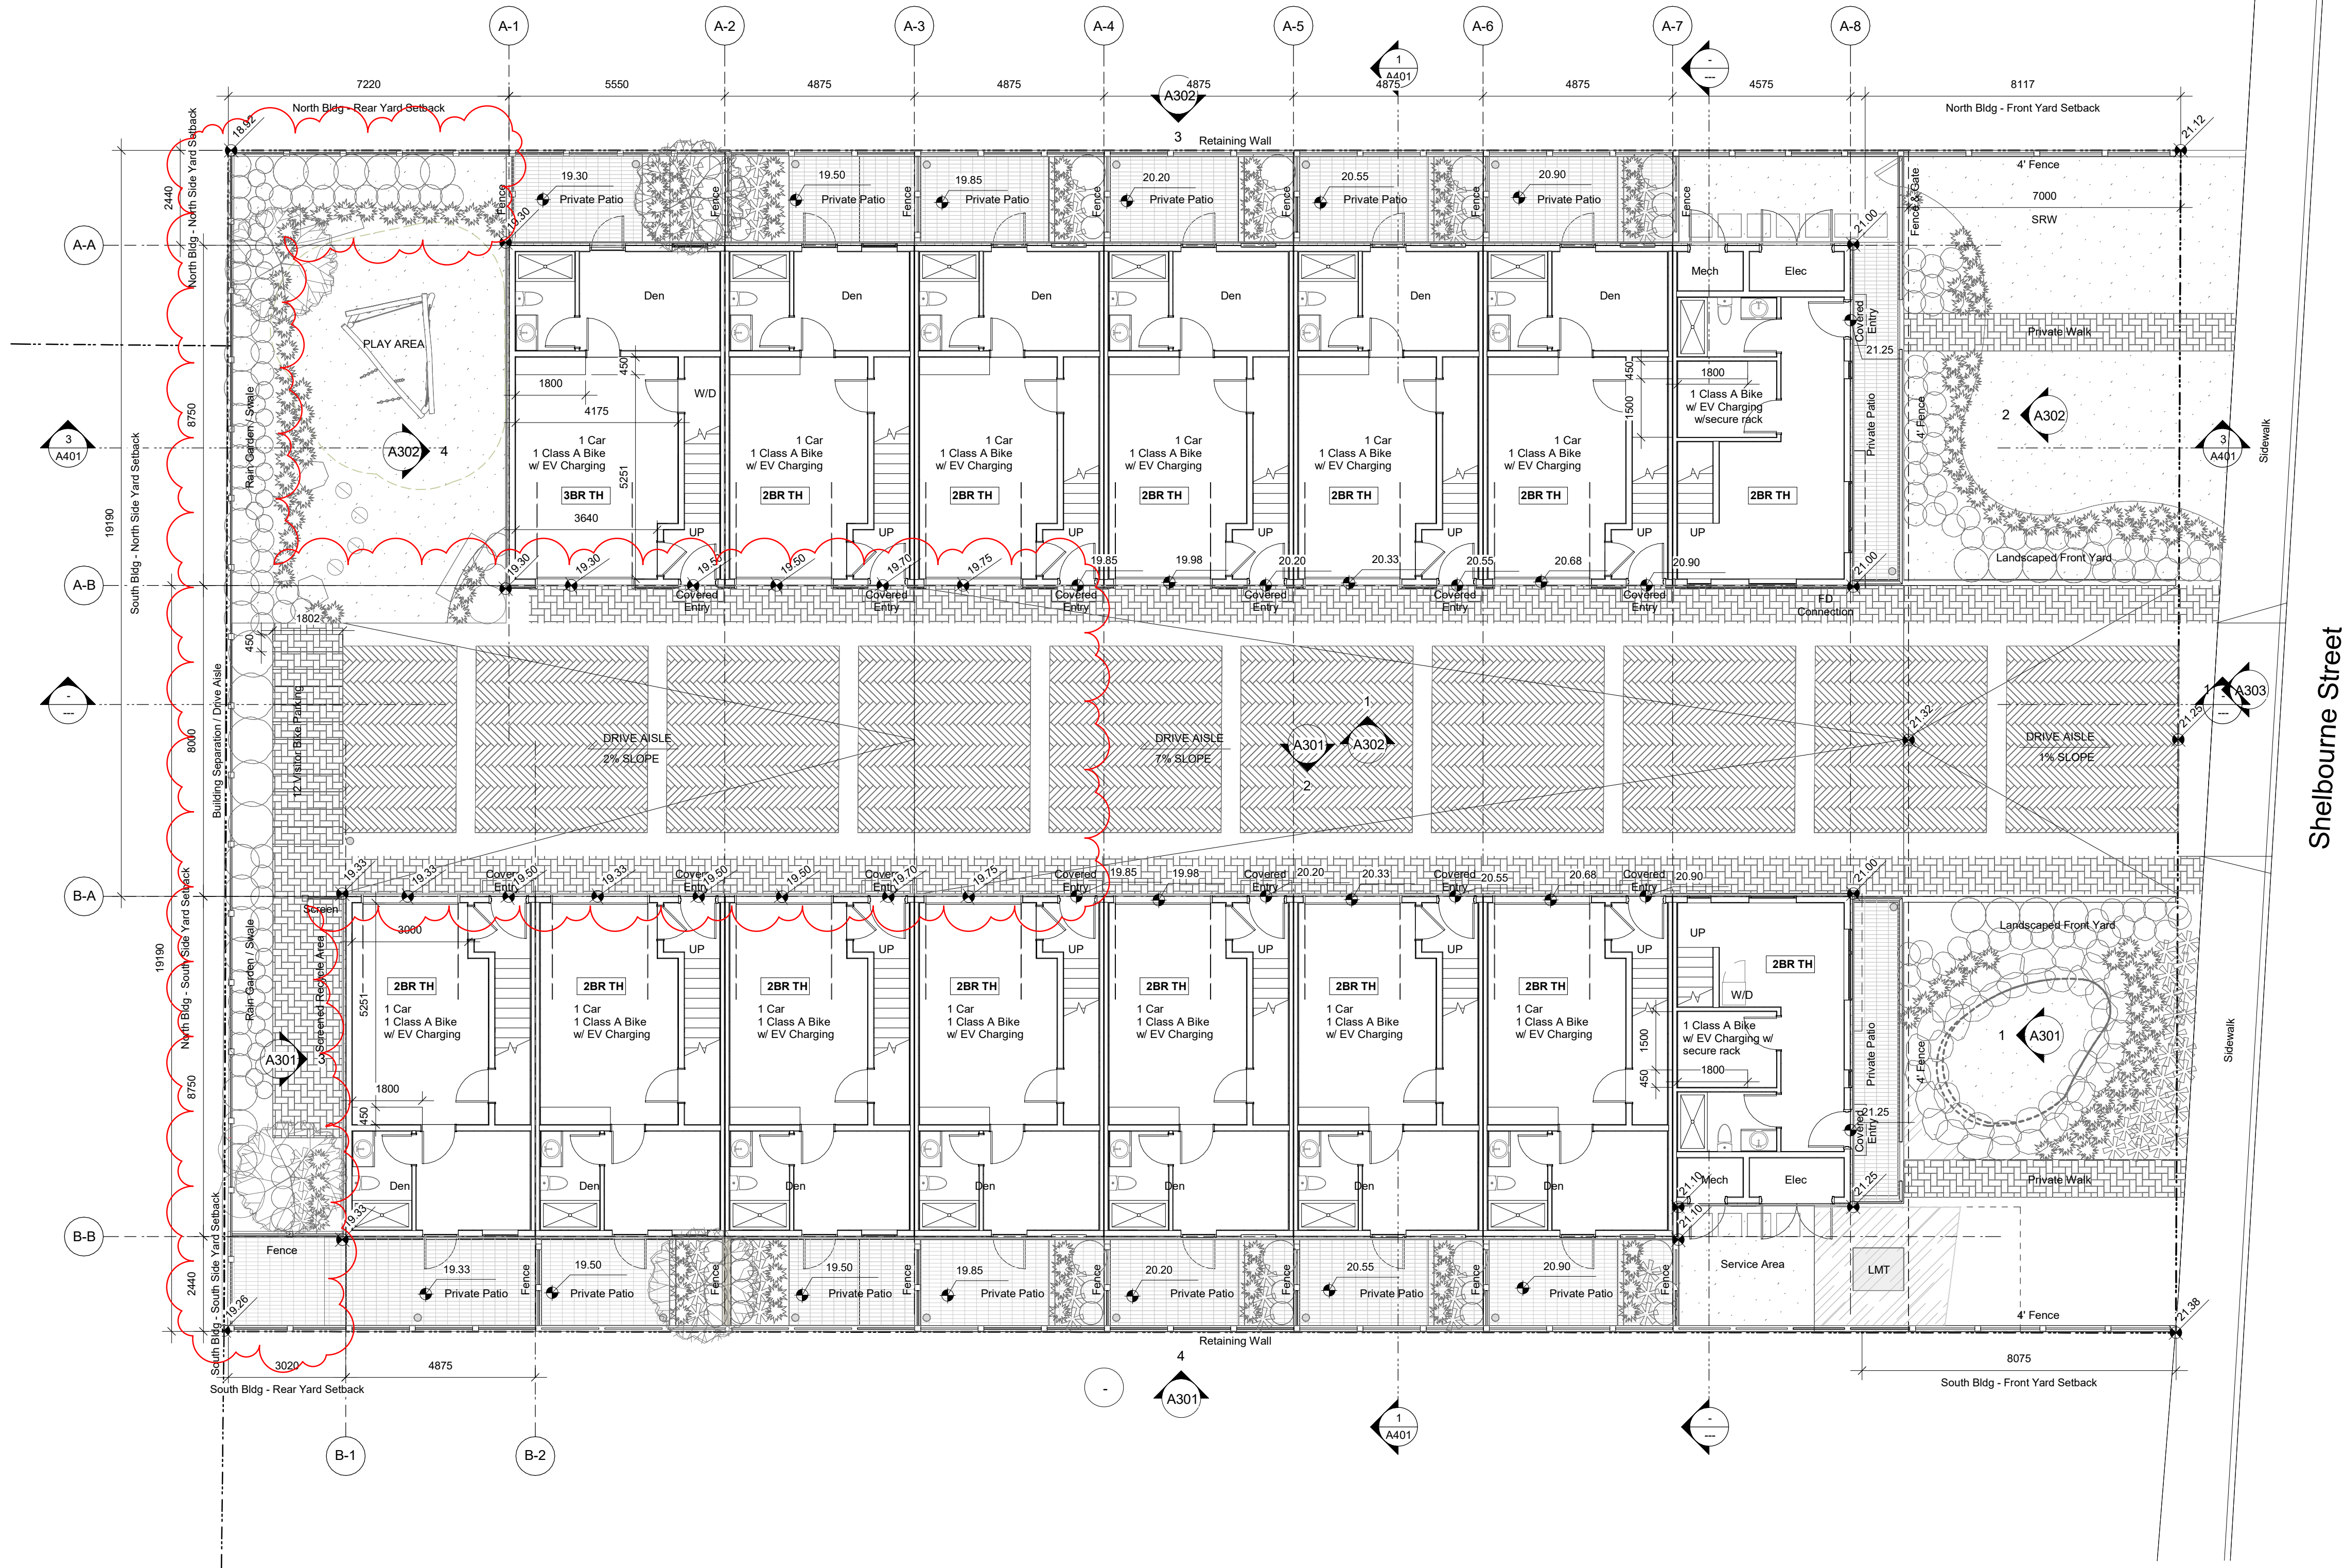


0 2500 5000 mm
1 : 100

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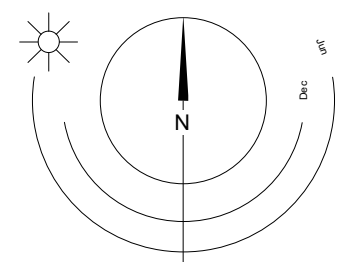


1 Level 2 - Overall Plan
A202 SCALE: 1 : 100

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FERNWOOD
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Street, Victoria, BC
L2 Plan

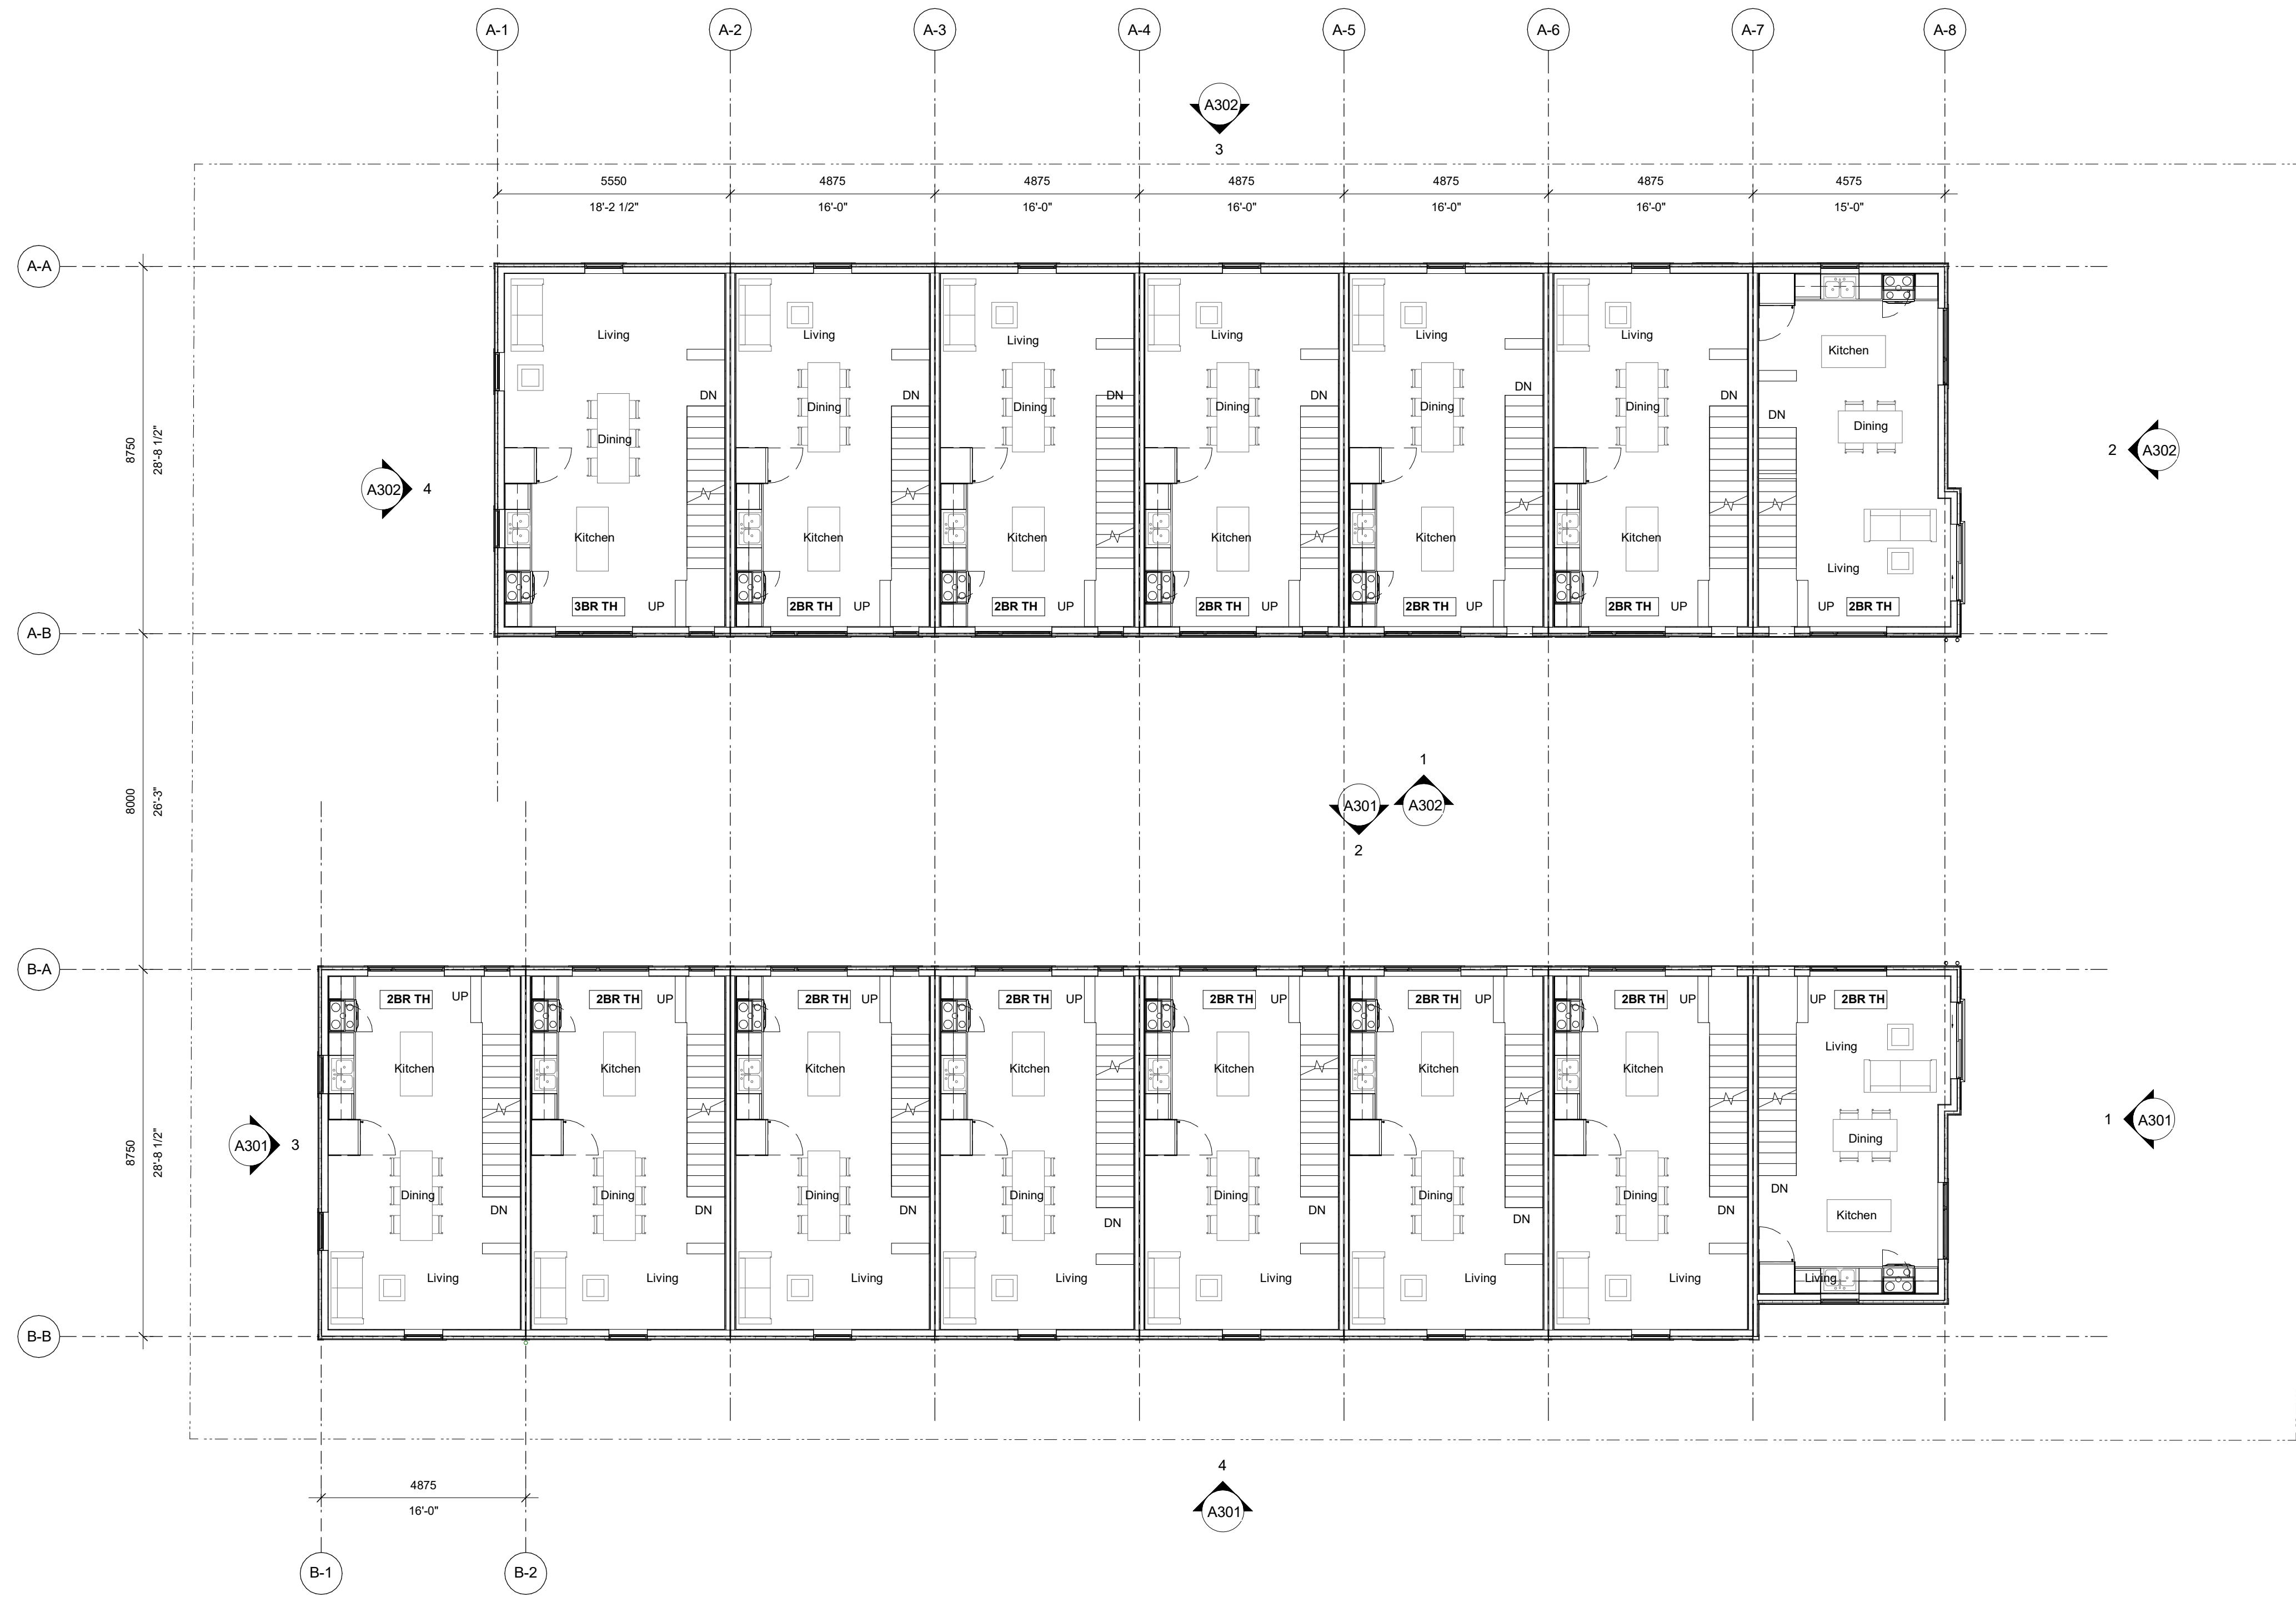


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A202

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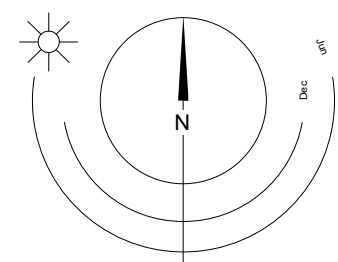


1 Level 3 - Overall Plan
A203 SCALE: 1 : 100

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Street, Victoria, BC
L3 Plan

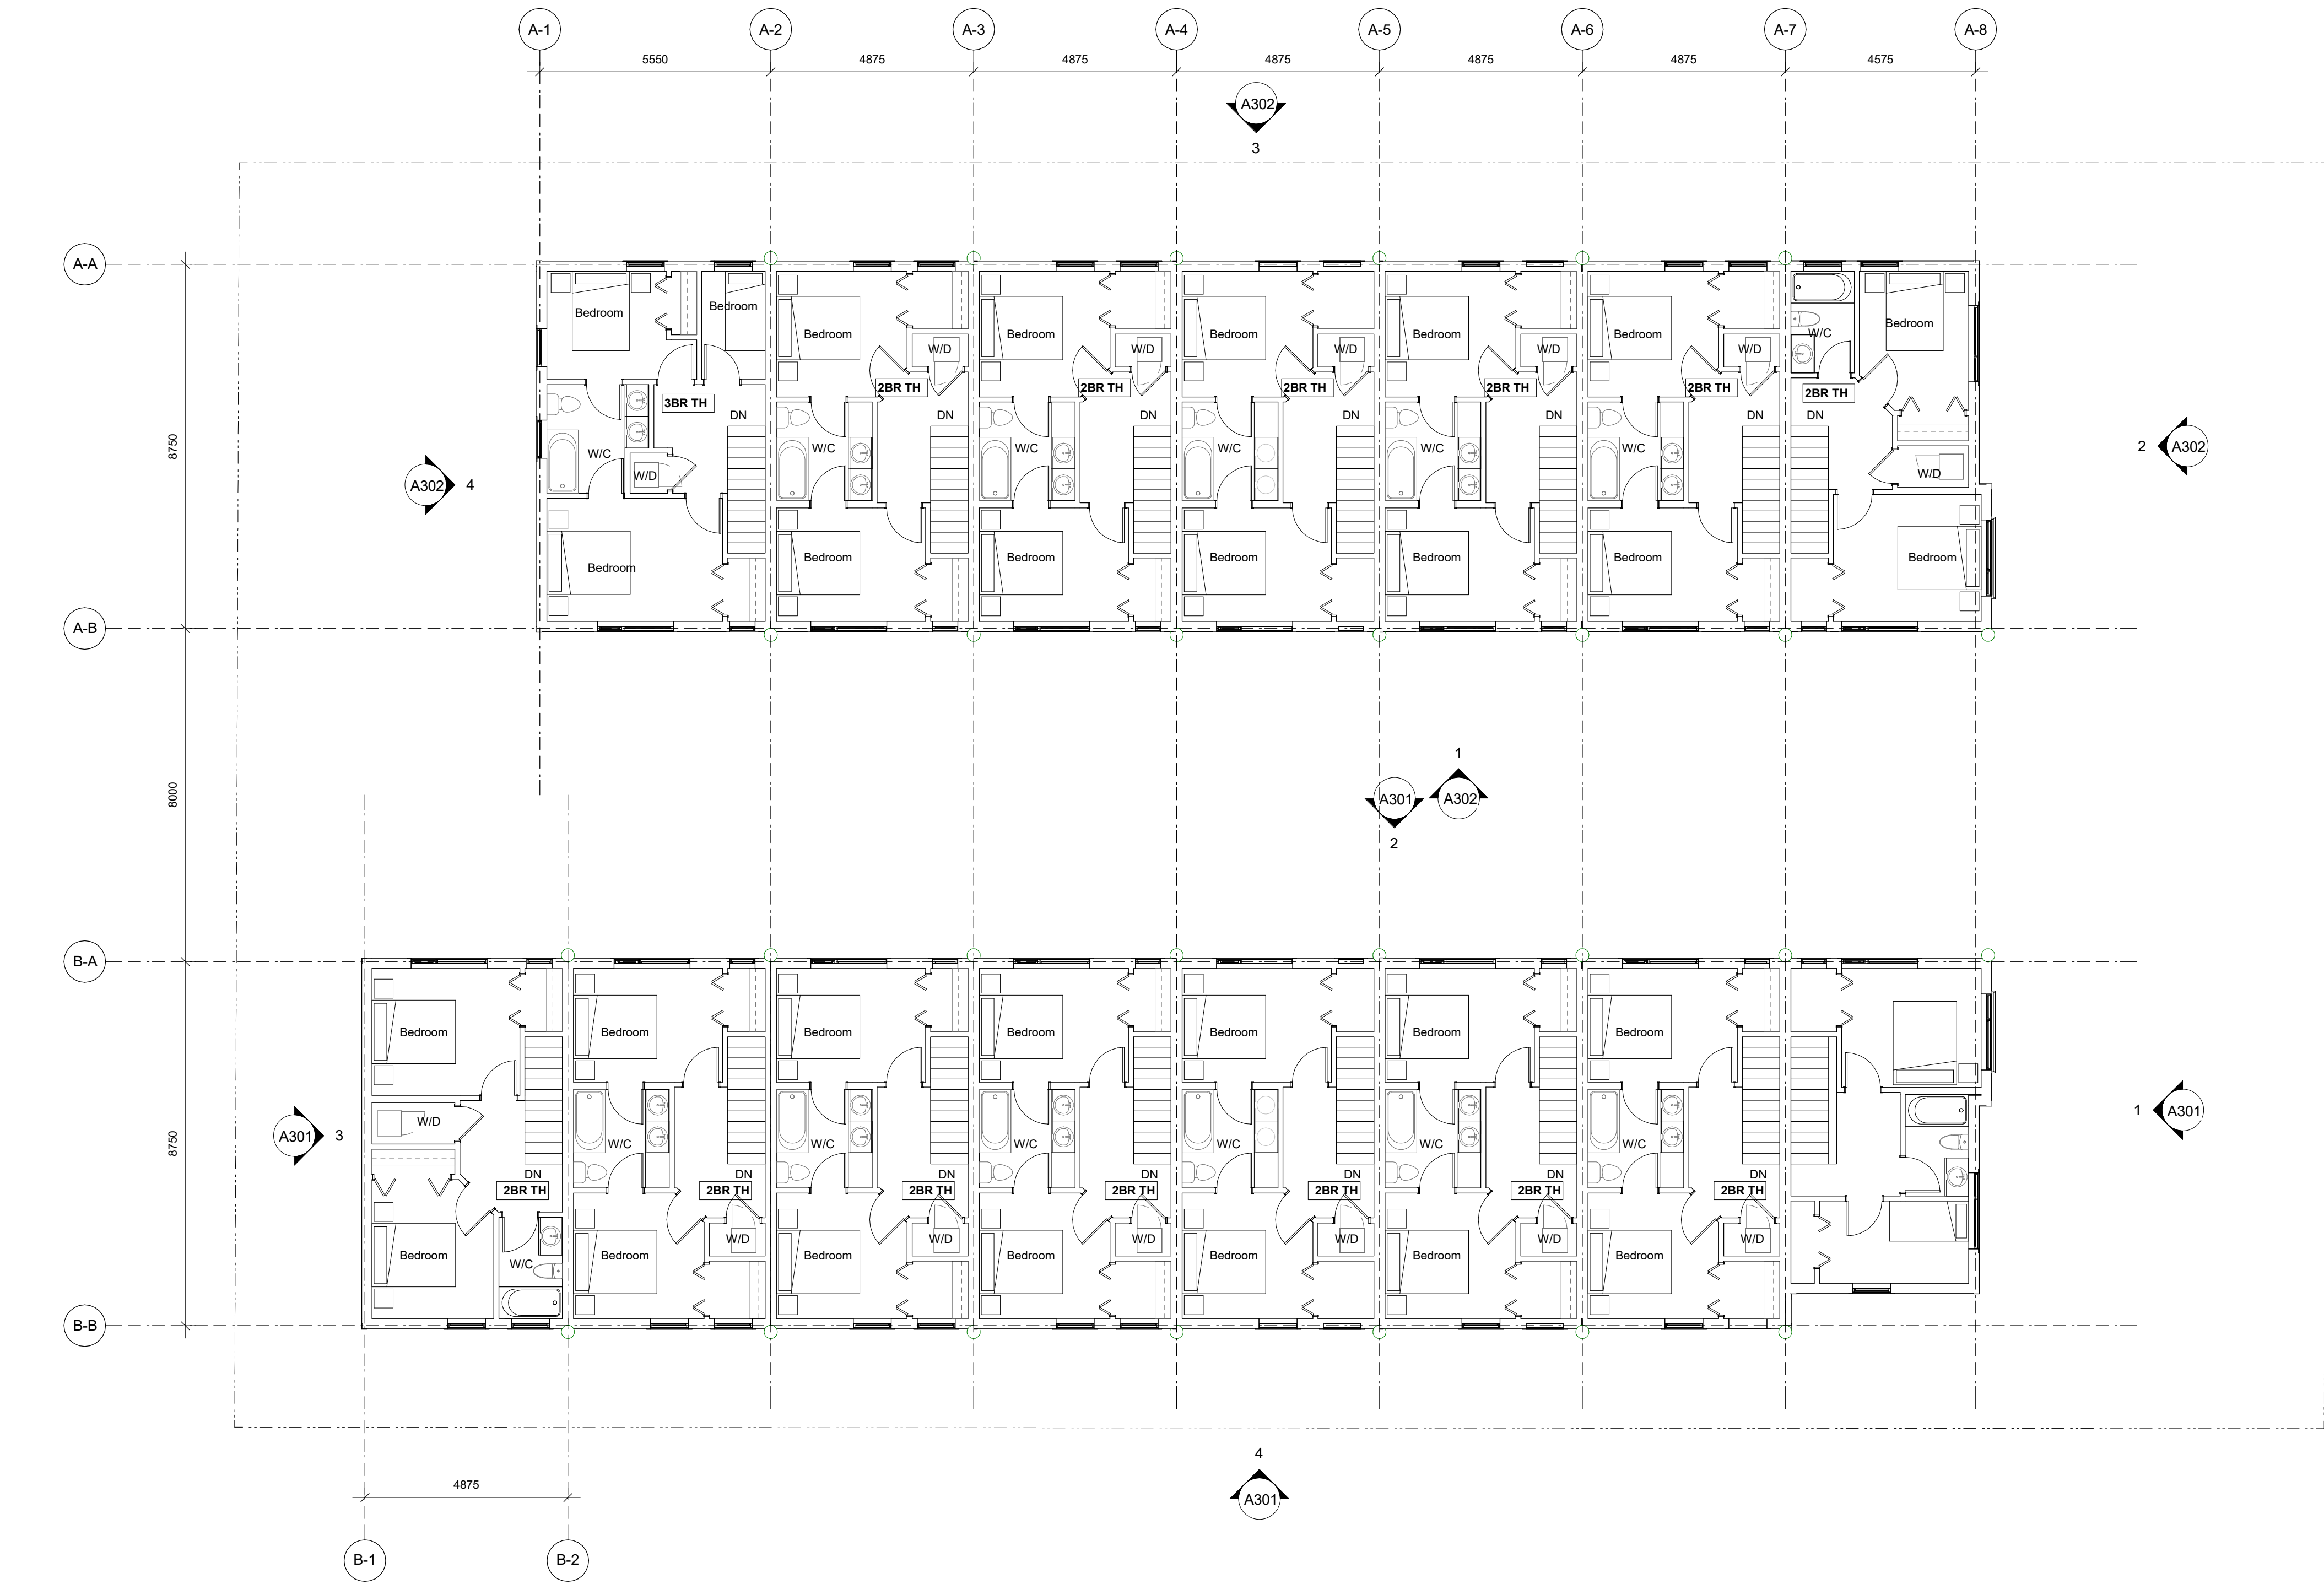


0 2500 5000 mm
1 : 100

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A203

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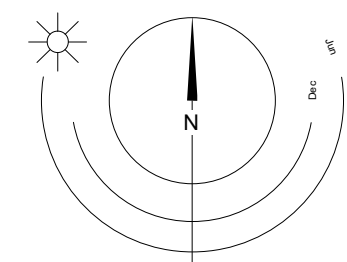
1 Roof - Overall Plan
A204 SCALE: 1 : 100

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**FERNWOOD
TOWNHOMES**
2540 & 2542 Shelbourne
Street, Victoria, BC
Roof Plan

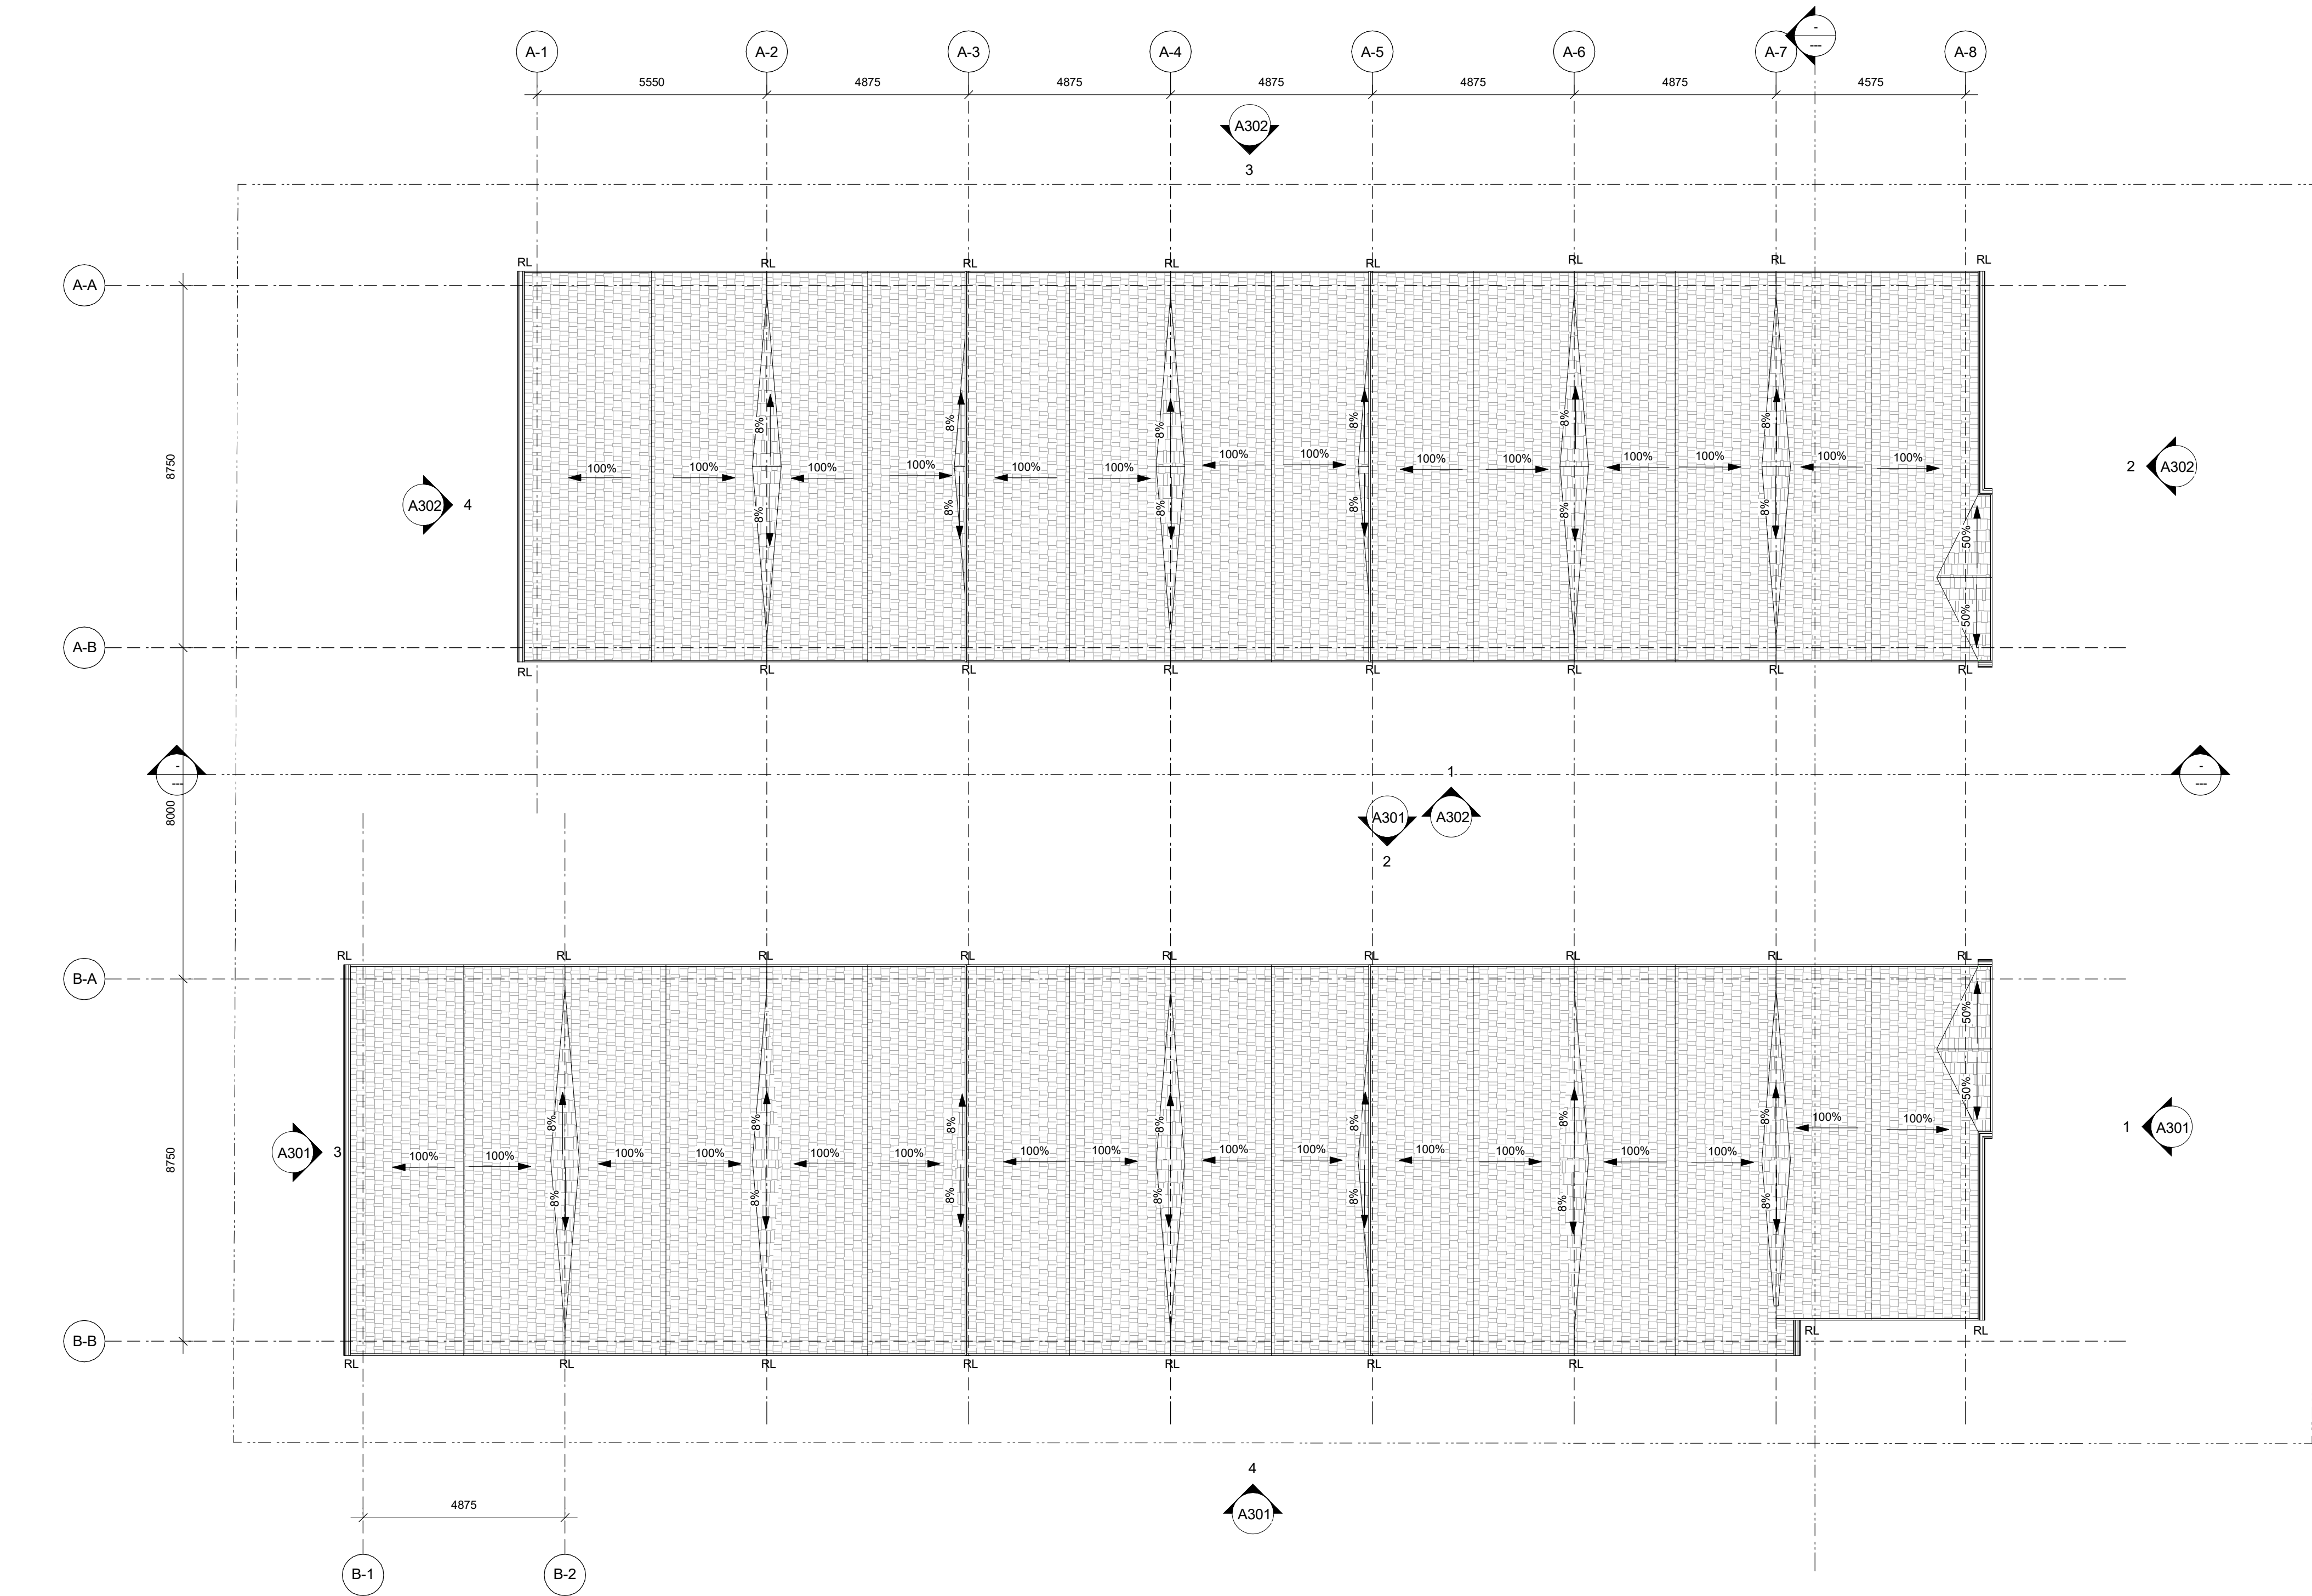

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1 : 100


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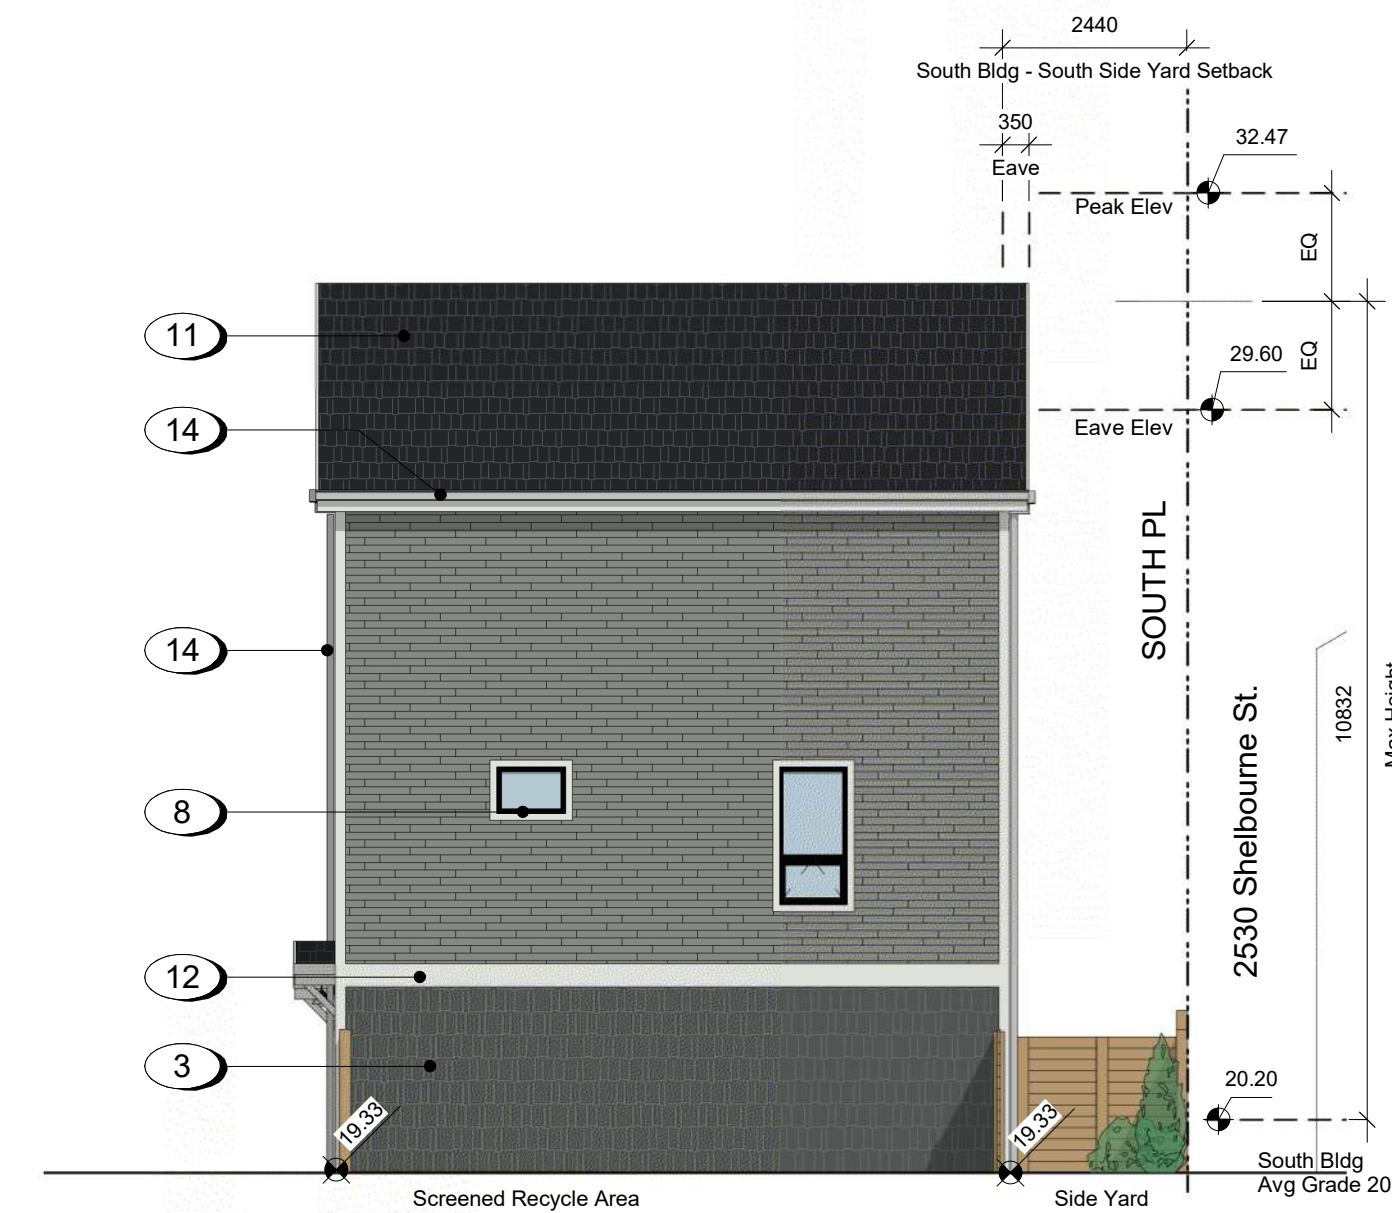
- 1 Fibre Cement Lap Siding - White
- 2 Fibre Cement Lap Siding - Slate Gray
- 3 Fibre Cement Shingles - Iron Gray
- 4 Fibre Cement Panels - White
- 5 Fibre Cement Panels - Slate Gray
- 6 Fibreglass OH Door - White
- 7 Fibre Cement Lap Siding - Sage
- 8 Low E Vinyl Window - Black Trim
- 9 Pre-finished Fibreglass Door - Colour Varies
- 10 Exterior Fibreglass Door Panel Painted Black
- 11 Asphalt Shingles - Black
- 12 Prefinished Fibre Cement Trim - White
- 13 Pre-finished Aluminum - Black
- 14 Rain Weater Leader / Conductor Head - Galvanized
- 15 Fibre Cement Lap Siding - Evening Blue
- 16 Frosted glass Entry Light



1 West Building - East Elevation Copy 1
A301 SCALE: 1 : 100



2 South Building - North Elevation
A301 SCALE: 1 : 100

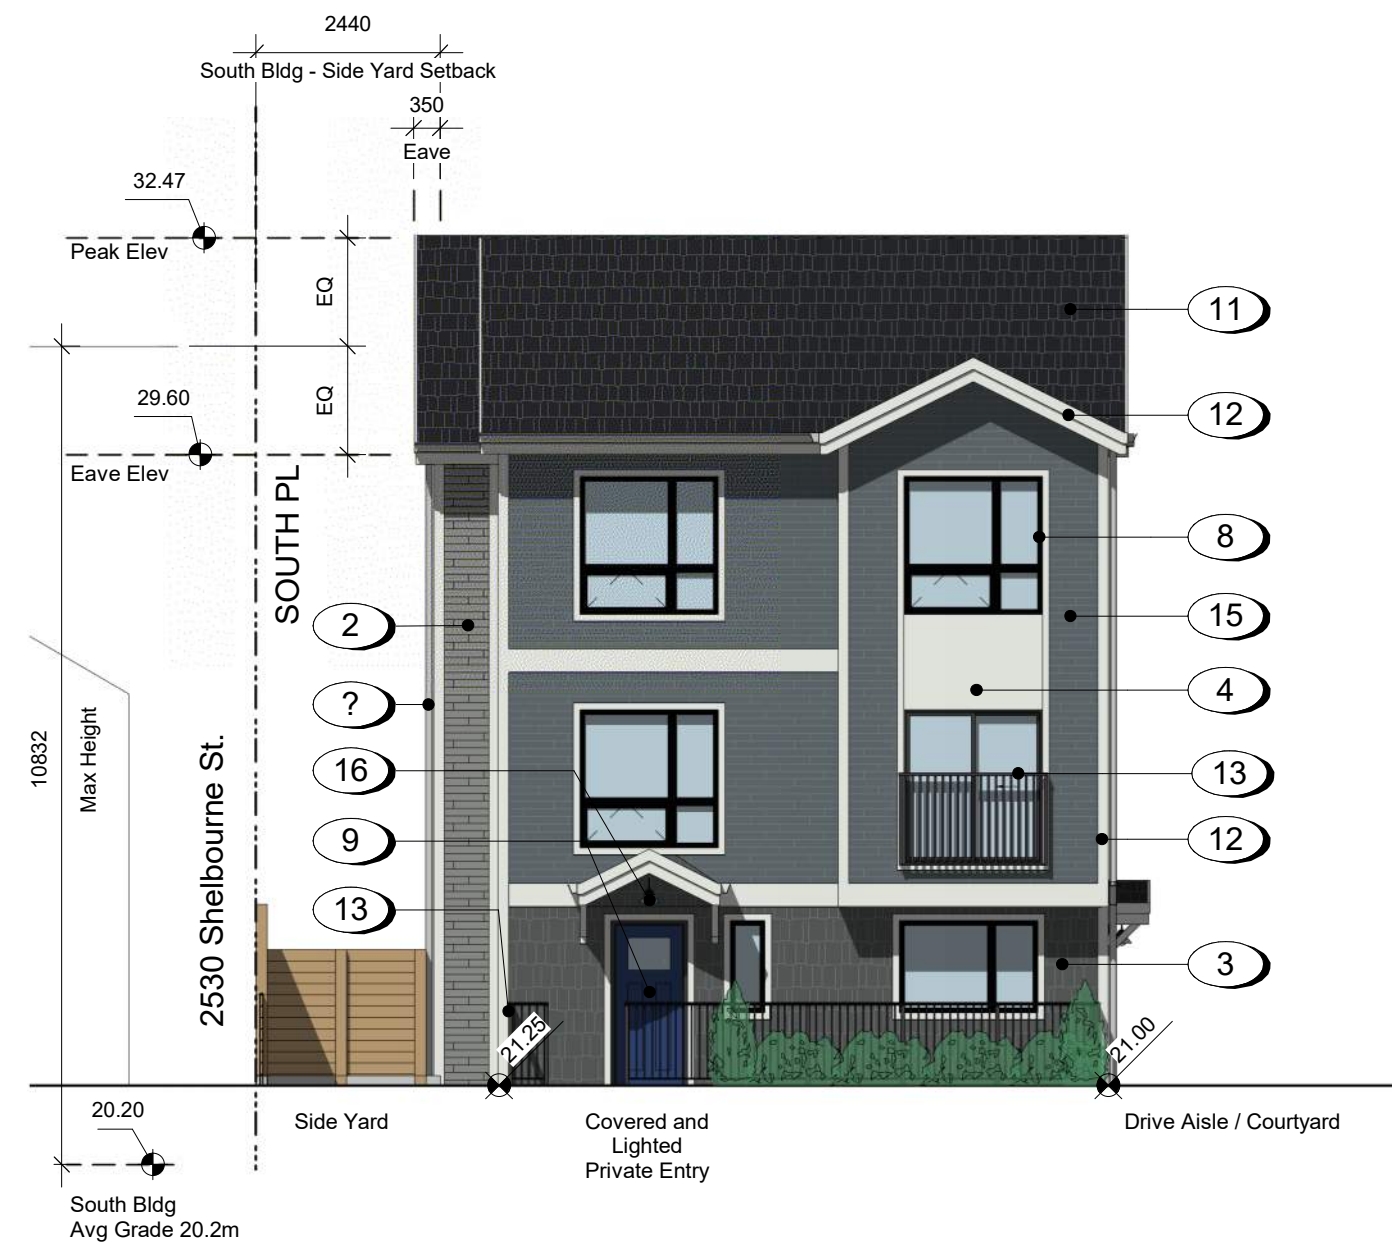

3 South Bldg - West Elevation
A301 SCALE: 1 : 100



4 South Building - South Elevation
A301 SCALE: 1 : 100

23/10/30 ISSUED FOR DP AMENDMENTS
23/09/01 ISSUED FOR DP AMENDMENTS
23/07/27 ISSUED FOR DP AMENDMENTS
23/04/20 ISSUED FOR DP AMENDMENTS
22/10/04 ISSUED FOR DP AMENDMENTS
22/10/24 ISSUED FOR ADP
22/07/18 ISSUED FOR REZONING

Plot Date 23/09/01 Drawing File
Drawn By ADM/MVR Checked By ADM
Scale 1 : 100 Project Number
NOTE: All dimensions are shown in millimeters.

FERNWOOD
TOWNHOMES
2540 & 2542 Shelbourne
Street, Victoria, BC
South Building
Elevations



- 1 Fibre Cement Lap Siding - White
- 2 Fibre Cement Lap Siding - Slate Gray
- 3 Fibre Cement Shingles - Iron Gray
- 4 Fibre Cement Panels - White
- 5 Fibre Cement Panels - Slate Gray
- 6 Fibreglass OH Door - White
- 7 Fibre Cement Lap Siding - Sage
- 8 Low E Vinyl Window - Black Trim
- 9 Pre-finished Fibreglass Door - Colour Varies
- 10 Exterior Fibreglass Door Panel Painted Black
- 11 Asphalt Shingles - Black
- 12 Prefinished Fibre Cement Trim - White
- 13 Pre-finished Aluminum - Black
- 14 Rain Weater Leader / Conductor Head - Galvanized
- 15 Fibre Cement Lap Siding - Evening Blue
- 16 Frosted glass Entry Light

23/10/30 ISSUED FOR DP AMENDMENTS
23/09/01 ISSUED FOR DP AMENDMENTS
23/07/27 ISSUED FOR DP AMENDMENTS
23/04/20 ISSUED FOR DP AMENDMENTS
22/10/04 ISSUED FOR DP AMENDMENTS
22/10/24 ISSUED FOR ADP
22/07/18 ISSUED FOR REZONING

Plot Date 23/09/01 Drawing File
Drawn By ADMMVR Checked By ADM
Scale 1 : 100 Project Number
NOTE: All dimensions are shown in millimeters.

**FERNWOOD
TOWNHOMES**
2540 & 2542 Shelbourne
Street, Victoria, BC
**North Building
Elevations**



dHKa
A302

dHK Architects
Victoria
977 Fort Street V8V 3K3 T 1-250-658-3367
Nanaimo
102-5190 Dublin Way V9T 0H2 T 1-250-585-5810
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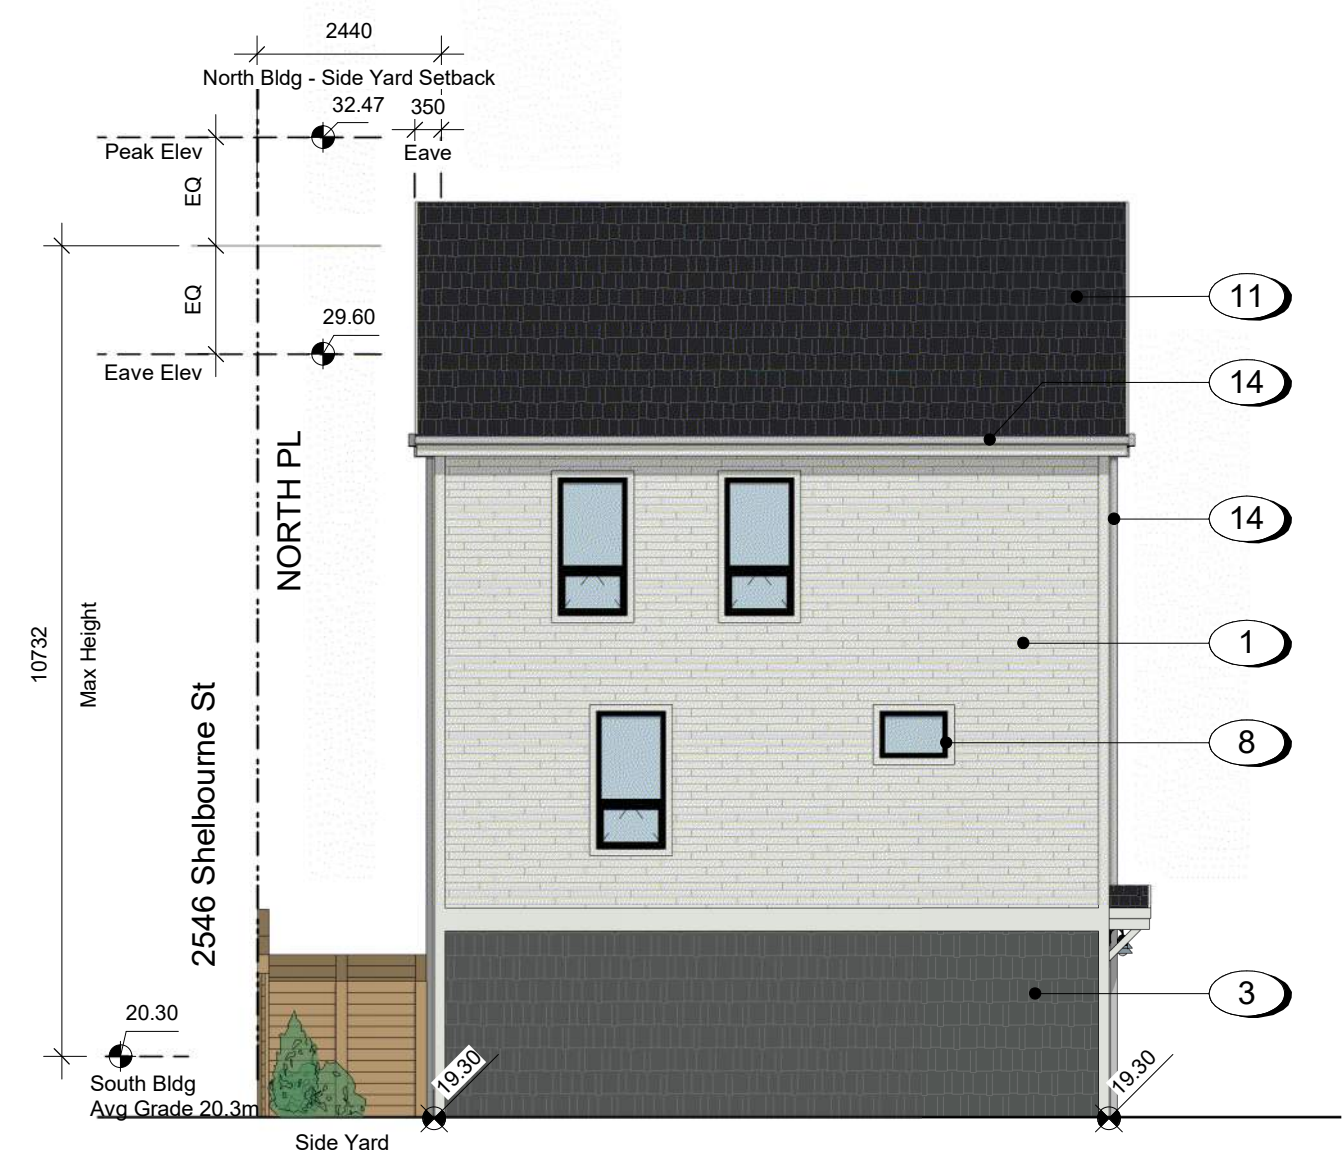
1 North Building - South Elevation
A302 SCALE: 1 : 100



2 North Building - East Elevation
A302 SCALE: 1 : 100



3 North Building - North Elevation
A302 SCALE: 1 : 100



4 West Elevation
A302 SCALE: 1 : 100



1 East Elevation on Shelbourne Street
A303 SCALE: 1 : 125

23/04/20 ISSUED FOR DP AMENDMENTS
22/10/04 ISSUED FOR DP AMENDMENTS
22/10/24 ISSUED FOR ADP
22/07/18 ISSUED FOR REZONING

Plot Date	23/09/01	Drawing File	
Drawn By	Author	Checked By	Checker
Scale	1 : 125	Project Number	

NOTE: All dimensions are shown in millimeters.

**FERNWOOD
TOWNHOMES**
2540 & 2542 Shelbourne
Street, Victoria, BC
Street Elevation


dHka




A303

dHKarchitects
Victoria
977 Fort Street V8V 3K3 T 1-250-658-3367
Nanaimo
102-5190 Dublin Way V9T 0H2 T 1-250-585-5810

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1 South to North Site Section
A401 / SCALE: 1 : 100

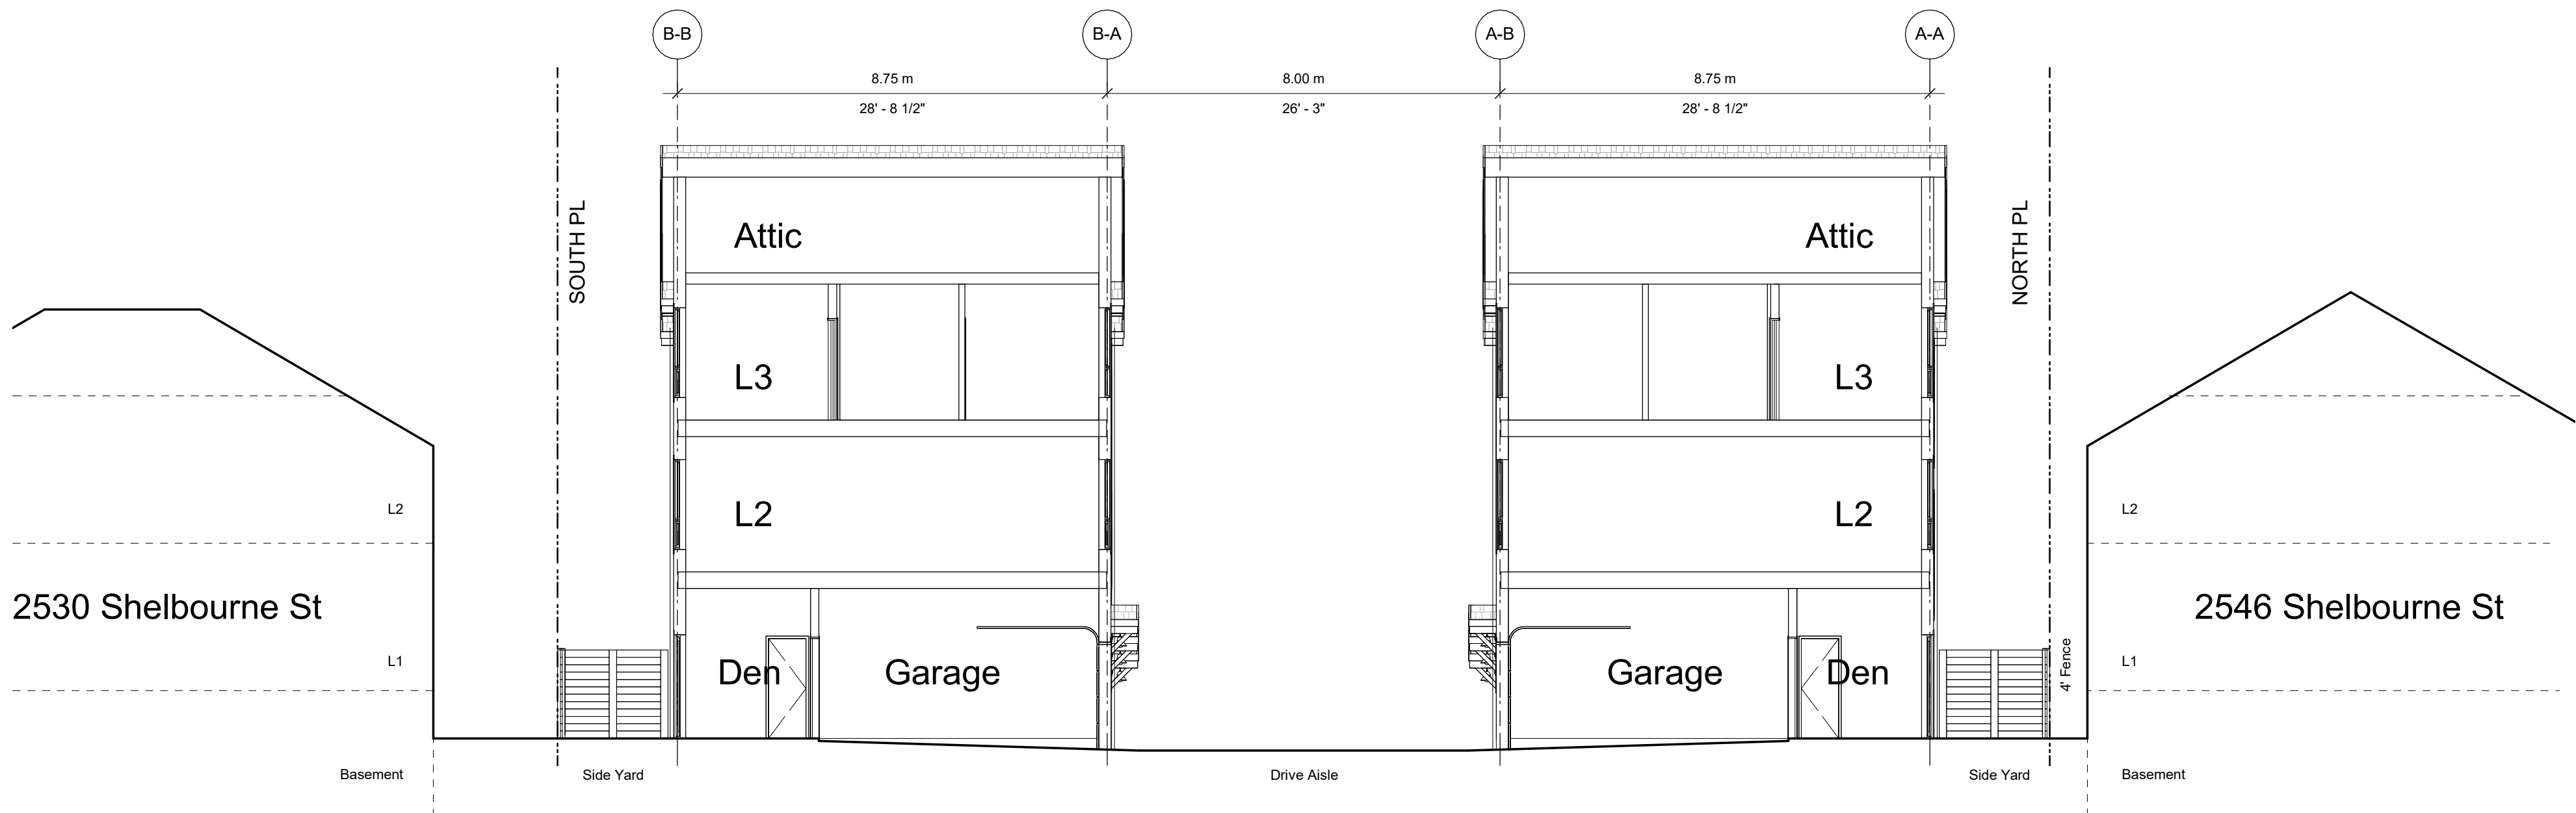


3 West to East Site Section Through Drive Aisle
A401 / SCALE: 1 : 100

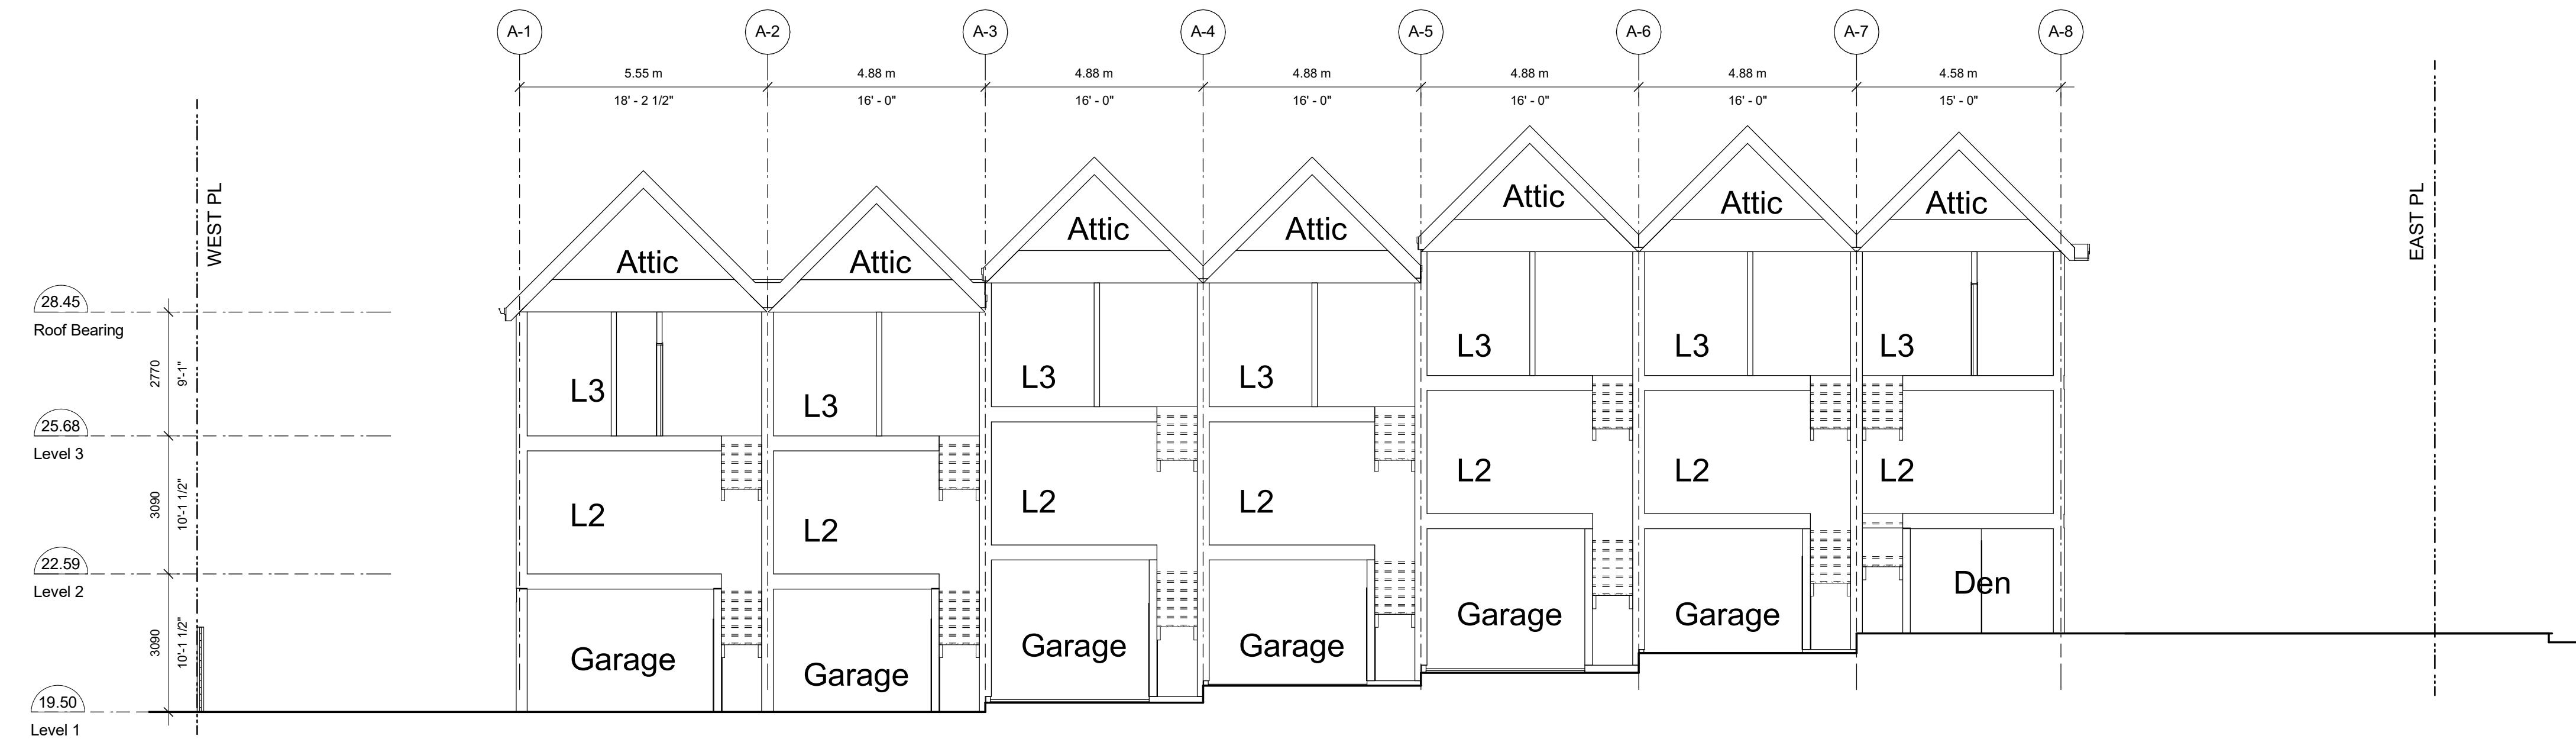23/04/20 ISSUED FOR DP AMENDMENTS
22/10/04 ISSUED FOR DP AMENDMENTS
22/10/24 ISSUED FOR ADP
22/07/18 ISSUED FOR REZONING

Plot Date 23/09/01 Drawing File
Drawn By ADMMVR Checked By ADM
Scale 1 : 100 Project Number
NOTE: All dimensions are shown in millimeters.



**FERNWOOD
TOWNHOMES**
2540 & 2542 Shelbourne
Street, Victoria, BC
Sections

dHka


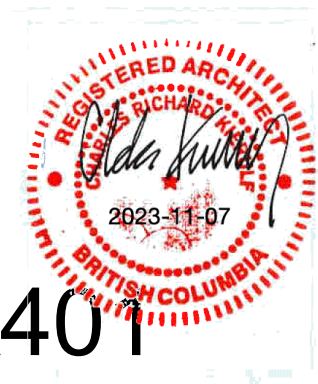


A401



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1 Level 1 Unit FARs
A900 SCALE: 1 : 200

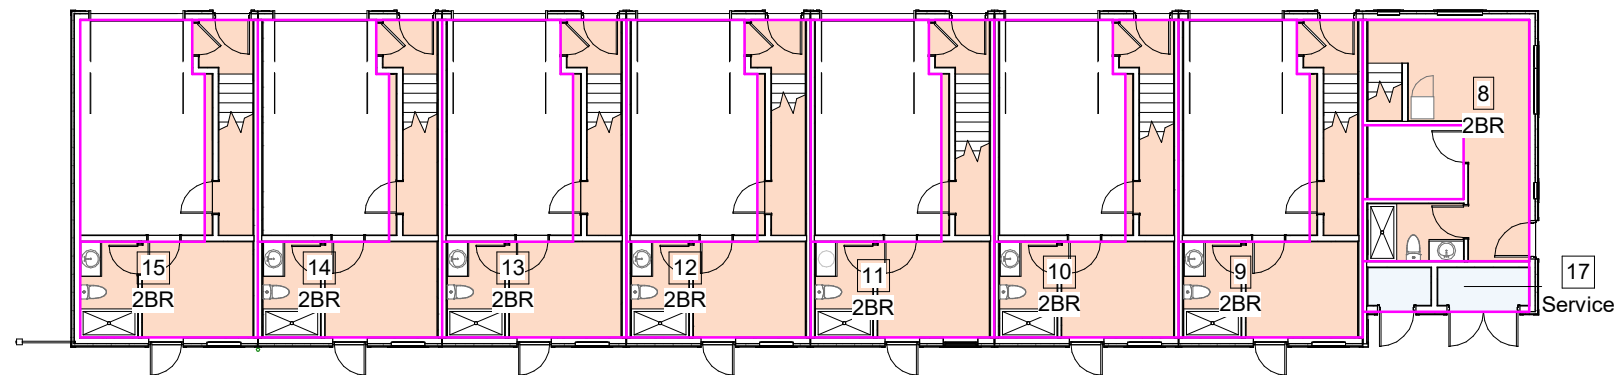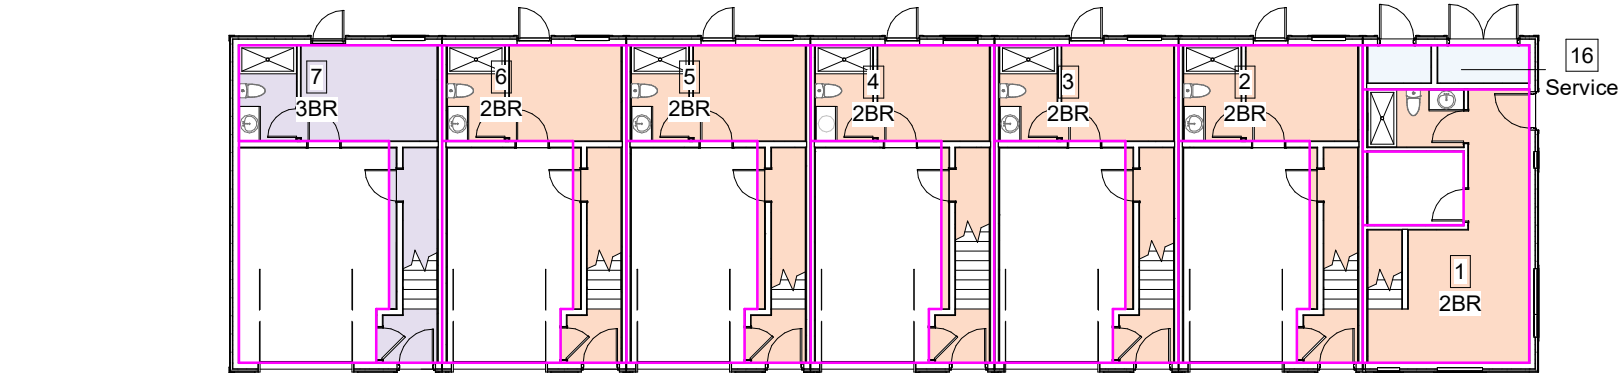

2 Level 2 Unit FARs
A900 SCALE: 1 : 200

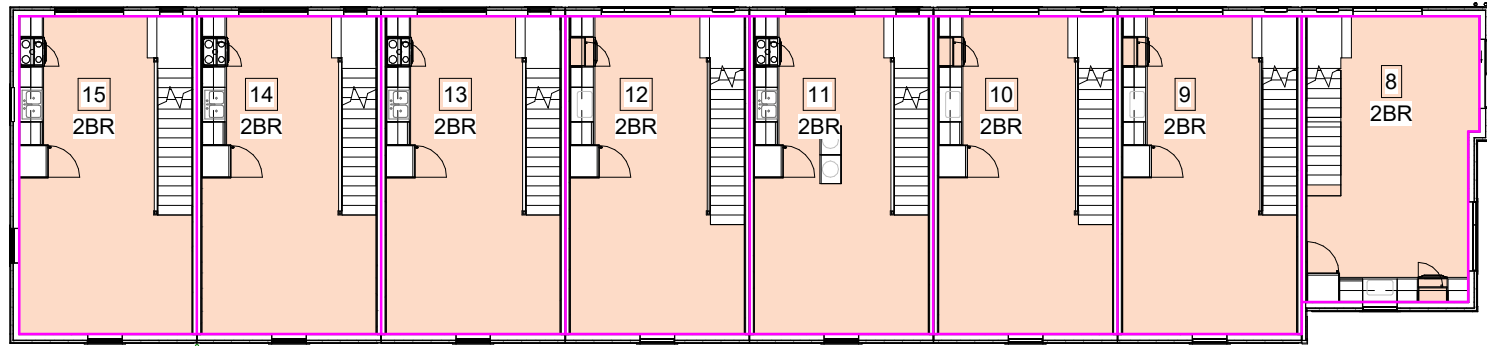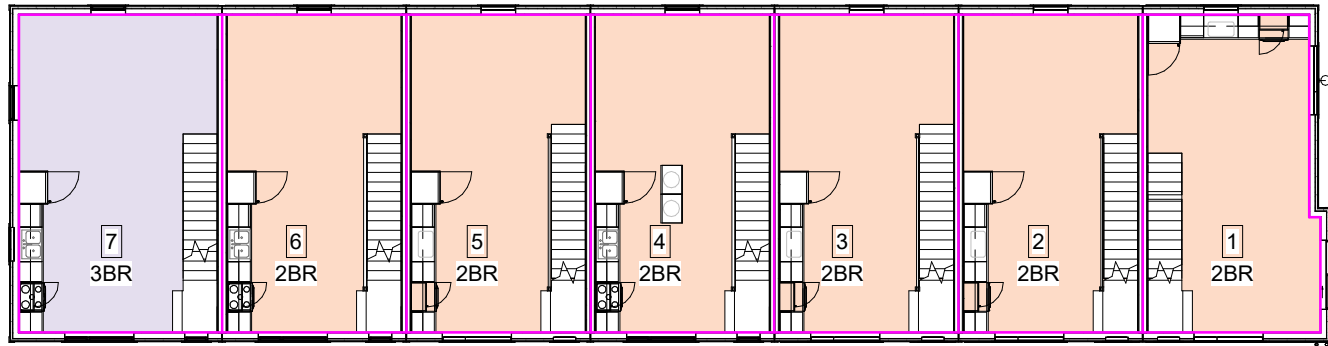

3 Level 3 Unit FARs
A900 SCALE: 1 : 200

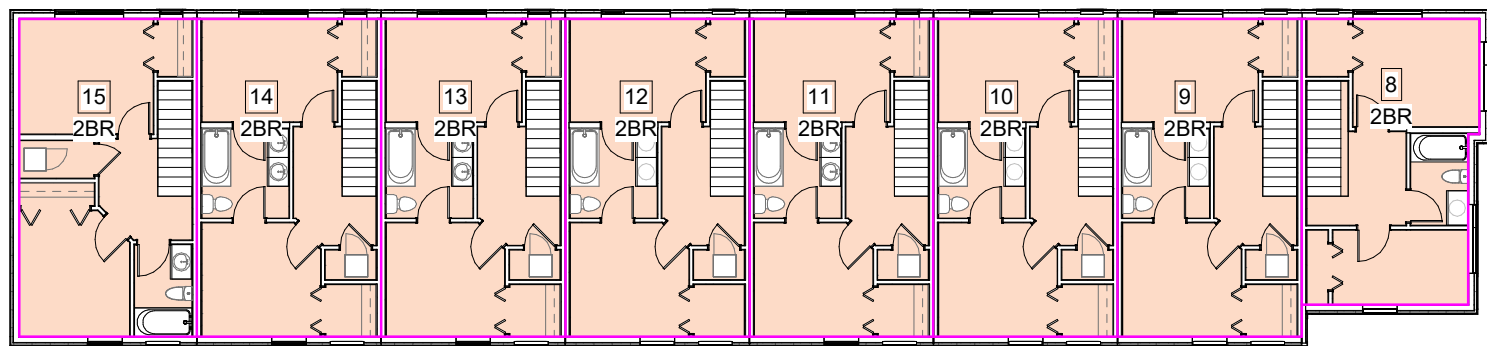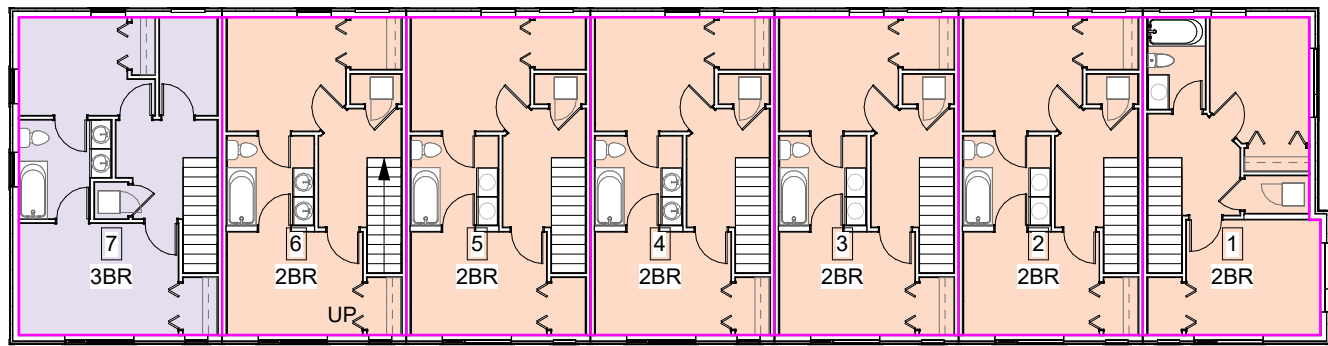Level Areas (FAR) - North Building	
Area	
Level 1	159.89 m²
Level 2	288.29 m²
Level 3	288.29 m²
	736.46 m²

Unit Areas (FAR) - North Building	
Level	Area
Service (North Building)	
Level 1	5.16 m²
Unit 1 (North Building)	
Level 1	26.66 m²
Level 2	37.94 m²
Level 3	37.94 m²
	102.53 m²

Unit 2 (North Building)	
Level 1	21.16 m²
Level 2	41.05 m²
Level 3	41.05 m²
	103.26 m²
Unit 3 (North Building)	
Level 1	21.13 m²
Level 2	41.05 m²
Level 3	41.05 m²
	103.23 m²

Unit 4 (North Building)	
Level 1	21.05 m²
Level 2	40.88 m²
Level 3	40.88 m²
	102.81 m²
Unit 5 (North Building)	
Level 1	21.19 m²
Level 2	41.05 m²
Level 3	41.05 m²
	103.29 m²

Unit 6 (North Building)	
Level 1	21.16 m²
Level 2	41.05 m²
Level 3	41.05 m²
	103.26 m²
Unit 7 (North Building)	
Level 1	22.40 m²
Level 2	45.26 m²
Level 3	45.26 m²
	112.93 m²
	736.46 m²

Level Areas (FAR) - South Building	
Area	
Level 1	176.29 m²
Level 2	319.88 m²
Level 3	319.88 m²
	816.04 m²

Unit Areas (FAR) - South Building	
Level	Area
Service (South Building)	
Level 1	5.90 m²
	5.90 m²
Unit 8 (South Building)	
Level 1	22.92 m²
Level 2	34.20 m²
Level 3	34.20 m²
	91.31 m²

Unit 9 (South Building)	
Level 1	21.16 m²
Level 2	41.05 m²
Level 3	41.05 m²
	103.26 m²
Unit 10 (South Building)	
Level 1	21.13 m²
Level 2	41.05 m²
Level 3	41.05 m²
	103.23 m²

Unit 11 (South Building)	
Level 1	21.05 m²
Level 2	40.88 m²
Level 3	40.88 m²
	102.81 m²
Unit 12 (South Building)	
Level 1	21.19 m²
Level 2	41.05 m²
Level 3	41.05 m²
	103.29 m²

Unit 13 (South Building)	
Level 1	21.16 m²
Level 2	41.05 m²
Level 3	41.05 m²
	103.26 m²
Unit 14 (South Building)	
Level 1	21.11 m²
Level 2	41.01 m²
Level 3	41.01 m²
	103.13 m²

Unit 15 (South Building)	
Level 1	20.69 m²
Level 2	39.59 m²
Level 3	39.59 m²
	99.86 m²
	816.04 m²

23/09/01 ISSUED FOR DP AMENDMENTS
23/07/27 ISSUED FOR DP AMENDMENTS
23/04/20 ISSUED FOR DP AMENDMENTS
22/10/04 ISSUED FOR DP AMENDMENTS

Plot Date 23/09/01 Drawing File
Drawn By Author Checked By Checker
Scale 1 : 200 Project Number
NOTE: All dimensions are shown in millimeters.

FERNWOOD
TOWNHOMES
2540 & 2542 Shelbourne
Street, Victoria, BC
Area Plans

dHKa

A900

dHKarchitects

Victoria

977 Fort Street

Nanaimo

977 Fort Street

V8V 3K3

102-5190 Dublin Way

V9T 0H2

T 1-250-658-3367

T 1-250-585-5810

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AREA CALCULATIONS

SITE AREA: 1,526 m² (16,426 s.f.)


TOTAL PROPOSED: 1,552.5 m² (16,711 s.f.)

FLOOR SPACE RATIO: 1.02 : 1 FSR

SITE COVERAGE 640 m² = 42%

OPEN SITE SPACE 504 m² = 33%

File: \\Projects\6020-001 Shelbourne Street Townhouse - Civil\04C Drawings\6020-001 Civil.dwg Plot Time: Sep. 5, 23 1:21 PM User: Sarah Campden

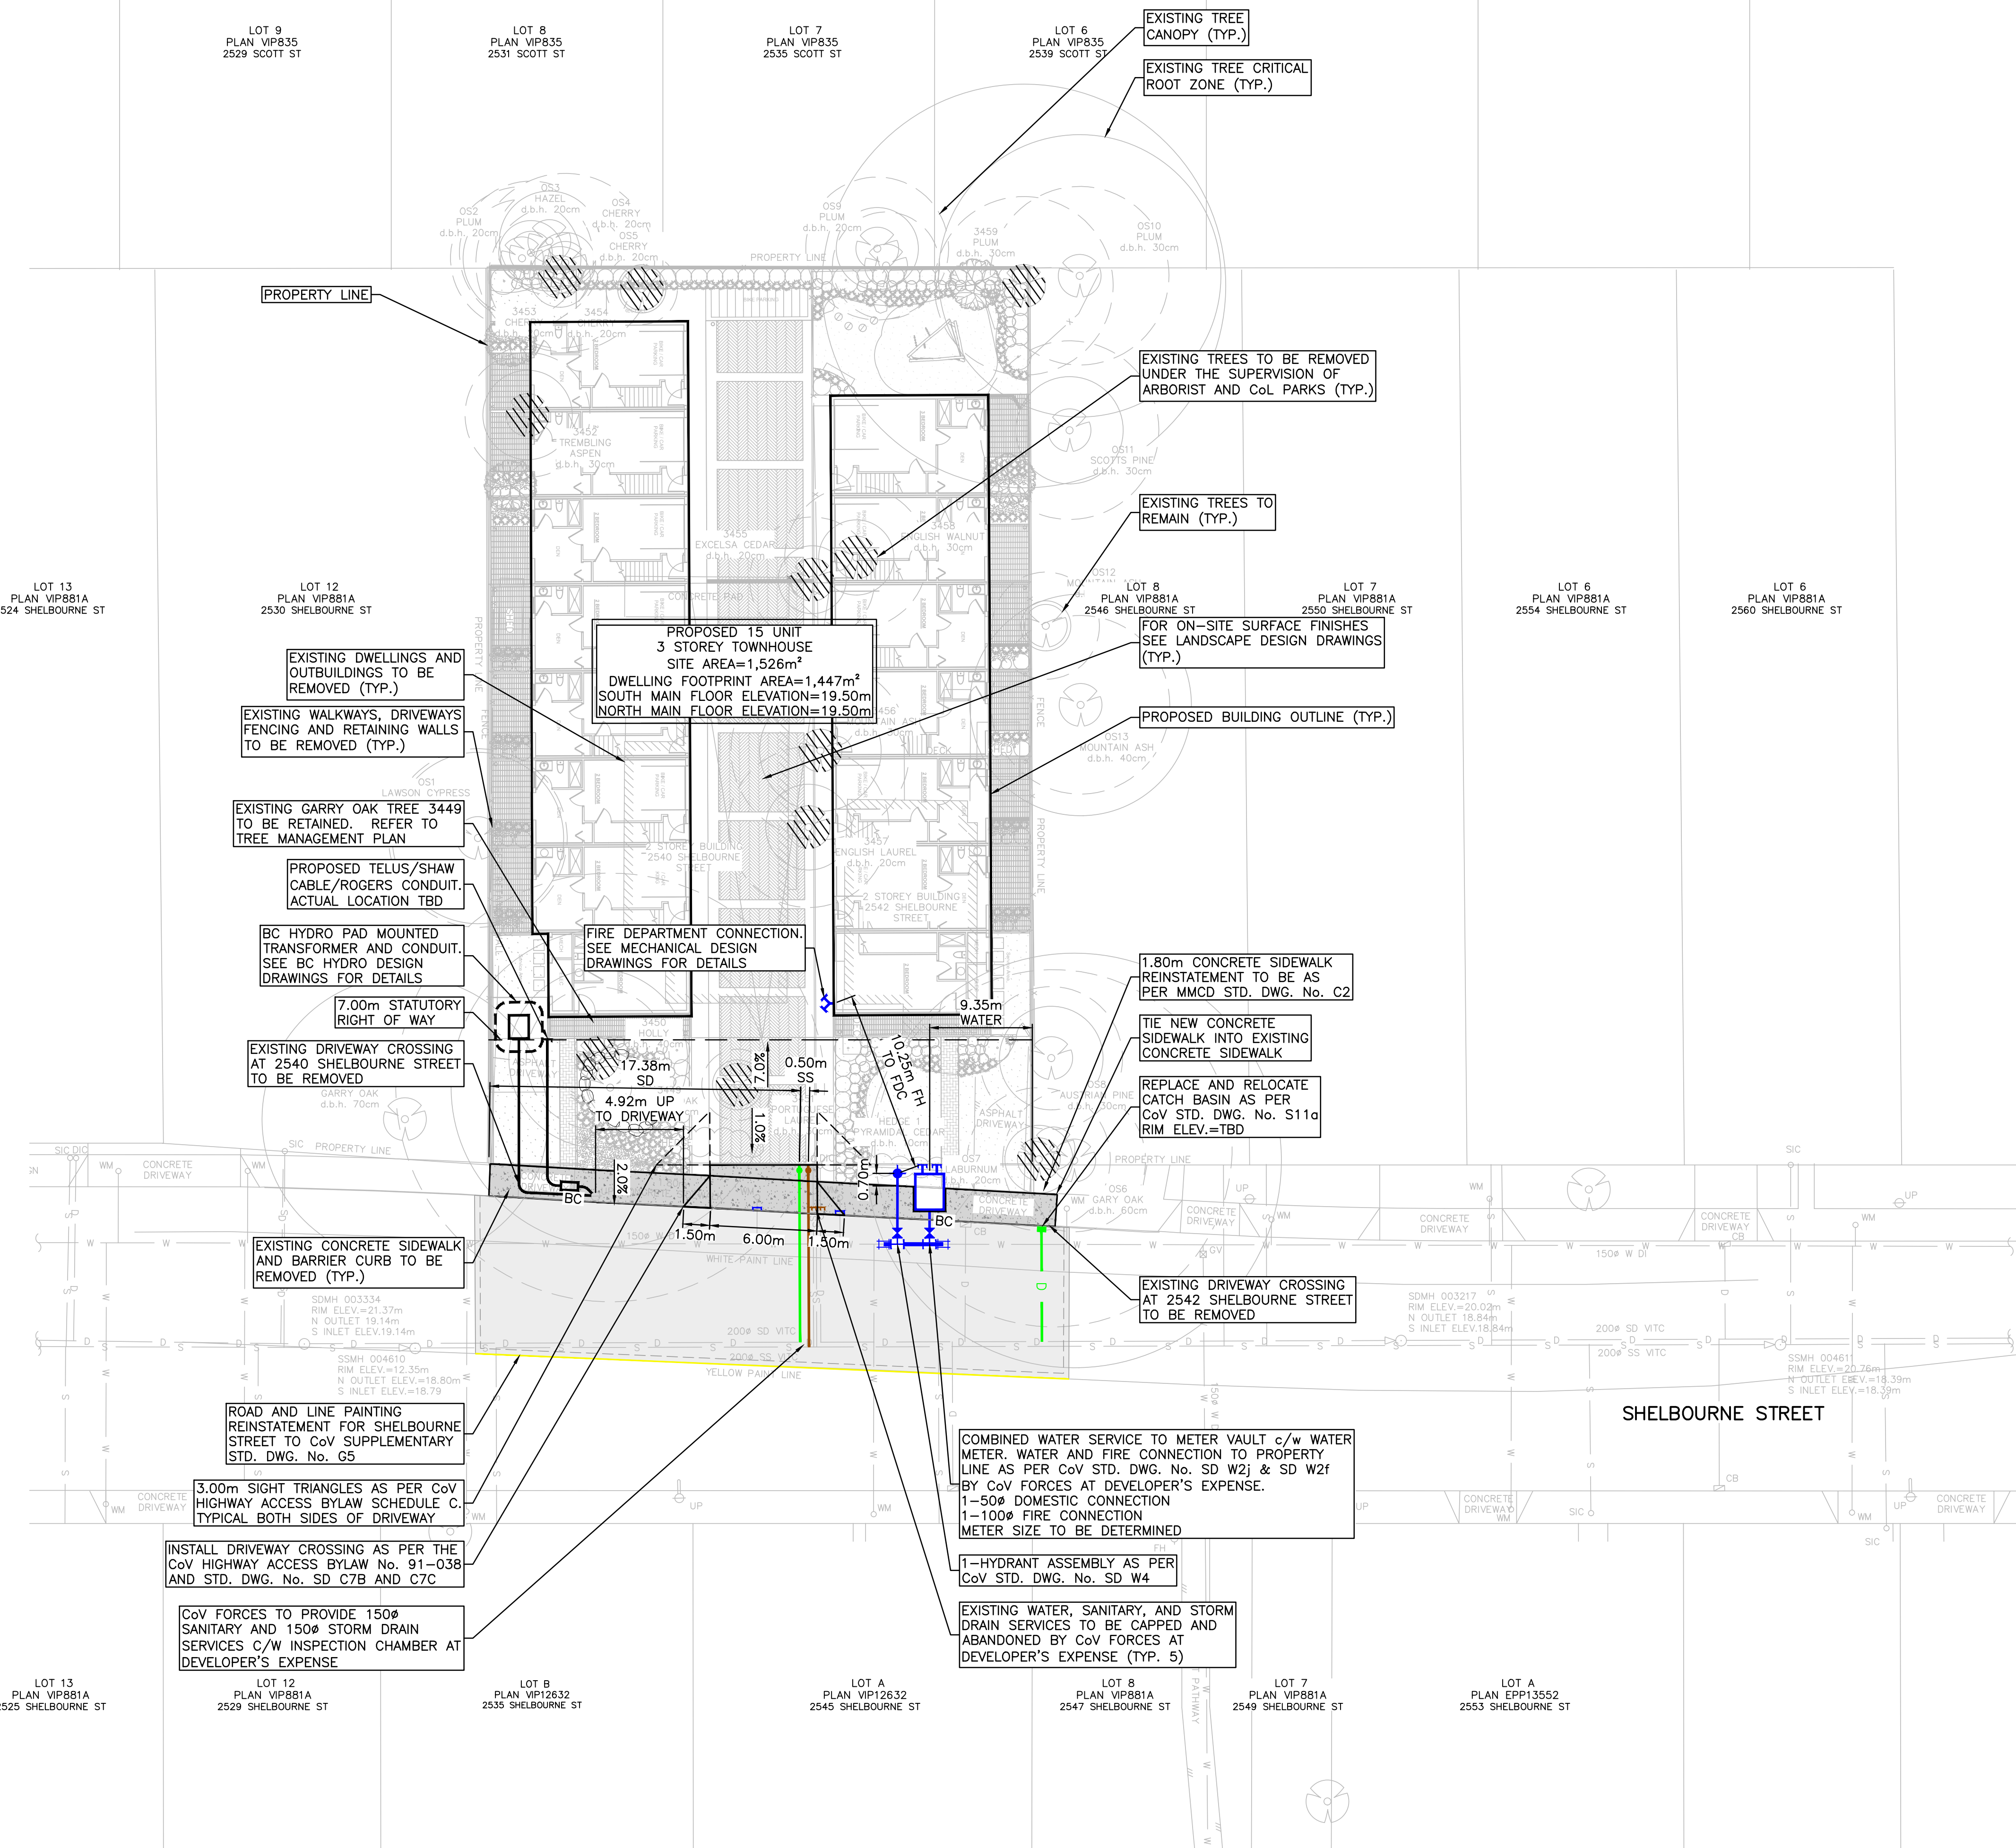

NOTES:

1. FOR GENERAL NOTES SEE SHEET C100 (TO FOLLOW).
2. ALL EXISTING SANITARY, DRAIN AND WATER LOCATIONS TO BE CONFIRMED IN THE FIELD PRIOR TO CONSTRUCTION.
3. FOR SHALLOW UTILITIES DESIGN, SEE SHEET C400 AND INDIVIDUAL UTILITY DESIGN DRAWINGS (TO FOLLOW). DESIGN TO BE DETERMINED BY THIRD PARTY UTILITIES AT A LATER DATE.
4. CONTRACTOR TO CONFIRM THAT SANITARY AND STORM DRAIN SERVICES HAVE BEEN CAPPED ON-SITE AND INSPECTED BY CoV FORCES.

ISSUES		
No.	DATE	ISSUED FOR
1	2022.11.04	REVIEW
2	2023.02.01	DEVELOPMENT PERMIT
3	2023.04.26	DEVELOPMENT PERMIT-2
4	2023.07.28	DEVELOPMENT PERMIT-3
5	2023.09.05	DEVELOPMENT PERMIT-4

CLIENT

ISSUED FOR
DEVELOPMENT PERMIT

SHELBOURNE STREET TOWNHOUSE
2540 & 2542 SHELBOURNE STREET
FRAME PROPERTIES

CITY OF VICTORIA

UNDERGROUND SERVICE INFORMATION			
INFORMATION IS AT PROPERTY LINE	STORM DRAIN		SANITARY SEWER
EXISTING DEPTH (m)			
PROPOSED DEPTH (m)			
PROPOSED INVERT ELEVATION (m)			
MAXIMUM DEPTH REQUESTED	YES	NO	YES NO

WORKS AND SERVICES CHECKLIST			
PLAN CHECKER		AUTHORIZED REPRESENTATIVE	
		NAME	NAME
UTILITY	HYDRO ELECTRICAL COMPANY		
	TELEPHONE COMPANY		
	GAS COMPANY		
	CABLE COMPANY		
MUNICIPAL	UNDERGROUND SERVICES		
	TRAFFIC		
	HIGHWAYS		

PRELIMINARY CIVIL
SITE SERVICING PLAN

DESIGNED TL	ENGINEER'S SEAL
DESIGN REVIEW AH	
DRAFTED SAC	
DRAFTING REVIEW	
PROJECT No. 6020-001	CLIENT DRAWING No.
SCALE H: AS NOTED V: AS NOTED	PERMIT No. REZ00808/DPV00216
HEL DRAWING No. C200	REVISION 1 OF 1 5




DESTROY ALL DRAWINGS SHOWING PREVIOUS REVISION

Nature-themed play



KOMPAN -Robinia Natural Playground climbing structure NRO852

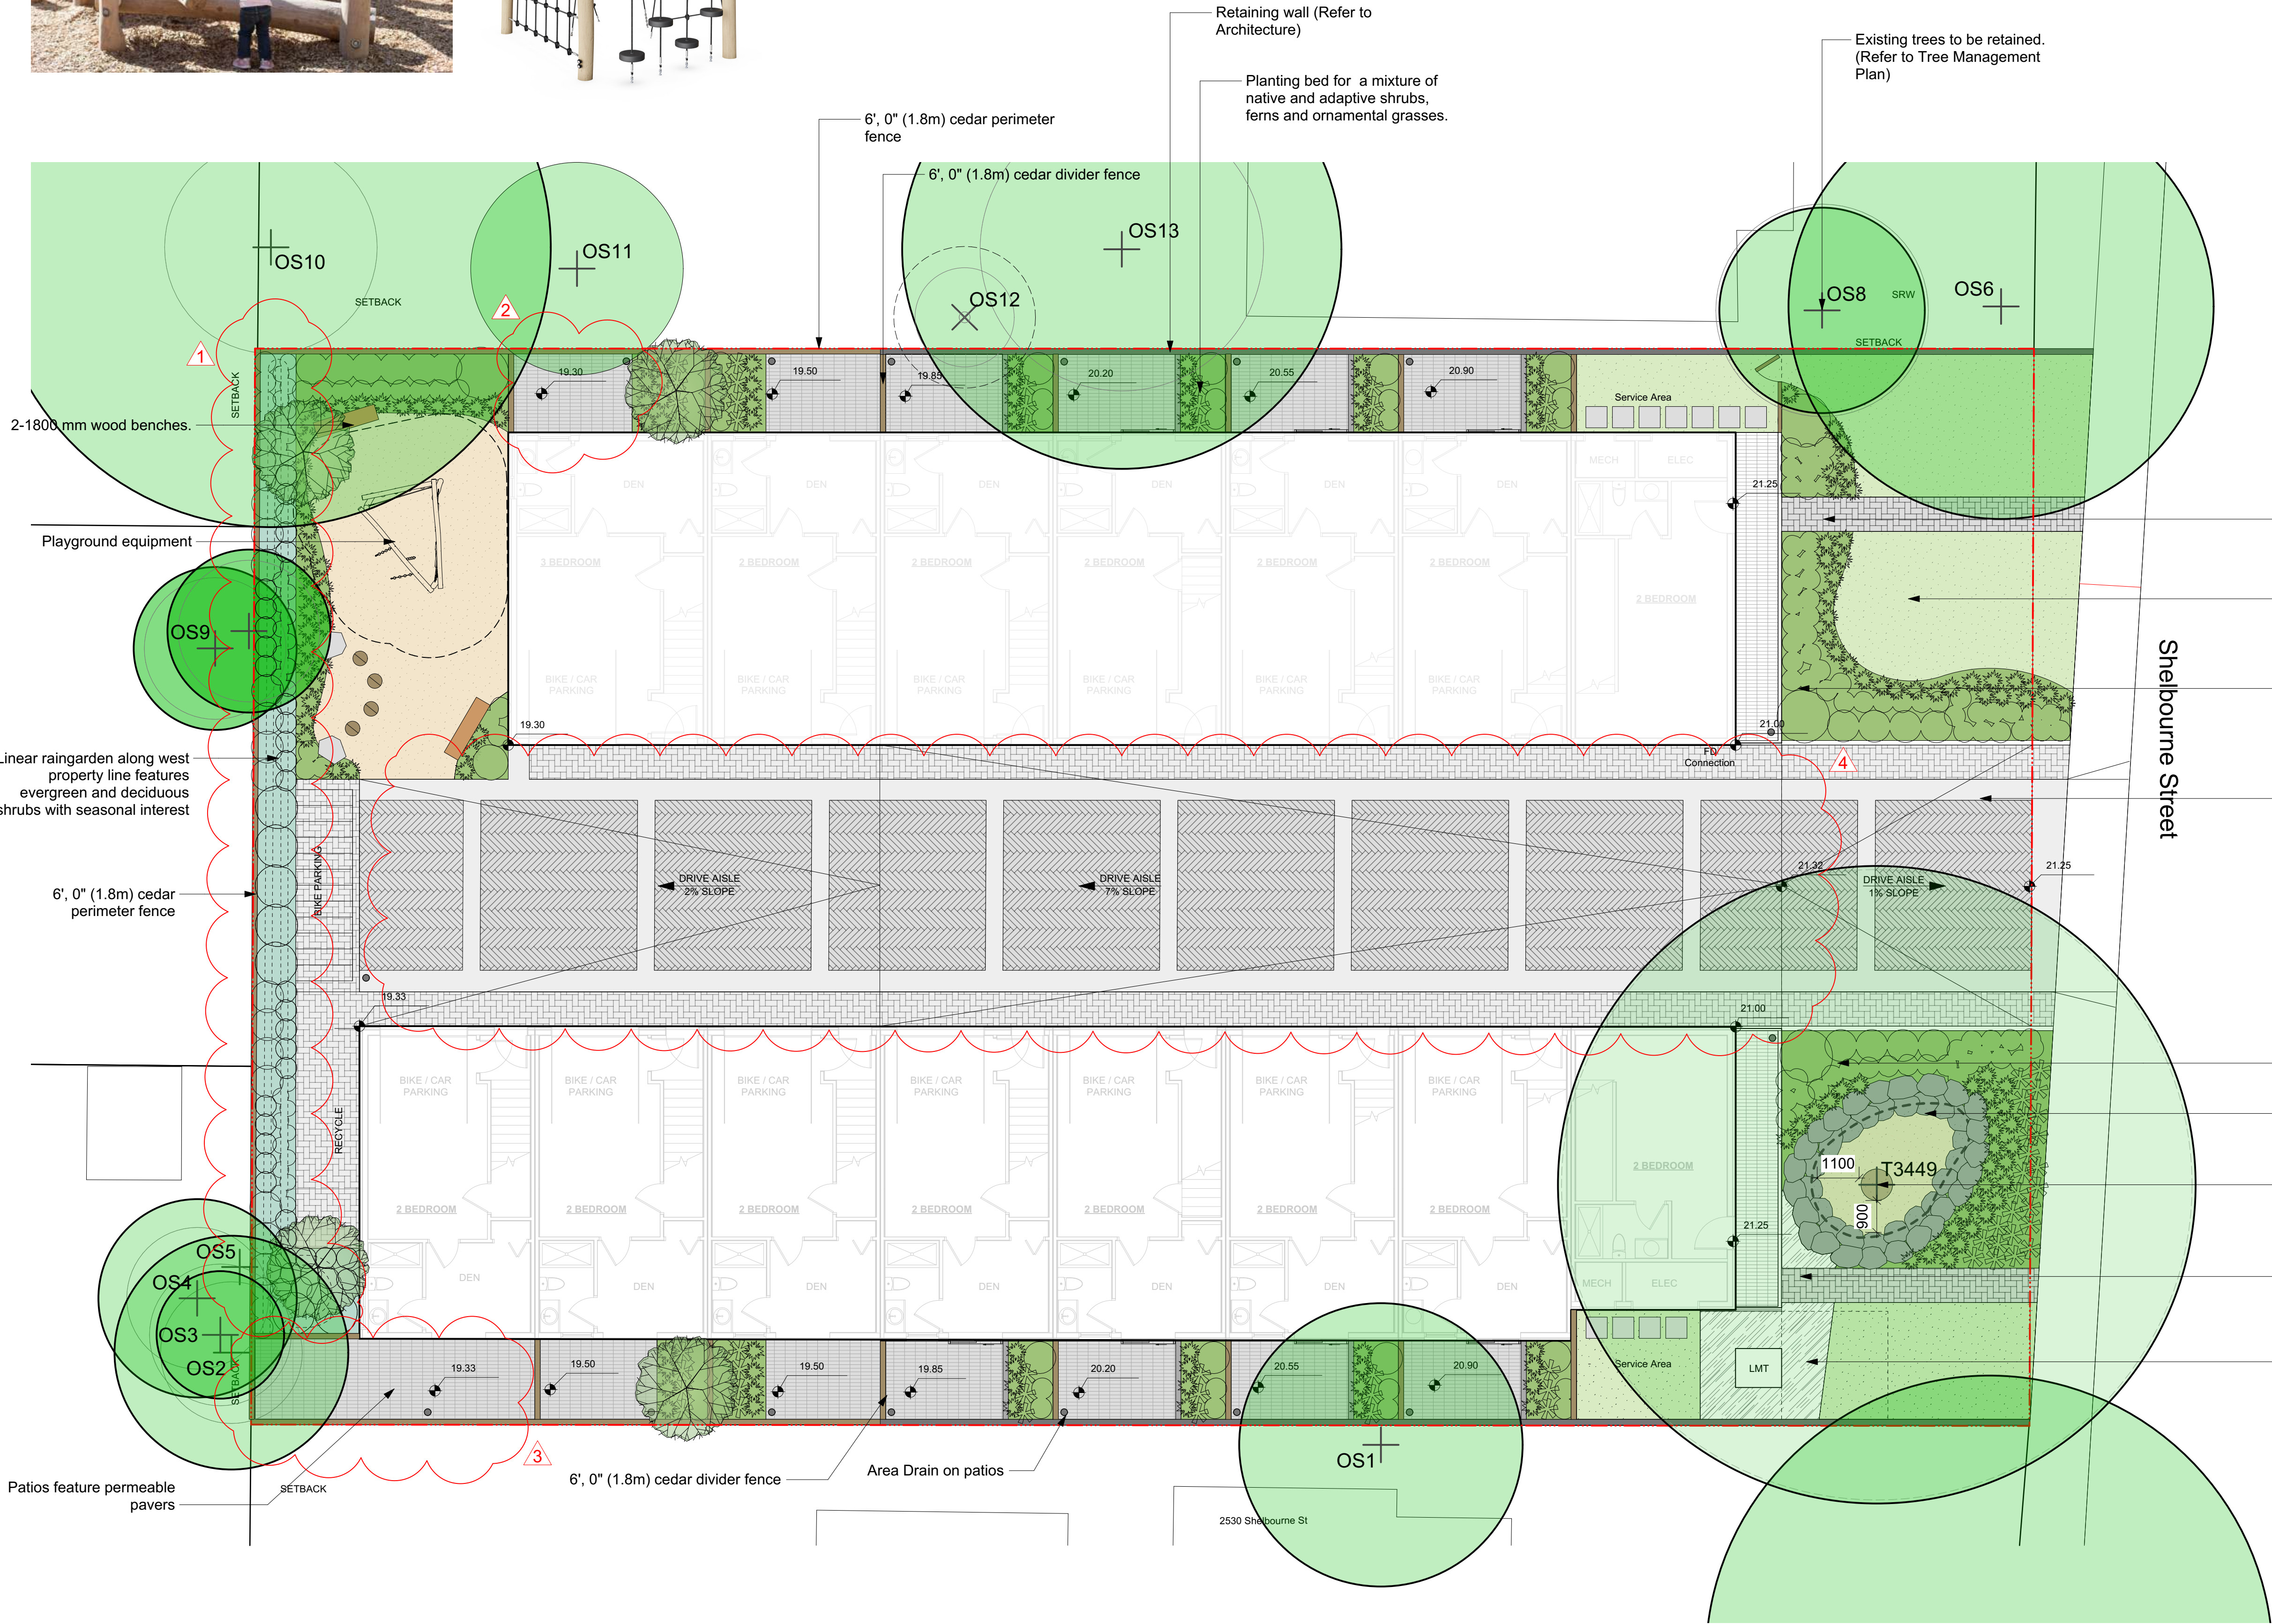

Recommended Nursery Stock

Trees

Total: 4

Botanical Name
Acer circinatum

Common Name
Vine Maple

Size
2M Ht.

Large Shrubs

Total: 43

Botanical Name
Cornus stolonifera 'Flaviramea'
Mahonia aquifolium
Philadelphus 'Belle Etoile'

Common Name
Yellowtwig Dogwood
Tall Oregon Grape
Belle Etoile Mock Orange

Size
#5 pot
#7 pot
#7 pot

Small Shrubs

Total: 187

Botanical Name
Cornus stolonifera 'Kelsey'
Gaultheria shallon
Nandina domestica 'Fire Power'
Spiraea douglasii

Common Name
Kelsey Dogwood
Salal
Fire Power Heavenly Bamboo
Hardhack

Size
#1 pot
#1 pot
#1 pot
#1 pot

Perennials, Annuals and Ferns

Total: 218

Botanical Name
Blechnum spicant
Helictotrichon sempervirens

Common Name
Deer Fern
Blue Oat Grass


Size
#1 pot
#1 pot

REVISION LEGEND

- 1. Planting bed along west PL replaced with rain garden. Planting revised.
- 2. Unit patio grading revised. Planting revised at fence line of unit patio.
- 3. Unit patio grading revised and patio expanded. Planting revised and planting bed relocated.
- 4. Drive aisle grading revised

LEGEND

- Lawn (Typ.)
- Planting Bed
- Permeable Pavers on Patios
- Decorative Concrete Pavers
- Concrete Pavers on Driveway (Herringbone Pattern)
- Safety Surfacing (Wood Chips)
- River Rock

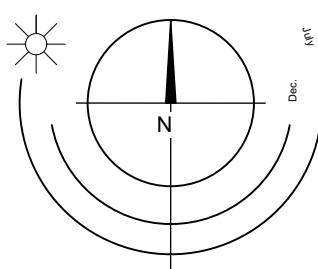

SCALE 1:100

0 5 10

Landscape Concept | 2540 Shelbourne




LADR LANDSCAPE ARCHITECTS


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#3-864 Queens Ave., Victoria B.C. V8T 1M5
Phone: (250) 598-0105


Nov 8, 2023
Sept 05, 2023
July 28, 2023

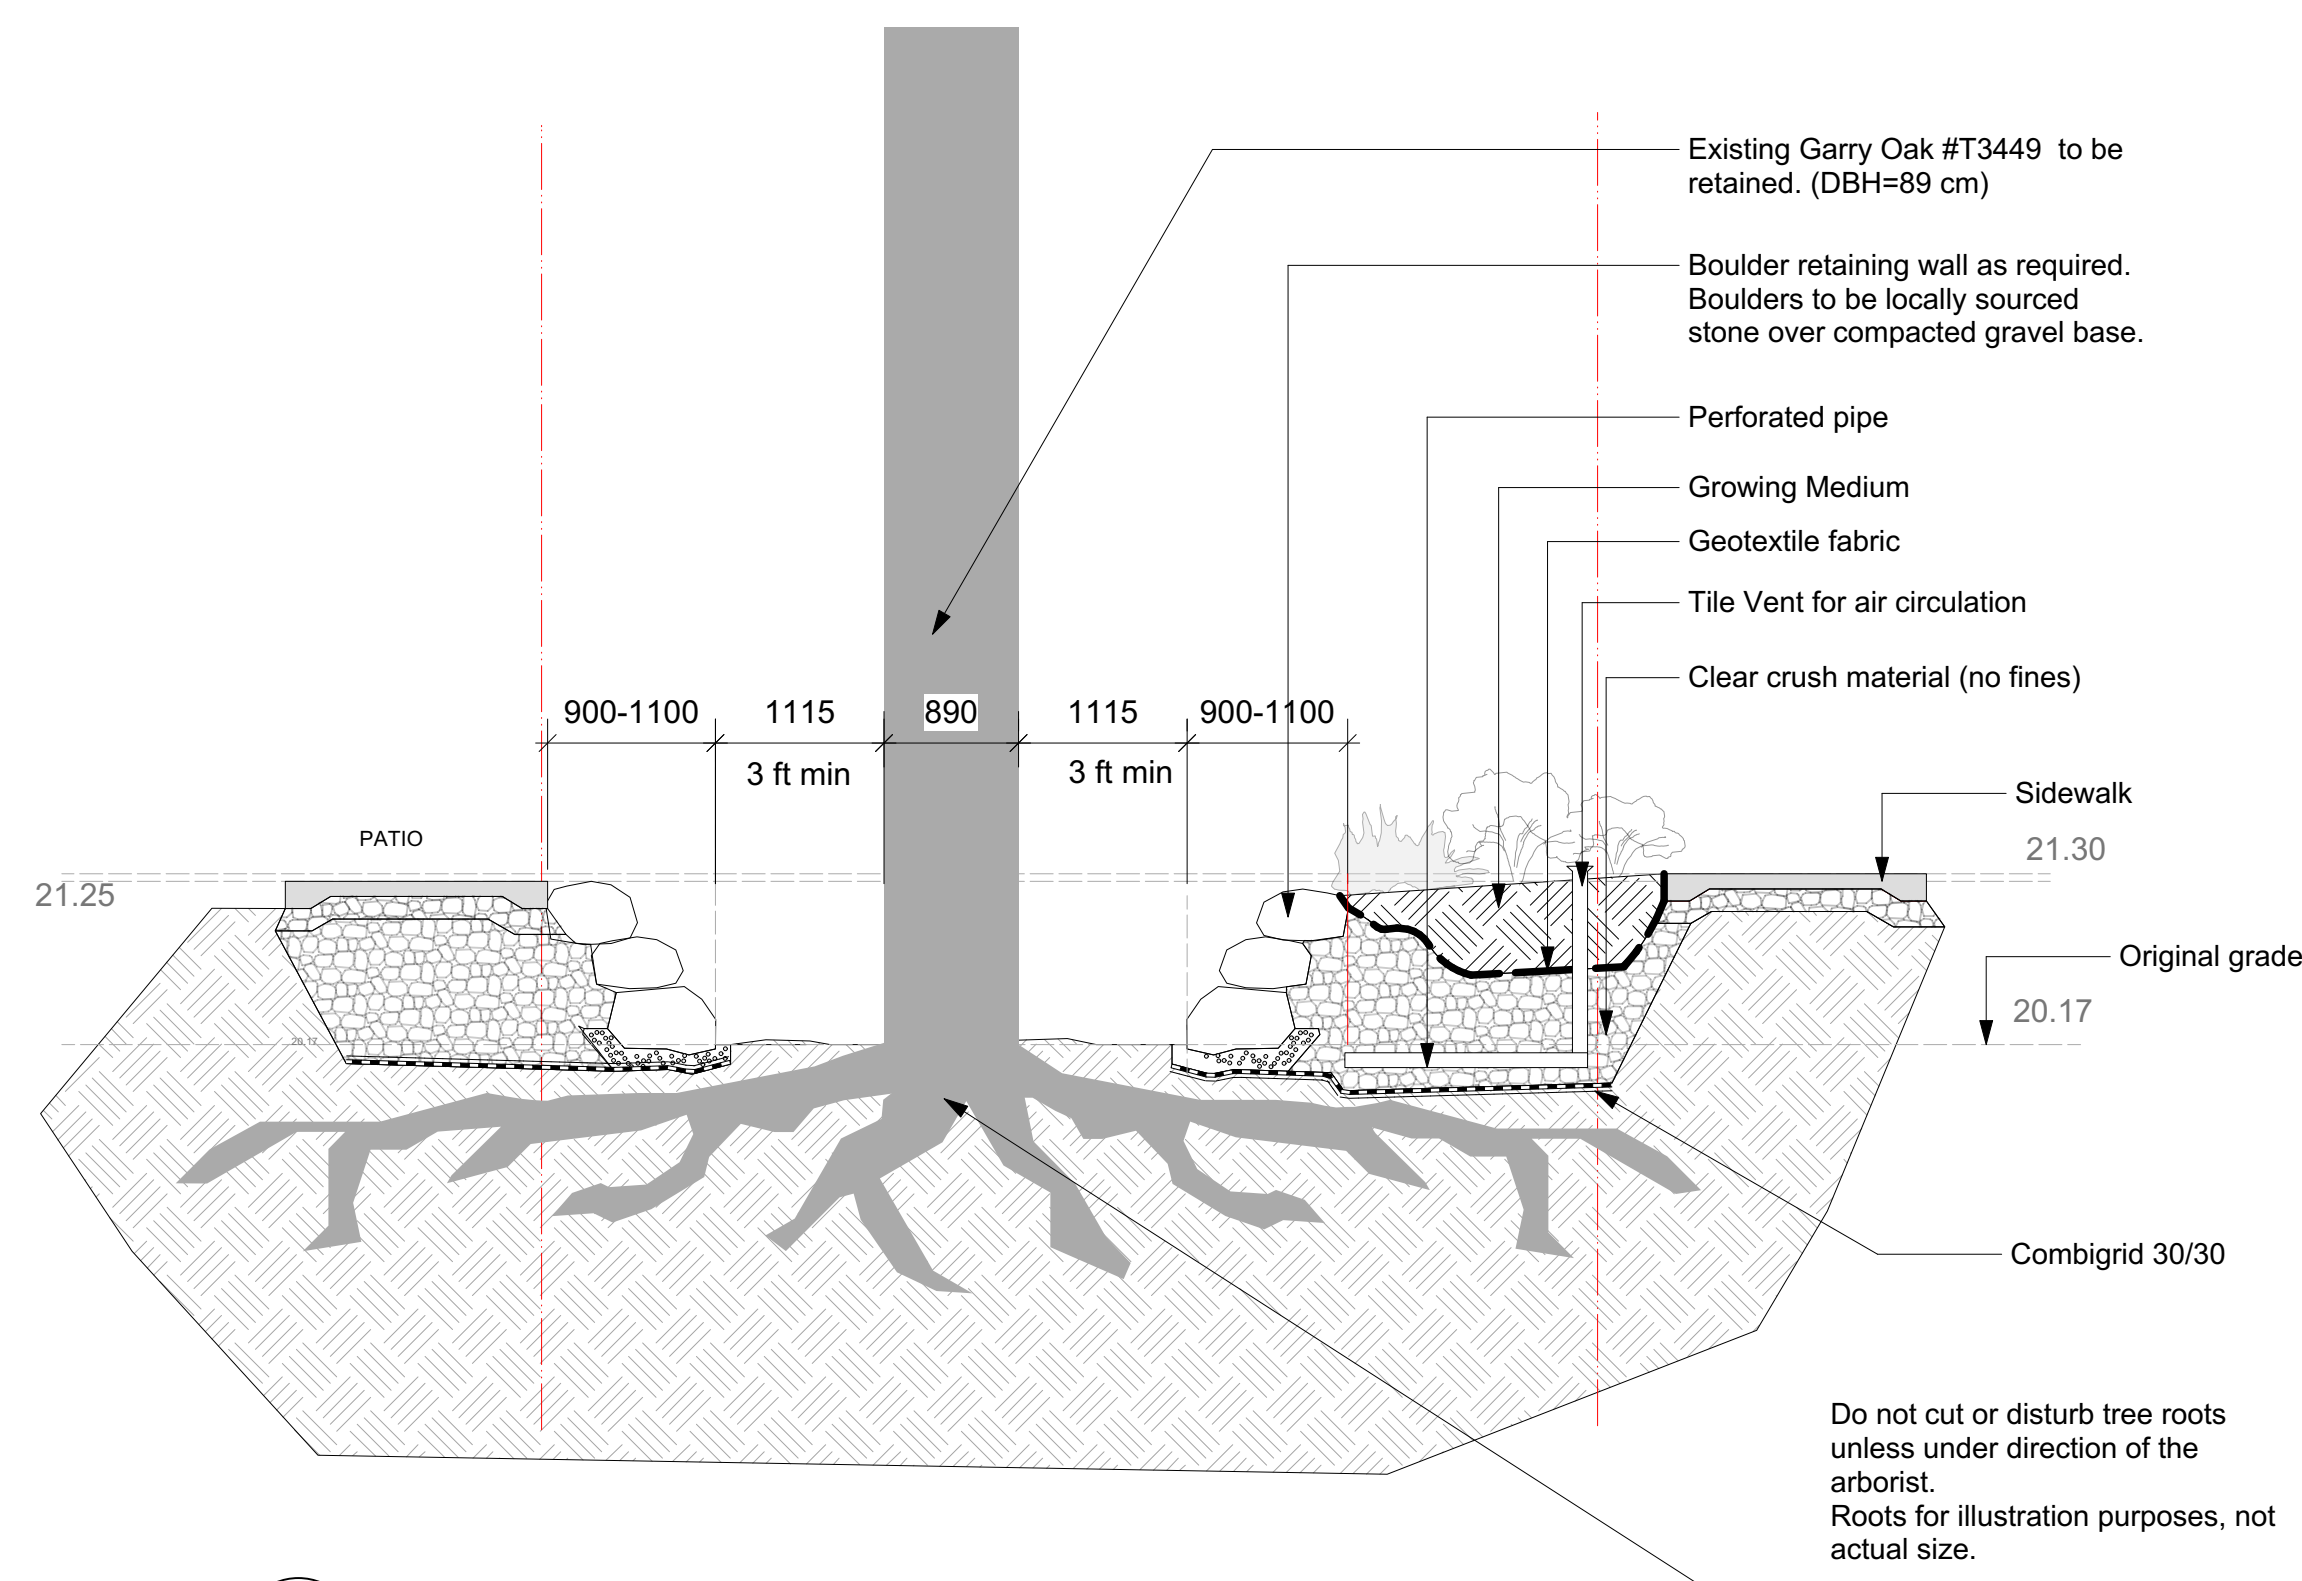


1 Boulder Tree Well Detail
Scale: 1:50

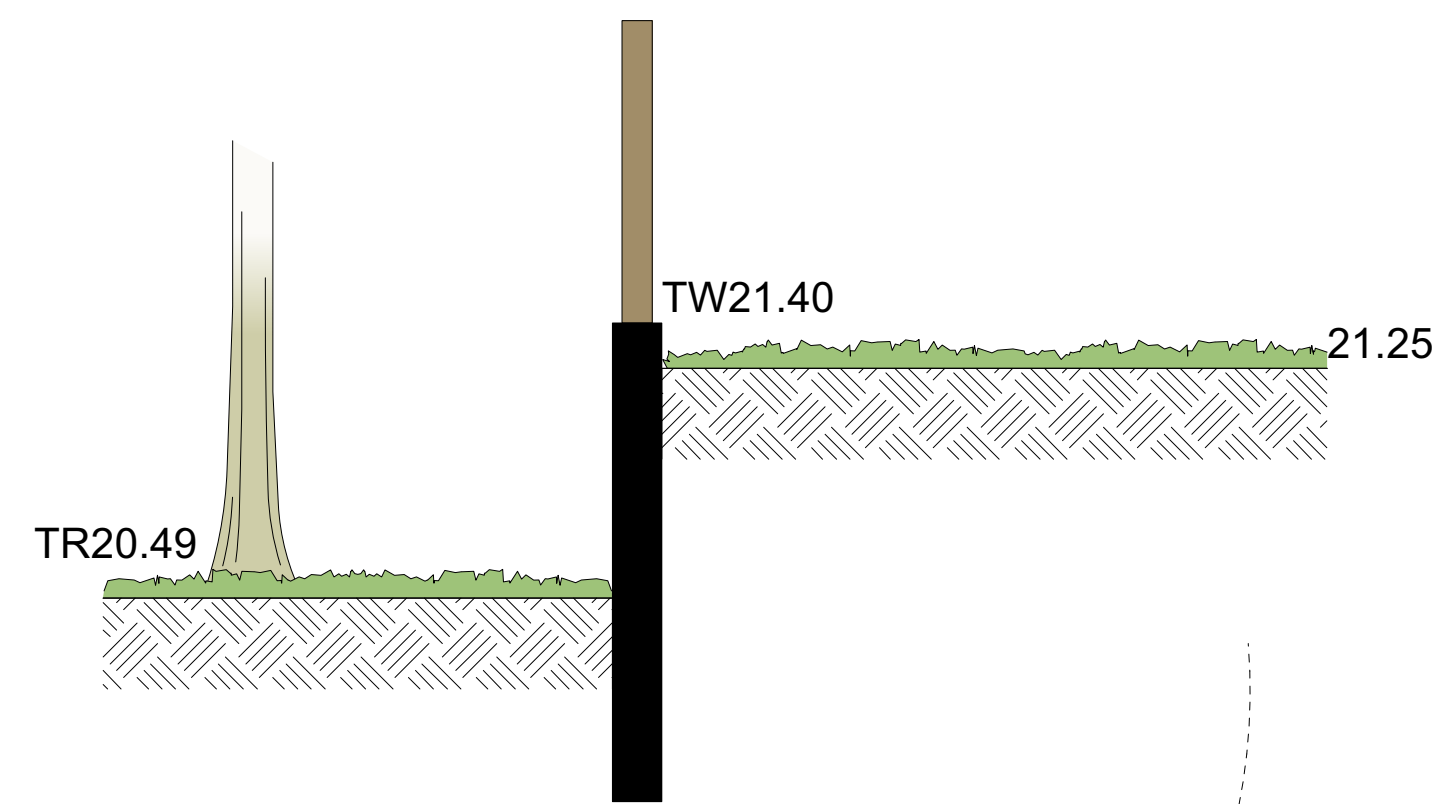


2 OS6 Existing Tree - Section
Scale: 1:25

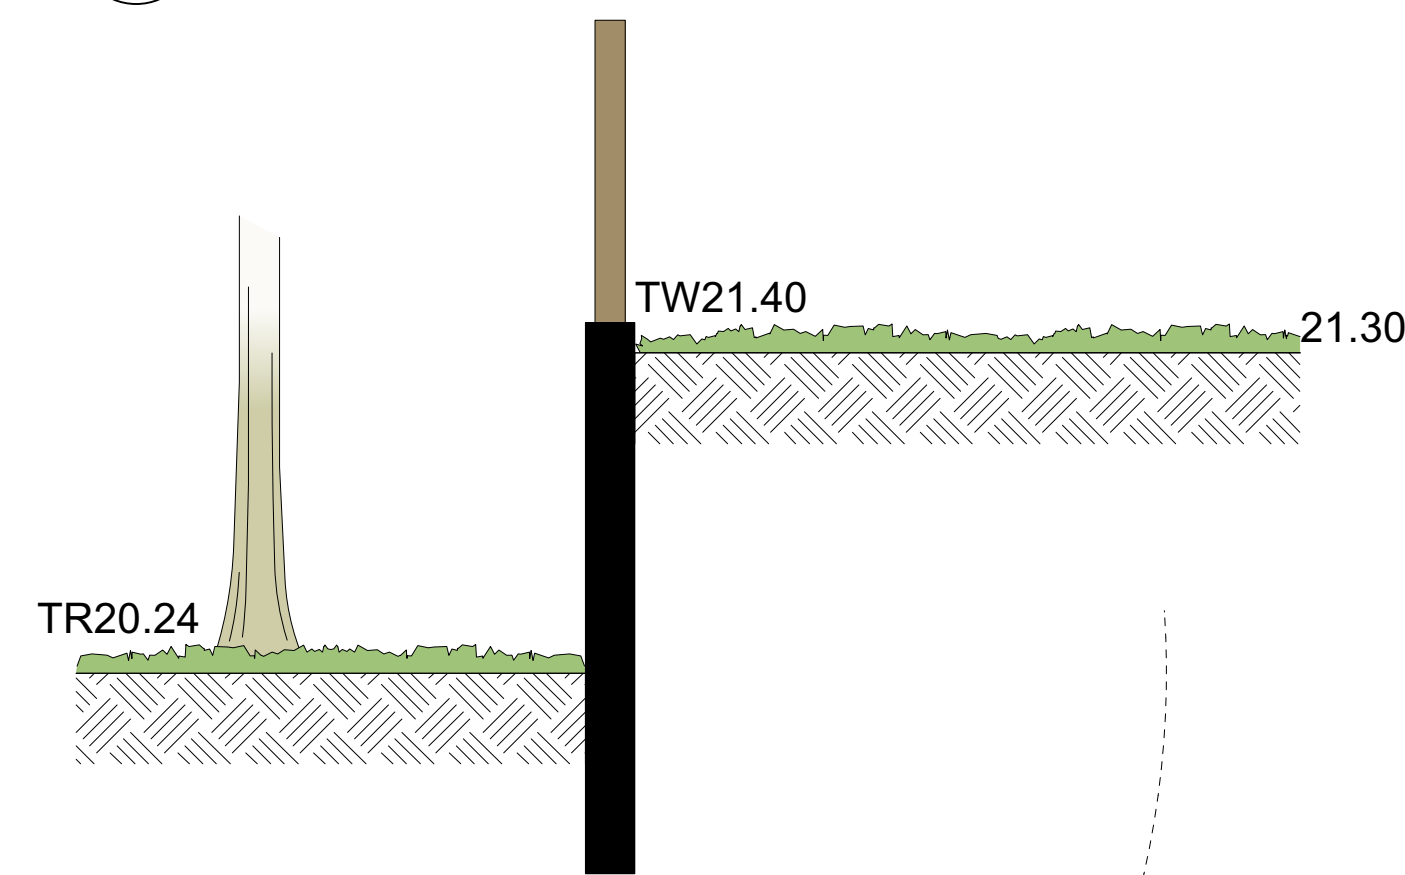


3 OS8 Existing Tree - Section
Scale: 1:25

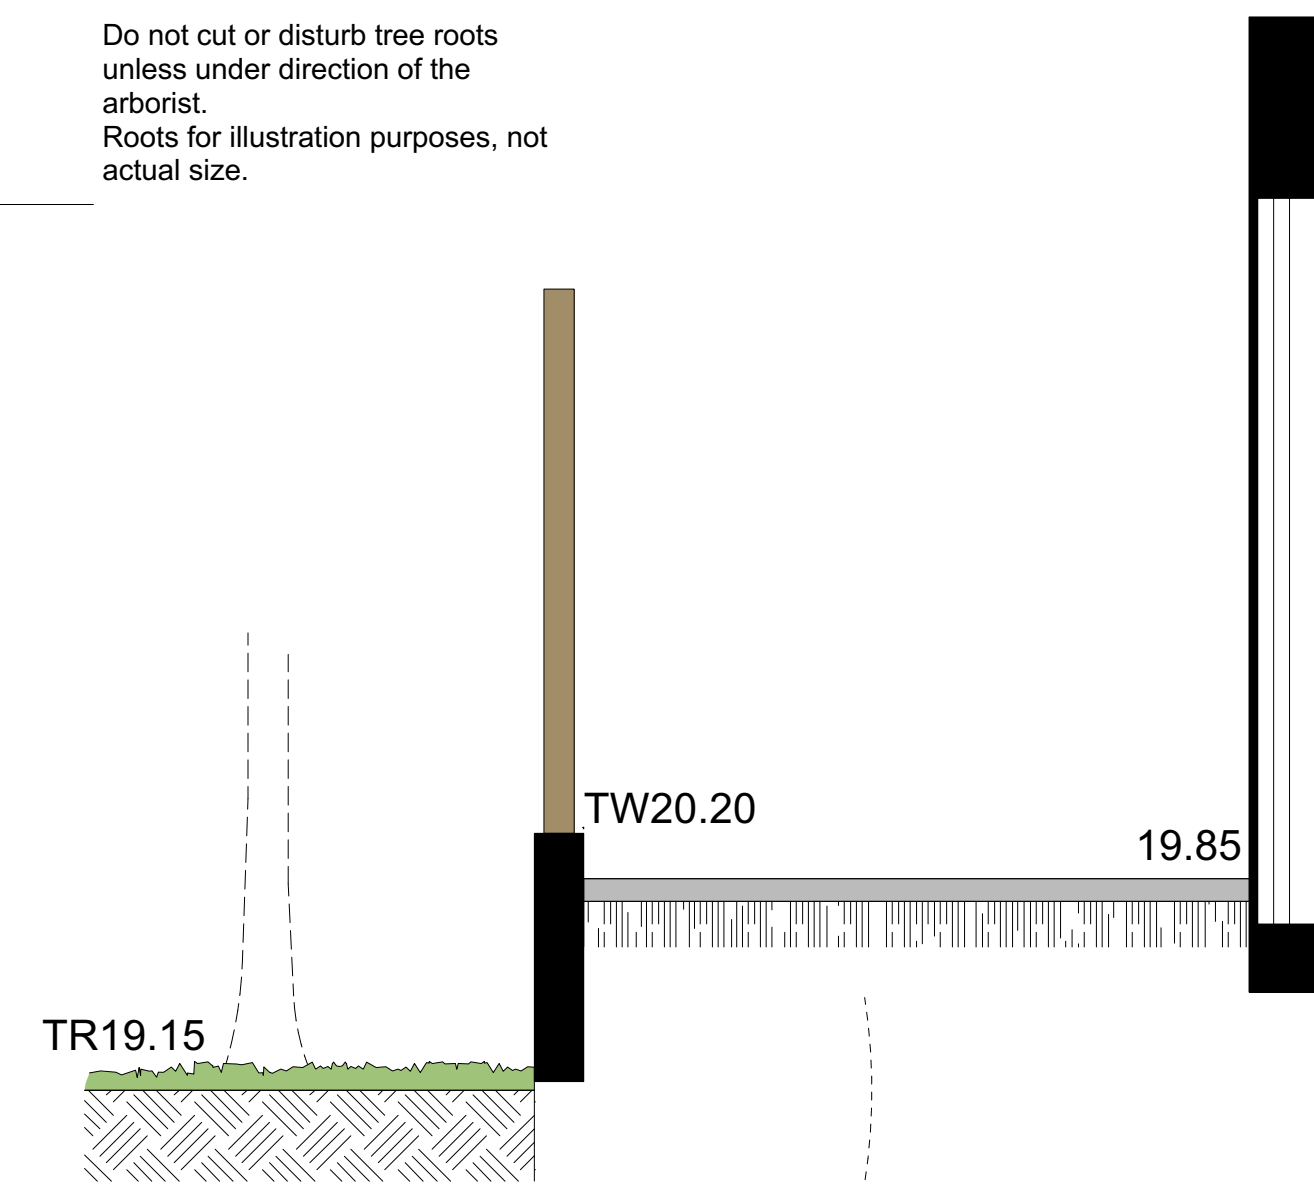


5 OS12 Existing Tree - Section
Scale: 1:25

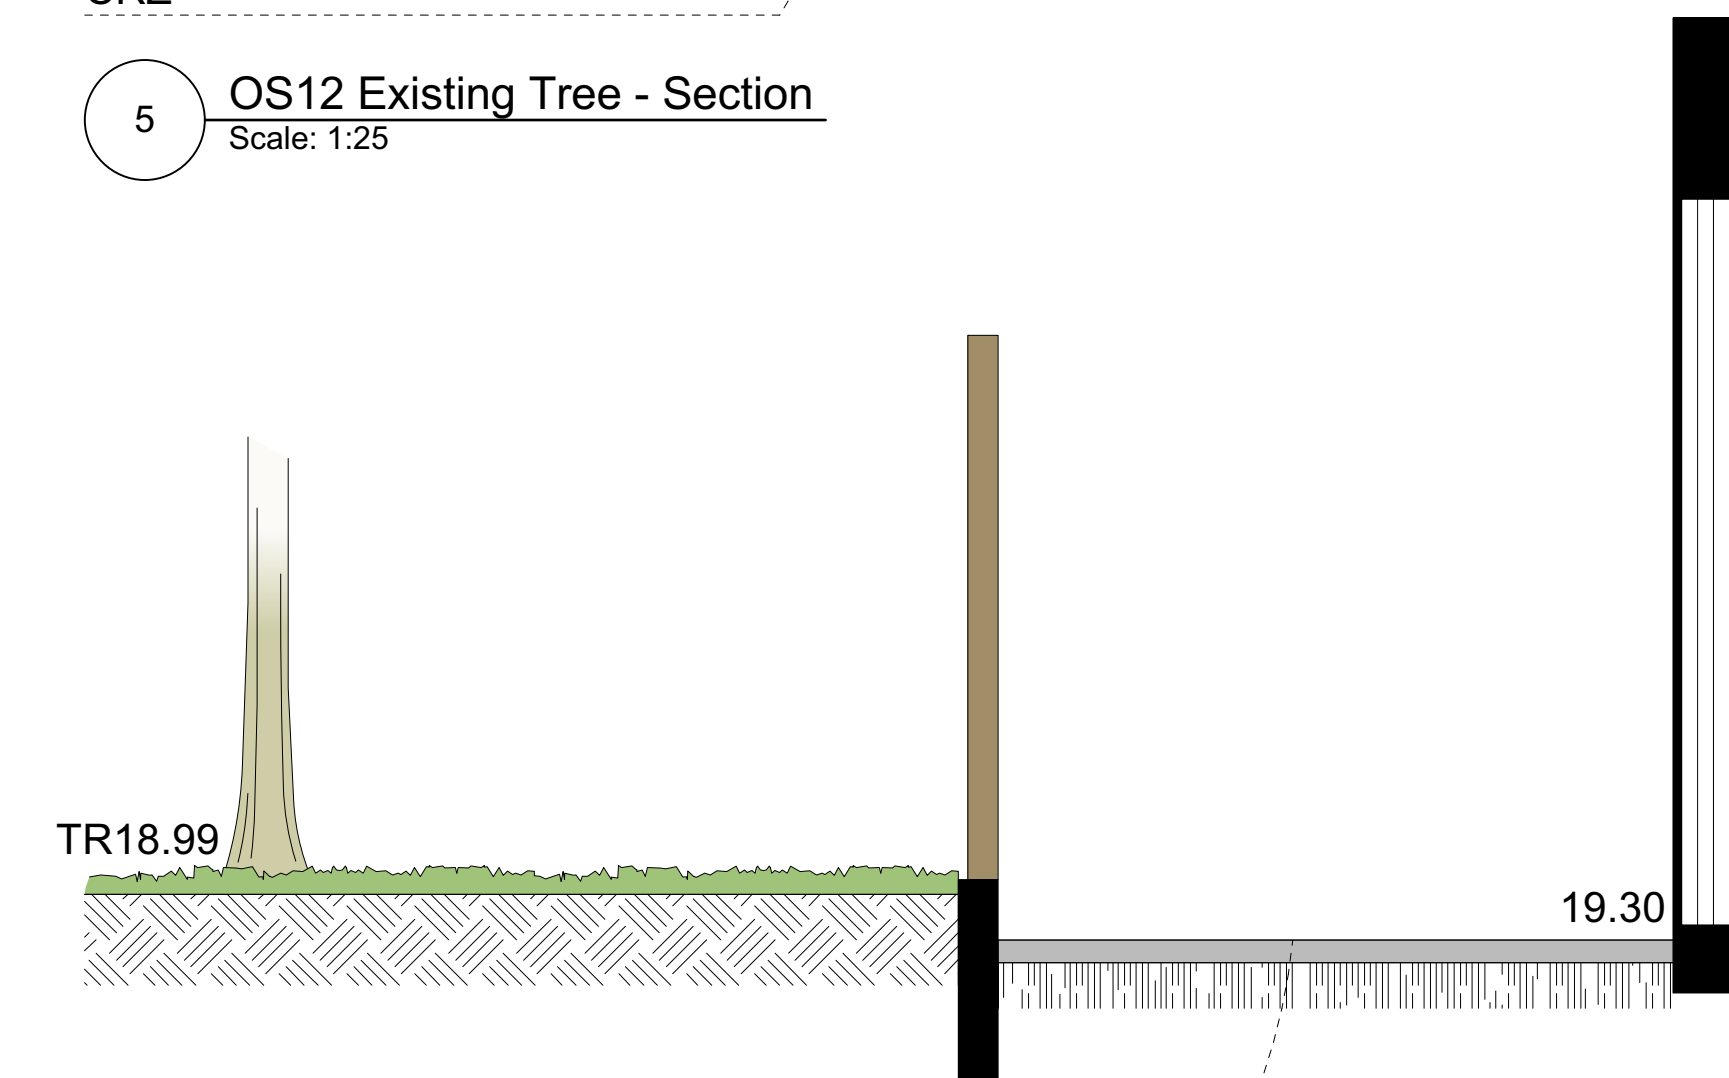


6 OS11 Existing Tree - Section
Scale: 1:25

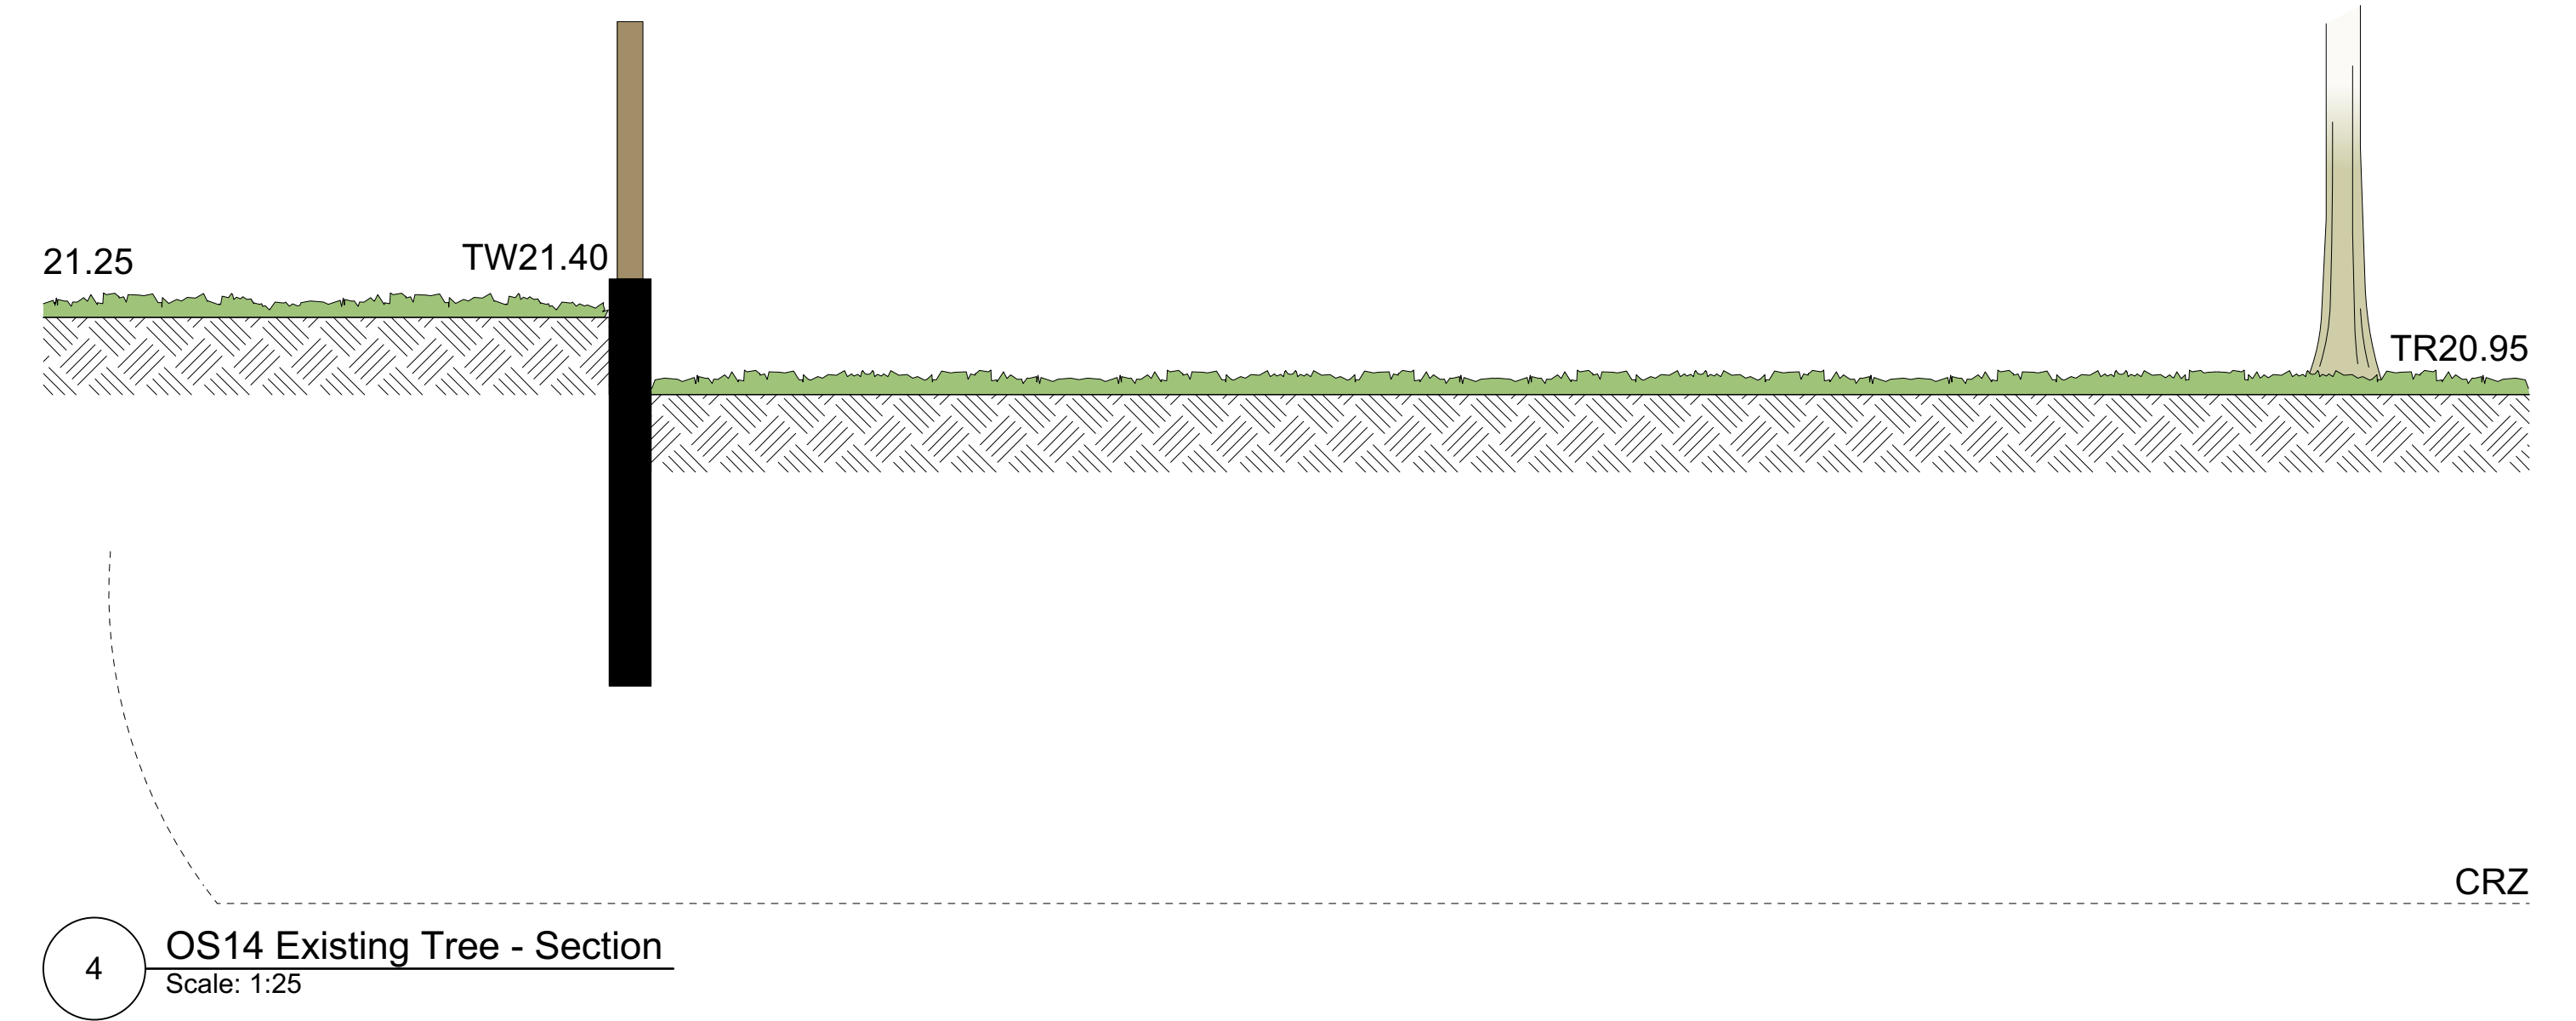

4 OS14 Existing Tree - Section
Scale: 1:25

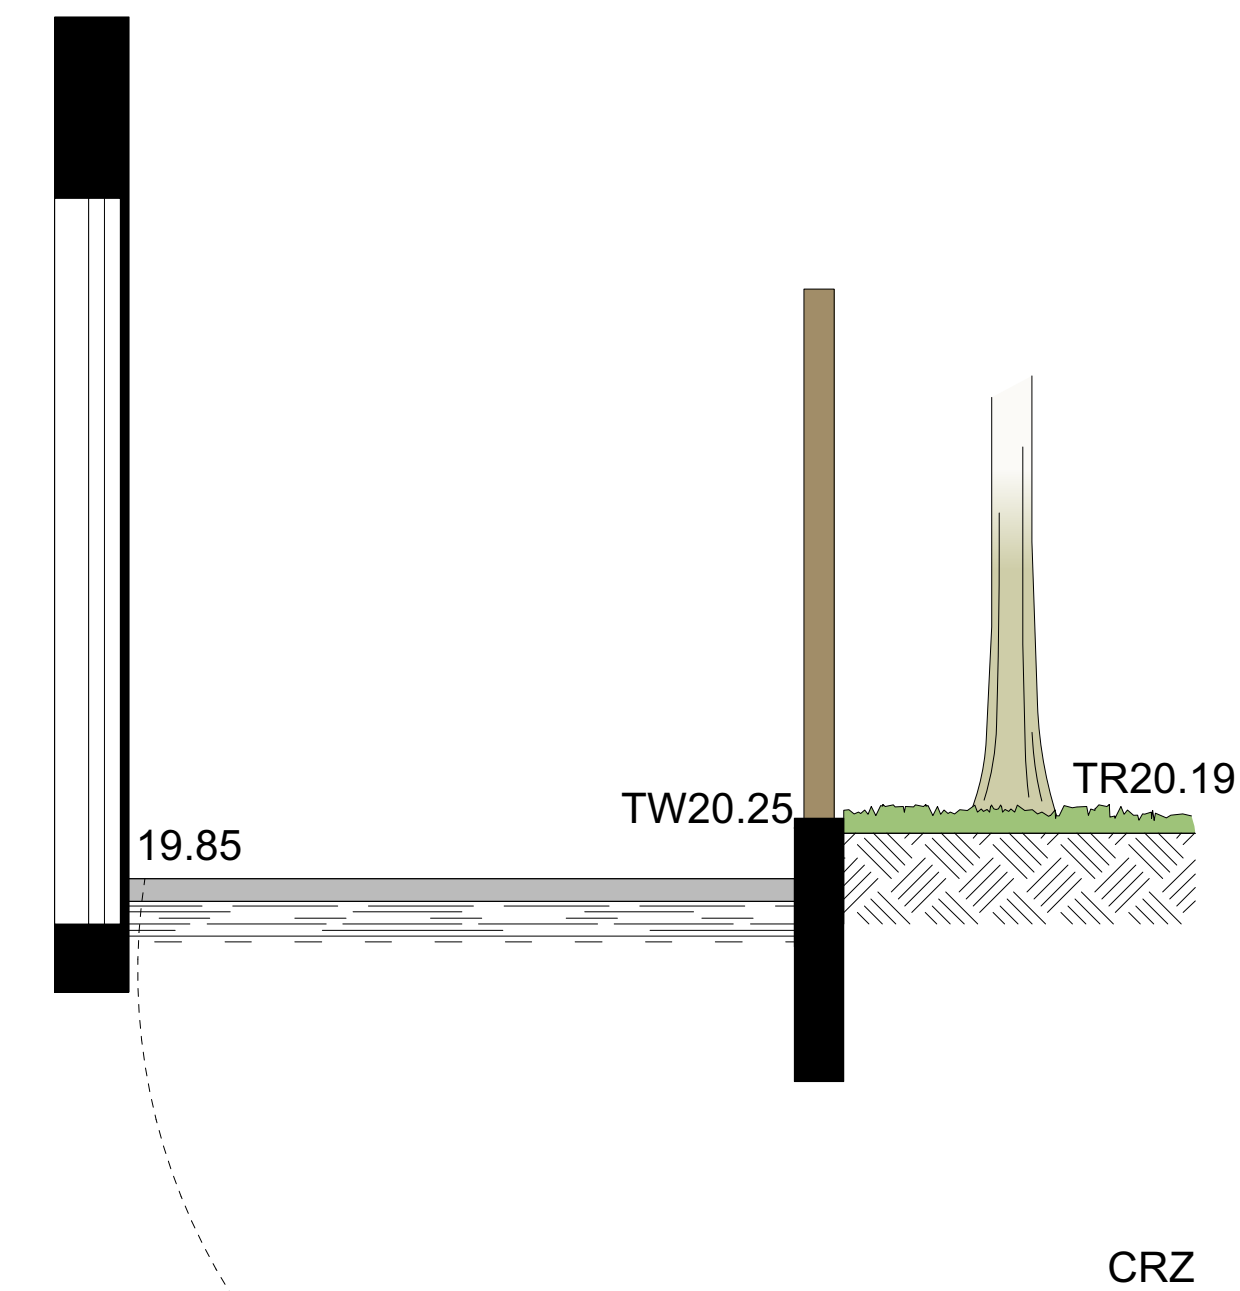


7 OS12 Existing Tree - Section
Scale: 1:25

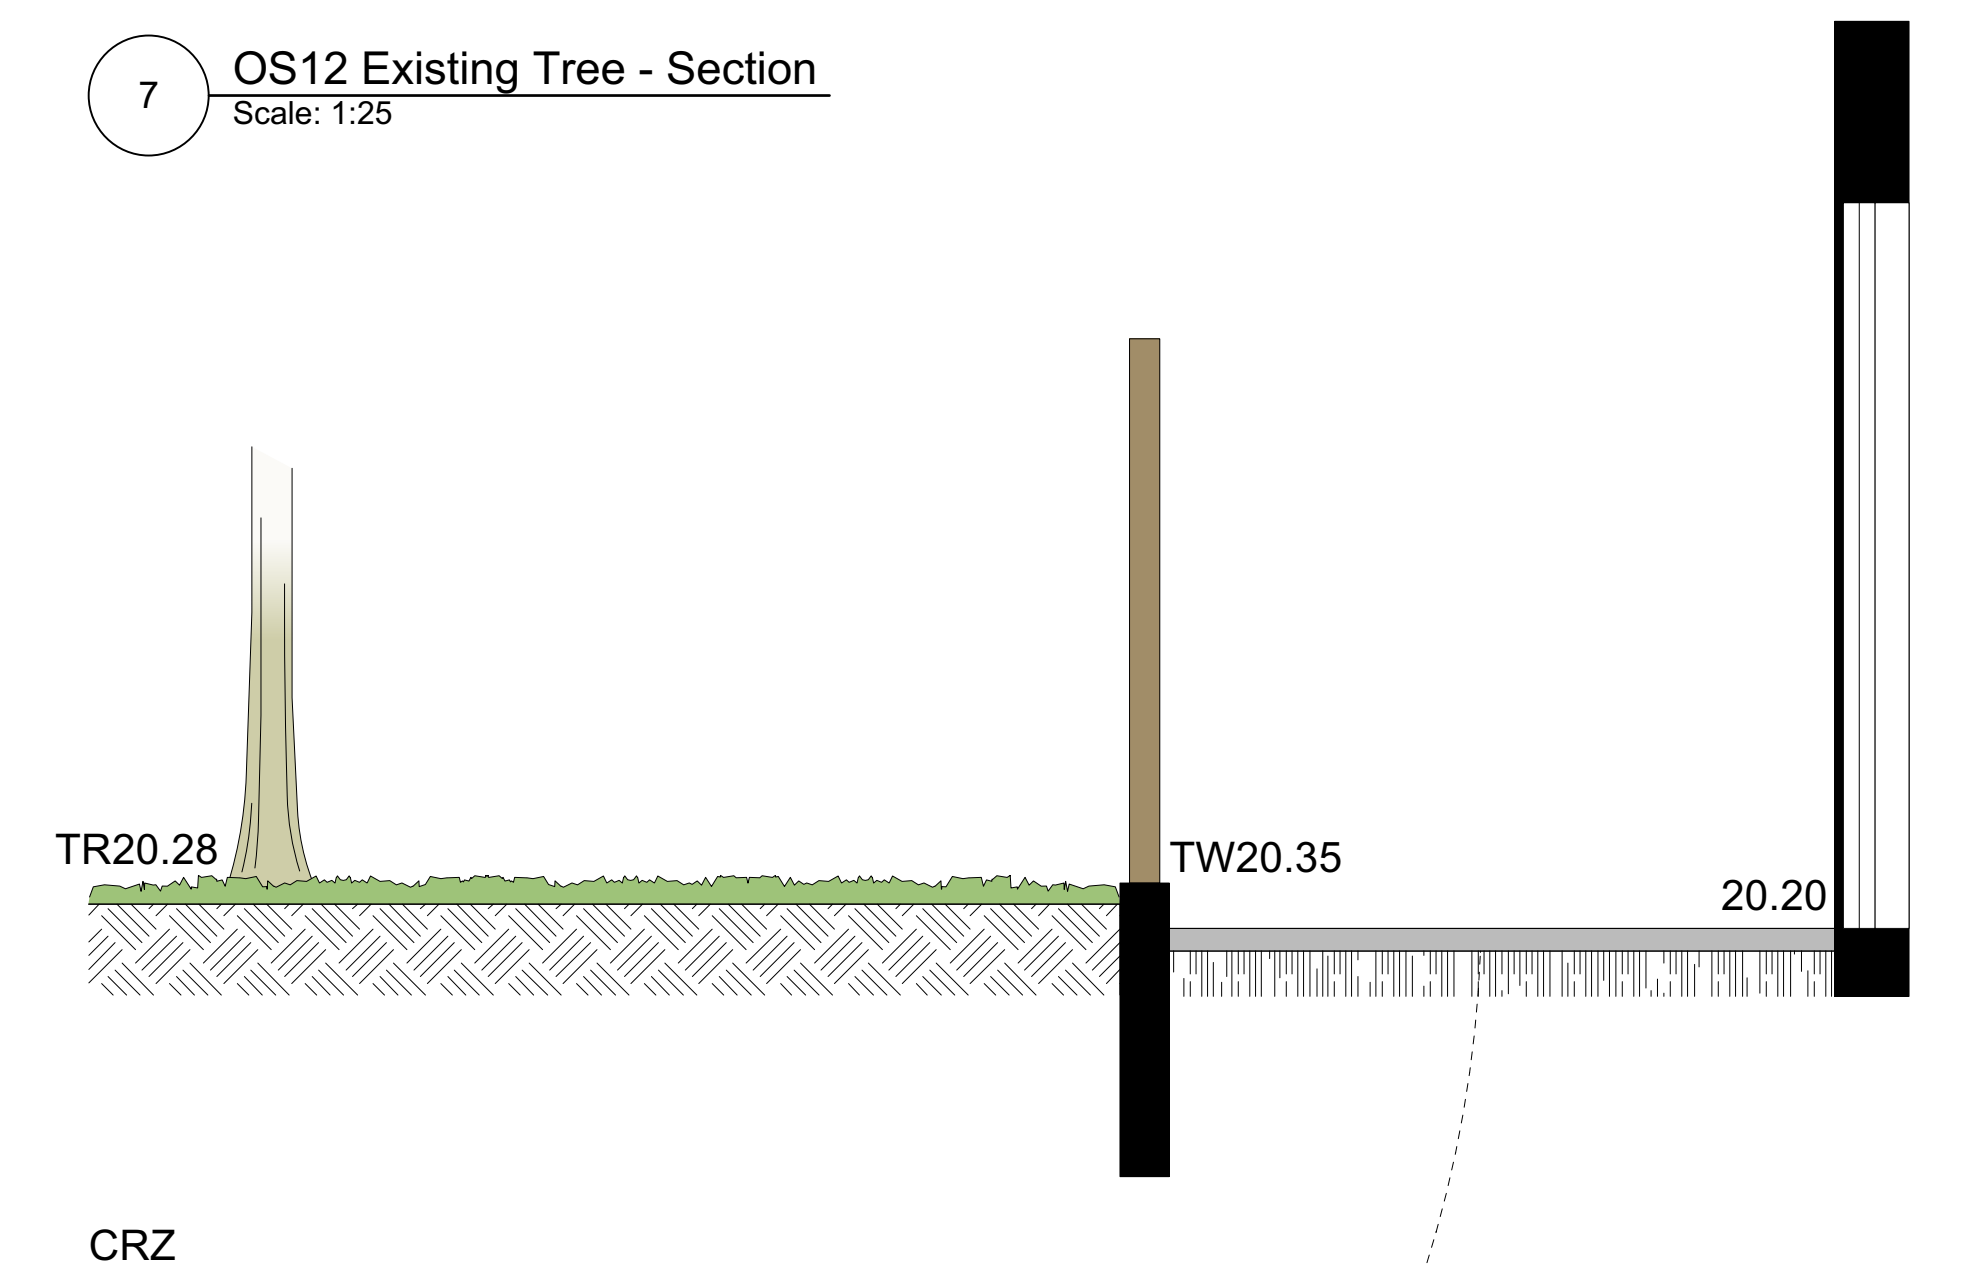

8 OS12 Existing Tree - Section
Scale: 1:25

Landscape Details | 2540 Shelbourne

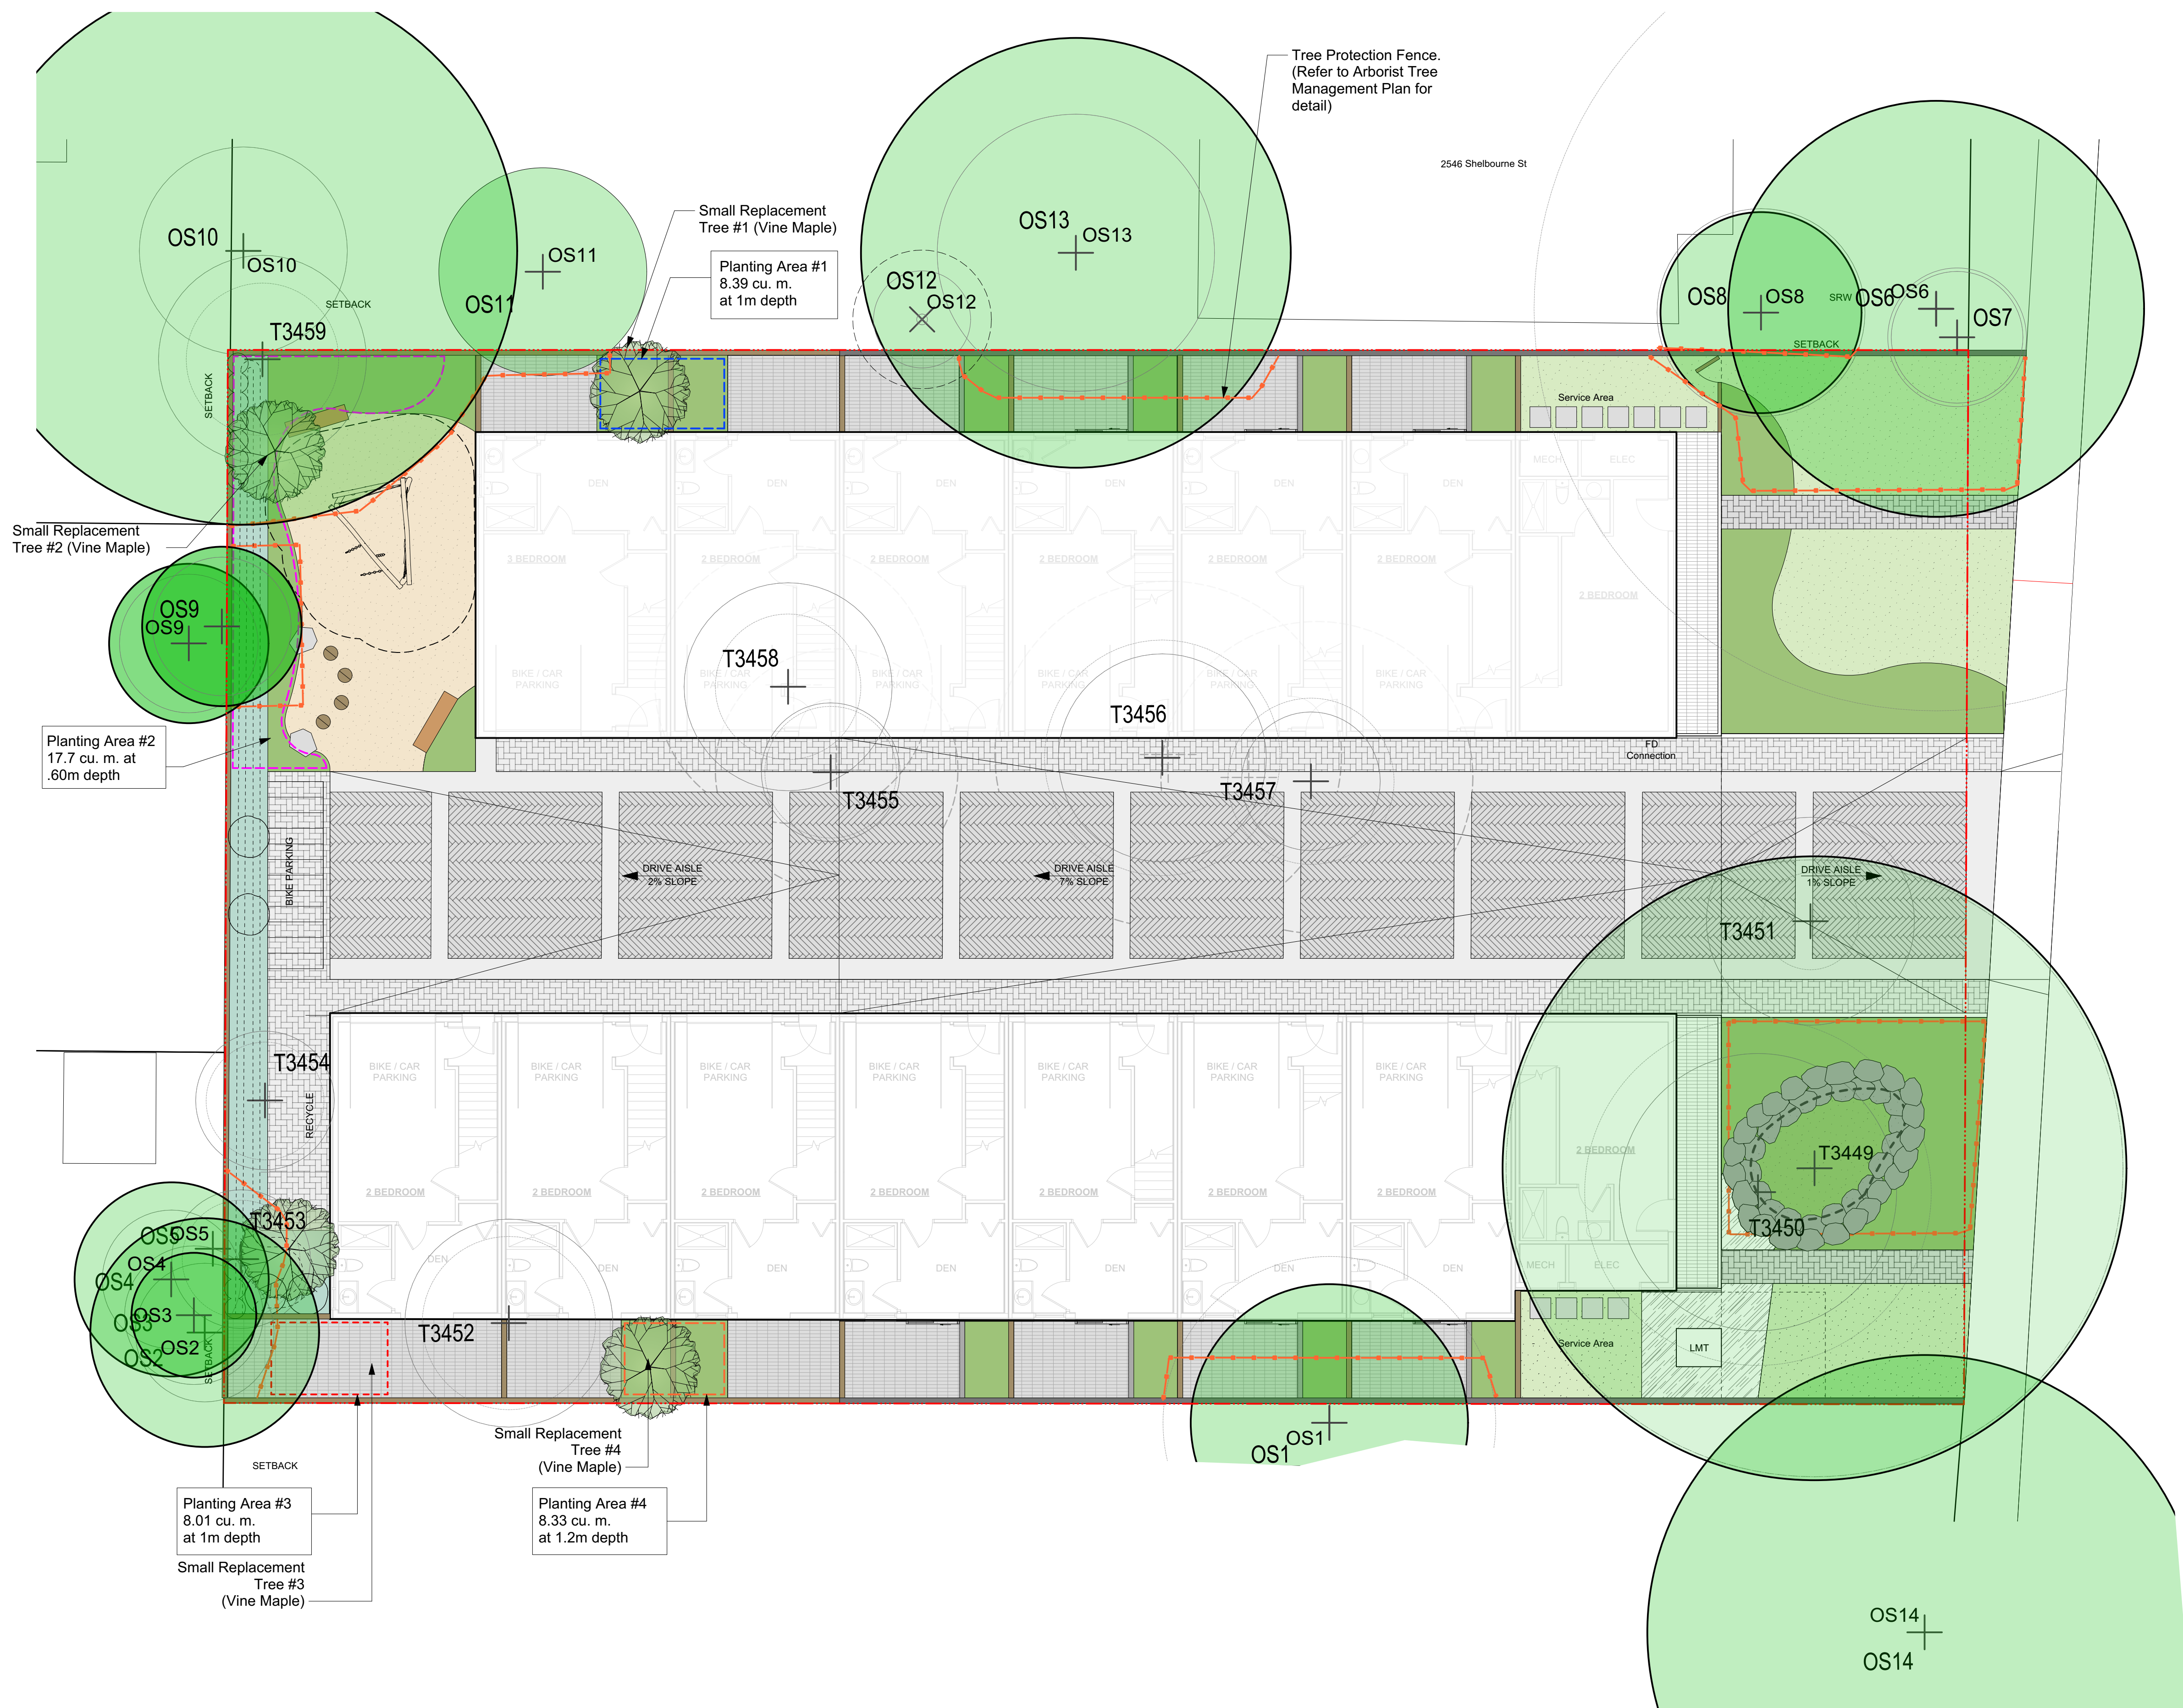

Tree Replacement Plan | 2540 Shelbourne