

PROJECT SITE (NTS)

CONTACTS

OWNER

Aryze Developments Inc. 1839 Fairfield Road Victoria, BC V85 1G9

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ARCHITECT

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LANDSCAPE DESIGNER

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CIVIL ENGINEER

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Nathan Dunlop ndunlop@mcelhanney.com 778.746.7417



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ARCHITECTURAL

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CIVIL

CONCEPTUAL SITE SERVICING PLAN

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LANDSCAPE

TREE REMOVAL & PROTECTION PLAN

TREE PLAN

GROUND FLOOR PLANTING PLAN

UPPER FLOOR PLANTING PLANS



1 BEECHWOOD ELEVATION PERSPECTIVE SCALE = 1:100





April 29, 2022 March 7, 2022 DATE DESCRIPTION



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1733-1737 Fairfield Rd

PERSPECTIVES

APRIL 29, 2022

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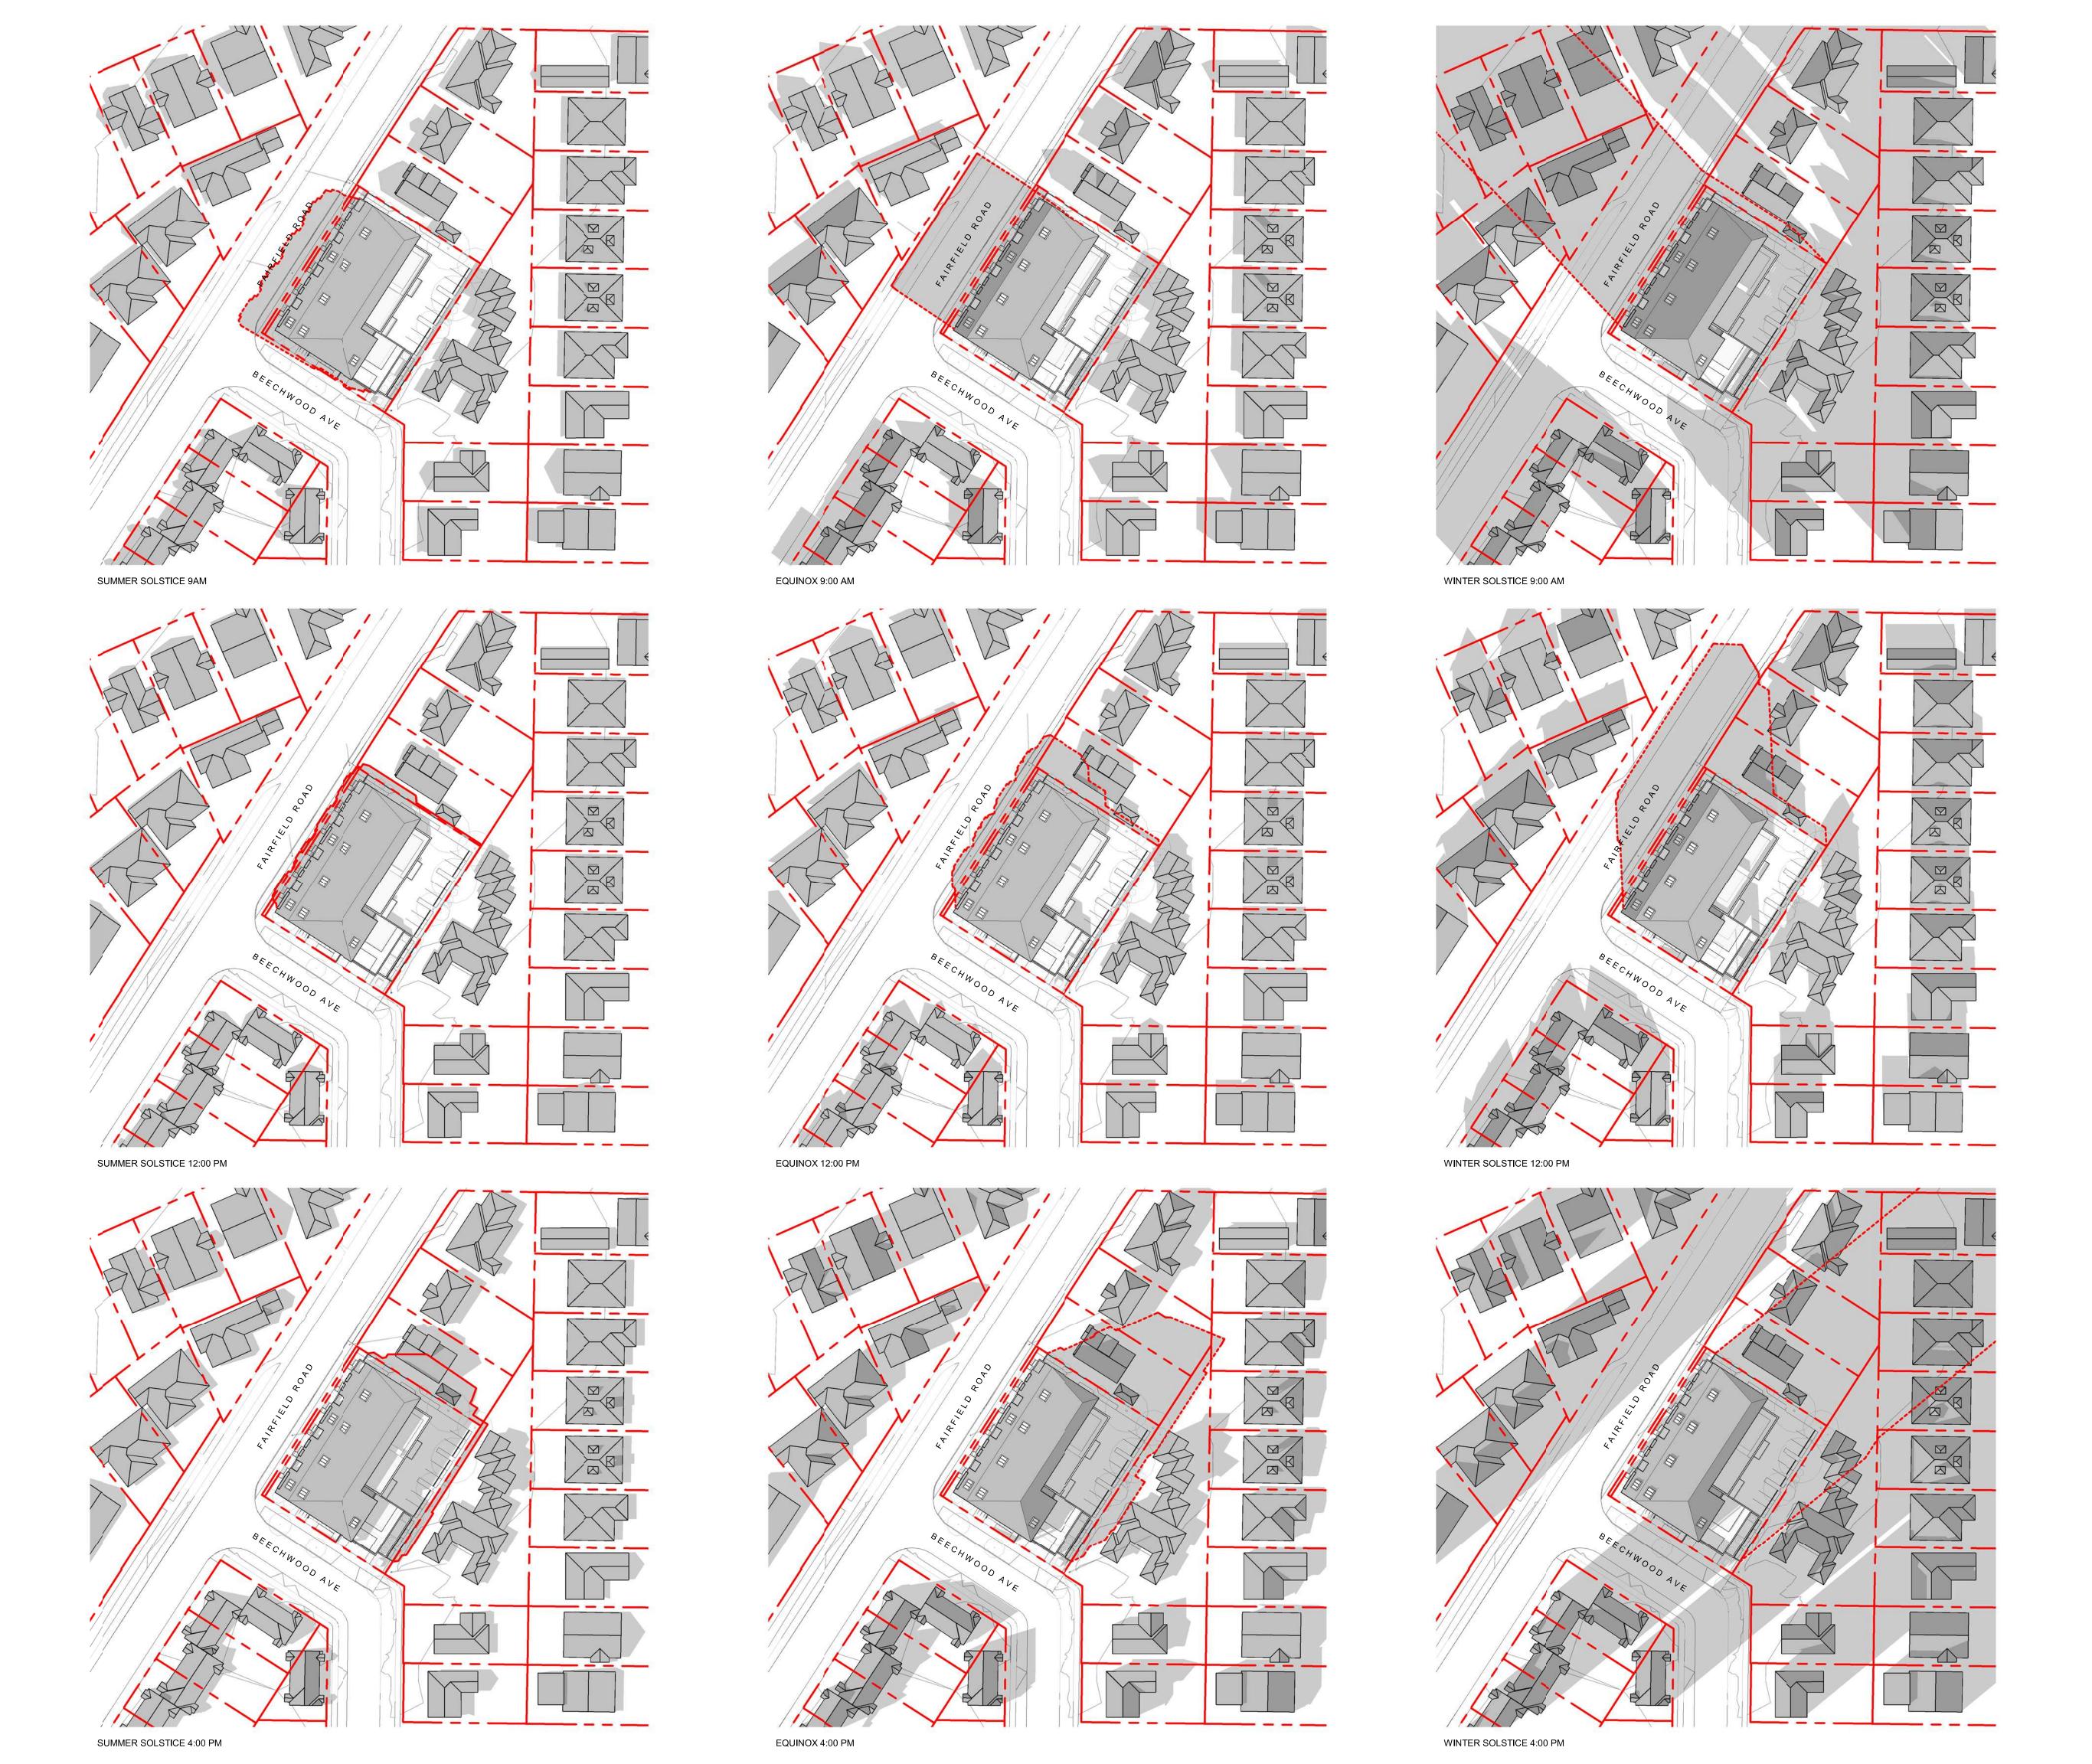





1 CONTEXT PERSPECTIVE FAIRFIELD ROAD
SCALE = 1:100


2 CONTEXT PERSPECTIVE BEECHWOOD AVE SCALE = 1:100






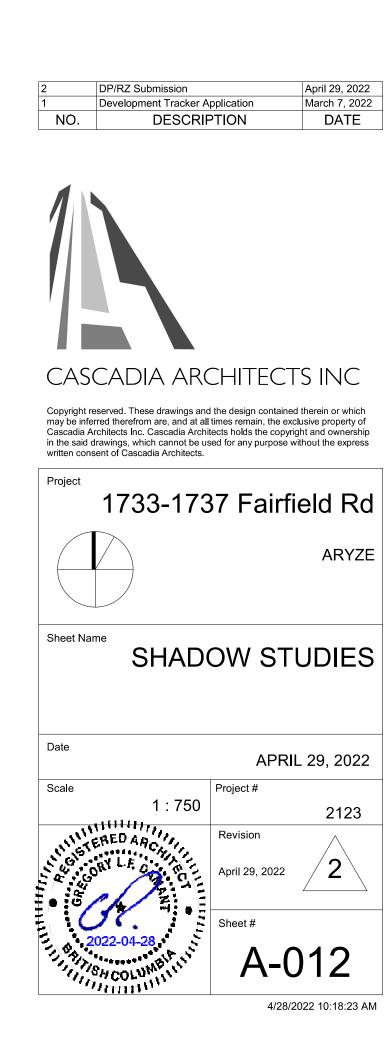

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1 EXISTING SURVEY
SCALE = 1:500

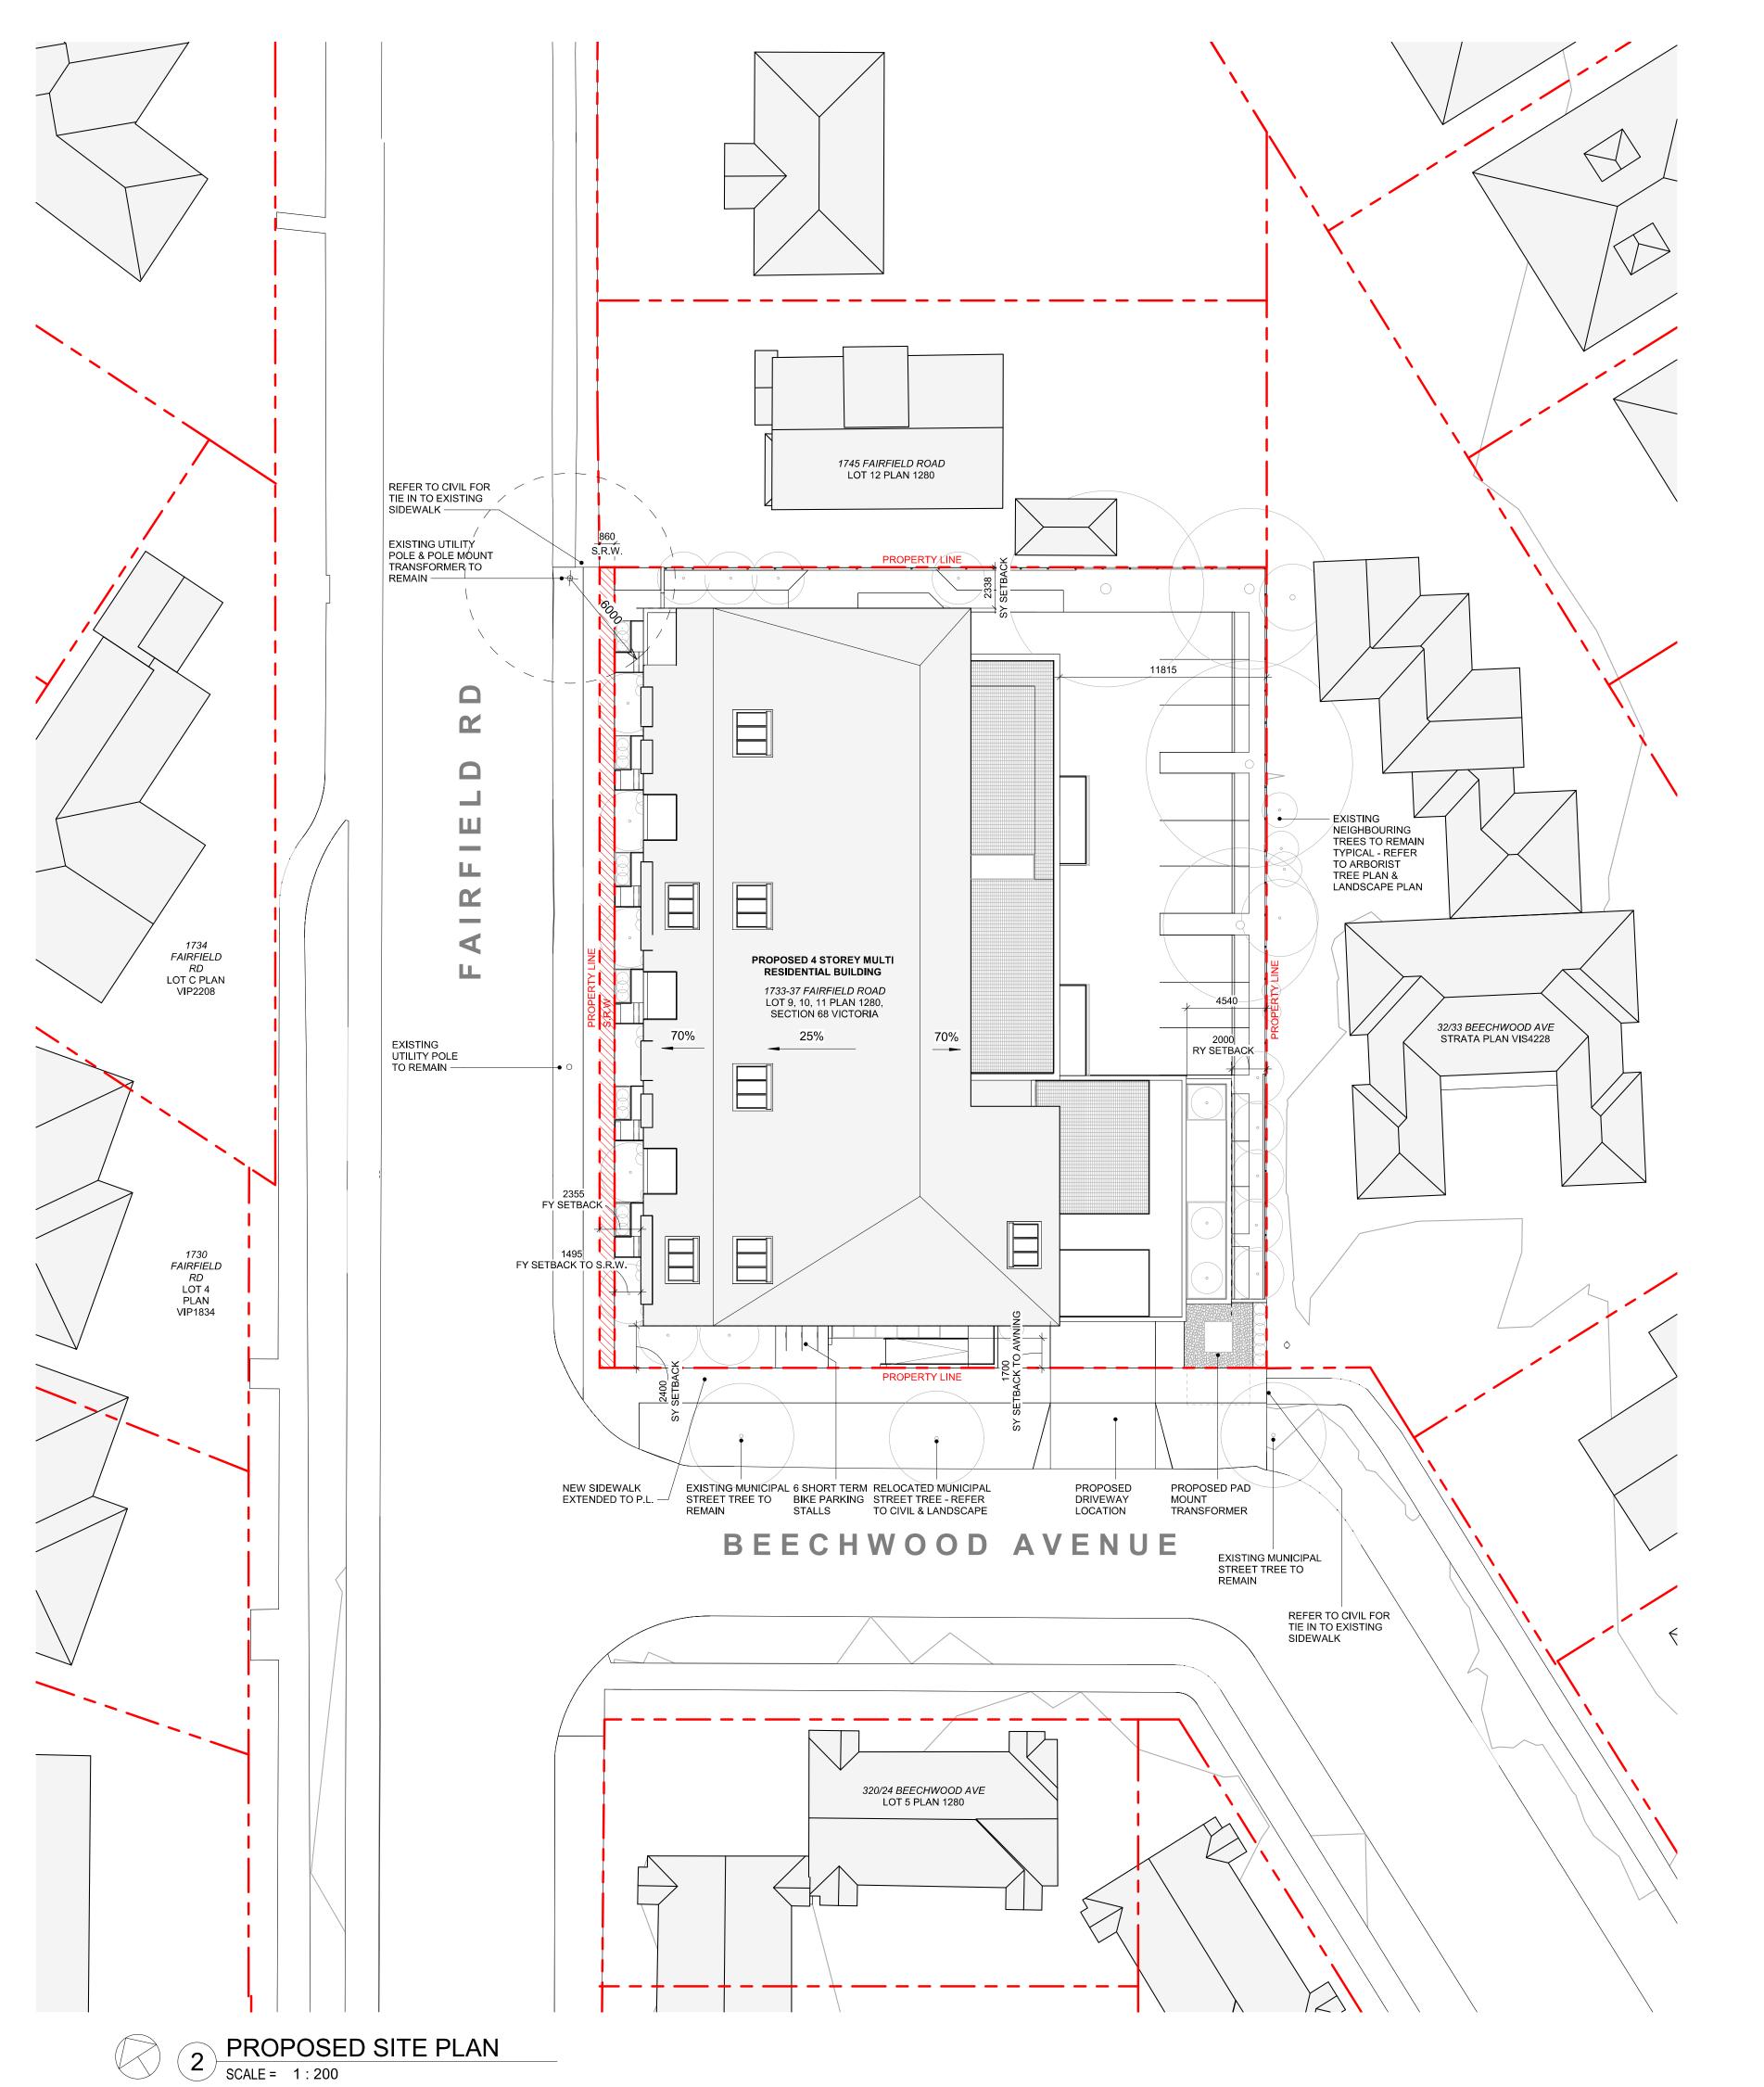DATA	
MUNICIPALITY	CITY OF VICTORIA
MUNICIPAL ADDRESS	1733-37 FAIRFIELD ROAD, VICTORIA BC
LEGAL DESCRIPTION	LOT 9, 10, 11, PLAN 1280, SECTION 68 VICTORIA
PROJECT DESCRIPTION	4 STOREY MULTI UNIT RESIDENTIAL BUILDING

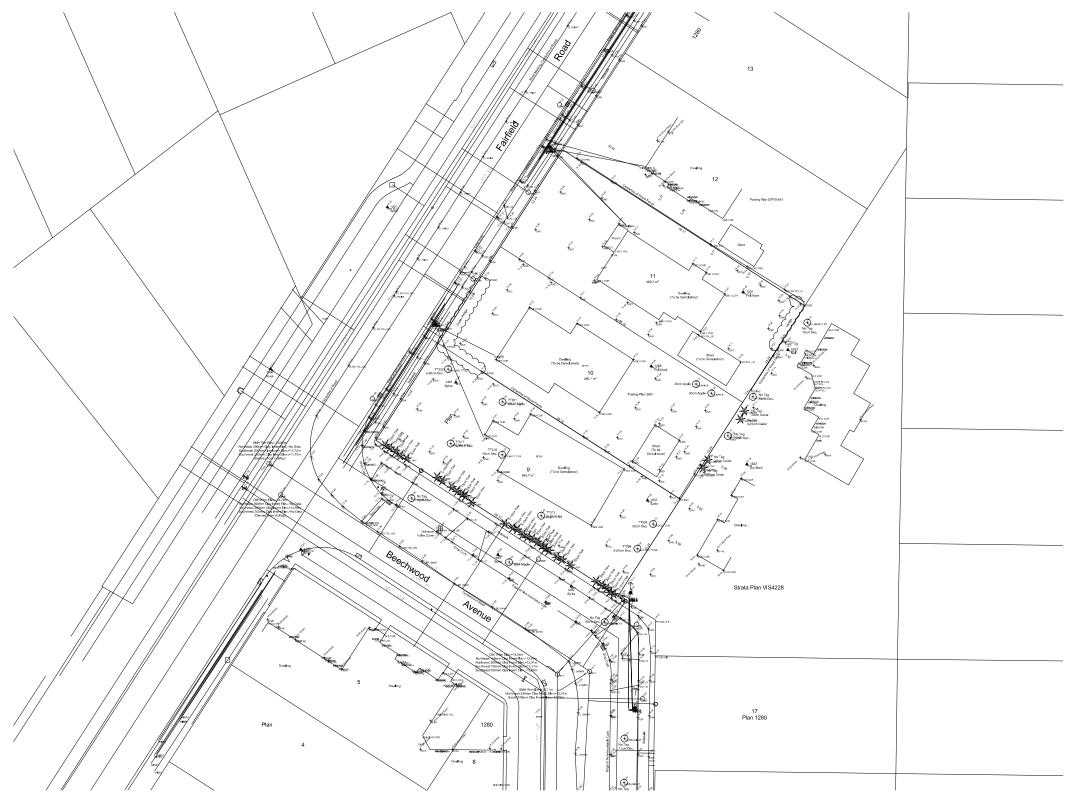NE (EXISTING) R1-G				
PROPOSED ZONE	UNKNOWN			
SITE AREA (m²)	1,741.93m²			
TOTAL FLOOR AREA (m²)	2931.43m ²			
COMMERCIAL FLOOR AREA (m²)	0			
FLOOR SPACE RATIO	1.68:1			
SITE COVERAGE (%)	65%			
OPEN SITE SPACE (%)	CE (%) 23%			
HEIGHT (m)	14.45m			
NUMBER OF STOREYS	4			
	REQUIRED	PROVIDED		
PARKING STALLS (#) ON SITE	28	21		
PARKING STALLS - VISITOR (#) ON SITE	2	1		
BICYCLE PARKING (#) SHORT TERM	6	6		
BICYCLE PARKING (#) LONG TERM	24	32		

BUILDING SETBACKS (m)	
FRONT YARD	2.36m
REAR YARD (TO BALCONY)	2.00m
REAR YARD (TO BUILDING FACE)	4.54m
INTERNAL SIDE YARD	2.34m
SIDE YARD (TO AWNING)	1.70m
SIDE YARD (TO BUILDING FACE)	2.40m
COMBINED SIDE YARDS	4.74m

RESIDENTIAL USE DETAILS			
TOTAL NUMBER OF UNITS	19		
UNIT TYPE	3BD+DEN(1), 3BD(1), 2BD(11), 2BD+DEN(1), 1 BD(1), 1BD +DEN(4)		
GROUND-ORIENTATED UNITS	6		
MINIMUM UNIT FLOOR AREA (m²)	74m²		
TOTAL RESIDENTIAL FLOOR AREA (m²)	2430m²		

NO. Development Tracker Application March 7, 2022 NO. DESCRIPTION DATE	2	DP/RZ Submission	April 29, 2022
NO. DESCRIPTION DATE	l	Development Tracker Application	March 7, 2022
	NO.	DESCRIPTION	DATE




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SITE PLAN & PROJECT DATA

APRIL 29, 2022



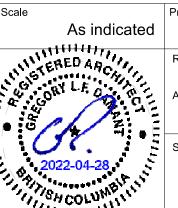


POINT NAME	NATURAL	PROPOSED	DISTANCE BE	ETWEEN POINTS	AVE. OF POINTS
Α	14.209	14.42	Point A & B	10.207	144.73
В	14.422	14.15	Point B & C	1.072	15.15
С	14.393	14.11	Point C & D	3.143	44.24
D	14.04	14.75	Point D & E	1.7	23.83
E	13.995	14.09	Point E & F	6.4	89.95
F	14.238	14.11	Point F & G	3.2	45.62
G	14.397	14.44	Point G & H	10.809	154.46
Н	14.183	14.39	Point H & I	0.403	5.72
1	14.194	14.28	Point I & J	2.541	36.18
J	14.345	14.28	Point J & K	12.88	184.17
K	14.315	14.41	Point K & L	13.503	194.09
L	14.432	14.72	Point L & M	5.7	82.06
M	14.362	14.69	Point M & N	0.905	12.99
N	14.344	14.67	Point N & O	12.159	173.53
0	14.199	14.64	Point O & S	6.114	87.00
S	14.259	14.76	Point S & T	2.904	41.34
Т	14.209	14.76	Point T & U	5.629	80.18
Ü	14.279	14.75	Point U & V	0.319	4.56
V	14.287	14.75	Point V & W	9.885	141.83
W	14.408	14.64	Point W & X	0.4	5.77
Х	14.417	14.64	Point X & Y	2.14	30.88
Y	14.447	14.61	Point Y & Z	2.96	42.72
Z	14.421	14.57	Point Z & A1	2.14	30.86
A1	14.419	14.70	Point A1 & A2	3.554	51.15
A2	14.365	14.75	Point A2 & A3	2.14	30.68
A3	14.311	14.54	Point A3 & A4	3.14	45.03
A4	14.371	14.52	Point A4 & A5	2.14	30.73
A5	14.348	14.75	Point A5 & A6	3.545	51.00
A6	14.425	14.75	Point A6 & A7	2.14	30.79
A7	14.352	14.49	Point A7 & A8	3.13	44.93
A8	14.359	14.47	Point A8 & A9	2.14	30.90
A9	14.523	14.75	Point A9 & A10	3.54	51.48
A10	14.56	14.75	Point A10 & A11	2.14	30.98
A11	14.393	14.43	Point A11 & A12	3.125	44.90
A12	14.345	14.44	Point A12 & A13	2.142	30.96
A13	14.562	14.75	Point A13 & A14	3.545	51.50
A14	14.491	14.75	Point A14 & A15	2.142	30.84
A15	14.306	14.34	Point A15 & A16	3.15	44.96
A16	14.242	14.31	Point A16 & A17	2.14	30.59
A17	14.344	14.75	Point A17 & A18	3.507	50.20
A18	14.287	14.75	Point A18 & A19	3	42.72
A19	14.193	14.26	Point A19 & A20	3.145	44.60
A20	14.171	14.20	Point A20 & A21	3.00	42.72
A21	14.301	14.75	Point A21 & A	3.534	50.74

Average Grade


177.15

14.31

2534.26

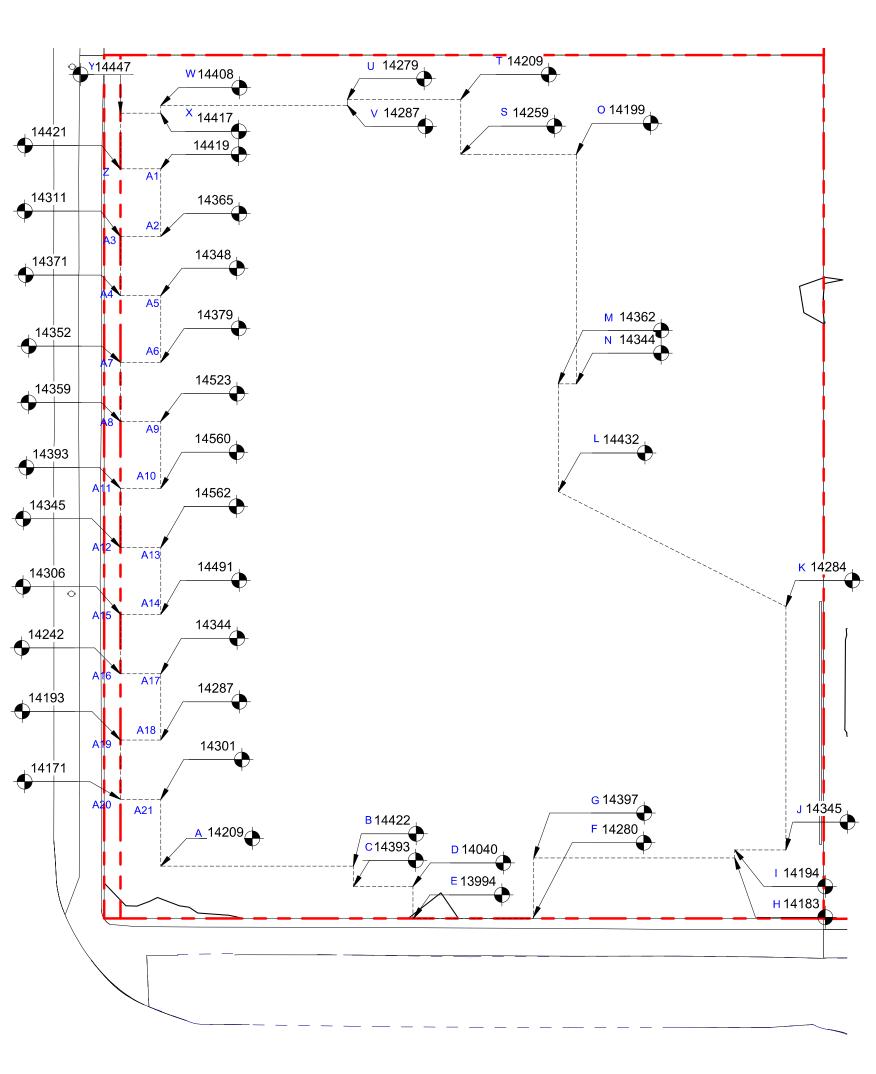


2 NATURAL GRADE KEY PLAN
SCALE = 1:200

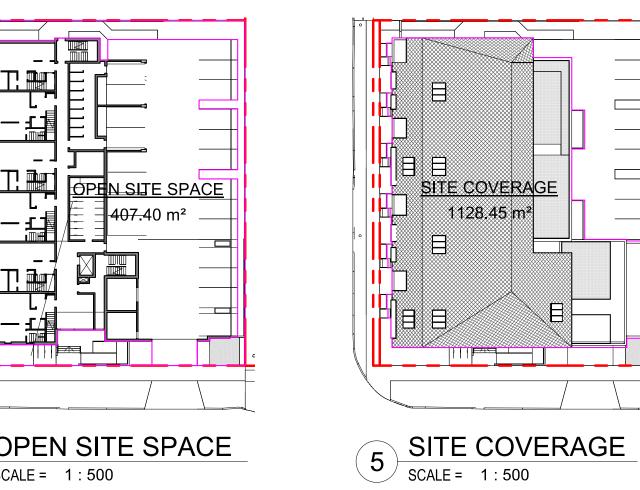


OPEN SITE SPACE


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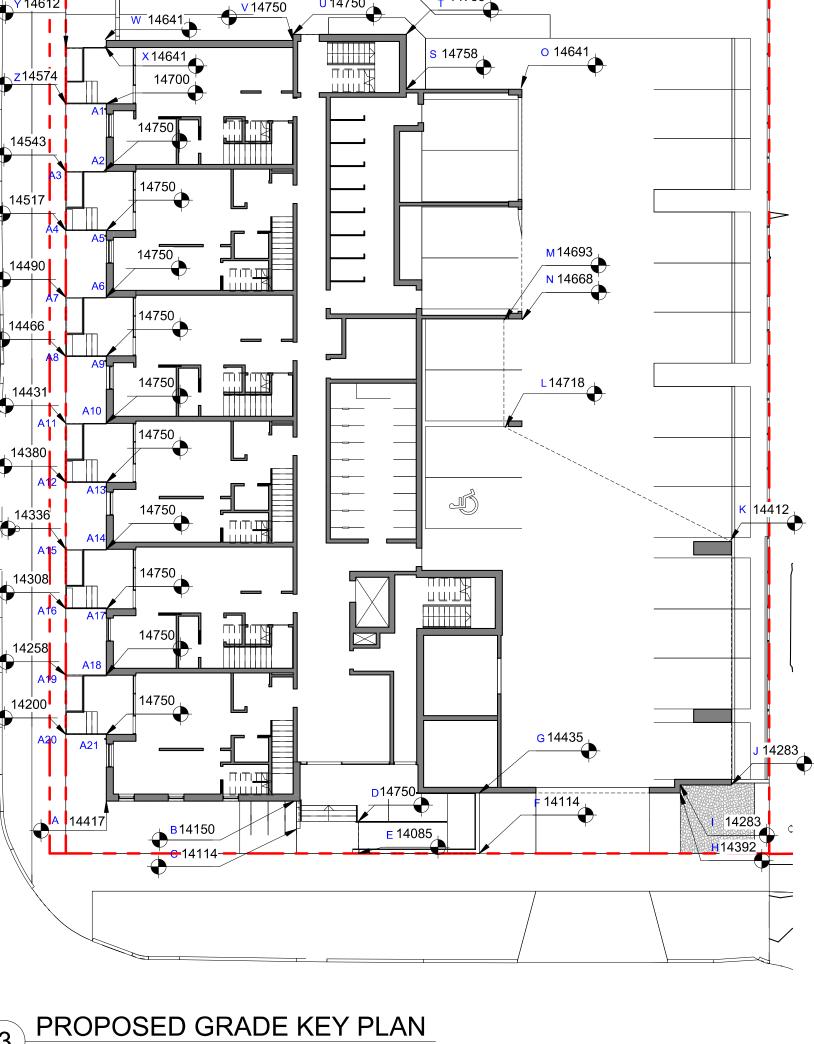


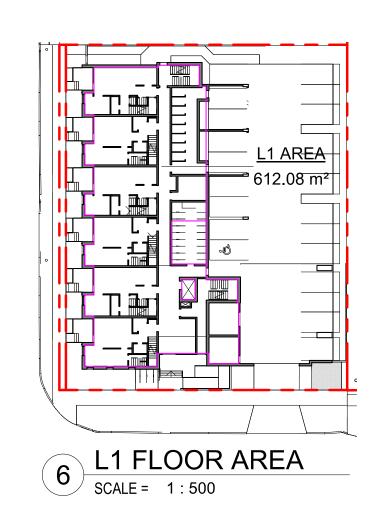7 L2 FLOOR AREA SCALE = 1:500

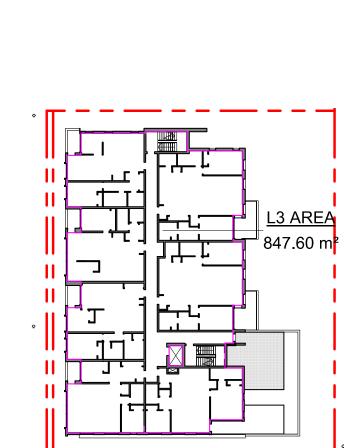

8 L3 FLOOR AREA SCALE = 1:500




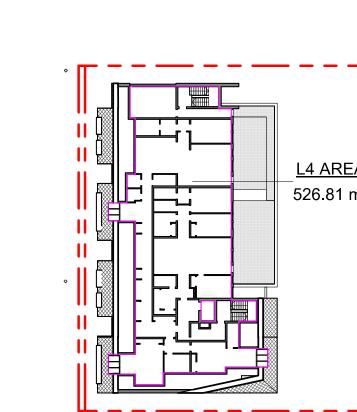


3 PROPOSED GRADE KEY PLAN
SCALE = 1:200



Level 1	612.08 m ²
Level 2	944.94 m²
Level 3	847.60 m²
Level 4	526.81 m²
FLOOR SPACE	
FLOOR SPACE	
FLOOR SPACE	E RATIO 41.93m ² = 1.68 FSR - 1.68 : 1

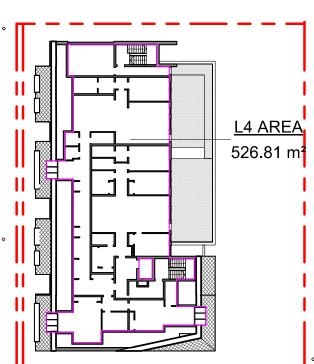

9 L4 FLOOR AREA SCALE = 1:500

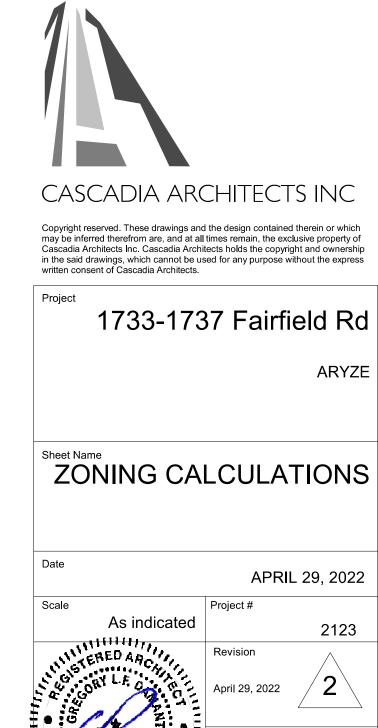

DP/RZ Submission


NO.

Development Tracker Application

DESCRIPTION

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April 29, 2022 March 7, 2022 DATE

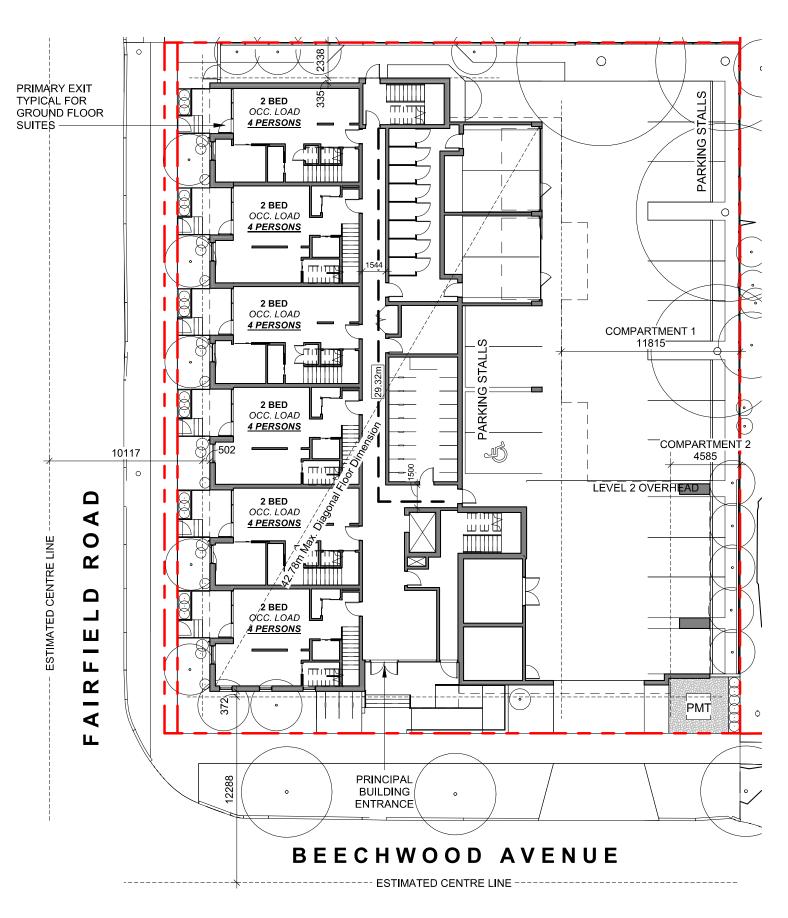

OCCUPANT LOAD: Occupancy: Group C
12 Bedrooms x 2 persons/bedroom


= 24 persons

MINIMUM EXIT WIDTH:

Ramps, Corridors, Passageways
the greater of 6.1mm x 24 = 146.4mm
or 1100mm (minimum 1500mm for accessible path of travel)

Stairs
the greater of 8mm x 24 = 192.0mm
or 1100mm

1 L1 CODE REVIEW KEY PLAN
SCALE = 1:250

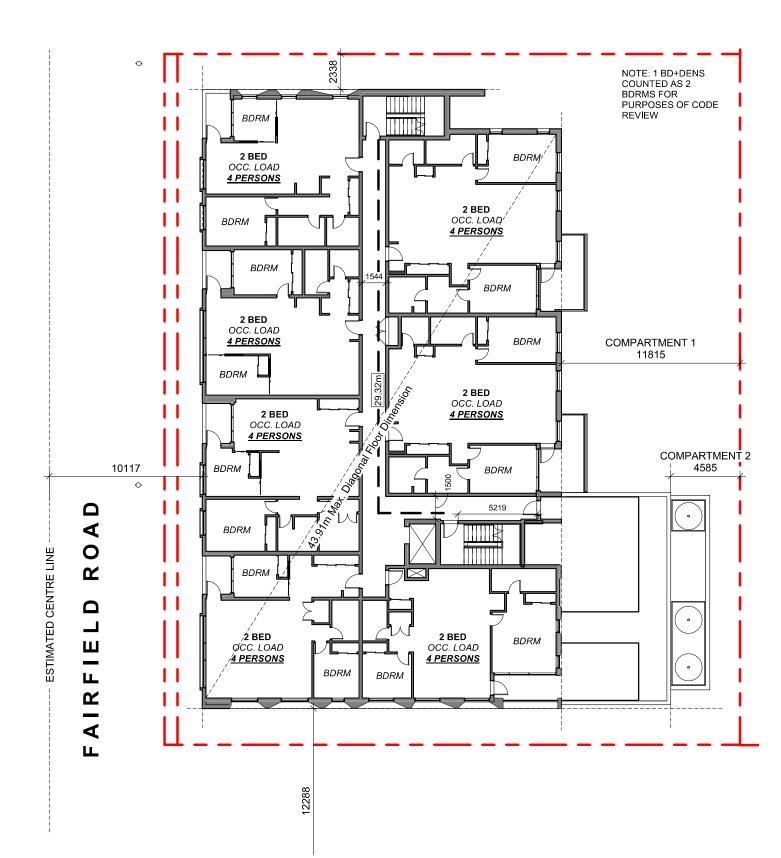


BEECHWOOD AVENUE

OCCUPANT LOAD: MINIMUM EXIT WIDTH:

Occupancy: Group C
14 Bedrooms x 2 persons/bedroom Ramps, Corridors, Passageways
the greater of 6.1mm x 28 = 170.8mm
or 1100mm (minimum 1500mm for or 1100mm = 28 persons accessible path of travel)

----- ESTIMATED CENTRE LINE

3 L3 CODE REVIEW KEY PLAN
SCALE = 1:250

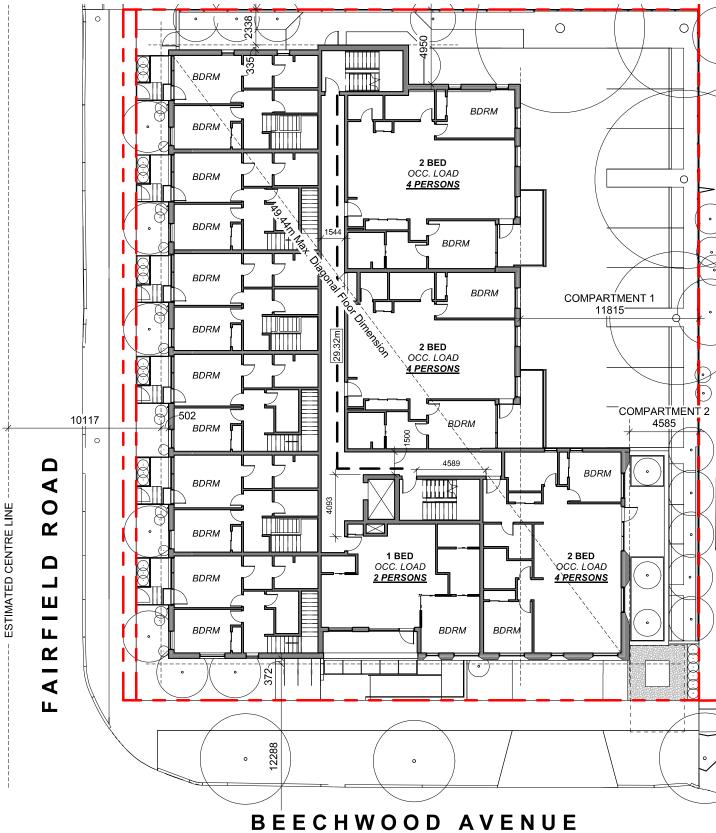

-+---- ESTIMATED CENTRE LINE -

accessible path of travel)

OCCUPANT LOAD:

MINIMUM EXIT WIDTH: Occupancy: Group C 7 Bedrooms x 2 persons/bedroom


Ramps, Corridors, Passageways
the greater of 6.1mm x 14 = 85.4mm
or 1100mm (minimum 1500mm for

"""

Stairs
the greater of 8mm x 14 = 112.0mm
or 1100mm

2 L2 CODE REVIEW KEY PLAN
SCALE = 1:250

= 14 persons

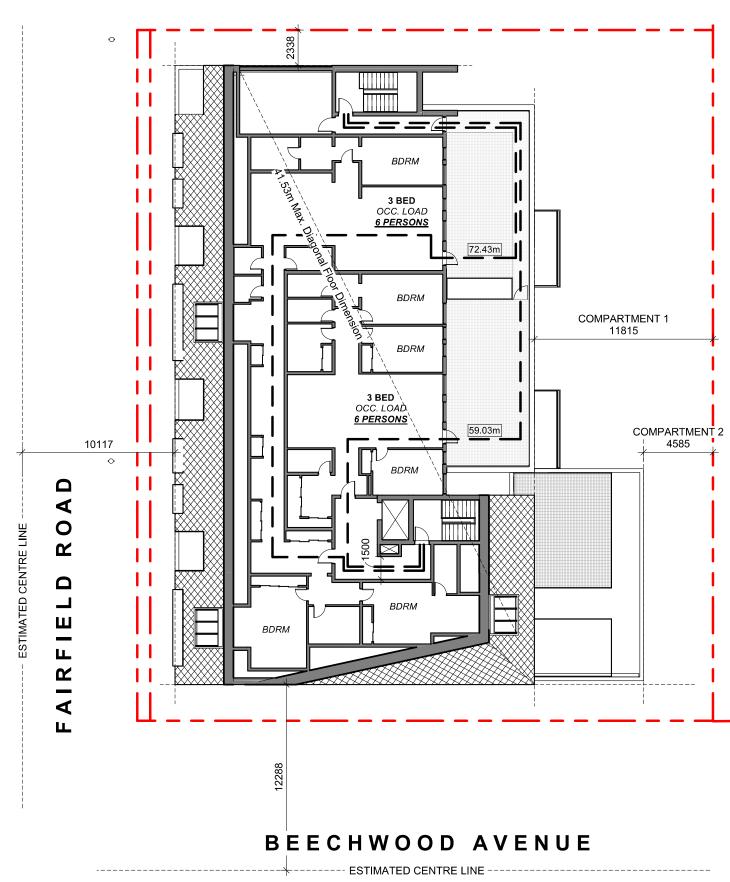

OCCUPANT LOAD: Occupancy: Group C
6 Bedrooms x 2 persons/bedroom = 12 persons

MINIMUM EXIT WIDTH: or 1100mm (minimum 1500mm for accessible path of travel)

Ramps, Corridors, Passageways the greater of 6.1mm x 12 = 73.2mm the greater of 8mm x 12 = 96mm

L4 CODE REVIEW KEY PLAN SCALE = 1:250

BUILDING CODE ANALYSIS

PROJECT TYPE	NEW CONSTRUCTION RENOVATION ADDITIO	N
GOVERNING BUILDING CODE	2018 BC BUILDING CODE	
MAJOR OCCUPANCY	A1 A2 A3 A4 B1 B2 B3 C D E F1 F2 F3	3.1.2.1
BUILDING AREA	I05I m ² (approx)	1.4.1.2
GRADE	I8.75 m geodetic	1.4.1.2
BUILDING HEIGHT (STOREYS)	4 STOREYS ABOVE GRADE 0 STOREYS BELOW GRADE	1.4.1.2

BUILDING FIRE SAFETY & CONSTRUCTION CLASSIFICATION

CLASSIFICATION	GROUP C, UP TO 4 STOREYS, SPRINKLERED	3.2.2.51
MAXIMUM BUILDING AREA	1800 m ²	3.2.2.51
No. OF STREETS FACING	I (BEECHWOOD AVE UNDER 9M MINIMUM STREET WIDTH)	3.2.2.10
CONSTRUCTION TYPES PERMITTED	✓ COMBUSTIBLE NON-COMBUSTIBLE	3.2.2.51
FIRE ALARM SYSTEM	YES NO	3.2.4.1
STANDPIPE SYSTEM	YES NO	3.2.5.8
HIGH BUILDING	YES NO	3.2.6.1
INTERCONNECTED FLOOR SPACE	YES NO EXCEPT WITHIN AT GRADE RESIDENTIAL UNITS	3.2.8


FIRE RESISTANCE RATINGS

HORIZONTAL SEPARATIONS	I hr	FLOORS	I hr	MEZZANINE	Unrated	ROOF	3.2.2.51
LOADBEARING WALLS, COLUMNS & ARCHES	I hr	(NOT LESS THE SUPPORTED		AT REQUIRED FO	OR		3.2.2.51
EXITS	I hr						3.4.4.1

EXITS FROM FLOOR AREAS

NUMBER OF EXITS REQUIRED	2		3.4.2.1
SEPARATION OF EXITS (MIN.)	1/2 MA	X. DIAGONAL FLOOR AREA, BUT NEED NOT BE > 9 m	3.4.2.3
MAX. TRAVEL DISTANCE ALLOWED	45	m, GROUP C	3.4.2.5
MEZZANINE	YES	NO	3.2.8

FIRE RESISTANCE RATING - KEY - - - - - - UNRATED FIRE SEPERATIONS **—----** 1.5 HOUR 2 HOUR

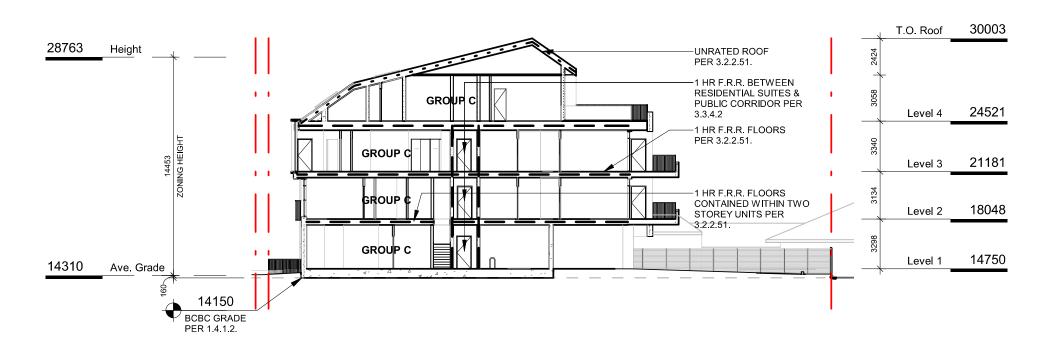

5 CODE REVIEW KEY SECTION

SCALE = 1:250

April 29, 2022 DATE DESCRIPTION




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CODE REVIEW


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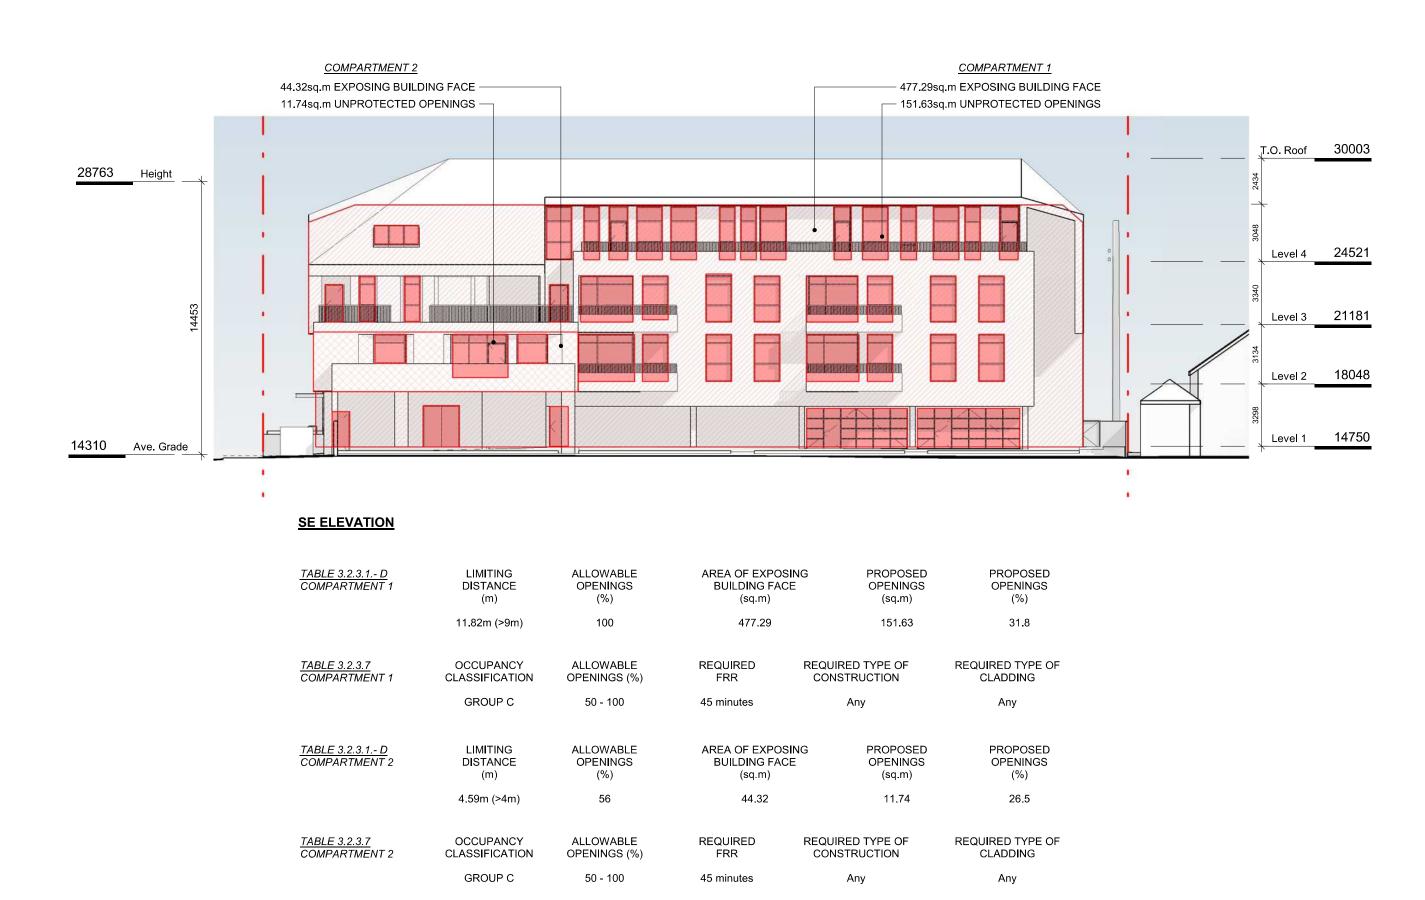
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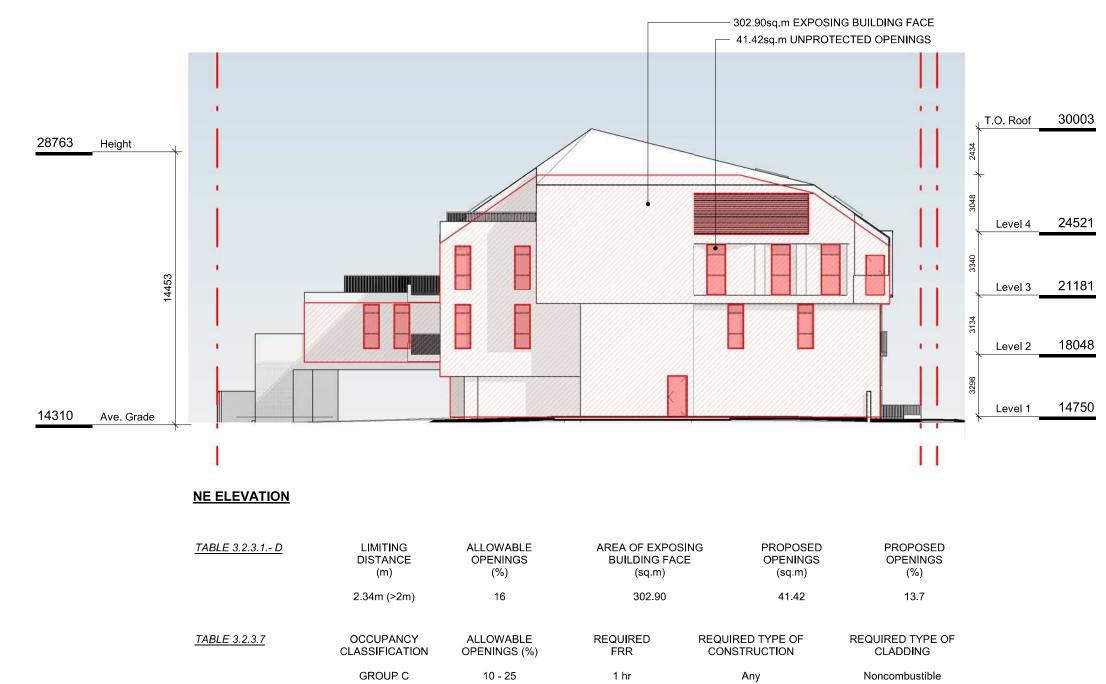


1 NW ELEVATION - LD KEY SCALE = 1:200




SE ELEVATION - LD KEY

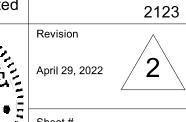SCALE = 1:200

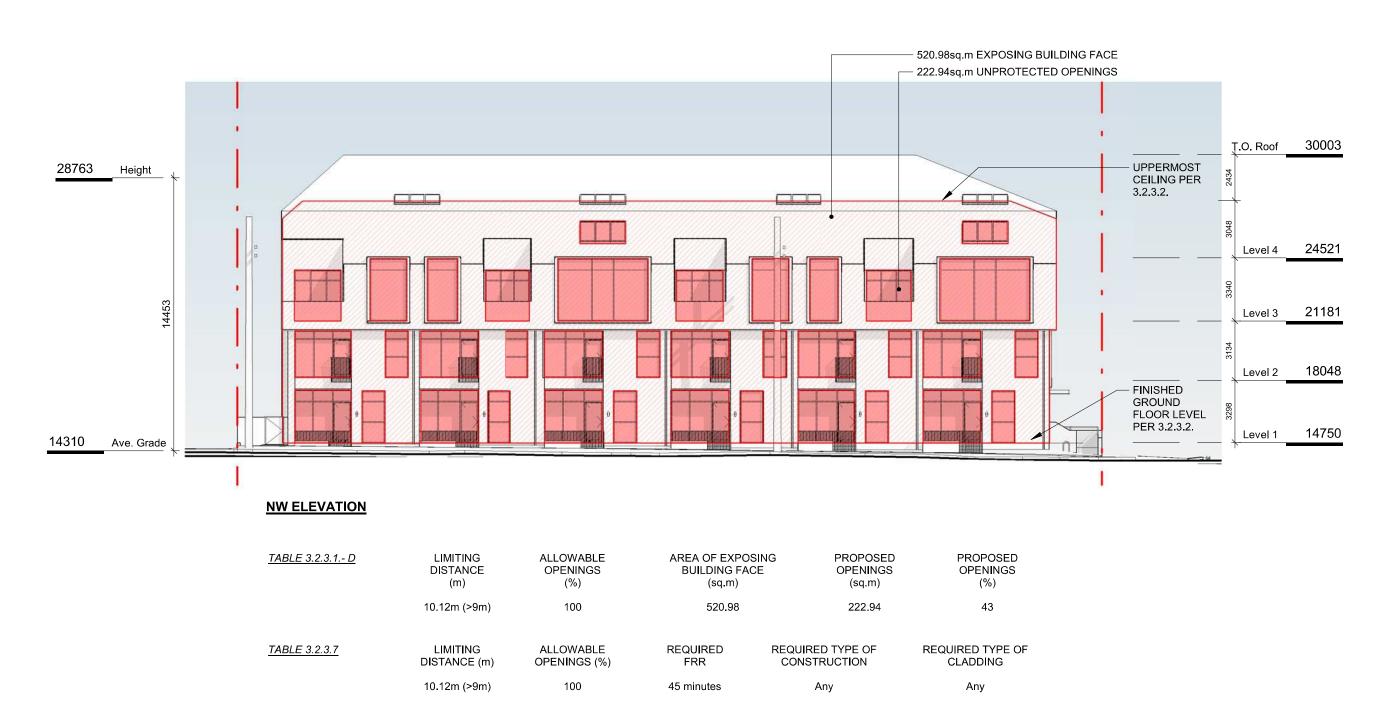

2 NE ELEVATION - LD KEY SCALE = 1:200

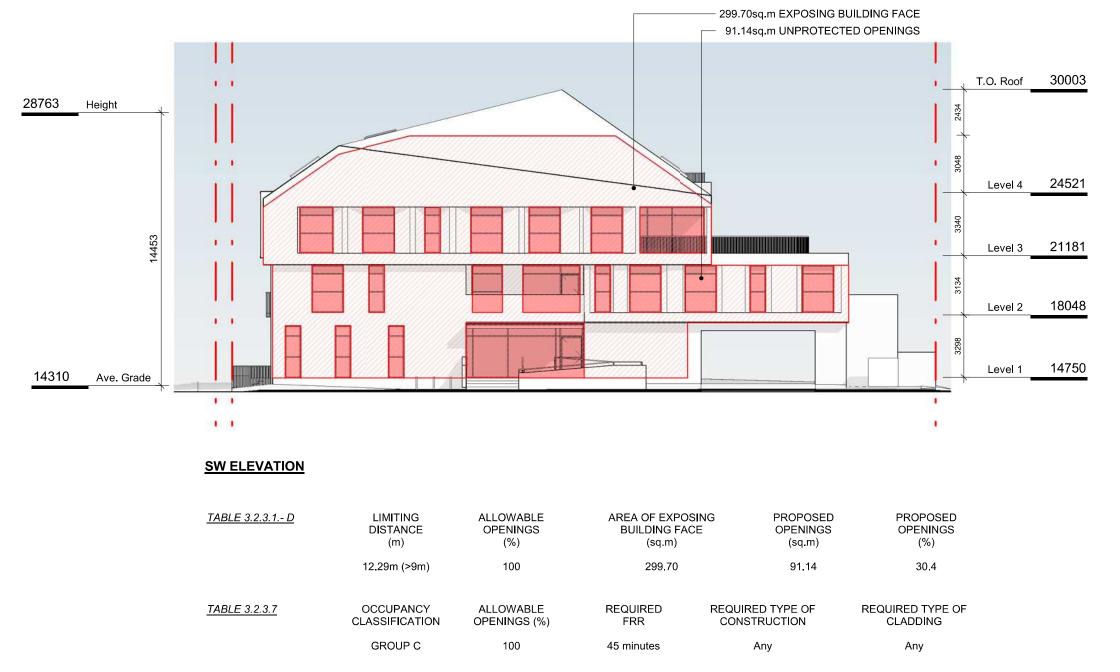

3 SW ELEVATION - LD KEY
SCALE = 1:200



DESCRIPTION

NO.

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April 29, 2022

DATE

BEECHWOOD AVENUE

DP/RZ Submission April 29, 2022
Development Tracker Application March 7, 2022
NO. DESCRIPTION DATE



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Project 1733-1737 Fairfield Rd

7.4.3.1

LEVEL 1 PROPOSED PLAN

APRIL 29, 2022

Scale

1:100

Rev

April

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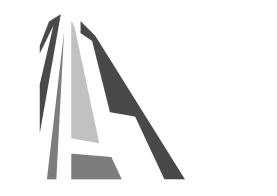
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Revision
April 29, 2022

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2DP/RZ SubmissionApril 29, 20221Development Tracker ApplicationMarch 7, 2022NO.DESCRIPTIONDATE



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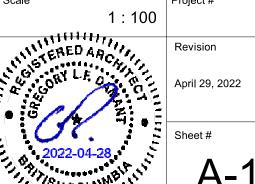
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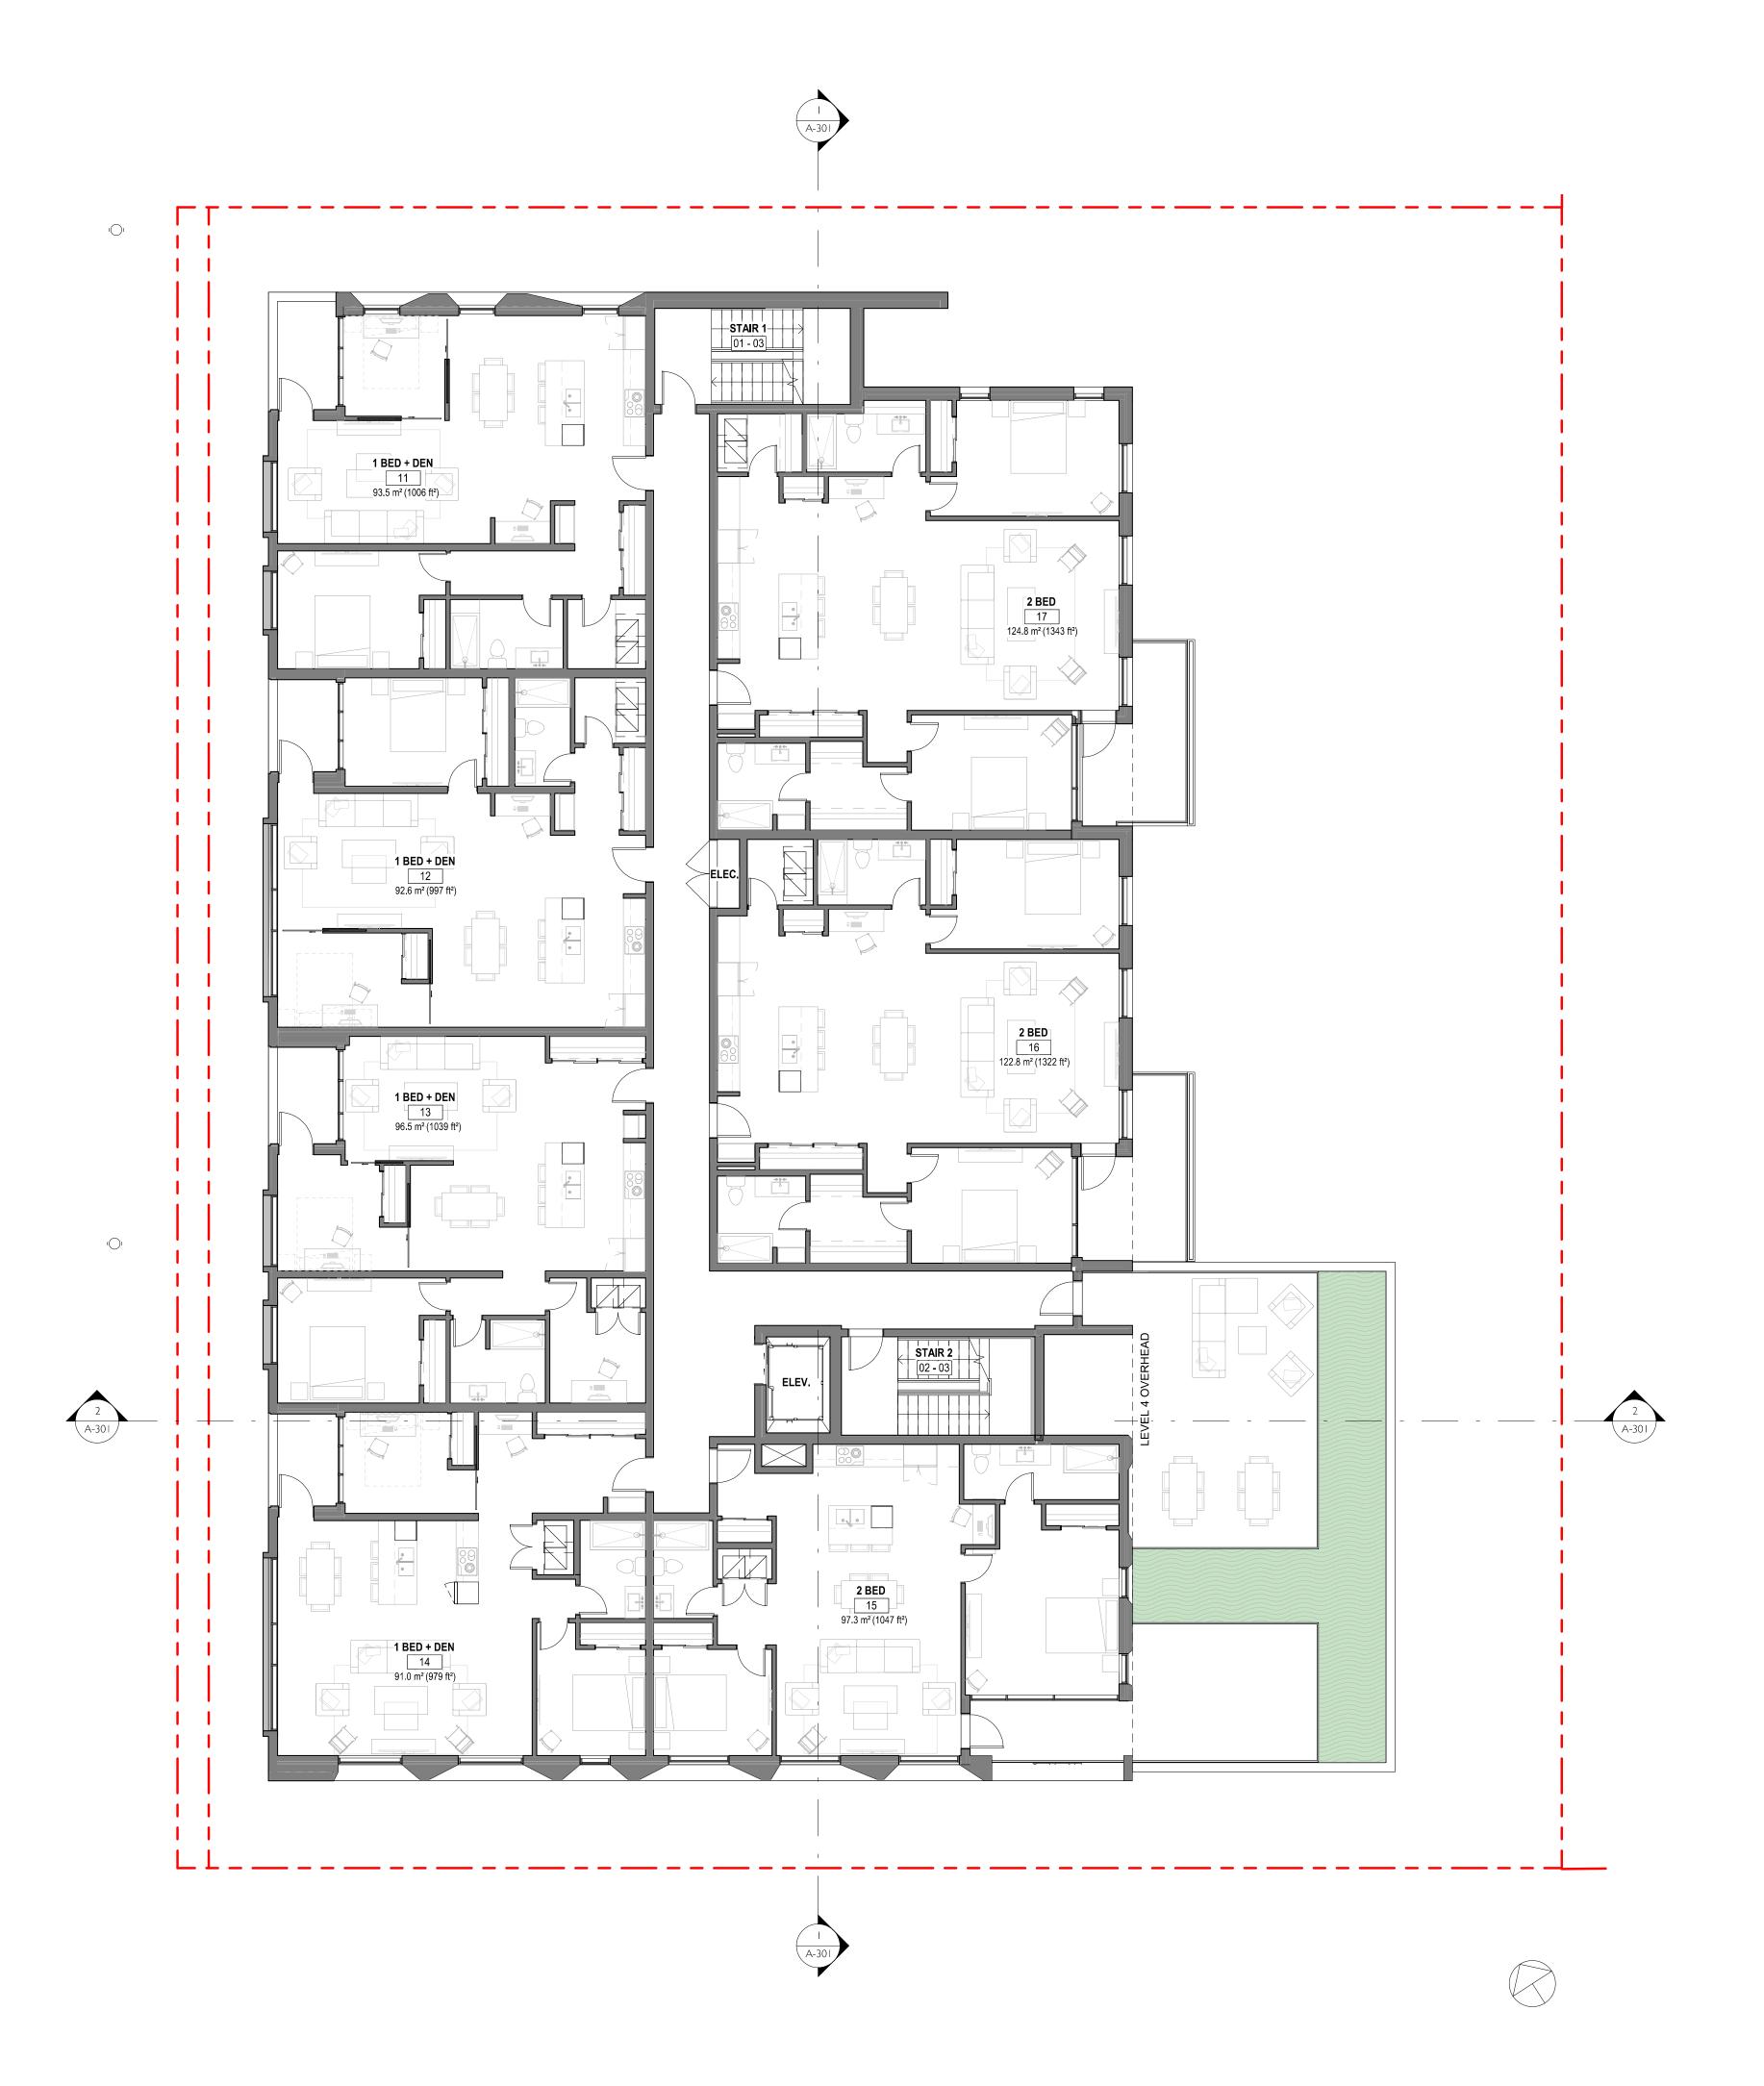
LEVEL 2 PROPOSED PLAN

Date APRIL 29, 2022



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2DP/RZ SubmissionApril 29, 20221Development Tracker ApplicationMarch 7, 2022NO.DESCRIPTIONDATE



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LEVEL 3 PROPOSED PLAN


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Revision
April 29, 2022

A-103

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2 DP/RZ Submission April 29, 2022
1 Development Tracker Application March 7, 2022
NO. DESCRIPTION DATE



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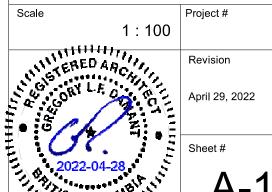
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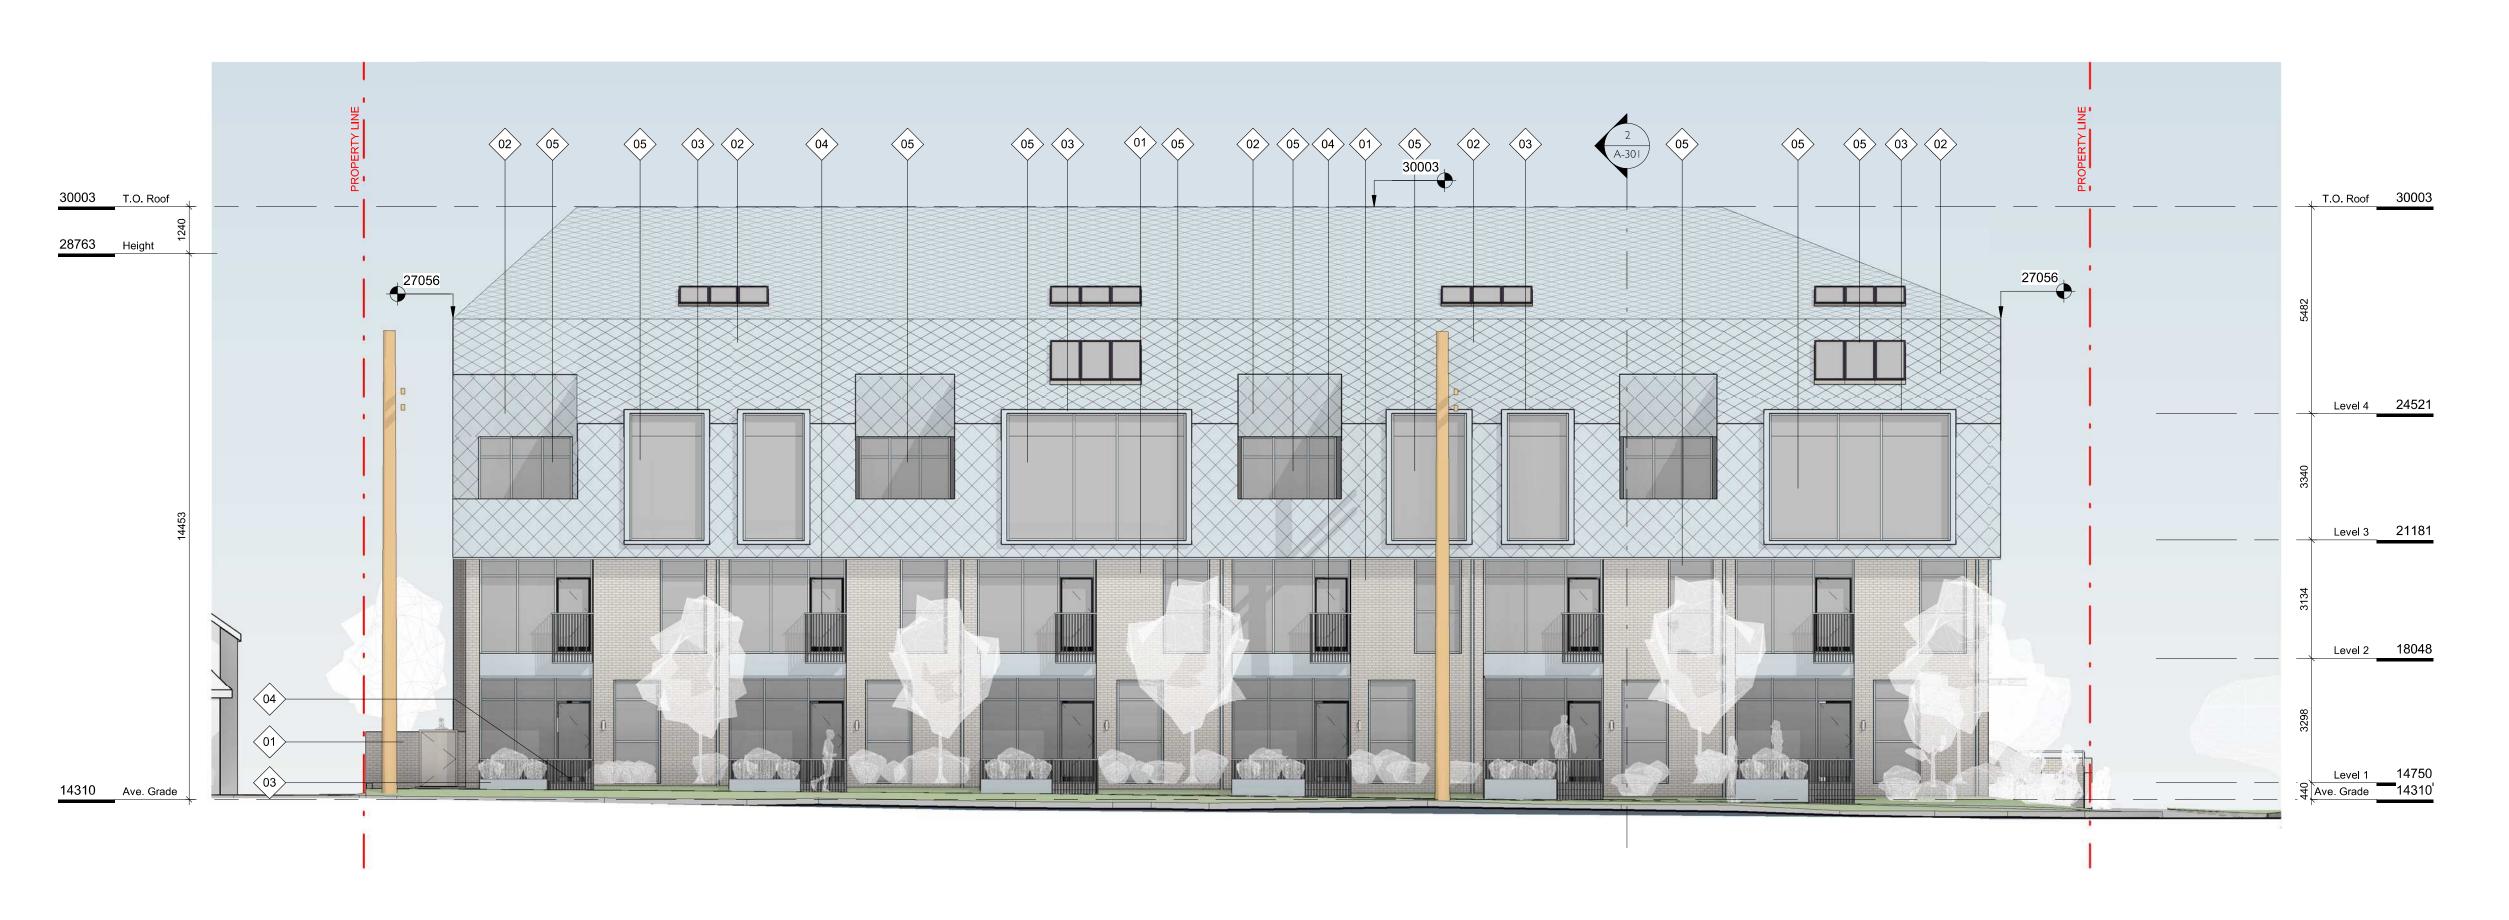
LEVEL 4 PROPOSED PLAN

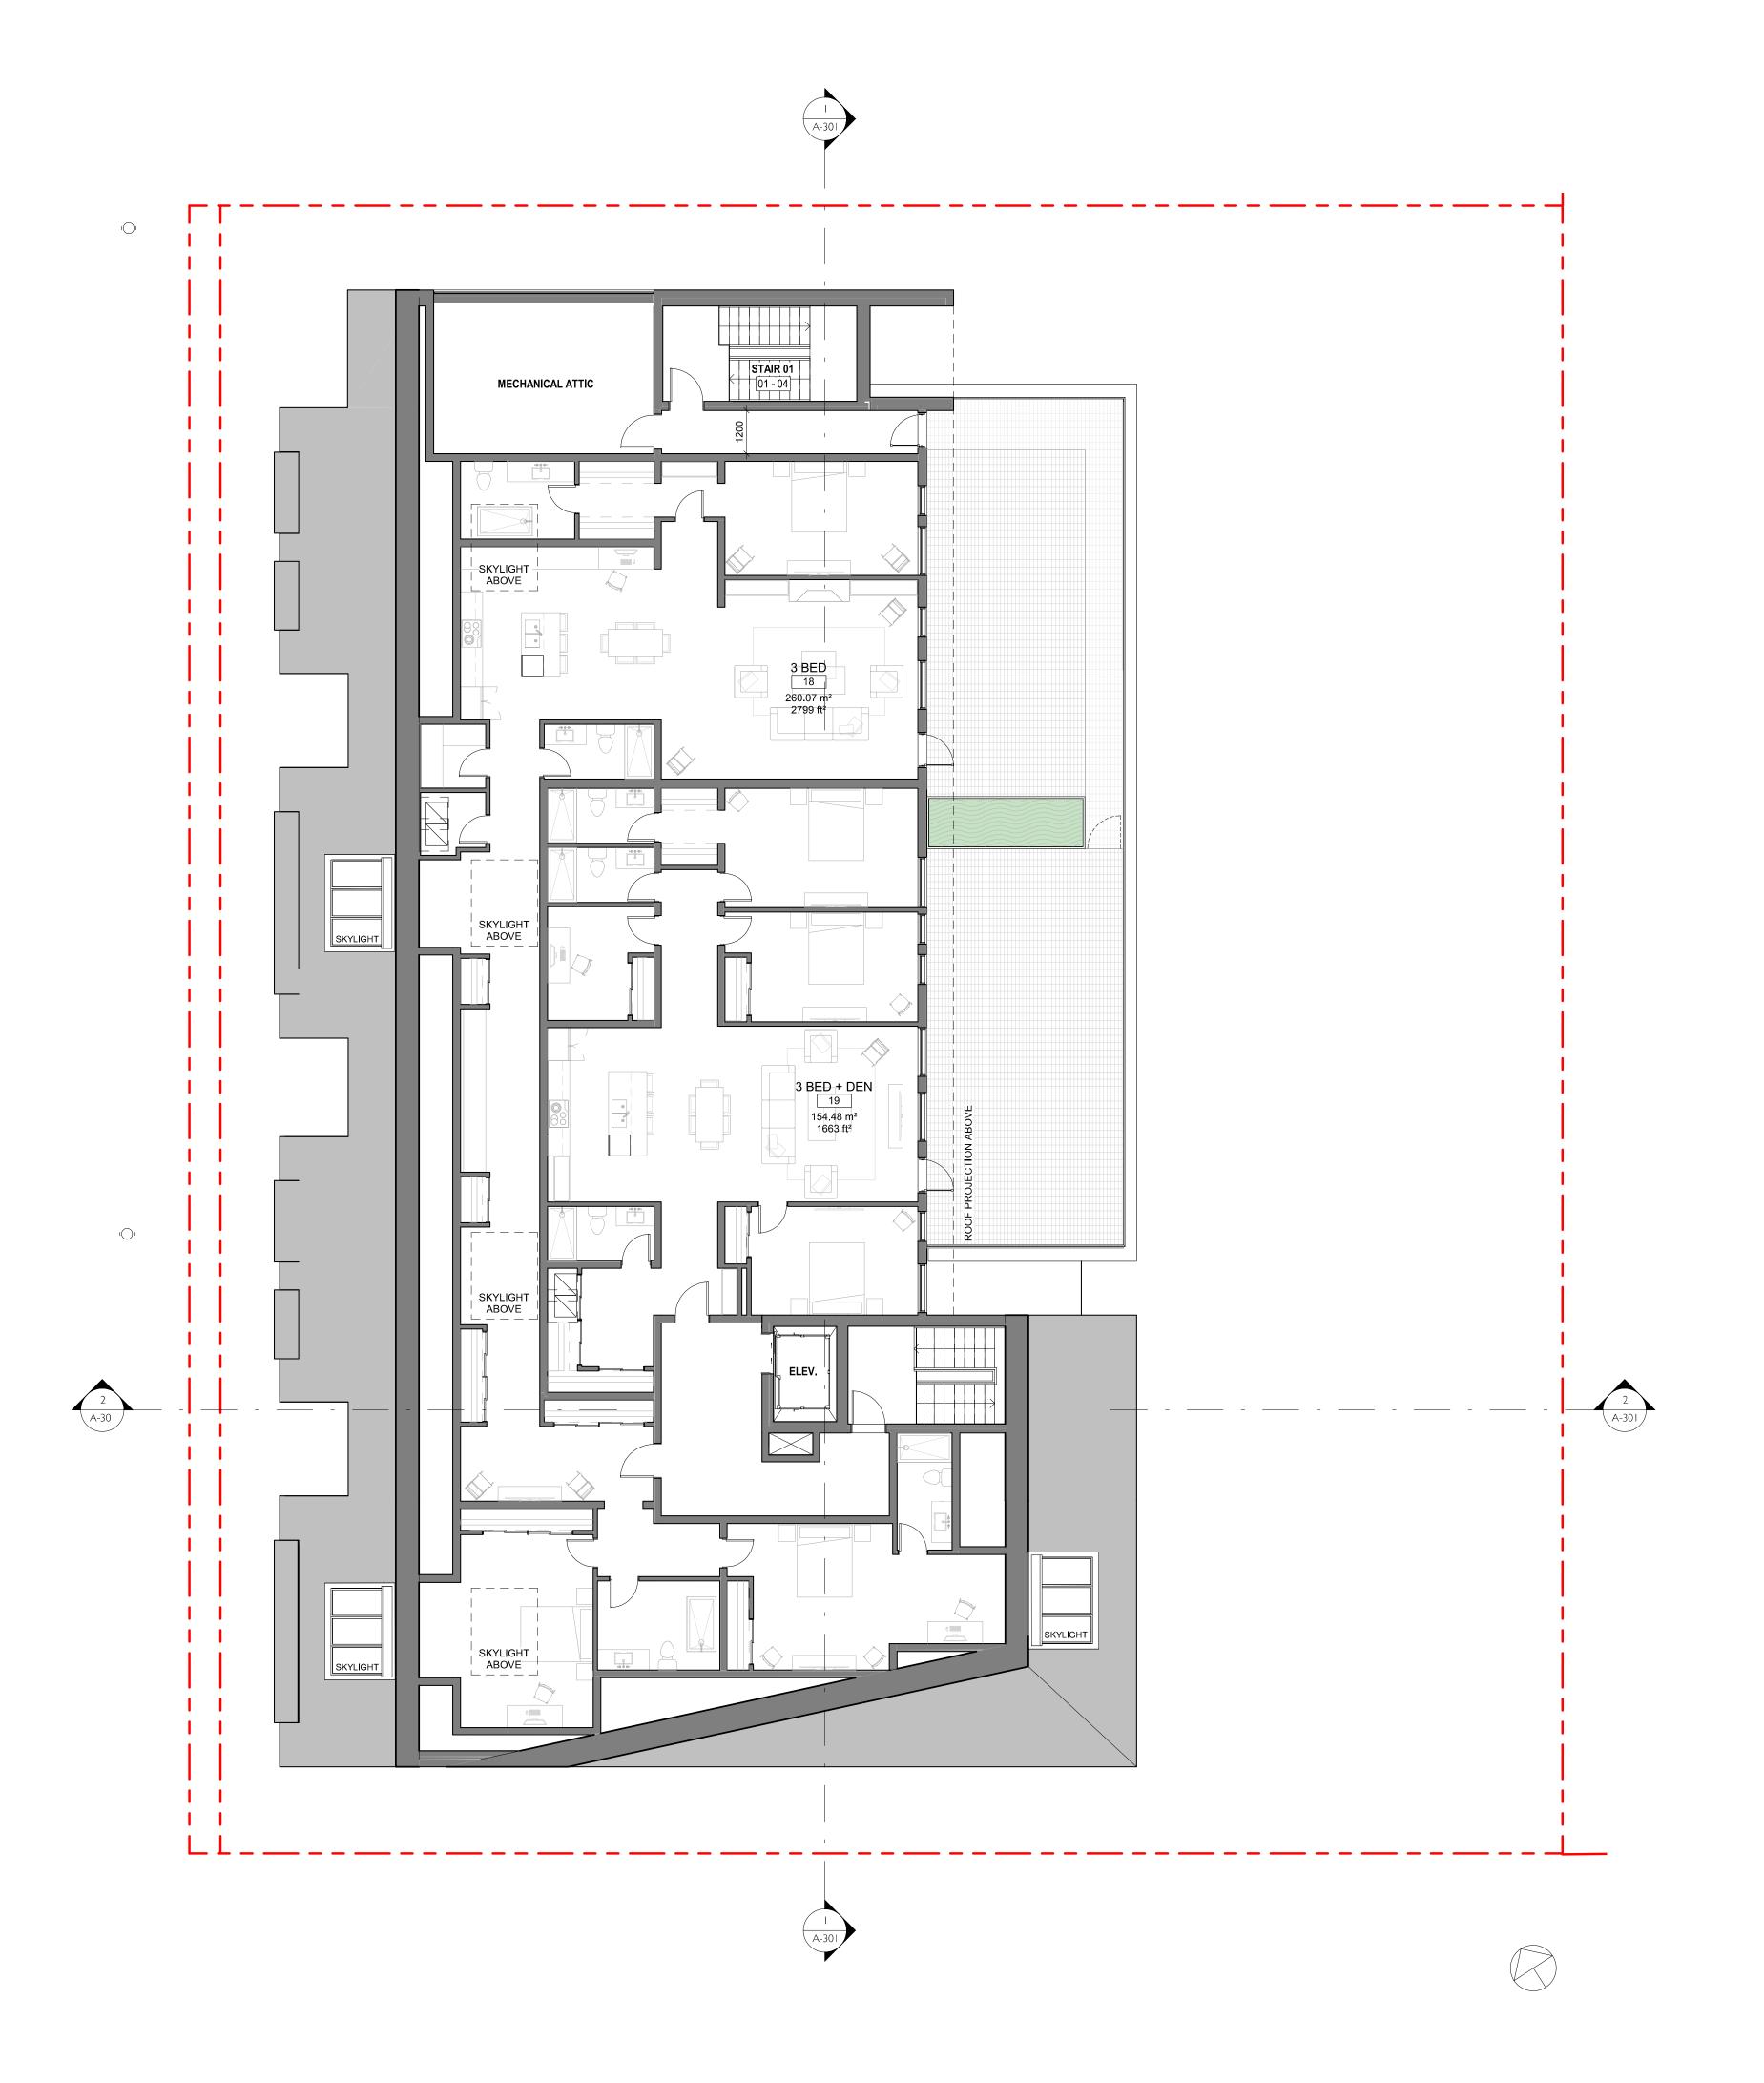APRIL 29, 2022




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1 NW ELEVATION SCALE = 1:100



2 SW ELEVATION SCALE = 1:100


FINISH SCHEDULE

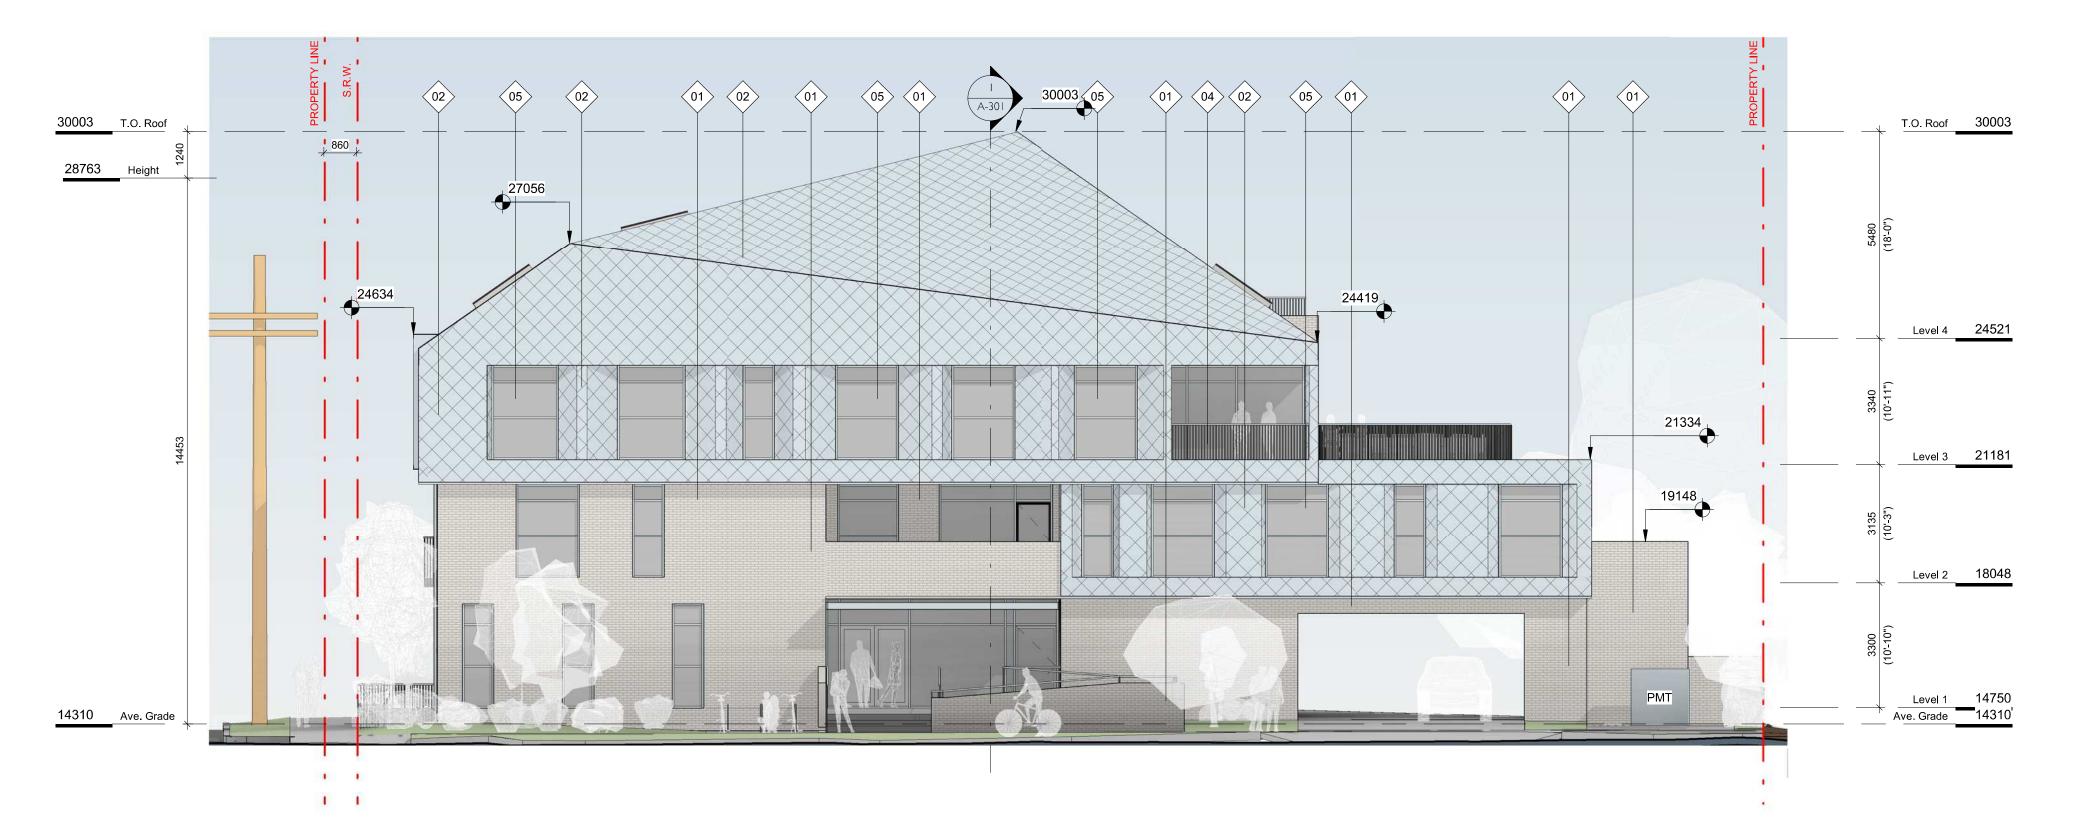- 01. BRICK LIGHT FINISH
- 02. PREFINISHED METAL FISHSCALE SHINGLE ZINC FINISH
- 03. PREFINISHED METAL ZINC FINISH
- 04. METAL PICKET GUARD
- 05. GLAZING

TRANSPARENT

ZINC FINISH

- 06. T&G WOOD
- **CLEAR FINISH**
- 07. HORIZONTAL WOOD FENCE **CLEAR FINISH**

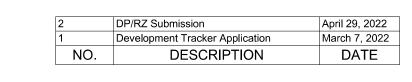



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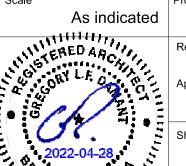
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EXTERIOR ELEVATIONS

APRIL 29, 2022




April 29, 2022

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SE ELEVATION SCALE = 1:100



FINISH SCHEDULE

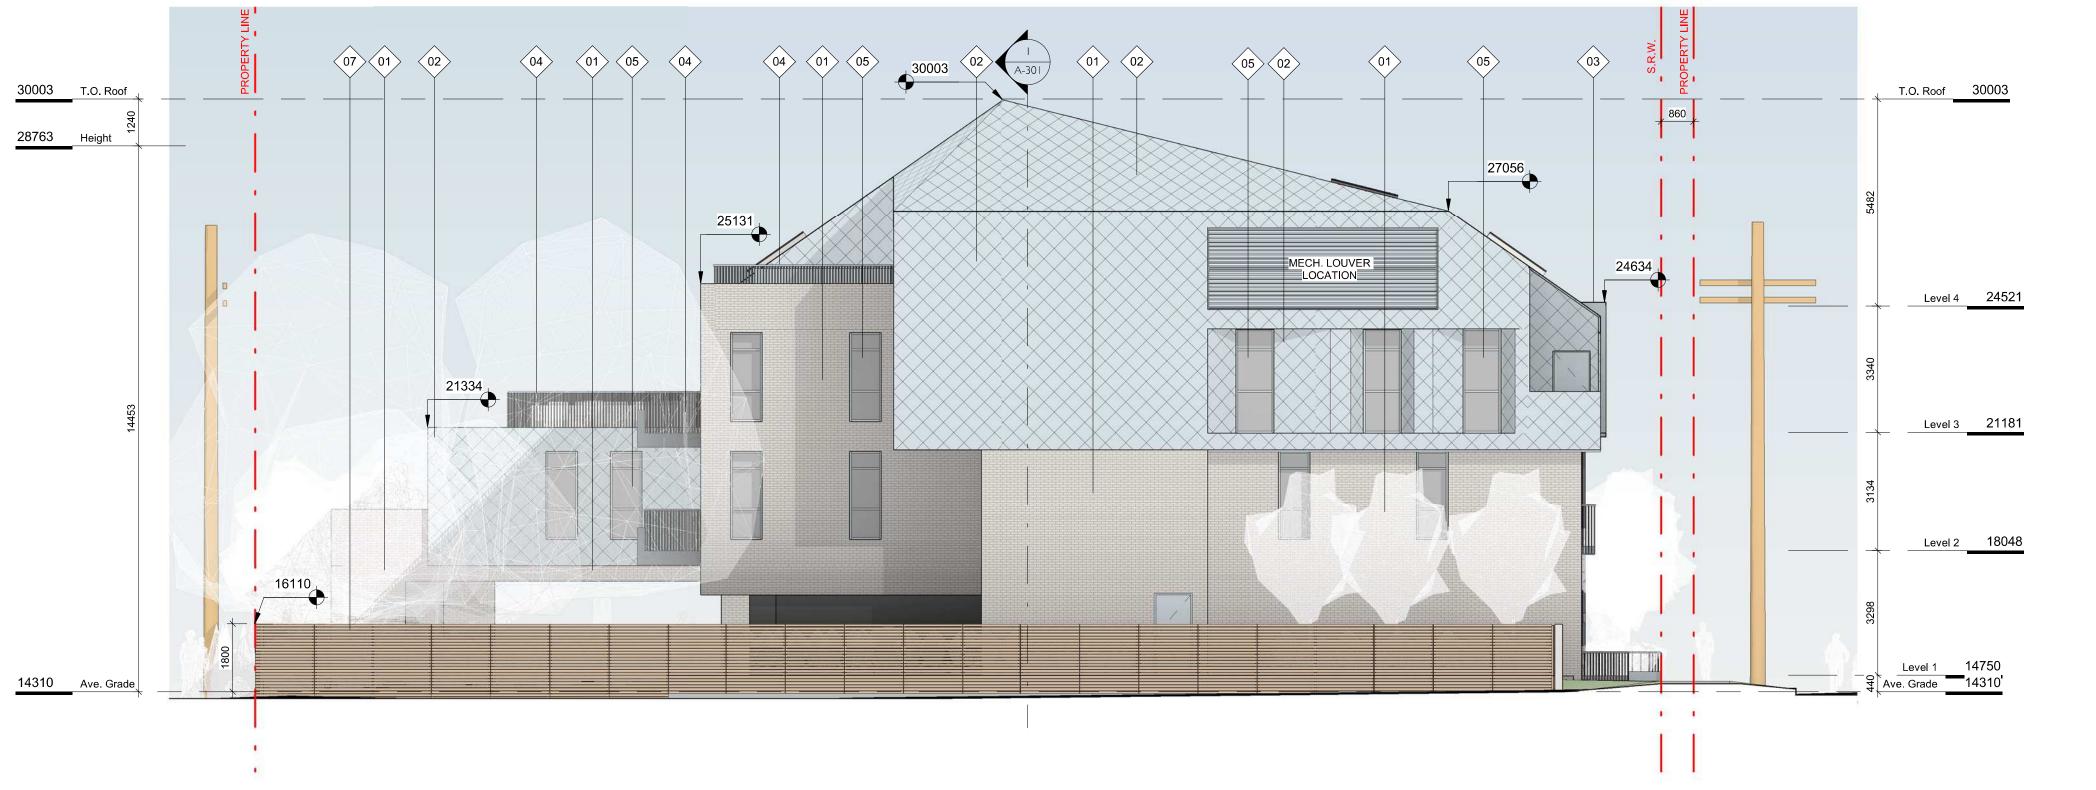01. BRICK LIGHT FINISH

02. PREFINISHED METAL FISHSCALE SHINGLE ZINC FINISH

03. PREFINISHED METAL ZINC FINISH

04. METAL PICKET GUARD ZINC FINISH

05. GLAZING TRANSPARENT

06. T&G WOOD
CLEAR FINISH

07. HORIZONTAL WOOD FENCE CLEAR FINISH

NE ELEVATION
SCALE = 1:100



As indicated

DP/RZ Submission

NO.

Development Tracker Application


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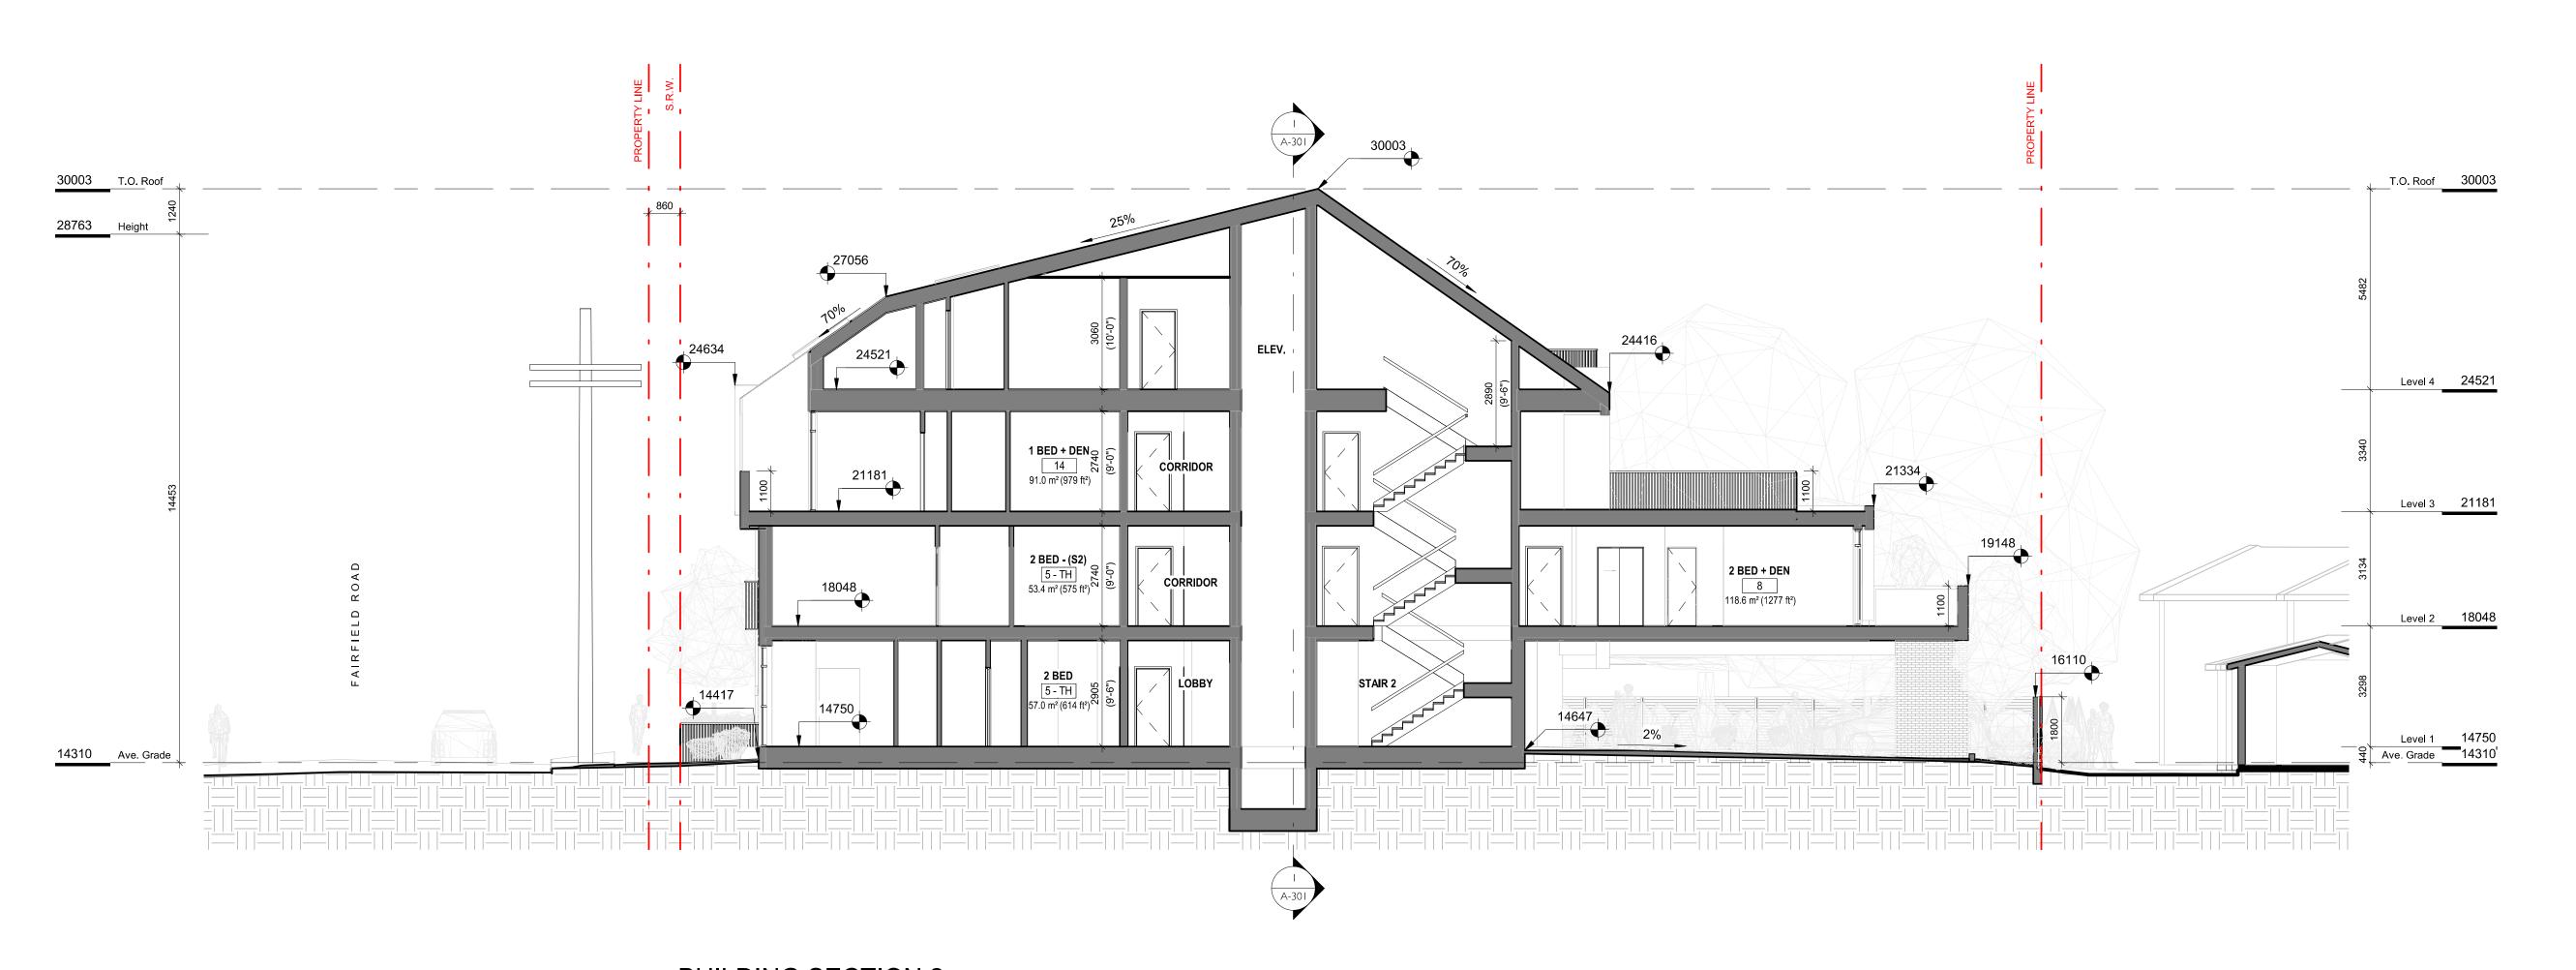
4/28/2022 10:21:50 AM

April 29, 2022

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April 29, 2022 March 7, 2022 DATE





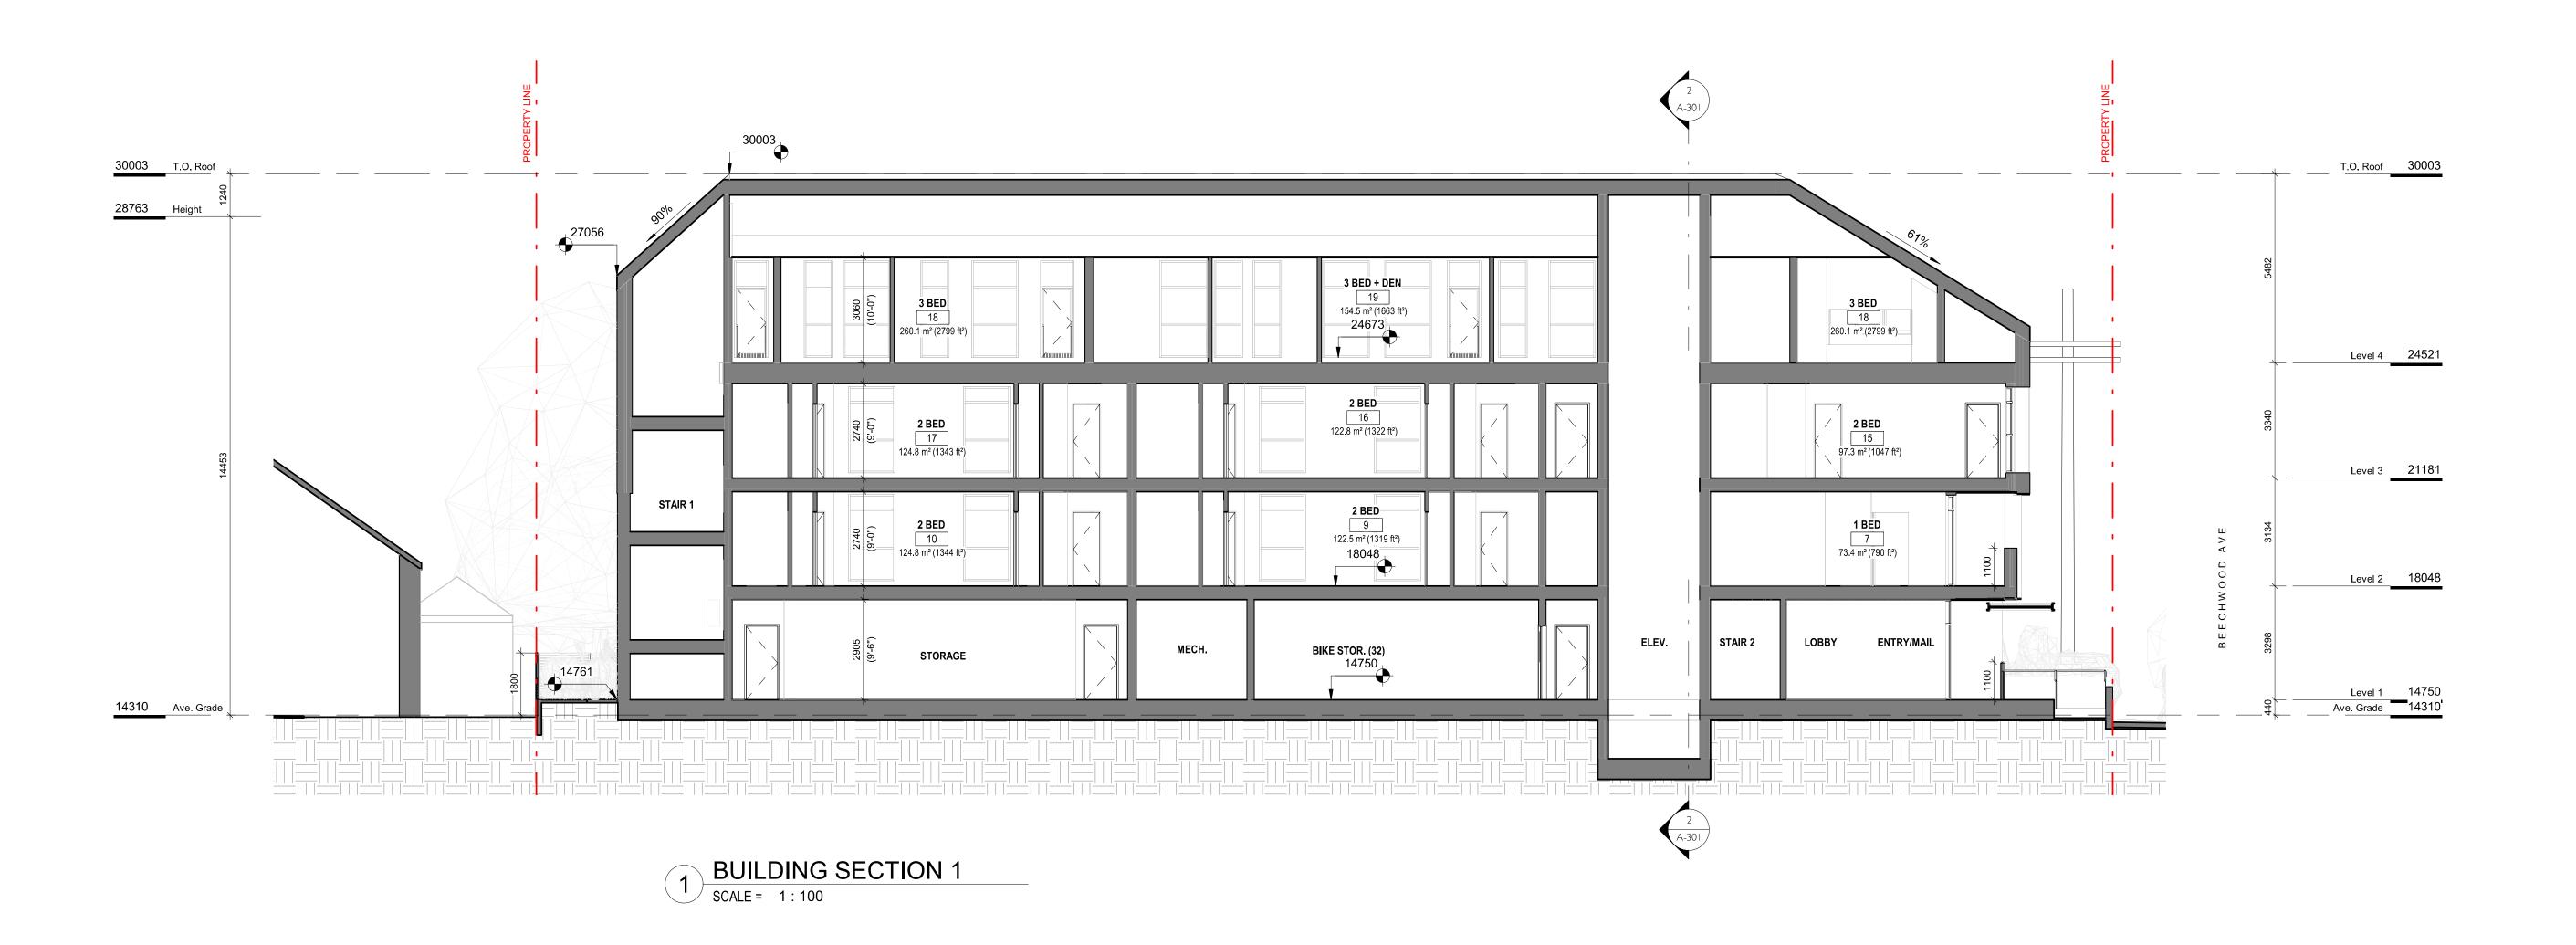


DP/RZ Submission

2 BUILDING SECTION 2
SCALE = 1:100

4/28/2022 10:22:54 AM

vious	Tag or	Surveyed ?	Location (On, Off, Shared,	Bylaw protected	Name		dbh	Ht	Critical root zone radius	Dripline radius	Condition	1	Retention Suitability (onsite	Relative	General field	Tree retention	Retentio
ig#	ID#	(Yes / No)	City)	? (Yes / No / City)	Common	Botanical	(cm)	(m)	(m)	(m)	Health	Structural	trees)		observations/remarks Multiple stems form at 3m above grade - included bark at main stem union with active response growth,	comments Project arborist to supervise all excavation	status
	M1	Yes	City	City	Purple leaf cherry plum	Prunus cerasifera	47	10	5.9	5	Good	Fair/good		Moderate	historic pruning wounds with associated surface decay.	required within the critical root zone. Will be impacted by the installation of the	Retain
	M2	Yes	City	City	Pacific sunset maple	Acer truncatum 'Pacific sunset'	5	6	0.6	1	Good	Good		Moderate	Recently planted - still staked, included bark at stem unions. Multiple stems form at 4m above grade - no major weaknesses	proposed water line. *Possible for transplant. Project arborist to	Remove
	М3	Yes	City	City	Purple leaf cherry plum	Prunus cerasifera	26	6	3.3	4	Good	Fair/good		Moderate	visible at stem unions, historic pruning wounds with associated surface decay. Codomimant stems form at .3m above grade - included bark - not	supervise all excavation required within the critical root zone. Located within the	Retain
313	3383	Yes	On	No	Fig Japanese	Ficus sp.	11, 8, 6	5	2	2	Good	Fair	Unsuitable	Good	active, historic pruning wounds with associated decay. Growing within close proximity to	footprint of the proposed building. Located within the footprint of the	Remove
316	3384	Yes	On	No	maple	Acer palmatum	3, 3, 6 28, 23,	5	1.2	1.5	Good	Fair	Unsuitable	Moderate	existing building. Multiple stems form at 1m above grade - narrow angles of attachment, stems topped and	proposed building. Located within the footprint of the	Remove
317	3385	Yes	On	Yes	dogwood Golden chain	Cornut nuttallii	34, 32	8	8.8	4	Fair	Fair/poor	Unsuitable	Moderate	decayed with sloughing bark. Topped historically at 7m above grade for overhead utilities clearance, stem decay with	proposed building. Located within the footprint of the	Remove
322	3386	Yes	On	Yes	tree Apple	Laburnum sp. Malus sp.	21, 28		3.9	3	Fair Fair	Poor	Unsuitable Unsuitable	Poor Moderate	sloughing bark. Topped historically at 5m above grade - multiple regrowth leaders form at topping locations.	proposed building. Located within the footprint of the proposed building.	Remove
						İ									Flowering cherry, multiple stems form at 2m above grade - narrow angles of attachment, main stem	Will be heavily impacted by excavation required to construct the foundation of the proposed building. Also located within the	
334	3388	Yes	On	Yes	Cherry	Prunus sp.	55	5	6.9	4	Fair	Fair/poor	Unsuitable	Moderate	topped historically at 4m above grade - large topping wound.	footprint of the proposed parking stall. Will be heavily impacted by excavation required to construct the foundation of the	Remove
298	3389	Yes	On	Yes	Cherry	Prunus sp.	19, 25	5	4.6	4	Fair	Fair/poor	Unsuitable	Moderate	Flowering cherry, codominant stems form at base - crossing at .5m above grade, large heading cuts.	proposed building. Will also be impacted by excavation for the proposed parking stall. Will be heavily impacted	Remove
	3390	Yes	On	No	English yew	Taxus baccata	10,8, 8, 6	5	2.5	1	Fair	Fair/poor	Unsuitable	Moderate	Growing within a hedge row of 5 yew trees spaced less than 1m apart.	by excavation required to construct the foundation of the proposed building.	Remove
	3391	Yes	On	No	English yew	Taxus baccata	5, 5, 5	5	1.4	1	Fair	Fair/poor	Unsuitable	Moderate	Growing within a hedge row of 5 yew trees spaced less than 1m apart.	Will be heavily impacted by excavation required to construct the foundation of the proposed building. Will be heavily impacted	Remove
	3392	Yes	On	No	English yew	Taxus baccata	10, 8,	5	2.5	1	Fair	Fair/poor	Unsuitable	Moderate	Growing within a hedge row of 5 yew trees spaced less than 1m apart.	by excavation required to construct the foundation of the proposed building. Will be heavily impacted	Remove
	3393	Yes	On	No	English yew	Taxus baccata	8, 8, 4, 3	5	1.9	1	Fair	Fair/poor	Unsuitable	Moderate	Growing within a hedge row of 5 yew trees spaced less than 1m apart.	by excavation required to construct the foundation of the proposed building. Will be heavily impacted	Remove
	3394	Yes	On	No	English yew	Taxus baccata	10, 9, 9, 4	5	2.6	1	Fair	Fair/poor	Unsuitable	Moderate	Growing within a hedge row of 5 yew trees spaced less than 1m apart.	by excavation required to construct the foundation of the proposed building. Will be heavily impacted	Remove
	3395	Yes	On	No	English yew	Taxus baccata	11,16	5	2.8	1	Fair	Fair/poor	Unsuitable	Moderate	Growing within a hedge row of 13 yew trees spaced less than 1m apart.	by excavation required to construct the foundation of the proposed building. Will be heavily impacted	Remove
	3396	Yes	On	No	English yew	Taxus baccata	18	5	2.3	1	Fair	Fair/poor	Unsuitable	Moderate	Growing within a hedge row of 13 yew trees spaced less than 1m apart.	by excavation required to construct the foundation of the proposed building. Will be heavily impacted	Remove
	3397	Yes	On	No	English yew	Taxus baccata	12, 8	5	2.1	1	Fair	Fair/poor	Unsuitable	Moderate	Growing within a hedge row of 13 yew trees spaced less than 1m apart.	by excavation required to construct the foundation of the proposed building. Will be heavily impacted	Remove
	3398	Yes	On	No	English yew	Taxus baccata	10,10, 8, 8	5	2.6	1	Fair	Fair/poor	Unsuitable	Moderate	Growing within a hedge row of 13 yew trees spaced less than 1m apart.	by excavation required to construct the foundation of the proposed building. Will be heavily impacted	Remove
	3399	Yes	On	No	English yew	Taxus baccata	14, 8	5	2.4	1	Fair	Fair/poor	Unsuitable	Moderate	Growing within a hedge row of 13 yew trees spaced less than 1m apart.	by excavation required to construct the foundation of the proposed building. Will be heavily impacted	Remove
	3400	Yes	On	No	English yew	Taxus baccata	12, 5	5	1.9	1	Fair	Fair/poor	Unsuitable	Moderate	Growing within a hedge row of 13 yew trees spaced less than 1m apart.	by excavation required to construct the foundation of the proposed building. Will be heavily impacted	Remove
	3401	Yes	On	No	English yew	Taxus baccata	8, 8, 5, 5	5	2	1	Fair	Fair/poor	Unsuitable	Moderate	Growing within a hedge row of 13 yew trees spaced less than 1m apart.	by excavation required to construct the foundation of the proposed building. Will be heavily impacted	Remove
	3402	Yes	On	No	English yew	Taxus baccata	8, 8, 5, 4	5	2	1	Fair	Fair/poor	Unsuitable	Moderate	Growing within a hedge row of 13 yew trees spaced less than 1m apart.	by excavation required to construct the foundation of the proposed building. Will be heavily impacted	Remove
	3403	Yes	On	No	English yew	Taxus baccata	8, 6, 5 , 4	5	1.8	1	Fair	Fair/poor	Unsuitable	Moderate	Growing within a hedge row of 13 yew trees spaced less than 1m apart.	by excavation required to construct the foundation of the proposed building. Will be heavily impacted by excavation required	Remove
	3404	Yes	On	No	English yew	Taxus baccata	10, 8, 5, 4	5	2.2	1	Fair	Fair/poor	Unsuitable	Moderate	Growing within a hedge row of 13 yew trees spaced less than 1m apart.	to construct the foundation of the proposed building. Will be heavily impacted by excavation required	Remove
	3405	Yes	On	No	English yew	Taxus baccata	14,10, 10	5	3.3	1	Fair	Fair/poor	Unsuitable	Moderate	Growing within a hedge row of 13 yew trees spaced less than 1m apart.	to construct the foundation of the proposed building. Will be heavily impacted	Remove
	3406	Yes	On	No	English yew	Taxus baccata	16	5	2	1	Fair	Fair/poor	Unsuitable	Moderate	Growing within a hedge row of 13 yew trees spaced less than 1m apart.	by excavation required to construct the foundation of the proposed building. Will be heavily impacted	Remove
	3407	Yes	On	No	English yew	Taxus baccata	10,10, 5, 5, 5	5	2.4	1	Fair	Fair/poor	Unsuitable	Moderate	Growing within a hedge row of 13 yew trees spaced less than 1m apart.	by excavation required to construct the foundation of the proposed building. Will be heavily impacted	Remove
	3408	Yes	On	No	English yew	Taxus baccata	12, 5, 5, 5	5	2.3	1	Fair	Fair/poor	Unsuitable	Moderate	Growing within a hedge row of 7 yew trees spaced less than 1.25m apart.	by excavation required to construct the foundation of the proposed building.	Remove
	3409	Yes	On	No	English yew	Taxus baccata	8, 4	5	1.3	1	Fair	Fair/poor	Unsuitable	Moderate	Growing within a hedge row of 7 yew trees spaced less than 1.25m apart.	Will be heavily impacted by excavation required to construct the foundation of the proposed building.	Remove
							5, 5,			4					Growing within a hedge row of 7 yew trees spaced less than 1.25m	Will be heavily impacted by excavation required to construct the foundation of the	
	3410	Yes	On	No	English yew	Taxus baccata	8, 8,				Fair		Unsuitable	Moderate	apart. Growing within a hedge row of 7 yew trees spaced less than 1.25m	proposed building. Will be heavily impacted by excavation required to construct the foundation of the	Remove
	3411	Yes	On	No	English yew	Taxus baccata	8, 5, 5	5	2.2	1	Fair	Fair/poor	Unsuitable	Moderate	apart. Growing within a hedge row of 7 yew trees spaced less than 1.25m	proposed building. Will be heavily impacted by excavation required to construct the foundation of the	Remove
	3412	Yes	On	No	English yew	Taxus baccata	8, 8, 8			1	Fair		Unsuitable	Moderate	apart. Growing within a hedge row of 7 yew trees spaced less than 1.25m	proposed building. Will be heavily impacted by excavation required to construct the foundation of the	Remove
	3413	Yes	On	No	English yew	Taxus baccata	10,12,	5	1.9	1	Fair	- 10 MANON	Unsuitable	Moderate	apart. Growing within a hedge row of 7 yew trees spaced less than 1.25m	proposed building. Will be heavily impacted by excavation required to construct the foundation of the	Remov
Γ	3414	Yes	On	No	English yew	Taxus baccata	5, 5, 5			1	Fair		Unsuitable	Moderate	apart. Growing within a hedge row of 5 yew trees spaced less than 1m apart. *1 Bylaw size stem within	proposed building. Will be heavily impacted by excavation required to construct the foundation of the	Remov
	3415	Yes	On	Yes*	English yew	Taxus baccata	11, 33		5	_1	Fair		Unsuitable	Moderate	Growing within a hedge row of 5 yew trees spaced less than 1m apart. *1 Bylaw size stem within	proposed building. Will be heavily impacted by excavation required to construct the foundation of the	Remov
	3416	Yes	On	Yes*	English yew	Taxus baccata	5, 5, 5, 6,		2.8	1	Fair		Unsuitable	Moderate	Growing within a hedge row of 5 yew trees spaced less than 1m apart. *1 Bylaw size stem within hedge.	proposed building. Will be heavily impacted by excavation required to construct the foundation of the	Remov
	3417	Yes	On	Yes*	English yew	Taxus baccata	6, 6	5	1.5	1	Fair		Unsuitable	Moderate	Growing within a hedge row of 5 yew trees spaced less than 1m apart. *1 Bylaw size stem within bedge.	proposed building. Will be heavily impacted by excavation required to construct the foundation of the proposed building.	Remov
_	3418	Yes	On	Yes*	English yew	Taxus baccata	13 12,13, 8 5 4		1.6	1	Fair	·	Unsuitable	Moderate	Growing within a hedge row of 5 yew trees spaced less than 1m apart. *1 Bylaw size stem within hedge.	proposed building. Will be heavily impacted by excavation required to construct the foundation of the proposed building	Remov
	3419	Yes	On	Yes*	English yew	Taxus baccata Thuja occidentalis	8, 5, 4 5 -	J	3.1				Unsuitable	Moderate	Hedge row consisting of approximately 30 individual stems - no bylaw stems.	proposed building. Will be heavily impacted by excavation required to construct the foundation of the	Remov
	Hedge	Yes	On	No				5	0.5	0.5	Fair	Fair	Inclutoria	IVIII WALLET	AND MARKET STEELING.	DEDING MAINTENANCE	- ACTUON
314	Hedge 1	Yes	On	No Yes	cedar	'smaragd' Malus sp.		5	4.7	0.5	Fair	Fair/poor	Unsuitable	Moderate Moderate	Codominant stems form at .3m above grade - no major weaknesses visible at stem union, ivy covered trunk.	proposed building. Located within the footprint of the proposed parking stall.	Remove
	1				cedar	'smaragd'	10cm					Fair/poor			Codominant stems form at .3m above grade - no major weaknesses visible at stem union,	Located within the footprint of the	

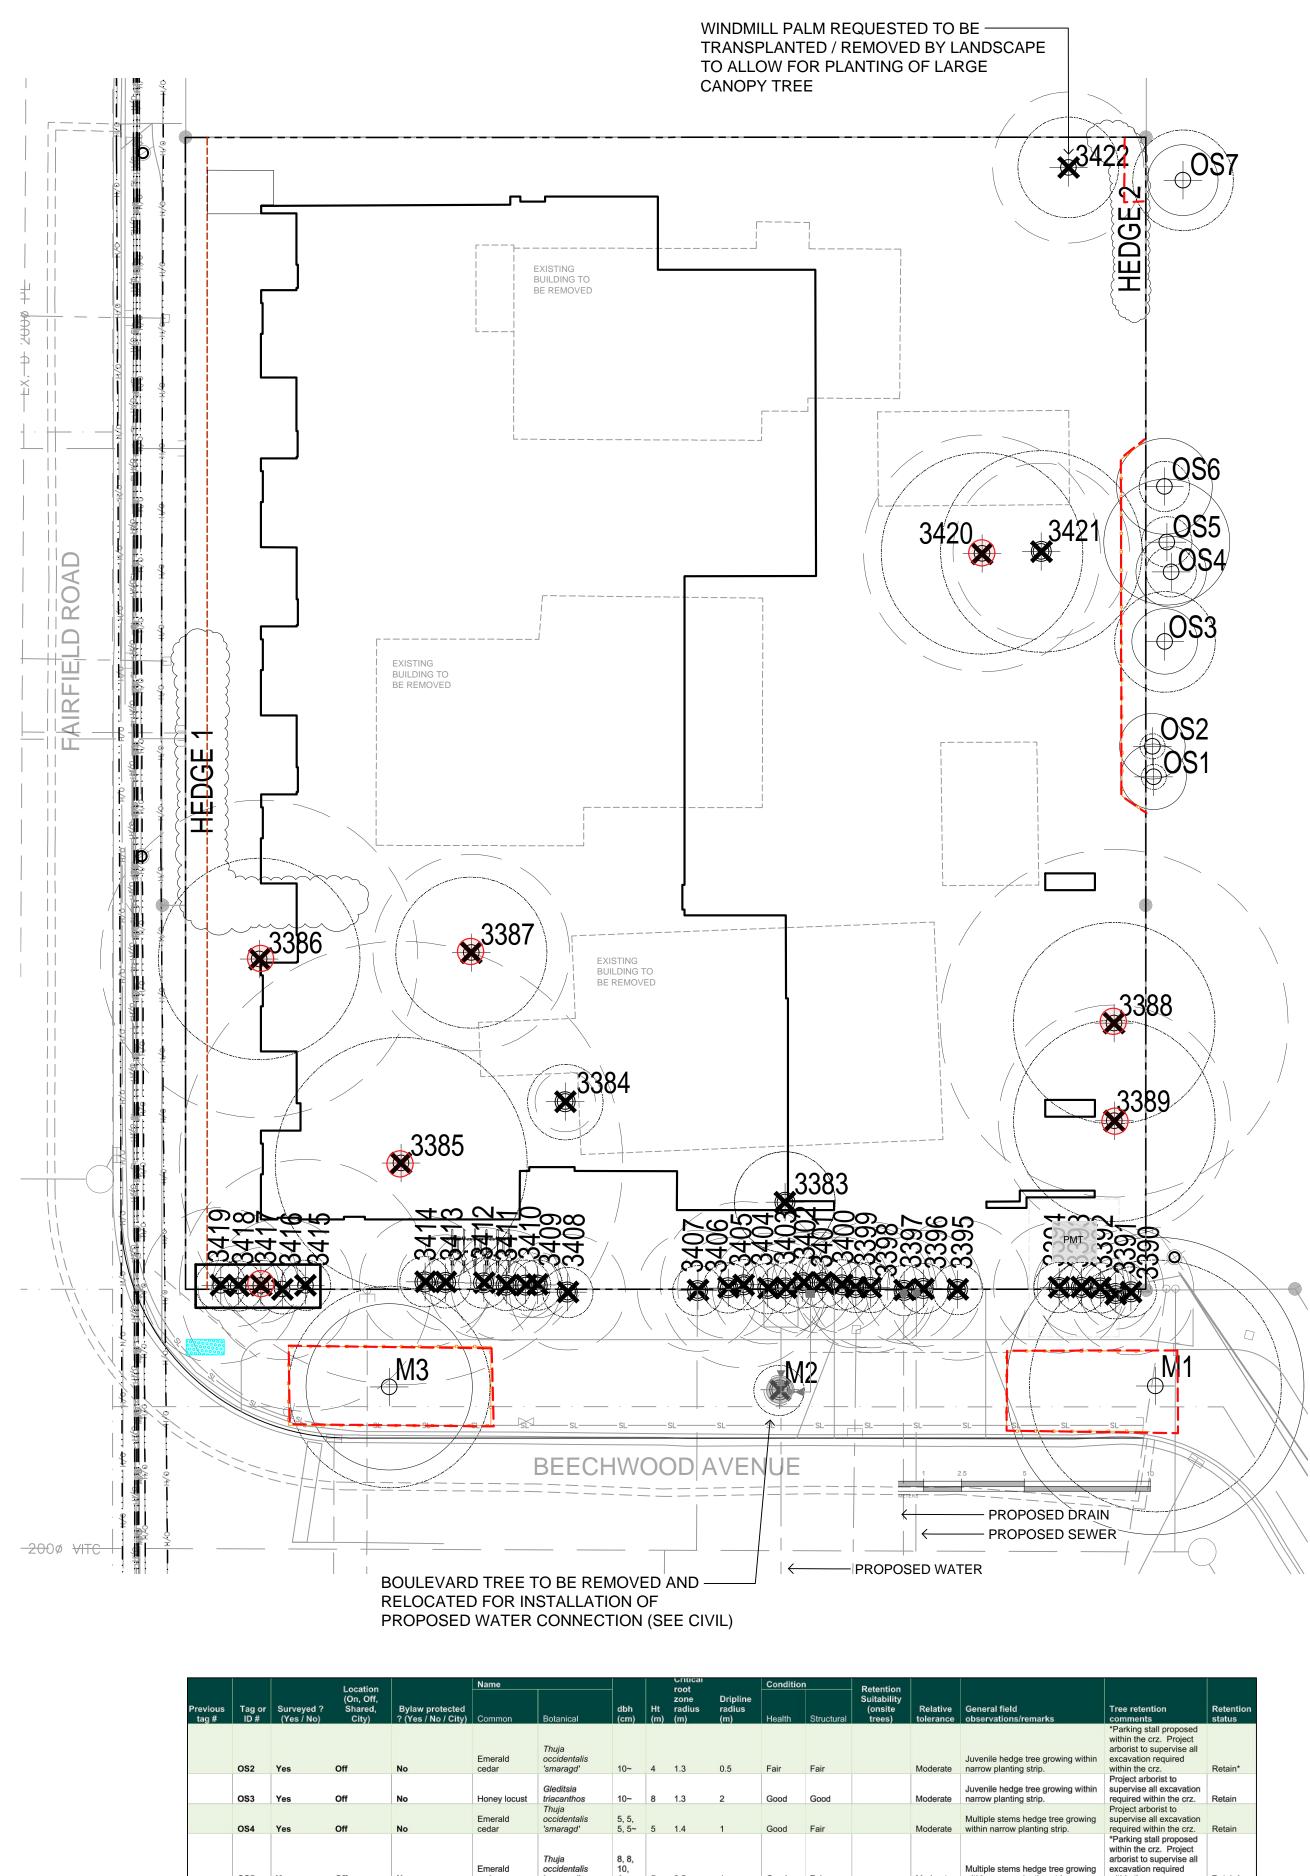

 Cherry
 Prunus sp.
 8, 6, 6~
 5
 1.9
 1
 Good
 Fair

NOTE: SEE ORIGINAL TREE INVENTORY AND TABLES IN REPORT PREPARED BY TALBOT & MACKENZIE

Acer palmatum 5, 5, 4, 4 5 1.4 2 Good Fair

within the crz.

*Parking stall proposed within the crz. Project arborist to supervise all excavation required within the crz.

Will be heavily impacted by excavation required

supervise all excavation required within the crz. Retain
*Parking stall proposed


within the crz. Possible for retention or transplanted elsewhere. Project arborist to

supervise all excavation required within the crz. Retain*

Moderate individual stems. No bylaw stems.

3.0 2 Good Fair Unsuitable Good Crown raised approx. 50% required within the c*CRZ calculated above and drawn as follows on Tree Management Plan (T1): CRZ + 0.5 * d.b.h. (drawn from the center of the stem)

to construct the proposed parking stalls Remove

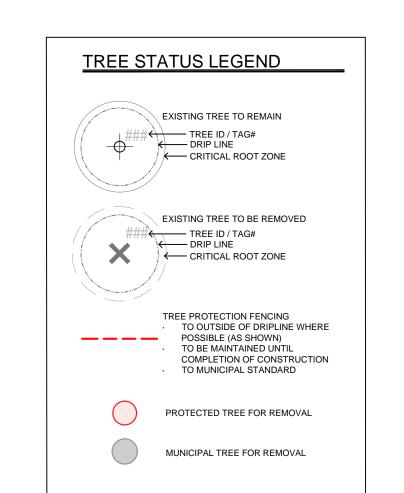



1608 Camosun Street, Victoria BC V8T 3E6 Info@biophiliacollective.ca 250 590 1156

OWNER/CLIENT:

ARYZE DEVELOPMENTS

PROJECT ADDRESS:

1733 FAIRFIELD, VICTORIA, BC

DESIGNED BY: BIANCA BODLEY DRAWN BY: KARIANNE HOWARTH

2 ISSUED FOR RZ/DP 22\05\02
1 ISSUED FOR DEVELOPMENT TRACKER 22\03\04
NO. ISSUE YY\MM\DD

SEAL

NORTH ARROW

DRAWING TITLE:

TREE REMOVAL & PROTECTION PLAN

DWG NO:

L0

SCALE: **1:150**





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SEAL


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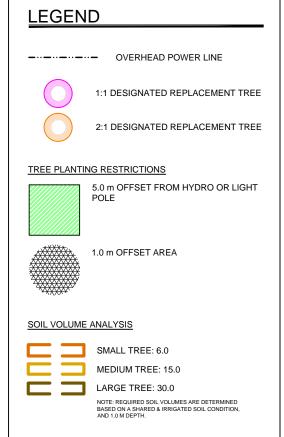
DRAWING TITLE:

LANDSCAPE SITE PLAN

DWG NO:

SCALE: **AS NOTED**



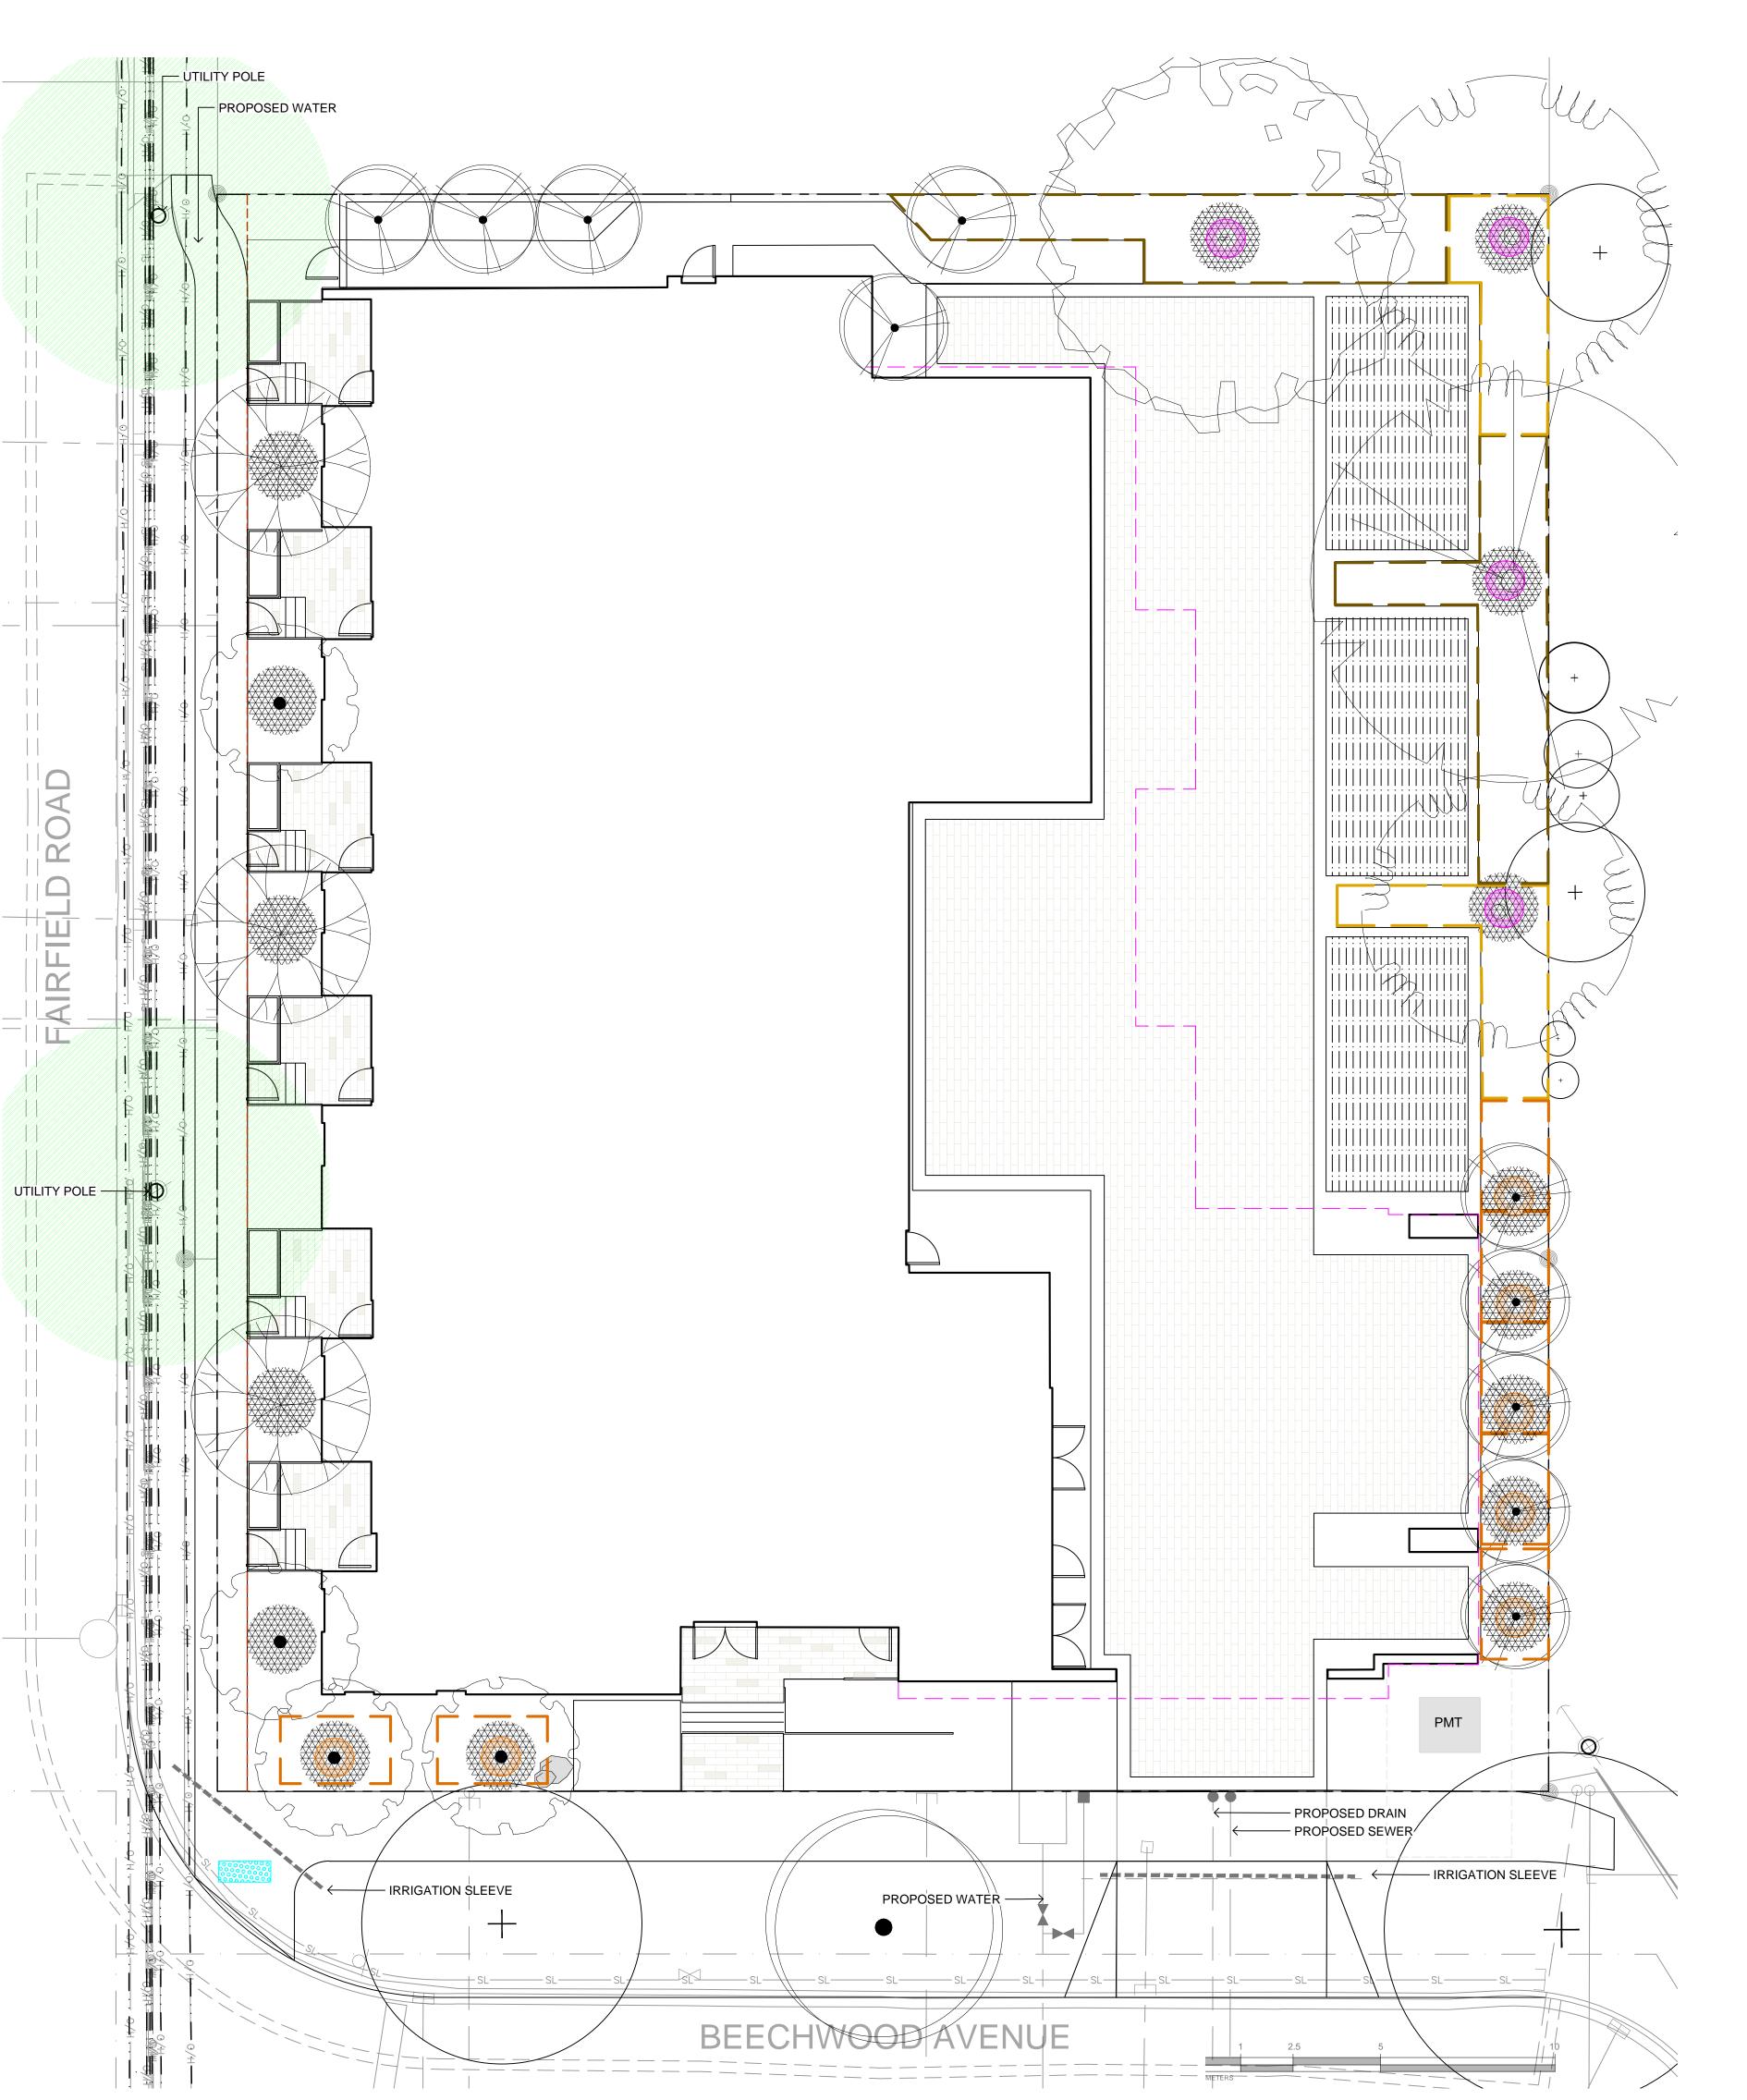

REPLACEMENT TREES TO BE PLANTED ON SITE

REPLACEMENT TREE SHORTFALL

TOTAL PROPOSED TREES ON SITE (REPLACEMENT(ACTUAL) + OTHER)

uantity	Symbol	Latin Name	Common Name	Container	Caliper	Size	Native	Remarks	Height at Maturity (m)	Spread at Maturity (m)
4		Acer griseum	Paperbark Maple	B&B	6 cm	>2 m		full/part sun	6-9	5-7
2	M. M	Fraxinus americana 'Autumn Applause'	Autumn Applause white ash	B&B	6 cm	>2 m		Medium	12-15	7-9
1		Liriodendron tulipifera	Tulip tree	B&B	6 cm	>2 m		full sun	18-24	9-12
10		Populus tremuloides 'Erecta'	Swedish Columnar Aspen	B&B	6 cm	>2 m		full sun	9-12	1.8-2.5
3		Styrax japonicus	Japanese snowbell	B&B	6 cm	>2 m		full sun - part shade	7.0	7.0
1		Quercus palustris	Pin Oak	B&B	6 cm	>2 m		full sun	10	10
1	•	BOULEVARD TREE TO BE DETERMINED BY PARKS AT BP		B&B	4cm					

TREE IMPACT SUMMARY TABLE						
TREE STATUS	TOTAL	To be RETAINED	To be REMOVED	REPLACEMENTS REQUIRED	MINIMUM REQUIRED FOR LOT SIZE	PROPOSED
ON-SITE TREES BYLAW PROTECTED	7	0	7	7	9	7.5
MUNICIPAL TREES	3	2	1	1		1
NEIGHBORING TREES, BYLAW PROTECTED	0	0	0	0		0

7.5 1.5 ACTUAL NUMBER : 11 4 x LARGE TREE (1:1) 7 x SMALL TREE (2:1)

2	ISSUED FOR RZ/DP	22\05\02
1	ISSUED FOR DEVELOPMENT TRACKER	22\03\04
IO.	ISSUE	YY\MM\DD

SEAL

B

OWNER/CLIENT:

PROJECT ADDRESS:

1733 FAIRFIELD,

DESIGNED BY: BIANCA BODLEY

DRAWN BY: KARIANNE HOWARTH

VICTORIA, BC

1608 Camosun Street, Victoria BC V8T 3E6

Info@biophiliacollective.ca 250 590 1156

ARYZE DEVELOPMENTS




DRAWING TITLE:

TREE PLANTING PLAN

DWG NO:

SCALE: **1:100**

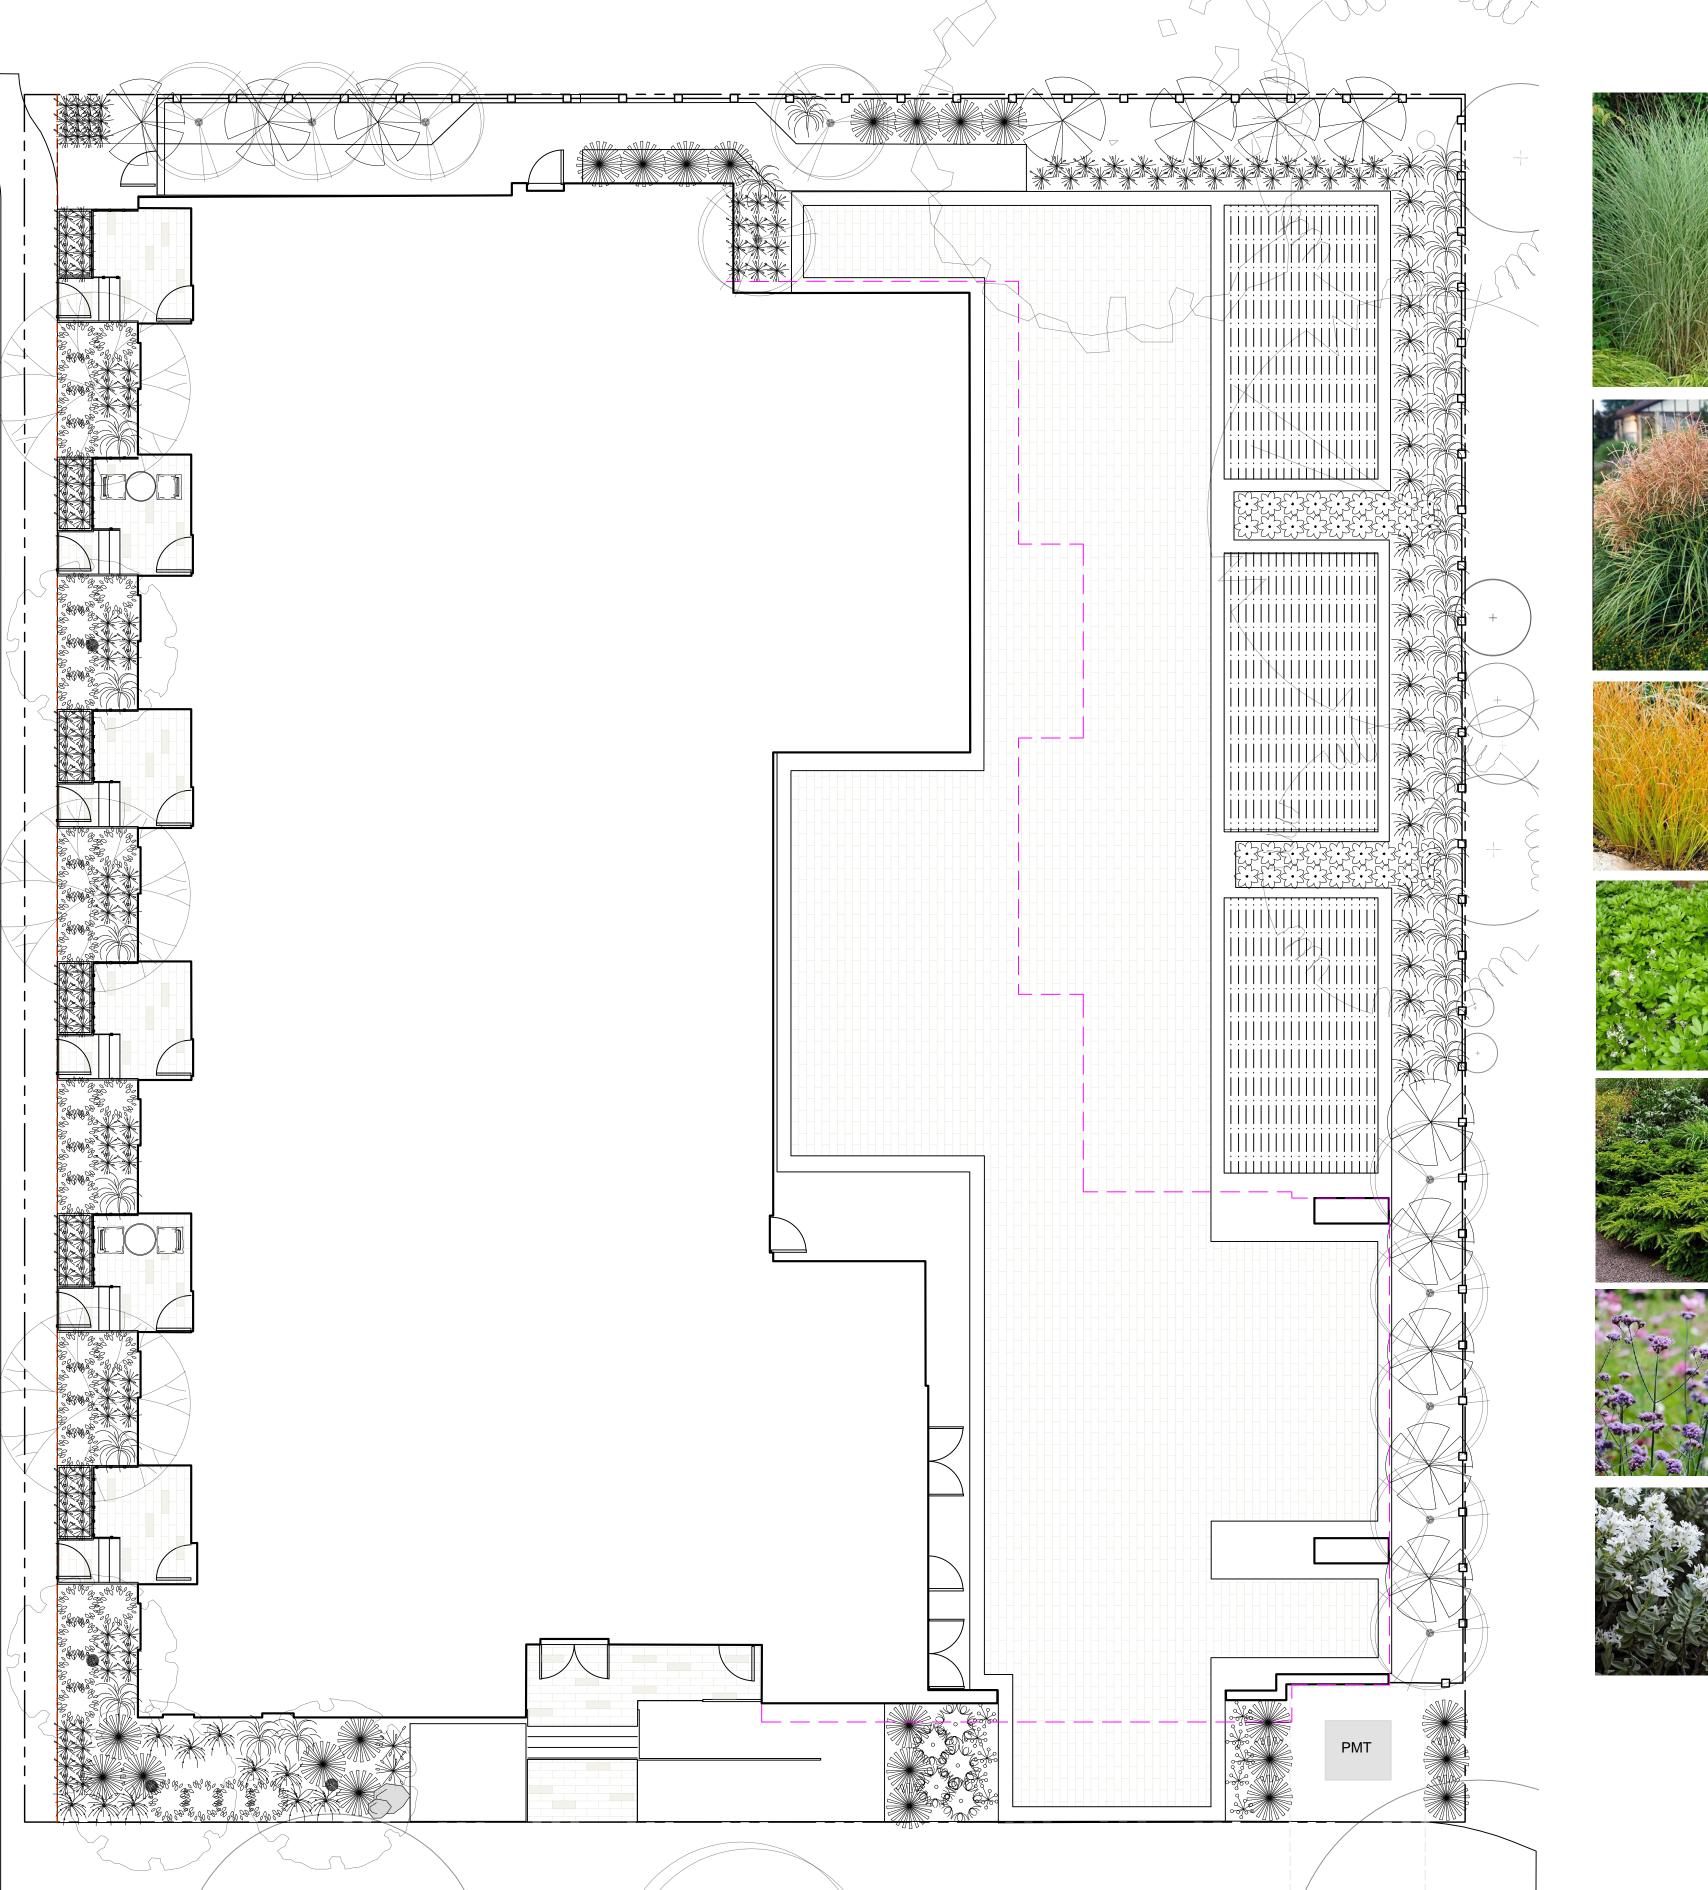

Quantity	Symbol	Latin Name	Common Name	Container	Native	Pollinator
1		Amelanchier canadensis	serviceberry	#5	у	у
1		Armeria maritima 'Alba'	White-flowered Thrift	tray		у
2	≈ ∵.	Arctostaphylos Uva-Ursi 'Massachusetts'	Kinnikinnick	tray	у	у
130	*	Carex testacea 'Prairie Fire'	New Zealand hair sedge	#1		
23		Cephalotaxus harringtonia 'Prostrata'	Spreading Japanese plum yew	#2		
4		Cerastium tomentosum	snow in summer	tray		у
12		Choisya ternata	Mexican mock orange	#3		у
29	*	Festuca glauca 'Elijah Blue'	Elijah Blue fescue	#1		
5	300	Hebe rakaiensis	Shrubby veronica	#1		у
35	18 8 8 8 8 8 8 8 8 8 8 8 8 8 8 8 8 8 8	llex crenata 'Compacta'	Compact Japanese Holly	#2		
35	*	Miscanthus sinensis 'Huron Light'	Huron Light maiden grass	#2		
33	*	Miscanthus sinensis 'Morning Light'	Chinese silver grass Morning Light	#2		
5		Pinus mugo 'Gnom'	Dwarf mountain pine	#2		
10		Pinus strobus 'Horsford Dwarf'	Horsford Dwarf Eastern white pine	#2		
6	and my many many many many many many many m	Rhododendron x 'Cunningham's White'	Cunningham's white rhododendron	#4		у
10	æ	Verbena bonariensis 'Lollipop'	Dwarf purpletop	#1		Υ



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1733 FAIRFIELD, VICTORIA, BC

DESIGNED BY: **BIANCA BODLEY** DRAWN BY: KARIANNE HOWARTH

2 ISSUED FOR RZ/DP


NORTH ARROW


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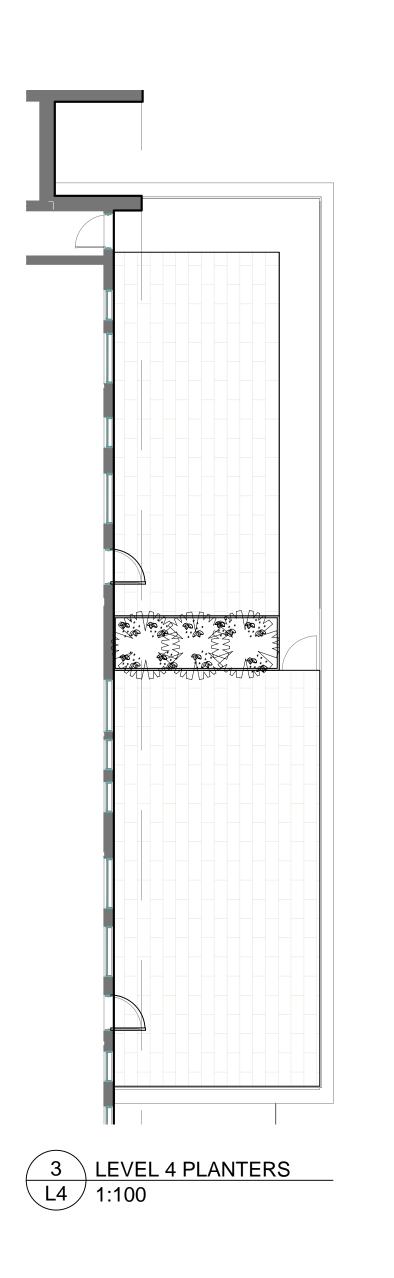
GROUND FLOOR PLANTING PLAN


DWG NO:

SCALE: 1:100



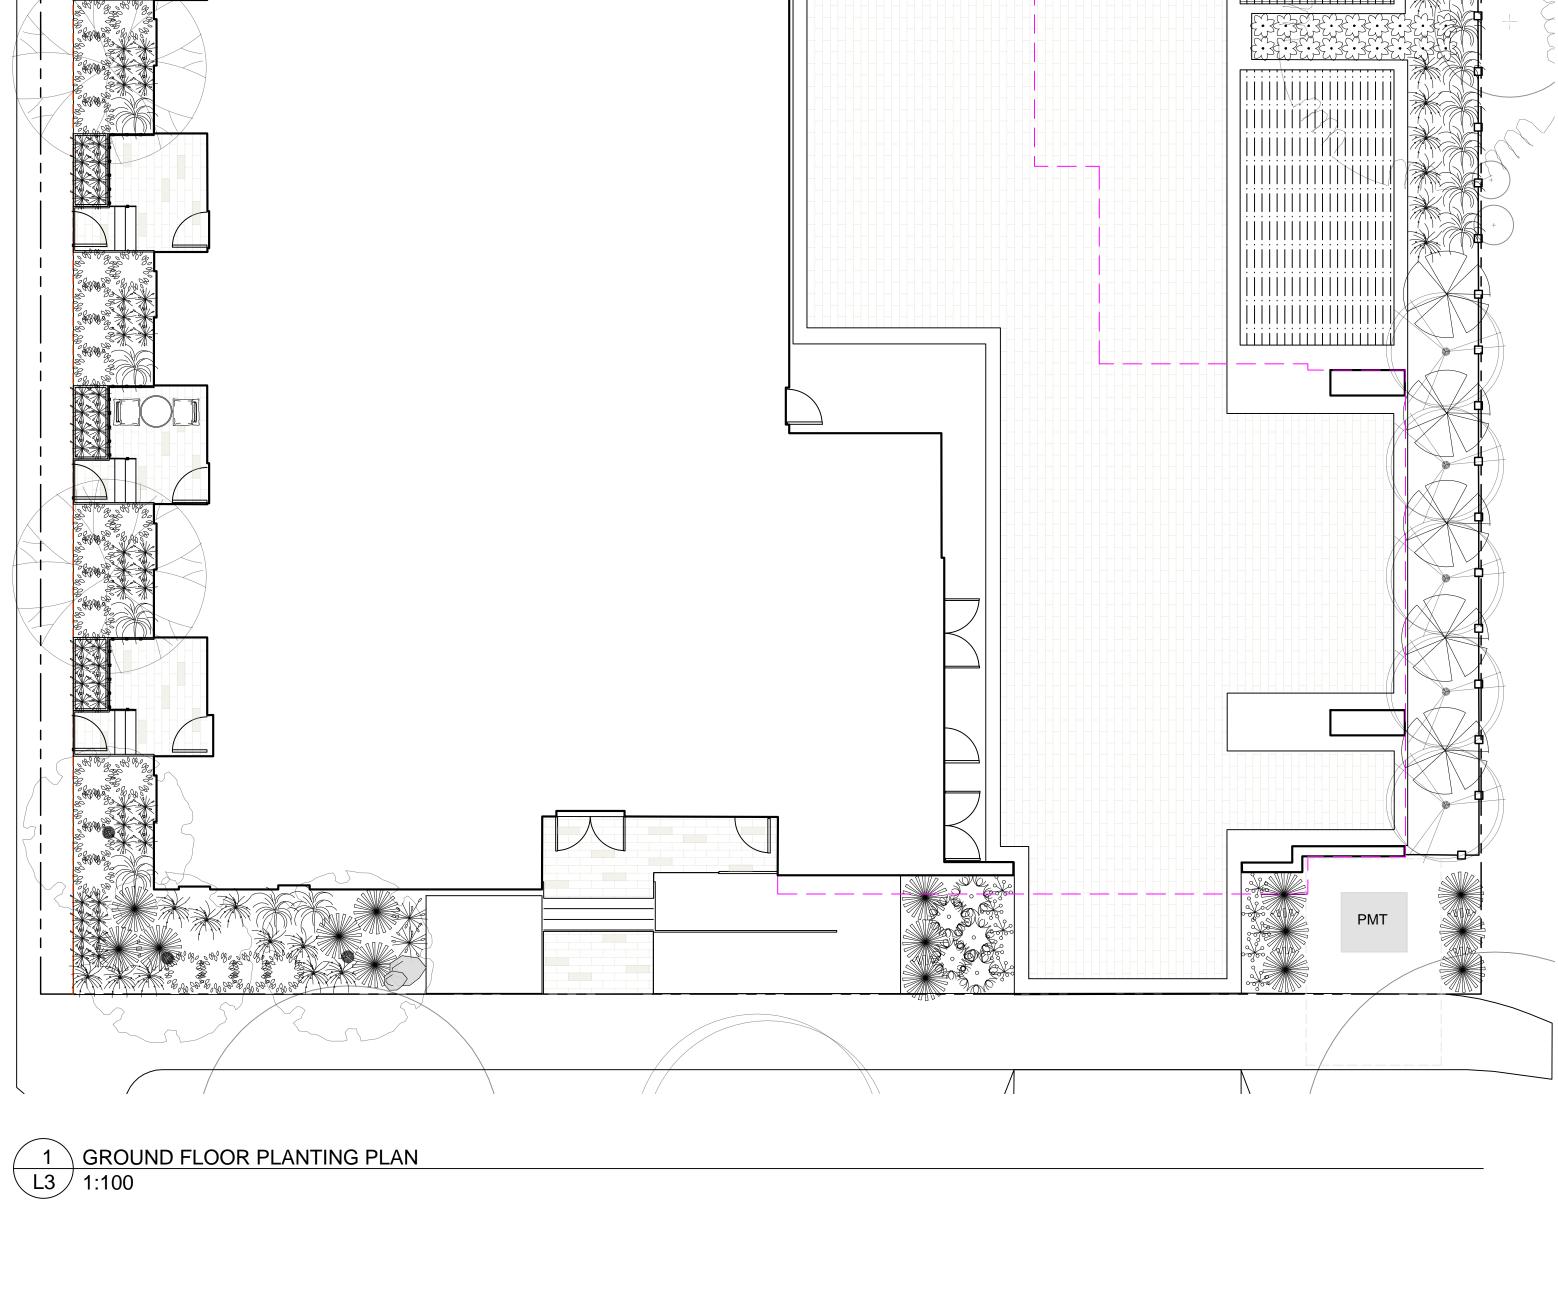

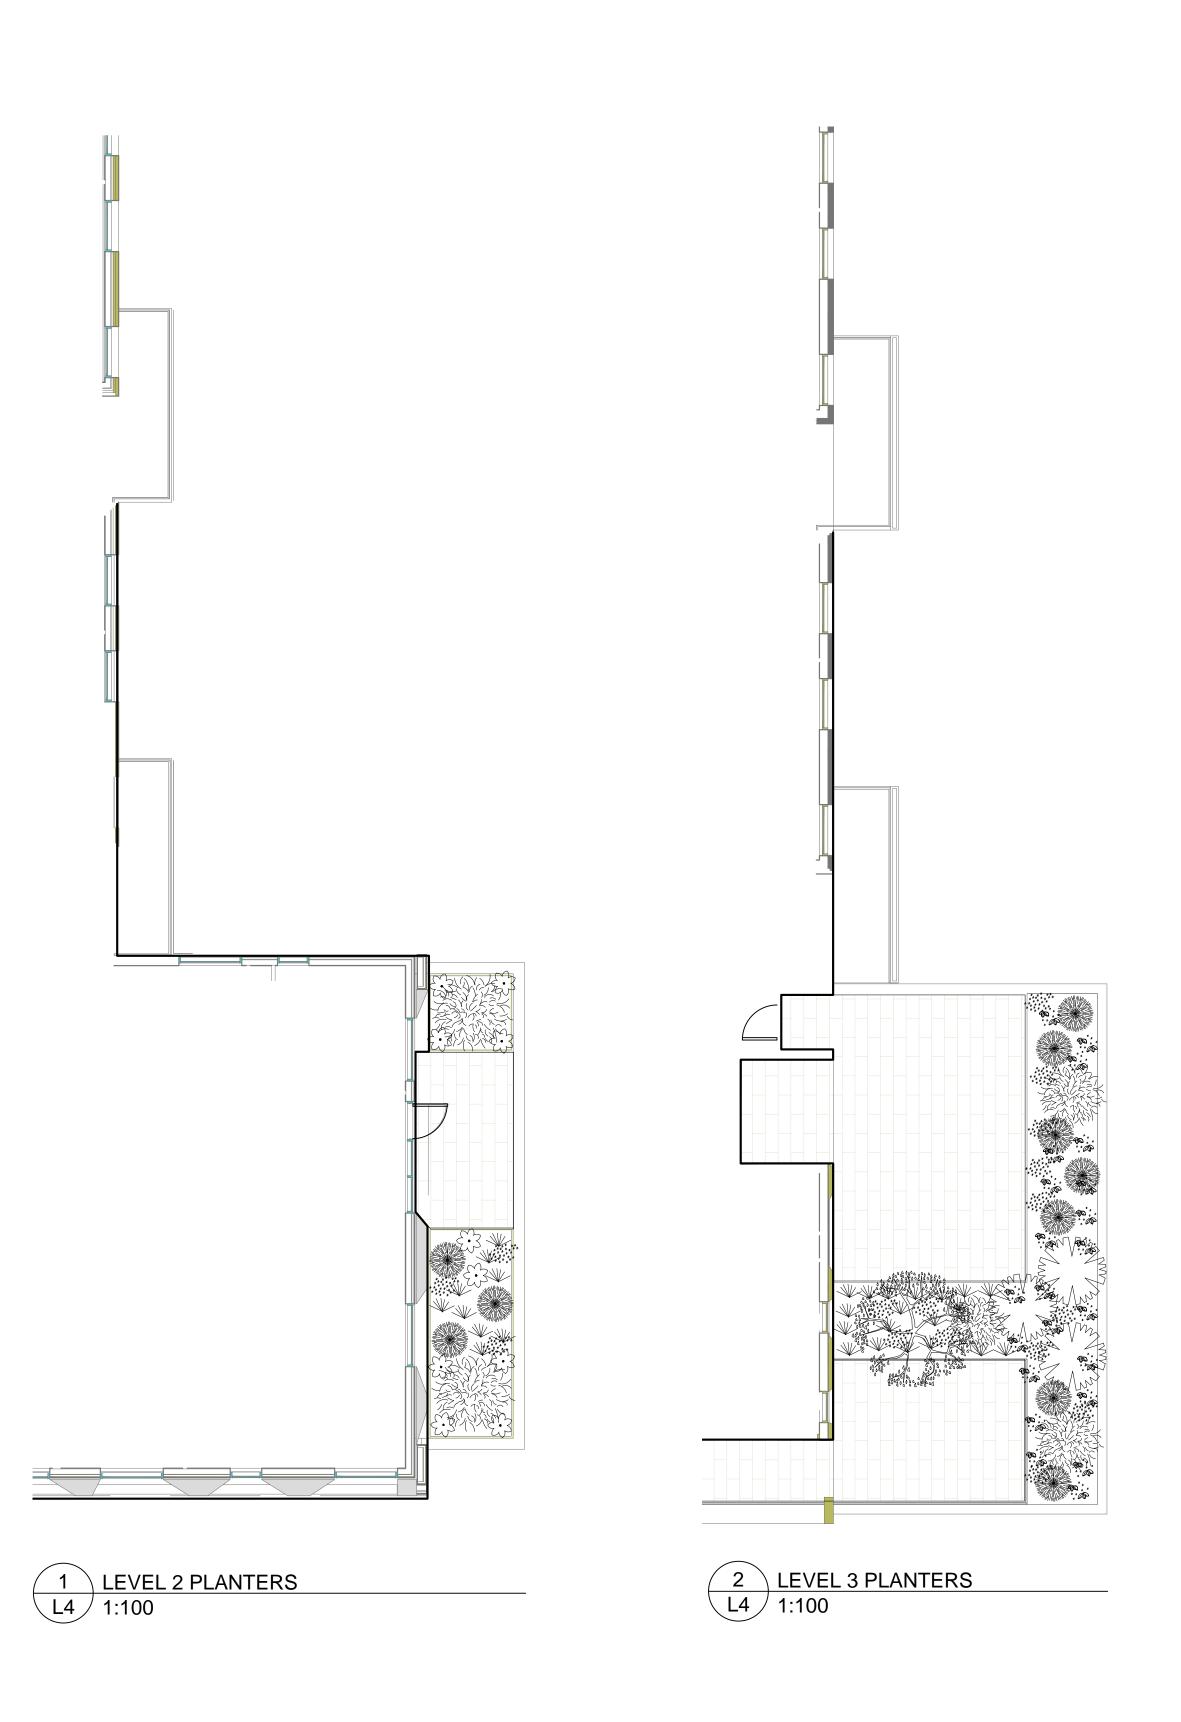

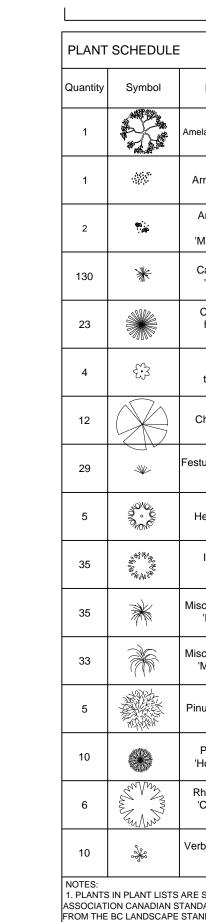

Quantity	Symbol	Latin Name	Common Name	Container	Native	Pollinator
1		Amelanchier canadensis	serviceberry	#5	у	у
1	<i>***</i> *********************************	Armeria maritima 'Alba'	White-flowered Thrift	tray		у
2	\$.`. ∵æ	Arctostaphylos Uva-Ursi 'Massachusetts'	Kinnikinnick	tray	у	у
130	*	Carex testacea 'Prairie Fire'	New Zealand hair sedge	#1		
23		Cephalotaxus harringtonia 'Prostrata'	Spreading Japanese plum yew	#2		
4		Cerastium tomentosum	snow in summer	tray		у
12		Choisya ternata	Mexican mock orange	#3		у
29	*	Festuca glauca 'Elijah Blue'	Elijah Blue fescue	#1		
5	3000	Hebe rakaiensis	Shrubby veronica	#1		у
35	28 88 88 88 88 88 88 88 88 88 88 88 88 8	llex crenata 'Compacta'	Compact Japanese Holly	#2		
35	*	Miscanthus sinensis 'Huron Light'	Huron Light maiden grass	#2		
33	A Company	Miscanthus sinensis 'Morning Light'	Chinese silver grass Morning Light	#2		
5		Pinus mugo 'Gnom'	Dwarf mountain pine	#2		
10		Pinus strobus 'Horsford Dwarf'	Horsford Dwarf Eastern white pine	#2		
6	The state of the s	Rhododendron x 'Cunningham's White'	Cunningham's white rhododendron	#4		у
10	æ.	Verbena bonariensis 'Lollipop'	Dwarf purpletop	#1		Y



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OWNER/CLIENT:

ARYZE DEVELOPMENTS

1733 FAIRFIELD, VICTORIA, BC

DESIGNED BY: **BIANCA BODLEY** DRAWN BY: KARIANNE HOWARTH

2 ISSUED FOR RZ/DP

SEAL

NORTH ARROW

DRAWING TITLE:

UPPER LEVEL PLANTING PLANS

DWG NO:

SCALE: AS NOTED

