



250-277-2296

LIST OF DRAWINGS

SHEET NUMBER	SHEET NAME
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A1.2	ARCH SITE PLAN
A2.1	BASEMENT LEVEL PLAN
A2.2	GROUND LEVEL PLAN
A2.3	LEVEL 2 PLAN
A2.4	LEVEL 3 PLAN
A2.5	LEVEL 4 - ROOF PLAN
A3.1	ELEVATIONS - FRONT + REAR
A3.2	ELEVATIONS - SIDES
A3.3	MATERIALS BOARD - SOUTH
A3.4	MARERIALS BOARD - EAST + WEST
A3.5	EAST ENTRANCE - ELEVATION
A4.1	SECTIONS
A5.1	3D VIEWS

CODE DATA


PRELIMINARY CODE ANALYSIS	
BUILDING AREA (FOOTPRINT):	1745 m ²
NO. OF STORIES:	4
BASEMENT:	YES
USE AND OCCUPANCY	
F3	STORAGE GARAGE
ARTICLE	
3.2.2.84	F3 UP TO 4 STORIES - SPRINKLERED
NO. OF STREETS	2
MAXIMUM BUILDING AREA	3600 m ²
CONSTRUCTION TYPE	NON - COMBUSTIBLE
FIRE RESISTANCE RATING	FLOOR TO BE NON-RATED FIRE SEPERATIONS
OCCUPANT LOAD:	NONE - VEHICLE PARKING ONLY
SPRINKLERED:	YES
TRAVEL DISTANCE (45m ALLOWED):	MAXIMUM - 28-37m

SITE AERIAL VIEW



EXISTING SITE PLAN



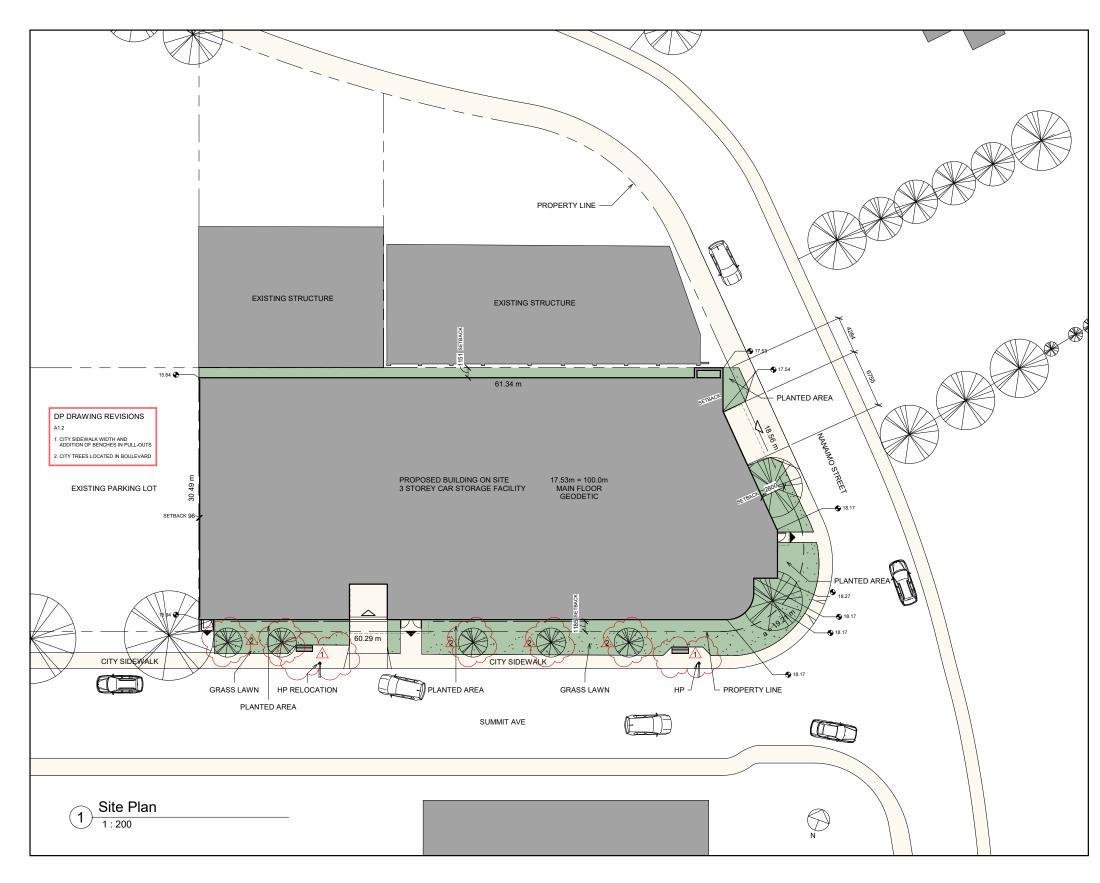



PROJECT INFORMATION

SITE DATA + ZONING						
CIVIC ADDRESS:	750 & 780 SUMMIT AVENUE					
LEGAL DESCRIPTION:						
CURRENT USE:	CLUB					
PROPOSED USE :	GARAGE					
ZONE (EXISTING) :	M2 - I					
DP AREA:	DPA 7A - CORRIDOR					
SITE AREA (m ²):	2031 m ²					
LOT WIDTH	30.49m					
FLOOR AREA	m ²	APPLICABLE TO FSR				
BASEMENT	670	0				
MAIN FLOOR	1745	1745				
SECOND FLOOR	1764	1764				
THIRD FLOOR	1764	1764				
ROOFTOP STAIRS	32	32				
TOTAL	5975	5305				
FLOOR SPACE RATIO	2.61 13.451 m 4					
BUILDING HEIGHT						
NUMBER OF STOREYS						
SETBACKS	•					
LOT BOUNDARY (SUMMIT):	1.7 m					
LOT BOUNDARY (NANAIMO):	0.725 m					
LOT BOUNDARIES - INTERIOR :	0.0 m					
SITE COVERAGE:	m ²	%				
BUILDING FOOTPRINT	1745	86				
DRIVEWAYS	61	3				
SOFT LANDSCAPE + SIDEWALK	225	11				
TOTAL SITE	2031	100				
LOADING SPACE:	NONE PROVIDED	VARIANCE REQUESTED				
PARKING SPACES:						
BIKE PARKING SPACES:	LONGTERM = 5	1 PER 1200 m ²				
SOFT LANDSCAPE + SIDEWALK	SHORT TERM = 6 11					
	TOTAL 11	LOCATED IN BASEMENT				

LEGEND



VEHICLE ACCESS




PEDESTRIAN EXIT

AVERAGE GRADE

GRADE POINTS:	CALCULATI	ONS:	AVERAGE:	DISTANCE:	TOTAL:		
A-B	(15.64+17.53	3)/2	16.585	60.45	1002.563		
B-C	(17.53+17.54)/2	17.535	3.85	67.510		
C-D	(17.54+18.17	')/2	266.879				
D-E	(18.17+18.27	')/2	98.661				
E-F	(18.27+18.17	')/2	18.22	2.64	48.101		
F-G	(18.17+18.21)/2	18.19	1.985 36.			
G-H	(18.21+18.19	9)/2	2 18.2 4.869 88				
H-J	(18.19+15.94	18.19+15.94)/2		1039.429			
J-A	(15.94+15.64)/2	441.331				
		3089.1					
BUILDING PERIM	ETER	183.016					
AVERAGE GRADE	E	16.879					
MAIN FLOOR GEO	DDETIC:	17.5	17.53				
MAIN FLOOR SLA	AIN FLOOR SLAB: 100						
TOP OF STAIR TO	OWER:	112.8 12.8					
HEIGHT OF STAIF	R TOWER:						
TOP OF STAIR GE	EODETIC:	30.33					
BUILDING HEIGH	т:	13.4	451				

ARCH SITE PLAN



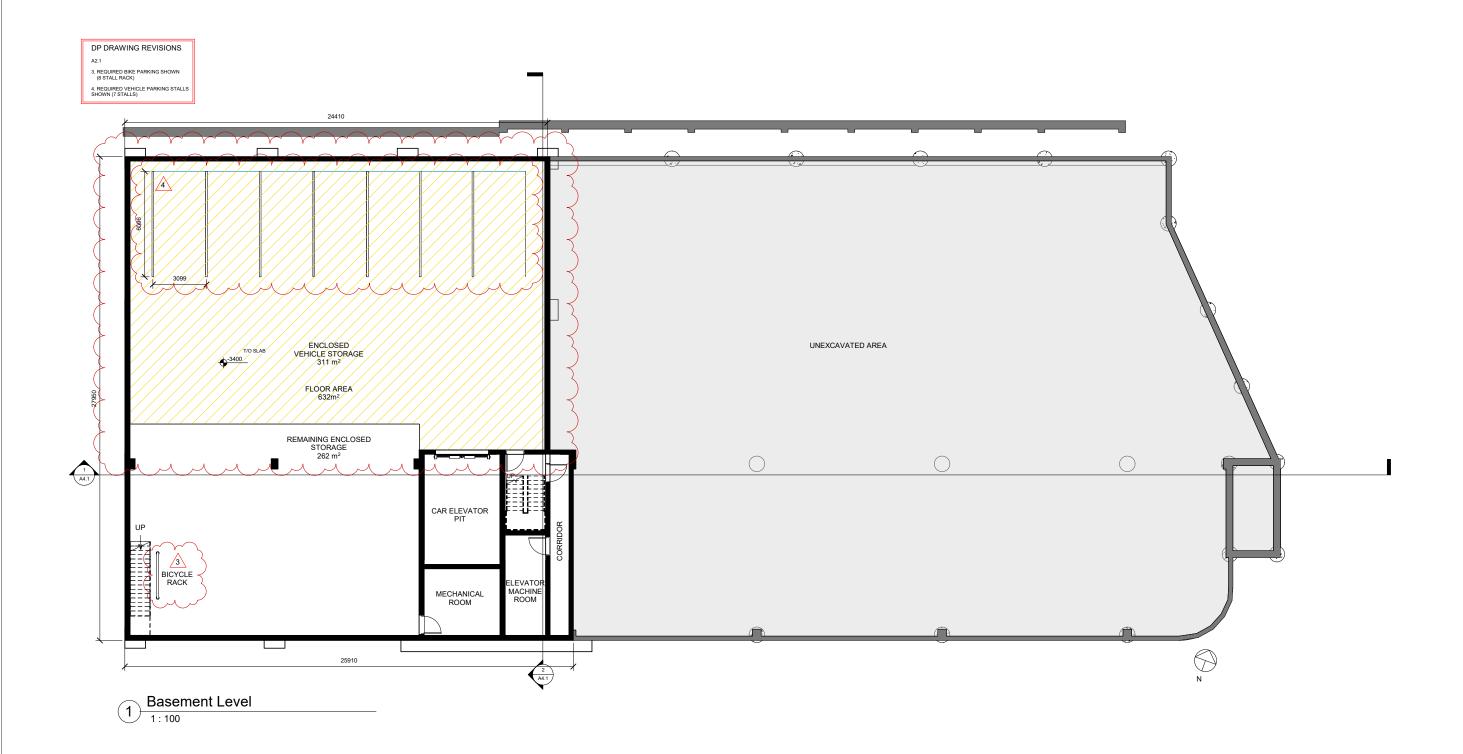





750 - 780 SUMMIT AVE





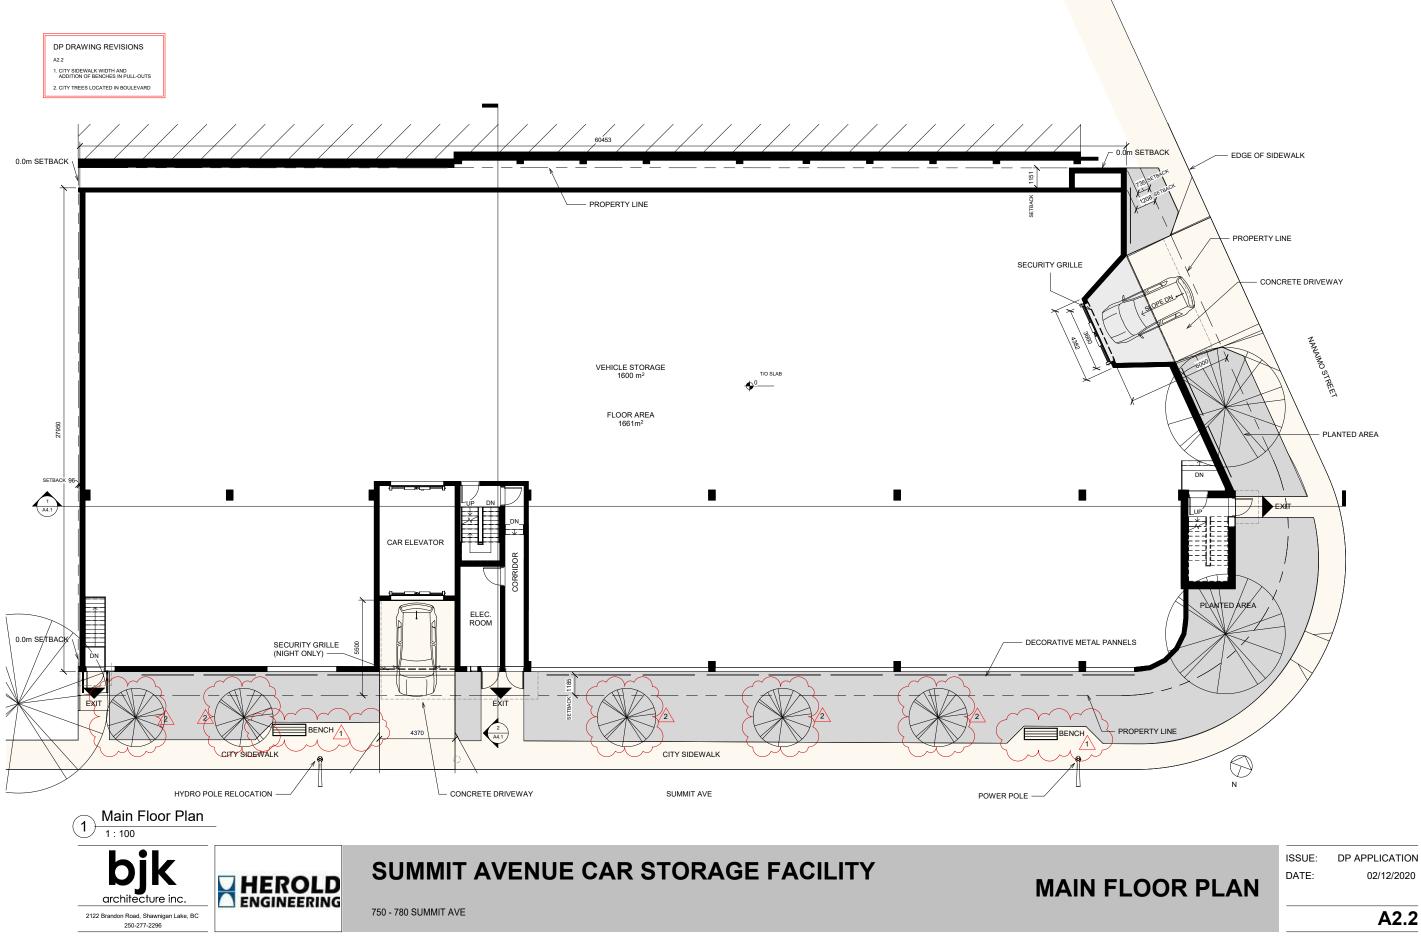


DP APPLICATION 02/12/2020

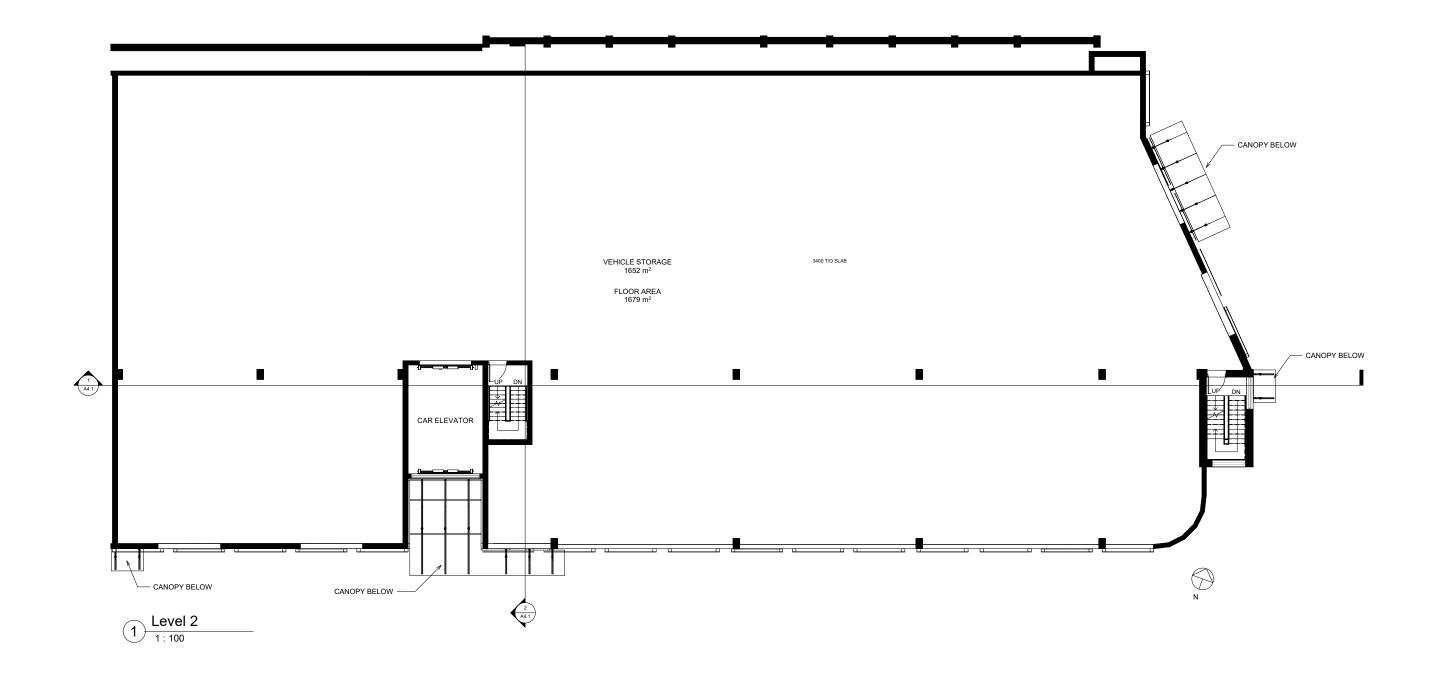

750 - 780 SUMMIT AVE


bjk architecture inc.

2122 Brandon Road, Shawnigan Lake, BC 250-277-2296

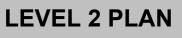



A2.3

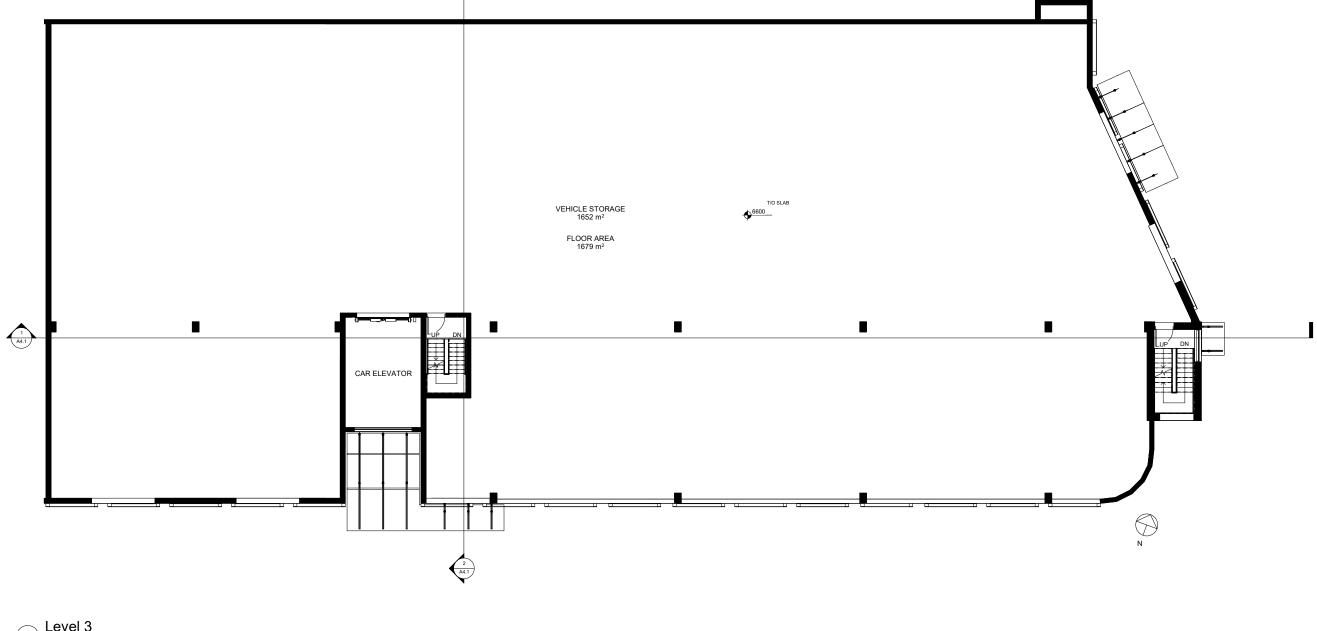

1 Level 3




SUMMIT AVENUE CAR STORAGE FACILITY

750 - 780 SUMMIT AVE

DP APPLICATION ISSUE: DATE: 02/12/2020





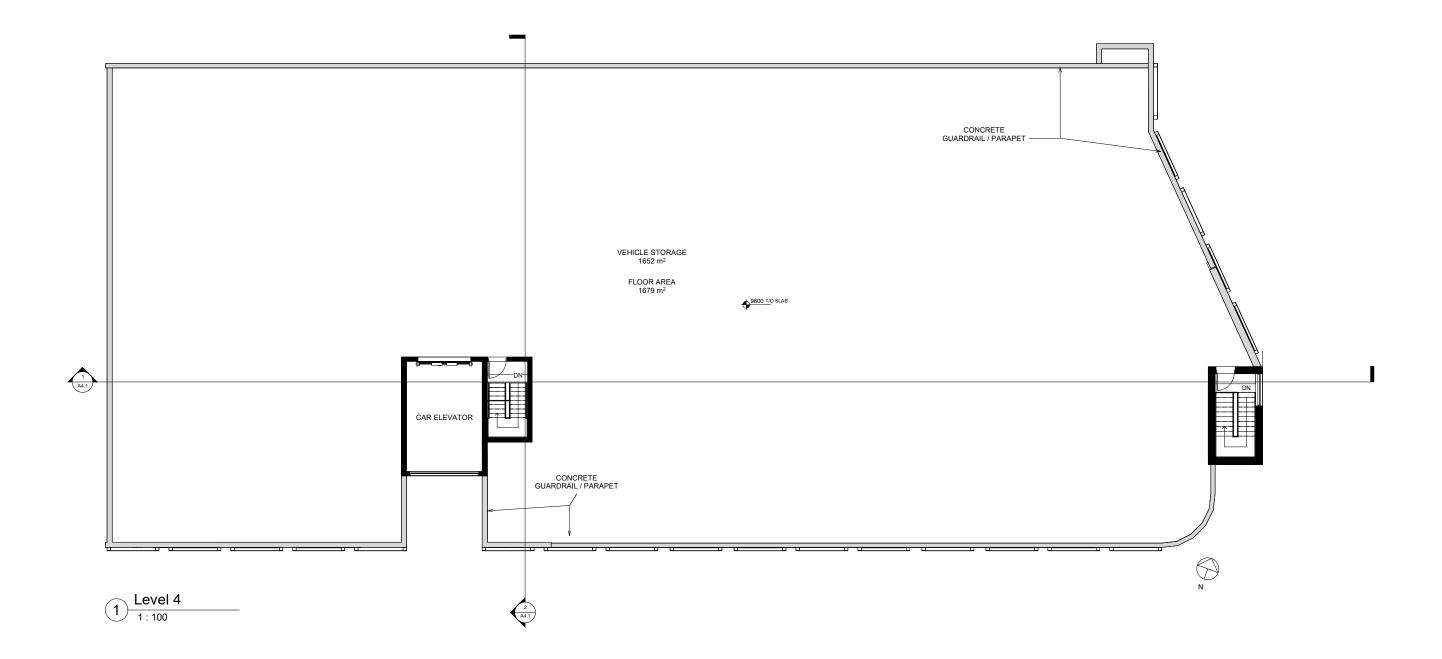




750 - 780 SUMMIT AVE


LEVEL 4 - ROOF PLAN







750 - 780 SUMMIT AVE

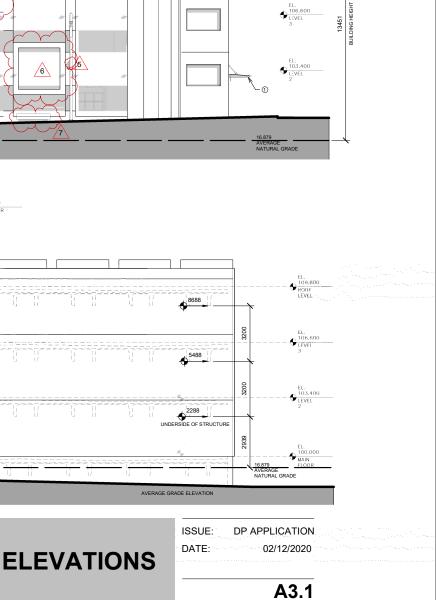

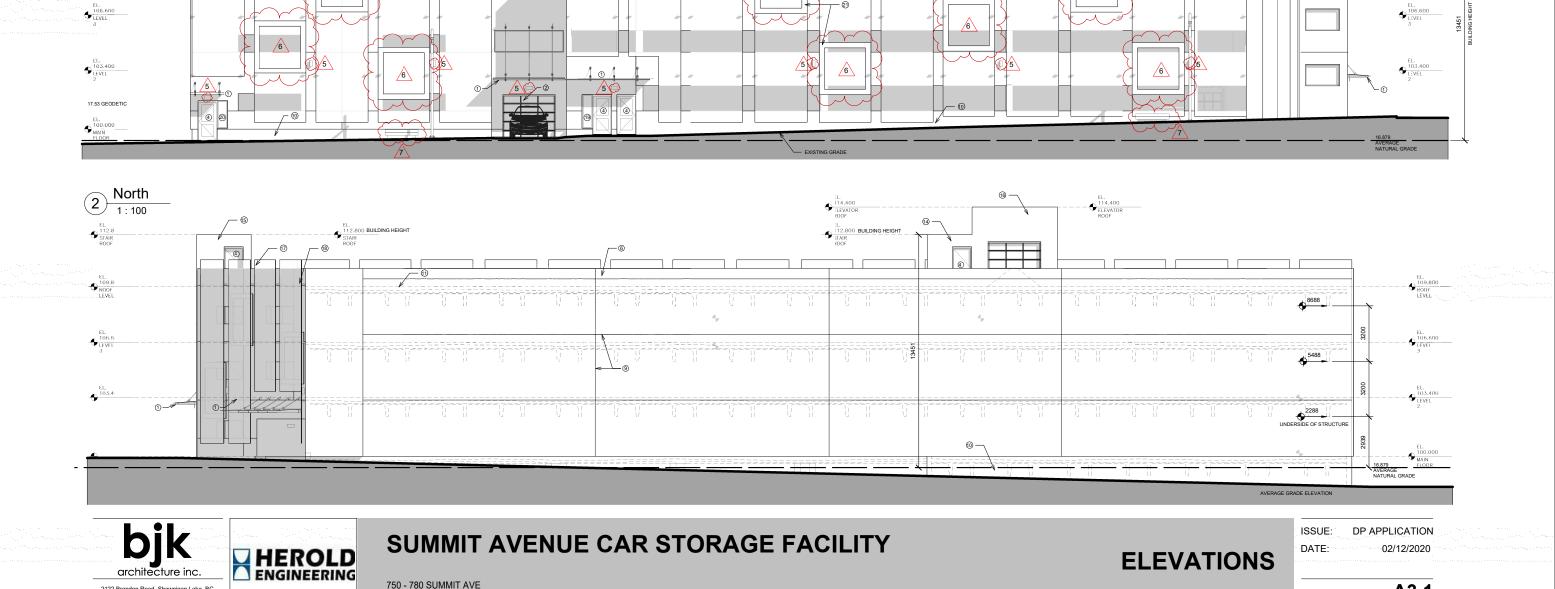

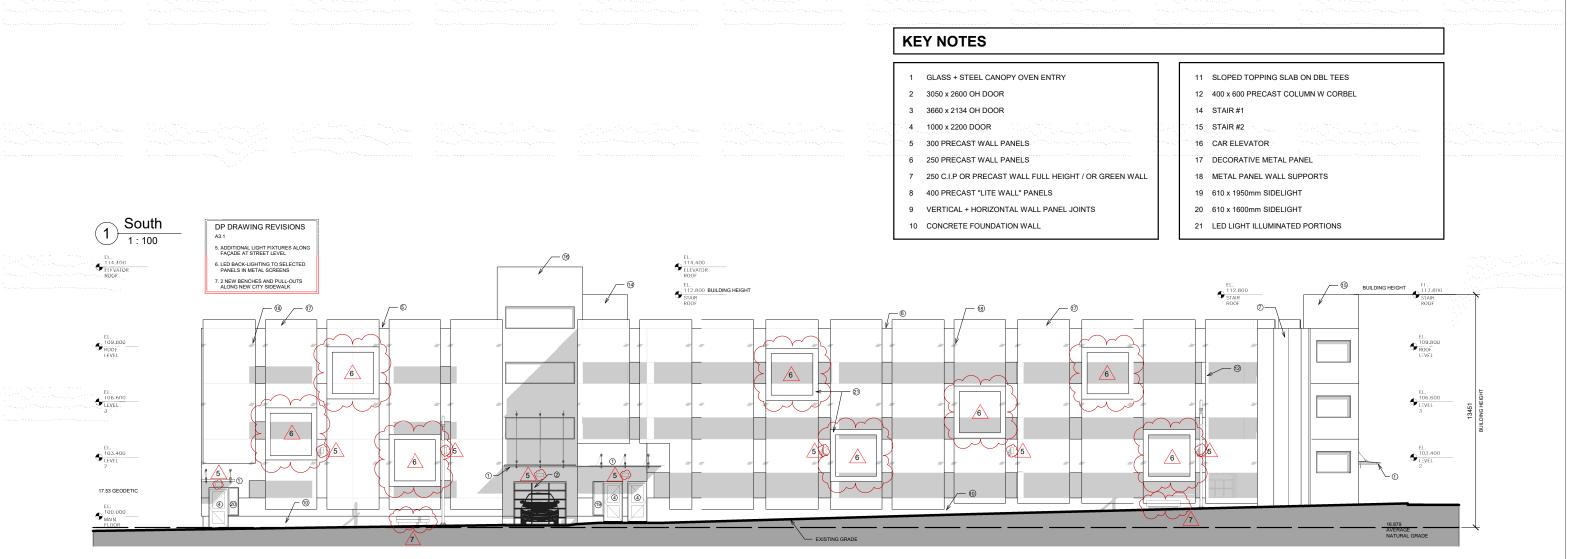


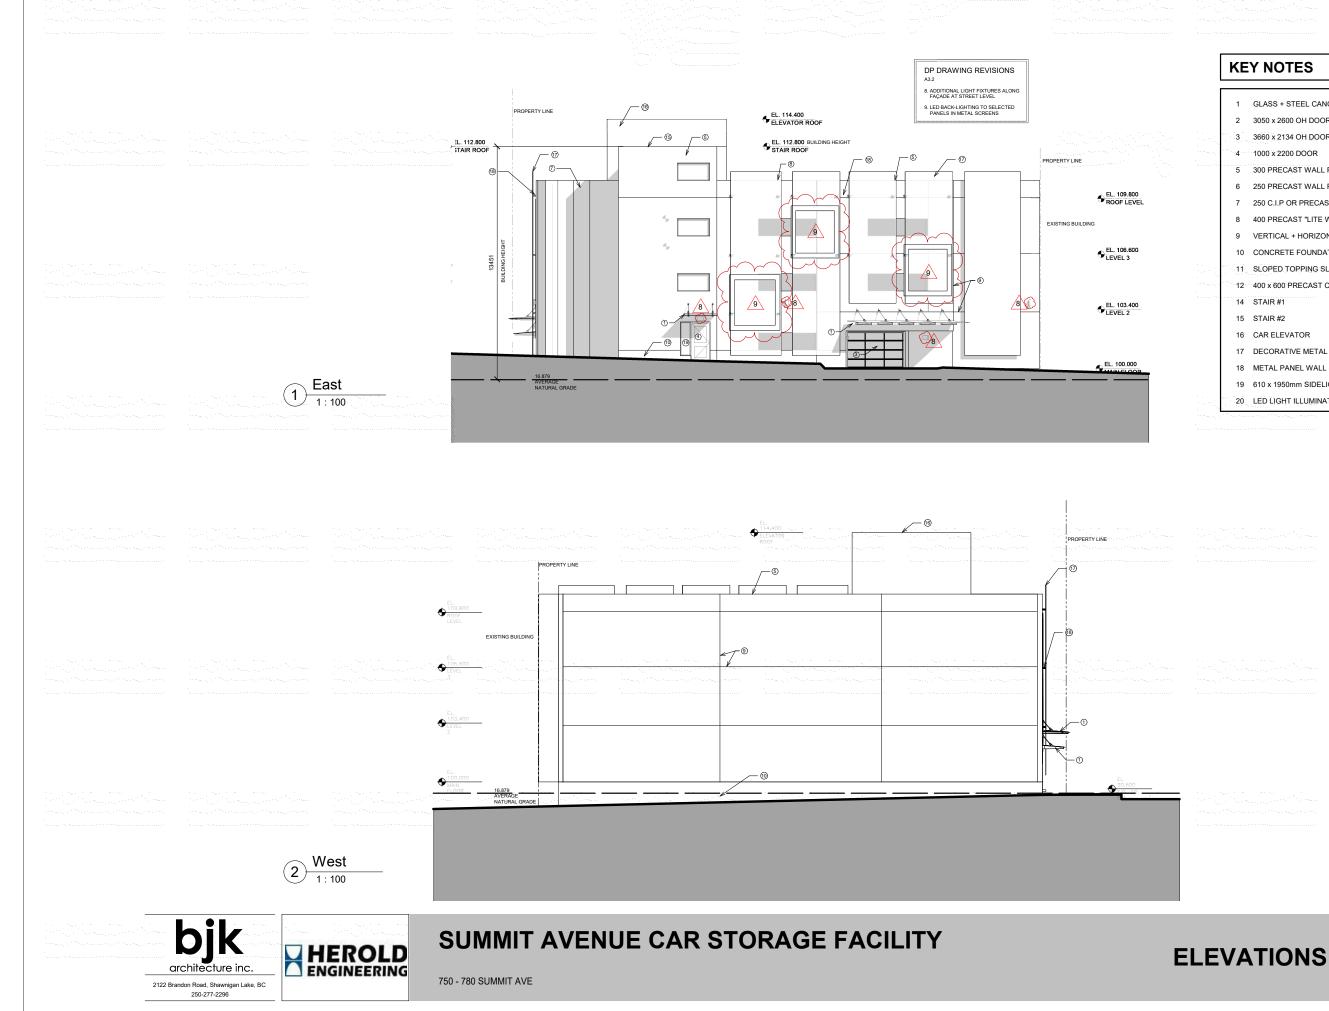

KEY NOTES 1 GLASS + STEEL CANOPY OVEN ENTRY 2 3050 x 2600 OH DOOR 3 3660 x 2134 OH DOOR 4 1000 x 2200 DOOR 5 300 PRECAST WALL PANELS 6 250 PRECAST WALL PANELS 7 250 C.I.P OR PRECAST WALL FULL HEIGHT / OR GREEN WALL 8 400 PRECAST "LITE WALL" PANELS 9 VERTICAL + HORIZONTAL WALL PANNEL JOINTS 10 CONCRETE FOUNDATION WALL 11 SLOPED TOPPING SLAB ON DBL TEES 12 400 x 600 PRECAST COLUMN W CORBEL 14 STAIR #1 15 STAIR #2 16 CAR ELEVATOR 17 DECORATIVE METAL PANEL 18 METAL PANEL WALL SUPPORTS 19 610 x 1950mm SIDELIGHT 20 LED LIGHT ILLUMINATED PORTIONS

ISSUE: DP APPLICATION DATE: 02/12/2020

A3.2

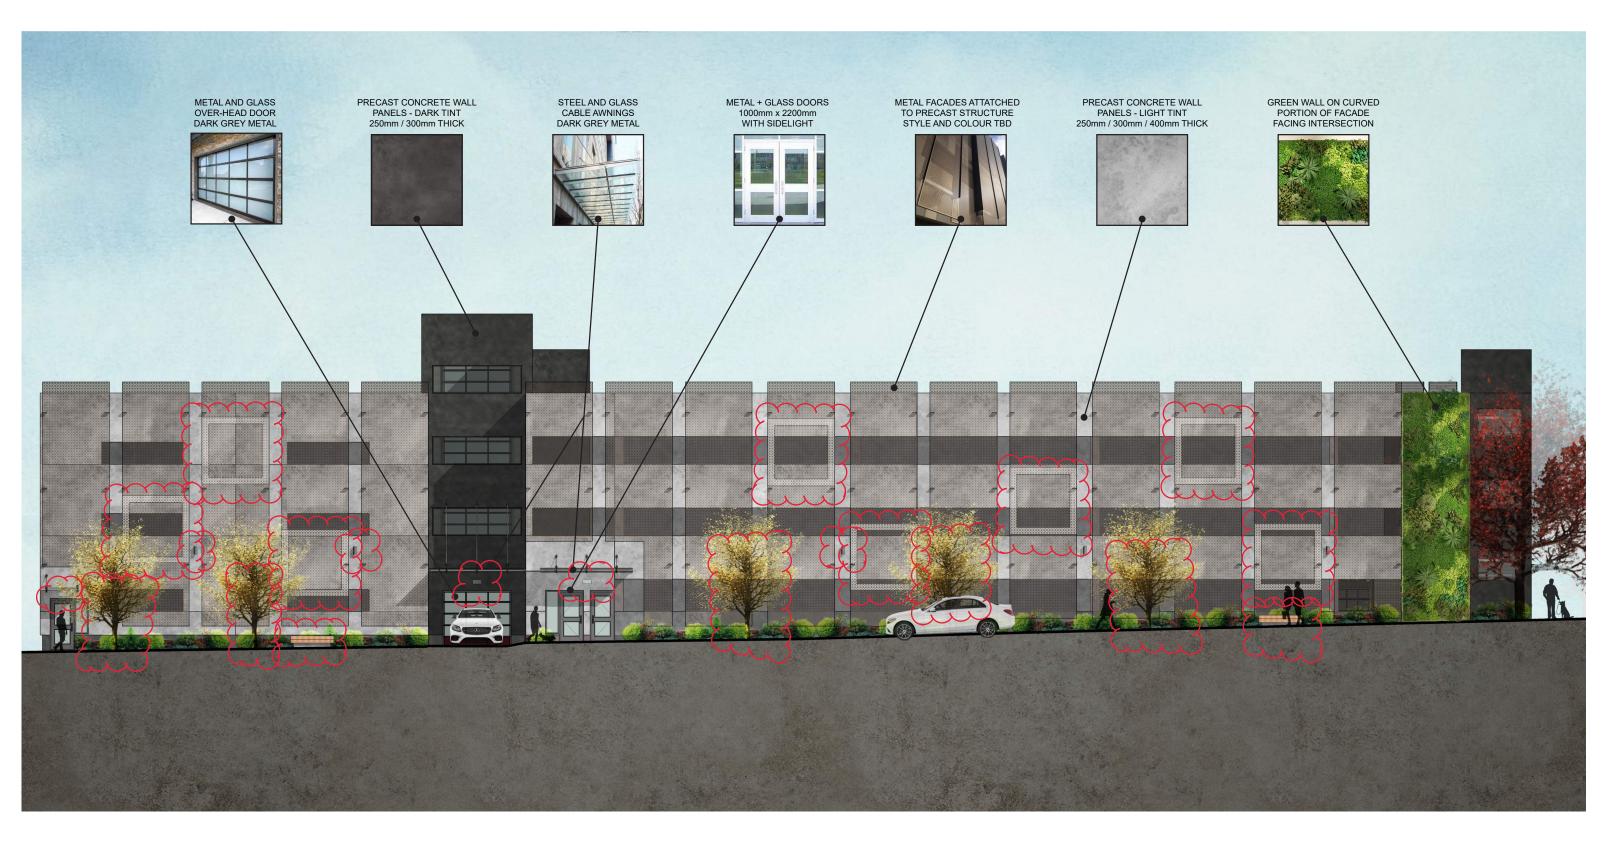




750 - 780 SUMMIT AVE

MATERIALS BOARD

ISSUE: DP A

DP APPLICATION 02/12/2020



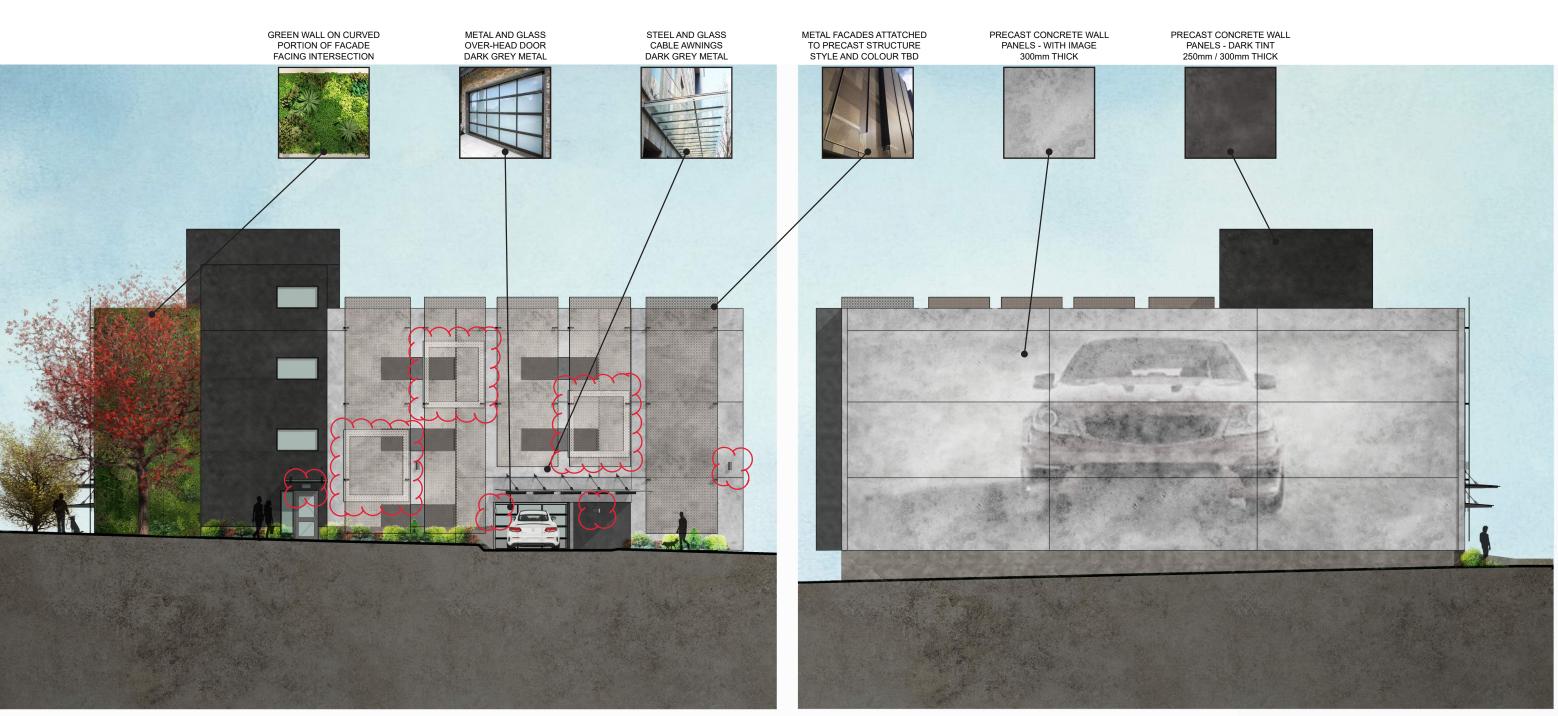

West Elevation

2

1:80






SUMMIT AVENUE CAR STORAGE FACILITY

750 - 780 SUMMIT AVE

MATERIALS BOARD

ISSUE: DP APPLICATION 02/12/2020

DATE:

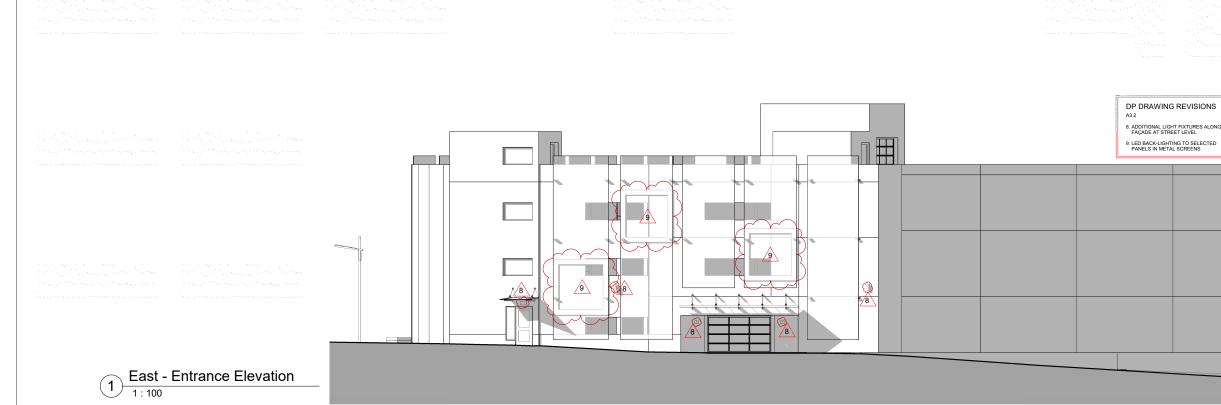







2 East - Entrance View 1




SUMMIT AVENUE CAR STORAGE FACILITY

750 - 780 SUMMIT AVE

EAST ENTRANCE -**ELEVATION + VIEWS**



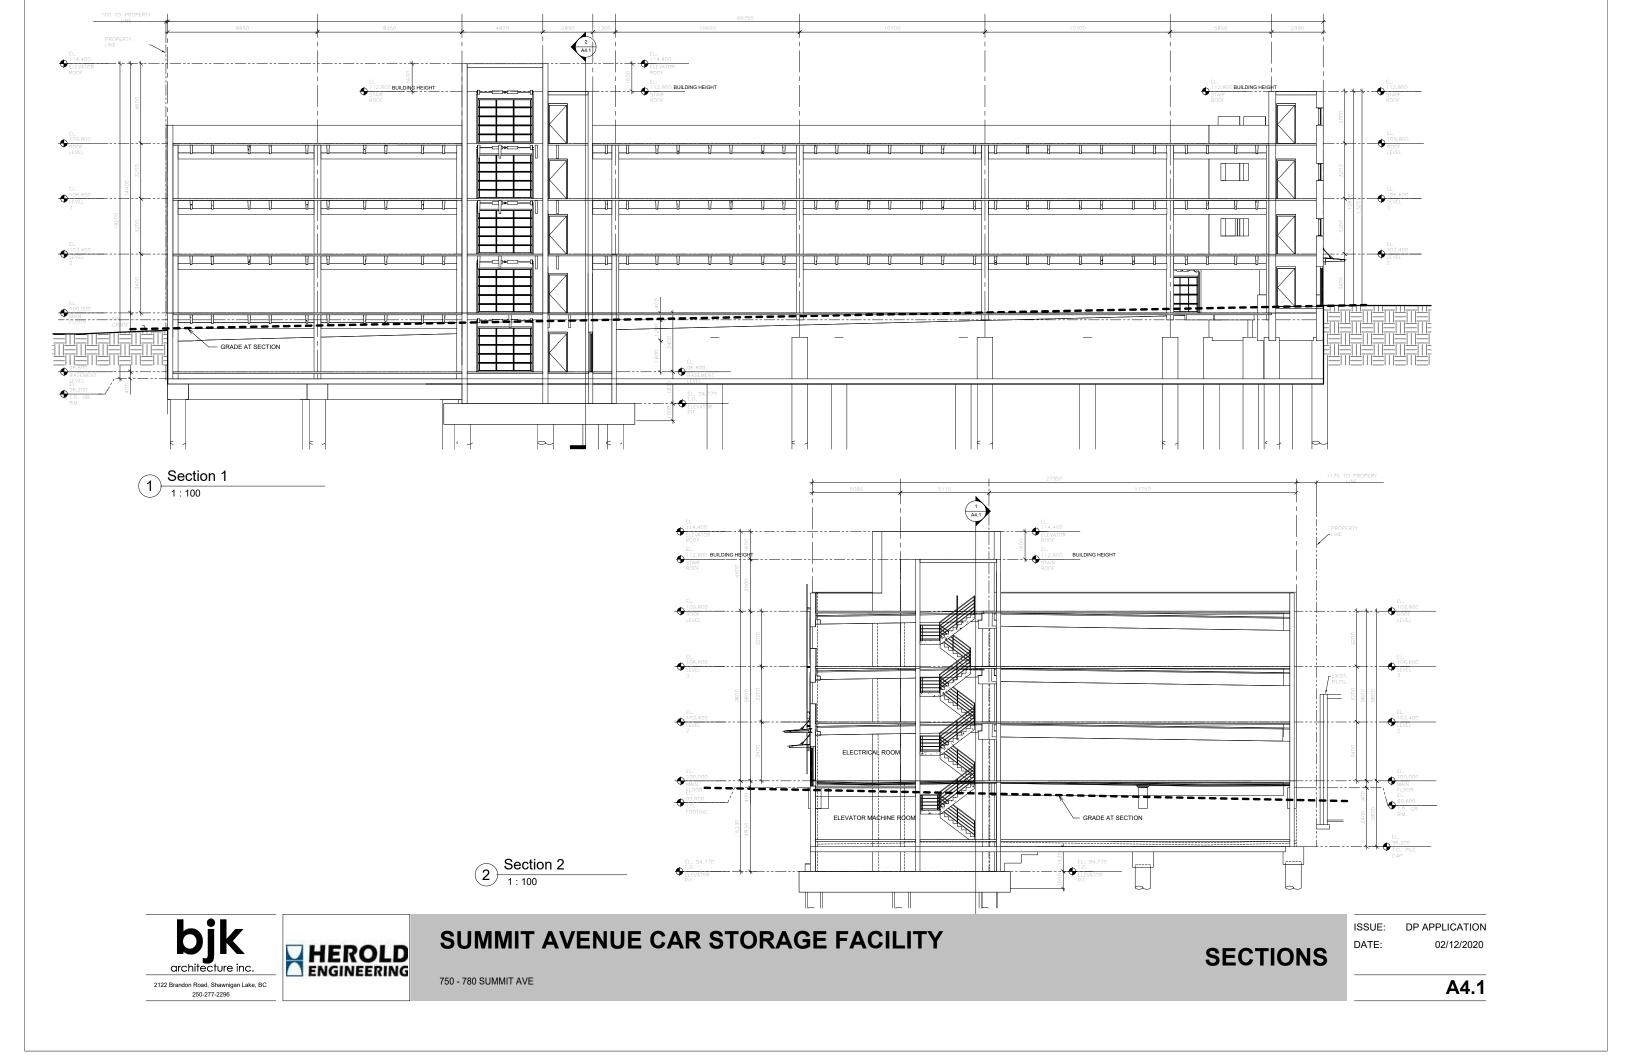
















750 - 780 SUMMIT AVE


3D Views



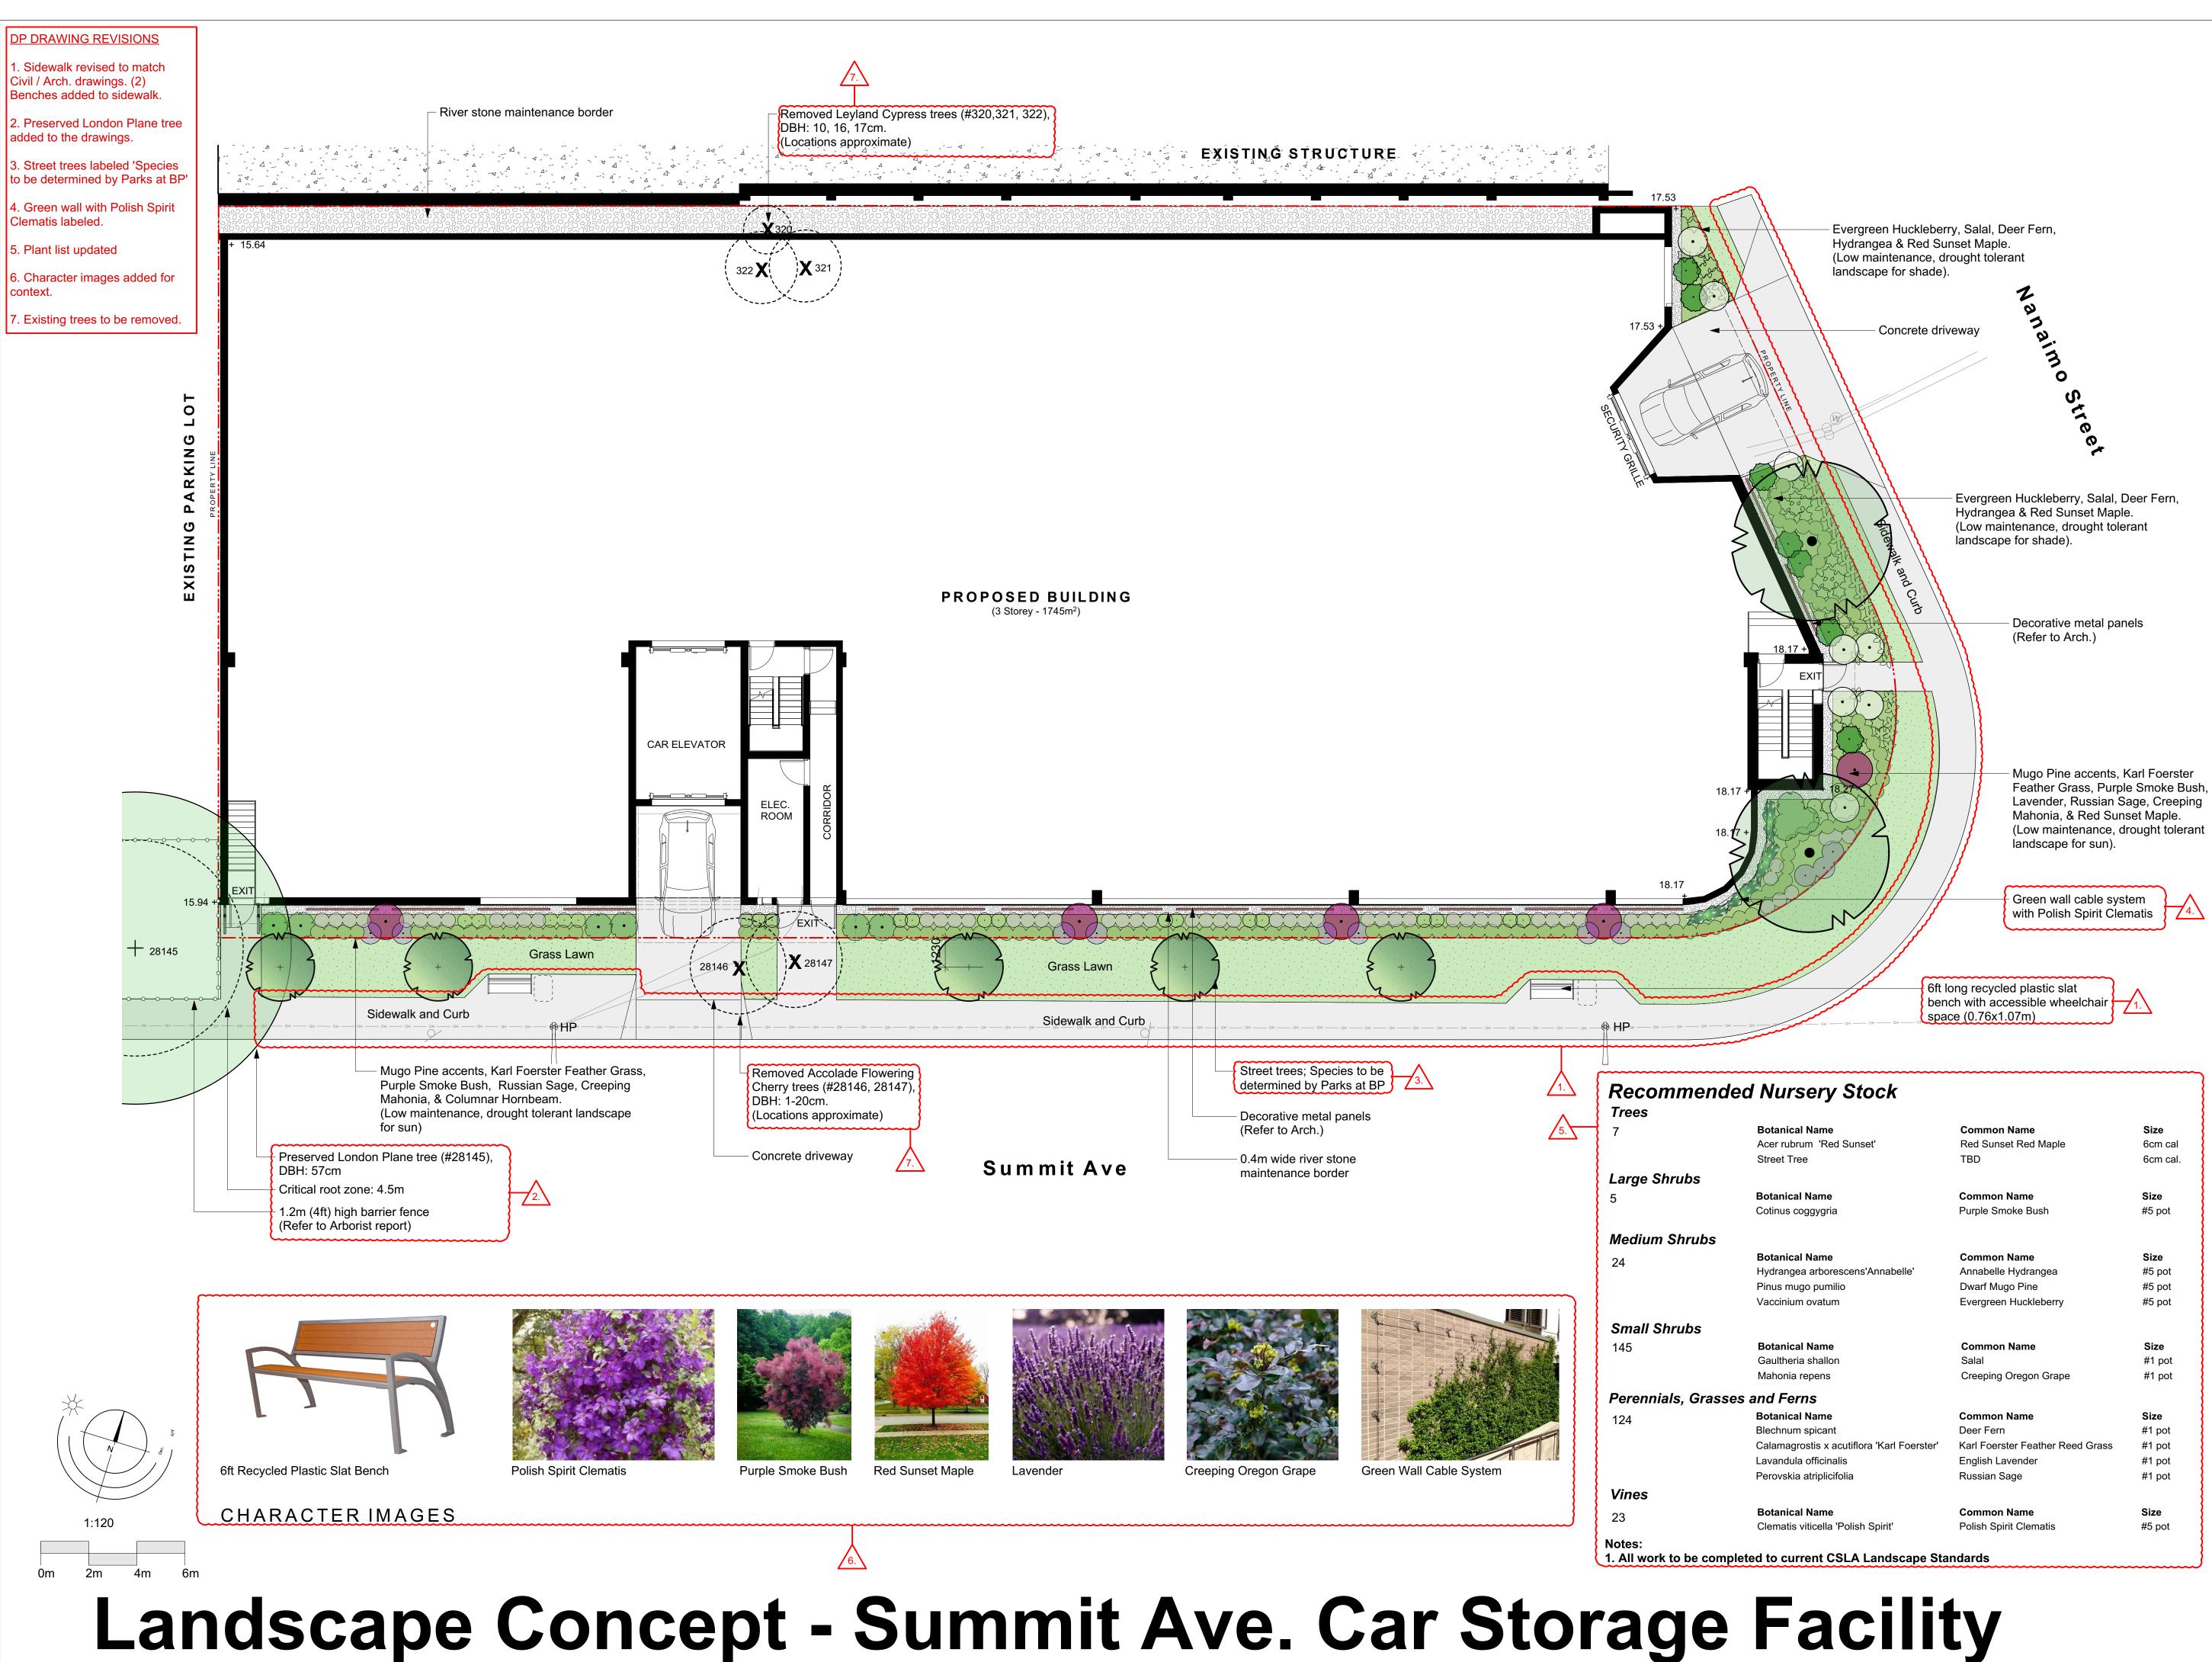

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l Name	Common Name	Size
um 'Red Sunset'	Red Sunset Red Maple	6cm cal
9e	TBD	6cm cal.
Name	Common Name	Size
oggygria	Purple Smoke Bush	#5 pot
I Name	Common Name	Size
a arborescens'Annabelle'	Annabelle Hydrangea	#5 pot
go pumilio	Dwarf Mugo Pine	#5 pot
n ovatum	Evergreen Huckleberry	#5 pot
I Name	Common Name	Size
a shallon	Salal	#1 pot
repens	Creeping Oregon Grape	#1 pot
ns		
l Name	Common Name	Size
spicant	Deer Fern	#1 pot
ostis x acutiflora 'Karl Foerster'	Karl Foerster Feather Reed Grass	#1 pot
a officinalis	English Lavender	#1 pot
atriplicifolia	Russian Sage	#1 pot
l Name	Common Name	Size
viticella 'Polish Spirit'	Polish Spirit Clematis	#5 pot
rent CSLA Landscape Sta	ndards	



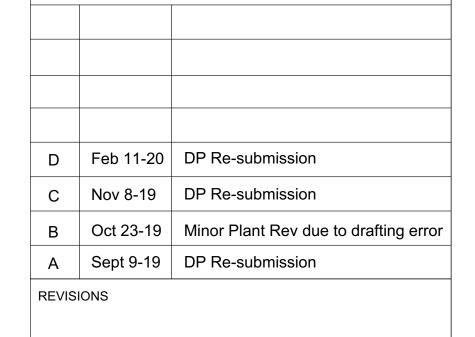

LADR LANDSCAPE ARCHITECTS

#3-864 Queens Ave. Victoria B.C. V8T 1M5 Phone: (250) 598-0105

PROJECT

750-780 Summit Avenue Car Storage Facility Victoria, BC

TITLE Landscape Concept Plan


SCALE 1:120

drawn S.L CHECKED B.W.

PROJECT No. 1916

DATE April. 18,2019

of 1 SHEET

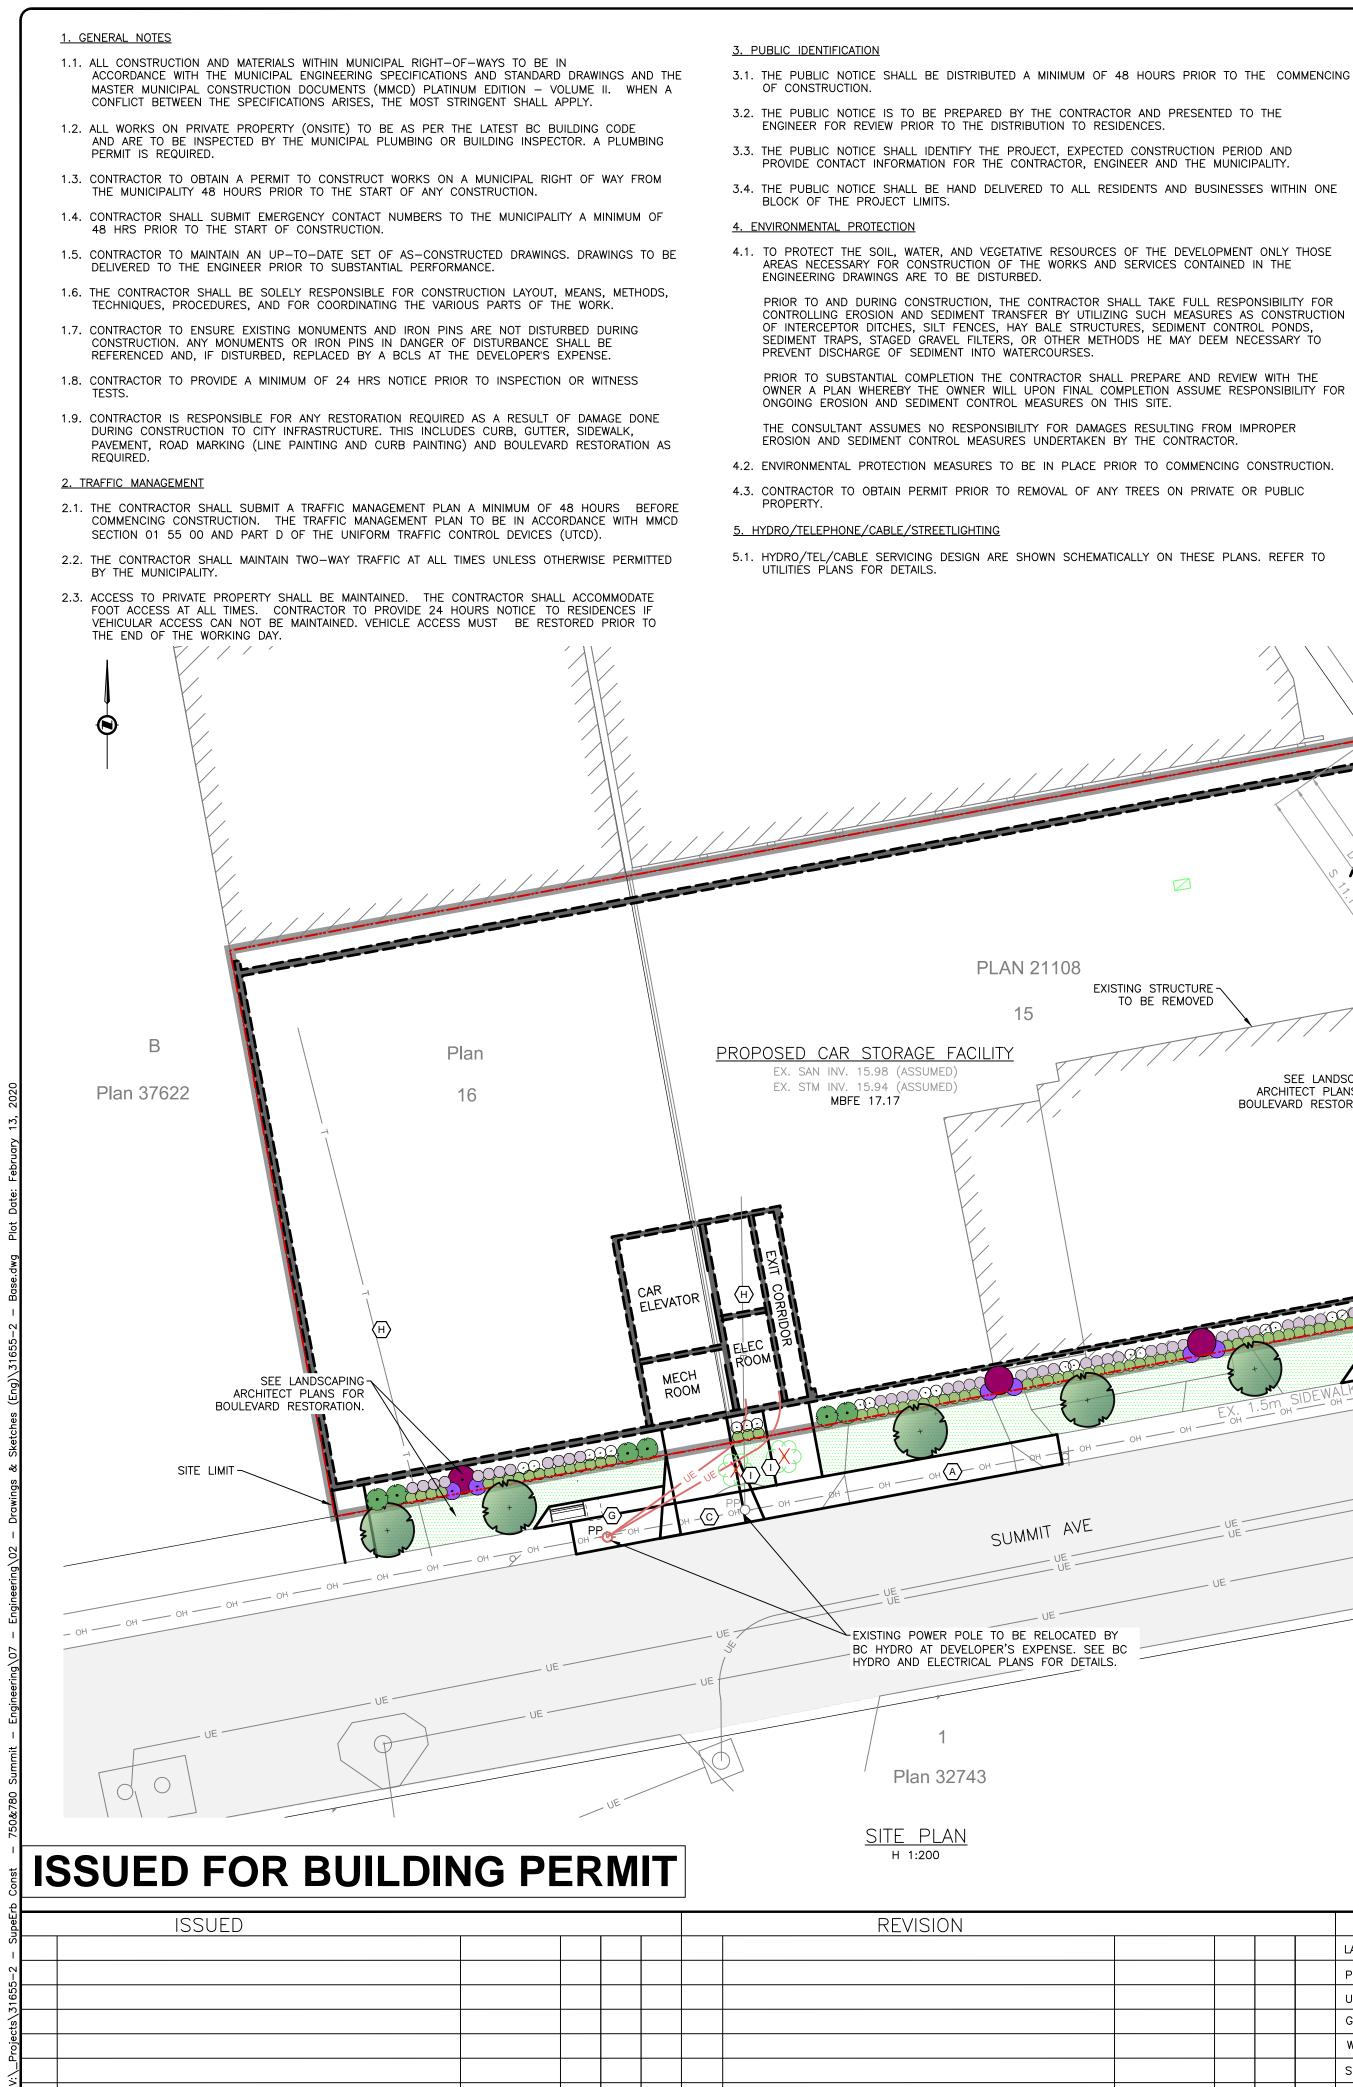

YYYYMMDD

DE

DA CK NO.

DESCRIPTION

DESCRIPTION

EXISTING STRUCTURE -

TO BE REMOVED

SEE LANDSCAPING

ARCHITECT PLANS FOR

BOULEVARD RESTORATION

- 6. QUALITY ASSURANCE TESTING
- 6.1. CONTRACTOR SHALL RETAIN AND PAY THE SERVICES OF A QUALIFIED INDEPENDENT GEOTECHNICAL ENGINEER FOR QUALITY ASSURANCE TESTING DURING CONSTRUCTION IN MUNICIPAL RIGHT-OF-WAY AND SHALL AT A MINIMUM PROVIDE:
 - a) GRANULAR BASE (SIDEWALKS/CURBS/GUTTER) MINIMUM ONE ON NANAIMO STREET AND TWO ON SUMMIT AVE b) CONCRETE MIX DESIGN
 - c) CONCRETE STRENGTH TESTS 1) ONE PER 150m OF SIDEWALK AND/OR CURB AND GUTTER. MINIMUM OF ONE PER DAY DURING CONCRETE PLACING.
- 7. TRENCHING, EXCAVATING, AND BACKFILLING
- 7.1. EXISTING UTILITIES SHOWN ARE AS PER MUNICIPAL RECORDS. THE CONTRACTOR SHALL EXPOSE ALL CROSSINGS PRIOR TO COMMENCING CONSTRUCTION. SHOULD ANY CONFLICT OR DISCREPANCIES ARISE, THE CONTRACT SHALL NOTIFY THE ENGINEER IMMEDIATELY.
- 7.2. PRIOR TO COMMENCEMENT OF EXCAVATION OR SOIL RELOCATION, CONTRACTORS MUST BE REGISTERED UNDER BYLAW 14-071, SCHEDULE G: CODE OF PRACTICE FOR CONSTRUCTION AND DEVELOPMENT ACTIVITIES. CONTACT MARCIN JEDYNAK, SUPERVISOR, INFRASTRUCTURE PLANNING AND UNDERGROUND UTILITIES, AT 250-361-0550 OR mjedynak@victoria.ca TO REGISTER.
- 7.3. ALL SERVICES SHALL BE INSPECTED BY THE ENGINEER AND/OR MUNICIPAL INSPECTOR PRIOR TO BACKFILLING.
- 7.4. CONTRACTOR TO ENSURE EXISTING SERVICES REMAIN IN SERVICE DURING CONSTRUCTION. <u>8. SEWER AND DRAIN</u>
- 8.1. ALL PIPE BEDDING AS PER MMCD STANDARD DETAIL DRAWING G4.
- 8.2. ALL DRAIN AND SEWER MAINS SHALL BE PVC SDR 35 UNLESS NOTED OTHERWISE.
- 8.3. ALL DRAIN AND SEWER SERVICES SHALL BE PVC SDR 28 UNLESS NOTED OTHERWISE.
- 8.4. CONTRACTOR TO ENSURE ALL SEWERS AND DRAINS WITHIN PUBLIC ROAD RIGHT OF WAYS TO HAVE A MINIMUM 1.0 M OF COVER UNLESS NOTED OTHERWISE.
- 8.5. ALL MANHOLES TO BE 1050 MM DIAMETER UNLESS NOTED OTHERWISE.
- <u>9.0 GAS</u>
- 9.1. GAS SERVICING IS SHOWN SCHEMATICALLY ON THESE PLANS, REFER TO FORTISBC PLANS FOR DETALED INSTRUCTIONS. MINIMUM COVER 600mm ON ALL GAS MAINS. 1.5m HORIZONTAL SEPARATION FROM WATER MAINS AND SERVICES, 1.0m SEPARATION FROM OTHER SERVICES. 9.2. CALL BC ONE CALL MINIMUM 72 HOURS PRIOR TO EXCAVATION 1-800-474-6886



- CITY OF VICTORIA STANDARD DETAIL DWG C7B.
- C NEW ACCESS TO CAR ELEVATOR. CONTRACTOR TO INSTALL NEW ACCESS TO CAR ELEVATOR AS PER DWG C7B.
- $\langle \overline{D} \rangle$ EXISTING DRAIN/WATER SERVICES TO BE REUSED. CITY OF VICTORIA CREWS TO TEST AND CLEAR EXISTING SERVICES, CAP EXISTING SEWER, AND INSTALL INSPECTION CHAMBERS AT THE DEVELOPERS EXPENSE. CONTRACTOR TO EXPOSE SERVICES AT PROPERTY LINE FOR THE CITY OF VICTORIA. CITY OF VICTORIA CREWS TO INSTALL NEW SERVICES AT THE DEVELOPERS EXPENSE IF REQUIRED. CONTRACTOR TO COMPLETE FULL PANEL RESTORATION OF DRIVEWAY DROP.
- (E) ONSITE WATER PER AVALON MECHANICAL DRAWINGS.
- $\langle F \rangle$ CONTRACTOR TO INSTALL TYPE 2 LANGLEY OIL INTERCEPTOR C/W MANHOLE SECTIONS FOR ACCESS AND 1050mm HIGH FLOW BYPASS MANHOLE PER DETAIL ON C1.
- (G) CONTRACTOR TO WIDEN SIDEWALK FOR 6FT LONG RECYCLED PLASTIC SLAT BENCH WITH ACCESSIBLE WHEELCHAIR SPACE (0.76x1.07m) AT POWER POLES. 1.5m OF CLEAR WALKING WIDTH OFF POWER POLES REQUIRED.
- $\langle H \rangle$ existing hydro/tel/com services to site to be abandoned by a qualified contractor at the DEVELOPER'S EXPENSE.
- $\langle 1 \rangle$ contractor to obtain tree removal permit and remove existing cherry trees.

		LEGEND												
JE			DITCH		UT 🗌	S	DARD &LS 🔶 LS	LAMP STAND						
		w	©	METER		ASIN 🖂	، P	, Tel.) ↔PP ✦PP	POLE(Hydro,					
	U	≫	⊚	FLUSH VALVE		E D	-	UE	U/G WIRING					
SURV			Χ	VALVE	D	RISER 💿		G	GAS					
NANAIMO	VICTORIA PHC			REDUCER	мс	BLE CURB	-	w	WATER					
HONE: 250-727-2214		+	-0-	HYDRANT	NMC	OUNT. CURB	-	S	SEWER					
				AIR VALVE		SPHALT	_	D	DRAIN	СК	DA	DE	YYYYMMDD	

