PROJECT INFORMATION

CIVIC ADDRESS 1230 GRANT STREET

1209,1218,1219,1220, and 1226 NORTH PARK STREET 1219 VINING STREET

1235 CALEDONIA AVENUE 1211 GLADESTONE AVENUE

LEGAL DESCRIPTION

LOT 4 VIP205 SECTION SR VICTORIA LOT 5 VIP205 SECTION SR VICTORIA LOT 6 VIP205 SECTION SR VICTORIA LOT 7 VIP205 SECTION SR VICTORIA N 56' OF LOT 8 VIP205 SECTION SR VICTORIA

REM LOT 8 VIP205 SECTION SR VICTORIA LOT 9 VIP205 SECTION SR VICTORIA LOT 18 VIP205 SECTION SR VICTORIA

LOT A SECTION 53, SPRING RIDGE, VIP55528

SITE AREA 8681.1 SM

PROJECT DESCRIPTION

THE PROJECT INVOLVES THE DEVELOPMENT OF 158 AFFORDABLE HOUSING RESIDENTIAL UNITS AND SUPPORT FACILITIES IN 2 APARTMENT AND 3 TOWNHOUSE BUILDINGS OVER ONE BASEMENT LEVEL OF PARKADE.

BUILDING HEIGHTS	BCBC	ZONING
APARTMENT 1	4 STOREYS	4 STOREYS, 12.0 M
APARTMENT 2	5 STOREYS	5 STOREYS, 14.78 M
TOWNHOUSE 1	3 STOREYS	4 STOREYS, 11.25 M
TOWNHOUSE 2	3 STOREYS	3 STOREYS, 10.65 M
TOWNHOUSE 3	3 STOREYS	3 STOREYS, 9.8 M

BCBC BUILDING AREAS APARTMENT 1 872 SM **APARTMENT 2** 875 SM TOWNHOUSE 1 653 SM **TOWNHOUSE 2** 652 SM 260 SM **TOWNHOUSE 3**

GROSS BUILDING AREAS BCBC ZONING **PARKADE** 3905 SM 275 SM* * AREA OF PARKADE EXCLUDING EXTERIOR WALLS, VEHICLE AND BICYCLE PARKING AND CIRCULATION.

APARTMENT 1		
LEVEL 1	800 SM	776 SM
LEVEL 2	872 SM	850 SM
LEVEL 3	872 SM	850 SM
LEVEL 4	723 SM	704 SM
TOTAL	3267 SM	3180 SM
<u>APARTMENT 2</u>		
LEVEL 1	789 SM	765 SM
LEVEL 2	656 SM	637 SM
LEVEL 3	831 SM	809 SM
LEVEL 4	831 SM	809 SM
LEVEL 5	690 SM	672 SM
TOTAL	3797 SM	3692 SM
TOWNHOUSE 1		
LEVEL 0	601 SM	566 SM

T014/1110110F 4		
TOWNHOUSE 1	224 214	
LEVEL 0	601 SM	566 SM
LEVEL 1	603 SM	581 SM
LEVEL 2	608 SM	592 SM
LEVEL 3	645 SM	633 SM
TOTAL	2457 SM	2372 S
TOWNHOUSE 2		
LEVEL 0	645 SM	606 SM
LEVEL 1	607 SM	590 SM
LEVEL 2	607 SM	590 SM
LEVEL 3	645 SM	632 SM

2504 SM 2418 SM ** DOES NOT CONTRIBUTE TO FSR.

TOWNHOUSE 3			
LEVEL 1	231 SM	222 SM	
LEVEL 2	243 SM	235 SM	
LEVEL 3	253 SM	246 SM	
TOTAL	727 SM	703 SM	

RESIDENTIAL UNIT SUMMARY

<u>APARTMENTS 1 & 2</u>	
14 STUDIO @	34 SM
38 ONE BED @	47 - 49 SM
7 ACCESSIBLE ONE BED @	53 SM
14 TWO BED @	61 - 76 SM
5 ACCESSIBLE TWO BED @	71 SM
12 THREE BED @	78 - 88 SM
1 ACCESSIBLE THREE BED @	98 SM
6 FOUR BED @	98 - 118 SN
97 TOTAL	

TOWNHOUSES 1-3 55 TWO BED @ 81 - 90 SM 2 ACCESSIBLE TWO BED @ 104 SM 2 THREE BED @ 118 SM 4 FOUR BED @ 130 SM 61 TOTAL

VEHICLE PARKING PARKADE 112 SURFACE 0 TOTAL 112

BICYCLE PARKING LONG TERM SHORT TERM TOTAL

VICTORIA ZONING BYLAW SUMMARY

ZONING

R-2

USE RESIDENTIAL

FLOOR SPACE RATIO GROSS BUILDING FLOOR AREA (ZONING) / SITE AREA 11759/8681.1 = 1.35

SITE COVERAGE

AREA OF LOT OCCUPIED BY ANY STRUCTURE/ SITE AREA 3544/8681.1 = 41%

OPEN SITE SPACE SITE AREA - (BUILDING AREA + SURFACE PARKING AREA)

8681.1 - 3460 = 5221.1 OPEN SITE SPACE/ SITE AREA 5221.1/ 8681.1 = 49%

AVERAGE GRADE (GEODETIC)

(SEE SITE PLAN FOR GRADE CALCULATION). ÀPARTMENT 1 33.5 M **APARTMENT 2** 33.4 M TOWNHOUSE ' 33.0 M 32.6 M **TOWNHOUSE 2 TOWNHOUSE 3** 32.8 M

HEIGHT OF BUILDINGS

(AS MEASURED FROM AVERAGE GRADE). **APARTMENT 1** 12.000 M 14.780 M **APARTMENT 2** 11.250 M TOWNHOUSE ? **TOWNHOUSE 2** 10.650 M **TOWNHOUSE 3** 9.800 M

VEHICLE PARKING

< 45 SM	.2 X 14 = 2.8
45 - 70 SM	.5 X 58 = 29
> 70 SM	.75 X 86 = 64.5
SUBTOTAL	96.3 (96)
VISITOR	.1 X 158 = 15.8 (16)
TOTAL REQUIRED	112
PROVIDED	117

BICYCLE PARKING

LONG TERM		
< 45 SM	14 X 11	= 14
> 45 SM	1.25 X 144	= 180
TOTAL LONG TERM	1 REQUIRED	194
TOTAL PROVIDED		194

SHORT TERM

RESIDENTIAL (THE GREATER OF) .1 X 158 OR 6 X 5 TOTAL SHORT TERM REQUIRED TOTAL PROVIDED

CODE ANALYSIS

REFERENCE DOCUMENT BCBC 2018

PARKADE OCCUPANCY CLASSIFICATIONS (TABLE 3.1.2.1)

BELOW GRADE PARKADE -GROUP F, DIVISION 3 - LOW HAZARD INDUSTRIAL

OCCUPANCY SEPARATIONS (TABLE 3.1.3.1)

BELOW GRADE PARKADE CONSIDERED AS A SEPARATE BUILDING AND SEPARATED FROM THE FLOORS OF ALL BUILDINGS ABOVE BY A 2 HOUR FIRE SEPARATION IN ACCORDANCE WITH 3.2.1.2.

BUILDING SIZE AND CONSTRUCTION RELATIVE TO OCCUPANCY

3.2.2.78 - GROUP F. DIVISION 3 - ANY HEIGHT, ANY AREA, SPRINKLERED FIRE SUPPRESSION - FULL SPRINKLERED ALLOWABLE HEIGHT - ANY HEIGHT ALLOWABLE AREA - ANY AREA **CONSTRUCTION - NON COMBUSTIBLE** FLOOR ASSEMBLIES - 2 HOUR

ACTUAL SIZE AND CONSTRUCTION

FIRE SUPPRESSION - FULL SPRINKLERED **HEIGHT - 1 STOREY** AREA - 3905 SM CONSTRUCTION - NON COMBUSTIBLE FLOOR ASSEMBLY - 2 HOUR SUPPORTING WALLS AND STRUCTURE - 2 HOUR

SUPPORTING WALLS AND STRUCTURE - 2 HOUR

APARTMENT 1

OCCUPANCY CLASSIFICATIONS (TABLE 3.1.2.1) GROUP C - RESIDENTIAL

OCCUPANCY SEPARATIONS (TABLE 3.1.3.1)

BUILDING SIZE AND CONSTRUCTION RELATIVE TO OCCUPANCY 3.2.2.51 - GROUP C, UP TO 4 STOREYS, SPRINKLERED

FIRE SUPPRESSION - FULLY SPRINKLERED ALLOWABLE HEIGHT - 4 STOREYS ALLOWABLE AREA - 1800 SM (BASED ON FOUR STOREYS) CONSTRUCTION - COMBUSTIBLE OR NON COMBUSTIBLE FLOOR ASSEMBLIES - 1 HOUR SUPPORTING WALLS AND STRUCTURE - 1 HOUR

ACTUAL SIZE AND CONSTRUCTION

ROOF ASSEMBLY - NONE

FIRE SUPPRESSION - FULLY SPRINKLERED HEIGHT - 4 STOREYS AREA - 872 SM CONSTRUCTION - COMBUSTIBLE FLOOR ASSEMBLY - 1 HOUR SUPPORTING WALLS AND STRUCTURE - 1 HOUR ROOF ASSEMBLY - NONE

APARTMENT 2

OCCUPANCY CLASSIFICATIONS (TABLE 3.1.2.1) **GROUP C - RESIDENTIAL**

OCCUPANCY SEPARATIONS (TABLE 3.1.3.1)

BUILDING SIZE AND CONSTRUCTION RELATIVE TO OCCUPANCY 3.2.2.50 - GROUP C. UP TO 6 STOREYS. SPRINKLERED

FIRE SUPPRESSION - FULLY SPRINKLERED ALLOWABLE HEIGHT - 6 STOREYS & 18 M ALLOWABLE AREA - 1800 SM (BASED ON FIVE STOREYS) CONSTRUCTION - COMBUSTIBLE OR NON COMBUSTIBLE FLOOR ASSEMBLIES - 1 HOUR SUPPORTING WALLS AND STRUCTURE - 1 HOUR ROOF ASSEMBLY - 1 HOUR

ACTUAL SIZE AND CONSTRUCTION

FIRE SUPPRESSION - FULLY SPRINKLERED HEIGHT - 5 STOREYS, 14.96 M AREA - 875 SM **CONSTRUCTION - COMBUSTIBLE** FLOOR ASSEMBLY - 1 HOUR SUPPORTING WALLS AND STRUCTURE - 1 HOUR ROOF ASSEMBLY - 1 HOUR

CODE ANALYSIS CONTINUED

TOWNHOUSE 1 OCCUPANCY CLASSIFICATIONS (TABLE 3.1.2.1) GROUP C - RESIDENTIAL

OCCUPANCY SEPARATIONS (TABLE 3.1.3.1)

BUILDING SIZE AND CONSTRUCTION RELATIVE TO OCCUPANCY 3.2.2.54 - GROUP C, UP TO 3 STOREYS, SPRINKLERED

FIRE SUPPRESSION - FULLY SPRINKLERED ALLOWABLE HEIGHT - 3 STOREYS ALLOWABLE AREA - 1800 SM (BASED ON THREE STOREYS) CONSTRUCTION - COMBUSTIBLE OR NON COMBUSTIBLE FLOOR ASSEMBLIES - 45 MIN.

SUPPORTING WALLS AND STRUCTURE - 45 MIN. ROOF - NONE

ACTUAL SIZE AND CONSTRUCTION

FIRE SUPPRESSION - FULLY SPRINKLERED **HEIGHT - 3 STOREYS WITH BASEMENT** AREA - 653 SM **CONSTRUCTION - COMBUSTIBLE** FLOOR ASSEMBLY - 45 MIN. SUPPORTING WALLS AND STRUCTURE - 45 MIN. **ROOF ASSEMBLY - NONE**

TOWNHOUSE 2

OCCUPANCY CLASSIFICATIONS (TABLE 3.1.2.1) GROUP C - RESIDENTIAL

OCCUPANCY SEPARATIONS (TABLE 3.1.3.1)

BUILDING SIZE AND CONSTRUCTION RELATIVE TO OCCUPANCY 3.2.2.54 - GROUP C, UP TO 3 STOREYS, SPRINKLERED

FIRE SUPPRESSION - FULLY SPRINKLERED ALLOWABLE HEIGHT - 3 STOREYS ALLOWABLE AREA - 1800 SM (BASED ON THREE STOREYS) CONSTRUCTION - COMBUSTIBLE OR NON COMBUSTIBLE FLOOR ASSEMBLIES - 45 MIN. SUPPORTING WALLS AND STRUCTURE - 45 MIN.

ACTUAL SIZE AND CONSTRUCTION

ROOF - NONE

FIRE SUPPRESSION - FULLY SPRINKLERED HEIGHT - 3 STOREYS WITH BASEMENT AREA - 652 SM CONSTRUCTION - COMBUSTIBLE FLOOR ASSEMBLY - 45 MIN. SUPPORTING WALLS AND STRUCTURE - 45 MIN. **ROOF ASSEMBLY - NONE**

OCCUPANCY CLASSIFICATIONS (TABLE 9.10.2.1)

GROUP C - RESIDENTIAL

FIRE-RESISTANCE RATINGS (TABLE 9.10.8.1) USE - RESIDENTIAL (GROUP C) MAXIMUM HEIGHT - 3 STOREYS MAXIMUM AREA - 600 SM CONSTRUCTION - COMBUSTIBLE OR NON COMBUSTIBLE FLOOR ASSEMBLIES - 45 MIN. SUPPORTING WALLS AND STRUCTURE - 45 MIN.

ACTUAL SIZE AND CONSTRUCTION

ROOF ASSEMBLY - NONE

FIRE SUPPRESSION - FULLY SPRINKLERED **HEIGHT - 3 STOREYS WITH BASEMENT** AREA - 392 SM **CONSTRUCTION - COMBUSTIBLE** FLOOR ASSEMBLY - 45 MIN. SUPPORTING WALLS AND STRUCTURE - 45 MIN. ROOF ASSEMBLY - NONE

SITE LOCATION

DRAWING INDEX

ARCHITECTURAL A001 PROJECT INFORMATION A002 SURVEY

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A201 ARCHITECTURAL SITE PLAN A202 AVERAGE GRADE CALCULATIONS

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A205 L3 PLAN A206 L4 PLAN

A207 L5 PLAN A208 ROOF PLAN

A301 ELEVATIONS - APARTMENT A302 ELEVATIONS - APARTMENT 2

A303 ELEVATIONS - APARTMENT 2 A304 ELEVATIONS - TOWNHOUSE 1 A305 ELEVATIONS - TOWNHOUSE 2

A306 ELEVATIONS - TOWNHOUSE 3 A307 SHADOW STUDIES

A308 VIEW ANALYSIS A309 VIEW ANALYSIS

A310 VIEW ANALYSIS A311 PERSPECTIVE STUDIES A312 PERSPECTIVE STUDIES

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A313 SKYLINE ANALYSIS

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A610 TOWNHOUSE 3

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A703 TOWNHOUSE S 1 & 2 UNIT PLANS A704 TOWNHOUSE 3 UNIT PLANS

A705 AMENITY ROOM

19-028-REZONING CONCEPTUAL SERVICING


LANDSCAPE

L1.01 LANDSCAPE OVERVIEW PLAN L1.02 LANDSCAPE MATERIALS SOUTH L1.03 LANDSCAPE MATERIALS NORTH L1.04 STORMWATER MANAGEMENT

L1.05 TREE RETENTION & REMOVAL PLAN L3.01 PLANTING PLAN SOUTH

L3.02 PLANTING PLAN NORTH L5.01 LANDSCAPE SECTIONS

> Revisions Bubbled areas indicate revisions compared to the previously submitted plans **Received Date: April 6, 2020**

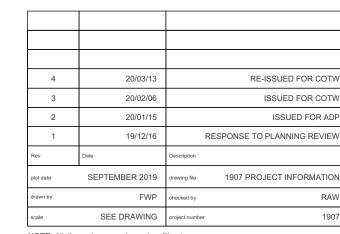


ISSUED FOR DP & REZONING




Location Plan




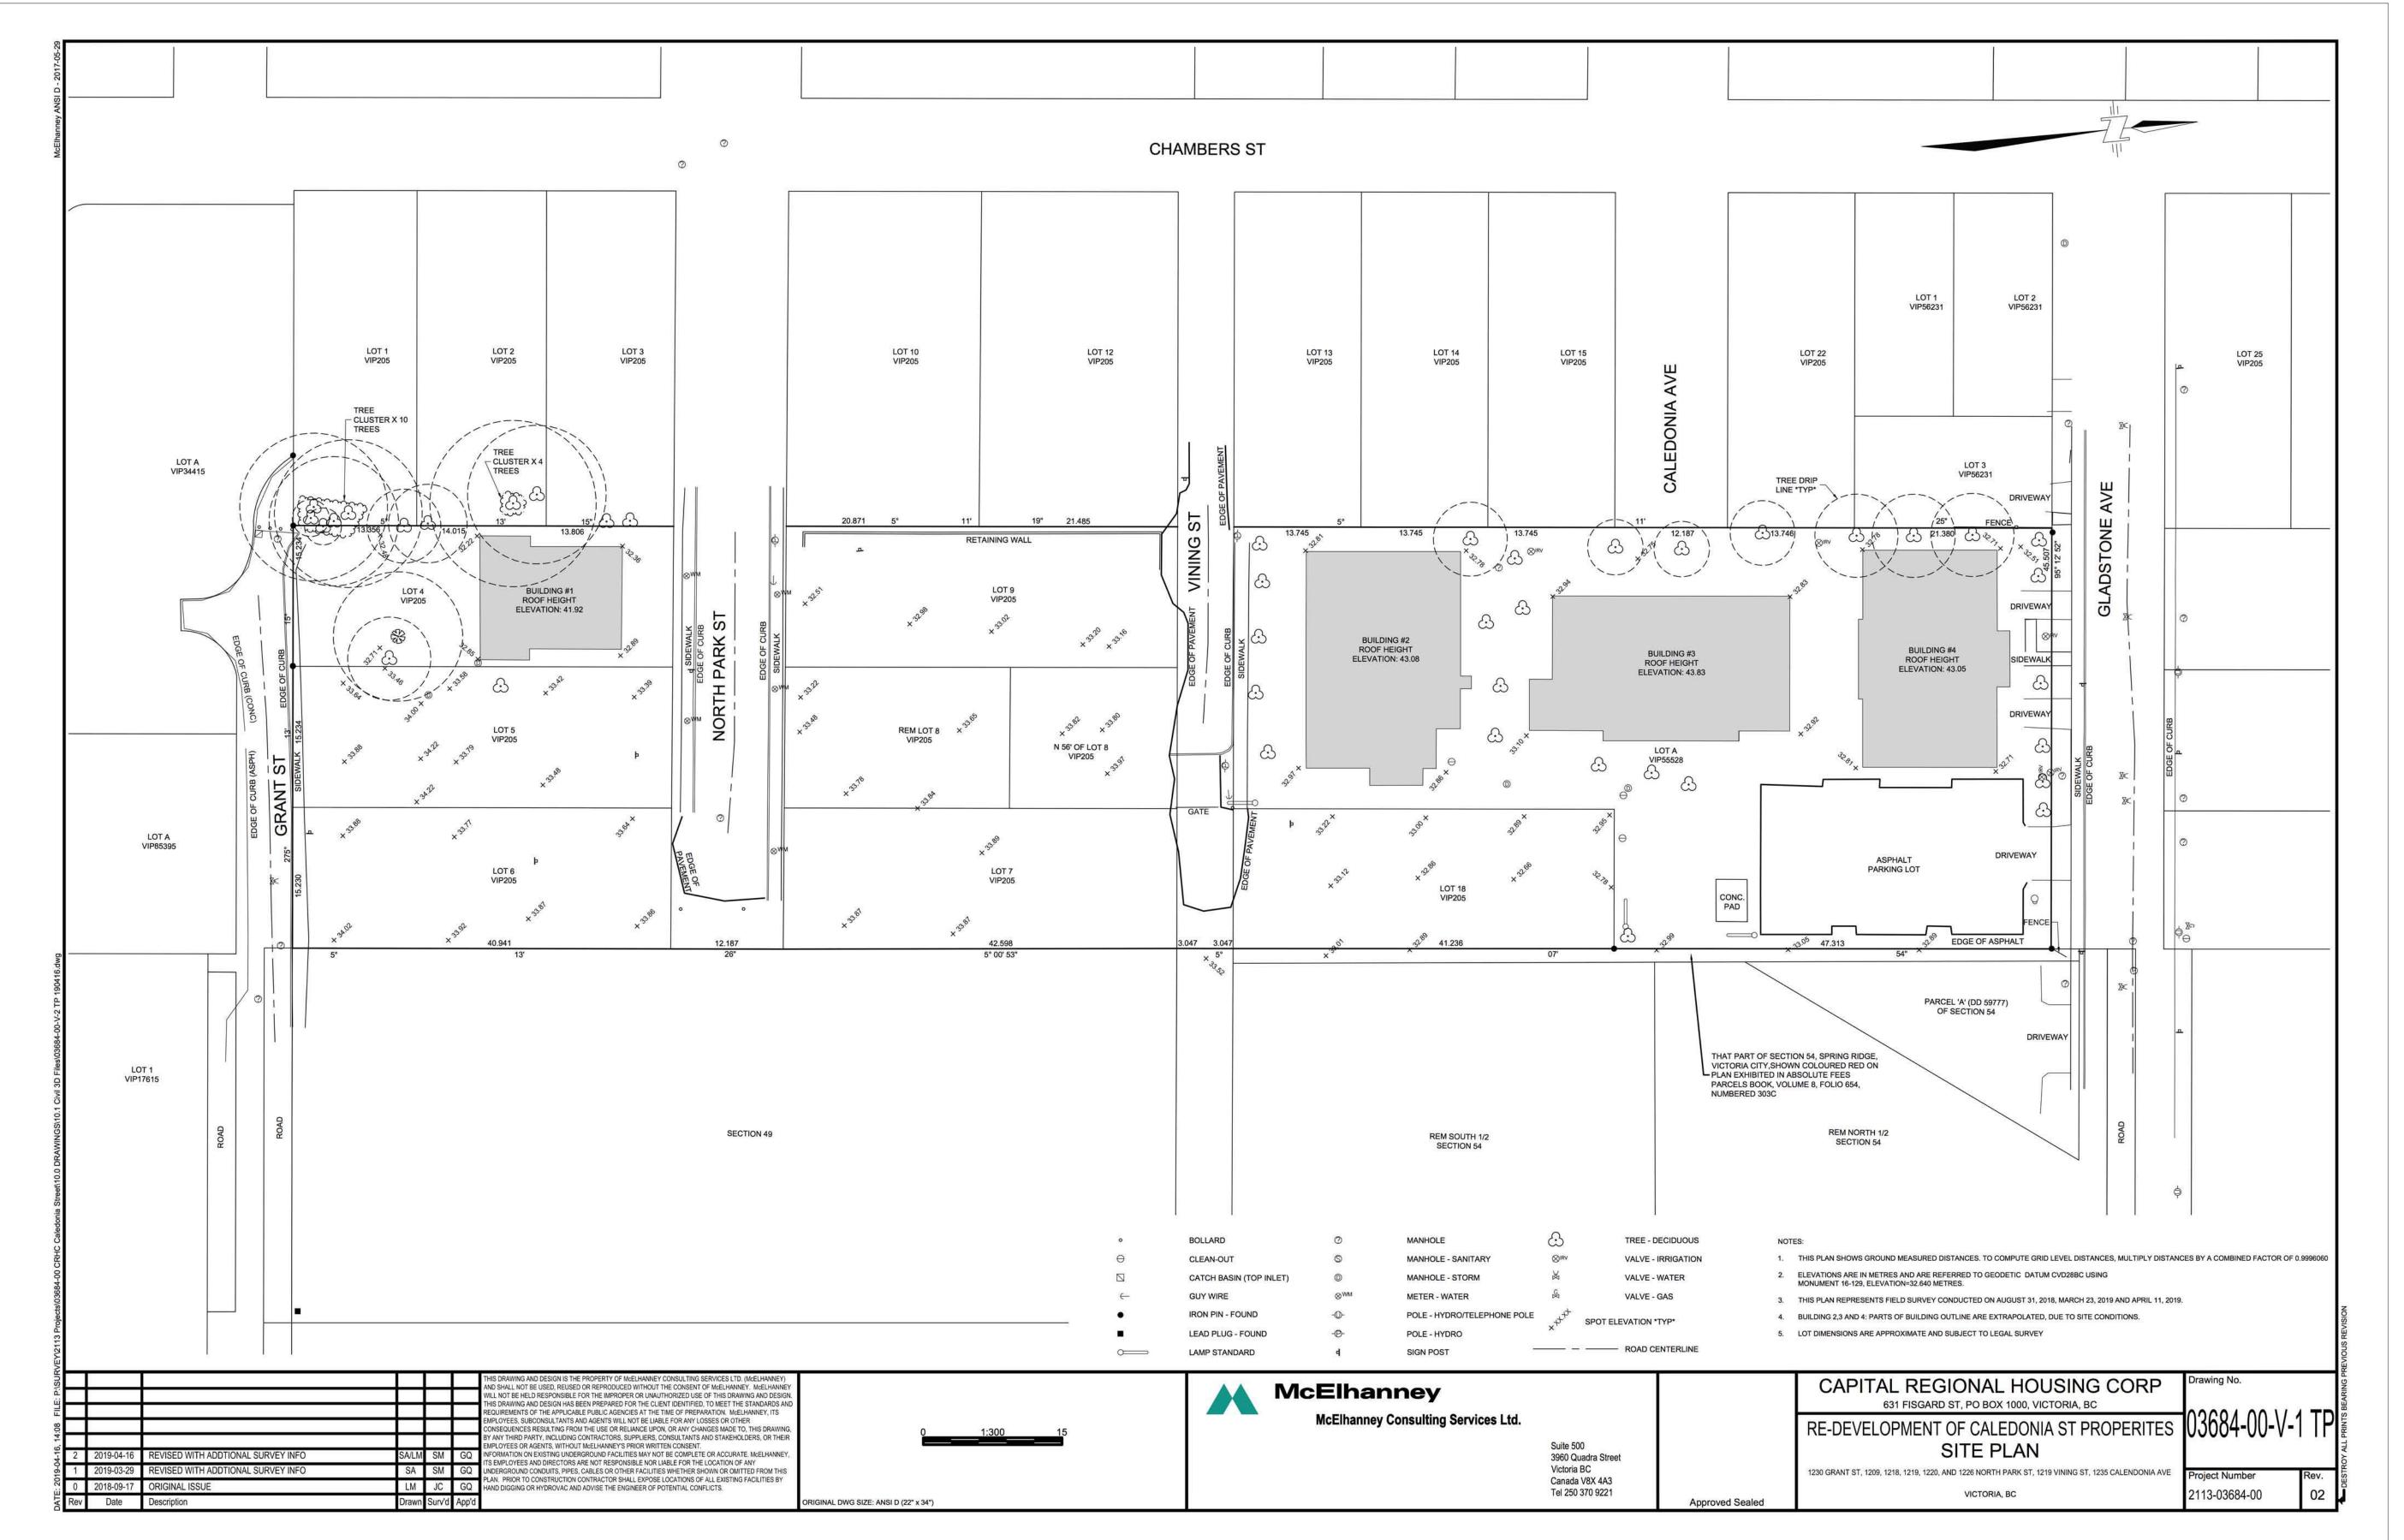

4	20/03/13		RE-ISSUED FOR COTV
3	20/02/06		ISSUED FOR COTV
2	20/01/15		ISSUED FOR ADI
1	19/12/16	RES	SPONSE TO PLANNING REVIEW
Rev	Date	Description	
plot date	SEPTEMBER 2019	drawing file	1907 PROJECT INFORATION
drawn by	FWP	checked by	RAV
scale	SEE DRAWING	project number	190

& REZUNING				
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VICTORIA OFFICE 977 Fort Street Victoria BC V8V3K3 T 1•250•658•3367	977 Fort Street 102-5190 Dublin Way Victoria BC V8V 3K3 Nanaimo BC V9T 2K8			
Caledonia				
Victoria, BC drawing title Survey				

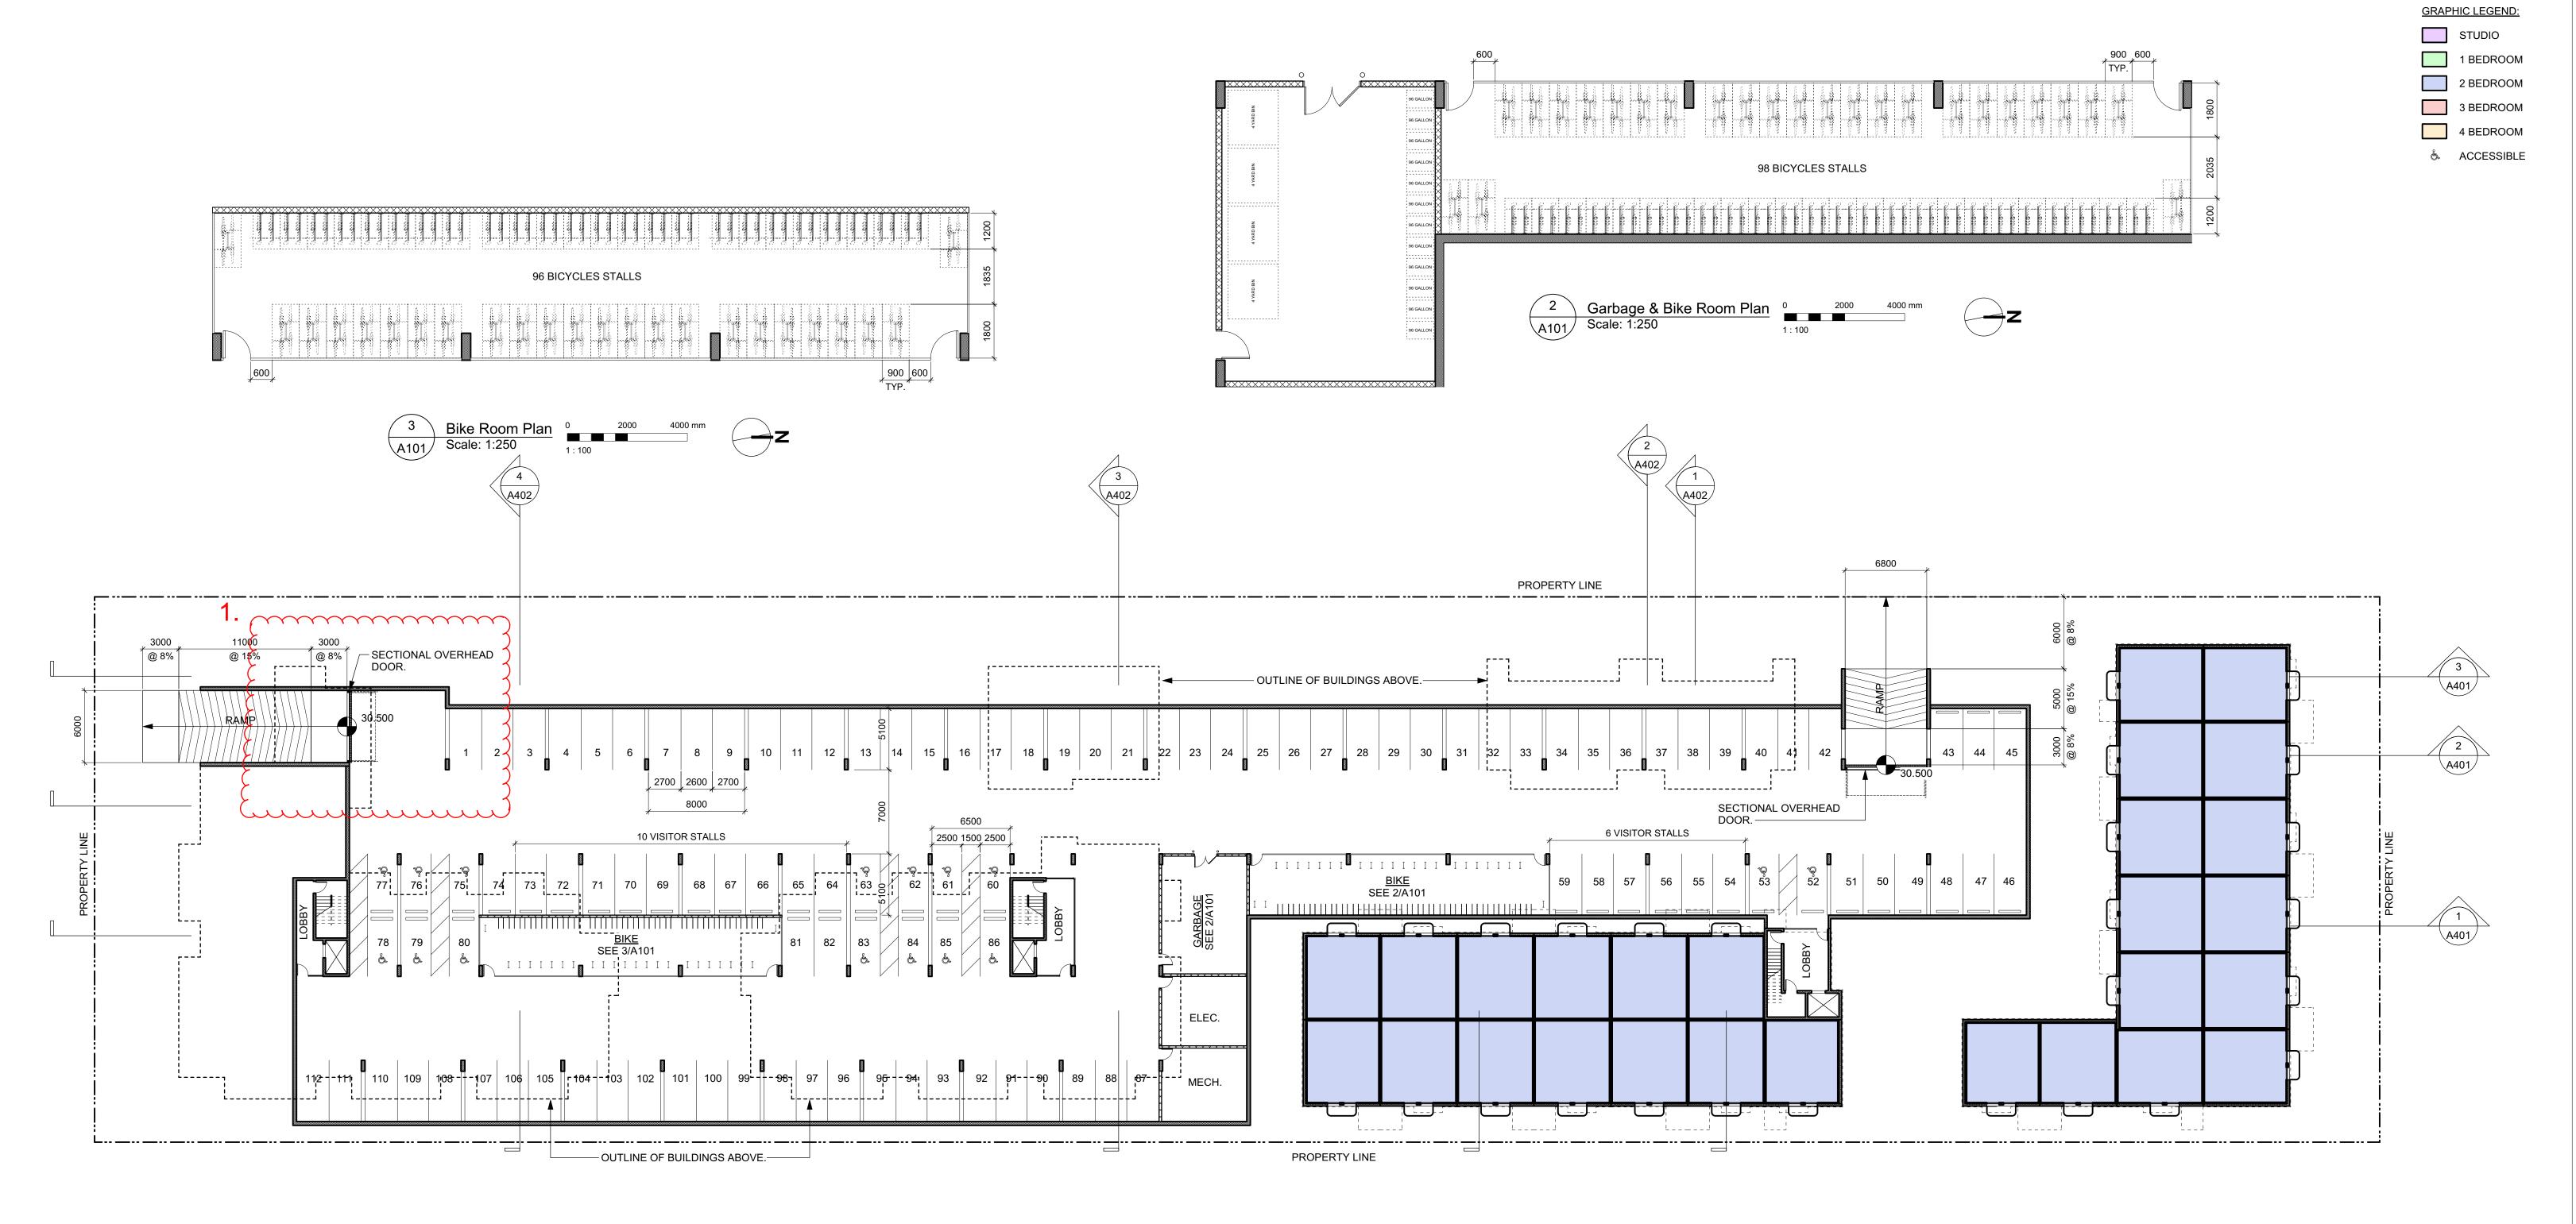

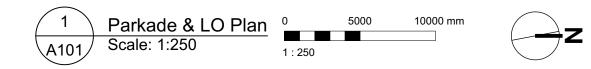


VEHICLE PARKING C	ALCULATION
UNITS < 45 SM UNITS 45-70 SM <u>UNITS >70 SM</u> SUBTOTAL	14 X .2 = 2.8 58 X .5 = 29 86 X .75 = 64.5 96.3 (96)
VISITOR TOTAL REQUIRED PROVIDED	158 X .1 = 15.8 (16) 112 117 (5 SURFACE)
LONG TERM BIKE PA	RKING CALCULATION
UNITS < 45 SM <u>UNITS > 45 SM</u> TOTAL REQUIRED PROVIDED	14 X 1 = 14 144 X 1.25 = 180 194 194

4	20/03/13	RE-ISSUED FOR	COTV
3	20/02/06	ISSUED FOR	COTV
2	20/01/15	ISSUED FO	OR ADI
1	19/12/16	RESPONSE TO PLANNING F	REVIEV
Rev	Date	Description	
plot date	SEPTEMBER 2019	drawing file 1907 A200 Pla	ans.vw
drawn by	FWP	checked by	RAV
scale	AS SHOWN	project number	1907

ISSUED FOR DP
& REZONING





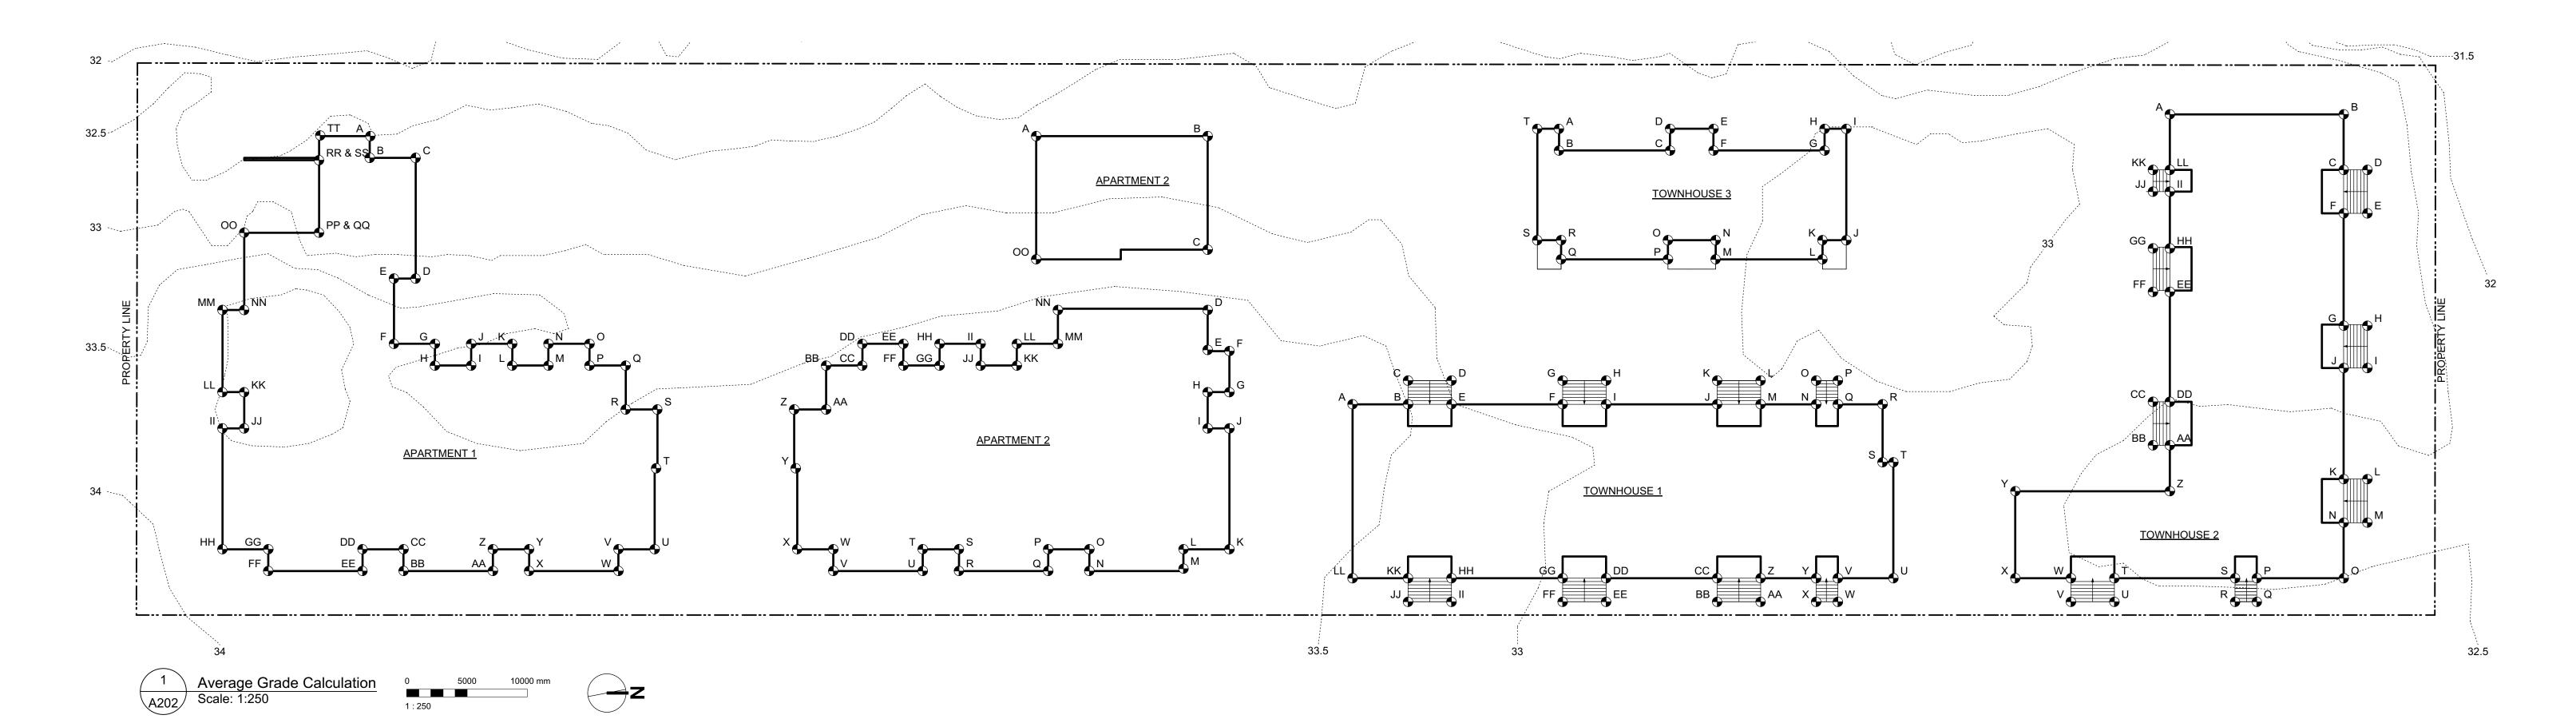

side	corner	+ corner	/ 2	average grade	X length of	TOTAL	
Siuc	grade point	grade point	, <u>, , , , , , , , , , , , , , , , , , </u>	per side	side	IOIAL	
A&B	32.5	32.6	2	32.6	1.8	58.6	
B&C	32.6	32.6	2	32.6	3.8	123.9	
C&D	32.6	33.3	2	33.0	10.0	329.5	
D&E	33.3	33.3	2	33.3	1.8	59.9	
E&F	33.3	33.8	2	33.6	5.4	181.2	
F&G	33.8	33.7	2	33.8	3.4	114.8	
G&H	33.7	33.5	2	33.6	1.8	60.5	
H&I	33.5	38.4	2	36.0	3.0	107.9	
I&J	38.4	33.5	2	36.0	1.8	64.7	
J&K	33.5	33.5	2	33.5	3.4	113.9	
K&L	33.5	33.4	2	33.5	1.8	60.2	
L&M	33.4	33.4	2	33.4	3.0	100.2	
M&N	33.4	33.5	2	33.5	1.8	60.2	
N&O	33.5	33.4	2	33.5	3.4	113.7	
O&P	33.4	33.3	2	33.4	1.8	60.0	
P&Q	33.3	33.3	2	33.3	3.0	99.9	
Q&R	33.3	33.5	2	33.4	3.6	121.4	
R&S	33.5	33.5	2	33.5	2.6	88.4	
S&T	33.5	33.7	2	33.6	4.9	163.6	
T&U	33.7	33.8	2	33.8	6.7	226.0	
U&V	33.8	33.8	2	33.8	3.0	101.4	
V&W	33.8	33.8	2	33.8	1.8	60.8	
W&X	33.8	33.8	2	33.8	7.4	250.1	
X&Y	33.8	33.8	2	33.8	1.8	60.8	
Y&Z	33.8	33.9	2	33.9	3.0	101.6	
Z&AA	33.9	33.9	2	33.9	1.8	61.0	
AA&BB	33.9	33.9	2	33.9	7.4	250.9	
BB&CC	33.9	33.9	2	33.9	1.8	61.0	
CCⅅ	33.9	33.9	2	33.9	3.4	115.3	
DD&EE	33.9	33.9	2	33.9	1.8	61.0	
EE&FF	33.9	33.9	2	33.9	7.8	264.4	
FF&GG	33.9	33.9	2	33.9	1.8	61.0	
GG&HH	33.9	33.9	2	33.9	3.8	128.8	
HH&II	33.9	34.0	2	34.0	10.0	339.5	
II&JJ	34.0	34.0	2	34.0	1.9	62.9	
JJ&KK	34.0	34.0	2	34.0	3.0	100.3	
KK&LL	34.0	34.0	2	34.0	1.8	61.2	
LL&MM	34.0	34.0	2	34.0	6.8	231.2	
MM&NN	34.0	34.0	2	34.0	1.8	61.2	
NN&OO	34.0	33.0	2	33.5	6.3	211.6	
OO&PP	33.0	32.9	2	33.0	6.2	204.3	
QQ&RR	31.2	31.2	2	31.2	6.2	191.9	
SS&TT	32.6	32.5	2	32.6	1.9	61.8	
TT&A	32.5	32.5	2	32.5	6.3	205.2	
							GRADE = TOTAL/Perimete
				Perimeter	167.5	5617.8	33.5

	CALCULATION						
APARTM					V 1 41 6		
side	corner grade point	+ corner grade point	/ 2	average grade per side	X length of side	TOTAL	
A 0 D	20.7	20.0		20.0	14.0	405.4	
A&B	32.7	32.8	2	32.8	14.2	465.1	
B&C	32.8	33.3	2	33.1	9.4	310.7	
C&D	33.3	33.5	2	33.4	5.0	167.0	
D&E	33.5	33.5	2	33.5	3.4	113.9	
E&F	33.5	33.5	2	33.5	1.8	60.3	
F&G	33.5	33.5	2	33.5	3.4	113.9	
G&H	33.5	33.5	2	33.5	1.8	60.3	
H&I	33.5	33.5	2	33.5	3.0	100.5	
I&J	33.5	33.5	2	33.5	1.8	60.3	
J&K	33.5	33.5	2	33.5	10.0	335.0	
K&L	33.5	33.6	2	33.5	3.8	127.4	
L&M	33.6	33.6	2	33.6	1.8	60.5	
M&N	33.6	33.6	2	33.6	7.8	262.1	
N&O	33.6	33.6	2	33.6	1.8	60.5	
O&P	33.6	33.6	2	33.6	3.4	114.2	
P&Q	33.6	33.6	2	33.6	1.8	60.5	
Q&R	33.6	33.7	2	33.7	7.4	249.0	
R&S	33.7	33.7	2	33.7	1.8	60.7	
S&T	33.7	33.7	2	33.7	3.0	101.1	
T&U	33.7	33.7	2	33.7	1.8	60.7	
U&V	33.7	33.7	2	33.7	7.4	249.4	
V&W	33.7	33.7	2	33.7	1.8	60.7	
W&X	33.7	33.7	2	33.7	3.0	101.1	
X&Y	33.7	33.6	2	33.7	6.7	225.3	
Y&Z	33.6	33.6	2	33.6	4.9	163.6	
Z&AA	33.6	33.6	2	33.6	2.6	88.7	
AA&BB	33.6	33.5	2	33.6	3.6	122.0	
BB&CC	33.5	33.5	2	33.5	3.0	100.5	
CCⅅ	33.5	33.5	2	33.5	1.8	60.3	
DD&EE	33.5	33.6	2	33.6	3.4	114.1	
EE&FF	33.5	33.5	2	33.5	1.8	60.3	
FF&GG	33.5	33.5	2	33.5	3.0	100.5	
GG&HH	33.5	33.5	2	33.5	1.8	60.3	
HH&II	33.5	33.5	2	33.5	3.4	113.9	
II&JJ	33.5	33.5	2	33.5	1.8	60.3	
JJ&KK	33.5	33.5	2	33.5	3.0	100.5	
KK&LL	33.5	33.5	2	33.5	1.8	60.3	
LL&MM	33.5	33.5	2	33.5	3.4	113.9	
MM&NN	33.5	33.5	2	33.5	2.8	93.8	
NN&OO	33.5	33.3	2	33.5	4.6	153.1	
OO&A	33.3	32.7	2	33.0	10.2	336.6	
							GRADE = TOTAL/Perimete
				Perimeter	164.0	5482.6	33.4

TOWNHO	CALCULATION DUSE 1						
side	corner grade point	+ corner grade point	/ 2	average grade per side	X length of side	TOTAL	
A&B	33.6	33.5	2	33.6	4.6	153.2	
B&C	33.5	33.4	2	33.5	2.0	65.6	
C&D	33.4	33.0	2	33.2	3.6	119.5	
D&E	33.0	33.0	2	33.0	2.0	64.7	
E&F	33.0	32.9	2	33.0	9.2	303.1	
F&G	32.9	32.9	2	32.9	2.0	64.5	
G&H	32.9	32.9	2	32.9	3.6	118.4	
H&I	32.9	32.9	2	32.9	2.0	64.5	
I&J	32.9	32.8	2	32.9	9.2	302.2	
J&K	32.8	32.9	2	32.9	2.0	64.4	
K&L	32.9	33.0	2	33.0	3.6	118.6	
L&M	33.0	32.8	2	32.9	2.0	64.5	
M&N	32.8	32.7	2	32.8	4.6	150.7	
N&O	32.7	32.8	2	32.8	2.0	64.2	
O&P	32.8	32.9	2	32.9	1.8	59.1	
P&Q	32.9	32.7	2	32.8	2.0	64.3	
Q&R	32.7	32.9	2	32.8	3.7	121.4	
R&S	32.9	32.7	2	32.8	4.8	157.4	
S&T	32.7	32.7	2	32.7	0.9	29.4	
T&U	32.7	32.7	2	32.7	9.6	313.9	
U&V	32.7	32.7	2	32.7	4.6	150.4	
V&W	32.7	32.7	2	32.7	2.0	64.1	
W&X	32.7	32.8	2	32.8	1.8	59.0	
X&Y	32.8	32.8	2	32.8	2.0	64.3	
Y&Z	32.8	32.8	2	32.8	4.6	150.9	
Z&AA	32.8	32.8	2	32.8	2.0	64.3	
AA&BB	32.8	32.9	2	32.9	3.6	118.3	
BB&CC	32.9	32.9	2	32.9	2.0	64.5	
CCⅅ	32.9	32.9	2	32.9	9.2	302.7	
DD&EE	32.9	32.9	2	32.9	2.0	64.5	
EE&FF	32.9	33.0	2	33.0	3.6	118.6	
FF&GG	33.0	33.0	2	33.0	2.0	64.7	
GG&HH	33.0	33.2	2	33.1	9.2	304.5	
HH&II	33.2	33.2	2	33.2	2.0	65.1	
II&JJ	33.2	33.3	2	33.3	3.6	119.7	
JJ&KK	33.3	33.3	2	33.3	2.0	65.3	
KK&LL	33.3	33.4	2	33.4	4.6	153.4	
LL&A	33.4	33.6	2	33.5	14.5	484.1	
							GRADE = TOTAL/Perimete
				Perimeter	149.8	4941.8	33.0

TOWNHO	OUSE 2						
side	corner grade point	+ corner grade point	/ 2	average grade per side	X length of side	TOTAL	
A&B	32.7	32.6	2	32.7	14.4	471.6	
B&C	32.6	32.6	2	32.6	4.6	150.0	
C&D	32.6	32.6	2	32.6	2.0	63.9	
D&E	32.6	32.6	2	32.6	3.6	117.4	
E&F	32.6	32.6	2	32.6	2.0	63.9	
F&G	32.6	32.6	2	32.6	9.2	299.9	
G&H	32.6	32.6	2	32.6	2.0	63.9	
H&I	32.6	32.6	2	32.6	3.6	117.4	
I&J	32.6	32.6	2	32.6	2.0	63.9	
J&K	32.6	32.5	2	32.6	9.2	299.5	
K&L	32.5	32.5	2	32.5	2.0	63.7	
L&M	32.5	32.5	2	32.5	3.6	117.0	
M&N	32.5	32.5	2	32.5	2.0	63.7	
N&O	32.5	32.5	2	32.5	4.6	149.5	
O&P	32.5	32.5	2	32.5	7.2	234.0	
P&Q	32.5	32.5	2	32.5	2.0	63.7	
Q&R	32.5	32.5	2	32.5	1.8	58.5	
R&S	32.5	32.5	2	32.5	2.0	63.7	
S&T	32.5	32.5	2	32.5	10.0	325.0	
T&U	32.5	32.5	2	32.5	2.0	63.7	
U&V	32.5	32.6	2	32.6	3.6	117.2	
V&W	32.6	32.6	2	32.6	2.0	63.9	
W&X	32.6	32.6	2	32.6	4.6	150.0	
X&Y	32.6	32.6	2	32.6	7.2	234.7	
Y&Z	32.6	32.6	2	32.5	12.8	416.0	
Z&AA			2				
	32.4	32.5		32.5	3.8	123.3	
AA&BB	32.5	32.5	2	32.5	1.4	45.5	
BB&CC	32.5	32.5	2	32.5	3.6	117.0	
CCⅅ	32.5	32.5	2	32.5	1.4	45.5	
DD&EE	32.5	32.8	2	32.7	9.2	300.4	
EE&FF	32.8	32.8	2	32.8	1.4	45.9	
FF&GG	32.8	32.8	2	32.8	3.6	118.1	
GG&HH	32.8	32.8	2	32.8	1.4	45.9	
HH&II	32.8	32.8	2	32.8	4.6	150.9	
II&JJ	32.8	32.9	2	32.9	1.4	46.0	
JJ&KK	32.9	32.9	2	32.9	1.8	59.2	
KK&LL	32.9	32.8	2	32.9	1.4	46.0	
LL&A	32.8	32.7	2	32.8	4.6	150.7	
							GRADE
							TOTAL/Peri


FOWNH	OUSE 3						
side	corner grade point	+ corner grade point	/ 2	average grade per side	X length of side	TOTAL	
4&B	32.6	32.6	2	32.6	1.8	58.7	
3&C	32.6	32.6	2	32.6	9.2	299.9	
C&D	32.6	32.6	2	32.6	1.8	58.7	
D&E	32.6	32.7	2	32.7	3.6	117.5	
E&F	32.7	32.8	2	32.8	1.8	59.0	
-&G	32.8	33.0	2	32.9	9.2	302.7	
G&H	33.0	33.0	2	33.0	1.8	59.4	
- &	33.0	33.0	2	33.0	1.8	59.4	
&J	33.0	33.0	2	33.0	9.3	305.7	
J&K	33.0	33.0	2	33.0	2.0	65.2	
<&L	33.0	33.0	2	33.0	1.6	52.3	
_&M	33.0	32.9	2	33.0	8.9	291.6	
Λ&N	32.9	32.9	2	32.9	1.6	52.1	
V&O	32.9	32.9	2	32.9	4.0	130.0	
O&P	32.9	32.9	2	32.9	1.6	52.1	
P&Q	32.9	32.8	2	32.9	8.9	290.7	
Q&R	32.8	32.8	2	32.8	1.6	52.0	
R&S	32.8	32.8	2	32.8	2.0	64.8	
S&T	32.8	32.6	2	32.7	9.3	303.6	
Г&А	32.6	32.6	2	32.6	1.8	58.7	
							GRADE = TOTAL/Perimeter
				Perimeter	83.3	2734.1	32.8


GRADE CALCULATION

4	20/03/13	RE-ISSUED FOR COTW
3	20/02/06	ISSUED FOR COTW
2	20/01/15	ISSUED FOR ADP
1	19/12/16	RESPONSE TO PLANNING REVIEW
Rev	Date	Description
plot date	SEPTEMBER 2019	drawing file 1907 A200 Plans.vwx
drawn by	FWP	checked by RAW
scale	AS SHOWN	project number 1907

NOTE: All dimensions are shown in millimeters. ISSUED FOR DP & REZONING

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VICTORIA OFFICE 977 Fort Street Victoria BC V8V3K3 T 1.250.658.3367	NANAIMO OFFICE 102-5190 Du Nanaimo BC T 1•250•585	blin Way V9T2K8
Caledonia		
Victoria BC		
Average Grade	Calculations	,
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4	20/03/13	RE-ISSUED FOR COTW
3	20/02/06	ISSUED FOR COTW
2	20/01/15	ISSUED FOR ADF
1	19/12/16	RESPONSE TO PLANNING REVIEW
Rev	Date	Description
plot date	SEPTEMBER 2019	drawing file 1907 A200 Plans.vwx
drawn by	FWP	checked by RAW
scale	AS SHOWN	project number 1907
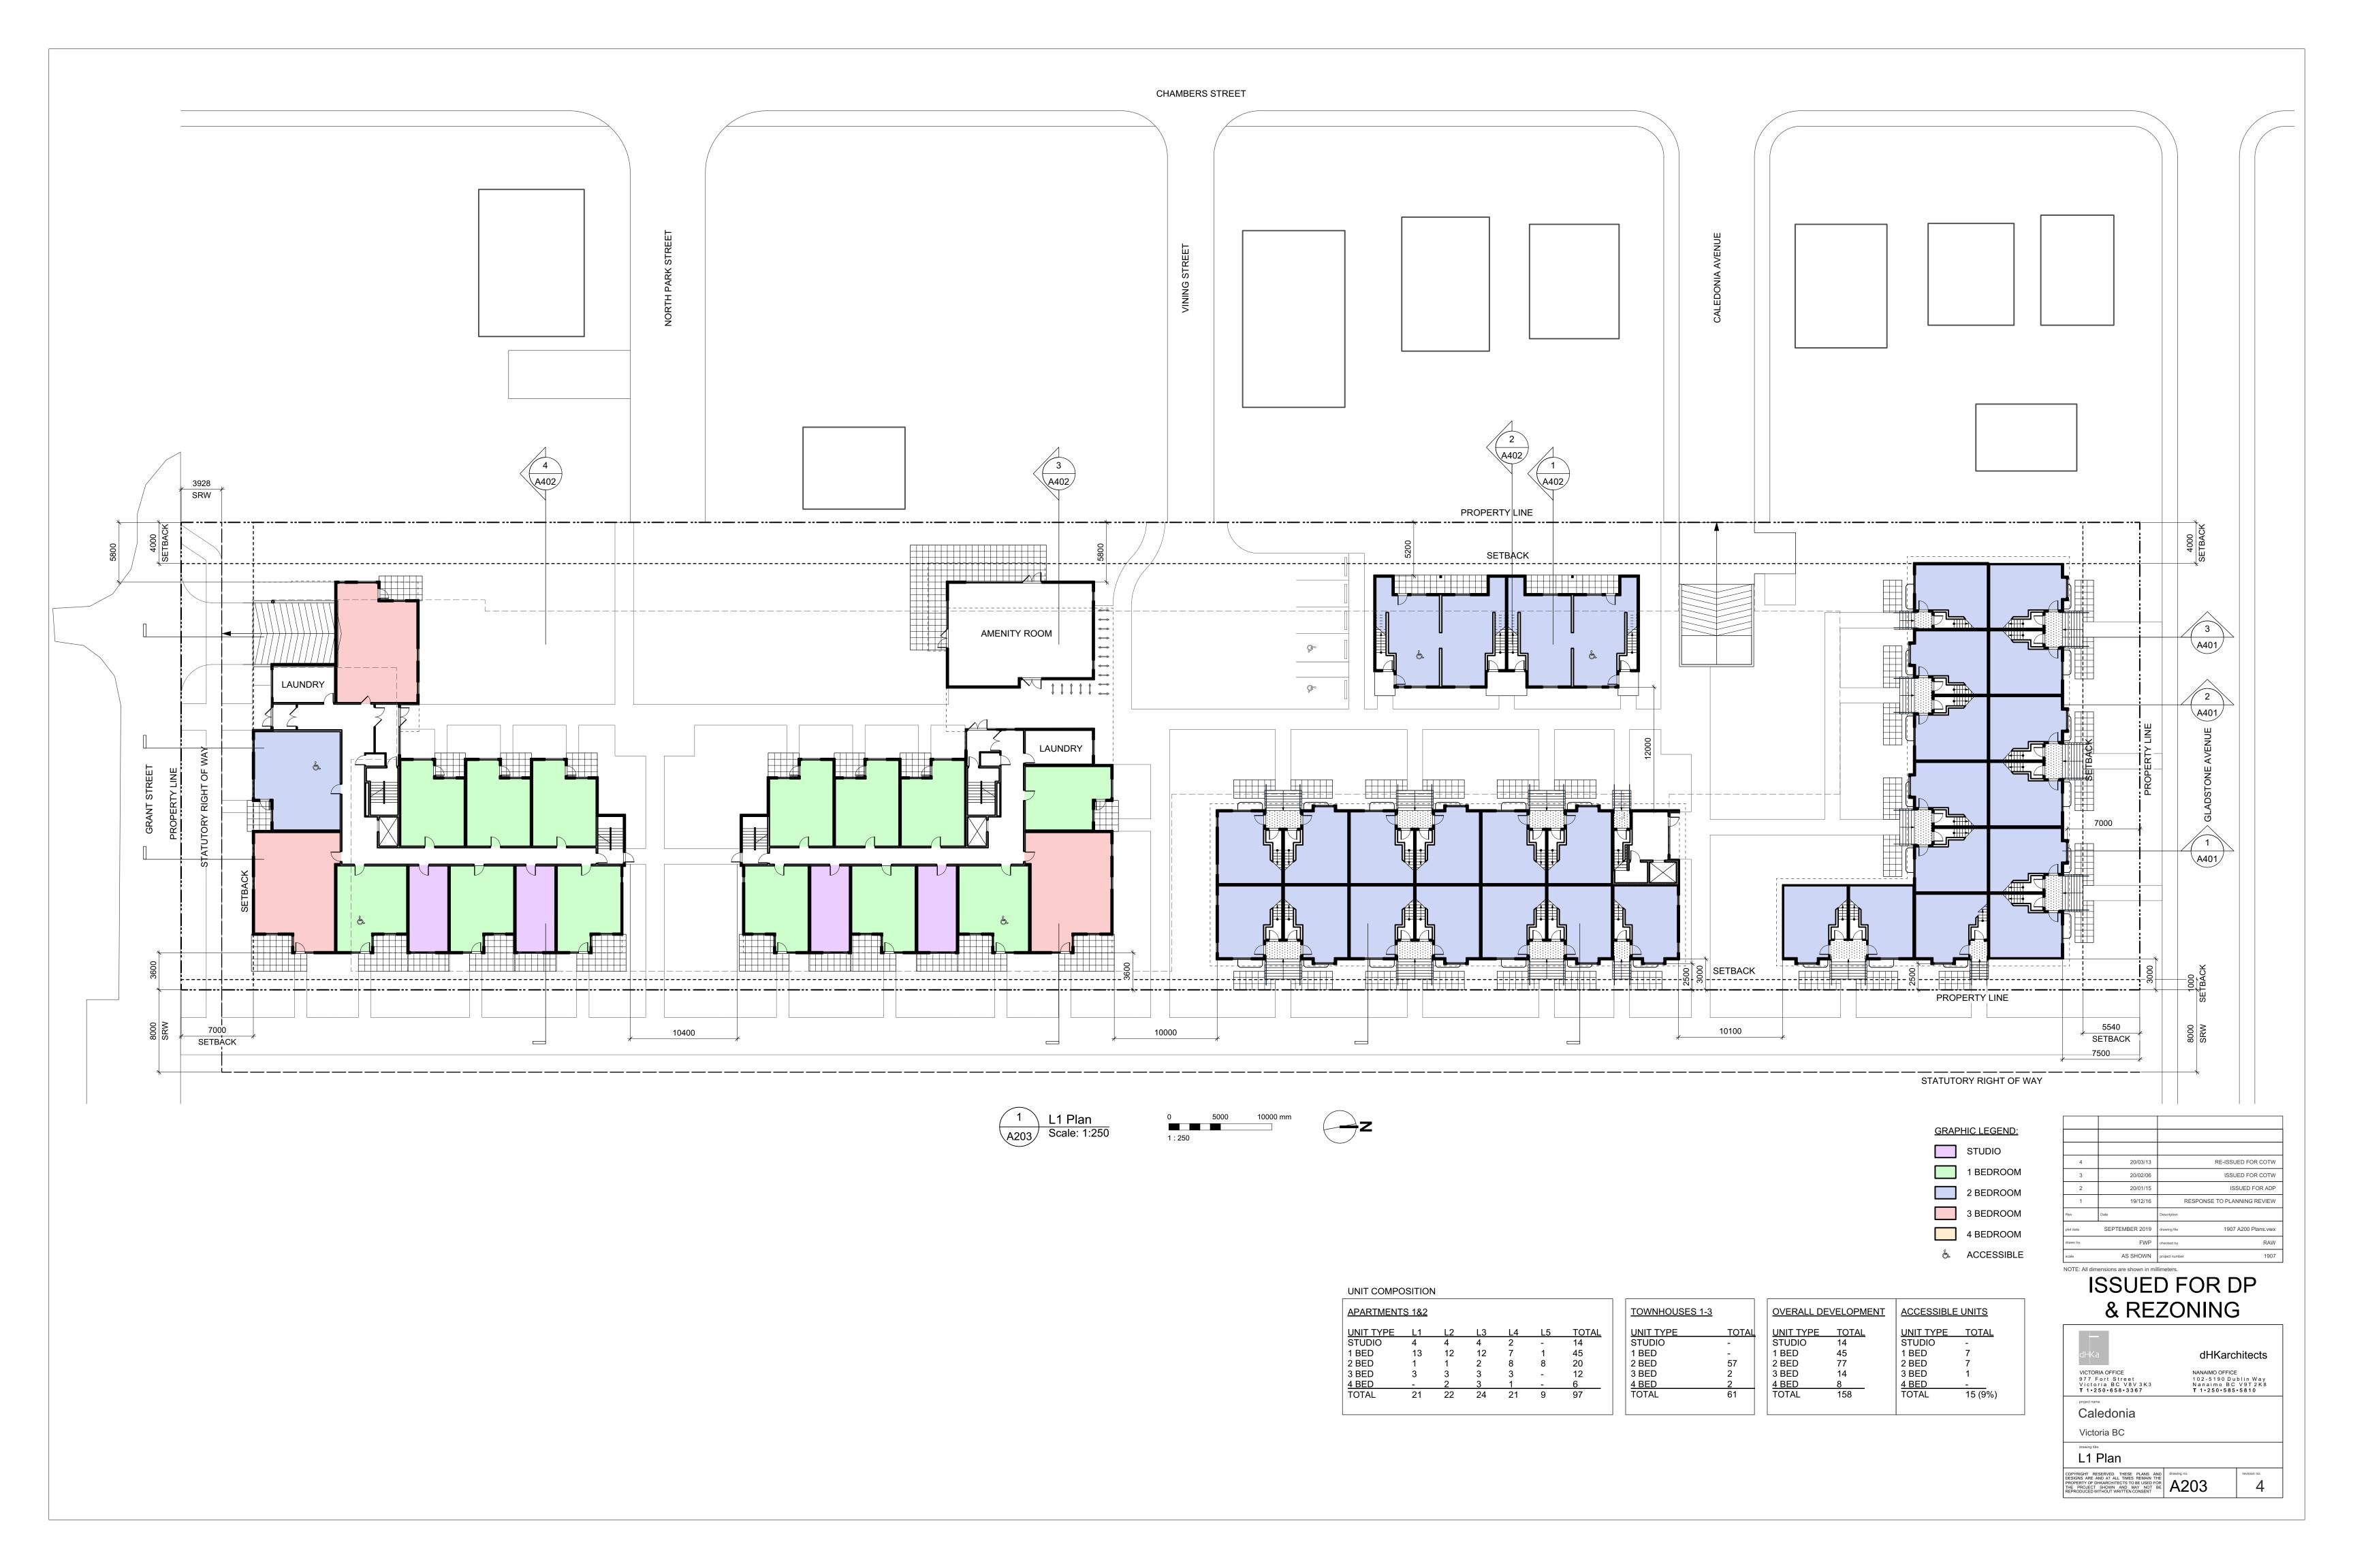
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project name		
Caledonia		
Victoria BC		
drawing title		
L2 Plan		
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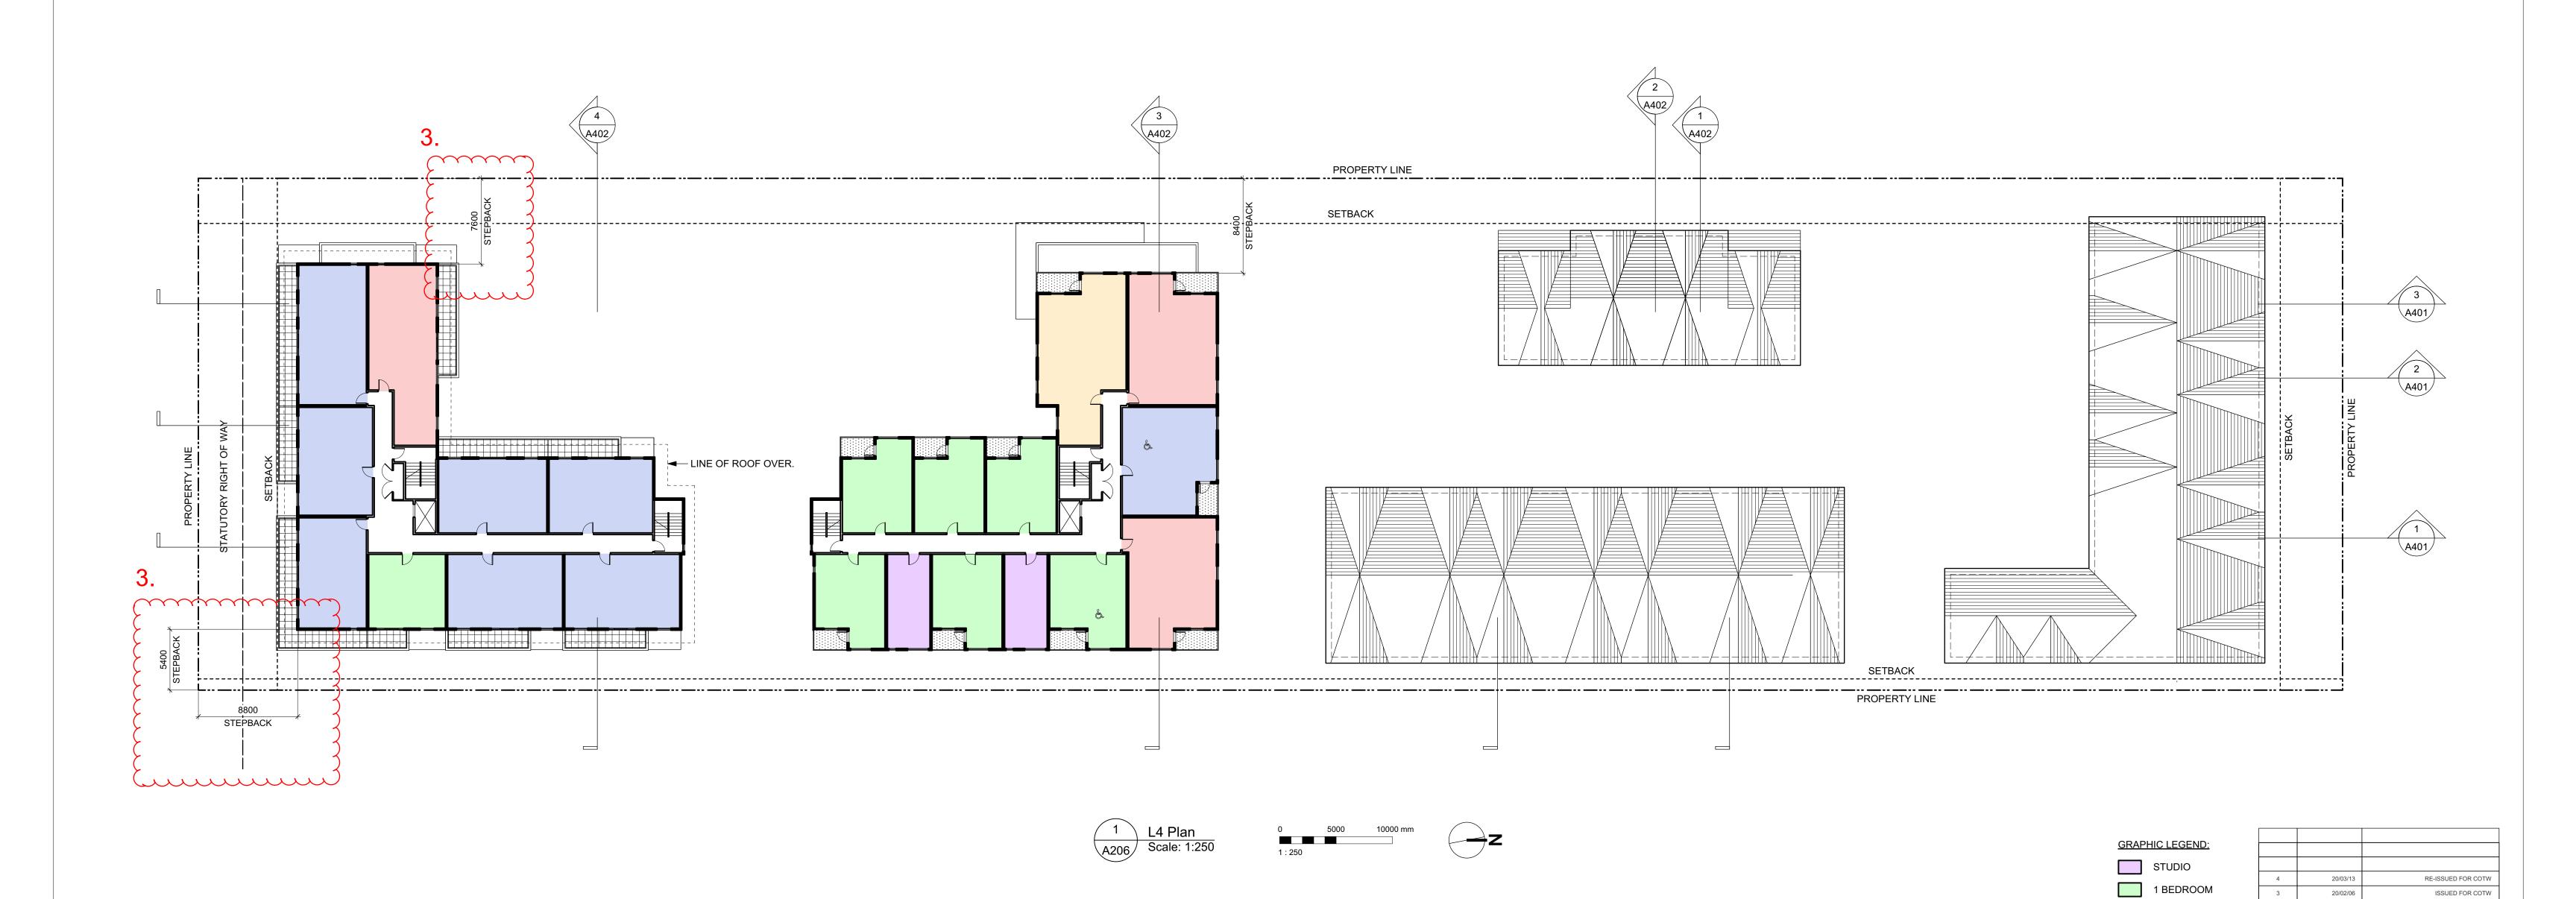


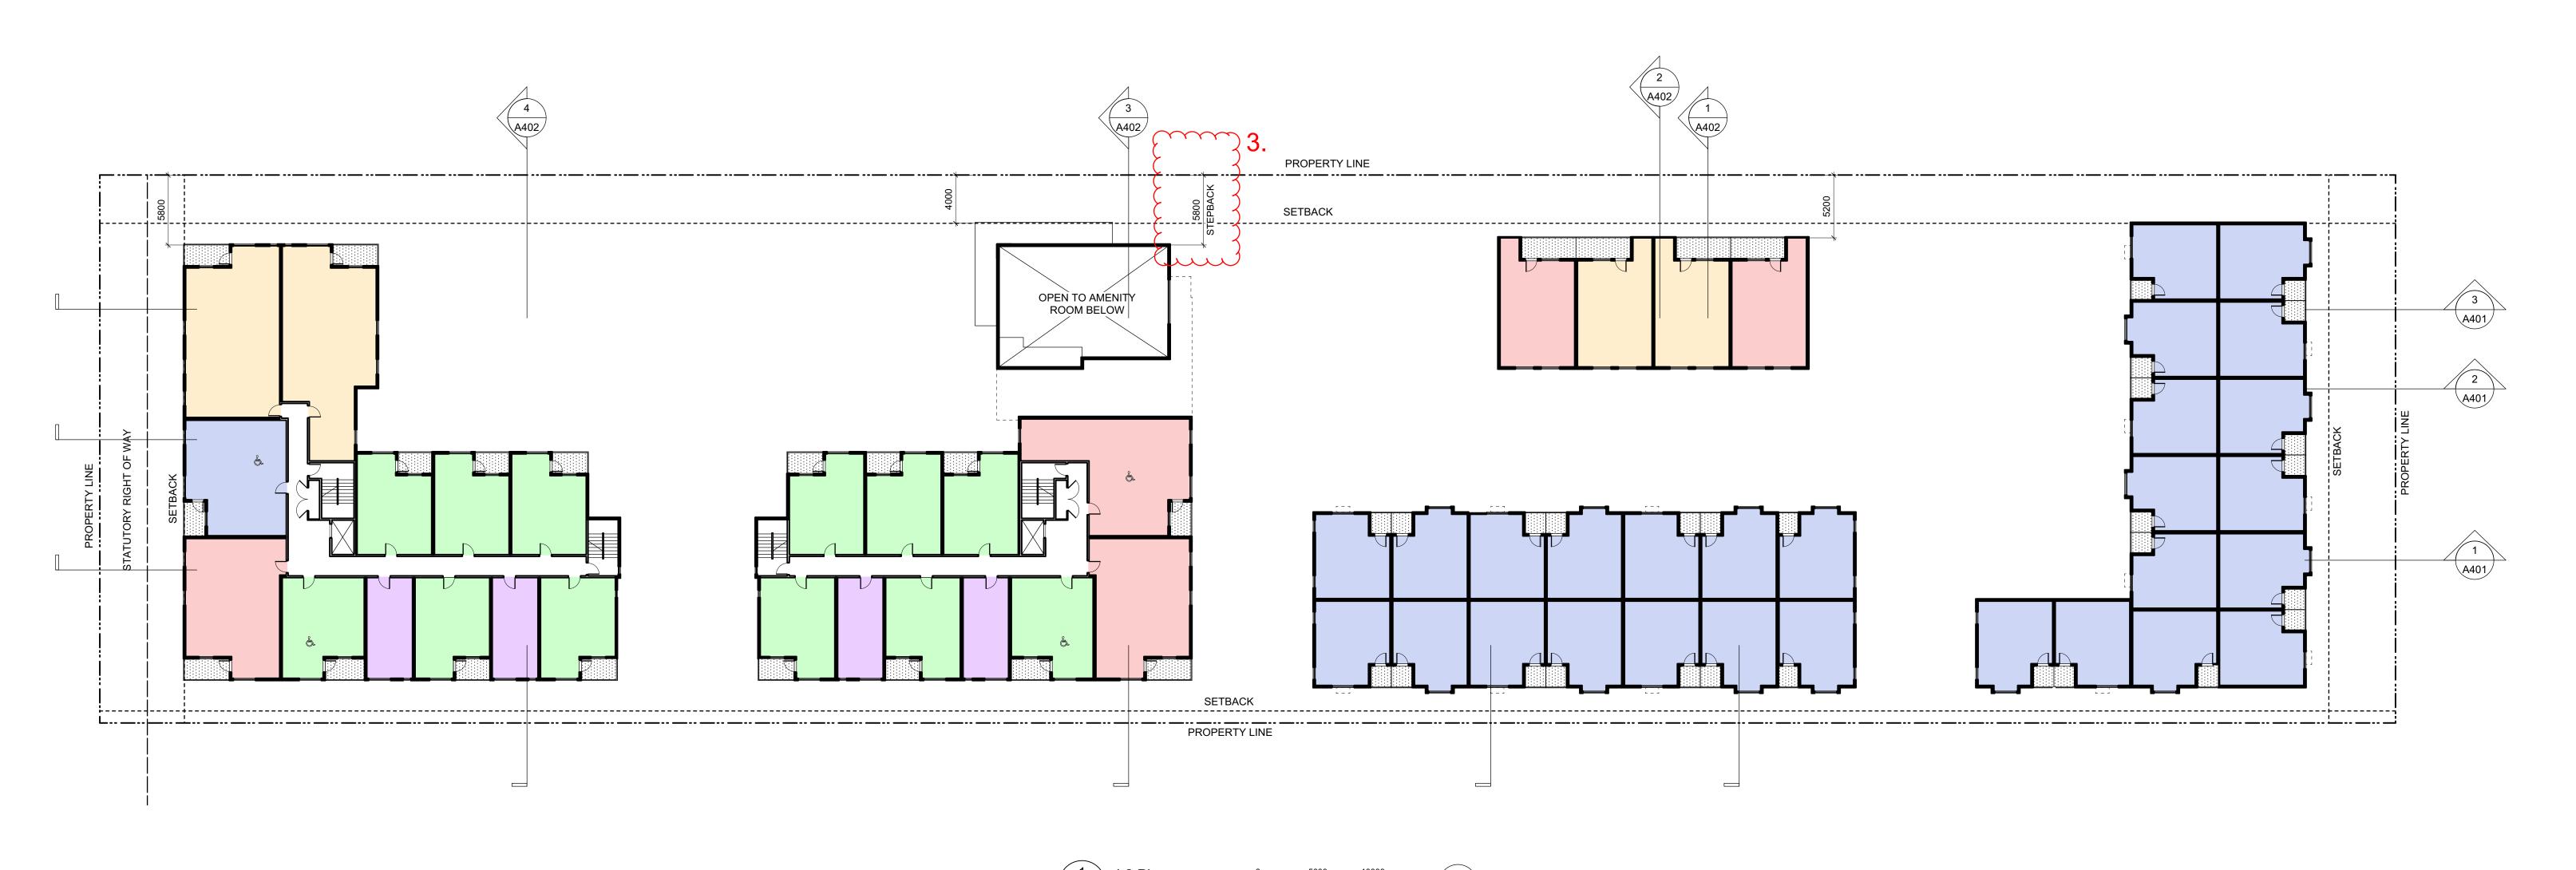

4	20/03/13	RE-ISSUED FOR COTW
3	20/02/06	ISSUED FOR COTW
2	20/01/15	ISSUED FOR ADP
1	19/12/16	RESPONSE TO PLANNING REVIEW
Rev	Date	Description
plot date	SEPTEMBER 2019	drawing file 1907 A200 Plans.vwx
drawn by	FWP	checked by RAW
scale	AS SHOWN	project number 1907

NOTE: All dimensions are shown in millimeters. ISSUED FOR DP & REZONING

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project name		
Caledonia		
Victoria BC		
drawing title		
L3 Plan		
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2 BEDROOM

3 BEDROOM

4 BEDROOM

& ACCESSIBLE

20/01/15

19/12/16

SEPTEMBER 2019 drawing file

VICTORIA OFFICE
977 Fort Street
Victoria BC V8V 3K3
T 1.250.658.3367

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Caledonia

Victoria BC

L4 Plan

FWP checked by

NOTE: All dimensions are shown in millimeters.

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& REZONING

AS SHOWN project number

ISSUED FOR ADP


1907 A200 Plans.vwx

RAW

RESPONSE TO PLANNING REVIEW

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4 BEDROOM

& ACCESSIBLE

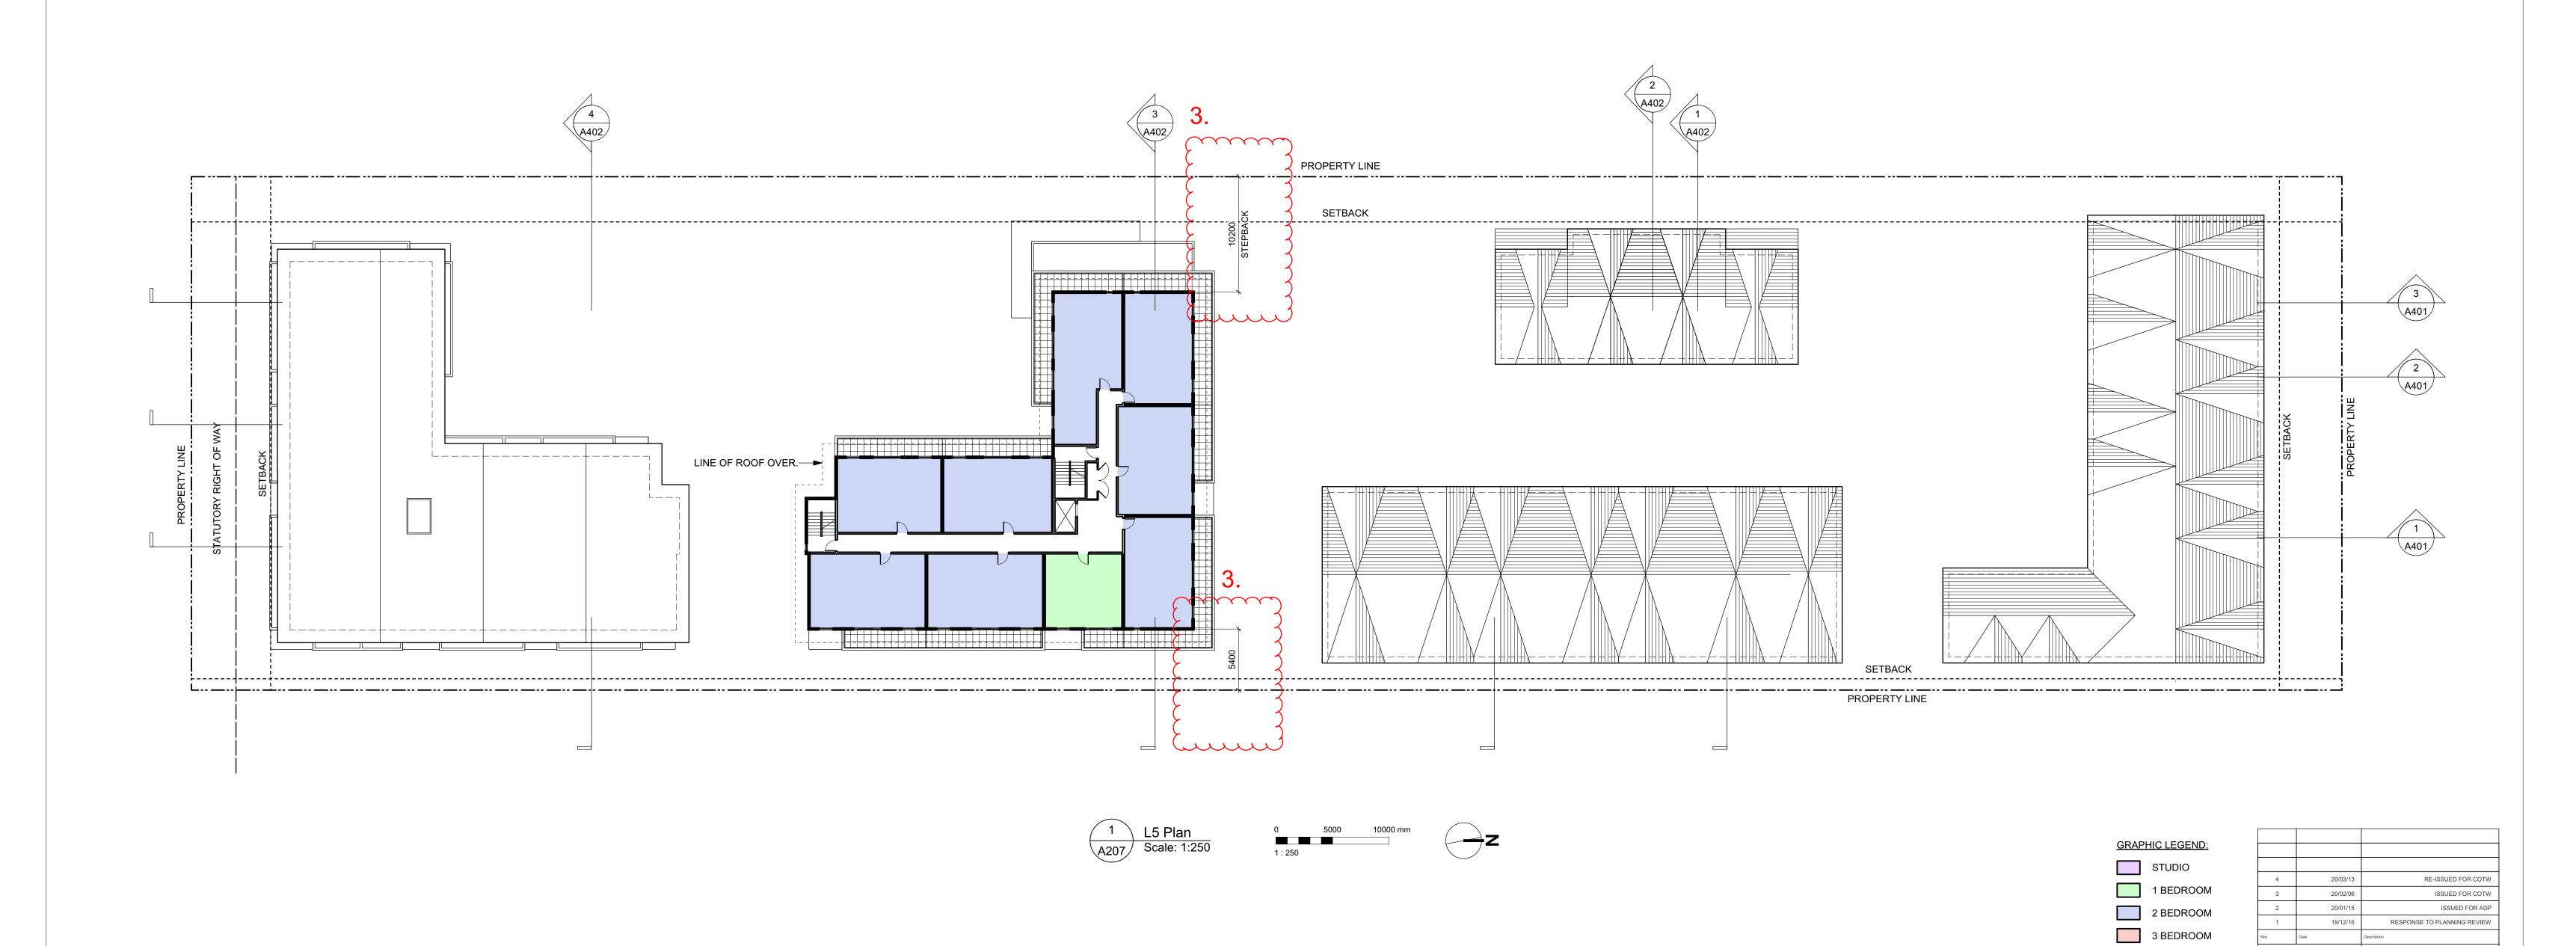SEPTEMBER 2019 drawing file

VICTORIA OFFICE
977 Fort Street
Victoria BC V8V 3K3
T 1-250-658-3367

Caledonia

Victoria BC

L5 Plan

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FWP checked by

NOTE: All dimensions are shown in millimeters.

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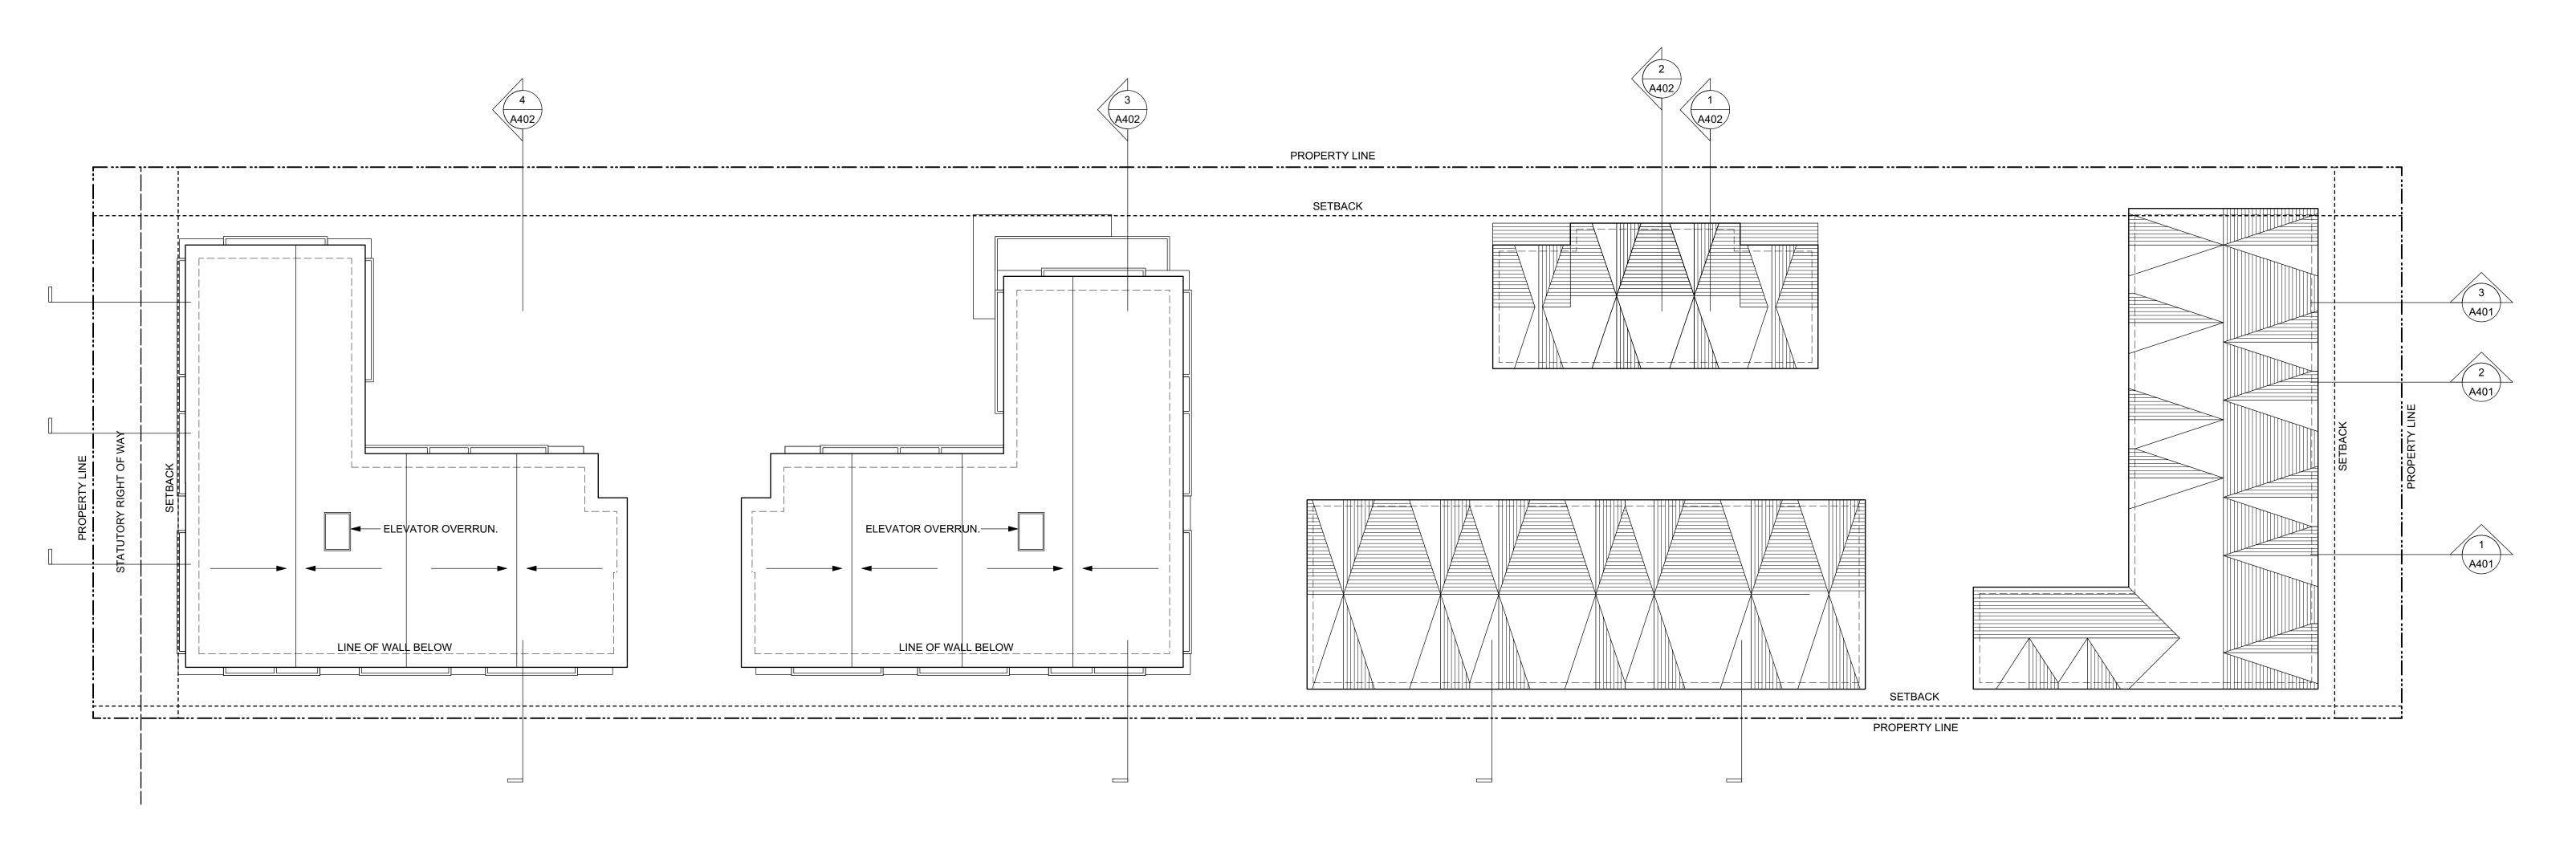
& REZONING

AS SHOWN project number

1907 A200 Plans.vwx

dHKarchitects

NANAIMO OFFICE 102-5190 Dublin Way Nanaimo BC V9T2K8 **T** 1•250•585•5810





4	20/03/13	RE-ISSUED FOR COTW
3	20/02/06	ISSUED FOR COTW
2	20/01/15	ISSUED FOR ADF
1	19/12/16	RESPONSE TO PLANNING REVIEW
Rev	Date	Description
plot date	SEPTEMBER 2019	drawing file 1907 A200 Plans.vwx
drawn by	FWP	checked by RAW
scale	AS SHOWN	project number 1907

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project name		
Caledonia		
Victoria BC		
drawing title		
Roof Plan		
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Apartment 1 - West
Scale: 1:100

COLOUR & MATERIALS LEGEND

- 1 BRICK VENEER Red Apartment 1 Only
- 2 FIBRE CEMENT PANEL Teal
- 3 VINYL WINDOWS & DOORS Teal
- DEFENDING ALLIMINUM CHARD FRAME & DIOVETO, T.
- PREFINISHED ALUMINUM GUARD, FRAME & PICKETS Teal
- 5 METAL FLASHING Teal
- 6 ACCENT PAINT COLOUR Rust
- 7 FIBRE CEMENT LAP SIDING Soft Brown
- 8 FIBRE CEMENT PANEL Warm Grey Apartment 2 Only
- 9 SOFFIT Warm Grey Apartment 2 Only
- 10 PAINTED CONCRETE Warm Grey
- 11 FIBRE CEMENT PANEL Warm White
- SOFFIT Warm White
- 13 FIBRE CEMENT LAP SIDING Medium Blue-Grey

- 14 FIBRE CEMENT LAP SIDING White
- 15 VINYL WINDOWS & DOORS Dark Grey
- 16 PREFINISHED ALUMINUM GUARD & FRAME Dark Grey
- 17 METAL FLASHING Dark Grey
- ASPHALT SHINGLES Warm Grey
- 19 FIBRE CEMENT SHINGLES Warm Grey
- VINYL WINDOWS & DOORS White
- 1 METAL DOWNSPOUT & FLASHING Light Warm Grey
- 2 FIBRE CEMENT PANEL Dark Grey
- FIBRE CEMENT PANEL Light Grey
- ACCENT PAINT COLOUR Bright Orange
- 25 ACCENT PAINT COLOUR Bright Blue
- 26 ACCENT PAINT COLOUR Chartreuse

4	20/03/13	RE-ISSUED FOR COTW
3	20/02/06	ISSUED FOR COTW
2	20/01/15	ISSUED FOR ADP
1	19/12/16	RESPONSE TO PLANNING REVIEW
Rev	Date	Description
plot date	SEPTEMBER 2019	drawing file 1907 A300 Elevations.vwx
drawn by	NLC	checked by RAW
scale	1:100	project number 1907

dHKa	dHKarc	hitects
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project name		
Caledonia		
Victoria BC		
drawing title		
Elevations - Ap	artment 1	
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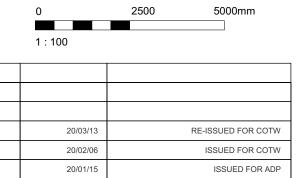


Apartment 2 - South
Scale: 1:100

COLOUR & MATERIALS LEGEND

- BRICK VENEER Red Apartment 1 Only
- 2 FIBRE CEMENT PANEL Teal
- 3 VINYL WINDOWS & DOORS Teal
- PREFINISHED ALUMINUM GUARD, FRAME & PICKETS Teal
- 5 METAL FLASHING Teal
- 6 ACCENT PAINT COLOUR Rust
- 7 FIBRE CEMENT LAP SIDING Soft Brown
- 8 FIBRE CEMENT PANEL Warm Grey Apartment 2 Only
- 9 SOFFIT Warm Grey Apartment 2 Only
- 10 PAINTED CONCRETE Warm Grey
- 11 FIBRE CEMENT PANEL Warm White
- SOFFIT Warm White
- 13 FIBRE CEMENT LAP SIDING Medium Blue-Grey

- 14 FIBRE CEMENT LAP SIDING White
- 15 VINYL WINDOWS & DOORS Dark Grey
- 16 PREFINISHED ALUMINUM GUARD & FRAME Dark Grey
- 17 METAL FLASHING Dark Grey
- 18 ASPHALT SHINGLES Warm Grey
- 19 FIBRE CEMENT SHINGLES Warm Grey
- VINYL WINDOWS & DOORS White
- 21 METAL DOWNSPOUT & FLASHING Light Warm Grey
- 22 FIBRE CEMENT PANEL Dark Grey
- FIBRE CEMENT PANEL Light Grey
- ACCENT PAINT COLOUR Bright Orange
- 25 ACCENT PAINT COLOUR Bright Blue
- 26 ACCENT PAINT COLOUR Chartreuse



ISSUED FOR DP & REZONING

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VICTORIA OFFICE 977 Fort Street Victoria BC V8V 3K3 T 1.250.658.3367	NANAIMO OFFICE 102-5190 Dublin V Nanaimo BC V9T T 1•250•585•581(
Caledonia	
Victoria BC	

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Apartment 2 - East A303 Scale: 1:100




Apartment 2 - West
Scale: 1:100

COLOUR & MATERIALS LEGEND

- 1 BRICK VENEER Red Apartment 1 Only
- 2 FIBRE CEMENT PANEL Teal
- 3 VINYL WINDOWS & DOORS Teal
- PREFINISHED ALUMINUM GUARD, FRAME & PICKETS Teal
- 5 METAL FLASHING Teal
- 6 ACCENT PAINT COLOUR Rust
- 7 FIBRE CEMENT LAP SIDING Soft Brown
- 8 FIBRE CEMENT PANEL Warm Grey Apartment 2 Only
- 9 SOFFIT Warm Grey Apartment 2 Only
- 10 PAINTED CONCRETE Warm Grey
- 11 FIBRE CEMENT PANEL Warm White
- SOFFIT Warm White
- 13 FIBRE CEMENT LAP SIDING Medium Blue-Grey

- 14 FIBRE CEMENT LAP SIDING White
- 15 VINYL WINDOWS & DOORS Dark Grey
- PREFINISHED ALUMINUM GUARD & FRAME Dark Grey
- 17 METAL FLASHING Dark Grey
- 18 ASPHALT SHINGLES Warm Grey
- 19 FIBRE CEMENT SHINGLES Warm Grey
- 20 VINYL WINDOWS & DOORS White
- 21 METAL DOWNSPOUT & FLASHING Light Warm Grey
- FIBRE CEMENT PANEL Dark Grey
- FIBRE CEMENT PANEL Light Grey
- ACCENT PAINT COLOUR Bright Orange
- 25 ACCENT PAINT COLOUR Bright Blue
- 26 ACCENT PAINT COLOUR Chartreuse

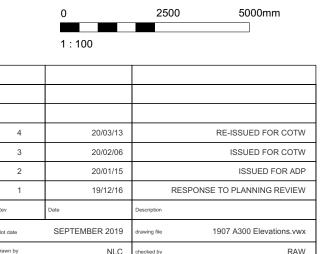


ISSUED FOR DP & REZONING

 dHKa	dHKarchitects
VICTORIA OFFICE 977 Fort Street Victoria BC V8V 3K3 T 1.250.658.3367	NANAIMO OFFICE 102-5190 Dublin Way Nanaimo BC V9T 2K8 T 1•250•585•5810
Caledonia Victoria BC	
Elevations - Apa	rtment 2

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Townhouse 1 - South
Scale: 1:100

34.90 L1

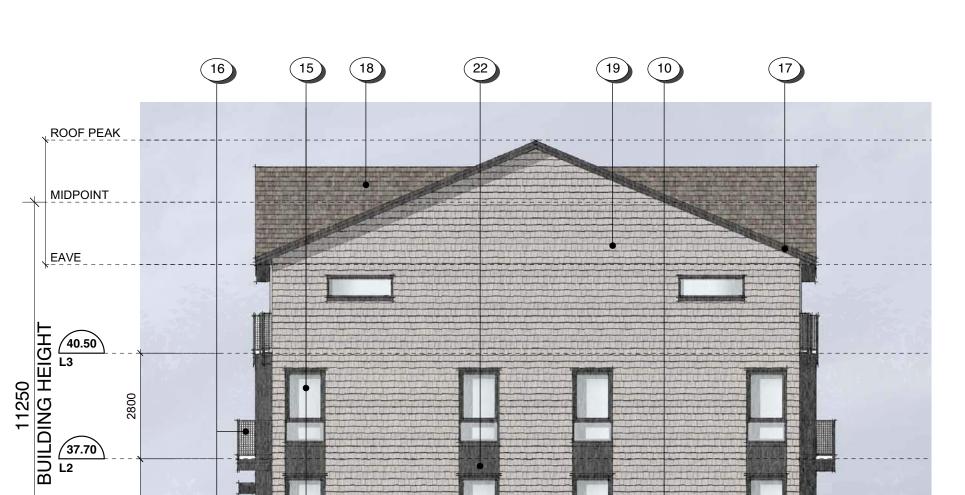33.00 AVG. GRADE



Townhouse 1 - East
A304 Scale: 1:100



Townhouse 1 - West
A304 Scale: 1:100

COLOUR & MATERIALS LEGEND


- 1 BRICK VENEER Red Apartment 1 Only
- 2 FIBRE CEMENT PANEL Teal
- 3 VINYL WINDOWS & DOORS Teal
- VINYL WINDOWS & DOORS Teal
- PREFINISHED ALUMINUM GUARD, FRAME & PICKETS Teal
- 5 METAL FLASHING Teal
- 6 ACCENT PAINT COLOUR Rust
- 7 FIBRE CEMENT LAP SIDING Soft Brown
- 8 FIBRE CEMENT PANEL Warm Grey Apartment 2 Only
- 9 SOFFIT Warm Grey Apartment 2 Only
- 10 PAINTED CONCRETE Warm Grey
- 11 FIBRE CEMENT PANEL Warm White
- SOFFIT Warm White
- 13 FIBRE CEMENT LAP SIDING Medium Blue-Grey

- 14 FIBRE CEMENT LAP SIDING White
- 15 VINYL WINDOWS & DOORS Dark Grey
- 16 PREFINISHED ALUMINUM GUARD & FRAME Dark Grey
- 17 METAL FLASHING Dark Grey
- 18 ASPHALT SHINGLES Warm Grey
- 19 FIBRE CEMENT SHINGLES Warm Grey
- 20 VINYL WINDOWS & DOORS White
- METAL DOWNSPOUT & FLASHING Light Warm Grey
- FIBRE CEMENT PANEL Dark Grey
- FIBRE CEMENT PANEL Light Grey
- ACCENT PAINT COLOUR Bright Orange
- 25 ACCENT PAINT COLOUR Bright Blue
- 26 ACCENT PAINT COLOUR Chartreuse

	1:100	25	00	5000mm
	1.100			
4	20/03/13			RE-ISSUED FOR COTW
3	20/02/06			ISSUED FOR COTW
2	20/01/15			ISSUED FOR ADP
1	19/12/16		RESPONSI	E TO PLANNING REVIEW
Rev	Date	Description		
plot date	SEPTEMBER 2019	drawing file		1907 A300 Elevations.vw
drawn by	NLC	checked by		RAV

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dHKa	dHKarc	hitects
VICTORIA OFFICE 977 Fort Street Victoria BC V8V 3K3 T 1-250-658-3367	NANAIMO OFFICE 102-5190 Du Nanaimo BC T 1•250•585	blin Way V9T 2K8
Caledonia		
Victoria BC drawing title Elevations - Tov	wnhouse 1	
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Townhouse 2 - South
Scale: 1:100

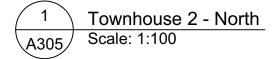

Townhouse 2 - East
A305 Scale: 1:100



Townhouse 2 - West
A305 Scale: 1:100


COLOUR & MATERIALS LEGEND

- 1 BRICK VENEER Red Apartment 1 Only
- 2 FIBRE CEMENT PANEL Teal
- 3 VINYL WINDOWS & DOORS Teal
- PREFINISHED ALUMINUM GUARD, FRAME & PICKETS Teal
- 5 METAL FLASHING Teal
- WETALT LASTING Teal
- 6 ACCENT PAINT COLOUR Rust
 7 FIBRE CEMENT LAP SIDING Soft Brown
- 8
- 8 FIBRE CEMENT PANEL Warm Grey Apartment 2 Only
- 9 SOFFIT Warm Grey Apartment 2 Only
- 10 PAINTED CONCRETE Warm Grey
- 11 FIBRE CEMENT PANEL Warm White
- SOFFIT Warm White
- 13 FIBRE CEMENT LAP SIDING Medium Blue-Grey

- 14 FIBRE CEMENT LAP SIDING White
- 15 VINYL WINDOWS & DOORS Dark Grey
- PREFINISHED ALUMINUM GUARD & FRAME Dark Grey
- 17 METAL FLASHING Dark Grey
- ASPHALT SHINGLES Warm Grey
- 19 FIBRE CEMENT SHINGLES Warm Grey
- 20 VINYL WINDOWS & DOORS White
- 1 METAL DOWNSPOUT & FLASHING Light Warm Grey
- FIBRE CEMENT PANEL Dark Grey
- FIBRE CEMENT PANEL Light Grey
- ACCENT PAINT COLOUR Bright Orange
- ACCENT PAINT COLOUR Bright Orange
- 25 ACCENT PAINT COLOUR Bright Blue
 26 ACCENT PAINT COLOUR Chartreuse

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4	20/03/13	RE-ISSUED FOR COTW
3	20/02/06	ISSUED FOR COTW
2	20/01/15	ISSUED FOR ADP
1	19/12/16	RESPONSE TO PLANNING REVIEW
Rev	Date	Description
plot date	SEPTEMBER 2019	drawing file 1907 A300 Elevations.vwx
drawn by	NLC	checked by RAW
scale	1:100	project number 1907

VICTORIA OFFICE 977 Fort Street Victoria BC V8V 3K3 T 1-250-658-3367	dHKarc NANAIMO OFFICE 102-5190 Du Nanaimo BC T 1-250-585	blin Way V9T 2K8
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Caledonia		
Victoria BC		
drawing title		
Elevations - To	wnhouse 2	
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17 20 19 21

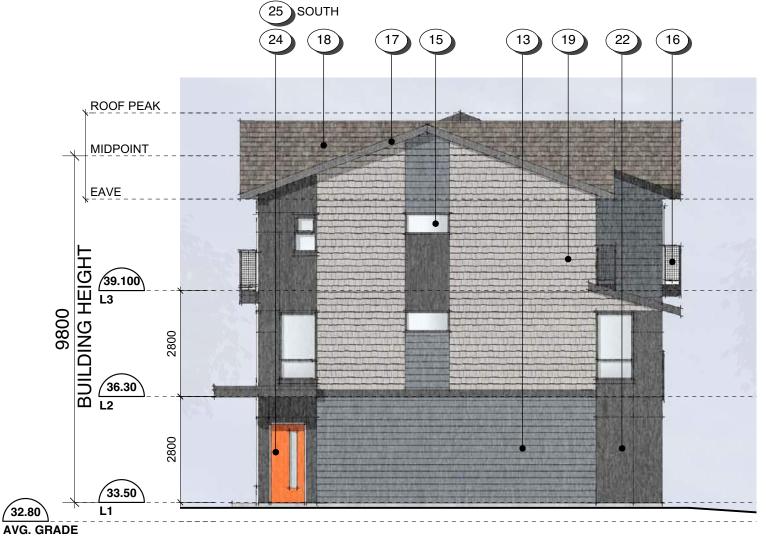

Townhouse 3 - West
A306 Scale: 1:100

COLOUR & MATERIALS LEGEND

- 1 BRICK VENEER Red Apartment 1 Only
- 2 FIBRE CEMENT PANEL Teal
- 3 VINYL WINDOWS & DOORS Teal
- PREFINISHED ALUMINUM GUARD, FRAME & PICKETS Teal
- 5 METAL FLASHING Teal
- 6 ACCENT PAINT COLOUR Rust
- 7 FIBRE CEMENT LAP SIDING Soft Brown
- 8 FIBRE CEMENT PANEL Warm Grey Apartment 2 Only
- 9 SOFFIT Warm Grey Apartment 2 Only
- 10 PAINTED CONCRETE Warm Grey
- 11 FIBRE CEMENT PANEL Warm White
- SOFFIT Warm White
- 13 FIBRE CEMENT LAP SIDING Medium Blue-Grey

- 14 FIBRE CEMENT LAP SIDING White
- 15 VINYL WINDOWS & DOORS Dark Grey
- 16 PREFINISHED ALUMINUM GUARD & FRAME Dark Grey
- 17 METAL FLASHING Dark Grey
- ASPHALT SHINGLES Warm Grey
- 19 FIBRE CEMENT SHINGLES Warm Grey
- 20 VINYL WINDOWS & DOORS White
- 21 METAL DOWNSPOUT & FLASHING Light Warm Grey
- FIBRE CEMENT PANEL Dark Grey
- FIBRE CEMENT PANEL Light Grey
- ACCENT PAINT COLOUR Bright Orange
- 25 ACCENT PAINT COLOUR Bright Blue
- 26 ACCENT PAINT COLOUR Chartreuse

	1.100	
4	20/03/13	RE-ISSUED FOR COTW
3	20/02/06	ISSUED FOR COTW
2	20/01/15	ISSUED FOR ADP

RESPONSE TO PLANNING REVIEW

1907 A300 Elevations.vwx


All dimensions are shown in millimeters. ISSUED FOR DP

19/12/16


SEPTEMBER 2019 drawing file

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dHKa	dHKarc	hitects
VICTORIA OFFICE 977 Fort Street Victoria BC V8V 3K3 T 1•250•658•3367	NANAIMO OFFICE 102-5190 Du Nanaimo BC T 1•250•585	blin Way V9T 2K8
Caledonia		
Victoria BC		
Elevations - To	wnhouse 3	
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9:00AM - SEPTEMBER 21ST

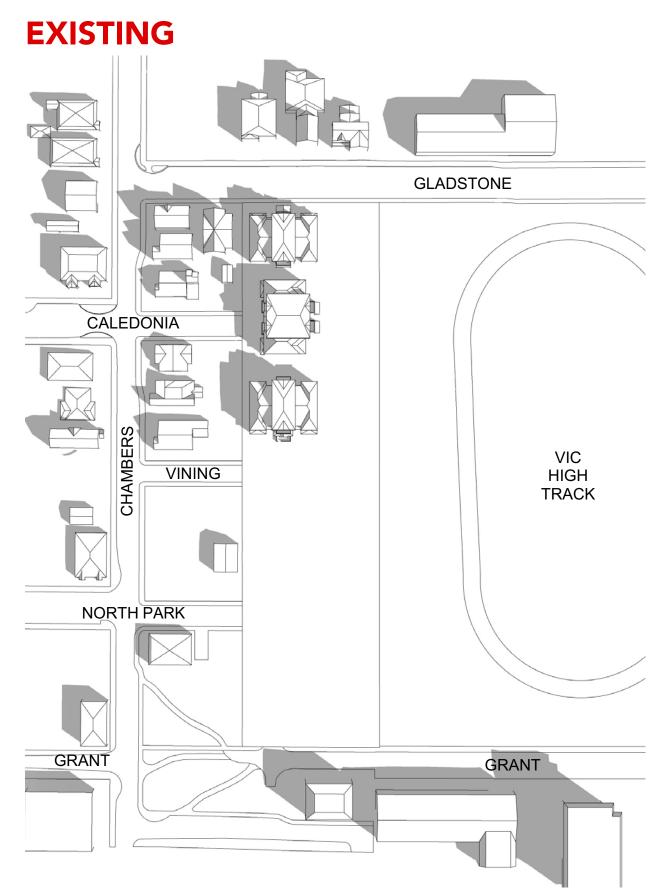

CALEDONIA

CALEDONIA

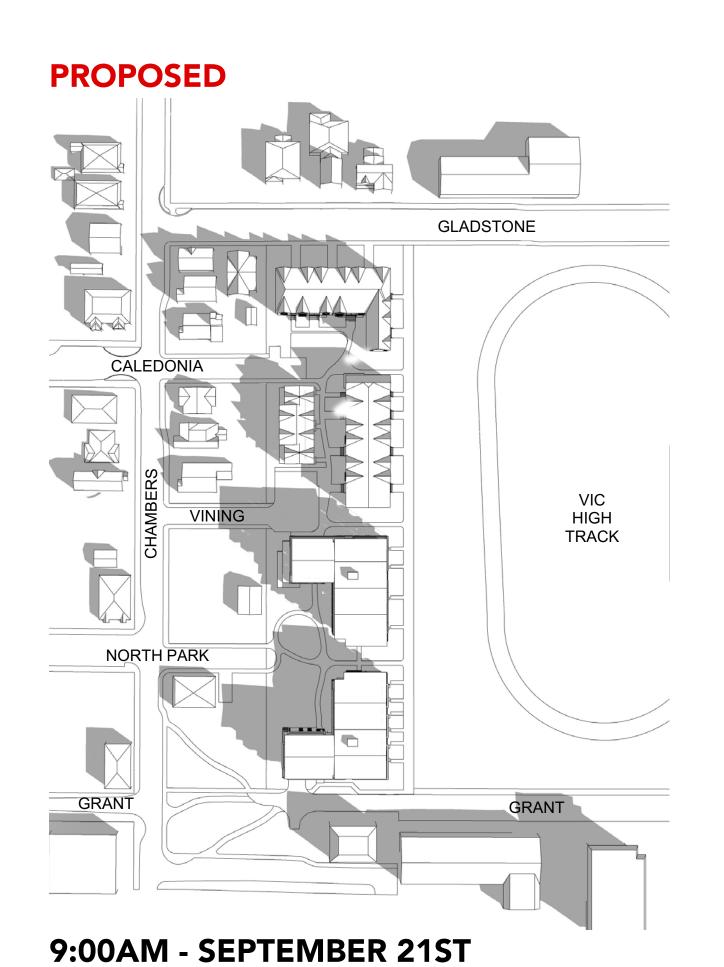
VIC HIGH TRACK

NORTH PARK


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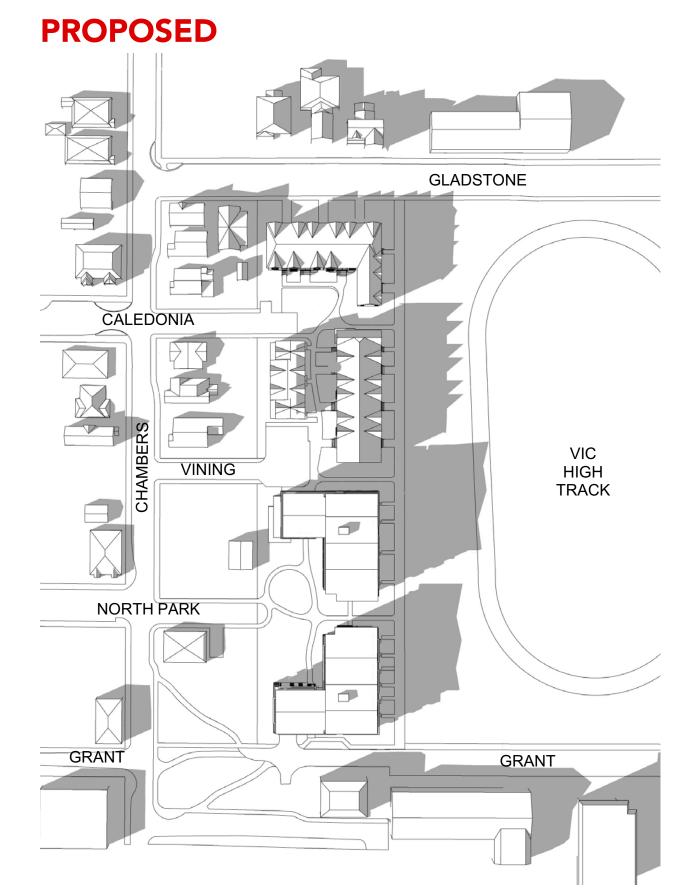
12:00PM - SEPTEMBER 21ST




12:00PM - SEPTEMBER 21ST

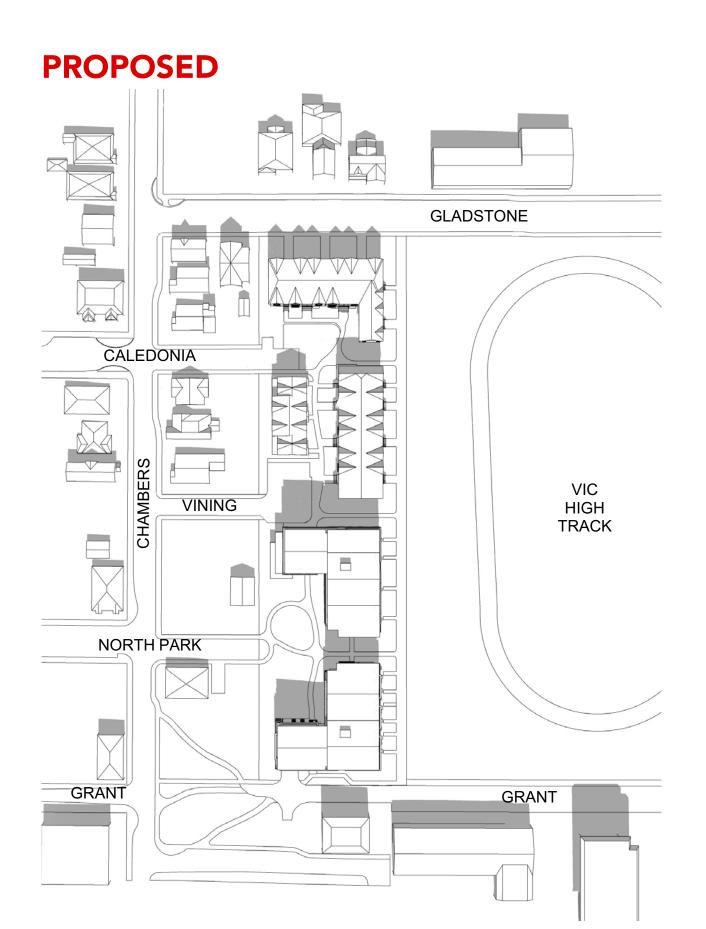


4:00PM - SEPTEMBER 21ST

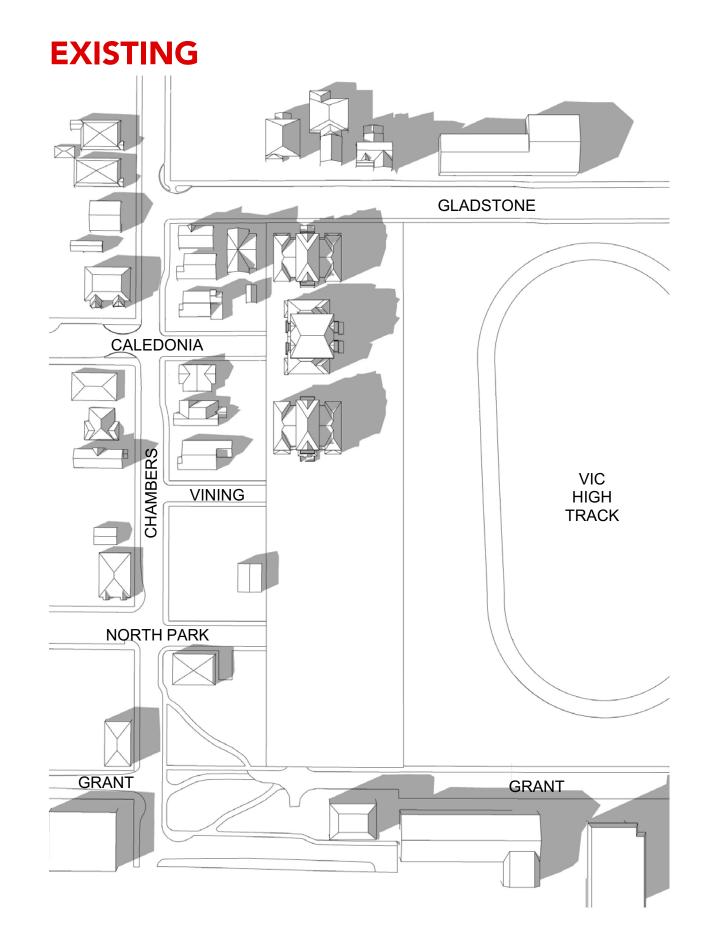

4:00PM - SEPTEMBER 21ST

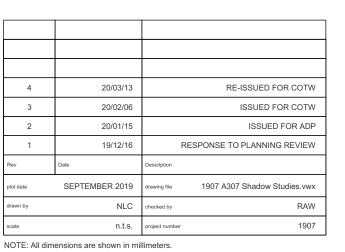

ISSUED FOR DP
& REZONING

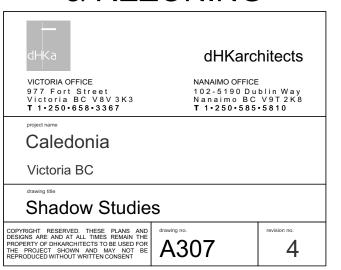



BEFORE - LOOKING WEST - FROM VIC HIGH



AFTER - LOOKING WEST - FROM VIC HIGH

4.

4	20/03/13	RE-ISSUED FOR COTW
3	20/02/06	ISSUED FOR COTW
2	20/01/15	ISSUED FOR ADP
1	19/12/16	RESPONSE TO PLANNING REVIEW
Rev	Date	Description
plot date	SEPTEMBER 2019	drawing file 1907 A307 Shadow Studies.vwx
drawn by	NLC	checked by RAW
scale	n.t.s.	project number 1907


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VICTORIA OFFICE 977 Fort Street Victoria BC V8V3K3 T 1•250•658•3367	NANAIMO OFFICE 102-5190 Du Nanaimo BC T 1•250•585	blin Way V9T2K8
Caledonia		
Victoria BC		
View Analysis		
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BEFORE LOOKING WEST - FROM GRANT STREET



BEFORE - LOOKING WEST - FROM GLADSTONE AVENUE



AFTER LOOKING WEST - FROM GRANT STREET

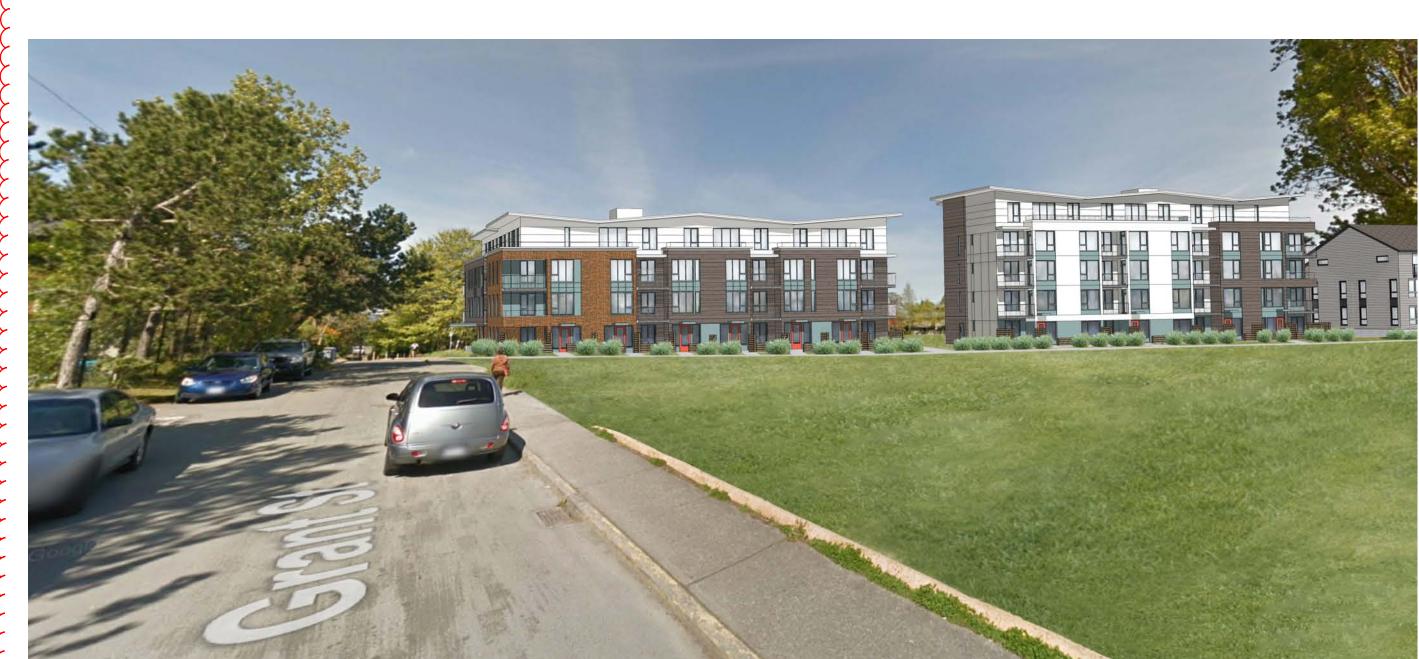


AFTER LOOKING WEST - FROM GLADSTONE AVENUE


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	4	20/03/13	RE-ISSUED FOR COTW
	3	20/02/06	ISSUED FOR COTW
	2	20/01/15	ISSUED FOR ADP
	1	19/12/16	RESPONSE TO PLANNING REVIEW
	Rev	Date	Description
	plot date	SEPTEMBER 2019	drawing file 1907 A307 Shadow Studies.vwx
	drawn by	NLC	checked by RAW
	scale	n.t.s.	project number 1907

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VICTORIA OFFICE 977 Fort Street Victoria BC V8V3K3 T 1•250•658•3367	NANAIMO OFFICE 102-5190 Du Nanaimo BC T 1•250•585	blin Way V9T2K8
Caledonia		
Victoria BC		
View Analysis		
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4.

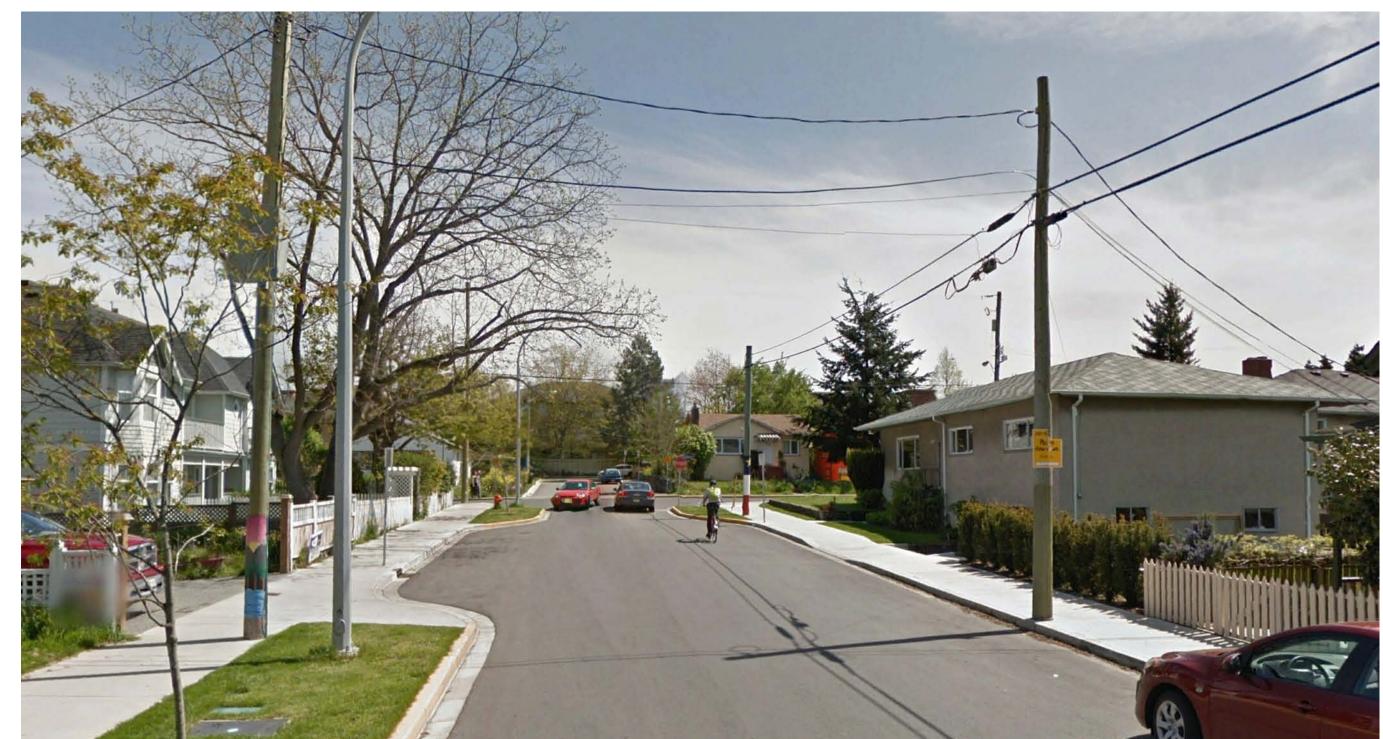


BEFORE LOOKING EAST - FROM CALEDONIA AVE.

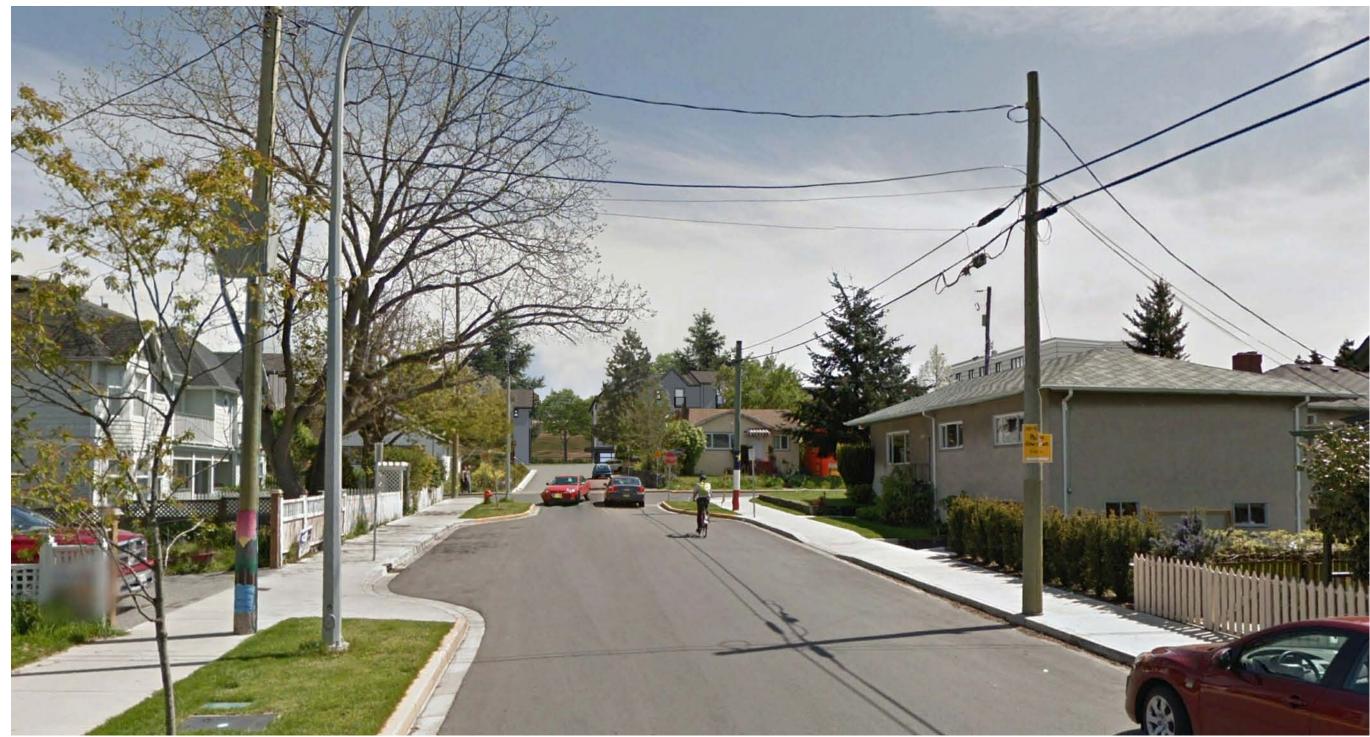

AFTER LOOKING EAST - FROM CALEDONIA AVE.



BEFORE LOOKING EAST - FROM NORTH PARK ST.

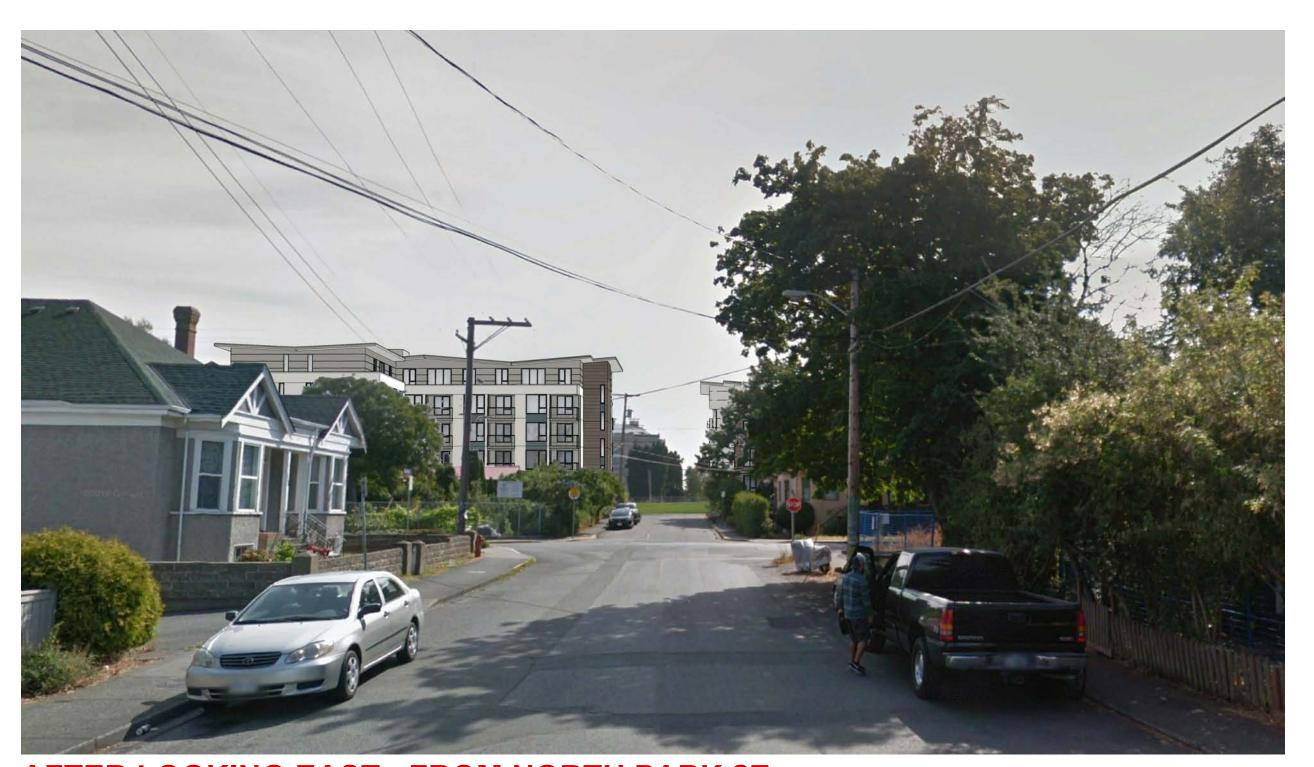

AFTER LOOKING EAST - FROM NORTH PARK ST.

4	20/03/13	RE-ISSUED FOR COTW
3	20/02/06	ISSUED FOR COTW
2	20/01/15	ISSUED FOR ADP
1	19/12/16	RESPONSE TO PLANNING REVIEW
Rev	Date	Description
plot date	SEPTEMBER 2019	drawing file 1907 A307 Shadow Studies.vwx
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NOTE: All dimensions are shown in millimeters. ISSUED FOR DP & REZONING

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Caledonia		
Victoria BC		
View Analysis		
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LOOKING SOUTH - GLADSTONE AVENUE



LOOKING EAST - NORTH PARK STREET



4	20/03/13	RE-ISSUED FOR COTW
3	20/02/06	ISSUED FOR COTW
2	20/01/15	ISSUED FOR ADP
1	19/12/16	RESPONSE TO PLANNING REVIEW
Rev	Date	Description
plot date	SEPTEMBER 2019	drawing file 1907 A307 Shadow Studies.vwx
drawn by	NLC	checked by RAW
scale	n.t.s.	project number 1907

NOTE: All dimensions are shown in millimeters. ISSUED FOR DP & REZONING

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VICTORIA OFFICE 977 Fort Street Victoria BC V8V3K3 T 1•250•658•3367	NANAIMO OFFICE 102-5190 Dublin Way Nanaimo BC V9T2K8 T 1•250•585•5810
Caledonia	
Victoria BC	
Perspective Stu	ıdies
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LOOKING EAST - VINING STREET



TOWNHOUSES - AT GLADSTONE AVENUE



APARTMENT - AT GRANT STREET



INTERIOR COURTYARD - LOOKING NORTH



PLAYGROUND & AMENITY AREA - LOOKING NORTH

4	20/03/13	RE-ISSUED FOR COT
3	20/02/06	ISSUED FOR COT
2	20/01/15	ISSUED FOR A
1	19/12/16	RESPONSE TO PLANNING REVIE
Rev	Date	Description
plot date	SEPTEMBER 2019	drawing file 1907 A307 Shadow Studies.v
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ISSUED FOR DP
& REZONING





Context Elevations
A313 Scale: 1: 300

4	20/03/13	RE-ISSUED FOR COTW
3	20/02/06	ISSUED FOR COTW
2	20/01/15	ISSUED FOR ADP
1	19/12/16	RESPONSE TO PLANNING REVIEW
Rev	Date	Description
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drawn by	FWP/NLC	checked by RAW
scale	1:300	project number 1907

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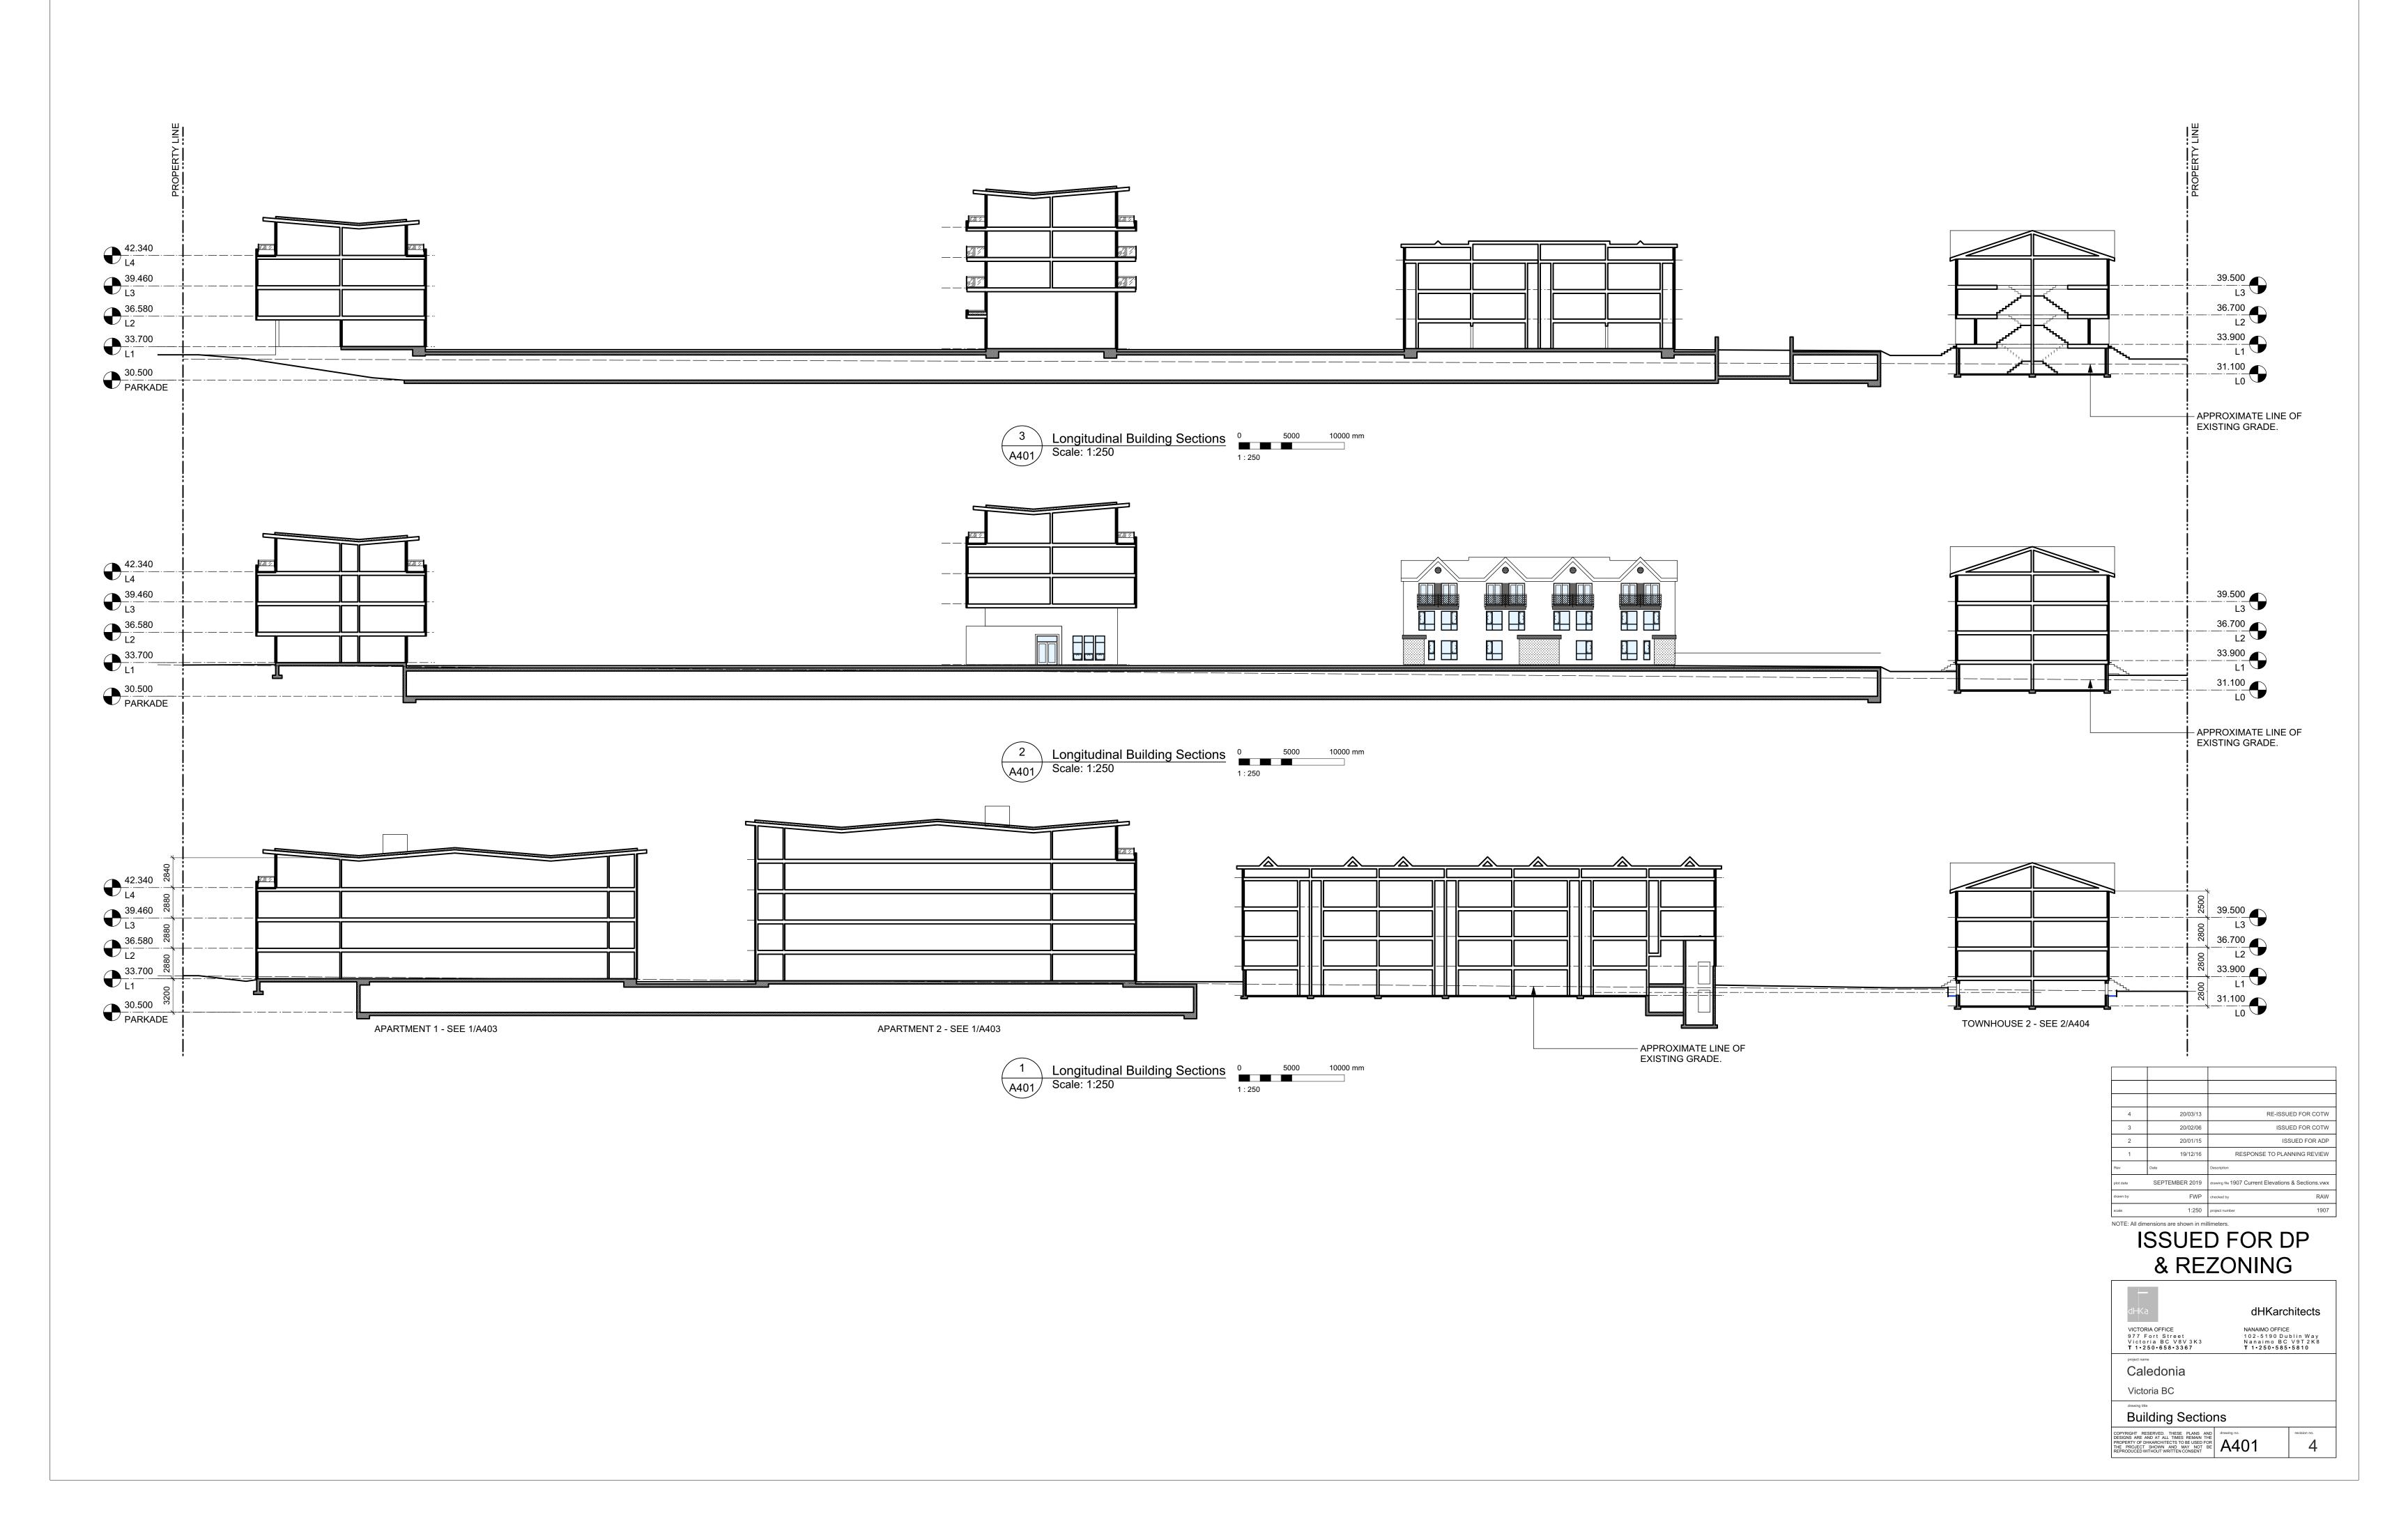
- dHKa	dHKarchitects
VICTORIA OFFICE 977 Fort Street /ictoria BC V8V3K3 [1•250•658•3367	NANAIMO OFFICE 102-5190 Dublin Way Nanaimo BC V9T 2K8 T 1•250•585•5810


T 1.250.658.3367	
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Caledonia	


Victoria BC

Streetscape Elevations


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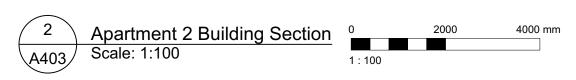





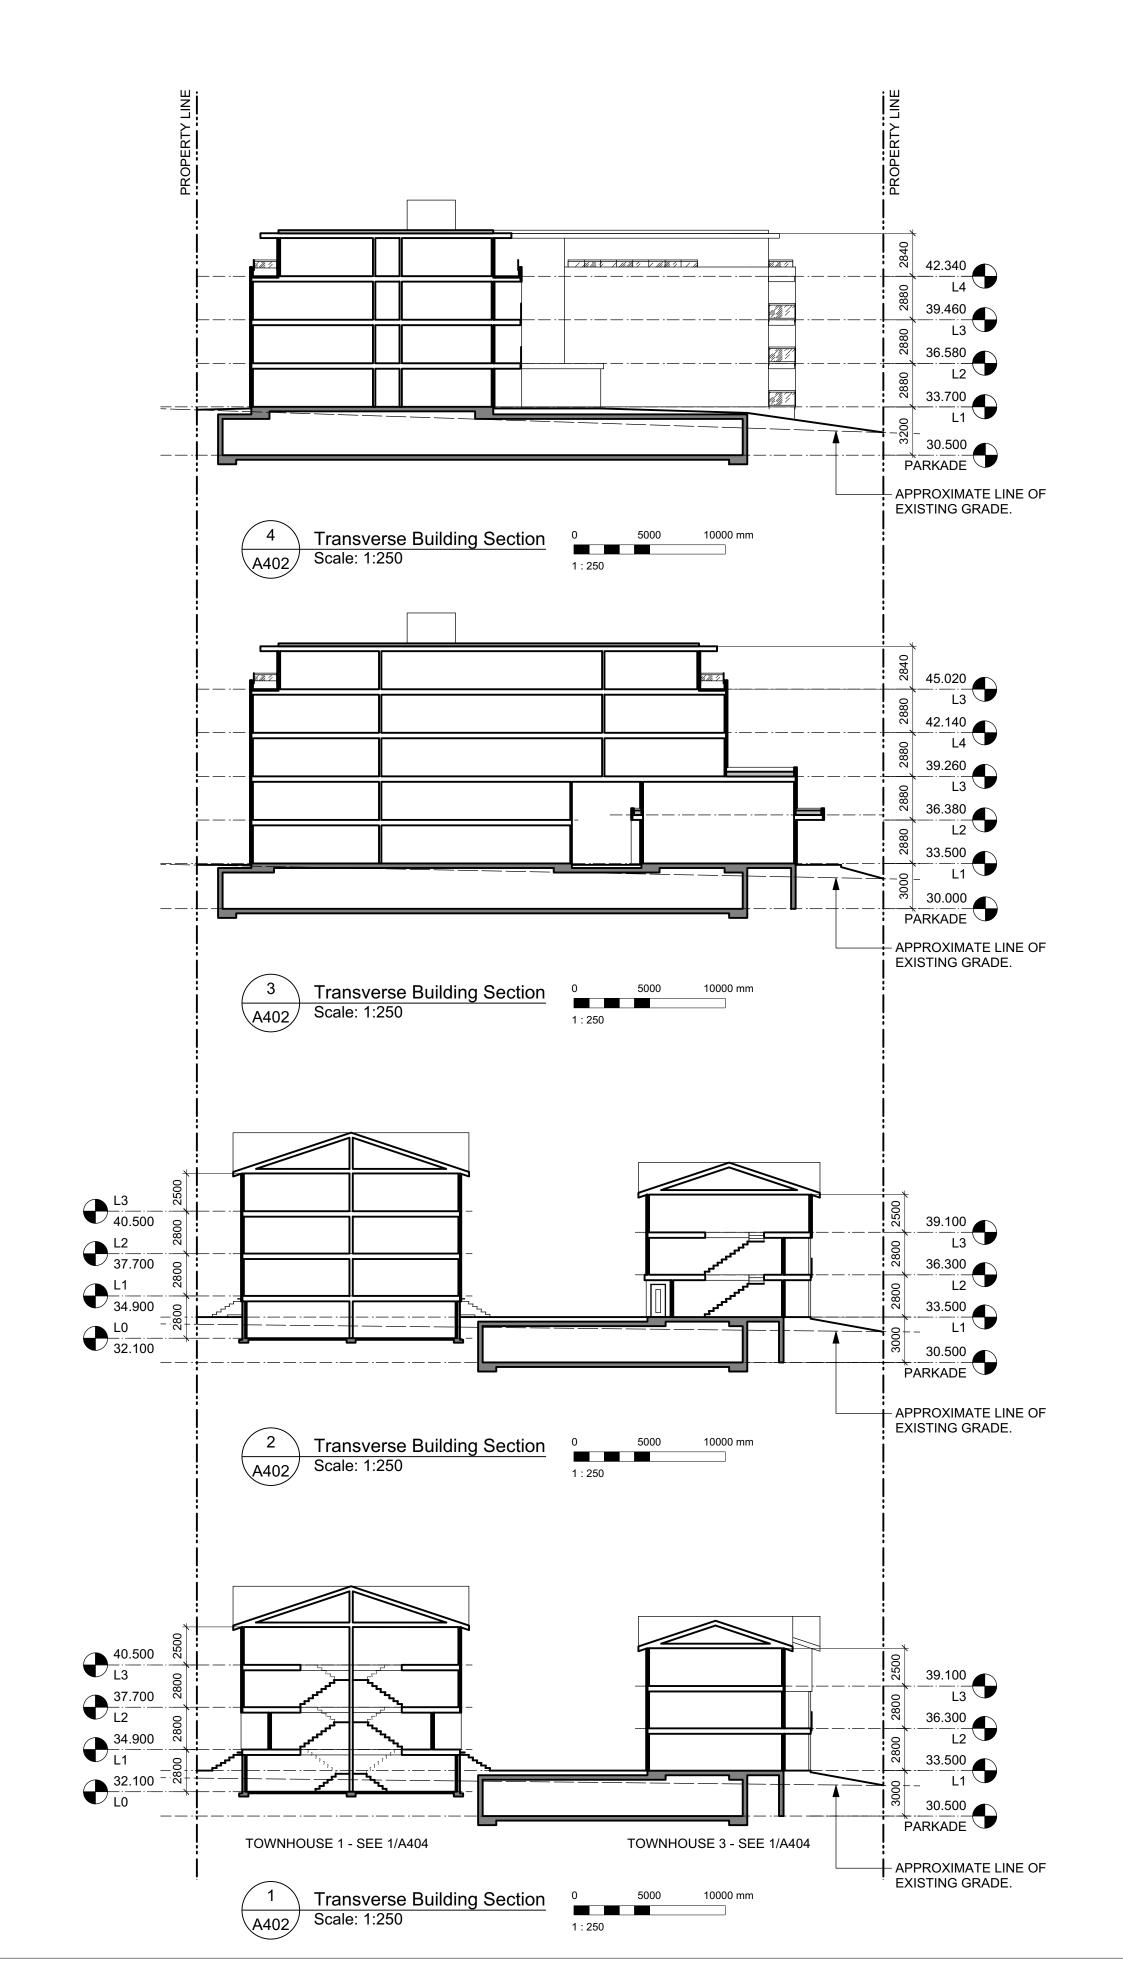
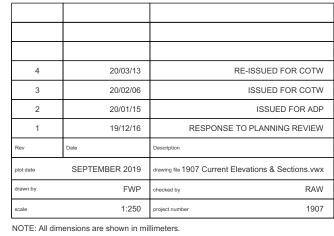
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Building Section	ns	
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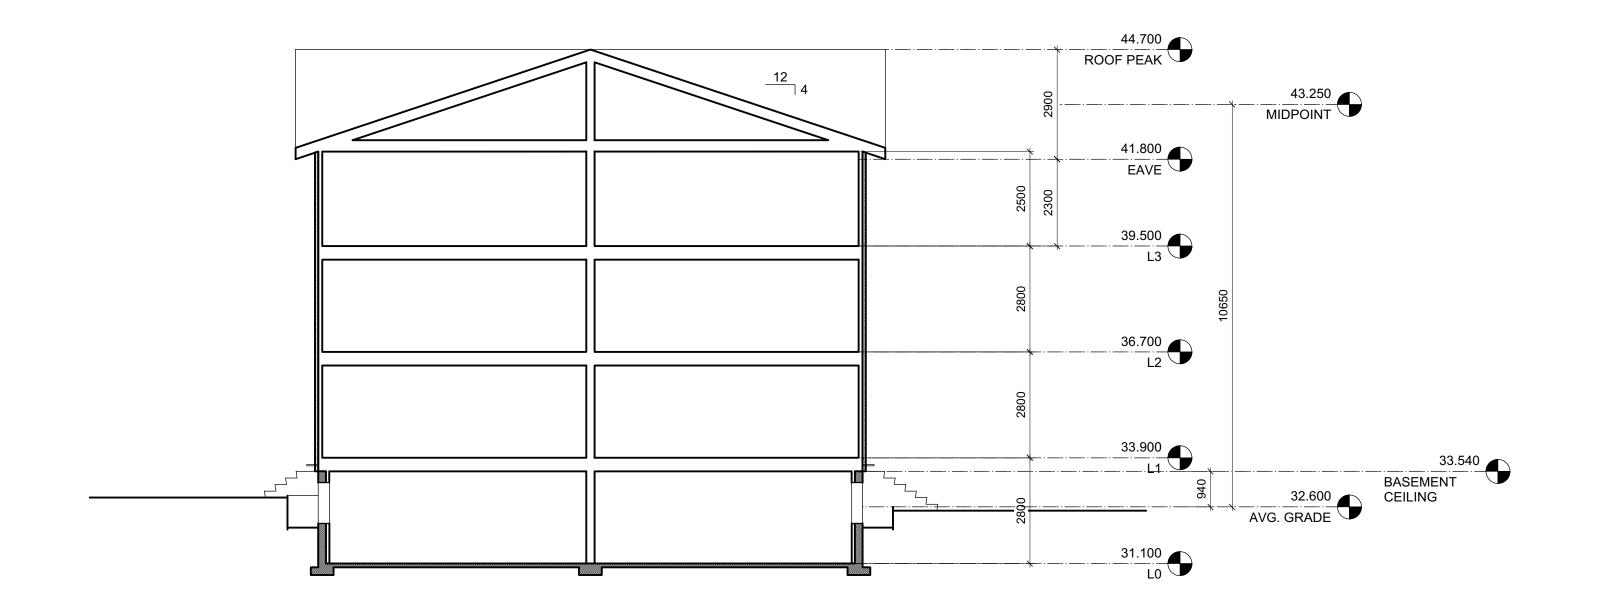





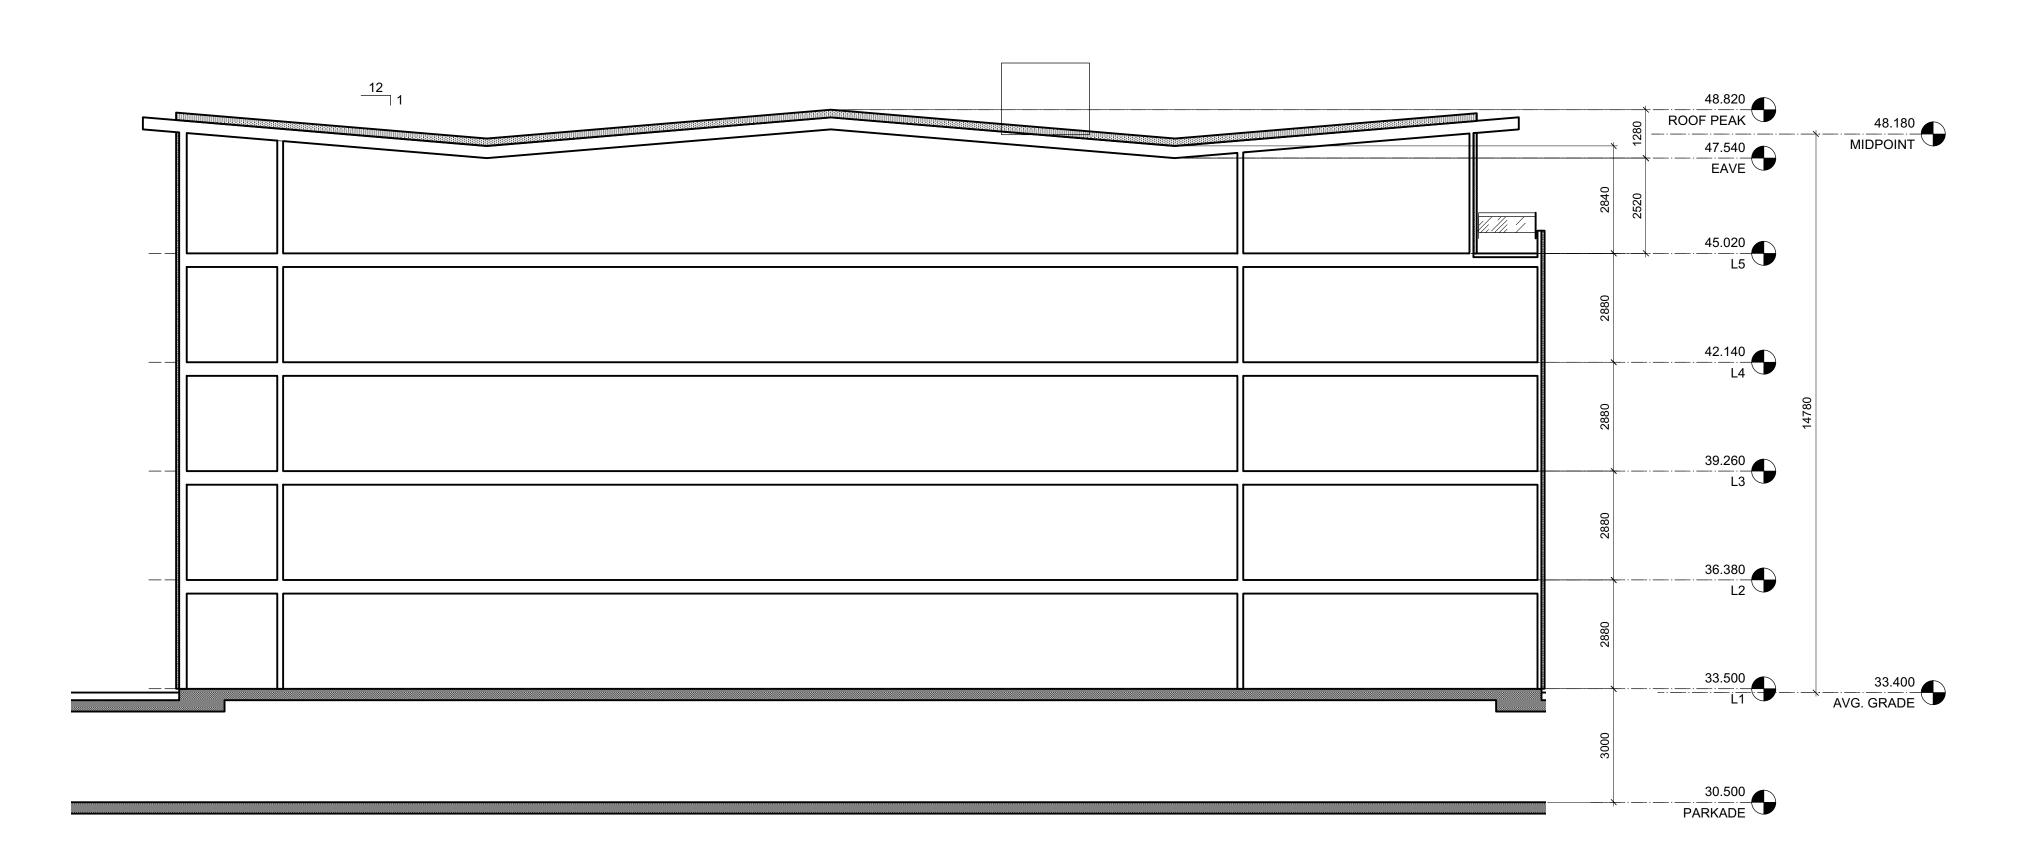

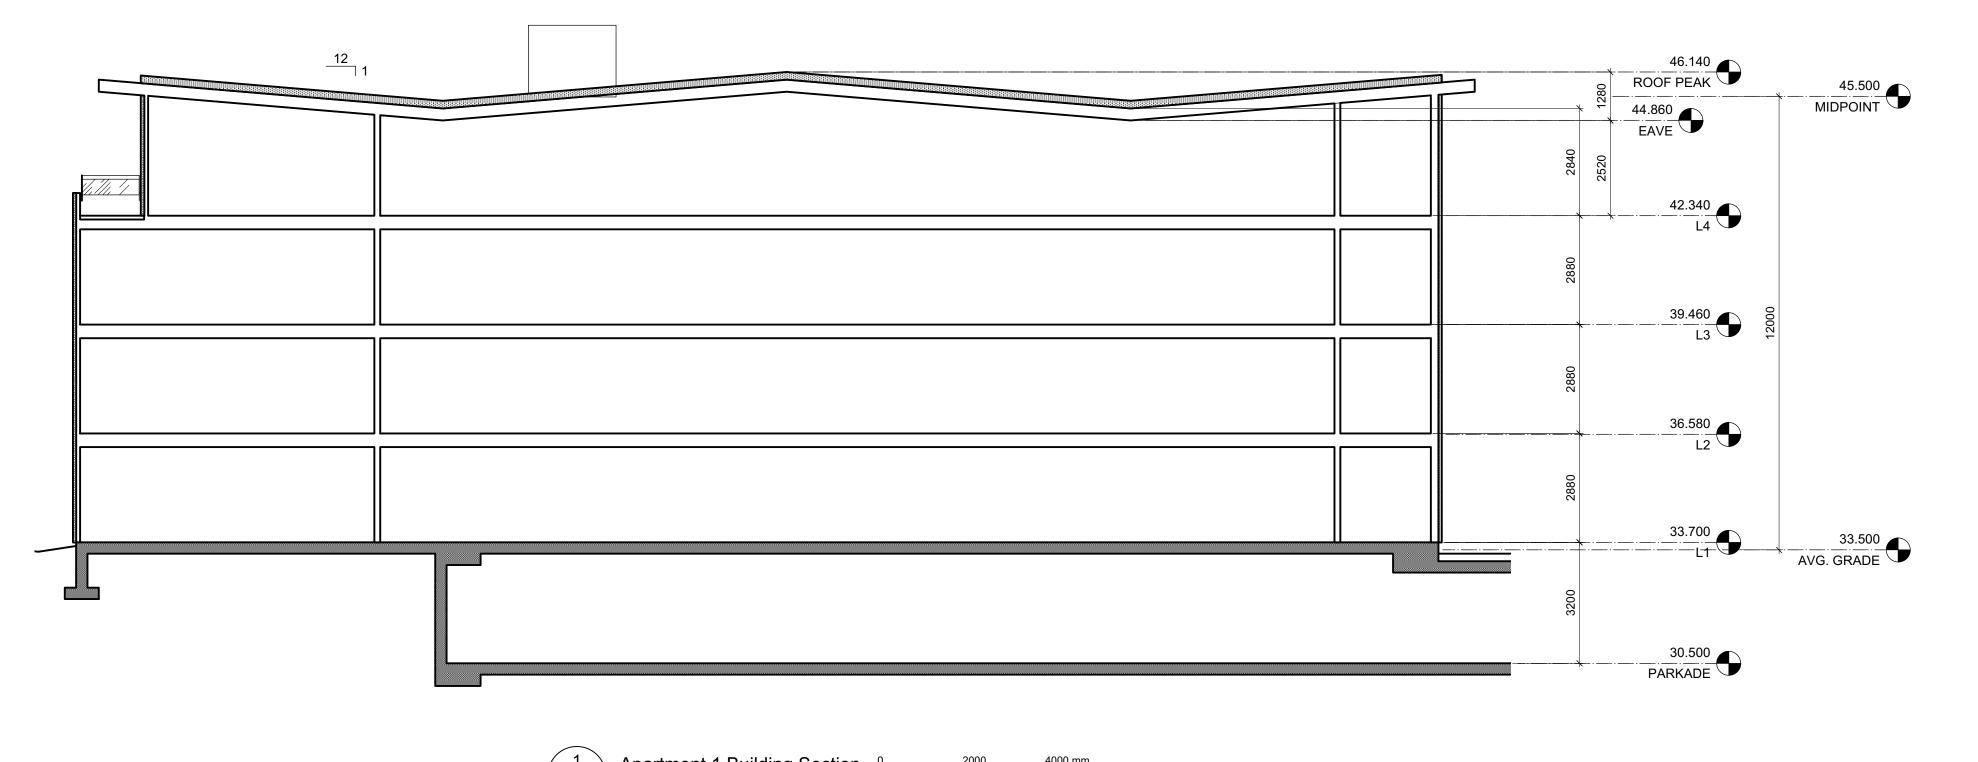
4	20/03/13	RE-ISSUED FOR C
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1	19/12/16	RESPONSE TO PLANNING REV
Rev	Date	Description
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drawn by	FWP	checked by
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Caledonia		
Victoria BC		
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Building Section	ns	
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Townhouses 1 & 3 Building Section
Scale: 1:100



4	20/03/13	RE-ISSUED FOR CO
3	20/02/06	ISSUED FOR CO
2	20/01/15	ISSUED FOR A
1	19/12/16	RESPONSE TO PLANNING REVI
Rev	Date	Description
plot date	SEPTEMBER 2019	drawing file 1907 Current Elevations & Sections.
drawn by	FWP	checked by
scale	1:100	project number 1

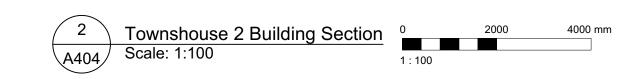NOTE: All dimensions are shown in millimeters. ISSUED FOR DP & REZONING

NANAIMO OFFICE 102-5190 Du Nanaimo BC T 1•250•585	blin Way V9T 2K8
102-5190 Du Nanaimo BC	blin Way V9T2K8
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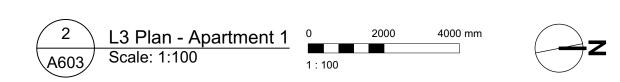
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3	20/02/06	ISSUED FOR COTW
2	20/01/15	ISSUED FOR ADF
1	19/12/16	RESPONSE TO PLANNING REVIEW
Rev	Date	Description
plot date	SEPTEMBER 2019	drawing file 1907 A200 Plans.vwx
drawn by	FWP	checked by RAW
scale	AS SHOWN	project number 1907

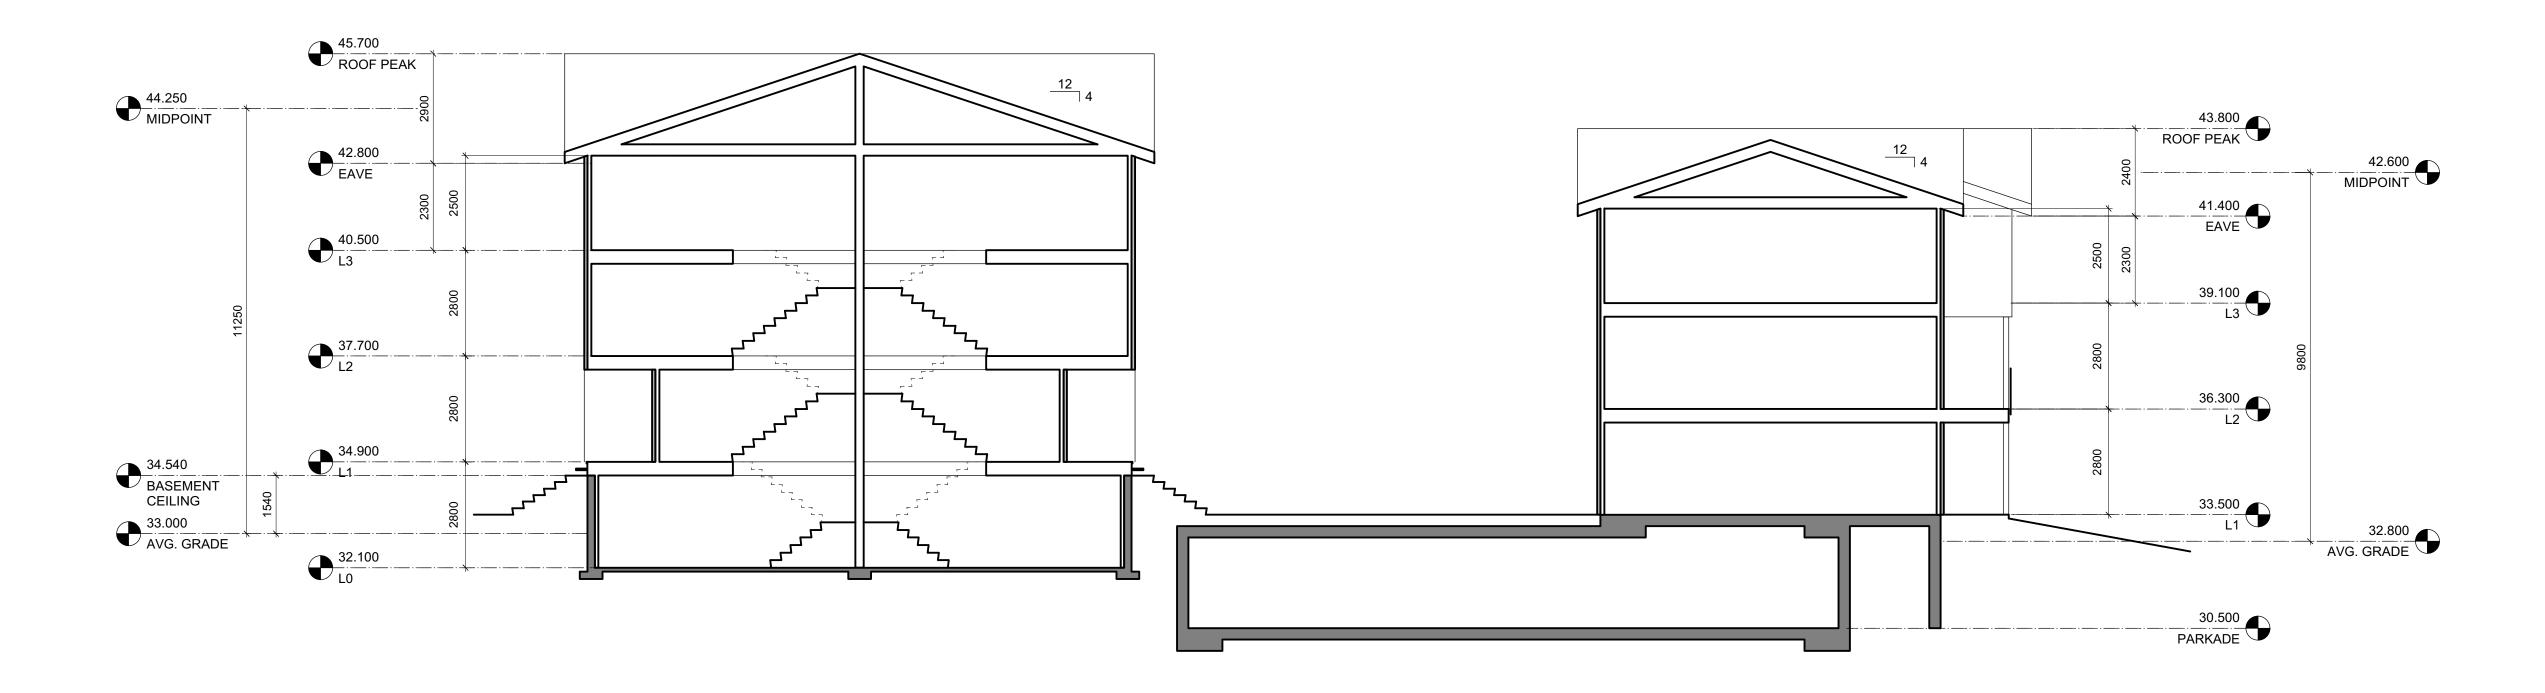
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	2 BEDROOM	T 1 • 2 5 0 • 6 5 8 • 3 3 6 7
	3 BEDROOM	Caledonia
	4 BEDROOM	Victoria BC
Ġ	ACCESSIBLE	L2 Plan - Ap
		COPYRIGHT RESERVED. THESE PLAN

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VICTORIA OFFICE 977 Fort Street Victoria BC V8V3K3 T 1.250.658.3367	NANAIMO OFFICE 102-5190 Du Nanaimo BC T 1•250•585	blin Way V9T 2K8
Caledonia		
Victoria BC		
L2 Plan - Apart	ments	
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4	20/03/13	RE-ISSUED FOR COTW
3	20/02/06	ISSUED FOR COTW
2	20/01/15	ISSUED FOR ADF
1	19/12/16	RESPONSE TO PLANNING REVIEW
Rev	Date	Description
plot date	SEPTEMBER 2019	drawing file 1907 A200 Plans.vwx
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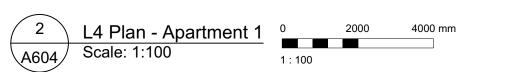
NOTE: All dimensions are shown in millimeters. ISSUED FOR DP & REZONING


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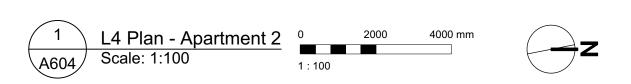
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977 Fort Street Victoria BC V8V 3K3 T 1•250•658•3367	102-5190 Du Nanaimo BC T 1•250•585	V 9 T 2 K 8
caledonia		
Victoria BC		
L3 Plan - Apart	ments	
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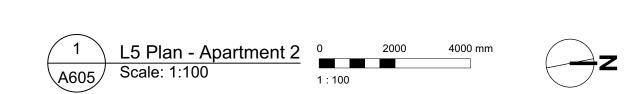


4	20/03/13	RE-ISSUED FOR COTW
3	20/02/06	ISSUED FOR COTV
2	20/01/15	ISSUED FOR ADP
1	19/12/16	RESPONSE TO PLANNING REVIEW
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drawn by	FWP	checked by RAW
scale	AS SHOWN	project number 1907

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Caledonia		
Victoria BC		
L4 Plan - Apart	ments	
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2	20/01/15	ISSUED FOR ADF
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Rev	Date	Description
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drawn by FWP		checked by RAW
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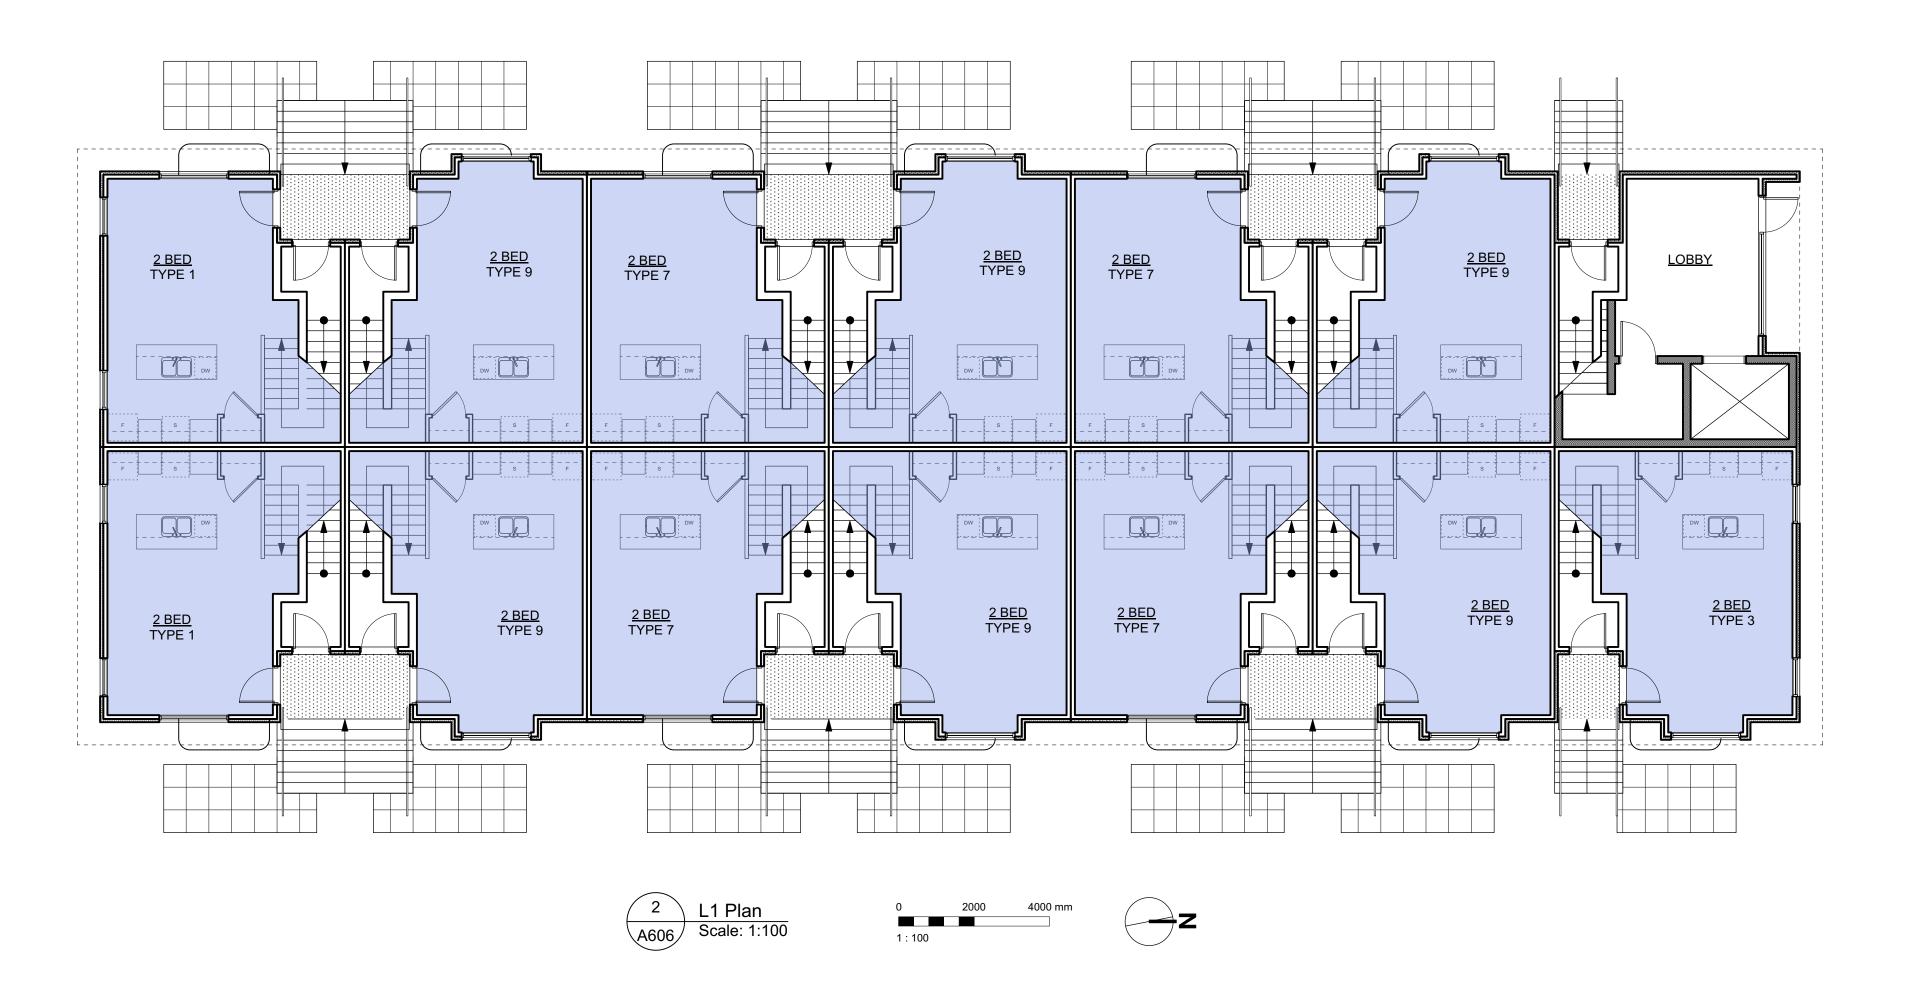
dHKarchitects

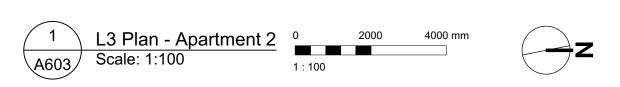
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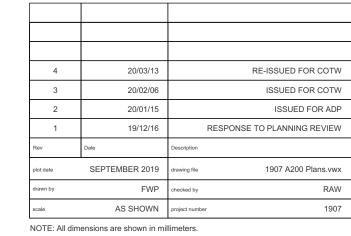
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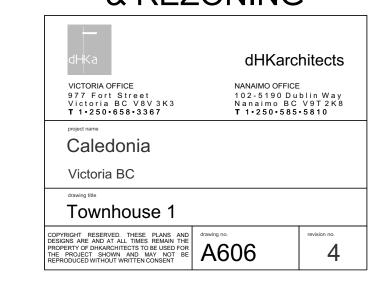
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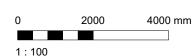




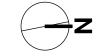






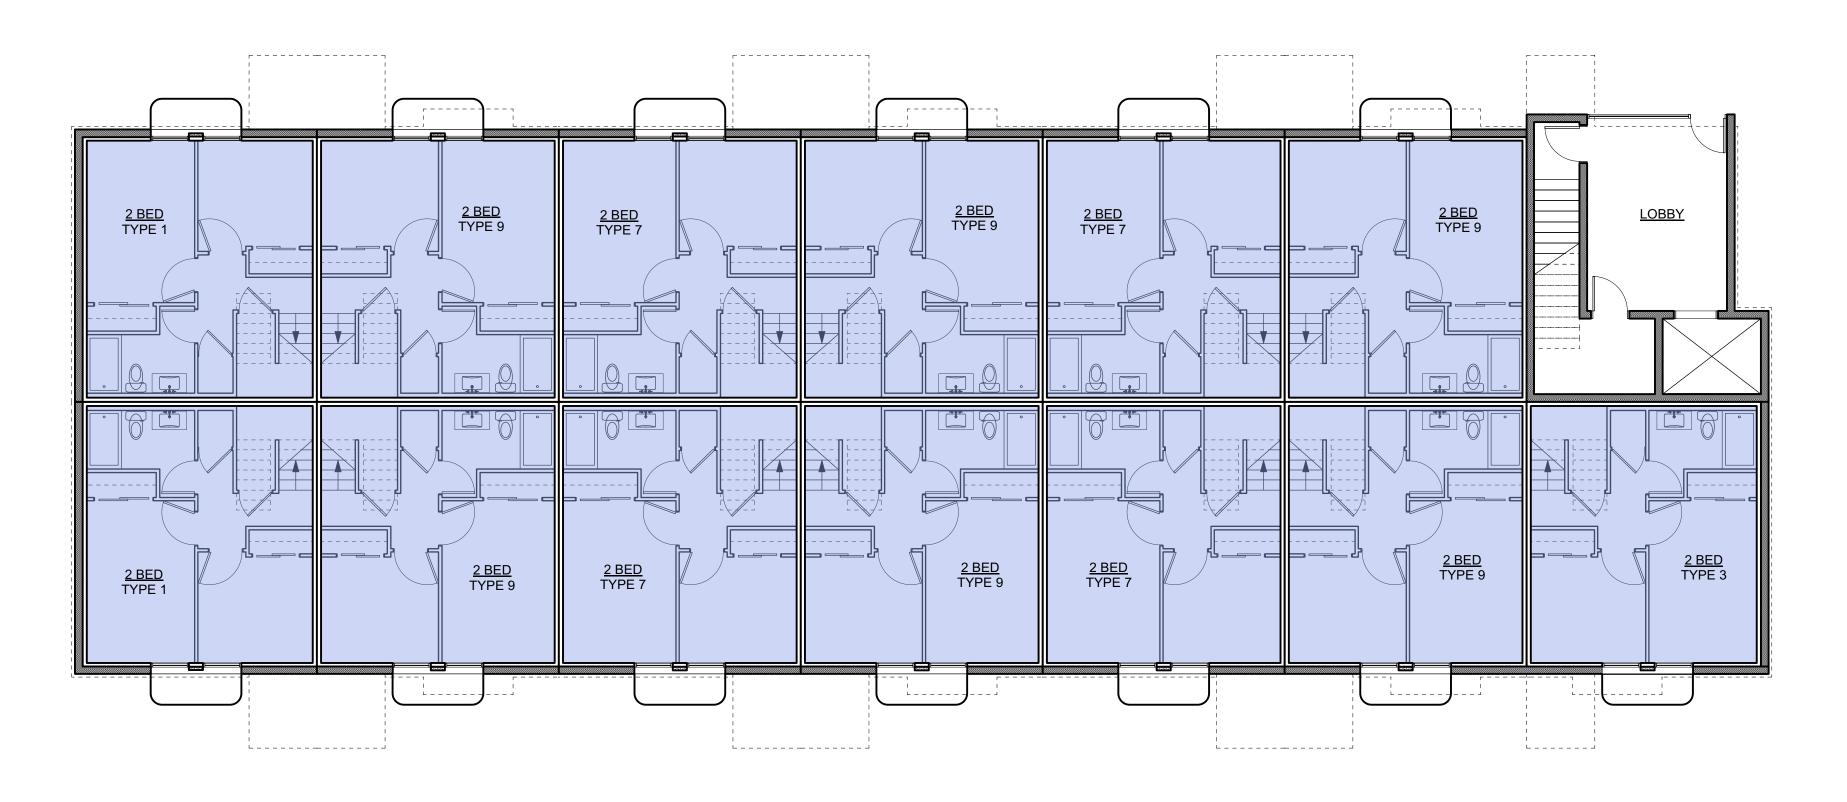







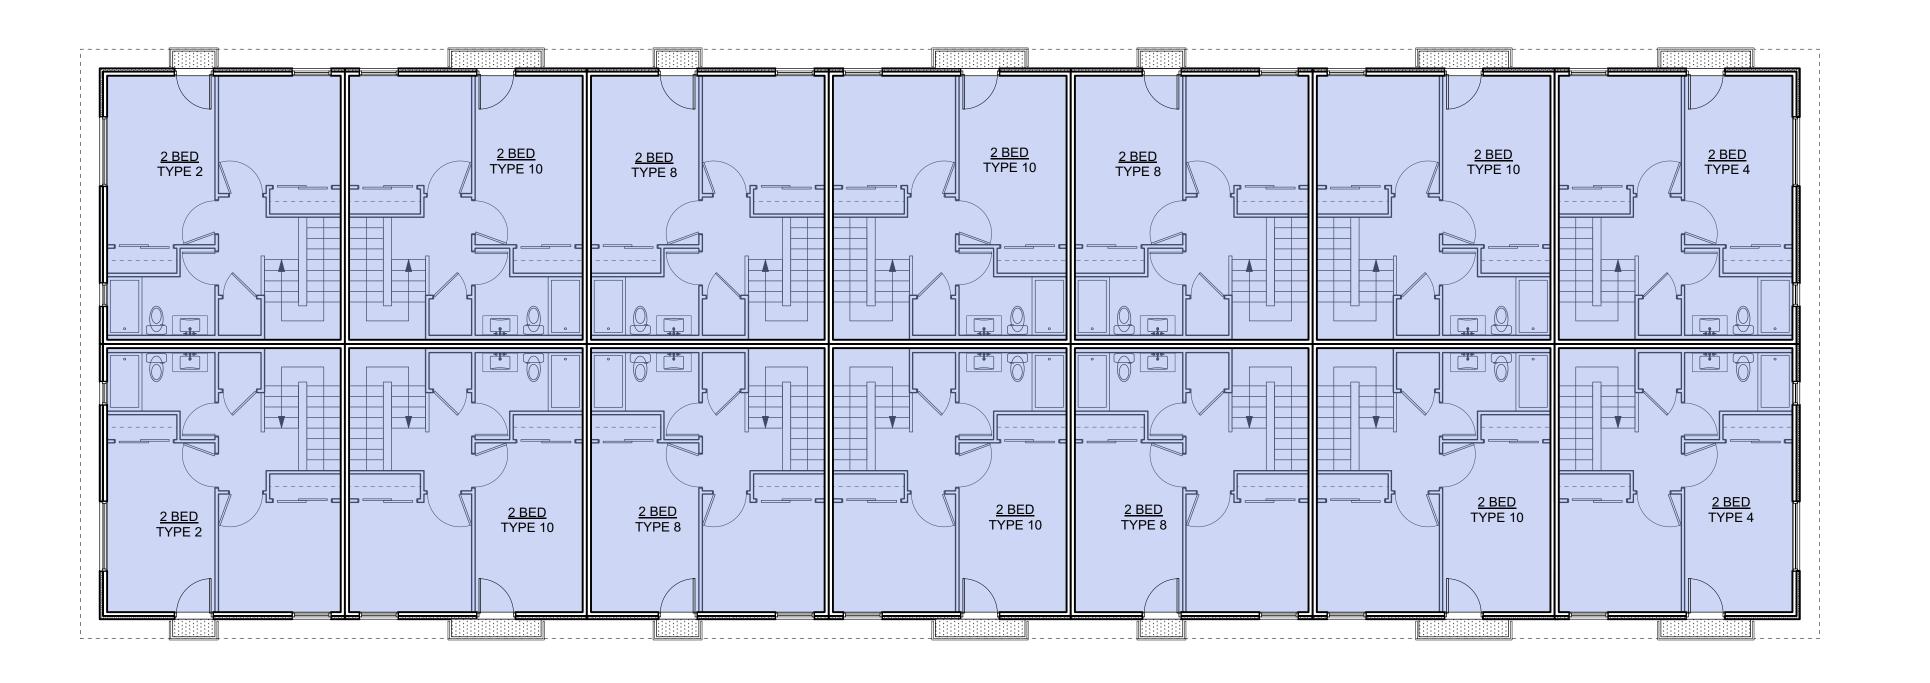




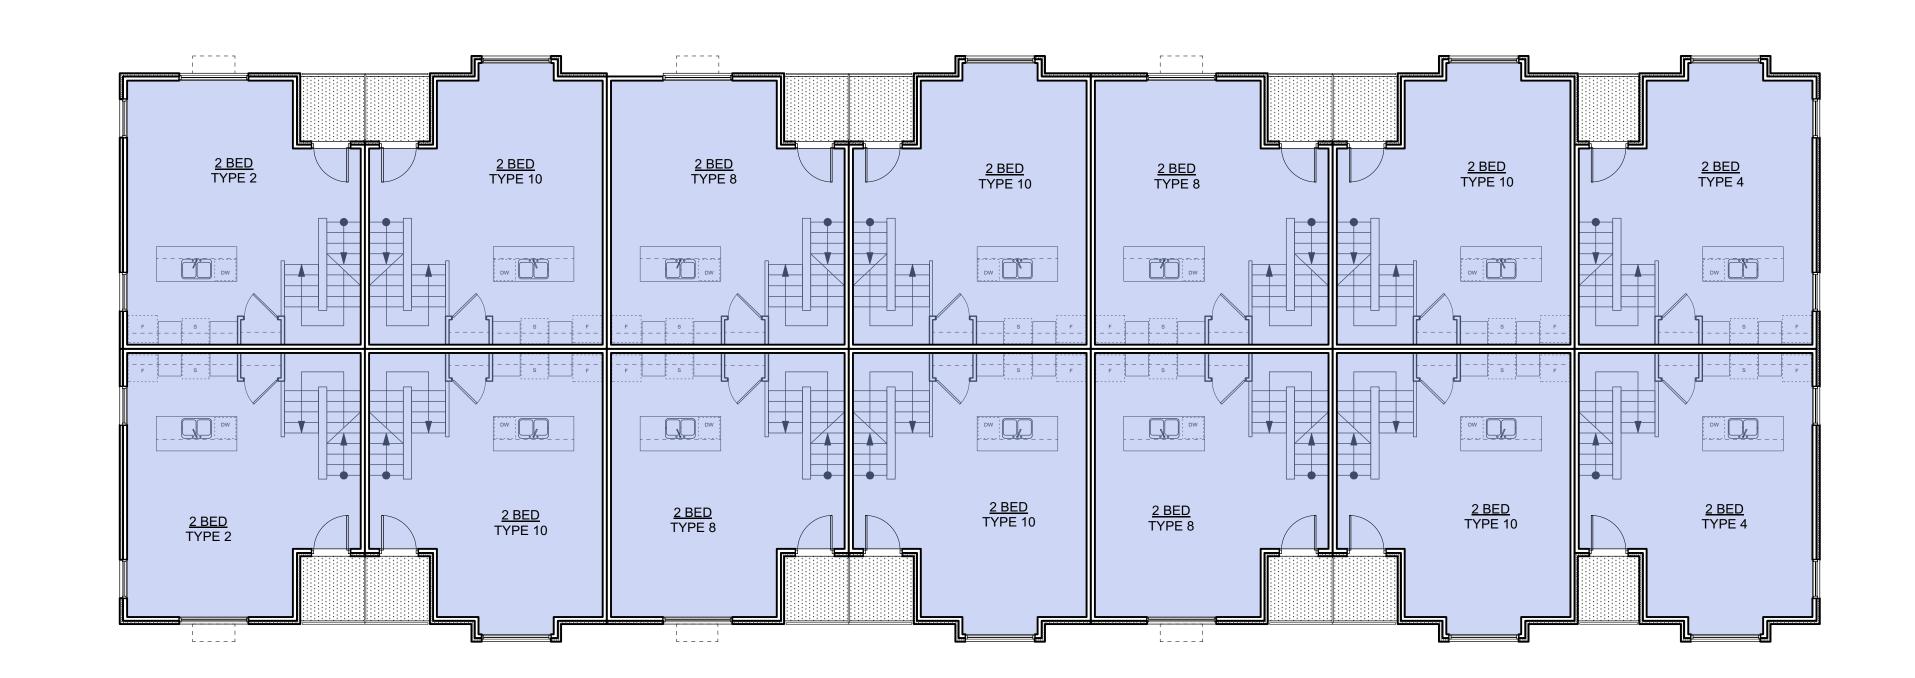

4	20/03/13	RE-ISSUED FOR CO
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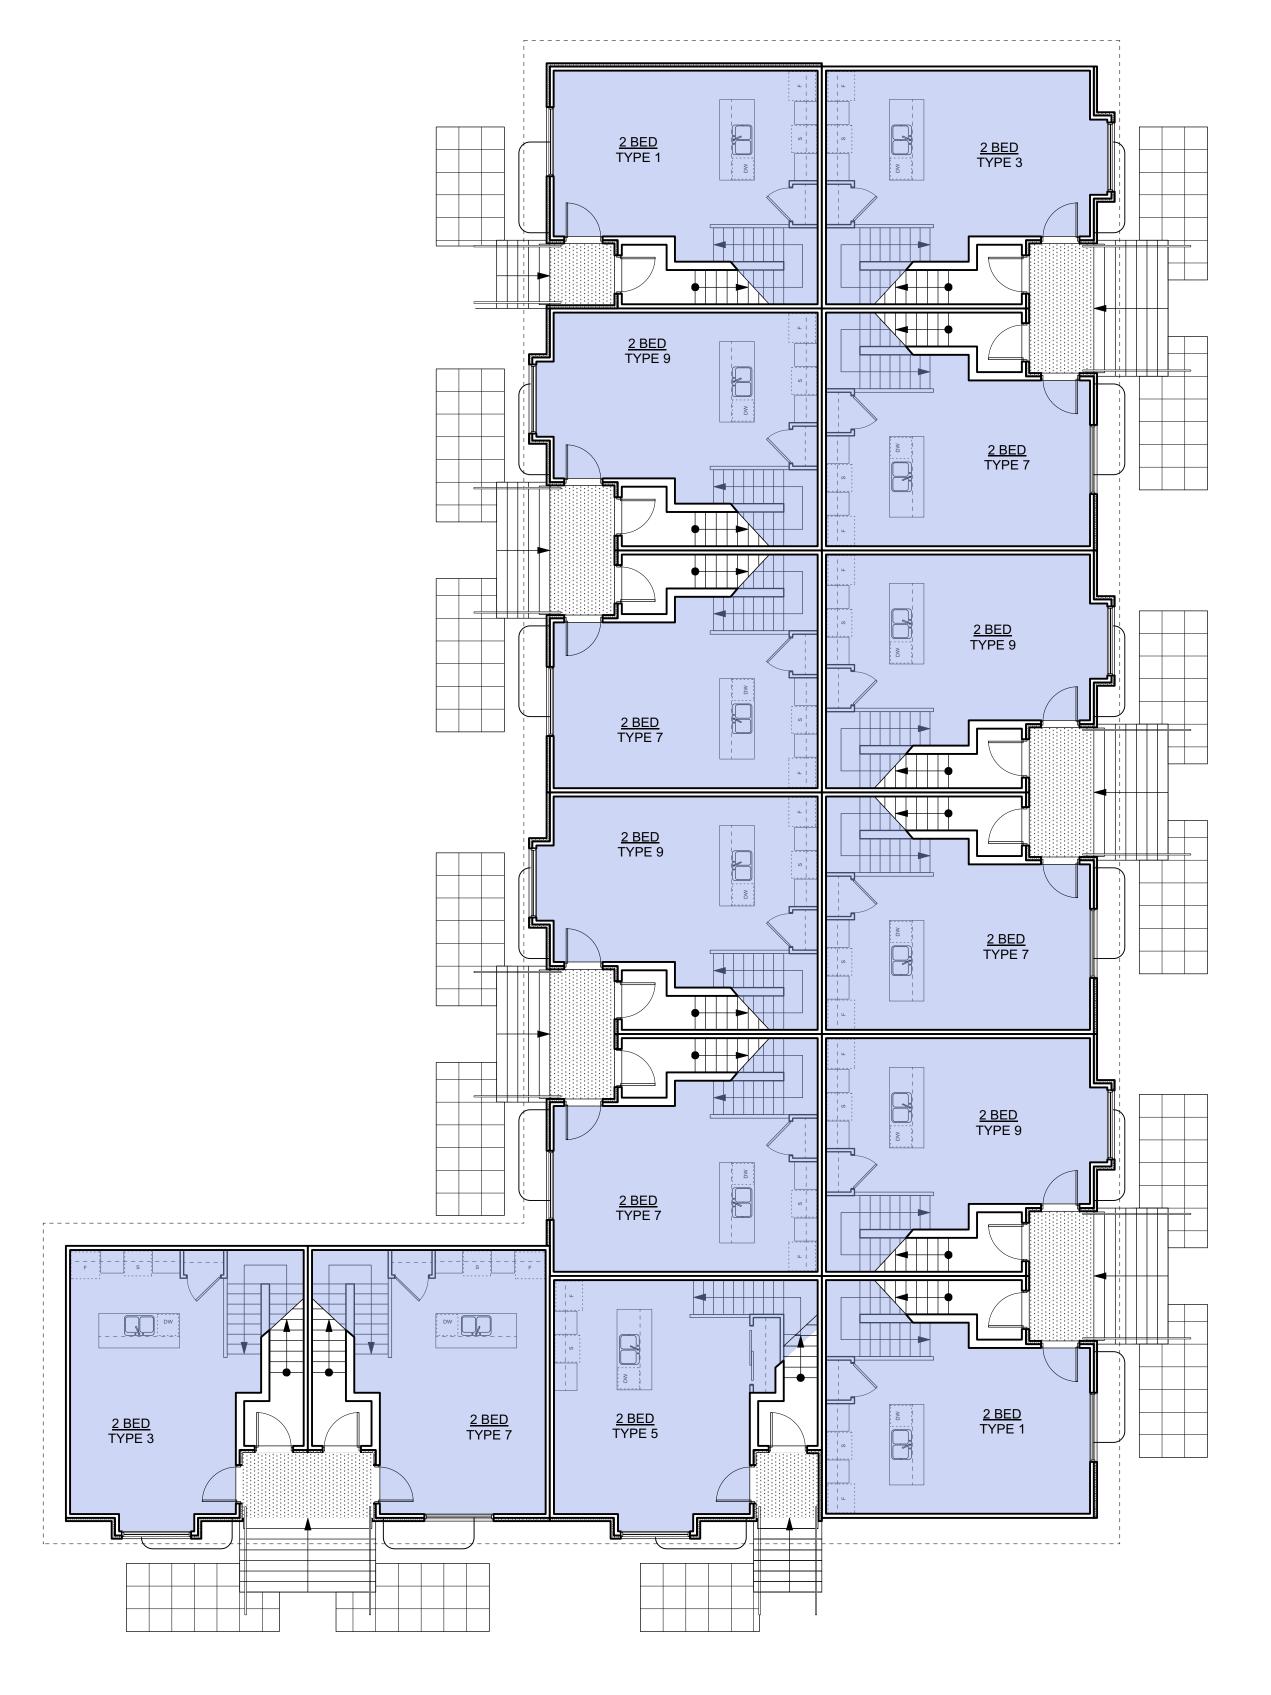


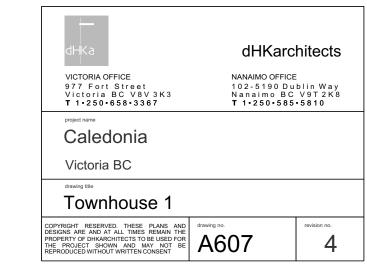




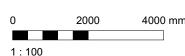







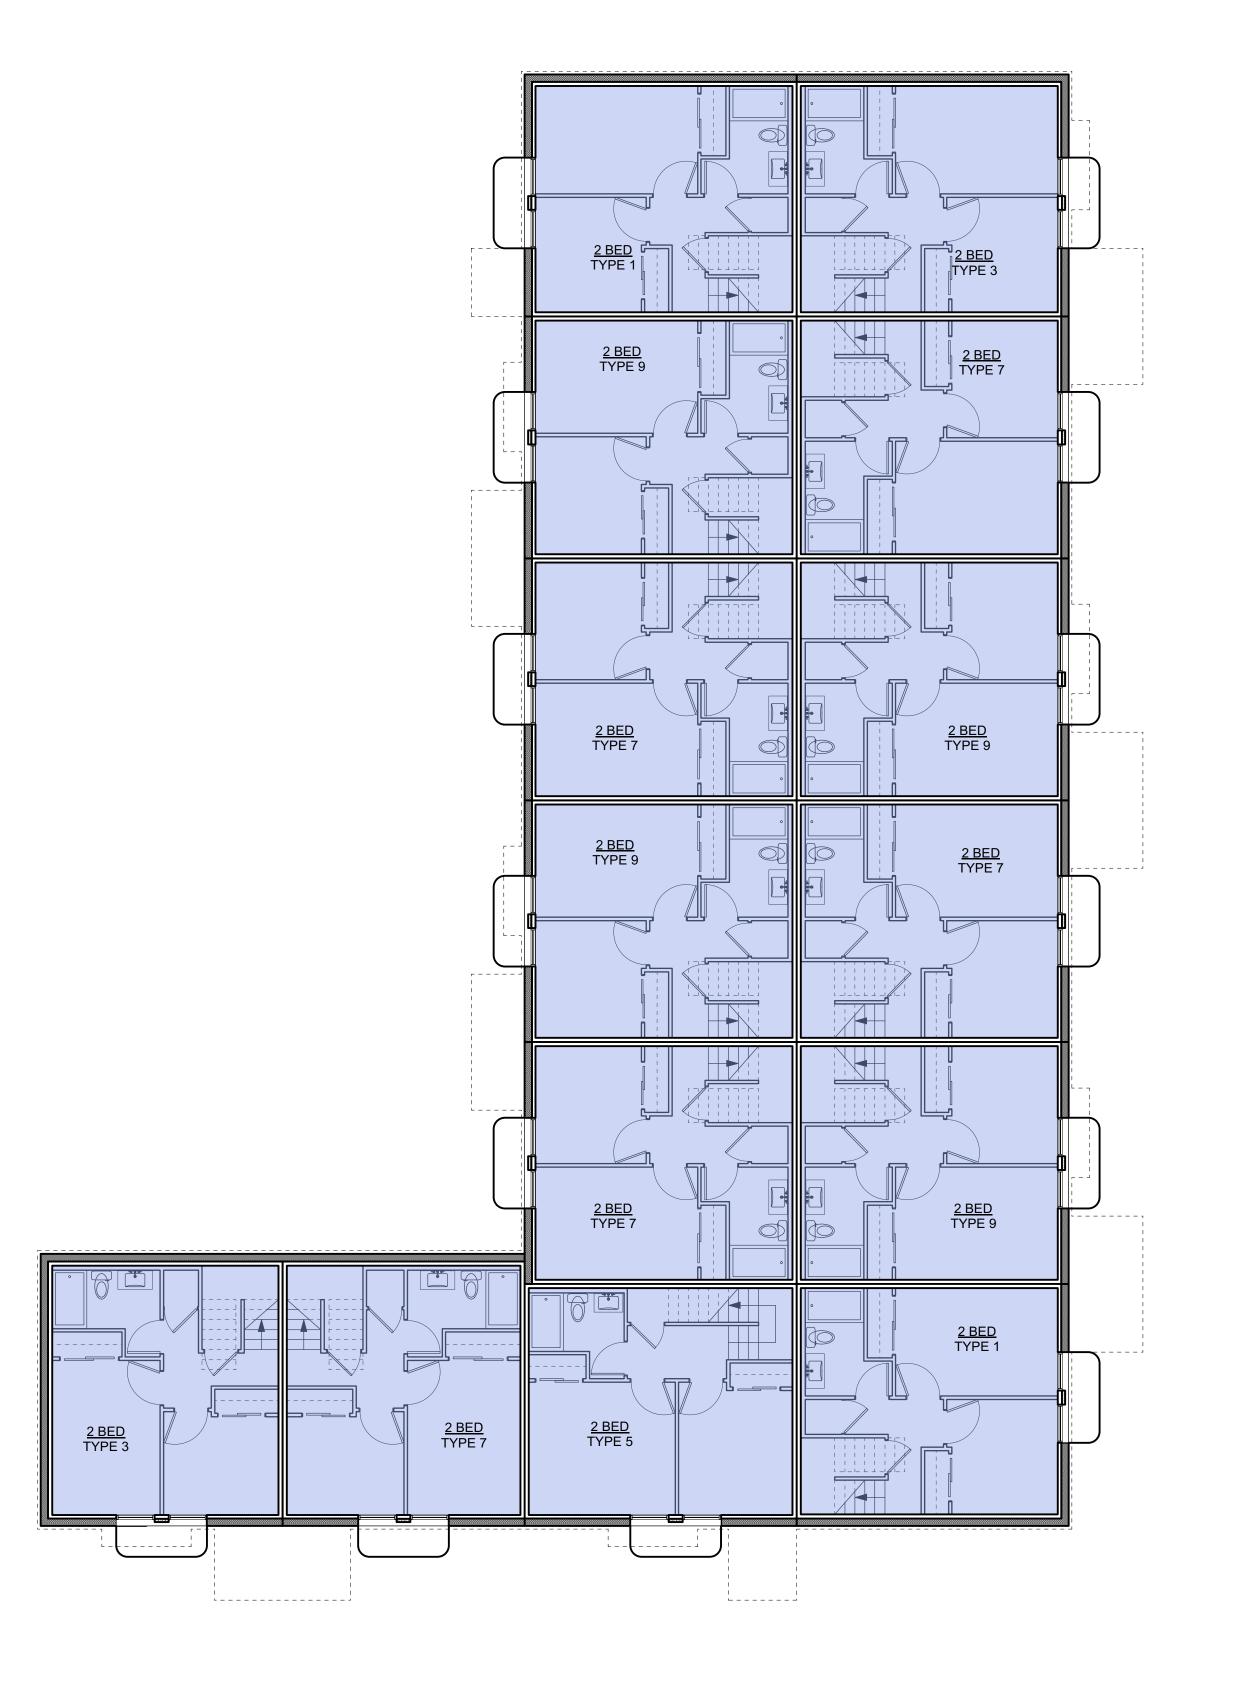


3 20/02/06 ISSUED FOR COTW 2 20/01/15 ISSUED FOR ADP 1 19/12/16 RESPONSE TO PLANNING REVIEW Rev Date Description plot date SEPTEMBER 2019 drawing file 1907 A200 Plans.vwx drawn by FWP checked by RAW			
3 20/02/06 ISSUED FOR COTW 2 20/01/15 ISSUED FOR ADP 1 19/12/16 RESPONSE TO PLANNING REVIEW Rev Date Description plot date SEPTEMBER 2019 drawing file 1907 A200 Plans.vwx drawn by FWP checked by RAW scale AS SHOWN project number 1907			
3 20/02/06 ISSUED FOR COTW 2 20/01/15 ISSUED FOR ADP 1 19/12/16 RESPONSE TO PLANNING REVIEW Rev Date Description plot date SEPTEMBER 2019 drawing file 1907 A200 Plans.vwx drawn by FWP checked by RAW scale AS SHOWN project number 1907			
3 20/02/06 ISSUED FOR COTW 2 20/01/15 ISSUED FOR ADP 1 19/12/16 RESPONSE TO PLANNING REVIEW Rev Date Description plot date SEPTEMBER 2019 drawing file 1907 A200 Plans.vwx drawn by FWP checked by RAW scale AS SHOWN project number 1907			
2 20/01/15 ISSUED FOR ADP 1 19/12/16 RESPONSE TO PLANNING REVIEW Rev Date Description plot date SEPTEMBER 2019 drawing file 1907 A200 Plans.vwx drawn by FWP checked by RAW scale AS SHOWN project number 1907	4	20/03/13	RE-ISSUED FOR COTW
1 19/12/16 RESPONSE TO PLANNING REVIEW Rev Date Description plot date SEPTEMBER 2019 drawing file 1907 A200 Plans.vvvx drawn by FWP checked by RAW scale AS SHOWN project number 1907	3	20/02/06	ISSUED FOR COTW
Rev Date Description plot date SEPTEMBER 2019 drawing file 1907 A200 Plans.vwx drawn by FWP checked by RAW scale AS SHOWN project number 1907	2	20/01/15	ISSUED FOR ADP
plot date SEPTEMBER 2019 drawing file 1907 A200 Plans.vwx	1	19/12/16	RESPONSE TO PLANNING REVIEW
drawn by FWP checked by RAW scale AS SHOWN project number 1907	Rev	Date	Description
scale AS SHOWN project number 1907	plot date	SEPTEMBER 2019	drawing file 1907 A200 Plans.vwx
	drawn by	FWP	checked by RAW
NOTE: All dimensions are shown in millimeters.	scale	AS SHOWN	project number 1907
	NOTE: All dimensions are shown in millimeters.		



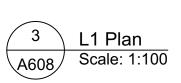

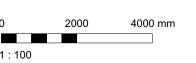


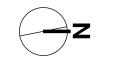








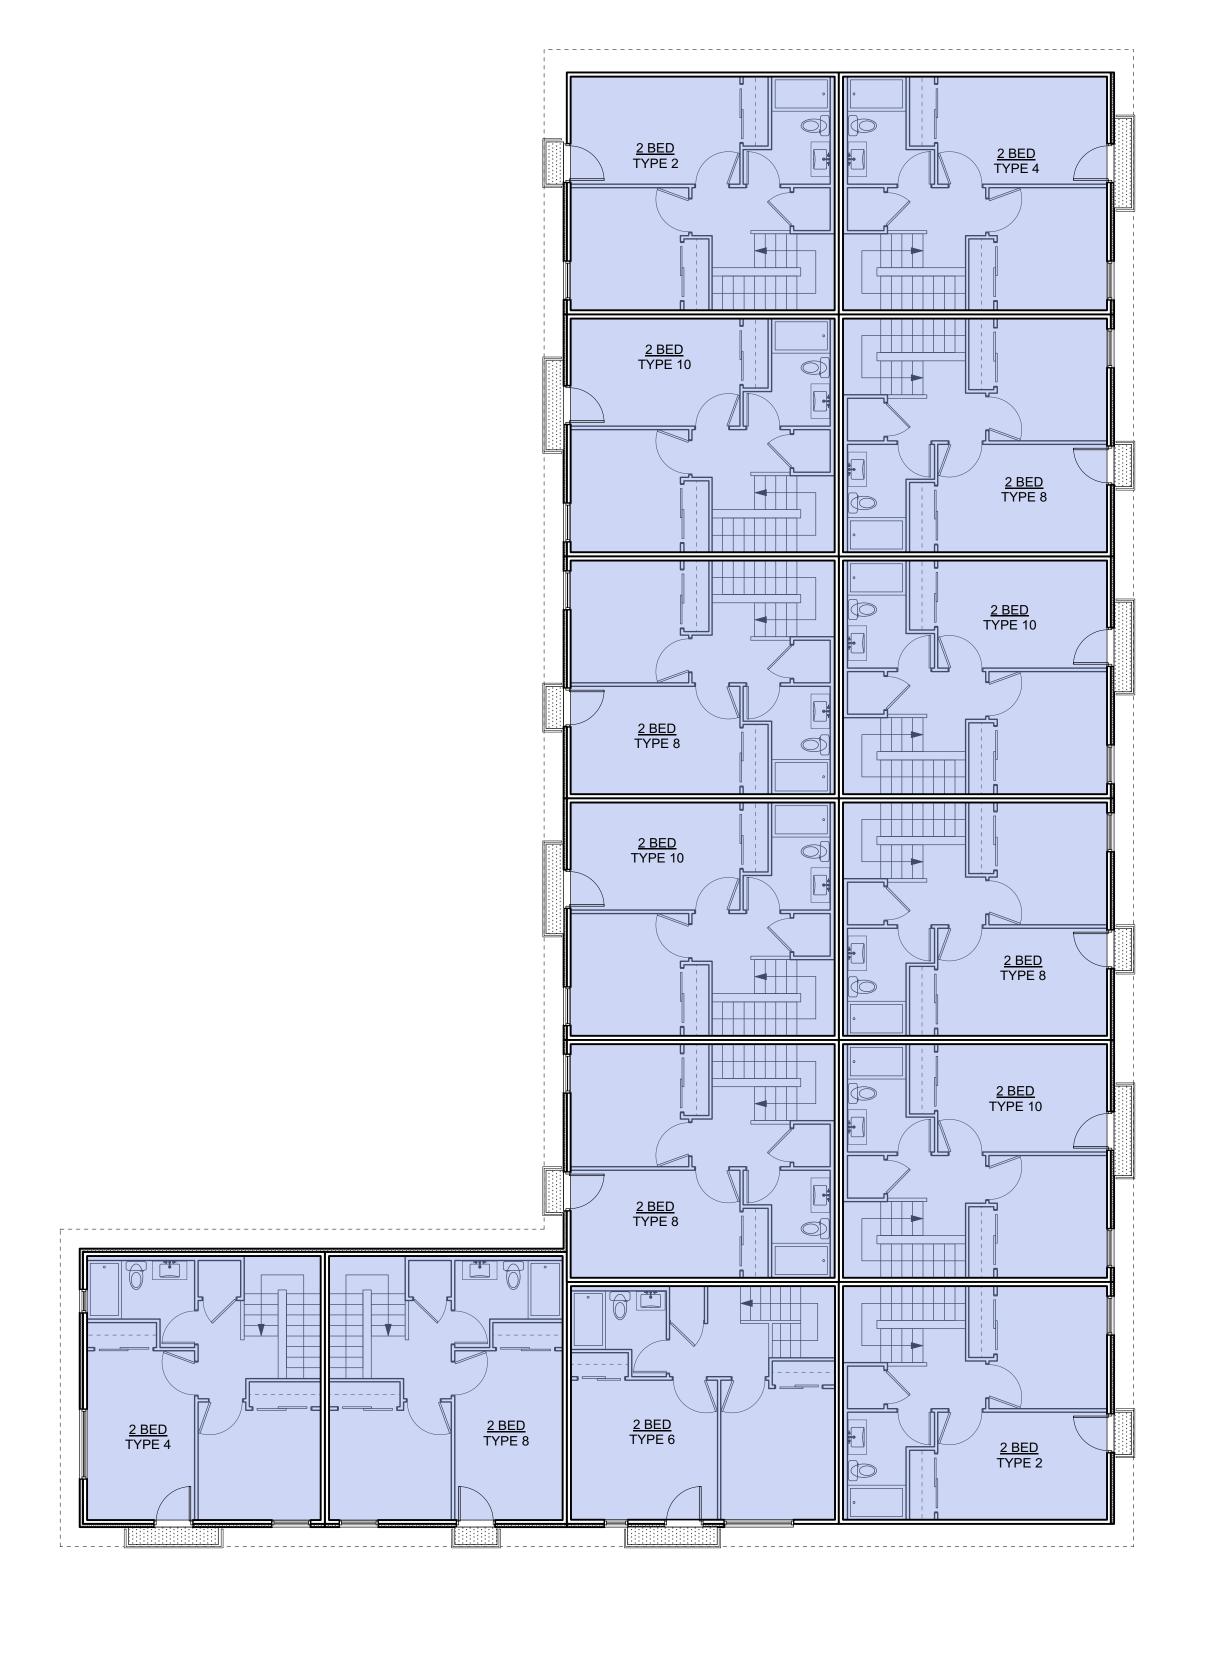


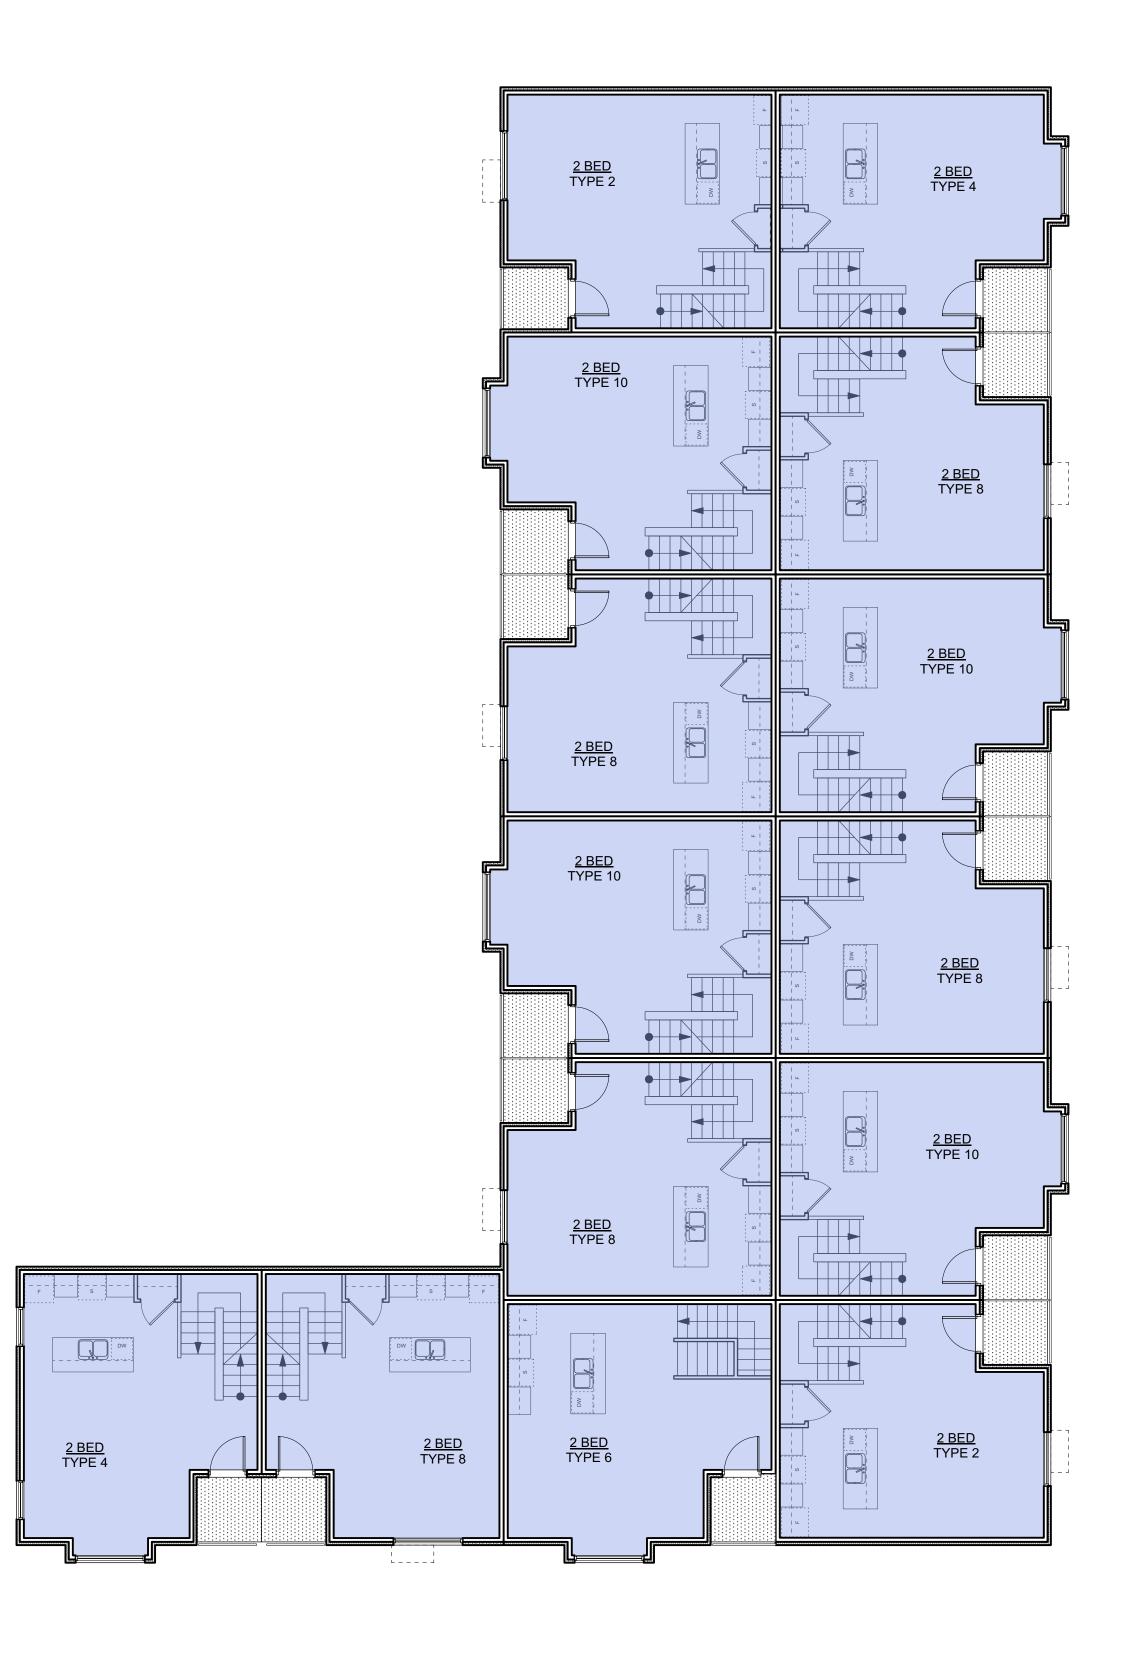


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3	20/02/06	ISSUED FOR COTW
2	20/01/15	ISSUED FOR ADP
1	19/12/16	RESPONSE TO PLANNING REVIEW
Rev	Date	Description
plot date	SEPTEMBER 2019	drawing file 1907 A200 Plans.vwx
drawn by	FWP	checked by RAW
scale	AS SHOWN	project number 1907

ISSUED FOR DP & REZONING



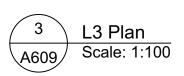


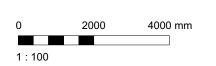









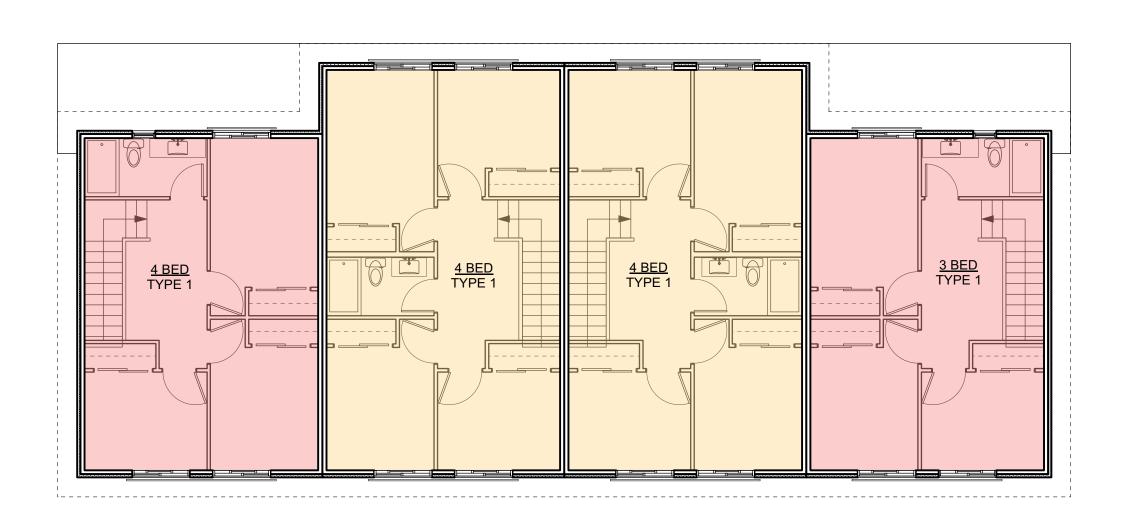



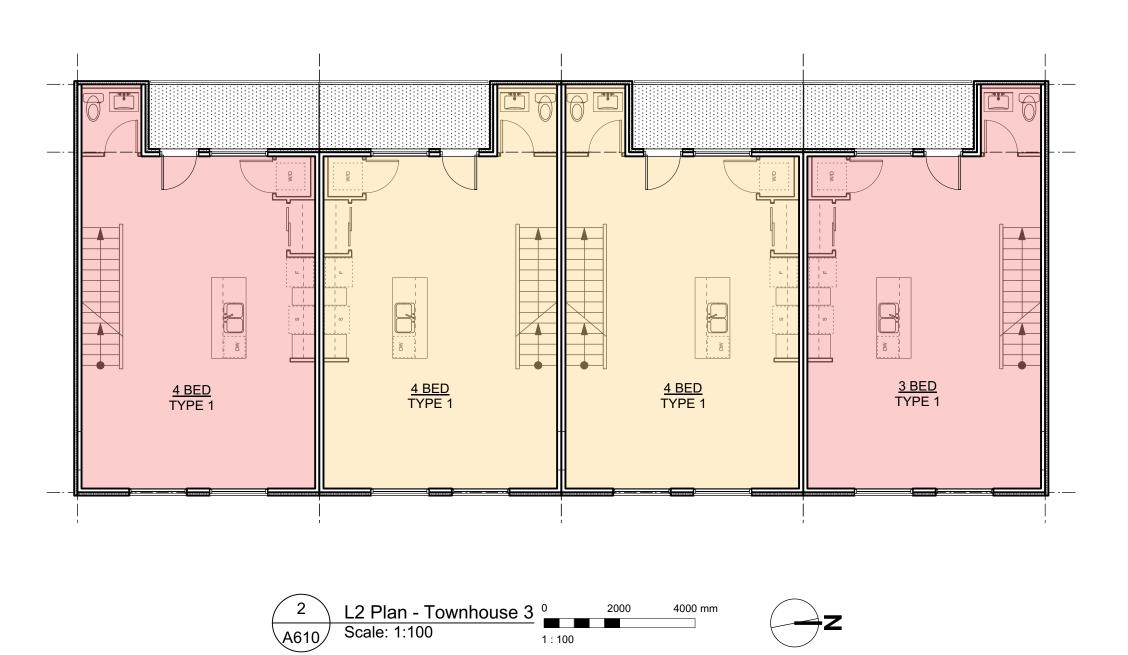

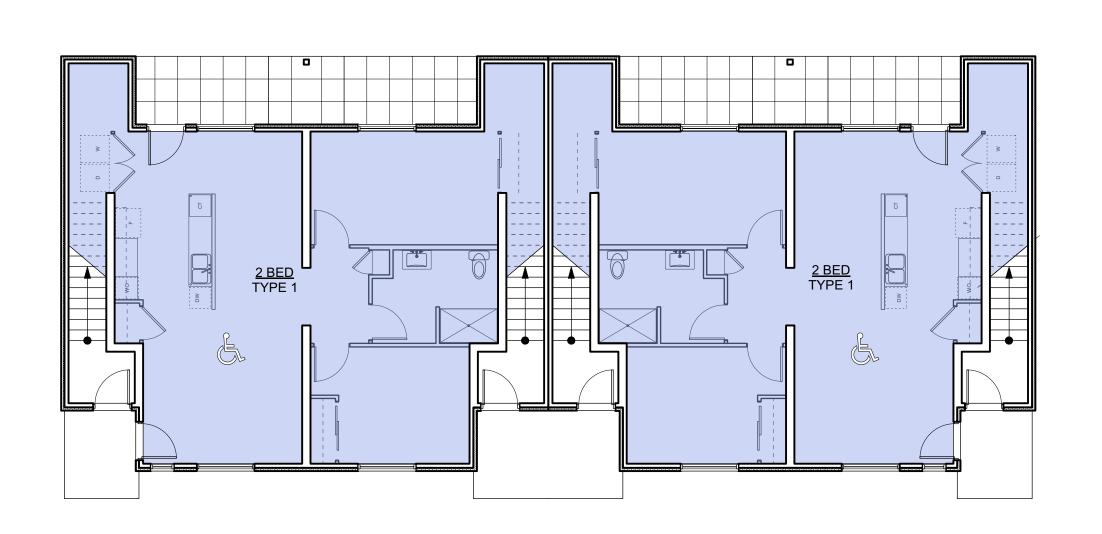



4	20/03/13	RE-ISSUED FOR COT
3	20/02/06	ISSUED FOR COT
2	20/01/15	ISSUED FOR AD
1	19/12/16	RESPONSE TO PLANNING REVIE
Rev	Date	Description
plot date	SEPTEMBER 2019	drawing file 1907 A200 Plans.vv
drawn by	FWP	checked by RA
scale	AS SHOWN	project number 190

GRAPHIC LEGEND:

1 BEDROOM

2 BEDROOM

3 BEDROOM

4 BEDROOM


& ACCESSIBLE

STUDIO


ISSUED FOR DP & REZONING


Q I L Z	A ILZOIIII			
dHKa	dHKarc	hitects		
VICTORIA OFFICE 977 Fort Street Victoria BC V8V3K3 T 1.250.658.3367	NANAIMO OFFICE 102-5190 Du Nanaimo BC T 1•250•585	blin Way V9T2K8		
caledonia				
Victoria BC				
Townhouse 3				
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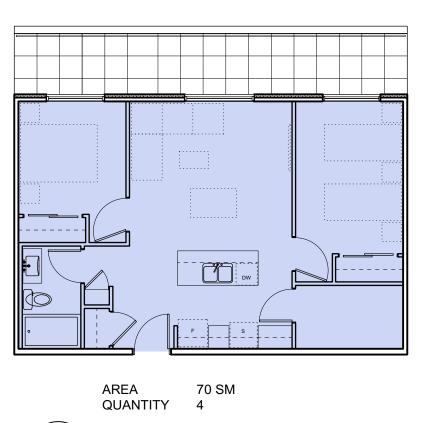


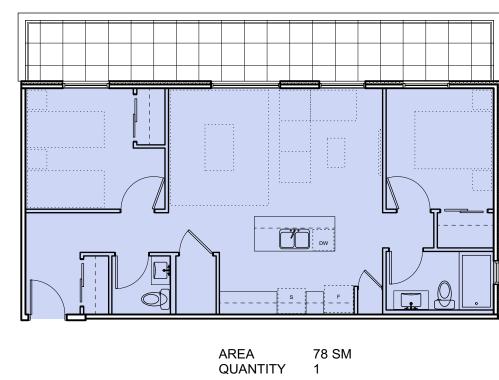



14 2 Bed Type 7 A701 Scale: 1:100




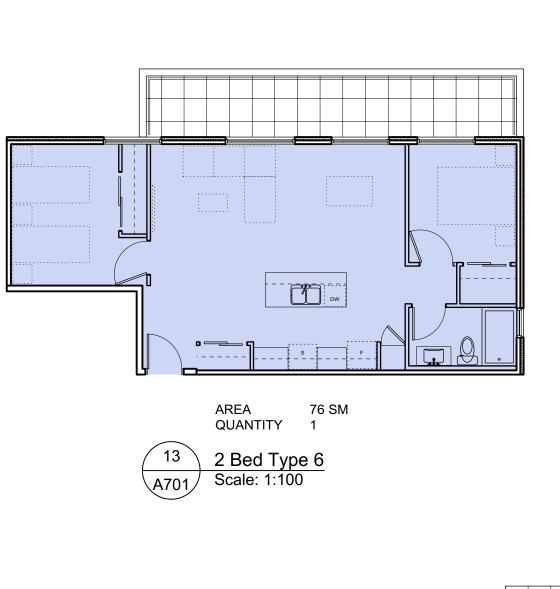


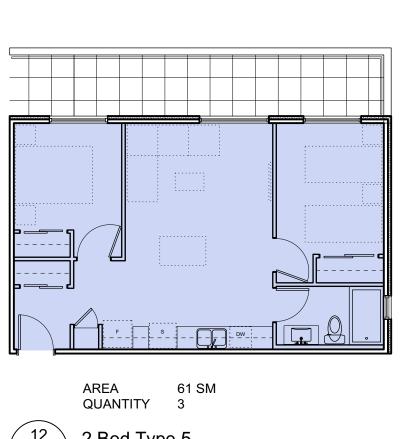


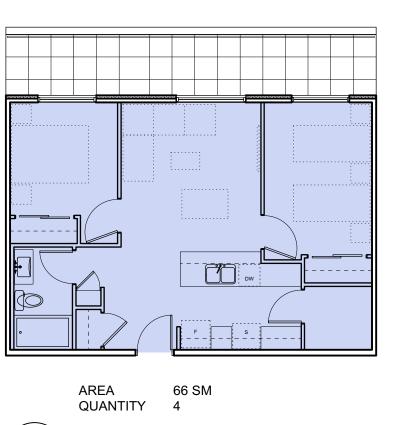

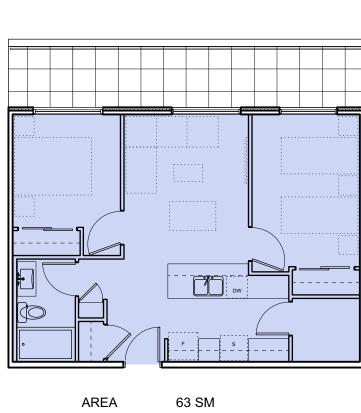

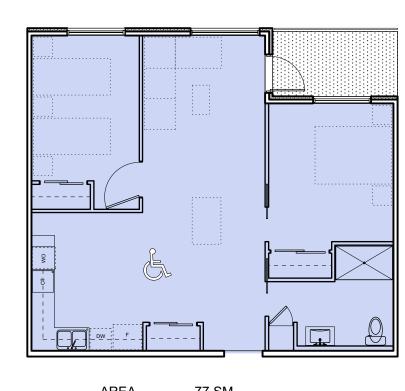

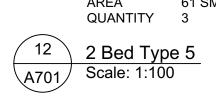


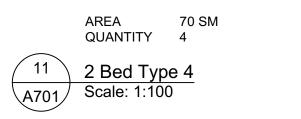


10 2 Bed Type 3 A701 Scale: 1:100


AREA 63 SM QUANTITY 2 9 2 Bed Type 2 A701 Scale: 1:100


AREA 77 SM QUANTITY 5 8 2 Bed Type 1 - Accessible A701 Scale: 1:100

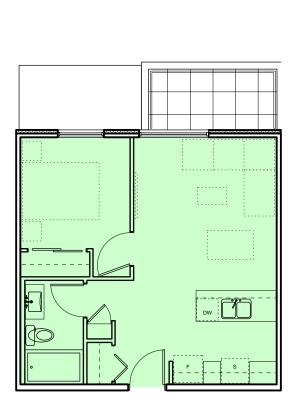



AREA 47 SM QUANTITY 2 1 Bed Type 3 Scale: 1:100

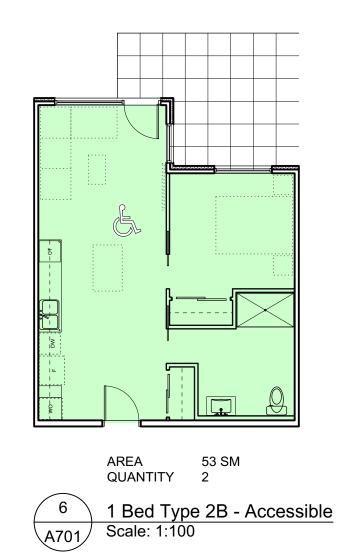


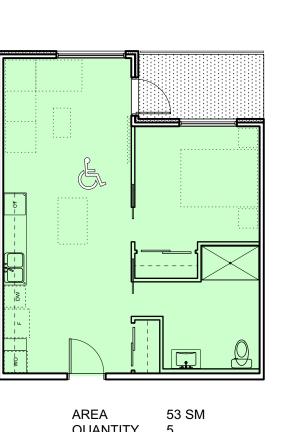

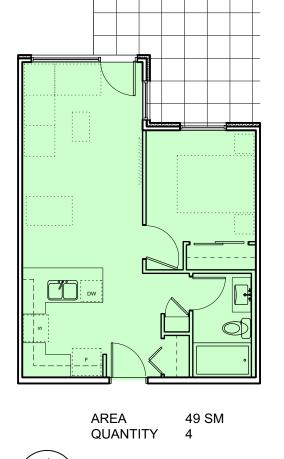

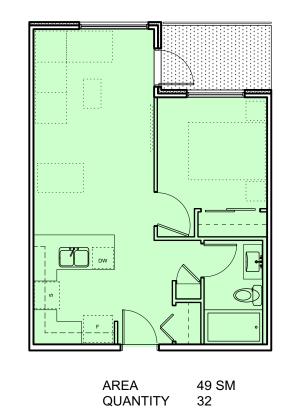

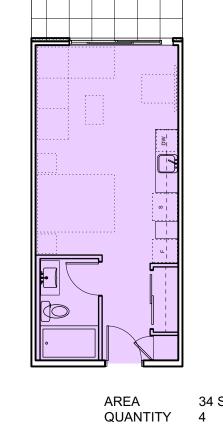

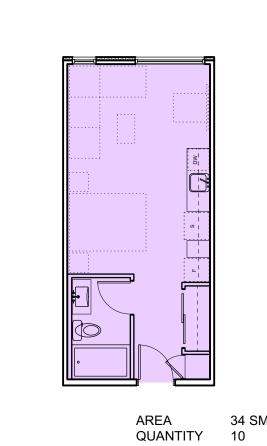

1 Studio Type 1A A701 Scale: 1:100

plot date	SEPTEMBER 2019	drawing file	1907 A200 Plans.vwx
drawn by	FWP	checked by	RAW
scale	AS SHOWN	project number	1907
	ISSUEI	DFOF	
	& KE	ZONII	NG
VICT 977 Vic T 1	ORIA OFFICE Fort Street toria BC V8V3K3 •250•658•3367	NANAIMO 102-51 Nanain	Karchitects OFFICE 90 Dublin Way no BC V9T 2K8 0.585.5810
Vic	toria BC		
		it Plans	
	drawn by scale NOTE: All of VICT 9 7 7 7 Vi c I T 1 1 1 1 1 1 1 1 1 1 1 1 1 1 1 1 1 1 1	drawn by FWP scale AS SHOWN NOTE: All dimensions are shown in mil ISSUE & RE WICTORIA OFFICE 977 Fort Street Victoria BC V8V 3 K3 T 1-250-658-3367 project name Caledonia Victoria BC drawing title	drawn by FWP checked by scale AS SHOWN project number NOTE: All dimensions are shown in millimeters. ISSUED FOF & REZONIN WICTORIA OFFICE 977 Fort Street Victoria BC V8V 3 K3 T 1·250·658·3367 Caledonia Victoria BC

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20/03/13

20/01/15

19/12/16

SEPTEMBER 2019 drawing file

RE-ISSUED FOR COTW

RESPONSE TO PLANNING REVIEW

ISSUED FOR COTW

1907 A200 Plans.vwx

ISSUED FOR ADP

	QUANTITY	5
5	1 Bed Type	e 2A - Acces
A701	Scale: 1:100	

111 3	
Type 2A - Accessible	4
1:100	A701

	QUANTITY 4
1	1 Bed Type 1B
01/	Scale: 1:100

	QUANTITY	32
3 A701	1 Bed Typ Scale: 1:10	


	AREA QUANTITY	34 SM 4
2	Studio Ty	<u> </u>
\A701	Scale. 1.10	U








AREA 88 SM QUANTITY 1


6 3 Bed Type 5 A702 Scale: 1:100

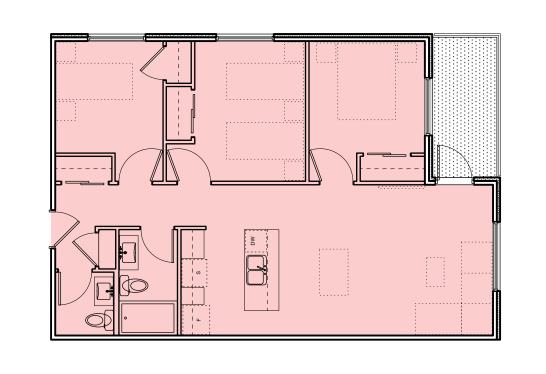


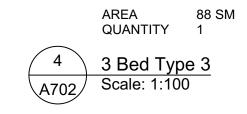


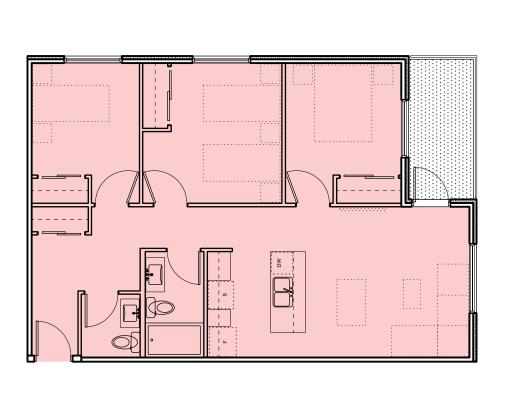

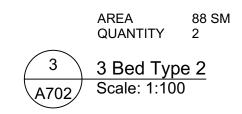

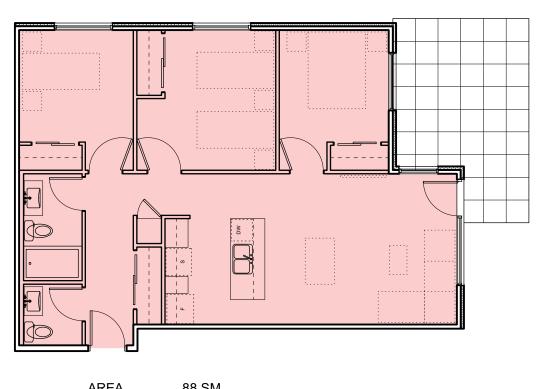


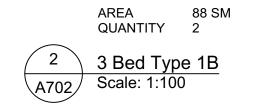

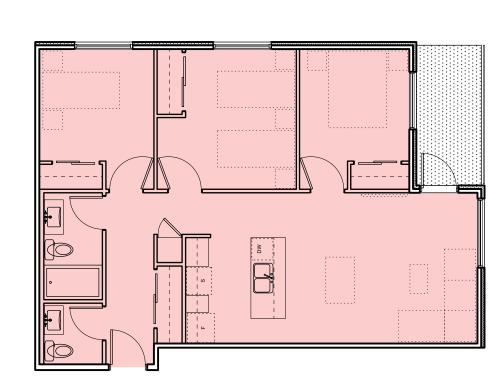

AREA QUANTITY

5 3 Bed Type 4 - Accessible Scale: 1:100

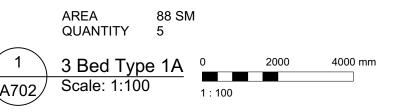

4	20/03/13	RE-ISSUED FOR COTW
3	20/02/06	ISSUED FOR COTW
2	20/01/15	ISSUED FOR ADP
1	19/12/16	RESPONSE TO PLANNING REVIEW
Rev	Date	Description
plot date	SEPTEMBER 2019	drawing file 1907 A200 Plans.vwx
drawn by	FWP	checked by RAW
scale	AS SHOWN	project number 1907

ISSUED FOR DP
& REZONING

- dHKa	dHKarchitects		
VICTORIA OFFICE 977 Fort Street Victoria BC V8V 3K3 T 1.250.658.3367	NANAIMO OFFICE 102-5190 Dublin Way Nanaimo BC V9T 2K8 T 1-250-585-58 10		
Caledonia			
Victoria BC			
drawing title			
Apartment Unit Plans			
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RE-ISSUED FOR COTW

ISSUED FOR COTW

1907 A200 Plans.vwx

dHKarchitects

RAW

ISSUED FOR ADP



RE-ISSUED FOR COTW

ISSUED FOR ADP

1907 A200 Plans.vwx

dHKarchitects


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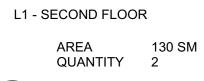
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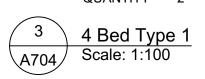
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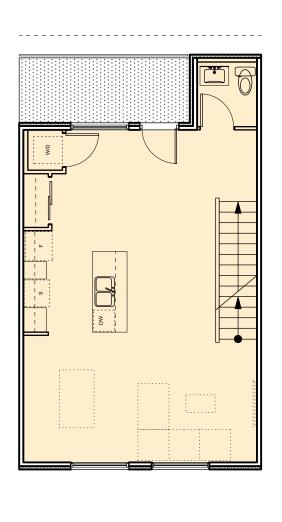
AS SHOWN project number

ISSUED FOR DP
& REZONING









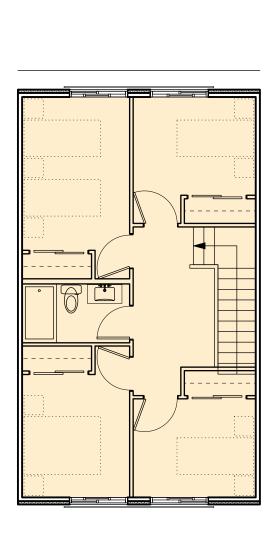

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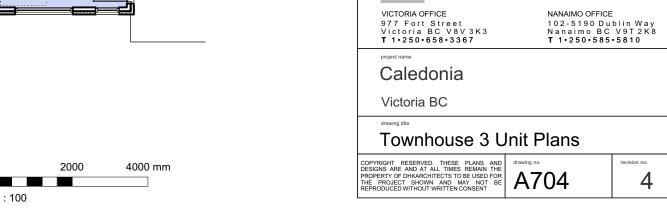


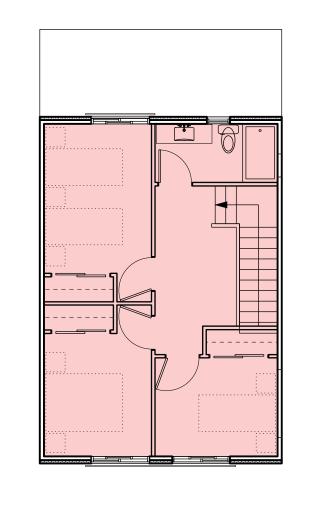





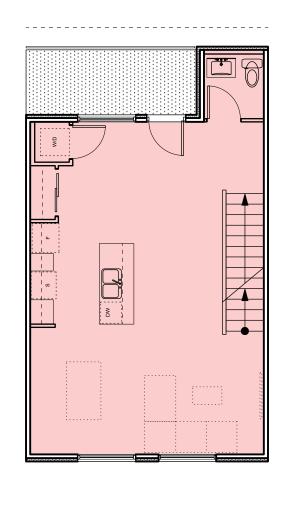


AREA QUANTITY	104 SM 2	
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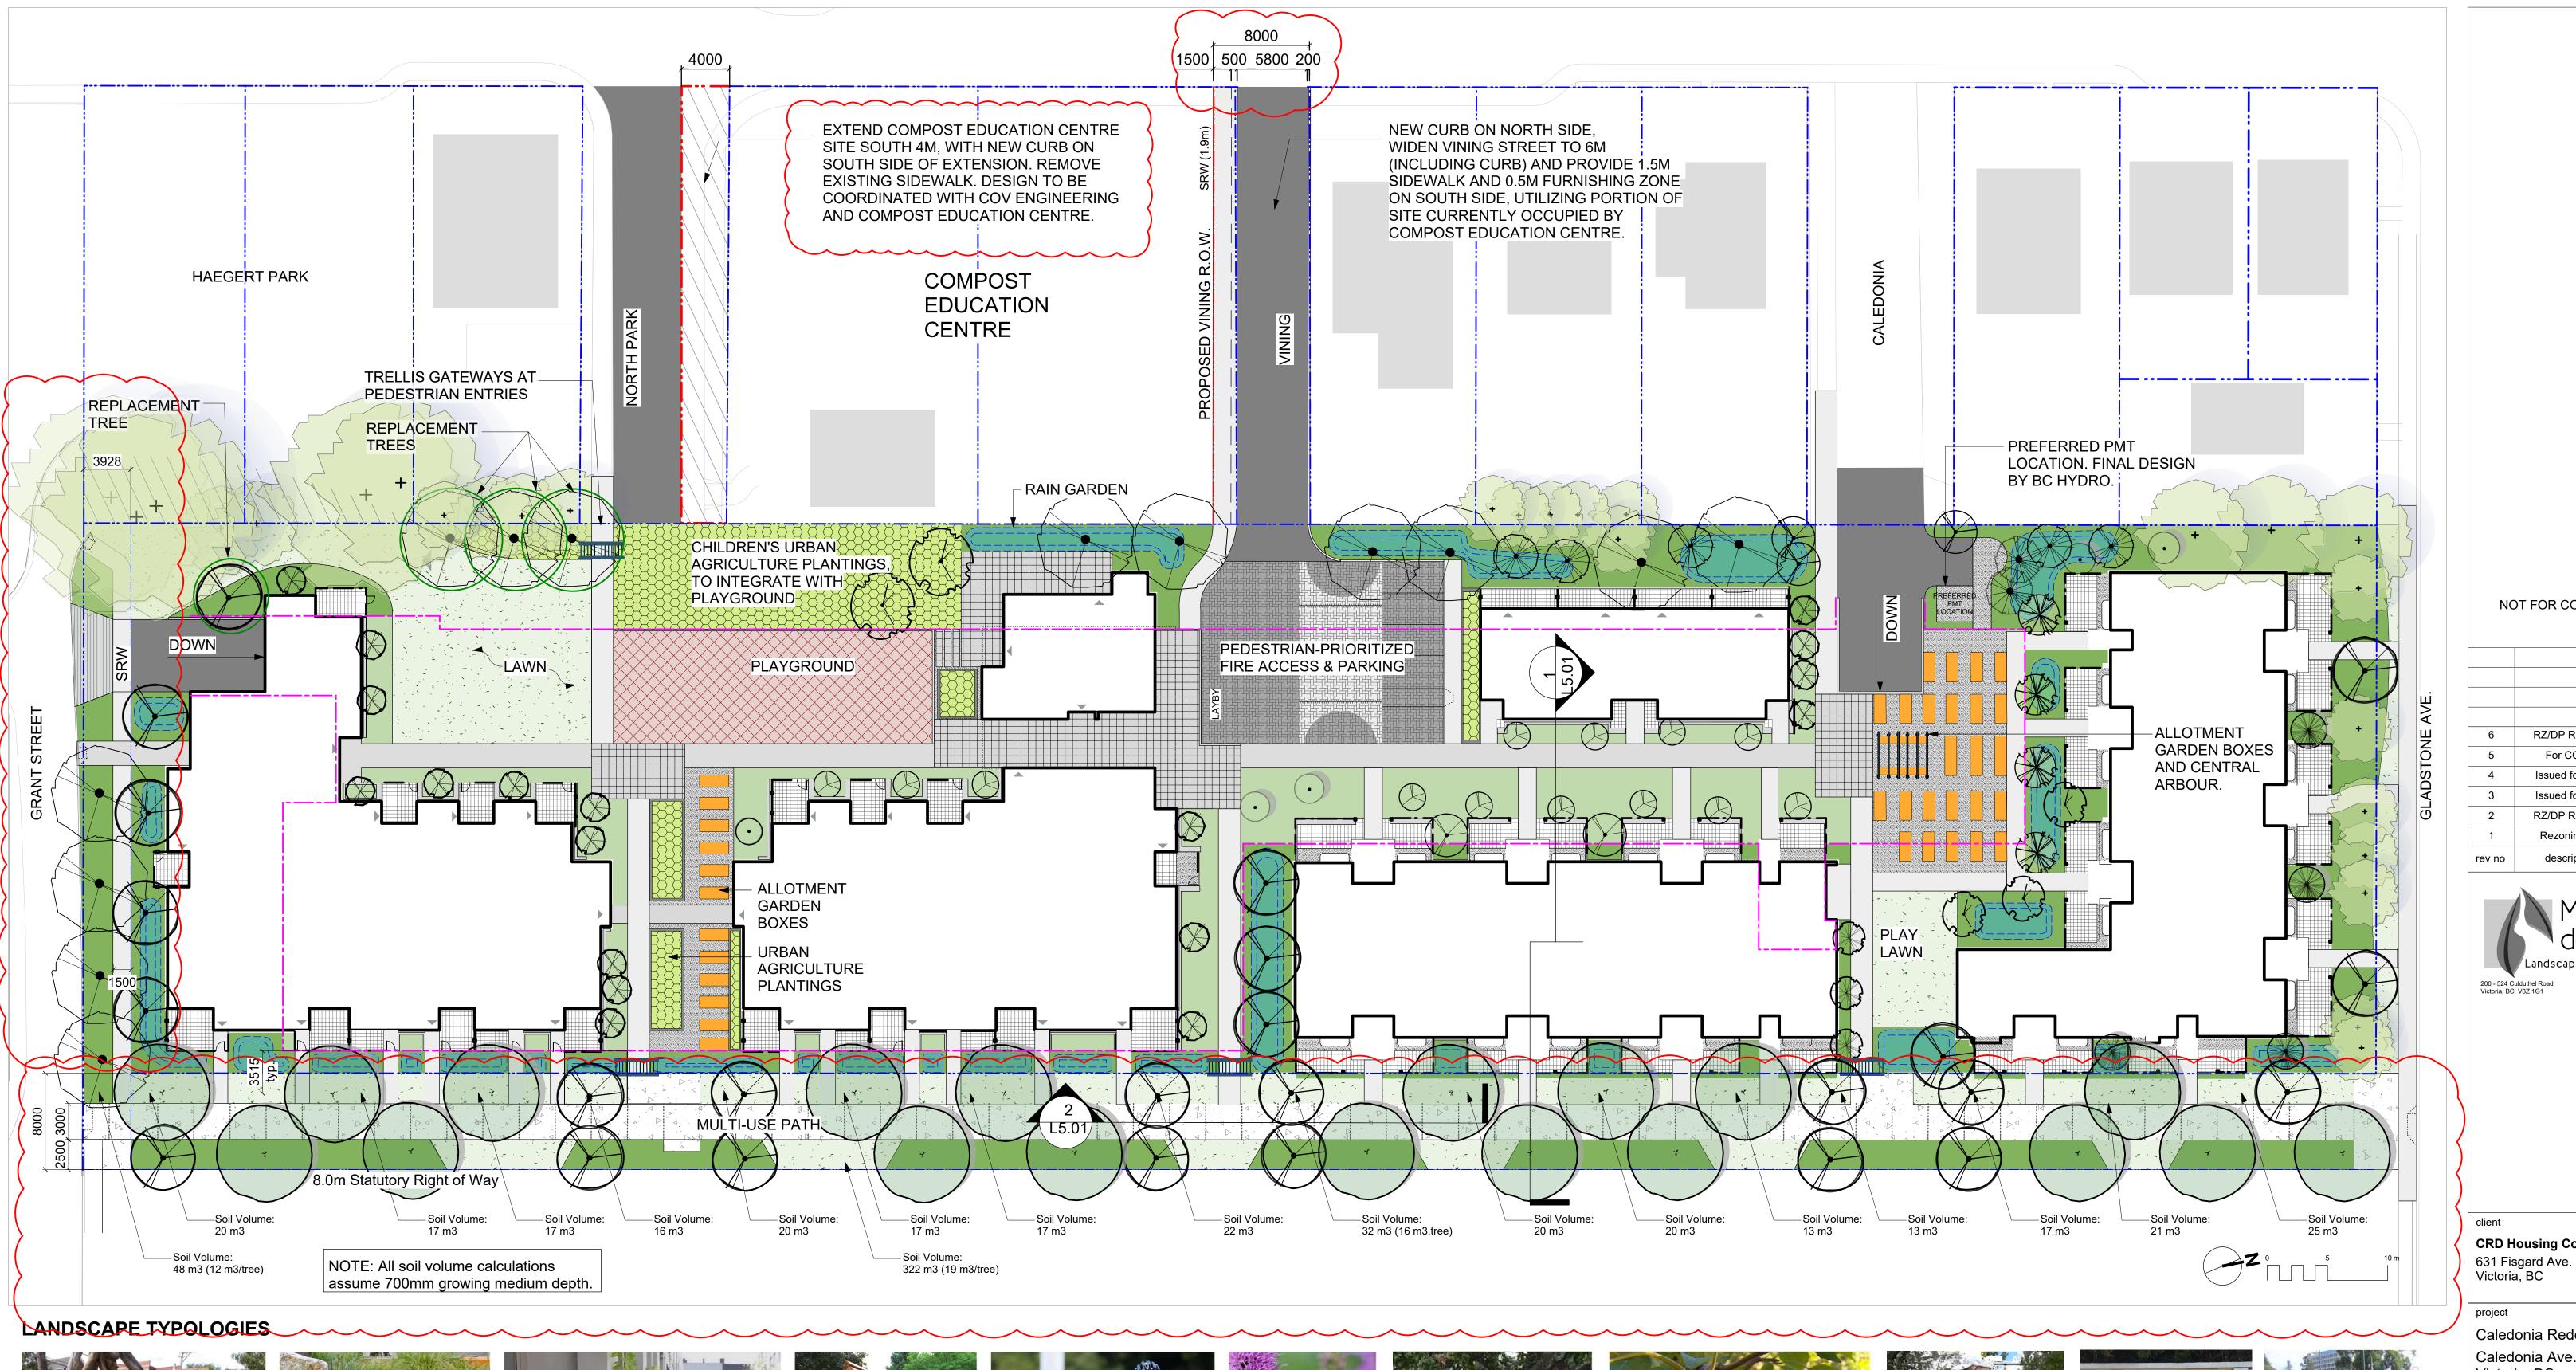


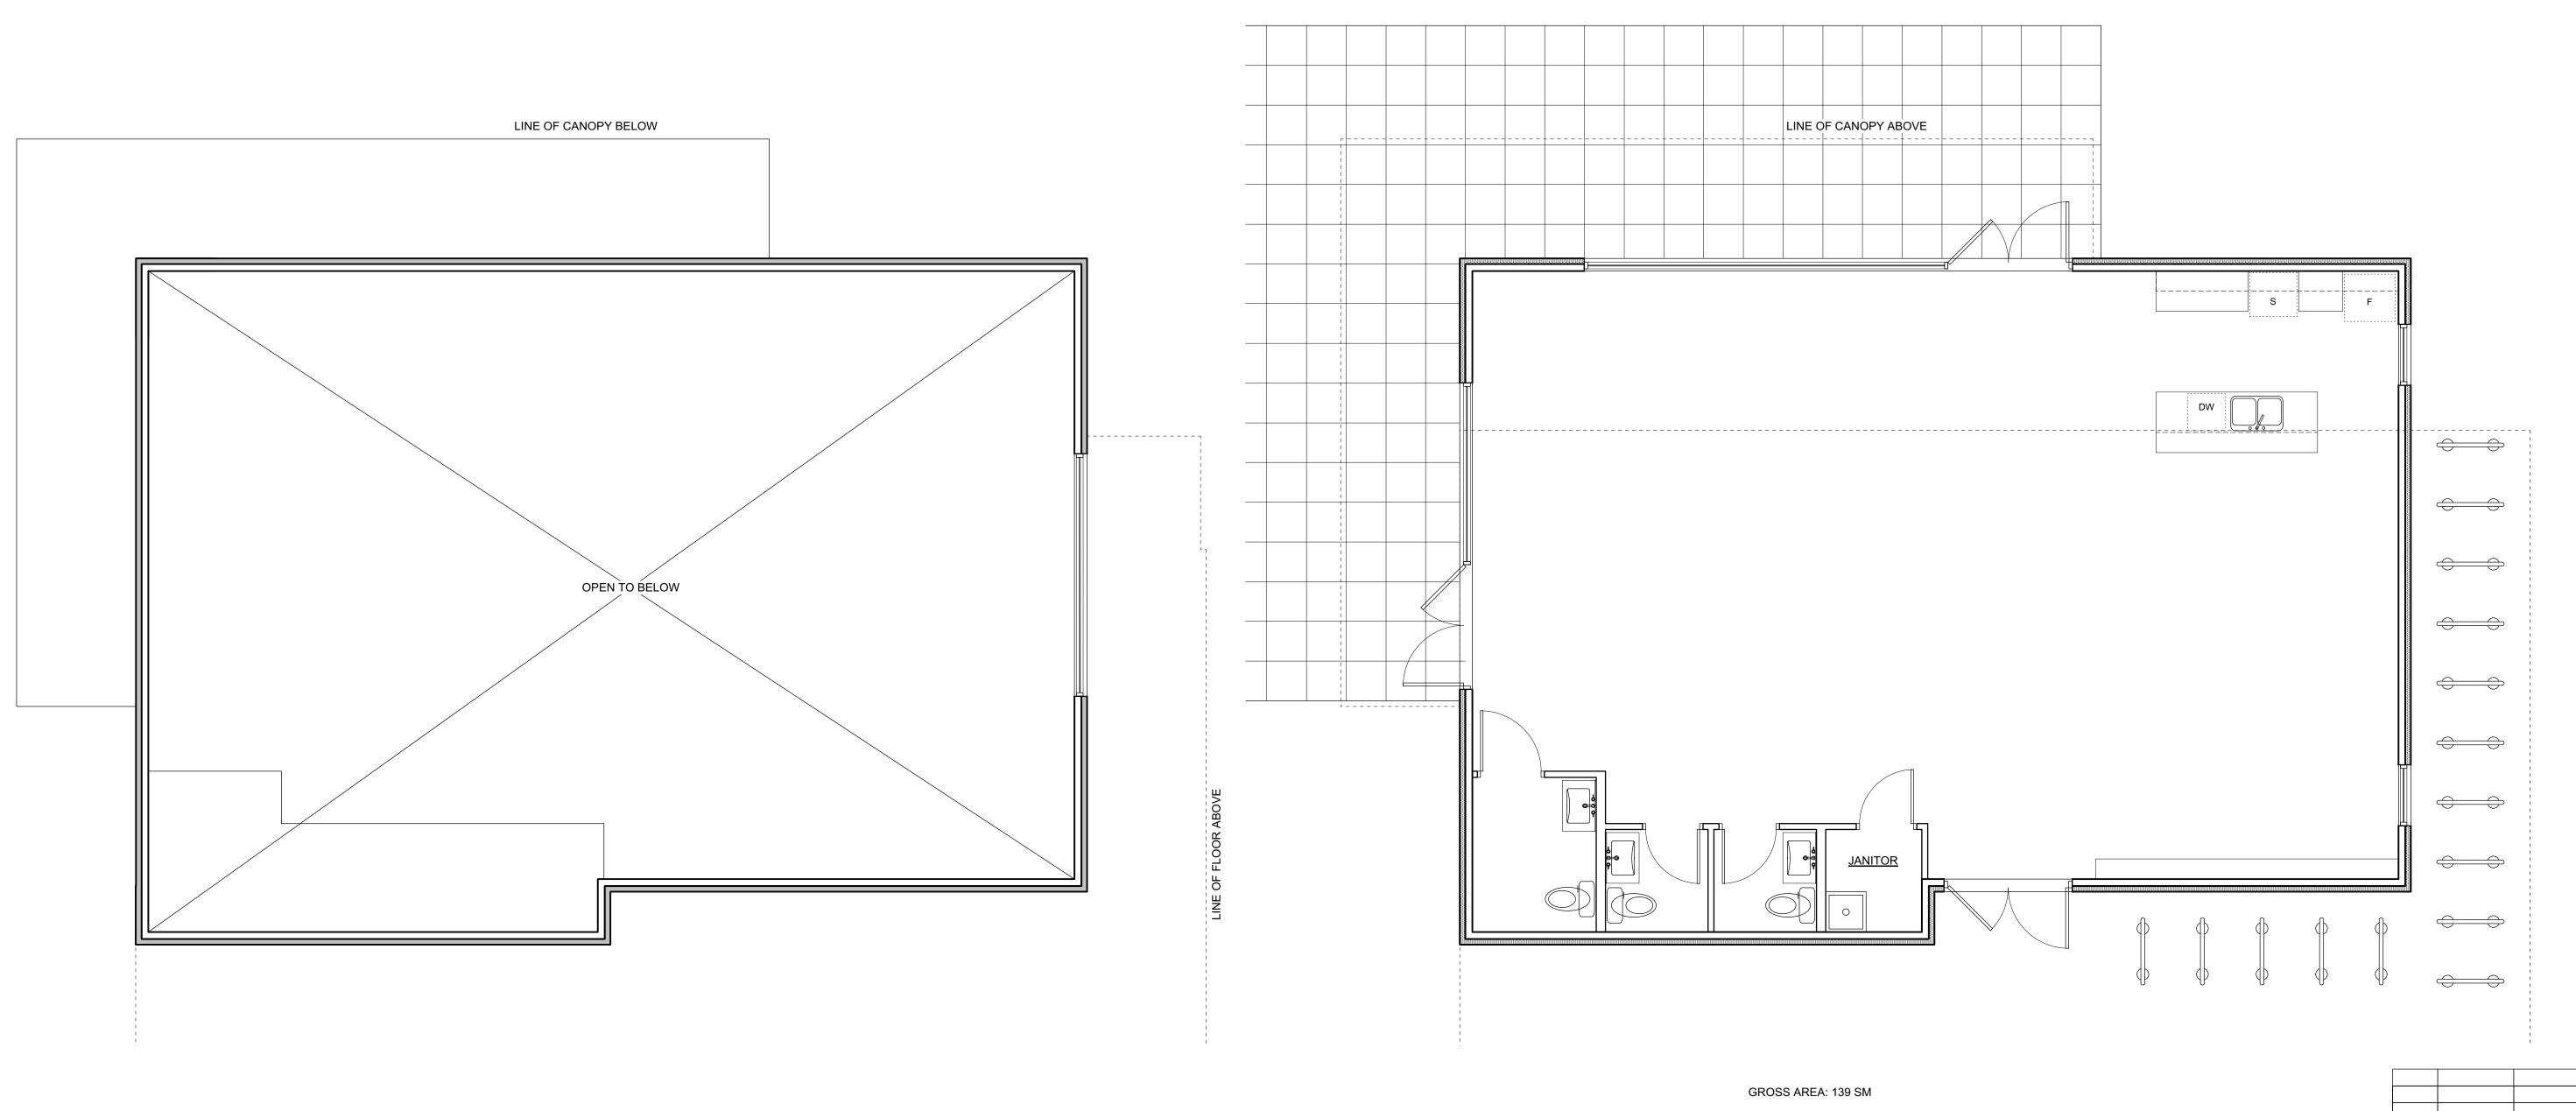

4	20/03/13	RE-ISSUED FOR COT
3	20/02/06	ISSUED FR COT
2	20/01/15	ISSUED FOR AD
1	19/12/16	RESPONSE TO PLANNING REVIE
Rev	Date	Description
plot date	SEPTEMBER 2019	drawing file 1907 A200 Plans.vw
drawn by	FWP	checked by RAI
scale	AS SHOWN	project number 190

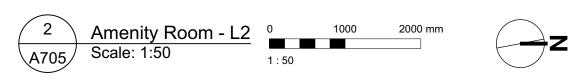ISSUED FOR DP & REZONING

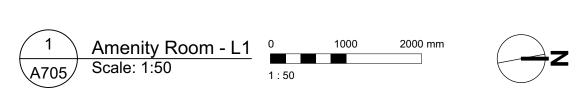dHKa	dHKarchitects
VICTORIA OFFICE 977 Fort Street Victoria BC V8V 3K3 T 1 • 250 • 658 • 3367	NANAIMO OFFICE 102-5190 Dublin Way Nanaimo BC V9T2K8 T 1•250•585•5810
project name	
Caledonia	
Victoria BC	
drawing title	
Amenity Room	





PLAY PLACES that foster fun and creativity.



RAIN GARDENS that slow & cleanse rainwater.



PERSONAL OUTDOOR AREAS that can be modified, beautified and funkified.



GATHERING PLACES that help neighbours get to know each other and support each other.



BICYCLE FACILITIES that make it easy for people of all ages to hop on their bikes.



PLANTINGS that provide food for birds, bees and butterflies.



OUTDOOR SOCIAL SPACES for gethering and sharing food.



PLANTINGS that provide beauty and food for people.



ACTIVE PLAY SPACES that support community



PUBLIC ART that celebrates Fernwood's artistic spirit.



COMMUNITY GARDEN PLOTS that boost local food security.

project no. 1: 250 @ 24"x36" scale drawn by checked by revison no.

6

NOT FOR CONSTRUCTION

6	RZ/DP Revision	20.04.03
5	For COTW	20.02.04
4	Issued for ADP	20.01.15
3	Issued for ADP	20.01.15
2	RZ/DP Revision	19.12.16
1	Rezoning/DP	19.09.26
rev no	description	date
	·	·



CRD Housing Corporation

Caledonia Redevelopment


Caledonia Ave. Victoria, BC

sheet title

Landscape **Overview Plan**

119.18

L1.01

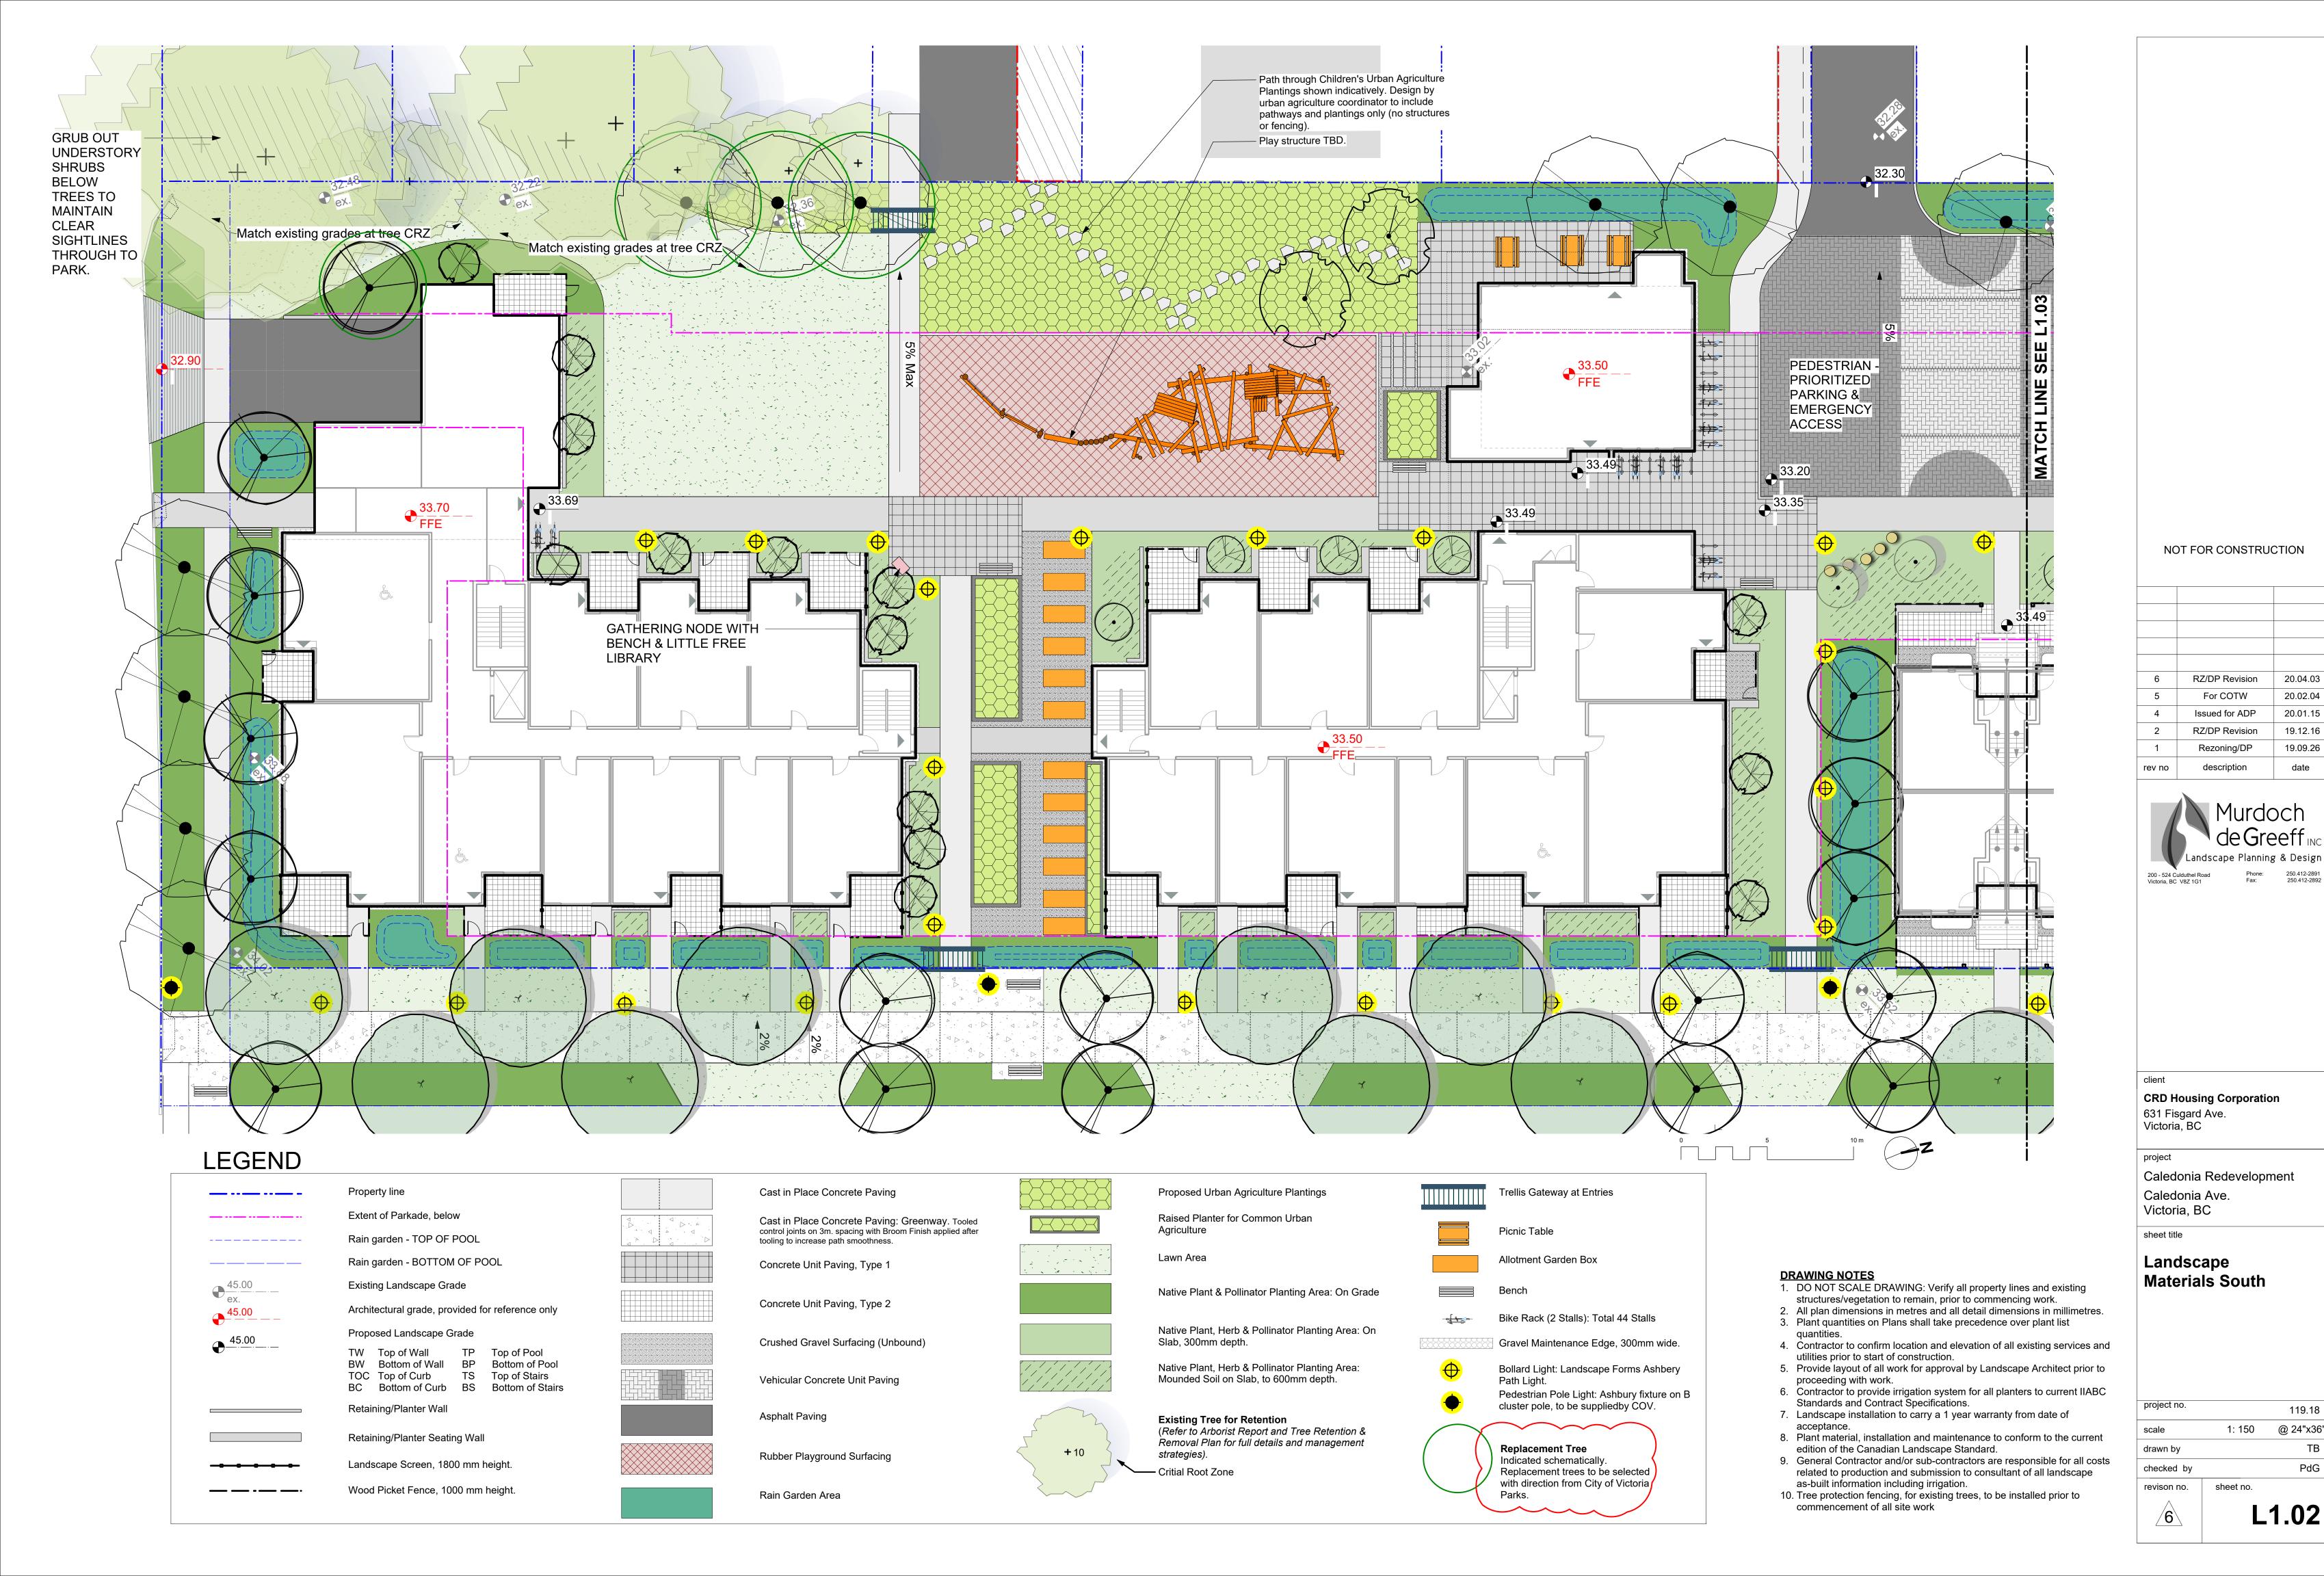

20.02.04 20.01.15


19.09.26

119.18

PdG

1: 150 @ 24"x36"

L1.02

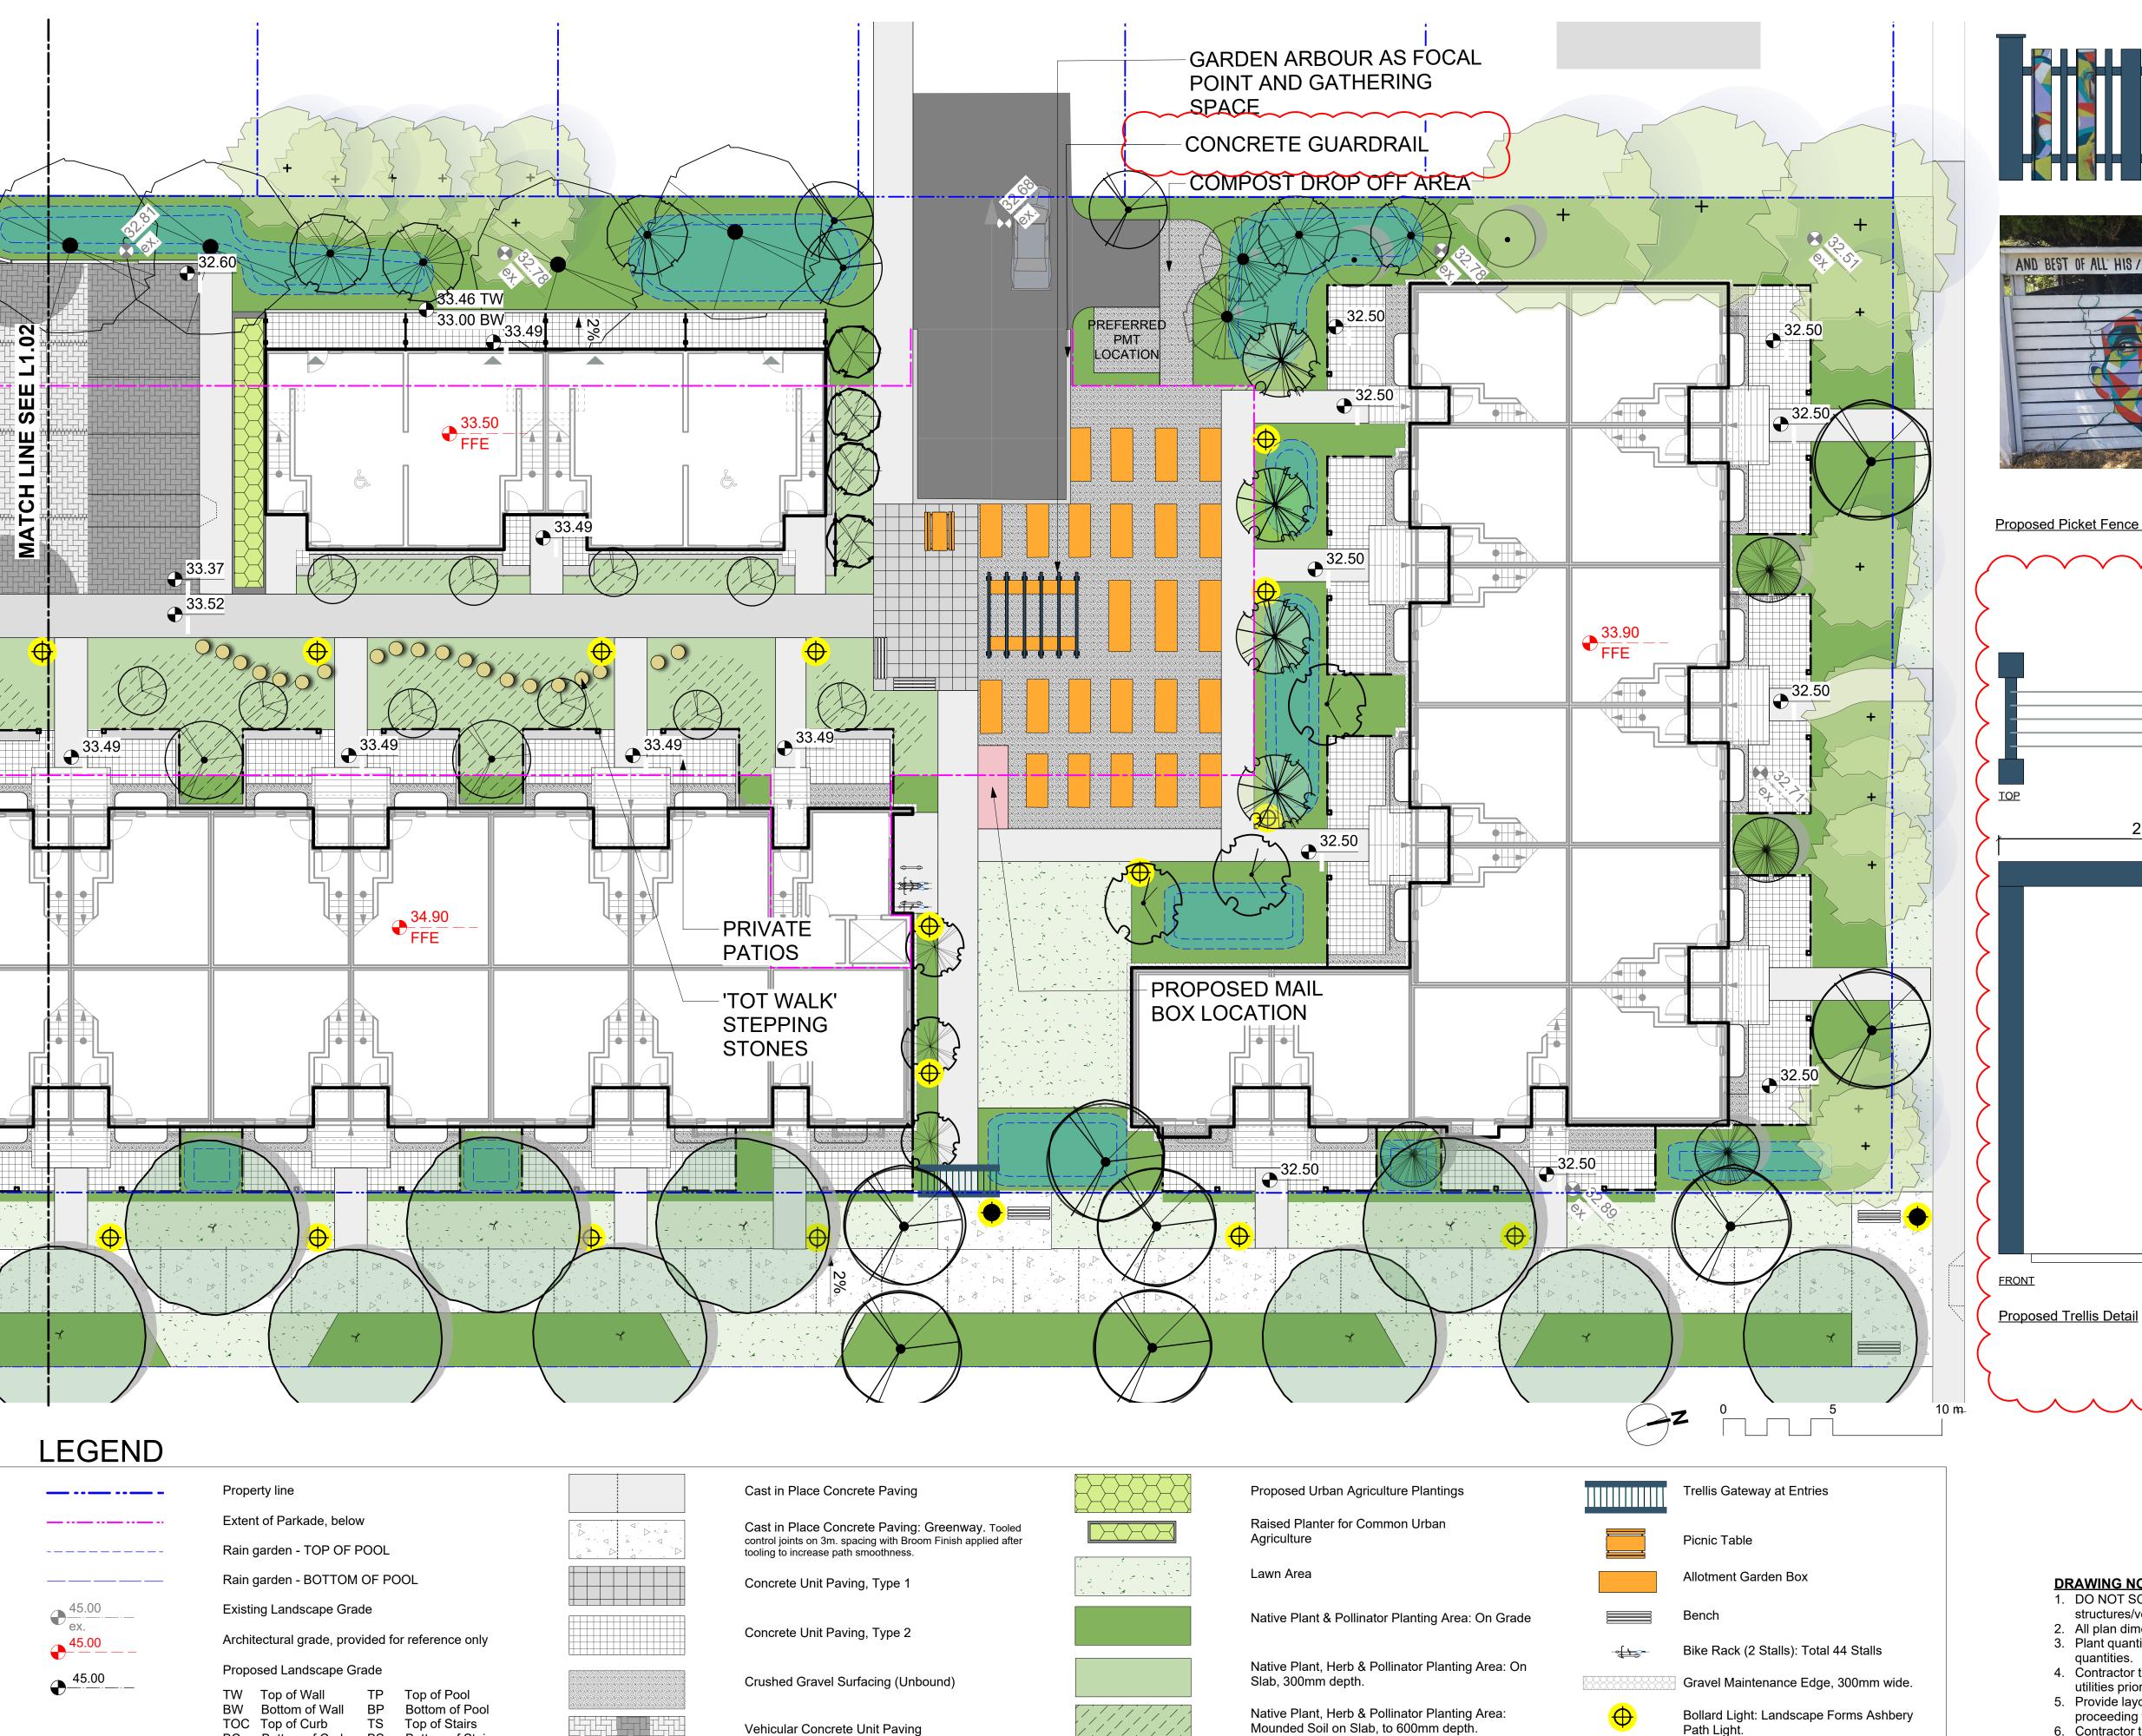

Asphalt Paving

Rain Garden Area

Rubber Playground Surfacing

BC Bottom of Curb BS Bottom of Stairs

Retaining/Planter Wall

Retaining/Planter Seating Wall

Landscape Screen, 1800 mm height.


Wood Picket Fence, 1000 mm height.



Repurposed
Fence Board
every 2-6



Proposed Picket Fence Detail

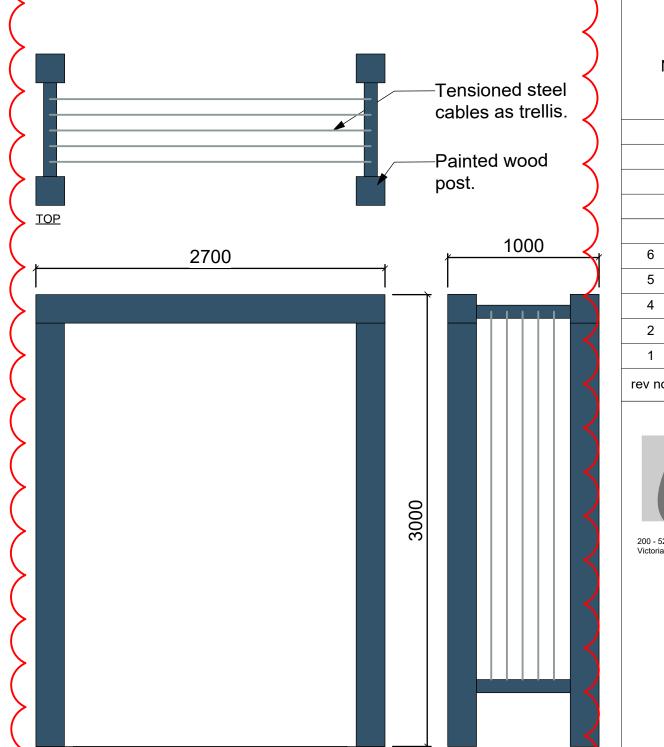

NOT FOR CONSTRUCTION

6	RZ/DP Revision	20.04.03
5	For COTW	20.02.04
4	Issued for ADP	20.01.15
2	RZ/DP Revision	19.12.16
1	Rezoning/DP	19.09.26
rev no	description	date
	·	



CRD Housing Corporation 631 Fisgard Ave. Victoria, BC

Caledonia Redevelopment

Victoria, BC

sheet title

Caledonia Ave.

Landscape **Materials North**

project no. 119.18 1: 150 @ 24"x36" scale drawn by checked by PdG revison no. sheet no. L1.03 6

DRAWING NOTES

Pedestrian Pole Light: Ashbury fixture on B

cluster pole, to be suppliedby COV.

Replacement trees to be selected

with direction from City of Victoria

Replacement Tree

Parks.

Indicated schematically.

Existing Tree for Retention

strategies).

Critial Root Zone

+ 10

(Refer to Arborist Report and Tree Retention &

Removal Plan for full details and management


- 1. DO NOT SCALE DRAWING: Verify all property lines and existing structures/vegetation to remain, prior to commencing work.
- 2. All plan dimensions in metres and all detail dimensions in millimetres. 3. Plant quantities on Plans shall take precedence over plant list
- 4. Contractor to confirm location and elevation of all existing services and


<u>SIDE</u>

- utilities prior to start of construction.
- 5. Provide layout of all work for approval by Landscape Architect prior to
- proceeding with work.
- 6. Contractor to provide irrigation system for all planters to current IIABC

commencement of all site work

- Standards and Contract Specifications. 7. Landscape installation to carry a 1 year warranty from date of
- acceptance. 8. Plant material, installation and maintenance to conform to the current edition of the Canadian Landscape Standard.
- 9. General Contractor and/or sub-contractors are responsible for all costs related to production and submission to consultant of all landscape as-built information including irrigation. 10. Tree protection fencing, for existing trees, to be installed prior to

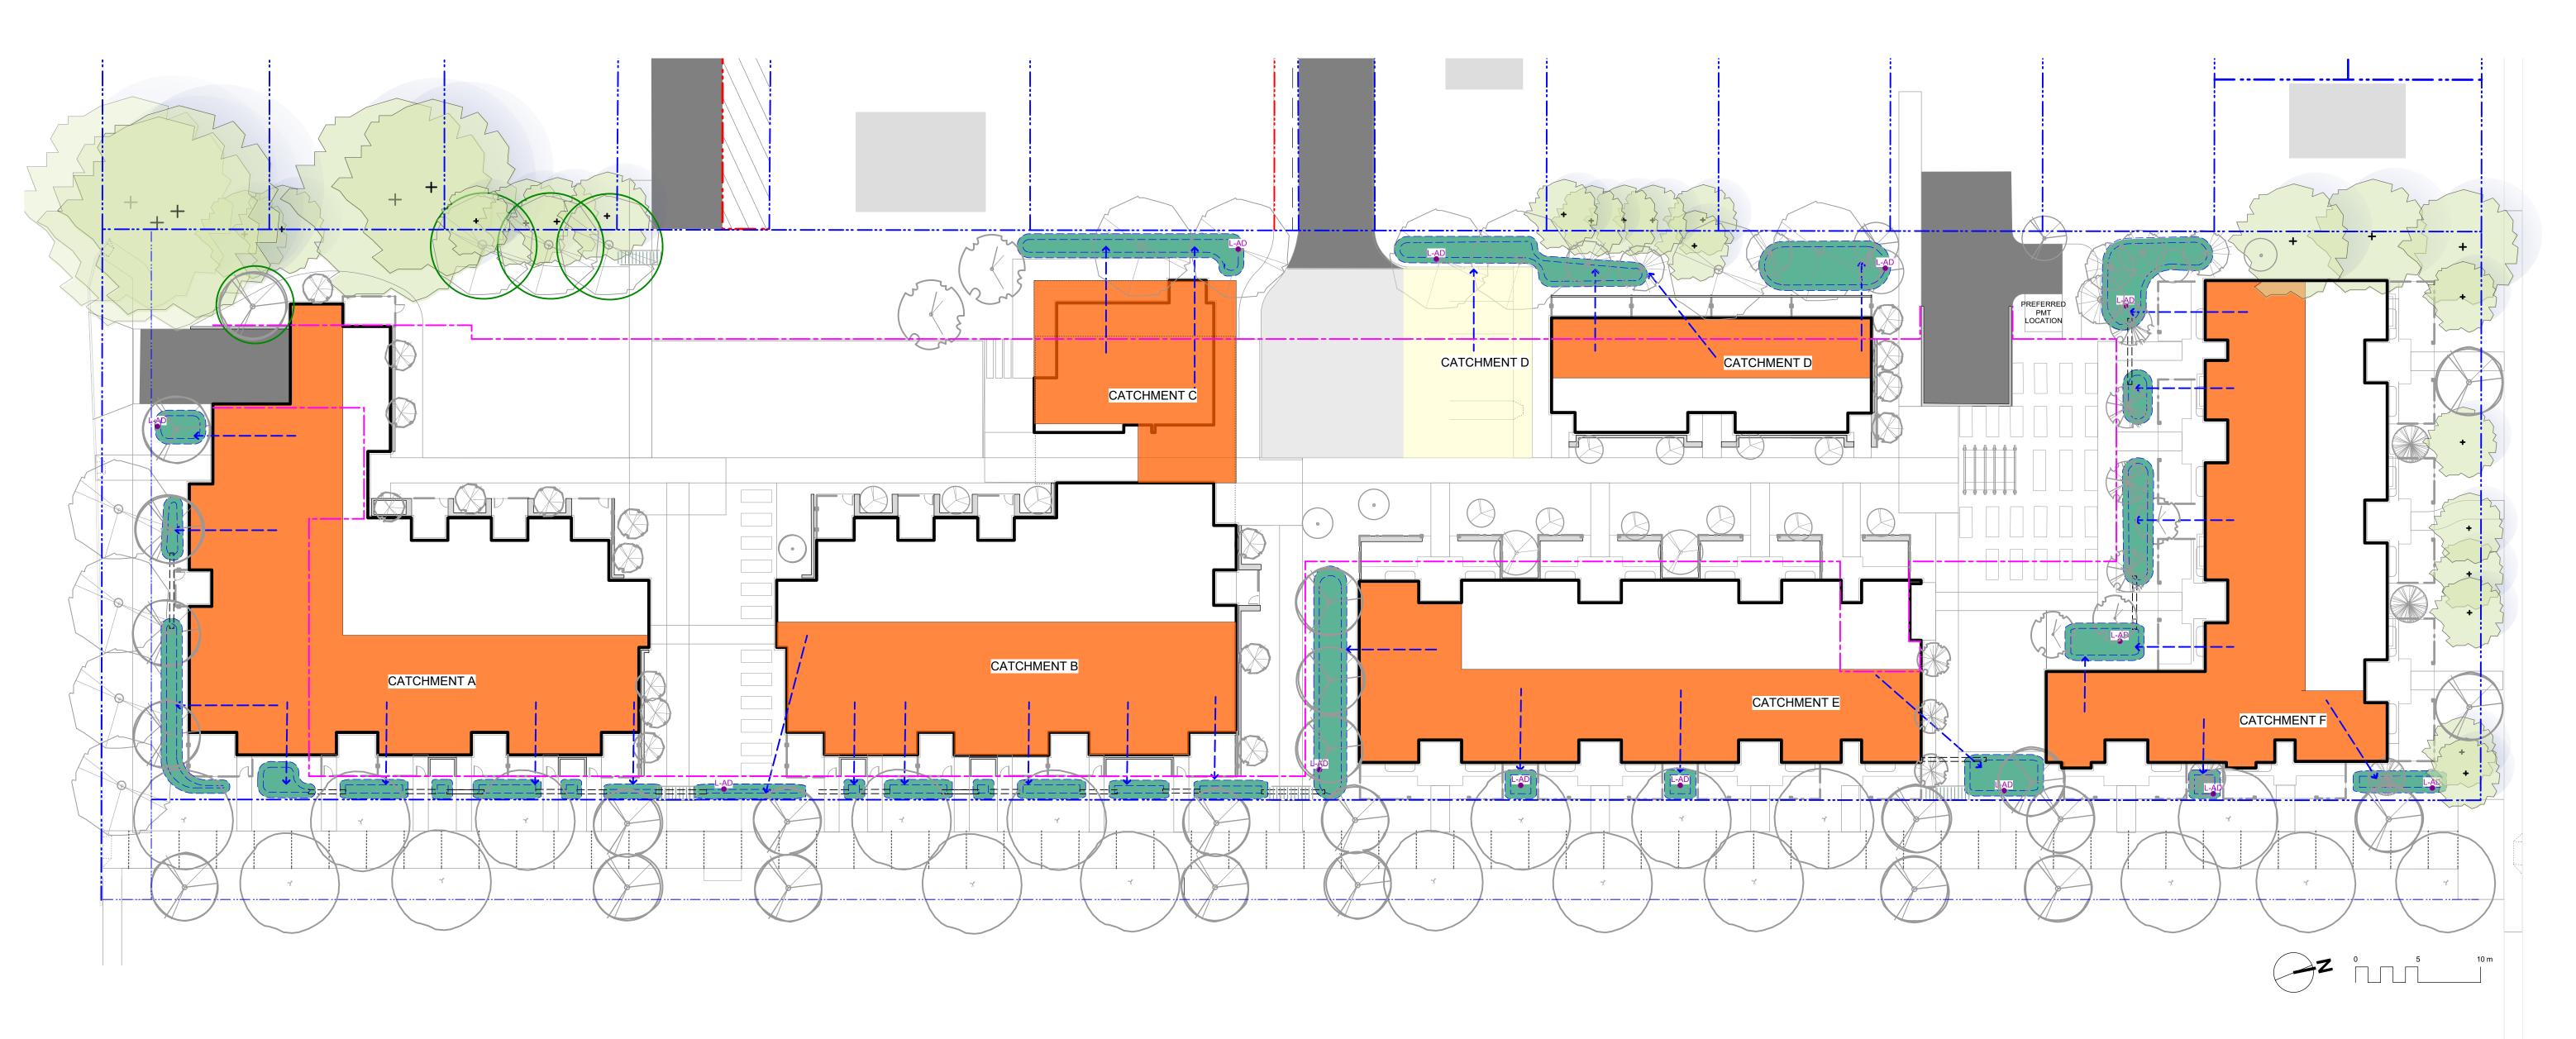

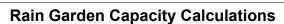

Rain Garden Cap	pacity Calculations	•						
Catchment Area	Contributing Impervious Area	Design Storm Runoff Volume Contributing to Rain Garden	Planter Growing Medium Depth	Stormwater Treatment Capacity per sq. m. of Rain Garden	Rain Garden Area	Rain Garden Capacity	Excess (+) or Deficient (-) Capacity	Soil Volume
	(sq. m.)	(cu. m./day)	(m.)	(cu. m./day)	(sq. m.)	(cu. m./day)	(cu.m./day)	(cu.m.)
Catchment A	560.0	28.0	0.60	0.8	40.0	30.0	2.0	24.0
Catchment B	360.0	18.0	0.60	0.8	25.0	18.8	0.8	15.0
Catchment C	220.0	11.0	0.60	0.8	34.0	25.5	14.5	20.4
Catchment D	280.0	14.0	0.60	0.8	30.0	22.5	8.5	18.0
Catchment E	365.0	18.3	0.60	0.8	33.0	18.5	0.3	19.8
Catchment F	415.0	20.8	0.60	0.8	63.0	47.3	26.5	37.8
total	2200.0	110.0			225.0	162.5	52.5	135.0

Assumptions

- Design storm is a 2 year storm event which equals 5 cm of water, in a 24 hr period.
- Rain Garden design based on 150 mm live ponding plus 20% of the sand/ compost growing medium volume (assuming growing medium has 20% void space) with a minimum infiltration rate of 2 cm/hour (or 48 cm per day), via perforated underdrain.


RAIN WATER MANAGEMENT NOTES

Water collected from portions of the building roofs flow to the rain gardens located throughout the site. Rain gardens have been situated


Rain gardens are designed to capture, slow flows, and treat runoff. Rain gardens will be designed with underdrains and a high □capacity overflow drain that will be connected to the onsite piped drainage system. The rain gardens are sized such that the bottom of the rain garden is 5% of the impervious area, which is the area required to manage Victoria's 2 year storm event.

Walkways will be sloped to drain to adjacent absorbant landscape. Larger paved areas such as driveways and turnarounds will be drained directly to the storm system.

Portions of the roof which cannot be easily connected to rain gardens will be drained directly to the storm system. The roof catchments are shown schematically and will be refined during detailed design.

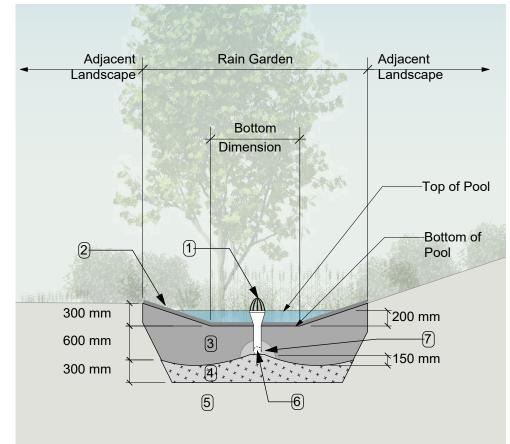

- RAIN GARDEN MATERIALS 1. Overflow drain, 200 mm domed grate + adapter
- 2. Composted mulch, 50 -70 mm depth
- 3. Bio-retention growing medium, 600 mm depth 4. Scarified/tilled subgrade, 300 mm depth
- 5. Existing subgrade/native material
- 6. 100 mm diameter (min) perforated pipe 7. 25 mm diameter drain rock, 100 mm depth
- Typical Rain Garden Scale: 1:50

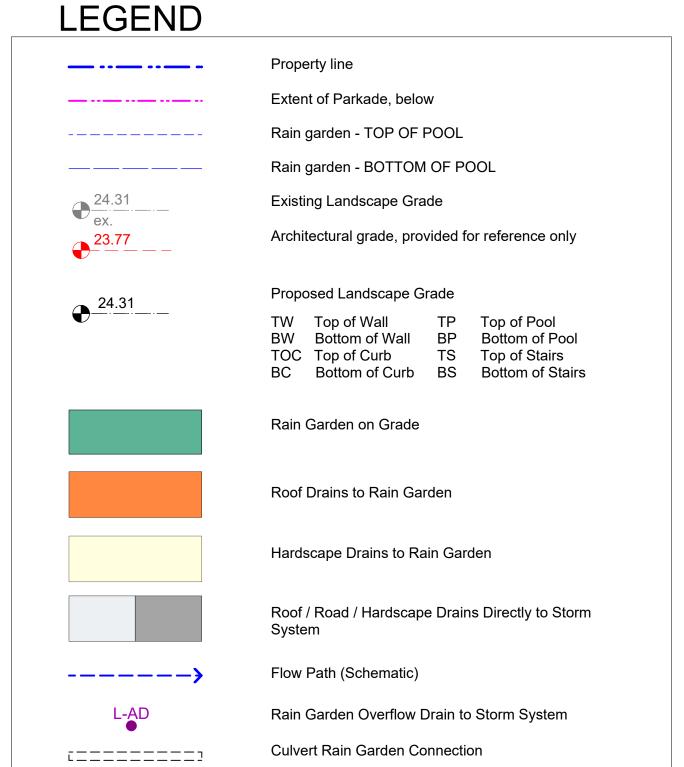

NOT FOR CONSTRUCTION

6	RZ/DP Revision	20.04.03
5	For COTW	20.02.04
4	Issued for ADP	20.01.15
2	RZ/DP Revision	19.12.16
1	Rezoning/DP	19.09.26
ev no	description	date




CRD Housing Corporation 631 Fisgard Ave. Victoria, BC

Caledonia Redevelopment Caledonia Ave. Victoria, BC

sheet title

Stormwater Management

project no.		119.18
scale	1: ###	@ 24"x36"
drawn by		ТВ
checked by		PdG
revison no.	sheet no.	
6	L	1.04

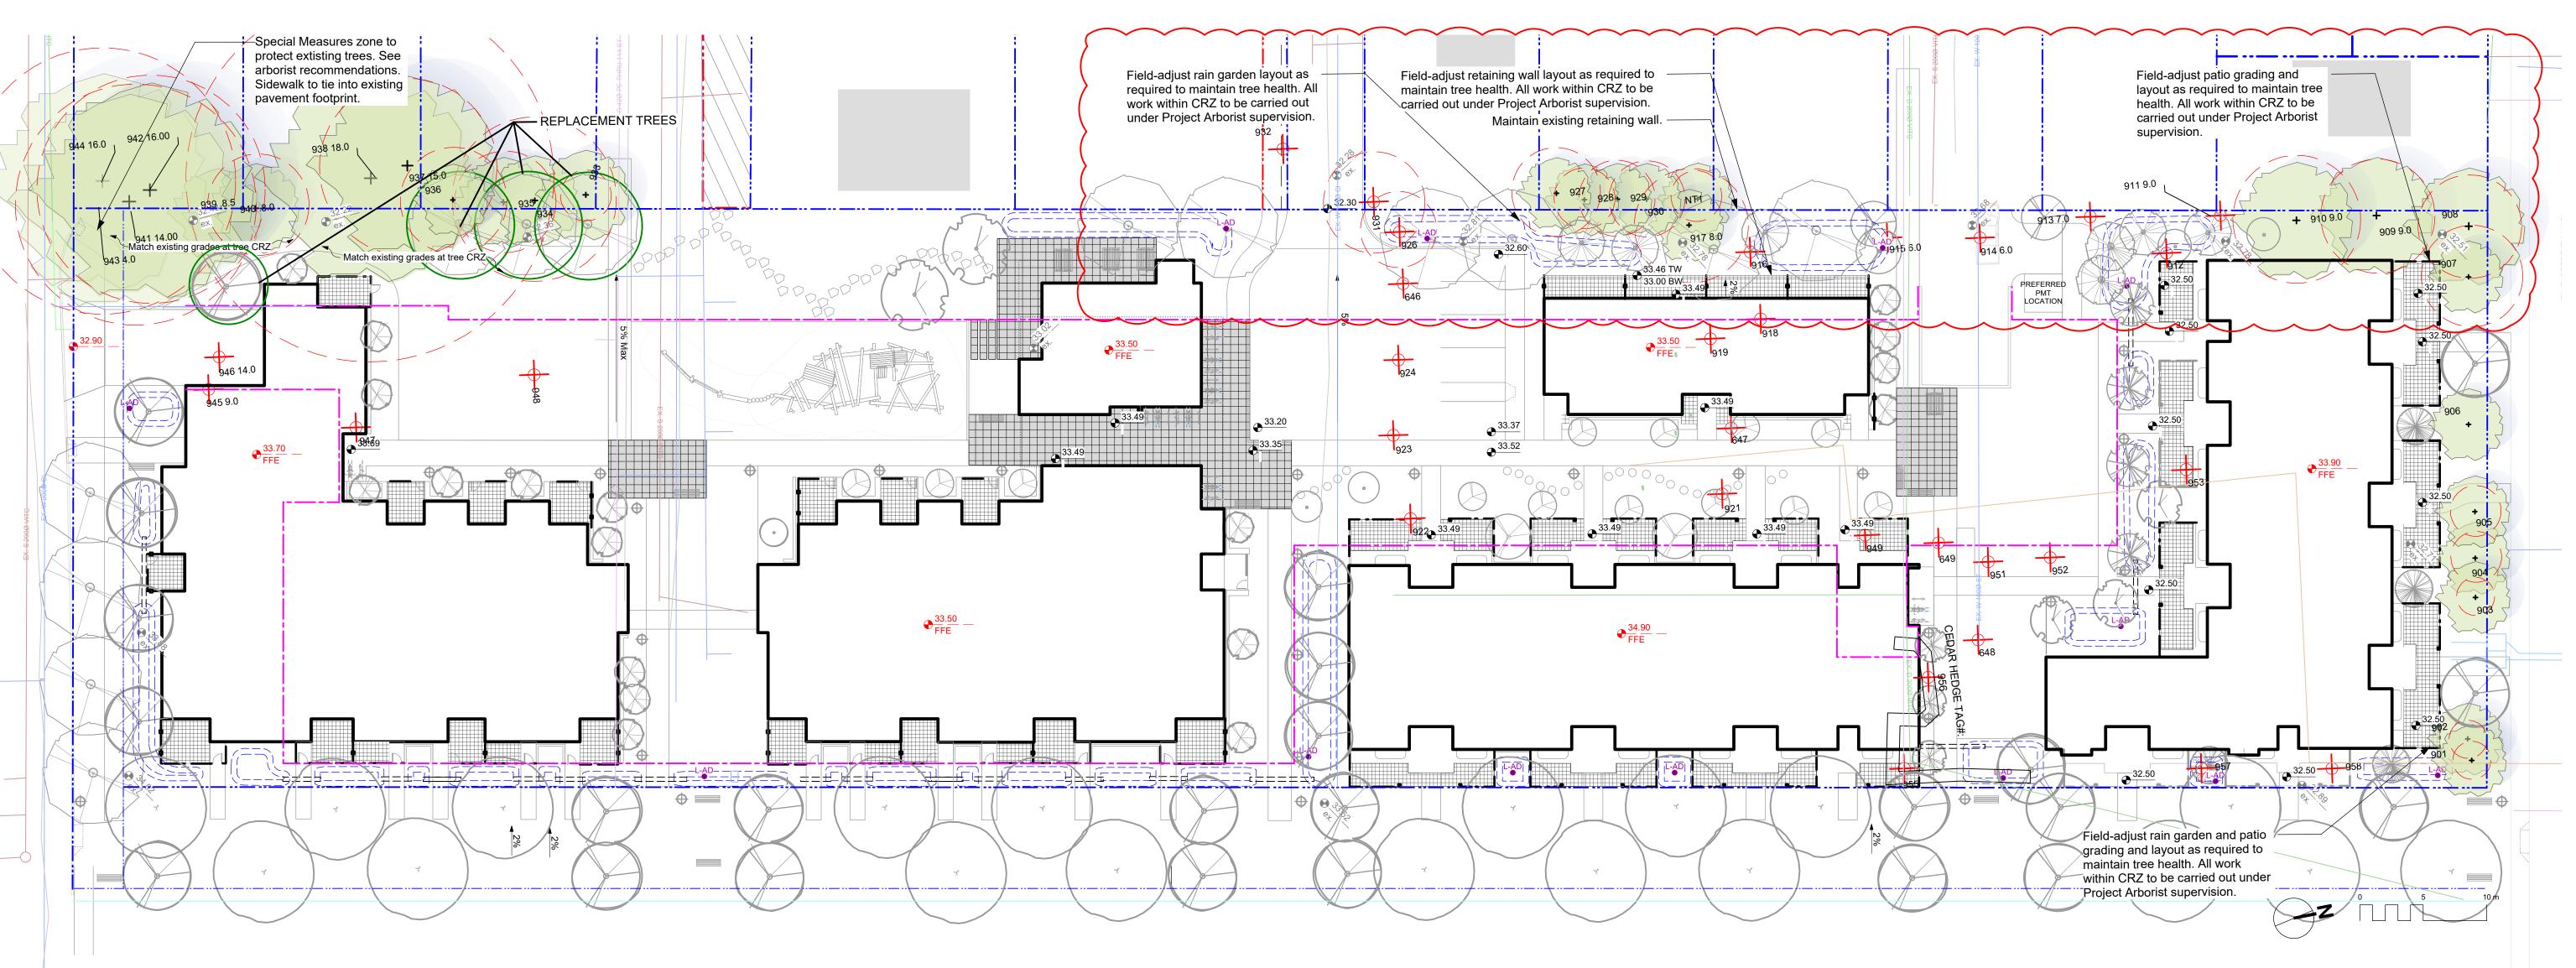

DRAWING NOTES


- DO NOT SCALE DRAWING: Verify all property lines and existing structures/vegetation to remain, prior to commencing work.
- 2. All plan dimensions in metres and all detail dimensions in millimetres.3. Plant quantities on Plans shall take precedence over plant list
- quantities.

 4. Contractor to confirm location and elevation of all existing services and
- utilities prior to start of construction.

 5. Provide layout of all work for approval by Landscape Architect prior to
- proceeding with work.
- 6. Contractor to provide irrigation system for all planters to current IIABC Standards and Contract Specifications.
- 7. Landscape installation to carry a 1 year warranty from date of
- acceptance.Plant material, installation and maintenance to conform to the current
- edition of the Canadian Landscape Standard.
 9. General Contractor and/or sub-contractors are responsible for all costs related to production and submission to consultant of all landscape as-built information including irrigation.
- 10. Tree protection fencing, for existing trees, to be installed prior to commencement of all site work

TREE SUMMARY* TOTAL TREES TO BE REMOVED: 31 TOTAL TREES TO BE RETAINED: 27 TOTAL BYLAW-PROTECTED TREES TO BE REMOVED: 2 TOTAL PROPOSED REPLACEMENT TREES: 4 * Based on Arborist's Report recieved from Talbot Mackenzie & Associates,

03/04/2020. Refer to Arborist report for details and Arborist recommendations.

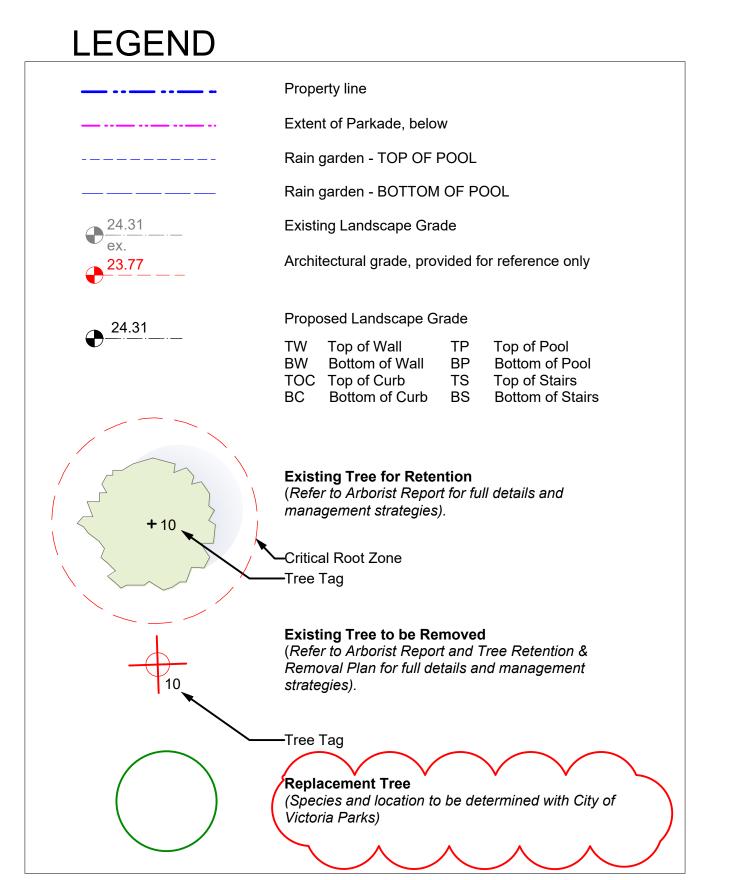

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CRD Housing Corporation
631 Fisgard Ave.
Victoria, BC


roject

Caledonia Redevelopment Caledonia Ave. Victoria, BC

sheet title

Tree Retention & Removal Plan

project no.		119.18
scale	1: 250	@ 24"x36"
drawn by		ТВ
checked by		PdG
revison no.	sheet no.	
6	L	1.05

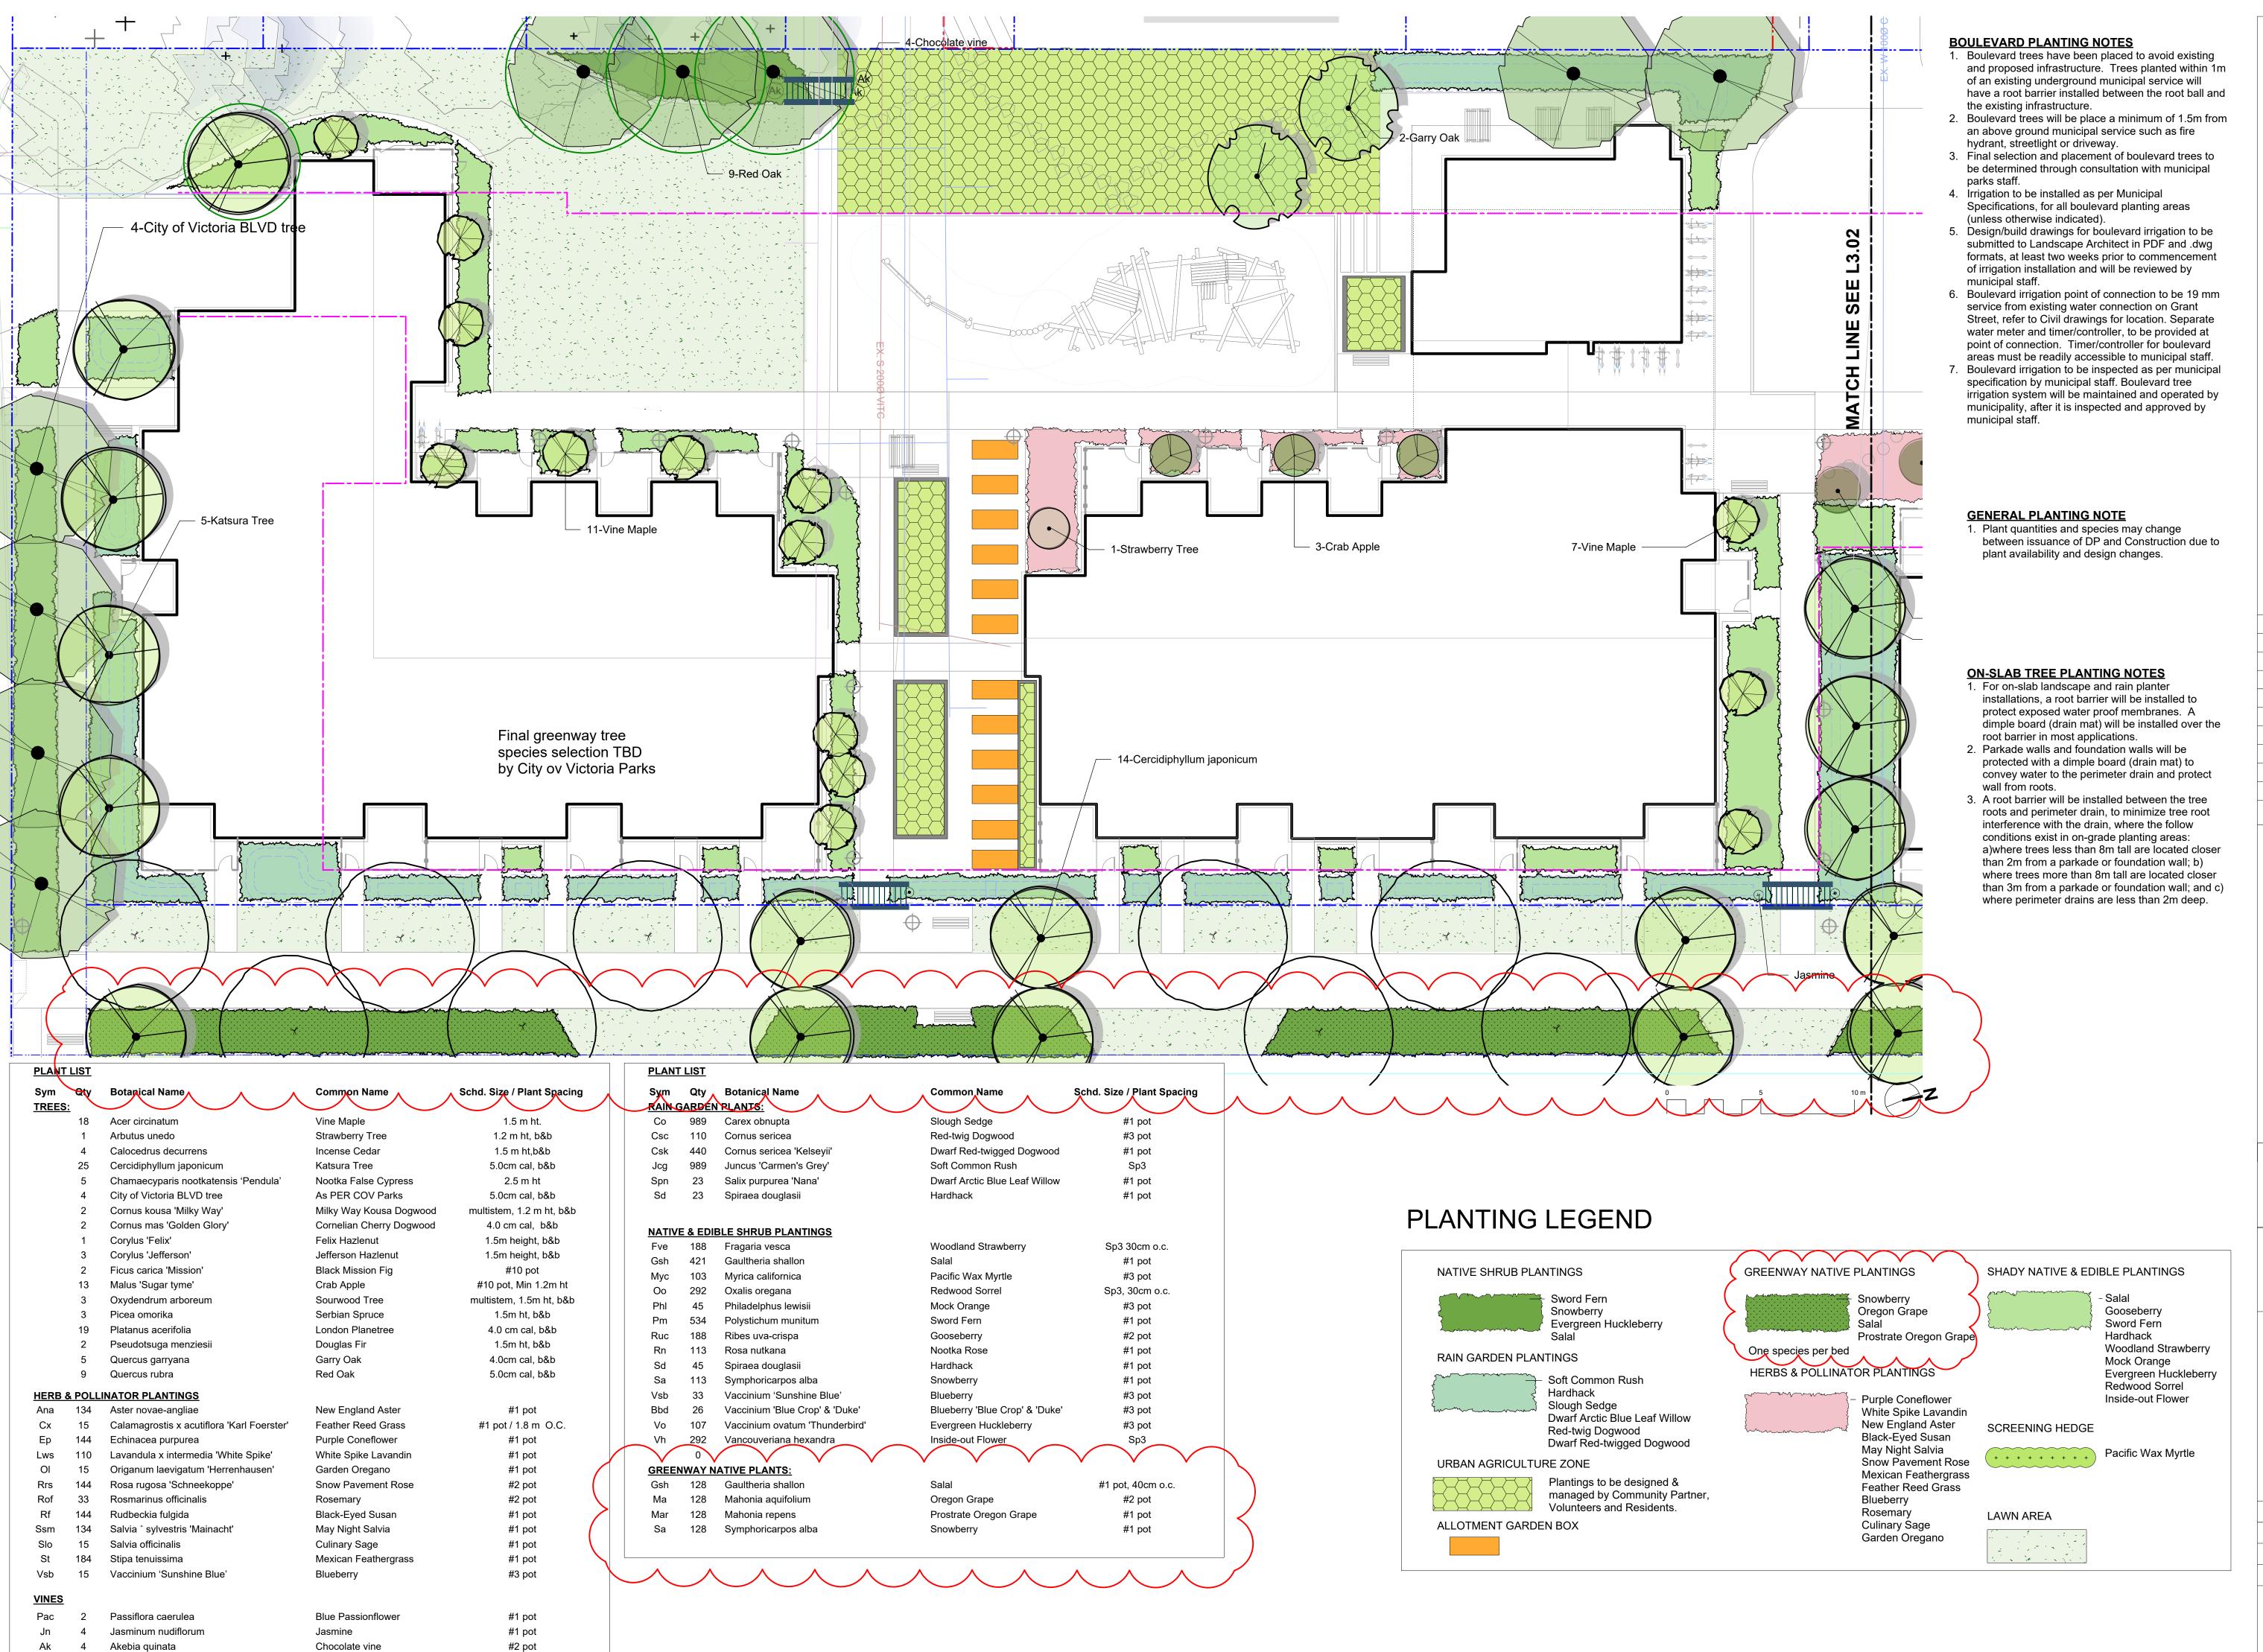

#2 pot

Hardy Kiwi

Actinidia arguta

6 RZ/DP Revision 20.04.03
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1 Rezoning/DP 19.09.26
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631 Fisgard Ave.
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Caledonia Redevelopment


Caledonia Redevelopment
Caledonia Ave.
Victoria, BC

sheet title

Planting Plan South

project no. 119.18
scale 1: 150 @ 24"x36"
drawn by TB
checked by PdG

revison no. sheet no. L3.01

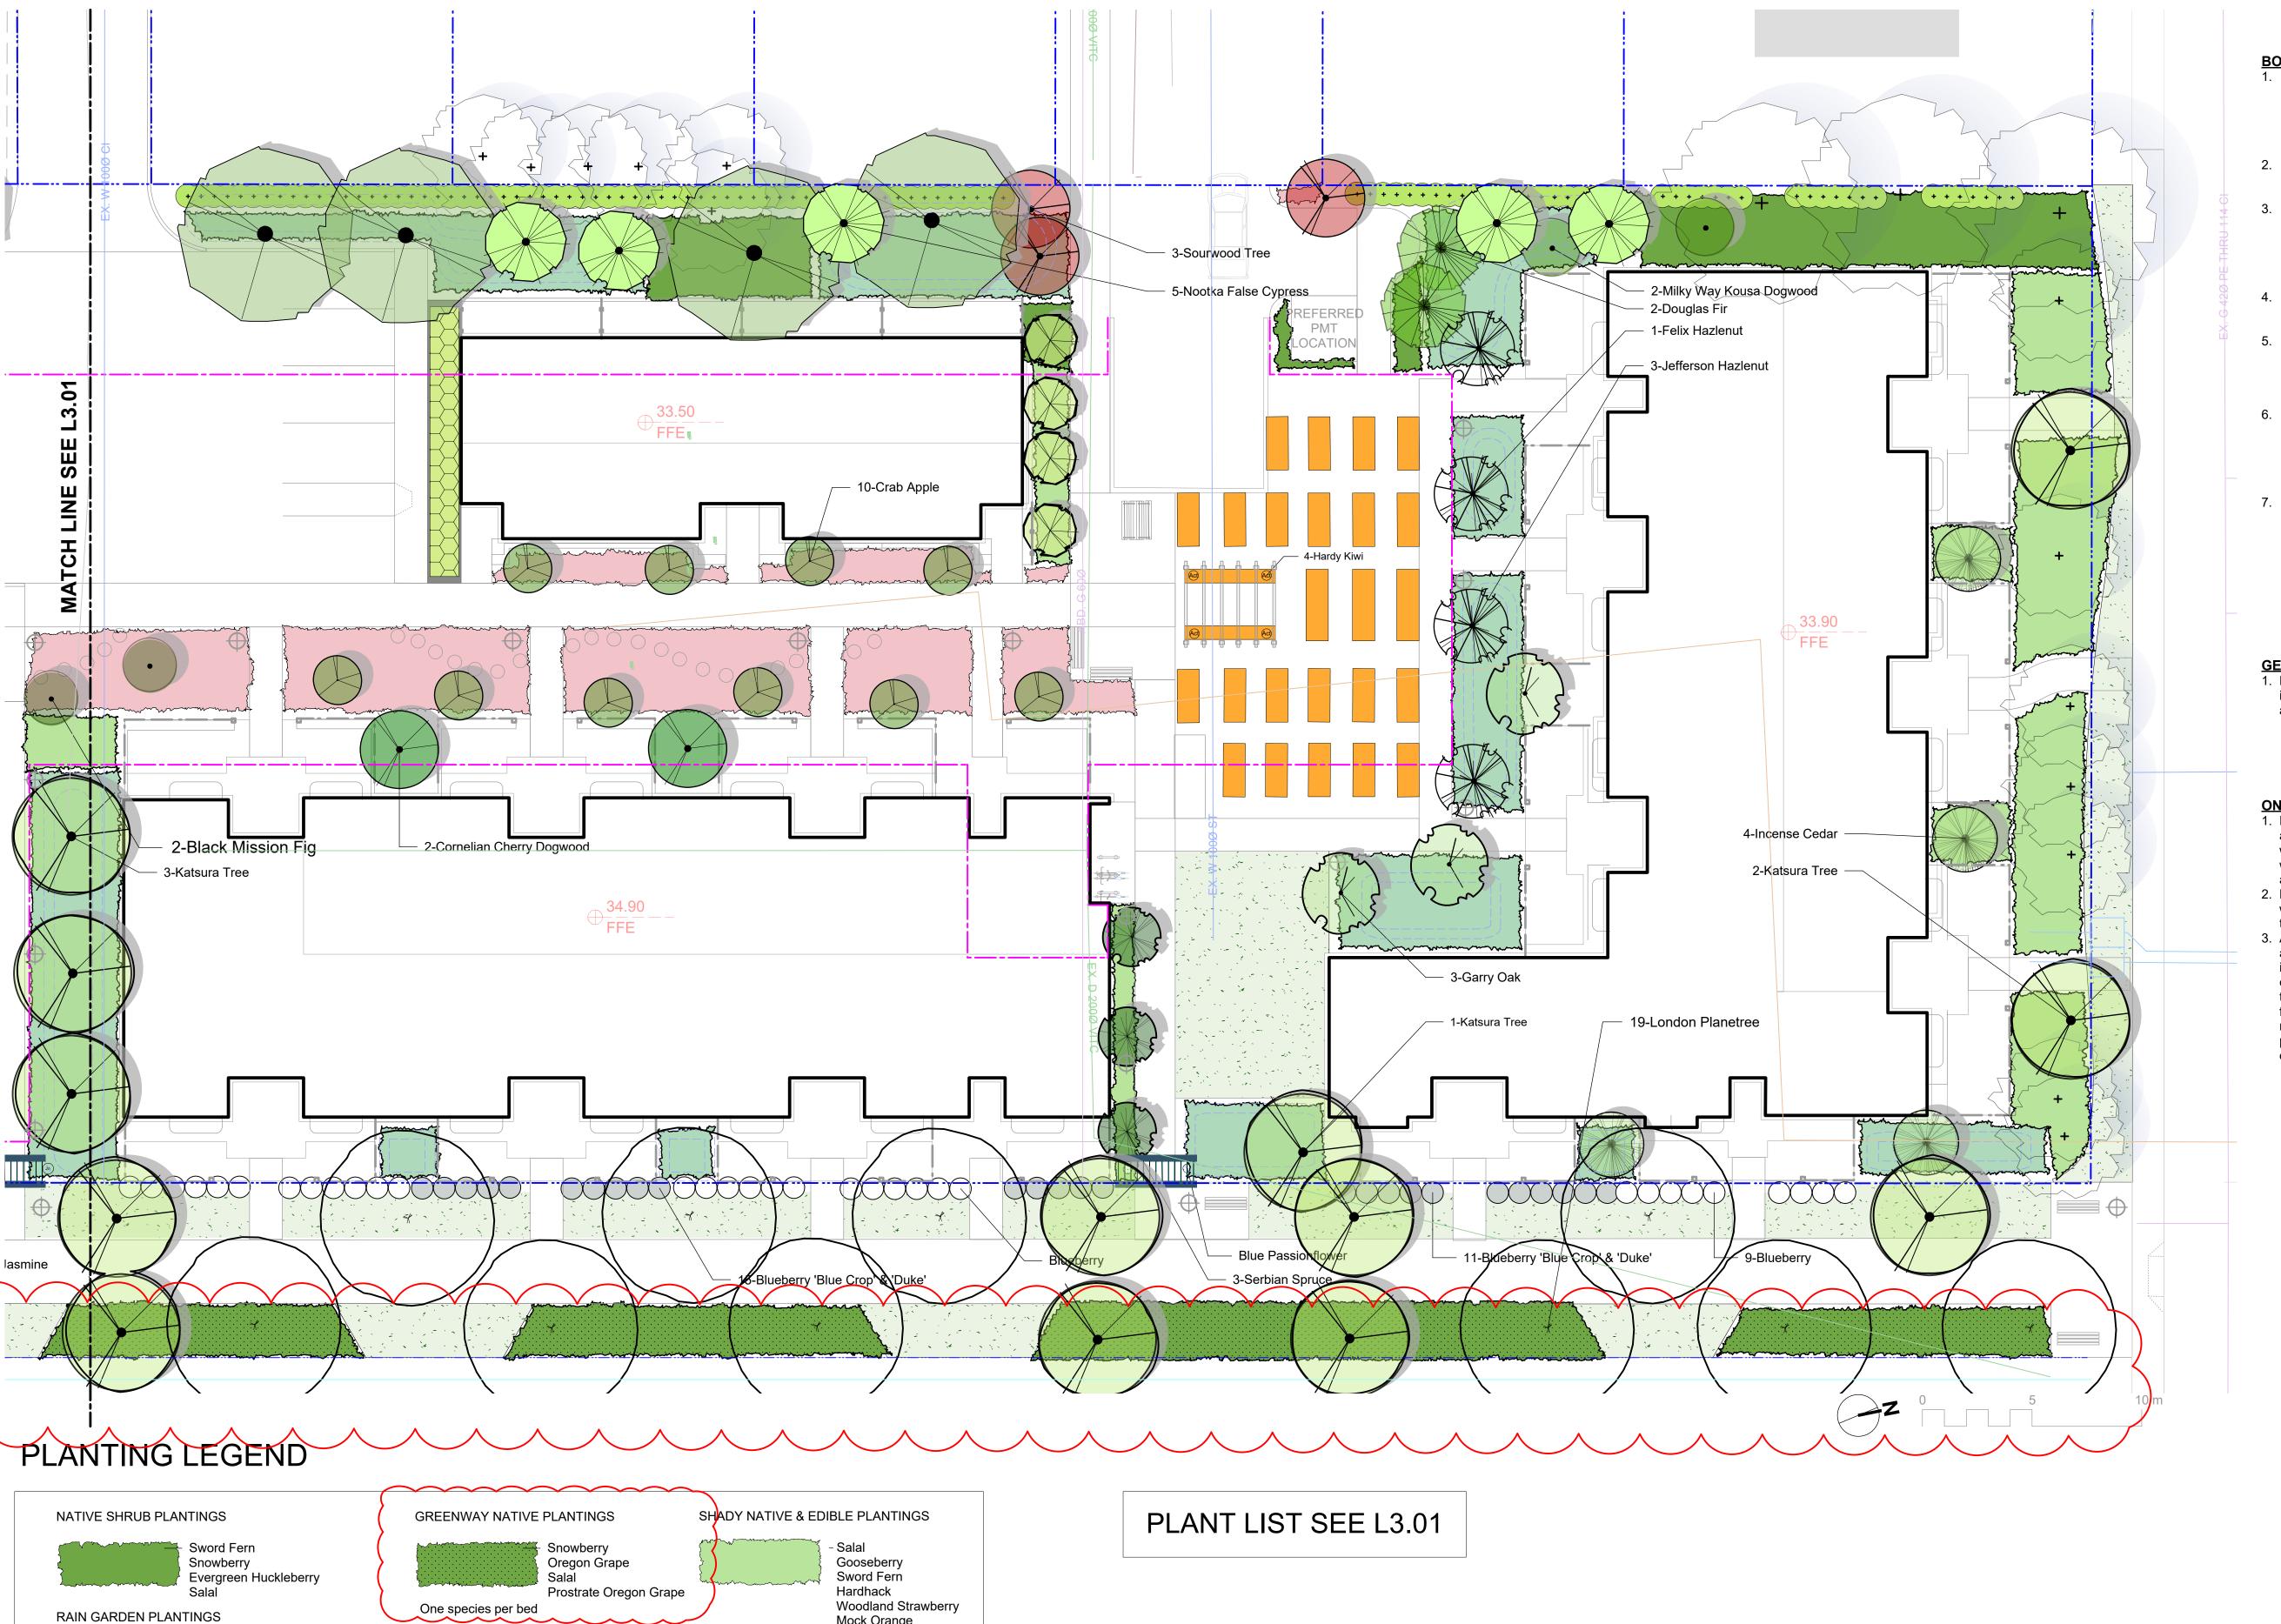

Mock Orange

Redwood Sorrel

Inside-out Flower

Pacific Wax Myrtle

SCREENING HEDGE

LAWN AREA

Evergreen Huckleberry

HERBS & POLLINATOR PLANTINGS

Purple Coneflower

New England Aster

Black-Eyed Susan May Night Salvia

White Spike Lavandin

Snow Pavement Rose

Mexican Feathergrass

Feather Reed Grass

Blueberry

Rosemary

Culinary Sage Garden Oregano

Soft Common Rush

Red-twig Dogwood

Dwarf Arctic Blue Leaf Willow

Dwarf Red-twigged Dogwood

Plantings to be designed &

Volunteers and Residents.

managed by Community Partner,

Hardhack

URBAN AGRICULTURE ZONE

ALLOTMENT GARDEN BOX

Slough Sedge

BOULEVARD PLANTING NOTES

- 1. Boulevard trees have been placed to avoid existing and proposed infrastructure. Trees planted within 1m of an existing underground municipal service will have a root barrier installed between the root ball and the existing infrastructure.
- 2. Boulevard trees will be place a minimum of 1.5m from an above ground municipal service such as fire hydrant, streetlight or driveway.
- 3. Boulevard tree species have been picked from the municipality's list of recommended boulevard trees or have been selected due their site-adapted qualities. Final selection of boulevard trees to be determined through consultation with municipal parks staff.
- 4. Irrigation to be installed as per Municipal Specifications, for all boulevard planting areas (unless otherwise indicated).
- 5. Design/build drawings for boulevard irrigation to be submitted to Landscape Architect in PDF and .dwg formats, at least two weeks prior to commencement of irrigation installation and will be reviewed by municipal staff.
- 6. Boulevard irrigation point of connection to be 19 mm service, refer to Civil drawings for location. Separate water meter and timer/controller, to be provided at point of connection. Timer/controller for boulevard areas must be readily accessible to municipal staff.
- 7. Boulevard irrigation to be inspected as per municipal specification by municipal staff. Boulevard tree irrigation system will be maintained and operated by municipality, after it is inspected and approved by municipal staff.

GENERAL PLANTING NOTE

1. Plant quantities and species may change between issuance of DP and Construction due to plant availability and design changes.

ON-SLAB TREE PLANTING NOTES

- 1. For on-slab landscape and rain planter installations, a root barrier will be installed to protect exposed water proof membranes. A dimple board (drain mat) will be installed over the root barrier in most applications.
- 2. Parkade walls and foundation walls will be protected with a dimple board (drain mat) to convey water to the perimeter drain and protect wall from roots.
- 3. A root barrier will be installed between the tree roots and perimeter drain, to minimize tree root interference with the drain, where the follow conditions exist in on-grade planting areas: a)where trees less than 8m tall are located closer than 2m from a parkade or foundation wall; b) where trees more than 8m tall are located closer than 3m from a parkade or foundation wall; and c) where perimeter drains are less than 2m deep.

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ev no	description	date



CRD Housing Corporation 631 Fisgard Ave. Victoria, BC

Caledonia Redevelopment Caledonia Ave. Victoria, BC

sheet title

Planting Plan North

project no.		119.18
scale	1: 150	@ 24"x36"
drawn by		ТВ
checked by		PdG
revison no.	sheet no.	
6	L	3.02



Section at Pedestrian Allee and Townhouses
Scale: 1:50



2 Section at Pedestrian Walkway
Scale: 1:50

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1	Rezoning/DP	19.09.26
rev no	description	date
		1



client

CRD Housing Corporation 631 Fisgard Ave. Victoria, BC

roject

Caledonia Redevelopment Caledonia Ave. Victoria, BC

sheet title

Landscape Sections

project no.		119.18
scale	1: 250	@ 24"x36'
drawn by		ТВ
checked by		PdG
revison no.	sheet no.	
6	L	.5.01

