

EXISTING ZONING - R1-B PROPOSED ZONING - SITE SPECIFIC PROPOSED - SITE PROPOSED - SFD 1 PROPOSED - SFD 2 PROPOSED - SFD 3 PROPOSED - SFD 4 LOT AREA 1997.63 M2 (21502.33 FT2) 23.59 M (77.38') LOT MIDTH 84.80 M (278.20') LOT DEPTH (AVG.) <u>SETBACKS</u> FRONT (E) 10.84 M (35.56') TO SFD 3 10.94 M (35.89') TO SFD 4 11.29 M(37.04') TO SFD 5 11.29 M (37.04') TO SFD 6 10.84 M (35.56') TO SFD 1 12.63 M (41.44') TO SFD 2 REAR (M) 5.68 M (18.64') 4.84 M (15.87') 5.92 M (19.42') TO SFD 1 5.92 M (19.42') TO SFD 3 SIDE (S) 1.50 M (4.92') 1.50 M (4.92') 5.92 M (19.42') TO SFD 4 SIDE (N) **5.92 M (19.42**') TO SFD 2 1.52 M (5.00') 1.51 M(4.95') SIDE (COMBINED) 7.57 M (24.84') 7.44 M (24.41') 7.57 M (24.84') 7.43 M (24.38') AVG. GRADE 19.98 M (65.55 FT) 19.81 M (64.99 FT) 19.45 M (63.81 FT) 19.13 M (62.76 FT) 6.66 M (21.85 FT) 6.64 M (21.78 FT) 6.70 M (21.98 FT) 6.86 M (22.51 FT) BUILDING HEIGHT 2 STOREYS 2 STOREYS 2 STOREYS 2 STOREYS STOREYS (COMBINED) FLOOR AREA UPPER FLOOR 546.29 M2 (5880.24 FT2) 69.29 M2 (745.86 FT2) 67.95 M2 (731.42 FT2) 67.95 M2 (731.42 FT2) 67.95 M2 (731.42 FT2) 61.73 M2 (664.51 FT2) 61.73 M2 (664.51 FT2) 498.88 M2 (5369.89 FT2) 62.36 M2 (671.26 FT2) 61.73 M2 (664.51 FT2) MAIN FLOOR CRANLSPACE EXCLUDED 424.16 M2 (4565.62 FT2) EXCL 53.02 M2 (570.75 FT2) EXCLUDED TOTAL FLOOR AREA 1045.17 M2 (11250.12 FT2) 131.02 M2 (1410.28 FT2) 130.31 M2 (1402.64 FT2) 129.68 M2 (1395.86 FT2) 129.68 M2 (1395.86 FT2) 0.523 FLOOR AREA RATIO 0.066 0.066 0.065 0.065 SITE COVERAGE 30.32 % (605.86 M2) 3.80 % (75.93 M2) 3.76 % (75.17 M2) 3.74 % (74.76 M2) 3.75 % (75.07 M2) 48.26% (964.08 M2) OPEN SITE SPACE 8 SPACES <u>PARKING</u> 1 SPACE 1 SPACE 1 SPACE 1 SPACE PROPOSED - SFD 5 PROPOSED - SFD 6 PROPOSED - SFD 7 PROPOSED - SFD 8 LOT AREA LOT WIDTH LOT DEPTH (AVG.) <u>SETBACKS</u> 2.64 M (8.66') 3.06 M (10.03') FRONT (E) 10.99 M (36.05') TO SFD T 10.84 M (35.56') TO SFD 8 11.29 M(37.04') TO SFD 4 REAR (M) 11.29 M(37.04') TO SFD 3 10.99 M (36.05') TO SFD 5 10.84 M (35.56') TO SFD 6 1.50 M (4.92') SIDE (S) 5.92 M (19.42') TO SFD 5 5.92 M (19.42') TO SFD 7 1.50 M (4.92') SIDE (N) 1.51 M(5.00') 5.92 M (19.42') TO SFD 8 1.50 M (4.92') 5.92 M (19.42') TO SFD 6 SIDE (COMBINED) 7.57 M (24.84') 7.43 M (24.38') 7.57 M (24.84') 7.42 M (24.34') 16.43 M (53.90 FT) 17.96 M (58.92 FT) 16.15 M (52.99 FT) AVG. GRADE 17.64 M (57.87 FT) BUILDING HEIGHT 7.18 M (23.56 FT) 7.08 M (23.23 FT) 7.09 M (23.26 FT) 7.09 M (23.26 FT) STOREYS 2 STOREYS 2 STOREYS 2 STOREYS 2 STOREYS FLOOR AREA 67.95 M2 (731.42 FT2) UPPER FLOOR 67.95 M2 (731.42 FT2) 69.29 M2 (745.86 FT2) 67.95 M2 (731.42 FT2) 61.73 M2 (664.51 FT2) MAIN FLOOR 62.36 M2 (671.26 FT2) 61.73 M2 (664.51 FT2) 61.73 M2 (664.51 FT2) CRANLSPACE EXCLUDED 53.02 M2 (570.75 FT2) EXCLUDED TOTAL FLOOR AREA 130.31 M2 (1402.64 FT2) 131.02 M2 (1410.28 FT2) 129.68 M2 (1395.86 FT2) 129.68 M2 (1395.86 FT2) FLOOR AREA RATIO 0.065 0.065 0.066 3.82 % (76.41 M2) 3.86 % (77.16 M2) 3.78 % (75.68 M2) 3.78 % (75.68 M2) SITE COVERAGE OPEN SITE SPACE <u>PARKING</u> 1 SPACE 1 SPACE 1 SPACE 1 SPACE




SITE DATA - 3120 WASHINGTON AVE. VICTORIA

LEGAL DESCRIPTION - Lot 7, Section 7A, Victoria District, Plan 431



DRAMING	<u>LIST</u> :		
DPO1	SITE PLAN & DATA	DP08	SFD-5
DPO2	AVERAGE GRADE	DP09	SFD-6
DP03	AVERAGE GRADE	DP10	SFD-7
DPO4	SFD-1	DP11	SFD-8
DP05	SFD-2	DP12	STREETSCAPE
DP06	SFD-3	DP13	COLOUR BOARD
DP07	SFD-4	L1-3	LANDSCAPE

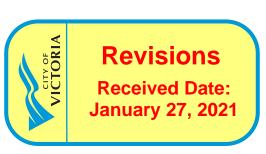

REV. NO. DESCRIPTION

SITE PLAN & DATA Revision: Sheet:

1. SFD #2 LOCATION REVISED; GRADE BEAM FOUNDATION TO BE USED TO ACCOMODATE OAK TREE; LANDSCAPING/ SITE DATA REVISED TO SUIT

Rev 1: MAY 29/20 Rev 2: OCT 13/20 Rev 3: JAN 13/21 Proj.No. ####

DP01

RE-ISSUED FOR DP

OCT 13, 2020

ZEBRADESIGN

1161 NEMPORT AVE Victoria, B.C. V85 5E6

Phone: (250) 360-2144 Fax: (250) 360-2115

Date: JUNE 24, 2020

3120 WASHINGTON


AYENUE - REZONING


Drawn By: C.C.

Scale: AS NOTED

Project:


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SEGMENT	Start	Finish	Average	Distance	Factor	Total Factors	Perimeter	Average grade (total factors / perimeter)
AB	19.92	20.13	20.03	10.16	203.45	710.38	35.56	19.977
ВС	20.13	20.04	20.09	7.42	149.03			
CD	20.04	19.83	19.94	10.16	202.54			
DE	19.83	19.84	19.84	0.89	17.65			
EF	19.84	19.84	19.84	0.20	3.97			
FG	19.84	19.84	19.84	1.22	24.20			
GH	19.84	19.84	19.84	0.20	3.97			
HA	19.84	19.92	19.88	5.31	105.56	AVE	RAGE GRA	ADE
			TOTAL	35.56	710.38		19.98	

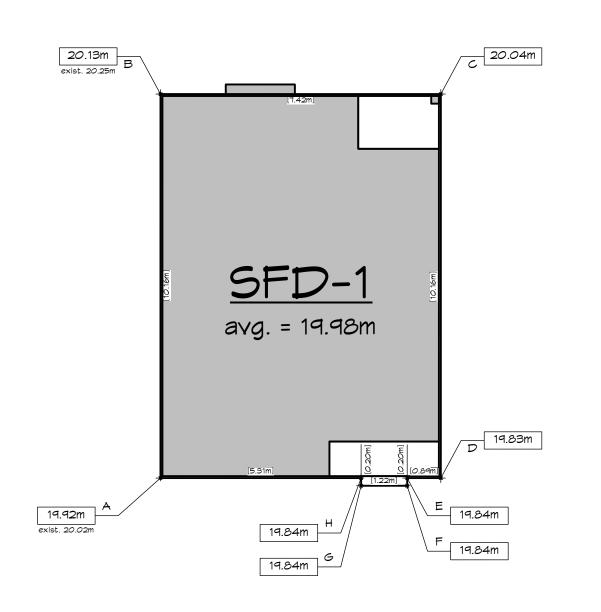


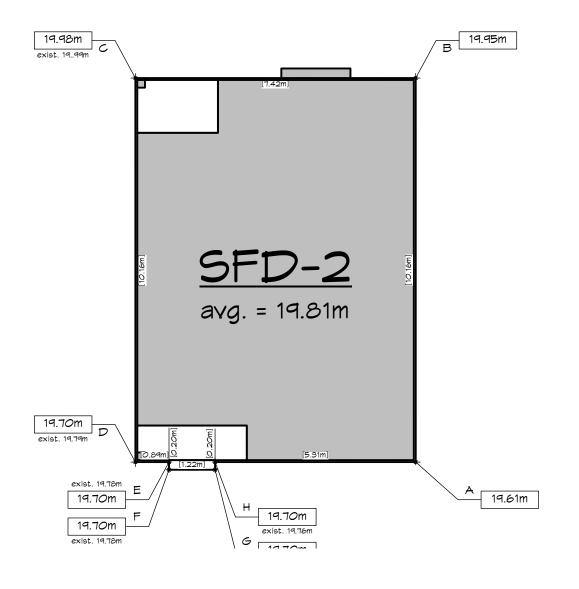


			SFD 2	- Average G	rade Calcula	ation		
SEGMENT	Start	Finish	Average	Distance	Factor	Total Factors	Perimeter	Average grade (total factors / perimeter)
AB	19.61	19.95	19.78	10.16	200.96	704.49	35.56	19.811
ВС	19.95	19.98	19.97	7.42	148.14			
CD	19.98	19.70	19.84	10.16	201.57			
DE	19.70	19.70	19.70	0.89	17.53			
EF	19.70	19.70	19.70	0.20	3.94			
FG	19.70	19.70	19.70	1.22	24.03			
GH	19.70	19.70	19.70	0.20	3.94			
НА	19.70	19.61	19.66	5.31	104.37	AVE	RAGE GRA	ADE
			TOTAL	35.56	704.49		19.81	

			SFD 3	- Average G	rade Calcula	ation		
SEGMENT	Start	Finish	Average	Distance	Factor	Total Factors	Perimeter	Average grade (total factors / perimeter)
AB	19.31	19.64	19.48	10.16	197.87	701.65	36.08	19.447
BC	19.64	19.64	19.64	7.42	145.73			
CD	19.64	19.20	19.42	10.16	197.31			
DE	19.20	19.23	19.22	0.89	17.10			
EF	19.23	19.20	19.22	0.46	8.84			
FG	19.20	19.26	19.23	1.22	23.46			
GH	19.26	19.29	19.28	0.46	8.87			
НА	19.29	19.31	19.30	5.31	102.48	AVE	RAGE GRA	ADE
			TOTAL	36.08	701.65		19.45	

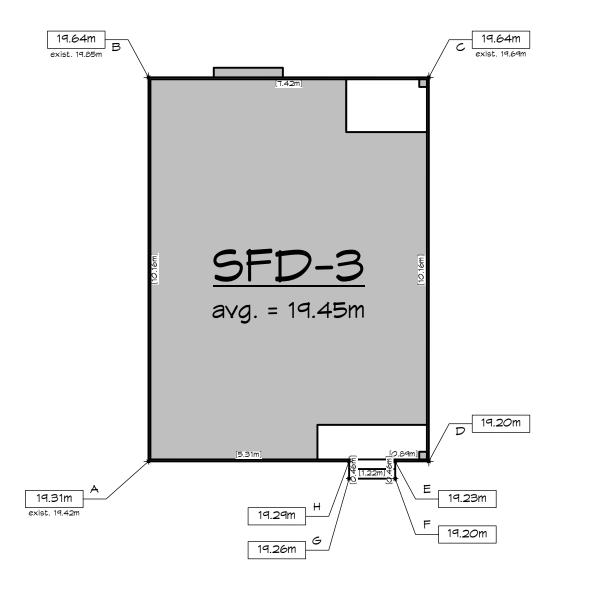

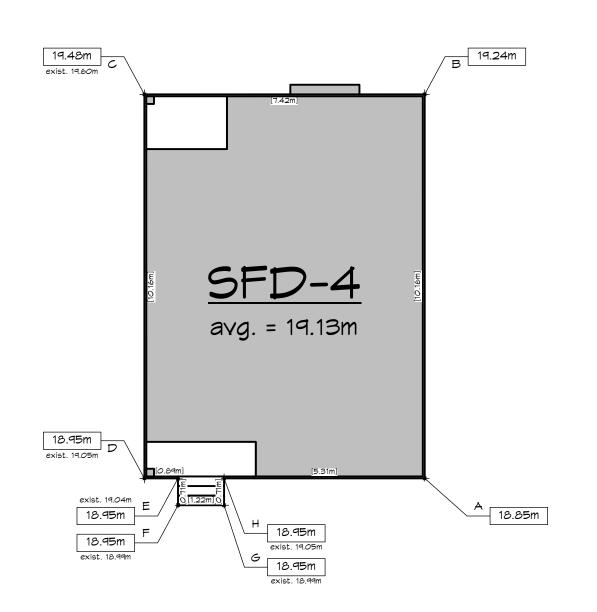

	SFD 4 - Average Grade Calculation											
SEGMENT	Start	Finish	Average	Distance	Factor	Total Factors	Perimeter	Average grade (total factors / perimeter)				
AB	18.85	19.24	19.05	10.16	193.50	699.85	36.58	19.132				
ВС	19.24	19.48	19.36	7.42	143.65							
CD	19.48	18.95	19.22	10.16	195.22							
DE	18.95	18.95	18.95	5.31	100.62							
EF	18.95	18.95	18.95	0.71	13.45							
FG	18.95	18.95	18.95	1.22	23.12							
GH	18.95	18.95	18.95	0.71	13.45							
HA	18.95	18.85	18.90	0.89	16.82	AVE	RAGE GRA	ADE				
			TOTAL	36.58	699.85		19.13					

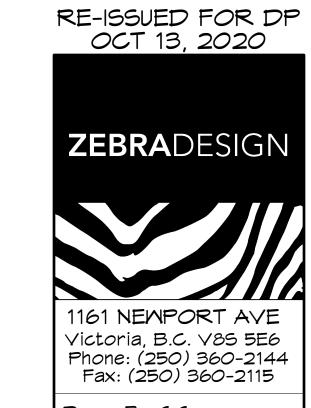

Drawn By: C.C.

Date: JUNE 24, 2020

Scale: AS NOTED

Project: 3120 WASHINGTON AVENUE - REZONING

Title: AVERAGE GRADE

Revision: Sheet:

Rev 1:

MAY 29/20

Rev 2:

OCT 13/20


Rev 3:

JAN 13/21

REV. NO. DESCRIPTION 2. AVERAGE GRADE REVISED (SFD #2)


DP02 Proj.No. ####


			SFD 5	- Average G	rade Calcula	ation		
SEGMENT	Start	Finish	Average	Distance	Factor	Total Factors	Perimeter	Average grade (total factors / perimeter)
AB	17.63	18.63	18.13	10.16	184.20	675.28	37.60	17.960
ВС	18.63	18.42	18.53	7.42	137.46			
CD	18.42	17.37	17.90	10.16	181.81			
DE	17.37	17.34	17.36	0.89	15.45			
EF	17.34	17.28	17.31	1.22	21.12			
FG	17.28	17.31	17.30	1.22	21.10			
GH	17.31	17.39	17.35	1.22	21.17			
HA	17.39	17.63	17.51	5.31	92.98	AVE	RAGE GRA	ADE
			TOTAL	37.60	675.28		17.96	

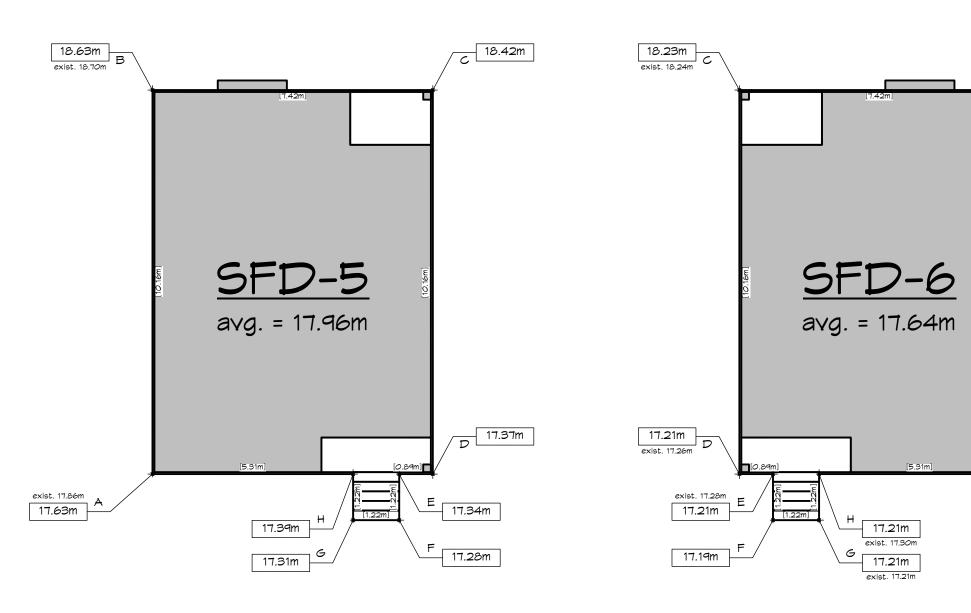


			SFD 6	- Average G	rade Calcula	ation		
SEGMENT	Start	Finish	Average	Distance	Factor	Total Factors	Perimeter	Average grade (total factors / perimeter)
AB	17.21	18.05	17.63	10.16	179.12	663.42	37.60	17.644
BC	18.05	18.23	18.14	7.42	134.60			
CD	18.23	17.21	17.72	10.16	180.04			
DE	17.21	17.21	17.21	5.31	91.39			
EF	17.21	17.19	17.20	1.22	20.98			
FG	17.19	17.21	17.20	1.22	20.98			
GH	17.21	17.21	17.21	1.22	21.00			
HA	17.21	17.21	17.21	0.89	15.32	AVE	RAGE GRA	ADE
			TOTAL	37.60	663.42		17.64	

			SFD 7	- Average G	rade Calcula	ation		
SEGMENT	Start	Finish	Average	Distance	Factor	Total Factors	Perimeter	Average grade (total factors / perimeter)
AB	16.01	16.99	16.50	10.16	167.64	617.80	37.60	16.431
ВС	16.99	16.85	16.92	7.42	125.55			
CD	16.85	16.01	16.43	10.16	166.93			
DE	16.01	16.01	16.01	0.89	14.25			
EF	16.01	15.90	15.96	1.22	19.47			
FG	15.90	15.98	15.94	1.22	19.45			
GH	15.98	16.01	16.00	1.22	19.51			
НА	16.01	16.01	16.01	5.31	85.01	AVE	RAGE GRA	ADE
			TOTAL	37.60	617.80		16.43	

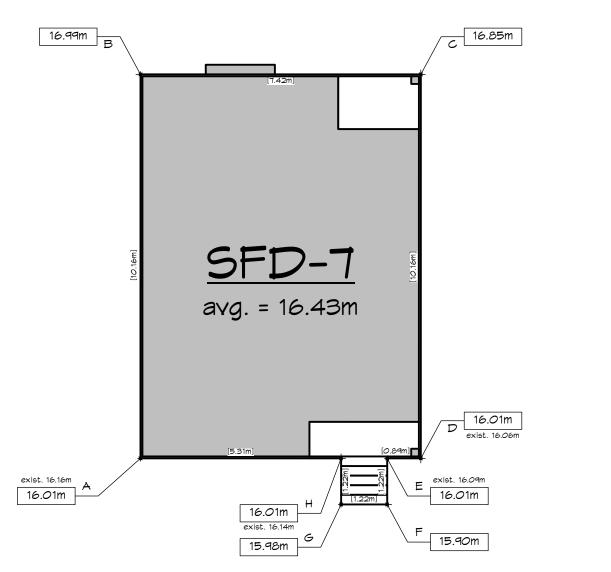

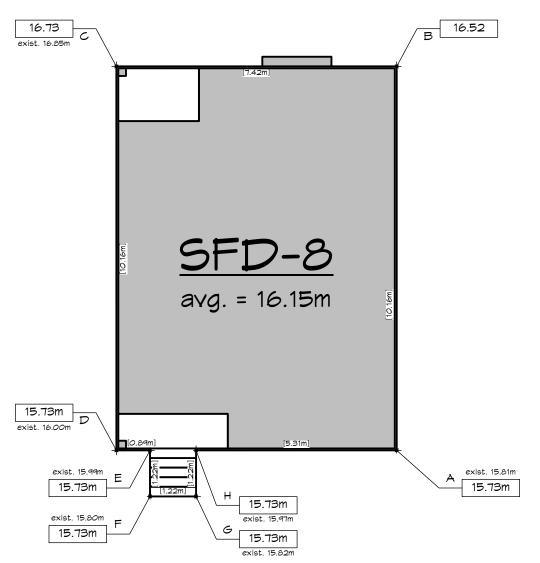

			SFD 8	- Average G	rade Calcula	ation		
SEGMENT	Start	Finish	Average	Distance	Factor	Total Factors	Perimeter	Average grade (total factors / perimeter)
AB	15.73	16.52	16.13	10.16	163.83	607.18	37.60	16.14
BC	16.52	16.73	16.63	7.42	123.36			
CD	16.73	15.73	16.23	10.16	164.90			
DE	15.73	15.73	15.73	0.89	14.00			
EF	15.73	15.73	15.73	1.22	19.19			
FG	15.73	15.73	15.73	1.22	19.19			
GH	15.73	15.73	15.73	1.22	19.19			
HA	15.73	15.73	15.73	5.31	83.53	AVE	RAGE GRA	ADE
			TOTAL	37.60	607.18		16.15	

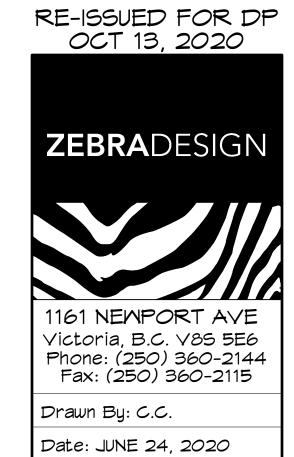

Scale: AS NOTED

Project:
3120 MASHINGTON
AVENUE - REZONING

Title: AVERAGE GRADE

AVERAGE GRAD

Revision: Sheet:

Rev 1:

MAY 29/20

Rev 2:

OCT 13/20


Rev 3:


JAN 13/21


REV. NO. DESCRIPTION DATE


3 NO CHANGES JAN 13/21


DP03
Proj.No. ####

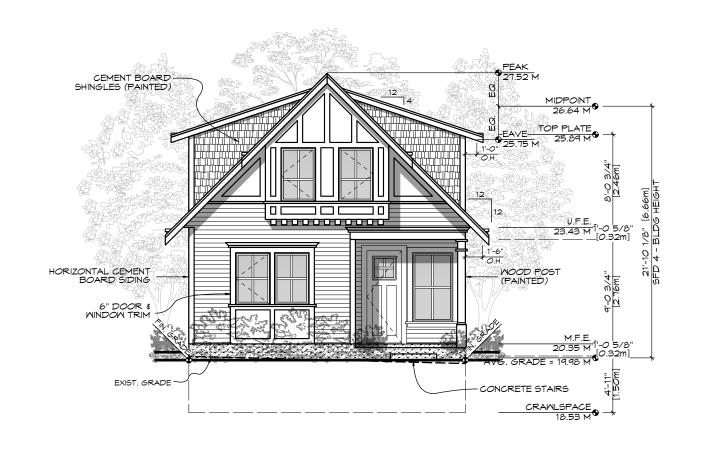


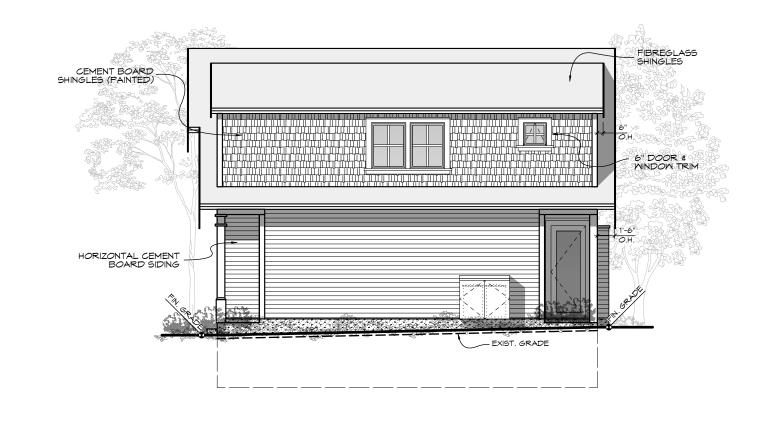


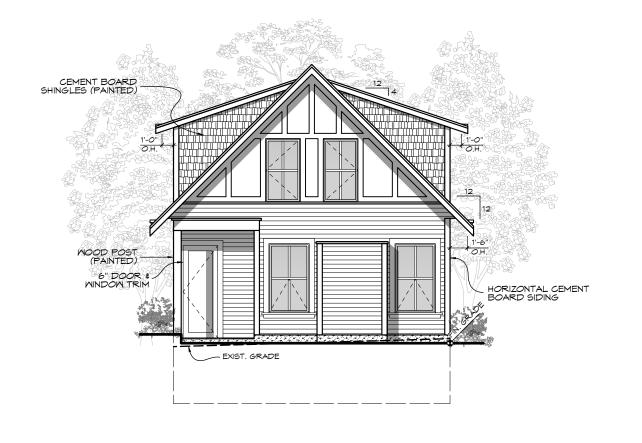


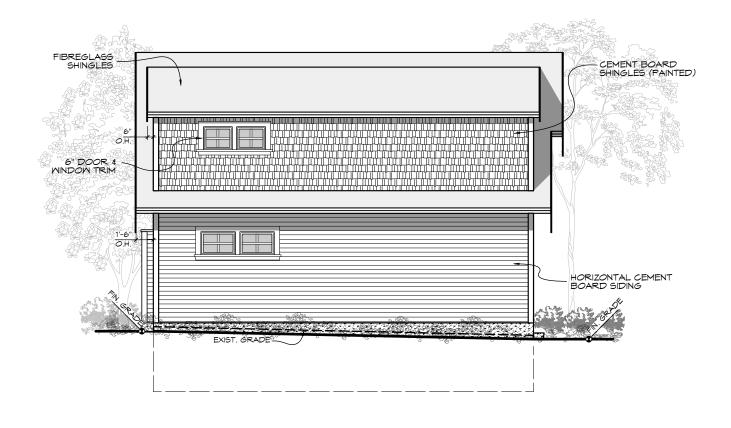


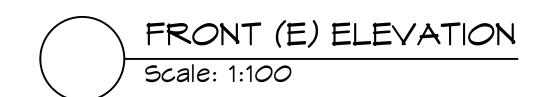


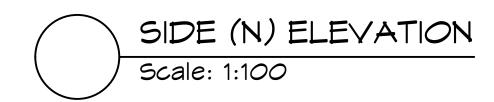


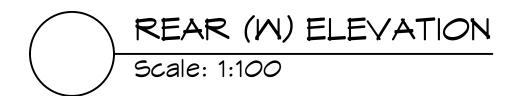


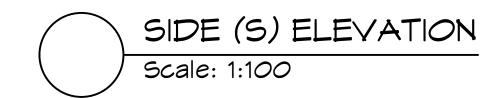


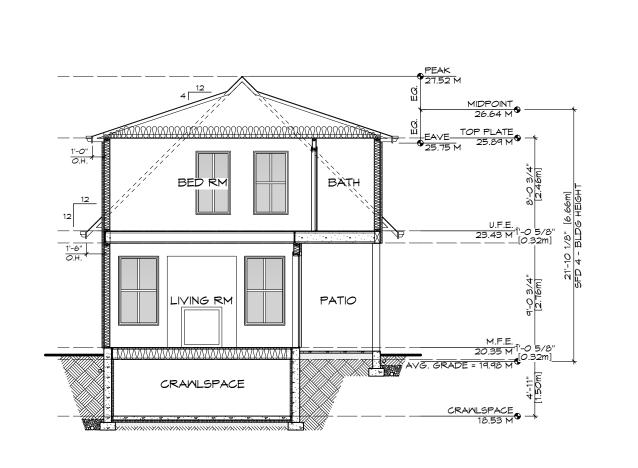

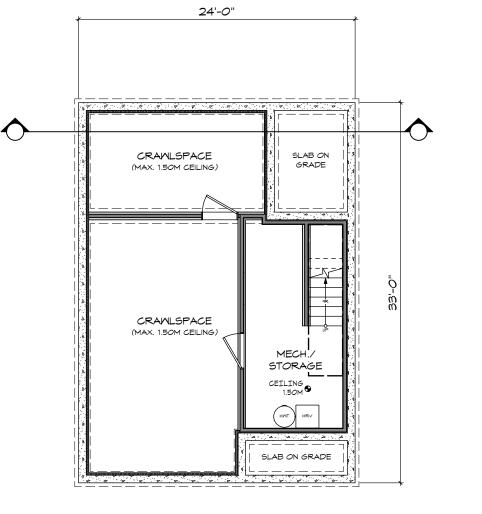

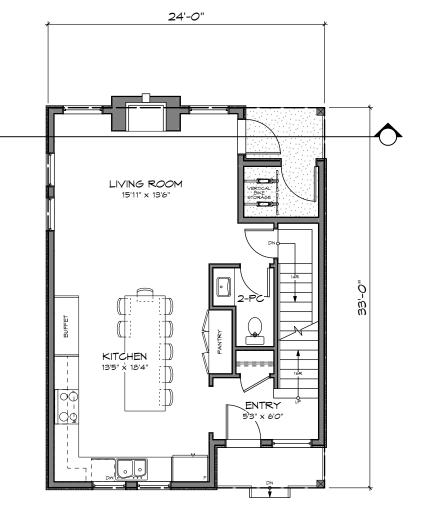

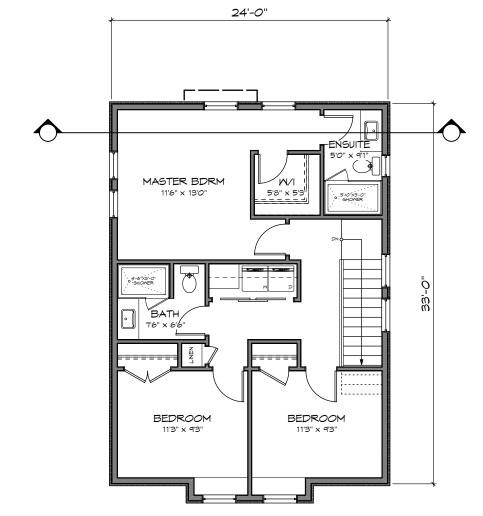

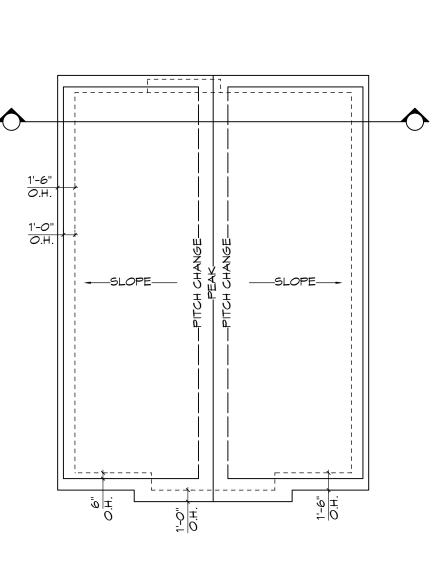

SECTION Scale: 1:100












RE-ISSUED FOR DP OCT 13, 2020 ZEBRADESIGN 1161 NEWPORT AVE Victoria, B.C. V85 5E6 Phone: (250) 360-2144 Fax: (250) 360-2115 Drawn By: C.C. Date: JUNE 24, 2020 Scale: AS NOTED Project: 3120 WASHINGTON AVENUE - REZONING Title: FLOOR PLANS & ELEVATIONS -SFD 1 Revision: Rev 1: MAY 29/20 Rev 2: OCT 13/20 Rev 3: JAN 13/21

DP04

REV. NO.	DESCRIPTION	DATE
Э	NO CHANGES	JAN 13/21

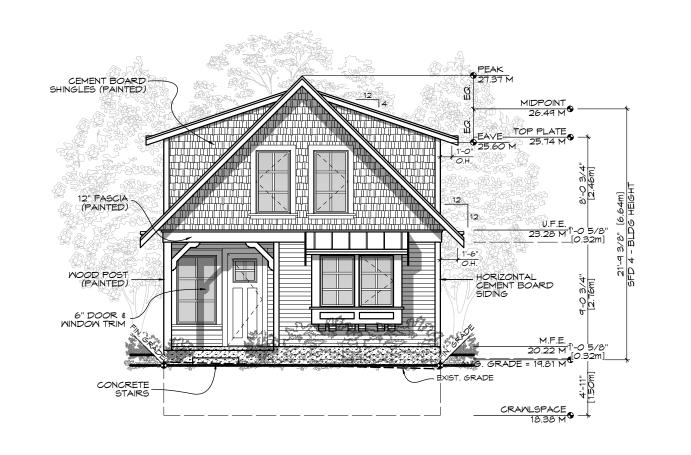


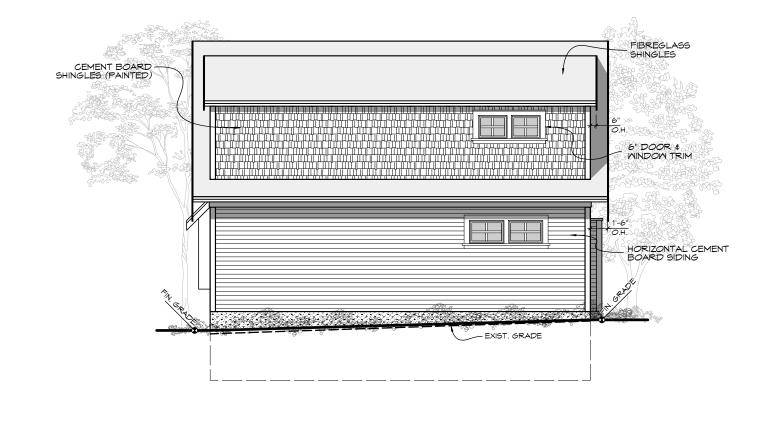


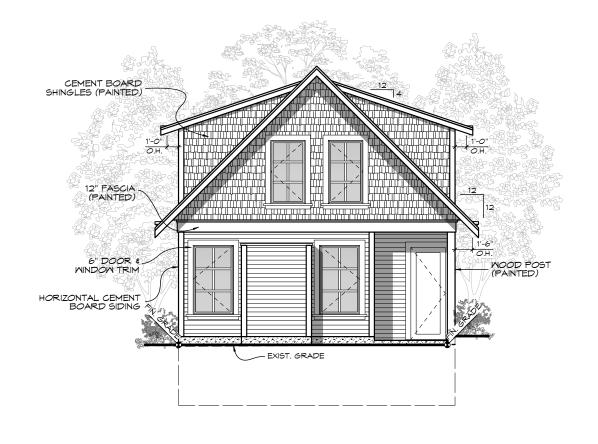








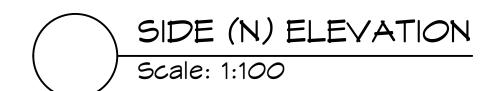


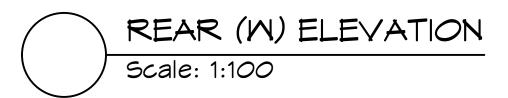


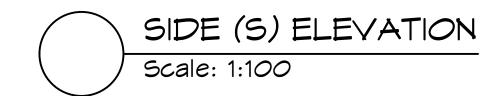


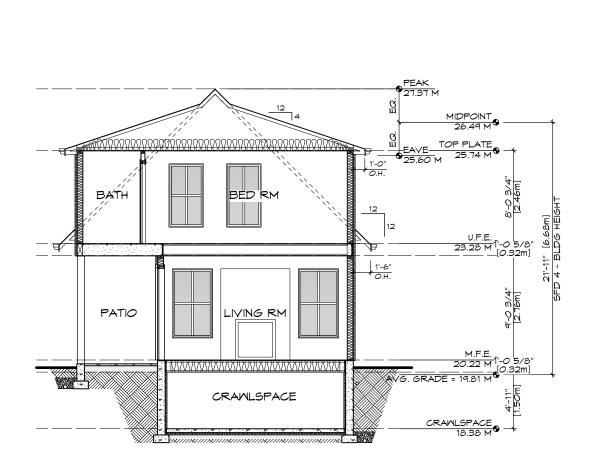

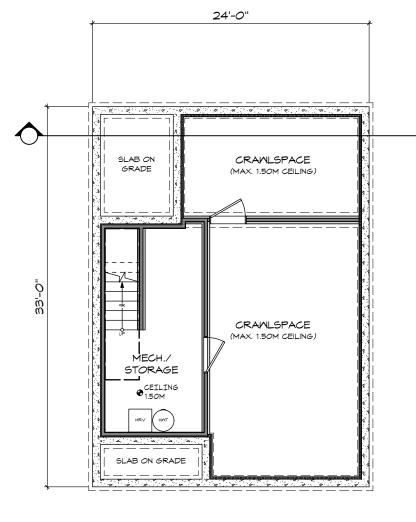

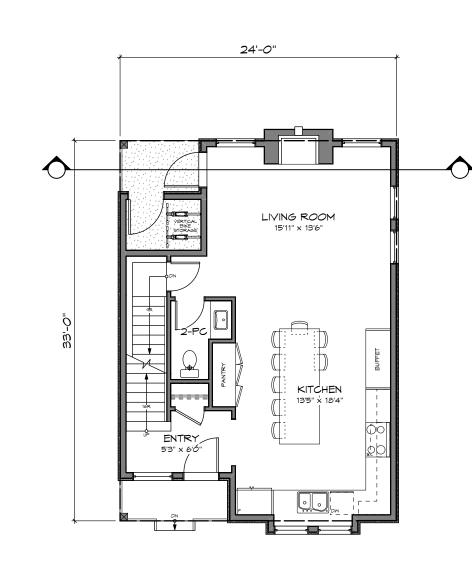

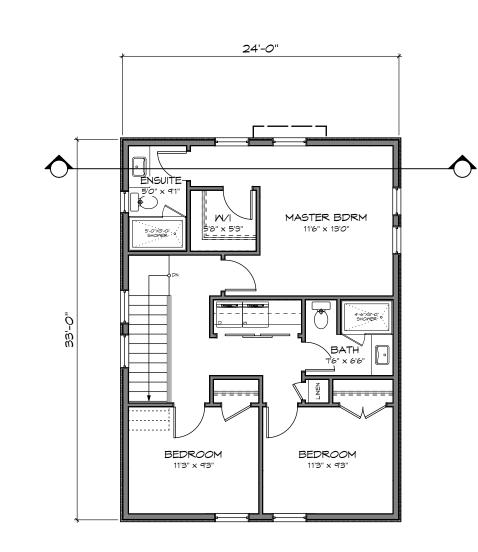

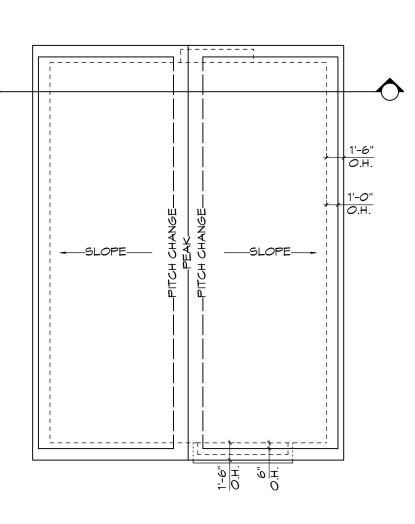

SECTION
Scale: 1:100









ZEBRADESIGN

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Drawn By: C.C.

Date: JUNE 24, 2020

Scale: AS NOTED

Project:
3120 WASHINGTON
AVENUE - REZONING

Title:
FLOOR PLANS &
ELEVATIONS SFD 2

Revision: Sheet:

Rev 1:
MAY 29/20
Rev 2:
OCT 13/20
Rev 3:
JAN 13/21

DP05

RE-ISSUED FOR DP


OCT 13, 2020

Proj.No. ####


REV. NO. DESCRIPTION DATE


3 2. AVERAGE GRADE/ BUILDING HEIGHT REVISED (SFD #2)

JAN 13/21

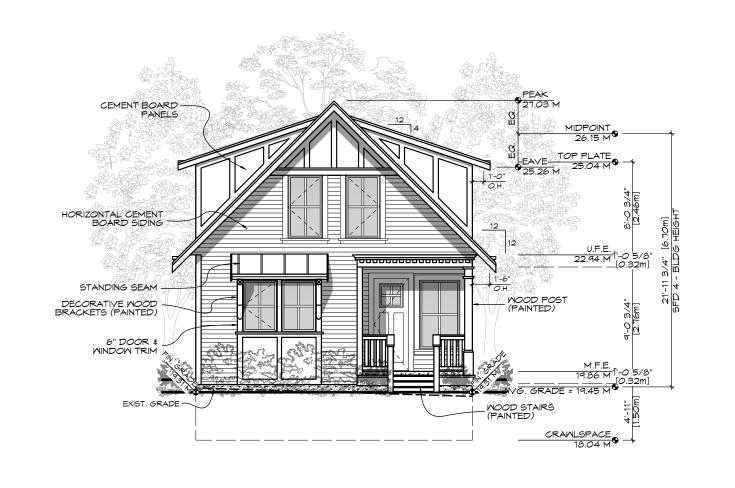





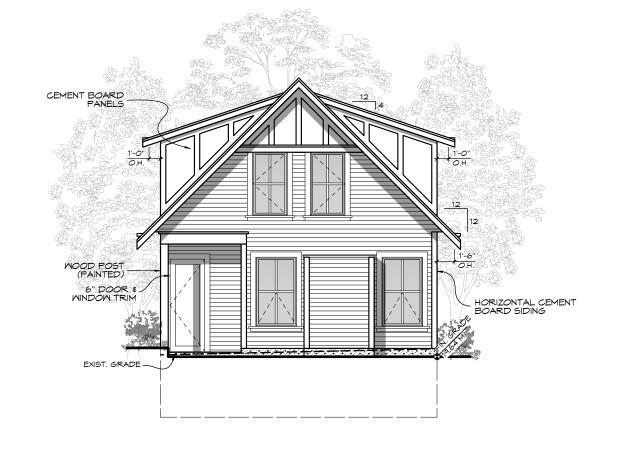


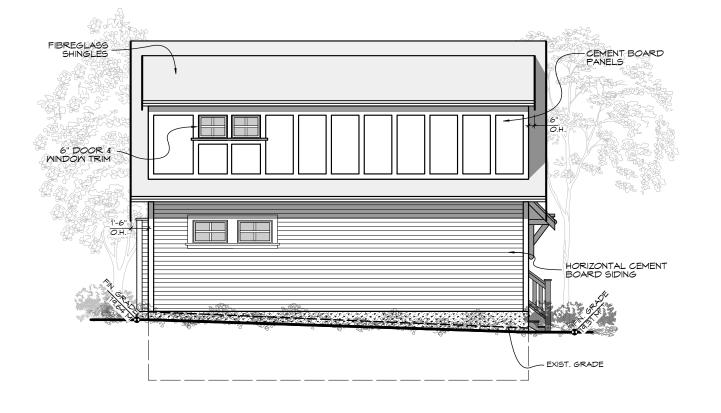





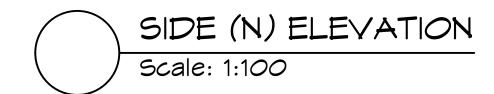


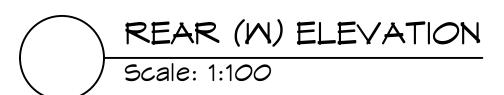


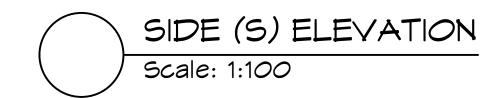


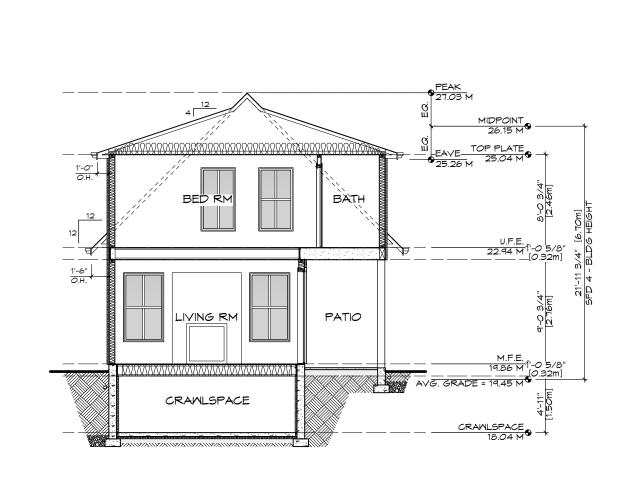

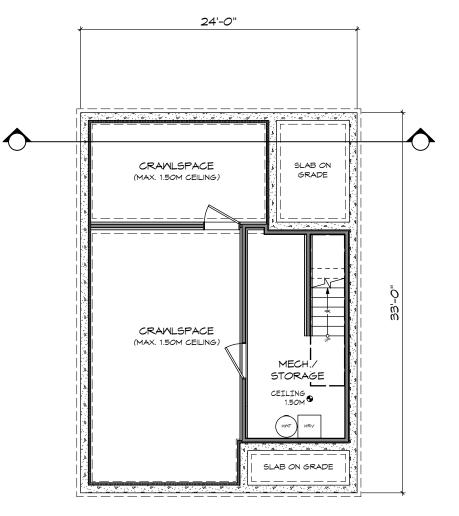

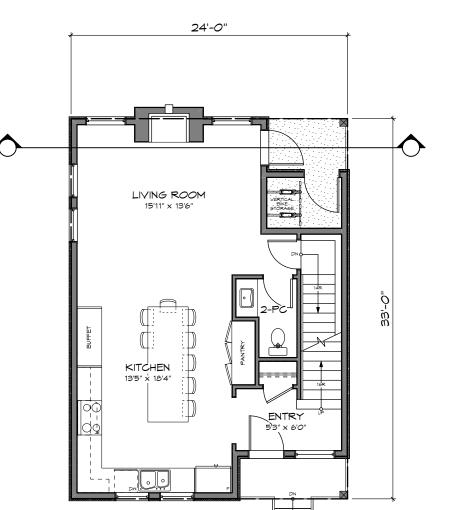

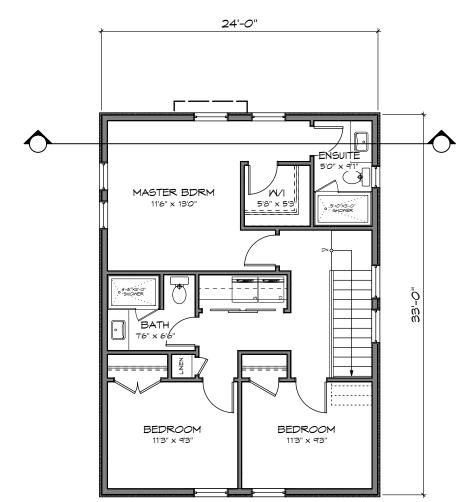

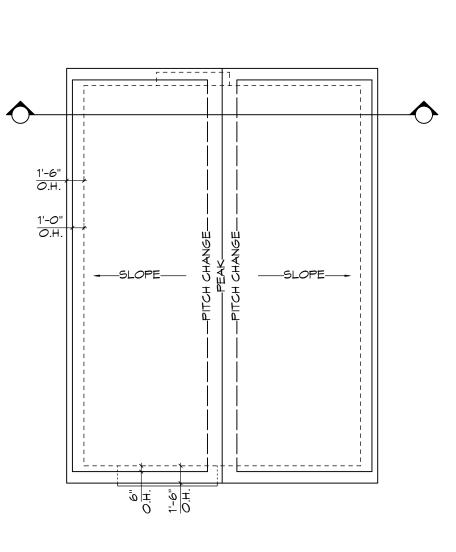

SECTION Scale: 1:100









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Rev 1:

MAY 29/20

Rev 2:

OCT 13/20

Rev 3:


JAN 13/21


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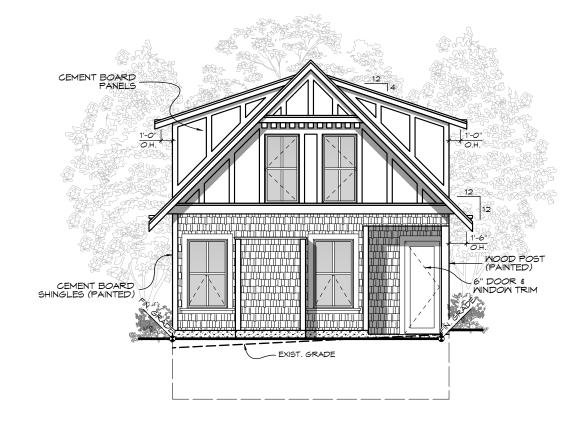
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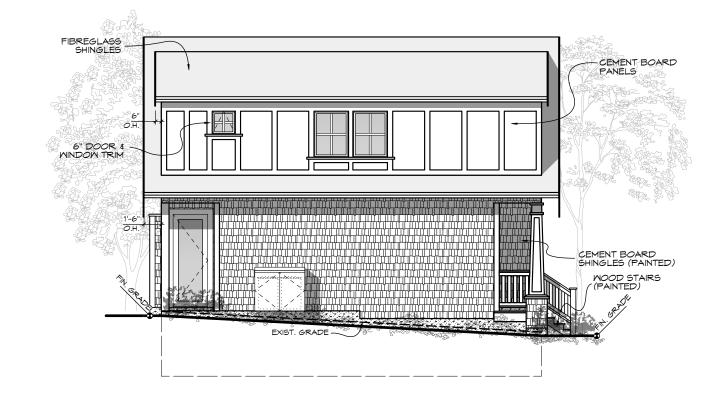
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REV. NO.	DESCRIPTION	DATE
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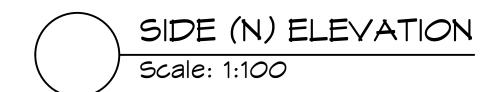











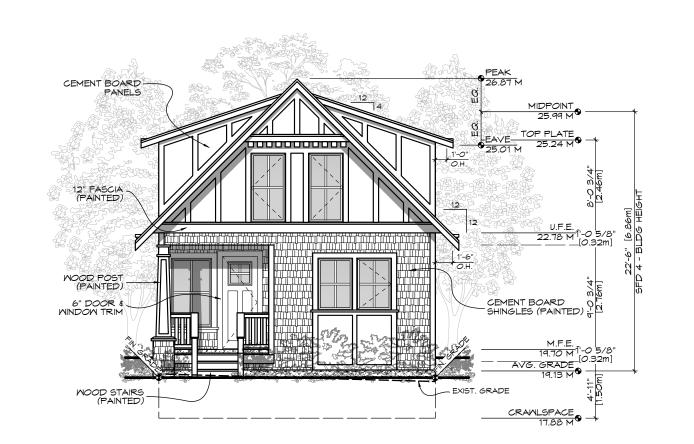


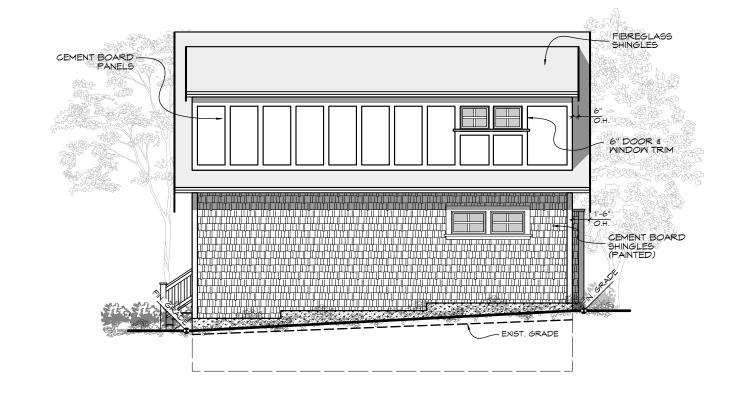


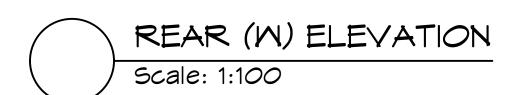


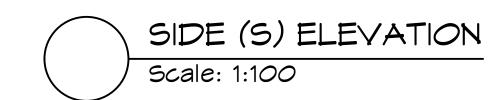


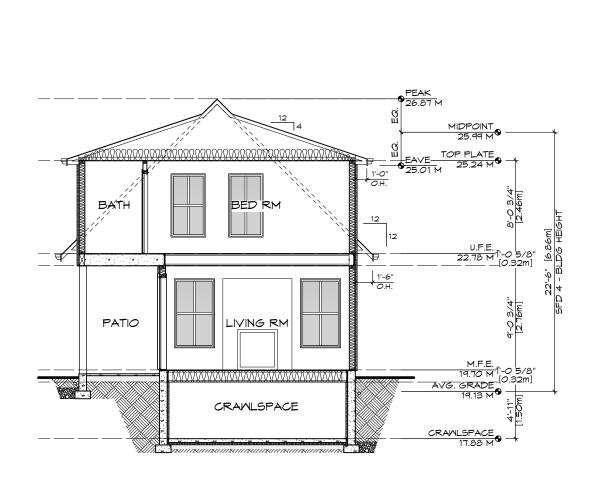

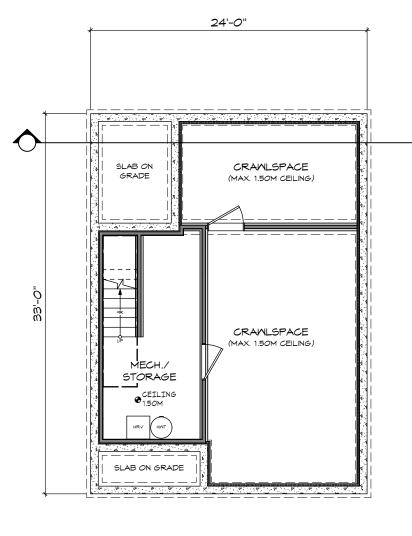

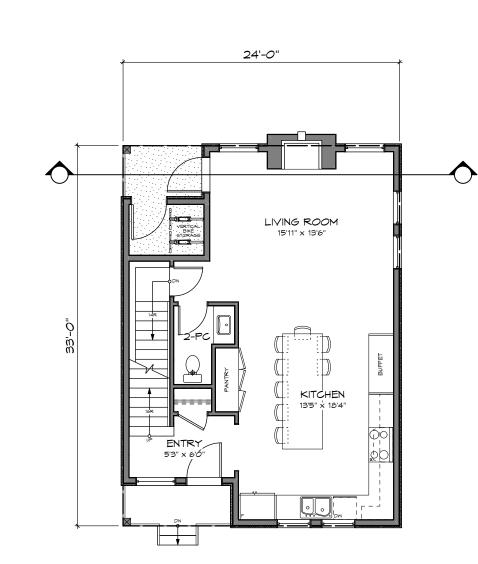

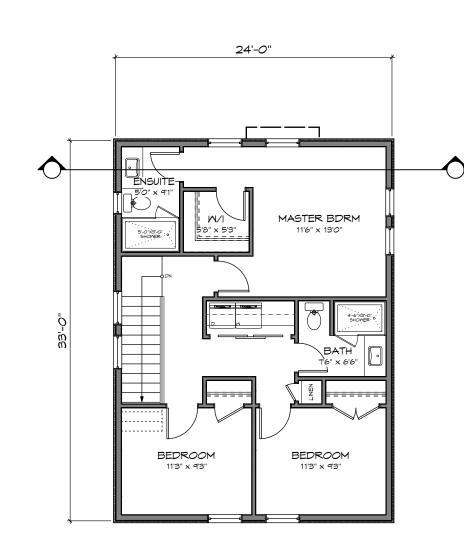

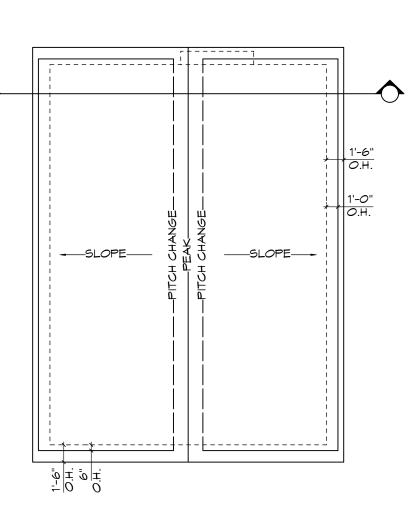

SECTION Scale: 1:100












RE-ISSUED FOR DP OCT 13, 2020 ZEBRADESIGN 1161 NEWPORT AVE Victoria, B.C. V85 5E6 Phone: (250) 360-2144 Fax: (250) 360-2115 Drawn By: C.C. Date: JUNE 24, 2020 Scale: AS NOTED Project: 3120 WASHINGTON AVENUE - REZONING Title: FLOOR PLANS & ELEVATIONS -SFD 4 Revision: Rev 1: MAY 29/20 Rev 2: OCT 13/20 Rev 3: JAN 13/21

DP07


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m	NO CHANGES	JAN 13/21

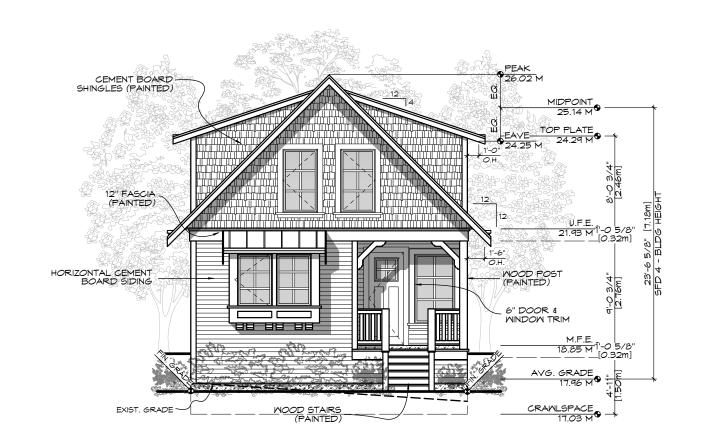


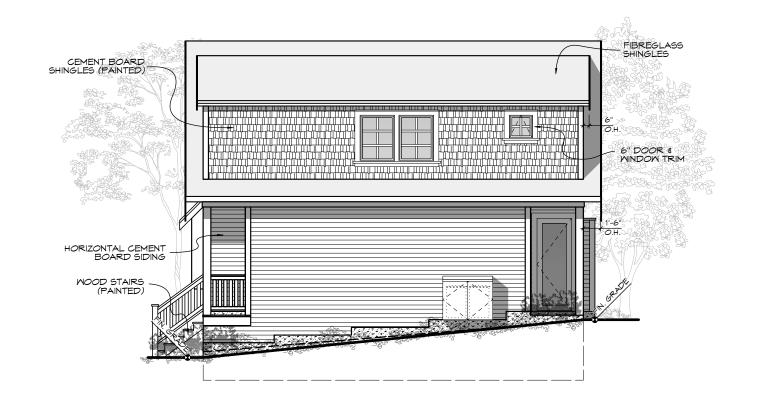


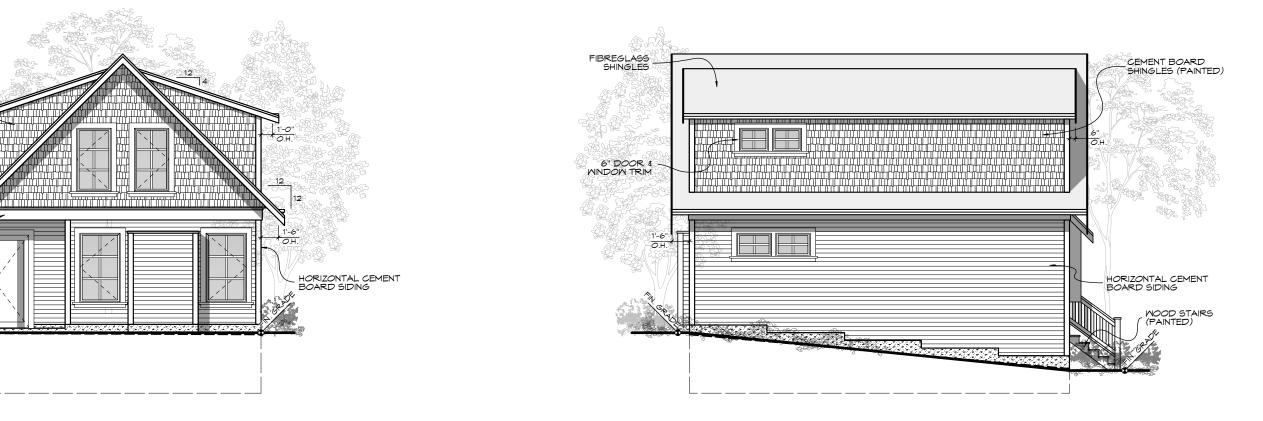





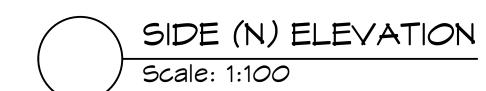


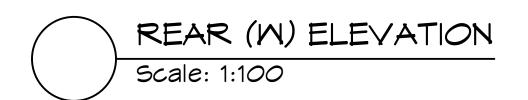


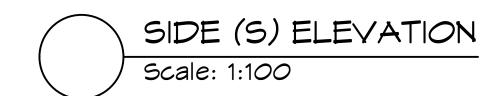


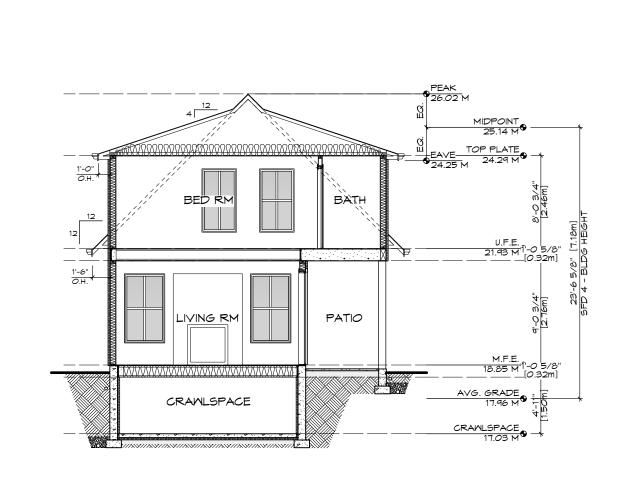

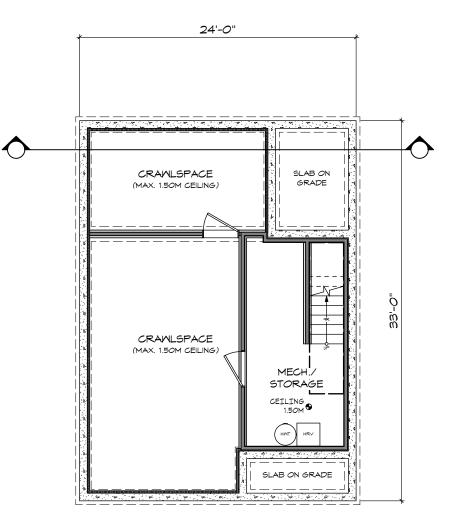

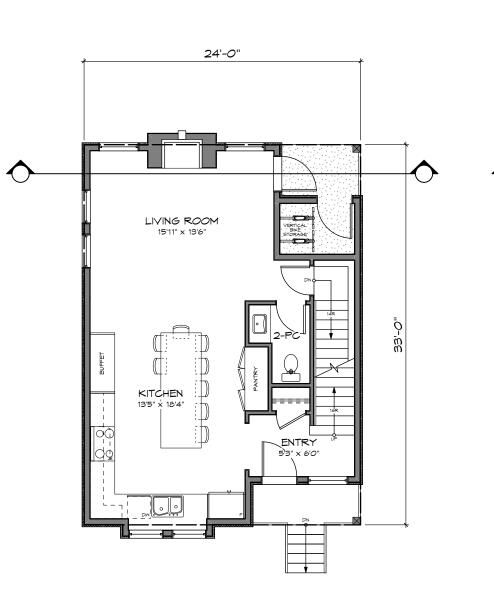

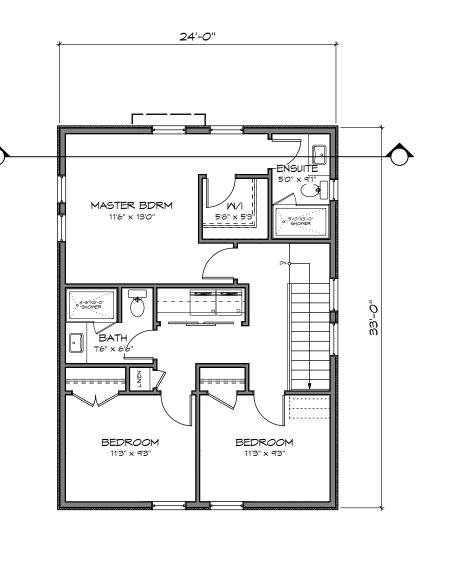

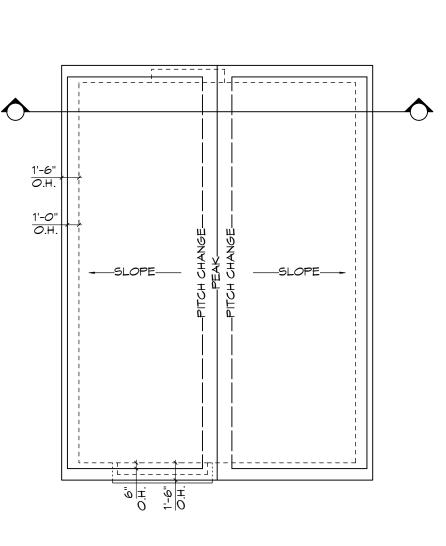

SECTION Scale: 1:100









ZEBRADESIGN 1161 NEWPORT AVE Victoria, B.C. V85 5E6 Phone: (250) 360-2144 Fax: (250) 360-2115 Drawn By: C.C. Date: JUNE 24, 2020 Scale: AS NOTED Project: 3120 WASHINGTON AVENUE - REZONING Title: FLOOR PLANS & ELEVATIONS -SFD 5 Revision:

Rev 1:

MAY 29/20

Rev 2:

OCT 13/20

Rev 3:

JAN 13/21


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DP08


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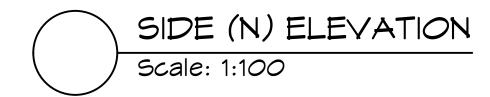
SFD 5


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m	NO CHANGES	JAN 13/21






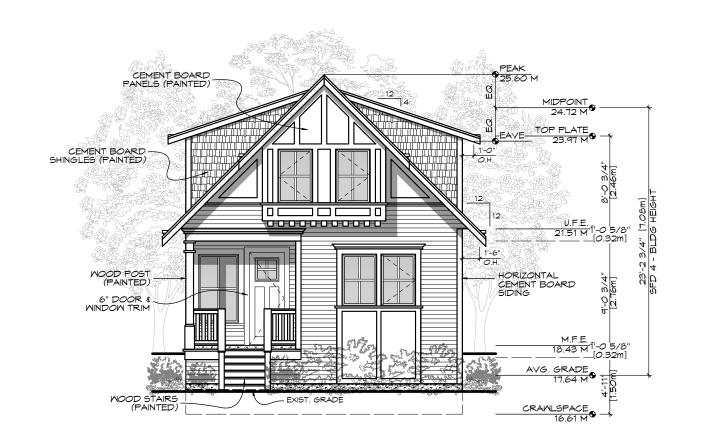

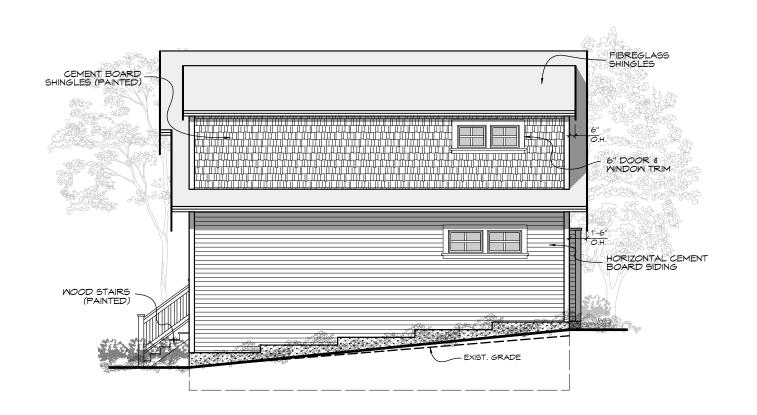


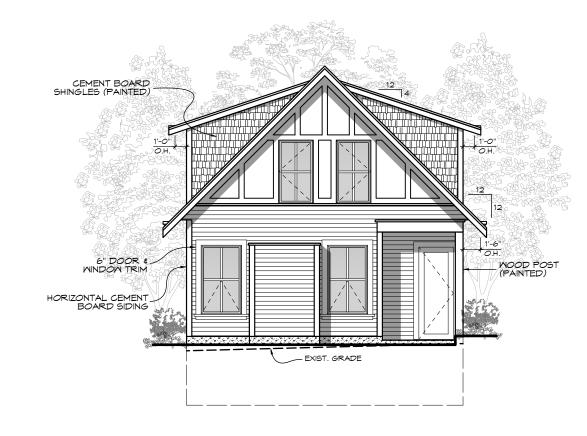


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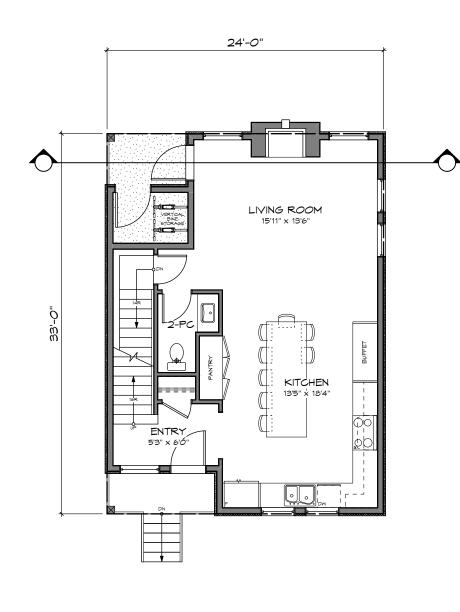
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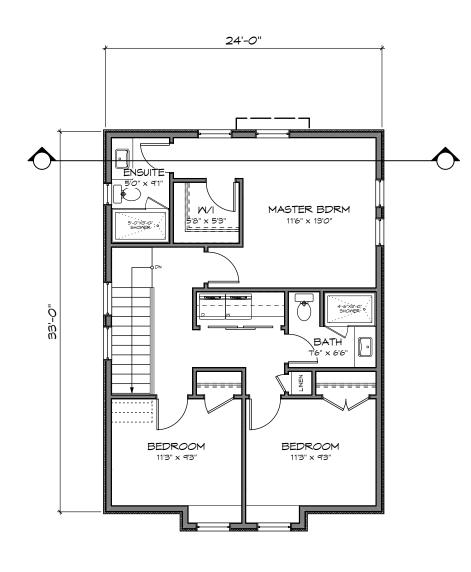


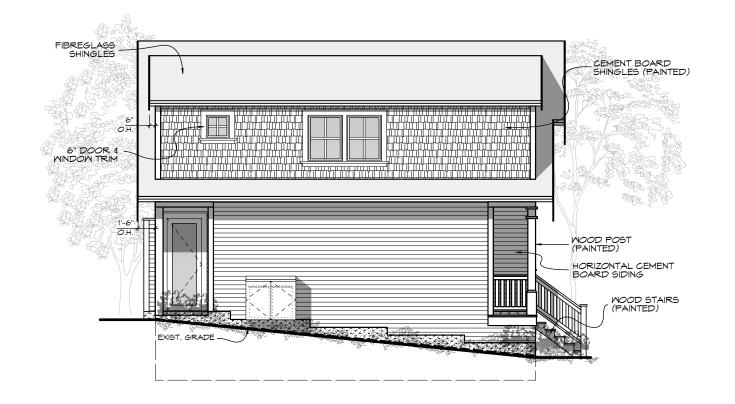


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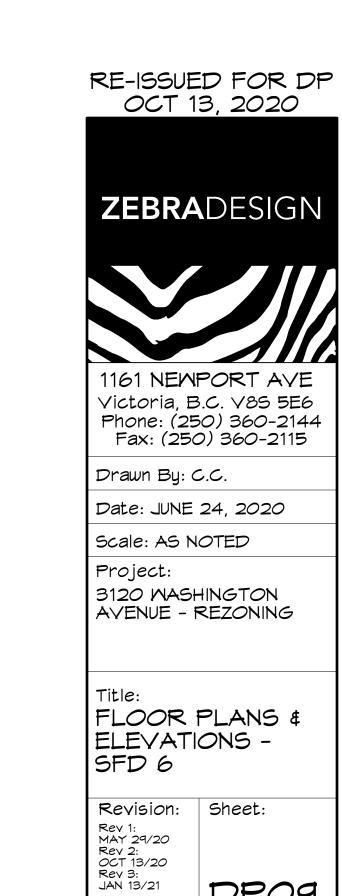
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UPPER FLOOR Scale: 1:100

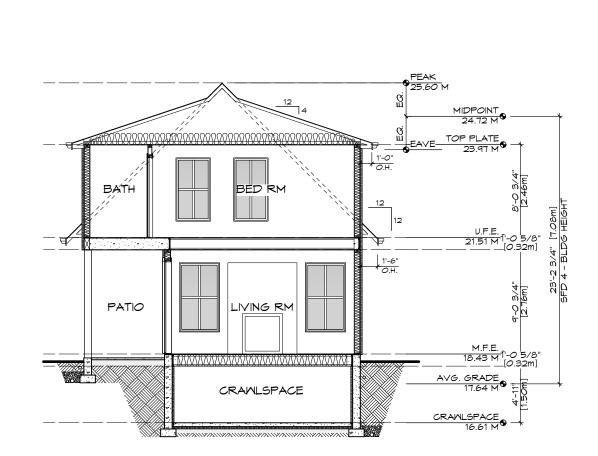

ROOF PLAN Scale: 1:100

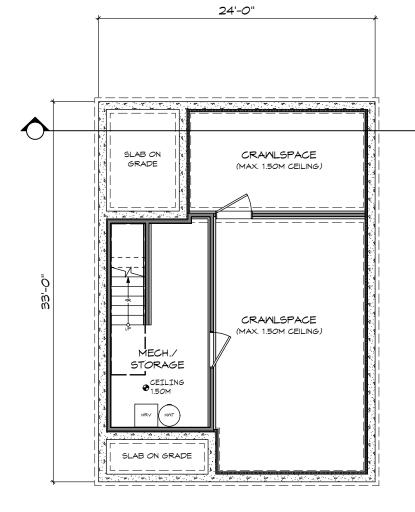



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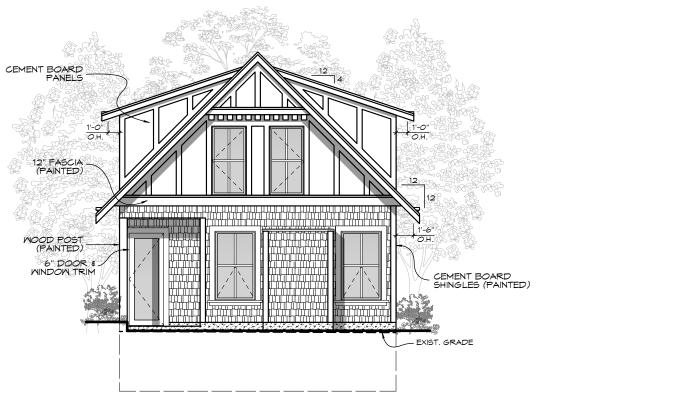
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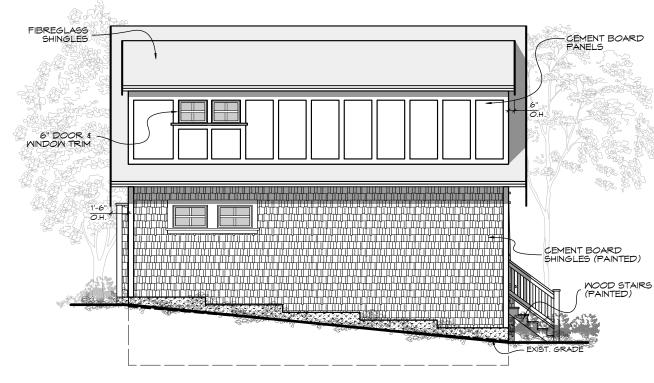
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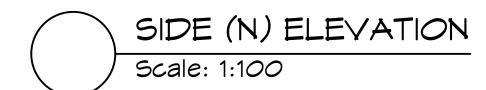


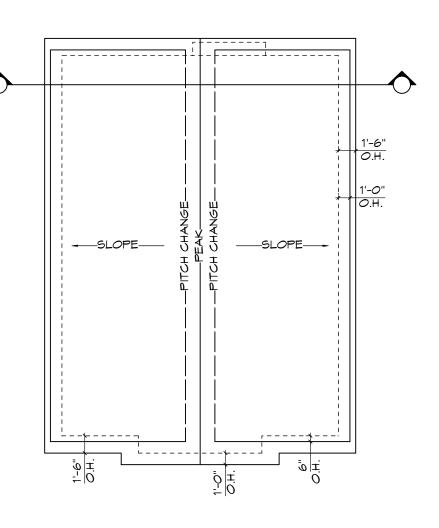







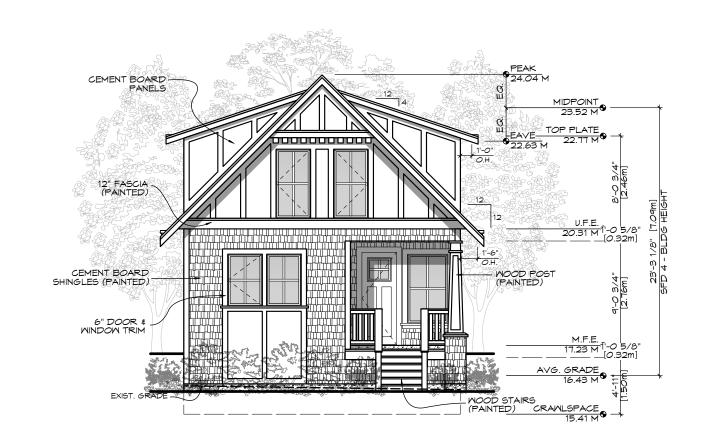


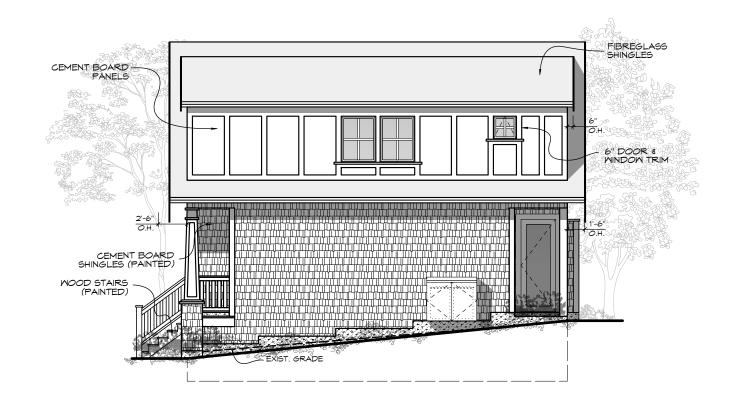


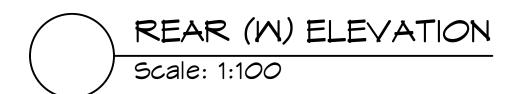





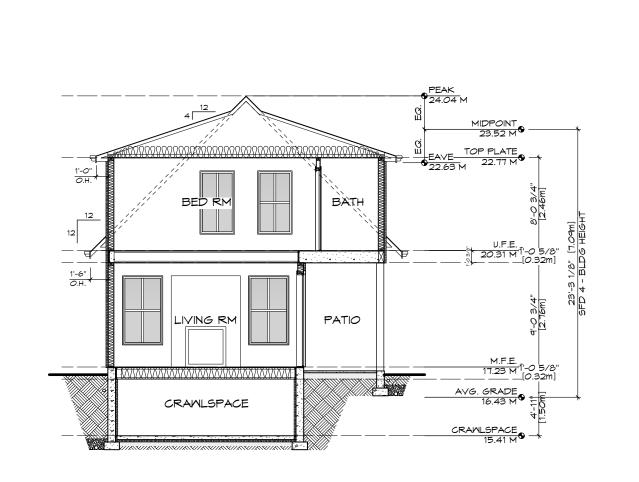

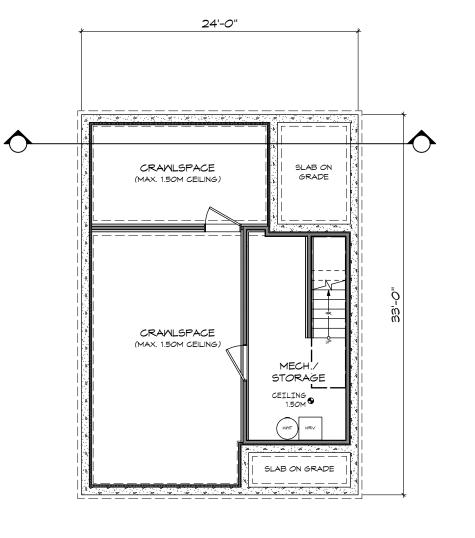

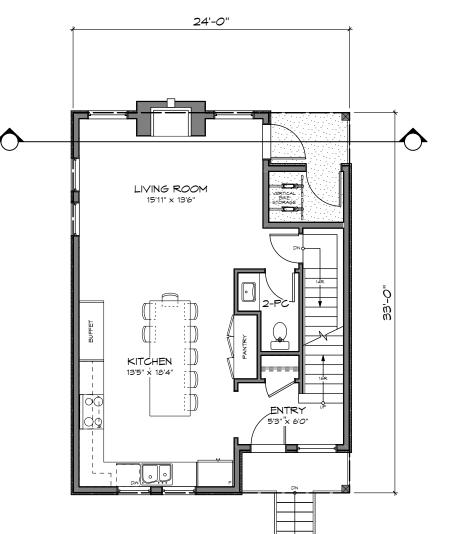

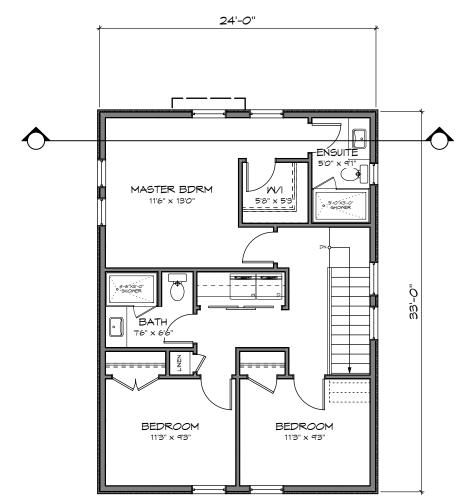

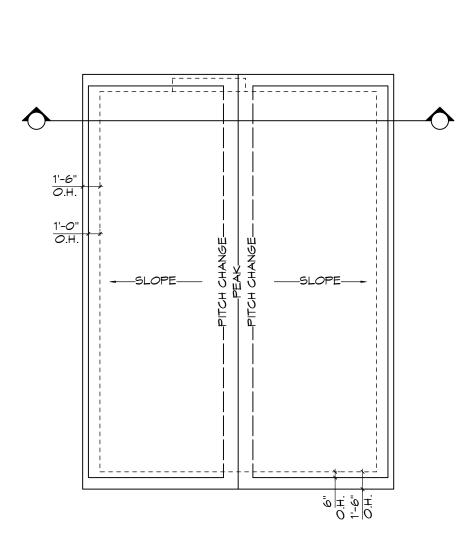

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Rev 1:

MAY 29/20

Rev 2:

OCT 13/20


Rev 3:


JAN 13/21

DP10

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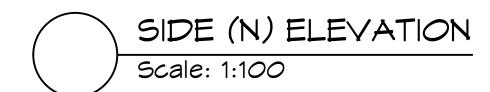
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ß	NO CHANGES	JAN 13/21




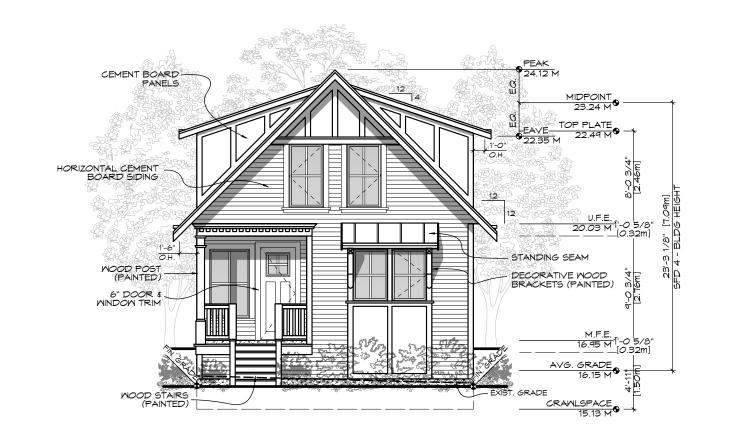


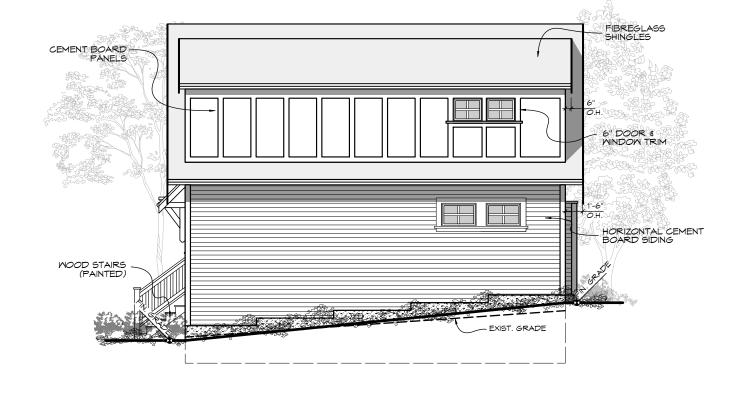








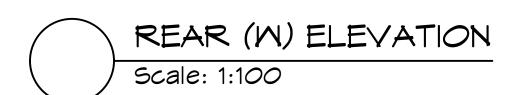


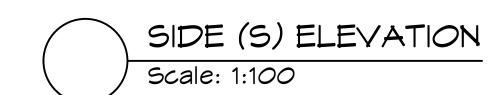


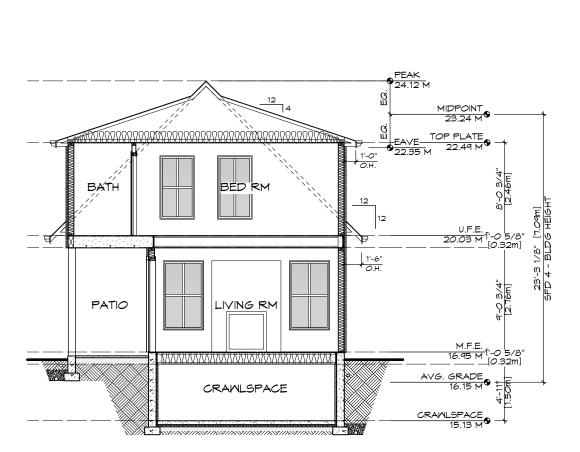

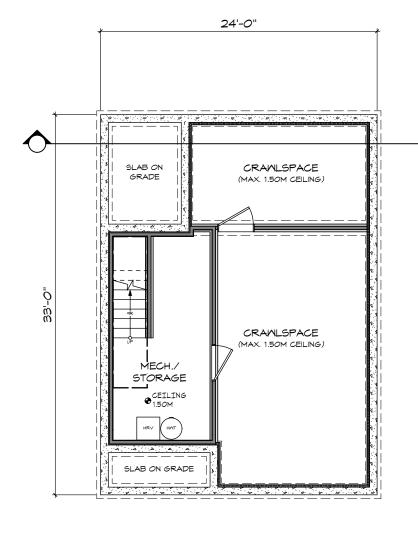

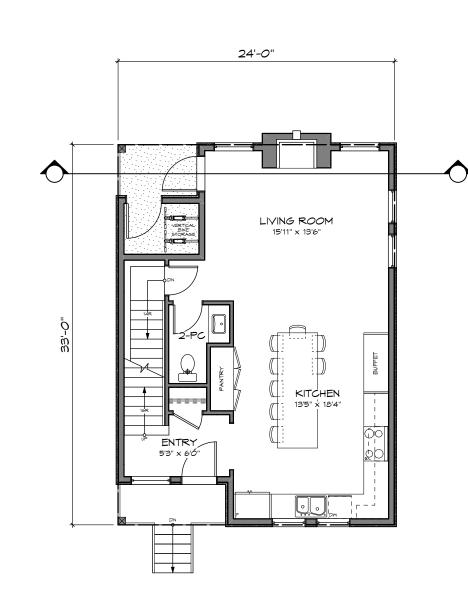

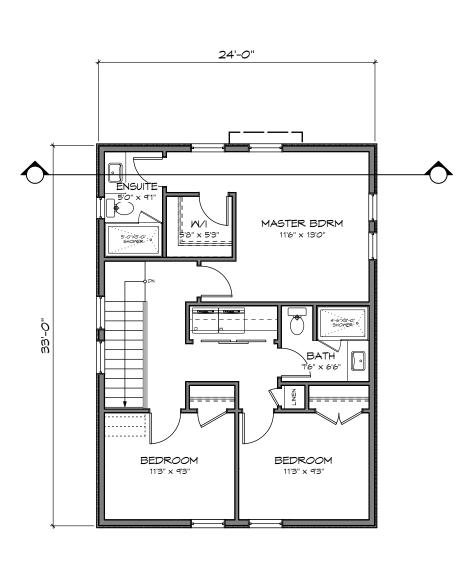

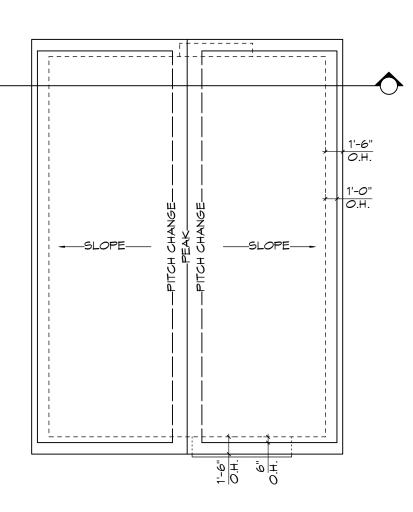

SECTION
Scale: 1:100









ZEBRADESIGN

1161 NEWPORT AVE
Victoria, B.C. V85 5E6
Phone: (250) 360-2144
Fax: (250) 360-2115

Drawn By: C.C.

Date: JUNE 24, 2020

Scale: AS NOTED

Project:
3120 WASHINGTON
AVENUE - REZONING

Title:
FLOOR PLANS &
ELEVATIONS SFD 8

Revision:
Rev 1:
MAY 29/20
Rev 2:
OCT 13/20
Rev 2:
OCT 13/20
Rev 3:
JAN 13/21

DP11

RE-ISSUED FOR DP OCT 13, 2020

Proj.No. ####


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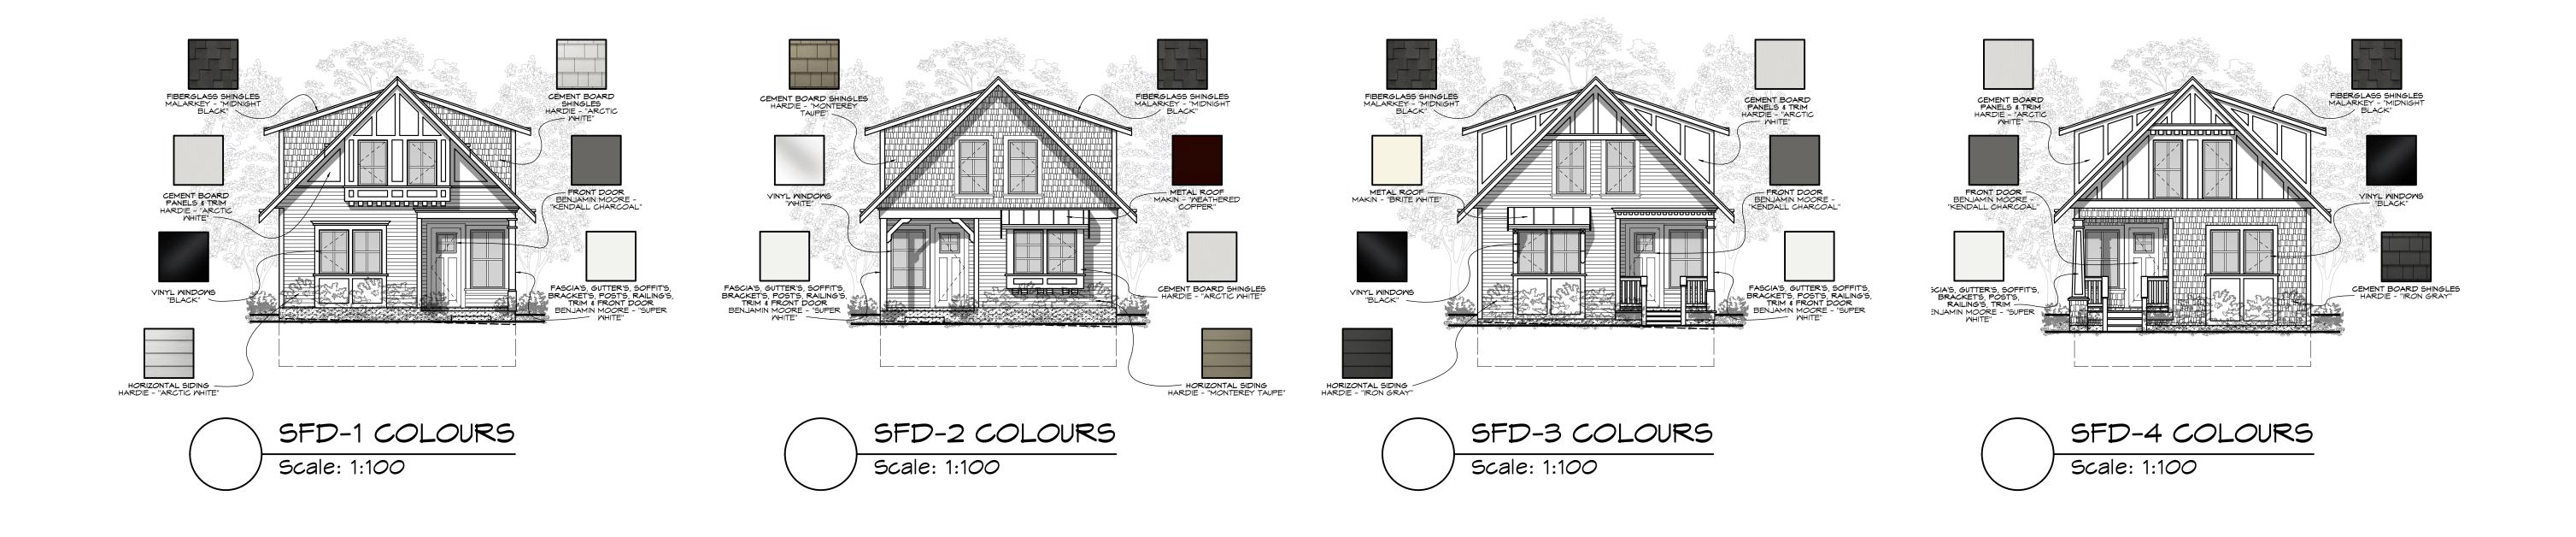
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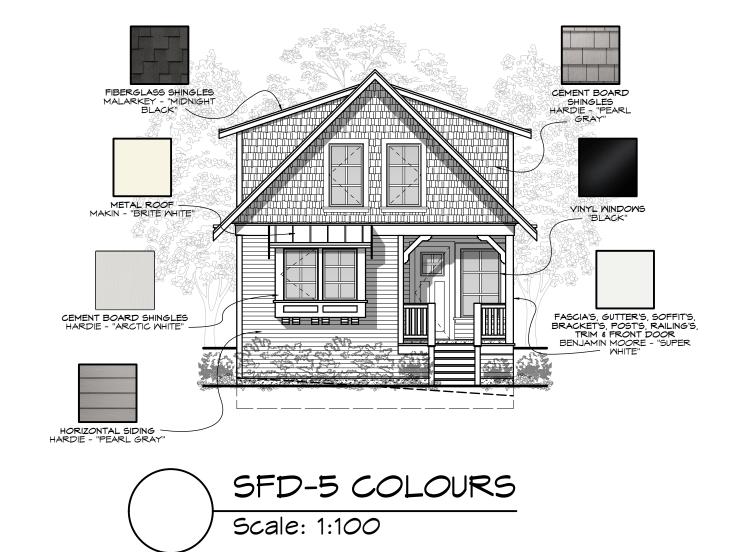
RE-ISSUED FOR DP OCT 13, 2020




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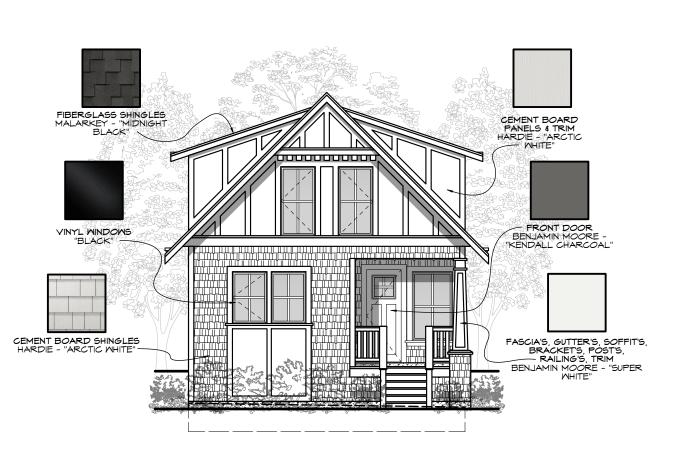
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			MAY 29/20 Rev 2:	
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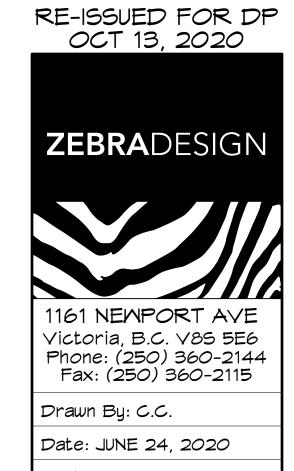
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Scale: AS NOTED Project:

3120 WASHINGTON AVENUE - REZONING

Title: COLOUR BOARD

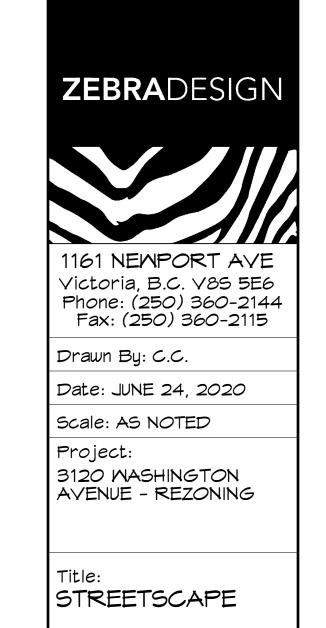
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Proj.No. ####

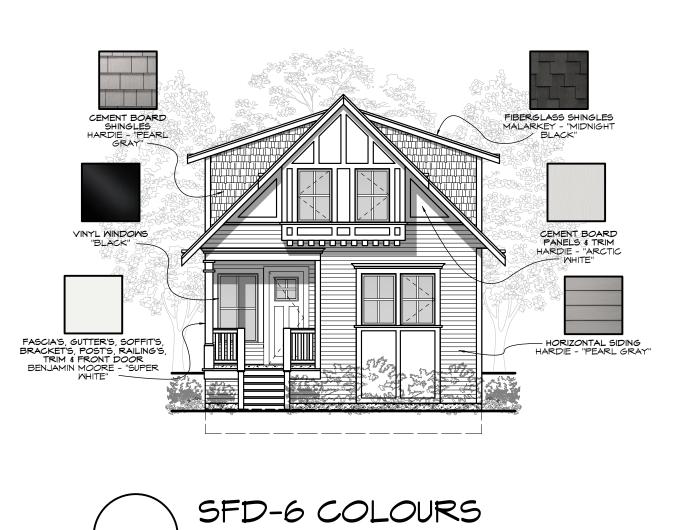Revision: Rev 1: MAY 29/20 Rev 2: OCT 13/20 Rev 3: JAN 13/21

JAN 13/21

REV. NO. DESCRIPTION NO CHANGES

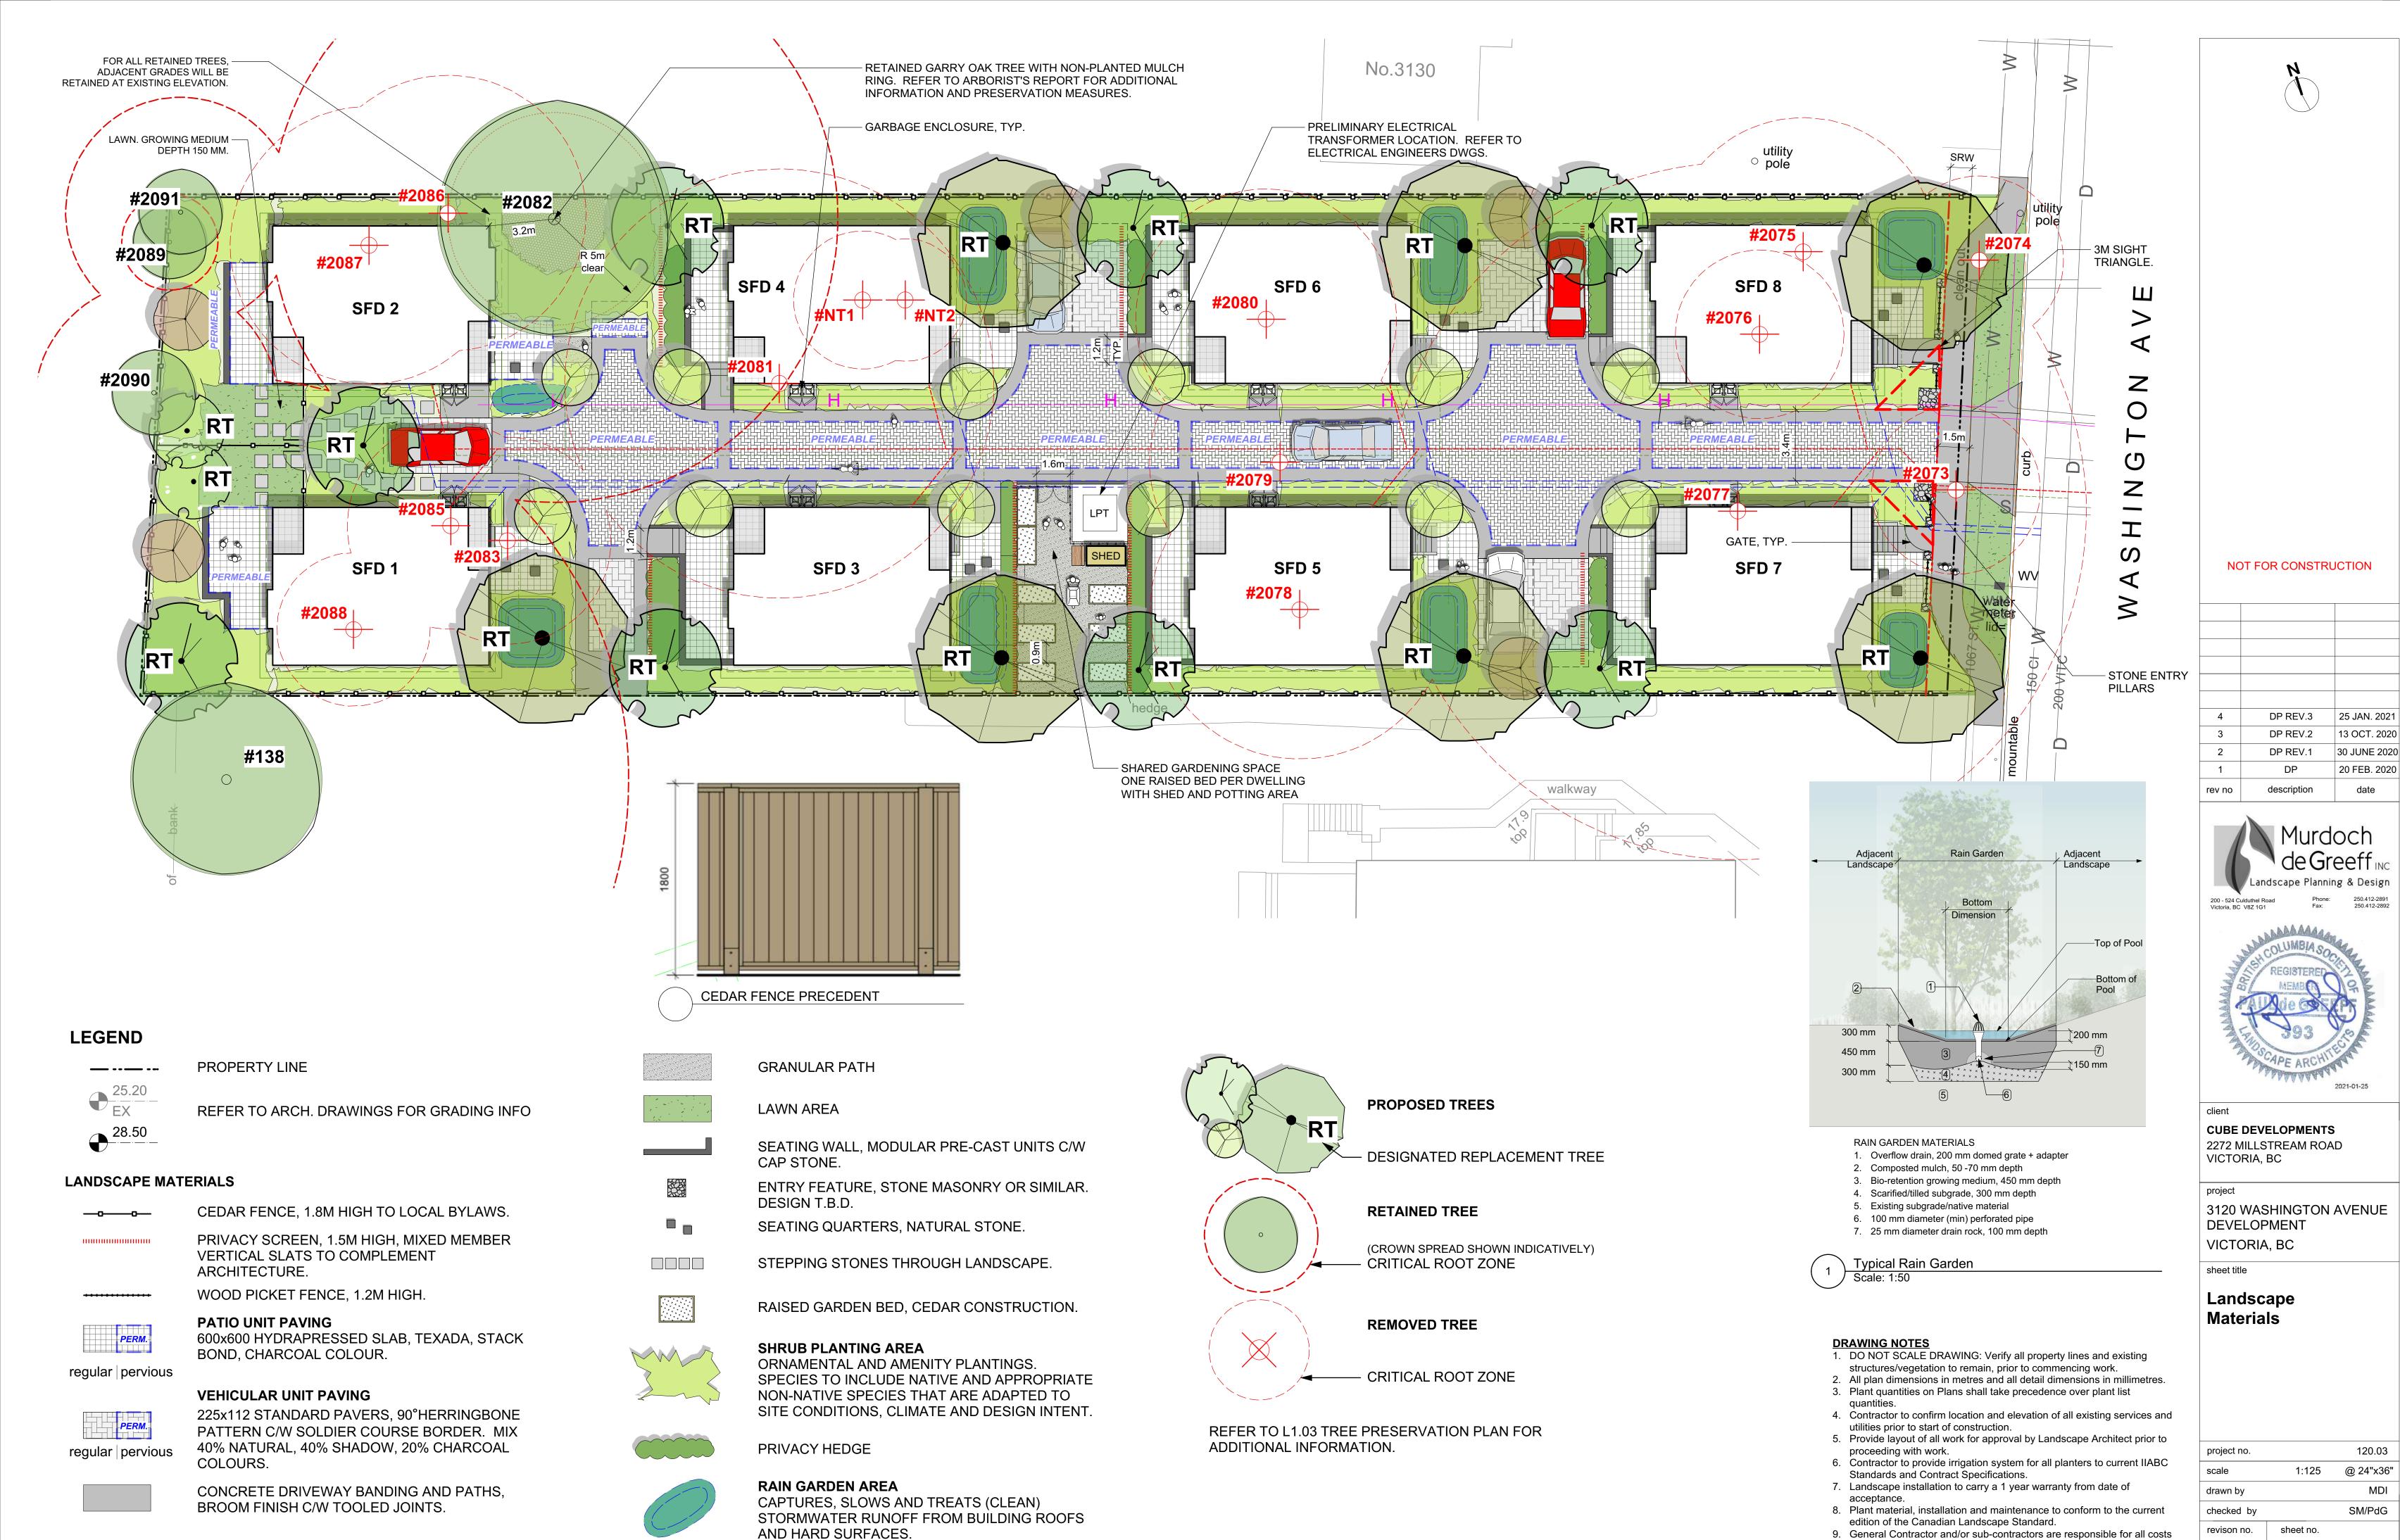

120.03

SM/PdG

L1.01


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related to production and submission to consultant of all landscape

10. Tree protection fencing, for existing trees, to be installed prior to

as-built information including irrigation.

commencement of all site work

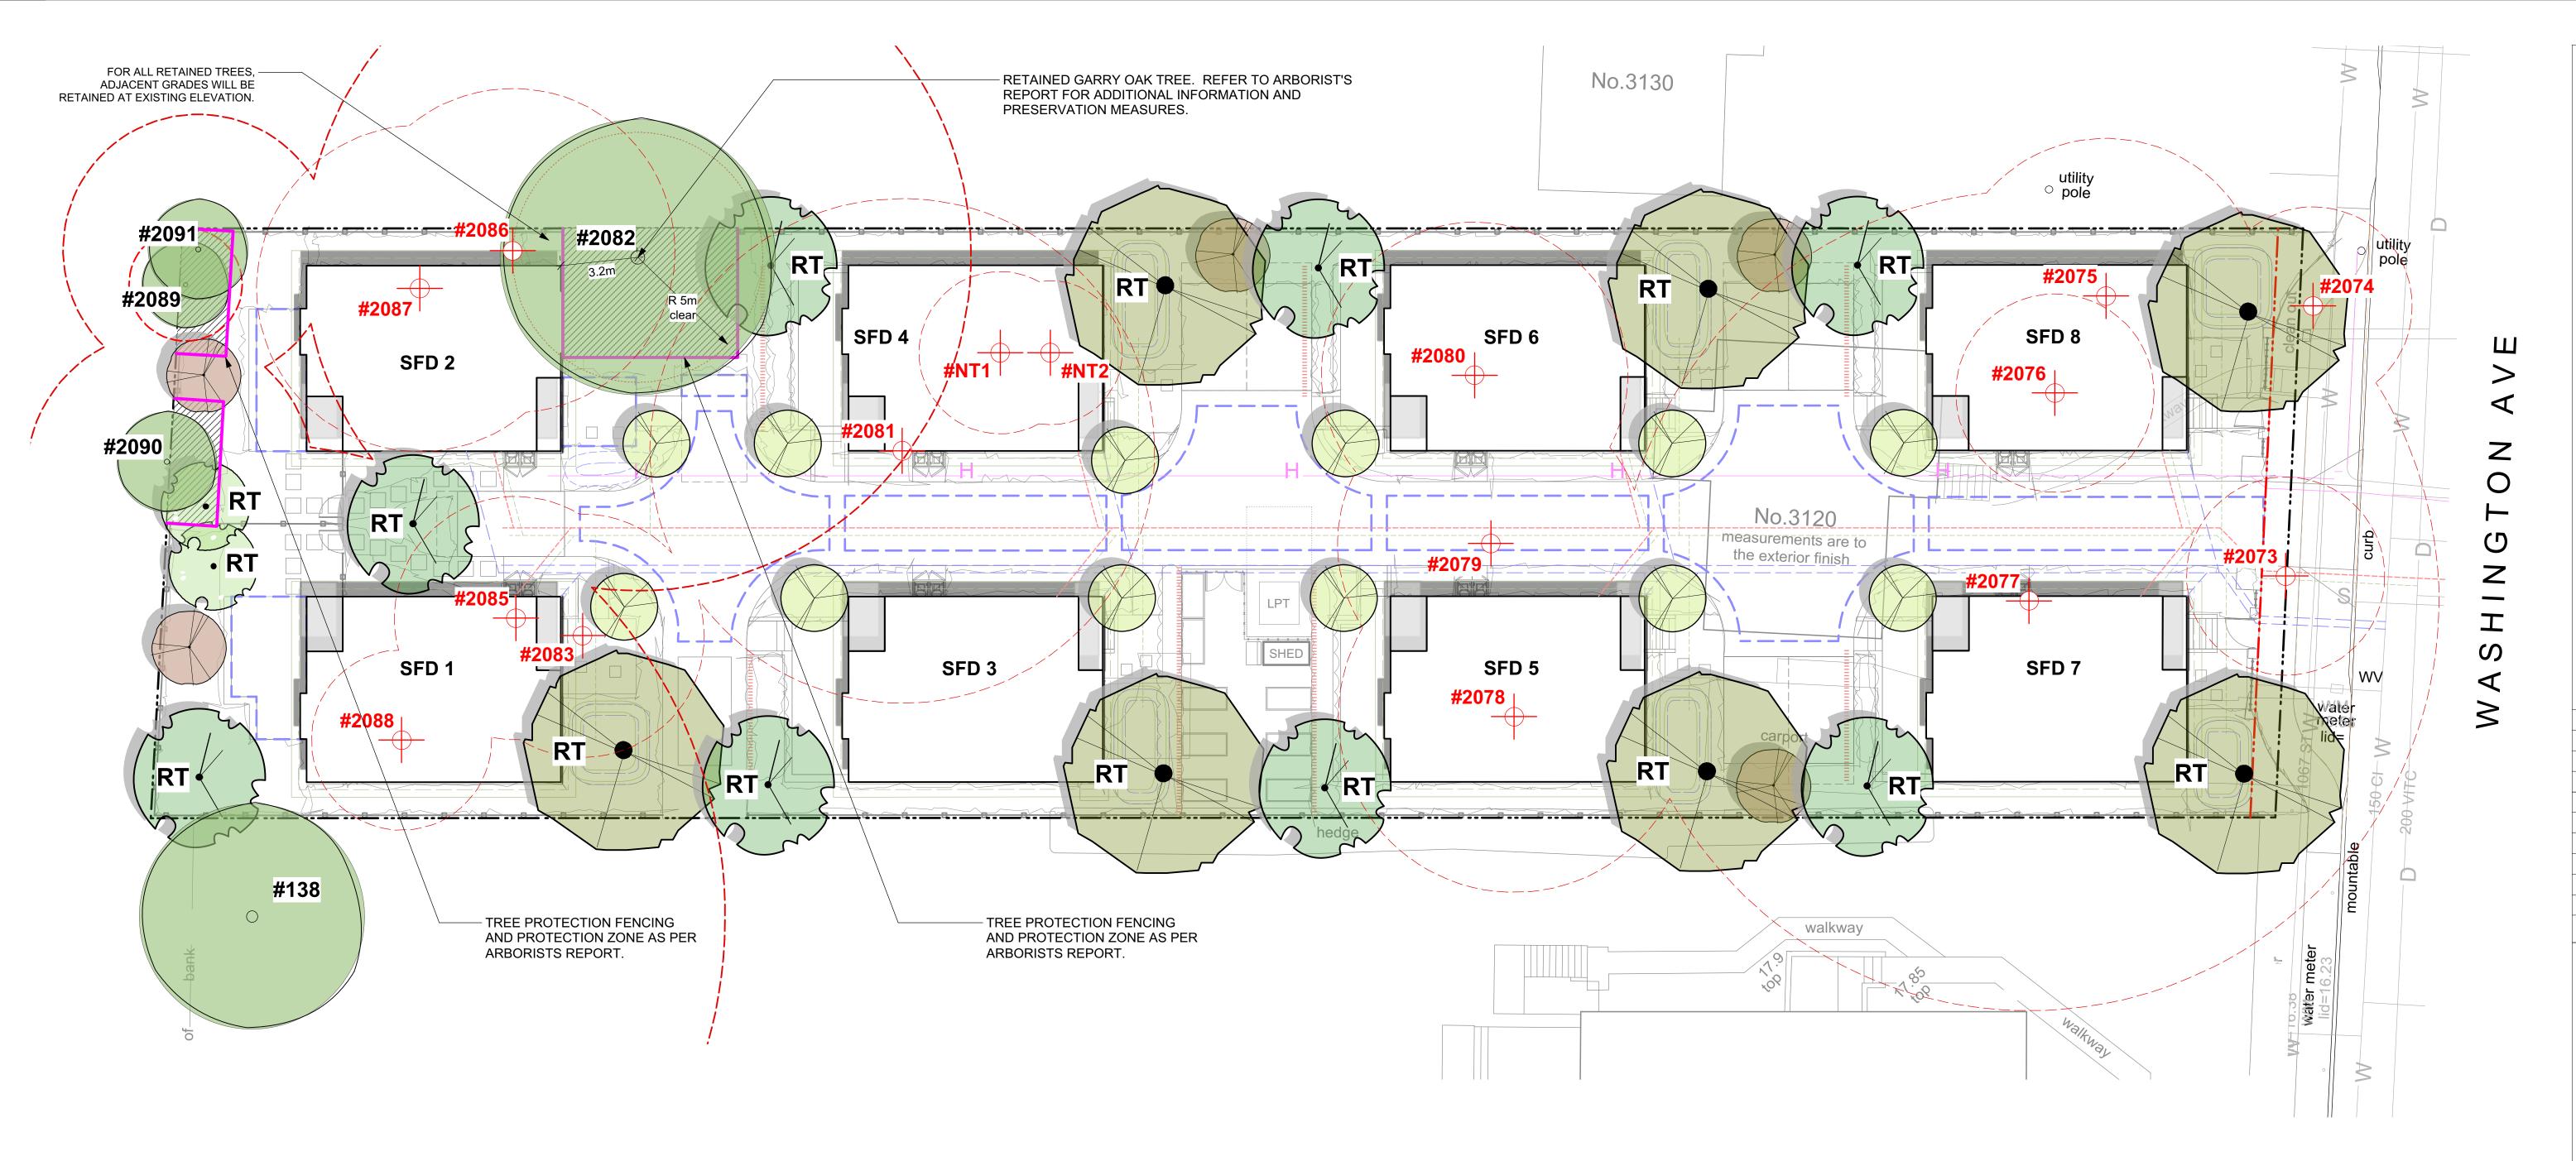


TREE SUMMARY


BYLAW PROTECTED TREES REMOVED: REPLACEMENT TREES: 16 TOTAL NEW TREES PROPOSED ONSITE: REPLACEMENT TREE RATIO = 2:1 AS PER CITY OF

VICTORIA BYLAWS. REFER L3.01 PLANTING PLANS FOR ADDITIONAL INFORMATION.

TREES WILL BE OF THE APPROPRIATE SCALE, SPECIES AND LOCATION TO MEET THE CITY OF VICTORIA REQUIREMENTS. FINAL SPECIES TO BE DETERMINED IN CONSULTATION WITH CITY OF VICTORIA PARKS STAFF.

REFER TO ARBORIST'S REPORT & TREE INVENTORY FOR ADDITIONAL INFORMATION.

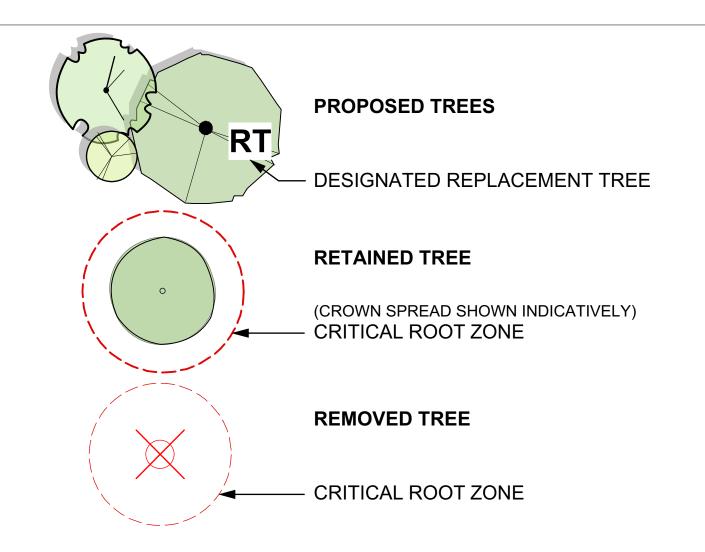

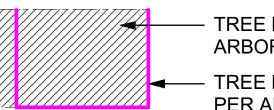

— TREE PROTECTION ZONE AS PER ARBORISTS REPORT.

— TREE PROTECTION FENCING AS PER ARBORISTS REPORT.

REFER TO ARBORISTS REPORT FOR ADDITIONAL INFORMATION.

DRAWING NOTES

- 1. DO NOT SCALE DRAWING: Verify all property lines and existing
- structures/vegetation to remain, prior to commencing work.

 2. All plan dimensions in metres and all detail dimensions in millimetres.
- 3. Plant quantities on Plans shall take precedence over plant list quantities.
- 4. Contractor to confirm location and elevation of all existing services and utilities prior to start of construction.
- 5. Provide layout of all work for approval by Landscape Architect prior to
- proceeding with work.
- 6. Contractor to provide irrigation system for all planters to current IIABC Standards and Contract Specifications.
- 7. Landscape installation to carry a 1 year warranty from date of acceptance.
- 8. Plant material, installation and maintenance to conform to the current
- edition of the Canadian Landscape Standard. 9. General Contractor and/or sub-contractors are responsible for all costs related to production and submission to consultant of all landscape as-built information including irrigation.
- 10. Tree protection fencing, for existing trees, to be installed prior to commencement of all site work



NOT FOR CONSTRUCTION

4	DP REV.3	25 JAN. 202
3	DP REV.2	13 OCT. 202
2	DP REV.1	30 JUNE 202
1	DP	20 FEB. 202
rev no	description	date
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CUBE DEVELOPMENTS 2272 MILLSTREAM ROAD

VICTORIA, BC


3120 WASHINGTON AVENUE DEVELOPMENT VICTORIA, BC

sheet title

Tree Preservation Plan

project no.		120.03
scale	1:125	@ 24"x36"
drawn by		MDI
checked by		SM/PdG
revison no.	sheet no.	
4		1.02



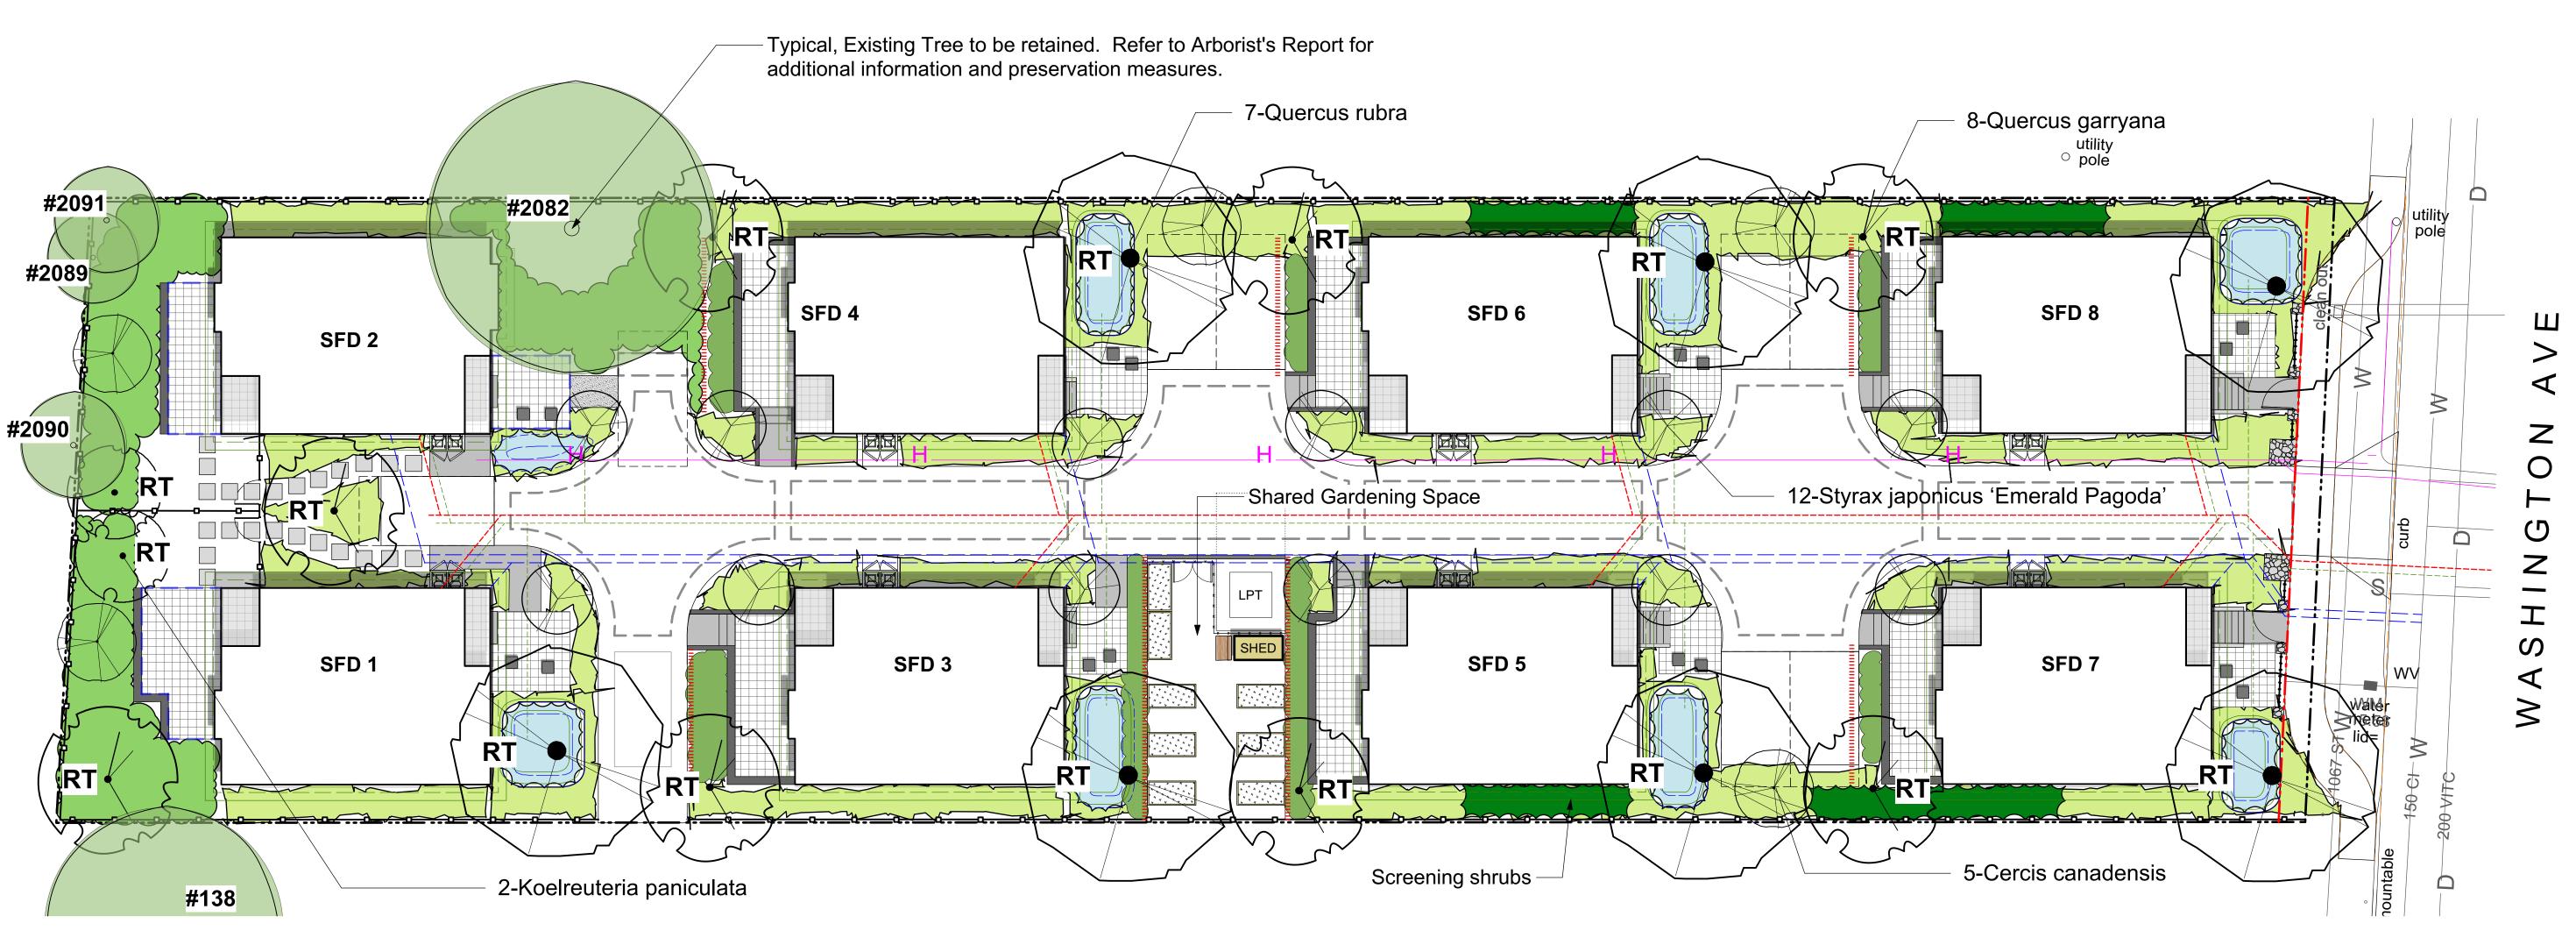

LEGEND

Hedge Plantings

sq. m.

Hybrid Yew (Taxus x media)

Boxwood (Buxus microphylla)

Rain Garden Plantings

Recommended Species:

Privet honeysuckle (Lonicera pileata)

Black-Eyed Susan (Rudbeckia fulgida)

Tall Verbena (Verbena bonariensis)

PROPOSED VEGETATION

PLANT LIST						
Sym Qty TREES:	Botanical Name	Common Name	chd. Size / Plant Spacing			
5	Cercis canadensis	Eastern Redbud	5.0cm cal, b&b			
2	Koelreuteria paniculata	Panicled Goldenraintree	5.0cm cal, b&b			
8	Quercus garryana	Garry Oak	5.0cm cal, b&b			
7	Quercus rubra	Red Oak	6.0cm cal, b&b			
12	Styrax japonicus 'Emerald Pagoda'	Japanese Snowbell	5.0cm cal, b&b			
0						

Total area approx. 77 sq m. Planting areas planted @ 2 x #3 pots /

Carman's Grey Blue Rush(Juncus patens 'Carman's Grey')


Crimson Flag (Schizostyiis coccinea 'Oregon Sunset')



Naturalized Shrub Plantings

Total area approx. 90 sq m. Planting areas planted @ 1 x #5 pot OR 2 x #3 pots OR 3 x #1 pots / sq. m.

Recommended Species: Sword fern (*Polystichum munitum*) Oregon Grape (Mahonia aquifolium) Salal (Gaultheria shallon) Red Flowering Current (Ribes sanguineum) Nootka Rose (Rosa nutkana) Snowberry (Symphoricarpos albus) Evergreen huckleberry (Vaccinium ovatum)

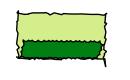

Mixed Shrub and Perennial Plantings

Total area approx. 340 sq m. Planting areas planted @ 2 x #3 pots OR 3 x #1 pots / sq. m.

Recommended Species:

Rose Creek Abelia (Abelia x chinensis 'Rose Creek')

Glacier Azalea (Azalea japonica 'Glacier')

Beautyberry (Callicarpa bodinieri var. giraldii Profusion')

Sageleaf Rockrose (Cistus salviifolius)

Witchhazel (Hamamelis mollis)

Strawberry Tree (*Arbutus Unedo*)

Barrenwort (Epimedium x rubrum)

Newport Dwarf Escallonia (Escallonia 'Newport Dwarf')

Topiarist's hebe (Hebe topiaria)

Lily turf (Liriope muscari)

Sword Fern (Polystichum munitum)

Soft Shield Fern (Polystichum setiferum)

RAIN WATER MANAGEMENT NOTES

Water collected from building roofs flow to the rain gardens located throughout the site or to permeable payment in drive aisle.

The rain gardens are sized such that the bottom of the rain garden is a minimum of 5% of the impervious area. Rain gardens will be designed with underdrains and a high capacity overflow drain that will be connected to the onsite piped drainage system.

Permeable paving is used to manage onsite vehicular impervious surfaces. All paths and where possible, residential patios will be drained towards absorbent landscape areas or rain gardens.

PLANTING RATIONALE

IRRIGATION AND LIGHTING NOTES

root zone (PRZ) of existing trees.

1. Contractor to field fit irrigation system around existing trees, to limit disturbance

construction. Sleeving shall extend 300 mm from edge of paving into planting

area, and shall have ends marked above grade unless otherwise shown on

Arborist to review (prior to installation) sleeving of irrigation lines in protected

Placement of electrical conduit through site to be coordinated with arborist.

Arborist to be onsite and supervise all excavation/trenching within PRZ of

2. Sleeves shall be installed at the necessary depths, prior to pavement

The planting plan is designed to meet the City's Food-Bearing, Pollinator and Native Plant Landscape Design Guidelines and offers a variety of ornamental and amenity planting areas with native and appropriate non-native species that are adapted to site conditions, climate and design intent and provide pollinator habitat.

SHARED GARDENING SPACE

The site plan includes a shared gardening space that includes one raised gardening box per dwelling unit, a small shed and potting area.

GENERAL PLANTING NOTE

1. Plant quantities and species may change between issuance of DP and Construction due to plant availability and design changes.

- 1. Grass boulevard shall be in accordance with the Subdivision and Development Servicing Bylaw.
- 2. Landscape within boulevard areas to be irrigated (unless otherwise indicated). 3. Boulevard irrigation point of connection to be 19 mm service, refer to Civil drawings for location Water meter and timer/controller, that is separate from building, to be provided at point of
- connection. Timer/controller for boulevard areas must be readily accessible to municipal staff. 4. Design and installation of boulevard irrigation system to meet current IIABC and Municipal Specifications.
- 5. Design/build drawings for boulevard irrigation to be submitted to Landscape Architect in PDF and .dwg formats, at least two weeks prior to commencement of irrigation installation and will be
- 6. Boulevard irrigation to be inspected as per municipal specification by municipal staff. Boulevard irrigation system will be maintained and operated by municipality, after it is inspected and approved by municipal staff.

ONSITE TREE PLANTING NOTES

1. Trees are placed to avoid existing and proposed infrastructure. Trees planted within 1m of an underground service will have a root barrier installed between the root ball and the infrastructure. Final coordination of trees in relation to site servicing to be completed at the BP phase.

NOT FOR CONSTRUCTION

4	DP REV.3	25 JAN. 202
3	DP REV.2	13 OCT. 202
2	DP REV.1	30 JUNE 202
1	DP	20 FEB. 202
rev no	description	date





CUBE DEVELOPMENTS

2272 MILLSTREAM ROAD VICTORIA, BC

3120 WASHINGTON AVENUE DEVELOPMENT

sheet title


VICTORIA, BC

Planting Plan

120.03 project no. 1:125

@ 24"x36" scale drawn by SM/PdG checked by revison no. 4 L3.01



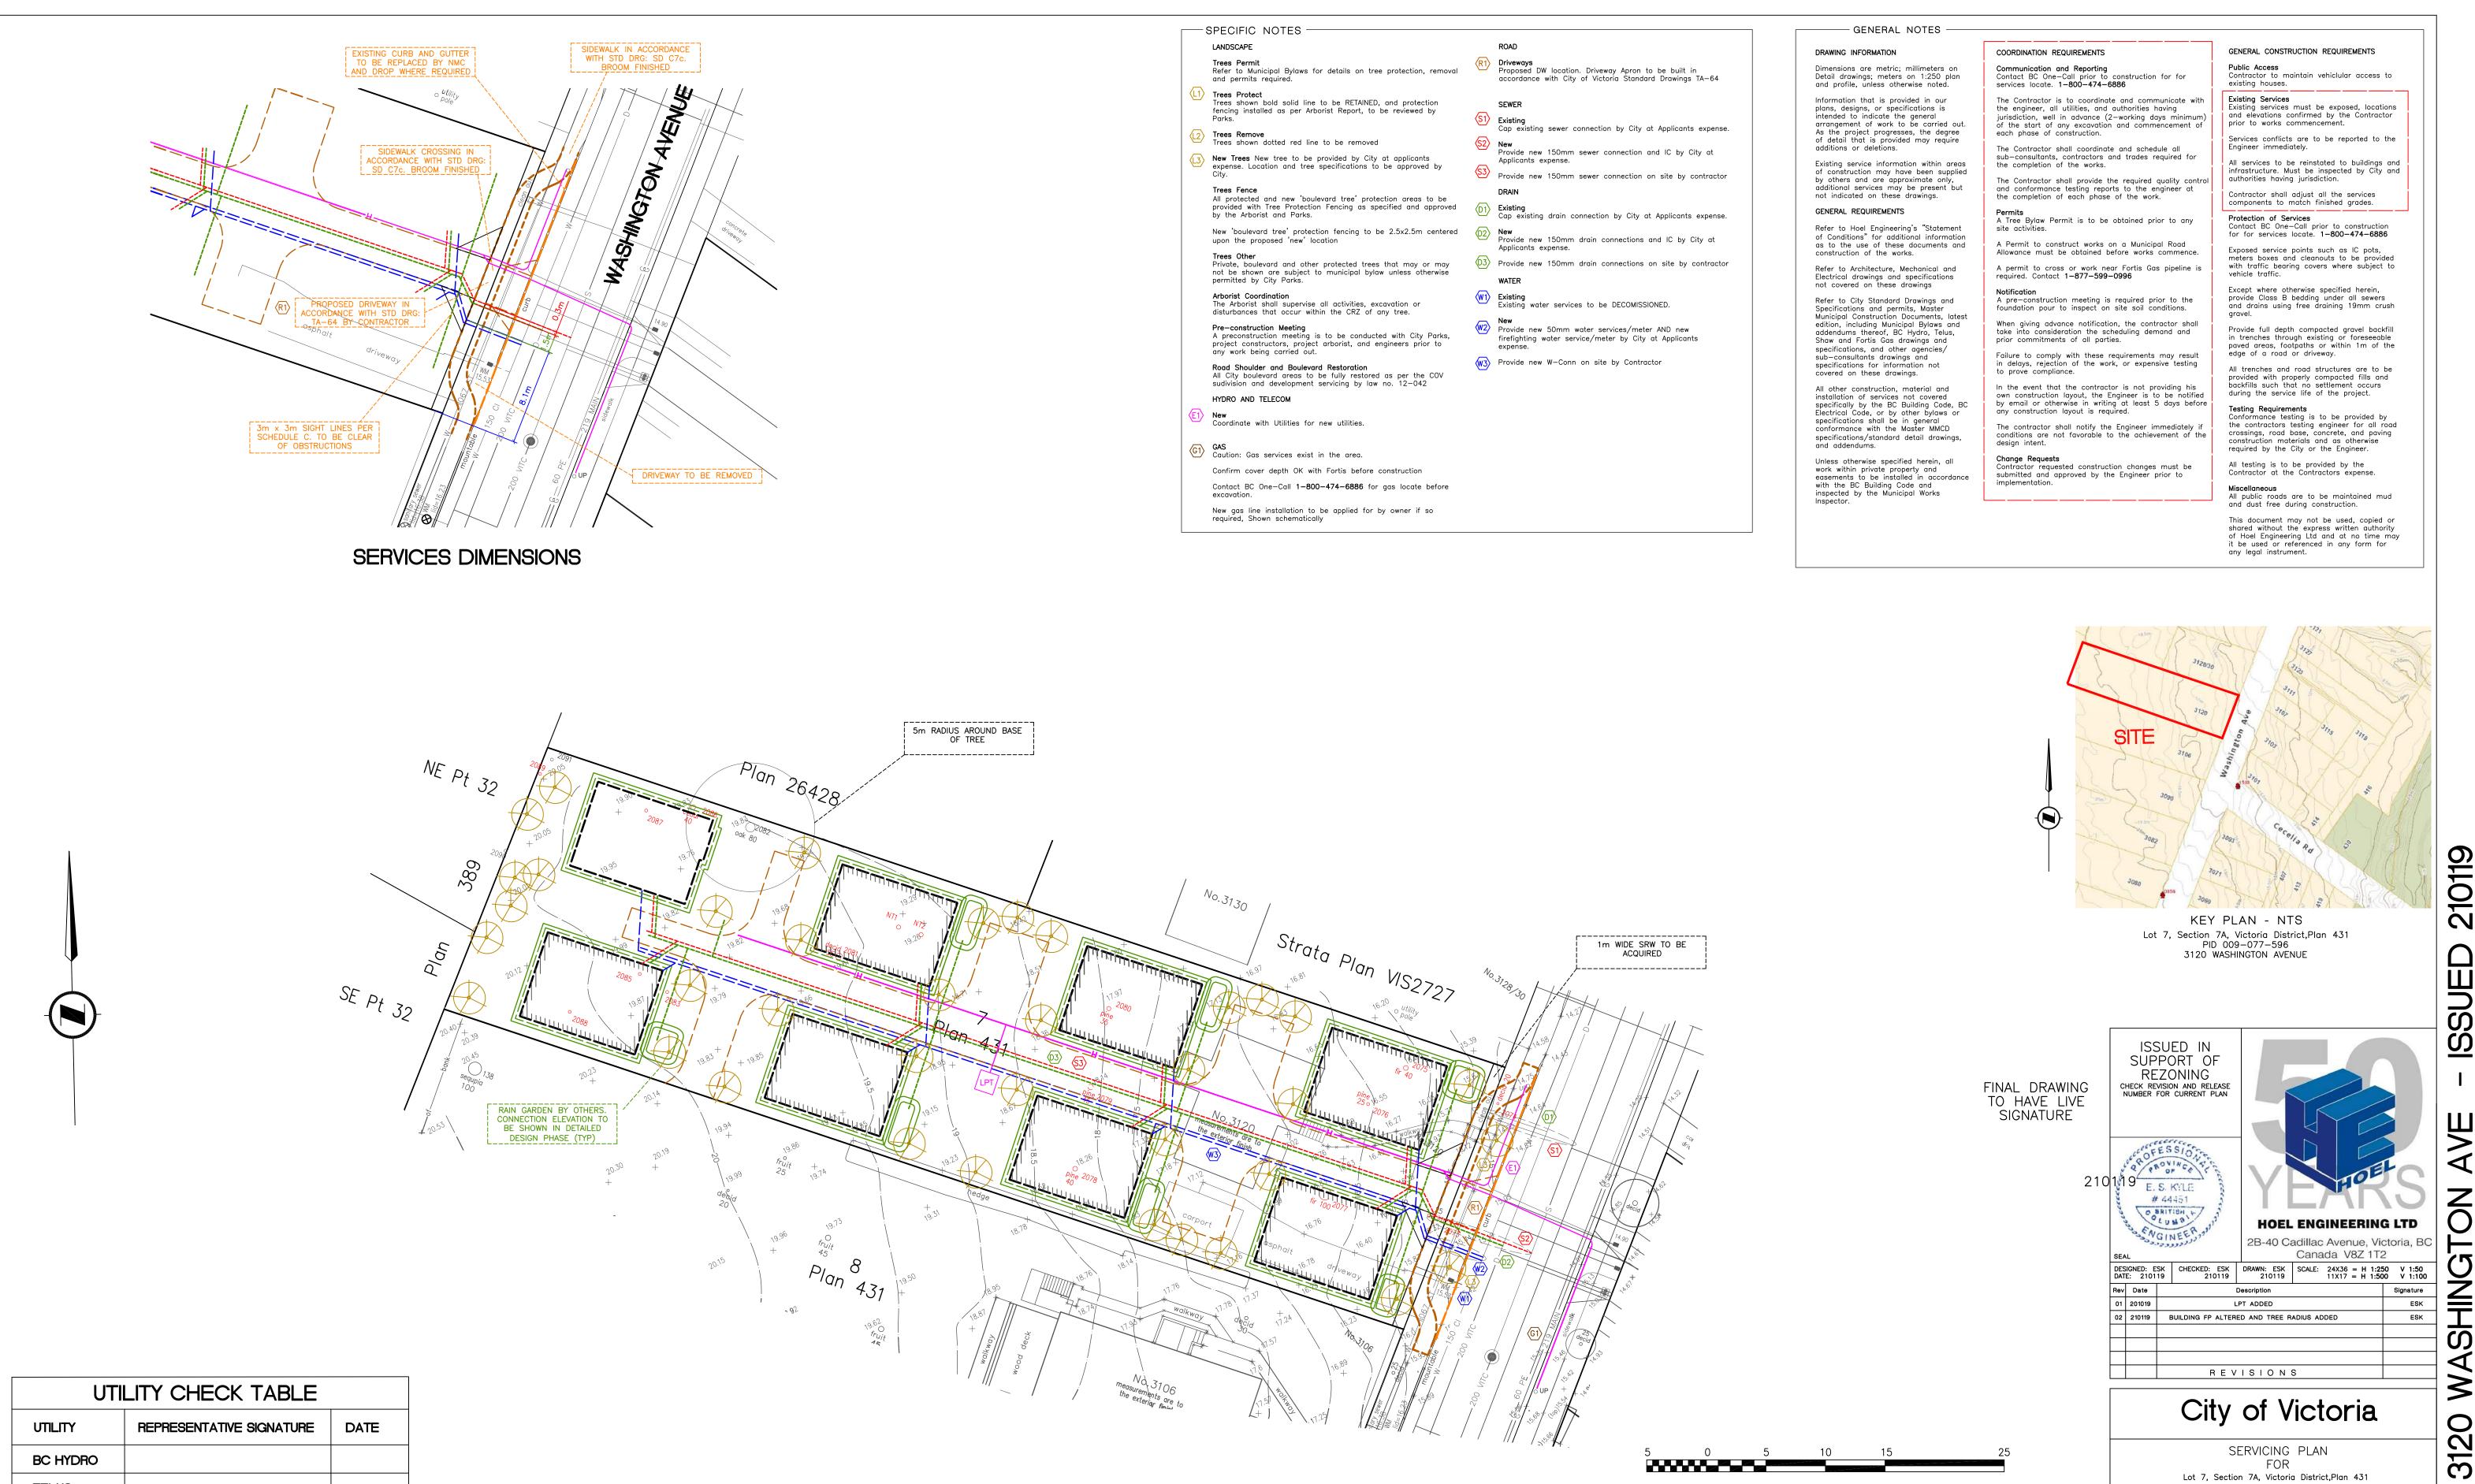

TELUS

SHAW

FORTIS BC

CITY OF VICT


210119 **ISSUED** SHING \forall


3120 WASHINGTON AVENUE

CV2007

FOR Lot 7, Section 7A, Victoria District,Plan 431

> **C1.1** | of 1 DESTROY PRINTS BEARING EARLIER RELEASE No.

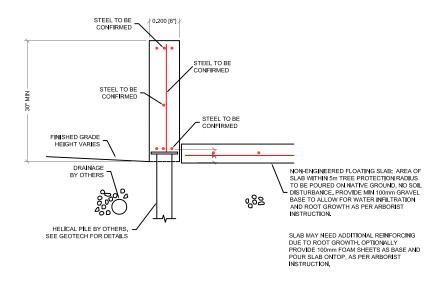

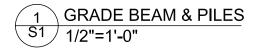





HOEL ENGINEERING LTD

2B-40 CADILAC AVE VICTORIA B.C. Phone (250) 475-6906 ekyle@hoel.bc.ca

CITY OF VICTORIA

project title

3 | 20 WASHINGTON STREET Victoria, BC

210118

sheet title

GENERAL Details

scale	drawn	sheet no.
As shown	ESK	C V
date	project no.	3-A
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