1551 & 1545 BAY | 1551 & 1545 BAY ST

PROJECT NUMBER: 2403

CONTACTS

LOCULED FOR DEZONUNG & DEVEL ORMENT DEDMIT. OZ JANULADY OGGE

ISSUED FOR RE	ZONING & DEV	'ELOPMENT PEF	RMIT - 27 JAN	NUARY 2025

LIENT	LIDA HOMES INC.
	6105 PATRICIA BAY HWY.
	VICTORIA, BC V8Y 15T
	CONT: DAVE STEPHENS

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CALID ENGINEERING + LANDSCAPE DESIGN

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EMAIL: engineer@calid.ca

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EVOKE ENVELOPE

SUITE 102 - 814 BROUGHTON ST

VICTORIA, BC V8W 1E4 **CONT: CHRIS RAUDOY** TEL: 250-415-8141

EMAIL: craudoy@EvokeBuildings.com



ARCHITECTURAL

COVER A000 A001 CODE COMPLIANCE A002 AREA CALCULATIONS AREA CALCULATIONS A003 SPATIAL SEPARATION A004

A005 SHADOW STUDY AND STREETSCAPE A101 **EXISTING SITE PLAN**

A102 PROPOSED SITE PLAN A201 LEVEL 1 PLAN A202 LEVEL 2-4 PLAN A203 LEVEL 5 PLAN A204 **ROOF PLAN** A211 **UNIT PLANS ELEVATIONS** A301 **ELEVATIONS** A302

A303 **DESIGN RATIONALE** RENDERINGS A304 A305 MATERIAL BOARD SECTIONS A401

SECTIONS A402 A403 SECTIONS SECTIONS A404

ELECTRICAL

E100 SITE PLAN, DETAILS, AND LEGEND

E101 SINGLE LINE DIAGRAM E102 **ROOF - ELECTRICAL LAYOUT**

CIVIL


CONCEPT SITE SERVICING PLAN AND NOTES C01

GRADING PLAN AND SECTIONS C02


LANDSCAPE

LANDSCAPE PLAN AND NOTES L01 L02 PLANTING PLAN AND NOTES



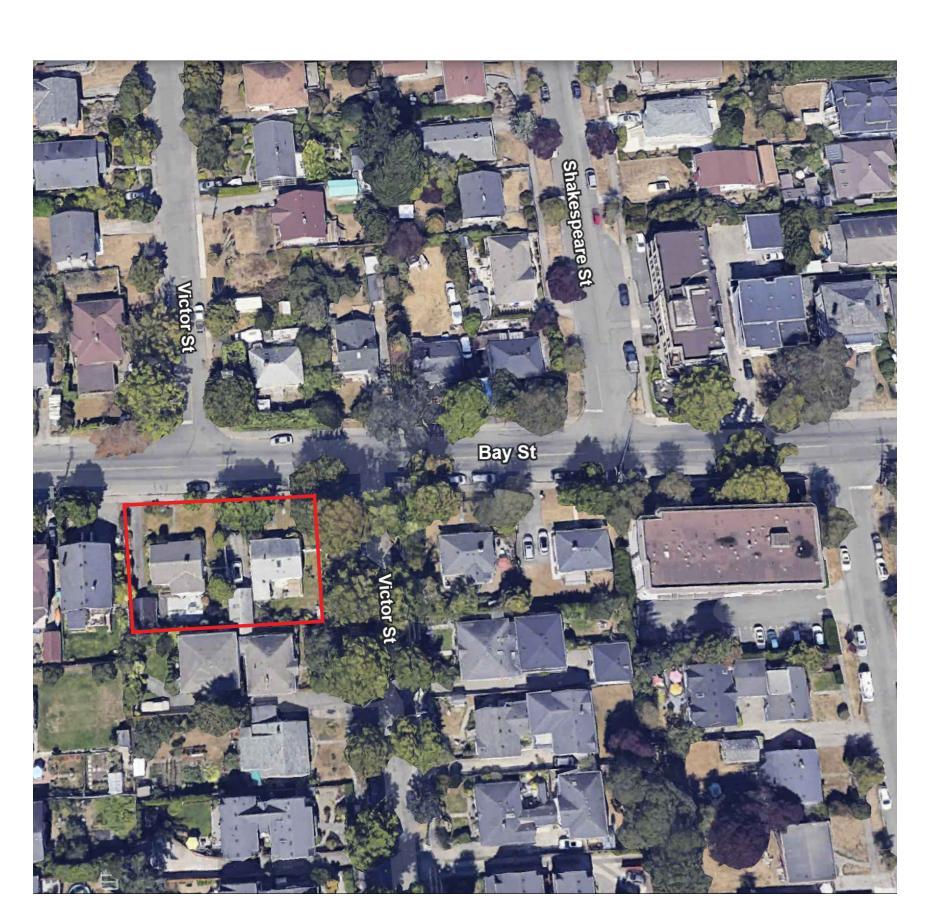




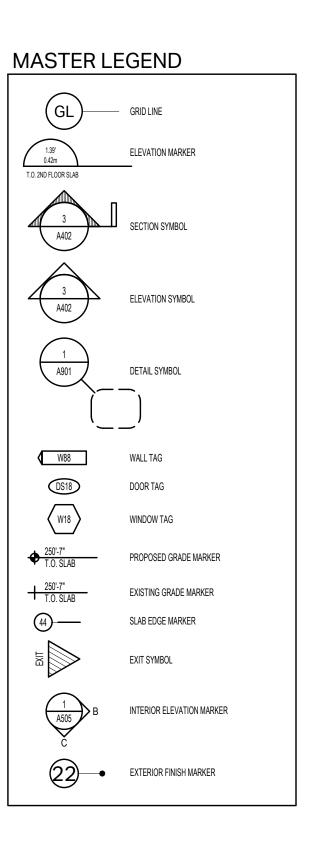



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4		
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NO.	REVISION	M/D/Y
PRO	JECT NAME	

1551 & 1545 BAY ST VICTORIA, BC

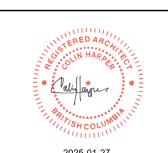PROJECT ADDRESS:


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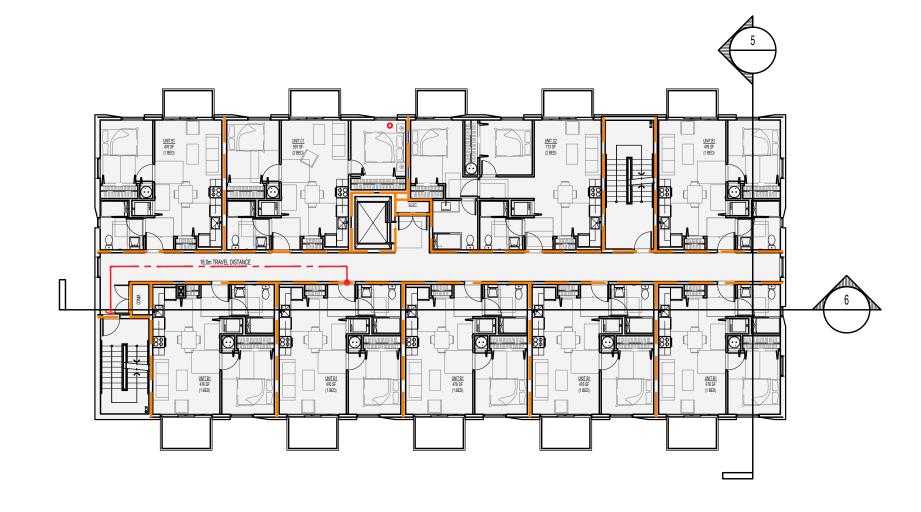



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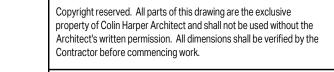
COVER PAGE

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SCALE:	N/A	REVIEW BY:	СН
PROJECT NO:	2403	DRAWN BY:	LG





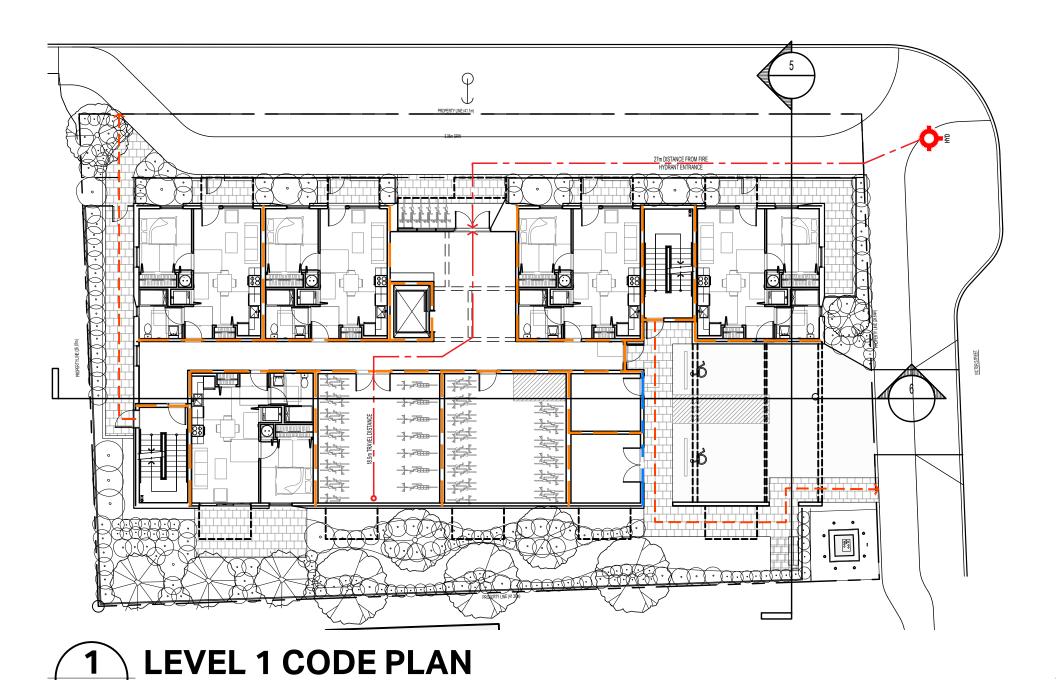

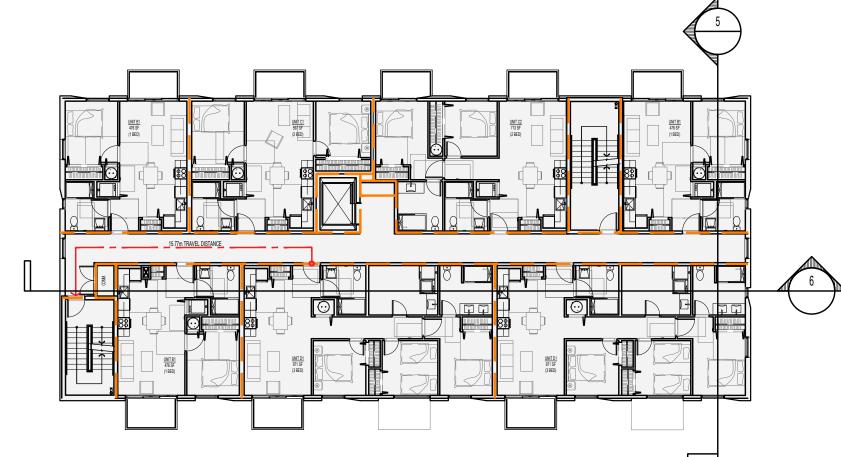



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FILE PROVIDED BY THE ARCHITECT. MAX. TRAVEL DISTANCE IS 45m. SEE BCBC 3.4.2.5.

THE MINIMUM DISTANCE BETWEEN EXITS SHOULD BE 9m. SEE BCBC 3.4.2.3.

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ISSUED FOR REZONING & DEVELOPMENT PERMIT REVISION PROJECT NAME

1551 & 1545 BAY ST VICTORIA, BC

PROJECT ADDRESS:

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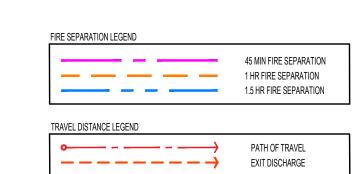


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CODE COMPLIANCE


PROJECT NO: 2403 DRAWN BY: AS NOTED REVIEW BY: DRAWING NO: A001


LEVEL 2-4 CODE PLAN



LEVEL 5 CODE PLAN

ROOF LEVEL CODE PLAN

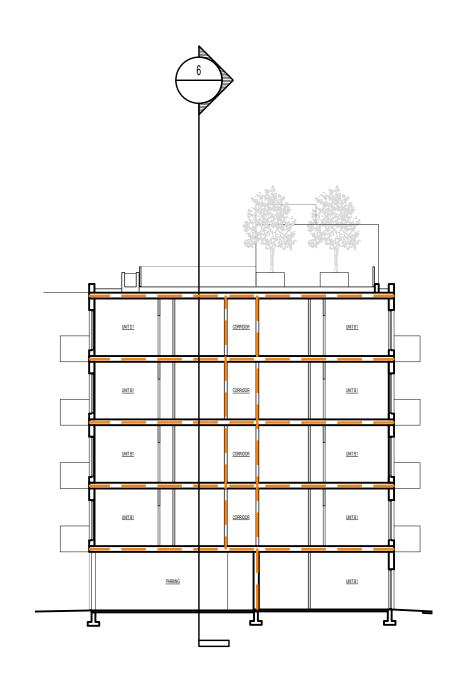

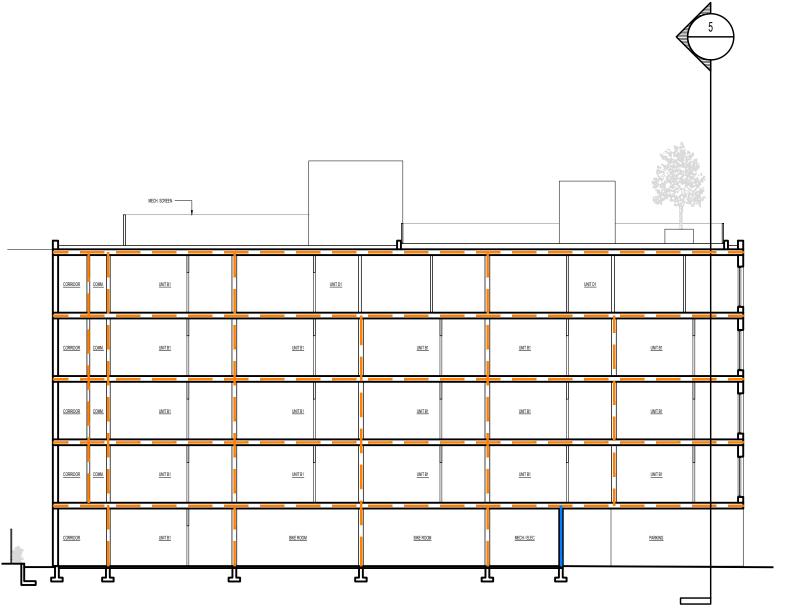

CODE SECTION

6 CODE SECTION

CODE ANALYSIS BC BUILDING CODE 2024 PR. #: 2304 DATE: 27-Jan-25

PROJECT DESCRIPTION 5-STOREY BUILDING OF WOOD FRAME COMBUSTIBLE CONSTRUCTION

TYPE OF WORK NEW CONSTRUCTION BASIS FOR CODE ANALYSIS PART 3 PER 1.3.3.2.(1)(c)(i)

BUILDING SIZE AND CONSTRUCTION

GOVERNING ARTICLE 3.2.2.51 PER 3.2.2.51.(d)(vi) GROUP C MAJOR OCCUPANCIES OCCUPANT LOAD PER 3.1.17.1.(1)(b) **BUILDING AREA** BUILDING HEIGHT (STOREYS) SPRINKLERED NFPA 13 - PER 3.2.2.51.(1)(a) & 3.2.5.12.(1)

COMBUSTIBLE OR NONCOMBUSTIBLE

PARKING STRUCTURES CONSIDERED AS SEPARATE BUILDINGS: TYPE OF CONBSTRUCTION PERMITTED

OTHER SAFETY REQUIREMENTS STANDPIPE & HOSE SYSTEM


YES (REQUIRED PER 3.2.5.8.(1)(a) LIMITING DISTANCE UNPROTECTED OPENINGS ARE IN COMPLIANCE. SEE SHEET A004 FIREFIGHTING ACCESS ROUTES COMPLIANT PER BCBC 3.2.5.5 PER 3.3.4.3.(1) STORAGE ROOM SPRINKLERS


REQUIRED FIRE SEPARATION / FIRE-RESISTANCE RATINGS


FRR BETWEEN SUITES PER 3.3.1.1.(1) FRR BETWEEN COMMERCIAL AND RESIDENTIAL PER 3.1.3.1.(1) FRR OF FLOOR ASSEMBLIES PER 3.2.2.51.(2)(a) FRR OF ROOF ASSEMBLIES PER 3.2.2.51.(2)(b) FRR BTW BIKE ROOM AND REMAINDER OF BUILDING PER 3.3.4.3.(2) FRR BTW STORAGE ROOM AND RESIDENTIAL PER 3.3.4.3.(2) FRR BTW ELECTRICAL ROOM AND REMAINDER OF BUILDING PER 3.6.2.1.(6) FRR BTW GARBAGE ROOM AND REMAINDER OF BUILDING PER 3.6.2.5

ACCESSIBILITY REQUIREMENTS

REQUIREMENTS FOR PERSON WITH DISABILITIES PER 3.8.2.1.(1)(b) AND ACCESSIBILE DESIGN REQUIREMENTS PER 3.8.3 REQUIREMENTS FOR ADAPTABLE DWELLING UNITS PER 3.8.5.1 ADAPTABLE DWELLING UNIT AND BUILDING ACCESS REQUIREMENTS

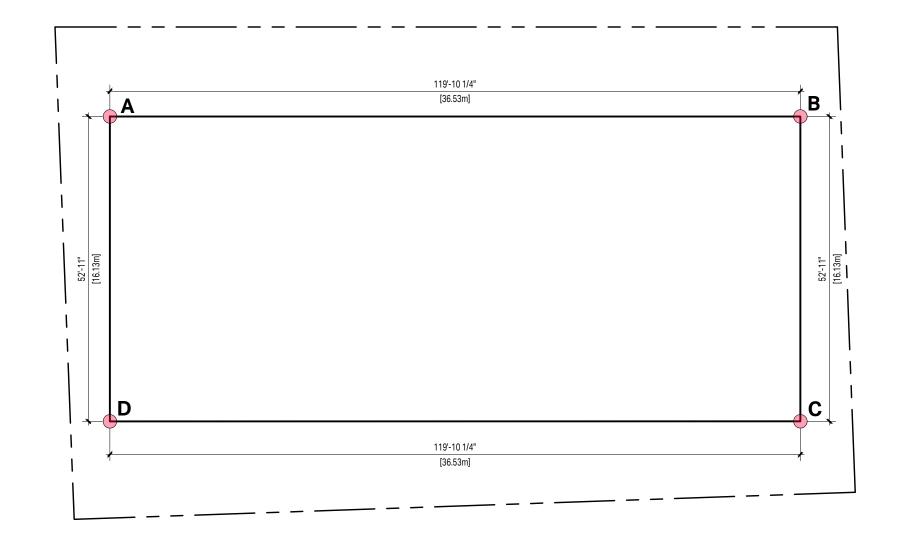

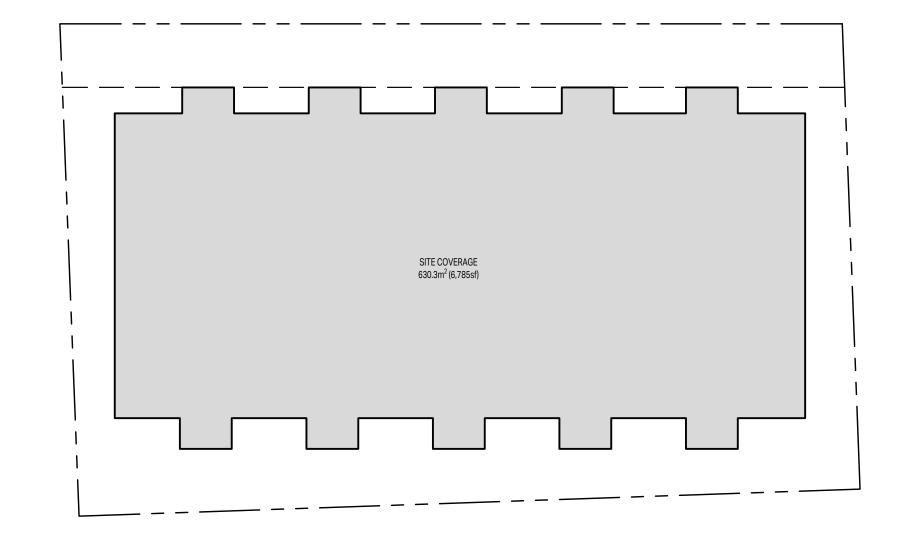

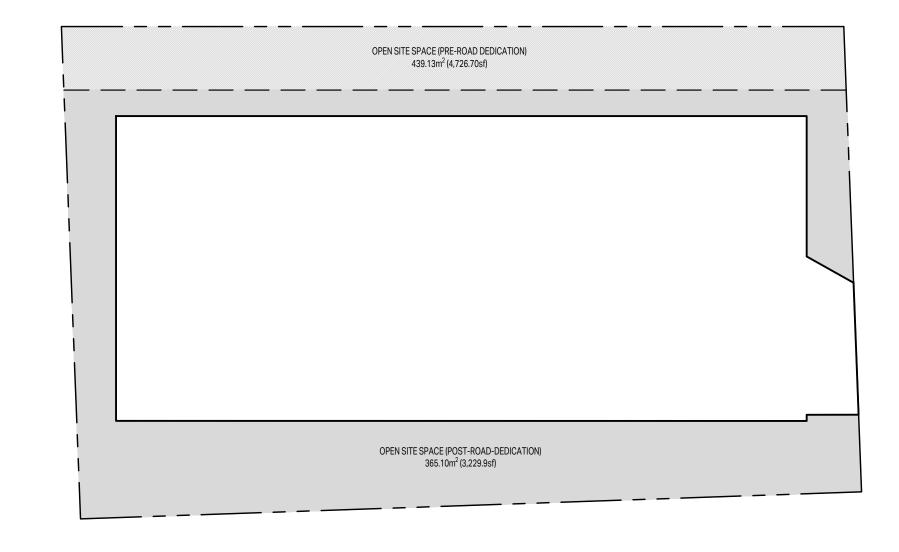



SITE COVERAGE



ZONING GRADE CALCULATION

GR/	ADE POINT	'S (m)		LENGTH (m)	GRADE CALCS	
Α	20.00	В	20.33	36.39	(20 + 20.33) ÷ 2 x 36.39m =	733.80
В	20.33	С	20.24	16.13	(20.33 + 20.24) ÷ 2 x 16.13m =	327.20
С	20.24	D	20.24	36.39	(20.24 + 20.24) ÷ 2 x 36.39m =	736.53
D	20.24	Α	20.00	16.13	(20.24 + 20) ÷ 2 x 16.13m =	324.54
TO	TALŞ			105.04		2122.07
AV	ERAGE GRA	ADE				20.20

Grade Points Existing Proposed Grade 20.33 20.33 20.33 Point B



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VICTORIA, BC V8Y 1T5

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Contractor before commencing work.

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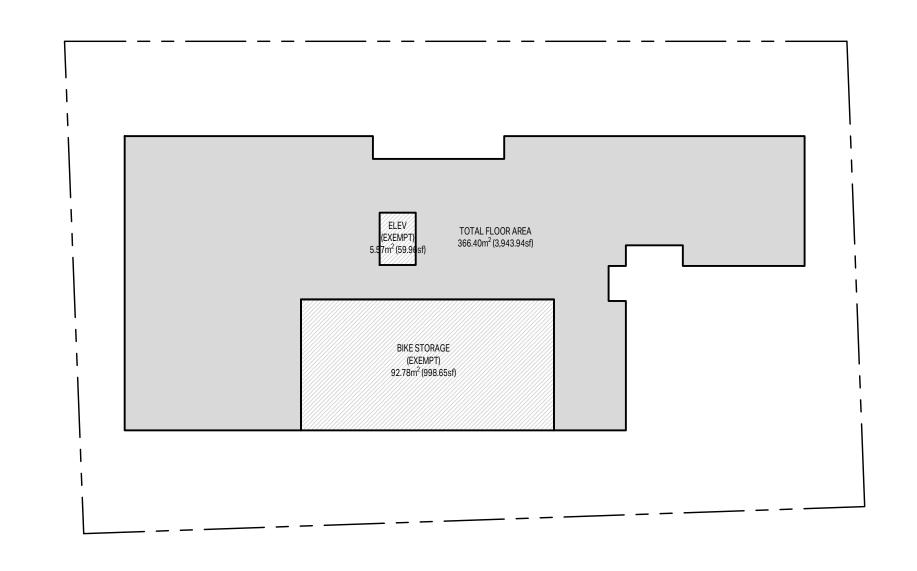



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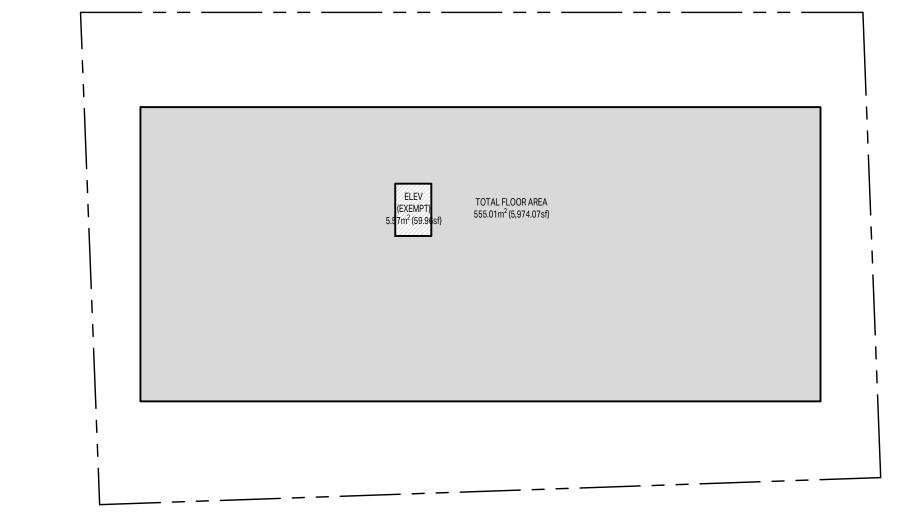
AREA CALCULATIONS

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SCALE:	1:200	REVIEW BY:	СН

DRAWING NO: A002






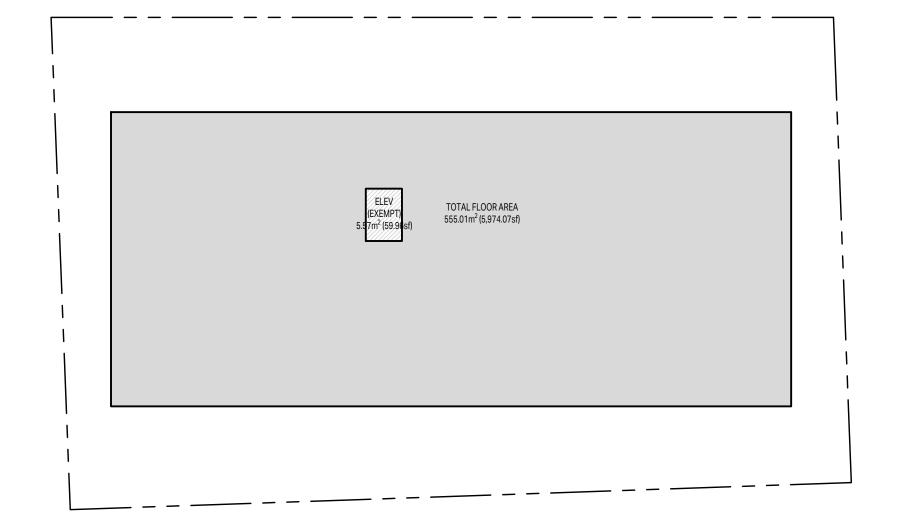









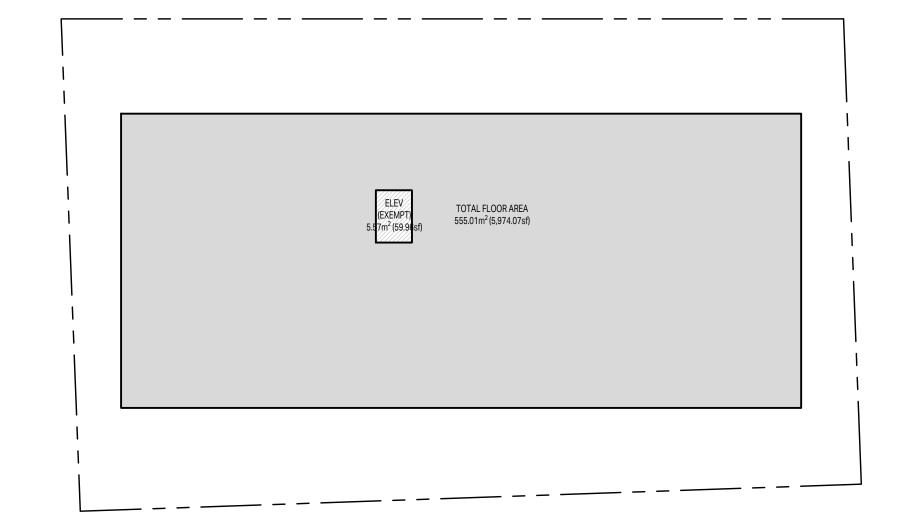

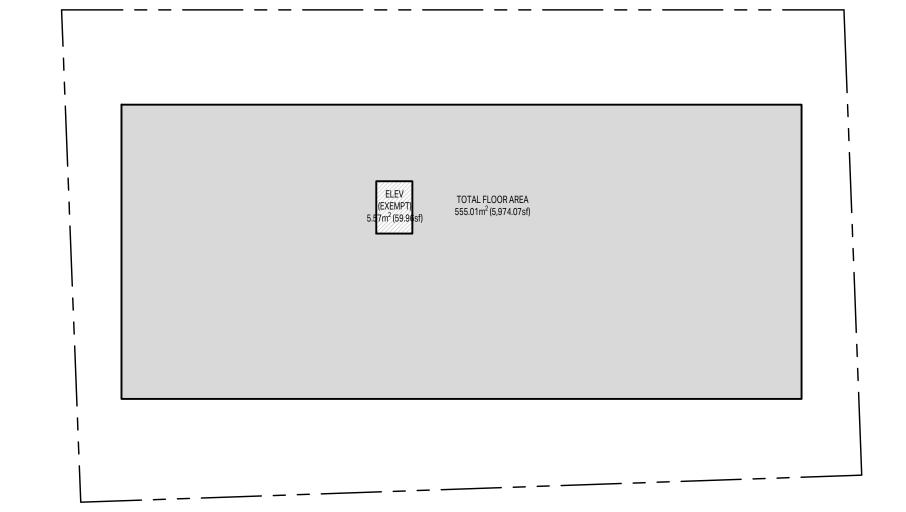


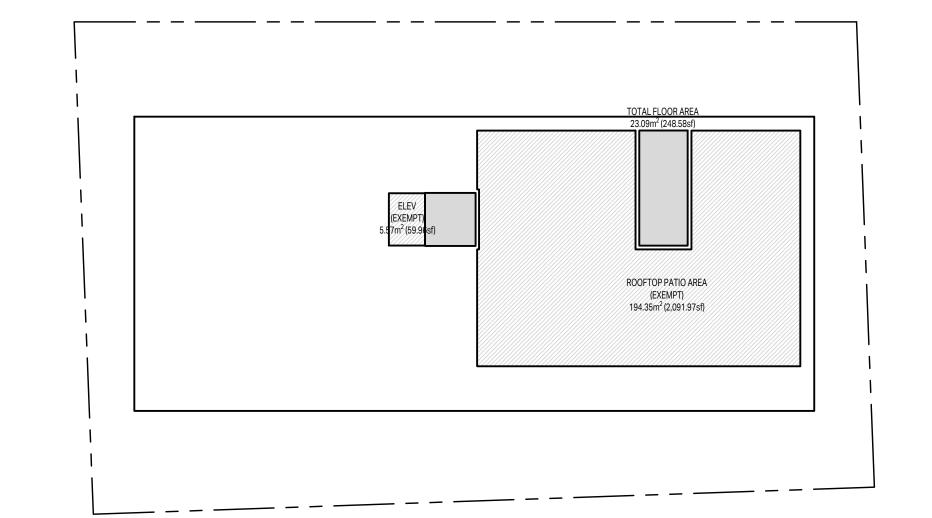









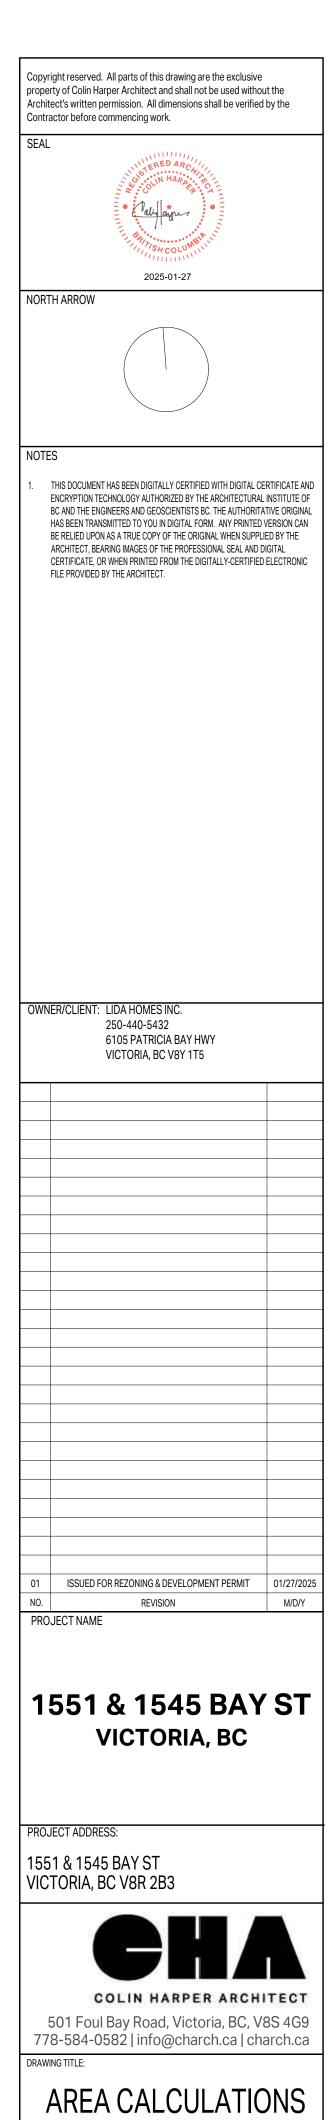

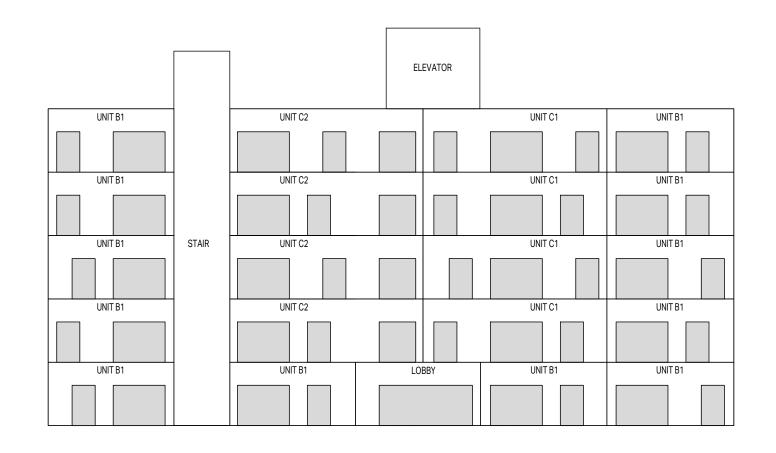


UNIT B1 SPATIAL SEPARATION CALCULATION BCBC 2024 PART 3 TABLE 3.2.3.1D	UNIT C1 SPATIAL SEPARATION CALCULATION BCBC 2024 PART 3 TABLE 3.2.3.1D	UNIT C2 SPATIAL SEPARATION CALCULATION BCBC 2024 PART 3 TABLE 3.2.3.1D	LOBBY SPATIAL SEPARATION CALCULATION BCBC 2024 PART 3 TABLE 3.2.3.1D
AREA OF EXPOSED BUILDING FACE: 22.4m² (241.6sq.ft) LIMITING DISTANCE: 14.79m (48.5ft) ALLOWABLE OPENINGS: 100% [22.4m² (241.6sq.ft)] PROPOSED OPENINGS: 34.7% [7.8m² (84.0sq.ft)]	AREA OF EXPOSED BUILDING FACE: 32.6m² (350.9sq.ft) LIMITING DISTANCE: 14.79m (48.5ft) ALLOWABLE OPENINGS: 100% [32.6m² (350.9sq.ft)] PROPOSED OPENINGS: 34.0% [11.1m² (119.0sq.ft)]	AREA OF EXPOSED BUILDING FACE: 34.3m² (368.9sq.ft) LIMITING DISTANCE: 14.79m (48.5ft) ALLOWABLE OPENINGS: 100% [34.3m² (368.9sq.ft)] PROPOSED OPENINGS: 36.7% [12.6m² (135.3sq.ft)]	AREA OF EXPOSED BUILDING FACE: 22.16m² (238.6sq.ft) LIMITING DISTANCE: 14.79m (48.5ft) ALLOWABLE OPENINGS: 100% [22.16m² (238.6sq.ft)] PROPOSED OPENINGS: 47.4% [10.51m² (113.2sq.ft)]
FIRE RESISTANCE RATING PER 3.2.3.7. 45 MIN. CLADDING PER 3.2.3.7. COMBUSTIBLE CONSTRUCTION PER 3.2.3.7. COMBUSTIBLE	FIRE RESISTANCE RATING PER 3.2.3.7. 45 MIN. CLADDING PER 3.2.3.7. COMBUSTIBLE CONSTRUCTION PER 3.2.3.7. COMBUSTIBLE	FIRE RESISTANCE RATING PER 3.2.3.7. 45 MIN. CLADDING PER 3.2.3.7. COMBUSTIBLE CONSTRUCTION PER 3.2.3.7. COMBUSTIBLE	FIRE RESISTANCE RATING PER 3.2.3.7. 45 MIN. CLADDING PER 3.2.3.7. COMBUSTIBLE CONSTRUCTION PER 3.2.3.7. COMBUSTIBLE

NORTH ELEVATION

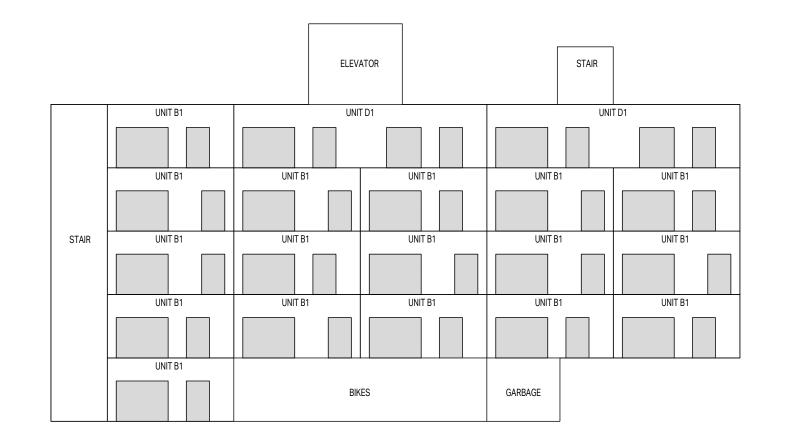


UNIT B1 SPATIAL SEPARATION CALCULATIO BCBC 2024 PART 3 TABLE 3.2.3:	•	UNIT D1 SPATIAL SEPARATION CALCULATIO BCBC 2024 PART 3 TABLE 3.2.3.	· · ·
AREA OF EXPOSED BUILDING FACE:	22.4m ² (241.6sq.ft)	AREA OF EXPOSED BUILDING FACE:	44.9m² (483.2sq.ft)
LIMITING DISTANCE:	3.43m (11.25ft)	LIMITING DISTANCE:	3.43m (11.25ft)
ALLOWABLE OPENINGS:	72.9% [16.3m ² (175.9sq.ft)]	ALLOWABLE OPENINGS:	47.5% [21.3m² (229.7sq.ft)]
PROPOSED OPENINGS:	37.7% [8.45m ² (91.0sq.ft)]	PROPOSED OPENINGS:	33.3% [14.96m² (161.0sq.ft)]
FIRE RESISTANCE RATING PER 3.2.3.7	. 45 MIN.	FIRE RESISTANCE RATING PER 3.2.3.7	7. 45 MIN.
CLADDING PER 3.2.3.7.	COMBUSTIBLE	CLADDING PER 3.2.3.7.	NONCOMBUSTIBLE
CONSTRUCTION PER 3.2.3.7.	COMBUSTIBLE	CONSTRUCTION PER 3.2.3.7.	COMBUSTIBLE



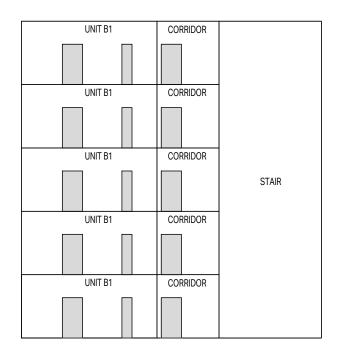


IIT B1		CORRIDOR		
ATIAL SEPARATION CALCULATION		SPATIAL SEPARATION	N CALCULATION	
BC 2024 PART 3 TABLE 3.2.3.1.	-D	BCBC 2024 PART 3	TABLE 3.2.3.1	D
EA OF EXPOSED BUILDING FACE:	24.1m ² (258.9sq.ft)	AREA OF EXPOSED BU	JILDING FACE:	11.0m ² (118.59sq.ft
/ITING DISTANCE:	2.0m (6.5ft)	LIMITING DISTANCE:		2.0m (6.5ft)
LOWABLE OPENINGS:	26.8% [6.4m ² (69.3sq.ft)]	ALLOWABLE OPENING	SS:	40.4% [4.4m ² (47.8sq.ft)]
OPOSED OPENINGS:	14.1% [3.4m ² (36.75sq.ft)]	PROPOSED OPENINGS	S:	20.6% [2.27m ² (24.5sq.ft)]
RE RESISTANCE RATING PER 3.2.3.7.	45 MIN.	FIRE RESISTANCE RAT	ING PER 3.2.3.7.	45 MIN.
ADDING PER 3.2.3.7.	NONCOMBUSTIBLE	CLADDING PER 3.2.3.7	'.	NONCOMBUSTIBLE
NSTRUCTION PER 3.2.3.7.	COMBUSTIBLE	CONSTRUCTION PER:	3.2.3.7.	COMBUSTIBLE

EAST ELEVATION

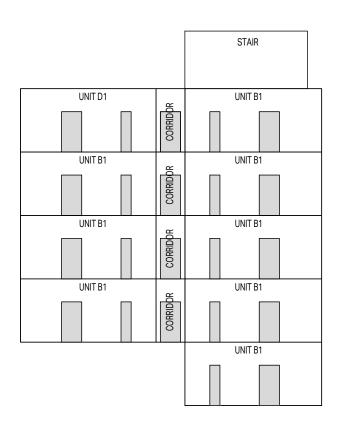


UNIT B1 SPATIAL SEPARATION CALCULATION BCBC 2024 PART 3 TABLE 3.2.3.1.		UNIT D1 SPATIAL SEPARATION CALCULATION BCBC 2024 PART 3 TABLE 3.2.3.1.		CORRIDOR SPATIAL SEPARATION CALCULATION BCBC 2024 PART 3 TABLE 3.2.3.1.	
AREA OF EXPOSED BUILDING FACE:	24.1m ² (258.9sq.ft)	AREA OF EXPOSED BUILDING FACE:	24.1m ² (258.9sq.ft)	AREA OF EXPOSED BUILDING FACE:	5.1m ² (55.0sq.ft)
LIMITING DISTANCE:	11.3m (37.0ft)	LIMITING DISTANCE:	11.3m (37.0ft)	LIMITING DISTANCE:	11.3m (37.0ft)
ALLOWABLE OPENINGS:	100% 24.1m ² (258.9sq.ft)	ALLOWABLE OPENINGS:	100% 24.1m ² (258.9sq.ft)	ALLOWABLE OPENINGS:	100% 5.1m ² (55.0sq.ft)
PROPOSED OPENINGS:	14.1% [3.4m ² (36.75sq.ft)]	PROPOSED OPENINGS:	14.1% [3.4m ² (36.75sq.ft)]	PROPOSED OPENINGS:	44.5% [2.27m ² (24.5sq.ft)]
FIRE RESISTANCE RATING PER 3.2.3.7.	N/A	FIRE RESISTANCE RATING PER 3.2.3.7.	N/A	FIRE RESISTANCE RATING PER 3.2.3.7.	N/A
CLADDING PER 3.2.3.7.	COMBUSTIBLE	CLADDING PER 3.2.3.7.	COMBUSTIBLE	CLADDING PER 3.2.3.7.	COMBUSTIBLE
CONSTRUCTION PER 3.2.3.7.	COMBUSTIBLE	CONSTRUCTION PER 3.2.3.7.	COMBUSTIBLE	CONSTRUCTION PER 3.2.3.7.	COMBUSTIBLE



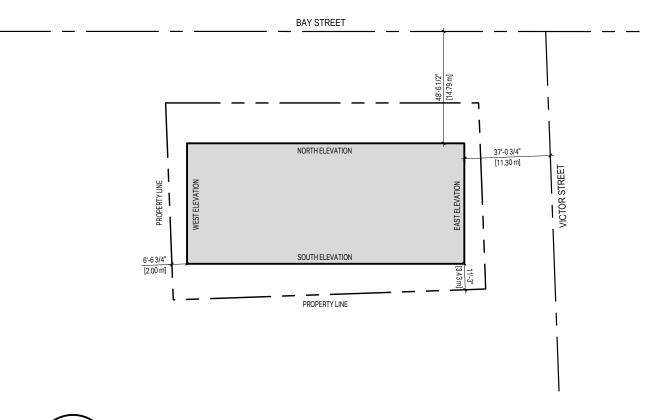




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01	ISSUED FOR REZONING & DEVELOPMENT PERMIT	01/27/202
NO.	REVISION	M/D/Y

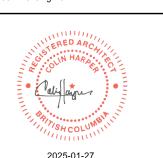1551 & 1545 BAY ST **VICTORIA, BC**

PROJECT ADDRESS:

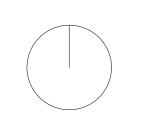1551 & 1545 BAY ST VICTORIA, BC V8R 2B3





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SPATIAL SEPARATION


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PROJECT NO: 2403 DRAWN BY: LG	CT NO:	PROJECT NO:







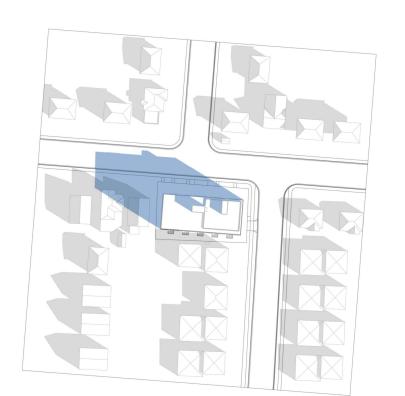

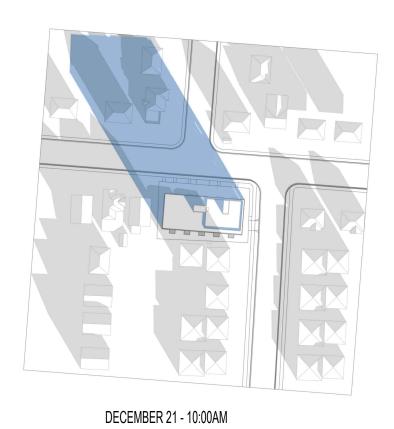
MARCH / SEPTEMBER 21 - 9:00AM

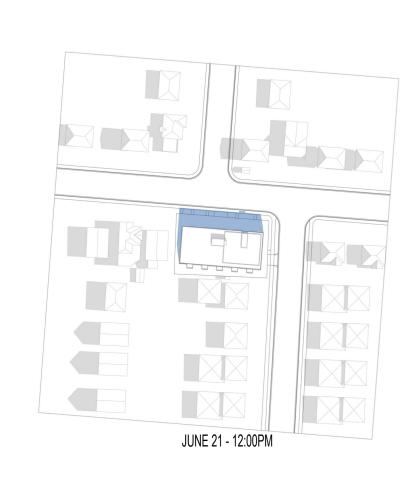


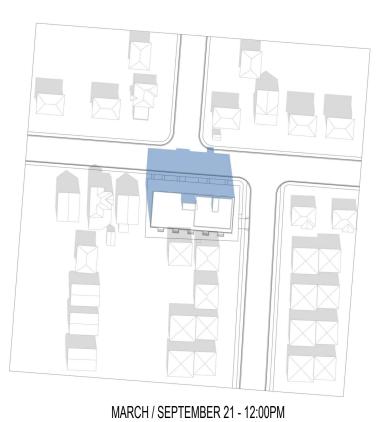

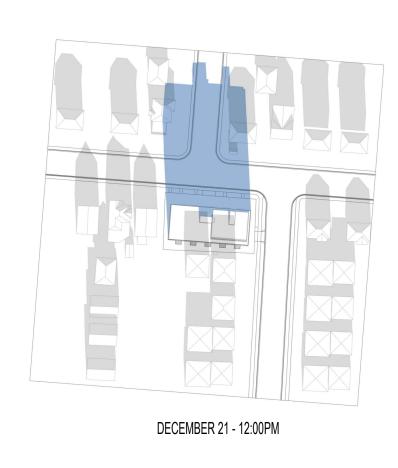



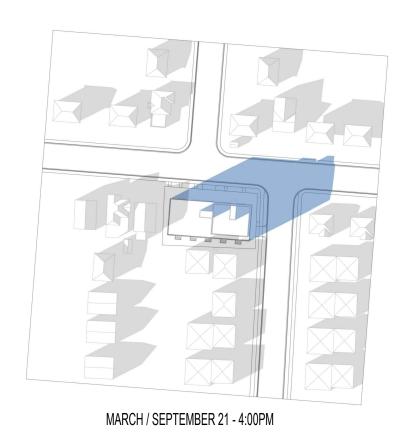

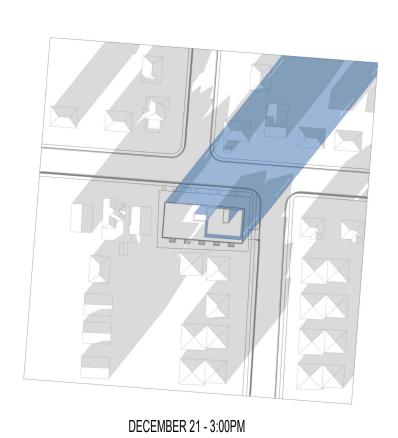











VICTOR ST.

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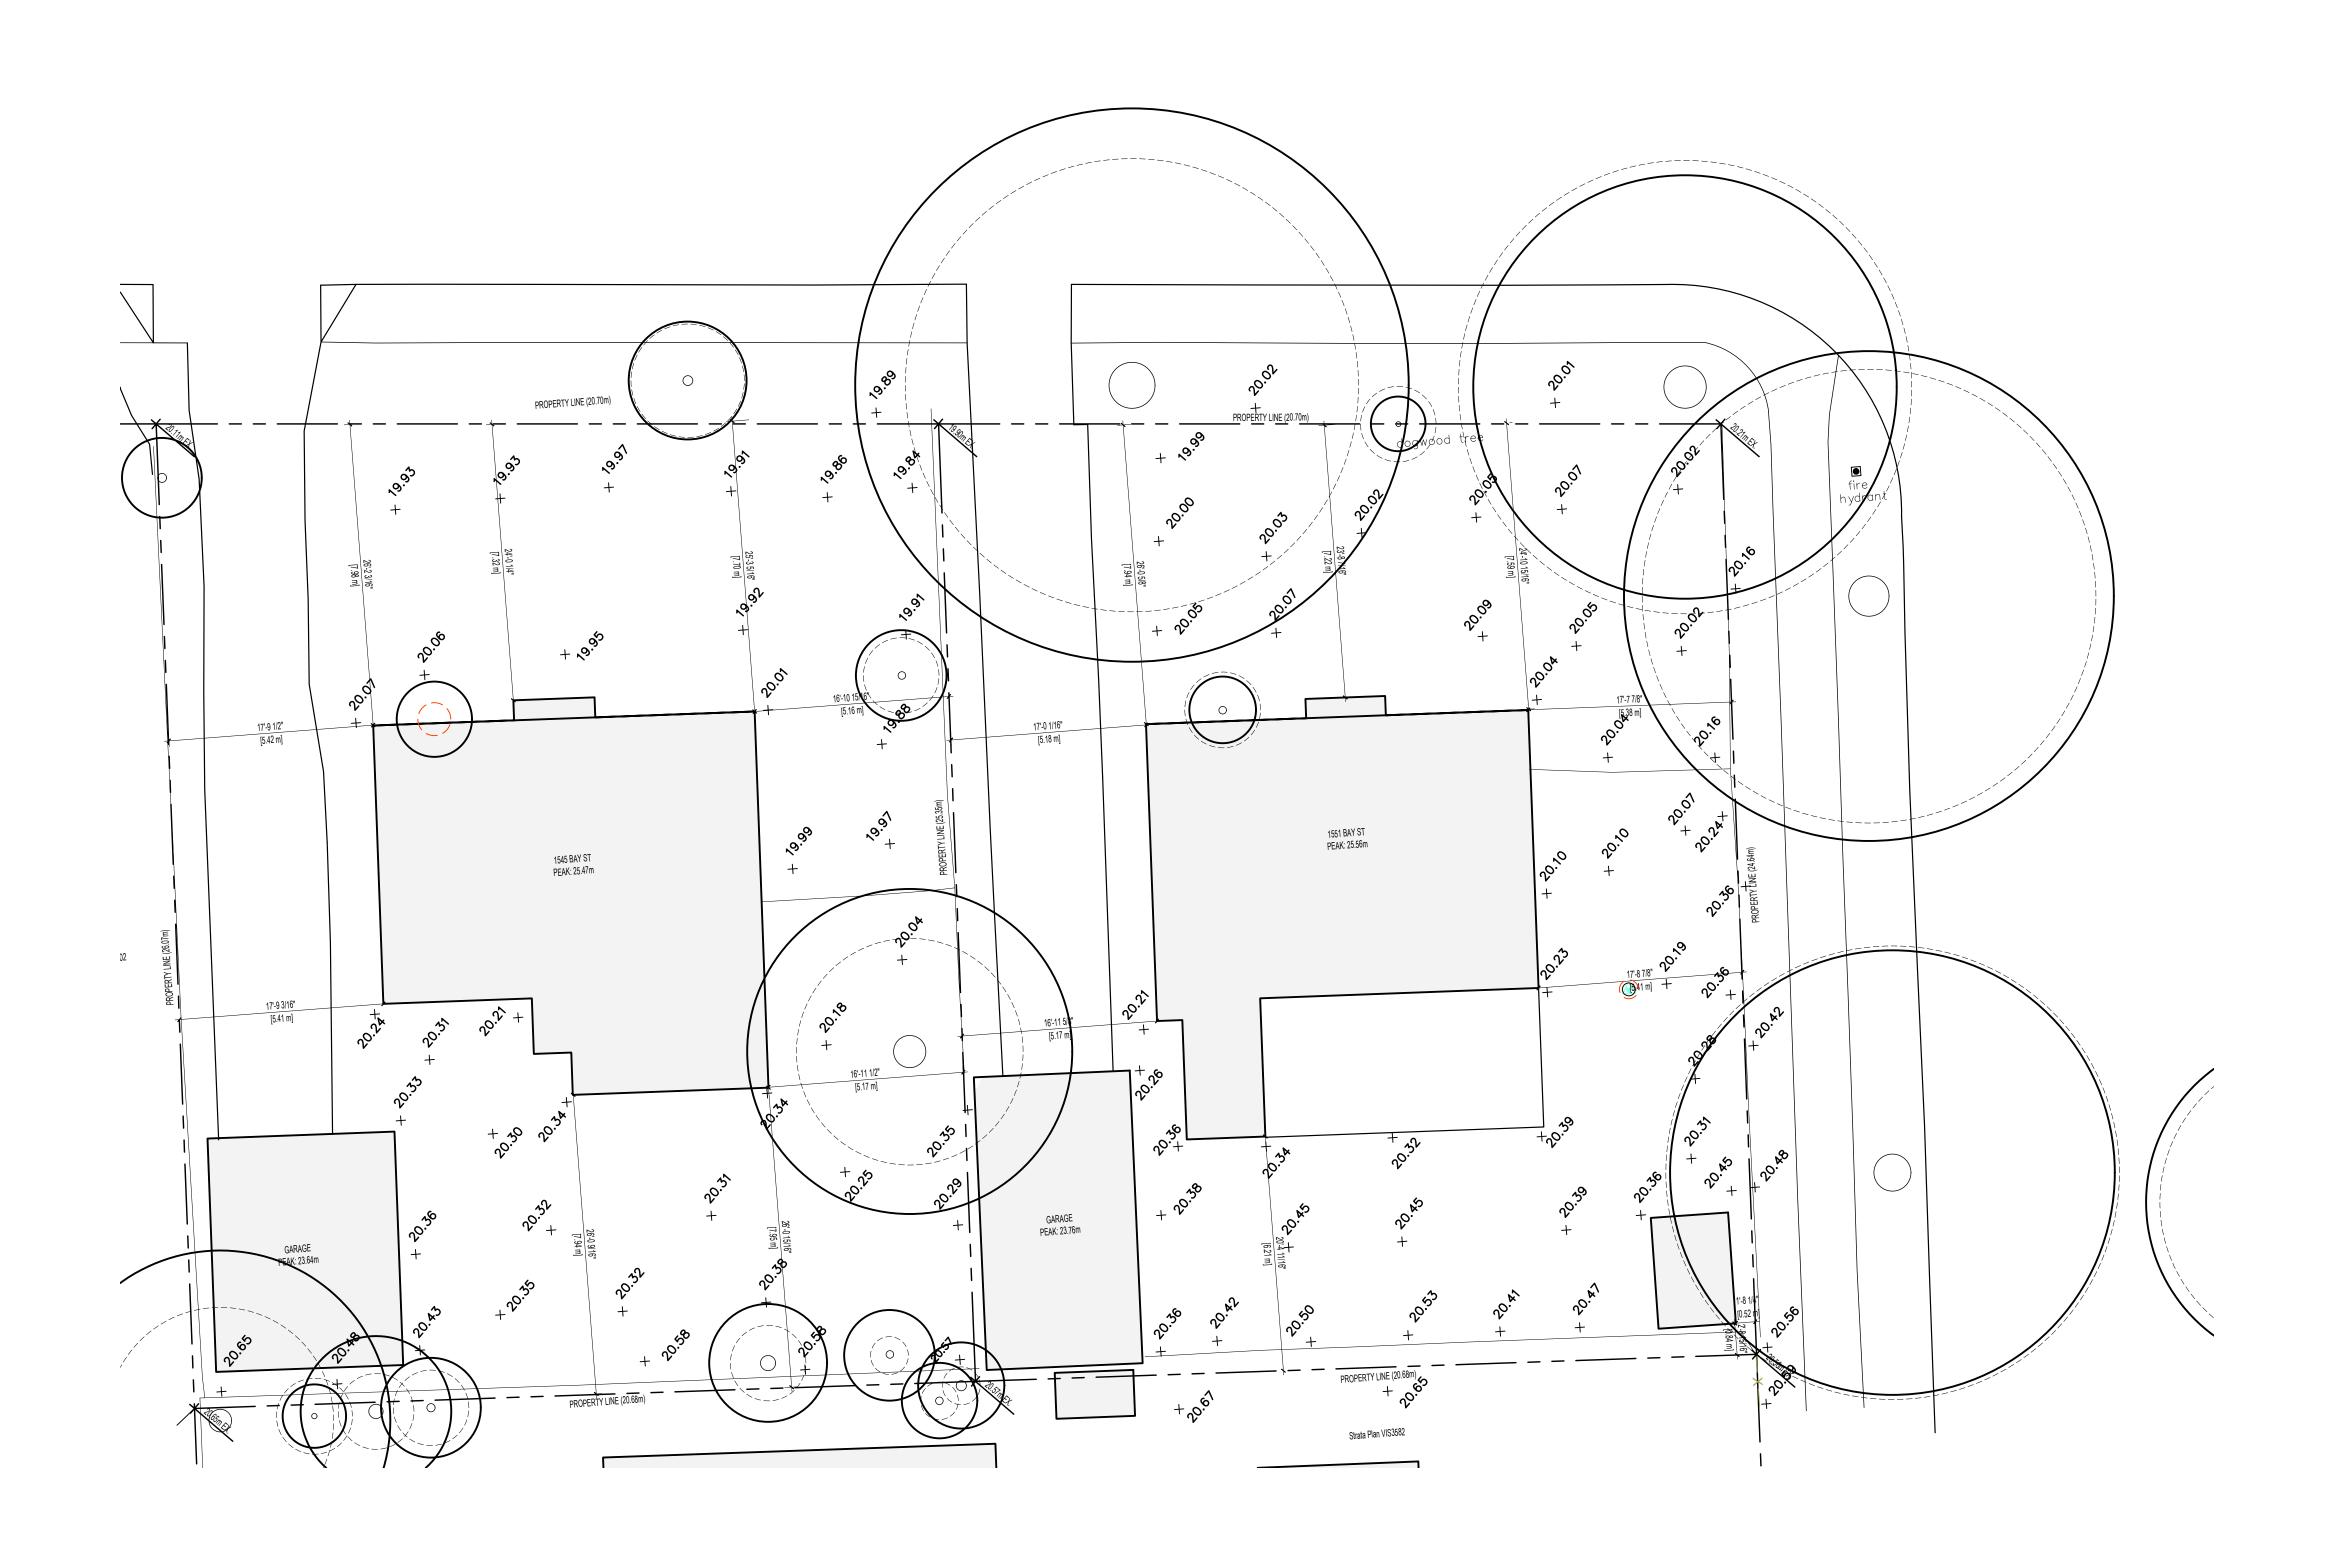
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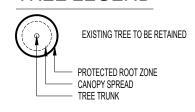
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SHADOW STUDY

		DRAWING NO:	A005
SCALE:	N/A	REVIEW BY:	СН
PROJECT NO:	2403	DRAWN BY:	LG

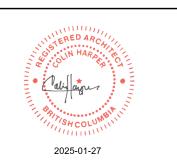


TREE LEGEND

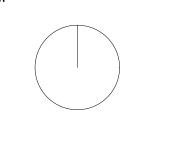


NOTE: SEE ARBORIST REPORT AND LANDSCAPE DRAWINGS FOR ADDITIONAL INFORMATION ON CRZ AND RETENTION MEASURES.

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PRO	JECT NAME	
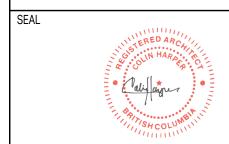
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PROJECT ADDRESS:


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EXISTING SITE PLAN

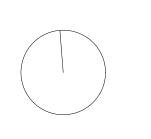PROJECT NO: 2403 DRAWN B SCALE: 1:100 REVIEW B	3Y:	CH	
PROJECT NO: 2403 DRAWN B			
	3Y:	LG	



1 PROPOSED SITE PLAN
1:100

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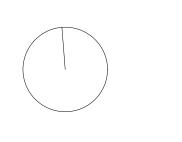
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PROJECT INFORMATION TABLE - 1551 & 1545 BAY STREET

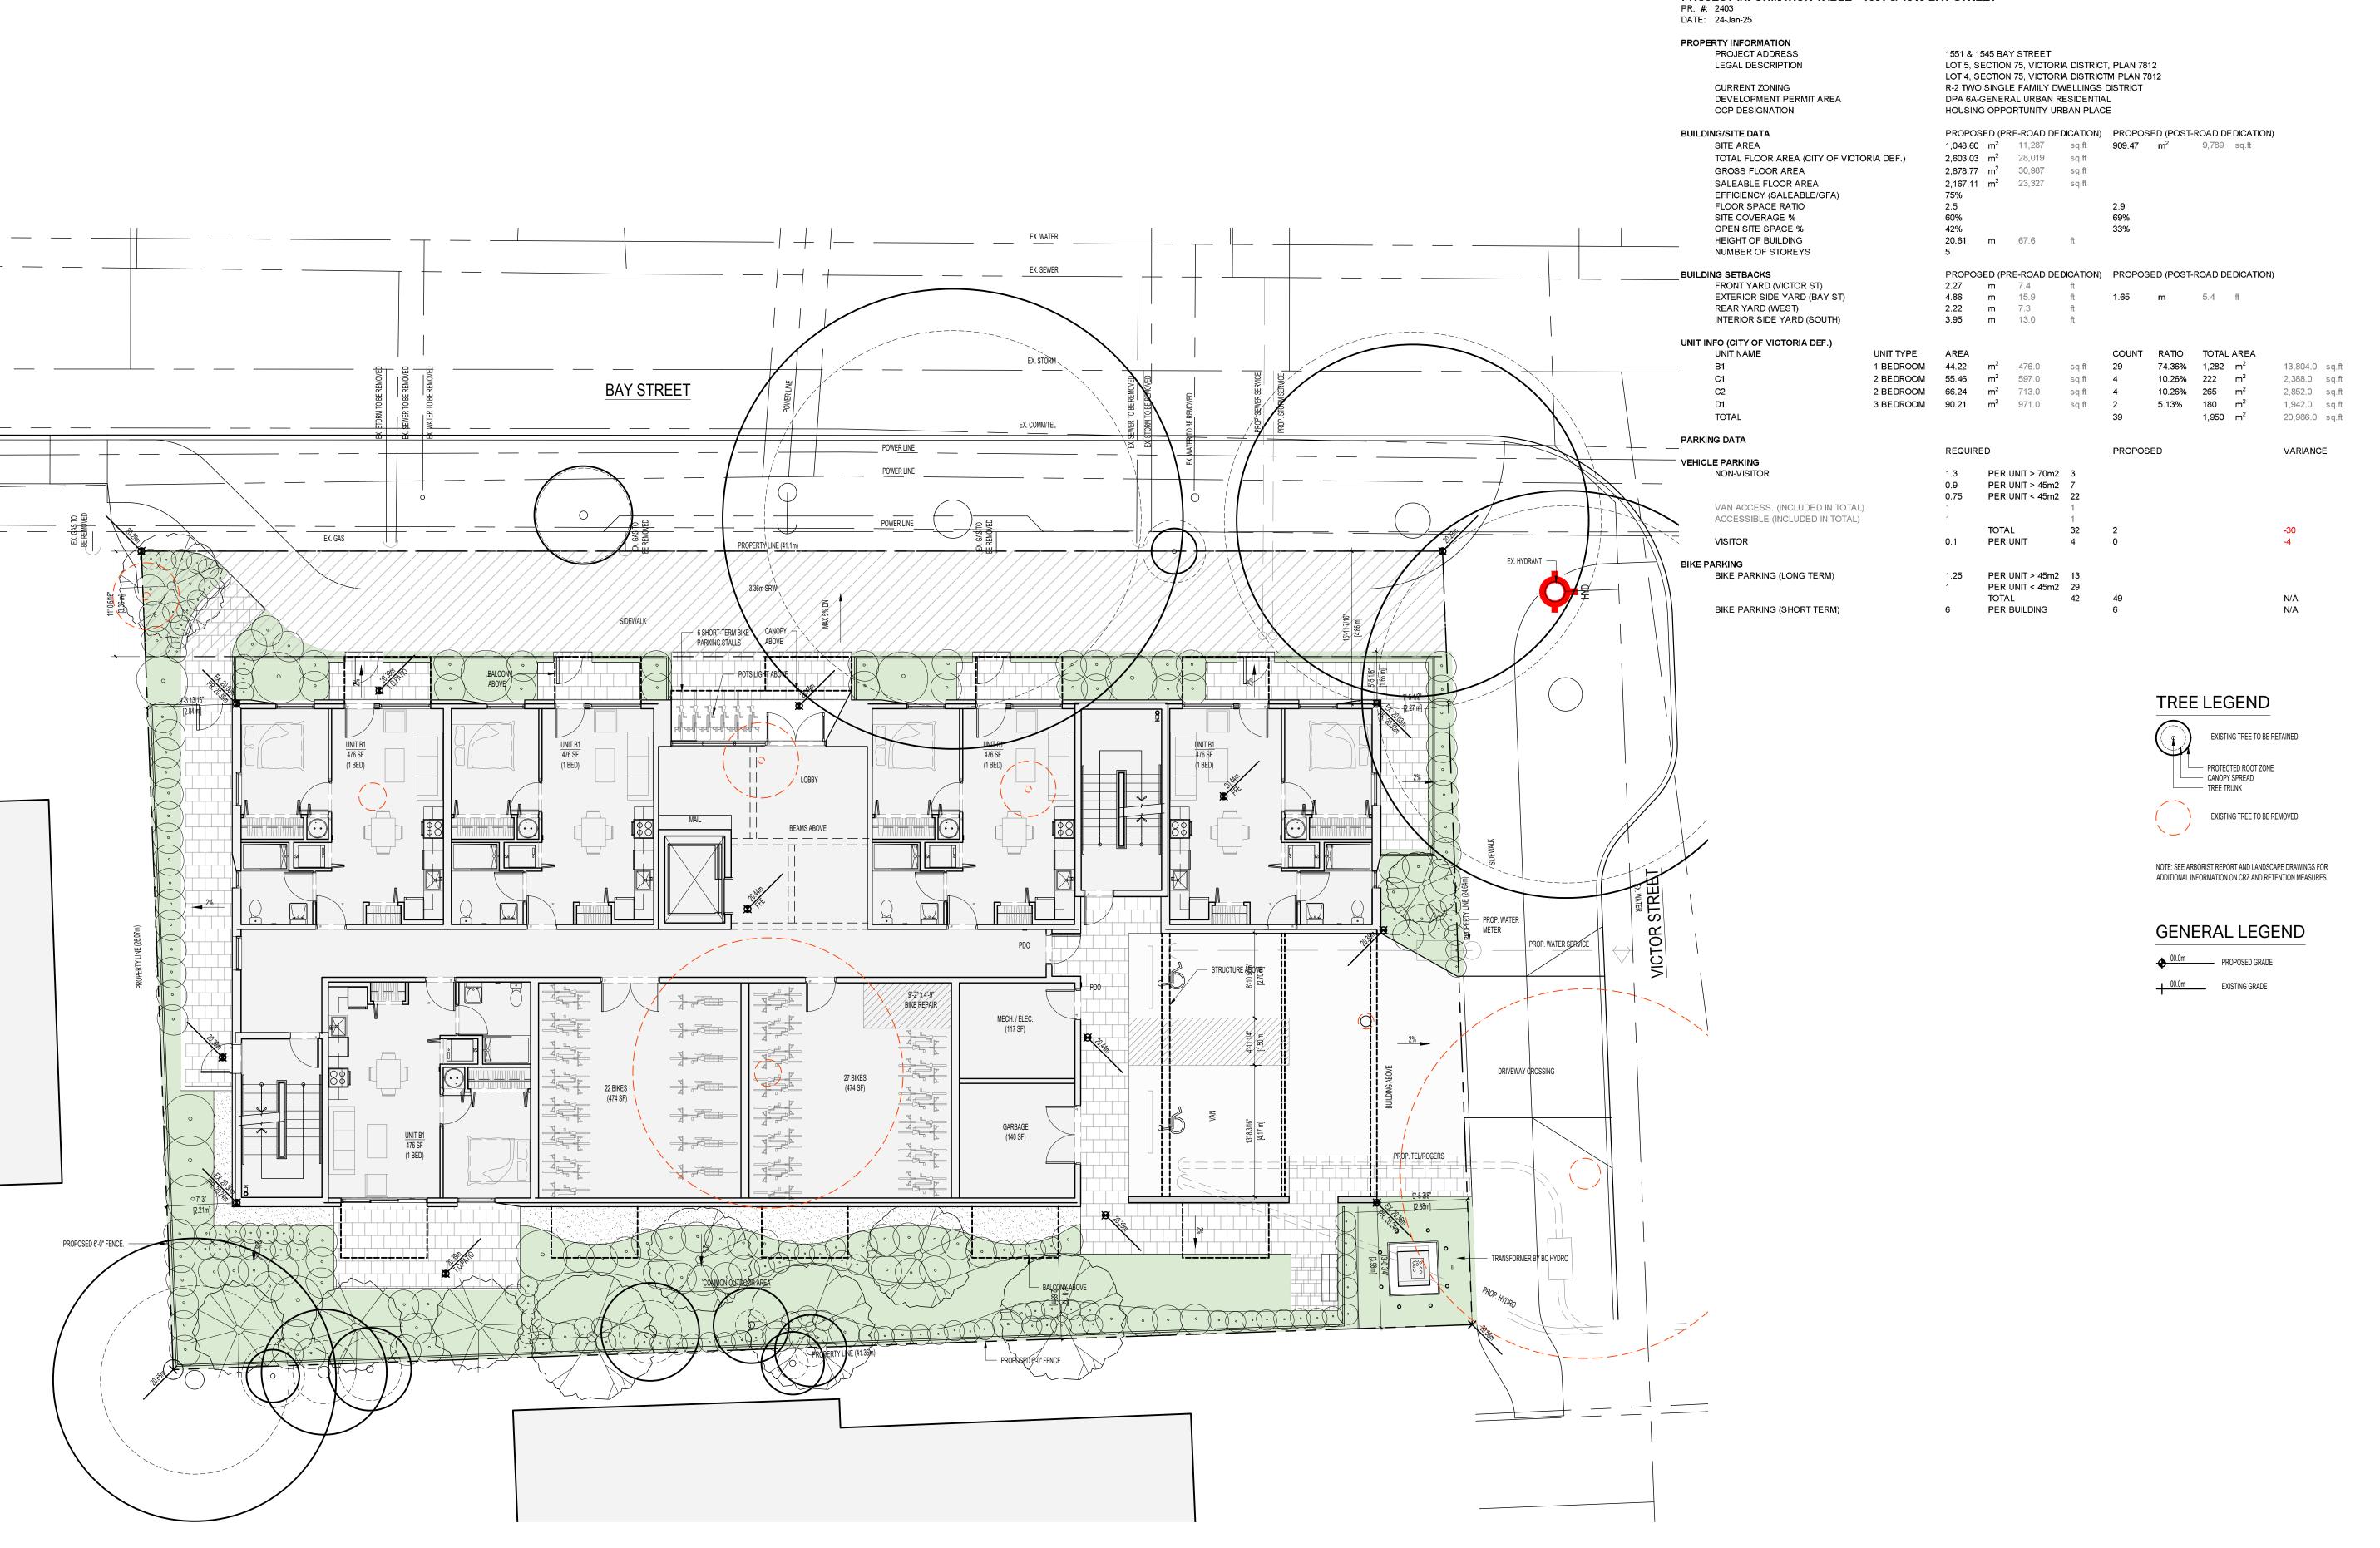

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PROJECT ADDRESS: 1551 & 1545 BAY

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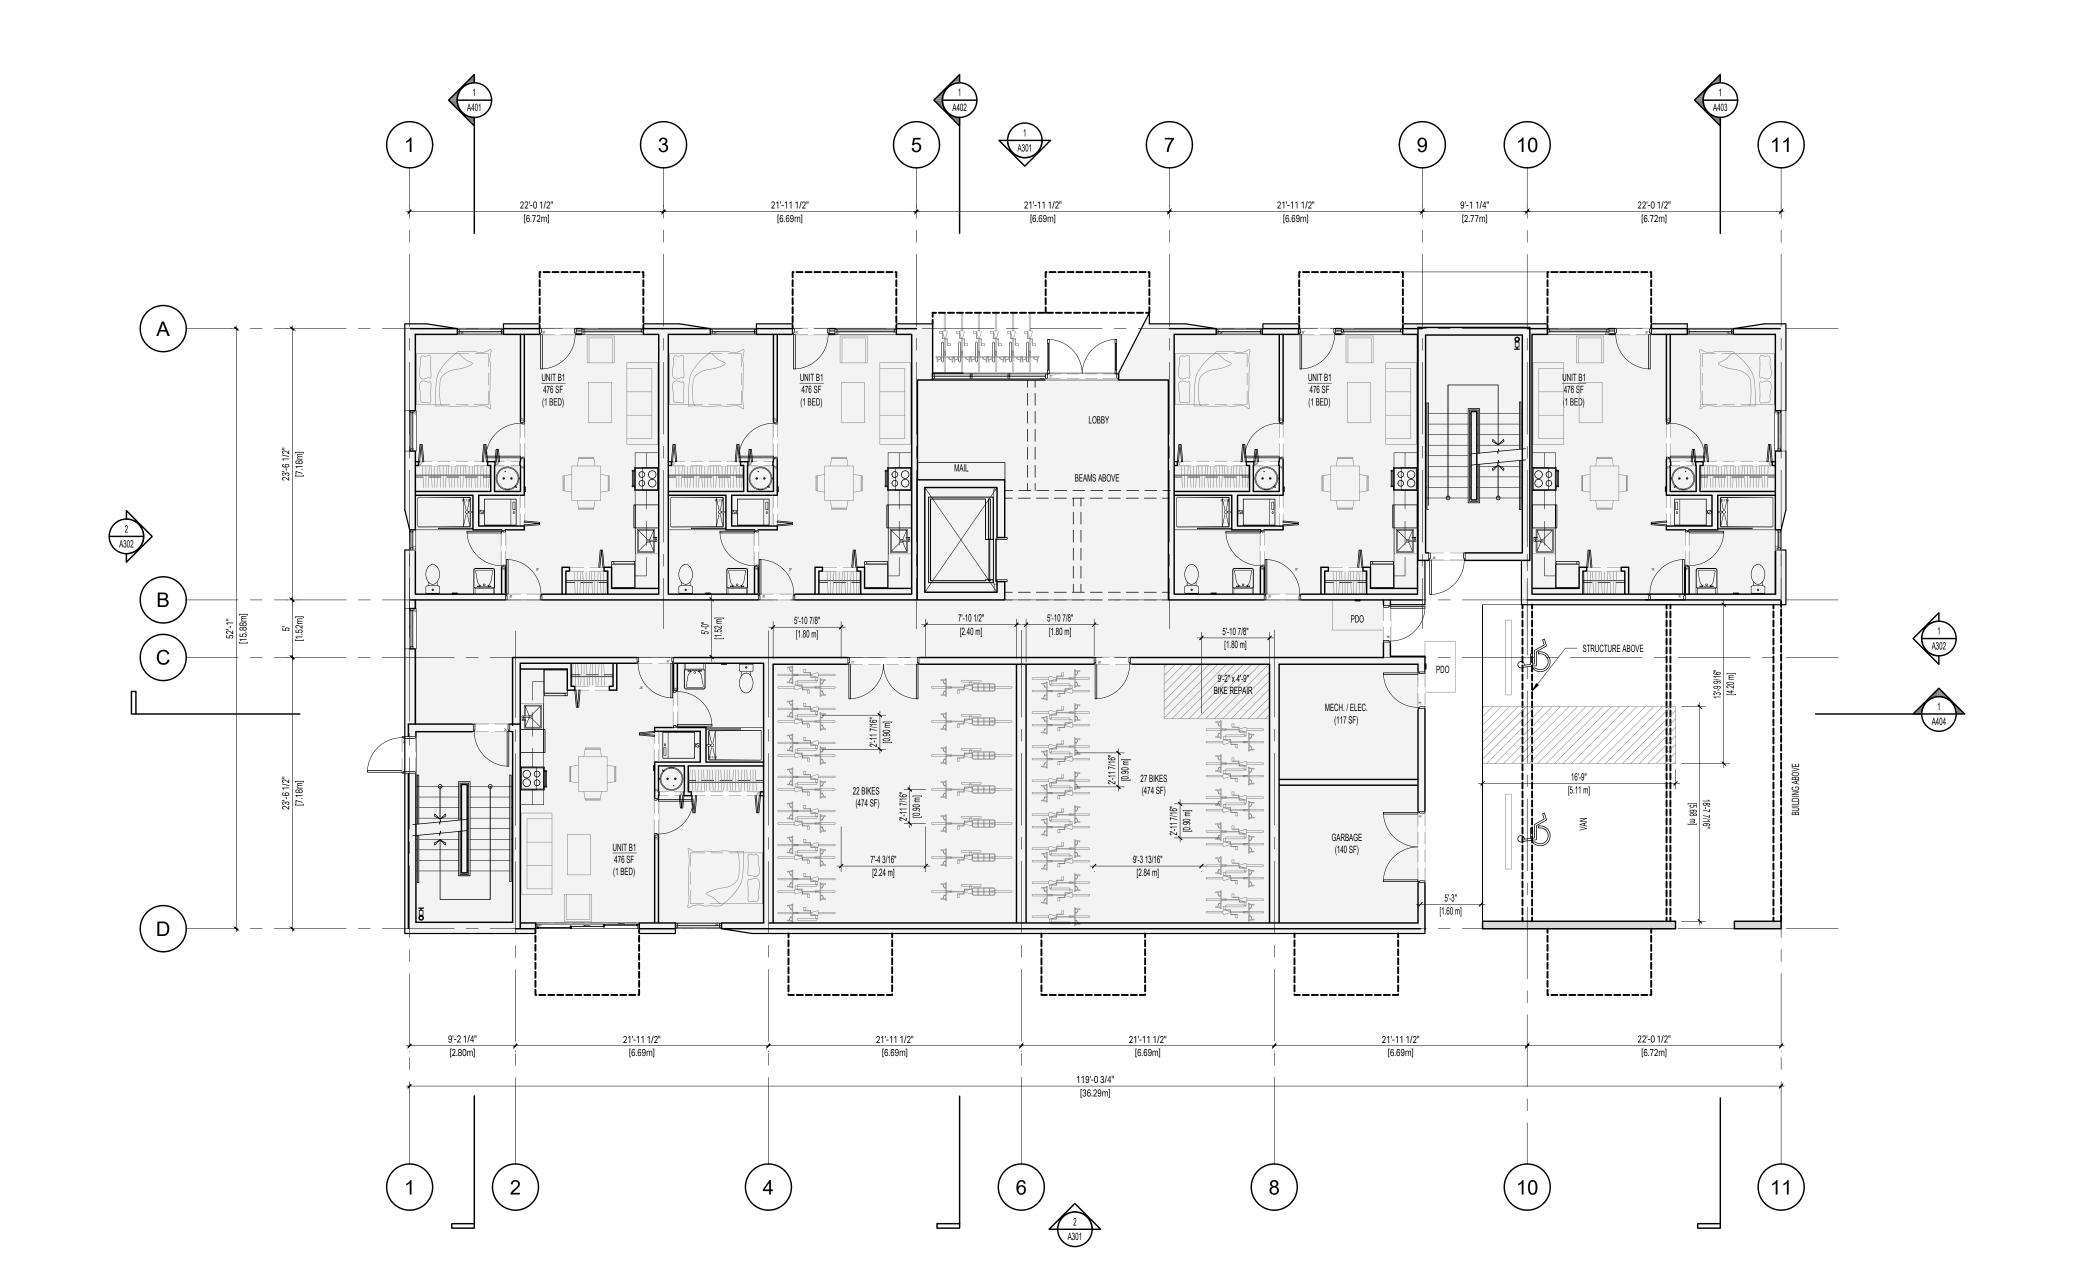
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SITE PLAN

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 2403
 DRAWN BY:
 LG

 SCALE:
 1:100
 REVIEW BY:
 CH

 DRAWING NO:
 A 102






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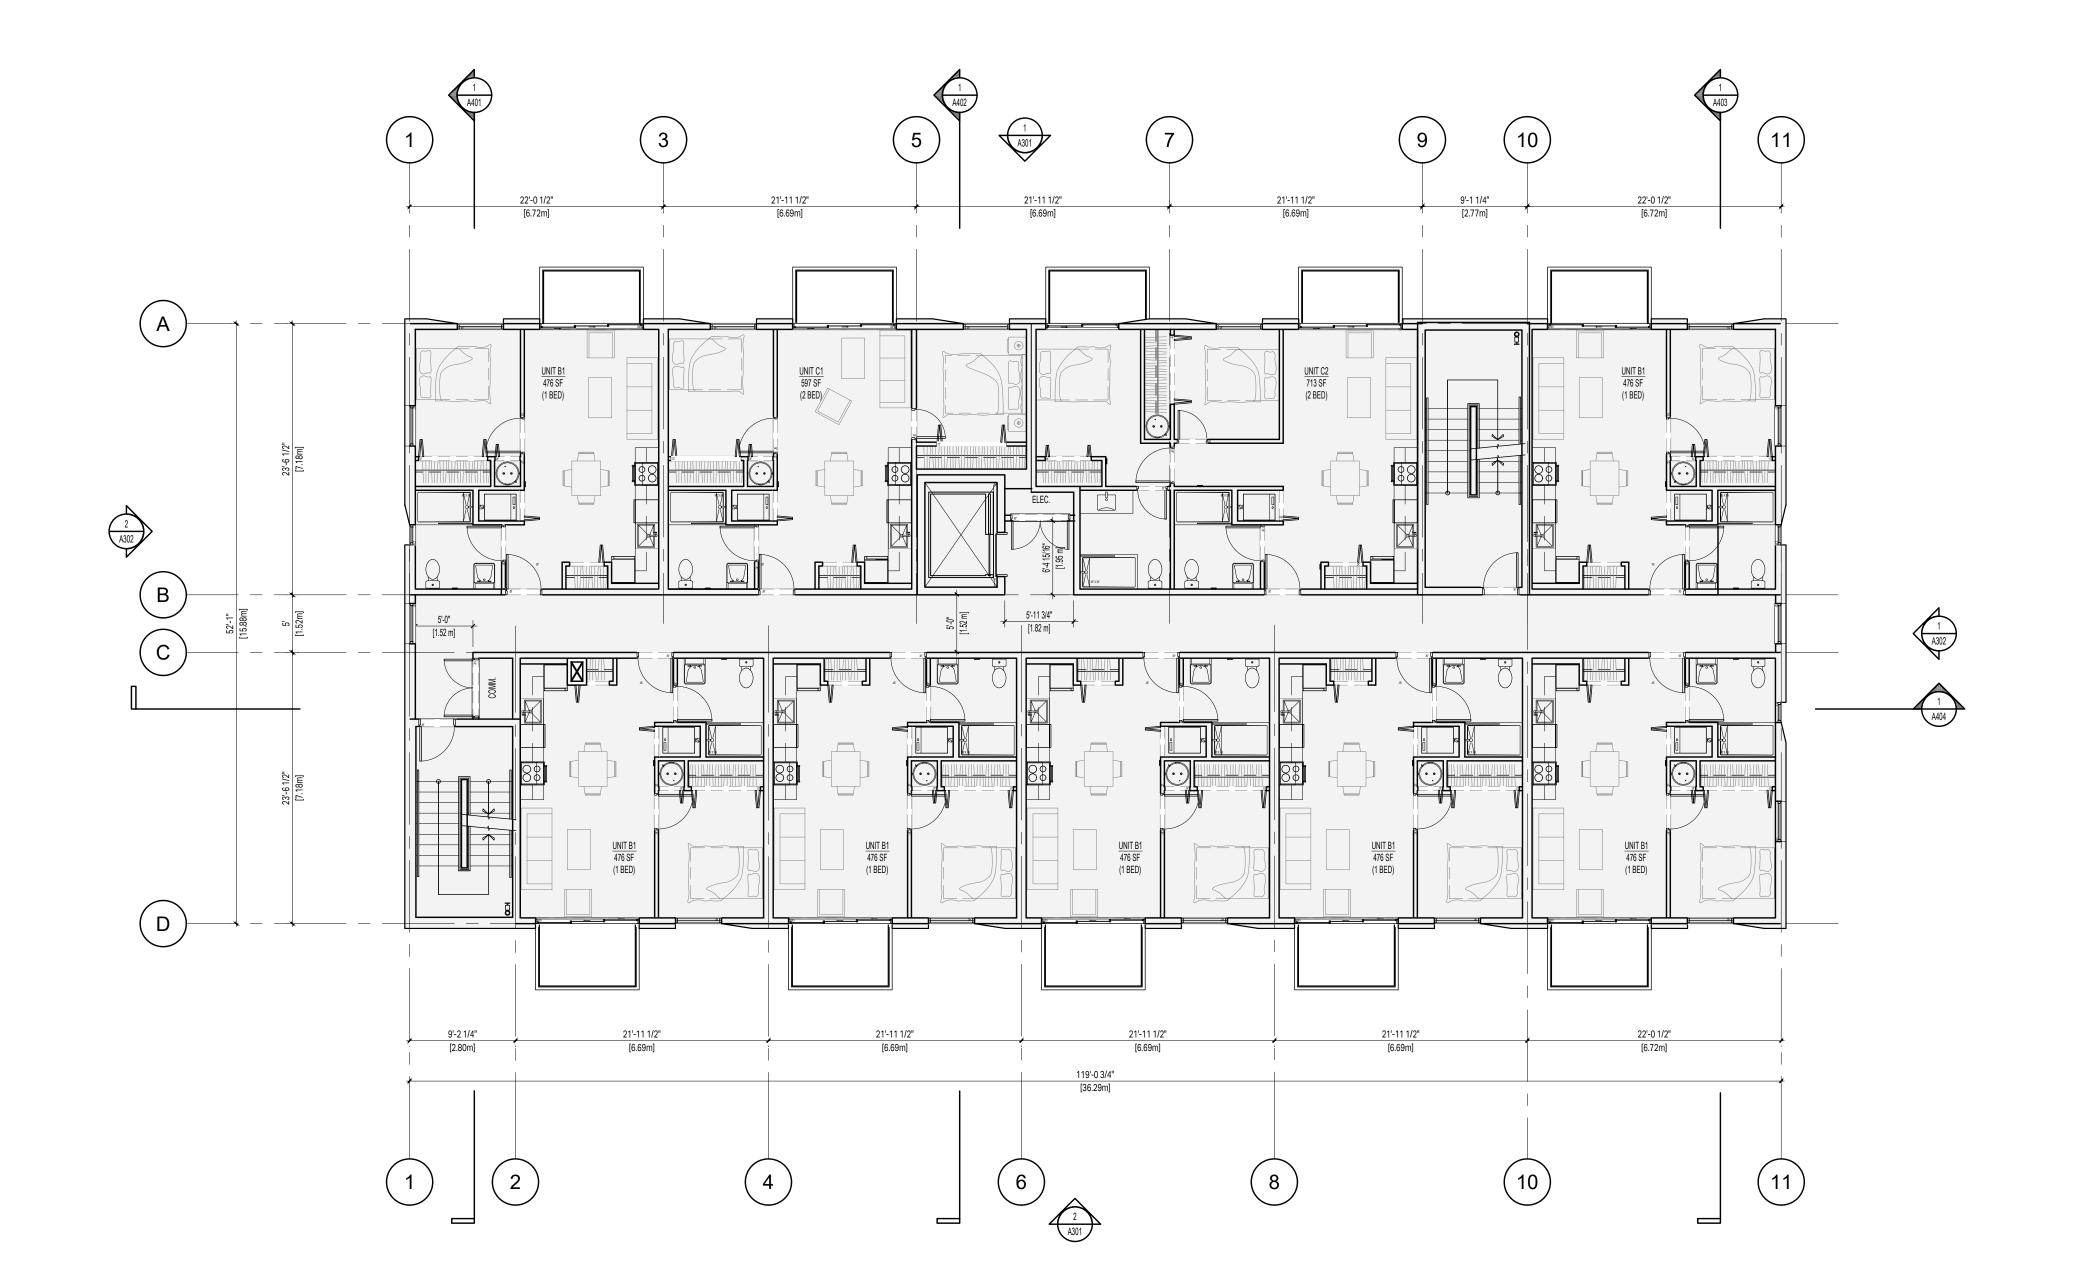
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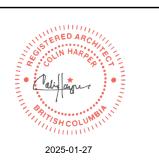
LEVEL 1 PLAN

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PROJECT NO: 2403 DRAWN BY: LG	SCALE:	1:100	REVIEW BY:	СН
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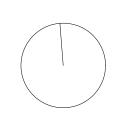


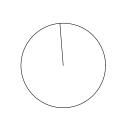

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PROJECT NAME




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LEVEL 2-4 PLAN

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 DRAWN BY:
 LG


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 1:100
 REVIEW BY:
 CH

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 A202




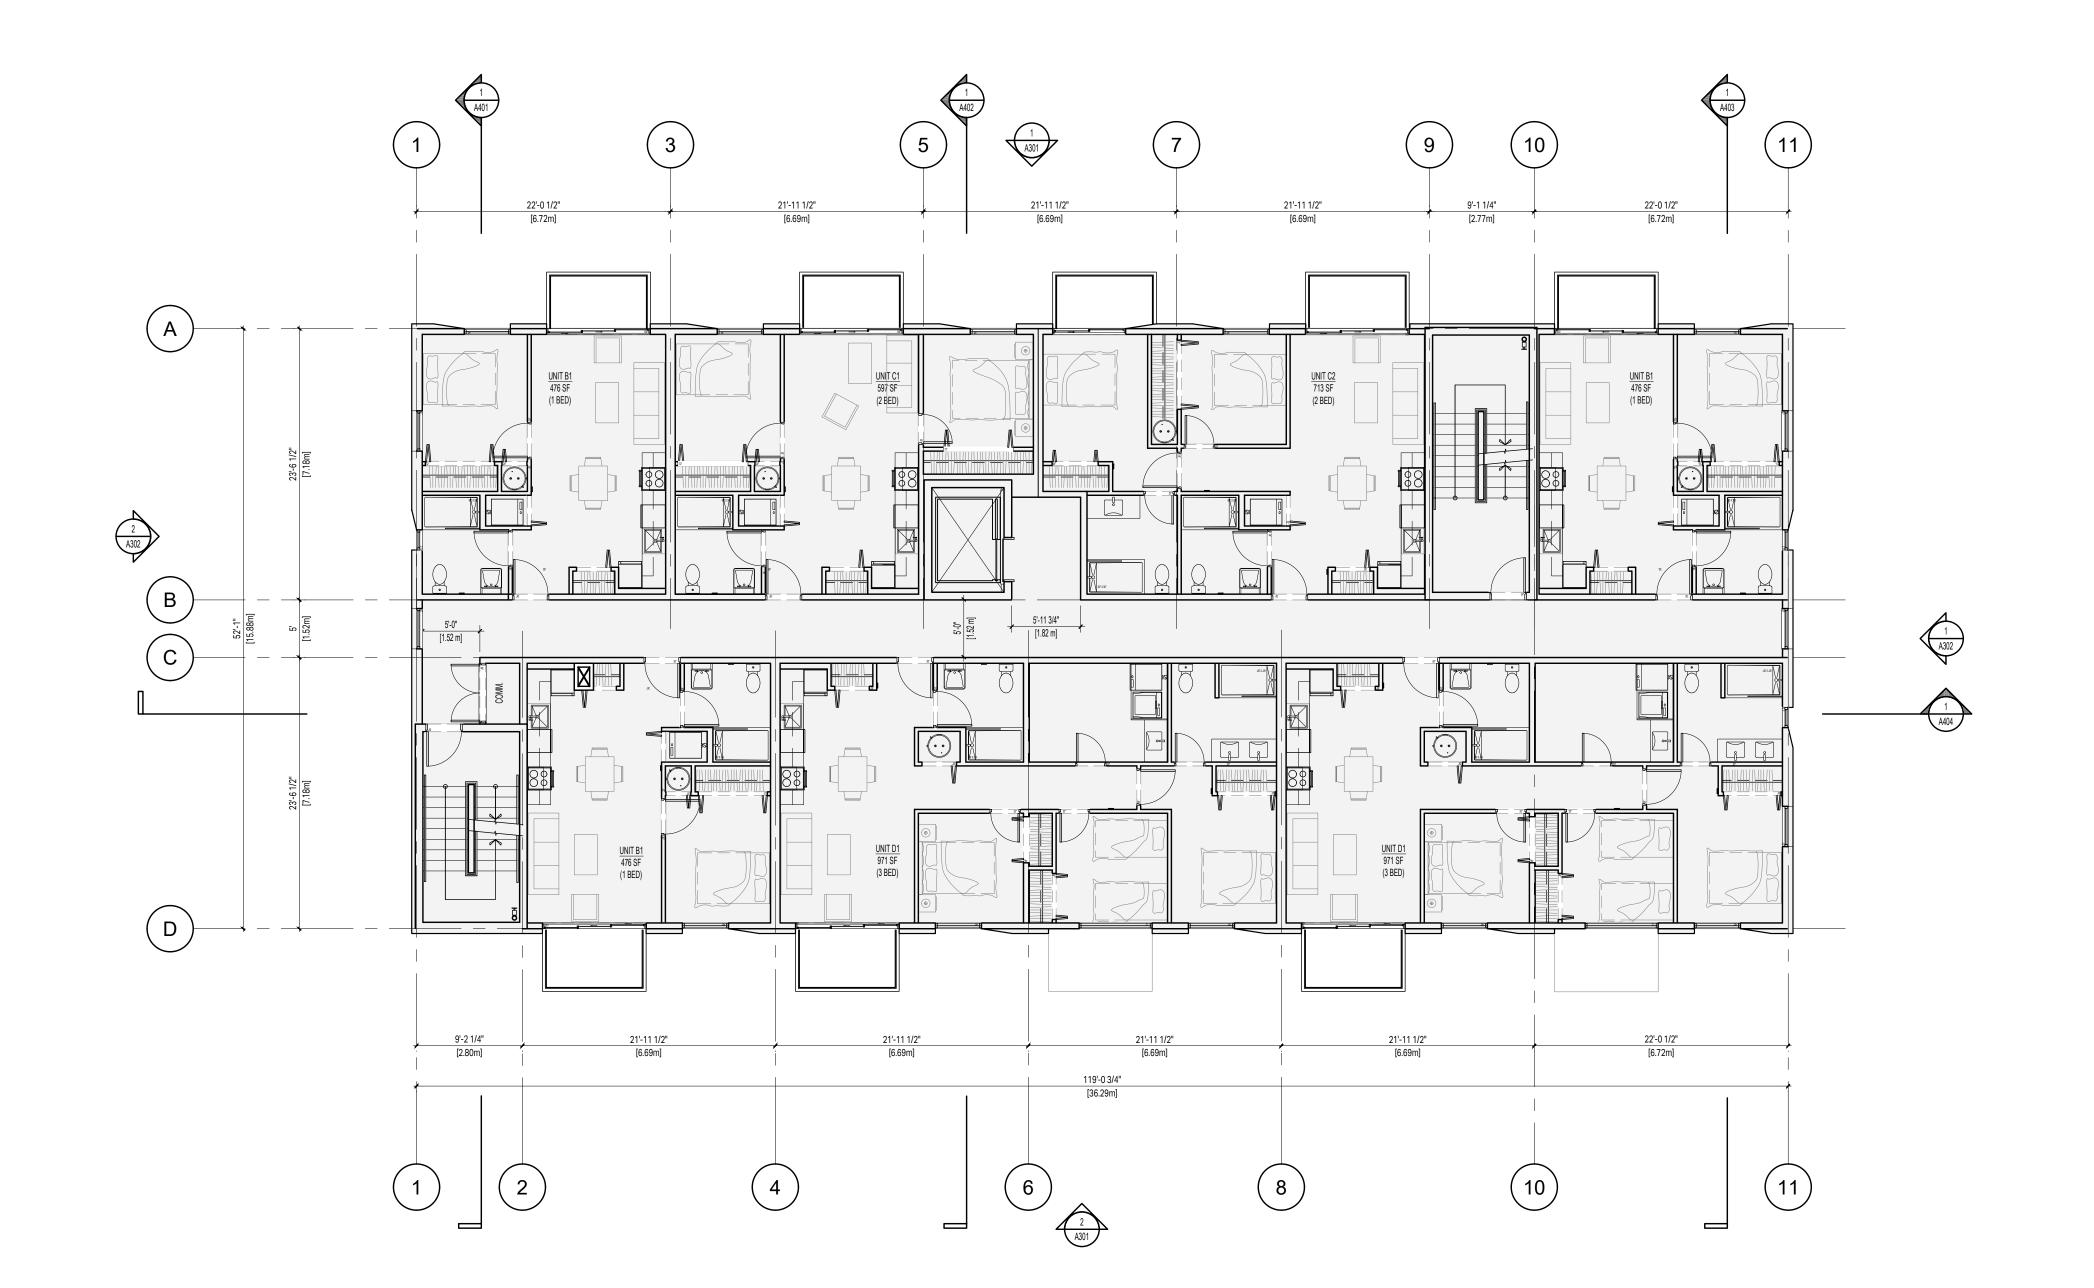

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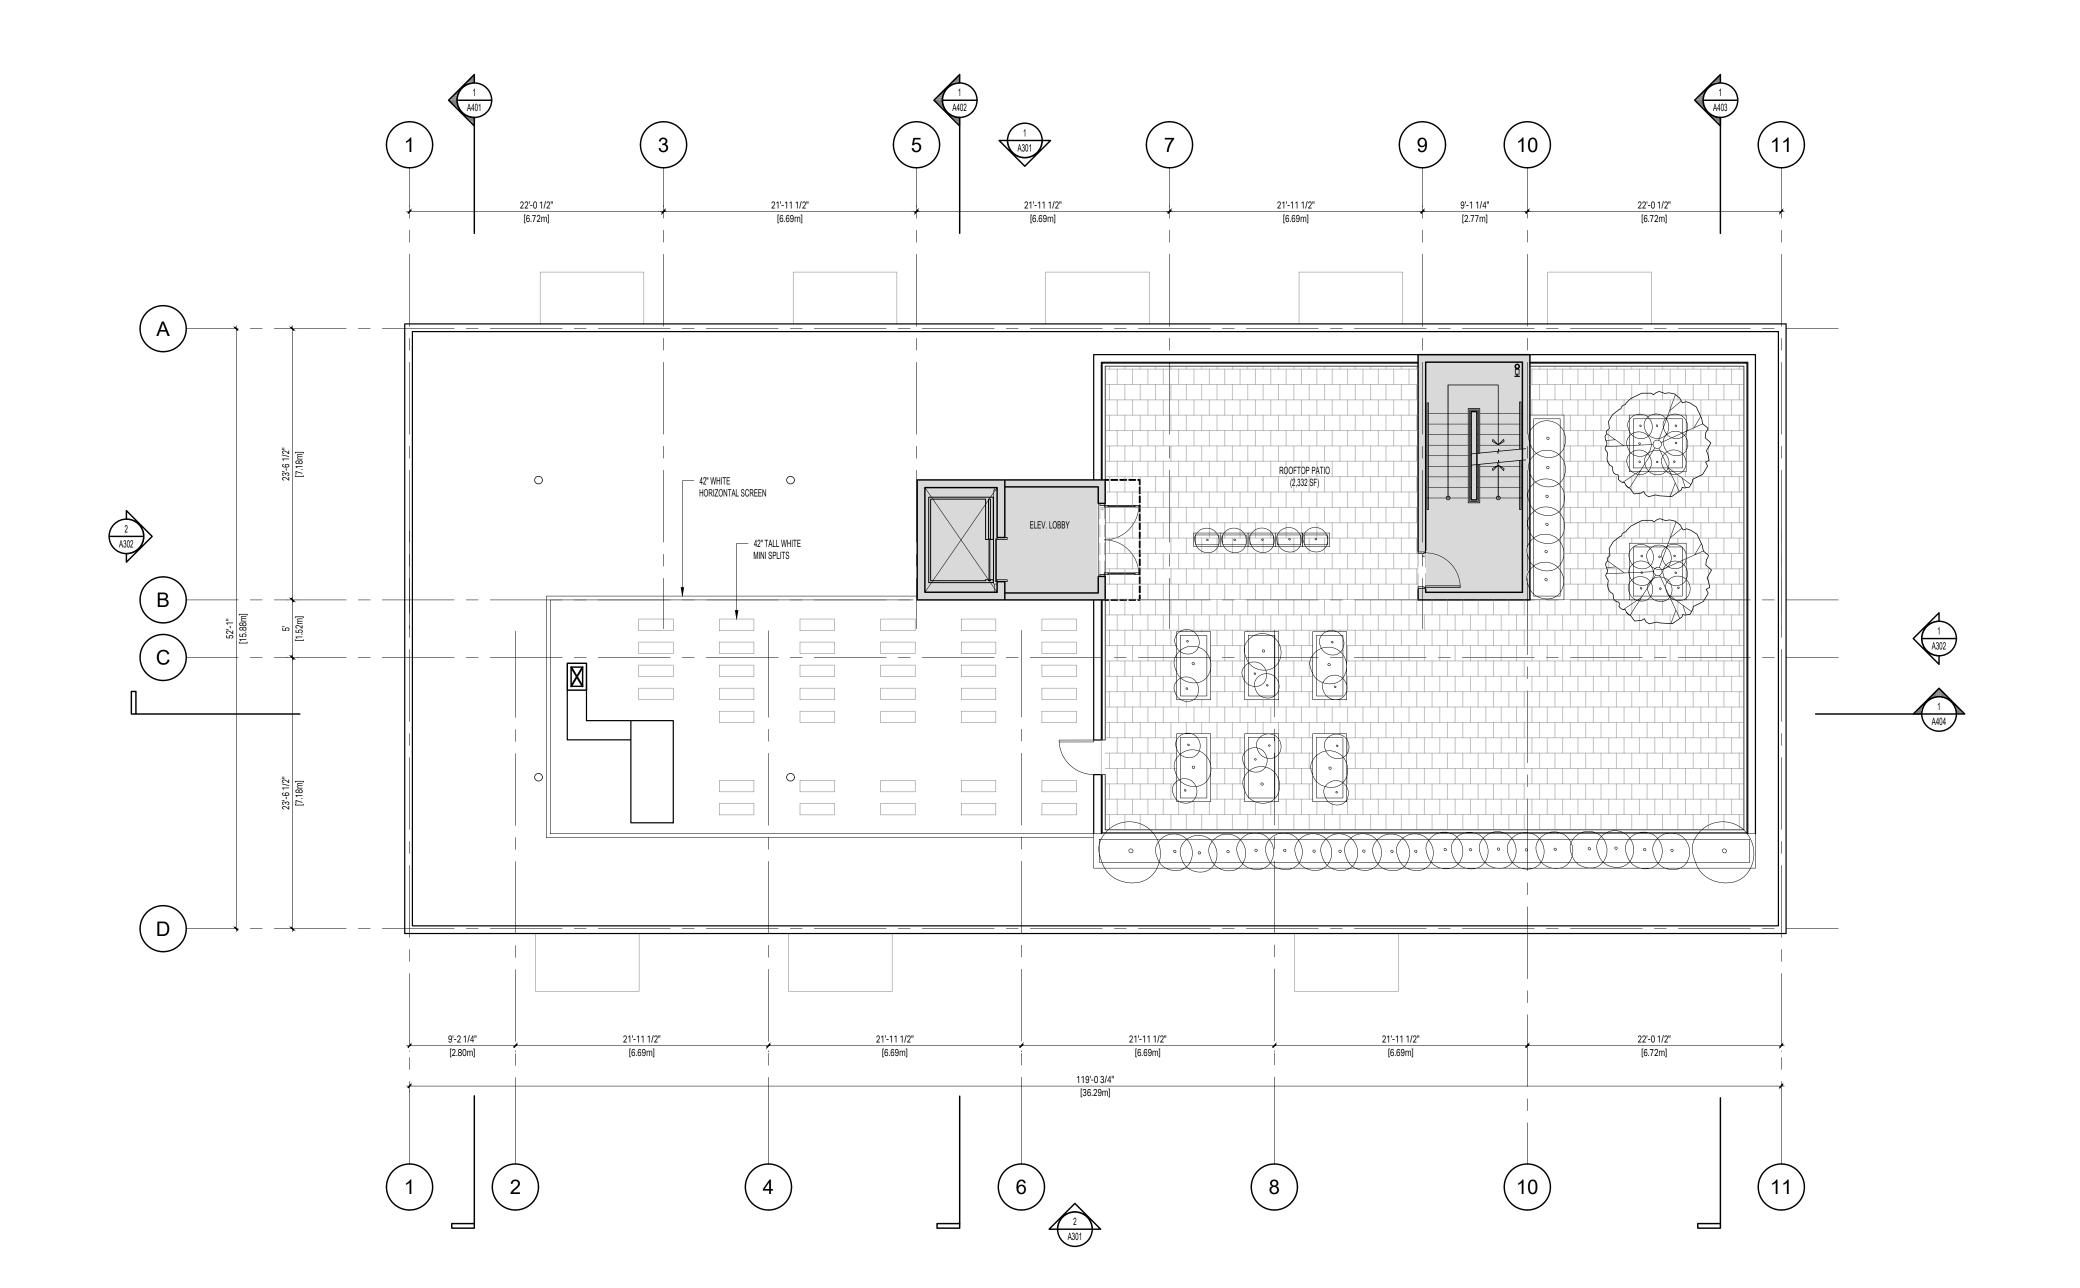
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LEVEL 5 PLAN

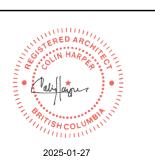2403 DRAWN BY: LG

100 REVIEW BY: CH

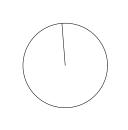DRAWING NO: A203






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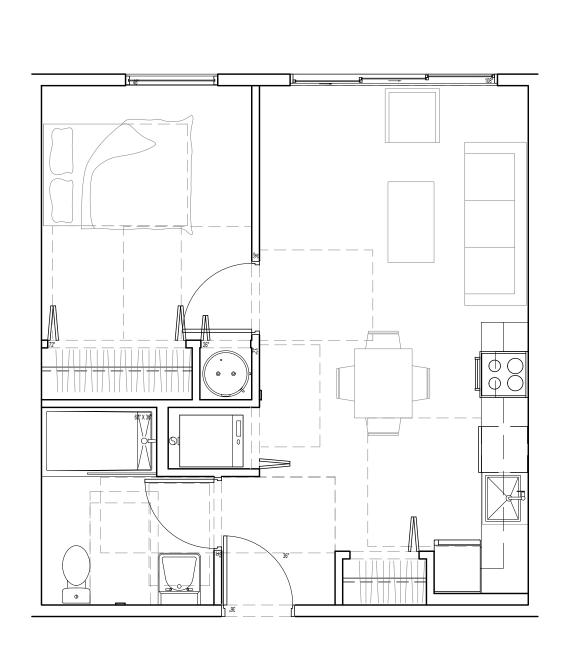
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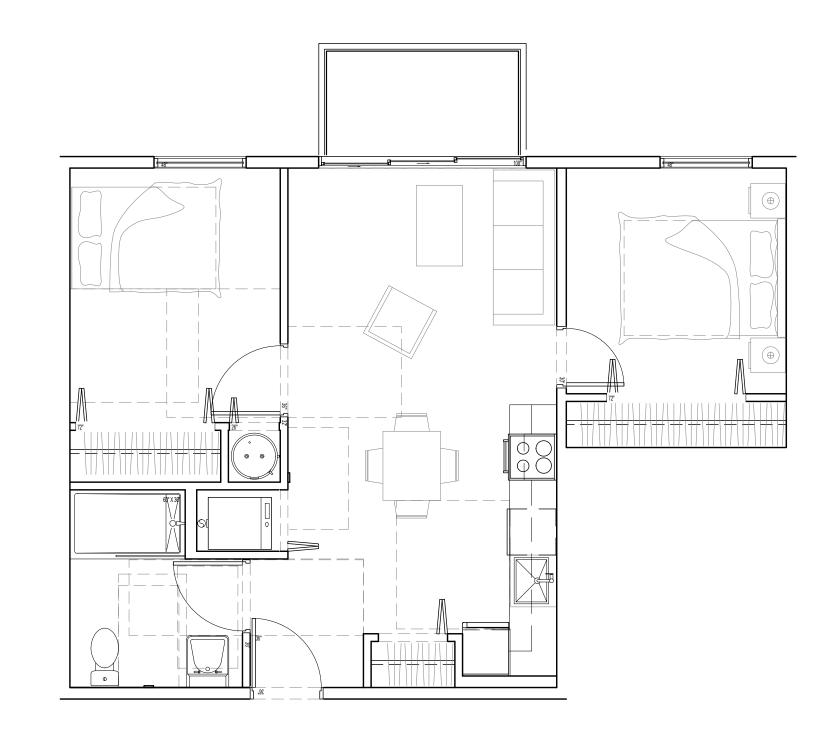
ROOF PLAN


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 REVIEW BY:
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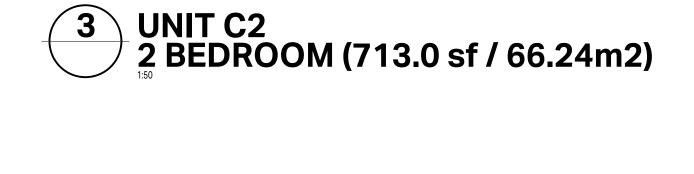
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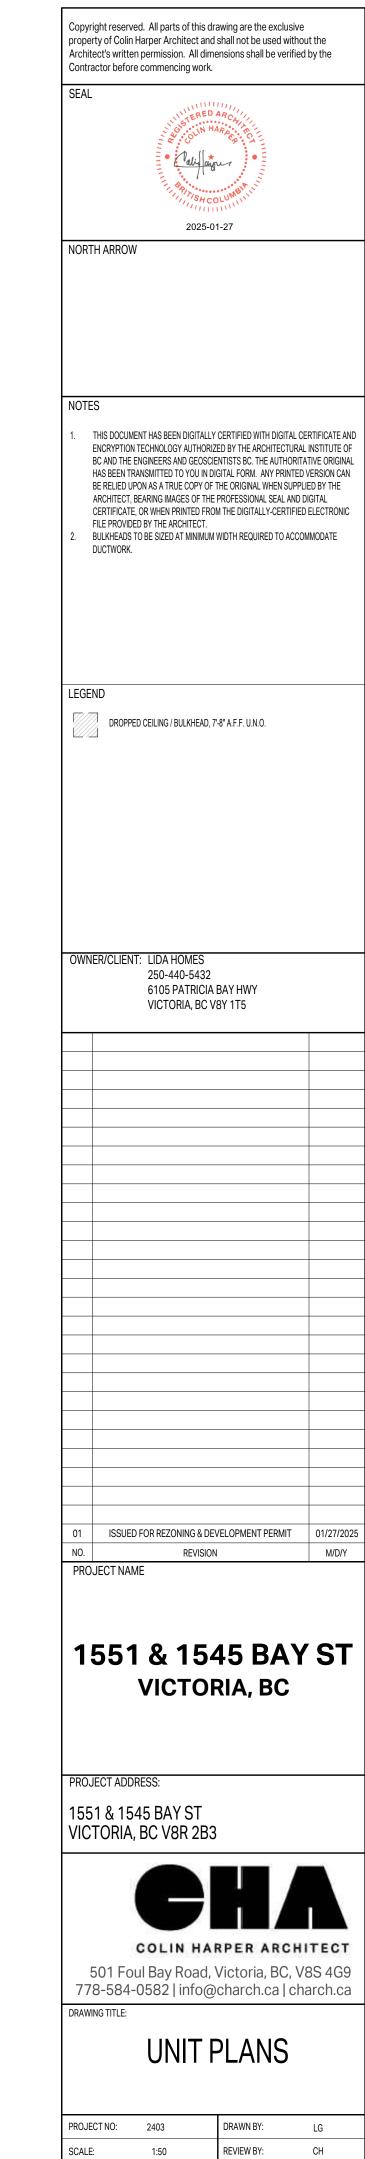




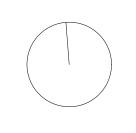



1 UNIT B1 1 BEDROOM (476.0 sf / 44.22m2) 2 UNIT C1 2 BEDROOM (597.0 sf / 55.46 m2)



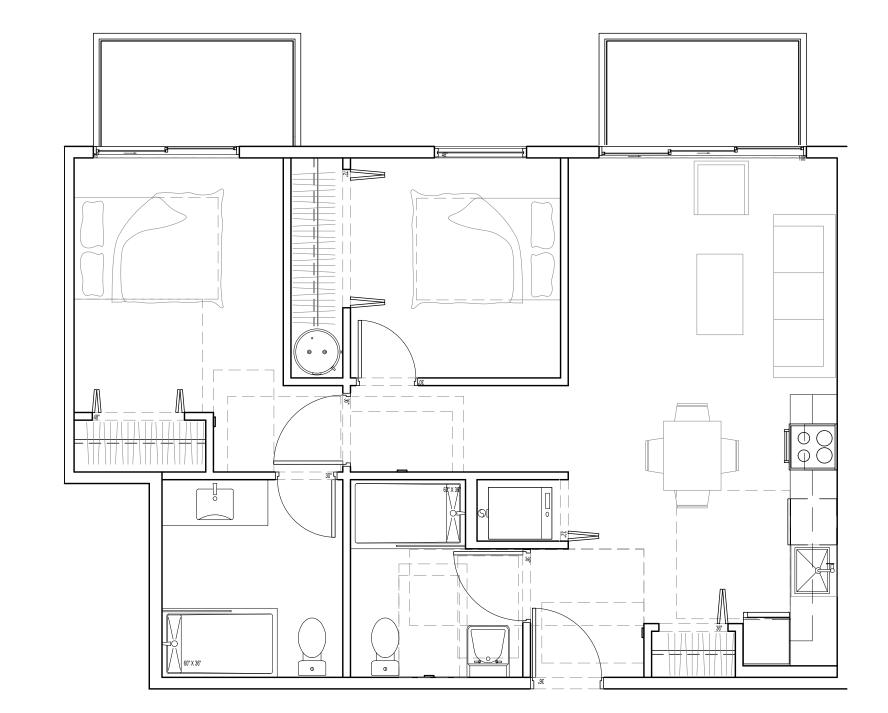

DRAWING NO: A211

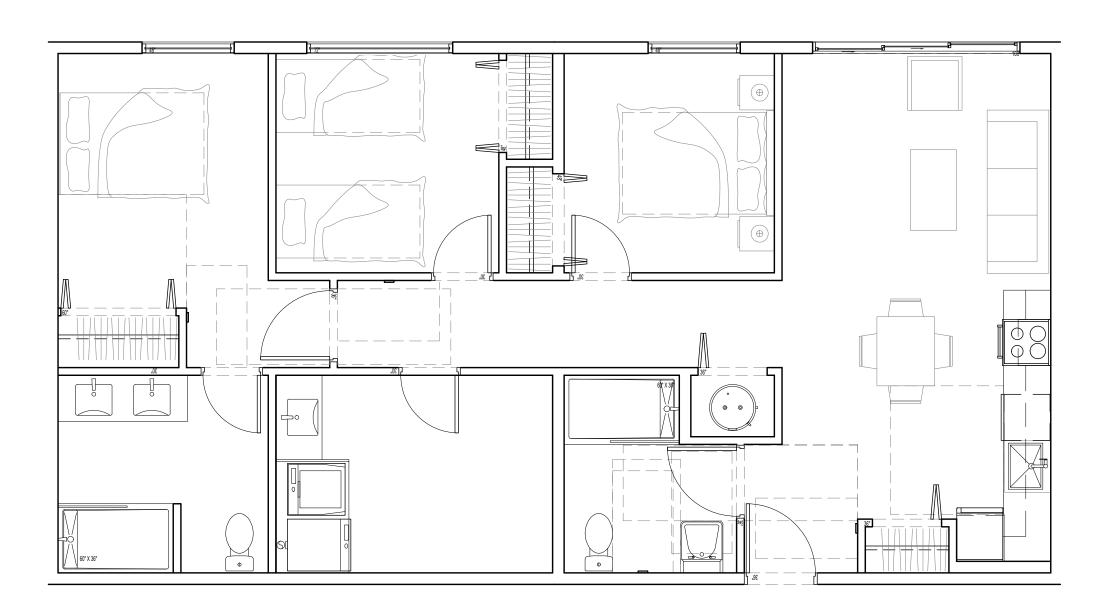

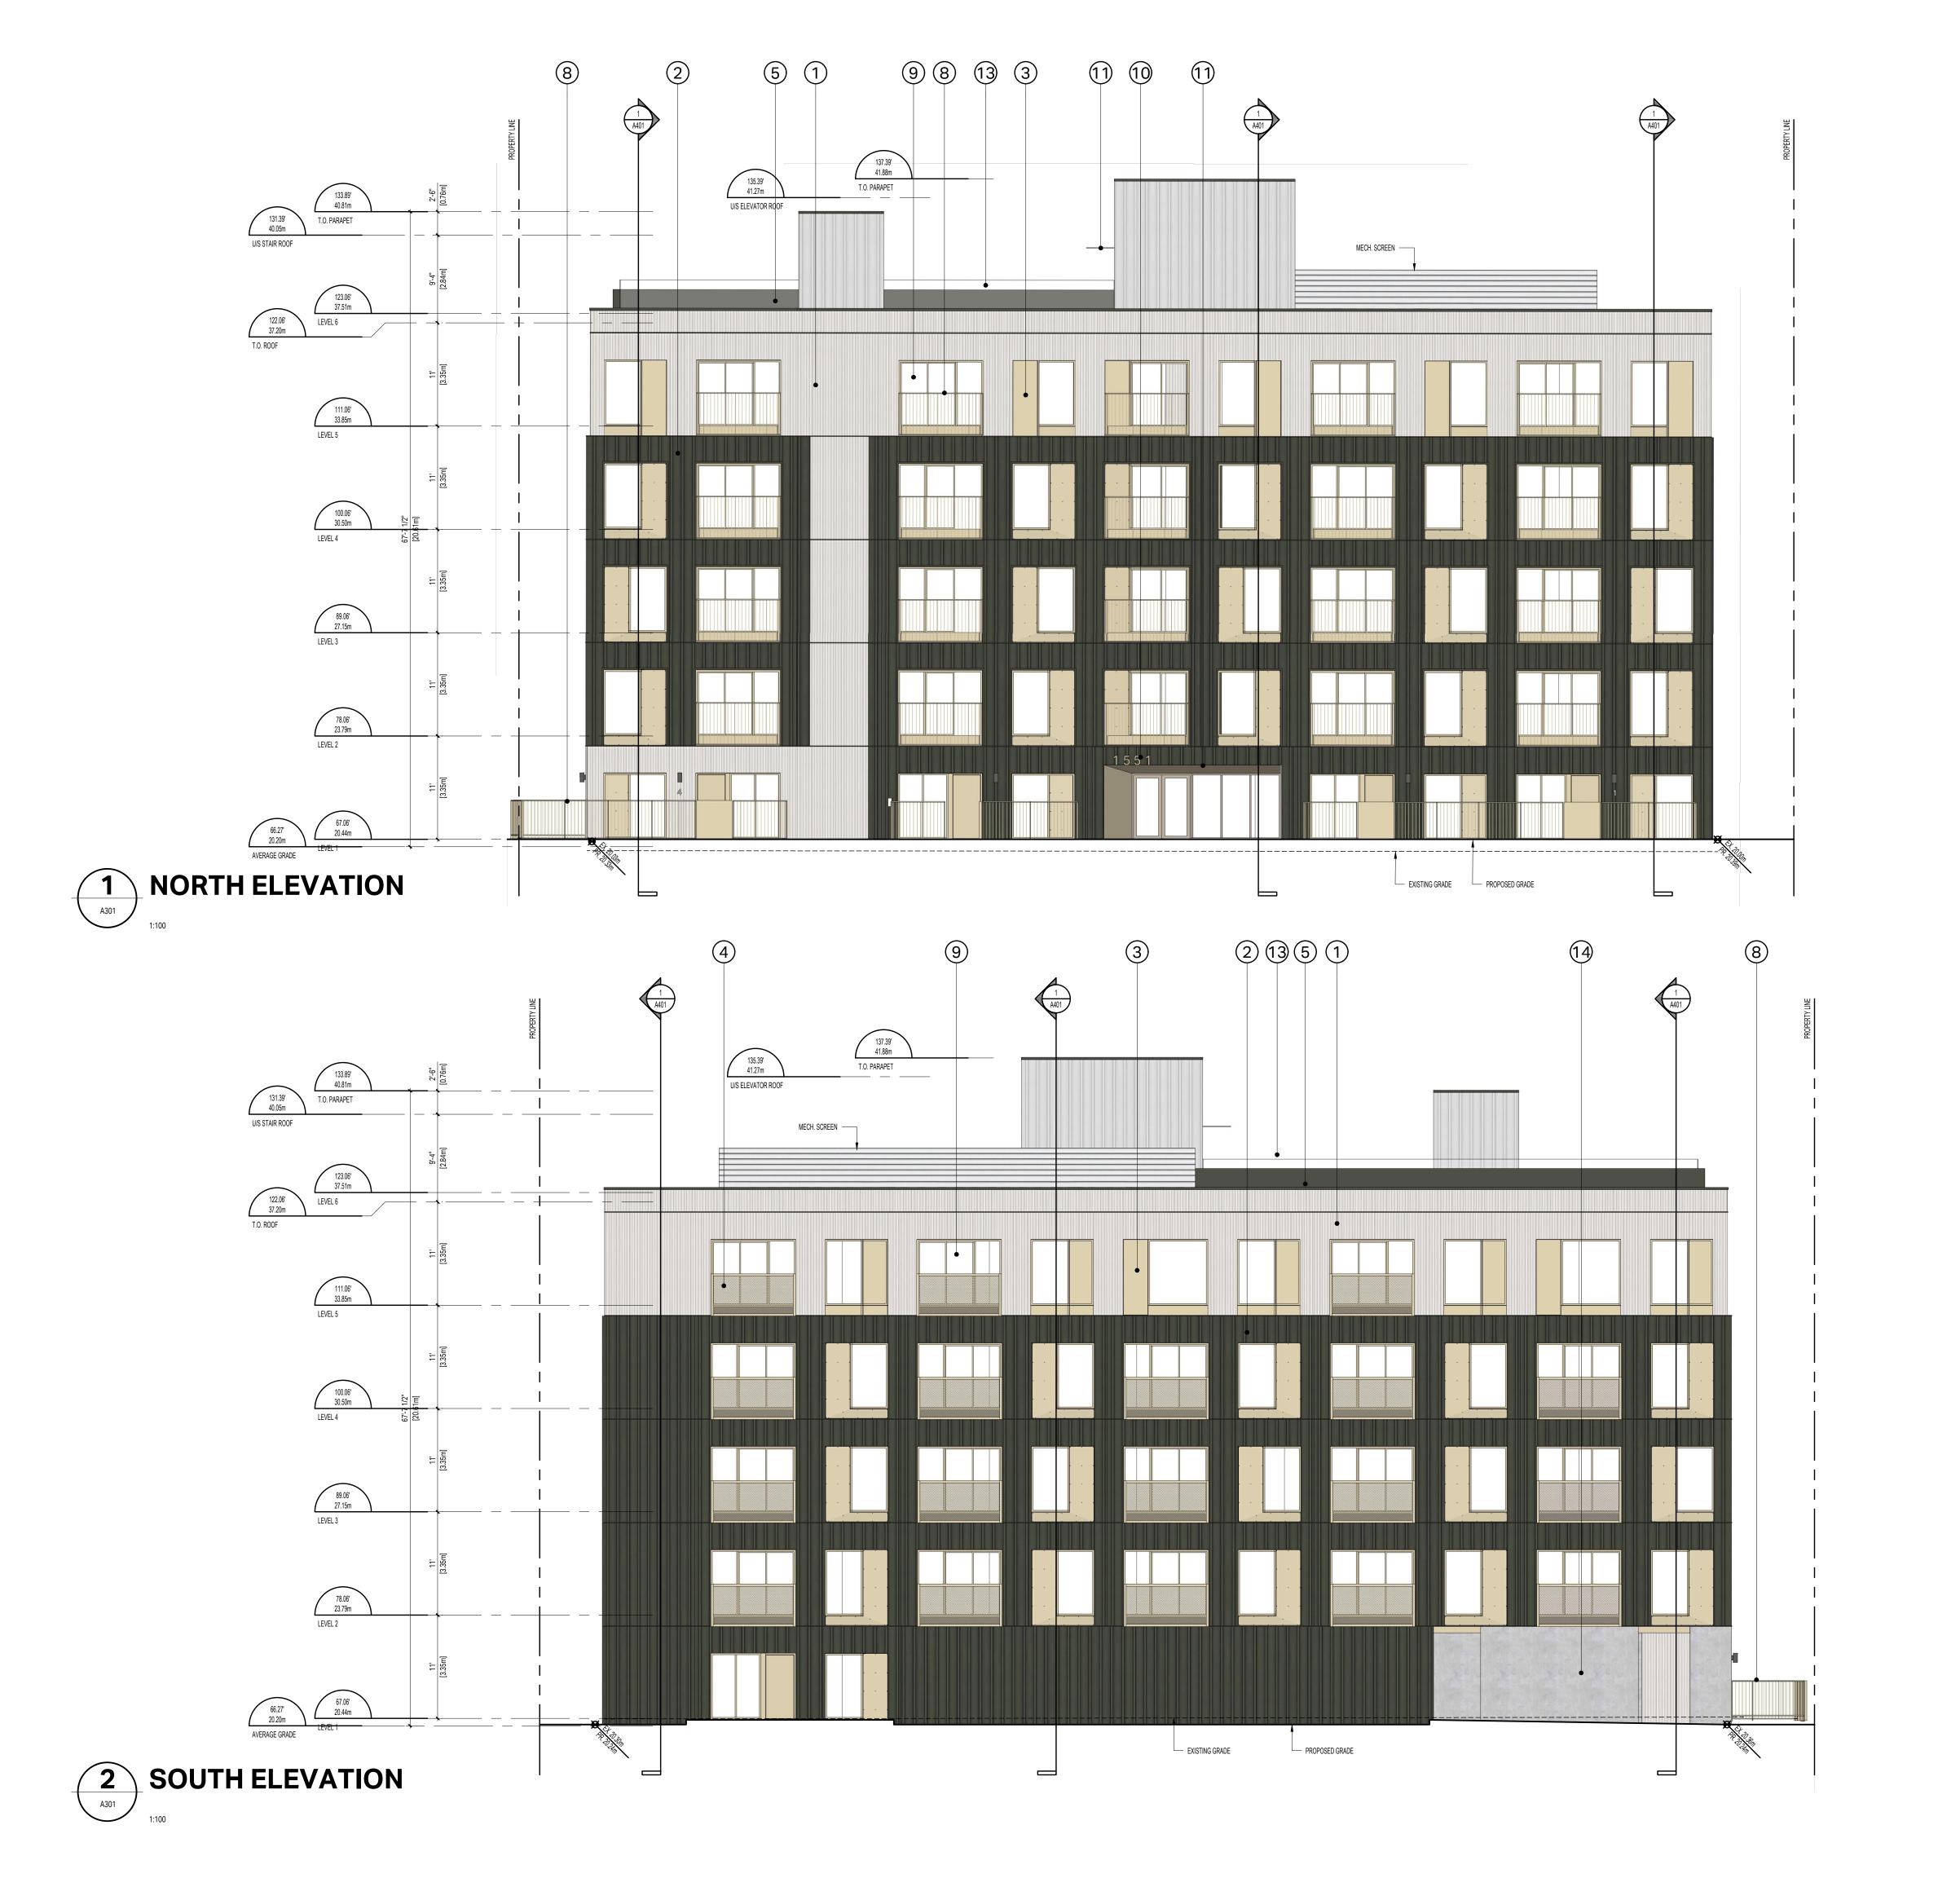

CERACLAD 8" REVEAL 2. 12" BOX RIB METAL PANEL (W/ 2" EXT INSULATION) 3. 4 GA. FACE MOUNTED METAL PANEL 4. PERFORATED METAL GUARD 5. BRAKE METAL FLASHING 6. SOLID WOOD DOOR

SCONCE LIGHTING

VINYL WINDOW/DOOR

12. STOREFRONT GLAZING

14. ARCHITECTURAL CONCRETE

13. GLASS GUARDRAIL

10. METAL SIGNAGE
11. METAL CANOPY

8. CUSTOM METAL PICKET GUARDRAIL

IRON ORE / FACTORY FINISH BEIGE / PRE-PAINTED BEIGE / PRE-PAINTED BEIGE / FACTORY FINISH BEIGE / PRE-PAINTED BEIGE / FACTORY FINISH BEIGE / PRE-PAINTED BEIGE / FACTORY FINISH BEIGE / FACTORY FINISH BEIGE / PRE-PAINTED BEIGE / FACTORY FINISH

CLEAR SEAL

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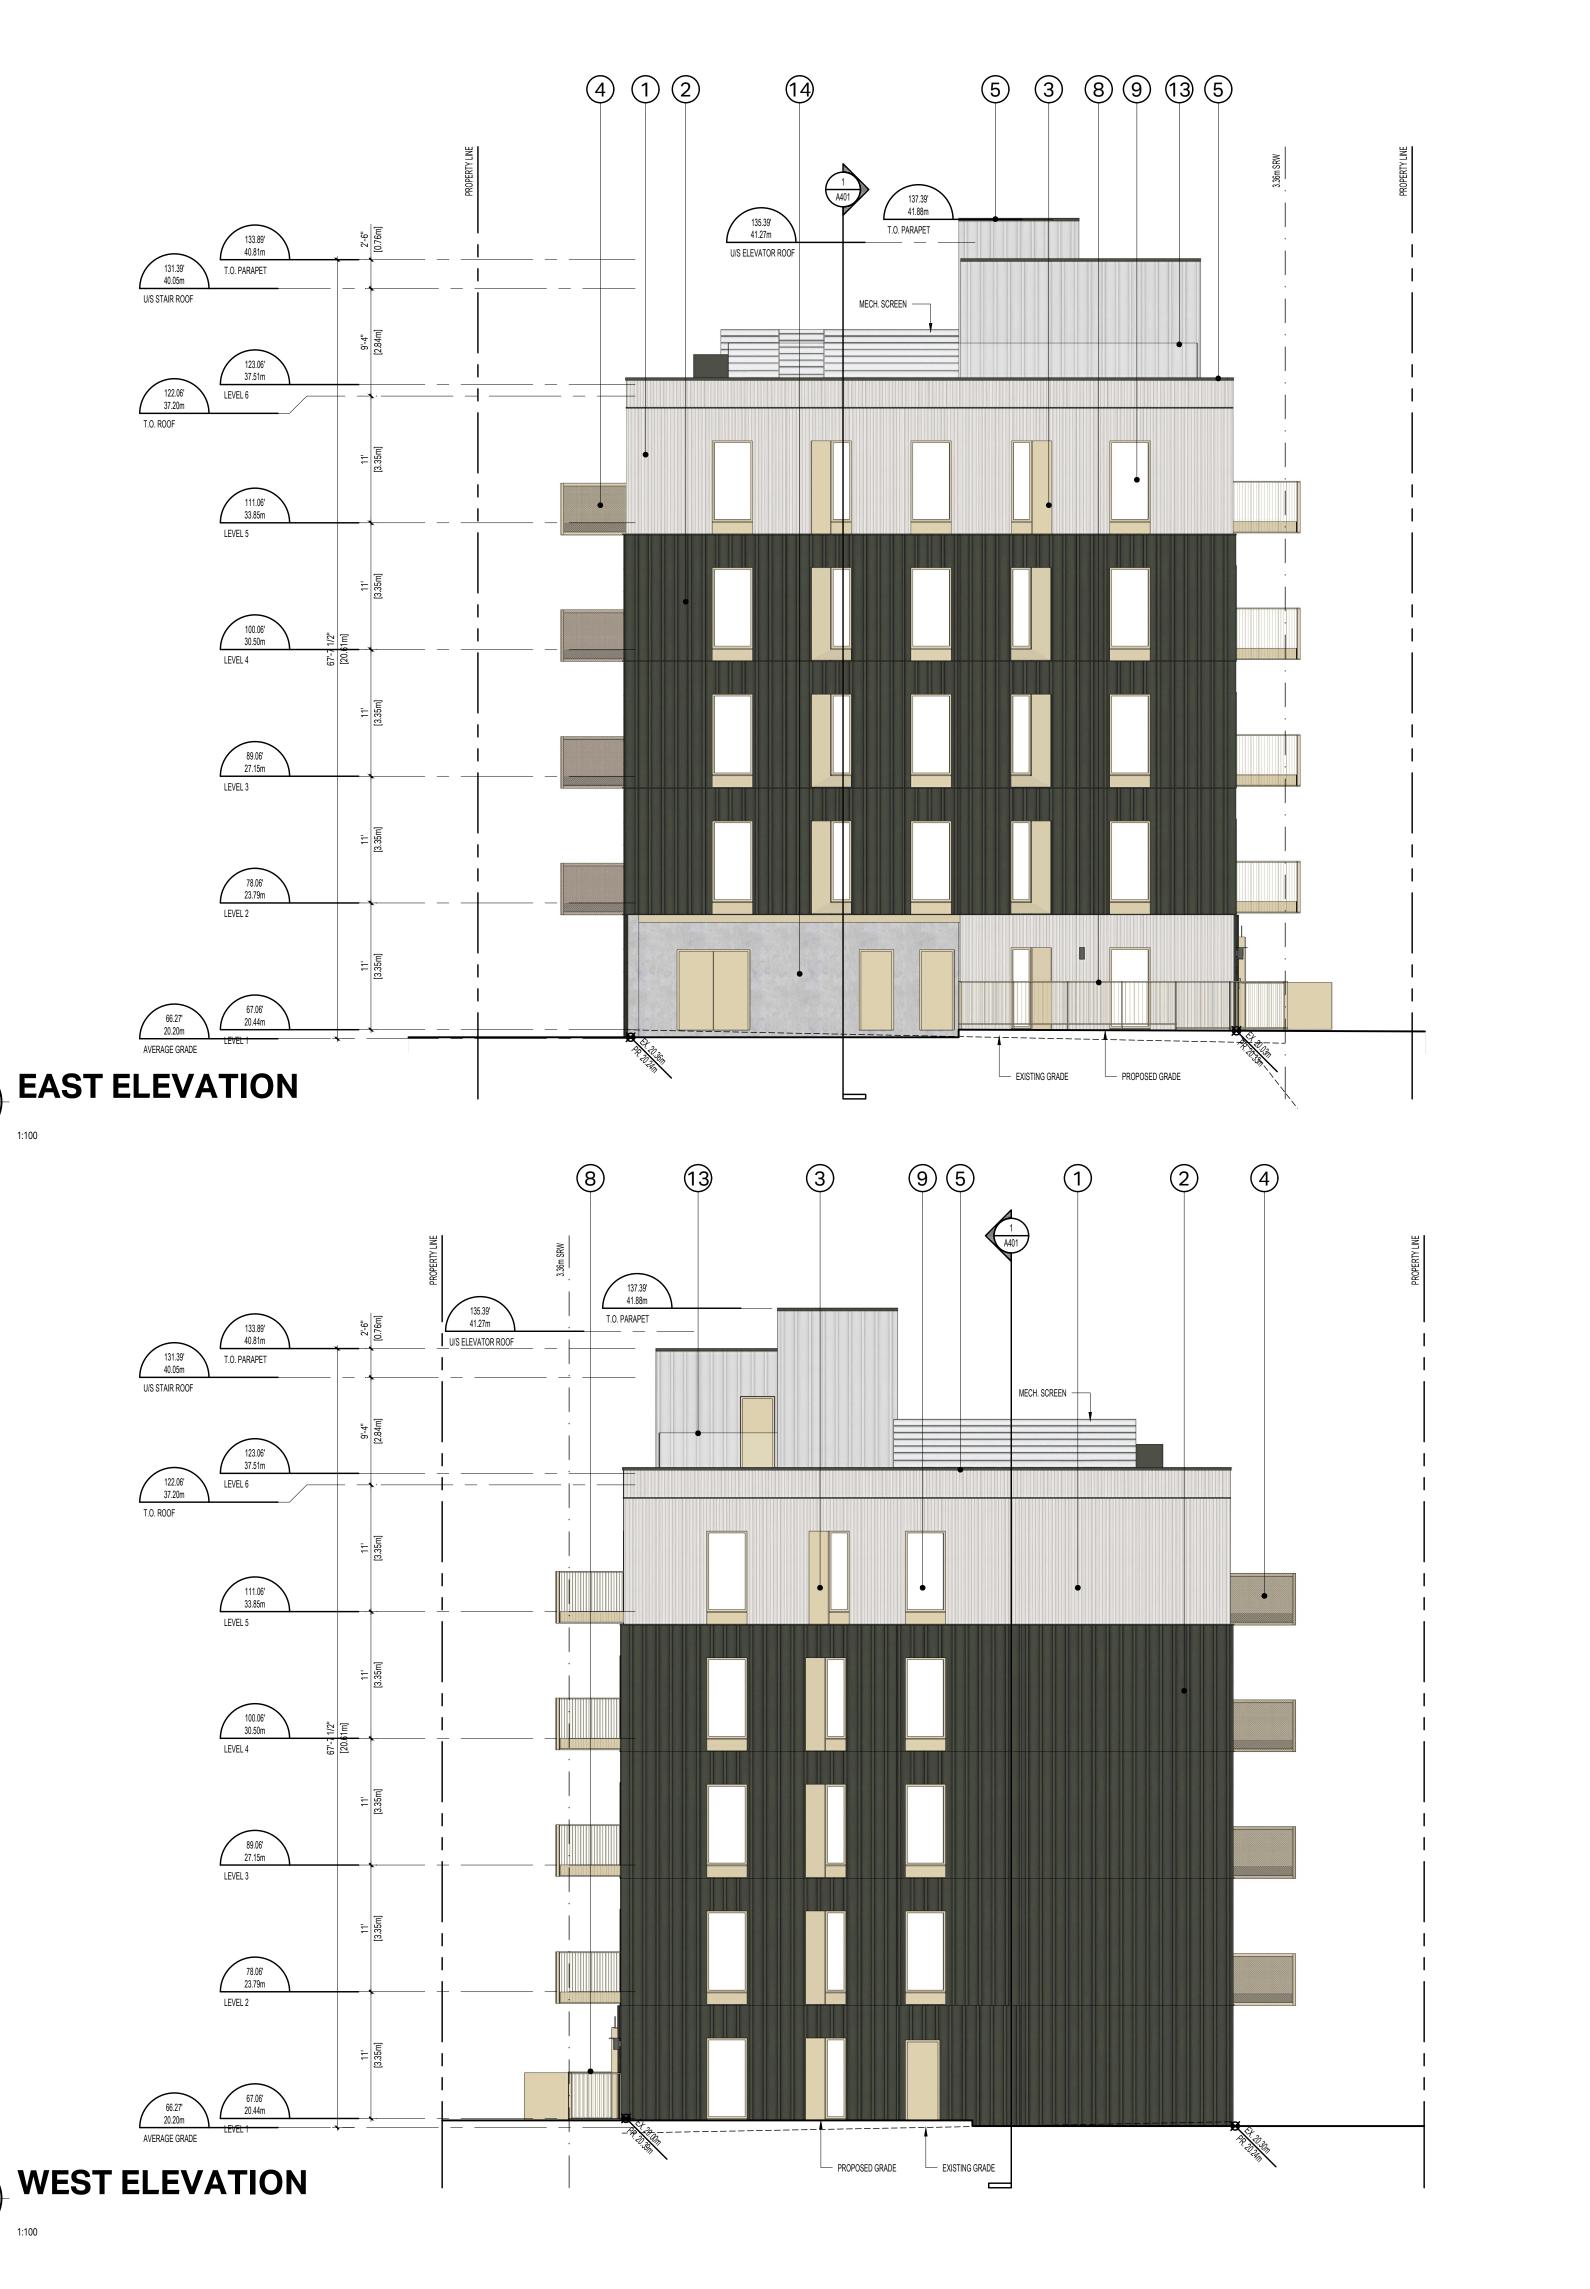
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ELEVATIONS

PROJECT NO: 2403 1:100 DRAWING NO: A301



!

MATERIAL

1. CERACLAD 8" REVEAL

2. 12" BOX RIB METAL PANEL (W/ 2" EXT INSULATION)

3. 4 GA. FACE MOUNTED METAL PANEL

4. PERFORATED METAL GUARD

5. BRAKE METAL FLASHING

6. SOLID WOOD DOOR

SCONCE LIGHTING

9. VINYL WINDOW/DOOR

10. METAL SIGNAGE
11. METAL CANOPY
12. STOREFRONT GLAZING
13. GLASS GUARDRAIL
14. ARCHITECTURAL CONCRETE

8. CUSTOM METAL PICKET GUARDRAIL

OFF-WHITE / FACTORY FINISH
BEIGE / PRE-PAINTED
BEIGE / PRE-PAINTED
BEIGE / FACTORY FINISH
BEIGE / FACTORY FINISH
BEIGE / PRE-PAINTED
BEIGE / PRE-PAINTED
BEIGE / PRE-PAINTED
BEIGE / PRE-PAINTED
BEIGE / FACTORY FINISH

BEIGE / FACTORY FINISH

CLEAR SEAL



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PROJECT NAME


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ELEVATIONS

SCALE:	1:100	REVIEW BY:	СН
PROJECT NO: 2	403	DRAWN BY:	LG



MINIMIZE UNIT DEPTH TO ACHIEVE MAXIMUM BUILDING SETBACKS

(DASHED RED LINES REPRESENT A TYPICAL MULTI-FAMILY FOOTPRINT DEPTH, BASED ON 30FT DEEP UNITS.
THE UNIT DEPTHS ARE AS SHALLOW AS POSSIBLE, SUBSEQUENTLY, BUILDING SETBACKS ARE NOT FEASIBLE.)

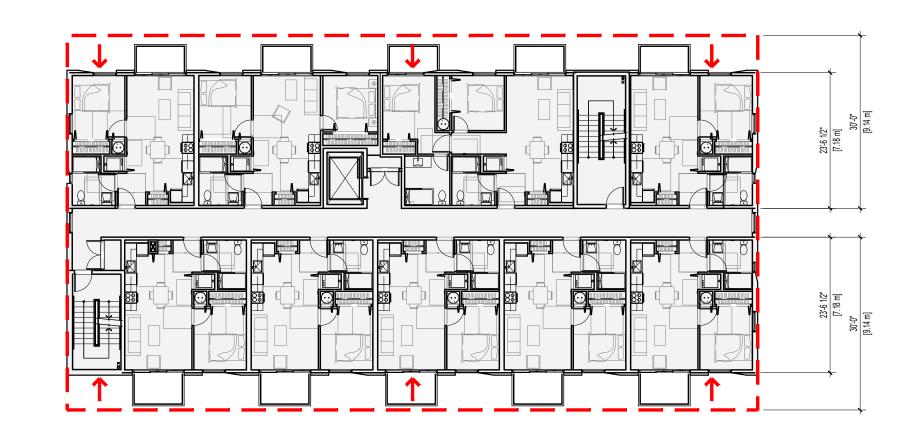


SIMPLE FORM

RICH AND SUBTLE FACADE

(IMPLEMENTING A SIMPLE FORM ALLOWS US TO ALLOCATE CONSTRUCTION BUDGET TO A MORE SOPHISTICATED FACADE WITH HIGHER QUALITY MATERIALS AND DETAILING.)

1 BUILDING FOOTPRINT



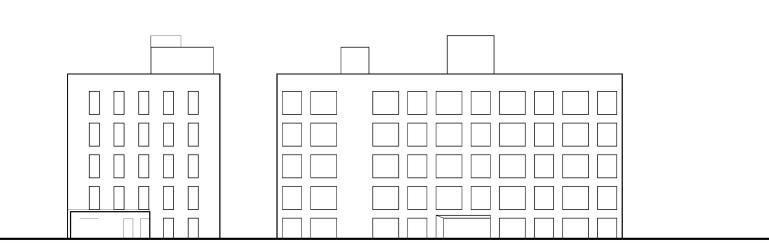

PANEL PATTERN

BREAK UP FACADE TO EMPHASIZE CORNER AND CREATE APPARENT STEPBACK AT UPPER FLOORS



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DESIGN RATIONALE



1 FRONT ELEVATION



3 SOUTHEAST CORNER



2 NORTHEAST CORNER



4 MAIN ENTRANCE

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PROJECT NAME

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PROJECT ADDRESS:

1551 & 1545 BAY ST VICTORIA, BC V8R 2B3



COLIN HARPER ARCHITECT 501 Foul Bay Road, Victoria, BC, V8S 4G9 778-584-0582 | info@charch.ca | charch.ca

RENDERINGS

PROJECT NO: 2403 DRAWN BY: KG

SCALE: N/A REVIEW BY: CH

DRAWING NO: A30





MATERIAL KEY



MATERIAL . CERACLAD 8" REVEAL 12" BOX RIB METAL PANEL (W/ 2" EXT INSULATION) . 4 GA. FACE MOUNTED METAL PANEL . PERFORATED METAL GUARD

5. BRAKE METAL FLASHING 6. SOLID WOOD DOOR 7. SCONCE LIGHTING CUSTOM METAL PICKET GUARDRAIL
 VINYL WINDOW/DOOR 9. VINYL WINDOWNDOOR
10. METAL SIGNAGE
11. METAL CANOPY
12. STOREFRONT GLAZING
13. GLASS GUARDRAIL
14. ARCHITECTURAL CONCRETE


BEIGE / FACTORY FINISH BEIGE / FACTORY FINISH
BEIGE / PRE-PAINTED
BEIGE / FACTORY FINISH
BEIGE / FRE-PAINTED
BEIGE / FACTORY FINISH
BEIGE / FACTORY FINISH
BEIGE / PRE-PAINTED
BEIGE / FACTORY FINISH N/A CLEAR SEAL

BEIGE / PRE-PAINTED

FINISH
OFF-WHITE / FACTORY FINISH
IRON ORE / FACTORY FINISH
BEIGE / PRE-PAINTED

MATERIAL BOARD

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OWNER/CLIENT: LIDA HOMES INC. 250-440-5432 6105 PATRICIA BAY HWY VICTORIA, BC V8Y 1T5

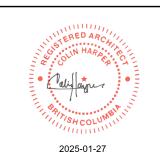ISSUED FOR REZONING & DEVELOPMENT PERMIT PROJECT NAME

1551 & 1545 BAY ST **VICTORIA, BC**

PROJECT ADDRESS:


1551 & 1545 BAY ST VICTORIA, BC V8R 2B3



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MATERIAL BOARD

DRAWING NO: A304



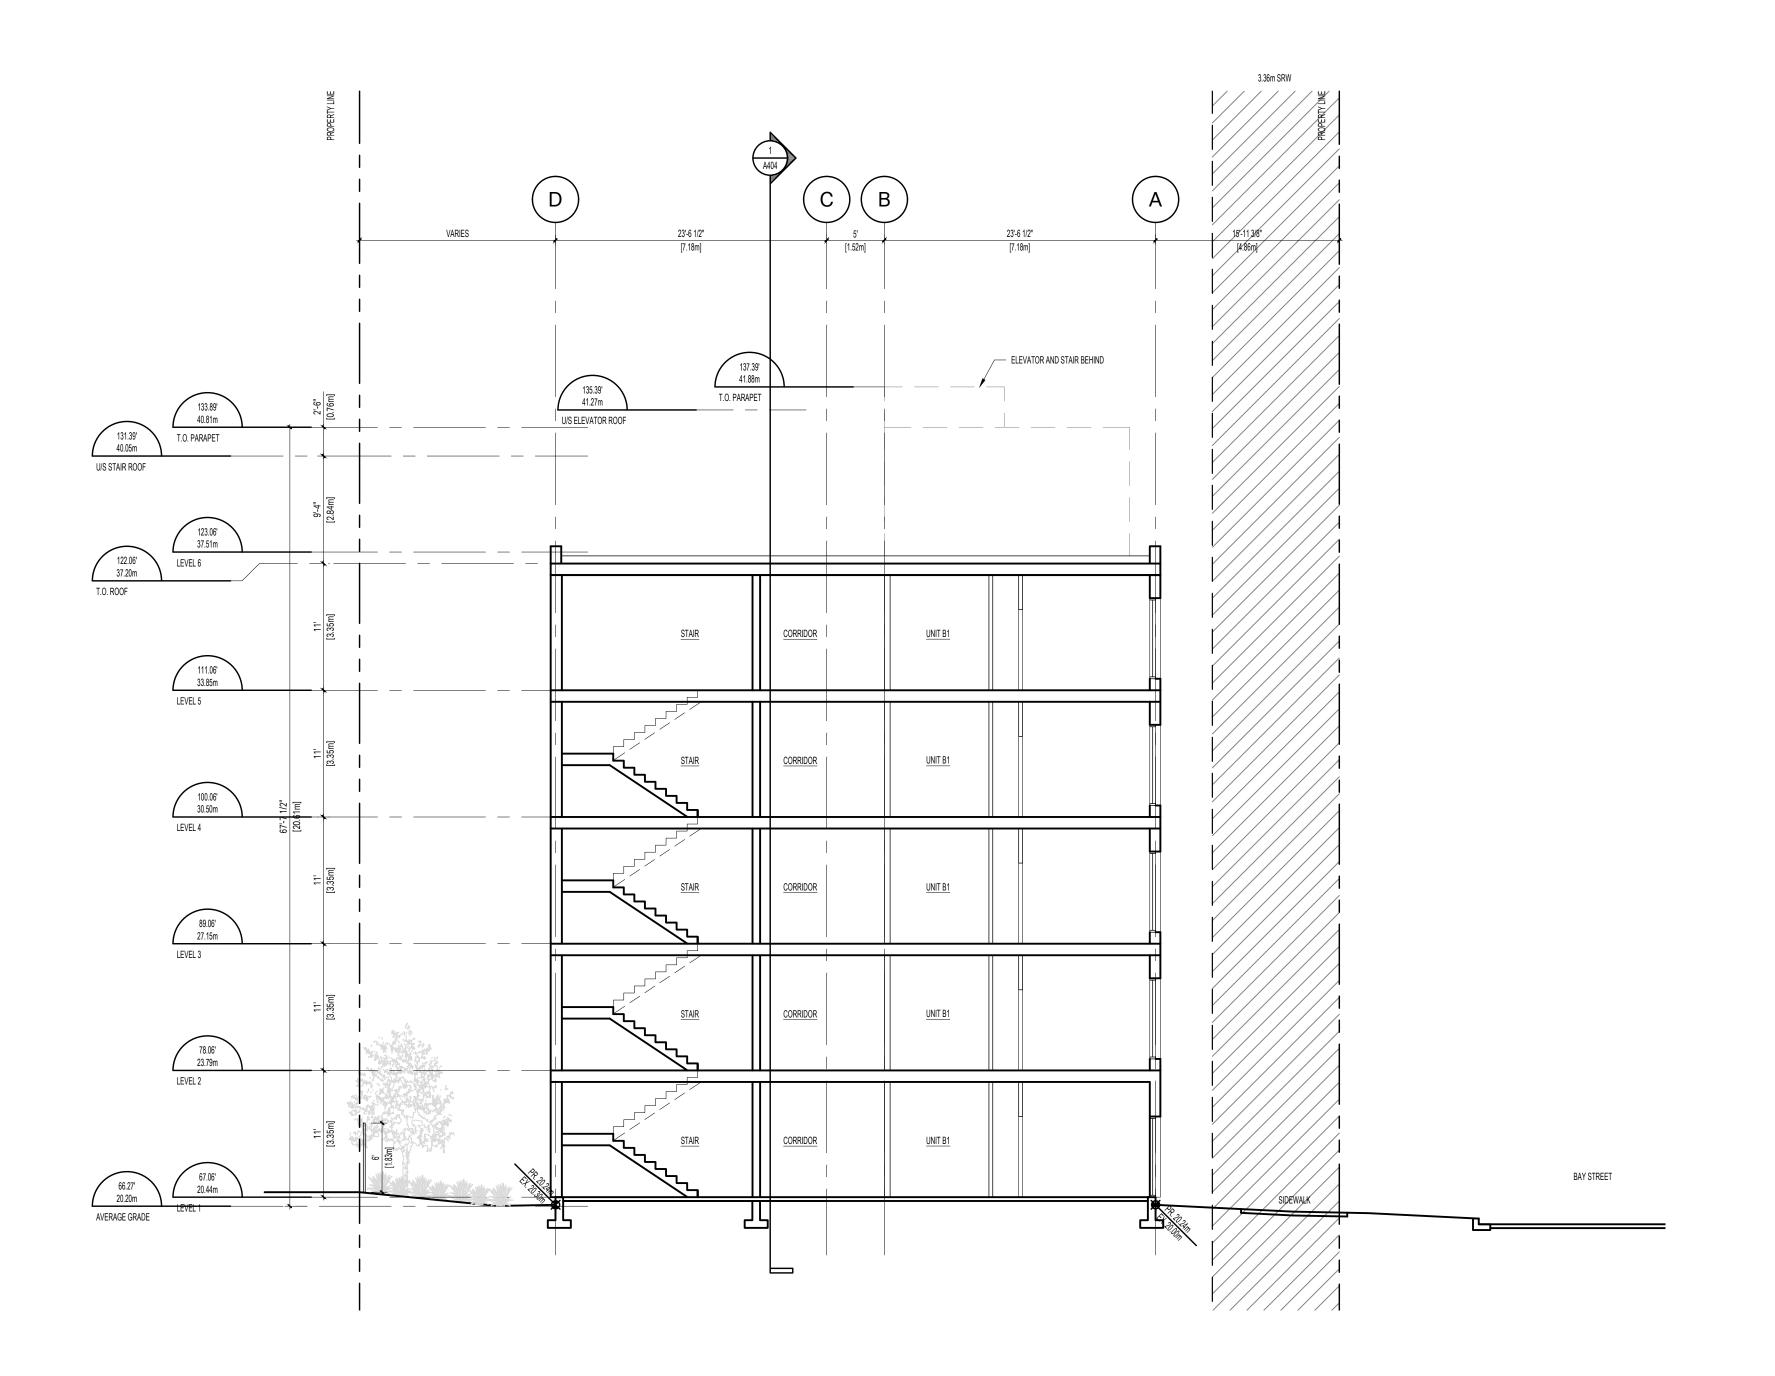

SE



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OWNER/CLIENT: LIDA HOMES INC. 250-440-5432 6105 PATRICIA BAY HWY VICTORIA, BC V8Y 1T5

01 ISSUED FOR REZONING & DEVELOPMENT PERMIT 01/27/2025
NO. REVISION M/D/Y
PROJECT NAME

1550 & 1545 BAY ST VICTORIA, BC

PROJECT ADDRESS:


1551 & 1545 BAY ST VICTORIA, BC V8R 2B3



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SECTIONS

		DRAWING NO:	A40
SCALE:	1:100	REVIEW BY:	СН
PROJECT NO:	2403	DRAWN BY:	LG

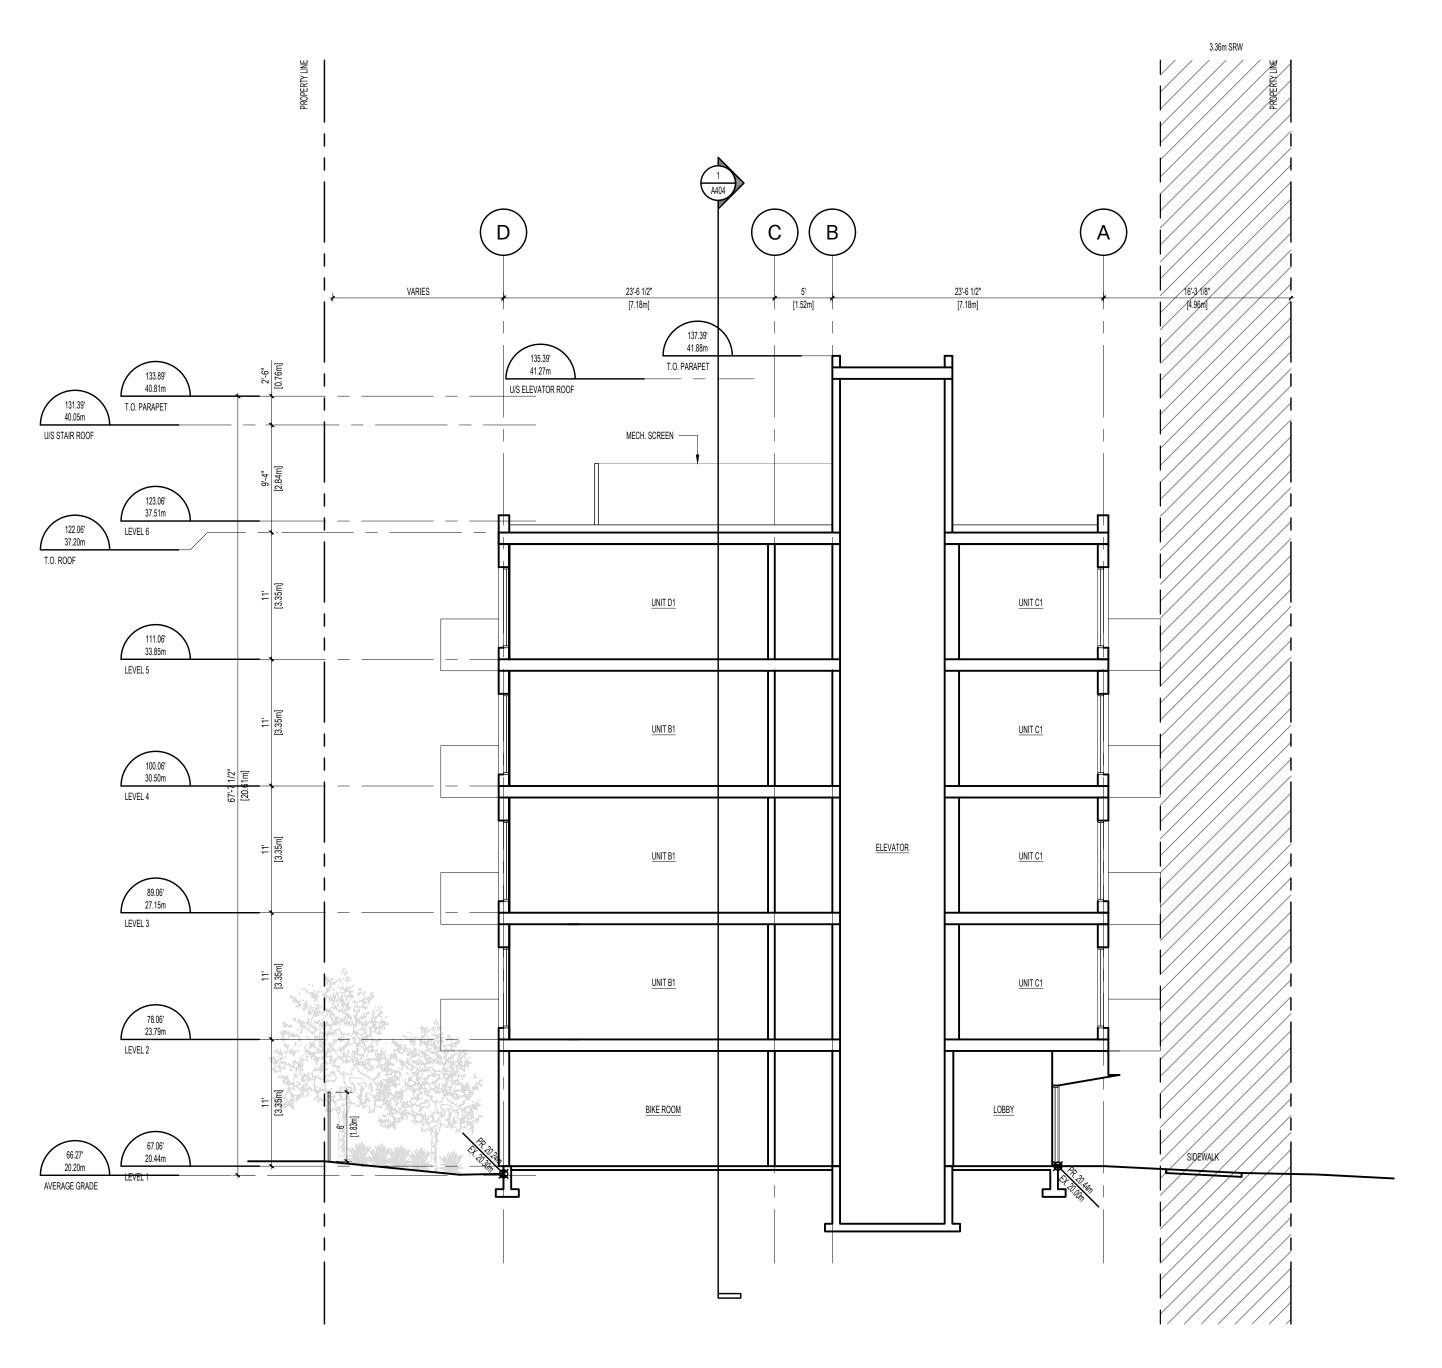

SECTION B

1:100

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1550 & 1545 BAY ST VICTORIA, BC

PROJECT ADDRESS:

1551 & 1545 BAY ST VICTORIA, BC V8R 2B3

PROJECT NAME




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SECTIONS

 PROJECT NO:
 2403
 DRAWN BY:
 LG


 SCALE:
 1:100
 REVIEW BY:
 CH

DRAWING NO: A402



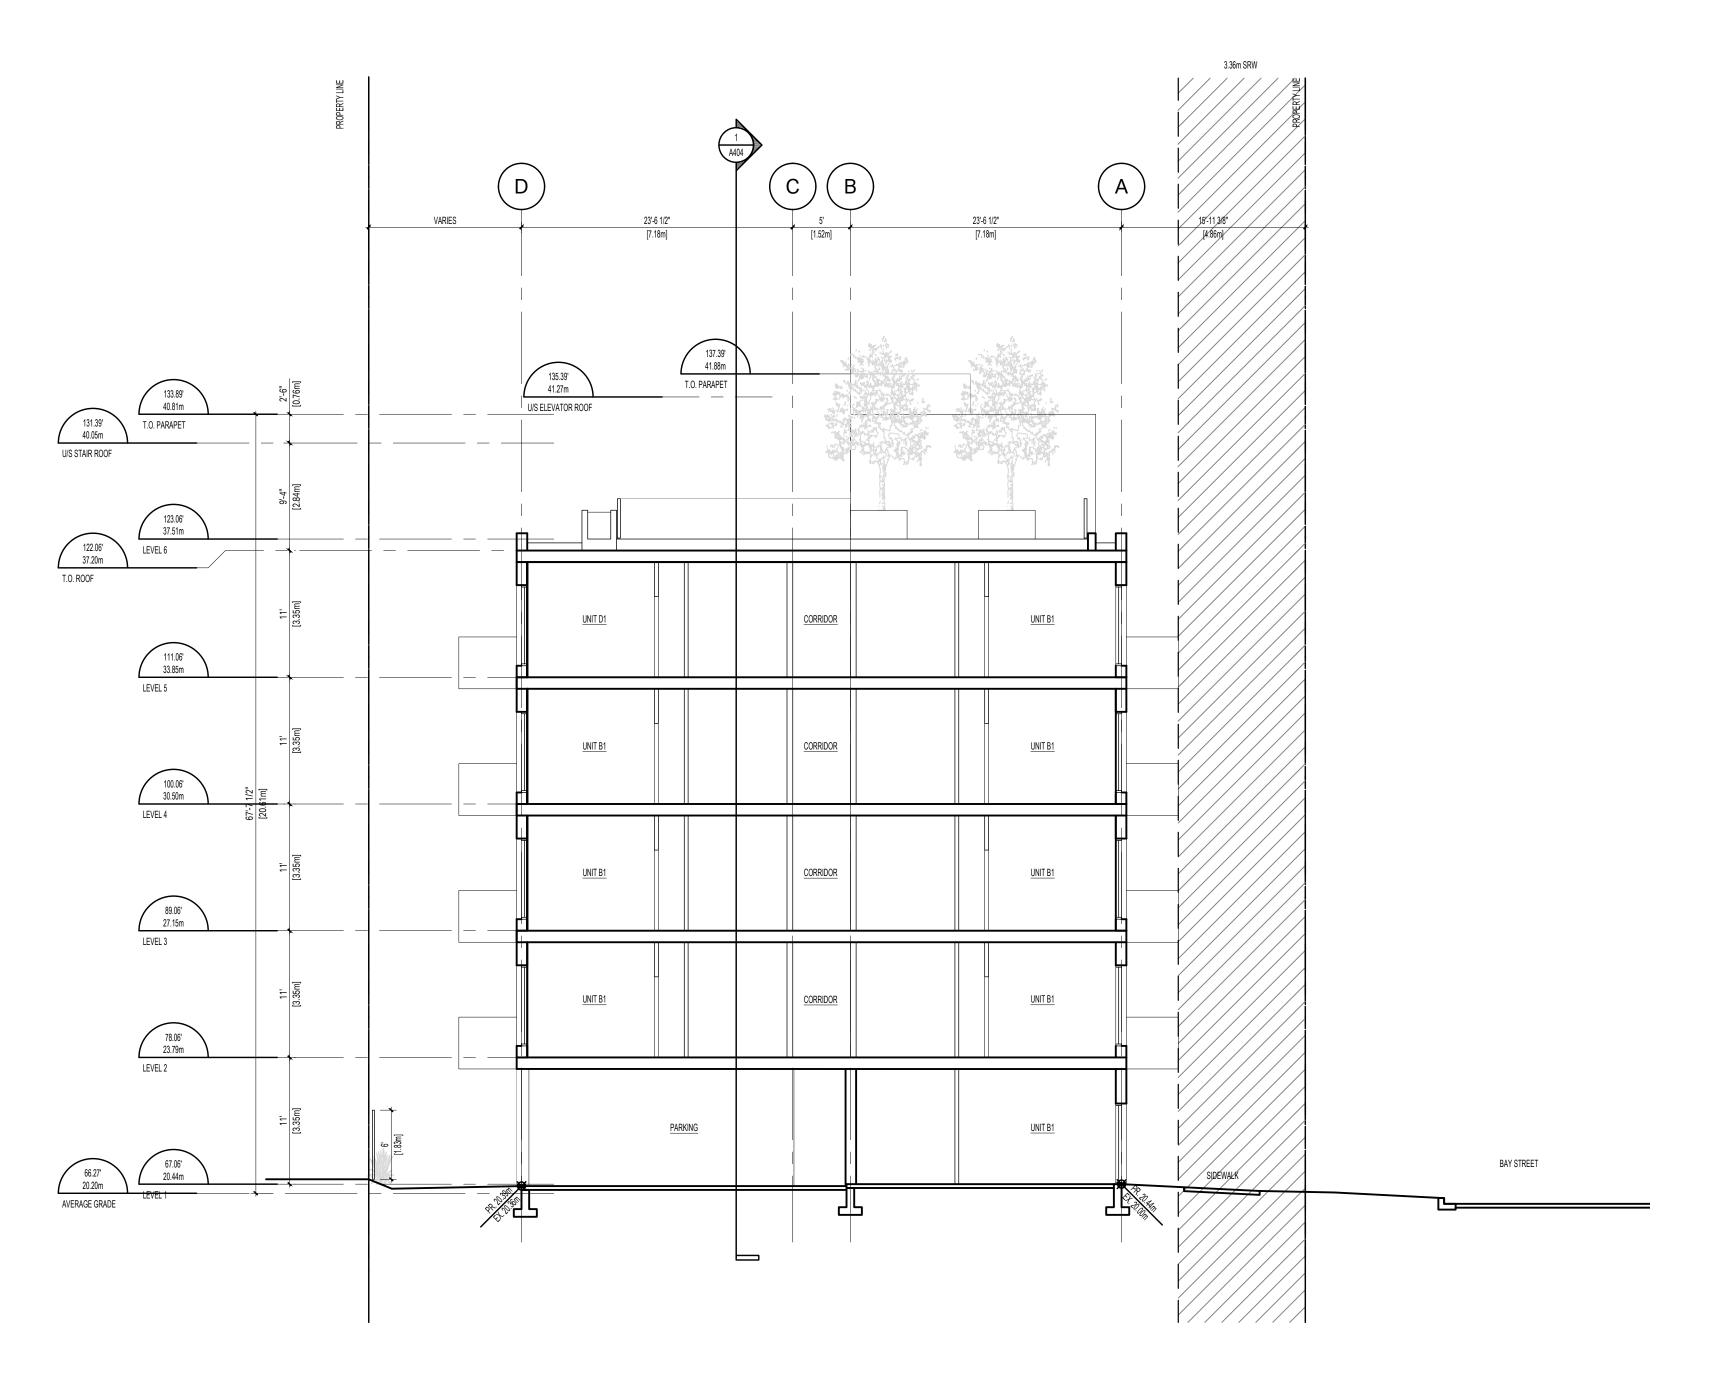

SE

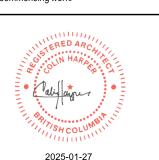

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NO. REVISION M/D/Y

1550 & 1545 BAY ST VICTORIA, BC

PROJECT ADDRESS:

1551 & 1545 BAY ST VICTORIA, BC V8R 2B3

PROJECT NAME




501 Foul Bay Road, Victoria, BC, V8S 4G9 778-584-0582 | info@charch.ca | charch.ca

SECTIONS

 PROJECT NO:
 2403
 DRAWN BY:
 LG

 SCALE:
 1:100
 REVIEW BY:
 CH


 DRAWING NO:
 A403

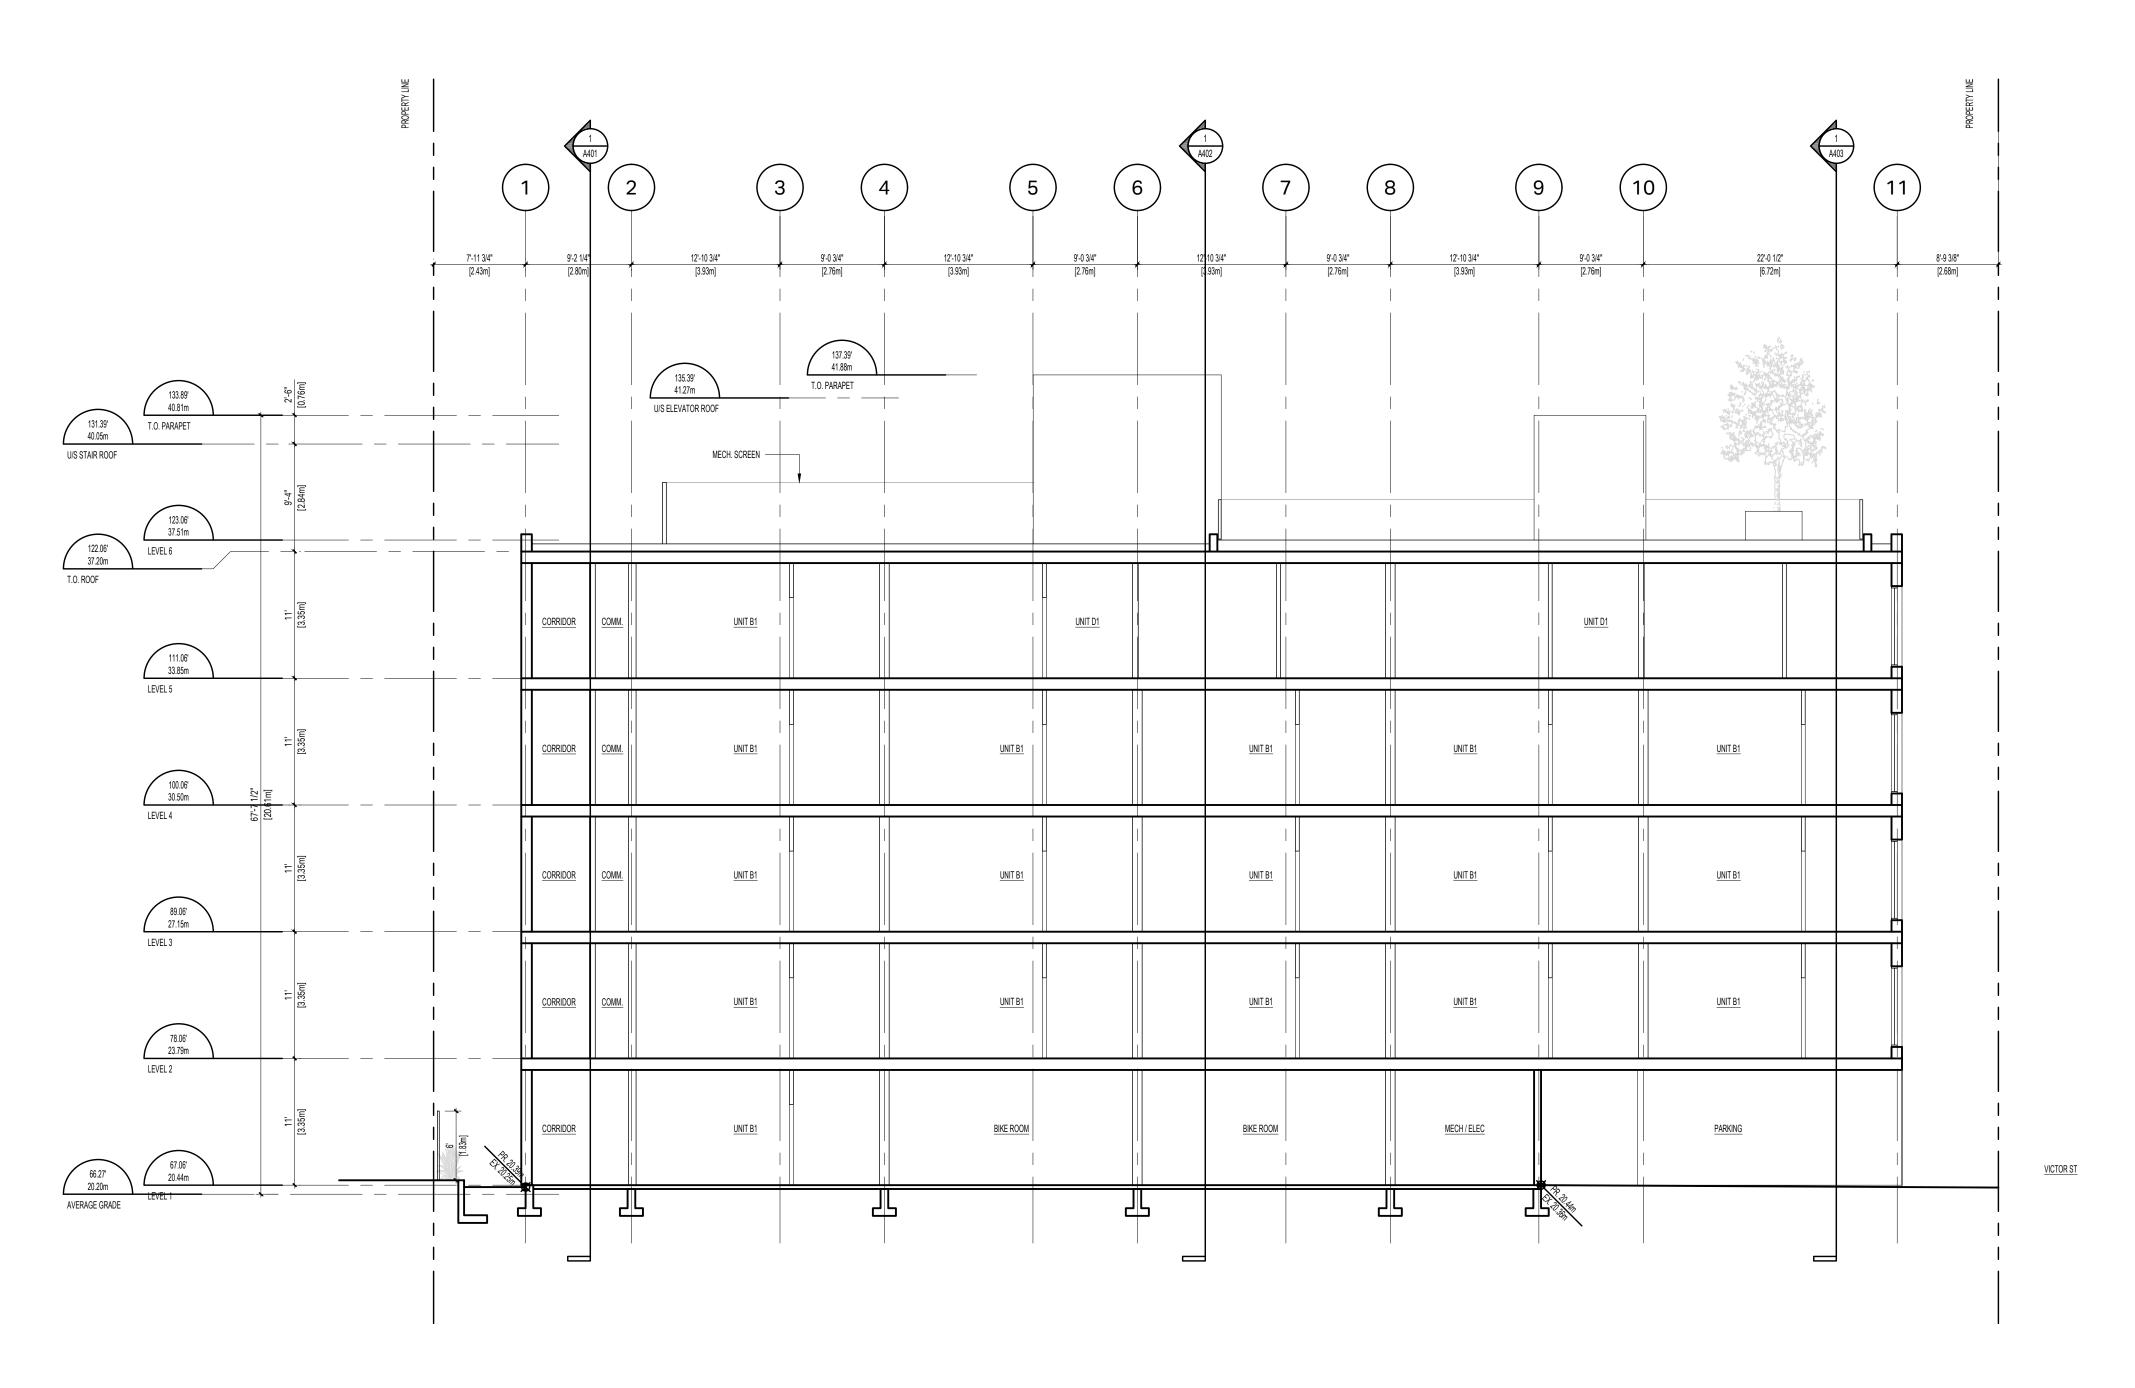

1 SECTION 1
1/A404 1:100

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1550 & 1545 BAY ST VICTORIA, BC

PROJECT ADDRESS:

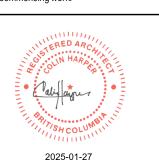PROJECT NAME


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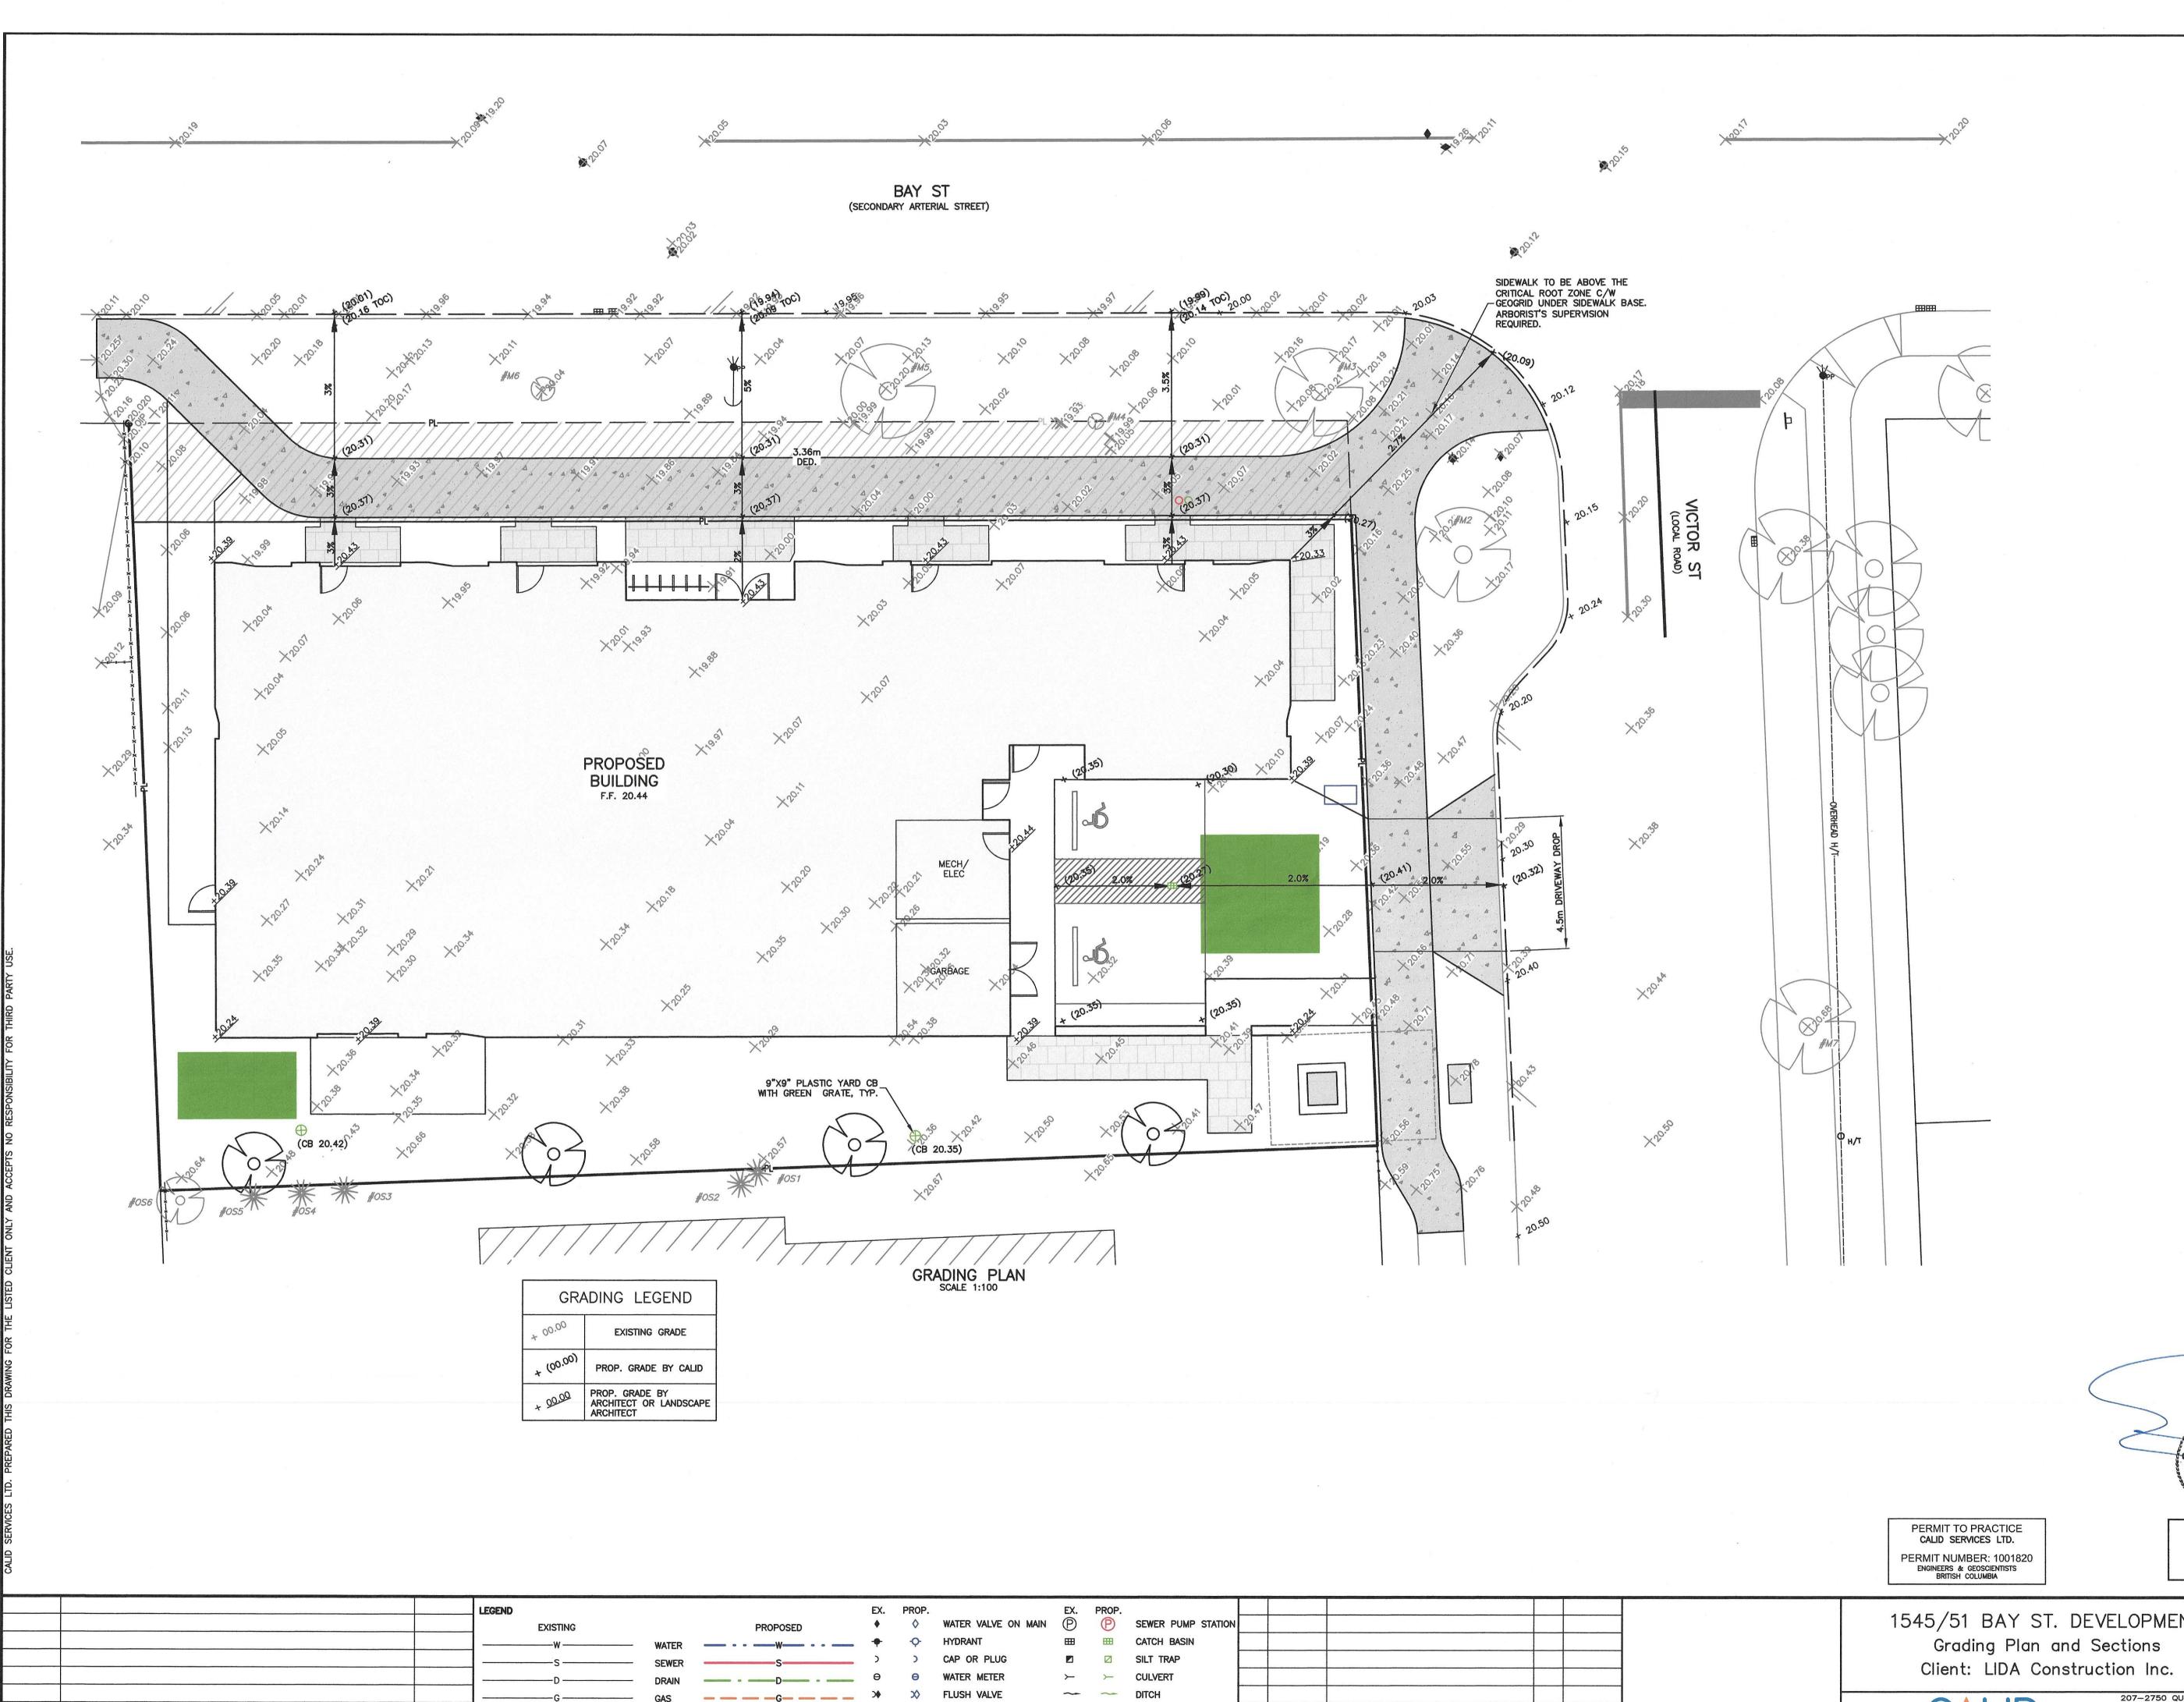


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SECTIONS

		DRAWING NO:	A404
SCALE:	1:100	REVIEW BY:	СН
PROJECT NO:	2403	DRAWN BY:	LG



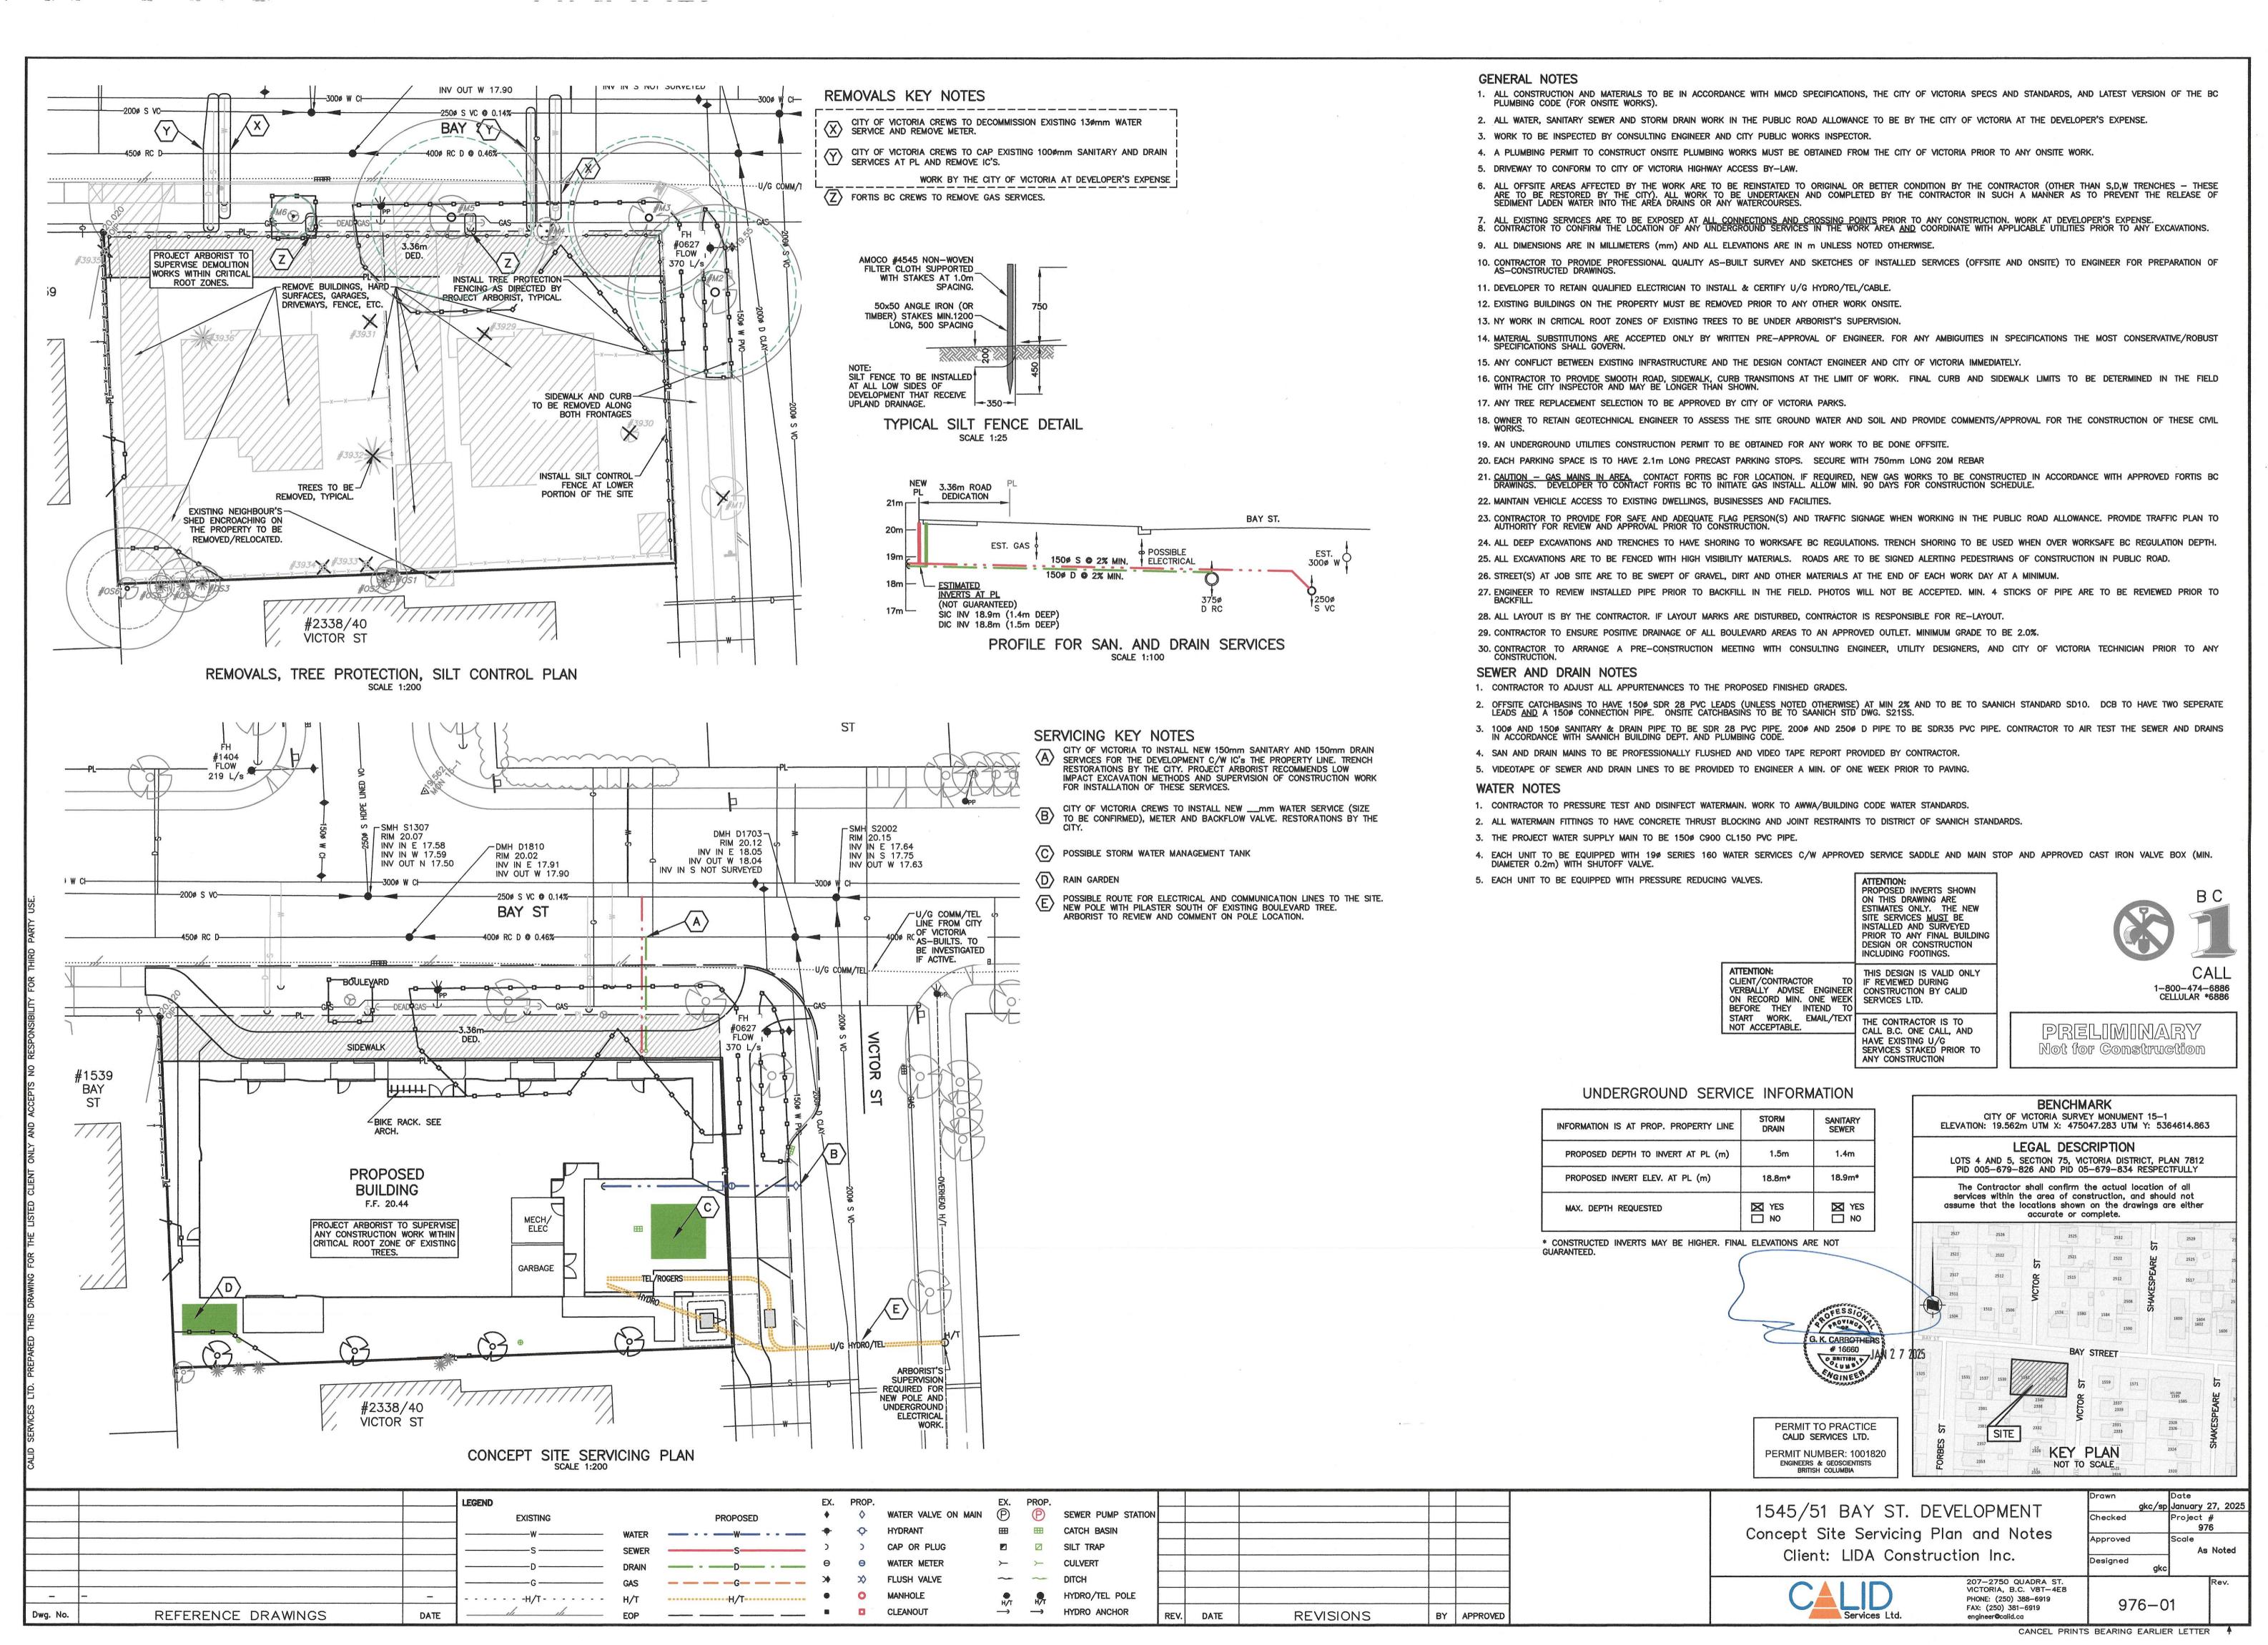

REFERENCE DRAWINGS

ATTENTION:
PROPOSED INVERTS SHOWN
ON THIS DRAWING ARE
ESTIMATES ONLY. THE NEW
SITE SERVICES MUST BE
INSTALLED AND SURVEYED
PRIOR TO ANY FINAL BUILDING
DESIGN OR CONSTRUCTION
INCLUDING FOOTINGS.


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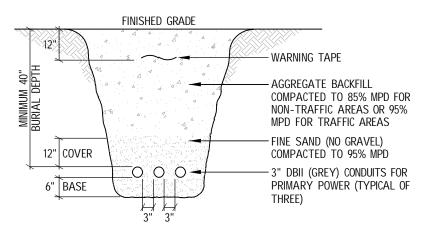
THE CONTRACTOR IS TO CALL B.C. ONE CALL, AND HAVE EXISTING U/G SERVICES STAKED PRIOR TO ANY CONSTRUCTION




Not for Construction

	LEGEND	t t	x. PRO	•	EX. PRO	P.						15/5/51 RAY ST DEVELODMENT gkc/sp January 27, 2025
	EXISTING	PROPOSED	> >	WATER VALVE ON MAIN	(P) (E	SEWER PUMP STATION						1545/51 BAY ST. DEVELOPMENT gkc/sp January 27, 2025 Checked Project #
	www/	ATER	• •	HYDRANT	##	CATCH BASIN						Grading Plan and Sections 976 Approved Scale
	SSE	WERS)	CAP OR PLUG		SILT TRAP						Client: LIDA Construction Inc.
	DDF	RAIN —— - —— D—— - ——	9 0	WATER METER	>	CULVERT						CHEFT. LIDA CONSTRUCTION INC. Designed gkc
	GA	s	♦ >>	FLUSH VALVE	~ ~	DITCH						207–2750 QUADRA ST. Rev.
	н/т н/	/TH/T	•	MANHOLE	HZT H	HYDRO/TEL POLE						VICTORIA, B.C. V8T-4E8 PHONE: (250) 388-6919
DATE	lEO)P		CLEANOUT		HYDRO ANCHOR	REV.	DATE	REVISIONS	BY	APPROVED	PHONE: (250) 388-6919 FAX: (250) 381-6919 engineer@calid.ca 976-02
												CANCEL PRINTS BEARING EARLIER LETTER



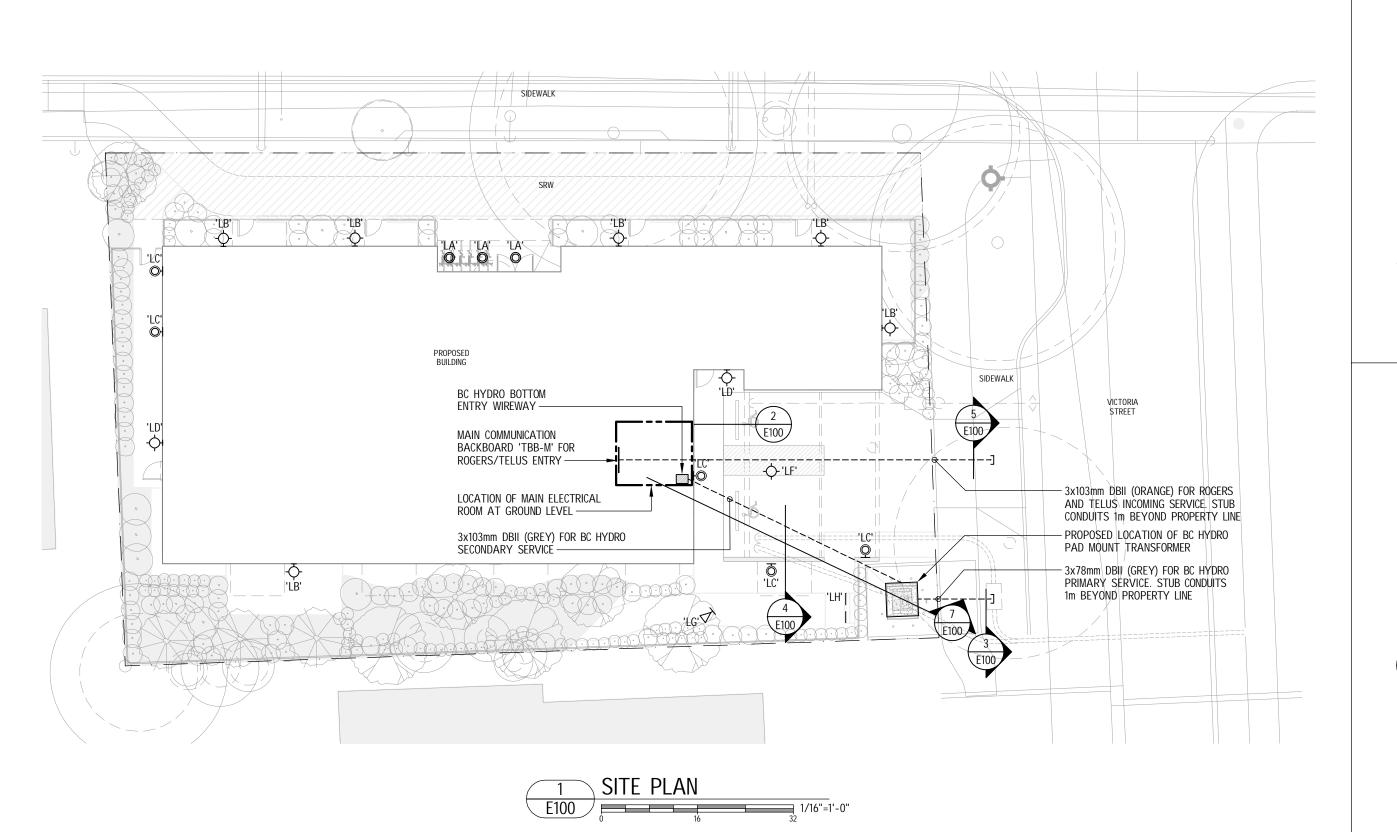

3 PRIMARY TRENCH DETAIL E100 NTS

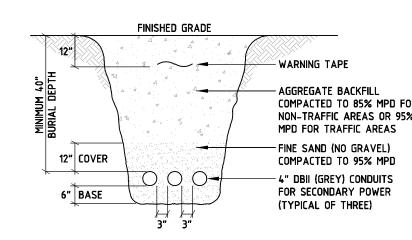


E100 NTS

FINISHED GRADE

6 DUCTS CLEARANCES DETAIL


E100 NTS

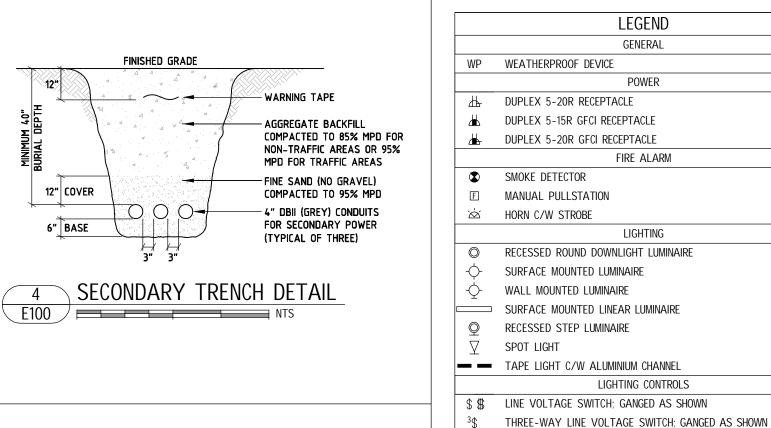




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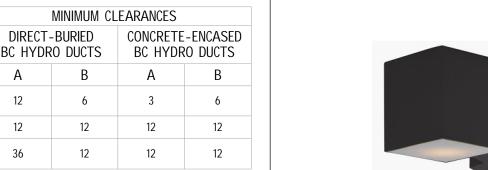
CLEARANCES (in)

STREET LIGHTS GAS MAINS

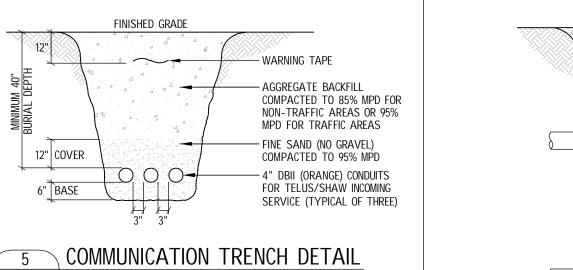TELEPHONE, CABLE TV OR

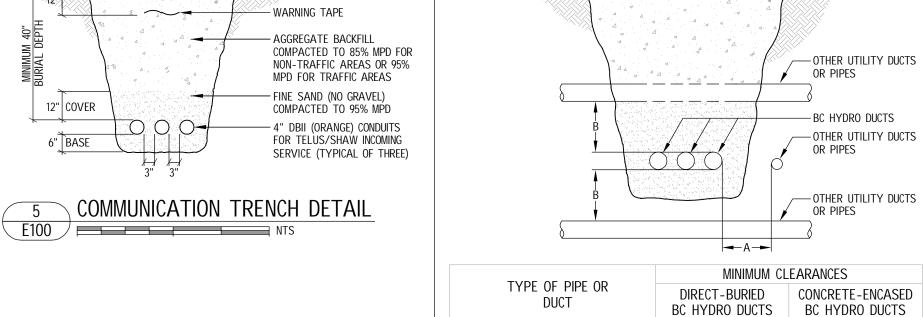SANITARY AND SEWER LINES


OIL PIPELINES, JET FUEL LINES, WATER,



WALL SCONCE LUMINAIRE TYPE 'LB'

MAIN ENTRY RECESSED DOWNLIGHT

LUMINAIRE TYPE 'LA'

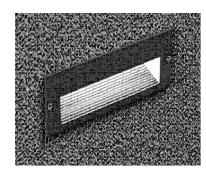

STEP LUMINAIRE TYPE 'LC'



WALL SCONCE LUMINAIRE TYPF 'I D'

NO.
PROJECT
155 BA

SUFACE MOUNTED LUMINAIRE TYPE 'LF'



EXTERIOR TAPE LUMINAIRE TYPE 'LH'



SUFACE MOUNTED LUMINAIRE TYPE 'A'

		51 AND 1554 Y STREET
	PROJECT	
	NO.	ISSUE
NCE LUMINAIRE LYPE LU	1	REVIEW

1554 BAY STREET VICTORIA, BC

IIILE		
SITE PLAN, LEGEND	DETAILS	AND


DEVELOPMENT PERMIT


24/01/25


12/12/24

DATE

PROJECT NO.	1-24-093	SHEET NO.
DRAWN	MT	
CHECKED PL		L100
DATE	JANUARY 2025	
SCALE	AS NOTED	rev 2

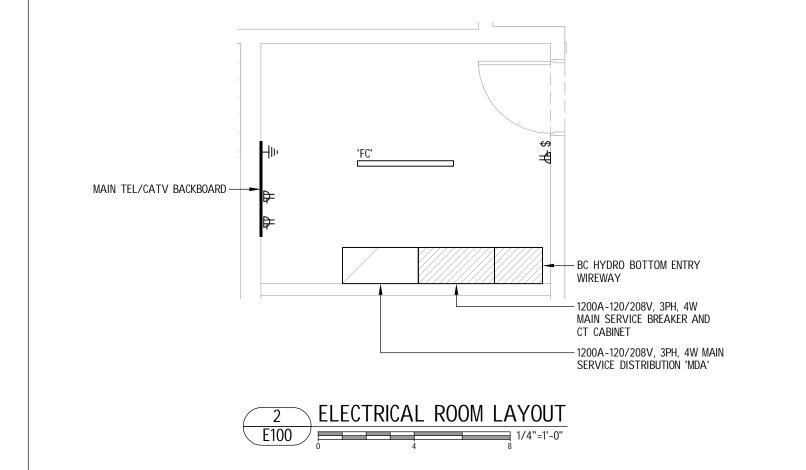


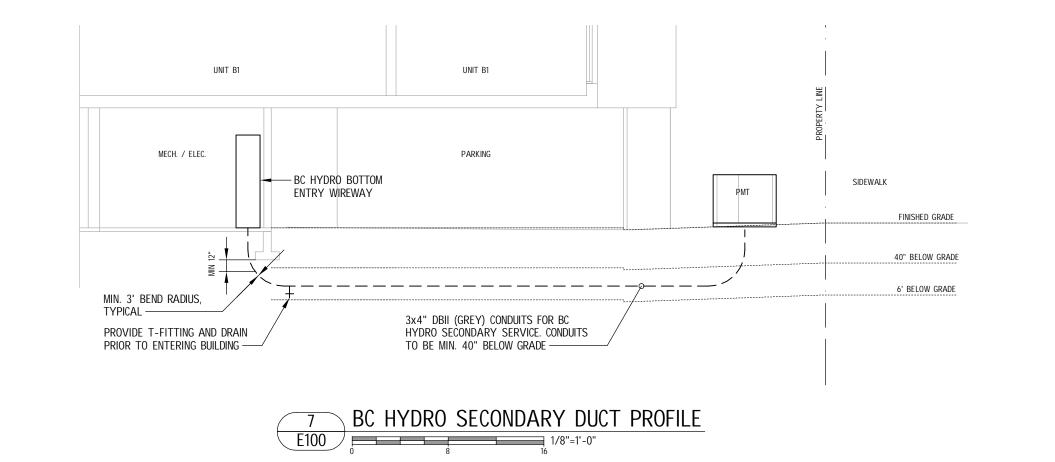


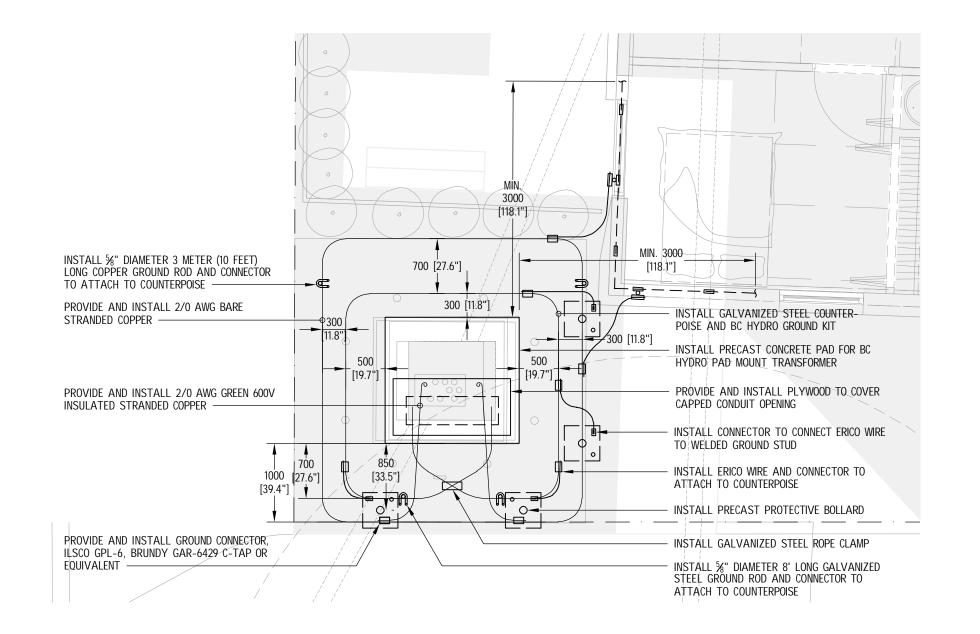

BC HYDRO COUNTERPOISE AND CUSTOMER GROUNDING DETAIL

E100 1/4"=1'-0"

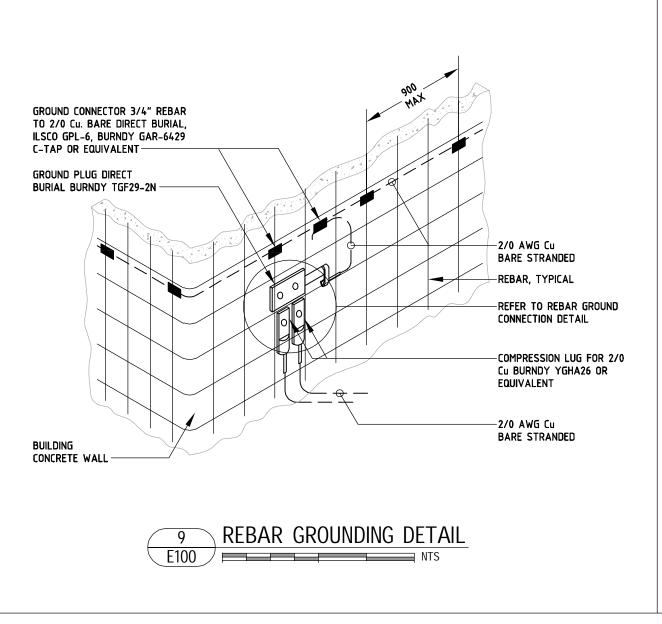

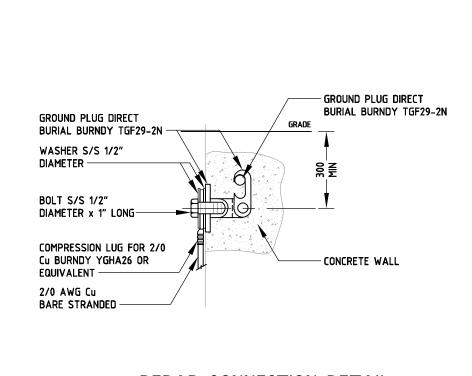


10 REBAR CONNECTION DETAIL E100 NTS

2' LONG LENSED LED STRIP LUMINAIRE TYPE 'FD'

4' LONG LENSED LED STRIP LUMINAIRE

TYPE 'FC'

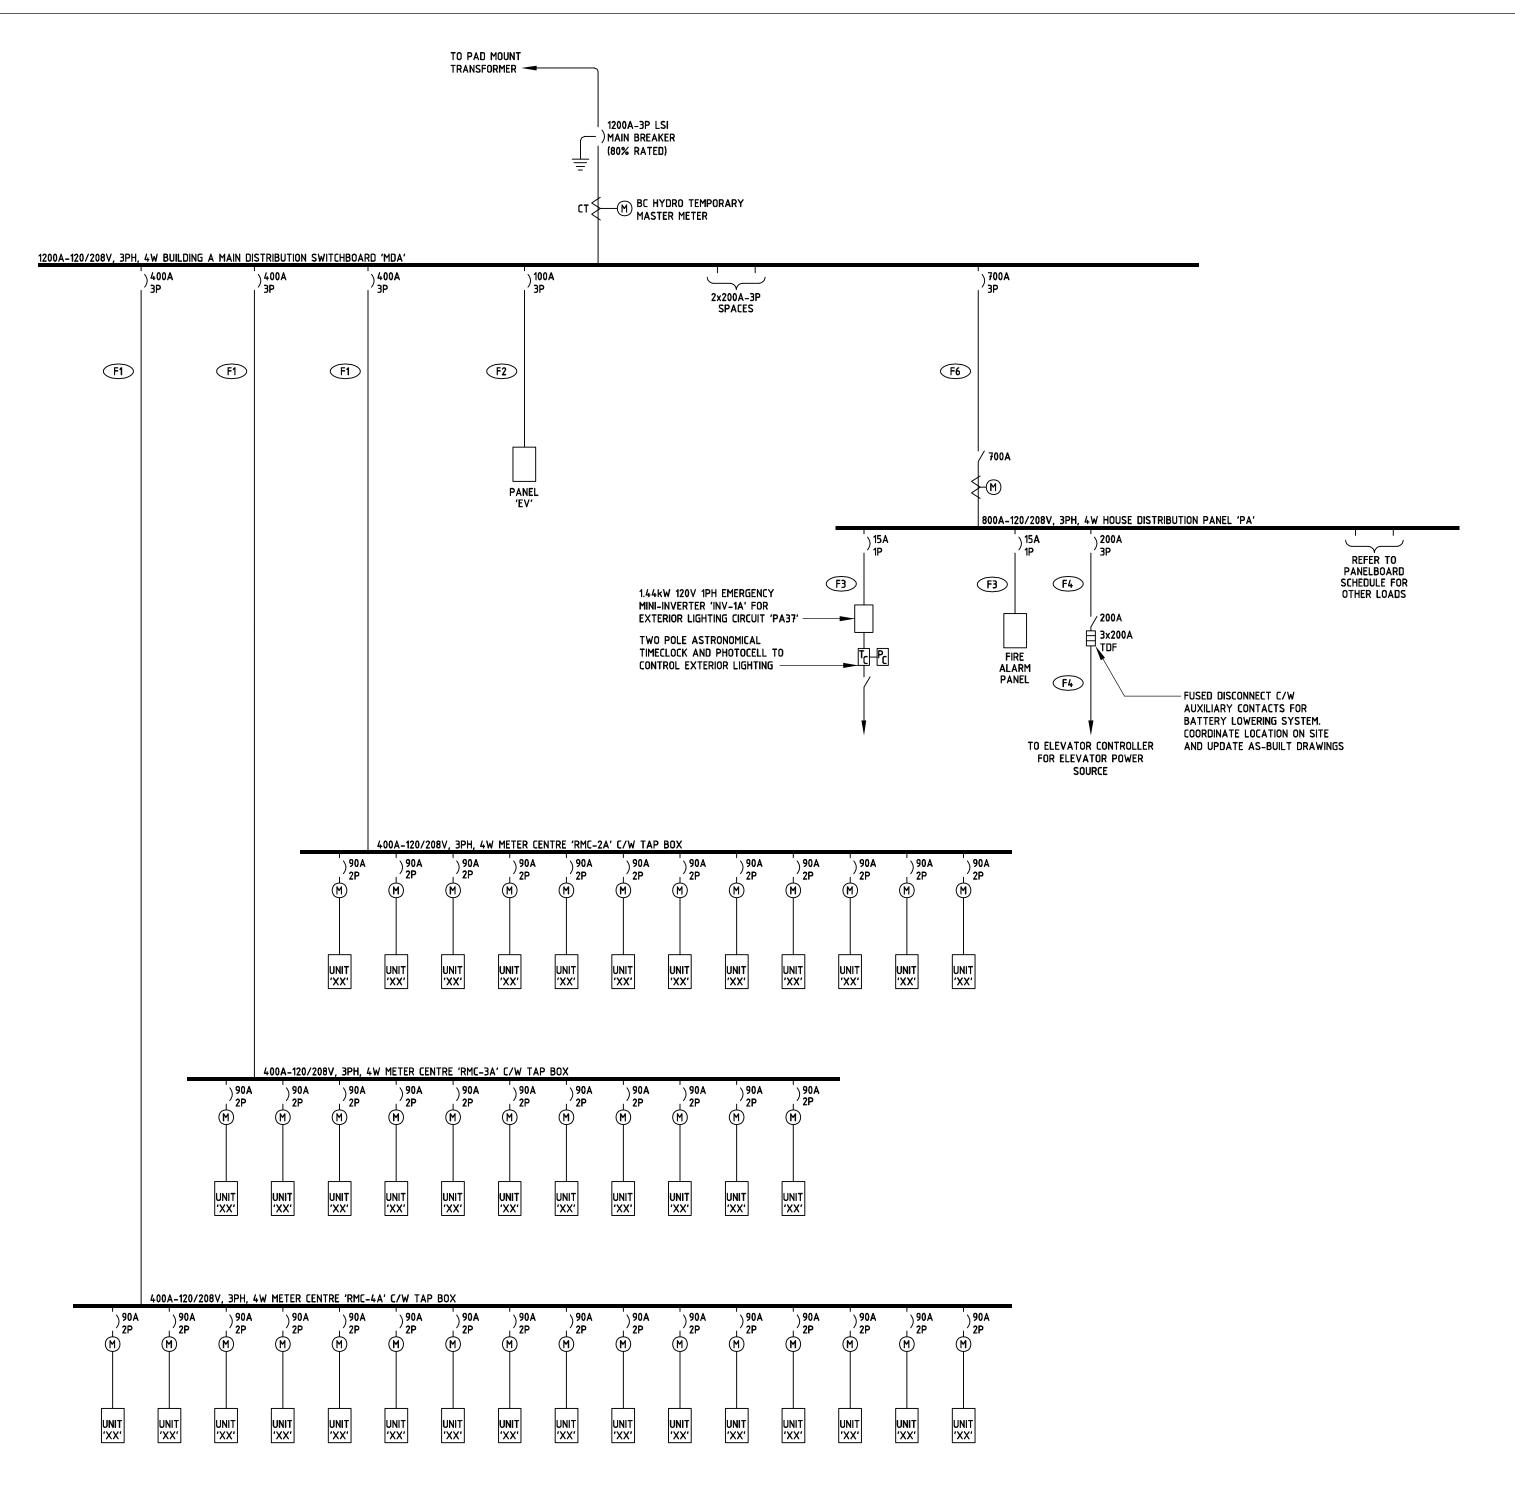

1200A, 120/208V, 3PH, 4W (80% RATED)

SINGLE LINE DIAGRAM

E101


NTS

FEEDER SCHEDULE

F1 'XX'
F2 'XX'
F3 'XX'
F4 'XX'
F5 'XX'
F6 'XX'

SUITE FEEDER SCHEDULE

UP TO 30 METERS (100 FEET) - 3c#1 ACWU90 UP TO 38 METERS (125 FEET) - 3c#1/0 ACWU90 UP TO 48 METERS (160 FEET) - 3c#2/0 ACWU90 UP TO 58 METERS (190 FEET) - 3c#2/0 ACWU90

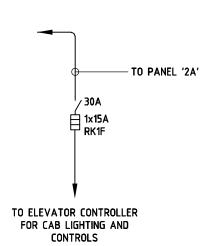

NOTES:

- ALL BREAKERS MUST BE SERIES RATED ACCORDING TO THE AVAILABLE FAULT CURRENT. PROVIDE COORDINATION STUDY AND ADJUST TRIP SETTINGS ACCORDINGLY.
- 2. PROVIDE SPRINKLER DRIP SHIELD FOR ALL ELECTRICAL EQUIPMENT UNLESS RECESSED OR FLUSH WITH WALL.
- 3. SUBSTITUTION OF ALUMINUM FEEDERS OF EQUIVALENT AMPACITY IN LIEU OF COPPER FEEDERS IS ACCEPTABLE FOR FEEDERS RATED MORE THAN 100A, EXCEPT FOR ELEVATOR DISTRIBUTION FEEDERS WHERE COPPER FEEDERS MUST BE USED. UPSIZE CONDUITS ACCORDINGLY.
- 4. TECK90, ACWU AND NMD90 NOT ACCEPTABLE IN PLENUM SPACES. PROVIDE WIRES IN EMT CONDUIT IN PLENUM SPACES.
- 5. NMD90 ACCEPTABLE ONLY IN AREAS CLASSIFIED AS COMBUSTIBLE CONSTRUCTION. CAUTION: SOME AREAS MAY BE CLASSIFIED AS NON-COMBUSTIBLE DESPITE USE OF WOOD STUDS. REFER TO ARCHITECTURAL PLANS FOR CONFIRMATION.
- 6. COORDINATE LOCATION OF ELEVATOR CONTROLLER, QUANTITY AND LOCATION OF FUSED DISCONNECTS, SIZE AND TYPE OF FUSES, AND FEEDER SIZES WITH ELEVATOR SHOP DRAWINGS AND/OR ELEVATOR SUPPLIER PRIOR TO ANY WORK.
- 7. PROVIDE FIRESTOP ASSEMBLY TO SEAL ALL ELECTRICAL PENETRATIONS THROUGH FIRE SEPARATIONS. FIRESTOP ASSEMBLY MUST SUFFICIENTLY PROVIDE THE FIRE (F) AND TEMPERATURE (T) RATING TO MATCH THE F AND T RATING OF THE FIREWALL AND FIRESEPERATION BETWEEN PARKING AREA AND REMINDER OF THE FLOOR AREA. REFER TO ARCHITECTURAL DRAWINGS

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2	DEVELOPMENT PERMIT	24/01/25
1	REVIEW	12/12/24
NO.	ISSUE	DATE


PROJECT

1551 AND 1554 BAY STREET

1554 BAY STREET VICTORIA, BC

SINGLE LINE DIAGRAM

T NO.	SHEE	1-24-093	PROJECT NO.
		MT	DRAWN
E10		PL	CHECKED
		JANUARY 2025	DATE
	REV	AS NOTED	SCALE

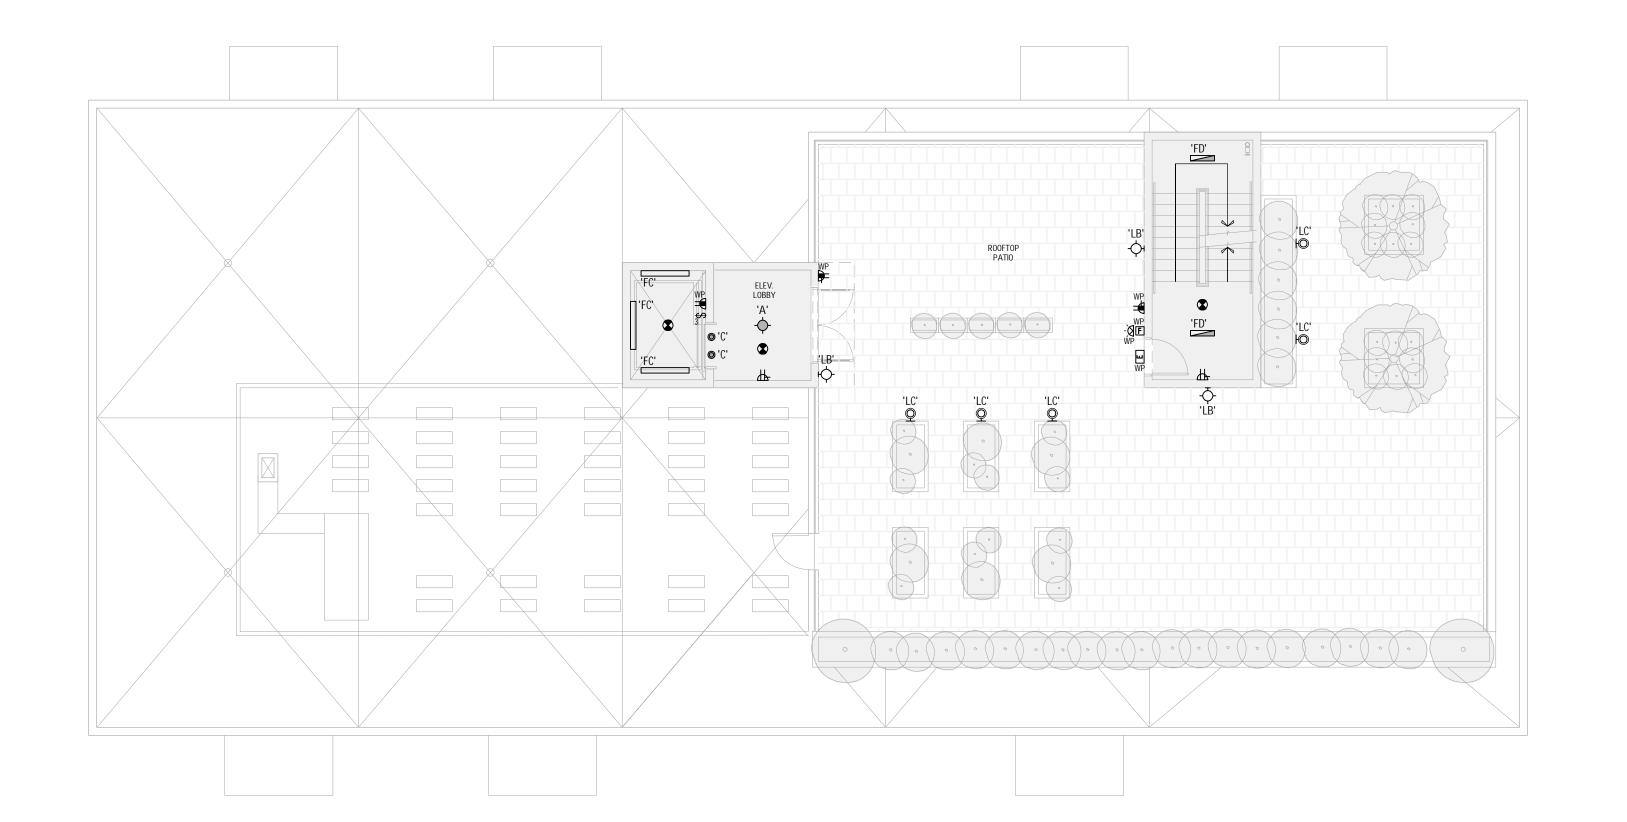



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2	DEVELOPMENT PERMIT	24/01/25
1	REVIEW	12/12/24
NO.	ISSUE	DATE
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PROJE


1551 AND 1554 BAY STREET

1554 BAY STREET VICTORIA, BC

TI

ROOF ELECTRICAL LAYOUT

ET NO.	-24-093	PROJECT NO.	
	MT	DRAWN	
E203	PL	CHECKED	
	RY 2025	DATE	
2	NOTED	SCALE	

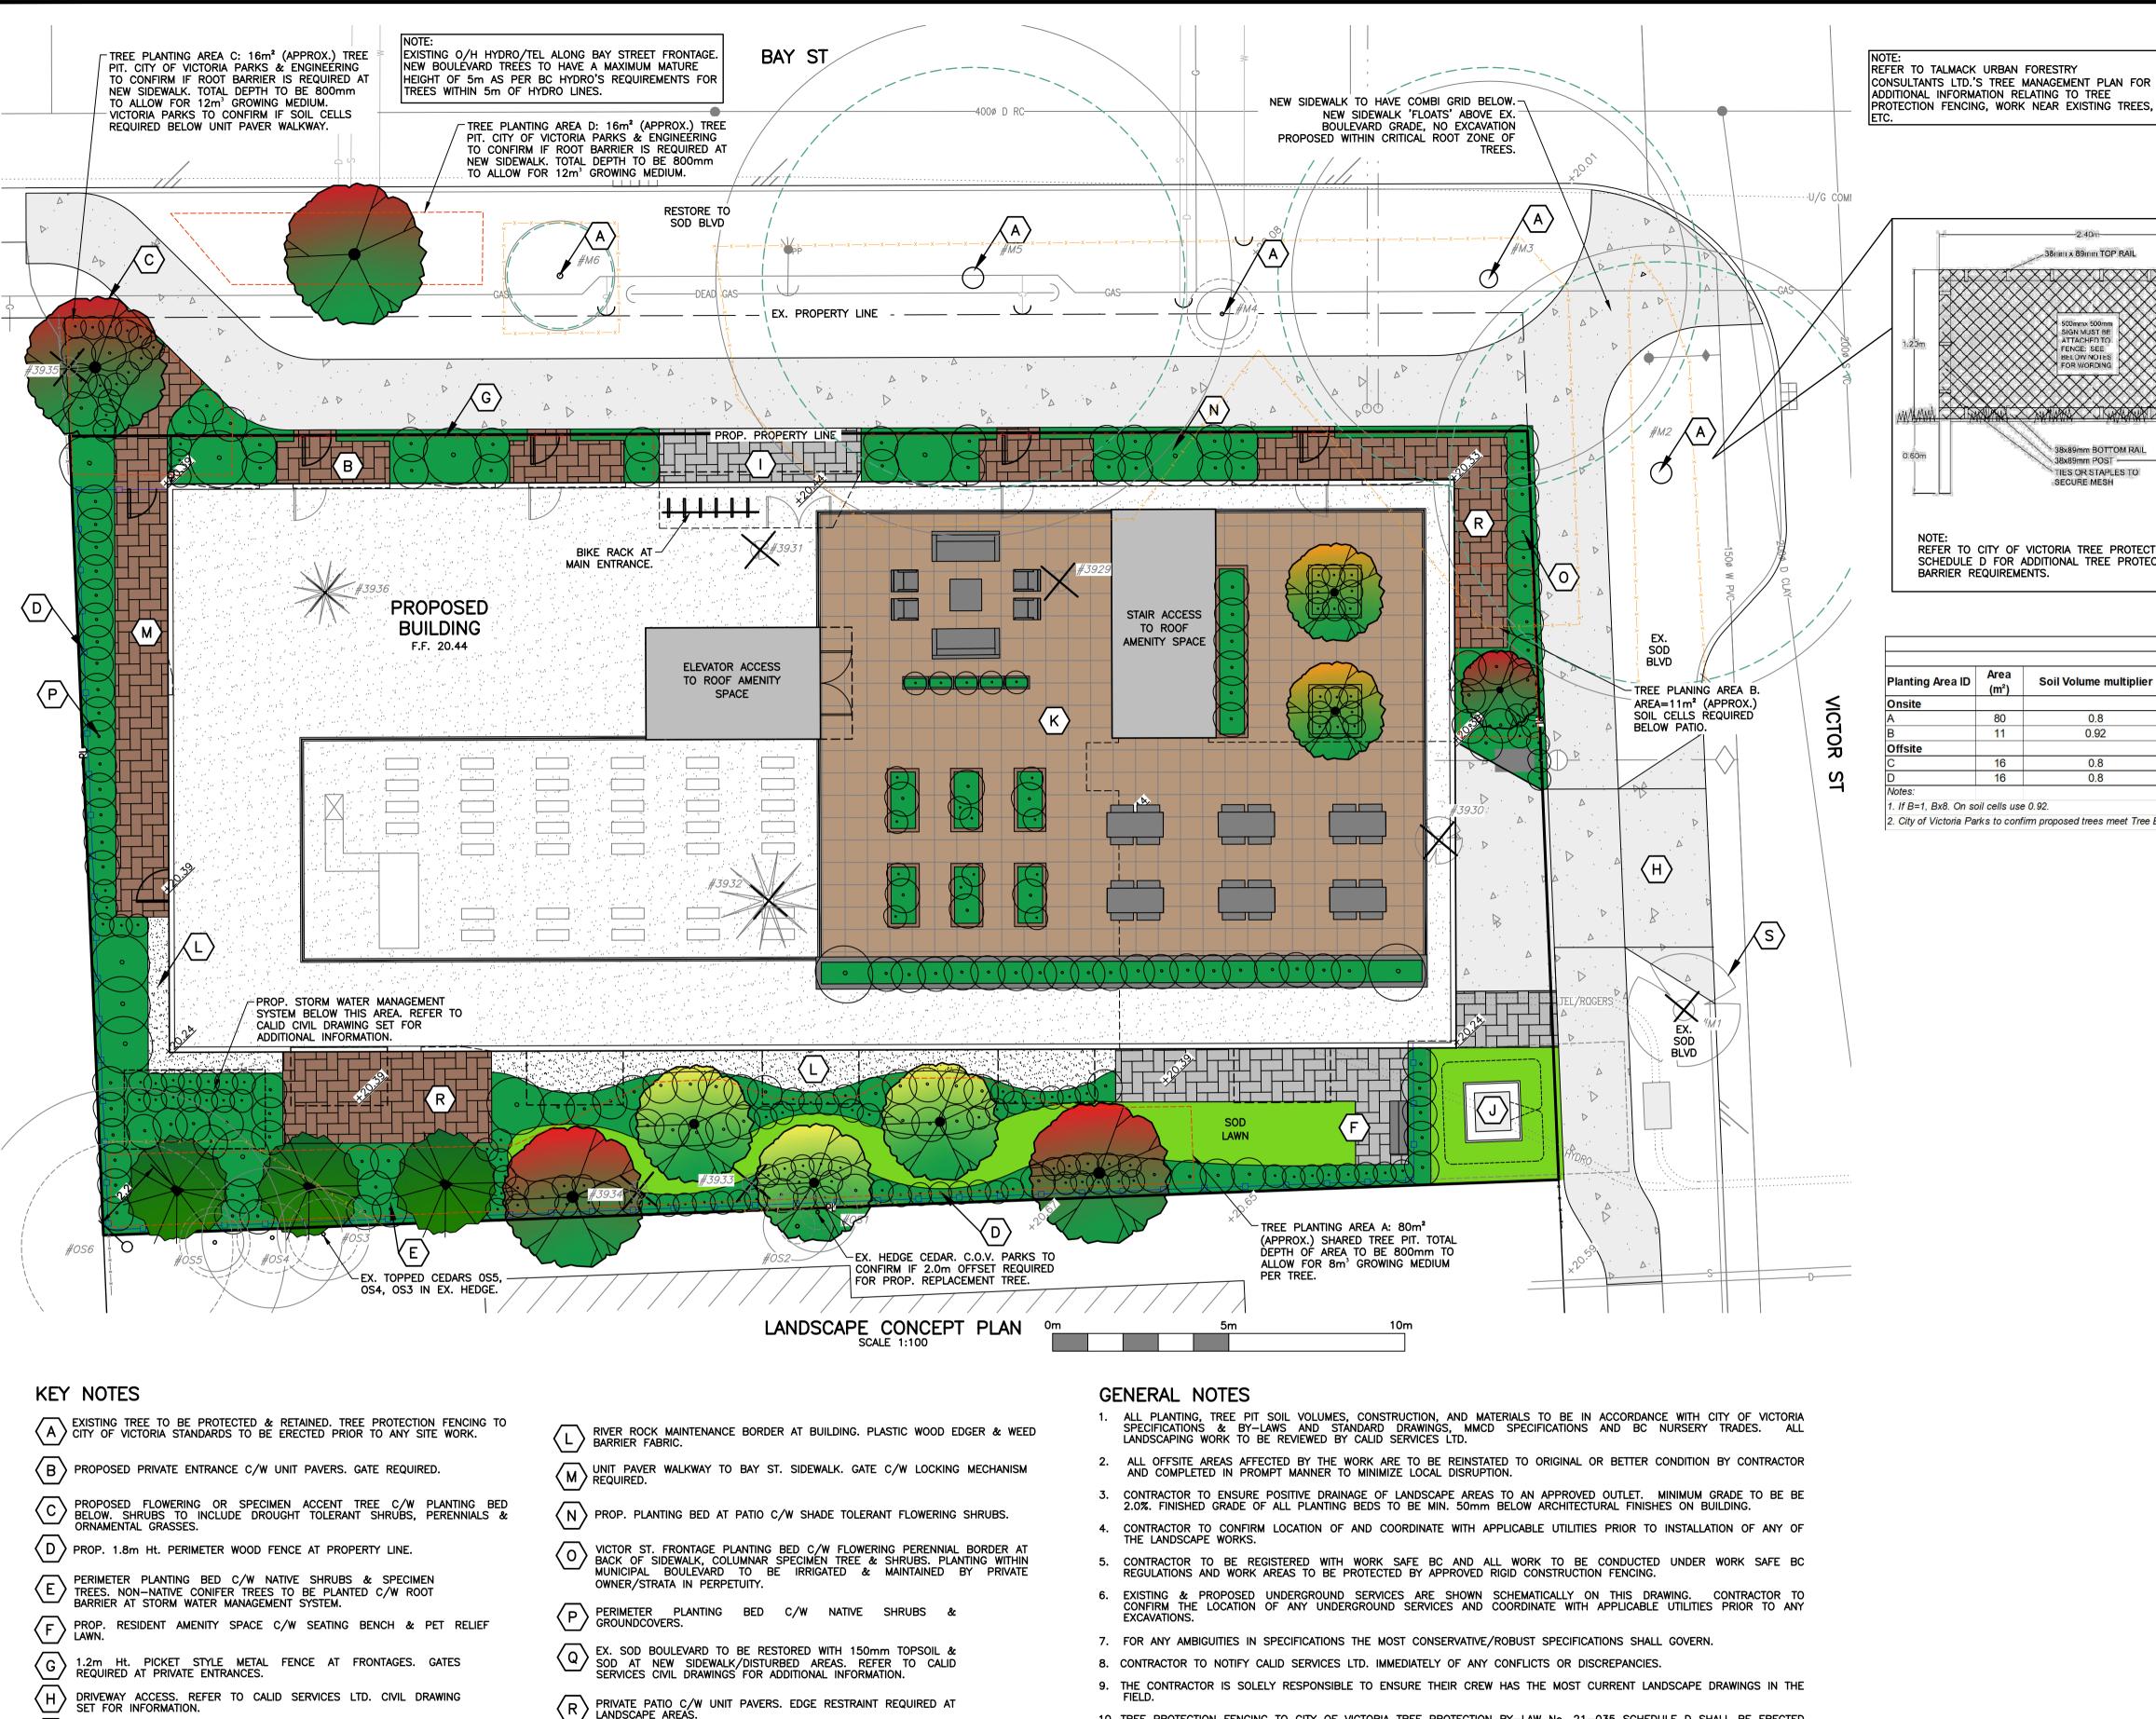

38mm x 89mm TOP RAIL

REFER TO CITY OF VICTORIA TREE PROTECTION BYLAW SCHEDULE D FOR ADDITIONAL TREE PROTECTION

38x89mm BOTTOM RAIL TIES OR STAPLES TO

ESTIMATED SOIL VOLUME										
		Replacement Trees Proposed				Soil Volume Required (m³)				
Planting Area ID	Area (m²)	Soil Volume multiplier	A. Estimated Soil Volume (m³)	B. Small	C. Medium	D. Large	E. Small	Total		
Onsite										
A	80	0.8	64	8	0	0	8	64		
В	11	0.92	10.12	1	0	0	1	8		
Offsite										
С	16	0.8	12.8	1	0	0	1	8		
D	16	0.8	12.8	1	0	0	1	8		
Notes:										

1. If B=1, Bx8. On soil cells use 0.92.

2. City of Victoria Parks to confirm proposed trees meet Tree Bylaw standards for small tree species, as not all proposed trees are not included on Schedule E.

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THE CONTRACTOR IS TO CALL B.C. ONE CALL, AND HAVE EXISTING U/G SERVICES STAKED PRIOR TO ANY CONSTRUCTION

1-800-474-6886 CELLULAR *6886

BENCHMARK



REVISIONS


BY APPROVED

10. TREE PROTECTION FENCING TO CITY OF VICTORIA TREE PROTECTION BY-LAW No. 21-035 SCHEDULE D SHALL BE ERECTED

AT ALL EXISTING TREES TO BE RETAINED PRIOR TO START OF ANY CONSTRUCTION/DEVELOPMENT RELATED ACTIVITIES OR 11. WELL-ROTTED, HIGH ORGANIC CONTENT, LOW WOOD CONTENT MULCH TO BE APPLIED TO BEDS AFTER FINISHED GRADING IS APPROVED AND PLANTING COMPLETE. MULCH TO BE FREE OF CHUNKS, STICKS, SOIL, STONES, ROOTS, ETC. LANDSCAPE CONTRACTOR TO ENSURE MINIMUM BARK MULCH DEPTH OF 50mm AFTER SETTLEMENT.

12. AUTOMATIC IRRIGATION SYSTEM REQUIRED. SOD LAWN TO BE IRRIGATED WITH MICRO-SPRAY, TREES AND PLANTING AREAS TO BE IRRIGATED WITH DRIP LINES TREES TO HAVE TWO (2) EMITTER LOOPS PER TREE. ALL WORK TO HABC AND CITY OF VICTORIA IRRIGATION STANDARDS. TIMER WITH MOISTURE SENSOR AND RAIN DELAY REQUIRED.

DATE

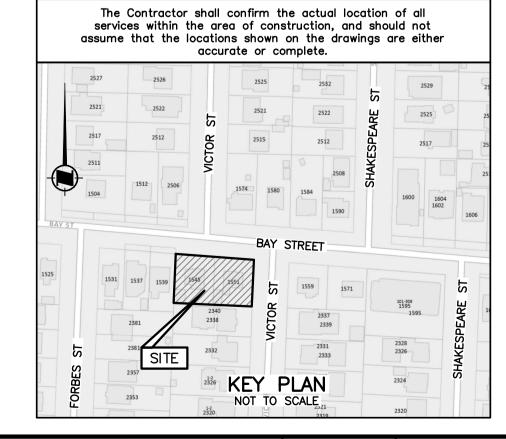

LEGEND

MAIN BUILDING ENTRANCE C/W UNIT PAVERS. BIKE RACK TO BE MOUNTED TO CONCRETE PAD WITH TAMPER-PROOF HARDWARE. BIKE RACK SIZE TO

ROOF TOP RESIDENT AMENITY PATIO C/W OUTDOOK COUCHES & DIMING INDEED.

AREA TO INCLUDE RESIDENT HERB GARDEN C/W TIMBER PLANTERS, SMALL FRUIT TREES IN PRE—FABRICATED PLANTERS AND A 1.0m Ht. PLANTER WITH SCREEN HEDGE. IRRIGATION SYSTEM REQUIRED FOR ALL PLANTERS.

SCHEMATIC PMT LOCATION. NO PLANTING TO BE WITHIN 1,2m OF

REFERENCE DRAWINGS

ALLOW FOR UTILITY BIKES AND E-BIKES.

J SCHEMATIC PMT LOCATION. NO PLANTING PMT AS PER BY HYDRO REQUIREMENTS.

 $\langle S \rangle$ EX. TREE TO BE REMOVED.

R PRIVATE PATIO C/W UNIT PAVERS. EDGE RESTRAINT REQUIRED AT LANDSCAPE AREAS.

TREES TO REMAIN CRITICAL ROOT ZONE (SOLID) AND DRIP LINE (DASHED) EXISTING TREES TO REMOVE TO REMOVE

UNIT PAVERS

PROP. RIVER ROCK PROP. STANDARD

WOOD FENCE 1.2m Ht. PICKET STYLE FENCE TEMPORARY TREE PROTECTION FENCING

1.8m Ht. PERIMETER

REGISTERED MEMBER DANIKAHAZEL PROVE


1545/51 BAY ST. DEVELOPMENT Landscape Plan & Notes Client: LIDA Construction Inc.

Checked 976 Approved As Noted

January 27, 202

207-2750 QUADRA ST. VICTORIA, B.C. V8T-4E8 PHONE: (250) 388-6919 FAX: (250) 381-6919 engineer@calid.ca

CANCEL PRINTS BEARING EARLIER LETTER 🕈

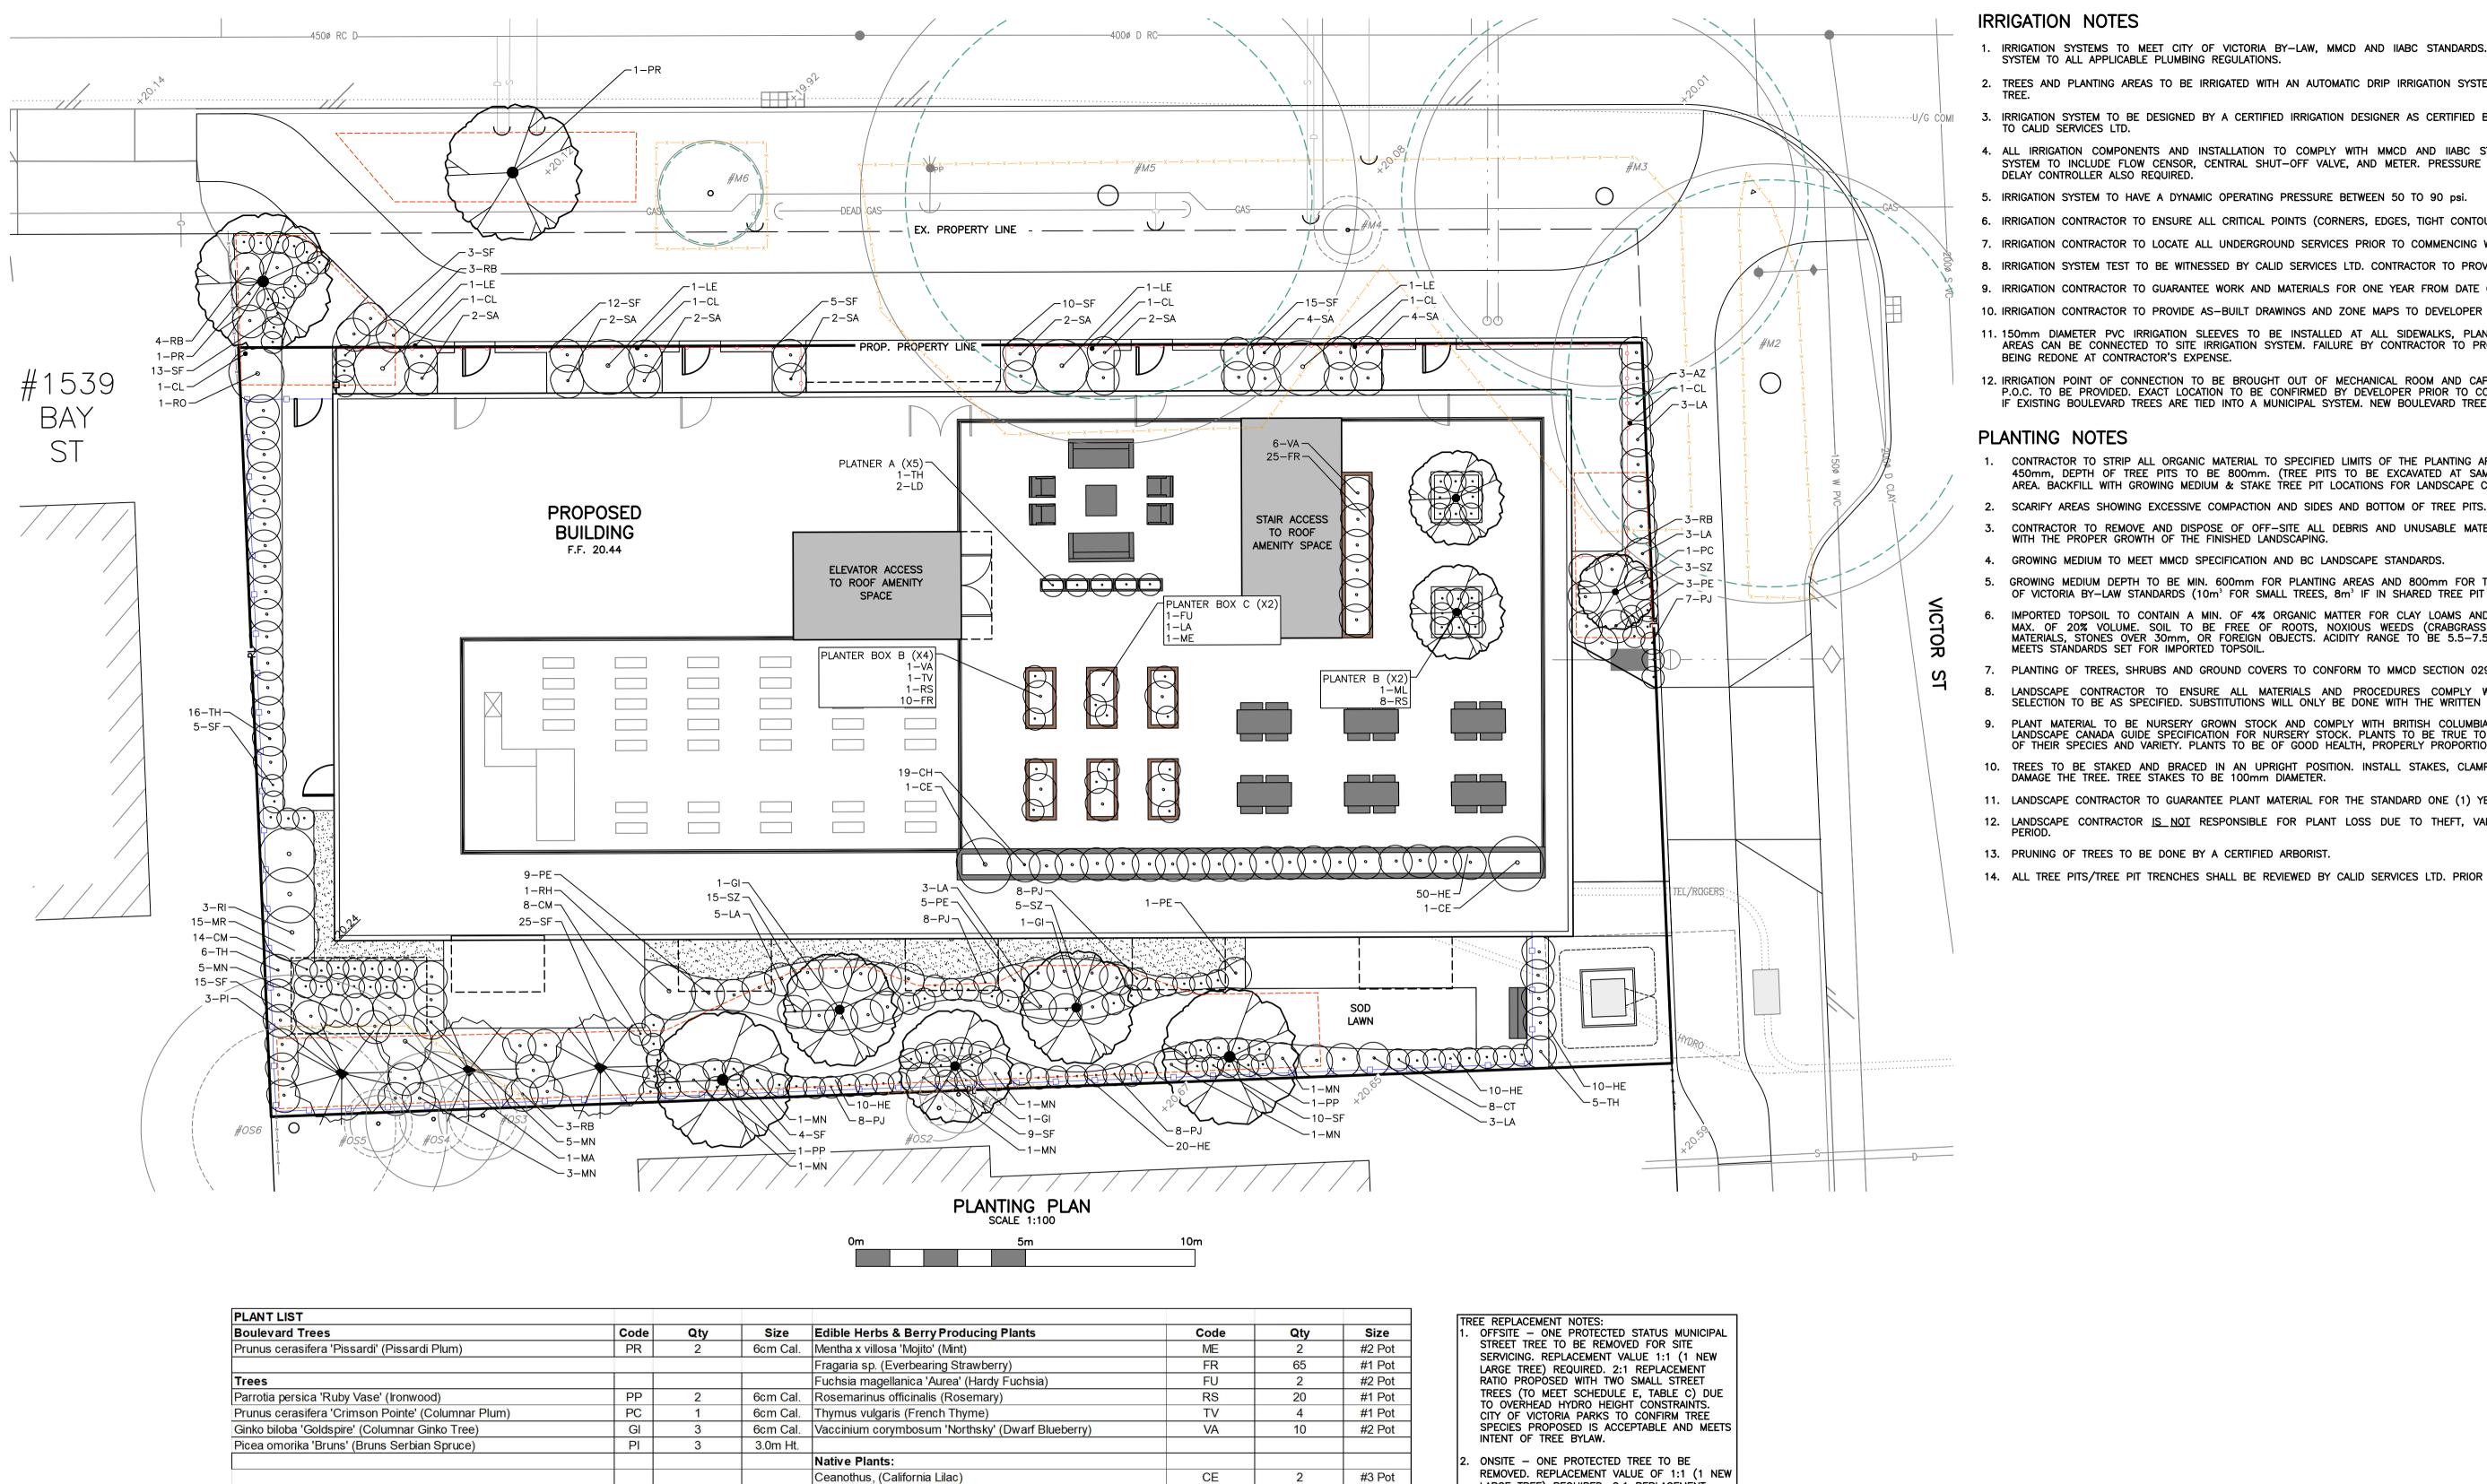

#3 Pot LARGE TREE) REQUIRED. 2:1 REPLACEMENT RATIO PROPÓSED WITH TWO SMALL TREES DUE TO BUILDING CONSTRAINTS. CITY OF VICTORIA #2 Pot PARKS TO CONFIRM TREE SPECIES PROPOSED #1 Pot ARE ACCEPTABLE AND MEETS INTENT OF TREE #2 Pot #1 Pot ONSITE — NEW TREE REQUIREMENTS BY LOT AREA AS PER SCHEDULE F OF CITY OF VICTORIA TREE BYLAW = 5. 1.2m Ht. DEVELOPER TO PAY CASH-IN-LIEU FOR ANY #3 Pot REQUIRED REPLACEMENT TREE THAT CANNOT BE #1 Pot

REV.

DATE

MA

MN

MR

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15

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19

- 1. IRRIGATION SYSTEMS TO MEET CITY OF VICTORIA BY-LAW, MMCD AND HABC STANDARDS. IRRIGATION CONTRACTOR TO INSTALL IRRIGATION SYSTEM TO ALL APPLICABLE PLUMBING REGULATIONS.
- 2. TREES AND PLANTING AREAS TO BE IRRIGATED WITH AN AUTOMATIC DRIP IRRIGATION SYSTEM. TREES TO HAVE TWO (2) EMITTER LOOPS PER
- ... U/G COMI 3. IRRIGATION SYSTEM TO BE DESIGNED BY A CERTIFIED IRRIGATION DESIGNER AS CERTIFIED BY HABC OR IA. SHOP DRAWINGS TO BE PROVIDED TO CALID SERVICES LTD.
 - 4. ALL IRRIGATION COMPONENTS AND INSTALLATION TO COMPLY WITH MMCD AND IIABC STANDARDS FOR LANDSCAPE IRRIGATION SYSTEMS. SYSTEM TO INCLUDE FLOW CENSOR, CENTRAL SHUT-OFF VALVE, AND METER. PRESSURE REGULATING DEVISE AND MOISTURE SENSOR/RAIN
 - 5. IRRIGATION SYSTEM TO HAVE A DYNAMIC OPERATING PRESSURE BETWEEN 50 TO 90 psi.
 - 6. IRRIGATION CONTRACTOR TO ENSURE ALL CRITICAL POINTS (CORNERS, EDGES, TIGHT CONTOURS, ETC.) RECEIVE FULL COVERAGE.
 - 7. IRRIGATION CONTRACTOR TO LOCATE ALL UNDERGROUND SERVICES PRIOR TO COMMENCING WORK.
 - 8. IRRIGATION SYSTEM TEST TO BE WITNESSED BY CALID SERVICES LTD. CONTRACTOR TO PROVIDE MINIMUM 72 HOUR NOTICE FOR REVIEW.
 - 9. IRRIGATION CONTRACTOR TO GUARANTEE WORK AND MATERIALS FOR ONE YEAR FROM DATE OF SUBSTANTIAL COMPLETION.
 - 10. IRRIGATION CONTRACTOR TO PROVIDE AS-BUILT DRAWINGS AND ZONE MAPS TO DEVELOPER ALONG WITH OPERATION MANUAL FOR OWNER.
 - 11. 150mm DIAMETER PVC IRRIGATION SLEEVES TO BE INSTALLED AT ALL SIDEWALKS, PLANTERS, WALLS, ETC. TO ENSURE ALL LANDSCAPE AREAS CAN BE CONNECTED TO SITE IRRIGATION SYSTEM. FAILURE BY CONTRACTOR TO PROVIDE IRRIGATION SLEEVES WILL RESULT IN WORK BEING REDONE AT CONTRACTOR'S EXPENSE.
 - 12. IRRIGATION POINT OF CONNECTION TO BE BROUGHT OUT OF MECHANICAL ROOM AND CAPPED FOR IRRIGATION CONTRACTOR TIE IN. 50mm P.O.C. TO BE PROVIDED. EXACT LOCATION TO BE CONFIRMED BY DEVELOPER PRIOR TO CONSTRUCTION.. VICTORIA PARKS DEPT. TO CONFIRM IF EXISTING BOULEVARD TREES ARE TIED INTO A MUNICIPAL SYSTEM. NEW BOULEVARD TREE TO BE CONNECTED TO MUNICIPAL SYSTEM.

PLANTING NOTES

- 1. CONTRACTOR TO STRIP ALL ORGANIC MATERIAL TO SPECIFIED LIMITS OF THE PLANTING AREAS. EXCAVATED DEPTH FOR SHRUBS TO BE MIN. 450mm, DEPTH OF TREE PITS TO BE 800mm. (TREE PITS TO BE EXCAVATED AT SAME TIME AS ANY SERVICING/UTILITY TRENCHING IN AREA. BACKFILL WITH GROWING MEDIUM & STAKE TREE PIT LOCATIONS FOR LANDSCAPE CONTRACTOR.)
- CONTRACTOR TO REMOVE AND DISPOSE OF OFF-SITE ALL DEBRIS AND UNUSABLE MATERIAL, ROOTS, STONES, ETC. THAT MAY INTERFERE WITH THE PROPER GROWTH OF THE FINISHED LANDSCAPING.
- 4. GROWING MEDIUM TO MEET MMCD SPECIFICATION AND BC LANDSCAPE STANDARDS.
- GROWING MEDIUM DEPTH TO BE MIN. 600mm FOR PLANTING AREAS AND 800mm FOR TREE PITS. TREE PIT SOIL VOLUMES TO MEET CITY OF VICTORIA BY-LAW STANDARDS (10m3 FOR SMALL TREES, 8m3 IF IN SHARED TREE PIT TRENCH).
- 6. IMPORTED TOPSOIL TO CONTAIN A MIN. OF 4% ORGANIC MATTER FOR CLAY LOAMS AND 2% ORGANIC MATTER FOR SAND LOAMS. TO A MAX. OF 20% VOLUME. SOIL TO BE FREE OF ROOTS, NOXIOUS WEEDS (CRABGRASS, COUCHGRASS, HORSETAIL, SEEDS, ETC.), TOXIC MATERIALS, STONES OVER 30mm, OR FOREIGN OBJECTS. ACIDITY RANGE TO BE 5.5-7.5 pH. NATIVE TOPSOIL MAY BE USED PROVIDED IT MEETS STANDARDS SET FOR IMPORTED TOPSOIL.
- PLANTING OF TREES, SHRUBS AND GROUND COVERS TO CONFORM TO MMCD SECTION 02950 SPECIFICATIONS
- LANDSCAPE CONTRACTOR TO ENSURE ALL MATERIALS AND PROCEDURES COMPLY WITH ACCEPTED LANDSCAPE PRACTICES. SPECIES SELECTION TO BE AS SPECIFIED. SUBSTITUTIONS WILL ONLY BE DONE WITH THE WRITTEN APPROVAL OF CALID SERVICES LTD.
- 9. PLANT MATERIAL TO BE NURSERY GROWN STOCK AND COMPLY WITH BRITISH COLUMBIA STANDARD FOR CONTAINER GROWN PLANTS AND LANDSCAPE CANADA GUIDE SPECIFICATION FOR NURSERY STOCK. PLANTS TO BE TRUE TO NAME, TYPE AND FORM, AND BE REPRESENTATIVE OF THEIR SPECIES AND VARIETY. PLANTS TO BE OF GOOD HEALTH, PROPERLY PROPORTIONED, NOT WEAK, INJURED OR THIN.
- 10. TREES TO BE STAKED AND BRACED IN AN UPRIGHT POSITION. INSTALL STAKES, CLAMPS, ANCHORS, ARBORTIE FABRIC TIES AS NOT TO DAMAGE THE TREE. TREE STAKES TO BE 100mm DIAMETER.
- 11. LANDSCAPE CONTRACTOR TO GUARANTEE PLANT MATERIAL FOR THE STANDARD ONE (1) YEAR MAINTENANCE PERIOD.
- 12. LANDSCAPE CONTRACTOR IS NOT RESPONSIBLE FOR PLANT LOSS DUE TO THEFT, VANDALISM, OR ANIMALS DURING THE MAINTENANCE
- 13. PRUNING OF TREES TO BE DONE BY A CERTIFIED ARBORIST
- 14. ALL TREE PITS/TREE PIT TRENCHES SHALL BE REVIEWED BY CALID SERVICES LTD. PRIOR TO BACKFILLING.



1-800-474-6886 CELLULAR *6886

THIS DESIGN IS VALID ONLY IF REVIEWED DURING CONSTRUCTION BY CALID SERVICES LTD.

THE CONTRACTOR IS TO CALL B.C. ONE CALL, AND HAVE EXISTING U/G SERVICES STAKED PRIOR TO ANY CONSTRUCTION

LEGEND

ML

CM

LD

PE

PJ

RB

RO

SZ

22

100

10

18

13

20

Roof Top Fruit Trees

Malus domestica (Apple Tree)

Lithodora diffusa (Lithodora)

Sarcococca humilis (Sweetbox)

REFERENCE DRAWINGS

Shizostylis coccinea (Crimson Flag Lily)

Azalea 'Hino Crimson' (Red Azalea)

Hemerocallis 'Stella de Oro' (Day Lily)

Lavandula angustifolia 'Hidcote' (Lavender)

Leucothoe fontanesia (Rainbow Fetterbush)

Pieris japonica 'Cavatine' (Dwarf Lily-of-the-Valley)

Rhododendron 'Baden Baden' (Red Rhododendron)

Rhododendron 'Christmas Cheer' (Pink Rhododendron)

Acent Shrubs, Perennials & Ornamental Grasses:

Carex testacea 'Orange Flame' (New Zealand Sedge)

Pennisetum alopercuroides 'Hamein' (Dwarf Fountain Grass)

Carex morrowii 'Gold Band' (Japanese Sedge)

CRITICAL ROOT ZONE (SOLID) AND DRIP LINE

#1 Pot

#3 Pot

Mahonia aquifolium (Dull Oregon Grape)

Mahonia repens, (Creeping Oregon Grape)

Ribes sanguineum (Red Flowering Currant)

Thuja occidentalis 'Emerald' (Emerald Arborvitae)

#5 Pot | 2. Plant substitutions to be reviewed & approved in writing by Calid Services Ltd.

#2 Pot | 3. Tree stakes to be 100mm diameter. Tree ties to be Arbortie™ or approved equal.

2cm Cal. | Mahonia nervosa (Cascade Oregon Grape)

#2 Pot Choisya ternata (Mexican Orange Blossom)

#2 Pot Clematis armandii (Evergreen Clematis)

#2 Pot | Polystichum munitum (Sword Fern)

1.8m Ht. PERIMETER WOOD FENCE 1.2m Ht. PICKET STYLE FENCE TEMPORARY TREE PROTECTION FENCING ---x---x--- EX. FENCING

#2 Pot 1. Sod lawns, trees and planting beds to be irrigated to City of Victoria Standards & By-law requirements.

#1 Pot | 4. Fruit trees to be special order from local fruit tree nursery. Variety to be hardy to Vancouver Island.

MEMBER **REVISIONS** BY APPROVED

DANIKAHAZELPRO

1545/51 BAY ST. DEVELOPMENT Planting Plan & Notes Client: LIDA Construction Inc.

PHONE: (250) 388-6919 FAX: (250) 381-6919

Approved

976-L02

dp/gkc/sp January 27, 202

976

As Noted

engineer@calid.ca CANCEL PRINTS BEARING EARLIER LETTER 🛛 🖣